## BOARD OF COMMISSIONERS

Meetings Second Tuesday

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MARCIA W. JOHNSON County Administrator



213 Persons Street Fort Valley, Georgia 31030 Phone 478-825-2535 Fax 478-825-2678

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> TERRY DEESE Sheriff

W. L. BROWN Tax Commissioner

KERRY ROOKS Coroner

LAURENS C. LEE Magistrate

# REQUEST FOR BID No. 16-002 Peach County Workforce Development Center Landscaping

Addendum No. 2

December 29, 2015

# PEACH COUNTY GEORGIA

Peach County Workforce Development Center Landscaping 425 James E. Khoury Blvd., Fort Valley, GA

# **PURPOSE:**

- 1. Revise plans bid set.
- 2. Add 12 monthly inspections and condition and recommendation reports
- 3. Replace landscape Architect with Peach County Public works Director
- 3. Re-Schedule Pre-Bid meeting and site visit

# **ADDENDUM 2:**

# 1. Revised Plans and Specifications:

The attached revised plans and specifications supersedes and/or replaces the plans and specifications included with RFB 16-002 (Exhibit 2). All references in RFB 16-002 to the "drawings and specifications" shall refer to the attached revised plans and specifications. All bids, and construction of the landscaping, shall be in accordance with the attached revised plans and specifications.

# 2. Replace landscape Architect with Peach County Public works Director:

All references to the "Landscape Architect" in the Plans and specifications shall be replaced with "Peach County Public works Director."

# 3. Monthly Inspections and condition and Recommendation Reports:

The contractor shall inspect the condition of the plant materials on a monthly basis for 12 consecutive months or throughout the entire warranty period whichever is longer, beginning upon substantial completion and acceptance of the work by the County. The monthly inspections shall continue throughout the entire warranty period. A written report will be submitted to the Peach County Public Works Director no later than five (5) working days after the completion of each inspection. The written report will outline the condition of all plant material, Dates landscape maintenance has taken place, and any warranty replacement actions taken by the contractor during the past month.

# 4. Re-Scheduled Pre-Bid Meeting and Site Visit

The Pre-Bid meeting and site visit originally scheduled for December 7, 2015 at 9:30 a.m. at the Peach County Regional Workforce Development Center 425 James E. Khoury Blvd. Fort Valley, GA 31030 is re-scheduled for January 6, 2016, 10:30 a.m. local time. Attendance of the pre-bid meeting and site visit is not mandatory, but is recommended.

# **MASTER PLAN**



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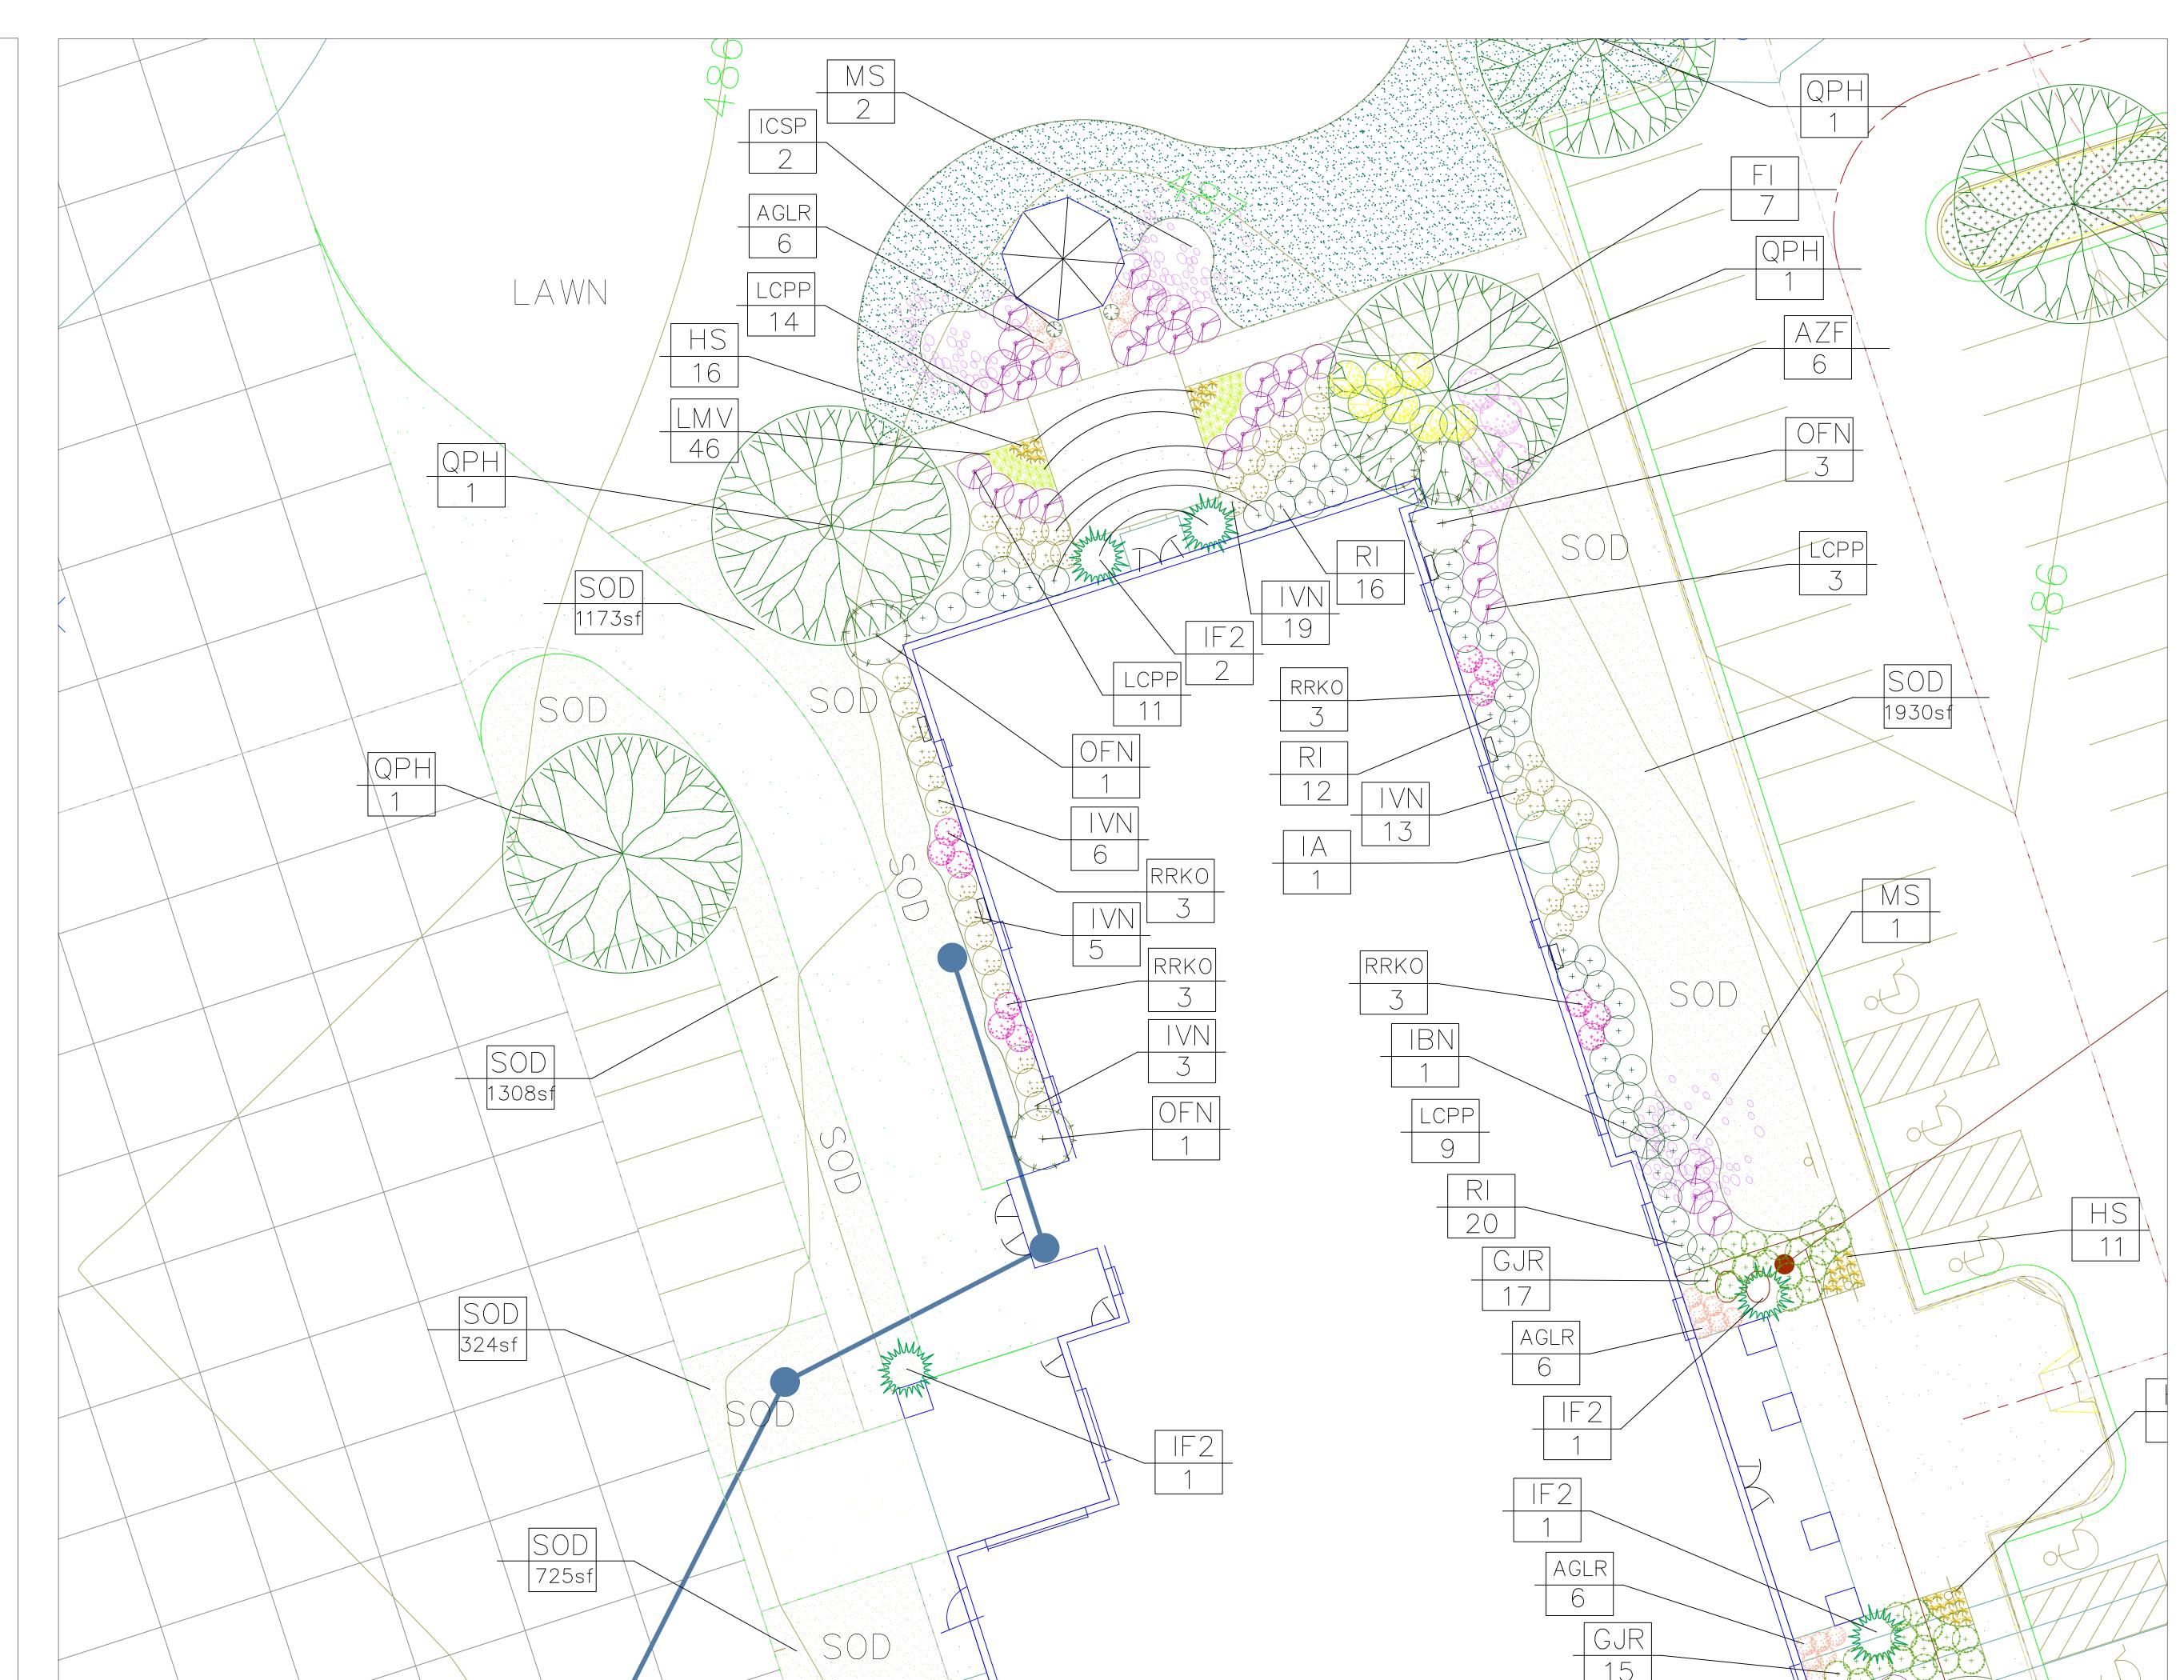
# REVISED BID SET

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05/21/2015	DATE
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LANDSCAPE PLANTING PLAN

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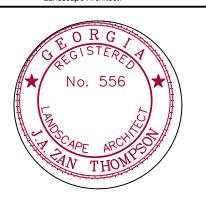


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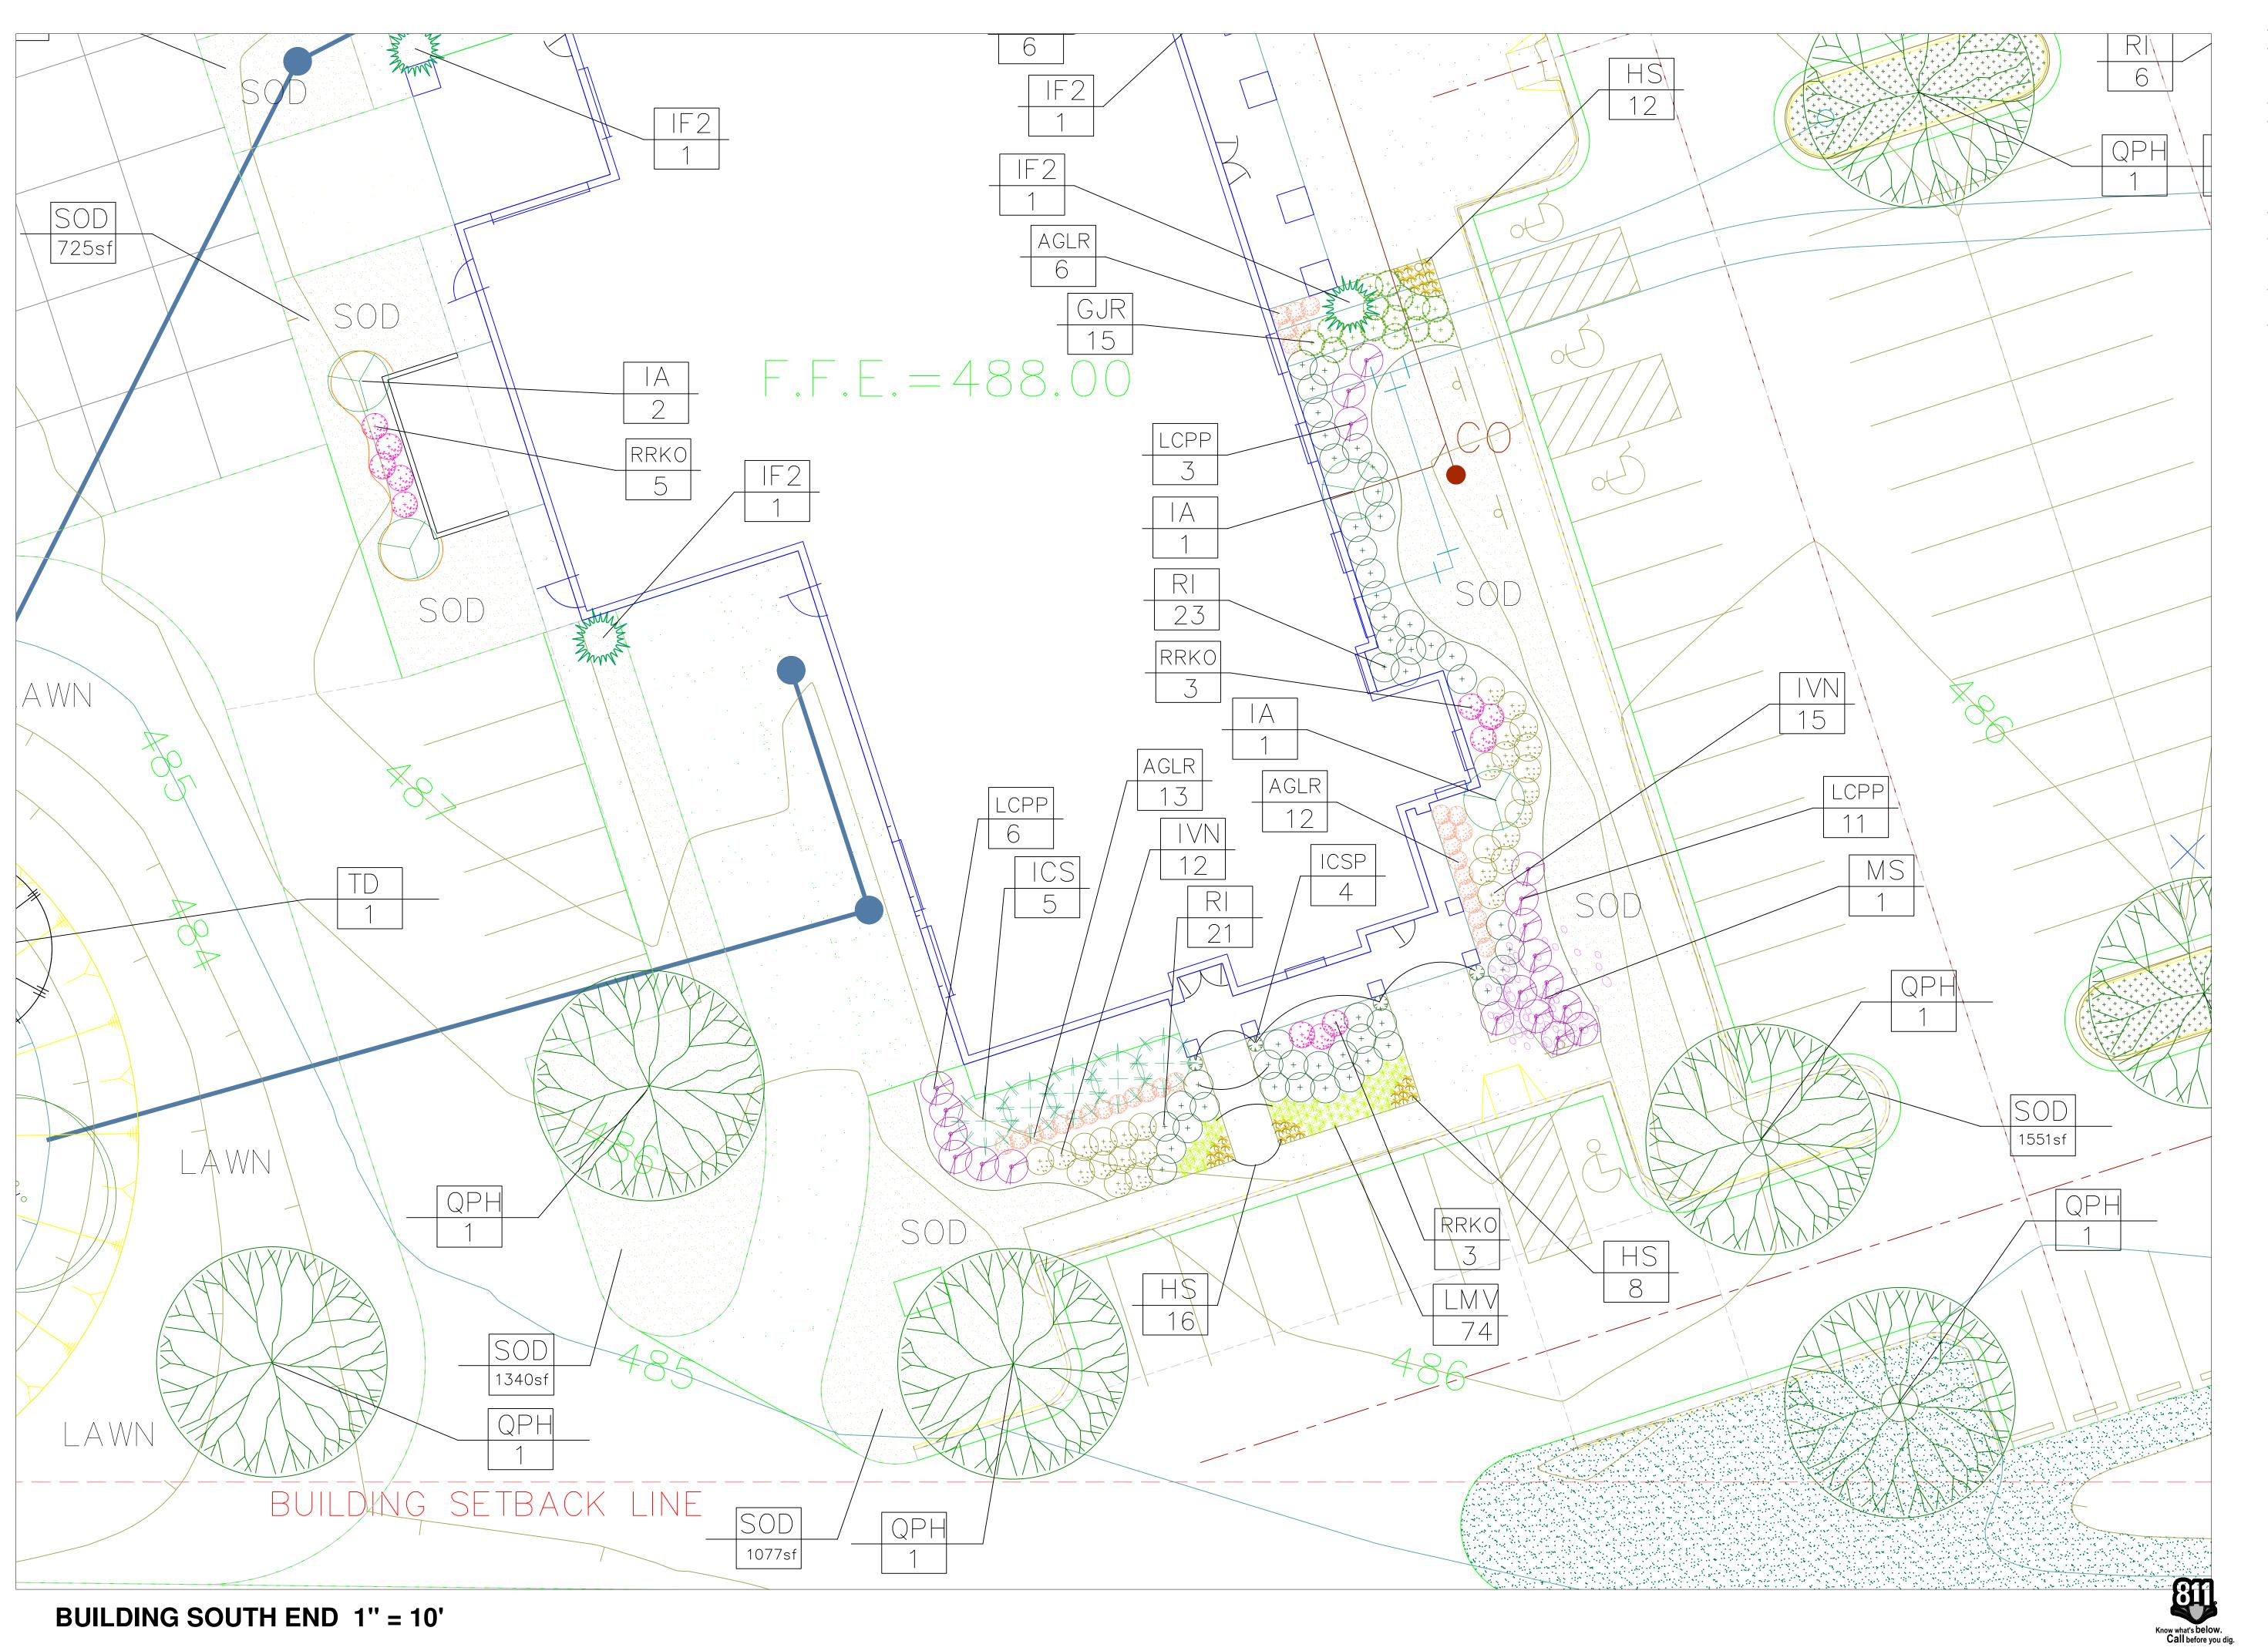
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SHEET NO.

LANDSCAPE PLANTING PLAN **BUILDING NORTH END PLAN** ZT **LA -2 CHECKED BY** 

**BUILDING NORT END 1" = 10'** 

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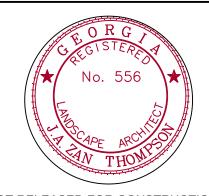


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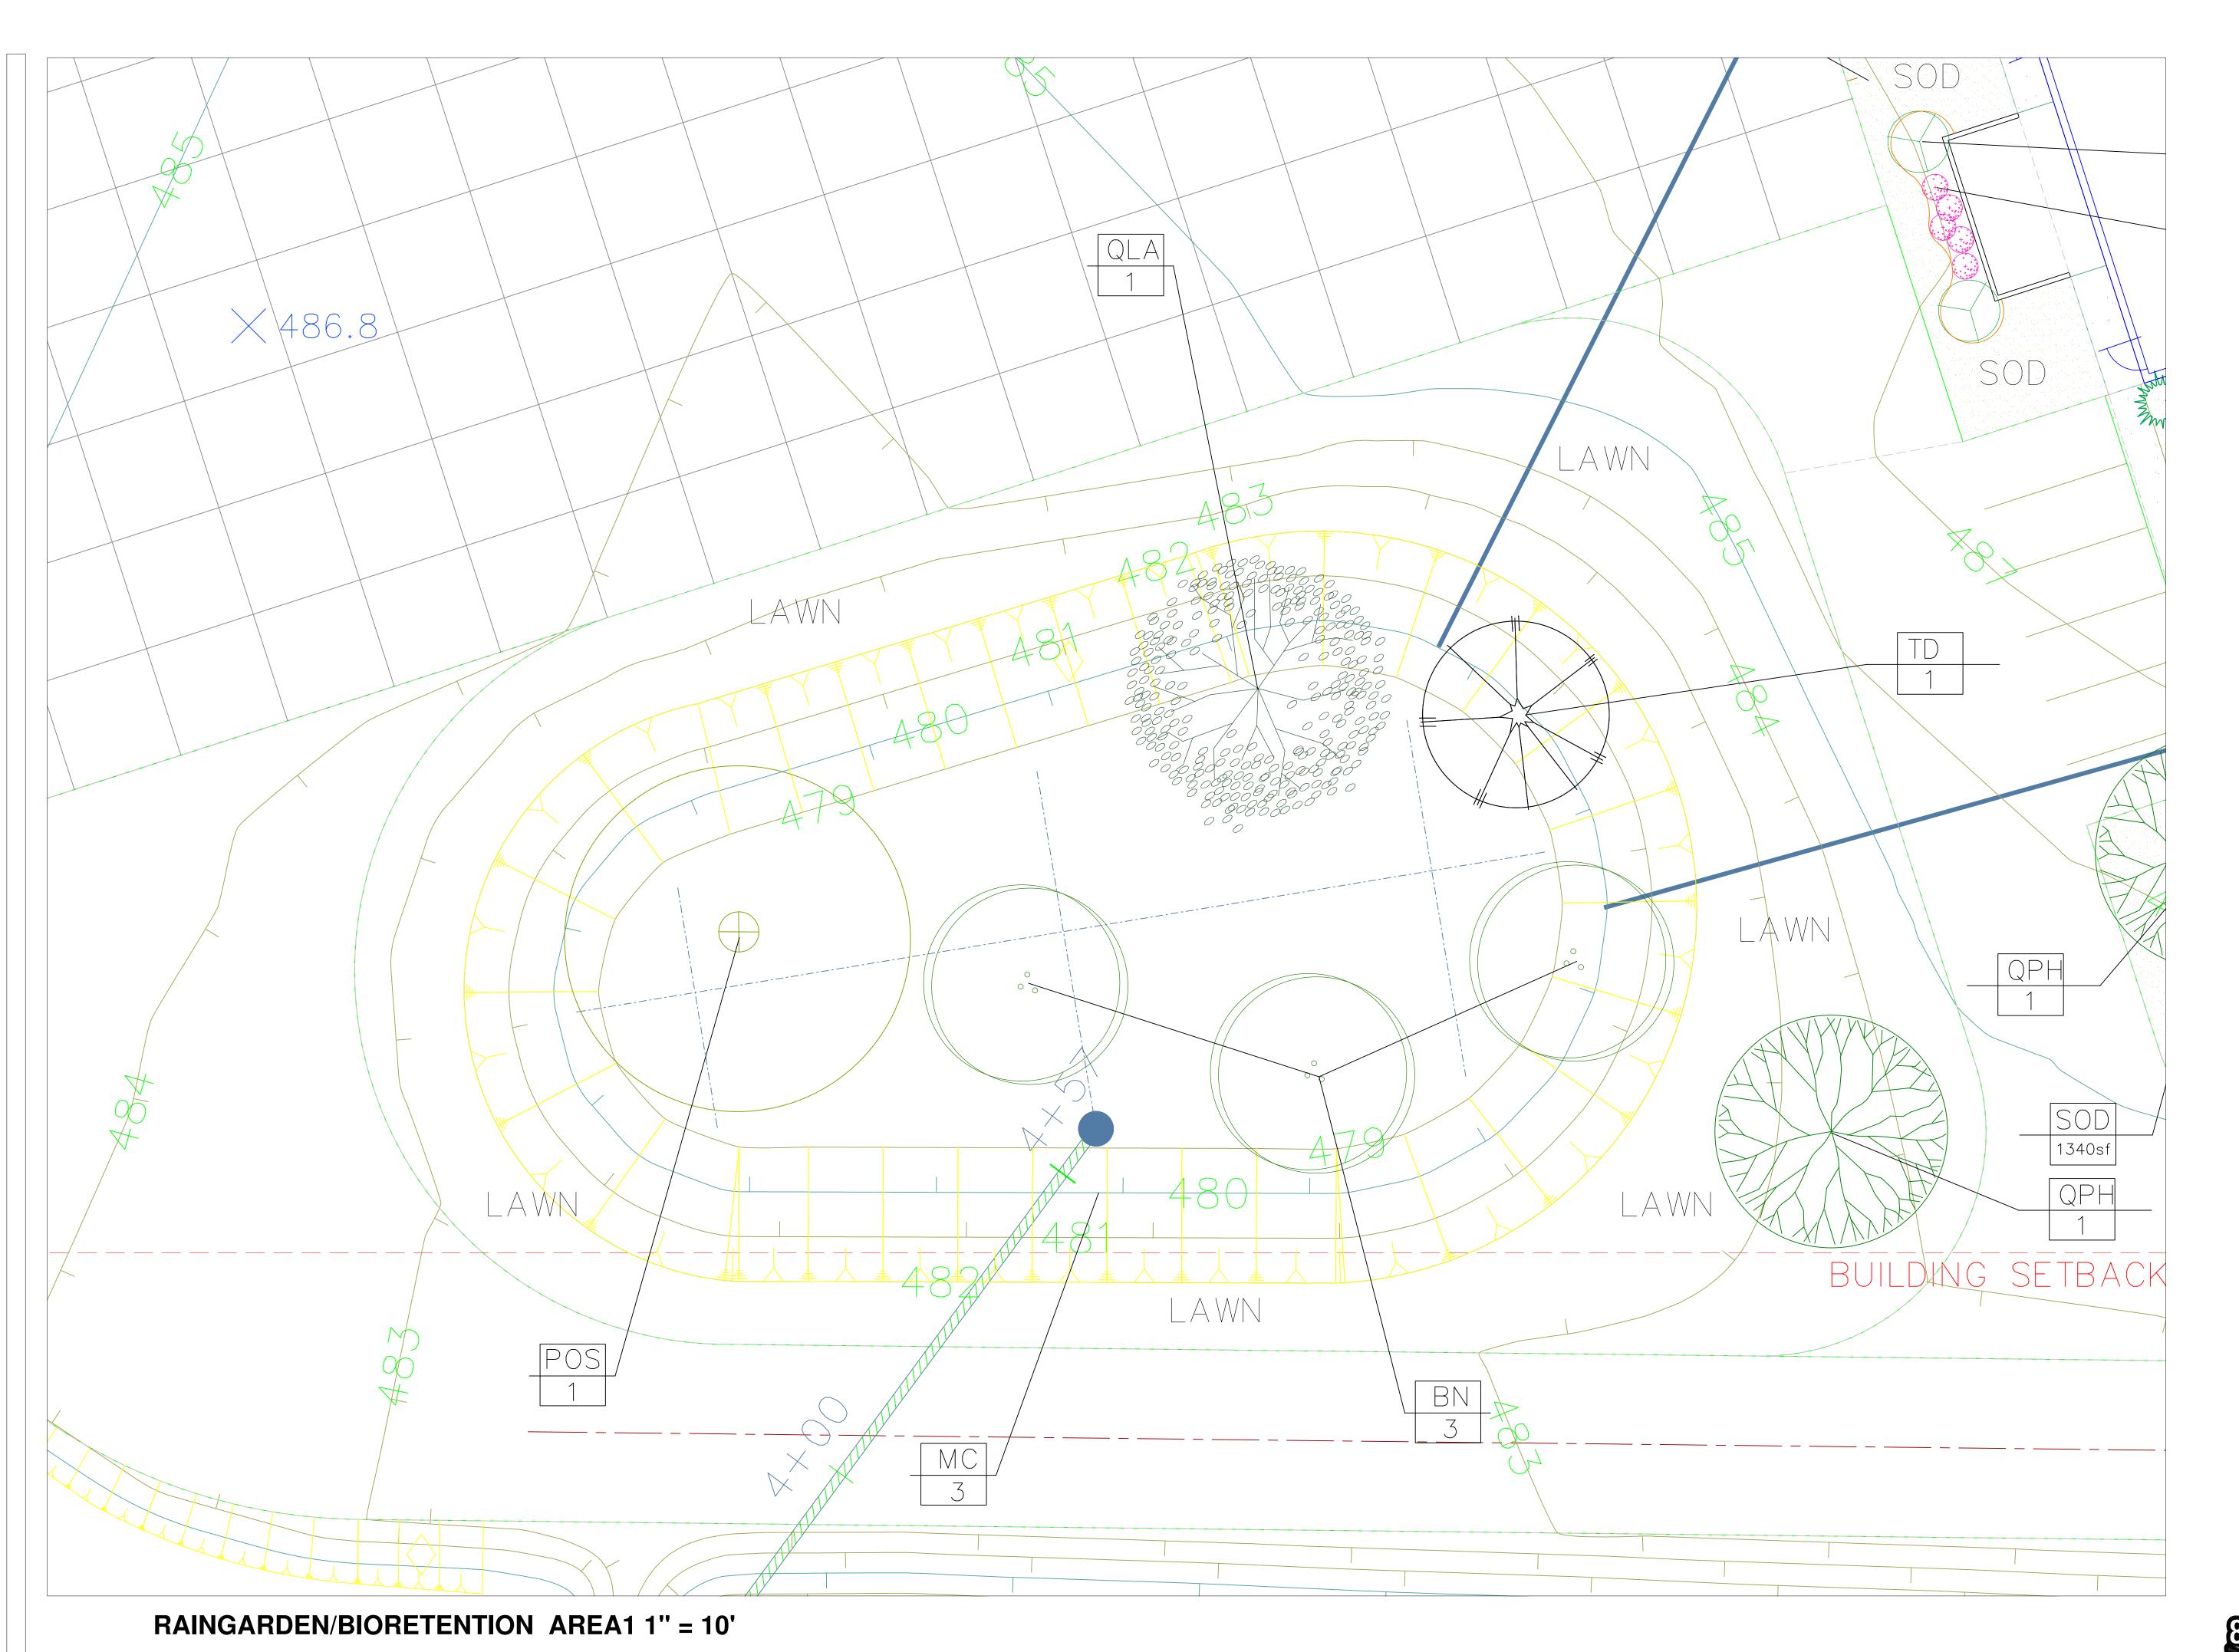
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REVISED BID SET

PROJECT NO. 982.03 05/21/2015 SHEET TITLE

SHEET NO.

LANDSCAPE PLANTING PLAN **BUILDING SOUTH END PLAN** CHECKED BY LA -3



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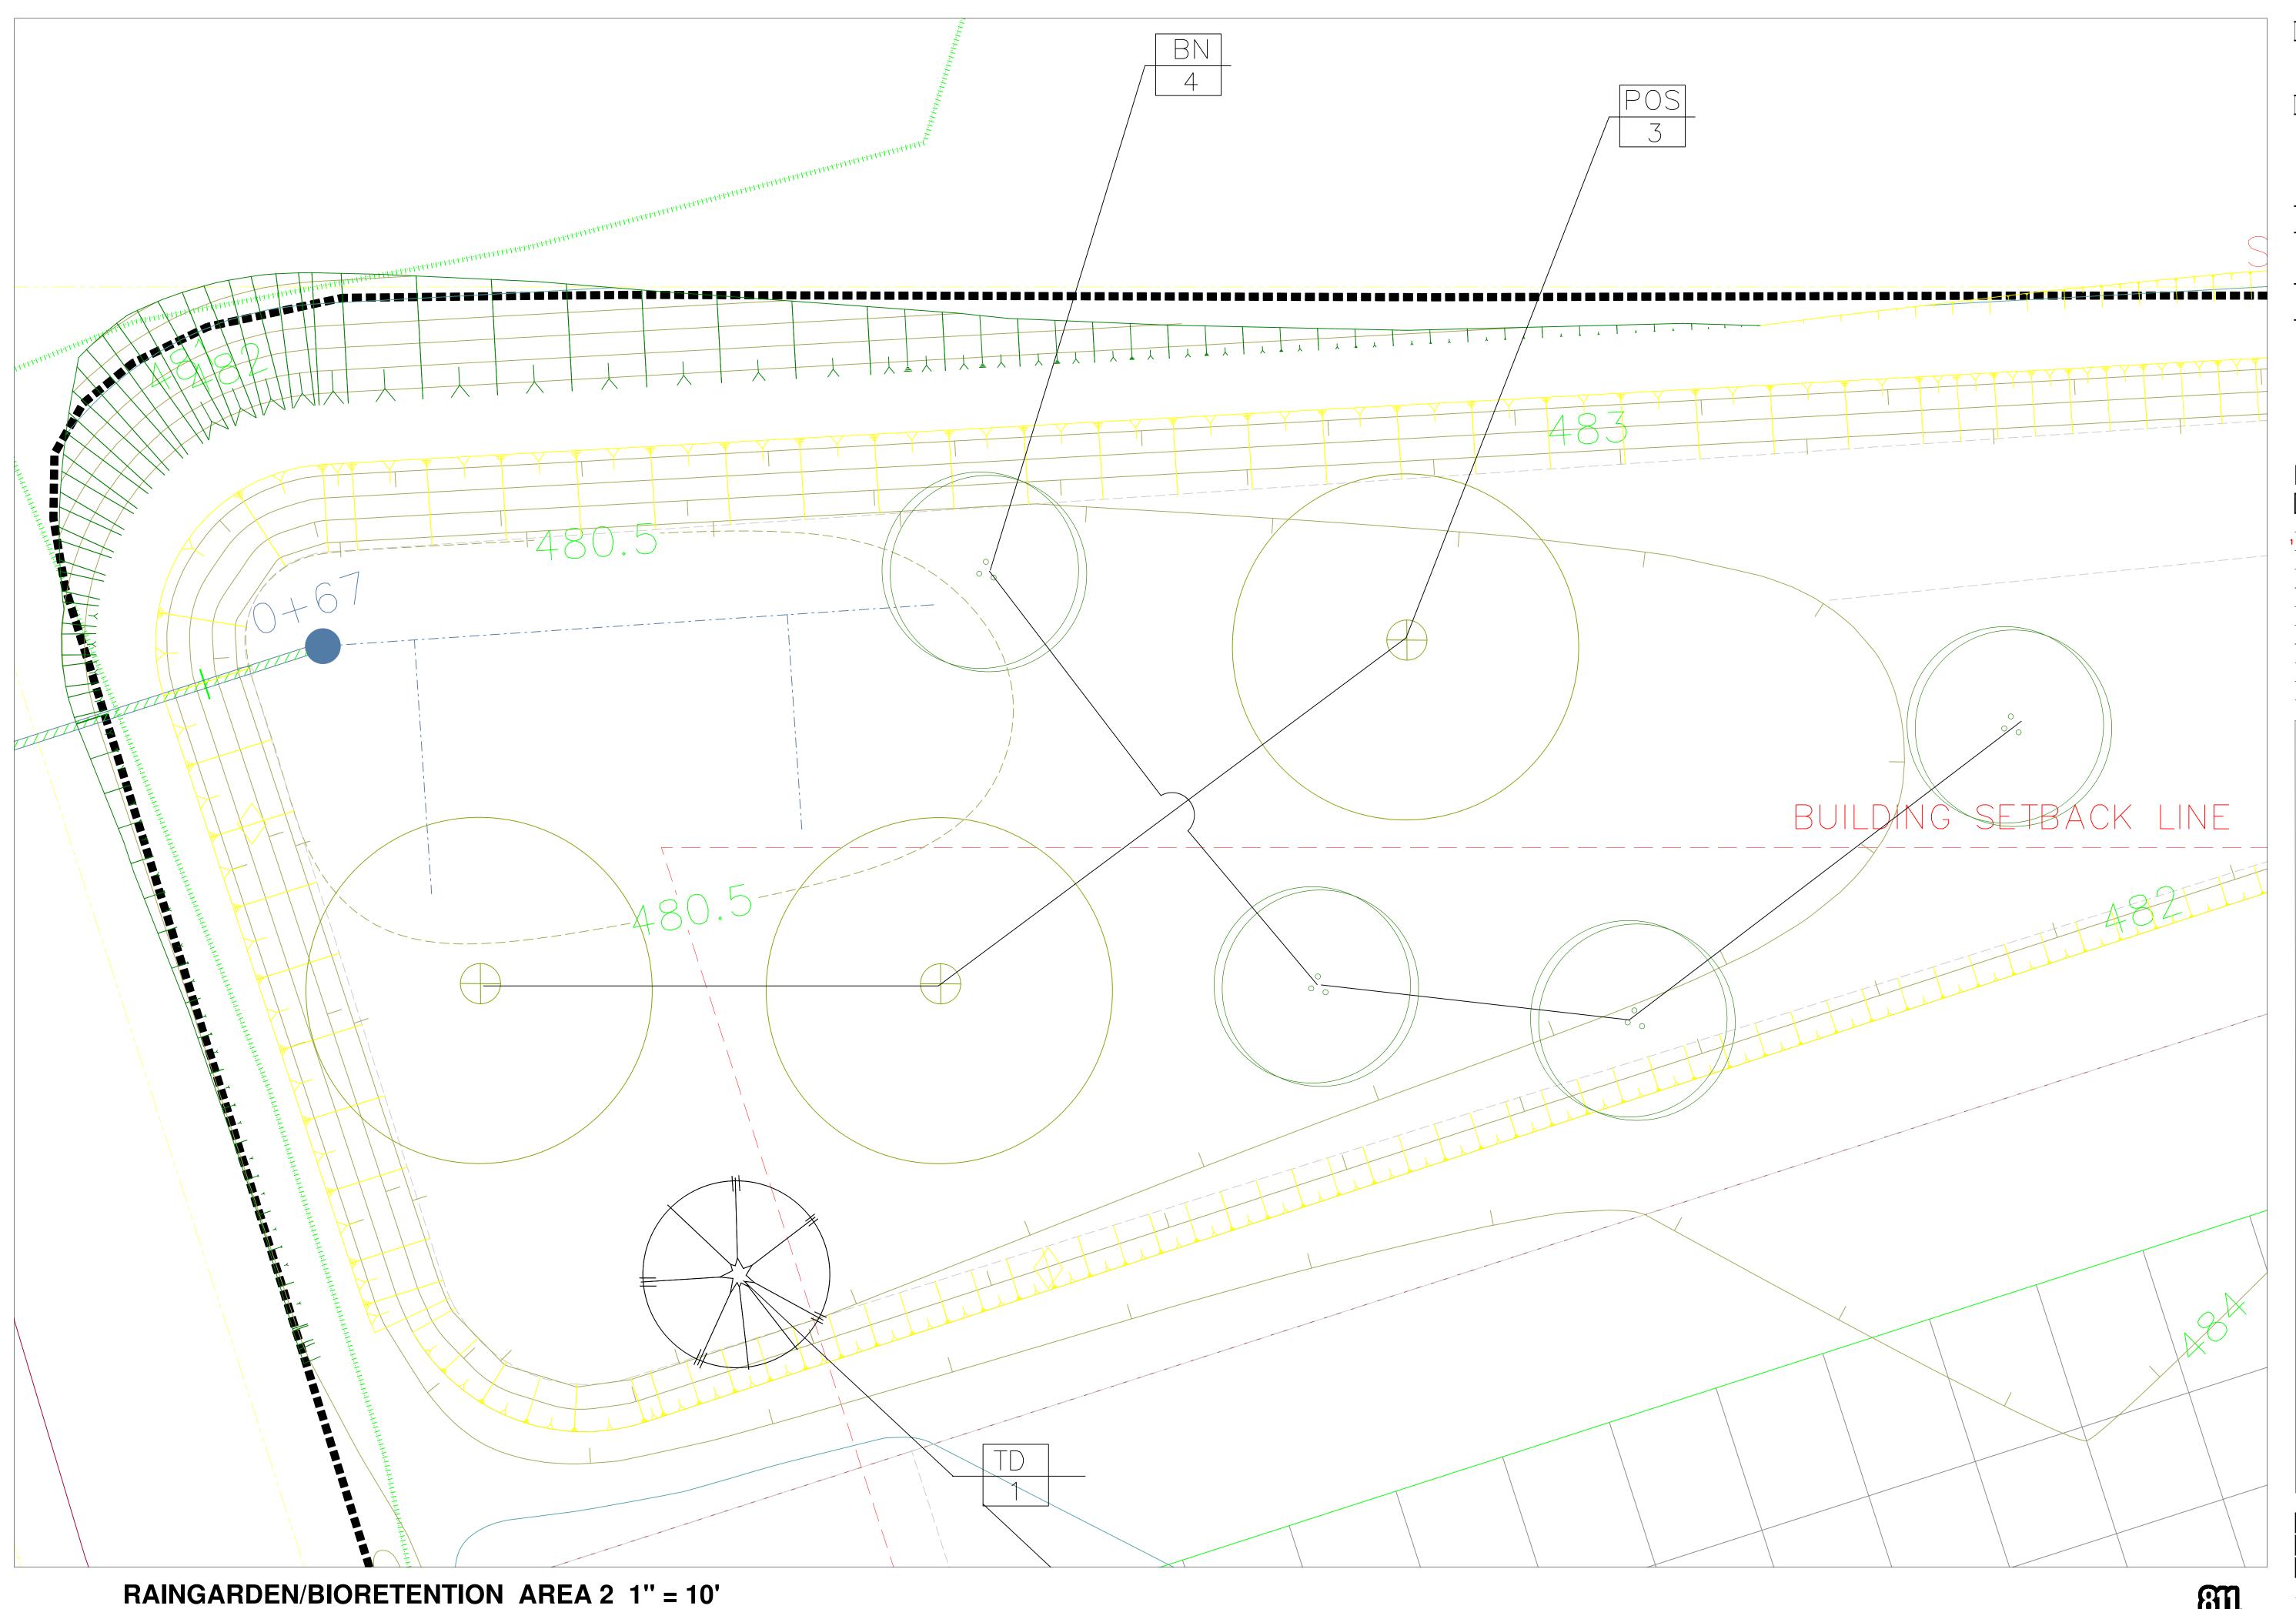
LANDSCAPE PLANTING PLAN
Raingarden/Bioretention Pond 1

LA -4

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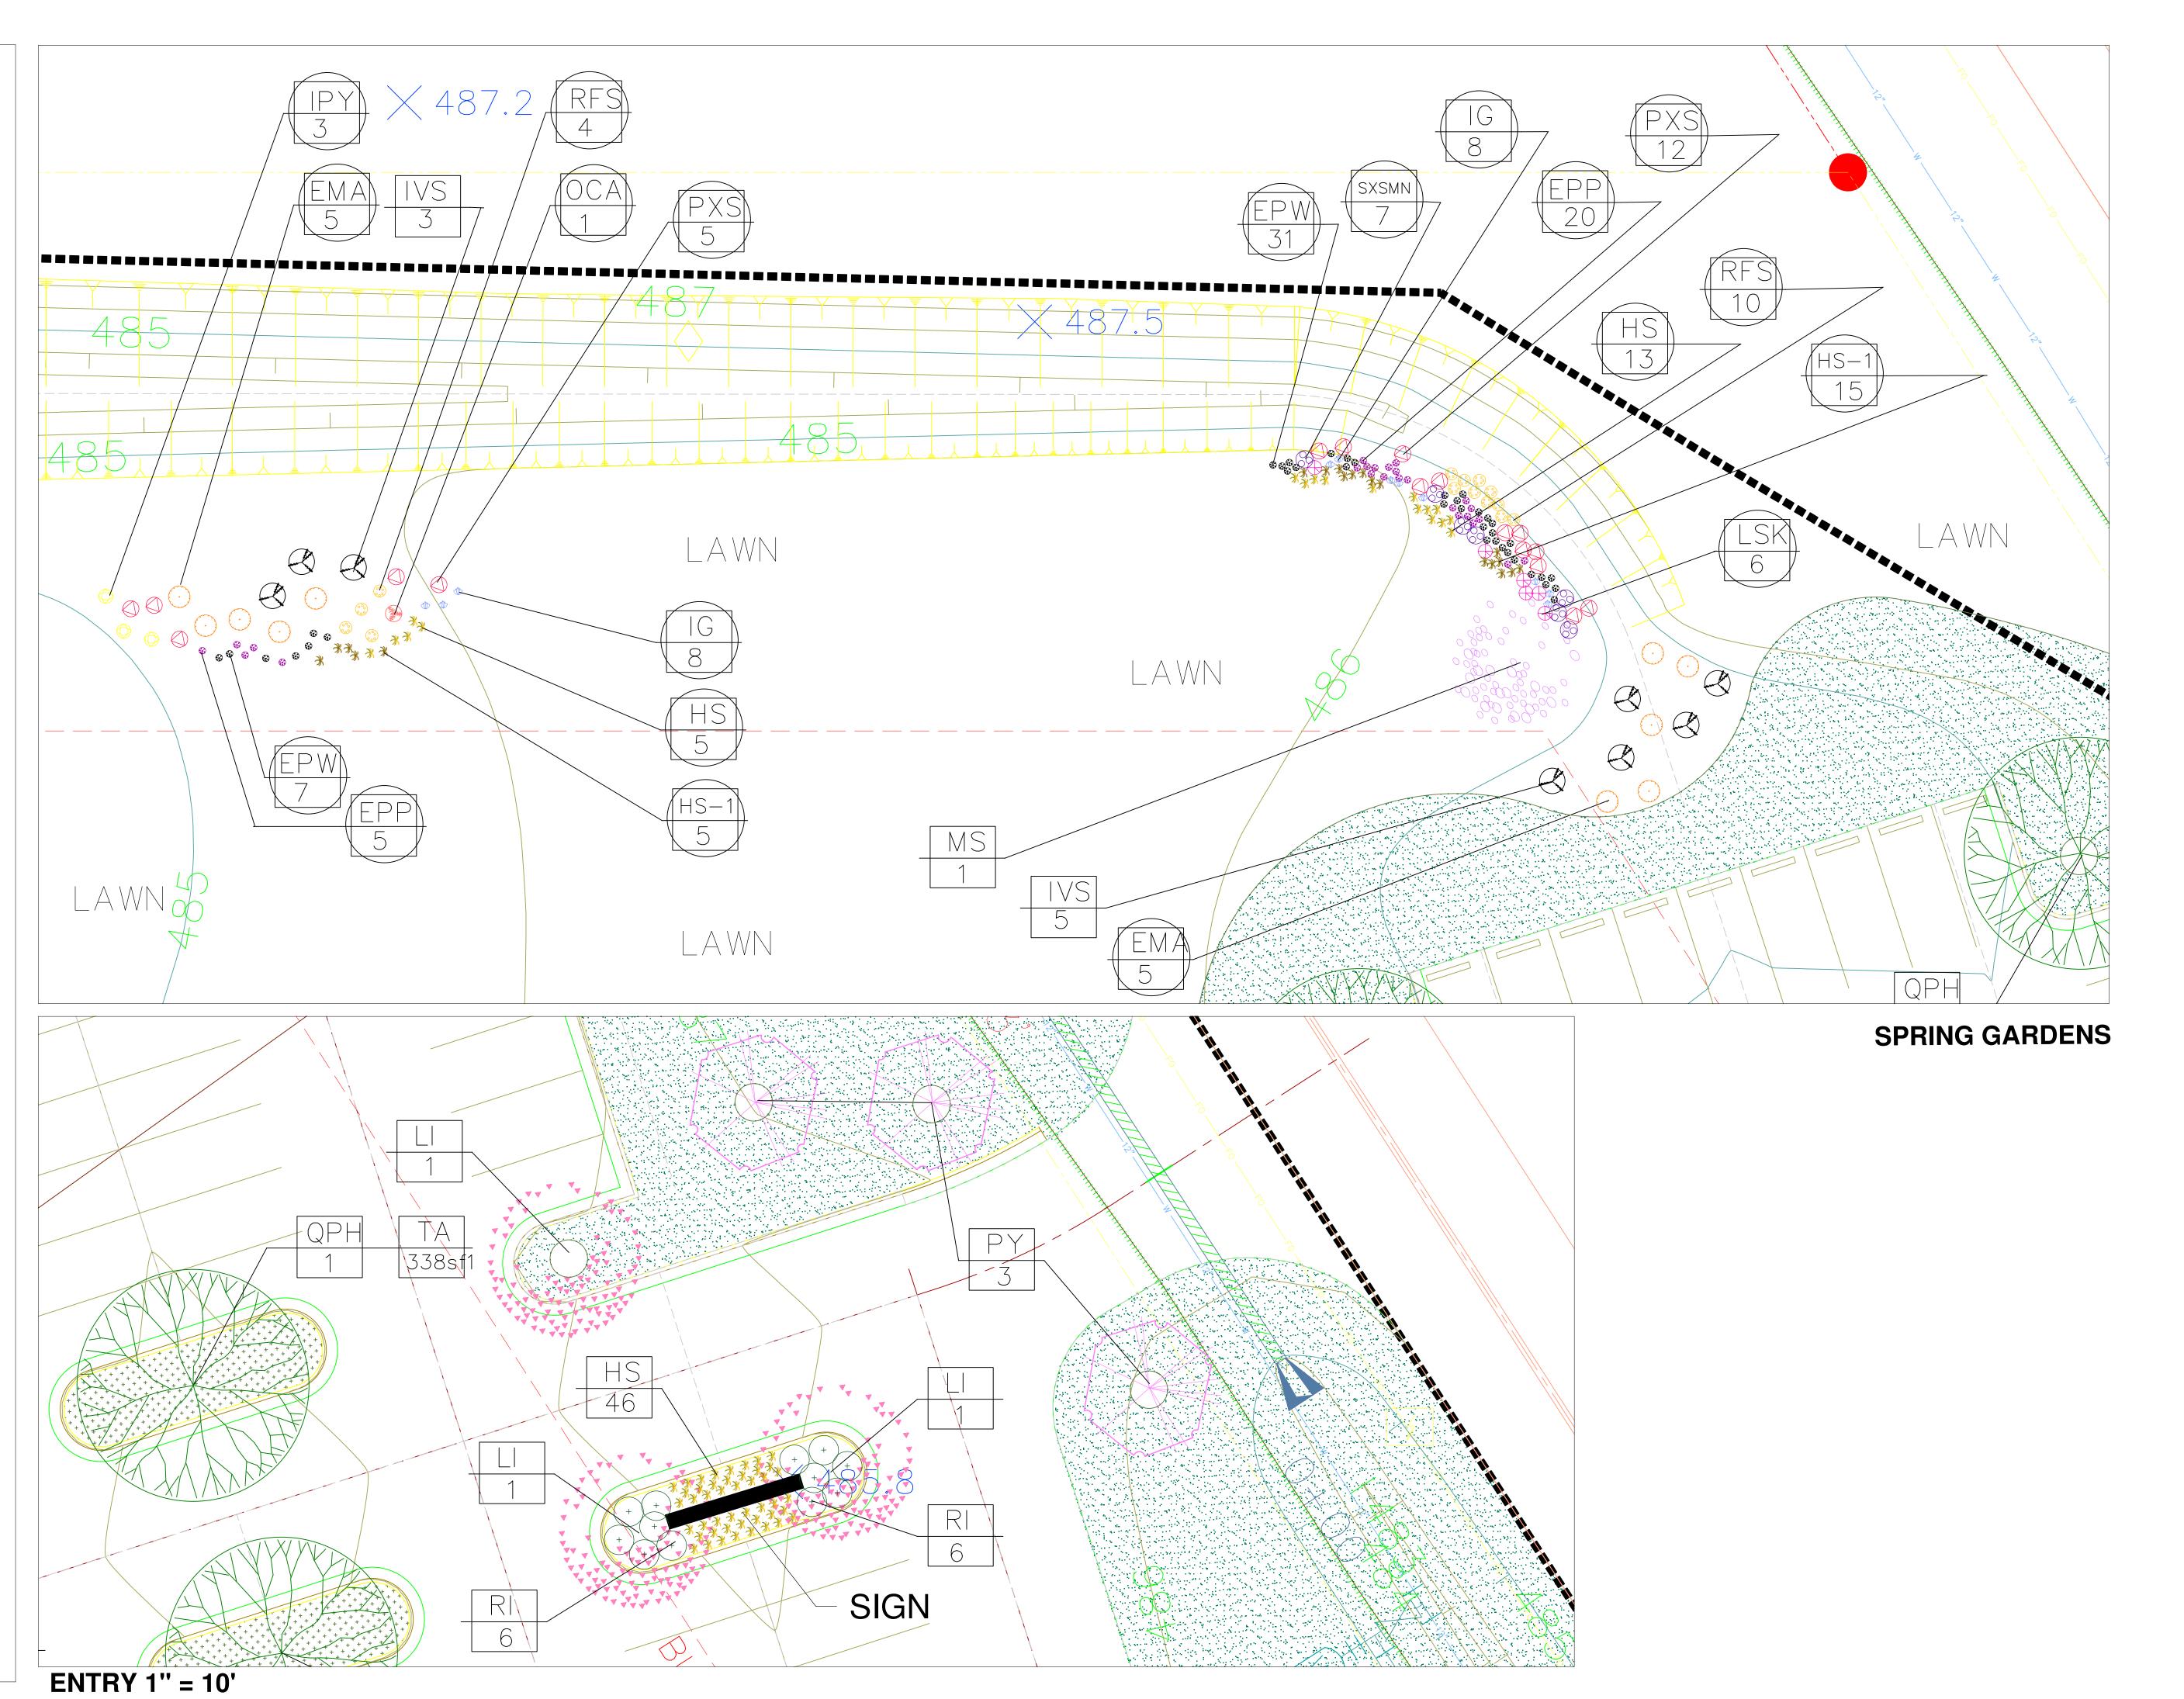
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ZT LA -6 **CHECKED BY** SHEET NO.

**BOTANICAL NAME** 

Bald Cypress

COMMONNAME

SIZE

REMARKS

Well Branched Full Form

Full Rich Color

Full Well Branched

Approved Substitutions, Emily Bruner Holly 6' HT. Approved Substitutions, Tulip Poplar 3" Cál

Taxodium distichum

Approved Substitutions, Shumard Oak or Overcup Oak same size

KEY SIZE BOTANICAL NAME COMMON NAME **REMARKS** AGLR Abelia grandiflora 'Little Richard' Little Richard Abelia 5 Gal. 5 Gal 33 |Forsythia intermedia Border Forsythia 3 Gal Gardenia jasminoides radicans Dw arf Gardenia 2 Gal. ok 5 Gal IBN Dw arf Burford Holly llex cornuta "Burfordii Nana" llex crenata 'Sky Pencil' 3 Gal Sky Pencil Holly **3**288 3 Gal llex vomitoria "Nana" Dw arf Yaupon Holly <sup>7</sup> Gal Anise Illicium anisatum 22 AZF 3 Gal Rose Purple Flow er Indica Azalea 'Formosa Formosa Southern Azalea 5 Gal. 3 Virginia Sw eetspire 19 Itea virginica LCPP 3 Gal **57**134 Purple Pixie Loropetlum Loropetalum chinense 'Purple Pixie' OFN 7 Gal. 5 Osmanthus fragrans Fragrant Tea-olive

# NOTES

CONTRACTOR SHALL MAKE NECESSARY SITE INSPECTIONS PRIOR TO BIDDING &/OR LANDSCAPE OPERATIONS TO FAMILIARIZE HIMSELF WITH SITE CONDITIONS. 2. PLANT MATERIAL SPECIFICATIONS SHOWING SIZE AND SPREAD OF MATERIAL SHALL BE ADHERED TO REGARDLESS OF CONTAINER SIZE, SIZE & SPREAD SHALL ALWAYS RULE OVER CONTAINER SIZE EXCEPT WHERE NO SIZE IS INDICATED. WHEN CONTAINER SIZES ARE SHOWN THEY SHALL BE FULL CONTAINERS, RATHER THAN RECENTLY "BUMPED" MATERIAL, LANDSCAPE ARCHITECT WILL INSPECT ALL PLANTS AND ANY DETERMINED BY LANDSCAPE ARCHITECT TO BE BUMPED' WILL HAVE TO BE REPLACED AT CONTRACTOR'S COST.

3. THE LANDSCAPE PLAN IS TO SERVE AS A GUIDE TO PLANTING. MINOR ADJUSTMENTS MAY BE REQUIRED IN THE 4. PLANT LOCATIONS ARE SUBJECT TO CHANGE BY LANDSCAPE ARCHITECT AND/OR OWNER. ALL PLANTS AND INSTALLATION ARE SUBJECT TO APPROVAL BY LANDSCAPE ARCHITECT.

5. IN THE EVENT OF VARIATION BETWEEN QUANTITIES SHOWN ON THE PLANT LIST AND THE PLANS, THE PLANS SHALL CONTROL. IMPROPER PLANT COUNTS MADE BY THE LANDSCAPE CONTRACTOR SHALL BE NO CAUSE FOR ADDITIONAL COST TO OWNER.

- 6. NO SUBSTITUTIONS SHALL BE MADE WITHOUT WRITTEN CONSENT OF THE OWNER AND LANDSCAPE ARCHITECT OR THE LANDSCAPE ARCHITECT WHO'S SEAL IS AFFIXED TO THESE DOCUMENTS. 7. ALL PLANTING BEDS SHALL RECEIVE 3" DEPTH OF PINE STRAW MULCH EXCEPT WHERE DIRECTED BY LANDSCAPE
- ARCHITECT. ALL NONE PLANTED, NONE GRASSED AREAS SHALL RECEIVE 2" COVER OF PINE STRAW. WHERE CYPRESS CHIPS ARE SPECIFIED, THEY SHALL BE CLEAN AND OF NATURAL COLOR AT A DEPTH OF 3" MINIMUM. KEEP ALL MULCH
- 8. ALL BED LINES SHALL BE 3" V-SHAPED TRENCH.
- 9. ALL PLANTINGS SHALL BE BACKFILLED WITH A MIXTURE OF 3/4 TOPSOIL AND 1/4 PEAT.
- 10. TOPSOIL MATERIAL SHALL BE FREE FROM HARD CLODS, STIFF CLAY, HARD PAN, STONES LARGER THAN 1" IN DIAMETER, NOXIOUS WEEDS AND PLANTS, SOD, PARTIALLY DISINTERGRATED DEBRIS, INSECTS, OR ANY OTHER UNDESIRABLE MATERIAL, PLANTS, OR SEEDS THAT WOULD BE TOXIC OR HARMFUL TO GROWTH. TOPSOIL SHOULD BE FERTILE, FRIABLE, AND OF A NATURALLY LOAMY CHARACTER WITHOUT ADMIXTURE OF SUBSOIL MATERIAL, OBTAINED FROM
- 11. CAUTION SHALL BE EXERCISED TO AVOID SETTLEMENT OF PLANT MATERIAL IN SOFT OR FILL AREAS. 12. IT SHALL BE THE LANDSCAPE CONTRACTOR'S RESPONSIBILITY TO PREVENT PLANTS FROM FALLING OR BEING BLOWN OVER, AND TO STRAIGHTEN OR REPLANT ALL PLANTS WHICH ARE DAMAGED DUE TO LACK OF GUYING OR STAKING. IF UNGUYED, PLANTS BLOWN OVER BY HIGH WINDS SHALL NOT BE A CAUSE OF ADDITIONAL EXPENSE TO OWNER, BUT SHALL BE THE FINANCIAL RESPONSIBILITY OF THE LANDSCAPE CONTRACTOR. GUYED TREES BLOWN OVER Y WINDS IN EXCESS OF 50 MILES PER HOUR SHALL NOT BECOME THE FINANCIAL RESPONSIBILITY OF THE LANDSCAPE

13. DURING THE COURSE OF THIS WORK, EXCESS WASTE MATERIAL SHALL BE REMOVED DAILY FROM THE SITE AND UPON COMPLETION OF ALL WORK. THE CONTRACTOR SHALL LEAVE THE SITE CLEAN AT ALL TIMES. 14. UPON COMPLETION OF ALL LANDSCAPING AN INSPECTION FOR ACCEPTANCE OF THE WORK SHALL BE HELD. THE LANDSCAPE CONTRACTOR SHALL NOTIFY THE LANDSCAPE ARCHITECT FOR SCHEDULING THE INSPECTION AT LEAST TEN (10)DAYS PRIOR TO THE ANTICIPATED INSPECTION DATE

15. THE LANDSCAPE CONTRACTOR IS HERE BY NOTIFIED OF THE EXISTANCE OF UNDERGROUND UTILITIES ON THE SITE. THEIR EXACT LOCATION SHALL BE VERIFIED IN THE FIELD PRIOR TO THE COMMENCEMENT OF ANY DIGGING OPERATIONS. IN THE EVENT ANY ARE UNCOVERED, THE LANDSCAPE CONTRACTOR SHALL PROMPTLY NOTIFY THE OWNER AND LANDSCAPE ARCHITECT. THE LANDSCAPE CONTRACTOR SHALL BE HELD RESPONSIBLE FOR REPAIR AND /OR

16. TREES LISTED AS OWNER PURCHASE WILL BE PURCHASED WITH FIVE YEAR GUARANTEE BY GROWER. LANDSCAPE CONTRACTOR WILL BE RESPONSABLE FOR SHIPPING ARRANGEMENTS AND SHIPPING COST FROM THE GROWER'S SITE TO THE PROJECT SITE. LANDSCAPE CONTRACTOR MUST UNLOAD ALL TREES IN ACCORD WITH THE REQUIREMENTS OF THE GROWER FOR FIVE YEAR GUARANTEE. TREES WILL BE SUBJECT TO MONITORING BY CONTRACTOR FOR THE FIVE YEAR PERIOD AND INSPECTION FORMS MUST BE SUBMITTED TO LANDSCAPE ARCHITECT FOR APPROVAL. FOLLOW ALL REQUIREMENTS OF THE SELECT TREE WARRANTY. z

NOTE ALL TREE PLANTING:

EACH TREE MUST BE PLANTED SUCH THAT THE TRUNK FLARE IS VISIBLE AT THE TOP OF THE ROOT BALL. TREES WHERE THE TRUNK FLARE IS NOT VISIBLE SHALL BE REJECTED. DO NOT COVER THE TOP OF THE ROOT BALL WITH SOIL.

IF TREE IS SHIPPED WITH A WIRE BASKET AROUND THE ROOT BALL, CUT THE WIRE BASKET AND REMOVE THE UPPER 1/3 OR MINIMUM 8" FROM TOP

# SELECT TREES WARRANTY REQUIREMENTS FOR CONTRACTOR

CONTRACTOR SHALL FOLLOW ALL INSTRUCTIONS INCLUDING ANY UPDATES PROVIDED AT TIME OF DELIVERY.

A. <u>UNLOADING, HANDLING, AND STAGING</u>

1. STAGING SYSTEMS SHOULD BE PREPARED IN ADVANCE TO ADEQUATELY HOLD TREES ABOVE GROUND FOR OPTIMUM TREE HEALTH PRIOR TO PLANTING, MANY TIMES, EVEN WITH THE BEST PLANNING & COORDINATION, TREES

2. USE EXTREME CAUTION WHEN HANDLING TREES. USE A STRAP CRADLE (ADEQUATE FOR WEIGHT AND SIZE OF ROOT BALL) ATTACHED TO THE ROOT BALL TO UNLOAD A MOVE TREES. STRAPPING & WIRE BASKETS CAN BREAK OR LOOSEN, NEVER MOVE, LIFT, OR HANDLE BY ATTACHING TO OR BY PUTTING PRESSURE ON THE TRUNK. BE VERY CAREFUL NOT TO DAMAGE OR SCAR TRUNKS & BRANCHES.

- 3. PRIOR TO UNLOADING, PROPER MOISTURE SHOULD BE MAINTAINED IN ROOT BALLS. TRUCKS SHOULD BE STAGED IN THE SHADE PRIOR TO UNLOADING. UNLOADING TIME SHOULD BE NO MORE THAN TWO HOURS PER TRUCK. 4. IMMEDIATELY AFTER UNLOADING (NO MORE THAN ONE HOUR AFTER UNLOADING) STAND THE TREES UP. THIS WILL
- REDUCE THE RISK OF SUN SCALD. PROPERLY STAGED TREES ARE STANDING, UNTIED & SPACED. 5. REMOVE THE CARDBOARD TRUNK PROTECTOR WITHIN 48 HOURS OF TREES BEING STOOD UPRIGHT TO REDUCE THE RISK OF DAMAGE. 6. MONITOR MOISTURE IN THE ROOT BALL BY PROBING WITH A SOIL PROBE & MANAGE SUPPLEMENTAL IRRIGATION
- ACCORDINGLY. BE CAREFUL NOT TO OVER OR UNDER IRRIGATE. 7. DURING COLD WEATHER PERIODS, ROOT BALLS MUST BE PROTECTED FROM FREEZING TEMPERTURES.
- B. PLANTING

  1. BEFORE PLANTING, REMOVE ANY PLASTIC WRAP & ANY CIRCLING ROOTS FROM THE ROOT BALL. HANDLE TREE
  ONLY BY ROOT BALL & BE CERTAIN YOUR EQUIPMENT, INCLUDING STRAP & CHAIN CRADLES ARE RATED FOR THE
- 2. EXCAVATE PLANTING HOLE AT LEAST TWO TIMES THE DIAMETER & 2" SHALLOWER THAN THE ROOT BALL.

WHENEVER POSSIBLE A TELEHANDLER WITH SIDE TILT CARRIAGE FORKS (BRANDS SUCH AS LULL OR JLG) MACHINE RATED TO HANDLE WEIGHTS OF ROOT BALLS AND TREES SHOULD BE USED TO SET ROOT BALLS IN PLANTING PITS.
FORKS SHOULD ALWAYS BE CAREFULLY POSITIONED ABOVE ROOT BALL TO LIFT ROOT BALL BY STRAPPING ON TOP OF
THE ROOT BALL WITH FOUR PICK UP POINTS FOR EVEN WEIGHT DISTRIBUTION. PRIOR TO SETTING ROOT BALL IN
PLANTING PIT, FORKS SHOULD BE ADJUSTED SO THAT TREE IS PLUMB. PLACE ROOT BALL AT A LEVEL WHERE THE TRUNK FLARE WILL BE 2" ABOVE SURROUNDING FINIDHED GRADE AFTER SETTLING.

4. SATURATE THE PLANTING HOLE WITH WATER AFTER BACKFILL IS 1/2 COMPLETE TO AID REMOVAL OF AIR FROM

5. AFTER INITIAL BACKFILL, WATERING, & THE TREE IS PLUMB, THEN ADD BACKFILL TO JUST BELOW THE TOP HORIZONTAL RING OF THE WIRE BASKET, COMPLETELY SATURATE PLANTING HOLE. ADJUST ROOT BALL (IF NECESSARY) BY ADJUSTING FORKS TO MAKE TREE STRAIGHT & PLUMB AND AT PROPER DEPTH.

6. IF FOR ANY REASO TREES NEED STRAIGHTENING, TREES CAN BE STRAIGHTENED BY CAREFULLY DIGGING OUT AROUND THE ROOT BALL, ATTACHING STRAP TO PART OF THE WIRE BASKET THAT IS STILL INTACT AROUND THE ROOT BALL, AND LIFTING. NEVER PULL, PUSH OR PUT PRESSURE ON THE TRUNK (REFER TO ACTIONS B.3-B.10 FOR INFORMATION TO COMPLETE THIS PROCESS). IF TREE ROOTS ARE SIGNIFICANTLY ESTABLISHED IN BACKFILL, IT IS BEST FOR THE HEALTH OF THE TREES TO WAIT UNTIL DORMANCY TO STRAIGHTEN TREES. STAKING SHOULD BE RE-ADJUSTED

7. AFTER ABOVE ITEMS HAVE BEEN COMPLETED AND TREE IS PLUMB WITH ROOT BALL AT PROPER DEPTH, GENTLY REMOVE FORKS AND ALSO REMOVE: A. THE SYNTHETIC WRAP, B. ANY CARDBOARD PACKAGING, C. THE TOP PORTION OF THE WIRE BASKET DOWN TO INCLUDE THE FIRST HORIZONTAL RING, D. THE BURLAP FROM THE TOP PORTION OF

8. COMPLETE THE BACKFILL & THOROUGHLY SATURATE WITH WATER. REPEAT THIS STEP IF NECESSARY TO MAKE

). IMMEDIATELY AFTER BACKFILL HAS SETTLED & THE TREE IS STRAIGHT & PLUMB, STAKE TREE TO PROVIDE STABILITY UNTIL ROOT SYSTEM IS THOROUGHLY ESTABLISHED IN THE BACKFILL. CHECK STAKING AS NEEDED TO MAKE SURE TRUNK DAMAGE DOES NOT OCCUR. CHECK TO CONFIRM THAT TREE & ROOT BALL IS STABLE BEFORE REMOVING. 11. MULCH THE AREA OVER THE ROOT BALL TO A DEPTH NO DEEPER THAN 1 1/2" TO 2". KEEP ALL MULCH AWAY

C. POST-PLANTING CARE AVAILABLE FROM SELECT TREES. MULCH THE AREA OVER THE ROOTBALL TO A DEPTH NO DEEPER THAN 3'. KEEP ALL MULCH AWAY FROM THE TRUNK FLARE. BARK TISSUE THAT IS IN CONTACT WITH MULCH IS LIKELY TO SOFTEN AND TO ATTRACT INSECTS AND

2. SOIL MOISTURE - "TREE MAINTENANCE SPREADSHEET" (AVAILABLE FROM ZT3 OR SELECT TREE) SHOULD BE UPDATED DURING FIRST TWO GROWING SEASONS, (APRIL 1 THROUGH OCTOBER 30)AND BE SUBMITTED TO LANDSCAPE ARCHITECT FOR REVIEW PRIOR TO SUBMITTAL TO SELECT TREES. SUBMITTAL TO SELECT TREES SHALL BE MADE WITHIN TWO BUSINESS DAYS. MONITOR MOISTURE IN TH EROOTBALL AND BACKFILL BY TAKING A CORE SOIL SAMPLE WITH A SOILO PROBE & MANAGE SUPPLEMENTAL IRRIGATION ACCORDINGLY. BE CAREFUL NOT TO OVER OR UNDER IRRIGATE. NOTE: TREES WILL NOT THRIVE AND WILL OFTEN DIE IN SATURATED SOILS. IRRIGATION SHOULD BE IMMEDIATELY STOPPED ON ALL TREES WITH EXCESS SOIL MOISTURE & RESTART ONLY WHEN SOIL PROBE INDICATES WATER IS NEEDED. TREES WITH EXCESS SOIL MOISTURE SHOULD BE MONITORED AND TREATED DAILY. SUBSURFACE DRAINAGE MAY BE REQUIRED TO CREATE PROPER SOIL MOISTURE. WHEN SOIL PROBING INDICATES THAT ROOTBALLS ARE IN NEED
OF WATER, TREEGATOR BAGS CAN BE ADDED IMMEDIATELY TO ALLOW FOR SLOW APPLICATION OF WATER.
TREEGATOR BAGS SHOULD NOT STAY ON THE TRUNK LONG ENOUGH TO SOFTEN TRUNK TISSUE OR TO PROVIDE A
HAVEN FOR PESTS. TREEGATOR BAGS SHOULD BE REMOVED APPROXIMATELY EVERY 8-10 DAYS FOR A PERIOD OF 1
TO 2 DAYS. IF PRACTICAL, THE BEST TIMES TO REMOVE TREEGATOR BAGS ARE DURING CLOUDY OR RAINY WEATHER.
THIS WILL MINIMIZE RISK OF SUNSCALD DAMAGE. WHILE THE TREEGATOR BAGS ARE OFF THE TREE, ALTERNATE

METHODES OF APPLYING WATER SHOULD BE USED IF NEEDED.

IF YOUR TREEGATOR BAGS ARE NOT DRAINING PROPERLY, TRY THESE RECOMMENDATIONS: FIRST-BE CERTAIN THAT WHILE FILLING THE PRODUCT TO APPROXIMATELY 1/4 CAPACITY LIFT UP GENTLY ON THE STRAPS AT THE TOP OF THE BAG. DOING SO ENSURES THAT THE WATER RELEASE HOLES ARE IN THE CORRECT POSITIONS EACH TIME THE BAG IS FILLED. SOMETIMES A TREEGATOR JUST NEEDS TO BE RESET, ESPECIALLY IF IT HAS BEEN LEFT IN A STATIC POSITION FOR AN EXTENDED PERIOD OF TIME. TO RESET YOUR TREEGATOR BAG EMPTY ANY REMAINING WATER FROM THE BAG (BE SURE TO HOLD THE TWO SIDES TOGETHER AS THE BAG IS UNZIPPED TO PREVENT DAMAGE TO THE ZIPPERS). THEN, LAY THE BAG FLAT AND SMOOTH OUT ANY WRINKLES OR KINKS THAT MAY HAVE FORMED. THEN ZIP UP AROUND TRUNK, FILL WITH WATER AND LET EMPTY SURE THERE IS NO DEBRIS COVERING THEN UP. WHEN FULL, RELEASE HOLES ARE LOCATED UNDERNEATH EACH CORNER OF THE BAG. CHECK TO SEE IF THEY ARE CLOGGED BY GENTLY LIFTING UP EACH CORNER UNTIL YOU CAN SEE THE WATER RELEASE HOLE LOCATIONS.

S. STAKING-COMPLETELY REMOVE ALL STAKING SYSTEMS AT THE APPROPRIATE TIME TO PREVENT TRUNK & STEM

DISEASE. REMOVE ANY OLD MULCH BEFORE APPLYING NEW MULCH.

6. NUTRITION-MONITOR NUTRITION AS NEEDED BY ANALYZING SOIL AND/OR TISSUE SAMPLES

# QTY

**04**60

## SIZE COMMON NAME KEY BOTANICAL NAME REMARKS SOD SEED Cynodon dactylon Sahara Bermudagrass Sahara 419 thick no w eeds Silver Fescue 1 Gallon Festuca cinerea <mark>20</mark> 86 LMV 1/4 Gallon Liriope muscari 'Variegata' Variegated Liriope OCA 1 Gallon Osmunda cinnamomea Cinnamon Fern 5,525 SF Space 15" O.C. Trachelospermum asiaticum Asiatic Jasmine Sprig./pint

Indian Haw thorn

Knock Out Rose

Raphiolepis indica

Rosa 'Radrazz'

Zoysia japonica x 5,376SF SOD2 Bermuda Improved Variety **Emerald Zoysia Grass** Bermuda Mohawk

SOD SOD

3 Gal

7 Gal. 5

Sahara, 419 approved opt

5,000SF seed Love Grass with Fiber Mat in Pond area

QT	Υ	KEY	BOTANICAL NAME	COMMONNAME	SIZE	REMARKS
25	-44	EPP	Echinacea purpurea	Purple Coneflow er	Pint	
38	69	EPW	Echinacea purpurea "Alba"	White Purple Coneflow er	Pint	
10	-65	EMA	Eupatorium maculatum "Atropurpureum"	Joe-Pye Weed	Gallon	
20	-80	HS-1	Hemerocallis x "Orange"	Orange Daylily	Bare Root	
<b>-</b> 12	<b>7</b> 132	HS	Hemerocallis x "Stella de Ore'	Stella de Ore Daylily	Bare Root	
11	24	IG	Iris germanica	German & Bearded Iris	Gallon	
3	40	IPY	Iris pseudacorus	Yellow Flag Iris	Gallon	
6	13	LSK	Listris spicata 'Kobold'	Kobold Gay Feather	Gallon	
1	14	OCA	Osmunda cinnamomea	Cinnamon Fern	Bare Root	
17	-30	PXS	Phlox x 'Starfire'	Starfire Phlox	Pint	
14	116	RFS	Rudbeckia fulgida speciosa	Blackeye Susan	Pint	
7	11	SXS-MN	Salvia x sylvestris 'May Night'	May Night Salvia	Pint	

# **REVISED PLAN NOTES:**

LAWN NOTE: APPLY FERTILIZE AND WEED CONTROL - USE WHAT IS THERE AND RESEED AS NEEDED TO HAVE FULL GRASS COVERAGE. HYDRO SEED APPLICATION RECOMMENDED.

SOD2: PLANT IN SPRING AFTER APPLYING ROUNDUP TO ACTIVELY GROWING EROSION CONTROL GRASS. 2 APPLICATIONS REQUIRED AT TWO WEEK INTERVAL

TREE ISLAND NOTE: DO NOT PLANT ASIATIC JASMINE UNTIL SPRING AND EXISTING EROSION CONTROL GRASS ARE ACTIVELY GROWING. THEN APPLY ROUND-UP, WAIT 2 WEEKS APPLY SECOND APPLICATION OF ROUND-UP. ONCE ALL EROSION CONTROL GRASS IS DEAD PLANT ASIATIC JASMINE. MAY NEED TO MULCH ISLANDS IN THE MEAN TIME. CONTRACTOR TO MAINTAIN & CONTROL WEEDS FOR ONE YEAR.

> 811 Know what's below.
> Call before you dig.

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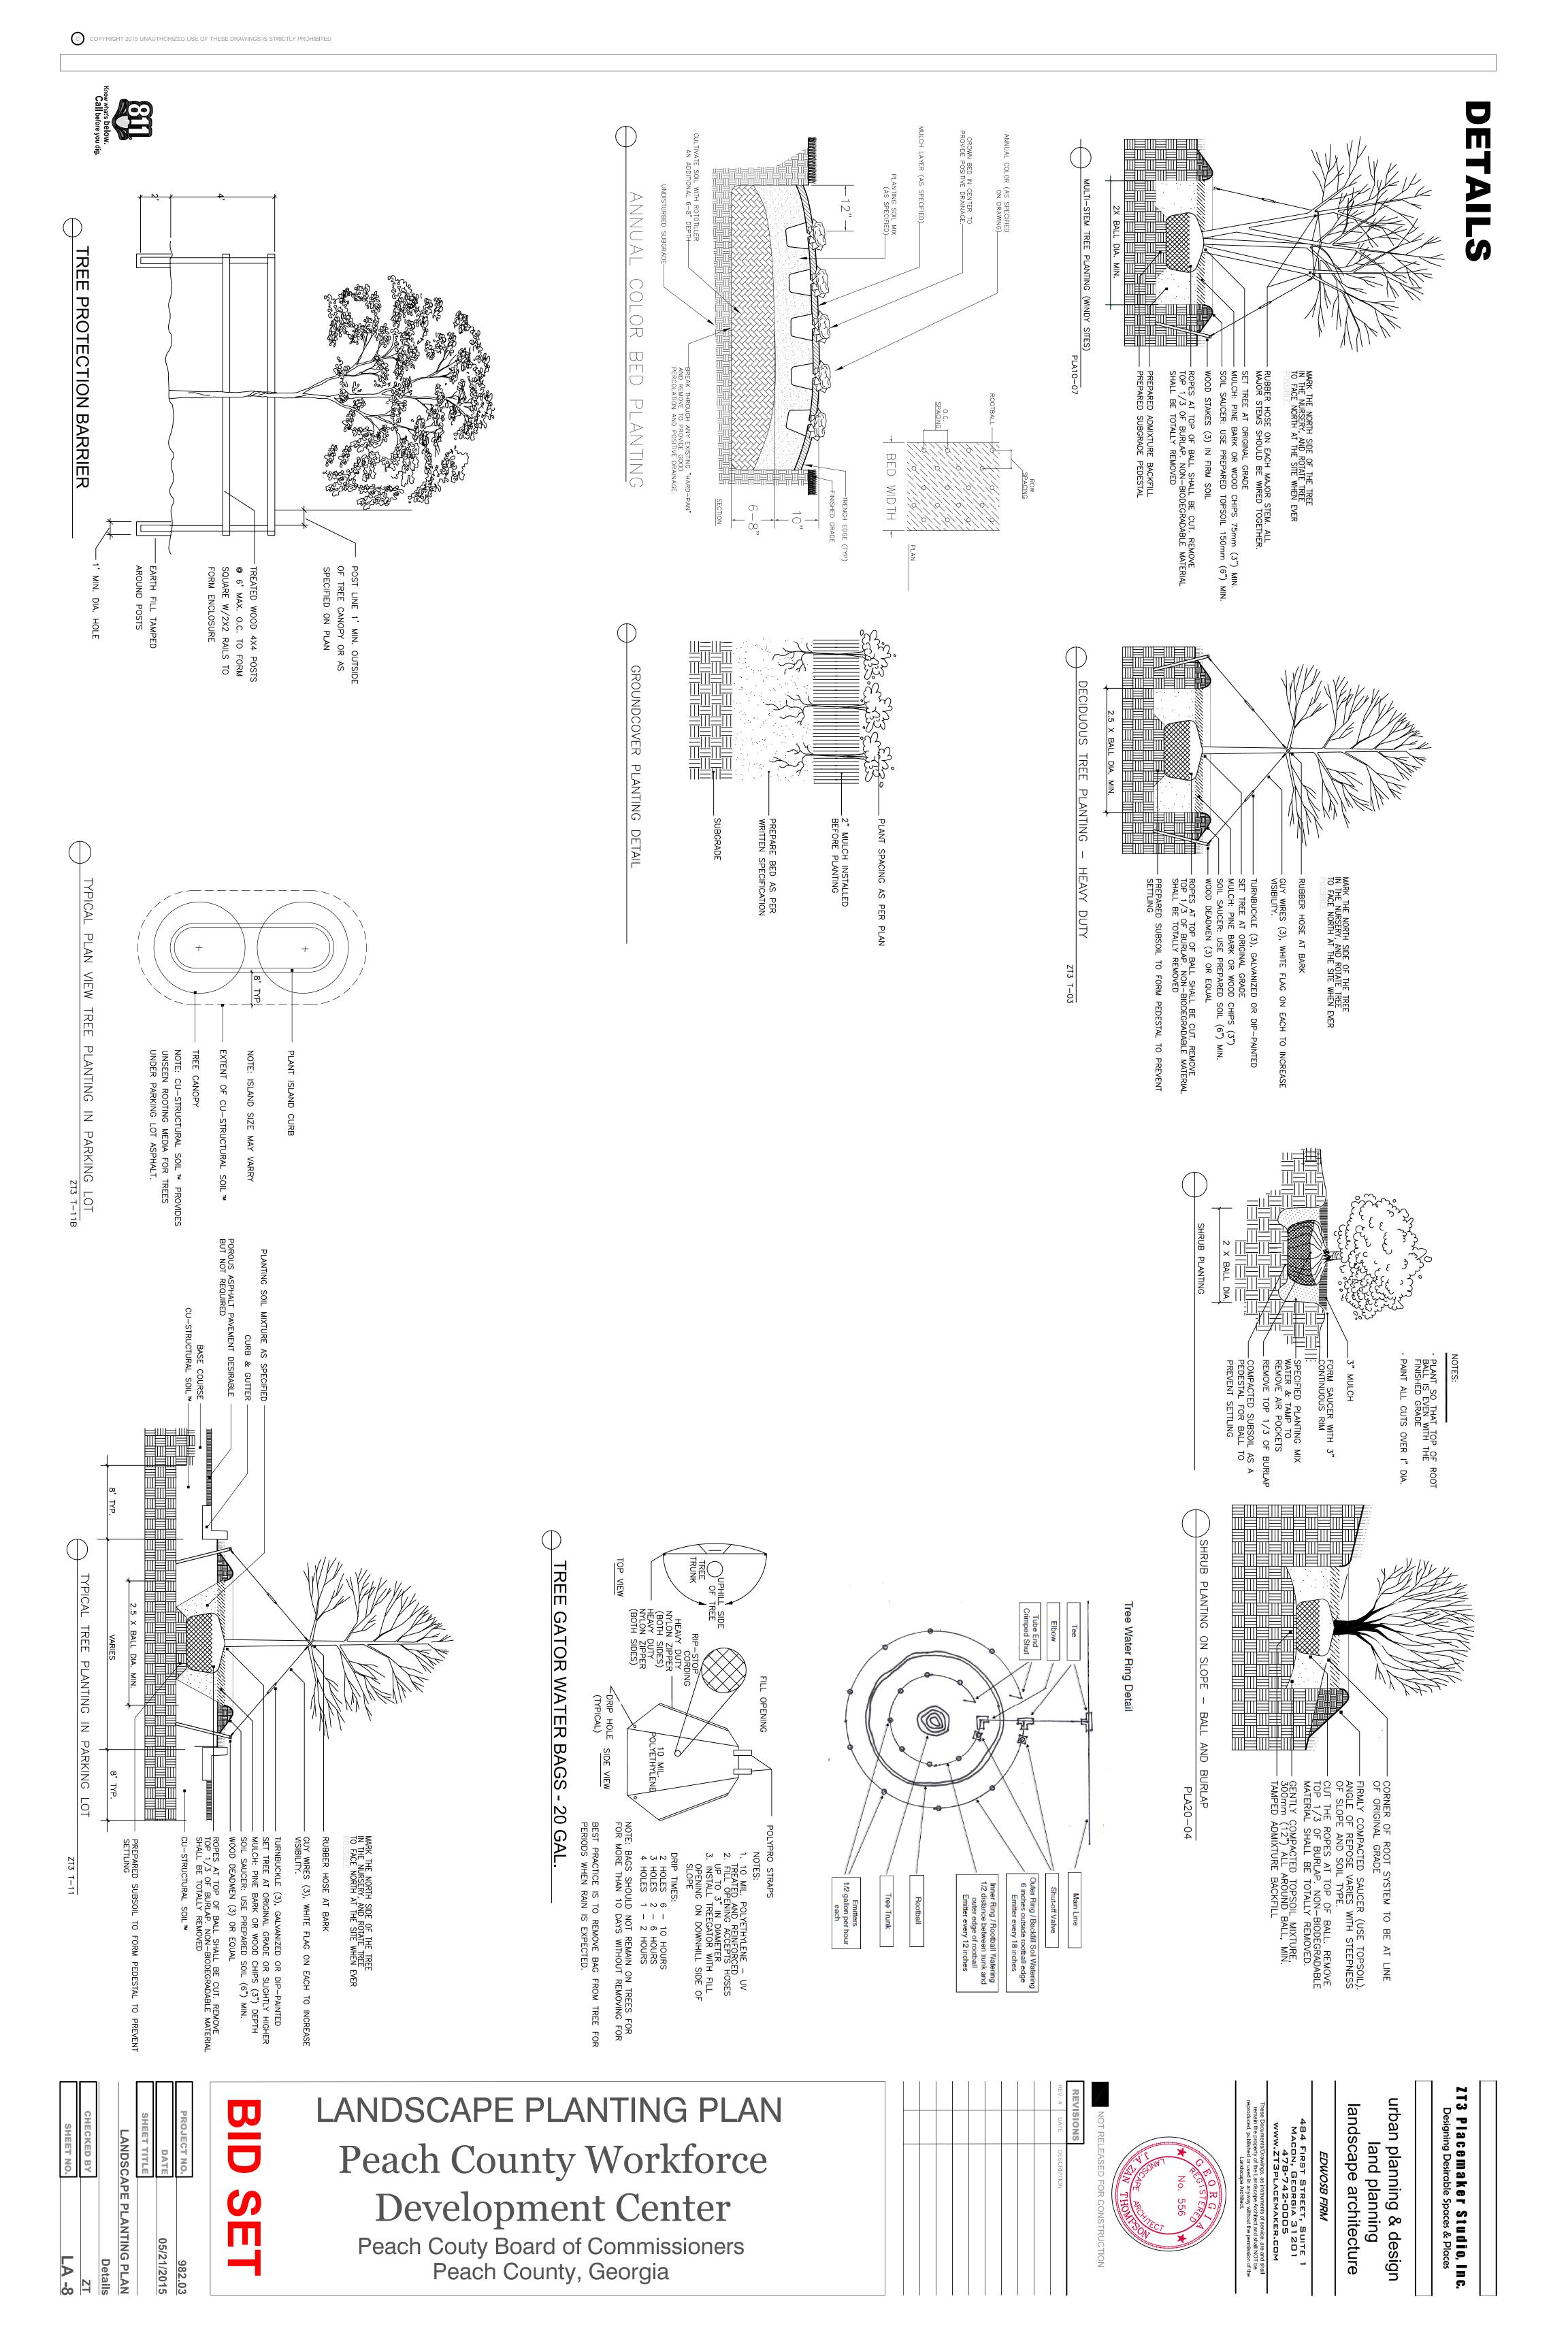
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REVISED **BID SET** 

PROJECT NO DATE 05/21/2015

> **SHEET TITLE** LANDSCAPE PLANTING PLAN

**Plant Schedule & Notes** CHECKED BY **LA** -7 SHEET NO.



# PLANTING OF TREES

**AND SHRUBS** 

# A. GENERAL

Section 1-A

# SCOPE OF WORK

All labor, materials and equipment required by or inferred from drawings and specifications to complete all of the landscaping and planting as shown on the drawings. Before commencing any work required under the contract, the Contractor shall find the location of all utilities, subsurface drainage and underground construction so that proper precautions may be taken not to disturb or damage any subsurface improvements.

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APPLICABLE SPECIFICATIONS AND STANDARDS Standardized Plant Names, latest edition committee on Horticultural Nomenclature.

American Standard for Nursery Stock, 1980 Edition American Association of Nurserymen

# $\mathcal{S}$ APPROVAL AND SELECTION OF MATERIALS AND WORK

The selection of all materials and the execution of all operations required under the specifications and drawings shall be subject to the approval of the Landscape Architects. They shall have the right to reject any and all materials and any and all work which, in their opinion, does not meet the requirements of the contract documents at any stage of the operations. All rejected materials shall be removed from the site by the Contractor.

Specific requirements concerning the various species and the manner in which they are to furnished are shown on the drawings and plant list.

- þ. Quality and Size. Plants shall be nursery-grown, freshly dug, normally shaped, and well-branches; full foliaged when in leaf and shall have healthy, well-developed root systems. Trees must be self supporting, with straight trunks and with leaders intact. All plants furnished shall be free of any insect infestations or their eggs, and shall have been grown under climatic conditions with temperature extremes similar to those of the locality of the project for a minimum of two years prior to use on this project. All plants shall be possible. No substitutions shall be permitted without written permission of the Landscape
- Architect.

  b. The Contractor shall submit for approval by the Landscape Architect, his sources for the various plant materials proposed. Photographs of the actual plant materials may be requested at the option of the Landscape Architect, a visit to these supply sources may be demanded for the purpose of close inspection and/or personal selection of the proposed material by the Landscape Architect.

  c. Stock furnished in the size range specified shall be interpreted to mean that not less than 50% shall be of the maximum size specified within each range.

  d. The determining measurements for trees shall be the caliper, height and spread. Caliper shall be taken 6" above the ground for trees up to 4" caliper and 12" above the ground for larger sizes. Height and spread dimensions specified refer to the main body of the plant. Take measurements with branches in normal position.

  e. Plants larger in size than those specified may be used with approval of the Landscape Architect at no additional cost to the Owner. If the use of larger plants is approved, the ball of earth or spread of roots shall be increased proportionately. Woody and leggy plants shall not be accounted.

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- e. d.
- not be accepted.

  Container grown plants in cans or wooden boxes of equal quality, as balled and burlapped plants, may be substituted in lieu thereof. Plants grown in containers shall be delivered and remain in containers in a shady location until planted. Plants in containers shall be watered prior to transportation and shall be kept moist until planted. The container must be removed prior to planting, care being exercised so as not to injure the plant roots.
- earth ball shall be made of jute and weight not less than 7.2 0Z. per square
- Peat: Reed peat, sedge peat, or moss peat at option of Contractor. shredded and suitable for horticultural purposes. Its pH value shait shall contain no more than 35% moisture by weight. ctor. Furnish: h air-dried, finely ween 5.5. and 6.5 and
- Pine Straw: shall be clean, fresh color and free of branches prevention chemical shall be installed under mulch. Color s and foreign Natural.  $\triangleright$
- Commercial fertilizer shall be a complete fertilizer, 50% of the nitrogen of which is derived from natural organic sources or ureaform. It shall be delivered to the site in standard size, standard size, It shall be stored in a

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Trees - ½ lb. per inch caliper, 8-8-8 fertilizer

Shrubs - Tablespoon per ft. height, 8-8-8 fertilizer.

25 lbs. per 1,000 sq. ft., 8-8-8 fertilizer.

Unless otherwise specified, use sound uniform stakes 2" x 2" x 5' long, l. Saplings or small tree trunks may not be used for staking material.

Use annealed galvanized steel wire, #14 gauge zinc coated iron

- Use suitable lengths of rubber or plastic garden hose, 1/2" diameter. Used hose will be

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- <u>Planting Soil</u> shall consist of one part existing soil and two parts planting mix. Planting mix shall consist of one part peat moss, one part decomposed pine bark and three parts topsoil. Alternative soil mix, submitted to the Landscape Architect shall be considered and approved or disapproved.
- Water shall be furnished by Owner. The Contractor shall furnish all hoses and labor to apply
- Herbicide. Use a commercial herbicide such as Scott's "Halts", or other approved equal as a pre-emergent weed killer.

# C. CERTIFICATES OF INSPECTION

Certificates of inspection shall accompany the invoice iou cach surprise.

by law for transportation. Inspection by federal or state governments at place of growt preclude rejection of the plants at the site.

D.PREPARATION, HANDLING AND DIGGING

Prepare plants for shipment in a manner that will prevent any damage to the branches, development at the site.

1. Protection against drying out. Handle plants so that roots, stems and branches certificates of inspection shall accompany the invoice for each shipment of plants as may be required y law for transportation. Inspection by federal or state governments at place of growth does not

- <u>Protection against drying out</u>. Handle plants so that roots, stems and branches are adequately protected at all times from drying out. Plants that cannot be planted immediately on delivery shall be kept in the shade, well protected with soil, wet moss or other acceptable material and shall be well-watered. Plants shall not remain unplanted for longer than three days after
- Digging. Retain as many fibrous roots as possible
- Balled Plants. Plants designated "B & B" shall be adequately balled with firm natural balls of soil in sizes as specified in American Standard for Nursery Stock. Balls shall be firmly wrapped with burlap and securely tied with heavy twine or rope. Plants with loose, broken or manufactured balls shall be rejected. Balls shall be lifted from the bottom only, not by stems or trunks, any such handling shall be grounds for immediate rejection of the material by the Landscape Architect.
- Groundcover beds shall be loosened and raked clean of debris and vegetation. Plants shall be evenly spaced and set to finish grade requirements. All areas prepared for planting in groundcovers shall be covered immediately with Pine Straw, to a depth of three (3) inches as specified herein.
- Planting beds shall be prepared by loosening all soil and raking beds clean of all debris ar vegetation. Herbicide and pre-emergent weed killer shall be applied as recommended by manufacturer. Plants shall be evenly spaced and set to finished grades. All beds shall be immediately covered with (3) inches of mulch as specified herein.
- Container Plants shall be removed just prior to planting in such a manner as to leave the root ball intact and undisturbed. If plants (i.e. azaleas) are pot bound, then longitudinal cuts should be made on the root ball to allow plant to "root out".

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- All plants, deciduous and evergreen, shall be planted at such times of the year as the Landscape Architect deems suitable, with the agreement of the Contractor to guarantee the material as herein specified. Actual planting shall be performed only during periods when weather
- 2 Layout of major planting. Locations for plants and outlines of areas to be planted shall be approved by the Landscape Architect before excavation is begun. Review the applicable architectural and engineering drawings and be familiar with the alignment of underground
- Dig pits as shown on drawings.
- Setting plants: All plants shall be set so that when settled they will bear the same relation to the required finished grades as they bore to the natural grade before transplanting. Each plant shall be planted in planting soil in the center of the pit.

shall be filled to the with other acceptabl the work is accepted as specified and as shown on the drawings, prior to inserting plants. backfill plant pits. Eliminate all air pockets. All shrubs shall be planted the individual pits are arranged in a group, the area between the pits required grade with clean soil from the excavation of the plant areas or

urban planning &

design

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Placemaker

Studio, Inc.

landscape

architecture

- þ. Set plants plumb and brace rigidly in position until the planting soil has been compacted around root balls. Roll burlap down root ball sufficiently to allow air and moisture to reach

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- Form shallow saucers capable of holding water about each plant by placing a mound of topsoil around the edge of each filled in pit.

  Mulching: Immediately after the work of planting has been completed, a layer of pine so or other approved or specified mulch (3) three inches deep shall be placed on the finisher. other approved or face about the plan.
  Where plants are e planted in groups, the area about the shall be covered with mulch.

  be hosed immediately after planting. The mulch around isolated plants of planting has been completed, a layer of pine straws) three inches deep shall be placed on the finished und isolated plants shall cover the entire area of the s, the area about the plant, as well as the entire area the area about the
- Water: All plants to

# A.STAKING AND PRUNING

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- <u>Staking</u> shall be completed immediately after planting. accordance with the detail drawings. Plants shall stand plumb after staking in
- planting and maintain stakes and wires until acceptance. Unless otherwise approved, place stakes one foot (minimum) away from trunk of tree. Drive stakes securely into the ground and fasten to the tree with double No. #14 wire through a suitable length of hose. Draw wire taunt and tie inside hose so that wire is not in contact with plants at any point and ends are hidden in Stake immediately
- <u>Pruning</u> of deciduous material shall be limited to the removal of injured twigs and branches Leave intact the normal shape of the plant. Use clean, sharp tools.
- Paint wounds and cuts o paint, covering all expos on deciduous material over  $\frac{1}{2}$ " diameter with an approved tree wound osed, living tissue.

# G. MAINTENANCE OF TREES, SHRUBS AND GROUNDCOVER

- Architect. This mainter necessary to maintain a Trees, shrubs, groundco which shall be 30 days a overs and grassed areas shall be maintained completely until acceptance, after planting operations are complete and approved by the Landscape nance shall include watering, mulching, weeding and all other operations thriving, natural and healthy growth of the plantings proposed. complete and approved by the Landscape, mulching, weeding and all other operations
- 2 Sidewalks, streets and other paved areas shall be kept clean when planting and maintenance operations are in progress.

# H. GUARANTEE AND REPLACEMENT

- The guarantee period shall begin at the acceptance of work or portions thereof, on the date substantial completion is recognized in writing by the Landscape Architect.
- 2 All plant material shall be guaranteed by the Contractor for a period of one calendar year from the date of acceptance. The Contractor shall be responsible for replacing all plants which die or are not in healthy and thriving condition during the guarantee period as determined by the Landscape Architect.
- $\dot{\mathfrak{D}}$ The Contractor shall replace, without cost to the Owner, and as soon as weather conditions permit, all dead plants and all plants not in a vigorous thriving condition, as determined by the Landscape Architect during and at the end of the guarantee period. The plants shall be free of dead branches and dead branch tips and shall bear foliage of a normal density, size and color. Replacements shall closely match adjacent specimens of the same species, and shall be subject to selection in the field by the Landscape Architect prior to digging.
- Acts of God, materials planted and damaged or destroyed by any phenomena considered as an Act of God e.g., unusually strong winds, fire, flood, extreme freeze, theft, hail or vandalism sh according to the law, belong to the "Owner" and shall be his responsibility. Materials on site a yet, not planted are not covered by this clause and shall be the responsibility of the landscape theft, hail or vandalism shall

# **CLEARING OF GROUND**

c, the grounds shall be cleared of all debris, entirely removed from the premises.



# LANDSCAPE PLANTING PLAN Peach County Workforce Development Center Peach Couty Board of Commissioners

Peach County, Georgia

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