


# PHASE I-ARBOR OAKS SUBDIVISION

LOCATED IN

THE TOWN OF SUMMERTON  
DORCHESTER COUNTY, SOUTH CAROLINA

SHT. NO. SHEET INDEX CURRENT REVISION

1	COVER SHEET	--	01-29-2002
2	OVERALL PLAN	--	01-29-2002
3	PRELIMINARY PLAT	4	05-10-2002
4	PRELIMINARY PLAT	4	05-10-2002
5	PRELIMINARY PLAT	4	05-10-2002
6	PRELIMINARY PLAT	4	05-10-2002
7	ROADWAY PLAN & PROFILE	4	05-10-2002
8	ROADWAY PLAN & PROFILE	4	05-10-2002
9	ROADWAY PLAN & PROFILE	4	05-10-2002
10	ROADWAY PLAN & PROFILE	4	05-10-2002
11	ROADWAY PLAN & PROFILE	4	05-10-2002
12	ROADWAY DETAILS	1	04-25-2002
13	GRADING & DRAINAGE PLAN	1	04-25-2002
14	GRADING & DRAINAGE PLAN	1	04-25-2002
15	GRADING & DRAINAGE PLAN	1	04-25-2002
16	GRADING & DRAINAGE PLAN	1	04-25-2002
17	DRAINAGE DETAILS	1	04-25-2002
18	WATER PLANS	5	06-24-2002
19	WATER PLANS	5	06-24-2002
20	WATER DETAILS	5	06-24-2002
21	SANITARY SEWER PLANS	3	04-26-2002
22	SANITARY SEWER PLANS	3	04-26-2002
23	SANITARY SEWER PLANS	3	04-26-2002
24	SANITARY SEWER PROFILES	3	04-26-2002
25	SANITARY SEWER PROFILES	3	04-26-2002
26	SANITARY SEWER PROFILES	3	04-26-2002
27	SANITARY SEWER PROFILES	3	04-26-2002
28	SANITARY SEWER DETAILS	3	04-26-2002
29	EROSION CONTROL PLAN	--	01-29-2002
30	EROSION CONTROL PLAN	--	01-29-2002
31	EROSION CONTROL PLAN	--	01-29-2002
32	EROSION CONTROL PLAN	--	01-29-2002
33	EROSION CONTROL DETAILS	--	01-29-2002

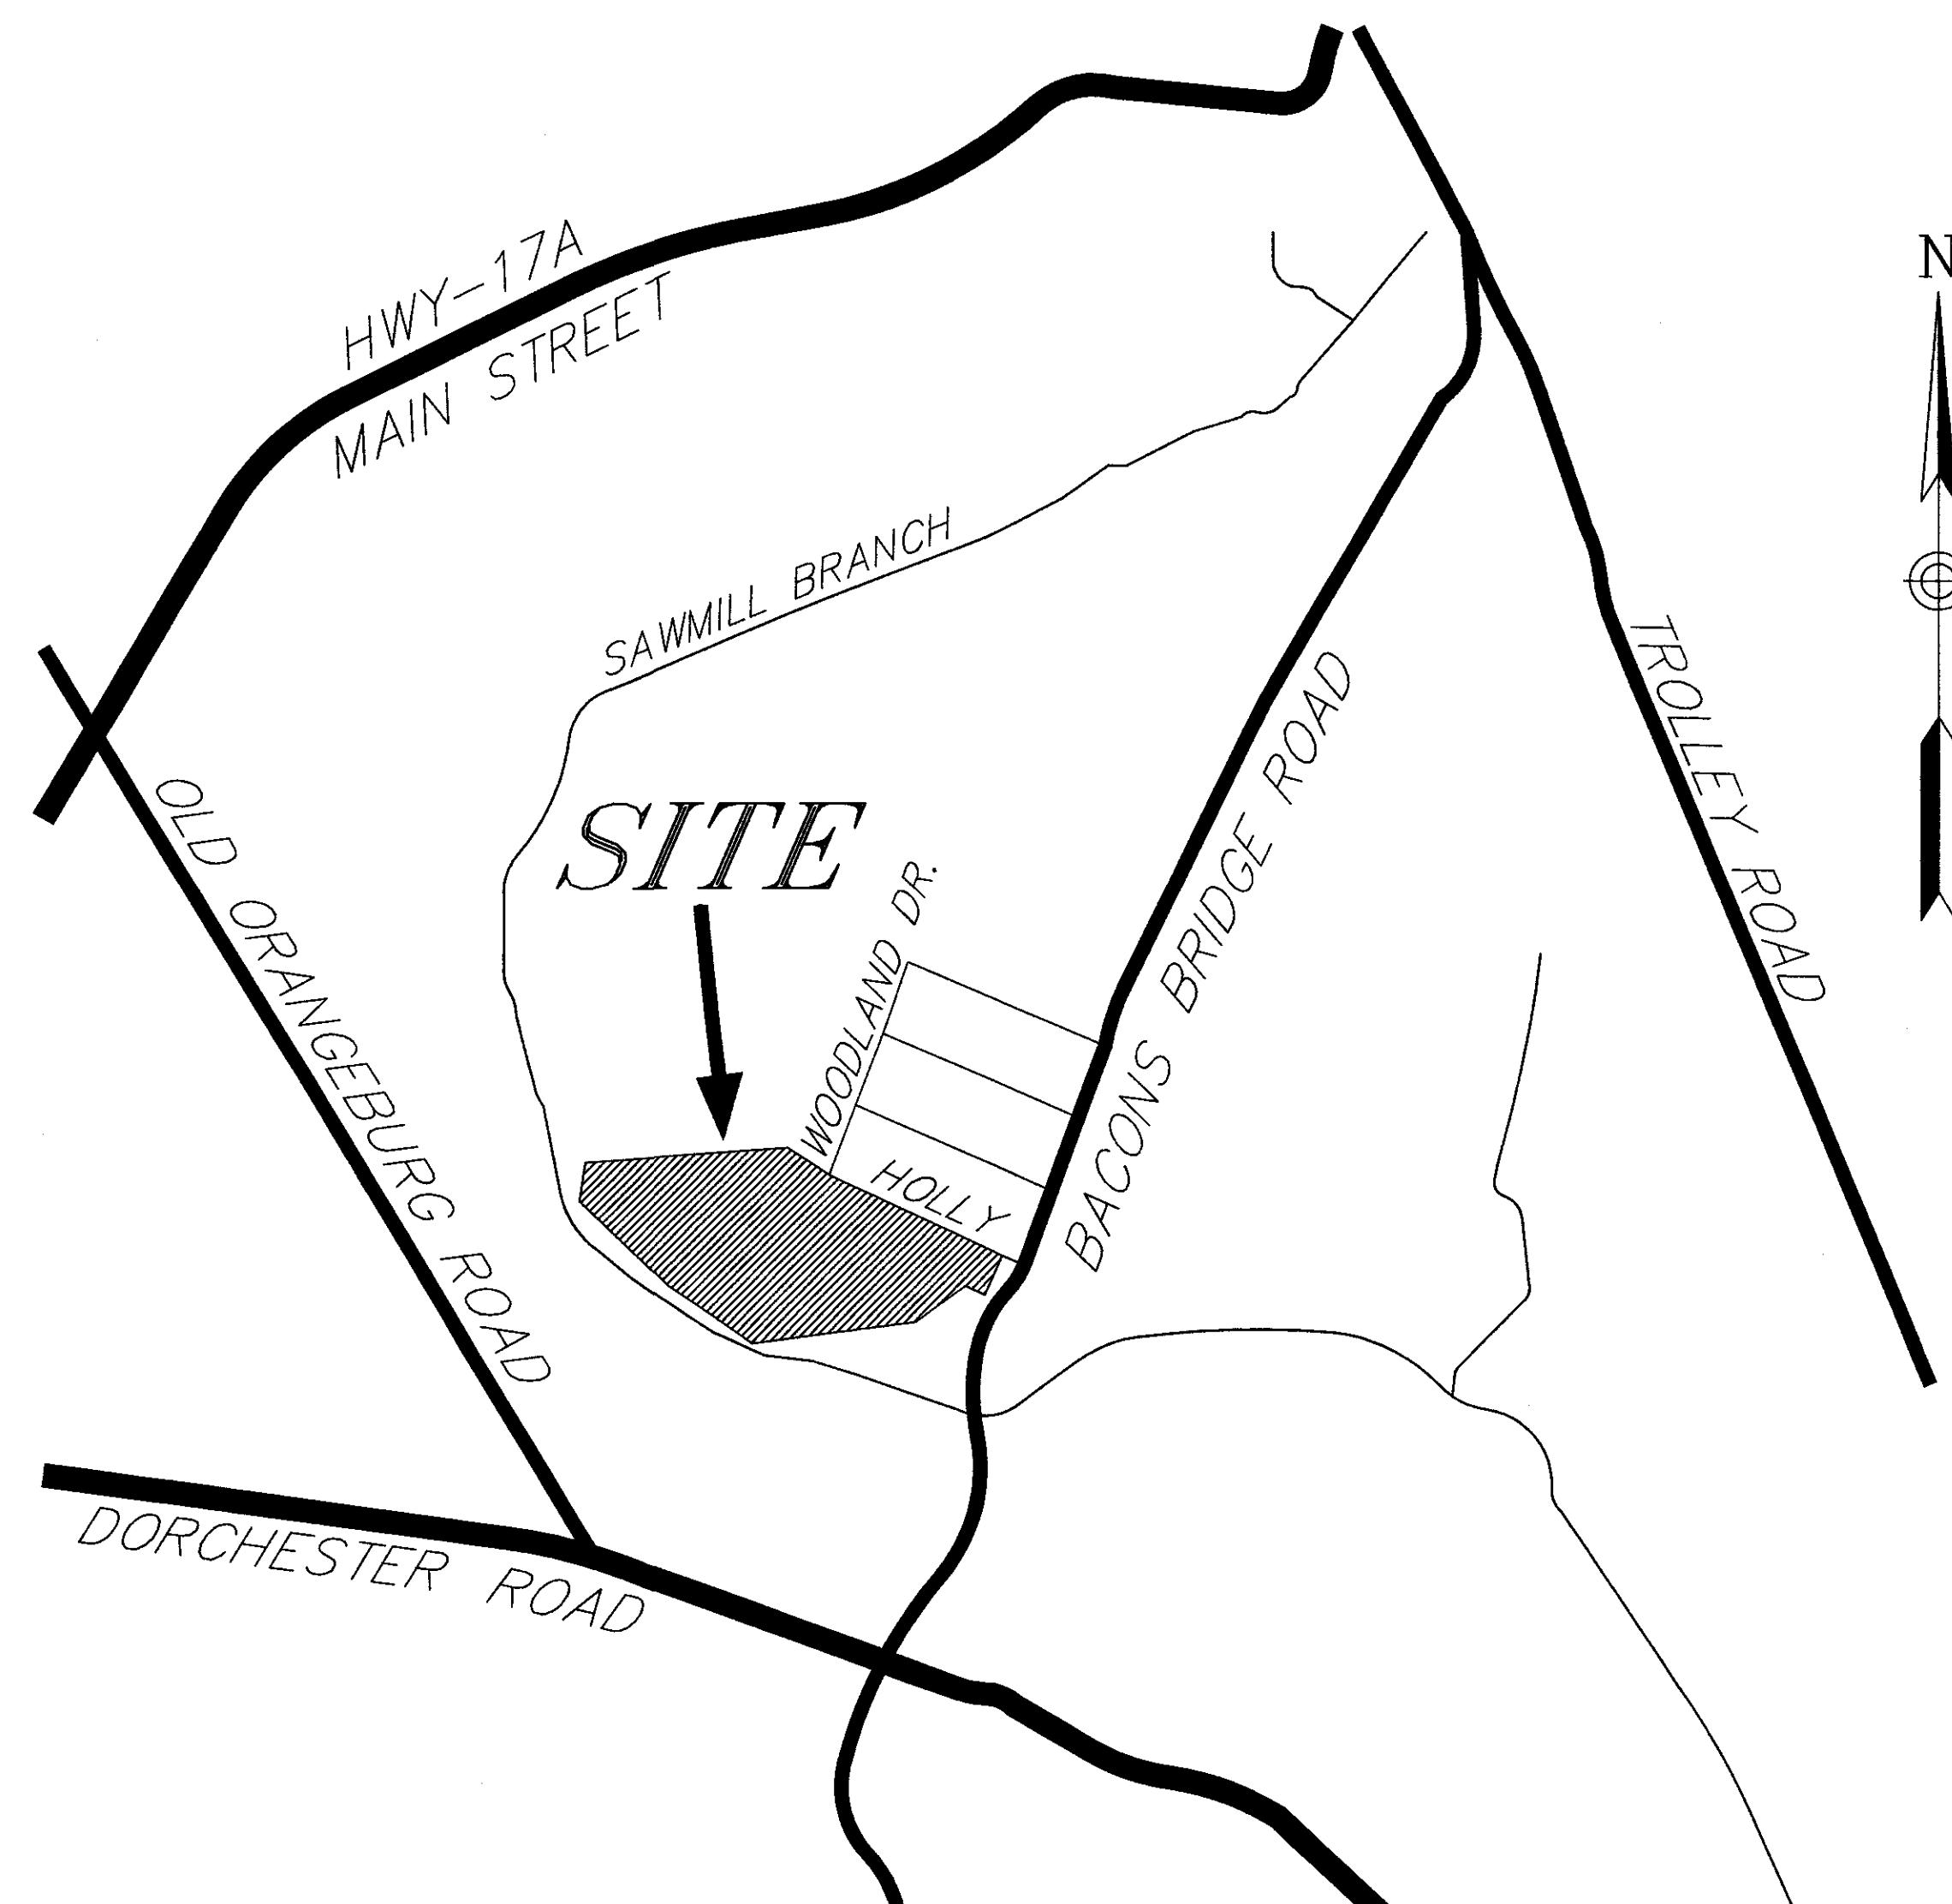


OWNER:

GRAMLING BROTHERS  
REAL ESTATE AND DEVELOPMENT  
P.O. Box 389  
GRAMLING, SOUTH CAROLINA 29348  
(864) 472-2157

ENGINEER:  
**TRICO**  
ENGINEERING CONSULTANTS, INC.

4425 BELLE OAKS DRIVE  
NORTH CHARLESTON, SOUTH CAROLINA 29405  
(843) 740-7700

TITLE		COVER SHEET	
PHASE I OF ARBOR OAKS SUBDIVISION		LOCATED IN	
THE TOWN OF SUMMERTON		DORCHESTER COUNTY, SOUTH CAROLINA	
 NOTICE IS HEREBY GIVEN THAT THE PLANS CONTAINED HEREIN HAVE BEEN APPROVED AS CONFORMING TO THE STANDARDS OF THE TOWN OF SUMMERTON, SOUTH CAROLINA. CIVIL ENGINEERING CONSULTANT TRICO ENGINEERING CONSULTANTS, INC. 4425 Belle Oaks Drive North Charleston, SC 29405 Phone: (843) 740-7700 Fax: (843) 740-7707 Visit us at: <a href="http://www.tricoengineering.com">www.tricoengineering.com</a>		4 05-10-2002 REVISED PLAT/ROAD PLANS PER SUMMERTON'S COMMENTS 4 04-26-2002 REVISED SEWER PLANS PER SEPI'S COMMENTS 2 04-30-2002 REVISED WATER PLANS PER SOPI'S COMMENTS 1 04-25-2002 REVISED DRAINS & PONDS AS PER DOW'S COMMENTS 1 04-25-2002 REVISED REVISIONS NO. DATE	
DESIGNED :	MEL	DRAWN :	MEL
CHECKED :	MCC	APPROVED :	MELC
SCALE :	1" = 30'	DATE :	29 JANUARY 2002
PROJECT NO. :	01-087	REVISIONS :	33

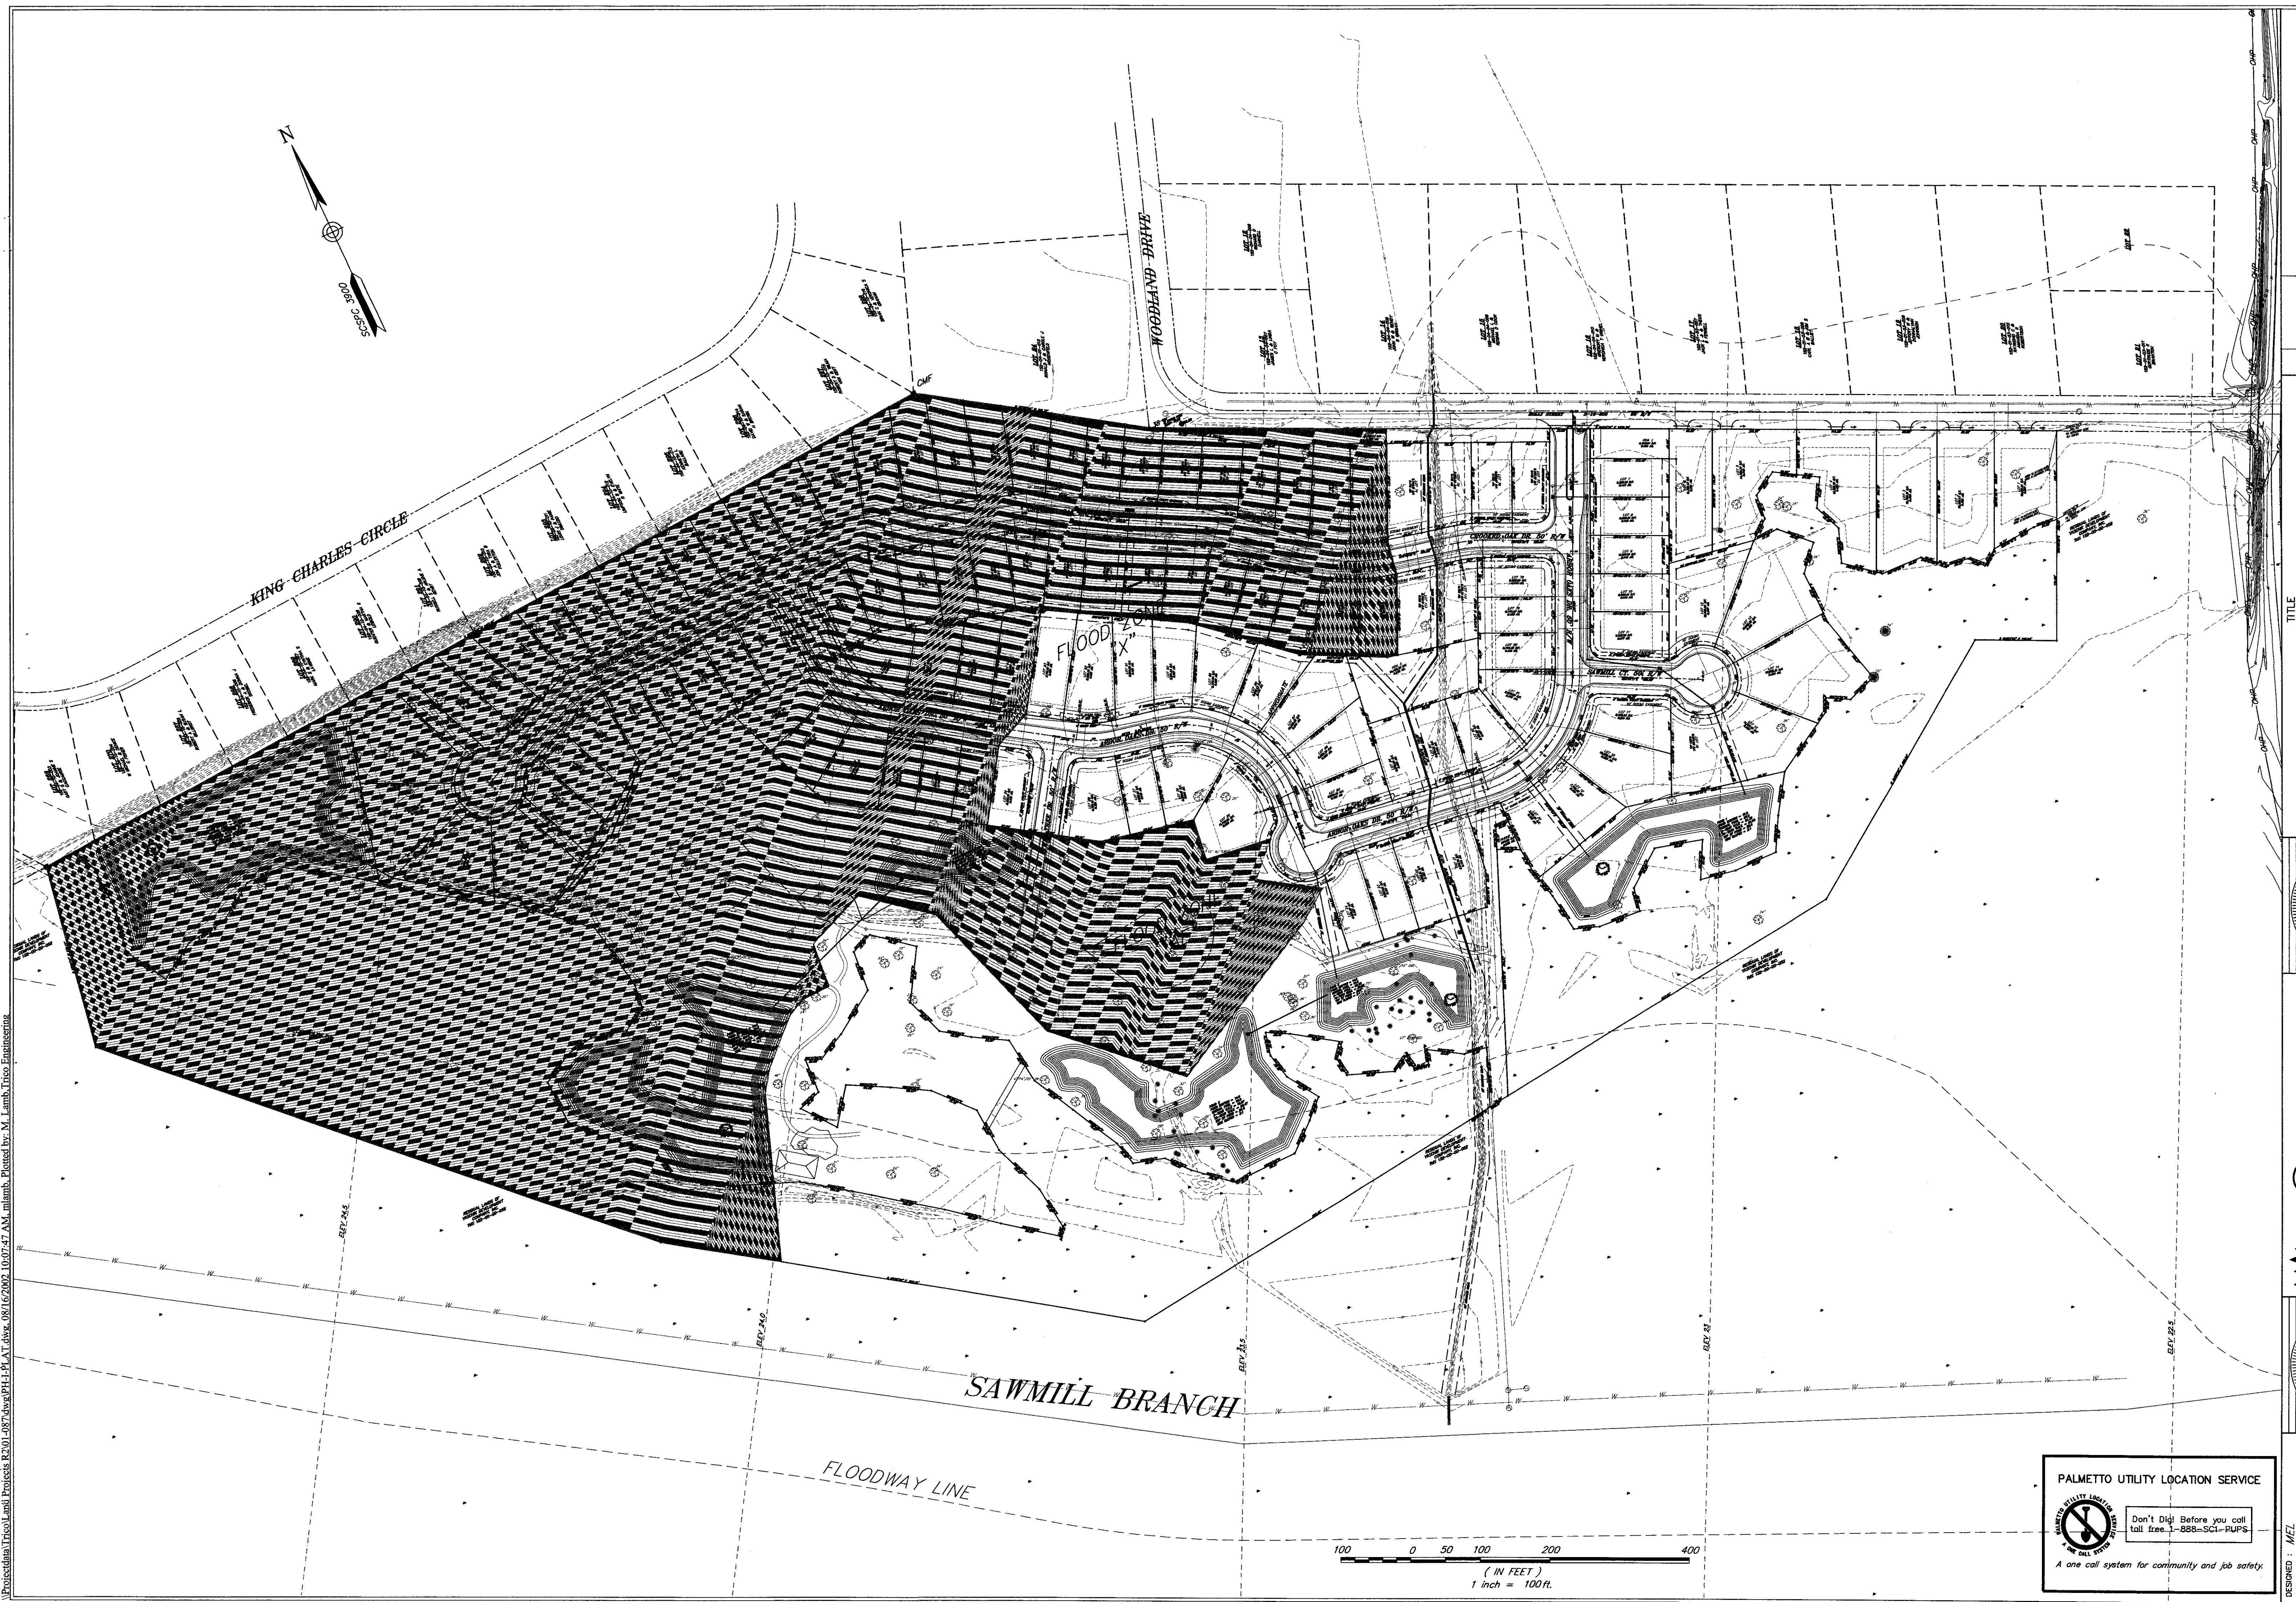

**TRICO**  
ENGINEERING CONSULTANTS, INC.  
Civil Engineering - Surveying - Landscape Architecture  
Land Planning - Wetland Consulting - GPS Services  
Visit us on <http://www.tricogeengineering.com>

**REVISIONS**

**NO. DATE**

**TITLE**

**OVERALL PLAN**

**PHASE I OF ARBOR OAKS SUBDIVISION**

**LOCATED IN**

**THE TOWN OF SUMMERTOWN**

**DORCHESTER COUNTY, SOUTH CAROLINA**


**NO. 005151**

**CERTIFICATE OF AUTOMATIC CALL-IN**


**TRICO ENGINEERING CONSULTANTS, INC.**


**4425 Bella Oaks Drive**  
**North Charleston, South Carolina 29405**  
**Phone: (843) 740-7700**  
**Fax: (843) 740-7707**  
**info@tricogeengineering.com**


**DATE : 29 JANUARY 2002**  
**PROJECT NO. : 01-087**  
**SHEET 2 of 33**

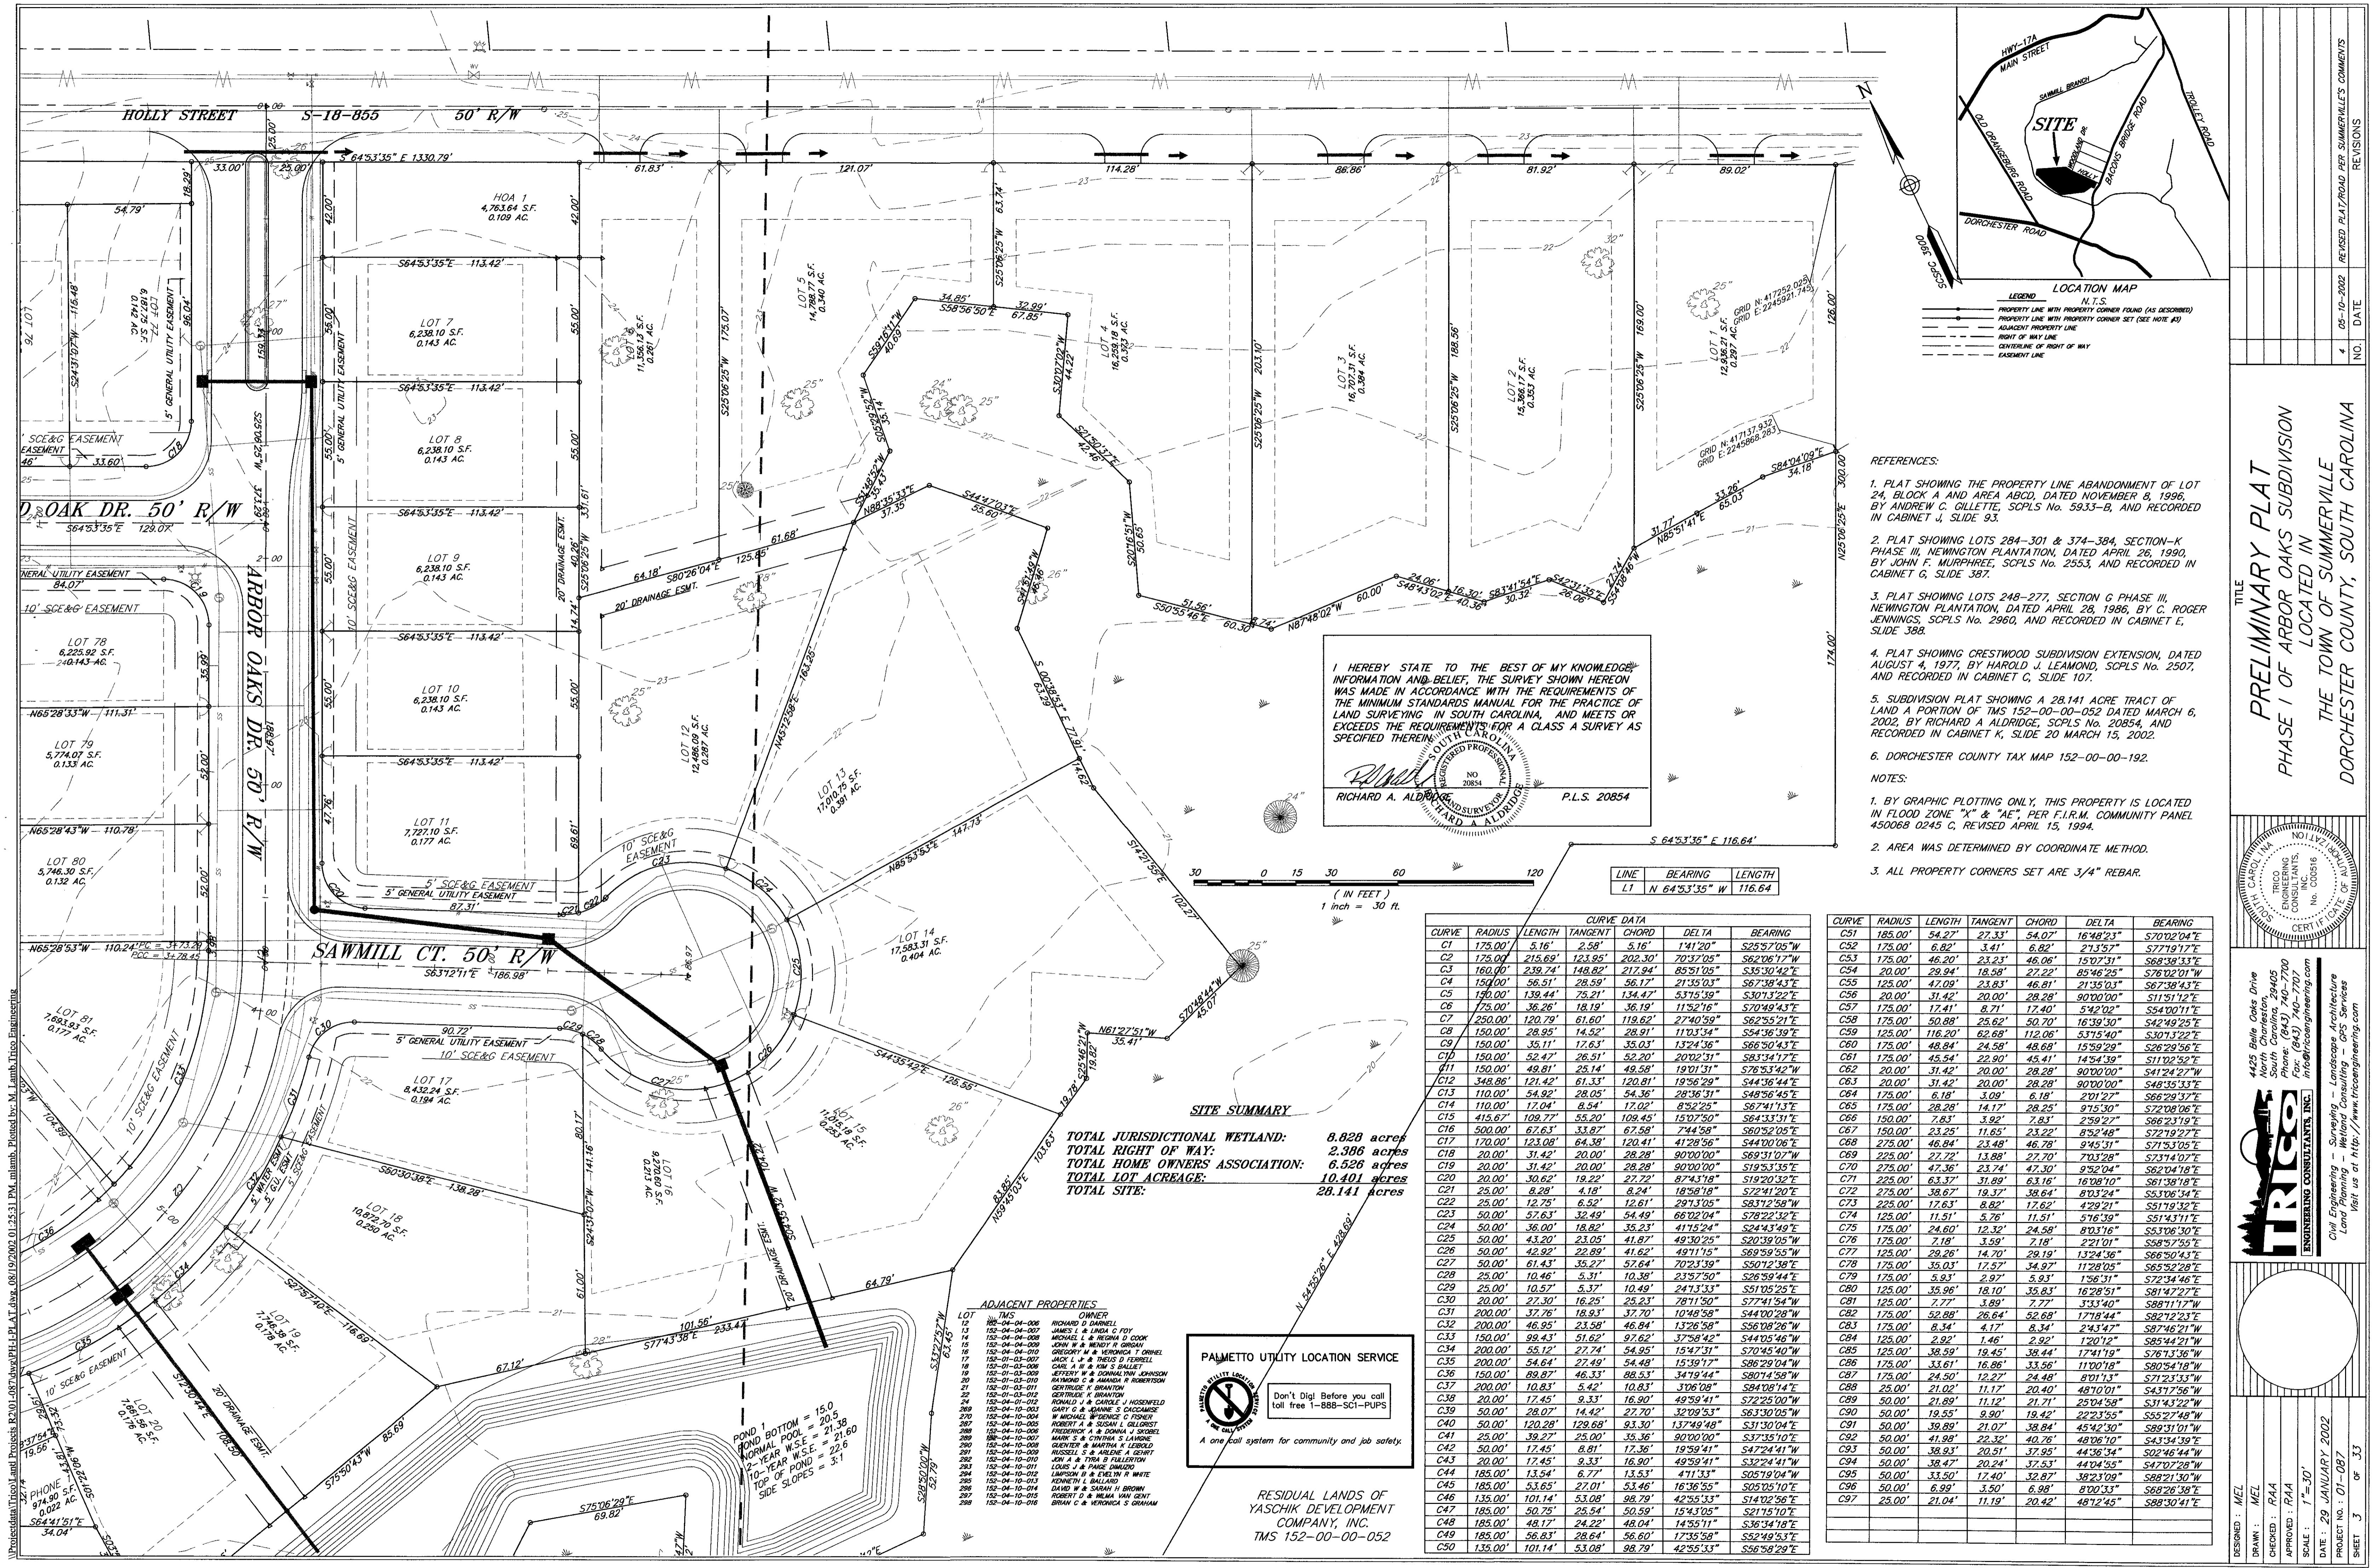




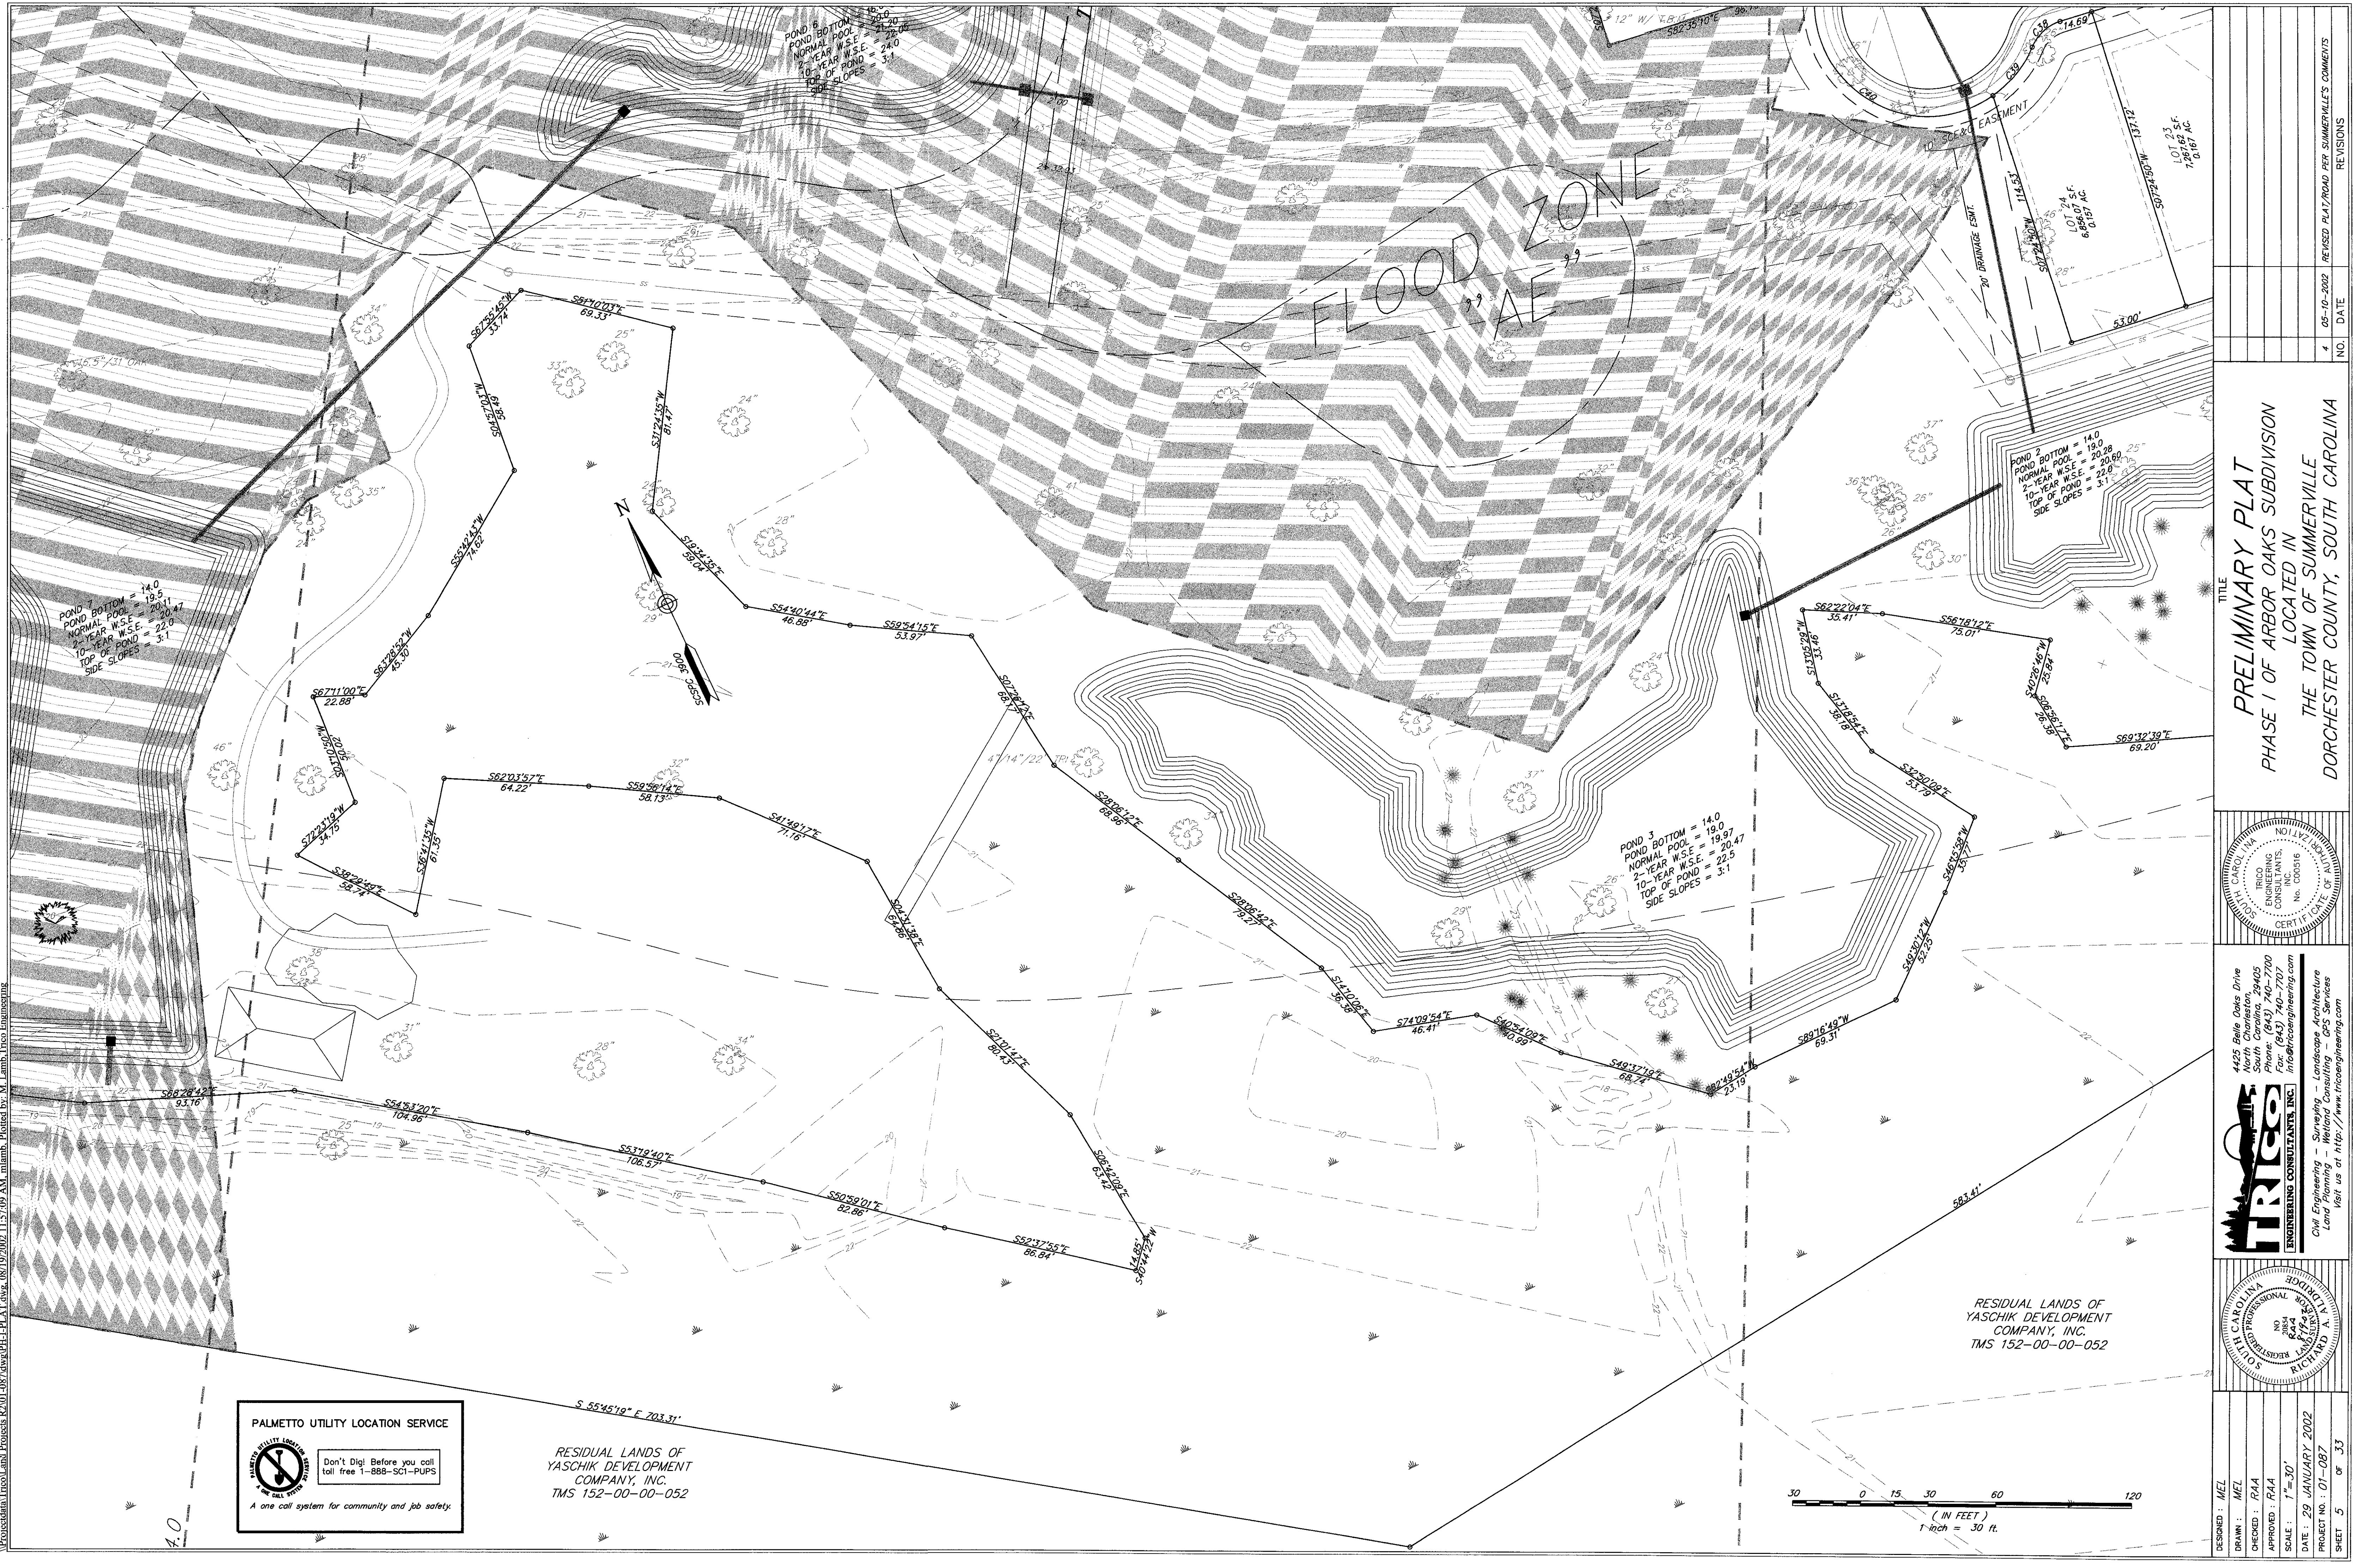

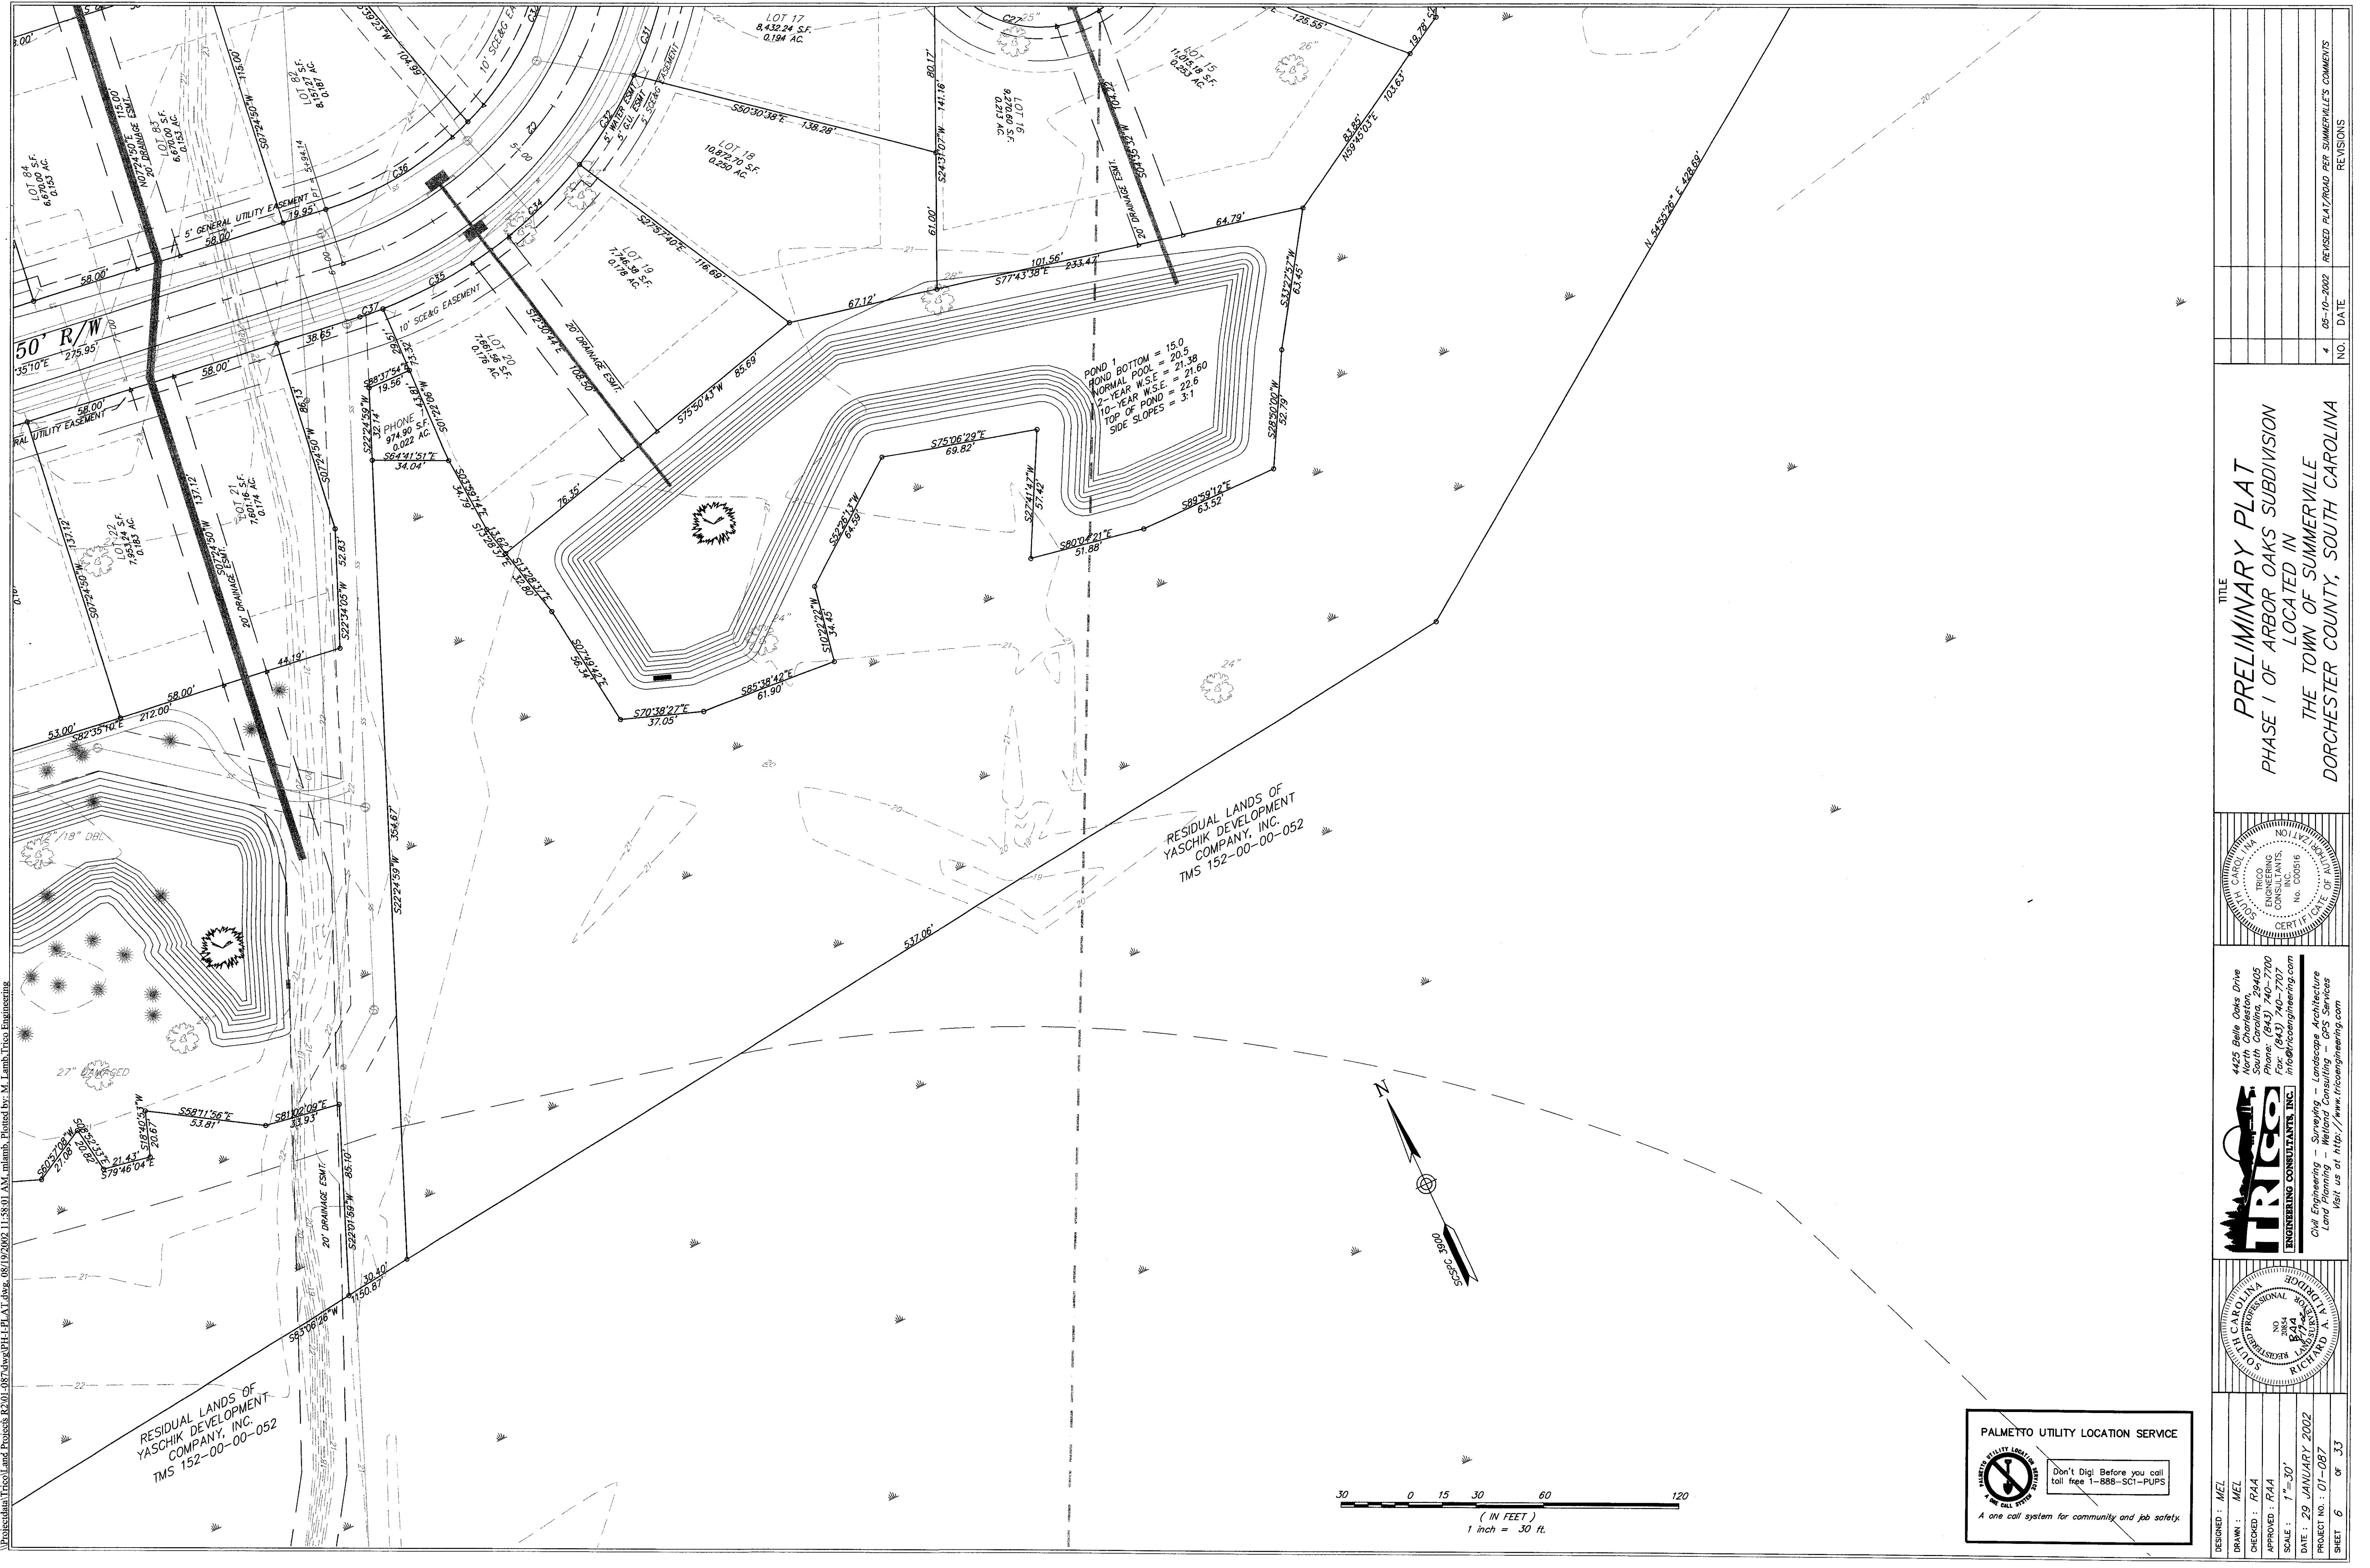

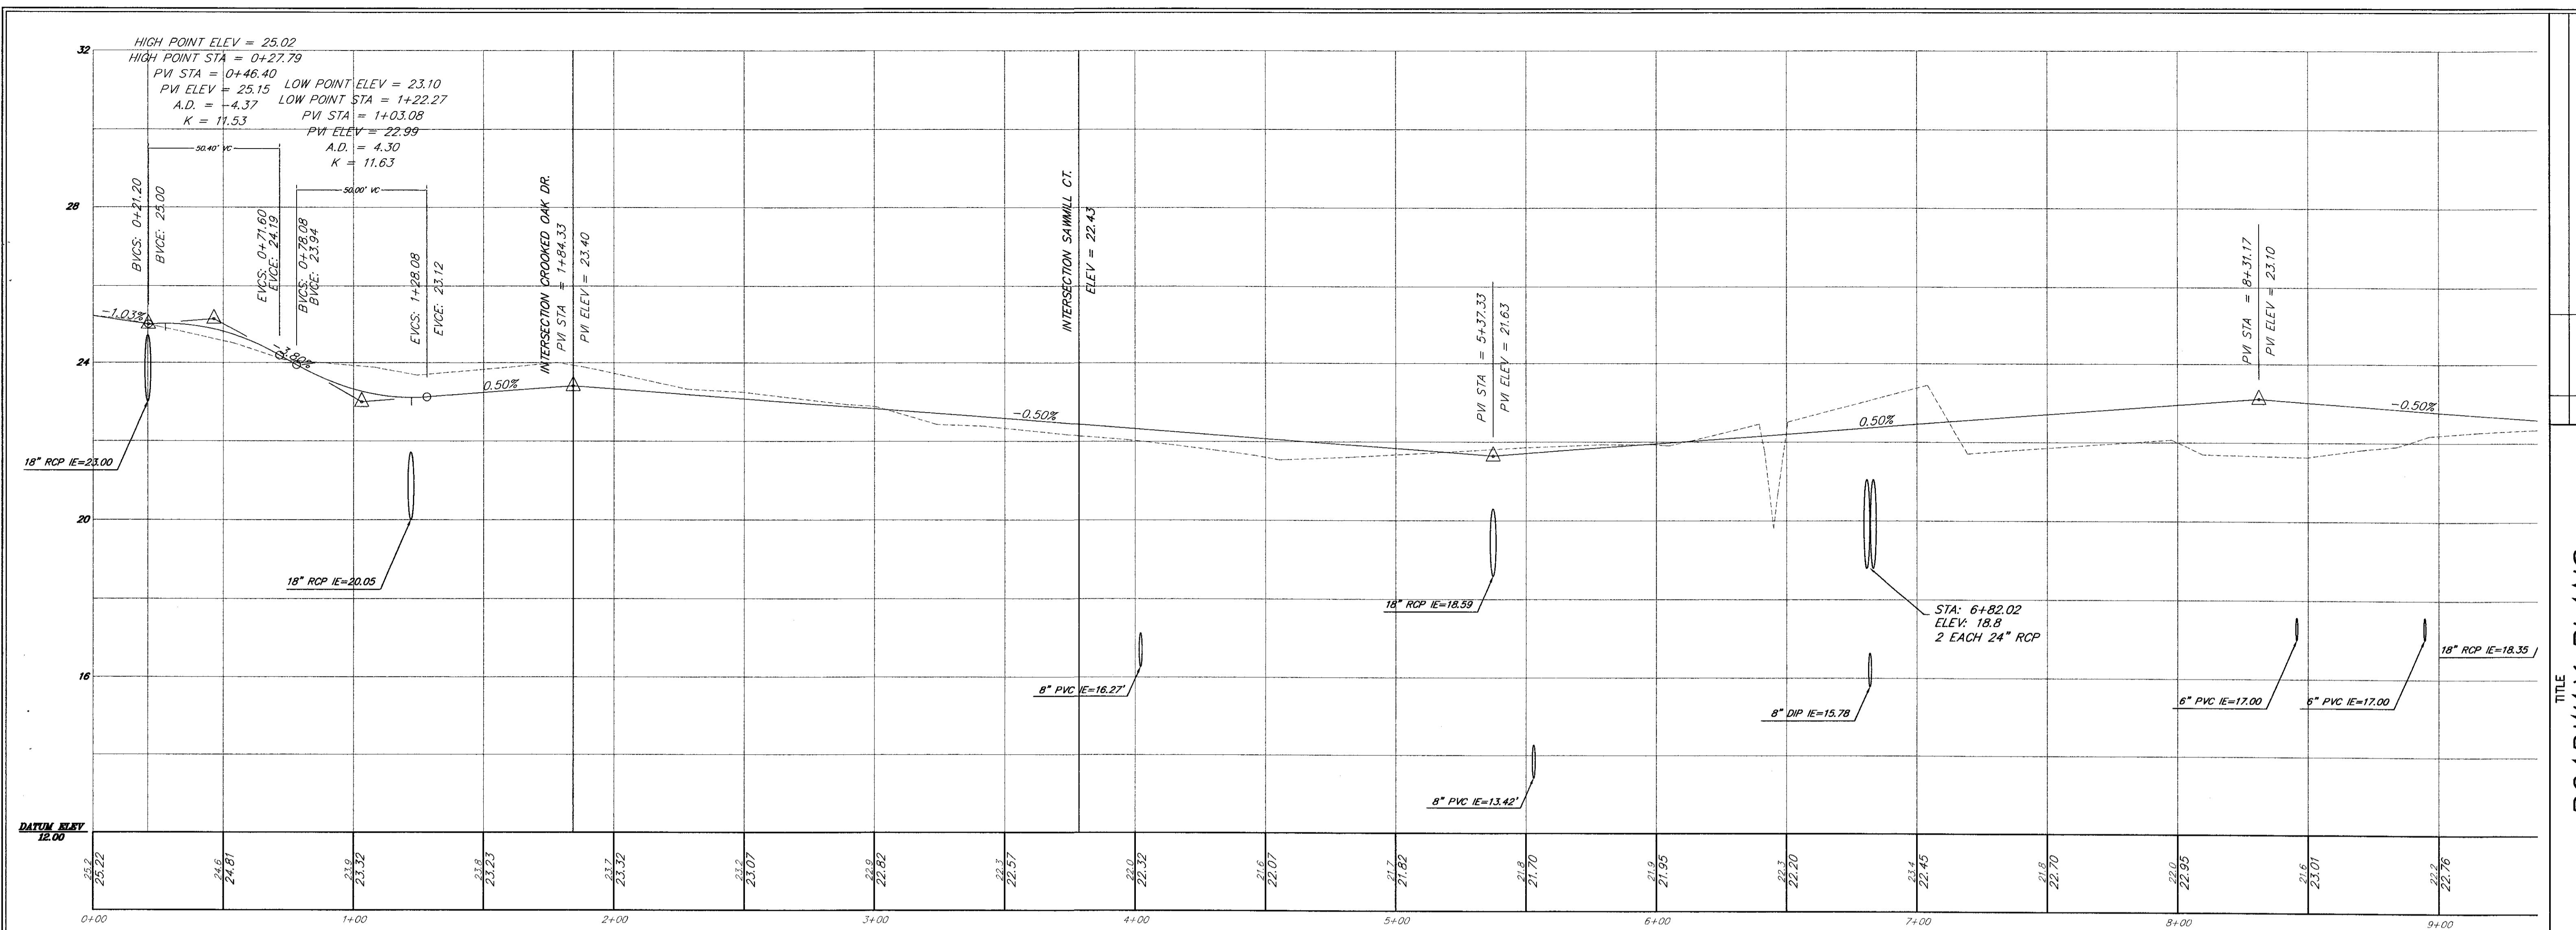


ARBOR OAKS DR.  
HORIZONTAL SCALE: 1"=30'  
VERTICAL SCALE: 1"=2'

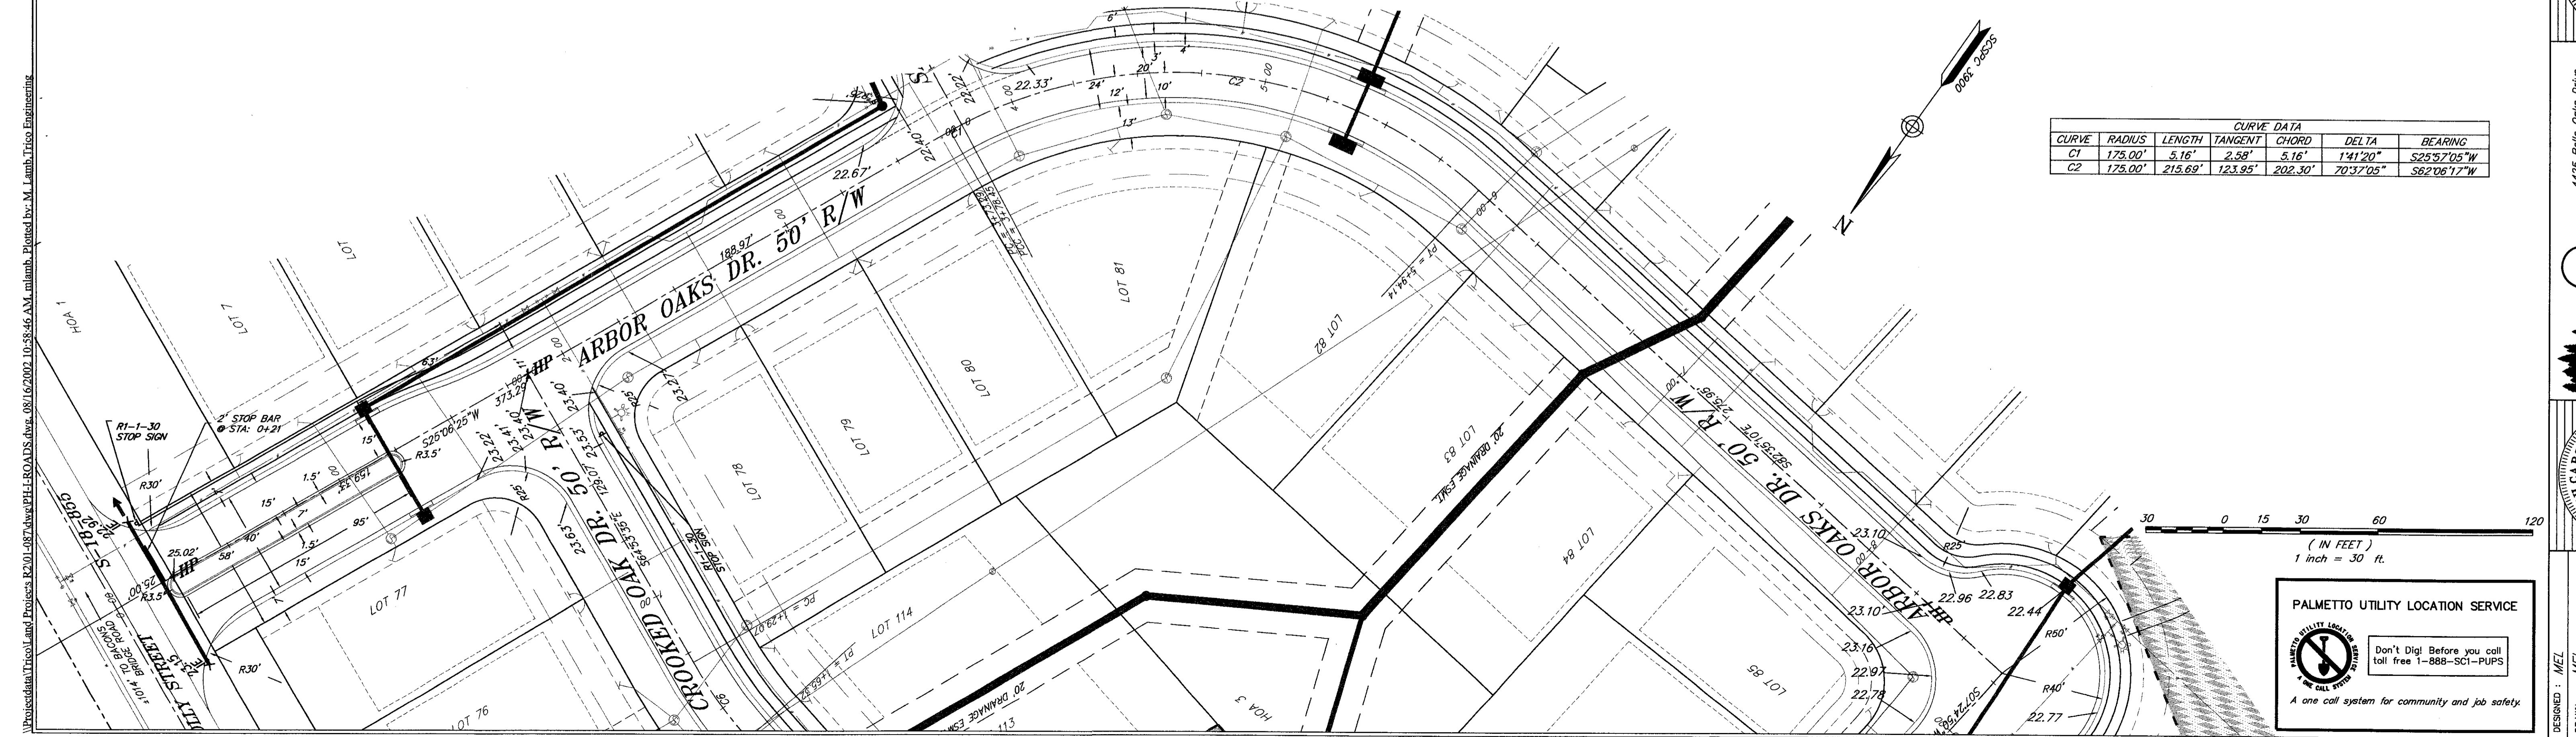

## ROADWAY PLANS


PHASE I OF ARBOR OAKS SUBDIVISION  
LOCATED IN  
THE TOWN OF SUMMERVILLE  
DORCHESTER COUNTY, SOUTH CAROLINA

REVISIONS  
NO. Date  
4 05-10-2022 REVISED PLAT/ROAD PLANS FOR SUMMERVILLE'S COMMENTS  
REVISIONS

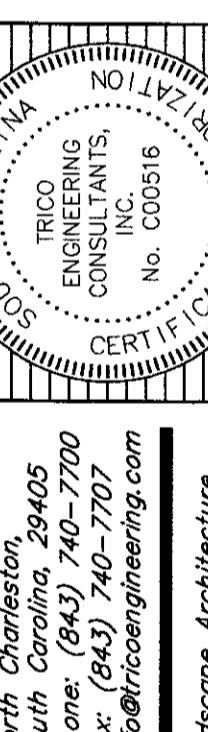


DESIGNED : MEL  
DRAWN : MEL  
CHECKED : TTB  
APPROVED : PGS  
Scale : 1"=30'  
DATE : 29 JANUARY 2002  
PROJECT NO.: 01-087  
SHEET 7 of 33

REVISIONS  
NO. Date  
4 05-10-2022 REVISED PLAT/ROAD PLANS FOR SUMMERVILLE'S COMMENTS  
REVISIONS

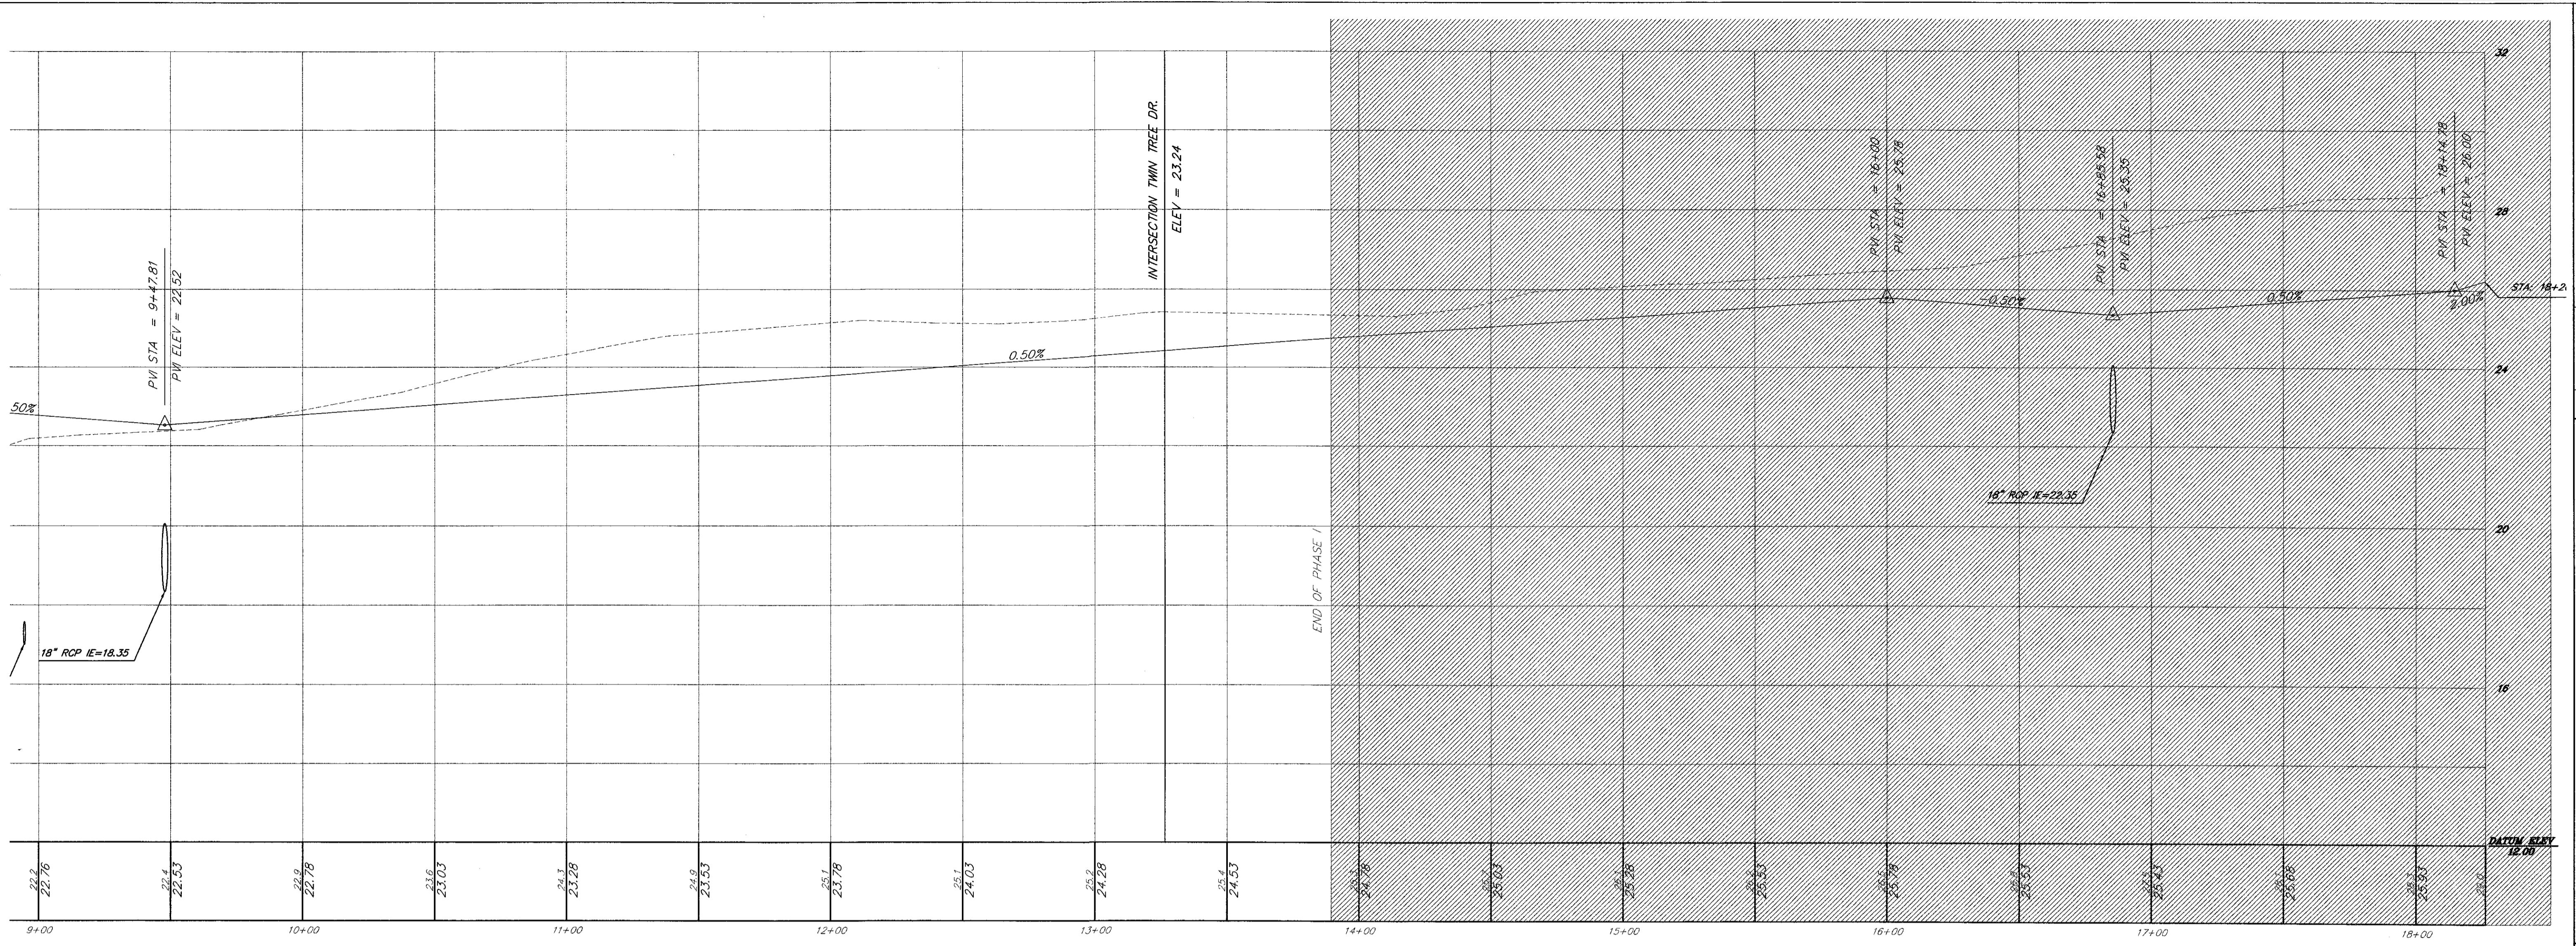


**ARBOR OAKS DR.**  
HORIZONTAL SCALE: 1"=30'  
VERTICAL SCALE: 1"=2'


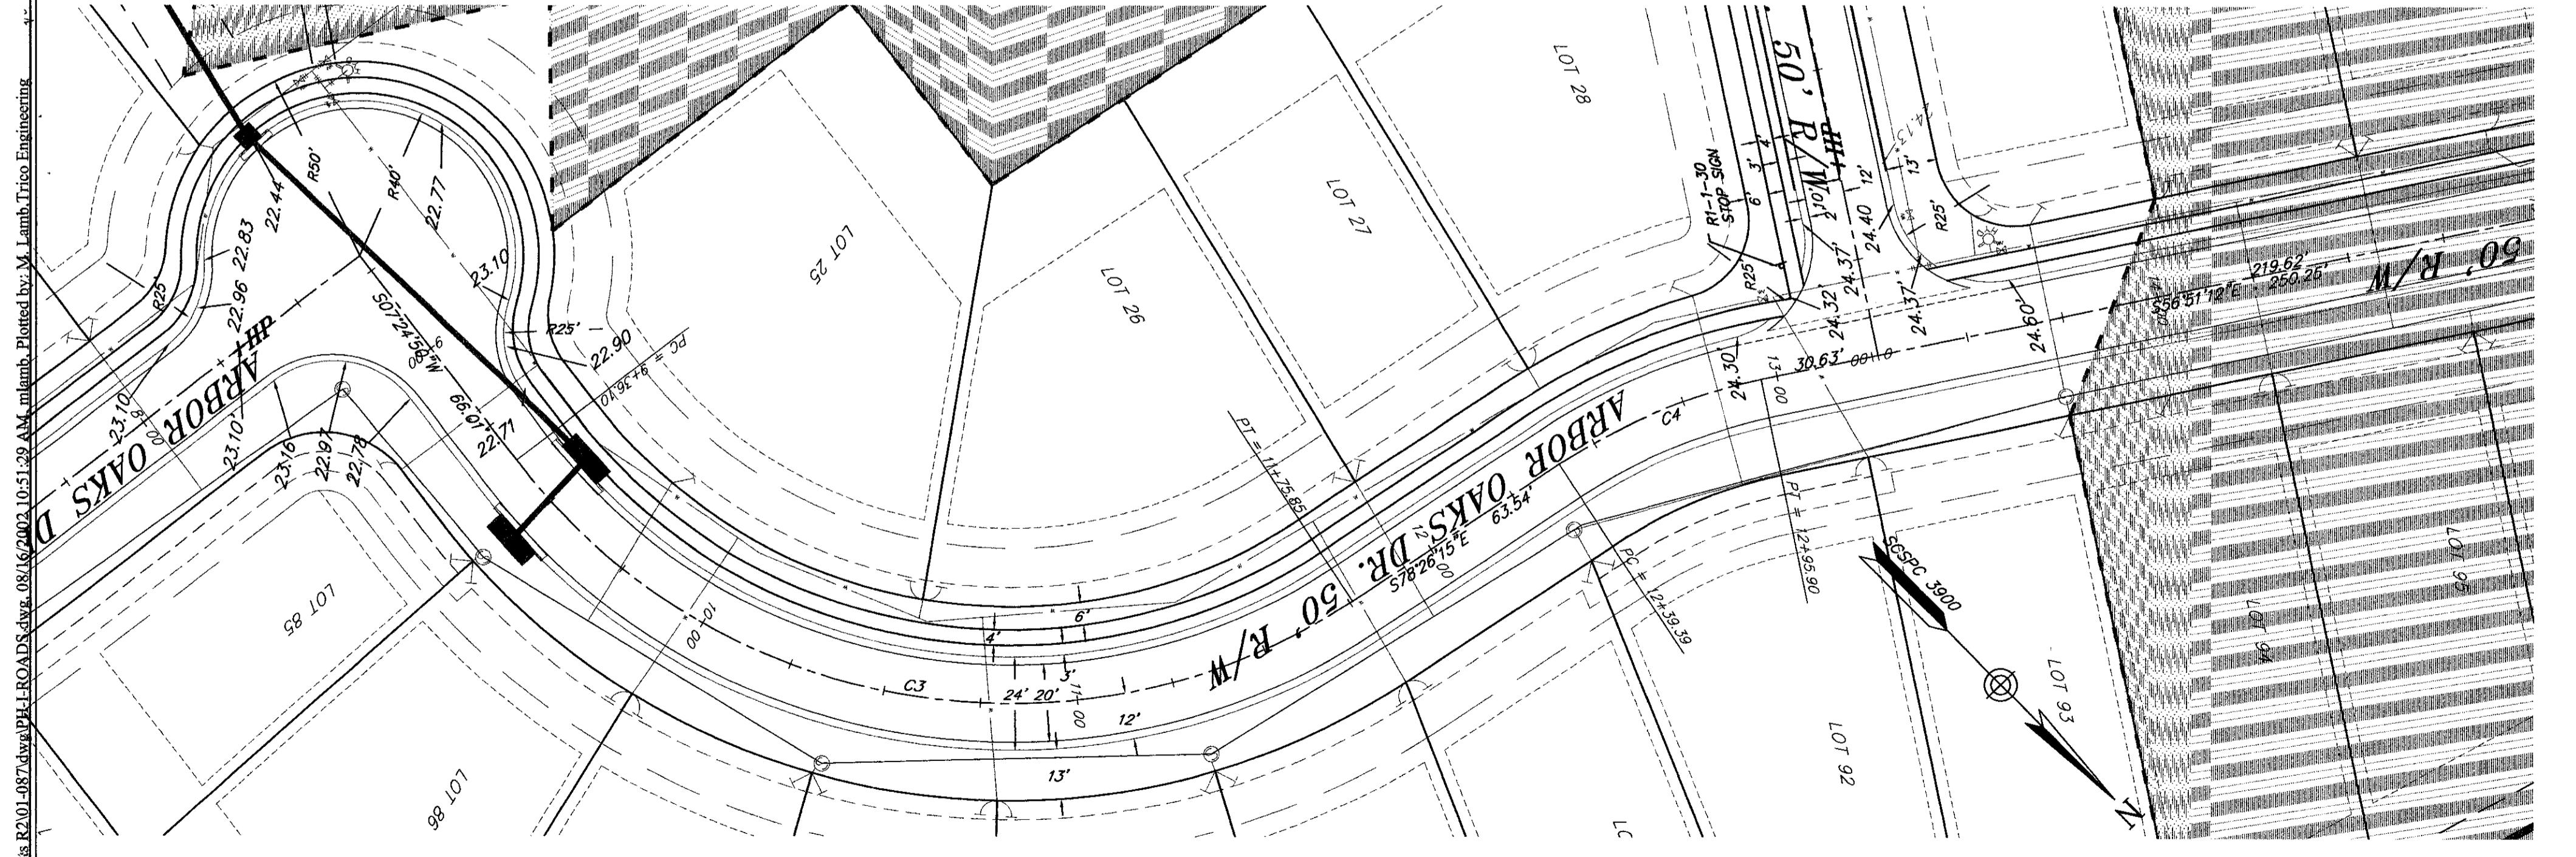


CURVE DATA					
CURVE	RADIUS	LENGTH	TANGENT	CHORD	DELTA
C1	175.00'	3.16'	2.58'	5.16'	141°20"
C2	175.00'	215.69'	123.95'	202.30'	7037°05"
C3	160.00'	239.74'	148.82'	217.94'	85351°05"
C4	150.00'	56.51'	26.59'	56.17'	21353°03"

30 0 15 30 60 120  
(IN FEET)  
1 inch = 30 ft

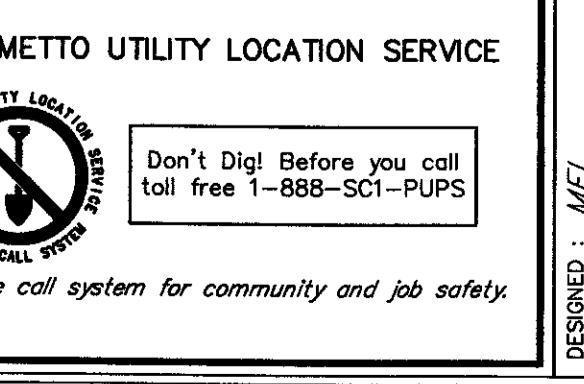


**ROADWAY PLANS**  
PHASE I OF ARBOR OAKS SUBDIVISION  
LOCATED IN  
THE TOWN OF SUMMERVILLE  
DORCHESTER COUNTY, SOUTH CAROLINA

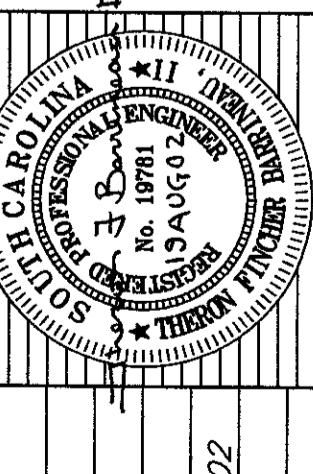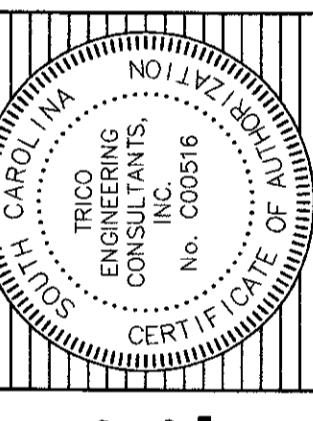


DESIGNED : MEL  
DRAWN : MEL  
CHECKED : FB  
APPROVED : FB  
SCALE : 1"=30'  
DATE : 29 JANUARY 2002  
PROJECT NO. : 01-087  
SHEET 8 of 33

ROADWAY PLANS  
PHASE I OF ARBOR OAKS SUBDIVISION  
LOCATED IN  
THE TOWN OF SUMMERVILLE  
DORCHESTER COUNTY, SOUTH CAROLINA


4 05-10-2002 REVISED PLAT ROAD PLANS FOR SUMMERTIME'S COMMENTS  
NO. DATE

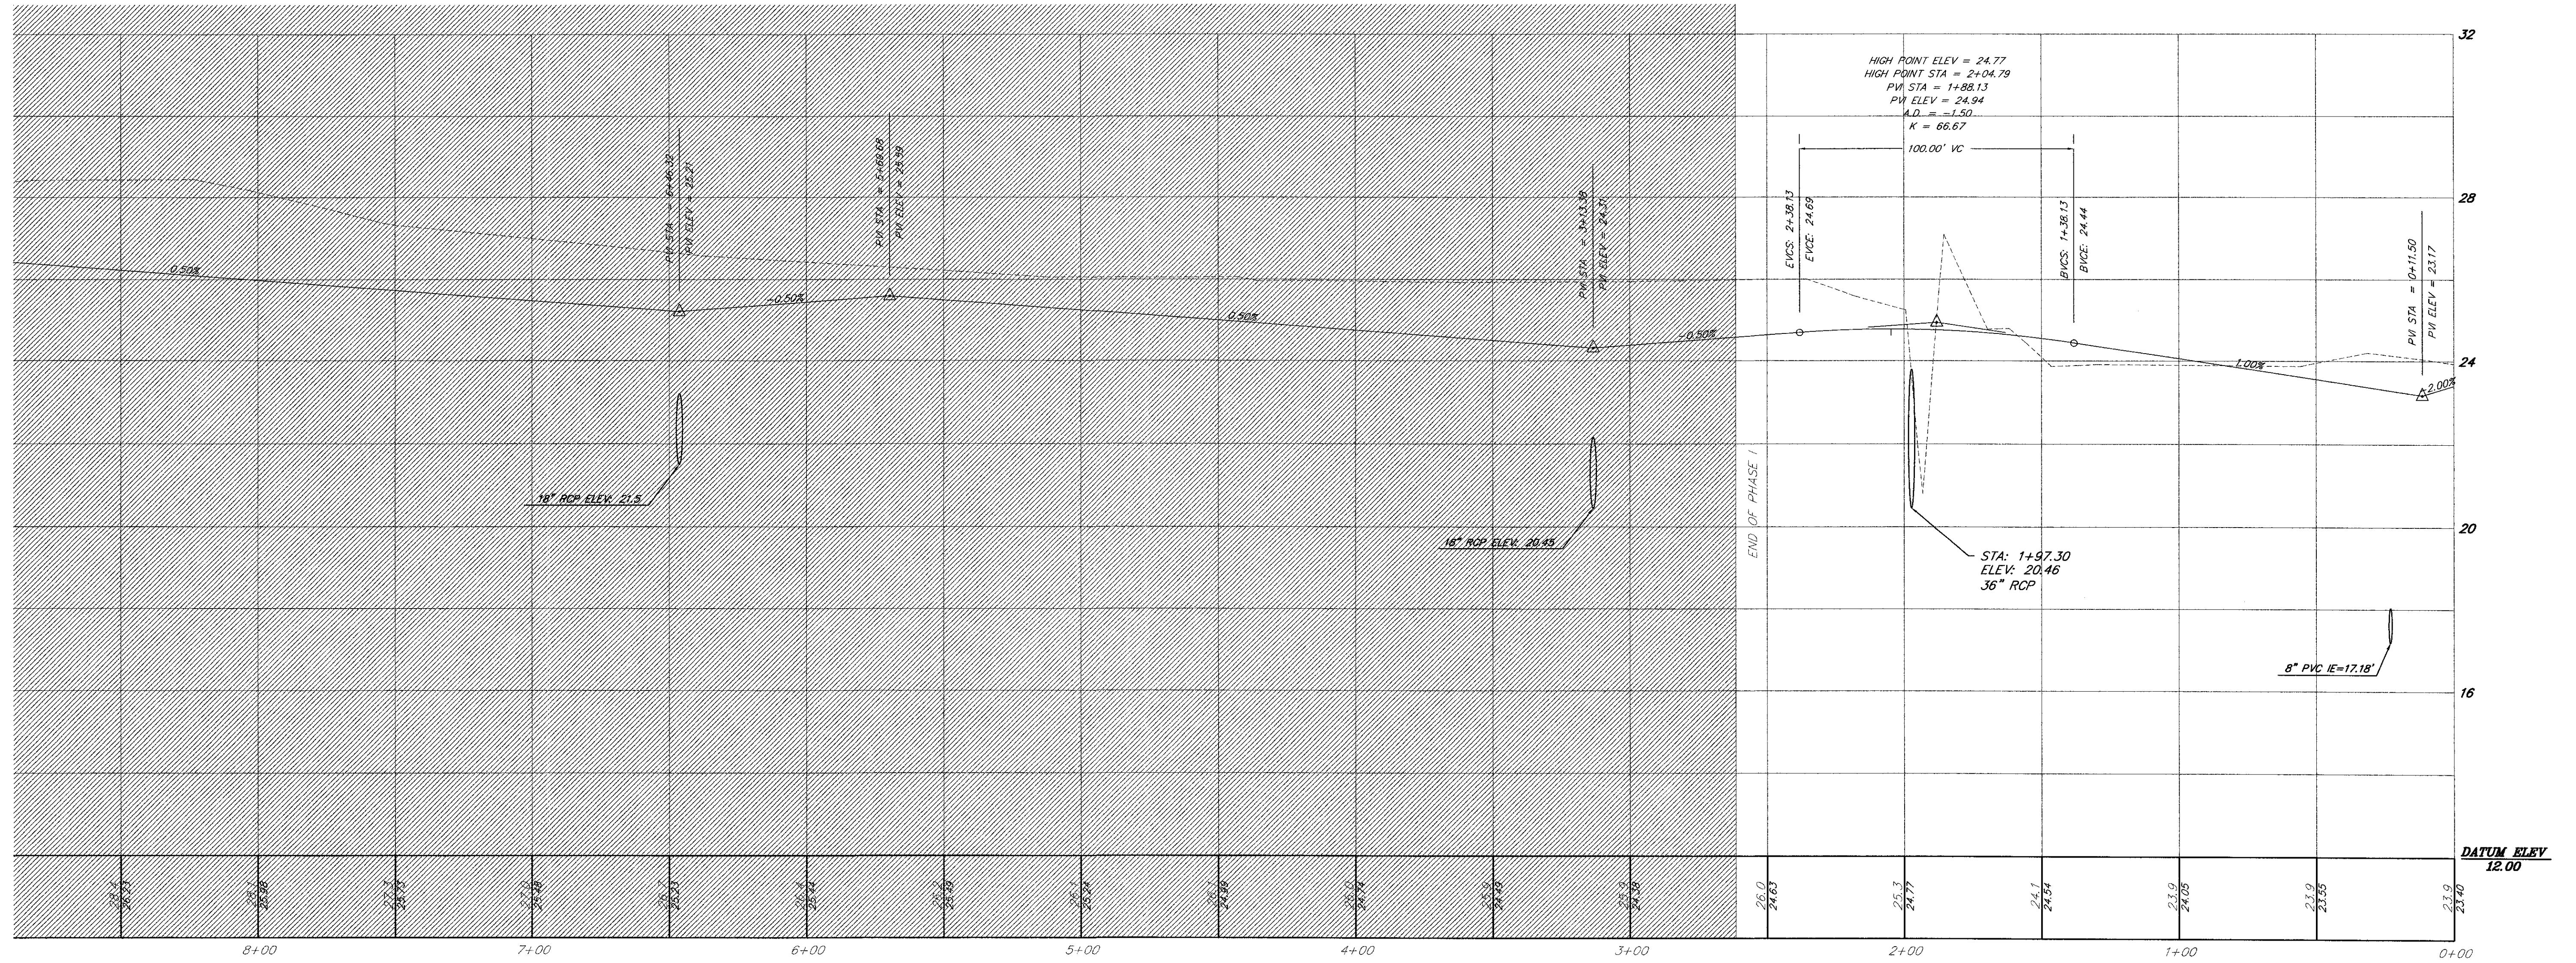




CROOKED OAK DR.  
HORIZONTAL SCALE: 1"=30'  
VERTICAL SCALE: 1"=2'

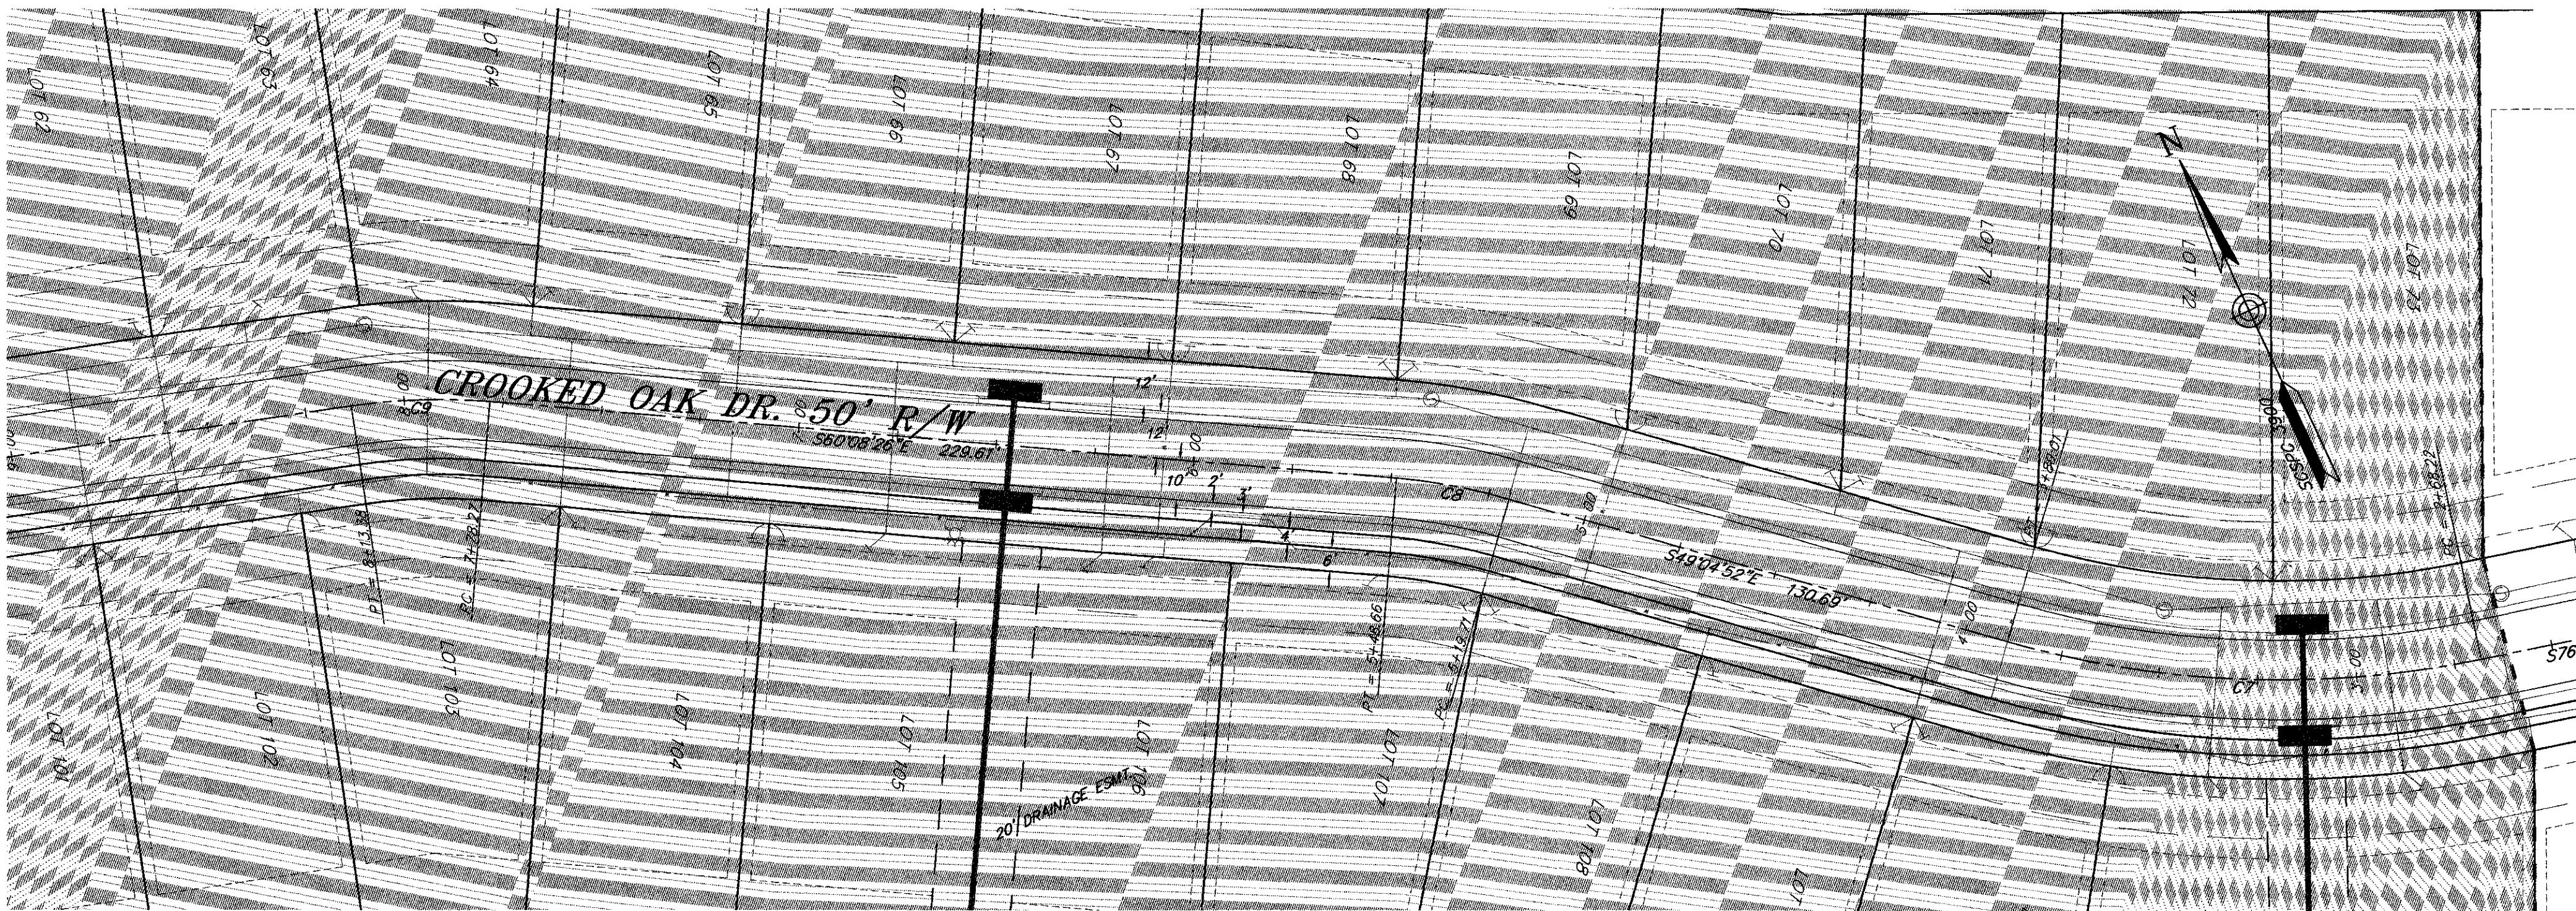






30 0 15 30 60 120  
(IN FEET)  
1 inch = 30 ft.

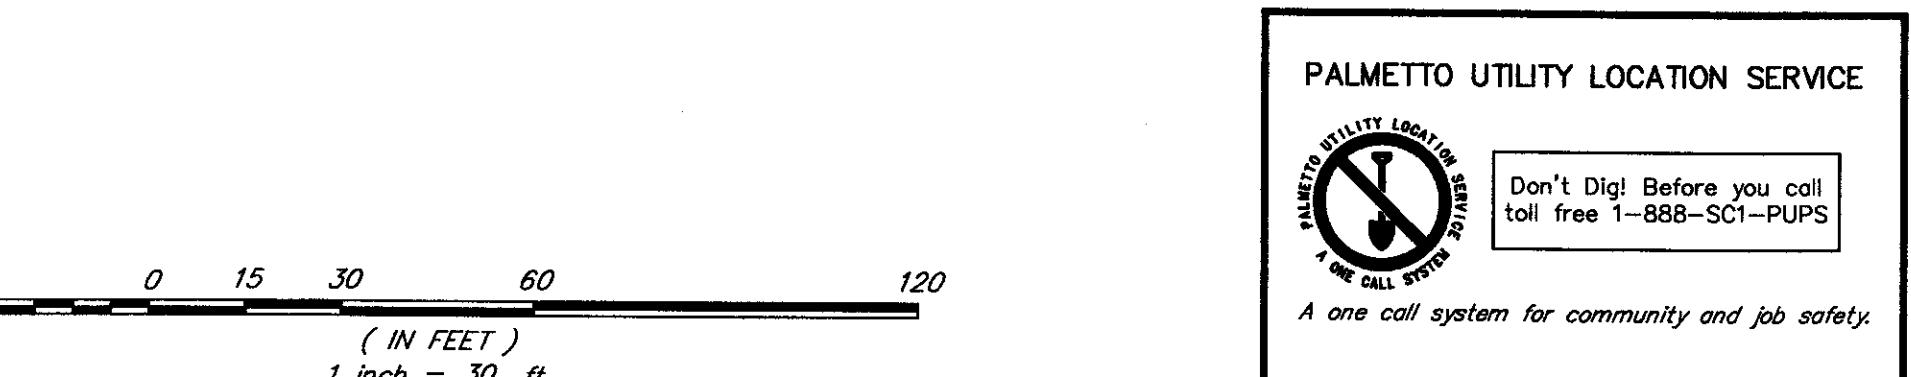

DESIGNED : MEL  
DRAWN : MEL  
CHECKED : TFB  
APPROVED : TFB  
SCALE : 1"=30'  
DATE : 29 JANUARY 2002  
PROJECT NO. : 01-087  
SHEET 9 OF 33

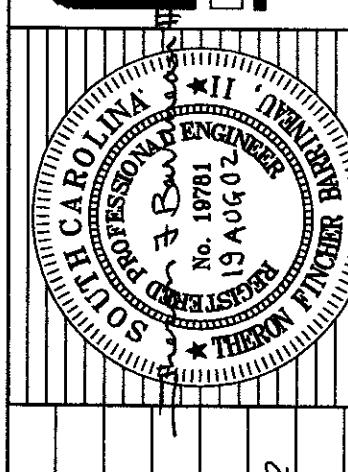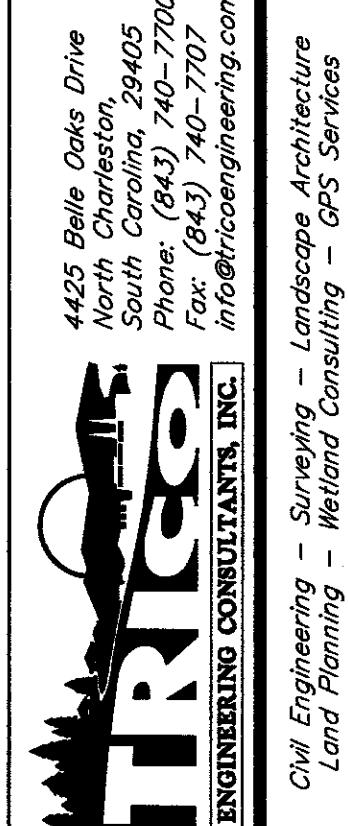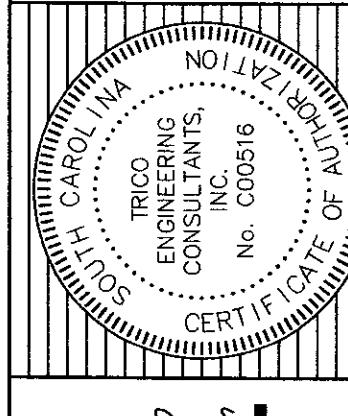

TITLE ROADWAY PLANS  
PHASE I OF ARBOR OAKS SUBDIVISION  
LOCATED IN  
THE TOWN OF SUMMERTON,  
DORCHESTER COUNTY, SOUTH CAROLINA  
NO. DATE  
4 05-10-2002 REVISED PLAT/ROAD PLANS PER SUMMERTON'S COMMENTS  
REVISIONS

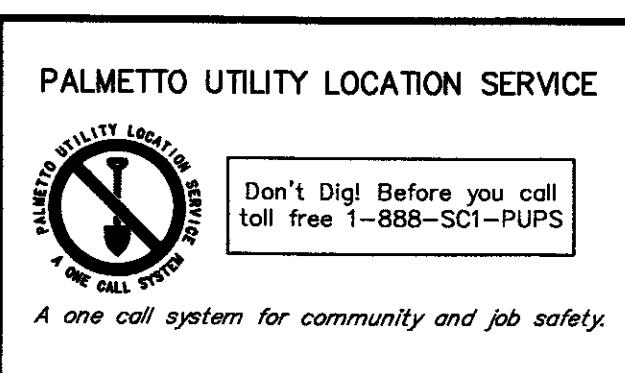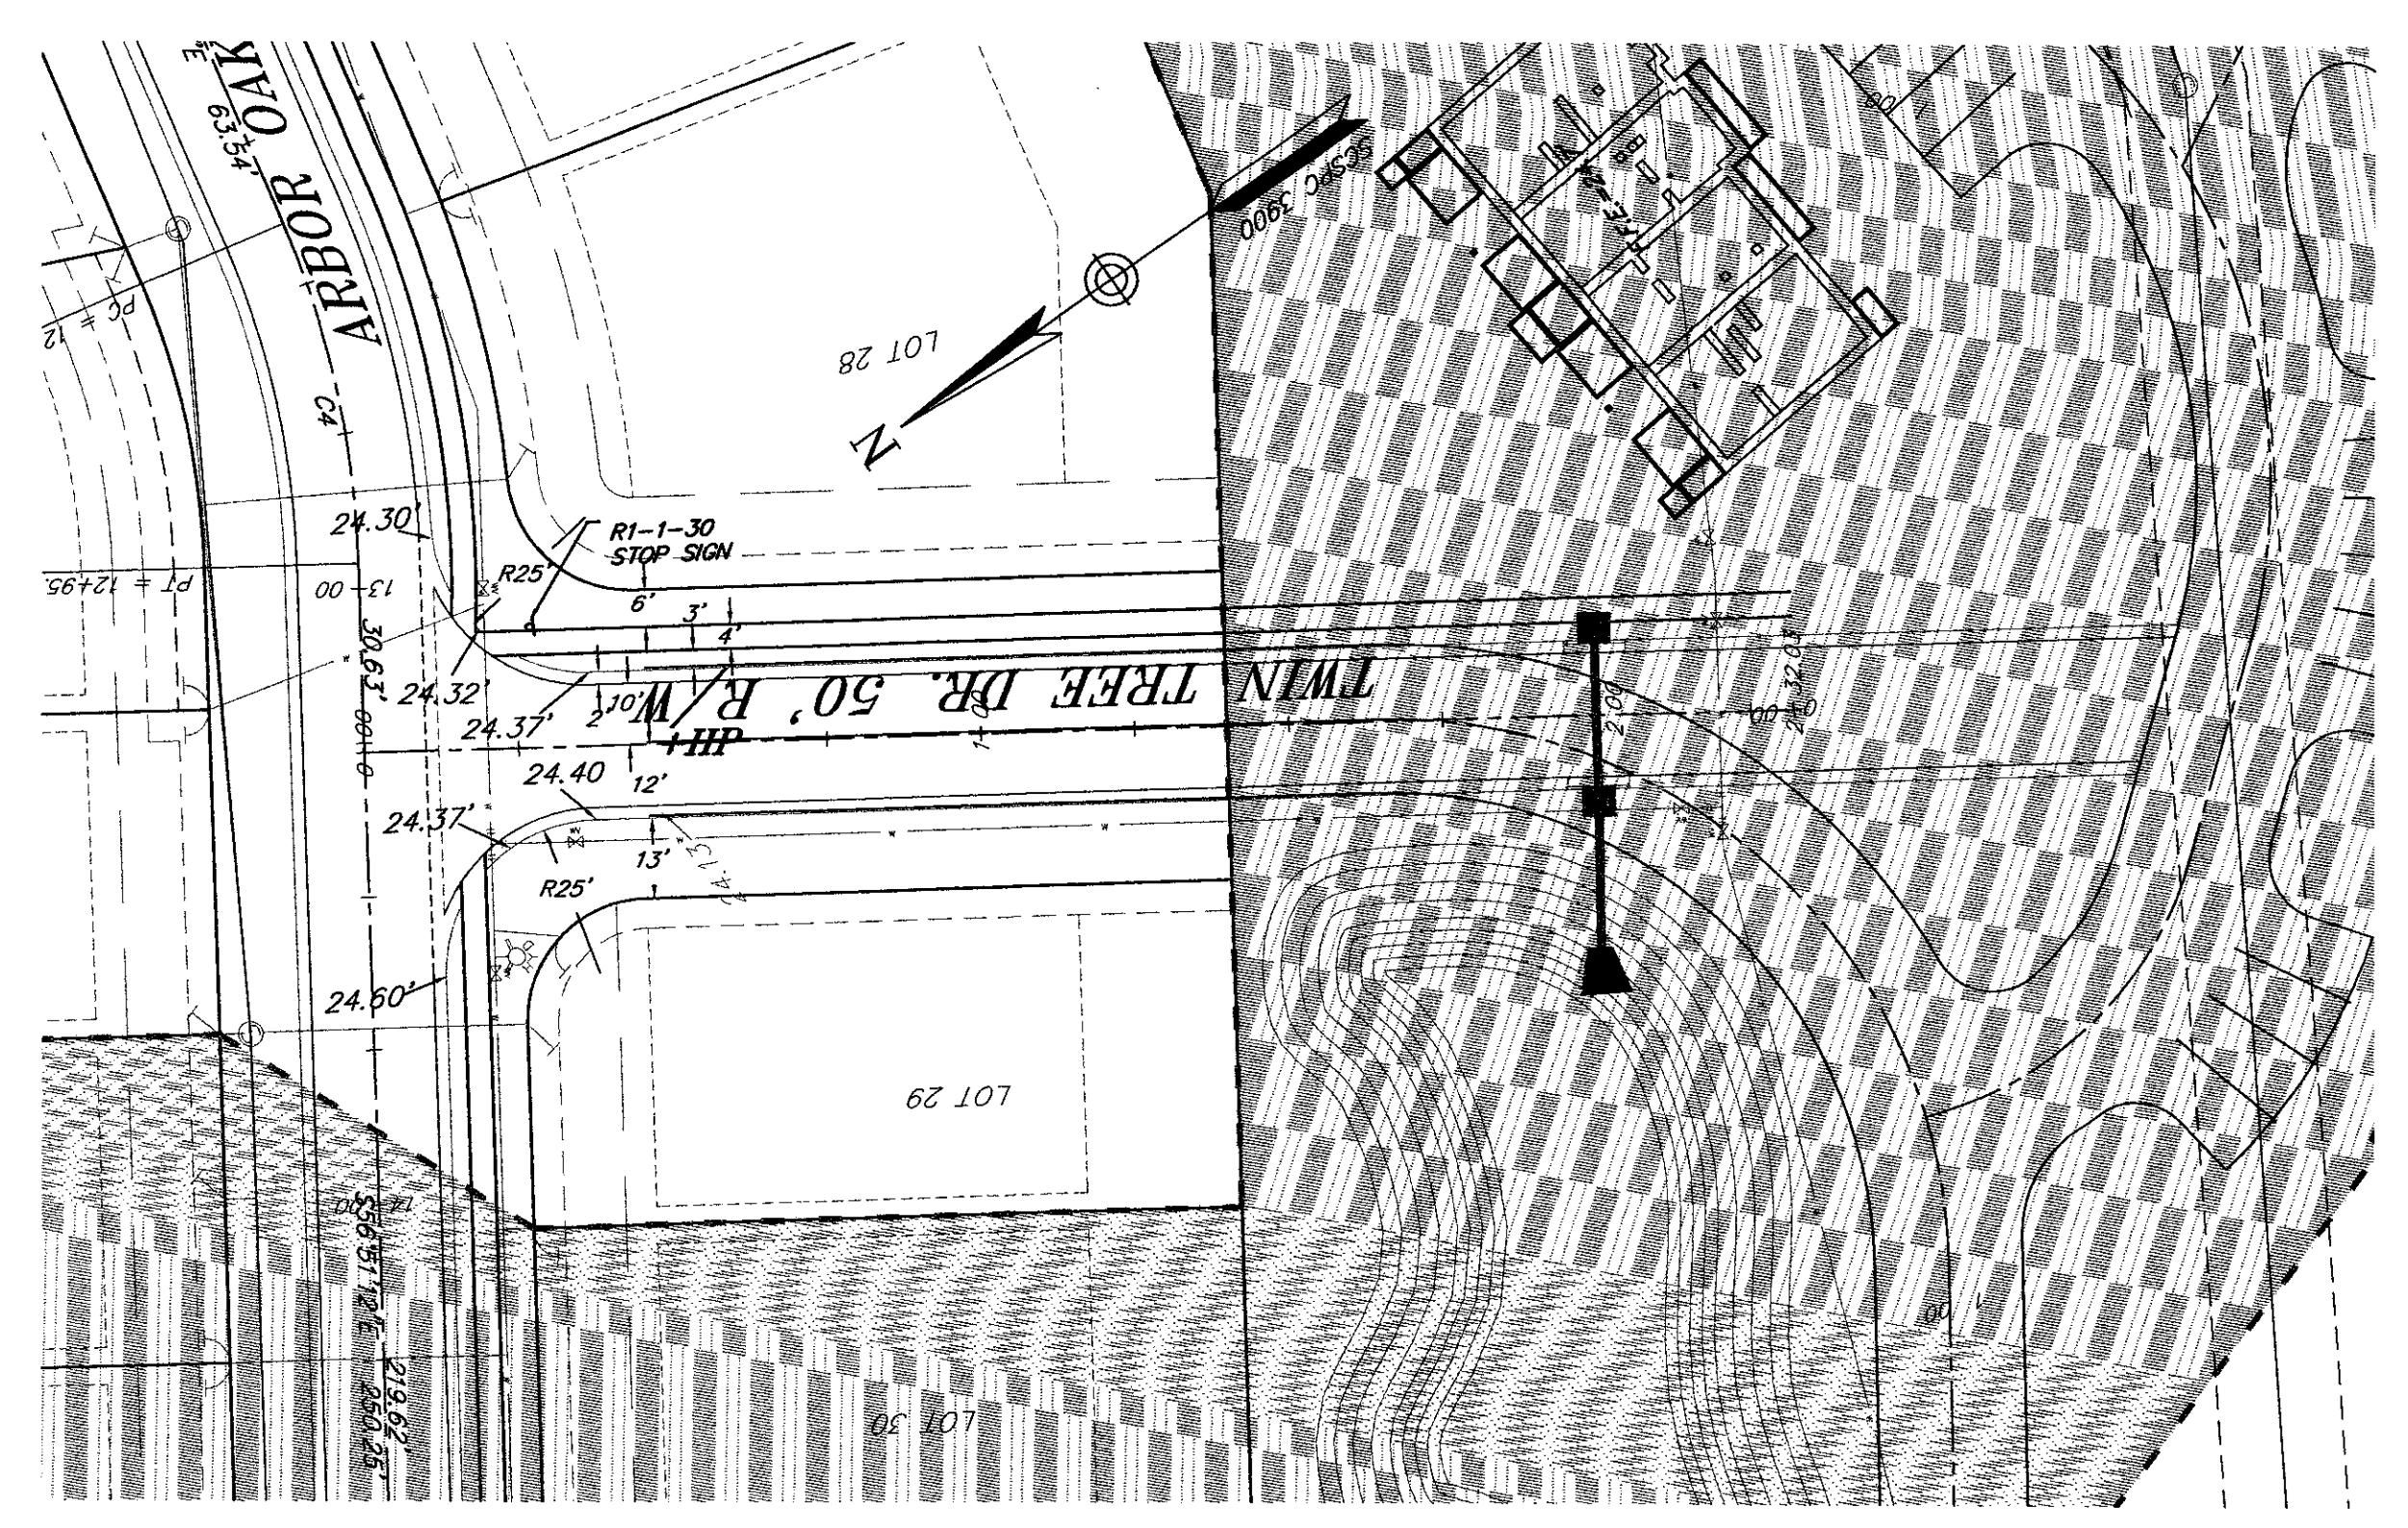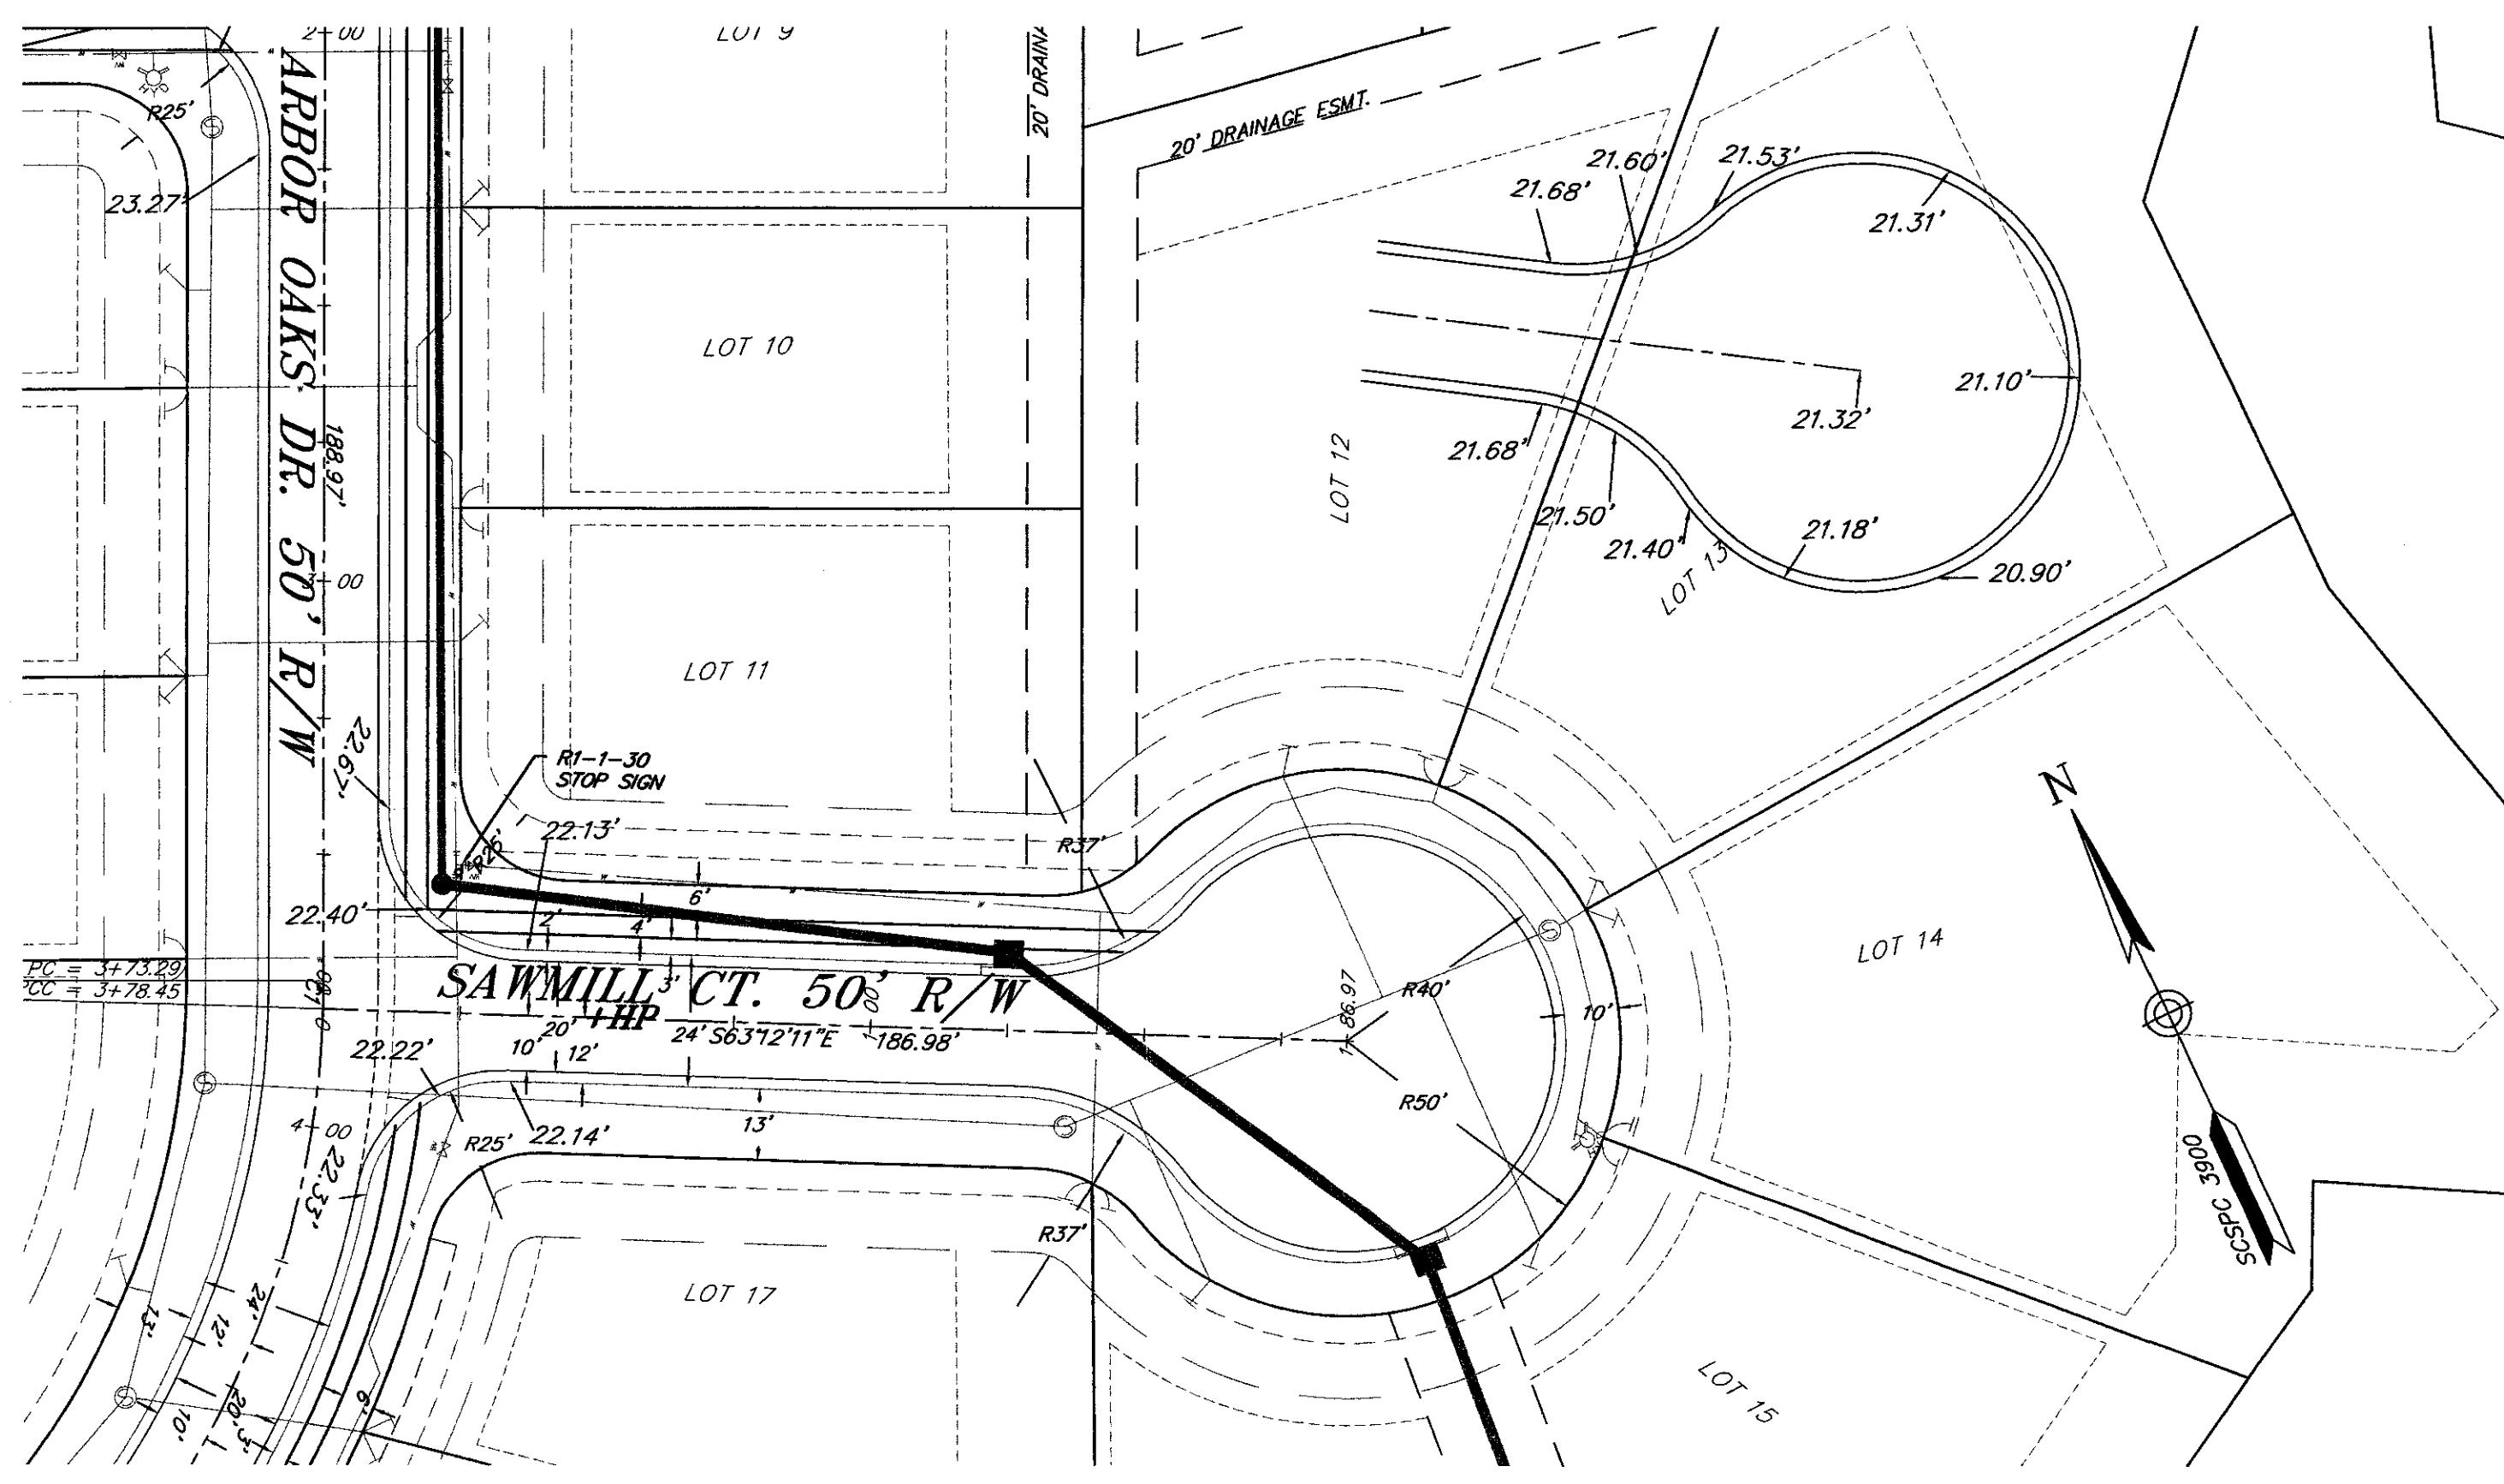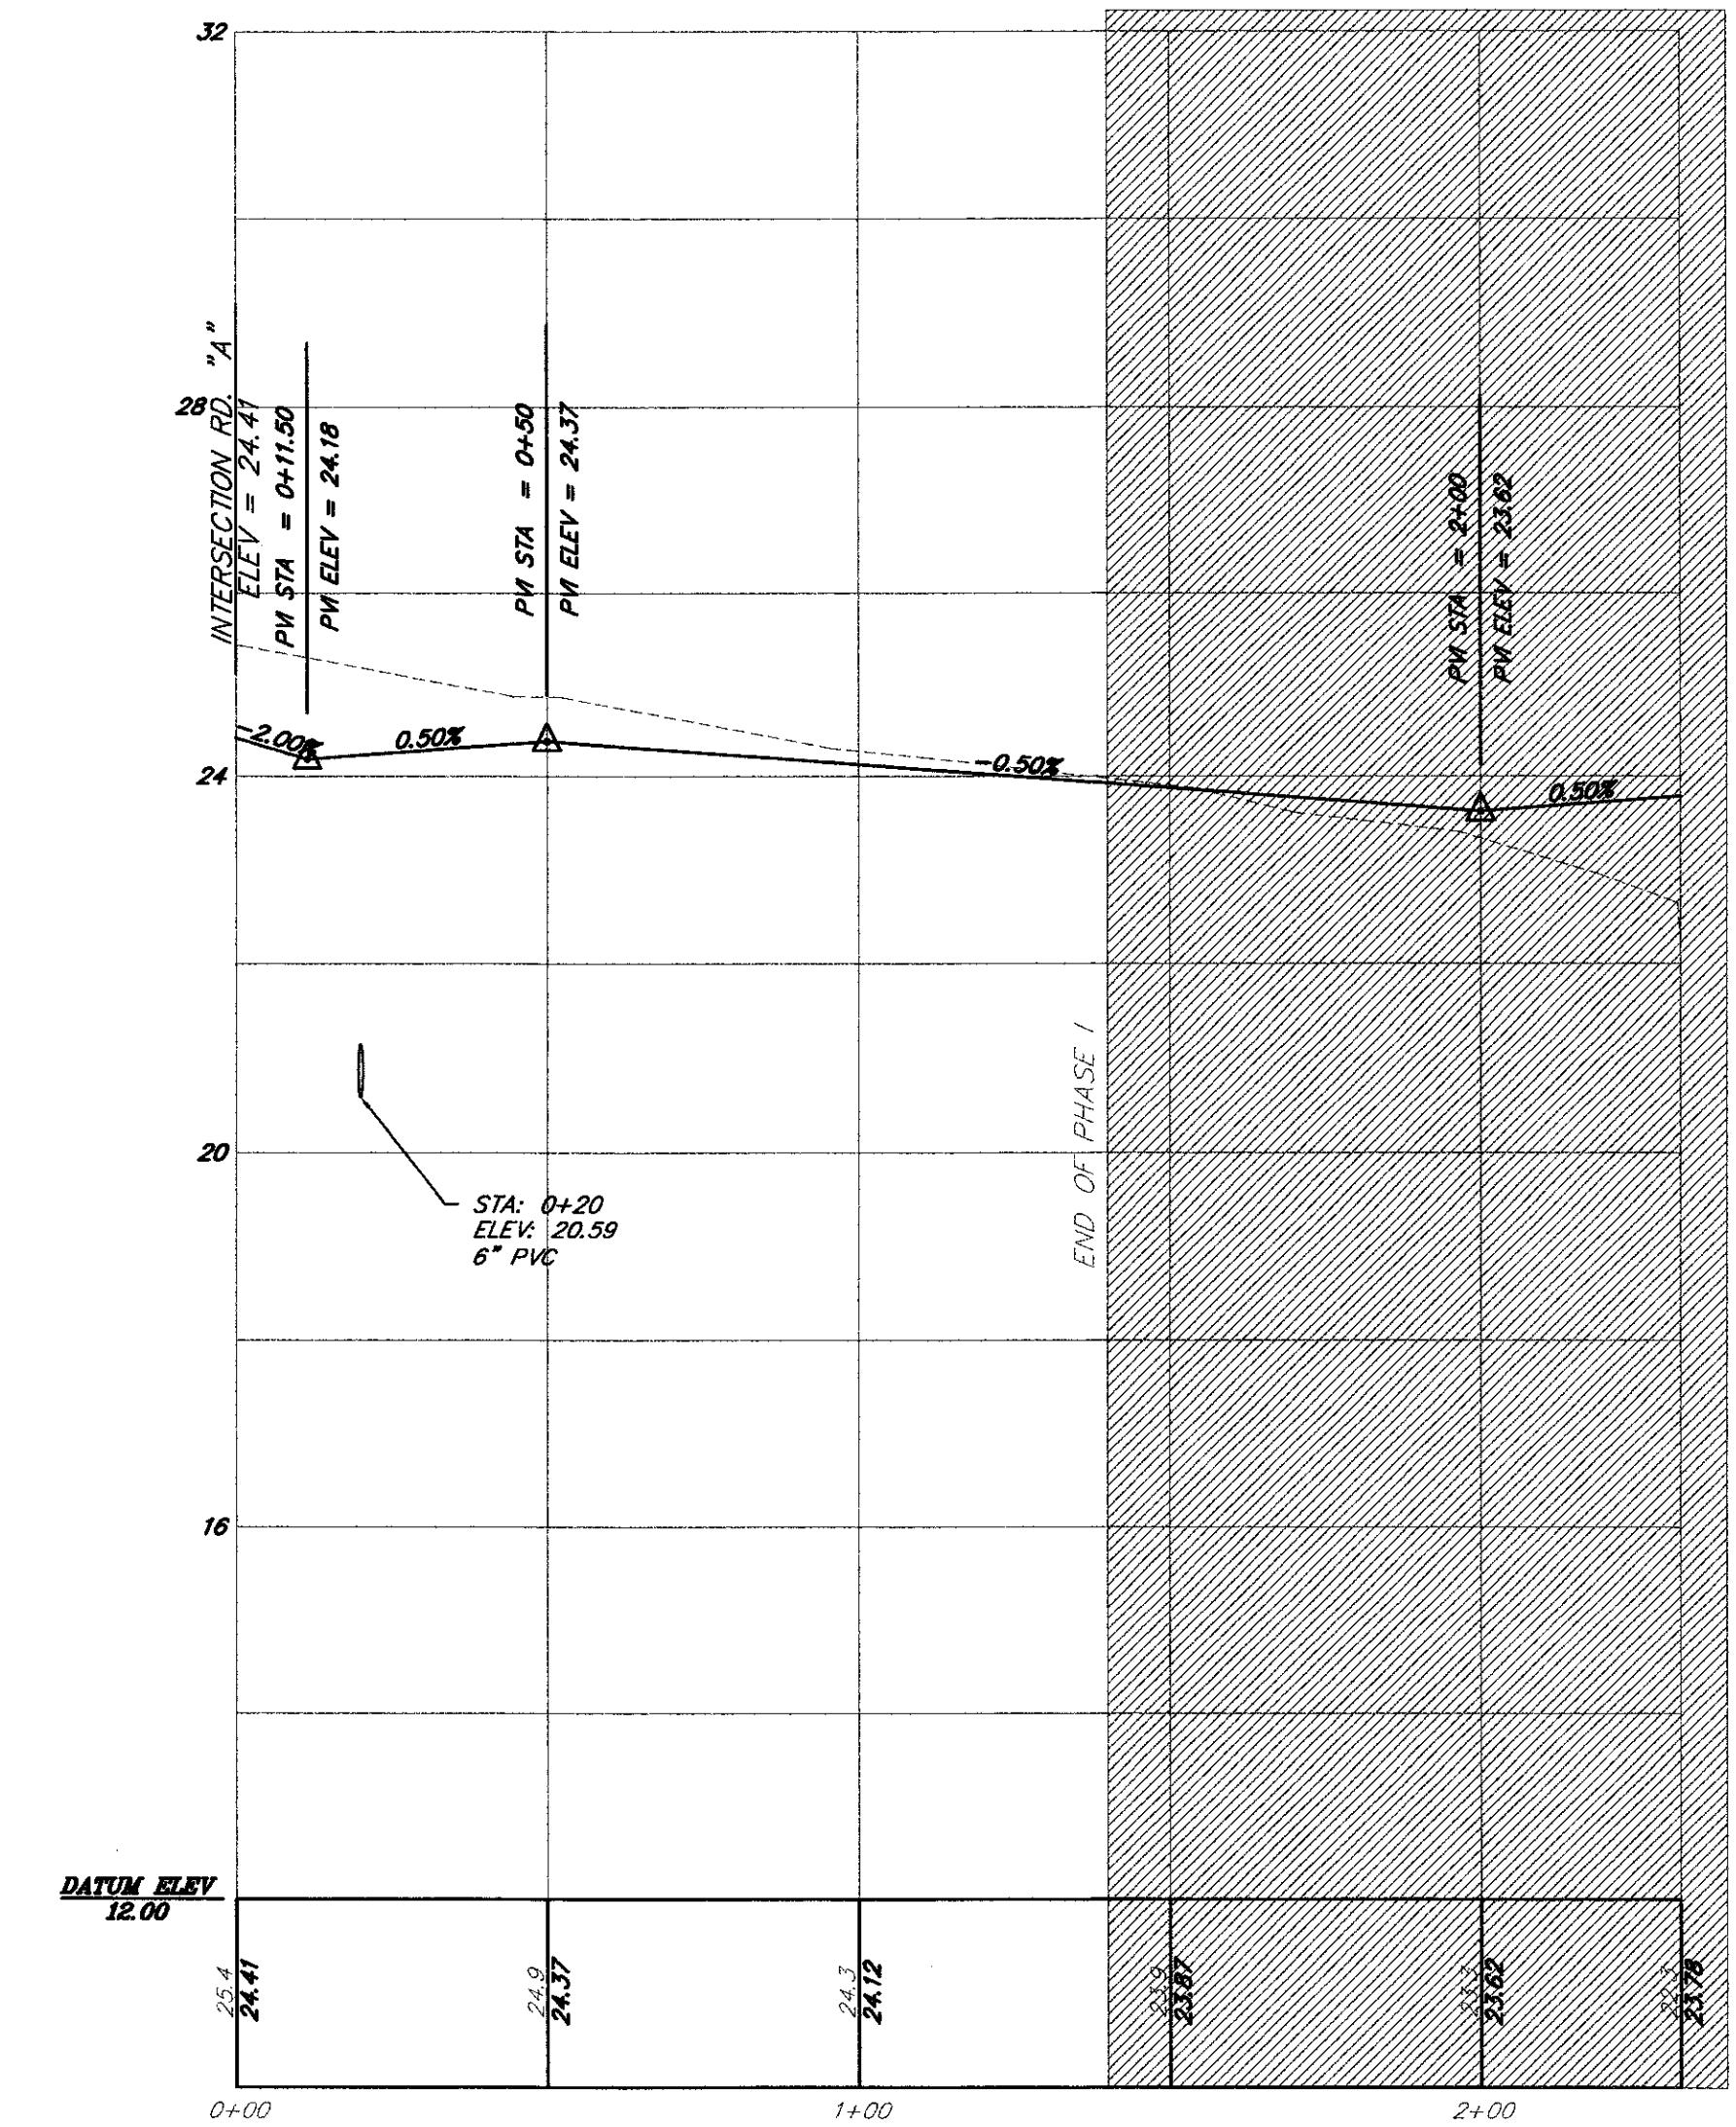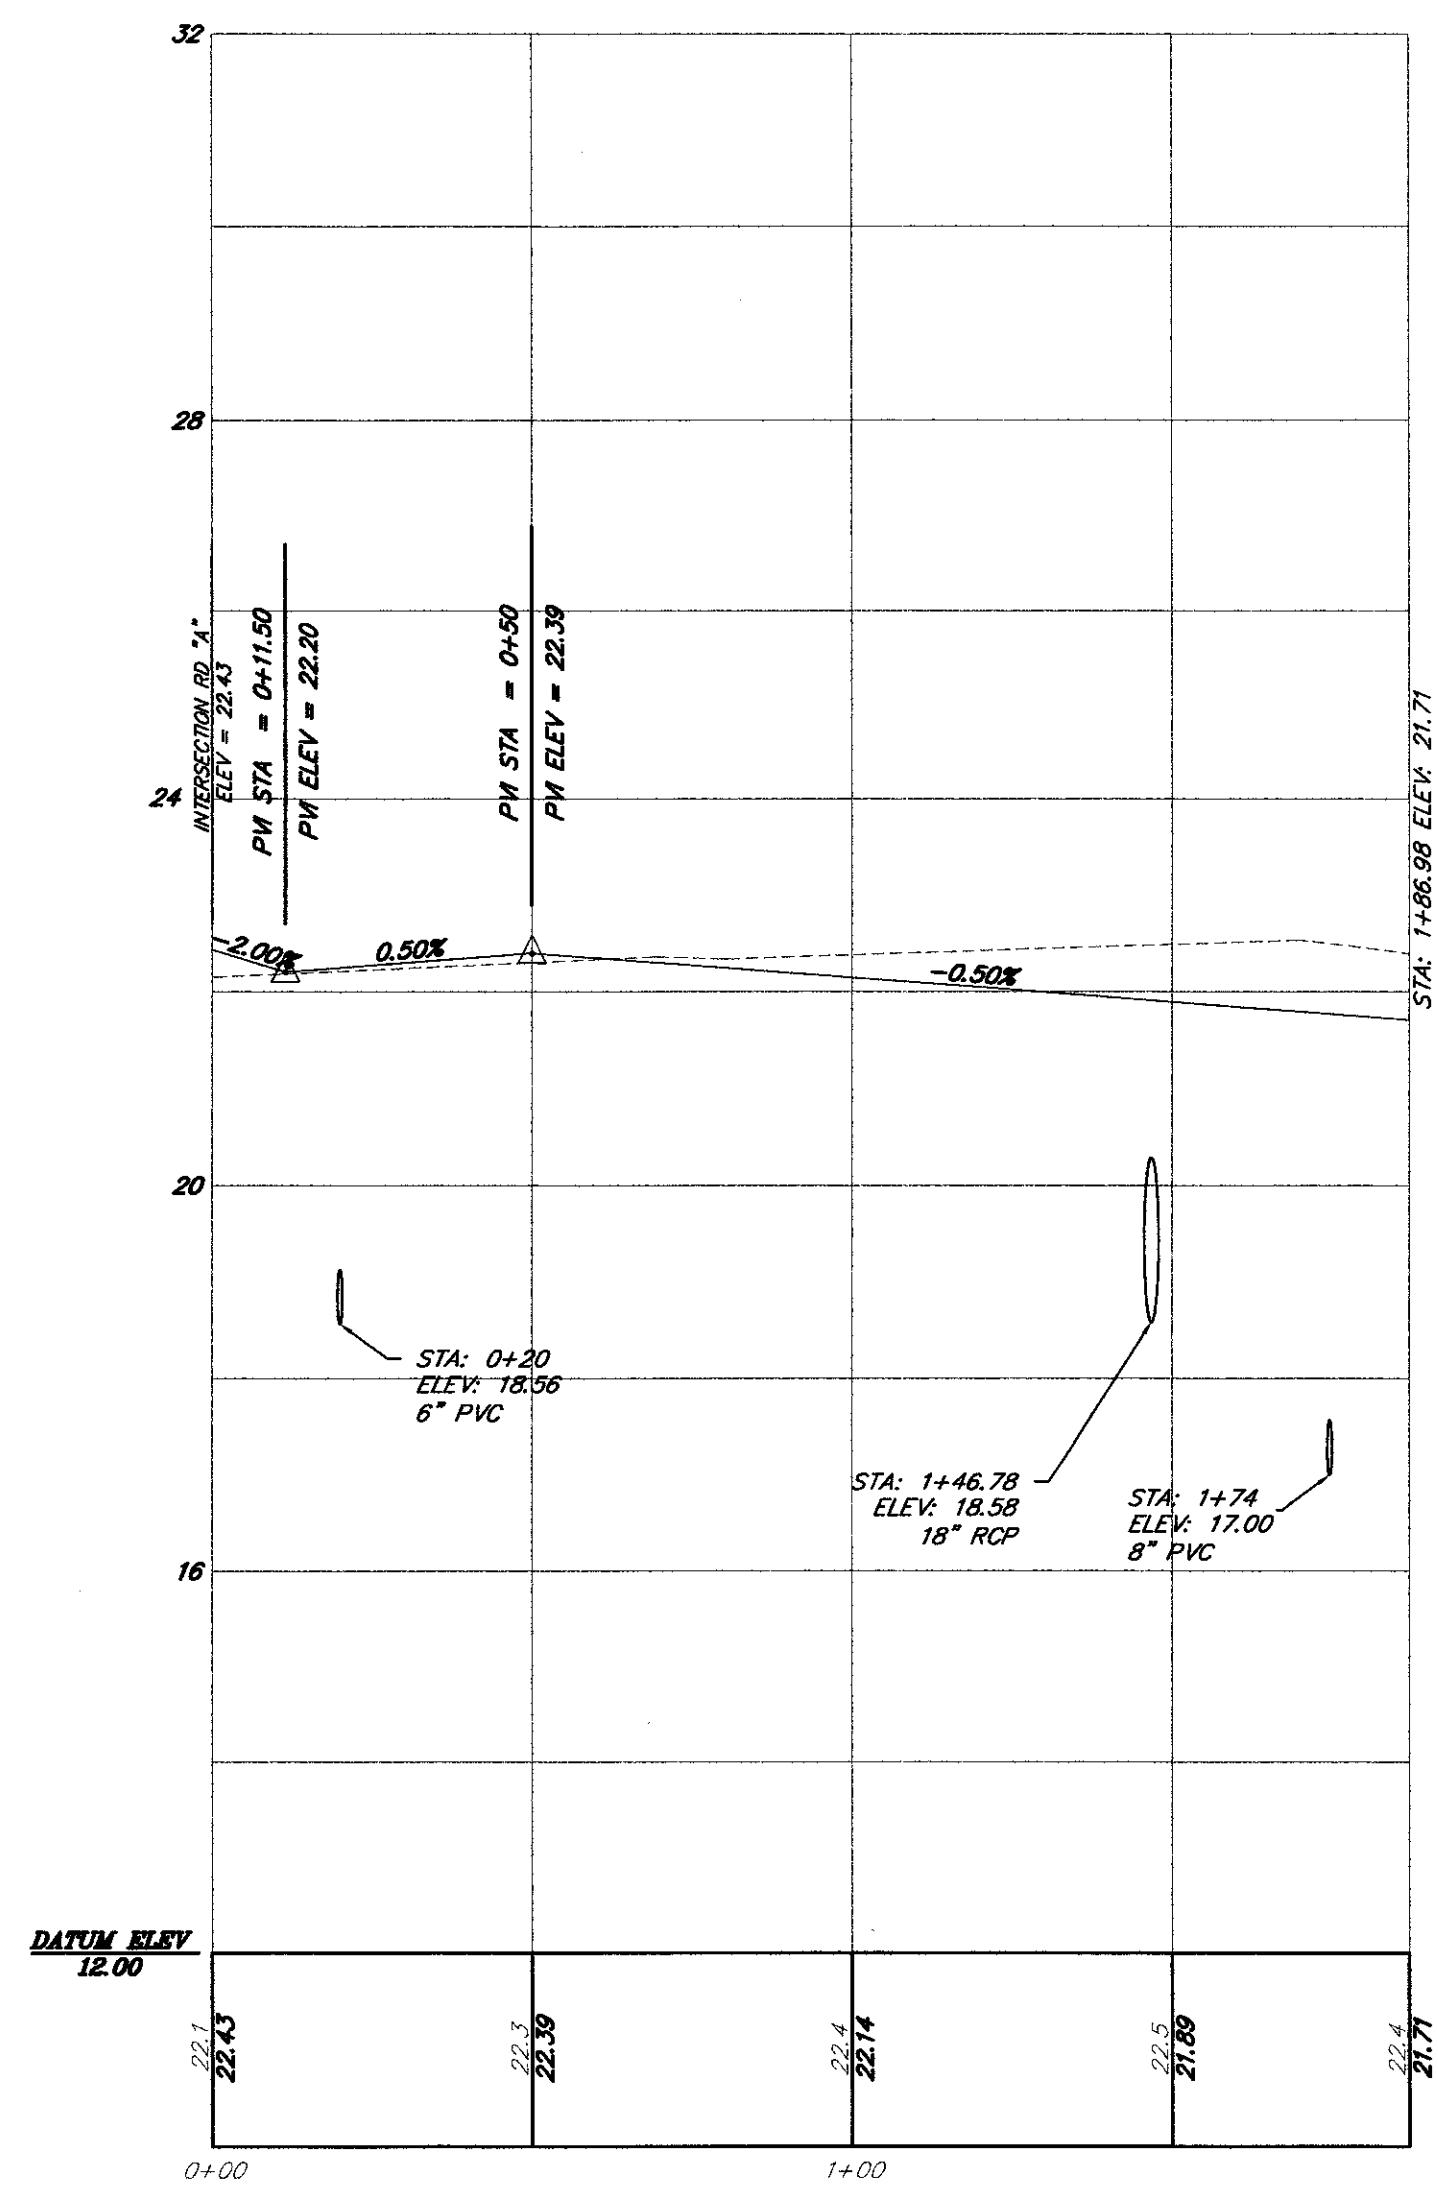


DESIGNED : MEL  
DRAWN : MEL  
CHECKED : TFB  
APPROVED : TFB  
SCALE : 1"=50'  
DATE : 29 JANUARY 2002  
PROJECT NO.: 01-087  
SHEET 10  
or 33


REVISED PLAT/ROAD PLANS FOR SUMMERSVILLE COMMENTS  
REVISIONS  
NO. DATE  
05-10-2002

**ROADWAY PLANS**  
**PHASE I OF ARBOR OAKS SUBDIVISION**  
**LOCATED IN**  
**THE TOWN OF SUMMERSVILLE**  
**DORCHESTER COUNTY, SOUTH CAROLINA**

4425 Belle Oaks Drive  
North Charleston, South Carolina, 29405  
Phone: (843) 740-7700  
Fax: (843) 740-7707  
Email: info@tricoengineering.com  
Civil Engineering - Surveying - Landscape Architecture  
Land Planning - Wetland Consulting - GIS Services  
Visit us at: http://www.tricoengineering.com




4425 Belle Oaks Drive  
North Charleston, South Carolina, 29405  
Phone: (843) 740-7700  
Fax: (843) 740-7707  
Email: info@tricoengineering.com  
Civil Engineering - Surveying - Landscape Architecture  
Land Planning - Wetland Consulting - GIS Services  
Visit us at: http://www.tricoengineering.com

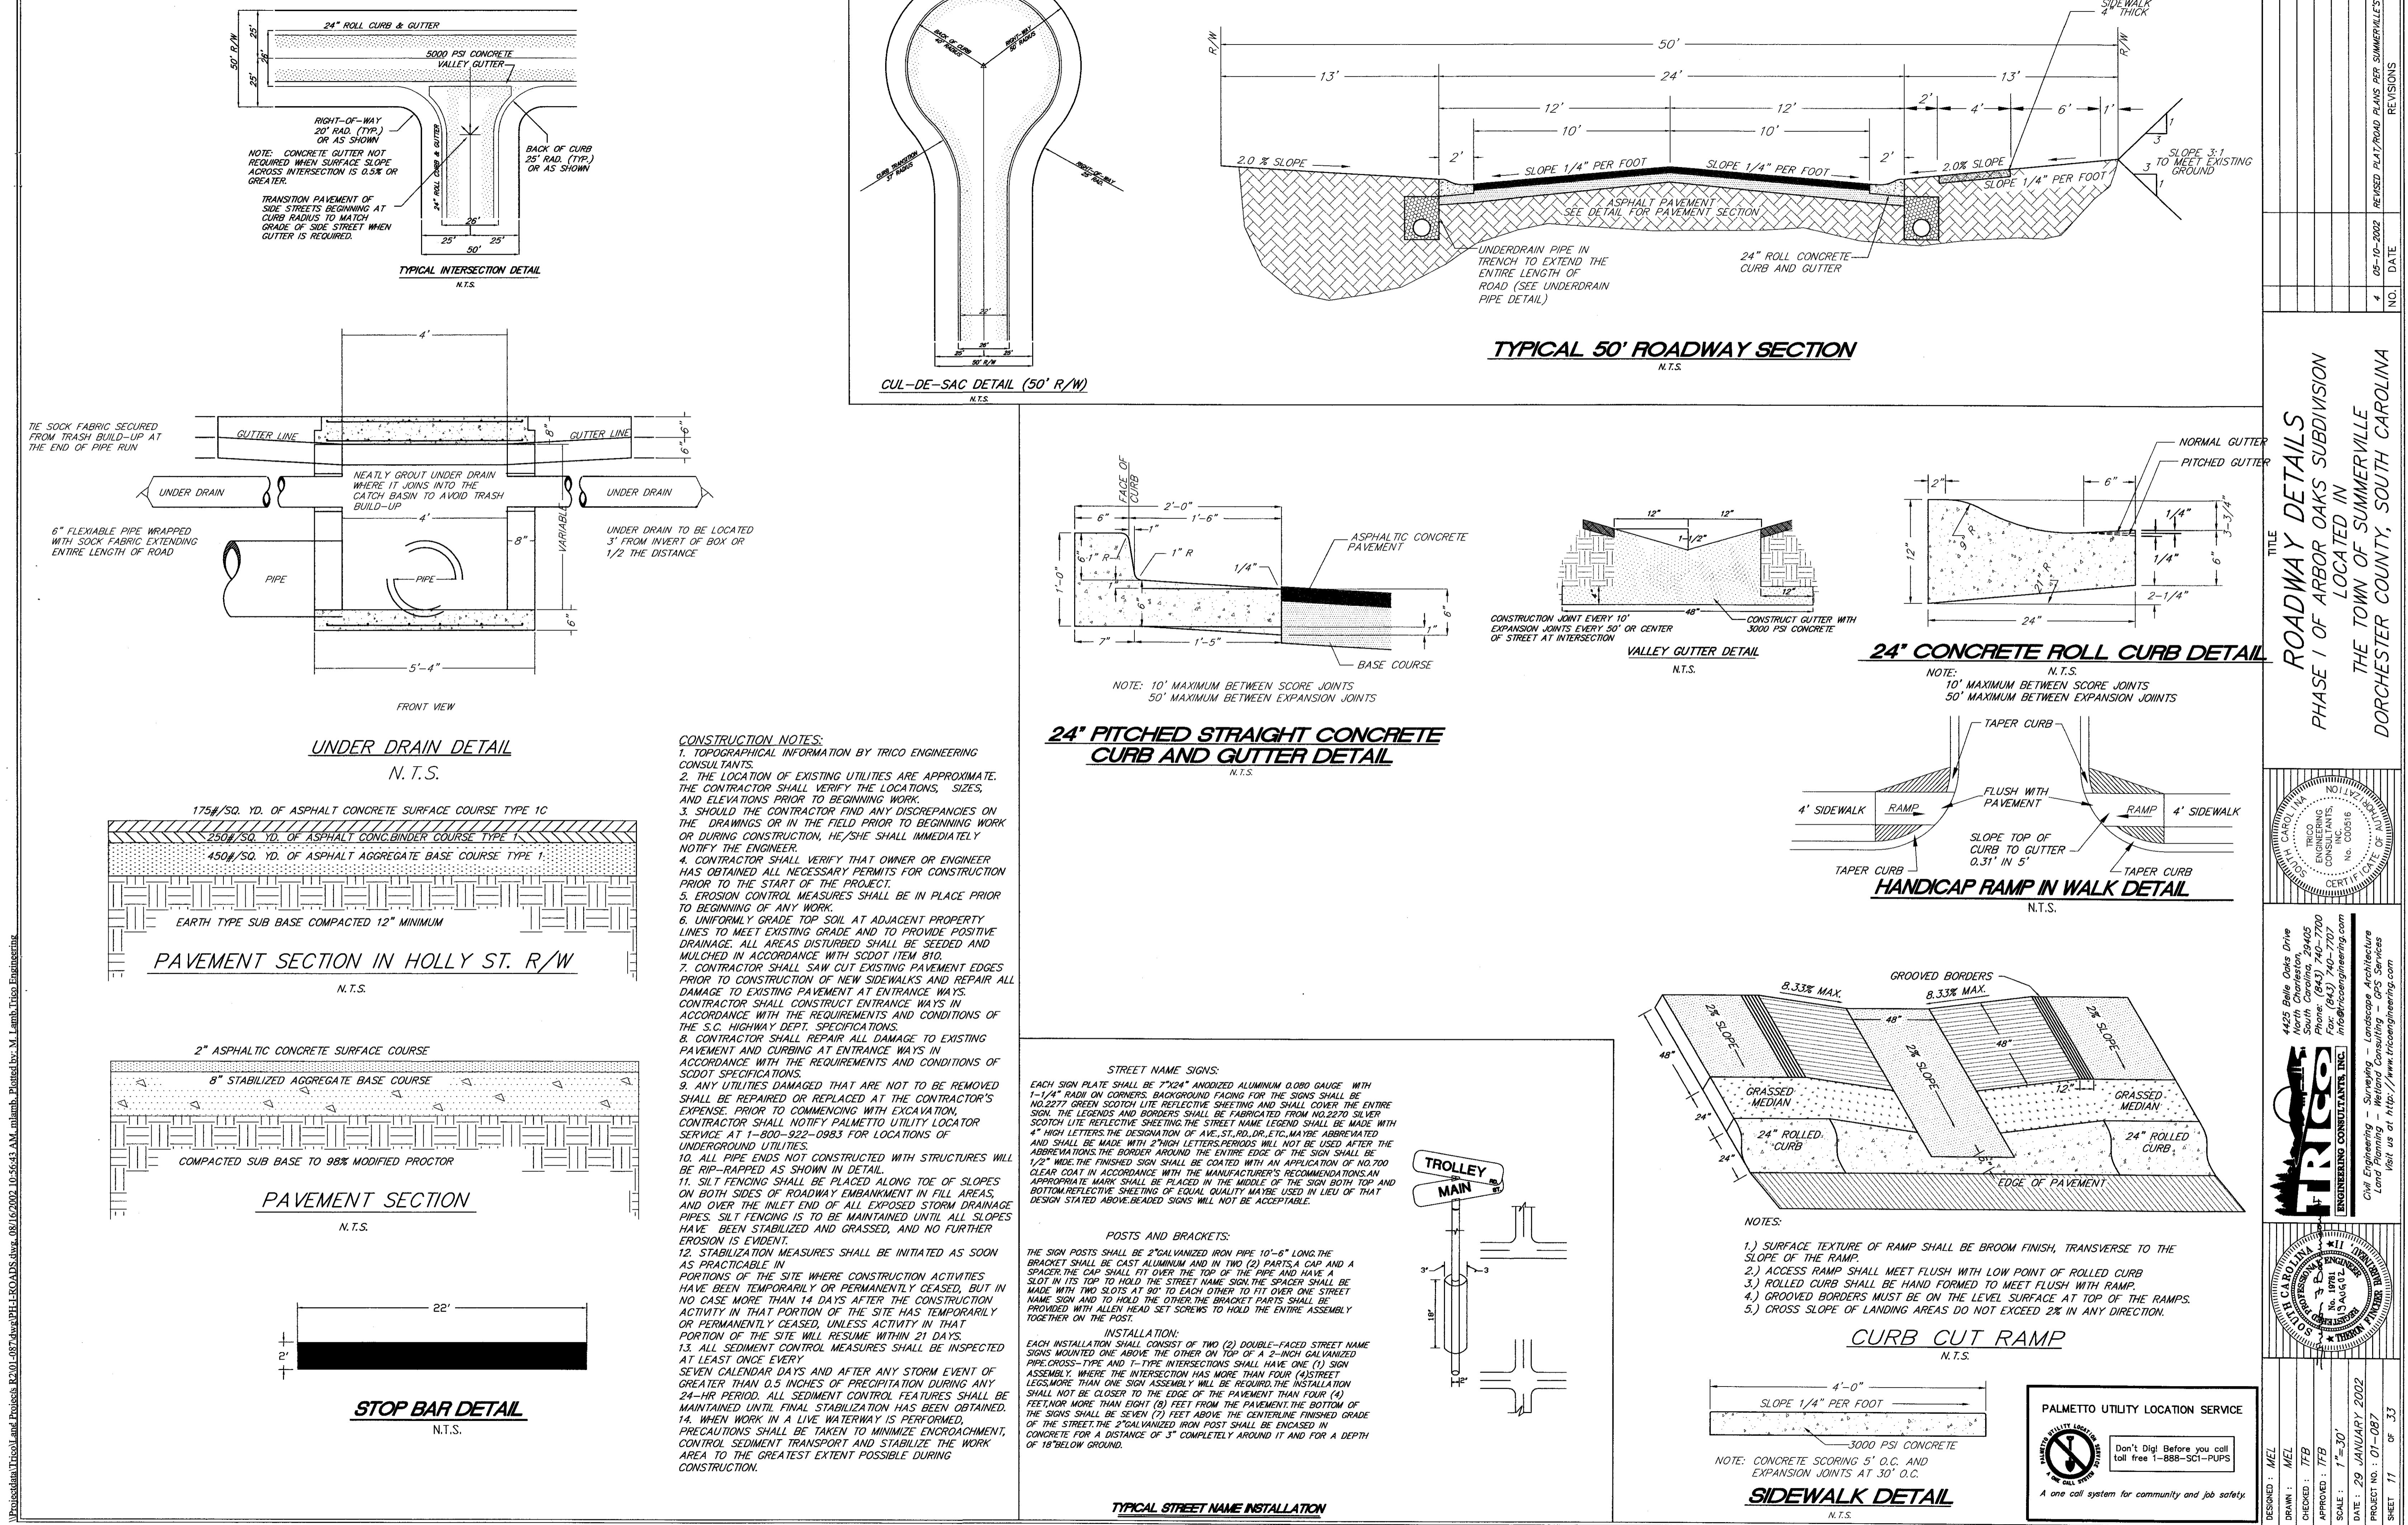

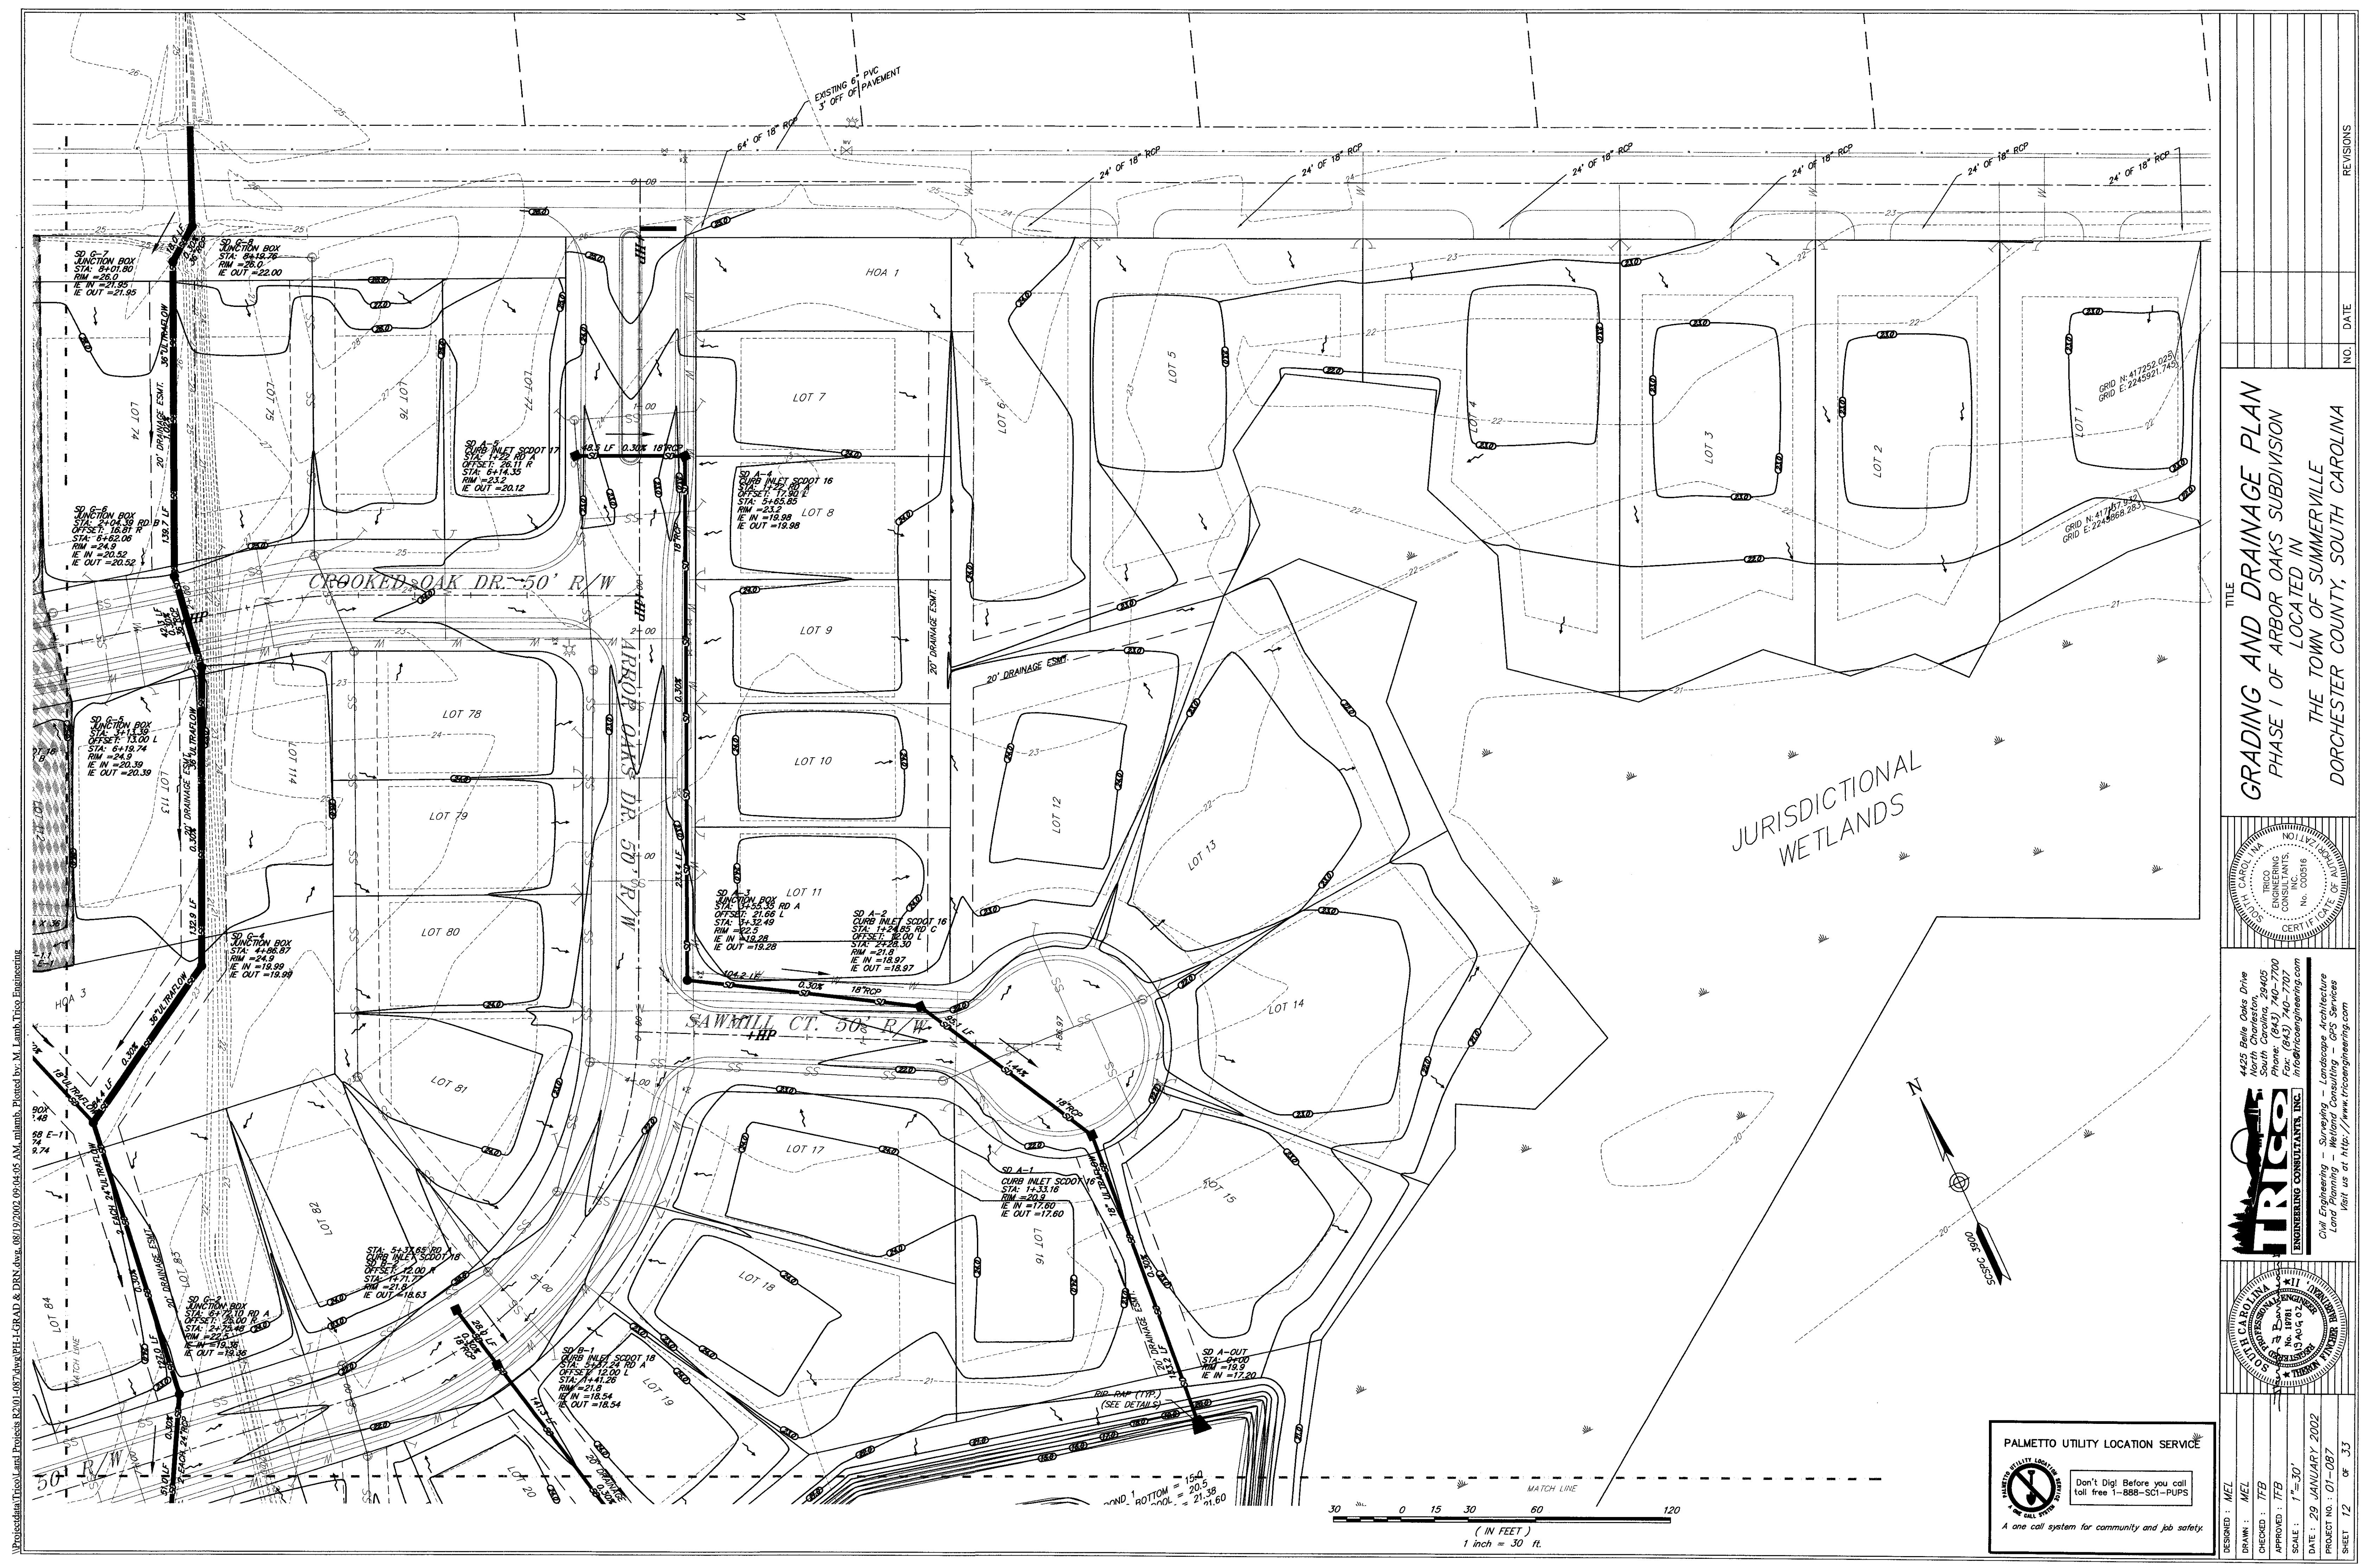






**TITLE**  
**GRADING AND DRAINAGE PLAN**  
**PHASE I OF ARBOR OAKS SUBDIVISION**  
**LOCATED IN**  
**THE TOWN OF SUMMERVILLE**  
**DORCHESTER COUNTY, SOUTH CAROLINA**

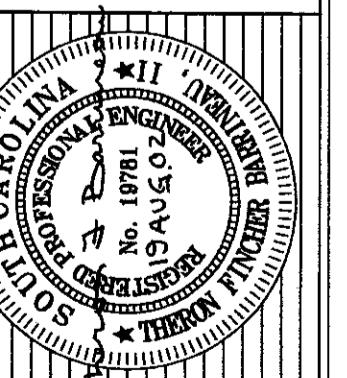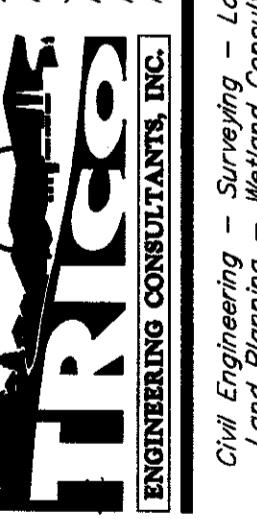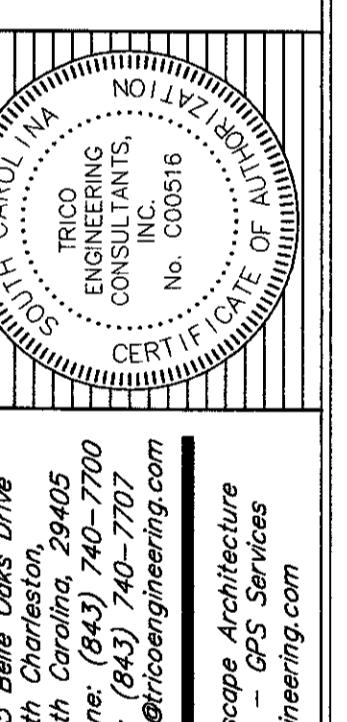

4425 Belle Oaks Drive  
North Charleston, 29405  
Phone: (843) 740-7707  
Fax: (843) 740-7707  
Civil Engineering - Surveying - Landscape Architecture  
Land Planning - Wetland Consulting - GFS Services  
Visit us at: <http://www.tricoengineering.com>

NO. DATE REVISIONS

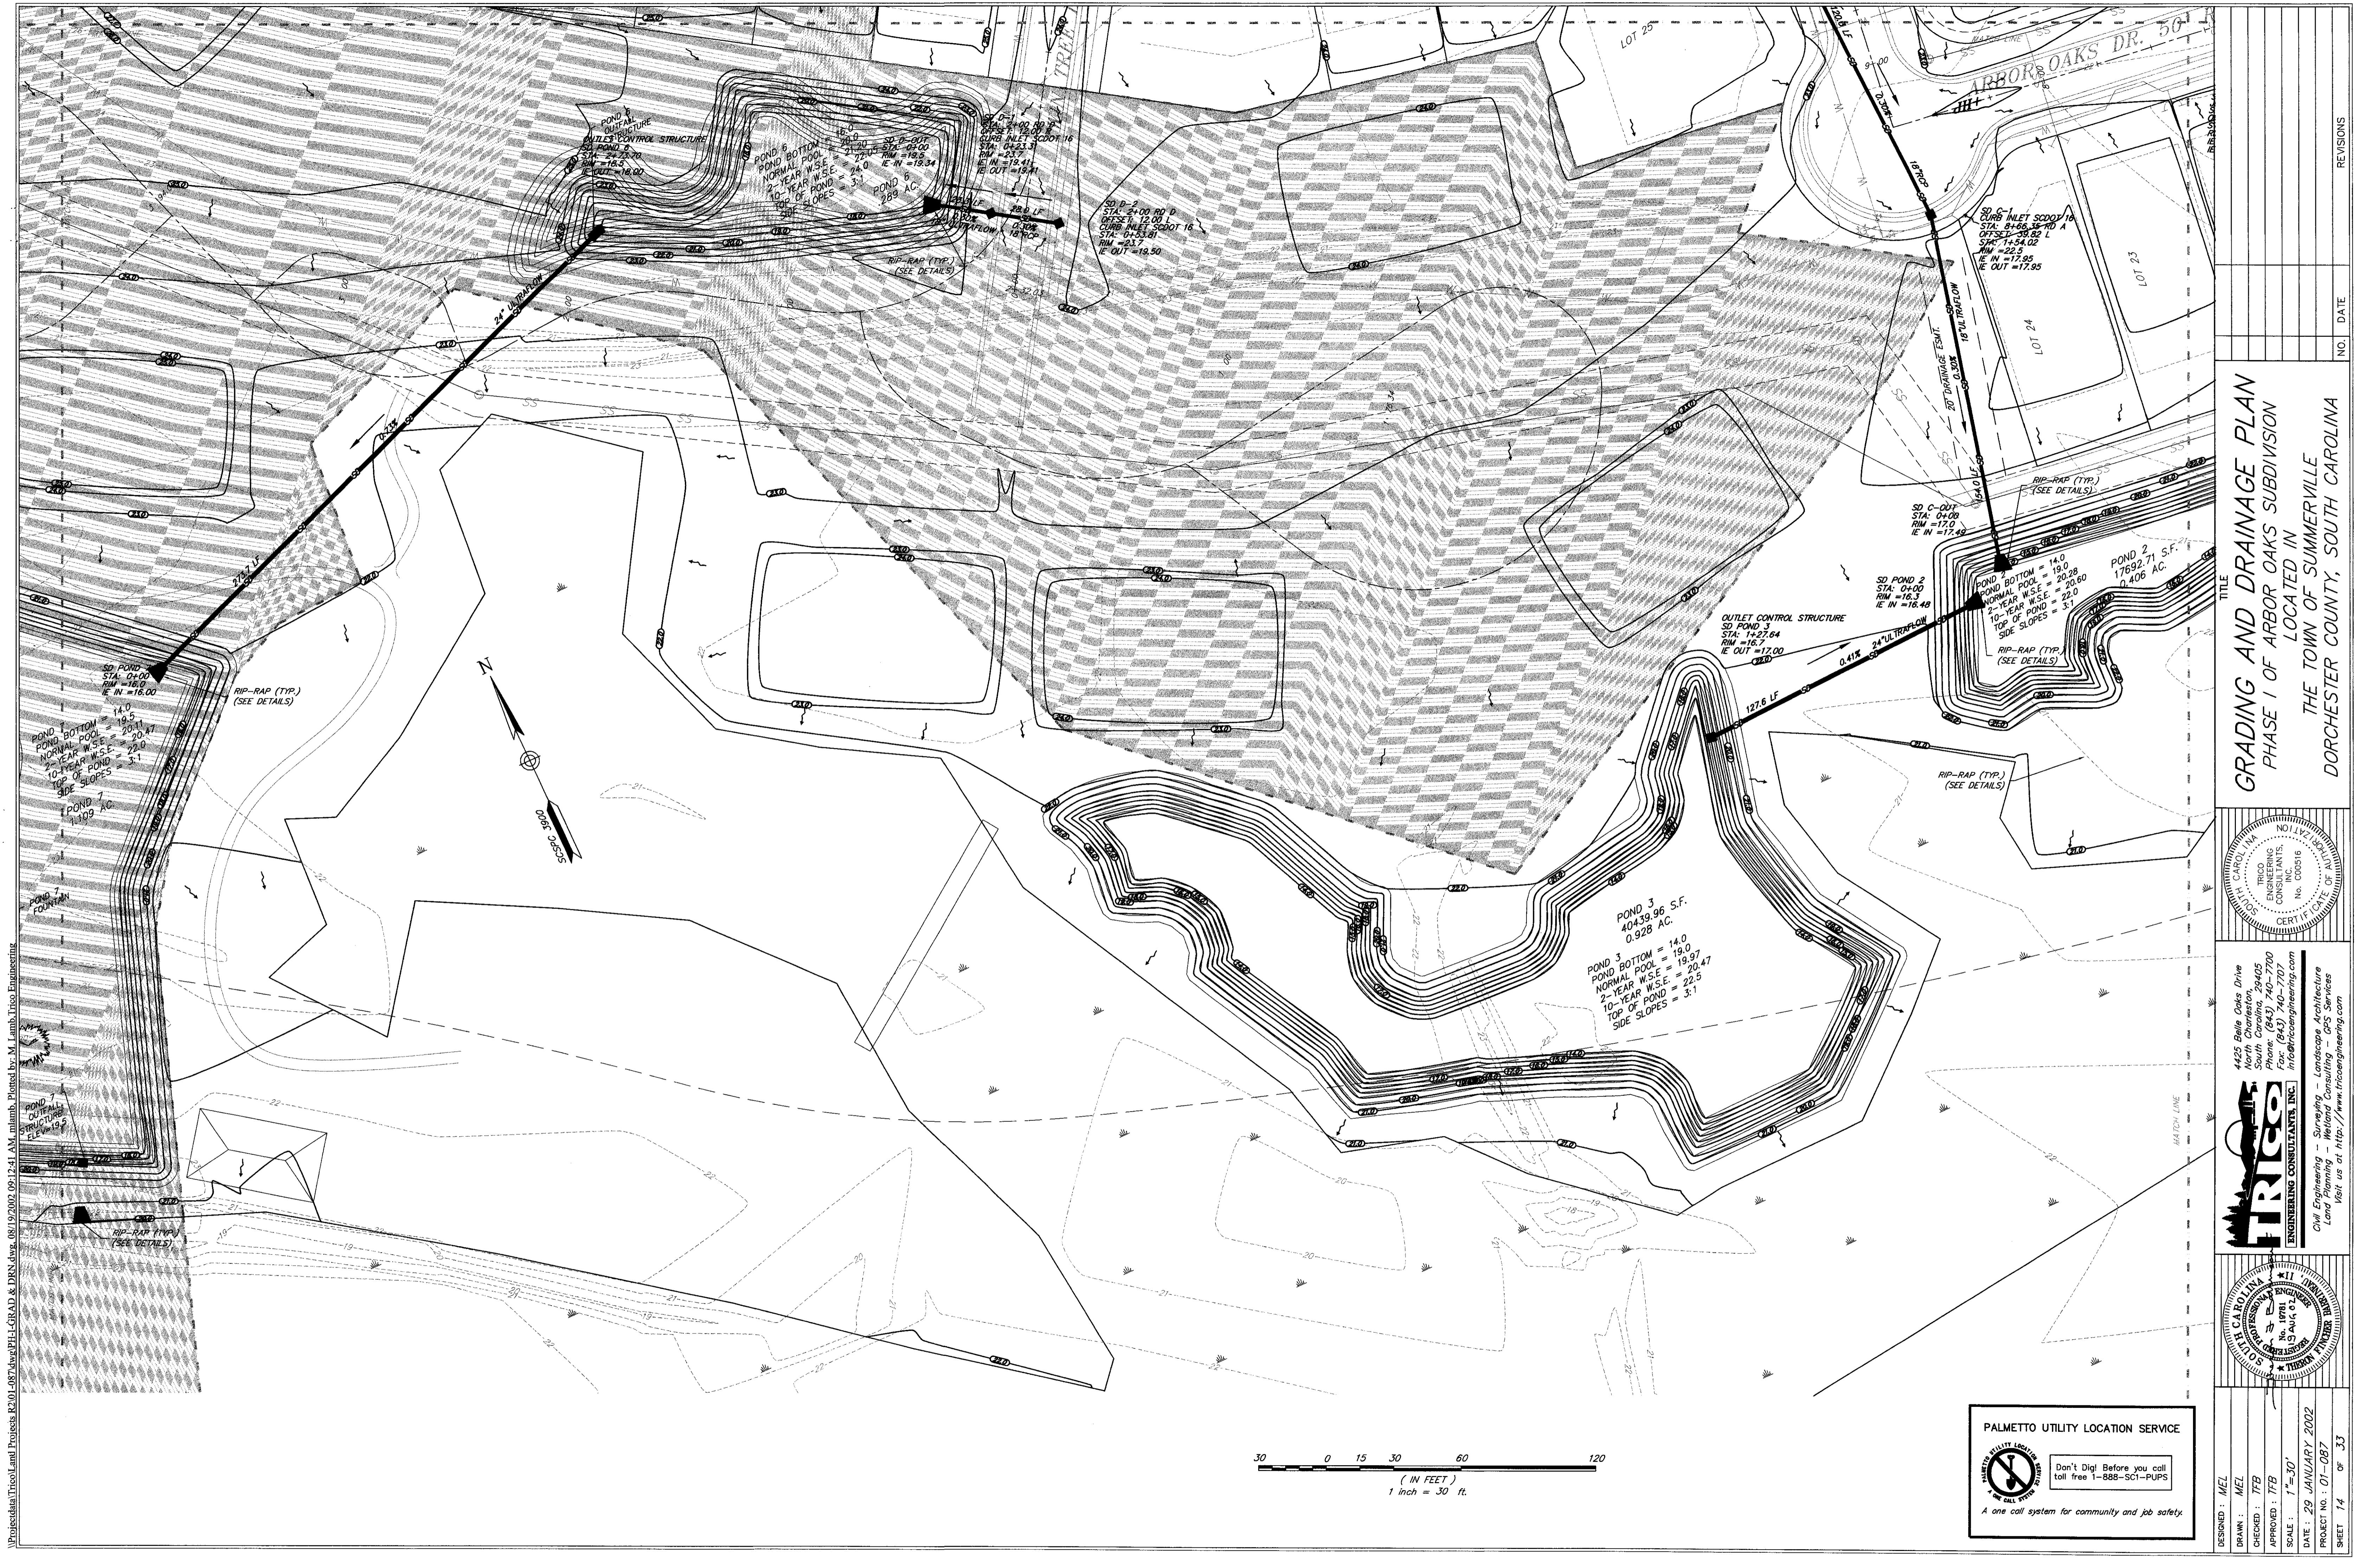

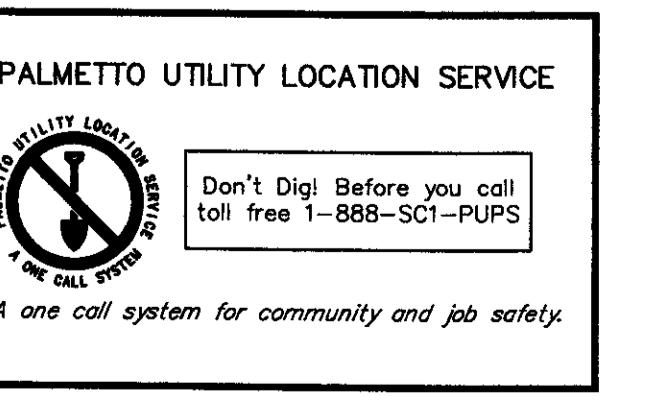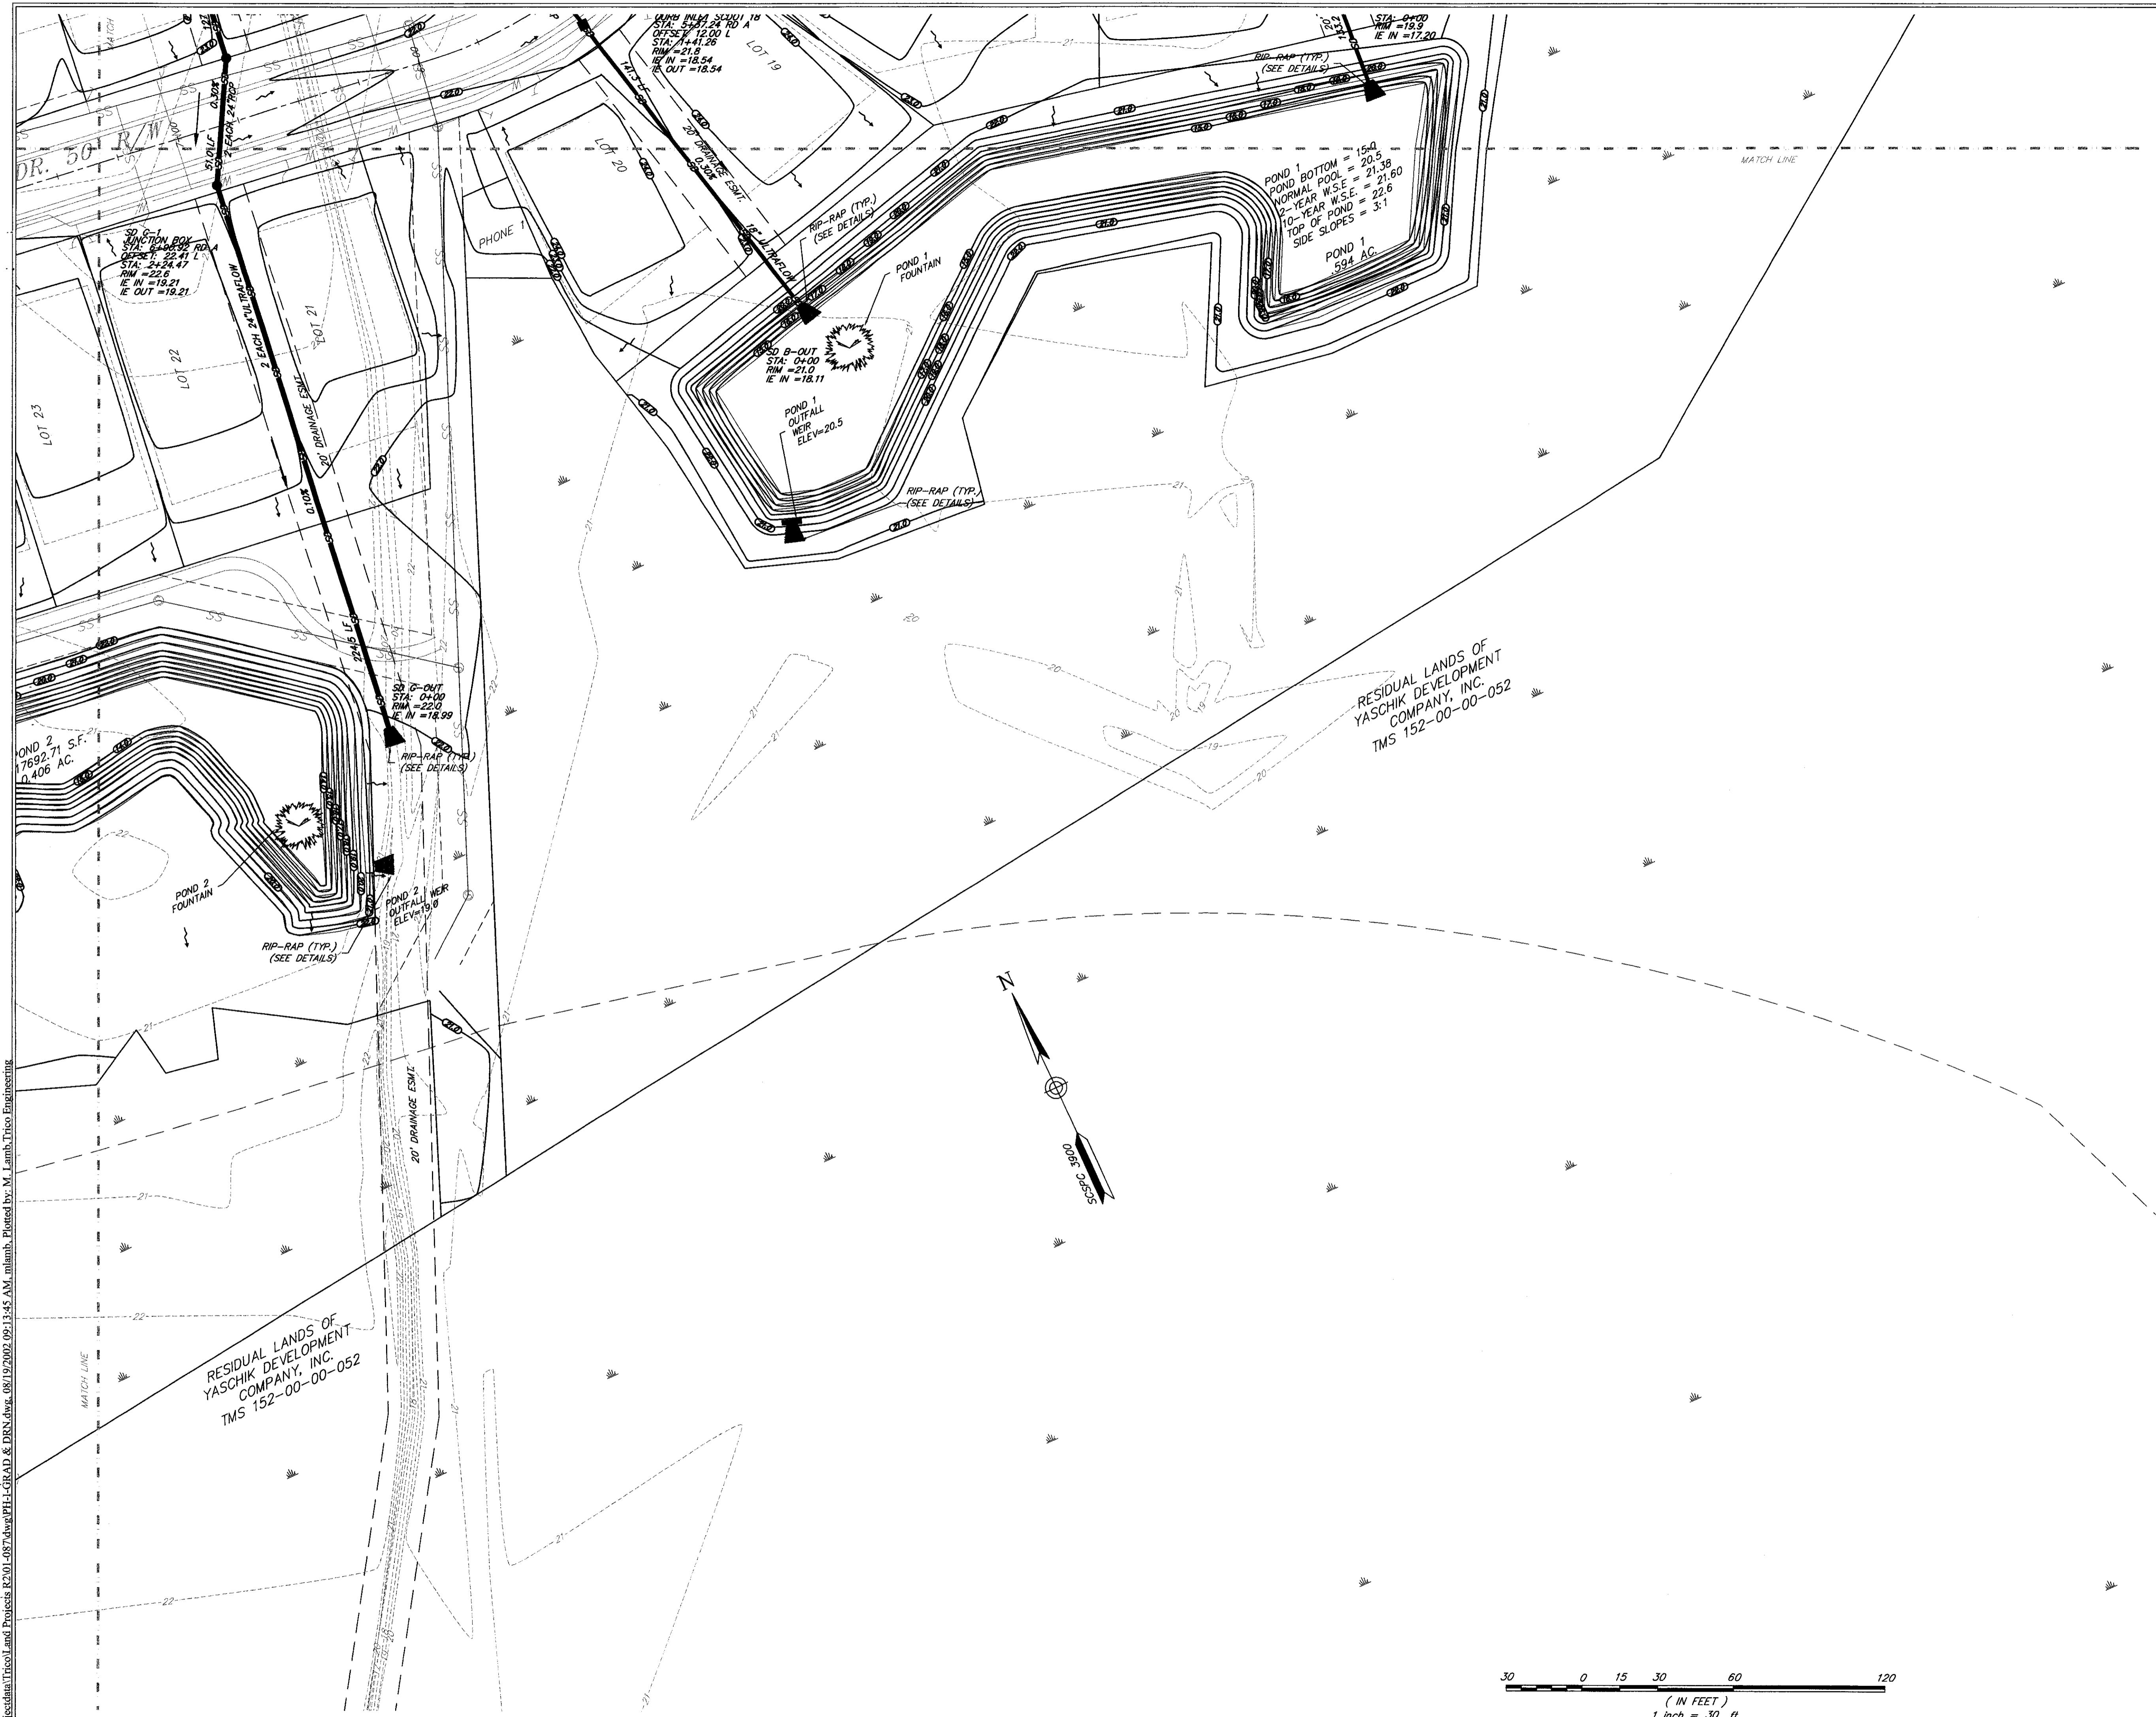

**GRADING AND DRAINAGE PLAN**  
PHASE 1 OF ARBOR OAKS SUBDIVISION  
LOCATED IN  
THE TOWN OF SUMMERTOWN,  
DORCHESTER COUNTY, SOUTH CAROLINA

DESIGNED : MEL  
DRAWN : MEL  
CHECKED : TFB  
APPROVED : TFB  
SCALE : 1"=30'  
DATE : 29 JANUARY 2002  
PROJECT NO. : 01-087  
SHEET 15 OF 33

TRICO  
ENGINEERING CONSULTANTS, INC.  
4425 Bella Oaks Drive  
South Charleston, 29405  
Phone: (843) 740-7700  
Fax: (843) 740-7701  
info@tricengineering.com  
Civil Engineering - Surveying - Landscape Architecture  
Land Planning - Wetland Consulting - GFS Services  
Visit us at: <http://www.tricengineering.com>

CERTIFICATE OF AUTOCAD  
NO. 112-1363  
TRICO ENGINEERING CONSULTANTS, INC.  
Engineering Consultants  
No. C00515


STATE OF SOUTH CAROLINA  
RECEIVED  
JAN 30 1978  
FEB 1 1978  
APR 1 1978  
MAY 1 1978  
JUN 1 1978  
JULY 1 1978  
AUG 1 1978  
SEPT 1 1978  
OCT 1 1978  
NOV 1 1978  
DEC 1 1978

## CONSTRUCTION NOTES



- ALL ELEVATIONS ARE BASED ON NGVD 29, ON SITE BENCHMARK LOCATED IN A POWER POLE NEAR LOT 68 AT ELEVATION 30.20.
- ALL WORK, METHODS, EQUIPMENT AND MATERIALS ARE TO BE IN ACCORDANCE WITH THE REQUIREMENTS OF THE TOWN OF SUMMerville ROAD CODE AND SPECIFICATIONS, LATEST EDITION.
- ALL STREET RIGHT OF WAYS, SANITARY SEWER EASEMENTS, AND DRAINAGE EASEMENTS TO BE CLEARED 100% AND ALL DEBRIS REMOVED.
- THE LOCATIONS OF EXISTING UTILITIES IS APPROXIMATE, THE CONTRACTOR SHALL VERIFY THE LOCATIONS, SIZES AND ELEVATIONS PRIOR TO BEGINNING WORK. SHOULD THE CONTRACTOR FIND ANY DISCREPANCIES ON THE DRAWINGS OR IN THE FIELD PRIOR TO BEGINNING WORK OR DURING CONSTRUCTION, HE SHALL IMMEDIATELY NOTIFY THE ENGINEER.
- CONTRACTOR SHALL VERIFY OWNER OR ENGINEER HAS OBTAINED ALL NECESSARY PERMITS FOR CONSTRUCTION PRIOR TO THE START OF THE PROJECT.
- PIPE UNDERDRAINS WILL BE CONSTRUCTED ALONG 100% OF ALL ROADWAY CURB INLETS AND JUNCTION BOXES, AND ALL AREAS DEEMED NECESSARY BY THE PROJECT ENGINEER OR COUNTY ENGINEER AND WILL BE CONSTRUCTED IN ACCORDANCE WITH THE SOUTH CAROLINA DEPARTMENT OF TRANSPORTATION STANDARD SPECIFICATIONS FOR HIGHWAY CONSTRUCTION, LATEST EDITION.
- ALL SWALE DITCHES SHALL BE GRADED, PRIOR TO COMPLETION OF STREETS, TO GRADES SET BY THE DESIGN ENGINEER WITH THE APPROVAL OF THE TOWN OF SUMMerville ENGINEER.
- UNIFORMLY GRADE TOP SOIL BEHIND CURB AND GUTTER AT ADJACENT PROPERTY LINES TO MEET EXISTING GRADES AT PROPERTY LINE.
- GRADE TO ENSURE POSITIVE DRAINAGE. FINISHED SURFACES SHALL FREE FROM SURFACE IRREGULARITIES.
- THE SITE MUST BE CLEARED AND GRUBBED PRIOR TO PLACING EARTHWORK FILL. UNSUITABLE "POCKETS" OF COMPRESSIBLE SOILS SHALL BE REMOVED, BACKFILLED, AND COMPACTED WITH SUITABLE SOIL.

- SHOULDERS OF ROADWAYS SHALL BE LEFT IN GOOD CONDITION, THAT IS ACCEPTABLE TO THE TOWN OF SUMMerville AND ALL TOPSOIL AND GRASS THAT IS DISTRIBUTED SHALL BE REPLACED IN ACCORDANCE WITH THE S.C. DEPT. OF TRANSPORTATION.
- ALL PIPE ENDS NOT CONSTRUCTED WITH STRUCTURES WILL BE RIPRAPPED AS SHOWN IN DETAIL.
- EROSION CONTROL MEASURES SHALL BE IN PLACE PRIOR TO BEGINNING OF ANY WORK.
- TOPOGRAPHICAL SURVEY PROVIDED BY TRICO ENGINEERING CONSULTANTS.
- ALL UTILITIES TO BE INSTALLED BEFORE CURB & GUTTER OR S.A.B.C. INSTALLED.


MANHOLE FRAME AND COVER  
SUNTER MACHINERY CO.  
MF-10B AND MC-10B  
OR APPROVED EQUAL

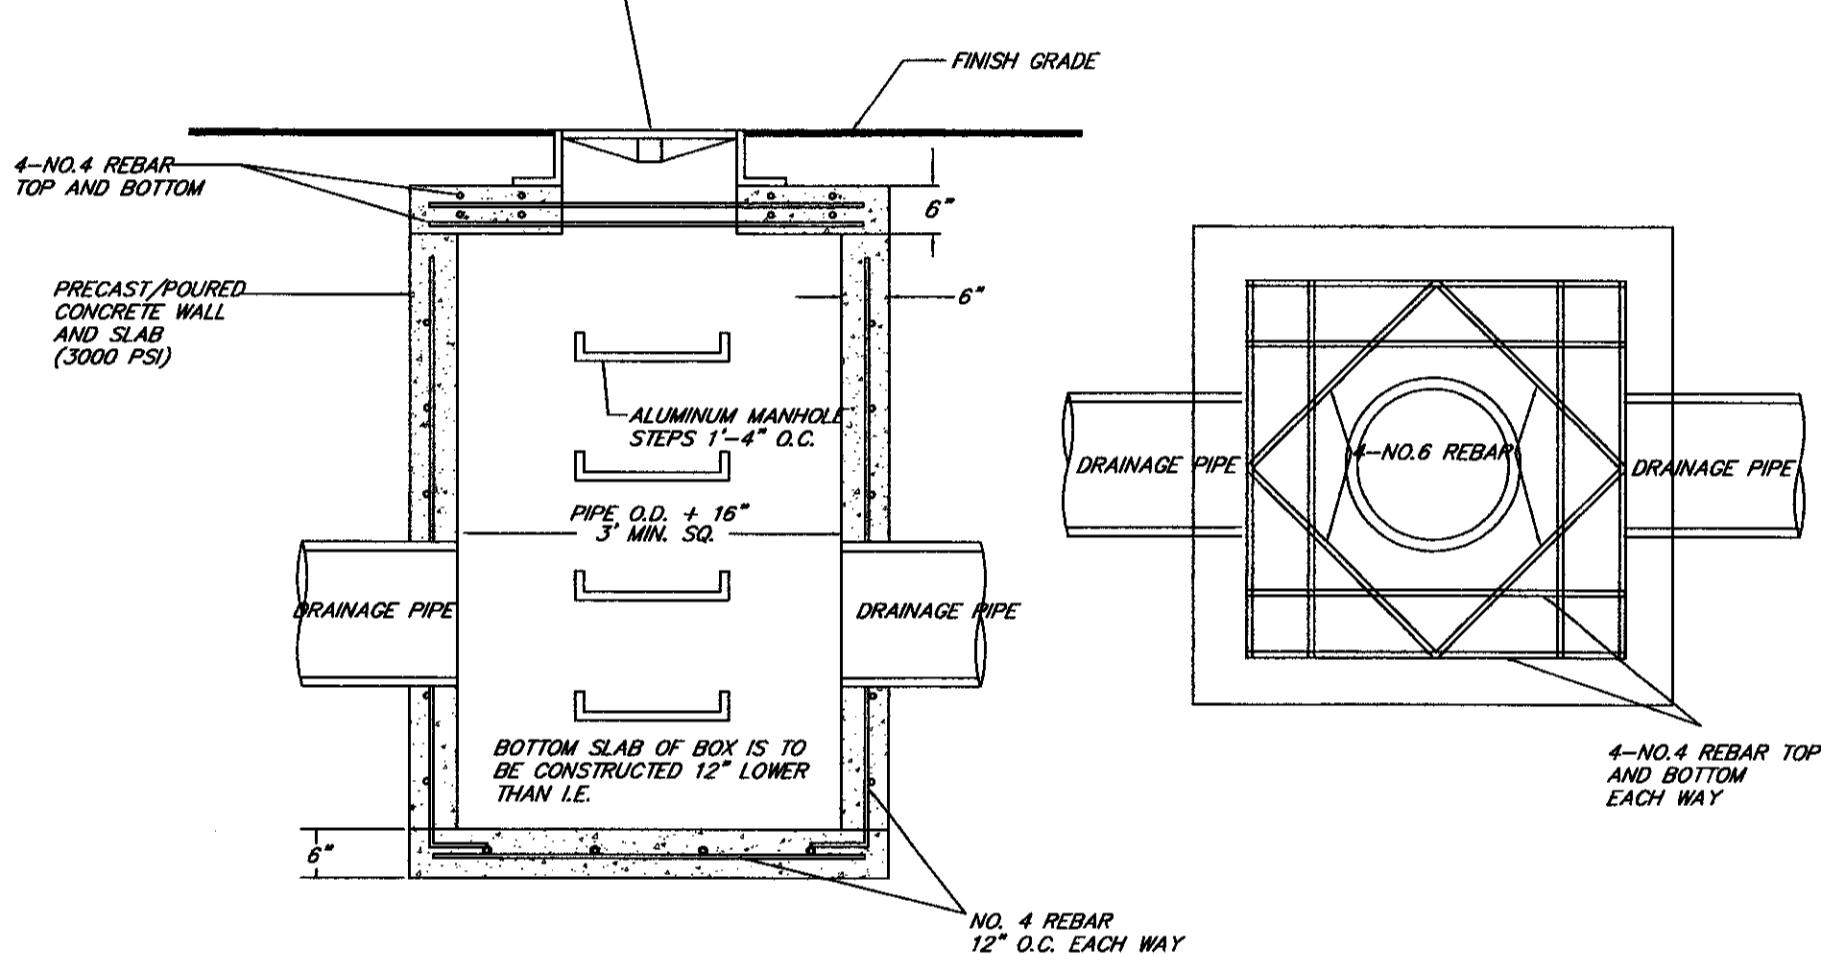


JUNCTION BOX DETAIL

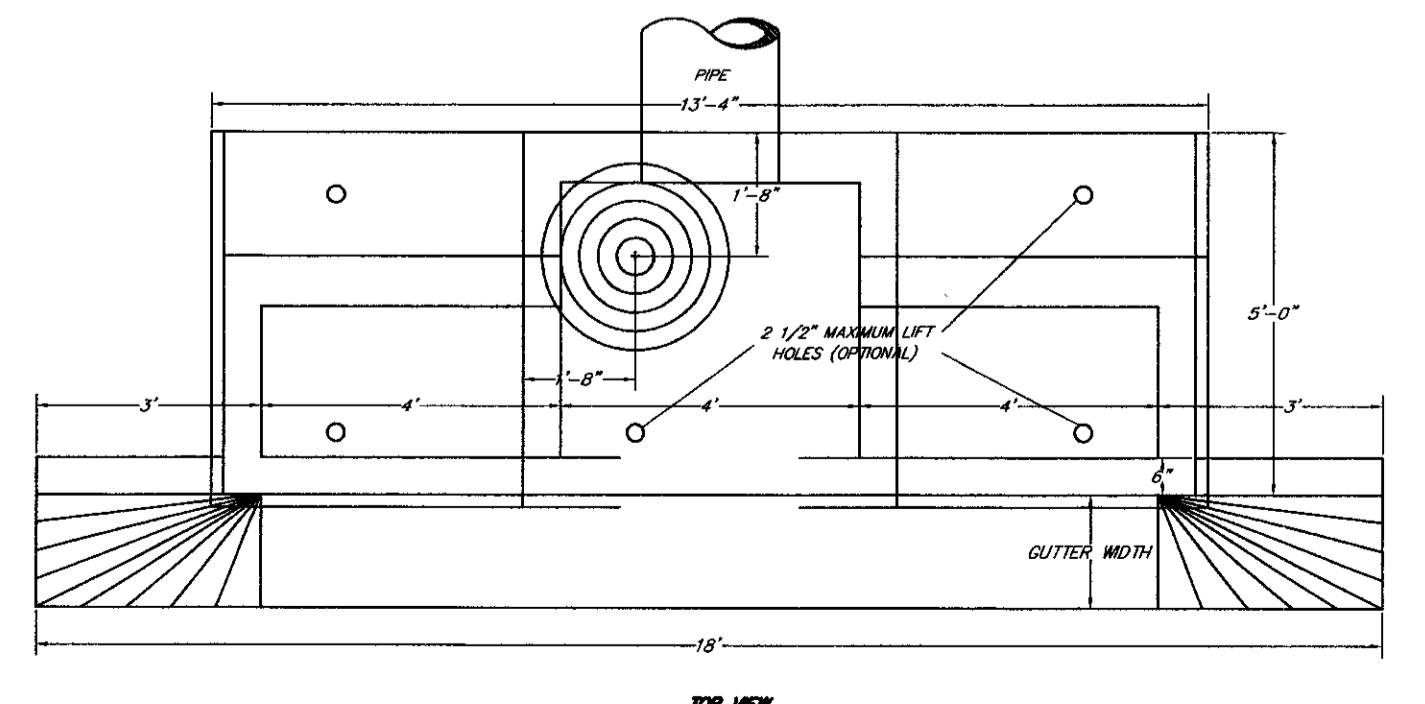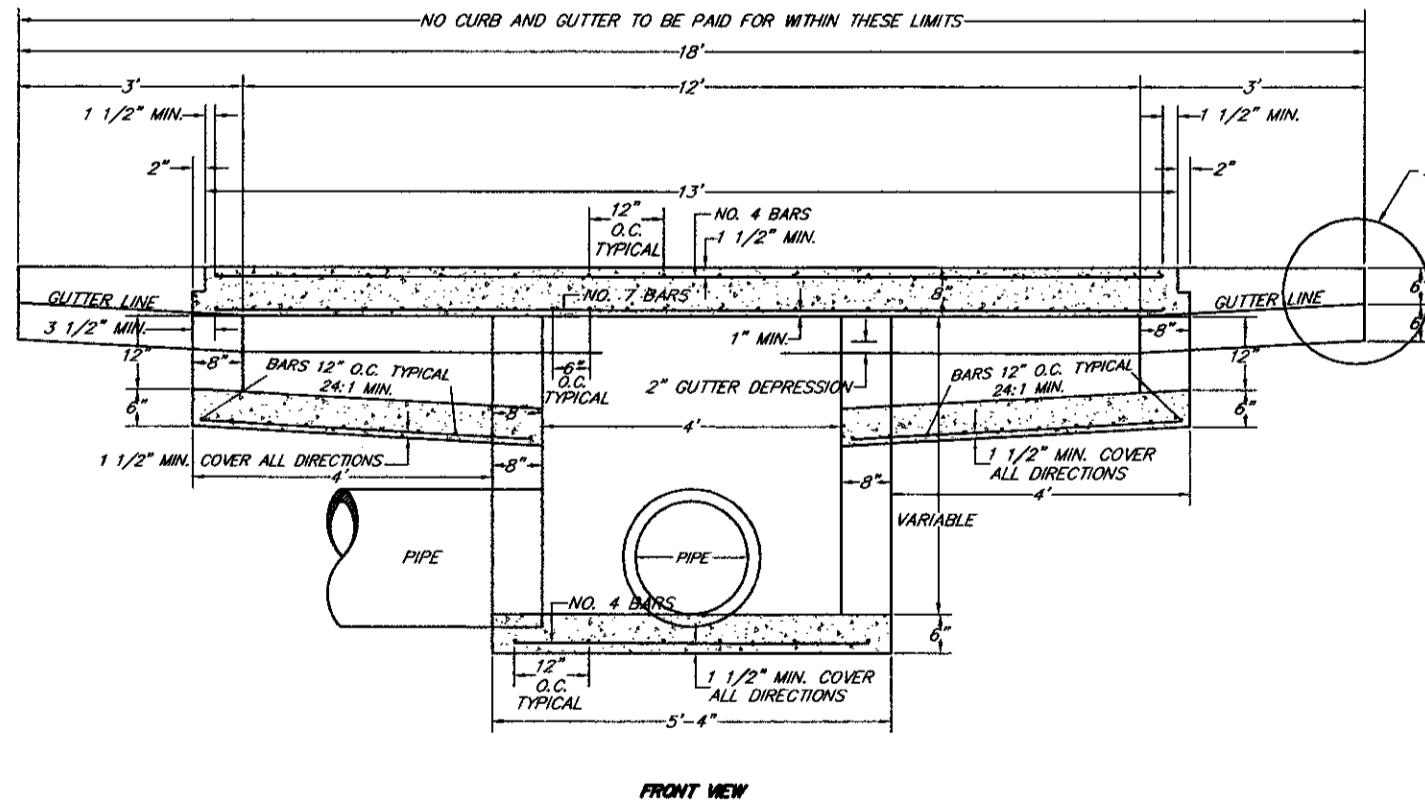


NOTE: SEE SCDOT CATCH BASIN TYPE 18  
DRAWING FOR SPECIFIC DETAILS AND NOTES.

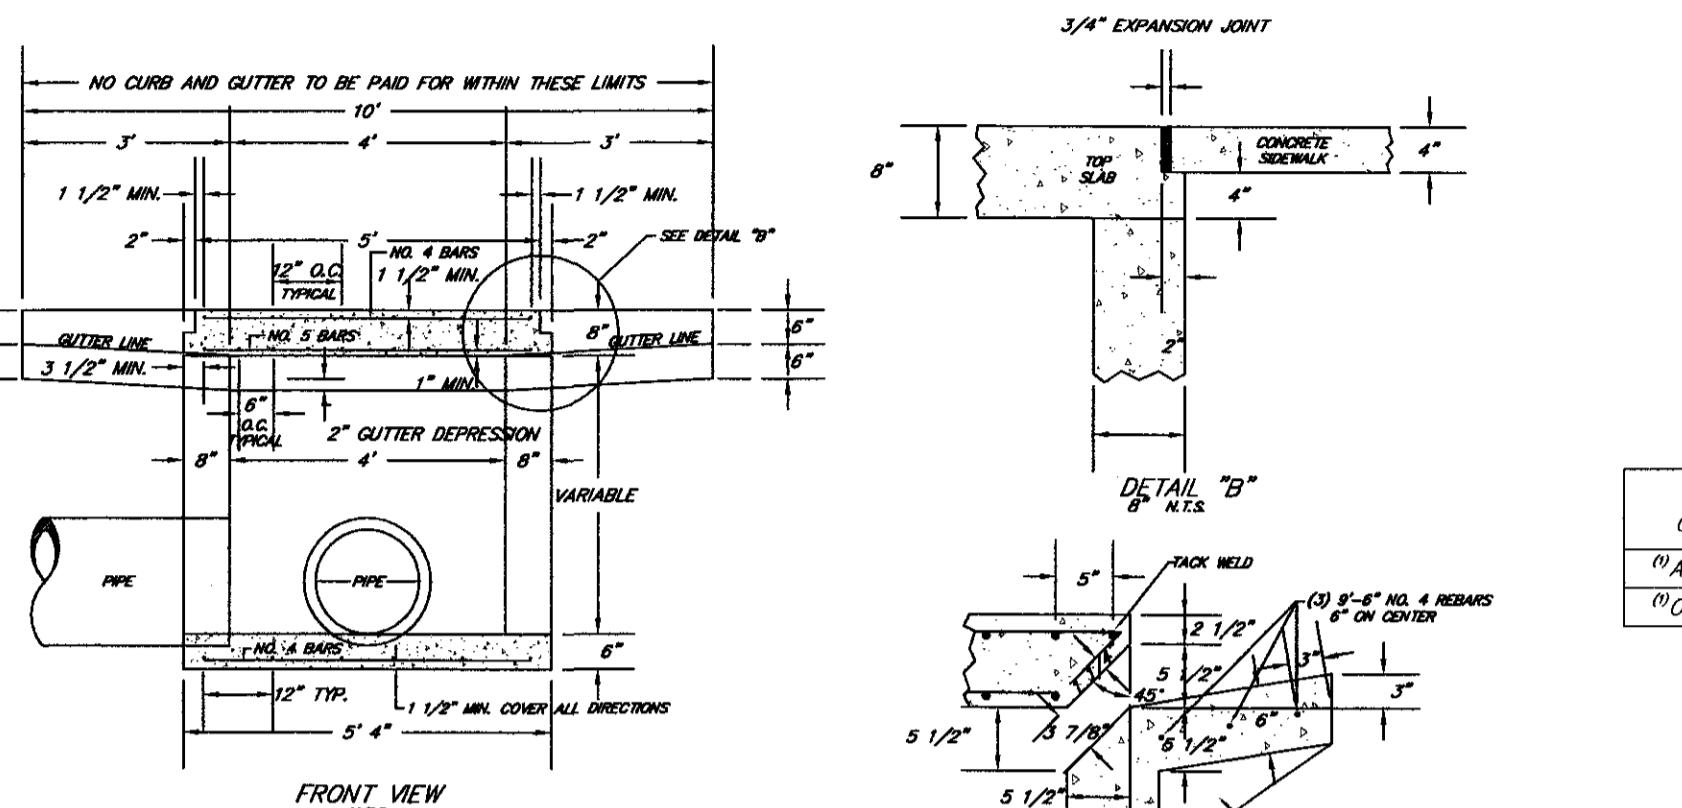

NOTE: SEE SCDOT CATCH BASIN TYPE 18  
DRAWING FOR SPECIFIC DETAILS AND NOTES.

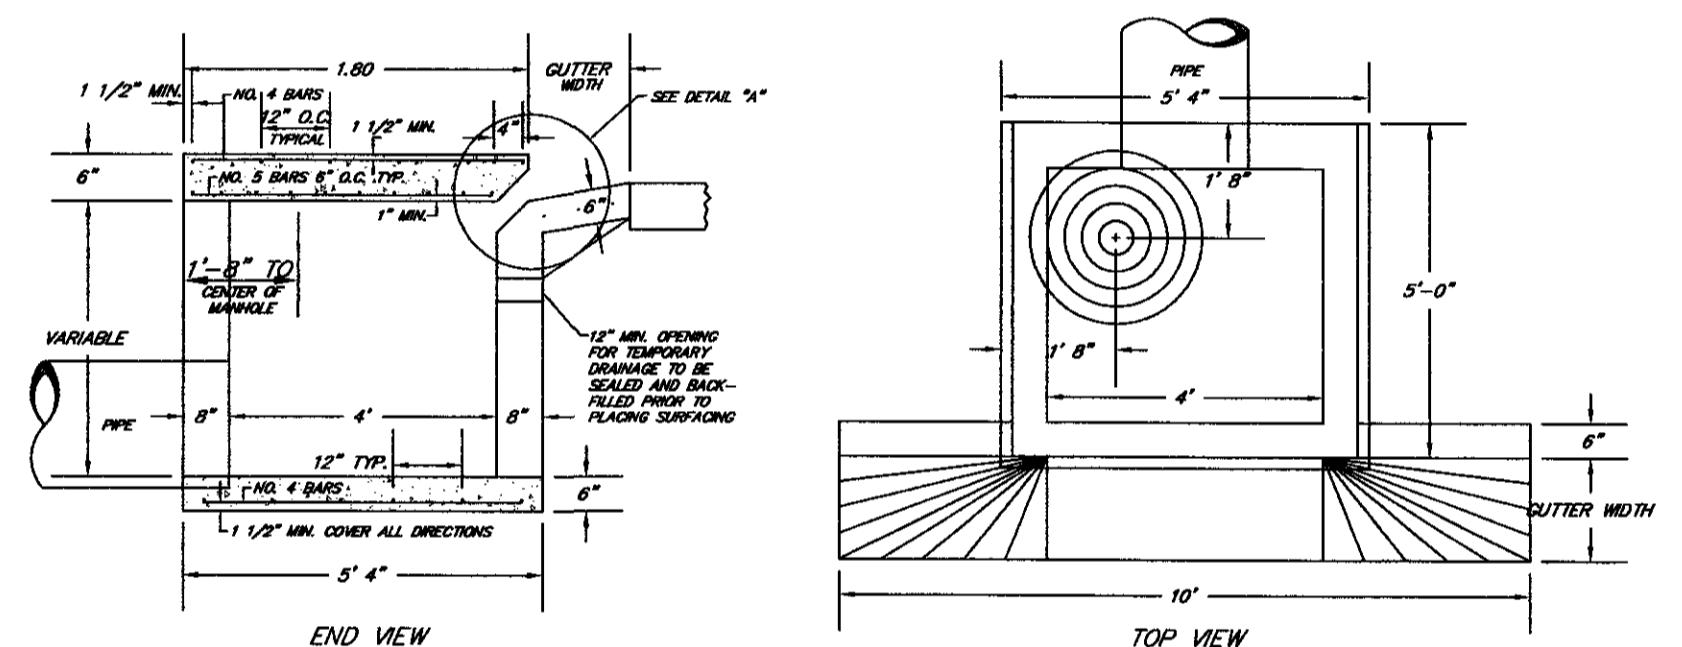





SCDOT TYPE 16

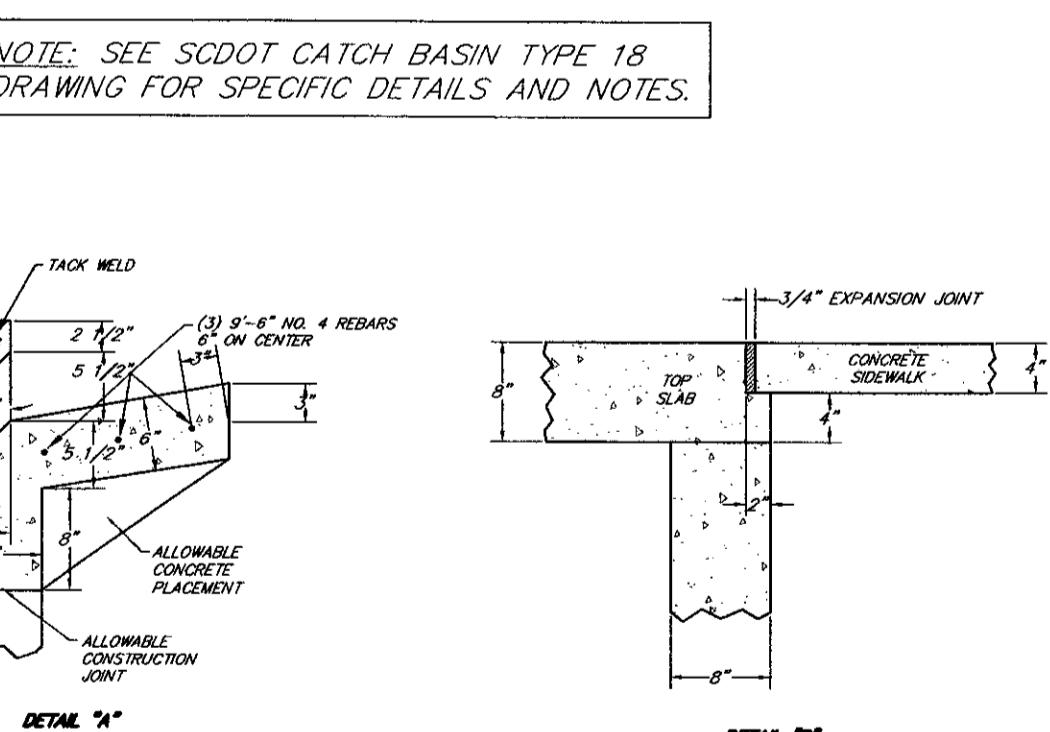

NOTE: SEE SCDOT CATCH BASIN TYPE 18  
DRAWING FOR SPECIFIC DETAILS AND NOTES.

NOTES:

- FOR CONSTRUCTION OF THE CATCH BASIN WALLS EITHER BRICK MASONRY OR CLASS A CONCRETE MAY BE USED. FOR CONCRETE THE WALLS ARE TO BE 6 IN. THICK WITH A REINFORCING STEEL AREA OF 0.20 SQ. INCH PER FT. FOR BRICK THE WALLS ARE TO BE 8 IN. THICK.
- THE BOTTOM SLAB OF THE BOX SHALL BE A MINIMUM OF 6 IN. THICK CLASS A CONCRETE WITH A REINFORCING STEEL AREA OF 0.20 SQ. INCH PER FT. WIRE MESH MAY BE USED IN LIEU OF STEEL BARS PROVIDED A MINIMUM OF 0.20 SQ. INCH PER FT. IS MET.
- FOR CONSTRUCTION OF THE CATCH BASIN TOP CLASS A OR BETTER CONCRETE SHALL BE USED WITH REINFORCING STEEL AS SHOWN.
- MORTAR SHALL BE TYPE S OR M.
- IF DESIRED THESE ITEMS MAY BE PRE CAST PRIOR TO INSTALLATION IN LIEU OF BEING CAST IN PLACE. THE USE OF PRE CAST UNITS WILL NOT RELIEVE THE CONTRACTOR OF THE RESPONSIBILITY OF OBTAINING SATISFACTORY INSTALLATIONS. SEE STANDARD DRAWINGS FOR PRE CAST STRUCTURES FOR ADDITIONAL DETAILS AND SPECIFICATIONS.
- REINFORCING STEEL SHALL BE DEFORMED AND SHALL CONFORM TO AASHTO M 31, GRADE 60. WIRE MESH SHALL CONFORM TO AASHTO M 55, AND M 221.
- THE NUMBER OF BOX OPENINGS SHALL BE CONSTRUCTED, AS DIRECTED BY THE ENGINEER, TO FIT FIELD CONDITIONS.
- STEPS ARE REQUIRED IN ALL DRAINAGE STRUCTURES THAT EXCEED 4.5' IN DEPTH.

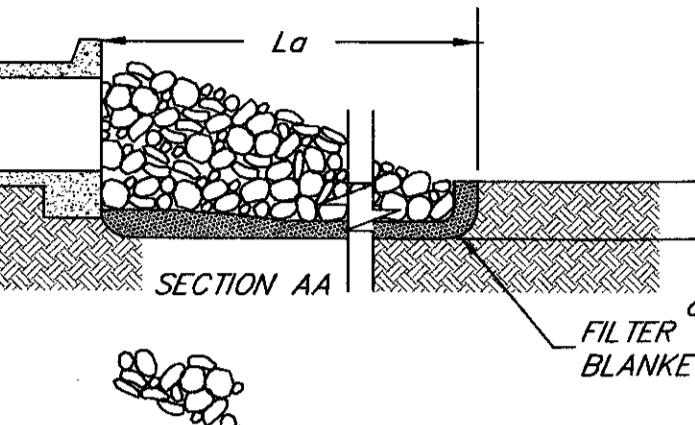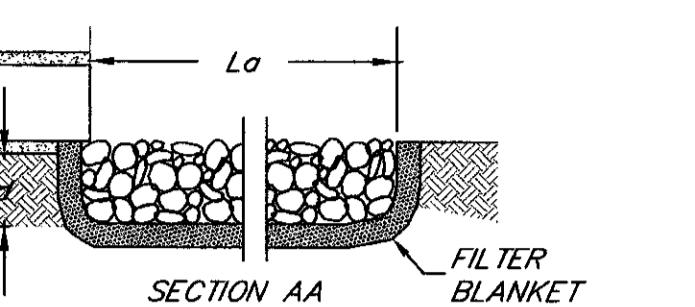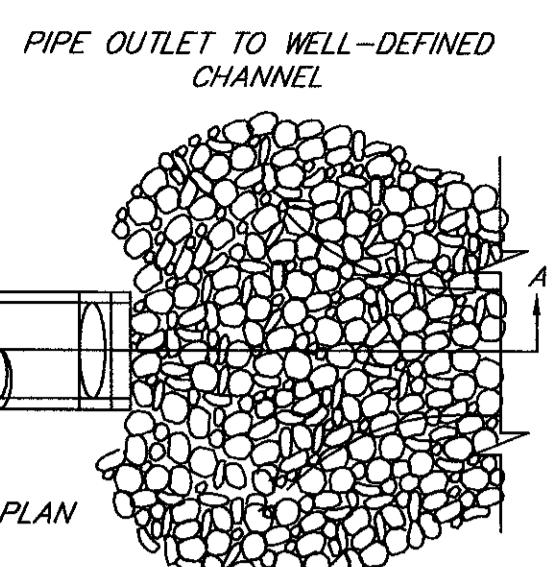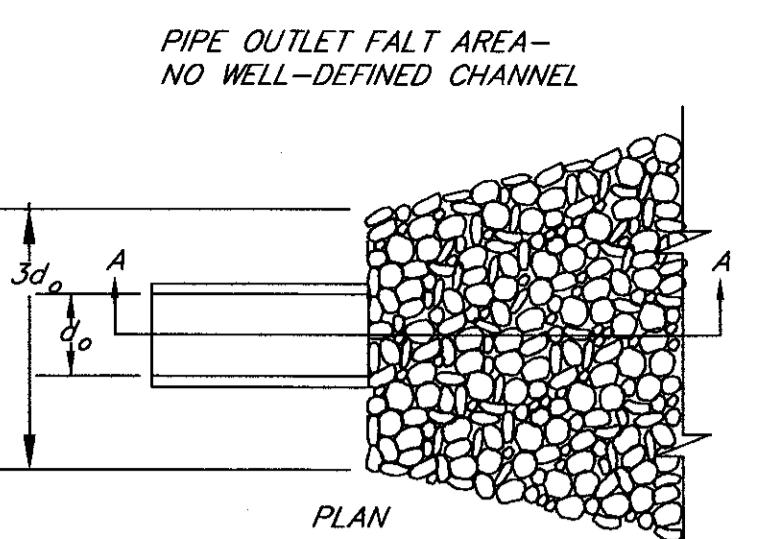

## NOTES:

- $L_0$  IS THE LENGTH OF THE RIPRAP APRON.
- $d = 1.5$  TIMES THE MAXIMUM STONE DIAMETER BUT NOT LESS THAN 6".

- IN A WELL-DEFINED CHANNEL EXTEND THE APRON UP THE CHANNEL BANKS TO AN ELEVATION OF 6' ABOVE THE MAXIMUM TAILWATER DEPTH OR TO THE TOP OF THE BANK, WHICHEVER IS LESS.
- A FILTER BLANKET OR FILTER FABRIC SHOULD BE INSTALLED BETWEEN THE RIPRAP AND SOIL FOUNDATION.

## OUTLET STABILIZATION STRUCTURE


N.T.S.

PIPE OUTLET	PIPE DIA. (in.)	# PIPES	SD (ft.)	Lo (ft.)	W (ft.)	d (in.)
M-A-1	24	1	6	5	8	9
M-O-2	24	1	6	5	8	9

## RIP-RAP DIMENSIONS


## NOTES:

- FOR CONSTRUCTION OF THE CATCH BASIN WALLS EITHER BRICK MASONRY OR CLASS A CONCRETE MAY BE USED. FOR CONCRETE THE WALLS ARE TO BE 6 IN. THICK WITH A REINFORCING STEEL AREA OF 0.20 SQ. INCH PER FT. FOR BRICK THE WALLS ARE TO BE 8 IN. THICK.
- THE BOTTOM SLAB OF THE BOX SHALL BE A MINIMUM OF 6 IN. THICK CLASS A CONCRETE WITH A REINFORCING STEEL AREA OF 0.20 SQ. INCH PER FT. WIRE MESH MAY BE USED IN LIEU OF STEEL BARS PROVIDED A MINIMUM OF 0.20 SQ. INCH PER FT. IS MET.
- FOR CONSTRUCTION OF THE CATCH BASIN TOP CLASS A OR BETTER CONCRETE SHALL BE USED WITH REINFORCING STEEL AS SHOWN.
- MORTAR SHALL BE TYPE S OR M.
- IF DESIRED THESE ITEMS MAY BE PRE CAST PRIOR TO INSTALLATION IN LIEU OF BEING CAST IN PLACE. THE USE OF PRE CAST UNITS WILL NOT RELIEVE THE CONTRACTOR OF THE RESPONSIBILITY OF OBTAINING SATISFACTORY INSTALLATIONS. SEE STANDARD DRAWINGS FOR PRE CAST STRUCTURES FOR ADDITIONAL DETAILS AND SPECIFICATIONS.
- REINFORCING STEEL SHALL BE DEFORMED AND SHALL CONFORM TO AASHTO M 31, GRADE 60. WIRE MESH SHALL CONFORM TO AASHTO M 55, AND M 221.
- THE NUMBER OF BOX OPENINGS SHALL BE CONSTRUCTED, AS DIRECTED BY THE ENGINEER, TO FIT FIELD CONDITIONS.
- STEPS ARE REQUIRED IN ALL DRAINAGE STRUCTURES THAT EXCEED 4.5' IN DEPTH.

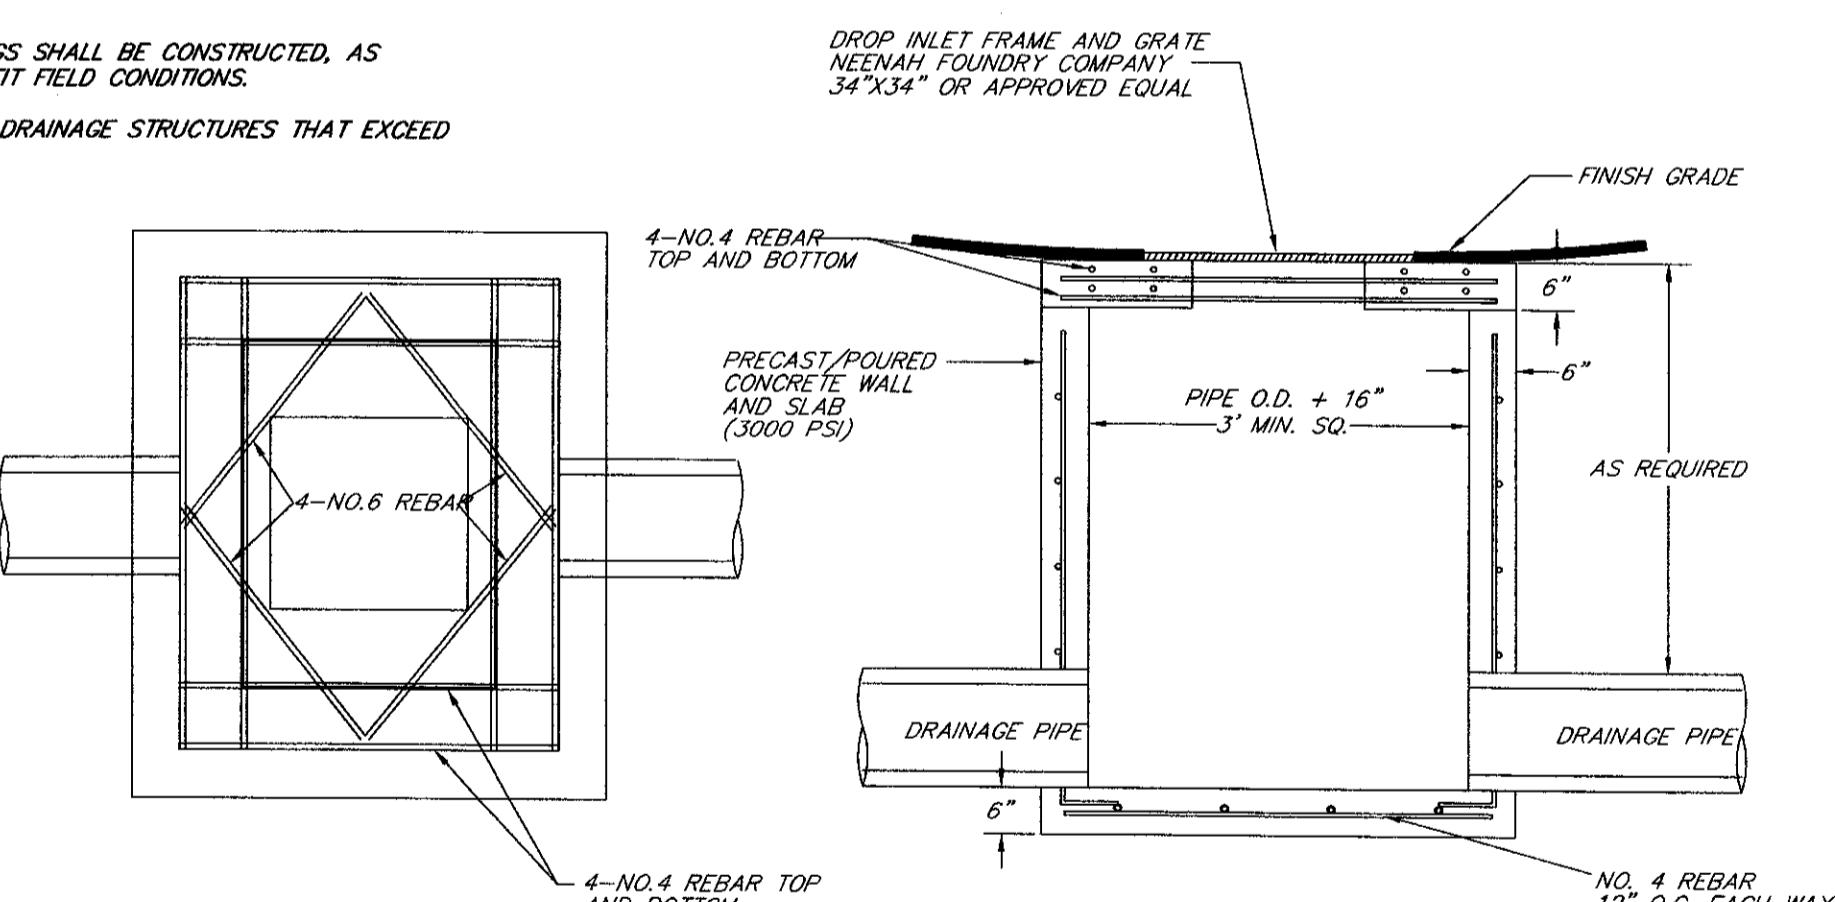




## DROP INLET DETAIL


N.T.S.

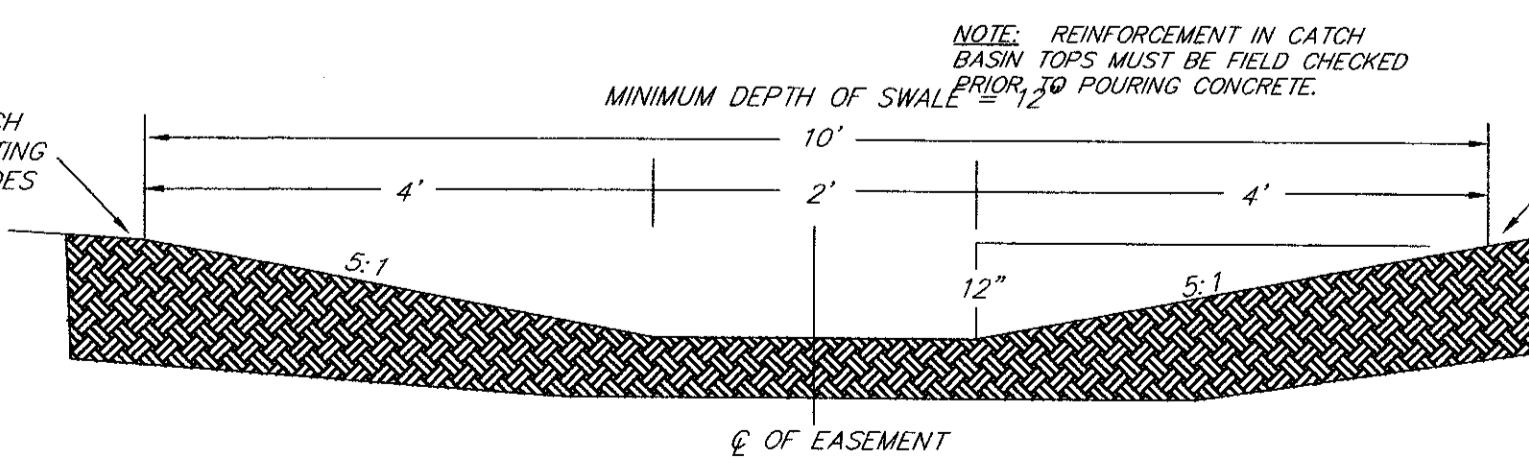


## GRASSED EARTH SWALE DETAIL




N.T.S.

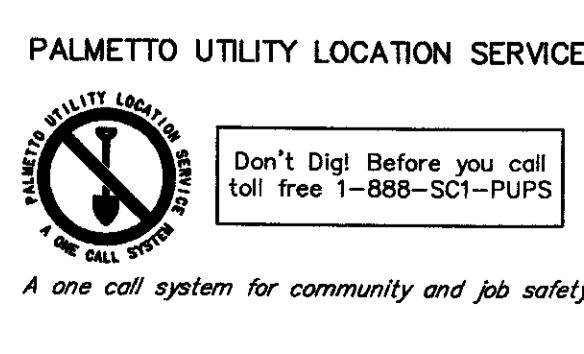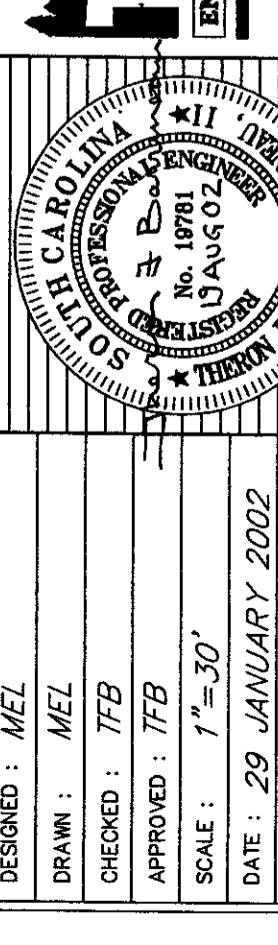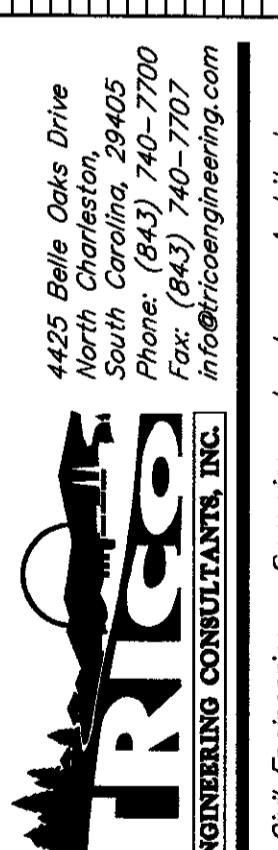TITLE: GRADING AND DRAINAGE DETAILS  
PHASE 1 OF ARBOR OAKS SUBDIVISION  
LOCATED IN  
THE TOWN OF SUMMerville  
DORCHESTER COUNTY, SOUTH CAROLINA

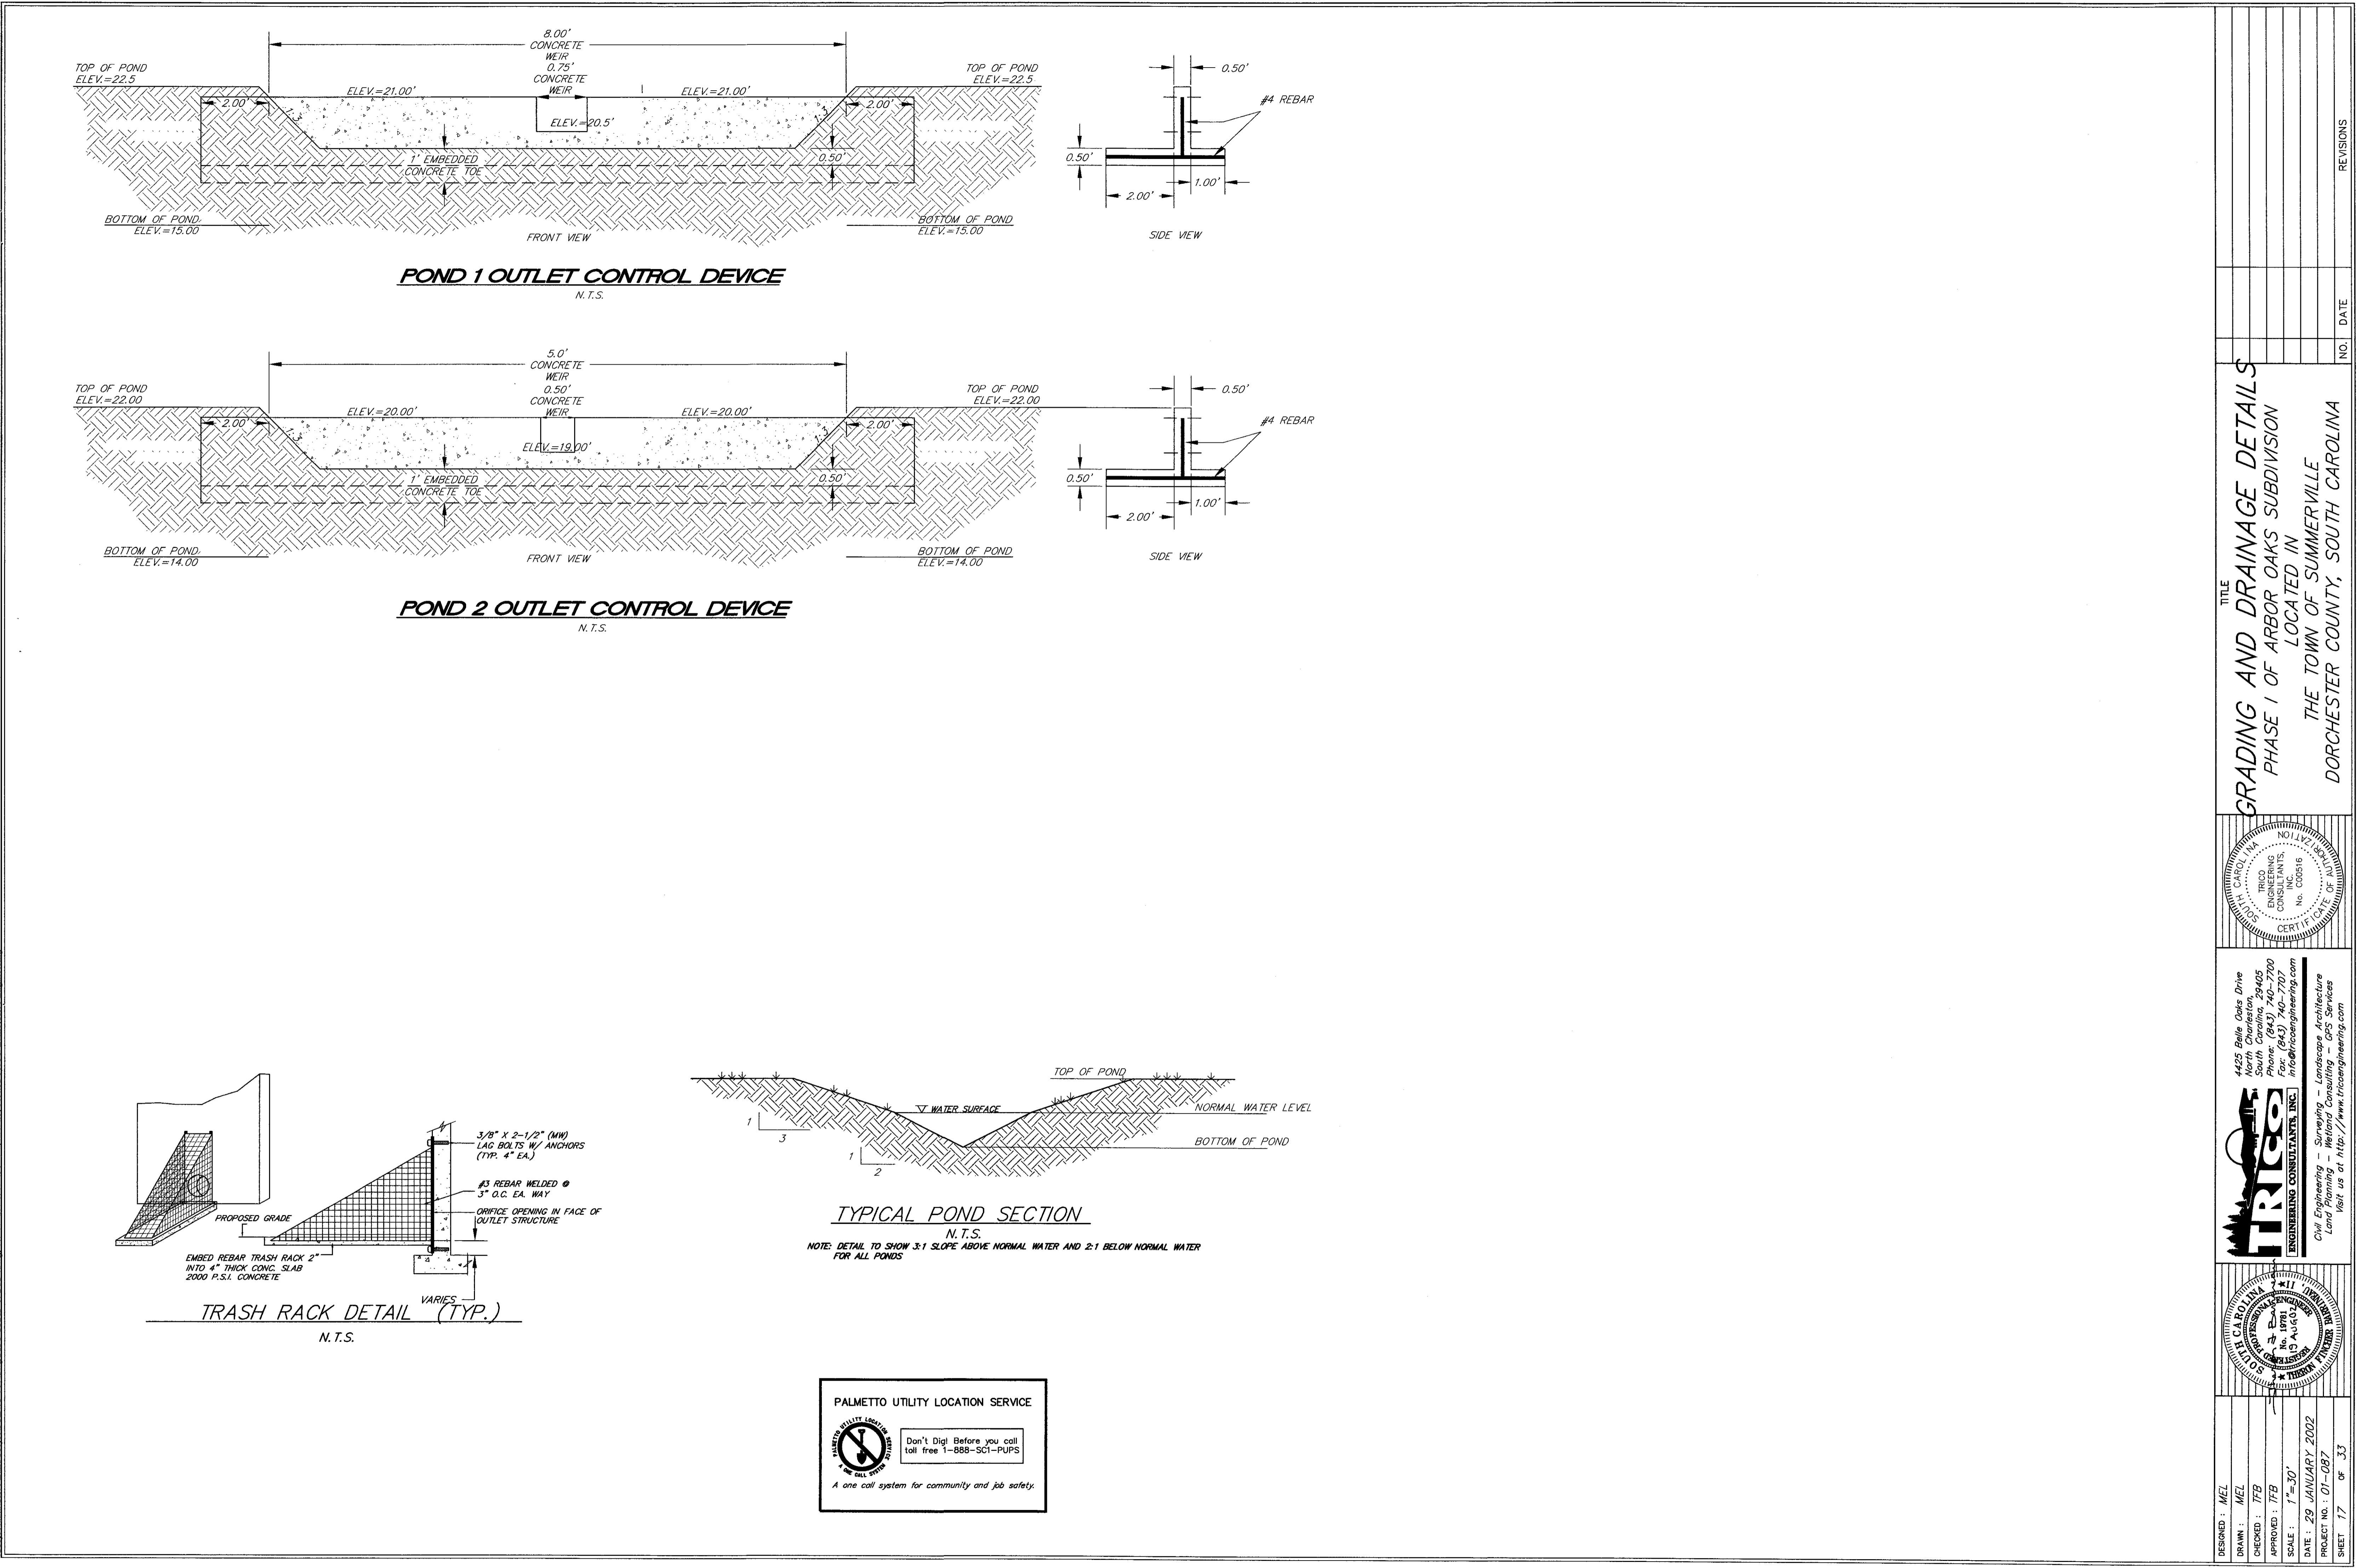

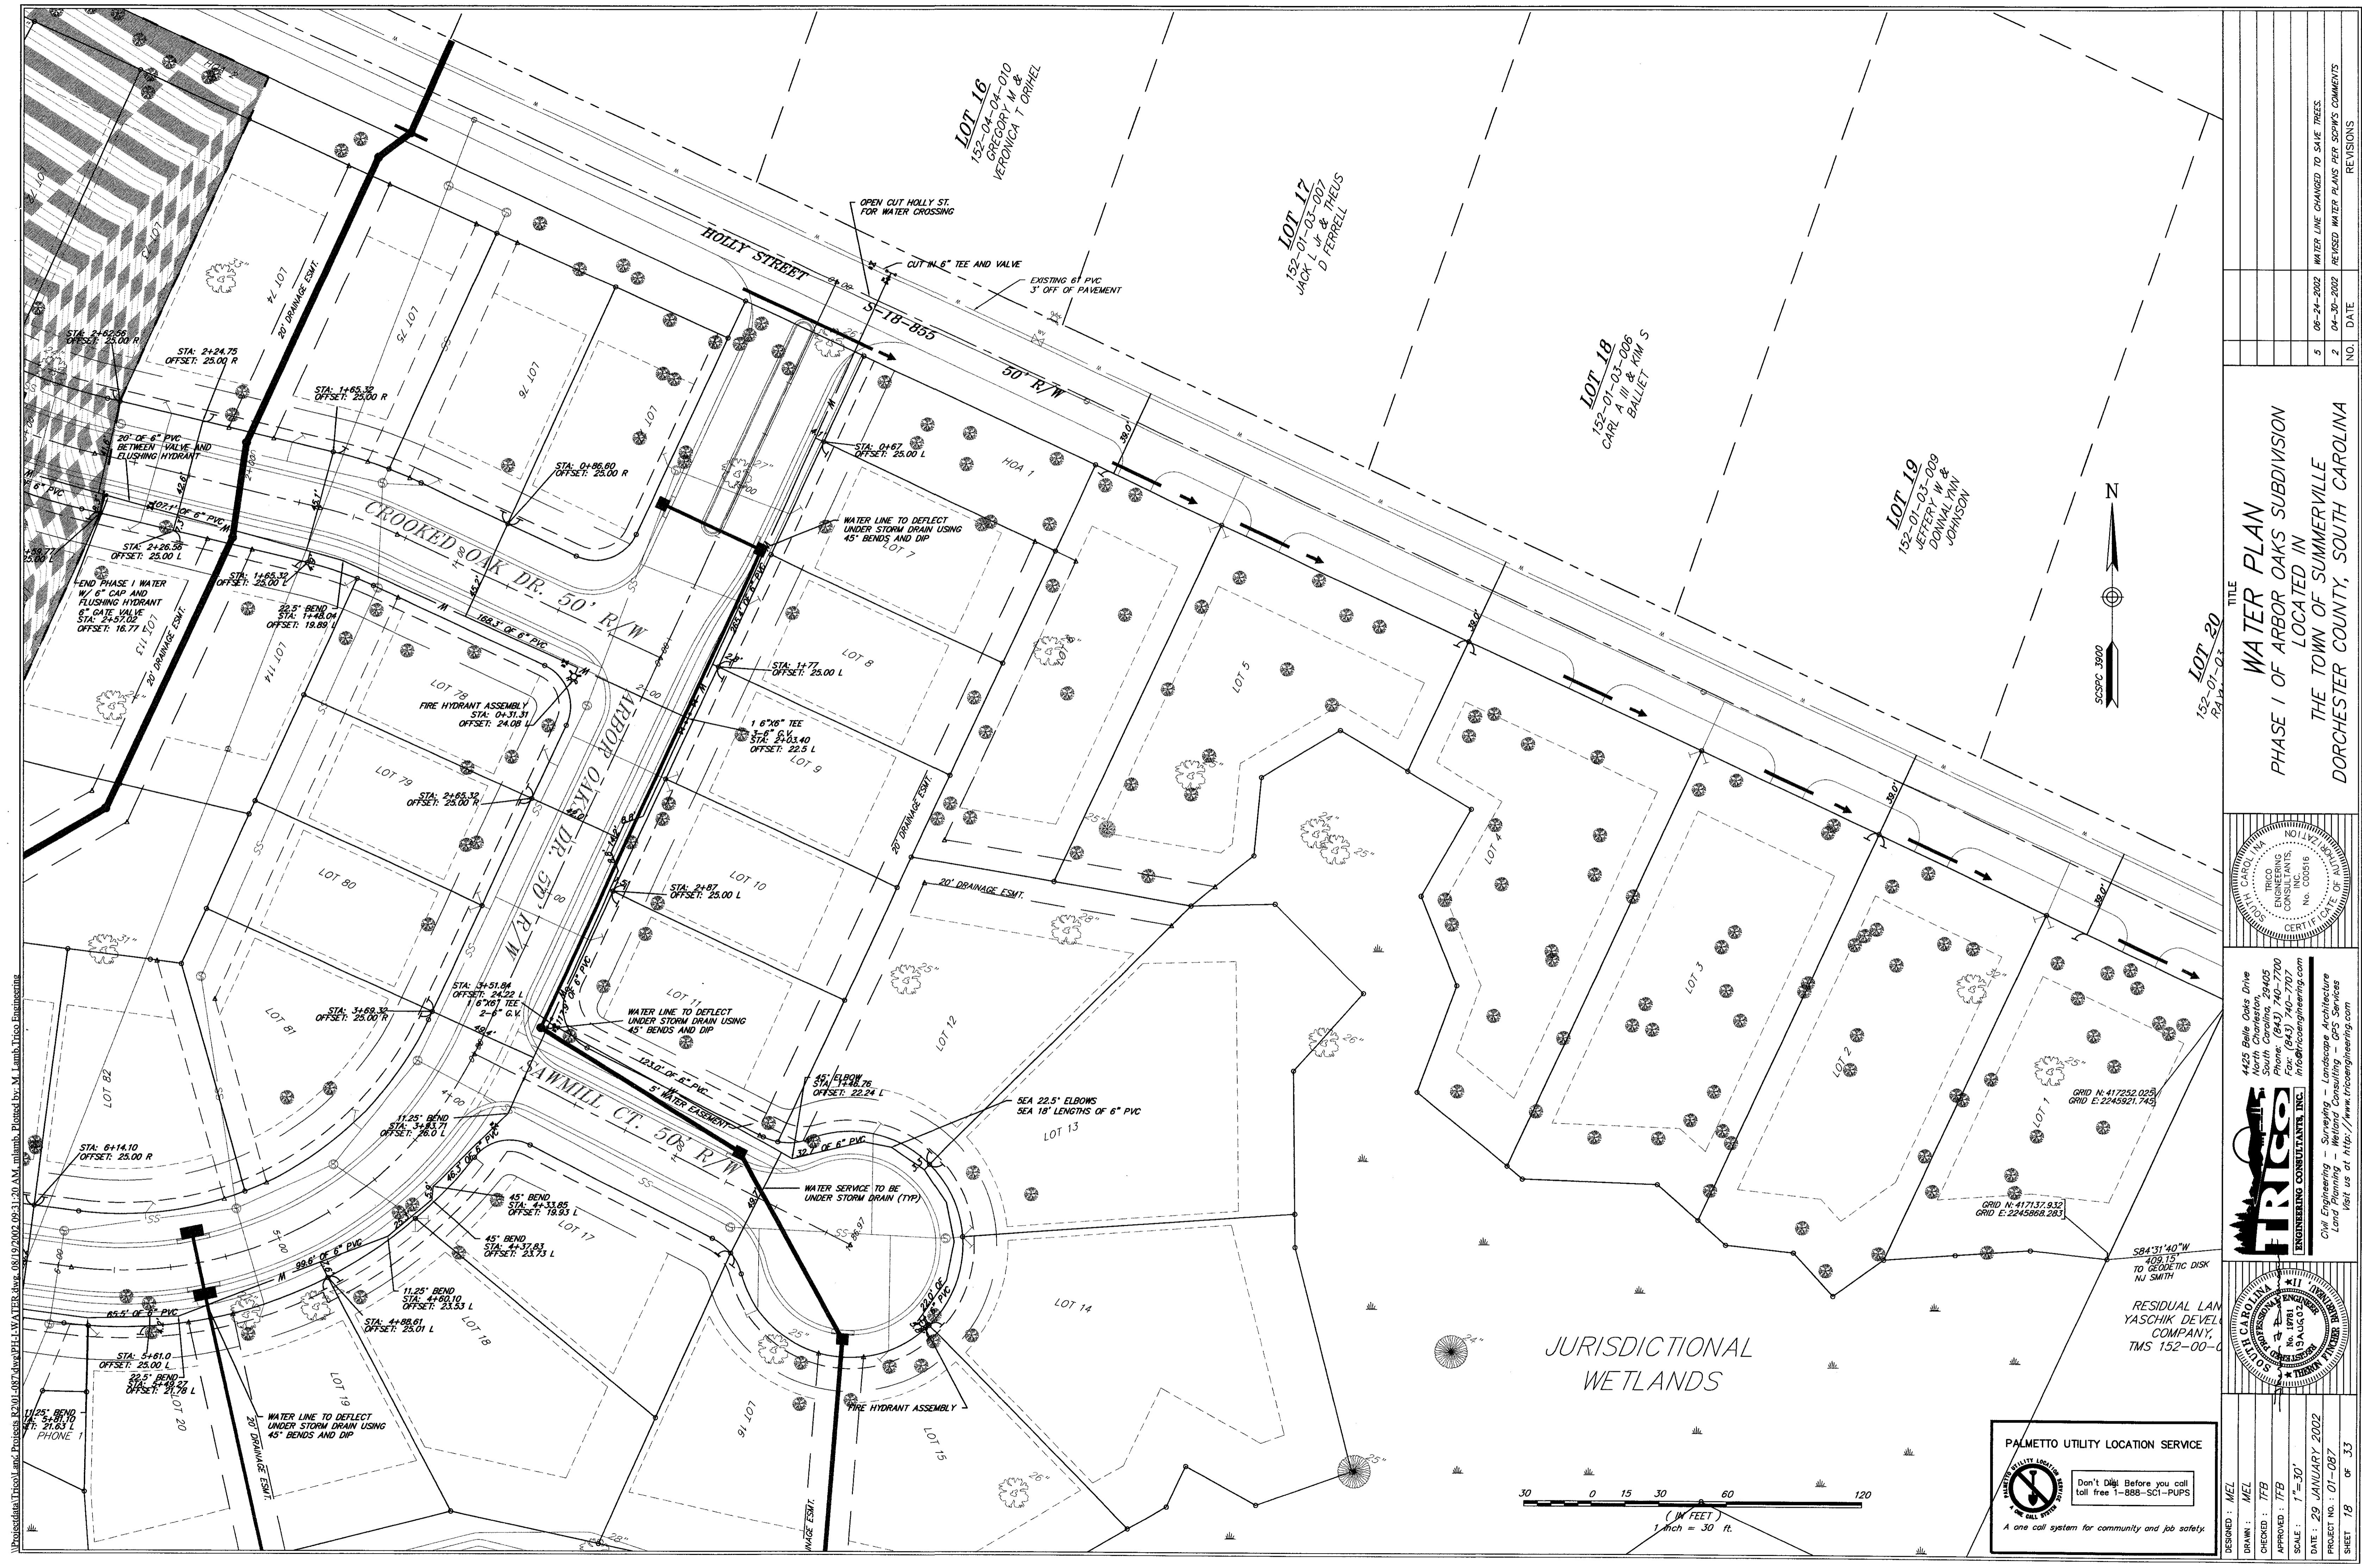

**WATER PLAN**  
**PHASE I OF ARBOR OAKS SUBDIVISION**  
**LOCATED IN**  
**THE TOWN OF SUMMERTOWN**  
**DORCHESTER COUNTY, SOUTH CAROLINA**

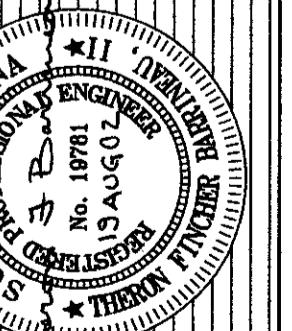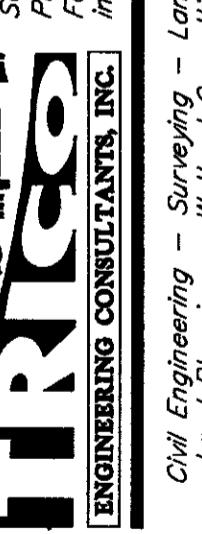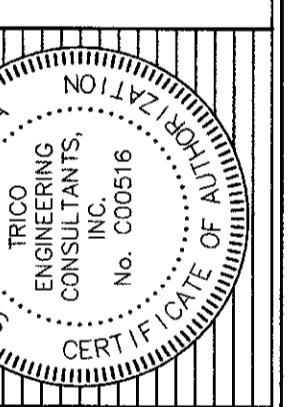



DESIGNED : MEL  
DRAWN : MEL  
CHECKED : TFB  
APPROVED :  
SCALE : 1=20'  
DATE : 29 JANUARY 2002  
PROJECT NO. : 01-087  
SHEET 19 OF 33

PROTECTION LINE  
Land Prices R201.087.dwg PHL.WATER.dwg 08/19/2002 09:32:08 AM.mlnmb. Plotted by: M.Lamb-TriCo Engineering


REVISIONS

5 08-24-2002 WATER LINE CHANGED TO SAVE TREES.  
2 04-30-2002 REVISED WATER PLANS PER SCWS COMMENTS  
NO. DATE

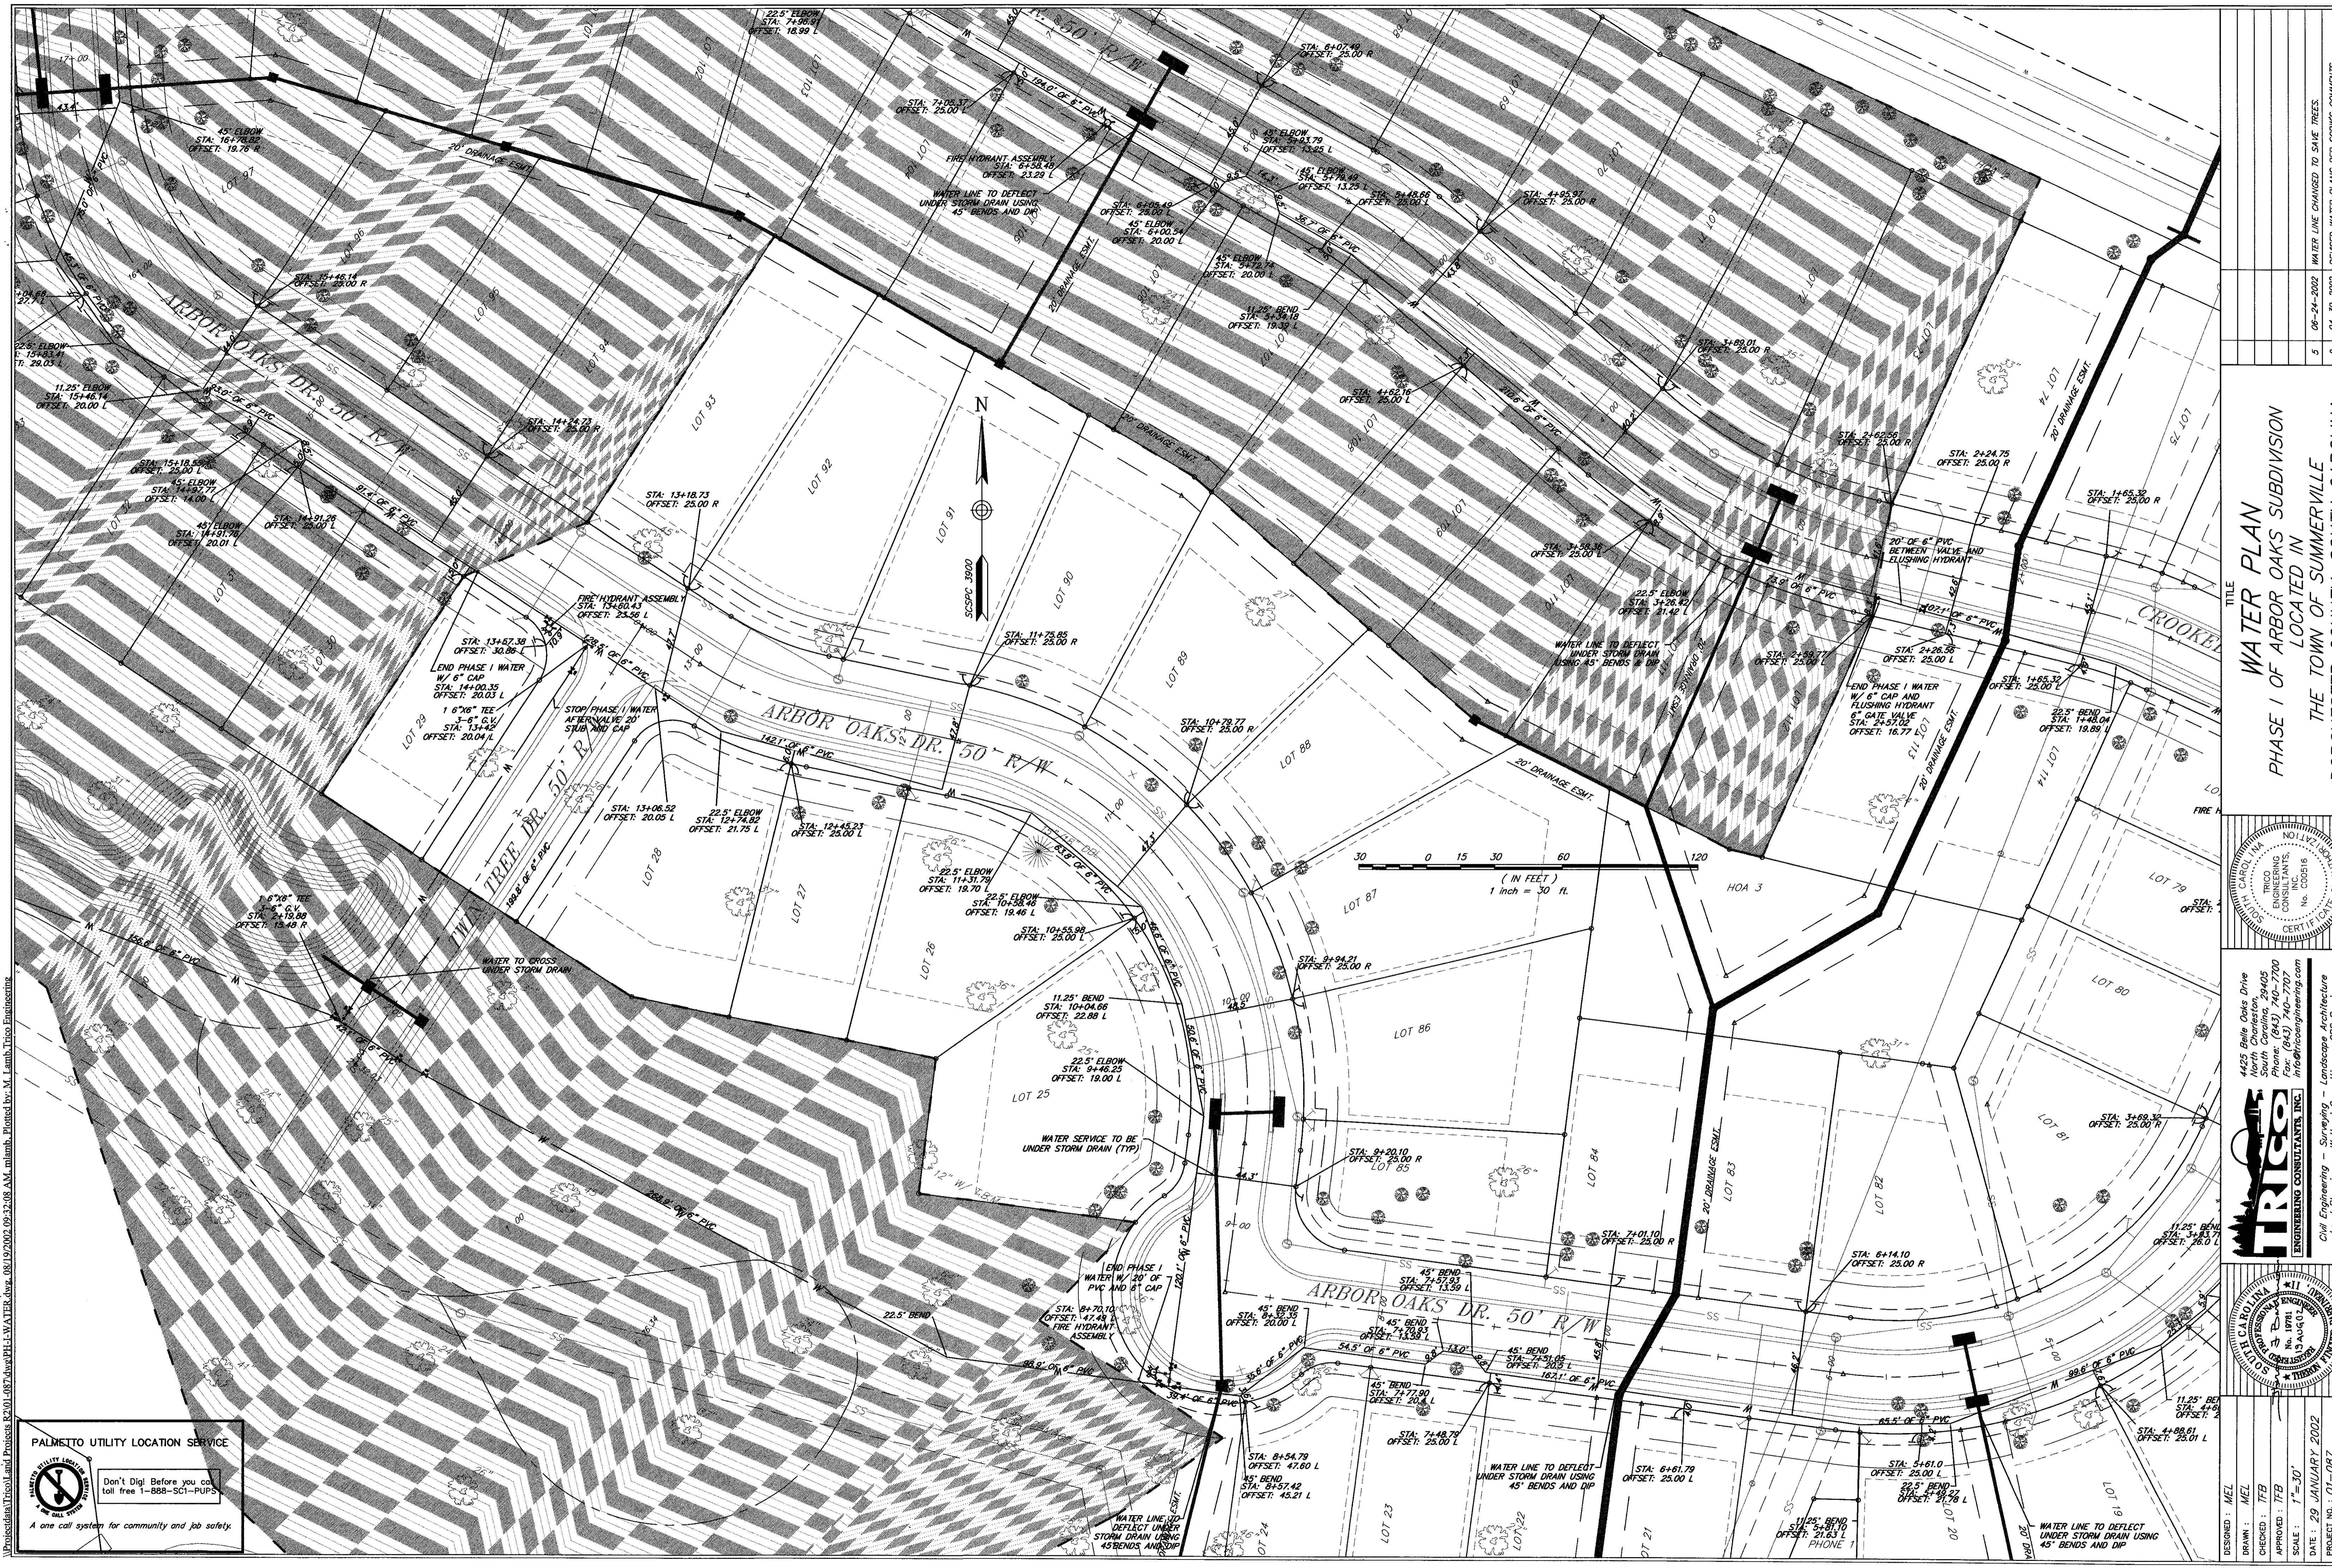

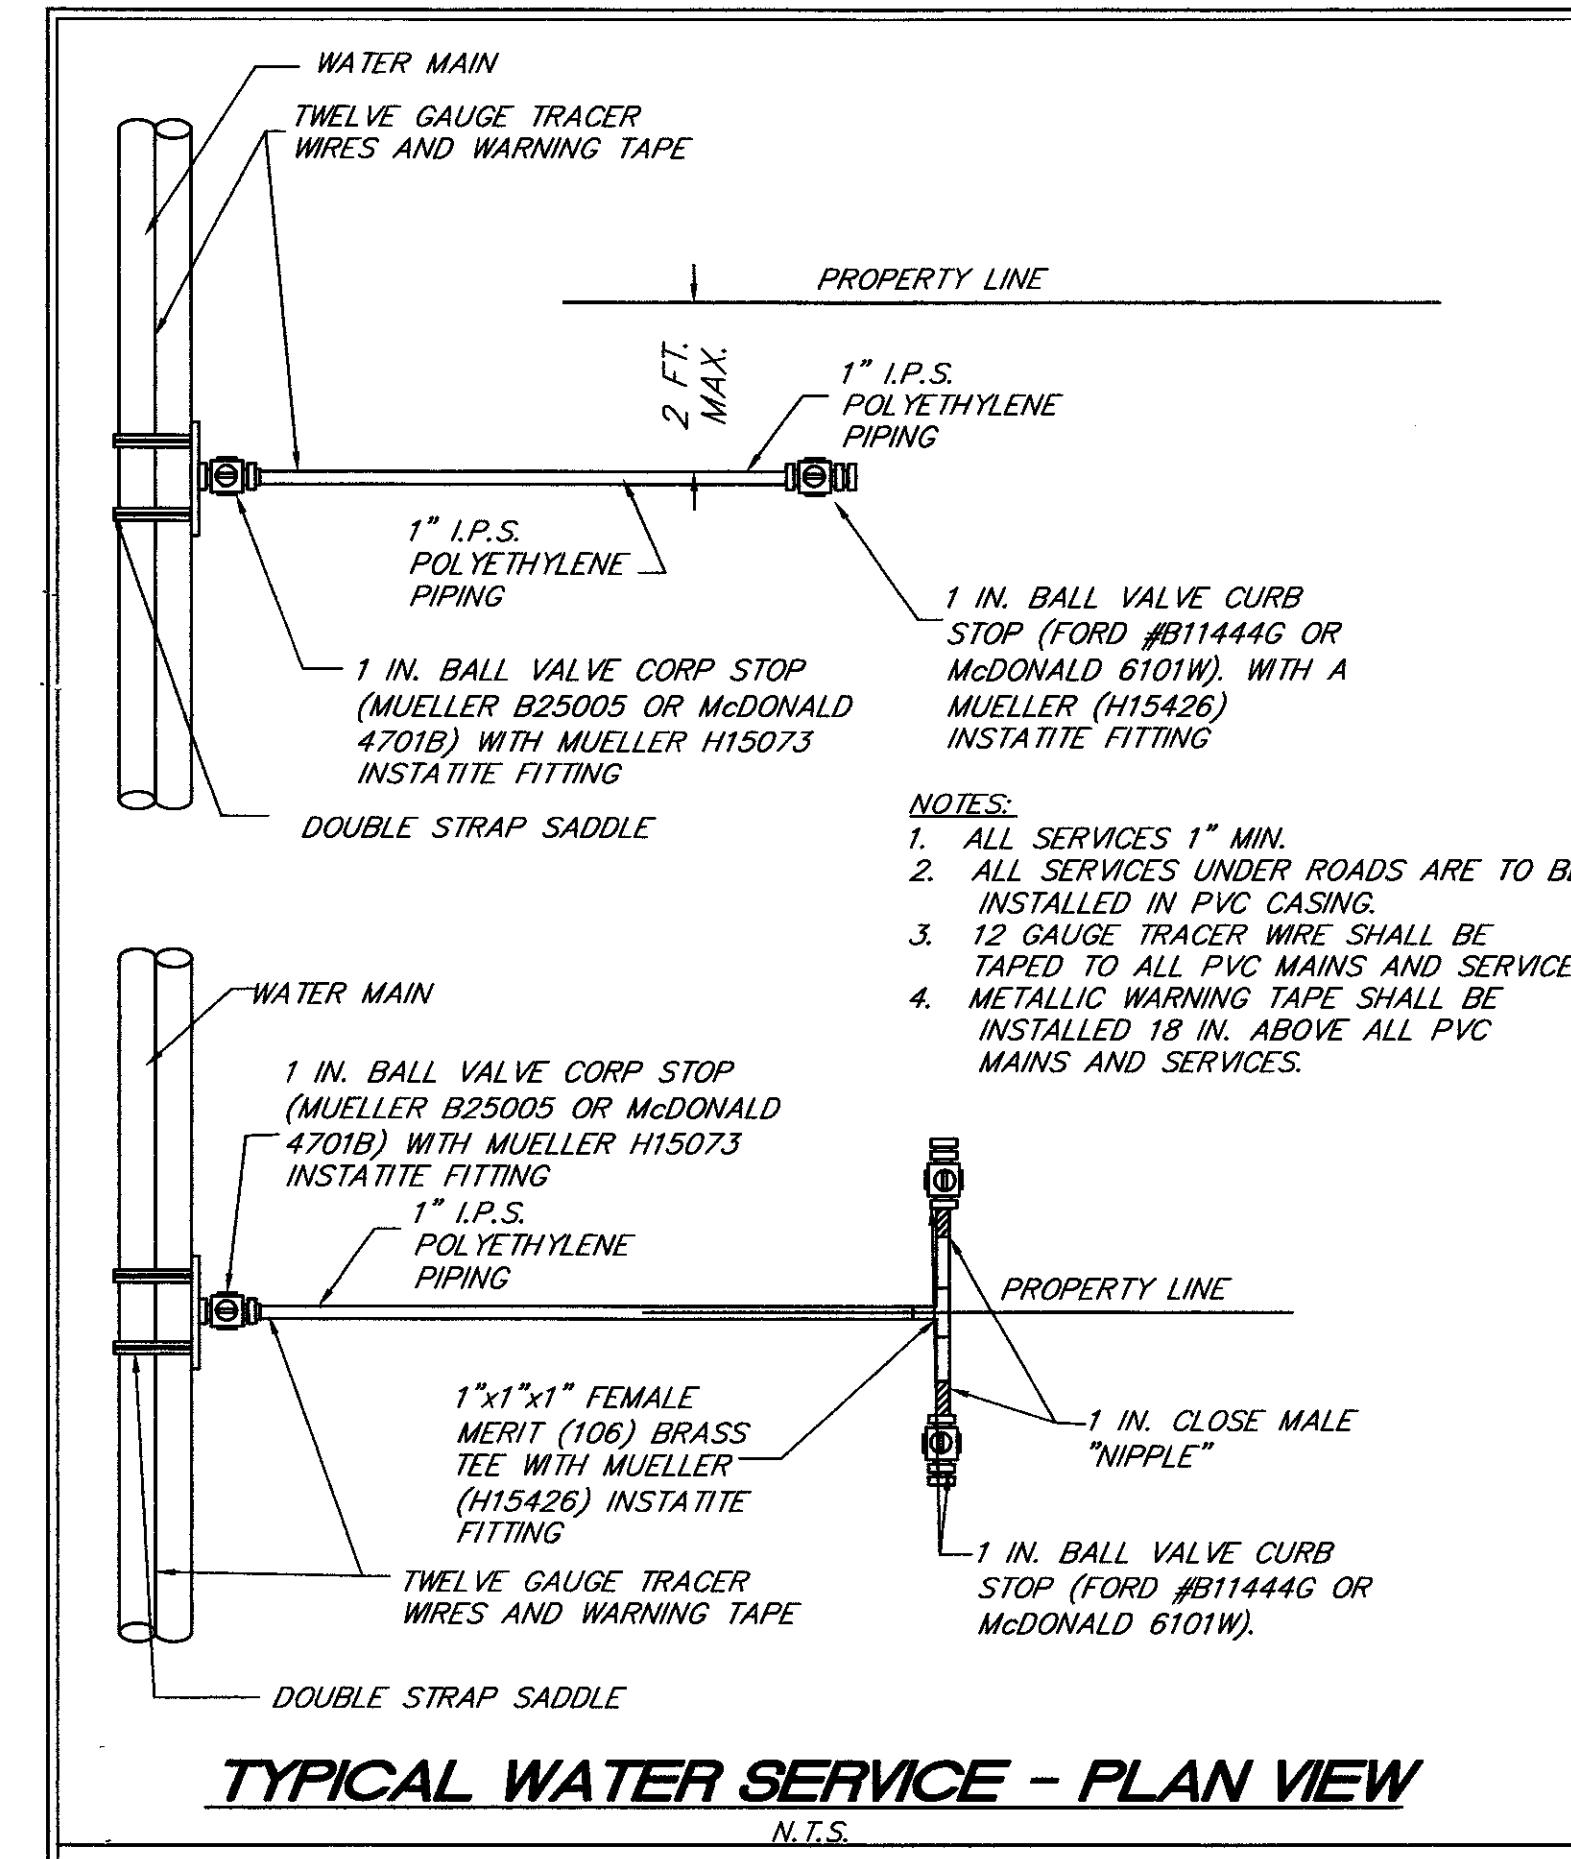


**TYPICAL WATER SERVICE - PLAN VIEW**

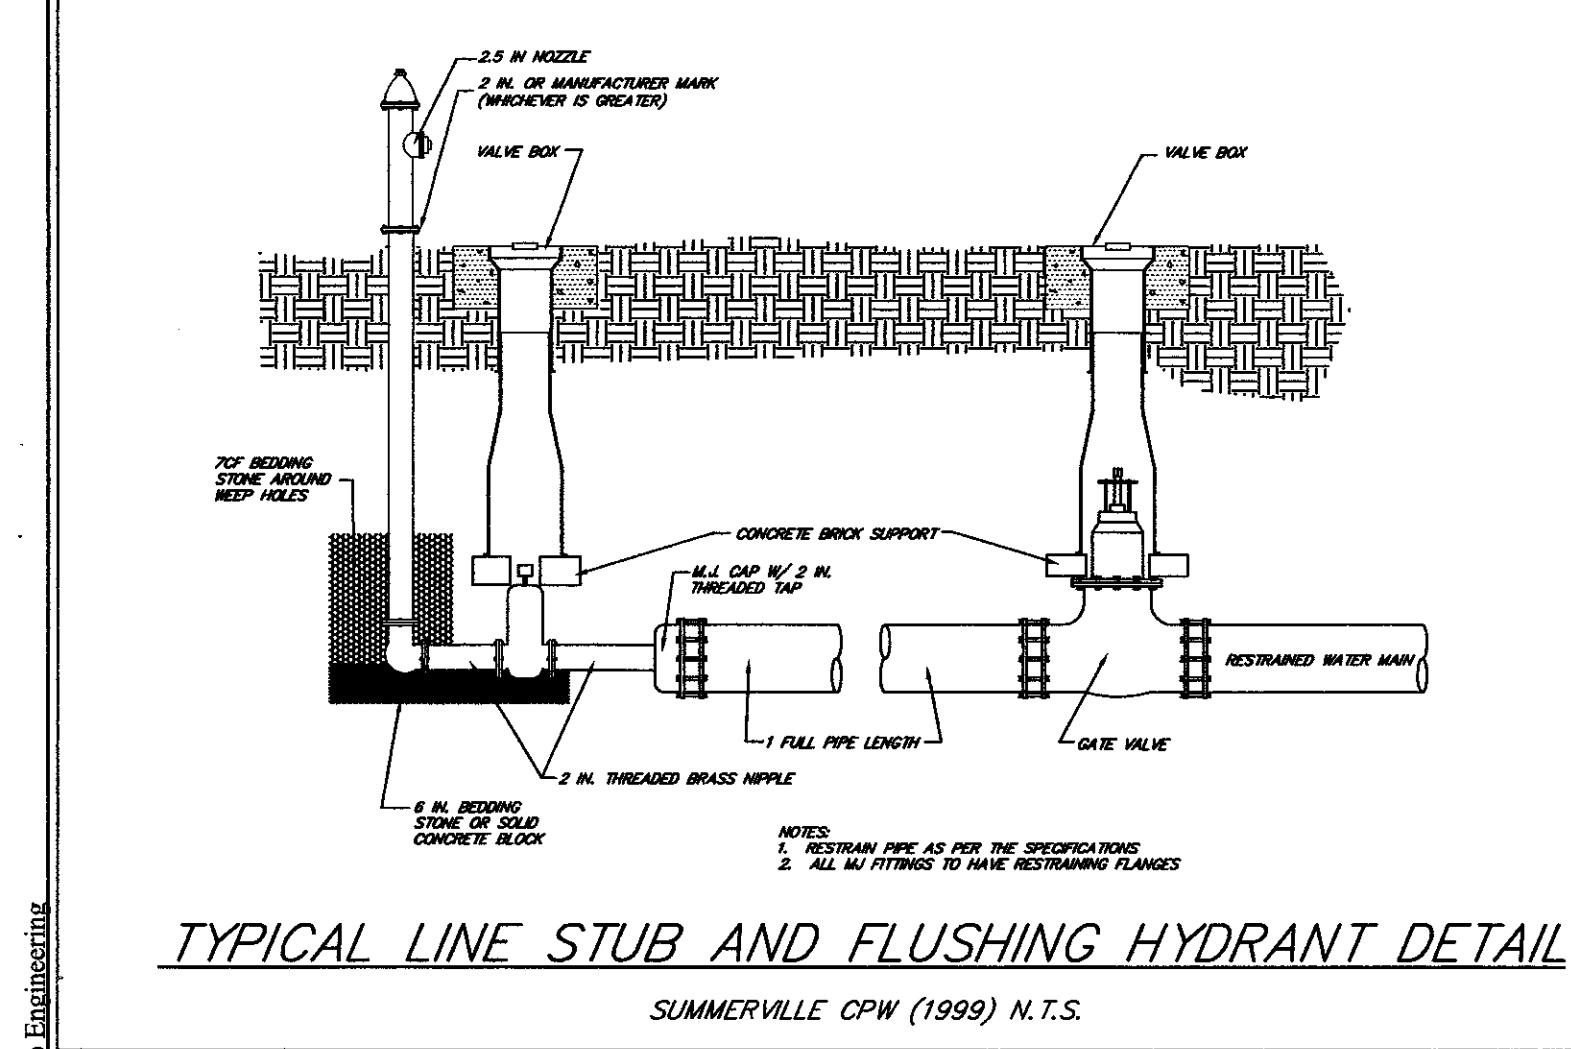

**TYPICAL LINE STUB AND FLUSHING HYDRANT DETAIL**

SUMMerville CPW (1999) N.T.S.

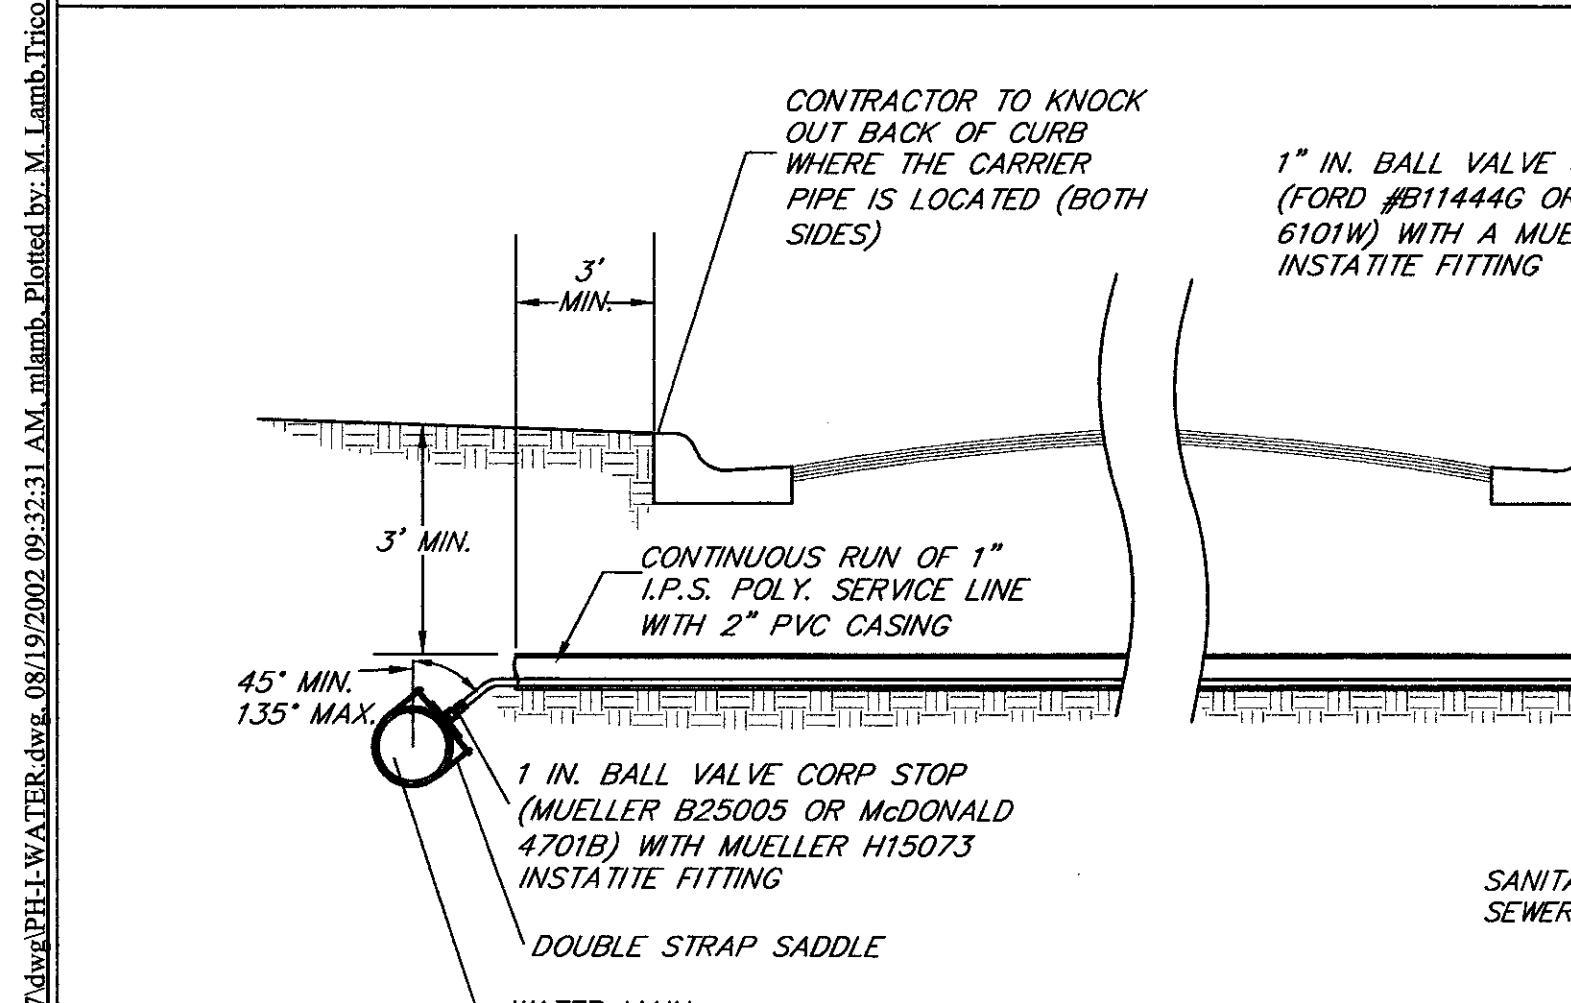

**TYPICAL DOMESTIC WATER SERVICE CARRIER PIPE FOR LONG SIDE SERVICES**

N.T.S.

Project No. R-201-087.dwg PH-1-WATER.dwg 08/9/2002 09:32:31 AM, Plotted by: M. Lamb, Trico Engineering


**CONSTRUCTION NOTES:**

- PIPE, FITTINGS, PACKING, JOINTING MATERIALS, VALVES AND FIRE HYDRANTS SHALL CONFORM TO SECTION C OF THE AMERICAN WATER WORKS ASSOCIATION (AWWA) STANDARDS. ALL MATERIALS OR PRODUCTS WHICH COME INTO CONTACT WITH THE WATER SHALL BE OF A MATERIAL WHICH IS CERTIFIED AS MEETING THE SPECIFICATIONS OF THE AMERICAN NATIONAL STANDARD INSTITUTE/NATIONAL SANITATION FOUNDATION STANDARD 61, DRINKING WATER SYSTEM COMPONENTS - HEALTH EFFECTS.
- CONSTRUCTION SPECIFICATIONS SHALL INCORPORATE THE PROVISIONS OF SECTION C OF THE AMERICAN WATER WORKS ASSOCIATION (AWWA) STANDARDS, SPECIFICATIONS AND/OR MANUFACTURER'S RECOMMENDED INSTALLATION PROCEDURES. THE MOST STRINGENT STANDARD SHALL PREVAIL.
- A CONTINUOUS AND UNIFORM BEDDING SHALL BE PROVIDED IN THE TRENCH FOR ALL LINED AND BACKFILLED TRENCHES. THE BEDDING SHALL BE 6" IN. THICK AROUND THE PIPE AND AT SUFFICIENT HEIGHT ABOVE THE PIPE TO EQUALLY SUPPORT AND PROTECT THE PIPE, STONES, OTHER THAN CRUSHED BEDDING, SHALL NOT COME IN CONTACT WITH THE PIPE AND SHALL NOT BE WITHIN SIX (6) INCHES OF THE PIPE.
- ALL WATER MAINS SHALL BE PROVIDED WITH A MINIMUM THIRTY-SIX (36) INCHES OF COVER.
- ALL SERVICES 1" MIN.
- ALL SERVICES UNDER ROADS ARE TO BE INSTALLED IN PVC CASING.
- 12 GAUZE TRACER WIRE SHALL BE TAPE TO ALL PVC MAINS AND SERVICES.
- METALLIC WARNING TAPE SHALL BE INSTALLED 18" IN. ABOVE ALL PVC MAINS AND SERVICES.


- NOTES:
- ALL SERVICES 1" MIN.
  - ALL SERVICES UNDER ROADS ARE TO BE INSTALLED IN PVC CASING.
  - 12 GAUZE TRACER WIRE SHALL BE TAPE TO ALL PVC MAINS AND SERVICES.
  - METALLIC WARNING TAPE SHALL BE INSTALLED 18" IN. ABOVE ALL PVC MAINS AND SERVICES.

- HYDRANT LEADS SHALL BE A MINIMUM OF SIX (6) INCHES IN DIAMETER. AUXILIARY GATE VALVES SHALL BE INSTALLED IN ALL HYDRANT LEADS.
- NO VALVES TO BE CONSTRUCTED UNDER CURB.
- USE MECHANICAL JOINT BENDS TO GET PIPE AROUND CUL-DE-SACS AND CURVES.
- TAPE #12 SINGLE STRAND TO ALL MAINS AND SERVICES. INSTALL 3" METALLIC WARNING TAPE 18" ABOVE ALL MAINS AND SERVICES.
- LOCATE FIRE HYDRANTS & VALVES ON OR AS CLOSE TO PROPERTY LINE AS POSSIBLE.
- ALL UTILITIES TO BE INSTALLED BEFORE CURB/GUTTER OR SABC INSTALLED.
- UTILITY CONTRACTOR SHALL RECOMPACT TRENCH CUTS IN ROADWAY UNDER STRICT COMPACTION CONTROL SUPERVISED BY THE ENGINEER AND SCPW REPRESENTATIVES.
- CONTRACTORS SHALL VERIFY ALL EXISTING UTILITIES AS TO LOCATION, SIZE, ELEVATION AND MATERIAL. PRIOR TO ANY CONSTRUCTION, CONTRACTOR SHALL ALSO NOTIFY ALL UTILITY COMPANIES OR AGENCIES THAT WILL BE AFFECTED DURING CONSTRUCTION OF THIS PROJECT PRIOR TO START.
- CONTRACTOR WILL BE RESPONSIBLE FOR SECURING ALL NECESSARY PERMITS OR VERIFY OWNER HAS OBTAINED PERMITS NEEDED FOR ALL PHASES OF CONSTRUCTION PRIOR TO START OF PROJECT.
- IN THE EVENT OF A CONFLICT WITH WATER, SEWER, DRAINAGE, OR OTHER UTILITY LINES, THE CONTRACTOR SHALL COORDINATE WITH THE ENGINEER AND FIELD ADJUST TO AVOID CONFLICTS.
- ALL SERVICES THAT RUN BEHIND PAVEMENT WILL BE PLACED IN 2" PVC CASING.
- INSTALLATION OF THE WATER MAIN SHALL BE A MINIMUM OF 2' OFF THE BACK OF THE CURB.
- ALL BLOCKING AND STRAPPING SHALL REMAIN OPEN FOR INSPECTION BY SCPW.
- ALL PVC PIPE USED MUST BE C900 PVC.
- SCPW SHALL BE NOTIFIED IN WRITING PRIOR TO START OF CONSTRUCTION.
- WATER MAIN CONSTRUCTION SHALL NOT BE INITIATED UNTIL FINAL ROAD & R/W GRADES (±0.5') ARE ACHIEVED.
- ALL BENDS SHALL BE MARKED WITH 2" CAPPED PVC PIPE UNTIL AS-BUILT SURVEYS ARE COMPLETE.

- NOTES:
- RESTRAIN PIPE AS PER THE SPECIFICATIONS
  - ALL FITTINGS TO HAVE RESTRAINING FLANGES

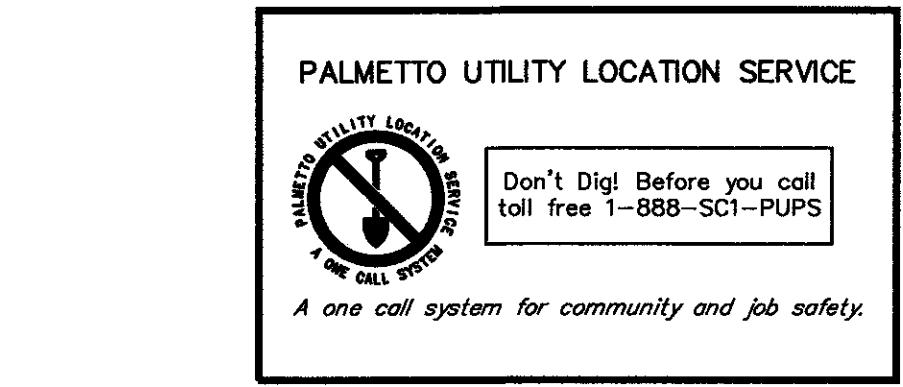

A one call system for community and job safety.

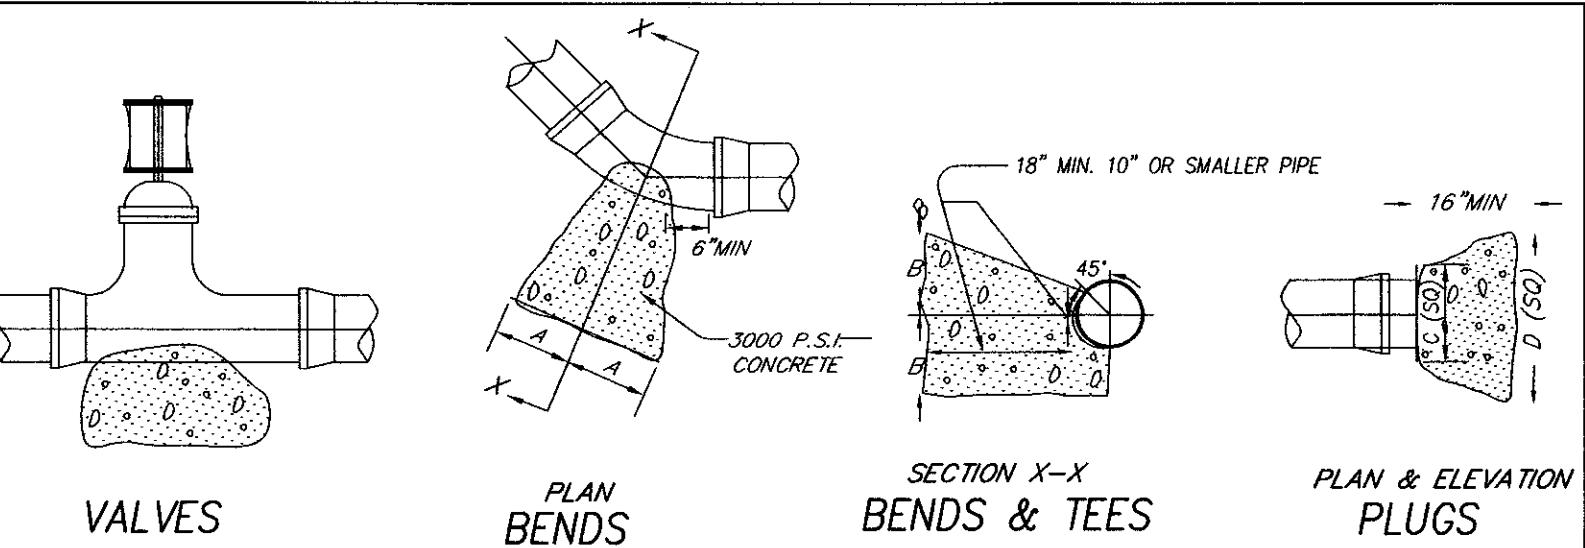


SIZE	1/4 BEND	1/8 BEND	1/16 BEND	TEES	PLUGS					
4" & SMALLER	A 6"	B 10"	C 5"	D 3"	E 6"	F 12"	G 6"	H 14"		
6"	I 16"	J 10"	K 9"	L 10"	M 6"	N 8"	O 10"	P 21"		
8"	Q 22"	R 13"	S 12"	T 13"	U 8"	V 10"	W 13"	X 16"	Y 12"	Z 29"

**TYPICAL THRUST BLOCK LOCATIONS FOR HORIZONTAL CHANGES IN DIRECTION**

N.T.S.


- NOTES:
- CONCRETE TO BE FORMED WITH 3/4" PLYWOOD.
  - BENDS AND/OR FITTINGS TO BE WRAPPED WITH POLYETHYLENE.
  - 6" STONE OR SOLID BLOCK REQUIRED UNDER BENDS / FITTINGS
  - FITTINGS WITHIN 10' OF EACH OTHER SHALL BE RODDED TOGETHER WITH 3/4" ALL THREAD ROD (2 MIN).
  - RESTRAINING FLANGES REQUIRED ON ALL FITTINGS, ALL FITTINGS TO BE M.J.
  - ALL BENDS SHALL BE MARKED WITH PVC PIPES TO GROUND SURFACE UNTIL AFTER AS-BUILT SURVEY IS COMPLETED.

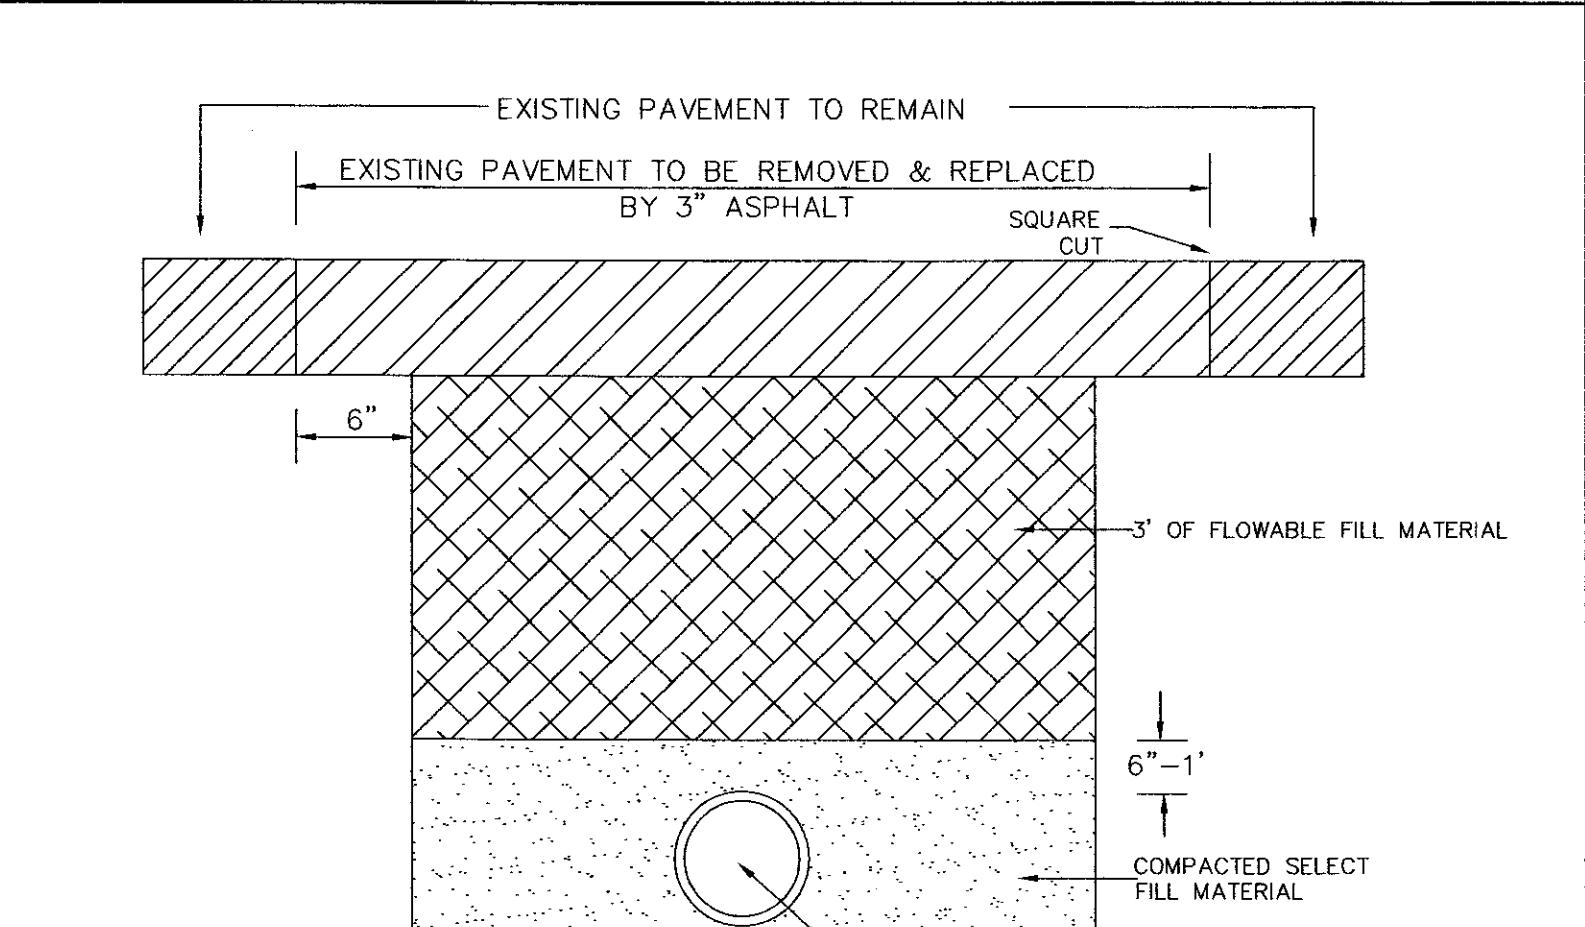

- \* STEEL PLATES SECURED WITH ASPHALT "RAMPS" SHALL BE REQUIRED UNTIL THE FILL HAS SET  
\* ASPHALT SHALL BE TYPE 1B

**TYPICAL ROAD CUT DETAIL**

N.T.S.

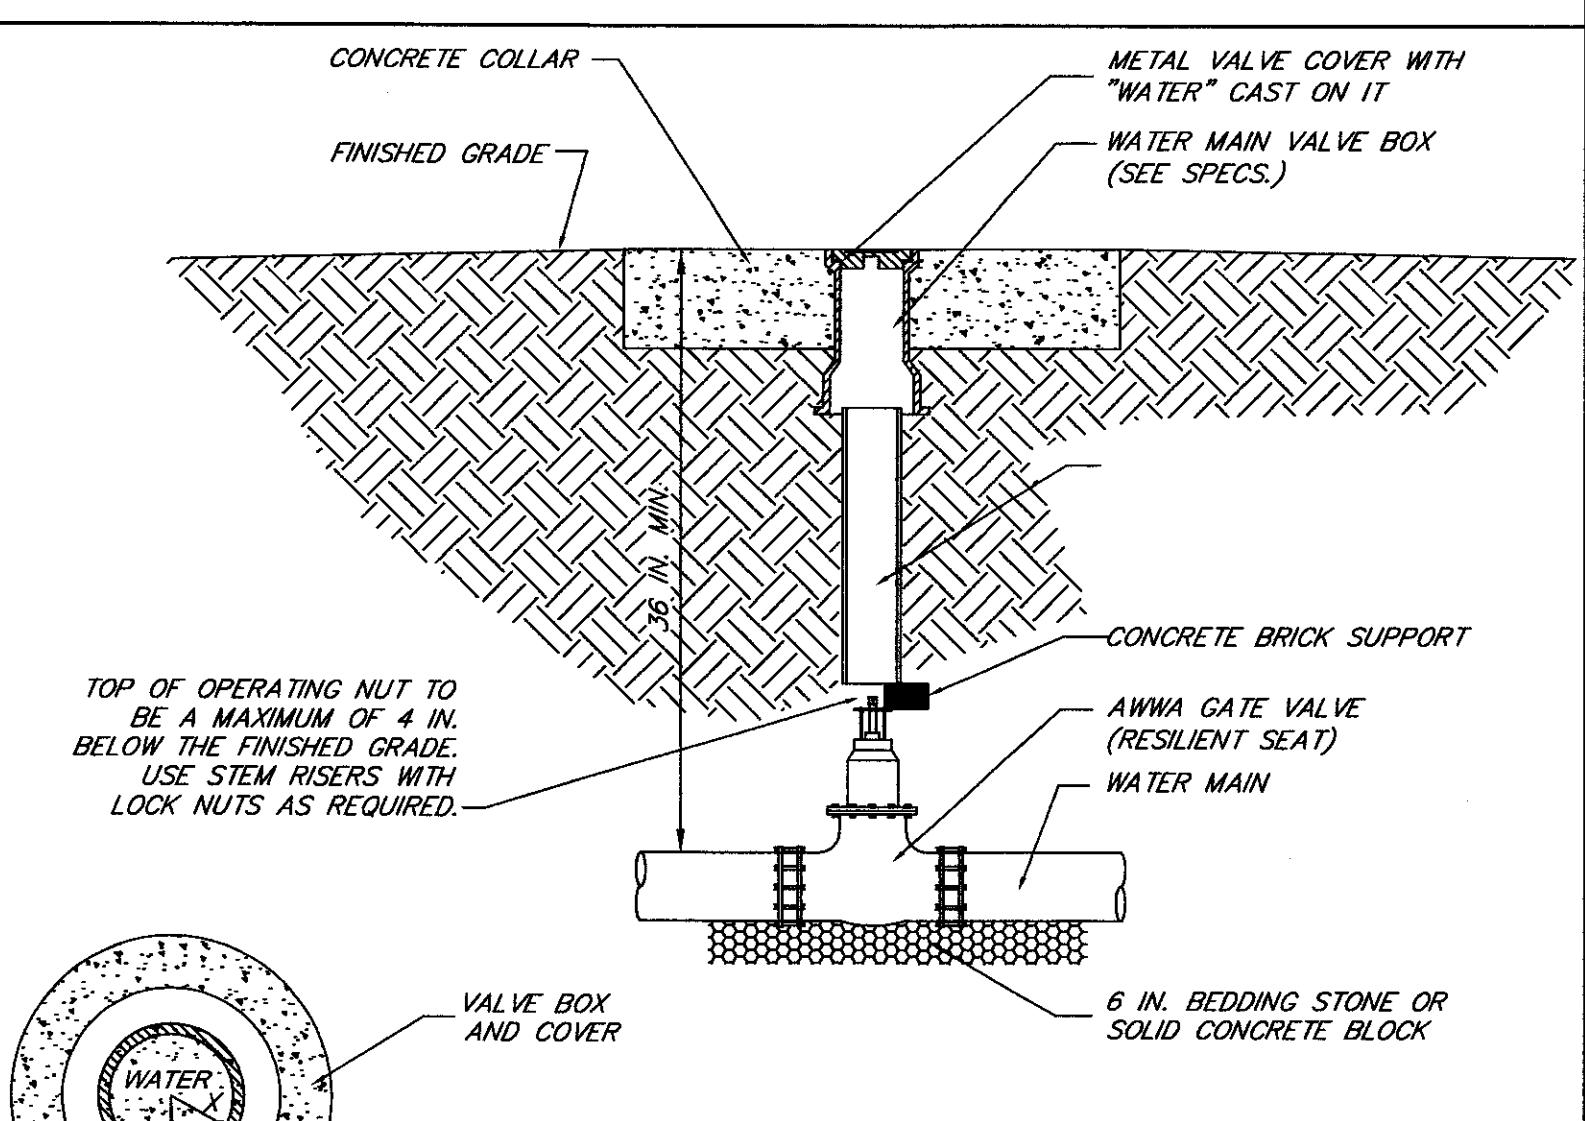


X=DIA. OF BOX + 2" MIN.  
Y=16" MINIMUM  
Z=MINIMUM 2" THICK

TRACER WIRE SHALL NOT BE INSTALLED INSIDE THE PVC SPOOL PIECE. IT SHALL ENTER AND EXIT THE VALVE BOX WHERE THE TOP SECTION OF THE BOX SCREWS TOGETHER WITH THE BOTTOM SECTION.

N.T.S.

PVC SPOOL PIECE CUT TO DESIRED LENGTH. IT SHALL STOP EVENLY WITH THE BOTTOM OF THE OPERATING NUT AND SHALL NOT REST ON THE BODY OF THE VALVE. SPOOL PIECE TO BE CUT FROM 6" IN. WATER MAIN PIPE.


N.T.S.

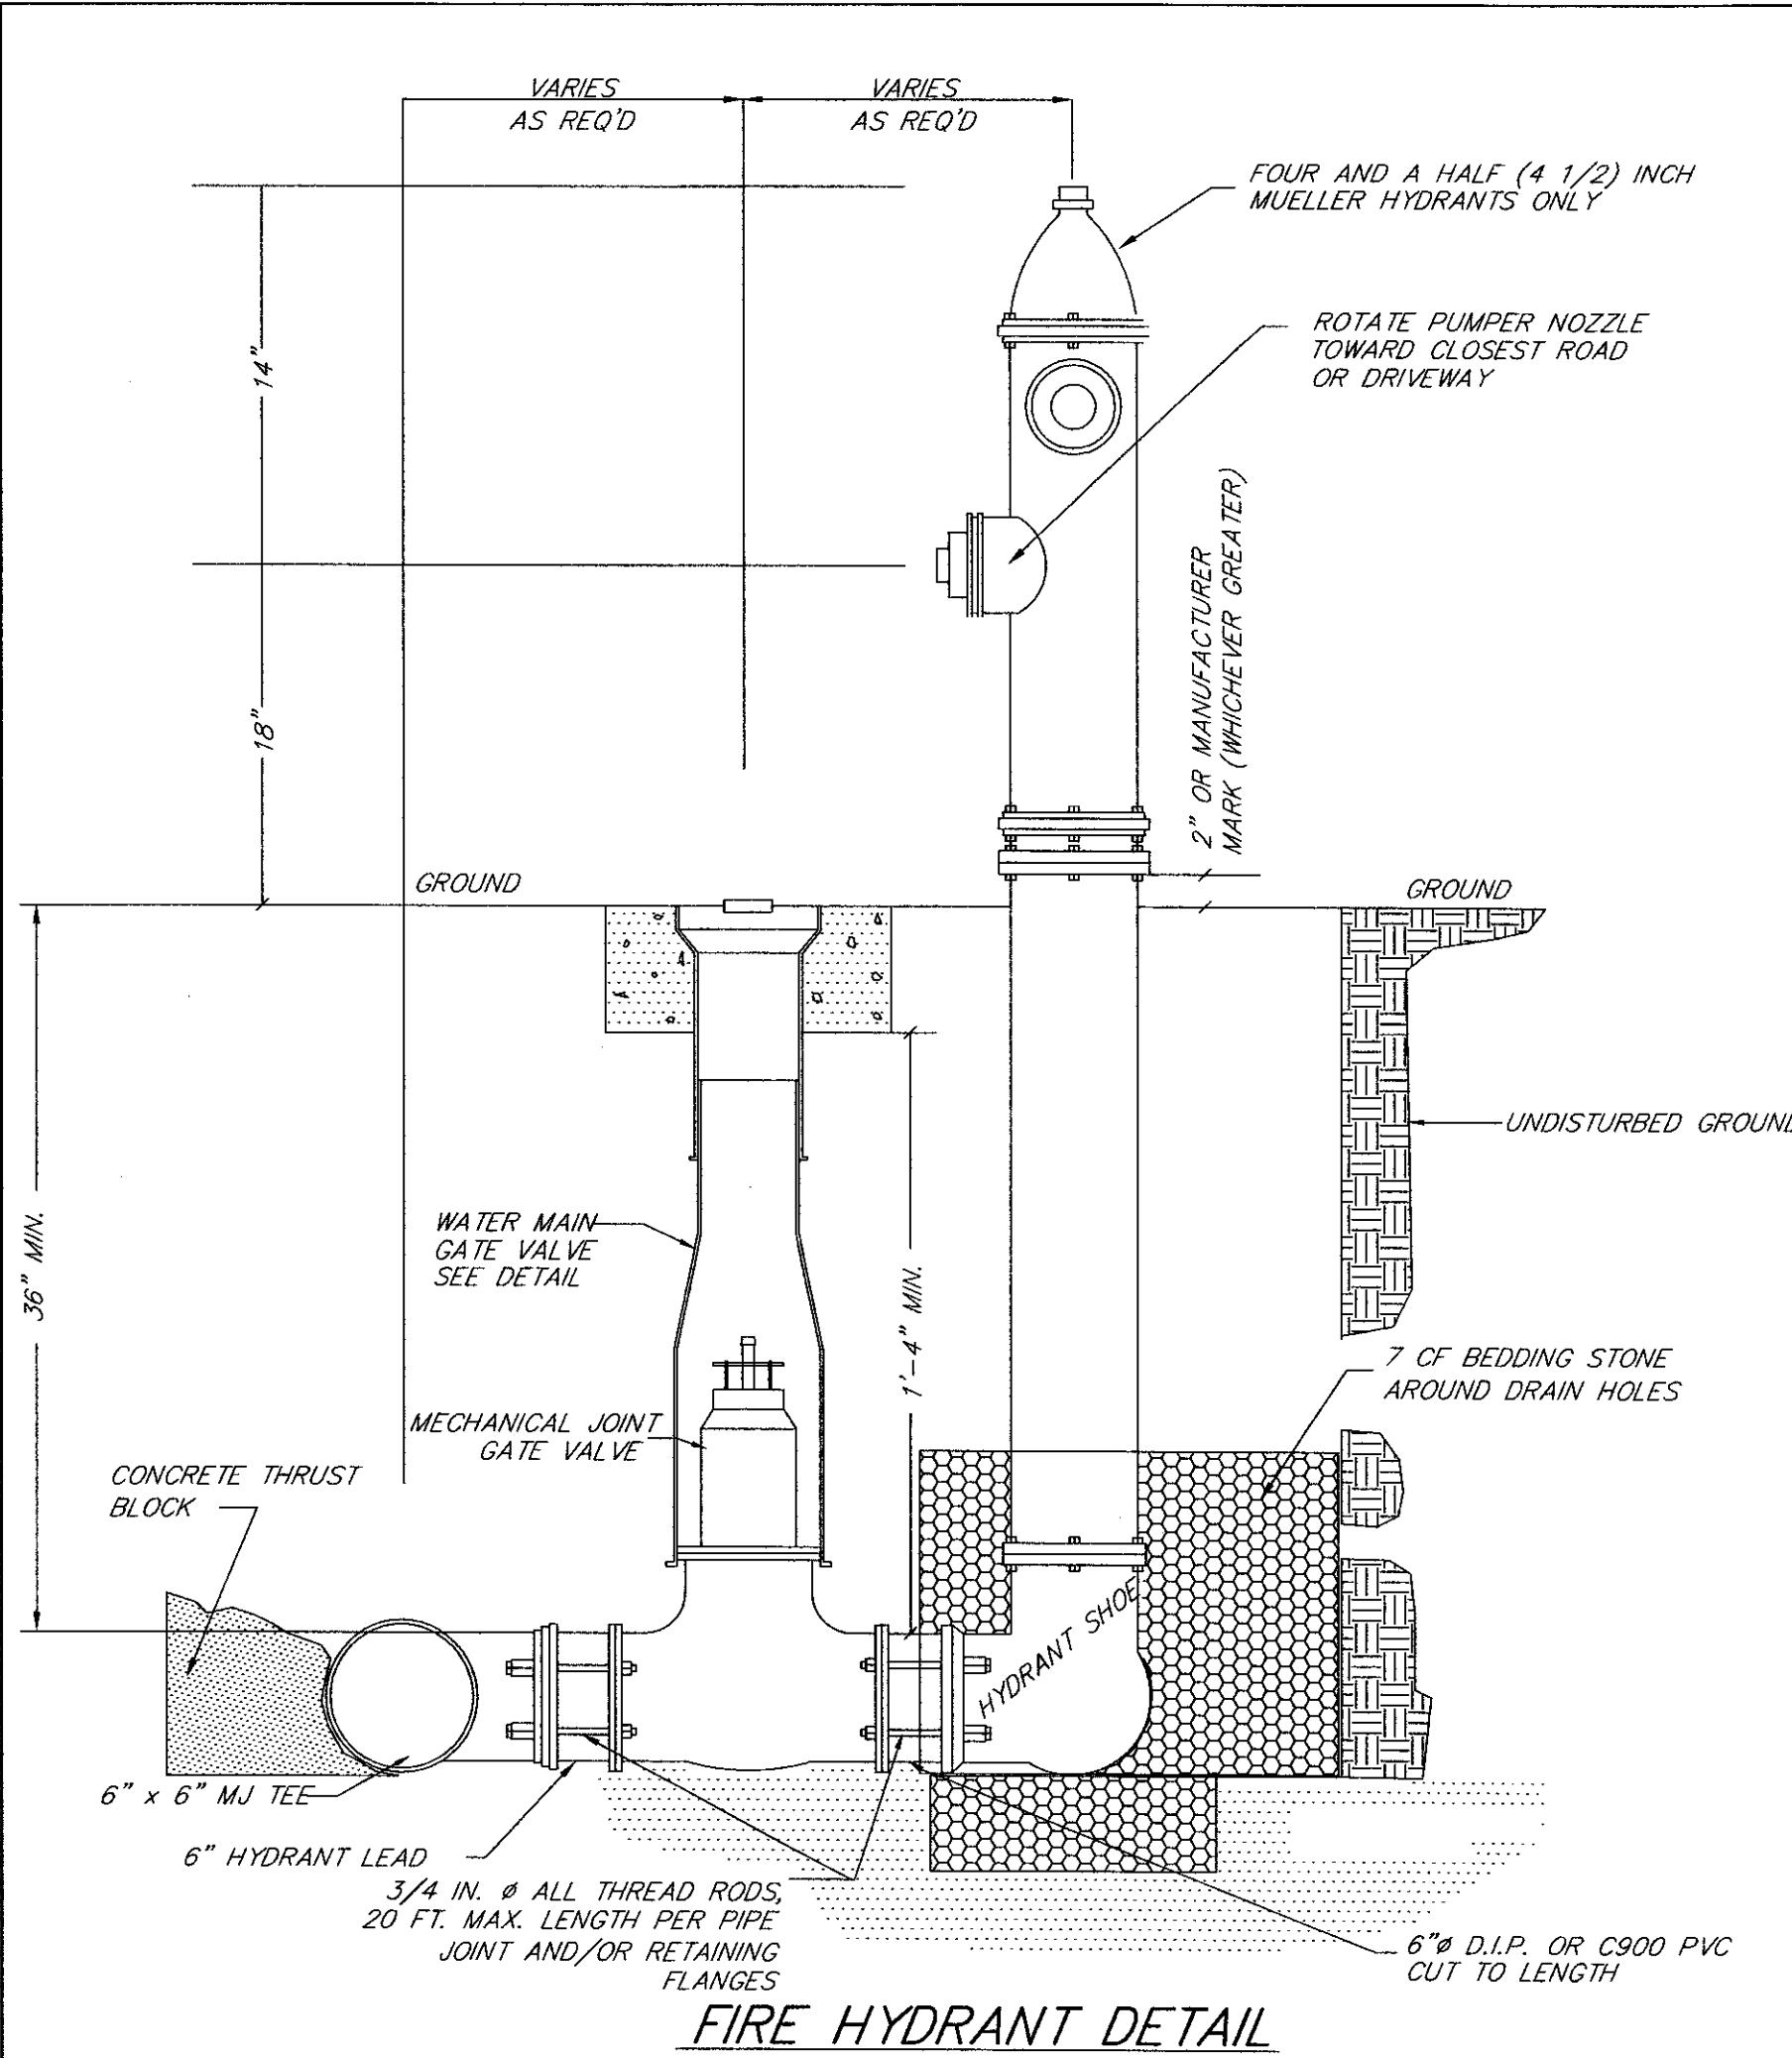

**FIRE HYDRANT DETAIL**


N.T.S.

- NOTES:
- HYDRANTS SHALL BE PAINTED YELLOW WITH WHITE CAPS & BONNET. DO NOT PAINT OPERATING NUT OR OIL RESERVOIR.
  - ALL MJ FITTINGS SHALL BE RESTRAINED WITH RESTRAINING FLANGES AND ALL THREAD ROD.
  - ALL PIPE AND FITTINGS CONTACT WITH CONCRETE BLOCKING SHALL BE WRAPPED IN POLYETHYLENE.
  - A MINIMUM THICKNESS OF 6 IN. BEDDING STONE OR A SOLID CONCRETE BLOCK IS REQUIRED UNDER ALL FITTINGS, VALVES AND HYDRANTS.

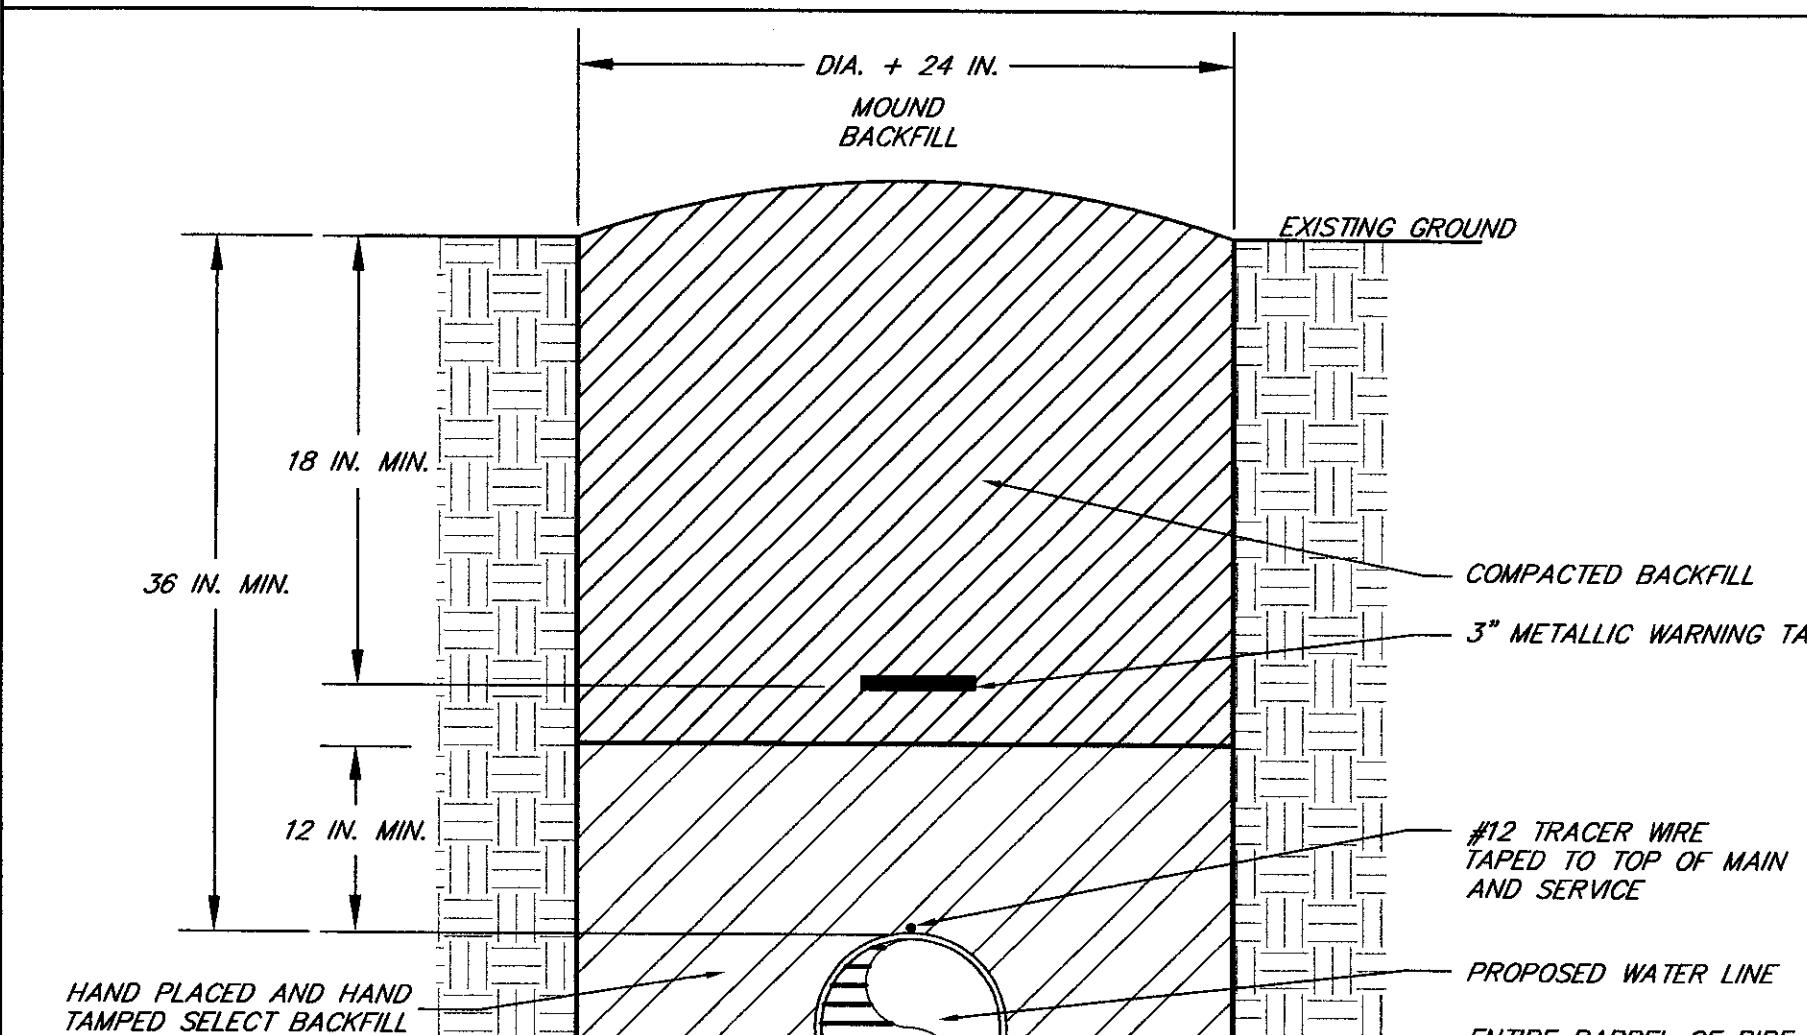

**TYPICAL WATER PIPE BEDDING DETAIL**

N.T.S.

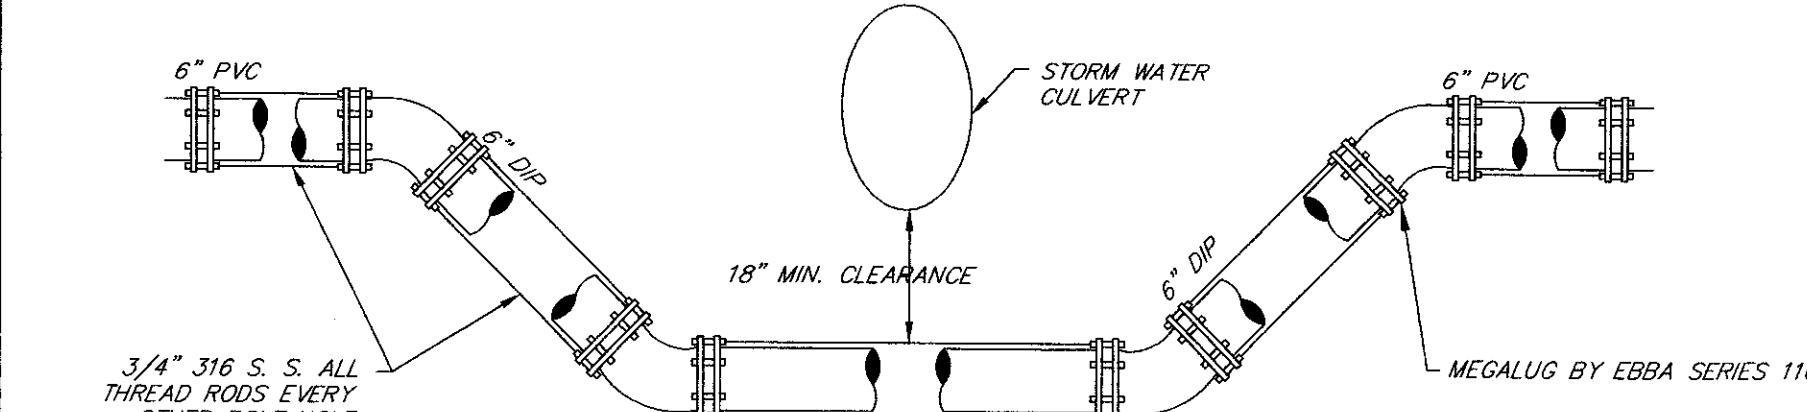

**TYPICAL WATER/STORM DRAIN CROSSING DETAIL**

N.T.S.

DESIGNED : <i>M.L.</i>	DRAWN : <i>M.L.</i>
CHECKED : <i>TFB</i>	APPROVED : <i>B</i>
SCALE : <i>N.T.S.</i>	DATE : <i>29 JAN 2002</i>
PROJECT NO. : <i>01-087</i>	REV'D : <i>24-01-02</i>
WATER PLANS PER COMMENTS	
REVISIONS	

5 06-24-2002 WATER LINE CHANGED TO SAVE TREES  
2 Oct-30-2002 REV'D WATER PLANS PER COMMENTS  
NO. DATE


THE TOWN OF SUMMerville, SOUTH CAROLINA  
DORCHESTER COUNTY, SOUTH CAROLINA


4425 Balle Oaks Drive  
North Charleston, South Carolina 29405  
Phone: (843) 740-1700  
Fax: (843) 740-1701  
[www.tricoengineering.com](http://www.tricoengineering.com)

Engineering - Surveying - Landscape Architecture  
Land Planning - Wetland - GFS Services  
Visit us at [www.tricoengineering.com](http://www.tricoengineering.com)


TRICO  
ENGINEERING CONSULTANTS, INC.  
Civil Engineering • Land Surveying • Landscape Architecture  
Land Planning • Wetland • GFS Services  
Visit us at [www.tricoengineering.com](http://www.tricoengineering.com)

THE STATE OF SOUTH CAROLINA  
DEPARTMENT OF TRANSPORTATION  
DIVISION OF HIGHWAYS  
CIVIL ENGINEERING  
WATER MAINS  
CITY OF SUMMerville  
SUMMerville, South Carolina  
August 11, 1978







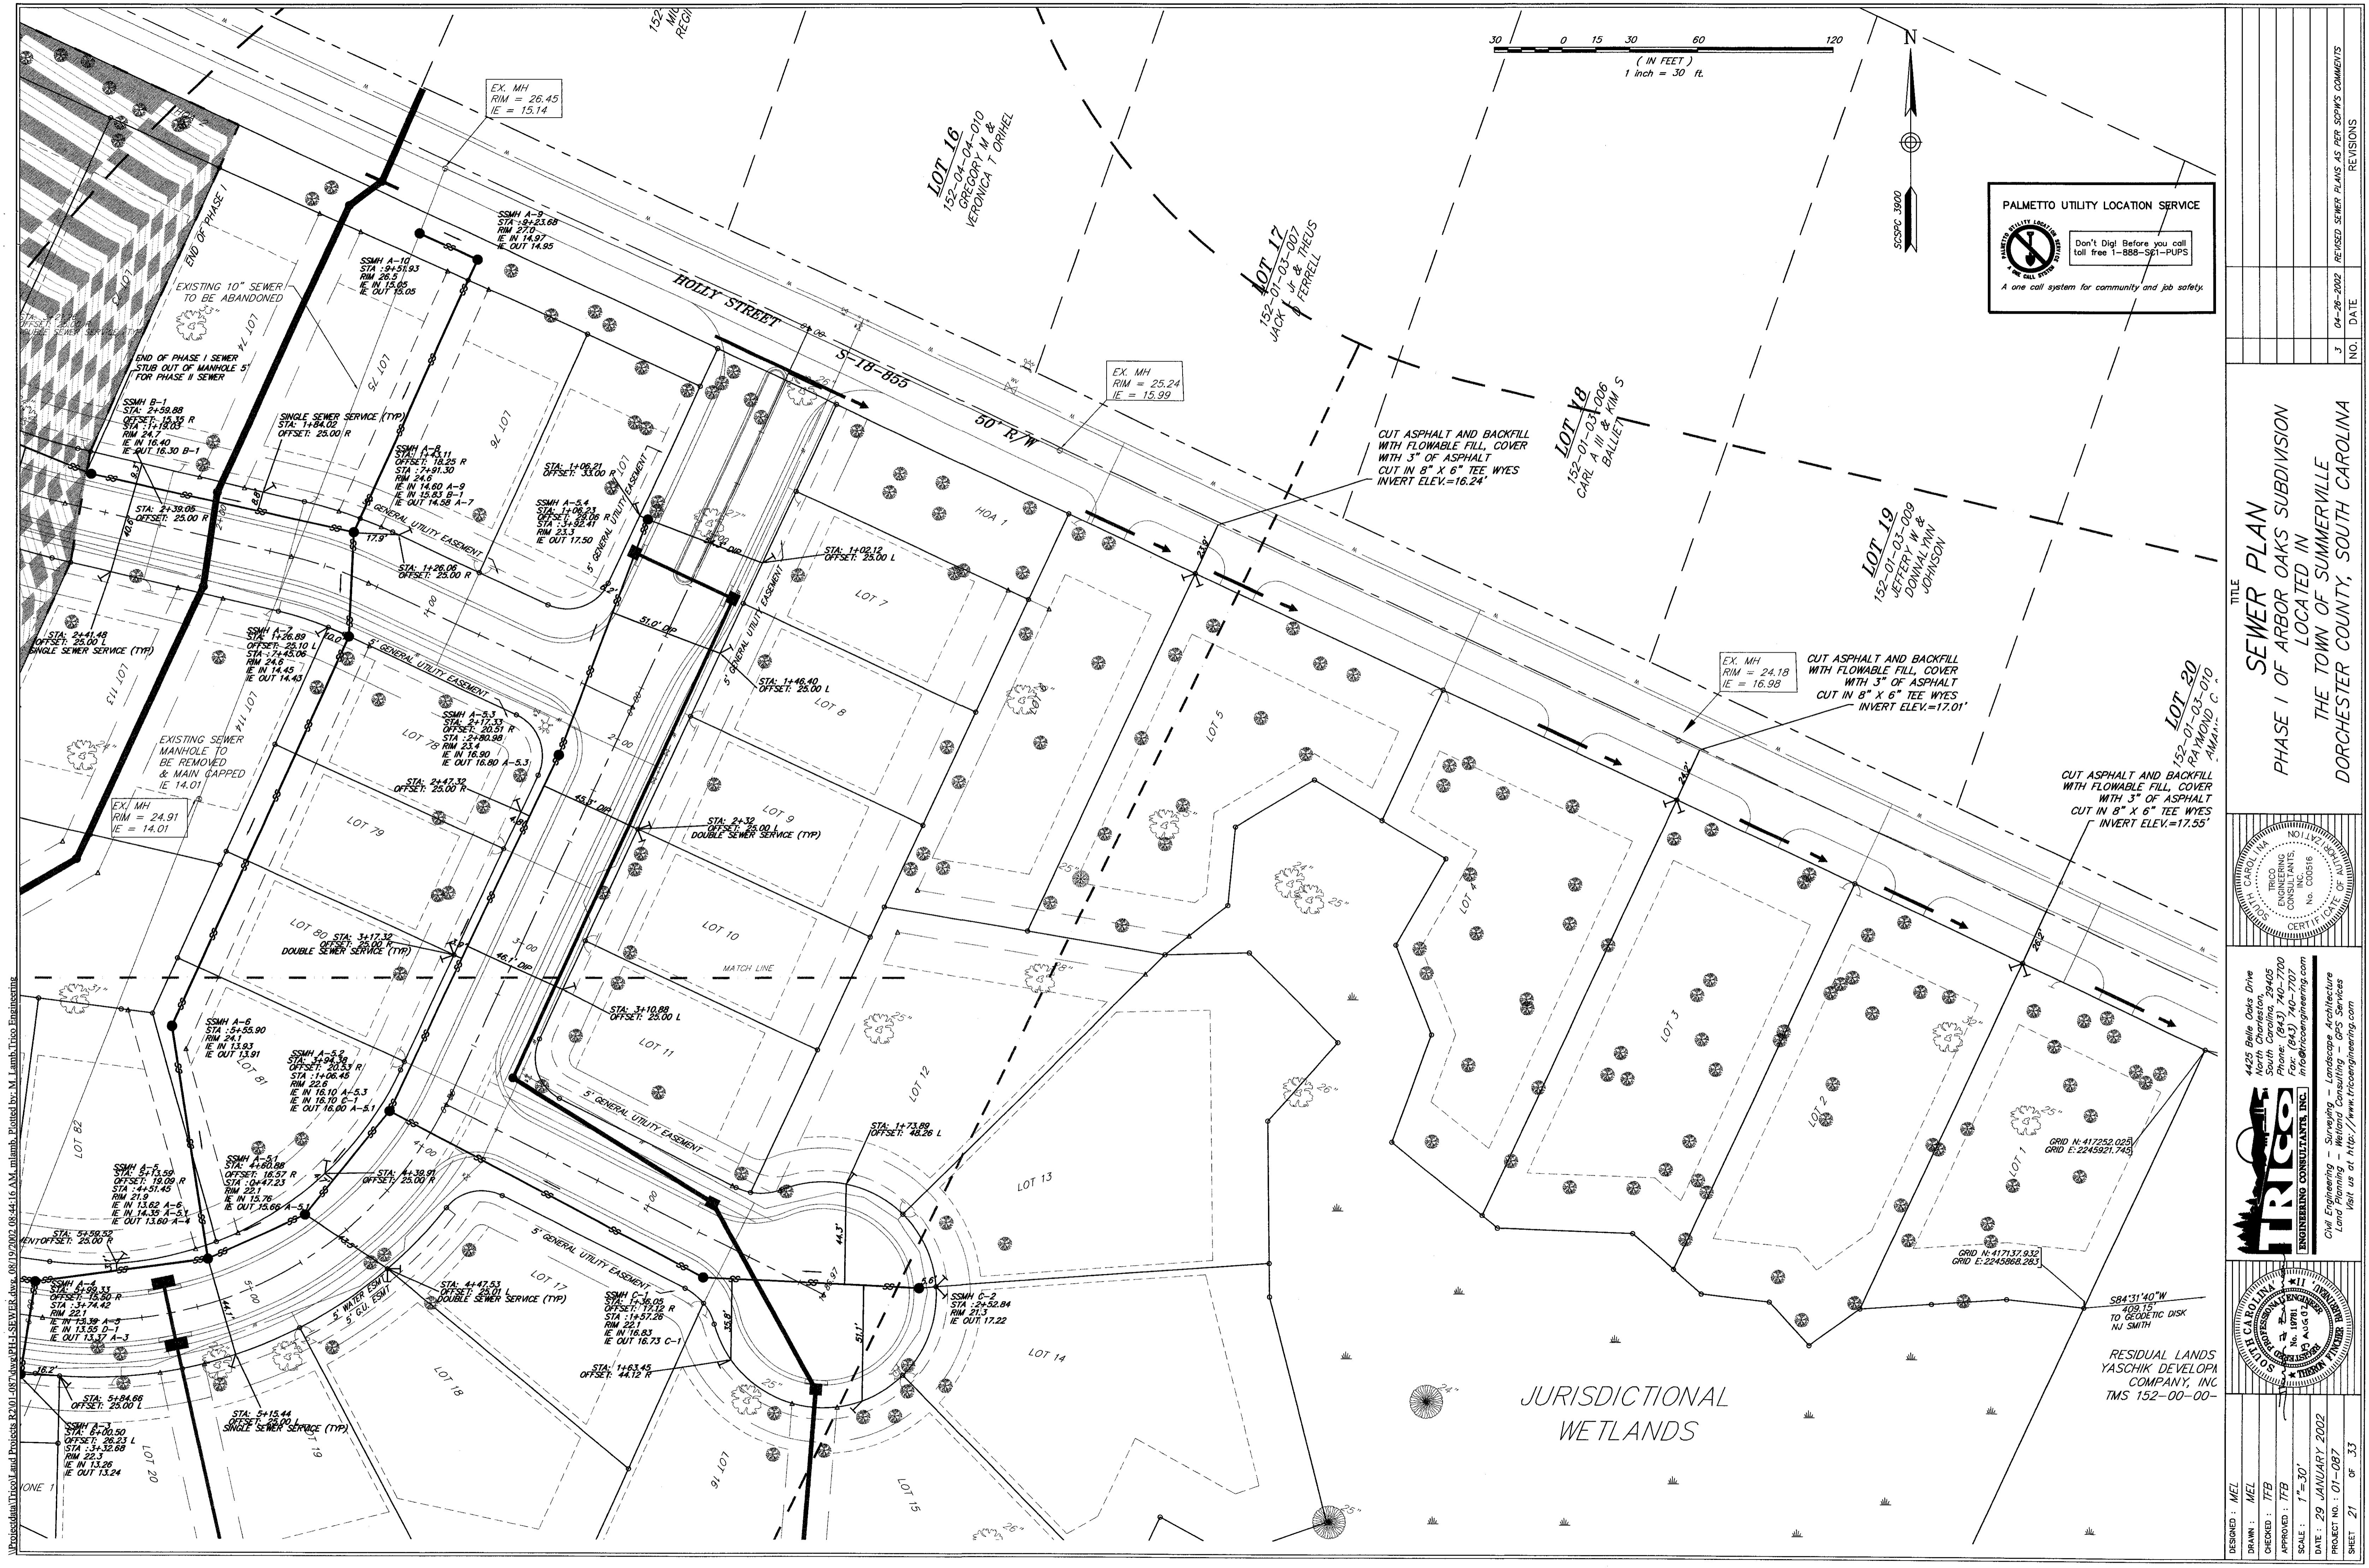



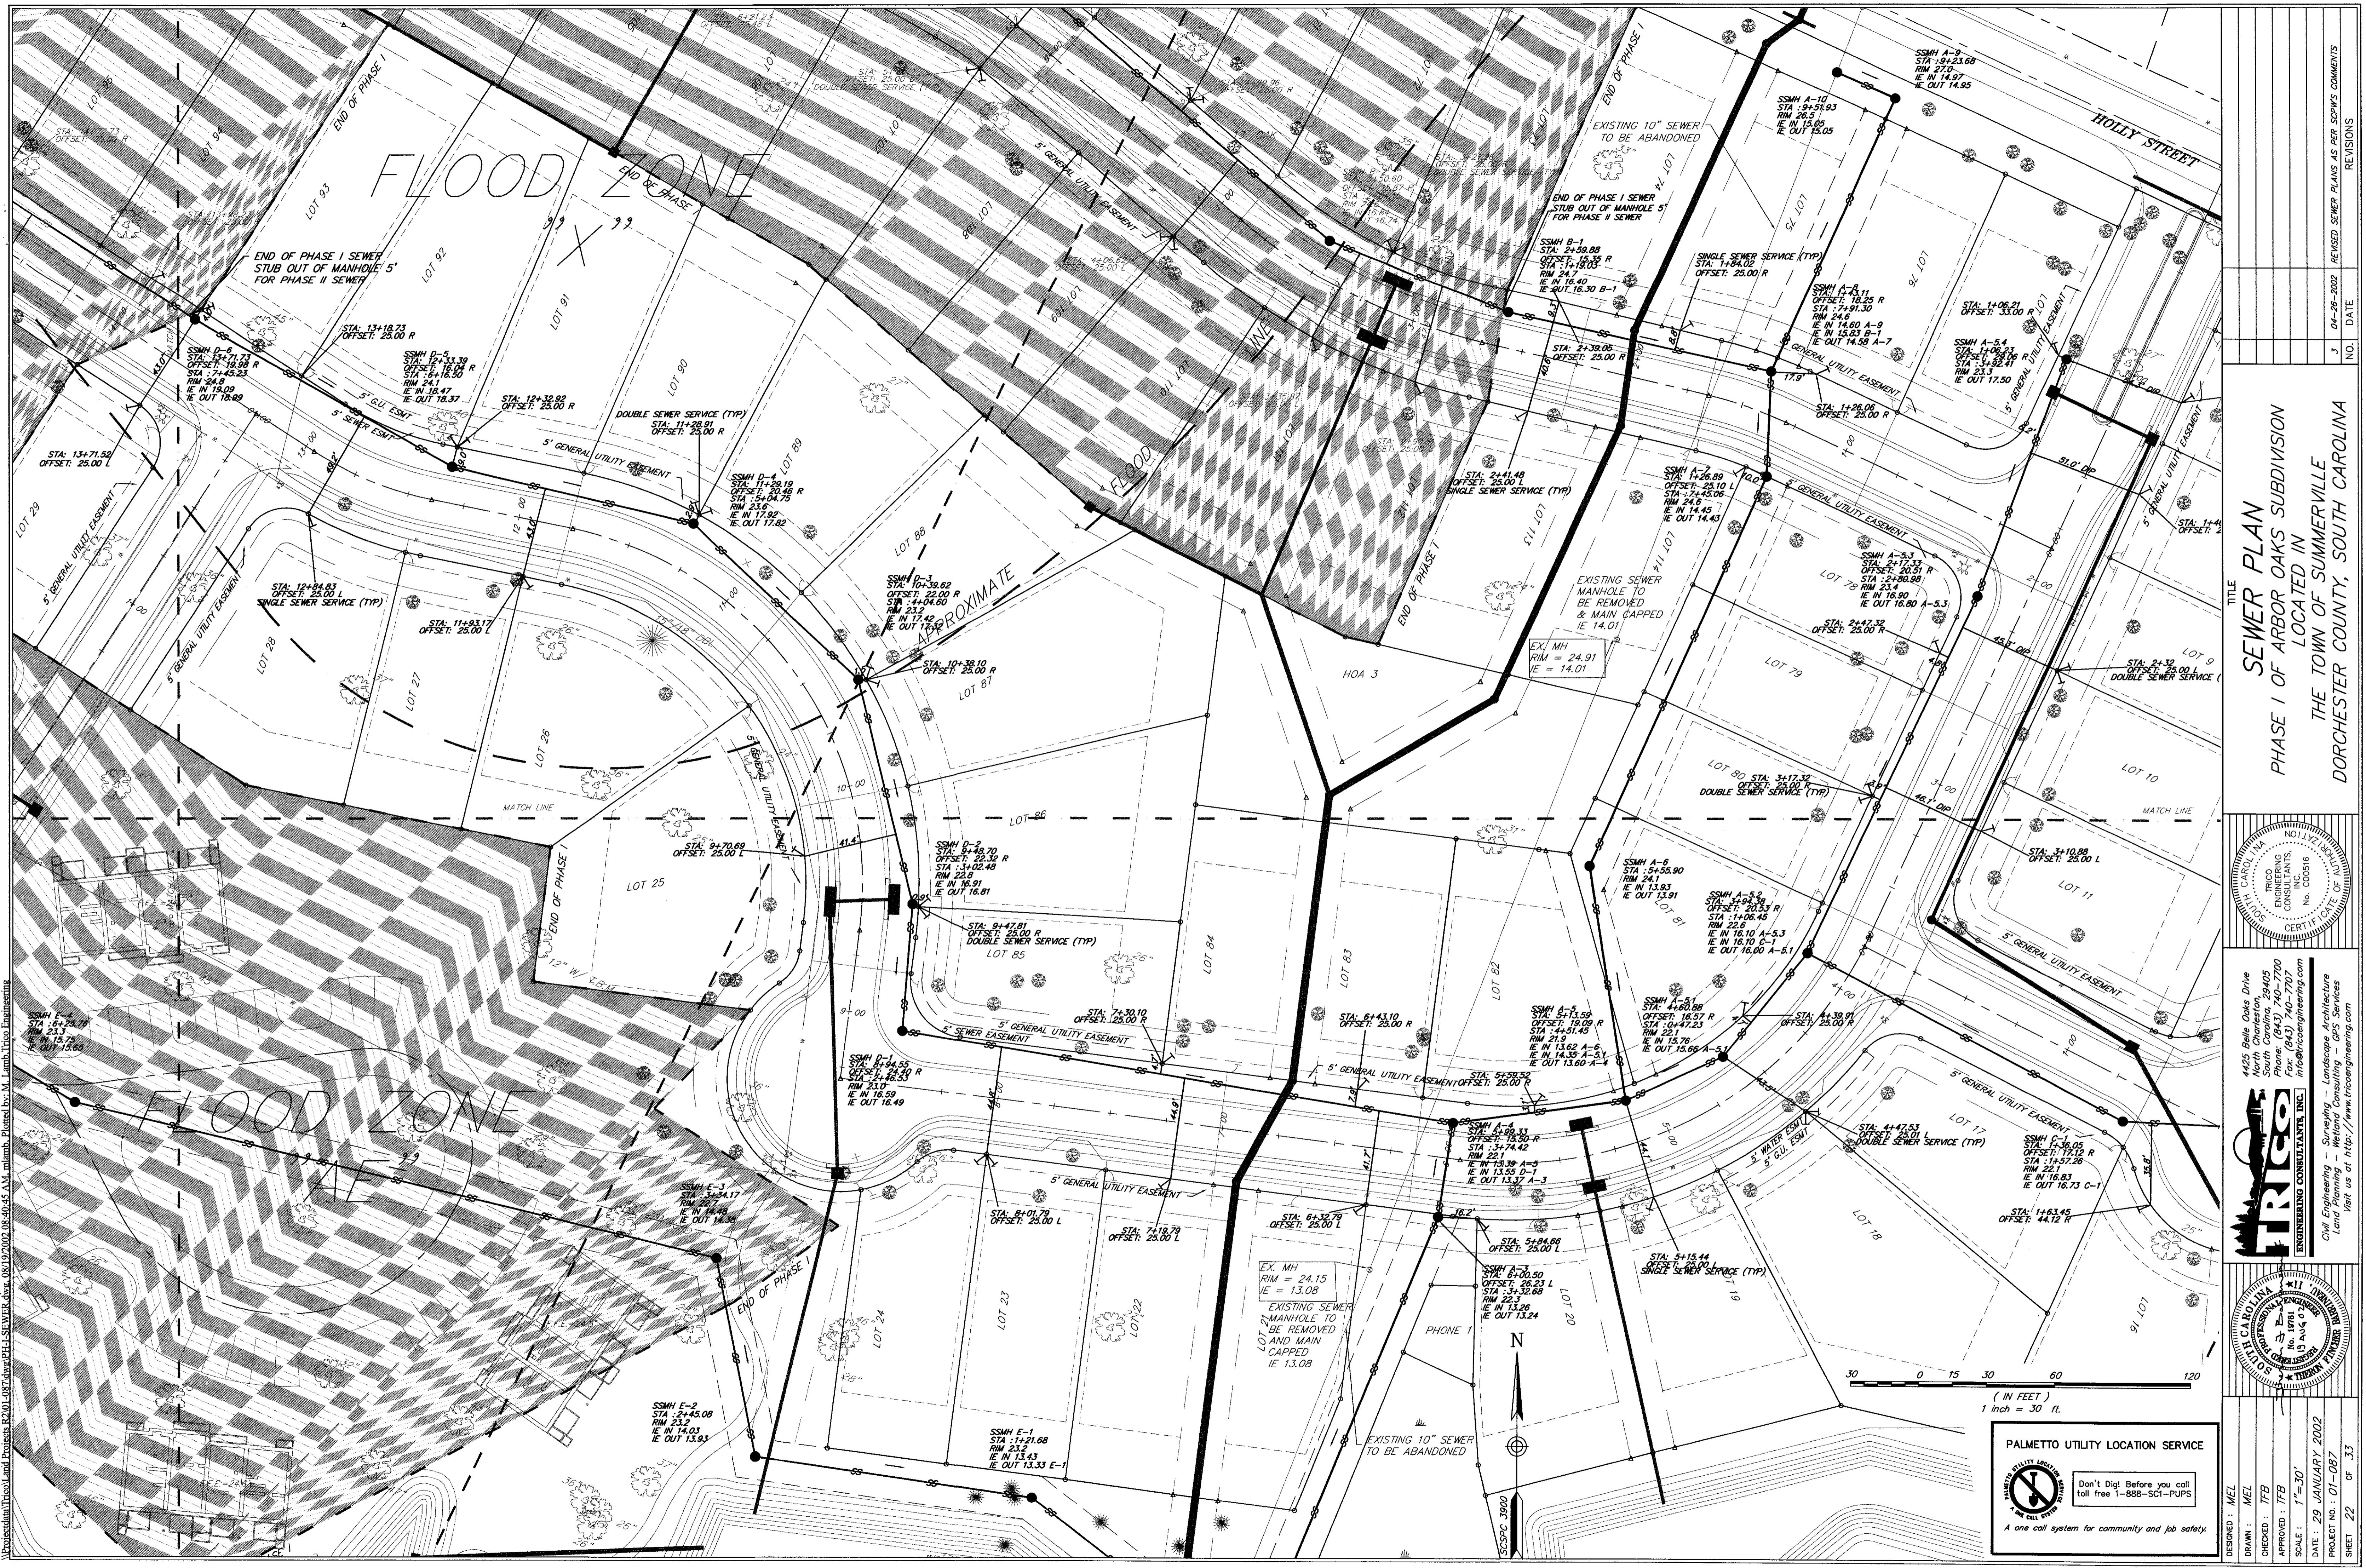




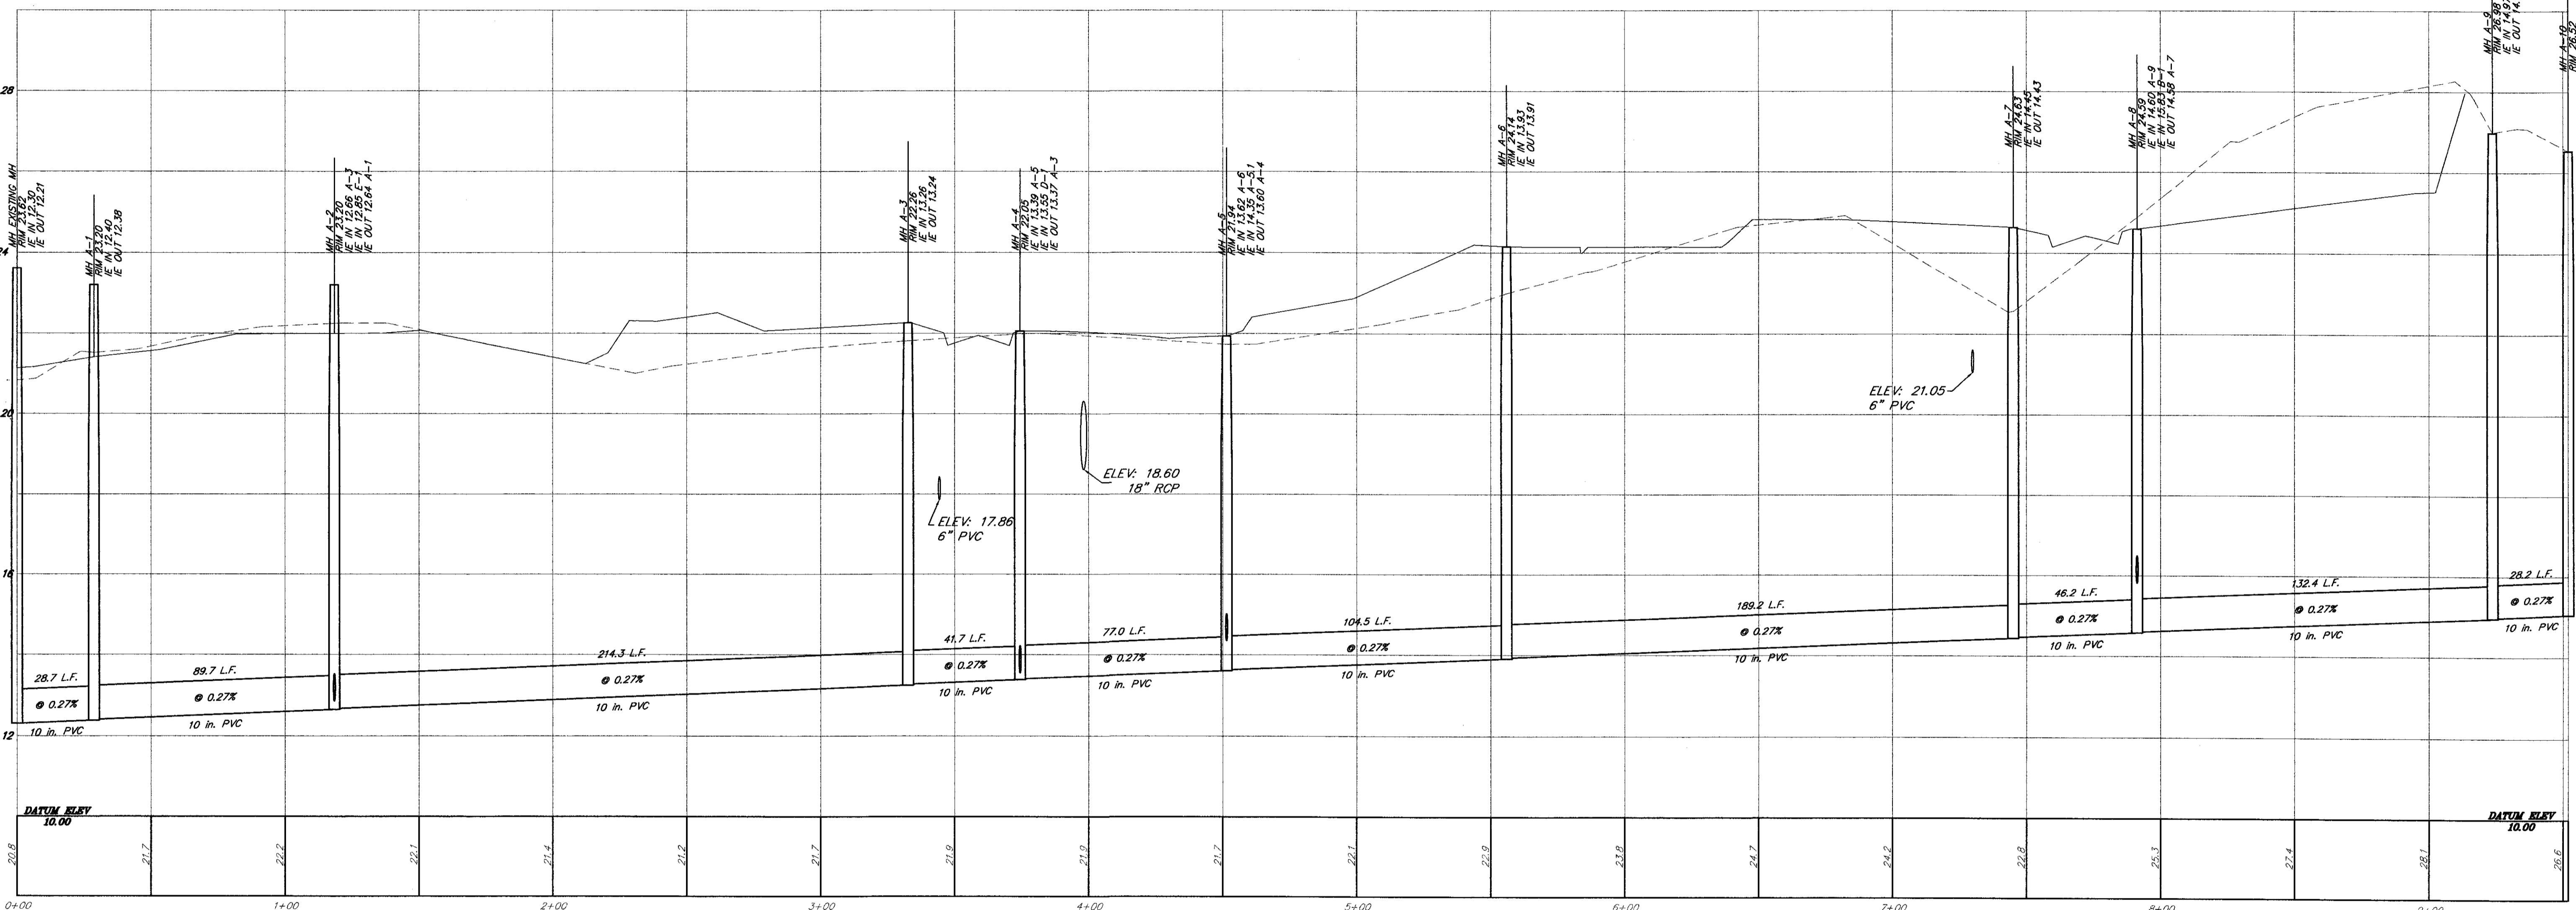


SEWER "A"  
HORIZONTAL SCALE: 1"=30'  
VERTICAL SCALE: 1"=2'

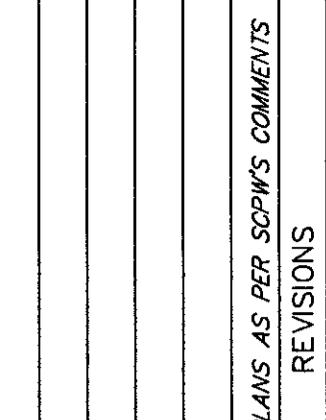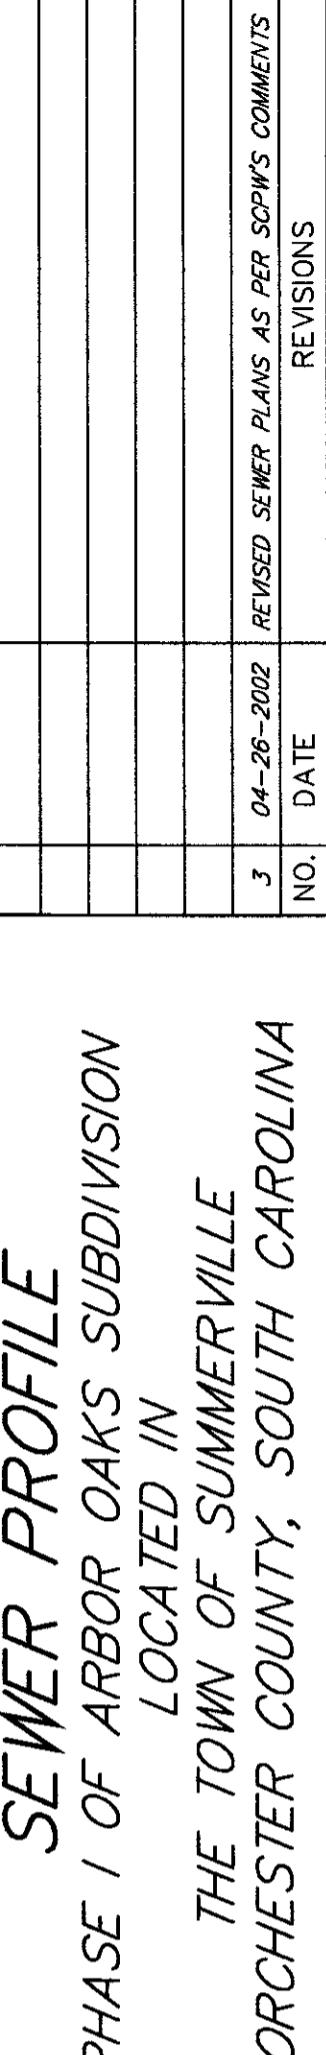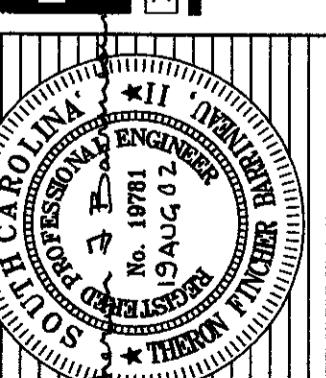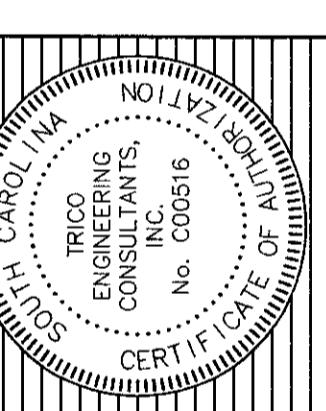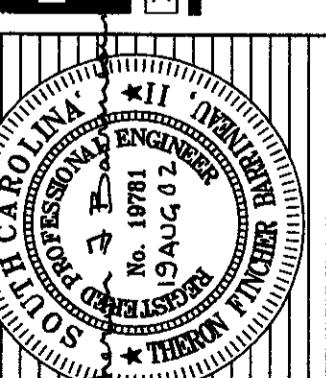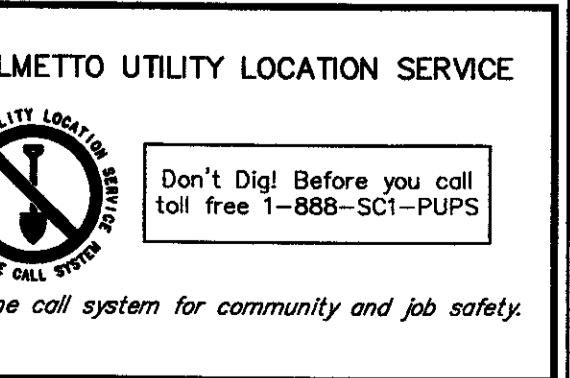
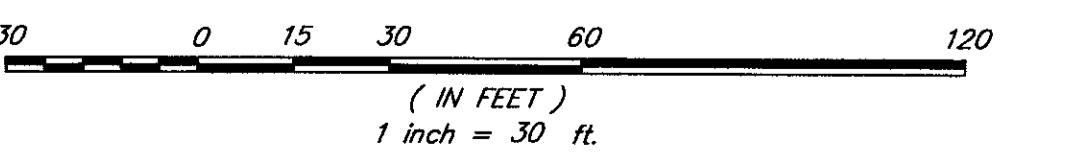


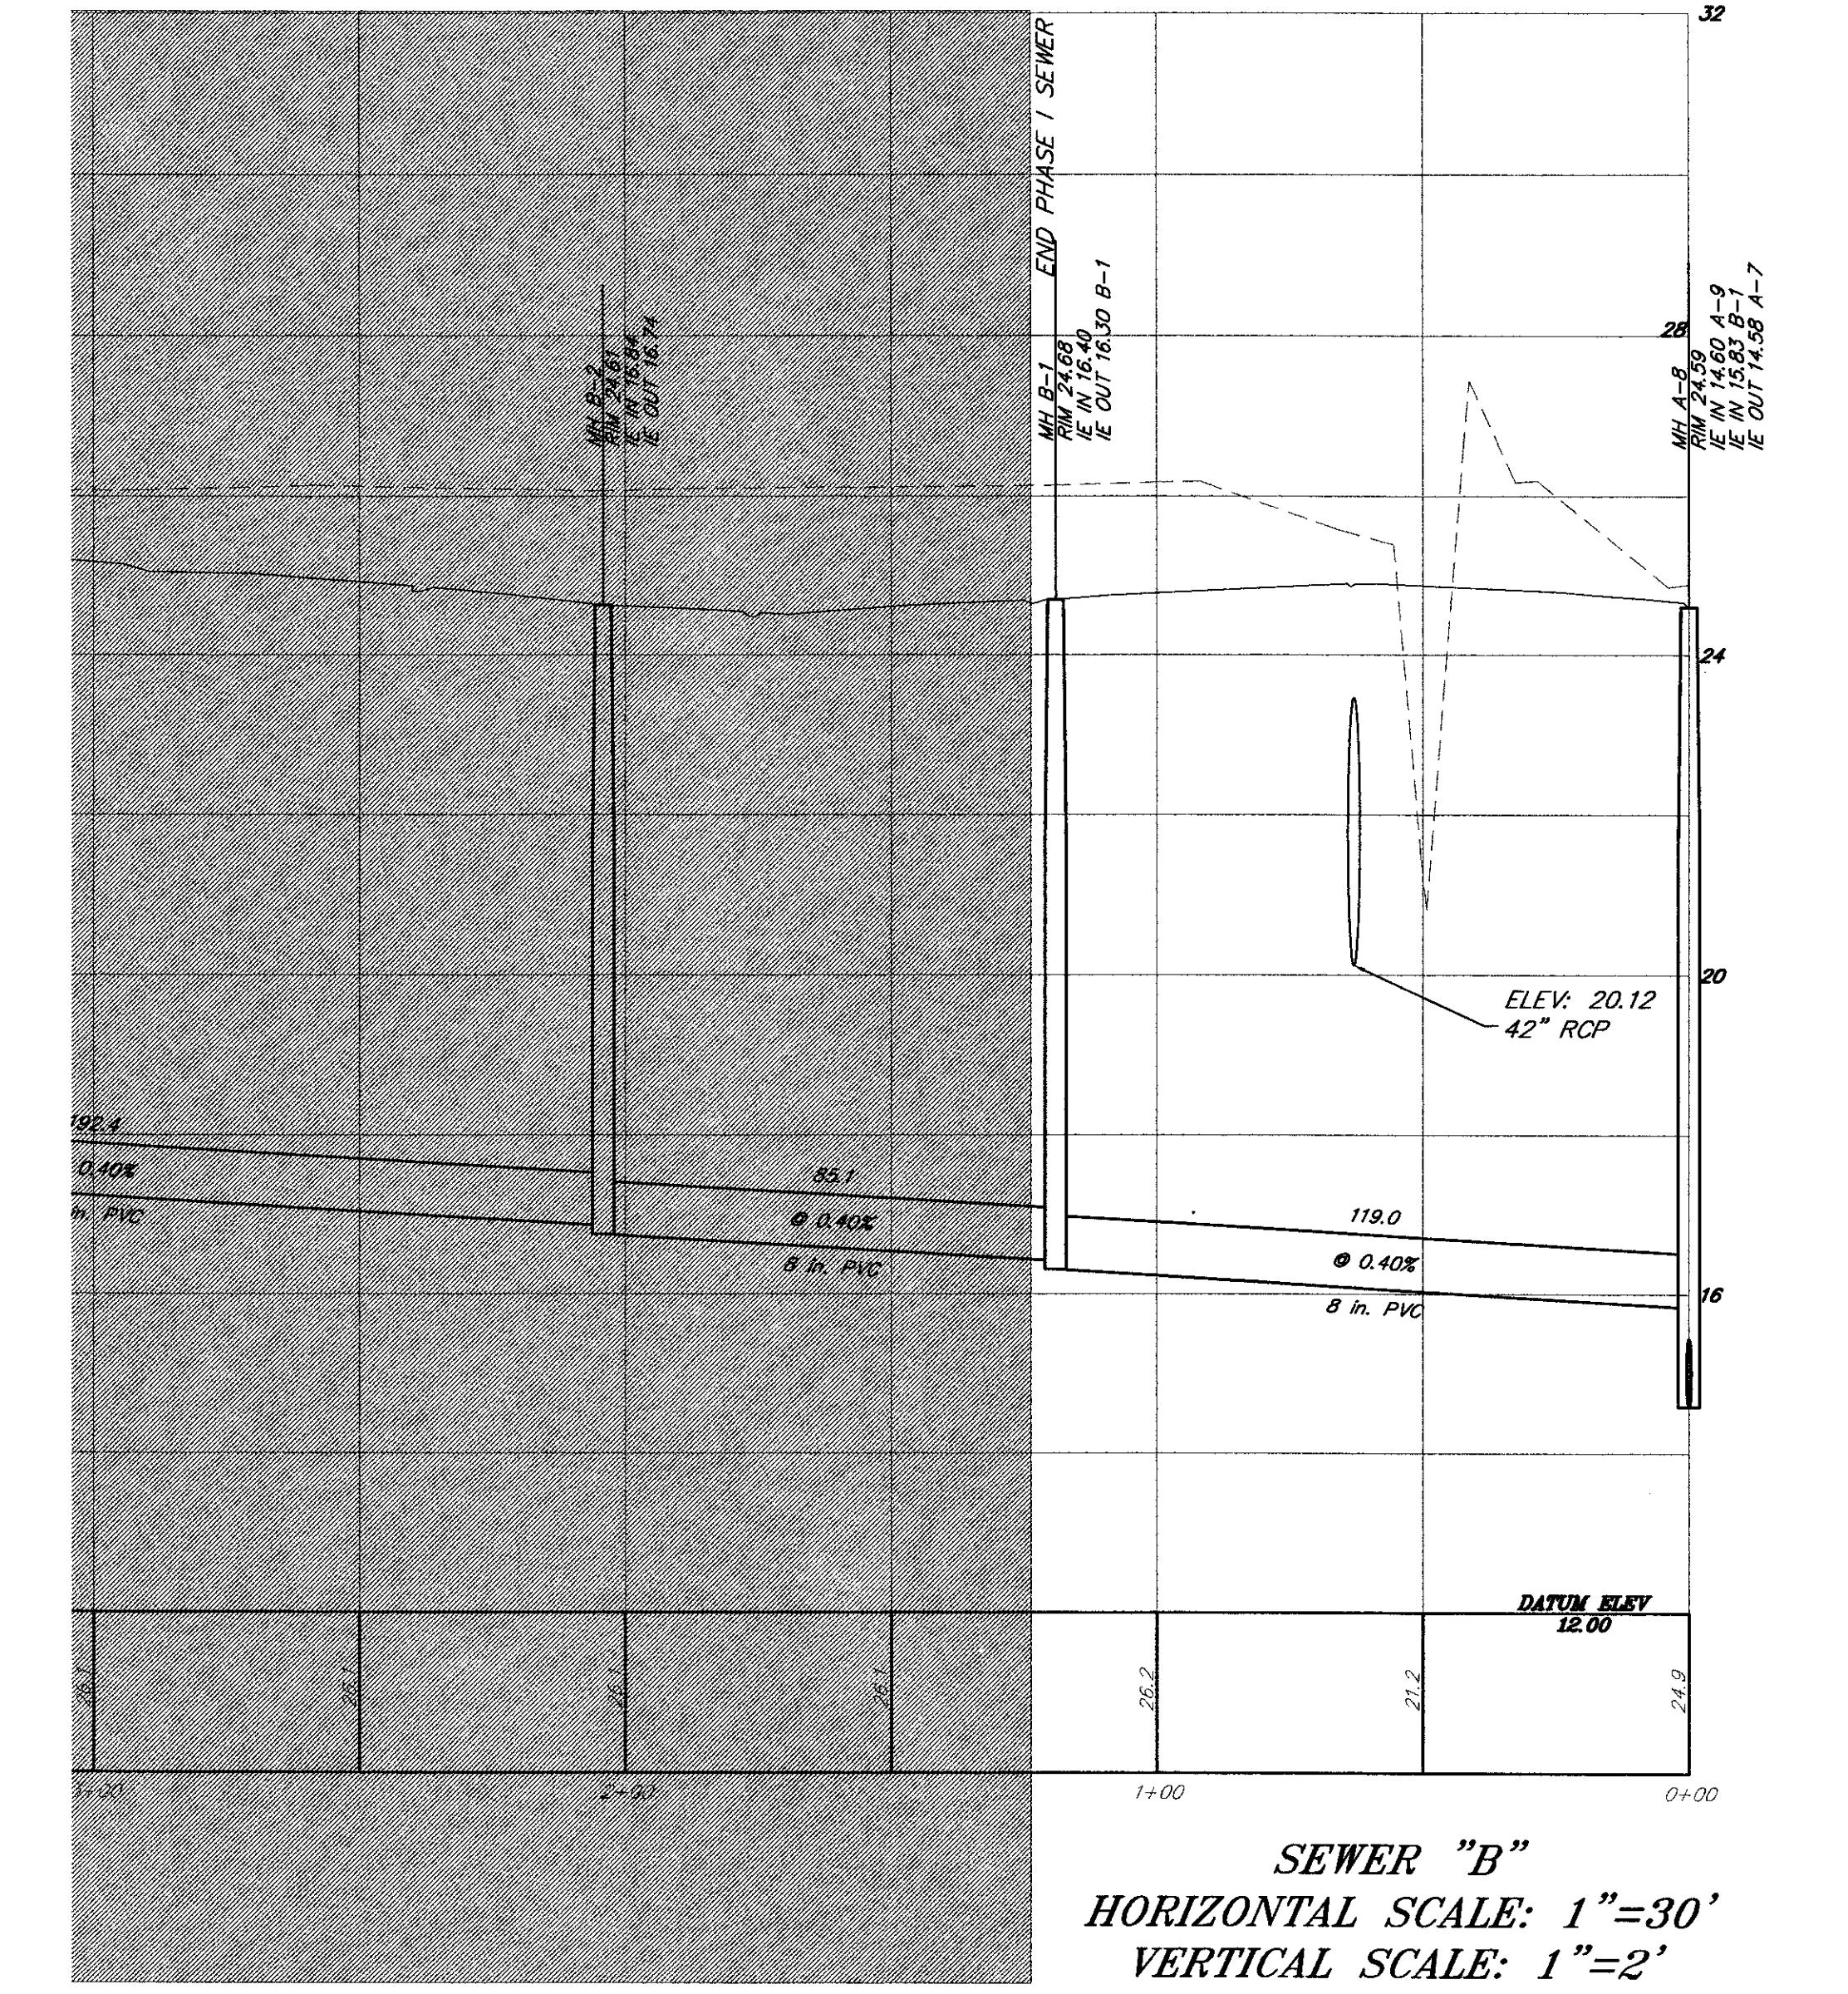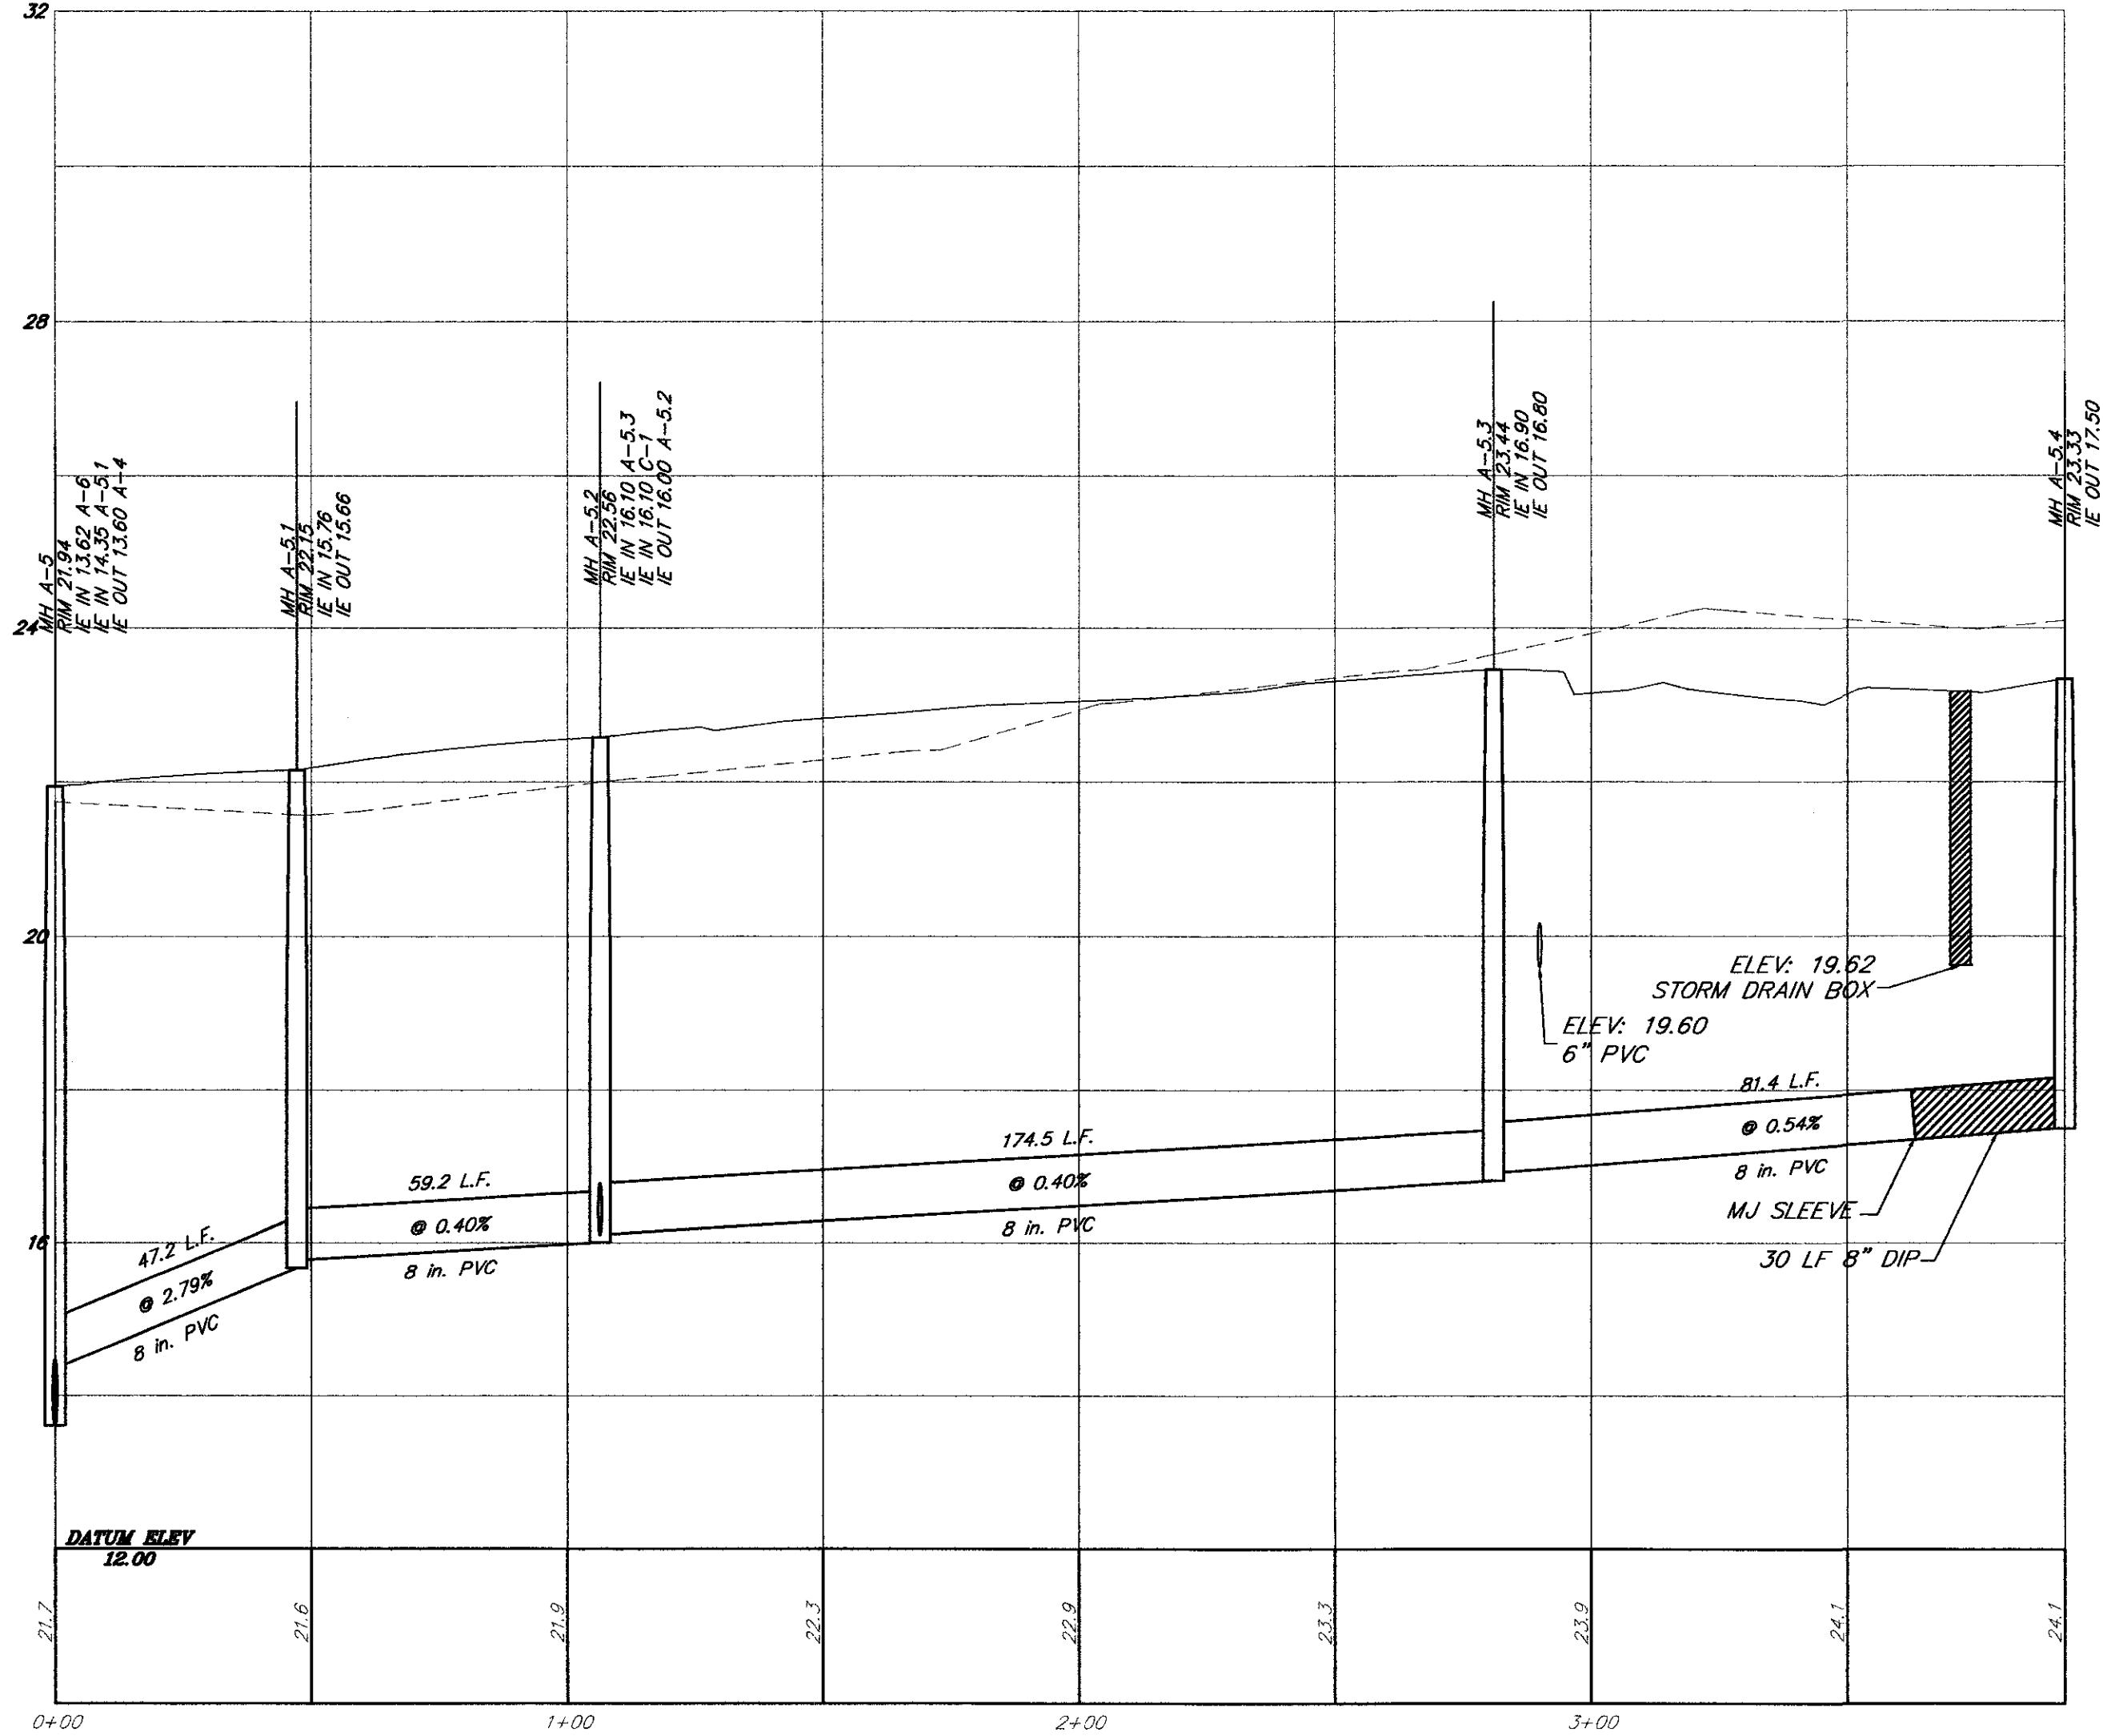


30 0 15 30 60 120  
(IN FEET)  
1 inch = 30 ft.

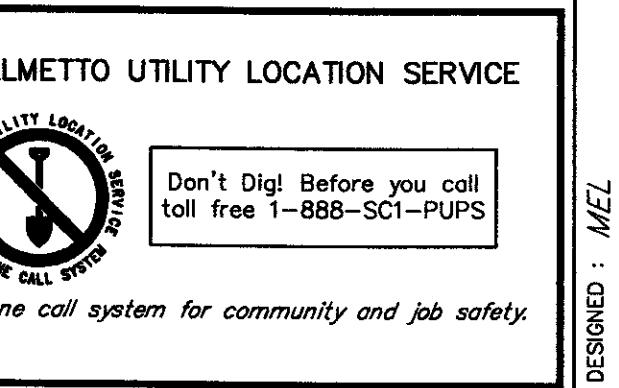



DESIGNED : <i>MEL</i>	DRAWN : <i>MEL</i>
CHECKED : <i>TFB</i>	APPROVED : <i>TFB</i>
SCALE : $1''=30'$	DATE : 29 JANUARY 2002
PROJECT NO. : 01-087	REVISIONS
SHEET 25 of 33	THE TOWN OF SUMMERTOWN, SOUTH CAROLINA
THE TOWN OF SUMMERTOWN, SOUTH CAROLINA	
DORCHESTER COUNTY, SOUTH CAROLINA	
LOCATED IN THE TOWN OF SUMMERTOWN, SOUTH CAROLINA	
PHASE 1 OF ARBOR OAKS SUBDIVISION	
TITLE: SEWER PROFILE	
TRICO ENGINEERING CONSULTANTS, INC.	
4425 Belle Oaks Drive North Charleston, 29405 Phone: (843) 740-7700 Fax: (843) 740-7707 <a href="http://www.tricoengineering.com">www.tricoengineering.com</a>	
Civil Engineering - Surveying - Landscape Architecture Land Planning - Wetland Services - GPS Services Visit us at <a href="http://www.tricoengineering.com">www.tricoengineering.com</a>	

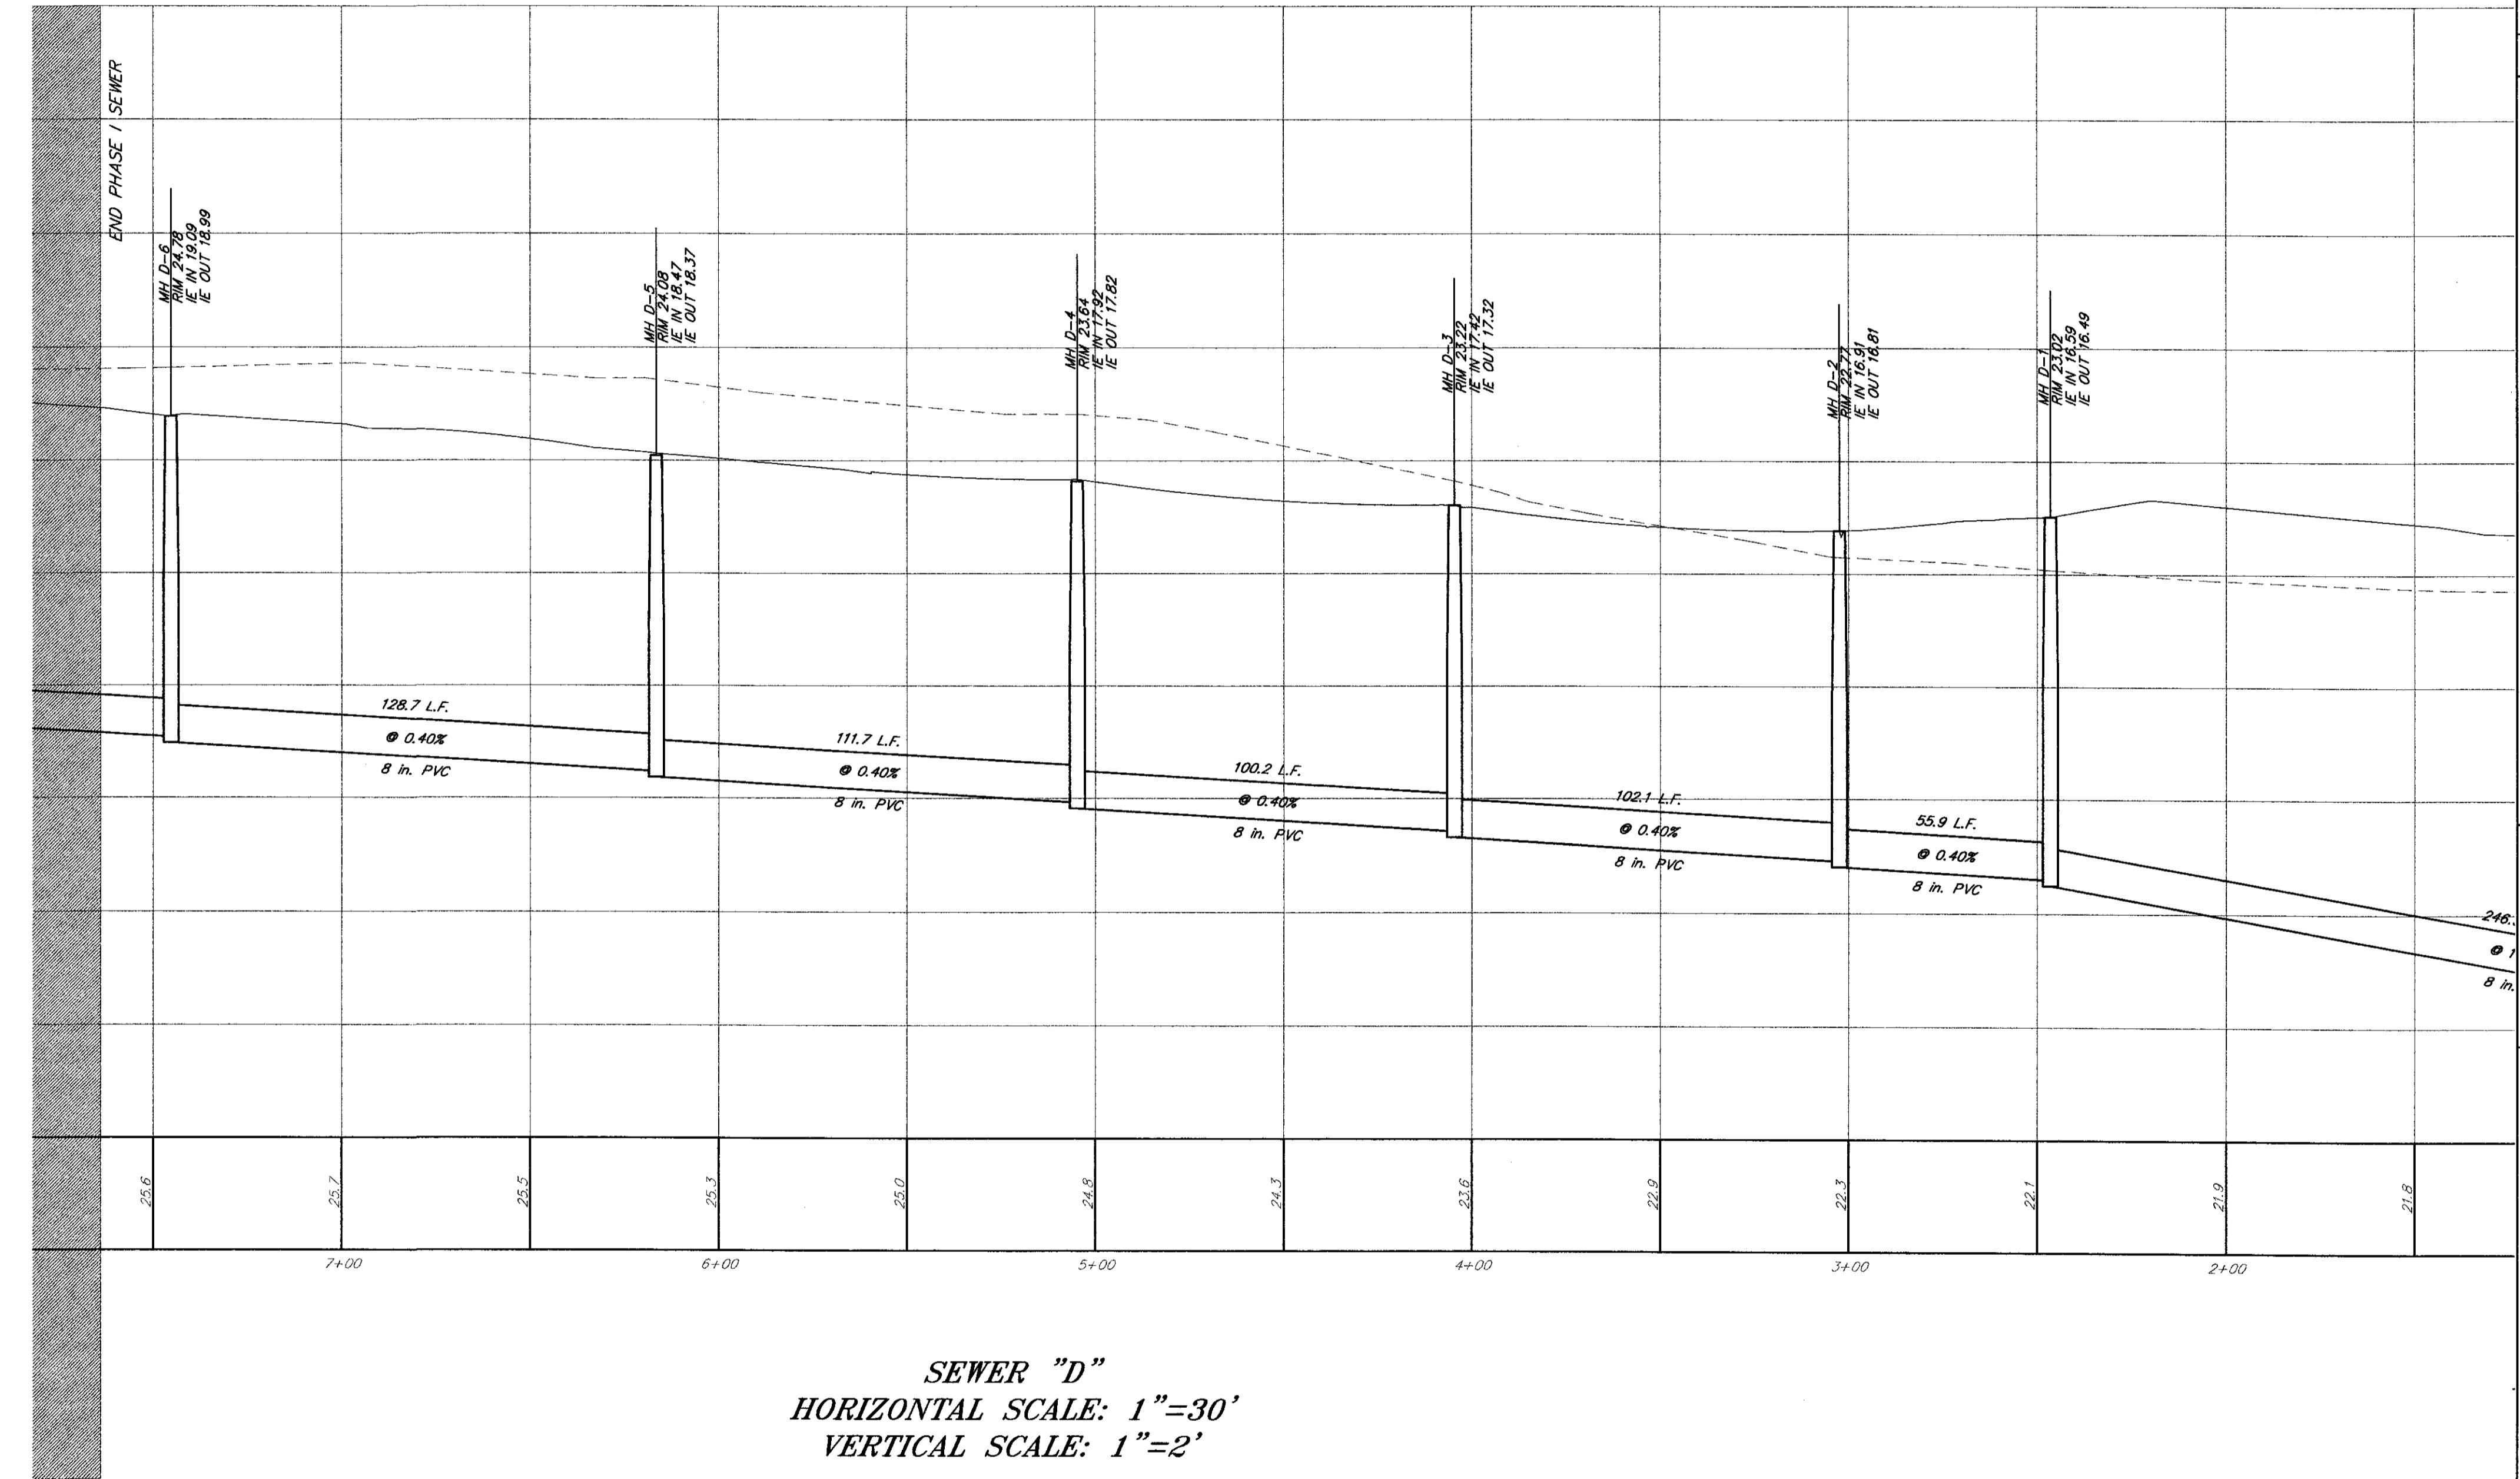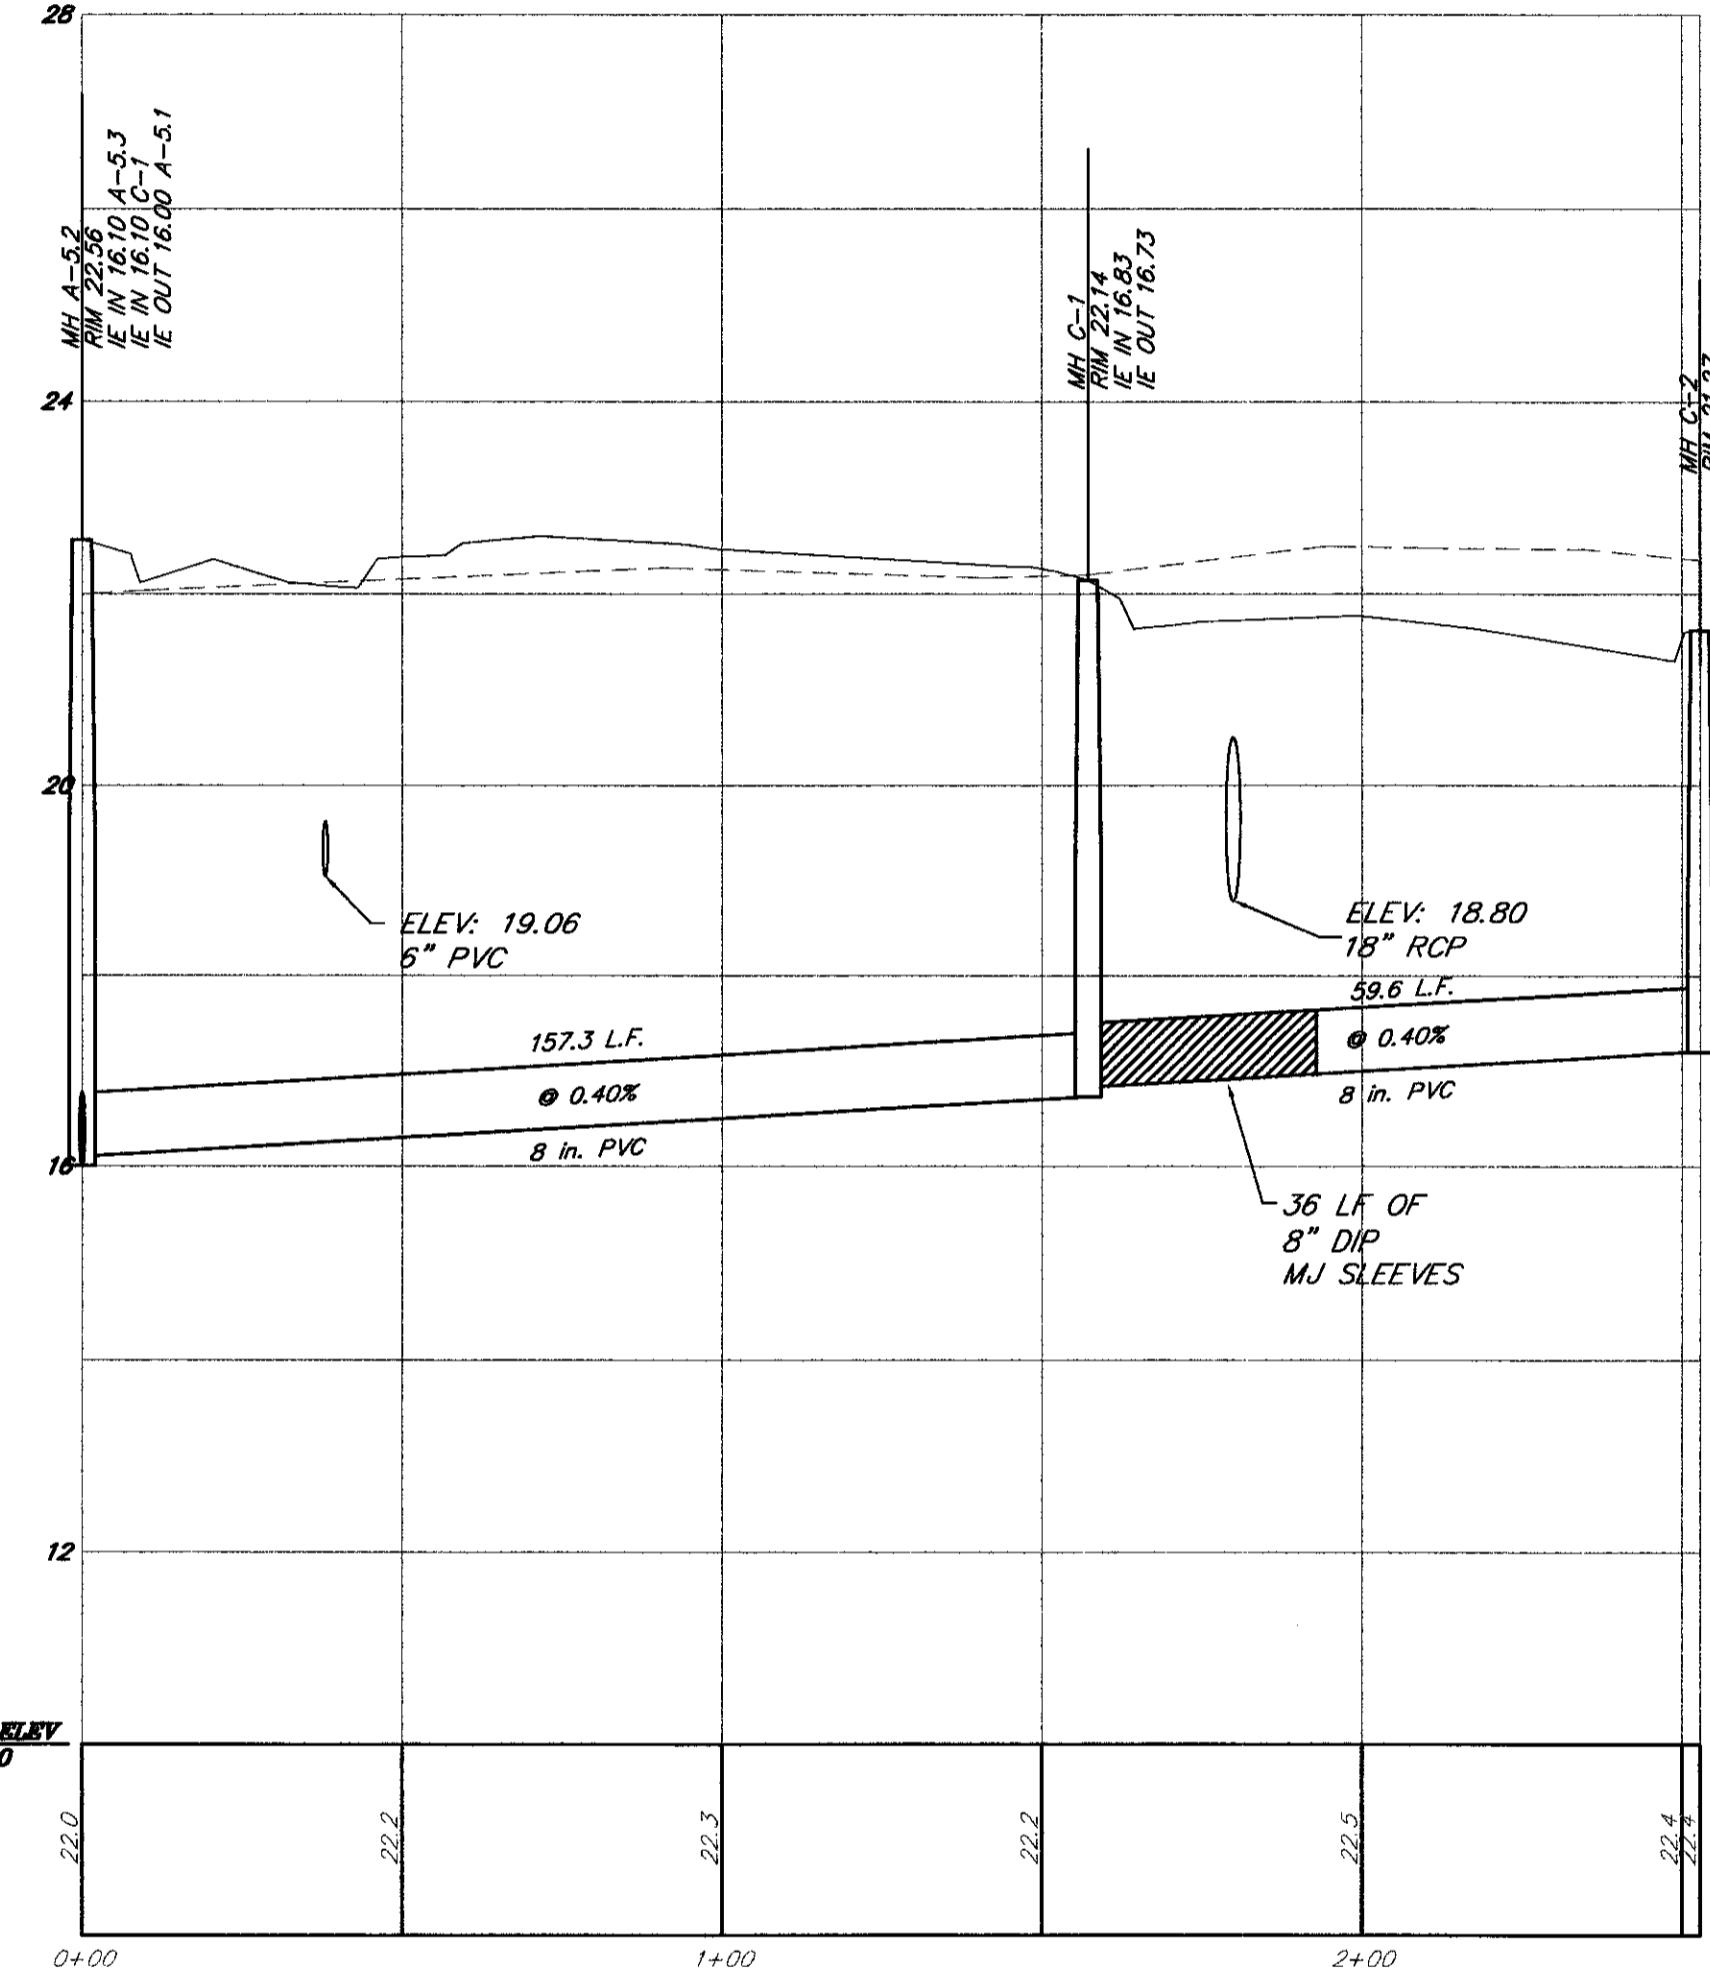


30 0 15 30 60 120  
(IN FEET)  
1 inch = 30 ft.

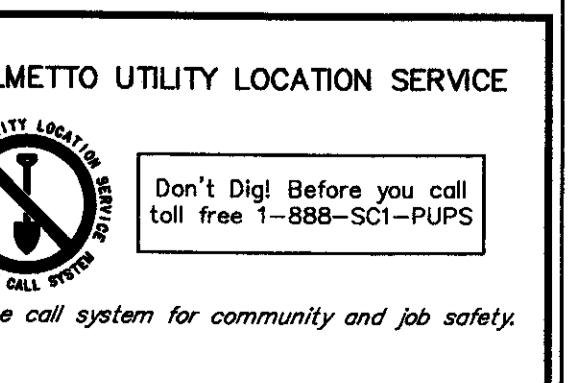

DESIGNED : <i>MEL</i>	DRAWN : <i>MEL</i>
CHECKED : <i>TB</i>	APPROVED : <i>BB</i>
SCALE : 1"=30'	DATE : 29 JANUARY 2002
PROJECT NO. : 01-087	PHONE : (843) 740-7700
SHEET 26 of 33	FAX : (843) 740-7707
TITLE: SEWER PROFILE PHASE I OF ARBOR OAKS SUBDIVISION LOCATED IN THE TOWN OF SUMMERTOWN DORCHESTER COUNTY, SOUTH CAROLINA	
NO. 00055 CERTIFICATE OF AUTOMATIC NOTIFICATION TRICO ENGINEERING CONSULTANTS, INC. 4425 Bella Oaks Drive North Charleston, 29405 Phone: (843) 740-7700 Fax: (843) 740-7707 info@tricoengineering.com	

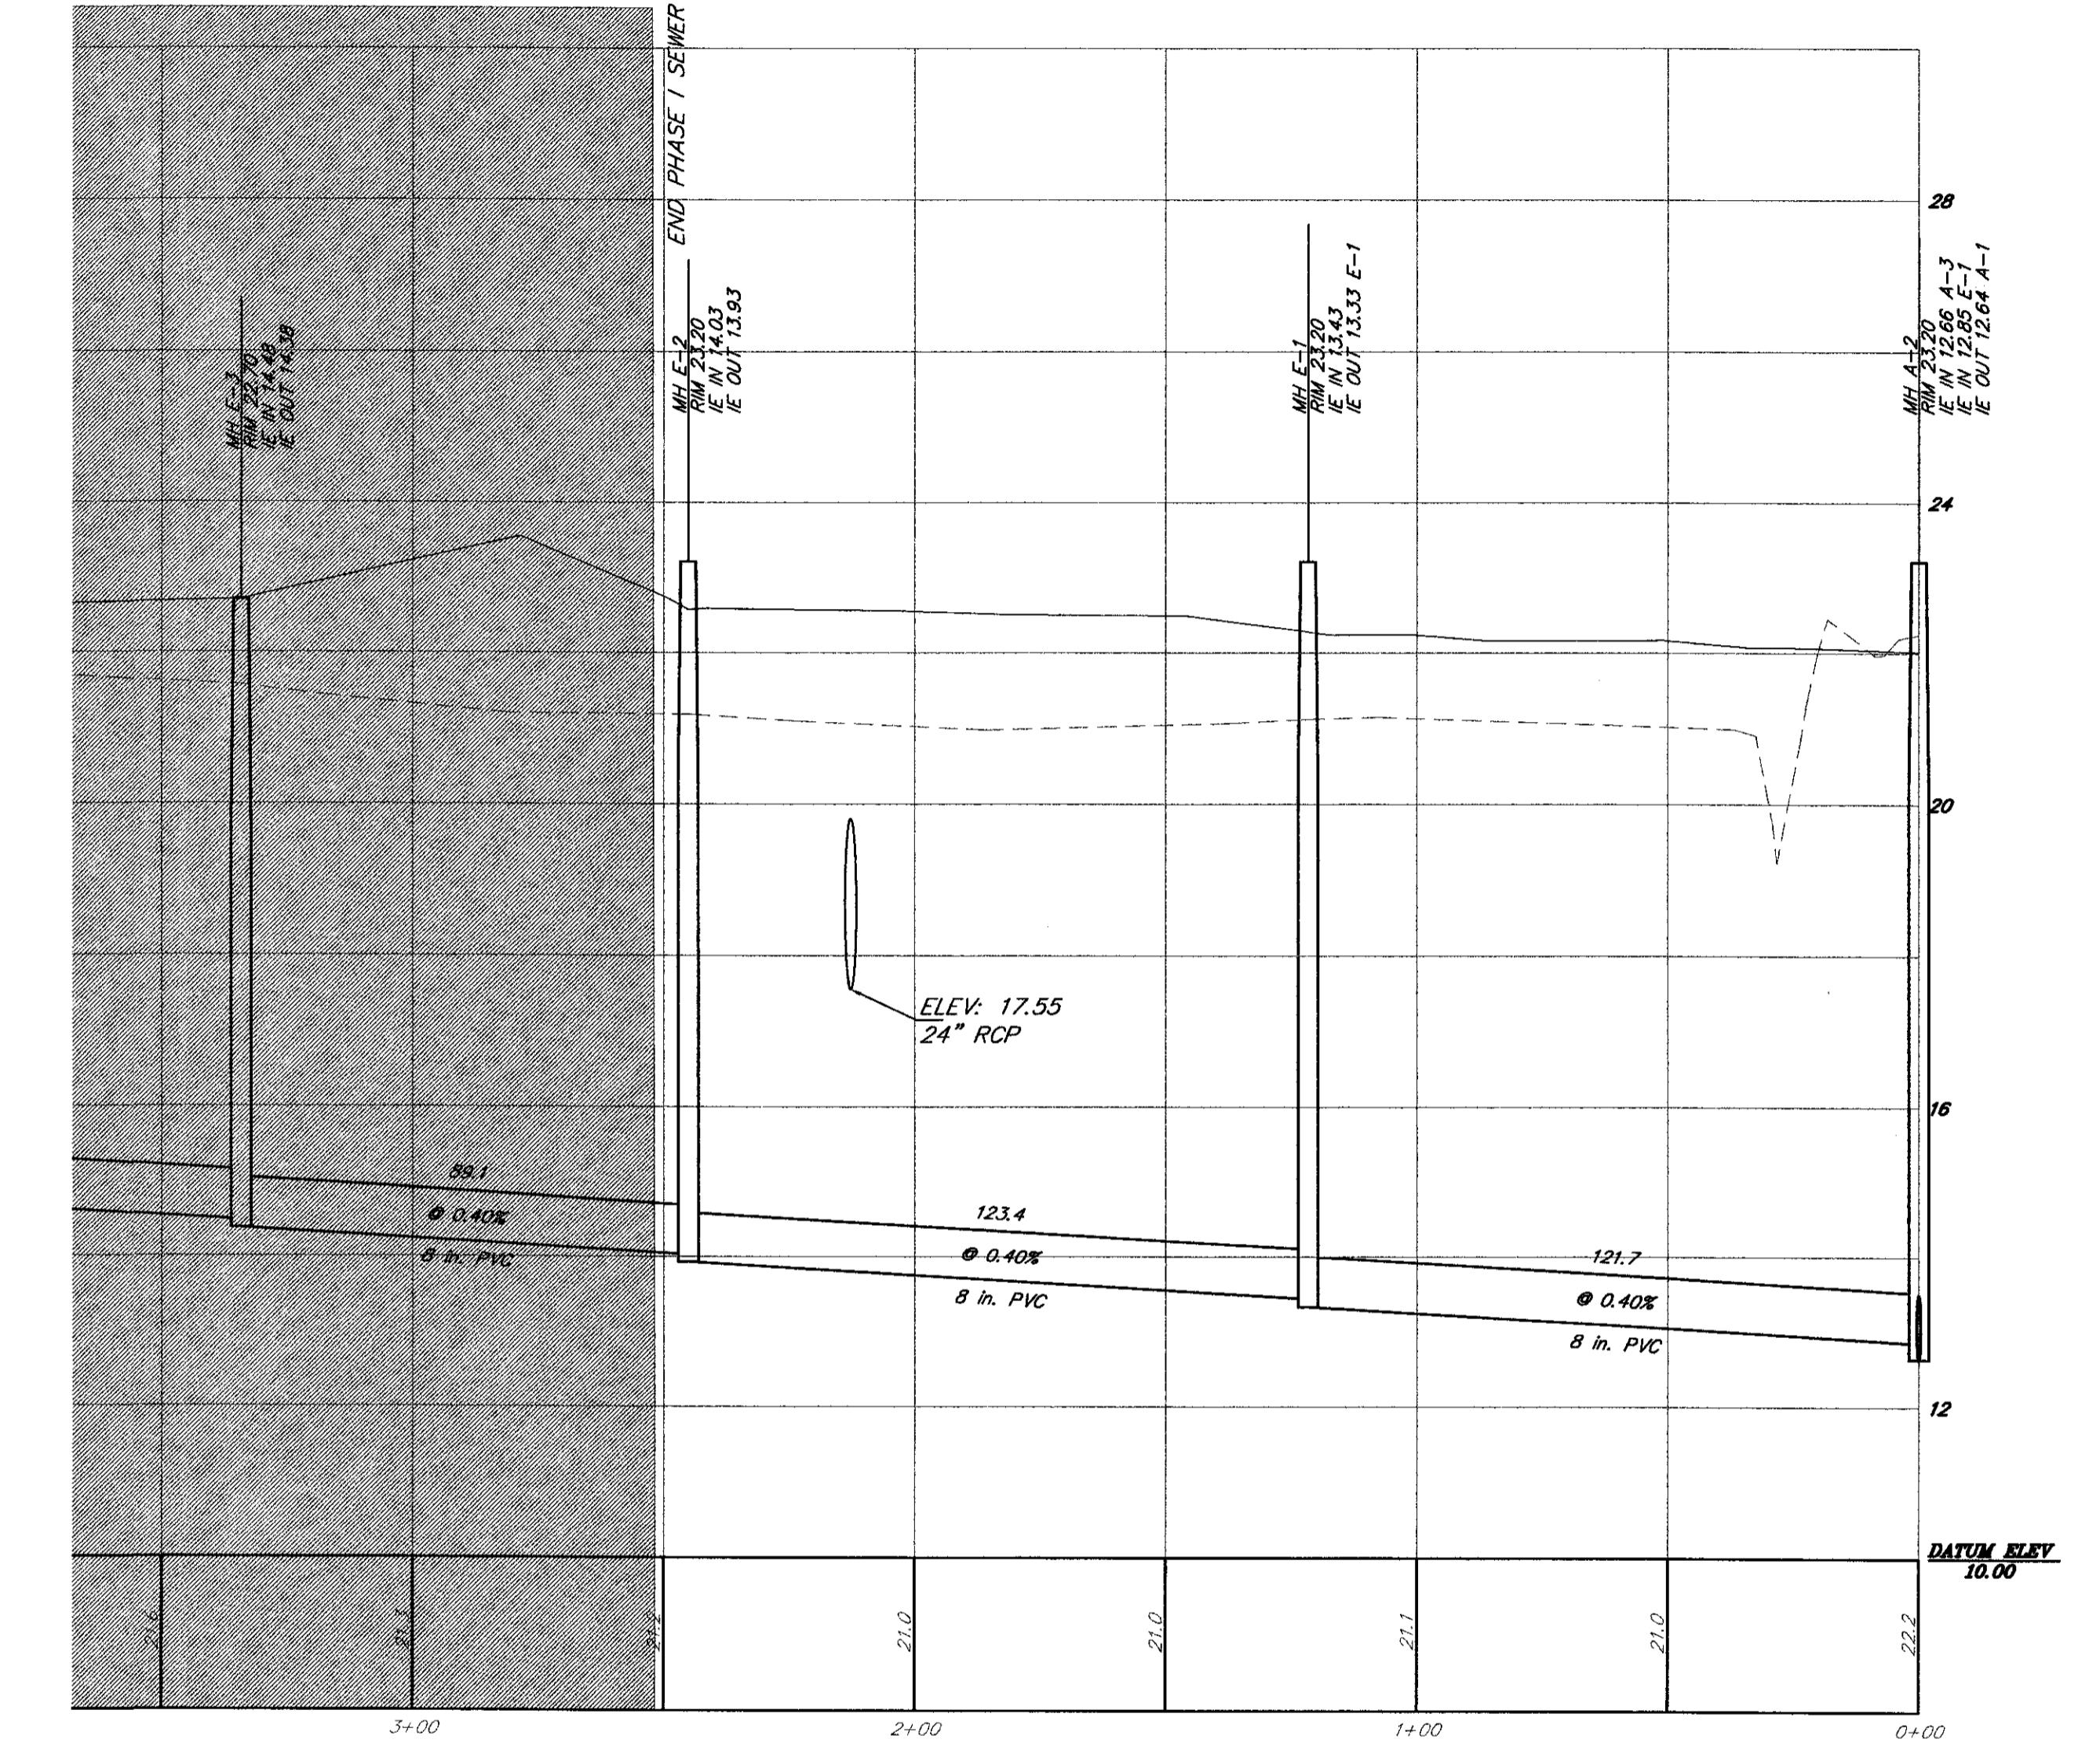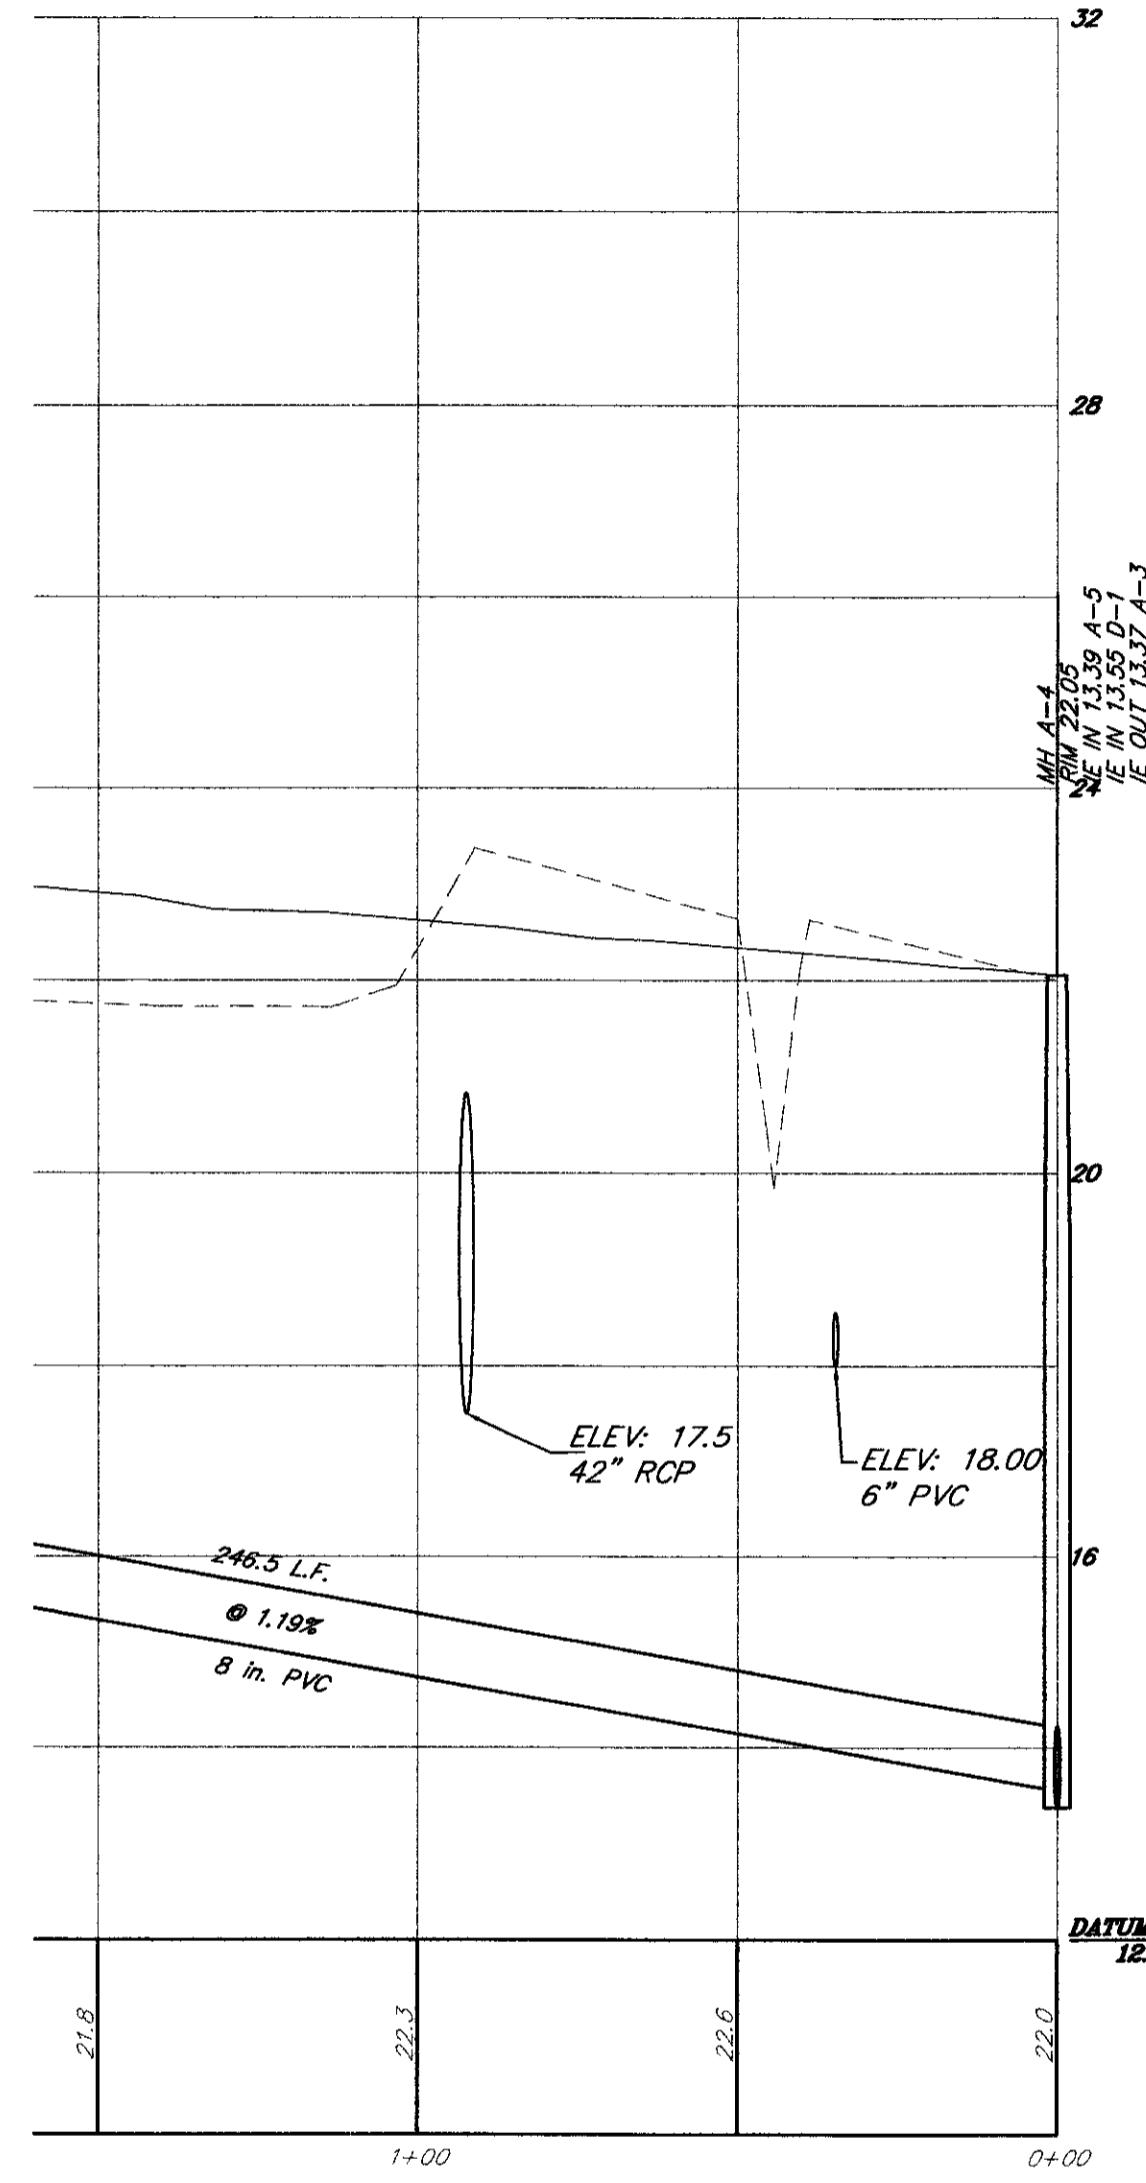

30 0 15 30 60 120  
(IN FEET)  
1 inch = 30 ft.

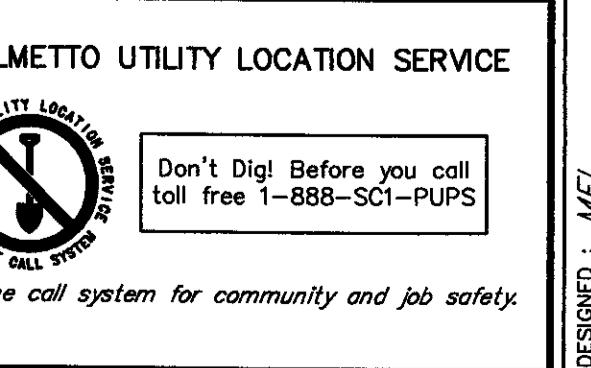

DESIGNED : <i>MEL</i>	DRAWN : <i>MEL</i>	CHECKED : <i>TJB</i>	APPROVED : <i>TJB</i>	SCALE : 1"=30'
DATE : 29 JANUARY 2002				
PROJECT NO. : 01-087				
SHEET 27 OF 33				

**TRICO**  
ENGINEERING CONSULTANTS INC.

1425 Belle Oaks Drive  
North Charleston, 29405  
Phone: 843-740-7700  
Fax: 843-740-7702  
Info@tricomeeting.com

Civil Engineering - Surveying - Landscape Architecture  
Land Planning - General Consulting - GPS Services  
Visit us at <http://www.tricomeeting.com>

**SCOTTISH ENGINEERS & SURVEYORS INC.**  
CIVIL ENGINEERING & LAND SURVEYING  
GENERAL CONTRACTING  
CONTRACTOR'S LICENSE NO. 180-00000  
CERTIFICATE OF AUTOMATION  
No. CO0015  
No. CO0016

