


NO.	DATE	REVISION DESCRIPTION	BY
1	12/29/2017	REVISED PER DRAWING CLARIFICATIONS	JLB
2	12/29/2017	REVISED PER DRAWING CLARIFICATIONS	JLB

NOTATION: ALL REVISIONS SHALL BE ACCORDING TO THE REVISIONS LISTED IN THIS DOCUMENT. PRINTS AND/OR COPIES OF PLANS WITHOUT SIGNATURE AND SEAL ARE INVALID.

**SEDIMENT & EROSION CONTROL PLAN**  
PLYLER PARK  
CITY OF MYRTLE BEACH, SOUTH CAROLINA  
PREPARED FOR: CITY OF MYRTLE BEACH

SCALE: 1" = 10'  
DATE: NOVEMBER 22, 2017  
DESIGNED BY:  
DRAWN BY:  
APPROV. BY:  
PROJECT NO.: 16113L  
**C2**  
FILE NO.:

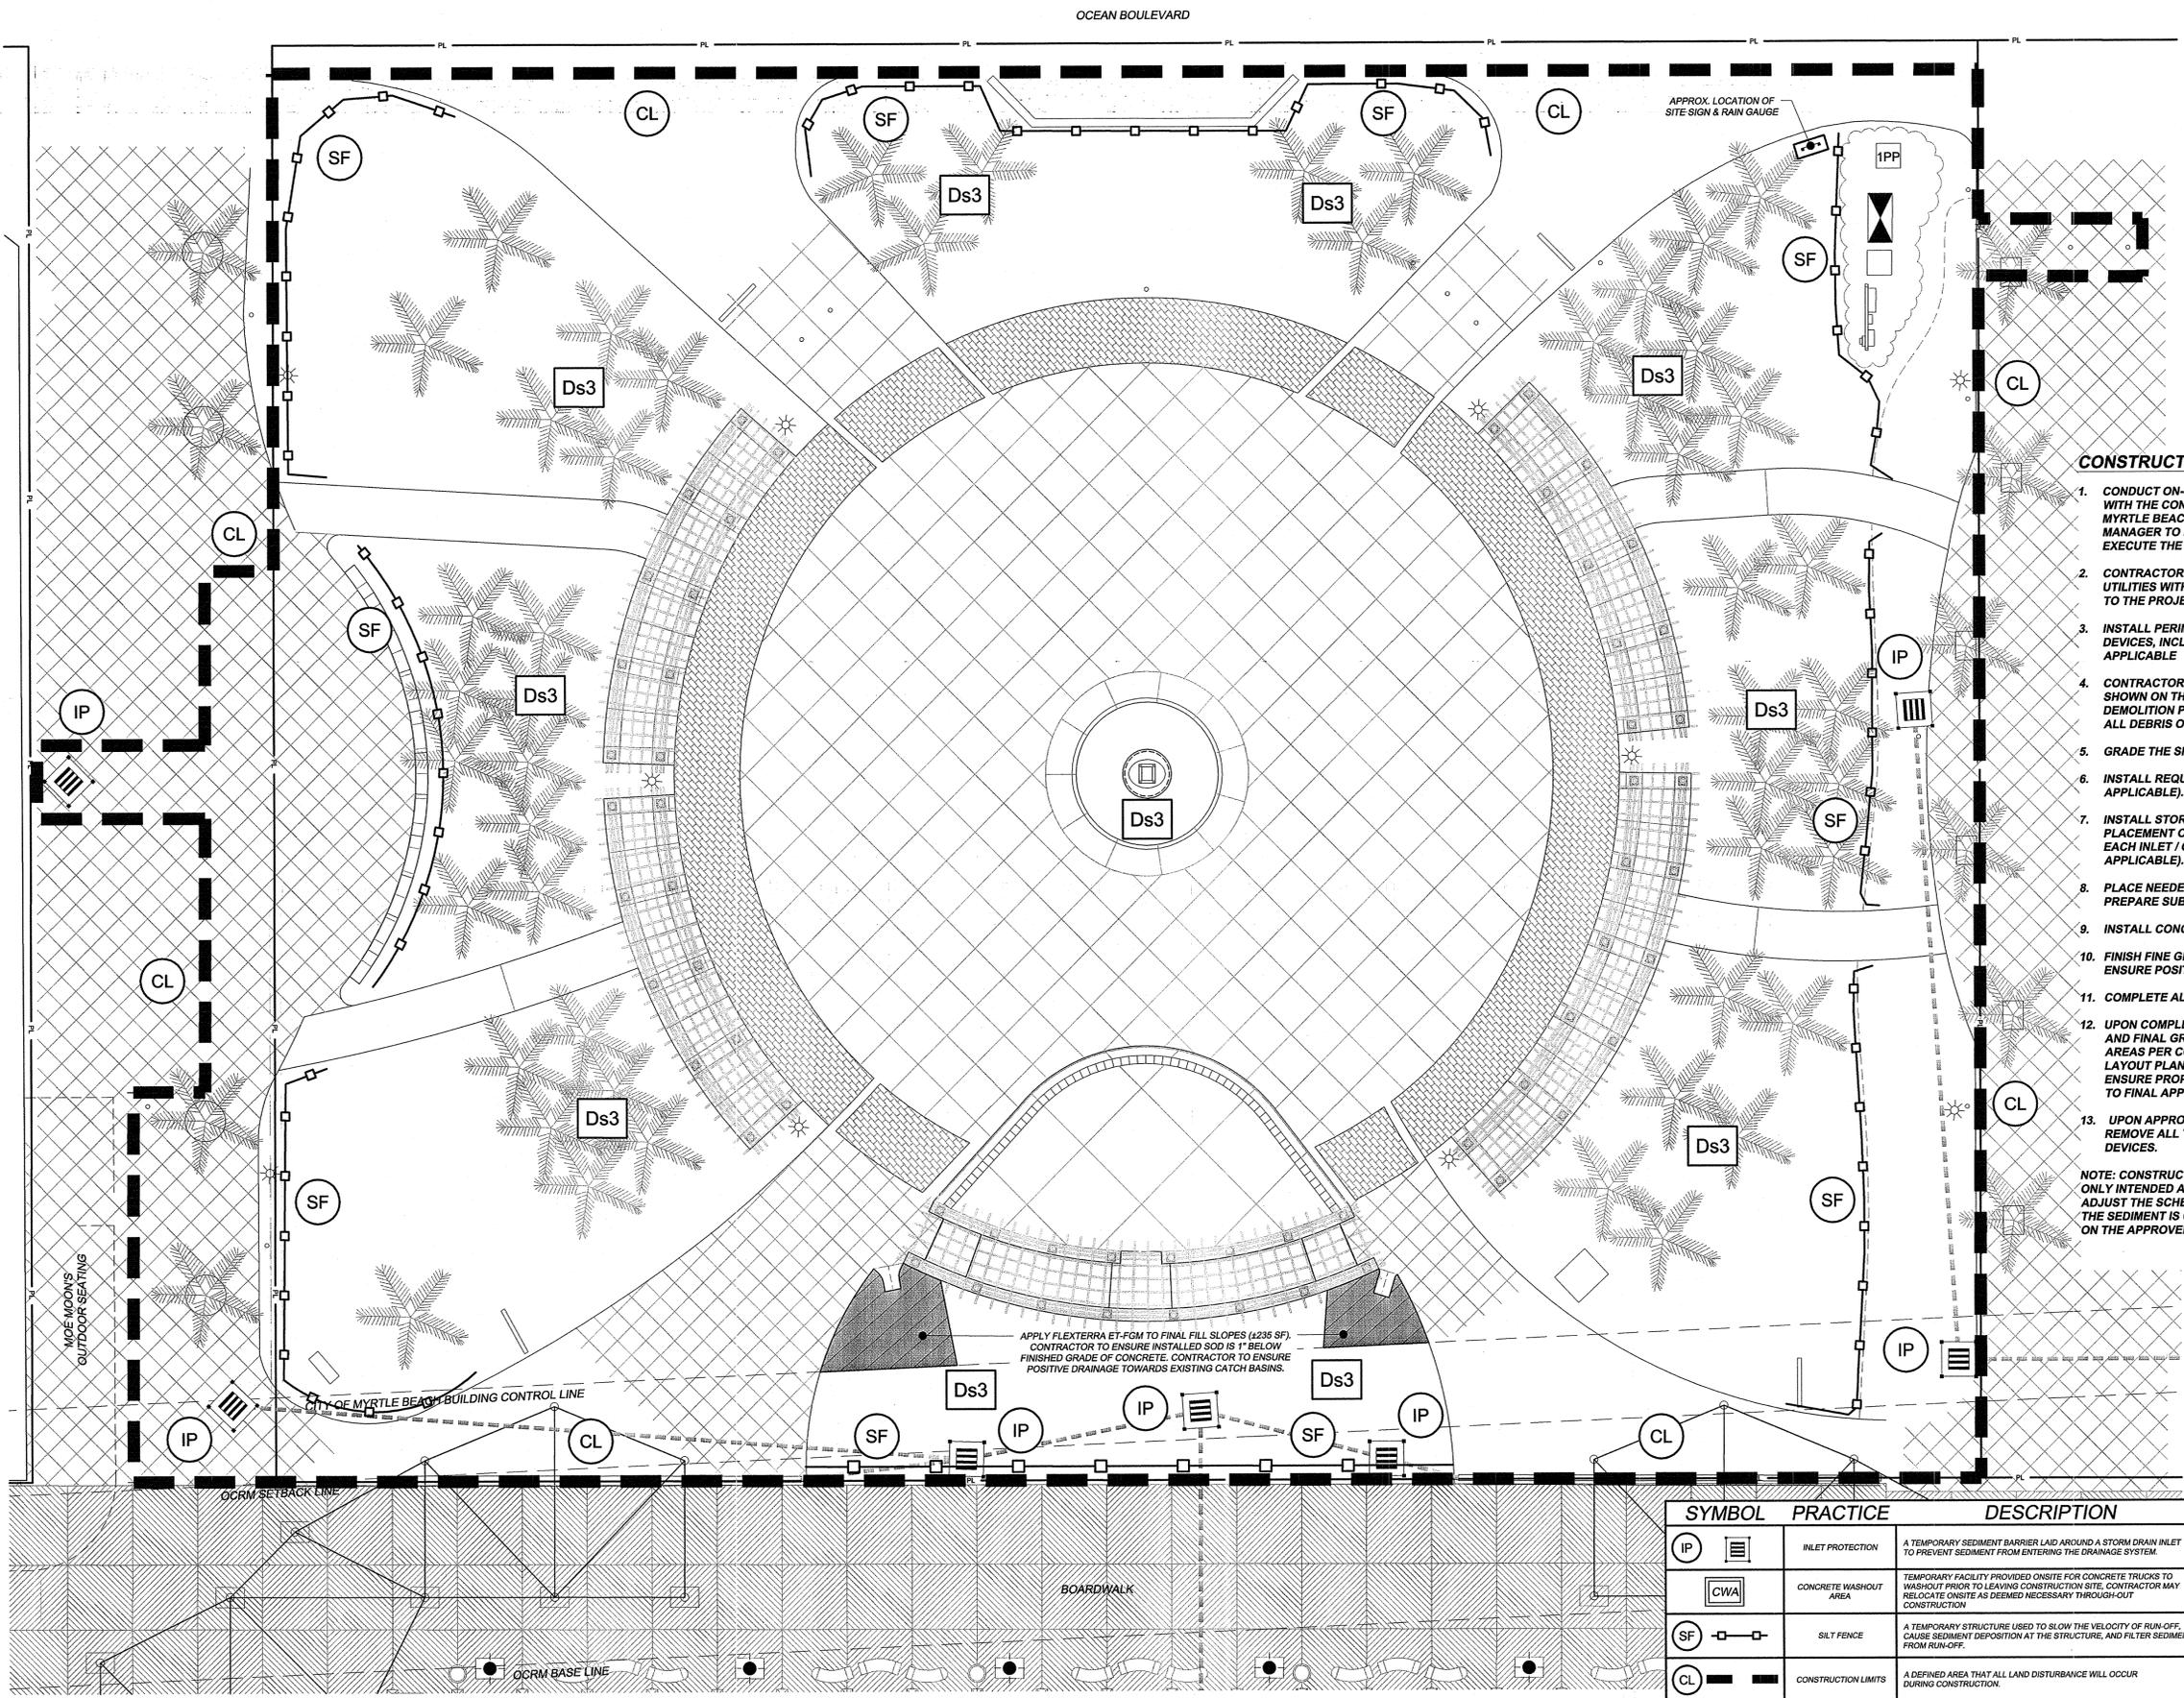

**CONSTRUCTION SEQUENCE:**

1. CONDUCT ON-SITE PRE-CONSTRUCTION MEETING WITH THE CONTRACTOR, OWNER, CITY OF MYRTLE BEACH, ENGINEER AND CONSTRUCTION MANAGER TO REVIEW THE PROJECT AND EXECUTE THE SWPPP.
2. CONTRACTOR TO LOCATE ALL EXISTING UTILITIES WITHIN AND IMMEDIATELY ADJACENT TO THE PROJECT AREA.
3. INSTALL PERIMETER EROSION CONTROL DEVICES, INCLUDING ALL TREE PROTECTION, IF APPLICABLE.
4. CONTRACTOR TO PERFORM ALL DEMOLITION AS SHOWN ON THE EXISTING CONDITIONS DEMOLITION PLAN AND LEGALLY DISPOSE OF ALL DEBRIS OFF SITE.
5. GRADE THE SITE (WHERE APPLICABLE).
6. INSTALL REQUIRED UTILITIES (WHERE APPLICABLE).
7. INSTALL STORM DRAINAGE SYSTEM WITH PLACEMENT OF INLET / OUTLET PROTECTION AS EACH INLET / OUTLET IS INSTALLED (WHERE APPLICABLE).
8. PLACE NEEDED FILL ON SITE, GRADE AND PREPARE SUBGRADE FOR CONCRETE AREA.
9. INSTALL CONCRETE FLATWORK / SIDEWALK.
10. FINISH FINE GRADING THE COMMON AREAS TO ENSURE POSITIVE DRAINAGE AS NEEDED.
11. COMPLETE ALL REMAINING SITE IMPROVEMENTS.
12. UPON COMPLETING ALL SITE IMPROVEMENTS AND FINAL GRADING, STABILIZE ALL DENUDE AREAS PER COMPONENT IDENTIFICATION & LAYOUT PLAN AND MAINTAIN ALL AREAS TO ENSURE PROPER GROUND STABILIZATION PRIOR TO FINAL APPROVAL.
13. UPON APPROVAL BY CITY OF MYRTLE BEACH, REMOVE ALL TEMPORARY EROSION CONTROL DEVICES.

NOTE: CONSTRUCTION SEQUENCE LISTED ABOVE IS ONLY INTENDED AS A GUIDELINE. CONTRACTOR MAY ADJUST THE SCHEDULE AS NECESSARY SO LONG AS THE SEDIMENT IS CONTAINED ONSITE AS DEPICTED ON THE APPROVED PLANS.

SYMBOL	PRACTICE	DESCRIPTION
IP	INLET PROTECTION	A TEMPORARY SEDIMENT BARRIER LAD AROUND A STORM DRAIN INLET TO PREVENT SEDIMENT FROM ENTERING THE DRAINAGE SYSTEM.
CWA	CONCRETE WASHOUT AREA	TEMPORARY FACILITY PROVIDED ONSITE FOR CONCRETE TRUCKS TO WASHOUT PRIOR TO LEAVING CONSTRUCTION SITE. CONTRACTOR MAY RELOCATE ONSITE AS DEEMED NECESSARY THROUGHOUT CONSTRUCTION.
SF	SILT FENCE	A TEMPORARY STRUCTURE USED TO SLOW THE VELOCITY OF RUN-OFF, CAUSE SEDIMENT DEPOSITION AT THE STRUCTURE, AND FILTER SEDIMENT FROM RUN-OFF.
CL	CONSTRUCTION LIMITS	A DEFINED AREA THAT ALL LAND DISTURBANCE WILL OCCUR DURING CONSTRUCTION.
Ds3	DISTURBED AREA STABILIZATION (WITH PERMANENT VEGETATION)	ESTABLISHING PERMANENT VEGETATIVE COVER SUCH AS TREES, SHRUBS, VINES, GRASSES, SOD, OR LEGUMES ON DISTURBED AREAS. SEE LANDSCAPE PLAN.

