



SHEET INDEX						
SHEET #	SHEET NAME	SHEET ISSUE DATE	CURRENT REV. NO.	REV. DESCRIPTION	REV. ISSUED BY	CURRENT REV. DATE
G000	COVER	2023-10-17	0	BIDDER QUESTIONS	BIDDING	2023-12-21
G000	PROJECT BOOK REQUIREMENTS	2023-10-17	P1	PERMIT REV.	PERMITTING	2023-11-10
G100	COMCHECK	2023-11-10	P1	PERMIT REV.	PERMITTING	2023-11-10
G199	LEGENDS & ABBREVIATIONS	2023-10-17	P1	PERMIT REV.	PERMITTING	2023-11-10
C101	SITE DEMOLITION PLAN	2023-10-17				
C102	SITE LAYOUT PLAN	2023-10-17				
C103	EROSION CONTROL - 1	2023-10-17				
C104	EROSION CONTROL - 2	2023-10-17				
C105	SITE GRADING PLAN	2023-10-17				
C106	SITE UTILITY PLAN	2023-10-17				
C201	SITE DETAILS - 1	2023-10-17				
C202	SITE DETAILS - 2	2023-10-17				
S001	STRUCTURAL NOTES	2023-10-17	P1	PERMIT REV.	PERMITTING	2023-11-10
S101	FOUNDATION PLAN	2023-10-17	P1	PERMIT REV.	PERMITTING	2023-11-10
S102	SECTIONS AND DETAILS	2023-10-17	P1	PERMIT REV.	PERMITTING	2023-11-10
AS101	ARCHITECTURAL SITE PLAN AND DETAILS	2023-10-17	0	BIDDER QUESTIONS	BIDDING	2023-12-21
A101	FIRST FLOOR PLAN ENLARGED PLANS AND ACCESSIBLE RESTROOM REQUIREMENTS	2023-10-17	P1	PERMIT REV.	PERMITTING	2023-11-10
A102	FIRST FLOOR PLAN ENLARGED PLANS AND ACCESSIBLE RESTROOM REQUIREMENTS	2023-10-17	P1	PERMIT REV.	PERMITTING	2023-11-10
A111	ROOF PLAN & DETAILS	2023-10-17	P1	PERMIT REV.	PERMITTING	2023-11-10
A301	FIRST FLOOR RCP	2023-10-17	P1	PERMIT REV.	PERMITTING	2023-11-10
A201	EXTERIOR ELEVATIONS	2023-10-17	P1	PERMIT REV.	PERMITTING	2023-11-10
A301	BUILDING SECTIONS	2023-10-17	P1	PERMIT REV.	PERMITTING	2023-11-10
A311	WALL SECTIONS	2023-10-17	P1	PERMIT REV.	PERMITTING	2023-11-10
A321	PLAN AND SECTION DETAILS	2023-10-17	P1	PERMIT REV.	PERMITTING	2023-11-10
A300	OPENING SCHEDULES AND DETAILS	2023-10-17	P1	PERMIT REV.	PERMITTING	2023-11-10
A600	3D DRAWINGS	2023-10-17	P1	PERMIT REV.	PERMITTING	2023-11-10
A700	INTERIOR FINISH SCHEDULE	2023-10-17	P1	PERMIT REV.	PERMITTING	2023-11-10
FR001	PRELIMINARY HYDRAULIC CALCULATIONS	2023-10-17	P1	PERMIT REV.	PERMITTING	2023-11-10
FR002	DETAILS & SPECIFICATIONS	2023-10-17	P1	PERMIT REV.	PERMITTING	2023-11-10
FP101	FIRST FLOOR PLAN - FIRE PROTECTION	2023-10-17	P1	PERMIT REV.	PERMITTING	2023-11-10
P101	FIRST FLOOR PLAN - WASTE	2023-10-17	P1	PERMIT REV.	PERMITTING	2023-11-10
P201	FIRST FLOOR PLAN - WATER AND GAS	2023-10-17	P1	PERMIT REV.	PERMITTING	2023-11-10
M001	SCHEDULES	2023-10-17	P1	PERMIT REV.	PERMITTING	2023-11-10
M101	FIRST FLOOR PLAN - HVAC	2023-10-17	P1	PERMIT REV.	PERMITTING	2023-11-10
E101	FLOOR PLAN - LIGHTING	2023-10-17	P1	PERMIT REV.	PERMITTING	2023-11-10
E102	FLOOR PLAN - ELECTRICAL	2023-10-17	P1	PERMIT REV.	PERMITTING	2023-11-10
E201	LEGENDS AND SCHEDULES	2023-10-17	P1	PERMIT REV.	PERMITTING	2023-11-10
S10	RESOURCE	2023-09-05	P2	PERMIT REV.	PERMITTING	2023-12-08

PROJECT TEAM / CONSULTANTS

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 KNOXVILLE, TN 37912  
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 CONTACT: AARON LOVE

TFM # 03970-F



**A04** PROJECT SITE MAP / LOCATION  
 NOT TO SCALE

NO.	ISSUED BY	DATE
P1	PERMITTING	2023-11-10
P2	PERMITTING	2023-12-08
0	BIDDING	2023-12-21

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SHEET DESCRIPTION  
 COVER

**G000**  
 PROJECT DATE: 2023-10-17  
 PROJECT NUMBER: 23030


**DIA**  
 Design Innovation  
 ARCHITECTS + INTERIORS + PLANNING  
 402 S. Gay Street, Suite 201, Knoxville, TN 37902  
 ph 865.637.8540 / fx 865.544.3940  
 www.dia-arch.com

A NEW PROJECT FOR:  
**ANDERSON COUNTY SPORTS TRAINING FACILITY**  
 ANDERSON COUNTY, TN



**GENERAL NOTES**

ARCH SITE PLAN

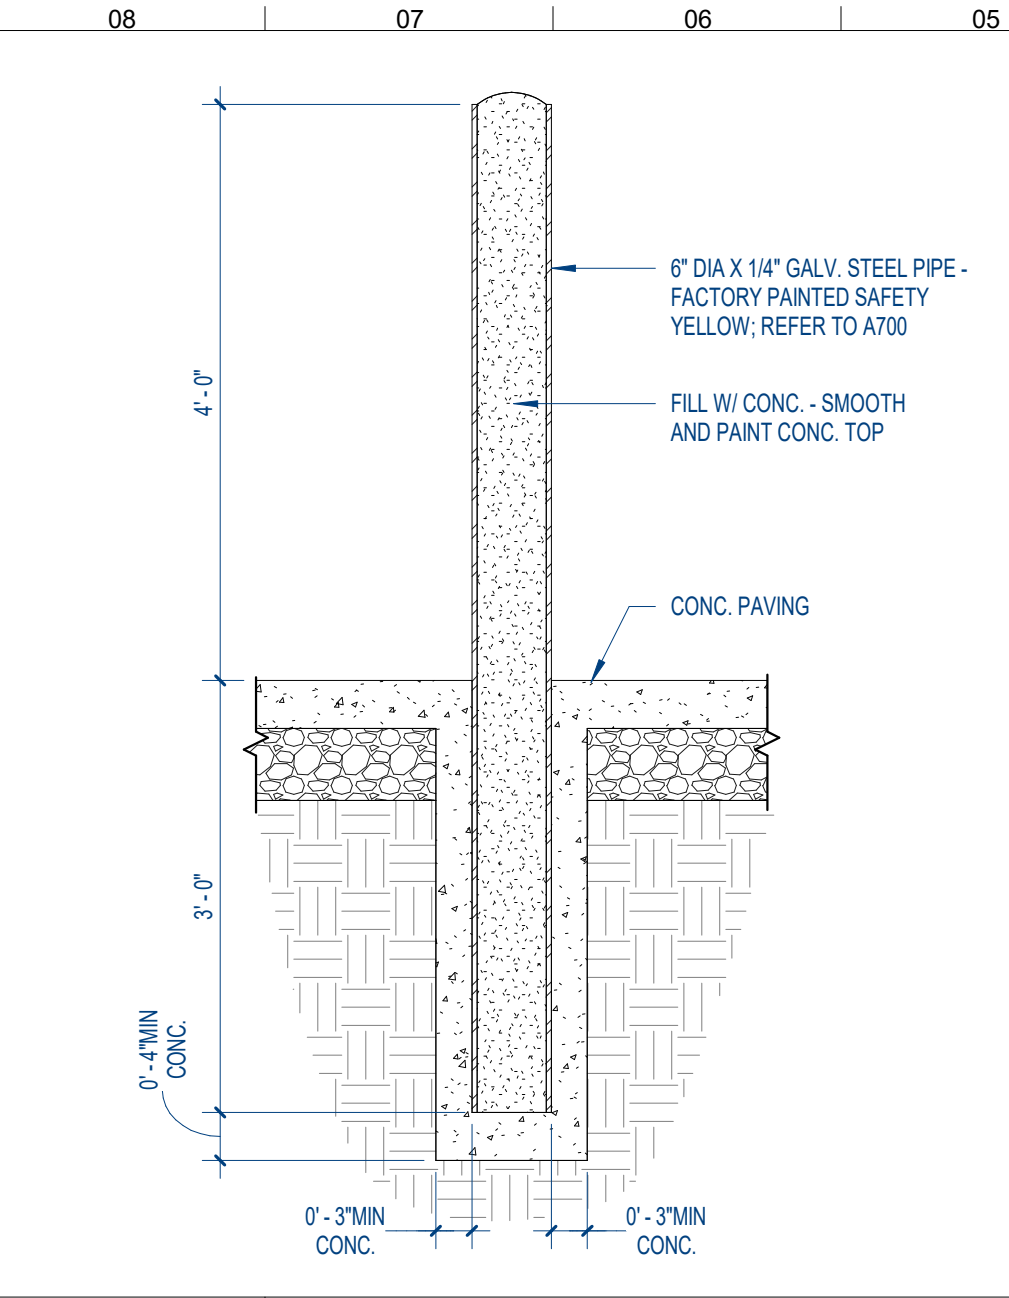


**U08** TYP. BOLLARD DETAIL  
 3/4" = 1'-0"

**KEYED NOTES**

ARCH SITE PLAN

- 01 ACCESSIBLE PARKING SPACES - REFER TO CIVIL
- 02 ACCESSIBLE RAMP AND TACTILE WARNING SURFACE - REFER TO CIVIL
- 03 POST MOUNTED ACCESSIBLE PARKING SIGNAGE - REFER TO CIVIL
- 04 RE-STRIPING EXISTING PAVING
- 05 APPROXIMATE EXTENT OF EXISTING RIP RAP. FIELD VERIFY
- 06 EXISTING BUILDING. NO WORK.
- 07 EXISTING CURB. FIELD VERIFY. NO WORK.
- 08 RIP RAP OVER GEOTEXTILE FABRIC. REFER TO CIVIL DRAWINGS
- 09 CANOPY, TYPICAL AT EACH BUILDING ENTRANCE. DRAIN TO KEYNOTE LEADER SIDE. ARROW INDICATES DIRECTION OF DRAIN
- 10 BOLLARD. TYPICAL EACH SIDE OF OVERHEAD DOOR. EACH OVERHEAD DOOR RECEIVES FOUR BOLLARDS
- 11 PROVIDE PRECAST CONCRETE SPLASH BLOCK AT EACH DOWNSPOUT UNLESS NOTED OTHERWISE
- 12 APPROXIMATE EXTENT OF NEW PAVEMENT. REFER TO CIVIL

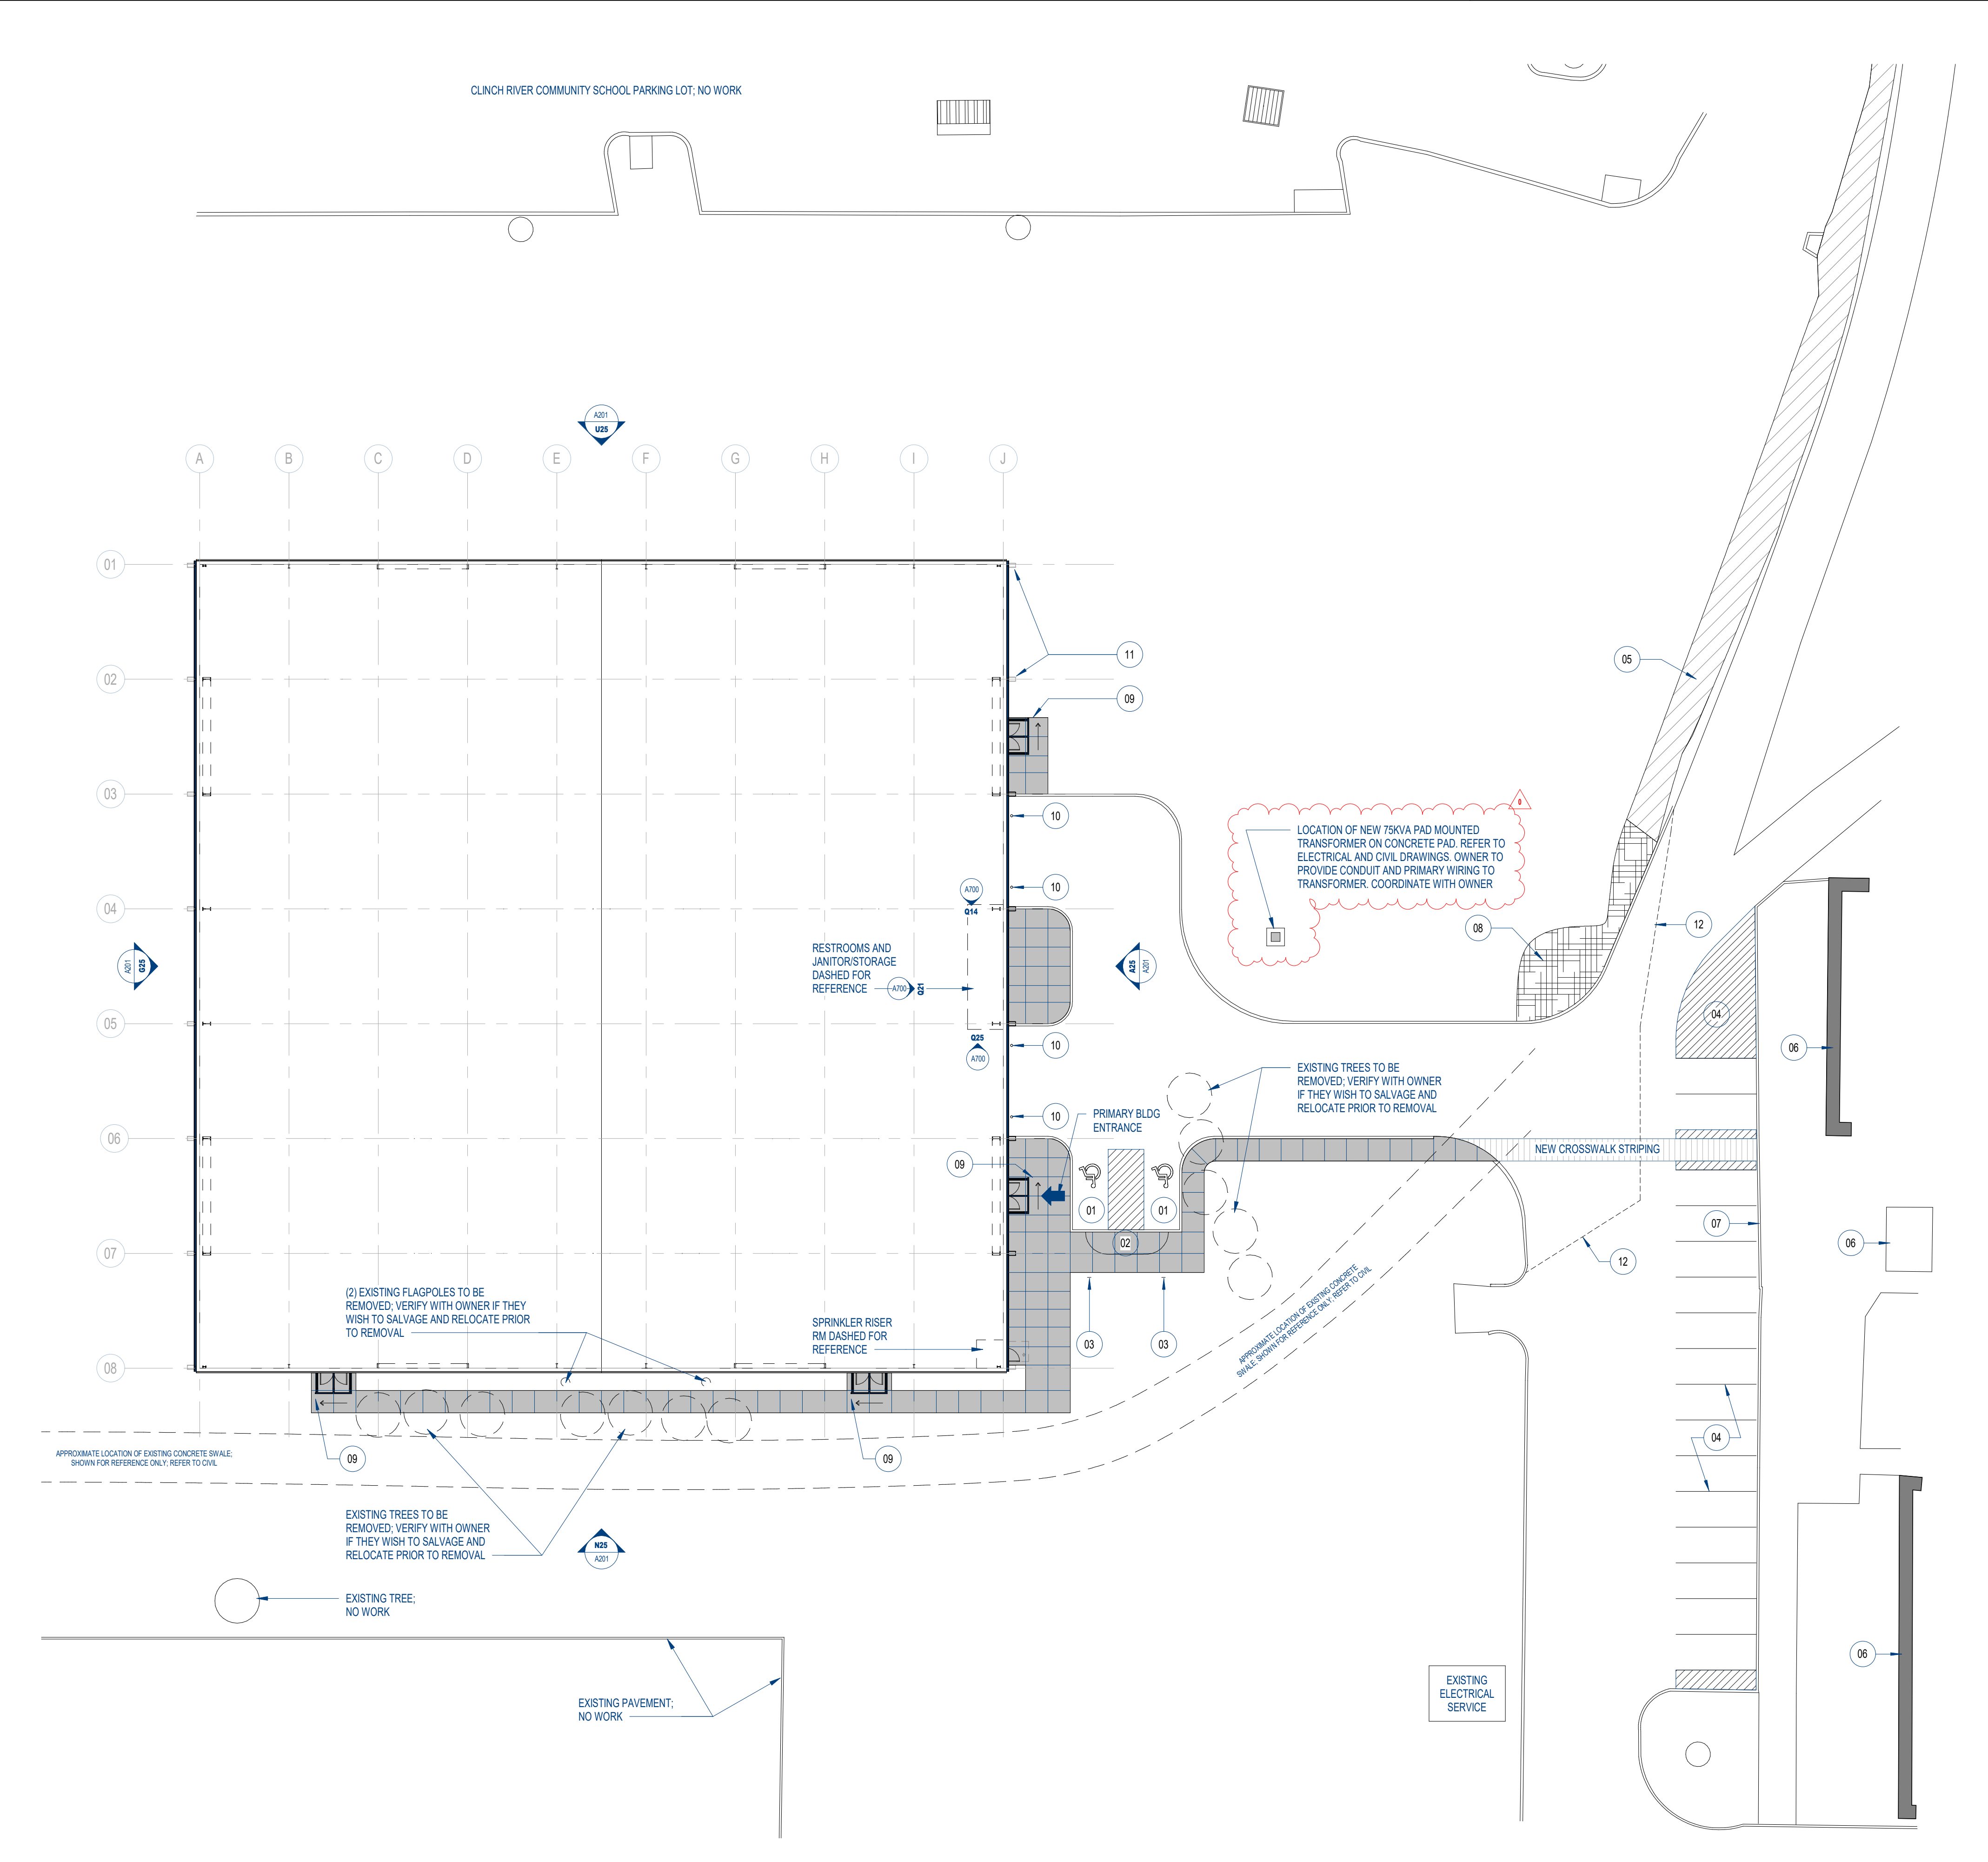



**A19** ARCH SITE PLAN  
 1" = 20'-0"  
 NEW CONSTRUCTION

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SHEET DESCRIPTION  
 ARCHITECTURAL SITE  
 PLAN AND DETAILS

**AS101**  
 PROJECT DATE: 2023-10-17  
 PROJECT NUMBER: 23030





TRANSFORMER PAD DETAIL  
NO SCALE

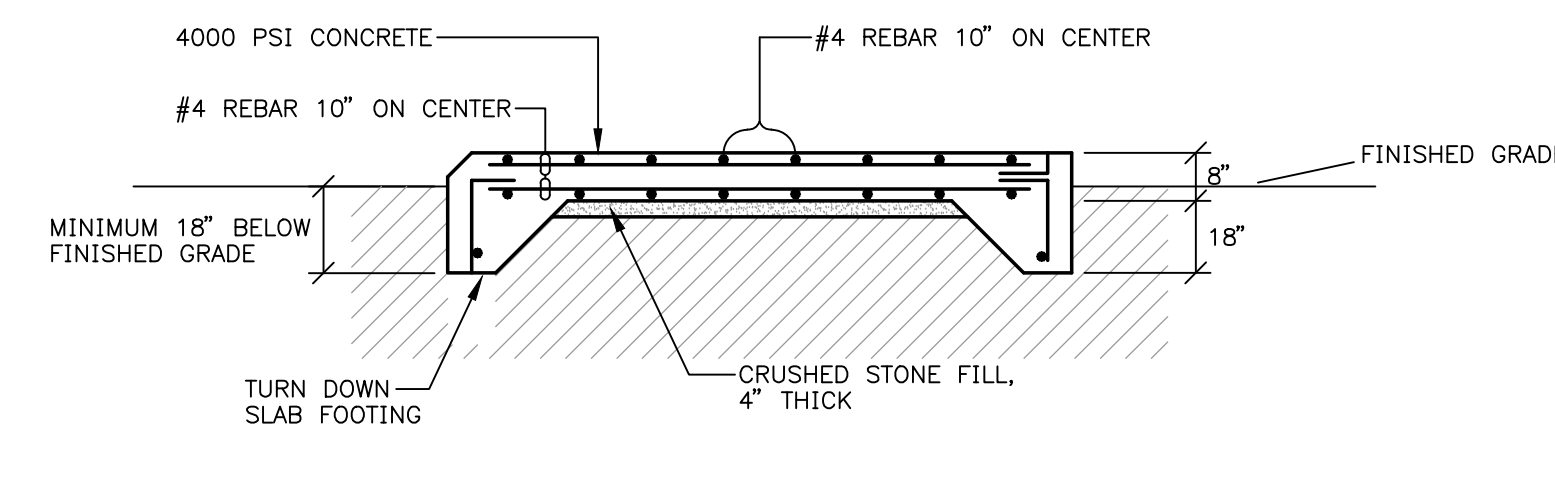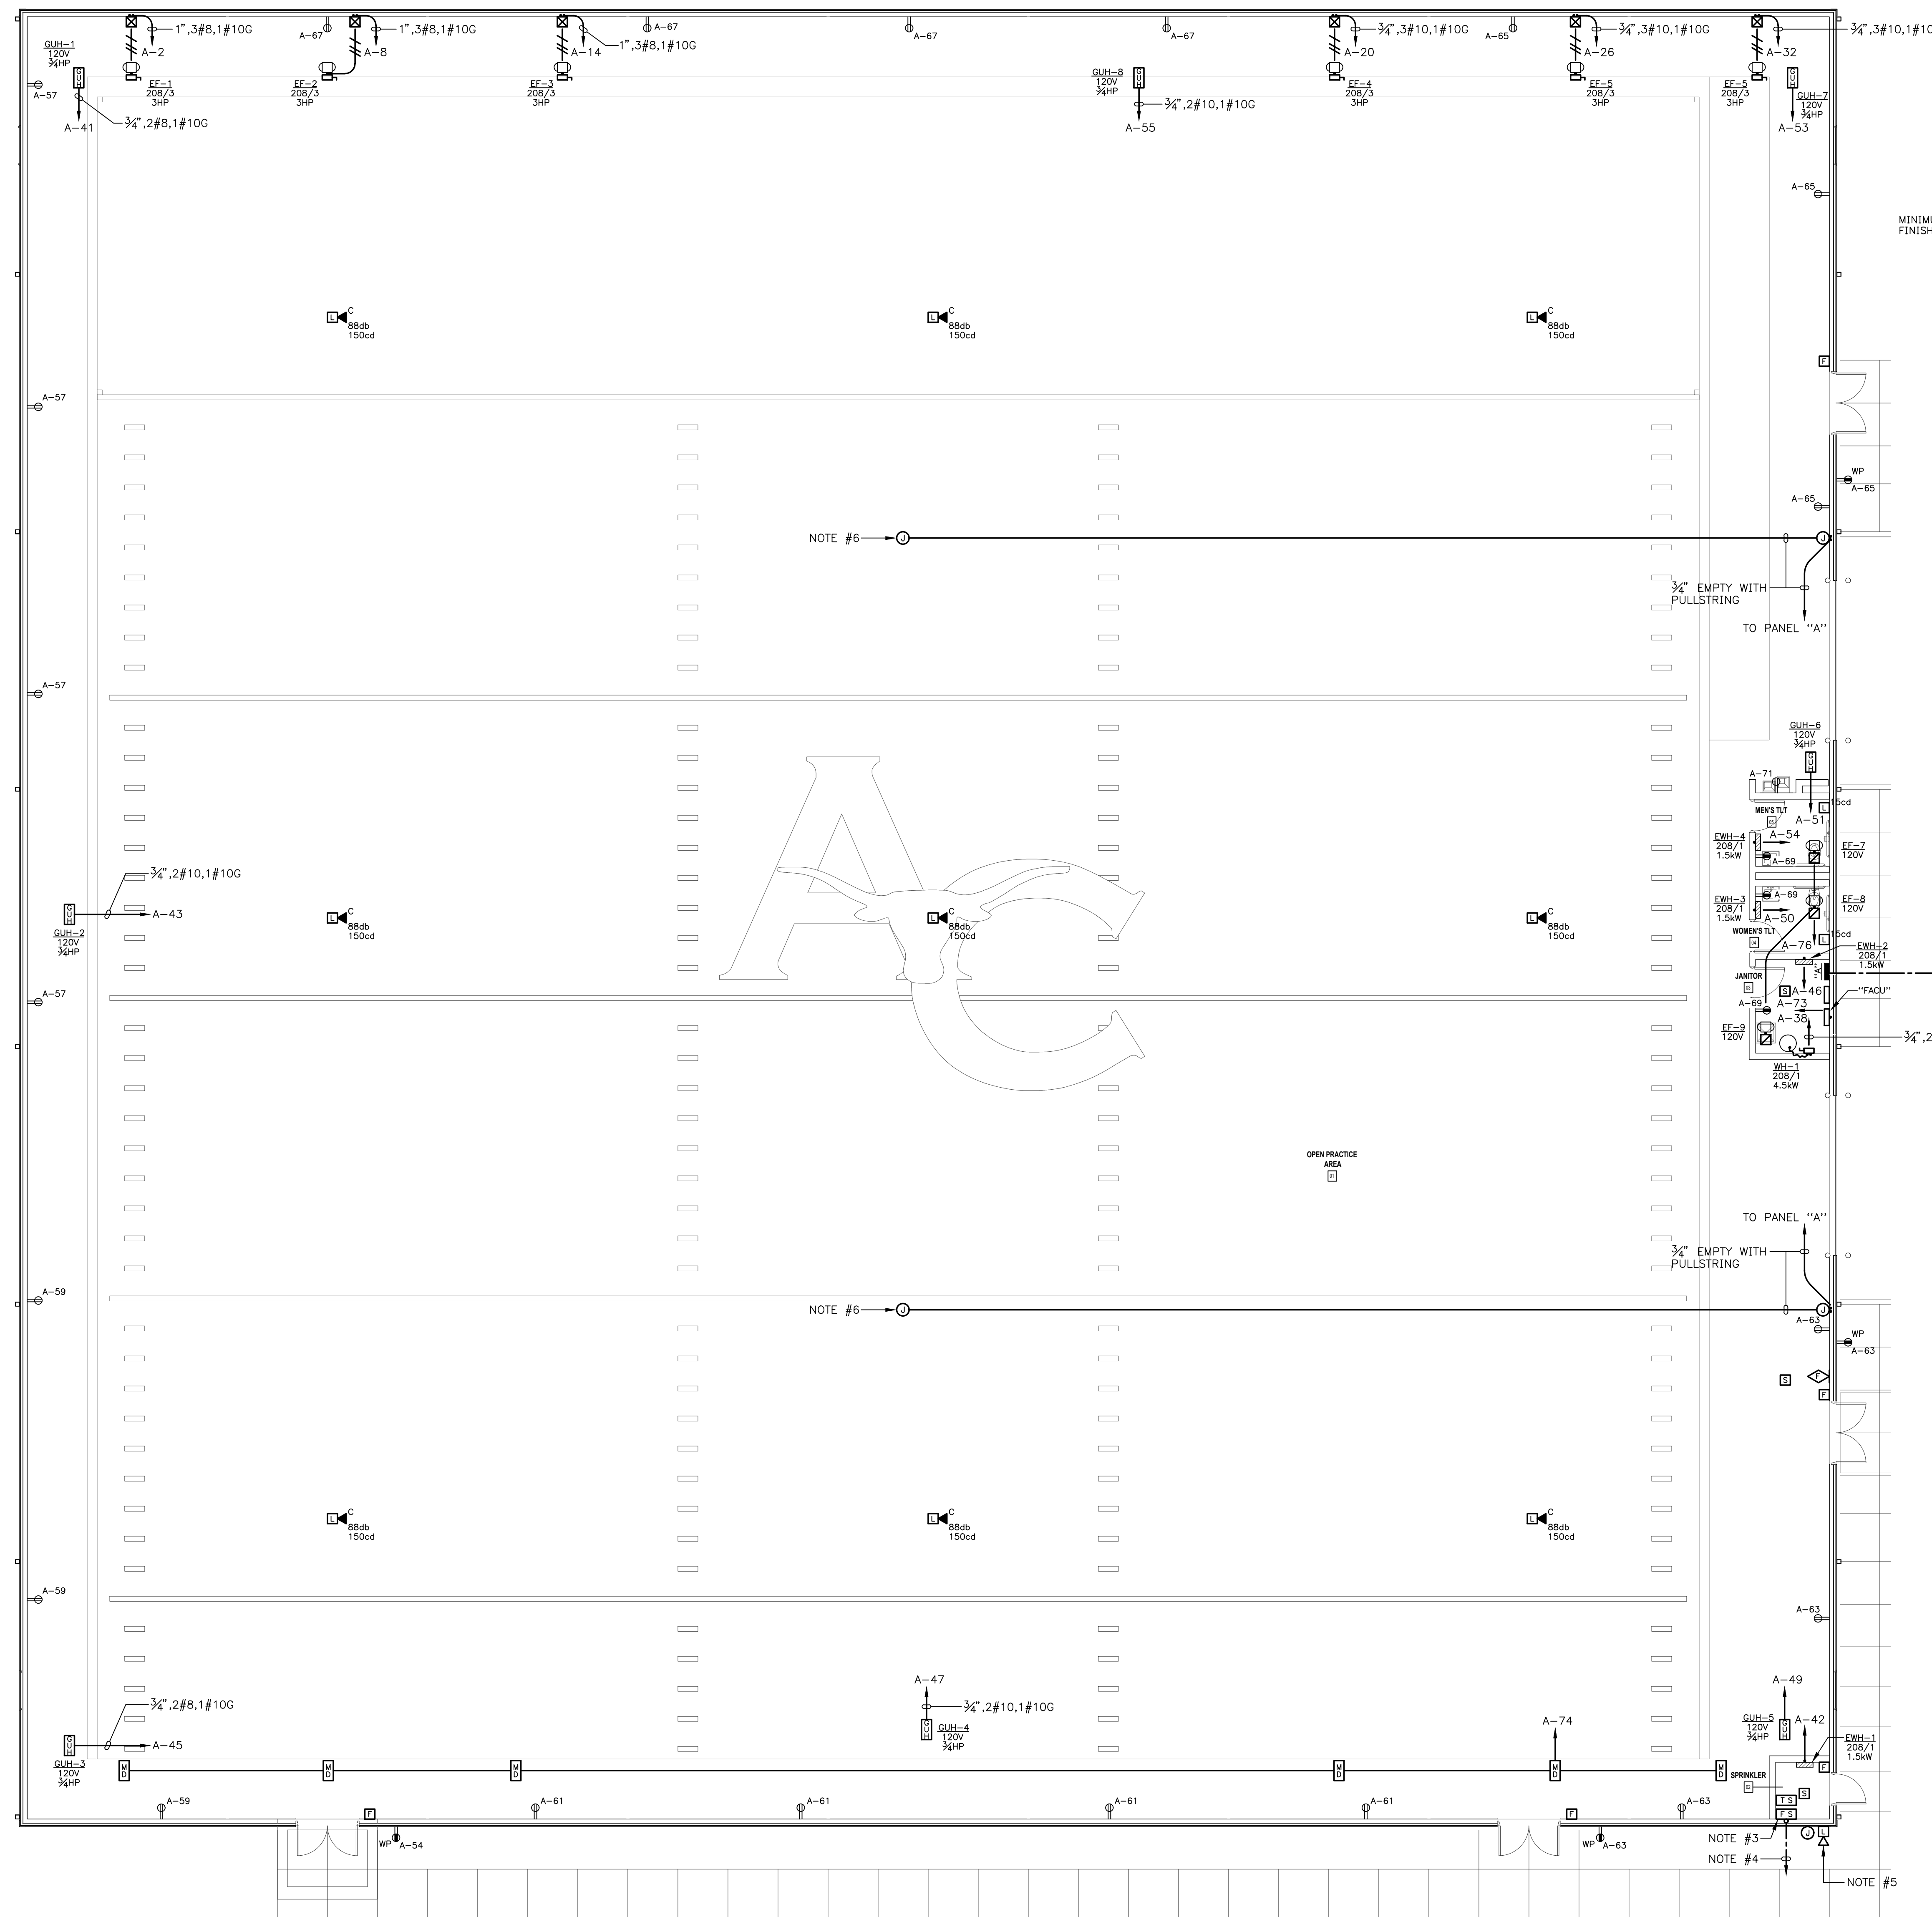COMMUNICATIONS/HVAC WIRING NOTES:

- PRIOR TO BEGINNING CONDUIT INSTALLATION FOR HVAC/PLUMBING EQUIPMENT ELECTRICAL CONTRACTOR SHALL CONFIRM WITH MECHANICAL/PLUMBING CONTRACTOR THE VOLTAGES FOR ALL HVAC/PLUMBING EQUIPMENT REQUIRING ELECTRICAL SERVICE. ELECTRICAL CONTRACTOR SHALL CALL ANY DISCREPANCIES BETWEEN ELECTRICAL DRAWINGS AND VOLTAGE INFORMATION PROVIDED BY MECHANICAL/PLUMBING CONTRACTOR TO THE ATTENTION OF ENGINEER PRIOR TO PROCEEDING WITH WORK.
- CONFIRM EXACT ROUGH-IN LOCATIONS FOR ALL HVAC/PLUMBING EQUIPMENT WITH MECHANICAL/PLUMBING CONTRACTOR PRIOR TO INSTALLATION OF CONDUIT.
- CONNECT ALL SPRINKLER FLOW/TAMPER SWITCHES TO BUILDING FIRE ALARM SYSTEM. QUANTITIES SHOWN ARE DIAGRAMMATIC ONLY. CONFIRM EXACT QUANTITIES WITH SPRINKLER SYSTEM SUBCONTRACTOR.
- EXTEND  $\frac{3}{4}$ " WITH FIRE ALARM WIRING TO WALL INDICATOR VALVE (WIV), POST INDICATOR VALVE, AND/OR BUTTERFLY VALVE AS NOTED ON FIRE PROTECTION DRAWINGS. CONNECT TAMPER SWITCHES AT WALL INDICATOR VALVE, POST INDICATOR VALVE, AND/OR BUTTERFLY VALVE TO BUILDING FIRE ALARM SYSTEM. REFER TO FIRE PROTECTION/SITE UTILITY DRAWINGS FOR EXACT LOCATION OF THESE VALVES.
- CONNECT SPRINKLER ALARM BELL ON EXTERIOR OF BUILDING. COORDINATE ROUGH-IN AND CONNECTION REQUIREMENTS WITH SPRINKLER SUBCONTRACTOR. PROVIDE "WEATHERPROOF" FIRE ALARM A/V DEVICE ON EXTERIOR OF BUILDING ADJACENT TO SPRINKLER BELL.
- PROVIDE ROUGH-IN FOR FUTURE INSTALLATION OF HIGH VOLUME LOW SPEED FAN. COORDINATE LOCATION WITH OWNER.
- CONTROL EF-7 AND EF-8 WITH DUAL CIRCUIT OCCUPANCY/VACANCY SENSOR SO THAT FAN RUNS WHEN ROOM LIGHTS ARE ON.
- PROPOSED LOCATION OF NEW 75KVA PADMOUNTED TRANSFORMER, 208Y/120V SECONDARY. PROVIDE CONCRETE PAD PER DETAIL. COORDINATE LOCATION AND CONNECTION REQUIREMENTS WITH OWNER.
- PROVIDE UNDERGROUND SECONDARY WIRING FROM NEW PADMOUNTED TRANSFORMER TO "SEE FEEDER DIAGRAM FOR REQUIREMENTS".
- NEW UNDERGROUND PRIMARY LINE PROVIDED BY ANDERSON COUNTY SCHOOLS. CLOSELY COORDINATE LOCATION AND REQUIREMENTS WITH OWNER.

FLOOR PLAN - ELECTRICAL

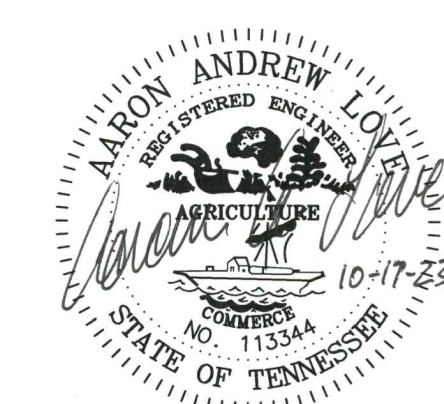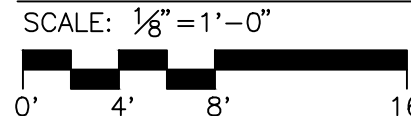

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SHEET DESCRIPTION  
FLOOR PLAN - ELECTRICAL

