



ADDENDUM NUMBER: 04

Randolph County Courthouse
 Clerk of Court Office Renovation
 Asheboro, NC

PROJECT NUMBER 15210.00

Feb 10, 2021

This Addendum issued prior to receipt of Bid hereby becomes a part of the Construction Documents for the above project.

All information contained in this Addendum supersedes and takes precedence over any conflicting information in the original Bidding Documents dated January 1, 2021 and any previous Addenda.

GENERAL INFORMATION


1. The following drawings have been re-issued under this addendum.
 - a. A101-1 - PHASE 1 - DEMOLITION AND NEW WORK PLANS
 - b. A101-2 - PHASE 2 - DEMOLITION AND NEW WORK PLANS
 - c. A101-3 - PHASE 3 - DEMOLITION AND NEW WORK PLANS
 - d. A101-4 - PHASE 4 - DEMOLITION AND NEW WORK PLANS
 - e. A201 - OVERALL REFLECTED CEILING PLAN AND DETAILS LEVEL 2
 - f. A201-1 - REFLECTED CEILING PLAN - PHASE 1
 - g. A201-2 - REFLECTED CEILING PLAN - PHASE 2
 - h. A201-3 - REFLECTED CEILING PLAN - PHASE 3
 - i. A201-4 - REFLECTED CEILING PLAN - PHASE 4
 - j. A701-4 - PHASE 1 - ENLARGED FLOOR PLAN AND INTERIOR ELEVATIONS
 - k. A900 – DOOR SCHEDULE
 - l. I200-1 - FLOOR FINISH AND PATTERN PLAN - PHASE 1
 - m. I200-2 - FLOOR FINISH AND PATTERN PLAN - PHASE 2
 - n. I200-3 - FLOOR FINISH AND PATTERN PLAN - PHASE 3
 - o. I200-4 - FLOOR FINISH AND PATTERN PLAN - PHASE 4
 - p. A701.4- ENLARGED FLOOR PLAN AND ELEVATIONS
2. The primary purpose for the reissuance of the drawings listed above is to *more clearly* designate conventional drywall partitions and demountable partitions. The demountable partition system will be provided by the owner.
3. We will be revising the bid form under addendum #5.
4. The following attended the site walk on 1/29/2021.

2:00pm	Daniel Myrick Penhall 919.229.8578	dmyrick@penhall.com
1:30pm	Brian Perrell Miraje Reconstruction & Development 336.292.9284 ext 25	brian@mirajerd.com
1:00pm	Doug Allen (336)-653-8381 (5 attendees)	doug@smithandallen.com
12:30pm	Joe Hogan (919) 636 -0417	JHogan@ehgllc.com



5. The Owner would like to keep the existing Knox Box in its current location. Disregard plans showing it to be relocated.

Attachments: Revised Sheets: A101-1, A101-2, A101-3, A101-4, A201, A201-1, A201-2, A201-3, A201-4, A400, A701-4, A900, I200, I200-1, I200-2, I200-3, I200-4

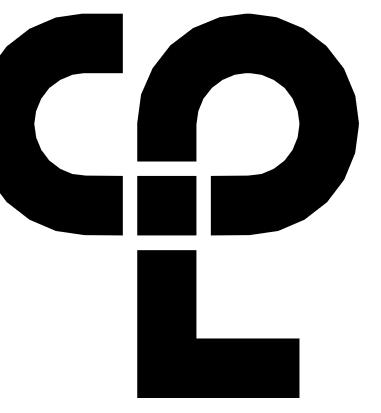

PROJECT INFORMATION

Project Number: 15210.00
Client Name: RANDOLPH COUNTY COURTHOUSE
Project Name: CLERK OF COURT OFFICE RENOVATION

Project Address: 176 E Salisbury St, Asheboro, NC 27203

REVISION SCHEDULE

11 01/27/20 Addendum 4
21

DEMOLITION GENERAL NOTES


- IT IS THE CONTRACTOR'S RESPONSIBILITY TO FAMILIARIZE THEMSELVES WITH ALL DETAILS INVOLVED IN THE DEMOLITION CONTRACT. SPECIFIC INSTRUCTION ON EACH ITEM WILL NOT BE GIVEN.
- GC IS RESPONSIBLE FOR KEEPING BUILDING WEATHERTIGHT DURING DEMOLITION WORK.
- GC IS TO PROVIDE DUST CONTROL BARRIERS AT ALL AREAS OF CONSTRUCTION.
- GC WILL SALVAGE ANY ITEMS PER OWNER'S LIST (BID).
- PC = PLUMBING CONTRACTOR, EC = ELECTRICAL CONTRACTOR, MC = MECHANICAL CONTRACTOR
- PATCH WALLS, FLOORS AND CEILINGS AT ALL WALL REMOVALS, TO MATCH SCHEDULED FINISHES.
- WORK AREAS SHALL BE MAINTAINED AND LEFT BROOM CLEANED AT END OF EACH DAY.
- EXISTING BUILDING AND STRUCTURE TO REMAIN EXCEPT AS NOTED.

FLOOR PLAN GENERAL NOTES

- ALL DRAWINGS ARE GRAPHIC REPRESENTATIONS OF APPROXIMATE LOCATIONS OF NEW MATERIALS. IT IS THE CONTRACTOR'S RESPONSIBILITY TO FIELD VERIFY ALL EXISTING CONDITIONS PRIOR TO COMMENCEMENT OF WORK.
- THE GENERAL CONTRACTOR IS RESPONSIBLE TO FIRESTOP ALL NEW PARTITIONS TO THE STRUCTURAL DECK ABOVE. FIRESTOPPING HEADS OF WALLS IS TO OCCUR AT ALL NEW WALL CONSTRUCTION WITHIN THE PROJECT.
- ALL WALL DIMENSIONS INDICATED ON FLOOR PLANS ARE TO FACE OF STUD FRAMING OR MASONRY UNLESS OTHERWISE NOTED.
- SEE SHEET #00 FOR INTERIOR PARTITION TYPES
- SEE A000 FOR INTERIOR AND EXTERIOR DOORS, WINDOWS, CURTAINWALLS, AND STOREFRONTS
- PROVIDE AN EDGE TRANSITION STRIP CENTERED UNDER ALL DOORS WHERE ADJACENT FLOOR FINISHES ARE OF DIFFERENT MATERIALS.
- PROVIDE ACCESS PANELS, MINIMUM 24" x 24", OR OF SIZES REQUIRED, WHERE PLUMBING AND HEATING VALVES, WATER SWITCHES, VENTILATION SPLITTER DAMPERS, ETC. ARE SHOWN ON PLUMBING, HEATING AND VENTILATION DRAWINGS.
- WORK AREAS SHALL BE MAINTAINED AND ALL WORK AREAS SHALL BE LEFT BROOMED CLEAN AT END OF EACH DAY.
- ALL DOORS AND WINDOW SYSTEMS TO HAVE SEALANT AROUND THE ENTIRE PERIMETER BOTH SIDES OF FRAMES.
- CONTRACTOR TO COORDINATE WITH OTHER TRADES FOR SEQUENCING OF WORK.
- REFER TO A700 FOR TYPICAL FIXTURE MOUNTING HEIGHTS AND ACCESSORIES
- EXISTING MASONRY WINDOW SILLS ARE NOT TO BE PAINTED.

DEMOLITION KEYNOTES

Mark	Demolition Note
B1	REMOVE EXISTING WALL BASE TYPICAL THROUGHOUT SUITE.
C1	REMOVE ACOUSTICAL CEILING SYSTEM AND HANGER WIRES. COORDINATE REMOVAL OF DUCTWORK/DIFFUSERS, LIGHTS, PIPING AND ALL OTHER CEILING MOUNTED ITEMS WITH OTHER CONTRACTORS.
C2	REMOVE GNB CEILING AND ASSOCIATED FRAMING. COORDINATE REMOVAL OF DUCTWORK/DIFFUSERS, LIGHTS, PIPING AND ALL OTHER CEILING MOUNTED ITEMS WITH OTHER CONTRACTORS.
D1	DEMOLISH EXISTING DOOR, FRAME, TRANSOM AND HARDWARE AS INDICATED. RESTORE REMAINING ADJACENT SURFACES TO ORIGINAL CONDITION. COORDINATE SALVAGE AND REUSE REQUIREMENTS WITH OWNER.
D2	REMOVE EXISTING DOOR HARDWARE, PIN DOORS CLOSED.
D3	DEMOLISH AND REUSE EXISTING DOOR AND FRAME. DOOR TO BE MOVED TO ADJACENT WALL.
F1	REMOVE EXISTING FLOOR FINISH AND PREPARE SURFACE TO RECEIVE NEW FINISH, TYPICAL THROUGHOUT SUITE.
F2	EXTENTS OF FLOORING REMOVAL IN THIS PHASE.
L1	REMOVE AND SALVAGE EXISTING FIRE EXTINGUISHER AND CABINET. REFER TO LIFE SAFETY PLANS FOR NEW LOCATION.
M1	DEMOLISH EXISTING MILLWORK AND COUNTERTOP. RESTORE REMAINING ADJACENT SURFACES TO ORIGINAL CONDITIONS.
S1	SELECTIVE DEMOLITION - REMOVE A PORTION OF EXISTING CHASE, VERIFY IF REMAINING CHANCE CAN BE DEMOLISHED.
T1	REMOVE EXISTING TOILET PARTITIONS AND ACCESSORIES. PATCH AND REPAIR SURFACES AS NECESSARY IN PREPARATION FOR NEW WORK. TOILET ACCESSORIES, INCLUDING MIRROR, PAPER TOWEL DISPENSER, TRASH RECEPTACLE, TOILET PAPER DISPENSER, GRAB BARS, ETC., TO BE REINSTALLED AFTER RENOVATION.
T2	REMOVE AND STORE EXISTING WALL MOUNTED RESTROOM ACCESSORIES, MIRRORS, AND SIGNAGE. RESTORE REMAINING ADJACENT SURFACES TO RECEIVE NEW FINISH. BATHROOM ACCESSORIES TO BE RE-USED INCLUDING PAPER TOWEL/TRASH RECEPTACLE, TOILET PAPER HOLDER AND GRAB BARS.
W1	REMOVE WALLS OR PORTIONS OF WALLS AS INDICATED. PATCH AND REPAIR AS REQUIRED TO COMPLETE RENOVATION SCOPE. ALL LOCATIONS MAY NOT BE TAGGED. VERIFY IN FIELD PRIOR TO COMPLETING DEMOLITION.
W2	REMOVE EXISTING WALL COVERING AND ADHESIVE. PREPARE SURFACE TO RECEIVE NEW PAINT FINISH.
W3	REMOVE MASONRY WALL AS INDICATED. PATCH AND REPAIR FLOOR AND ADJACENT WALL AS REQUIRED TO COMPLETE RENOVATION SCOPE. ALL LOCATIONS MAY NOT BE TAGGED. VERIFY IN FIELD PRIOR TO COMPLETING DEMOLITION.
W4	PATCH AND REPAIR HOLES IN MASONRY WALLS.
W5	DEMOLISH TEMPORARY CONSTRUCTION BARRIER AFTER WORK IS COMPLETED.
X1	REMOVE AND STORE WALL PLAQUE.
X2	DEMOLISH EXISTING PLATFORM. PREPARE SURFACE BELOW FOR NEW FINISH.

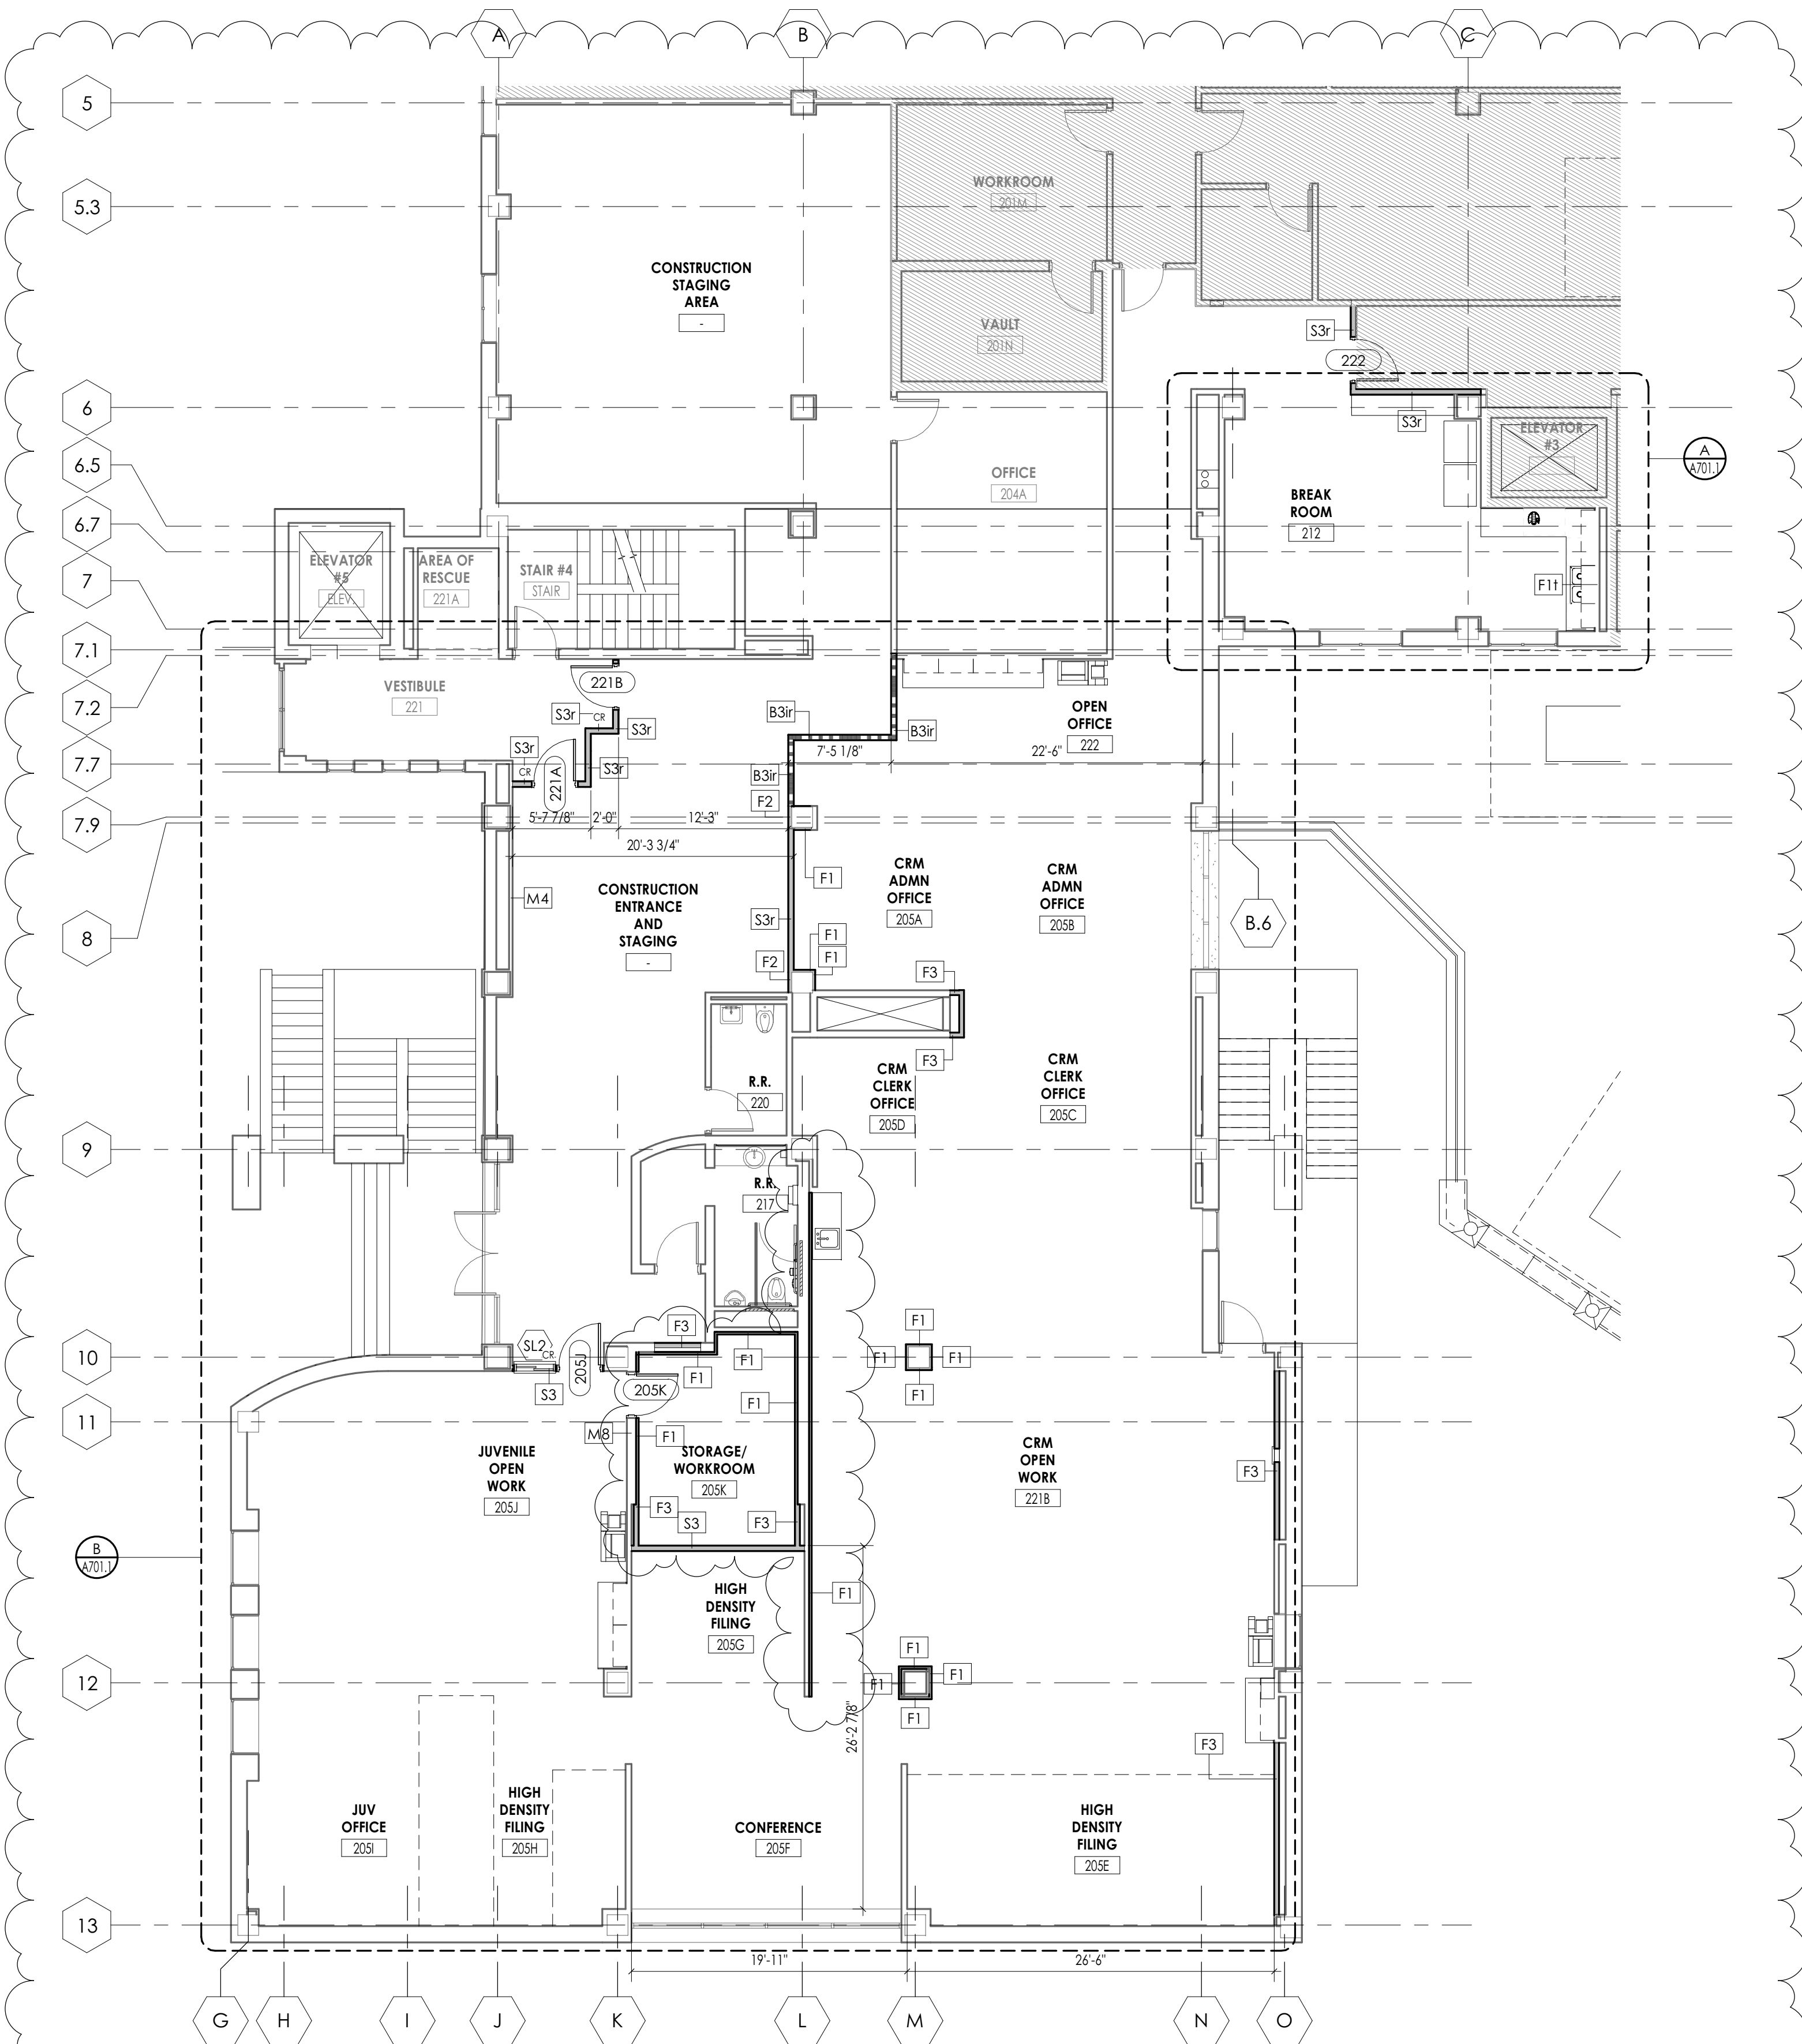

ANNOTATION AND DIMENSIONED CONVENTIONAL DRYWALL PARTITIONS FLOOR PLAN - PHASE 1


1/8" = 1'-0"
REFER TO I100 SERIES FOR DEMOUNTABLE PARTITIONS



TRUE NORTH PROJECT NORTH

DOOR NUMBER	FIRE RATING (MIN)	PANEL TYPE	DOOR PANELS				DOOR FINISHES				DOOR FRAME				GLAZING TYPE	COMMENTS
			WIDTH	HEIGHT	WIDTH	HEIGHT	PANEL FINISH SIDE 1	PANEL FINISH SIDE 2	FRAME TYPE	JAMB WIDTH	HEAD HEIGHT	FRAME DEPTH	FRAME FINISH	HW SET		
LVL 2																
205J		PNL-FG-WD	3'-0"	7'-0"	3'-0"	7'-0"	WD/ST	WD/ST	FRM-00HM1	0'-2"	0'-2"	0'-5 3/4"	HM/PT	3		
205K		PNL-F-WD	3'-0"	7'-0"	3'-0"	7'-0"	WD/ST	WD/ST	FRM-00HM1	0'-2"	0'-2"	0'-8 7/8"	HM/PT	5		
221A	20	PNL-NV-WD	3'-0"	7'-0"	3'-0"	7'-0"	WD/ST	WD/ST	FRM-00HM1	0'-2"	0'-2"	0'-5 3/4"	HM/PT	3	CARD READER	
221B	20	PNL-NV-WD	3'-0"	7'-0"	3'-0"	7'-0"	WD/ST	WD/ST	FRM-00HM1	0'-2"	0'-2"	0'-5 3/4"	HM/PT	3	CARD READER	
222		PNL-NV-WD	3'-0"	7'-0"	3'-0"	7'-0"	WD/ST	G1	FRM-00HM1	0'-2"	0'-2"	0'-5 3/4"	HM/PT	7		

REFER TO SHEET A000 FOR DOOR AND HARDWARE TYPES

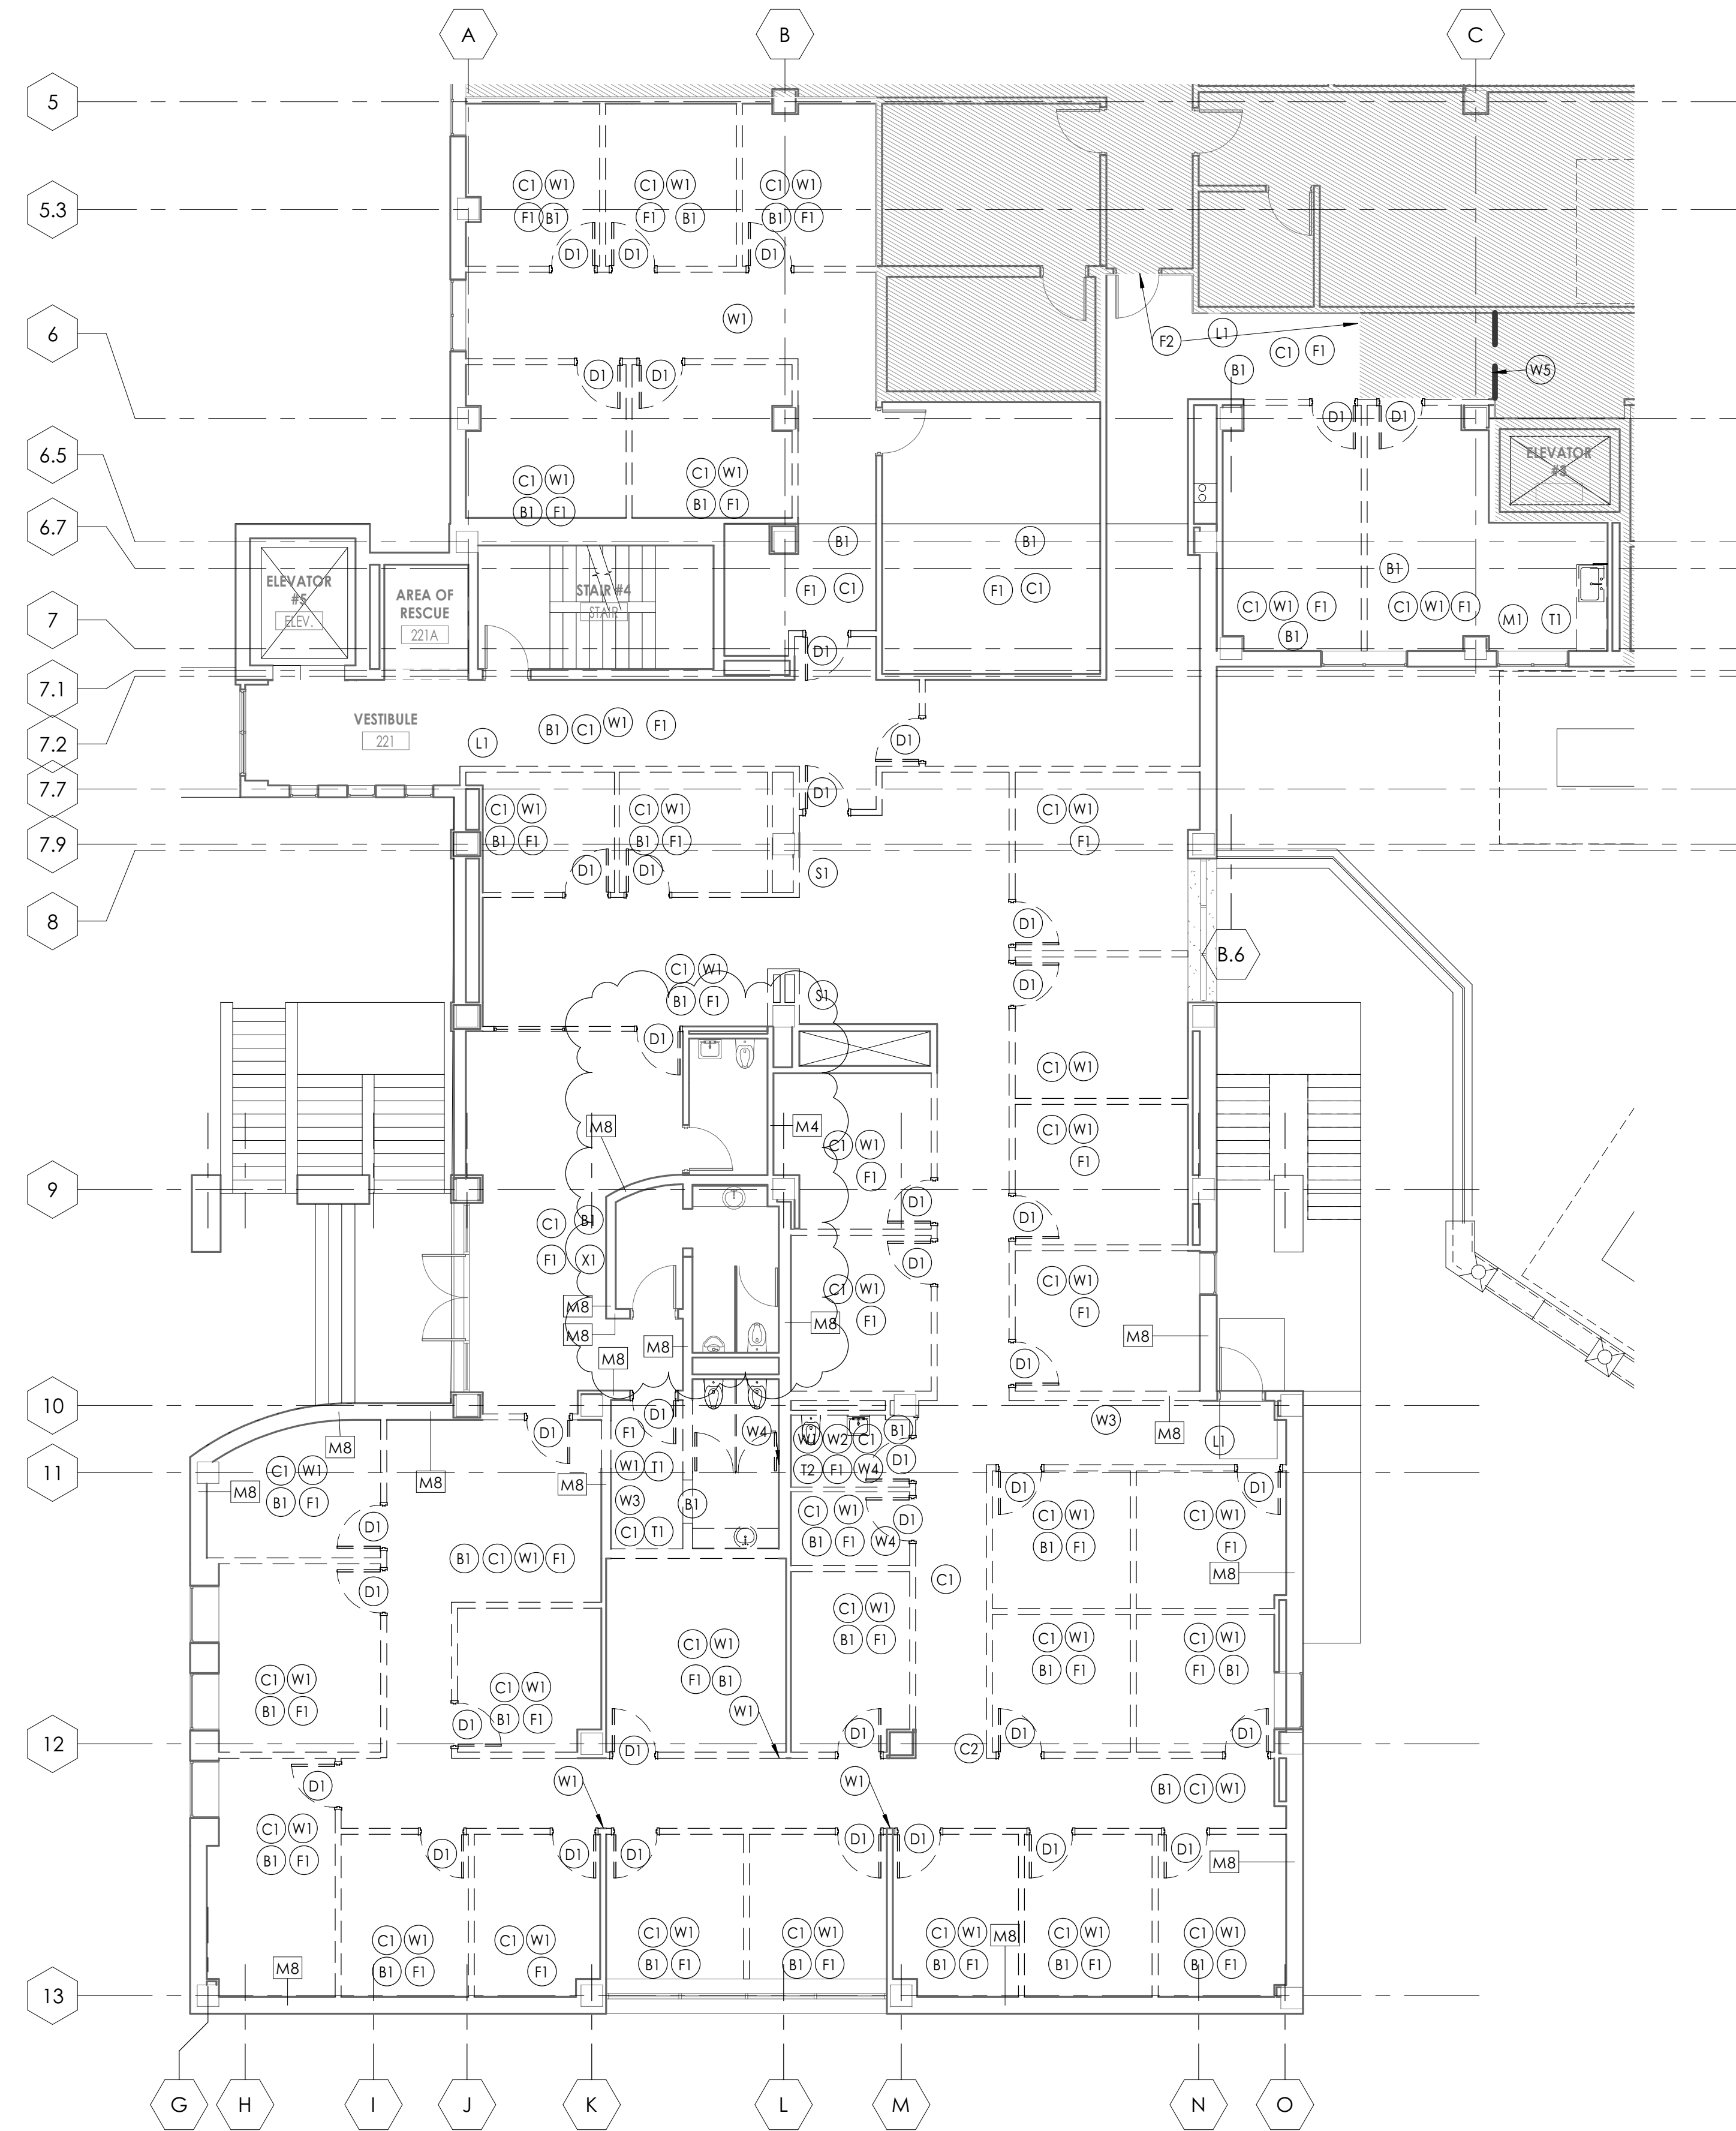


DEMOLITION PLAN - LVL 2 - PHASE 1

1/8" = 1'-0"



TRUE NORTH PROJECT NORTH

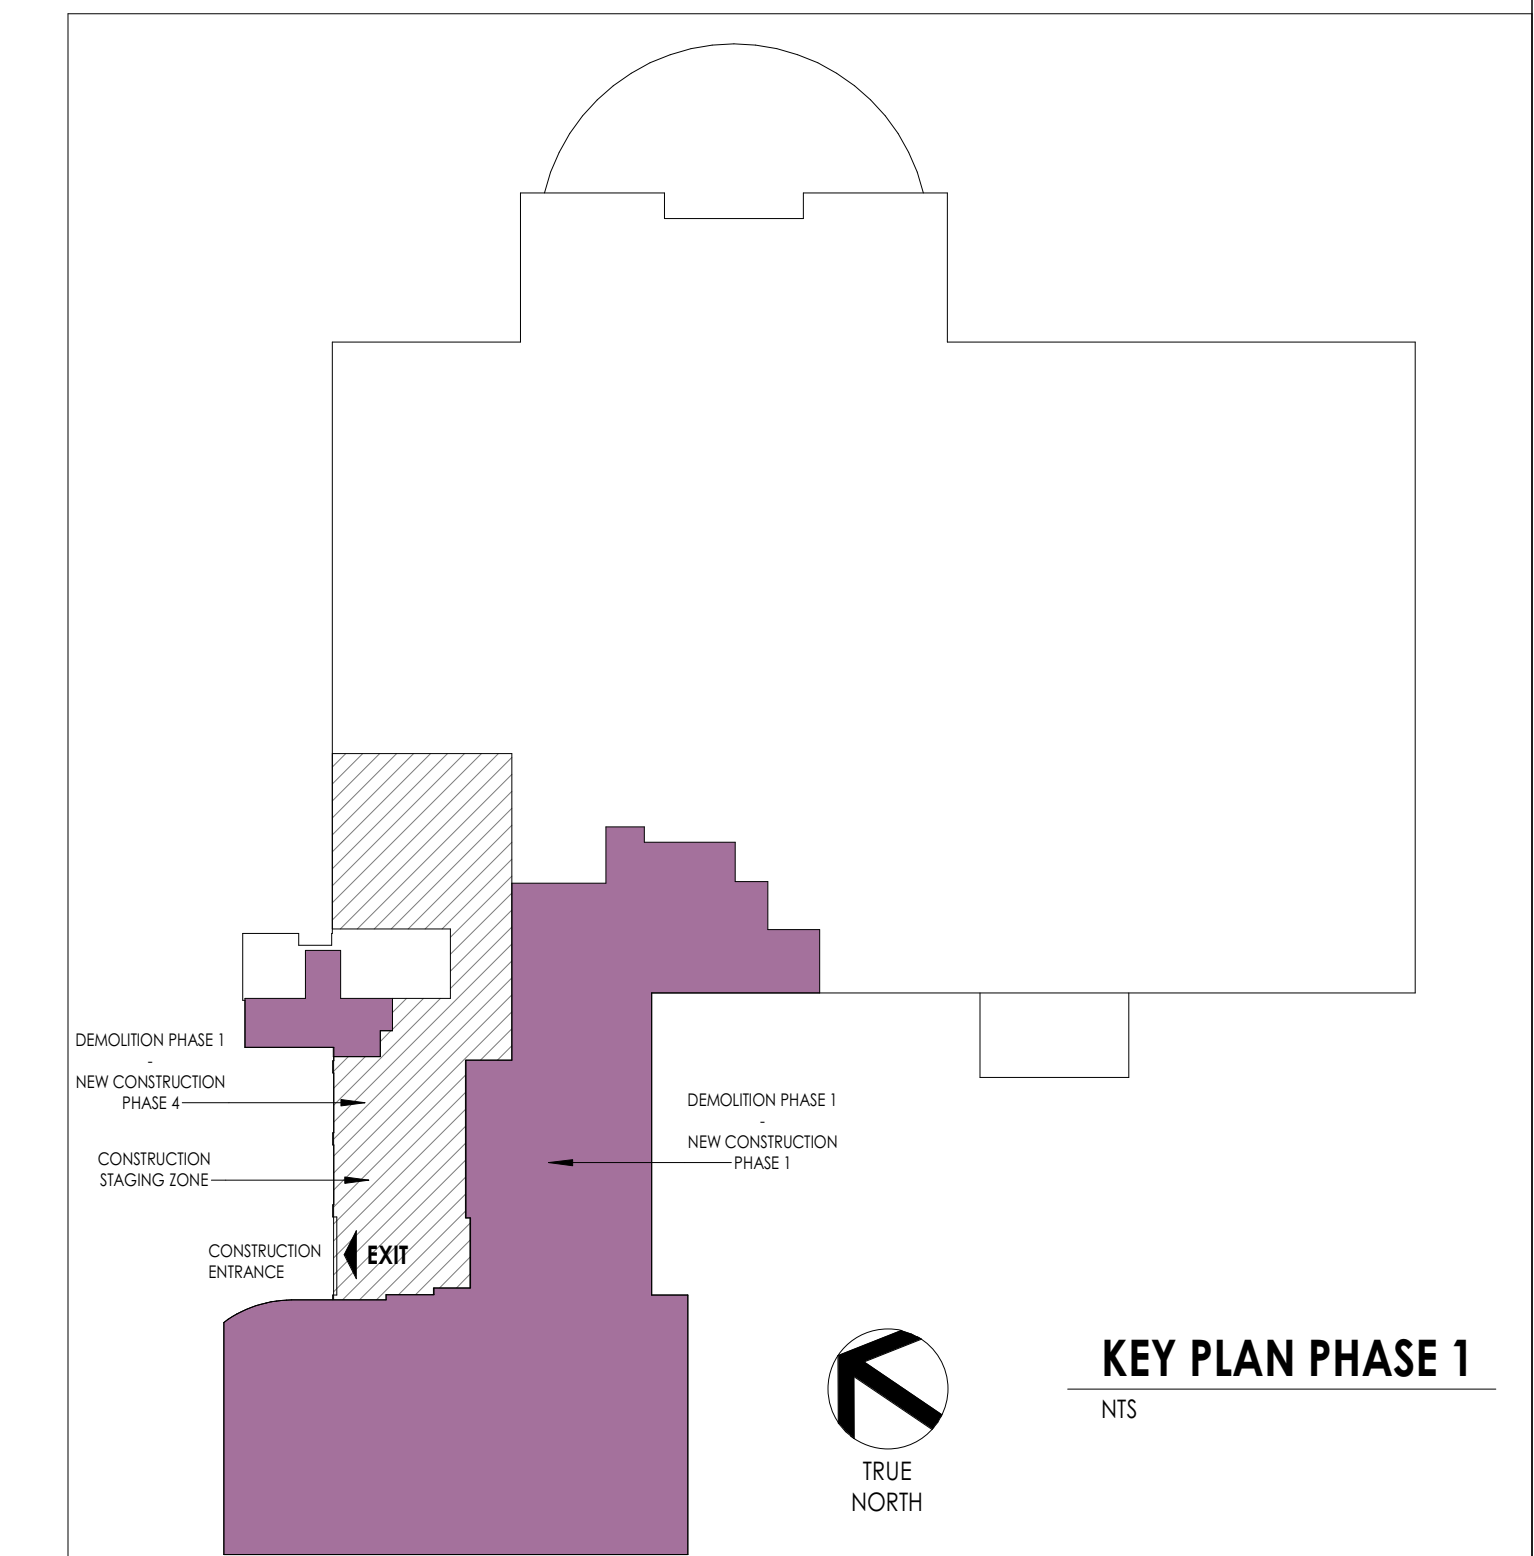


KEY PLAN PHASE 1

NTS

SHEET INFORMATION

Issue: 01/06/21
BID DOCUMENTS
Drawn By: CPL
Checked By: CPL
Drawing Title: PHASE 1 - DEMOLITION AND NEW WORK PLANS

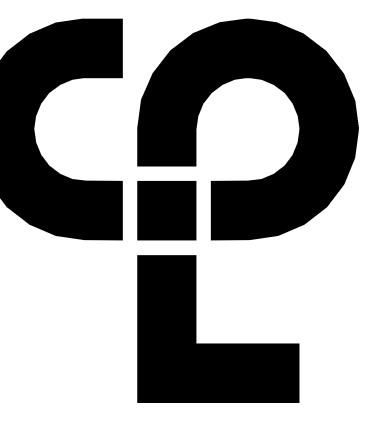

DEMOLITION GENERAL NOTES


- IT IS THE CONTRACTORS RESPONSIBILITY TO FAMILIARIZE THEMSELVES WITH ALL DETAILS INVOLVED IN THE DEMOLITION CONTRACT. SPECIFIC INSTRUCTION ON EACH ITEM WILL NOT BE GIVEN.
- GC IS RESPONSIBLE FOR KEEPING BUILDING WEATHERTIGHT DURING DEMOLITION WORK.
- GC IS TO PROVIDE DUST CONTROL BARRIERS AT ALL AREAS OF CONSTRUCTION.
- GC WILL SALVAGE ANY ITEMS PER OWNERS LIST (BD).
- PC = PLUMBING CONTRACTOR, EC = ELECTRICAL CONTRACTOR, MC = MECHANICAL CONTRACTOR.
- PATCH WALLS, FLOORS AND CEILINGS AT ALL WALL REMOVALS, TO MATCH SCHEDULED FINISHES.
- WORK AREAS SHALL BE MAINTAINED AND LEFT BROOM CLEANED AT END OF EACH DAY.
- EXISTING BUILDING AND STRUCTURE TO REMAIN EXCEPT AS NOTED.

FLOOR PLAN GENERAL NOTES

- ALL DRAWINGS ARE GRAPHIC REPRESENTATIONS OF APPROXIMATE LOCATIONS OF NEW MATERIALS. IT IS THE CONTRACTORS RESPONSIBILITY TO FIELD VERIFY ALL EXISTING CONDITIONS PRIOR TO COMMENCEMENT OF WORK.
- THE GENERAL CONTRACTOR IS RESPONSIBLE TO FIRESTOP ALL NEW PARTITIONS TO THE STRUCTURAL DECK ABOVE. FIRESTOPPING HEADS OF WALLS IS TO OCCUR AT ALL NEW WALL CONSTRUCTION WITHIN THE PROJECT.
- ALL WALL DIMENSIONS INDICATED ON FLOOR PLANS ARE TO FACE OF STUD FRAMING OR MASONRY UNLESS OTHERWISE NOTED.
- SEE SHEET A400 FOR INTERIOR PARTITION TYPES
- SEE A400 FOR INTERIOR AND EXTERIOR DOORS, WINDOWS, CURTAINWALLS, AND STOREFRONTS
- PROVIDE AN EDGE TRANSITION STRIP CENTERED UNDER ALL DOORS WHERE ADJACENT FLOOR FINISHES ARE OF DIFFERENT MATERIALS.
- PROVIDE ACCESS PANELS, MINIMUM 24" x 24", OR OF SIZES REQUIRED, WHERE PLUMBING AND HEATING VALVES, WATER SWITCHES, VENTILATION SPLITTER DAMPERS, ETC. ARE SHOWN ON PLUMBING, HEATING AND VENTILATION DRAWINGS.
- WORK AREAS SHALL BE MAINTAINED AND ALL WORK AREAS SHALL BE LEFT BROOMED CLEAN AT END OF EACH DAY.
- ALL DOORS AND WINDOW SYSTEMS TO HAVE SEALANT AROUND THE ENTIRE PERIMETER BOTH SIDES OF FRAMES.
- CONTRACTOR TO COORDINATE WITH OTHER TRADES FOR SEQUENCING OF WORK.
- REFER TO A700 FOR TYPICAL FIXTURE MOUNTING HEIGHTS AND ACCESSORIES
- EXISTING MASONRY WINDOW SILLS ARE NOT TO BE PAINTED.

DEMOLITION KEYNOTES

Mark	Demolition Note
B1	REMOVE EXISTING WALL BASE TYPICAL THROUGHOUT SUITE.
C1	REMOVE ACOUSTICAL CEILING SYSTEM AND HANGER WIRES. COORDINATE REMOVAL OF DUCTWORK/DIFFUSERS, LIGHTS, PIPING AND ALL OTHER CEILING MOUNTED ITEMS WITH OTHER CONTRACTORS.
C2	REMOVE GNB CEILING AND ASSOCIATED FRAMING. COORDINATE REMOVAL OF DUCTWORK/DIFFUSERS, LIGHTS, PIPING AND ALL OTHER CEILING MOUNTED ITEMS WITH OTHER CONTRACTORS.
D1	DEMOLISH EXISTING DOOR, FRAME, TRANSOM AND HARDWARE AS INDICATED. RESTORE REMAINING ADJACENT SURFACES TO ORIGINAL CONDITION. COORDINATE SALVAGE AND REUSE REQUIREMENTS WITH OWNER.
D2	REMOVE EXISTING DOOR HARDWARE, PIN DOORS CLOSED.
D3	DEMOLISH AND REUSE EXISTING DOOR AND FRAME. DOOR TO BE MOVED TO ADJACENT WALL.
F1	REMOVE EXISTING FLOOR FINISH AND PREPARE SURFACE TO RECEIVE NEW FINISH, TYPICAL THROUGHOUT SUITE.
F2	EXTENTS OF FLOORING REMOVAL IN THIS PHASE.
L1	REMOVE AND SALVAGE EXISTING FIRE EXTINGUISHER AND CABINET. REFER TO LIFE SAFETY PLANS FOR NEW LOCATION.
M1	DEMOLISH EXISTING MILLWORK AND COUNTERTOP. RESTORE REMAINING ADJACENT SURFACES TO ORIGINAL CONDITIONS.
S1	SELECTIVE DEMOLITION - REMOVE A PORTION OF EXISTING CHASE, VERIFY IF REMAINING CHASE CAN BE DEMOLISHED.
T1	REMOVE EXISTING TOILET PARTITIONS AND ACCESSORIES. PATCH AND REPAIR SURFACES AS NECESSARY IN PREPARATION FOR NEW WORK. TOILET ACCESSORIES, INCLUDING MIRROR, PAPER TOWEL DISPENSER/TRASH RECEPTACLE, TOILET PAPER DISPENSER, GRAB BARS, ETC. TO BE REINSTALLED AFTER RENOVATION.
T2	REMOVE AND STORE EXISTING WALL MOUNTED RESTROOM ACCESSORIES, MIRRORS, AND SIGNAGE. RESTORE REMAINING ADJACENT SURFACES TO RECEIVE NEW FINISH. BATHROOM ACCESSORIES TO BE RE-USED INCLUDING PAPER TOWEL/TRASH RECEPTACLE, TOILET PAPER HOLDER AND GRAB BARS.
W1	REMOVE WALLS OR PORTIONS OF WALLS AS INDICATED. PATCH AND REPAIR AS REQUIRED TO COMPLETE RENOVATION SCOPE. ALL LOCATIONS MAY NOT BE TAGGED. VERIFY IN FIELD PRIOR TO COMPLETING DEMOLITION.
W2	REMOVE EXISTING WALL COVERING AND ADHESIVE. PREPARE SURFACE TO RECEIVE NEW PAINT FINISH.
W3	REMOVE MASONRY WALL AS INDICATED. PATCH AND REPAIR FLOOR AND ADJACENT WALL AS REQUIRED TO COMPLETE RENOVATION SCOPE. ALL LOCATIONS MAY NOT BE TAGGED. VERIFY IN FIELD PRIOR TO COMPLETING DEMOLITION.
W4	PATCH AND REPAIR HOLES IN MASONRY WALLS.
WS	DEMOLISH TEMPORARY CONSTRUCTION BARRIER AFTER WORK IS COMPLETED.
X1	REMOVE AND STORE WALL PLAQUE.
X2	DEMOLISH EXISTING PLATFORM. PREPARE SURFACE BELOW FOR NEW FINISH.

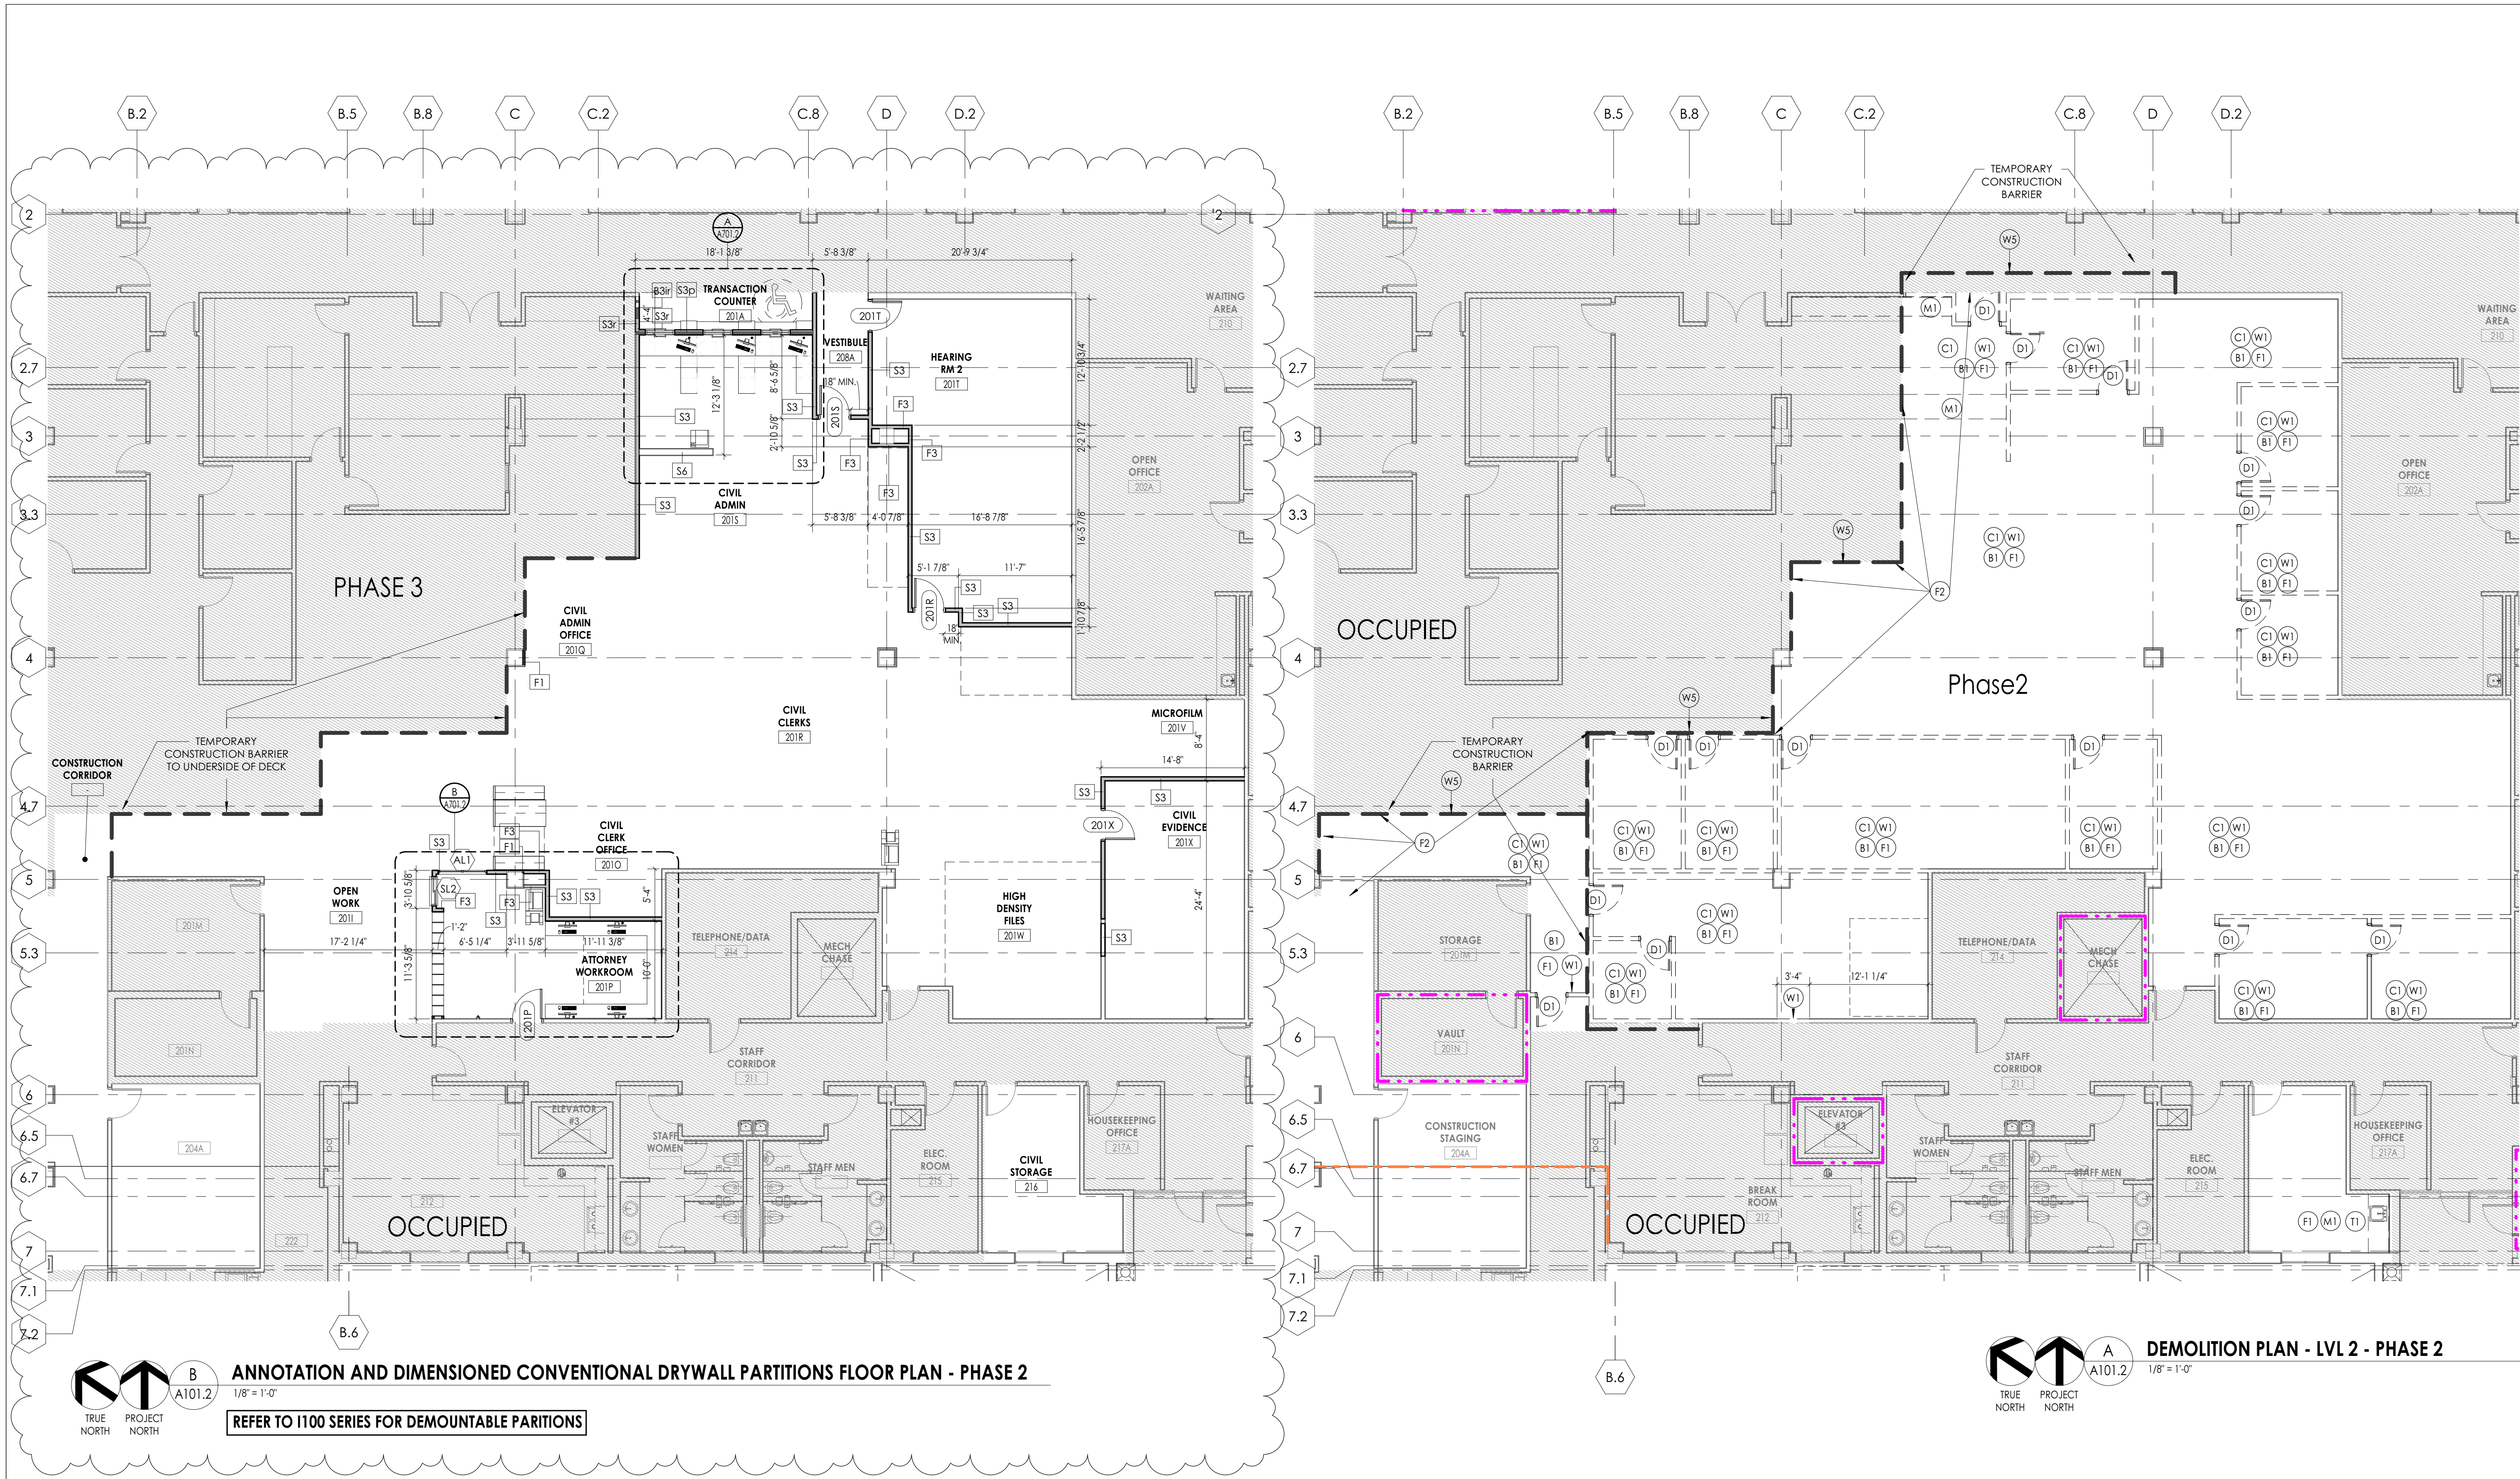


ANNOTATION AND DIMENSIONED CONVENTIONAL DRYWALL PARTITIONS FLOOR PLAN - PHASE 2
1/8" = 1'-0"
REFER TO I100 SERIES FOR DEMOUNTABLE PARTITIONS


DEMOLITION PLAN - LVL 2 - PHASE 2
1/8" = 1'-0"

CONVENTIONAL DRYWALL PARTITIONS DOOR SCHEDULE- PHASE 2

DOOR NUMBER	FIRE RATING (MIN)	PANEL TYPE	DOOR PANELS				DOOR FRAME		DOOR				
			SINGLE PANEL DIMENSIONS		TOTAL PANEL DIMENSIONS		FRAME DIMENSIONS		DOOR				
		PANEL 1	PANEL 2	PANELS 1 & 2	WIDTH	HEIGHT	JAMB WIDTH	HEAD HEIGHT	FRAME DEPTH	FRAME FINISH	HW SET	GLAZING TYPE	COMMENTS
LVL 2													
201P		PNL-F-WD	3'-0"	7'-0"	3'-0" 7'-0"	0'-0"	0'-2"	0'-2"	0'-5 3/4"	HMA/PT	8		
201R		PNL-F-WD	3'-0"	7'-0"	3'-0" 7'-0"	0'-0"	0'-2"	0'-2"	0'-5 3/4"	HMA/PT	10		
201S		PNL-F-WD	3'-0"	7'-0"	3'-0" 7'-0"	0'-0"	0'-2"	0'-2"	0'-5 3/4"	HMA/PT	9		
201T		PNL-F-WD	3'-0"	7'-0"	3'-0" 7'-0"	0'-0"	0'-2"	0'-2"	0'-5 3/4"	HMA/PT	9		
201X		PNL-F-WD	3'-0"	7'-0"	3'-0" 7'-0"	0'-0"	0'-2"	0'-2"	0'-5 3/4"	HMA/PT	5		

REFER TO SHEET A400 FOR DOOR AND HARDWARE TYPES.

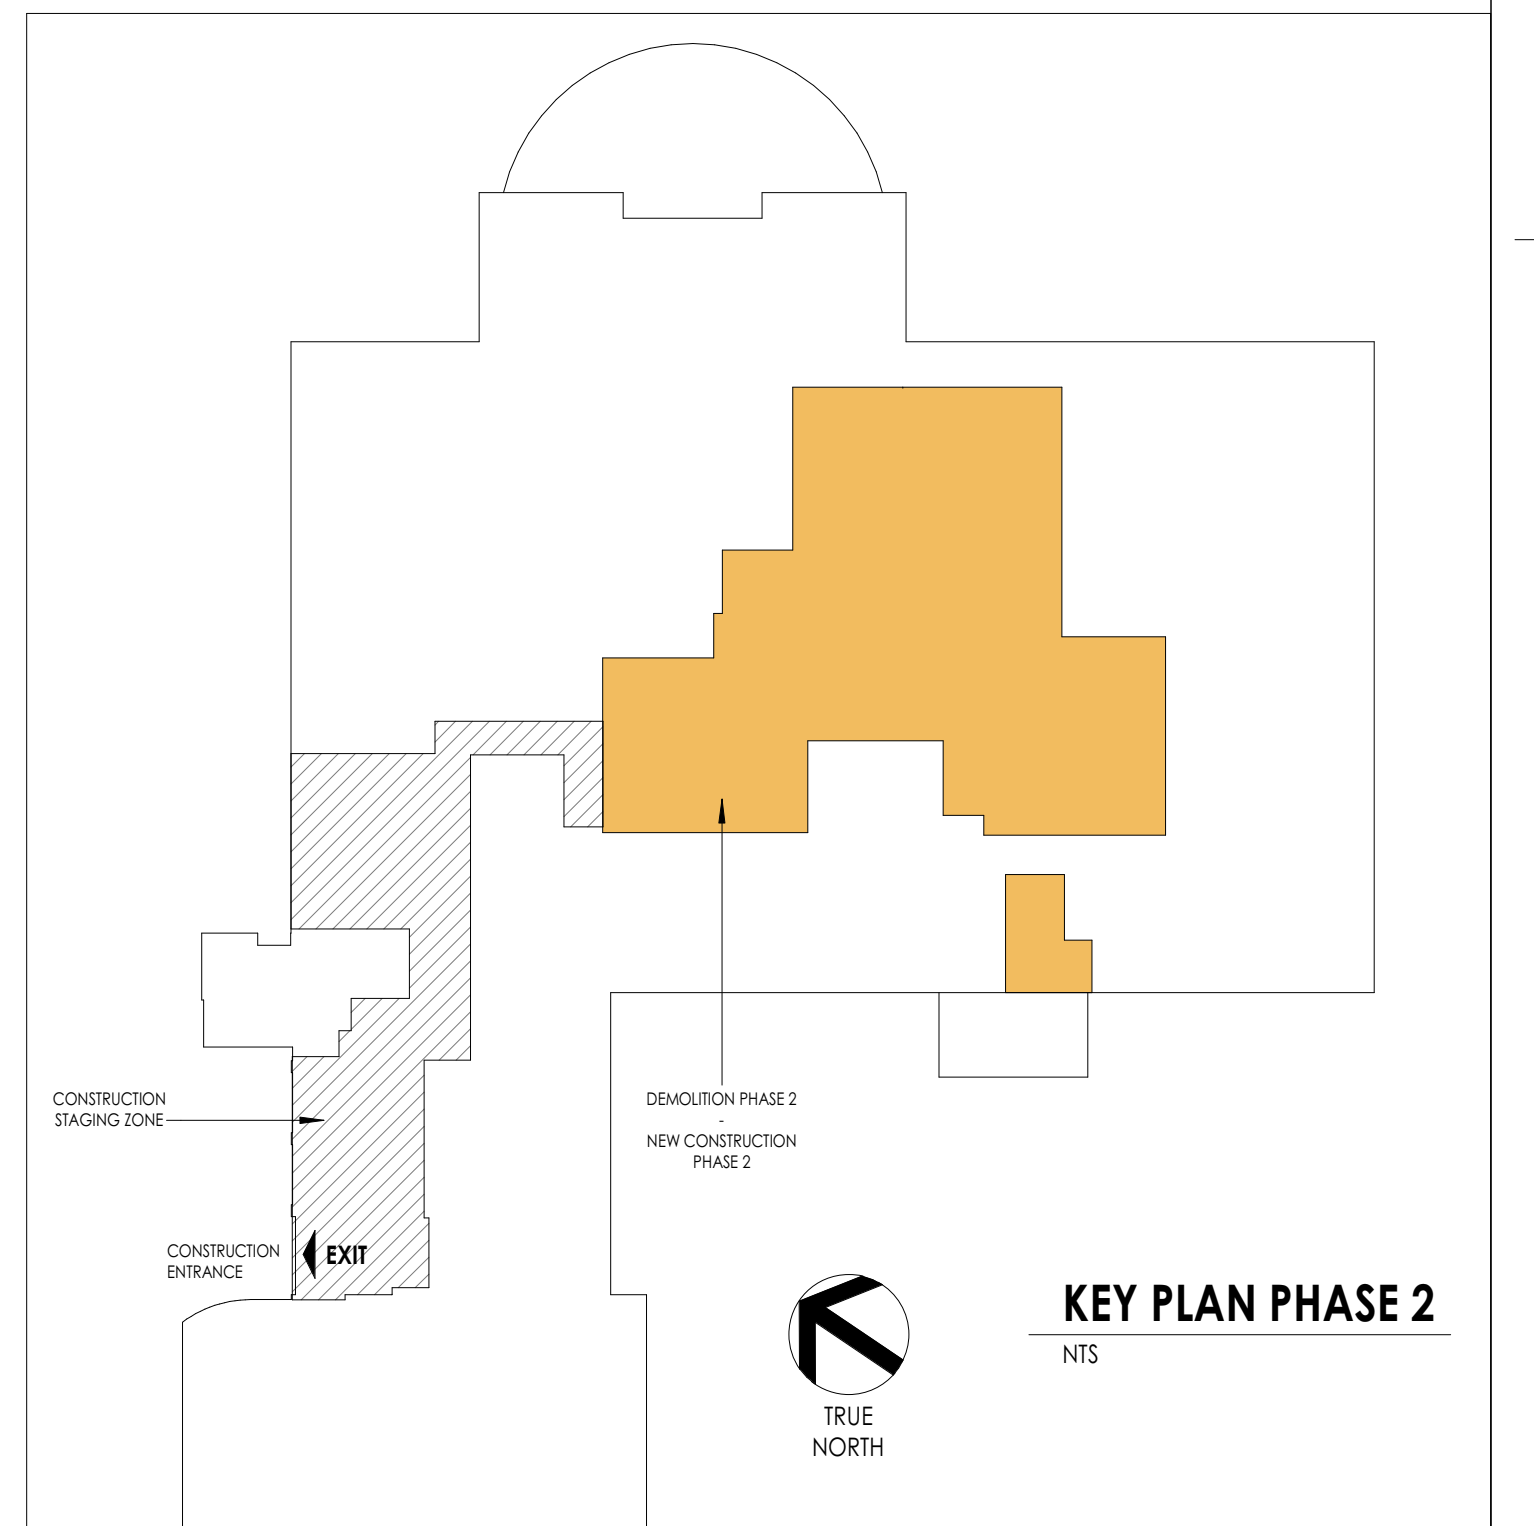

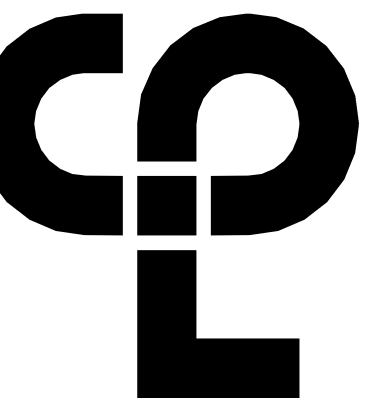

PROJECT INFORMATION

Project Number: 15210.00
Client Name: RANDOLPH COUNTY COURTHOUSE
Project Name: CLERK OF COURT OFFICE RENOVATION

Project Address: 176 E Salisbury St, Asheboro, NC 27203

REVISION SCHEDULE

11 01/27/20 Addendum 4
21

DEMOLITION GENERAL NOTES



- IT IS THE CONTRACTORS RESPONSIBILITY TO FAMILIARIZE THEMSELVES WITH ALL DETAILS INVOLVED IN THE DEMOLITION CONTRACT. SPECIFIC INSTRUCTION ON EACH ITEM WILL NOT BE GIVEN.
- GC IS RESPONSIBLE FOR KEEPING BUILDING WEATHERTIGHT DURING DEMOLITION WORK.
- GC IS TO PROVIDE DUST CONTROL BARRIERS AT ALL AREAS OF CONSTRUCTION.
- GC WILL SALVAGE ANY ITEMS PER OWNER'S LIST (BID).
- PC = PLUMBING CONTRACTOR, EC = ELECTRICAL CONTRACTOR, MC = MECHANICAL CONTRACTOR
- PATCH WALLS, FLOORS AND CEILINGS AT ALL WALL REMOVALS, TO MATCH SCHEDULED FINISHES.
- WORK AREAS SHALL BE MAINTAINED AND LEFT BROOM CLEANED AT END OF EACH DAY.
- EXISTING BUILDING AND STRUCTURE TO REMAIN EXCEPT AS NOTED.

FLOOR PLAN GENERAL NOTES

- ALL DRAWINGS ARE GRAPHIC REPRESENTATIONS OF APPROXIMATE LOCATIONS OF NEW MATERIALS. IT IS THE CONTRACTORS RESPONSIBILITY TO VERIFY ALL EXISTING CONDITIONS PRIOR TO COMMENCEMENT OF WORK.
- THE GENERAL CONTRACTOR IS RESPONSIBLE TO FIRESTOP ALL NEW PARTITIONS TO THE STRUCTURAL DECK ABOVE. FIRESTOPPING HEADS OF WALLS IS TO OCCUR AT ALL NEW WALL CONSTRUCTION WITHIN THE PROJECT.
- ALL WALL DIMENSIONS INDICATED ON FLOOR PLANS ARE TO FACE OF STUD FRAMING OR MASONRY UNLESS OTHERWISE NOTED.
- SEE SHEET A400 FOR INTERIOR PARTITION TYPES
- SEE A400 FOR INTERIOR AND EXTERIOR DOORS, WINDOWS, CURTAIN WALLS, AND STOREFRONTS
- PROVIDE AN EDGE TRANSITION STRIP CENTERED UNDER ALL DOORS WHERE ADJACENT FLOOR FINISHES ARE OF DIFFERENT MATERIALS.
- PROVIDE ACCESS PANELS, MINIMUM 24" x 24", OR OF SIZES REQUIRED, WHERE PLUMBING AND HEATING VALVES, WATER SWITCHES, VENTILATION SPLITTER DAMPERS, ETC. ARE SHOWN ON PLUMBING, HEATING AND VENTILATION DRAWINGS.
- WORK AREAS SHALL BE MAINTAINED AND ALL WORK AREAS SHALL BE LEFT BROOMED CLEAN AT END OF EACH DAY.
- ALL DOORS AND WINDOW SYSTEMS TO HAVE SEALANT AROUND THE ENTIRE PERIMETER, BOTH SIDES OF FRAMES.
- CONTRACTOR TO COORDINATE WITH OTHER TRADES FOR SEQUENCING OF WORK.
- REFER TO A700 FOR TYPICAL FIXTURE MOUNTING HEIGHTS AND ACCESSORIES
- EXISTING MASONRY WINDOW SILLS ARE NOT TO BE PAINTED.

DEMOLITION KEYNOTES


Mark	Demolition Note
B1	REMOVE EXISTING WALL BASE TYPICAL THROUGHOUT SUITE.
C1	REMOVE ACOUSTICAL CEILING SYSTEM AND HANGER WIRES. COORDINATE REMOVAL OF DUCTWORK/DIFFUSERS, LIGHTS, PIPING AND ALL OTHER CEILING MOUNTED ITEMS WITH OTHER CONTRACTORS.
C2	REMOVE GNB CEILING AND ASSOCIATED FRAMING. COORDINATE REMOVAL OF DUCTWORK/DIFFUSERS, LIGHTS, PIPING AND ALL OTHER CEILING MOUNTED ITEMS WITH OTHER CONTRACTORS.
D1	DEMOLISH EXISTING DOOR, FRAME, TRANSOM AND HARDWARE AS INDICATED. RESTORE REMAINING ADJACENT SURFACES TO ORIGINAL CONDITION. COORDINATE SALVAGE AND REUSE REQUIREMENTS WITH OWNER.
D2	REMOVE EXISTING DOOR HARDWARE. PIN DOORS CLOSED.
D3	DEMOLISH AND REUSE EXISTING DOOR AND FRAME. DOOR TO BE MOVED TO ADJACENT WALL.
F1	REMOVE EXISTING FLOOR FINISH AND PREPARE SURFACE TO RECEIVE NEW FINISH. TYPICAL THROUGHOUT SUITE.
F2	EXTENTS OF FLOORING REMOVAL IN THIS PHASE.
L1	REMOVE AND SALVAGE EXISTING FIRE EXTINGUISHER AND CABINET. REFER TO LIFE SAFETY PLANS FOR NEW LOCATION.
M1	DEMOLISH EXISTING MILLWORK AND COUNTERTOP. RESTORE REMAINING ADJACENT SURFACES TO ORIGINAL CONDITIONS.
S1	SELECTIVE DEMOLITION - REMOVE A PORTION OF EXISTING CHASE, VERIFY IF REMAINING CHANCE CAN BE DEMOLISHED.
T1	REMOVE EXISTING TOILET PARTITIONS AND ACCESSORIES. PATCH AND REPAIR SURFACES AS NECESSARY IN PREPARATION FOR NEW WORK. TOILET ACCESSORIES, INCLUDING MIRROR, PAPER TOWEL DISPENSER, TRASH RECEPTACLE, TOILET PAPER DISPENSER, GRAB BARS, ETC. TO BE REINSTALLED AFTER RENOVATION.
T2	REMOVE AND STORE EXISTING WALL MOUNTED RESTROOM ACCESSORIES, MIRRORS, AND SIGNAGE. RESTORE REMAINING ADJACENT SURFACES TO RECEIVE NEW FINISH. BATHROOM ACCESSORIES TO BE RE-USED INCLUDING PAPER TOWEL/TRASH RECEPTACLE, TOILET PAPER HOLDER AND GRAB BARS.
W1	REMOVE WALLS OR PORTIONS OF WALLS AS INDICATED. PATCH AND REPAIR AS REQUIRED TO COMPLETE RENOVATION SCOPE. ALL LOCATIONS MAY NOT BE TAGGED. VERIFY IN FIELD PRIOR TO COMPLETING DEMOLITION.
W2	REMOVE EXISTING WALL COVERING AND ADHESIVE. PREPARE SURFACE TO RECEIVE NEW PAINT FINISH.
W3	REMOVE MASONRY WALL AS INDICATED. PATCH AND REPAIR FLOOR AND ADJACENT WALL AS REQUIRED TO COMPLETE RENOVATION SCOPE. ALL LOCATIONS MAY NOT BE TAGGED. VERIFY IN FIELD PRIOR TO COMPLETING DEMOLITION.
W4	PATCH AND REPAIR HOLES IN MASONRY WALLS.
WS	DEMOLISH TEMPORARY CONSTRUCTION BARRIER AFTER WORK IS COMPLETED.
X1	REMOVE AND STORE WALL PLAQUE.
X2	DEMOLISH EXISTING PLATFORM. PREPARE SURFACE BELOW FOR NEW FINISH.

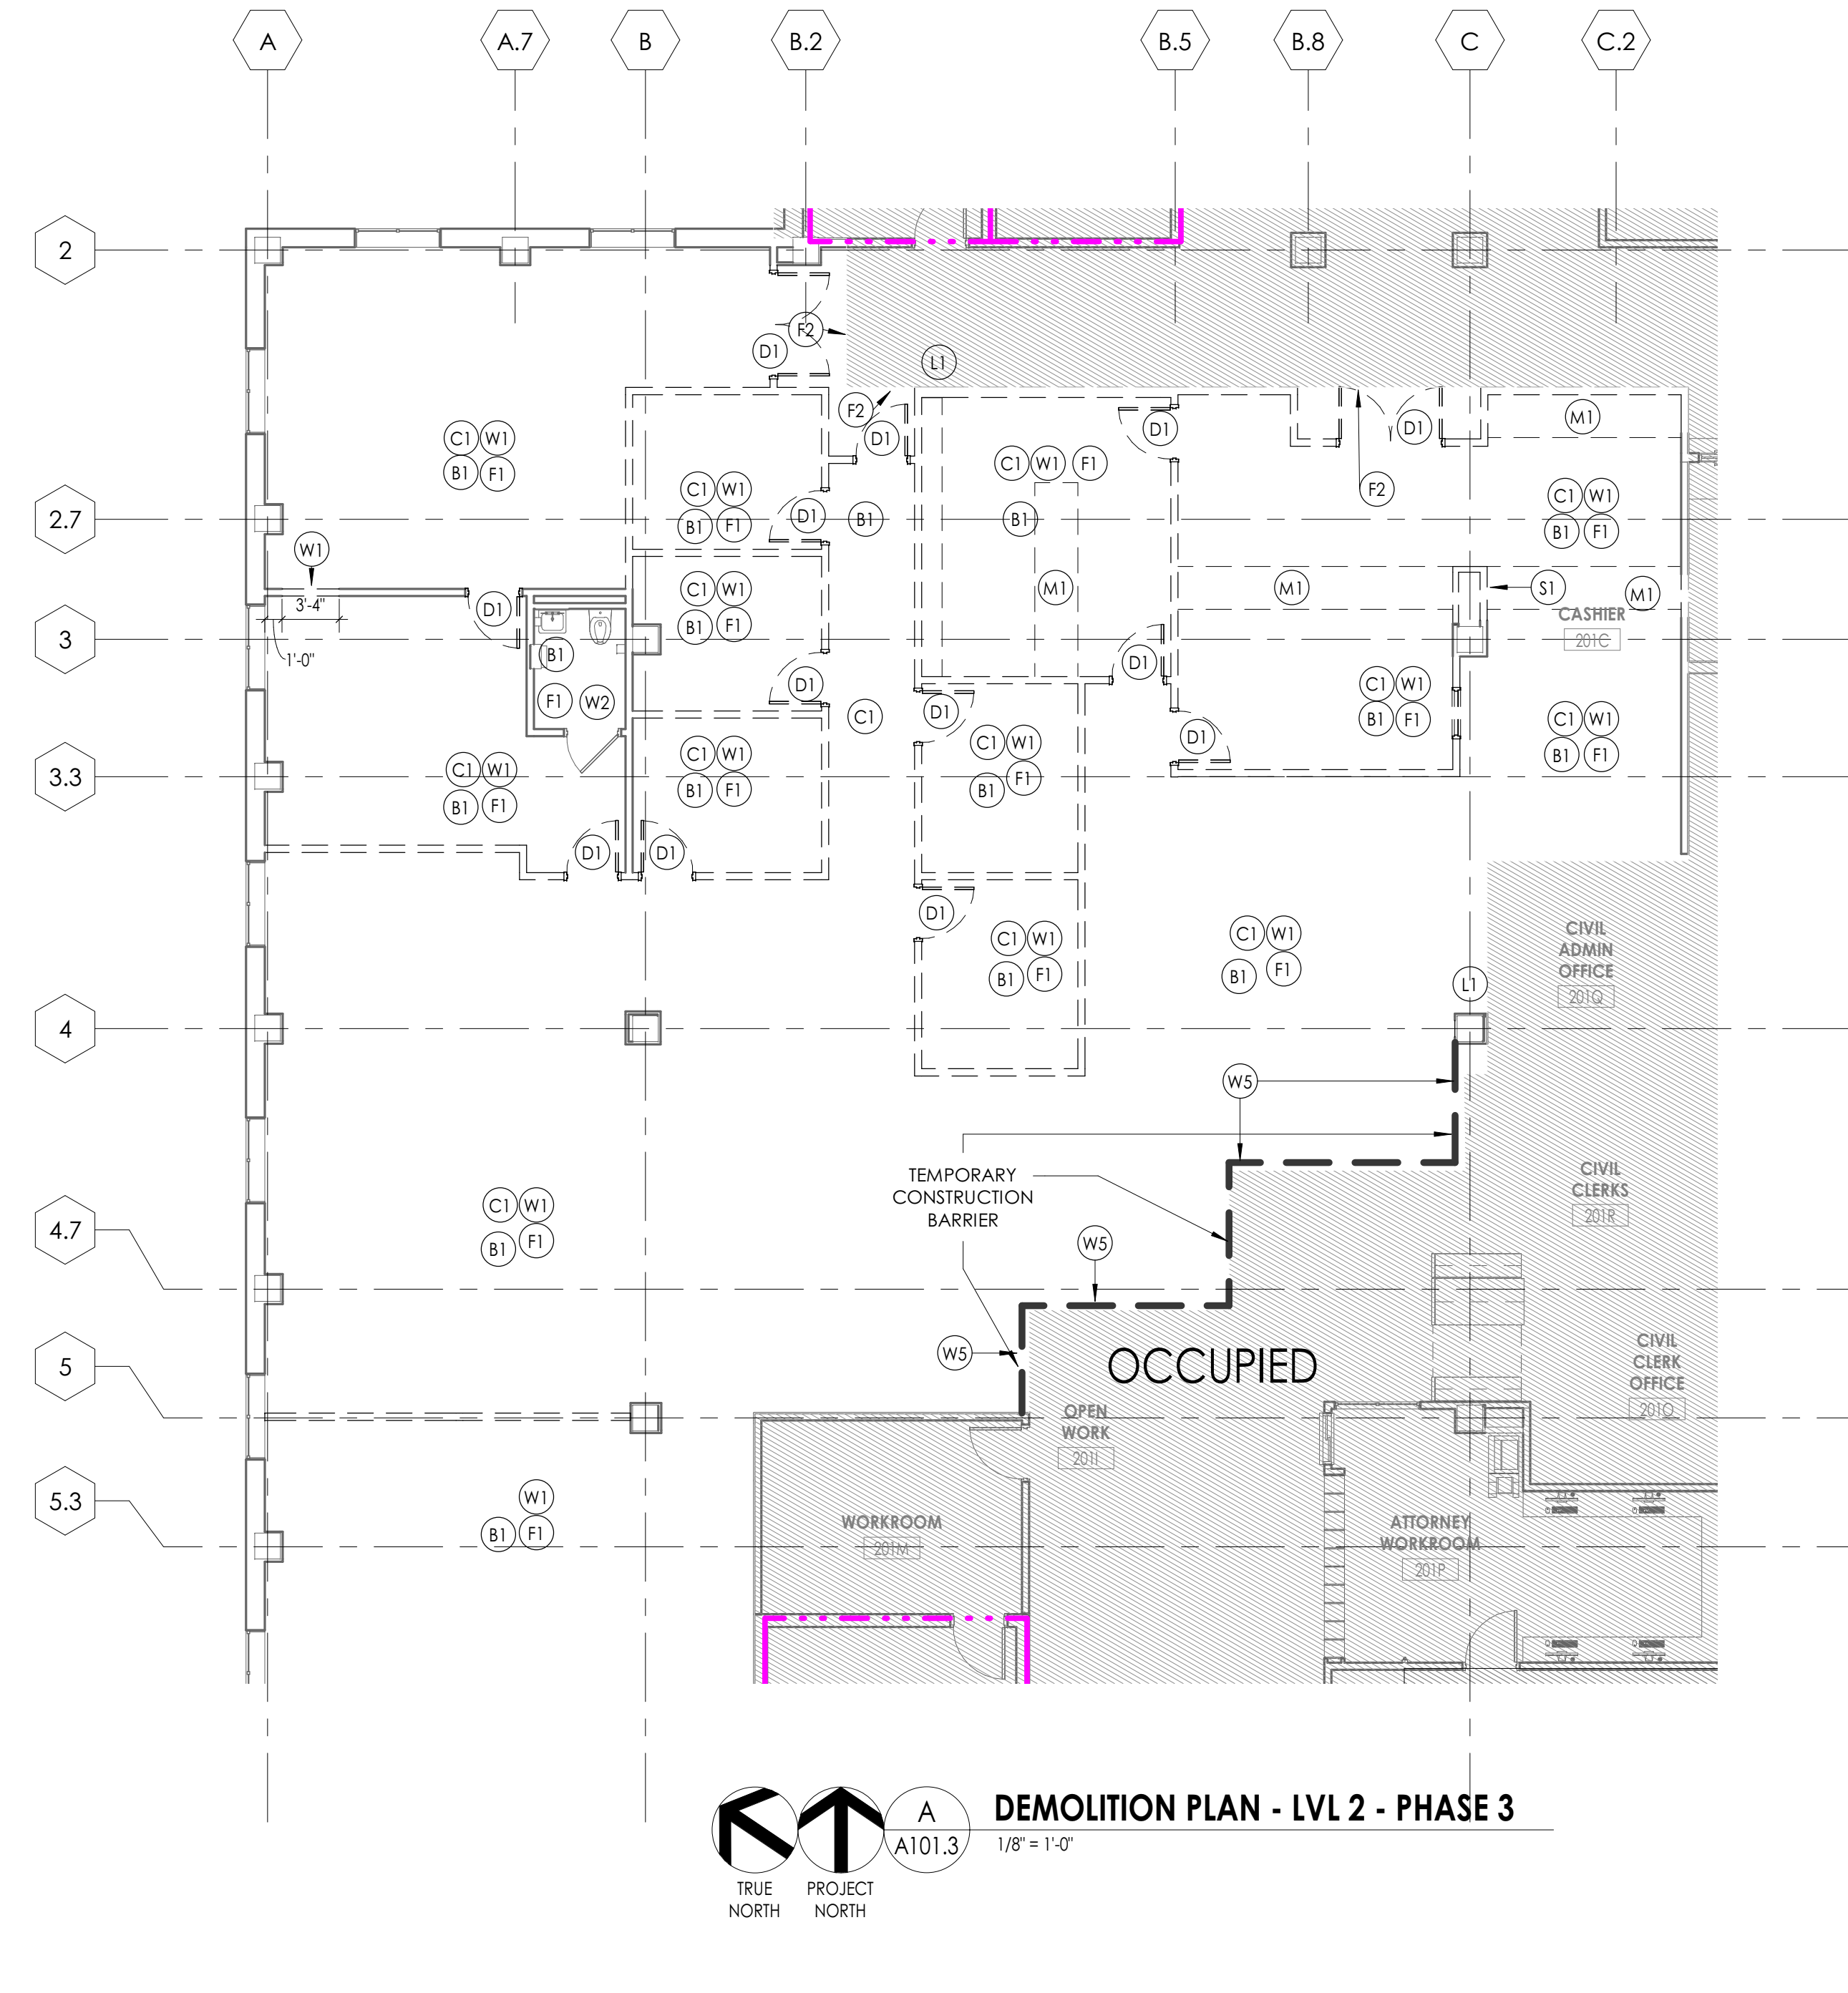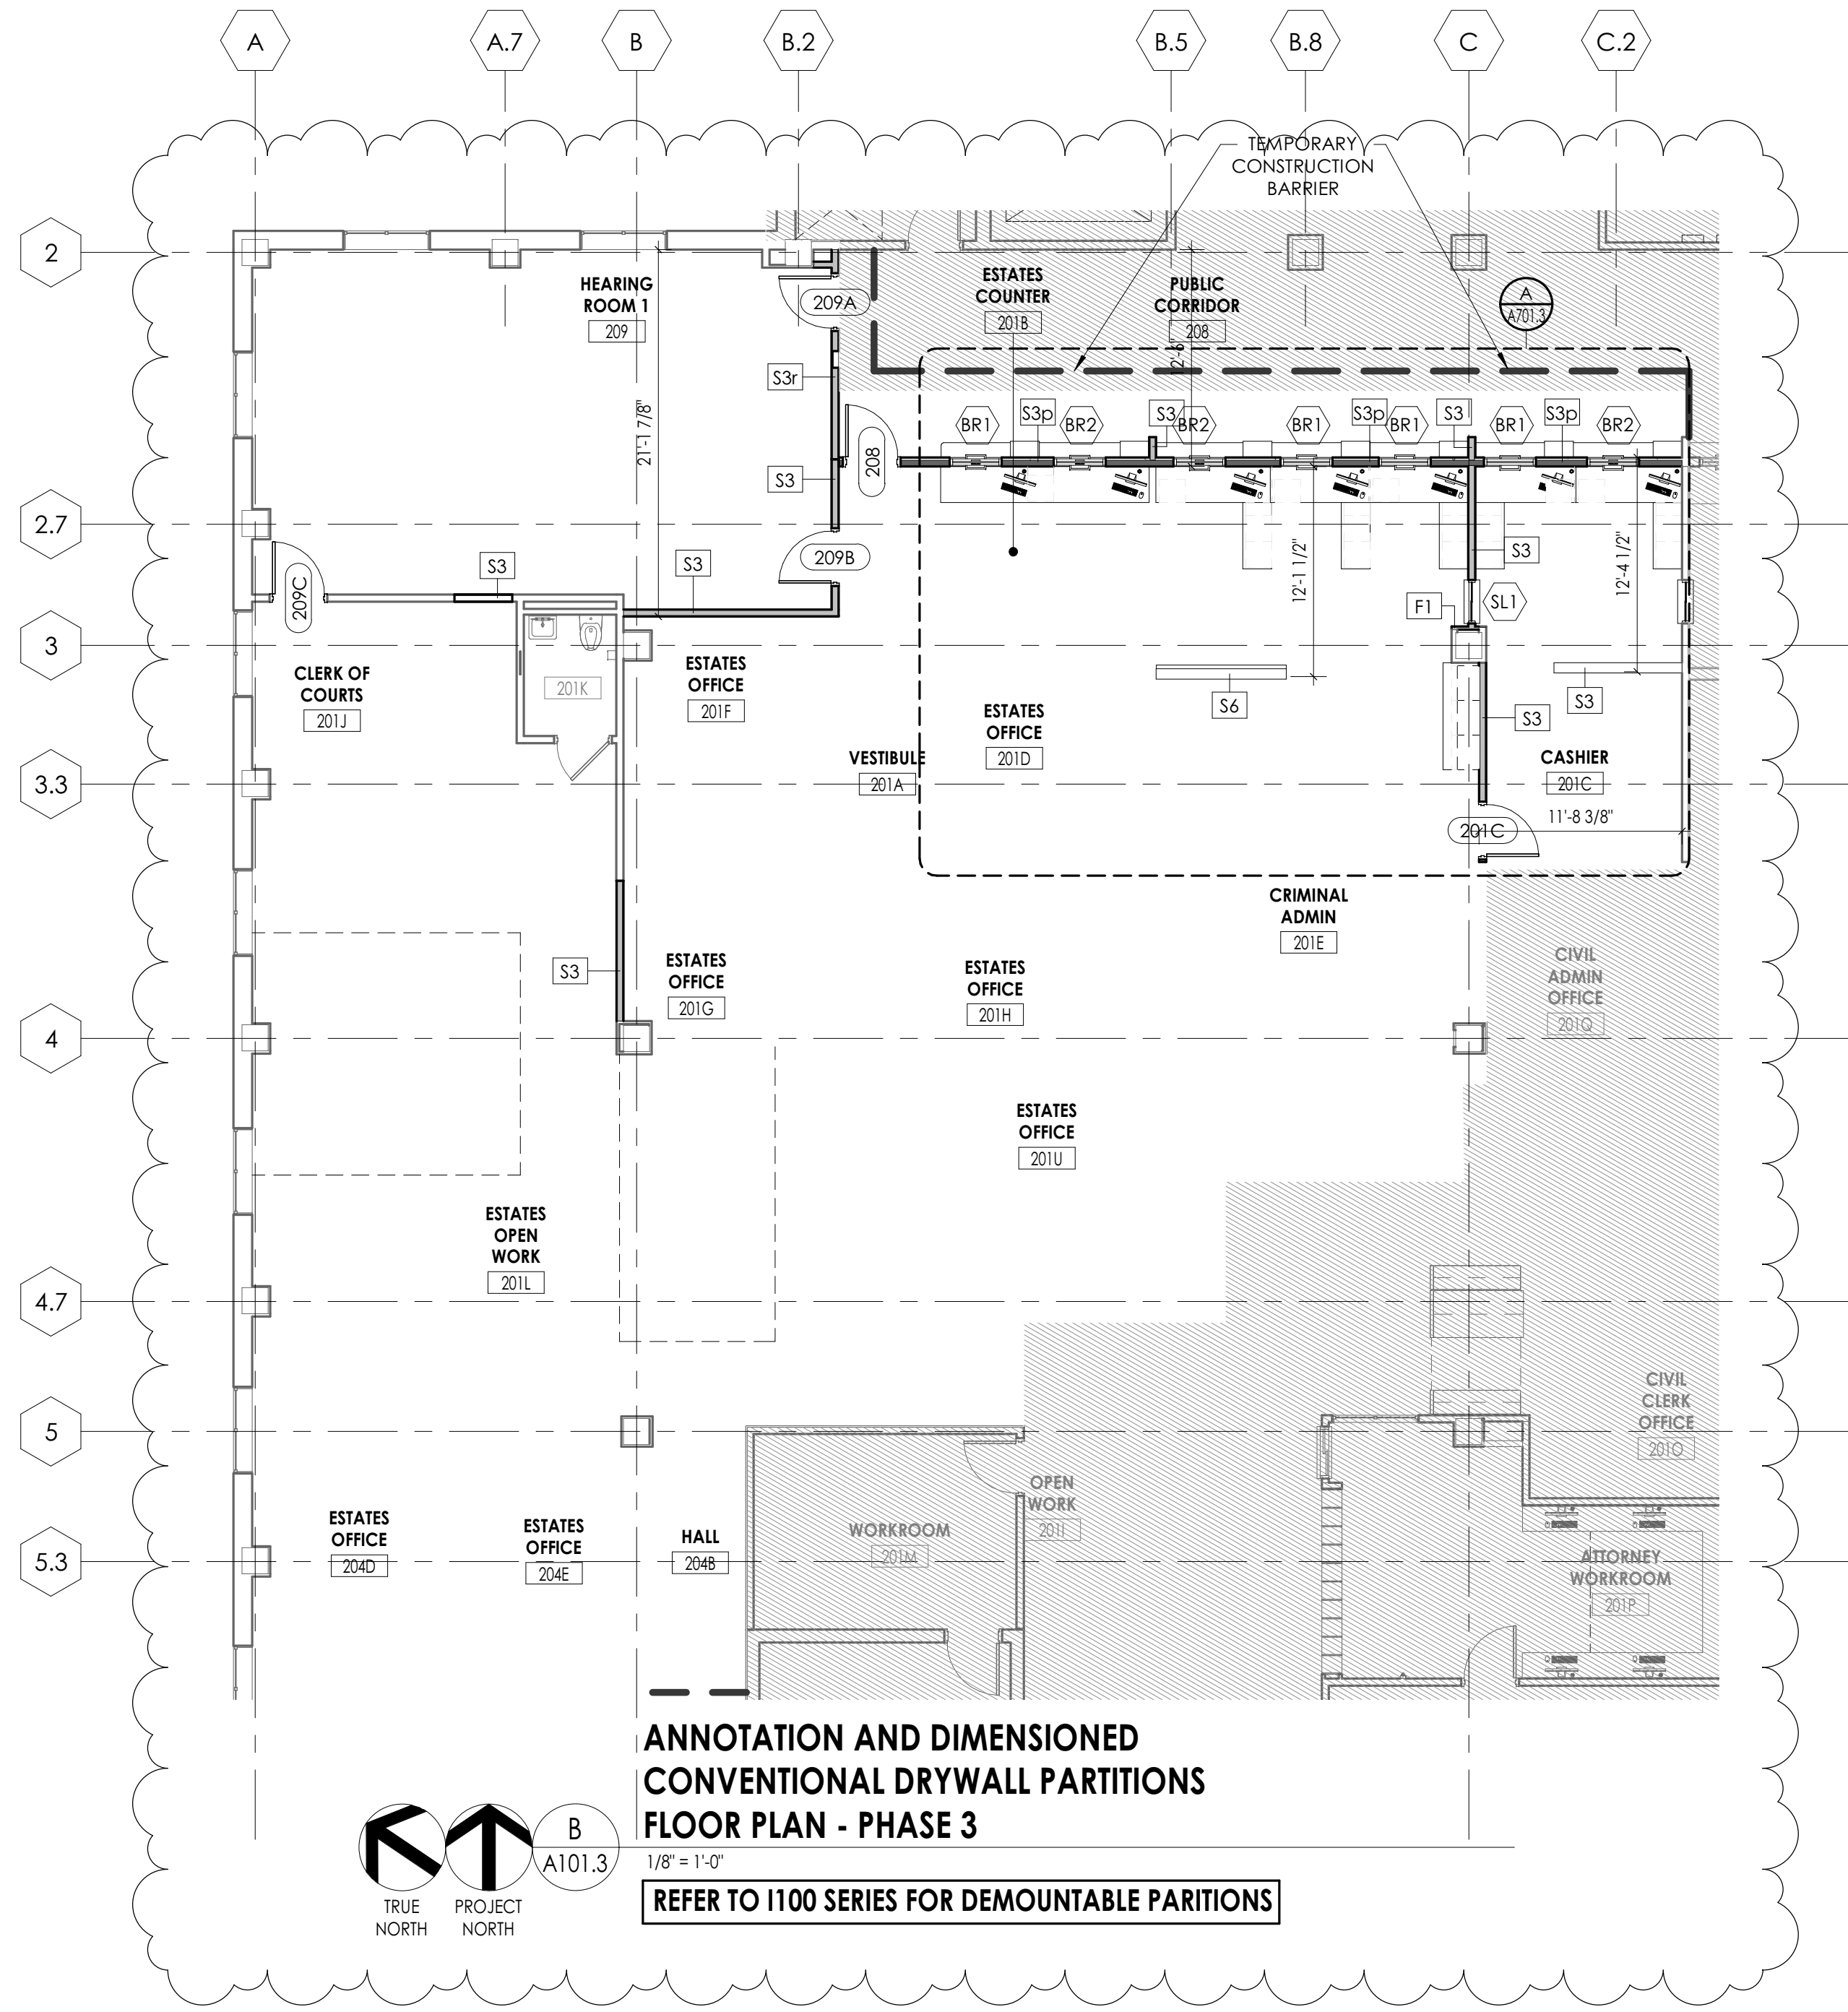

CONVENTIONAL DRYWALL PARTITIONS DOOR SCHEDULE- PHASE 3

DOOR NUMBER	FIRE RATING (MIN)	PANEL TYPE	SINGLE PANEL DIMENSIONS				DOOR PANELS				DOOR FRAME				GLAZING TYPE	DOOR COMMENTS
			WIDTH	HEIGHT	TOTAL PANEL DIMENSIONS		PANEL FINISHES		FRAME DIMENSIONS			FRAME FINISH	HW SET			
					WIDTH	HEIGHT	THICKNESS	UNDERCUT	PANEL FINISH SIDE 1	PANEL FINISH SIDE 2	FRAME TYPE			JAMB WIDTH		
LVL 2																
201C		PNLF-WD	3'-0"	7'-0"	3'-0"	7'-0"	0'-1 3/4"	0'-0"	WD/ST	<By Category>	FRM-00HM1	0'-2"	0'-2"	0'-5 3/4"	HM/PT	8
208		PNLF-WD	3'-0"	7'-0"	3'-0"	7'-0"	0'-1 3/4"	0'-0"	WD/ST	<By Category>	FRM-00HM1	0'-2"	0'-2"	0'-7 1/8"	HM/PT	9
209A		PNLF-WD	3'-0"	7'-0"	3'-0"	7'-0"	0'-1 3/4"	0'-0"	WD/ST	<By Category>	FRM-00HM1	0'-2"	0'-2"	0'-5 3/4"	HM/PT	9
209B		PNLF-WD	3'-0"	7'-0"	3'-0"	7'-0"	0'-1 3/4"	0'-0"	WD/ST	<By Category>	FRM-00HM1	0'-2"	0'-2"	0'-5 3/4"	HM/PT	9
209C		PNLF-WD	3'-0"	7'-0"	3'-0"	7'-0"	0'-1 3/4"	0'-0"	WD/ST	<By Category>	FRM-00HM1	0'-2"	0'-2"	0'-5 7/8"	HM/PT	10

REFER TO SHEET A400 FOR DOOR AND HARDWARE TYPES.

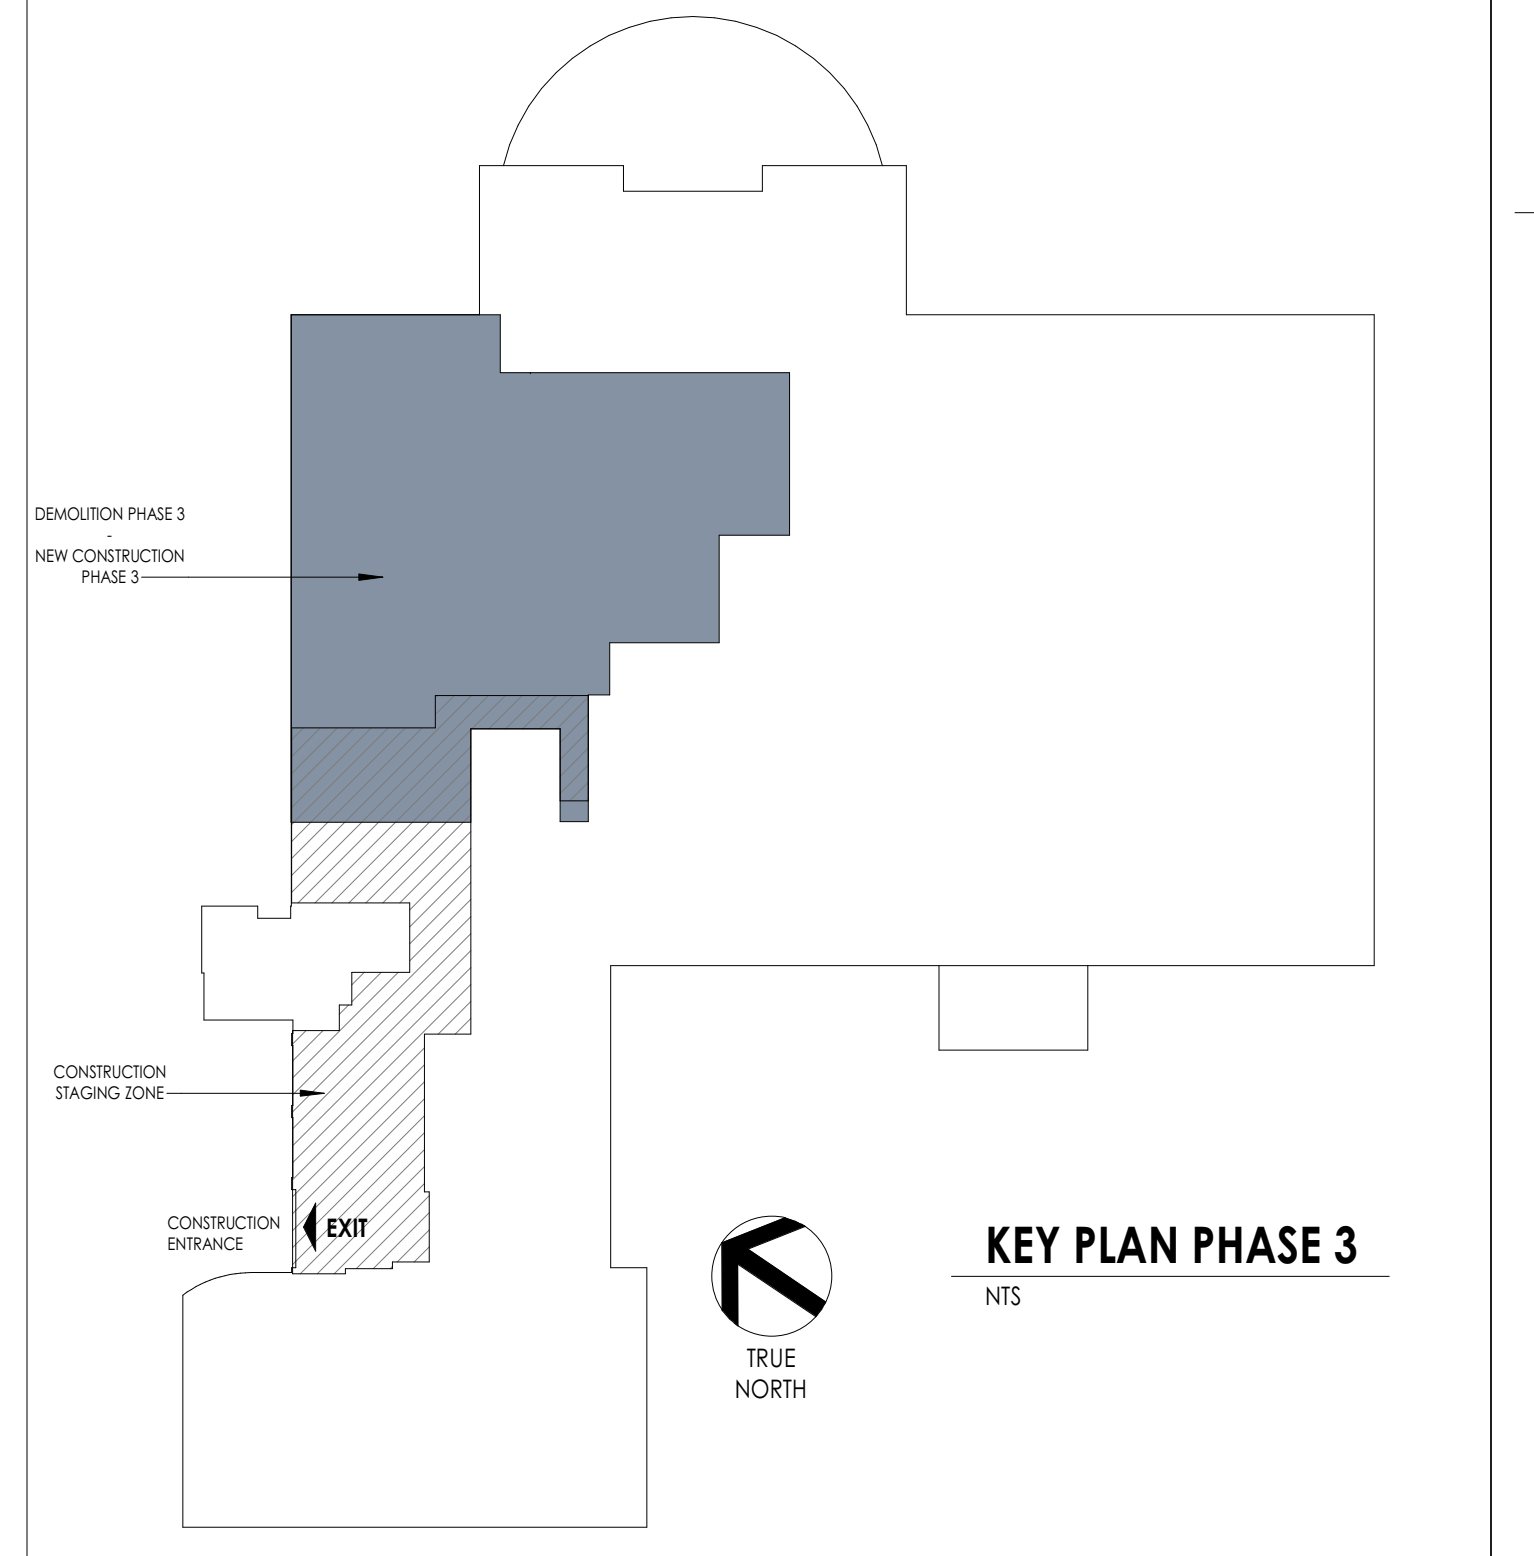


SHEET INFORMATION

Issue: 01/26/21
BID DOCUMENTS
Drawn By: CFL
Checked By: CFL
Drawing Title: PHASE 3 - DEMOLITION AND NEW WORK PLANS

KEY PLAN PHASE 3

NTS

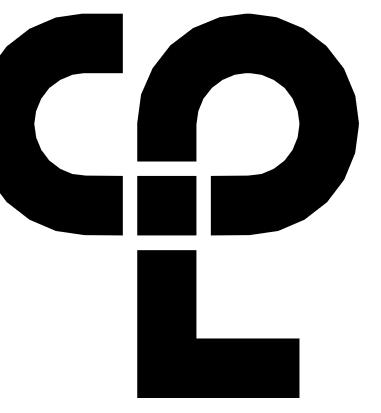

PROJECT INFORMATION

Project Number: 15210.00
Client Name: RANDOLPH COUNTY COURTHOUSE
Project Name: CLERK OF COURT OFFICE RENOVATION

Project Address: 176 E Salisbury St, Asheboro, NC 27203

REVISION SCHEDULE

11 01/27/20 Addendum 4
21

DEMOLITION GENERAL NOTES


- IT IS THE CONTRACTOR'S RESPONSIBILITY TO FAMILIARIZE THEMSELVES WITH ALL DETAILS INVOLVED IN THE DEMOLITION CONTRACT. SPECIFIC INSTRUCTION ON EACH ITEM WILL NOT BE GIVEN.
- GC IS RESPONSIBLE FOR KEEPING BUILDING WEATHERTIGHT DURING DEMOLITION WORK.
- GC IS TO PROVIDE DUST CONTROL BARRIERS AT ALL AREAS OF CONSTRUCTION.
- GC WILL SALVAGE ANY ITEMS PER OWNER'S LIST (BID).
- PC = PLUMBING CONTRACTOR, EC = ELECTRICAL CONTRACTOR, MC = MECHANICAL CONTRACTOR.
- PATCH WALLS, FLOORS AND CEILINGS AT ALL WALL REMOVALS, TO MATCH SCHEDULED FINISHES.
- WORK AREAS SHALL BE MAINTAINED AND LEFT BROOM CLEANED AT END OF EACH DAY.
- EXISTING BUILDING AND STRUCTURE TO REMAIN EXCEPT AS NOTED.

FLOOR PLAN GENERAL NOTES


- ALL DRAWINGS ARE GRAPHIC REPRESENTATIONS OF APPROXIMATE LOCATIONS OF NEW MATERIALS. IT IS THE CONTRACTOR'S RESPONSIBILITY TO FIELD VERIFY ALL EXISTING CONDITIONS PRIOR TO COMMENCEMENT OF WORK.
- THE GENERAL CONTRACTOR IS RESPONSIBLE TO FIRESTOP ALL NEW PARTITIONS TO THE STRUCTURAL DECK ABOVE. FIRESTOPPING HEADS OF WALLS IS TO OCCUR AT ALL NEW WALL CONSTRUCTION WITHIN THE PROJECT.
- ALL WALL DIMENSIONS INDICATED ON FLOOR PLANS ARE TO FACE OF STUD FRAMING OR MASONRY UNLESS OTHERWISE NOTED.
- SEE SHEET A600 FOR INTERIOR PARTITION TYPES.
- SEE A600 FOR INTERIOR AND EXTERIOR DOORS, WINDOWS, CURTAIN WALLS, AND STOREFRONTS.
- PROVIDE AN EDGE TRANSITION STRIP CENTERED UNDER ALL DOORS WHERE ADJACENT FLOOR FINISHES ARE OF DIFFERENT MATERIALS.
- PROVIDE ACCESS PANELS, MINIMUM 24" x 24", OR OF SIZES REQUIRED, WHERE PLUMBING AND HEATING VALVES, WATER SWITCHES, VENTILATION SPLITTER DAMPERS, ETC. ARE SHOWN ON PLUMBING, HEATING AND VENTILATION DRAWINGS.
- WORK AREAS SHALL BE MAINTAINED AND ALL WORK AREAS SHALL BE LEFT BROOMED CLEAN AT END OF EACH DAY.
- ALL DOORS AND WINDOW SYSTEMS TO HAVE SEALANT AROUND THE ENTIRE PERIMETER, BOTH SIDES OF FRAMES.
- CONTRACTOR TO COORDINATE WITH OTHER TRADES FOR SEQUENCING OF WORK.
- REFER TO A700 FOR TYPICAL FIXTURE MOUNTING HEIGHTS AND ACCESSORIES LEGEND.
- EXISTING MASONRY WINDOW SILLS ARE NOT TO BE PAINTED.

DEMOLITION KEYNOTES

Mark	Demolition Note
B1	REMOVE EXISTING WALL BASE TYPICAL THROUGHOUT SUITE.
C1	REMOVE ACOUSTICAL CEILING SYSTEM AND HANGER WIRES. COORDINATE REMOVAL OF DUCTWORK/DIFFUSERS, LIGHTS, PIPING AND ALL OTHER CEILING MOUNTED ITEMS WITH OTHER CONTRACTORS.
C2	REMOVE GIB CEILING AND ASSOCIATED FRAMING. COORDINATE REMOVAL OF DUCTWORK/DIFFUSERS, LIGHTS, PIPING AND ALL OTHER CEILING MOUNTED ITEMS WITH OTHER CONTRACTORS.
D1	DEMOLISH EXISTING DOOR, FRAME, TRANSOM AND HARDWARE AS INDICATED. RESTORE REMAINING ADJACENT SURFACES TO ORIGINAL CONDITION. COORDINATE SALVAGE AND REUSE REQUIREMENTS WITH OWNER.
D2	REMOVE EXISTING DOOR HARDWARE. PIN DOORS CLOSED.
D3	DEMOLISH AND REUSE EXISTING DOOR AND FRAME. DOOR TO BE MOVED TO ADJACENT WALL.
F1	REMOVE EXISTING FLOOR FINISH AND PREPARE SURFACE TO RECEIVE NEW FINISH, TYPICAL THROUGHOUT SUITE.
F2	EXTENTS OF FLOORING REMOVAL IN THIS PHASE.
L1	REMOVE AND SALVAGE EXISTING FIRE EXTINGUISHER AND CABINET. REFER TO LIFE SAFETY PLANS FOR NEW LOCATION.
M1	DEMOLISH EXISTING MILLWORK AND COUNTERTOP. RESTORE REMAINING ADJACENT SURFACES TO ORIGINAL CONDITIONS.
S1	SELECTIVE DEMOLITION - REMOVE A PORTION OF EXISTING CHASE, VERIFY IF REMAINING CHANCE CAN BE DEMOLISHED.
T1	REMOVE EXISTING TOILET PARTITIONS AND ACCESSORIES. PATCH AND REPAIR SURFACES AS NECESSARY IN PREPARATION FOR NEW WORK. TOILET ACCESSORIES, INCLUDING MIRROR, PAPER TOWEL DISPENSER/TRASH RECEPTACLE, TOILET PAPER DISPENSER, GRAB BARS, ETC., TO BE REINSTALLED AFTER RENOVATION.
T2	REMOVE AND STORE EXISTING WALL MOUNTED RESTROOM ACCESSORIES, MIRRORS, AND SIGNAGE. RESTORE REMAINING ADJACENT SURFACES TO RECEIVE NEW FINISH. BATHROOM ACCESSORIES TO BE RE-USED INCLUDING PAPER TOWEL/TRASH RECEPTACLE, TOILET PAPER HOLDER AND GRAB BARS.
W1	REMOVE WALLS OR PORTIONS OF WALLS AS INDICATED. PATCH AND REPAIR AS REQUIRED TO COMPLETE RENOVATION SCOPE. ALL LOCATIONS MAY NOT BE TAGGED. VERIFY IN FIELD PRIOR TO COMPLETING DEMOLITION.
W2	REMOVE EXISTING WALL COVERING AND ADHESIVE. PREPARE SURFACE TO RECEIVE NEW PAINT FINISH.
W3	REMOVE MASONRY WALL AS INDICATED. PATCH AND REPAIR FLOOR AND ADJACENT WALL AS REQUIRED TO COMPLETE RENOVATION SCOPE. ALL LOCATIONS MAY NOT BE TAGGED. VERIFY IN FIELD PRIOR TO COMPLETING DEMOLITION.
W4	PATCH AND REPAIR HOLES IN MASONRY WALLS.
W5	DEMOLISH TEMPORARY CONSTRUCTION BARRIER AFTER WORK IS COMPLETED.
X1	REMOVE AND STORE WALL PLAQUE.
X2	DEMOLISH EXISTING PLATFORM. PREPARE SURFACE BELOW FOR NEW FINISH.

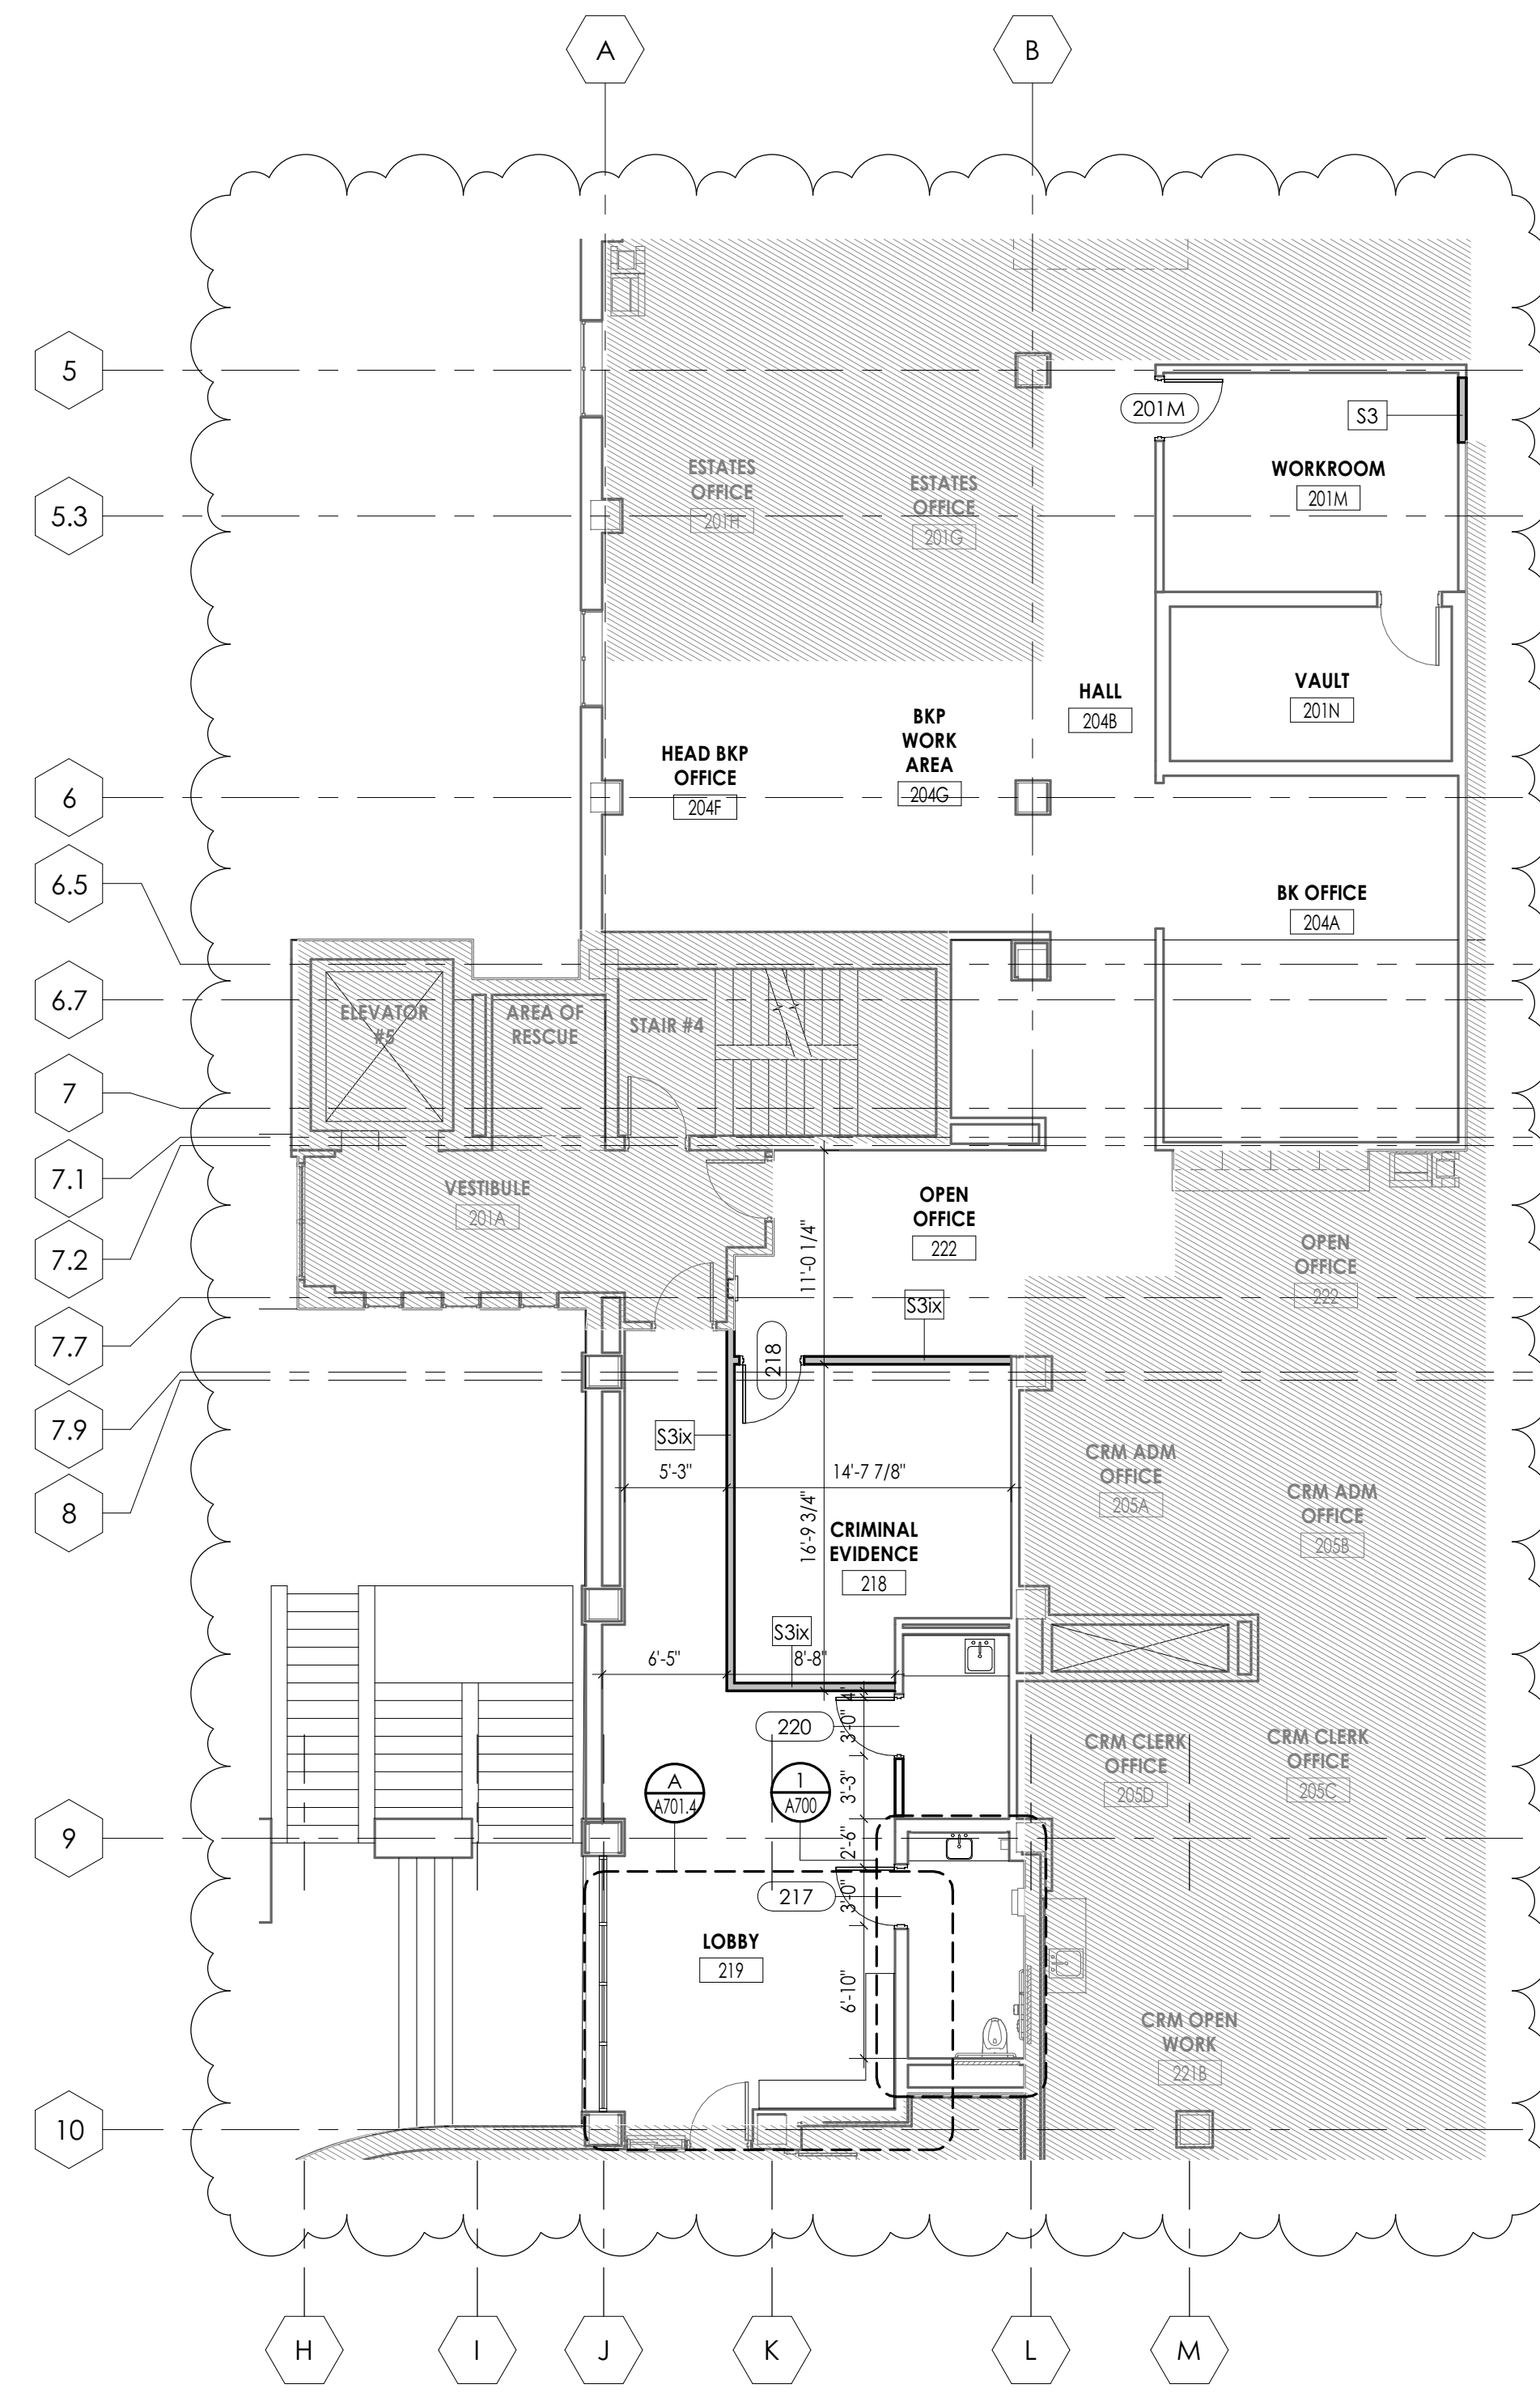


ANNOTATION AND DIMENSIONED CONVENTIONAL DRYWALL PARTITIONS FLOOR PLAN - PHASE 4

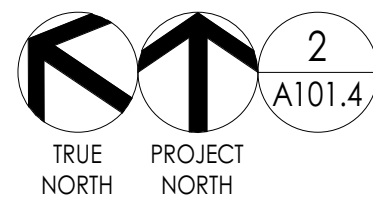


1/8" = 1'-0"

REFER TO 1100 SERIES FOR DEMOUNTABLE PARTITIONS

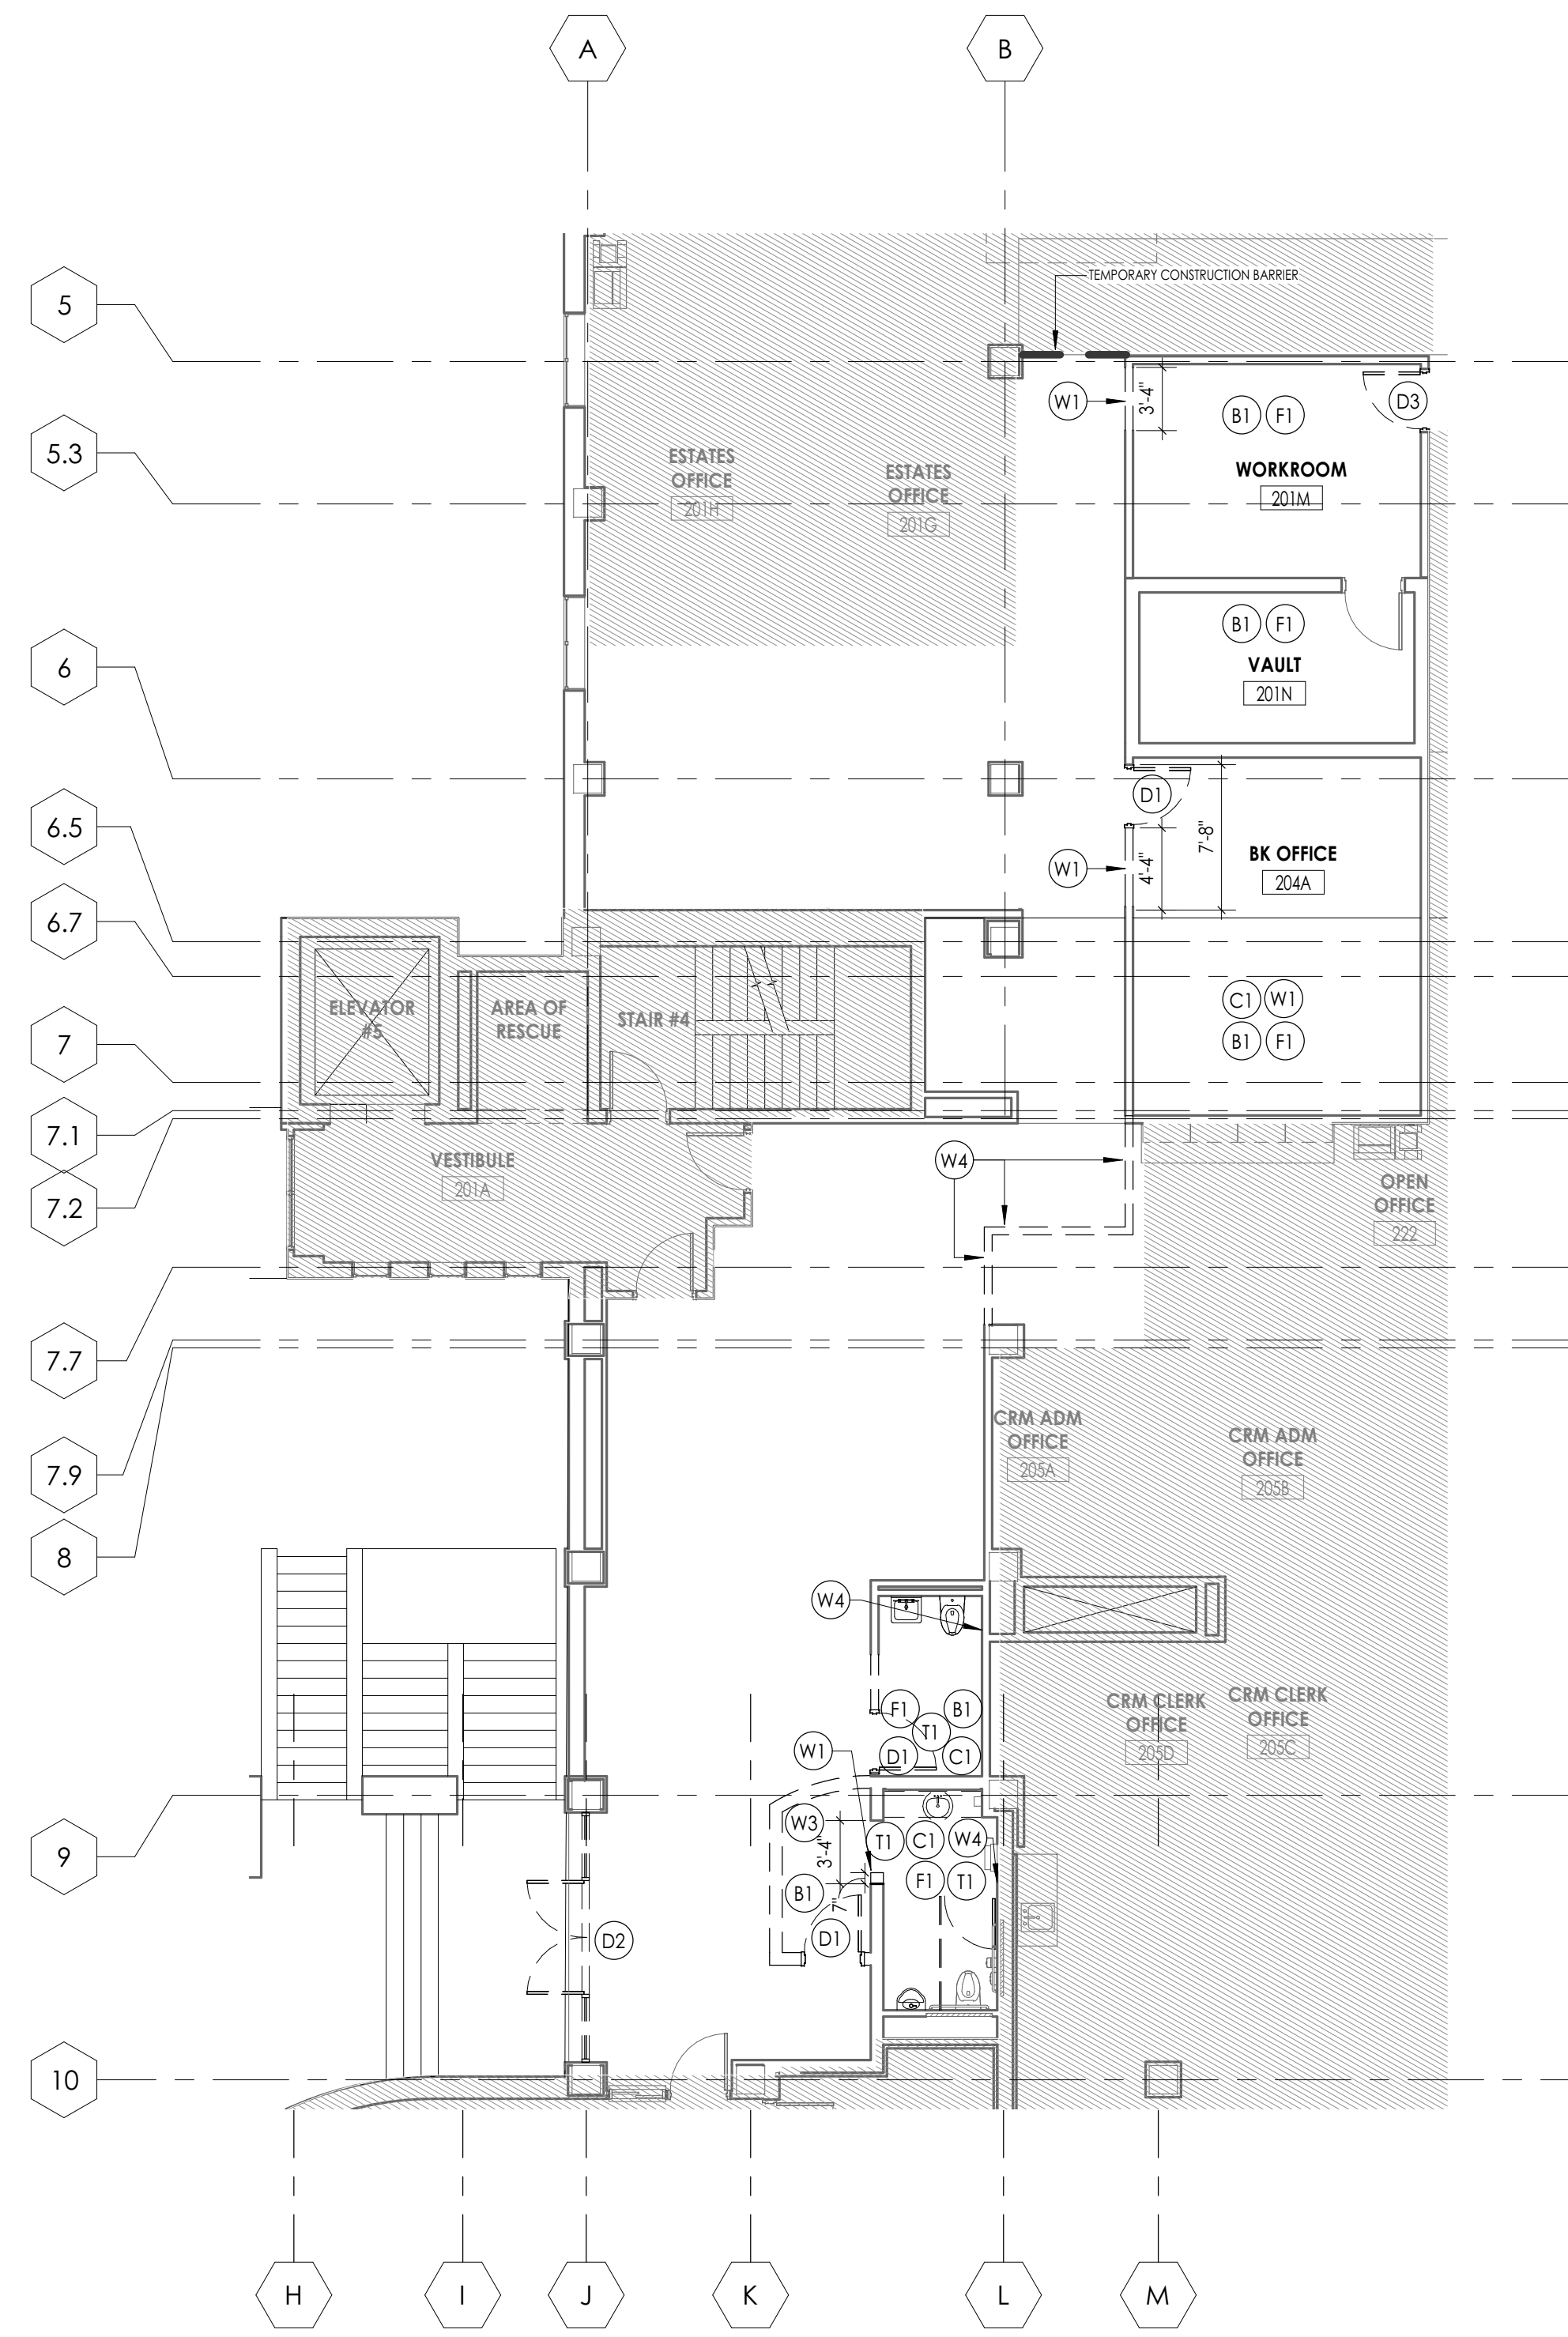

DEMOLITION PLAN - LVL 2 - PHASE 4

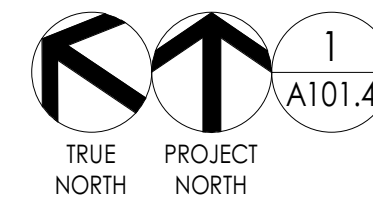


1/8" = 1'-0"

DOOR SCHEDULE - PHASE 4 - CONVENTIONAL DRYWALL PARTITIONS

DOOR NUMBER	FIRE RATING (MIN)	PANEL TYPE		SINGLE PANEL DIMENSIONS			DOOR PANELS			PANEL FINISHES		DOOR FRAME					DOOR COMMENTS		
		PANEL 1	PANEL 2	WIDTH	HEIGHT	PANELS 1 & 2	WIDTH	HEIGHT	THICKNESS	UNDERCUT	PANEL FINISH SIDE 1	PANEL FINISH SIDE 2	FRAME DIMENSIONS			GLAZING TYPE			
													JAMB WIDTH	HEAD HEIGHT	FRAME DEPTH			FRAME FINISH	HW SET
201M		PNL-NW-WD		3'-0"	7'-0"	3'-0"	7'-0"	0'-1 3/4"	0'-0"	WD/ST	WD/ST	FRM-DOH1	0'-2"	0'-2"	0'-5 7/8"	HM/PT	8		
217		PNL-E-WD		3'-0"	7'-0"	3'-0"	7'-0"	0'-1 3/4"	0'-0"	WD/ST	WD/ST	FRM-DOH1	0'-2"	0'-2"	0'-8 1/8"	HM/PT	4		OCCUPANCY INDICATOR LOCK HARDWARE
218		PNL-F-WD		3'-0"	7'-0"	3'-0"	7'-0"	0'-1 3/4"	0'-0"	WD/ST	WD/ST	FRM-DOH1	0'-2"	0'-2"	0'-5 3/4"	HM/PT	8		CARD READER
220		PNL-F-WD		3'-0"	7'-0"	3'-0"	7'-0"	0'-1 3/4"	0'-0"	WD/ST	WD/ST	FRM-DOH1	0'-2"	0'-2"	0'-5 7/8"	HM/PT	6		OCCUPANCY INDICATOR LOCK HARDWARE

REFER TO SHEET A600 FOR DOOR AND HARDWARE TYPES

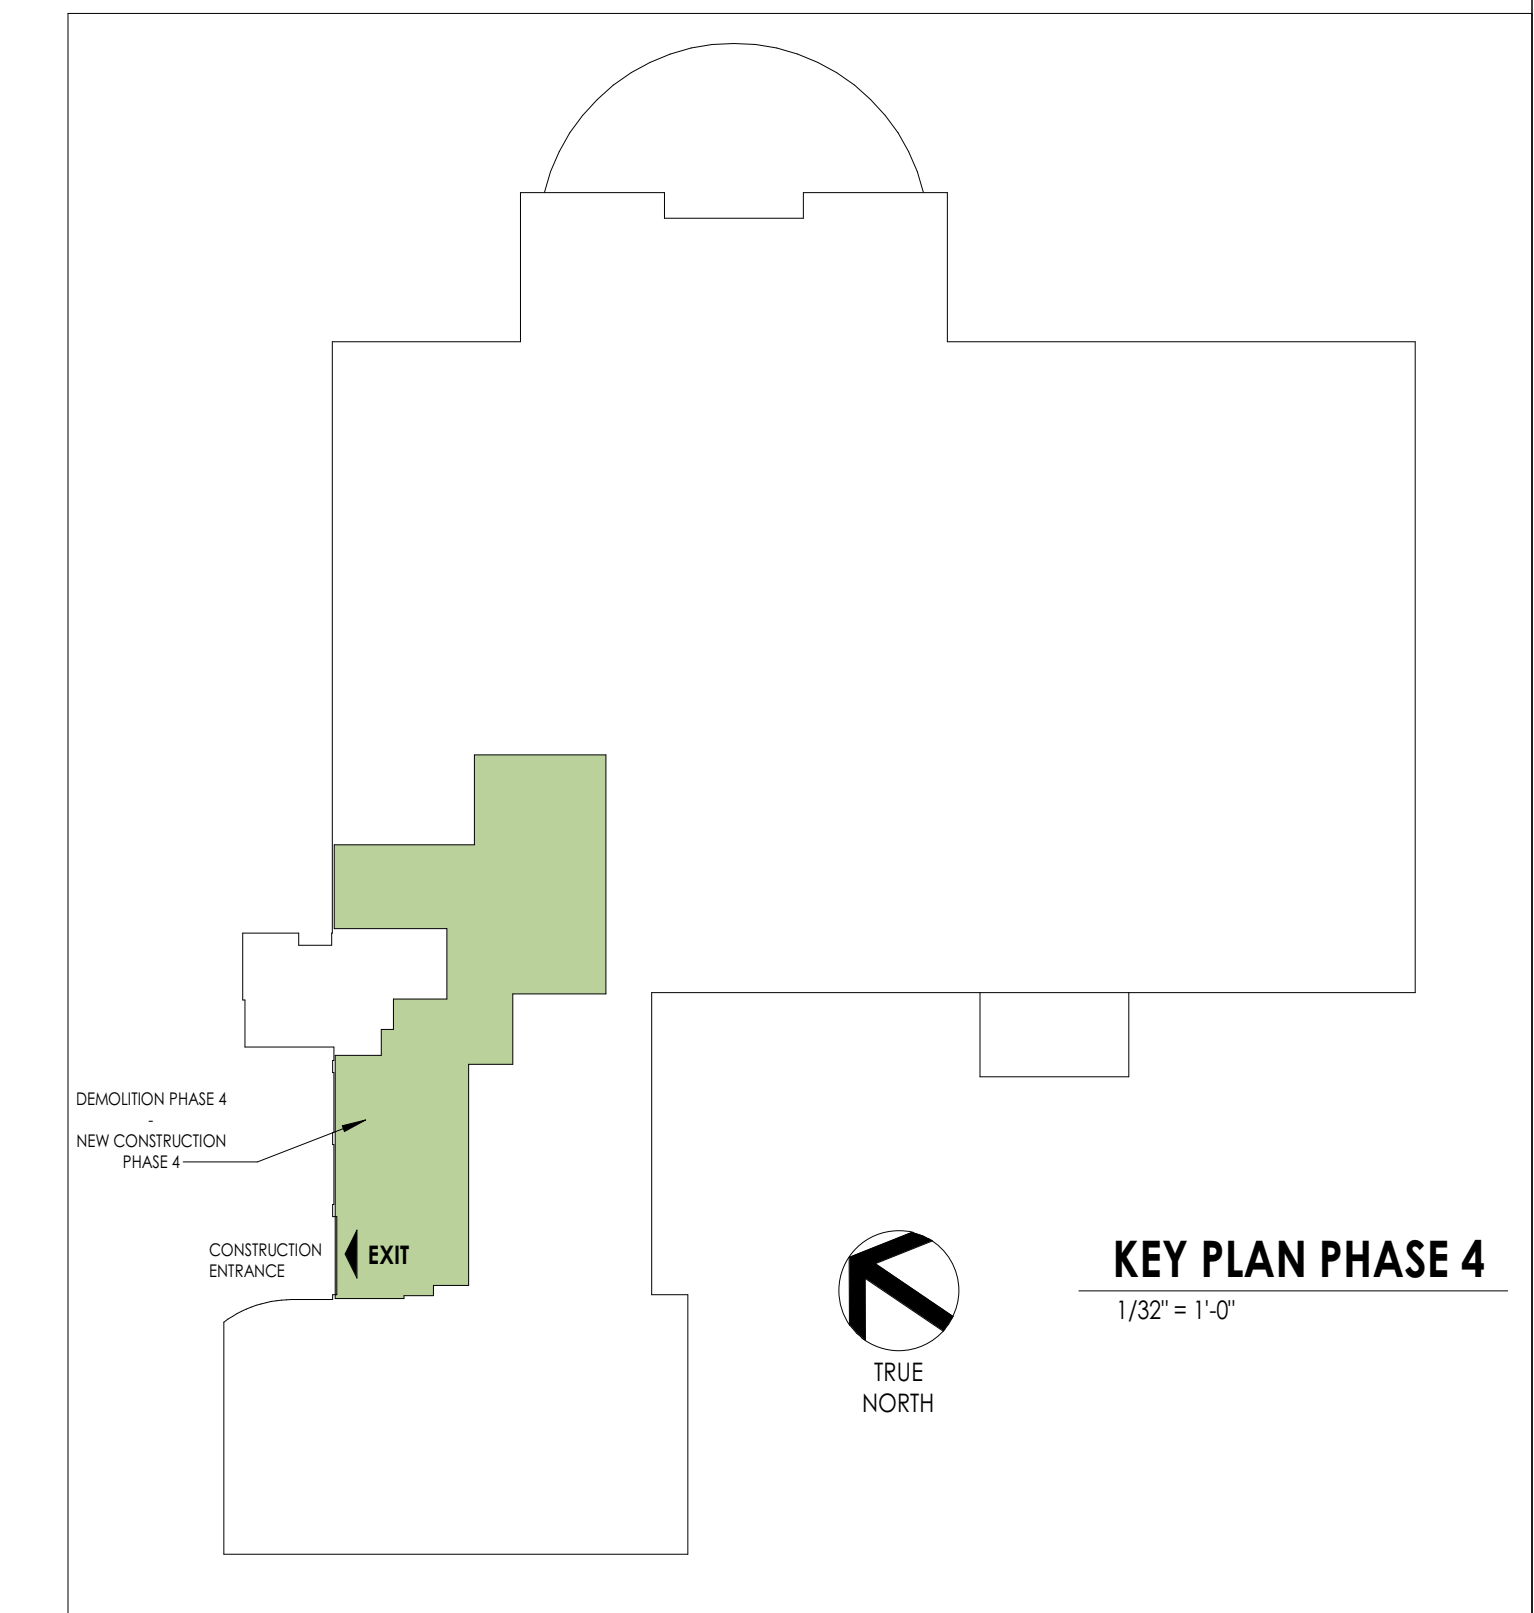

KEY PLAN PHASE 4

1/32" = 1'-0"

SHEET INFORMATION


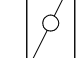
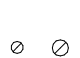

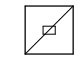





Issue: 01/26/21
Bid Documents
Drawn By: CPL
Checked By: CPL
Drawing Title: PHASE 4 - DEMOLITION AND NEW WORK PLANS

GENERAL CEILING NOTES

1. ALL DRAWINGS ARE GRAPHIC REPRESENTATION OF APPROXIMATE LOCATIONS OF NEW MATERIALS FOR CONSTRUCTION. IT IS THE CONTRACTOR'S RESPONSIBILITY TO FIELD VERIFY ALL CONDITIONS PRIOR TO COMMENCEMENT OF WORK.
2. REFER TO A200 SERIES FOR FLOOR PLAN.
3. FOR ANY DISCREPANCY BETWEEN THE REFLECTED CEILING PLAN AND THE FLOOR PLAN, THE FLOOR PLAN SHALL TAKE PRECEDENCE. ANY DISCREPANCIES SHALL BE CALLED TO THE ATTENTION OF THE ARCHITECT.
4. IT IS THE CONTRACTOR'S RESPONSIBILITY TO FIRE STOP MECHANICAL, ELECTRICAL AND PLUMBING ITEMS, INCLUDING BUT NOT LIMITED TO DUCTWORK AND CONDUIT PENETRATIONS THROUGH FLOORS AND WALLS.
5. THE CONTRACTOR SHALL COORDINATE CEILING INSTALLATIONS WITH MECHANICAL, ELECTRICAL AND PLUMBING DRAWINGS.
6. REFER TO "H" SERIES DRAWINGS FOR DIFFUSERS AND GRILLE LOCATIONS.
7. REFER TO "E" SERIES DRAWINGS FOR LIGHTING TYPES AND CONTROLS.
8. REFER TO "P" SERIES DRAWINGS FOR SPRINKLER HEAD LOCATIONS.
9. WORK AREAS SHALL BE MAINTAINED AND ALL WORK AREAS SHALL BE LEFT BROOMED CLEAN AT THE END OF EACH DAY.
10. CENTER CEILING GRID (EACH WAY) IN ROOMS SCHEDULED TO RECEIVE ACOUSTICAL CEILING SYSTEMS UNLESS OTHERWISE NOTED.
11. CONTRACTOR TO VERIFY WITH ARCHITECT THE INSTALLATION OF ANY CEILING TILES LESS THAN 4' IN WIDTH.
12. PROVIDE MOISTURE RESISTANT GYP. BD. AT ALL TOILET ROOM, JANITOR'S CLOSET AND OTHER WET LOCATION CEILING ASSEMBLIES.
13. ALL GYP. BD. CEILINGS AND SOFFITS SHALL BE PRIMED AND PAINTED SCHEDULED COLOR ON ALL FACES AND UNDERSIDE SURFACE.
14. CONTRACTOR TO VERIFY SOFFIT SIZE WITH MILLWORK SHOP DRAWINGS. PROVIDE 7" OVERHANG ON EXPOSED EDGES UNLESS NOTED OTHERWISE.
15. WHERE APPLICABLE ALL FIXTURES AND DEVICES SHALL BE CENTERED ON A CEILING TILE.

CEILING SYMBOL LEGEND

NOTE: THE LEGEND MAY CONTAIN SYMBOLS THAT ARE NOT USED IN THIS PROJECT.

-  2'x2' LIGHT
-  2'x4' LIGHTS
-  RECESSED CAN LIGHT FIXTURE
-  SUPPLY AIR DIFFUSERS
-  RETURN AIR DIFFUSERS
-  EXHAUST DIFFUSERS
-  LINEAR SLOT AIR DIFFUSERS
-  GYPSUM WALL BOARD CEILING
-  ACOUSTICAL TILE CEILING
-  ACT-1 CEILING TYPE AND CEILING HEIGHT ABOVE FINISHED FLOOR

CEILING KEYNOTES





- 1 CONSTRUCTION OF CEILING TO BE COMPLETED IN A LATER PHASE
- 2 TEMPORARY WALL TO BE BUILT TO THE UNDERSIDE OF NEW SOFFIT
- 3 CEILING TO BE BUILT AS MONOLITHIC SYSTEM. DEMOUNTABLE WALLS TO BE CLIPPED TO UNDERSIDE OF CEILING.
- 4 EXPANSION JOINT

PROJECT INFORMATION

Project Number: 15210.00
Client Name: RANDOLPH COUNTY COURTHOUSE
Project Name: CLERK OF COURT OFFICE RENOVATION
Project Address: 176 E Salisbury St, Asheboro, NC 27203

REVISION SCHEDULE

11 01/27/20 Addendum 4
21

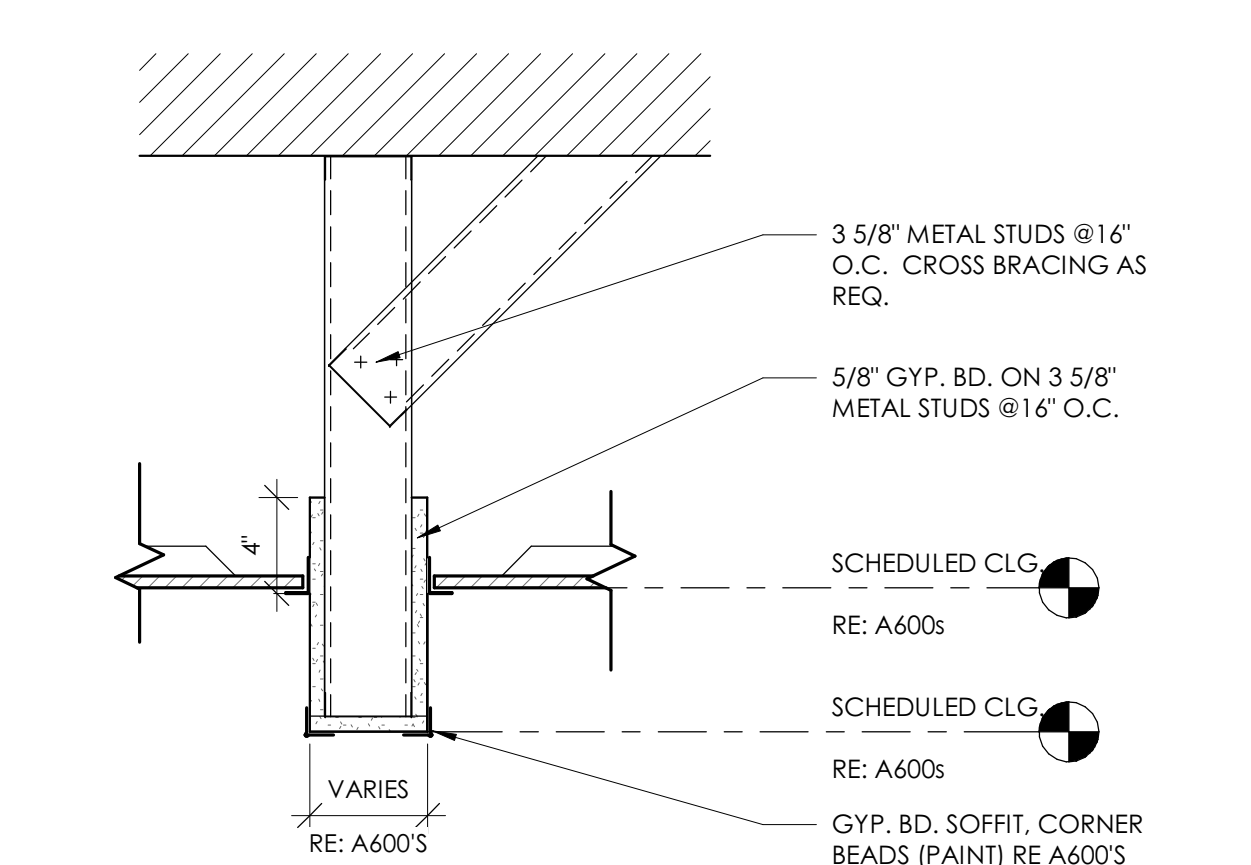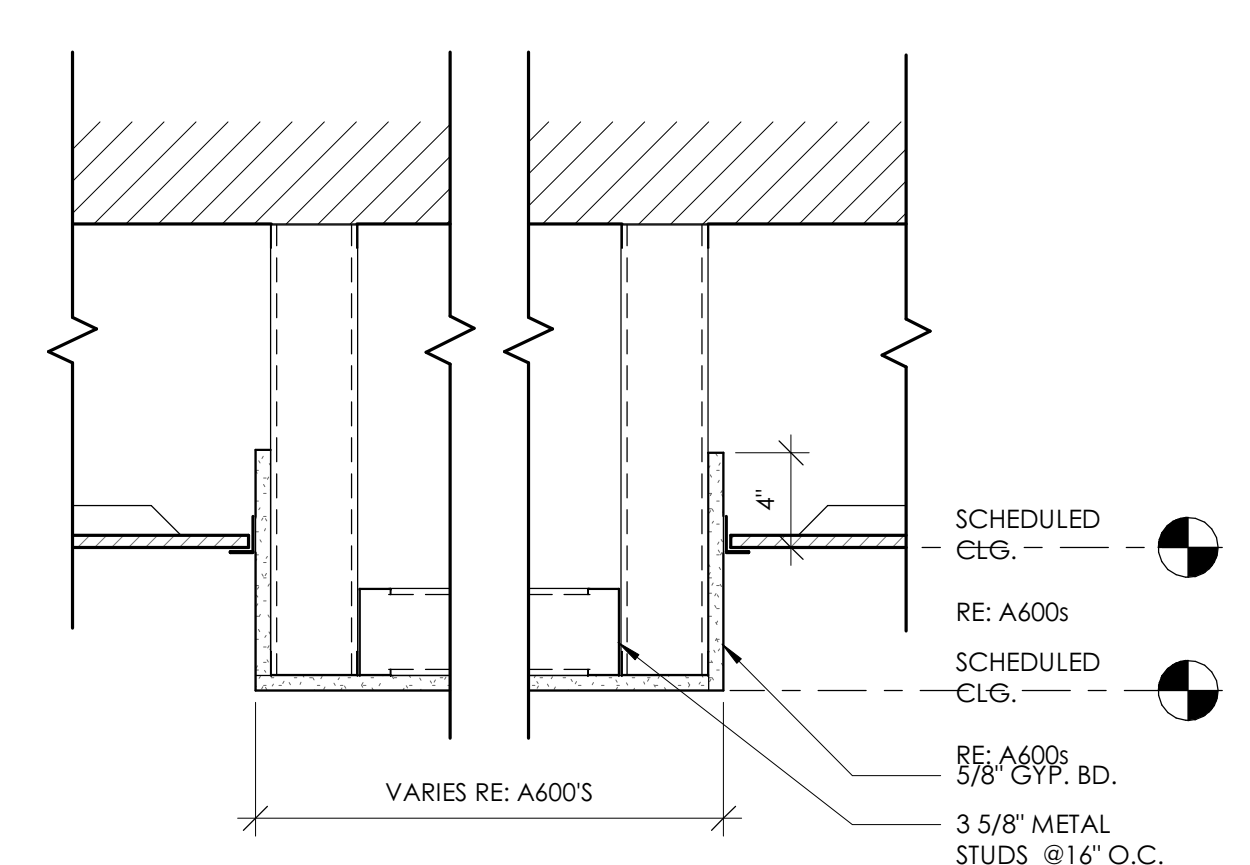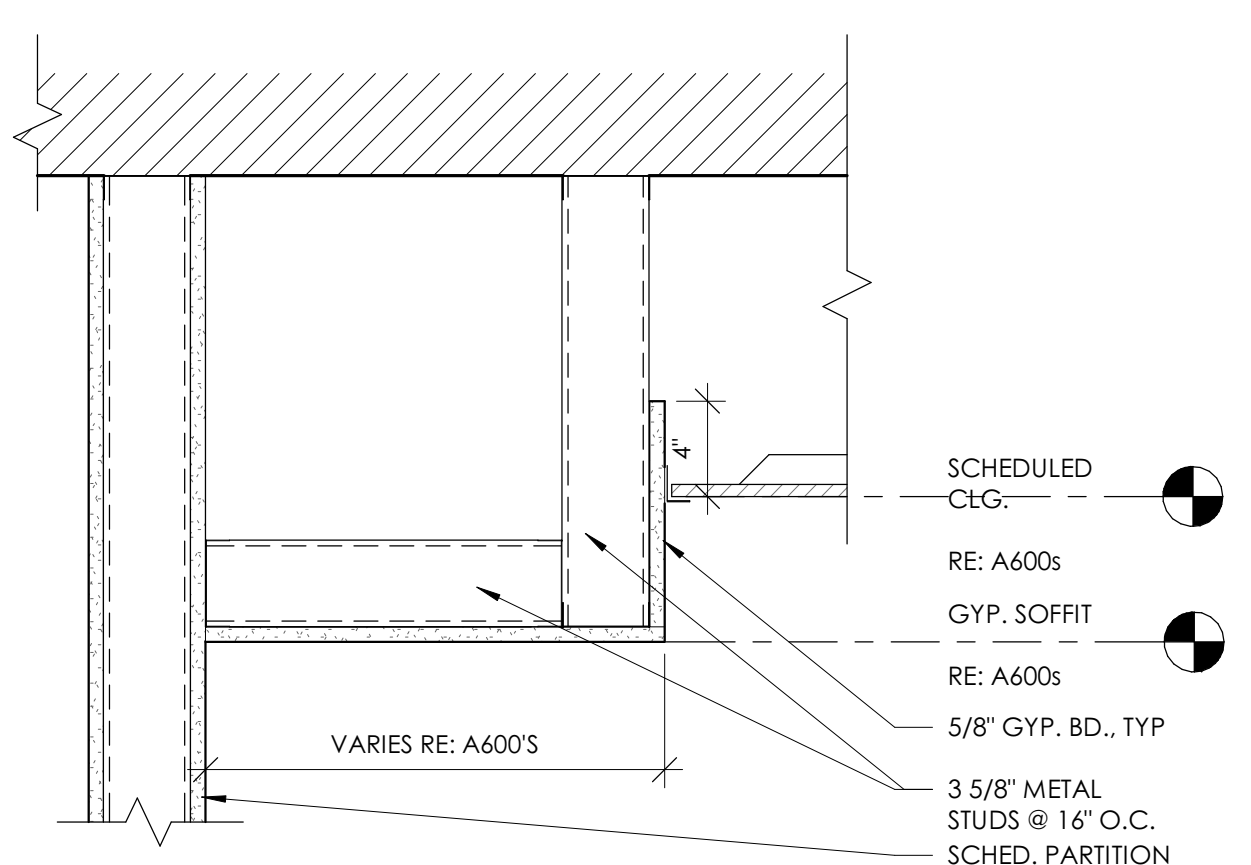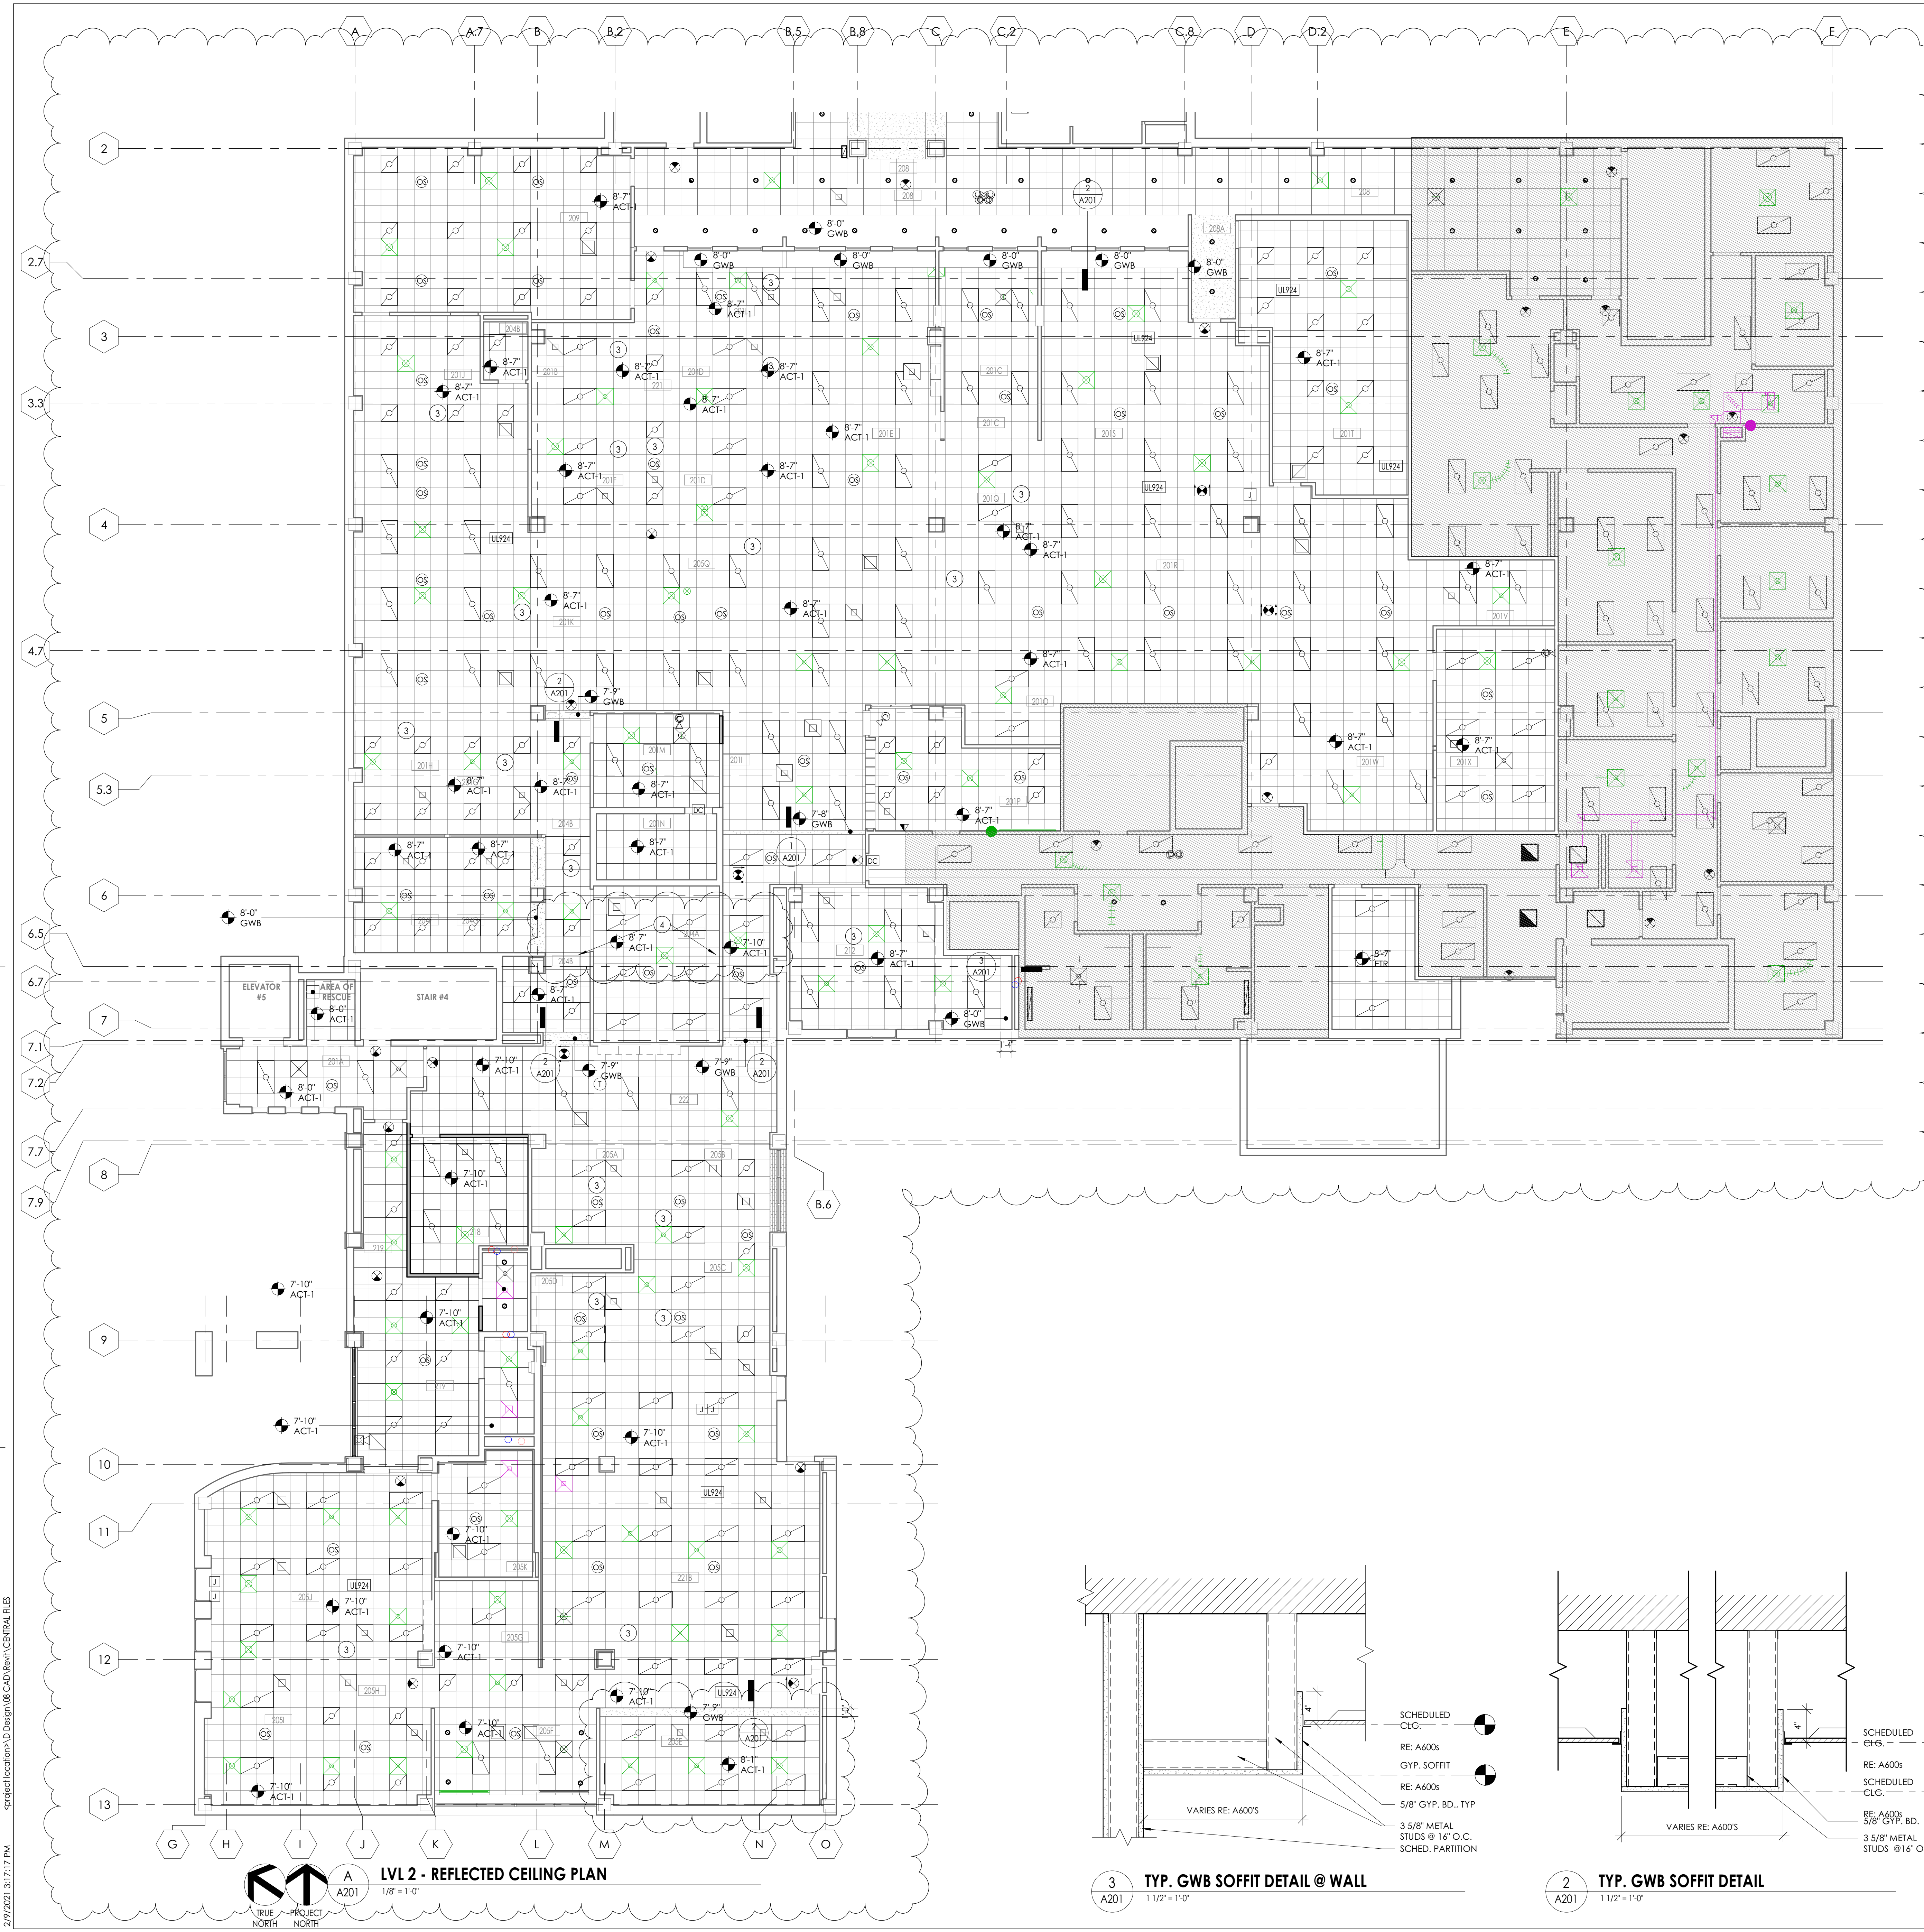

LVL 2 - REFLECTED CEILING PLAN
A201
1/8" = 1'-0"



3 TYP. GWB SOFFIT DETAIL @ WALL
A201 1 1/2" = 1'-0"

2 TYP. GWB SOFFIT DETAIL
A201 1 1/2" = 1'-0"

1 BULKHEAD DETAIL
A201 1 1/2" = 1'-0"

SHEET INFORMATION

Issue: 01/26/21
BID DOCUMENTS
Drawn By: CFL
Checked By: CFL
Drawing Title: OVERALL REFLECTED CEILING PLAN AND DETAILS LEVEL 2

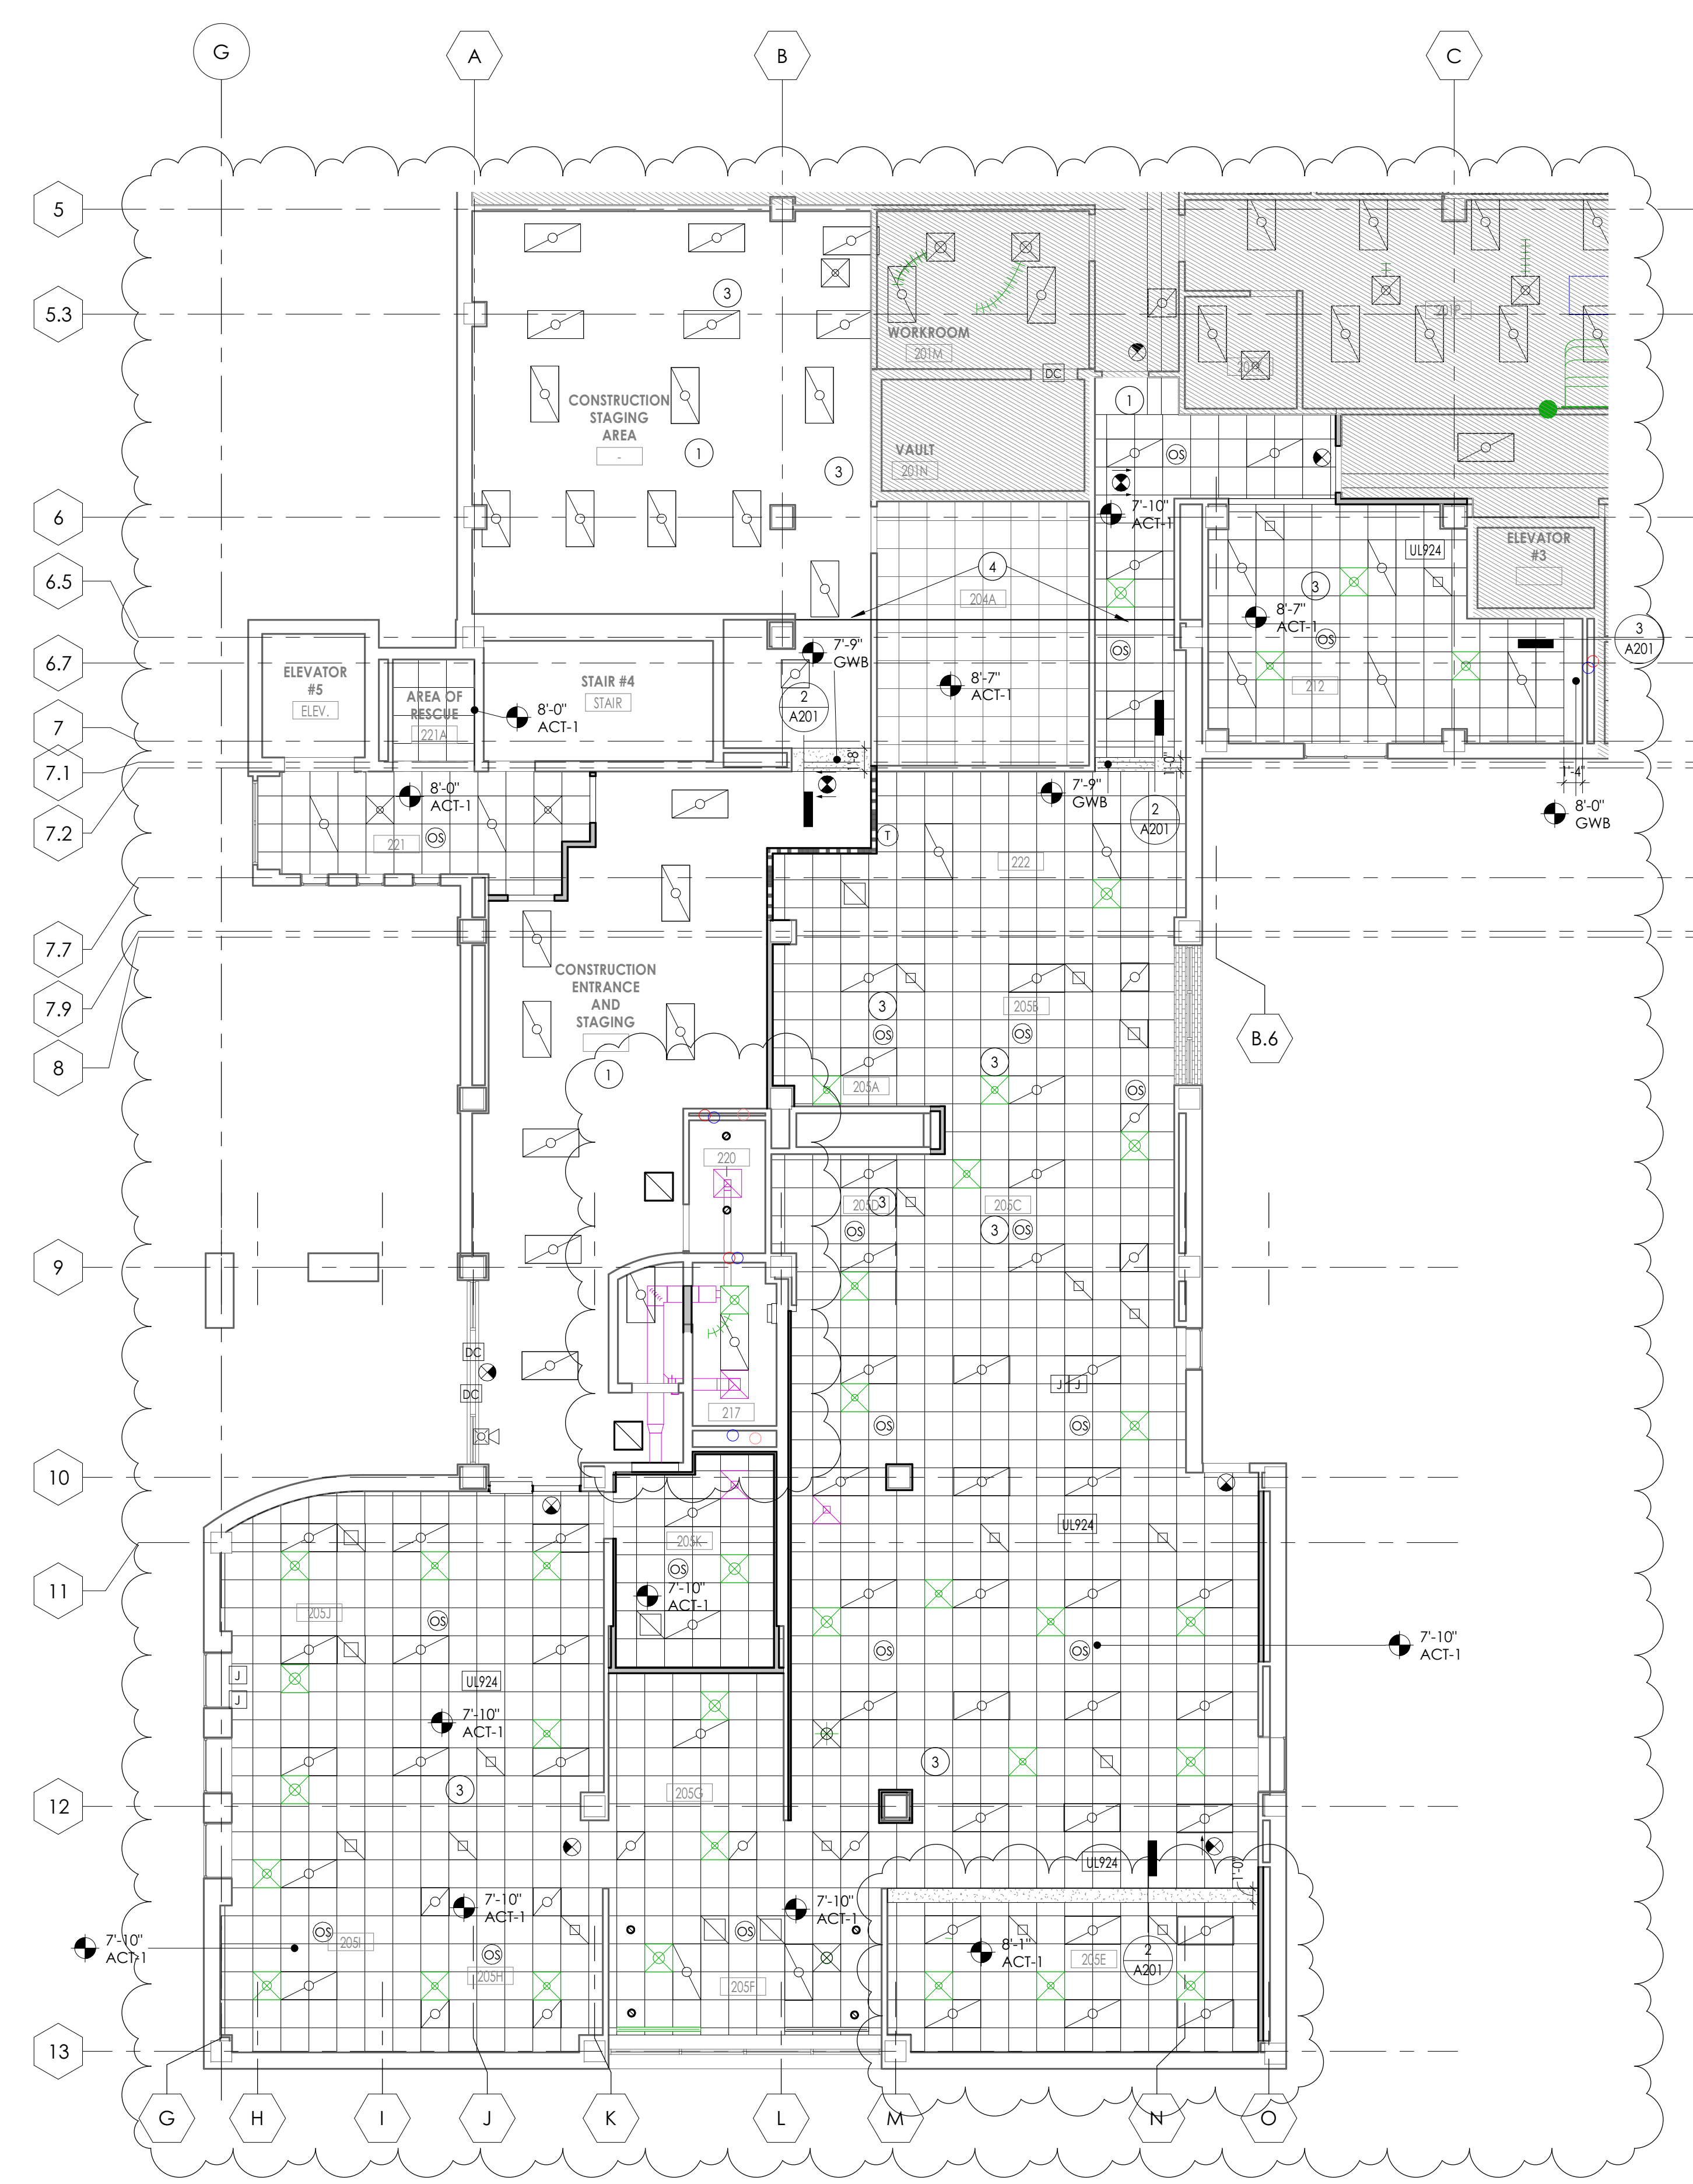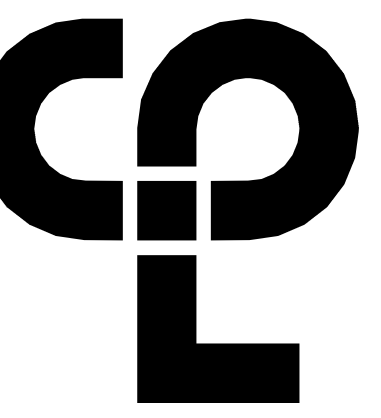

LVL 2 - REFLECTED CEILING PLAN - PHASE 1
1 A201.1
1/8" = 1'-0"
TRUE NORTH PROJECT NORTH

GENERAL CEILING NOTES

1. ALL DRAWINGS ARE GRAPHIC REPRESENTATION OF APPROXIMATE LOCATIONS OF NEW MATERIALS FOR CONSTRUCTION. IT IS THE CONTRACTOR'S RESPONSIBILITY TO FIELD VERIFY ALL CONDITIONS PRIOR TO COMMENCEMENT OF WORK.
2. REFER TO A200 SERIES FOR FLOOR PLAN.
3. FOR ANY DISCREPANCY BETWEEN THE REFLECTED CEILING PLAN AND THE FLOOR PLAN, THE FLOOR PLAN SHALL TAKE PRECEDENCE. ANY DISCREPANCIES SHALL BE CALLED TO THE ATTENTION OF THE ARCHITECT.
4. IT IS THE CONTRACTOR'S RESPONSIBILITY TO FIRE STOP MECHANICAL, ELECTRICAL AND PLUMBING ITEMS, INCLUDING BUT NOT LIMITED TO DUCTWORK AND CONDUIT PENETRATIONS THROUGH FLOORS AND WALLS.
5. THE CONTRACTOR SHALL COORDINATE CEILING INSTALLATIONS WITH MECHANICAL, ELECTRICAL AND PLUMBING DRAWINGS.
6. REFER TO "H" SERIES DRAWINGS FOR DIFFUSERS AND GRILLE LOCATIONS.
7. REFER TO "E" SERIES DRAWINGS FOR LIGHTING TYPES AND CONTROLS.
8. REFER TO "P" SERIES DRAWINGS FOR SPRINKLER HEAD LOCATIONS.
9. WORK AREAS SHALL BE MAINTAINED AND ALL WORK AREAS SHALL BE LEFT BROOMED CLEAN AT THE END OF EACH DAY.
10. CENTER CEILING GRID (EACH WAY) IN ROOMS SCHEDULED TO RECEIVE ACOUSTICAL CEILING SYSTEMS UNLESS OTHERWISE NOTED.
11. CONTRACTOR TO VERIFY WITH ARCHITECT THE INSTALLATION OF ANY CEILING TILES LESS THAN 4' IN WIDTH.
12. PROVIDE MOISTURE RESISTANT GYP. BD. AT ALL TOILET ROOM, JANITOR'S CLOSET AND OTHER WET LOCATION CEILING ASSEMBLIES.
13. ALL GYP. BD. CEILINGS AND SOFFITS SHALL BE PRIMED AND PAINTED SCHEDULED COLOR ON ALL FACES AND UNDERSIDE SURFACE.
14. CONTRACTOR TO VERIFY SOFFIT SIZE WITH MILLWORK SHOP DRAWINGS. PROVIDE 2" OVERHANG ON EXPOSED EDGES UNLESS NOTED OTHERWISE.
15. WHERE APPLICABLE ALL FIXTURES AND DEVICES SHALL BE CENTERED ON A CEILING TILE.

CEILING SYMBOL LEGEND

NOTE: THE LEGEND MAY CONTAIN SYMBOLS THAT ARE NOT USED IN THIS PROJECT.

- Z2X LIGHT
- Z24 LIGHTS
- RECESSED CAN LIGHT FIXTURE
- SUPPLY AIR DIFFUSERS
- RETURN AIR DIFFUSERS
- EXHAUST DIFFUSERS
- LINEAR SLOT AIR DIFFUSERS
- GYPSUM WALL BOARD CEILING
- ACOUSTICAL TILE CEILING
- ACT-1 CEILING TYPE AND CEILING HEIGHT ABOVE FINISHED FLOOR

CEILING KEYNOTES


- 1 CONSTRUCTION OF CEILING TO BE COMPLETED IN A LATER PHASE
- 2 TEMPORARY WALL TO BE BUILT TO THE UNDERSIDE OF NEW SOFFIT
- 3 CEILING TO BE BUILT AS MONOLITHIC SYSTEM. DEMOUNTABLE WALLS TO BE CLIPPED TO UNDERSIDE OF CEILING.
- 4 EXPANSION JOINT

PROJECT INFORMATION

Project Number: 15210.00
Client Name: RANDOLPH COUNTY COURTHOUSE
Project Name: CLERK OF COURT OFFICE RENOVATION
Project Address: 176 E Salisbury St, Asheboro, NC 27203


REVISION SCHEDULE

11 01/27/20 Addendum 4
21

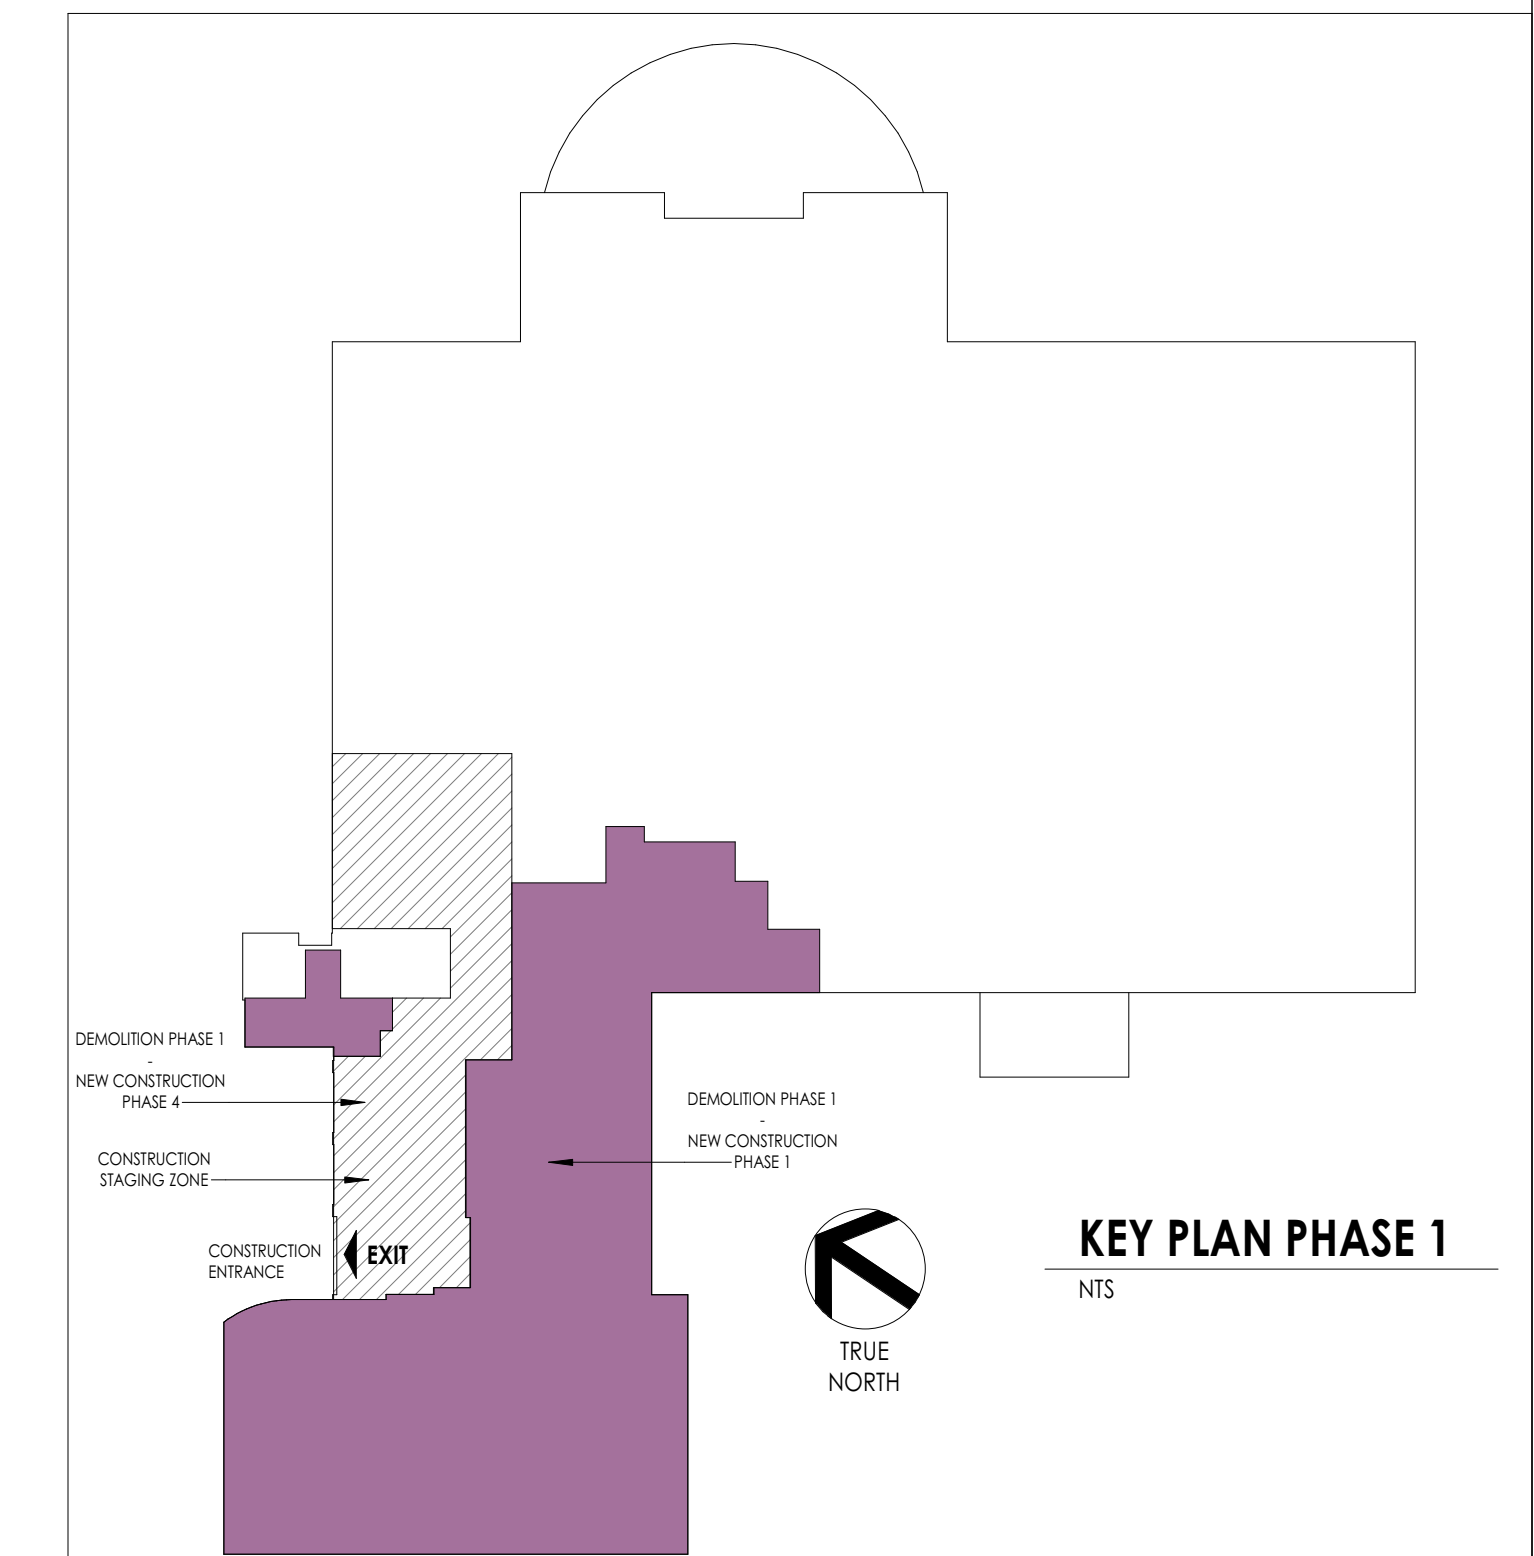

SHEET INFORMATION

Issue: 01/26/21
Bid Documents
Drawn By: CPL
Checked By: CPL
Drawing Title: REFLECTED CEILING PLAN - PHASE 1

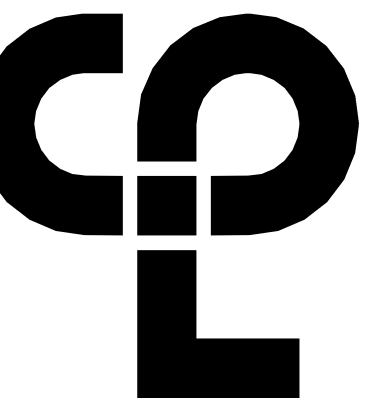

GENERAL CEILING NOTES

1. ALL DRAWINGS ARE GRAPHIC REPRESENTATION OF APPROXIMATE LOCATIONS OF NEW MATERIALS FOR CONSTRUCTION. IT IS THE CONTRACTOR'S RESPONSIBILITY TO FIELD VERIFY ALL CONDITIONS PRIOR TO COMMENCEMENT OF WORK.
2. REFER TO A200 SERIES FOR FLOOR PLAN.
3. FOR ANY DISCREPANCY BETWEEN THE REFLECTED CEILING PLAN AND THE FLOOR PLAN, THE FLOOR PLAN SHALL TAKE PRECEDENCE. ANY DISCREPANCIES SHALL BE CALLED TO THE ATTENTION OF THE ARCHITECT.
4. IT IS THE CONTRACTOR'S RESPONSIBILITY TO FIRE STOP MECHANICAL, ELECTRICAL AND PLUMBING ITEMS, INCLUDING BUT NOT LIMITED TO DUCTWORK AND CONDUIT PENETRATIONS THROUGH FLOORS AND WALLS.
5. THE CONTRACTOR SHALL COORDINATE CEILING INSTALLATIONS WITH MECHANICAL, ELECTRICAL AND PLUMBING DRAWINGS.
6. REFER TO "H" SERIES DRAWINGS FOR DIFFUSERS AND GRILLE LOCATIONS.
7. REFER TO "E" SERIES DRAWINGS FOR LIGHTING TYPES AND CONTROLS.
8. REFER TO "P" SERIES DRAWINGS FOR SPRINKLER HEAD LOCATIONS.
9. WORK AREAS SHALL BE MAINTAINED AND ALL WORK AREAS SHALL BE LEFT BROOMED CLEAN AT THE END OF EACH DAY.
10. CENTER CEILING GRID (EACH WAY) IN ROOMS SCHEDULED TO RECEIVE ACOUSTICAL CEILING SYSTEMS UNLESS OTHERWISE NOTED.
11. CONTRACTOR TO VERIFY WITH ARCHITECT THE INSTALLATION OF ANY CEILING TILES LESS THAN 4" IN WIDTH.
12. PROVIDE MOISTURE RESISTANT GYP. BD. AT ALL TOILET ROOM, JANITOR'S CLOSET AND OTHER WET LOCATION CEILING ASSEMBLIES.
13. ALL GYP. BD. CEILINGS AND SOFFITS SHALL BE PRIMED AND PAINTED SCHEDULED COLOR ON ALL FACES AND UNDERSIDE SURFACE.
14. CONTRACTOR TO VERIFY SOFFIT SIZE WITH MILLWORK SHOP DRAWINGS. PROVIDE 7" OVERHANG ON EXPOSED EDGES UNLESS NOTED OTHERWISE.
15. WHERE APPLICABLE ALL FIXTURES AND DEVICES SHALL BE CENTERED ON A CEILING TILE.


CEILING SYMBOL LEGEND

NOTE: THE LEGEND MAY CONTAIN SYMBOLS THAT ARE NOT USED IN THIS PROJECT.


- ZxZ LIGHT
- Zx4 LIGHTS
- RECESSED CAN LIGHT FIXTURE
- SUPPLY AIR DIFFUSERS
- RETURN AIR DIFFUSERS
- EXHAUST DIFFUSERS
- LINEAR SLOT AIR DIFFUSERS
- GYPSUM WALL BOARD CEILING
- ACOUSTICAL TILE CEILING
- ACT-1 CEILING TYPE AND CEILING HEIGHT ABOVE FINISHED FLOOR

CEILING KEYNOTES

- 1 CONSTRUCTION OF CEILING TO BE COMPLETED IN A LATER PHASE
- 2 TEMPORARY WALL TO BE BUILT TO THE UNDERSIDE OF NEW SOFFIT
- 3 CEILING TO BE BUILT AS MONOLITHIC SYSTEM. DEMOUNTABLE WALLS TO BE CLIPPED TO UNDERSIDE OF CEILING.
- 4 EXPANSION JOINT

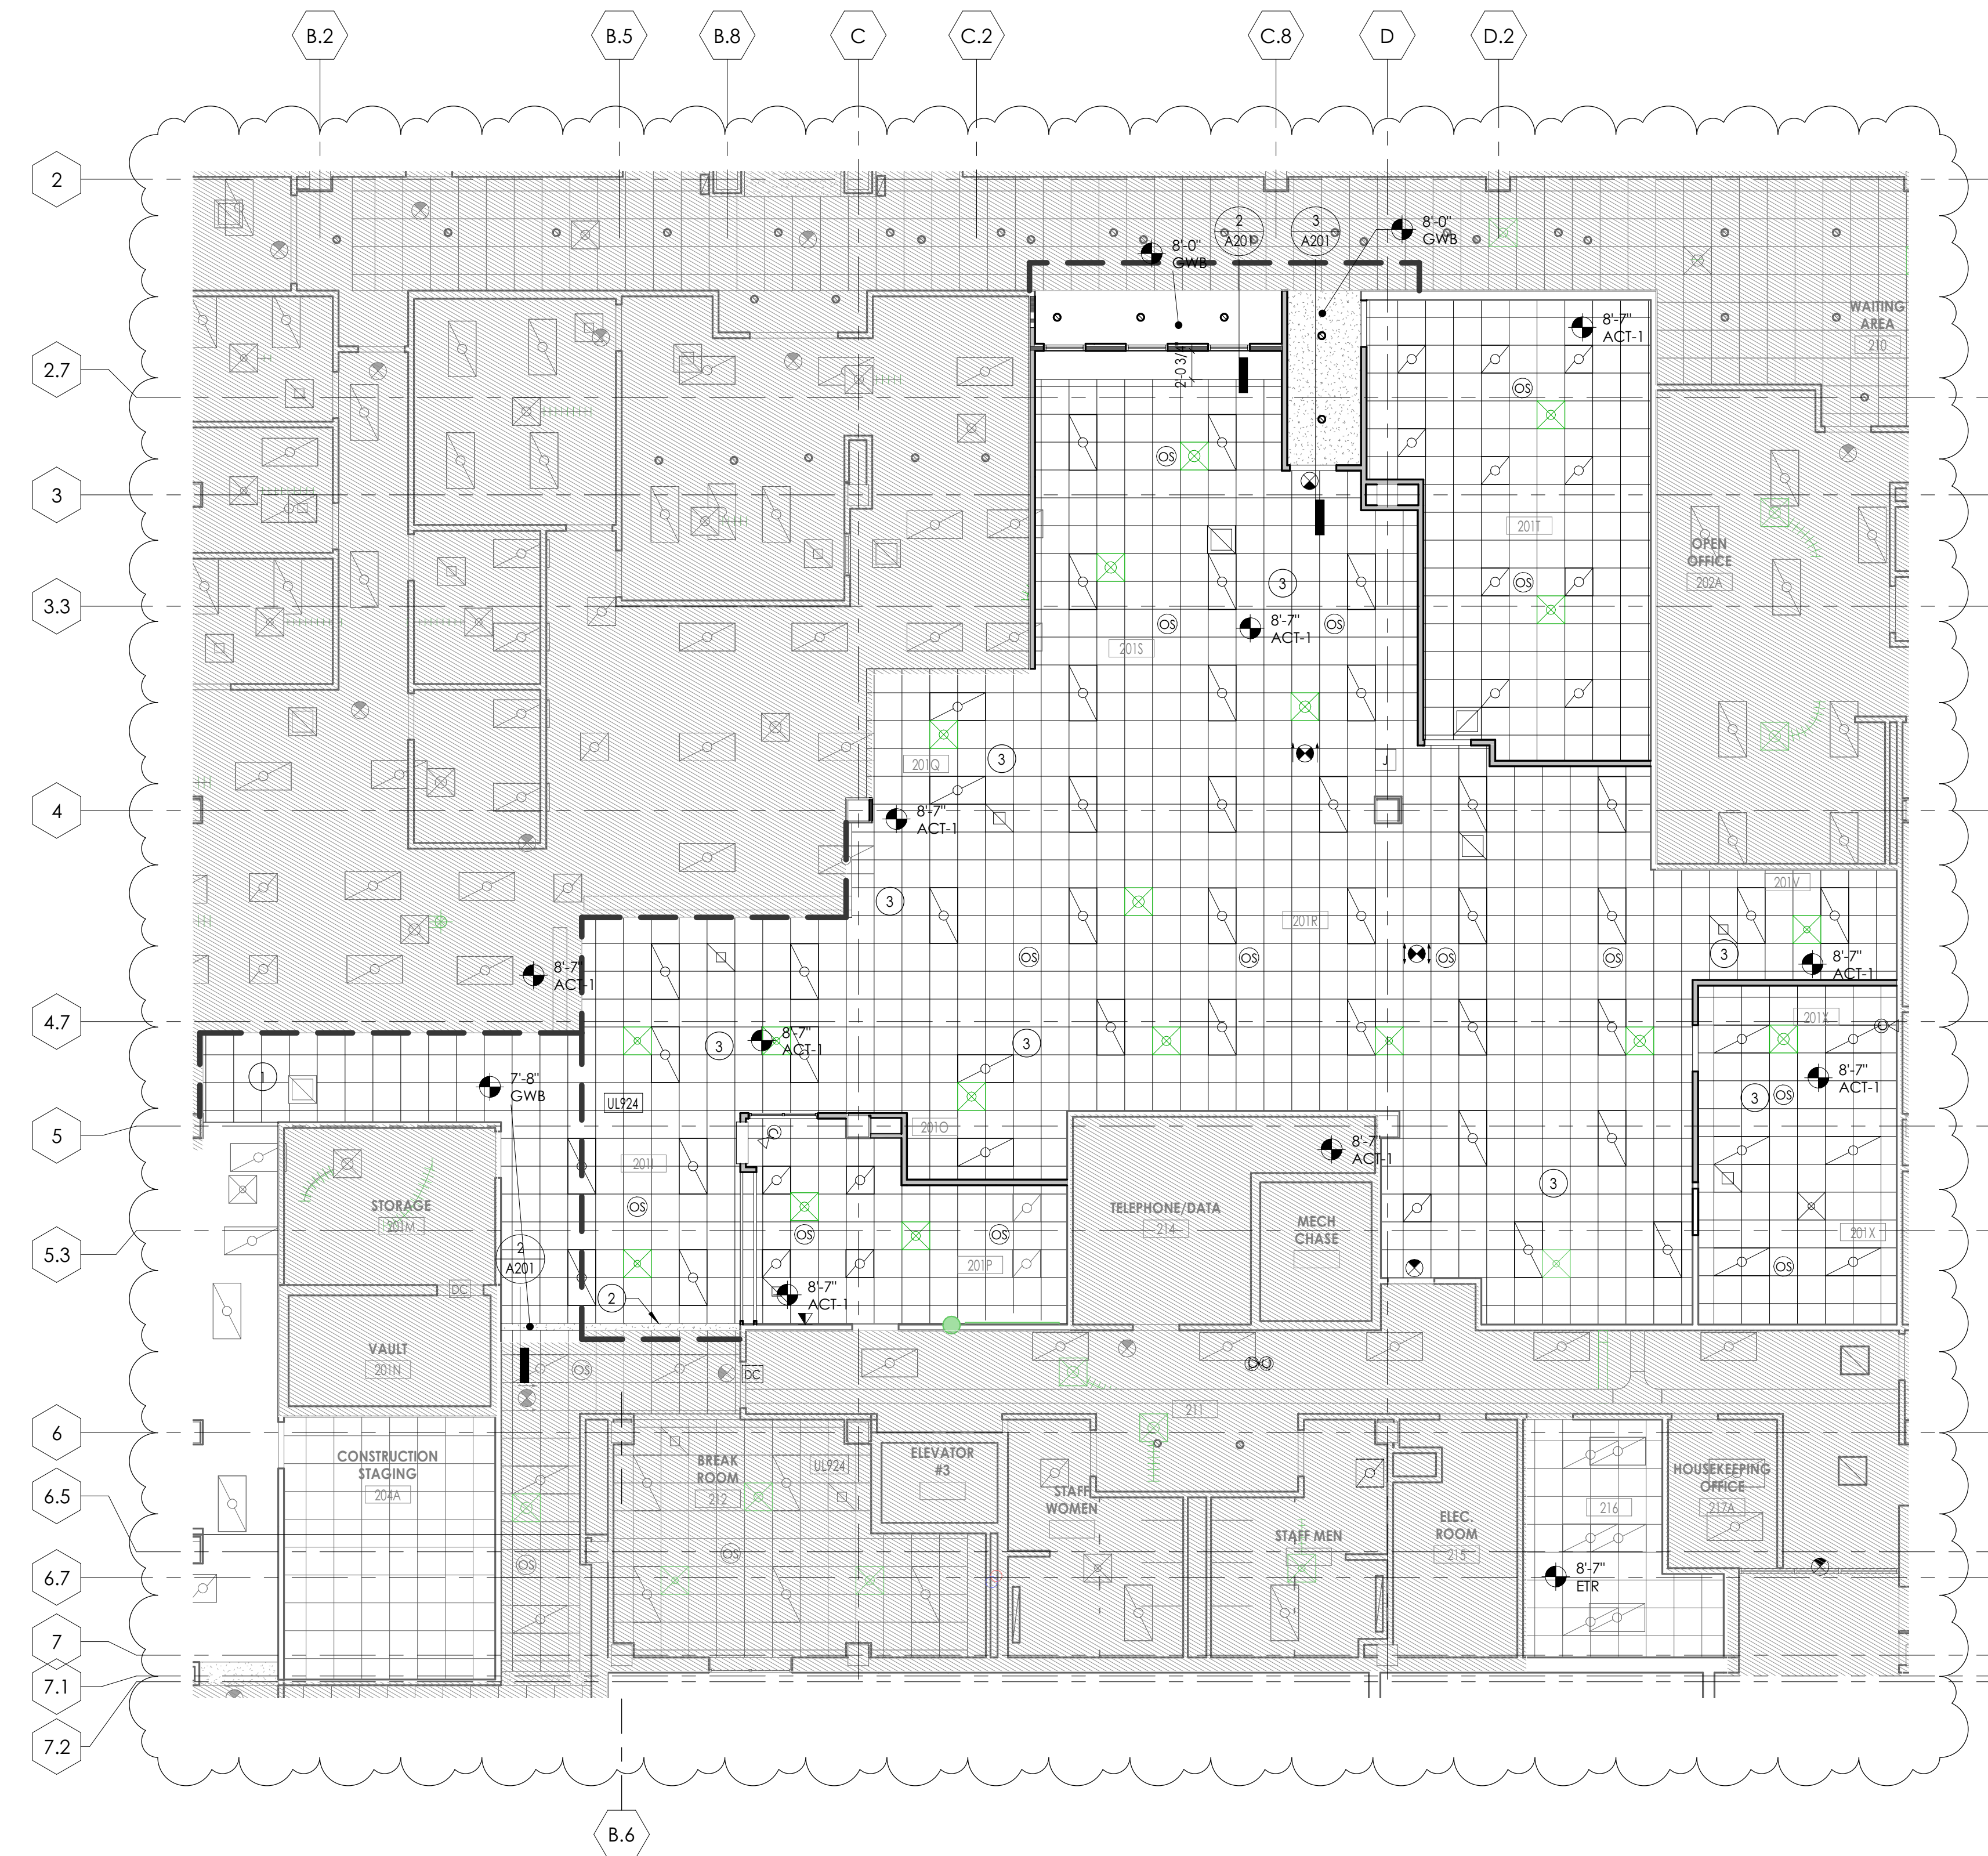

LVL 2 - REFLECTED CEILING PLAN - PHASE 2
 1 A201.2 1/8" = 1'-0"
 TRUE PROJECT NORTH NORTH

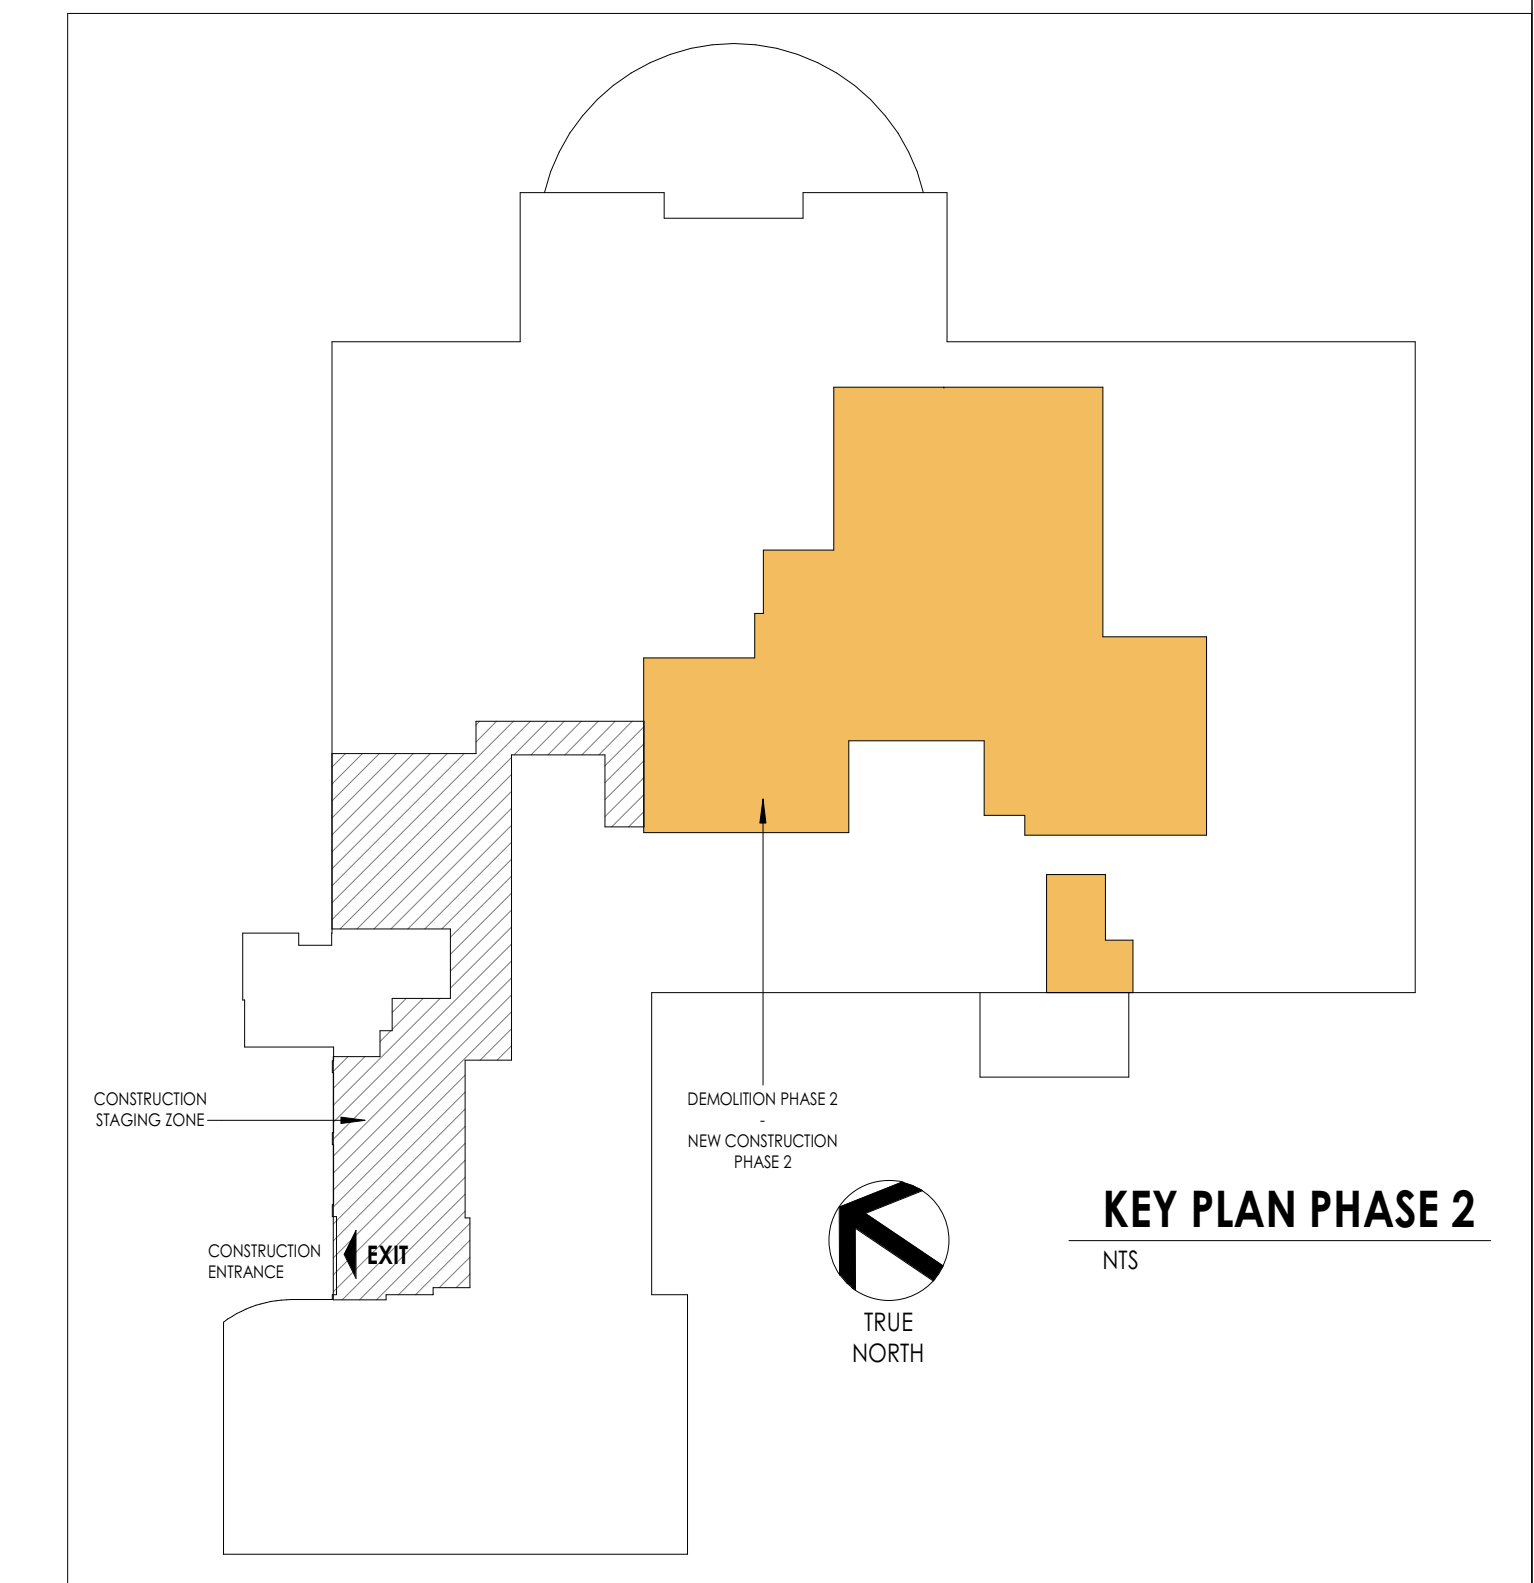

PROJECT INFORMATION


Project Number: 15210.00
 Client Name: RANDOLPH COUNTY COURTHOUSE
 Project Name: CLERK OF COURT OFFICE RENOVATION
 Project Address: 176 E Salisbury St, Asheboro, NC 27203

REVISION SCHEDULE

7 Date: 01/27/20
 11 Addendum 4
 21

SHEET INFORMATION

Issue: 01/26/21
 BID DOCUMENTS
 Drawn By: CPL
 Checked By: CPL
 Drawing Title: REFLECTED CEILING PLAN - PHASE 2

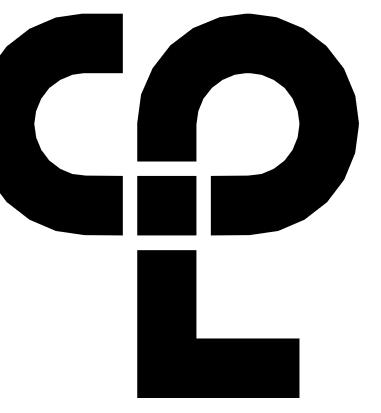

CPL | Architecture Engineering Planning
328 EAST MARKET ST. SUITE 200
GREENSBORO, NC 27401
CPLteam.com

GENERAL CEILING NOTES

1. ALL DRAWINGS ARE GRAPHIC REPRESENTATION OF APPROXIMATE LOCATIONS OF NEW MATERIALS FOR CONSTRUCTION. IT IS THE CONTRACTOR'S RESPONSIBILITY TO FIELD VERIFY ALL CONDITIONS PRIOR TO COMMENCEMENT OF WORK.
2. REFER TO A200 SERIES FOR FLOOR PLAN.
3. FOR ANY DISCREPANCY BETWEEN THE REFLECTED CEILING PLAN AND THE FLOOR PLAN, THE FLOOR PLAN SHALL TAKE PRECEDENCE. ANY DISCREPANCIES SHALL BE CALLED TO THE ATTENTION OF THE ARCHITECT.
4. IT IS THE CONTRACTOR'S RESPONSIBILITY TO FIRE STOP MECHANICAL, ELECTRICAL AND PLUMBING ITEMS, INCLUDING BUT NOT LIMITED TO DUCTWORK AND CONDUIT PENETRATIONS THROUGH FLOORS AND WALLS.
5. THE CONTRACTOR SHALL COORDINATE CEILING INSTALLATIONS WITH MECHANICAL, ELECTRICAL AND PLUMBING DRAWINGS.
6. REFER TO "H" SERIES DRAWINGS FOR DIFFUSERS AND GRILLE LOCATIONS.
7. REFER TO "E" SERIES DRAWINGS FOR LIGHTING TYPES AND CONTROLS.
8. REFER TO "P" SERIES DRAWINGS FOR SPRINKLER HEAD LOCATIONS.
9. WORK AREAS SHALL BE MAINTAINED AND ALL WORK AREAS SHALL BE LEFT BROOMED CLEAN AT THE END OF EACH DAY.
10. CENTER CEILING GRID (EACH WAY) IN ROOMS SCHEDULED TO RECEIVE ACOUSTICAL CEILING SYSTEMS UNLESS OTHERWISE NOTED.
11. CONTRACTOR TO VERIFY WITH ARCHITECT THE INSTALLATION OF ANY CEILING TILES LESS THAN 4' IN WIDTH.
12. PROVIDE MOISTURE RESISTANT GYP. BD. AT ALL TOILET ROOM, JANITOR'S CLOSET AND OTHER WET LOCATION CEILING ASSEMBLIES.
13. ALL GYP. BD. CEILINGS AND SOFFITS SHALL BE PRIMED AND PAINTED SCHEDULED COLOR ON ALL FACES AND UNDERSIDE SURFACE.
14. CONTRACTOR TO VERIFY SOFFIT SIZE WITH MILLWORK SHOP DRAWINGS. PROVIDE 2" OVERHANG ON EXPOSED EDGES UNLESS NOTED OTHERWISE.
15. WHERE APPLICABLE ALL FIXTURES AND DEVICES SHALL BE CENTERED ON A CEILING TILE.


CEILING SYMBOL LEGEND

NOTE: THE LEGEND MAY CONTAIN SYMBOLS THAT ARE NOT USED IN THIS PROJECT.


- Zxz LIGHT
- Zx4 LIGHTS
- RECESSED CAN LIGHT FIXTURE
- SUPPLY AIR DIFFUSERS
- RETURN AIR DIFFUSERS
- EXHAUST DIFFUSERS
- LINEAR SLOT AIR DIFFUSERS
- GYPSUM WALL BOARD CEILING
- ACOUSTICAL TILE CEILING
- CEILING TYPE AND CEILING HEIGHT ABOVE FINISHED FLOOR

CEILING KEYNOTES

- 1 CONSTRUCTION OF CEILING TO BE COMPLETED IN A LATER PHASE
- 2 TEMPORARY WALL TO BE BUILT TO THE UNDERSIDE OF NEW SOFFIT
- 3 CEILING TO BE BUILT AS MONOLITHIC SYSTEM. DEMOUNTABLE WALLS TO BE CLIPPED TO UNDERSIDE OF CEILING.
- 4 EXPANSION JOINT

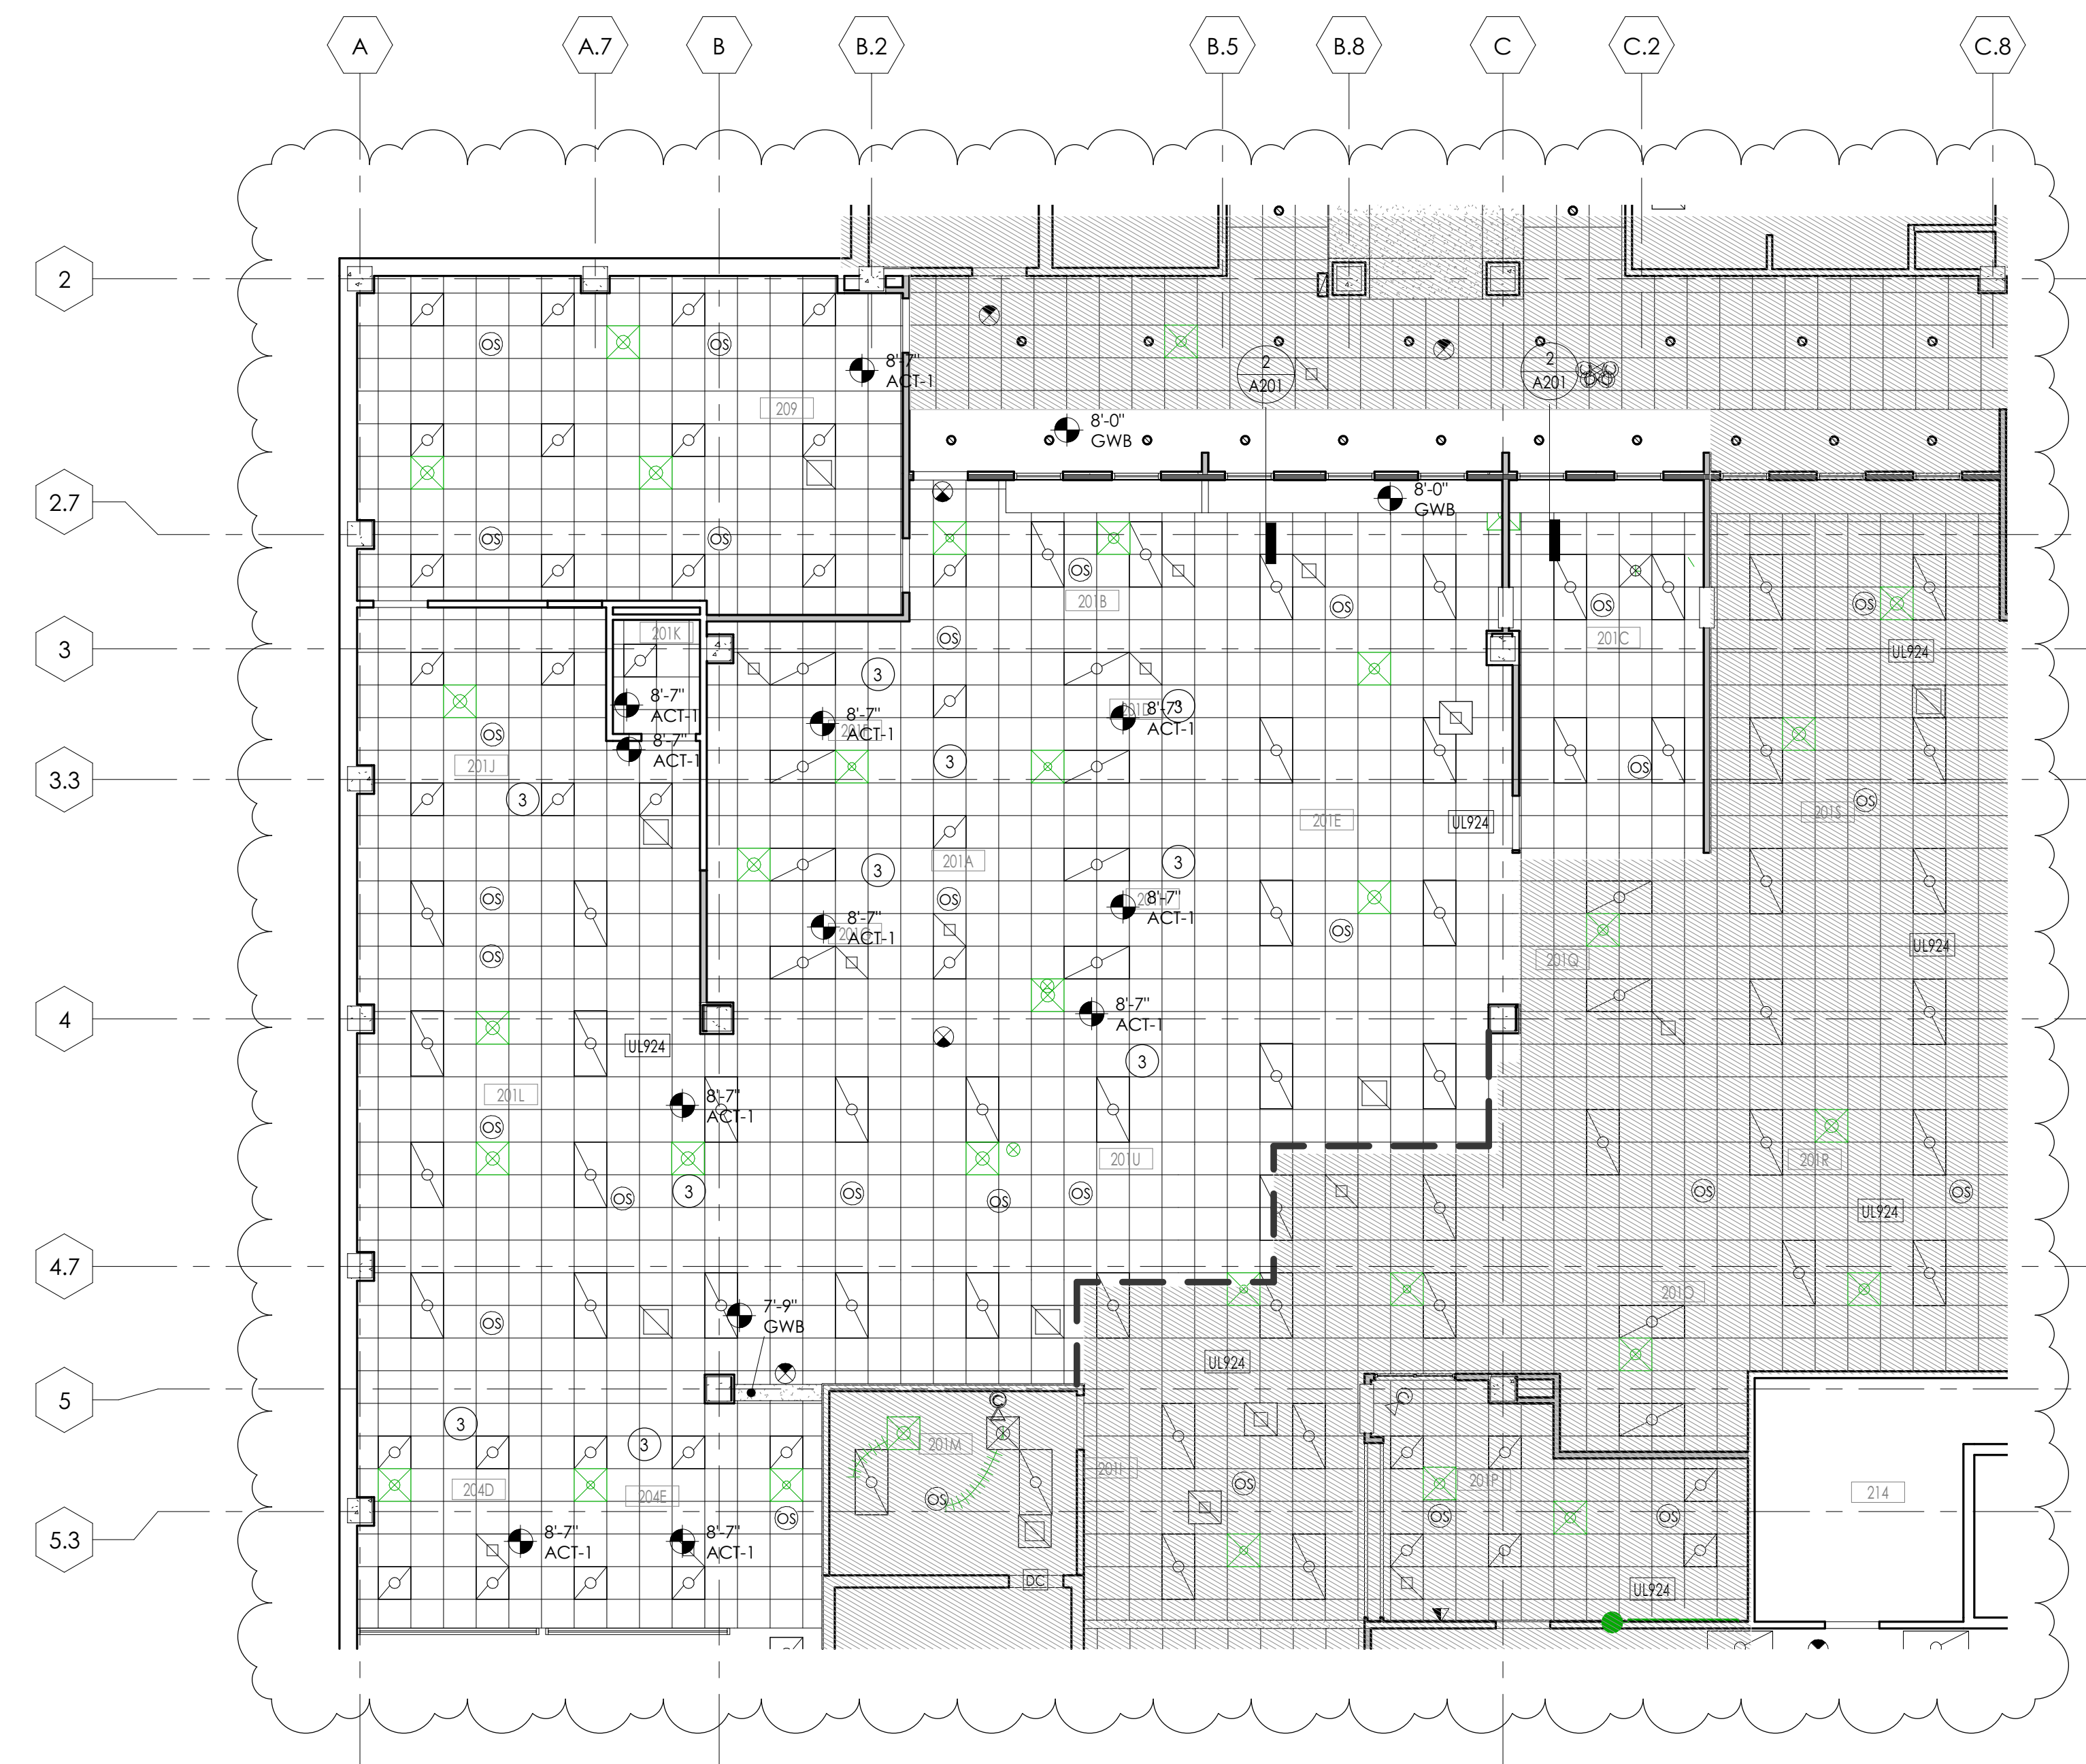

LVL 2 - REFLECTED CEILING PLAN - PHASE 3
A201.3 1/8" = 1'-0"
TRUE NORTH PROJECT NORTH

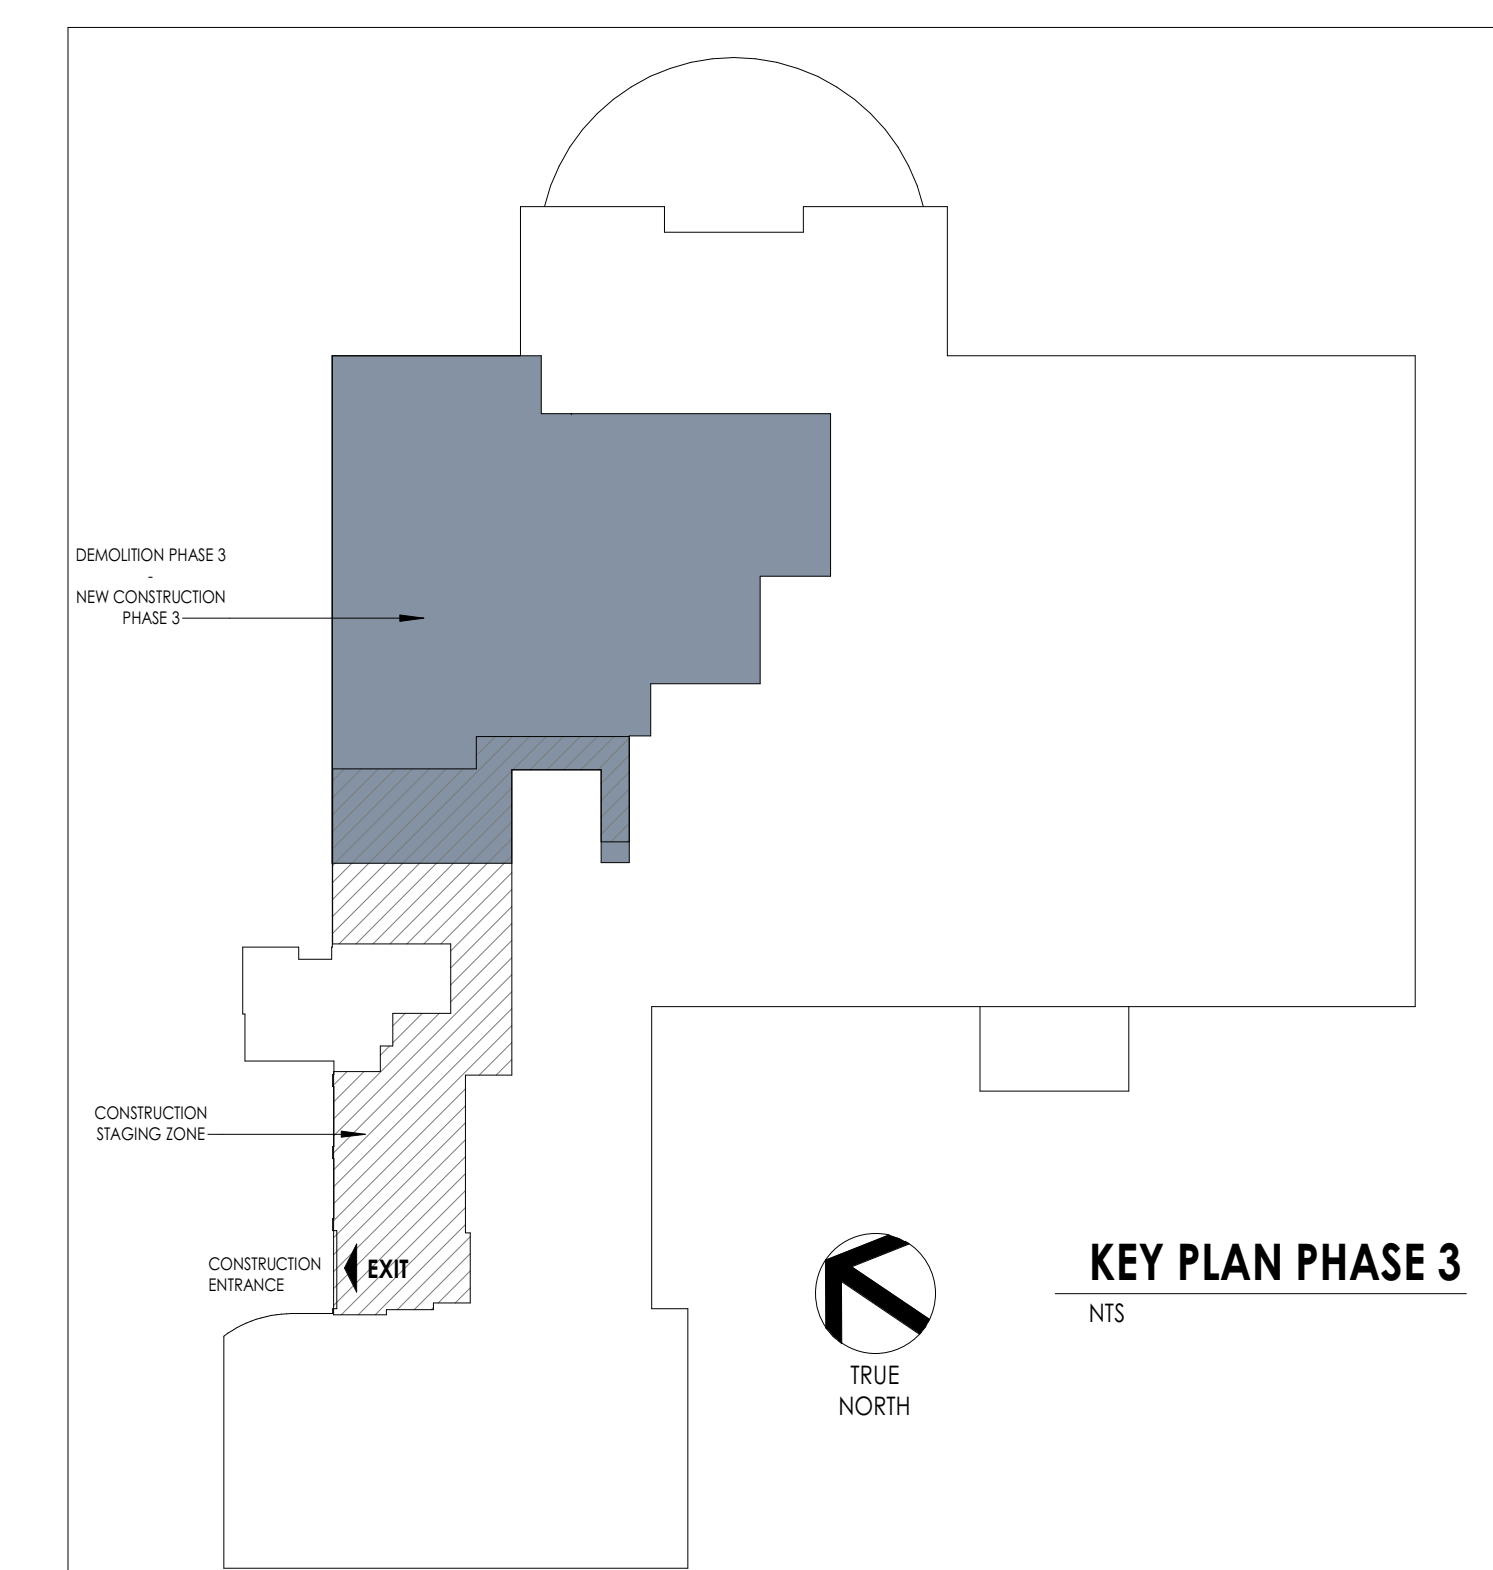

PROJECT INFORMATION


Project Number: 15210.00
Client Name: RANDOLPH COUNTY COURTHOUSE
Project Name: CLERK OF COURT OFFICE RENOVATION
Project Address: 176 E Salisbury St, Asheboro, NC 27203

REVISION SCHEDULE

7 Date: 01/27/20
11 01/27/20 Addendum 4
21

SHEET INFORMATION

Issue: 01/26/21
BID DOCUMENTS
Drawn By: CPL
Checked By: CPL
Drawing Title: REFLECTED CEILING PLAN - PHASE 3

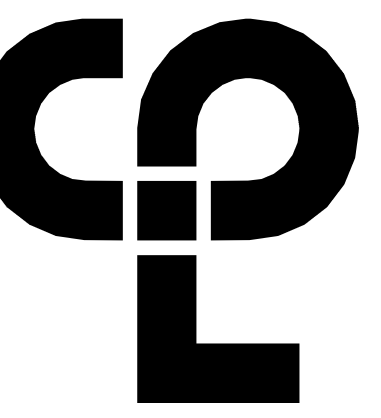

CPL | Architecture Engineering Planning
328 EAST MARKET ST., SUITE 200
GREENSBORO, NC 27401
CPLteam.com

GENERAL CEILING NOTES

1. ALL DRAWINGS ARE GRAPHIC REPRESENTATION OF APPROXIMATE LOCATIONS OF NEW MATERIALS FOR CONSTRUCTION. IT IS THE CONTRACTOR'S RESPONSIBILITY TO FIELD VERIFY ALL CONDITIONS PRIOR TO COMMENCEMENT OF WORK.
2. REFER TO A200 SERIES FOR FLOOR PLAN.
3. FOR ANY DISCREPANCY BETWEEN THE REFLECTED CEILING PLAN AND THE FLOOR PLAN, THE FLOOR PLAN SHALL TAKE PRECEDENCE. ANY DISCREPANCIES SHALL BE CALLED TO THE ATTENTION OF THE ARCHITECT.
4. IT IS THE CONTRACTOR'S RESPONSIBILITY TO FIRE STOP MECHANICAL, ELECTRICAL AND PLUMBING ITEMS, INCLUDING BUT NOT LIMITED TO DUCTWORK AND CONDUIT PENETRATIONS THROUGH FLOORS AND WALLS.
5. THE CONTRACTOR SHALL COORDINATE CEILING INSTALLATIONS WITH MECHANICAL, ELECTRICAL AND PLUMBING DRAWINGS.
6. REFER TO "H" SERIES DRAWINGS FOR DIFFUSERS AND GRILLE LOCATIONS.
7. REFER TO "E" SERIES DRAWINGS FOR LIGHTING TYPES AND CONTROLS.
8. REFER TO "P" SERIES DRAWINGS FOR SPRINKLER HEAD LOCATIONS.
9. WORK AREAS SHALL BE MAINTAINED AND ALL WORK AREAS SHALL BE LEFT BROOMED CLEAN AT THE END OF EACH DAY.
10. CENTER CEILING GRID (EACH WAY) IN ROOMS SCHEDULED TO RECEIVE ACOUSTICAL CEILING SYSTEMS UNLESS OTHERWISE NOTED.
11. CONTRACTOR TO VERIFY WITH ARCHITECT THE INSTALLATION OF ANY CEILING TILES LESS THAN 4' IN WIDTH.
12. PROVIDE MOISTURE RESISTANT GYP. BD. AT ALL TOILET ROOM, JANITOR'S CLOSET AND OTHER WET LOCATION CEILING ASSEMBLIES.
13. ALL GYP. BD. CEILINGS AND SOFFITS SHALL BE PRIMED AND PAINTED SCHEDULED COLOR ON ALL FACES AND UNDERSIDE SURFACE.
14. CONTRACTOR TO VERIFY SOFFIT SIZE WITH MILLWORK SHOP DRAWINGS. PROVIDE 7" OVERHANG ON EXPOSED EDGES UNLESS NOTED OTHERWISE.
15. WHERE APPLICABLE ALL FIXTURES AND DEVICES SHALL BE CENTERED ON A CEILING TILE.


CEILING SYMBOL LEGEND

NOTE: THE LEGEND MAY CONTAIN SYMBOLS THAT ARE NOT USED IN THIS PROJECT.


- Z'XZ LIGHT
- Z'4' LIGHTS
- RECESSED CAN LIGHT FIXTURE
- SUPPLY AIR DIFFUSERS
- RETURN AIR DIFFUSERS
- EXHAUST DIFFUSERS
- LINEAR SLOT AIR DIFFUSERS
- GYPSUM WALL BOARD CEILING
- ACOUSTICAL TILE CEILING
- ACT-1 CEILING TYPE AND CEILING HEIGHT ABOVE FINISHED FLOOR

CEILING KEYNOTES

- 1 CONSTRUCTION OF CEILING TO BE COMPLETED IN A LATER PHASE
- 2 TEMPORARY WALL TO BE BUILT TO THE UNDERSIDE OF NEW SOFFIT
- 3 CEILING TO BE BUILT AS MONOLITHIC SYSTEM. DEMOUNTABLE WALLS TO BE CLIPPED TO UNDERSIDE OF CEILING.
- 4 EXPANSION JOINT

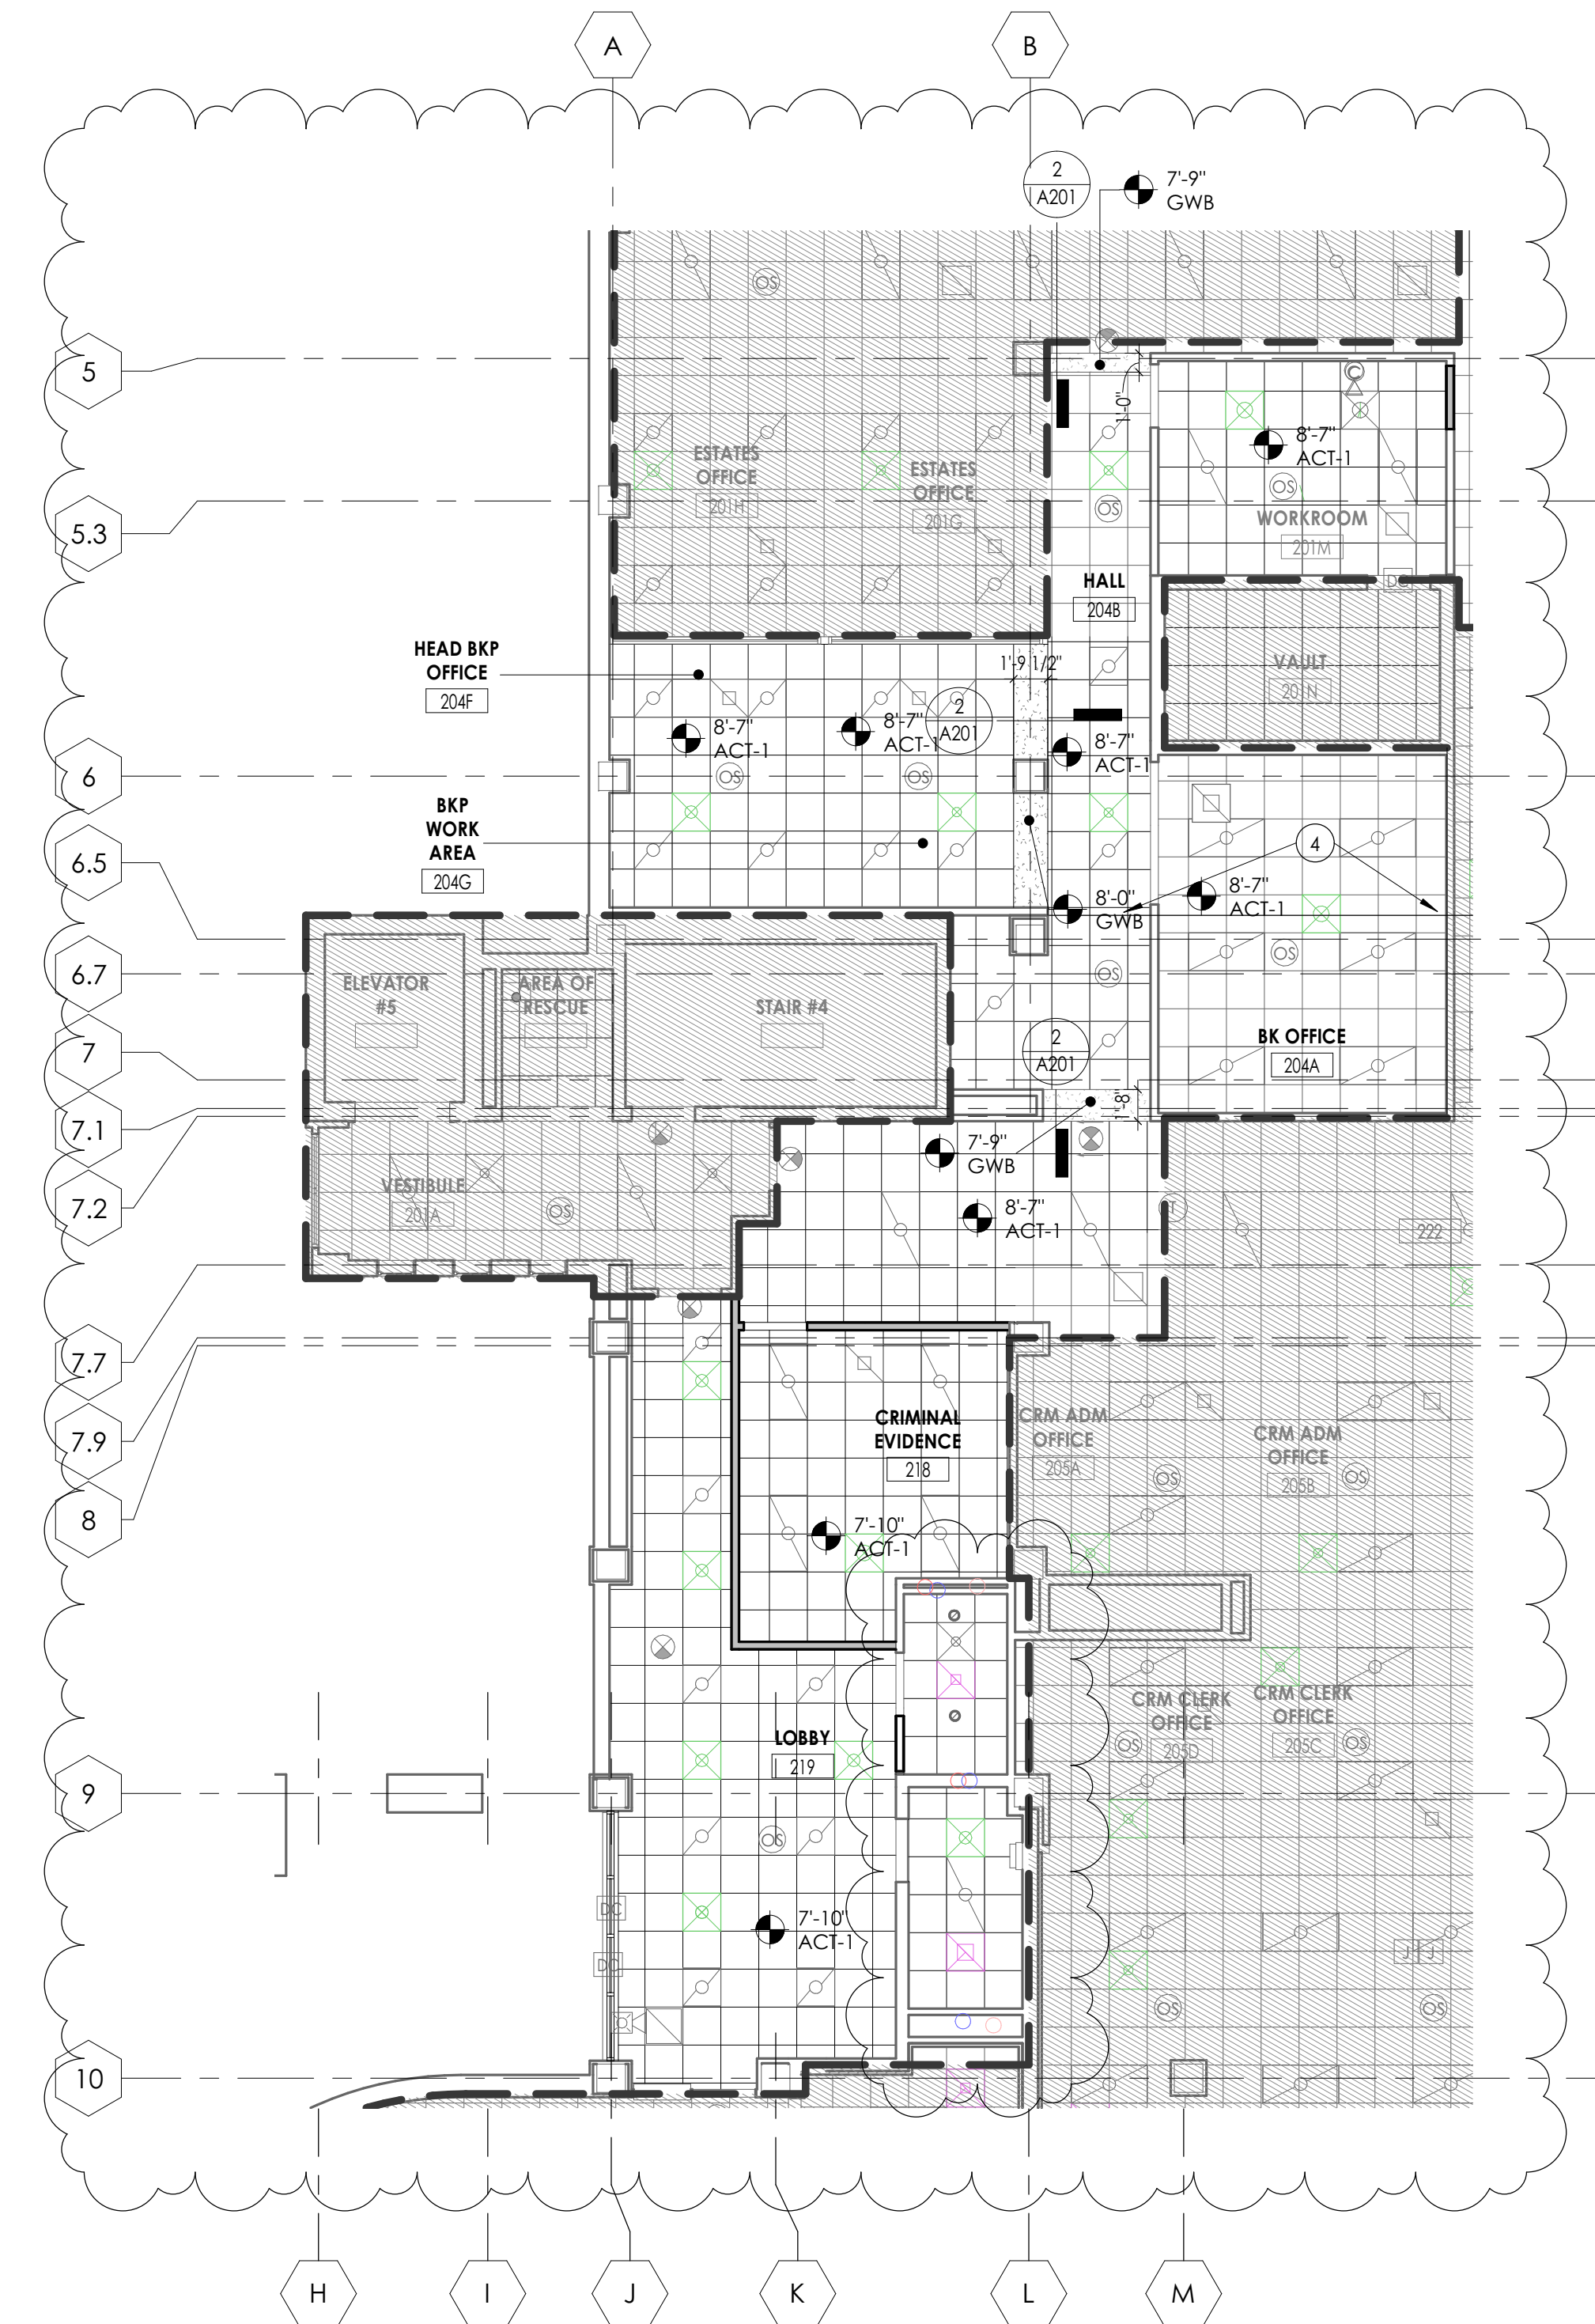

LVL 2 - REFLECTED CEILING PLAN - PHASE 4
1
A201.4
1/8" = 1'-0"

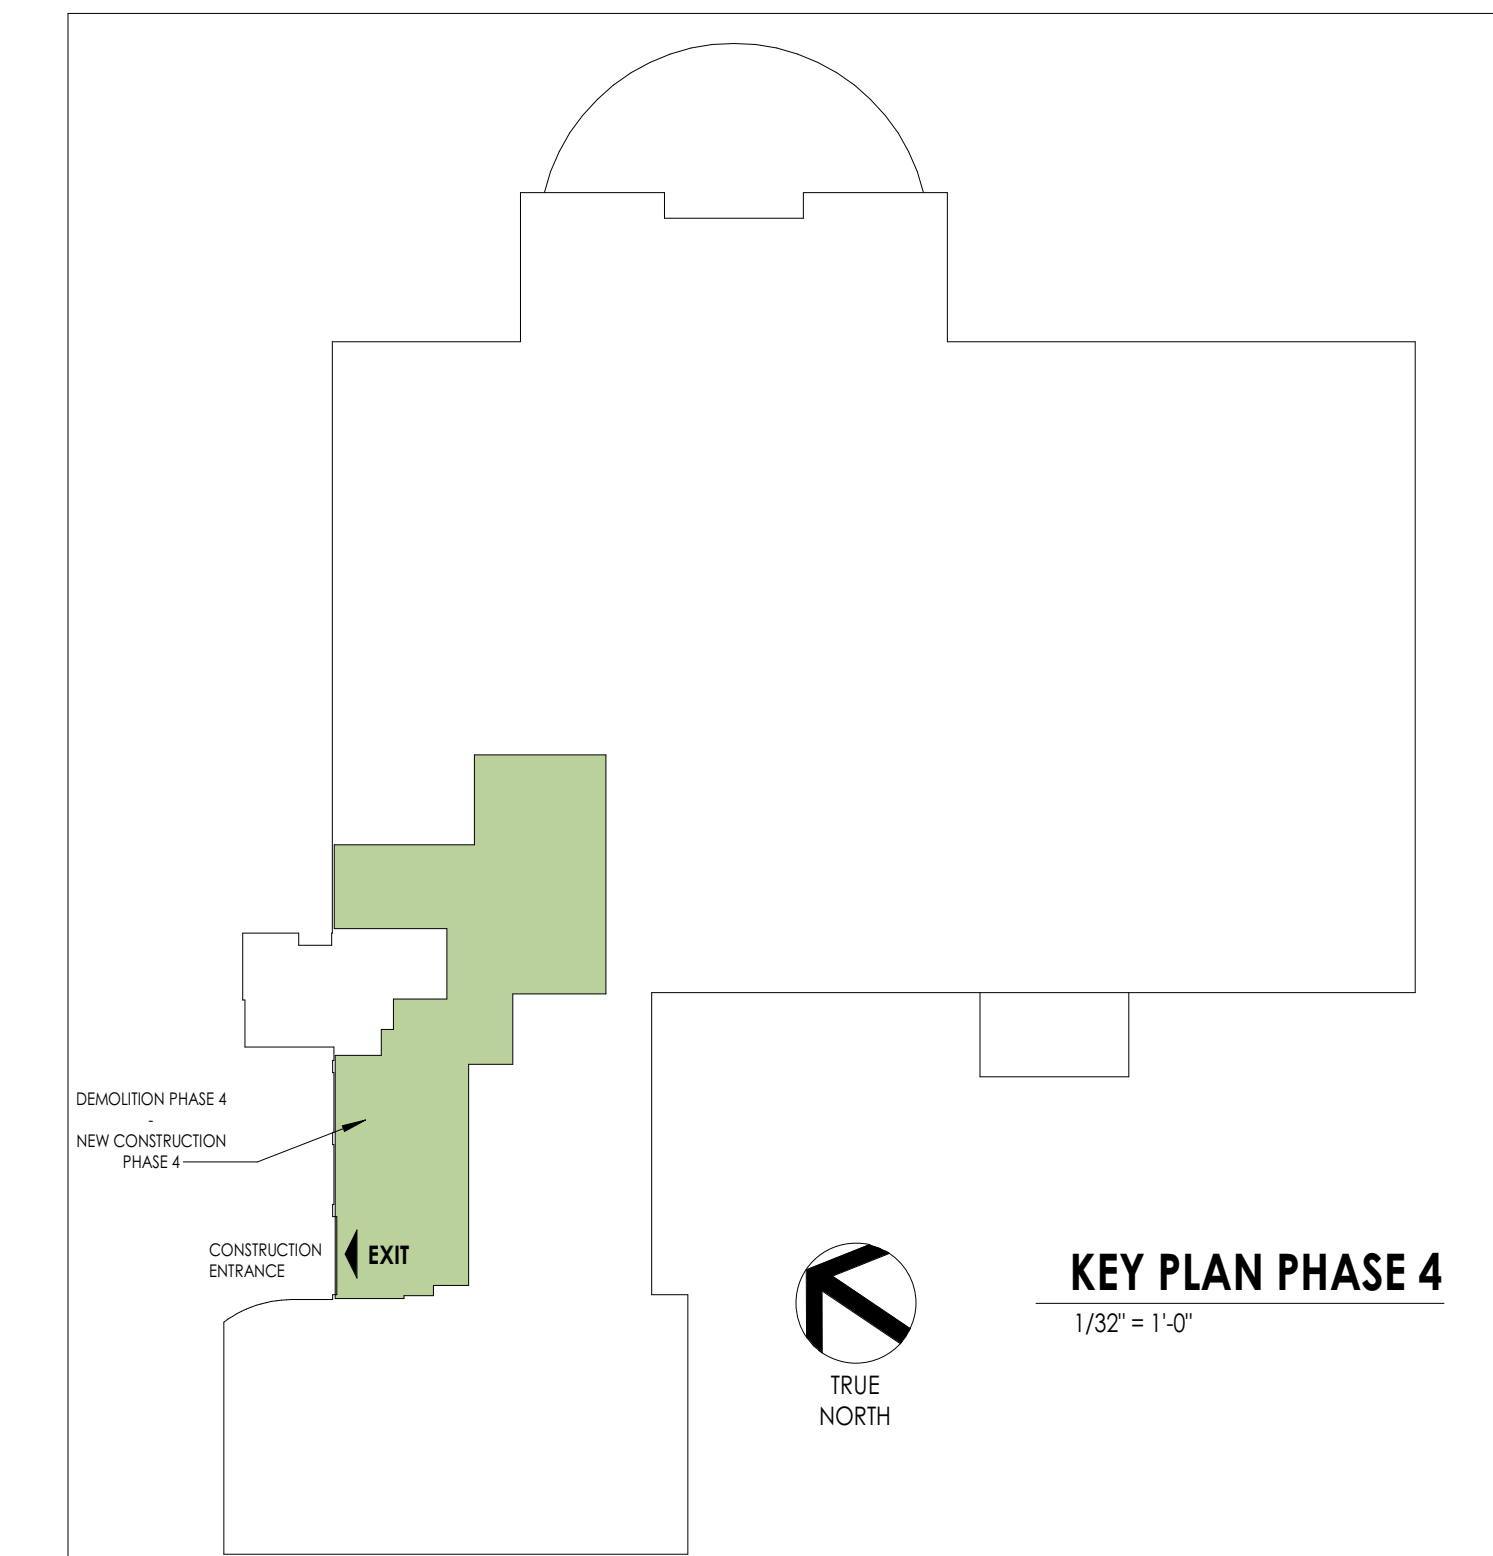

PROJECT INFORMATION

Project Number: 15210.00
Client Name: RANDOLPH COUNTY COURTHOUSE
Project Name: CLERK OF COURT OFFICE RENOVATION
Project Address: 176 E Salisbury St, Asheboro, NC 27203

REVISION SCHEDULE

11 01/27/20 Addendum 4
21


SHEET INFORMATION

Issue: 01/26/21
Bid Documents
Drawn By: CPL
Checked By: CPL
Drawing Title: REFLECTED CEILING PLAN - PHASE 4

PARTITION GENERAL NOTES

- ALL WALL TYPES MAY NOT BE USED ON THIS PROJECT.
- UNLESS NOTED OTHERWISE ALL PARTITIONS ARE FULL HEIGHT, EXTEND & SECURE TO UNDERSIDE OF CONCRETE OR METAL DECK ABOVE.
- PROVIDE UL APPROVED JOINT AT ALL TOP OF WALL AND WALL TO WALL CONDITIONS AT ALL RATED WALLS.
- PROVIDE DEFLECTION TRACKS AT METAL STUD PARTITIONS THAT TERMINATE AT THE UNDERSIDE OF STRUCTURE AND DECK.
- ALL PENETRATIONS IN FIRE RATED PARTITIONS TO BE FIRE STOPPED AND SEALED. REFER TO SPEC DIVISION 7.
- REFER TO STRUCTURAL DRAWINGS FOR MASONRY WALL REINFORCEMENT.
- ALL PARTITIONS SHALL BE SEALED TO PREVENT PASSAGE FOR SMOKE.
- CONTRACTOR TO REFER TO CODE/LIFE SAFETY DRAWINGS FOR RATED PARTITIONS AND UL ASSEMBLIES.
- REFER TO INTERIOR DRAWINGS FOR LOCATIONS OF WALL TILE AND OTHER SPECIALTY WALL FINISHES.
- PARTITION TYPES WITH ONE SIDE OF DOUBLE DRYWALL TO BE PLACED SO THAT THE DOUBLE SIDE IS ON CORRIDOR AND/OR HIGH TRAFFIC SIDE OF WALL.
- REFER TO SPECIFICATIONS FOR METAL STUD GAUGE REQUIREMENTS.
- CONTRACTOR IS RESPONSIBLE TO COORDINATE ALL PARTITION ACCESSORIES (APPLIED FINISHES, RESILIENT CHANNEL, ADDITIONAL LAYERS OF SHEATHING, ETC.) ITEMS SHOWN IN TYPICAL WALL CONSTRUCTION DETAILS MAY HAVE TO BE ARRANGED ON DIFFERENT SIDES OF WALL ASSEMBLY TO ACHIEVE FLUSH CONTINUOUS WALL SURFACES. ANY CONFLICTS SHOULD BE BROUGHT TO THE ATTENTION OF THE ARCHITECT.
- REFER TO ADD FOR KNEE WALL DETAILS.
- REFER TO ADD FOR DISMOUNTABLE PARTITION WALL ELEVATIONS.

PARTITION TYPE TAG LEGEND

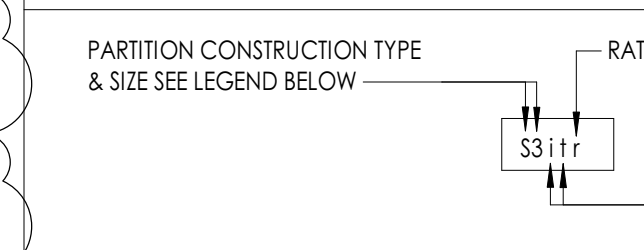



PARTITION CONSTRUCTION TYPE & SIZE LEGEND

- S3** STEEL STUDS - FINISH BOTH SIDES
 - 1 = 1 5/8" C STUD
 - 2 = 2 1/2" C STUD
 - 3 = 3 5/8" C STUD
 - 4 = 4" C STUD
 - 6 = 6" C STUD
 - 8 = 8" C STUD
- F1** STEEL STUD CURRING - FINISH ONE SIDE
 - 1 = 1 5/8" C STUD
 - 2 = 2 1/2" C STUD
 - 3 = 3 5/8" C STUD
 - 4 = 4" C STUD
 - 6 = 6" C STUD
 - 8 = 8" C STUD
- W1** STEEL STUD SHAFT WALL ASSEMBLY
 - 2 = 2 1/2" CH SHAFT WALL STUD
 - 4 = 4" CH SHAFT WALL STUD
 - 6 = 6" CH SHAFT WALL STUD
- B1** CONSTRUCTION BARRIER/TEMP WALL
 - 1 = 1 5/8" C STUD
 - 2 = 2 1/2" C STUD
 - 3 = 3 5/8" C STUD
 - 4 = 4" C STUD
 - 6 = 6" C STUD
 - 8 = 8" C STUD
- M1** CONCRETE MASONRY UNIT
 - 4 = 4" NOMINAL CMU
 - 6 = 6" NOMINAL CMU
 - 8 = 8" NOMINAL CMU
 - 10 = 10" NOMINAL CMU
 - 12 = 12" NOMINAL CMU
- L1** LUMBER (WOOD) STUDS - FINISH BOTH SIDES
 - 4 = 2x4" NOMINAL LUMBER WOOD STUDS
 - 6 = 2x6" NOMINAL LUMBER WOOD STUDS
 - 8 = 2x8" NOMINAL LUMBER WOOD STUDS
- L1A** LUMBER (WOOD) STUD CURRING - FINISH ONE SIDE
 - 4 = 2x4" NOMINAL LUMBER WOOD STUDS
 - 6 = 2x6" NOMINAL LUMBER WOOD STUDS
 - 8 = 2x8" NOMINAL LUMBER WOOD STUDS
- A** APPLIED FINISH - NON SELF SUPPORTING/ATTACHED TO OTHER STRUCTURE
- C1** RESILIENT CHANNEL - NON SELF SUPPORTING/ATTACHED TO OTHER STRUCTURE
 - 1 = 1 1/2" RC-1 RESILIENT CHANNEL
 - 2 = 1 1/2" RC-2 RESILIENT CHANNEL
- H1** HAT CHANNEL - NON SELF SUPPORTING/ATTACHED TO OTHER STRUCTURE
 - 1 = 7/8" HAT CHANNEL
 - 2 = 1 1/2" HAT CHANNEL
- Z1** ZEE-FURRING - NON SELF SUPPORTING/ATTACHED TO OTHER STRUCTURE
 - 1 = 1" ZEE FURRING
 - 1.5 = 1 1/2" ZEE FURRING
 - 2 = 2" ZEE FURRING
 - 2.5 = 2 1/2" ZEE FURRING
 - 3 = 3" ZEE FURRING

PARTITION TYPE SUFFIX


- ACCESSORIES SUFFIX:**
- I** - SOUND ATTENUATING BATT INSULATION (FIBERGLASS) FRICTION FIT BETWEEN STUDS TO FILL CAVITY
 - W** - SOUND ATTENUATING FIRE BATT INSULATION (ROCK WOOL) FRICTION FIT BETWEEN STUDS TO FILL CAVITY
 - 1** - CERAMIC WALL TILE (1) SIDE W/ THINSET MORTAR BED, 5/8" CEMENT BACKER BOARD IN LIEU OF 5/8" GYP. AT TILE LOCATIONS - SEE INTERIOR ELEVATIONS FOR TILE EXTENTS
 - 11** - CERAMIC WALL TILE (2) SIDES W/ THINSET MORTAR BED, 5/8" CEMENT BACKER BOARD IN LIEU OF 5/8" GYP. AT TILE LOCATIONS - SEE INTERIOR ELEVATIONS FOR TILE EXTENTS
 - D** - INTERIOR VENEER MASONRY/STONE APPLIED FINISH. REFER TO DETAILS FOR CONSTRUCTION, AND INTERIOR ELEVATIONS FOR EXTENTS
 - g** - CMU WALL GROUT CORES SOLID
 - s** - ADD 1/2" RC1 RESILIENT SOUND CHANNEL BEHIND SPECIFIED SHEATHING
 - k** - ADD ADDITIONAL (1) LAYER OF 5/8" GYP BOARD, TO ONE SIDE OF WALL
 - kk** - ADD ADDITIONAL (2) LAYERS OF 5/8" GYP BOARD, (1) EA. SIDE OF WALL
 - e** - ADD ADDITIONAL (1) LAYER OF 5/8" FRIT PLYWOOD BOLTED TO WALL FOR MOUNTING OF ELECTRICAL PANELS/EQUIPMENT WHERE NOTED ON ELEC. DWGS.
 - v** - SUBSTITUTE (1) LAYER OF 5/8" SOUNDBLOCK GYP. W/ INTEGRAL VISCOELASTIC POLYMER CORE FOR (1) LAYER OF SPECIFIED 5/8" TYPE X GYP.
 - w** - SUBSTITUTE 5/8" SOUNDBLOCK GYP. W/ INTEGRAL VISCOELASTIC POLYMER CORE FOR ALL LAYER OF SPECIFIED 5/8" TYPE X GYP.
 - x** - COPPER MAGNETIC/RF SHIELDING REFER TO PHYSICIST REPORT FOR REQUIREMENTS
 - c** - WALL FINISH TO TERMINATE 6" ABV. HIGHEST ADJACENT CEILING STUDS TO RUN TO UNDERSIDE OF DECK ABOVE.
 - y** - WALL STRUCTURE TERMINATES 12" ABV. HIGHEST ADJACENT CEILING. PROVIDE STRUCTURAL BRACING AT TOP OF WALL AS REQUIRED.
 - n** - KNEE WALL. REFER TO INTERIOR ELEVATIONS FOR HEIGHT & SILL CONDITION. REFER TO STRUCTURAL DETAILS FOR REQUIRED SUPPLEMENTAL STEEL AND ANCHORING REQUIREMENTS
- RATING SUFFIX:**
- r** - 1 HR RATED ASSEMBLY REFER TO UL DETAILS FOR RATED CONSTRUCTION REQUIREMENTS
 - rd** - 2 HR RATED ASSEMBLY REFER TO UL DETAILS FOR RATED CONSTRUCTION REQUIREMENTS
 - rd-3** - 3 HR RATED ASSEMBLY REFER TO UL DETAILS FOR RATED CONSTRUCTION REQUIREMENTS
 - dd** - 4 HR RATED ASSEMBLY REFER TO UL DETAILS FOR RATED CONSTRUCTION REQUIREMENTS

MIN. PLUMBING CHASE DIMENSIONAL REQUIREMENTS

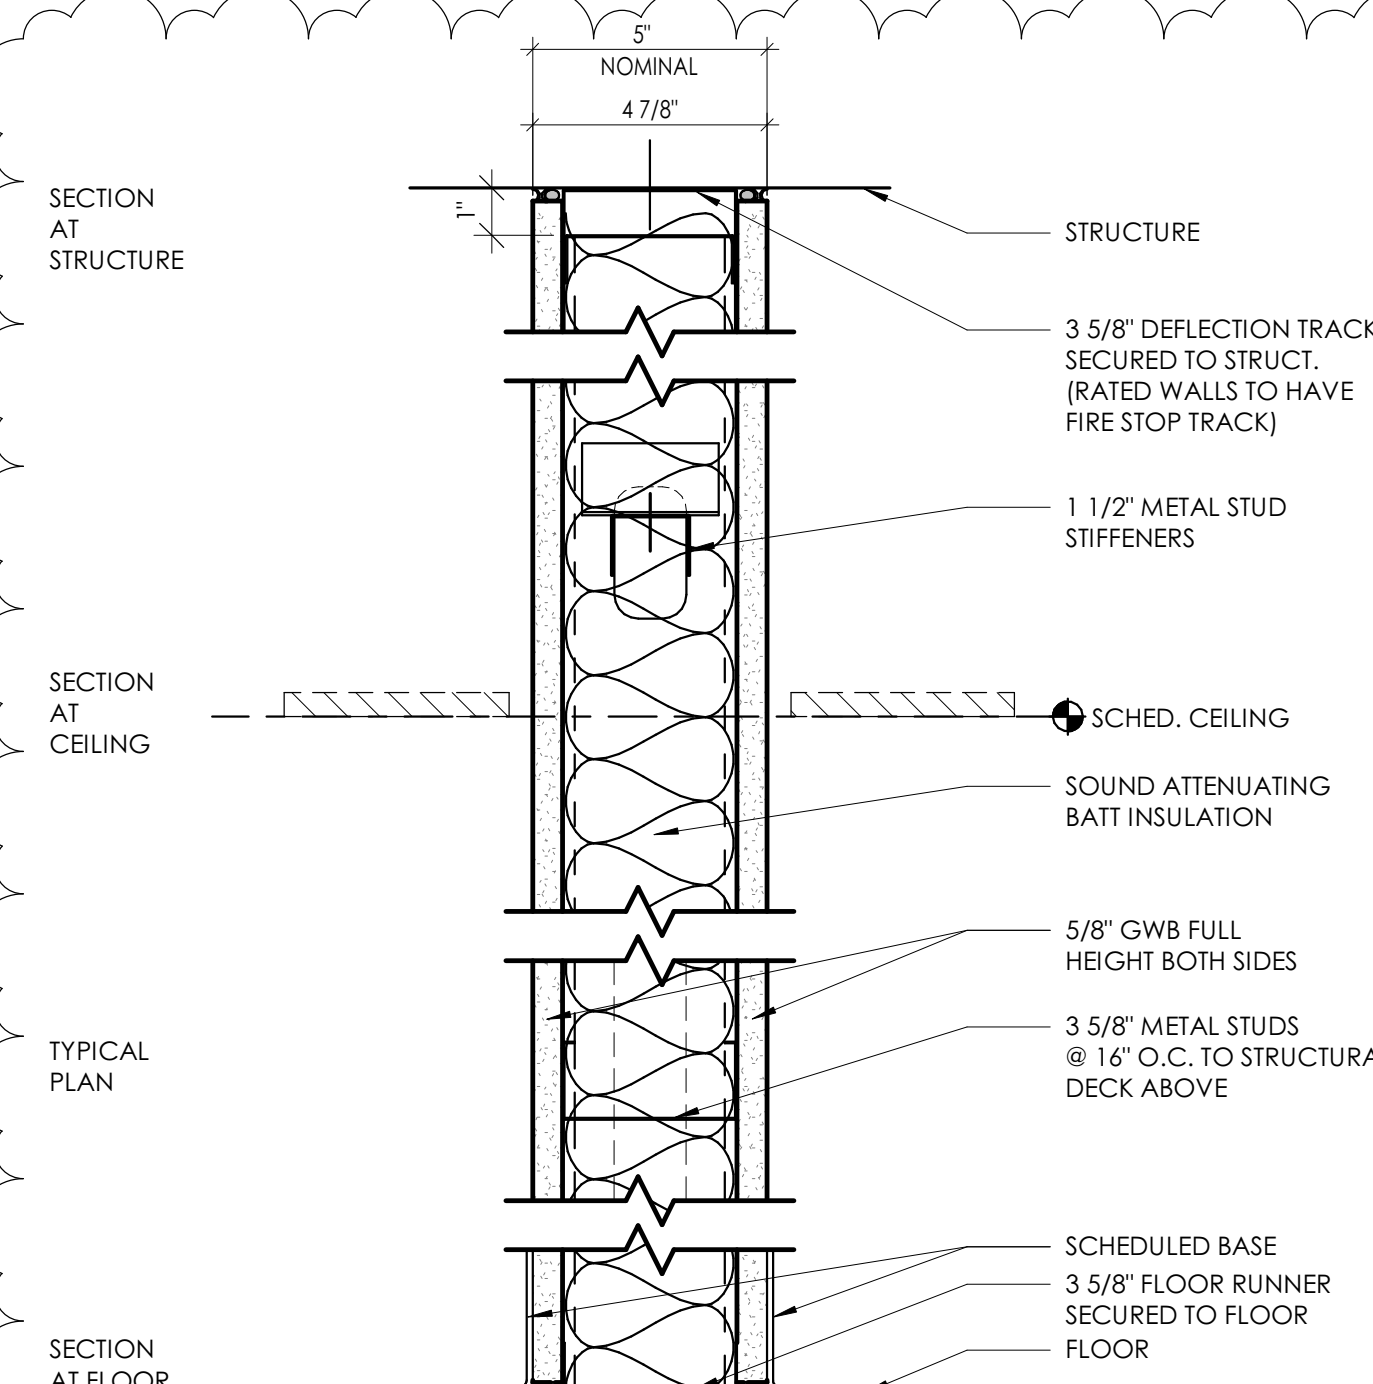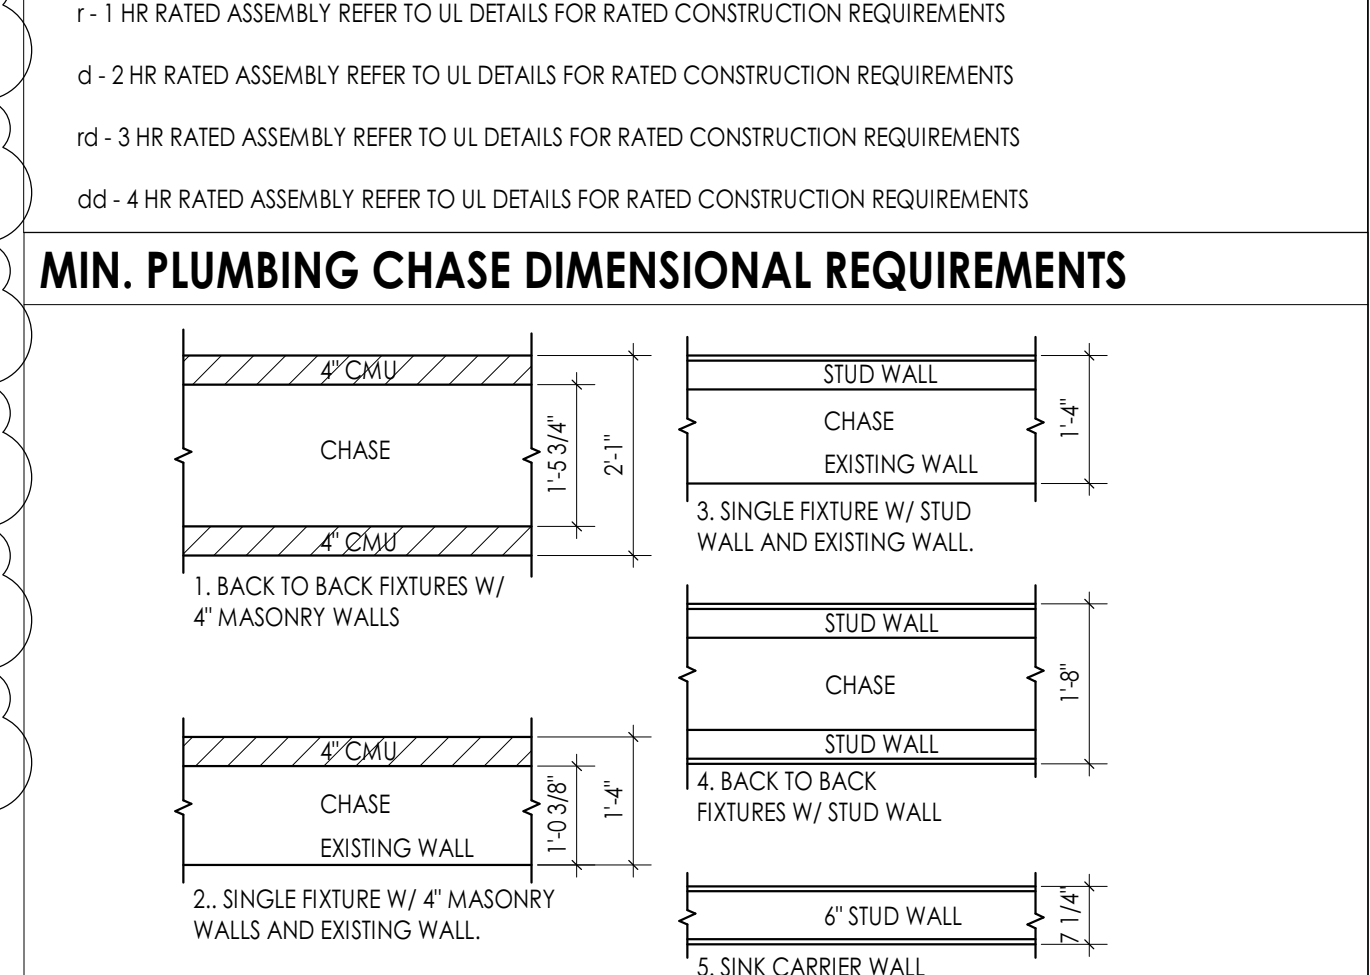


TYPE	STC TEST NUMBER &/OR FIRE TEST LAB DESIGN TEST NUMBER	FIRE RATING	STC	NOTES
S3	NGC 2518	NR	49	TERM 6' ABOVE CEILING
S3P	NGC 2518	NR	49	BULLET RESISTANT PANEL & GWB - TERM 6' ABOVE CEILING
S3x	NA	NR	49	TERM. AT DECK
S3r	UL-U465	1HR	49	FIRE/ACOUSTICAL SEALANT AT TOP AND BOTTOM. EXTEND TO STRUCTURE

BASED ON NGC 2518 @ 40 STC, REDUCED 3 STC FOR 20 GA STUDS.

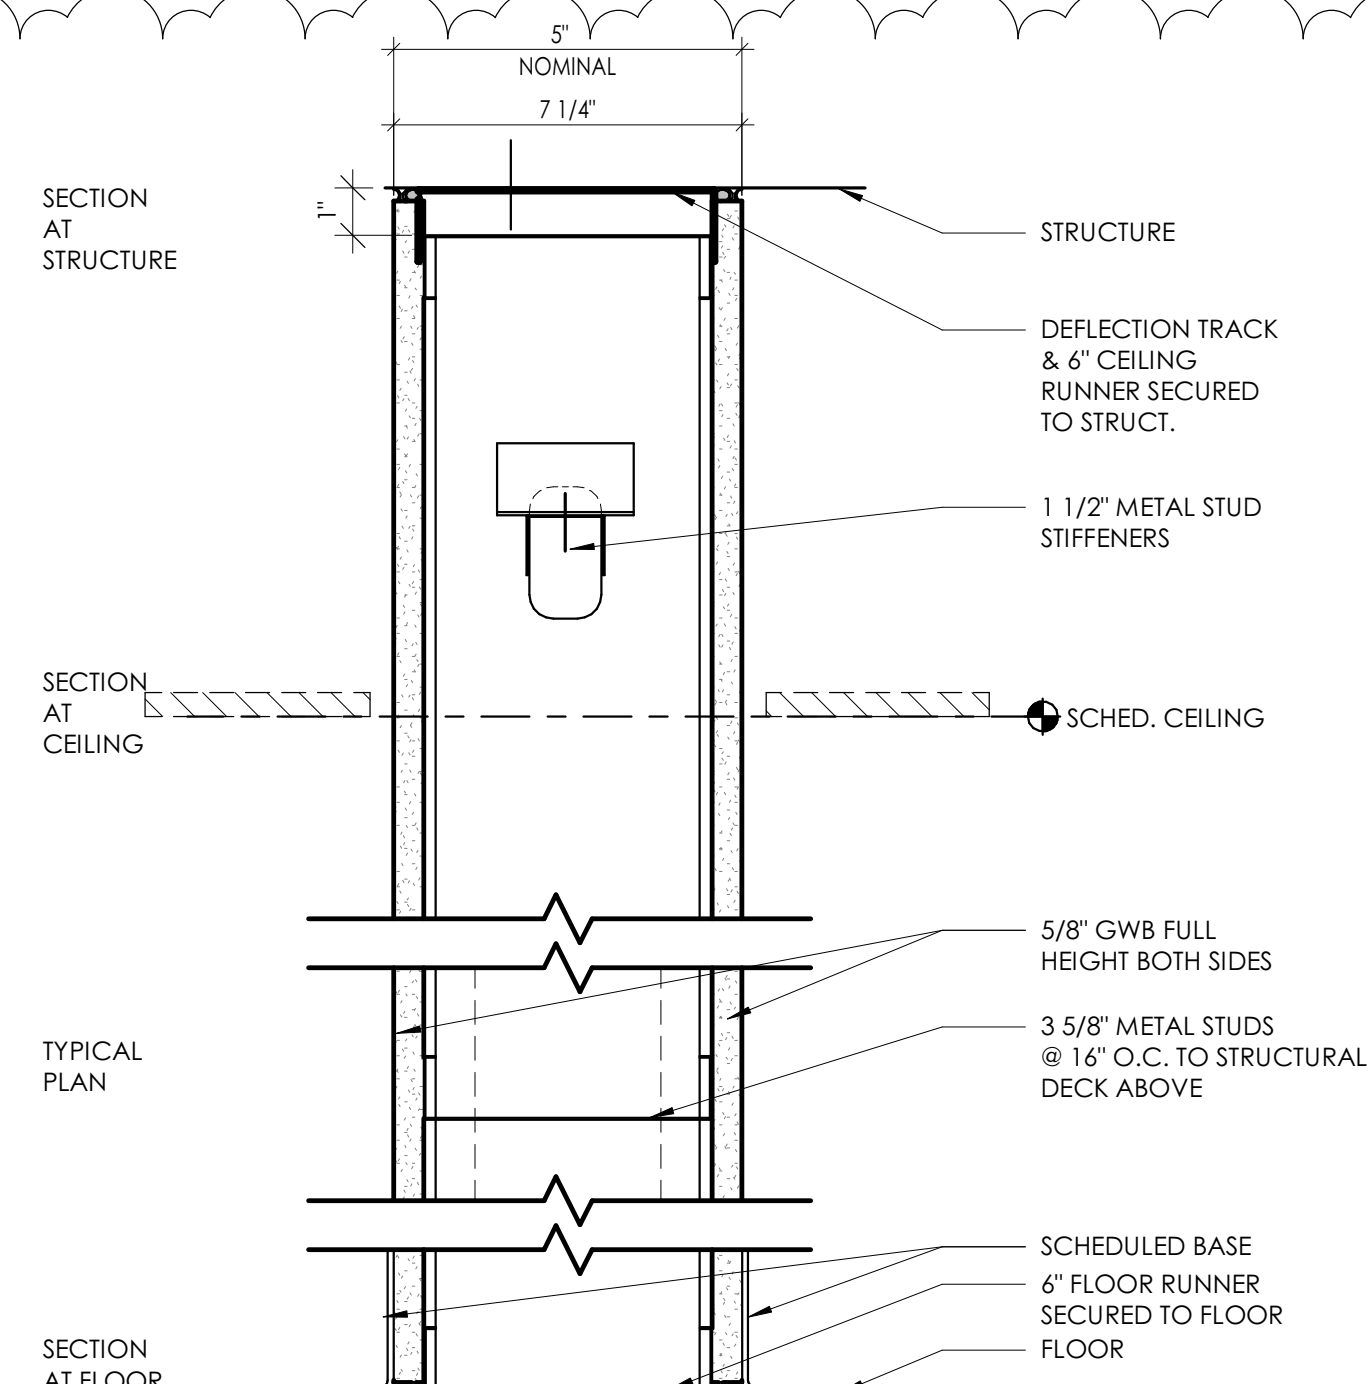


TYPE	STC TEST NUMBER &/OR FIRE TEST LAB DESIGN TEST NUMBER	FIRE RATING	STC	NOTES
S6	NA	NR	42	HALF WALL AT ADMIN. REFER TO DTL

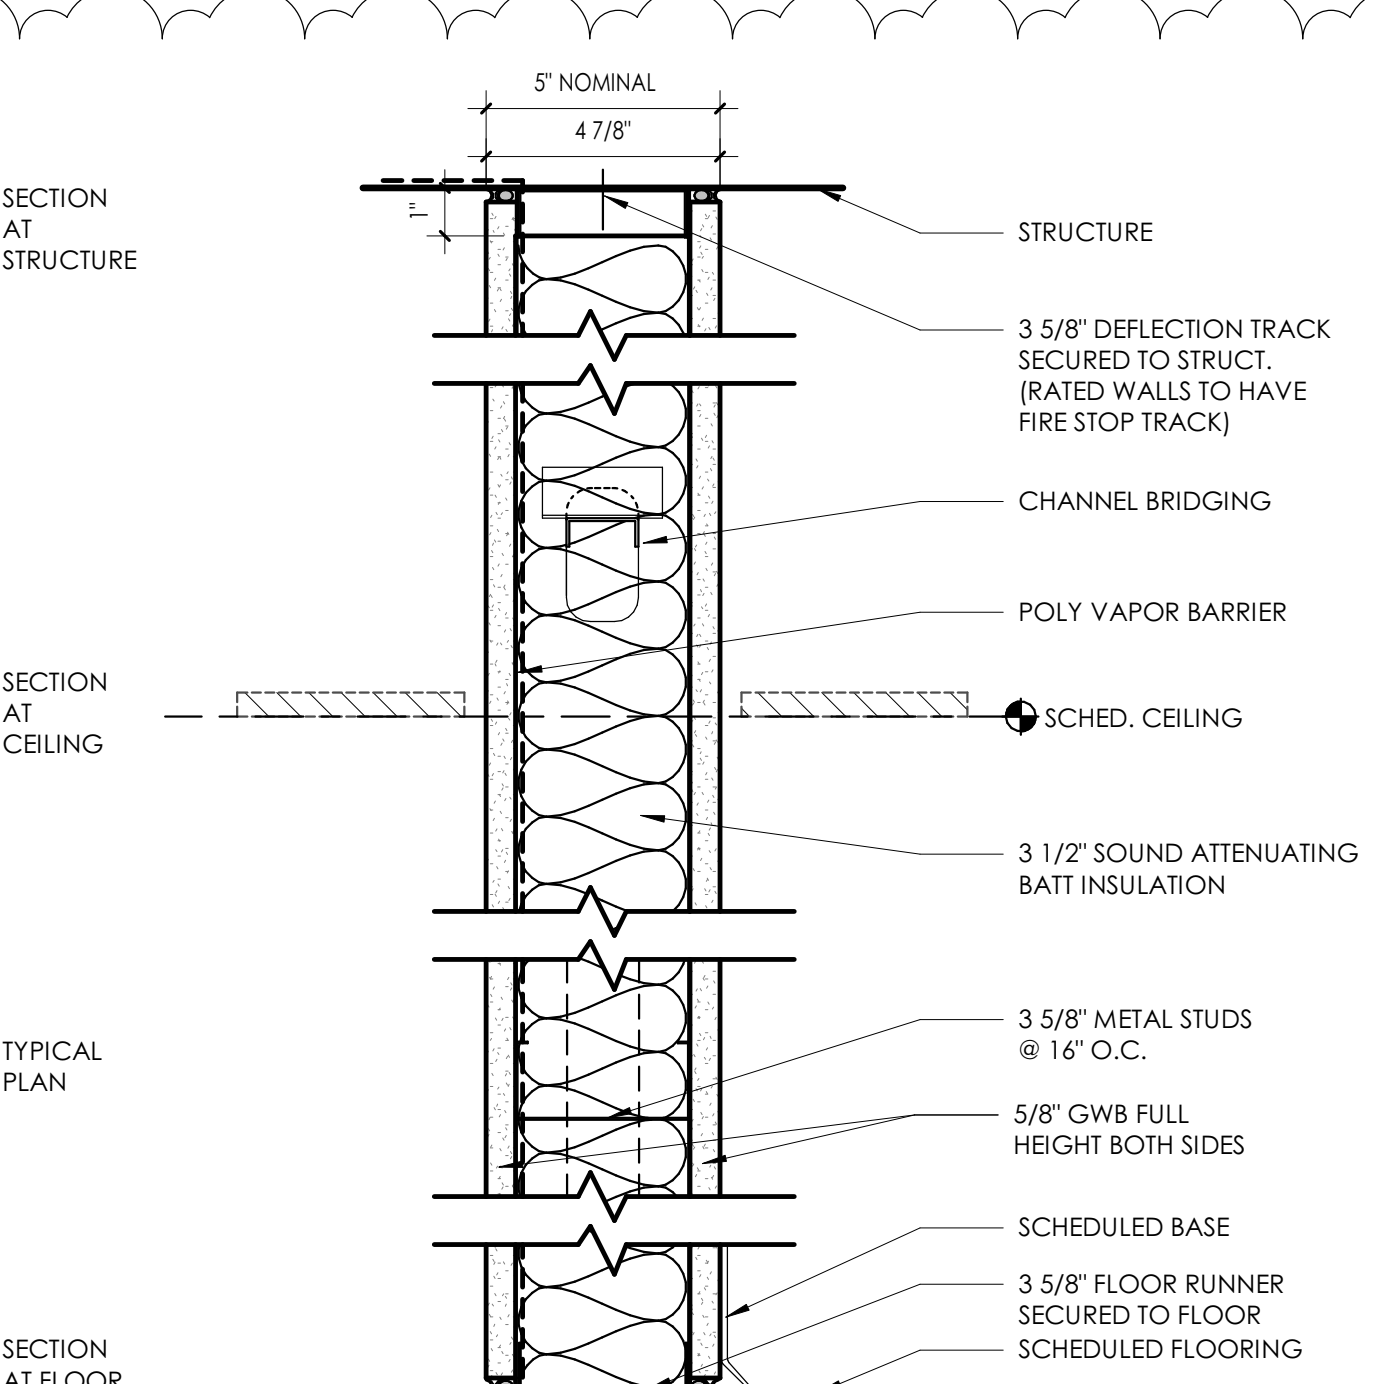


TYPE	STC TEST NUMBER &/OR FIRE TEST LAB DESIGN TEST NUMBER	FIRE RATING	STC	NOTES
B3P	NGC 2013004 UL # UL - U465	1HR	40	FIRE/ACOUSTICAL SEALANT AT TOP AND BOTTOM BOTH SIDES

NOTE: FURRING EXCEEDING 8FT IN HEIGHT SHALL BE BRACED AT 8FT O.C. BACK TO STRUCTURE. PROVIDE ATTACHMENT CLIPS AT FIRE PROOFING.

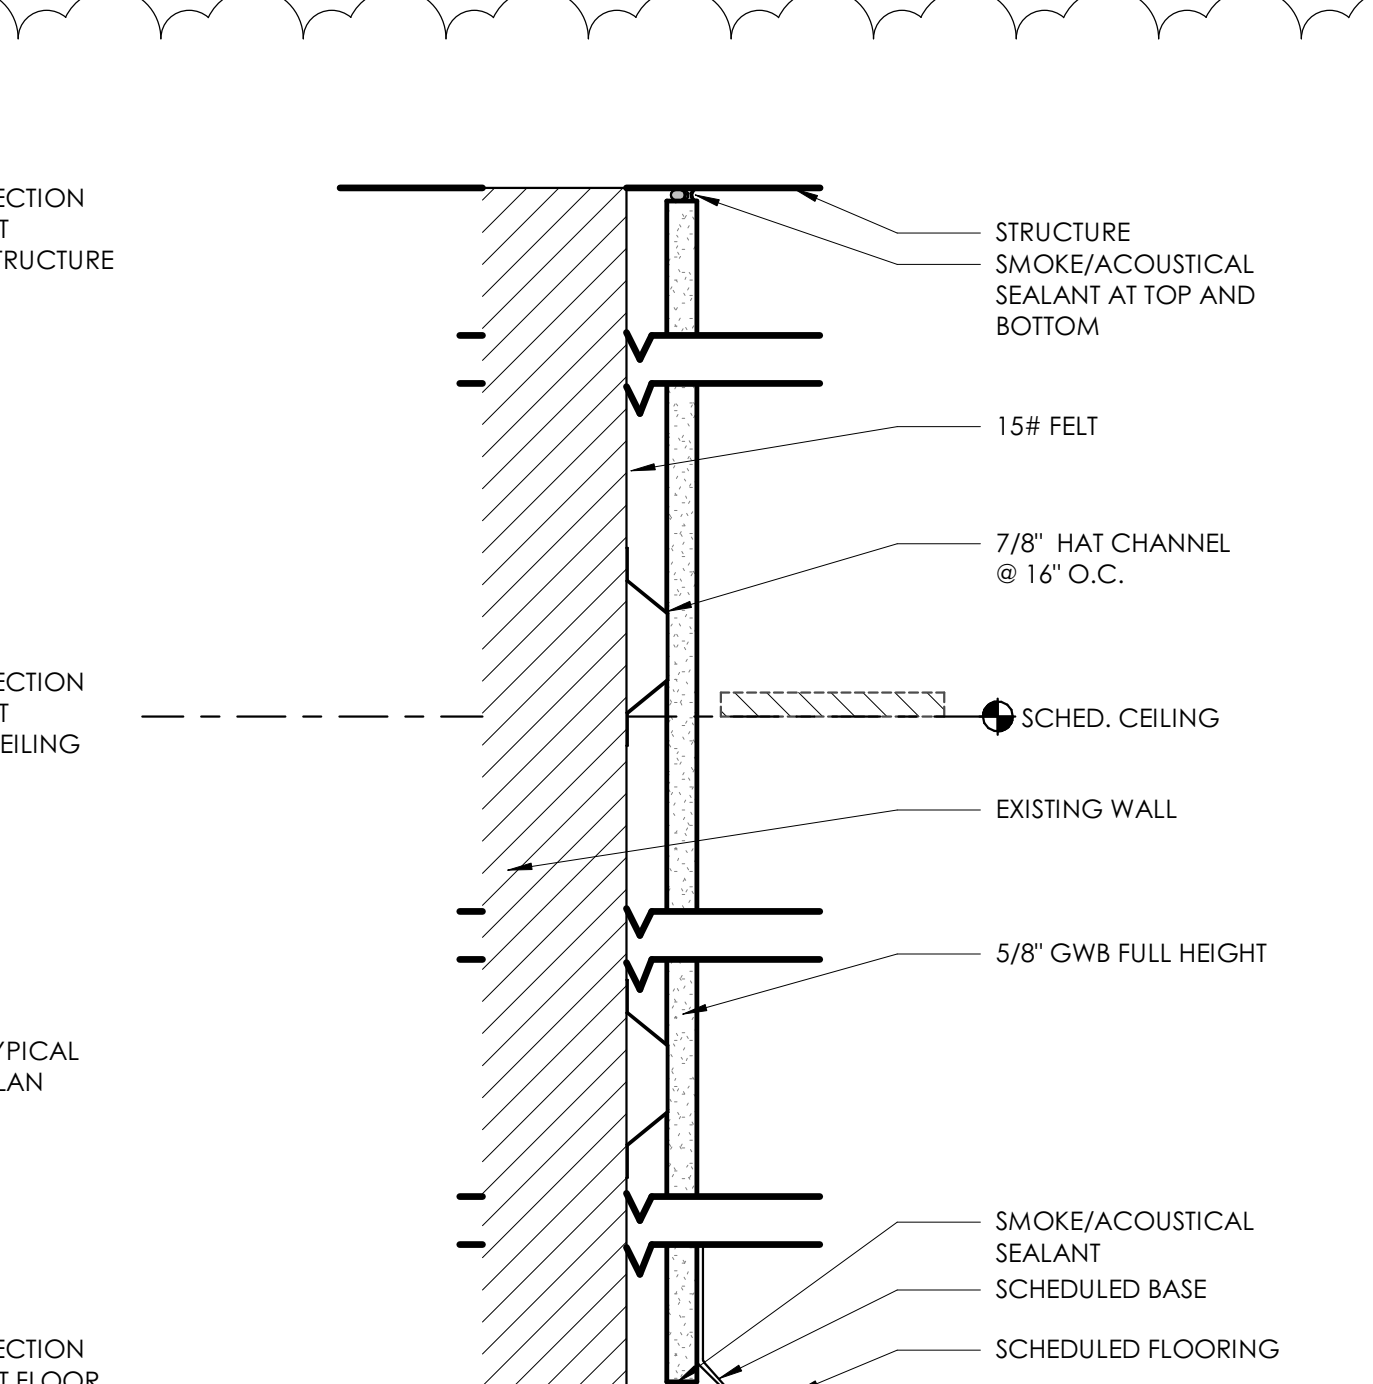


TYPE	STC TEST NUMBER &/OR FIRE TEST LAB DESIGN TEST NUMBER	FIRE RATING	STC	NOTES
F1		NR	NA	

NOTE: FURRING EXCEEDING 8FT IN HEIGHT SHALL BE BRACED AT 8FT O.C. BACK TO STRUCTURE. PROVIDE ATTACHMENT CLIPS AT FIRE PROOFING.

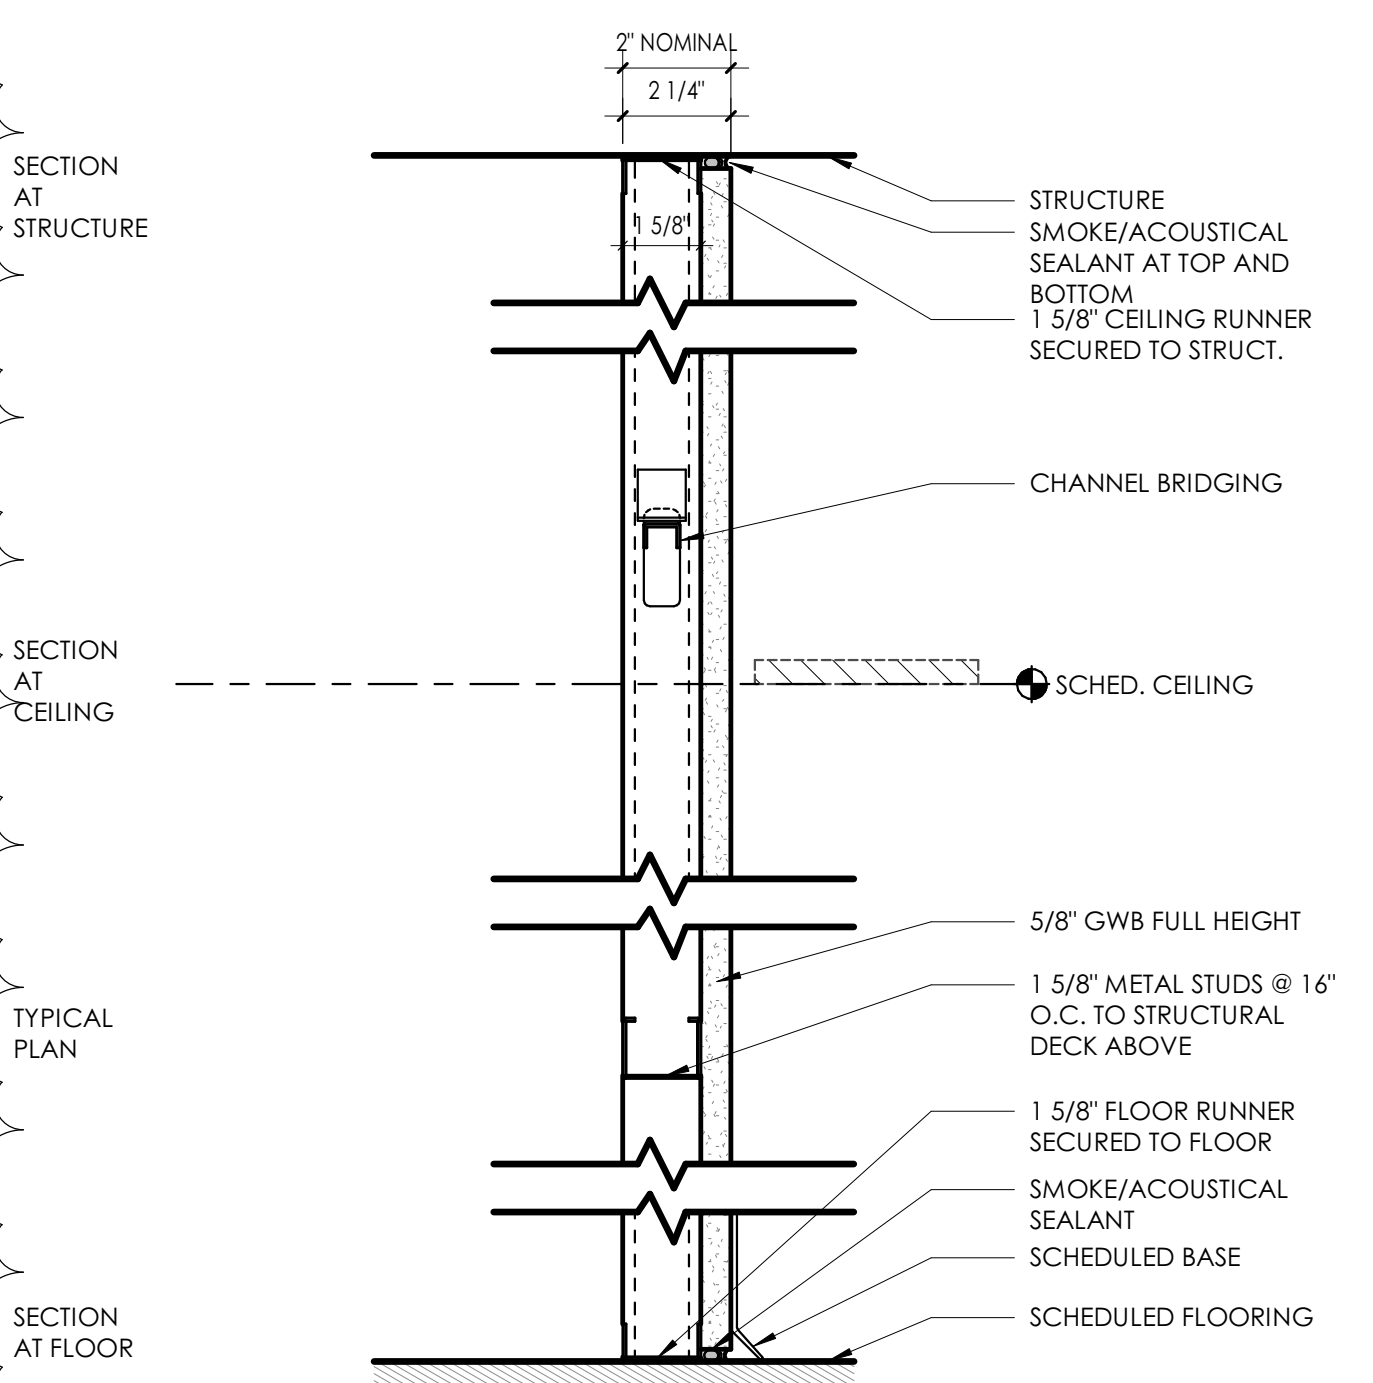


TYPE	STC TEST NUMBER &/OR FIRE TEST LAB DESIGN TEST NUMBER	FIRE RATING	STC	NOTES
F3		NR	NA	

NOTE: FURRING EXCEEDING 8FT IN HEIGHT SHALL BE BRACED AT 8FT O.C. BACK TO STRUCTURE. PROVIDE ATTACHMENT CLIPS AT FIRE PROOFING.

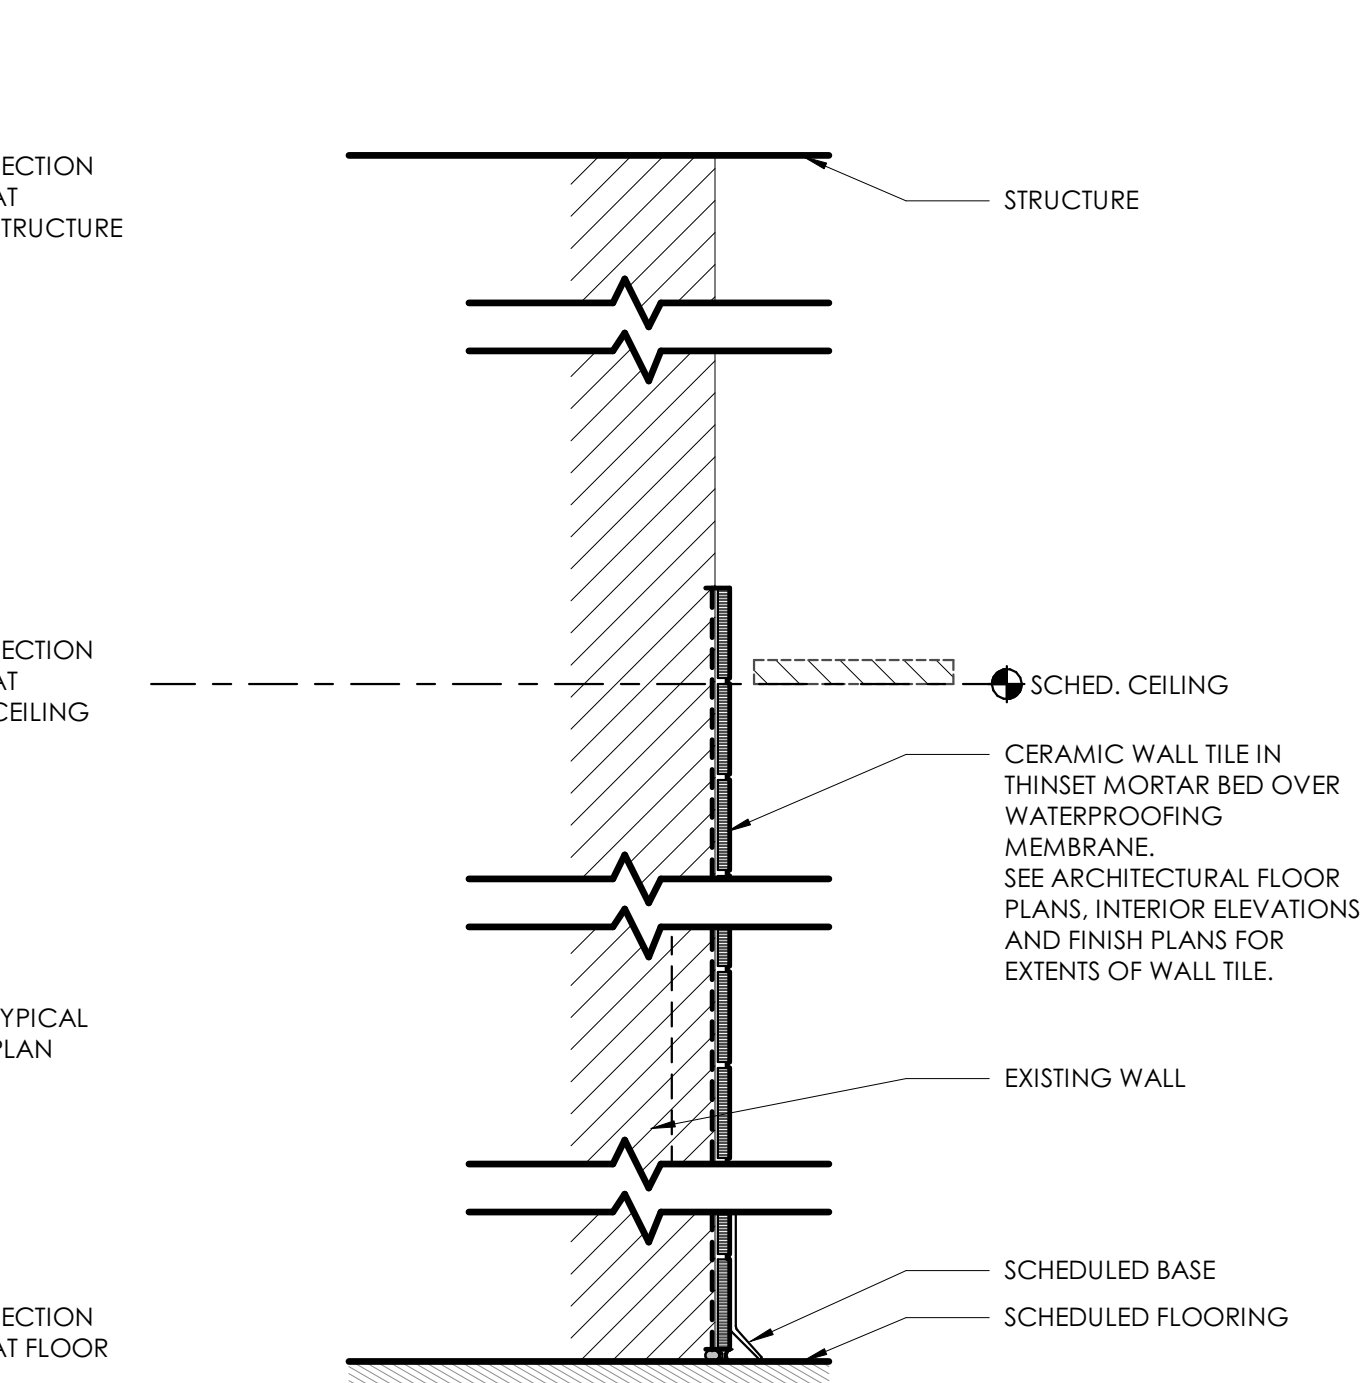

TYPE	STC TEST NUMBER &/OR FIRE TEST LAB DESIGN TEST NUMBER	FIRE RATING	STC	NOTES
F11		NR	NA	


NOTE: FURRING EXCEEDING 8FT IN HEIGHT SHALL BE BRACED AT 8FT O.C. BACK TO STRUCTURE. PROVIDE ATTACHMENT CLIPS AT FIRE PROOFING.

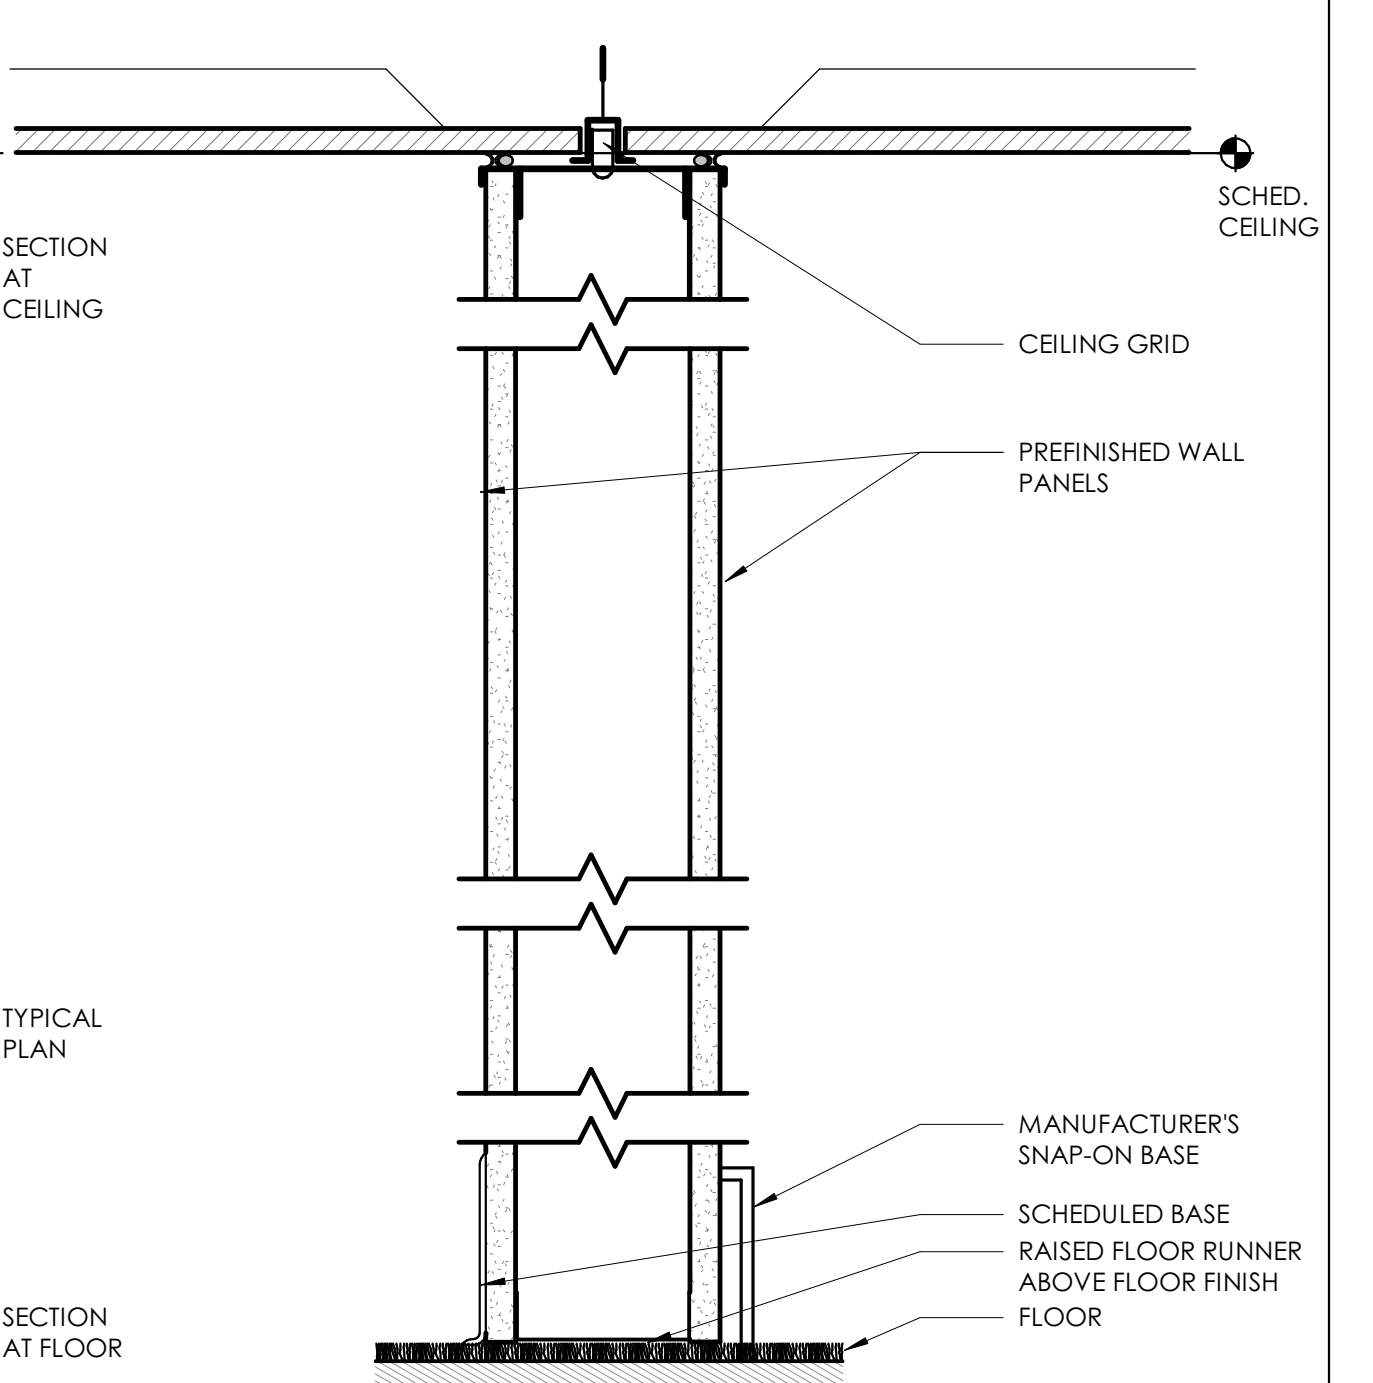


TYPE	STC TEST NUMBER &/OR FIRE TEST LAB DESIGN TEST NUMBER	FIRE RATING	STC	NOTES
D1	-	-	-	-
D2	-	-	-	-
D3	-	-	-	CHOOSE LAM FINISH FROM MANUFACTURER'S STANDARD LINE.
D4	-	-	-	CHOOSE LAM FINISH FROM MANUFACTURER'S STANDARD LINE.
D5	-	-	-	CHOOSE LAM FINISH FROM MANUFACTURER'S STANDARD LINE.
D6	-	-	-	CHOOSE LAM FINISH FROM MANUFACTURER'S STANDARD LINE.
D7	-	-	-	CHOOSE LAM FINISH FROM MANUFACTURER'S STANDARD LINE.
D8	-	-	-	MOUNTS TO UNDERSIDE OF SOFFIT.

DEMOUNTABLE PARTITION

TYPE MARK	GLAZING DESCRIPTION
G1	1/4" CLEAR FLOAT GLASS
G2	1/4" CLEAR FLOAT GLASS - TEMPERED
G3	1-1/4" LEVEL 2 BALLISTIC RESISTANT SECURITY GLAZING

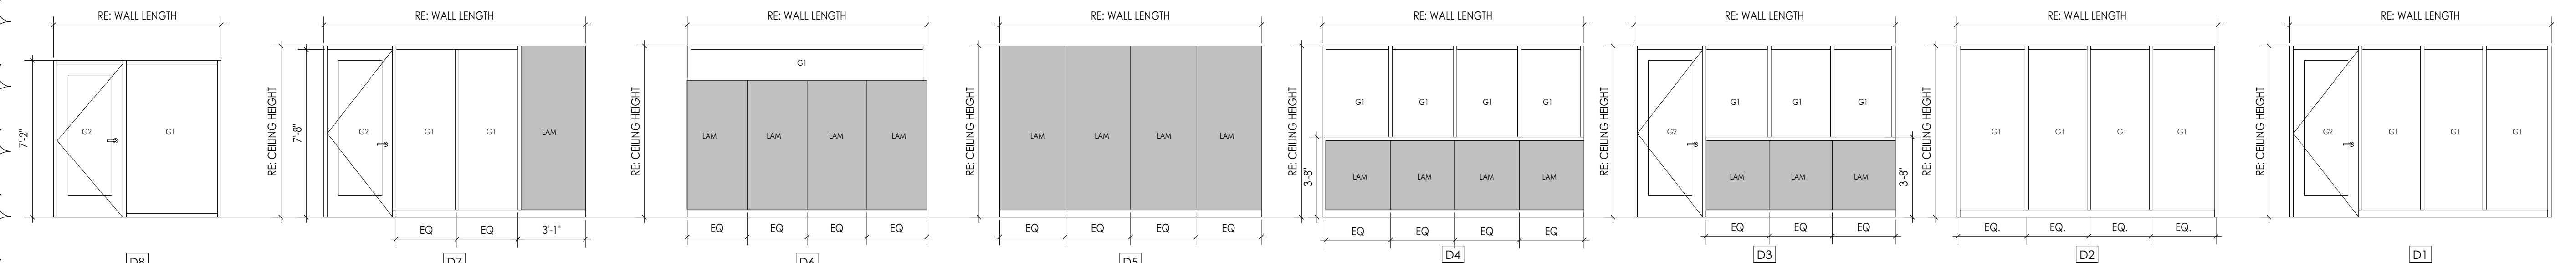

DEMOUNTABLE WALL TYPES
1/4" = 1'-0"

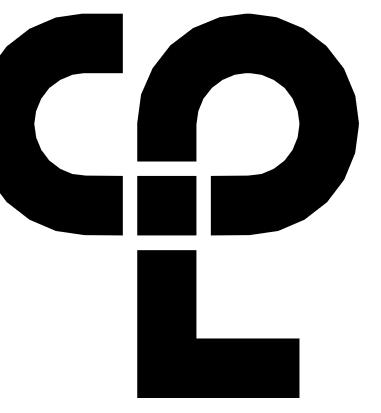

CFL | Architecture Engineering Planning
328 EAST MARKET ST, SUITE 200
GREENSBORO, NC 27401
CFLteam.com

PROJECT INFORMATION

Project Number: 15210.00
Client Name: RANDOLPH COUNTY COURTHOUSE
Project Name: CLERK OF COURT OFFICE RENOVATION
Project Address: 176 E Salisbury St, Asheboro, NC 27203

REVISION SCHEDULE

Date: 01/27/20
Description: Addendum 4

GENERAL INTERIOR ELEVATIONS NOTES

1. ALL DRAWINGS ARE GRAPHIC REPRESENTATIONS OF APPROXIMATE LOCATIONS OF EXISTING AND NEW MATERIALS. IT IS THE CONTRACTOR'S RESPONSIBILITY TO FIELD VERIFY ALL EXISTING CONDITIONS PRIOR TO COMMENCEMENT OF WORK.
2. REFER TO A700 FOR TOILET FIXTURE AND ACCESSORIES LEGEND AND MOUNTING HEIGHTS.
3. REFER TO A200 SERIES DRAWINGS FOR ADDITIONAL SPECIALTIES.
4. ALL FURNITURE AND EQUIPMENT SHOWN IS PROVIDED BY OWNER UNLESS NOTED OTHERWISE. ITEMS SHOWN ON THESE DOCUMENTS ARE FOR COORDINATION OF M.E.P. INFRASTRUCTURE TO OPERATE ITEMS INCLUDED UNDER THE SCOPE.
5. PROVIDE SUPPORT BLOCKING AND STRAPPING FOR ALL MILLWORK, CASEWORK, AND WALL MOUNTED ACCESSORIES.
6. REFER TO SPECS FOR ALL TOILET ROOM ACCESSORIES PROVIDED BY OWNER.
7. PROVIDE MOISTURE RESISTANT GWB BEHIND ALL CERAMIC WALL TILE INSTALLATIONS.
8. PROVIDE FULL FINISHED END PANELS ON ALL EXPOSED MILLWORK.
9. PROVIDE FILLER PANEL WHERE MILLWORK MEETS WALL.
10. PROVIDE SUPPORT BRACKETS AT WORK SURFACES, 48" MAX BETWEEN BRACKETS UNLESS NOTED OTHERWISE.
11. SEE ROOM FINISH SCHEDULE AND COLOR LEGEND FOR FINISHES.
12. REFER TO A600 SERIES DRAWINGS FOR CEILING HEIGHTS.
13. REFER TO 1 SERIES DRAWINGS AND A700 SERIES DRAWINGS FOR MILLWORK FINISHES.
14. FIELD VERIFY ALL DIMENSIONS PRIOR TO SHOP DRAWING SUBMITTAL.
15. GROMMETS TO BE INSTALLED IN FIELD AND COORDINATED WITH I.T. EQUIPMENT.

INTERIOR ELEVATION GENERAL FINISH NOTES




1. COUNTERTOP TO BE SOLID SURFACE MATERIAL REFER TO DETAILS XXXXX FOR INFO. (U.N.O.)
2. COUNTERTOP TO BE HIGH PRESSURE LAMINATE (XXX). REFER TO DETAIL XXXXX FOR INFO. (U.N.O.)
3. COUNTERTOP TO BE QUARTZ COUNTERTOP (XXX).
4. MILLWORK TO BE HIGH PRESSURE LAMINATE REFER TO DETAIL XXX FOR INFO. (U.N.O.)
5. SOFFIT TO BE HIGH PRESSURE LAMINATE REFER TO DETAIL XXX FOR INFO. (U.N.O.)
6. COLUMN & MILLWORK TO BE HIGH PRESSURE LAMINATE REFER TO DETAILS XXX FOR INFO. (U.N.O.)

INTERIOR ELEVATION LEGEND

CABLE TELEVISION	TV
CARD READER	CR
CODE BLUE BUTTON	CB
ELECTRICAL OUTLET	E
FIRE ALARM AND STROBE	FAS
FIRE ALARM PULL STATION	F
FINISHED END PANEL	FE
FLOOR DRAIN	FL
LIGHT SWITCH	S
MEDICAL AIR	A
MODULAR CASEWORK	MCW
MEDICAL EQUIPMENT	ME
NURSE CALL	NC
NURSE LIGHT	NL
OXYGEN	O
TELEPHONE/DATA DROP	T/D
TELEPHONE DROP	W
TELEMETRY	T
THERMOSTAT	TH
VACUUM	V
VACUUM SLIDE	VS

INTERIOR ELEVATION/ PLAN KEYNOTES

- 1 PLAM-1
- 2 PLAM-2
- 3 SSM-1 COUNTERTOP, BACKSPASH AND SIDESPLASH WHERE APPLICABLE
- 4 TILE BACKSPASH - TW-1 AND TW-2 50/50 HERRINGBONE PATTERN
- 5 TRANSACTION WINDOW
- 6 DEMOUNTABLE WALL SYSTEMS. REFER TO SPECIFICATIONS
- 7 PROVIDE BLOCKING FOR TELEVISION WALL BRACKET
- 8 EQUIPMENT OFCI
- 9 MOCCKETT 2" PLATED GROMMET - TGS-26D - SATIN CHROME
- 10 HAFELE WORK SURFACE RIGID COUNTER BRACKET - WHITE - COORDINATE WITH TRANSACTION TRAYS AND CASHIER DRAWERS
- 11 BULLET RESISTANT COUNTERTOP STATIONARY DEAL TRAY 16"X11"D X1-1/2"H
- 12 CASHIER DRAWER OSCI - VERIFY DIMENSIONS WITH OWNER COORDINATE WITH BRACKETS
- 13 PLAM-3
- 14 DOUBLE SIDED SLOTTED JUDGES/ATTORNEY'S BOXES PAPER ORGANIZATION PLAM-2
- 15 BALLISTIC ANODIZED ALUMINUM 4" SPEAK THRU
- 16 PLAM-4
- 17 PT-3 ACCENT PAINT
- 18 BASE AS SPECIFIED.
- 19 PLAM-5
- 20 CPU CABINET TO HAVE WIRE HOLE AND (1) ZG1-90 GROMMET WITH ZGAVG2-90 CAP.
- 21 FINISHED PLAM PANEL
- 22 PENCIL DRAWER
- 23 ADJUSTABLE HEIGHT SHELVING
- 24 F3 WALL ALIGN FACE OF WALL WITH BRICK FACE.

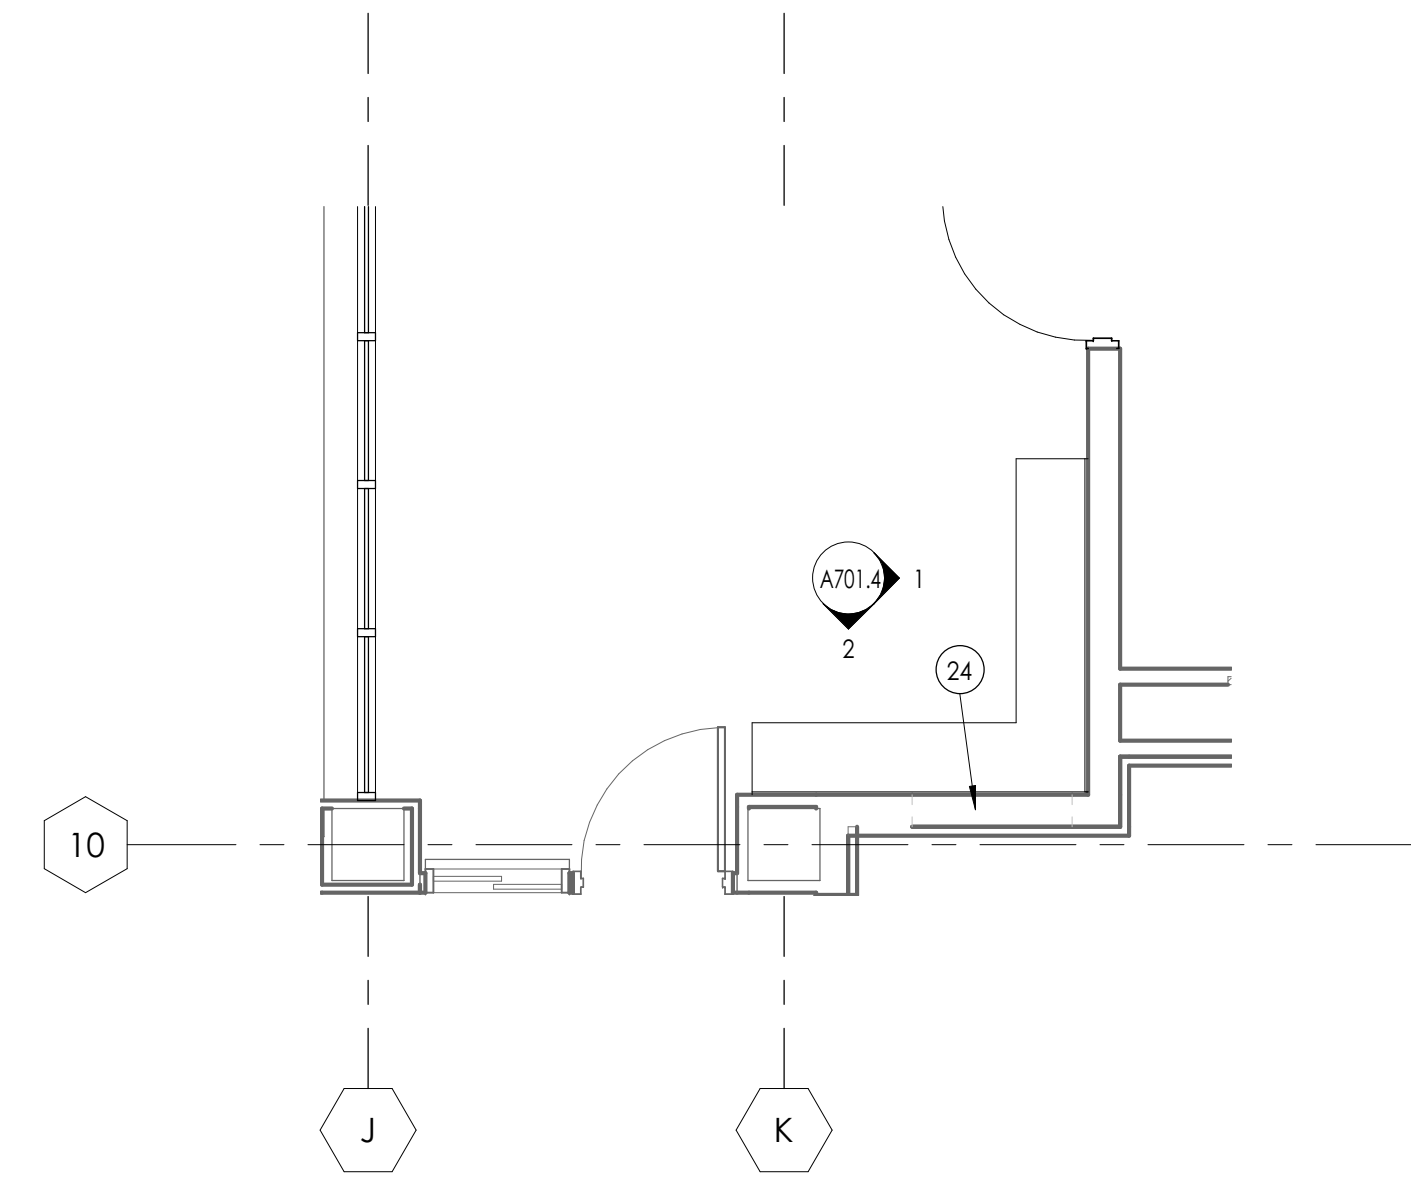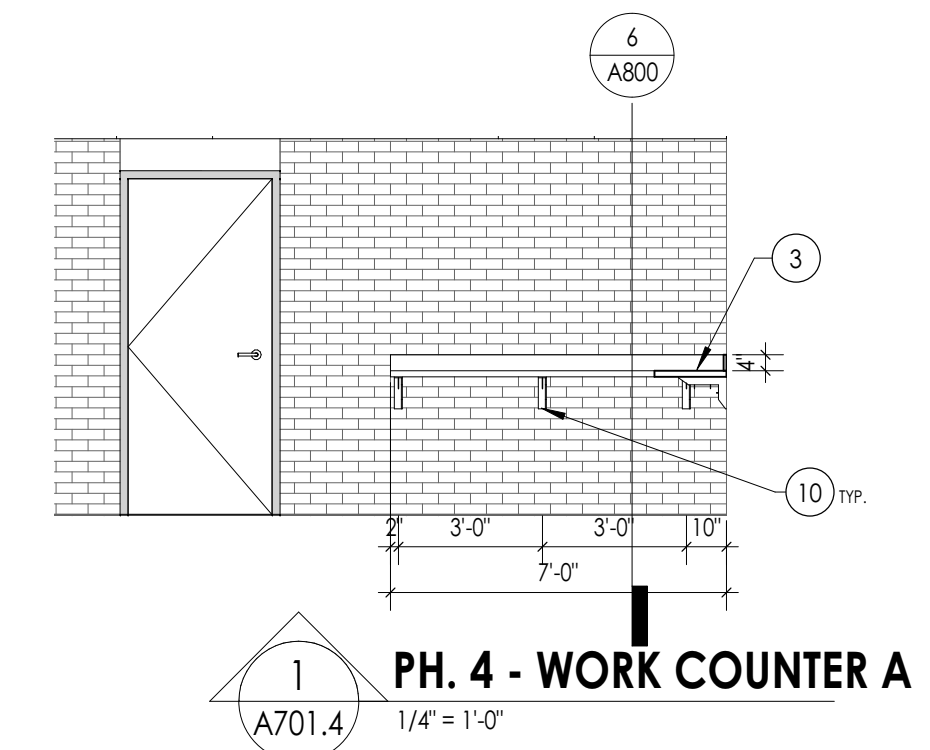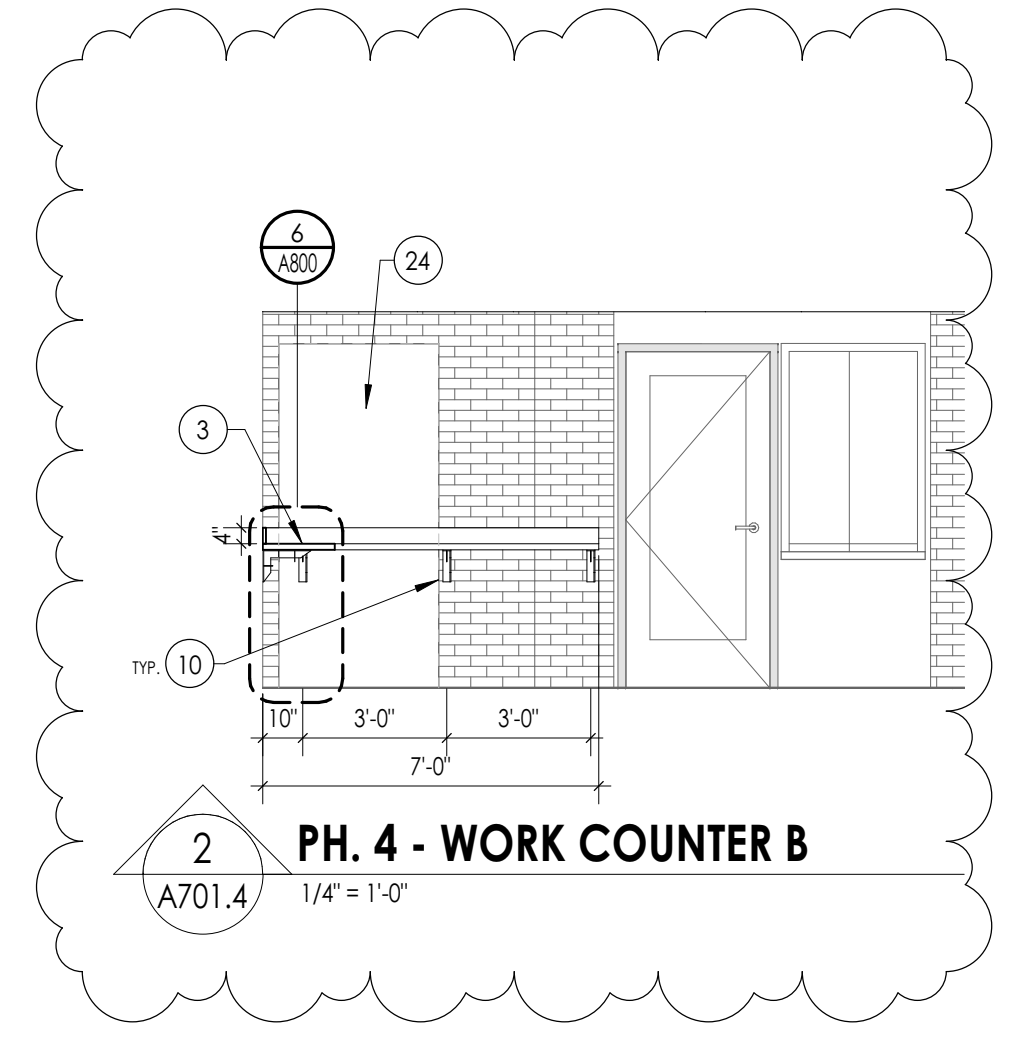


2/9/2021 3:21:17 PM s:\project\locations\08-Design\08-CAD\Revit\CEN\PH4_RLEB

SHEET INFORMATION

Issue: 01/26/21
Bid Documents
Drawn By: CFL
Checked By: CFL
Drawing Title: PHASE 4 - ENLARGED FLOOR PLAN AND INTERIOR ELEVATIONS

A701.4

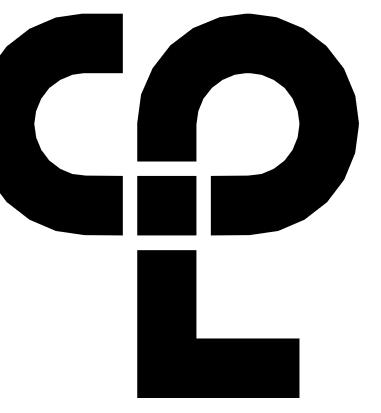

CFL | Architecture Engineering Planning
328 EAST MARKET ST. SUITE 200
GREENSBORO, NC 27401
CFLteam.com

DOOR AND FRAME NOTES

1. REFER TO A900S FOR DOOR & FRAME SCHEDULE
2. ALL FRAMES ARE TO RECEIVE FULL PERIMETER SEALANT, INTERIOR AND EXTERIOR
3. ALL DOOR AND WINDOW DIMENSIONS ARE TO BE VERIFIED IN FIELD PRIOR TO FABRICATION
4. SEE SCHEDULE FOR DOOR & FRAME MATERIAL

DOOR AND FRAME SCHEDULE LEGEND

NOTE: THE LEGEND MAY CONTAIN SYMBOLS THAT ARE NOT USED IN THIS PROJECT.

DOOR OR FRAME MATERIAL		DOOR OR FRAME FINISH	
ACR	ACROVYN DOOR	PTD	PAINT
ACR-L	ACROVYN LEAD LINED DOOR	ST	WOOD STAIN
ALUM	ALUMINIUM	DB	DARK BRONZE(ANODIZED)
HM	HOLLOW METAL	SS	STAINLESS STEEL
HM-L	HOLLOW METAL LEAD LINED	BE	BAKED ENAMEL
IHM	INSULATED HOLLOW METAL		
WD	WOOD		
WD-L	WOOD LEAD LINED		

GLAZING TYPES

TYPE MARK	GLAZING DESCRIPTION
G1	1/4" CLEAR FLOAT GLASS
G2	1/4" CLEAR FLOAT GLASS - TEMPERED
G3	1-1/4" LEVEL 2 BALLISTIC RESISTANT SECURITY GLAZING

GENERAL DOOR INFORMATION:

VERIFY ALL DOOR HARDWARE WITH SELECTED SUB8 DURING THE SUBMITTAL PROCESS.
THE INFORMATION BELOW APPLIES TO ALL INTERIOR DOOR PANELS AND HARDWARE UNLESS NOTED OTHERWISE IN DOOR SCHEDULE OR DOOR PANEL ELEVATIONS. ALTERNATES TO THE BASIS OF DESIGN TO BE REVIEWED WITH ARCHITECT PRIOR TO THE FINAL SELECTION. DETERMINE KEYING AND REVIEW ALL INFORMATION PRESENTED WITH ARCHITECT AND OWNER.
IF REQUIRED - COORDINATE / DEMOUNTABLE PARTITION/2HR WALL FRAME THICKNESSES WITH THE DOOR FRAME PROVIDER.
NOTE THE FINAL WALL THICKNESS.
INTERIOR DOOR PANEL AND FRAME BOD:
- DOOR PANELS: SOLID WOOD PANEL - 1 3/4" THICK, ROTARY BIRCH STAINED IN FIELD - MATCH STAIN BY DESIGNER
- GLASS PANEL - TEMPERED SAFETY GLASS
- DOOR FRAME + CASING: ALUMINIUM FRAME CONSTRUCTION CLEAR ANODIZED
DOORS 101 AND 102 KAWNEER MEDIUM STYLE FRAME.
- FINISH: AS INDICATED IN SCHEDULE

INTERIOR DOOR HARDWARE BOD:

- ASSA ABLOY STUDIO COLLECTION; CL3100 SERIES OR EQUAL
- LEVER IS NJ TYPE
- ROSETTE IS TYPE E2
- FINISH: CLEAR ANNOIDIZED

LOCKING HARDWARE:

USE CORBIN RUSSWIN, SCHLAGE OR FALCON B SERIES OR NOTED BY SUBCONTRACTOR OR EQUAL.

DOOR HARDWARE 1

DEMOUNTABLE PARTITION LOCKSET - BY DEMOUNTABLE PARTITION MANUFACTURER
PROVIDE ACOUSTICAL SEALS AND SWEEPS ON DOORS

DOOR HARDWARE 2

DEMOUNTABLE PARTITION NON LOCKING PIVOT DOOR
PROVIDE ACOUSTICAL SEALS AND SWEEPS ON DOORS

DOOR HARDWARE 3

(3) - MCKINNEY SQUARE BARREL HINGE OR EQUAL
CORBIN RUSSWIN CL3151 OFFICE SERIES ANSI F81
PROVIDE OPERATOR/ ELECTRIC STRIKE ACCESS

DOOR HARDWARE 4

PRIVACY FUNCTION - PUBLIC TOILET ROOM
(3) - MCKINNEY SQUARE BARREL HINGE OR EQUAL
PULL HANDLE AND LOCK - CL3120 ANSI F76A PRIVACY LOCK OR EQUAL

DOOR HARDWARE 5

STORAGE FUNCTION
(3) - MCKINNEY SQUARE BARREL HINGE OR EQUAL

(1) - STORAGE LOCKSET - CORBIN RUSSWIN ASSA ABLOY OR EQUAL CL3157 ANSI NO. F86

(1) - DOOR CLOSER

(1) - KICKPLATE: ROOM SIDE ONLY

(1) - WALL MOUNTED DOOR STOP

DOOR HARDWARE 6

MOTHER'S ROOM
(3) - MCKINNEY SQUARE BARREL HINGE OR EQUAL

(1) - WALL MOUNTED DOOR STOP

PROVIDE ACOUSTICAL SEALS AND SWEEPS ON DOORS

PROVIDE PRIVACY INDICATOR - NOTIFY ARCHITECT IF ALTERNATE DOOR PULL IS REQUIRED.

DOOR HARDWARE 7

NON LOCKING CORRIDOR
(3) - MCKINNEY SQUARE BARREL HINGE OR EQUAL

(1) - WALL MOUNTED DOOR STOP

PROVIDE ACOUSTICAL SEALS AND SWEEPS ON DOORS

DOOR HARDWARE 8 WORK ROOM

(3) - MCKINNEY SQUARE BARREL HINGE OR EQUAL

(1) - STORAGE LOCKSET - CORBIN RUSSWIN ASSA ABLOY OR EQUAL CL3157 ANSI NO. F86

(1) - WALL MOUNTED DOOR STOP

EVIDENCE ROOM MAY REQUIRE CIPHER LOCK OR CARD READER DOOR LEVER

- ASSA ABLOY STUDIO COLLECTION; CL3100 SERIES OR EQUAL

DOOR HARDWARE 9

BALLISTIC DOORS (REFER TO ALTERNATE NO. 003)
(3) - MCKINNEY SQUARE BARREL HINGE OR EQUAL

(1) - CLASSROOM LOCKSET - CORBIN RUSSWIN ASSA ABLOY OR EQUAL CL3352

(1) - WALL MOUNTED DOOR STOP

PROVIDE ACOUSTICAL SEALS AND SWEEPS ON DOORS

DOOR HARDWARE 10

HEARING ROOM DOORS
(3) - MCKINNEY SQUARE BARREL HINGE OR EQUAL

(1) - CLASSROOM LOCKSET - CORBIN RUSSWIN ASSA ABLOY OR EQUAL CL3352

(1) - WALL MOUNTED DOOR STOP


PROVIDE ACOUSTICAL SEALS AND SWEEPS ON DOORS

DOOR HARDWARE 11

(3) - MCKINNEY SQUARE BARREL HINGE OR EQUAL


CORBIN RUSSWIN CL3151 OFFICE SERIES ANSI F81

PROVIDE OPERATOR/ ELECTRIC STRIKE ACCESS

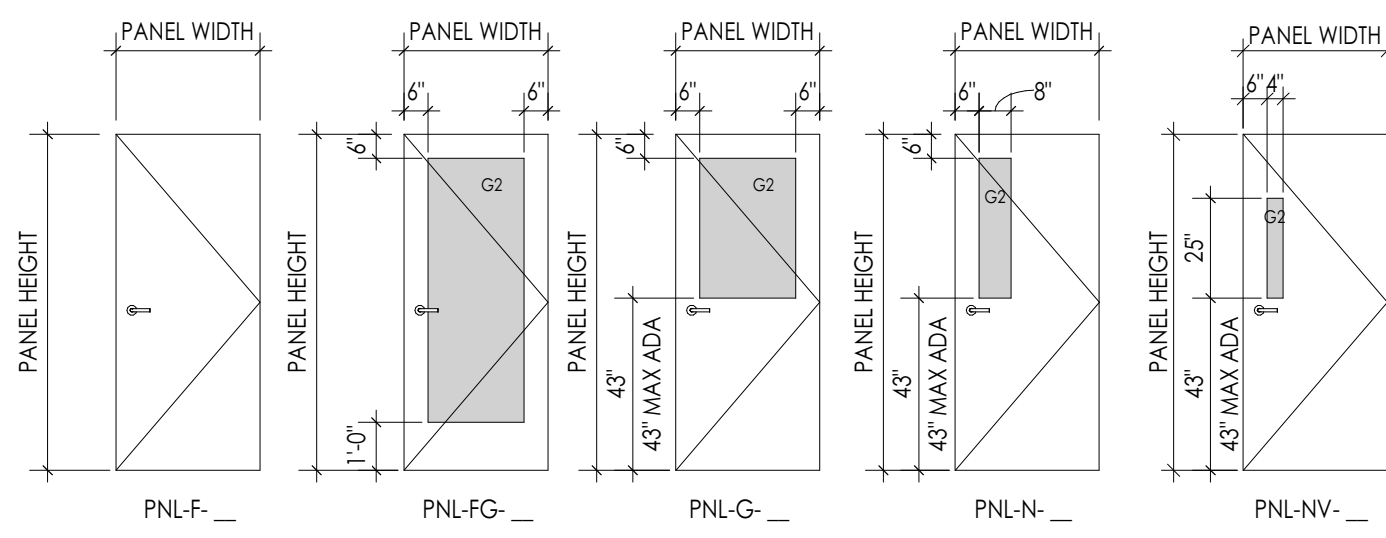


DOOR PANEL TYPES

1/4" = 1'-0"

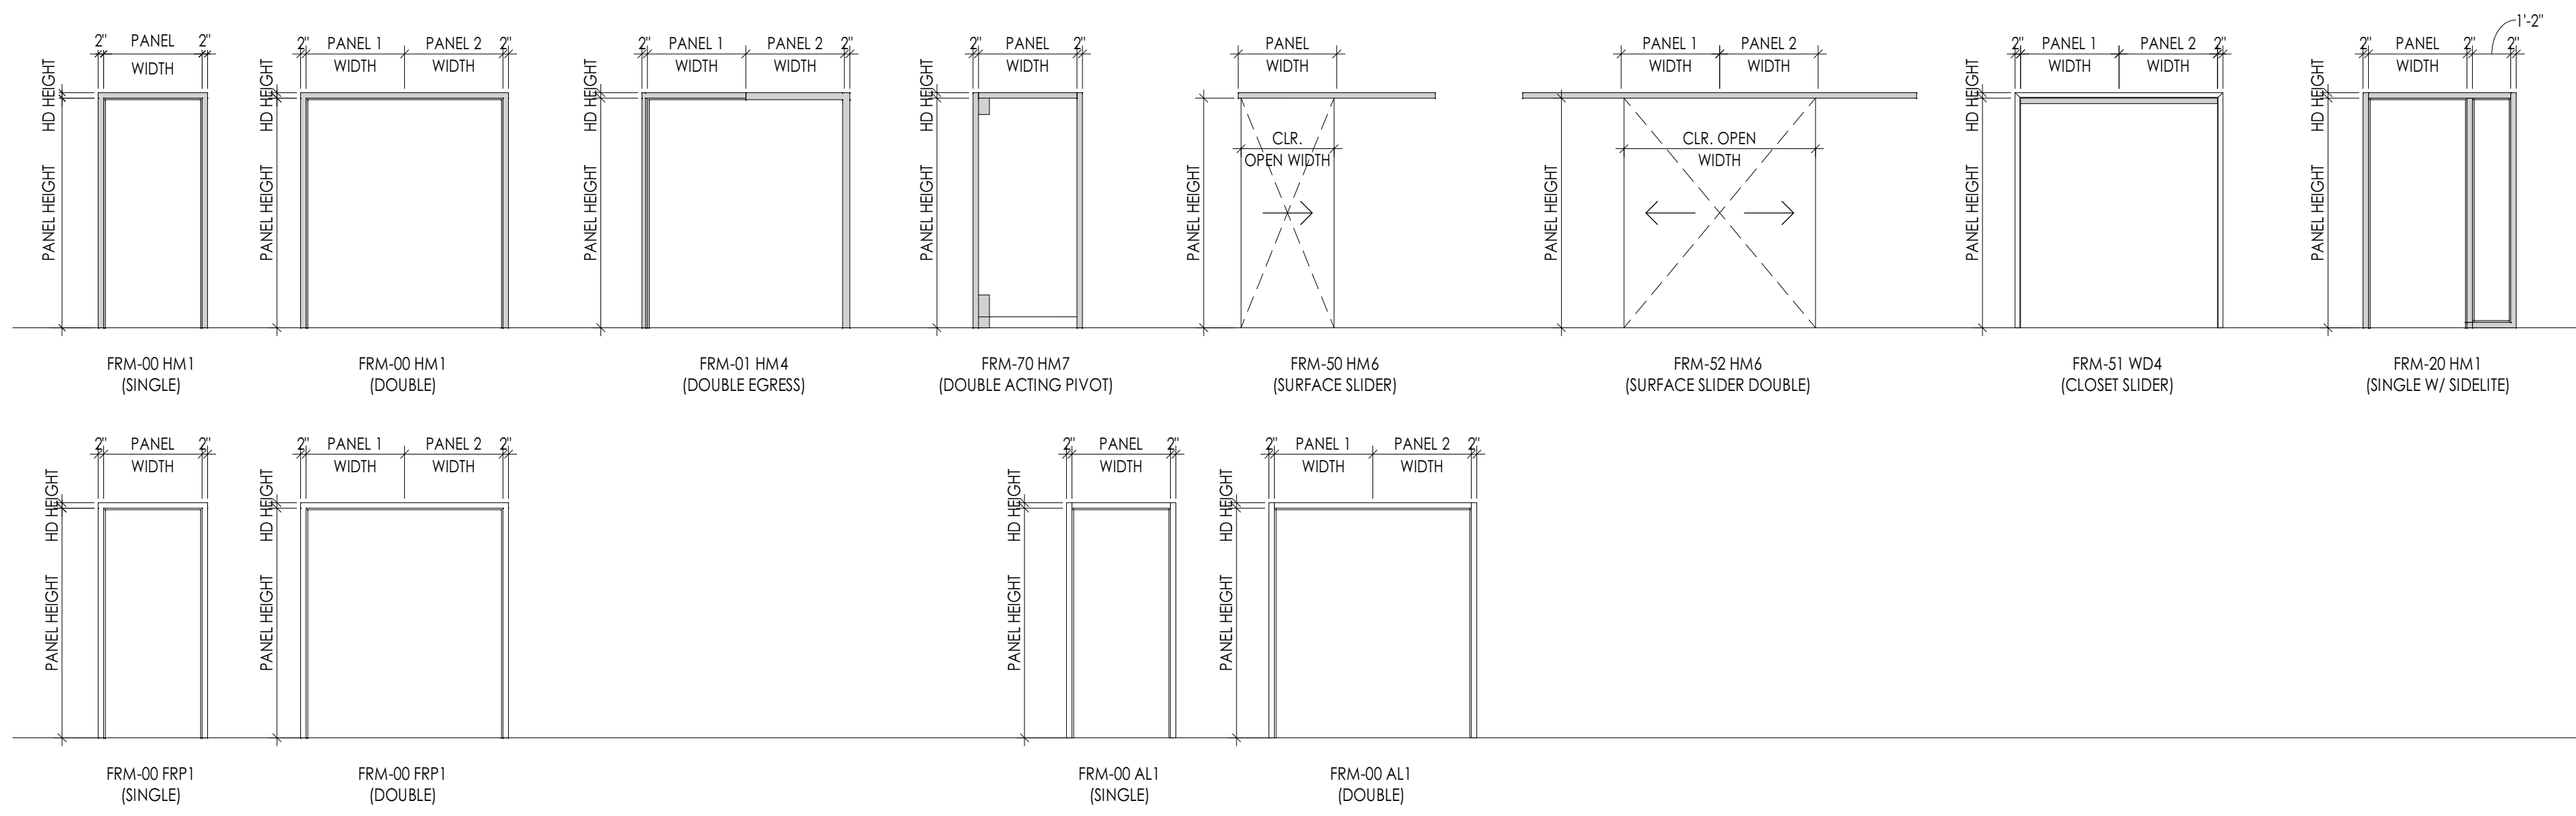

DOOR FRAME TYPES

1/4" = 1'-0"

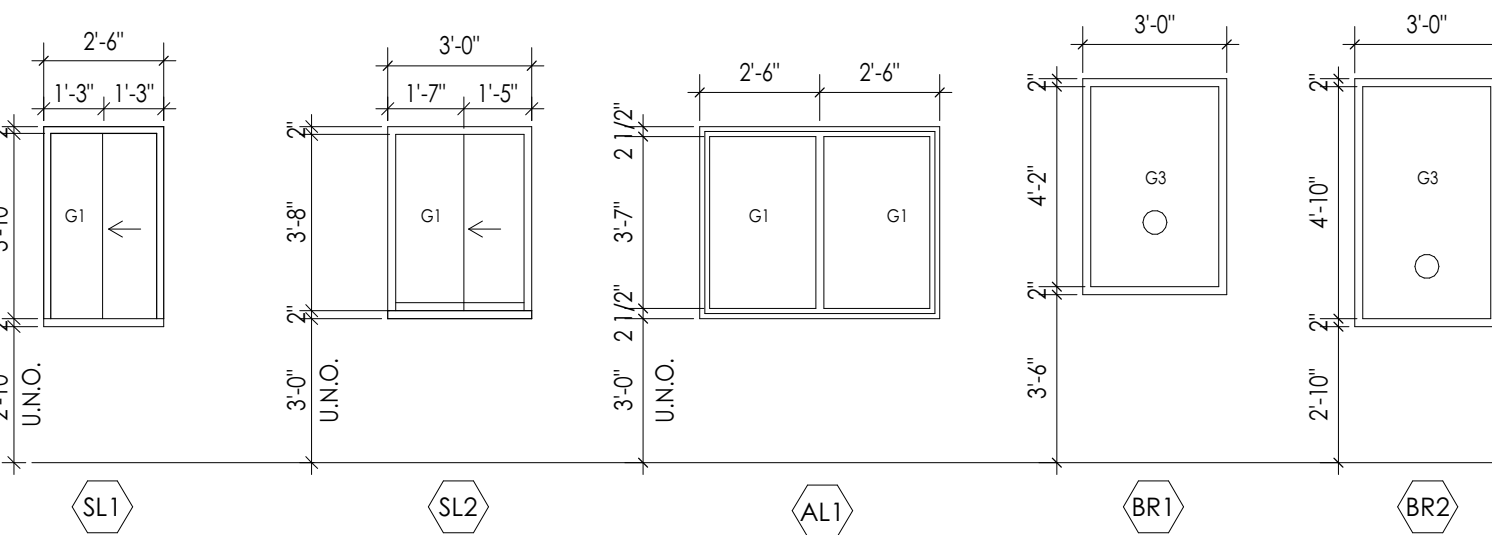

WINDOW TYPES

1/4" = 1'-0"

PROJECT INFORMATION

Project Number: 15210.00

Client Name: RANDOLPH COUNTY COURTHOUSE

Project Name: CLERK OF COURT OFFICE RENOVATION

Project Address: 176 E Salisbury St, Asheboro, NC 27203

REVISION SCHEDULE

Date: 01/27/20

Description: Addendum 4

21

SHEET INFORMATION

Issue: 01/26/21

BID DOCUMENTS

Drawn By: CFL


Checked By: CFL

Showing Title: DOOR PANELS, FRAME TYPES, WINDOW TYPES, AND DEMOUNTABLE PARTITION/STOREFRONTS

FINISH PLAN KEY NOTES

- EXPOSED BRICK SURFACES ARE TO BE PAINTED PT-1.
- WALL PAINT TO MATCH EXISTING IN PUBLIC LOBBY AND CORRIDOR. COORDINATE WITH MAINTENANCE TO DETERMINE COLOR AND SHEEN.
- LVT TO BE INSTALLED IN DOUBLE HERRINGBONE PATTERN.
- DOOR FRAME TO BE PAINTED (PT-4) ONLY ON SIDE WHERE NEW FINISHES ARE TO BE INSTALLED. OTHER SIDE OF DOOR FRAME TO BE PAINTED TO MATCH EXISTING IN CORRIDOR. REFER TO INTERIOR FINISH SCHEDULE FOR MORE INFORMATION.
- EXISTING EXPOSED BRICK TO REMAIN UNPAINTED.
- NEW FINISHES TO BE COMPLETED IN LATER PHASE.
- RAISED SUBFLOOR AT HIGH DENSITY FILING. COORDINATE WITH HIGH DENSITY FILING CONTRACTOR TO INSTALL FLOOR COVERING OVER RAISED SUBFLOOR.

FLOOR PATTERNING LEGEND

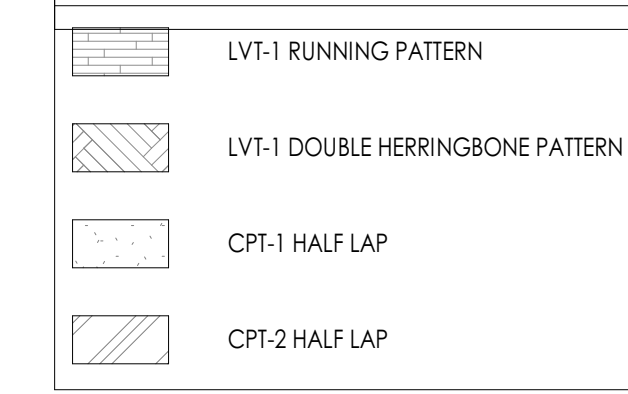

FINISH PLAN GENERAL NOTES


- ALL NEW AND EXISTING HOLLOW METAL DOORS, DOOR FRAMES AND WINDOW FRAMES IN PROJECT SCOPE SHALL BE PAINTED (PT-4), UNLESS NOTED OTHERWISE (U.N.O.).
- ALL LOUVERS, VENTS, GRILLES AND OTHER MISCELLANEOUS MECHANICAL AND ELECTRICAL DEVICES ARE TO BE PAINTED TO MATCH THE SURFACE ON WHICH THEY APPEAR, UNLESS NOTED OTHERWISE (U.N.O.).
- REFER TO A200 SERIES DRAWINGS FOR CEILING TYPES AND SOFFIT FINISHES.
- UNDERSIDE OF SOFFITS TO MATCH FACE OF SOFFIT. SEE A200 SERIES FOR PAINT ACCIDENT SPECIFICATIONS. PAINT OVER CEILING JOINTS (PF-2).
- REFER TO A700 SERIES INTERIOR ELEVATIONS FOR MILLWORK FINISHES.
- HIGH PRESSURE PLASTIC LAMINATE ON VERTICAL SURFACES TO RUN VERTICALLY, UNLESS NOTED OTHERWISE (U.N.O.).
- REFER TO 1200S FOR FLOOR PATTERNING PLANS & DETAILS.
- REFER TO 200S FOR WALL PROTECTION PLANS & DETAILS.
- ALL FLOOR FINISHES SHALL TRANSITION AT THE CENTERLINE OF THE DOOR, UNLESS NOTED OTHERWISE (U.N.O.). INSTALL TRANSITION STRIPS PER DETAILS ON 1000.
- ALL GROUT TO BE SEALED A MINIMUM OF TWO TIMES PRIOR TO COMPLETION.
- WHERE KICKSPACES OCCUR AT MILLWORK, FLOOR FINISH SHOWN ON PLANS SHALL RUN UNDERNEATH KICKSPACE AS WELL.
- REFER TO A900 FOR DEMOUNTABLE PARTITION ELEVATIONS.

FINISH ABBREVIATIONS

NOTE: THE LEGEND MAY CONTAIN ABBREVIATIONS THAT ARE NOT IN THIS PROJECT.



ACT	ACOUSTICAL CEILING TILE	PT	PAINT
AWP	ACOUSTICAL WALL PANEL	PTM	PATCH TO MATCH
CC	CUBICLE CURTAIN	RB	RESILIENT BASE
CG	CORNER GUARD	SSM	SOLID SURFACE MATERIAL
CPT	CARPET	ST	STONE VENEER
DS	DIVIDER STRIP	SV	SHEET VINYL
DWP	DIGITAL WALL PANEL	TB	TILE BASE
EPI	EPOXY PAINT	TF	TILE FLOOR
ETR	EXISTING TO REMAIN	TR	TRIM
EXP	EXPOSED	TS	TRANSITION STRIP
FILM	FILM	TW	TILE WALL
FRP	FIBER REINFORCED PANEL	WD	WOOD
GRT	GROUT	WS	WRITEABLE SURFACE
HPL	HIGH PRESSURE PLASTIC LAMINATE	WT	WINDOW TREATMENT
LVT	LUXURY VINYL TILE		

FINISH PLAN SYMBOLS LEGEND

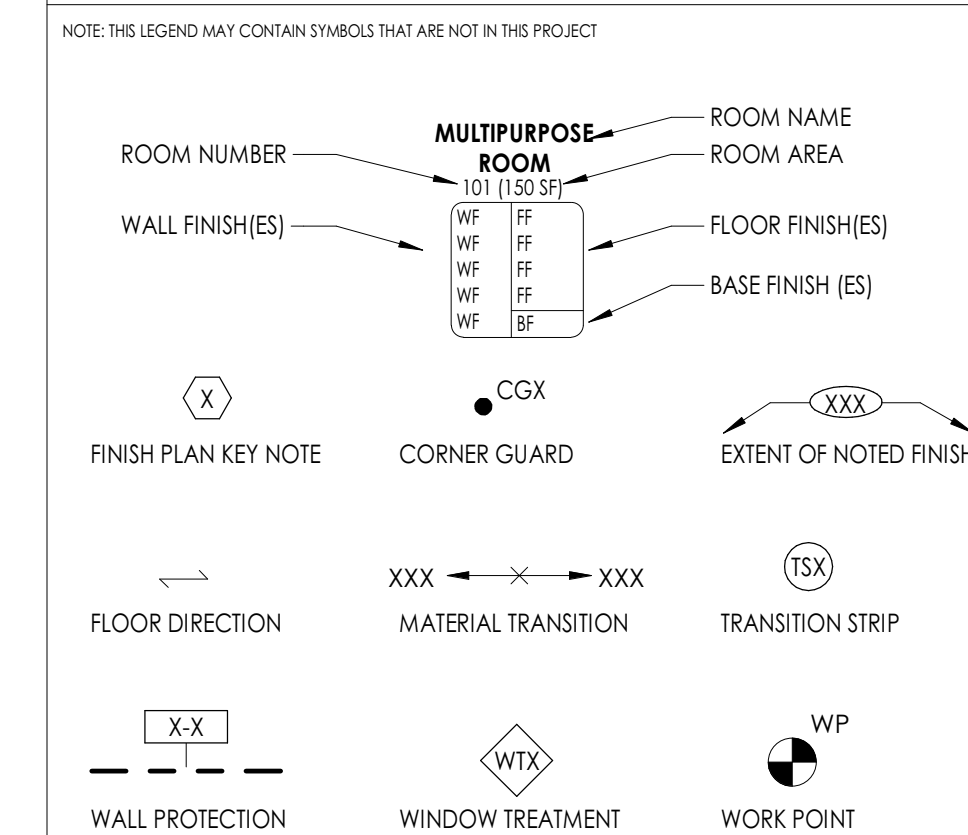

TYPICAL TRANSITION TYPES:

SCALE: 3/8" = 1'-0"
 NOTE: USE DETAIL FOR SAME MATERIAL TRANSITIONS WITH OR WITHOUT DOOR.

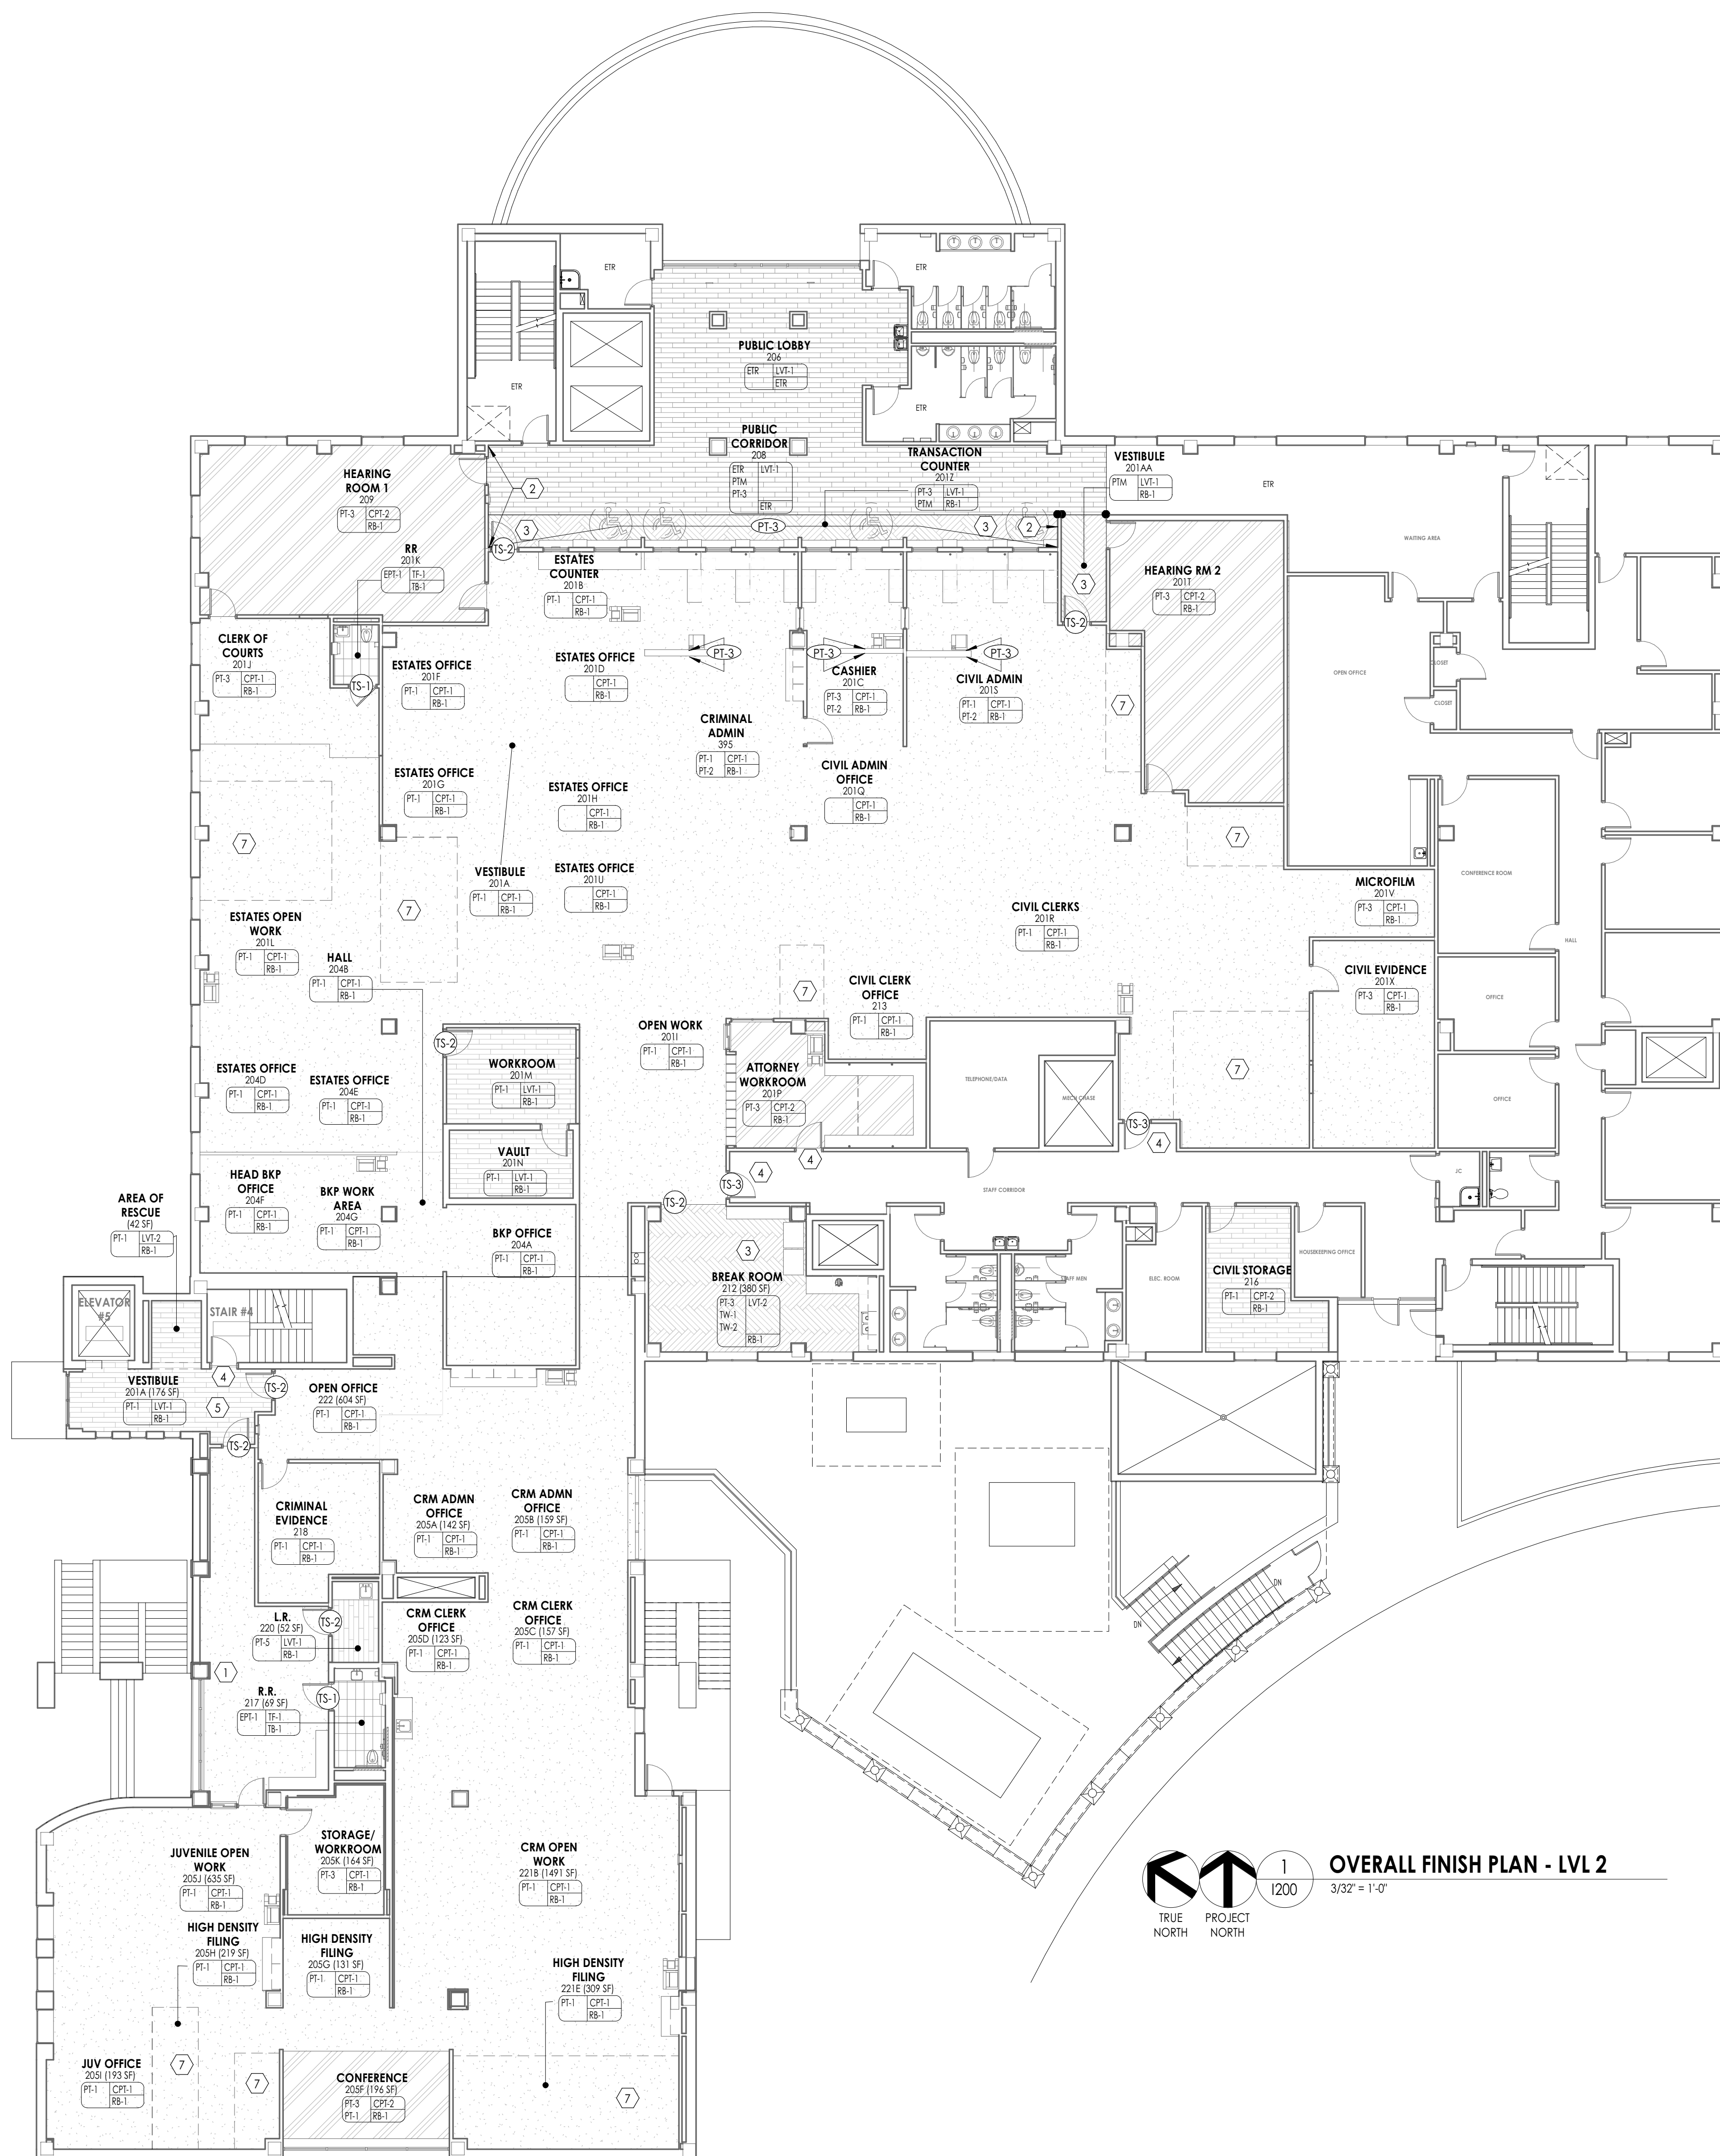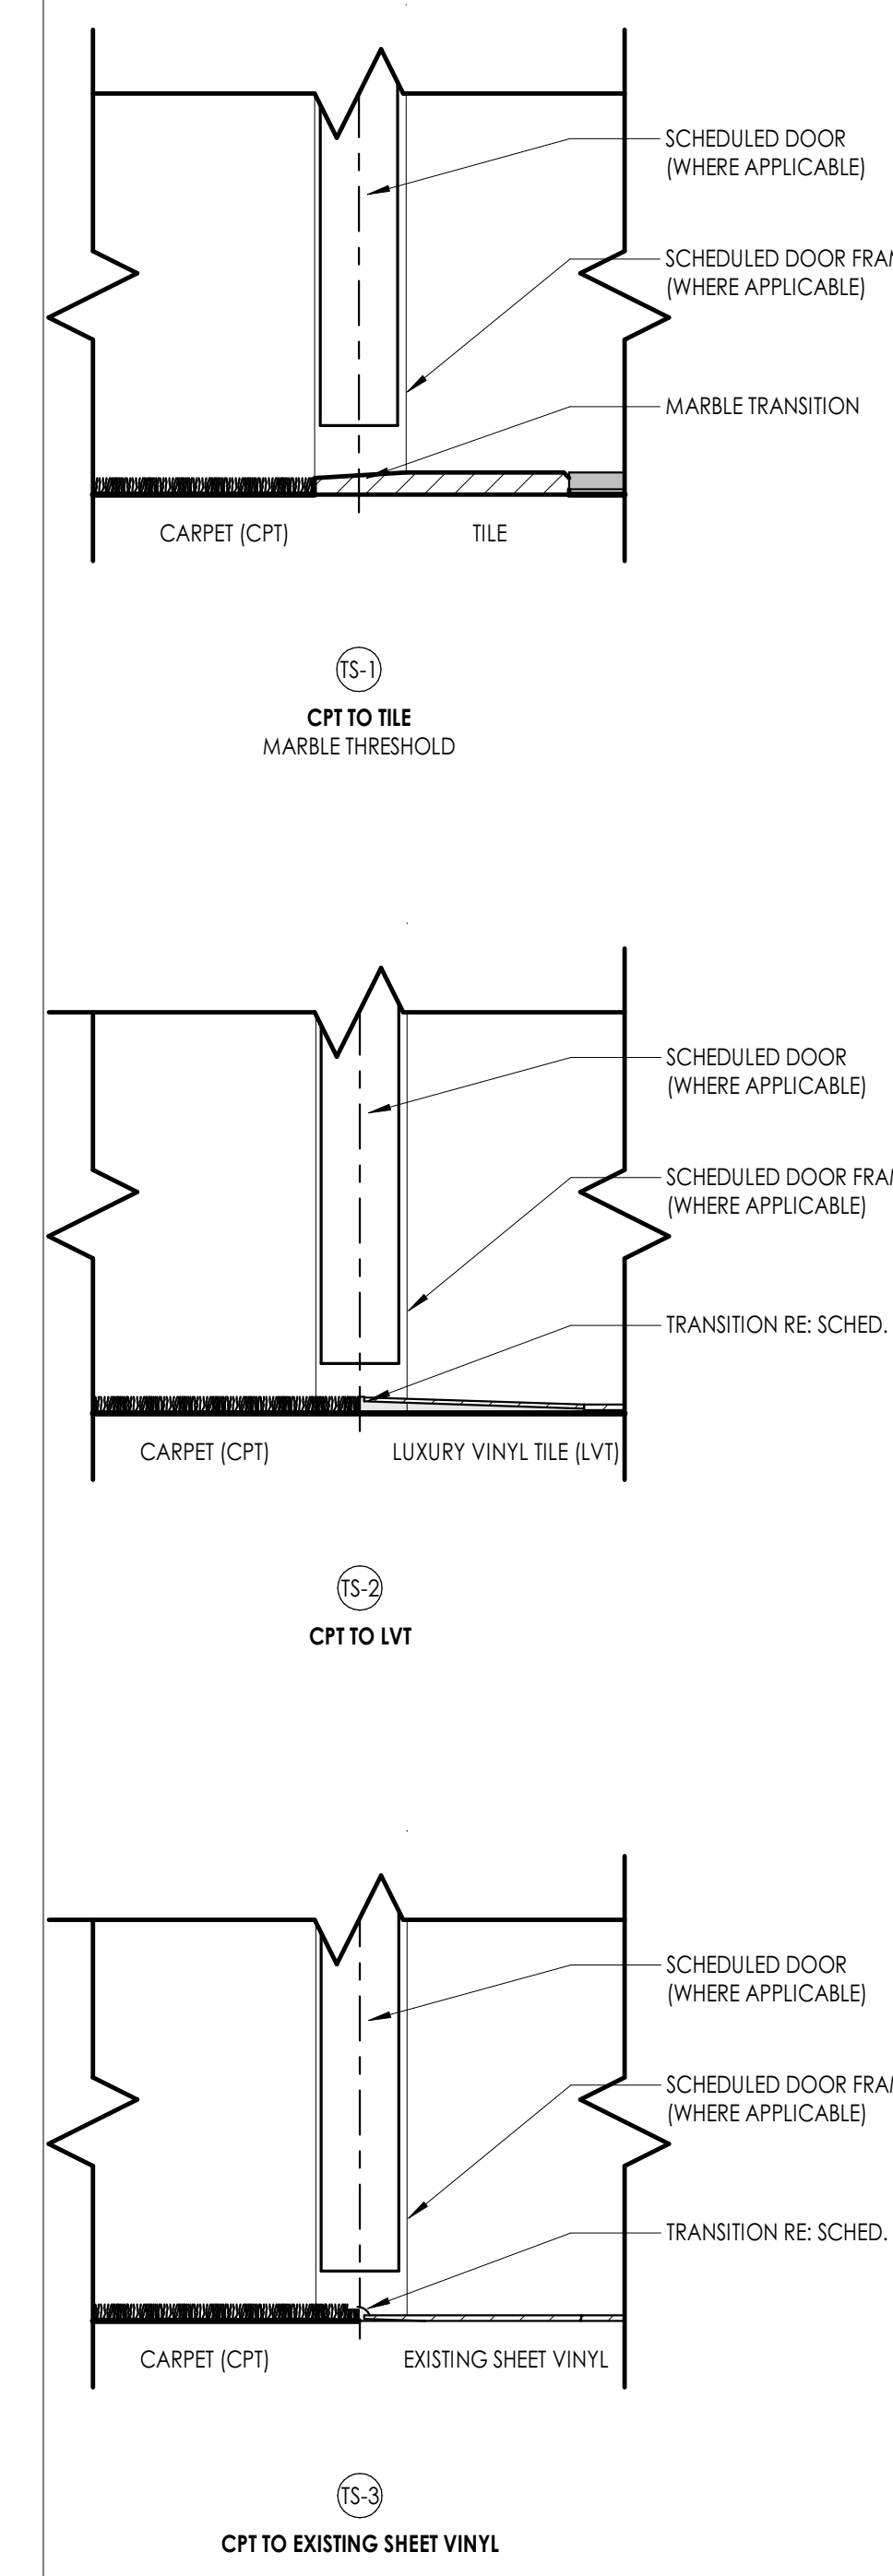

1 OVERALL FINISH PLAN - LVL 2
 3/32" = 1'-0"
 TRUE NORTH PROJECT NORTH

INTERIOR FINISH SCHEDULE

FINISH CODE	MANUFACTURER	PATTERN/STYLE	COLOR	SIZE	NOTES
ACOUSTICAL CEILING TILE (ACT)					
ACT-1	ARMSTRONG	CALLA	WHITE	2x2	
CARPET (CPT)					
CPT-1	MOHAWK	81496 81496 VISUAL EDGE ANGLED PERCEPTION	593 INDIGO INK	12x36	
CPT-2	MOHAWK	128Y36 - 81497 VISUAL EDGE HIDDEN DIMENSION	593 INDIGO INK	12x36	
CORNER GUARD (CG)					
CG-1	KOROSEAL	KOROGARD 07: WING SIZE 3/4"	SATIN		INSTALLED AT CORNERS WHERE EXISTING CORRIDOR WALL TILE ENDS TO MEET NEW GYP WING WALL. CUT TO MATCH TILE HEIGHT
EPOXY PAINT (EPI)					
EPI-1	SHERWIN WILLIAMS	SW7064	PASSIVE		
GROUT (GRT)					
GRT-1	TEC		STERLING 909		
LUXURY VINYL TILE (LVT)					
LVT-1	MILLIKEN	WOOD CHERRY	CHE17	7x48	
PAINT (PT)					
PT-1	SHERWIN WILLIAMS	SW7003	TOQUE WHITE		CEILING AND OPEN OFFICE AREAS
PT-2	SHERWIN WILLIAMS	SW7064	PASSIVE		MOTHERS ROOM AND BREAKROOM
PT-3	SHERWIN WILLIAMS	SW7029	AGREEABLE GRAY		PRIVATE OFFICES AND HEARING ROOMS
PT-4	SHERWIN WILLIAMS	SW7043	BLACK FOX		HV DOOR TRIM
PLASTIC LAMINATE (PLAM)					
PLAM-1	FORMICA	969-42	NAVY BLUE		
PLAM-2	FORMICA	6923-58	MACCHIATO WALNUT		
PLAM-3	FORMICA	9244-58	CLASSIC WHITE		
PLAM-4	FORMICA	6699-58	PALOMA POLAR		
PLAM-5	FORMICA	464-58	GREYSTONE		
RESILIENT BASE (RB)					
RB-1	ROPPE	PV4085 #85 FASHION	193 BLACK BROWN	4-1/4" X1/4"	
SOLID SURFACE MATERIAL (SSM)					
SSM-1	CORIAN		SAVANNAH		
TILE - BASE (TB)					
TB-1	MOSAIC TILE	UNIQUE STONE	BLACK 01UNBLA	3x24	BULLNOSE MATTE
TILE - FLOOR (TF)					
TF-1	MOSAIC TILE	UNIQUE STONE	BLACK 01UNBLA1224	12x24	RESTROOM FLOOR
TILE - WALL (TW)					
TW-1	NEMO	ABSTRACT	WHITE GLOSSY ABS10209A	2'x9"	BREAKROOM
TW-2	NEMO	ABSTRACT	WHITE MATTE ABS10209H	2'x9"	BREAKROOM
TRANSITION (TS)					
TS-1		MARBLE TRANSITION			CPT TO TILE
TS-2	MANNINGTON	FUSION TRANSITION STRIP 2.55	523 BLACK BROWN		CPT TO LVT
TS-3	ROPPE	#159	193 BLACK BROWN		CPT TO EXISTING SHEET VINYL

FINISH PLAN GENERAL NOTES


1. ALL NEW AND EXISTING HOLLOW METAL DOORS, DOOR FRAMES AND WINDOW FRAMES IN PROJECT SCOPE SHALL BE PAINTED (PT-4), UNLESS NOTED OTHERWISE (U.N.C.).
2. ALL LOUVERS, VENTS, GRILLES AND OTHER MISCELLANEOUS MECHANICAL AND ELECTRICAL DEVICES ARE TO BE PAINTED TO MATCH THE SURFACE ON WHICH THEY APPEAR, UNLESS NOTED OTHERWISE (U.N.C.).
3. REFER TO A200 SERIES DRAWINGS FOR CEILING TYPES AND SOFFIT FINISHES.
4. UNDERSIDE OF SOFFITS TO MATCH FACE OF SOFFIT. SEE A200 SERIES FOR PAINT ACCENT SPECIFICATIONS. PAINT GYM CEILINGS (PF-2).
5. REFER TO A700 SERIES INTERIOR ELEVATIONS FOR MILLWORK FINISHES.
6. HIGH PRESSURE PLASTIC LAMINATE ON VERTICAL SURFACES TO RUN VERTICALLY, UNLESS NOTED OTHERWISE (U.N.C.).
7. REFER TO 1200S FOR FLOOR PATTERNING PLANS & DETAILS.
8. REFER TO 200S FOR WALL PROTECTION PLANS & DETAILS.
9. ALL FLOOR FINISHES SHALL TRANSITION AT THE CENTERLINE OF THE DOOR, UNLESS NOTED OTHERWISE (U.N.C.). INSTALL TRANSITION STRIPS PER DETAILS ON 1000.
10. ALL GROUT TO BE SEALED A MINIMUM OF TWO TIMES PRIOR TO COMPLETION.
11. WHERE KICKSPACES OCCUR AT MILLWORK, FLOOR FINISH SHOWN ON PLANS SHALL RUN UNDERNEATH KICKSPACE AS WELL.
12. REFER TO A900 FOR DEMOUNTABLE PARTITION ELEVATIONS.

FINISH ABBREVIATIONS

NOTE: THE LEGEND MAY CONTAIN ABBREVIATIONS THAT ARE NOT IN THIS PROJECT

ACT	ACOUSTICAL CEILING TILE	PT	PAIN
AWP	ACOUSTICAL WALL PANEL	PTM	PATCH TO MATCH
CC	CUBICLE CURTAIN	RB	RESILIENT BASE
CG	CORNER GUARD	SSM	SOLID SURFACE MATERIAL
CPF	CORNER FINISH	ST	STONE VENEER
DS	DIVIDER STRIP	SV	SHEET VINYL
DWP	DIGITAL WALL PANEL	TB	TILE BASE
EPT	EPOXY PAINT	TF	TILE FLOOR
ETR	EXISTING TO REMAIN	TR	TRIM
EXP	EXPOSED	TS	TRANSITION STRIP
FILM	FILM	TW	TILE WALL
FRP	FIBER REINFORCED PANEL	WD	WOOD
GRT	GROUT	WS	WRITEABLE SURFACE
HPL	HIGH PRESSURE PLASTIC LAMINATE	WT	WINDOW TREATMENT
LVT	LUXURY VINYL TILE		




FINISH PLAN SYMBOLS LEGEND

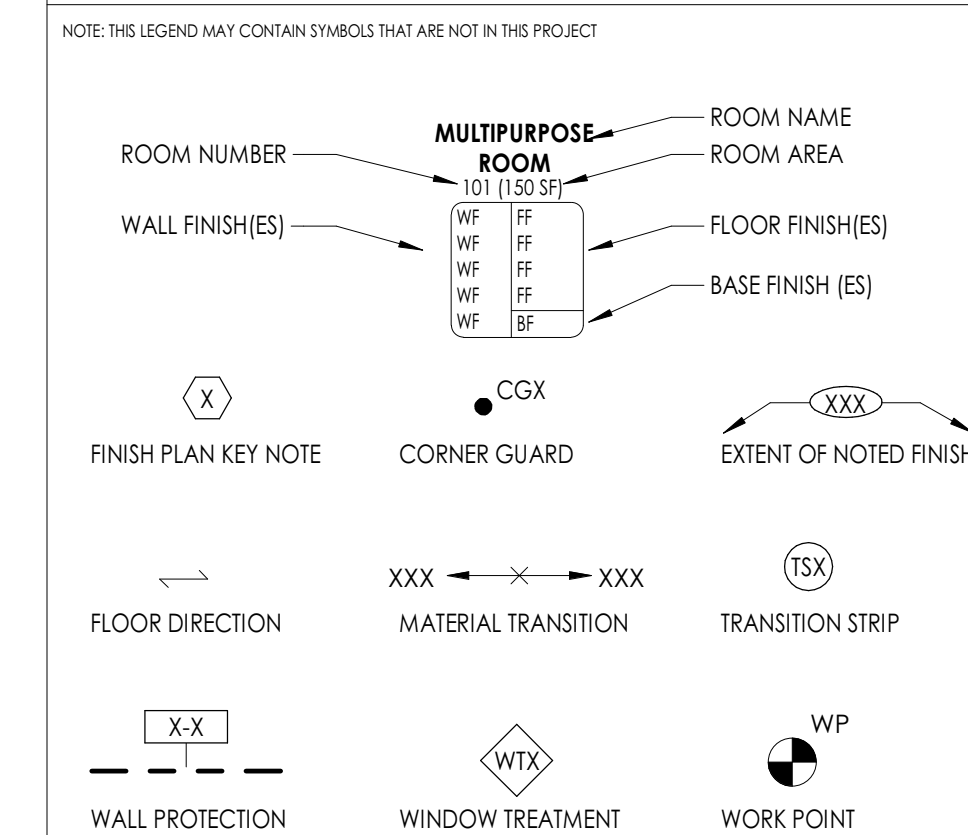

FINISH PLAN KEY NOTES

1. EXPOSED BRICK SURFACES ARE TO BE PAINTED PT-1.
2. WALL PAINT TO MATCH EXISTING IN PUBLIC LOBBY AND CORRIDOR. COORDINATE WITH MAINTENANCE TO DETERMINE COLOR AND SHEEN.
3. LVT TO BE INSTALLED IN DOUBLE HERRINGBONE PATTERN.
4. DOOR FRAME TO BE PAINTED (PT-4) ONLY ON SIDE WHERE NEW FINISHES ARE TO BE INSTALLED. OTHER SIDE OF DOOR FRAME TO BE PAINTED TO MATCH EXISTING IN CORRIDOR. REFER TO INTERIOR FINISH SCHEDULE FOR MORE INFORMATION.
5. EXISTING EXPOSED BRICK TO REMAIN UNPAINTED.
6. NEW FINISHES TO BE COMPLETED IN LATER PHASE.
7. RAISED SUBFLOOR AT HIGH DENSITY FILING. COORDINATE WITH HIGH DENSITY FILING CONTRACTOR TO INSTALL FLOOR COVERING OVER RAISED SUBFLOOR.
8. COORDINATE FLOOR FINISHES WITH EXISTING CONTROL JOINT.

FLOOR PATTERNING LEGEND

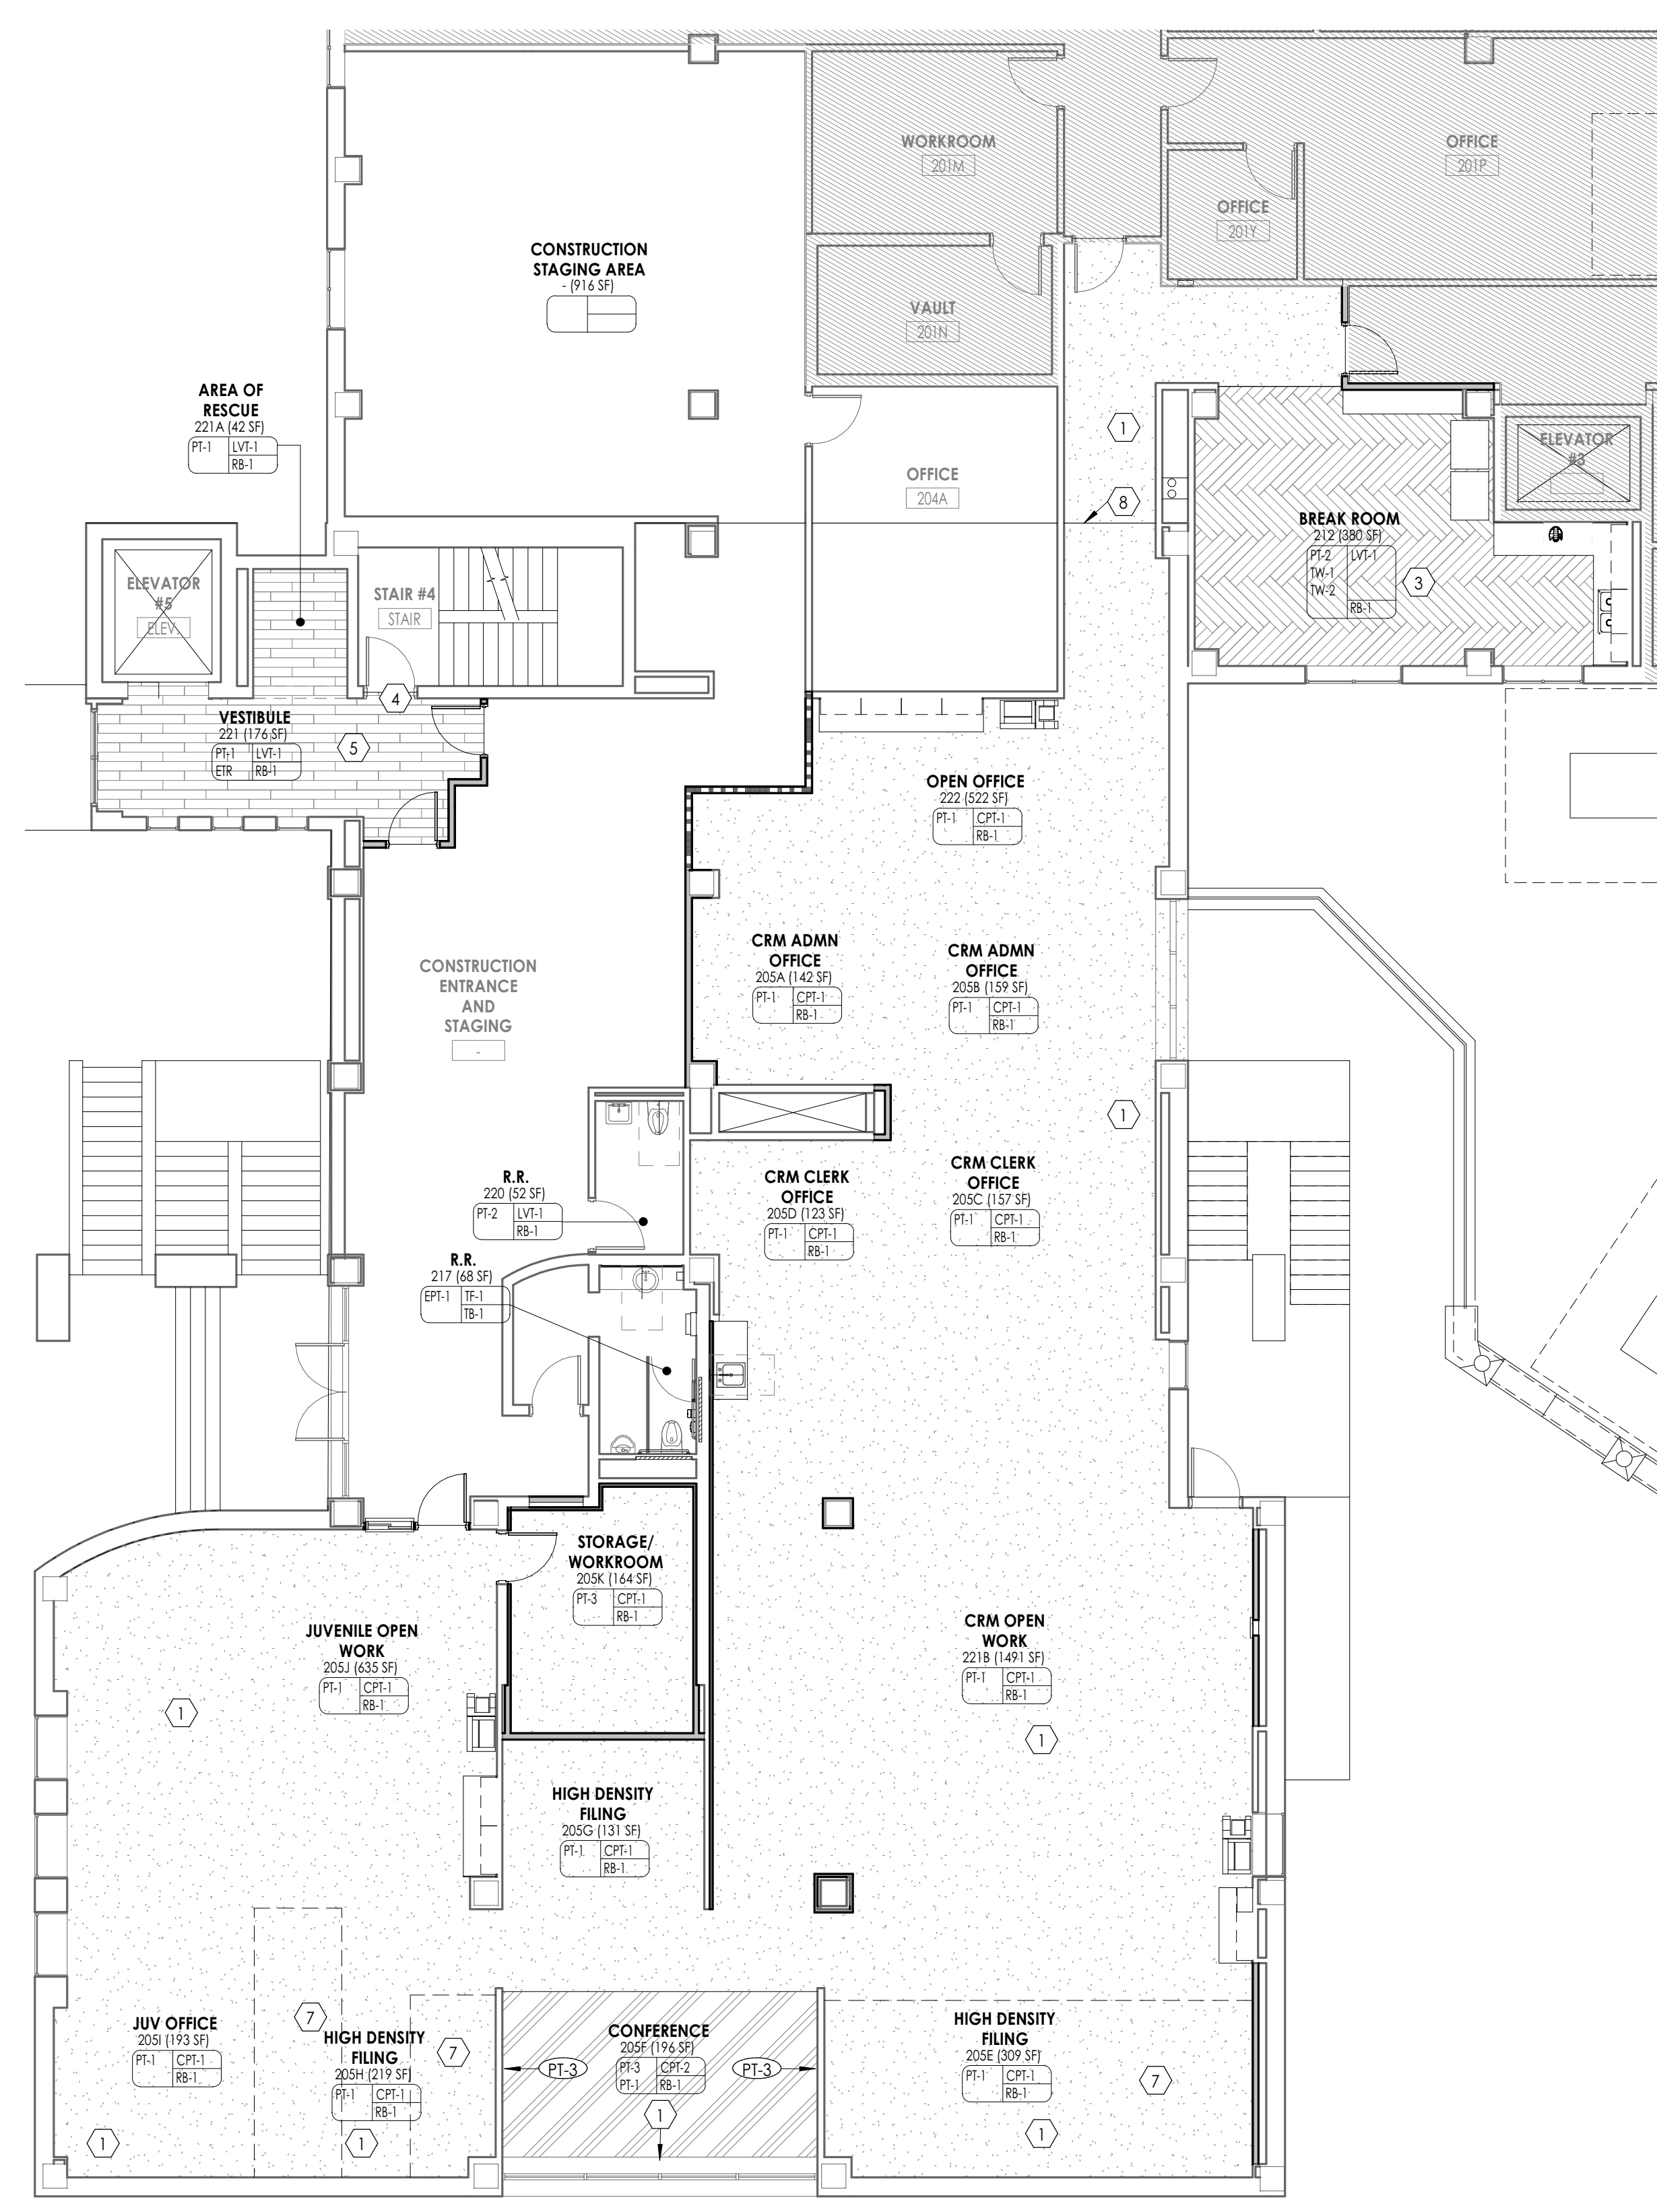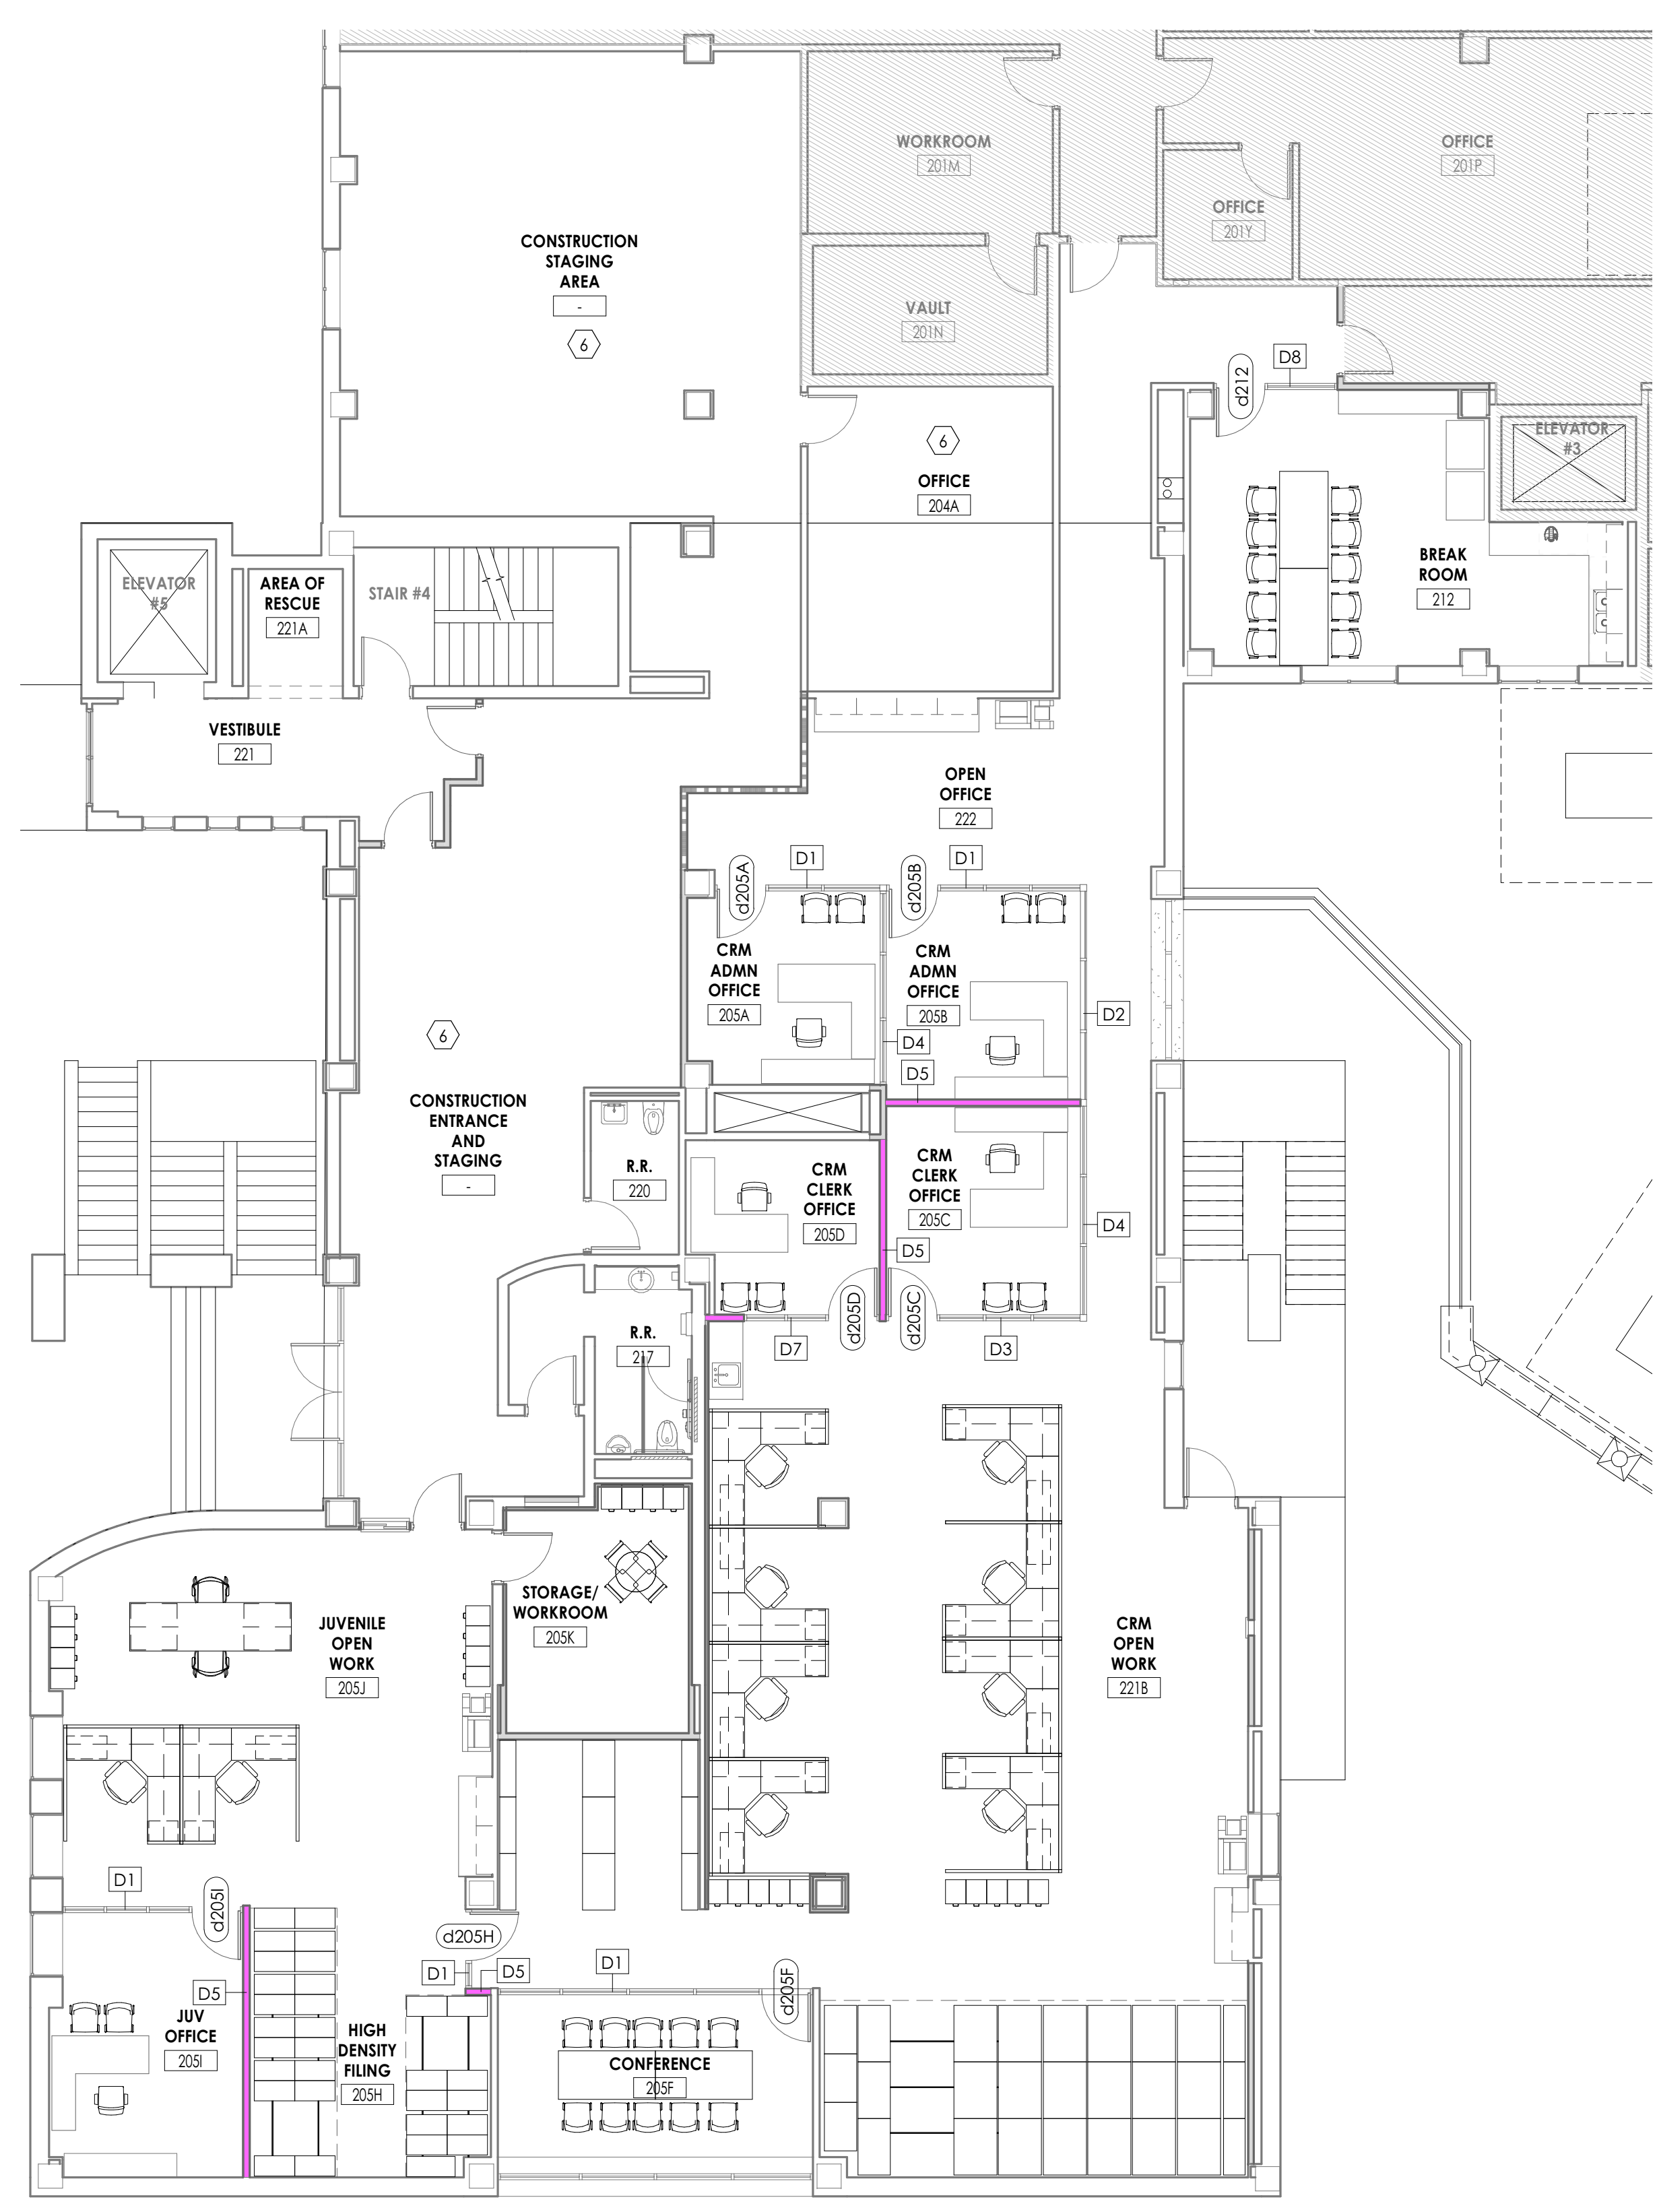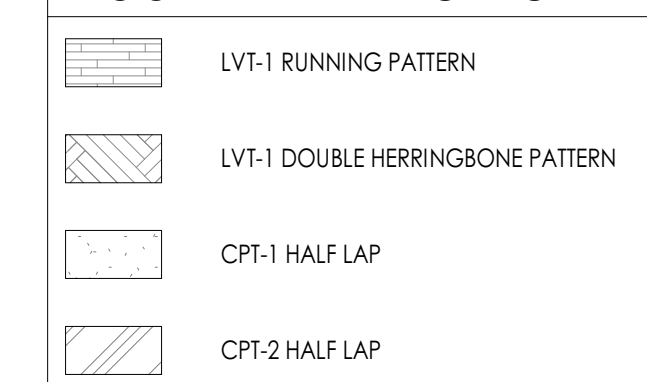


LVL 02 - FURNITURE/DEMOUNTABLE PARTITION PLAN - PHASE 1
1/8" = 1'-0"
REFER TO A101 SERIES FOR CONVENTIONAL DRYWALL PARTITIONS

LVL 02 - FINISH PLAN - PHASE 1
1/8" = 1'-0"

DOOR SCHEDULE- PHASE 1 - DEMOUNTABLE PARTITIONS

DOOR NUMBER	FIRE RATING (MIN)	PANEL TYPE	DOOR PANELS				DOOR FRAME				HW SET	GLAZING	COMMENTS		
			WIDTH	HEIGHT	PANEL FINISH	PANEL FINISH	FRAME TYPE	JAMB WIDTH	HEAD HEIGHT	FRAME DEPTH					
LVL 2															
0205A		PNL-FG-AL	3'-0"	7'-0"	3'-0"	7'-0"	ALUM	ALUM	FRM-00AL(CW)	0'-0"	0'-0"	0'-4 3/4"	ALUM	1	DEMOUNTABLE WALL DOOR ASSEMBLY
0205B		PNL-FG-AL	3'-0"	7'-0"	3'-0"	7'-0"	ALUM	ALUM	FRM-00AL(CW)	0'-0"	0'-0"	0'-4 3/4"	ALUM	1	DEMOUNTABLE WALL DOOR ASSEMBLY
0205C		PNL-FG-AL	3'-0"	7'-0"	3'-0"	7'-0"	ALUM	ALUM	FRM-00AL(CW)	0'-0"	0'-0"	0'-4 3/4"	ALUM	1	DEMOUNTABLE WALL DOOR ASSEMBLY
0205D		PNL-FG-AL	3'-0"	7'-0"	3'-0"	7'-0"	ALUM	ALUM	FRM-00AL(CW)	0'-0"	0'-0"	0'-4 3/4"	ALUM	1	DEMOUNTABLE WALL DOOR ASSEMBLY
0205F		PNL-FG-AL	3'-0"	7'-0"	3'-0"	7'-0"	ALUM	ALUM	FRM-00AL(CW)	0'-0"	0'-0"	0'-4 3/4"	ALUM	2	DEMOUNTABLE WALL DOOR ASSEMBLY
0205H		PNL-FG-AL	3'-0"	7'-0"	3'-0"	7'-0"	ALUM	ALUM	FRM-00AL(CW)	0'-0"	0'-0"	0'-4 3/4"	ALUM	2	DEMOUNTABLE WALL DOOR ASSEMBLY
0205I		PNL-FG-AL	3'-0"	7'-0"	3'-0"	7'-0"	ALUM	ALUM	FRM-00AL(CW)	0'-0"	0'-0"	0'-4 3/4"	ALUM	1	DEMOUNTABLE WALL DOOR ASSEMBLY
0212		PNL-FG-AL	3'-0"	7'-0"	3'-0"	7'-0"	ALUM	GI	FRM-00AL(CW)	0'-0"	0'-0"	0'-4 3/4"	ALUM	2	DEMOUNTABLE WALL DOOR ASSEMBLY



REFER TO SHEET A900 FOR DOOR AND HARDWARE TYPES

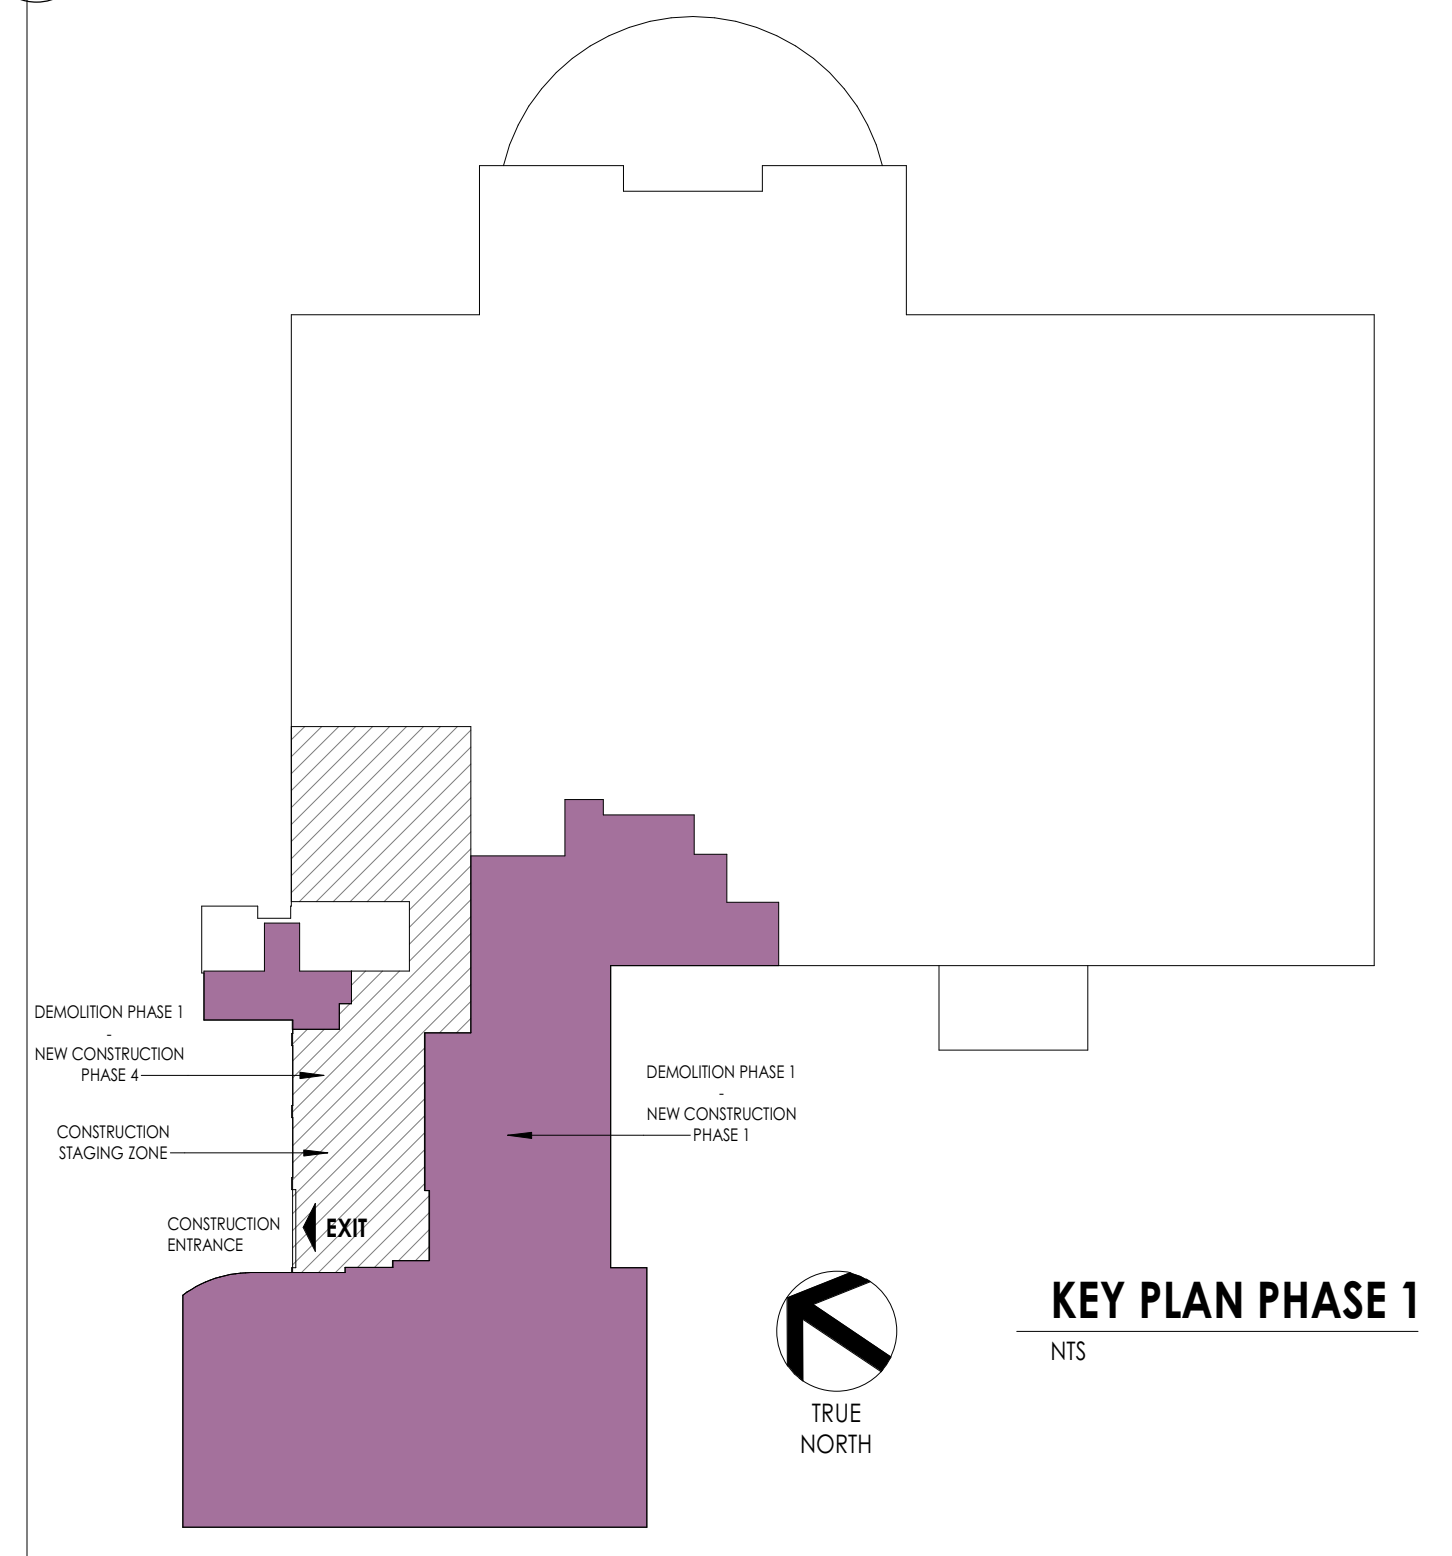

PROJECT INFORMATION
Project Number: 15210.00
Client Name: RANDOLPH COUNTY COURTHOUSE
Project Name: CLERK OF COURT OFFICE RENOVATION
Project Address: 176 E Salisbury St, Asheboro, NC 27203

REVISION SCHEDULE
11 01/27/20 Addendum 4
21

SHEET INFORMATION
Issue: 01/26/21
Bid Documents
Drawn By: CPL
Checked By: CPL
Drawing Title: FLOOR FINISH AND PATTERN PLAN - PHASE 1

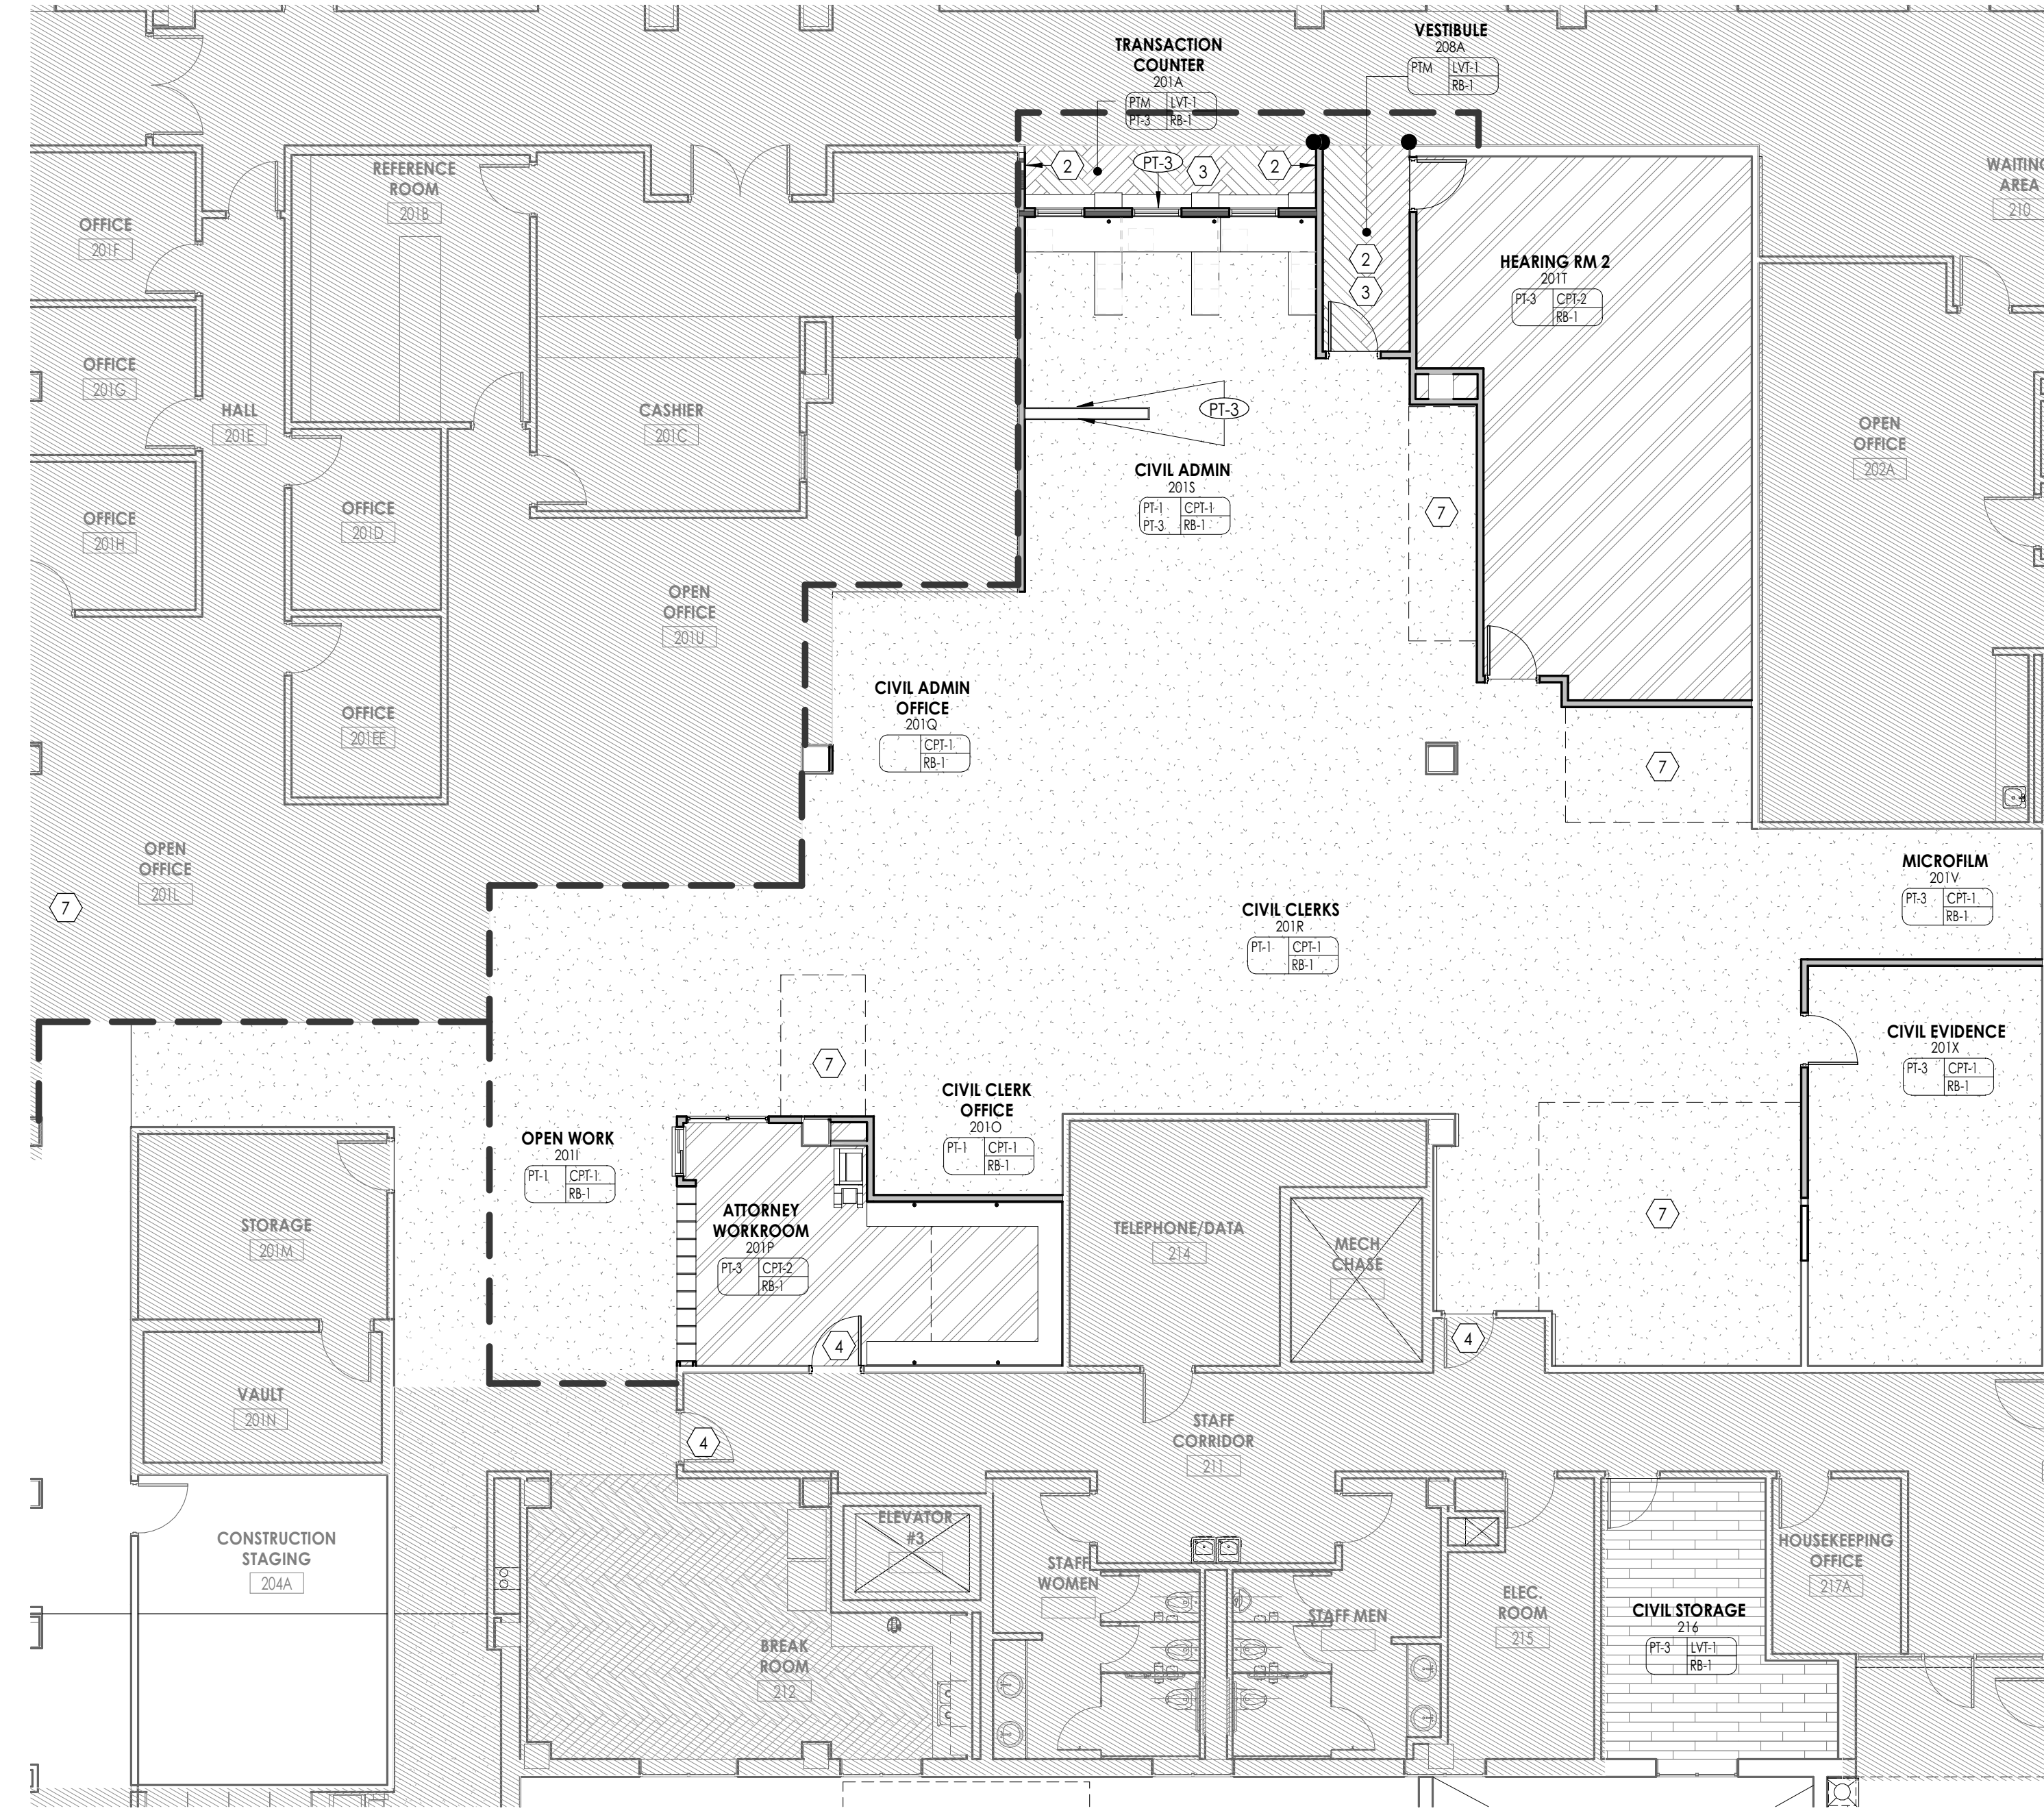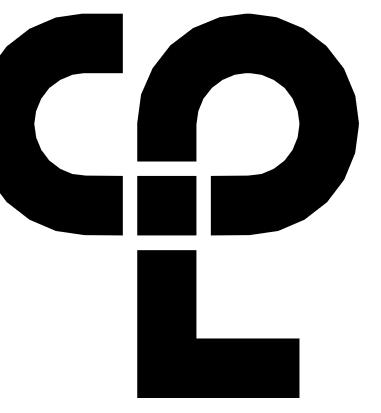

FINISH PLAN GENERAL NOTES


1. ALL NEW AND EXISTING HOLLOW METAL DOORS, DOOR FRAMES AND WINDOW FRAMES IN PROJECT SCOPE SHALL BE PAINTED (PT-4), UNLESS NOTED OTHERWISE (U.N.C.).
2. ALL LOUVERS, VENTS, GRILLES AND OTHER MISCELLANEOUS MECHANICAL AND ELECTRICAL DEVICES ARE TO BE PAINTED TO MATCH THE SURFACE ON WHICH THEY APPEAR, UNLESS NOTED OTHERWISE (U.N.C.).
3. REFER TO A200 SERIES DRAWINGS FOR CEILING TYPES AND SOFFIT FINISHES.
4. UNDERSIDE OF SOFFITS TO MATCH FACE OF SOFFIT. SEE A200 SERIES FOR PAINT ACCENT SPECIFICATIONS. PAINT OVER CEILING(S) (PF-2).
5. REFER TO A700 SERIES INTERIOR ELEVATIONS FOR MILLWORK FINISHES.
6. HIGH PRESSURE PLASTIC LAMINATE ON VERTICAL SURFACES TO RUN VERTICALLY, UNLESS NOTED OTHERWISE (U.N.C.).
7. REFER TO 1200S FOR FLOOR PATTERNING PLANS & DETAILS.
8. REFER TO 200S FOR WALL PROTECTION PLANS & DETAILS.
9. ALL FLOOR FINISHES SHALL TRANSITION AT THE CENTERLINE OF THE DOOR, UNLESS NOTED OTHERWISE (U.N.C.). INSTALL TRANSITION STRIPS PER DETAILS ON 1000.
10. ALL GROUT TO BE SEALED A MINIMUM OF TWO TIMES PRIOR TO COMPLETION.
11. WHERE KICKSPACES OCCUR AT MILLWORK, FLOOR FINISH SHOWN ON PLANS SHALL RUN UNDERNEATH KICKSPACE AS WELL.
12. REFER TO A900 FOR DEMOUNTABLE PARTITION ELEVATIONS.

FINISH ABBREVIATIONS

NOTE: THE LEGEND MAY CONTAIN ABBREVIATIONS THAT ARE NOT IN THIS PROJECT

ACT	ACOUSTICAL CEILING TILE	PT	PAINT
AWP	ACOUSTICAL WALL PANEL	PTM	PATCH TO MATCH
CC	CUBICLE CURTAIN	RB	RESILIENT BASE
CG	CORNER GUARD	SSM	SOLID SURFACE MATERIAL
CPT	CARPET	ST	STONE VENEER
DS	DIVIDER STRIP	SV	SHEET VINYL
DWP	DIGITAL WALL PANEL	TB	TILE BASE
EPT	EPOXY PAINT	TF	TILE FLOOR
ETR	EXISTING TO REMAIN	TR	TRIM
EXP	EXPOSED	TS	TRANSITION STRIP
FILM	FILM	TW	TILE WALL
FRP	FIBER REINFORCED PANEL	WD	WOOD
GRT	GROUT	WS	WRITABLE SURFACE
HPL	HIGH PRESSURE PLASTIC LAMINATE	WT	WINDOW TREATMENT
LVT	LUXURY VINYL TILE		


FINISH PLAN SYMBOLS LEGEND

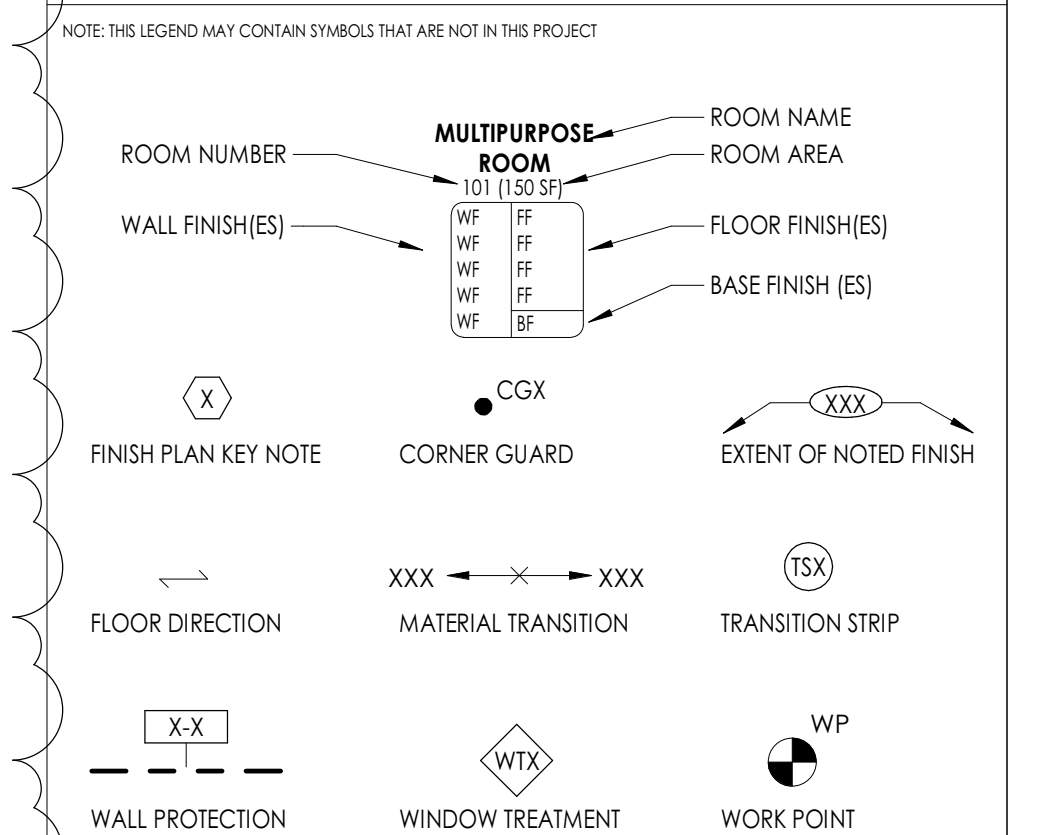

FINISH PLAN KEY NOTES

1. EXPOSED BRICK SURFACES ARE TO BE PAINTED PT-1.
2. WALL PAINT TO MATCH EXISTING IN PUBLIC LOBBY AND CORRIDOR. COORDINATE WITH MAINTENANCE TO DETERMINE COLOR AND SHEEN.
3. LVT TO BE INSTALLED IN DOUBLE HERRINGBONE PATTERN.
4. DOOR FRAME TO BE PAINTED (PT-4) ONLY ON SIDE WHERE NEW FINISHES ARE TO BE INSTALLED. OTHER SIDE OF DOOR FRAME TO BE PAINTED TO MATCH EXISTING IN CORRIDOR. REFER TO INTERIOR FINISH SCHEDULE FOR MORE INFORMATION.
5. EXISTING EXPOSED BRICK TO REMAIN UNPAINTED.
6. NEW FINISHES TO BE COMPLETED IN LATER PHASE.
7. RAISED SUBFLOOR AT HIGH DENSITY FILING. COORDINATE WITH HIGH DENSITY FILING CONTRACTOR TO INSTALL FLOOR COVERING OVER RAISED SUBFLOOR.
8. COORDINATE FLOOR FINISHES WITH EXISTING CONTROL JOINT.

FLOOR PATTERNING LEGEND

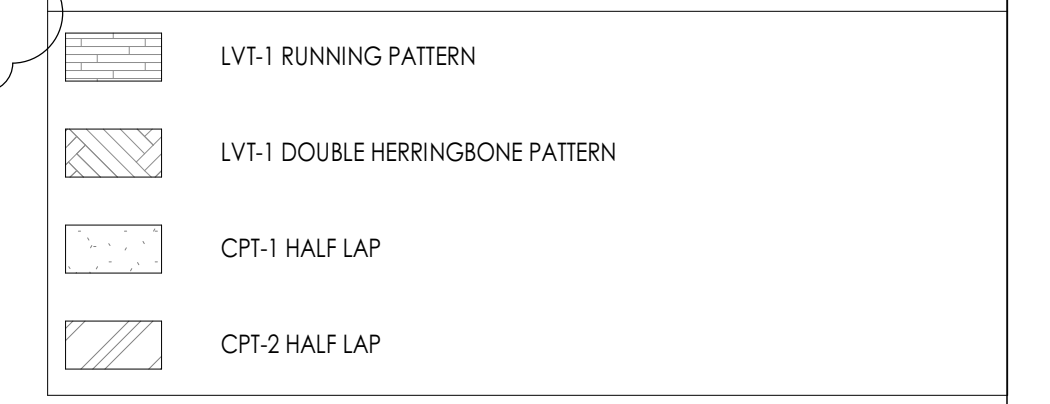


LVL 02 - FURNITURE/DEMOUNTABLE PARTITION PLAN - PHASE 2
1/8" = 1'-0"
REFER TO A101 SERIES FOR CONVENTIONAL DRYWALL PARTITIONS

LVL 02 - FINISH PLAN - PHASE 2
1/8" = 1'-0"

DOOR SCHEDULE- PHASE 2 - DEMOUNTABLE

DOOR NUMBER	FIRE RATING (MIN)	DOOR PANELS							DOOR FRAME				HW SET	GLAZING TYPE	DOOR COMMENTS	
		PANEL TYPE	SINGLE PANEL DIMENSIONS		TOTAL PANEL DIMENSIONS		PANEL FINISHES		FRAME DIMENSIONS		FRAME FINISH					
		PANEL 1	WIDTH	HEIGHT	WIDTH	HEIGHT	UNDERCUT	PANEL FINISH SIDE 1	PANEL FINISH SIDE 2	FRAME TYPE	JAMB WIDTH	HEAD HEIGHT	FRAME DEPTH	FRAME FINISH		
d201Q		PNL-FG-AL	3'-0"	7'-0"	3'-0"	7'-0"	0'-0"	ALUM	ALUM	FRM-00AL(CW)	0'-0"	0'-0"	0'-4 3/4"	ALUM	1	DEMOUNTABLE WALL DOOR ASSEMBLY
d201C		PNL-FG2-AL	3'-0"	7'-0"	3'-0"	7'-0"	0'-0"	ALUM	ALUM	FRM-00AL(CW)	0'-0"	0'-0"	0'-4 3/4"	ALUM	1	DEMOUNTABLE WALL DOOR ASSEMBLY
d201V		PNL-FG-AL	3'-0"	7'-0"	3'-0"	7'-0"	0'-0"	ALUM	G1	FRM-00AL(CW)	0'-0"	0'-0"	0'-4 3/4"	ALUM	2	DEMOUNTABLE WALL DOOR ASSEMBLY


REFER TO SHEET A900 FOR DOOR AND HARDWARE TYPES

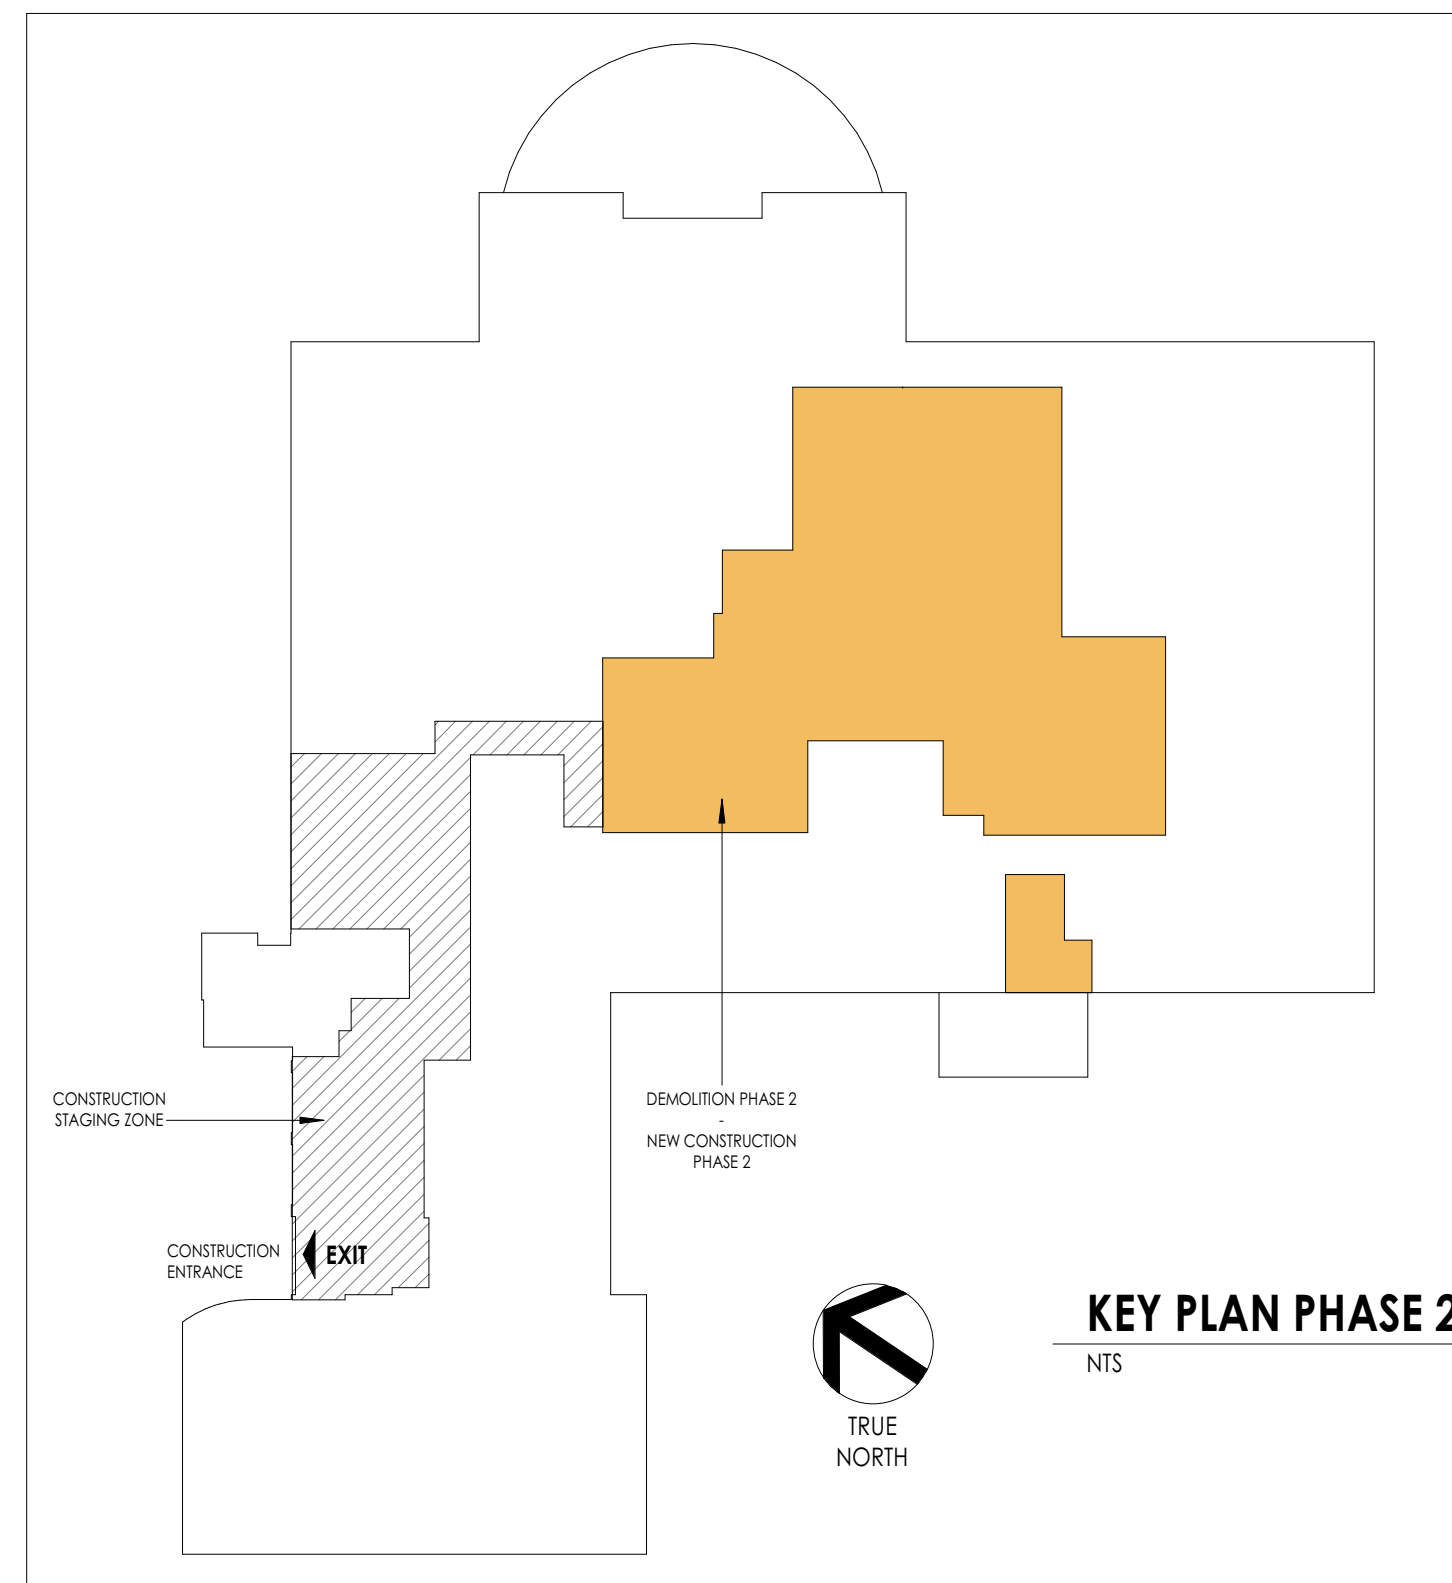

PROJECT INFORMATION
Project Number: 15210.00
Client Name: RANDOLPH COUNTY COURTHOUSE
Project Name: CLERK OF COURT OFFICE RENOVATION
Project Address: 176 E Salisbury St, Asheboro, NC 27203

REVISION SCHEDULE
11 01/27/20 Addendum 4
21

SHEET INFORMATION
Issue: 01/26/21
Bid Documents
Drawn By: CPL
Checked By: CPL
Drawing Title: FLOOR FINISH AND PATTERN PLAN - PHASE 2

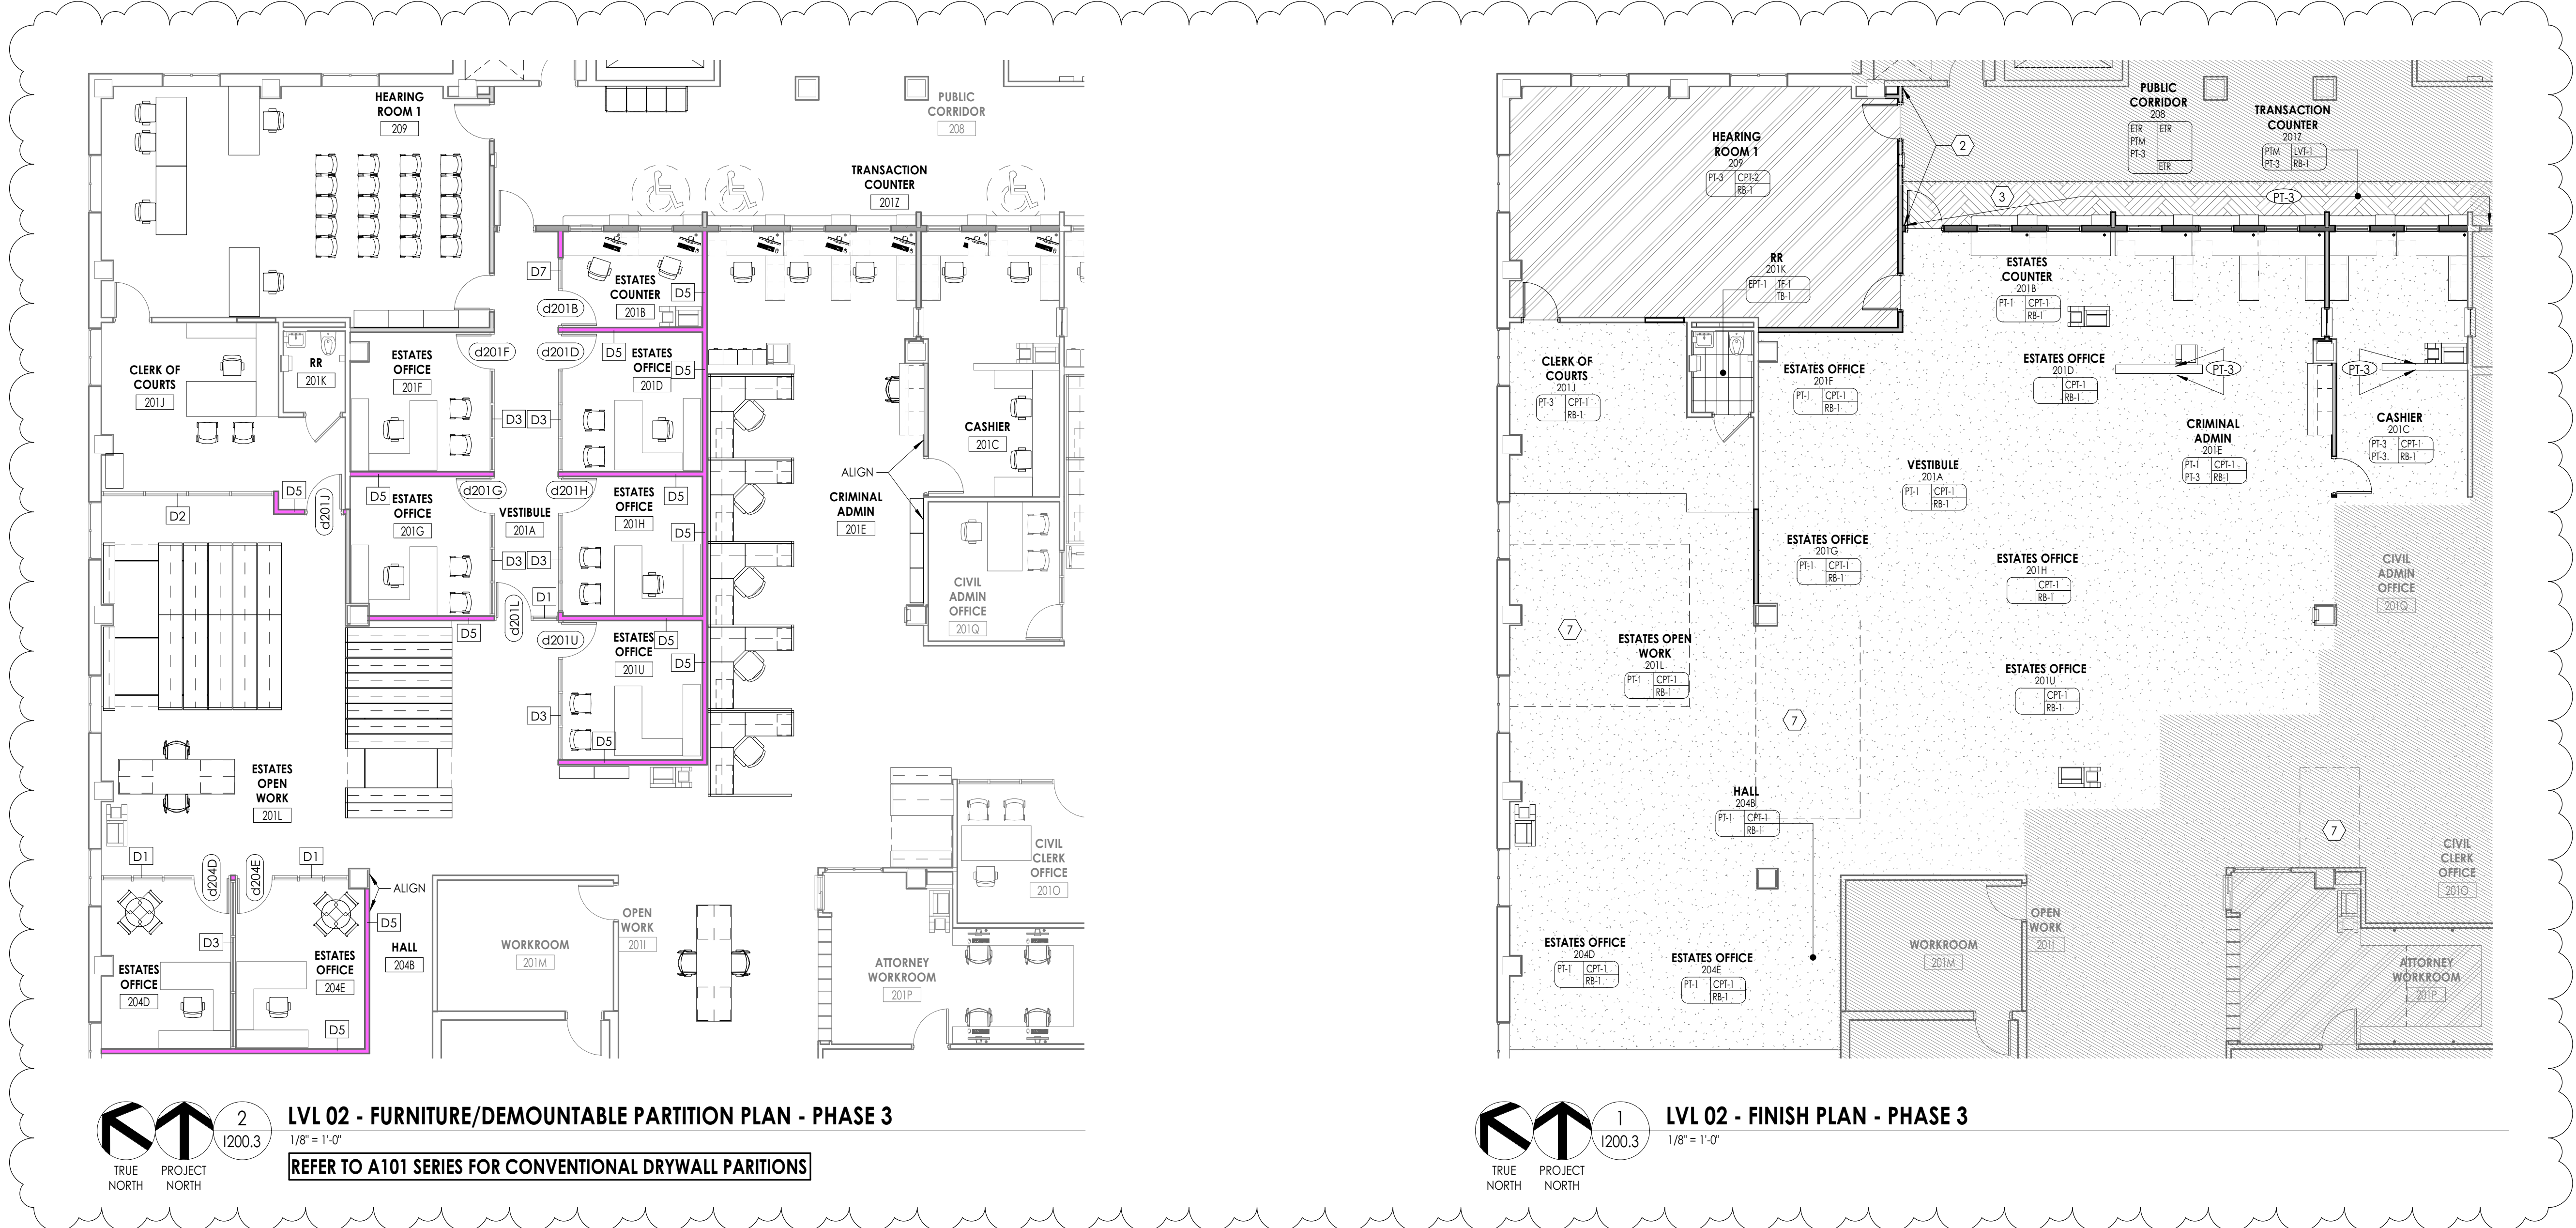


- FINISH PLAN GENERAL NOTES**
1. ALL NEW AND EXISTING HOLLOW METAL DOORS, DOOR FRAMES AND WINDOW FRAMES IN PROJECT SCOPE SHALL BE PAINTED (PT-4), UNLESS NOTED OTHERWISE (U.N.C.).
 2. ALL LOUVERS, VENTS, GRILLES AND OTHER MISCELLANEOUS MECHANICAL AND ELECTRICAL DEVICES ARE TO BE PAINTED TO MATCH THE SURFACE ON WHICH THEY APPEAR, UNLESS NOTED OTHERWISE (U.N.C.).
 3. REFER TO A200 SERIES DRAWINGS FOR CEILING TYPES AND SOFFIT FINISHES.
 4. UNDERSIDE OF SOFFITS TO MATCH FACE OF SOFFIT. SEE A200 SERIES FOR PAINT ACCENT SPECIFICATIONS. PAINT OVER CEILING(S) (PT-2).
 5. REFER TO A700 SERIES INTERIOR ELEVATIONS FOR MILLWORK FINISHES.
 6. HIGH PRESSURE PLASTIC LAMINATE ON VERTICAL SURFACES TO RUN VERTICALLY, UNLESS NOTED OTHERWISE (U.N.C.).
 7. REFER TO 1200S FOR FLOOR PATTERNING PLANS & DETAILS.
 8. REFER TO 200S FOR WALL PROTECTION PLANS & DETAILS.
 9. ALL FLOOR FINISHES SHALL TRANSITION AT THE CENTERLINE OF THE DOOR, UNLESS NOTED OTHERWISE (U.N.C.). INSTALL TRANSITION STRIPS PER DETAILS ON 1000.
 10. ALL GROUT TO BE SEALED A MINIMUM OF TWO TIMES PRIOR TO COMPLETION.
 11. WHERE KICKSPACES OCCUR AT MILLWORK, FLOOR FINISH SHOWN ON PLANS SHALL RUN UNDERNEATH KICKSPACE AS WELL.
 12. REFER TO A900 FOR DEMOUNTABLE PARTITION ELEVATIONS.


FINISH ABBREVIATIONS

NOTE: THE LEGEND MAY CONTAIN ABBREVIATIONS THAT ARE NOT IN THIS PROJECT

ACT	ACOUSTICAL CEILING TILE	PT	PAINT
AWP	ACOUSTICAL WALL PANEL	PTM	PATCH TO MATCH
CC	CUBICLE CURTAIN	RB	RESILIENT BASE
CG	CORNER GUARD	SSM	SOLID SURFACE MATERIAL
CPF	CARPET	ST	STONE VENEER
DS	DIVIDER STRIP	SV	SHEET VINYL
DWP	DIGITAL WALL PANEL	TB	TILE BASE
EPT	EPOXY PAINT	TF	TILE FLOOR
ETR	EXISTING TO REMAIN	TR	TRIM
EXP	EXPOSED	TS	TRANSITION STRIP
FILM	FILM	TW	TILE WALL
FRP	FIBER REINFORCED PANEL	WD	WOOD
GRT	GROUT	WS	WRITEABLE SURFACE
HPL	HIGH PRESSURE PLASTIC LAMINATE	WT	WINDOW TREATMENT
LVT	LUXURY VINYL TILE		

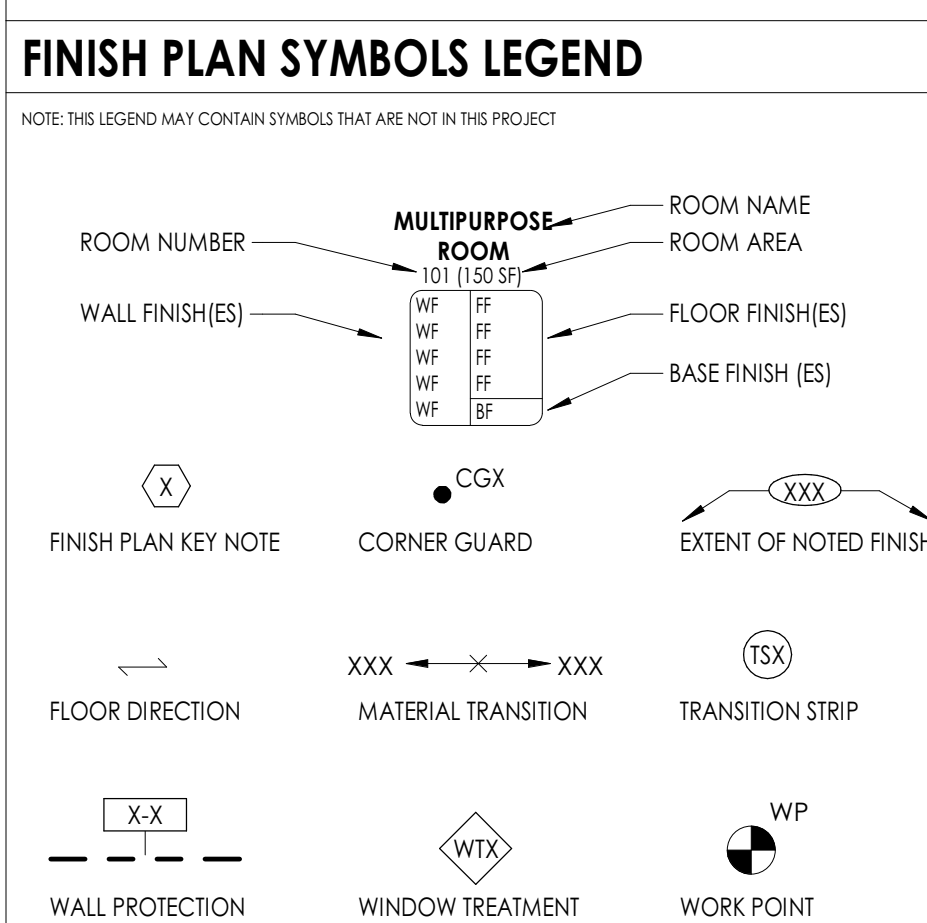

- FINISH PLAN KEY NOTES**
1. EXPOSED BRICK SURFACES ARE TO BE PAINTED PT-1.
 2. WALL PAINT TO MATCH EXISTING IN PUBLIC LOBBY AND CORRIDOR. COORDINATE WITH MAINTENANCE TO DETERMINE COLOR AND SHEEN.
 3. LVT TO BE INSTALLED IN DOUBLE HERRINGBONE PATTERN.
 4. DOOR FRAME TO BE PAINTED (PT-4) ONLY ON SIDE WHERE NEW FINISHES ARE TO BE INSTALLED. OTHER SIDE OF DOOR FRAME TO BE PAINTED TO MATCH EXISTING IN CORRIDOR. REFER TO INTERIOR FINISH SCHEDULE FOR MORE INFORMATION.
 5. EXISTING EXPOSED BRICK TO REMAIN UNPAINTED.
 6. NEW FINISHES TO BE COMPLETED IN LATER PHASE.
 7. RAISED SUBFLOOR AT HIGH DENSITY FILING. COORDINATE WITH HIGH DENSITY FILING CONTRACTOR TO INSTALL FLOOR COVERING OVER RAISED SUBFLOOR.
 8. COORDINATE FLOOR FINISHES WITH EXISTING CONTROL JOINT.

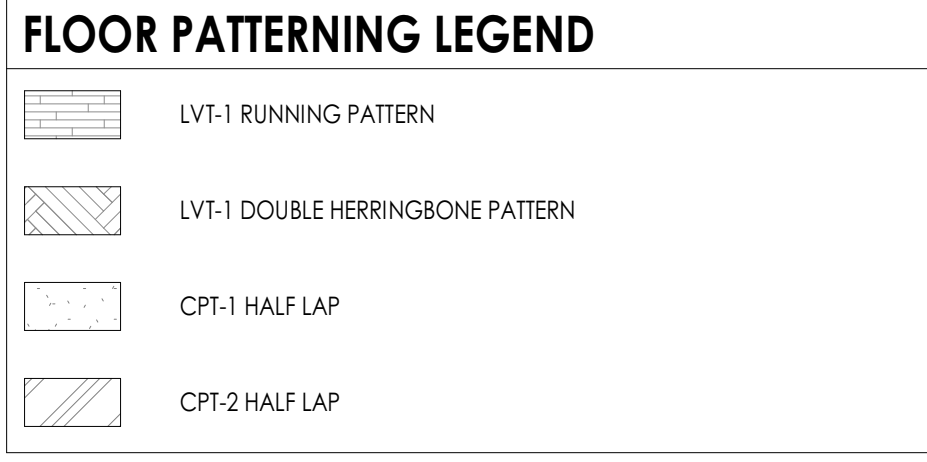


LVL 02 - FURNITURE/DEMOUNTABLE PARTITION PLAN - PHASE 3
1/8" = 1'-0"
REFER TO A101 SERIES FOR CONVENTIONAL DRYWALL PARTITIONS

LVL 02 - FINISH PLAN - PHASE 3
1/8" = 1'-0"



DOOR SCHEDULE- PHASE 3 - DEMOUNTABLE

DOOR NUMBER	FIRE RATING (MIN)	PANEL TYPE	DOOR PANELS					DOOR FRAME				GLAZING TYPE	COMMENTS				
			SINGLE PANEL DIMENSIONS		TOTAL PANEL DIMENSIONS			PANEL FINISHES		FRAME DIMENSIONS				FRAME FINISH	HW SET		
			WIDTH	HEIGHT	WIDTH	HEIGHT	THICKNESS	UNDERCUT	PANEL FINISH SIDE 1	PANEL FINISH SIDE 2	JAMB WIDTH					HEAD HEIGHT	FRAME DEPTH
d201B		PNL-FG-AL	3'-0"	7'-0"	3'-0"	7'-0"	0'-1 3/4"	0'-0"	ALUM	<By Category>	FRM-00AL(CW)	0'-0"	0'-0"	0'-4 3/4"	ALUM	1	DEMOUNTABLE WALL DOOR ASSEMBLY
d201D		PNL-FG-AL	3'-0"	7'-0"	3'-0"	7'-0"	0'-1 3/4"	0'-0"	ALUM	<By Category>	FRM-00AL(CW)	0'-0"	0'-0"	0'-4 3/4"	ALUM	1	DEMOUNTABLE WALL DOOR ASSEMBLY
d201F		PNL-FG-AL	3'-0"	7'-0"	3'-0"	7'-0"	0'-1 3/4"	0'-0"	ALUM	<By Category>	FRM-00AL(CW)	0'-0"	0'-0"	0'-4 3/4"	ALUM	1	DEMOUNTABLE WALL DOOR ASSEMBLY
d201G		PNL-FG-AL	3'-0"	7'-0"	3'-0"	7'-0"	0'-1 3/4"	0'-0"	ALUM	<By Category>	FRM-00AL(CW)	0'-0"	0'-0"	0'-4 3/4"	ALUM	1	DEMOUNTABLE WALL DOOR ASSEMBLY
d201H		PNL-FG-AL	3'-0"	7'-0"	3'-0"	7'-0"	0'-1 3/4"	0'-0"	ALUM	<By Category>	FRM-00AL(CW)	0'-0"	0'-0"	0'-4 3/4"	ALUM	1	DEMOUNTABLE WALL DOOR ASSEMBLY
d201I		PNL-FG-AL	3'-0"	7'-0"	3'-0"	7'-0"	0'-1 3/4"	0'-0"	WD/ST	<By Category>	FRM-00HM	0'-2"	0'-2"	0'-5 3/4"	ALUM	1	DEMOUNTABLE WALL DOOR ASSEMBLY
d201L		PNL-FG-AL	3'-0"	7'-0"	3'-0"	7'-0"	0'-1 3/4"	0'-0"	ALUM	<By Category>	FRM-00AL(CW)	0'-0"	0'-0"	0'-4 3/4"	ALUM	1	DEMOUNTABLE WALL DOOR ASSEMBLY
d201U		PNL-FG-AL	3'-0"	7'-0"	3'-0"	7'-0"	0'-1 3/4"	0'-0"	ALUM	<By Category>	FRM-00AL(CW)	0'-0"	0'-0"	0'-4 3/4"	ALUM	1	DEMOUNTABLE WALL DOOR ASSEMBLY
d204D		PNL-FG-AL	3'-0"	7'-0"	3'-0"	7'-0"	0'-1 3/4"	0'-0"	ALUM	<By Category>	FRM-00AL(CW)	0'-0"	0'-0"	0'-4 3/4"	ALUM	1	DEMOUNTABLE WALL DOOR ASSEMBLY
d204E		PNL-FG-AL	3'-0"	7'-0"	3'-0"	7'-0"	0'-1 3/4"	0'-0"	ALUM	<By Category>	FRM-00AL(CW)	0'-0"	0'-0"	0'-4 3/4"	ALUM	1	DEMOUNTABLE WALL DOOR ASSEMBLY

REFER TO SHEET A900 FOR DOOR AND HARDWARE TYPES.


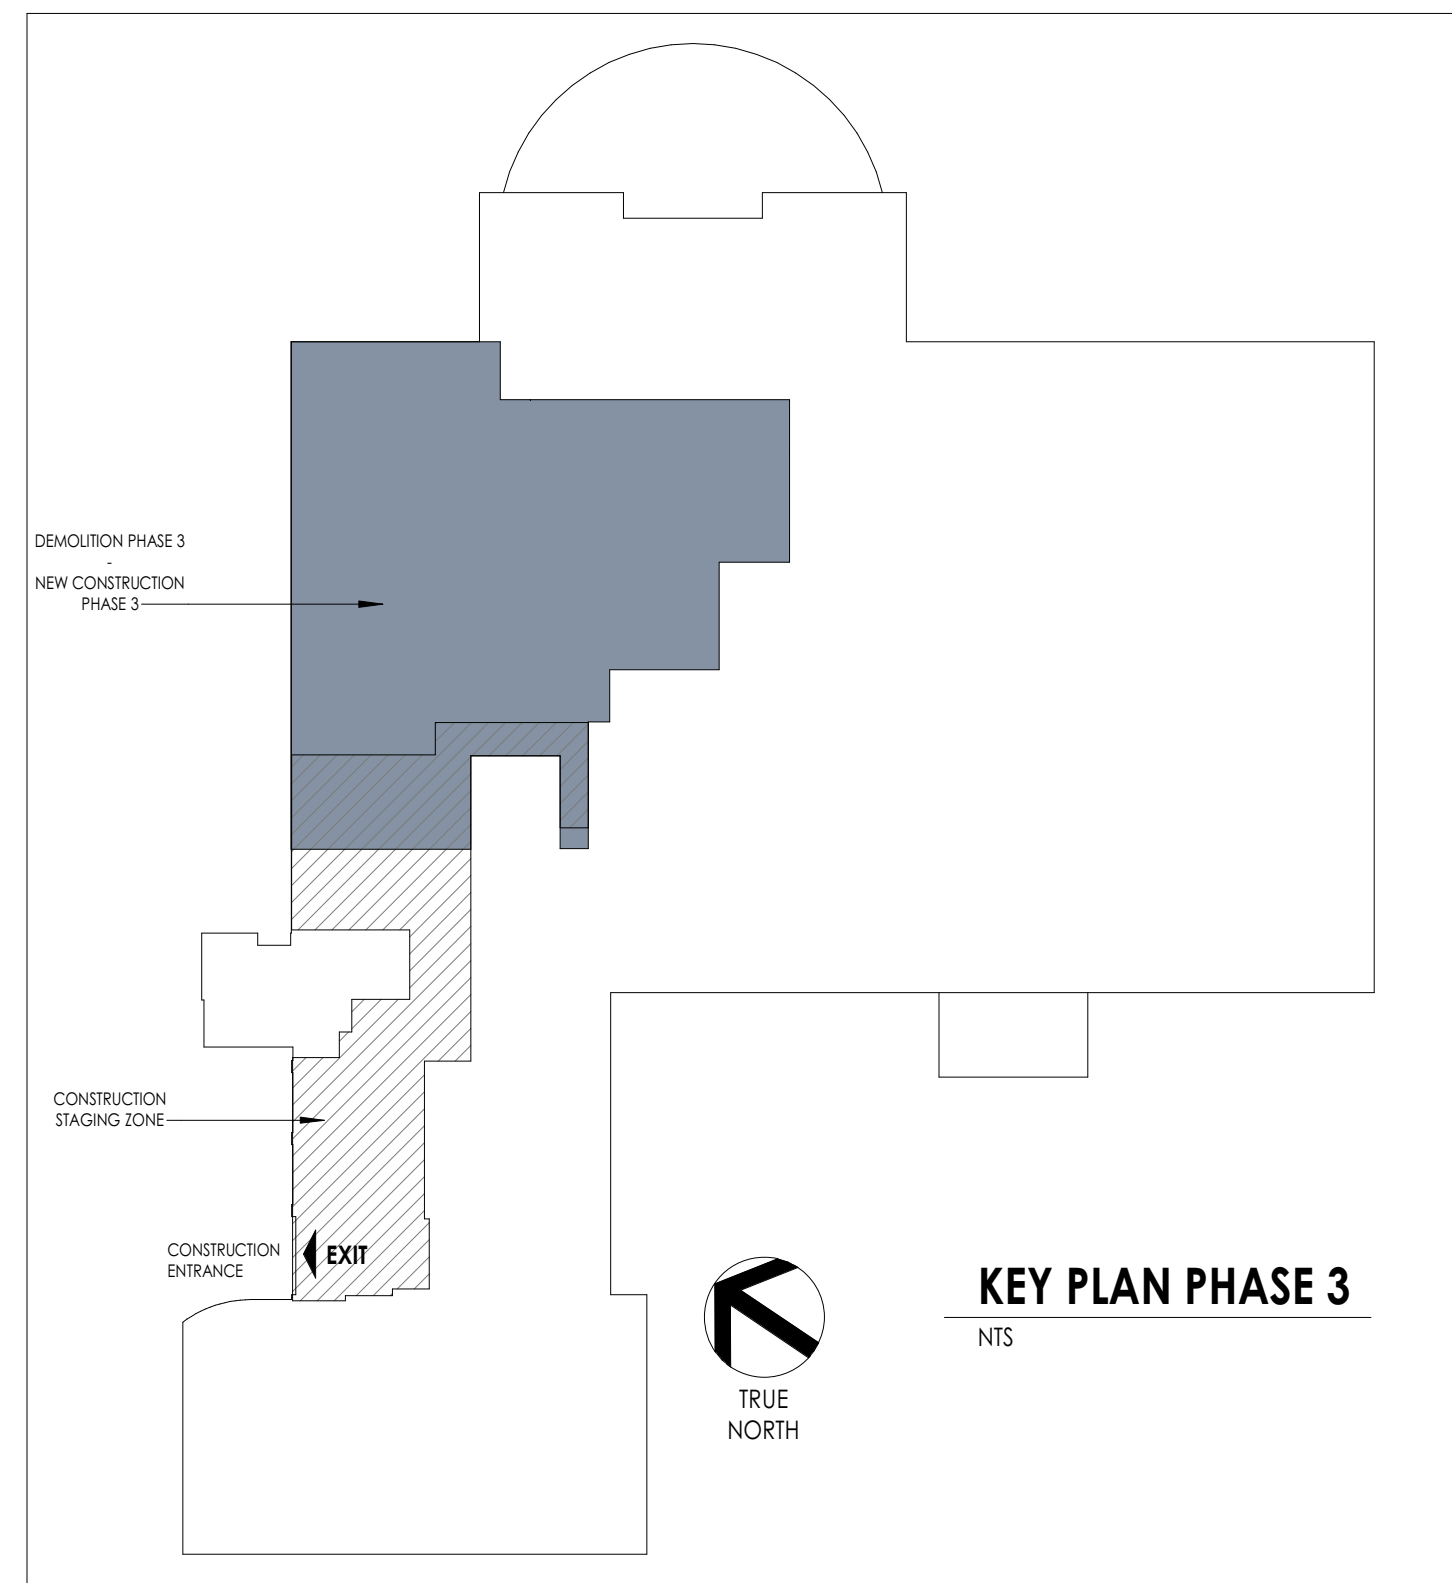


SHEET INFORMATION
Issue: 01/26/21
BID DOCUMENTS
Drawn By: CPL
Checked By: CPL
Drawing Title: FLOOR FINISH AND PATTERN PLAN - PHASE 3

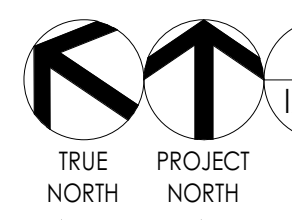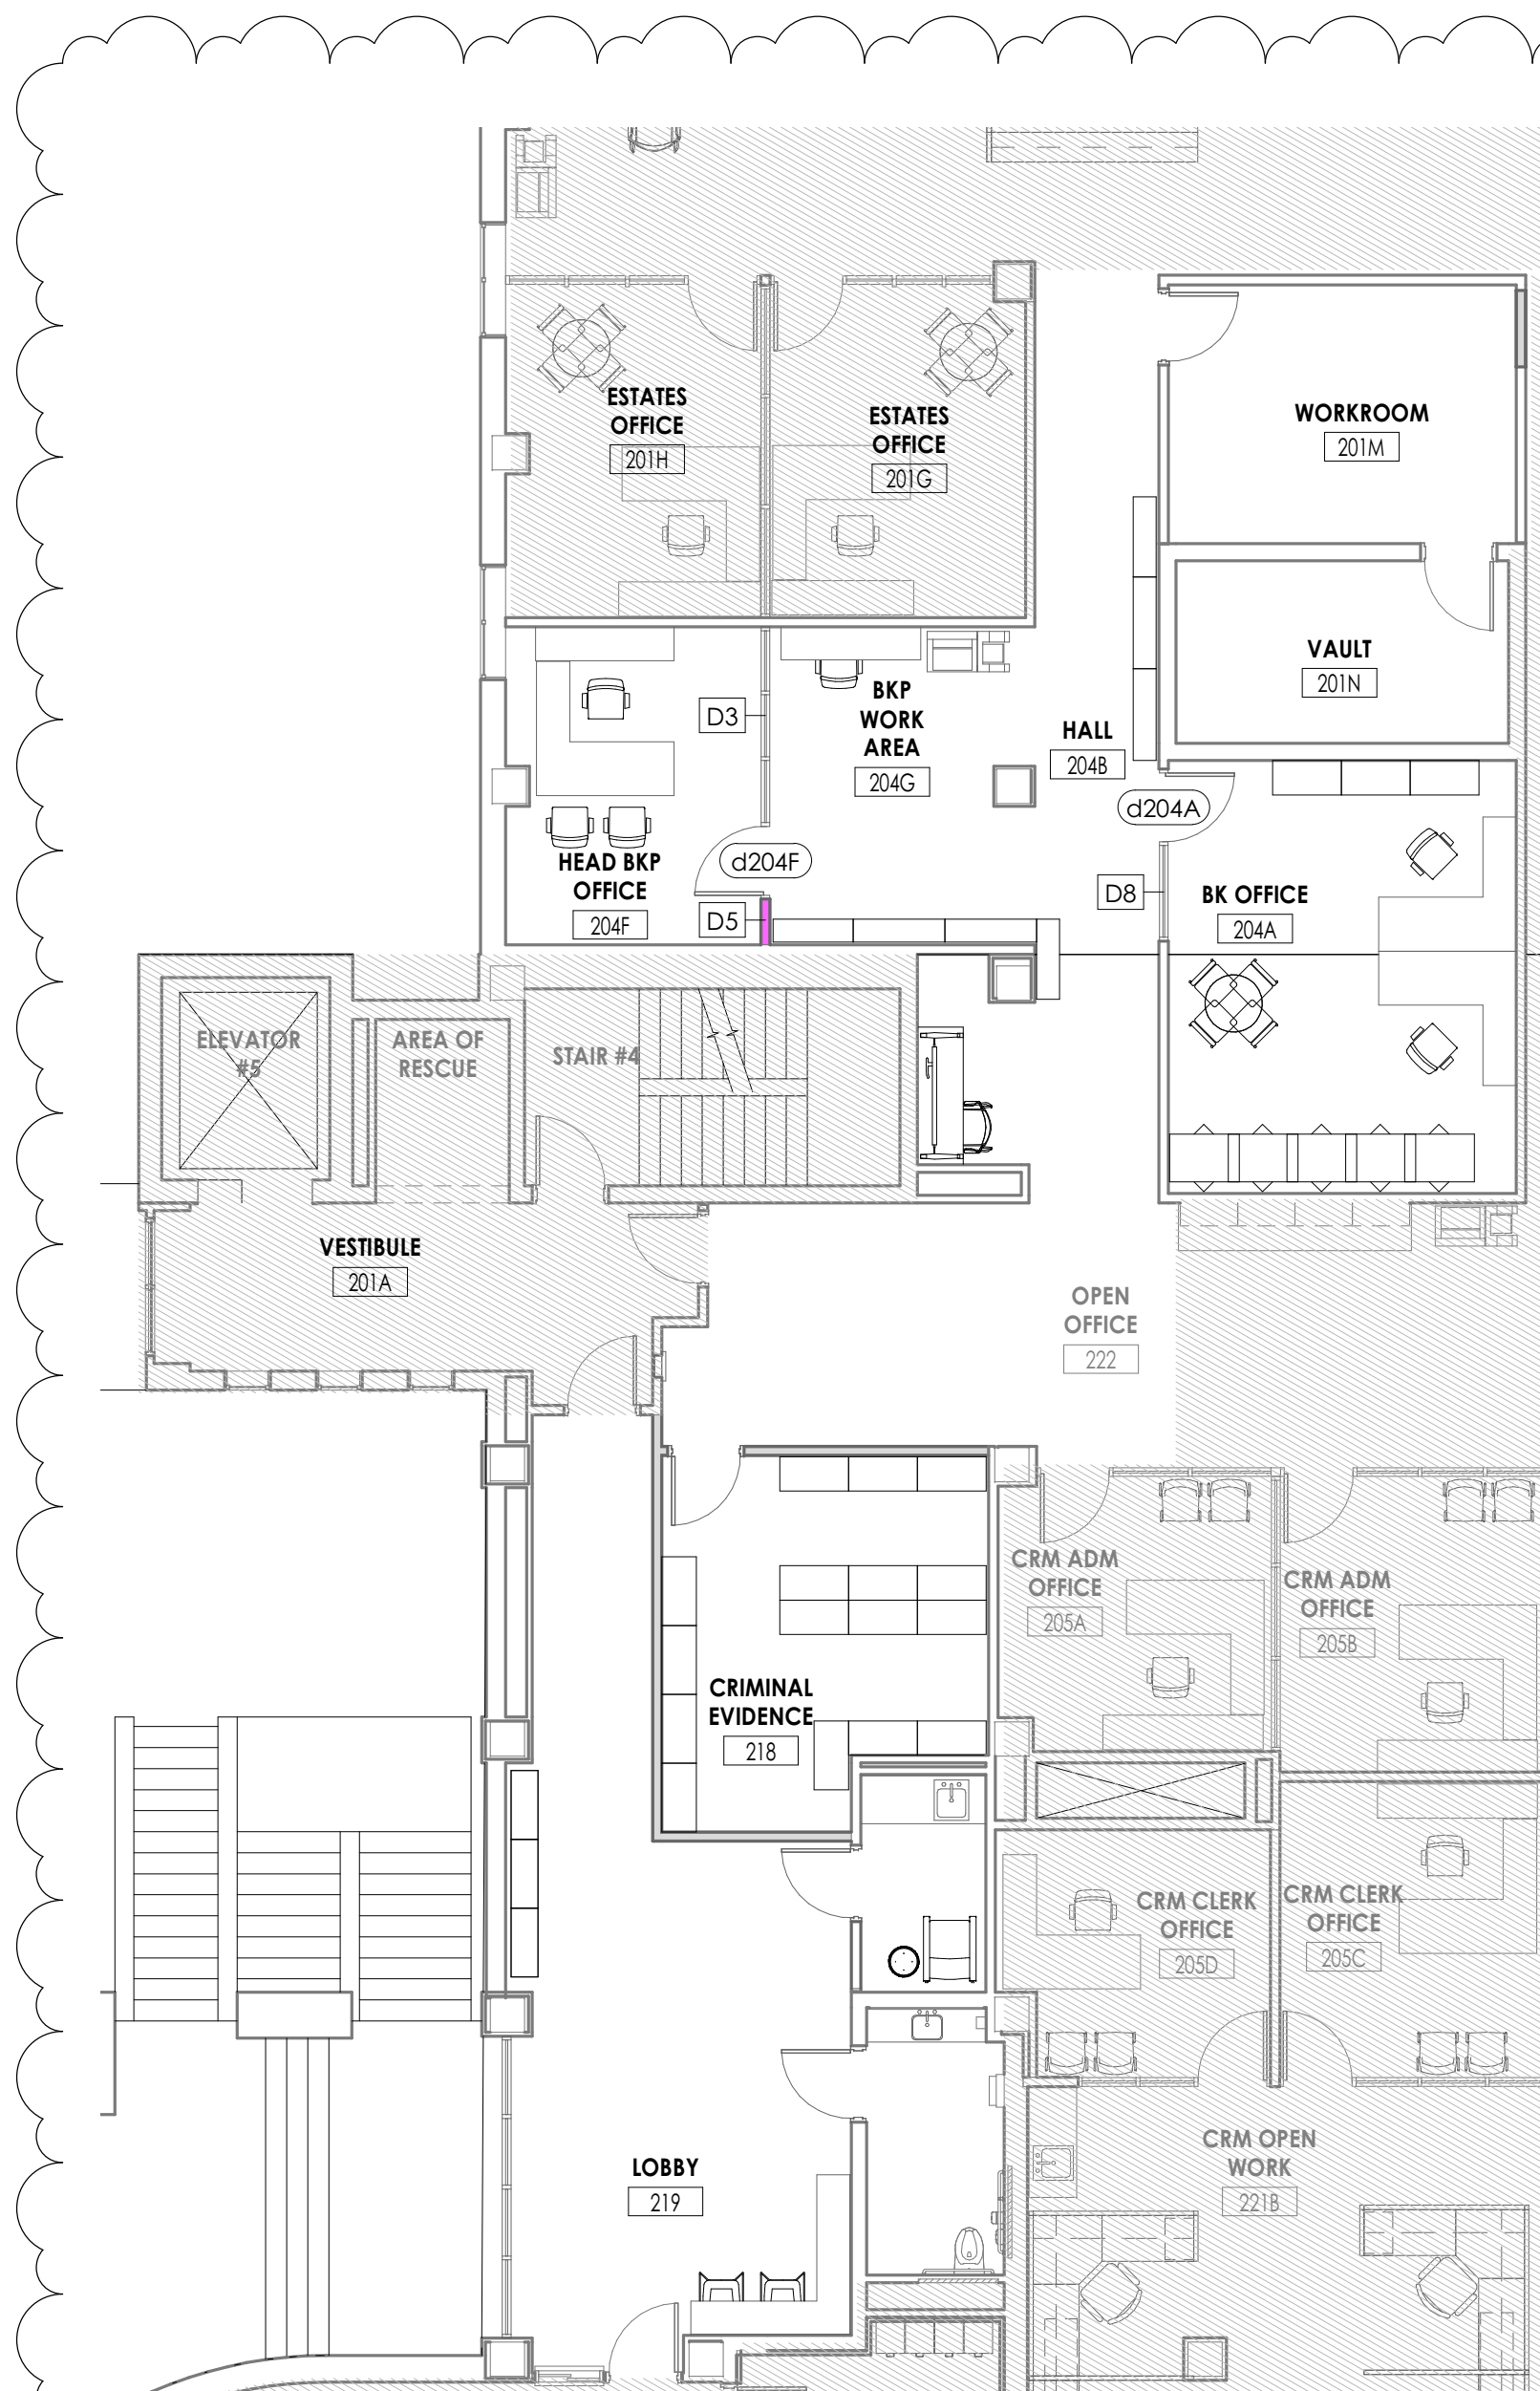

LVL 02 - FURNITURE/DEMOUNTABLE PARTITION PLAN - PHASE 4
1/8" = 1'-0"

REFER TO A101 SERIES FOR CONVENTIONAL DRYWALL PARTITIONS

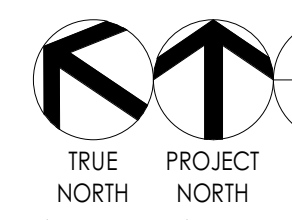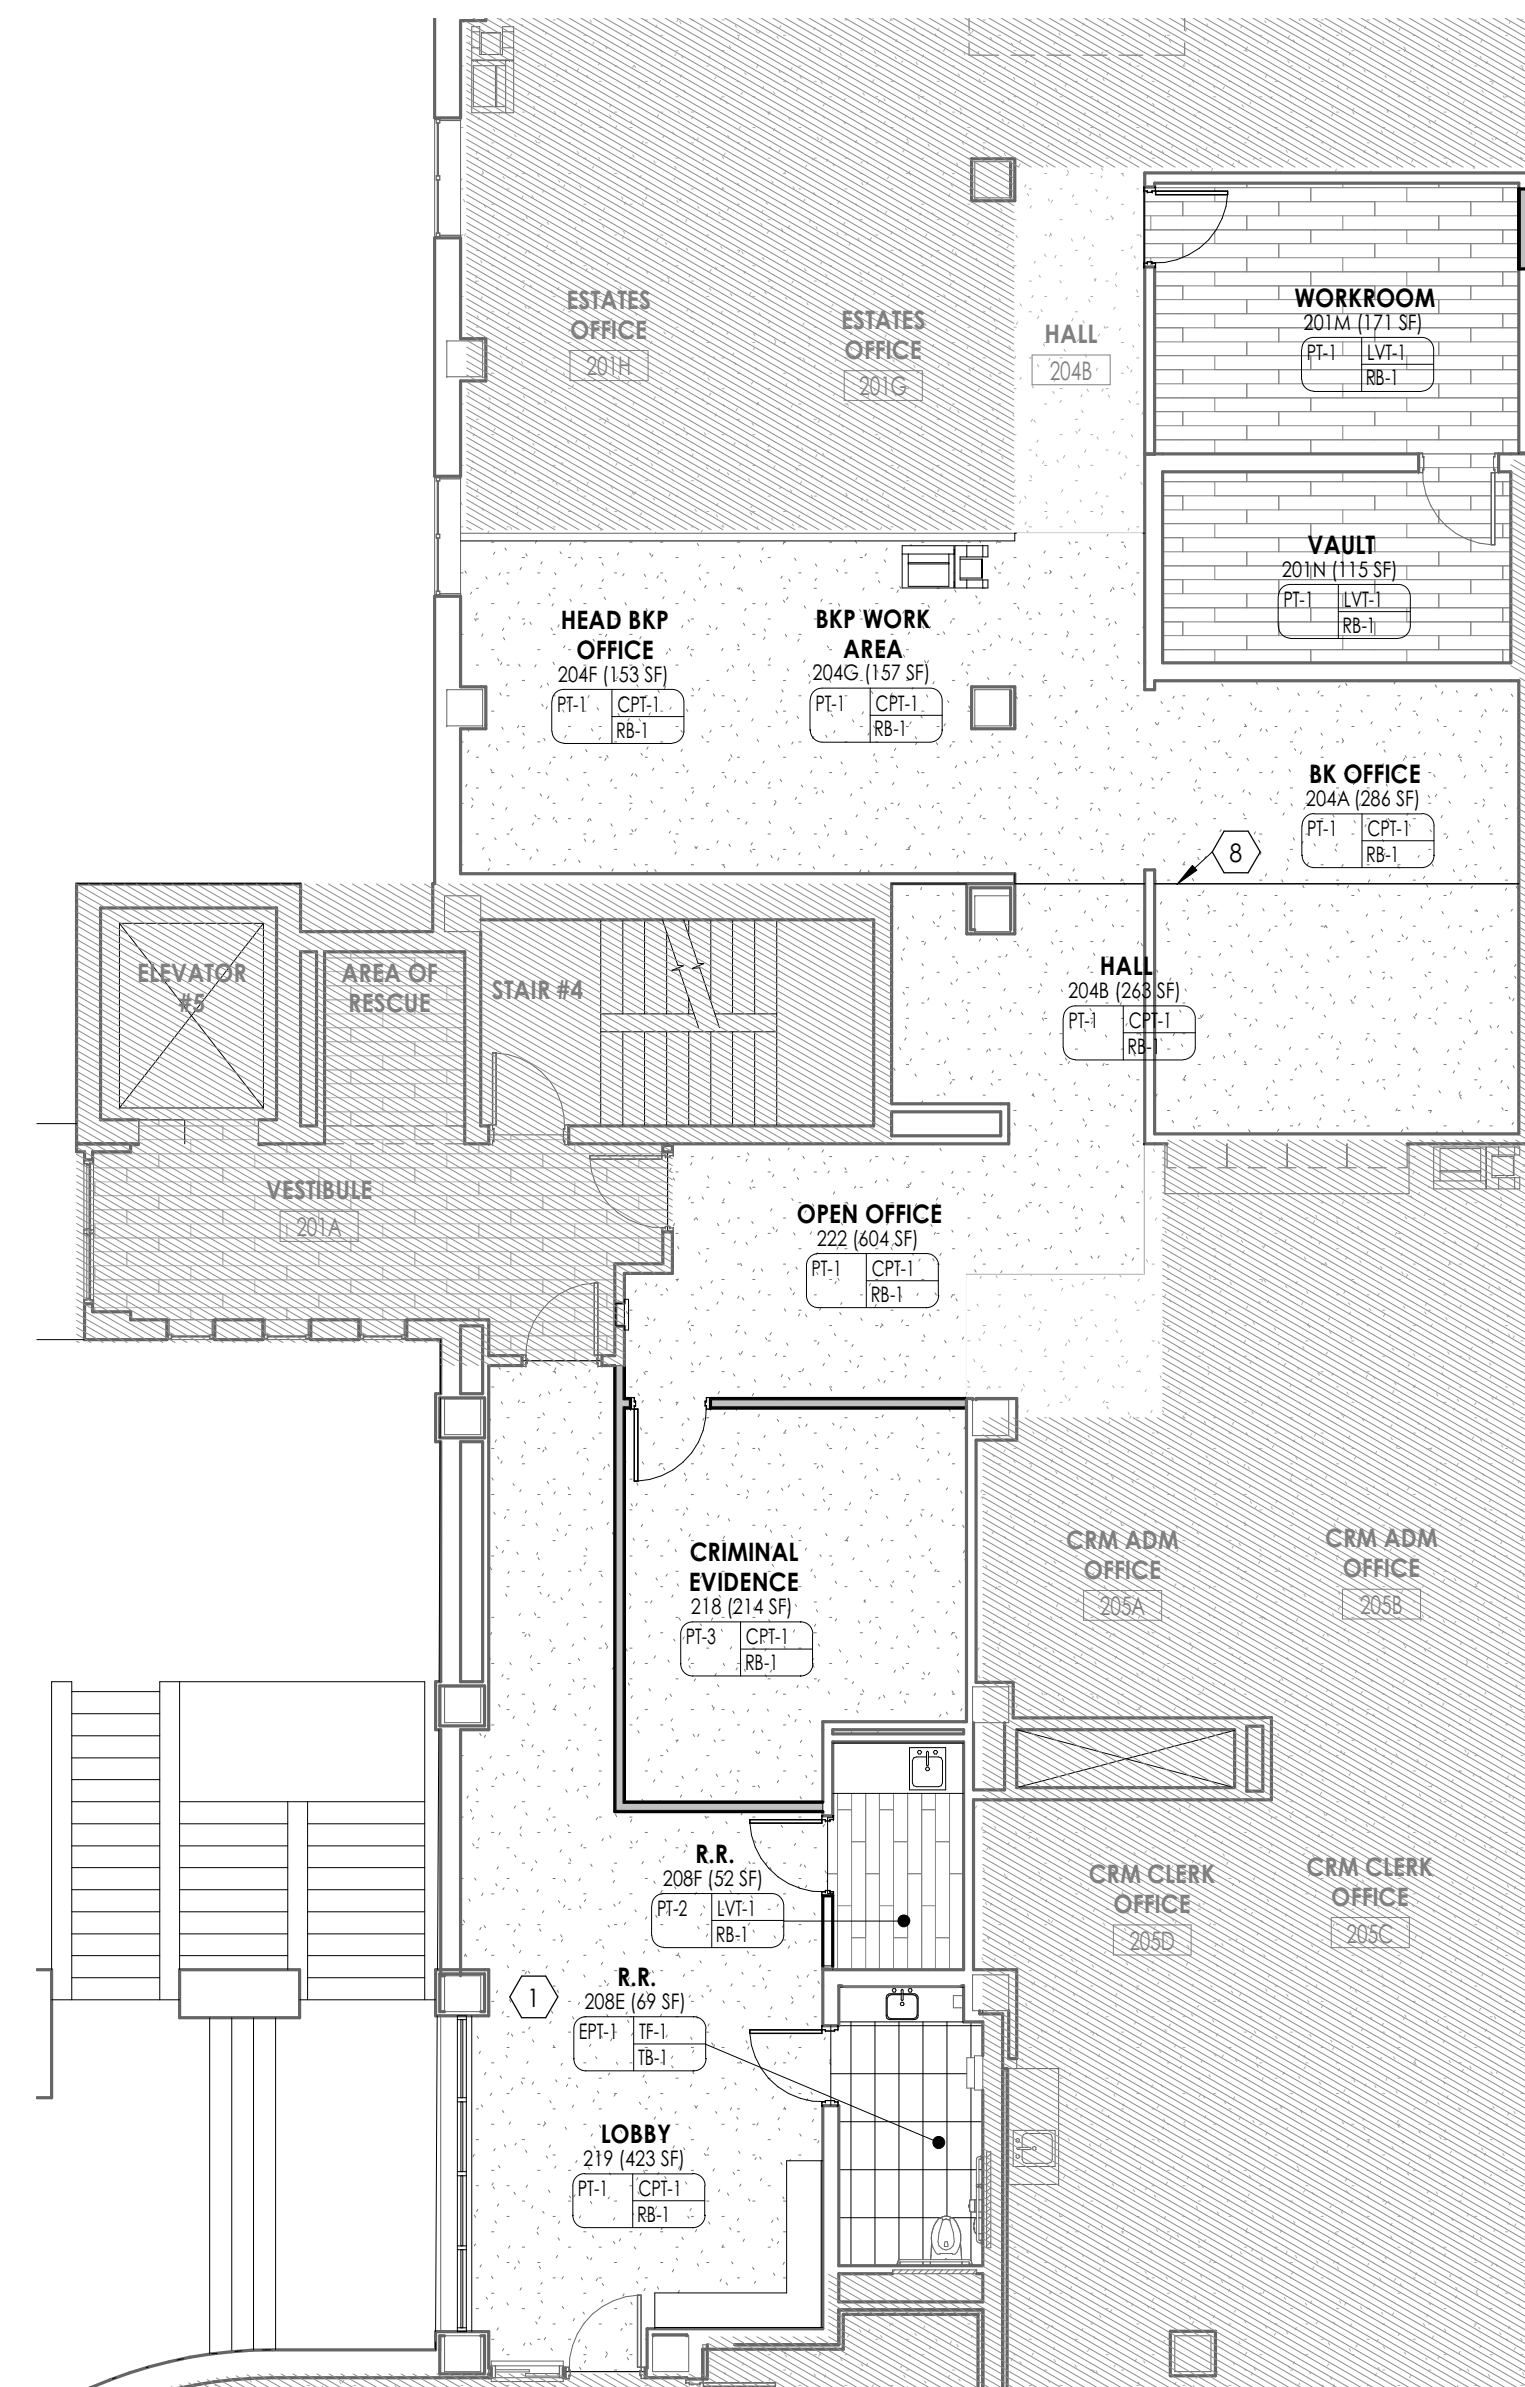

LVL 02 - FINISH PLAN - PHASE 4
1/8" = 1'-0"

FINISH PLAN GENERAL NOTES


1. ALL NEW AND EXISTING HOLLOW METAL DOORS, DOOR FRAMES AND WINDOW FRAMES IN PROJECT SCOPE SHALL BE PAINTED (PT-4), UNLESS NOTED OTHERWISE (U.N.C.).
2. ALL LOUVERS, VENTS, GRILLES AND OTHER MISCELLANEOUS MECHANICAL AND ELECTRICAL DEVICES ARE TO BE PAINTED TO MATCH THE SURFACE ON WHICH THEY APPEAR, UNLESS NOTED OTHERWISE (U.N.C.).
3. REFER TO A200 SERIES DRAWINGS FOR CEILING TYPES AND SOFFIT FINISHES.
4. UNDERSIDE OF SOFFITS TO MATCH FACE OF SOFFIT. SEE A200 SERIES FOR PAINT ACCENT SPECIFICATIONS. PAINT OVER CEILINGS (PF-2).
5. REFER TO A700 SERIES INTERIOR ELEVATIONS FOR MILLWORK FINISHES.
6. HIGH PRESSURE PLASTIC LAMINATE ON VERTICAL SURFACES TO RUN VERTICALLY, UNLESS NOTED OTHERWISE (U.N.C.).
7. REFER TO 1203 FOR FLOOR PATTERNING PLANS & DETAILS.
8. REFER TO 2006 FOR WALL PROTECTION PLANS & DETAILS.
9. ALL FLOOR FINISHES SHALL TRANSITION AT THE CENTERLINE OF THE DOOR, UNLESS NOTED OTHERWISE (U.N.C.). INSTALL TRANSITION STRIPS PER DETAILS ON 1000.
10. ALL GROUT TO BE SEALED A MINIMUM OF TWO TIMES PRIOR TO COMPLETION.
11. WHERE KICKSPACES OCCUR AT MILLWORK, FLOOR FINISH SHOWN ON PLANS SHALL RUN UNDERNEATH KICKSPACE AS WELL.
12. REFER TO A900 FOR DEMOUNTABLE PARTITION ELEVATIONS.

FINISH ABBREVIATIONS

NOTE: THE LEGEND MAY CONTAIN ABBREVIATIONS THAT ARE NOT IN THIS PROJECT

ACT	ACOUSTICAL CEILING TILE	PT	PAINT
AWP	ACOUSTICAL WALL PANEL	PTM	PATCH TO MATCH
CC	CUBICULE CURTAIN	RB	RESILIENT BASE
CG	CORNER GUARD	SSM	SOLID SURFACE MATERIAL
CPF	CARPET	ST	STONE VENEER
DS	DIVIDER STRIP	SV	SHEET VINYL
DWP	DIGITAL WALL PANEL	TB	TILE BASE
EPT	EPOXY PAINT	TF	TILE FLOOR
ETR	EXISTING TO REMAIN	TR	TRIM
EXP	EXPOSED	TS	TRANSITION STRIP
FILM	FILM	TW	TILE WALL
FRP	FIBER REINFORCED PANEL	WD	WOOD
GRT	GROUT	WS	WRITABLE SURFACE
HPL	HIGH PRESSURE PLASTIC LAMINATE	WT	WINDOW TREATMENT
LVT	LUXURY VINYL TILE		


FINISH PLAN SYMBOLS LEGEND

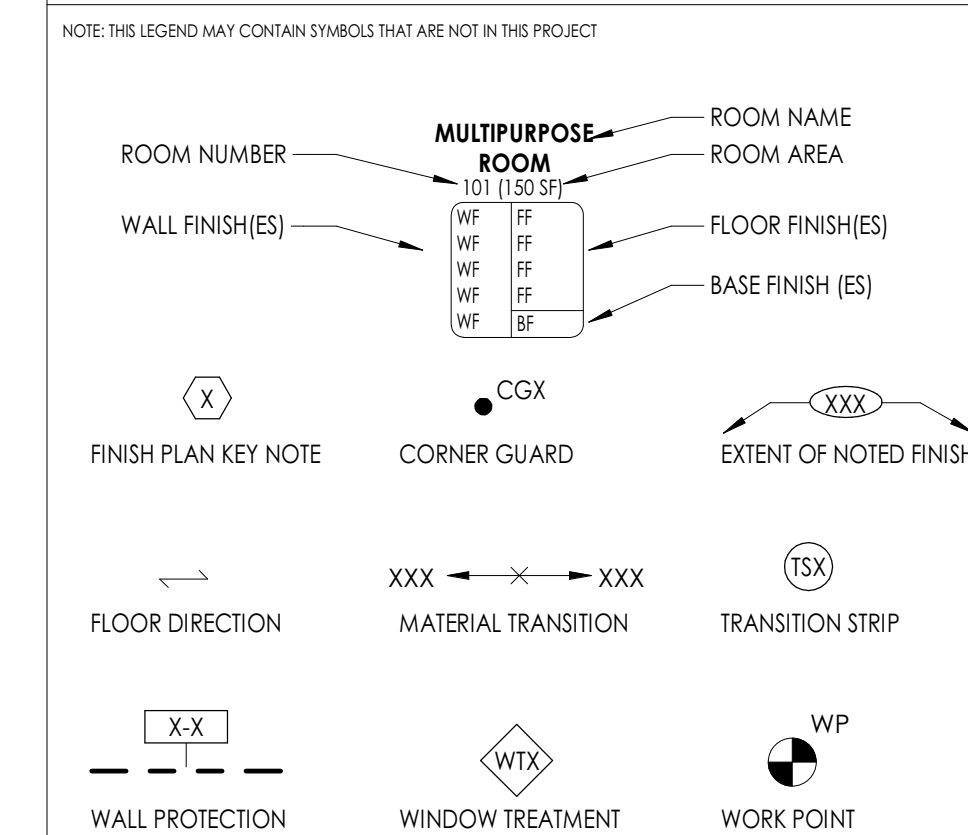

FINISH PLAN KEY NOTES

1. EXPOSED BRICK SURFACES ARE TO BE PAINTED PT-1.
2. WALL PAINT TO MATCH EXISTING IN PUBLIC LOBBY AND CORRIDOR. COORDINATE WITH MAINTENANCE TO DETERMINE COLOR AND SHEEN.
3. LVT TO BE INSTALLED IN DOUBLE HERRINGBONE PATTERN.
4. DOOR FRAME TO BE PAINTED (PT-4) ONLY ON SIDE WHERE NEW FINISHES ARE TO BE INSTALLED. OTHER SIDE OF DOOR FRAME TO BE PAINTED TO MATCH EXISTING IN CORRIDOR. REFER TO INTERIOR FINISH SCHEDULE FOR MORE INFORMATION.
5. EXISTING EXPOSED BRICK TO REMAIN UNPAINTED.
6. NEW FINISHES TO BE COMPLETED IN LATER PHASE.
7. RAISED SUBFLOOR AT HIGH DENSITY FILING. COORDINATE WITH HIGH DENSITY FILING CONTRACTOR TO INSTALL FLOOR COVERING OVER RAISED SUBFLOOR.
8. COORDINATE FLOOR FINISHES WITH EXISTING CONTROL JOINT.

FLOOR PATTERNING LEGEND

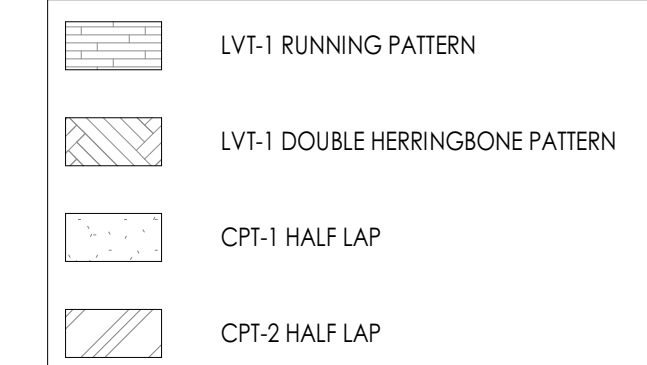

DOOR SCHEDULE- PHASE 4 - DEMOUNTABLE

DOOR		DOOR PANELS										DOOR FRAME					DOOR	
DOOR NUMBER	FIRE RATING (MIN)	PANEL TYPE		SINGLE PANEL DIMENSIONS		TOTAL PANEL DIMENSIONS				PANEL FINISHES		FRAME TYPE	FRAME DIMENSIONS			HW SET	GLAZING TYPE	COMMENTS
		PANEL 1	PANEL 2	WIDTH	HEIGHT	WIDTH	HEIGHT	THICKNESS	UNDERCUT	PANEL FINISH SIDE 1	PANEL FINISH SIDE 2		JAMB WIDTH	HEAD HEIGHT	FRAME DEPTH			
LVL 2																		
α204A		PNL-FG-AL		3'-0"	7'-0"	3'-0"	7'-0"	0'-1 3/4"	0'-0"	ALUM	G1	FRM-ODAL(CW)	0'-0"	0'-0"	0'-4 3/4"	ALUM	2	DEMOUNTABLE WALL DOOR ASSEMBLY
α204F		PNL-FG-AL		3'-0"	7'-0"	3'-0"	7'-0"	0'-1 3/4"	0'-0"	ALUM	G1	FRM-ODAL(CW)	0'-0"	0'-0"	0'-4 3/4"	ALUM	1	DEMOUNTABLE WALL DOOR ASSEMBLY

REFER TO SHEET A900 FOR DOOR AND HARDWARE TYPES.

