ABBREVIATIONS

AC acoustical ACM acoustical mylar AFF above finished floor BLK block BRZ bronze CPT carpet (ed) CK caulk (ing) CLG ceiling CER ceramic CLR coloring CT ceramic tile

CMU concrete masonry unit

DTL detail DNG drawing DF drinking fountain ELEC electric (al) EP epoxy paint EWH electric water heater

FAC factory applied finish FIN finish (ed) FLR floor (ing) FBO furnished by others GA gauge GALV galvanized

GPBD gypsum board HBD hardboard

HDW hardware HWD hardwood HCW hollow core wood HM hollow metal INCL include (d), (ing)

KIT kitchen

PLAS plastic

PWD plywood

QT quarry tile

PLAM plastic laminate

LAM laminate (d) MES metal edge strip MISC miscellaneous NIC not in contract

OC on center (s) OPP opposite paint (ed) PNL paneling PBD particle board

room RB rubber base

SPEC specification (s) STUC stucco SYM symmetry (ical)

TZ terrazzo THK thick (ness) THR threshold T&G tongue & groove UNF unfinished VIN vinyl VCT vinyl composite tile VWC vinyl wall covering

WRGB water-resistant gyp bd WIN window WG wired glass

SECTION NUMBER

DETAIL NUMBER

DETAIL REFERENCE

- ELEVATION NUMBER

DETAIL NUMBERS

SECTION REFERENCE

- SHEET NUMBER WHERE DRAWN

- SHEET NUMBER WHERE DRAWN

INTERIOR ELEVATION INDICATOR

SHEET NUMBER WHERE DRAWN

SHEET NUMBER WHERE DRAWN

WSCT wainscot

GRAPHIC SYMBOLS

201 DOOR NUMBER — DOOR NUMBER

WINDOW NUMBER

ROOM AND SPACE NUMBER

TOILET ACCESSORIES **EQUIPMENT**

REFERENCE GRID

STONE FILL

CONCRETE

BRICK

CONCRETE BLOCK

ROUGH WOOD

FINISH WOOD

STEEL (LARGE SCALE)

STEEL (SMALL SCALE)

A9.2

(4 | A3.3 | 2

BATT OR BLOWN-IN INSULATION RIGID INSULATION GYPSUM BOARD

MARBLE

ACOUSTICAL TILE

Gresham Schelton ENGINEERING

CONSULTANTS

ARCHITECT

architecture planning interior design 904 WEST CYNTHIA TRAIL

GOODLETTSVILLE, TN 37072-3517 PHONE (615) 855 - 0406

BUILDING CODES

International Building Code (IBC), 2012 edition International Mechanical Code (IMC), 2012 edition International Plumbing Code (IPC), 2012 edition ADA Standards for Accessible Design, 2010 edition

CODE INFORMATION


OCCUPANCY CLASSIFICATION - IBC SECTION 304 - BUSINESS GROUP B (LESS THAN 50 OCCUPANTS) OCCUPANT LOAD - IBC TABLE 1004.1.2 BUSINESS, 100 SF GROSS PER OCCUPANT /ACCESSORY EQUIPMENT /STORAGE 300 SF GROSS PER OCCUPANT ALLOWABLE HEIGHT/AREA - IBC TABLE 503 - HEIGHT = 40', ALLOWABLE AREA BUSINESS = 9,000 CONSTRUCTION TYPE - IBC TABLE 602.3: TYPE VB

EXIT ACCESS TRAVEL DISTANCE - IBC TABLE 1016.1 - MAXIMUM TRAVEL DISTANCE FOR NON-SPRINKLED = 200' EGRESS WIDTH PER OCCUPANT SERVED - IBC TABLE 1005.3.2 = STAIRWAYS 0.3" /OTHER 0.2" PER OCCUPANT

BUILDING DATA

BUILDING ADDITION: 253 SF AT 300 SF PER OCCUPANT = 1 OCCUPANT EXISTING BUILDING FIRST FLOOR: 439 SF PER OCCUPANT AT 100 SF PER OCCUPANT = 5 OCCUPANTS EXISTING BUILDING SECOND FLOOR: 439 SF AT 300 SF PER OCCUPANT = 2 OCCUPANTS TOTAL BUILDING: 1,130.5 SF TOTAL WITH 8 OCCUPANTS TOTAL TOILET BUILDING HEIGHT: 20'-11"

D	RAWING INDEX	REV. NO.	REV. DAT
COVER	DRAWING		
A0.1	CODES AND INFO	2	5/18/2018
<u>ARCHI</u>	ITECTURAL		
A2.1 A3.1 A3.2 A5.1 A8.2	FLOOR PLAN BUILDING ELEVATIONS BUILDING SECTIONS OPENINGS WALL SECTIONS	2 0 0 0 0	5/18/2018 2/9/2018 2/9/2018 2/9/2018 2/9/2018
STRUC	CTURAL		
S2.1 S2.2	FOUNDATION PLAN ROOF FRAMING PLAN	0	2/26/2018 2/26/2018
<u>PLUMI</u>	BING		
P1.0 P2.0	PLUMBING FLOOR PLAN PLUMBING SCHEDULES	0	2/14/2018 2/14/2018
MECH	ANICAL		
M1.0	MECHANICAL FLOOR PLAN RICAL	0	2/14/2018
E1.1 E2.1 E3.1	ELECTRICAL SITE PLAN, SITE DETAILS FLOOR PLANS, LEGEND, NOTES, DETAILS, SCHEDULES RISER DIAGRAM, SPECIFICATIONS, ENERGY CODE COMPLIANCE	0 0 0	2/9/2018 2/9/2018 2/9/2018

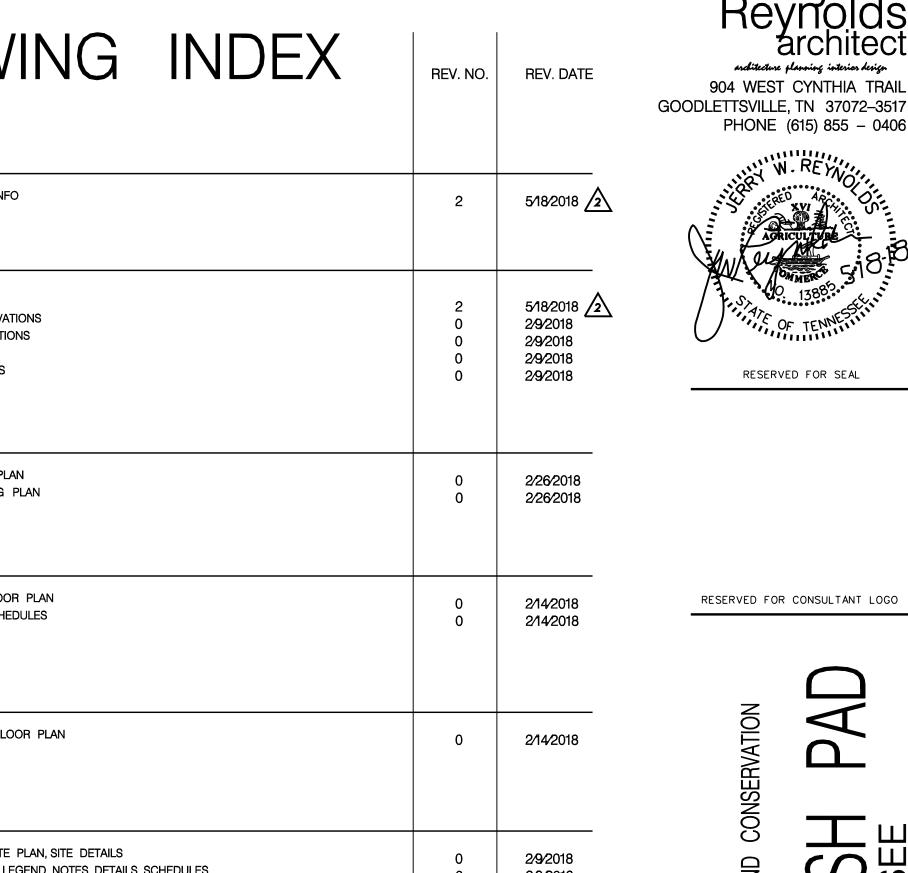

RESERVED FOR SEAL RESERVED FOR CONSULTANT LOGO

904 WEST CYNTHIA TRAIL

PHONE (615) 855 - 0406


5/18/18 JR REVIEW COMMENTS


SCALE NOT TO SCALE

CODES AND INFO

APPROVAL STAMPS

ELECTRICAL SITE PLAN SCALE: 1/16" = 1' - 0"

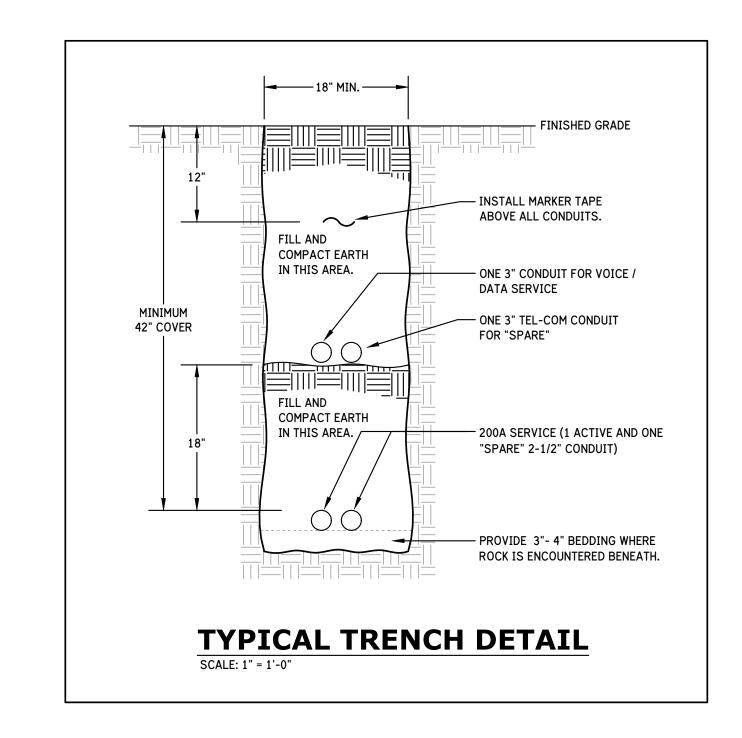

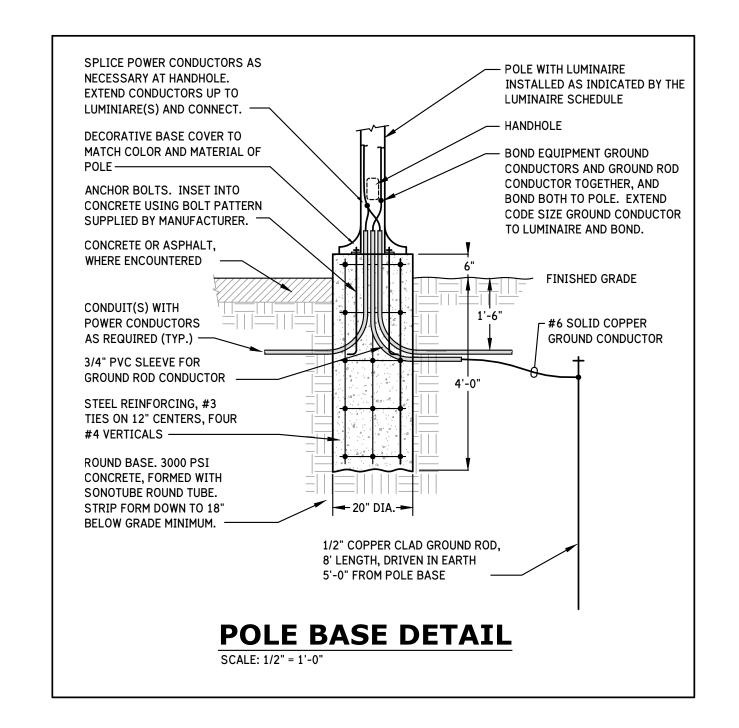


GENERAL NOTES:

- A. VERIFY AND COMPLY WITH ALL POWER COMPANY REQUIREMENTS, STANDARDS, AND DETAILS FOR ALL WORK RELATED TO PROVISION OF ELECTRICAL SERVICE TO FACILITY. COORDINATE ALL WORK WITH POWER COMPANY REPRESENTATIVE.
- B. VERIFY AVAILABLE AND OWNER'S PREFERRED TELECOM SERVICE PROVIDERS, AND VERIFY AND COMPLY WITH ALL TELECOM SERVICE PROVIDER REQUIREMENTS, STANDARDS, AND DETAILS FOR ALL WORK RELATED TO PROVISION OF TELECOM SERVICES TO FACILITY. COORDINATE ALL WORK WITH TELECOM SERVICE PROVIDERS REPRESENTATIVES.
- C. THOROUGHLY COORDINATE ALL UNDERGROUND ELECTRICAL WORK WITH THE WORK OF ALL OTHER TRADES TO AVOID CONFLICTS AND DELAYS. REVIEW INTENDED ELECTRICAL ROUTINGS WITH DISCIPLINE LEAD PERSONNEL FOR EACH TRADE AND LATEST REVISION OF OTHER TRADE DRAWINGS PRIOR TO COMMENCING EACH ASPECT OF UNDERGROUND SITE ELECTRICAL INSTALLATION.
- D. PROVIDE POLE BASE, PER DETAIL, FOR EACH SITE LIGHTING POLE SHOWN ON SITE PLAN ON THIS DRAWING.
- E. UNLESS OTHERWISE NOTED, INSTALL LIGHT POLE BASES HORIZONTALLY CENTERED 24" BACK FROM WALKWAY PAVEMENT.

KEYED NOTES:

- 200A UG ELECTRICAL SERVICE LATERAL TO FACILITY. SEE "POWER RISER DIAGRAM".
- PROVIDE (2) 3-INCH EMPTY UG CONDUITS, 1 EACH FOR VOICE / DATA SERVICE AND "SPARE" TELECOM TO FACILITY, ROUTED FROM TELECOM DEMARC LOCATION ON BUILDING EXTERIOR TO EXISTING UTILITY POLE. ROUTE UP POLE AND TERMINATE AT POLE END PER TELECOM SERVICE PROVIDER DIRECTION. STUB UP TO 18" AFG, CAP, AND SECURE TO EXTERIOR WALL AT BUILDING END.
- 3 EXISTING UTILITY COMPANY POLE, ON WHICH ELECTRIC SERVICE TRANSFORMERS AND TELECOM SERVICE FOR FACILITY WILL BE LOCATED.

Jerry W. Reynolds architect architecture planning interior design 904 WEST CYNTHIA TRAIL GOODLETTSVILLE, TN 37072-3517 PHONE (615) 855 - 0406

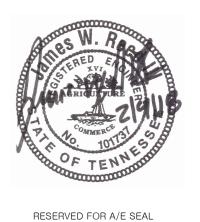

RESERVED FOR CONSULTANT LOGO

SECREATION FUND
SPARTMENT OF ENVIRONMENT AND CONSERVATION
PMENT BUILDING

ARK SPLASH
TSVILLE TENNESSEE

PROJECT INFORMATION

DRAWN BY JAMES REED

DESIGNED BY JAMES REED

APPROVED BY JAMES REED

JOB NO. 5171556

DATE 2/9/2018


SCALE AS NOTED

ELECTRICAL SITE PLAN, SITE DETAILS

DRAWING NUMBER

E1.1

CADD FILE NO.

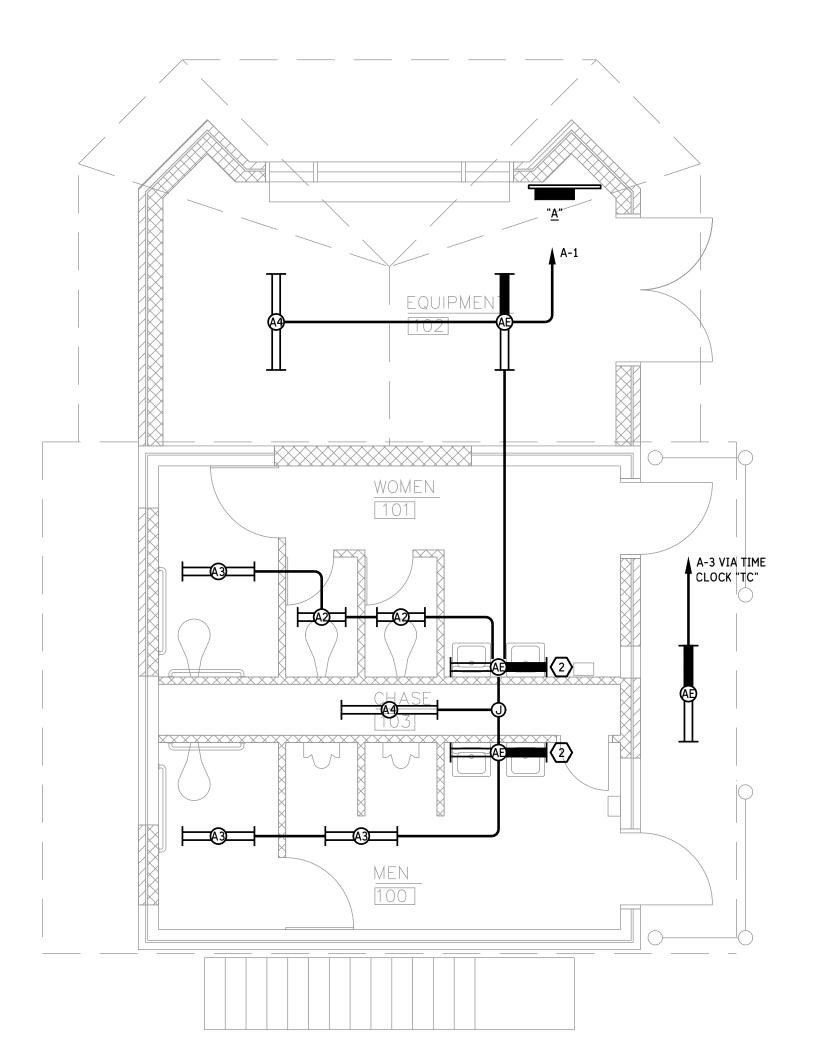


GENERAL NOTES:

- A. BASIS OF DESIGN IS VENDOR DRAWINGS PROVIDED TO ENGINEER FOR "PEAY PARK SPLASH PAD PHASE 1", REVOO, DATED 13/NOV/2017, PREPARED BY VORTEX USA INC. OF CARROLTON, TEXAS. OBTAIN AND COORDINATE ELECTRICAL WORK WITH LATEST REVISION OF THESE DRAWINGS, OR OTHERS AS DIRECTED BY
- B. FIELD VERIFY EXACT LOCATION OF ALL EQUIPMENT IN EQUIPMENT ROOM, AND COORDINATE EQUIPMENT ARRANGEMENT WITH EQUIPMENT VENDOR'S REPRESENTATIVE PRIOR TO ROUGH-IN OF ANY ELECTRICAL SERVICE TO FOLIRMENT.
- C. ELECTRICAL SERVICE TO AND CONNECTIONS TO EQUIPMENT ARE REQUIRED TO BE MADE USING NEMA 4X COMPONENTS.


KEYED NOTES:

- PROVIDE ELECTRICAL EQUIPMENT SUPPORT RACK OF 1-5/8" x 1-5/8" STEEL FRAMING CHANNEL, EQUIVALENT TO ATKORE "UNISTRUT", COOPER "B-LINE", OR T&B "KINDORF" PRODUCT, SECURED TO WALL AND FLOOR AT BOTH ENDS WITH DEVICES AND FITTINGS OFFERED BY MANUFACTURER FOR THE APPLICATION
- SPECIFIED LUMINAIRE IS NOT WALL-MOUNTED. INSTALL CEILING-MOUNTED TIGHT TO WALL.
- TIME SWITCH "TS" FOR CONTROL OF EXTERIOR BUILDING-MOUNTED LIGHTING AND SITE LIGHTING INSTALL 6'-0" AFF TO TOP. PROVIDE 7-DAY ASTRONOMIC SWITCH, DPST, RATED 40A PER POLE,
 120-277VAC, 100-HOUR CAPACITOR-DRIVEN BACK-UP, NEMA 3R, EQUIVALENT TO TORK MODEL EWZ103.

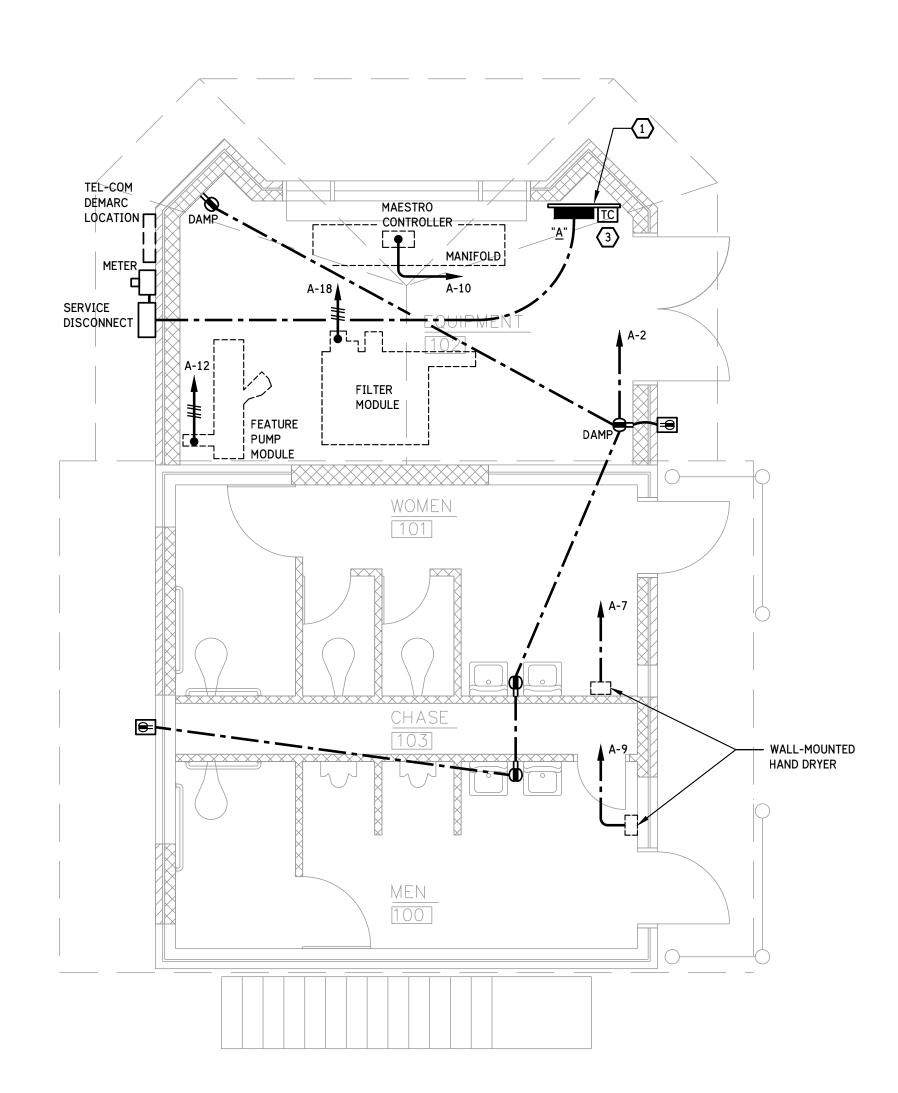

RESTROOM / EQUIPMNET BUILDING LIGHTING PLAN SCALE: 1/4" = 1'-0"

LEGEND LINEAR TYPE LUMINAIRE - "A2" (ETC.) REFERS TO DESIGNATION IN LUMINAIRE SCHEDULE. HALF SHADING INDICATES LUMINAIRE PROVIDED WITH EMERGENCY BATTERY BACKUP POWER, INTEGRAL TO LUMINAIRE. POST TOP MOUNTED AREA / SITE LUMINAIRE - "SA" REFERS TO DESIGNATION IN LUMINAIRE SCHEDULE. GROUND FAULT CIRCUIT INTERRUPTING DUPLEX RECEPTACLE - 120-VOLT, 20-AMP DUPLEX RECEPTACLE WITH INTEGRAL GFCI PROTECTION AND SELF-TESTING. DAMP LOCATION GROUND FAULT CIRCUIT INTERRUPTING DUPLEX RECEPTACLE -INSTALLED WITH AN ALUMINUM FLIP-OPEN STYLE DAMP LABEL COVER. WEATHERPROOF CONTINUOUS USE RECEPTACLE - 120-VOLT, 20-AMP WEATHER RESISTANT (WR) GFCI RECEPTACLE INSTALLED IN ALUMINUM "WHILE-IN-USE" COVER, THOMAS & BETTS RED-DOT #CKMUV OR EQUAL. JUNCTION BOX - SIZE AND USE AS REQUIRED. PANELBOARD - FLUSH OR SURFACE MOUNTED AS INDICATED. MOUNT TOP OF PANEL AT 6'-0" OR AT NEAREST MASONRY JOINT. "A" INDICATES THE PANEL DESIGNATION. SEE PANELBOARD SCHEDULE FOR PANELBOARD REQUIREMENTS. TIME CLOCK FOR CONTROL OF EXTERIOR BUILDING-MOUNTED LIGHTING - INSTALL 60" AFF TO TOP. PROVIDE 7-DAY ASTRONOMIC SWITCH, DPST, RATED 40A PER POLE, 120-277VAC, 100-HOUR CAPACITOR-DRIVEN BACK-UP, NEMA 4X ENCLOSURE, EQUIVALENT TO TORK MODEL EWZ103. CONDUIT OR CABLE INSTALLED IN CEILING OR WALL CONSTRUCTION. A-1,3 HOMERUN - EXTEND CONDUIT TO THE PANELBOARD BREAKER(S) OR DEVICE INDICATED. CIRCUITS SHARING A COMMON NEUTRAL SHALL BE CONNECTED TO DIFFERENT PHASES WITHIN THE PANELBOARD REGARDLESS OF THE NUMBERING ON THE DRAWINGS. CROSSHASHES INDICATE THE NUMBER OF CONDUCTORS IN A CIRCUIT, WHERE GREATER THAN TWO. CONDUCTORS SHALL BE A MINIMUM OF #12 FOR CIRCUITS RATED MORE THAN THAN TWO. CONDUCTORS SHALL BE A FIRM HOLD OF THE STATE OF THE SHALL BE PROVIDED WITH A GREEN CODE-SIZED EQUIPMENT GROUNDING CONDUCTOR. — - CONDUIT OR CABLE INSTALLED UNDERGROUND OR BENEATH THE FLOOR STRUCTURE.

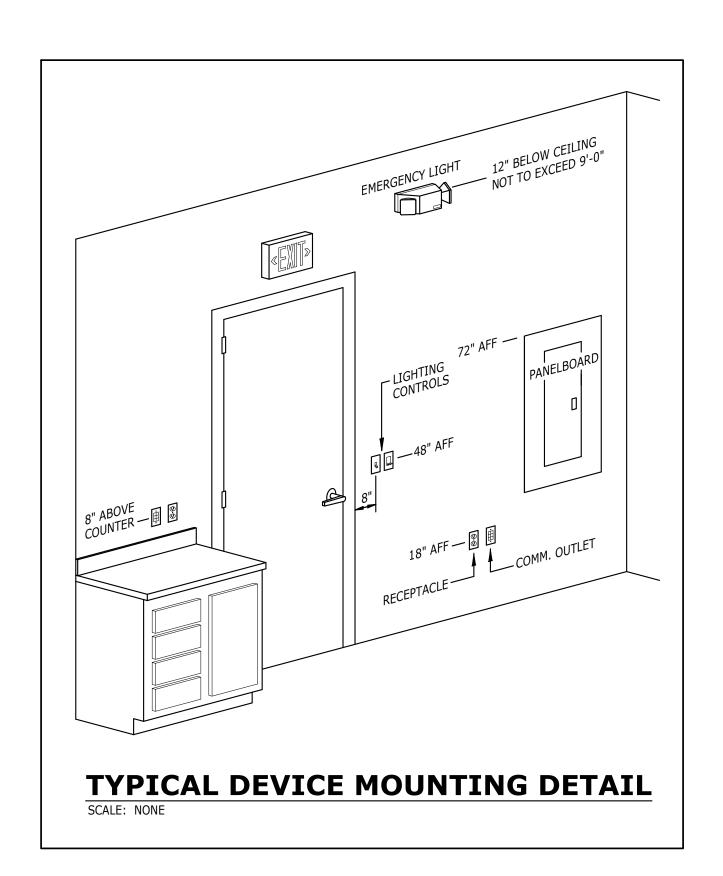

RESTROOM / EQUIPMNET BUILDING POWER PLAN SCALE: 1/4" = 1'-0"

A DESIGNATION	VOLTS: 208Y/120 AMPS: 225 SCCR: 25 KA TRIM: SURFACE		LUGS 2" x 6"	ΑΦ: ΒΦ: CΦ: TOT		5.6	KW KW KW KW	<u>'</u>				
DE	SCRIPTION		BKR	KW		-	ΑВ	С		KW	BKR	DESCRIPTION
LTG - RR / EQUIP BLDG	IST FLR INDOOR		20 / 1	0.4	1	\bigcirc	 - -	$ \cdot $	2	1.0	20 / :	1 RCPTS - RR / EQUIP BLDG IST FLR
LTG - RR / EQUIP BLDG	IST FLR EXTERIOR	VIA "TC"	20 / 1	0.1	3 -	$\overline{ }$	┢	<u> </u>	4		20 / :	1 S PA R E
LTG - SITE		VIA "TC"	20 / 1	0.6	5	$\overline{ }$	- -	╆╱┤	6		20 / :	1 S PA R E
HAND DRYER - WOMEN			20 / 1	1.0	7	\bigcirc	- -	-	8		20 / :	1 S PA R E
HAND DRYER - MEN			20 / 1	1.0	9	\bigcirc	╅		10	0.9	20 / :	1 MAESTRO CONTROLLER
SPARE			20 / 1		11	\cap	- -	╆╱╴	12	1.8	20 /	FEATURE PUMP MODULE
S PA R E 20 / 1			13	\bigcirc	 - -		14	1.8				
S PA R E 20 / 1			15	\cap	╅		16	1.8	/ 3	3		
PROVISION			17	\cap	- -	╆╱┤	18	1.8	20 /	FILTER MODULE		
PROVISION			19	\bigcirc	 - -	$+ \bigcirc$	20	1.8				
PROVISION					21	\subseteq	┢	$+ \bigcirc$	22	1.8	/ 3	3
PROVISION					23	$\overline{\mathcal{L}}$	- -	╆╱┤	24			PROVISION
PROVISION			25	\bigcirc	 		26			PROVISION		
PROVISION			27	$\overline{}$	┢	_	28			PROVISION		
PROVISION			29	\cap	- -	∔ △	30			PROVISION		

	LUMINAIRE SCHEDULE							
A2	NOMINAL 2-FOOT x 9"W x 4"D LUMINAIRE; IP-65; VANDAL RESISTANT; WET LABELED; INTEGRAL MOTION SENSOR CLG SURFACE-MOUNTED							
	20 W LED - NOMINAL 2000L, 3500°K, 80+ CRI							
	ECLIPSE CAT. NO. 572-SPL-20W-EBU-35K-WH-MS1							
А3	NOMINAL 3-FOOT x 9"W x 4"D LUMINAIRE; IP-65; VANDAL RESISTANT; WET LABELED; INTEGRAL MOTION SENSOR CLG SURFACE-MOUNTED							
	40 W LED - NOMINAL 4000L, 3500°K, 80+ CRI							
	ECLIPSE CAT. NO. 573-SPL-40W-EBU-35K-WH-MS1							
A4	NOMINAL 4-FOOT x 9"W x 4"D LUMINAIRE; IP-65; VANDAL RESISTAN WET LABELED; INTEGRAL MOTION SENSOR CLG SURFACE-MOUNTED							
	50 W LED - NOMINAL 5000L, 3500°K, 80+ CRI							
	ECLIPSE CAT. NO. 574-SPL-50W-EBU-35K-WH-MS1							
AE	NOMINAL 4-FOOT x 9"W x 4"D LUMINAIRE; IP-65 VANDAL; RESISTANT WET LABELED; INTEGRAL MOTION SENSOR INTEGRAL BATTERY BACK-UP; CEILING SURFACE-MOUNTED							
	50 W LED - NOMINAL 5000L, 3500°K, 80+ CRI							
	ECLIPSE CAT. NO. 574-SPL-50W-EBU-35K-WH-MS1-EL85							

Jerry W. Reynolds architect
architecture planning interior design
904 WEST CYNTHIA TRAIL
GOODLETTSVILLE, TN 37072-3517
PHONE (615) 855 - 0406



RESERVED FOR CONSULTANT LOGO

ND RECREATION FUND

E DEPARTMENT OF ENVIRONMENT AND CONSERVATION

EQUIPMENT BUILDING

PARK SPLASH PAR

THE STATE OF THE ST

NO. DATE BY REVISION

DRAWN BY JAMES REED

PROJECT INFORMATION

DRAWN BY JAMES REED

DESIGNED BY JAMES REED

APPROVED BY JAMES REED


JOB NO. 5171556


DATE 2/9/2018

SCALE AS NOTED

FLOOR PLANS, LEGEND, NOTES, DETAILS, SCHEDULES

E2.1

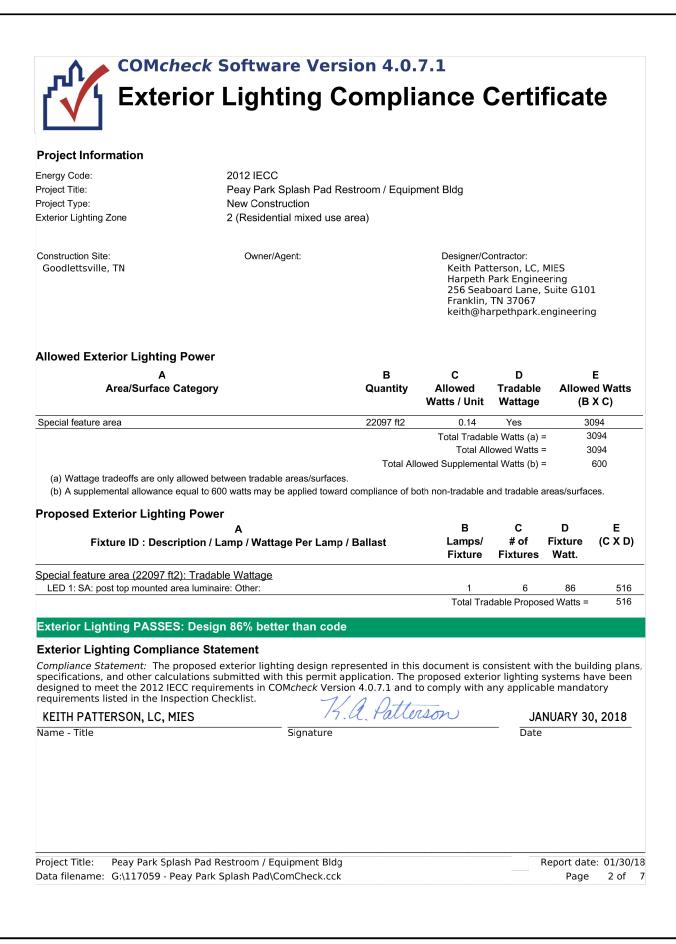

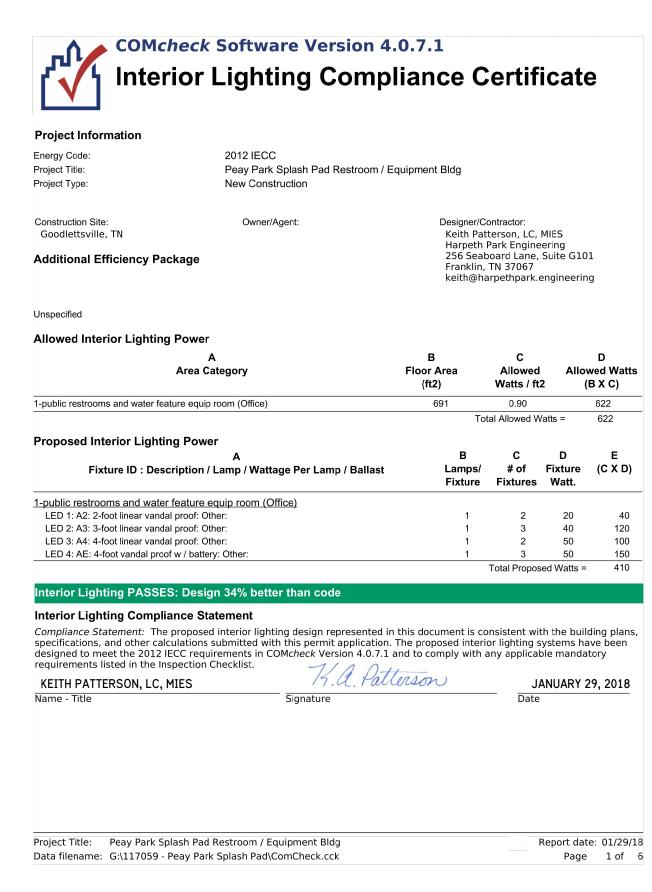

SPECIFICATIONS


1.01 THE ELECTRICAL CONTRACT WORK SHALL INCLUDE ALL ELECTRICAL MATERIALS AND INSTALLATION TO RESULT IN A BUILDING READY AND SUITABLE FOR USE AS INTENDED BY OWNER. THE CONTRACTOR SHALL REFER TO ALL PLANS AND SPECIFICATIONS WITHIN THE CONTRACT DOCUMENTS TO DETERMINE THE SCOPE OF WORK FOR THE PROJECT.


1.02 ALL ELECTRICAL INSTALLATIONS SHALL BE MADE IN ACCORDANCE WITH THE LATEST EDITION OF THE NATIONAL ELECTRICAL CODE AND OTHER CODES IN FORCE WITHIN THE JURISDICTION OF THE PROJECT. ALL MATERIALS EMPLOYED SHALL BE UL LISTED AND APPROVED AND BEAR THE UL OFFICIAL LABELS WHERE SUCH LABELING IS CUSTOMARY. IN THE EVENT THAT LOCAL CODES ARE MORE RIGID THAN THE NATIONAL ELECTRIC CODE, BOTH CODES SHALL THEN BE CONSIDERED AS JOINTLY GOVERNING AND THE REQUIREMENTS OF THE MOST RIGID SHALL THEN PREVAIL. THE CONTRACTOR SHALL BE RESPONSIBLE FOR THE PROPER SELECTION AND APPLICATION OF MATERIALS AND METHODS OF THEIR INSTALLATION. PRINCIPAL FEATURES ARE AS FOLLOWS:

- A. LIGHTING FIXTURES AND LAMPS.
- B. ELECTRICAL SERVICE ENTRANCE.
- C. A SYSTEM OF ELECTRICAL FEEDERS, PANELBOARDS, AND BRANCH CIRCUIT WIRING TO PROVIDE A COMPLETE POWER DISTRIBUTION SYSTEM.
- D. WIRING DEVICES INCLUDING OUTLETS, SWITCHES, AND COVERPLATES.
- LIGHTING, INCLUDING EGRESS AND EMERGENCY LIGHTING.
- CONNECTION OF EQUIPMENT, INCLUDING HVAC, PLUMBING, AND OTHER EQUIPMENT AS INDICATED ON THE PLANS.
- G. RACEWAYS, OUTLET BOXES, AND OTHER PROVISIONS FOR OWNER-PROVIDED DATA NETWORK AND COMMUNICATION SYSTEMS.
- H. DEMOLITION AND REMOVAL OF EXISTING ELECTRICAL SYSTEMS.
- 1.03 POWER SERVICE
- A. POWER SERVICE SHALL BE 208Y/120-VOLTS, 3-PHASE, 4-WIRE.
- 1.04 DISTRIBUTION SYSTEM


A. DISTRIBUTION EQUIPMENT AND BRANCH CIRCUIT PANELBOARDS SHALL BE MOLDED CASE CIRCUIT BREAKER EQUIPMENT HAVING THE NECESSARY INTERRUPTING RATINGS BUT NOT LESS THAN 10,000 AIC. GROUND FAULT SENSING AND AUTOMATIC INTERRUPTING SHALL BE FURNISHED ON ANY OUTDOOR POWER CIRCUITS AND AS OTHERWISE REQUIRED. EQUIPMENT SHALL BE SQUARE-D OR EQUAL.

- B. ALL CONDUCTORS SHALL BE COPPER.
- C. CONDUIT SHALL BE AS PERMITTED BY APPLICABLE CODES. MINIMUM CONDUIT SIZE SHALL BE 3/4-INCHES. CONDUIT FOR BUILDING INTERIOR SHALL BE ELECTRICAL METALLIC TUBING (EMT) WITH SET-SCREW FITTINGS. CONDUIT BELOW GRADE AND UNDER THE SLAB SHALL BE PVC RIGID NON-METALLIC CONDUIT (RNC). EXTERIOR CONDUIT AND CONDUIT SUBJECT TO DAMAGE SHALL GALVANIZED RIGID METAL CONDUIT (RMC). UNLESS PARTICULARLY STATED OTHERWISE, ALL CONDUIT AND WIRING SHALL BE RUN CONCEALED.
- D. WHERE ALLOWED BY CODE, INTERIOR BRANCH CIRCUITS RATED 50-AMPERES OR LESS MAY USE METAL CLAD (TYPE "MC") CABLE.
- 1.05 GROUNDING
- A. PROVIDE CODE GROUNDING FOR ALL INSTALLED SYSTEMS. EACH CONDUIT SHALL HAVE A GREEN, INSULATED, CODE-SIZED GROUND CONDUCTOR THAT SHALL BE BONDED TO ALL METAL PARTS. THE CONDUIT SYSTEM SHALL NOT BE USED AS THE SOLE GROUNDING PATH.
- 1.06 LIGHTING
- A. LIGHTING SHALL BE FURNISHED FOR ALL OCCUPIED SPACES WITHIN AND OUTSIDE THE BUILDING. LIGHTING LEVELS SHALL BE ADEQUATE FOR TASK PERFORMED AND GENERALLY COMPLY WITH IES RECOMMENDATIONS. CONTROLS SHALL BE CONVENIENT FOR THE USE INTENDED WITH LOCAL SWITCHING AND 3-WAY OR 4-WAY CONTROLS AS NECESSARY. EXTERIOR LIGHTING SHALL BE AS NOTED ON DRAWINGS.
- 1.07 CONNECTION OF EQUIPMENT
- A. THE ELECTRICAL CONTRACTOR SHALL CONNECT ALL MECHANICAL EQUIPMENT FURNISHED BY OTHER TRADES INCLUDING HVAC EQUIPMENT AND PLUMBING EQUIPMENT. THE ELECTRICAL CONTRACTOR SHALL REVIEW SUBMITTAL AND CUTSHEET INFORMATION OF EACH PIECE OF EQUIPMENT AND SHALL VERIFY VOLTAGE, CAPACITY AND PHASE OF EQUIPMENT PRIOR TO ROUGH-IN. ANY CONFLICTS SHALL BE BROUGHT TO THE ATTENTION OF THE OWNER'S REPRESENTATIVES AND EQUIPMENT SUPPLIERS. WHERE REQUIRED, THE ELECTRICAL CONTRACTOR SHALL FURNISH DISCONNECT SWITCHES AND MANUAL MOTOR STARTERS. ALL MOTOR STARTER HEATER ELEMENTS AND OVERCURRENT PROTECTION SHALL BE CHECKED FOR PROPER APPLICATION TO THE DEVICE BEING SERVED. DISCONNECTS AND SWITCHES SHALL BE SQUARE-D COMPANY OR EQUAL.
- 1.08 WIRING DEVICES
- WIRING DEVICES SHALL BE INSTALLED AS INDICATED ON THE PLANS AND WHERE NECESSARY TO CONNECT EQUIPMENT. A STANDARD SIZE NYLON WALL PLATES SHALL BE INSTALLED FOR EACH DEVICE. THE COLOR OF THE WALL PLATE AND WIRING DEVICE SHALL BE SELECTED BY THE OWNER'S REPRESENTATIVE. ALL WIRING DEVICES SHALL BE MOUNTED FLUSH IN WALL UNLESS INDICATED OTHERWISE.
- B. TOGGLE SWITCHES SHALL BE SPECIFICATION GRADE RATED 120-277 VOLTS, 20-AMPS, BACK- AND SIDE-WIRED. PROVIDE SINGLE POLE, 3-WAY, OR 4-WAY AS REQUIRED. HUBBELL #CS1221 SERIES OR EQUAL.
- C. RECEPTACLES SHALL BE SPECIFICATION GRADE RATED 20-AMPS AT 120-VOLTS, BACK- AND SIDE-WIRED. STANDARD RECEPTACLES SHALL BE HUBBELL #HBL5352 SERIES OR EQUAL. GROUND-FAULT PROTECTED RECEPTACLES SHALL BE PROVIDED WITH AN LED VISUAL INDICATOR, HUBBELL #GF20L SERIES OR EQUAL.
- D. RECEPTACLES INSTALLED OUTDOORS SHALL BE SPECIFICATION GRADE, GFCI, 120-VOLT, 20-AMP WEATHER RESISTANT (WR) WITH WHILE-IN-USE COVER: HUBBELL #GFTR20 SERIES WITH RED DOT #CKMUV COVER, OR AS APPROVED.
- 1.09 EMERGENCY POWER
- A. EXIT LIGHTING AND CERTAIN OTHER LUMINAIRES SHALL BE EQUIPPED WITH INDIVIDUALLY MOUNTED BATTERY PACKS WITH AUTOMATIC CHARGING AND SWITCHING OPERATIONS IN THE EVENT OF LOSS OF NORMAL BUILDING POWER. THE EMERGENCY POWER SHALL BE WIRING TO AN UNSWITCHED "HOT" CONDUCTOR TO ALLOW FOR PROPER OPERATION.
- 1.10 MATERIALS
- A. BASIC MATERIALS AND DEVICES REQUIRED IN THE WIRING SYSTEMS SHALL BE UL APPROVED STANDARDS. IN THE EVENT THAT UL STANDARD IS REVISED, SUPPLEMENTED, OR MODIFIED, ETC., THE LATEST REQUIREMENTS SHALL THEN GOVERN.
- B. AT THE REQUEST OF THE OWNER OR HIS DESIGNATED REPRESENTATIVE, THE CONTRACTOR SHALL SUBMIT A LIST OF MATERIALS PROPOSED TO BE USED IN THE CONSTRUCTION OR PROVIDE SAMPLES, ETC., FULLY ESTABLISHING THE TYPE, GRADE, AND QUALITY OF EACH DEVICE OR ITEM OF MATERIAL. THE CONTRACTOR SHALL BE RESPONSIBLE FOR INSTALLING ONLY SUCH DEVICES AND MATERIALS AS OBVIOUSLY MEET GOVERNING REQUIREMENTS.
- C. CABINETS SHALL BE CONSTRUCTED OF SHEET STEEL, OF CODE GAUGE, AND FOR EITHER SURFACE OR FLUSH MOUNTING AS SHOWN ON DRAWINGS. SURFACES SHALL BE BONDERIZED TO RESIST CORROSION OR RUSTING. CABINETS FOR INTERIOR INSTALLATION IN FINISHED SPACES SHALL HAVE DOOR AND TRIMS PAINTED TO MATCH SURROUNDINGS.
- D. CABINETS MOUNTED OUTDOORS SHALL BE OF WEATHERPROOF CONSTRUCTION WITH A FINISH TO ADEQUATELY PROTECT THE METAL AGAINST ACTION OF THE ELEMENTS. A MEANS OF LOCKING COVERS OR DOORS OVER THE CIRCUIT PROTECTIVE SECTIONS SHALL BE PROVIDED.
- 1.11 WORK QUALITY
- A. ALL ELECTRICAL WORK SHALL BE SPECIFIED TO BE PERFORMED IN A WORKMANLIKE AND PROFESSIONAL MANNER BY WORKMEN SKILLED IN THE TRADE REQUIRED. THE WORK SHALL RESULT IN A FINISHED AND OPERATING SYSTEM.
- 1.12 GUARANTEE
- A. THE ELECTRICAL CONTRACTOR SHALL GUARANTEE ALL WORK TO BE FREE OF GROUNDS AND SHORT CIRCUITS AND SHALL REPAIR OR REPLACE ALL DEFECTIVE WORK WITHIN A PERIOD OF ONE YEAR AFTER THE DATE OF SUBSTANTIAL COMPLETION.
- 1.13 CODES, PERMITS, FEES
- A. THE ELECTRICAL CONTRACTOR SHALL PAY FOR AND SECURE ALL NECESSARY PERMITS. THE CONTRACTOR IS RESPONSIBLE FOR ALL CHARGES, FEES OR CONTRIBUTIONS TO CONSTRUCTION REQUIRED BY THE ELECTRICAL UTILITY.

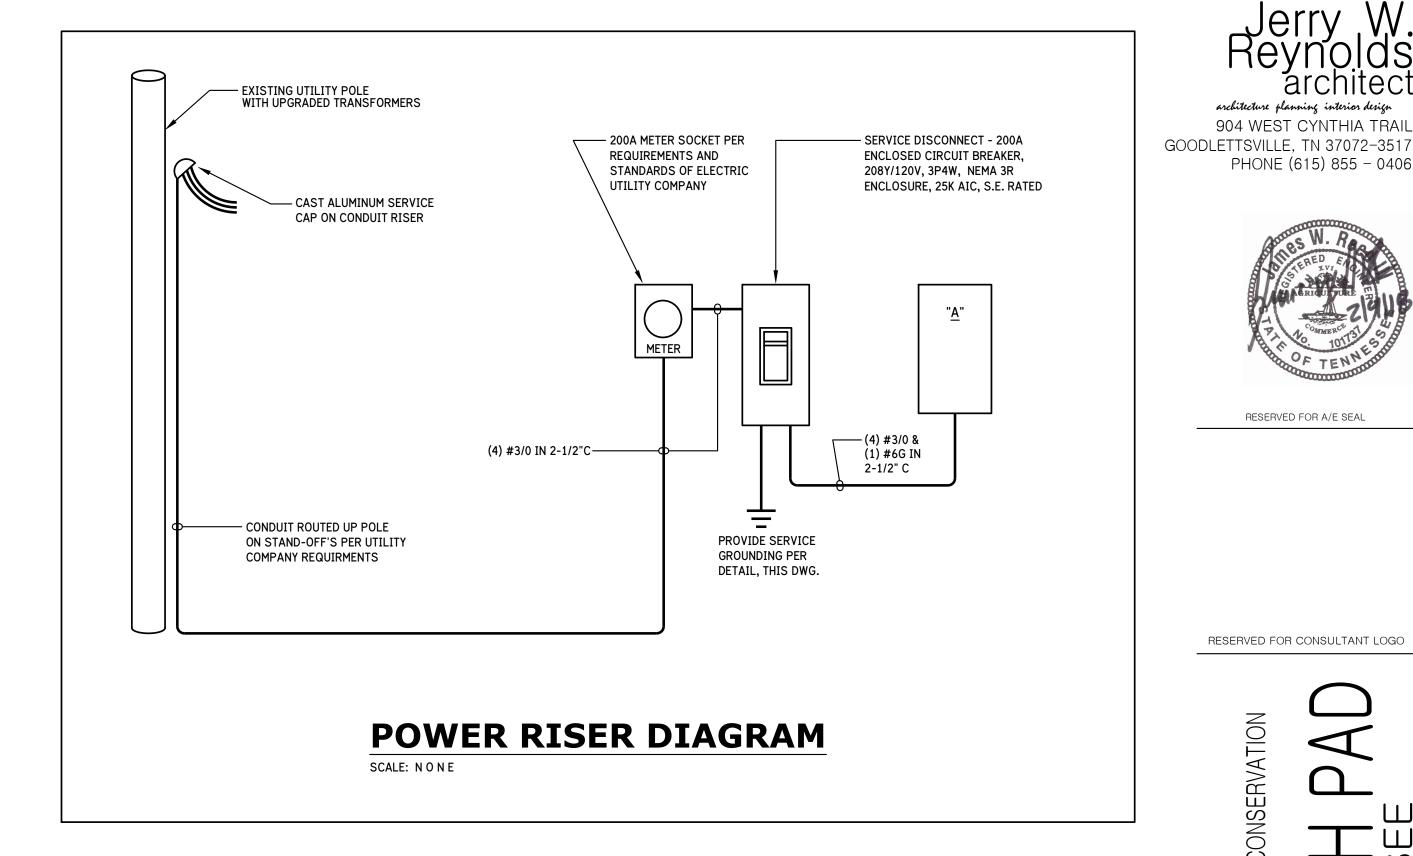

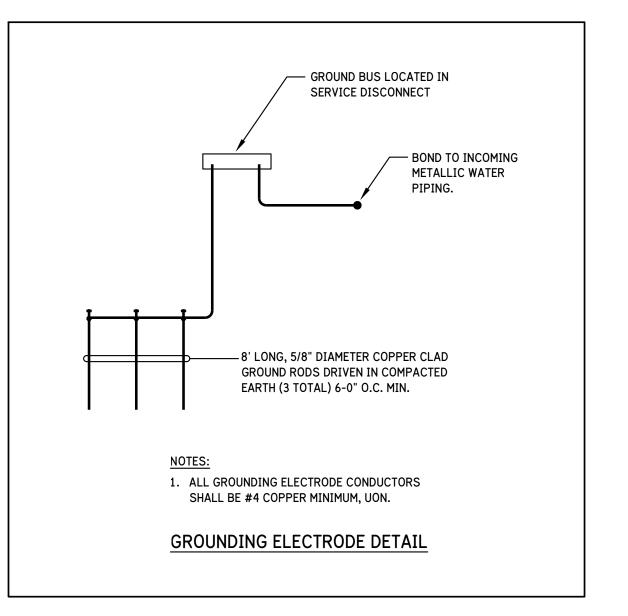



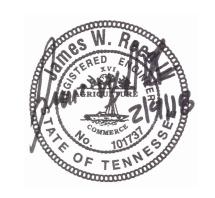

PHONE (615) 855 - 0406

RESERVED FOR A/E SEAL

RESERVED FOR CONSULTANT LOGO

PROJECT INFORMATION

DRAWN BY JAMES REED DESIGNED BY JAMES REED APPROVED BY JAMES REED JOB NO. 5171556 DATE 2/9/2018

NO. DATE BY REVISION

RISER DIAGRAM,

AS NOTED

CADD FILE NO.

SCALE