

**CONTRACT PLANS COMPONENTS:**

- ROADWAY PLANS
- SIGNING AND PAVEMENT MARKING PLANS
- SIGNALIZATION PLANS
- LIGHTING PLANS
- LANDSCAPE AND IRRIGATION PLANS
- STRUCTURAL PLANS

FDOT FPN# 431759-2-54-01

# INDIAN RIVER COUNTY BOARD OF COUNTY COMMISSIONERS

RECEIVED

JAN 08, 2018

INDIAN RIVER COUNTY  
ENGINEERING DIVISION

**INDEX OF SHEETS**

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**STATE ROUTE 60  
WIDENING, MILL & RESURFACE  
FROM 44TH AVENUE TO 38TH AVENUE**

&

**43RD AVENUE  
RECONSTRUCTION  
FROM 19TH STREET TO 26TH STREET**

**BEGIN BRIDGE STATION 129+62.455  
END BRIDGE STATION 130+94.455**

PUBLIC WORKS DIRECTOR:  
RICHARD B. SZPYRKA, P.E.

COUNTY ENGINEER:  
JAMES W. ENNIS, P.E.

PROJECT MANAGER:  
WILLIAM JOHNSON, P.E.

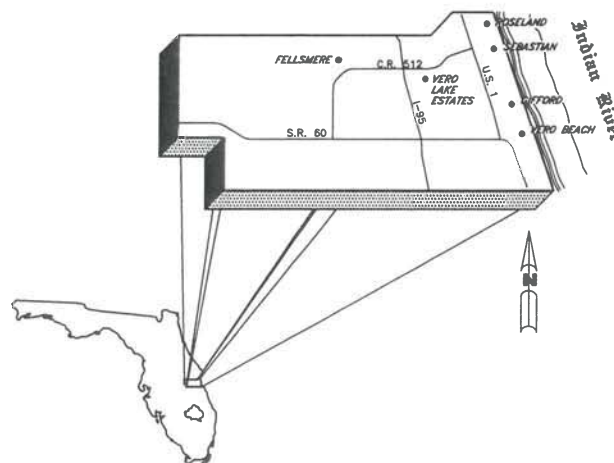
**LENGTH OF PROJECT**

	SR 60		43RD AVE.	
	MILES	FEET	MILES	FEET
ROADWAY	0.476	2512	0.806	4254
BRIDGES	-	-	0.033	174
NET LENGTH OF PROJECT	0.476	2512	0.839	4428
EXCEPTIONS	-	-	-	-
GROSS LENGTH OF PROJECT	0.476	2512	0.839	4428

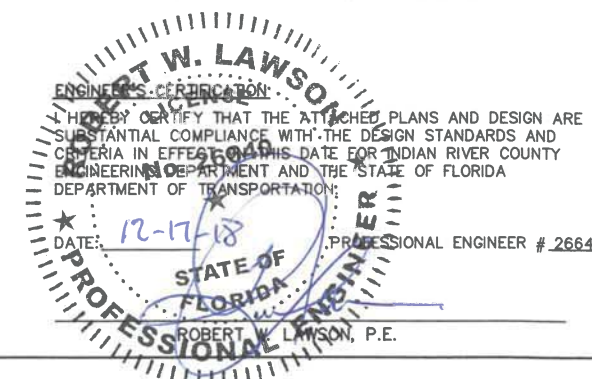
THESE PLANS HAVE BEEN PREPARED IN ACCORDANCE WITH AND ARE GOVERNED BY THE FLORIDA DEPARTMENT OF TRANSPORTATION, DESIGN STANDARDS (2017-2018 EDITION) AND SUPPLEMENTS THERETO.

**GOVERNING SPECIFICATIONS:**

THE FLORIDA DEPARTMENT OF TRANSPORTATION, STANDARD SPECIFICATIONS FOR ROAD & BRIDGE CONSTRUCTION, 2017 EDITION, SUPPLEMENTS THERETO, AND SPECIAL PROVISIONS THERETO IF NOTED IN THE CONTRACT SPECIFICATIONS FOR THIS PROJECT.



ATTENTION IS DIRECTED TO THE FACT THAT THESE PLANS MAY HAVE BEEN ALTERED IN SIZE BY REPRODUCTION. THIS MUST BE CONSIDERED WHEN OBTAINING SCALED DATA.



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EB7817 / LB7062

Department of Public Works  
Engineering Division

No.	
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By:	
Date:	

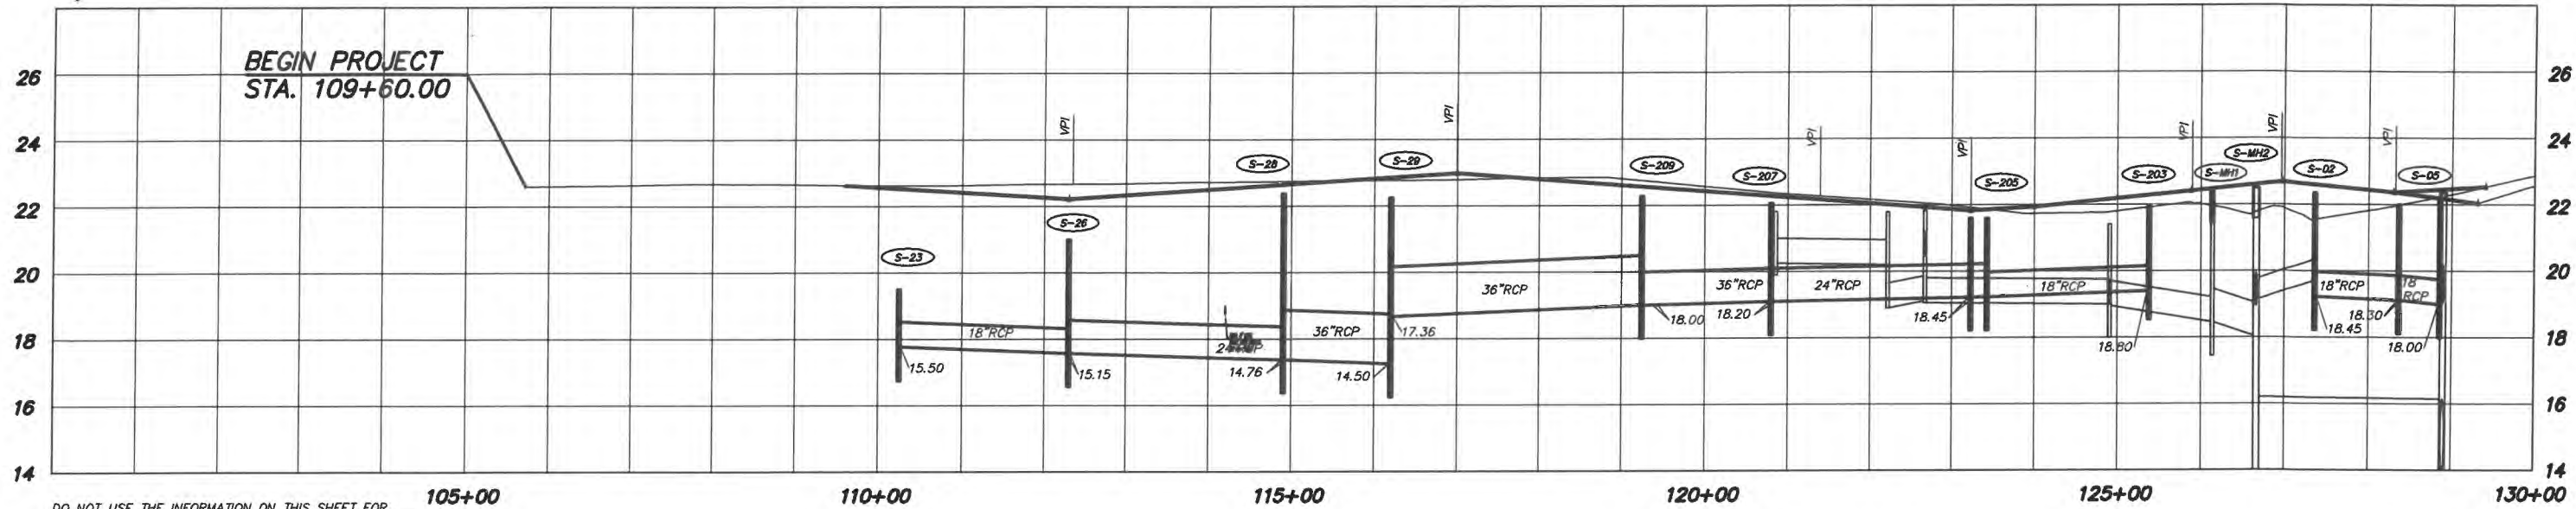
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Date: 6/2017

**STATE ROUTE 60  
&  
43RD AVENUE**

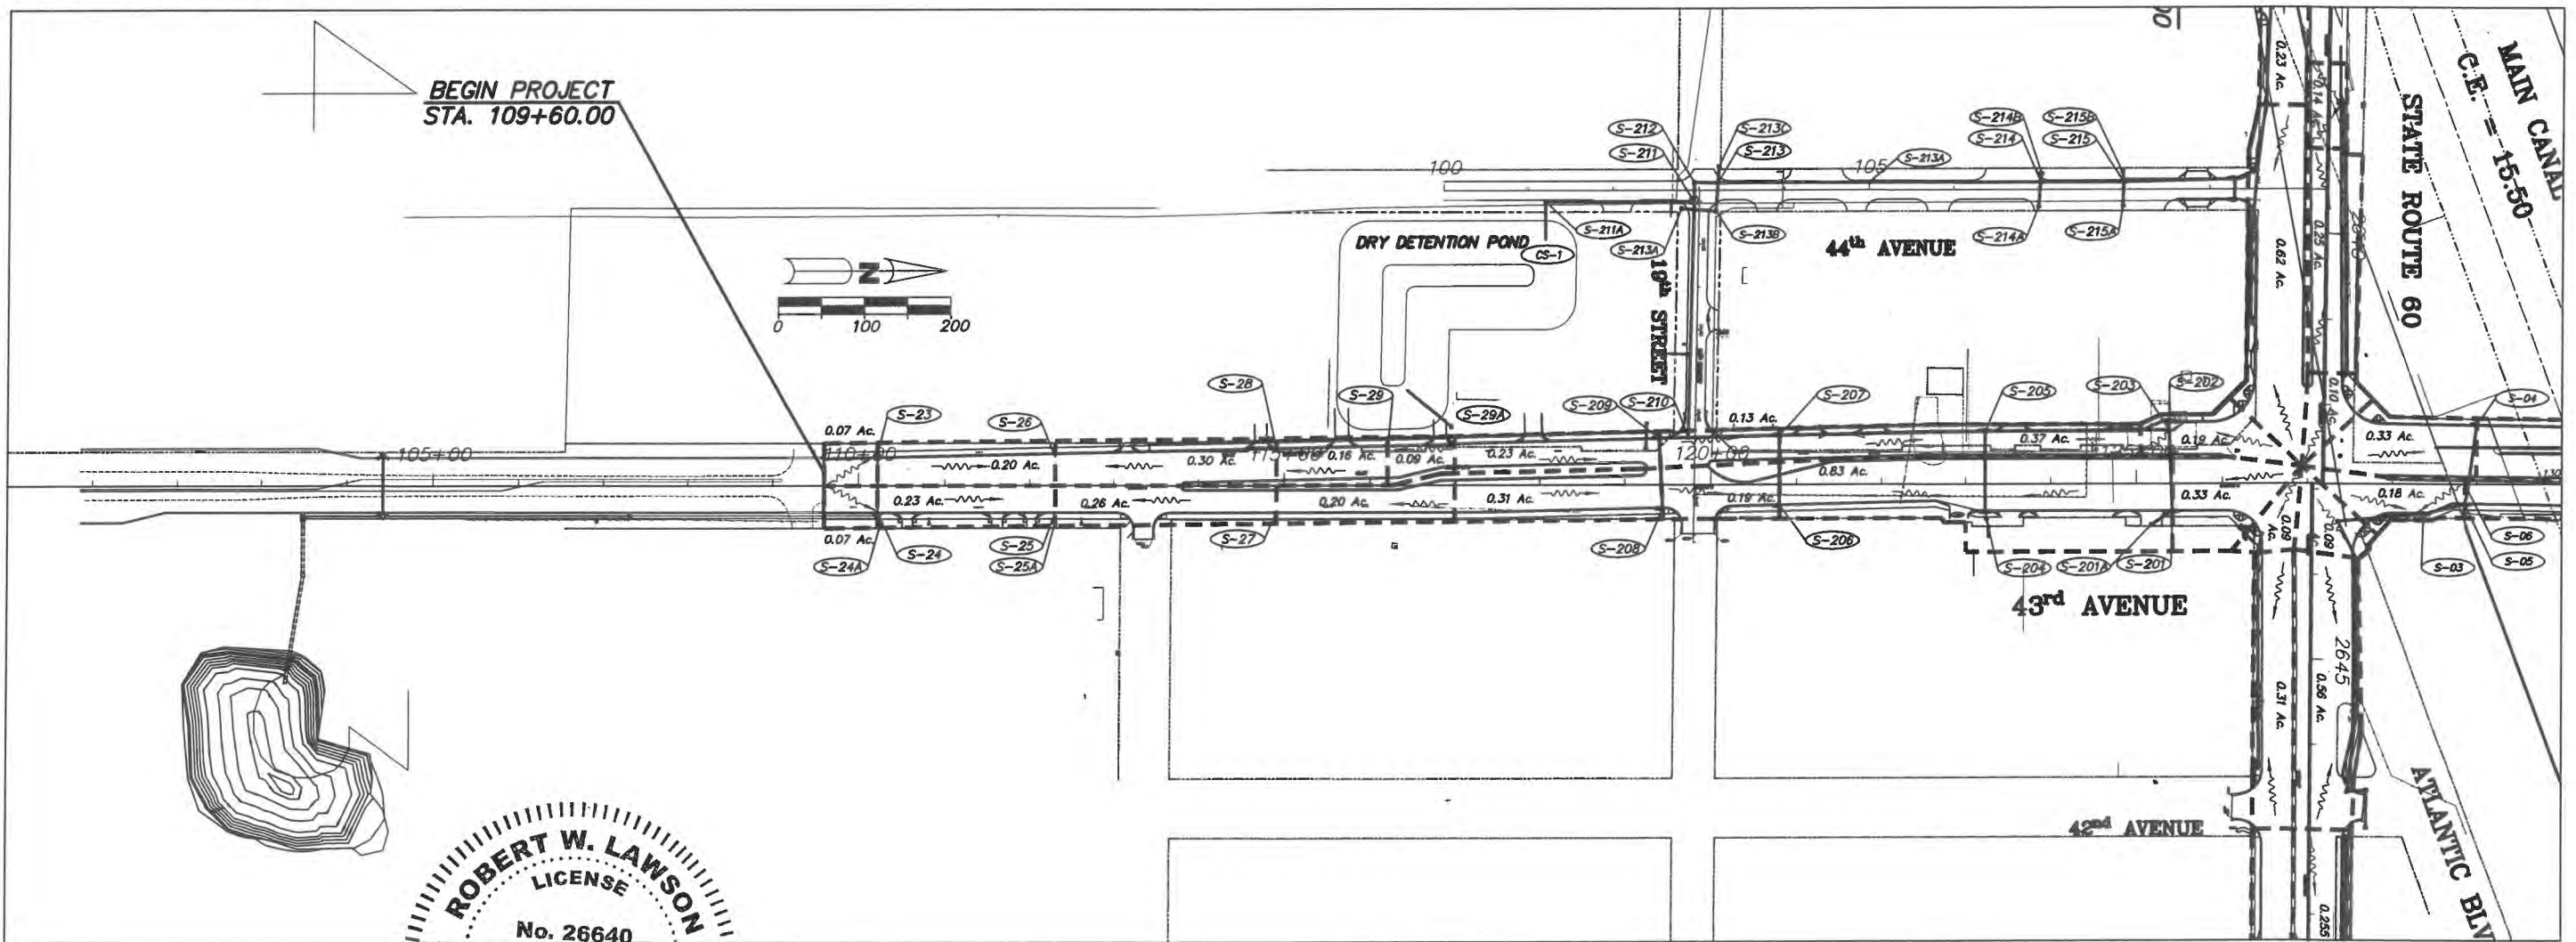
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LNW#	WP1027

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**ROBERT W. LAWSON**  
 LICENSE  
 No. 26640  
 PROFESSIONAL ENGINEER  
 STATE OF FLORIDA  
 DEC 17 2018

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INDIAN RIVER COUNTY  
 FLORIDA  
**Department of Public Works**  
 Engineering Division

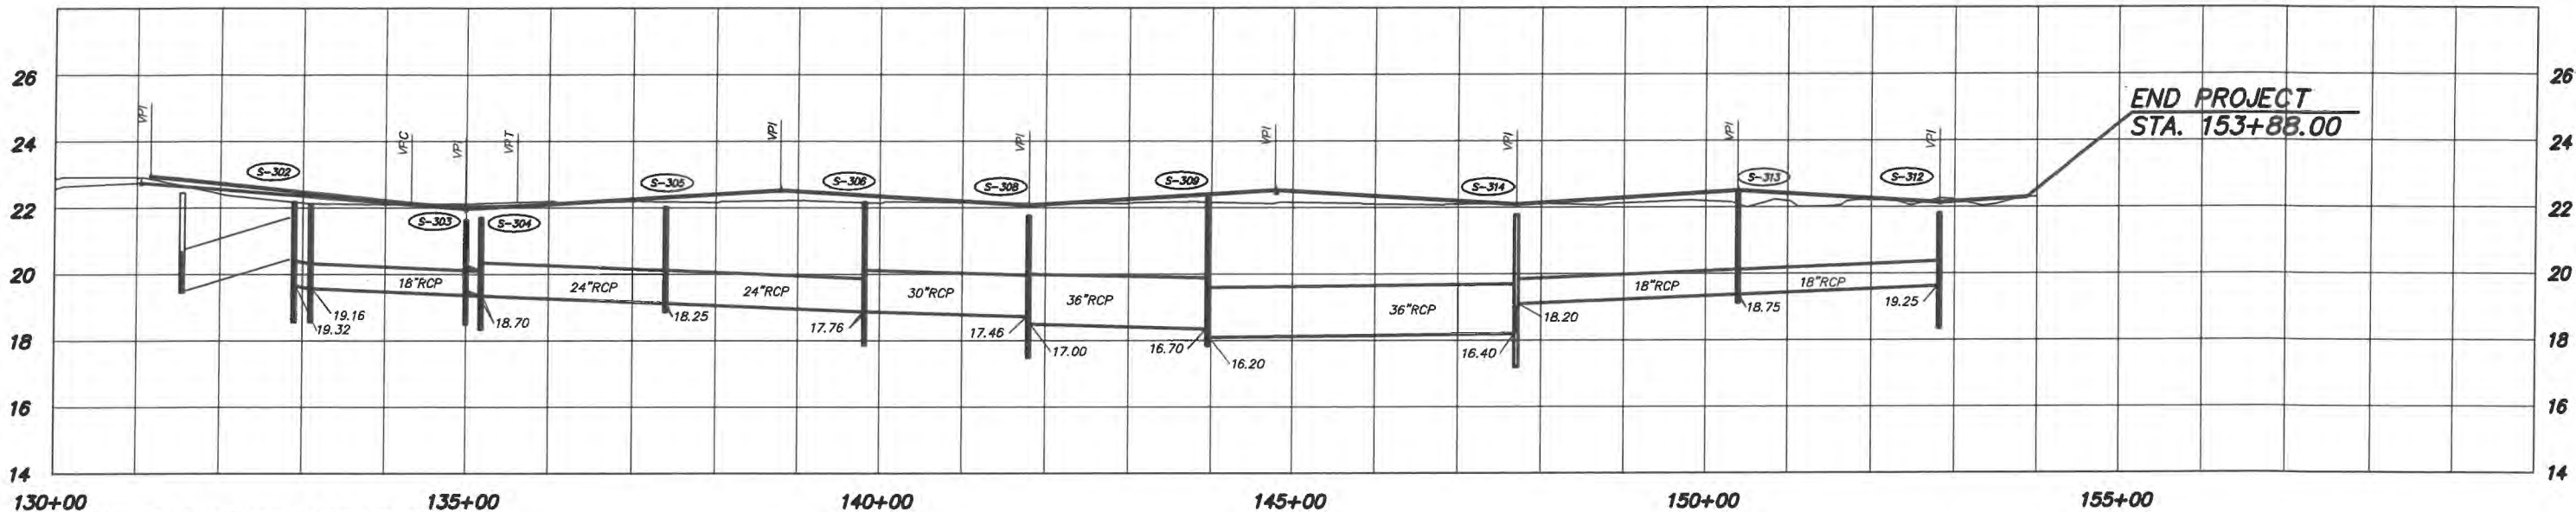
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 FOR  
**SR 60 & 43RD AVENUE**

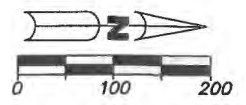
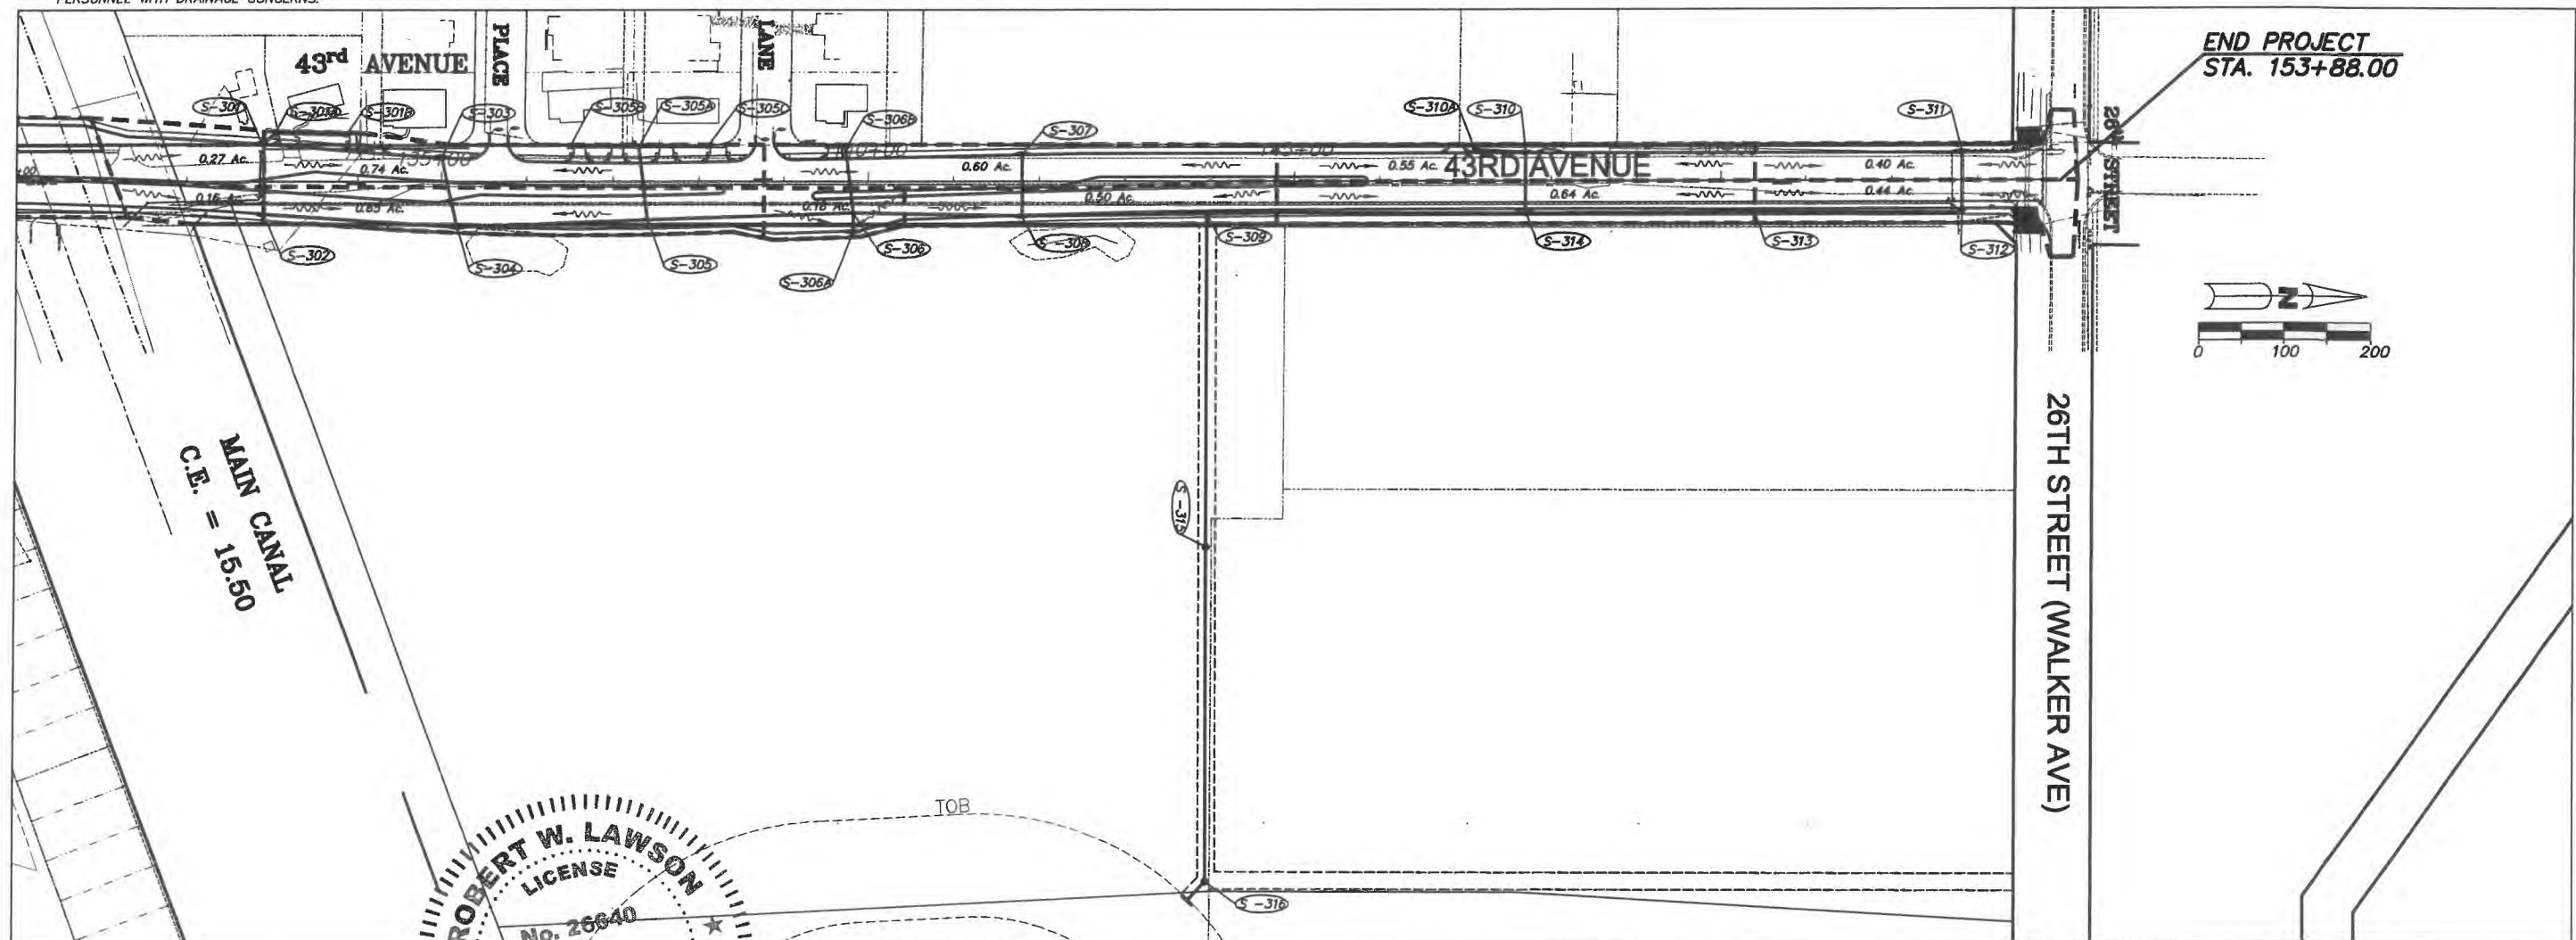
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**ROBERT W. LAWSON**  
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 Engineering Division

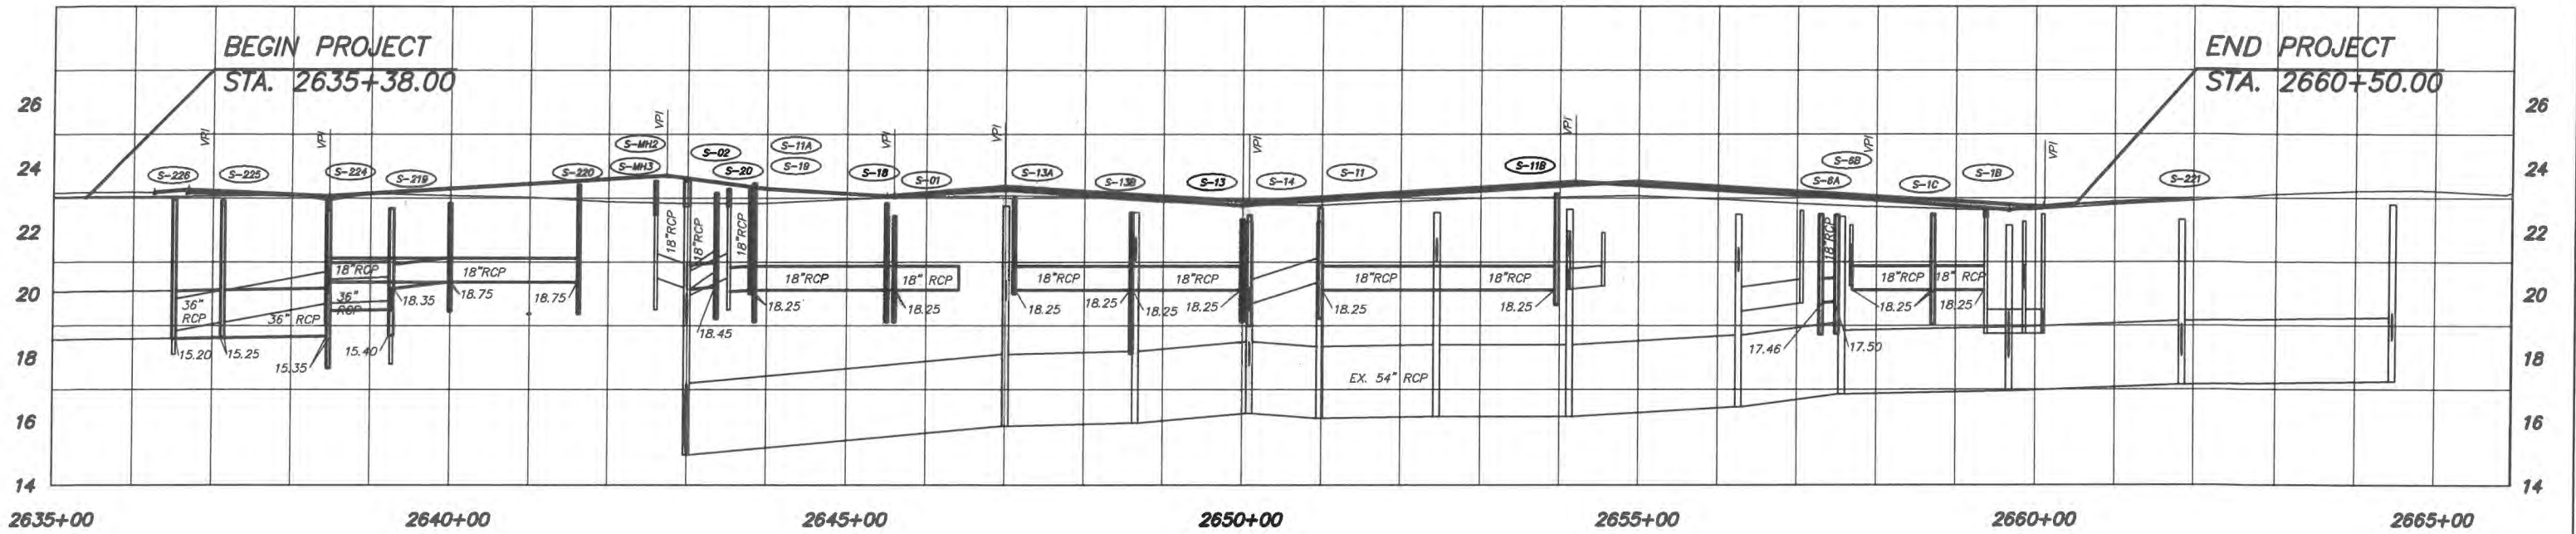
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 FOR  
 SR 60 & 43RD AVENUE

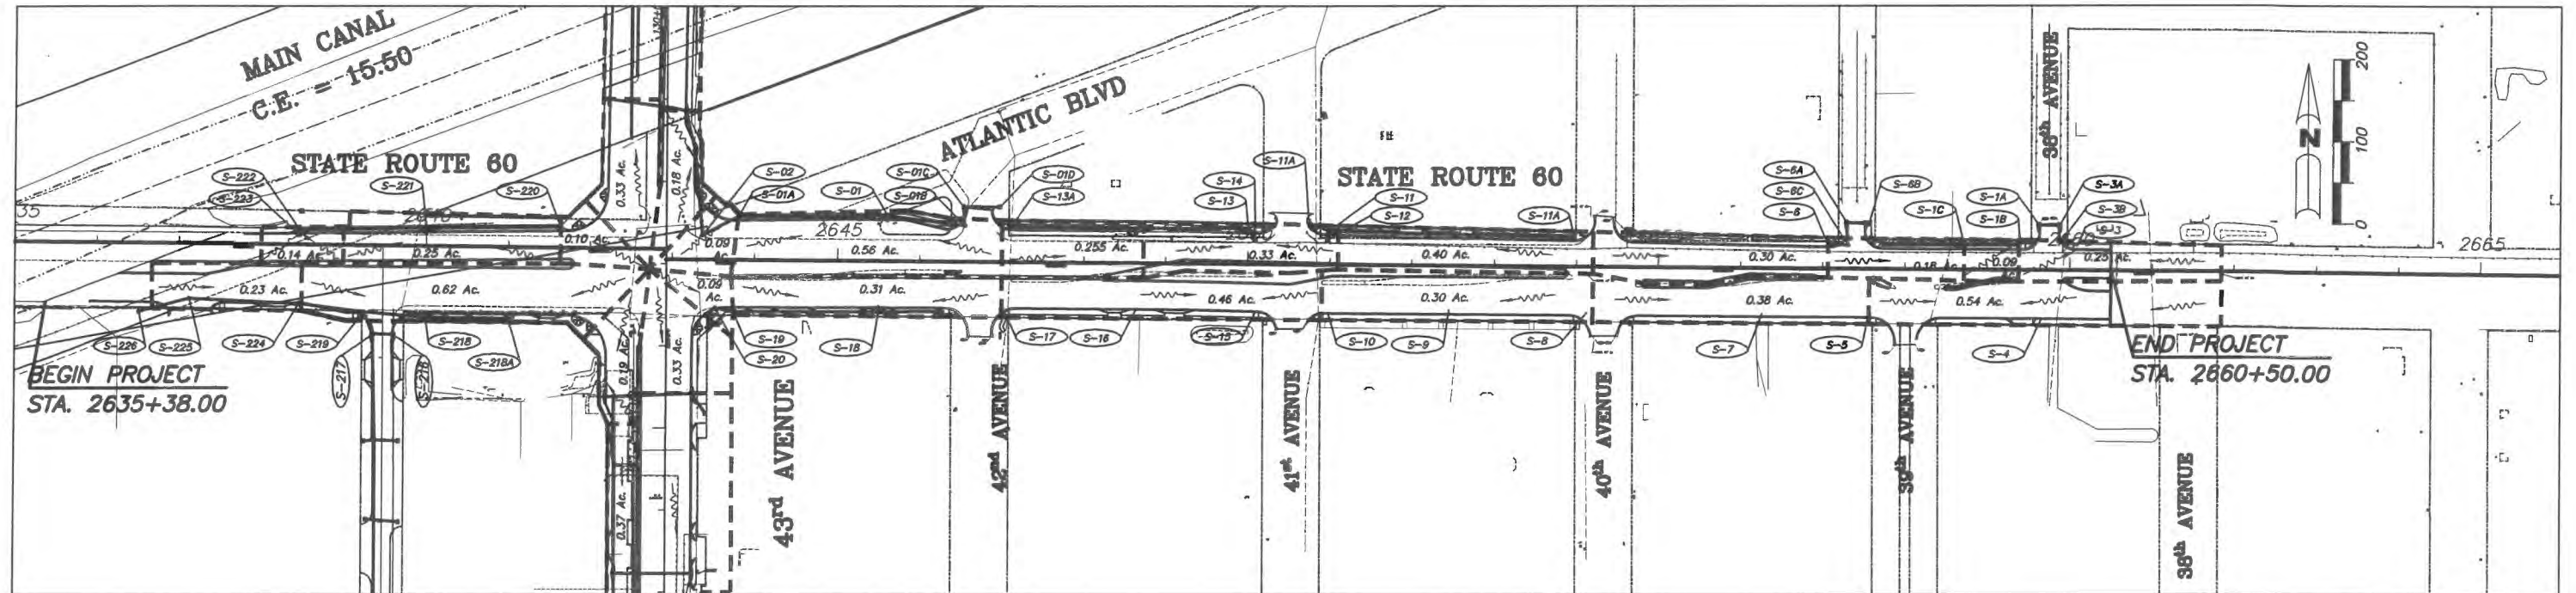
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


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**ROBERT W. LAWSON**  
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 PROFESSIONAL ENGINEER  
 LB7082

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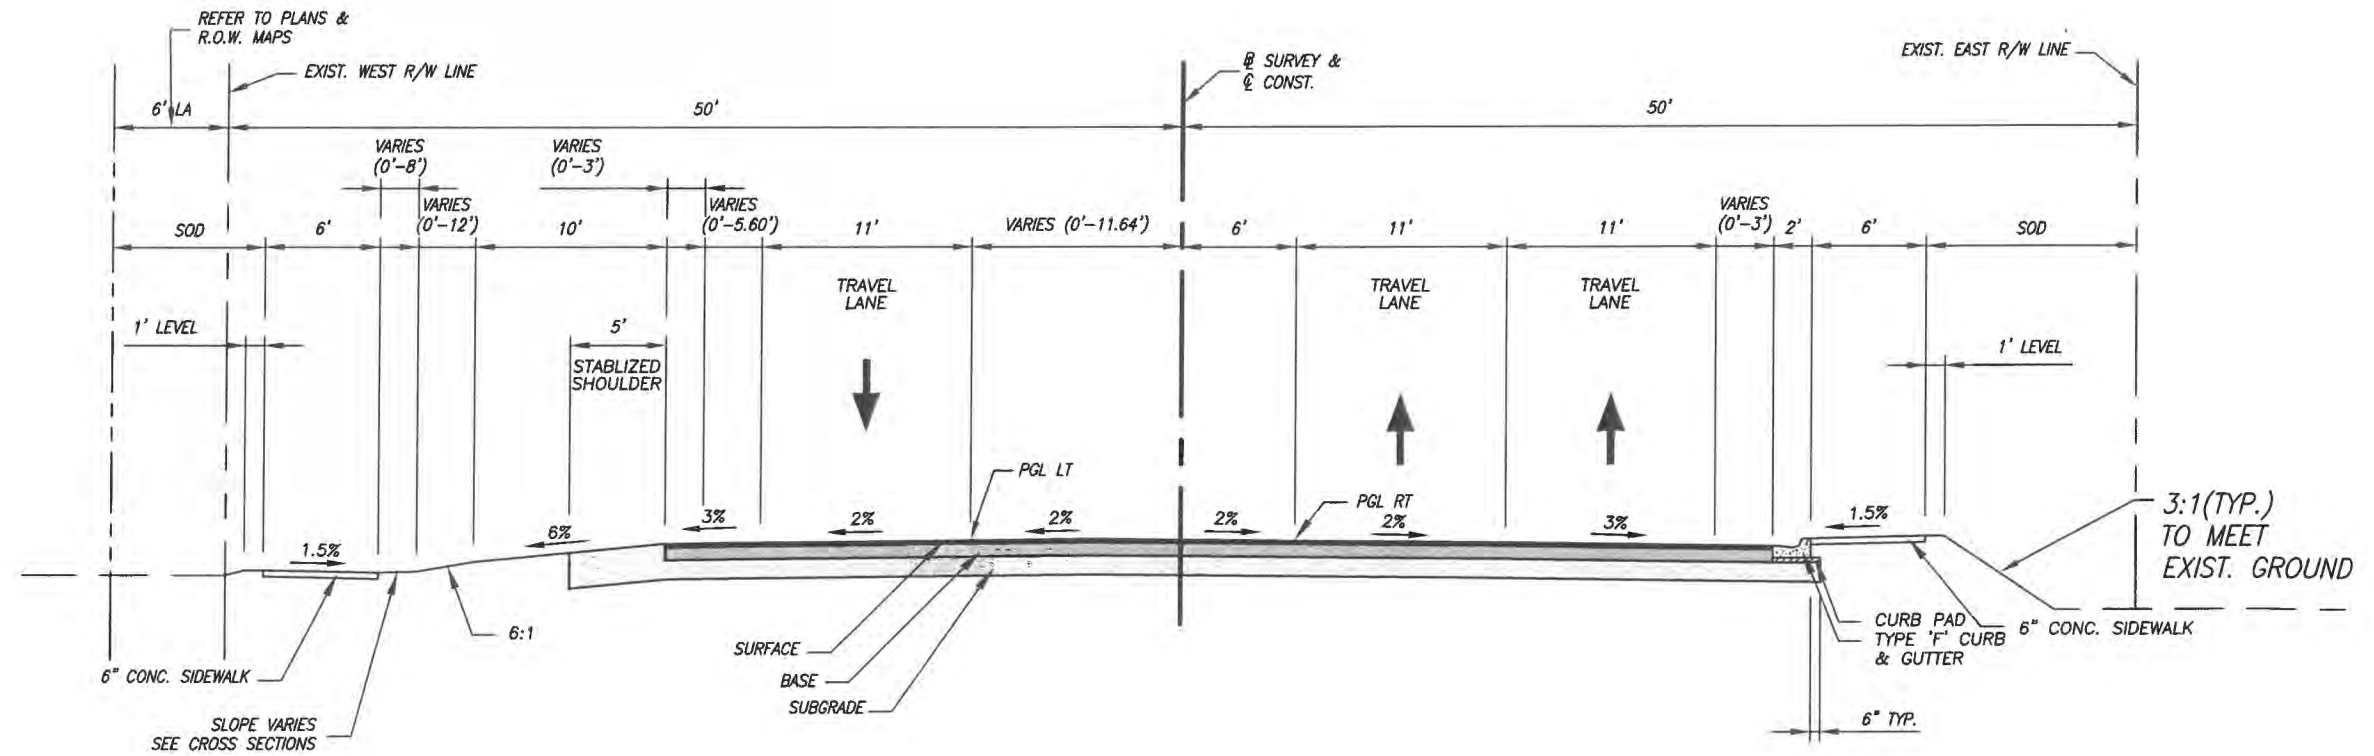
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**TYPICAL SECTION NOTES:**

1. ALL PAVED AREAS WITHIN THE PROJECT LIMITS WHICH ARE NOT SPECIFICALLY COVERED BY A "TYPICAL SECTION" SHALL BE CONSTRUCTED IN ACCORDANCE WITH THE PAVEMENT SPECIFICATIONS INDICATED HEREON, UNLESS OTHERWISE NOTED.
2. WHEN LOCATED ON THE HIGH SIDE OF THE ROADWAY, CURB & GUTTER TYPE "F" SHALL BE MODIFIED IN ACCORDANCE WITH FDOT STANDARD INDEX NO. 300
3. CURB PADS SHALL BE CONSTRUCTED OF 6" BASEROCK OR 3" OF B-12.5 AND SHALL EXTEND A MINIMUM OF 6" BEYOND THE BACK OF CURB. COST OF CURB PAD SHALL BE INCLUDED IN THE PRICE FOR CURB & GUTTER

**DESIGN SPEED 45 MPH**

**TYPICAL SECTION  
STA. 109+60.00 TO STA. 113+98.70  
43RD AVENUE**

NEW CONSTRUCTION	
SURFACE:	1" TYPE FC-9.5 ASPHALTIC CONCRETE SURFACE COURSE (TRAFFIC C) OVER 1-1/2" TYPE SP-12.5 (TRAFFIC C) ASPHALTIC CONCRETE STRUCTURAL COURSE
BASE:	9" CEMENTED COQUINA SHELL (DOUBLE COURSE) WITH RC-70 PRIME COAT (LBR 100)
SUBGRADE:	12" STABILIZED SUBGRADE TYPE "B" (LBR-40)



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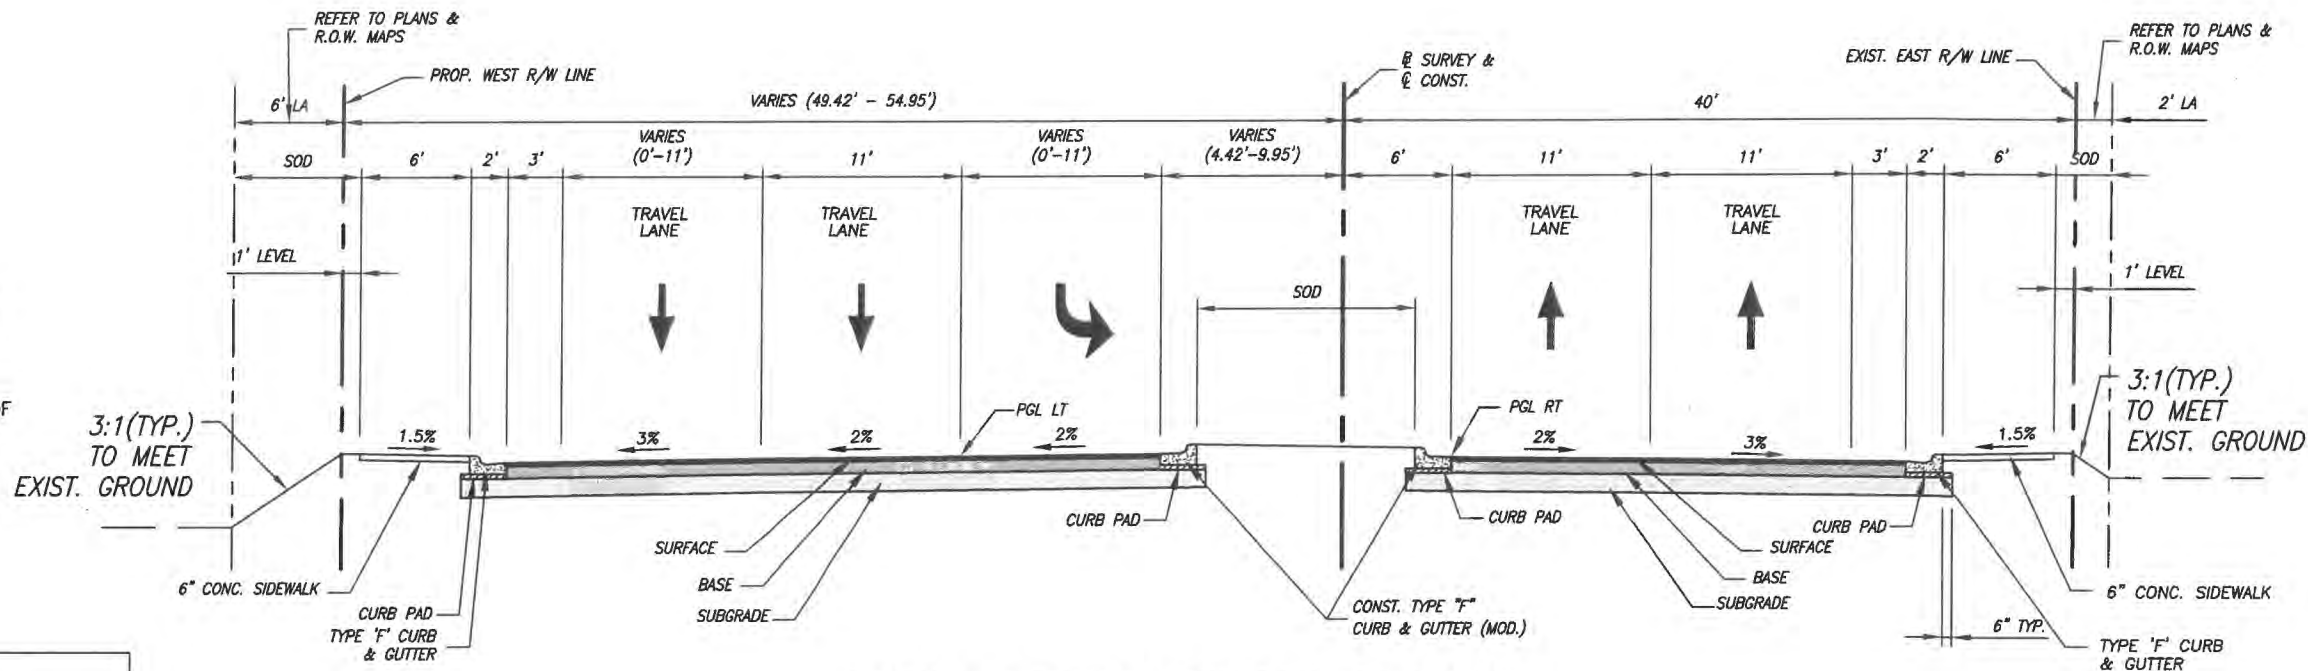
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FOR  
SR 60 & 43RD AVENUE

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LNW# WP1027



**TYPICAL SECTION NOTES:**

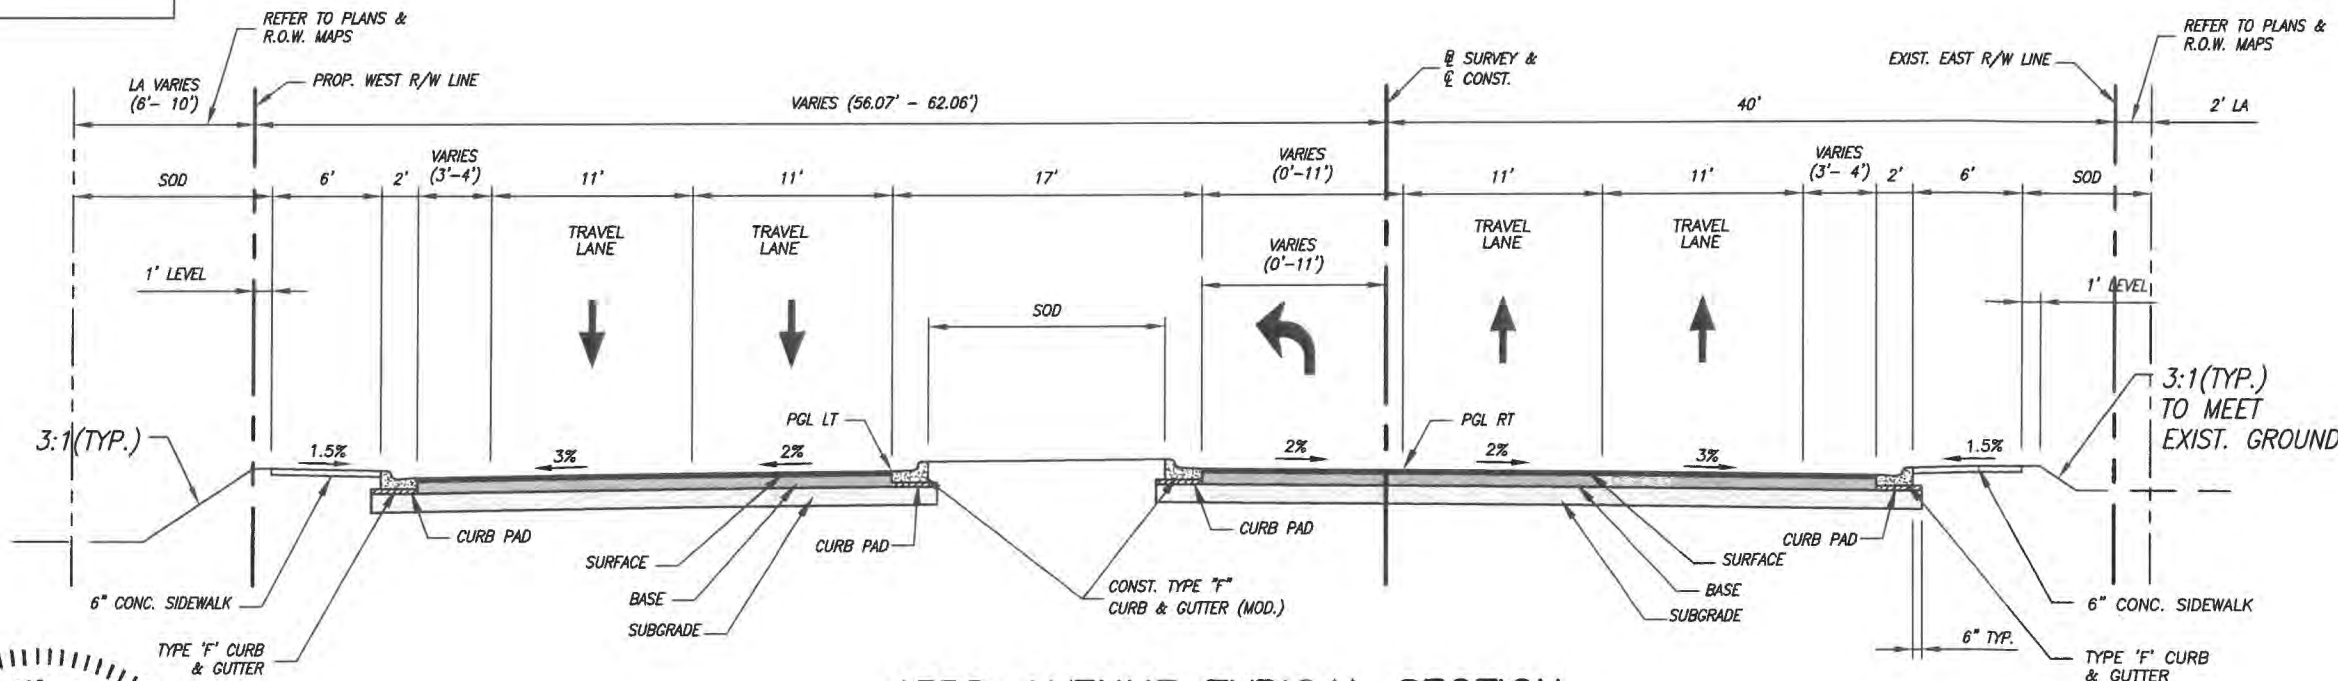
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**43RD AVENUE TYPICAL SECTION  
STA. 113+98.70 TO STA. 116+83**

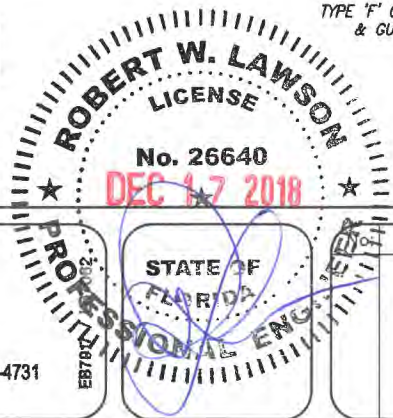
**NEW CONSTRUCTION**

**SURFACE:** 1" TYPE FC-9.5 ASPHALTIC CONCRETE SURFACE COURSE (TRAFFIC C) OVER 1-1/2" TYPE SP-12.5 (TRAFFIC C) ASPHALTIC CONCRETE STRUCTURAL COURSE  
**BASE:** 9" CEMENTED COQUINA SHELL (DOUBLE COURSE) WITH RC-70 PRIME COAT (LBR 100)  
**SUBGRADE:** 12" STABILIZED SUBGRADE TYPE "B" (LBR-40)



**43RD AVENUE TYPICAL SECTION  
STA. 116+83 TO STA. 119+83.50**

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 TYPICAL SECTIONS  
 FOR  
 SR 60 & 43RD AVENUE

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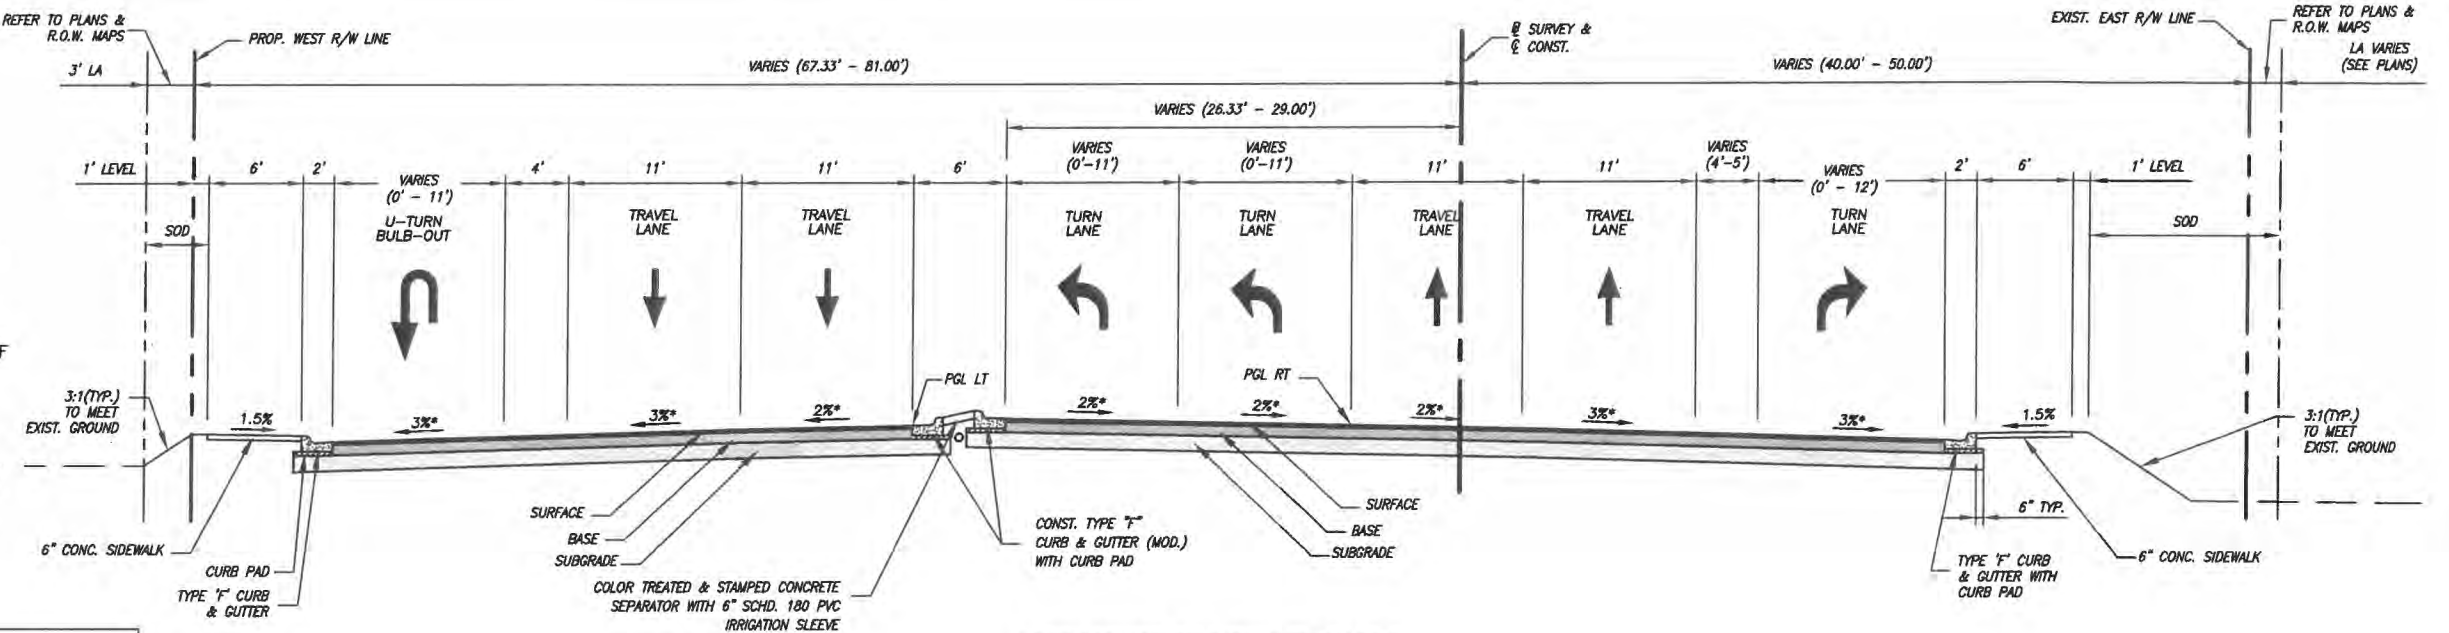
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LNW# WP1027



**TYPICAL SECTION NOTES:**

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4. OVERBUILD CONSISTING OF 1" TYPE FC-9.5 OVER OVERBUILD SP IS REQUIRED ON SR 60 AND THRU THE INTERSECTION AS INDICATED ON THE PLANS.

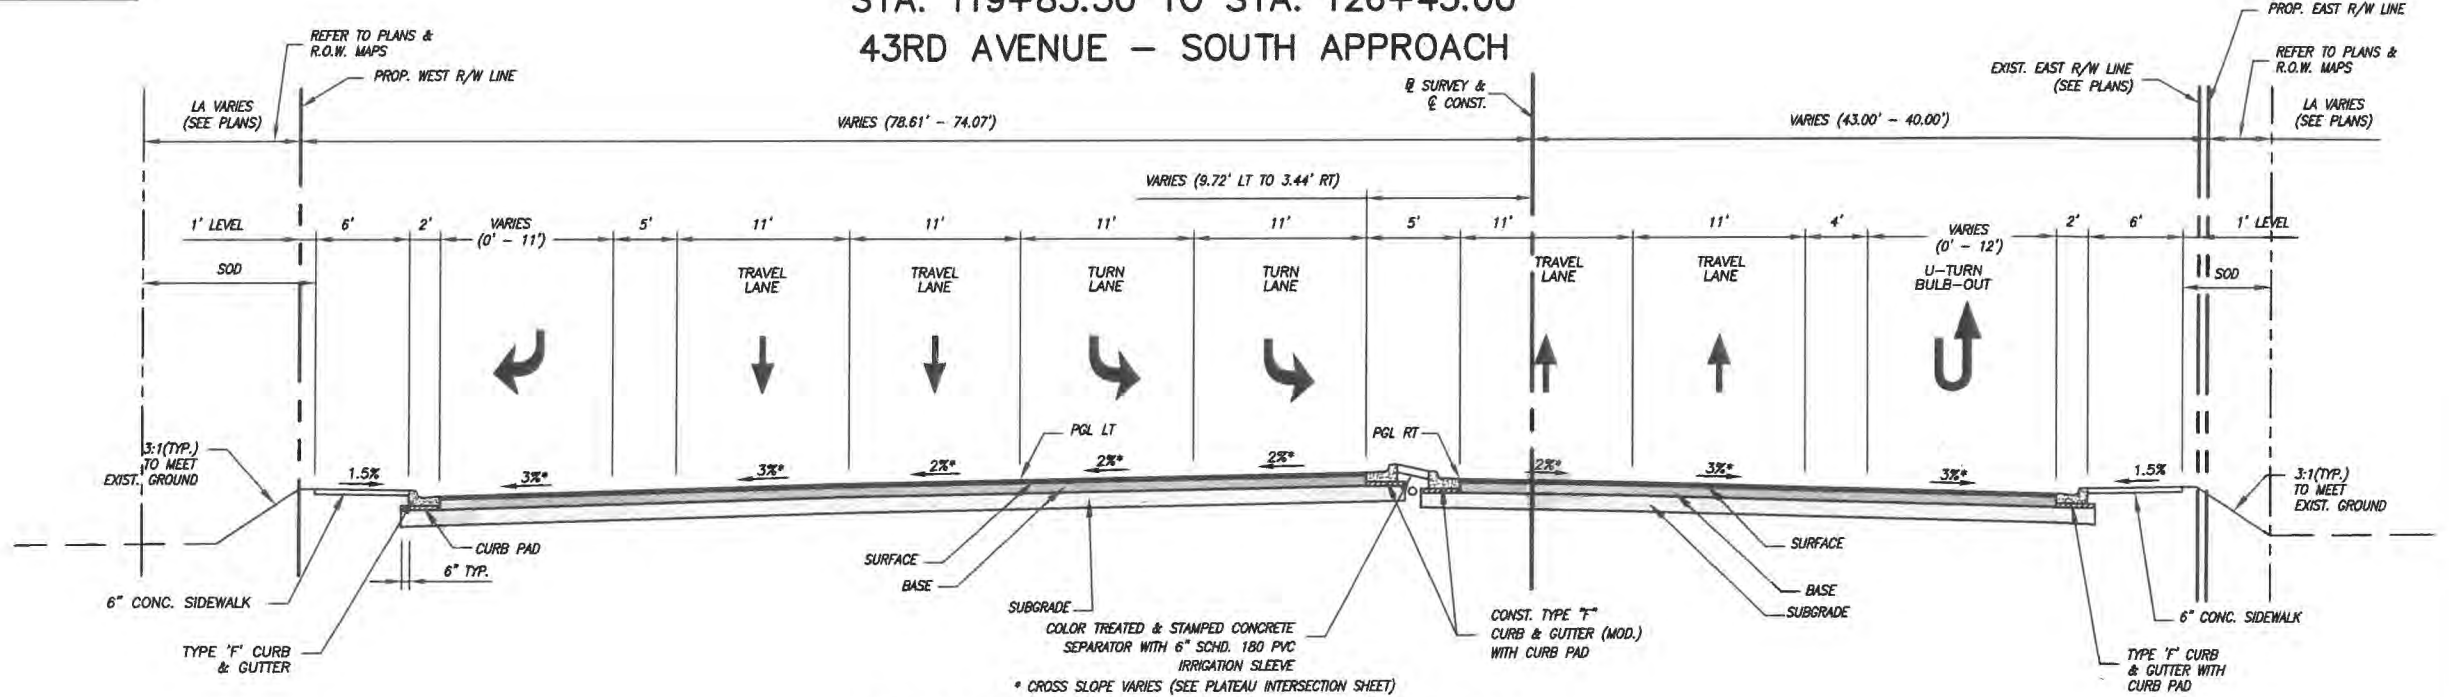


**NEW CONSTRUCTION**

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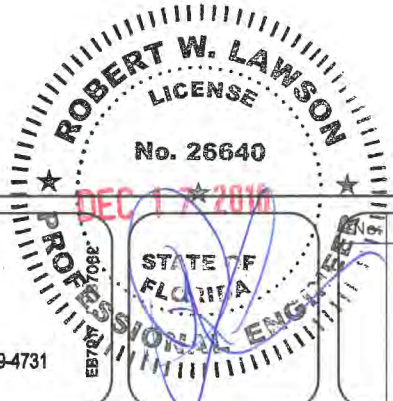
**EXPANDED INTERSECTION - TYPICAL SECTION**  
**STA. 119+83.50 TO STA. 126+45.00**  
**43RD AVENUE - SOUTH APPROACH**

**DESIGN SPEED 45 MPH**




**EXPANDED INTERSECTION - TYPICAL SECTION**  
**STA. 127+50.00 TO STA. 133+48.80**  
**43RD AVENUE - NORTH APPROACH**

NOTE:  
 BRIDGE STA. 129+62.455 TO STA. 130+94.455  
 REFER TO BRIDGE PLANS.



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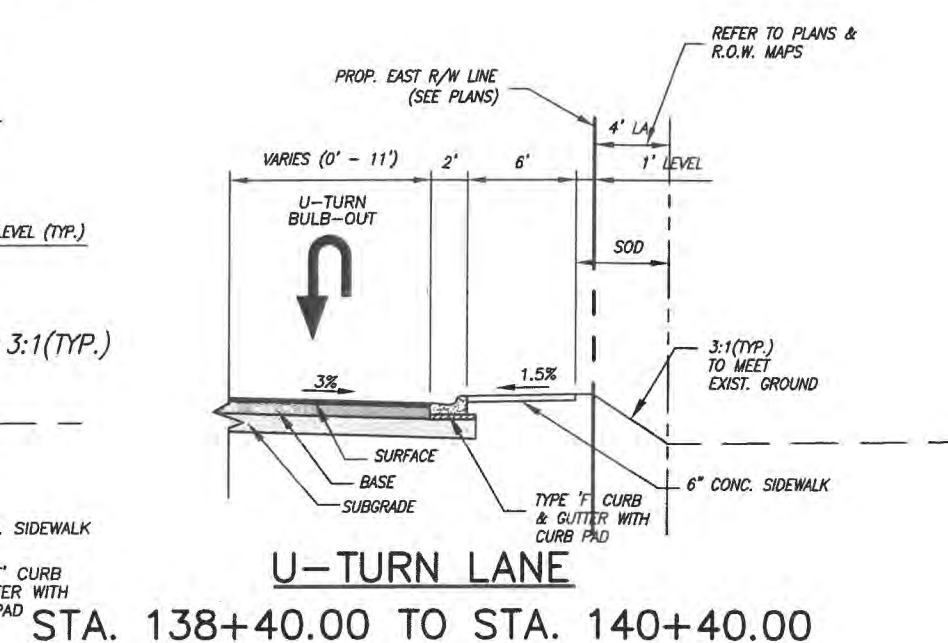
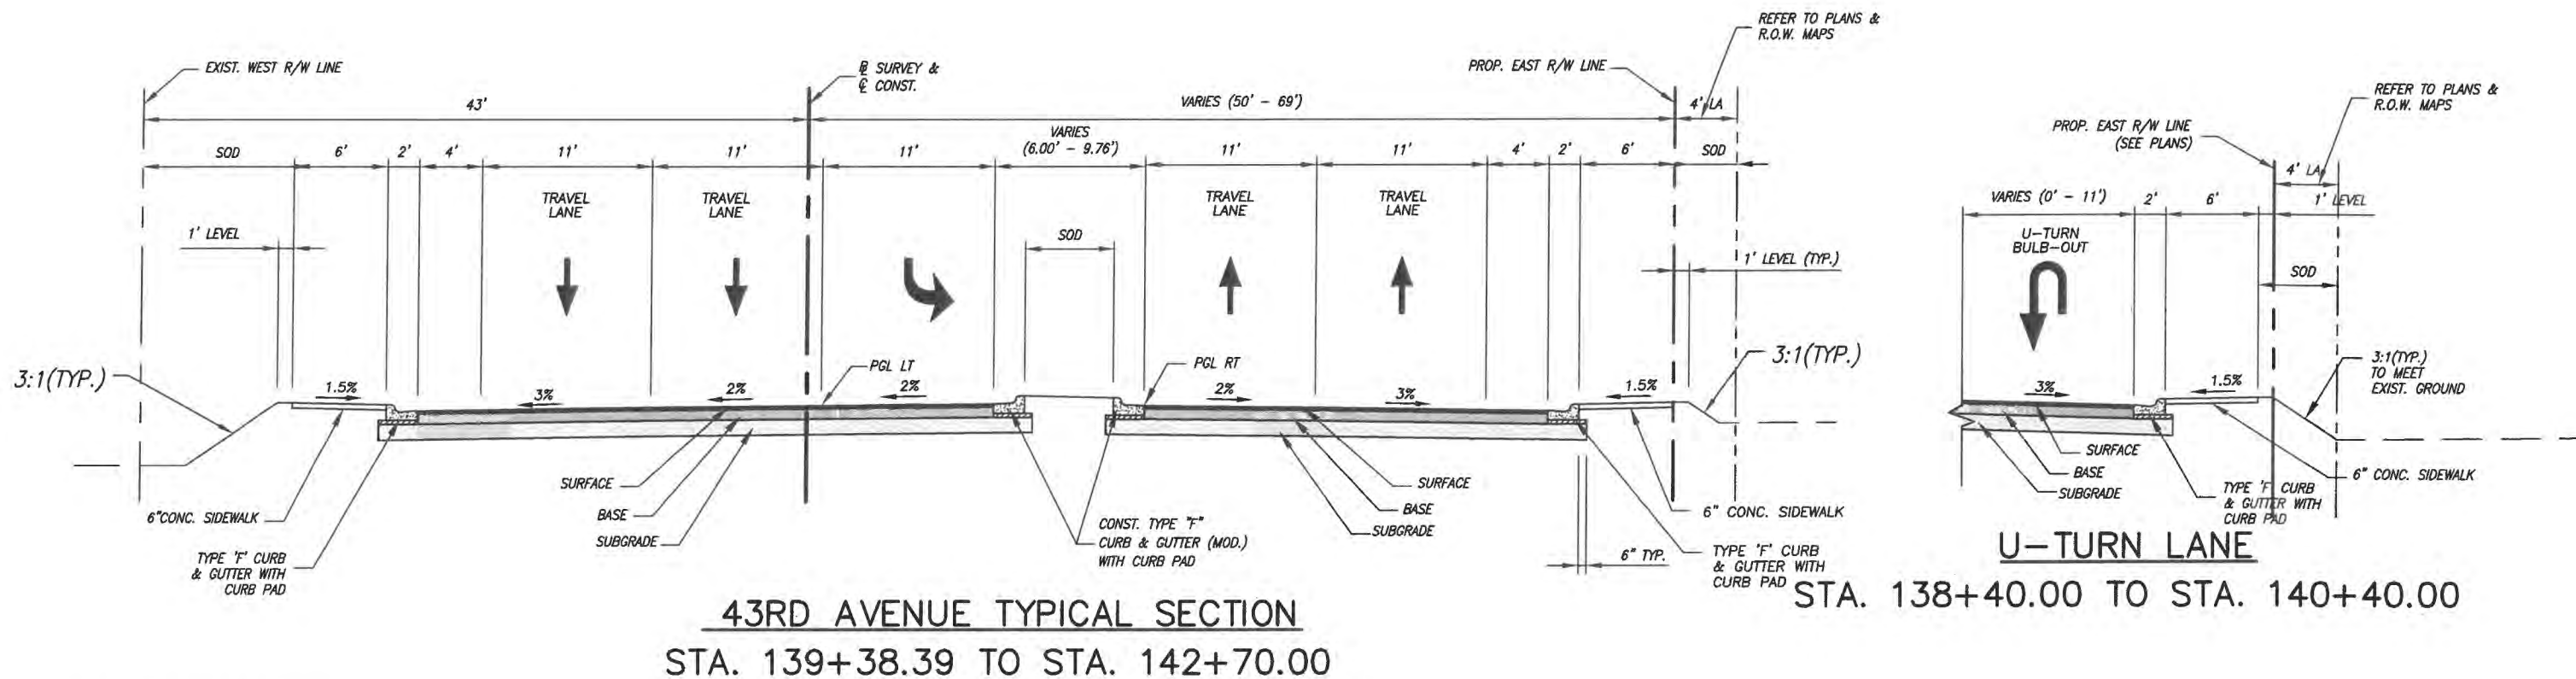
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**FOR**  
**SR 60 & 43RD AVENUE**

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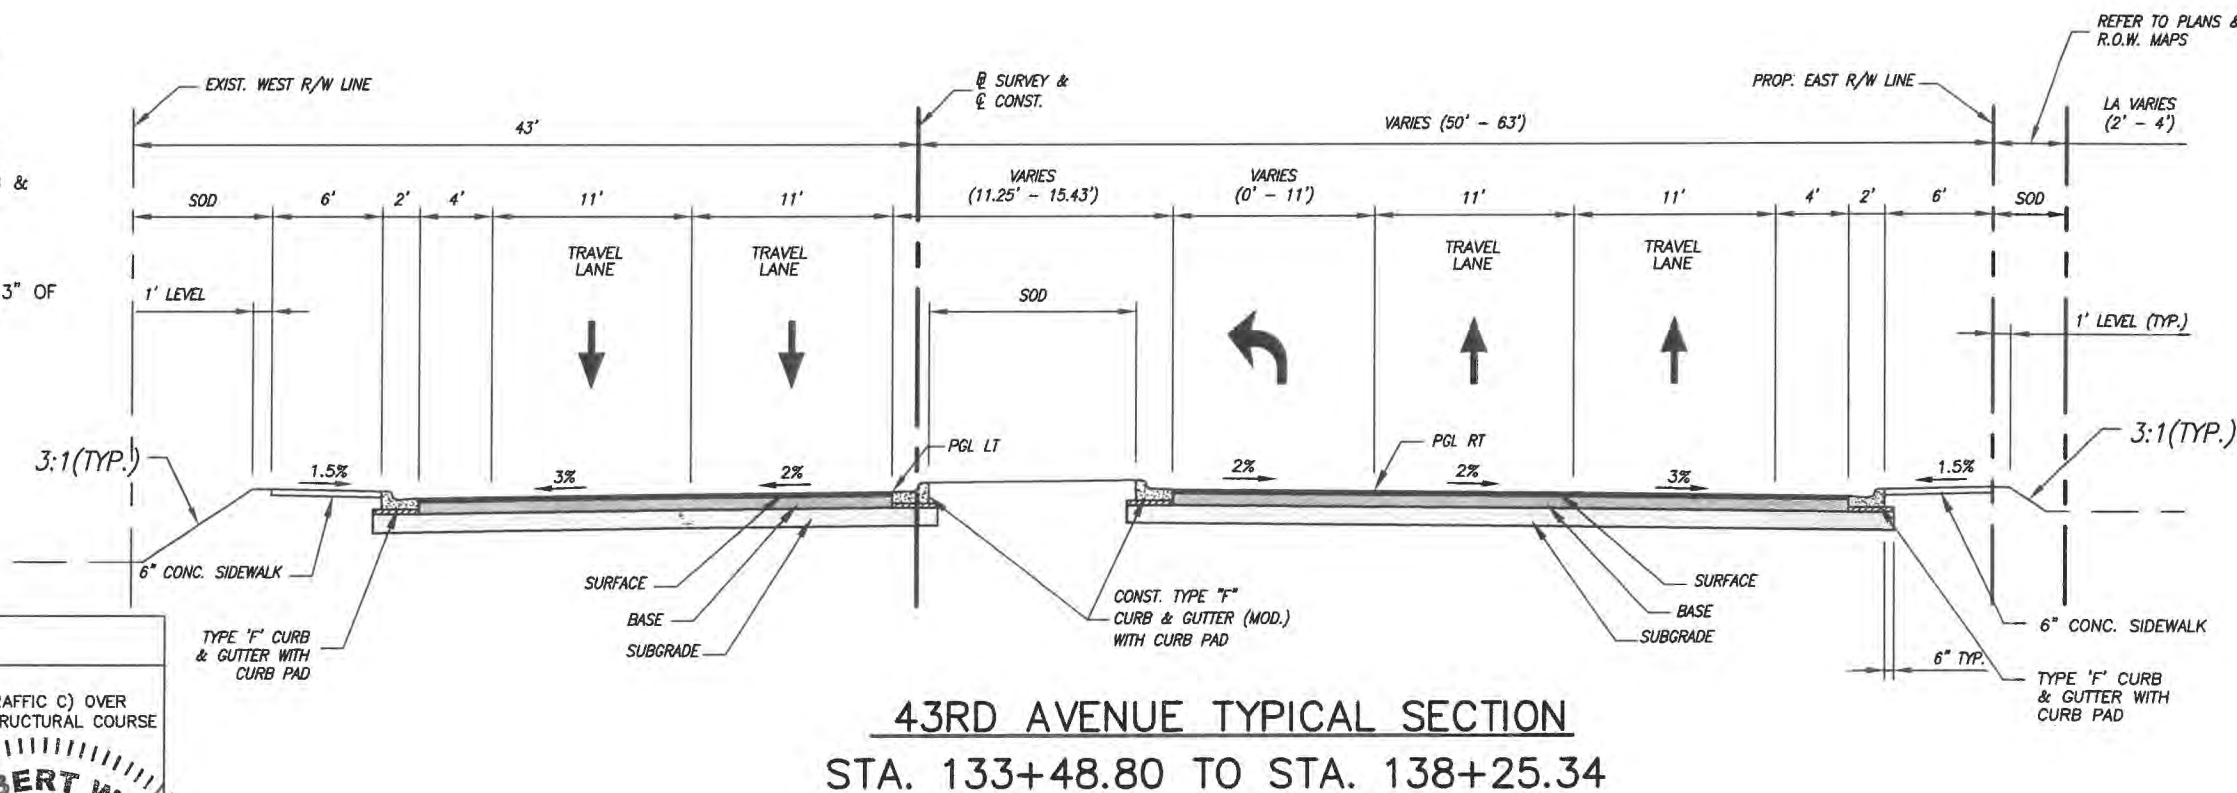
  
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**TYPICAL SECTION NOTES:**

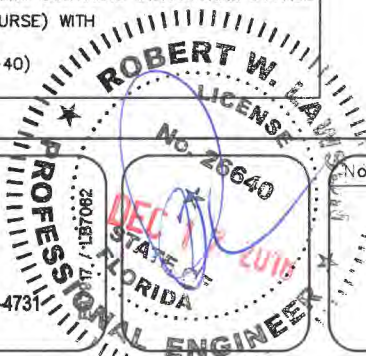
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
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**NEW CONSTRUCTION**

**SURFACE:** 1" TYPE FC-9.5 ASPHALTIC CONCRETE SURFACE COURSE (TRAFFIC C) OVER 1-1/2" TYPE SP-12.5 (TRAFFIC C) ASPHALTIC CONCRETE STRUCTURAL COURSE  
**BASE:** 9" CEMENTED COQUINA SHELL (DOUBLE COURSE) WITH RC-70 PRIME COAT (LBR 100)  
**SUBGRADE:** 12" STABILIZED SUBGRADE TYPE "B" (LBR-40)



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**Engineering Division**

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Project:  
**TYPICAL SECTIONS**  
**FOR**  
**SR 60 & 43RD AVENUE**

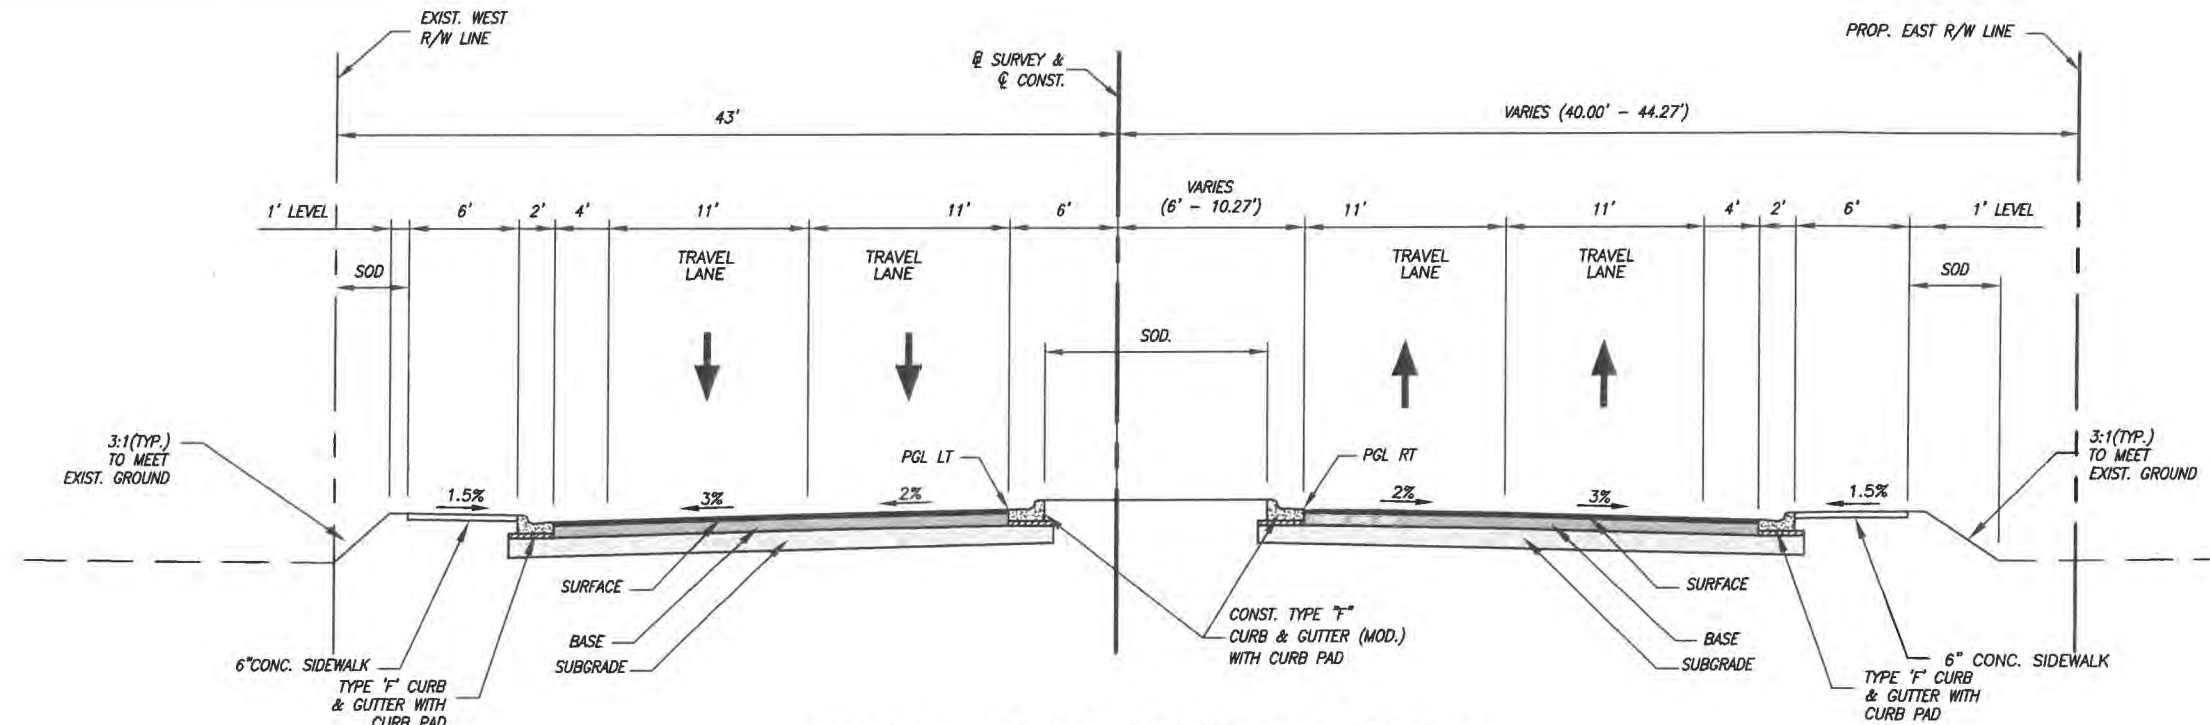
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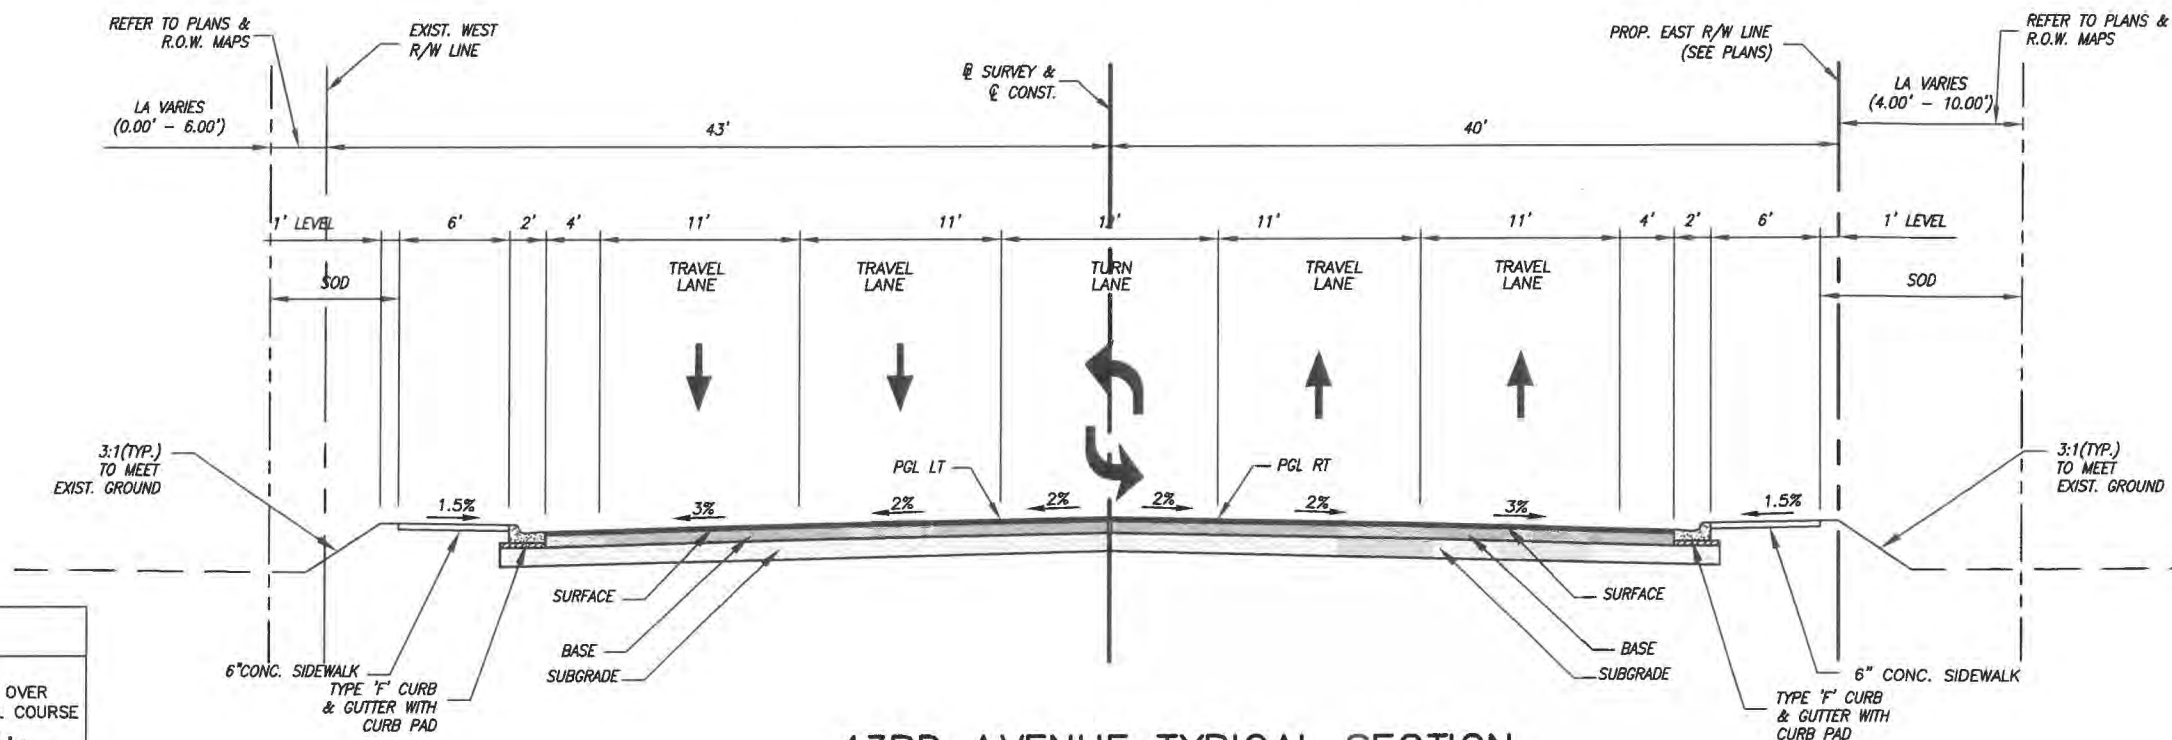
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**43RD AVENUE TYPICAL SECTION  
STA. 142+70.00 TO STA. 145+80.81**

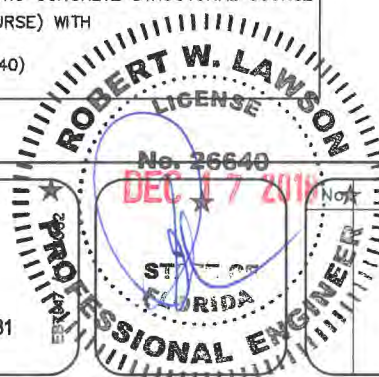
**DESIGN SPEED 45 MPH**



**43RD AVENUE TYPICAL SECTION  
STA. 145+80.81 TO STA. 153+88**

**NEW CONSTRUCTION**

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Engineering Division*

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 FOR  
 SR 60 & 43RD AVENUE

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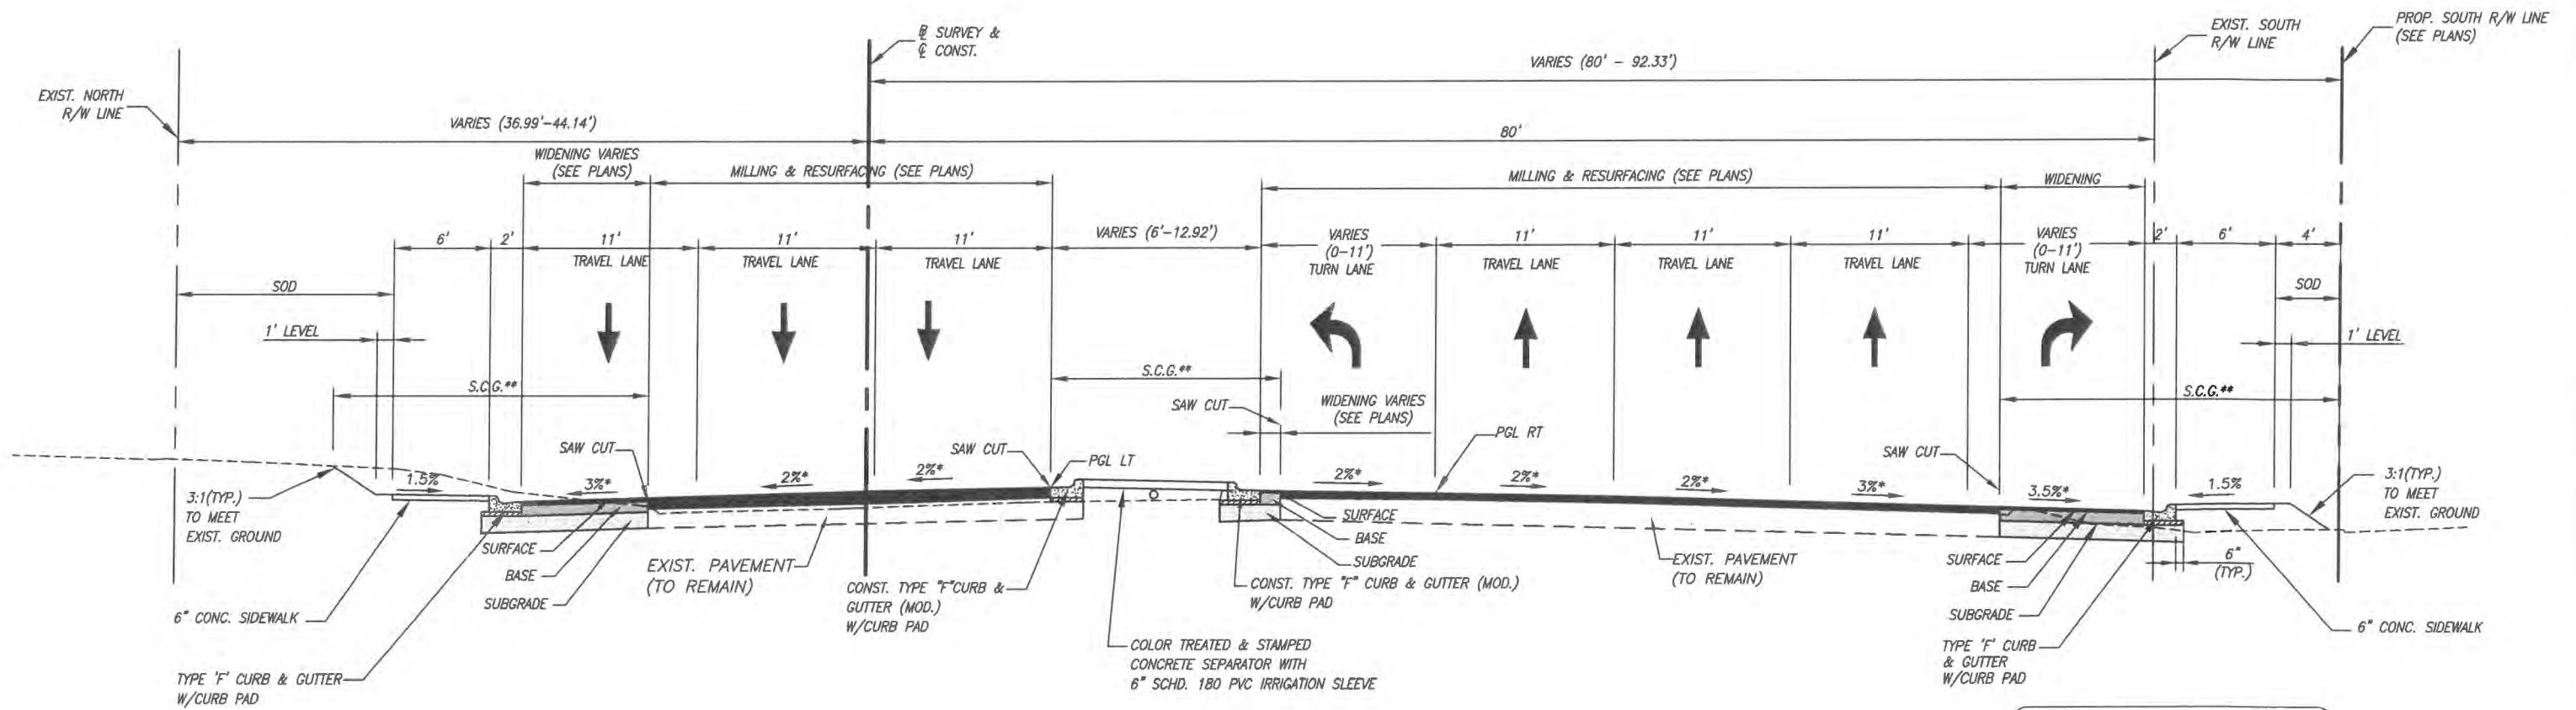
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**TYPICAL SECTION NOTES:**

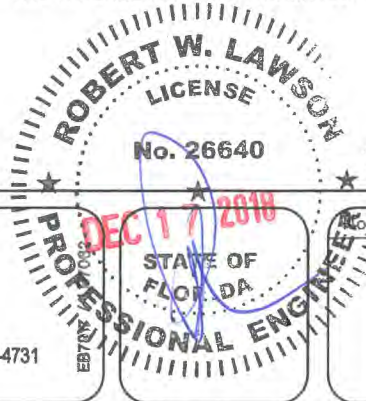
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4. OVERBUILD. CONSISTING OF 1" FC-9.5 OVER OVERBUILD TYPE SP IS REQUIRED ON SR 60 THRU THE INTERSECTION AS INDICATED ON THE PLANS

\* CROSS SLOPE VARIES (SEE PLATEAU INTERSECTION SHEET)  
 \*\* STANDARD CLEARING & GRUBBING

**STA. 2635+80 TO STA. 2641+74.81 (RIGHT)**  
**STA. 2636+67.18 TO STA. 2641+74.81 (LEFT)**  
**TYPICAL SECTION**  
**SR 60**

WIDENING	
SURFACE:	1" TYPE FC-9.5 ASPHALTIC CONCRETE SURFACE COURSE (TRAFFIC C) OVER 1-1/2" TYPE SP-12.5 (TRAFFIC C) ASPHALTIC CONCRETE STRUCTURAL COURSE
BASE:	9" CEMENTED COQUINA SHELL (DOUBLE COURSE) WITH RC-70 PRIME COAT (LBR 100)
SUBGRADE:	12" STABILIZED SUBGRADE TYPE "B" (LBR-40)

MILLING & RESURFACING	
MILLING:	MILL EXISTING PAVEMENT (VARIABLE DEPTH) (LOCATIONS ARE SHOWN ON THE PLANS)
OVERBUILD:	1" TYPE FC-9.5 ASPHALTIC SURFACE COURSE (TRAFFIC C) (100 LB/SY) AND OVERBUILD AS REQUIRED WITH TYPE SP ASPHALT CONCRETE



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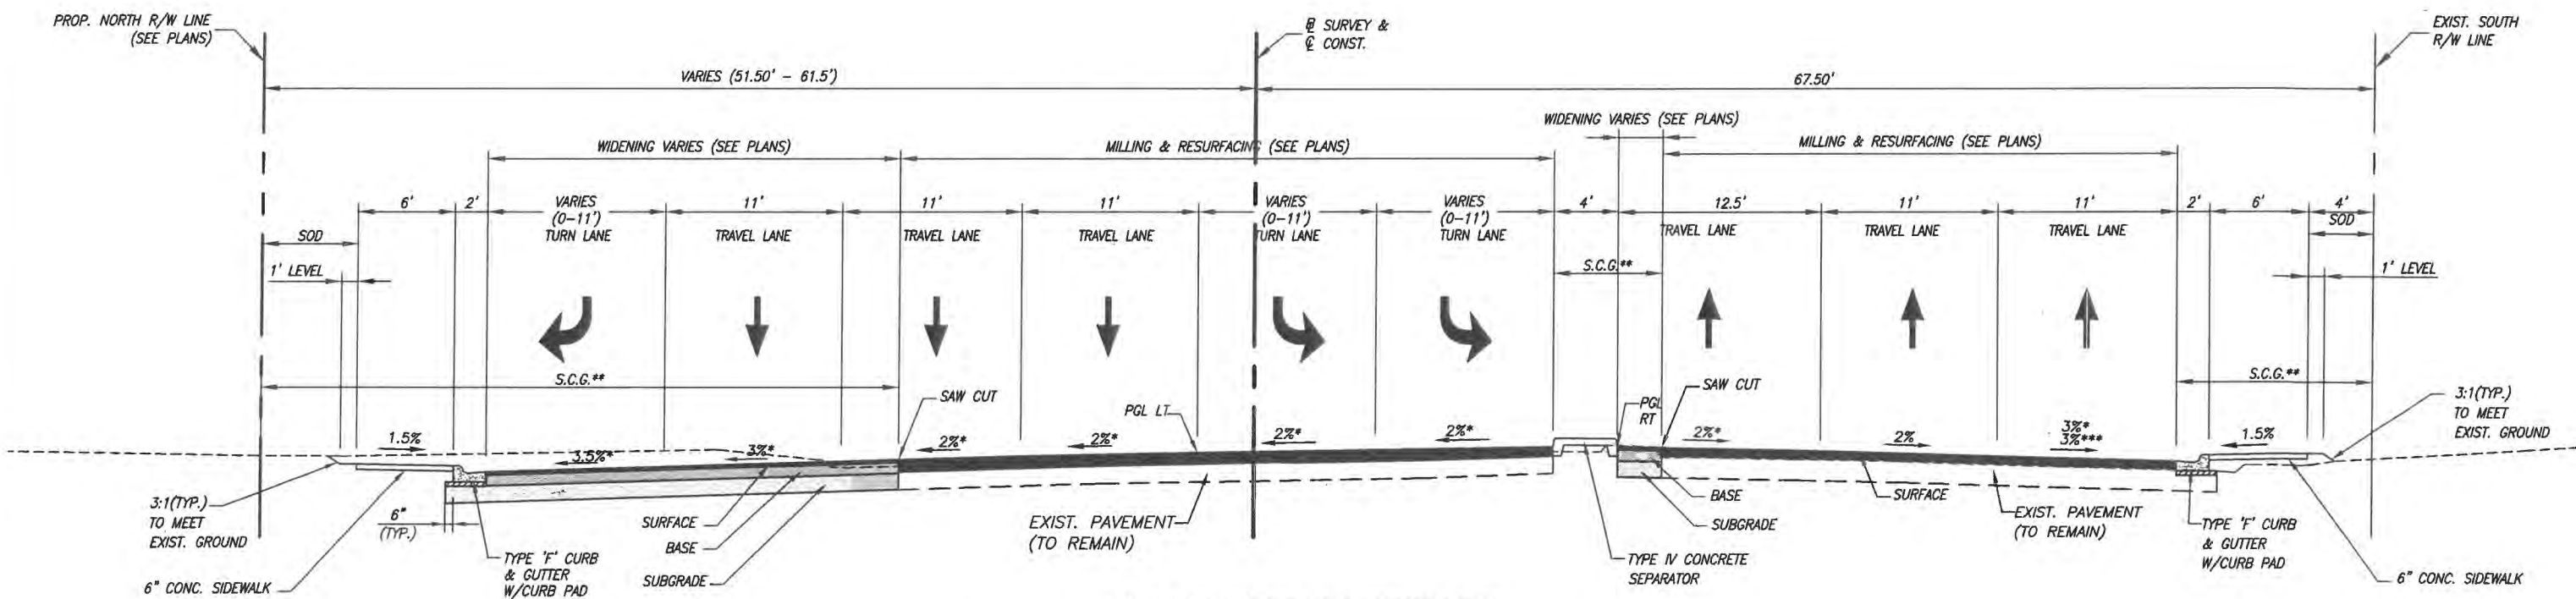
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**FOR**  
**SR 60 & 43RD AVENUE**

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\* CROSS SLOPE VARIES (SEE PLATEAU INTERSECTION SHEET)  
 REFER TO SHEET 27 FOR PLATEAU GRADING WITHIN THE INTERSECTION OF SR 60 & 43RD AVENUE  
 \*\* STANDARD CLEARING & GRUBBING  
 \*\*\* CROSS SLOPE VARIES FROM 3% TO 4% STA. 2647+29 TO 2649+23 RIGHT

**STA. 2643+71.60 TO STA. 2649+23.00**  
**TYPICAL SECTION**  
**SR 60**

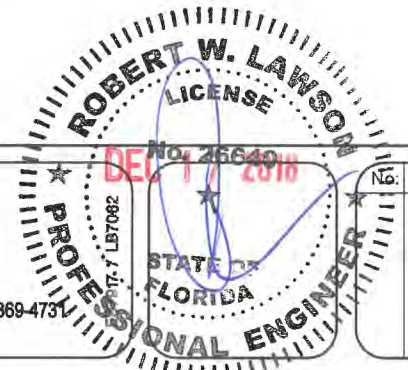
**DESIGN SPEED 45 MPH**

**TYPICAL SECTION NOTES:**

1. ALL PAVED AREAS WITHIN THE PROJECT LIMITS WHICH ARE NOT SPECIFICALLY COVERED BY A "TYPICAL SECTION" SHALL BE CONSTRUCTED IN ACCORDANCE WITH THE PAVEMENT SPECIFICATIONS INDICATED HEREON, UNLESS OTHERWISE NOTED.
2. WHEN LOCATED ON THE HIGH SIDE OF THE ROADWAY, CURB & GUTTER TYPE "F" SHALL BE MODIFIED IN ACCORDANCE WITH FDOT STANDARD INDEX NO. 300
3. CURB PADS SHALL BE CONSTRUCTED OF 6" BASEROCK OR 3" OF B-12.5 AND SHALL EXTEND A MINIMUM OF 6" BEYOND THE BACK OF CURB. COST OF CURB PAD SHALL BE INCLUDED IN THE PRICE FOR CURB & GUTTER
4. OVERBUILD CONSISTING OF 1" TYPE FC-9.5 OVER OVERBUILD TYPE SP IS REQUIRED ON SR 60 AND THRU THE INTERSECTION AS INDICATED ON THE PLANS.

WIDENING	
SURFACE:	1" TYPE FC-9.5 ASPHALTIC CONCRETE SURFACE COURSE (TRAFFIC C) OVER 1-1/2" TYPE SP-12.5 (TRAFFIC C) ASPHALTIC CONCRETE STRUCTURAL COURSE
BASE:	9" CEMENTED COQUINA SHELL (DOUBLE COURSE) WITH RC-70 PRIME COAT (LBR 100)
SUBGRADE:	12" STABILIZED SUBGRADE TYPE "B" (LBR-40)

MILLING & RESURFACING	
MILLING:	MILL EXISTING PAVEMENT (VARIABLE DEPTH) (LOCATIONS ARE SHOWN ON THE PLANS)
OVERBUILD:	1" TYPE FC-9.5 ASPHALTIC SURFACE COURSE (TRAFFIC C) (100 LB/SY) AND OVERBUILD AS REQUIRED WITH TYPE SP ASPHALT CONCRETE



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Revision:	By:	Date:

INDIAN RIVER COUNTY  
 FLORIDA  
 Department of Public Works  
 Engineering Division

Scale:	NTS
Approved:	HWD
Drawn:	FM
Checked:	HWD
Date:	6/2017
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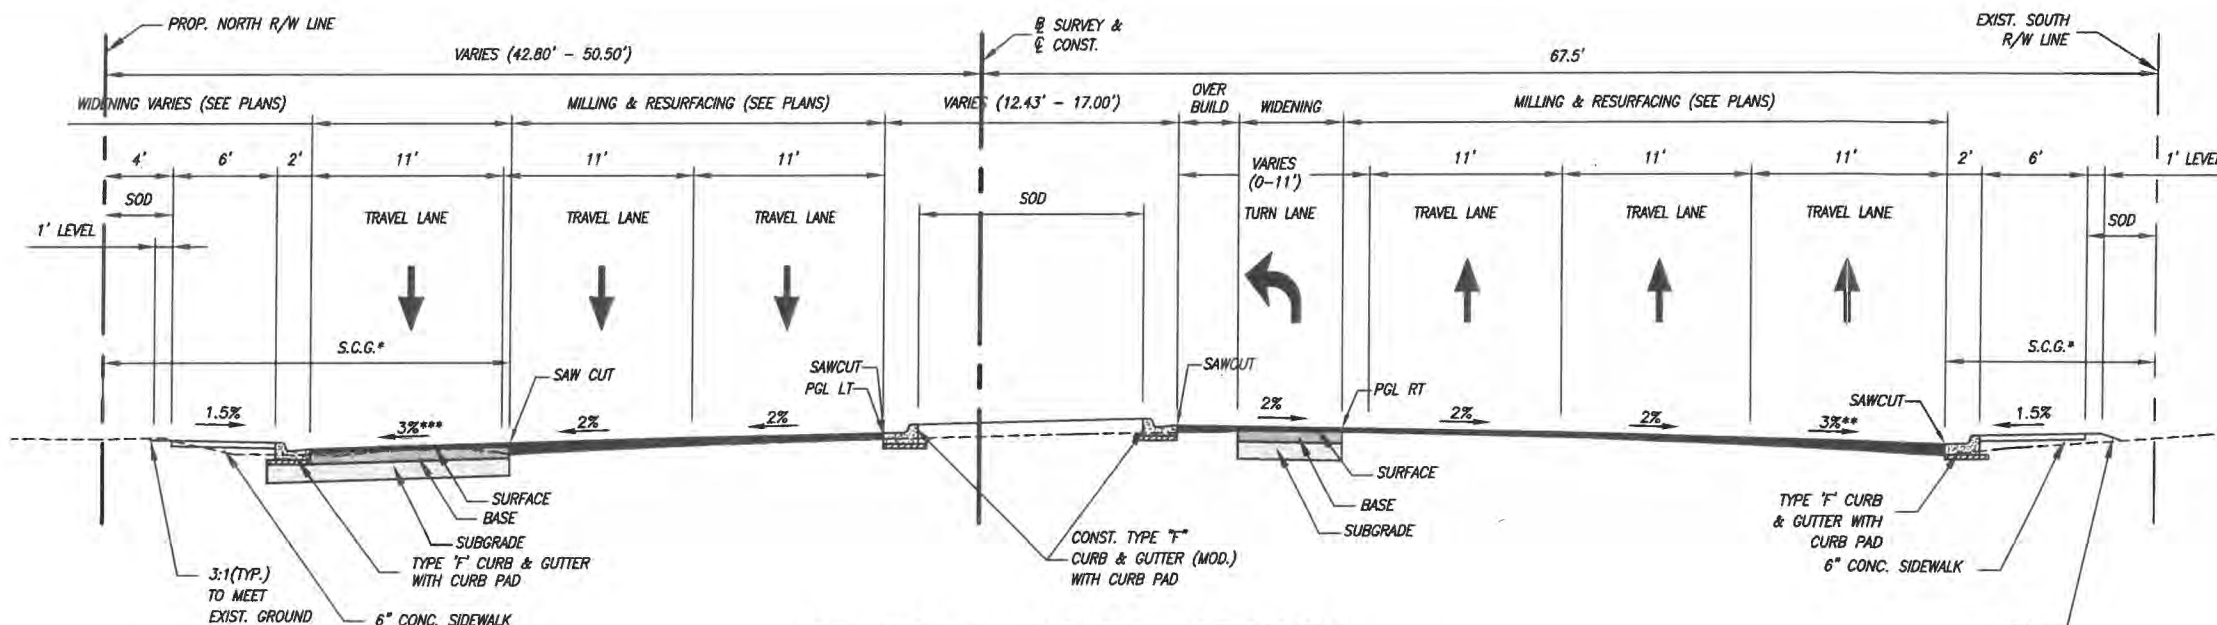
Project:  
 TYPICAL SECTIONS  
 FOR  
 SR 60 & 43RD AVENUE

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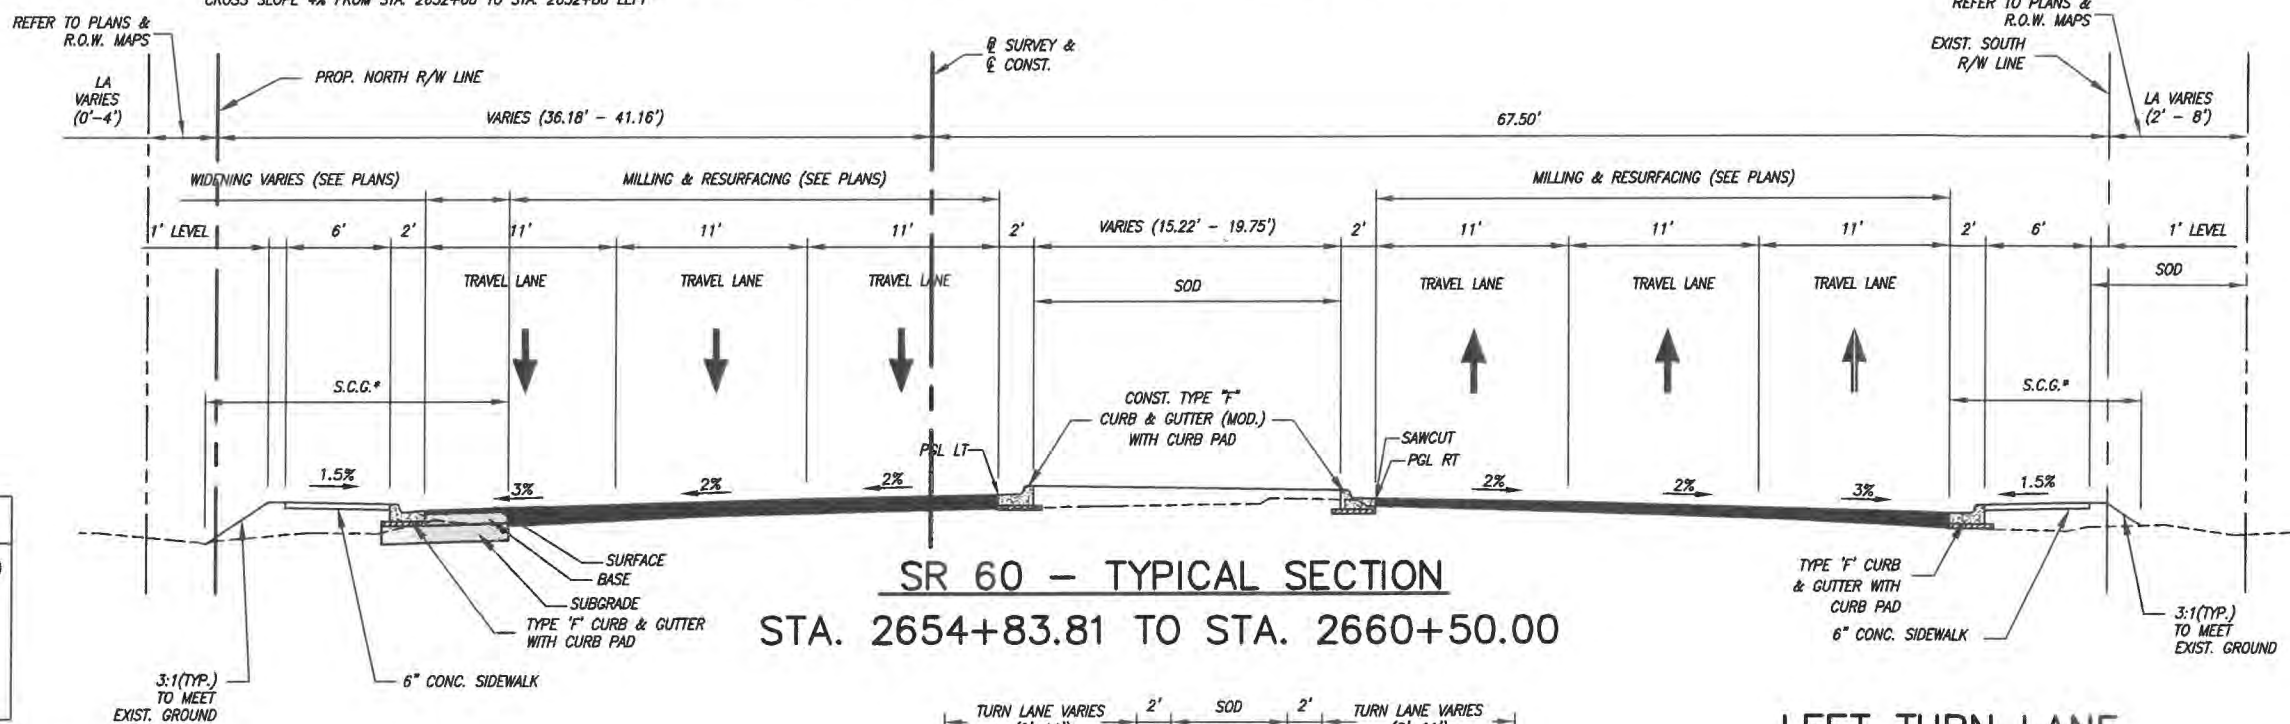
**TYPICAL SECTION NOTES:**

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4. OVERBUILD CONSISTING OF 1" TYPE FC-9.5 OVER OVERBUILD TYPE SP IS REQUIRED ON SR 60 AND THRU THE INTERSECTION AS INDICATED ON THE PLANS.



**SR 60 - TYPICAL SECTION**  
STA. 2649+23.00 TO STA. 2653+83.16

\* STANDARD CLEARING & GRUBBING  
 \*\* CROSS SLOPE VARIES 3% TO 4% FROM STA. 2647+29 TO 2648+29 RIGHT, STA. 2649+23 TO STA. 2650+23 RIGHT  
 CROSS SLOPE 4% FROM STA. 2648+29 TO STA. 2649+23 RIGHT  
 \*\*\* CROSS SLOPE VARIES 3% TO 4% FROM STA. 2651+00 TO 2652+80 LEFT, STA. 2652+80 TO STA. 2653+80 LEFT  
 CROSS SLOPE 4% FROM STA. 2652+00 TO STA. 2652+80 LEFT



**SR 60 - TYPICAL SECTION**  
STA. 2654+83.81 TO STA. 2660+50.00

**DESIGN SPEED 45 MPH**

**WIDENING**

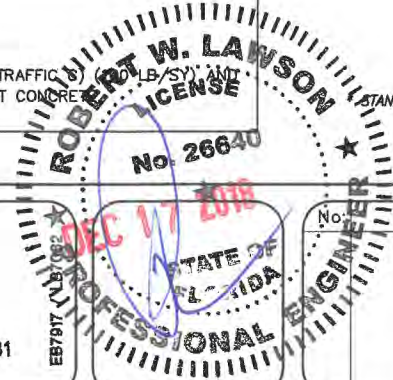
<b>SURFACE:</b>	1" TYPE FC-9.5 ASPHALTIC CONCRETE SURFACE COURSE (TRAFFIC C) OVER 1-1/2" TYPE SP-12.5 (TRAFFIC C) ASPHALTIC CONCRETE STRUCTURAL COURSE
<b>BASE:</b>	9" CEMENTED COQUINA SHELL (DOUBLE COURSE) WITH RC-70 PRIME COAT (LBR 100)
<b>SUBGRADE:</b>	12" STABILIZED SUBGRADE TYPE "B" (LBR-40)

**MILLING & RESURFACING**

<b>MILLING:</b>	MILL EXISTING PAVEMENT (VARIABLE DEPTH) (LOCATIONS ARE SHOWN ON THE PLANS)
<b>OVERBUILD:</b>	1" TYPE FC-9.5 ASPHALTIC SURFACE COURSE (TRAFFIC C) OVER 1-1/2" TYPE SP-12.5 (TRAFFIC C) ASPHALTIC CONCRETE STRUCTURAL COURSE OVERBUILD AS REQUIRED WITH TYPE SP ASPHALT CONCRETE

**LEFT TURN LANE**

- 2655+61.68 TO 2656+90.30
- 2658+63.04 TO 2659+25.15
- 2654+83.81 TO 2656+11.68
- 2658+50.83 TO 2659+12.90



No.	Revision:	By:	Date:



Department of Public Works  
Engineering Division

Scale:	NTS
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Drawn:	FM
Checked:	HWD
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Field Book No:	

Project:  
TYPICAL SECTIONS  
FOR  
SR 60 & 43RD AVENUE

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SUMMARY OF PAY ITEMS

NO.	ITEM	UNIT	QUANTITY
	ROADWAY CONSTRUCTION		
0101 1	MOBILIZATION	LS	1
0102 1	MAINTENANCE OF TRAFFIC (INCLUDES PEDESTRIAN MOT)	LS	1
0102 14	TRAFFIC CONTROL OFFICER (OFF DUTY LAW ENFORCEMENT)	MH	300
0102 99	CHANGEABLE VARIABLE MESSAGE SIGN (18)	ED	7520
0104	N.P.D.E.S. COMPLIANCE	LS	1
0104 10 3	SEDIMENT BARRIER	LF	16456
0104 11	FLOATING TURBIDITY BARRIER	LF	560
0104 18	INLET PROTECTION SYSTEM	EA	69
0110 1 1	CLEARING AND GRUBBING	LS	1
0120 1	REGULAR EXCAVATION	CY	12656
0120 6	EMBANKMENT (COMPACTED IN PLACE)	CY	5781
0160 4	12" STABILIZED SUBGRADE TYPE "B" (LBR 40)	SY	44046
0285 707	9" CEMENTED COQUINA	SY	40554
0286 1	TURNOUT CONSTRUCTION, CONCRETE	SY	1526
0286 2	TURNOUT CONSTRUCTION, ASPHALT	SY	1183
0327 70 1	MILL EXISTING ASPHALT PAVEMENT, VARIABLE DEPTH	SY	2944
0334 1 13	TYPE SP ASPHALT CONCRETE OVERBUILD	TN	7200
0334 1 13	SUPERPAVE ASPHALTIC CONCRETE, SP-12.5, TRAFFIC C, 1-1/2" THICK	SY	40554
0337 7 32	ASPHALT CONCRETE FRICTION COURSE, FC-9.5, TRAFFIC C, RUBBER, 1" THICK	SY	60965
0400 0 11	CONCRETE CLASS NS, GRAVITY WALL	CY	81.9
0400 1 2	CONCRETE CLASS I, ENDWALLS	CY	6.33
0400 2 2	CONCRETE CLASS II, ENDWALLS	CY	27.4
0415 1 1	REINFORCING STEEL - ROADWAY	LB	1648
0425 1311	INLETS, CURB, TYPE P-1, <10'	EA	5
0425 1321	INLETS, CURB, TYPE P-2, <10'	EA	4
0425 1341	INLETS, CURB, TYPE P-4, <10'	EA	1
0425 1351	INLETS, CURB, TYPE P-5, <10'	EA	17
0425 1352	INLETS, CURB, TYPE P-5, >10'	EA	1
0425 1361	INLETS, CURB, TYPE P-6, <10'	EA	10
0425 1421	INLETS, CURB, TYPE J-2, <10'	EA	2
0425 1451	INLETS, CURB, TYPE J-5, <10'	EA	1
0425 1452	INLETS, CURB, TYPE J-5, >10'	EA	1
0425 1461	INLETS, CURB, TYPE J-8, <10'	EA	2
0425 1521	INLETS, DITCH BOTTOM, TYPE C, <10'	EA	26
0425 1521	INLETS, DITCH BOTTOM, TYPE C, <10' (MODIFIED)	EA	1
0425 1705	INLETS, GUTTER, TYPE V, <10'	EA	2
425 1511	INLETS, DITCH BOTTOM, TYPE P-X, <10'	EA	2
425 1512	INLETS, DITCH BOTTOM, TYPE P-X, >10'	EA	1
0425 2 41	MANHOLES, P-7, <10'	EA	3
0425 2 43	MANHOLES, P-7, PARTIAL	EA	1
0425 2 61	MANHOLES, P-8, <10'	EA	3
0425 2 63	MANHOLES, P-8, PARTIAL	EA	1
0425 2 71	MANHOLES, J-7, <10'	EA	5
0425 2 91	MANHOLES, J-8, >10'	EA	10
0425 4	INLETS, ADJUST	EA	7
0425 5	MANHOLE, ADJUST	EA	7
0425 6	VALVE BOXES, ADJUST	EA	38
430174115	PIPE CULVERT, RCP, ROUND, 15" SD	LF	30
430174118	PIPE CULVERT, RCP, ROUND, 18" SD	LF	3957
430174124	PIPE CULVERT, RCP, ROUND, 24" SD	LF	1143
430174130	PIPE CULVERT, RCP, ROUND, 30" SD	LF	198
430174136	PIPE CULVERT, RCP, ROUND, 36" SD	LF	2231
430174142	PIPE CULVERT, RCP, ROUND, 42" SD	LF	814
430175215	PIPE CULVERT, RCP, ROUND, 48"	LF	85
0443 70 3	FRENCH DRAIN, 18"	LF	1616
0515 1 1	PIPE HANDRAIL - GUIDERAIL, ALUMINUM	LF	1177
0520 1 10	CONCRETE CURB & GUTTER, TYPE F	LF	21539
0520 5 41	TRAFFIC SEPARATOR CONCRETE - TYPE IV, 4' WIDE	LF	457
0520 70	CONCRETE TRAFFIC SEPARATOR, SPECIAL-VARIABLE WIDTH (COLOR TREATED AND STAMPED CONCRETE)	SY	575
0522 2	SIDEWALK CONCRETE, 6" THICK	SY	6242
0570 1 2	PERFORMANCE TURF, SOD	SF	15606
630-2-11	2-2" PVC CONDUITS	LF	20
635-2-12	PULL & SPLICE BOX, F & I (30"x48"x24")	EA	2

PAY ITEMS & CONTINGENCY ITEMS FOOTNOTES:

- ITEM 0102 1 INCLUDES ALL ITEMS FOR MAINTENANCE OF TRAFFIC WHICH ARE NOT INCLUDED FOR PAYMENT UNDER SEPARATE ITEMS. COST OF MOT SHALL INCLUDE BUT NOT BE LIMITED TO SIGNS, TEMP BARRIER WALL INCLUDING BRIDGE PHASING, TEMP. RAMP, TEMP STRIPING, ADEQUATE AND PROPER DRAINAGE DURING PROCESS OF THE WORK AND PEDESTRIAN MOT.
- ITEM 0110 1 1 INCLUDES REMOVAL OF EXISTING DRAINAGE STRUCTURES & PIPES; CULVERTS; SIGNS; FENCE; CURBS; TRAFFIC SEPARATOR; SIDEWALKS; ASPHALT; BASE; CONCRETE; GUARDRAIL; F.D.P.'S; TEMPORARY CONSTRUCTION DETOURS; AND ANY OTHER ITEMS TO BE REMOVED THAT ARE NOT SPECIFICALLY COVERED UNDER ANOTHER SEPARATE PAY ITEM. INCLUDES ALL NECESSARY SAW CUTTING. INCLUDES TREE TRIMMING FOR UTILITY INSTALLATION AND OR RELOCATION AND FOR STREET LIGHTING INSTALLATION
- ITEM 0120 1 INCLUDES ALL EARTHWORK ITEMS (EXCAVATION AND EMBANKMENT) FOR ROADWAY, CURB, SIDEWALK, AND DRIVEWAY CONSTRUCTION. INCLUDES FINAL GRADING & SHAPING AS NECESSARY FOR FINAL RESTORATION.
- ITEM 0120 6 FOR ROADWAY, CURB, SIDEWALK, AND DRIVEWAY CONSTRUCTION. INCLUDES FINAL GRADING & SHAPING AS NECESSARY FOR FINAL RESTORATION.
- ITEM 0160 4 INCLUDES COMPACTION OF SUBGRADE IN ACCORDANCE WITH SECTION 120-9 OF THE FDOT SPECIFICATIONS.
- ITEM 0334 1 13 INCLUDES BITUMINOUS MATERIAL, PRIME COAT AND TACK COAT, AS REQUIRED. 0337 7 32
- ITEM 0120 6 THIS ITEM IS FILL COMPACTED IN PLACE.
- ITEM 0425 1311 INCLUDES TEMPORARY SHEET PILING AS NEEDED FOR DRAINAGE INSTALLATION. THRU 0425 1705
- ITEM 0425 1421 THIS ITEM INCLUDES ALL LABOR, MATERIALS, & EQUIPMENT FOR THE CONTROL STRUCTURE. 0425 2 71 0425 2 63 0425 4
- ITEM 0522 2 INCLUDES THICKENED EDGE. ALL CONC. SIDEWALKS AND DRIVEWAYS SHALL BE 6" THICK FIBER REINFORCED CONC.
- ITEM 1050 11223 INCLUDES MAGNETIC TRACER WIRE.
- ALL ITEMS MAY BE INCREASED, DECREASED OR DELETED AS DIRECTED BY THE ENGINEER.

LEGEND

- ANCHOR
- CLEAN OUT
- CATCH BASIN
- ⊙— DRAINAGE MANHOLE
- ⊕— ELECTRIC MANHOLE
- FIRE HYDRANT
- ⊙— SANITARY MANHOLE
- ⊕— SIGN
- ⊕— TELEPHONE MANHOLE
- ⊕— WATER METER
- ⊕— WOOD UTILITY POLE
- CLF— CHAIN-LINK FENCE
- WF— WOOD FENCE
- FOUND CONCRETE MONUMENT
- FOUND IRON PIPE
- ⊕— FOUND ELECTRIC BOX/METER
- ⊕— FOUND BELLSOUTH MANHOLE
- ⊕— GATE VALVE
- ⊕— GUARDRAIL
- ⊕— MAIL BOX
- SW— SURFACE WATER
- FOUND IRON ROD WITH CAP
- ▲— FOUND P-K NAIL
- FOUND PERMANENT CONTROL POINT
- SET 5/8" IRON ROD WITH CAP NO. LB4103
- △— SET P-K NAIL WITH DISC NO. LB4103
- BLACK OLIVE TREE
- PALM TREE
- OAK TREE
- UN— UNKNOWN SPECIES TREE

SUMMARY OF PAY ITEMS

NO.	ITEM	UNIT	QUANTITY
1050 11223	6" HDPE FORCE MAIN CASING	LF	85
1050 31206	UTILITY PIPE - PVC, F&I 6"	LF	845
	SIGNING & PAVEMENT MARKINGS		
0700 2011	SINGLE POST SIGN, F&I, <12 SF	AS	64
0700 2013	SINGLE POST SIGN, F&I, 21-30 SF	AS	9
0700 2040	SINGLE POST SIGN, RELOCATE	AS	13
0705 111	DELINEATOR, FLEXIBLE TUBULAR	EA	18
0706 3	RETRO-REFLECTIVE PAVEMENT MARKER	EA	780
0711 11111	THERMOPLASTIC, STANDARD, WHITE, SOLID, 6"	NM	3.14
0711 11122	THERMOPLASTIC, STANDARD, WHITE, SOLID, 8"	LF	2135
0711 11123	THERMOPLASTIC, STANDARD, WHITE, SOLID, 12"	LF	2086
0711 11124	THERMOPLASTIC, STANDARD, WHITE, SOLID, 18"	LF	455
0711 11125	THERMOPLASTIC, STANDARD, WHITE, SOLID, 24"	LF	563
0711 11131	THERMOPLASTIC, STANDARD, WHITE, SKIP, 6"	GM	3.59
0711 11160	THERMOPLASTIC, STANDARD, WHITE, MESSAGE	EA	17
0711 11170	THERMOPLASTIC, STANDARD, WHITE, ARROW	EA	88
0711 11211	THERMOPLASTIC, STANDARD, YELLOW, SOLID, 6"	NM	2.26
0711 11222	THERMOPLASTIC, STANDARD, YELLOW, SOLID, 18"	LF	77
0711 11231	THERMOPLASTIC, STANDARD, YELLOW, SKIP, 6"	GM	0.44
	SIGNAL		
630 2 11	CONDUIT (F&I)(UNDERGROUND)	LF	12057
630 2 12	CONDUIT (F&I)(UNDERPAVEMENT)(DIRECTIONAL BORE)	LF	1083
630 2 15	CONDUITS (F&I)(BRIDGE MOUNTED)	LF	1620
632 7 1	CABLE (SIGNAL)(F&I)	PI	1
633 1 123	FIBER OPTIC CABLE (F&I)(UNDERGROUND)(96 SINGLE MODE)	LF	7296
633 3 15	FIBER OPTIC CONNECTION HARDWARE (F&I)(PRETERMINATED PATCH PANEL)	EA	1
635 2 11	PULL & SPLICE BOXES (F&I)	EA	23
635 2 13	PULL & SPLICE BOXES (F&I)(FIBER OPTICS)	EA	26
639 1 123	ELECTRICAL POWER SERVICE (F&I)(UNDERGROUND)	AS	1
639 2 1	ELECTRICAL SERVICE WIRE (F&I)(POLE)	LF	200
639 3 11	ELECTRICAL SERVICE DISCONNECT (F&I)(POLE)	EA	1
641 2 12	PRE-STRESSED CONCRETE POLE (F&I)(P-11)	EA	1
641 2 80	CONCRETE POLE REMOVAL (COMPLETE/DEEP)	EA	4
646 1 11	ALUMINUM SIGNAL POLES (F&I)(PEDESTAL)	EA	8
649 31 105	MAST ARM (F&I)(SINGLE ARM W/O LUM)(78")	EA	1
649 31 109	MAST ARM (F&I)(SINGLE ARM W/ LUM)(70.5")	EA	2
649 31 118	MAST ARM (F&I)(DOUBLE ARM W/O LUM)(70.5"-60")	EA	1
650 1 24	TRAFFIC SIGNAL (F&I)(3-SECT)(1 WAY)(ALUM)	AS	16
650 1 29	TRAFFIC SIGNAL (F&I)(5-SECT)(1 WAY)(ALUM)	AS	4
653 1 11	PEDESTRIAN SIGNAL (F&I)(LED, 1 WAY)	AS	8
660 4 11	VEHICLE DETECTION (F&I)(VIDEO)(CABINET EQUIPMENT)	EA	4
660 4 12	VEHICLE DETECTION (F&I)(VIDEO)(ABOVE GROUND)	EA	4
665 1 11	PEDESTRIAN DETECTOR (F&I)(STD)	EA	8
670 5 110	TRAFFIC CONTROLLER ASSEMBLY (F&I)(NEMA)	AS	1
670 5 600	CONTROLLER ASSEMBLY (REMOVE)	AS	1
682 1 133	CCTV CAMERA (F&I)(NON-PRESSURIZED)(IP, HIGH DEF)	EA	1
684 1 1	MANAGED FIELD ETHERNET SWITCH (F&I)	EA	1
685 106	SYSTEM AUXILIARIES (UNINTERRUPTIBLE POWER SOURCE)(F&I)	EA	1
700 3 201	SIGN PANEL (F&I)(OVERHEAD)(12 SF)	EA	4
700 5 21	INTERNALLY ILLUMINATED SIGN (F&I)(NAME)(OVERHEAD)(12 SF)	EA	4

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**ROBERT W. LAWSON**  
 LICENSE  
 No. 26640  
 JAN 22 2019  
 STATE OF FLORIDA  
 PROFESSIONAL ENGINEER

Revision: \_\_\_\_\_ By: \_\_\_\_\_ Date: \_\_\_\_\_

**Department of Public Works**  
 Engineering Division

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 Approved: **HWD**  
 Drawn: **FM**  
 Checked: **HWD**  
 Date: **6/2017**  
 Field Book No: \_\_\_\_\_

Project:  
**QUANTITIES & GENERAL NOTES**  
 FOR  
**SR 60 & 43RD AVENUE**

Sheet: **13**  
 Of: **99**  
 Project No. **LHW WP1027**



SUMMARY OF PAY ITEMS

NO.	ITEM	UNIT	QUANTITY
LIGHTING			
715 1 12	LIGHTING CONDUCTOR, F&I, INSULATED, No. 4	LF	36765
715 2 11 1	LIGHTING CONDUIT, F&I, UNDERGROUND, 2" PVC SCH. 40	LF	11094
715 4 111	CONFLICT LIGHT POLE COMPLETE W/ CONCRETE BASE, F&I, WIND SPEED 160	EA	36
715 4 111	STANDARD LIGHT POLE COMPLETE W/ CONCRETE BASE, F&I, WIND SPEED 160	EA	30
715 5 11	LUMINAIRE AND BRACKET ARM MOUNTED ON SIGNAL POLE, F&I	EA	4
715 14 11	PULL BOX (F&I) (ROADSIDE), MOULDED	EA	71
715 500 1	POLE CABLE DISTRIBUTION SYSTEM, IP-68	EA	70
715 7 11	LOAD CENTER (INCLUDES ALL COMPONENTS LISTED ON SERVICE POINT DETAILS DRAWING)	EA	3
LANDSCAPE			
HARDSCAPE			
526 1 2	BELGARD (HOLLAND 4"x8" BOMM)(RED, CHESNUT, CHARCOAL)(45' HERRINGBONE)	SY	290
523 1	DURATHERM (INTEGRATED PAVING CONCEPTS)(CINNAMON)(WAGON WHEEL)	SY	800
520 2 13	HEADER CURB	LF	632
PLANT LIST			
TREES			
580 5 5532	GORDONIA IASANTHUS (LOBLOLLY BAY)(8-10'x 4-5' 2.75 CAL)	EA	9
580 5 572	LIGUSTRUM JAPONICUM (JAPANESE PRIVET)(8-10' OA MULTISTEM)	EA	14
580 4 235	PHOENIX SYLVESTRIS (SYLVESTER DATE PALM)(16' CT)	EA	3
580 4 345	SABAL PALMETTO (SABAL PALM)(16-20' CT)	EA	5
SHRUBS			
580 7 177	ILEX BOMITORIA "Schillings" (DWARF YAUPONHOLLY)(#7 FULL)(24" OC)	EA	48
580 7 337	MYRCIANTHES FRAGRANS (SIMPSON'S STOPPER)(#7)(24" O.C.)	EA	59
E575 1	BAHIA SOD (PASPALUM NOTATUM)	SY	5450
E575 1 4	ST. AUGUSTINE SOD	SY	3400
	ROOT BARRIER (24" DEEPROOT)	LF	145
	FLORIMULCH	CY	16
05090 1	IRRIGATION SYSTEM	LS	1

PAY ITEMS & CONTINGENCY ITEMS FOOTNOTES:

ITEM 0509 01 INCLUDES ALL WELLS, PUMP STATIONS, CONTROLLERS, PIPING, HEADS, VALVES, FIXTURES, ENCLOSURES, CONCRETE WORK, SLEEVES, PANELS, AND ALL ELSE NECESSARY FOR A COMPLETE INSTALLATION AND SYSTEM.

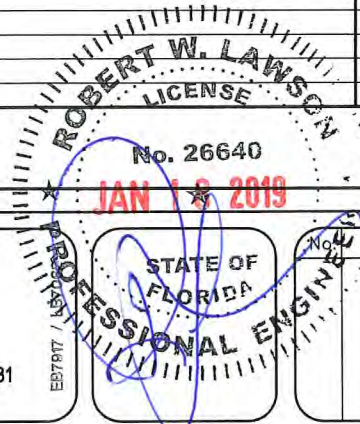
ITEM 580 5 13 INCLUDES ROOT BARRIER AND FLORIMULCH.

580 4 235

580 4 345

SUMMARY OF PAY ITEMS

NO.	ITEM	UNIT	QUANTITY
BRIDGE			
0101 1	MOBILIZATION	LS	1
BRIDGE REMOVAL			
0101 3	DEMOLITION & REMOVAL OF EXISTING BARRIERS, RAILINGS, SLAB, AND 4 WING WALLS AS REQUIRED AND DEBRIS PILES AND GUARDRAILS	LS	1
SUPERSTRUCTURE			
450 1 2	PRESTRESSED BEAMS TYPE II	LF	778.13
400 2 4	CLASS II CONC. FOR BRIDGE DECK AND DIAPHRAGM	CY	144
415 1 4	REINFORCING STEEL FOR BRIDGE DECK AND DIAPHRAGM	LB	44,548
400 148 10	CONC. TRAFFIC RAILING BARRIER - 32" VERTICAL SHAPE	LF	348.67
460 70 2	ALUMINUM PEDESTRIAN BARRIER RAILING	LF	348.67
440 7	BRIDGE FLOOR GROOVING	SY	523
400 147	COMPOSITE NEOPRENE PADS	CF	1.64
SUBSTRUCTURE			
400 2 4	CLASS II CONC. FOR PILE CAPS, PEDESTALS AND SEISMIC BLOCKS	CY	60
415 1 5	REINFORCING STEEL FOR PILE CAPS, PEDESTALS AND SEISMIC BLOCKS	LB	16,156
455 3 2	PRESTRESSED PILES 2.00 18"x 65 FT TEST PILE	LF	130
455 3 2	PRESTRESSED PILES 11.00 18"x 50 FT END BENTS	LF	550
455 3 2	PRESTRESSED PILES 2.00 18"x 50 FT WING BENTS	LF	100
455 3 2	PRESTRESSED PILES 13.00 18"x 50 FT INTERMEDIATE BENTS INCLUDING DEBRIS PILES	LF	620
455 137	P.D.A. TESTING	EA	2
SIDEWALKS AND MEDIAN			
400 2 4	CLASS II CONC. FOR SIDEWALKS	CY	98
415 1 4	REINFORCING STEEL FOR SIDEWALKS	LB	2,824
APPROACH SLAB EXTENSIONS			
400 2 10	CLASS II CONC. FOR APPROACH SLABS	CY	62
415 1 9	REINFORCING STEEL FOR APPROACH SLABS	LB	12,170
530 4 6	(REVTMENT MAT)(CANAL EXCAVATION AS REQUIRED SHALL BE INCLUDED) INCLUDING REMOVAL OF EXISTING TO PLACE NEW END BENTS	SF	2,934
715 2117	4" PVC CONDUIT	LF	1,400



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Department of Public Works  
 Engineering Division

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 Drawn: FM  
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 Date: 6/2017  
 Field Book No: \_\_\_\_\_

Project:  
 QUANTITIES & GENERAL NOTES  
 FOR  
 SR 60 & 43RD AVENUE

Sheet: 13A  
 Of: 99  
 Project No.  
 LNW# WP1027



# GENERAL NOTES

- PRIOR TO COMMENCEMENT OF ANY EXCAVATION, THE CONTRACTOR SHALL COMPLY WITH FLORIDA STATUTE 553.851 FOR THE PROTECTION OF UNDERGROUND GAS PIPELINES.
- ALL GRADES SHOWN ARE FINISHED GRADES, UNLESS OTHERWISE NOTED.
- STATIONING AND OFFSETS REFER TO THE CENTERLINE OF CONSTRUCTION, UNLESS OTHERWISE NOTED.
- ALL RETURN RADI DIMENSIONS, STATIONS, OFFSETS, AND ELEVATIONS REFER TO THE EDGE OF PAVEMENT, UNLESS OTHERWISE NOTED.
- BENCHMARK (B.M.) LOCATIONS ARE INDICATED BY THE SYMBOL: 
- B.M. DATUM IS NATIONAL GEODETIC VERTICAL DATUM OF 1929 (NGVD-29).
- ANY EXISTING SECTION CORNER, QUARTER SECTION CORNER AND INDIAN RIVER COUNTY SURVEY CONTROL MONUMENTS WITHIN THE LIMITS OF CONSTRUCTION SHALL BE PROTECTED. IF A MONUMENT IS IN DANGER OF BEING DISTURBED, AND HAS NOT BEEN PROPERLY REFERENCED, THE CONTRACTOR SHALL NOTIFY THE DISTRICT LOCATION SURVEYOR, WITHOUT DELAY, BY TELEPHONE.
- ANY PUBLIC LAND CORNER WITHIN THE LIMITS OF CONSTRUCTION SHALL BE PROTECTED. IF A CORNER MONUMENT IS IN DANGER OF BEING DISTURBED, AND HAS NOT BEEN PROPERLY REFERENCED, THE CONTRACTOR SHALL NOTIFY THE DISTRICT LOCATION SURVEYOR, WITHOUT DELAY, BY TELEPHONE.
- ANY NGVD-29 MONUMENT WITHIN THE LIMITS OF CONSTRUCTION SHALL BE PROTECTED. IF A MONUMENT IS IN DANGER OF BEING DISTURBED, THE CONTRACTOR SHOULD NOTIFY:  
MARK MAINTENANCE SECTION  
GEODETIC INFORMATION CENTER ATTN: N/CG-162  
ROCKVILLE, MARYLAND 20852  
TELEPHONE: 301-443-8319
- NO CONSTRUCTION SHALL COMMENCE UNTIL ALL REQUIRED PERMITS AND APPROVALS HAVE BEEN SECURED AND THE CONTRACTOR IS ISSUED A "NOTICE TO PROCEED".
- CONTRACTOR SHALL UTILIZE CONSTRUCTION METHODS AND DEVICES AS INDICATED IN FDOT STANDARD INDEXES 100, 101, 102, 103, 104 AND 105 WHERE NECESSARY IN ORDER TO COMPLY WITH ALL STATE, LOCAL AND NPDES WATER QUALITY STANDARDS.
- CONTRACTOR SHALL MAINTAIN TRAFFIC AT ALL TIMES DURING CONSTRUCTION IN ACCORDANCE WITH FDOT INDEX NOS. 600 THRU 660 AND SHALL PROVIDE ALL BARRICADES, LIGHTING, SIGNAGE AND FLAGMEN AS NECESSARY TO PROVIDE FOR THE SAFETY OF THE PUBLIC IN THE AREA OF THE WORK. MAINTENANCE OF TRAFFIC SHALL BE IN ACCORDANCE WITH CURRENT FDOT ROADWAY & TRAFFIC DESIGN STANDARDS AND SPECIFICATIONS AND THE MANUAL ON UNIFORM TRAFFIC CONTROL DEVICES (MUTCD).
- EXISTING DRAINAGE STRUCTURES AND PIPES WITHIN THE LIMITS OF CONSTRUCTION SHALL REMAIN, UNLESS OTHERWISE NOTED.
- DURING CONSTRUCTION, SHOULD ANY DRAINAGE STRUCTURES (INCLUDING PIPES) BE FOUND THAT ARE NOT SHOWN ON THE PLANS, NOTIFY THE ENGINEER IMMEDIATELY.
- EXISTING UTILITIES ARE TO BE ADJUSTED OR RELOCATED BY OTHERS AS DIRECTED BY THE ENGINEER, UNLESS OTHERWISE NOTED.
- IN REFERENCE TO EXISTING UTILITIES AND UTILITY ADJUSTMENTS:  
A. THE LOCATION OF UTILITIES SHOWN ON THE PLANS ARE APPROXIMATE ONLY. THE EXACT LOCATIONS SHALL BE DETERMINED BY THE CONTRACTOR PRIOR TO CONSTRUCTION. IN ADDITION, THE CONTRACTOR SHALL BE RESPONSIBLE TO VERIFY IF "OTHER" UTILITIES (NOT SHOWN ON THE PLANS) EXIST WITHIN THE AREA OF CONSTRUCTION. SHOULD THERE BE UTILITY CONFLICTS, THE CONTRACTOR SHALL INFORM THE ENGINEER AND NOTIFY THE RESPECTIVE UTILITY OWNER(S) TO RESOLVE UTILITY CONFLICTS AND UTILITY ADJUSTMENTS, AS REQUIRED.  
B. FOR EXISTING UTILITY SYMBOLS, SEE FDOT STANDARD INDEX 002.  
C. WATER AND SANITARY SEWER UTILITY WORK SHALL BE IN CONFORMANCE WITH ALL CODES, STANDARDS, AND ORDINANCES CURRENTLY ADOPTED BY THE STATE OF FLORIDA D.E.P., INDIAN RIVER COUNTY H.R.S., AND THE LOCAL UTILITY DEPT. OWNING THE FACILITIES.
- CONTRACTOR SHALL USE EXTREME CAUTION WHEN WORKING IN OR AROUND AREAS OF OVERHEAD OR UNDERGROUND UTILITIES.
- CONTRACTOR SHALL NOTIFY SUNSHINE STATE "ONE CALL" (1-800-432-4770) AND ALL AFFECTED UTILITIES 48 HOURS IN ADVANCE OF ANY CONSTRUCTION SO THAT A COMPANY REPRESENTATIVE MAY BE PRESENT.

**EXISTING UTILITY OWNERS:**

IRC UTILITIES DEPARTMENT	ARJUNA WERAGODA, PE	772-226-1821
AT&T BROADBAND	CRAIG BOWERS	772-778-9635
IRC TELECOMMUNICATION DIVISION	MANNY CABO	772-226-1318
FLORIDA POWER & LIGHT Co.	DENNIS G. PAGANO	772-489-6204
FP&L PROJECTS & RELOCATIONS	BILL HESTER	772-337-7099
FLORIDA GAS TRANSMISSION Co.	JOSEPH SANCHEZ	407-838-7000
AT&T	MARK GUTIERREZ	772-460-4443
COMCAST CABLE	WILSON LOPEZ	772-940-9310
VERO BEACH ELECTRICAL ENGINEERING JILL GLOVER		772-978-5459
CITY GAS COMPANY OF FLORIDA	GLEN "BOCK" KREINHAGEN	772-871-2551 EXT. 23
SEBASTIAN RIVER WCD	ROBERT ULEVICH	772-562-9176
INDIAN RIVER FARMS WCD	DAVID GUNTER	772-562-2141
IRC TRAFFIC	JOHN ANKENY	772-226-1563
VERO BEACH WATER & SEWER DEPT.	TODD YOUNG	772-978-5209

- WHEN WORKING WITHIN TEN (10') FEET OF A TRAFFIC SIGNAL POLE, INDIAN RIVER COUNTY TRAFFIC OPERATIONS SHALL BE NOTIFIED: 772-567-8000.
- INTERSECTING ROADS AND DRIVEWAYS SHALL BE GRADED AS DIRECTED BY THE ENGINEER, UNLESS OTHERWISE NOTED ON THE PLANS.
- WHERE OPEN-CUTS OF THE EXISTING ROADWAY ARE MADE IN ORDER TO INSTALL PIPELINES, CONDUITS OR SLEEVES, REPAIR THE PAVEMENT IN ACCORDANCE WITH THE "OPEN-CUT PAVEMENT REPAIR DETAIL" IN THESE PLANS. MAINTAIN REPAIRED PAVEMENT FOR THE DURATION OF THE PROJECT.
- IN REFERENCE TO THE PROPOSED DRAINAGE STRUCTURES & PIPE:  
A. SPECIAL ATTENTION IS DIRECTED TO THE FACT THAT PORTIONS OF SOME DRAINAGE STRUCTURES MAY EXTEND INTO THE COMPACTED SUBGRADE PORTION OF THE ROAD BED. EXTREME CAUTION WILL BE NECESSARY DURING COMPACTION OPERATIONS IN THESE LOCATIONS.  
B. CONCRETE PIPE CULVERT (R.C.P.) SHALL BE CLASS III, WALL B UNLESS OTHERWISE NOTED.  
C. ALL STORM STRUCTURE TOPS SHALL BE ADJUSTED AT TIME OF FINAL PAVEMENT OR CURB CONSTRUCTION. FINAL ADJUSTMENT OF ALL TOPS SHALL BE THE RESPONSIBILITY OF THE UNDERGROUND CONTRACTOR.  
D. THE LENGTHS OF PIPE SHOWN HEREON HAVE BEEN DETERMINED BY CALCULATING THE DISTANCE BETWEEN THE "CENTERLINE" OF THE INLETS AND/OR MANHOLES.  
E. ALL DITCH BOTTOM INLETS SHALL HAVE AN EYEBOLT AND CHAIN IN ACCORDANCE WITH FDOT INDEX 201.  
F. THE CONTRACTOR SHALL VERIFY THE EXISTING INVERT ELEVATIONS AND DIMENSIONS OF ALL EXISTING DRAINAGE STRUCTURES PRIOR TO FABRICATION OF PROPOSED DRAINAGE STRUCTURES.  
G. OFFSETS TO CURB INLETS ARE AT EDGE OF PAVEMENT.
- ALL MAILBOXES CURRENTLY SERVED FROM THE ROADWAY BEFORE CONSTRUCTION, MUST BE SERVED IN THE SAME MANNER AFTER CONSTRUCTION. CONFORM WITH FDOT STANDARD INDEX 532. COST OF THIS ITEM SHALL BE INCLUDED UNDER THE CONTRACT PRICE FOR CLEARING AND GRUBBING. CONTRACTOR SHALL CONTACT THE US POSTAL SERVICE MR. DAVE SAVILLE AT 772-713-4622 PRIOR TO BEGINNING OF CONSTRUCTION TO COORDINATE MAIL SERVICE REQUIREMENTS. MAIL SERVICE SHALL REMAIN AVAILABLE AT ALL TIMES DURING CONSTRUCTION.
- ALL EXISTING FDOT / INDIAN RIVER COUNTY SIGNS WITHIN THE LIMITS OF CONSTRUCTION WHICH ARE TO BE RELOCATED OR REMOVED SHALL BE REMOVED BY THE CONTRACTOR AND STOCKPILED WITHIN THE RIGHT-OF-WAY FOR REMOVAL OR RELOCATION BY INDIAN RIVER COUNTY FORCES. NOTIFY INDIAN RIVER COUNTY TRAFFIC OPERATIONS AT 772-567-8000.
- CONTRACTOR SHALL EXERCISE CAUTION WHILE REMOVING AND/OR RELOCATING EXISTING SIGNS IN ORDER TO PREVENT ANY UNNECESSARY DAMAGE TO THE SIGNS. SIGNS WHICH ARE DAMAGED BEYOND USE, AS DETERMINED BY THE ENGINEER, SHALL BE REPLACED BY THE CONTRACTOR AT HIS EXPENSE.
- MAINTENANCE OF TRAFFIC SHALL BE IN ACCORDANCE WITH CURRENT FDOT ROADWAY AND TRAFFIC DESIGN STANDARDS AND SPECIFICATIONS AND THE MANUAL ON UNIFORM TRAFFIC CONTROL STANDARDS (MUTCD).
- THE CONTRACTOR SHALL BE RESPONSIBLE FOR DOCUMENTING THE EXISTING PAVEMENT MARKINGS BEFORE RESURFACING WORK IS STARTED AND THIS INFORMATION SHALL BE USED IN CONJUNCTION WITH TEMPORARY STRIPING AND FINISHED STRIPING.
- EXCAVATED SOILS AND EXISTING ROCK BASE MAY BE USED FOR EMBANKMENT CONSTRUCTION PROVIDED THAT THE MATERIAL IS CLEAN FILL, FREE OF ORGANIC MATERIALS, ROOTS OR OTHER DELETERIOUS MATERIALS, AND CONFORMS WITH FDOT SPECIFICATIONS AND FDOT STANDARD INDEX 505.
- ANY BORROW MATERIAL REQUIRED FOR THE PROJECT SHALL BE FURNISHED BY THE CONTRACTOR FROM AREAS PROVIDED BY HIM.
- ALL MUCK AND PLASTIC MATERIAL WITHIN THE LIMITS OF CONSTRUCTION SHALL BE REMOVED BY THE CONTRACTOR IN ACCORDANCE WITH FDOT STANDARD INDEX 500.
- NONE OF THE EXISTING BASE THAT IS REMOVED DURING CONSTRUCTION SHALL BE USED IN THE CONSTRUCTION OF THE PROPOSED BASE, UNLESS AUTHORIZED BY THE ENGINEER.
- ALL VEGETATION, DEBRIS, PAVEMENT, CONCRETE OR OTHER UNSUITABLE MATERIALS SHALL BE LEGALLY DISPOSED OF OFF-SITE IN AN AREA PROVIDED BY THE CONTRACTOR.
- ALL EXISTING IRRIGATION SYSTEM COMPONENTS CONFLICTING WITH THE PROPOSED CONSTRUCTION SHALL BE REMOVED AND DISPOSED OF BY THE CONTRACTOR. EXISTING PIPES SHALL BE CAPPED PRESSURE TIGHT AT THE R/W LINE OR LIMITS OF CONSTRUCTION. EXISTING CONTROL WIRING SHALL BE CUT, SEALED AND LEFT BURIED BELOW GRADE AT THE R/W LINE OR LIMITS OF CONSTRUCTION. IN ALL CASES, THE CONTRACTOR SHALL CLEARLY MARK IN THE FIELD ALL IRRIGATION SYSTEM BREAKS IN A MANNER ACCEPTABLE TO THE ENGINEER FOR FUTURE RE-CONNECTION OR EXTENSION BY OTHERS. THE COST FOR IRRIGATION SYSTEM REMOVAL, CAPPING PIPE AND SEALING WIRING AND ALL OTHER WORK RELATING TO EXISTING IRRIGATION SYSTEMS SHALL BE INCLUDED IN THE CONTRACT PRICE FOR CLEARING AND GRUBBING.
- DRIVEWAY SLOPES MAY BE MODIFIED AS DIRECTED BY THE ENGINEER TO MATCH EXISTING CONDITIONS.
- ALL EXISTING INLETS, MANHOLES & MANHOLE CASTINGS WHICH ARE REMOVED WITHIN THE LIMITS OF ANY R/W'S SHALL BE STOCKPILED WITHIN THE R/W FOR REMOVAL BY COUNTY FORCES. CONTACT IRC ROAD & BRIDGE DIVISION AT (561)233-3956.
- THE CONTRACTOR SHALL COMPLETELY REMOVE EXISTING ASPHALT & BASE MATERIAL FROM AREAS TO BE SOLDED. BACKFILL SHALL CONSIST OF CLEAN, GRANULAR FILL MATERIAL.

**CONTAMINATION NOTES:**

RECOMMENDED PLANS NOTES (1-DEWATERING, 2-IDENTIFIED AREAS OF CONTAMINATION, 3-UNIDENTIFIED AREAS OF CONTAMINATION, 4-BRIDGE ASBESTOS):

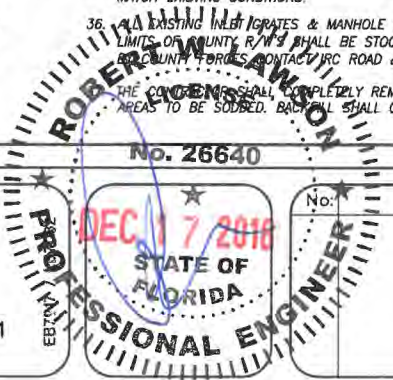
- THERE IS IDENTIFIED GROUNDWATER CONTAMINATION ON PROPERTIES ADJACENT TO THE FDOT RIGHT-OF-WAY (ROW). IF DEWATERING METHODS WILL BE EMPLOYED IN THE AREAS LISTED BELOW, CONTAMINATION IMPACTS MAY OCCUR.  
? APPROXIMATELY STA 116+00 TO STA 133+40  
? APPROXIMATELY STA 2636+00 TO STA 2650+00  
THE CONTRACTOR SHALL PROVIDE A MINIMUM OF 2-WEEKS NOTIFICATION TO THE INDIAN RIVER COUNTY ENGINEER WHEN APPROACHING THE ABOVE REFERENCED AREAS.  
THE CONTRACTOR SHALL NOTIFY THE INDIAN RIVER COUNTY ENGINEER OR A DESIGNATED QUALIFIED ENVIRONMENTAL INDIVIDUAL/CONSULTANT FOR TECHNICAL ASSISTANCE BEFORE APPLYING FOR A DEWATERING PERMIT FROM ANY ENVIRONMENTAL REGULATORY AGENCY TO AVOID POTENTIAL CONTAMINATION PLUME EXACERBATION AND DETERMINE PROPER GROUNDWATER MANAGEMENT ASSOCIATED WITH THE ABOVE REFERENCED SITES.  
A COORDINATION MEETING BETWEEN THE INDIAN RIVER COUNTY ENGINEER OR A DESIGNATED QUALIFIED ENVIRONMENTAL INDIVIDUAL/CONSULTANT AND THE CONTRACTOR SHALL BE HELD PRIOR TO THE START OF CONSTRUCTION TO COORDINATE ACTIVITIES WITHIN THE ABOVE MENTIONED AREAS.
- THERE IS IDENTIFIED GROUNDWATER CONTAMINATION WITHIN THE PROJECT CORRIDOR. IF GROUND DISTURBING ACTIVITIES (REACHING THE SATURATED SOILS) ARE SCHEDULED, CONTAMINATION IMPACTS MAY OCCUR IN THE AREAS LISTED BELOW:  
OAPPROXIMATELY STATION (STA) 127+60 LT TO STA 128+60 LT (MARKS MOBILE'S PLUME - NW CORNER)  
O APPROXIMATELY STATION (STA) 2643+20 TO STA 2646+60 RT (YOUNG'S MARKET'S AND VERO BEACH DRY CLEANERS PLUMES - SE CORNER)  
OAPPROXIMATELY STATION (STA) 2640+40 TO STA 2641+20 RT (TOM'S MOBILE'S PLUME - SW CORNER)  
THE INDIAN RIVER COUNTY ENGINEER WILL HAVE A CONTAMINATION ASSESSMENT AND REMEDIATION (CAR) CONTRACTOR WORKING UNDER A SEPARATE CONTRACT TO PERFORM MONITORING DURING CONSTRUCTION ACTIVITIES IN THESE AREAS. THE CONTRACTOR SHALL PROVIDE A MINIMUM OF 2-WEEKS NOTIFICATION TO THE INDIAN RIVER COUNTY ENGINEER WHEN APPROACHING THE ABOVE REFERENCED AREA(S).  
A COORDINATION MEETING BETWEEN THE INDIAN RIVER COUNTY ENGINEER OR A DESIGNATED QUALIFIED ENVIRONMENTAL INDIVIDUAL/CONSULTANT AND THE CONTRACTOR SHALL BE HELD PRIOR TO THE START OF CONSTRUCTION TO COORDINATE ACTIVITIES WITHIN THE ABOVE MENTIONED AREAS.

3. UNIDENTIFIED AREAS OF CONTAMINATION  
WHEN ENCOUNTERING OR EXPOSING ANY ABNORMAL CONDITION INDICATING THE PRESENCE OF A HAZARDOUS OR TOXIC WASTE, OR CONTAMINANTS, CEASE OPERATIONS IMMEDIATELY IN THE VICINITY AND NOTIFY THE INDIAN RIVER COUNTY ENGINEER. THE PRESENCE OF TANKS OR BARRELS; DISCOLORED EARTH, METAL, WOOD, GROUND WATER, ETC.; VISIBLE FUMES; ABNORMAL ODORS; EXCESSIVELY HOT EARTH; SMOKE; OR OTHER CONDITIONS THAT APPEAR ABNORMAL MAY INDICATE HAZARDOUS OR TOXIC WASTES OR CONTAMINANTS AND MUST BE TREATED WITH EXTREME CAUTION.  
MAKE EVERY EFFORT TO MINIMIZE THE SPREAD OF CONTAMINATION INTO UNCONTAMINATED AREAS. IMMEDIATELY PROVIDE FOR THE HEALTH AND SAFETY OF ALL WORKERS AT THE JOB SITE AND MAKE PROVISIONS NECESSARY FOR THE HEALTH AND SAFETY OF THE PUBLIC THAT MAY BE EXPOSED TO ANY POTENTIALLY HAZARDOUS CONDITIONS. PROVISIONS SHALL MEET ALL APPLICABLE LOCAL, STATE, AND FEDERAL LAWS, RULES, REGULATIONS OR CODES COVERING HAZARDOUS CONDITIONS AND WILL BE IN A MANNER COMMENSURATE WITH THE GRAVITY OF THE CONDITIONS.  
THE INDIAN RIVER COUNTY ENGINEER AND/OR CONTRACTOR WILL COORDINATE AND MOBILIZE A QUALIFIED CONTAMINATION ASSESSMENT/REMEDATION (CAR) CONTRACTOR. QUALIFICATIONS OF SUCH CAR CONTRACTOR SHALL INCLUDE, BUT NOT BE LIMITED TO: EXPERIENCE AND PERSONNEL TO PREPARE CONTAMINATION ASSESSMENT PLANS, CONDUCT CONTAMINATION ASSESSMENTS, PREPARE SITE ASSESSMENT REPORTS, REMEDIATION PLANS, IMPLEMENT REMEDIAL ACTION PLANS, RISK BASED CORRECTIVE ACTIONS, STORAGE TANKS SYSTEM REMOVAL, HIGHWAY SPILL RESPONSE AS WELL AS EXPERIENCE WITH INFRASTRUCTURE/CONSTRUCTION ACTIVITIES WITHIN (POTENTIALLY) CONTAMINATED AREAS SPECIFIC TO TRANSPORTATION SYSTEMS.  
ALL THE WORK PERFORMED BY THE CAR CONTRACTOR SHALL BE PERFORMED IN COMPLIANCE WITH ALL APPLICABLE LOCAL, STATE AND FEDERAL REGULATIONS GOVERNING WORKER SAFETY AND ENVIRONMENTAL REGULATIONS. THIS IS TO INCLUDE OCCUPATIONAL EXPOSURE TO CONTAMINATED SOILS, GROUNDWATER, WASTES AND ATMOSPHERE DURING THE CONSTRUCTION OF ALL FEATURES INCLUDED IN THE CONSTRUCTION PLANS. IN ADDITION, THE CAR CONTRACTOR MUST BE STAFFED WITH FLORIDA LICENSED TECHNICAL PROFESSIONALS (GEOLOGISTS AND ENGINEERS) WHO WILL BE INVOLVED WITH THE PROJECT AND KNOWLEDGEABLE OF THE WORK ACTIVITIES CONDUCTED WITHIN THE IDENTIFIED CONTAMINATED AREAS AND WHO WOULD SIGN AND SEAL PROJECT REPORTS AS REQUIRED FOR SUBMITTAL TO THE APPROPRIATE ENVIRONMENTAL REGULATORY AGENCIES.

THE INDIAN RIVER COUNTY ENGINEER WILL IMMEDIATELY NOTIFY THE FLORIDA DEPARTMENT OF TRANSPORTATION (FDOT) DISTRICT VI CONTAMINATION IMPACT COORDINATOR (DCIC) AT (305) 470-5228 AFTER ENCOUNTERING THE UNIDENTIFIED AREAS OF CONTAMINATION. PRELIMINARY INVESTIGATION BY THE CAR CONTRACTOR WILL DETERMINE THE COURSE OF ACTION NECESSARY FOR SITE SECURITY AND THE STEPS NECESSARY UNDER APPLICABLE LAWS, RULES, AND REGULATIONS FOR ADDITIONAL ASSESSMENT AND/OR REMEDIATION WORK TO RESOLVE THE CONTAMINATION ISSUE.

FOLLOWING COMPLETION OF THE PROJECT, THE CAR CONTRACTOR SHALL BE REQUIRED TO PROVIDE COPIES OF ALL REPORTS SUBMITTED TO REGULATORY AGENCIES, WASTE MATERIAL PROFILES, MANIFESTS AND/OR DISPOSAL RECEIPTS FOR THE HANDLING OF ALL CONTAMINATED MEDIA INCLUDING BUT NOT LIMITED TO GROUND WATER, WASTE WATER, SOILS, SOLID WASTES, SLUDGE, HAZARDOUS WASTES, AIR MONITORING RECORDS AND SAMPLE RESULTS FOR ALL MATERIALS TESTED AND ANALYZED TO THE INDIAN RIVER COUNTY ENGINEER AND THE FDOT DCIC.

1. PRIOR TO INITIATING ANY BRIDGE MODIFICATION, REHABILITATION OR DEMOLITION ACTIVITY ON BRIDGE #884056, THE CONSTRUCTION CONTRACTOR SHALL SUBMIT A NOTICE OF ASBESTOS RENOVATION OR DEMOLITION [DEF FORM 62-257.900(1)] TO THE FLORIDA DEPARTMENT OF ENVIRONMENTAL PROTECTION (FDEP), OR THEIR DESIGNEE, A MINIMUM OF TEN (10) WORKING DAYS PRIOR TO INITIATING ANY RENOVATION OR DEMOLITION ACTIVITIES.



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**Department of Public Works**  
**Engineering Division**

Scale:	N.T.S.
Approved:	HWD
Drawn:	FM
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Date:	8/2017
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Project:  
**QUANTITIES & GENERAL NOTES**  
FOR  
SR 60 & 43RD AVENUE

Sheet:	14
Of:	99
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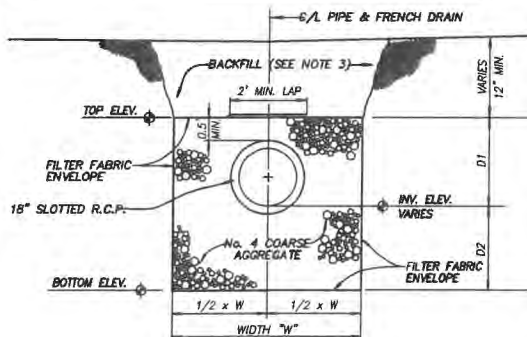












CROSS SECTION

TYPICAL DETAIL - FRENCH DRAIN

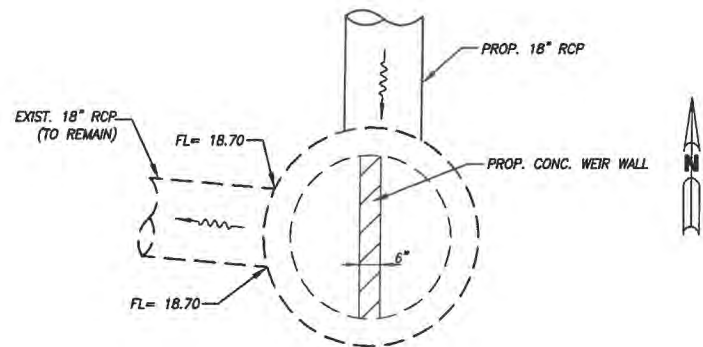
FRENCH DRAIN GENERAL NOTES:

- 1) CONFORM WITH ALL REQUIREMENTS OF FDOT INDEX No. 285 EXCEPT AS SHOWN ON, AND/OR MODIFIED BY, THIS DETAIL AND THESE GENERAL NOTES.
- 2) ALL FILTER FABRIC JOINTS SHALL LAP A MINIMUM OF TWO (2) FEET.
- 3) PROVIDE CLEAN SAND BACKFILL ABOVE FRENCH DRAIN LOCATED UNDER GRASSED AREAS. PROVIDE SELECT BACKFILL IN ACCORDANCE w/ SECTION 44.3 OF THE FDOT SPECIFICATIONS ABOVE FRENCH DRAIN LOCATED UNDER ROADWAY PAVEMENT OR DRIVEWAY PAVEMENT.
- 4) PROVIDE ALL SHORING, SHEETING AND/OR BRACING AS REQUIRED FOR CONSTRUCTION OF THE FRENCH DRAIN WITHIN THE R/W. THE COST OF SHORING, SHEETING AND BRACING SHALL BE INCLUDED IN THE CONTRACT UNIT PRICE FOR FRENCH DRAIN (PER LF).
- 5) ALL PIPES TERMINATING WITHIN THE FRENCH DRAIN WITHOUT A MANHOLE/ INLET SHALL BE CAPPED WITH A PREFABRICATED C.M.P. CAP OR PLUGGED WITH A MASONRY PLUG IN ACCORDANCE WITH FDOT INDEX NO. 280.

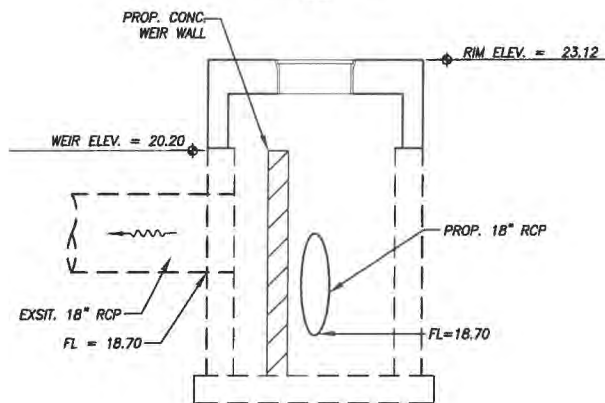
FRENCH DRAIN DATA			
	S-100 TO S-102	S-220 TO S-222	S-218A TO S-218
TOTAL LENGTH	360'	290'	92'
DEPTH - "D1"	2.75'	2.75'	2.75'
DEPTH - "D2"	0.75'	0.75'	0.75'
TRENCH WIDTH	6.00'	6.00'	6.00'
PIPE SIZE/MAT'L	18" R.C.P.	18" R.C.P.	18" R.C.P.
PIPE INV. ELEV.	19.10'	18.75'	18.75'
TRENCH TOP ELEV.	21.85'	21.50'	21.50'
TRENCH BOT. ELEV.	16.35'	18.00'	18.00'

FRENCH DRAIN DATA		
	S-01 TO S-01A	S-13A TO S-13
TOTAL LENGTH	168'	264'
DEPTH - "D1"	2.75'	2.75'
DEPTH - "D2"	0.75'	0.75'
TRENCH WIDTH	6.00'	6.00'
PIPE SIZE/MAT'L	18" R.C.P.	18" R.C.P.
PIPE INV. ELEV.	18.60'	18.25'
TRENCH TOP ELEV.	21.00'	21.00'
TRENCH BOT. ELEV.	17.50'	17.50'

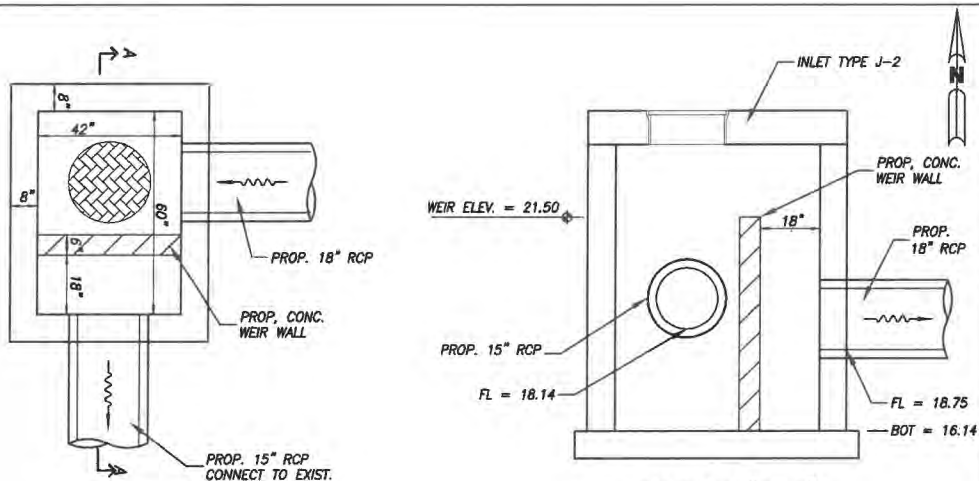
FRENCH DRAIN DATA		
	S-11A TO S-11	S-1C
TOTAL LENGTH	286'	96'
DEPTH - "D1"	2.75'	2.75'
DEPTH - "D2"	0.75'	0.75'
TRENCH WIDTH	6.00'	6.00'
PIPE SIZE/MAT'L	18" R.C.P.	18" R.C.P.
PIPE INV. ELEV.	18.25'	18.25'
TRENCH TOP ELEV.	21.00'	21.00'
TRENCH BOT. ELEV.	17.50'	17.50'



PLAN VIEW  
N.T.S.



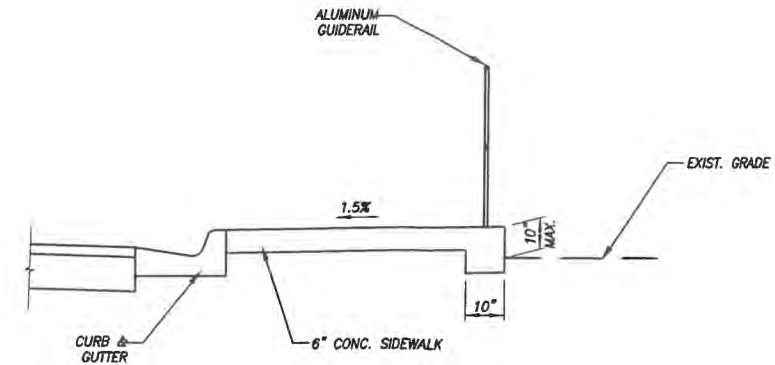
CONTROL STRUCTURE S-12 DETAIL



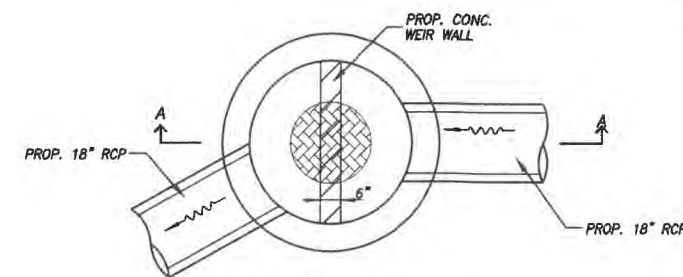
PLAN VIEW  
N.T.S.

SECTION "A-A"  
N.T.S.

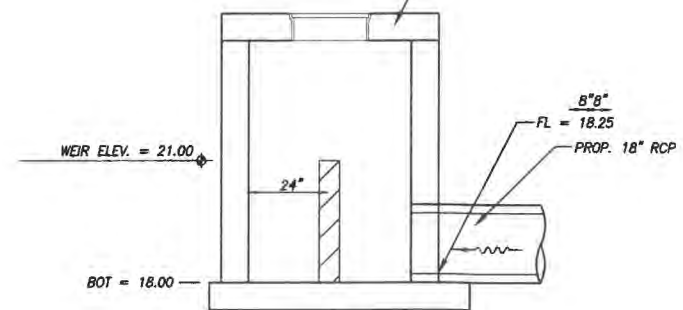
CONTROL STRUCTURE S-222 DETAIL



THICKENED EDGE SIDEWALK



PLAN VIEW  
N.T.S.



SECTION "A-A"  
N.T.S.

CONTROL STRUCTURE S-01A DETAIL



Revision: By: Date:



Department of Public Works  
Engineering Division

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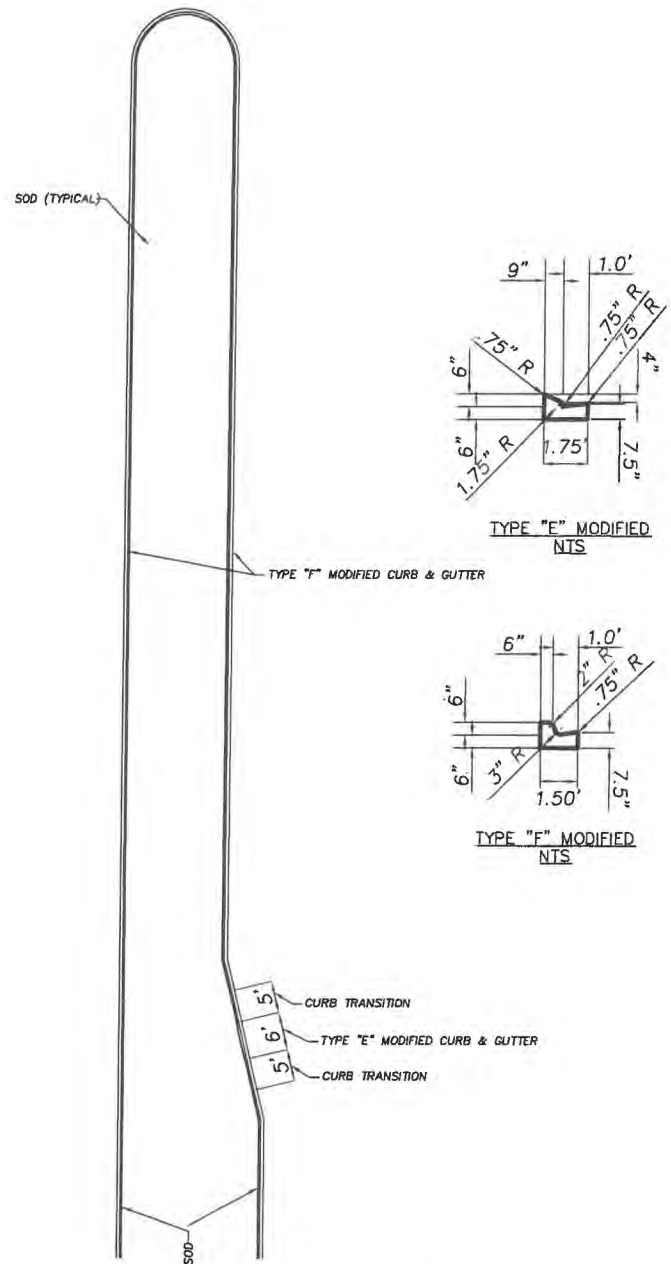
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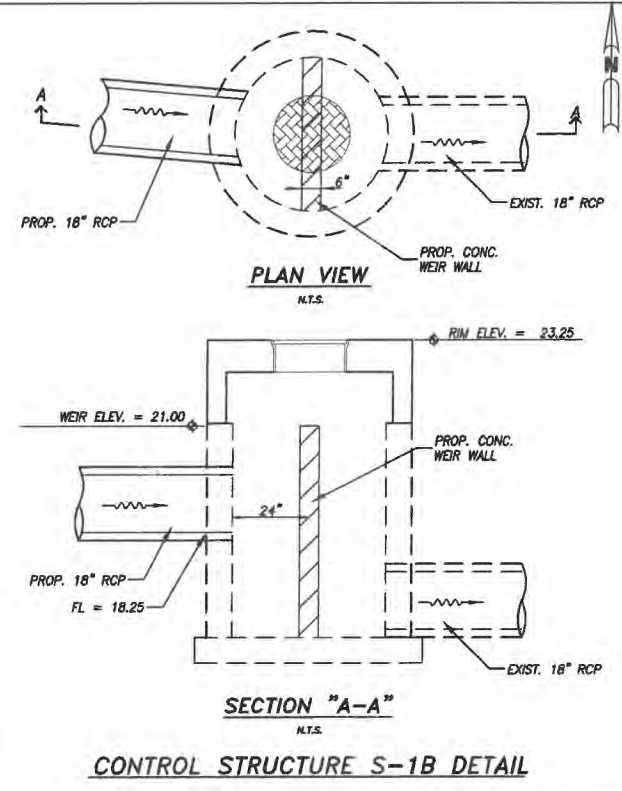
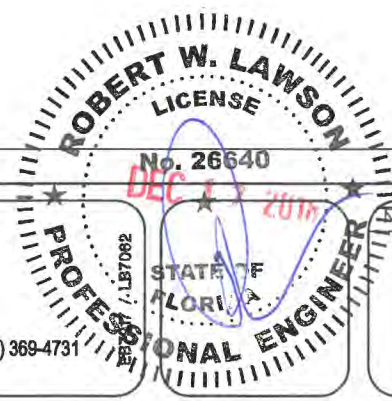
LNW# WP1027



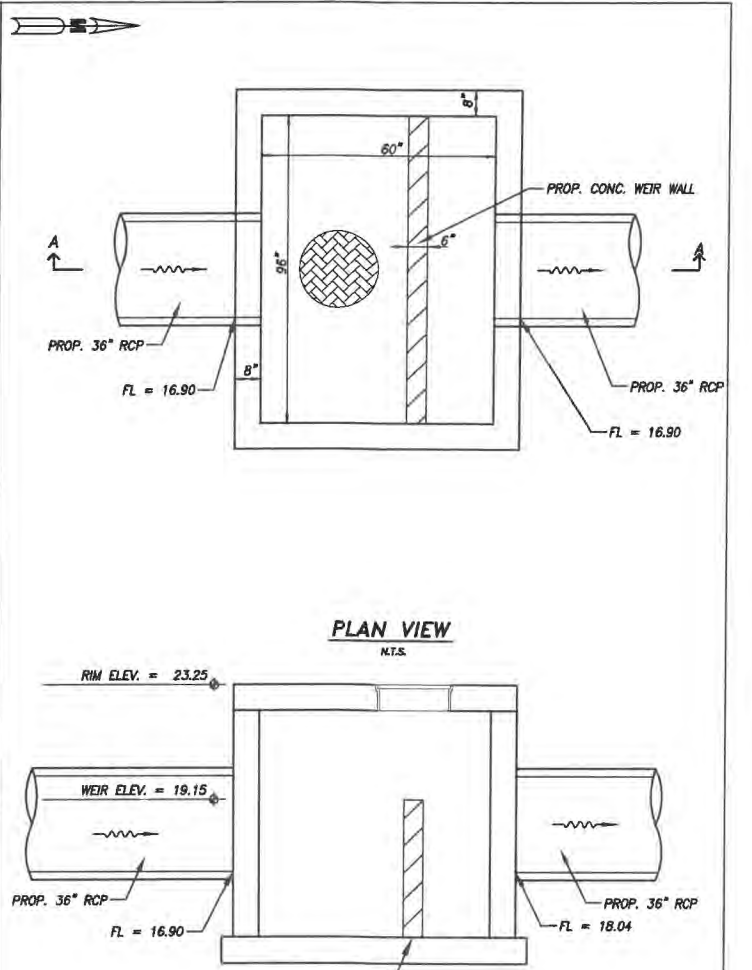


**MODIFIED CURB FOR MOWER ACCESS**

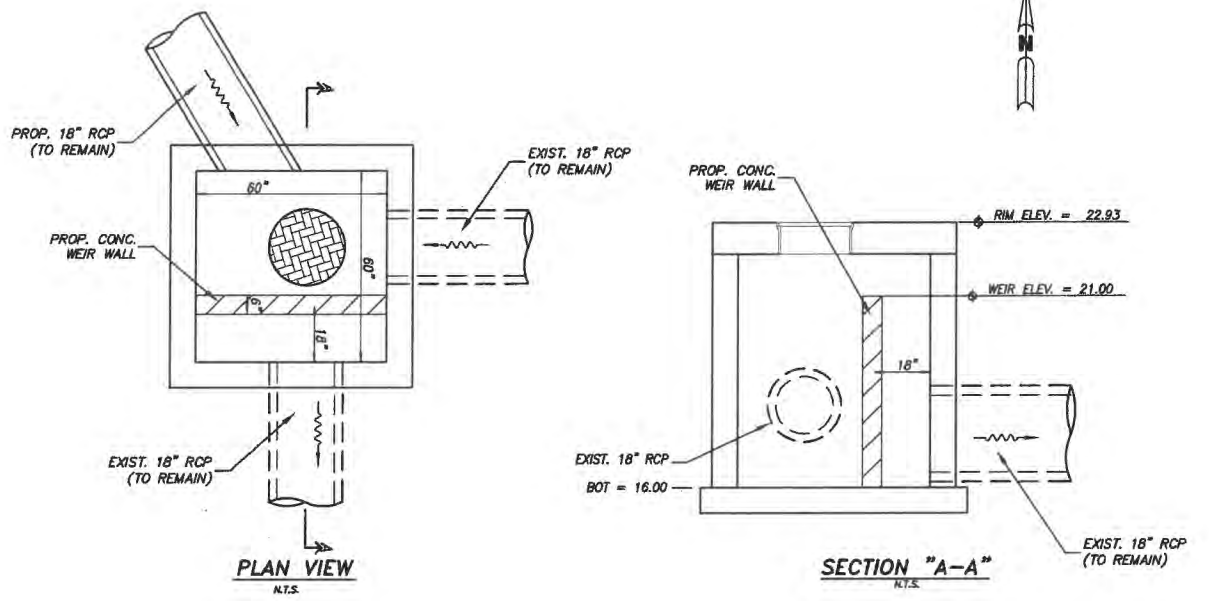
**NOTES:**  
 1. TO BE CONSTRUCTED AT ALL LEFT TURN LANES.



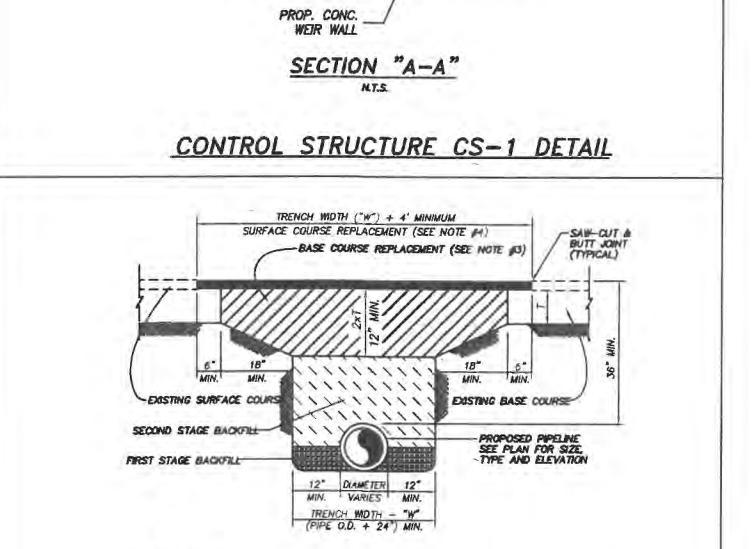
**CONTROL STRUCTURE S-18 DETAIL**



**CONTROL STRUCTURE CS-1 DETAIL**

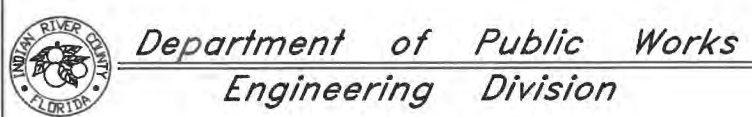


**CONTROL STRUCTURE S-14 DETAIL**



**NOTES:**  
 1. ALL WORK AND MATERIALS SHALL CONFORM WITH F.O.D.T. STANDARD SPECIFICATIONS, LATEST EDITION, AND ALL CONDITIONS OF THE R/W PERMIT ISSUED BY THE F.O.D.T., COUNTY OR LOCAL ROAD AGENCY.  
 2. FIRST AND SECOND STAGE BACKFILL SHALL BE PLACED IN 6" MAX. LIFTS (COMPACTED THICKNESS) AND SHALL BE COMPACTED TO 100% OF THE AASHTO T-99 MAXIMUM DENSITY.  
 3. BASE REPLACEMENT OVER TRENCH SHALL BE THREE TIMES THE THICKNESS OF THE EXISTING BASE COURSE. BASE COURSE REPLACEMENT MATERIAL SHALL BE LIMEPOCK ONLY AND SHALL BE PLACED IN 2 OR 3 EQUAL LIFTS (6" MAX. COMPACTED THICKNESS) AND COMPACTED TO 100% OF THE AASHTO T-99 MAXIMUM DENSITY. NO EXISTING BASE MATERIAL SHALL BE USED FOR THE BASE COURSE REPLACEMENT. FINISHED BASE COURSE AND VERTICAL SURFACE OF SAW-CUTS SHALL RECEIVE PRIME & TACK COATS.  
 4. SURFACE COURSE REPLACEMENT SHALL MATCH THE THICKNESS AND TYPE OF MATERIAL(S) OF THE EXISTING PAVEMENT, AS A MINIMUM, PROVIDED 2" OF THE SP 12.5 ASPHALTIC CONCRETE.

**OPEN-CUT PAVEMENT REPAIR DETAIL**

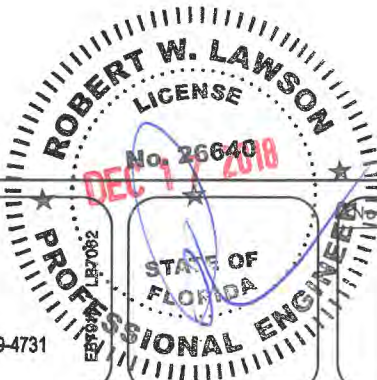
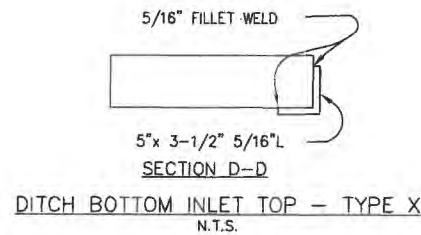
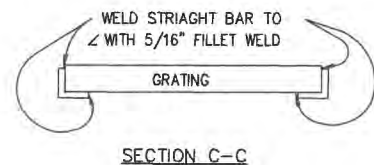
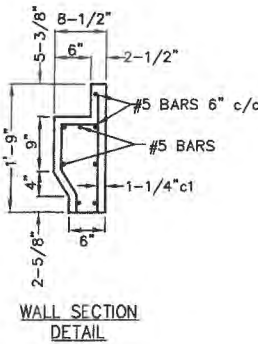
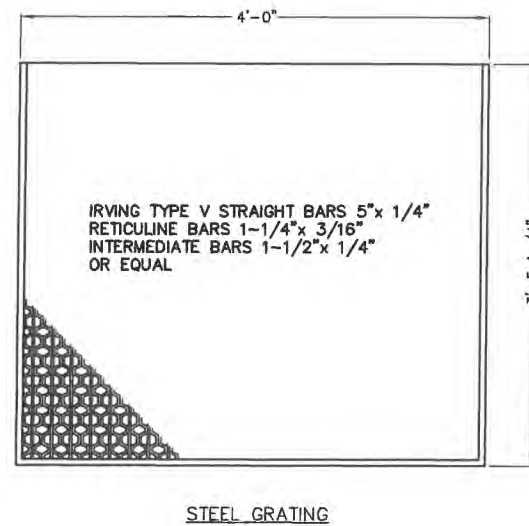
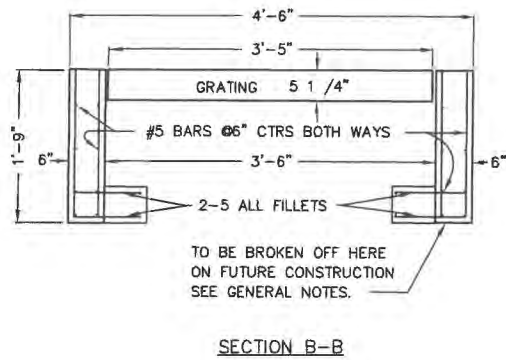
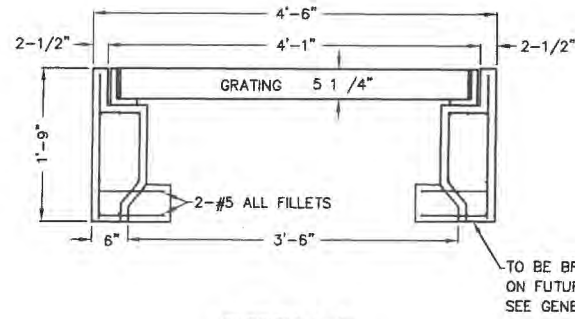
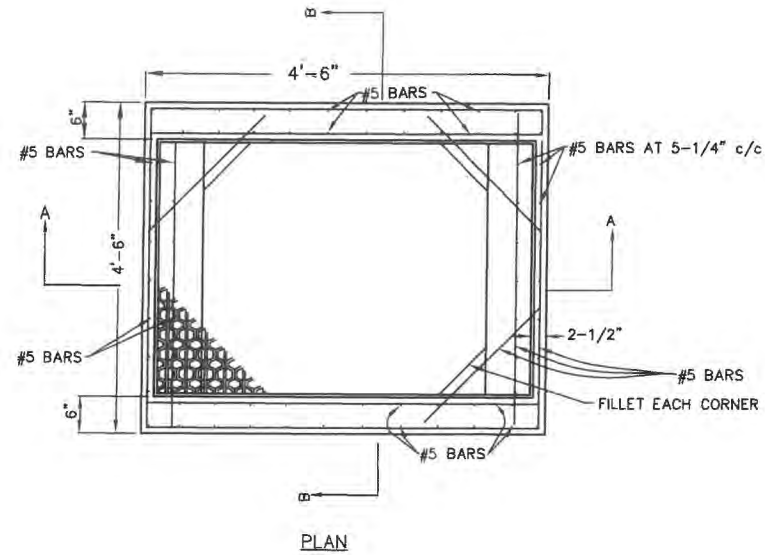


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Project: DETAILS FOR SR 60 & 43RD AVENUE

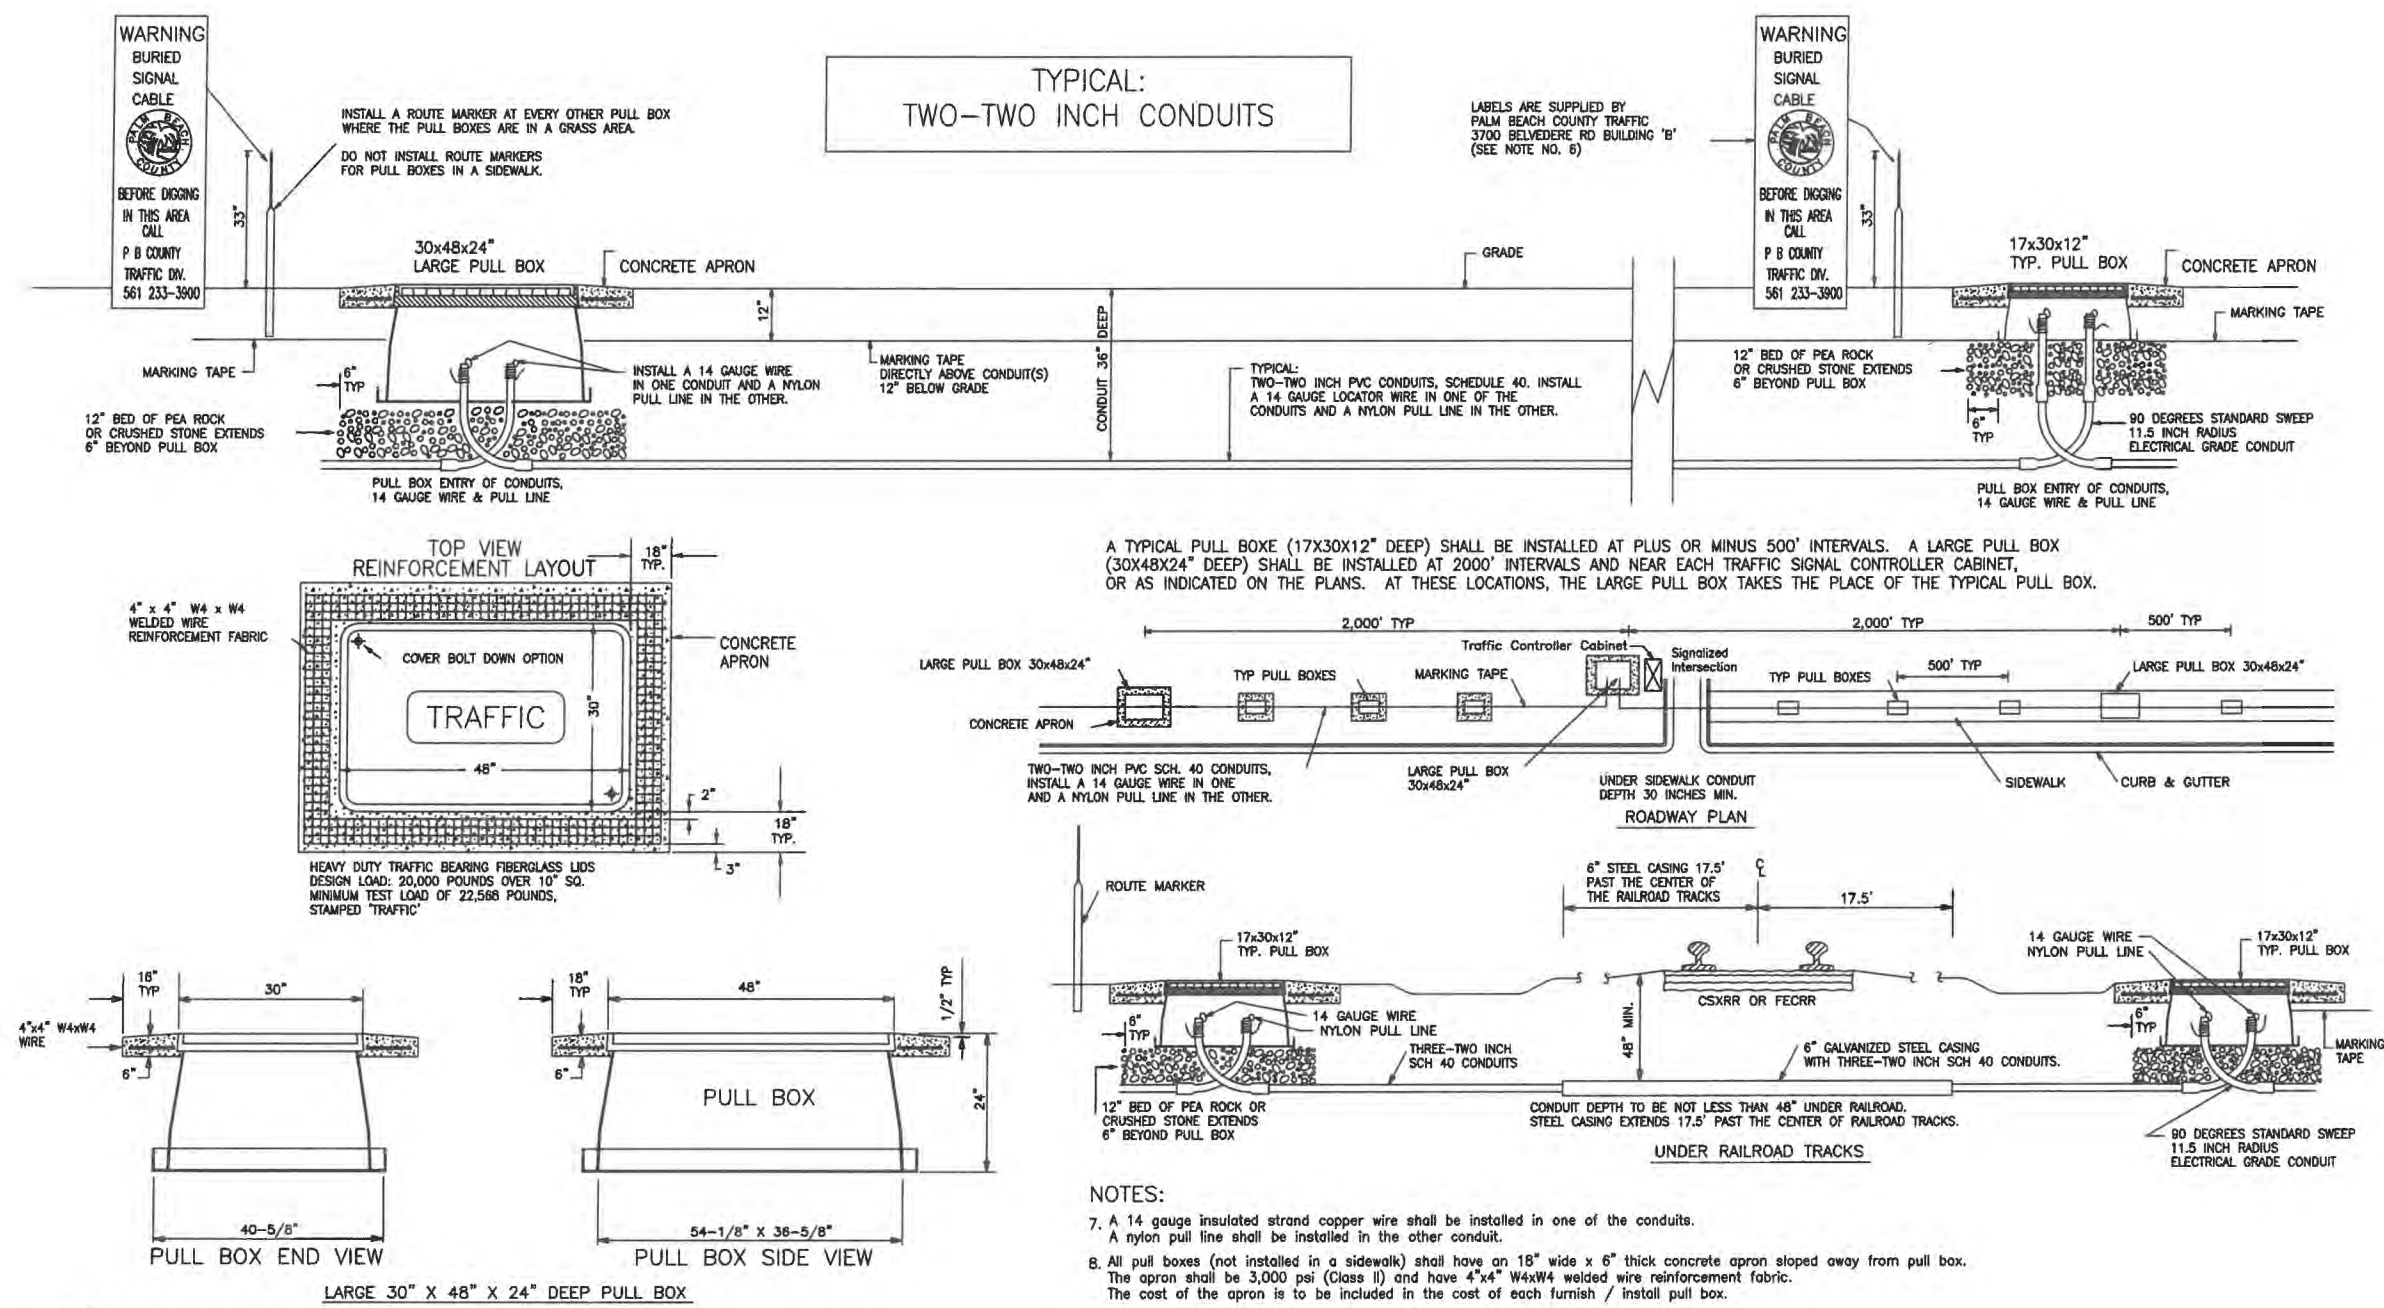
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


- NOTES:**
- For applications not covered in this typical the contractor shall refer to the FDOT Standard Specifications for Road and Bridge Construction.
  - All pull boxes and lids shall be Heavy Duty Traffic Bearing Fiberglass Composite (Rated 20,000 pounds over ten inch square). Pull box lids shall be stamped 'TRAFFIC'.
  - Ends of conduit shall be sealed in accordance with Section 630 (Conduit) of the FDOT Standard Specifications for Road and Bridge Construction.
  - One run of conduit (between pull boxes) shall not contain more than 360 degrees of bend including pull box bends.
  - Marking Tape: 3 inches wide marked 'CAUTION TRAFFIC SIGNAL CABLE BURIED BELOW'. Tape shall be orange with black 2 inches high block letters on non color fading material. The marking tape shall be continuous from pull box to pull box.
  - Palm Beach County Traffic Operations, 3700 Belvedere Rd, 561-233-3900, will supply the Contractor with warning labels for the route markers. The Contractor shall install one warning labels per marker.

- NOTES:**
- A 14 gauge insulated strand copper wire shall be installed in one of the conduits. A nylon pull line shall be installed in the other conduit.
  - All pull boxes (not installed in a sidewalk) shall have an 18" wide x 6" thick concrete apron sloped away from pull box. The apron shall be 3,000 psi (Class II) and have 4"x4" W4xW4 welded wire reinforcement fabric. The cost of the apron is to be included in the cost of each furnish / install pull box.
  - Do not install a pull box within four feet of a public sidewalk curb ramp.



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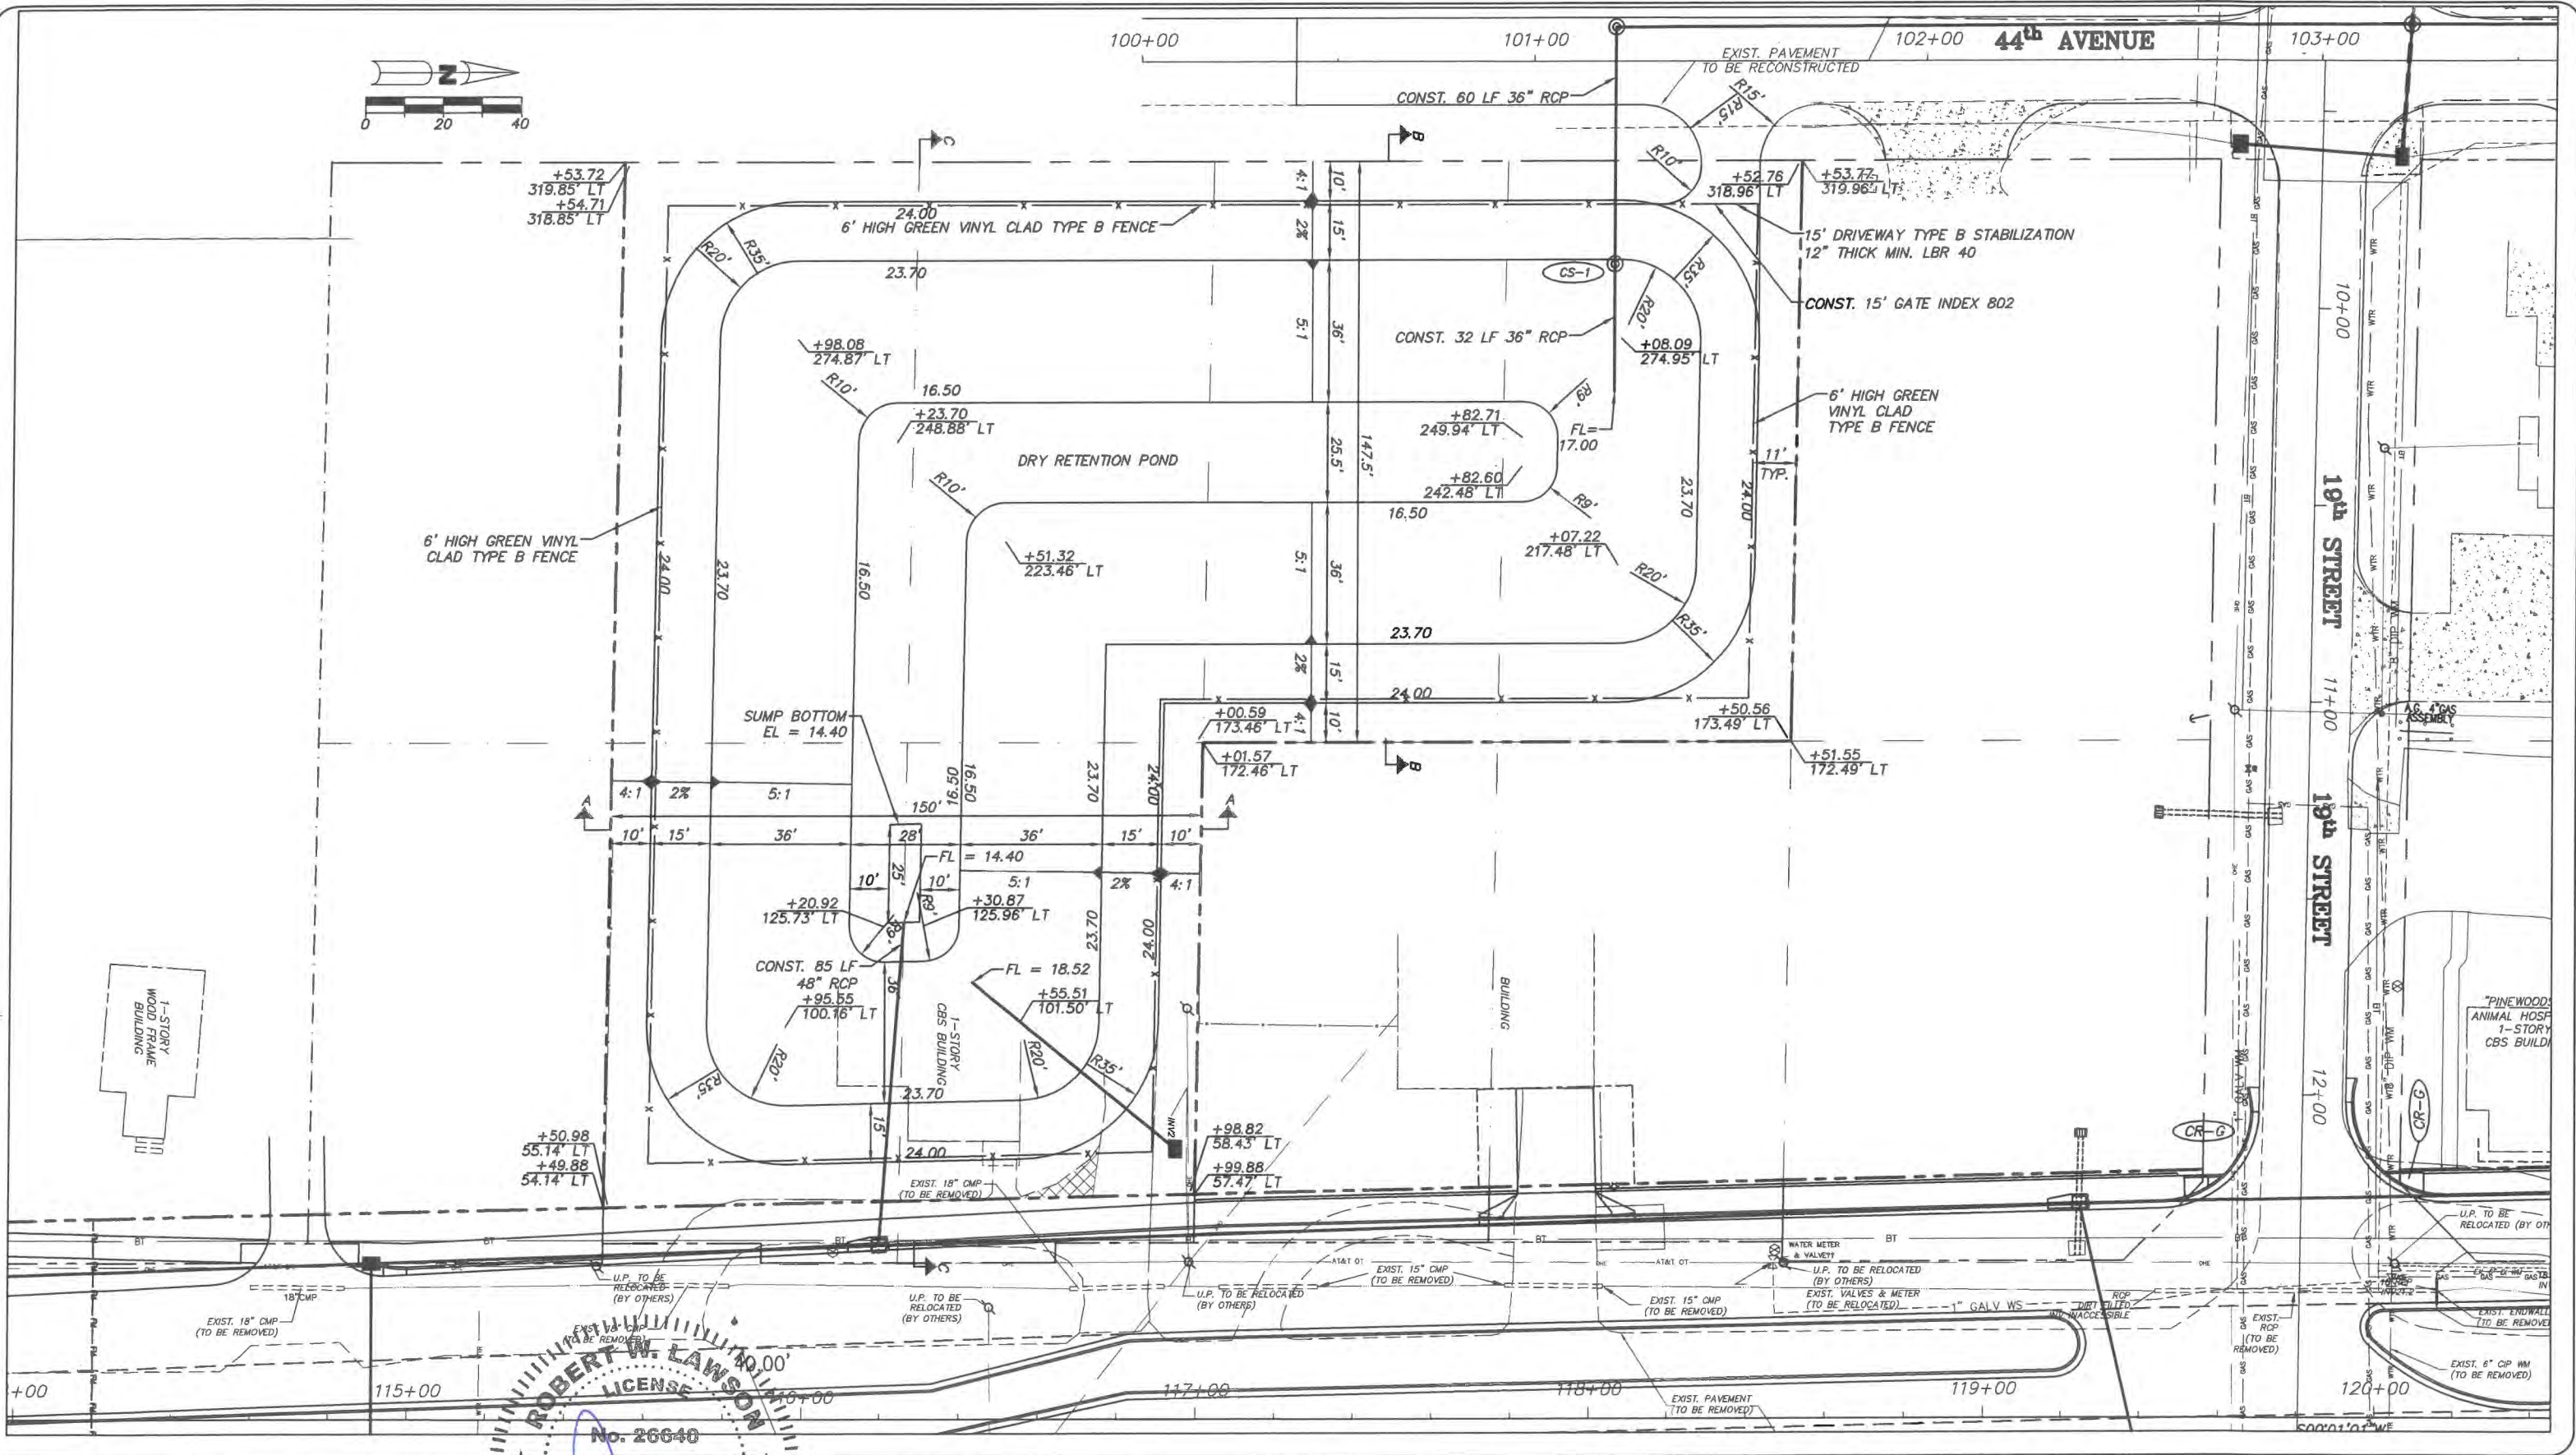
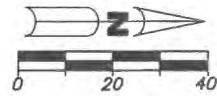
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**SR 60 & 43RD AVENUE**

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**ROBERT W. LAWSON**  
 LICENSE  
 No. 26640  
 DEC 17 2016  
 STATE OF FLORIDA  
 PROFESSIONAL ENGINEER

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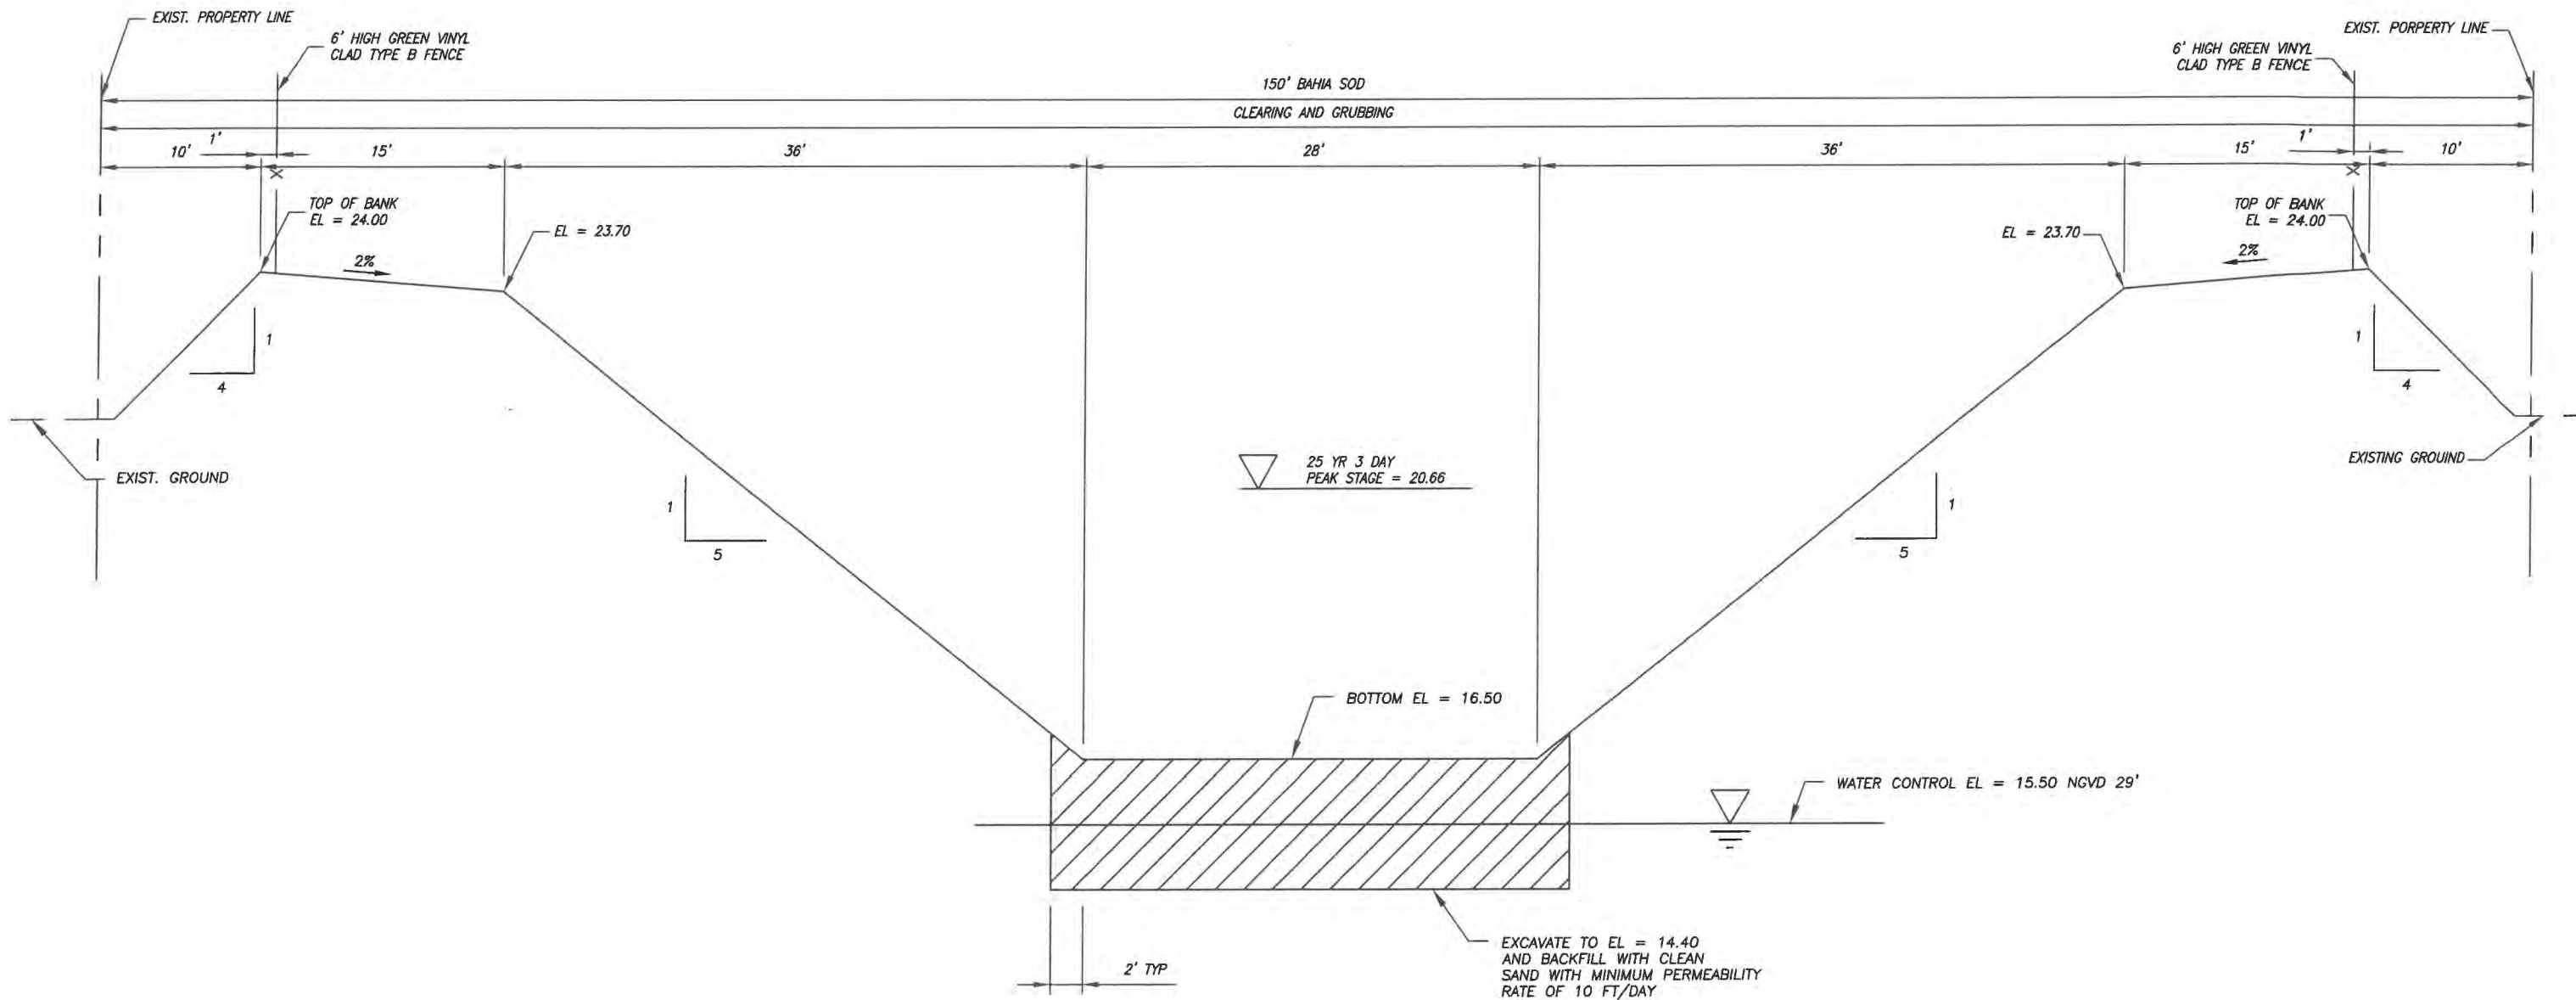
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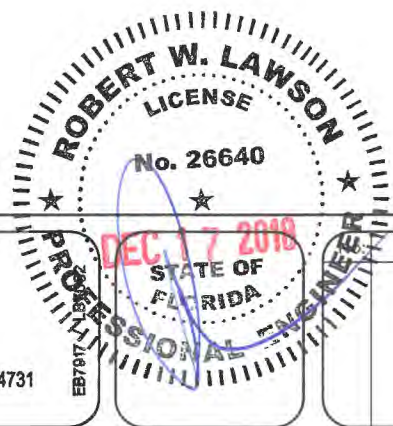
Project:  
 PLAN SHEETS  
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**RETENTION AREA #1**  
**SECTION A-A**



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**FOR**  
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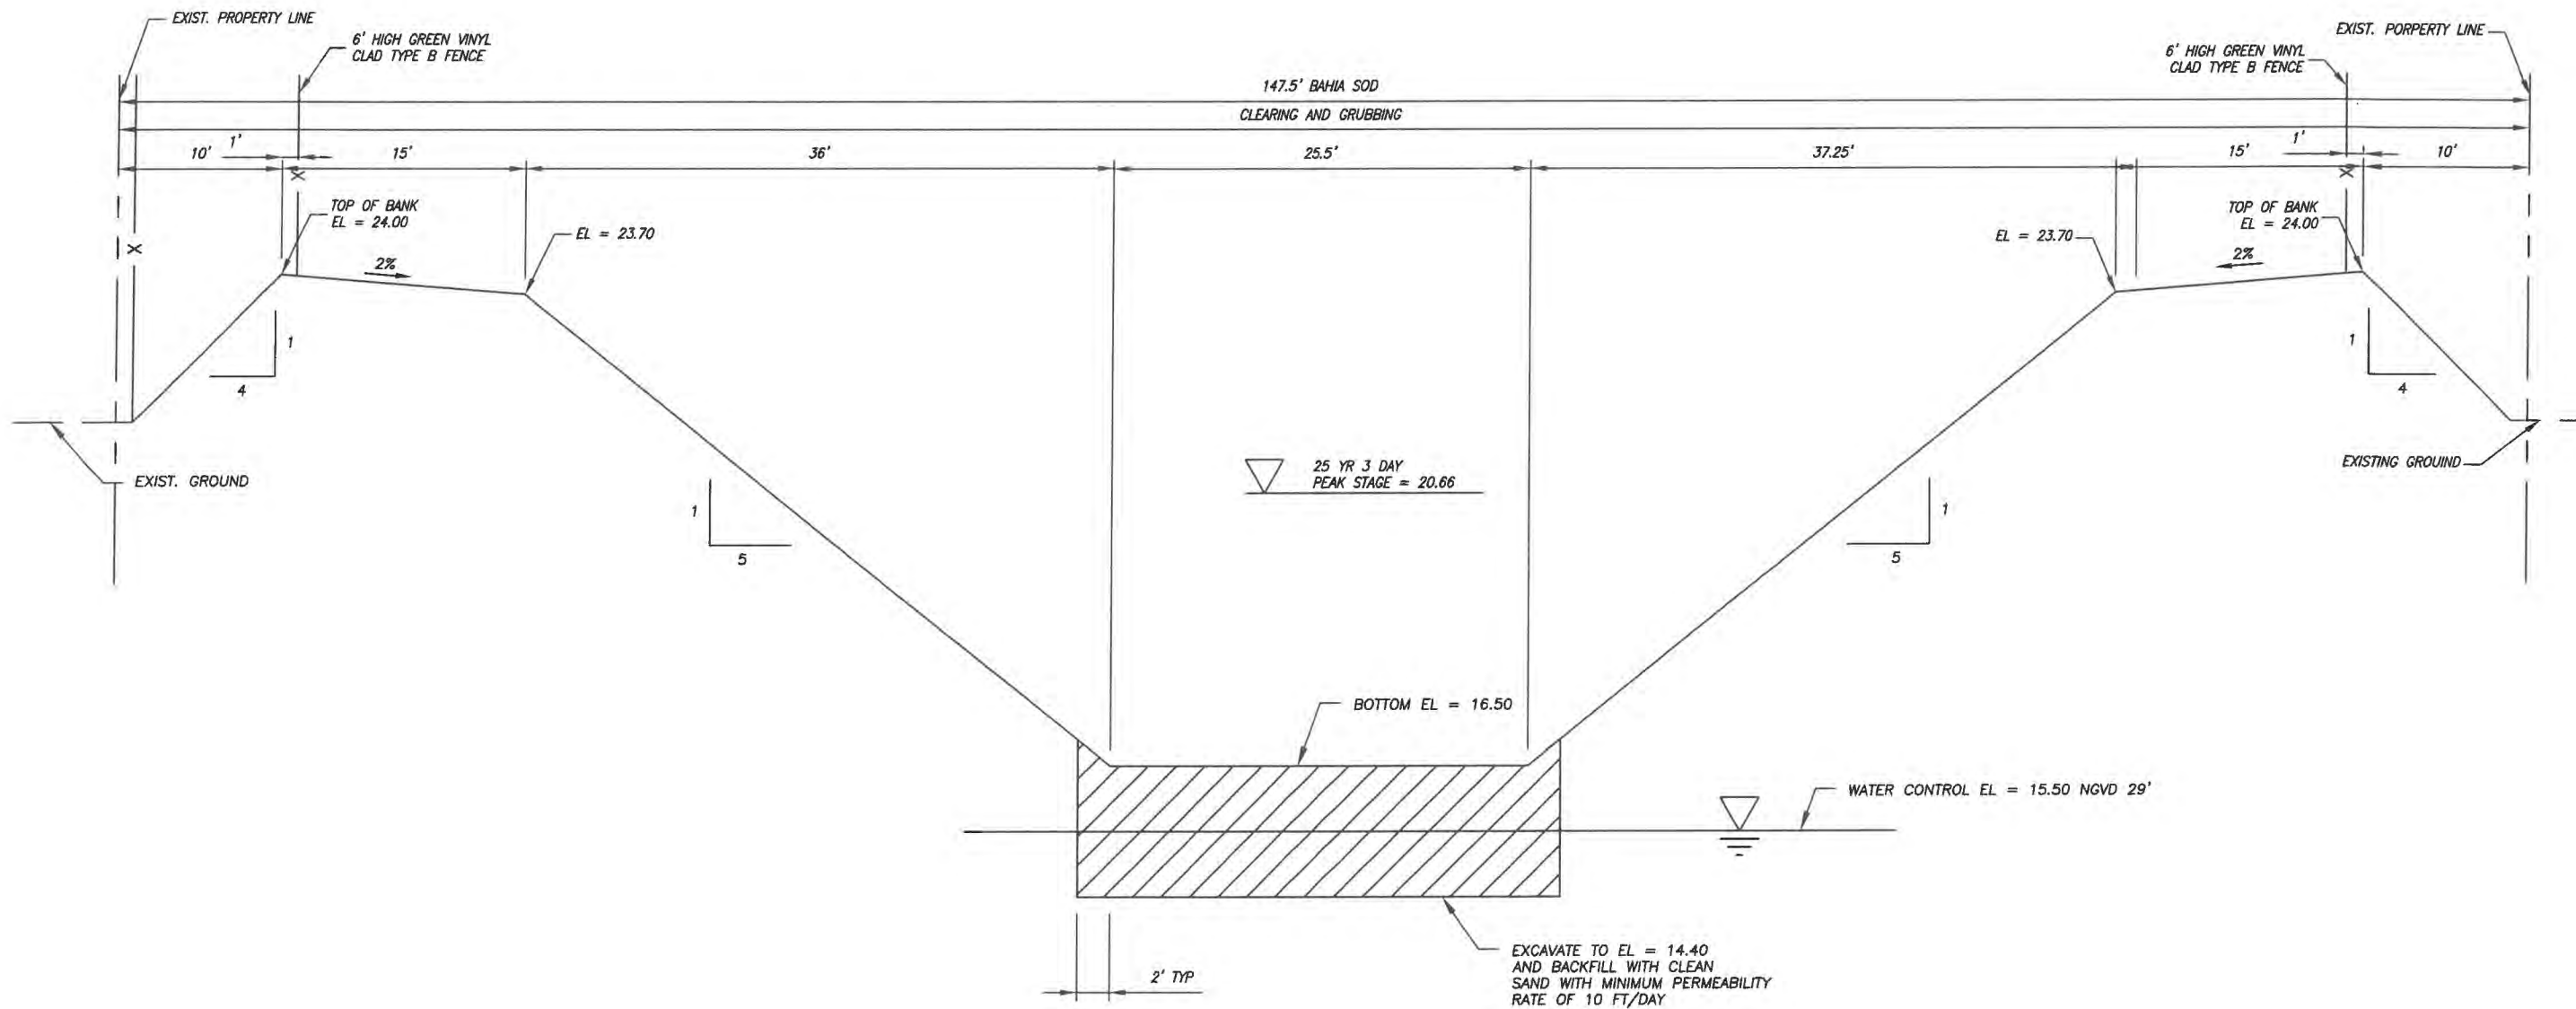
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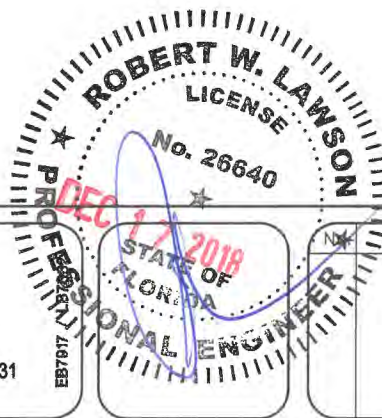
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**RETENTION AREA #1  
SECTION B-B**



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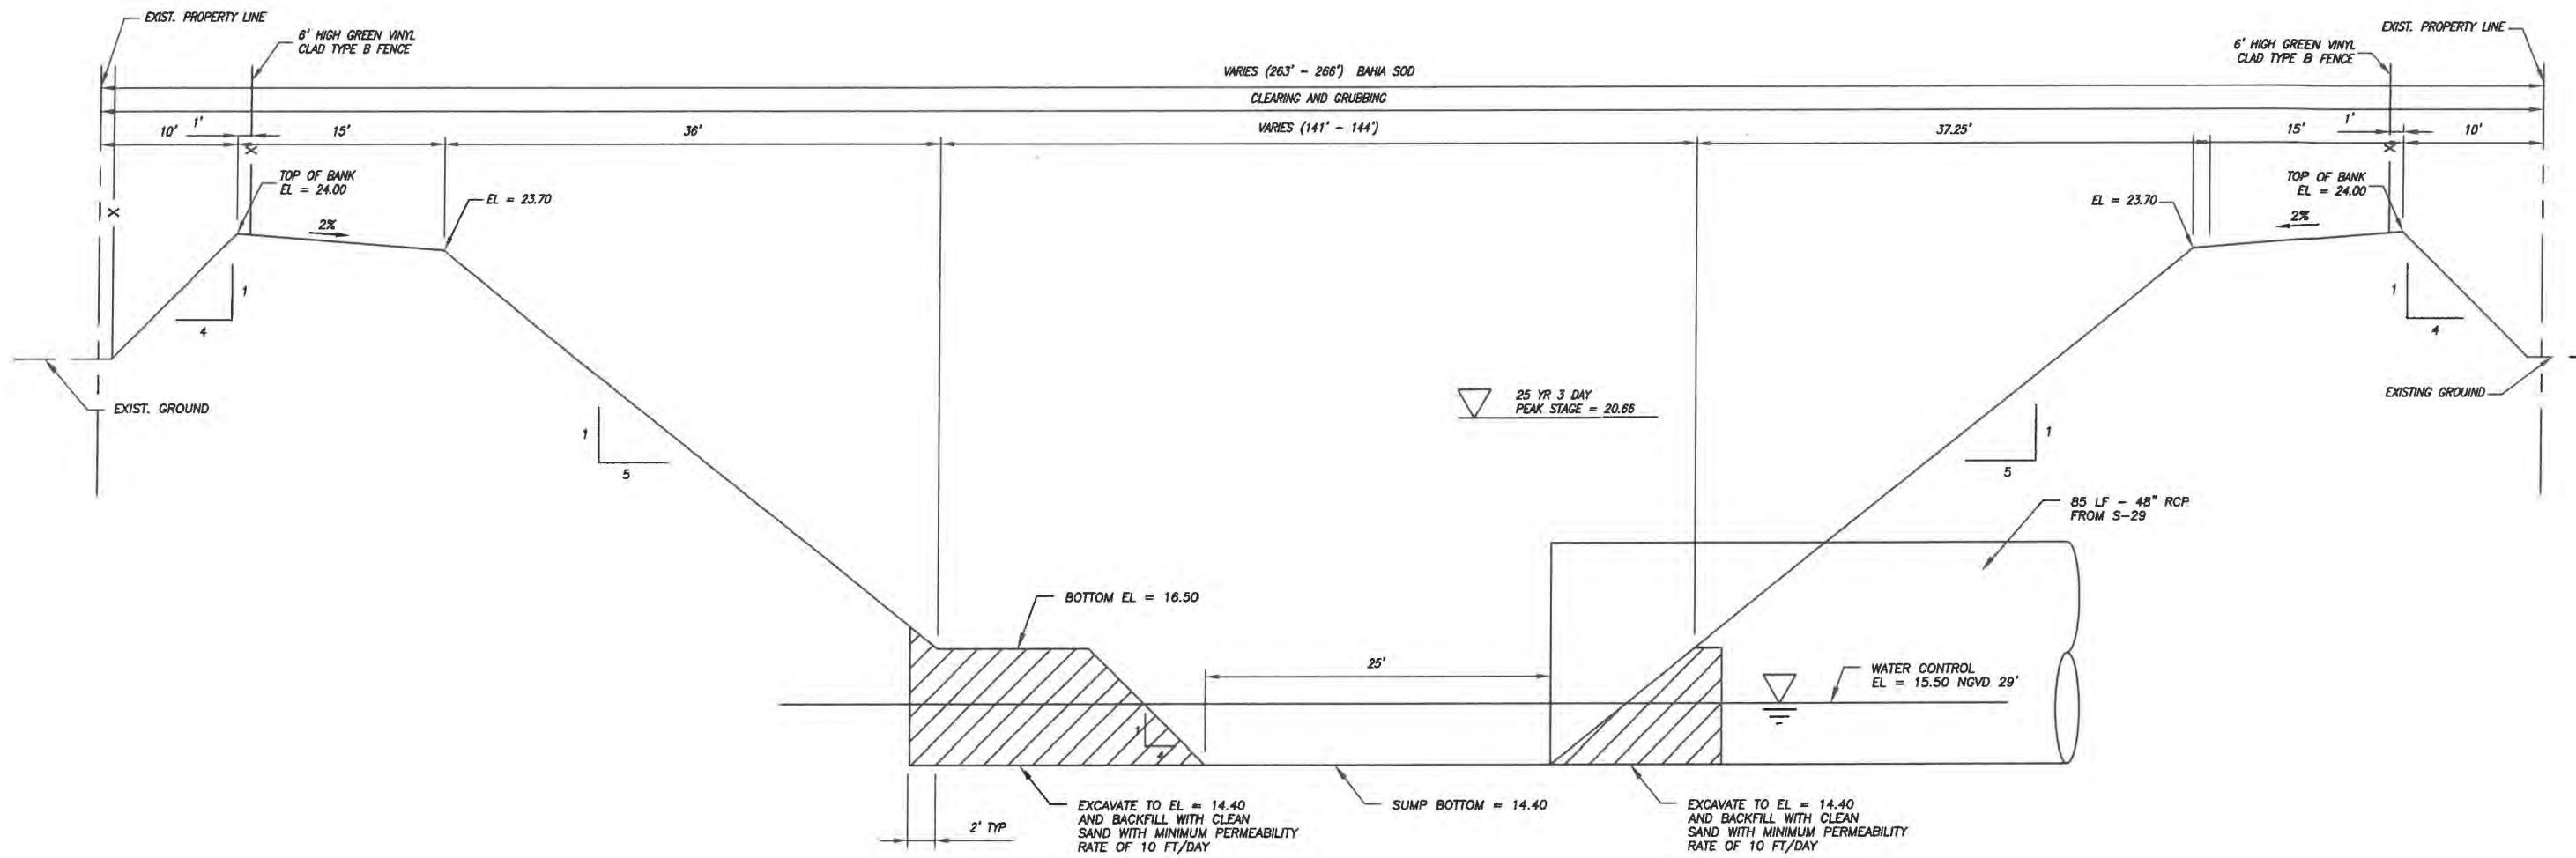
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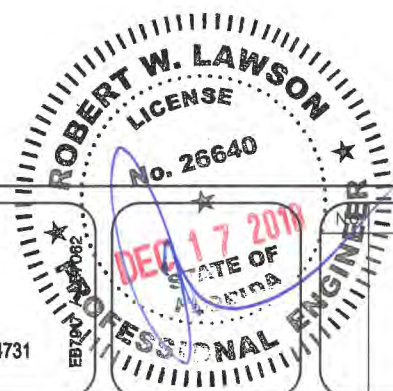
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**DETAILS  
FOR  
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**RETENTION AREA #1  
SECTION C-C**



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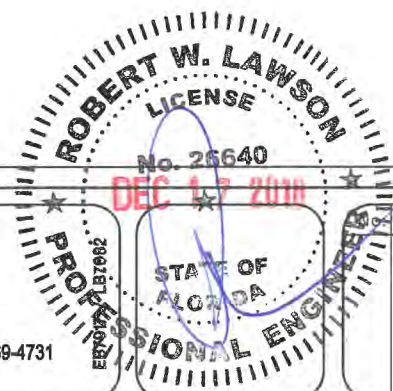
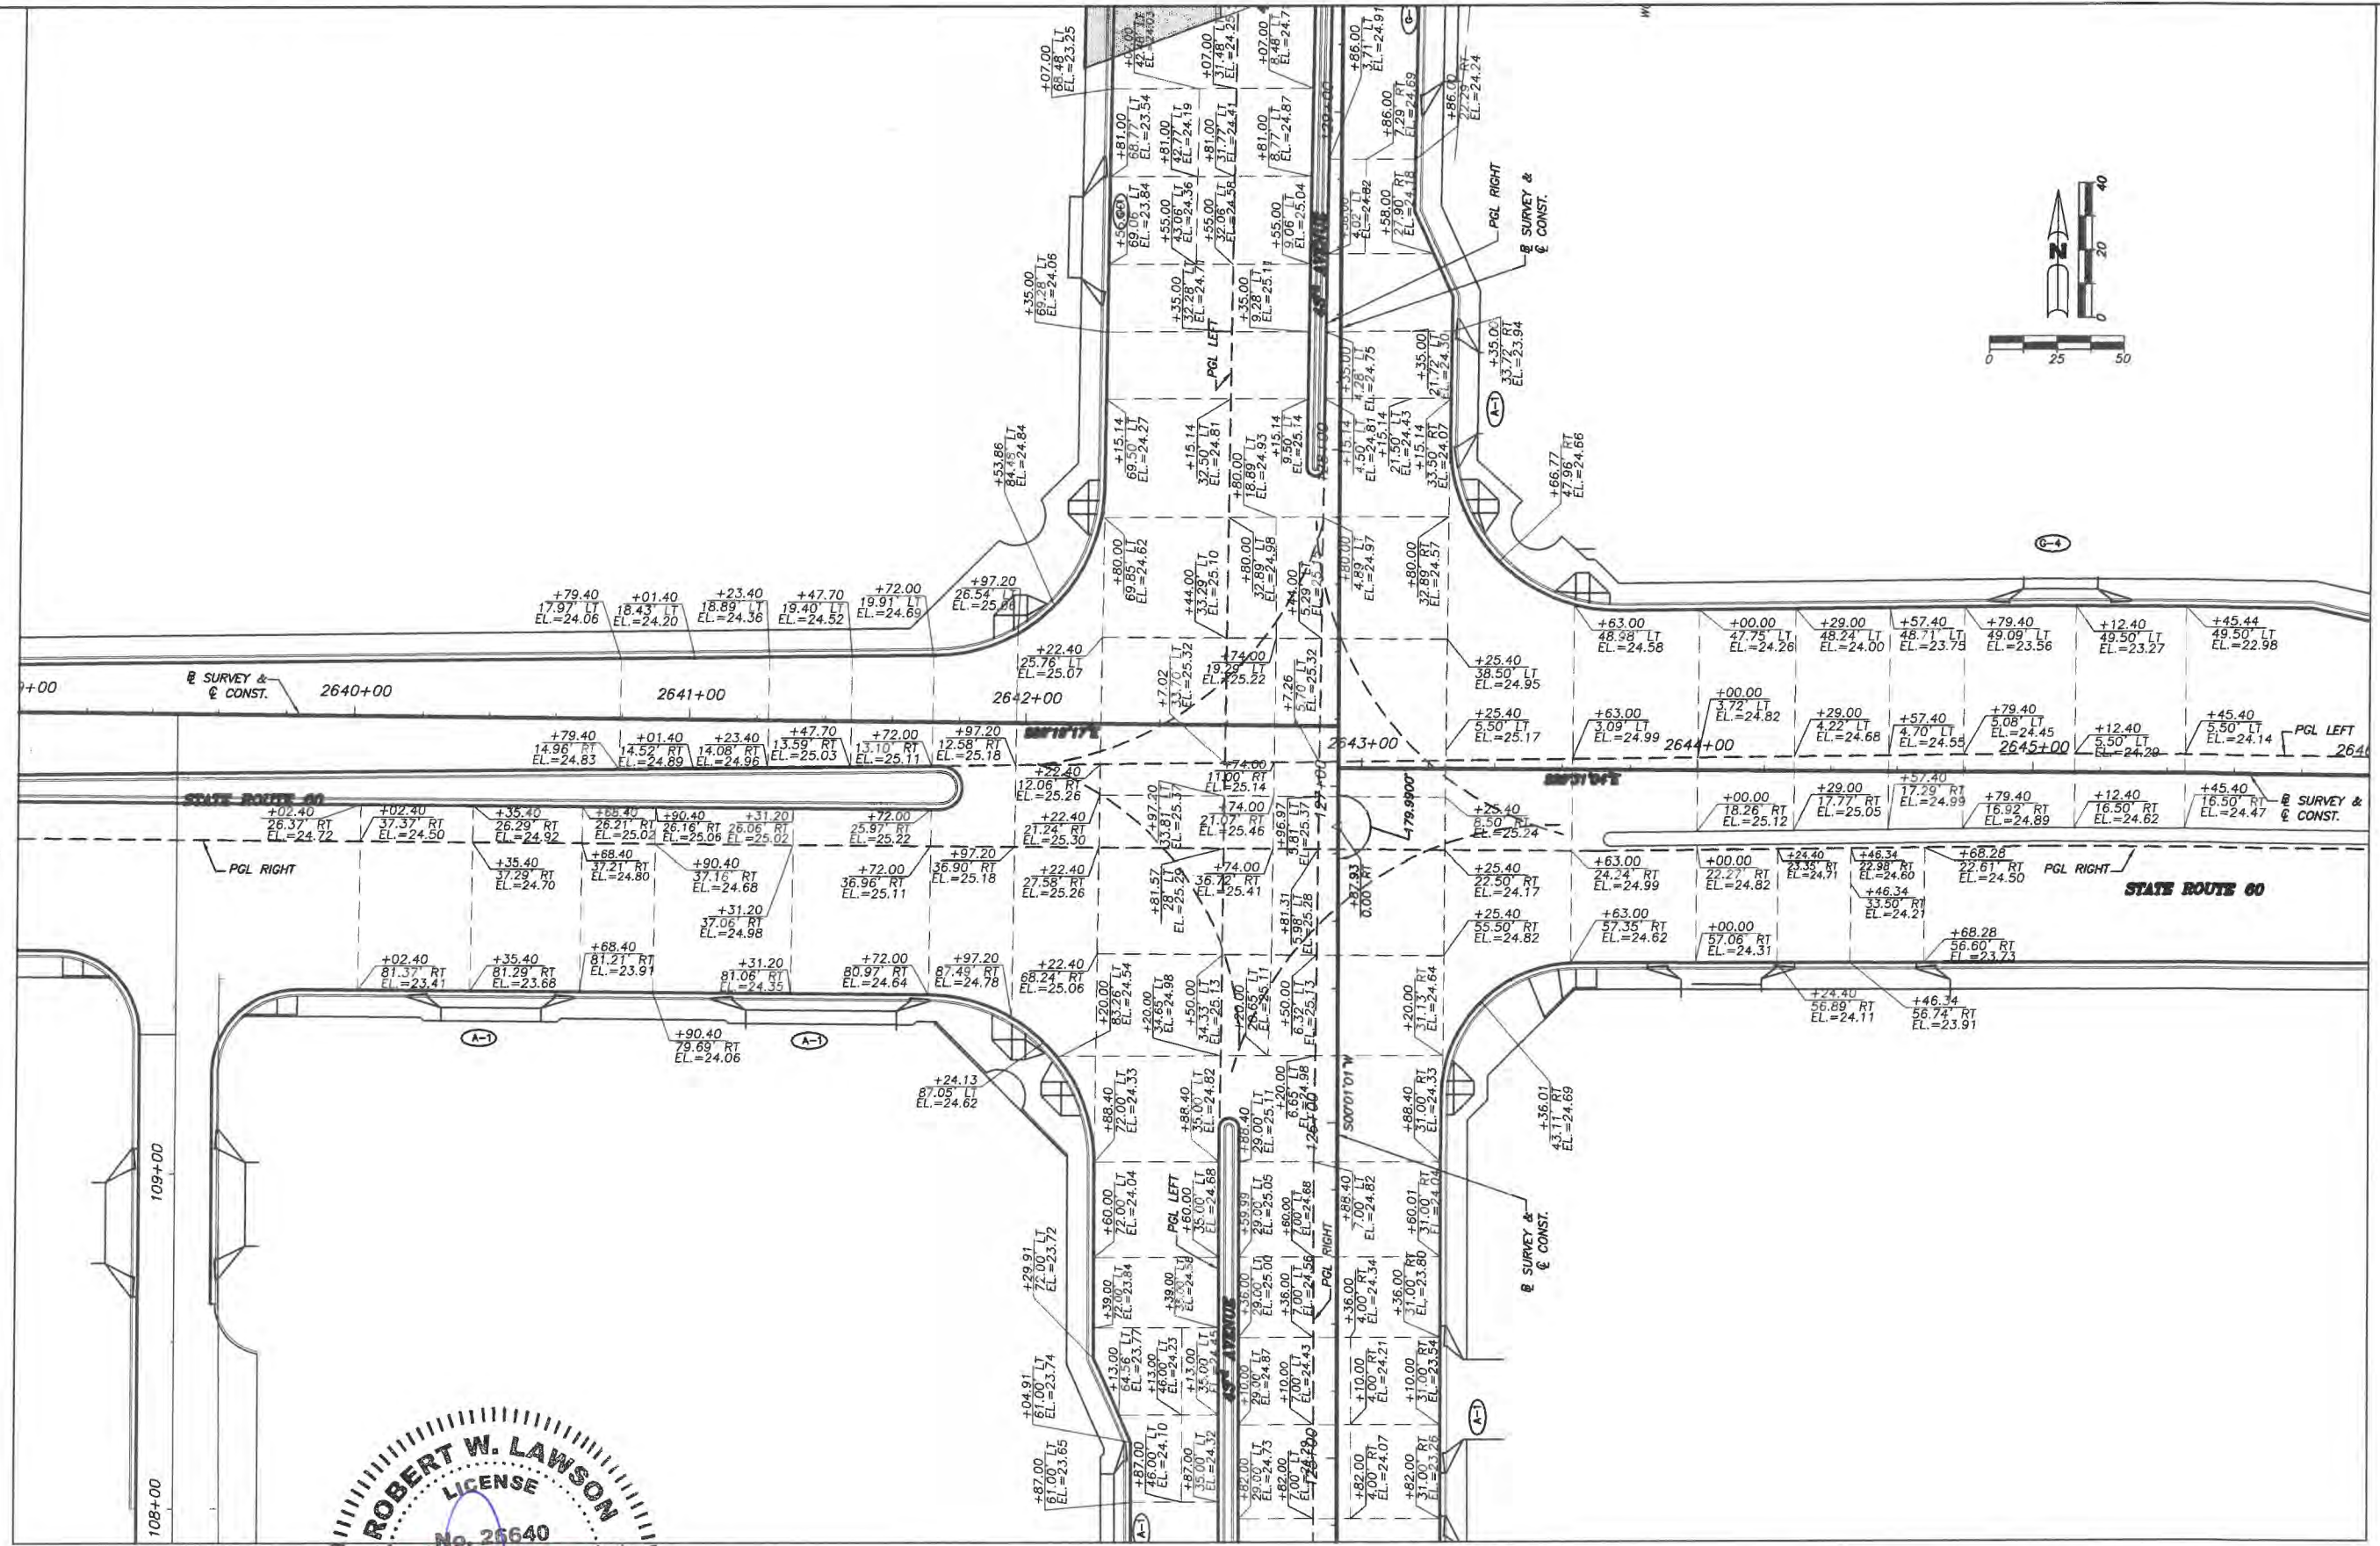
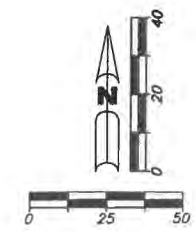
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
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Project:  
 INTERSECTION PLATEAU GRADING  
 FOR  
 SR 60 & 43RD AVENUE

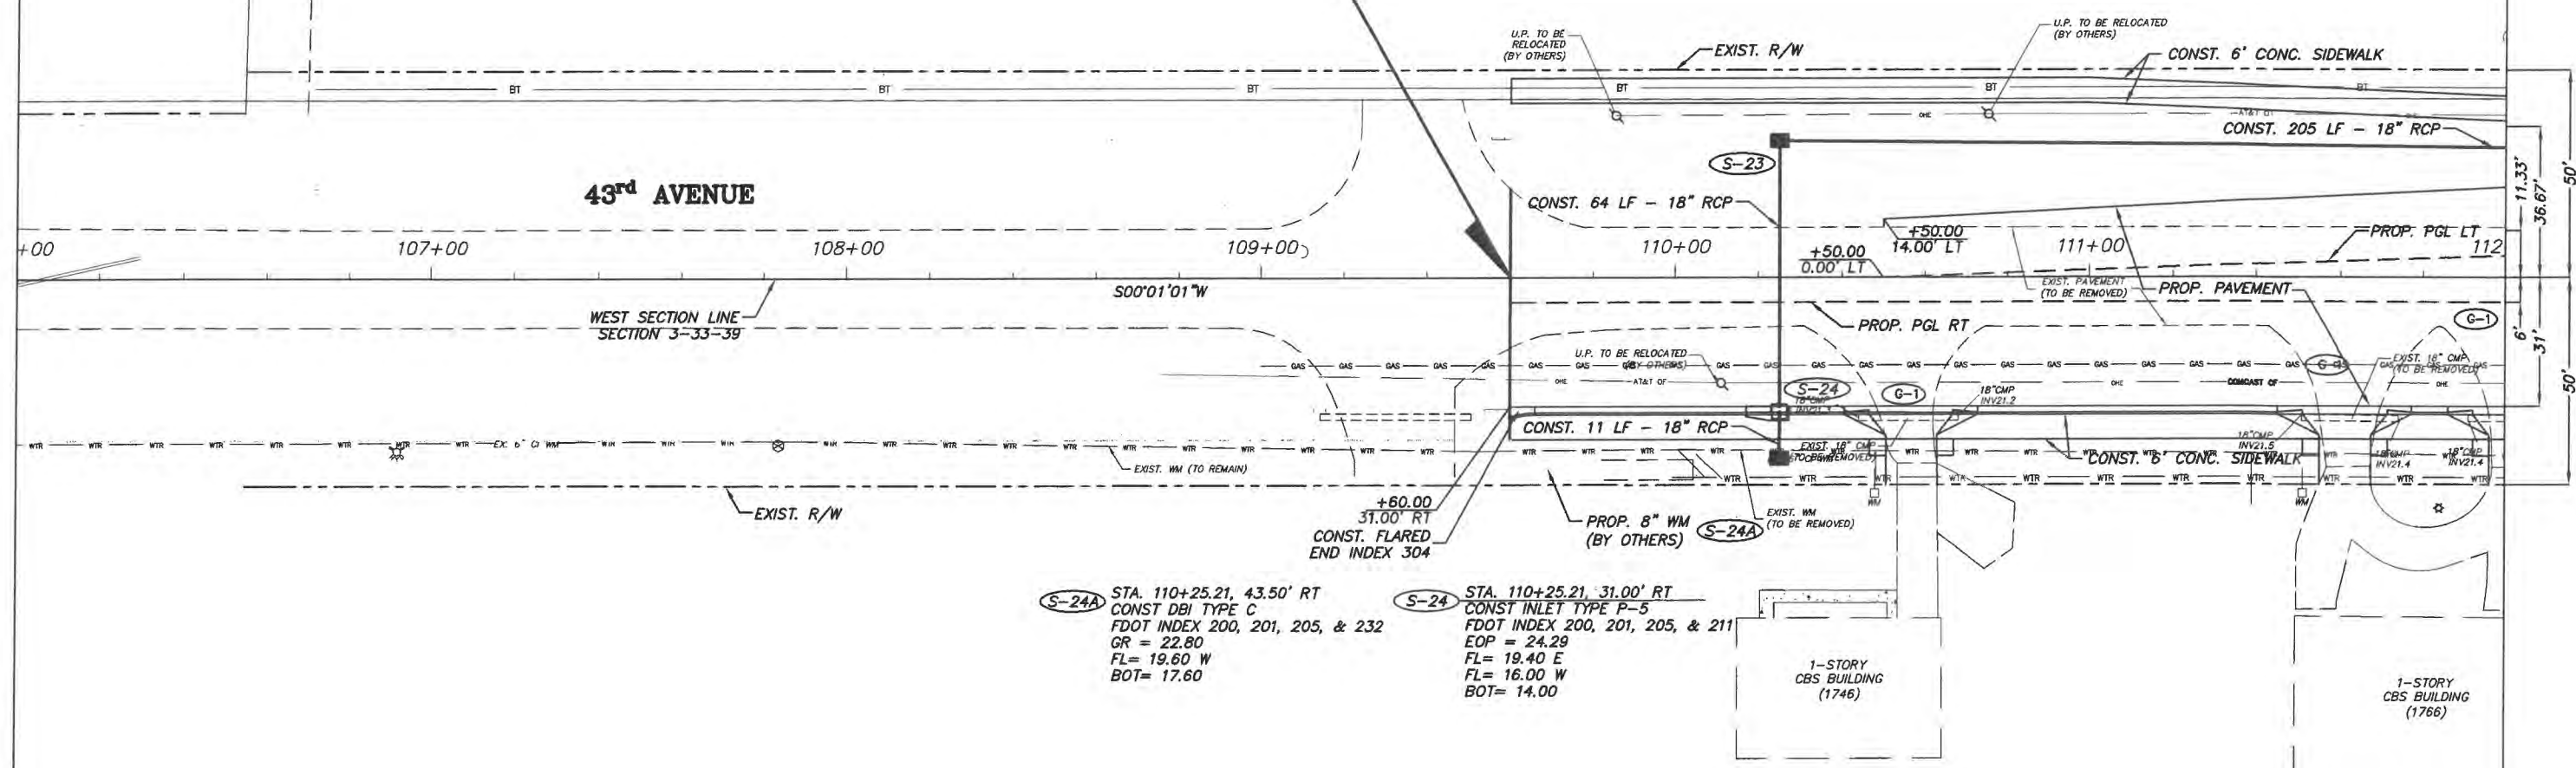
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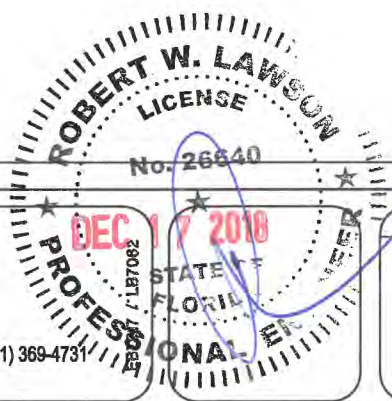
BEGIN PROJECT STA. 109+60.00  
SAWCUT & BUTT JOINT. MATCH  
EXIST. PAVEMENT

S-23 STA. 110+25.21, 33.00' LT  
CONST DBI TYPE P-X  
FDOT INDEX 200, 201, 205, & 232  
GR = 19.50  
FL = 15.50 N E  
BOT = 13.50



S-24A STA. 110+25.21, 43.50' RT  
CONST DBI TYPE C  
FDOT INDEX 200, 201, 205, & 232  
GR = 22.80  
FL = 19.60 W  
BOT = 17.60

S-24 STA. 110+25.21, 31.00' RT  
CONST INLET TYPE P-5  
FDOT INDEX 200, 201, 205, & 211  
EOP = 24.29  
FL = 19.40 E  
FL = 16.00 W  
BOT = 14.00



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S-26 STA. 112+30, 31.00' LT  
 CONST DBI TYPE P-X  
 FDOT INDEX 200, 201, 205, & 232  
 GR = 22.00  
 FL = 17.50 E  
 FL = 15.15 N S  
 BOT = 13.15

S-28 STA. 114+91, 40' LT  
 CONST INLET TYPE P-X  
 FDOT INDEX 200, 201, 205, & 232  
 GR = 24.75  
 FL = 19.80 E  
 FL = 14.76 N S  
 BOT = 12.76

S-29 STA. 116+20, 43.18' LT  
 CONST INLET TYPE J-5  
 FDOT INDEX 200, 201, 205, & 211  
 EOP = 25.13  
 FL = 17.36 N  
 FL = 14.50 S W  
 BOT = 12.50

S-29A STA. 116+95, 69' LT  
 CONST DBI TYPE C  
 FDOT INDEX 200, 201, 205, & 232  
 GR = 22.10  
 FL = 18.90 SW  
 BOT = 17.90

S-28 STA. 114+91, 40' LT  
 CONST INLET TYPE P-X  
 FDOT INDEX 200, 201, 205, & 232  
 GR = 24.75  
 FL = 19.80 E  
 FL = 14.76 N S  
 BOT = 12.76

S-28 STA. 114+91, 40' LT  
 CONST INLET TYPE P-X  
 FDOT INDEX 200, 201, 205, & 232  
 GR = 24.75  
 FL = 19.80 E  
 FL = 14.76 N S  
 BOT = 12.76

S-28 STA. 114+91, 40' LT  
 CONST INLET TYPE P-X  
 FDOT INDEX 200, 201, 205, & 232  
 GR = 24.75  
 FL = 19.80 E  
 FL = 14.76 N S  
 BOT = 12.76

S-27 STA. 114+91, 31.00' RT  
 CONST INLET TYPE P-5  
 FDOT INDEX 200, 201, 205, & 211  
 EOP = 24.66  
 FL = 20.00 W  
 BOT = 18.00

S-25 STA. 112+30, 31.00' RT  
 CONST INLET TYPE P-6  
 FDOT INDEX 200, 201, 205, & 211  
 EOP = 23.80  
 FL = 19.40 E  
 FL = 18.00 W  
 BOT = 16.00

S-25A STA. 112+30, 43.50' RT  
 CONST DBI TYPE C  
 FDOT INDEX 200, 201, 205, & 232  
 GR = 22.80  
 FL = 19.60 W  
 BOT = 17.60

S-25 STA. 112+30, 31.00' RT  
 CONST INLET TYPE P-6  
 FDOT INDEX 200, 201, 205, & 211  
 EOP = 23.80  
 FL = 19.40 E  
 FL = 18.00 W  
 BOT = 16.00

S-25A STA. 112+30, 43.50' RT  
 CONST DBI TYPE C  
 FDOT INDEX 200, 201, 205, & 232  
 GR = 22.80  
 FL = 19.60 W  
 BOT = 17.60

S-25 STA. 112+30, 31.00' RT  
 CONST INLET TYPE P-6  
 FDOT INDEX 200, 201, 205, & 211  
 EOP = 23.80  
 FL = 19.40 E  
 FL = 18.00 W  
 BOT = 16.00

S-25A STA. 112+30, 43.50' RT  
 CONST DBI TYPE C  
 FDOT INDEX 200, 201, 205, & 232  
 GR = 22.80  
 FL = 19.60 W  
 BOT = 17.60

S-25 STA. 112+30, 31.00' RT  
 CONST INLET TYPE P-6  
 FDOT INDEX 200, 201, 205, & 211  
 EOP = 23.80  
 FL = 19.40 E  
 FL = 18.00 W  
 BOT = 16.00

S-25A STA. 112+30, 43.50' RT  
 CONST DBI TYPE C  
 FDOT INDEX 200, 201, 205, & 232  
 GR = 22.80  
 FL = 19.60 W  
 BOT = 17.60

S-25 STA. 112+30, 31.00' RT  
 CONST INLET TYPE P-6  
 FDOT INDEX 200, 201, 205, & 211  
 EOP = 23.80  
 FL = 19.40 E  
 FL = 18.00 W  
 BOT = 16.00

S-25A STA. 112+30, 43.50' RT  
 CONST DBI TYPE C  
 FDOT INDEX 200, 201, 205, & 232  
 GR = 22.80  
 FL = 19.60 W  
 BOT = 17.60

LOCATED AT STA. 114+20  
 CONST. 85 LF - 6" HDPE  
 FORCE MAIN CASING WITH  
 MAGNETIC LOCATOR TAPE  
 ALONG PIPE LENGTH AND  
 ENDS OF PIPE TOP EL=18.00

UP. TO BE  
 REMAINED

UP. TO BE  
 RELOCATED  
 (BY OTHERS)

UP. TO BE  
 RELOCATED  
 (BY OTHERS)

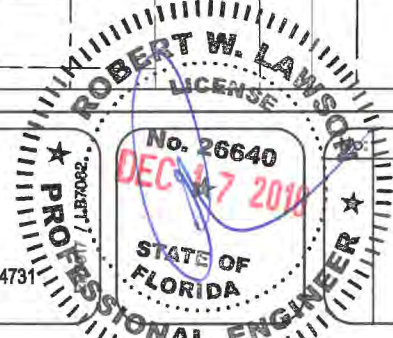
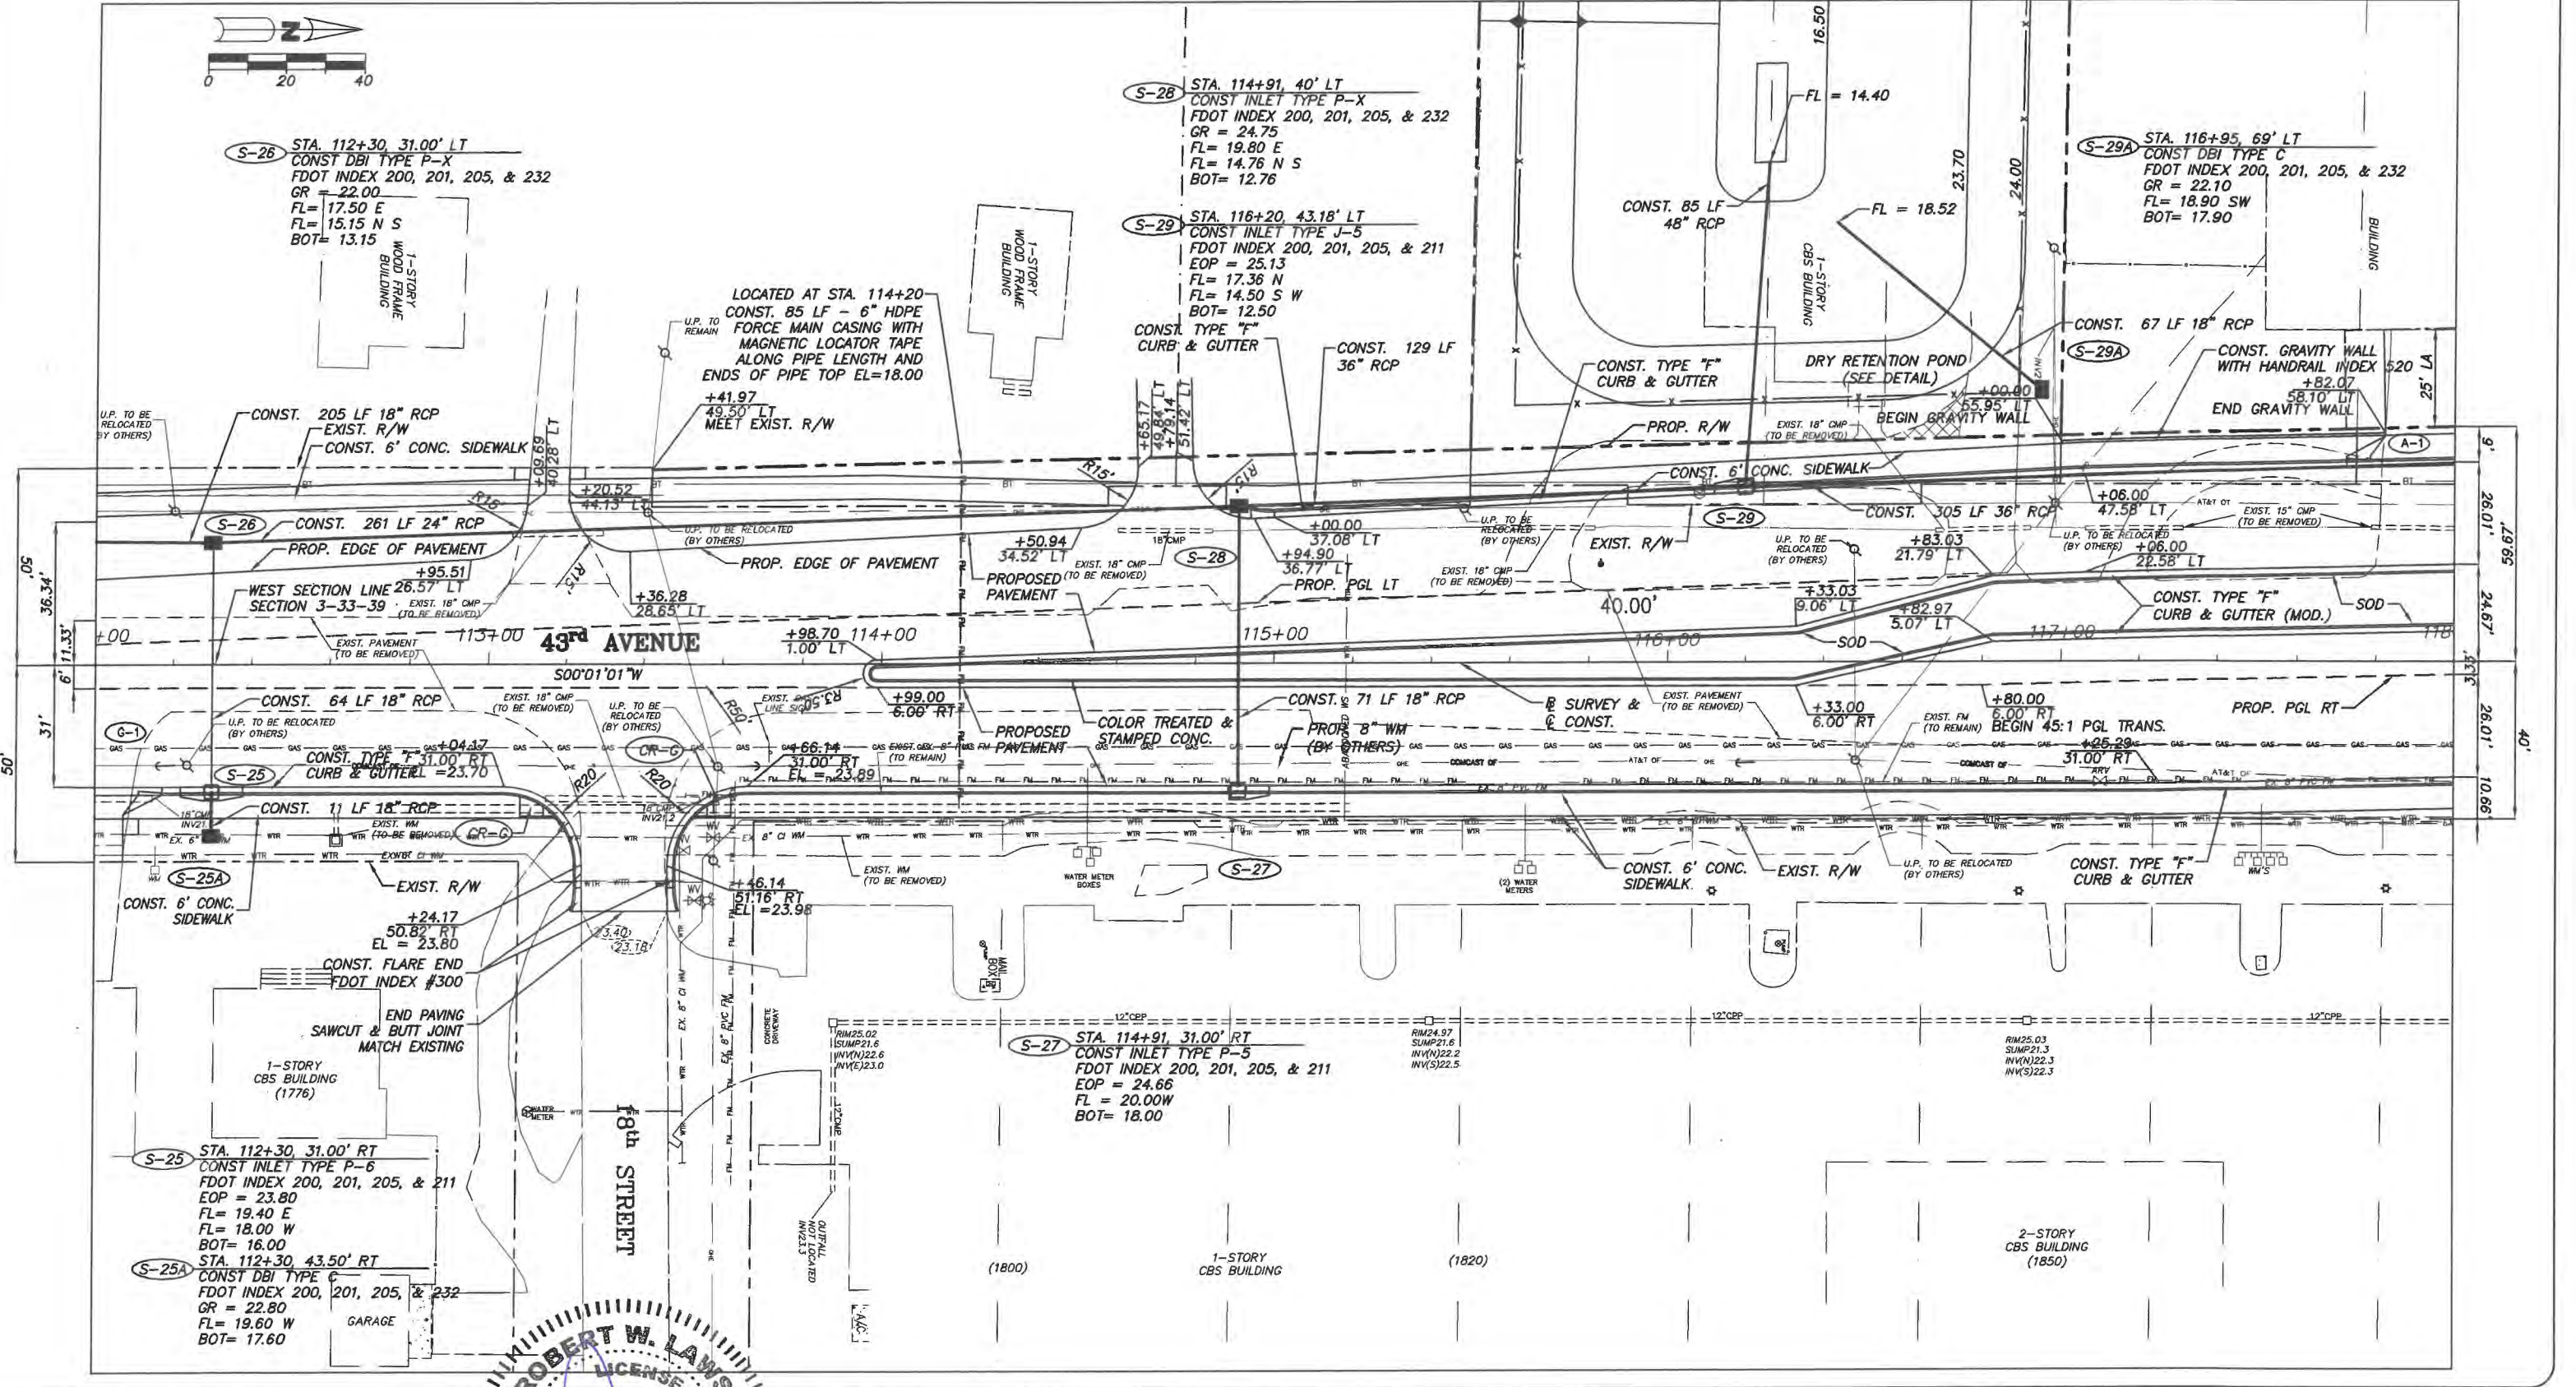
UP. TO BE  
 RELOCATED  
 (BY OTHERS)

UP. TO BE  
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UP. TO BE  
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 (BY OTHERS)

UP. TO BE  
 RELOCATED  
 (BY OTHERS)



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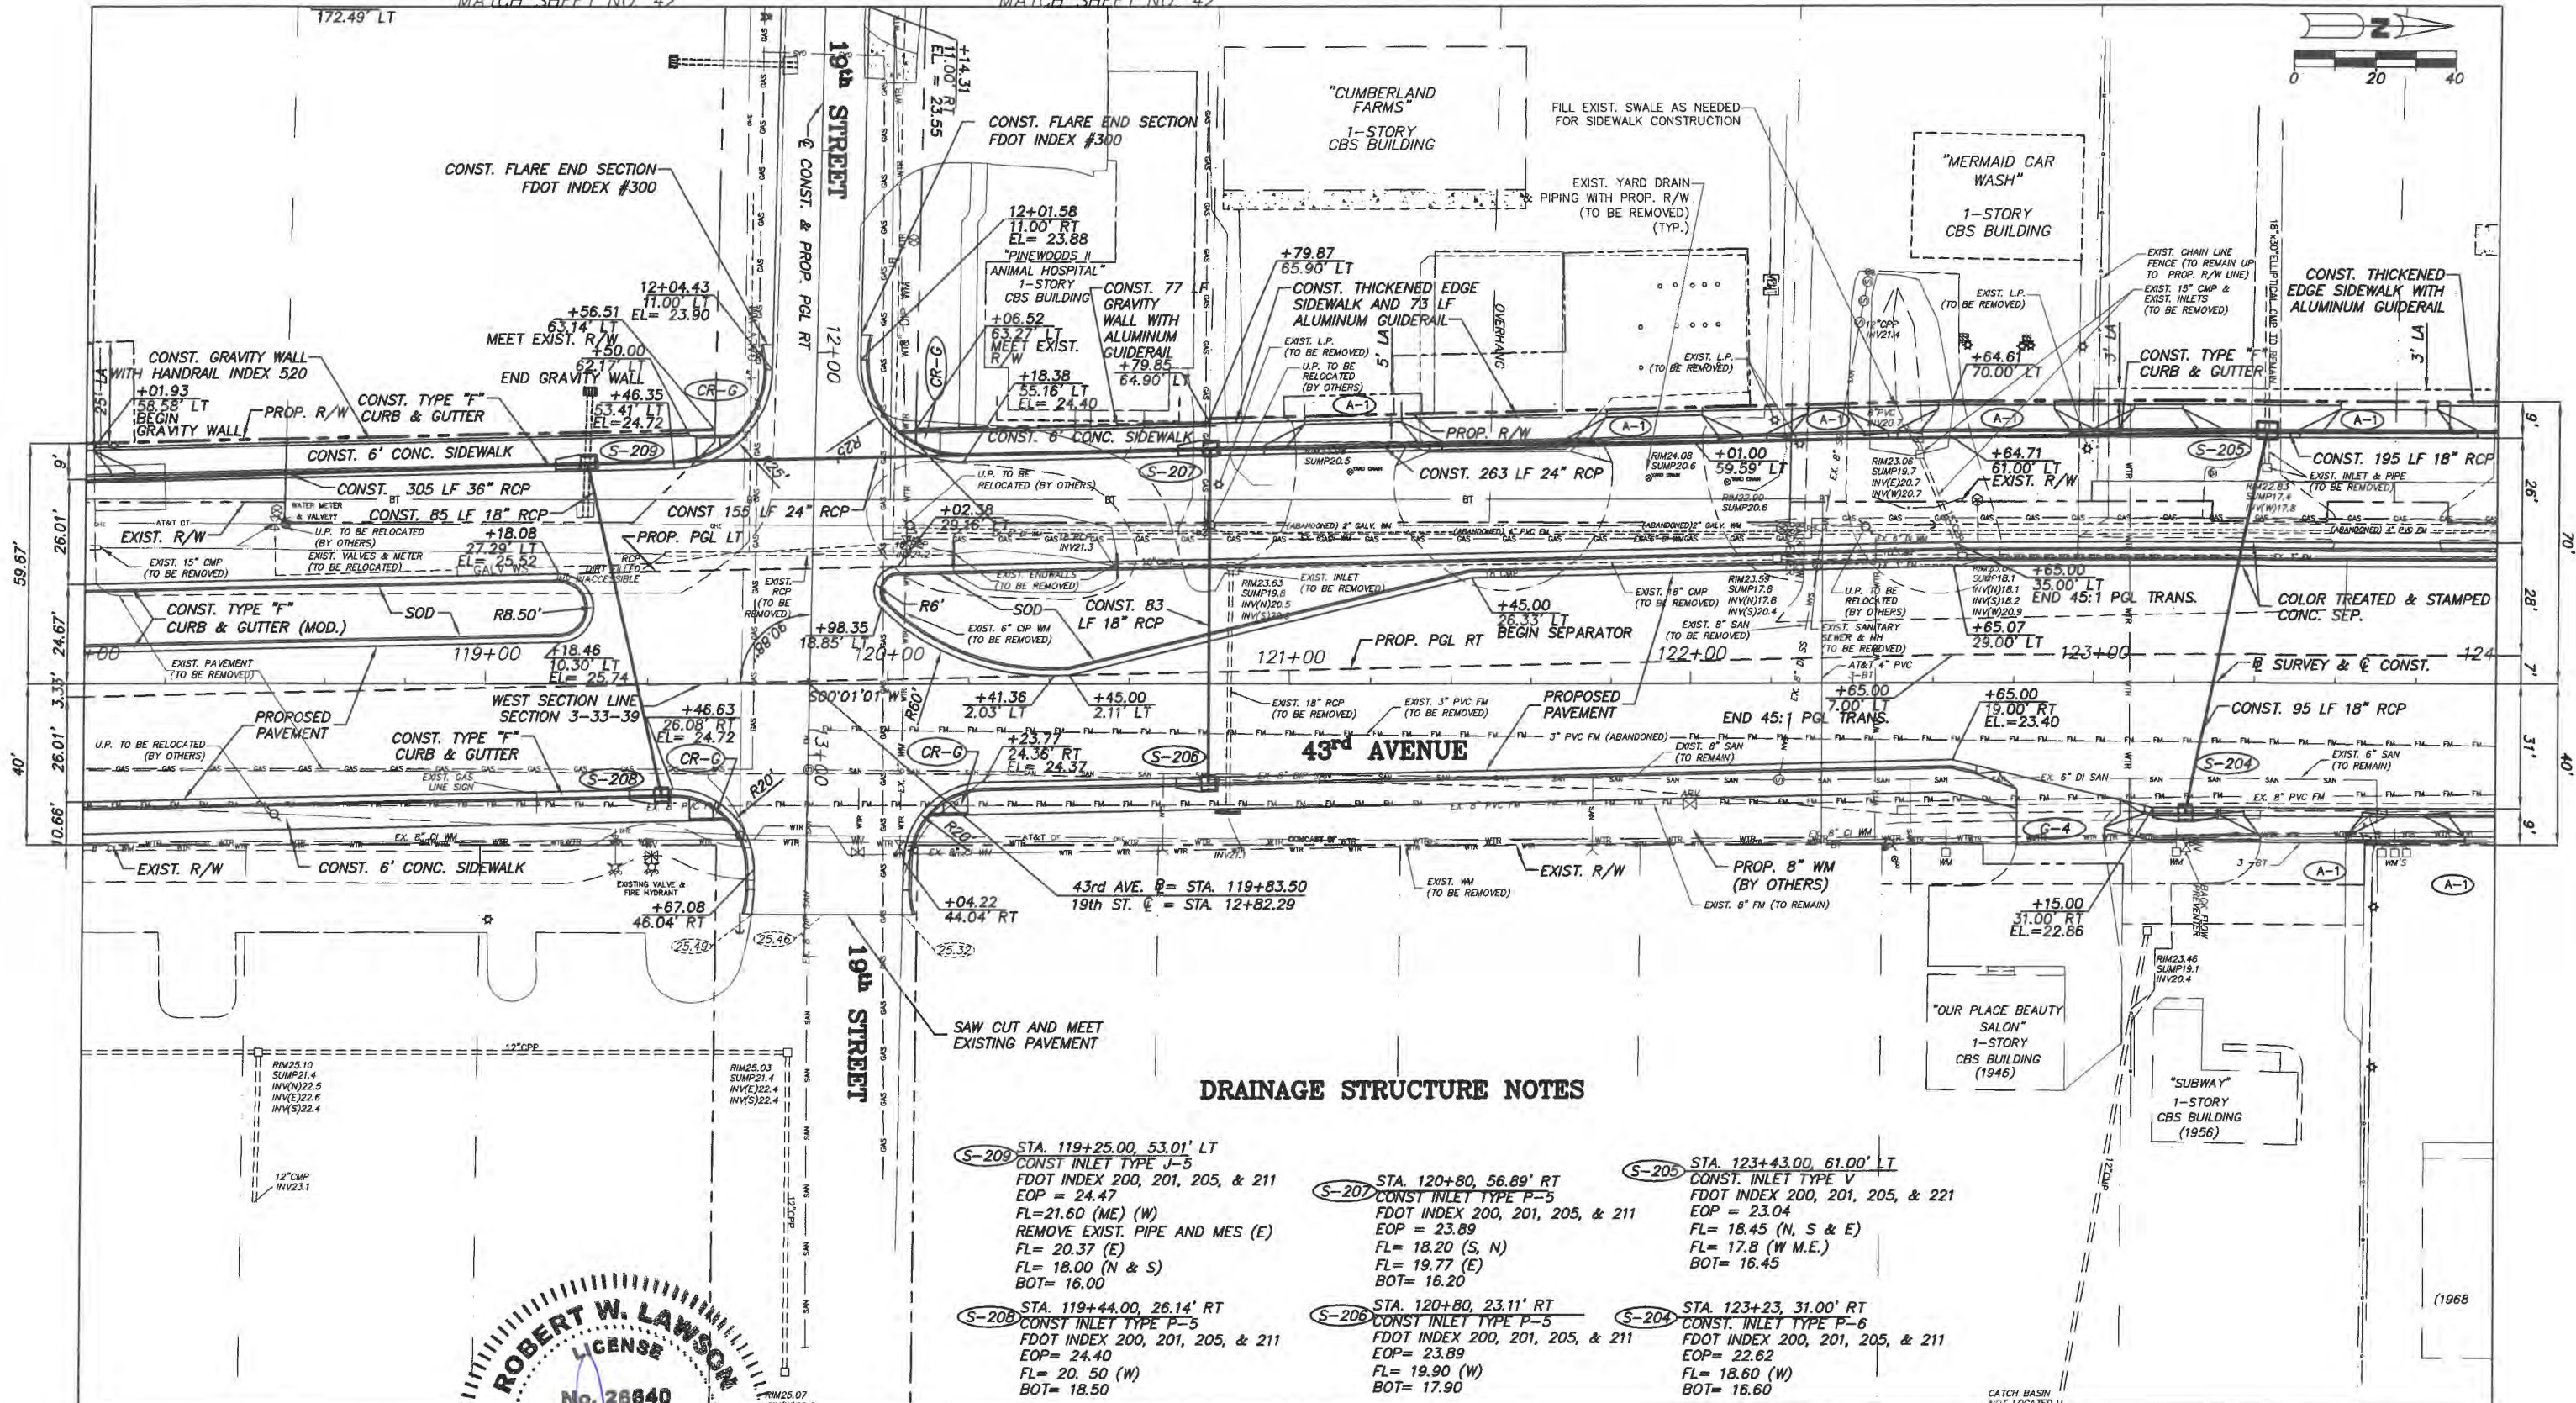
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 Engineering Division

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 FOR  
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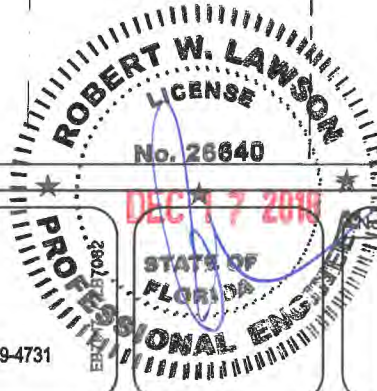
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**DRAINAGE STRUCTURE NOTES**

- (S-209) STA. 119+25.00, 53.01' LT  
CONST. INLET TYPE J-5  
FDOT INDEX 200, 201, 205, & 211  
EOP = 24.47  
FL=21.60 (ME) (W)  
REMOVE EXIST. PIPE AND MES (E)  
FL= 20.37 (E)  
FL= 18.00 (N & S)  
BOT= 16.00
- (S-207) STA. 120+80, 56.89' RT  
CONST. INLET TYPE P-5  
FDOT INDEX 200, 201, 205, & 211  
EOP = 23.89  
FL= 18.20 (S, N)  
FL= 19.77 (E)  
BOT= 16.20
- (S-205) STA. 123+43.00, 61.00' LT  
CONST. INLET TYPE V  
FDOT INDEX 200, 201, 205, & 221  
EOP = 23.04  
FL= 18.45 (N, S & E)  
FL= 17.8 (W M.E.)  
BOT= 16.45
- (S-208) STA. 119+44.00, 26.14' RT  
CONST. INLET TYPE P-5  
FDOT INDEX 200, 201, 205, & 211  
EOP= 24.40  
FL= 20.50 (W)  
BOT= 18.50
- (S-206) STA. 120+80, 23.11' RT  
CONST. INLET TYPE P-5  
FDOT INDEX 200, 201, 205, & 211  
EOP= 23.89  
FL= 19.90 (W)  
BOT= 17.90
- (S-204) STA. 123+23, 31.00' RT  
CONST. INLET TYPE P-6  
FDOT INDEX 200, 201, 205, & 211  
EOP= 22.62  
FL= 18.60 (W)  
BOT= 16.60







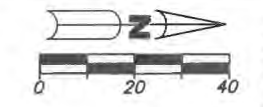


C.E. = 15.50  
MAIN CANAL

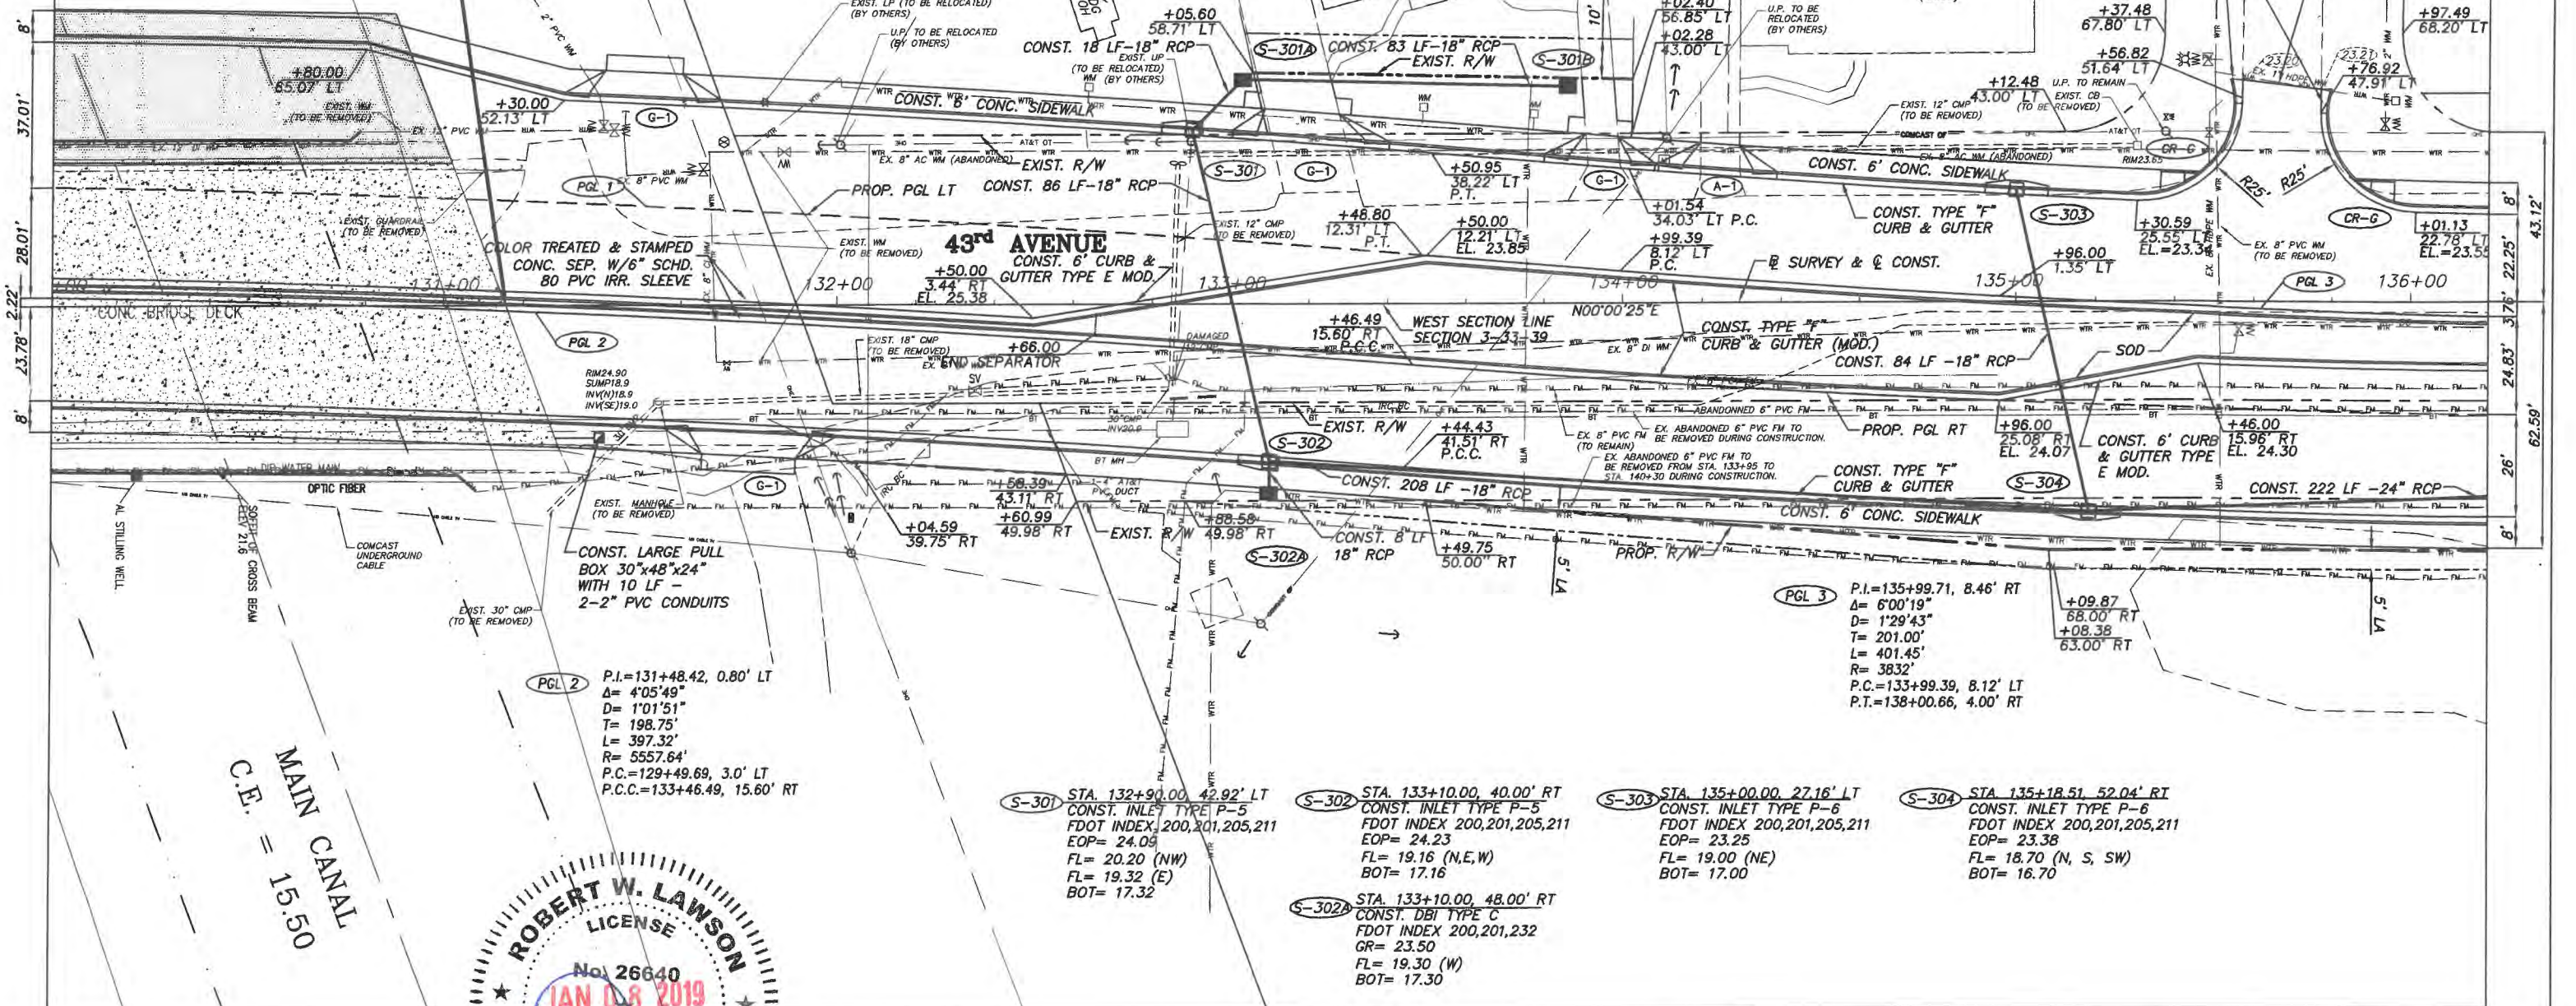
PROP. BRIDGE WIDENING  
(SEE BRIDGE PLANS)  
WORK OVER SURFACE WATERS  
(0.09 AC)

EXISTING BRIDGE

END APPROACH SLAB  
STA. 131+15.60



21st PLACE



PGL 2  
P.I.=131+48.42, 0.80' LT  
Δ= 4'05\"/>

S-301A  
STA. 133+03.00, 57.00' LT  
CONST. DBI TYPE C  
FDOT INDEX 200,201,232  
GR= 24.00  
FL= 20.50 (SE, N)  
BOT= 18.50

S-301B  
STA. 133+86.00, 55.00' LT  
CONST. DBI TYPE C  
FDOT INDEX 200,201,232  
GR= 24.10  
FL= 20.60 (S)  
BOT= 18.60

PGL 3  
P.I.=135+99.71, 8.46' RT  
Δ= 6'00\"/>

S-301  
STA. 132+90.00, 42.92' LT  
CONST. INLET TYPE P-5  
FDOT INDEX 200,201,205,211  
EOP= 24.09  
FL= 20.20 (NW)  
FL= 19.32 (E)  
BOT= 17.32

S-302  
STA. 133+10.00, 40.00' RT  
CONST. INLET TYPE P-5  
FDOT INDEX 200,201,205,211  
EOP= 24.23  
FL= 19.16 (N,E,W)  
BOT= 17.16

S-303  
STA. 135+00.00, 27.16' LT  
CONST. INLET TYPE P-6  
FDOT INDEX 200,201,205,211  
EOP= 23.25  
FL= 19.00 (NE)  
BOT= 17.00

S-304  
STA. 135+18.51, 52.04' RT  
CONST. INLET TYPE P-6  
FDOT INDEX 200,201,205,211  
EOP= 23.38  
FL= 18.70 (N, S, SW)  
BOT= 16.70

S-302A  
STA. 133+10.00, 48.00' RT  
CONST. DBI TYPE C  
FDOT INDEX 200,201,232  
GR= 23.50  
FL= 19.30 (W)  
BOT= 17.30



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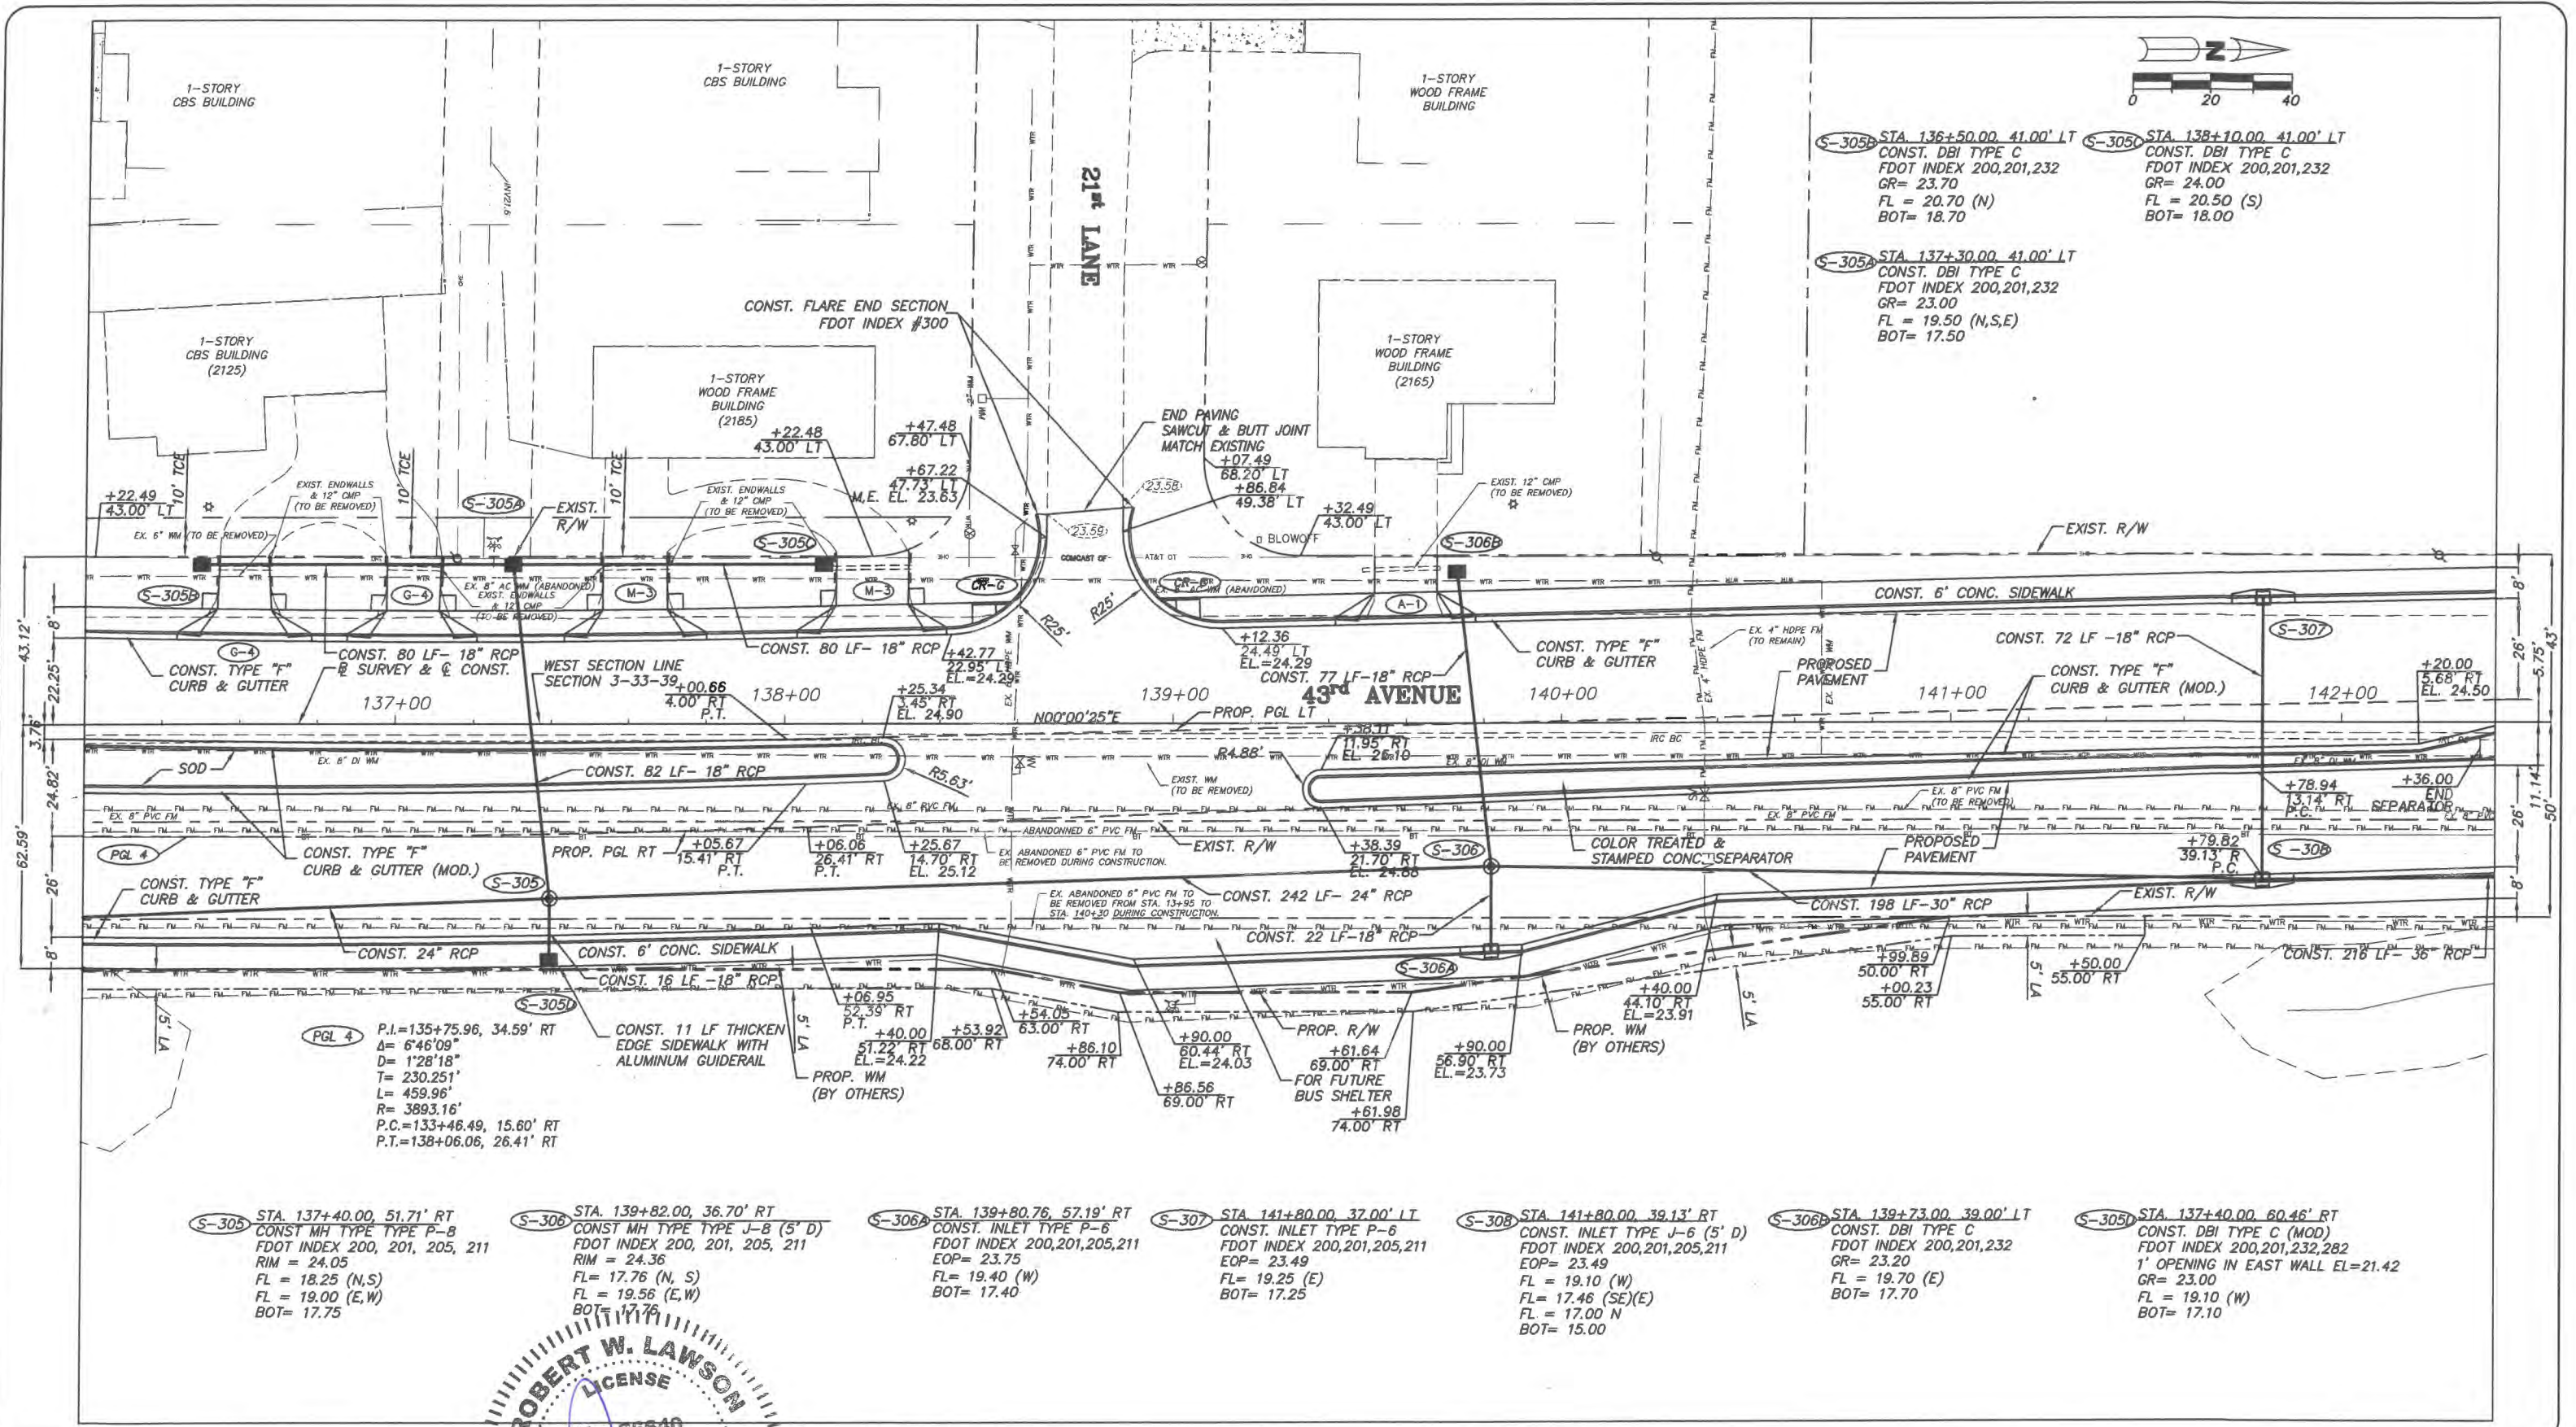
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Department of Public Works  
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SR 60 & 43RD AVENUE

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S-305B STA. 136+50.00, 41.00' LT  
 CONST. DBI TYPE C  
 FDOT INDEX 200,201,232  
 GR= 23.70  
 FL = 20.70 (N)  
 BOT= 18.70

S-305A STA. 138+10.00, 41.00' LT  
 CONST. DBI TYPE C  
 FDOT INDEX 200,201,232  
 GR= 24.00  
 FL = 20.50 (S)  
 BOT= 18.00

S-305A STA. 137+30.00, 41.00' LT  
 CONST. DBI TYPE C  
 FDOT INDEX 200,201,232  
 GR= 23.00  
 FL = 19.50 (N,S,E)  
 BOT= 17.50

PGL 4  
 P.I.=135+75.96, 34.59' RT  
 Δ= 6'46"09"  
 D= 1'28"18"  
 T= 230.251'  
 L= 459.96'  
 R= 3893.16'  
 P.C.=133+46.49, 15.60' RT  
 P.T.=138+06.06, 26.41' RT

S-305 STA. 137+40.00, 51.71' RT  
 CONST. MH TYPE TYPE P-8  
 FDOT INDEX 200, 201, 205, 211  
 RIM = 24.05  
 FL = 18.25 (N,S)  
 FL = 19.00 (E,W)  
 BOT= 17.75

S-306 STA. 139+82.00, 36.70' RT  
 CONST. MH TYPE TYPE J-8 (5' D)  
 FDOT INDEX 200, 201, 205, 211  
 RIM = 24.36  
 FL = 17.76 (N, S)  
 FL = 19.56 (E,W)  
 BOT= 17.76

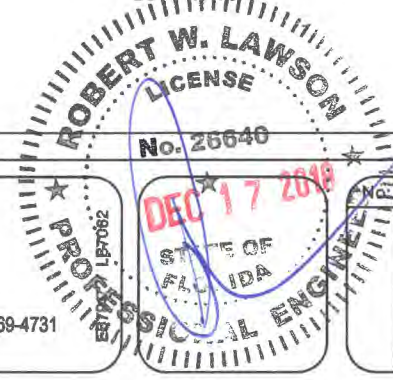
S-306A STA. 139+80.76, 57.19' RT  
 CONST. INLET TYPE P-6  
 FDOT INDEX 200,201,205,211  
 EOP= 23.75  
 FL= 19.40 (W)  
 BOT= 17.40

S-307 STA. 141+80.00, 37.00' LT  
 CONST. INLET TYPE P-6  
 FDOT INDEX 200,201,205,211  
 EOP= 23.49  
 FL= 19.25 (E)  
 BOT= 17.25

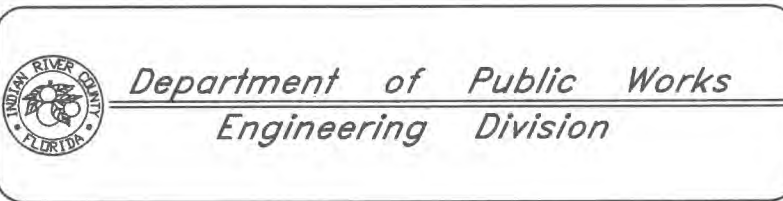
S-308 STA. 141+80.00, 39.13' RT  
 CONST. INLET TYPE J-6 (5' D)  
 FDOT INDEX 200,201,205,211  
 EOP= 23.49  
 FL = 19.10 (W)  
 FL = 17.46 (SE)(E)  
 FL = 17.00 N  
 BOT= 15.00

S-306B STA. 139+73.00, 39.00' LT  
 CONST. DBI TYPE C  
 FDOT INDEX 200,201,232  
 GR= 23.20  
 FL = 19.70 (E)  
 BOT= 17.70

S-305D STA. 137+40.00, 60.46' RT  
 CONST. DBI TYPE C (MOD)  
 FDOT INDEX 200,201,232,282  
 1' OPENING IN EAST WALL EL=21.42  
 GR= 23.00  
 FL = 19.10 (W)  
 BOT= 17.10



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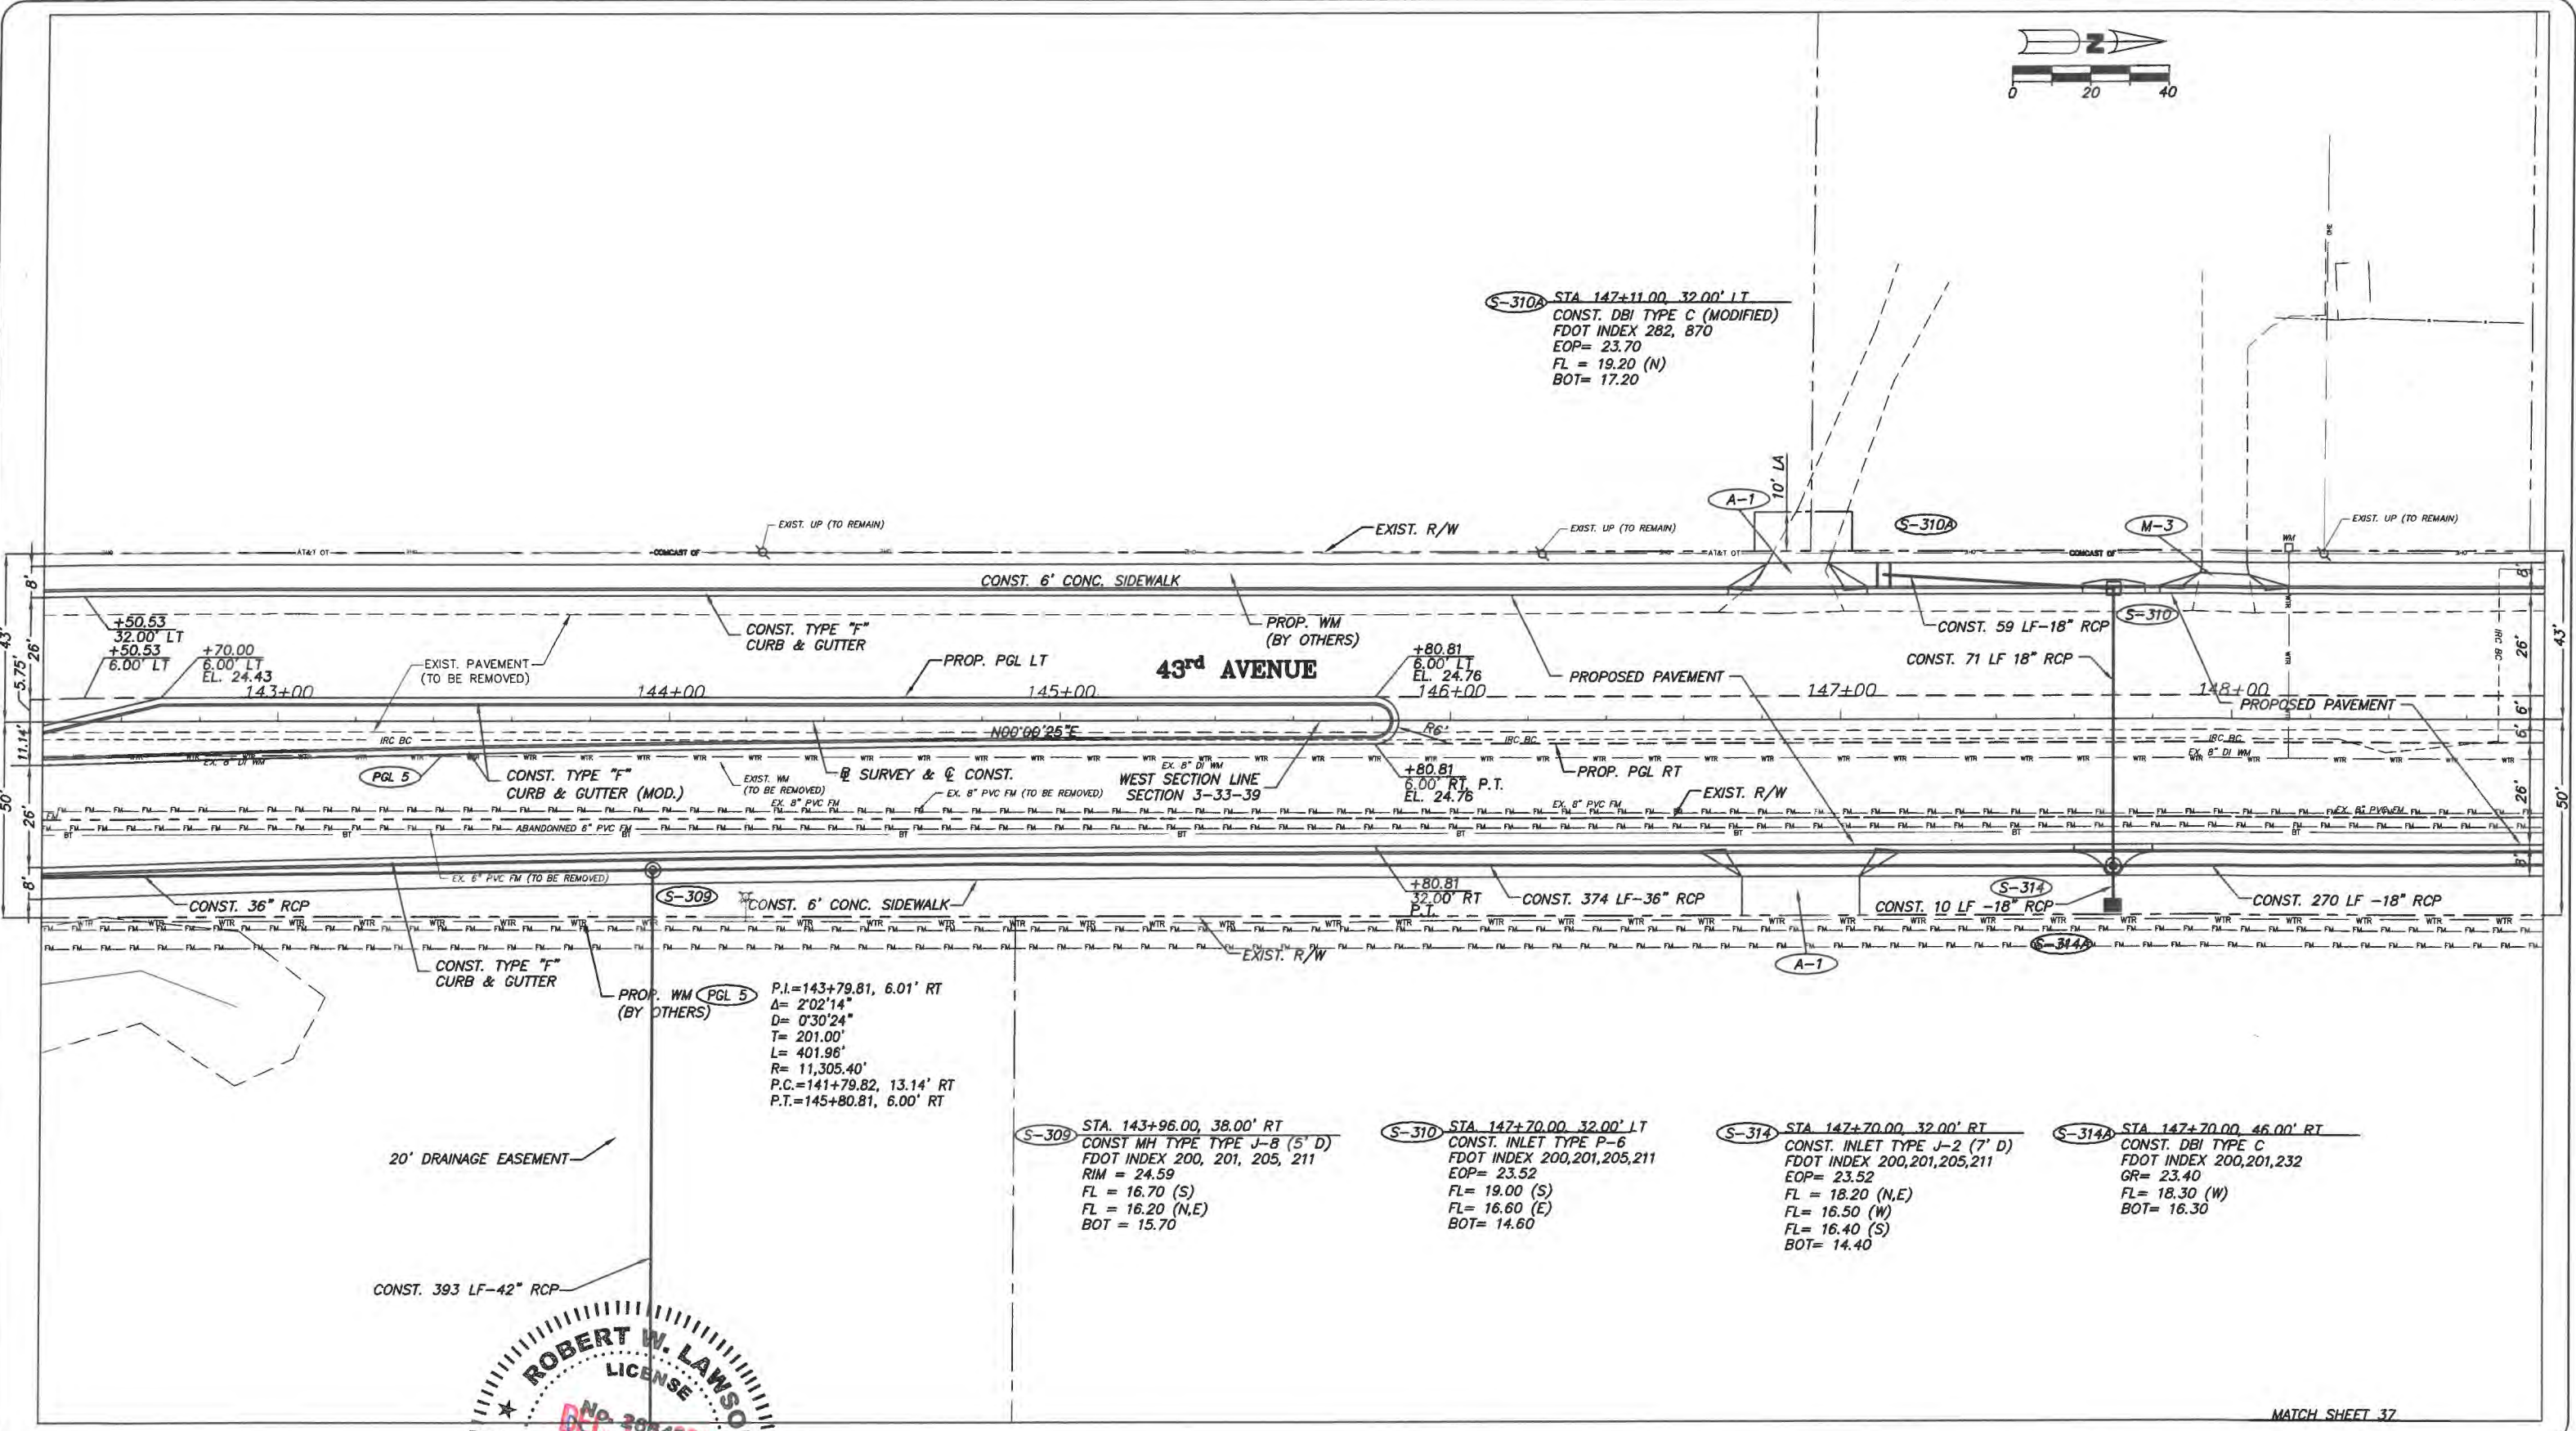
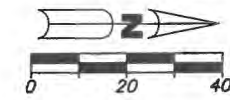


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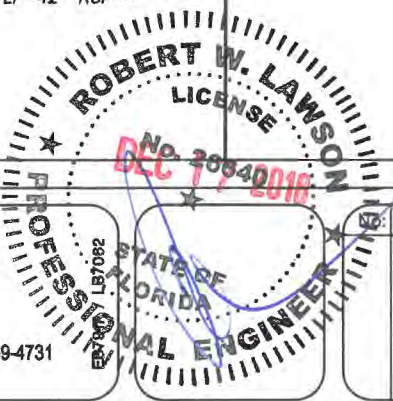
P.I.=143+79.81, 6.01' RT  
 Δ= 2'02'14"  
 D= 0'30'24"  
 T= 201.00'  
 L= 401.96'  
 R= 11,305.40'  
 P.C.=141+79.82, 13.14' RT  
 P.T.=145+80.81, 6.00' RT

S-309 STA. 143+96.00, 38.00' RT  
 CONST. MH TYPE TYPE J-B (5' D)  
 FDOT INDEX 200, 201, 205, 211  
 RIM = 24.59  
 FL = 16.70 (S)  
 FL = 16.20 (N,E)  
 BOT = 15.70

S-310 STA. 147+70.00, 32.00' LT  
 CONST. INLET TYPE P-6  
 FDOT INDEX 200,201,205,211  
 EOP= 23.52  
 FL= 19.00 (S)  
 FL= 16.60 (E)  
 BOT= 14.60


S-314 STA. 147+70.00, 32.00' RT  
 CONST. INLET TYPE J-2 (7' D)  
 FDOT INDEX 200,201,205,211  
 EOP= 23.52  
 FL = 18.20 (N,E)  
 FL= 16.50 (W)  
 FL= 16.40 (S)  
 BOT= 14.40

S-314A STA. 147+70.00, 46.00' RT  
 CONST. DBI TYPE C  
 FDOT INDEX 200,201,232  
 GR= 23.40  
 FL= 18.30 (W)  
 BOT= 16.30



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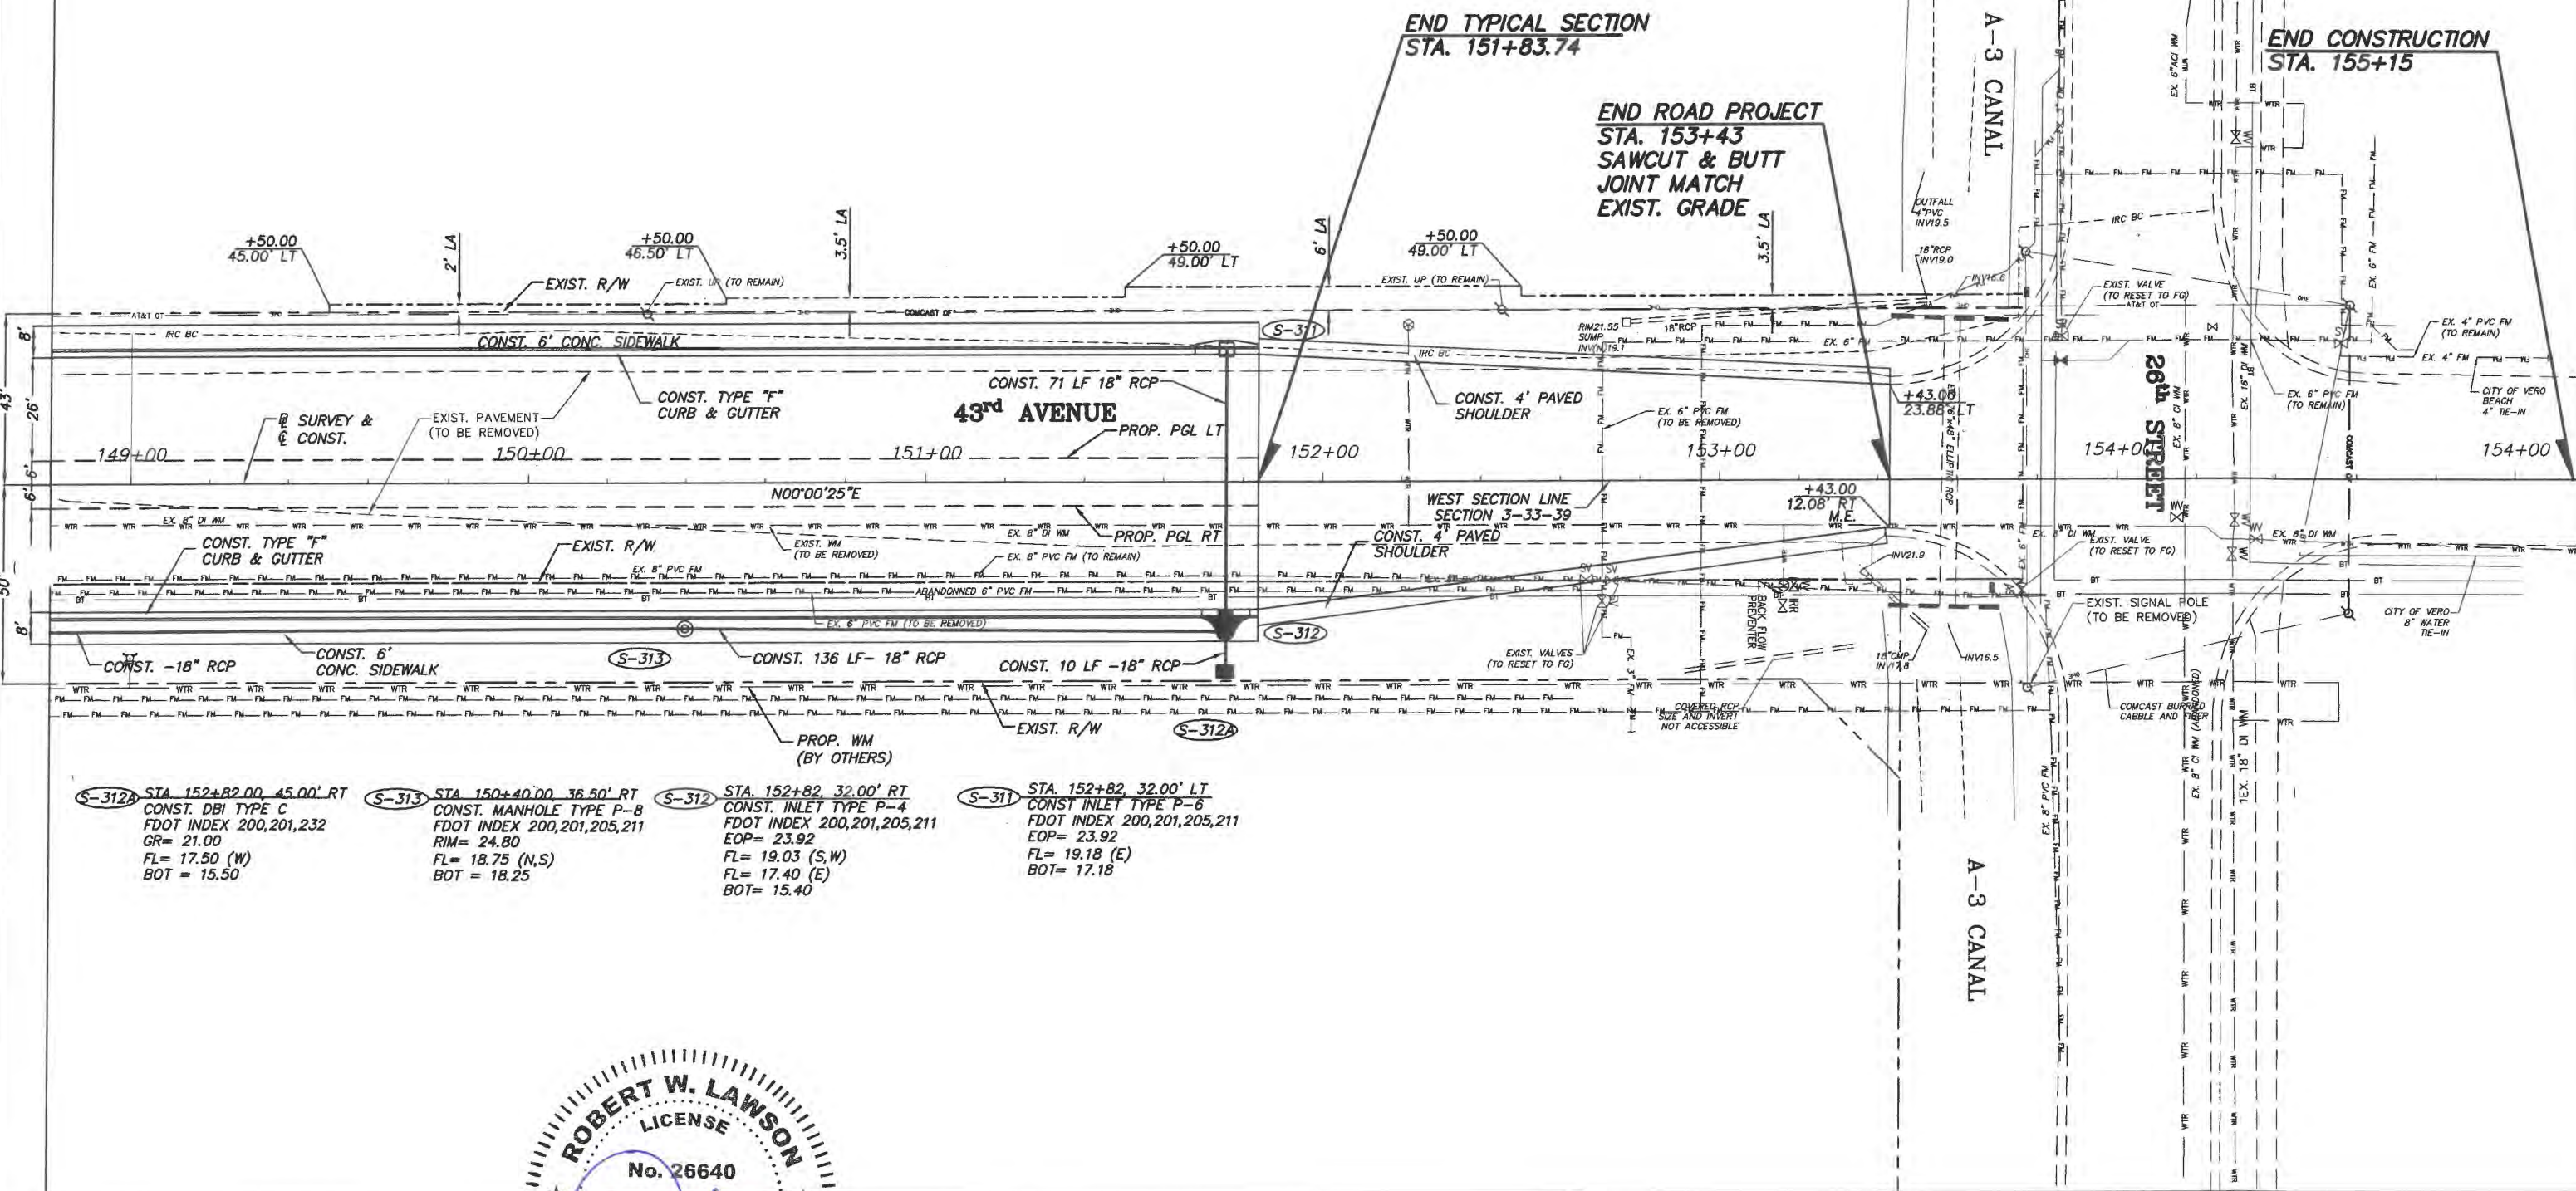
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MATCH SHEET 37



- NOTE:
- CONTRACTOR TO REMOVE, STORE DURING CONSTRUCTION, AND RELOCATE AT A LOCATION DIRECTED BY THE ENGINEER THE EXISTING WOODEN CROSS MONUMENT AND FLOWERS AS CLOSE AS POSSIBLE TO THE CURRENT LOCATION UPON COMPLETION OF CONSTRUCTION.
  - CONTRACTOR TO INSPECT THE EXISTING 48"x 76" PIPES AT THE A-3 CANAL AND REPLACE EXISTING PIPES AS DIRECTED BY THE ENGINEER.



- S-312 STA 152+82.00 45.00' RT  
CONST. DBI TYPE C  
FDOT INDEX 200,201,232  
GR= 21.00  
FL= 17.50 (W)  
BOT = 15.50
- S-313 STA 150+40.00 36.50' RT  
CONST. MANHOLE TYPE P-B  
FDOT INDEX 200,201,205,211  
RIM= 24.80  
FL= 18.75 (N,S)  
BOT = 18.25
- S-312 STA 152+82 32.00' RT  
CONST. INLET TYPE P-4  
FDOT INDEX 200,201,205,211  
EOP= 23.92  
FL= 19.03 (S,W)  
FL= 17.40 (E)  
BOT= 15.40
- S-311 STA 152+82 32.00' LT  
CONST. INLET TYPE P-6  
FDOT INDEX 200,201,205,211  
EOP= 23.92  
FL= 19.18 (E)  
BOT= 17.18



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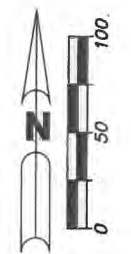
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MATCH SHEET 35



**S-315** STA. 143+96.00, 428.00' RT  
CONST MH TYPE TYPE J-8 (6" Ø)  
FDOT INDEX 200, 201, 205, 211  
RIM = 24.00  
FL = 16.00 (W, E)  
BOT = 15.25

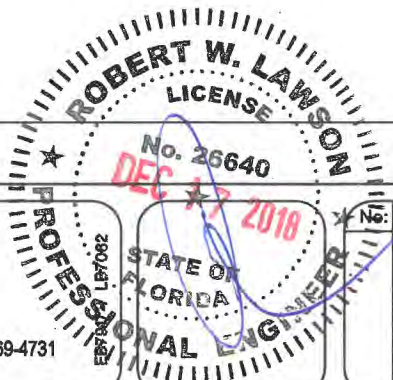
**S-316** STA. 143+96.00, 821.00' RT  
CONST MH TYPE TYPE J-8 (7" Ø)  
FDOT INDEX 200, 201, 205, 211  
RIM = 24.00  
FL = 15.60 (S, W)  
BOT = 14.85

CONST. 42" RCP

CONST. 393 LF-42" RCP

CONST. 28 LF-42" RCP

**S-317** CONST. 42" STRAIGHT  
CONC. ENDWALL  
FDOT INDEX 250  
FL = 15.40



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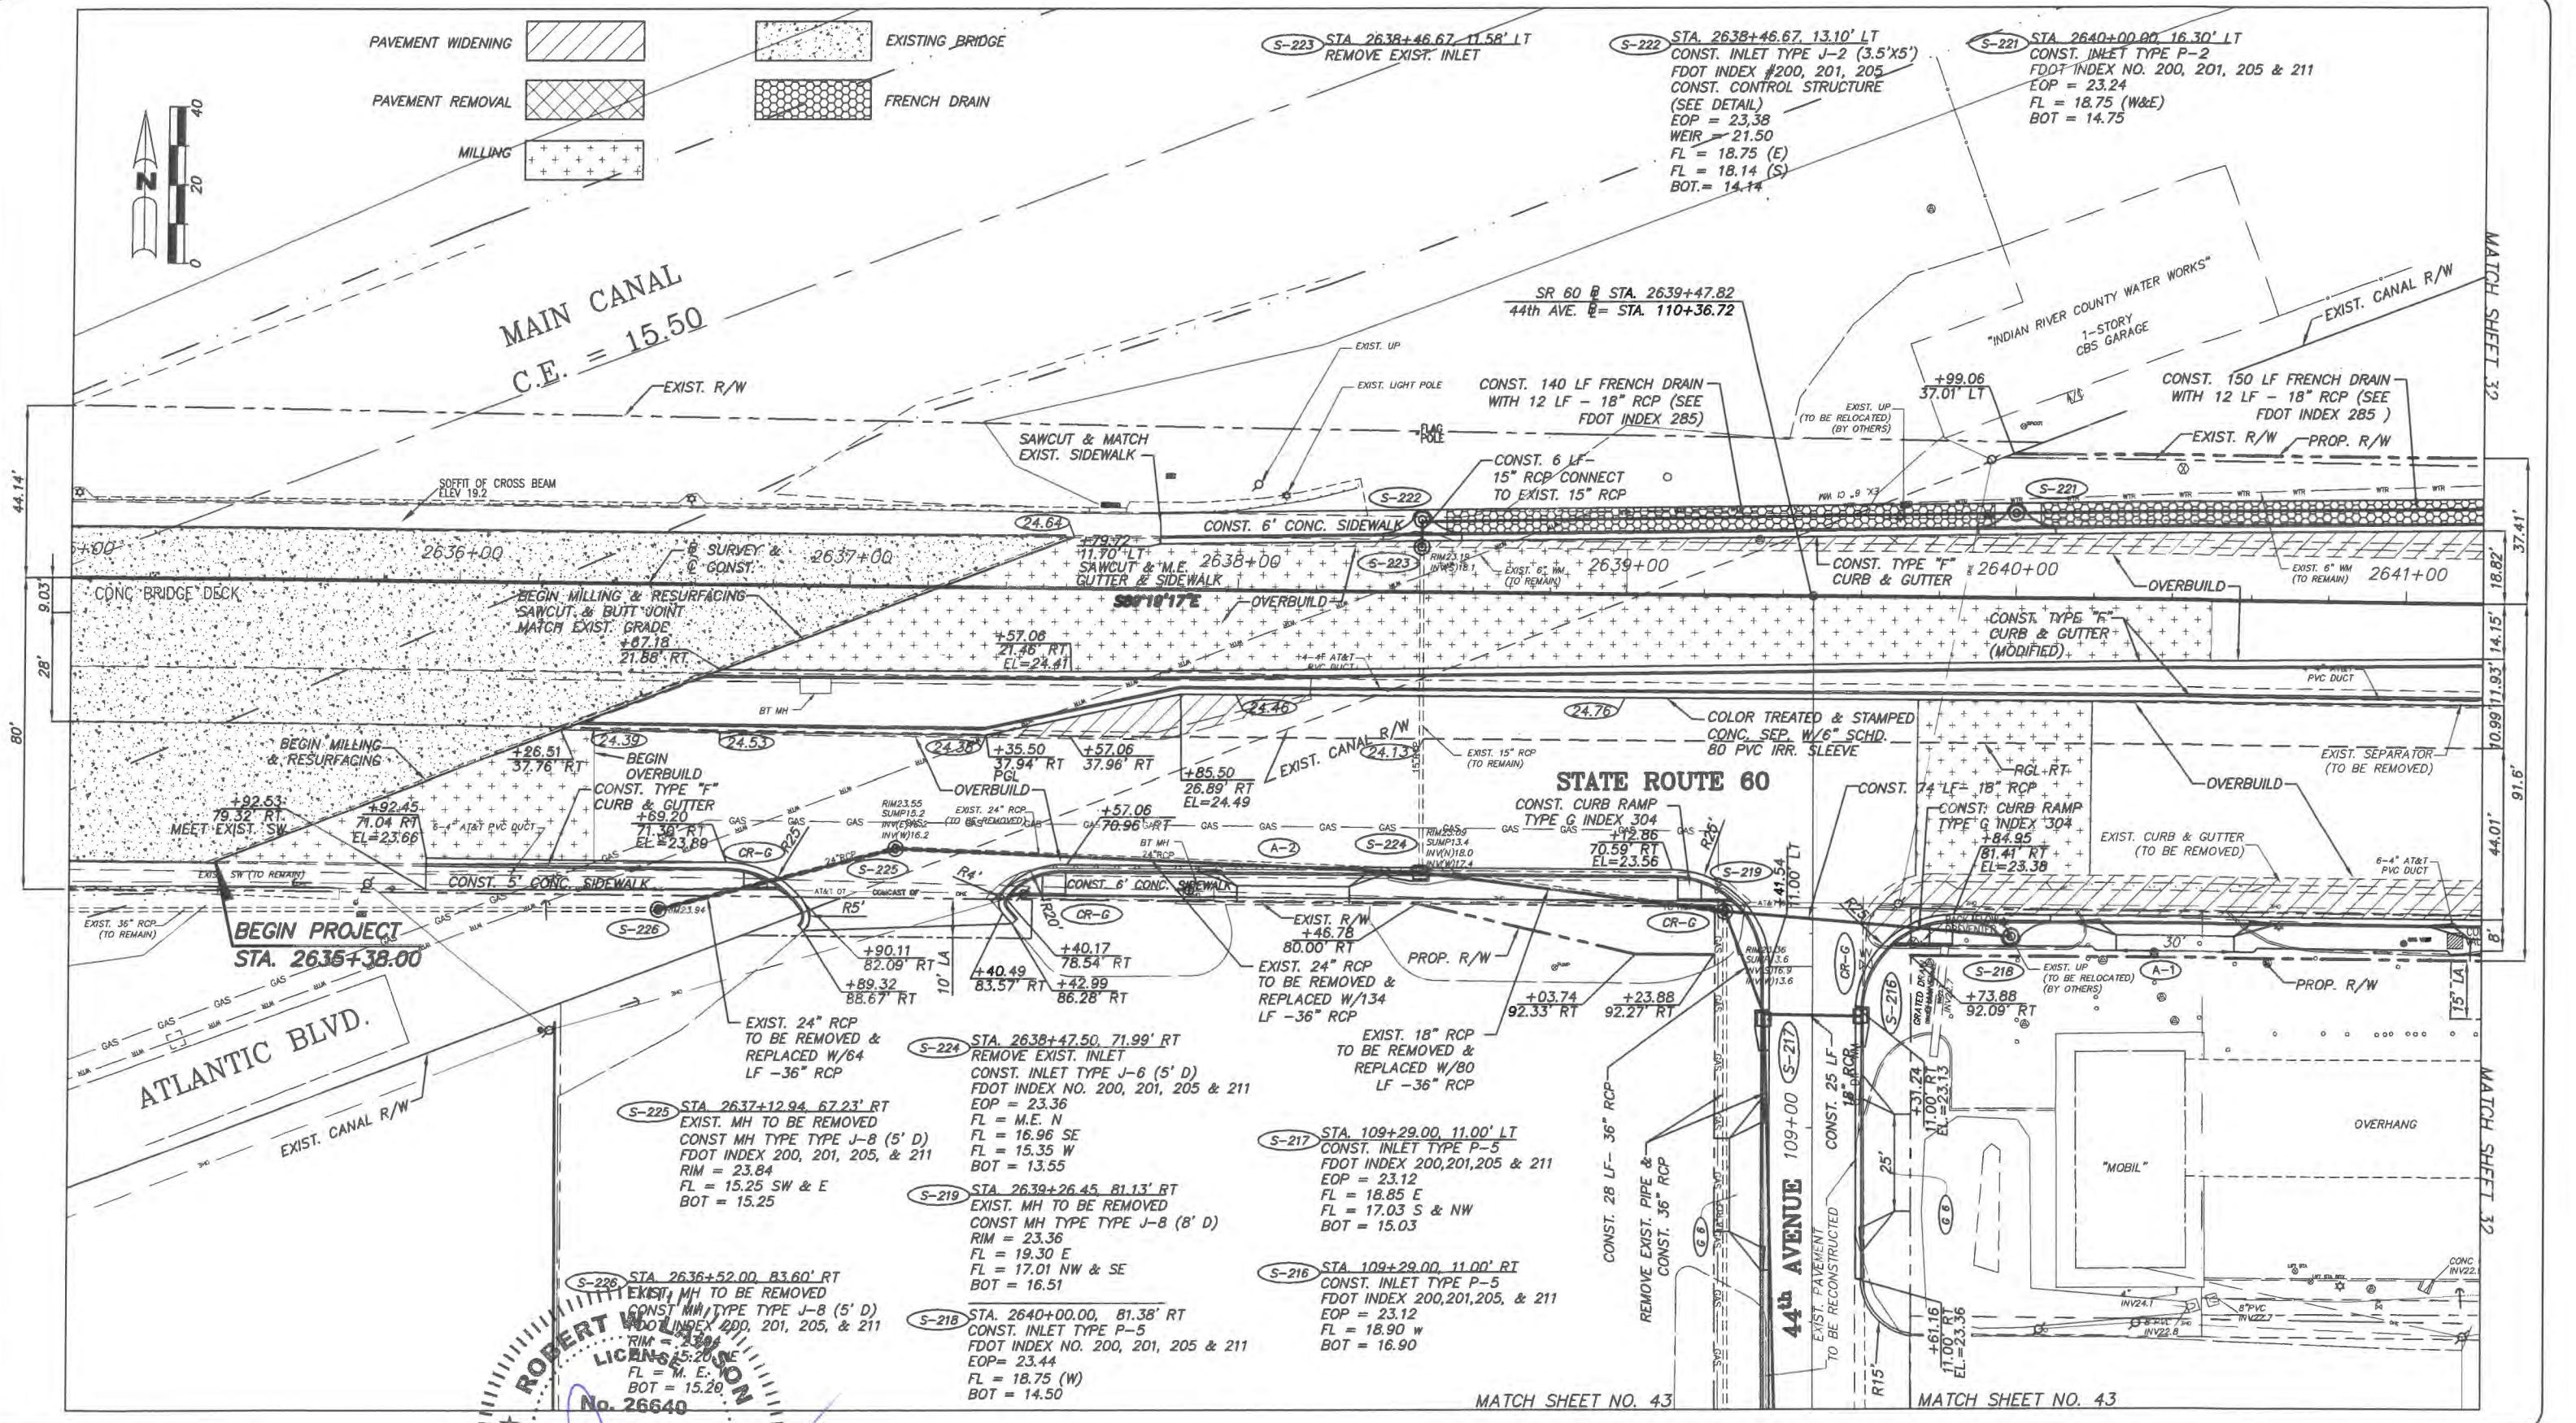
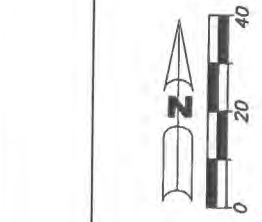
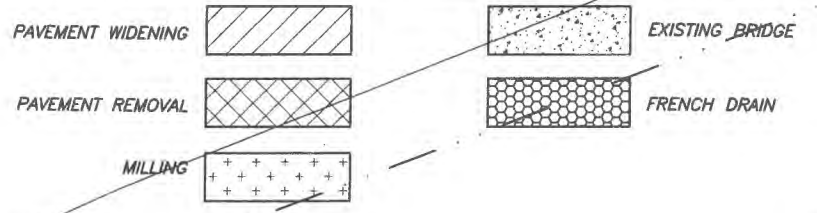
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**ROBERT W. JOHNSON**  
 LICENSED PROFESSIONAL ENGINEER  
 No. 26640  
 DEC 17 2016  
 STATE OF FLORIDA

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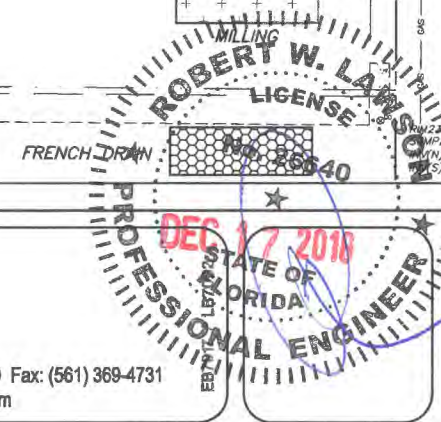
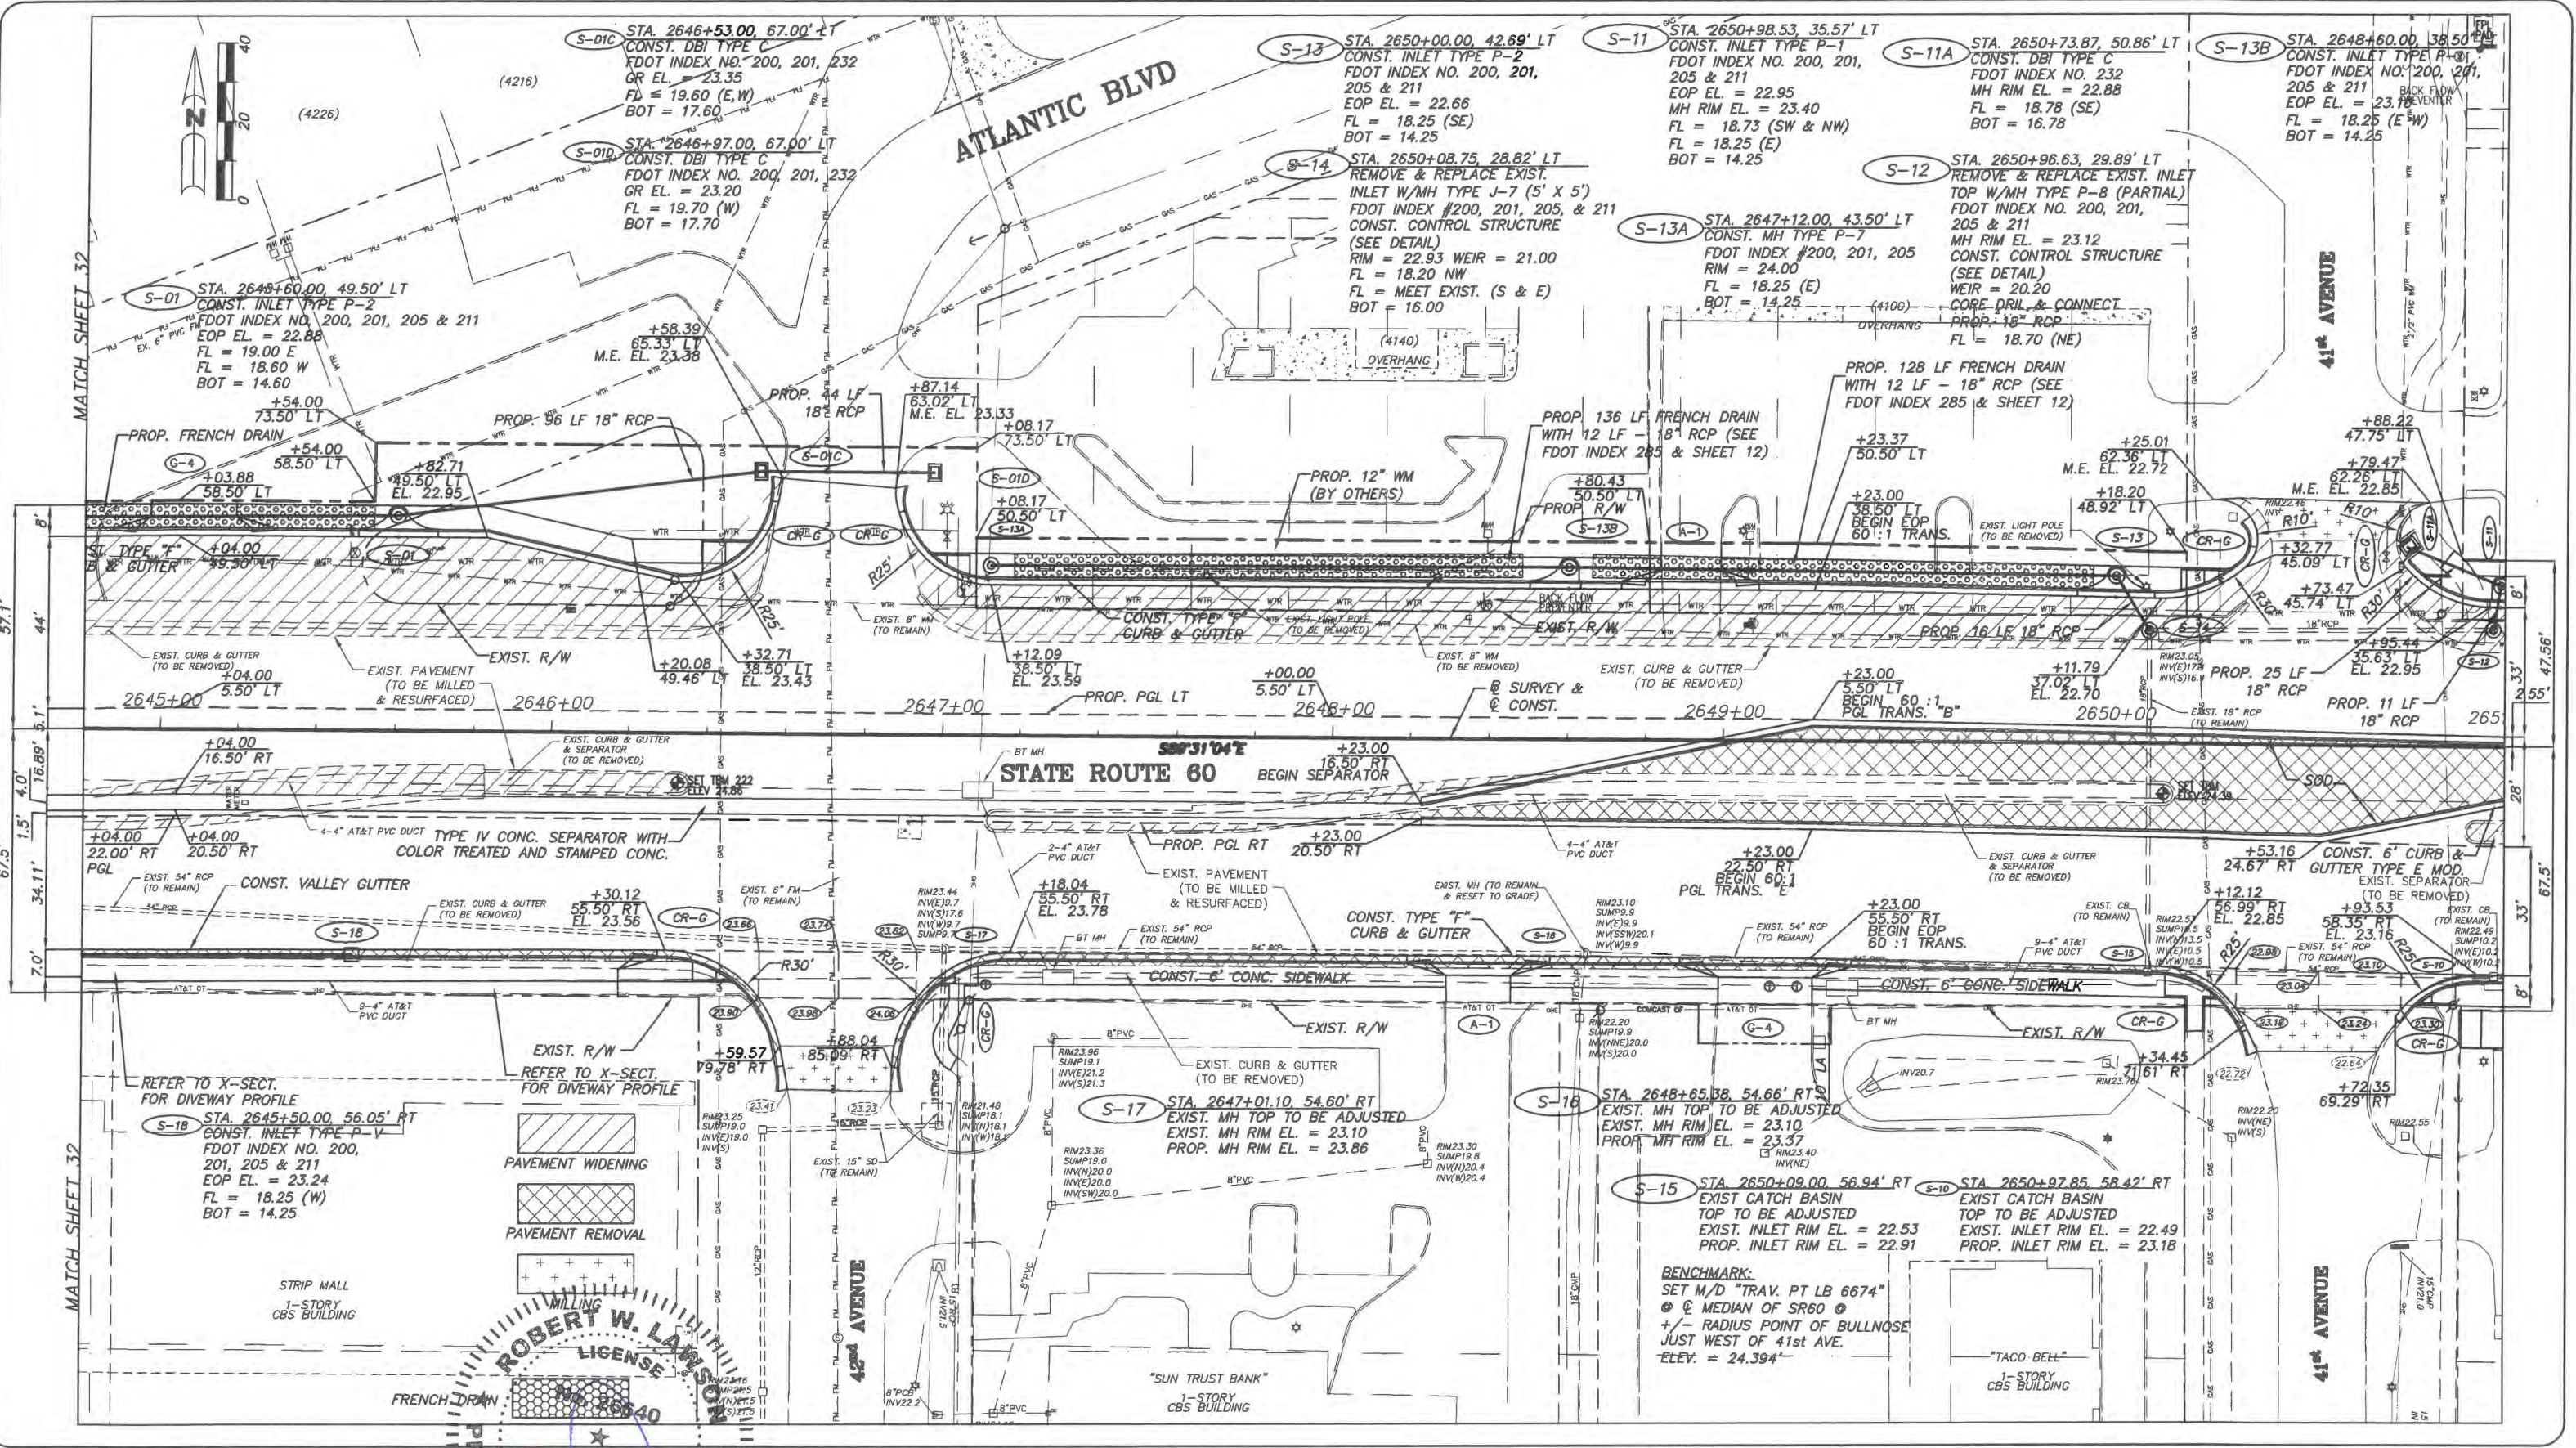
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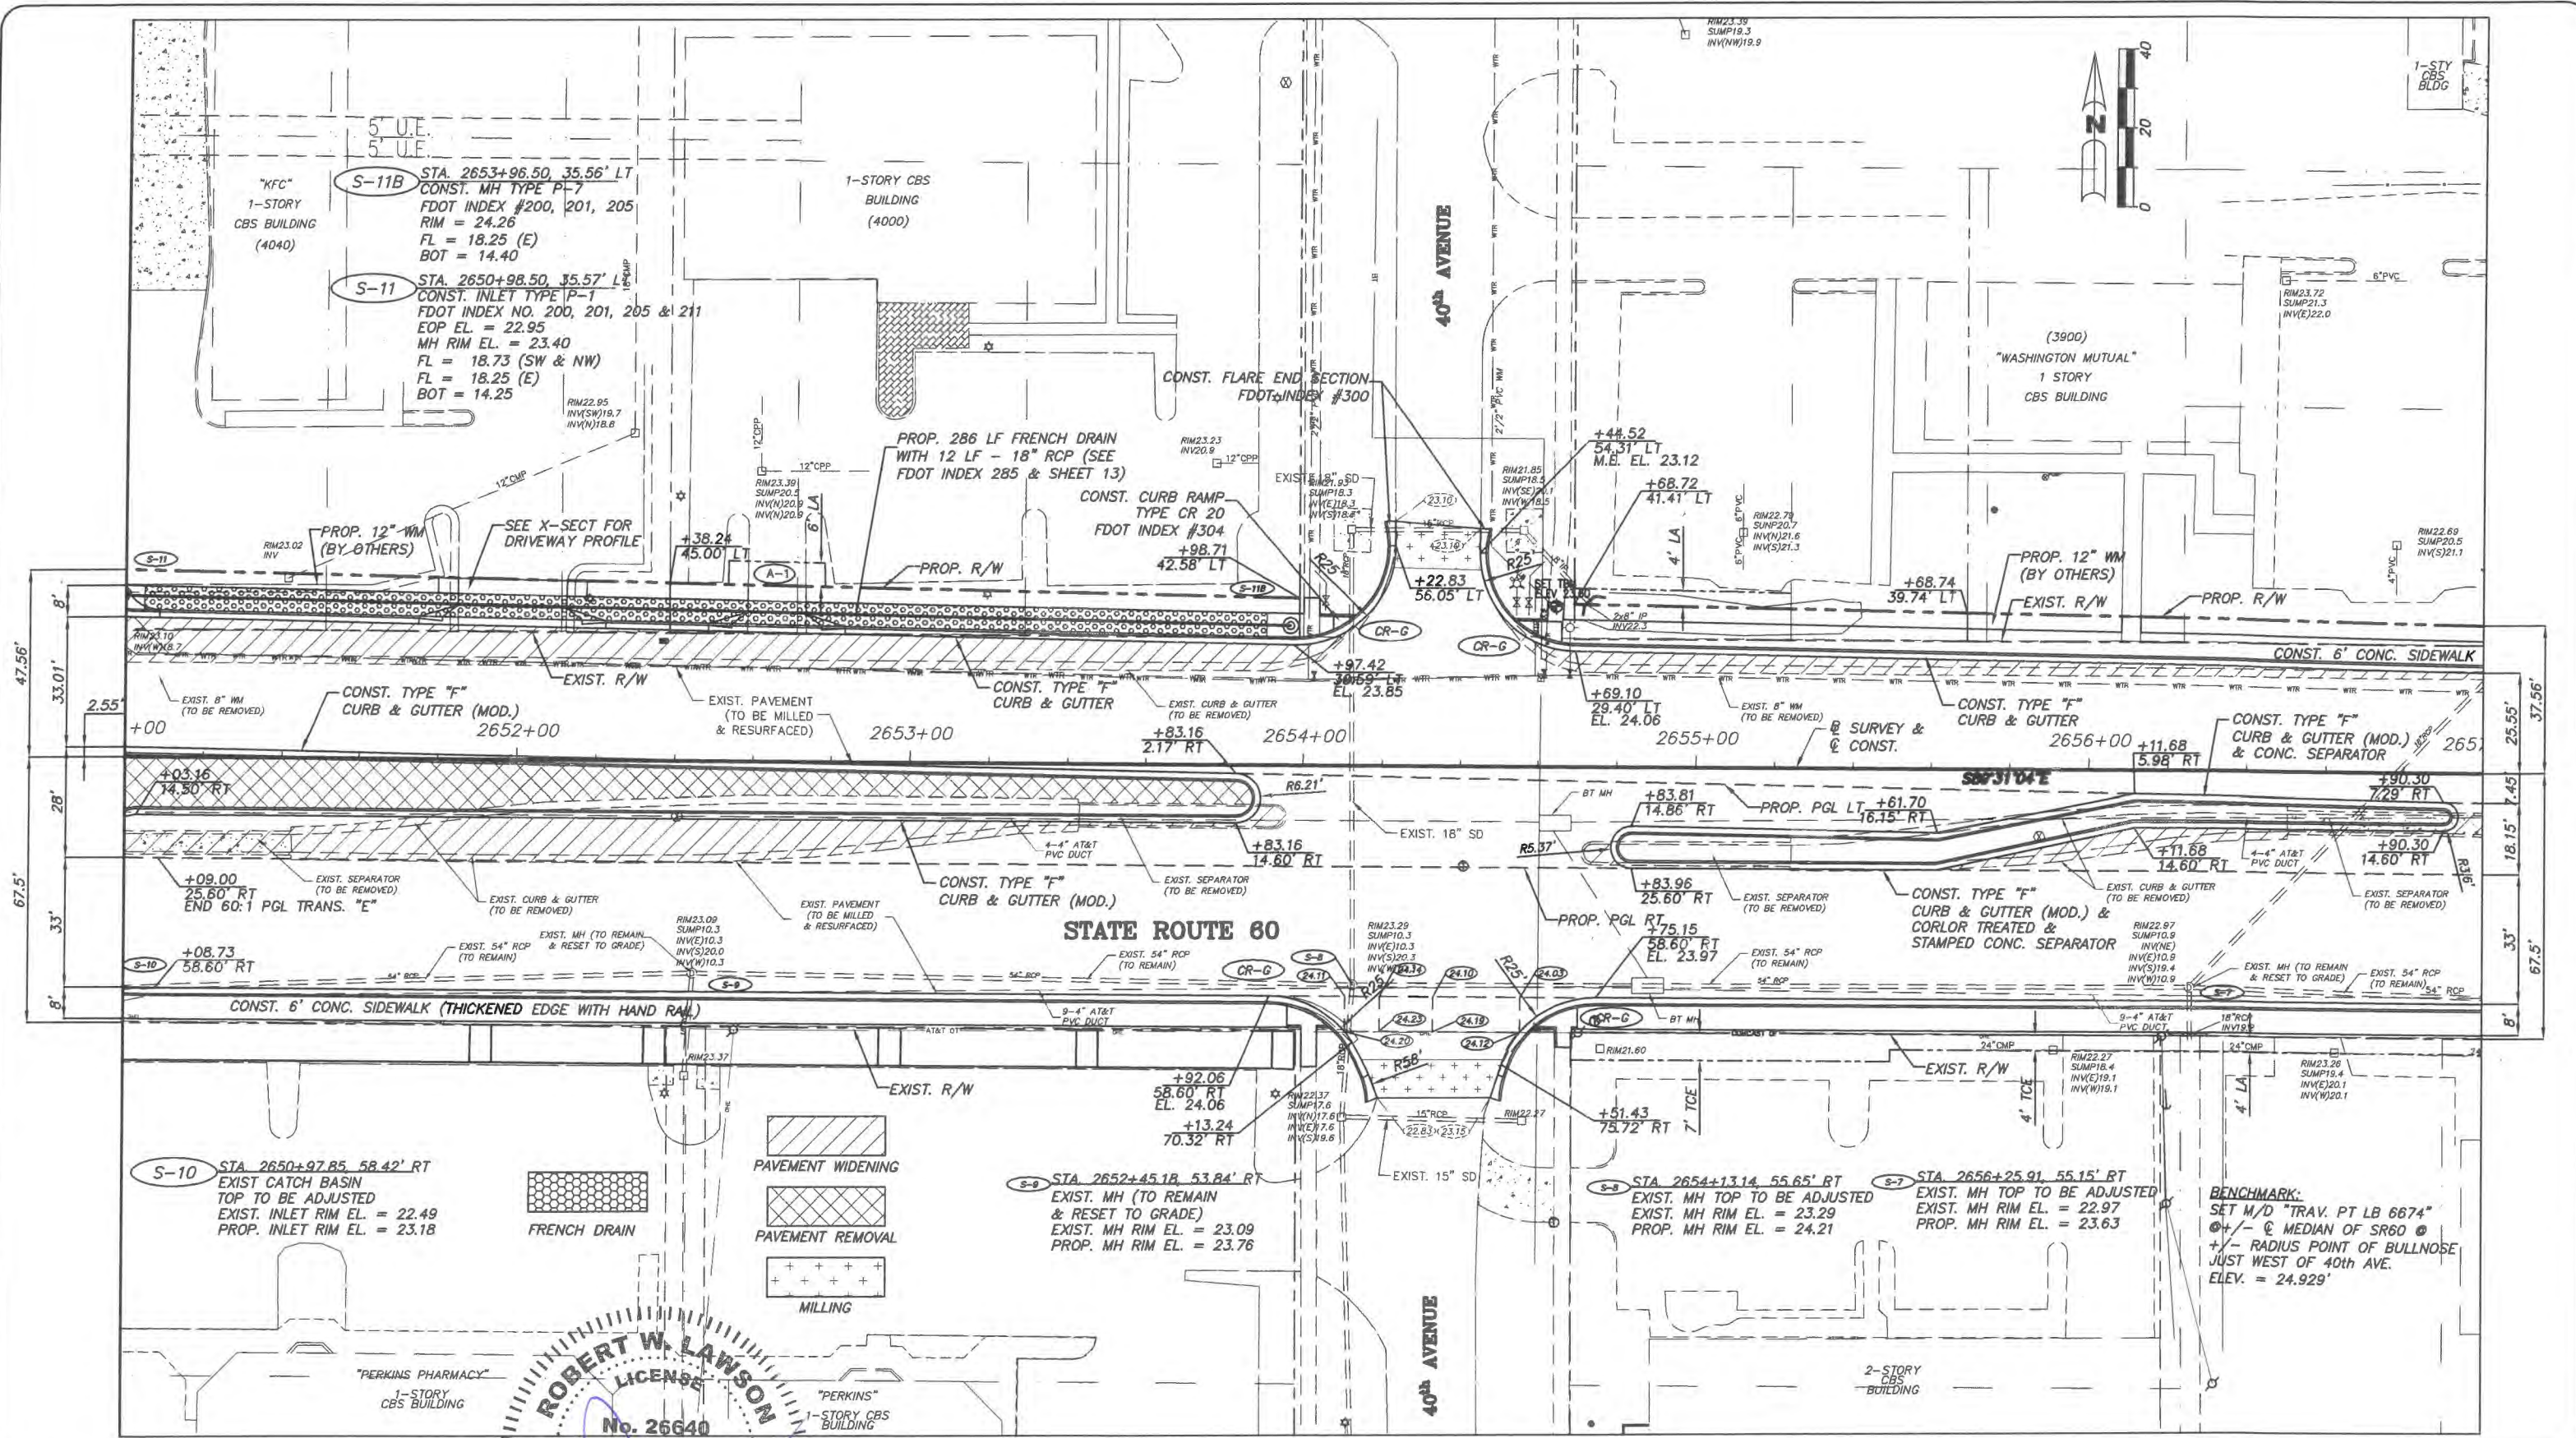
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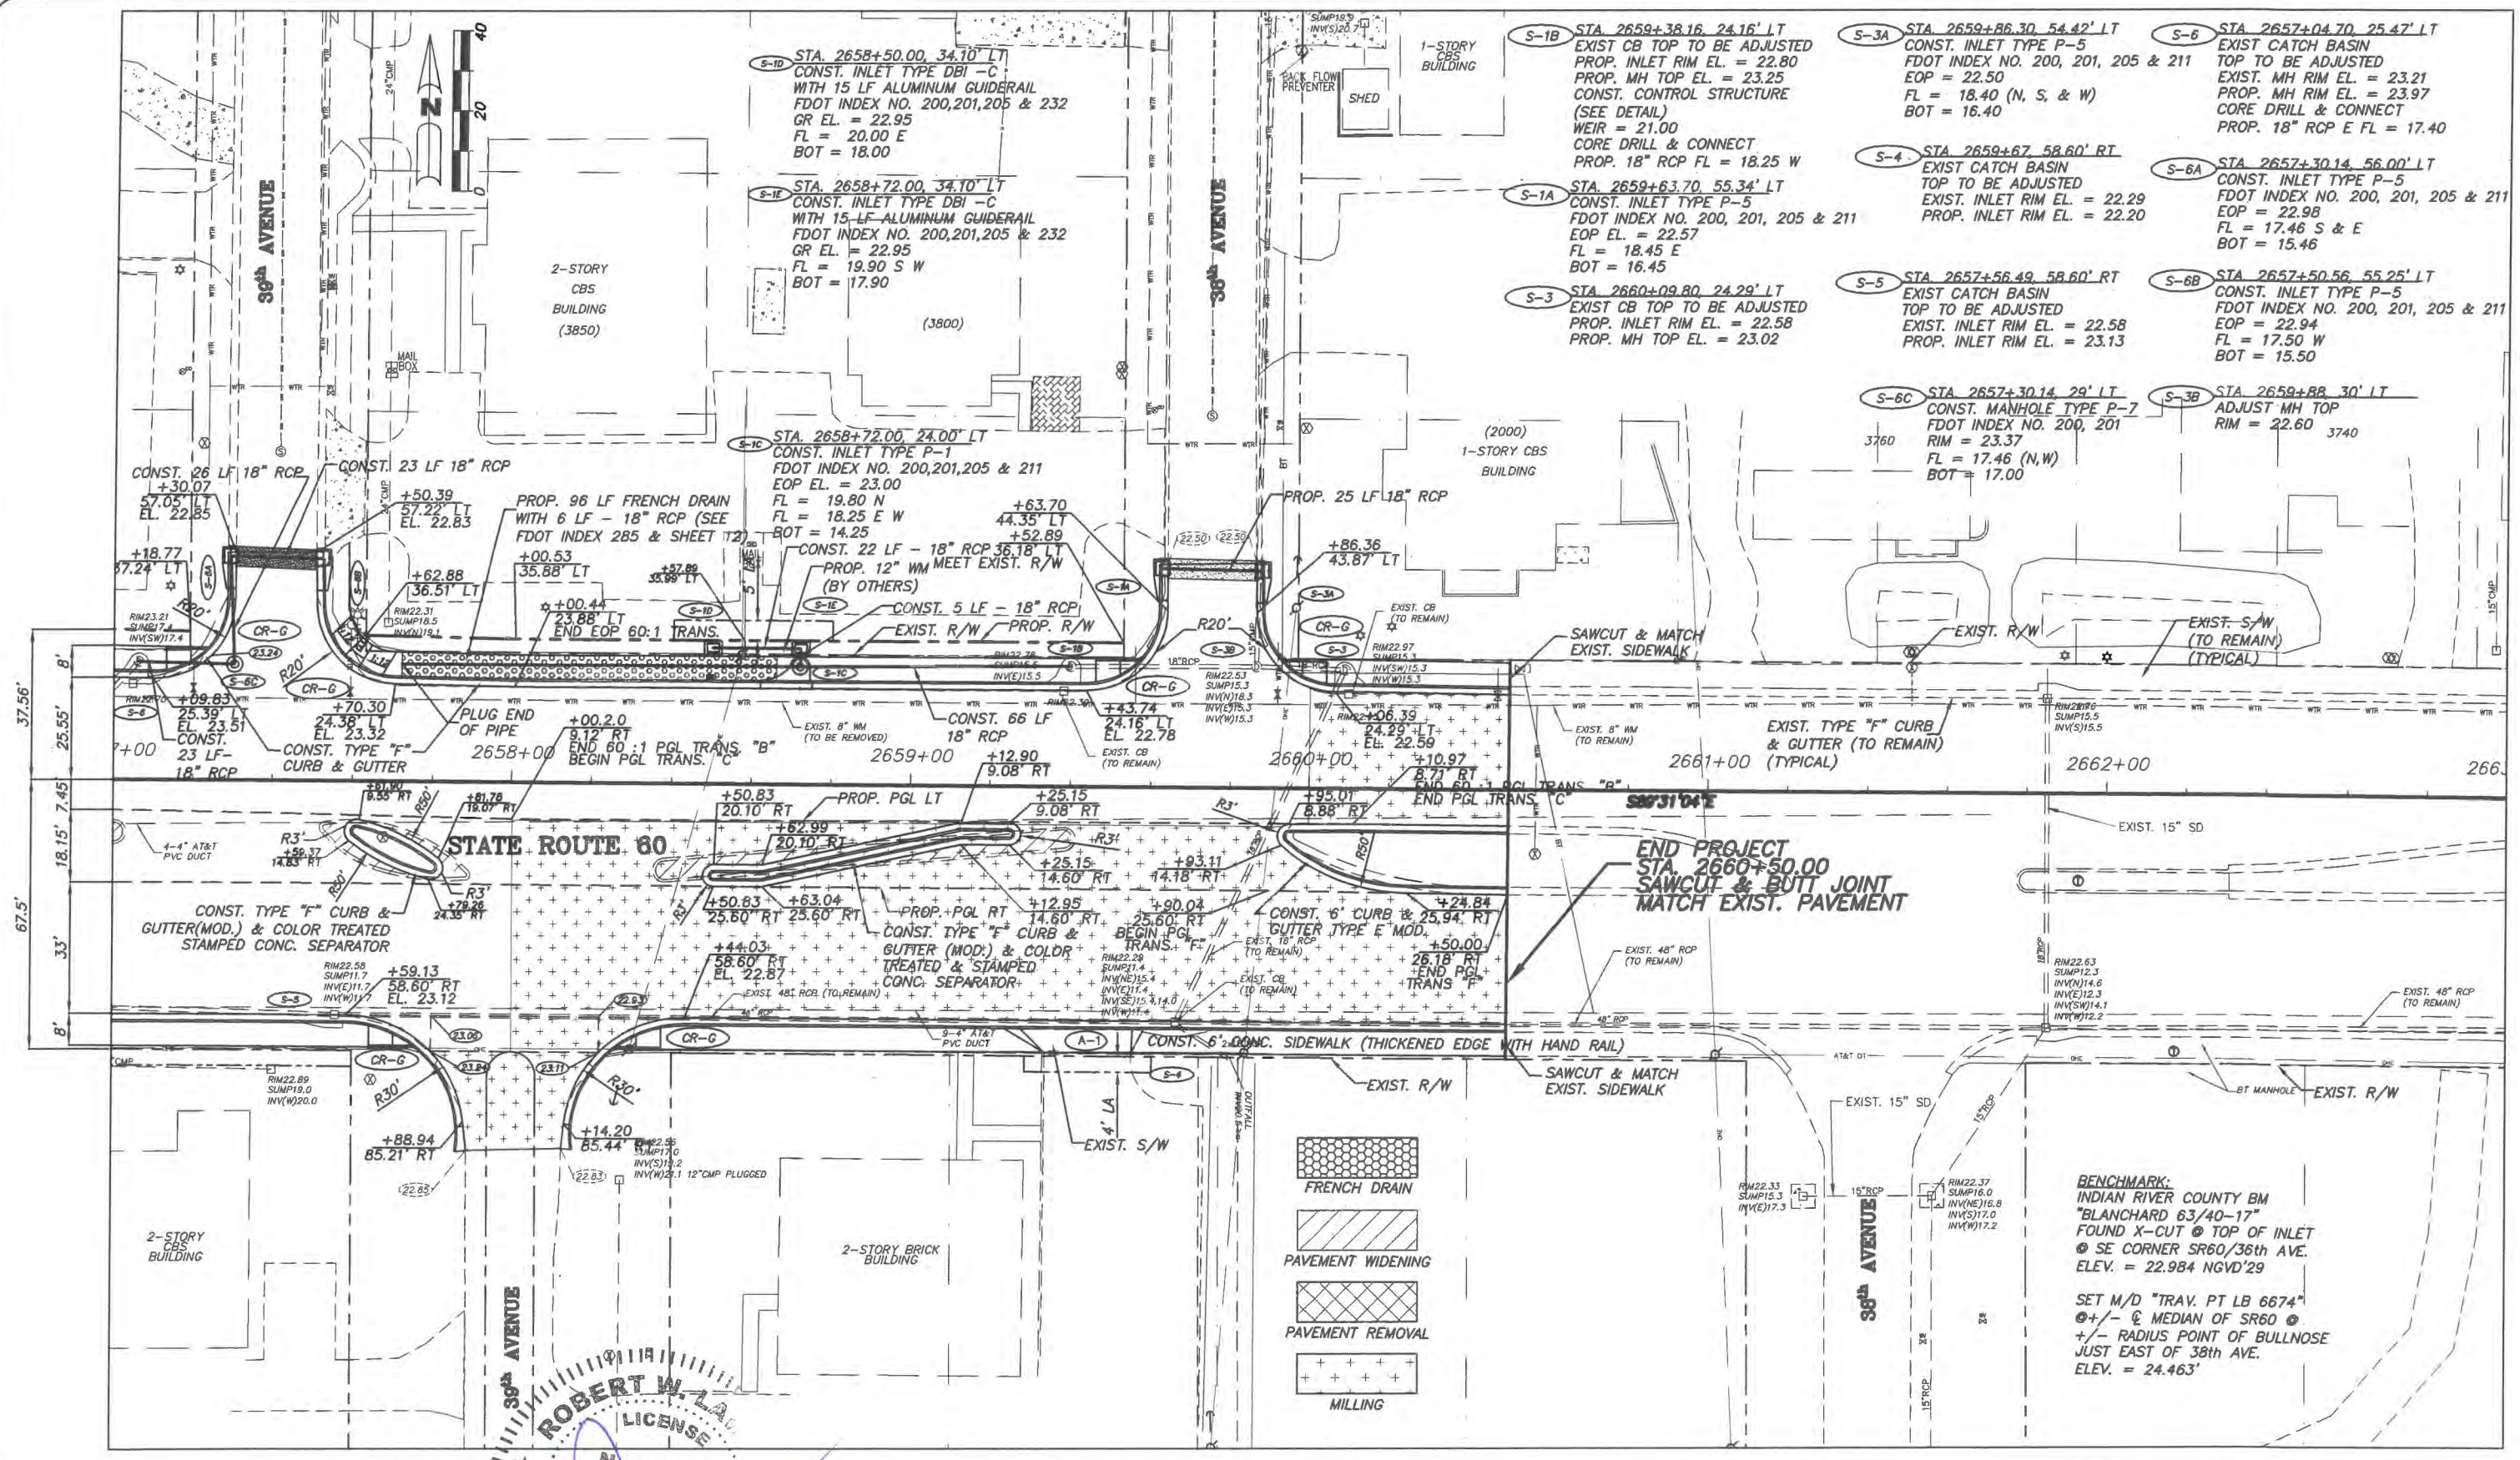
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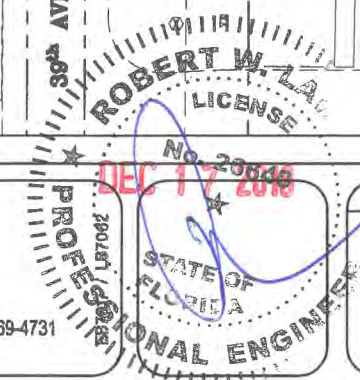
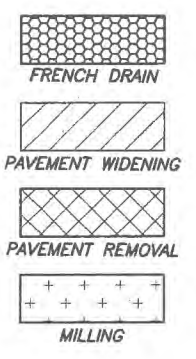




- S-1B STA 2659+38.16 24.16' LT  
EXIST CB TOP TO BE ADJUSTED  
PROP. INLET RIM EL. = 22.80  
PROP. MH TOP EL. = 23.25  
CONST. CONTROL STRUCTURE  
(SEE DETAIL)  
WEIR = 21.00  
CORE DRILL & CONNECT  
PROP. 18" RCP FL = 18.25 W
- S-3A STA 2659+86.30 54.42' LT  
CONST. INLET TYPE P-5  
FDOT INDEX NO. 200, 201, 205 & 211  
EOP = 22.50  
FL = 18.40 (N, S, & W)  
BOT = 16.40
- S-6 STA 2657+04.70 25.47' LT  
EXIST CATCH BASIN  
TOP TO BE ADJUSTED  
EXIST. MH RIM EL. = 23.21  
PROP. MH RIM EL. = 23.97  
CORE DRILL & CONNECT  
PROP. 18" RCP E FL = 17.40
- S-4 STA 2659+67.80 58.60' RT  
EXIST CATCH BASIN  
TOP TO BE ADJUSTED  
EXIST. INLET RIM EL. = 22.29  
PROP. INLET RIM EL. = 22.20
- S-6A STA 2657+30.14 56.00' LT  
CONST. INLET TYPE P-5  
FDOT INDEX NO. 200, 201, 205 & 211  
EOP = 22.98  
FL = 17.46 S & E  
BOT = 15.46
- S-5 STA 2657+56.49 58.60' RT  
EXIST CATCH BASIN  
TOP TO BE ADJUSTED  
EXIST. INLET RIM EL. = 22.58  
PROP. INLET RIM EL. = 23.13
- S-6B STA 2657+50.56 55.25' LT  
CONST. INLET TYPE P-5  
FDOT INDEX NO. 200, 201, 205 & 211  
EOP = 22.94  
FL = 17.50 W  
BOT = 15.50
- S-3 STA 2660+09.80 24.29' LT  
EXIST CB TOP TO BE ADJUSTED  
PROP. INLET RIM EL. = 22.58  
PROP. MH TOP EL. = 23.02
- S-5 STA 2657+30.14 29' LT  
CONST. MANHOLE TYPE P-7  
FDOT INDEX NO. 200, 201  
RIM = 23.37  
FL = 17.46 (N,W)  
BOT = 17.00
- S-3B STA 2659+88.30' LT  
ADJUST MH TOP  
RIM = 22.60 3740

**BENCHMARK:**  
INDIAN RIVER COUNTY BM  
"BLANCHARD 63/40-17"  
FOUND X-CUT @ TOP OF INLET  
@ SE CORNER SR60/38th AVE.  
ELEV. = 22.984 NGVD'29

SET M/D "TRAV. PT LB 6674"  
@ +/- E MEDIAN OF SR60 @  
+/- RADIUS POINT OF BULLNOSE  
JUST EAST OF 38th AVE.  
ELEV. = 24.463'



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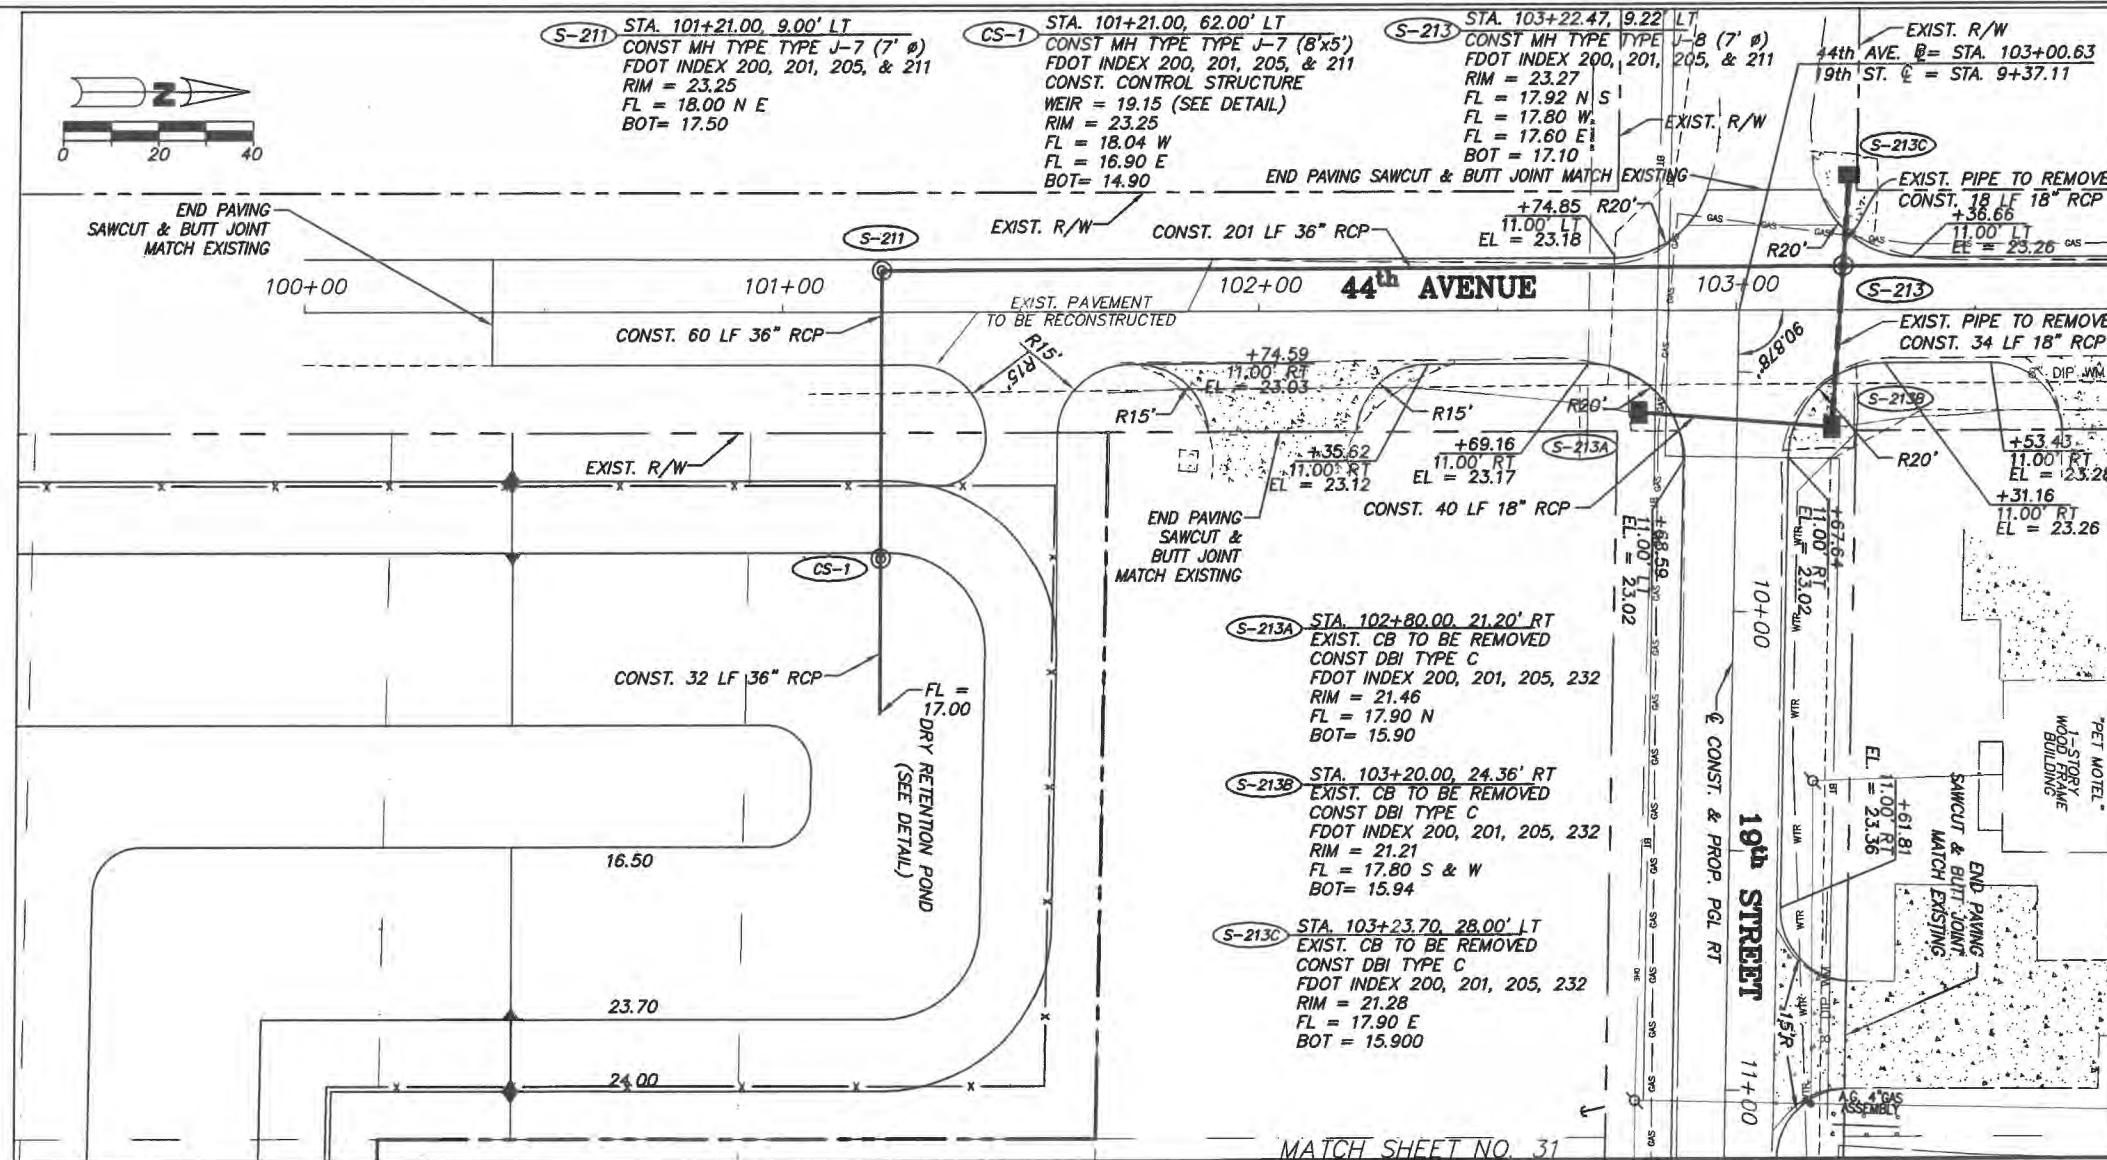
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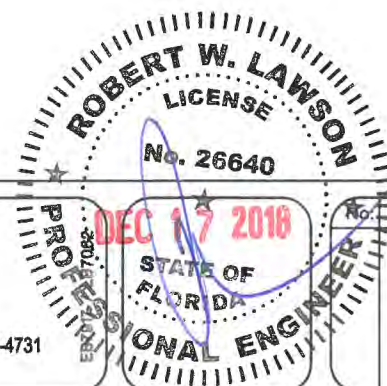
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44TH AVENUE PLAN SHEET



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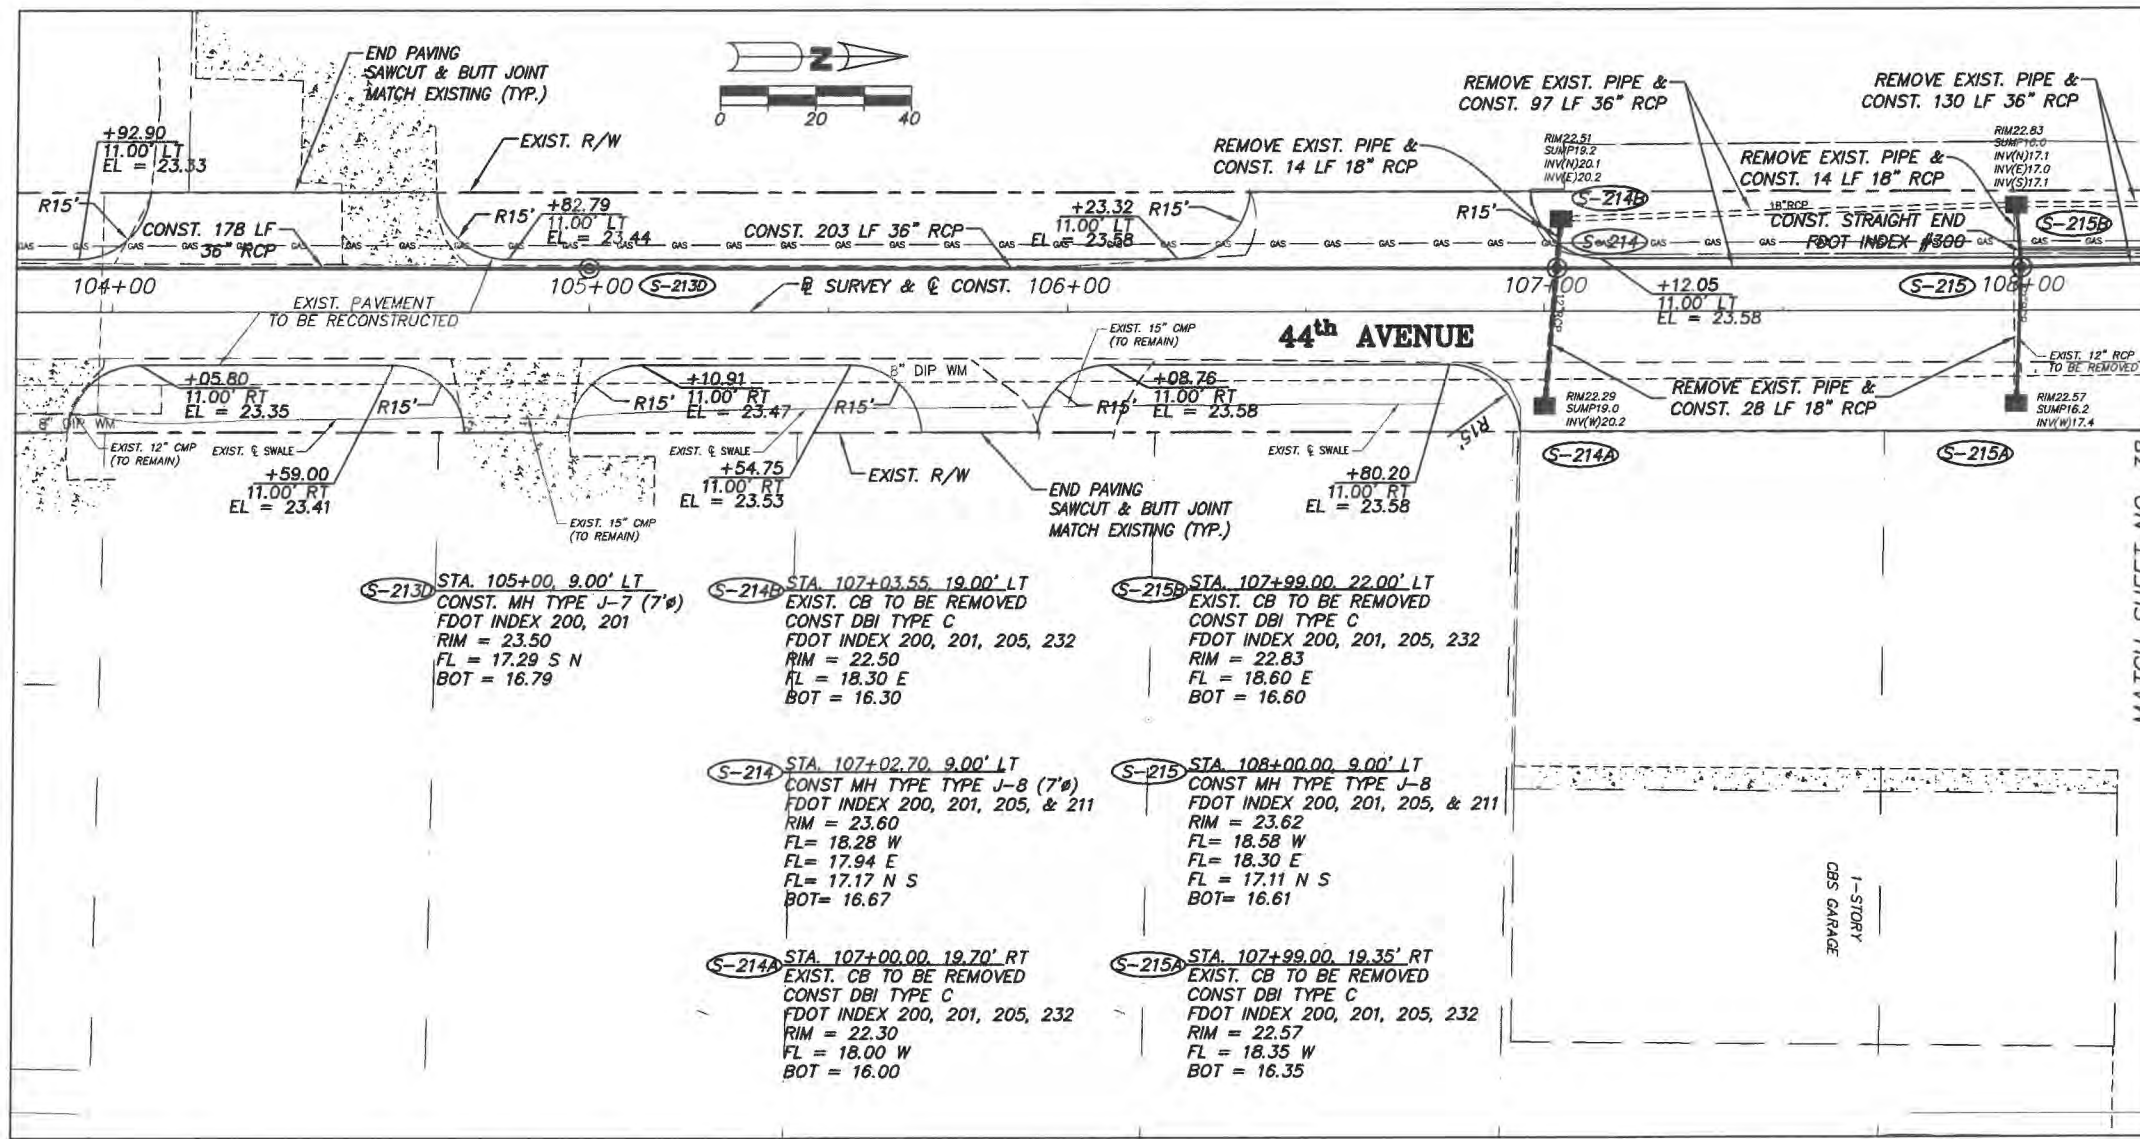
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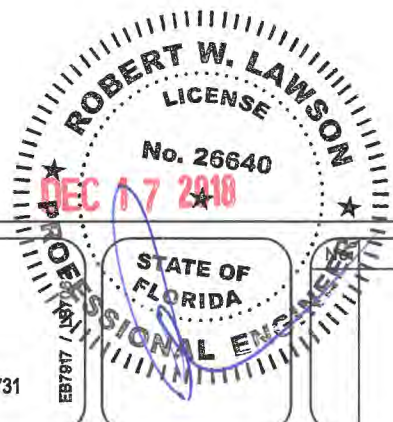
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44TH AVENUE PLAN SHEET



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BEGIN PROJECT STA. 109+60  
 SAWCUT & MATCH  
 EXIST. PAVEMENT ELEV.=25.25

APPROXIMATE EXIST. GROUND

3.3%

-0.30%

PGL LT & RT

FYDRANT

S-23

EXIST. 6" CI WM

EX. GAS MAIN

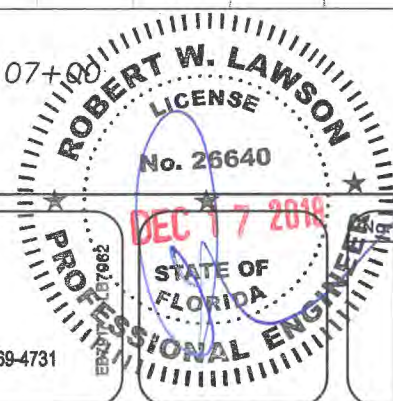
CONST. 64 LF 18" RCP  
 FROM S-24

FL=15.50

CONST. 205 LF 18" RCP  
 FROM S-23 TO S-26

106+00      107+00      108+00      109+00      110+00      111+00      112+00

43RD AVENUE



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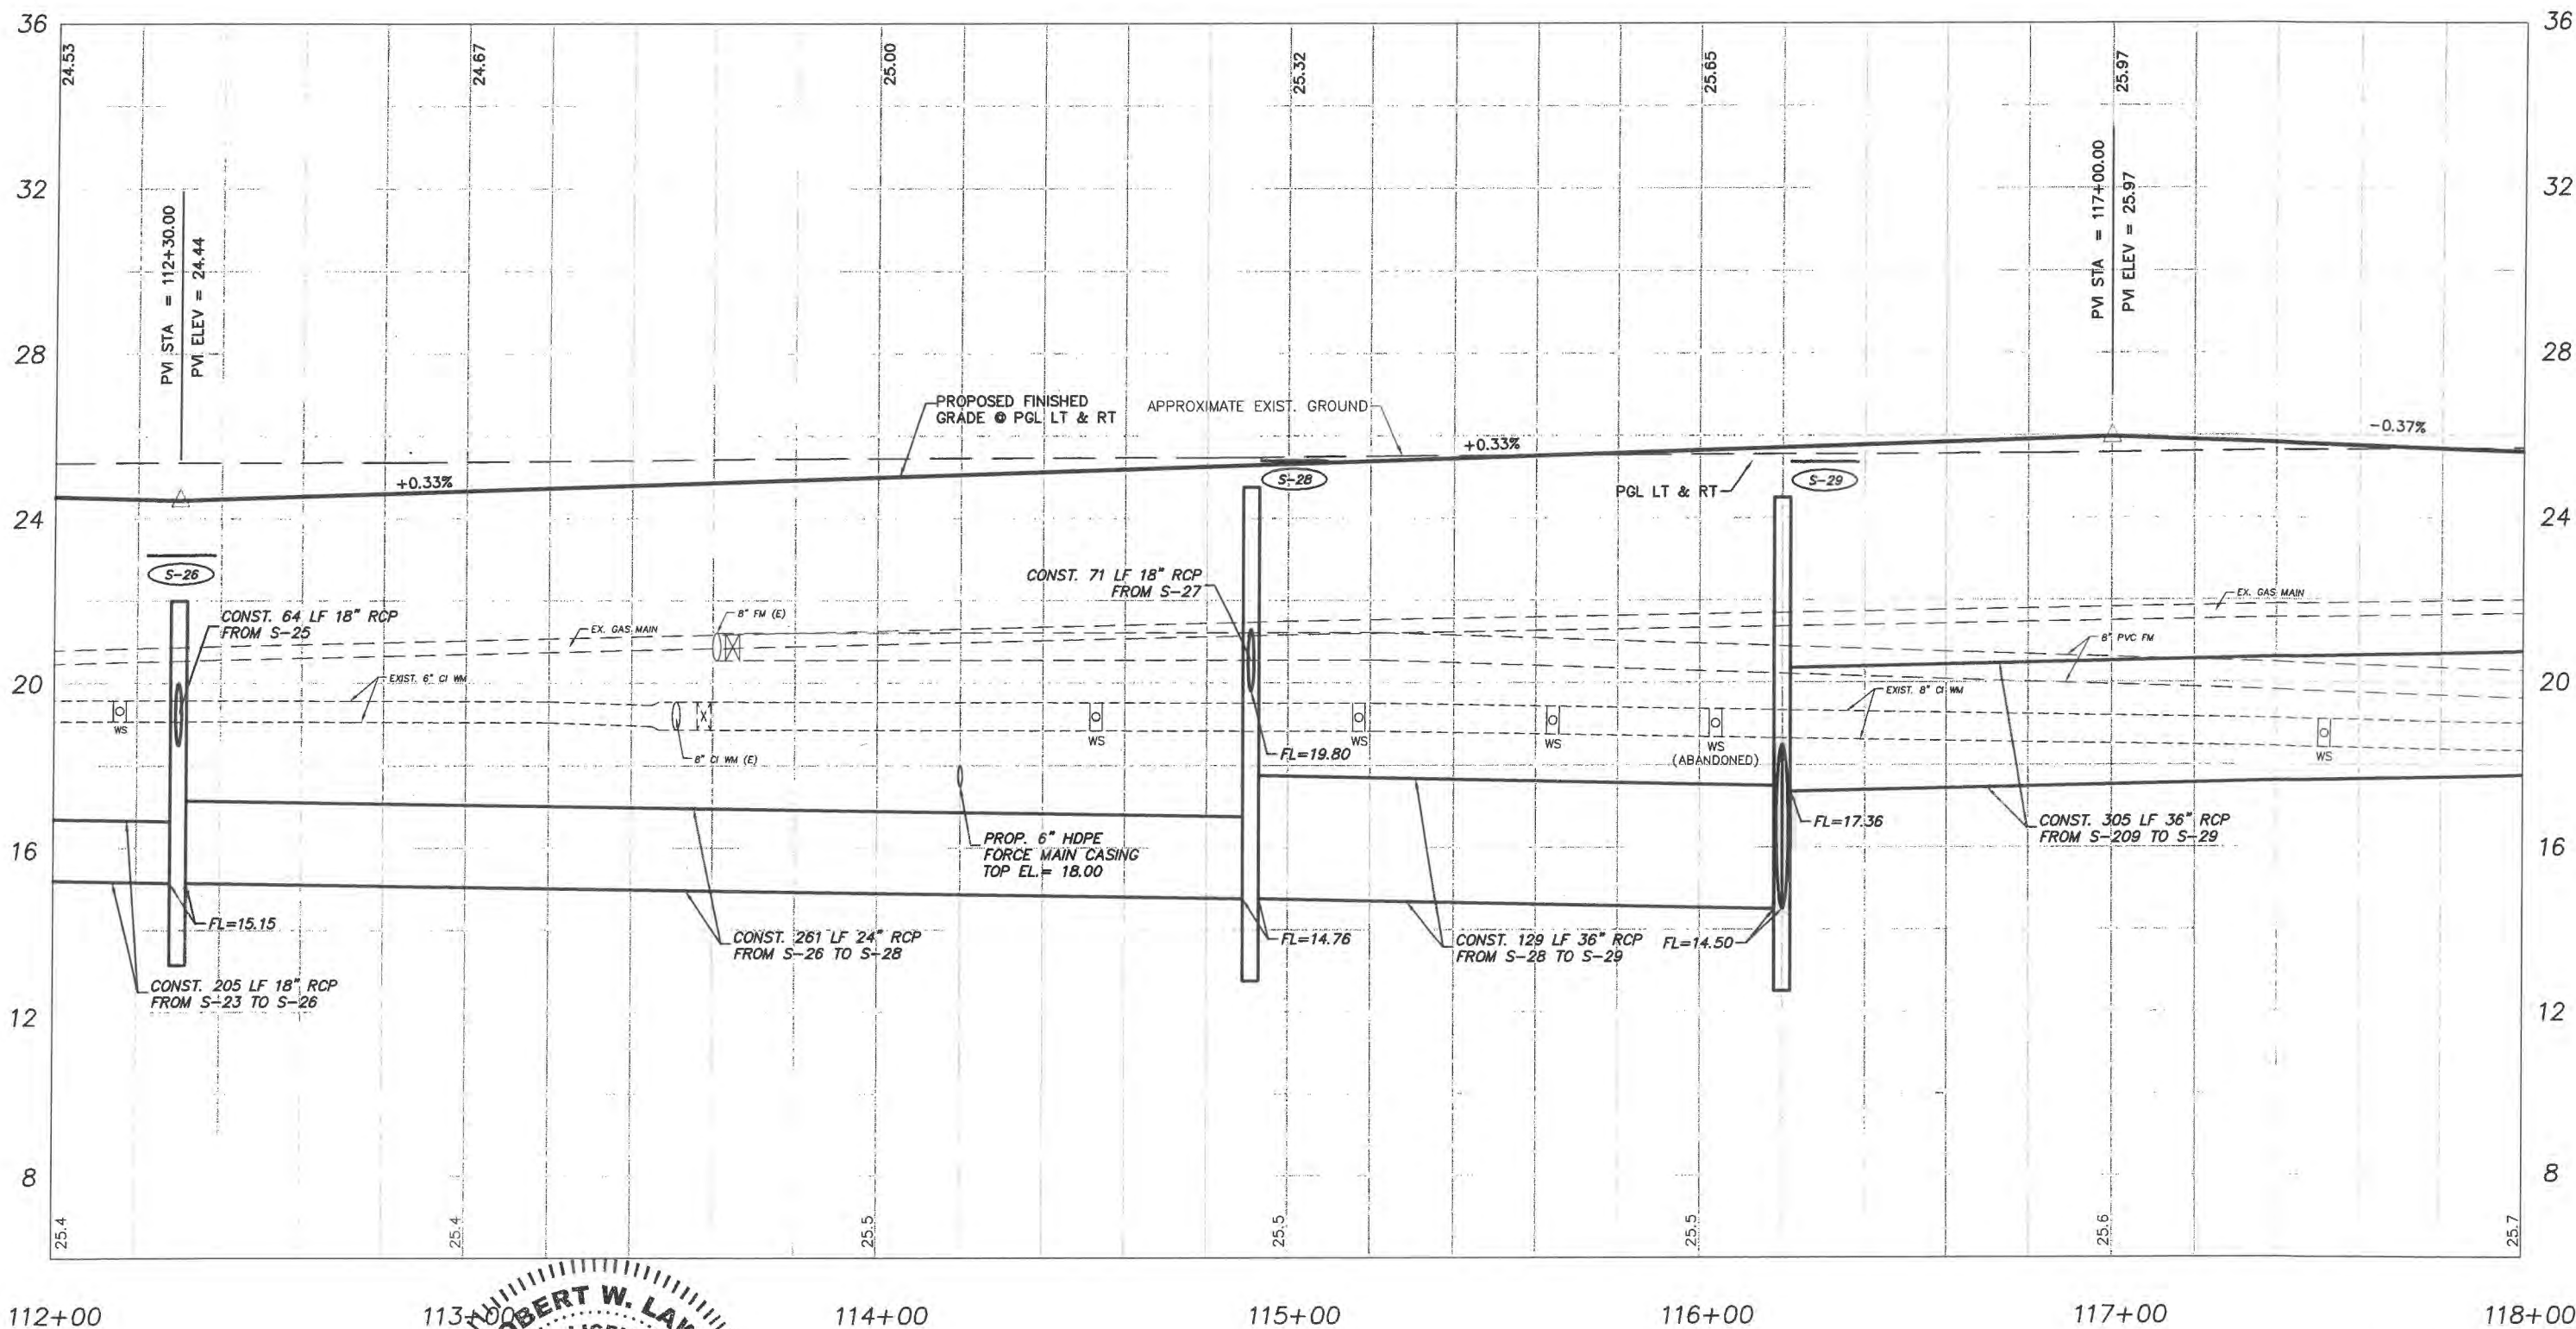
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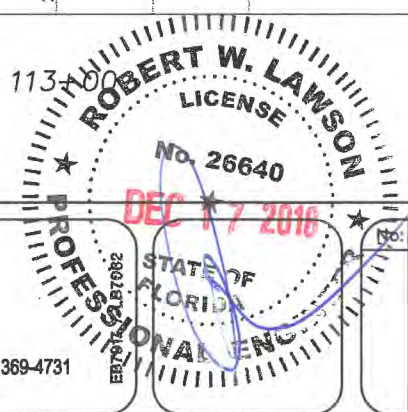
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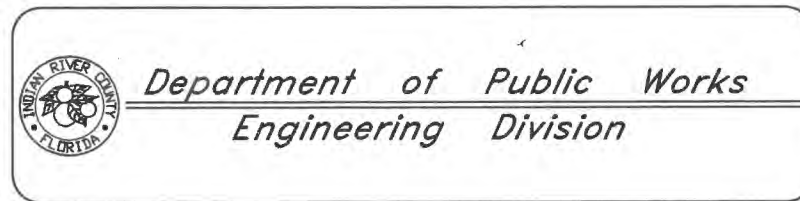


112+00      113+00      114+00      115+00      116+00      117+00      118+00

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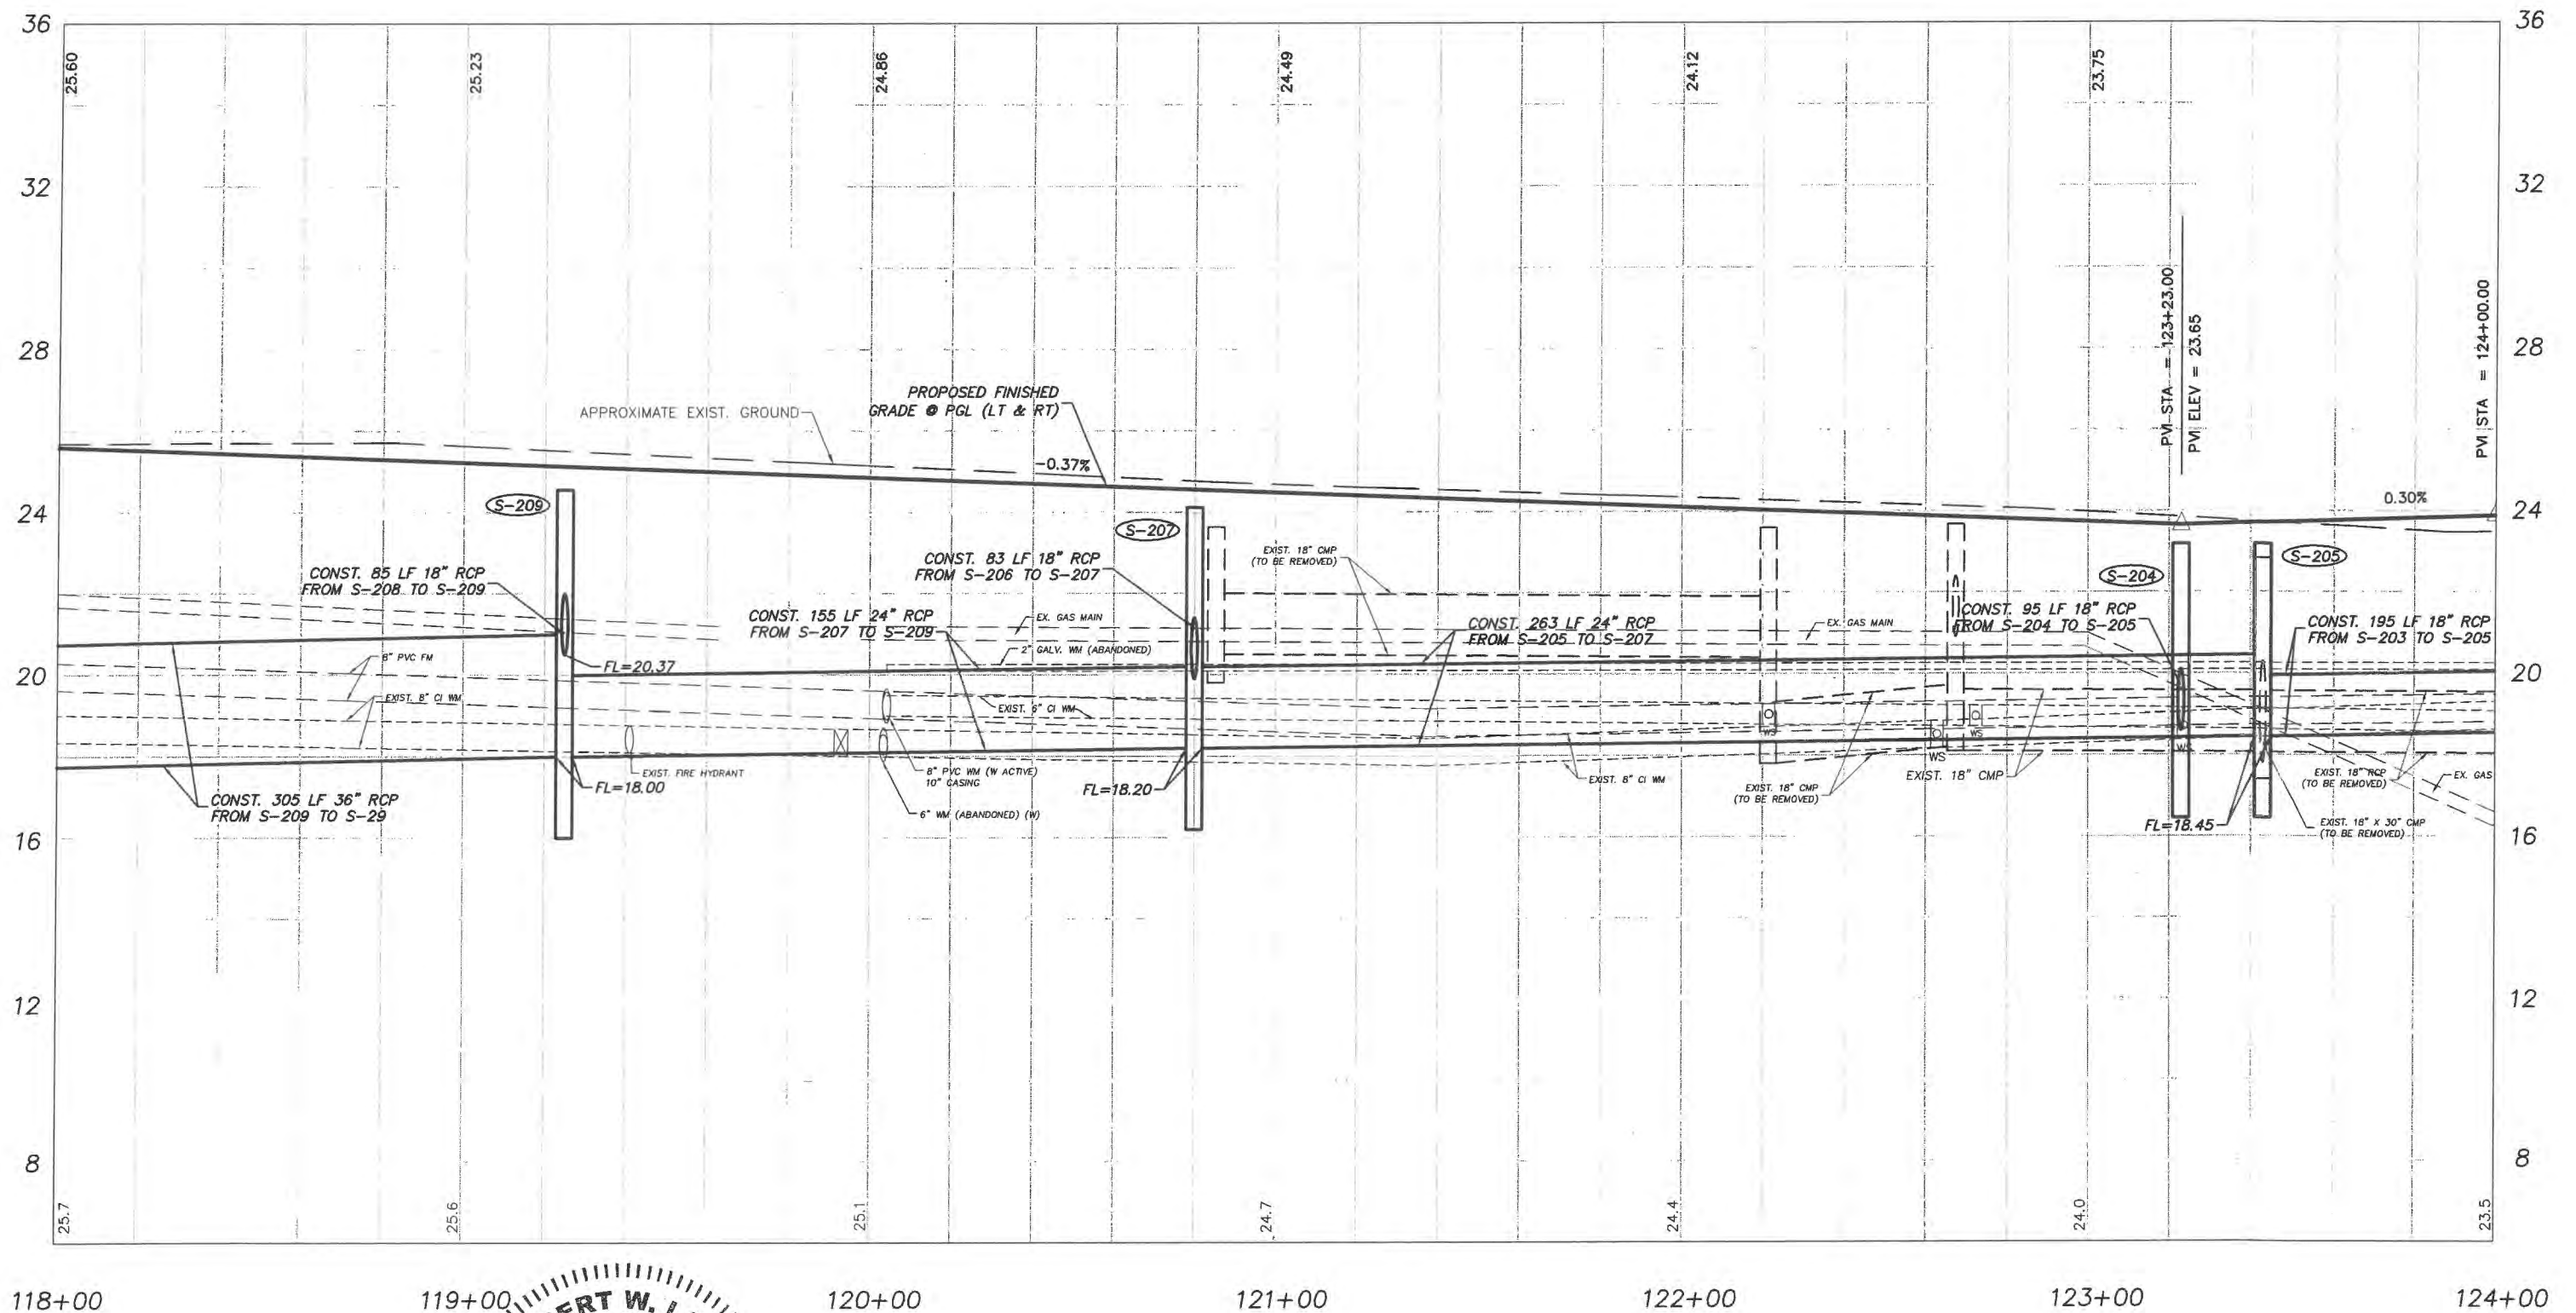
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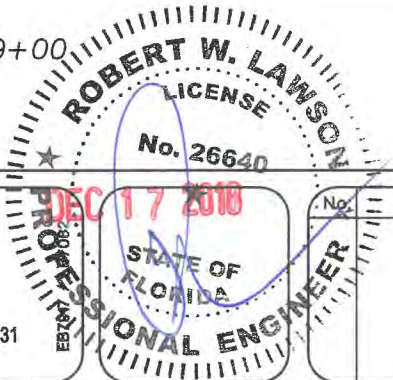
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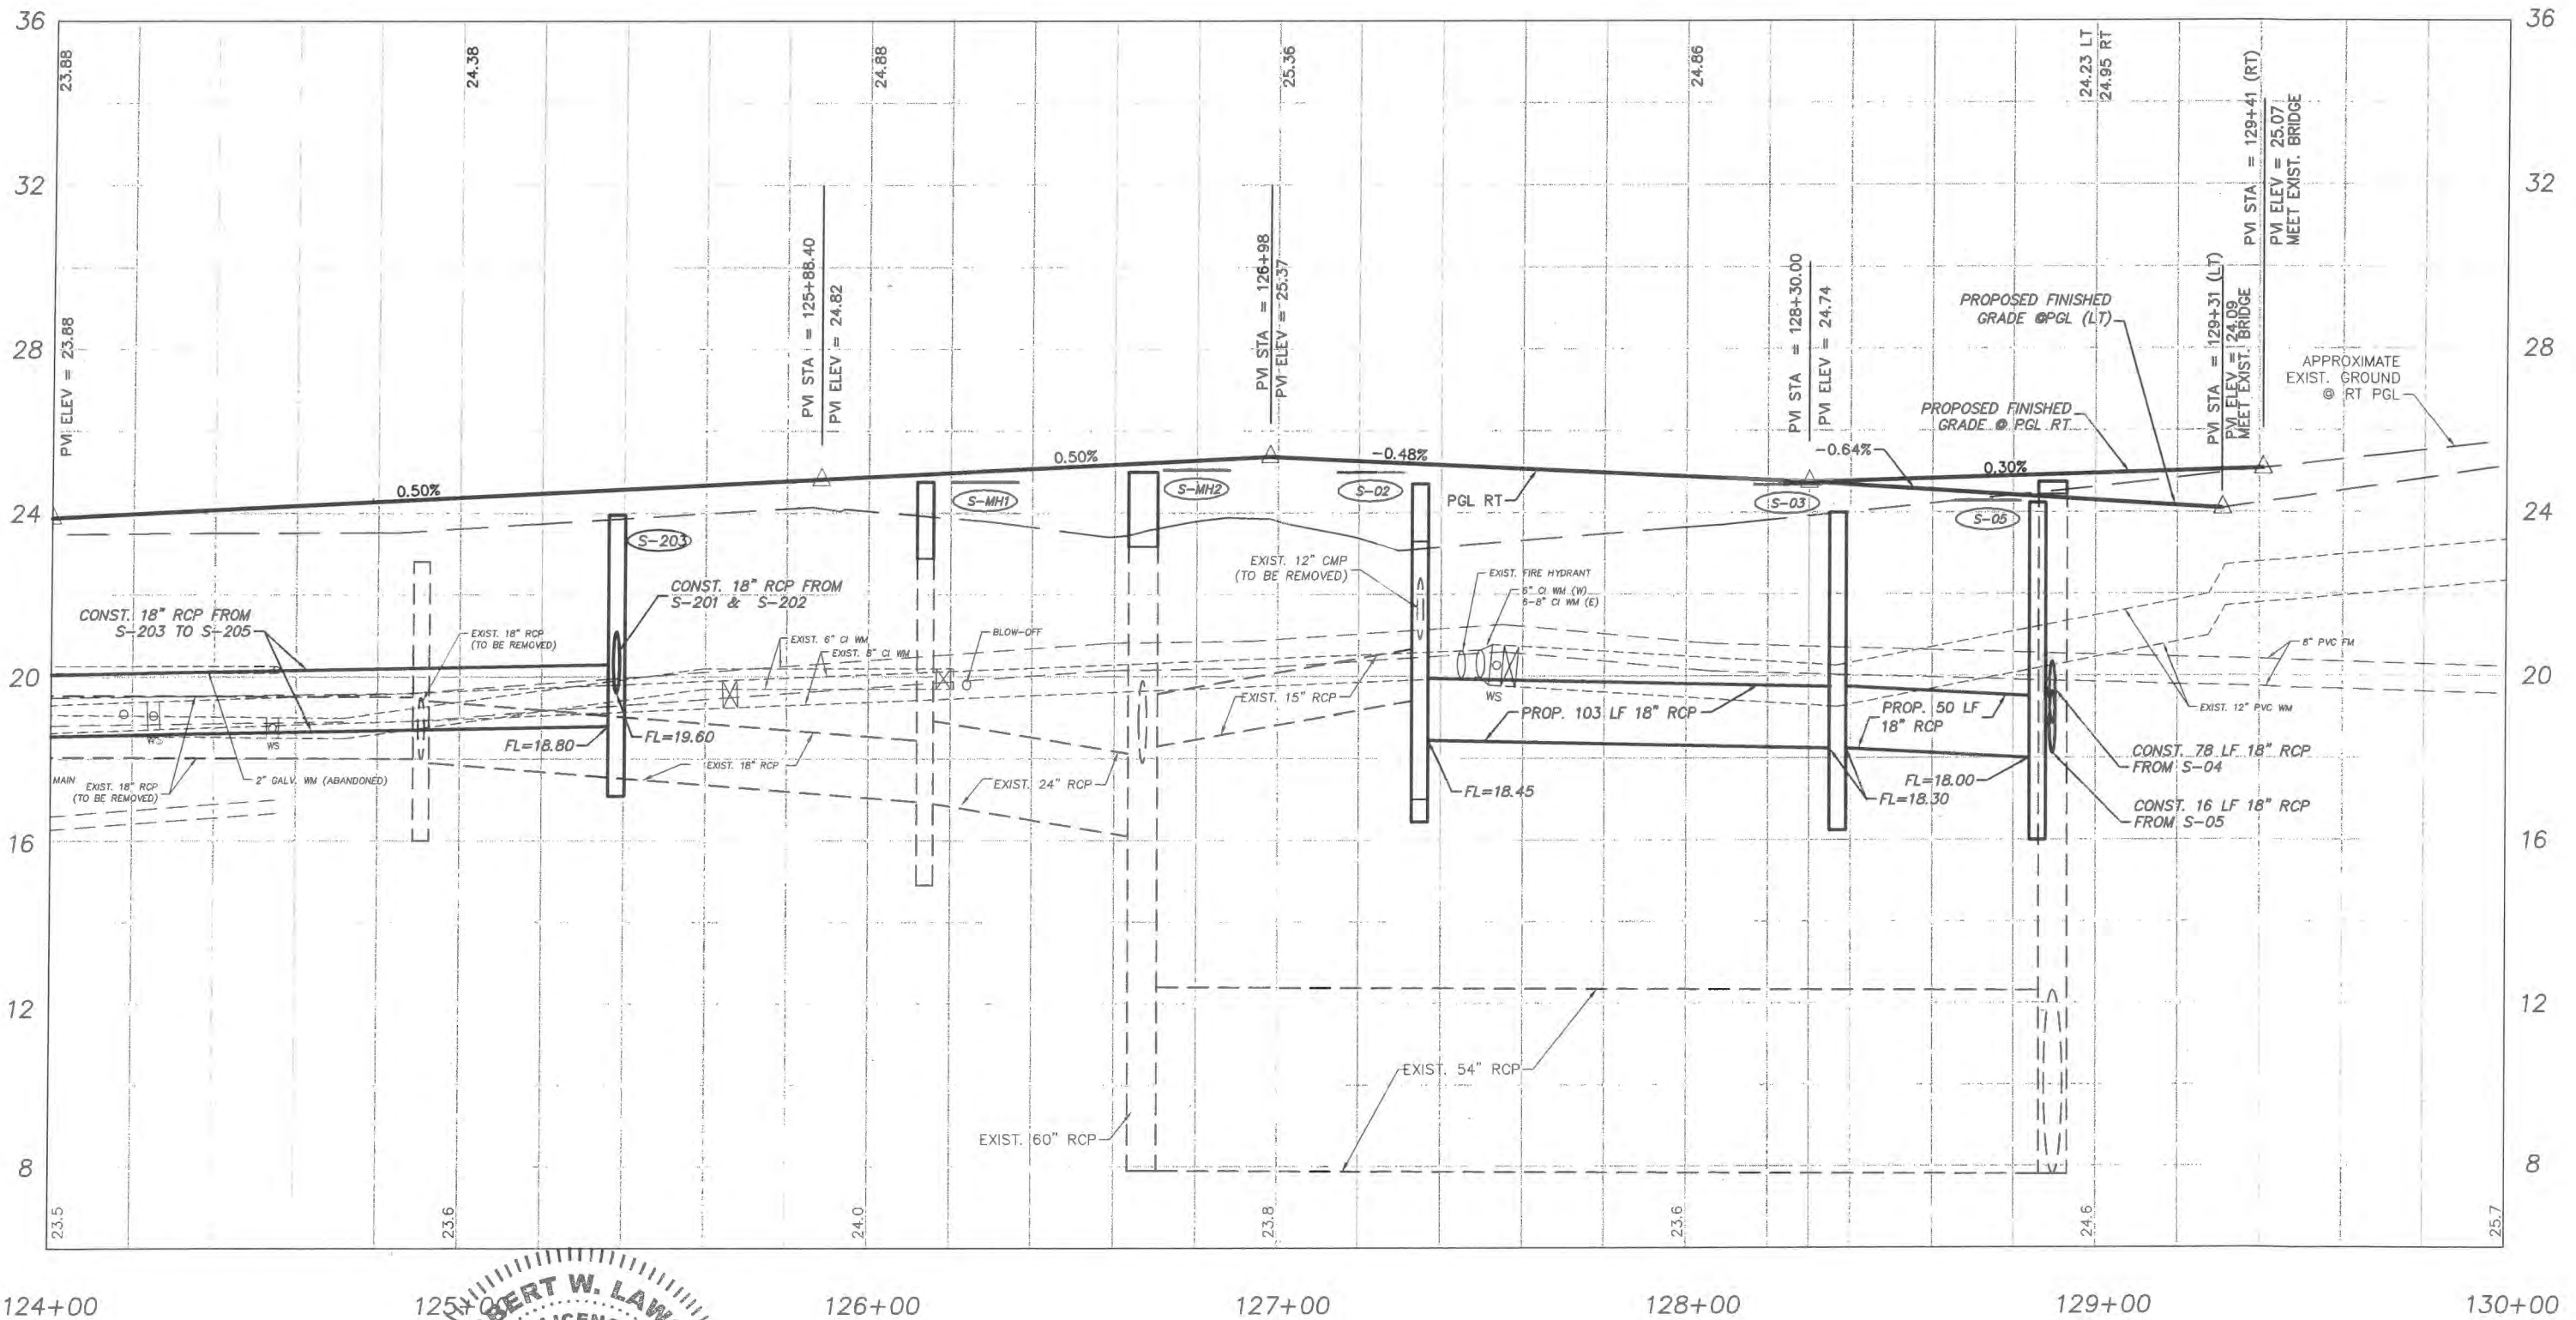
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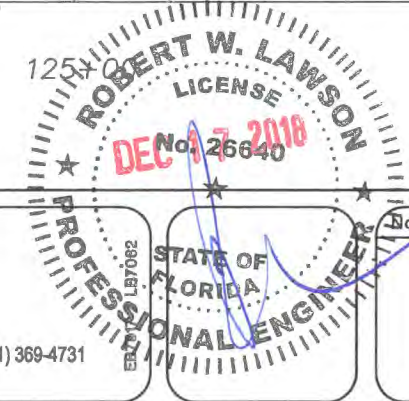
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124+00      125+00      126+00      127+00      128+00      129+00      130+00

43RD AVENUE



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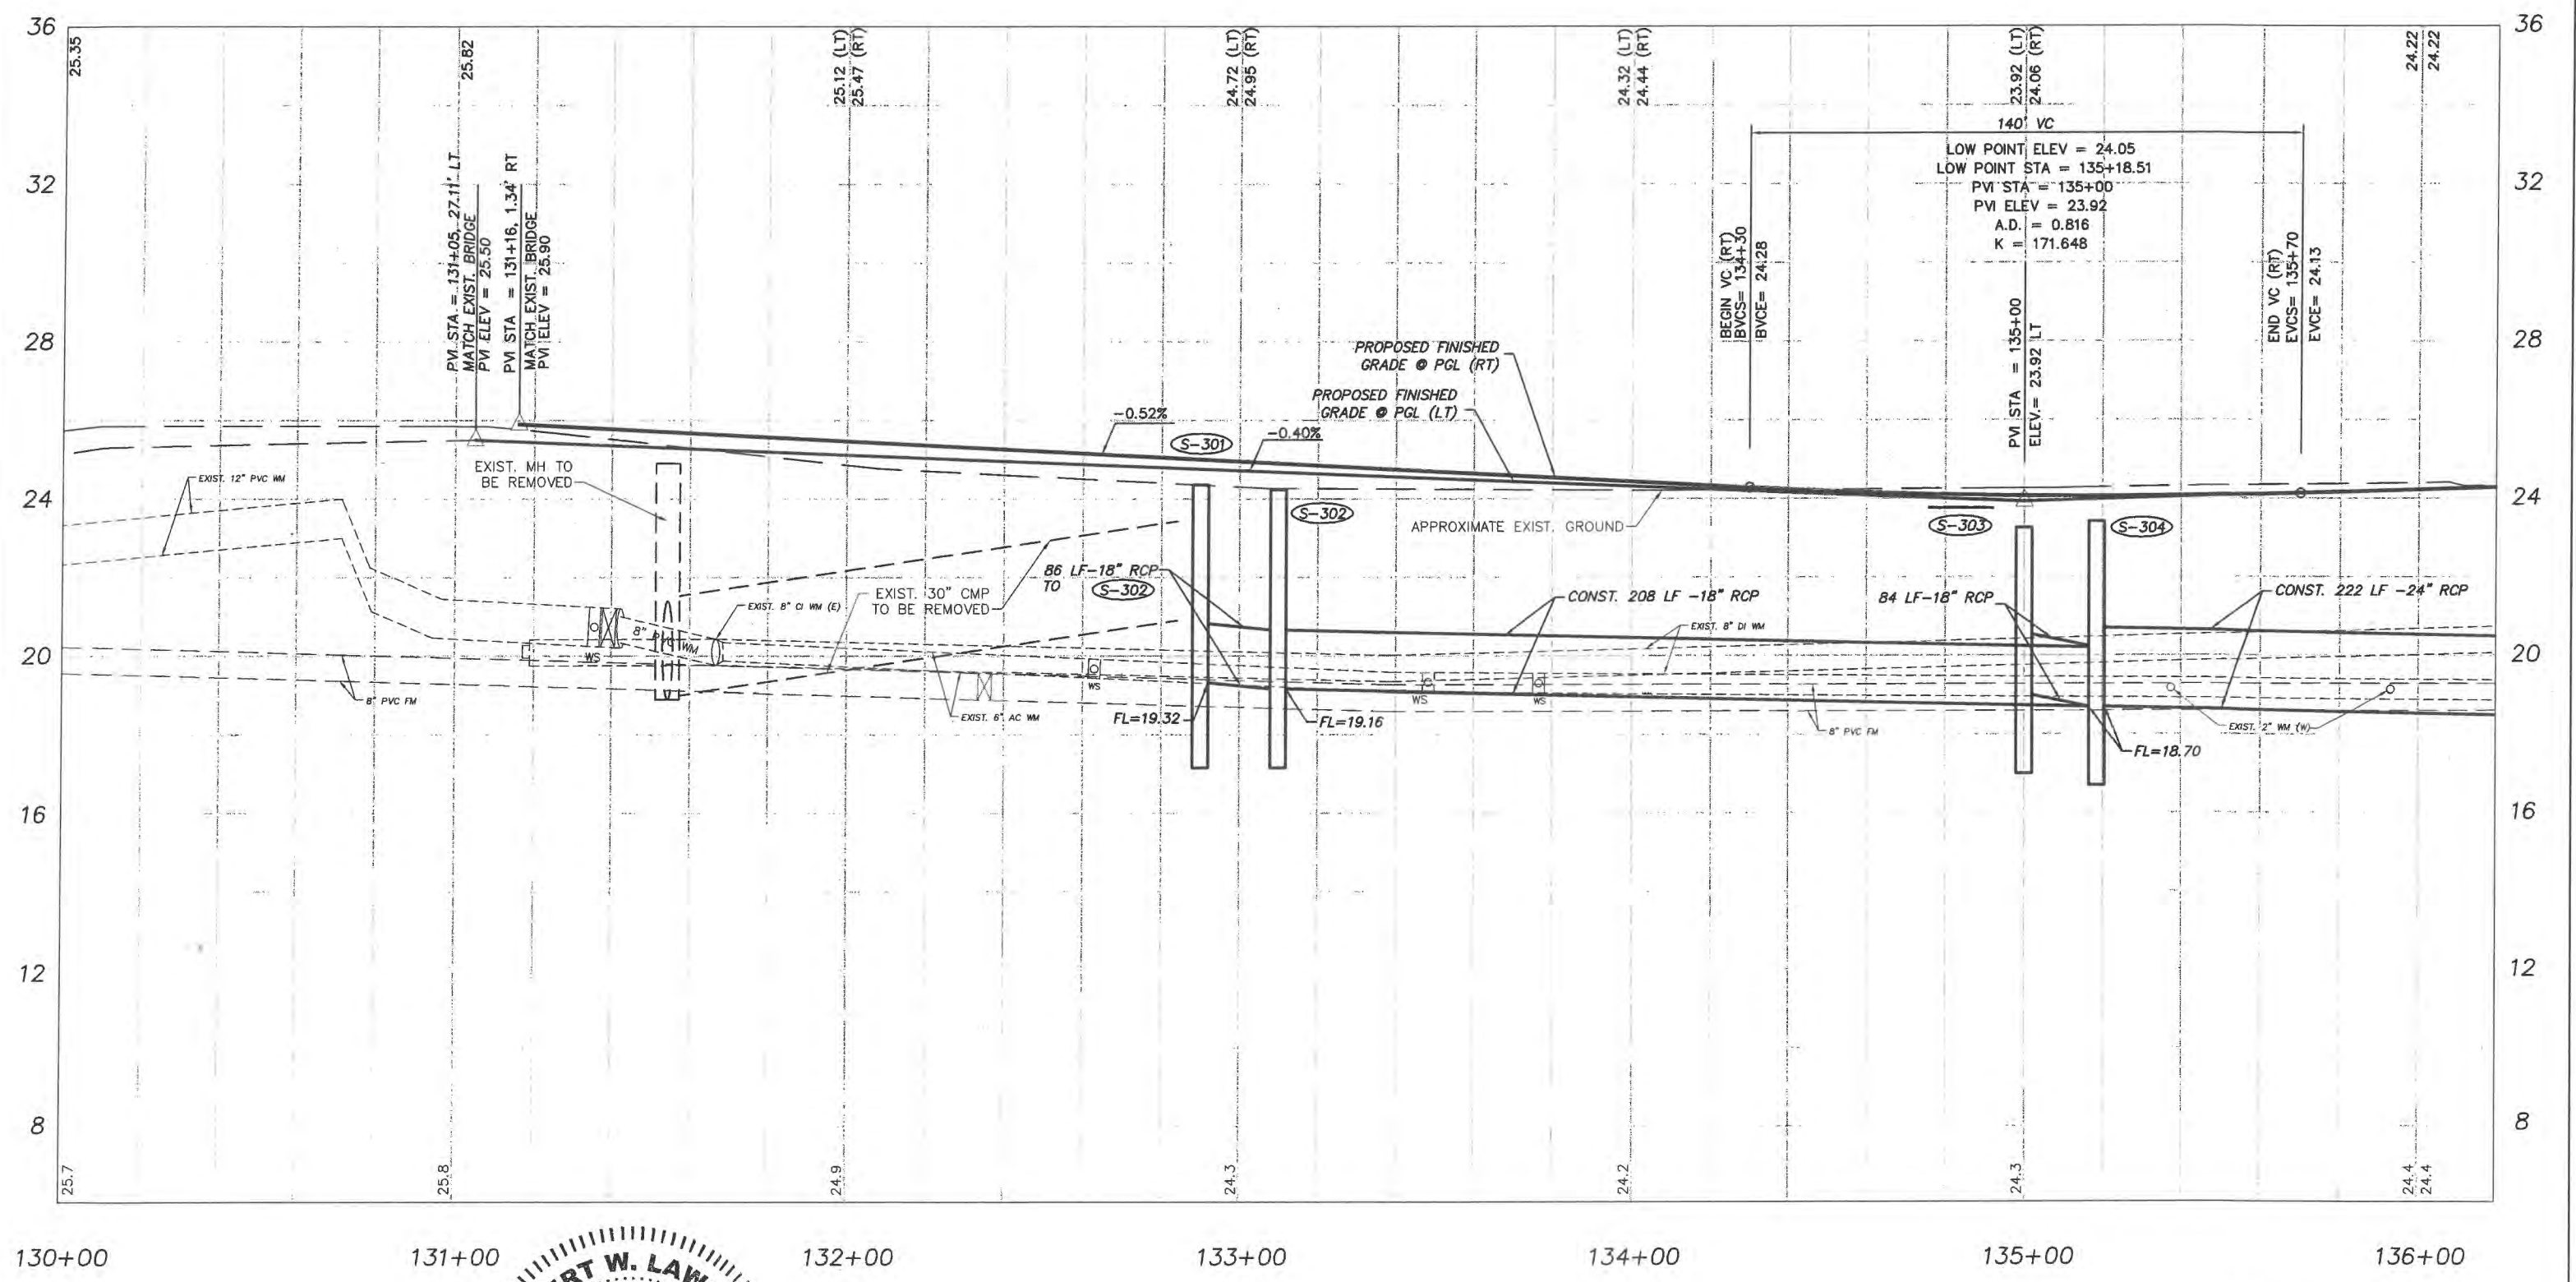
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130+00                      131+00                      132+00                      133+00                      134+00                      135+00                      136+00

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**ROBERT W. LAWSON**  
 LICENSE  
 No. 26640  
 DEC 17 2011  
 STATE OF FLORIDA  
 PROFESSIONAL ENGINEER

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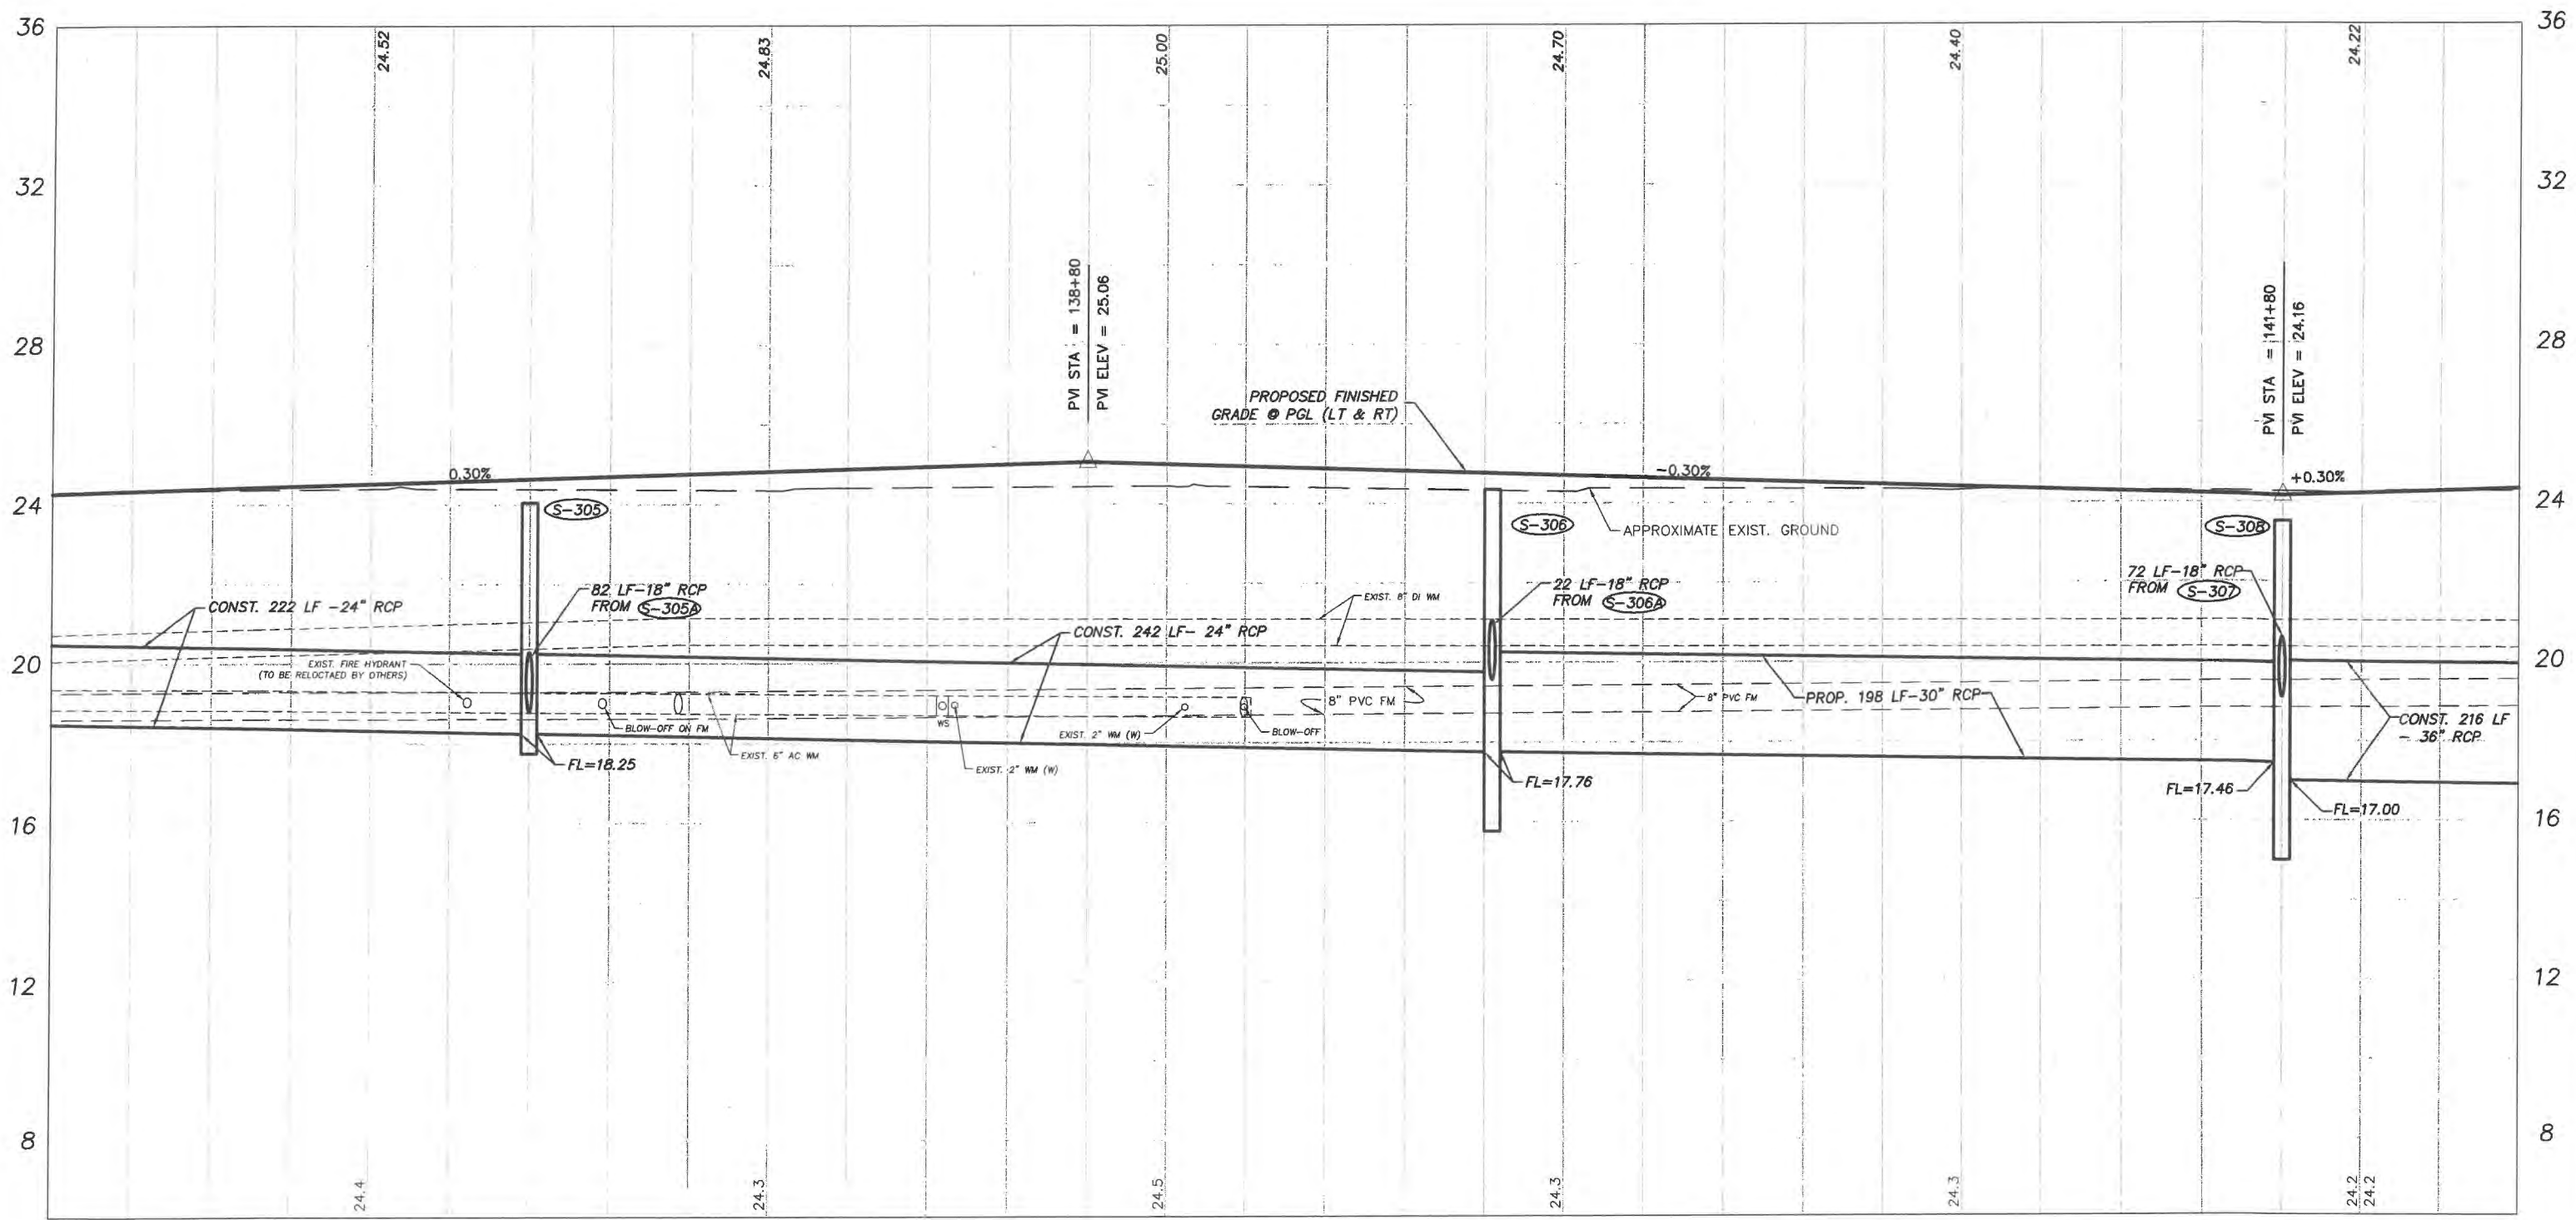
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 FLORIDA  
 Department of Public Works  
 Engineering Division

Scale: 1" = 4' VERT.  
 1" = 40' HORIZ.  
 Approved: HWD  
 Drawn: FM  
 Checked: HWD  
 Date: 6/2017  
 Field Book No:

Project:  
 PROFILE SHEETS  
 FOR  
 SR 60 & 43RD AVENUE

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137+00

138+00

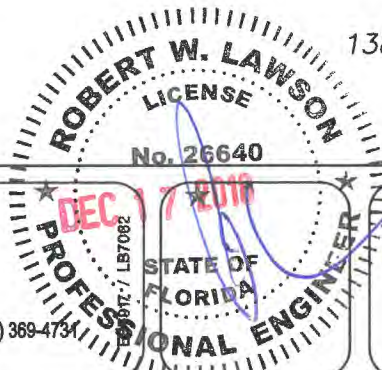
139+00

140+00

141+00

142+00

43RD AVENUE



No.	Revision:	By:	Date:



Department of Public Works  
Engineering Division

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1" = 40' HORIZ.  
Approved: HWD  
Drawn: FM  
Checked: HWD  
Date: 6/2017  
Field Book No:

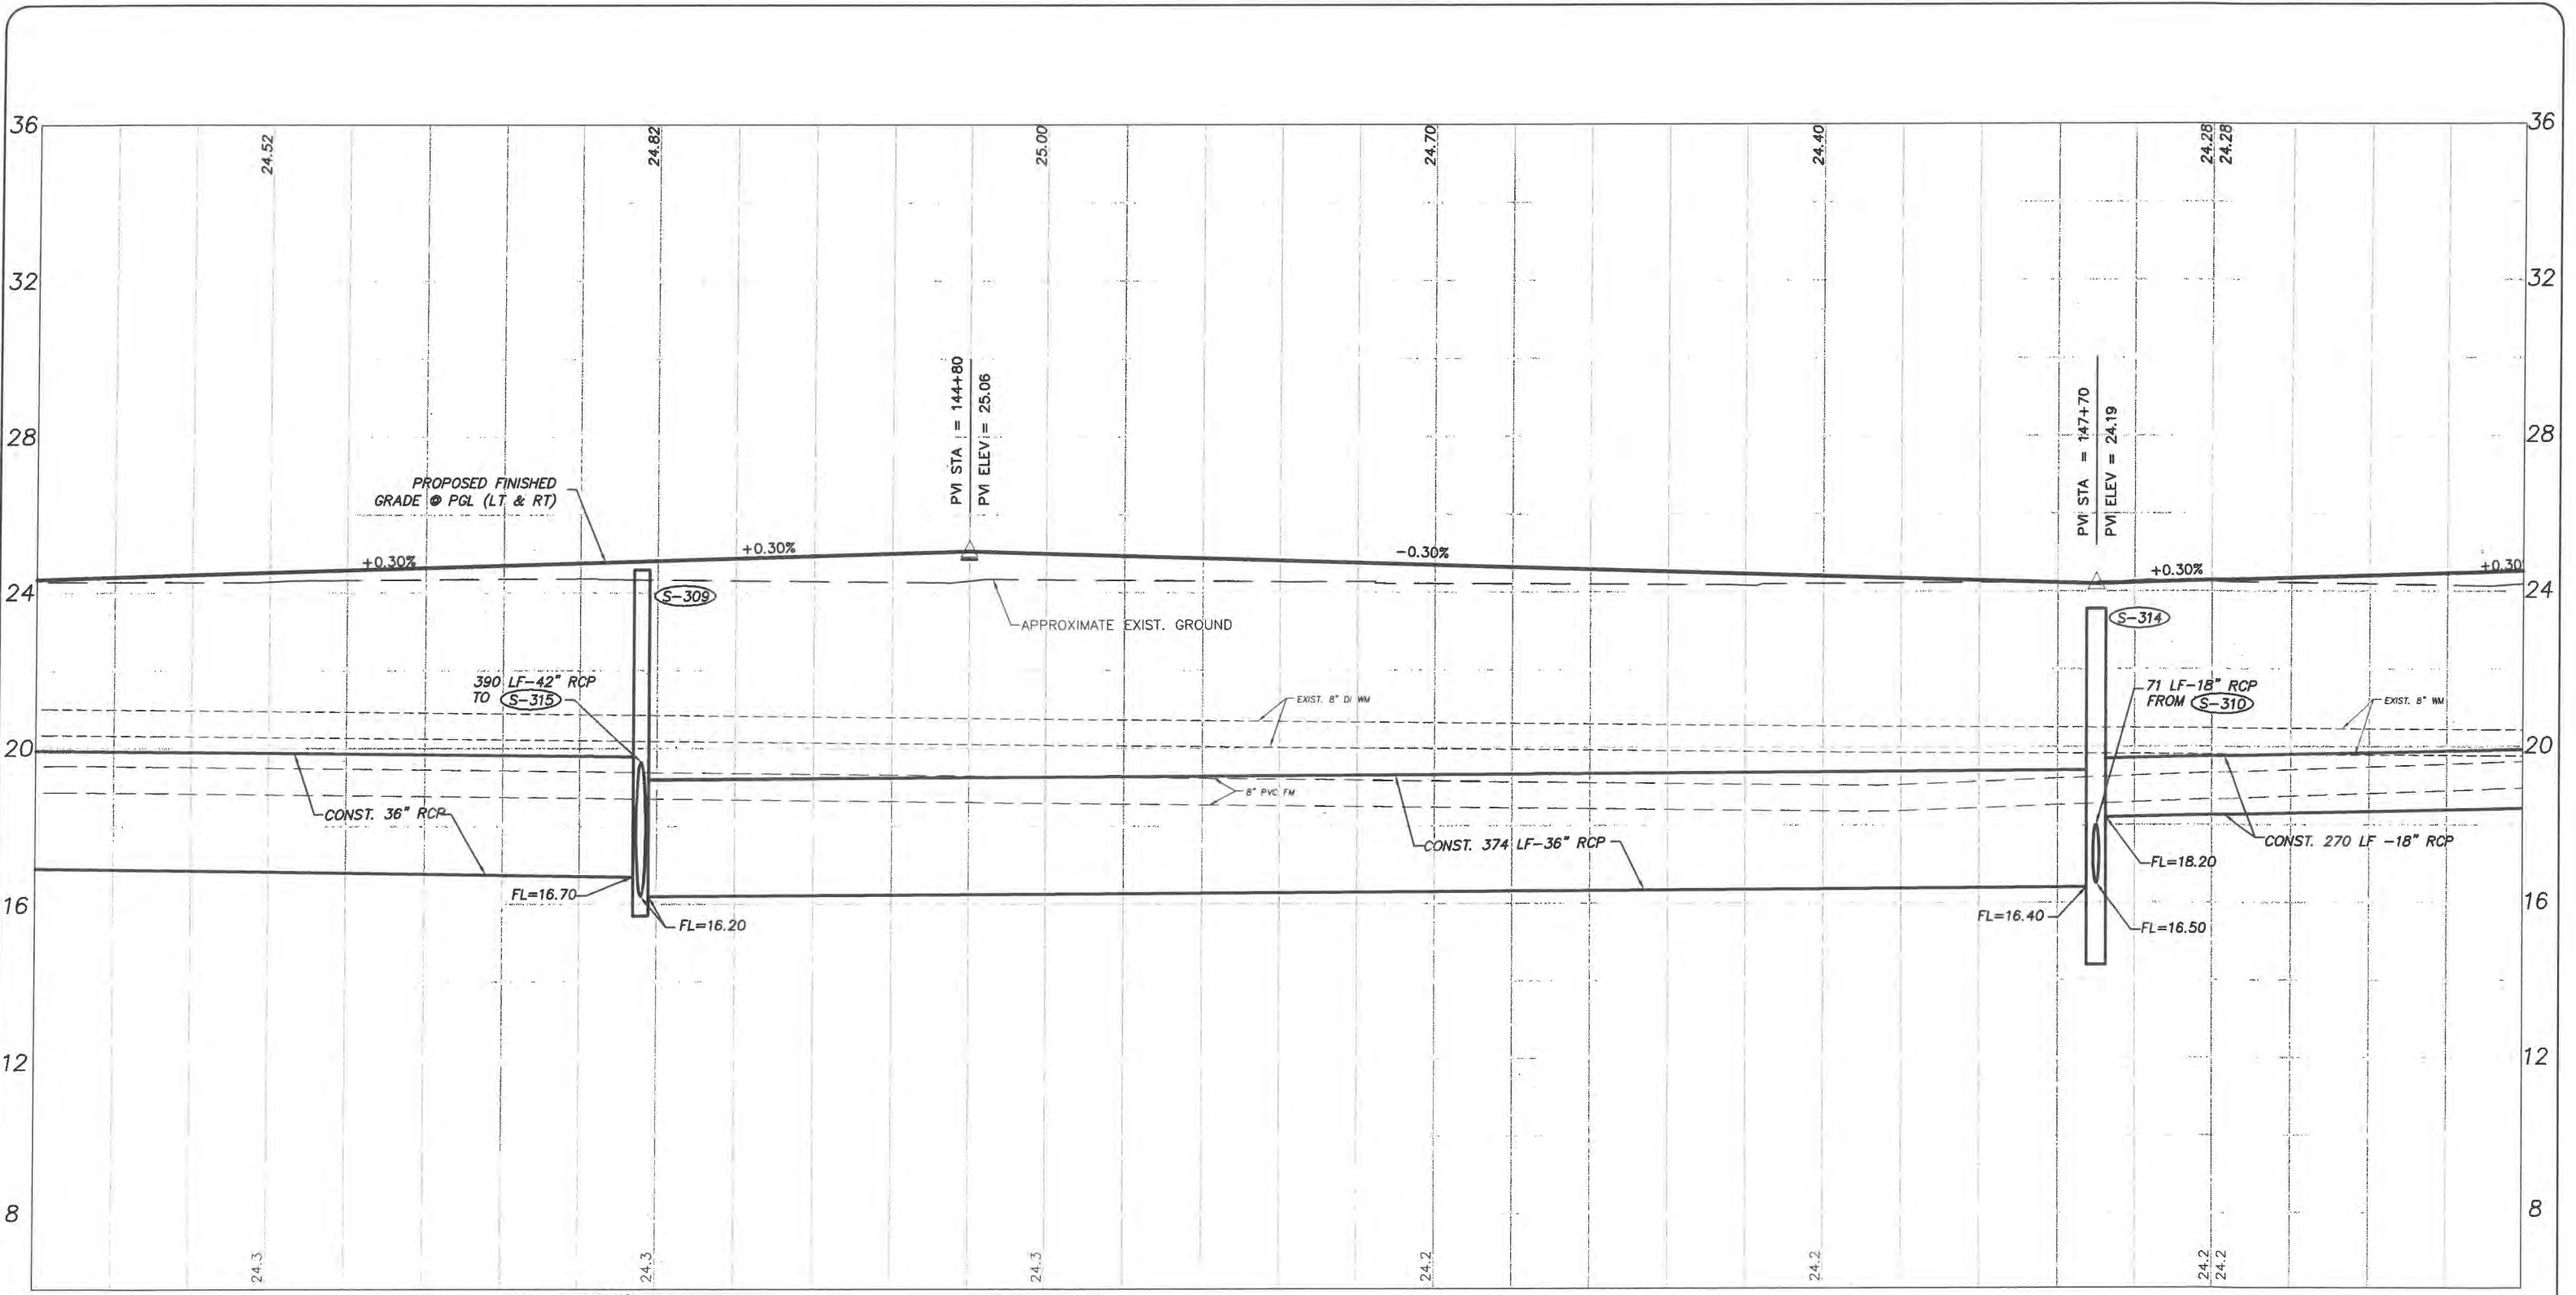
Project:  
PROFILE SHEETS  
FOR  
SR 60 & 43RD AVENUE

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Project No.  
LNW# WP1027

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143+00

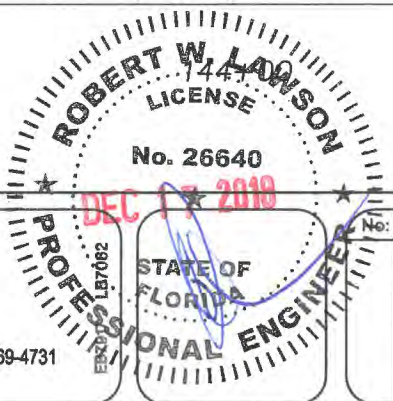
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146+00

147+00

148+00

43RD AVENUE



No.	Revision:	By:	Date:



Department of Public Works  
Engineering Division

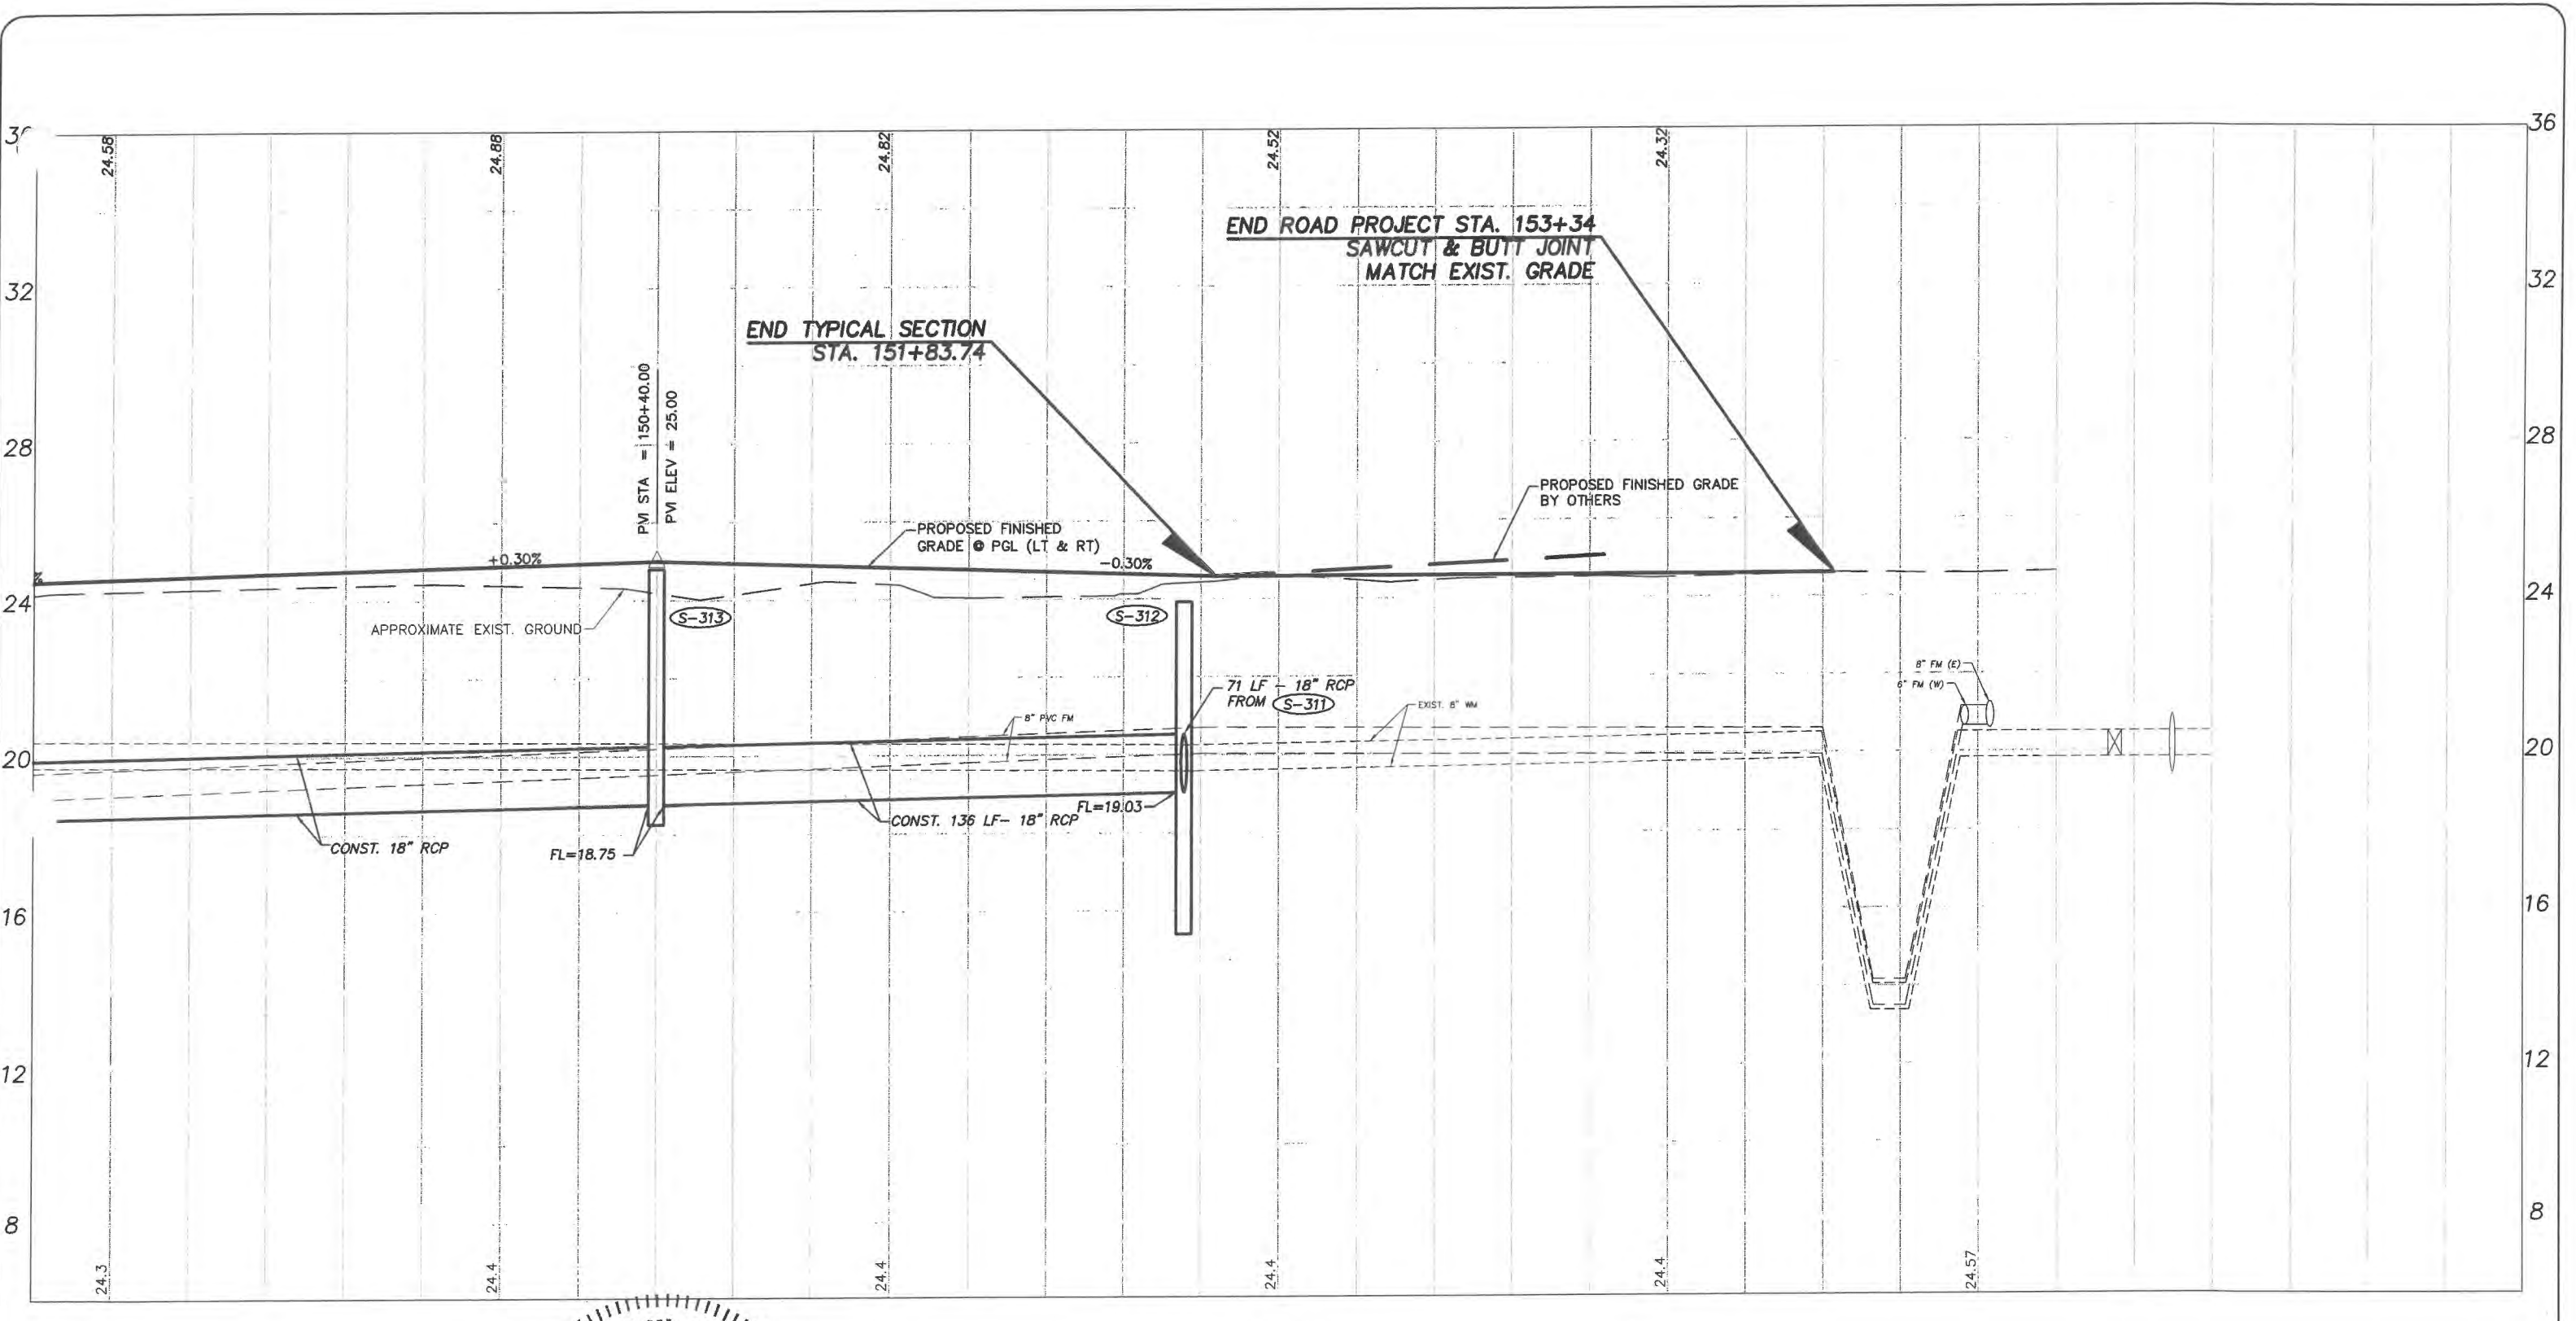
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Date: 6/2017  
Field Book No:

Project:  
PROFILE SHEETS  
FOR  
SR 60 & 43RD AVENUE

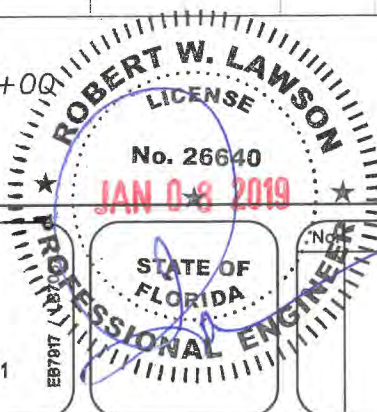
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Of: 99  
Project No.  
LNW# WP1027

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149+00      150+00      151+00      152+00      153+00      43RD AVENUE



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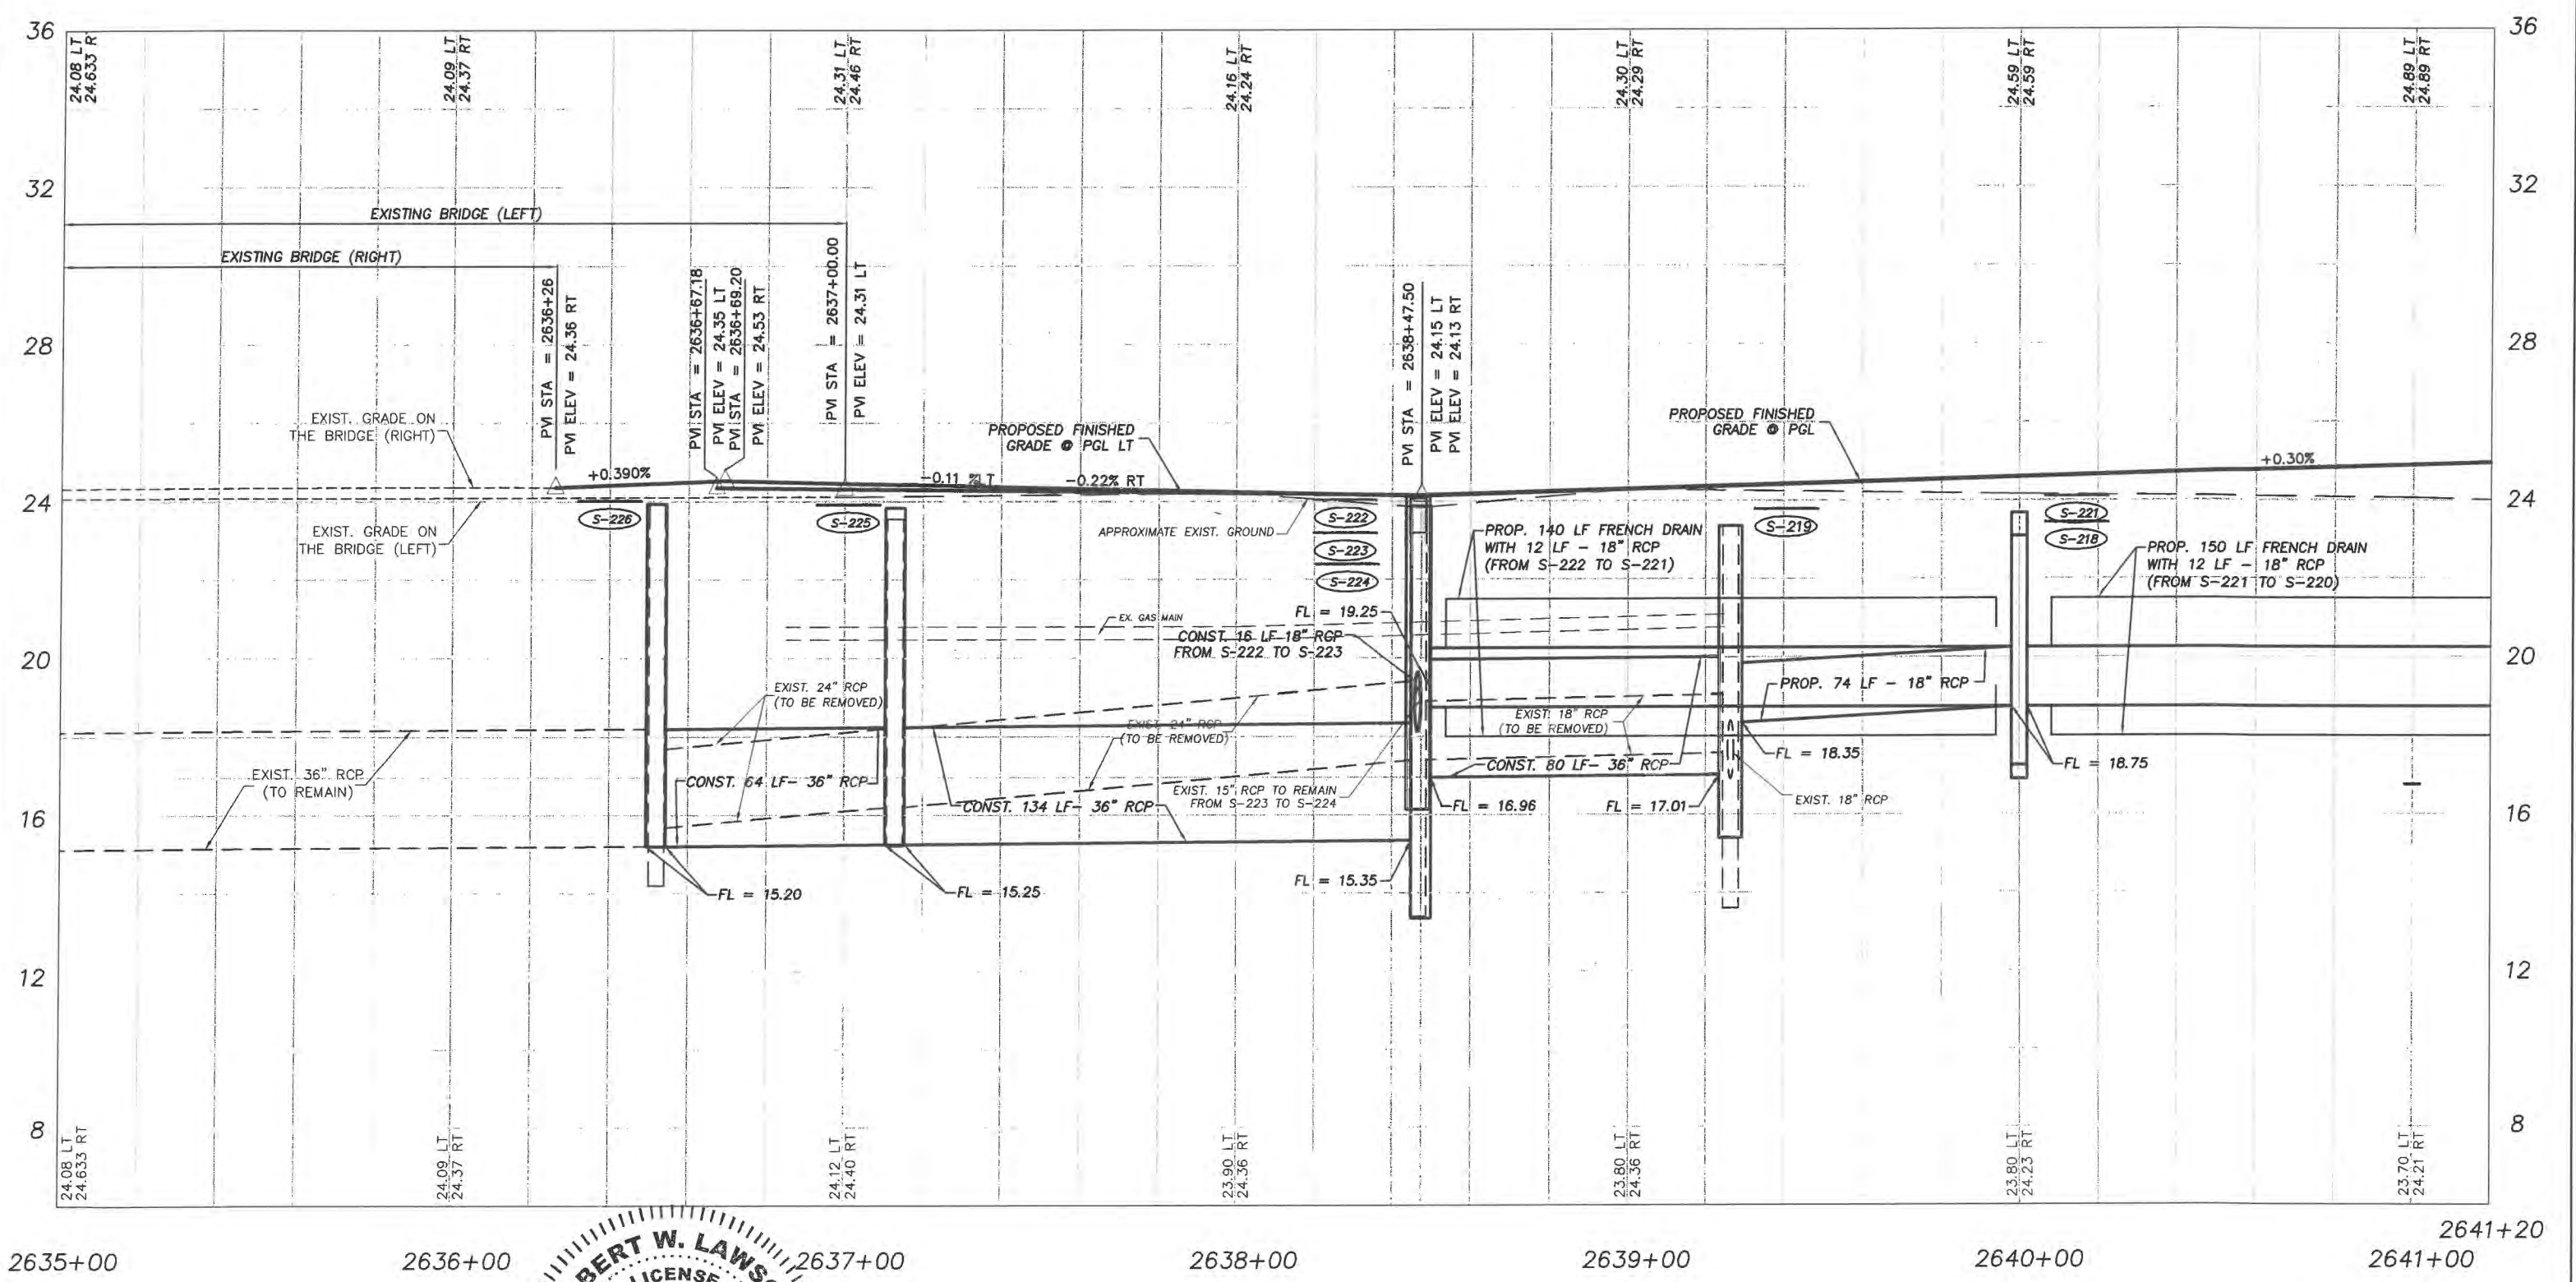
**Department of Public Works**  
 Engineering Division

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Project: PROFILE SHEETS  
 FOR  
 SR 60 & 43RD AVENUE

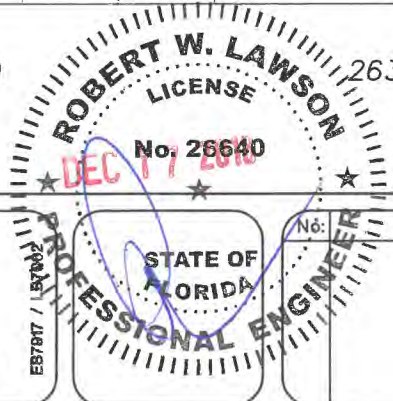
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2635+00      2636+00      2637+00      2638+00      2639+00      2640+00      2641+20

SR 60



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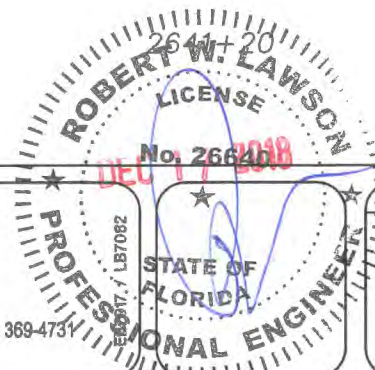
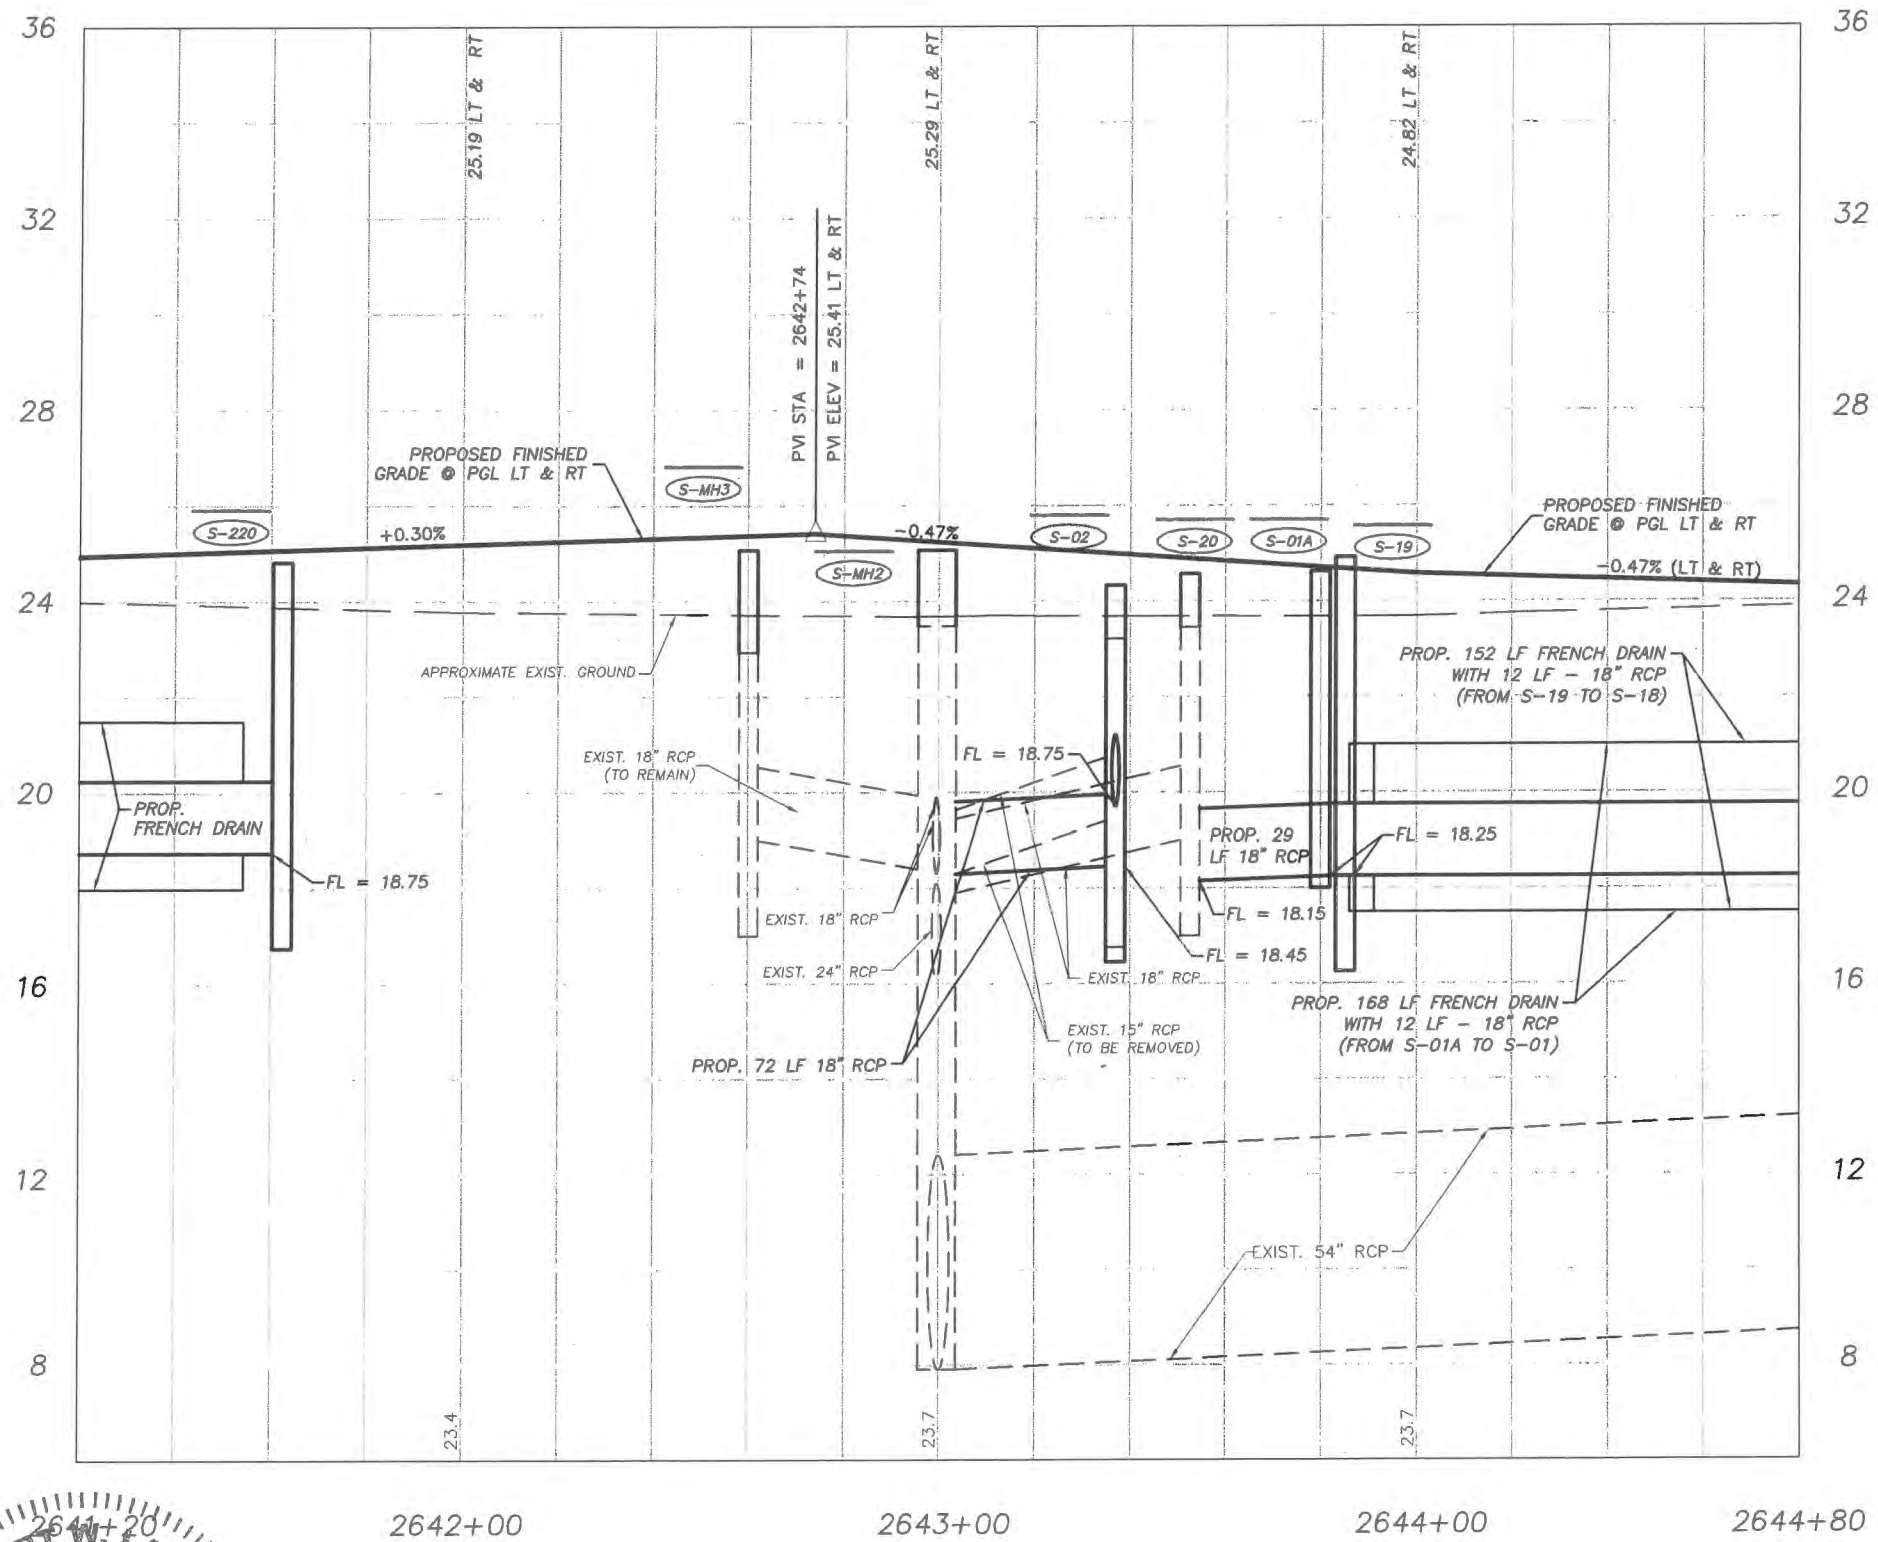
**Department of Public Works**  
 Engineering Division

Scale: 1" = 4' VERT.  
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 Drawn: FM  
 Checked: HWD  
 Date: 6/2017  
 Field Book No:

Project: PROFILE SHEETS  
 FOR  
 SR 60 & 43RD AVENUE

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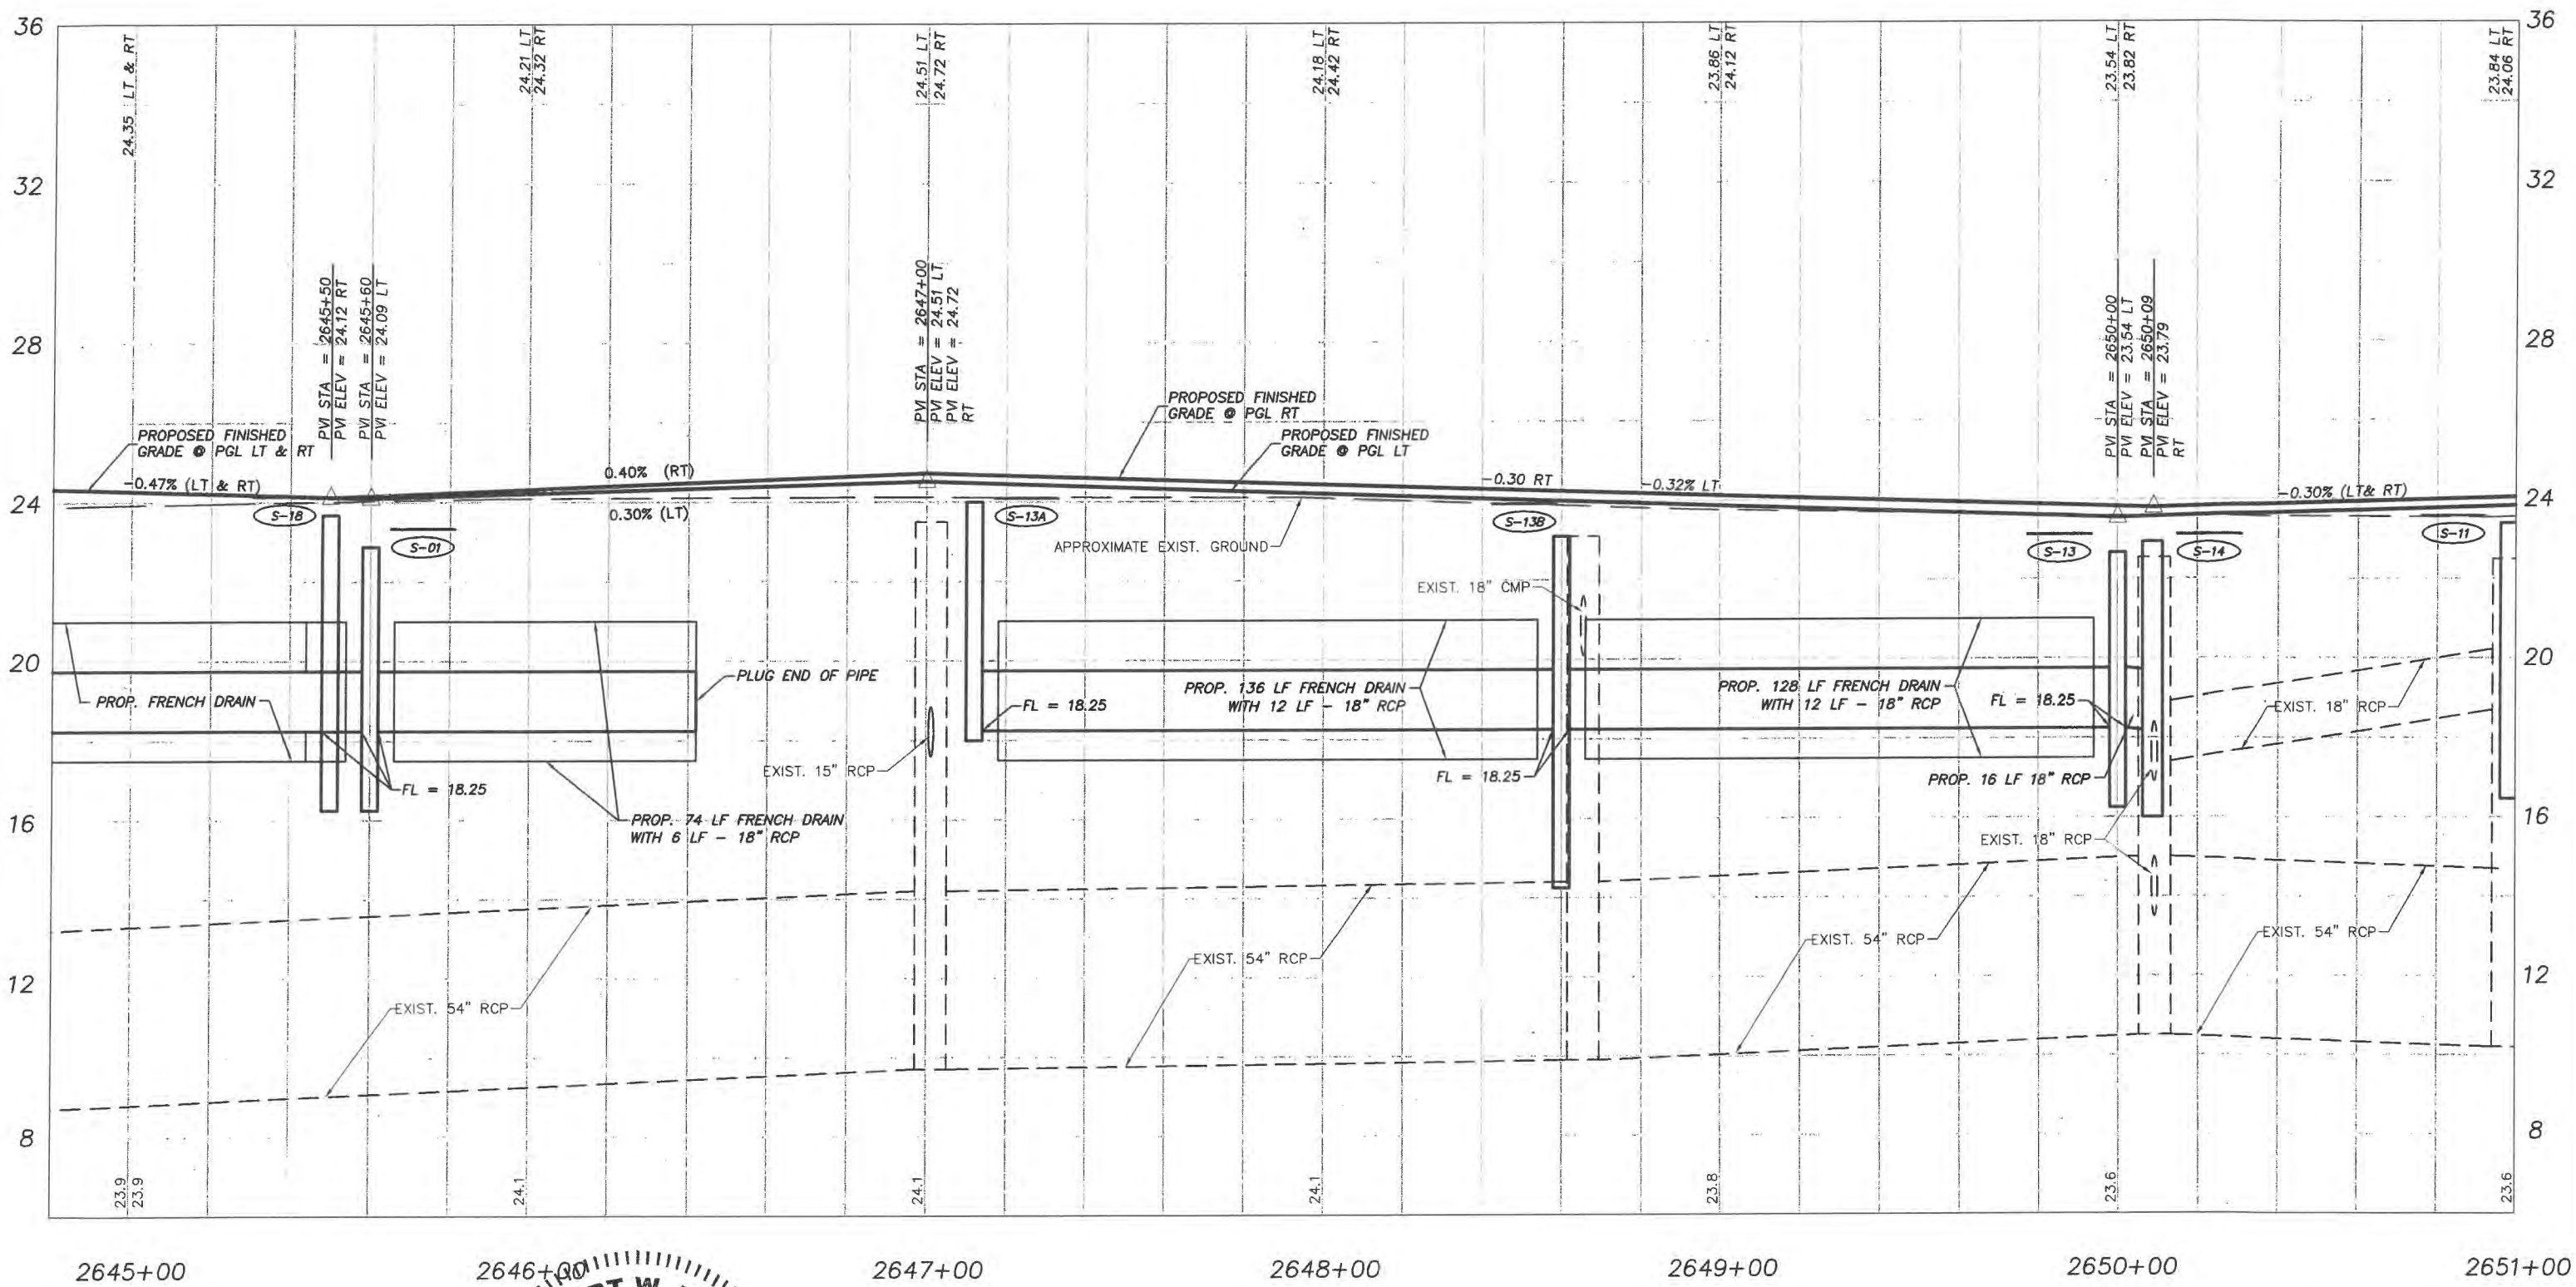
Department of Public Works  
Engineering Division

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Drawn: FM  
Checked: HWD  
Date: 6/2017  
Field Book No:

Project: PROFILE SHEETS  
FOR  
SR 60 & 43RD AVENUE

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2645+00      2646+00      2647+00      2648+00      2649+00      2650+00      2651+00

SR 60

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 No. 286400  
 STATE OF FLORIDA  
 PROFESSIONAL ENGINEER  
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Scale: 1" = 4' VERT.  
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 Checked: HWD  
 Date: 6/2017  
 Field Book No:

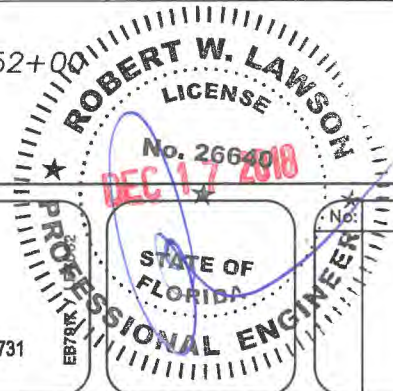
Project:  
 PROFILE SHEETS  
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SR 60



Revision: By: Date:



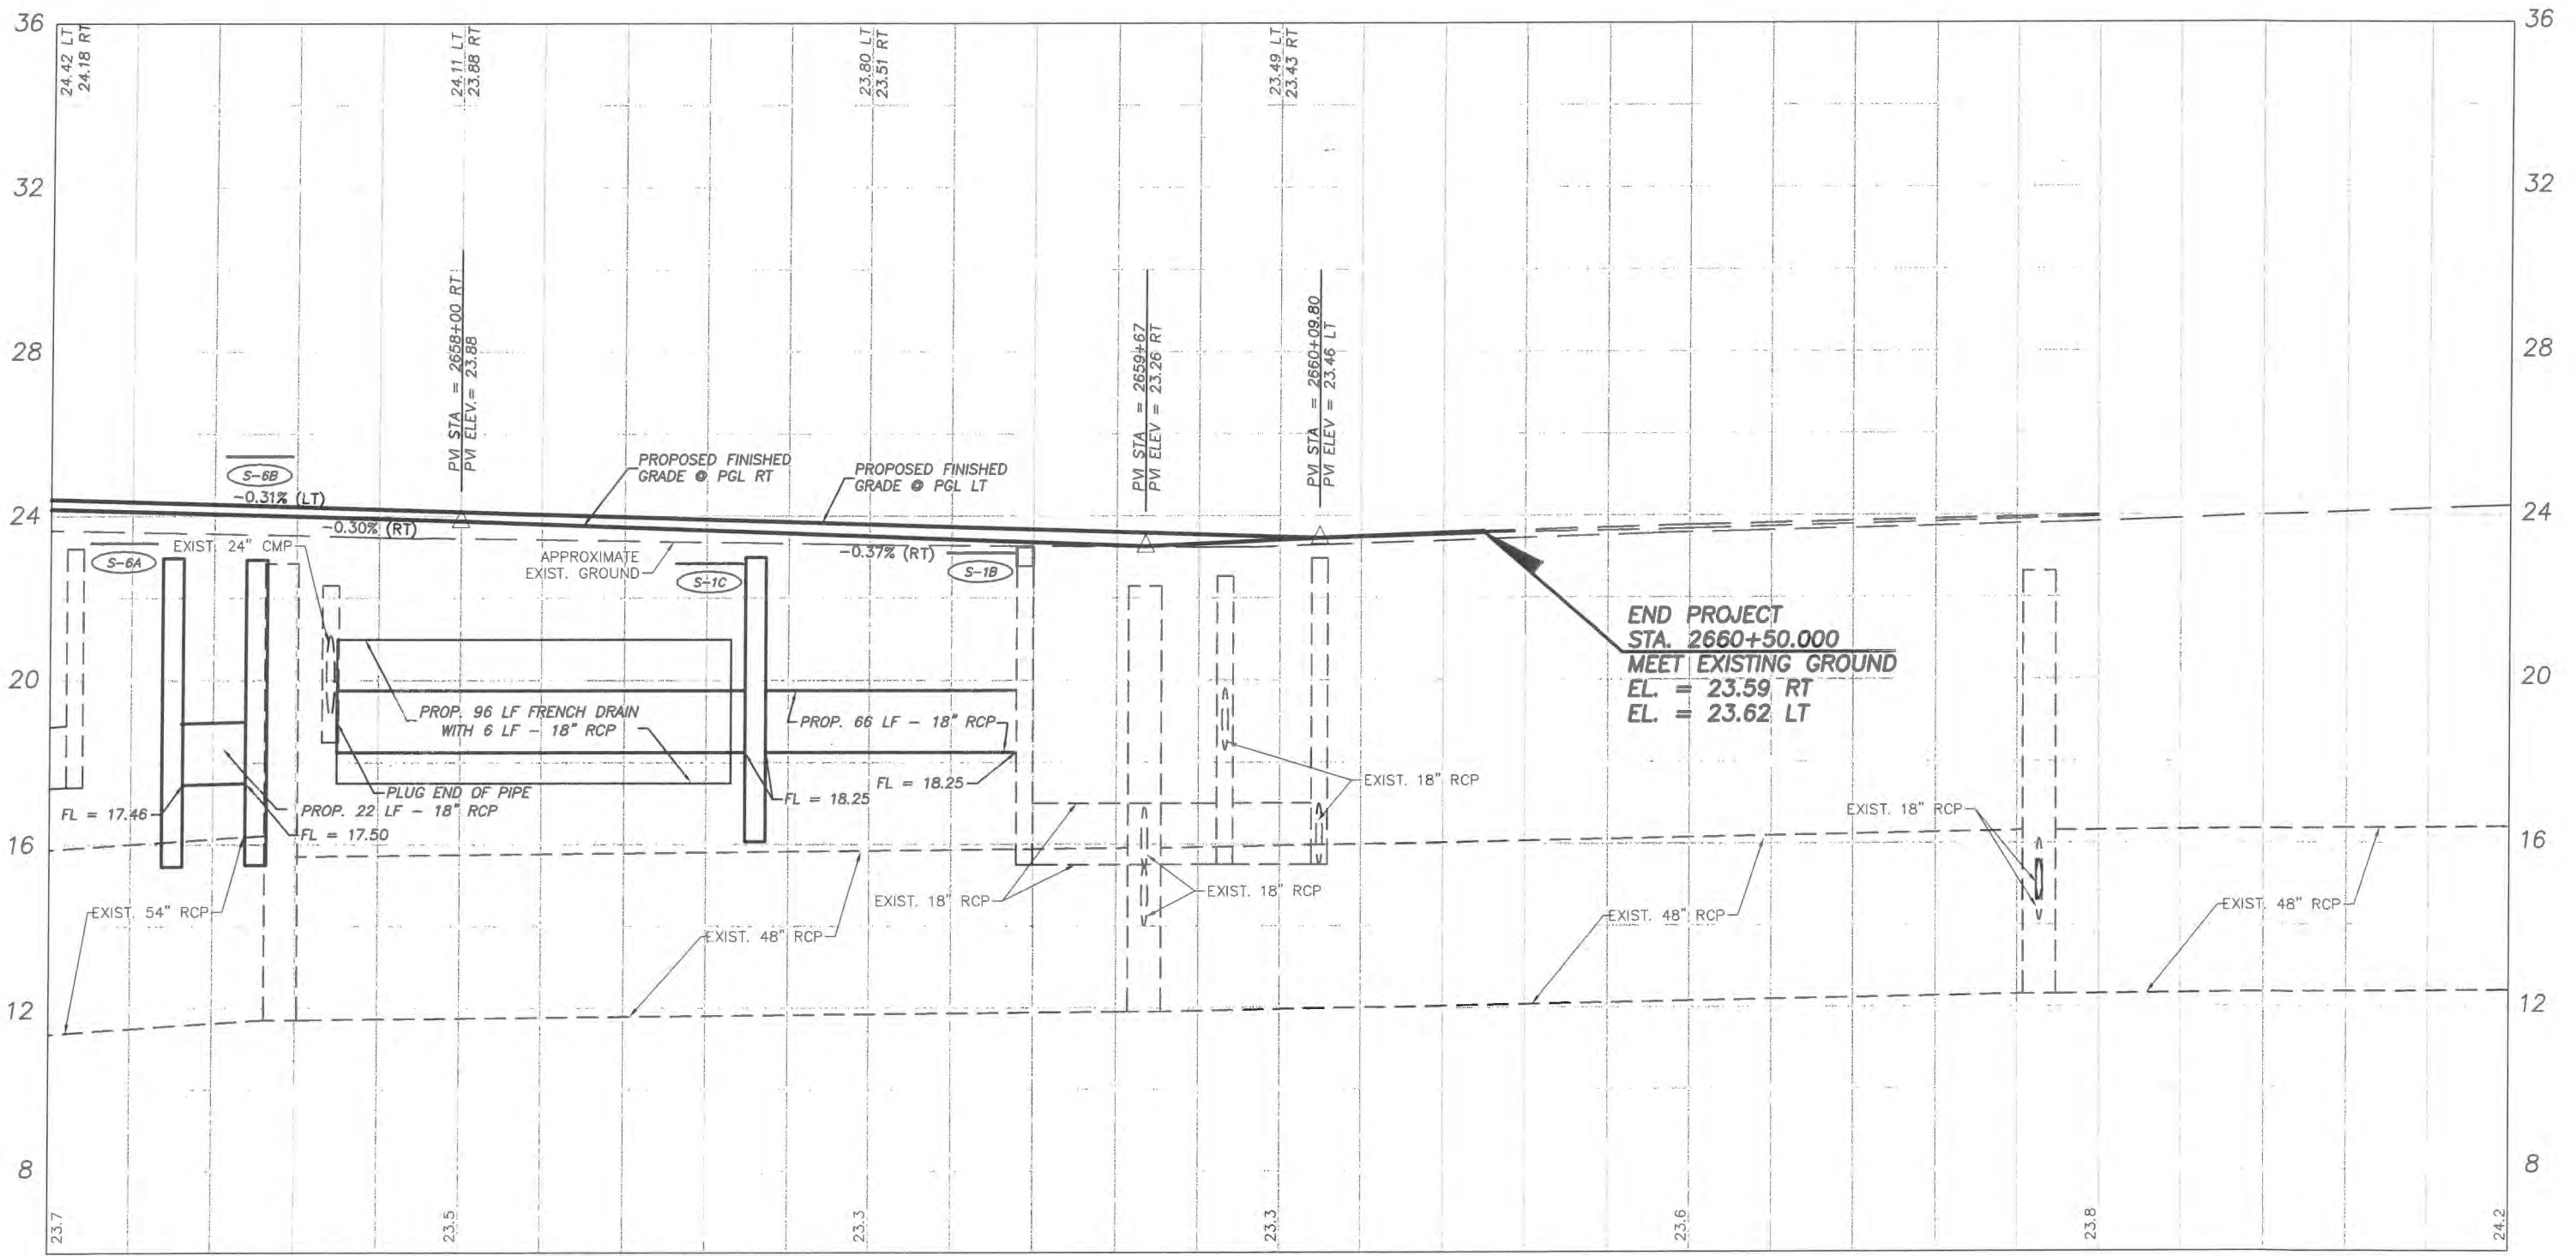
Department of Public Works  
Engineering Division

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Field Book No:

Project:  
PROFILE SHEETS  
FOR  
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LNW# WP1027





**END PROJECT**  
**STA. 2660+50.00**  
**MEET EXISTING GROUND**  
 EL. = 23.59 RT  
 EL. = 23.62 LT

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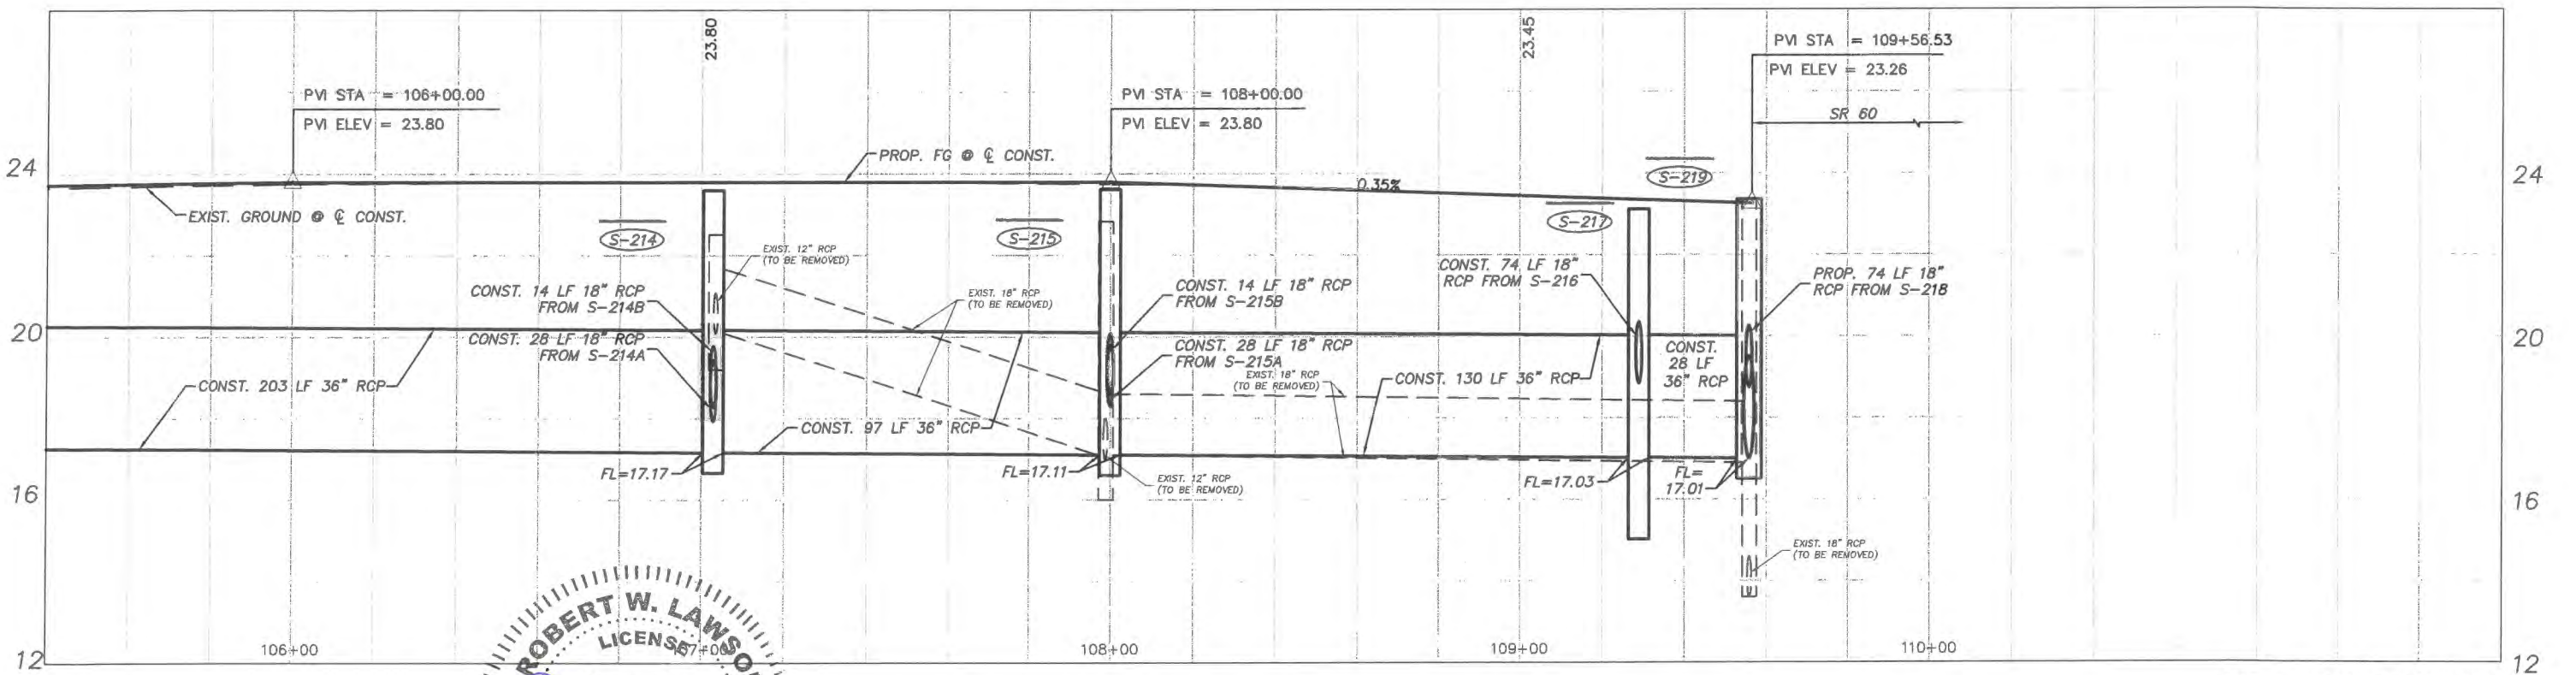
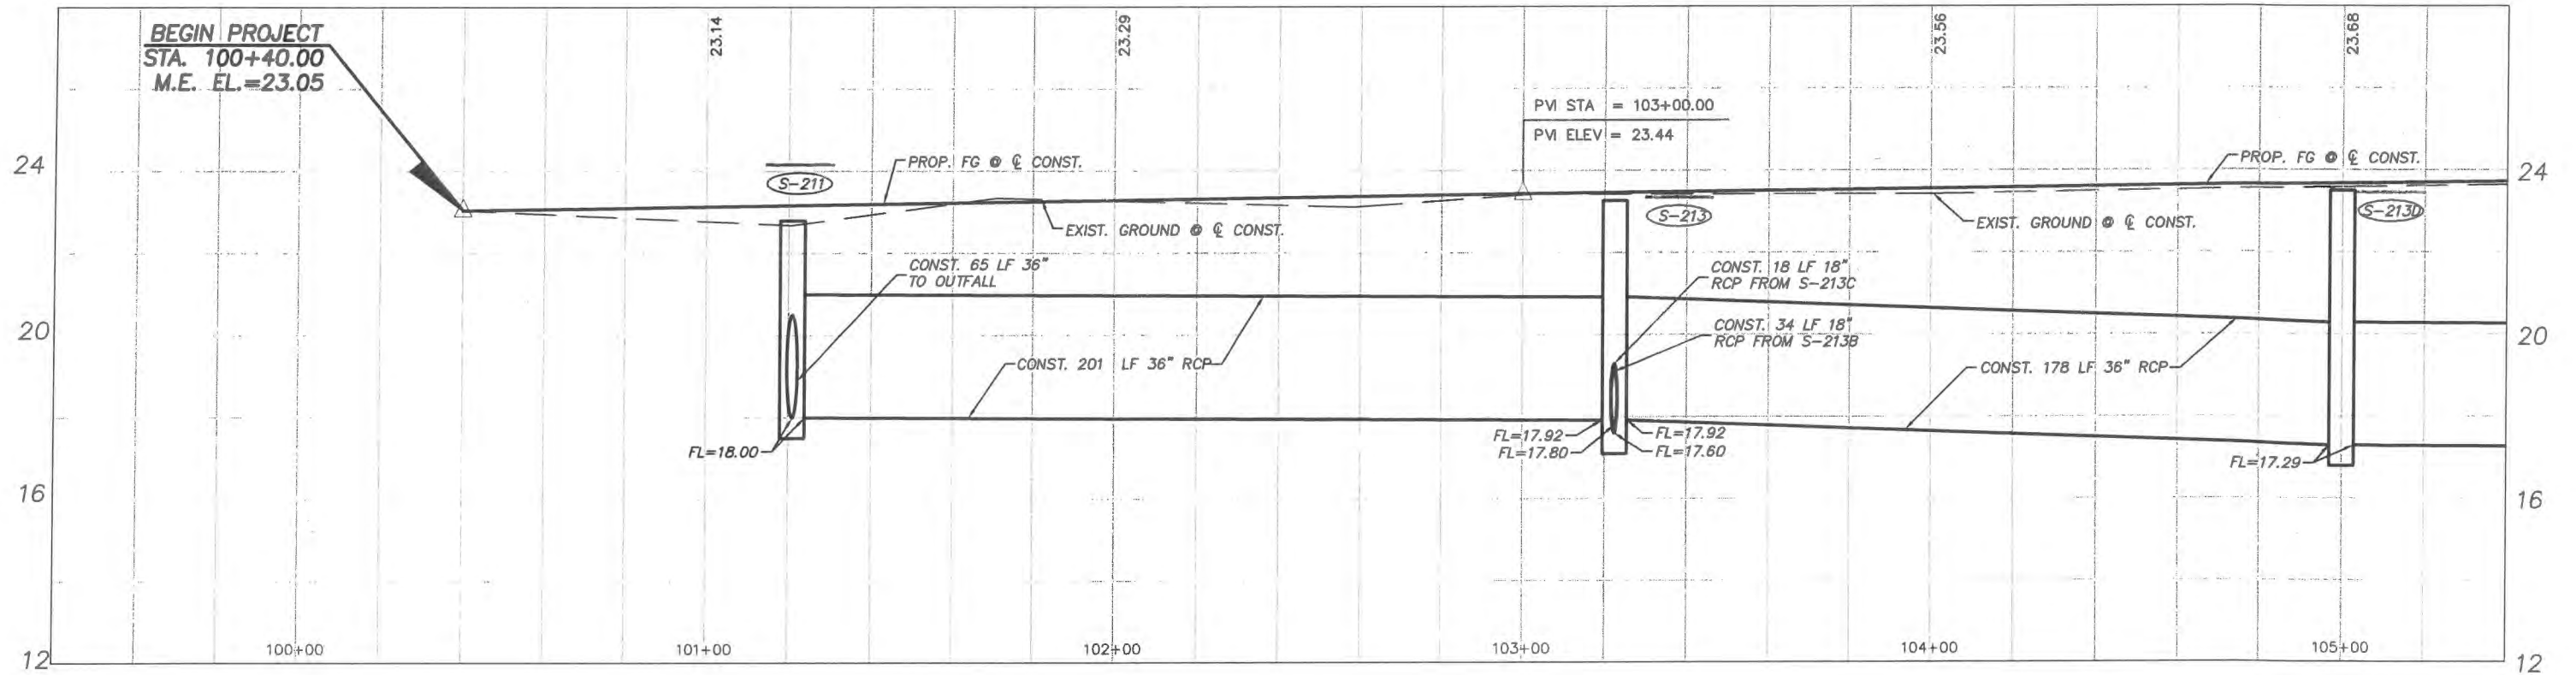
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Project:  
 PROFILE SHEETS  
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44TH AVENUE PROFILE

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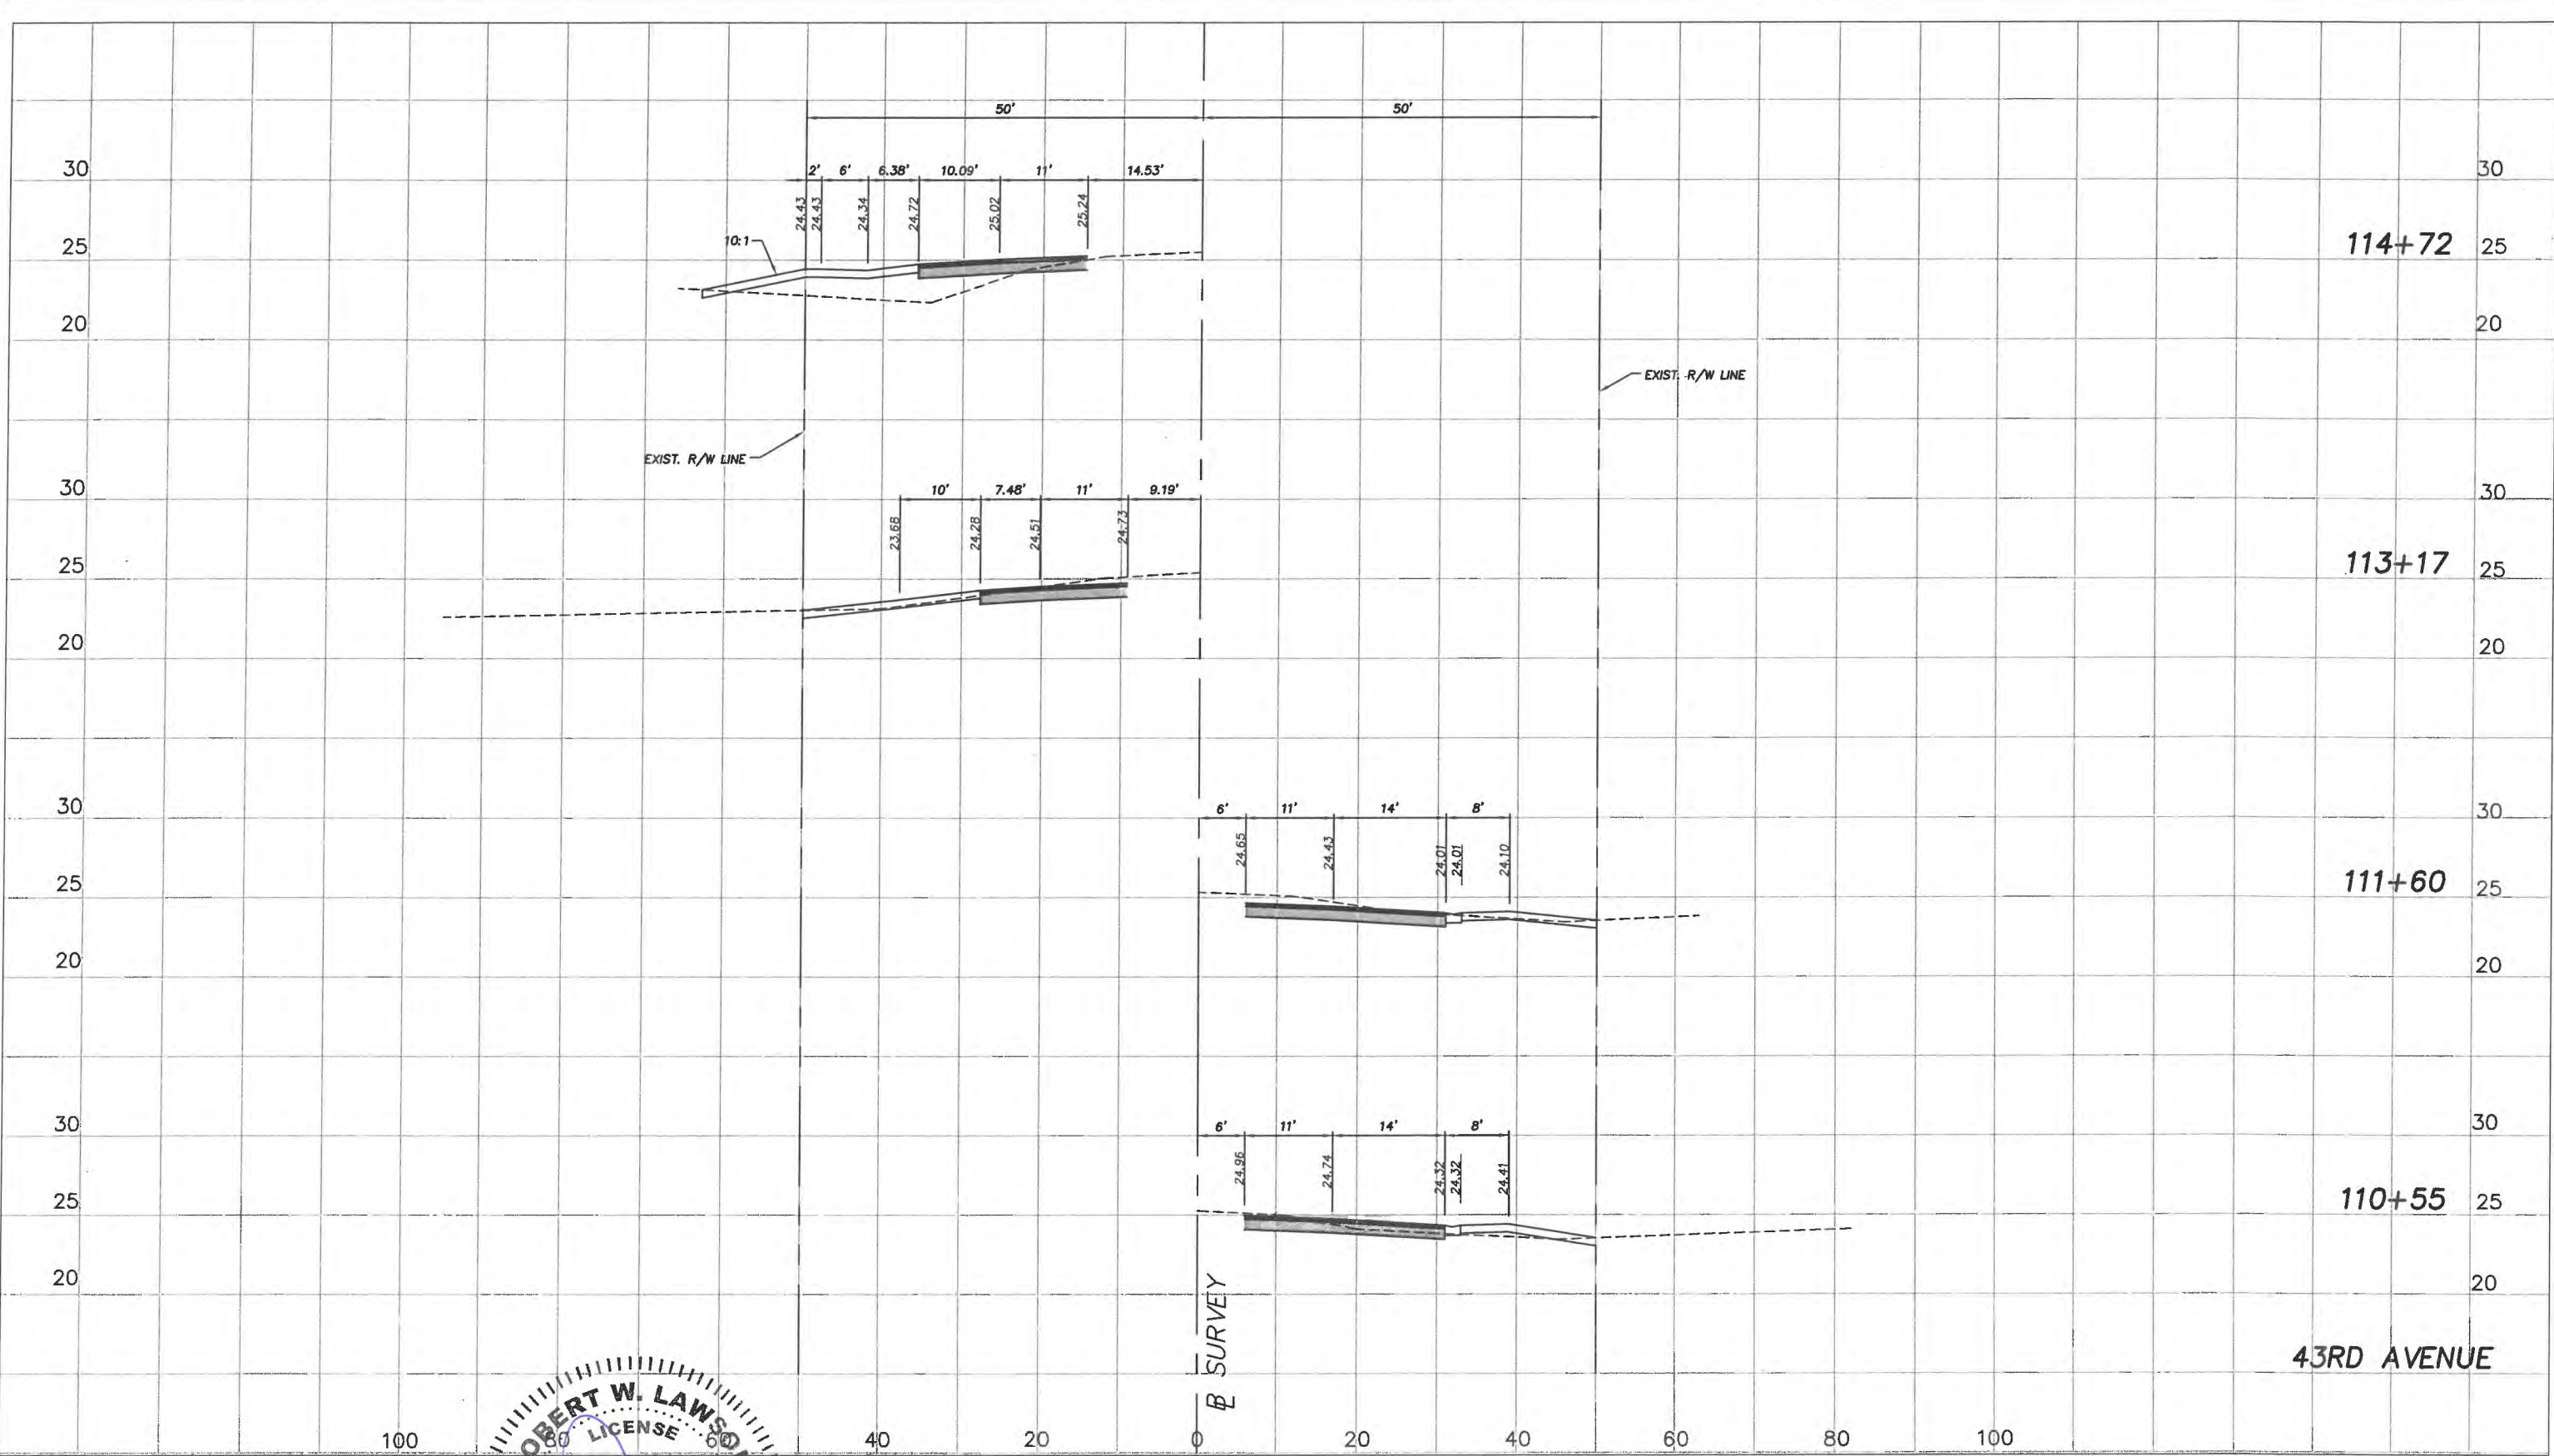
**INDIAN RIVER COUNTY**  
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Scale: 1" = 4' VERT.  
 1" = 40' HORIZ.  
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 Drawn: FM  
 Checked: HWD  
 Date: 6/2017  
 Field Book No:

Project:  
 PROFILE SHEETS  
 FOR  
 SR 60 & 43RD AVENUE

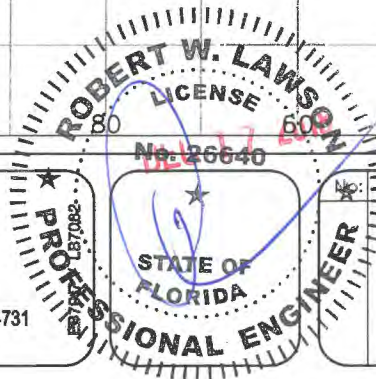
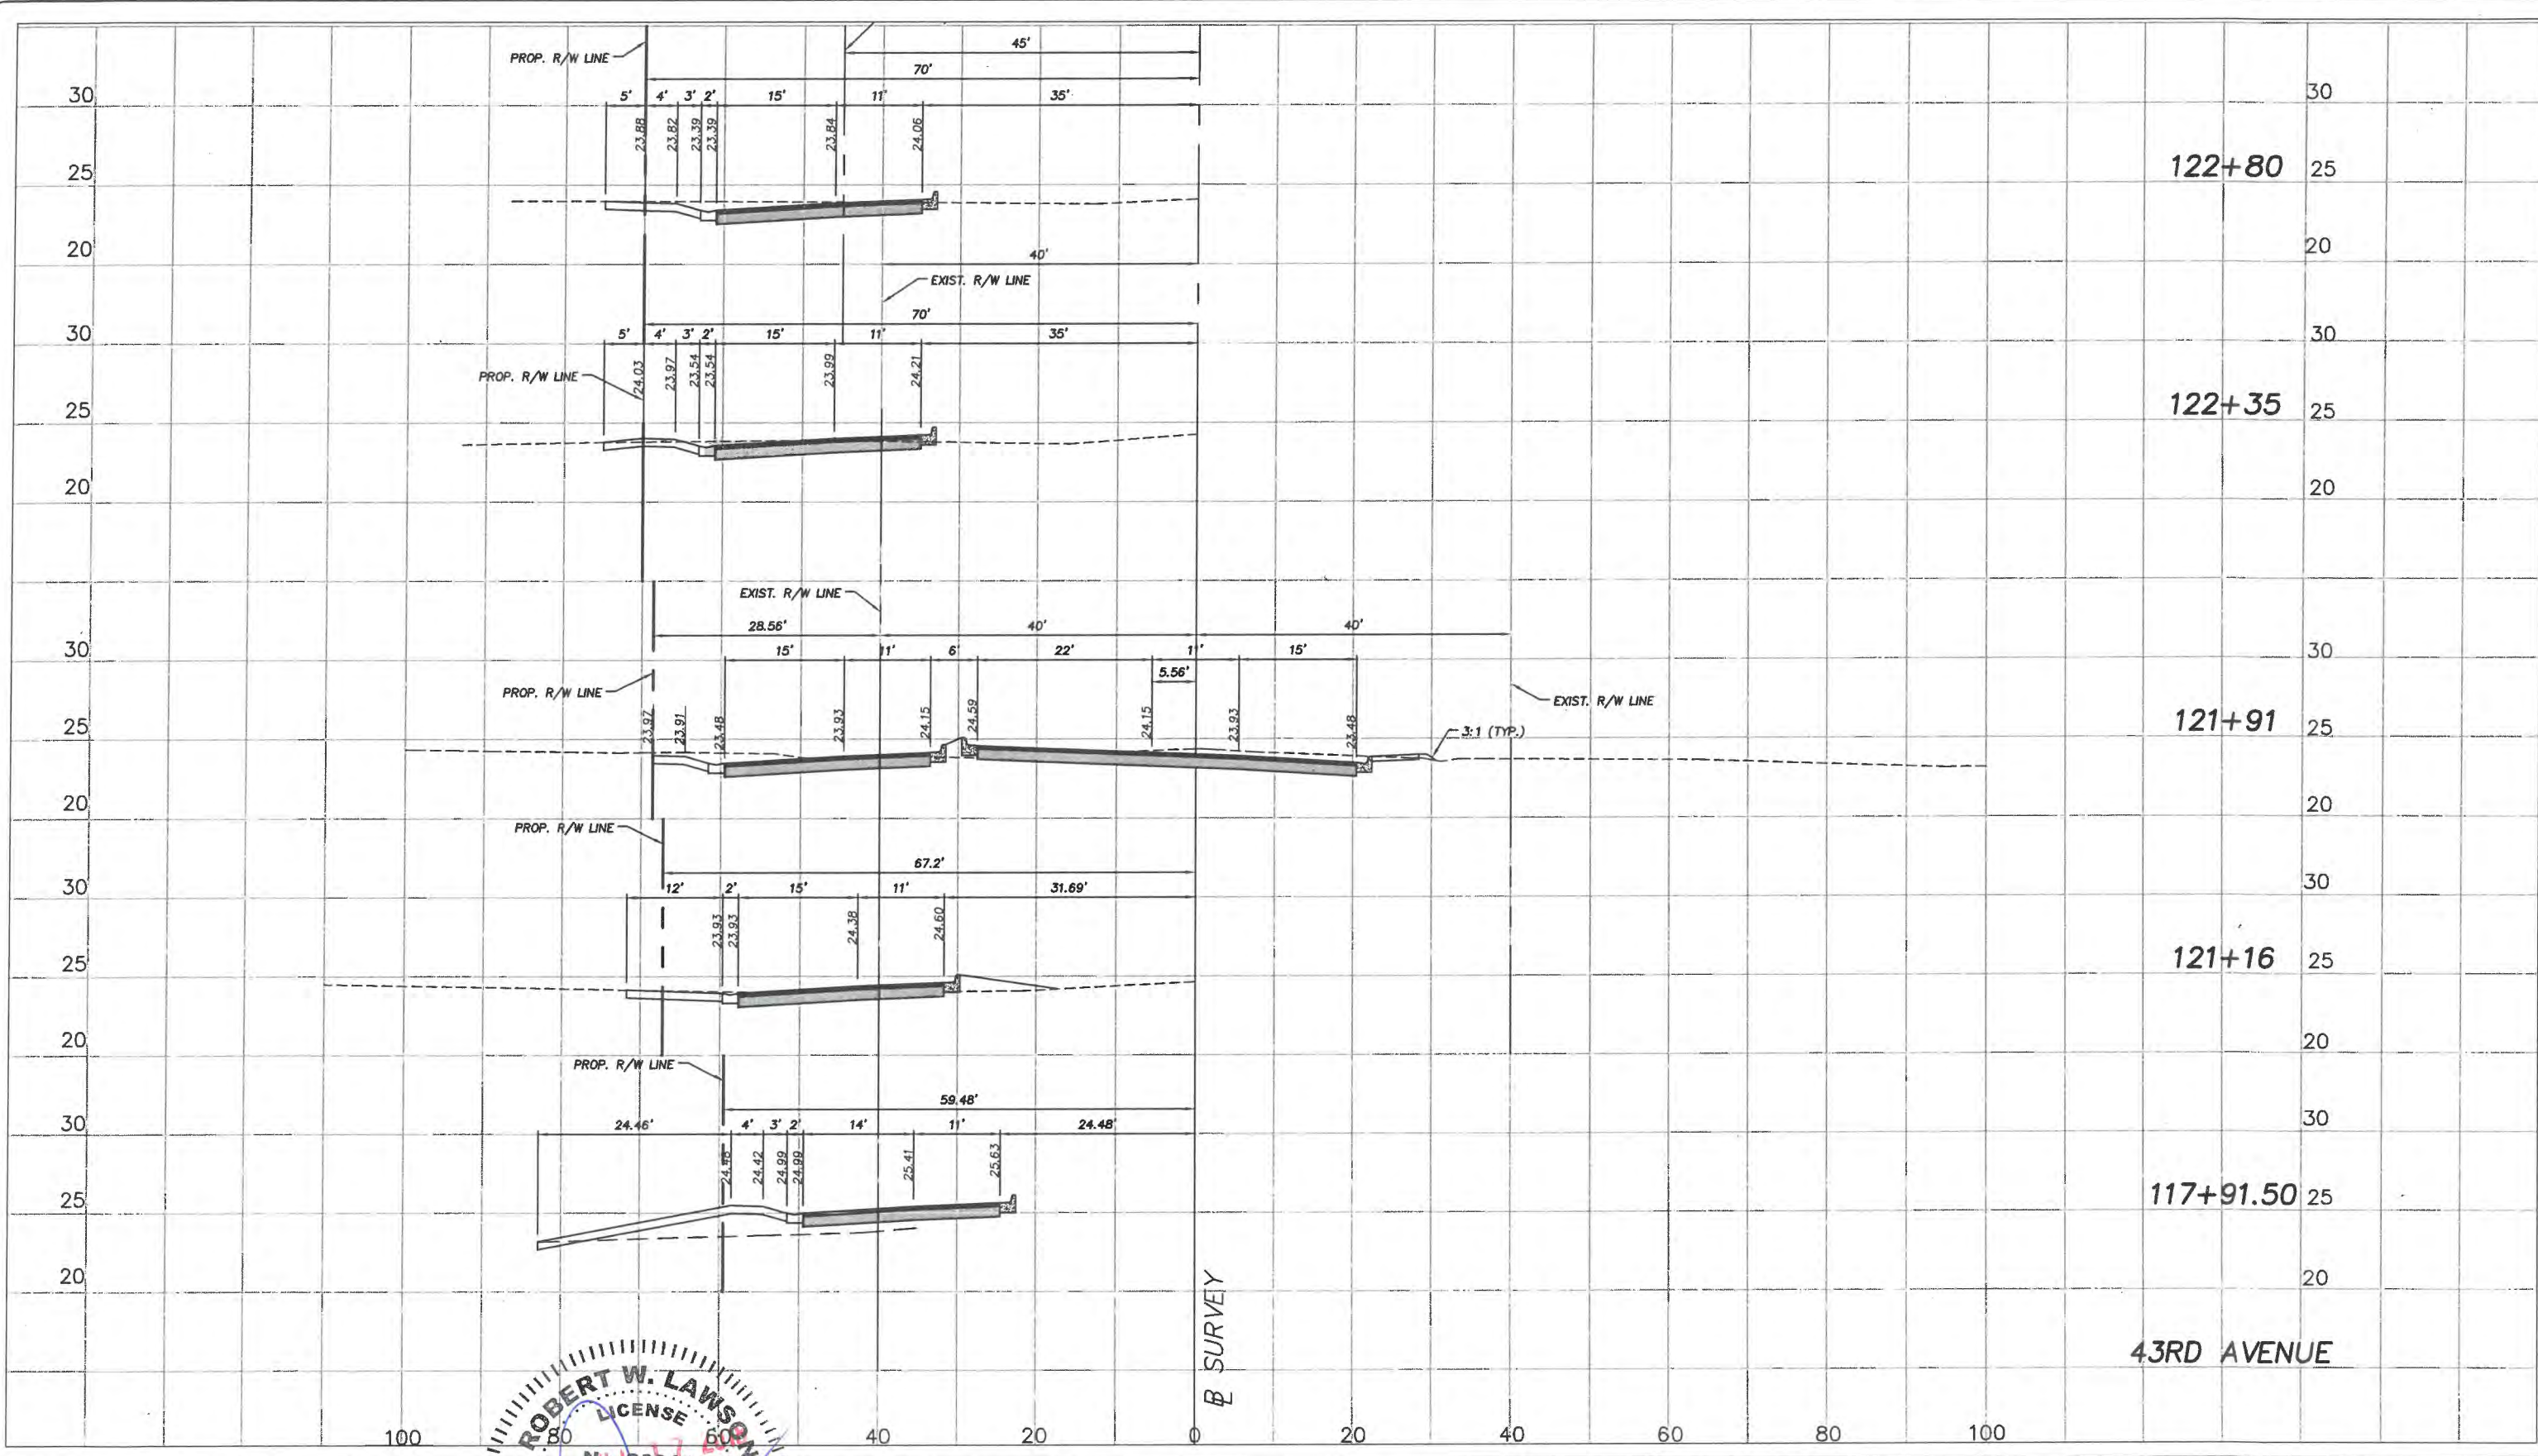
Sheet: 57  
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 LNW# WP1027





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Revision: By: Date:



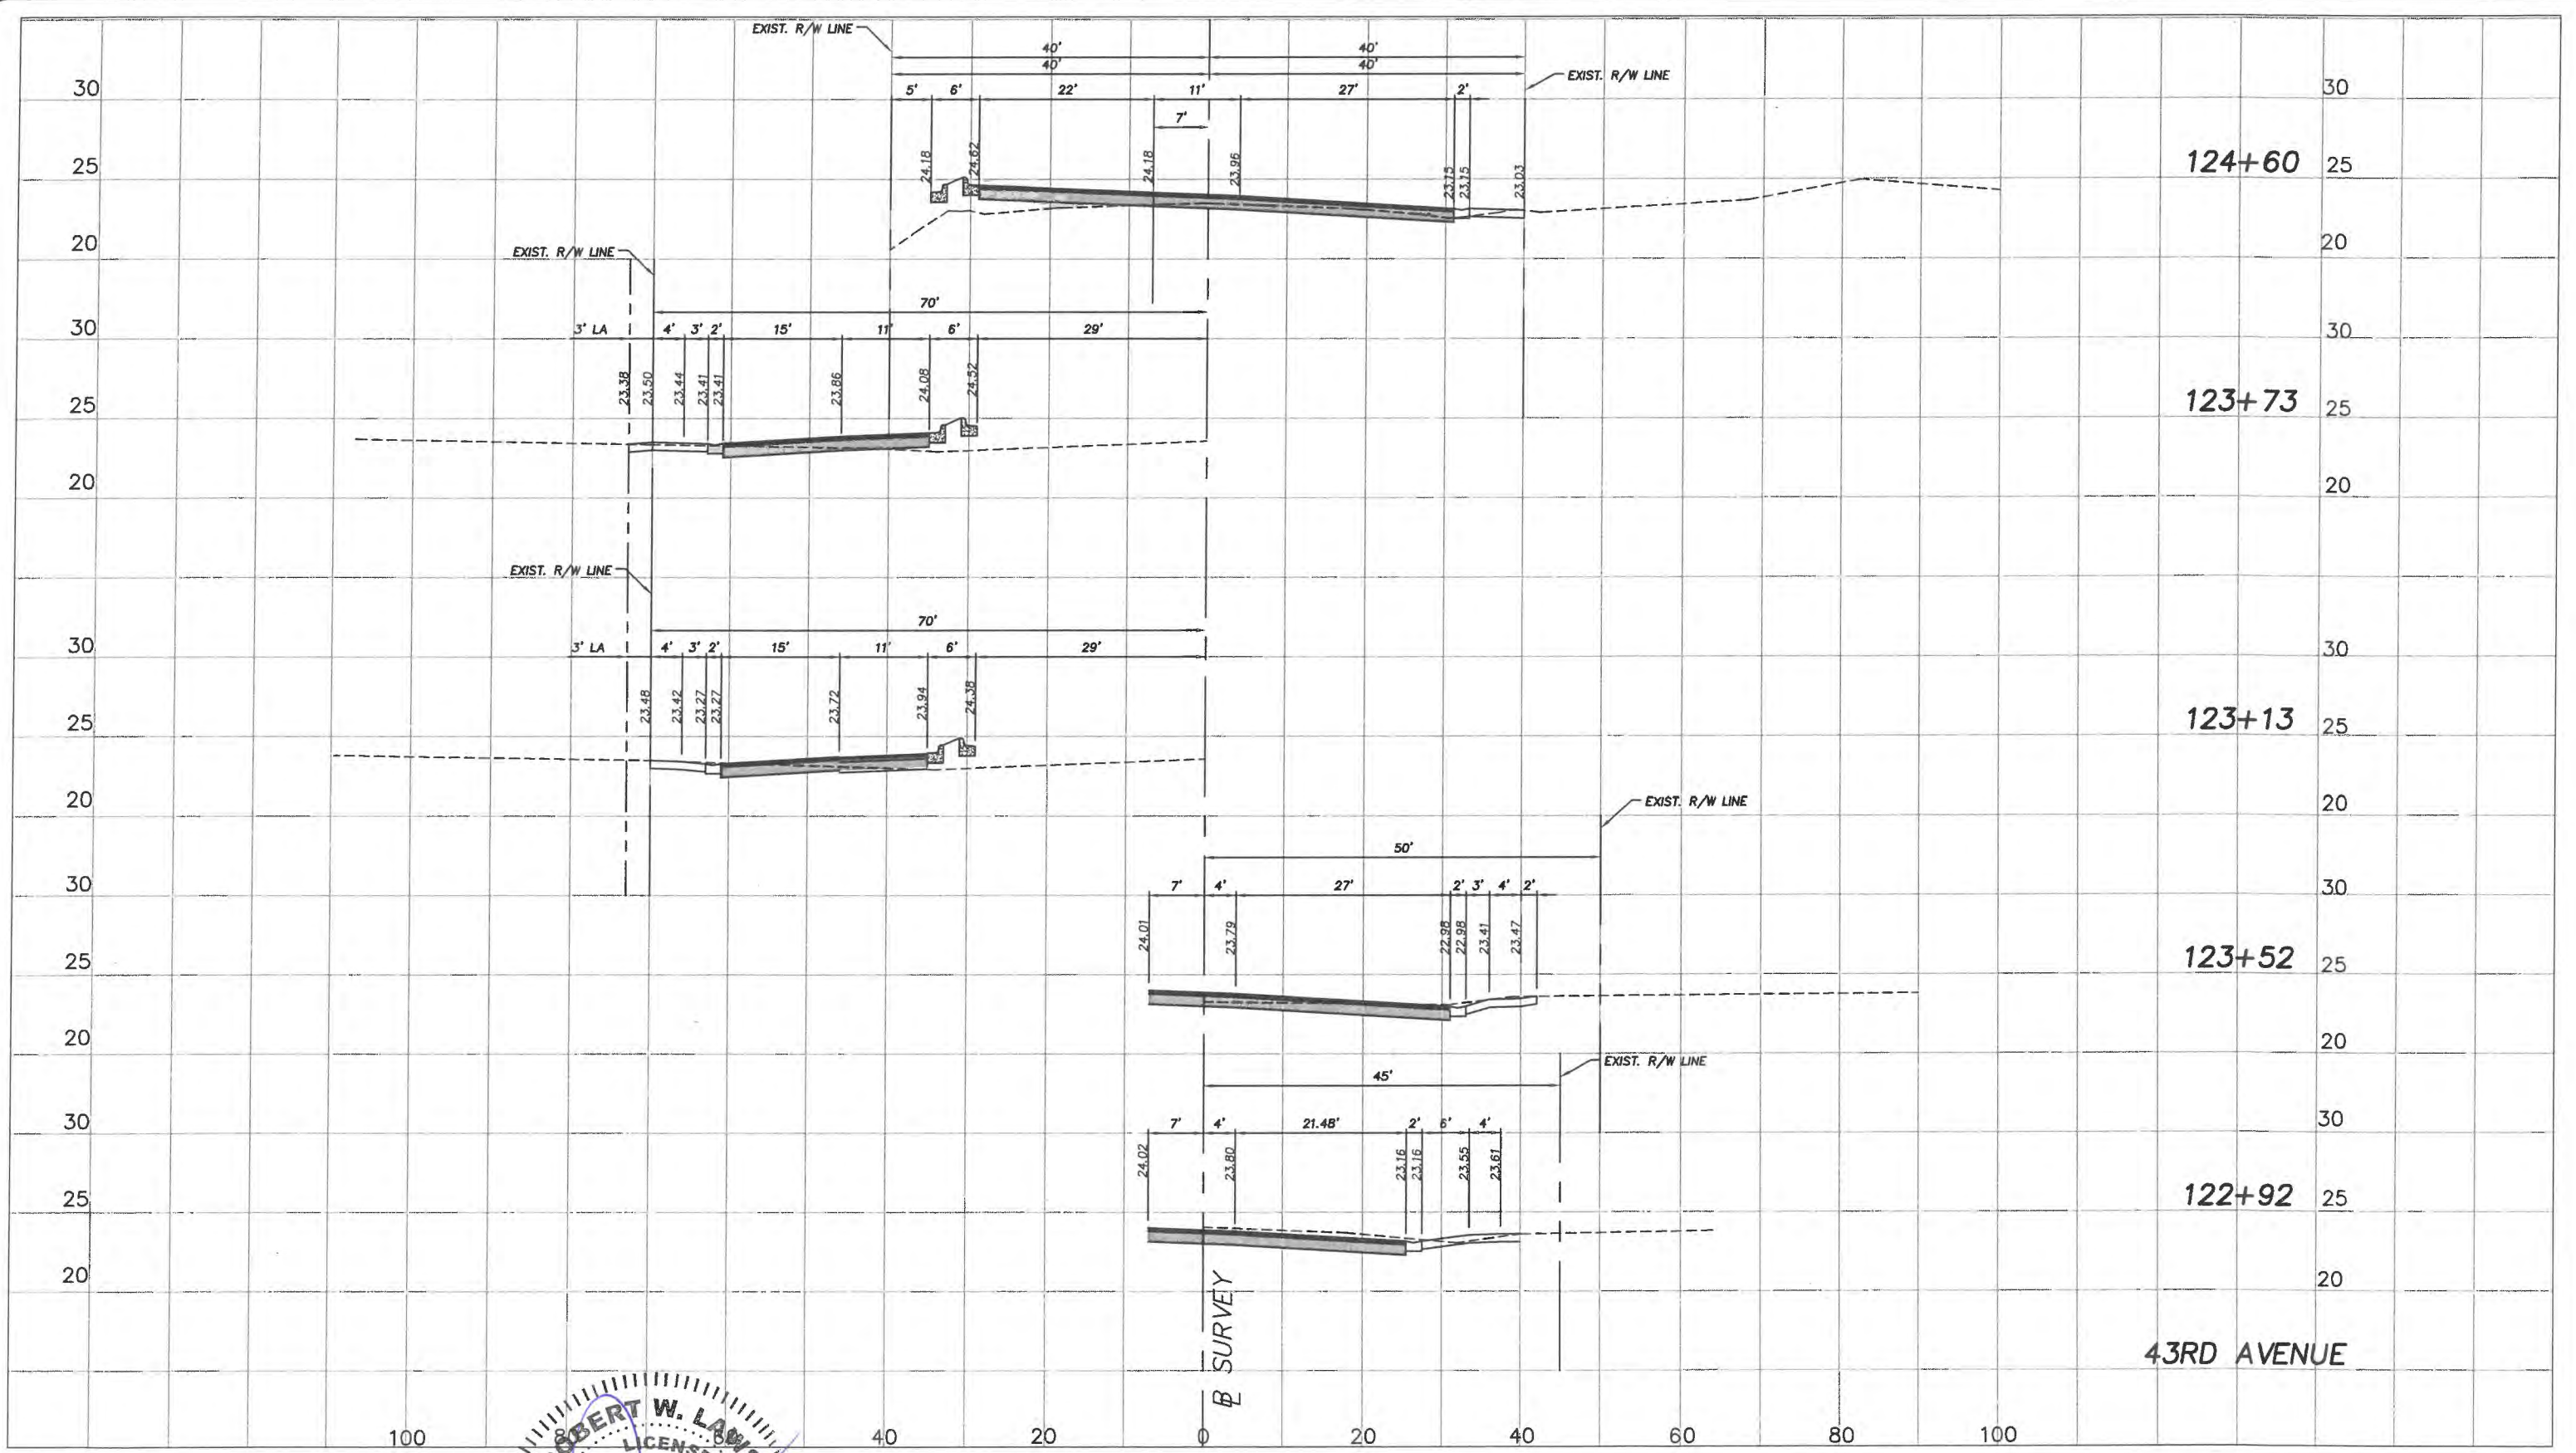
Department of Public Works  
Engineering Division

Scale: 1"=10' VERT.  
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Date: 6/2017  
Field Book No:

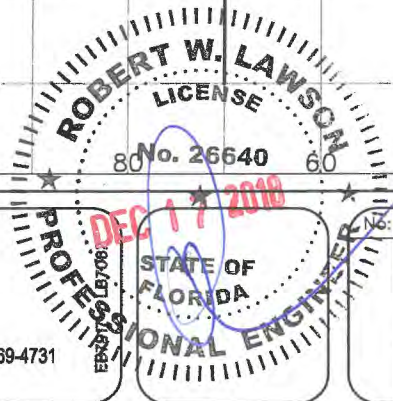
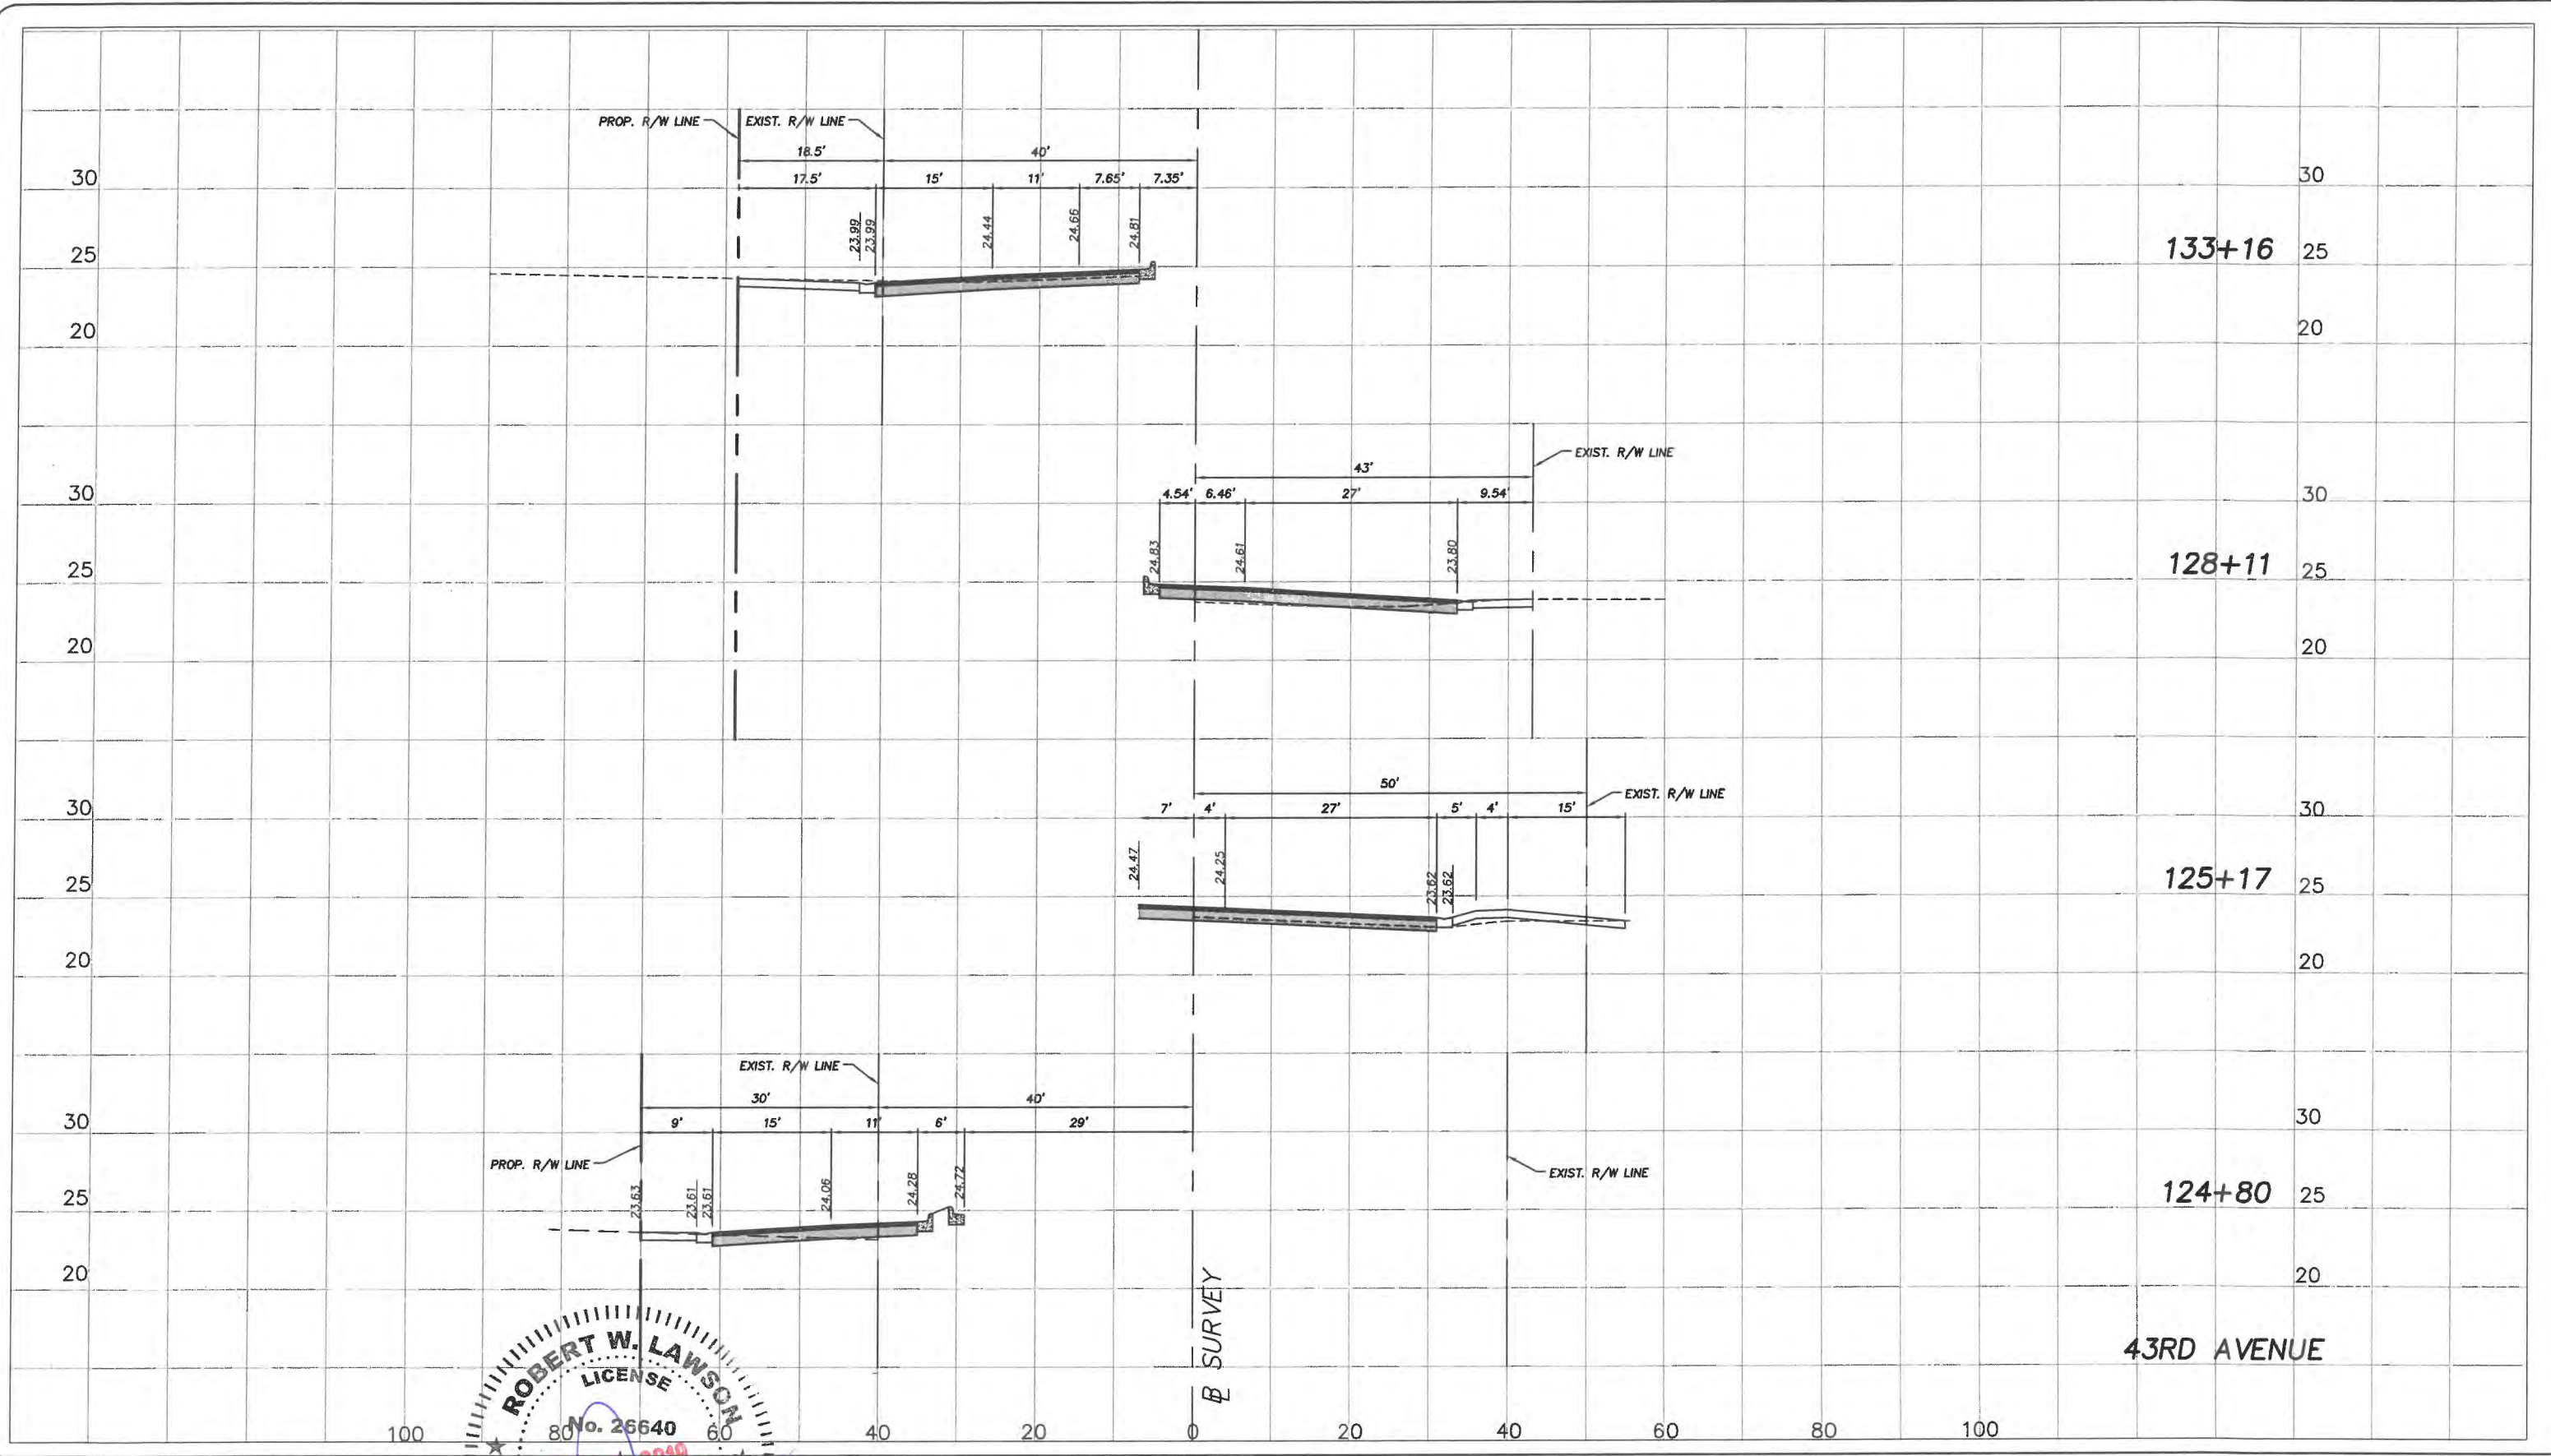
Project: DRIVEWAY PROFILES  
FOR  
SR 60 & 43RD AVENUE

Sheet: 59  
Of: 99  
Project No.  
LNW/ WP1027









Revision:	By:	Date:



Department of Public Works  
Engineering Division

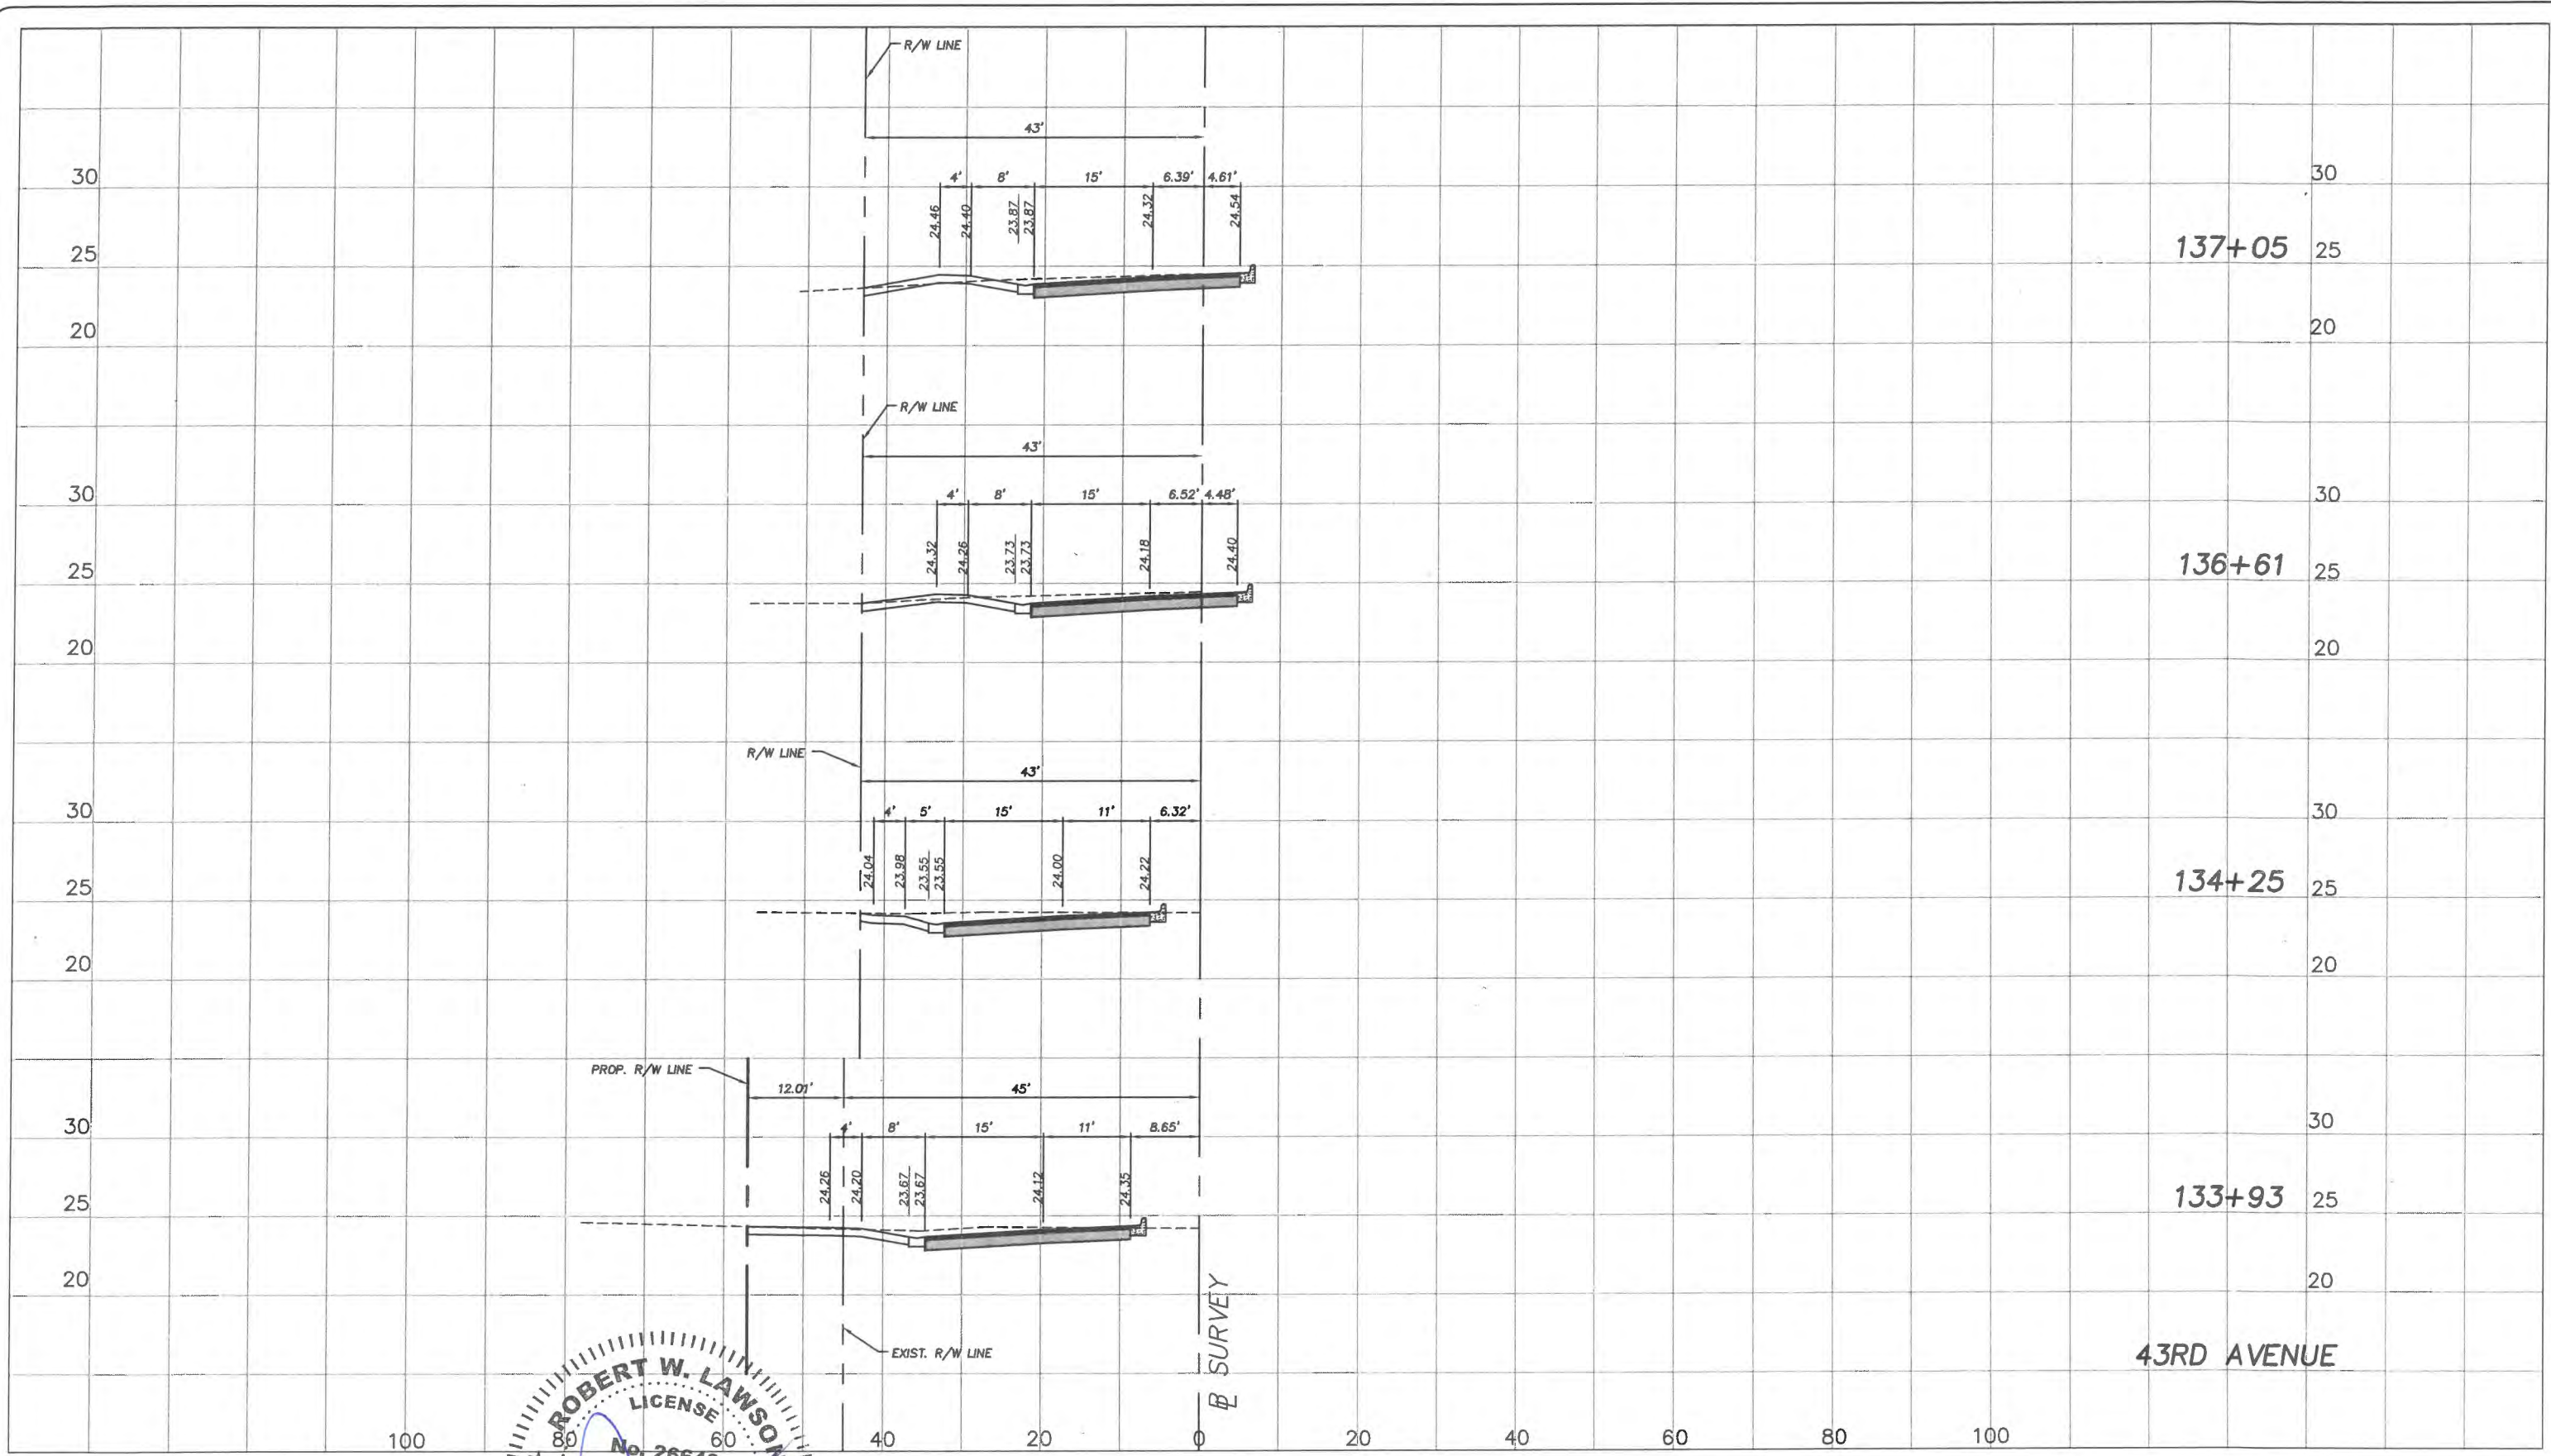
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Date: 6/2017  
Field Book No:

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FOR  
SR 60 & 43RD AVENUE

Sheet: 61  
Of: 99  
Project No.  
LNW# WP1027


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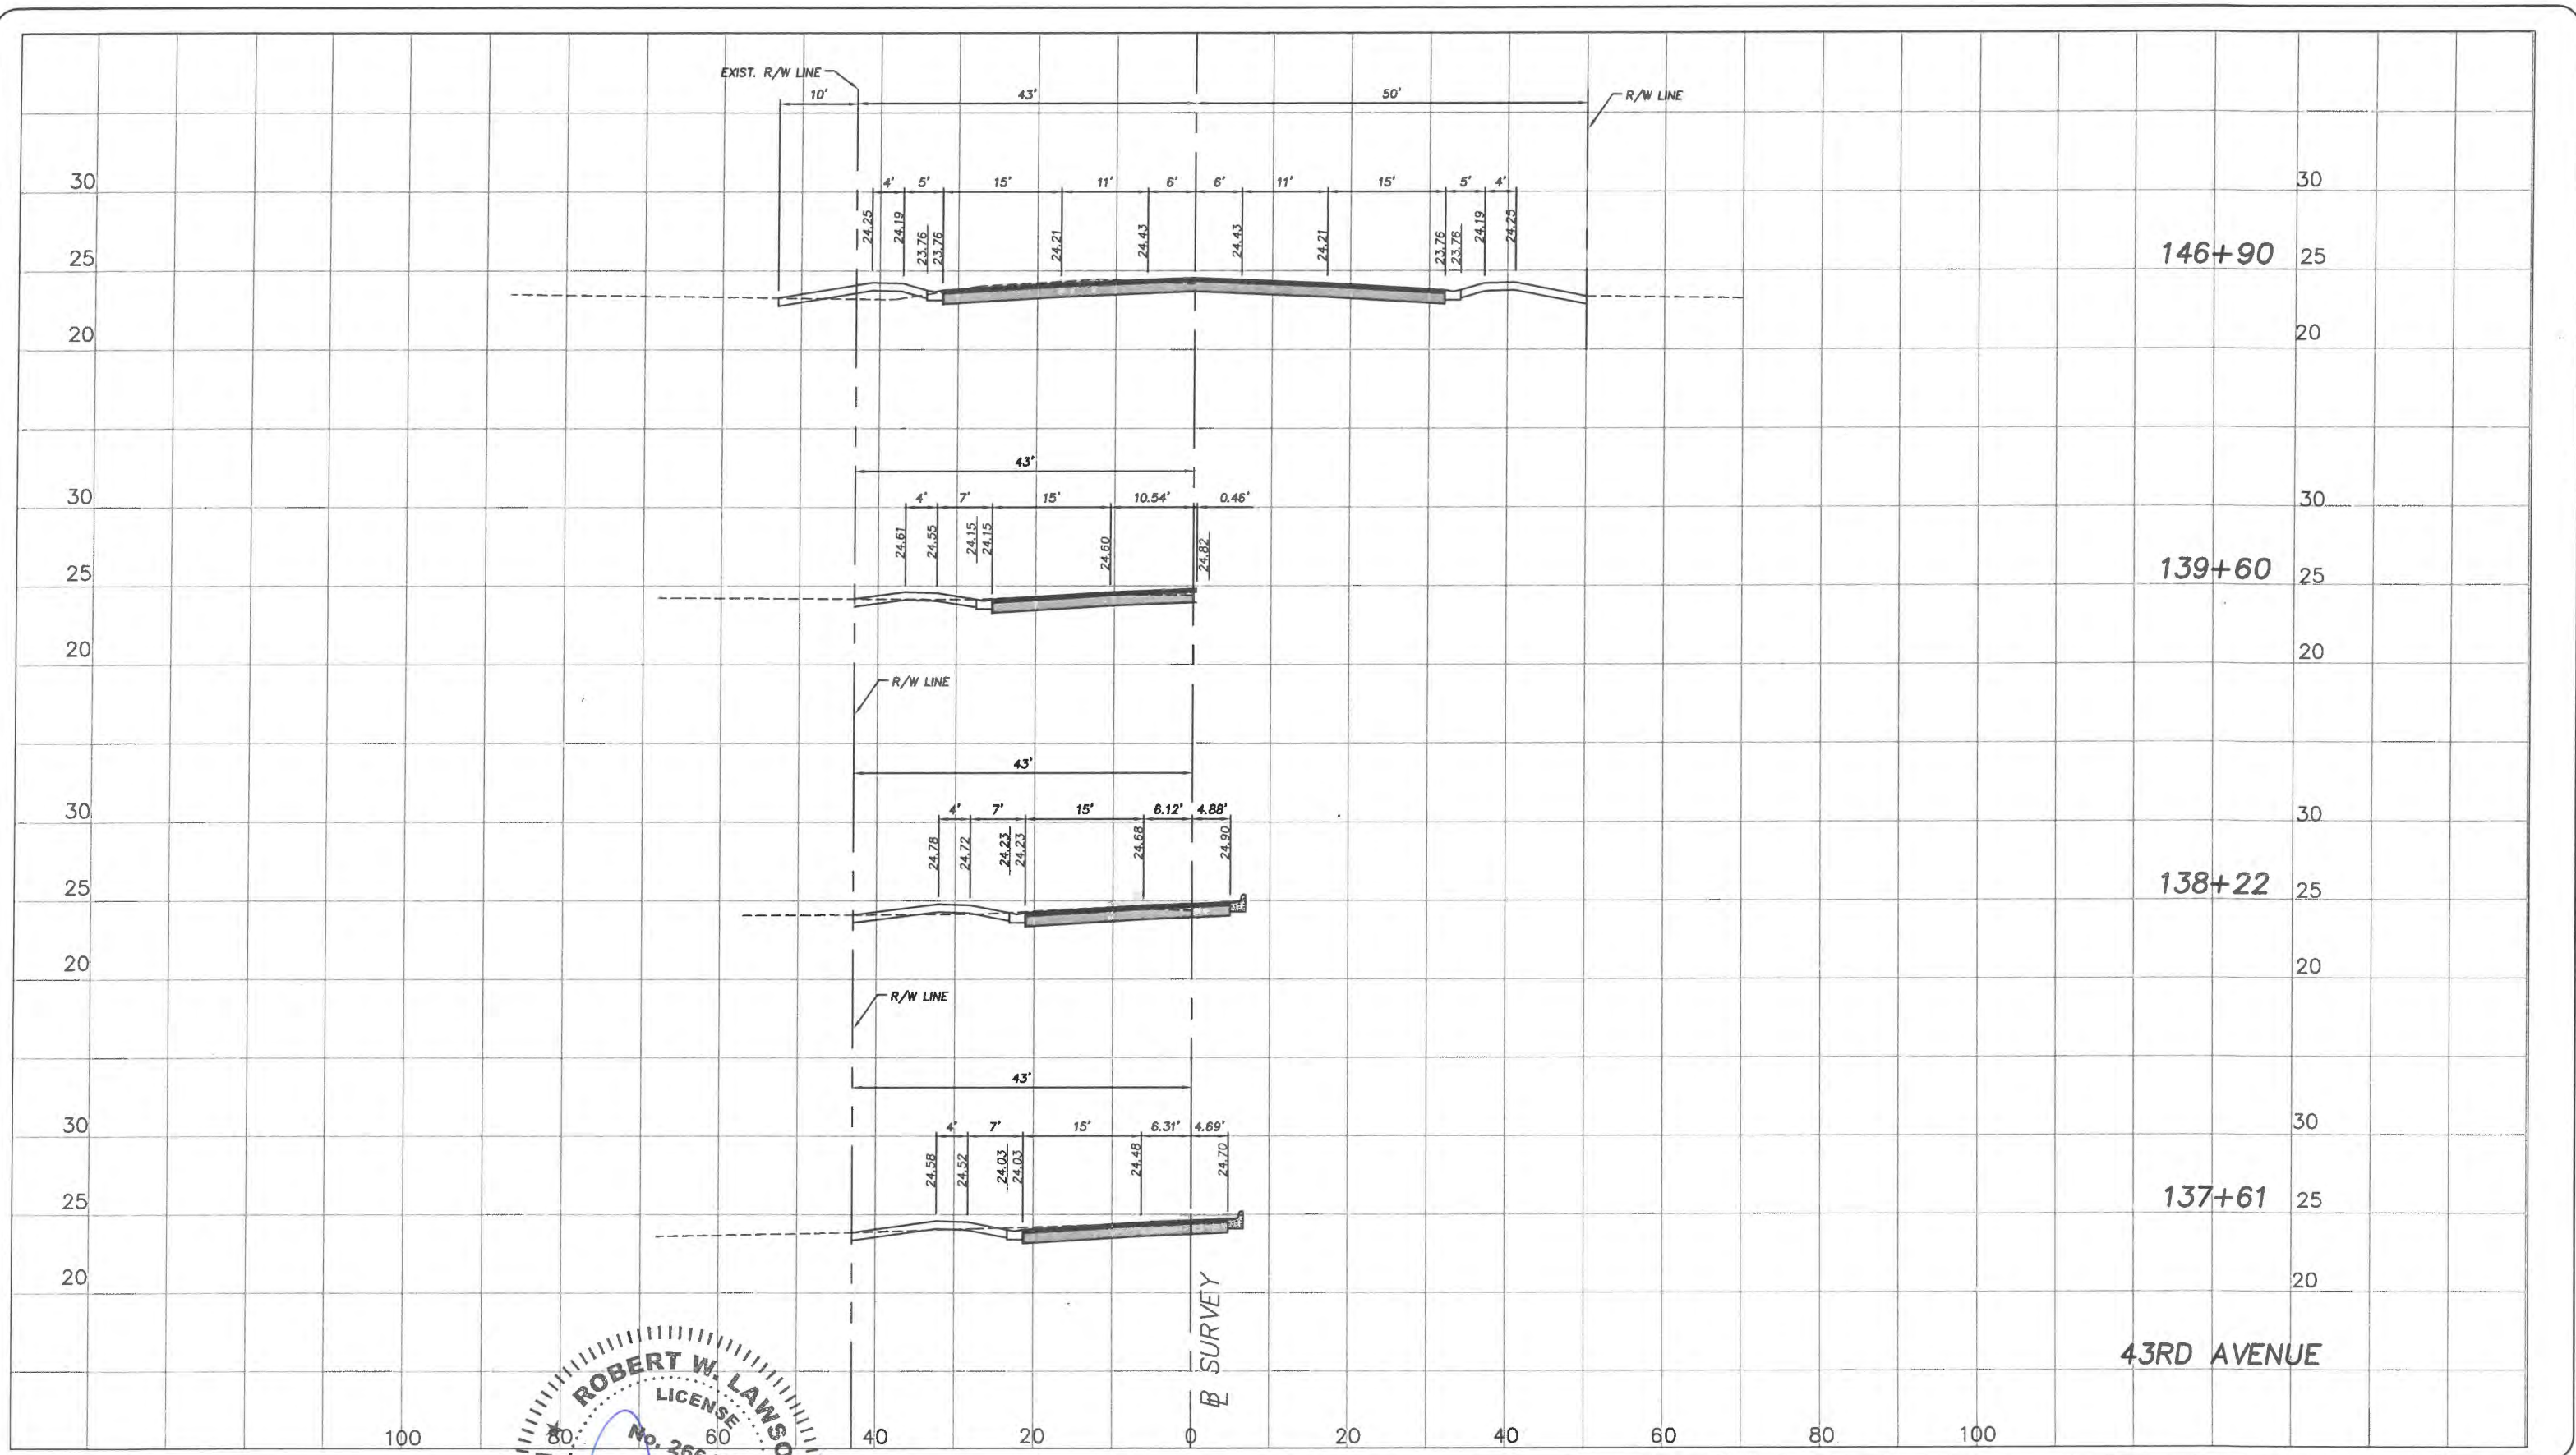
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 DRIVEWAY PROFILES  
 FOR  
 SR 60 & 43RD AVENUE

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 LNW# WP1027


  
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
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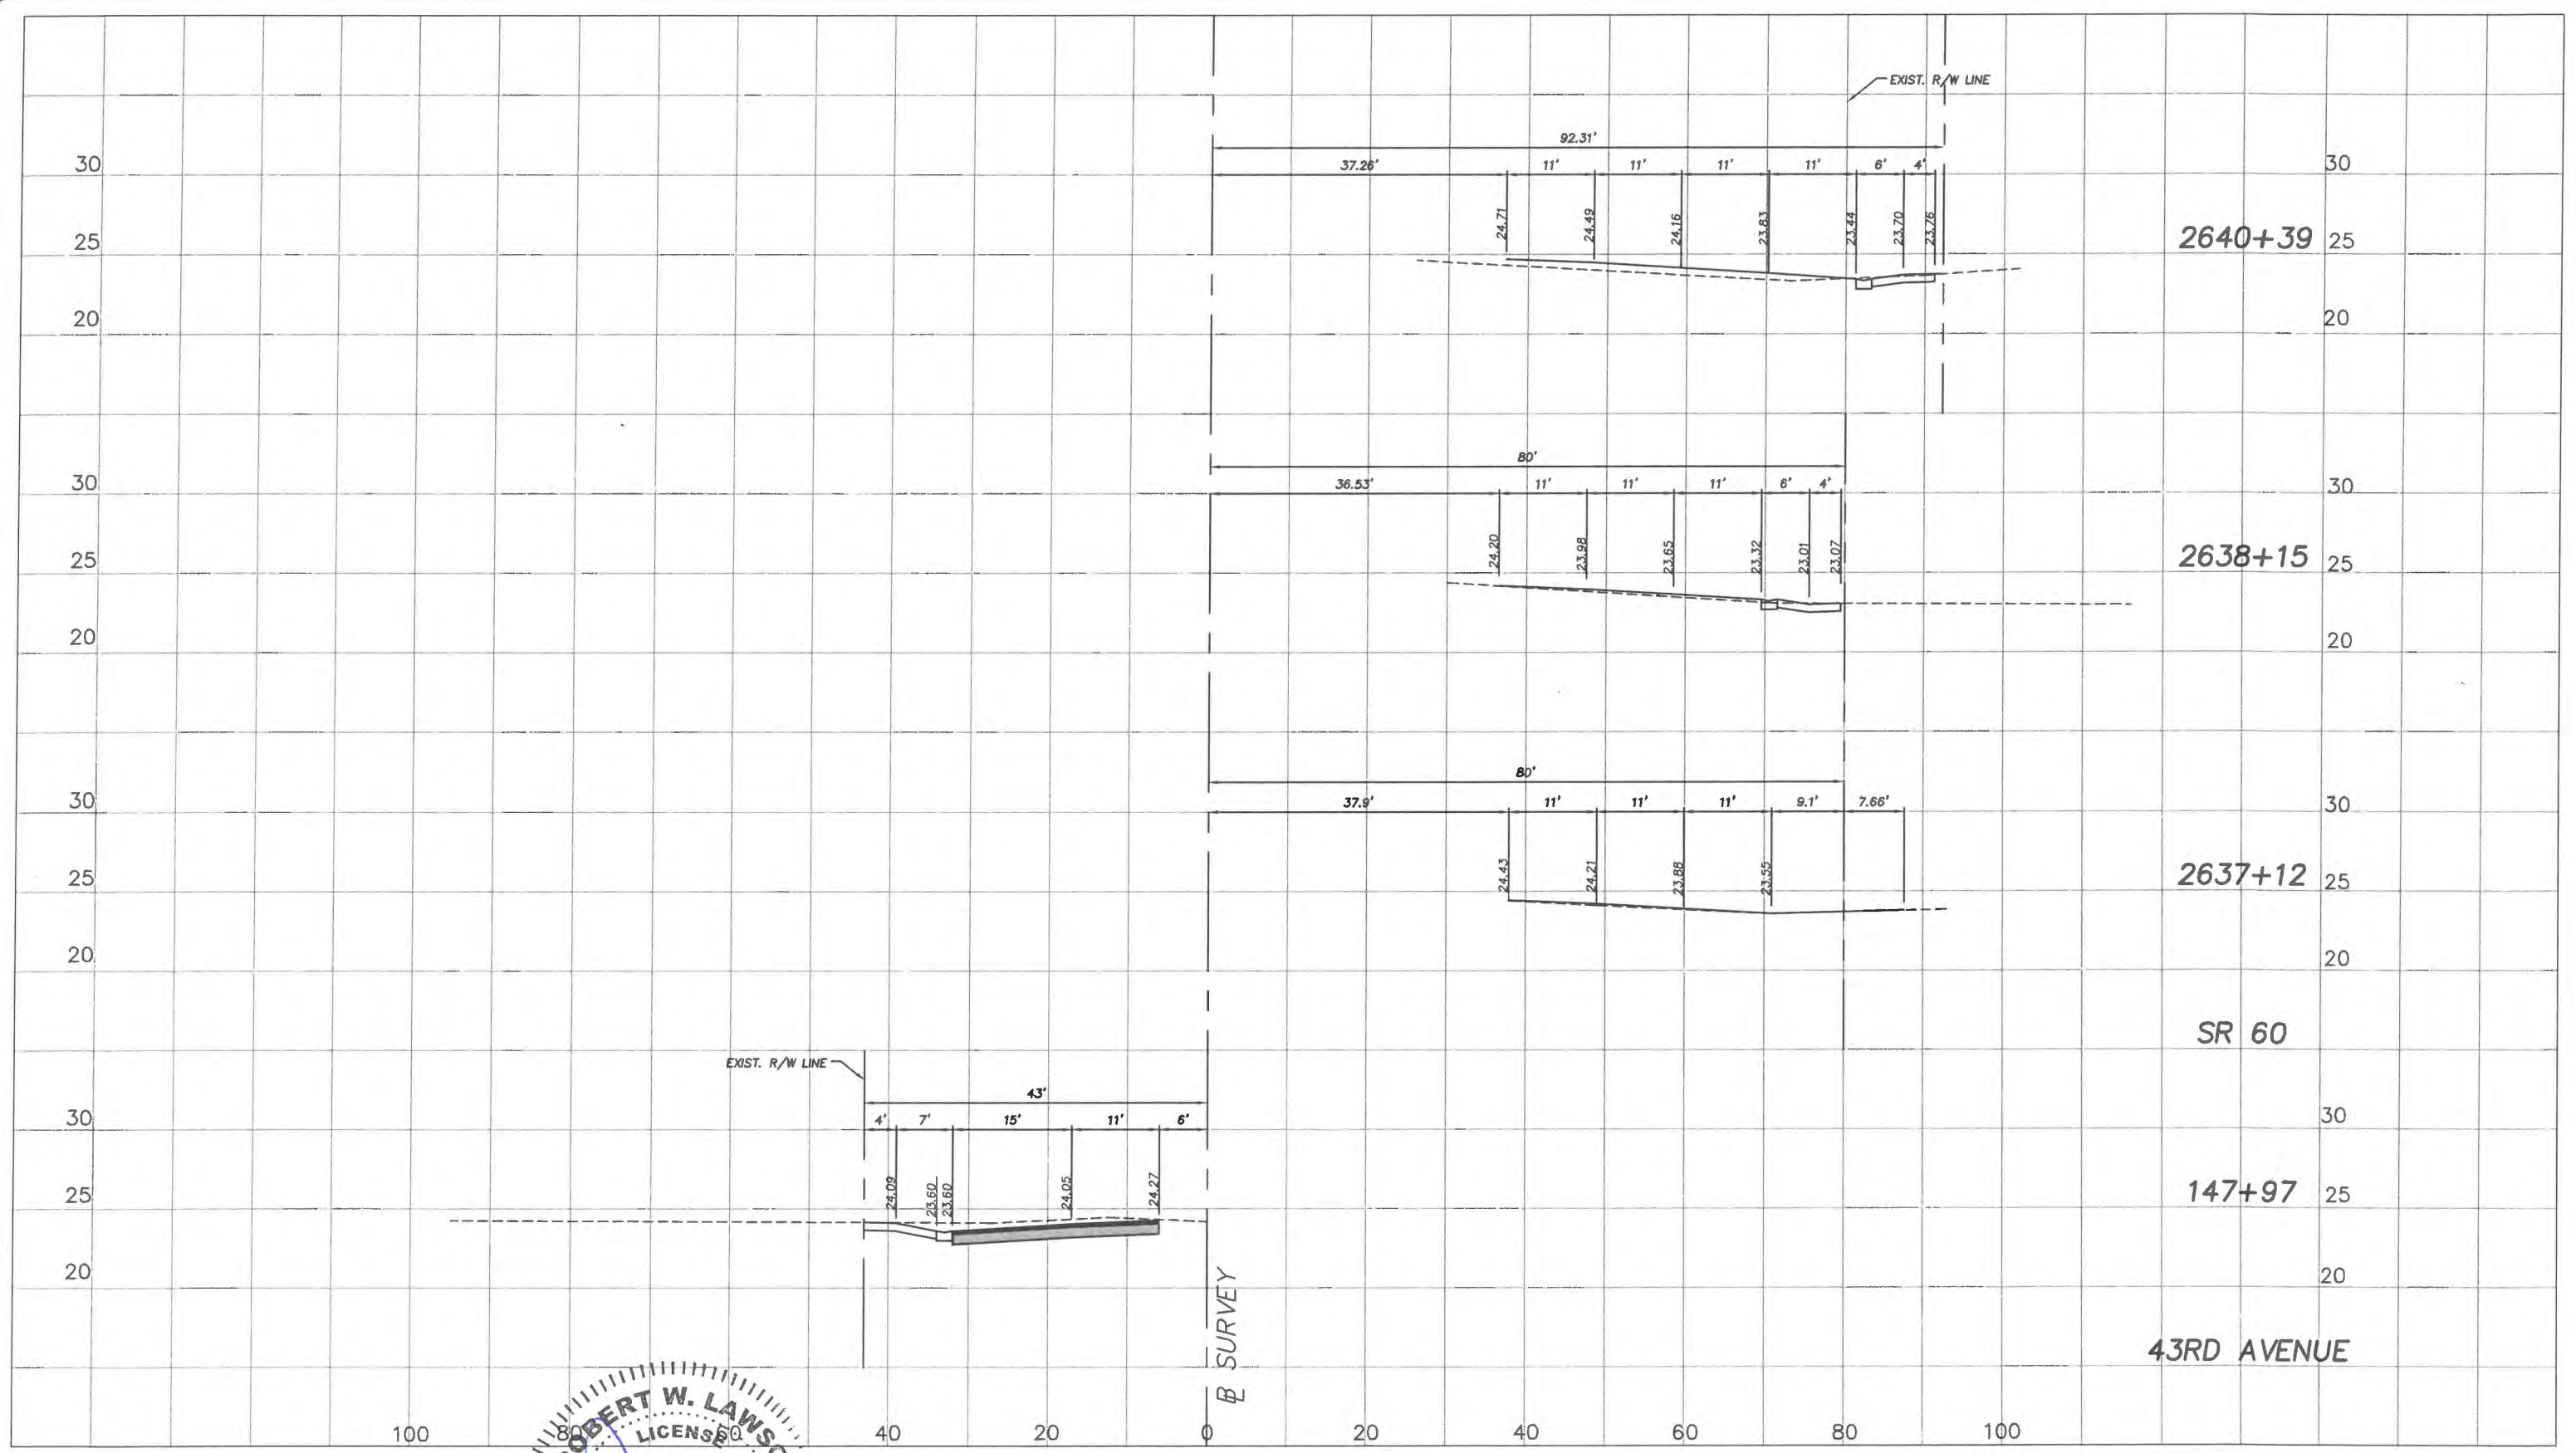
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 Date: 6/2017  
 Field Book No:

Project:  
 DRIVEWAY PROFILES  
 FOR  
 SR 60 & 43RD AVENUE

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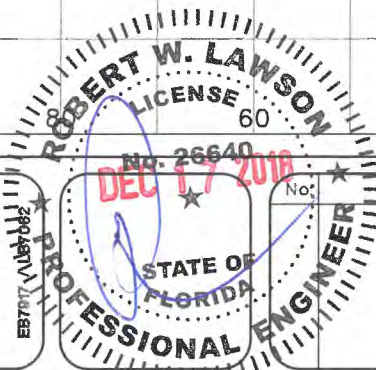
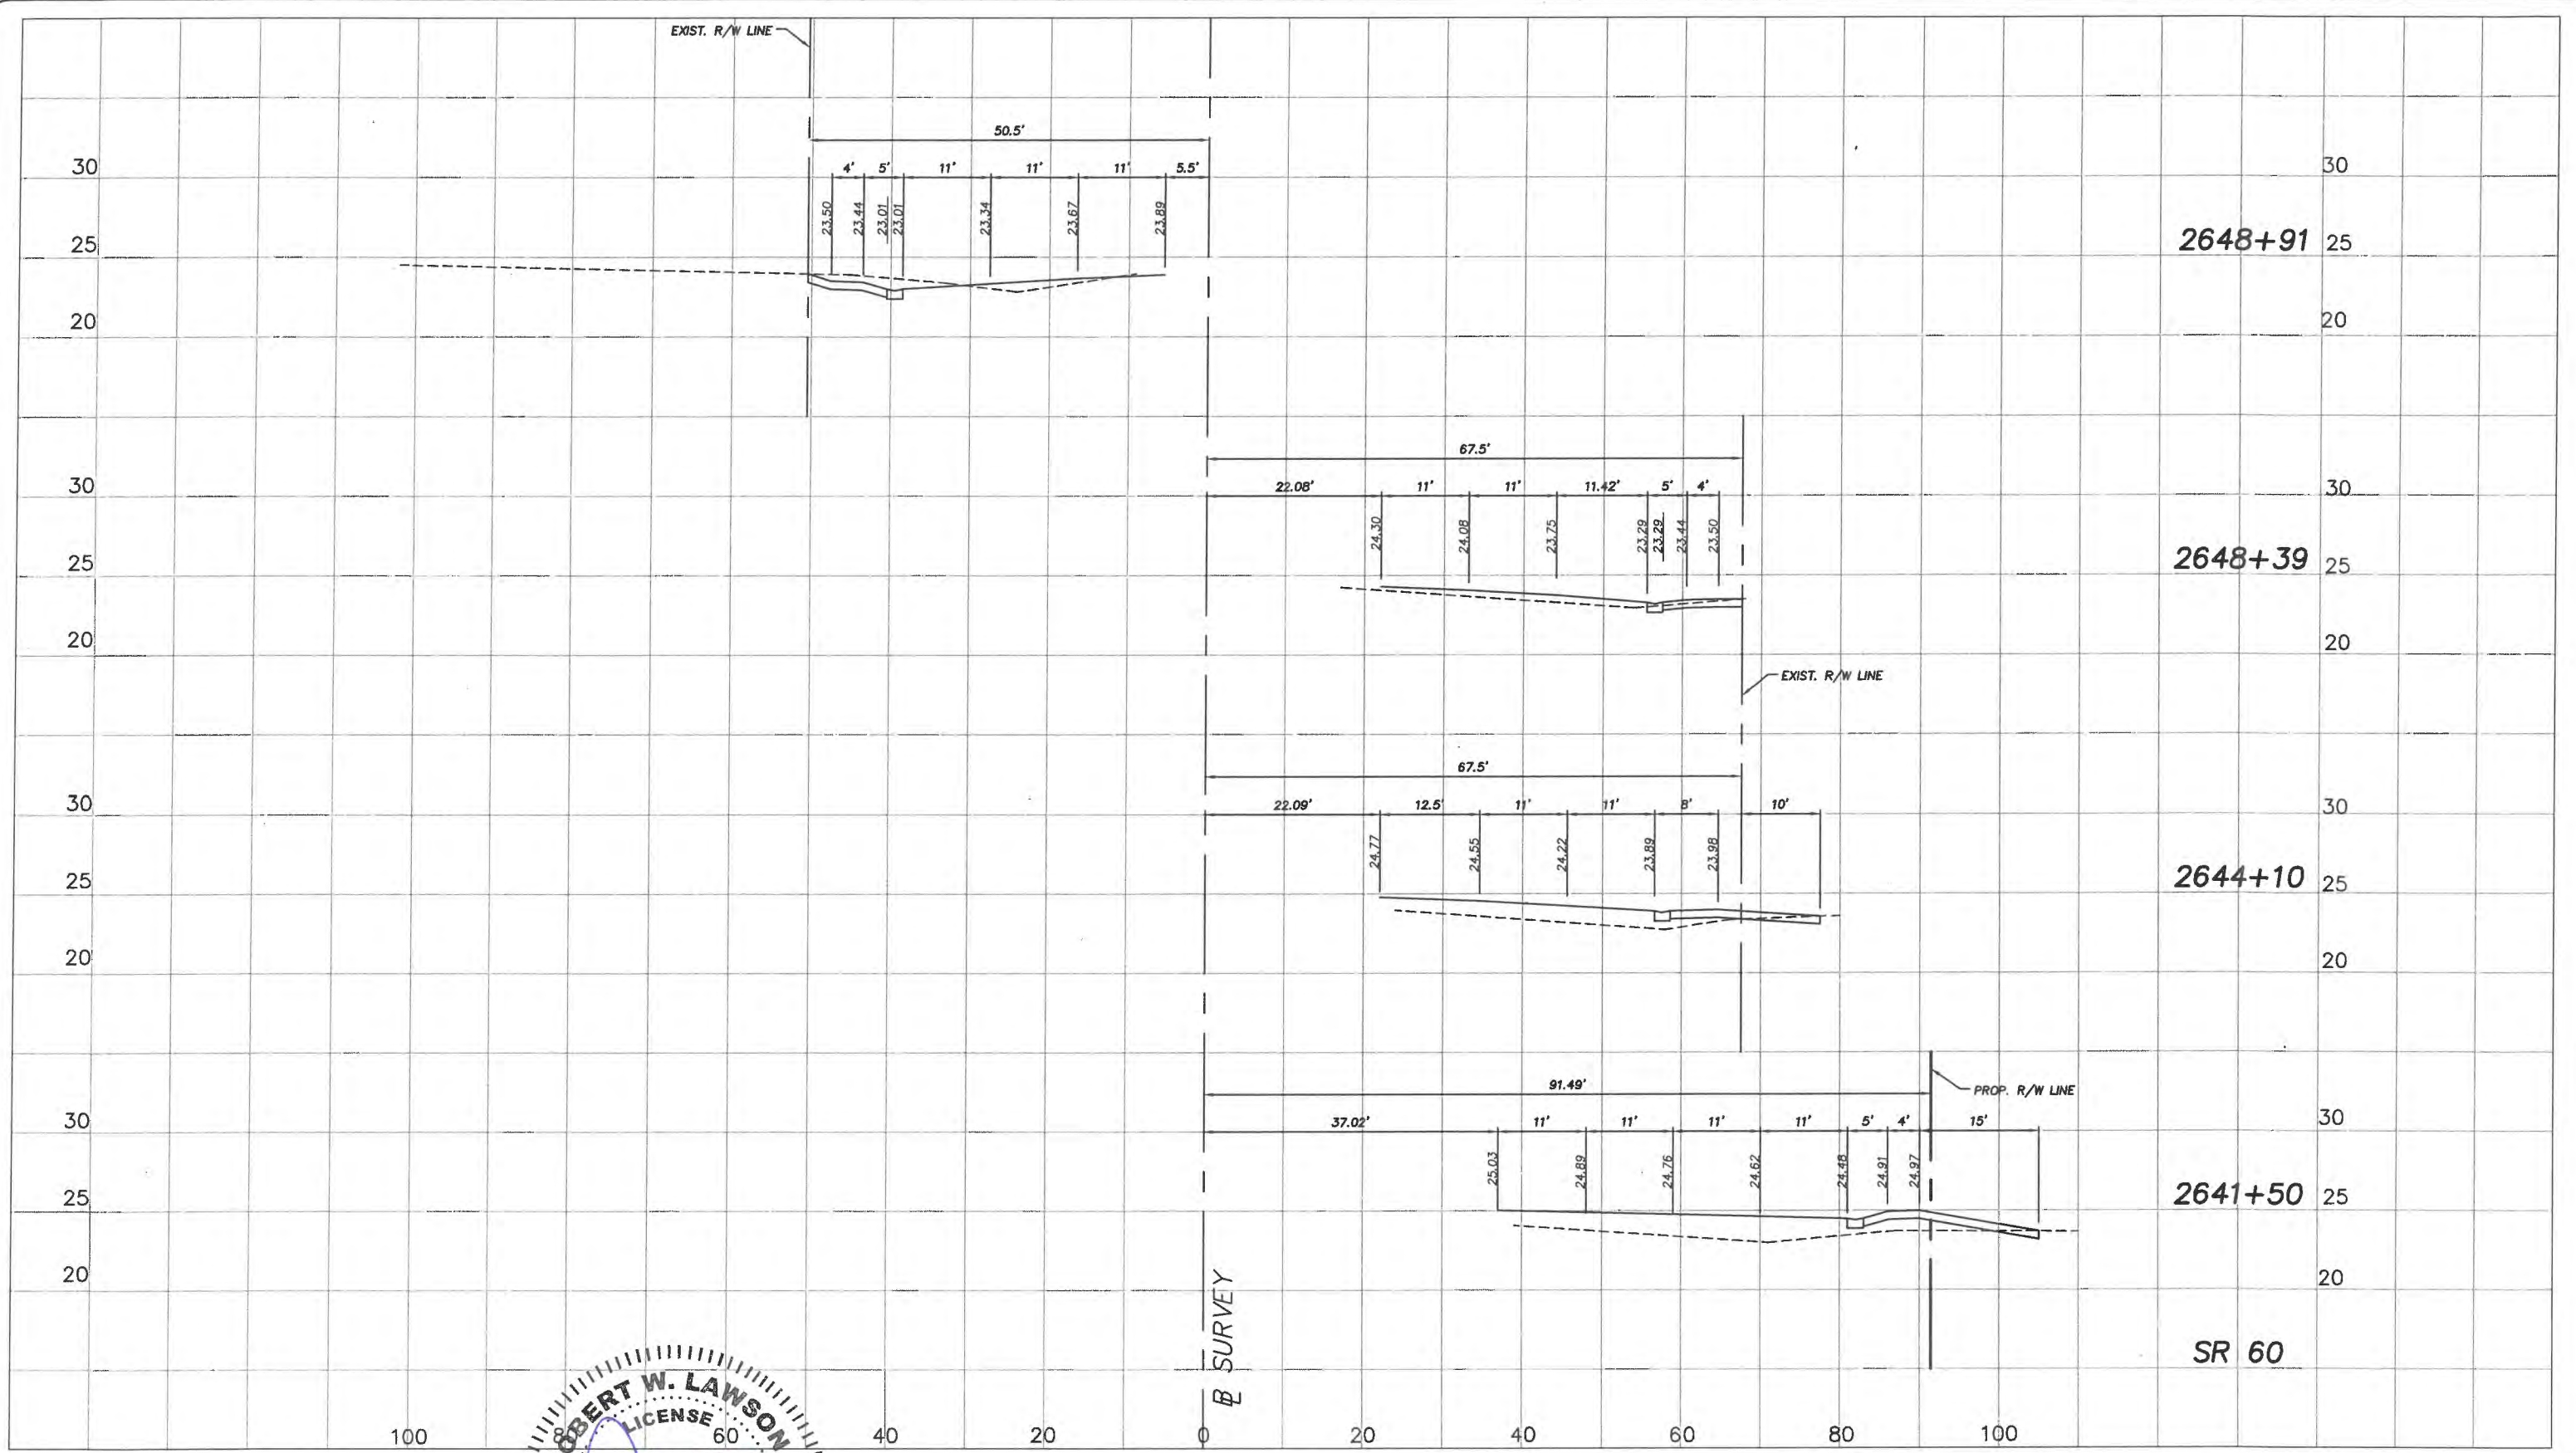




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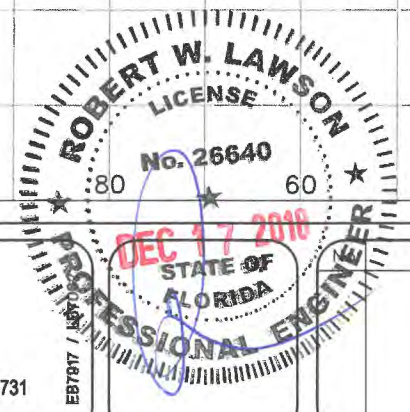
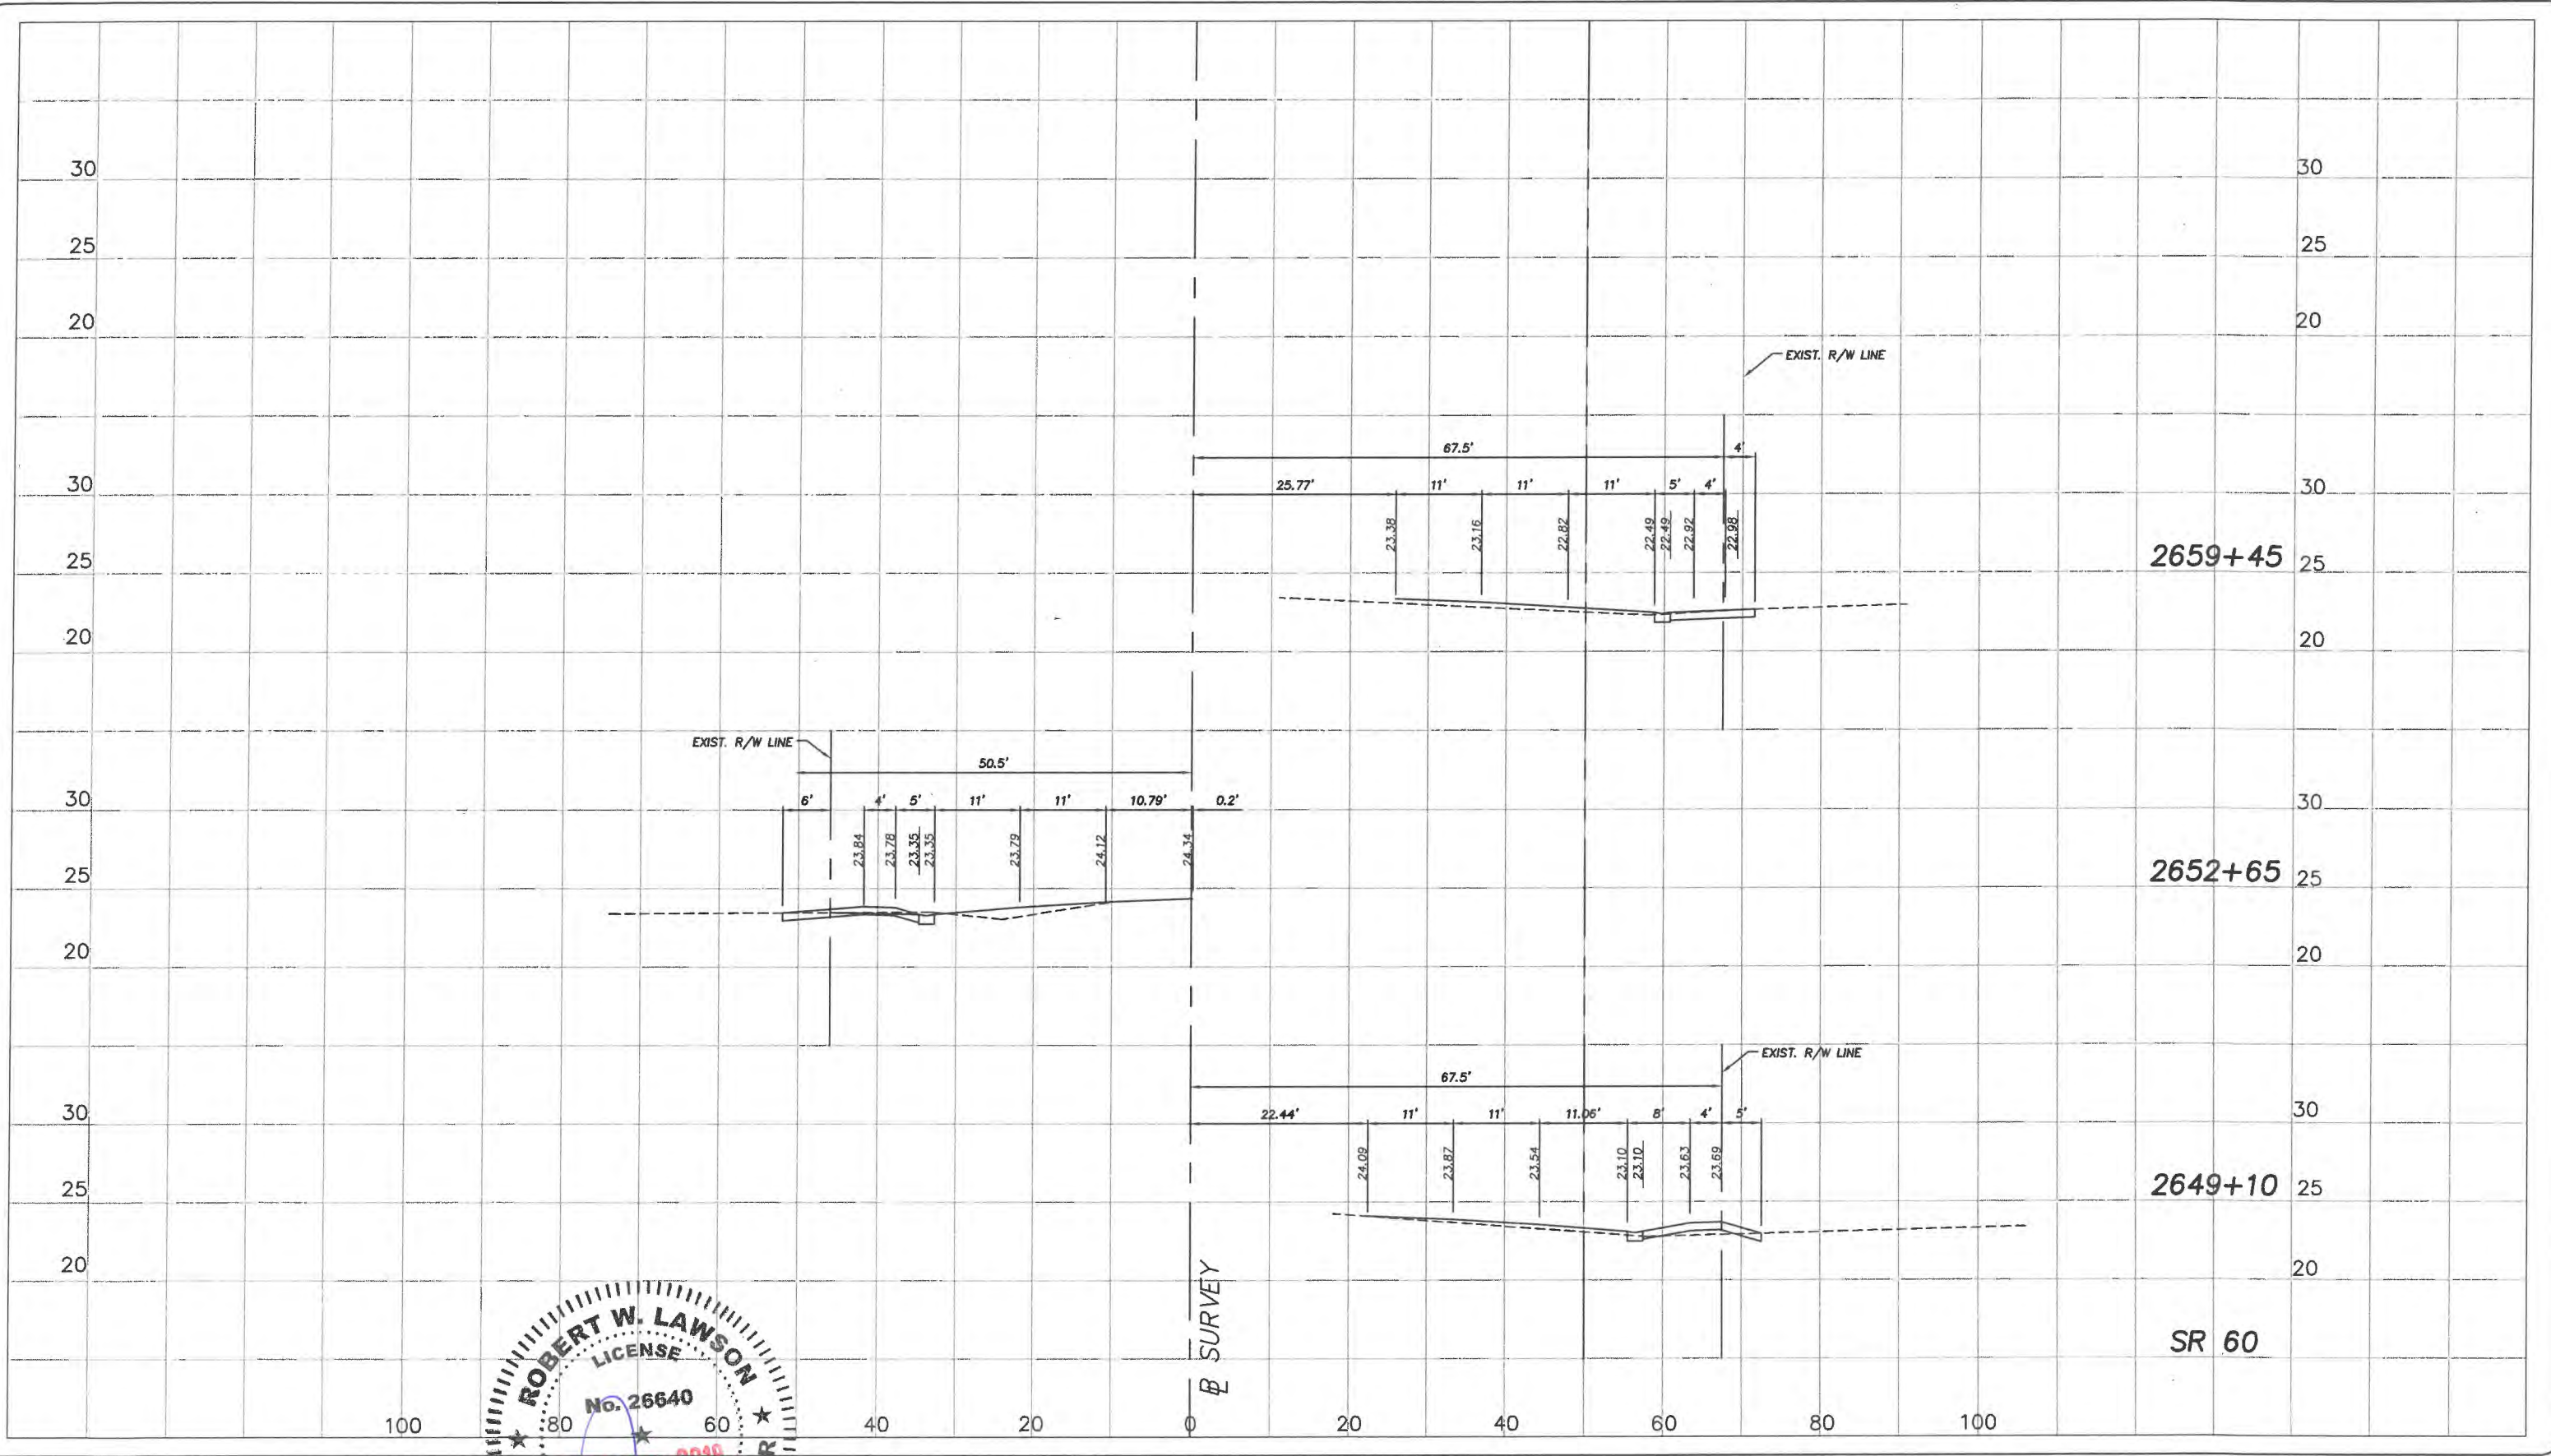
Department of Public Works  
Engineering Division

Scale: 1"=10' VERT.  
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Date: 6/2017  
Field Book No: \_\_\_\_\_

Project:  
DRIVEWAY PROFILES  
FOR  
SR 60 & 43RD AVENUE

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LNW# WP1027





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Scale: 1"=10' VERT.  
1"=20' HORIZ.  
Approved: HWD  
Drawn: FM  
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Date: 6/2017  
Field Book No: \_\_\_\_\_

Project:  
DRIVEWAY PROFILES  
FOR  
SR 60 & 43RD AVENUE

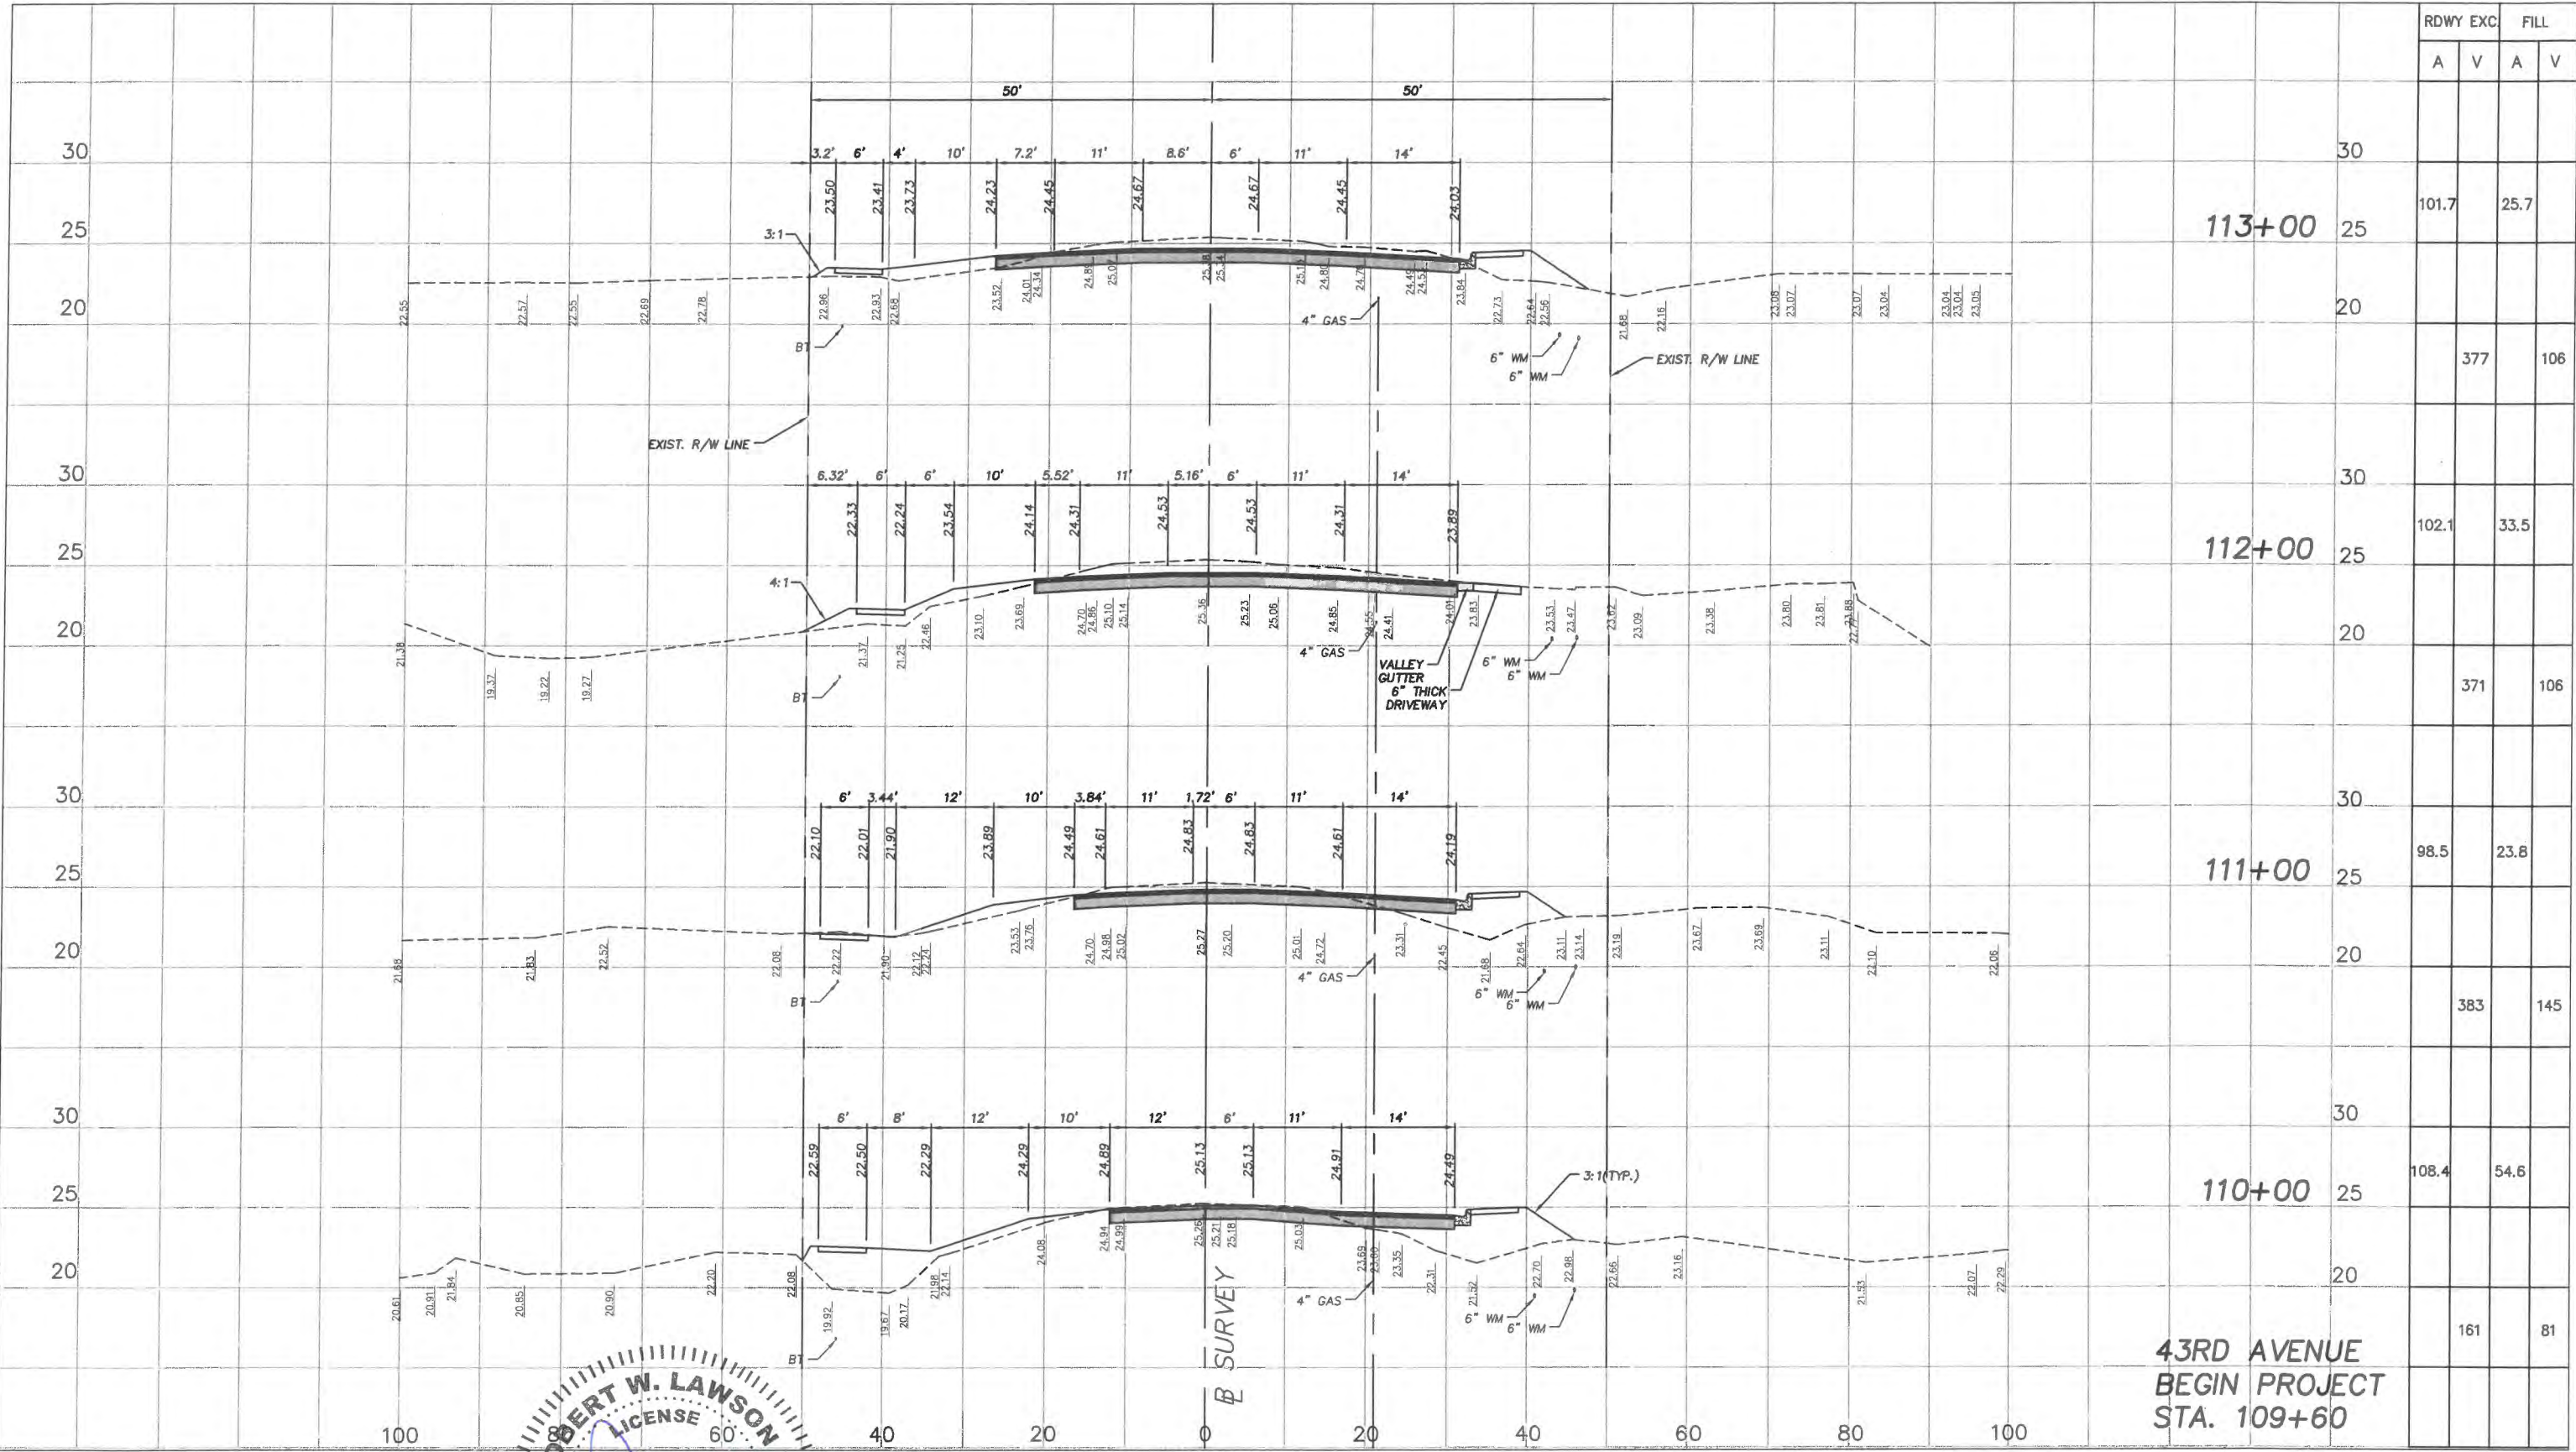
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Project No.  
LNW# WP1027

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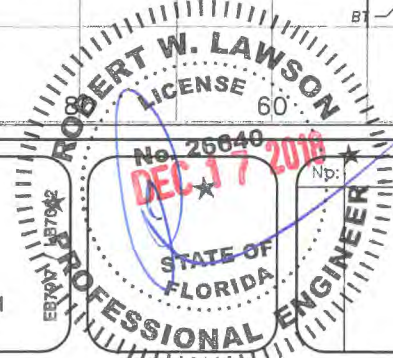
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EB787 / 10/17/16





Station	RDWY EXC		FILL	
	A	V	A	V
113+00				
112+00				
111+00				
110+00				
43RD AVENUE BEGIN PROJECT STA. 109+60	101.7	25.7	102.1	33.5
	377	106	371	106
	98.5	23.8		
	383	145		
	108.4	54.6		
	161	81		



Revision:	By:	Date:



Department of Public Works  
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Scale: 1"=10' VERT.  
1"=20' HORIZ.  
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Checked: HWD  
Date: 6/2017  
Field Book No:

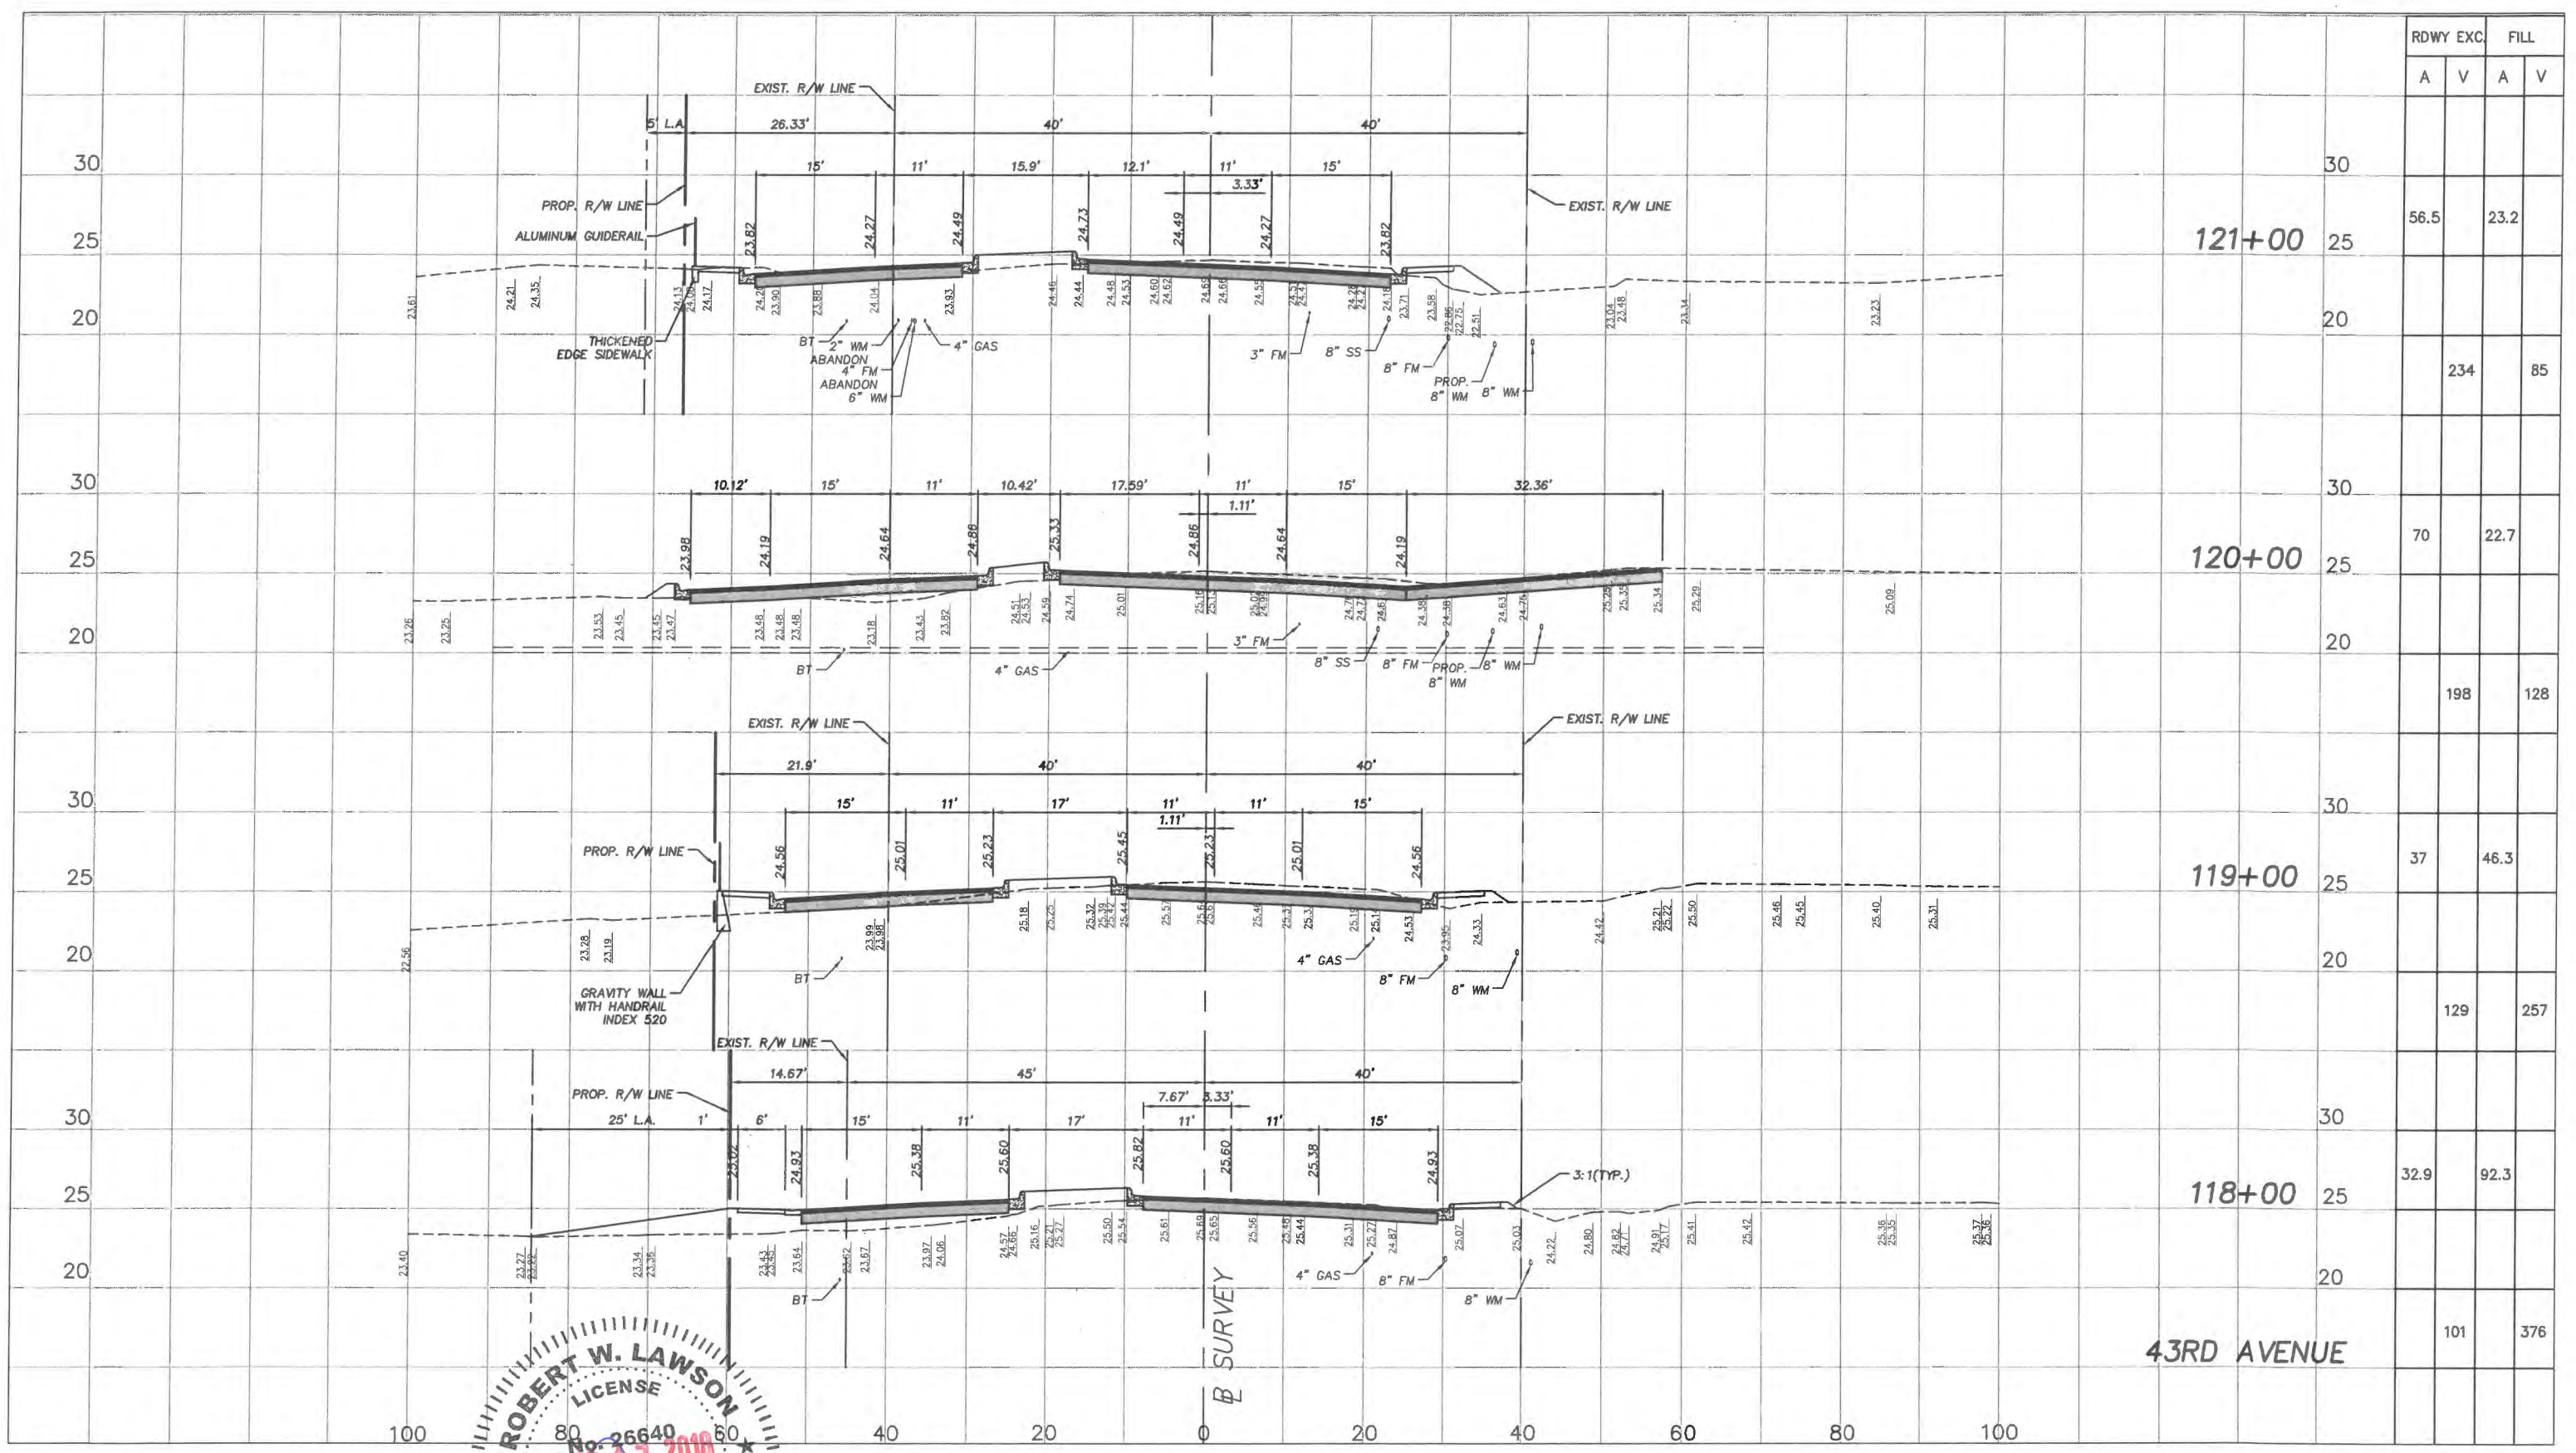
Project:  
CROSS SECTIONS  
FOR  
SR 60 & 43RD AVENUE

Sheet: 67  
Of: 99  
Project No.  
LNW WP1027

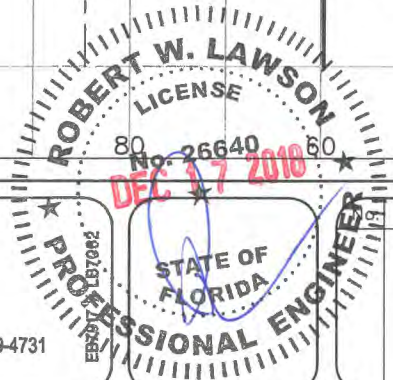








Station	Elevation	RDWY EXC.		FILL	
		A	V	A	V
121+00	25	56.5		23.2	
120+00	25	70		22.7	
119+00	25	37		46.3	
118+00	25	32.9		92.3	
43RD AVENUE		101		376	



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Department of Public Works  
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Scale: 1"=10' VERT.  
 1"=20' HORIZ.  
 Approved: HWD  
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 Field Book No:

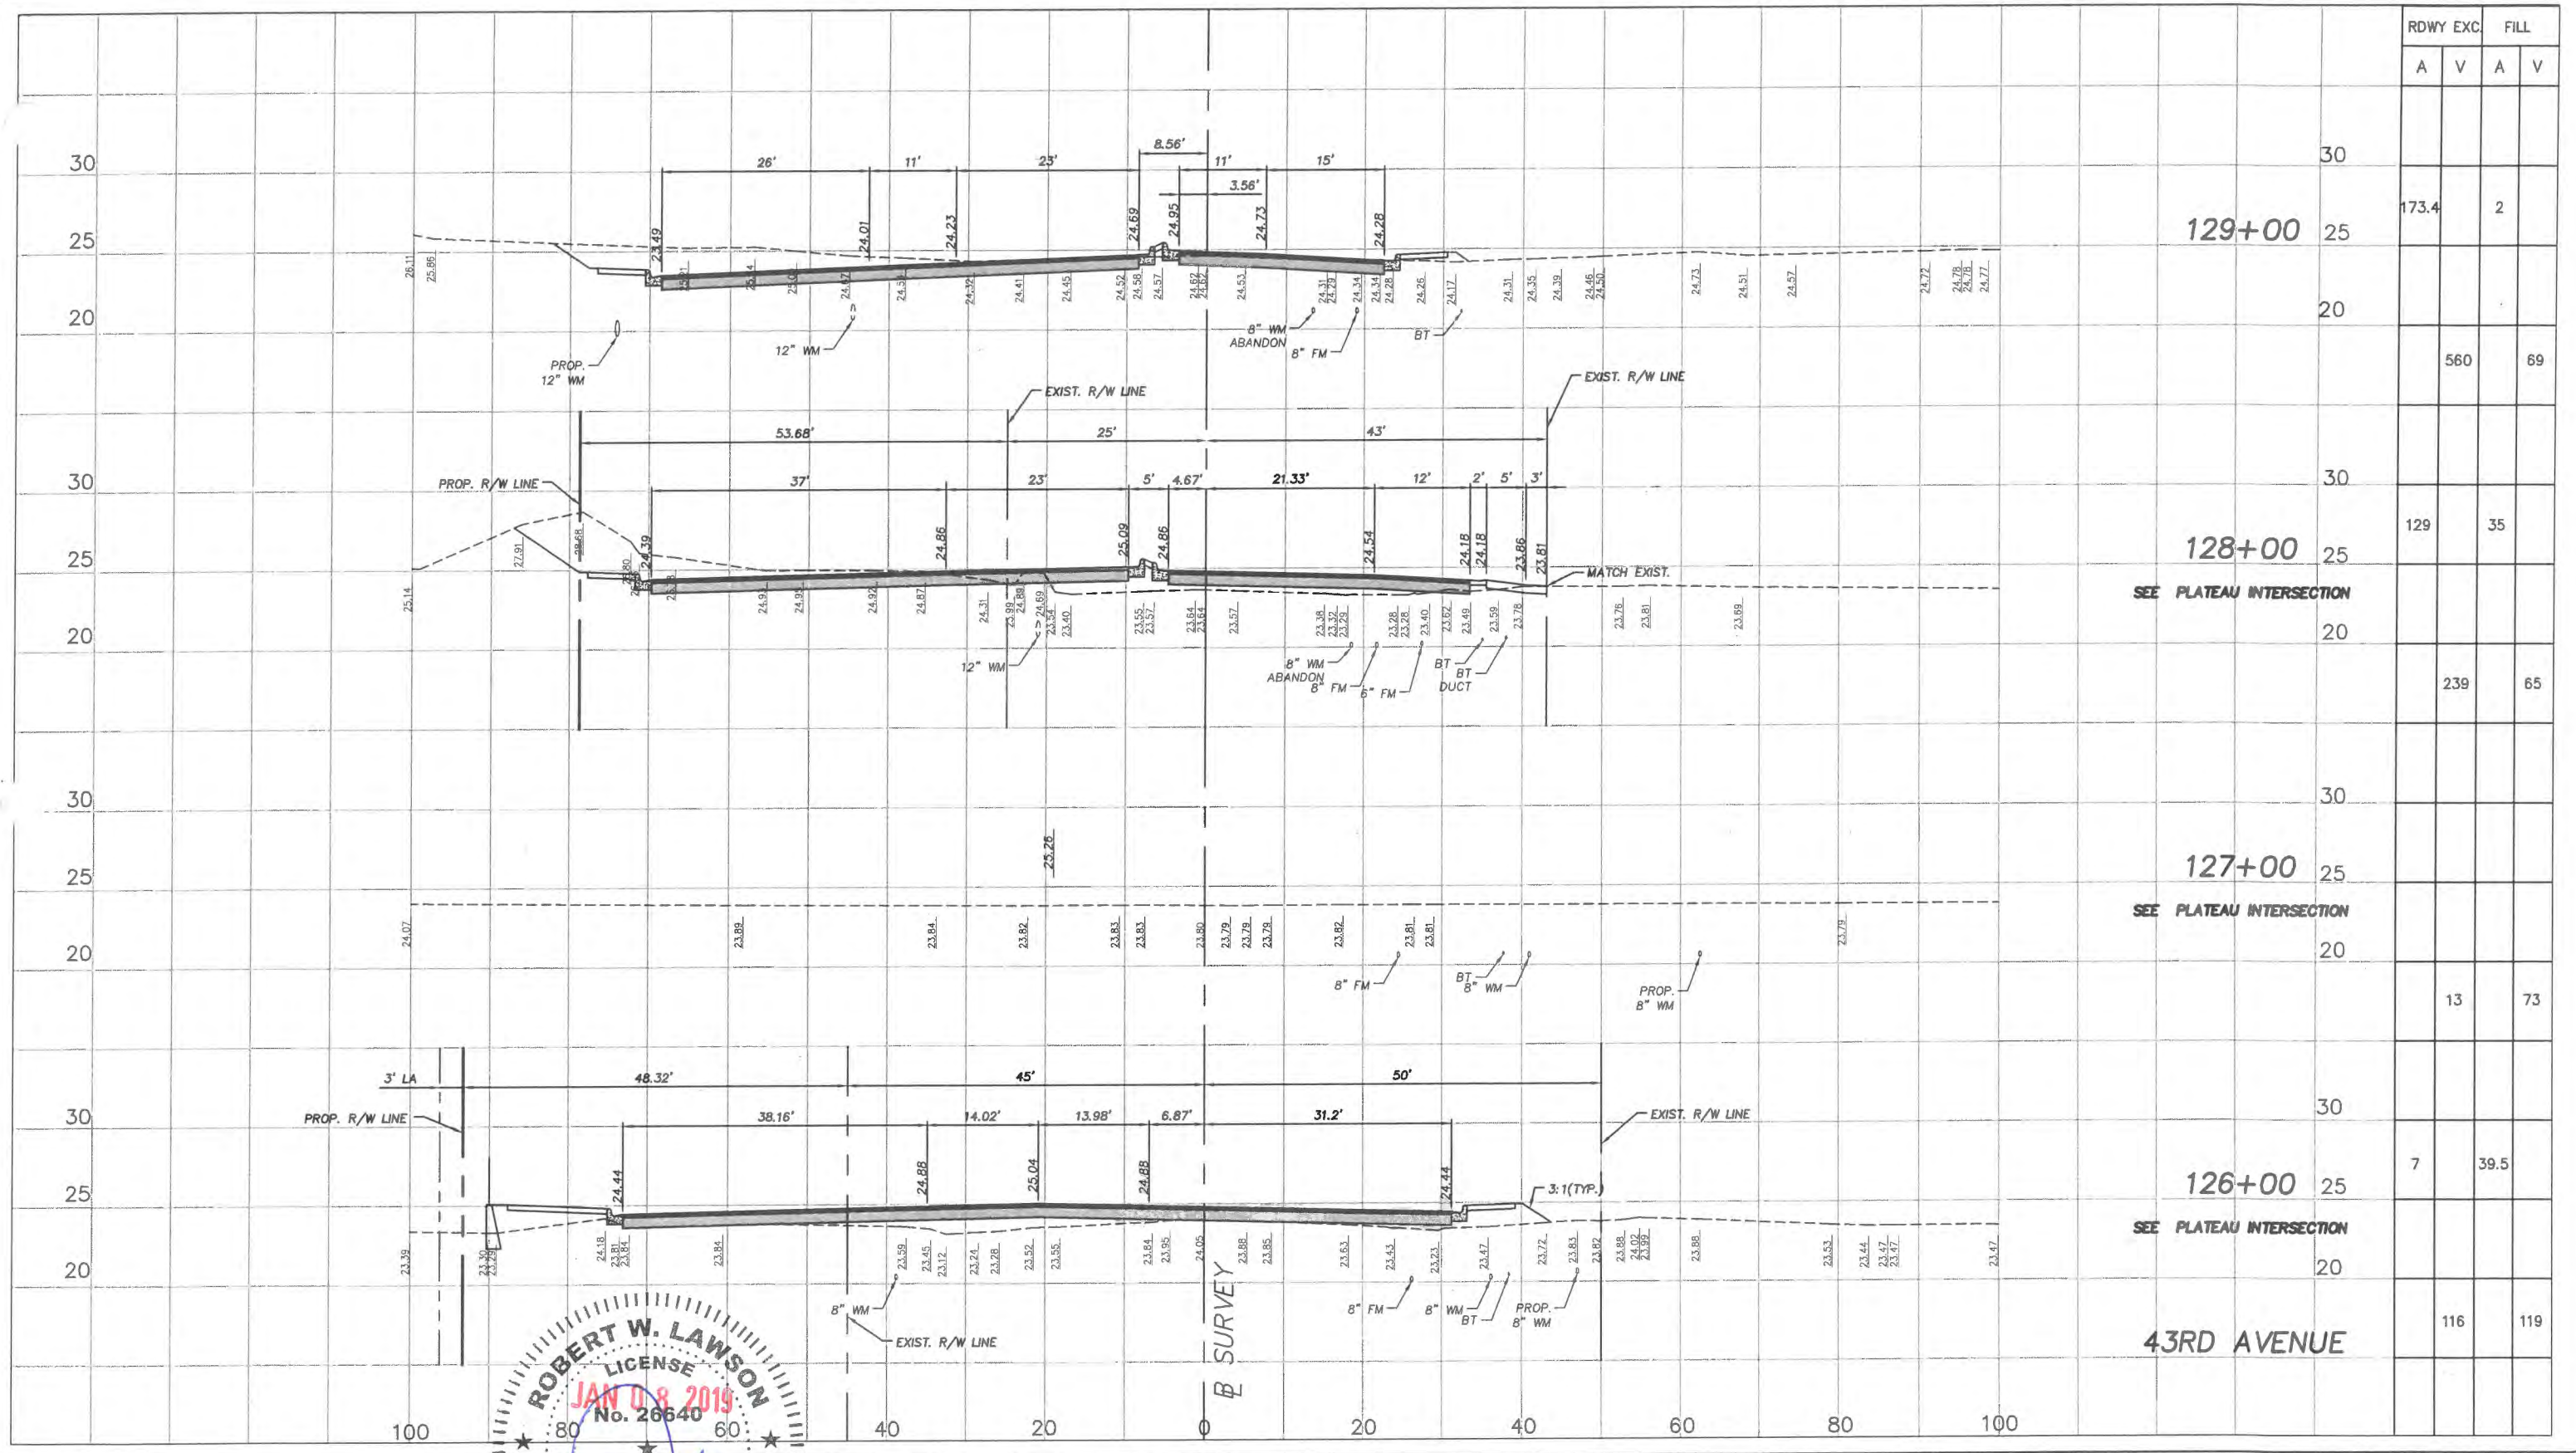
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 CROSS SECTIONS  
 FOR  
 SR 60 & 43RD AVENUE

Sheet: 69  
 Of: 99  
 Project No.  
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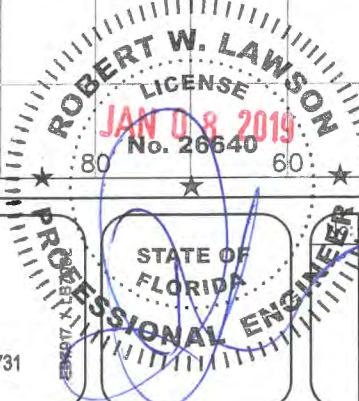








RDWY	EXC	FILL	
		A	V
129+00	173.4		2
128+00	129		35
127+00	239		65
126+00	7		39.5
43RD AVENUE	116		119



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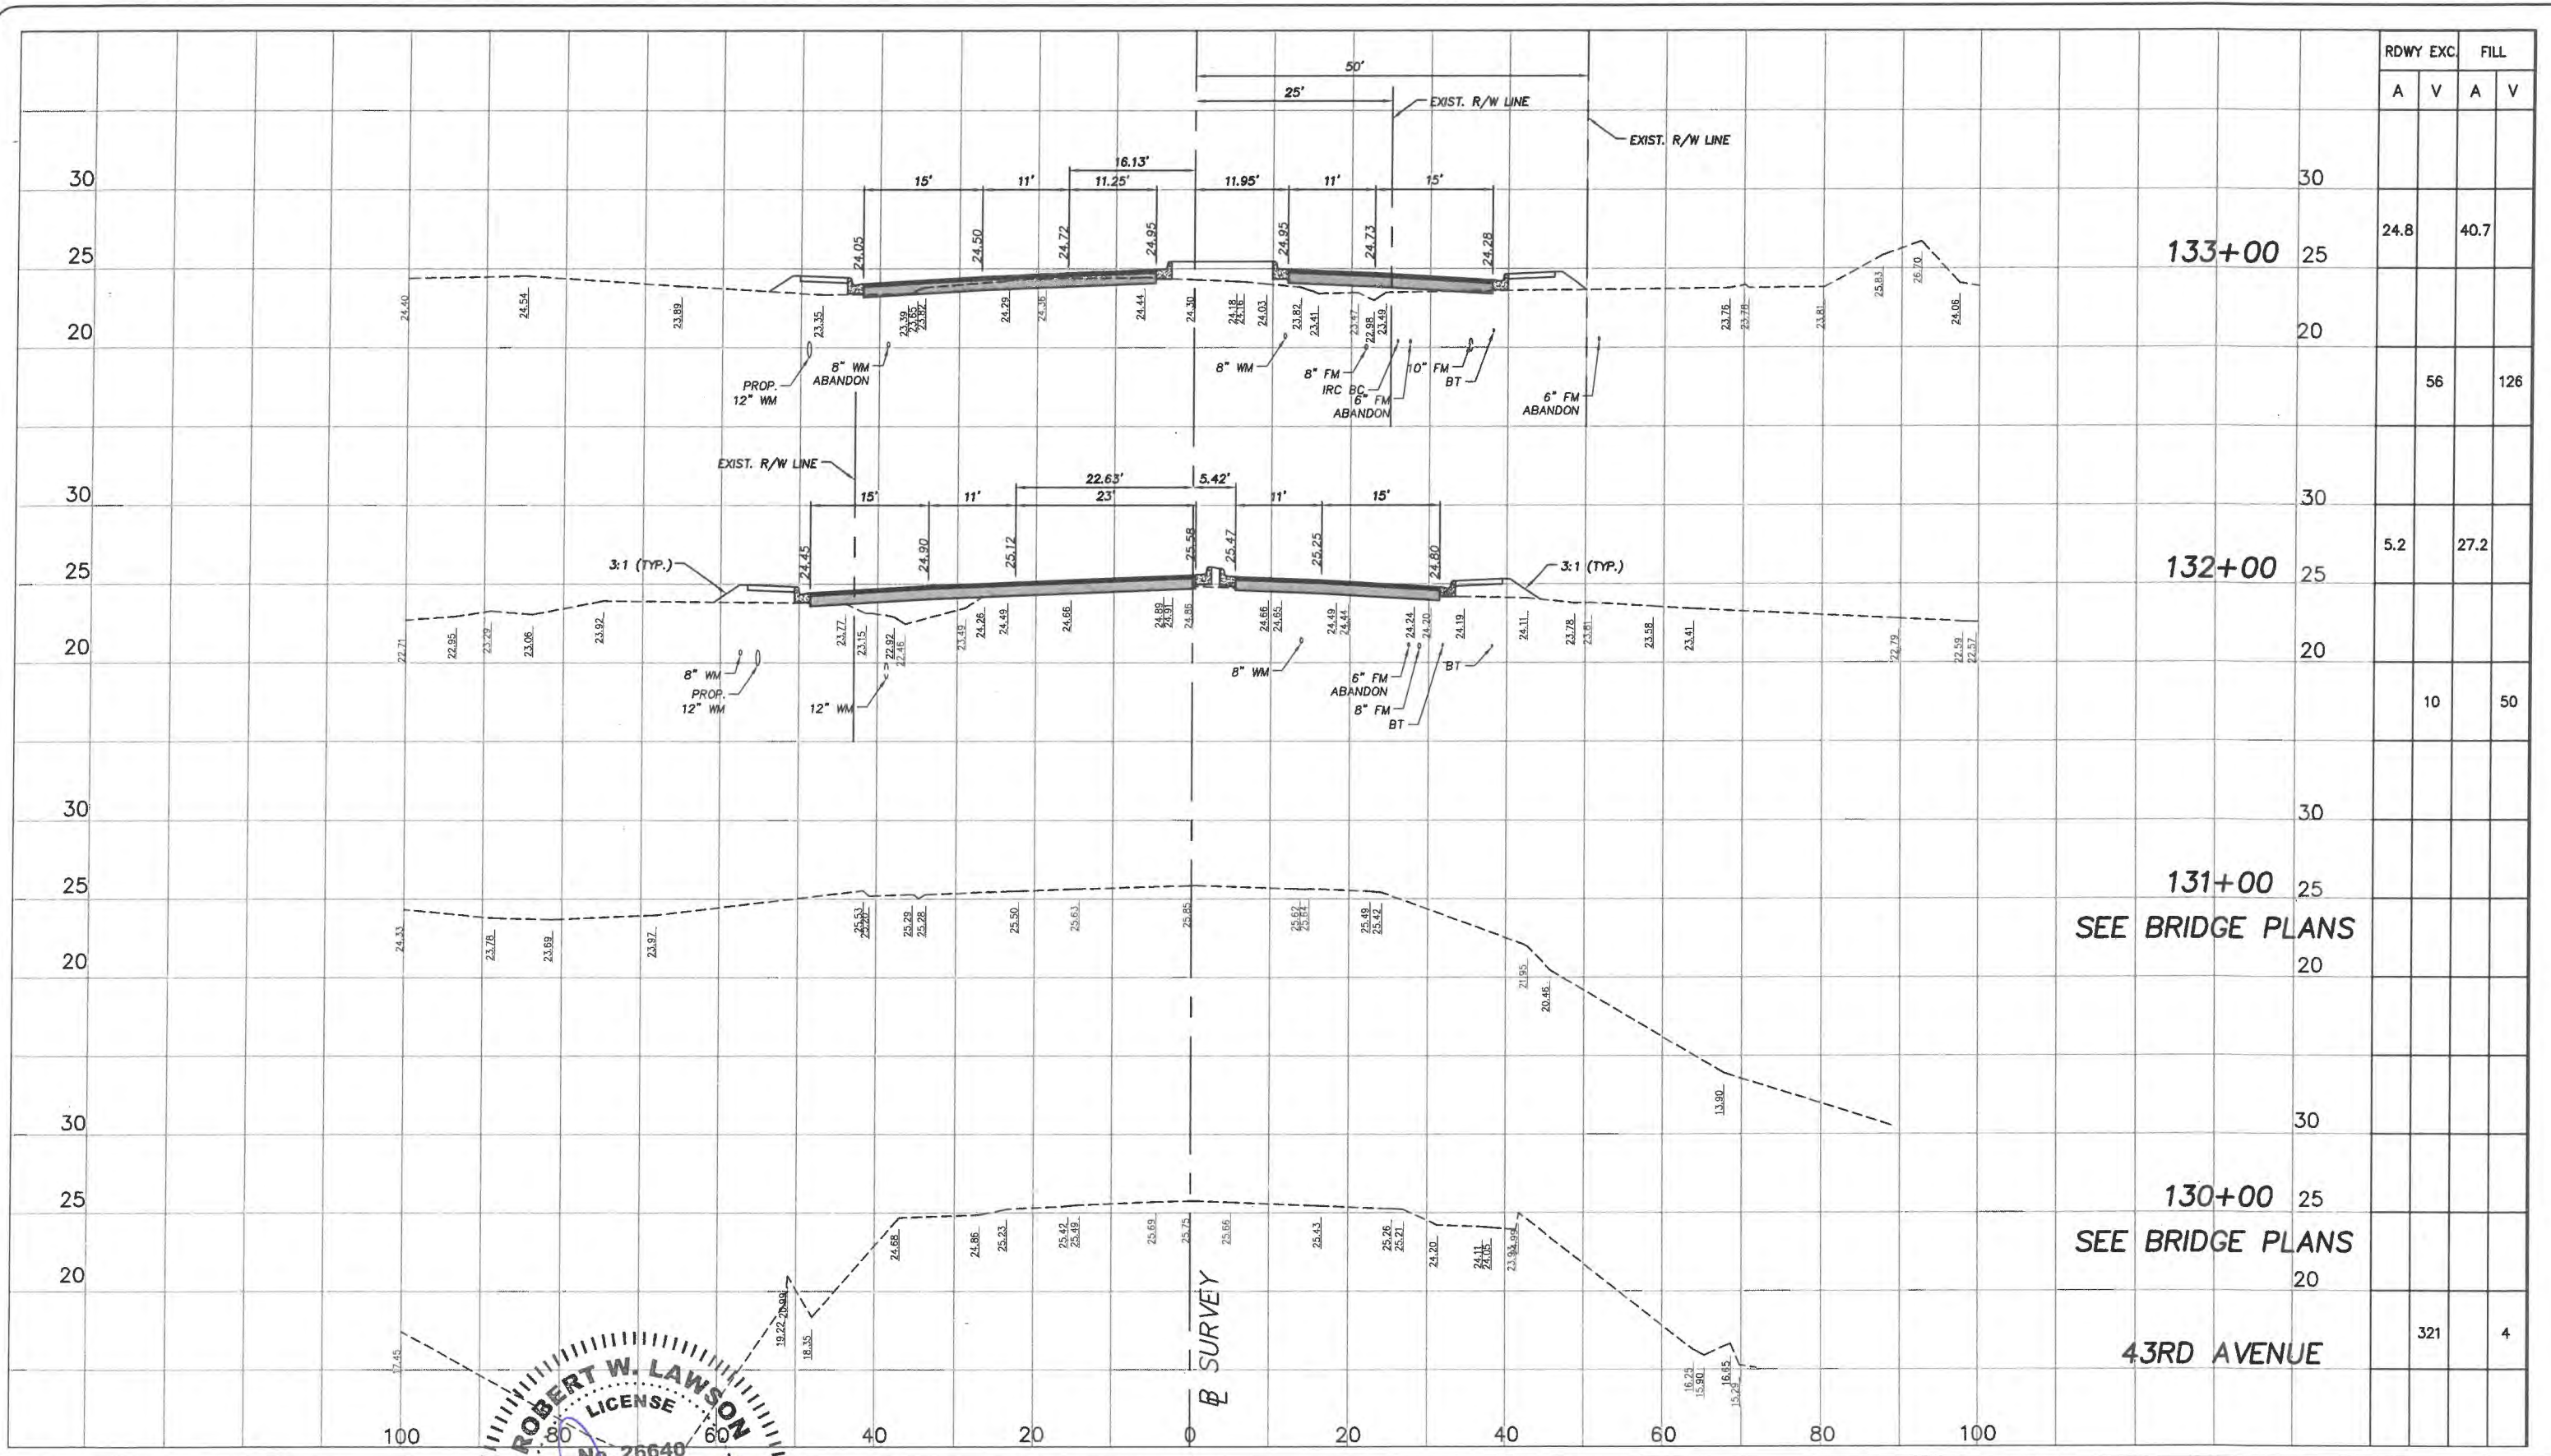
**FLORIDA RIVER COUNTY**  
 Department of Public Works  
 Engineering Division

Scale: 1"=10' VERT.  
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 Drawn: FM  
 Checked: HWD  
 Date: 6/2017  
 Field Book No: \_\_\_\_\_

Project:  
 CROSS SECTIONS  
 FOR  
 SR 60 & 43RD AVENUE

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Station	RDWY EXC.		FILL	
	A	V	A	V
133+00		24.8	40.7	
132+00		5.2	27.2	
131+00				
130+00				
43RD AVENUE		321	4	

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 DEC 17 2018

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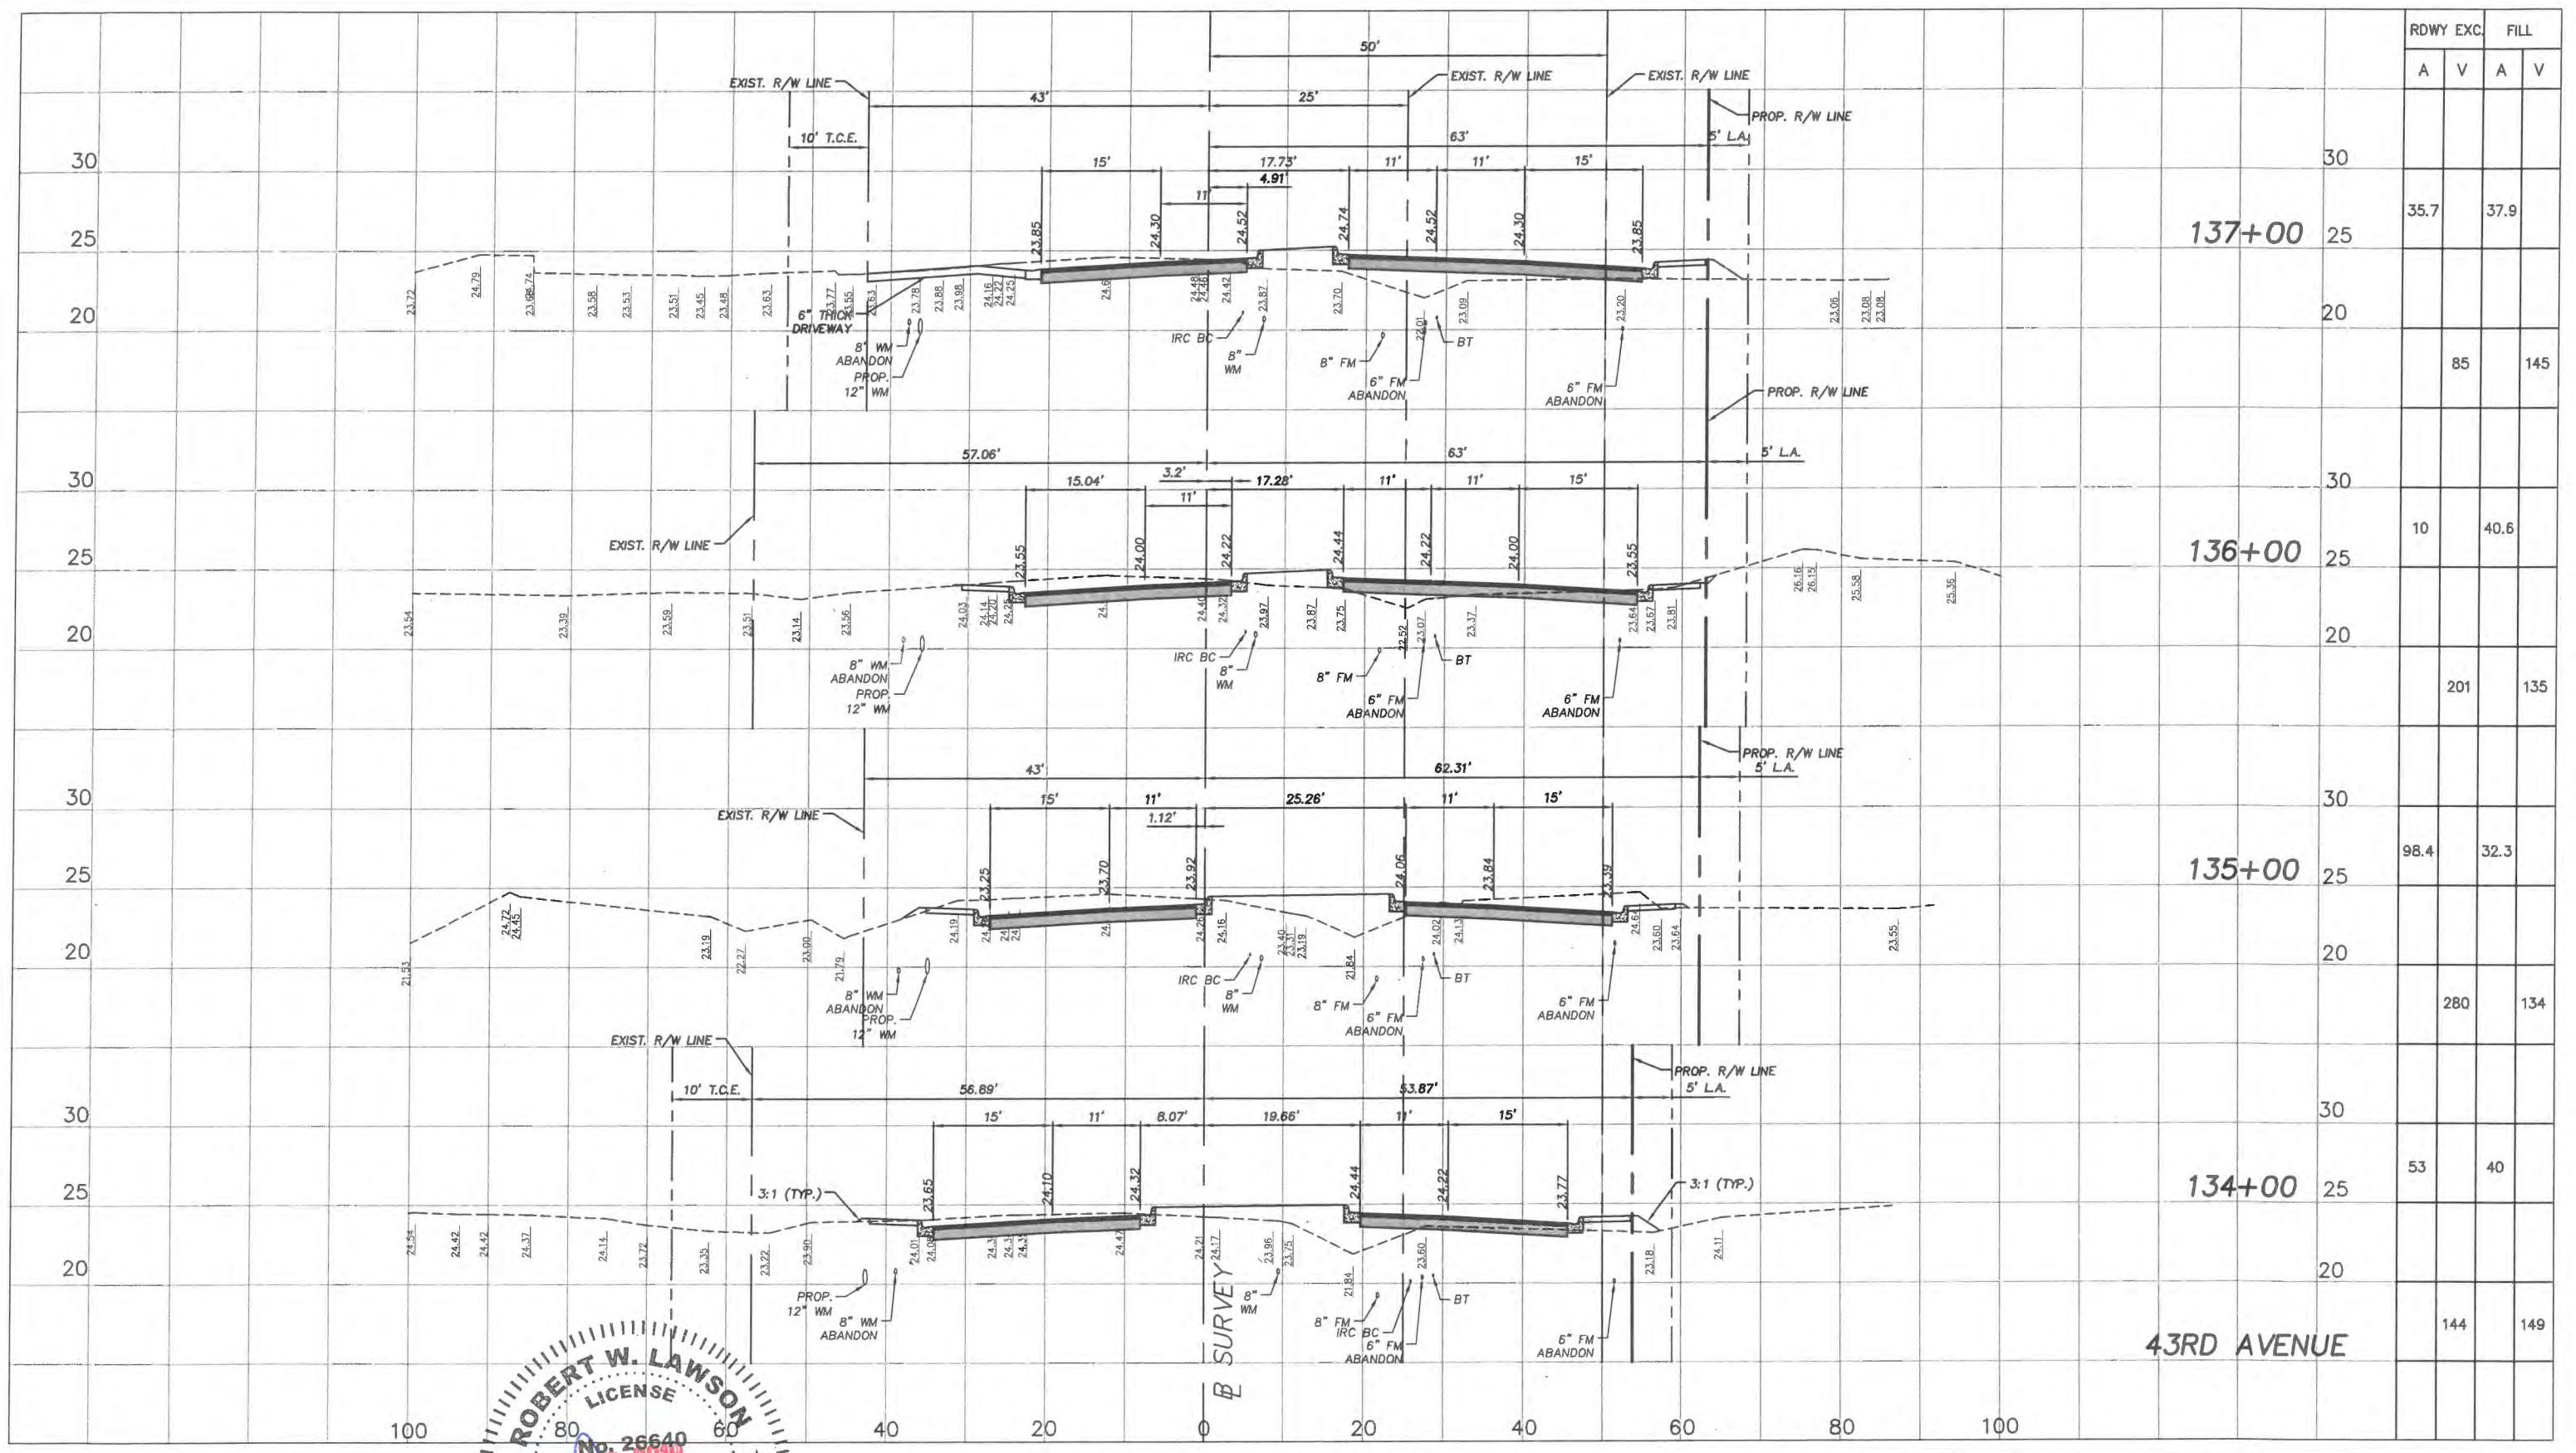
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Scale: 1"=10' VERT.  
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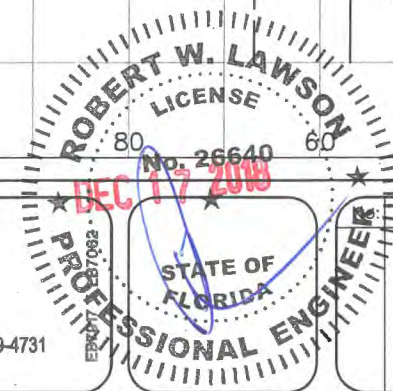
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 CROSS SECTIONS  
 FOR  
 SR 60 & 43RD AVENUE

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 Project No.  
 LNW# WP1027

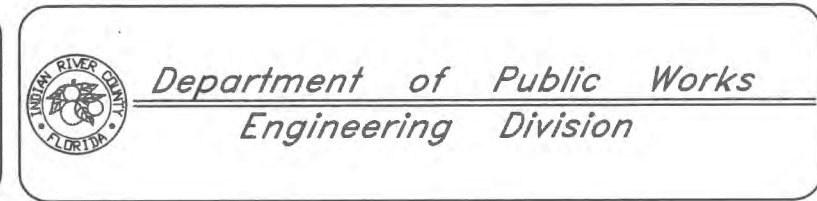




	RDWY EXC.	FILL				
			A	V	A	V
137+00	35.7	37.9				
136+00	10	40.6				
135+00	98.4	32.3				
134+00	53	40				
43RD AVENUE	144	149				



Revision: \_\_\_\_\_ By: \_\_\_\_\_ Date: \_\_\_\_\_



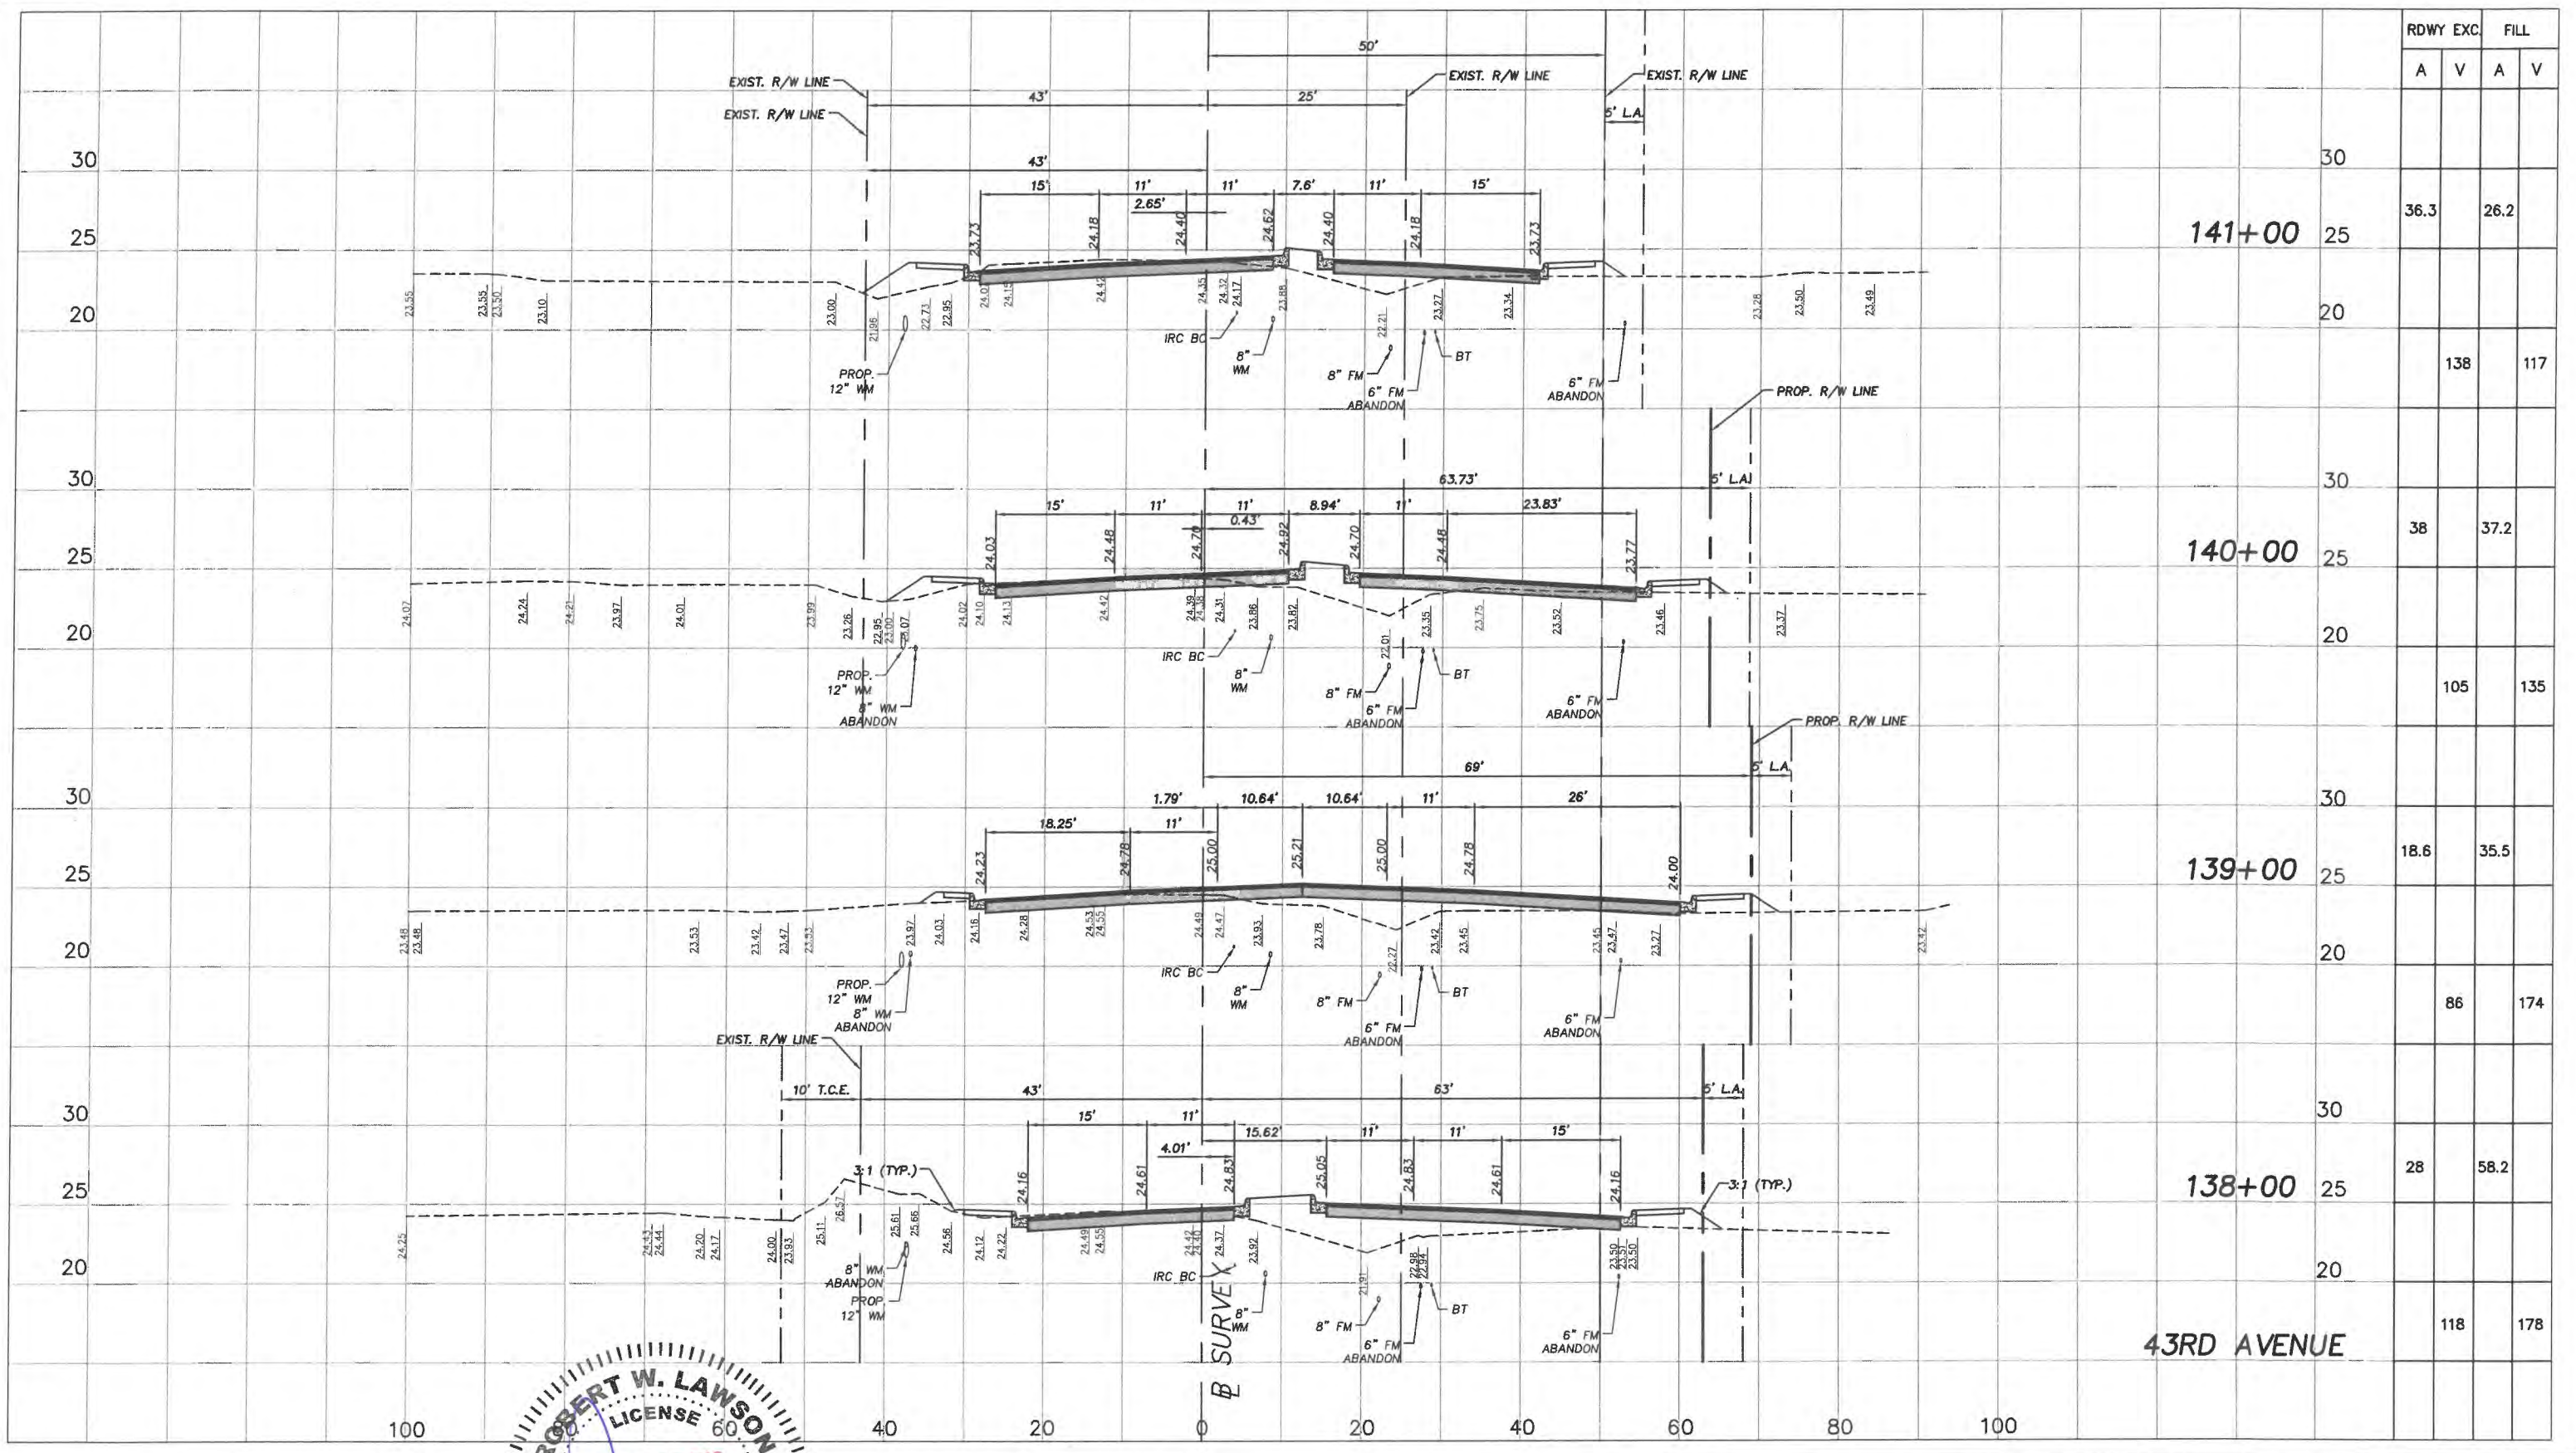
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 Checked: HWD  
 Date: 6/2017  
 Field Book No: \_\_\_\_\_

Project: CROSS SECTIONS FOR SR 60 & 43RD AVENUE

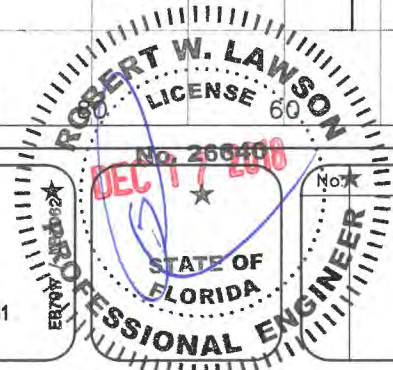
Sheet: 73  
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RDWY	EXC.		FILL	
	A	V	A	V
141+00	36.3		26.2	
140+00	38		37.2	
139+00	18.6		35.5	
138+00	28		58.2	
43RD AVENUE	118		178	



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 Engineering Division

Scale: 1"=10' VERT.  
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 Approved: HWD  
 Drawn: FM  
 Checked: HWD  
 Date: 6/2017  
 Field Book No:

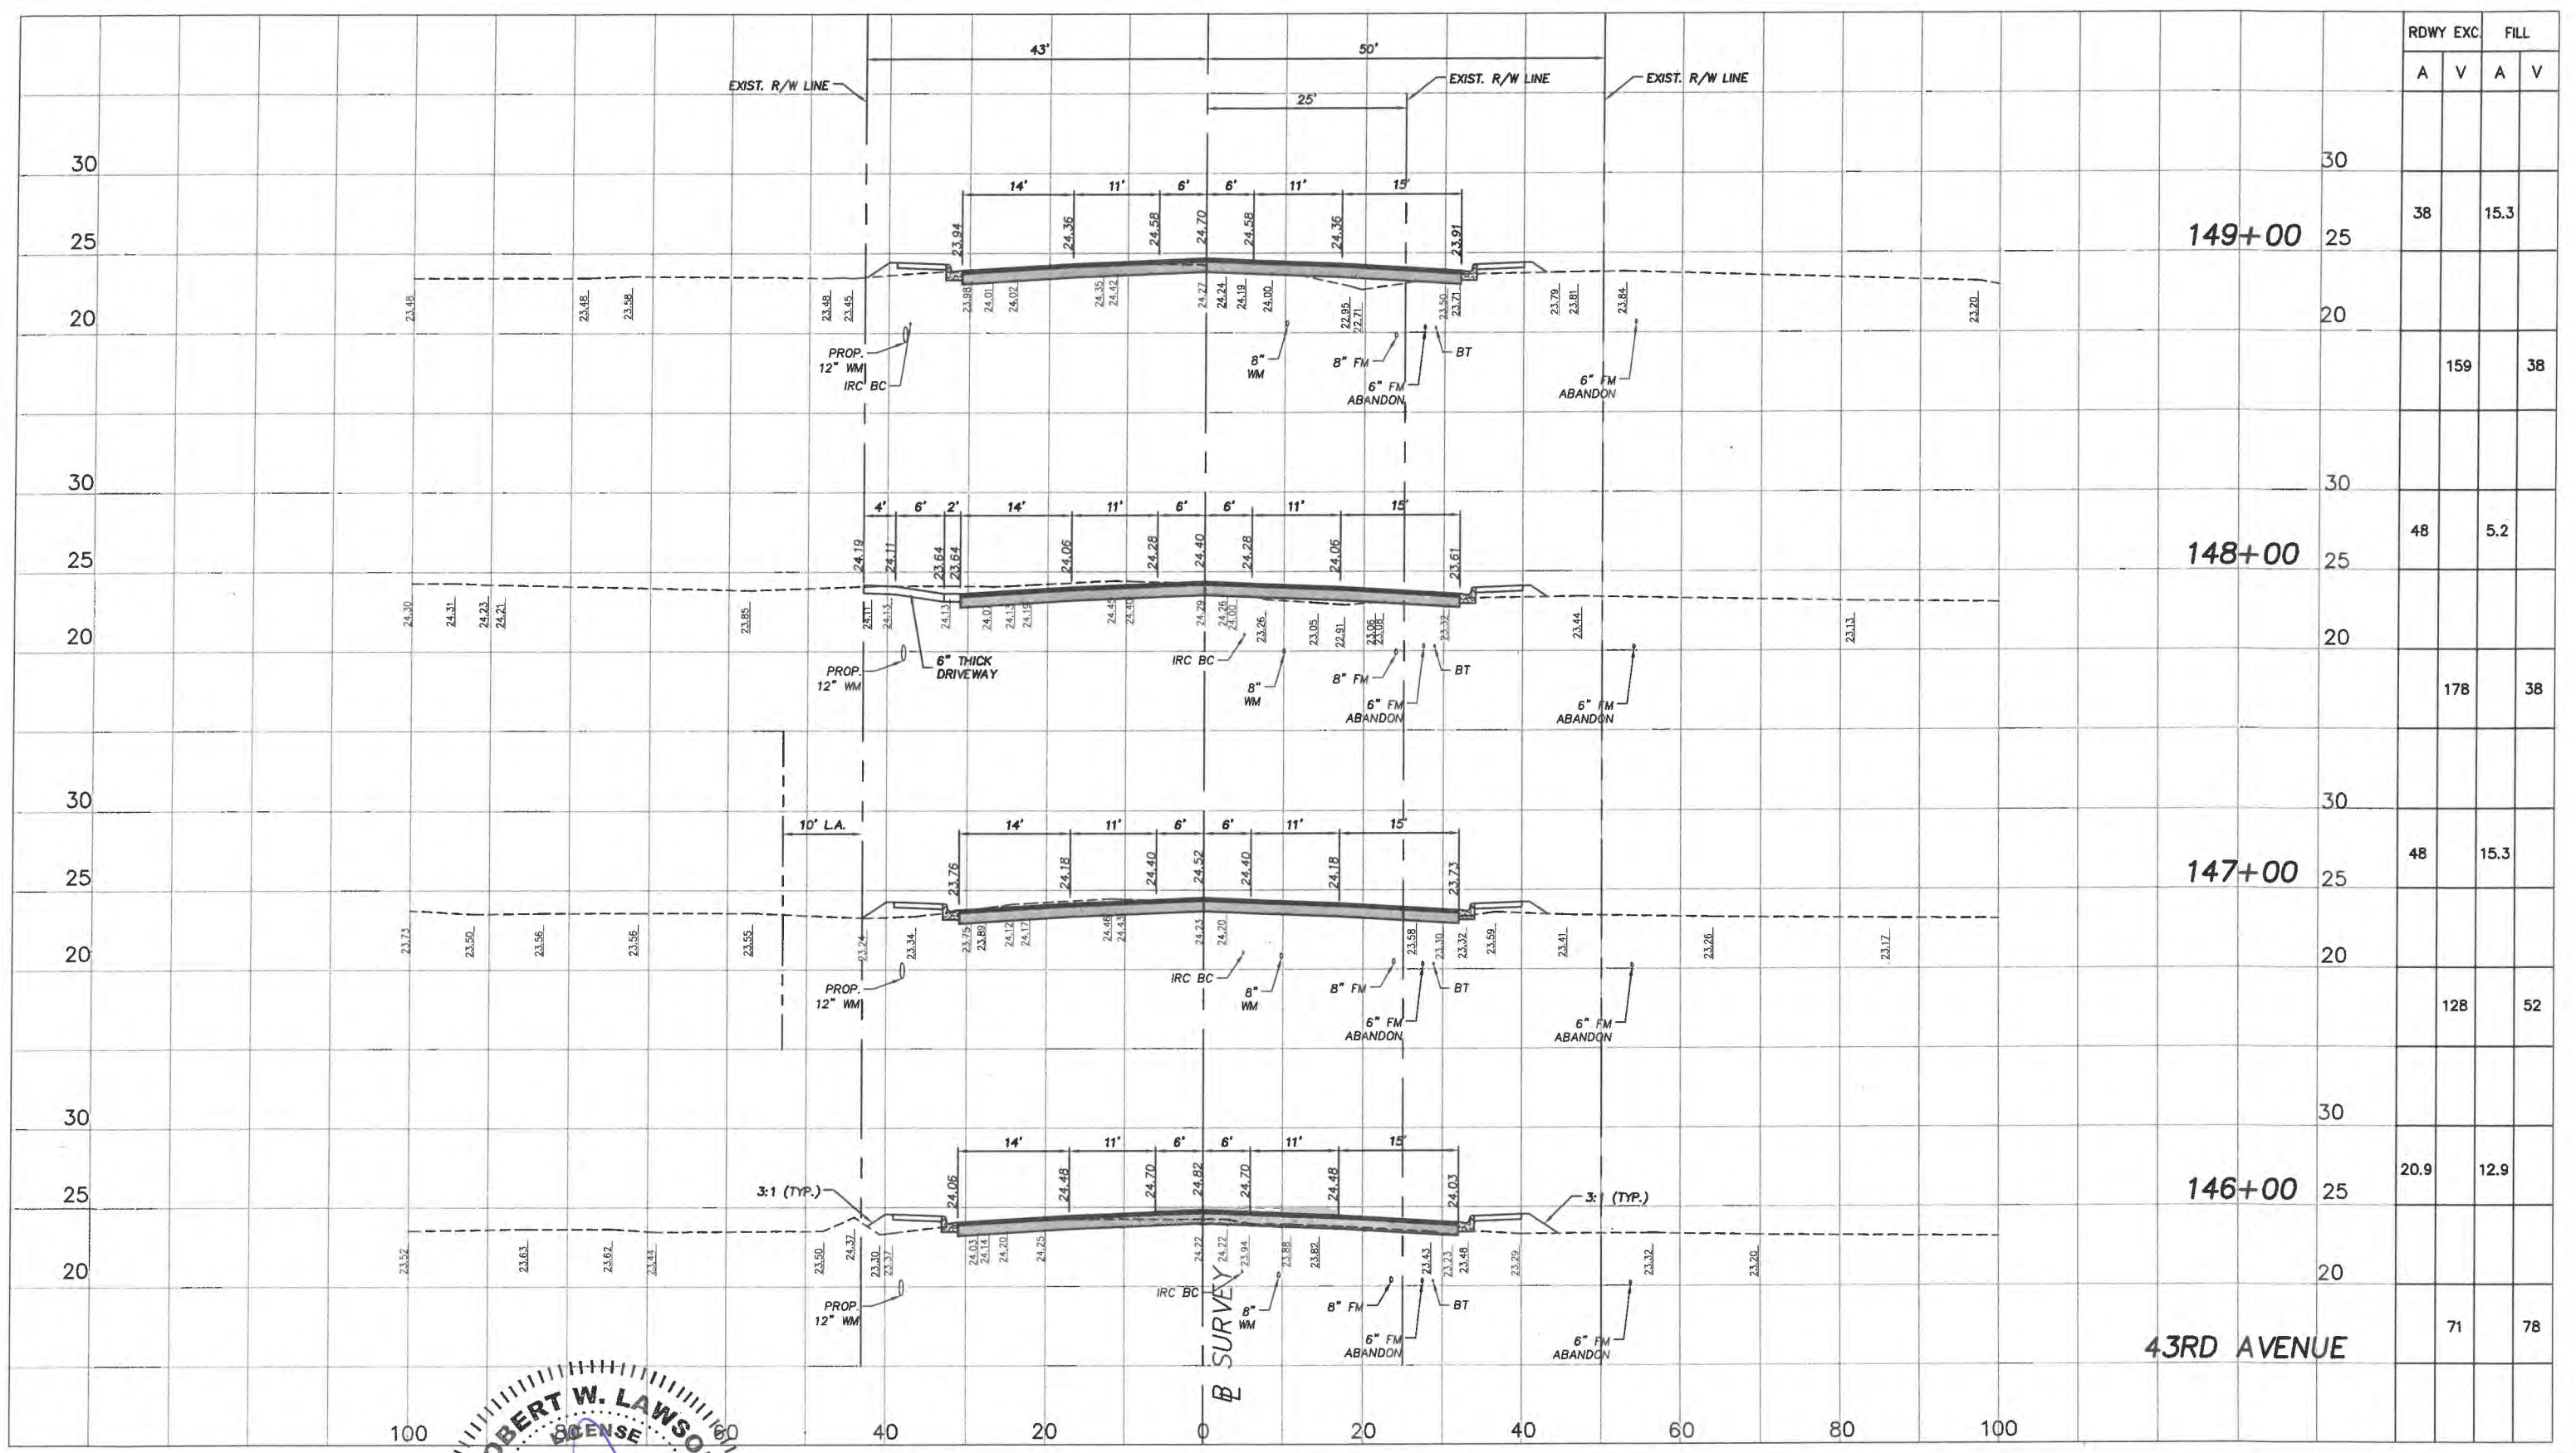
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 CROSS SECTIONS  
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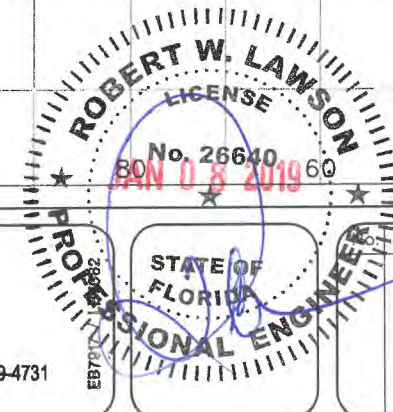
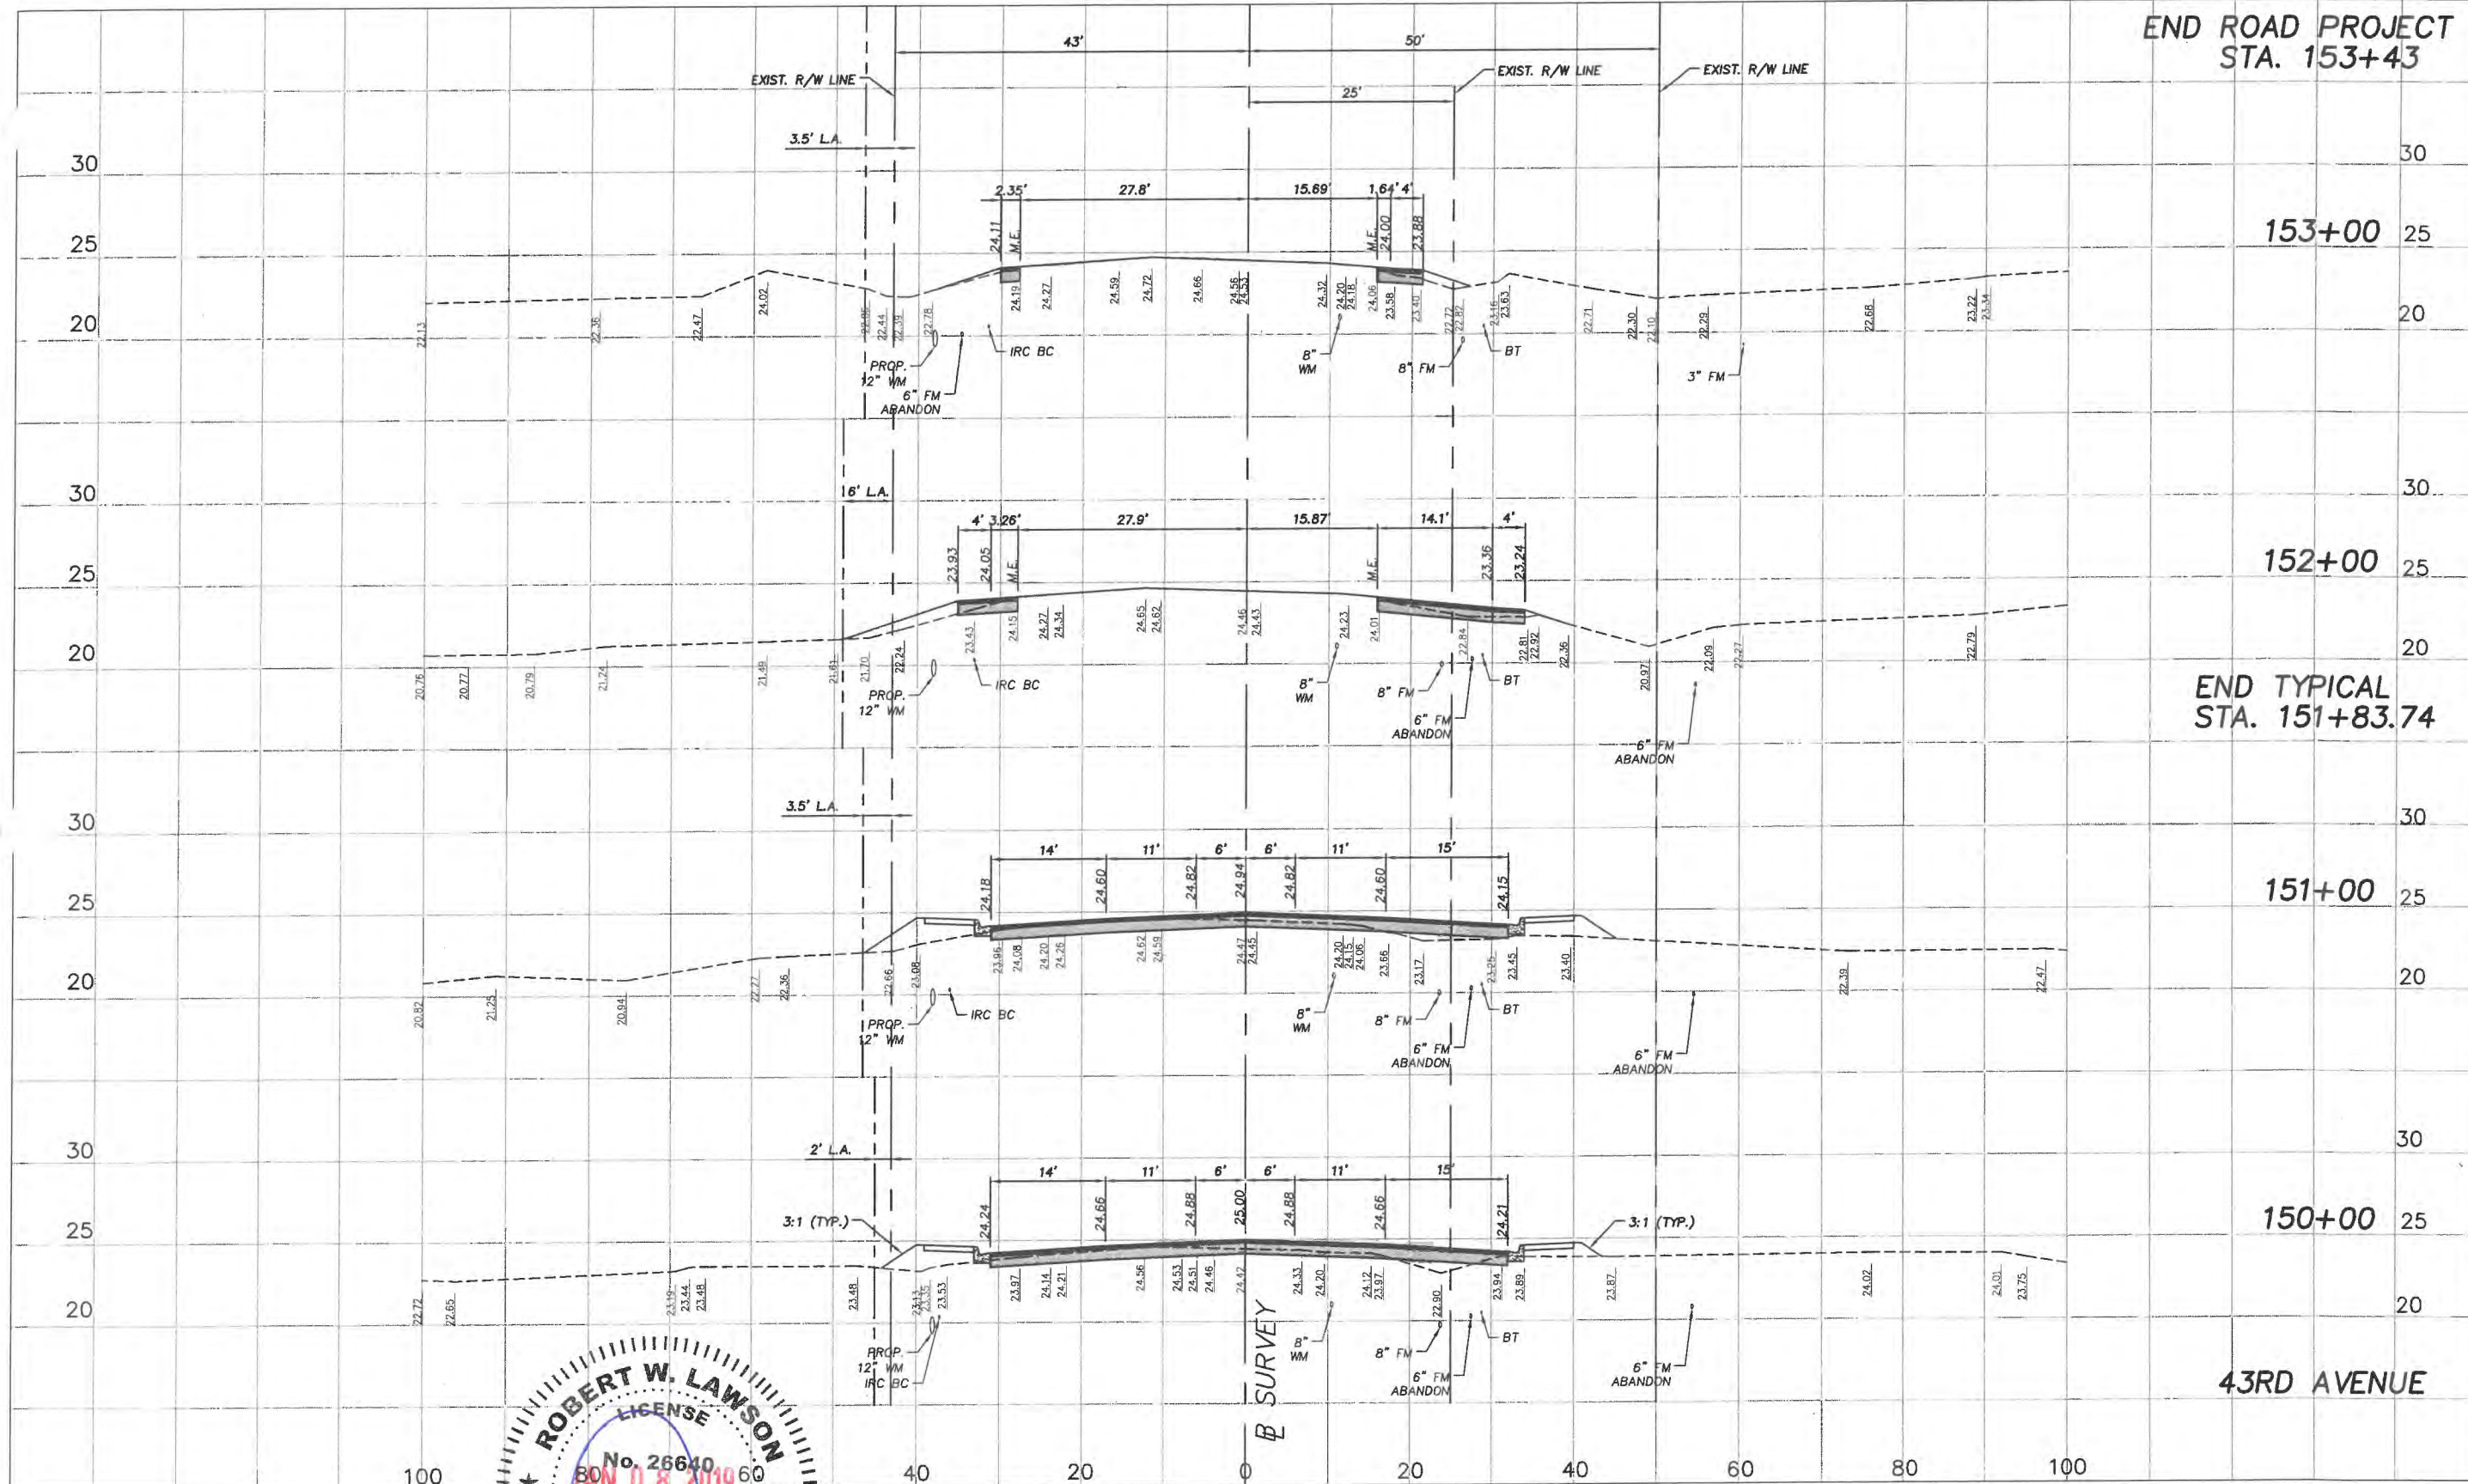
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149+00		38		15.3
148+00		48		5.2
147+00		48		15.3
146+00		20.9		12.9
43RD AVENUE		71		78

No:	Revision:	By:	Date:



END ROAD PROJECT  
STA. 153+43

RDWY EXC.		FILL	
A	V	A	V
	8		6
9.5		7	
	47		54
15.8		22.3	
	109		90
43.1		26.4	
	146		81
36		17.5	
	137		61



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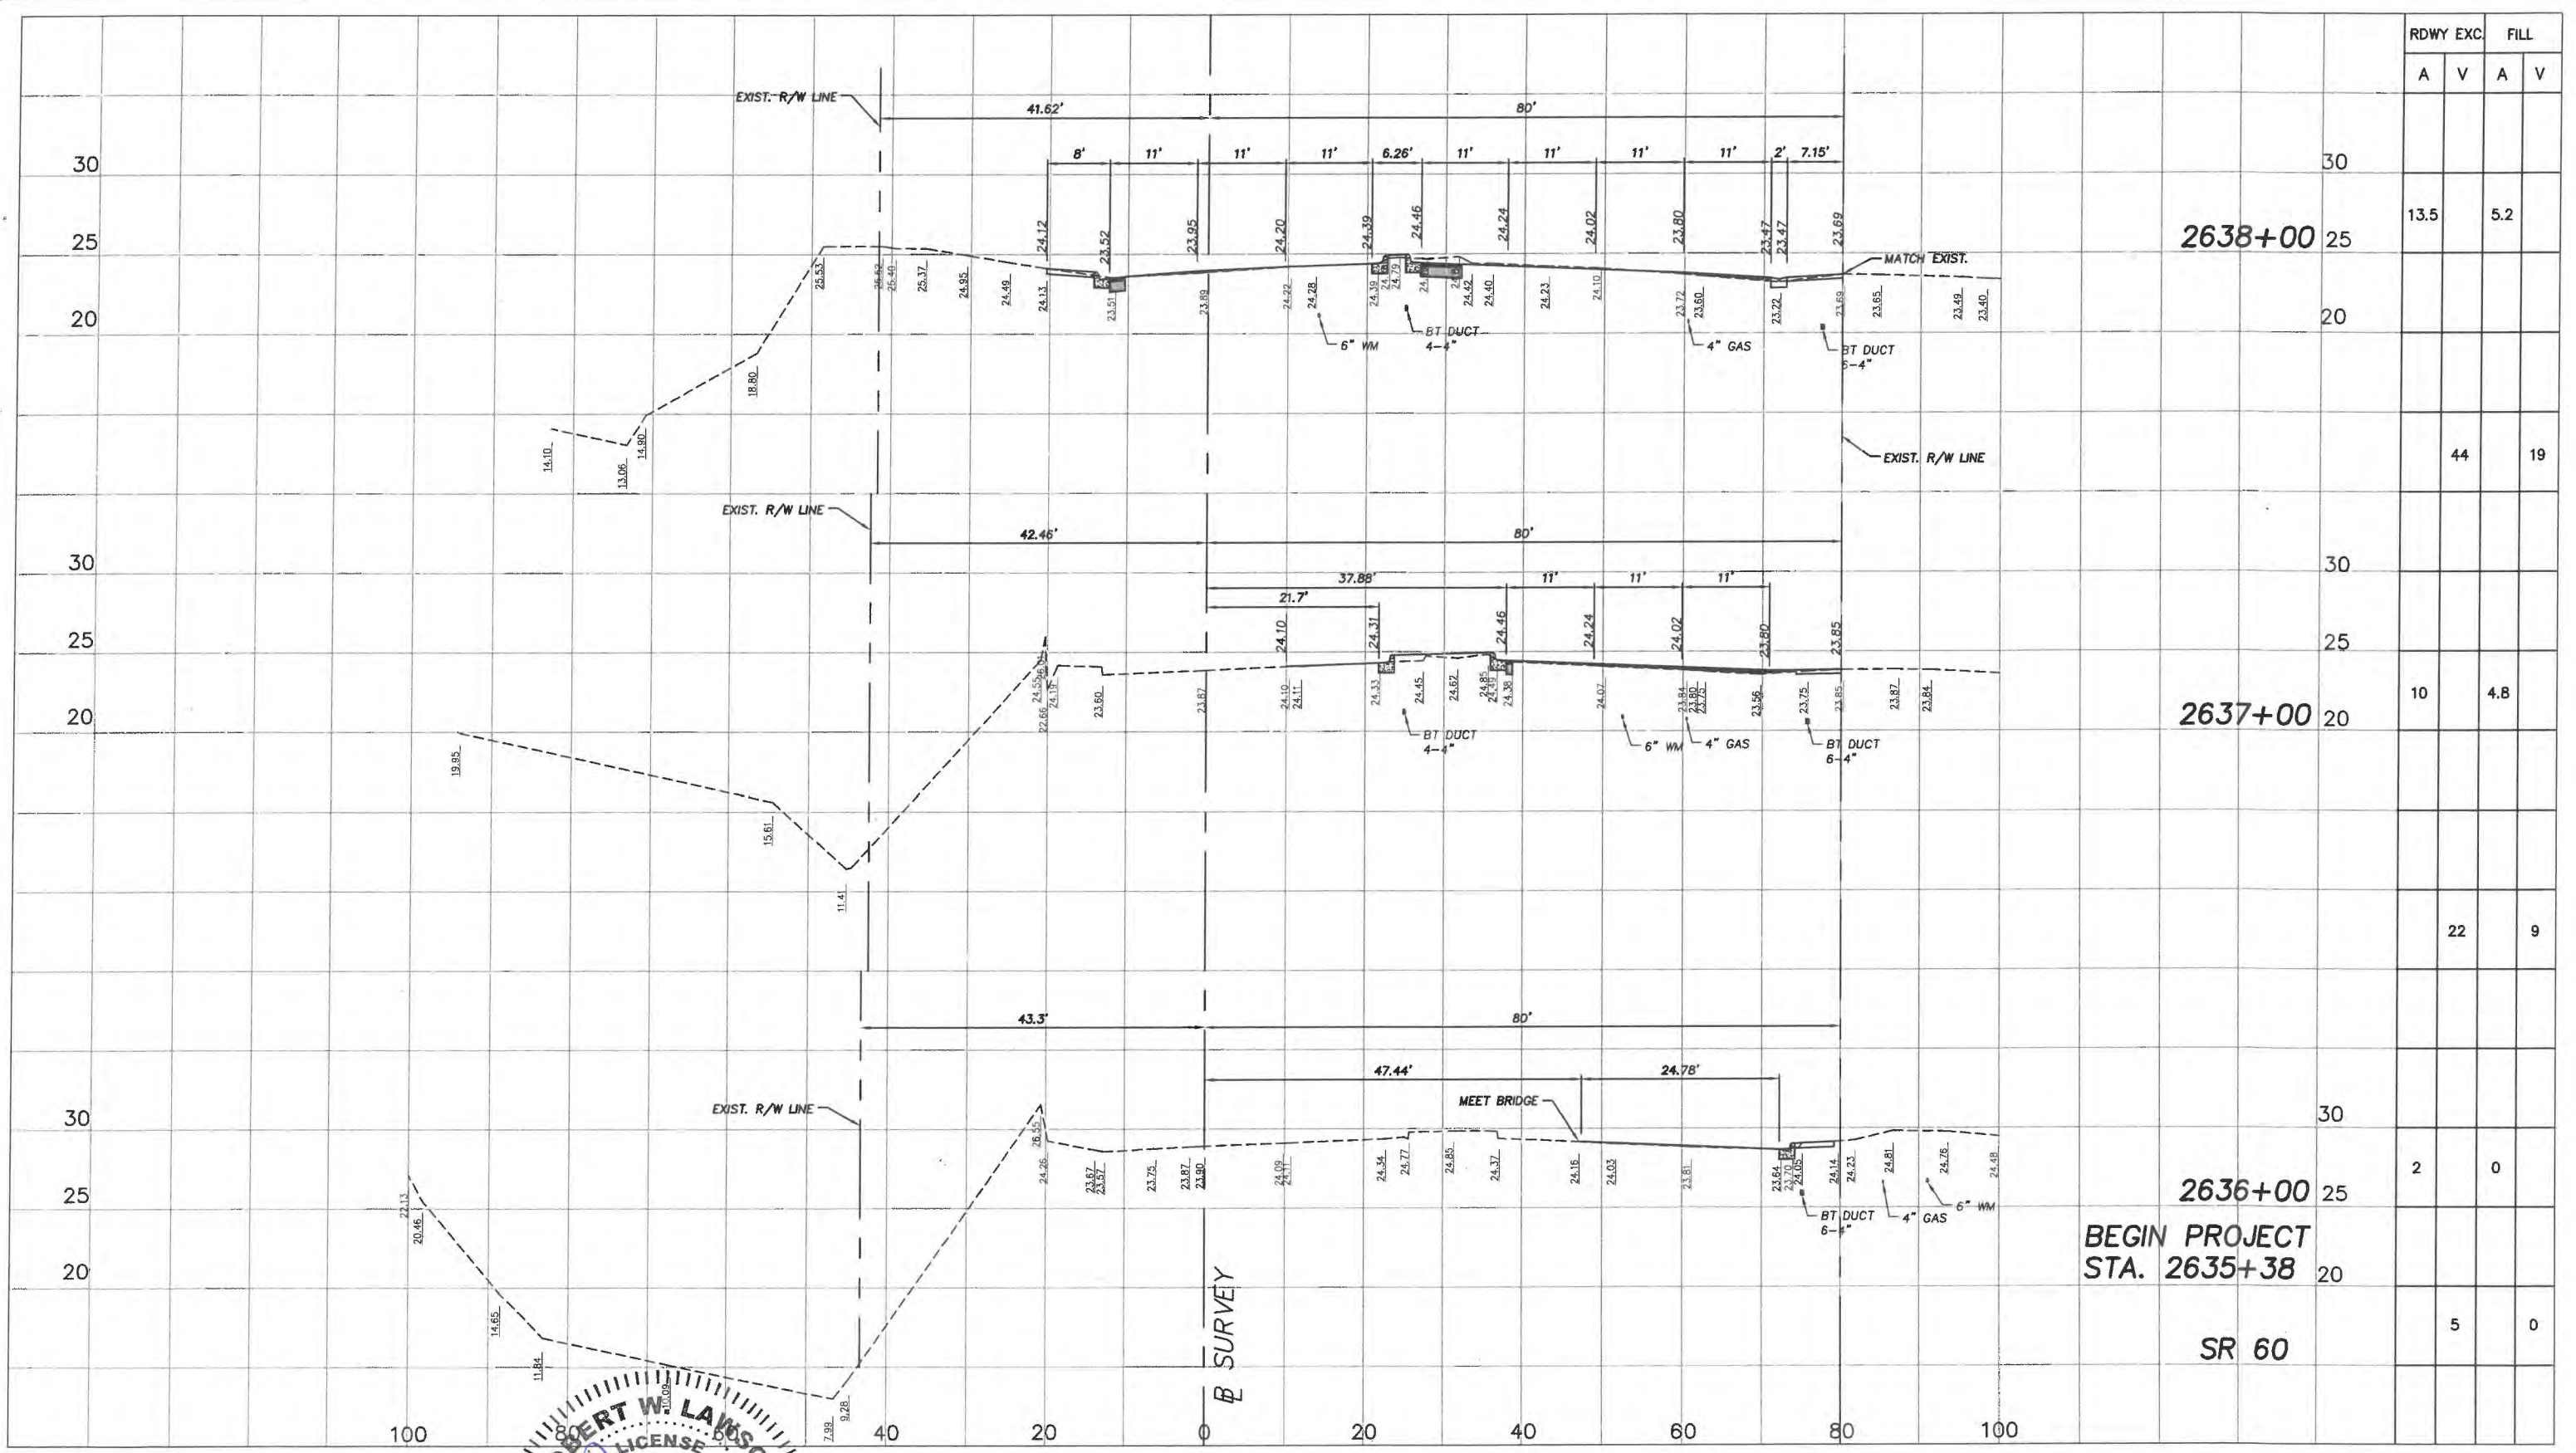
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FLORIDA  
**Department of Public Works**  
Engineering Division

Scale: 1"=10' VERT.  
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Checked: HWD  
Date: 6/2017  
Field Book No:

Project:  
CROSS SECTIONS  
FOR  
SR 60 & 43RD AVENUE

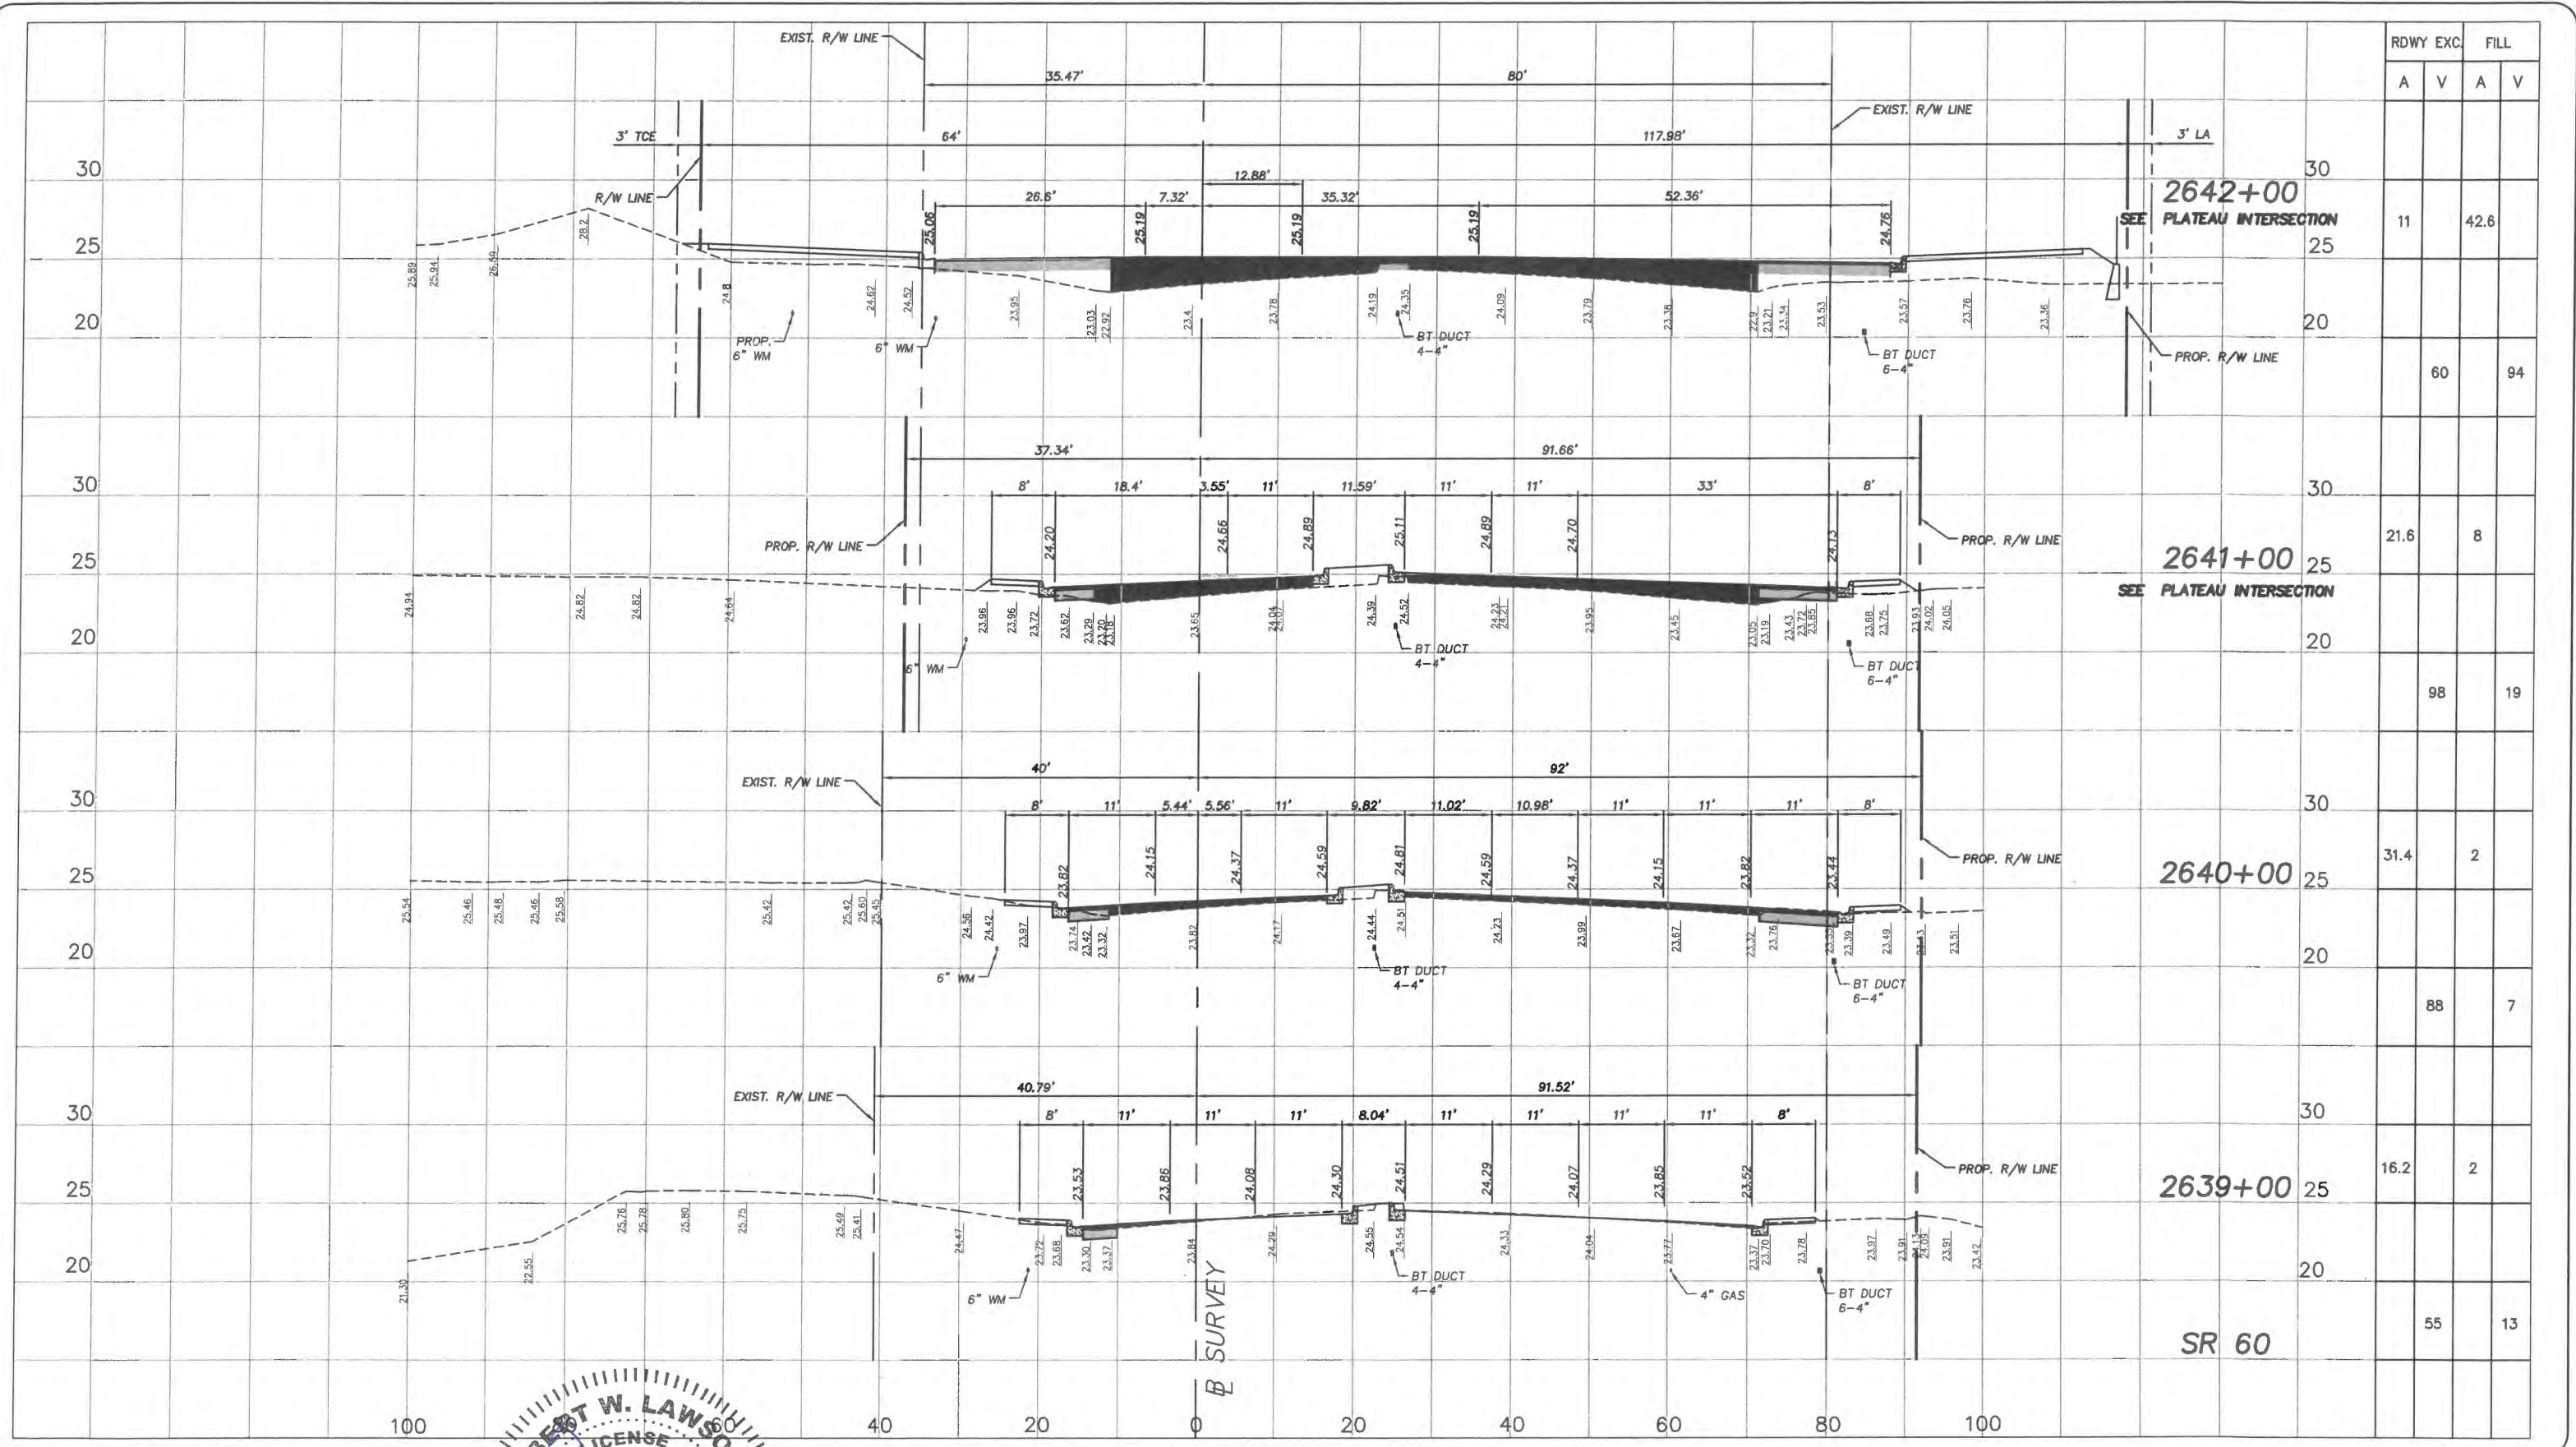
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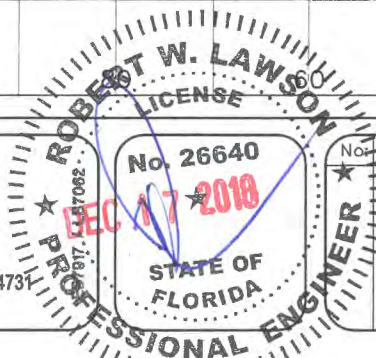
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2637+00		10		4.8
2636+00		2		0
SR 60		5		0



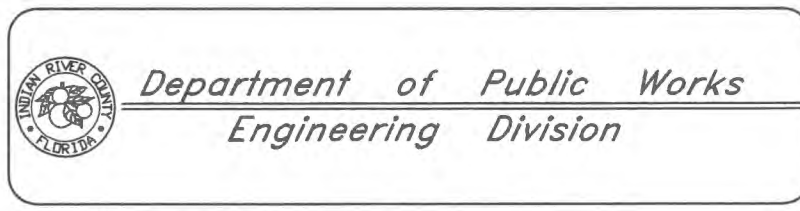


RDWY EXC.	FILL	
	A	V
11		42.6
	60	94
21.6		8
	98	19
31.4		2
	88	7
16.2		2
	55	13

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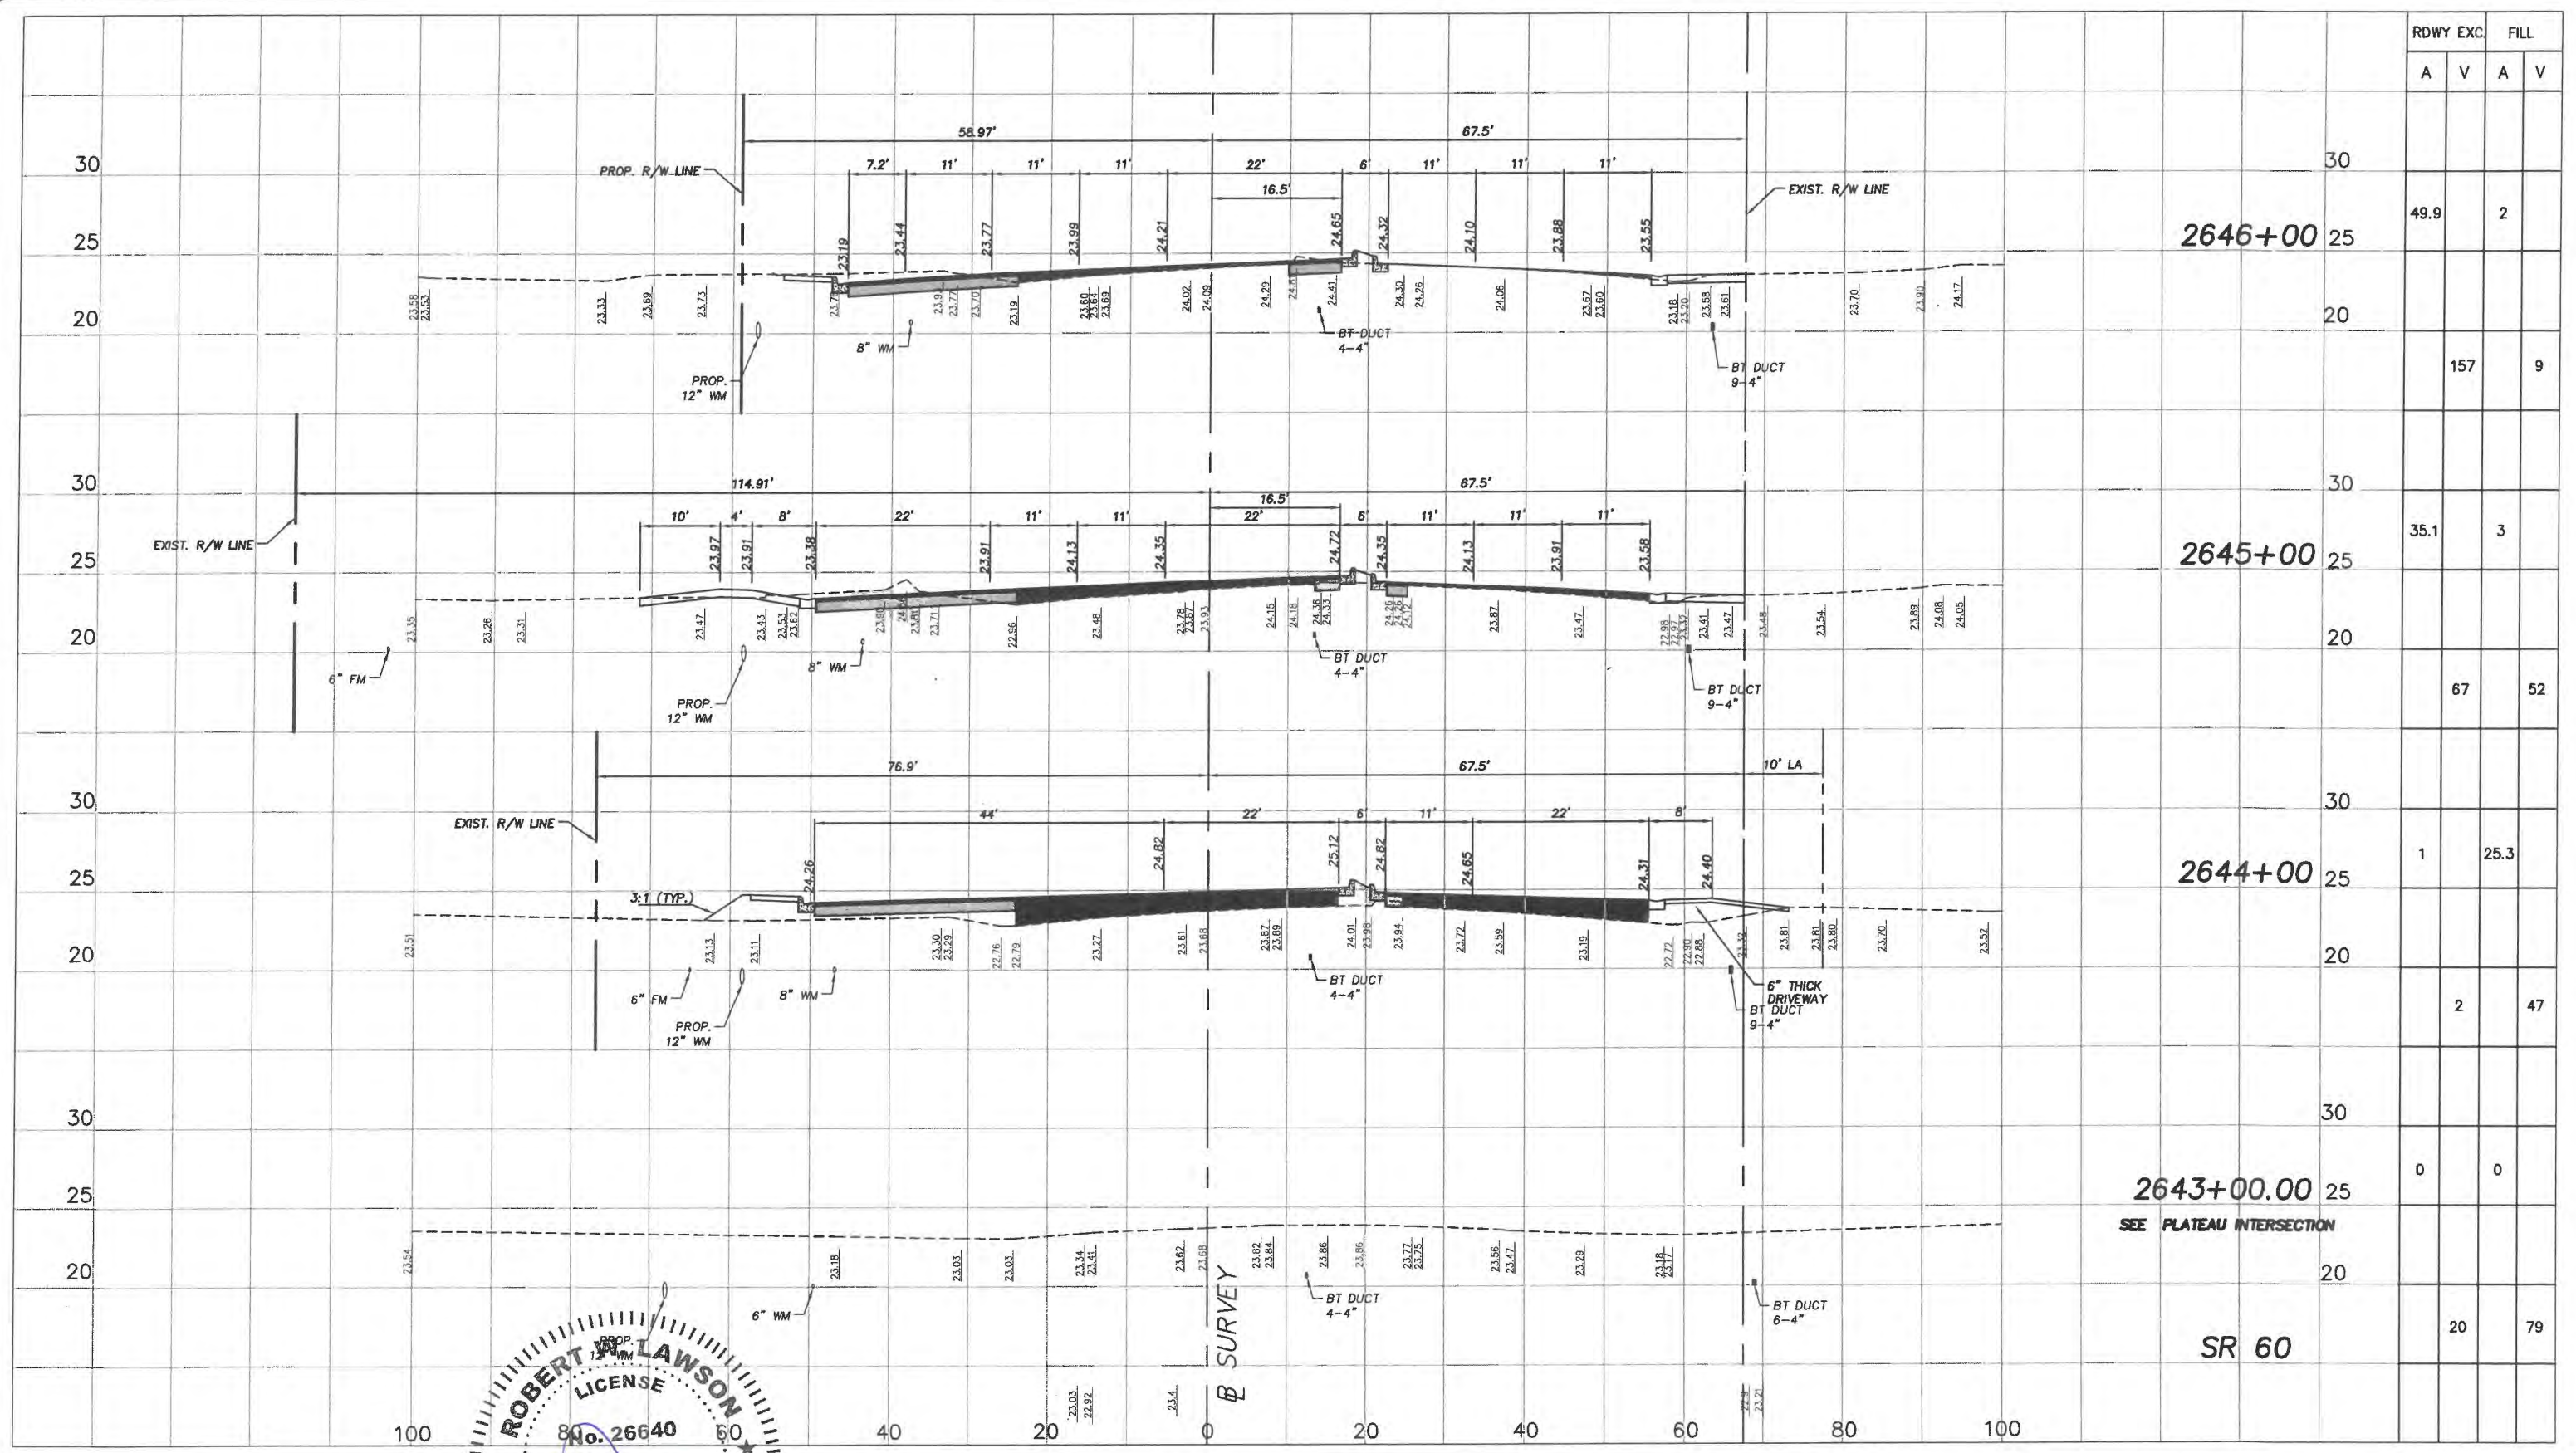


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 Date: 6/2017  
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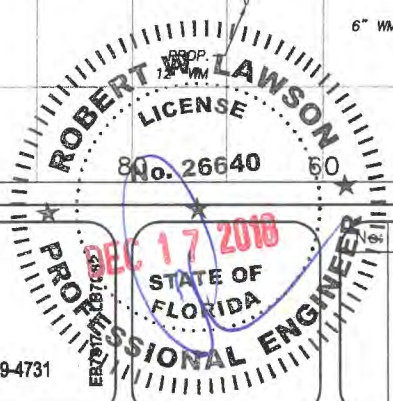
Project:  
**CROSS SECTIONS  
 FOR  
 SR 60 & 43RD AVENUE**

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Station	RDWY EXC.		FILL	
	A	V	A	V
2646+00		49.9		2
2645+00		35.1		3
2644+00		1		25.3
2643+00.00		0		0
SR 60		20		79



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**Department of Public Works**  
 Engineering Division

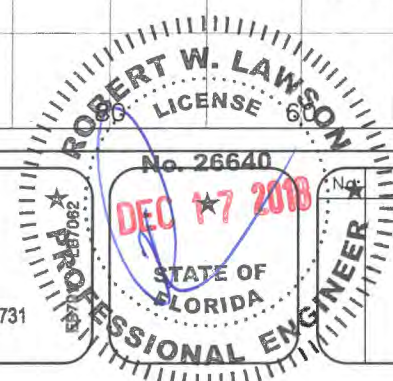
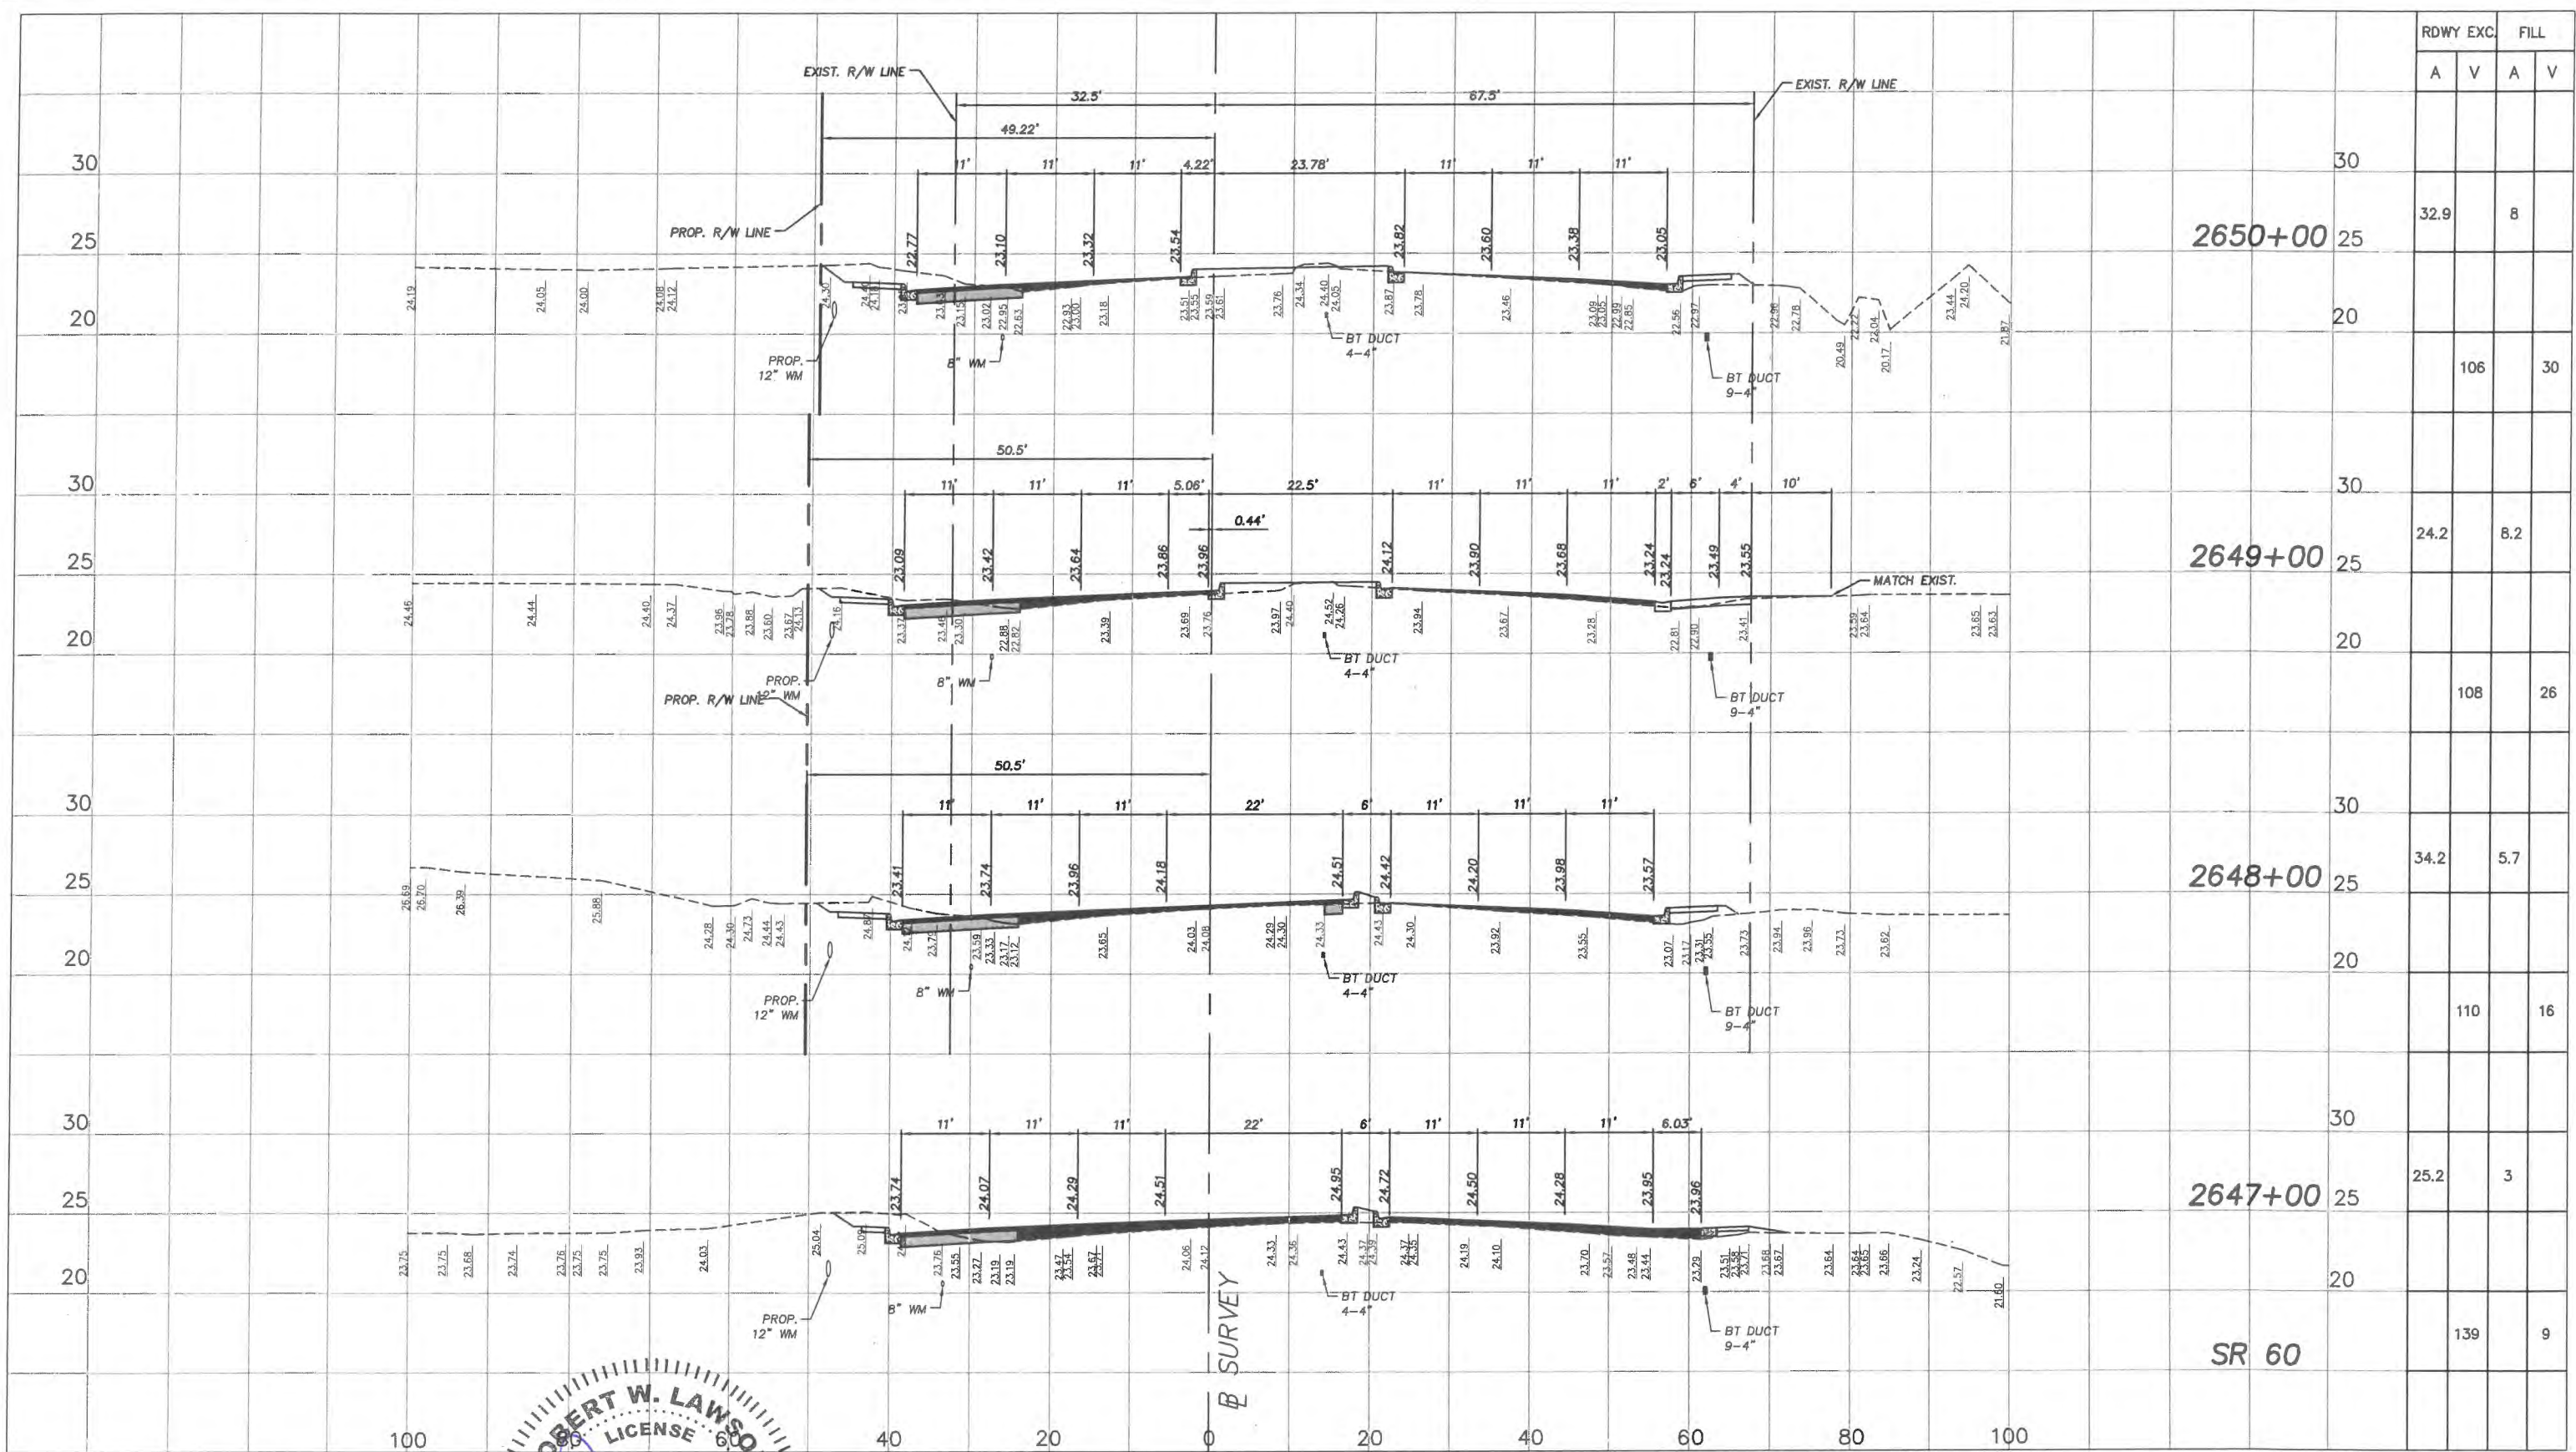
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Project:  
**CROSS SECTIONS**  
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**SR 60 & 43RD AVENUE**

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RDWY EXC.		FILL	
A	V	A	V



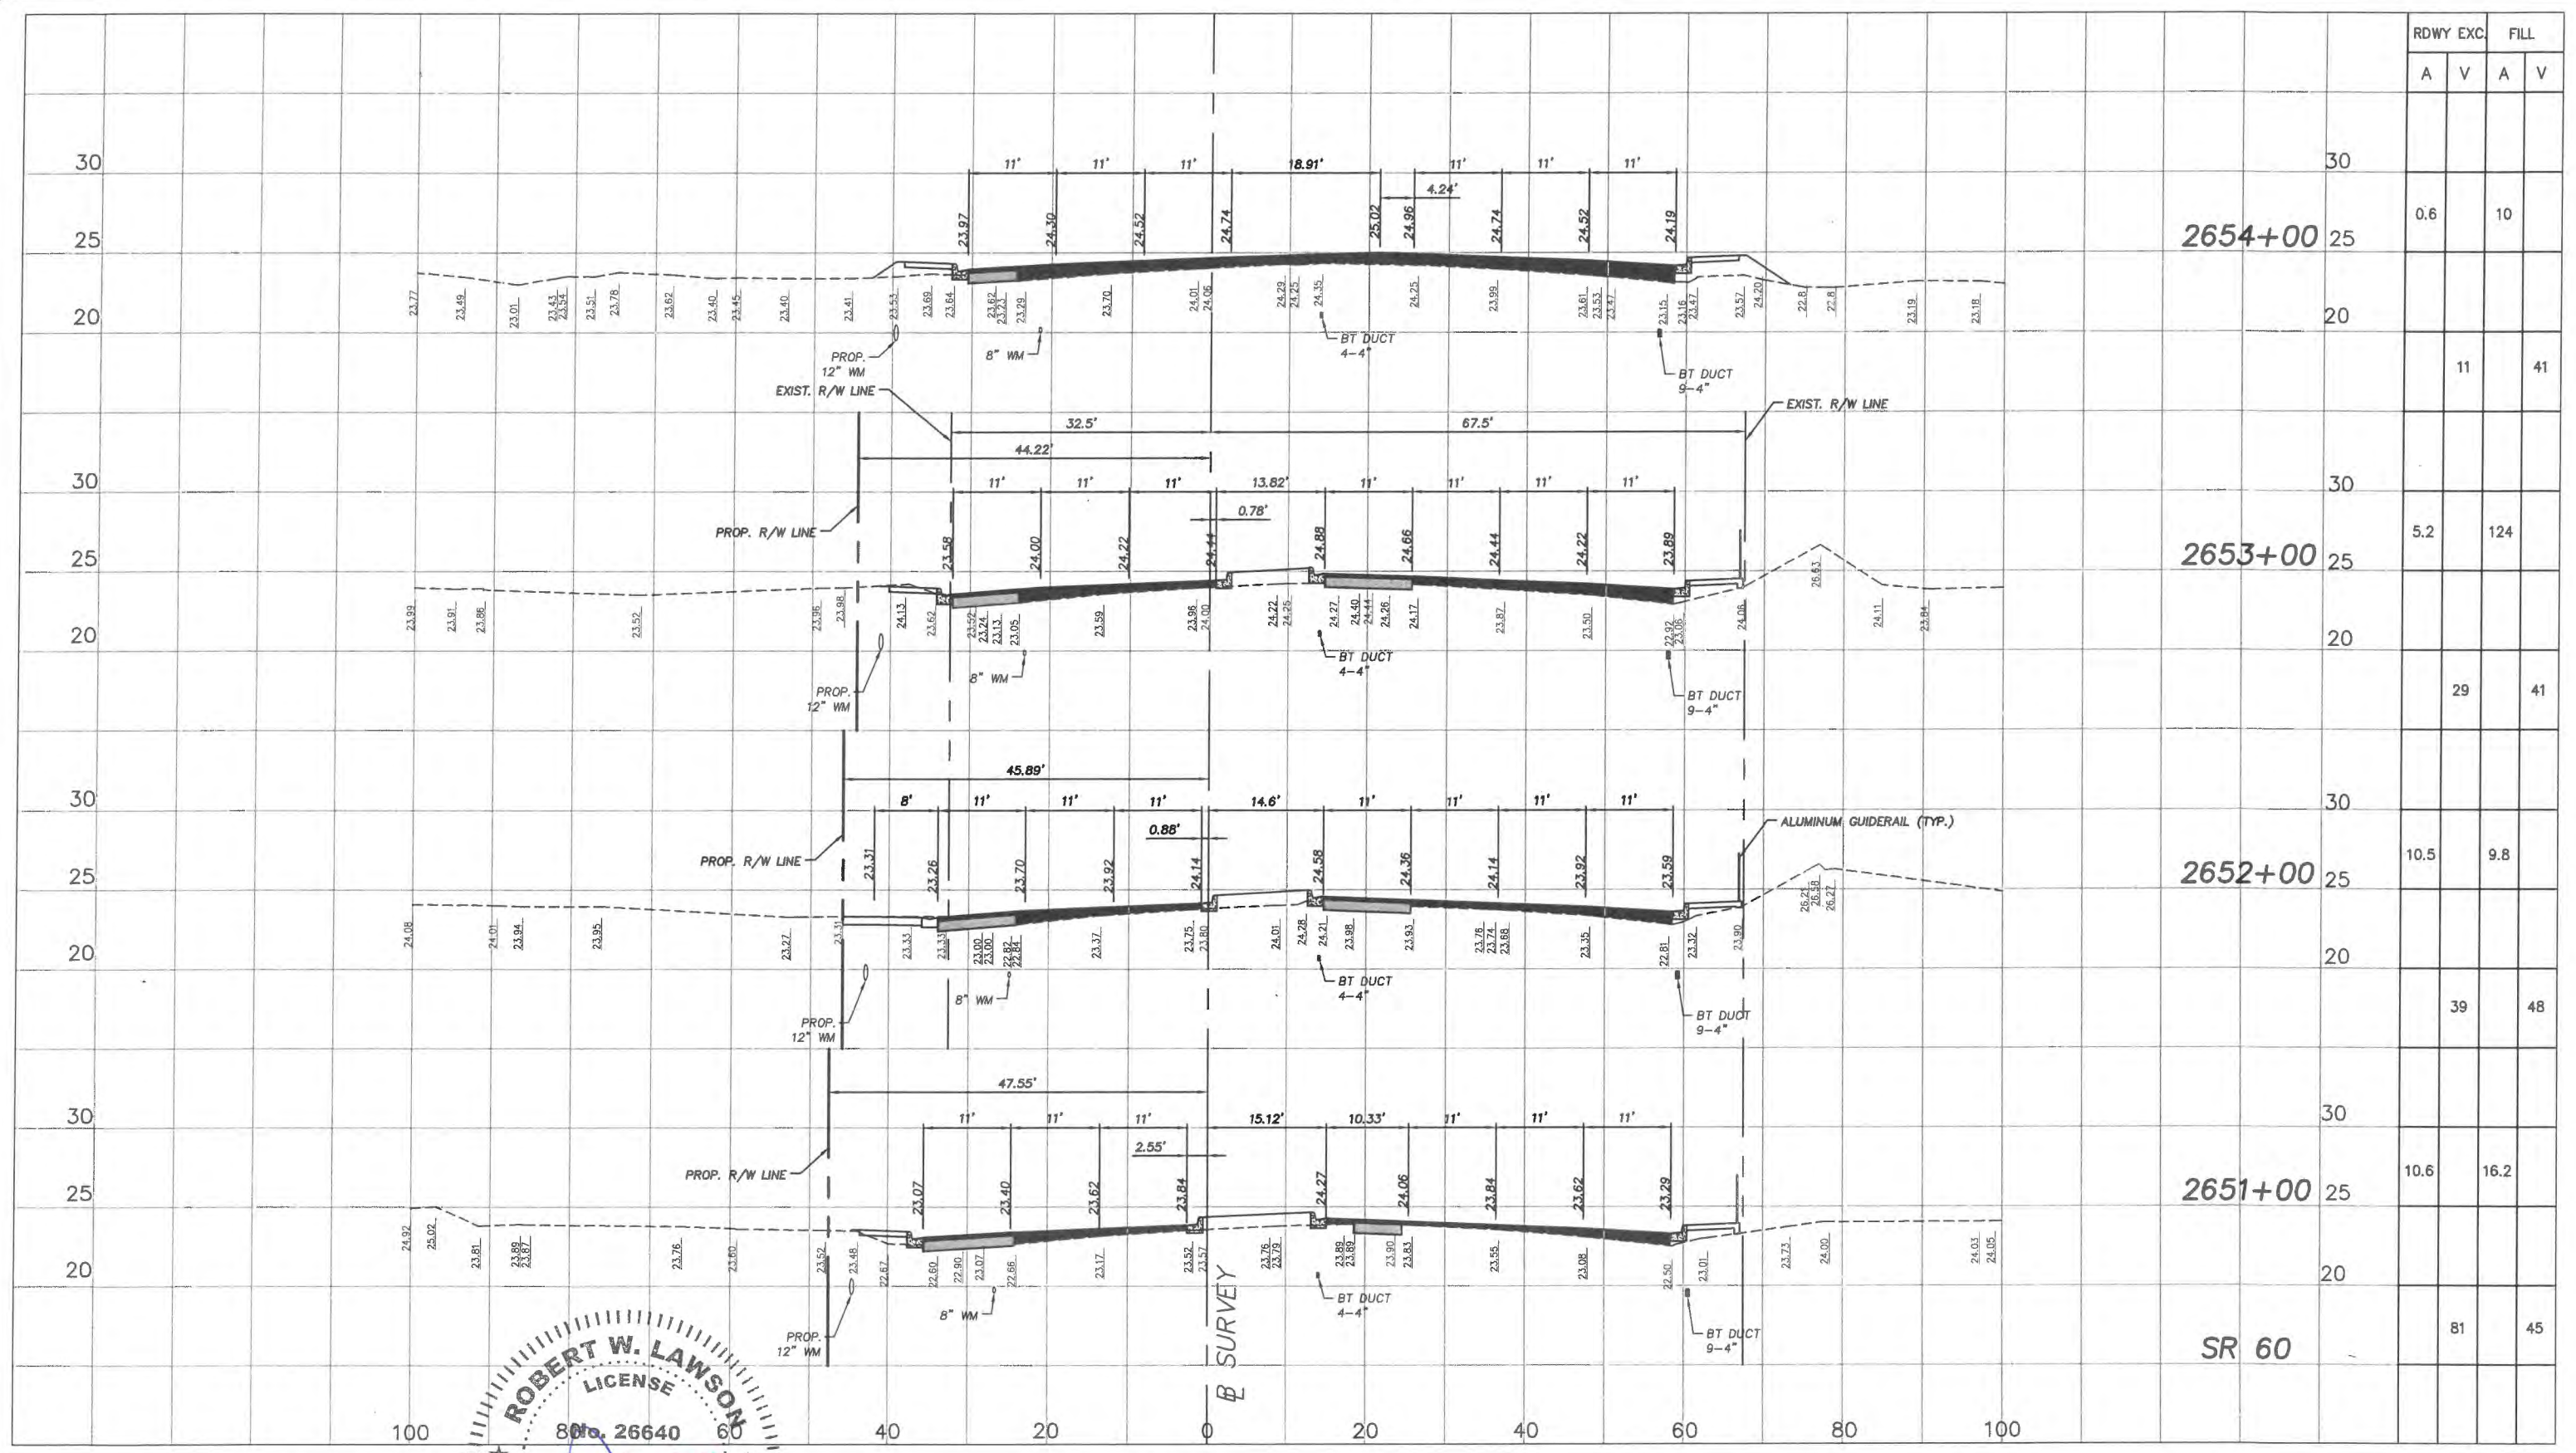
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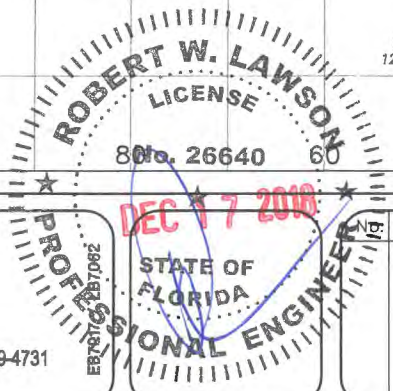
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**CROSS SECTIONS**  
**FOR**  
**SR 60 & 43RD AVENUE**

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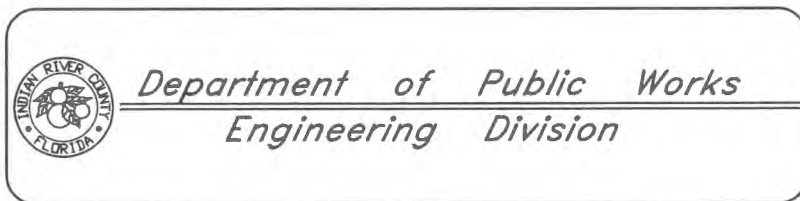


RDWY EXC.		FILL	
A	V	A	V
0.6		10	
	11		41
5.2		124	
	29		41
10.5		9.8	
	39		48
10.6		16.2	
	81		45



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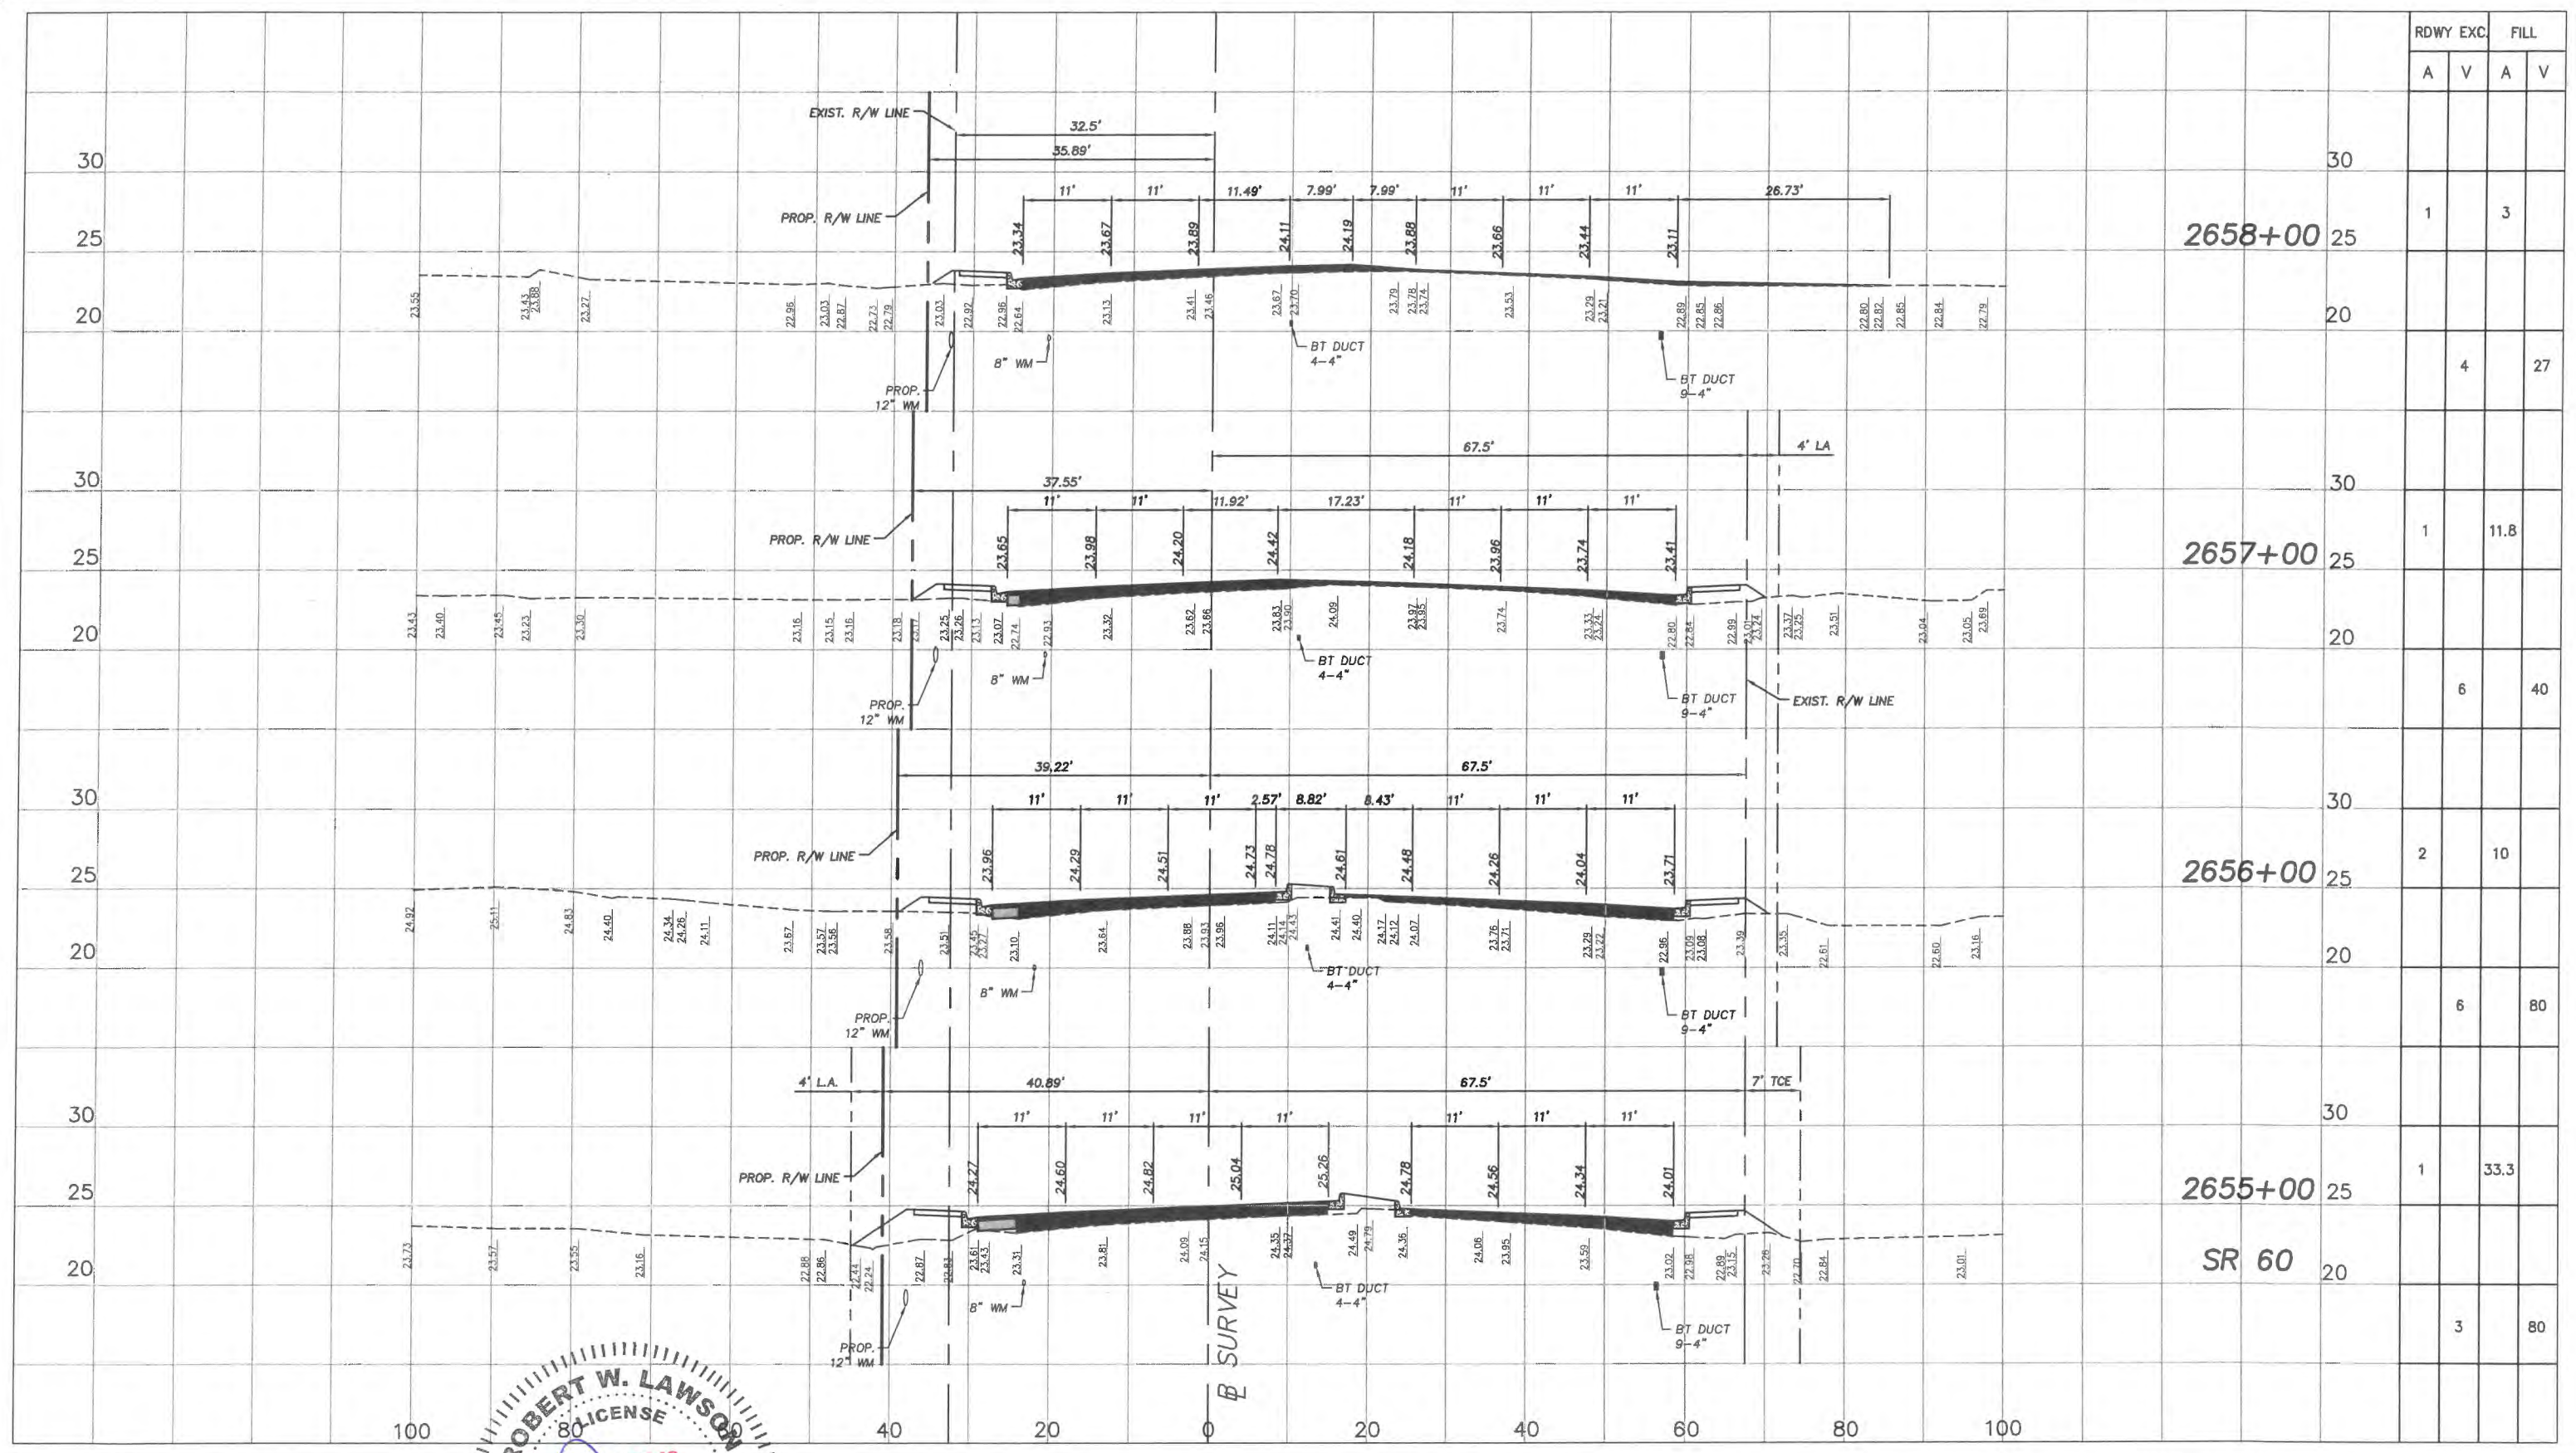


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 CROSS SECTIONS  
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 SR 60 & 43RD AVENUE

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Station	RDWY EXC.		FILL	
	A	V	A	V
2658+00		1		3
2657+00		1		11.8
2656+00		2		10
2655+00		1		33.3
SR 60		3		80

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 Boynton Beach, Florida 33426

**ROBERT W. LAWSON**
  
 80-C LICENSE
   
 No. 266149
   
 PROFESSIONAL ENGINEER
   
 STATE OF FLORIDA

Revision:	By:	Date:



Department of Public Works
   
 Engineering Division

Scale: 1"=10' VERT.
   
 1"=20' HORIZ.
   
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 Drawn: FM
   
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 Date: 6/2017
   
 Field Book No:

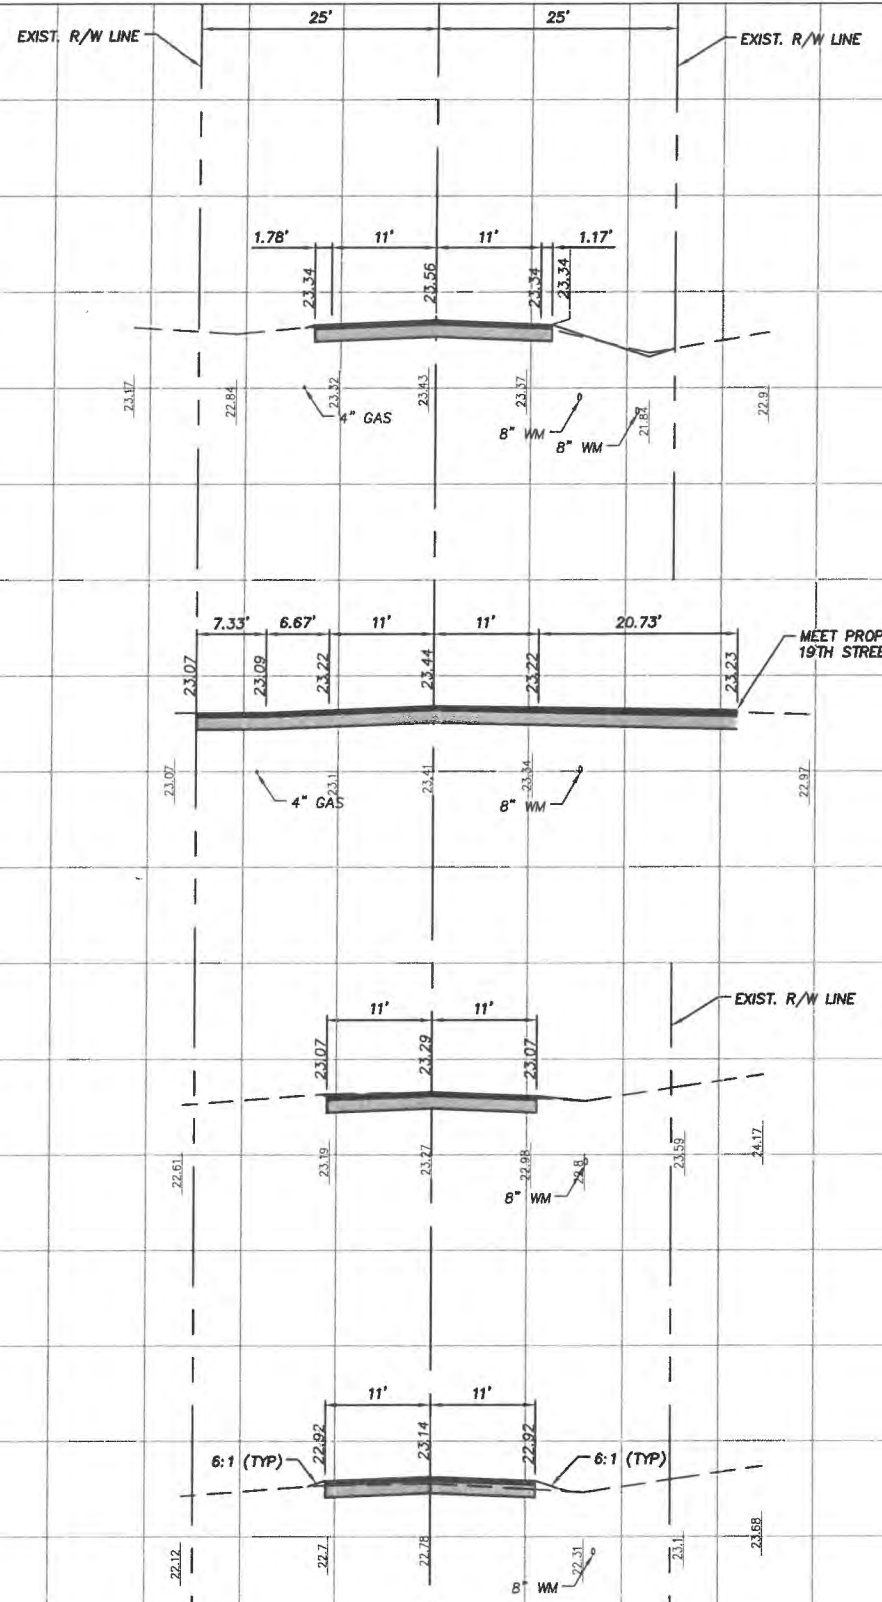
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**FOR**
  
**SR 60 & 43RD AVENUE**

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 Project No.
   
 LNW# WP1027





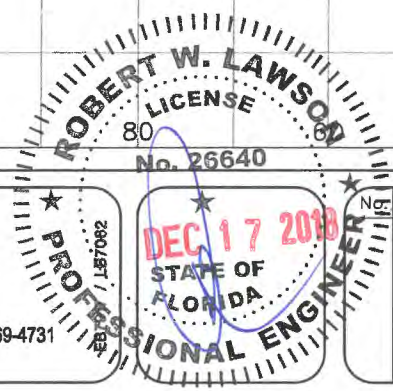




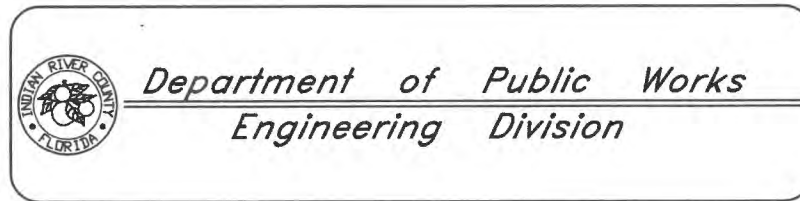
Station	Elevation	RDWY EXC.		FILL	
		A	V	A	V
104+00	25	22	0		
	20			146	0
103+00	25	57	0		
	20			146	0
102+00	25	22	0		
	20			77	2
101+00	25	19.8	1		
	20			44	2

44TH AVENUE  
 BEGIN PROJECT  
 STA. 100+40

100



Revision:	By:	Date:



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 1"=20' HORIZ.  
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Project:  
 CROSS SECTIONS  
 FOR  
 SR 60 & 43RD AVENUE

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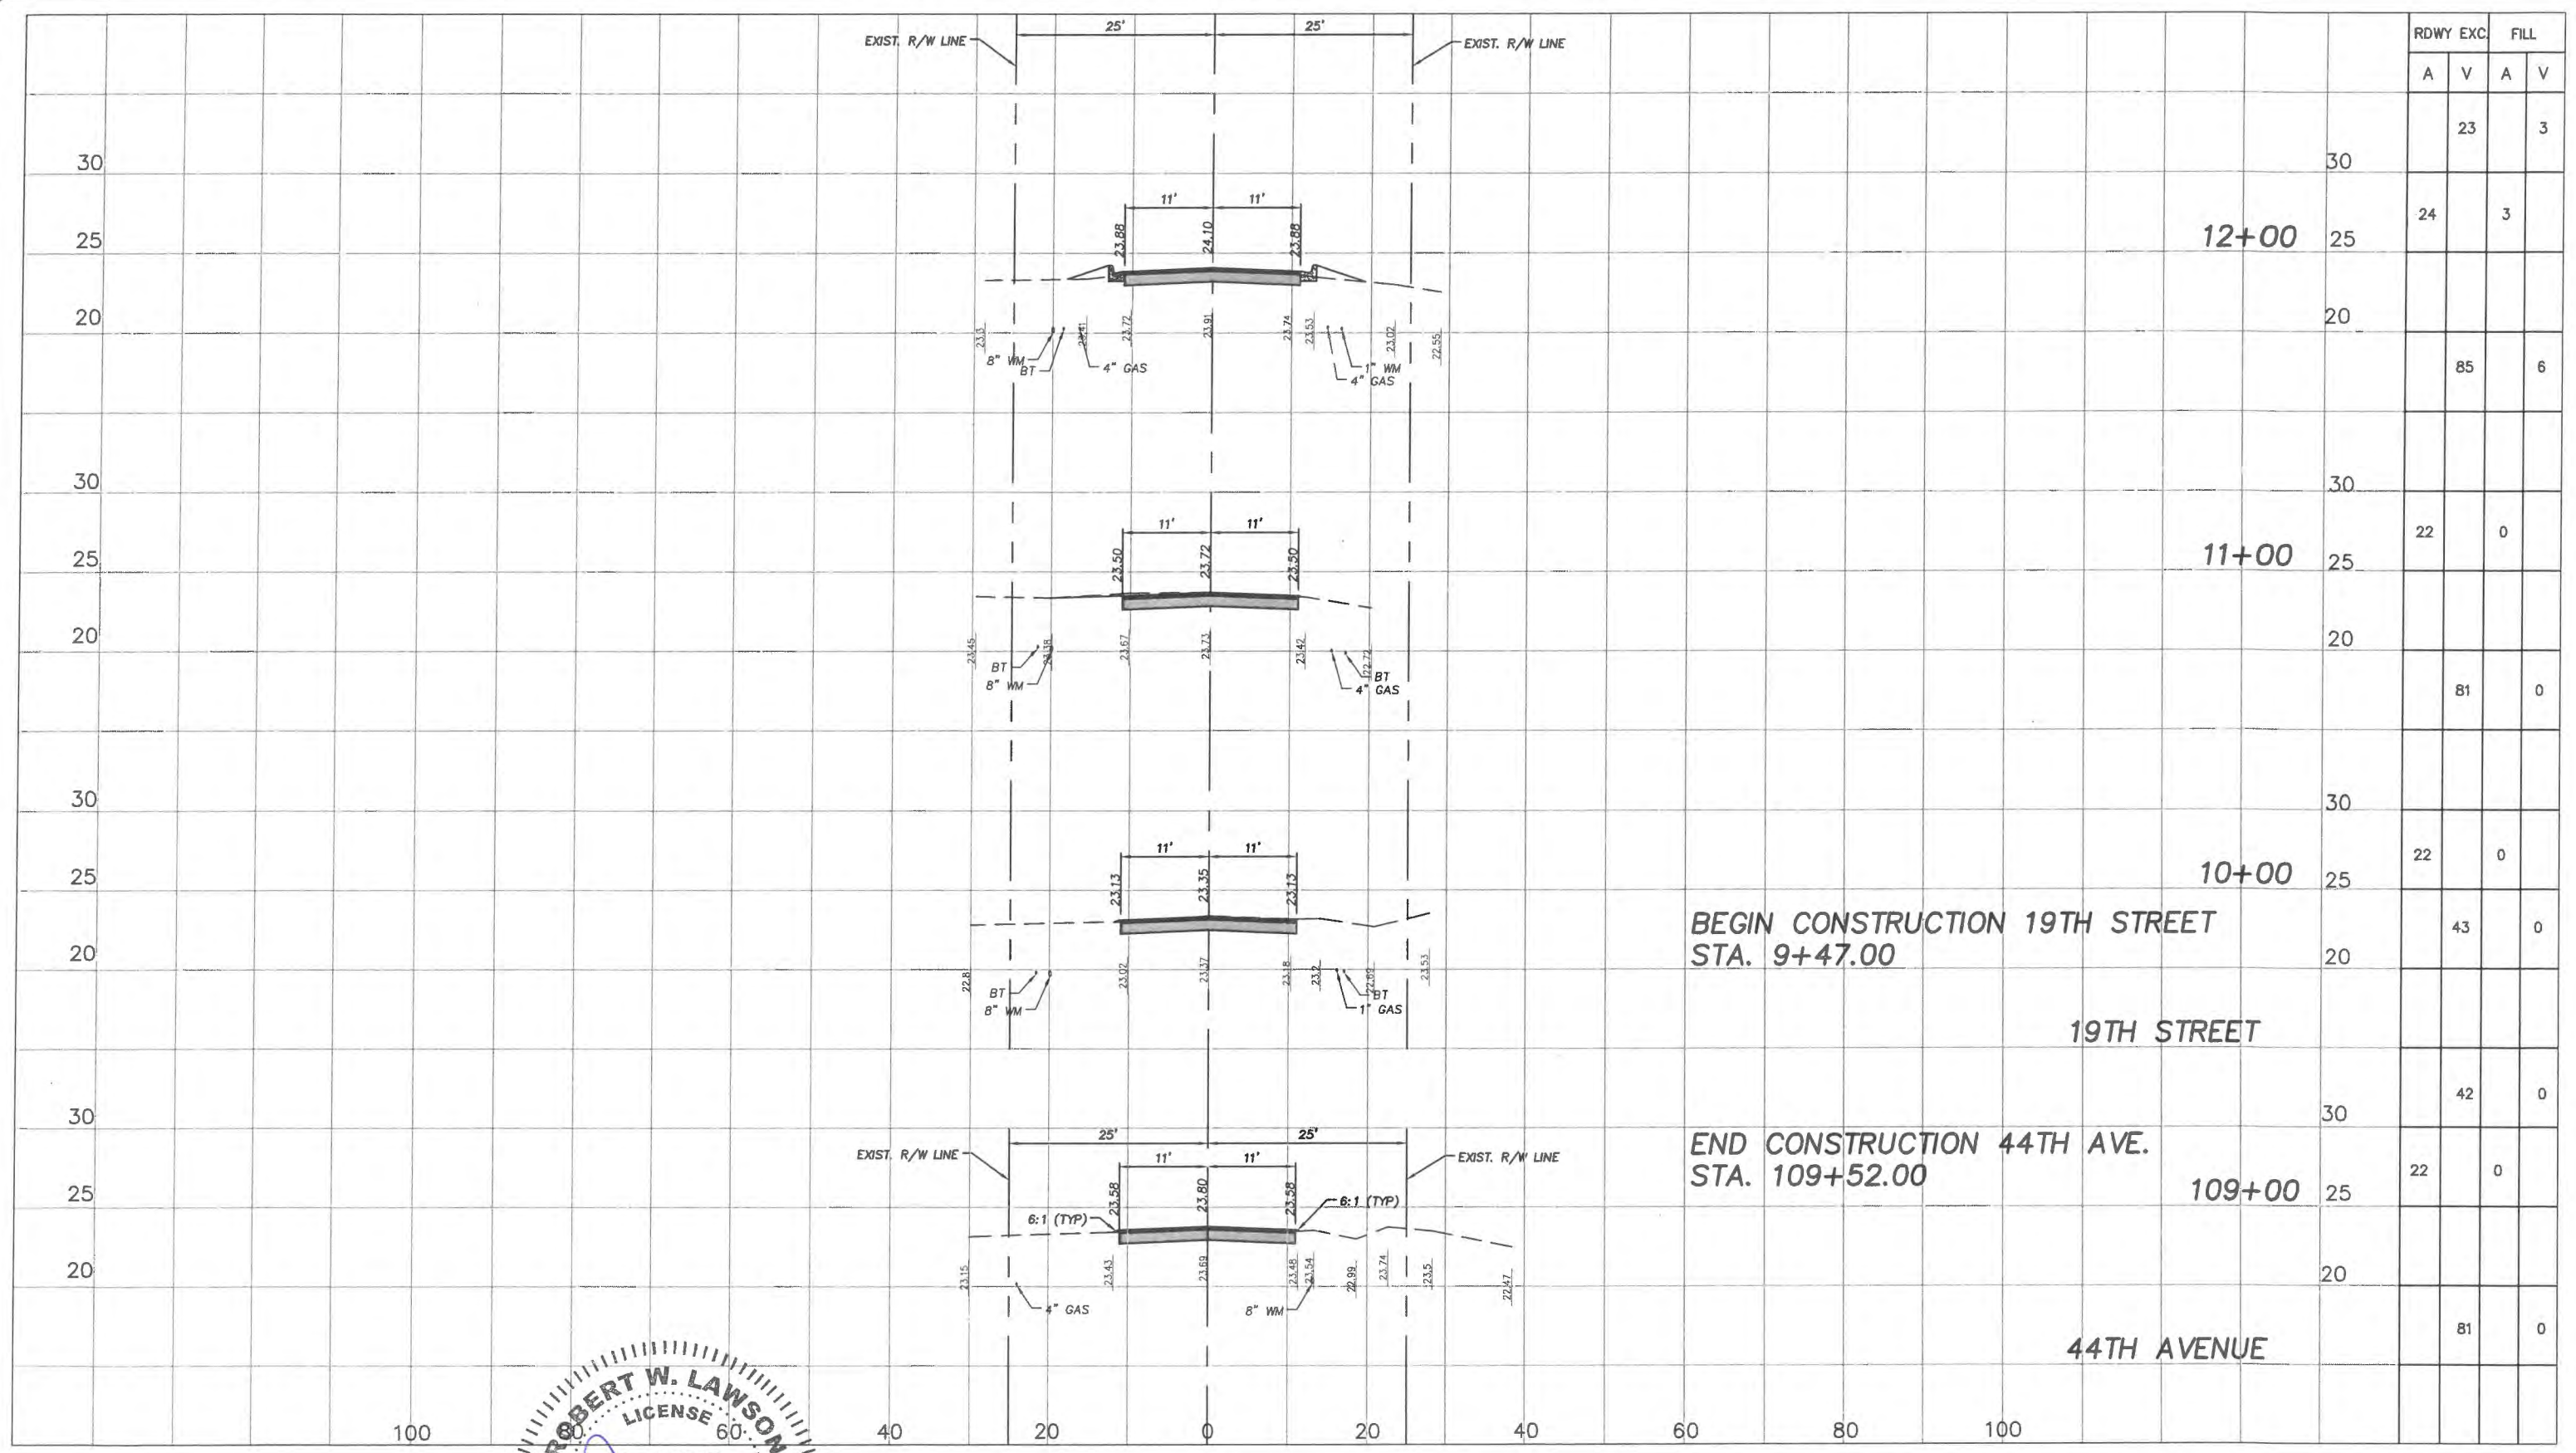


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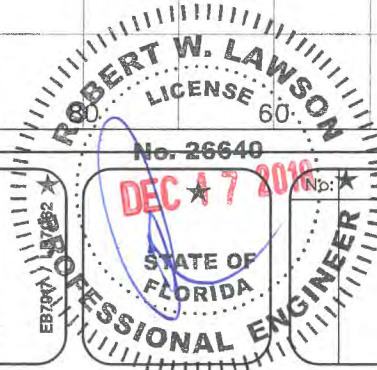
RDWY EXC.	FILL	
	A	V
	23	3
	24	3
	85	6
	22	0
	81	0
	22	0
	43	0
	42	0
	22	0
	81	0

BEGIN CONSTRUCTION 19TH STREET  
STA. 9+47.00

19TH STREET

END CONSTRUCTION 44TH AVE.  
STA. 109+52.00

44TH AVENUE





# N.P.D.E.S. STORMWATER POLLUTION PREVENTION PLAN

THE CONTRACTOR SHALL PREPARE AND PROVIDE INDIAN RIVER COUNTY WITH A SPECIAL PLAN FOR THE PREVENTION, CONTROL AND ABATEMENT OF EROSION AND WATER POLLUTION.

THIS PLAN SHALL BE PREPARED IN ACCORDANCE WITH THE GENERAL REQUIREMENTS AND/OR ANY SPECIAL CONDITIONS OF ALL PERMITS WHICH AUTHORIZE THE CONSTRUCTION OF THE PROJECT. IN THE EVENT THERE ARE NO PERMITS REQUIRED TO CONSTRUCT THE PROJECT, OR THE APPROVED PERMITS TO DO SPECIFICALLY ADDRESS EROSION AND WATER POLLUTION OR THEY DO NOT CONTROL SPECIAL CONDITIONS RELATED TO EROSION AND WATER POLLUTION, THE PROJECT STORMWATER POLLUTION PREVENTION PLAN FOR CONSTRUCTION ACTIVITIES SHALL BE GOVERNED BY FLORIDA DEPARTMENT OF TRANSPORTATION STANDARDS SPECIFICATIONS FOR ROAD AND BRIDGE CONSTRUCTION (LATEST EDITION) SUBARTICLES 7-1.1, 7-2.2, 7-8.2, AND ARTICLES 104.1 THROUGH 104.9.

THE CONTRACTOR'S PART OF THE SWPPP WILL INCLUDE HIS EROSION CONTROL AND STORMWATER MANAGEMENT PLAN DURING CONSTRUCTION AND ALL ADDITIONAL MEASURES HE WILL EMPLOY TO DISPOSE, CONTROL, OR OTHERWISE PREVENT THE DISCHARGE OF SOLIDS, HAZARDOUS, AND SANITARY WASTES TO WATERS. PROCEDURES TO CONTROL ON-SITE TRACKING AND SPILLING OF SOIL BY VEHICLES AND CONSTRUCTION EQUIPMENT SHALL ALSO BE INCLUDED. THE CONTRACTOR SHALL ALSO INCLUDE A PROCEDURE FOR CLEANUP AND REPORTING OF NON-STORM WATER DISCHARGES SUCH AS CONTAMINATED GROUNDWATER AND ACCIDENTAL SPILLS OF CONTAMINANTS. THE CONTRACTOR'S PART OF SWPPP INCLUDING REQUIRED SIGNED CERTIFICATION STATEMENTS SHALL BE FURNISHED TO AND APPROVED BY INDIAN RIVER COUNTY PRIOR TO INITIATION OF ANY SOIL DISTURBING ACTIVITIES.

THE SWPPP FOR CONSTRUCTION ACTIVITIES SHALL BE PREPARED IN ACCORDANCE WITH THE FORMAT AND GUIDELINES SET FORTH IN THE EPA DOCUMENT NUMBER 833-R-92-001, DATED OCTOBER 1992, TITLED "STORMWATER MANAGEMENT FOR CONSTRUCTION ACTIVITIES" AND THE CONTRACTOR'S PROPOSED SEQUENCE OF OPERATIONS. THE SWPPP FOR CONSTRUCTION ACTIVITIES SHALL DESCRIBE, BUT NOT BE LIMITED TO THE FOLLOWING ITEMS OR ACTIVITIES:

THE CONTRACTOR SHALL APPLY FOR AND OBTAIN AN NPDES PERMIT FROM THE FDEP. THE CONTRACTOR SHALL PREPARE AND SUBMIT THE NOTICE OF INTENT ALONG WITH THE APPROPRIATE SWPP, SUPPORTING DOCUMENTS, AND PERMIT FEE TO THE FDEP PRIOR TO CONSTRUCTION COMMENCEMENT.

1. FOR EACH PHASE OF CONSTRUCTION OPERATIONS OR ACTIVITIES, THE CONTRACTOR SHALL SUPPLY THE FOLLOWING INFORMATION
  - A. LOCATIONS OF ALL EROSION CONTROL DEVICES.
  - B. TYPES OF ALL EROSION CONTROL DEVICES.
  - C. ESTIMATED LENGTH OF TIME EROSION CONTROL DEVICES WILL BE IN OPERATION.
  - D. MONITORING SCHEDULES FOR MAINTENANCE OF EROSION CONTROL DEVICES.
  - E. METHOD OF MAINTENANCE OF EROSION CONTROL DEVICES.
  - F. METHODS OF CONTAINMENT OR REMOVAL OF POLLUTANTS OR HAZARDOUS WASTES.

2. THE CONTRACTOR SHALL FURNISH THE ENGINEER THE NAME AND TELEPHONE NUMBER OF THE PERSON WHO WILL BE RESPONSIBLE FOR MONITORING AND MAINTAINING THE EROSION CONTROL DEVICES.

3. THE CONTRACTOR SHALL SUBMIT A COPY OF HIS SWPPP FOR CONSTRUCTION ACTIVITIES TO THE ENGINEER FOR HIS REVIEW AND APPROVAL ON OR BEFORE THE PROJECT PRECONSTRUCTION MEETING. THE CONTRACTOR SHALL PREPARE AND SUBMIT THE SWPPP AND FDEP NOI TO THE FDEP PRIOR TO THE PROJECT PRECONSTRUCTION MEETING.

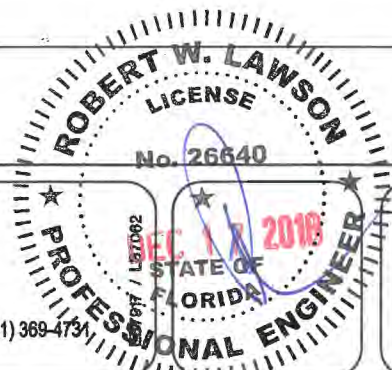
NO CONSTRUCTION ACTIVITIES SHALL COMMENCE UNTIL THE SWPPP FOR CONSTRUCTION ACTIVITIES HAS BEEN REVIEWED AND RECEIVED APPROVAL FROM THE ENGINEER AND FDEP.

THE CONTRACTOR SHALL SUBMIT TWO (2) COPIES OF THE APPROVED SWPPP FOR CONSTRUCTION ACTIVITIES TO THE ENGINEER AND ONE (1) COPY OF THE APPROVED SWPPP FOR CONSTRUCTION ACTIVITIES TO INDIAN RIVER COUNTY PRIOR TO THE BEGINNING OF CONSTRUCTION.

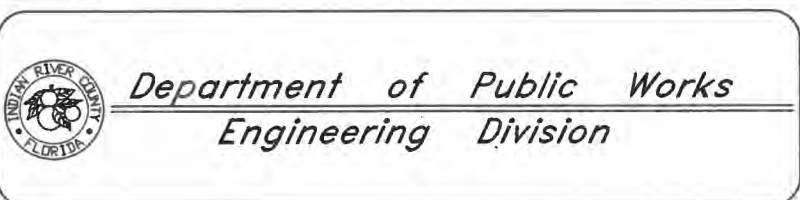
4. THE CONTRACTOR SHALL BE RESPONSIBLE FOR IMPLEMENTING, MONITORING AND MODIFYING THE SWPPP FOR CONSTRUCTION ACTIVITIES TO MEET CHANGING PROJECT SITE CONDITIONS.

5. THE CONTRACTOR SHALL MAINTAIN A COPY OF THE APPROVED SWPPP FOR CONSTRUCTION ACTIVITIES AT A CENTRAL LOCATION ON THE PROJECT SITE AT ALL TIMES AND BE RESPONSIBLE FOR COMPLIANCE WITH THE APPROVED SWPPP FOR CONSTRUCTION ACTIVITIES.

6. FULL PAYMENT FOR ALL WORK AND MATERIALS NECESSARY FOR PREPARATION, SUBMITTAL AND SUBSEQUENT MODIFICATION OF THE CONTRACTOR'S SWPPP FOR CONSTRUCTION ACTIVITIES AND FOR IMPLEMENTING IT DURING CONSTRUCTION SHALL BE INCLUDED IN THE MOBILIZATION PAY ITEM (L.S.) AND THE N.D.P.E.S. COMPLIANCE PAY ITEM (LS).



No:	Revision:	By:	Date:

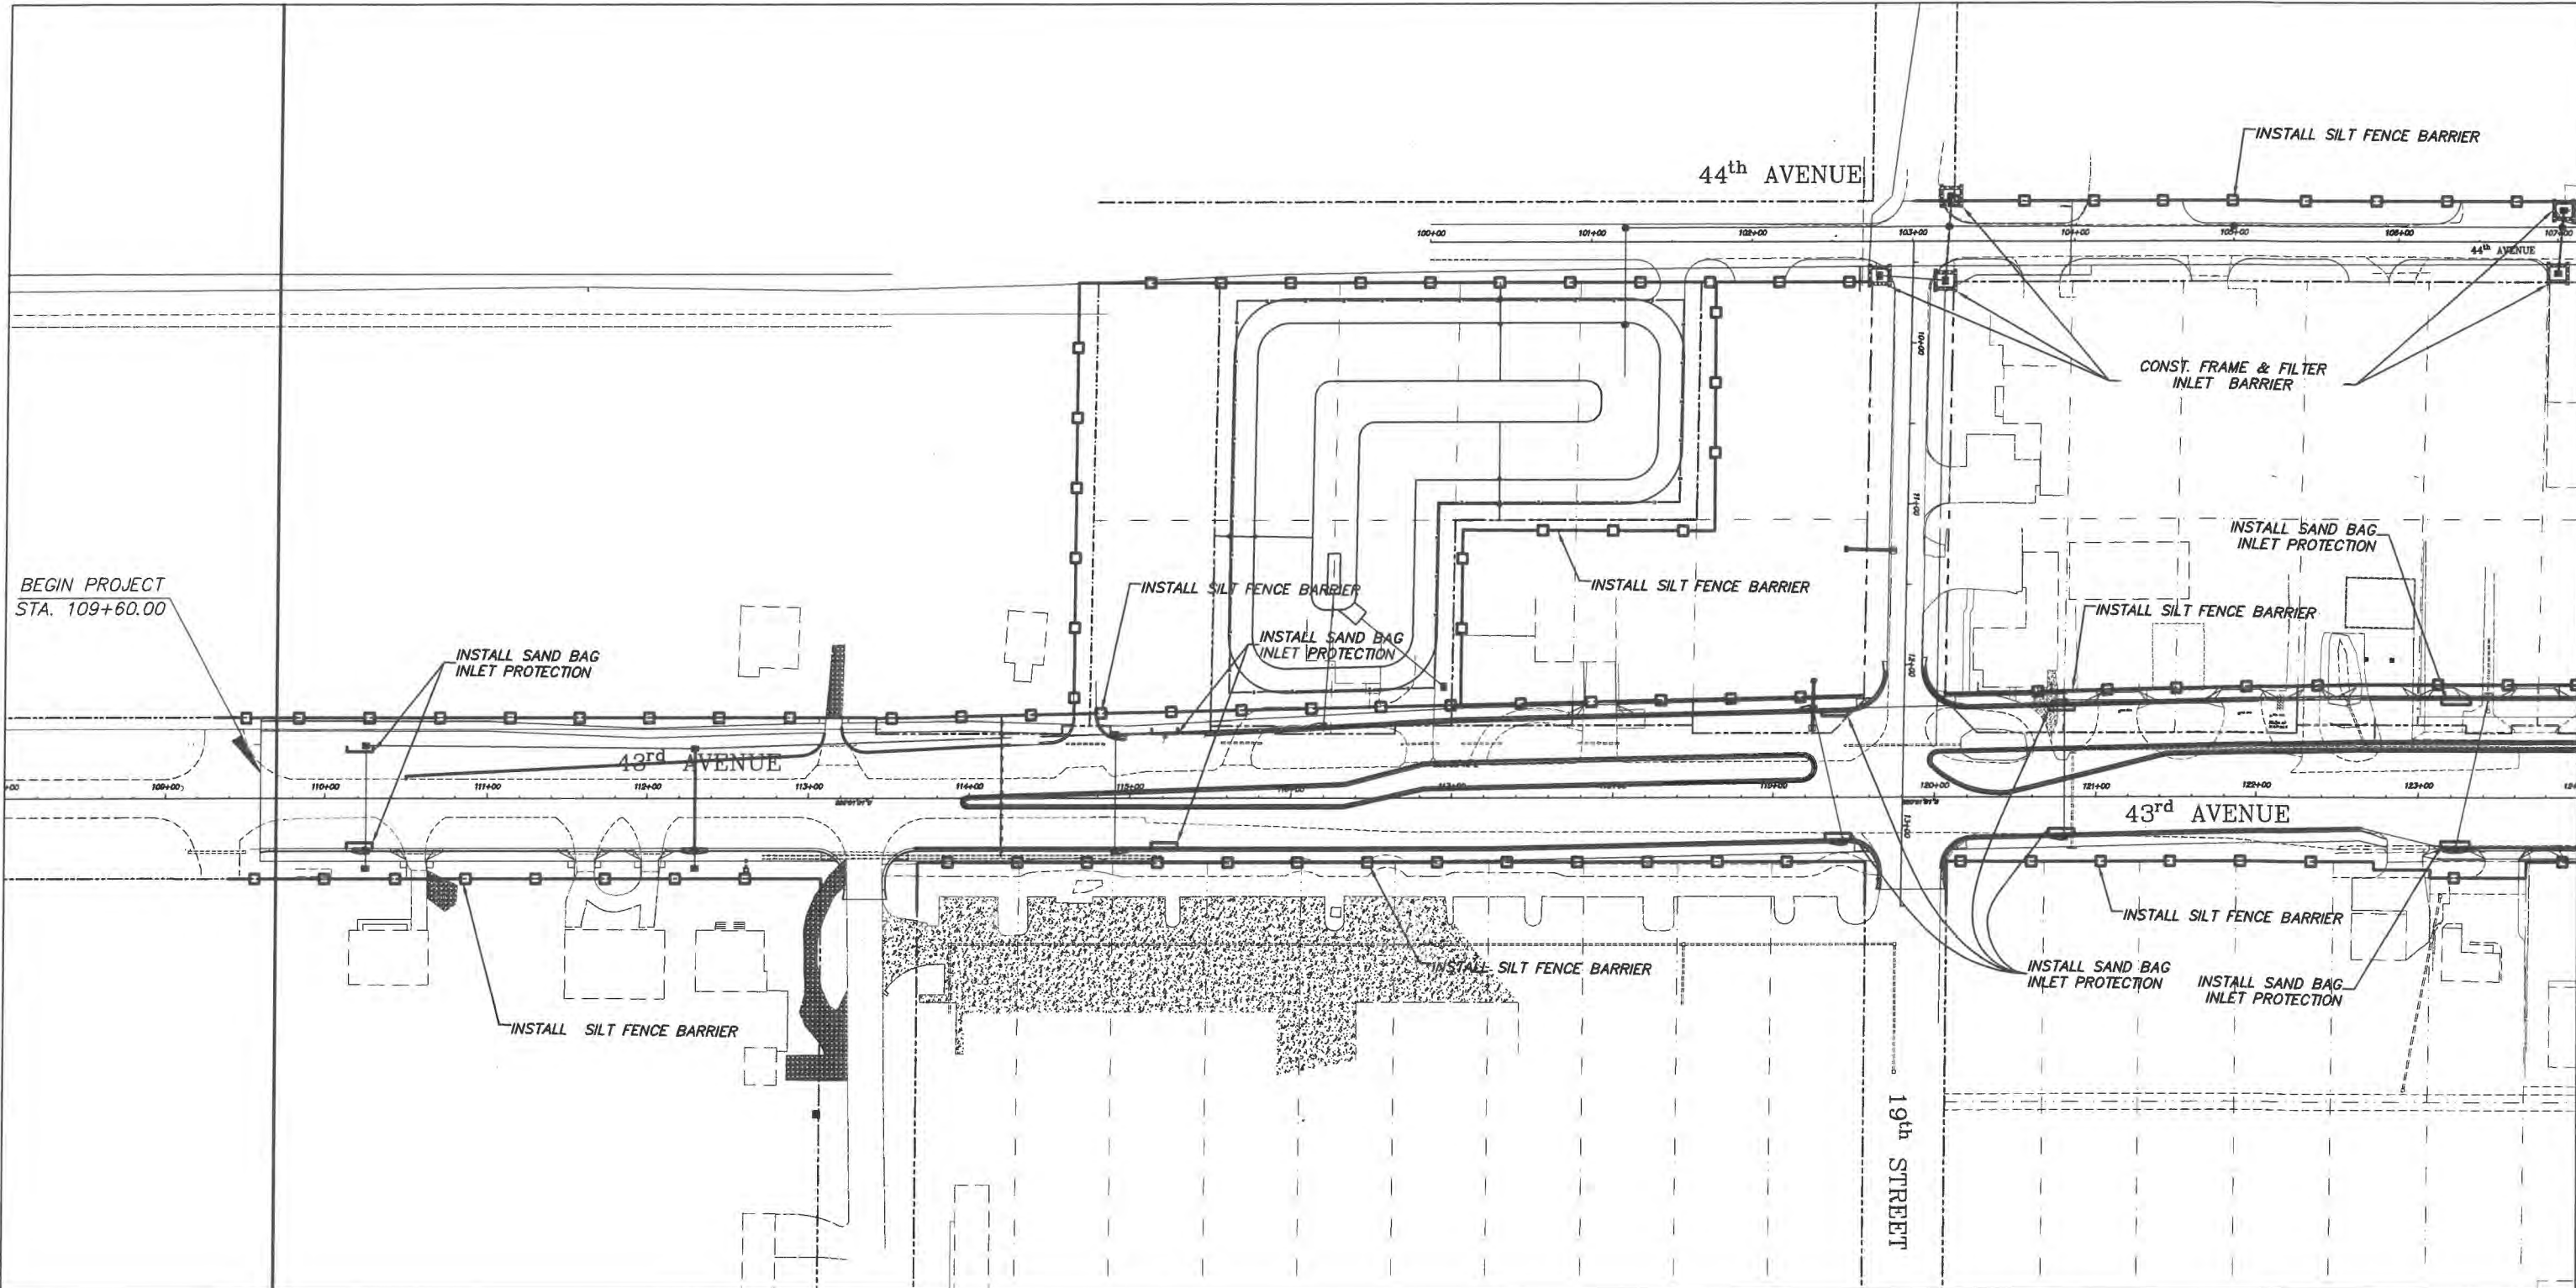


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 Field Book No:

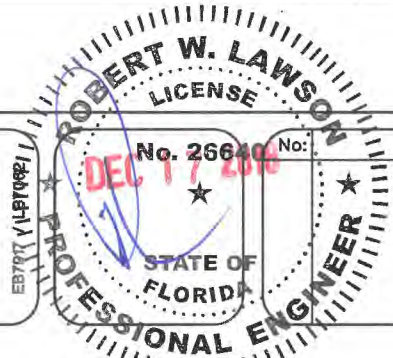
Project:  
 STORM WATER POLLUTION  
 PREVENTION PLAN  
 FOR  
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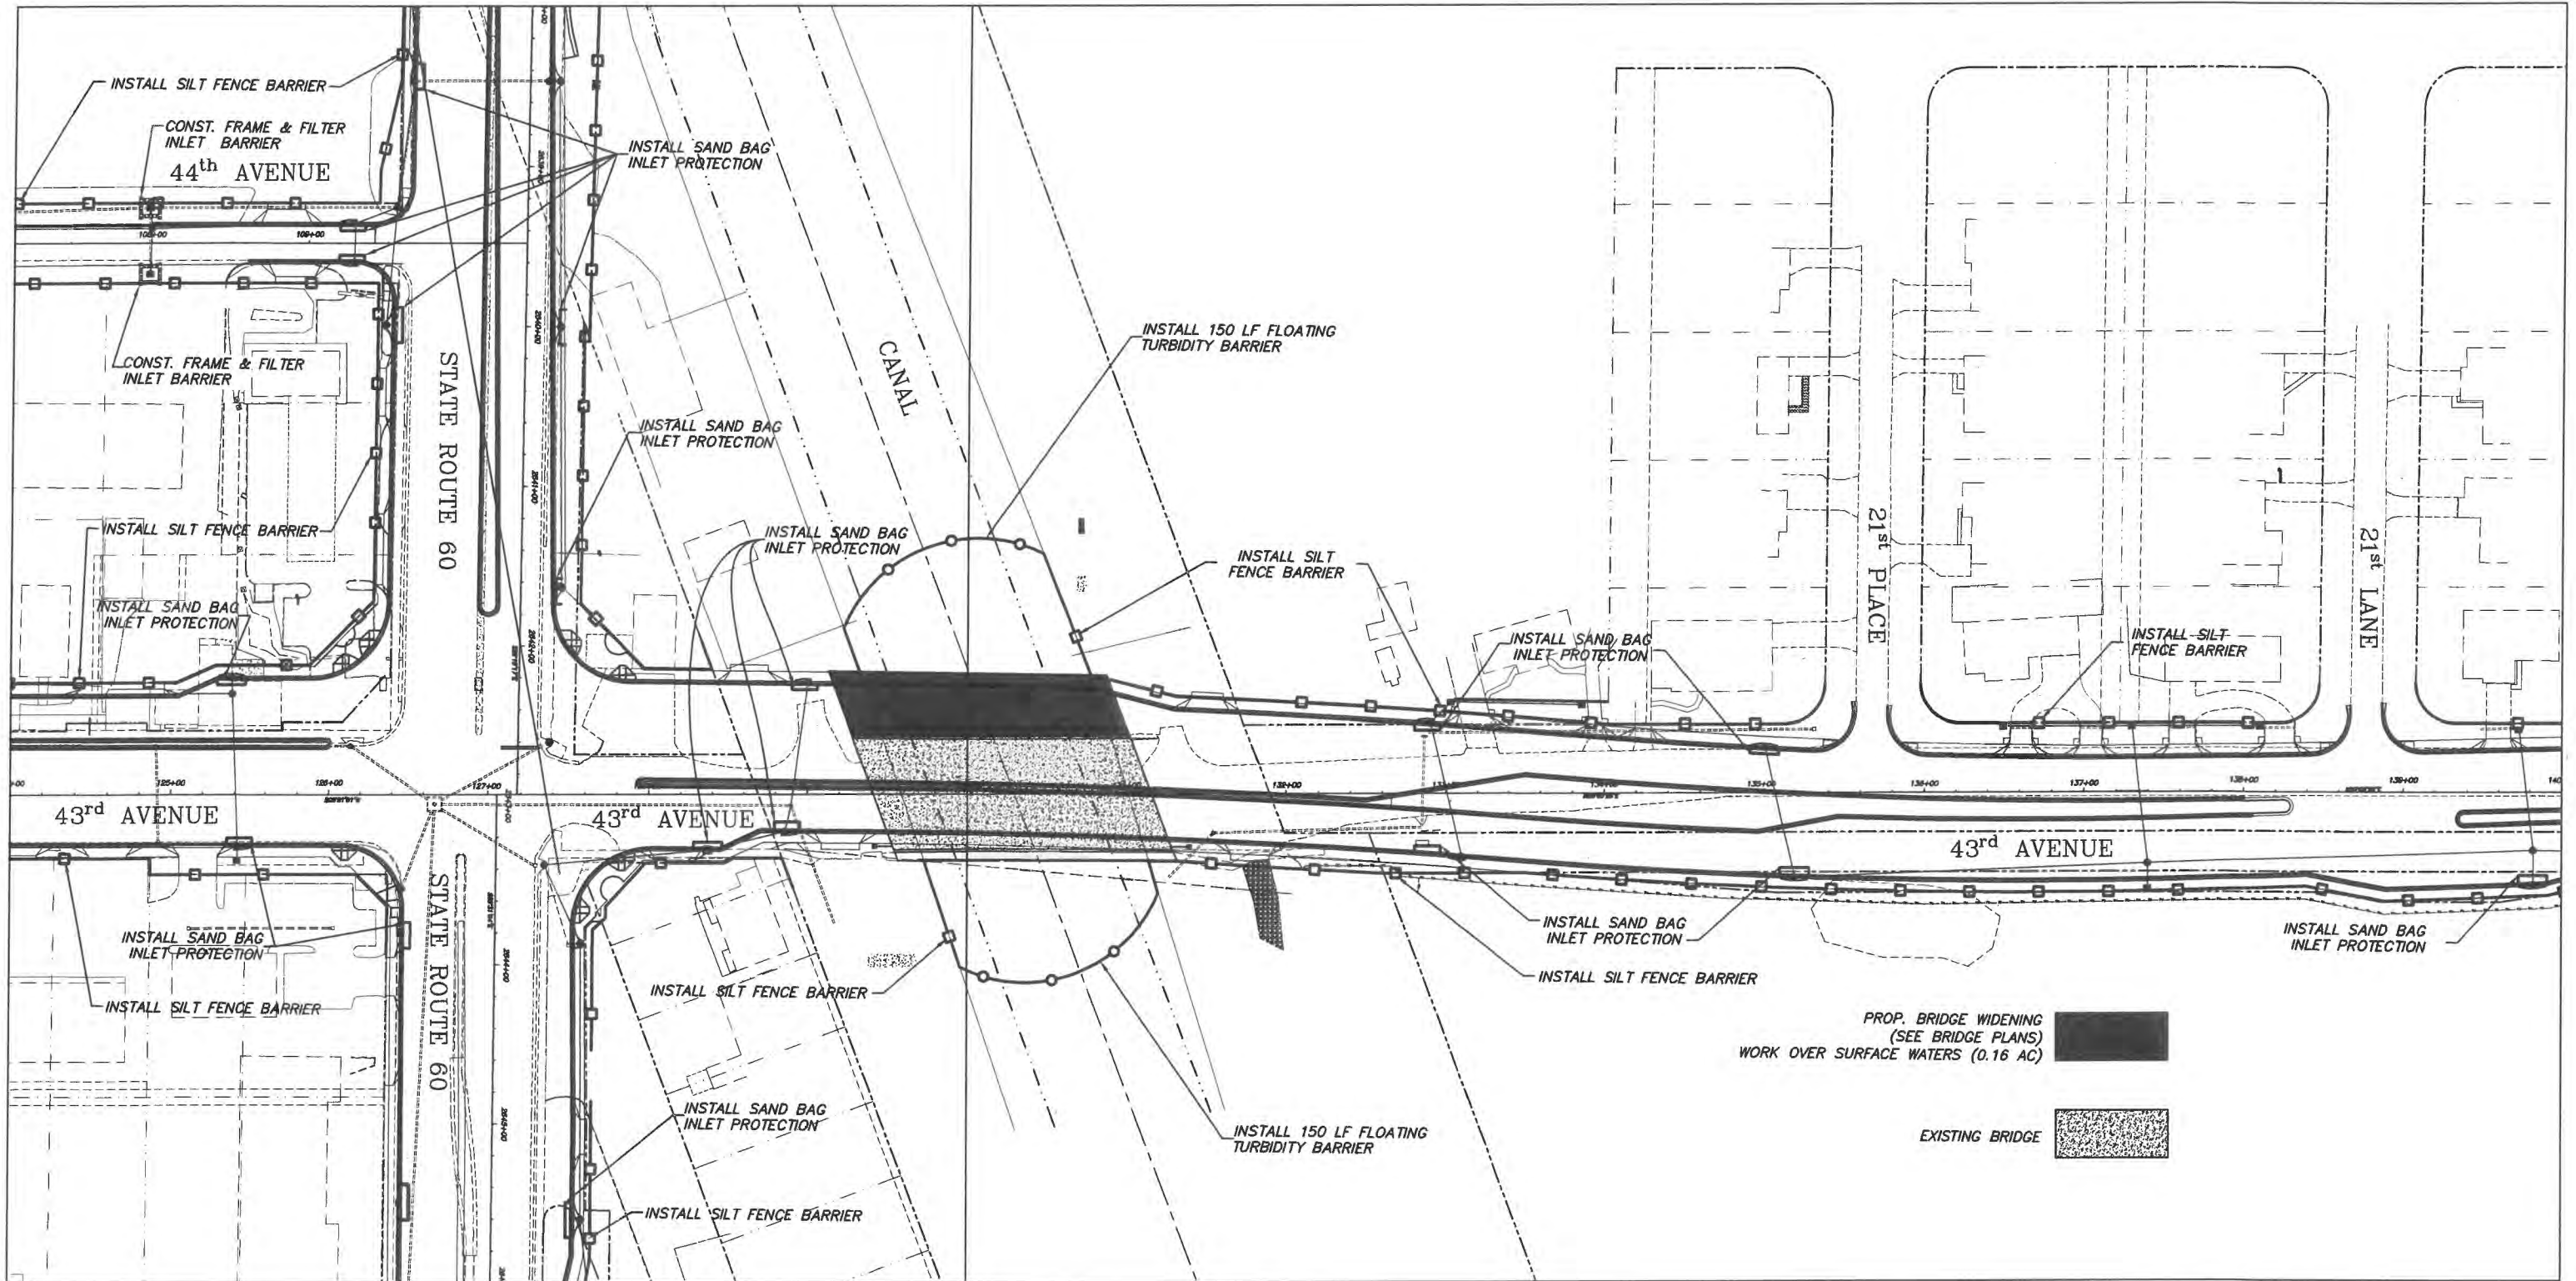
Department of Public Works  
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Project:  
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PROP. BRIDGE WIDENING  
 (SEE BRIDGE PLANS)  
 WORK OVER SURFACE WATERS (0.16 AC)

EXISTING BRIDGE

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**ROBERT W. LAWSON**  
 LICENSE  
 No. 26640  
 DEC 17 2018  
 STATE OF FLORIDA  
 PROFESSIONAL ENGINEER

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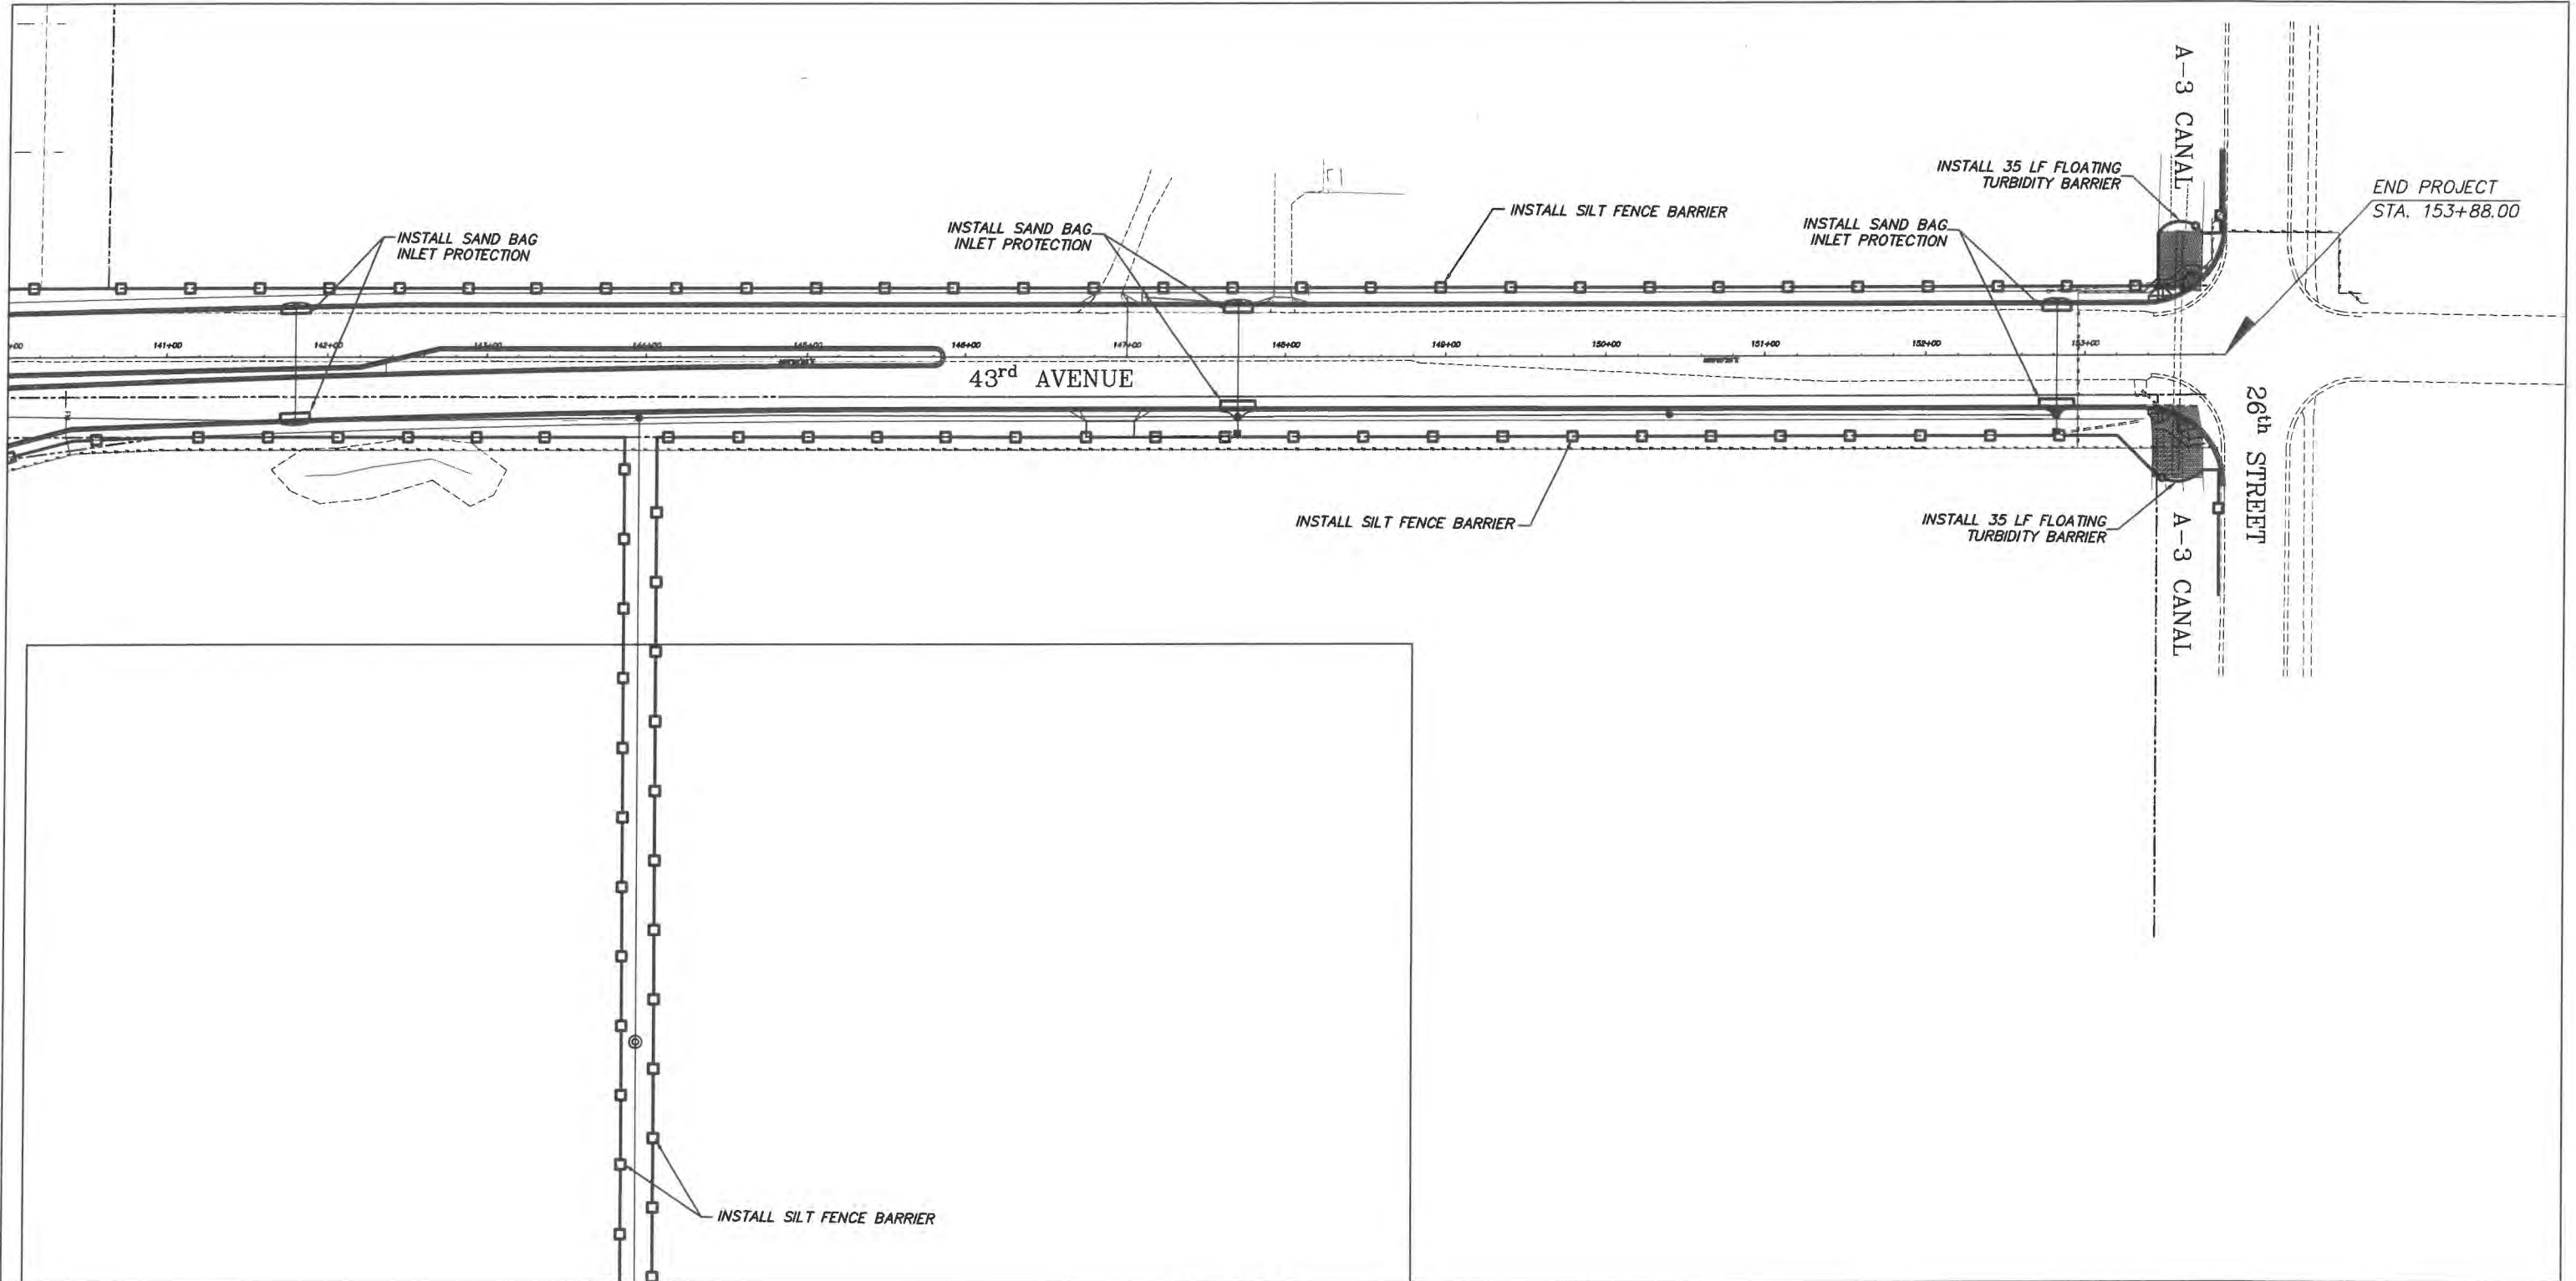
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**Engineering Division**

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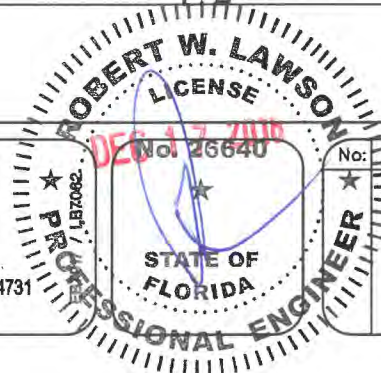
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**STORM WATER POLLUTION PREVENTION PLAN FOR SR 60 & 43RD AVENUE**

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MATCH SHEET 80



No.	Revision:	By:	Date:



Department of Public Works  
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Scale: 1" = 100'  
Approved: HWD  
Drawn: FM  
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Date: 6/2017  
Field Book No:

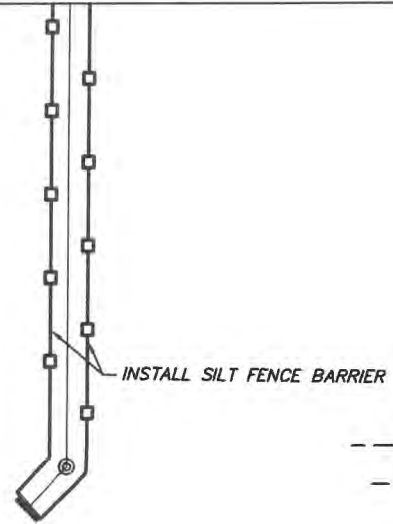
Project:  
STORM WATER POLLUTION  
PREVENTION PLAN  
FOR  
SR 60 & 43RD AVENUE

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Of: 99  
Project No.  
LNW# WP1027

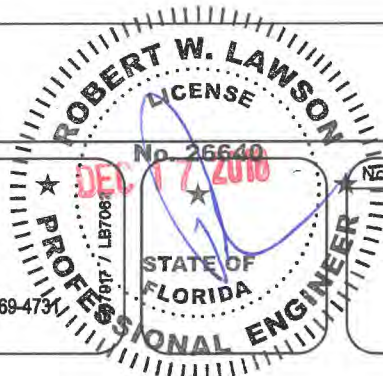
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MATCH SHEET 79



MATCH SHEET 26



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 SR 60 & 43RD AVENUE

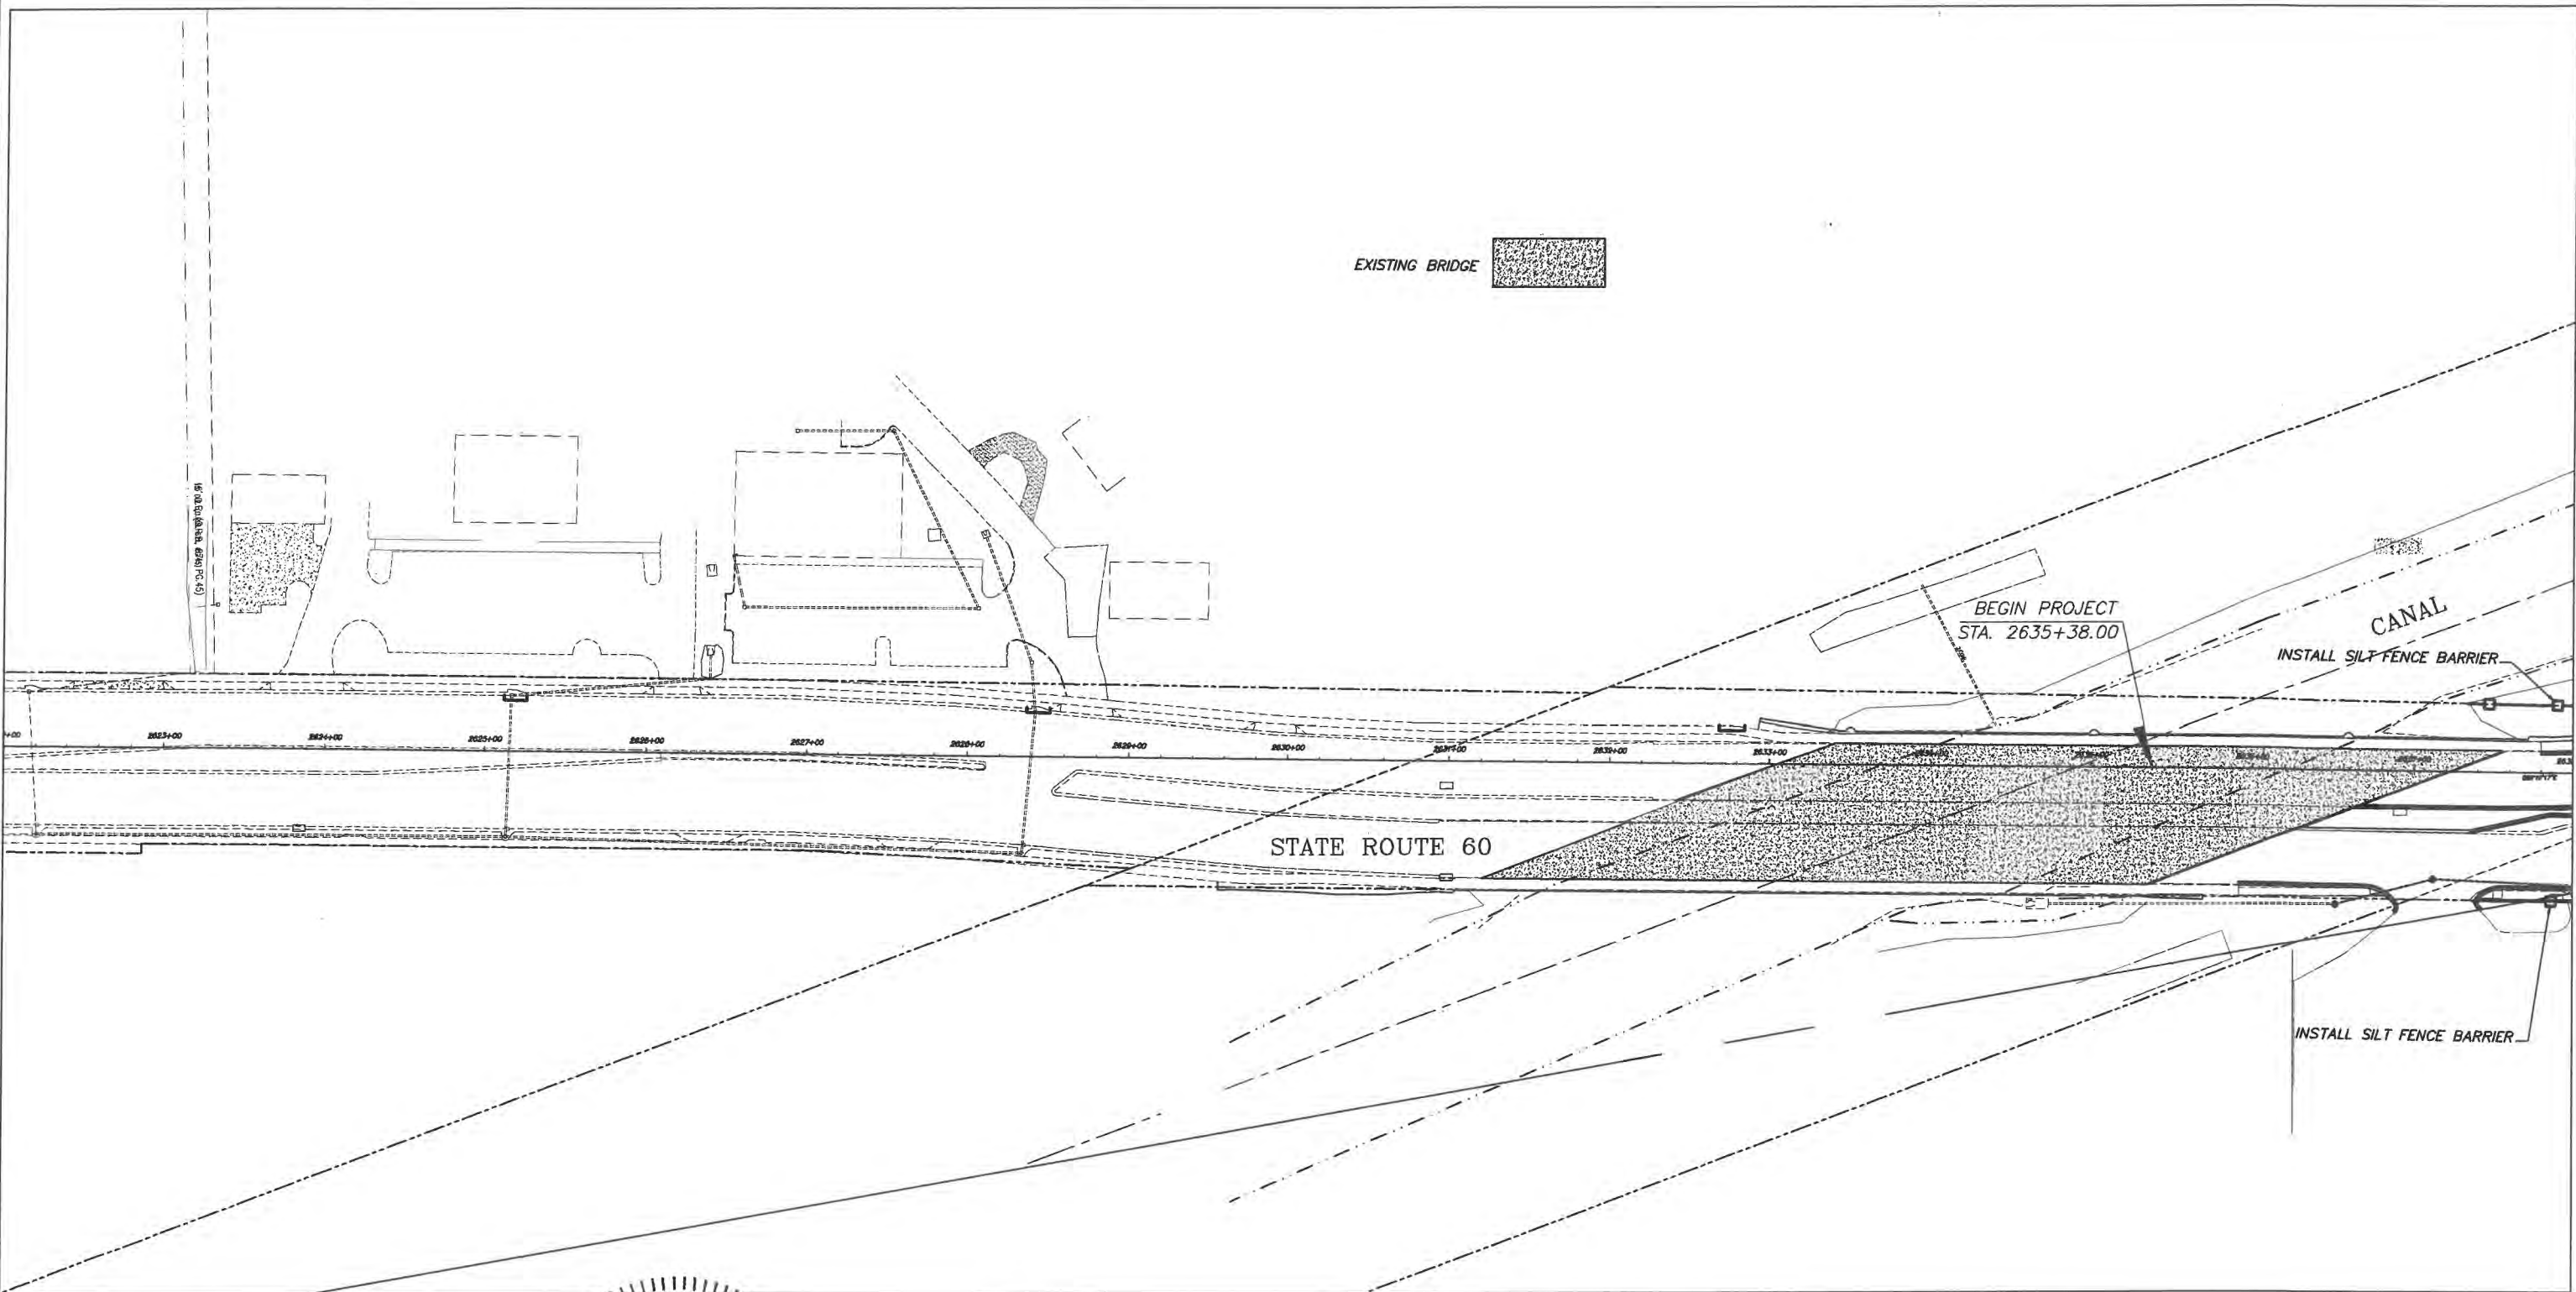
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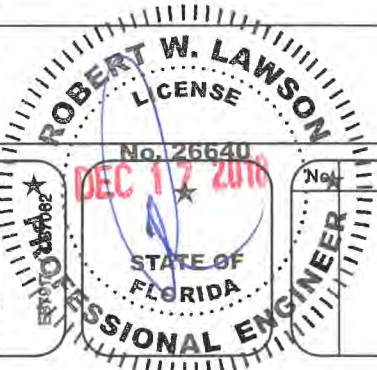
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MATCH SHEET 78

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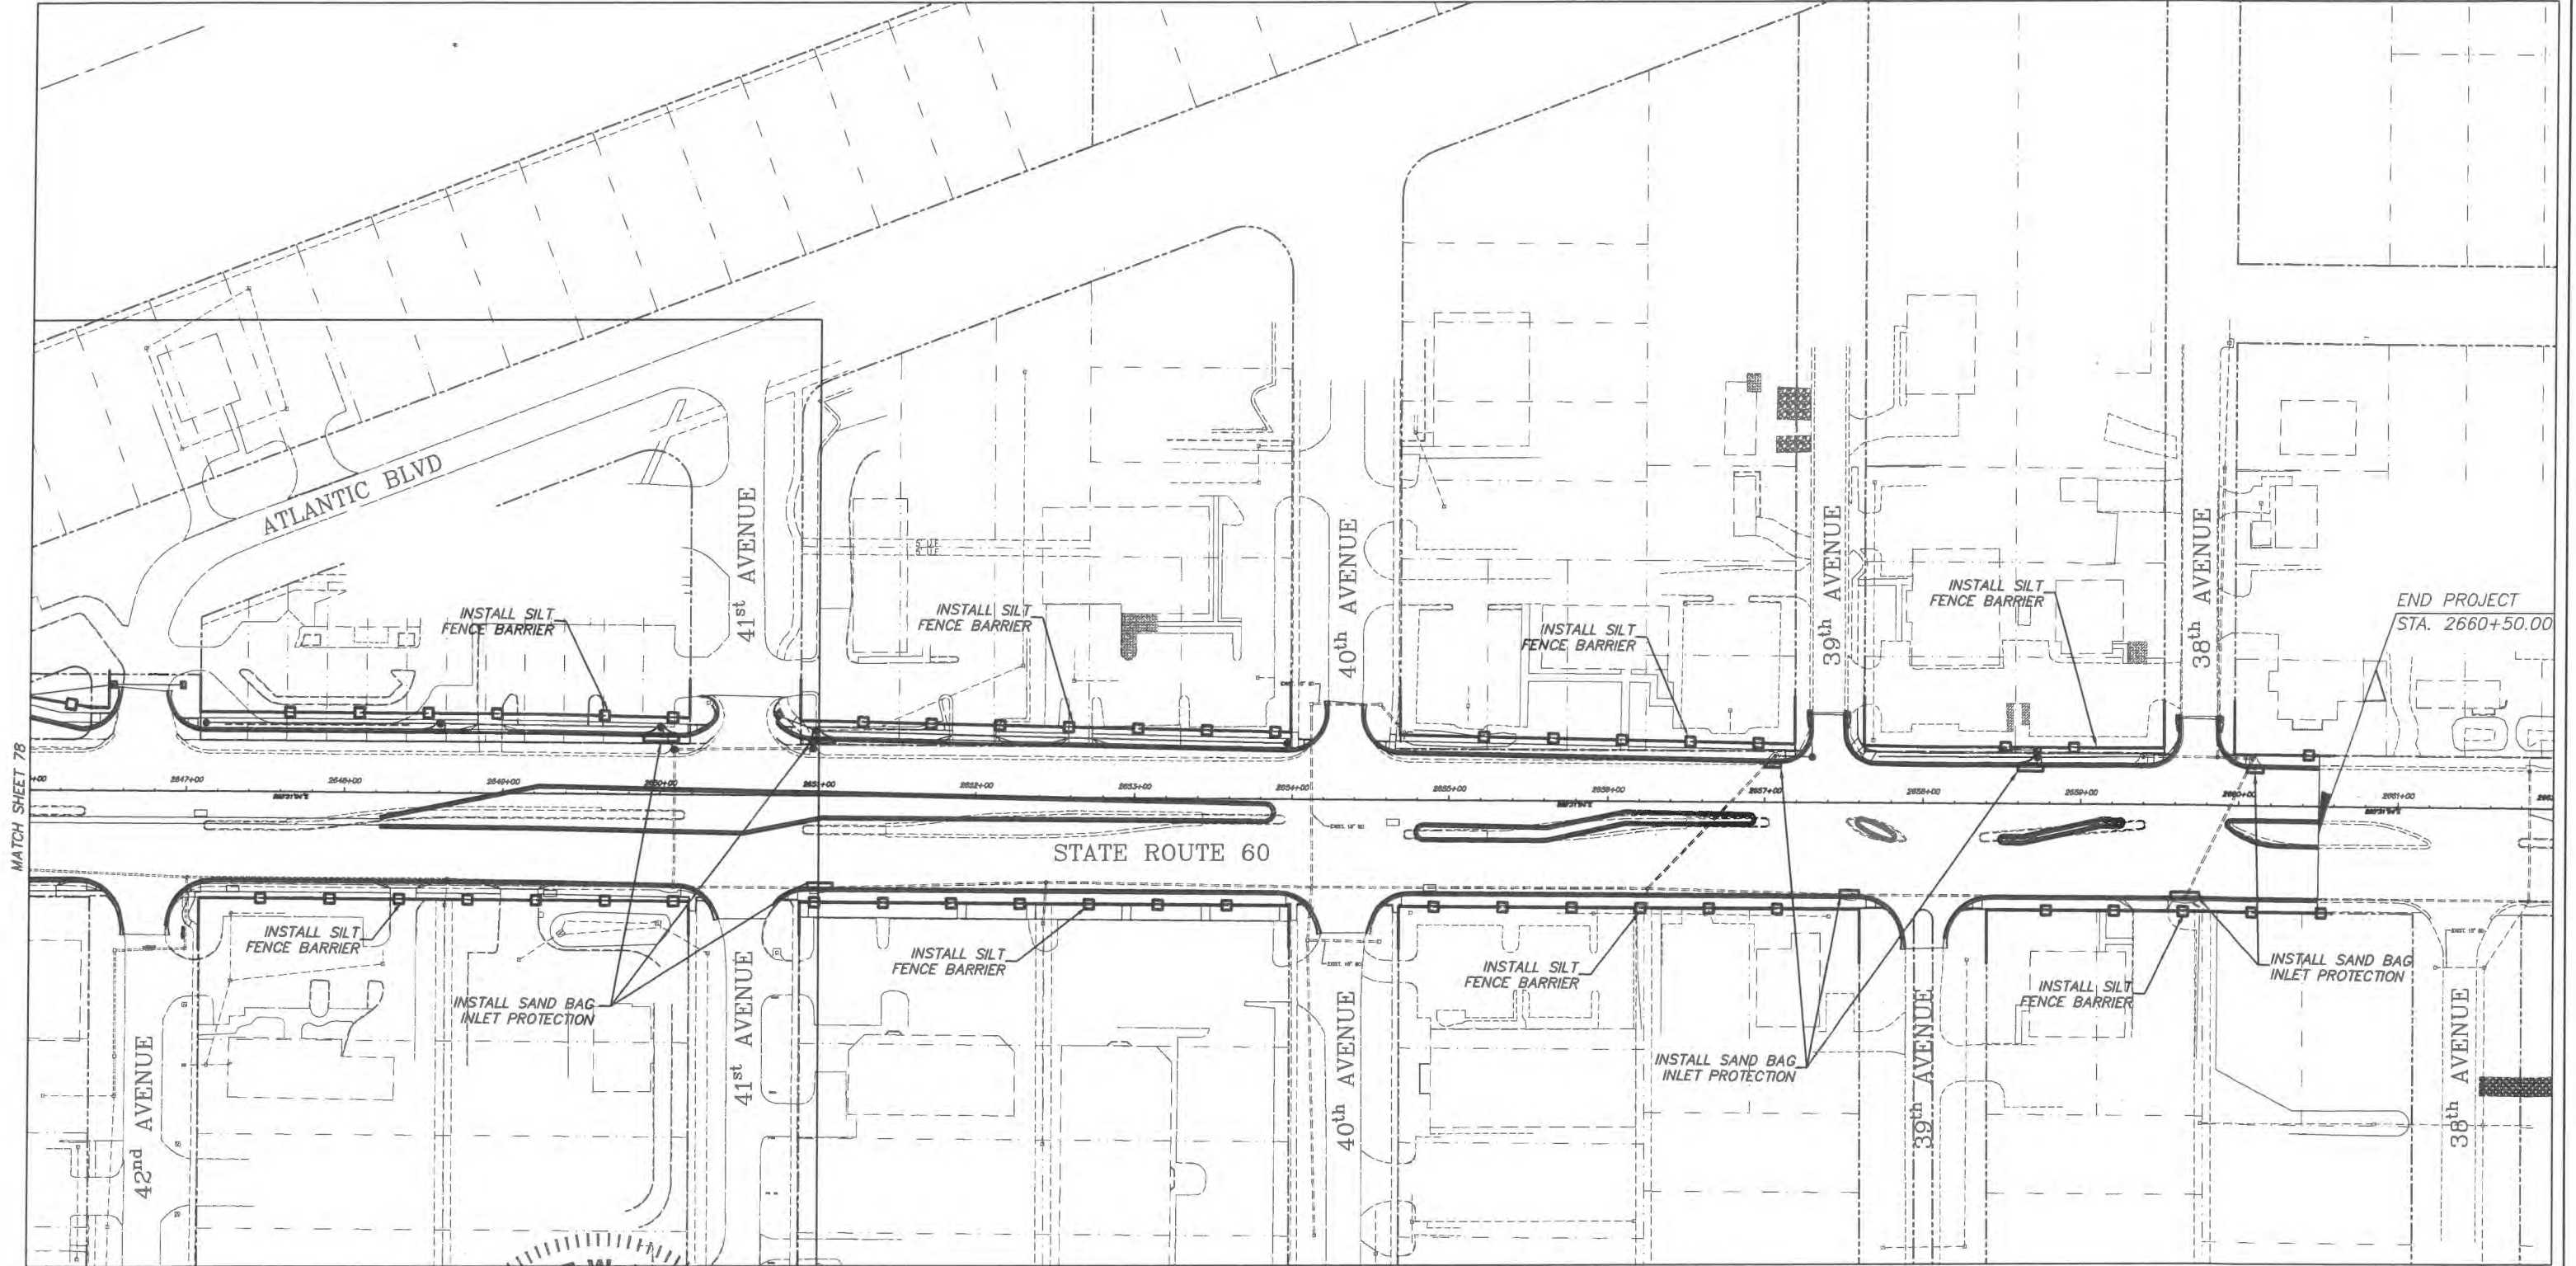
**Department of Public Works**  
**Engineering Division**

Scale: 1" = 100'  
 Approved: HWD  
 Drawn: FM  
 Checked: HWD  
 Date: 6/2017  
 Field Book No:

Project:  
 STORM WATER POLLUTION  
 PREVENTION PLAN  
 FOR  
 SR 60 & 43RD AVENUE

Sheet: 93  
 Of: 99  
 Project No.  
 LNW# WP1027





**ROBERT W. LAWSON**  
 LICENSE  
 No. 26640  
 DEC 17 2018  
 STATE OF FLORIDA  
 PROFESSIONAL ENGINEER

No.	Revision:	By:	Date:



*Department of Public Works*  
**Engineering Division**

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Sheet: 94  
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GB310 / LC2600026P

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**TRAFFIC CONTROL PLAN GENERAL NOTES:**

1. ALL TRAFFIC CONTROL DEVICES AND SCHEMES SHALL CONFORM TO THE FDOT STANDARD SPECIFICATIONS FOR ROAD AND BRIDGE CONSTRUCTION (LATEST EDITION), THE FDOT DESIGN STANDARDS (LATEST EDITION), AND FHWA MANUAL OF UNIFORM TRAFFIC CONTROL DEVICES (MUTCD 2009 EDITION).
2. THESE CONSTRUCTION ACTIVITIES MAY GENERALLY BE CONSTRUCTED IN A SEQUENCE WHICH BEST EXPEDITES THE CONSTRUCTION AT THE DISCRETION OF THE ENGINEER. TRAFFIC DISRUPTIONS WHICH ARE NOT SHOWN ON THE TRAFFIC CONTROL PLAN, BUT WHICH ARE NECESSARY TO CONSTRUCT THE PROJECT SHALL BE SUBMITTED IN WRITING TO THE ENGINEER AND APPROVAL SHALL BE OBTAINED 3 FULL BUSINESS DAYS PRIOR TO COMMENCEMENT OF WORK. SUBMITTAL MATERIAL SHALL INCLUDE SKETCHES, CALCULATIONS, AND OTHER DATA REQUIRED BY THE ENGINEER.
3. FOURTEEN DAYS PRIOR TO THE BEGINNING OF THE CONSTRUCTION THE CONTRACTOR WILL FURNISH AND INSTALL VMS SIGNS TO NOTIFY RESIDENTS OF THE IMPENDING WORK. THESE SIGNS WILL STAY IN PLACE UP TO THE BEGINNING OF THE CONSTRUCTION.
4. THE CONTRACTOR SHALL NOTIFY THE DISTRICT PUBLIC INFORMATION OFFICE AND THE PROJECT ENGINEER OF PROPOSED LANE CLOSURES OR TEMPORARY DETOURS 14 WORKING DAYS IN ADVANCE. THE CONTRACTOR SHALL NOTIFY THE LOCAL POLICE DEPARTMENTS, FIRE DEPARTMENTS, AND EMS WITHIN 48 HOURS OF ANTICIPATED DISRUPTION OF NORMAL FLOW OF TRAFFIC.
5. ALLOWABLE ON-SITE CONSTRUCTION WORK HOURS ARE FROM 8:00 AM TO 6:00 PM MONDAY THROUGH FRIDAY.
6. NO DETOUR OR LANE CLOSURES WILL BE ALLOWED WITHOUT ASSURANCE THAT THE PRIME AND SUBCONTRACTORS HAVE PLANNED THE OPERATIONS TO ACHIEVE RE-OPENING ACCORDING TO THE CONTRACT.
7. ACCESS TO ADJACENT PROPERTIES SHALL BE MAINTAINED BY THE CONTRACTOR DURING ALL PHASES OF CONSTRUCTION.
8. MAIL DELIVERY, GARBAGE PICKUP AND OTHER MUNICIPAL SERVICES SHALL BE MAINTAINED ON ALL ADJACENT PROPERTIES DURING ALL PHASES OF CONSTRUCTION.
9. WHENEVER CONSTRUCTION EQUIPMENT IS BEING DRIVEN OR TRANSPORTED ON THE OPEN TRAVEL LANES, THE CONTRACTOR SHALL UTILIZE FDOT STANDARD INDEX NO. 619.
10. THE CONTRACTOR SHALL PROVIDE ANY AND ALL MATERIALS AND EQUIPMENT NEEDED TO MEET DROP-OFF REQUIREMENTS OF FDOT STANDARD INDEX NO. 600. PAYMENT FOR ALL MATERIALS AND EQUIPMENT SHALL BE INCLUDED UNDER PAY THE ITEM, MAINTENANCE OF TRAFFIC.
11. THE CONTRACTOR SHALL INSTALL EROSION CONTROL MEASURES PRIOR TO BEGINNING CONSTRUCTION AND SHALL MAINTAIN DRAINAGE DURING CONSTRUCTION OPERATIONS TO ENSURE SAFE VEHICULAR OPERATIONS AS WELL AS TO PROHIBIT ANY UNDUE IMPACT ON OFF-SITE DRAINAGE OR ENVIRONMENTAL CONCERNS. PROVISIONS SHALL BE SUBMITTED TO THE ENGINEER FOR APPROVAL PRIOR TO USE AND SHALL INCLUDE PROVISIONS AS REQUIRED IN THE NPDES AND OTHER PERMITS.
12. EXCAVATIONS DEEPER THAN 18 INCHES AND ANY OTHER WORK WHICH MAY ADVERSELY AFFECT THE PERFORMANCE OF ANY UTILITY SHALL NOT BE DONE ON SATURDAYS. ALL SATURDAY WORK MUST BE APPROVED BY THE ENGINEER.
13. DRIVEWAY SLOPES MAY BE MODIFIED AS DIRECTED BY THE ENGINEER TO MATCH EXISTING CONDITIONS DURING CONSTRUCTION.

**SIGNING AND PAVEMENT MARKINGS:**

14. THE CONTRACTOR SHALL REMOVE OR COVER ANY EXISTING OR PROPOSED SIGNS AND/OR PAVEMENT MARKINGS WHICH CONFLICT WITH THE TRAFFIC CONTROL THROUGH THE WORK ZONE. WHEN THE CONFLICT NO LONGER EXISTS THE CONTRACTOR SHALL RESTORE THE SIGNS AND/OR PAVEMENT MARKINGS TO THEIR ORIGINAL POSITION. REMOVAL OF PAVEMENT MARKINGS IN AREAS WHICH WILL NOT BE MILLED, BUT WHERE RESTRIPING OCCURS, SHALL BE BY SAND OR WATER BLASTING OR ANY OTHER METHOD THAT WILL NOT MATERIALLY DAMAGE THE SURFACE TEXTURE OF THE PAVEMENT AND WHICH WILL ELIMINATE THE PREVIOUS MARKING PATTERN REGARDLESS OF WEATHER AND LIGHT CONDITIONS. USE OF BLACK PAINT TO COVER EXISTING PAVEMENT MARKINGS SHALL BE PROHIBITED.
15. ALL EXISTING PAVEMENT MARKINGS AND RPM'S THAT HAVE BEEN ALTERED OR REMOVED DUE TO CONSTRUCTION OPERATIONS, AND WHICH WILL NOT BE REPLACED BY NEW MARKINGS AND RPM'S, AS SHOWN ON THE PAVEMENT MARKING PLANS, SHALL BE REPLACED UPON COMPLETION OF THE PHASES OF CONSTRUCTION WHICH REQUIRE THEIR ALTERATION OR REMOVAL. DURING AND AFTER COMPLETION OF EACH CONSTRUCTION PHASE, THE CONTRACTOR SHALL PROVIDE ALL NECESSARY TEMPORARY PAVEMENT MARKINGS (I.E. LANE LINES, ARROWS, CROSSWALKS, STOP BARS, RPM'S, ETC.) UNTIL THE FINAL FRICTION COURSE IS PLACED AND PERMANENT MARKINGS INSTALLED.
16. THE CONTRACTOR SHALL INSTALL CONSTRUCTION SIGNING PRIOR TO COMMENCEMENT OF CONSTRUCTION AND MAINTAIN SIGNING DURING ALL PHASES OF CONSTRUCTION.
17. INSTALL TEMPORARY PAINT (STRIPING/MARKINGS) AND RPM'S SUBSEQUENT TO INSTALLATION OF FINAL SURFACE COURSE PAVING AND PERMANENT THERMOPLASTIC (STRIPING/MARKINGS) AND RPM'S SUBSEQUENT TO A 14 DAY CURING PERIOD.

**LIGHTING:**

18. THE CONTRACTOR SHALL MAINTAIN THE EXISTING LEVEL OF ILLUMINATION ON THE TRAVELED ROADWAY THROUGHOUT CONSTRUCTION.

**PEDESTRIAN, BICYCLES AND WHEELCHAIRS:**

20. PEDESTRIAN WALKWAYS, BUS STOPS AND PEDESTRIAN ACCESS SHALL BE MAINTAINED FREE OF ANY OBSTRUCTIONS SUCH AS HOLES, DEBRIS, MUD, CONSTRUCTION EQUIPMENT, STORED MATERIALS, ETC. ANY HAZARDS NEAR OR ADJACENT TO WALKWAYS, BUS STOPS AND ACCESS TO TRANSIT VEHICLES SHALL BE CLEARLY DELINEATED.
21. WHEN SAFE PEDESTRIAN ACCESS/WALKWAYS CANNOT BE PROVIDED, PEDESTRIANS SHALL BE DIRECTED TO ALTERNATIVE ROUTES BY APPROPRIATE TRAFFIC CONTROL DEVICES. PEDESTRIAN, BICYCLE AND WHEELCHAIR TRAFFIC SHALL BE GUIDED AND MAINTAINED USING APPROVED WARNING LIGHTS, SIGNING AND CHANNELIZATION DEVICES. SUCH DEVICES SHALL BE MAINTAINED IN ACCORDANCE WITH THE MUTCD SECTIONS ON WORK ZONE TRAFFIC CONTROL FOR PEDESTRIANS AND CHAPTER 6D, PEDESTRIAN AND WORKER SAFETY.
22. IT SHALL BE THE RESPONSIBILITY OF CONTRACTOR TO INSTALL ANY NECESSARY PAVEMENT, ROAD ROCK, PAVEMENT MARKINGS AND SIGNAGE TO ACCOMMODATE AN EXISTING ALTERNATIVE WALK ROUTE.

**PHASING NOTES:**

**PHASE 1** -UTILIZING INDICES 600, 613, 615, 616, 618, 635, 660 - 43RD AVE. STA. 109+60 TO STA. 153+88, SR 60 STA. 2635+38 TO STA. 2660+50.

1. PHASE 1 CONSTRUCTION CONSISTS OF PLACING OF TURBIDITY BARRIERS, SEDIMENT BARRIERS, AND INLET PROTECTION AND ALL CLEARING AND GRUBBING.
2. INSTALL ADVANCE CONSTRUCTION AHEAD WARNING SIGNS, BARRICADES, AND CONSTRUCTION SIGNS, AND REMOVE CONFLICTING MARKINGS AND SIGNS.
3. TEMPORARY MARKINGS SHALL BE INSTALLED FOR TRAFFIC CONTROL.

**PHASE 2** -UTILIZING INDICES 600, 613, 615, 616, 618, 635, 660 - 43RD AVE. STA. 109+60 TO STA. 153+88, SR 60 STA. 2635+38 TO STA. 2660+50.

1. PHASE 2 CONSISTS OF ALL ROADWAY CONSTRUCTION, STORM WATER DRAINAGE CONSTRUCTION, AND CURB & GUTTER & SIDEWALK INSTALLATION ON THE NORTH AND SOUTH SIDE OF SR 60 AND THE EAST AND WEST SIDE OF 43RD AVENUE.
2. ACCESS TO PROPERTIES ON SHALL BE MAINTAINED AT ALL TIMES.
3. INSTALL ADVANCE CONSTRUCTION AHEAD WARNING SIGNS, BARRICADES, AND CONSTRUCTION SIGNS, AND REMOVE CONFLICTING MARKINGS AND SIGNS.
4. DROP-OFF CONDITIONS SHALL MEET THE REQUIREMENTS AS OUTLINED IN FDOT STANDARD INDEX NO. 600 AND ANY DROP-OFF CONDITION THAT IS CREATED SHALL BE RESTORED WITHIN THE SAME WORK PERIOD.
5. CONSTRUCT STORM WATER DRAINAGE AND ROADWAY WIDENING ON NORTH AND SOUTH SIDES OF SR 60 AND THE EAST AND WEST SIDES OF 43RD AVE. CONSTRUCTION INCLUDES EMBANKMENT AND EXCAVATION; ALL WORK ASSOCIATED WITH DRAINAGE STRUCTURES AND PIPES; GRADING; ALL WORK ASSOCIATED WITH PLACING OF PAVED ROADWAY, CURB AND GUTTER, SIDEWALK, AND RELATED ITEMS IN TYPICAL SECTION; PLACEMENT OF NEW LIGHTING; ADJUSTMENT TO EXISTING LIGHTING; SODDING; SIGNALIZATION; AND PROTECTION OF EXISTING IRRIGATION SYSTEMS.
6. MAINTAIN A POSTED SPEED LIMIT OF 45 MPH.

**PHASE 3** -UTILIZING INDICES 600, 613, 615, 616, 619, 635, 660 43RD AVE. STA. 109+60 TO STA. 153+88, SR 60 STA. 2635+38 TO STA. 2660+50.

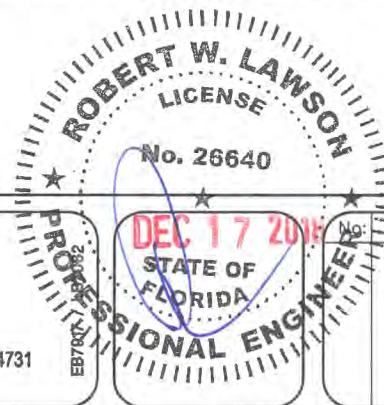
1. PHASE 3 CONSISTS OF ALL ROADWAY CONSTRUCTION, STORM WATER DRAINAGE CONSTRUCTION, AND CURB & GUTTER, MEDIAN CONSTRUCTION ON SR 60 AND 43RD AVE.
2. INSTALL ADVANCE CONSTRUCTION AHEAD WARNING SIGNS, BARRICADES, AND CONSTRUCTION SIGNS, AND REMOVE CONFLICTING MARKINGS AND SIGNS.
3. MAINTAIN A POSTED SPEED LIMIT OF 45 MPH.

**PHASE 4** -UTILIZING INDICES 600, 613, 615, 616, 619, 635, 660 43RD AVE. STA. 109+60 TO STA. 153+88, SR 60 STA. 2635+38 TO STA. 2660+50.

1. PHASE 4 CONSISTS OF INSTALLATION OF SIGNING AND APPLICATION OF PAVEMENT MARKINGS AND RPM'S.
2. INSTALL ADVANCE CONSTRUCTION AHEAD WARNING SIGNS, BARRICADES, AND CONSTRUCTION SIGNS, AND REMOVE CONFLICTING MARKINGS AND SIGNS.
3. MAINTAIN A POSTED SPEED LIMIT OF 45 MPH.
4. THE FDOT AND/OR INDIAN RIVER COUNTY MAY REQUIRE THAT PHASE 3 BE PERFORMED DURING NIGHT TIME.

**PHASE 5** -UTILIZING INDICES 600, 613, 615, 616, 619, 635, 660 43RD AVE. STA. 109+60 TO STA. 153+88, SR 60 STA. 2635+38 TO STA. 2660+50.

1. PHASE 5 CONSISTS OF INSTALLATION OF SIGNING AND APPLICATION OF PAVEMENT MARKINGS AND RPM'S.
2. INSTALL ADVANCE CONSTRUCTION AHEAD WARNING SIGNS, BARRICADES, AND CONSTRUCTION SIGNS, AND REMOVE CONFLICTING MARKINGS AND SIGNS.
3. MAINTAIN A POSTED SPEED LIMIT OF 45 MPH.



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Department of Public Works  
 Engineering Division

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 Date: 6/2017  
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Project:  
 TRAFFIC CONTROL PLANS  
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 SR 60 & 43RD AVENUE

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Indian River County Traffic Engineering has underground conduit for traffic signal interconnections in this area as well as other traffic signal equipment. It shall be the contractor's responsibility to contact Sunshine State One Call System at 1-800-432-4770 for locations of this equipment at least 72 hours prior to any construction.

Regarding Traffic Control Plan General Note #5 shown on sheet 94, lane closures are restricted to outside the normal peak hours of traffic, lane closures shall occur during the hours of 9:00 AM to 4:00 PM unless otherwise approved by the County Public Works Director or his designee.

For full road closures, Portable Changeable Message Signs are required to pre-advertise the roadway closure, a minimum of seven (7) days in advance of the road closure and during the duration of the road closure. The use of Portable Changeable Message Signs for lane closures on thoroughfare plan roadways will be required. Messages are to be as approved by the Public Works Department and shown on the TCP.

It shall be the responsibility of the contractor to ensure that all subcontractors are in full compliance with all traffic control regulations.

It shall be the responsibility of the contractor working on County roadways or within Right-of-Ways to establish maintenance of traffic prior to any work being performed. The contractor shall frequently monitor the work zone set-up to ensure that all signing is properly placed and that warning signs remain at the proper advance posting distance from the work area. Any signs that do not apply to the work zone shall be removed or covered. The contractor shall remove the work zone set-up at the conclusion of the work.

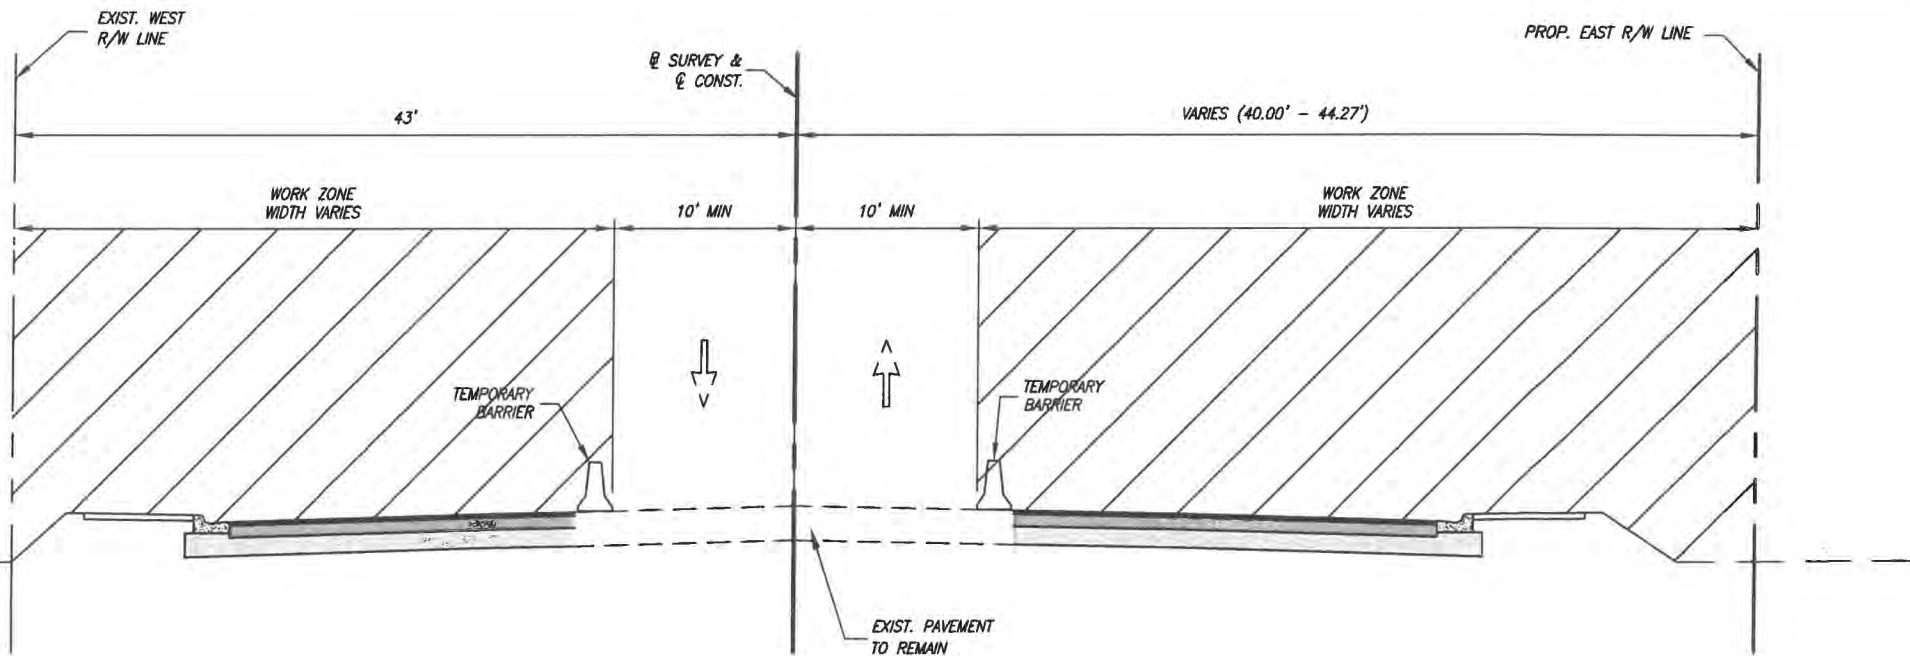
It is the policy of the Traffic Engineering Division to randomly monitor the contractor's compliance with all regulations while working on County roadways and within right-of-ways. Matters of public safety shall be attended to immediately upon notification by the County Public Work Director or his designee.

The contractor shall notify the County Traffic Engineering twenty-four (24) hours in advance of any lane closings at (772) 226-1547. For full road closures, the county shall be notified a minimum of ten (10) days in advance of the planned closure. Public Works Department staff shall inspect the Maintenance of Traffic for compliance with the approved TCP prior to construction commencement.

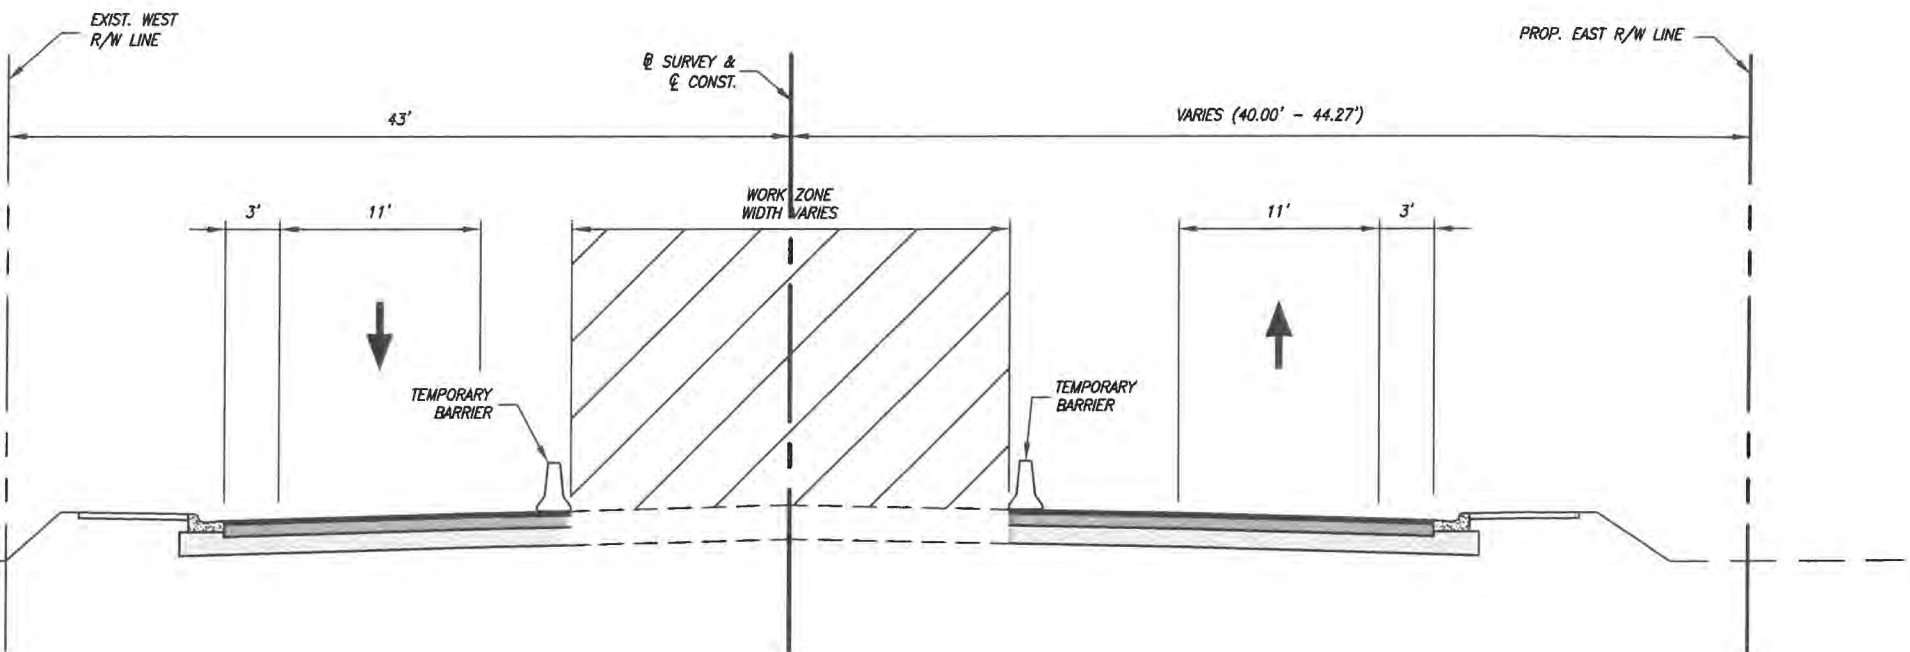
Construction at or Near Signalized Intersections shall comply with Indian River County Traffic Engineering Division's Special Conditions for Right-of-Way Construction.

Retro-reflective raised pavement markers are required in all areas where lane shifts may occur, all temporary centerline pavement markings within the work zone, and all other work zone applications per FDOT Design Standards, 2015 Indices 600.

Contractor may provide optional base material slope wedges to mitigate drop off conditions per index 600.

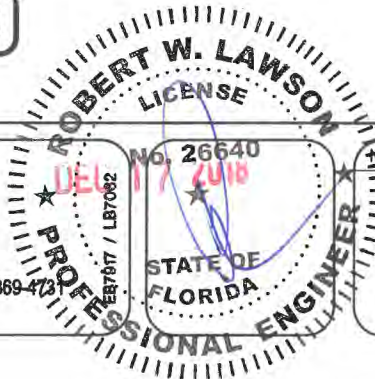


**PHASE II 43RD AVENUE**  
**STA. 109+60 TO STA. 153+88**

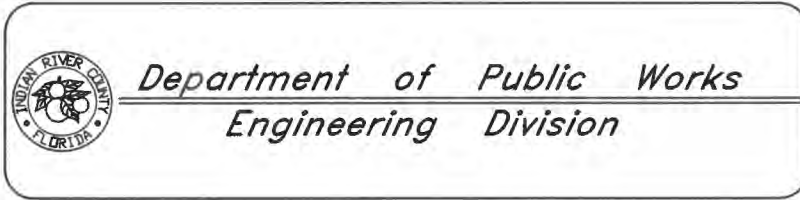


**PHASE III 43RD AVENUE**  
**STA. 109+60 TO STA. 153+88**

DESIGN SPEED 45 MPH



No.	Revision:	By:	Date:

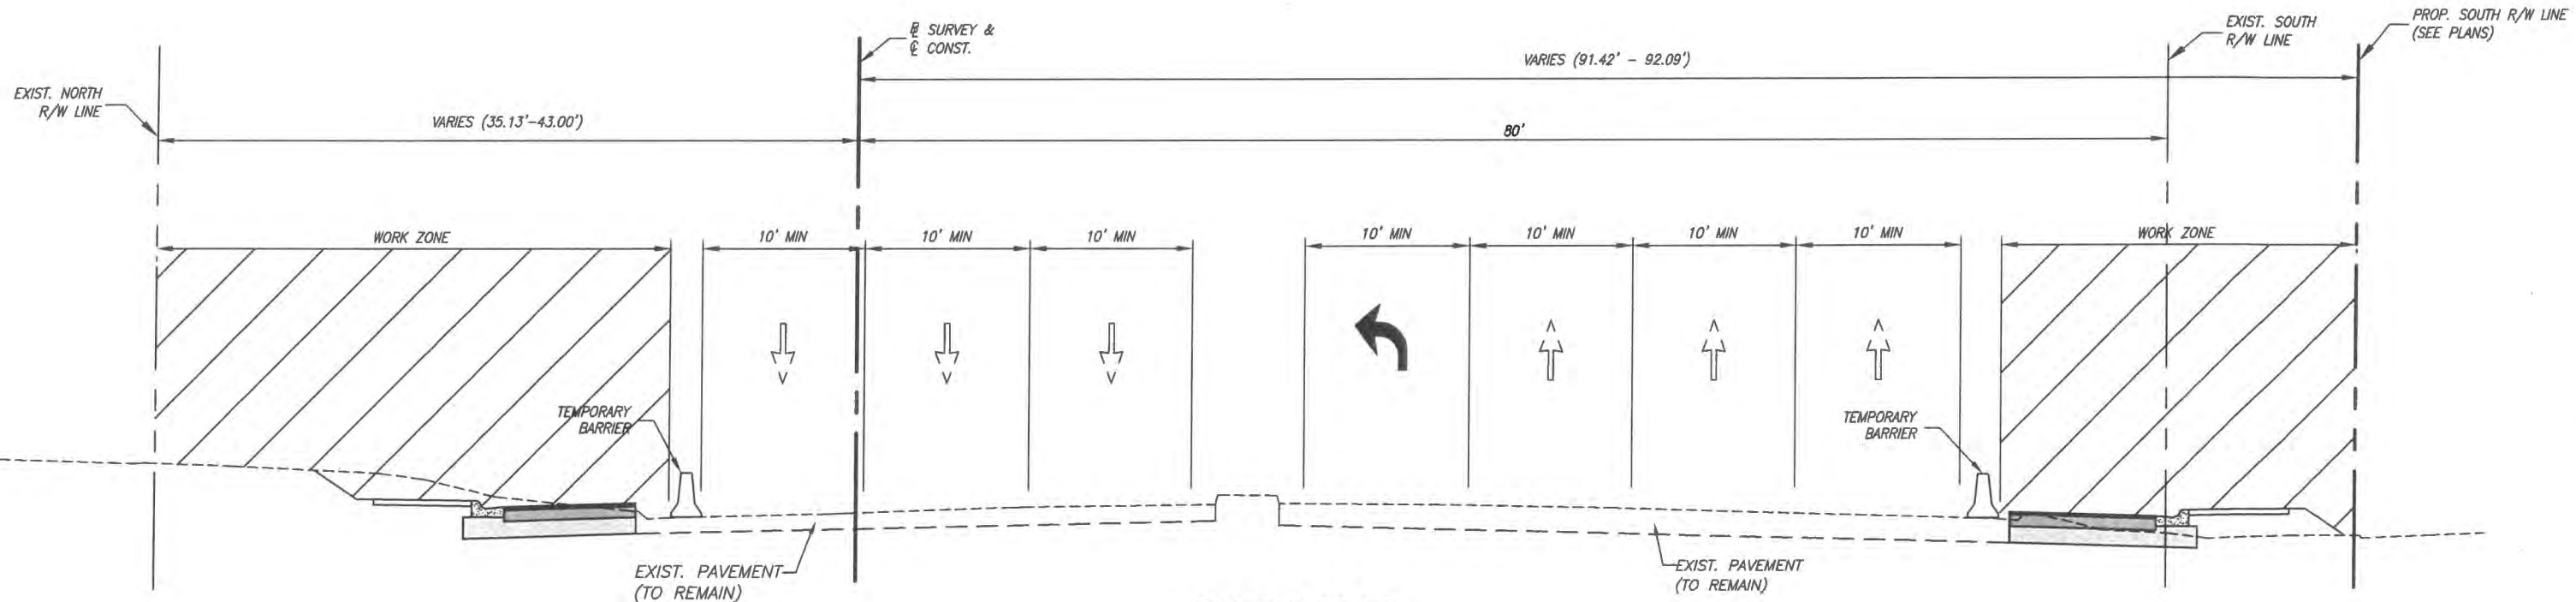


Scale:  
 Approved: HWD  
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Project:  
**TRAFFIC CONTROL PLANS**  
**FOR**  
**SR 60 & 43RD AVENUE**

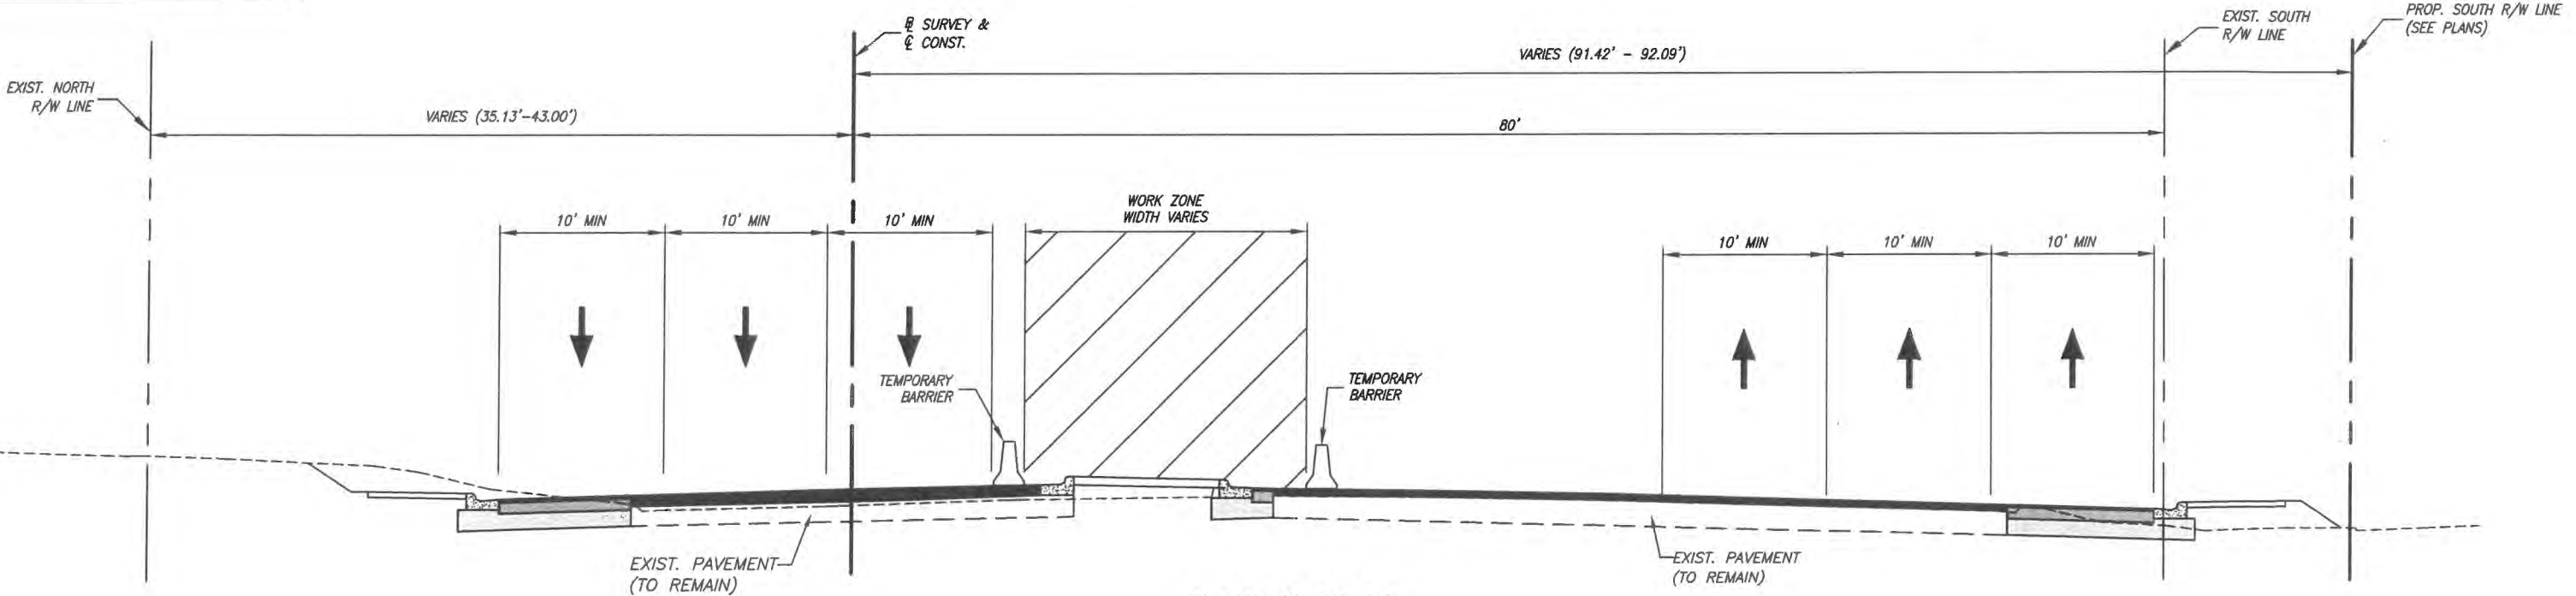
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DESIGN SPEED 45 MPH

**PHASE II SR 60**  
STA. 2635+38 TO STA. 2660+50



**PHASE III SR 60**  
STA. 2635+38 TO STA. 2660+50

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**ROBERT W. LAWSON**  
LICENSE  
No. 26640  
DEC 7 2018  
STATE OF FLORIDA  
PROFESSIONAL ENGINEER

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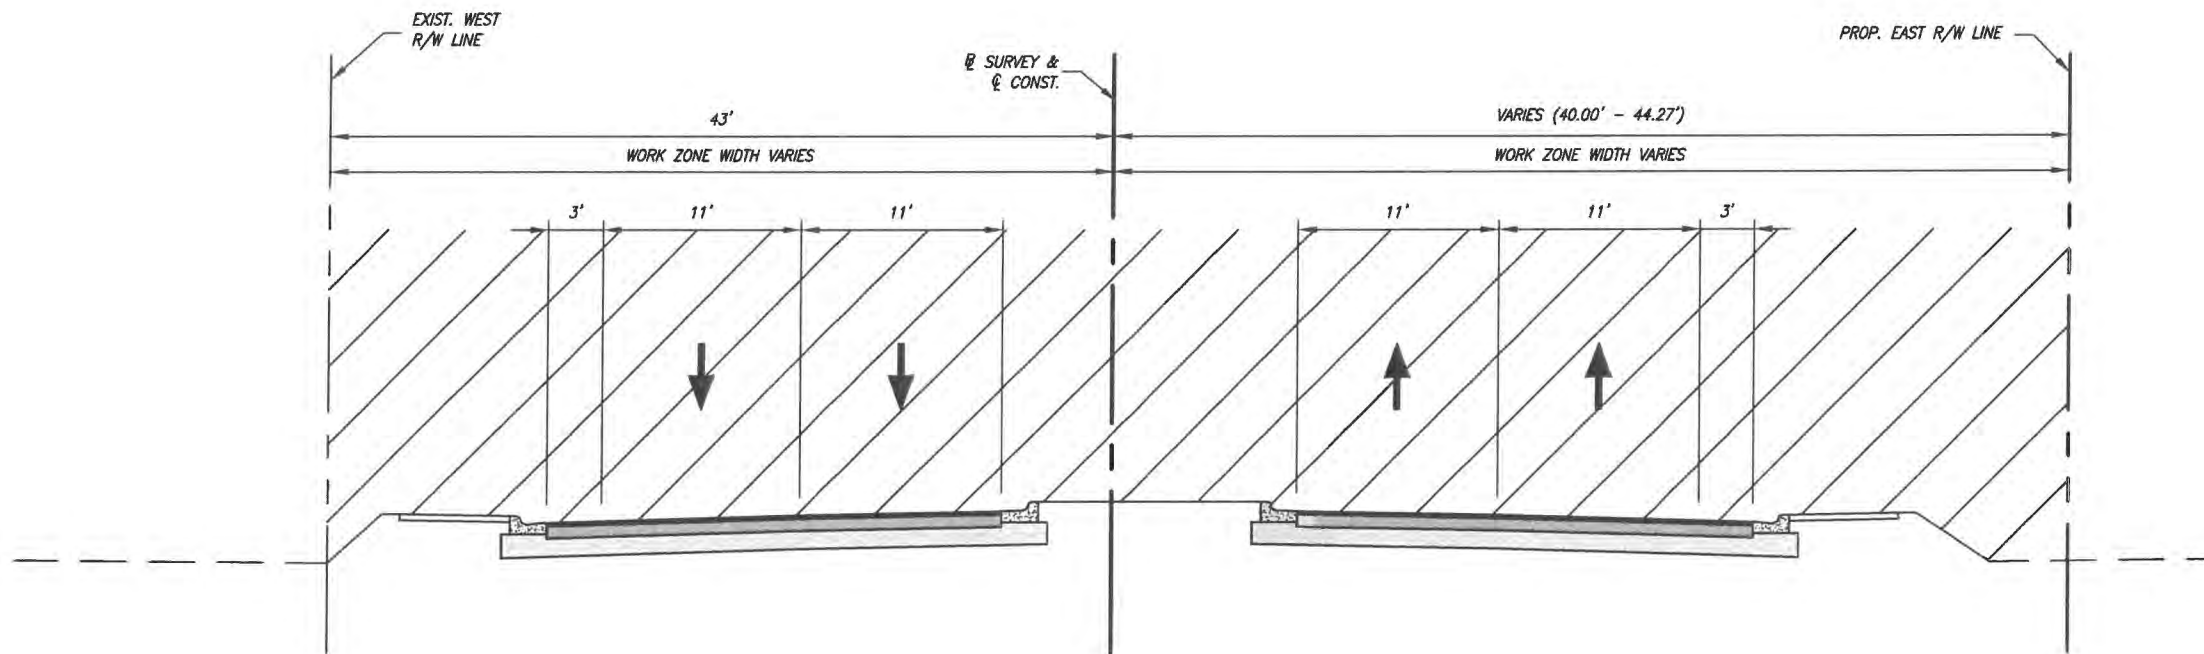
**INDIAN RIVER COUNTY**  
FLORIDA  
*Department of Public Works*  
*Engineering Division*

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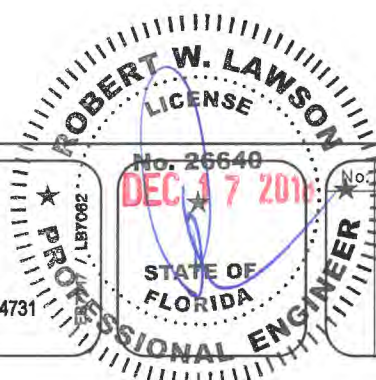
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**PHASE IV 43RD AVENUE TYPICAL SECTION**  
**STA. 109+60 TO STA. 153+88**

**DESIGN SPEED 45 MPH**



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*Department of Public Works*  
*Engineering Division*

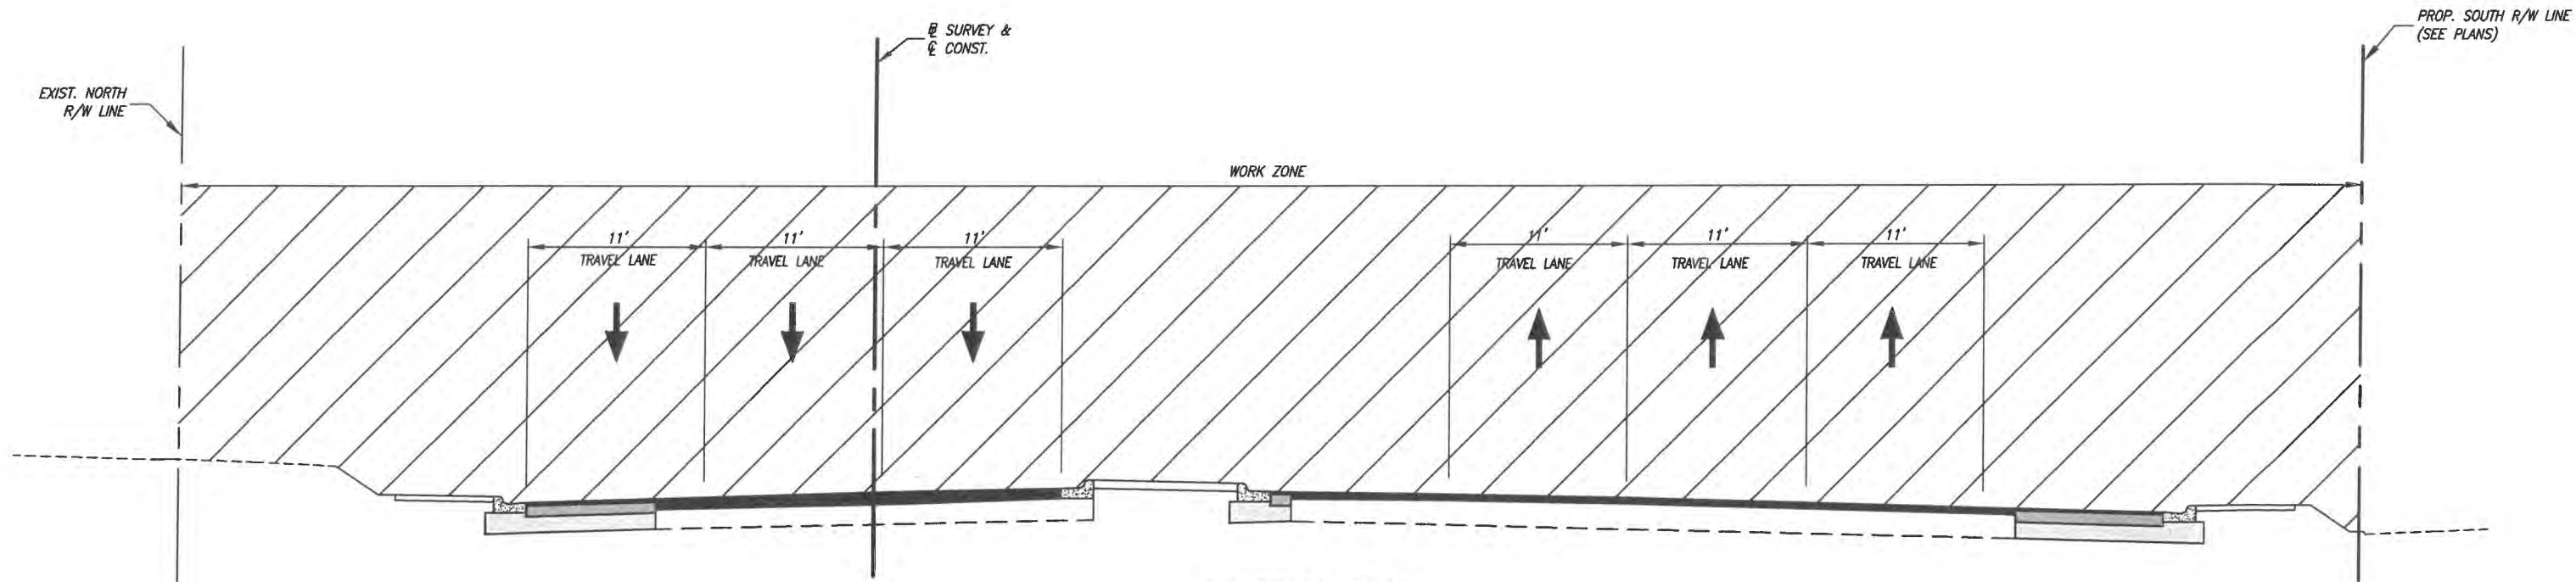
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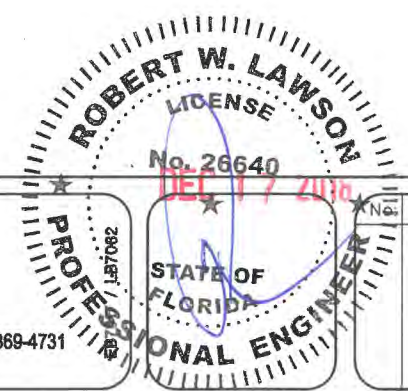
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PHASE IV SR 60  
 STA. 2635+38 TO STA. 2660+50

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# INDIAN RIVER COUNTY BOARD OF COUNTY COMMISSIONERS



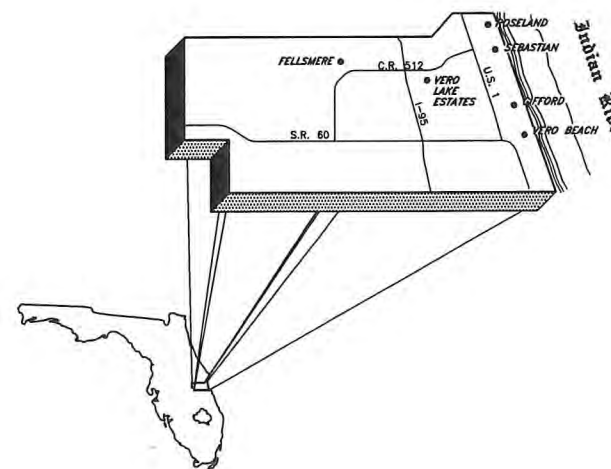
SUMMARY OF PAY ITEMS			
NO.	ITEM	UNIT	QUANTITY
0700 2011	SINGLE POST SIGN, F&I, <12 SF	AS	64
0700 2013	SINGLE POST SIGN, F&I, 21>30 SF	AS	9
077 20 40	SINGLE POST SIGN, RELOCATE	AS	13
0705 11 1	DELINEATOR, FLEXIBLE TUBULAR	EA	18
0706 3	RETRO-REFLECTIVE PAVEMENT MARKERS	EA	780
0711 11111	THERMOPLASTIC, STANDARD, WHITE, SOLID, 6"	NM	3.14
0711 11122	THERMOPLASTIC, STANDARD, WHITE, SOLID, 8"	LF	2135
0711 11123	THERMOPLASTIC, STANDARD, WHITE, SOLID, 12"	LF	2086
0711 11124	THERMOPLASTIC, STANDARD, WHITE, SOLID, 18"	LF	455
0711 11125	THERMOPLASTIC, STANDARD, WHITE, SOLID, 24"	LF	563
0711 11131	THERMOPLASTIC, STANDARD, WHITE, SKIP, 6"	GM	3.59
0711 11160	THERMOPLASTIC, STANDARD, WHITE, MESSAGE	EA	17
0711 11170	THERMOPLASTIC, STANDARD, WHITE, ARROW	EA	88
0711 11211	THERMOPLASTIC, STANDARD, YELLOW, SOLID, 6"	NM	2.26
0711 11222	THERMOPLASTIC, STANDARD, YELLOW, SOLID, 18"	LF	77
0711 11231	THERMOPLASTIC, STANDARD, YELLOW, SKIP, 6"	GM	0.44

INDEX OF SHEETS	
SHEET No.	DESCRIPTION
S-1	COVER SHEET
S-2 - S-13	SIGNING & PAVEMENT MARKING PLANS

## STATE ROUTE 60 & 43<sup>RD</sup> AVENUE PROJECT C.P.#0512

THESE PLANS HAVE BEEN PREPARED IN ACCORDANCE WITH AND ARE GOVERNED BY THE FLORIDA DEPARTMENT OF TRANSPORTATION, DESIGN STANDARDS (2017-2018) AND SUPPLEMENTS THERETO.

**GOVERNING SPECIFICATIONS:**  
THE FLORIDA DEPARTMENT OF TRANSPORTATION, STANDARD SPECIFICATIONS FOR ROAD & BRIDGE CONSTRUCTION, 2017 EDITION, SUPPLEMENTS THERETO, AND SPECIAL PROVISIONS THERETO IF NOTED IN THE CONTRACT SPECIFICATIONS FOR THIS PROJECT.



PUBLIC WORKS DIRECTOR:  
RICHARD B. SZPYRKA, P.E.

COUNTY ENGINEER:  
JAMES W. ENNIS, P.E.

PROJECT MANAGER:  
WILLIAM JOHNSON, P.E.

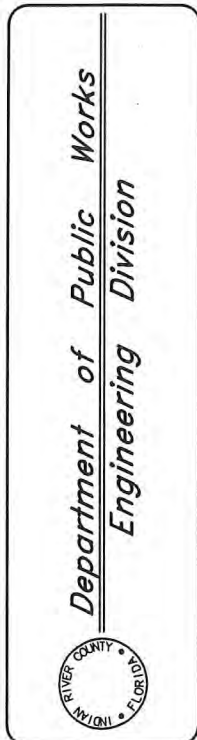
ATTENTION IS DIRECTED TO THE FACT THAT THESE PLANS MAY HAVE BEEN ALTERED IN SIZE BY REPRODUCTION. THIS MUST BE CONSIDERED WHEN OBTAINING SCALED DATA.



I HEREBY CERTIFY THAT THE ATTACHED PLANS AND DESIGN ARE IN SUBSTANTIAL COMPLIANCE WITH THE DESIGN STANDARDS AND CRITERIA IN EFFECT ON THIS DATE FOR INDIAN RIVER COUNTY ENGINEERING DEPARTMENT AND THE STATE OF FLORIDA DEPARTMENT OF TRANSPORTATION.

DATE: 1-18-19 PROFESSIONAL ENGINEER # 26640

ROBERT W. LAWSON, P.E.



Revision:	Date:
No:	By:
Scale: N.T.S.	
Approved: HWD	
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Checked: FM	
Date: 06/2017	

SIGNING & PAVEMENT MARKING PLANS  
FOR  
SR 60 & 43RD AVENUE

Sheet: S-1
Of: S-13
Project No. WP1027

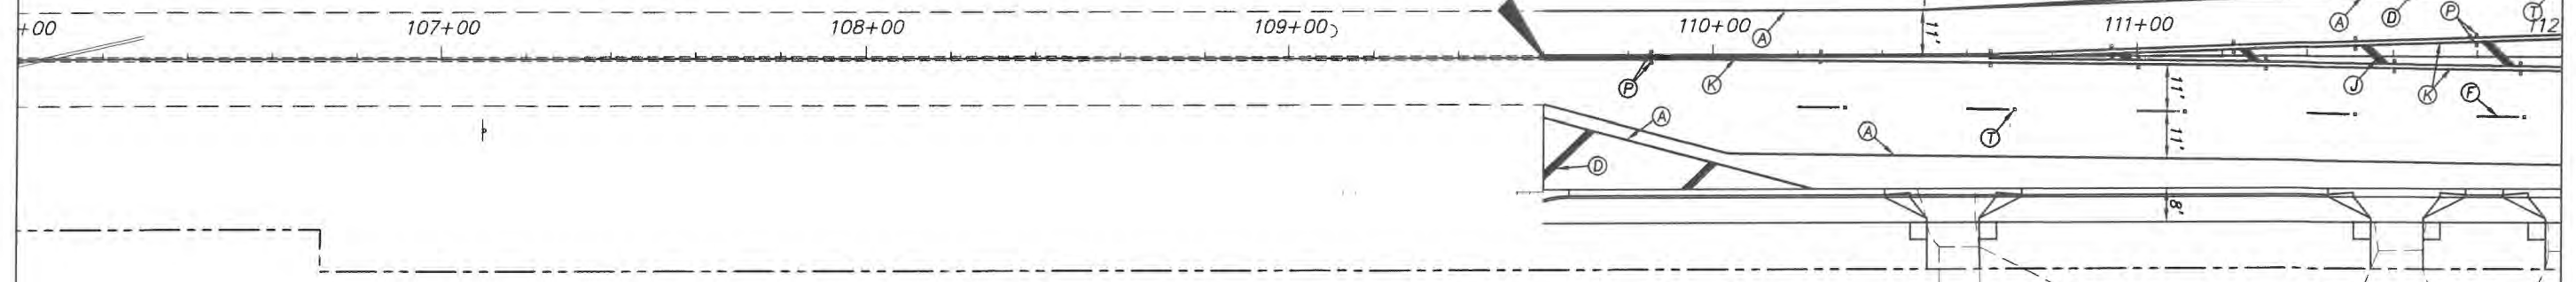
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**BEGIN PAVEMENT MARKINGS  
MATCH EXIST. PAVEMENT MARKINGS  
STA. 109+60.00**

**43<sup>rd</sup> AVENUE**

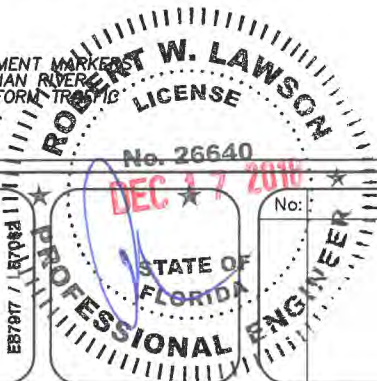


**STRIPING KEY**

- (A) = 6" SOLID WHITE
- (B) = 8" SOLID WHITE
- (C) = 12" SOLID WHITE
- (D) = 18" SOLID WHITE
- (E) = 24" SOLID WHITE
- (F) = 6" SKIP WHITE TYP. (10' - 30')
- (G) = 6" SKIP WHITE TYP. (6' - 10')
- (H) = 6" SKIP WHITE TYP. (2' - 4')
- (I) = 6" SOLID YELLOW
- (J) = 18" SOLID YELLOW
- (K) = 6" DOUBLE YELLOW
- (L) = 6" SKIP YELLOW TYP. (10' - 30')
- (M) = 6" SKIP YELLOW TYP. (6' - 10')
- (N) = 6" SKIP YELLOW TYP. (2' - 4')
- (P) = RPM BI-DIRECTIONAL AMBER/AMBER
- (R) = FDP WHITE
- (S) = FDP YELLOW
- (T) = RPM BI-DIRECTIONAL WHITE/RED
- \* = REFLECTIVE PAVEMENT MARKER

**NOTES**

ALL PAVEMENT MARKINGS AND REFLECTIVE PAVEMENT MARKERS SHALL BE IN ACCORDANCE WITH THE LATEST INDIAN RIVER COUNTY TYPICAL DRAWING, THE MANUAL ON UNIFORM TRAFFIC CONTROL DEVICES, & F.D.O.T DESIGN STANDARDS.



**ARCADIS**  
ARCADIS U.S., INC.  
1500 Gateway Blvd. Suite 200  
Boynton Beach, Florida 33426  
Tel: (561) 697-7000 Fax: (561) 369-4731  
www.arcadis-us.com

No.	Revision:	By:	Date:

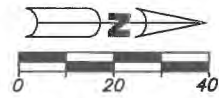
INDIAN RIVER COUNTY  
FLORIDA  
**Department of Public Works  
Engineering Division**

Scale: 1"=40'  
Approved: HWD  
Drawn: FM  
Checked: HWD  
Date: 6/2017  
Field Book No:

Project:  
**SIGNING & PAVEMENT MARKING PLANS**  
**FOR**  
**SR 60 & 43RD AVENUE**

Sheet: S-2  
Of: S-13  
Project No.  
LNW# WP1027



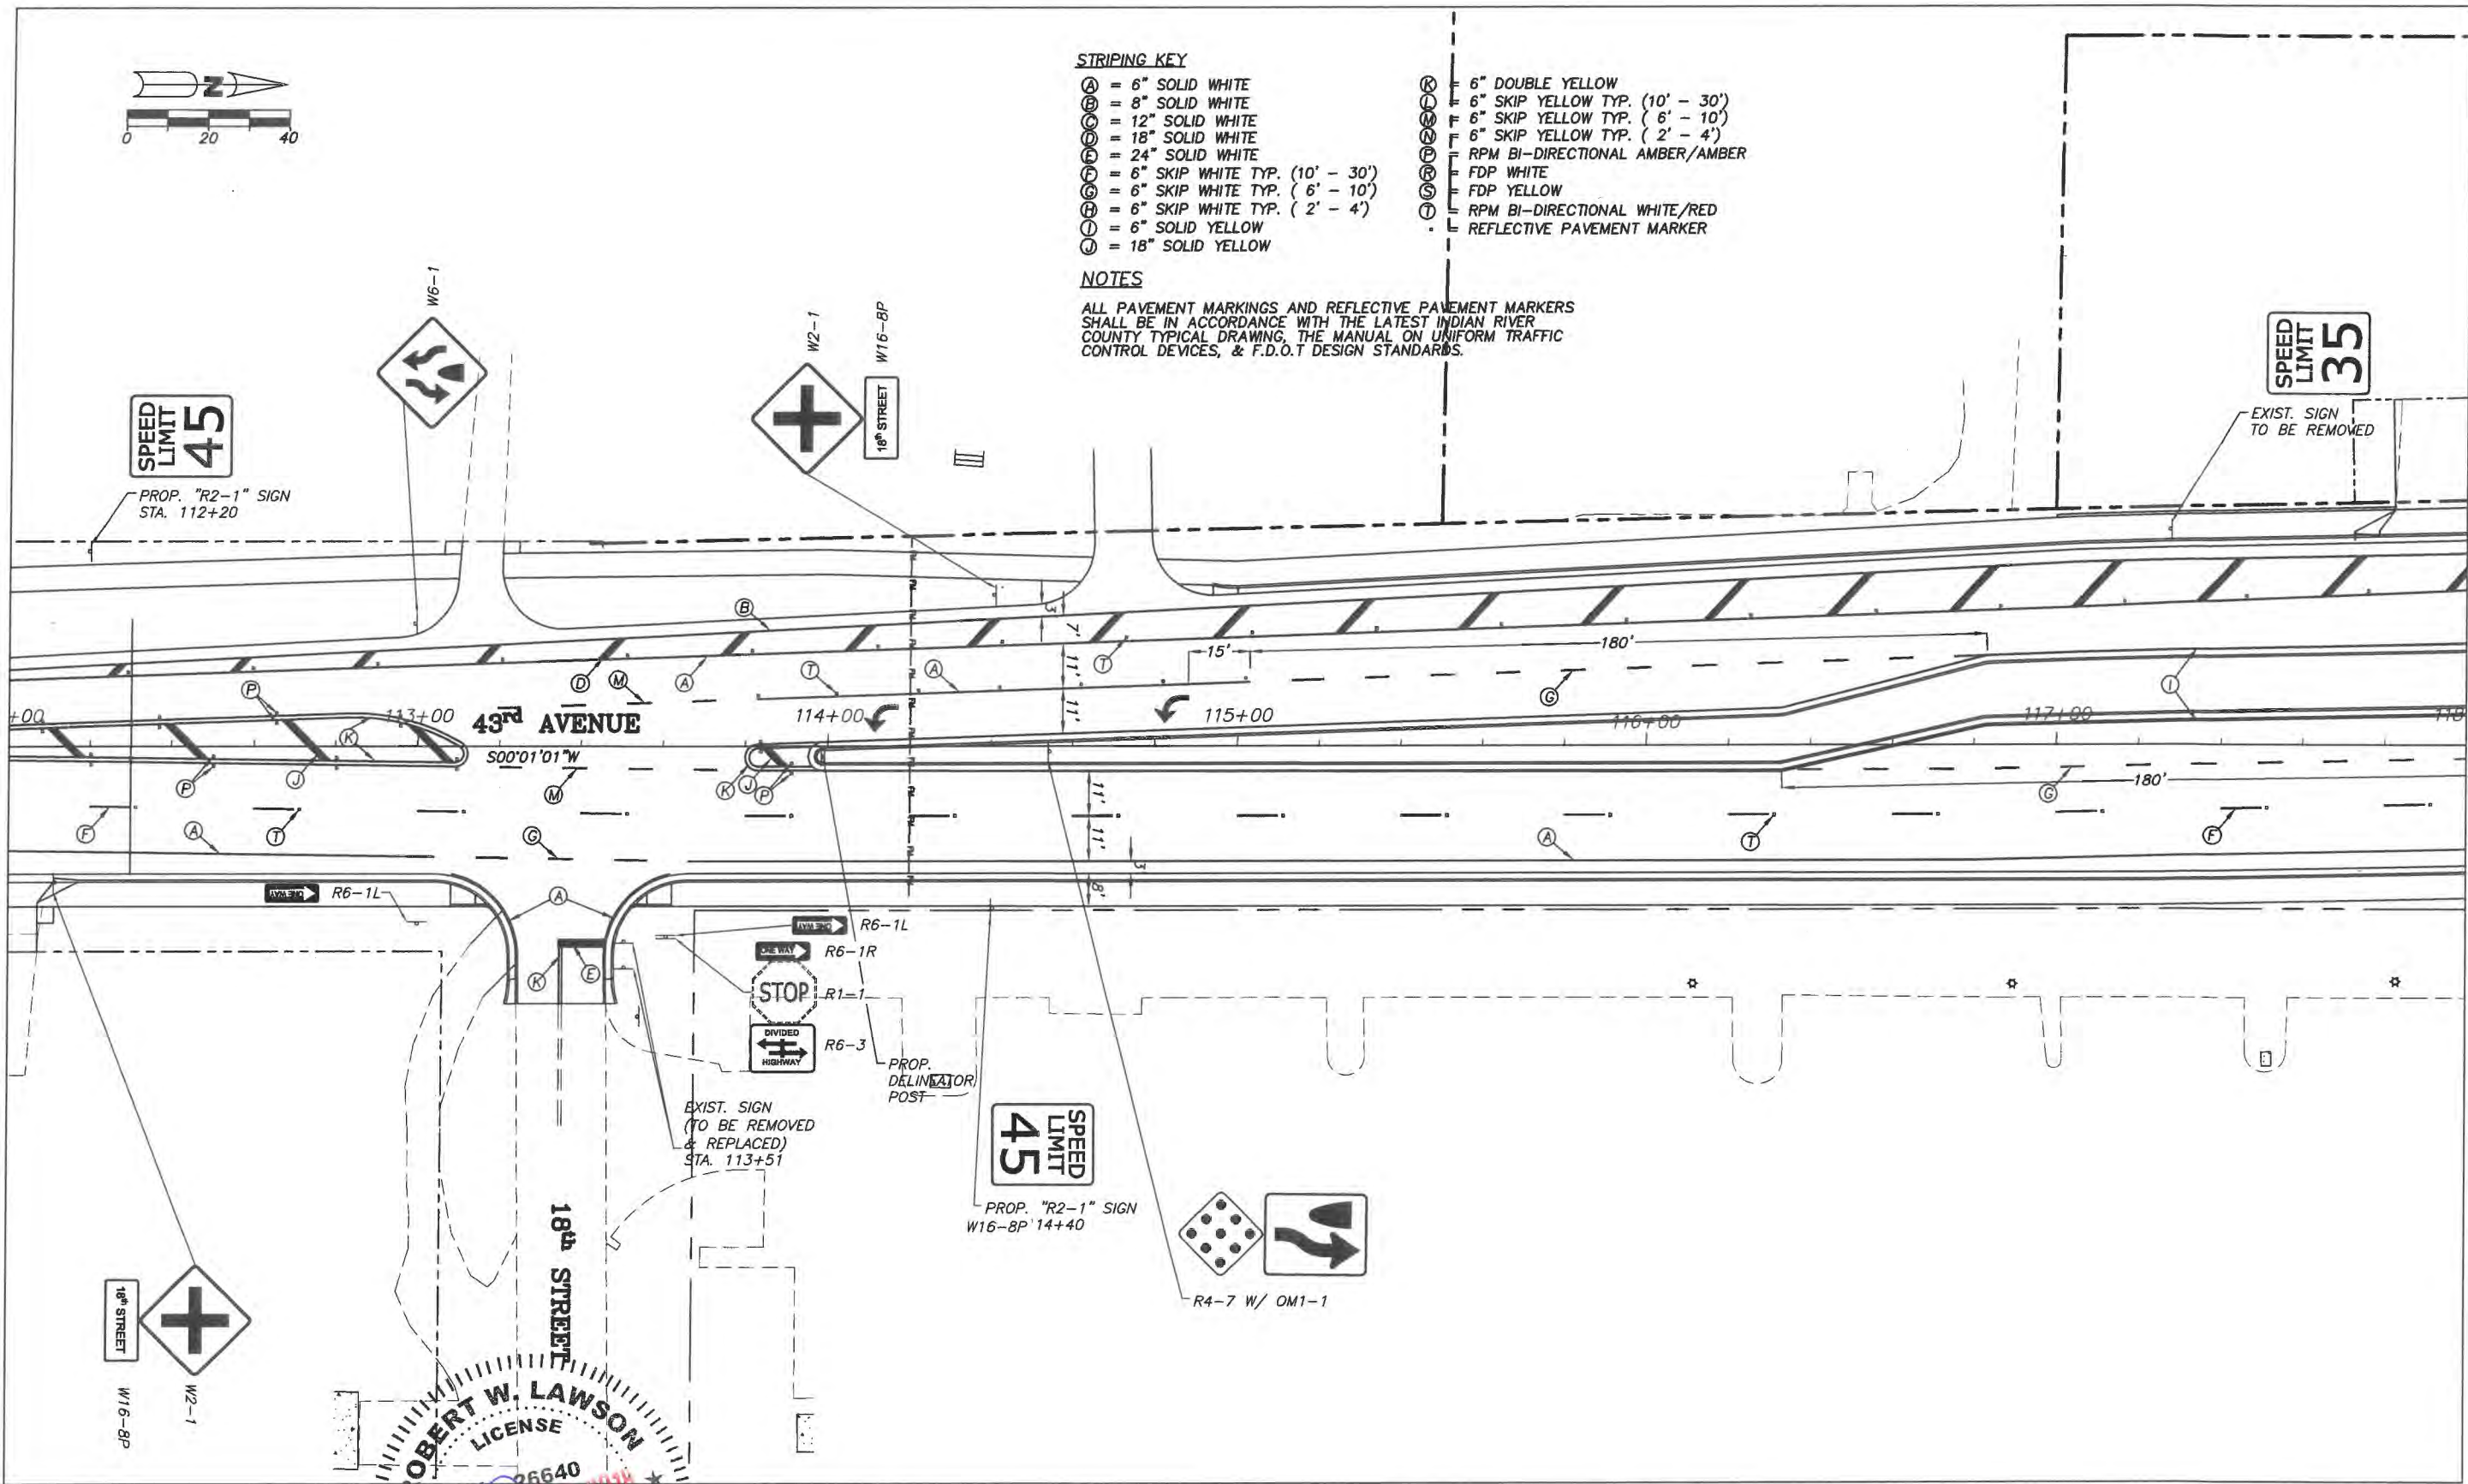


**STRIPING KEY**

- Ⓐ = 6" SOLID WHITE
- Ⓑ = 8" SOLID WHITE
- Ⓒ = 12" SOLID WHITE
- Ⓓ = 18" SOLID WHITE
- Ⓔ = 24" SOLID WHITE
- Ⓚ = 6" SKIP WHITE TYP. (10' - 30')
- Ⓛ = 6" SKIP WHITE TYP. (6' - 10')
- Ⓜ = 6" SKIP WHITE TYP. (2' - 4')
- Ⓝ = 6" SOLID YELLOW
- Ⓞ = 18" SOLID YELLOW
- Ⓟ = 6" DOUBLE YELLOW
- Ⓠ = 6" SKIP YELLOW TYP. (10' - 30')
- Ⓡ = 6" SKIP YELLOW TYP. (6' - 10')
- Ⓢ = 6" SKIP YELLOW TYP. (2' - 4')
- Ⓣ = RPM BI-DIRECTIONAL AMBER/AMBER
- Ⓤ = FDP WHITE
- Ⓥ = FDP YELLOW
- Ⓦ = RPM BI-DIRECTIONAL WHITE/RED
- Ⓧ = REFLECTIVE PAVEMENT MARKER

**NOTES**

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**ROBERT W. LAWSON**  
 LICENSE  
 No. 26640  
 DEC 17 2016  
 STATE OF FLORIDA  
 PROFESSIONAL ENGINEER

**ARCADIS**  
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Revision:	By:	Date:

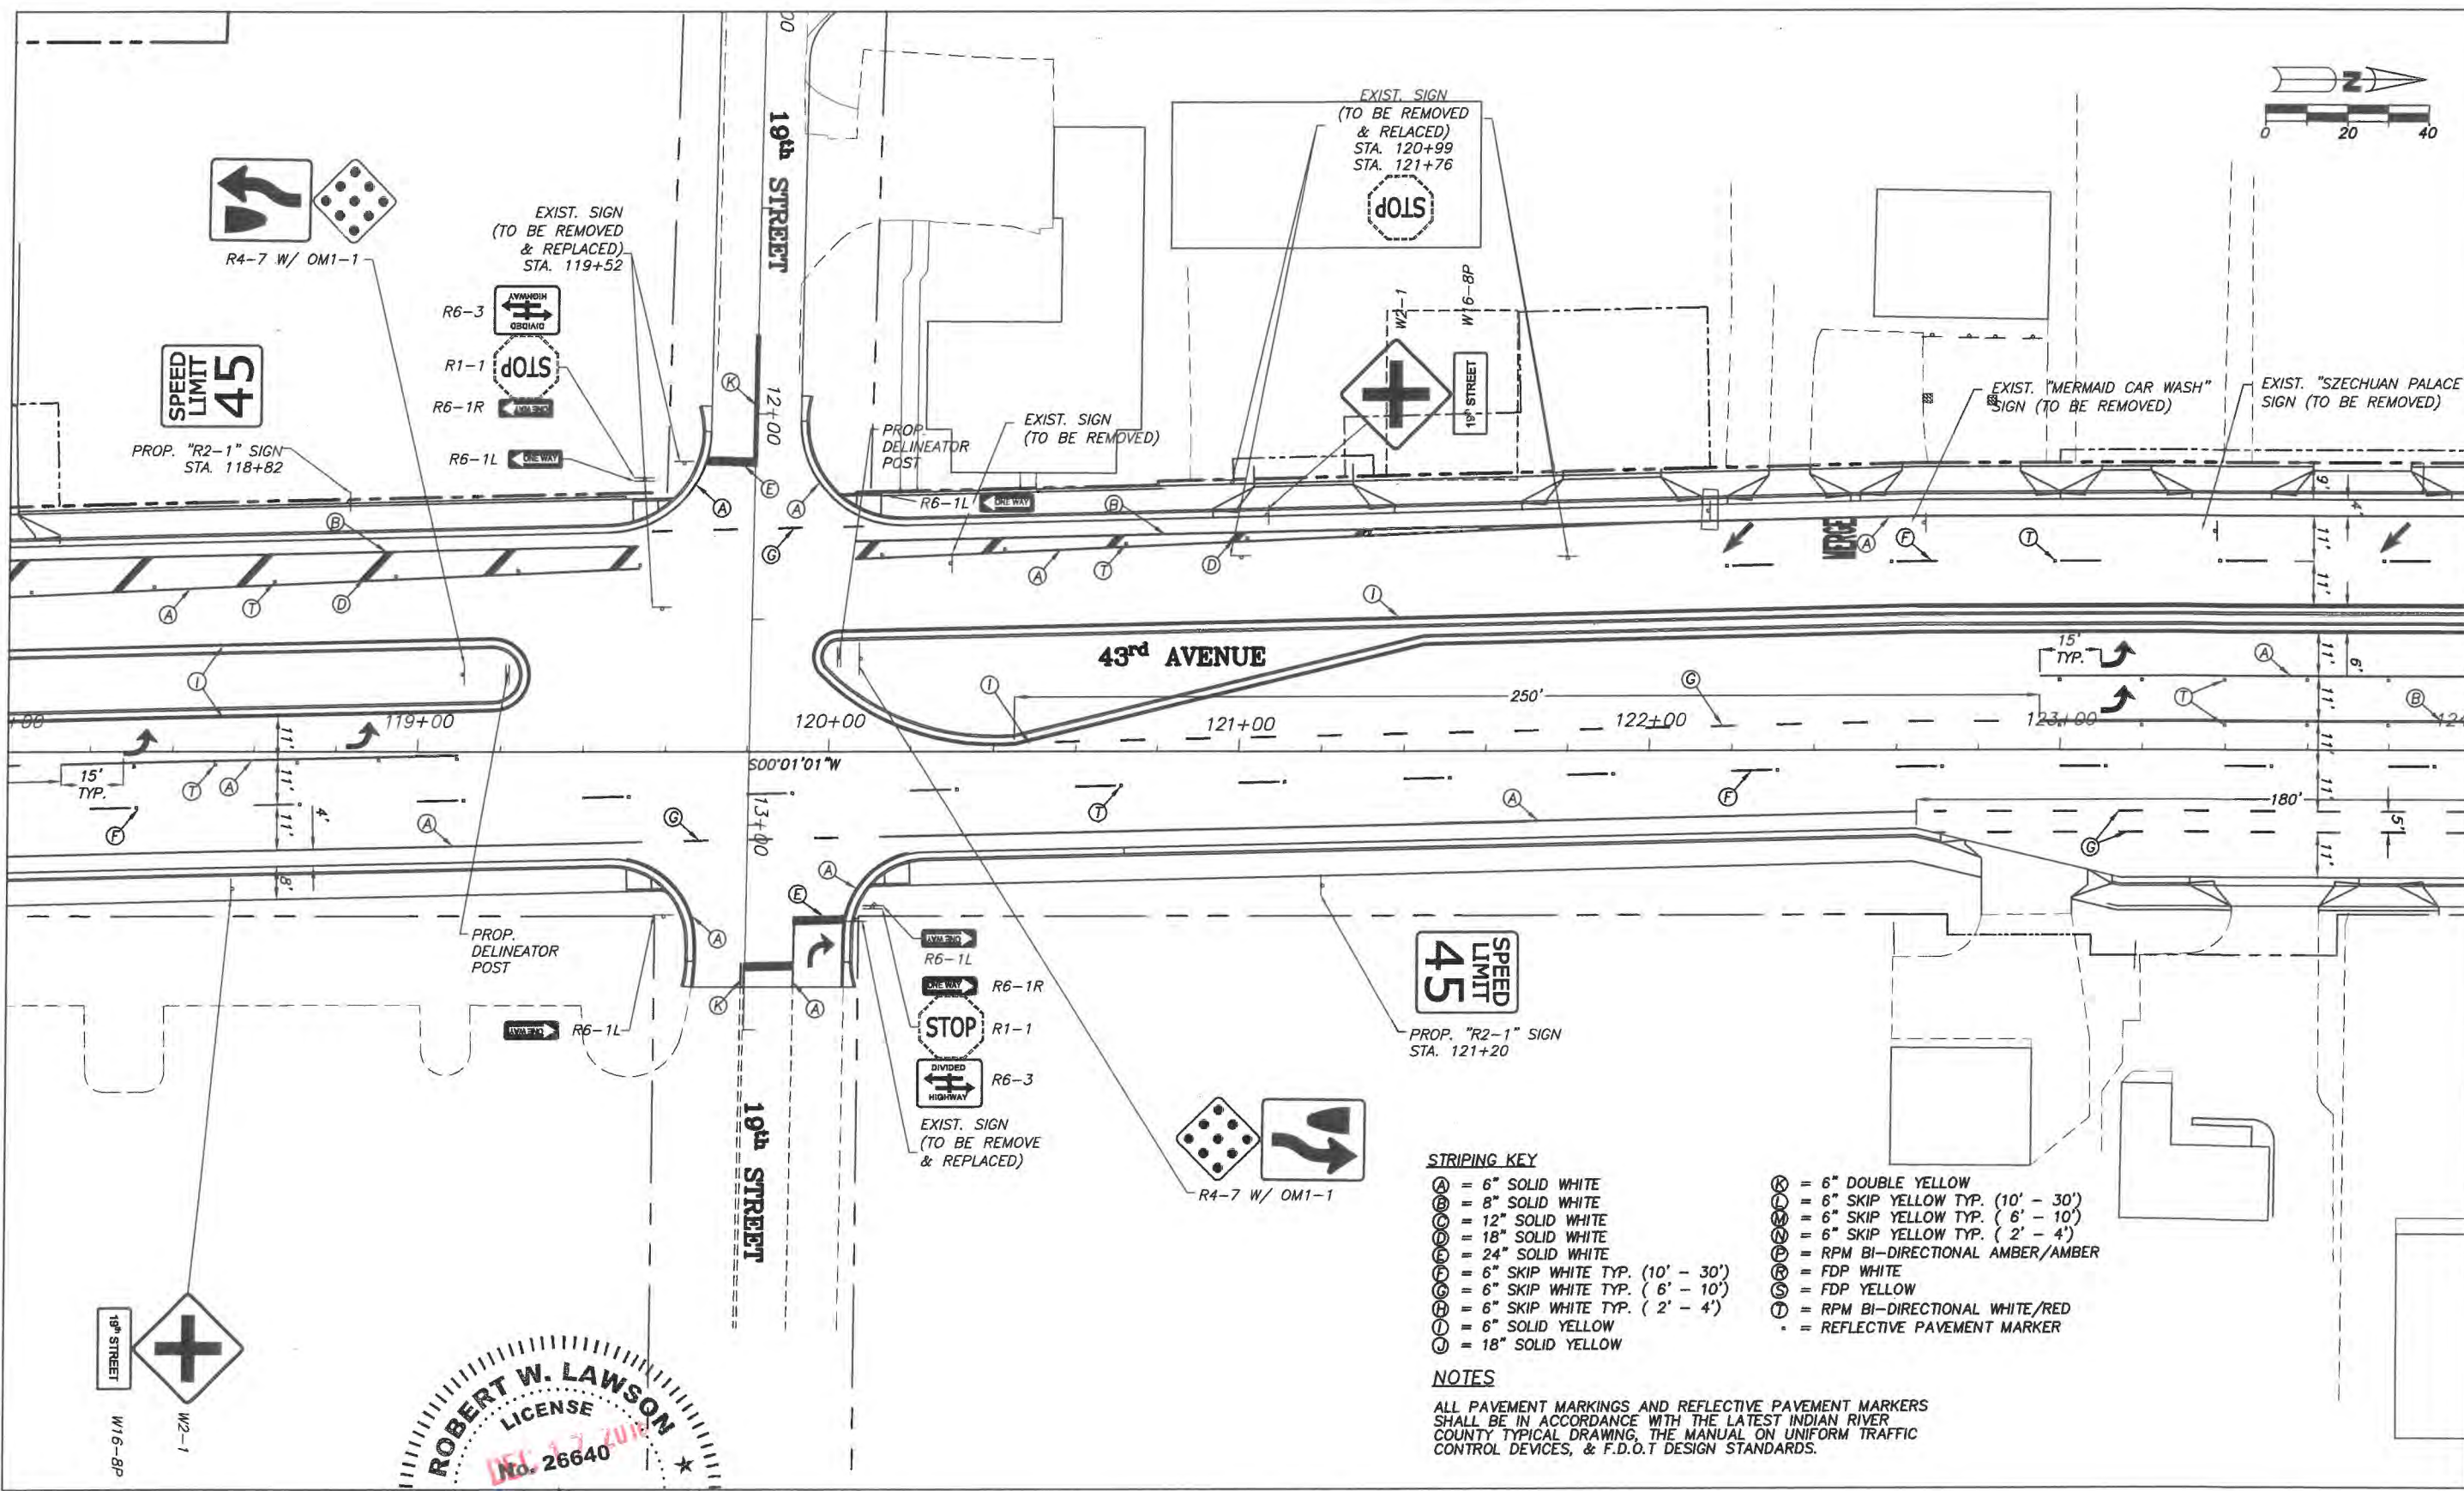
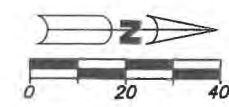
**Department of Public Works**  
 Engineering Division

Scale: 1"=40'  
 Approved: HWD  
 Drawn: FM  
 Checked: HWD  
 Date: 6/2017  
 Field Book No:

Project:  
 SIGNING & PAVEMENT MARKING PLANS  
 FOR  
**SR 60 & 43RD AVENUE**

Sheet: S-3  
 Of: S-13  
 Project No.  
 LNW/ WP1027



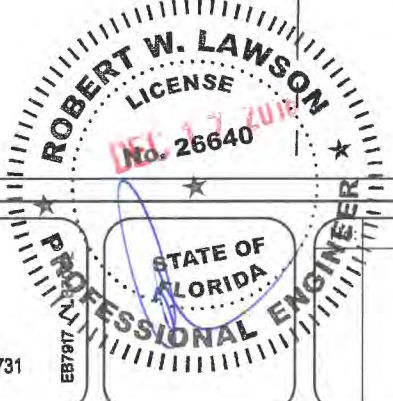


**STRIPING KEY**

- (A) = 6" SOLID WHITE
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- (D) = 18" SOLID WHITE
- (E) = 24" SOLID WHITE
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- (R) = FDP WHITE
- (S) = FDP YELLOW
- (T) = RPM BI-DIRECTIONAL WHITE/RED
- (U) = REFLECTIVE PAVEMENT MARKER

**NOTES**

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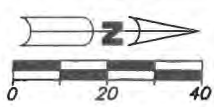
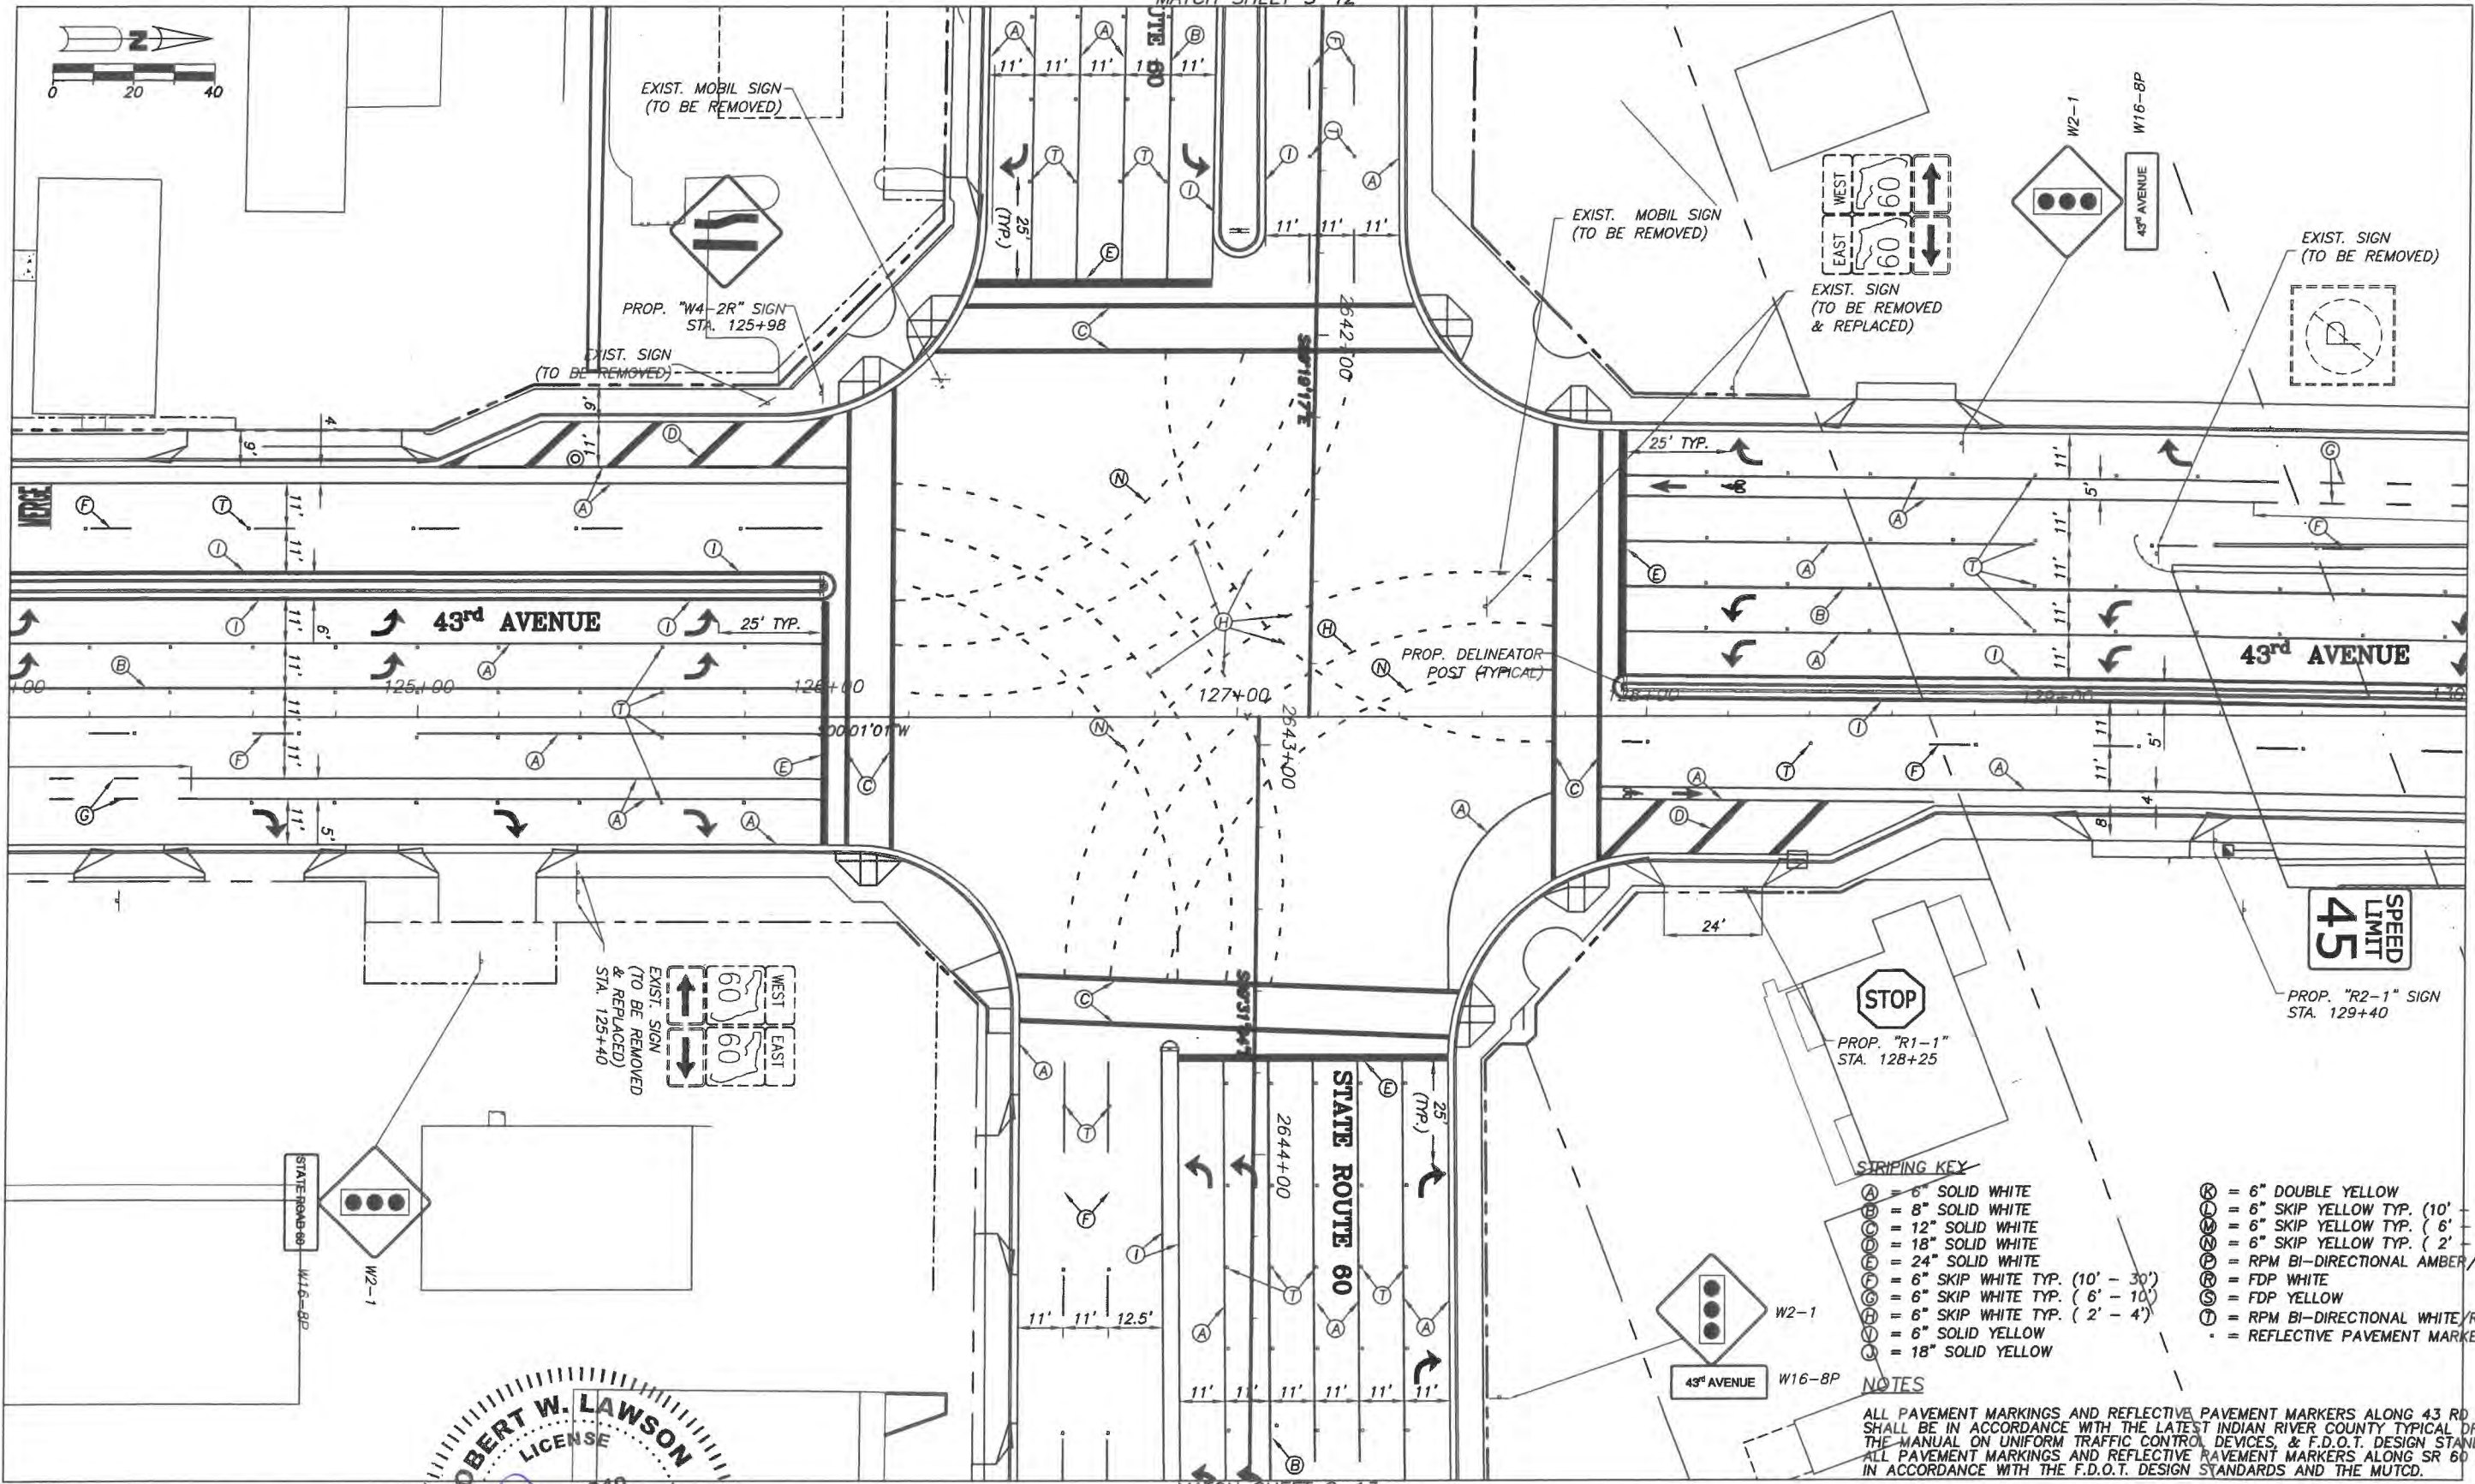
Department of Public Works  
 Engineering Division

Scale:	1"=40'
Approved:	HWD
Drawn:	FM
Checked:	HWD
Date:	6/2017
Field Book No:	

Project:  
 SIGNING & PAVEMENT MARKING PLANS  
 FOR  
**SR 60 & 43RD AVENUE**

Sheet:	S-4
Of:	S-13
Project No.	
LNW/ WP1027	






- STRIPING KEY**
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  - (E) = 24" SOLID WHITE
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  - (P) = RPM BI-DIRECTIONAL AMBER/AMBER
  - (R) = FDP WHITE
  - (S) = FDP YELLOW
  - (T) = RPM BI-DIRECTIONAL WHITE/RED
  - (\*) = REFLECTIVE PAVEMENT MARKER

**NOTES**

ALL PAVEMENT MARKINGS AND REFLECTIVE PAVEMENT MARKERS ALONG 43 RD AVE. SHALL BE IN ACCORDANCE WITH THE LATEST INDIAN RIVER COUNTY TYPICAL DRAWING, THE MANUAL ON UNIFORM TRAFFIC CONTROL DEVICES, & F.D.O.T. DESIGN STANDARDS. ALL PAVEMENT MARKINGS AND REFLECTIVE PAVEMENT MARKERS ALONG SR 60 SHALL BE IN ACCORDANCE WITH THE F.D.O.T. DESIGN STANDARDS AND THE MUTCD.




Revision: \_\_\_\_\_ By: \_\_\_\_\_ Date: \_\_\_\_\_


**Department of Public Works**  
**Engineering Division**

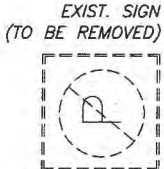
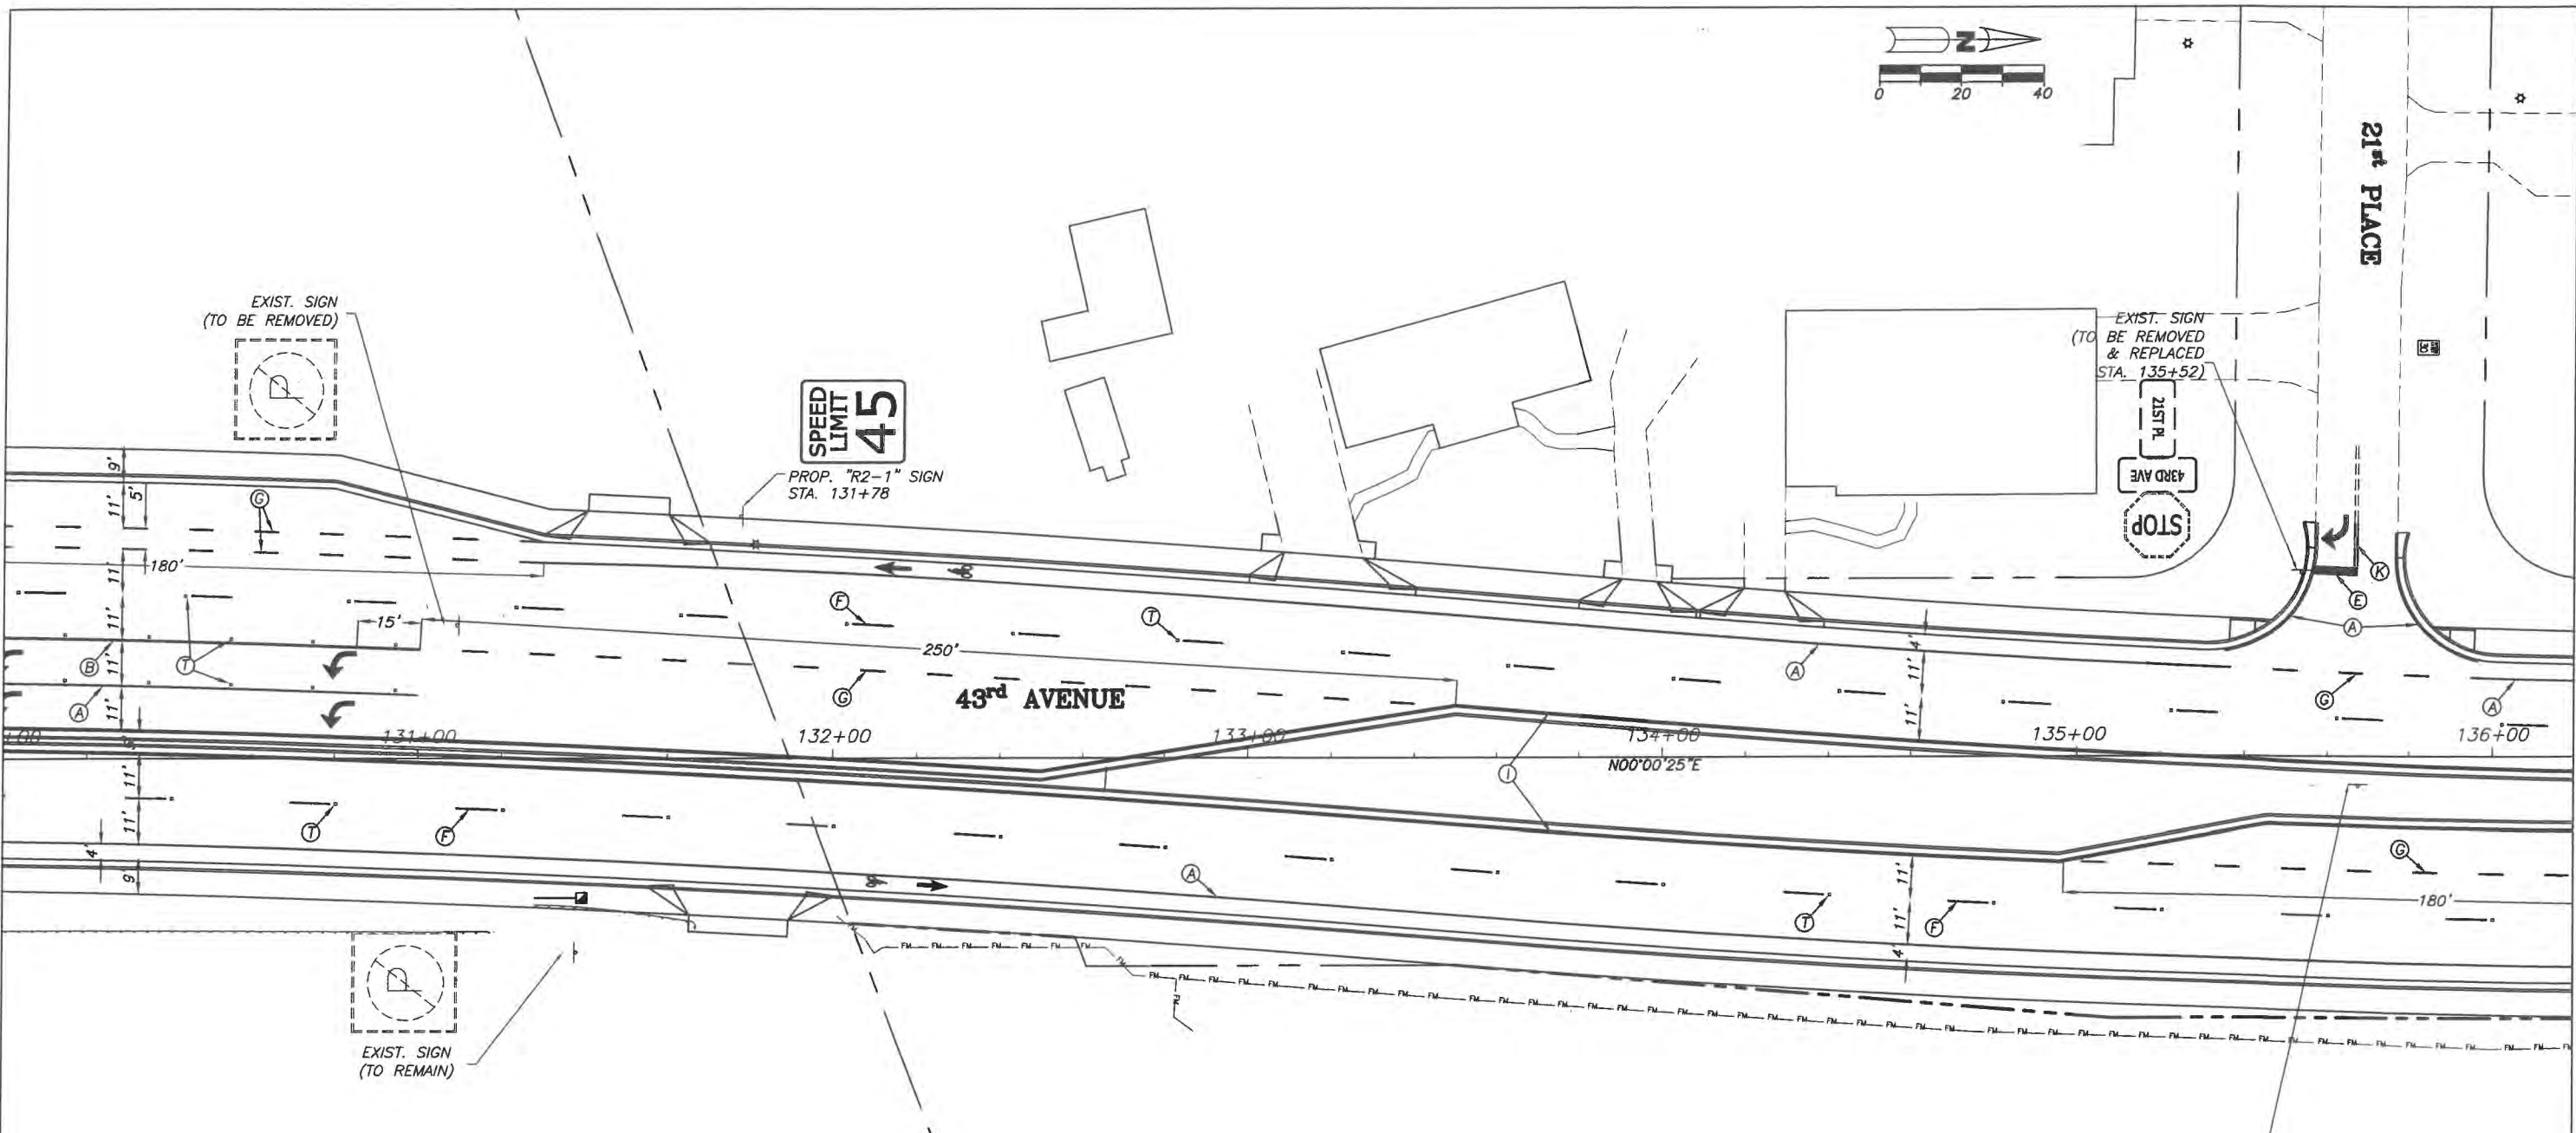
Scale: 1"=40'  
 Approved: HWD  
 Drawn: FM  
 Checked: HWD  
 Date: 6/2017  
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Project:  
**SIGNING & PAVEMENT MARKING PLANS**  
 FOR  
**SR 60 & 43RD AVENUE**

Sheet: S-5  
 Of: S-13  
 Project No.  
 LNW# WP1027

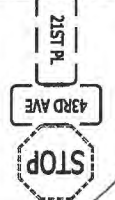
  
**ARCADIS U.S., INC.**  
 1500 Gateway Blvd. Suite 200  
 Boynton Beach, Florida 33426  
 Tel: (561) 697-7000 Fax: (561) 369-4731  
 www.arcadis-us.com





PROP. "R2-1" SIGN  
STA. 131+78

EXIST. SIGN  
(TO BE REMOVED  
& REPLACED  
STA. 135+52)



**STRIPING KEY**

- (A) = 6" SOLID WHITE
- (B) = 8" SOLID WHITE
- (C) = 12" SOLID WHITE
- (D) = 18" SOLID WHITE
- (E) = 24" SOLID WHITE
- (F) = 6" SKIP WHITE TYP. (10' - 30')
- (G) = 6" SKIP WHITE TYP. (6' - 10')
- (H) = 6" SKIP WHITE TYP. (2' - 4')
- (I) = 6" SOLID YELLOW
- (J) = 18" SOLID YELLOW
- (K) = 6" DOUBLE YELLOW
- (L) = 6" SKIP YELLOW TYP. (10' - 30')
- (M) = 6" SKIP YELLOW TYP. (6' - 10')
- (N) = 6" SKIP YELLOW TYP. (2' - 4')
- (P) = RPM BI-DIRECTIONAL AMBER/AMBER
- (R) = FDP WHITE
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- (T) = RPM BI-DIRECTIONAL WHITE/RED
- \* = REFLECTIVE PAVEMENT MARKER

**NOTES**

ALL PAVEMENT MARKINGS AND REFLECTIVE PAVEMENT MARKERS SHALL BE IN ACCORDANCE WITH THE LATEST INDIAN RIVER COUNTY TYPICAL DRAWING, THE MANUAL ON UNIFORM TRAFFIC CONTROL DEVICES, & F.D.O.T DESIGN STANDARDS.



R6-1R WITH R3-2

**ARCADIS**  
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**ROBERT W. LAWSON**  
LICENSE  
No. 26640  
STATE OF FLORIDA  
PROFESSIONAL ENGINEER  
EB7017 / LB7082

No.	Revision:	By:	Date:



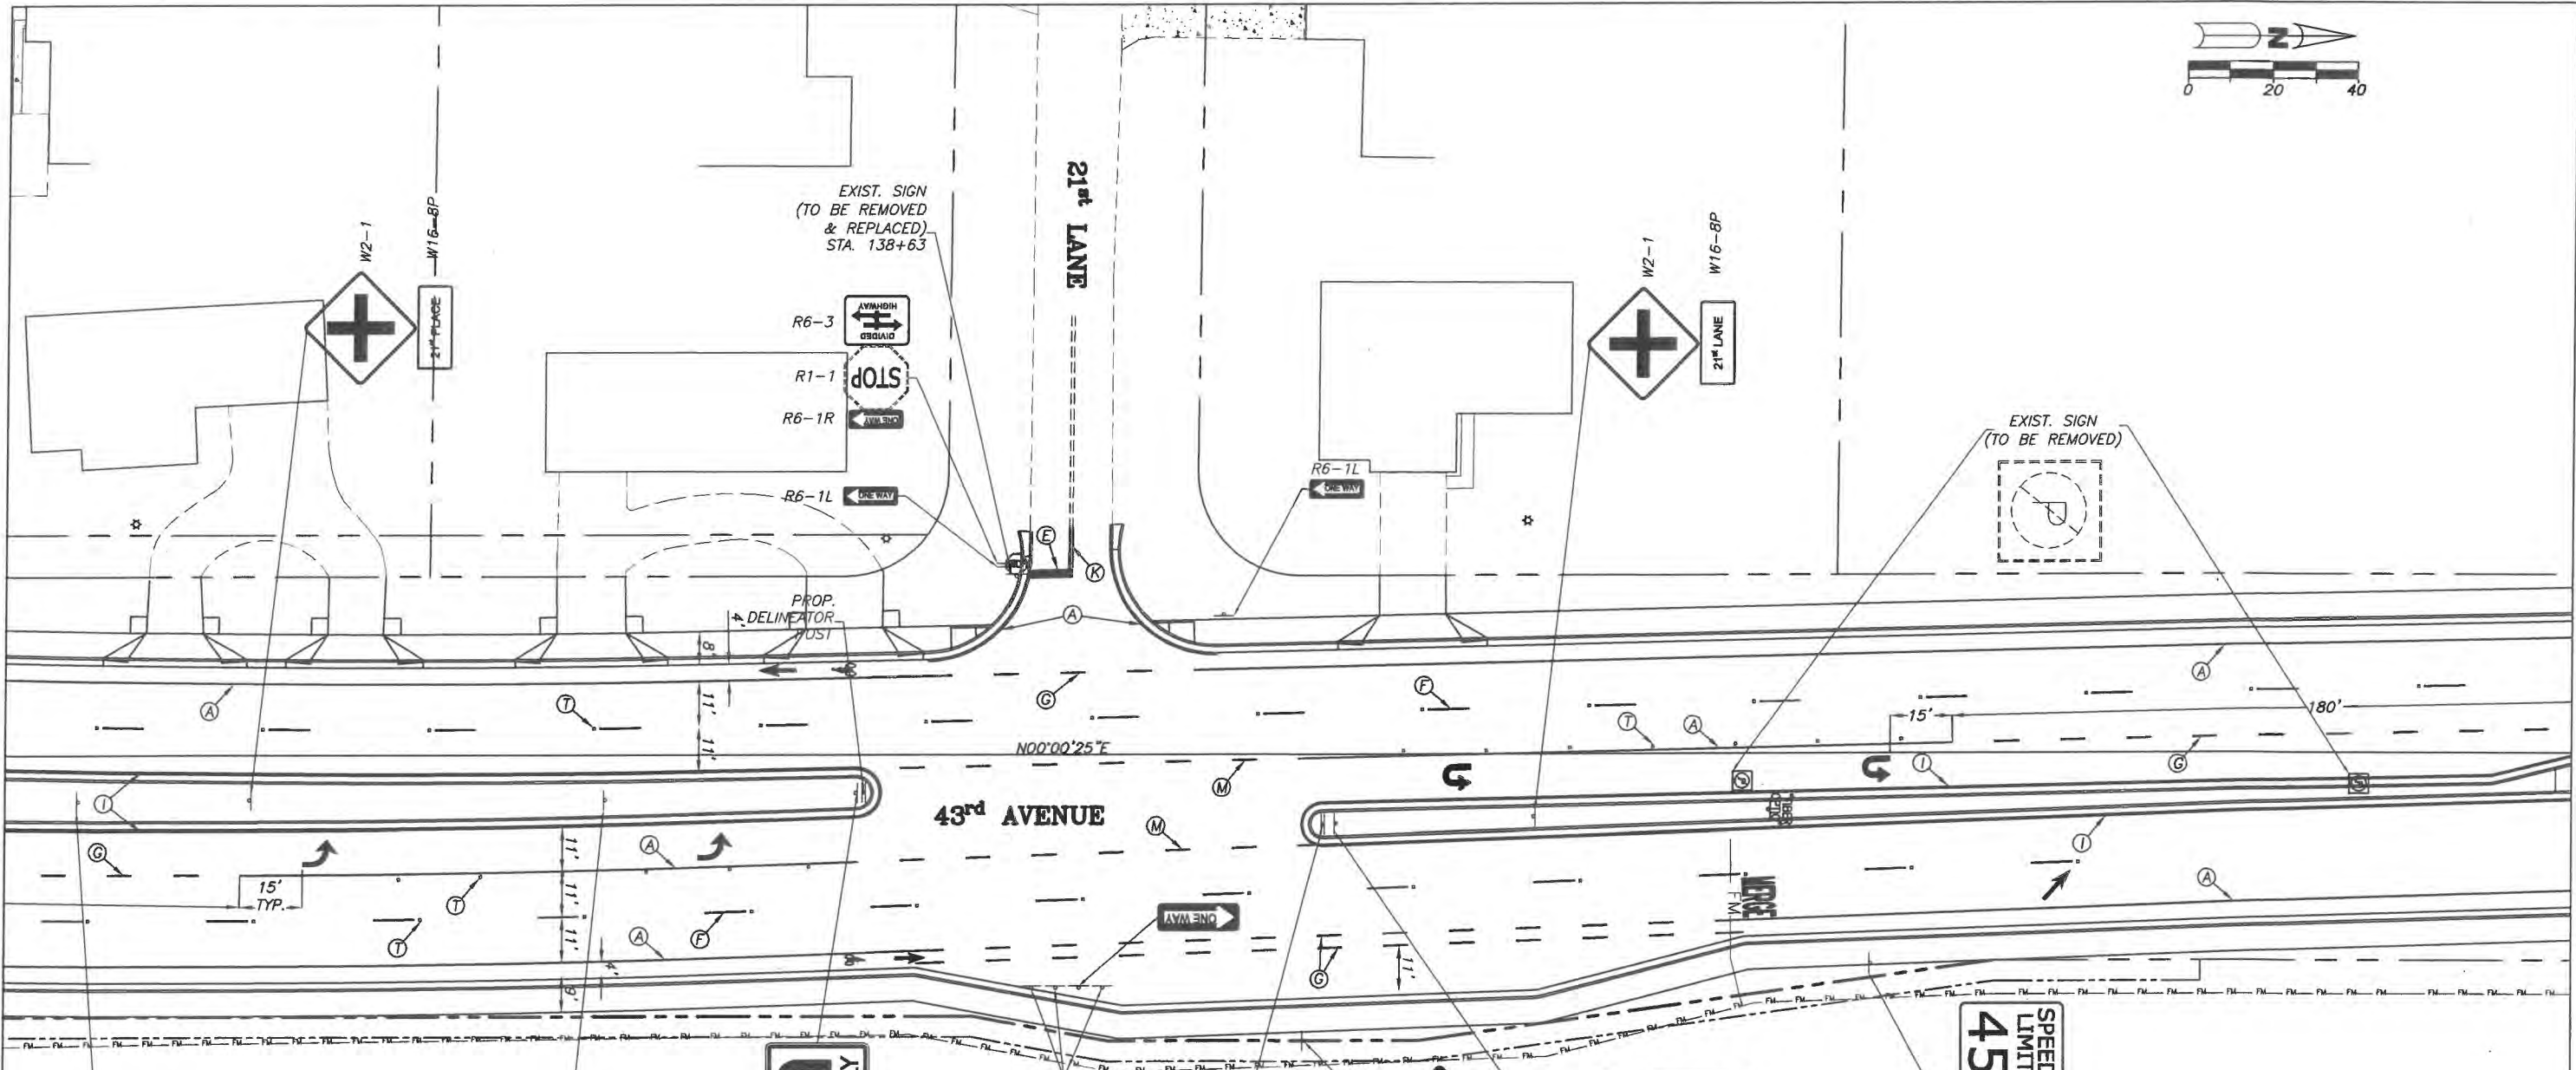
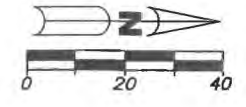
Department of Public Works  
Engineering Division

Scale: 1"=40'  
Approved: HWD  
Drawn: FM  
Checked: HWD  
Date: 6/2017  
Field Book No:

Project:  
SIGNING & PAVEMENT MARKING PLANS  
FOR  
SR 60 & 43RD AVENUE

Sheet: S-6  
Of: S-13  
Project No.  
LNW# WP1027





**SPEED LIMIT 45**

PROP. "R2-1" SIGN  
STA. 140+70

**STRIPING KEY**

- |                                      |                                       |
|--------------------------------------|---------------------------------------|
| (A) = 6" SOLID WHITE                 | (K) = 6" DOUBLE YELLOW                |
| (B) = 8" SOLID WHITE                 | (L) = 6" SKIP YELLOW TYP. (10' - 30') |
| (C) = 12" SOLID WHITE                | (M) = 6" SKIP YELLOW TYP. (6' - 10')  |
| (D) = 18" SOLID WHITE                | (N) = 6" SKIP YELLOW TYP. (2' - 4')   |
| (E) = 24" SOLID WHITE                | (P) = RPM BI-DIRECTIONAL AMBER/AMBER  |
| (F) = 6" SKIP WHITE TYP. (10' - 30') | (R) = FDP WHITE                       |
| (G) = 6" SKIP WHITE TYP. (6' - 10')  | (S) = FDP YELLOW                      |
| (H) = 6" SKIP WHITE TYP. (2' - 4')   | (T) = RPM BI-DIRECTIONAL WHITE/RED    |
| (I) = 6" SOLID YELLOW                | (*) = REFLECTIVE PAVEMENT MARKER      |
| (J) = 18" SOLID YELLOW               |                                       |

**NOTES**

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**SPEED LIMIT 35**

EXIST. SIGN  
TO BE REMOVED

**ONLY**

PROP. "R3-5U"  
24" x 30"  
STA. 138+24

CASE 1  
YELLOW REFLECTORS

PROP. DELINEATOR  
POST

W4-2

R4-7 W/ OM1-1

**ROBERT W. LAWSON**  
LICENSE  
No. 26640  
STATE OF FLORIDA  
PROFESSIONAL ENGINEER  
JAN 8 2019

Revision:      By:      Date:

**ARCADIS**  
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www.arcadis-us.com

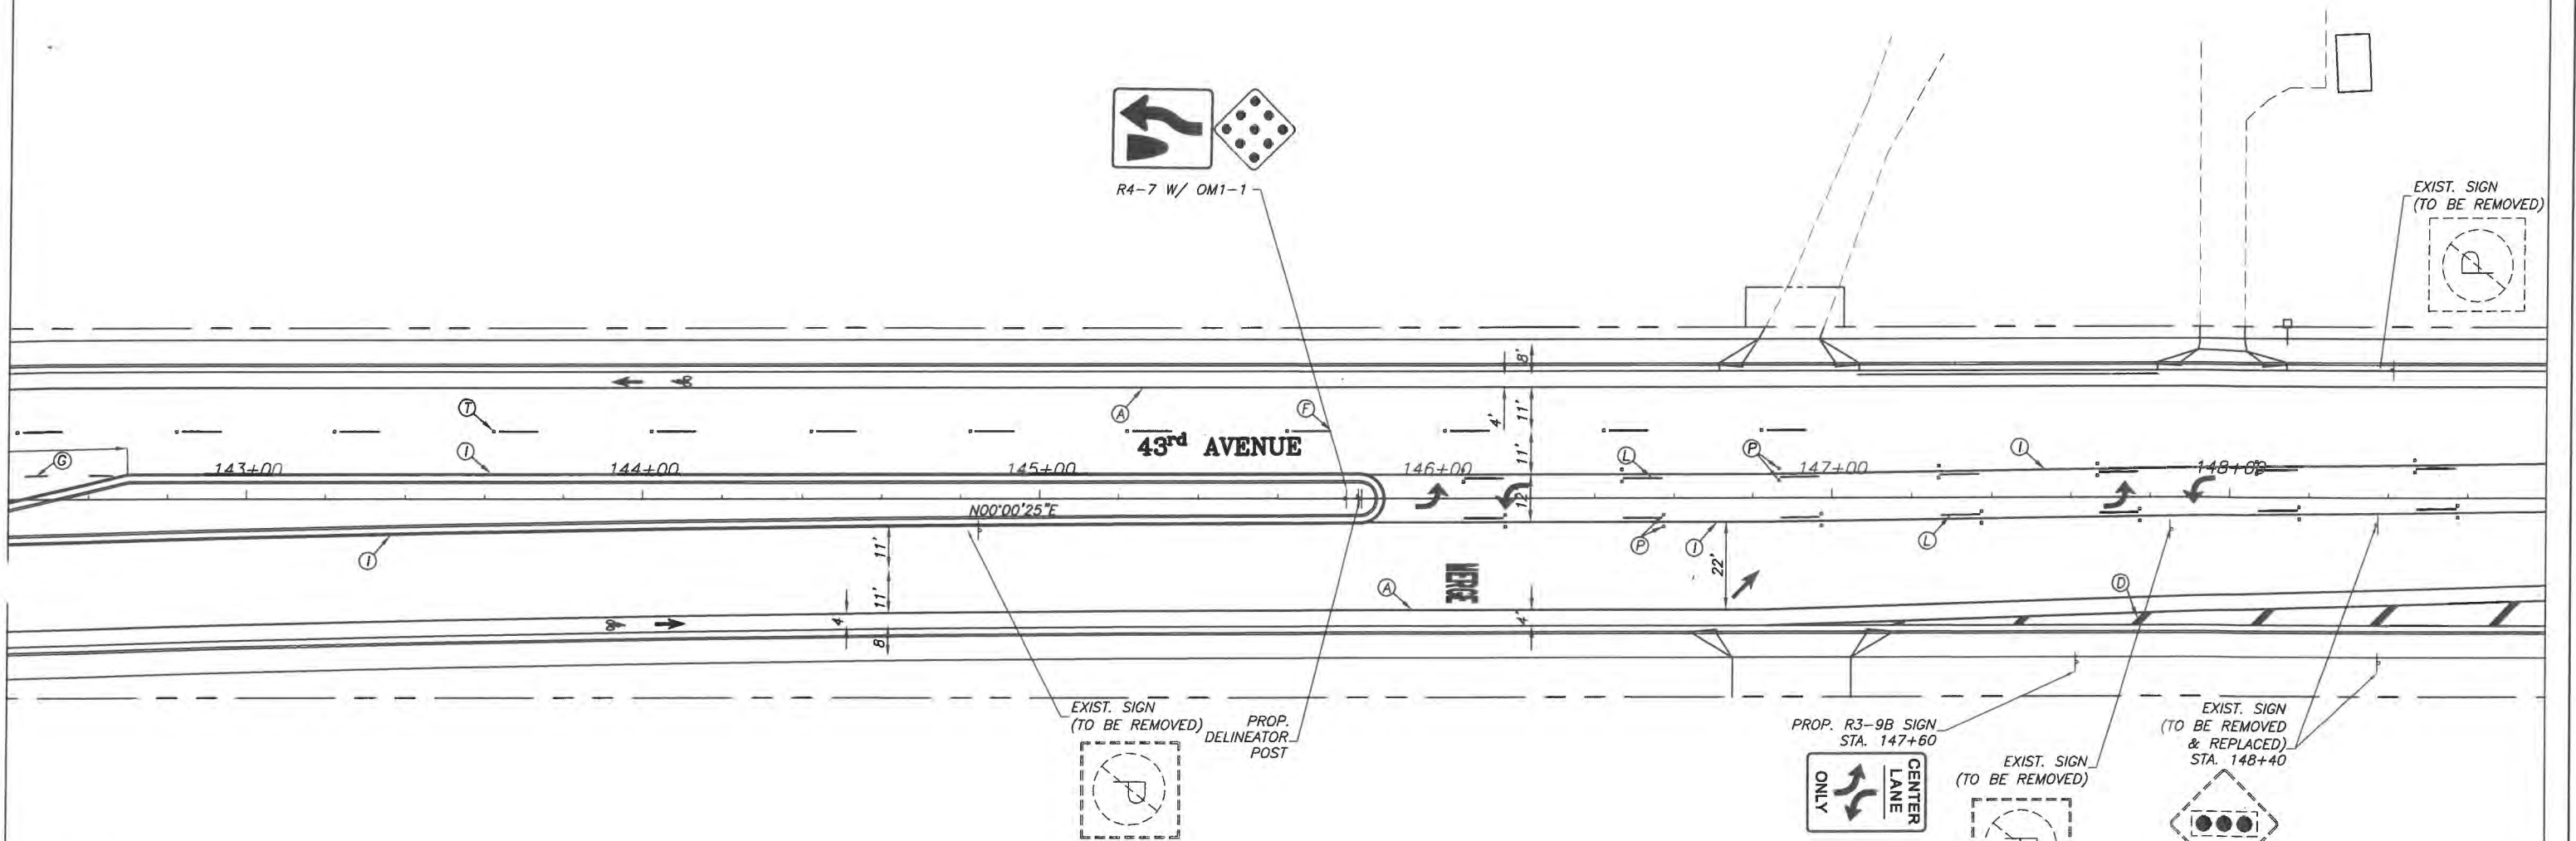
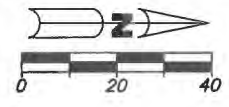
**INDIAN RIVER COUNTY**  
FLORIDA  
**Department of Public Works**  
**Engineering Division**

Scale: 1"=40'  
Approved: HWD  
Drawn: FM  
Checked: HWD  
Date: 6/2017  
Field Book No:

Project:  
**SIGNING & PAVEMENT MARKING PLANS**  
**FOR**  
**SR 60 & 43RD AVENUE**

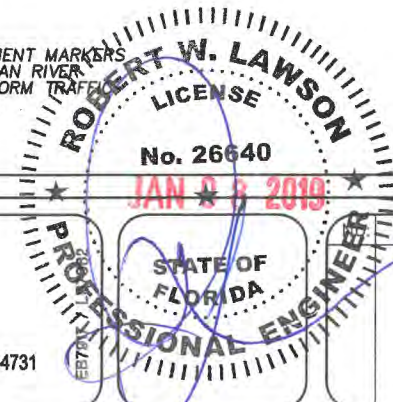
Sheet: S-7  
Of: S-13  
Project No.  
LNW WP1027





- STRIPING KEY**
- Ⓐ = 6" SOLID WHITE
  - Ⓑ = 8" SOLID WHITE
  - Ⓒ = 12" SOLID WHITE
  - Ⓓ = 18" SOLID WHITE
  - Ⓔ = 24" SOLID WHITE
  - Ⓕ = 6" SKIP WHITE TYP. (10' - 30')
  - Ⓖ = 6" SKIP WHITE TYP. ( 6' - 10')
  - Ⓗ = 6" SKIP WHITE TYP. ( 2' - 4')
  - Ⓘ = 6" SOLID YELLOW
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  - Ⓛ = 6" SKIP YELLOW TYP. (10' - 30')
  - Ⓜ = 6" SKIP YELLOW TYP. ( 6' - 10')
  - Ⓝ = 6" SKIP YELLOW TYP. ( 2' - 4')
  - Ⓟ = RPM BI-DIRECTIONAL AMBER/AMBER
  - Ⓡ = FDP WHITE
  - Ⓢ = FDP YELLOW
  - Ⓣ = RPM BI-DIRECTIONAL WHITE/RED
  - = REFLECTIVE PAVEMENT MARKER
- Ⓛ = 6" SKIP YELLOW TYP. (10' - 30')
  - Ⓜ = 6" SKIP YELLOW TYP. ( 6' - 10')
  - Ⓝ = 6" SKIP YELLOW TYP. ( 2' - 4')
  - Ⓟ = RPM BI-DIRECTIONAL AMBER/AMBER
  - Ⓡ = FDP WHITE
  - Ⓢ = FDP YELLOW
  - Ⓣ = RPM BI-DIRECTIONAL WHITE/RED
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 www.arcadis-us.com

Revision:	By:	Date:

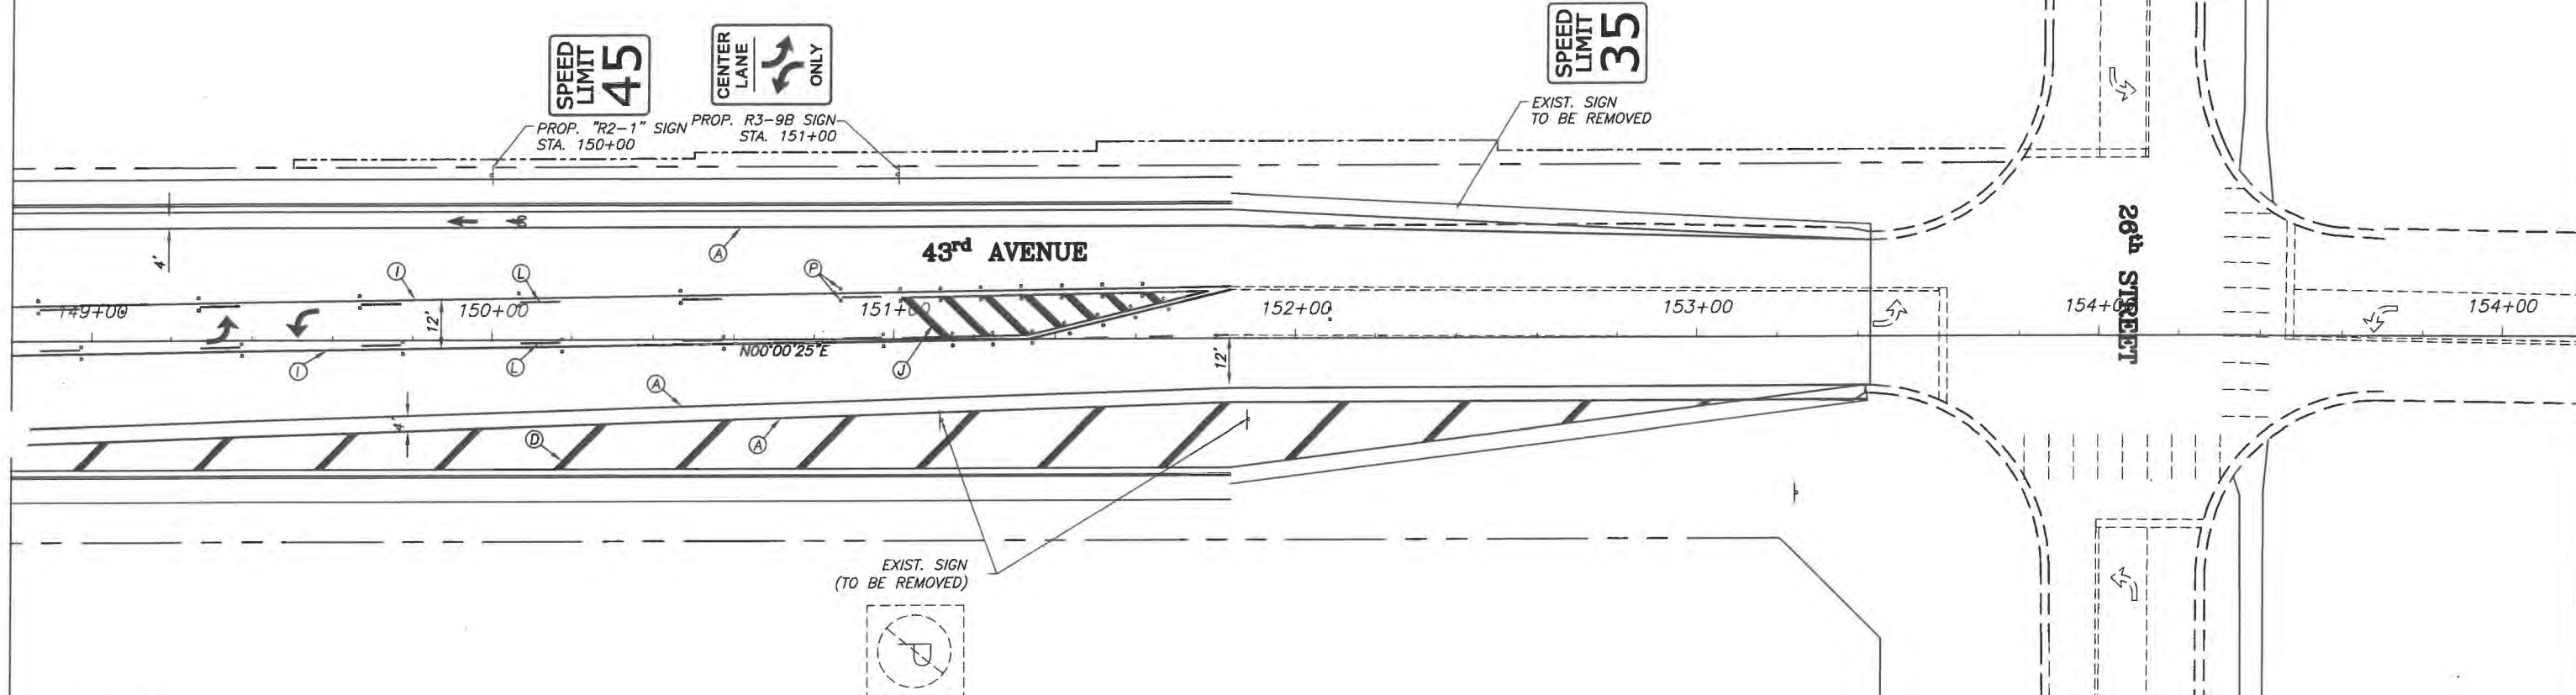
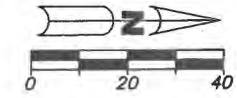
INDIAN RIVER COUNTY  
 Department of Public Works  
 Engineering Division

Scale: 1"=40'  
 Approved: HWD  
 Drawn: FM  
 Checked: HWD  
 Date: 6/2017  
 Field Book No:

Project:  
 SIGNING & PAVEMENT MARKING PLANS  
 FOR  
 SR 60 & 43RD AVENUE

Sheet: S-8  
 Of: S-13  
 Project No.  
 LNW# WP1027



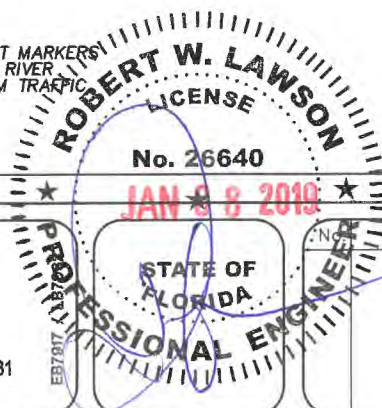


**STRIPING KEY**

- |                                    |                                     |
|------------------------------------|-------------------------------------|
| Ⓐ = 6" SOLID WHITE                 | Ⓚ = 6" DOUBLE YELLOW                |
| Ⓑ = 8" SOLID WHITE                 | Ⓛ = 6" SKIP YELLOW TYP. (10' - 30') |
| Ⓒ = 12" SOLID WHITE                | Ⓜ = 6" SKIP YELLOW TYP. (6' - 10')  |
| Ⓓ = 18" SOLID WHITE                | Ⓨ = 6" SKIP YELLOW TYP. (2' - 4')   |
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| Ⓡ = 6" SKIP WHITE TYP. (2' - 4')   | Ⓣ = RPM BI-DIRECTIONAL WHITE/RED    |
| Ⓢ = 6" SOLID YELLOW                | • = REFLECTIVE PAVEMENT MARKER      |
| Ⓣ = 18" SOLID YELLOW               |                                     |

**NOTES**

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Revision:	By:	Date:



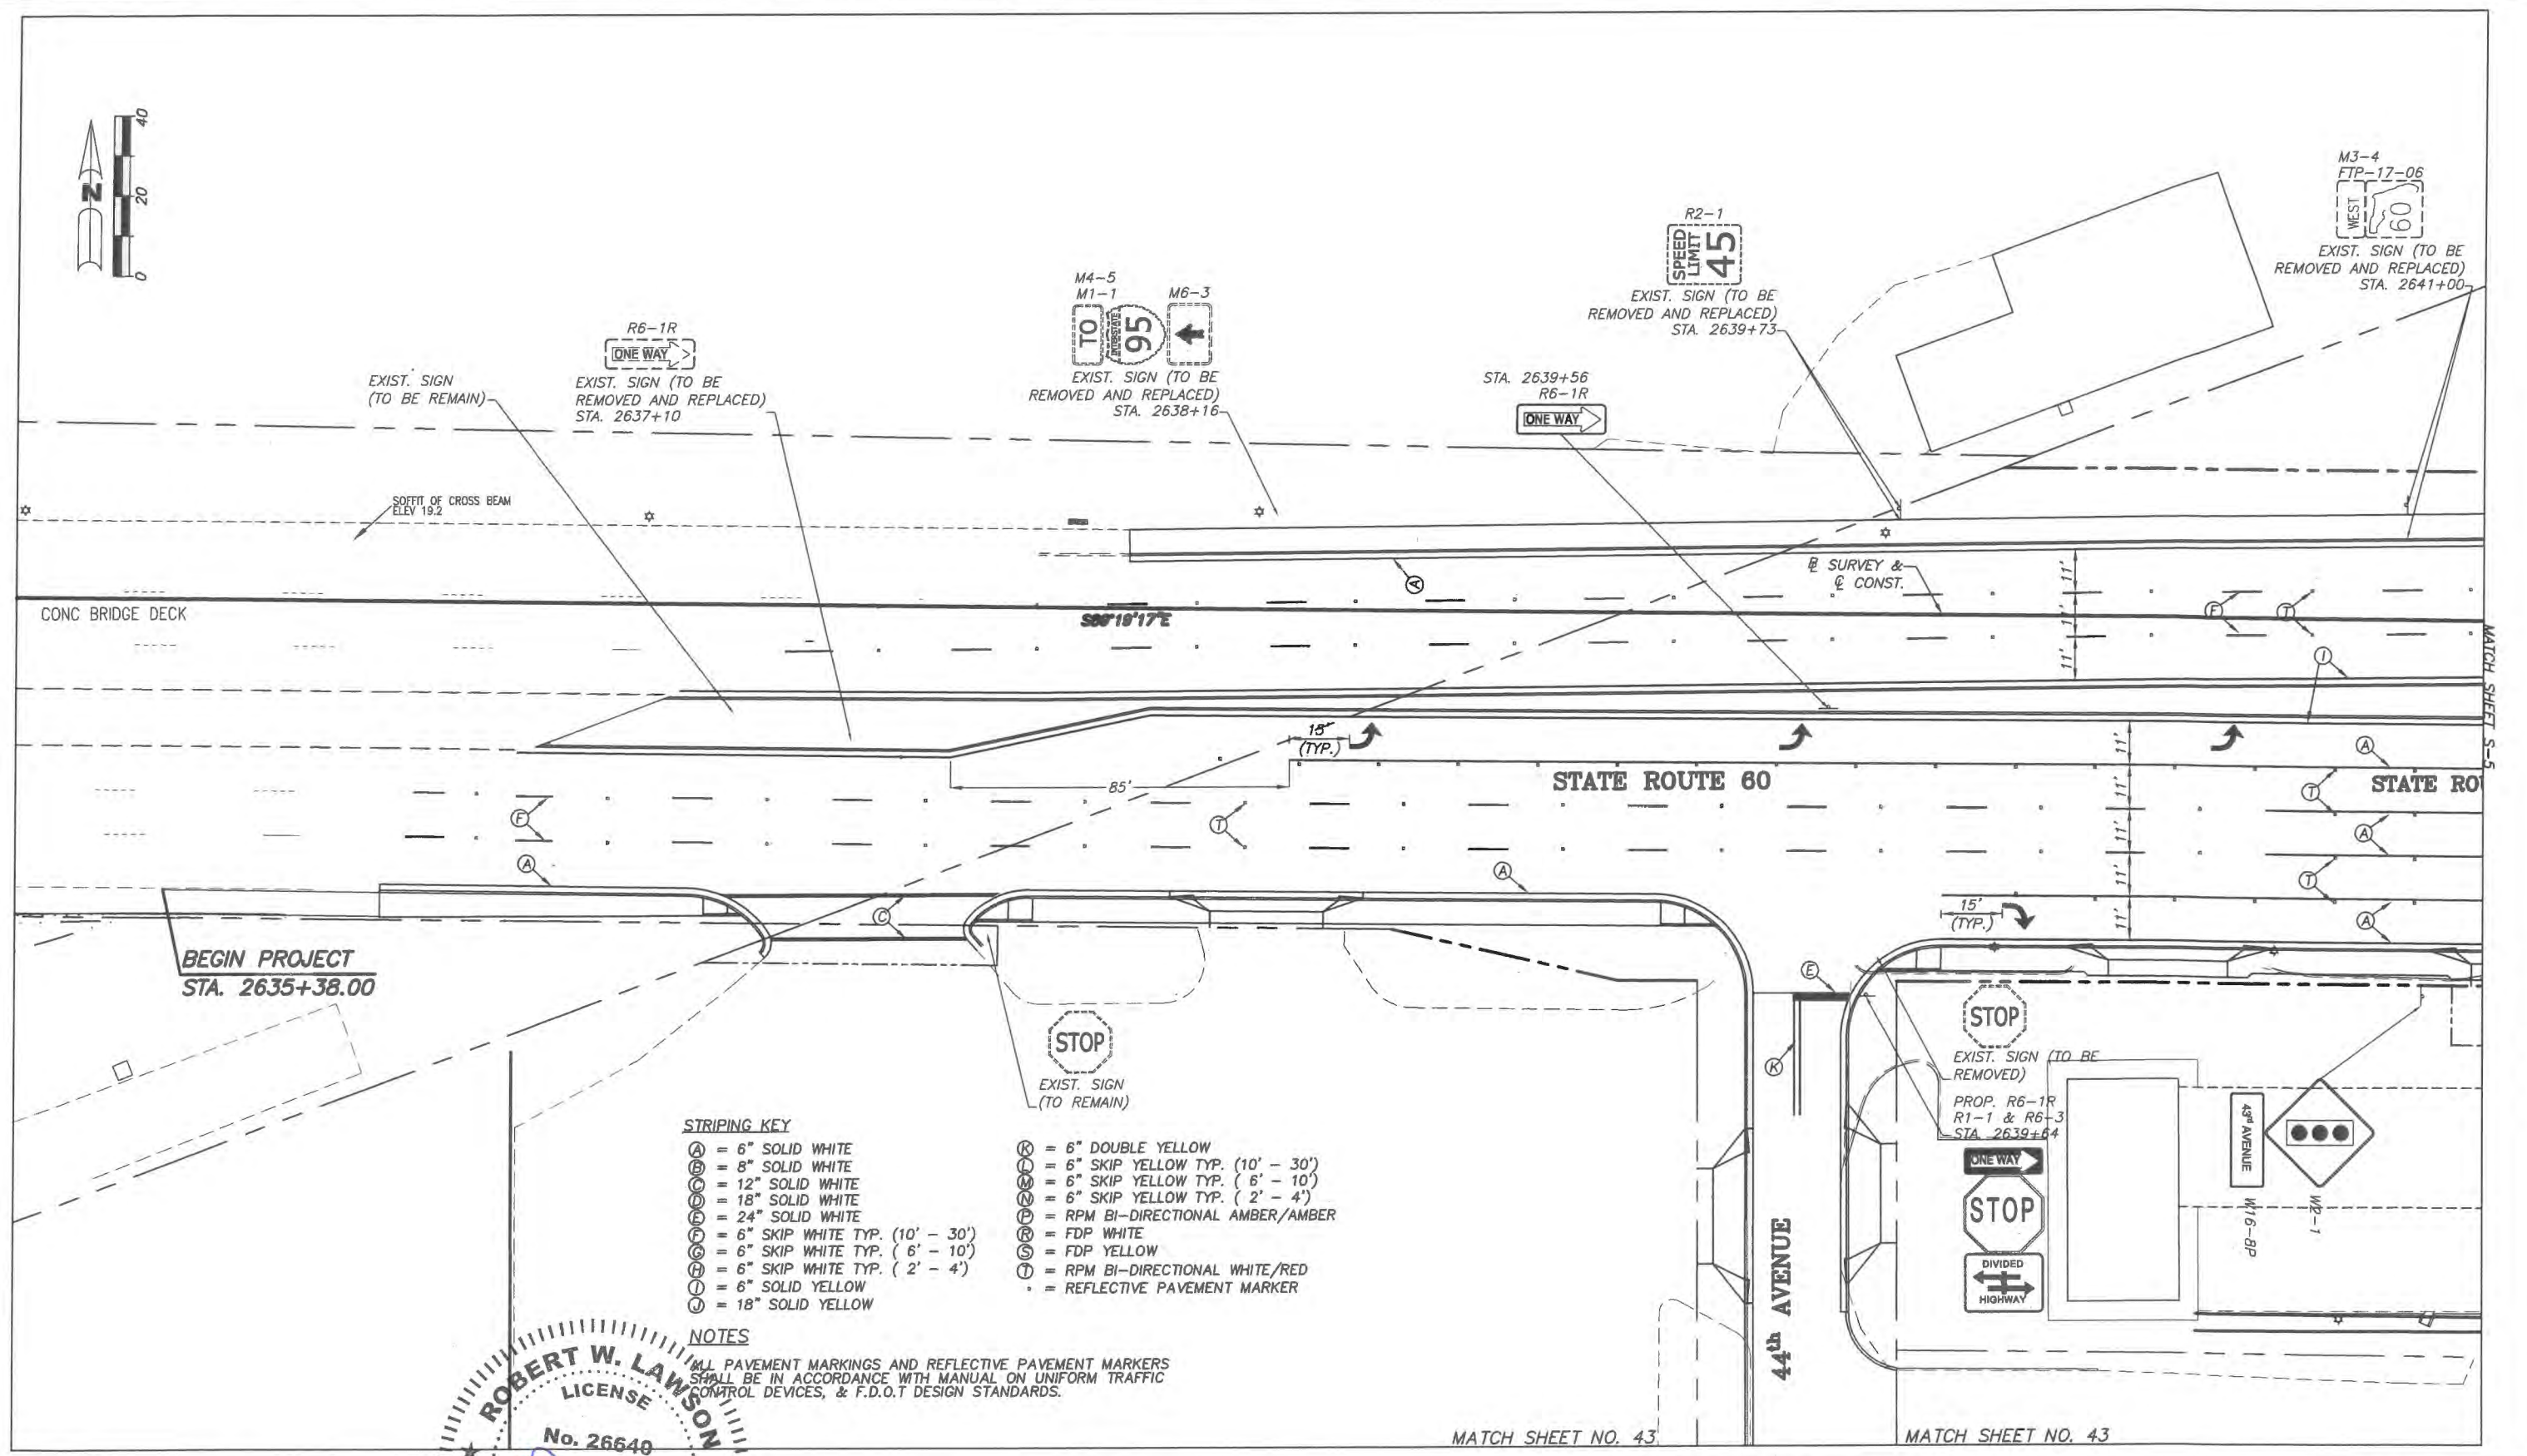
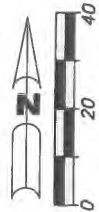
Department of Public Works  
 Engineering Division

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 SIGNING & PAVEMENT MARKING PLANS  
 FOR  
 SR 60 & 43RD AVENUE

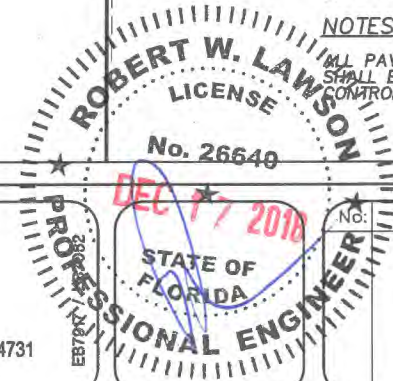
Sheet: S-9  
 Of: S-13  
 Project No.  
 LNW# WP1027






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  - (S) = FDP YELLOW
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**NOTES**  
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No.	Revision:	By:	Date:


**Department of Public Works**  
 Engineering Division

Scale: 1"=40'  
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 SIGNING & PAVEMENT MARKING PLANS  
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 SR 60 & 43RD AVENUE

Sheet: S-10  
 Of: S-13  
 Project No.  
 LNWP 1027

  
**ARCADIS U.S., INC.**  
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 Boynton Beach, Florida 33426  
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 www.arcadis-us.com





ATLANTIC BLVD

BLOCK 2

41<sup>ST</sup> AVENUE

PROP. R6-1R  
R1-1 & R6-3.  
STA. 2646+53

EXIST. SIGN  
(TO BE REMOVED)

EXIST. SIGN  
(TO BE REMOVED & REPLACED)  
STA. 2647+20

EXIST. BUSINESS SIGN  
(TO BE REMOVED)

PROP. R6-1R  
R1-1 & R6-3.  
STA. 2650+30  
EXIST. SIGN  
(TO BE REMOVED)  
STA. 2650+30

EXIST. SIGN  
(TO BE REMOVED)

EXIST. BUSINESS SIGN  
(TO BE REMOVED)

TRACT A

BLOCK 2

MATCH SHEET S-5

2645+00      2646+00      2647+00      2648+00      2649+00      2650+00      265

STATE ROUTE 60

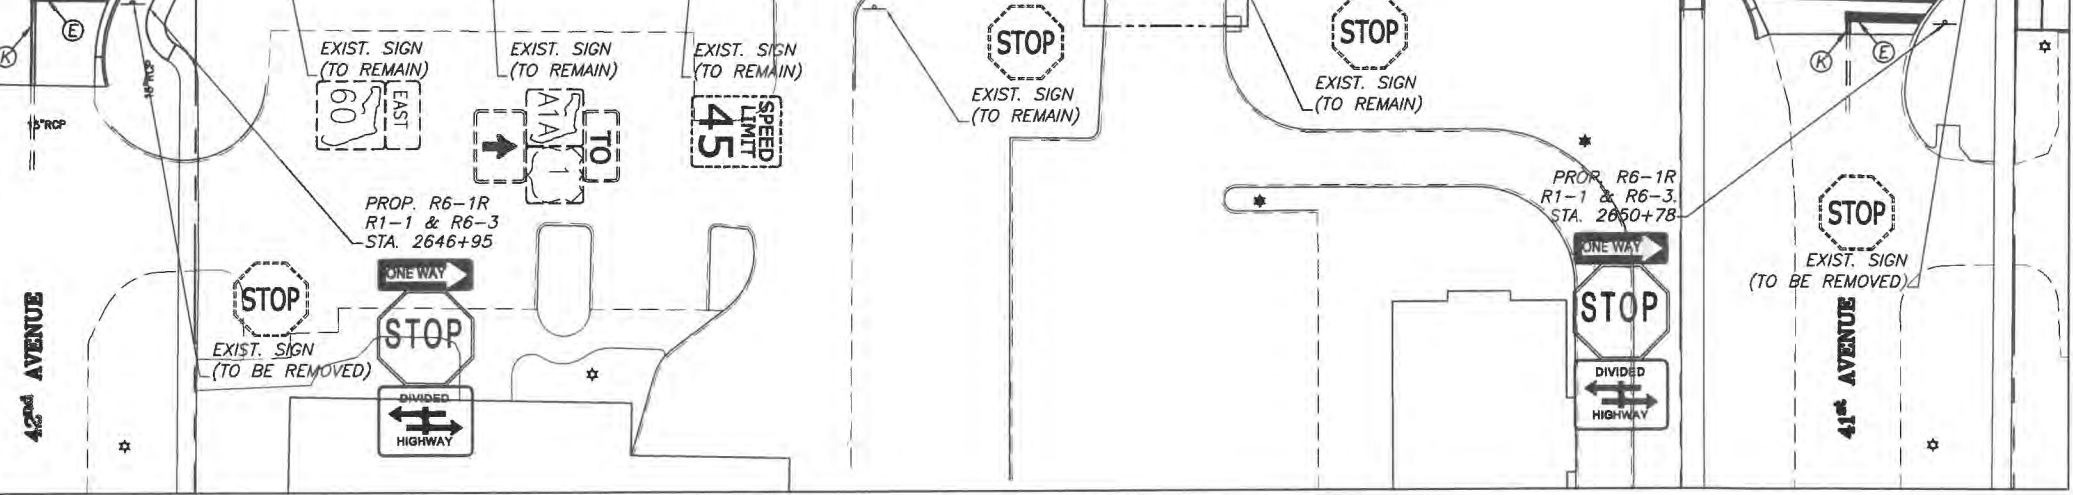
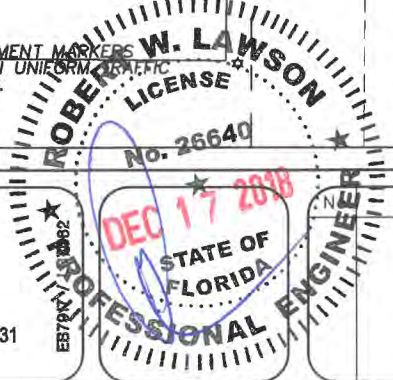
Ⓢ SURVEY &  
Ⓣ CONST.

**STRIPING KEY**

- Ⓐ = 6" SOLID WHITE
- Ⓑ = 8" SOLID WHITE
- Ⓒ = 12" SOLID WHITE
- Ⓓ = 18" SOLID WHITE
- Ⓔ = 24" SOLID WHITE
- Ⓕ = 6" SKIP WHITE TYP. (10' - 30')
- Ⓖ = 6" SKIP WHITE TYP. (6' - 10')
- Ⓗ = 6" SKIP WHITE TYP. (2' - 4')
- Ⓙ = 6" SOLID YELLOW
- Ⓚ = 18" SOLID YELLOW
- Ⓛ = 6" DOUBLE YELLOW
- Ⓜ = 6" SKIP YELLOW TYP. (10' - 30')
- Ⓝ = 6" SKIP YELLOW TYP. (6' - 10')
- Ⓟ = 6" SKIP YELLOW TYP. (2' - 4')
- Ⓠ = RPM BI-DIRECTIONAL AMBER/AMBER
- Ⓡ = FDP WHITE
- Ⓢ = FDP YELLOW
- Ⓣ = RPM BI-DIRECTIONAL WHITE/RED
- = REFLECTIVE PAVEMENT MARKER

**NOTES**

ALL PAVEMENT MARKINGS AND REFLECTIVE PAVEMENT MARKERS SHALL BE IN ACCORDANCE WITH THE MANUAL ON UNIFORM TRAFFIC CONTROL DEVICES, & F.D.O.T DESIGN STANDARDS.



**ARCADIS**  
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www.arcadis-us.com

Revision:	By:	Date:

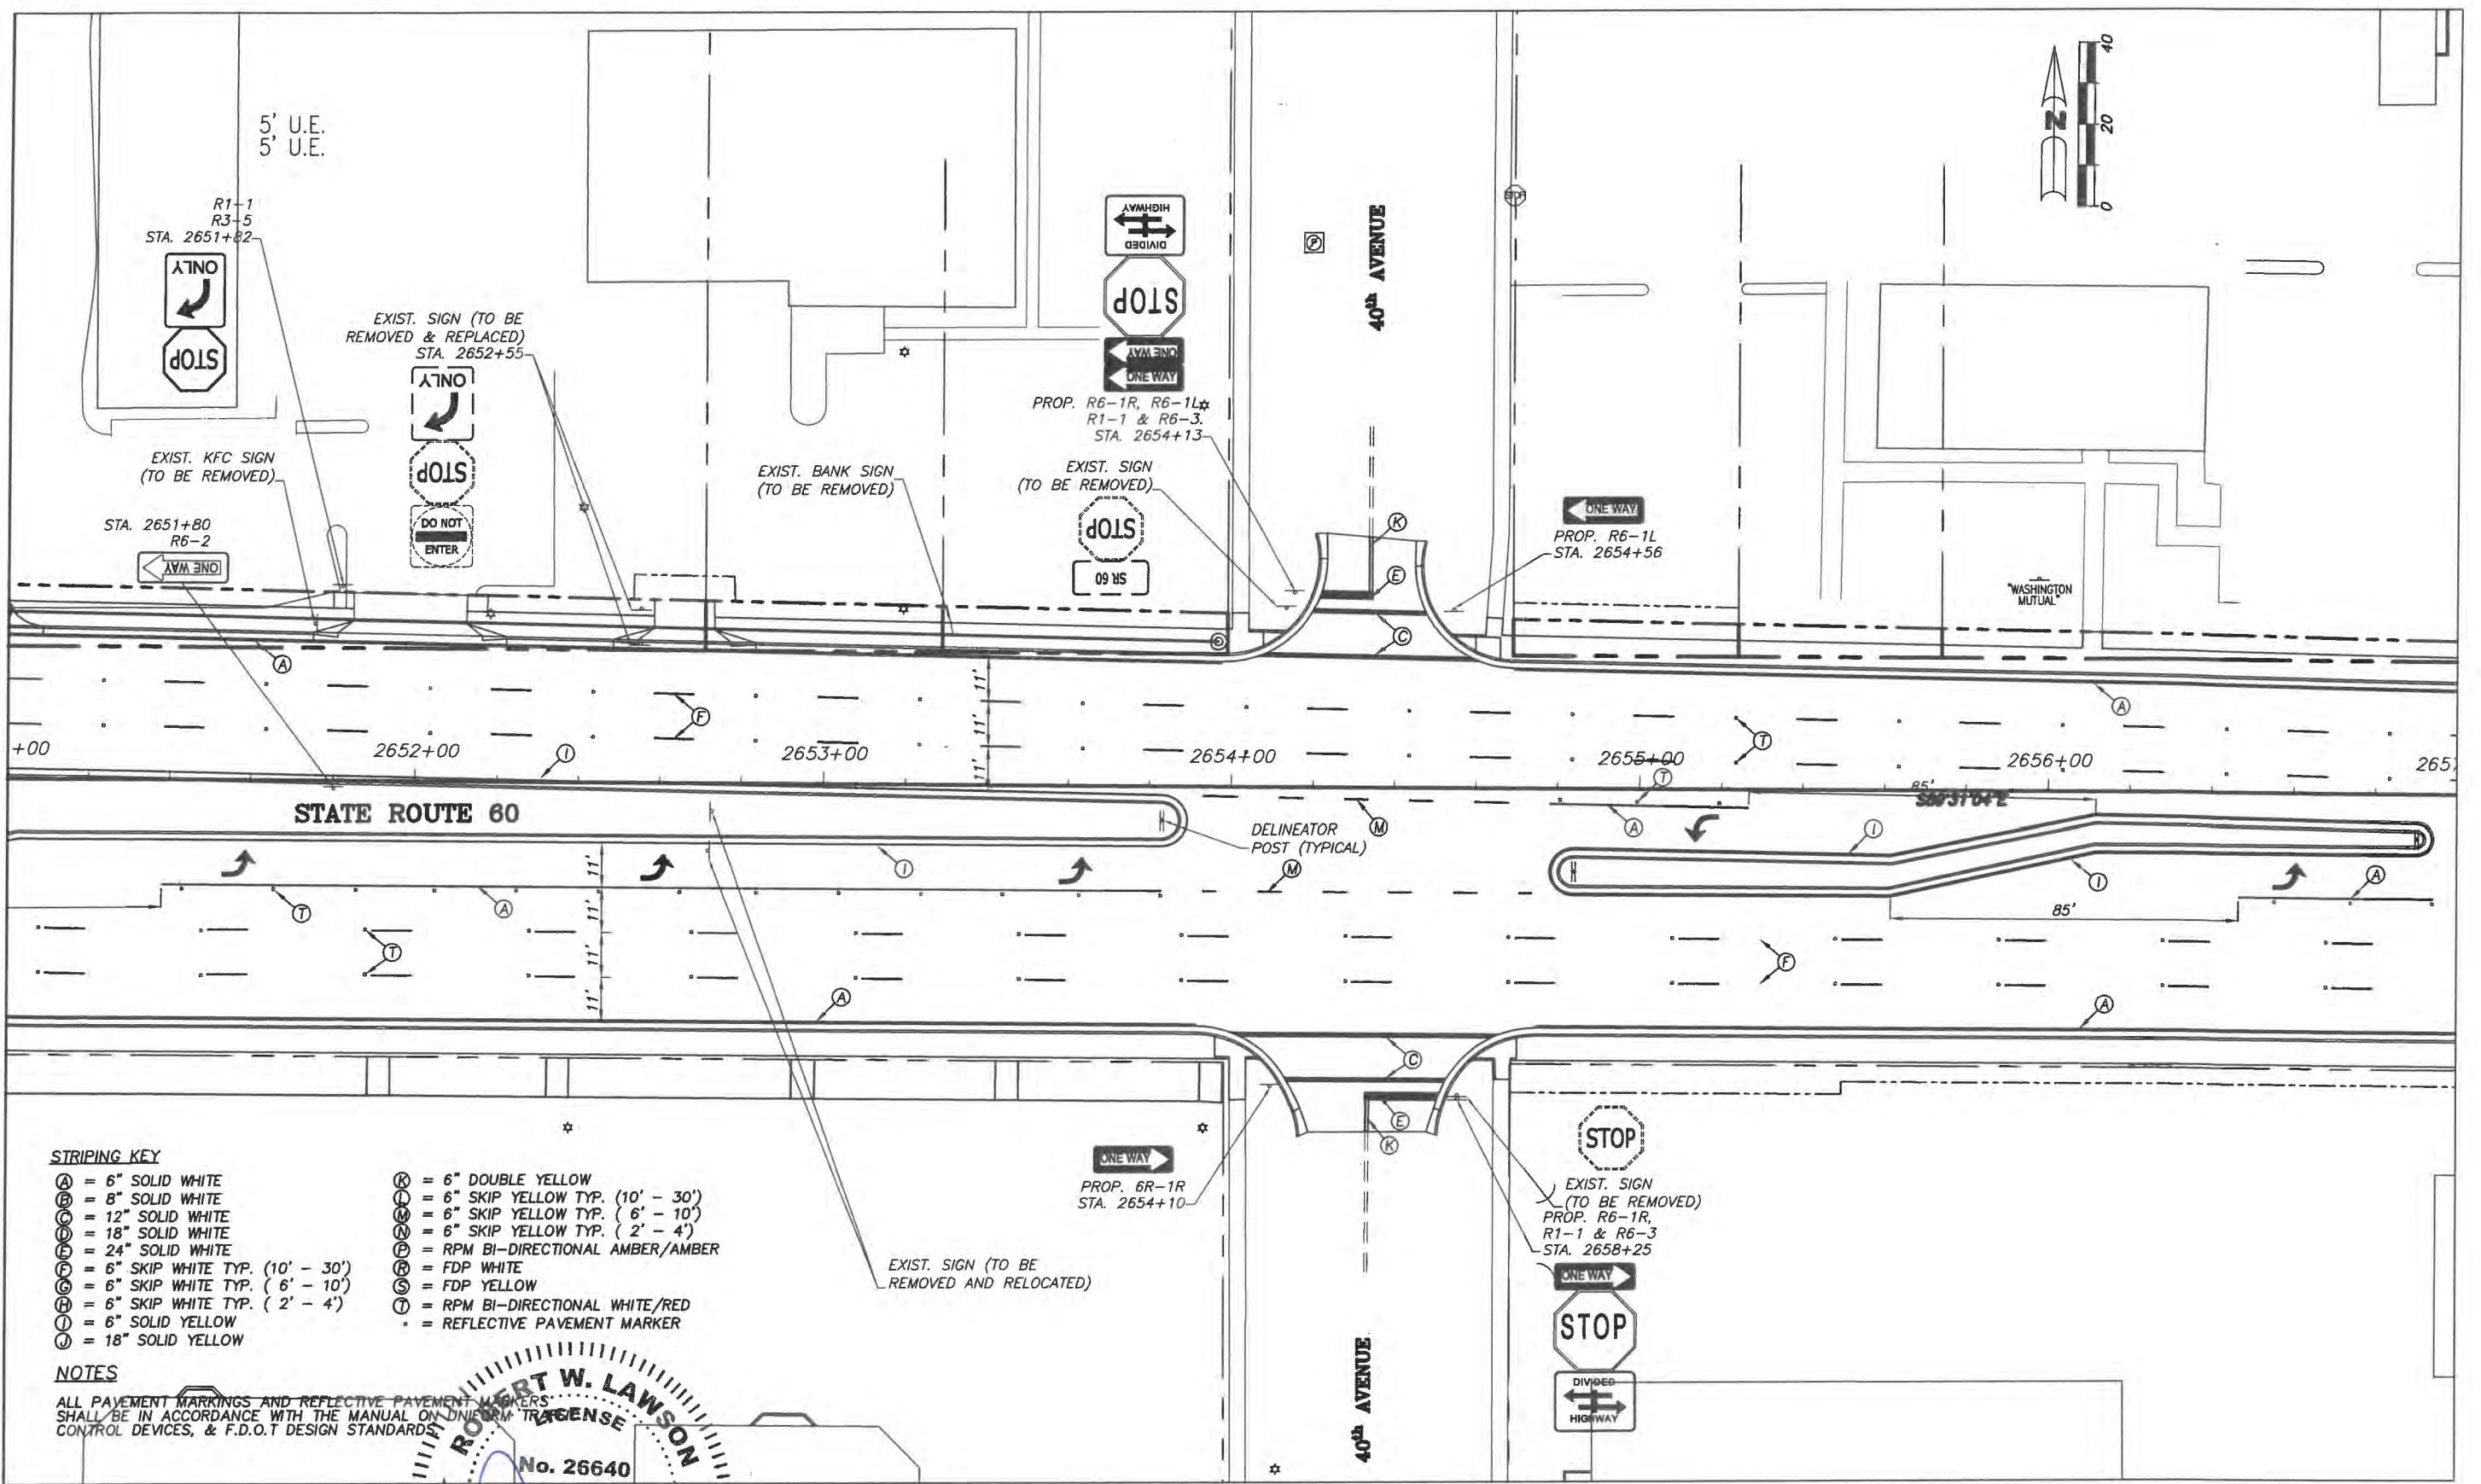
INDIAN RIVER COUNTY  
FLORIDA  
**Department of Public Works**  
Engineering Division

Scale: 1"=40'  
Approved: HWD  
Drawn: FM  
Checked: HWD  
Date: 6/2017  
Field Book No:

Project:  
SIGNING & PAVEMENT MARKING PLANS  
FOR  
SR 60 & 43RD AVENUE

Sheet: S-11  
Of: S-13  
Project No.  
LNW/ WP1027



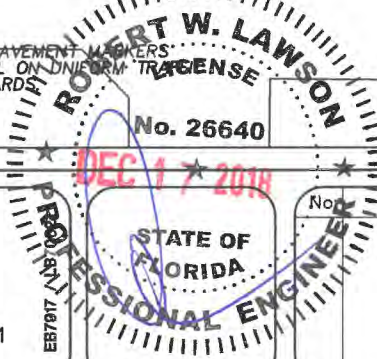


**STRIPING KEY**

- (A) = 6" SOLID WHITE
- (B) = 8" SOLID WHITE
- (C) = 12" SOLID WHITE
- (D) = 18" SOLID WHITE
- (E) = 24" SOLID WHITE
- (F) = 6" SKIP WHITE TYP. (10' - 30')
- (G) = 6" SKIP WHITE TYP. (6' - 10')
- (H) = 6" SKIP WHITE TYP. (2' - 4')
- (I) = 6" SOLID YELLOW
- (J) = 18" SOLID YELLOW
- (K) = 6" DOUBLE YELLOW
- (L) = 6" SKIP YELLOW TYP. (10' - 30')
- (M) = 6" SKIP YELLOW TYP. (6' - 10')
- (N) = 6" SKIP YELLOW TYP. (2' - 4')
- (P) = RPM BI-DIRECTIONAL AMBER/AMBER
- (R) = FDP WHITE
- (S) = FDP YELLOW
- (T) = RPM BI-DIRECTIONAL WHITE/RED
- (\*) = REFLECTIVE PAVEMENT MARKER

**NOTES**

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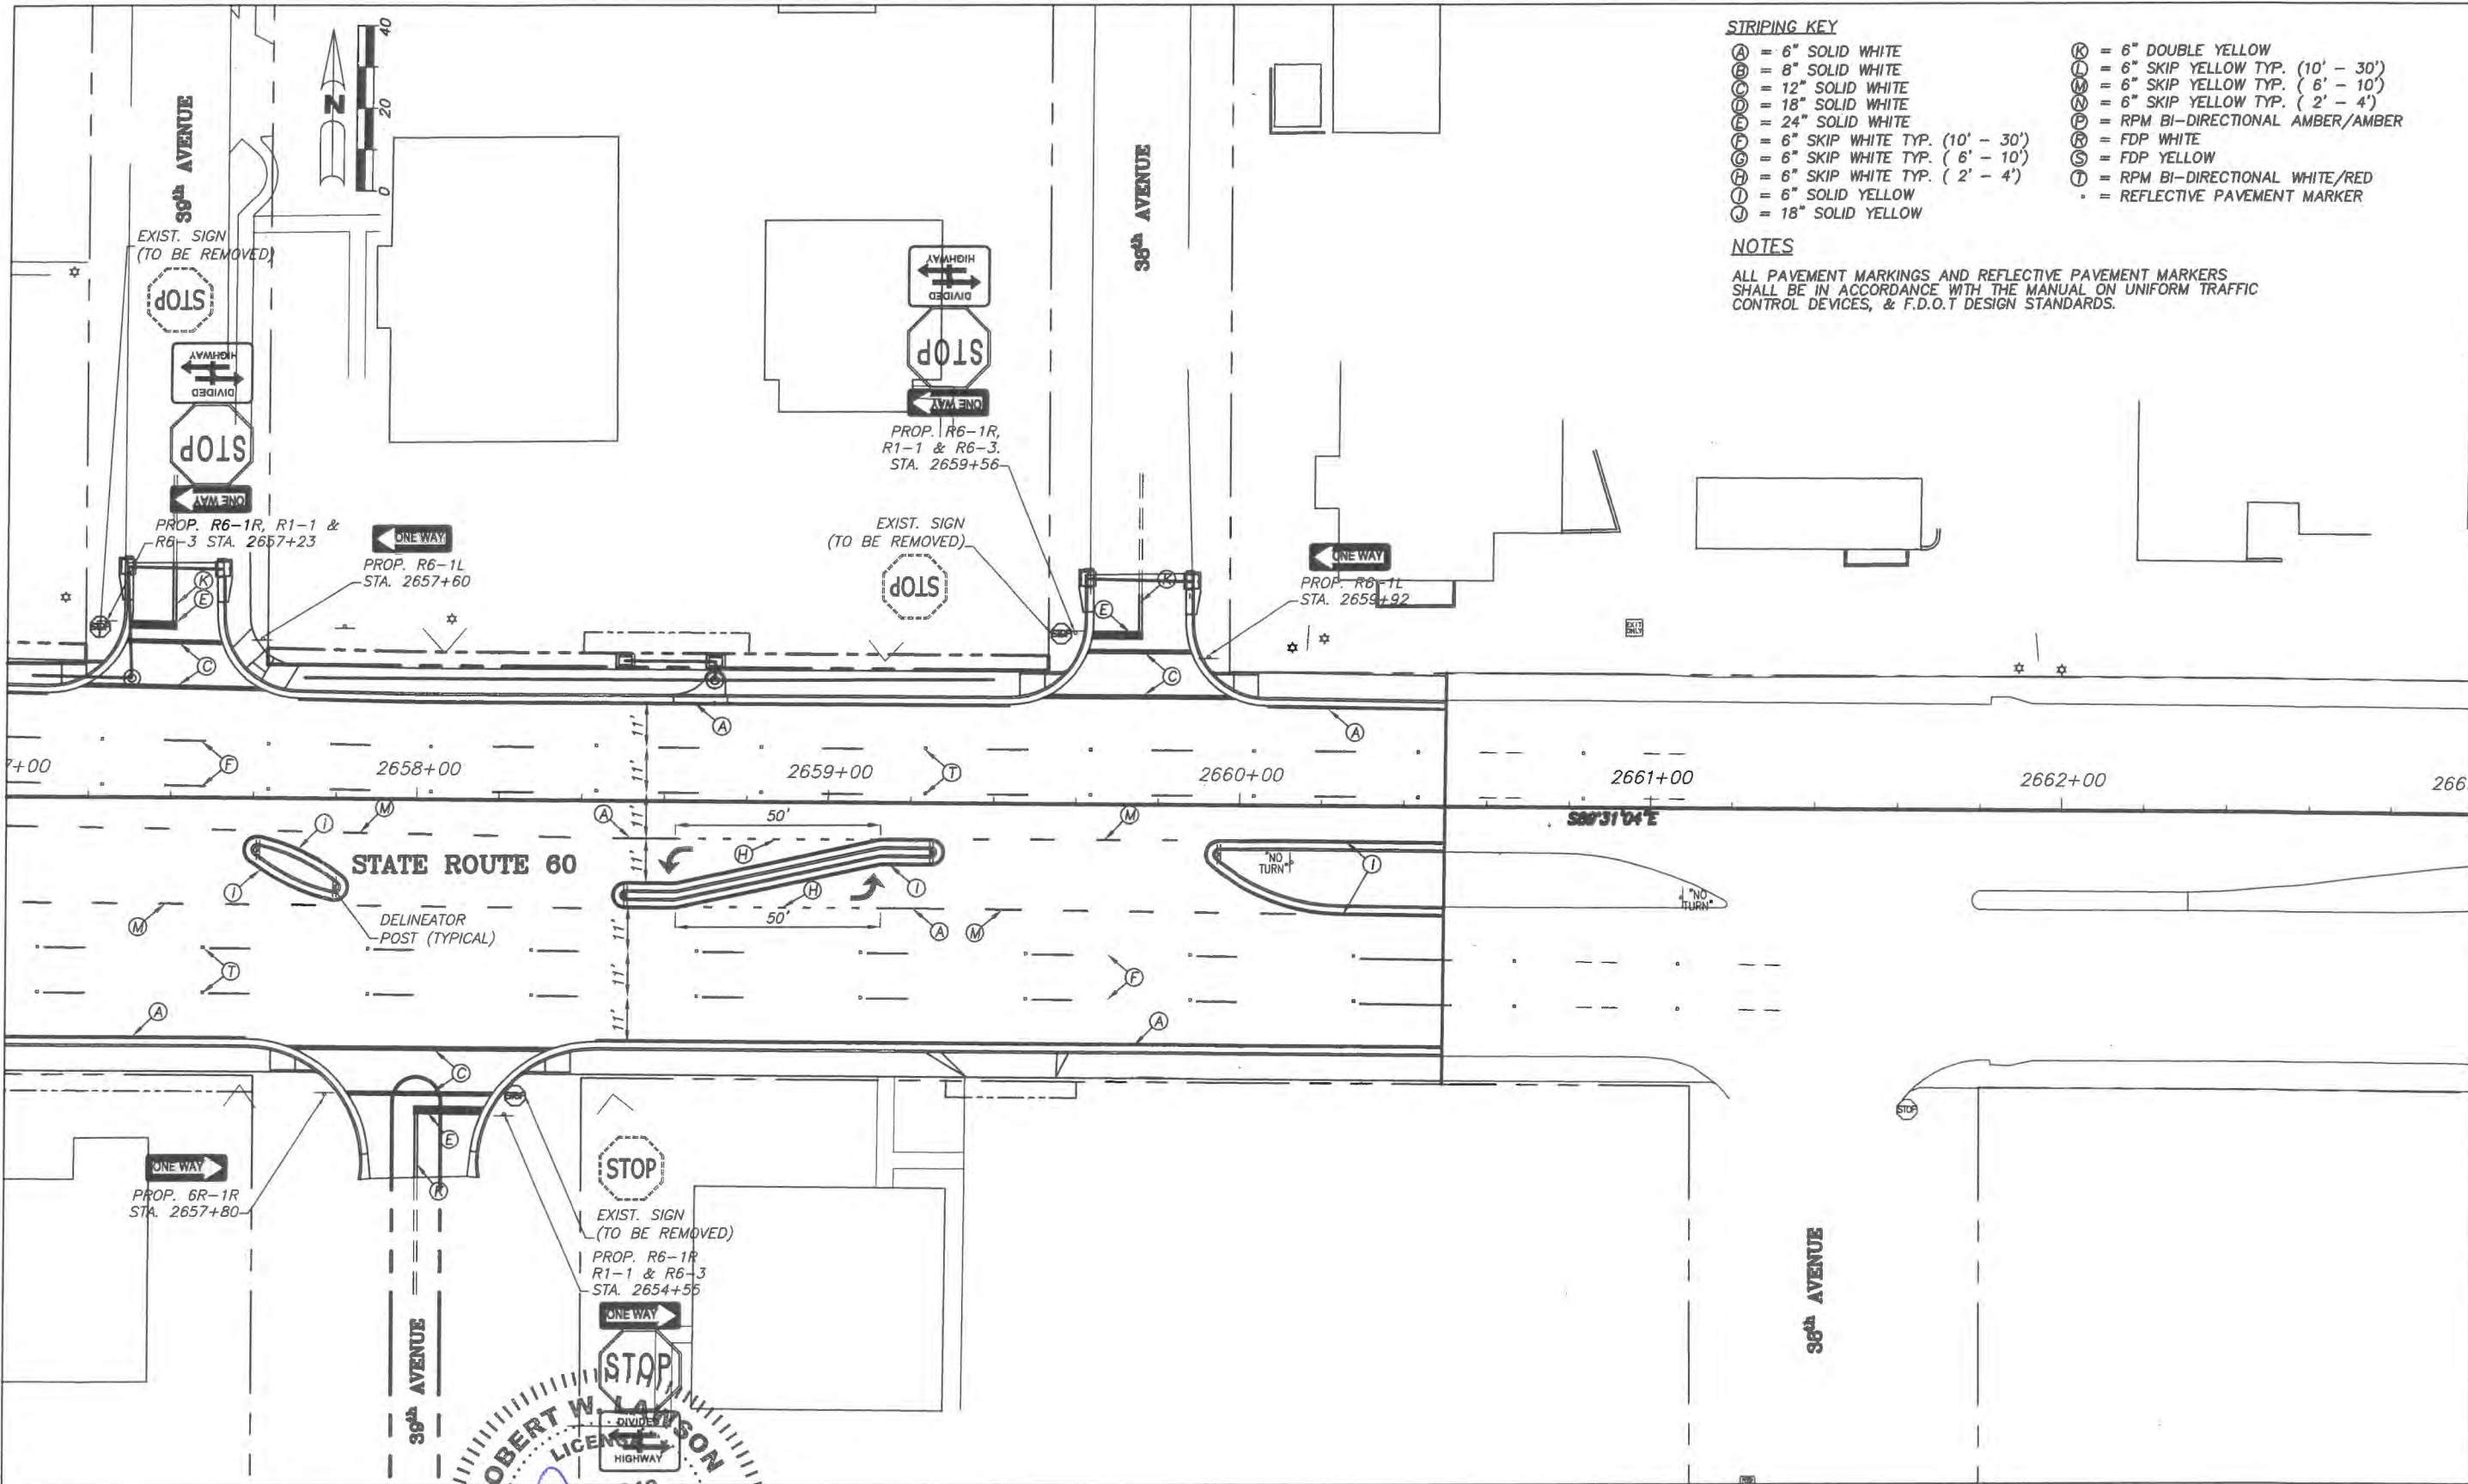
INDIAN RIVER COUNTY  
 FLORIDA  
 Department of Public Works  
 Engineering Division

Scale: 1"=40'  
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 SR 60 & 43RD AVENUE

Sheet: S-12  
 Of: S-13  
 Project No.  
 LNW# WP1027





**STRIPING KEY**

- A = 6" SOLID WHITE
- B = 8" SOLID WHITE
- C = 12" SOLID WHITE
- D = 18" SOLID WHITE
- E = 24" SOLID WHITE
- F = 6" SKIP WHITE TYP. (10' - 30')
- G = 6" SKIP WHITE TYP. (6' - 10')
- H = 6" SKIP WHITE TYP. (2' - 4')
- I = 6" SOLID YELLOW
- J = 18" SOLID YELLOW

- K = 6" DOUBLE YELLOW
- L = 6" SKIP YELLOW TYP. (10' - 30')
- M = 6" SKIP YELLOW TYP. (6' - 10')
- N = 6" SKIP YELLOW TYP. (2' - 4')
- P = RPM BI-DIRECTIONAL AMBER/AMBER
- R = FDP WHITE
- S = FDP YELLOW
- T = RPM BI-DIRECTIONAL WHITE/RED
- = REFLECTIVE PAVEMENT MARKER

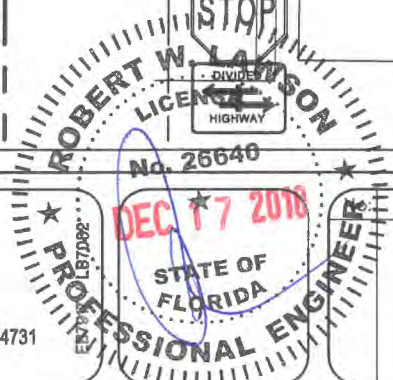
**NOTES**

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088310 / LC26000269



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Department of Public Works  
Engineering Division

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Sheet: S-13  
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Project No. \_\_\_\_\_  
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