SHEET INDEX


SHEET NO.	DESCRIPTION	SHEET TOTALS
1	TITLE SHEET	1
2	SUMMARY OF ESTIMATED QUANTITIES	1
3	TYPICAL SECTION	1
3A	DETAIL SHEET	1
4	RIGHT OF WAY DATA SHEET	1
5	GENERAL NOTES	1
5A	REFERENCE DATA SHEET	1
6	PLAN SHEET	1
EC1	EROSION CONTROL DATA SHEET	1
D1	DRAINAGE & EROSION CONTROL SHEET	1
LL1–LL6	LIGHTING SHEET	6
LA1	LANDSCAPING SHEET	1
X1 – X2	CROSS SECTIONS	2
		TOTAL 19

CITY OF BEAUFORT



PLAN AND PROFILE OF SC-170 SIDEWALK EXTENSION

FROM: ROBERT SMALLS PKWY (SC-170) TO: SPANISH MOSS TRAIL

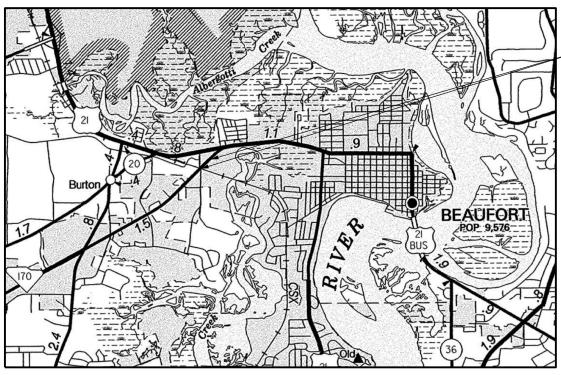

LAYOUT

Latltude 32°26'15" N Longitude 80°42'27" W End 32°26'19" N Longitude 80°42'23" W Hydraulic and NPDES Design provided by: ROBERT SMALLS PKWY (SC-170) BEGIN CONSTRUCTION Designs may be obtained from the SCDOT Regional Production Group

THE INITIALS ABOVE DO NOT RELIEVE THE ENGINEER OF RECORD OF THE RESPONSIBILITY TO DESIGN THIS PROJECT IN ACCORDANCE WITH ALL APPLICABLE CRITERIA.

NPDES PERMIT INFORMATION

Disturbed Area = 0.125 Acre(s)

Approximate Location of Roadway is

SCDOT REVIEW	RIGHT-0	OF-WAY DATE	CONSTF INITIAL	UCTION DATE
PRECONSTRUCTION SUPPORT - ROAD				
PRECONSTRUCTION SUPPORT - STRUCTURES				
RPG - DESIGN MANAGER				
RPG - PROGRAM MANAGER				

BEAUFORT

THE INITIALS ABOVE DO NOT RELIEVE THE ENGINEER OF RECORD OF THE RESPONSIBILITY TO DESIGN THIS PROJECT IN ACCORDANCE WITH ALL APPLICABLE CRITERIA.

	For Right Of Wa	ay Acquisition:	
-	Consultant Engineer of Record	Date	

3 DAYS BEFORE DIGGING IN

Hydraulic Design Reference for these plans is the:

Edition of SCDOT's "Requirements for Hydraulic Design Studies"

Design Reference for these plans is the:

AASHTO "A Policy on Geometric Design of Highways and Streets"

> SOUTH CAROLINA **CALL 811**


SOUTH CAROLINA 811 (SC811) WWW.SC811.COM
ALL UTILITIES MAY NOT BE A MEMBER OF SC811

> RAILROAD INVOLVEMENT? YES/NO

TOTAL (MILES) SC - 170 NET LENGTH OF ROADWAY 0.11 0.11 NET LENGTH OF BRIDGES NET LENGTH OF PROJECT 0.11 0.11 LENGTH OF EXCEPTIONS GROSS LENGTH OF PROJECT 0.11 0.11

EQUALITIES IN STATIONING: NONE

NOTE: EXCEPT AS MAY OTHERWISE BE SPECIFIED ON THE PLANS OR IN THE SPECIAL PROVISIONS, ALL MATERIALS AND WORKMANSHIP ON THIS PROJECT SHALL TO CONFORM WITH SOUTH CAROLINA DEPARTMENT OF TRANSPORTATION STANDARD SPECIFICATIONS FOR HIGHWAY CONSTRUCTION (2007 EDITION) AND STANDARD DRAWINGS FOR ROAD CONSTRUCTION IN EFFECT AT THE TIME OF LETTING.

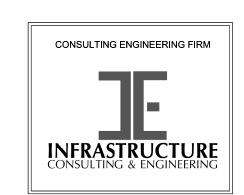

ST A. 10+33.13

ST A. 16+26.39

END CONSTRUCTION

ENGINE	ER OF RECORD
No. 32916	OF AUTHORITIES OF AUT
FOR CONSTRUCTION:	

STATE	COUNTY	FILE NO.	PROJECT NO.	ROUTE NO.	SHEET NO.
SC	BEAUFORT			SC-170	2

SUMMARY OF ESTIMATED QUANTITIES

PAYITEM	DESCRIPTION	QUANTITY	UNIT
1031000	MOBILIZATION	1.00	LS
1032010	BONDS AND INSURANCE	1.00	LS
1050800	CONSTRUCTION STAKES, LINES & GRADES	1.00	EA
1071000	TRAFFIC CONTROL	1.00	LS
2012000	CLEARING & GRUBBING WITHIN ROADWAY	1.00	LS
2021010	REMOVAL & DISPOSAL OF EXISTING DROP INLET	1.00	EA
2024100	REMOVAL & DISPOSAL OF EXISTING CURB	265.00	LF
2027000	REMOVAL & DISPOSAL OF EXISTING CONCRETE	360.00	SY
2031000	UNCLASSIFIED EXCAVATION	20.00	CY
2033000	BORROW EXCAVATION	90.00	CY
3100320	HOT MIX ASPHALT BASE COURSE - TYPE B	40.00	TN
4011004	LIQUID ASPHALT BINDER PG 64-22	5.90	TN
4030340	HOT MIX ASPHALT SURFACE COURSE - TYPE C	65.00	TN
6271015	8" WHITE SOLID LINES THERMOPLASTIC - 125 MIL.	236.00	LF
6271025	24" WHITE SOLID LINES THERMOPLASTIC - 125 MIL.	46.00	LF
6271074	4" YELLOW SOLID LINES(PVT.EDGE LINES) THERMO-90 MIL.	32.00	LF
6020005	PERMANENT CONSTRUCTION SIGNS (GROUND MOUNTED) SCHEME D	100.00	SF
6651091	SINGLE DECORATIVE LIGHT POLE WITH SINGLE LIGHT	3.00	EA
675027Y	FURNISH & INSTALL 4.0" SCHD 80 PVC CONDUIT(DIRECTION BORED)	120.00	LF
6760020	2" SCHEDULE 80 PVC CONDUIT	540.00	LF
6770319	#8Cu,1,600V,RHH,RHW,USE	1690.00	LF
6800530	17X30X28D.ELEC.UNGRD.ENCLOS/HD	2.00	EA
6888110	INSTALL STREET LIGHT LUMINAIRE	4.00	EA
7191605	CATCH BASIN -TYPE 16	1.00	EA
7198320	JUNCTION BOX - CONVERT DROP INLET 24" X 36"	2.00	EA
7198392	JUNCTION BOX - CONVERT CB T-16	1.00	EA
7203110	CONCRETE CURB AND GUTTER(1'-6") VERTICAL FACE	190.00	LF
7204100	CONCRETE SIDEWALK(4" UNIFORM)	358.00	SY
7209000	PEDESTRIAN RAMP CONSTRUCTION	43.00	SY
8100100	PERMANENT COVER	0.08	ACRE
8100200	TEMPORARY COVER	0.08	ACRE
8104005	FERTILIZER (NITROGEN)	8.00	LB
8104010	FERTILIZER (PHOSPHORIC ACID)	8.00	LB
8104015	FERTILIZER (POTASH)	8.00	LB
8105005	AGRICULTURAL GRANULAR LIME	160.00	LB
8110001	LANDSCAPING	1.00	LS
8151203	HYDRAULIC EROSION CONTROL PRODUCT (HECP) - TYPE 3	0.05	ACRE
8153000	SILT FENCE	400.00	LF
8153090	REPLACE/REPAIR SILT FENCE	40.00	LF
8154050	REMOVAL OF SILT RETAINED BY SILT FENCE	100.00	LF







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CHECKE	D BY: <u>JCH</u>		DATE	SHEET 2


BEAUFORT COUNTY CITY OF BEAUFORT

ROBERT SMALLS PKWY (SC-170) SUMMARY OF ESTIMATED QUANTITIES

HEET 2 SCALE: NTS

STATE	COUNTY	FILE NO.	PROJECT NO.	ROUTE NO.	SHEET NO.
SC	BEAUFORT			SC-170	3

TYPICAL SECTIONS

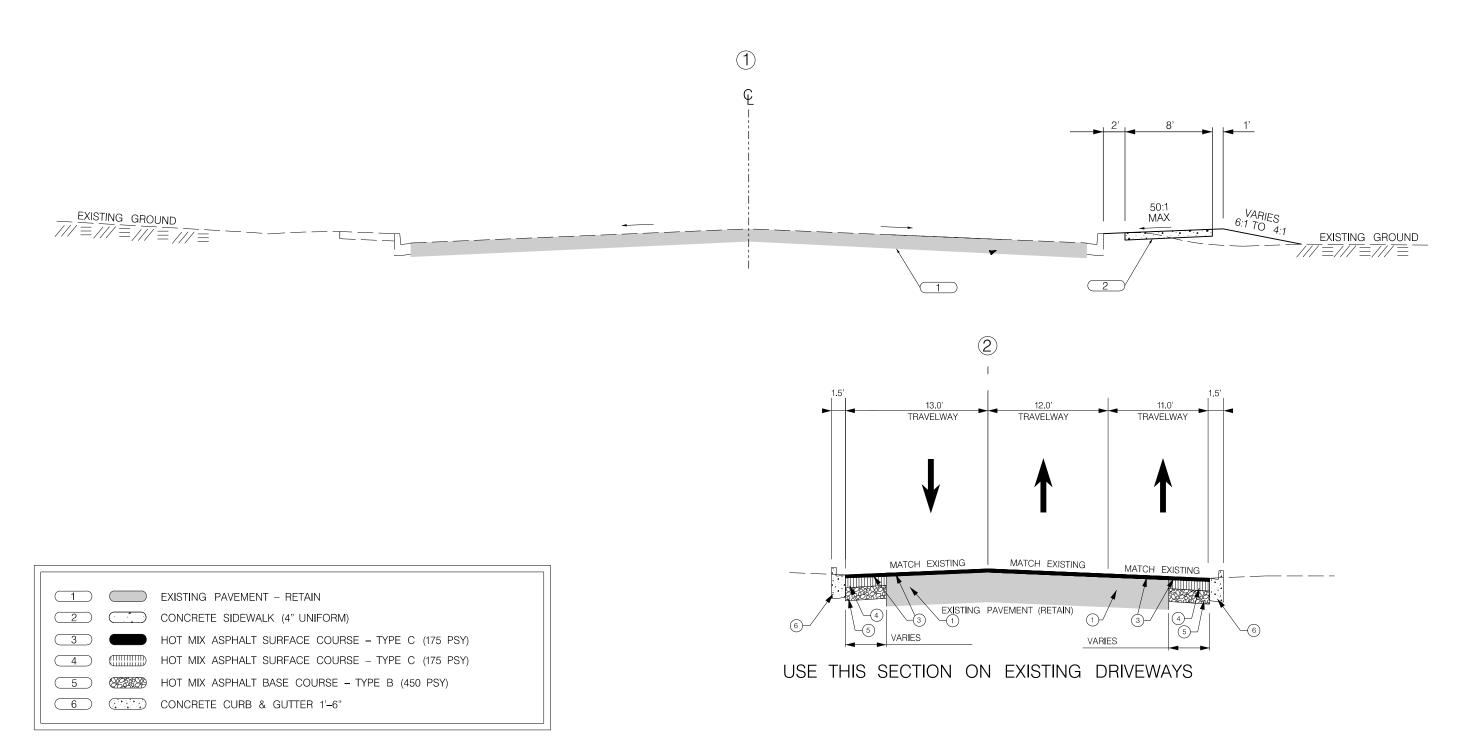

TEINFRASTRUCTURECONSULTING & ENGINEERING





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ROBERT						1
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			DATE		BY: <u>TKC</u>	DRAWN
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CITY OF BEAUFORT


ERT SMALLS PARKWAY (SC-170)
TYPICAL SECTIONS

TYPICAL SECTIONS

BEAUFORT COUNTY

SCALE:



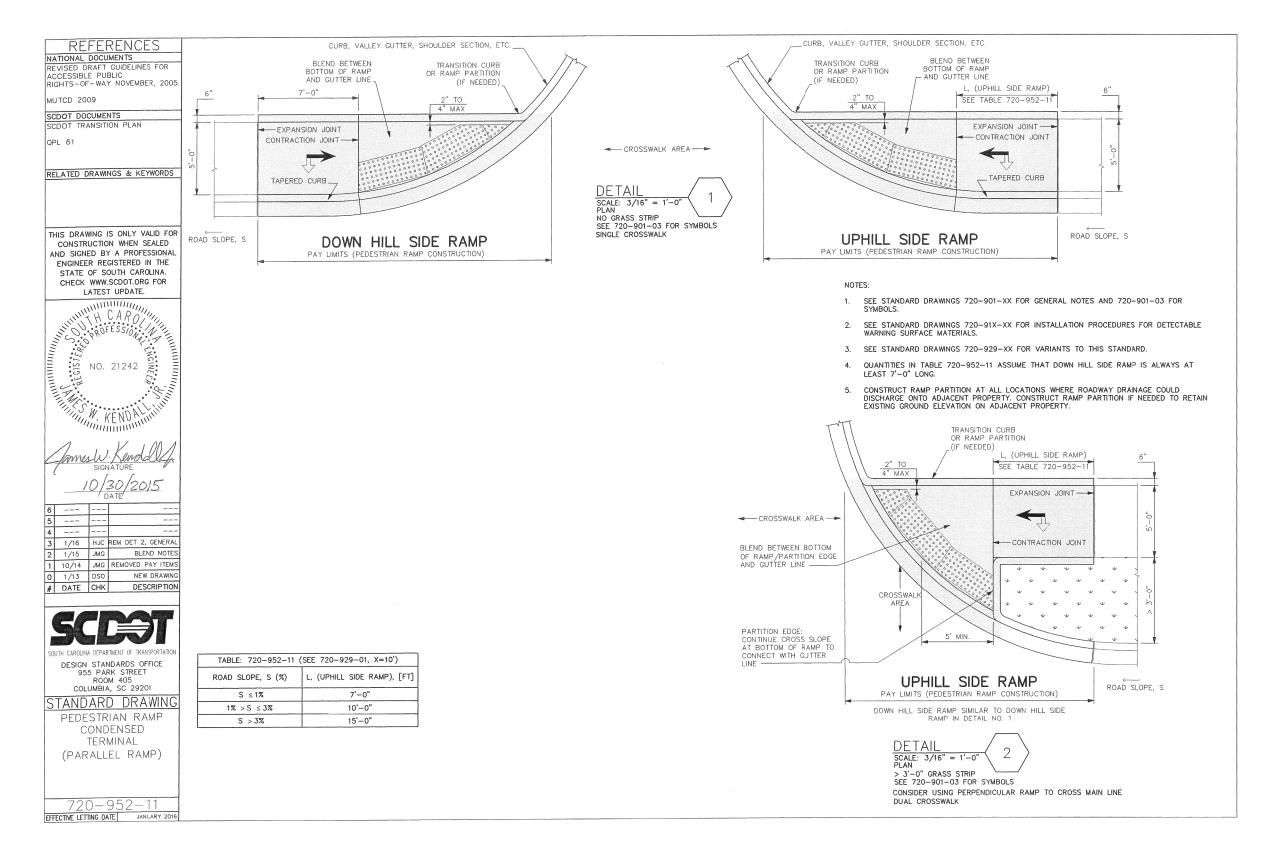

TEINFRASTRUCTURECONSULTING & ENGINEERING

4						RT COUNTY
3					CITY OF	BEAUFORT
2						
1					BOBERT SMALL	S PKWY (SC-170)
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CHECKE	D BY:		DATE		SHEET 3A	SCALE: NTS

STATE COUNTY FILE NO. PROJECT ROUTE SHEET NO. NO. NO. SC—170 4

RIGHT OF WAY DATA SHEET

TRACT NO.	PROPERTY OWNER	TAX MAP REFERENCE	TOTAL TRACT	OUTFALL DITCH ACRES	OBTAIN LEFT F	RIGHT	TOTAL	REMAINDER LEFT ACRES	REMAINDER RIGHT ACRES	DATE ACQUIRED	TYPE OF INSTRUMENT	OUTFALL DITCH PERMISSION (YES)	SLOPE PERMISSION (YES)	DRAINAGE STRUCTURE PERMISSION (YES)	EROSION CONTROL PERMISSION (YES)	ENTRANCE CONSTRUCTION PERMISSION (YES)	REMARKS	
1	CITY OF BEAUFORT – SPANISH MOSS TRIAL												YES		YES			
2	BEAUFORT PLAZA INC % LEITH PAUL TRASK	R122 029 000 0137 0000	2.95															
3	BEAUFORT PLAZA INC % LEITH PAUL TRASK	R122 029 000 0517 0000	0.5										YES		YES	YES		
4	BEAUFORT PLAZA INC	R122 029 000 128A 0000	7.30										YES		YES	YES		
5	BEAUFORT PLAZA INC % LEITH PAUL TRASK	R122 029 000 117A 000	0.61															
	T																	
	T																	
											1			1				
												1		1				
																		NOTES:
																		TOTAL OBTAIN INCLUDES HIGHLAND, MARSH AND OUTFALL DITCHES. OBTAINS WILL BE SHOWN IN
																		SOUARE FEET AND ACRES. ACRES WILL BE SHOWN IN PARENTHESES UNDER SQUARE FEET IN RURAL
																		AREAS OBTAINS MAY BE SHOWN IN ACRES ONLY. OUTFALL DITCHES WILL BE SHOWN IN ACRES ONLY.
																		SHOW REMAINDER IN SQUARE
																		FEET WHEN LESS THAN 0.25
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CHECKED BY: DATE	SHEET 4

BEAUFORT COUNTY CITY OF BEAUFORT

ROBERT SMALLS PKWY (SC-170) RIGHT OF WAY DATA SHEET

SHEET 4 SCALE:

STATE	COUNTY	FILE NO.	PROJECT NO.	ROUTE NO.	SHEET NO.
SC	BEAUFORT			SC-170	5

GENERAL NOTES

GENERAL CONSTRUCTION NOTES:

THE CITY ENGINEER MUST SPECIFICALLY AUTHORIZE CHANGES INVOLVING INCREASED COST OF THE PROJECT OR CHANGES IN ALIGNMENT.

WATER VALVES, GAS VALVES, AND SEWER MANHOLES SHALL BE ADJUSTED BY THE CONTRACTOR (RAISED OF LOWERED) TO MATCH THE SIDEWALK PROFILE AND SHALL NOT BE PARTIALLY LOCATED WITHIN THE SIDEWALK, NO ADDITIONAL PAYMENT WILL BE MADE FOR ADJUSTING THESE VALVES OR MANHOLES. THIS WORK SHALL BE CONSIDERED INCIDENTAL IN THE UNIT COST OF CLEARING AND GRUBBING AND SHALL INCLUDE ALL WORKMANSHIP AND MATERIALS NECESSARY TO COMPLETE THIS ITEM.

THE LOCATIONS OF EXISTING UTILITIES SHOWN ON THE PLANS HAVE BEEN DETERMINED FROM AVAILABLE INFORMATION AND ARE PROVIDED FOR THE CONVENIENCE OF THE CONTRACTOR. THE ENGINEER ASSUMES NO RESPONSIBILITY FOR THE ACCURACY OR COMPLETENESS OF THE UTILITIES INFORMATION SHOWN ON THE DRAWINGS. IT IS THEREFORE THE CONTRACTOR'S RESPONSIBILITY TO CONFIRM THAT THE PROPER COORDINATION WITH THE VARIOUS UTILITY OWNERS HAS BEEN PERFORMED.

THE CONTRACTOR SHALL COOPERATE WITH THE UTILITY OWNERS DURING RELOCATION OPERATIONS. THE CONTRACTOR SHALL EXERCISE CAUTION WHEN CROSSING AN UNDERGROUND UTILITY WHETHER SHOWN ON THE DRAWINGS OR LOCATED BY THE UTILITY COMPANY. COST OF DAMAGES TO ANY UTILITIES AS A RESULT OF CONSTRUCTION SHALL BE THE RESPONSIBILITY OF THE CONTRACTOR.

ALL WORKMANSHIP AND MATERIALS USED ON THIS PROJECT SHALL CONFORM TO THE SCDOT STANDARD SPECIFICATIONS FOR HIGHWAY CONSTRUCTION (2007 EDITION), SCDOT 2007 SUPPLEMENTAL SPECIFICATIONS, SCDOT SUPPLEMENTAL TECHNICAL SPECIFICATIONS IN EFFECT AT THE TIME OF LETTING, AND SCDOT 2009 STANDARD DRAWINGS EXCEPT WHERE OTHERWISE NOTED IN THE PLANS.

ALL EXISTING ROAD SIGNS AFFECTED BY CONSTRUCTION ACTIVITIES SHALL BE RETAINED, RELOCATED, OR REMOVED AS DIRECTED BY ROIGNEER. PAYMENT FOR THIS WORK SHALL BE INCLUDED IN THE LUMP SUM COST FOR CLEARING AND GRUBBING.

ALL NEW SIGNS SHALL BE PLACED IN ACCORDANCE WITH THE MANUAL ON UNIFORM TRAFFIC CONTROL DEVICES AND SCDOT STANDARD DRAWINGS. NEW 2P & 3P SIGN SUPPORTS REQUIRED FOR RELOCATED SIGNS WILL BE PAID PER LINEAR FOOT INSTALLED AND ACCEPTED.

THE CONTRACTOR SHALL FURNISH, INSTALL, AND MAINTAIN ALL NECESSARY PROVISIONS FOR TRAFFIC CONTROL FOR THE DURATION OF THE PROJECT. THESE PROVISIONS, AS IN EACH CASE IS APPLICABLE, WILL CONFORM TO THE REQUIREMENTS CONTAINED IN THE SCDOT STANDARD SPECIFICATIONS, STANDARD DRAWINGS, SUPPLEMENTAL SPECIFICATIONS, SPECIAL PROVISIONS, THE FEDERAL HIGHWAY ADMINISTRATION MANUAL ON UNIFORM TRAFFIC CONTROL DEVICES, AND AS DIRECTED BY THE ENGINEER. THE CONTRACTOR SHALL SUBMIT THE TRAFFIC CONTROL PLAN TO THE COUNTY FOR APPROVAL BEFORE BEGINNING CONSTRUCTION.

THE LUMP SUM COST FOR TRAFFIC CONTROL SHALL INCLUDE ALL WORK AS DIRECTED ABOVE. THIS LUMP SUM COST SHALL INCLUDE TEMPORARY CONSTRUCTION SIGNS, BARRICADES, DRUMS, CONES, LIGHTS, AND OTHER ITEMS AS REQUIRED TO COMPLETE THIS WORK,

CONTRACTOR SHALL REFER TO SCDOT STD, DWG, 605-010-02 FOR PLACEMENT OF PERMANENT CONSTRUCTION SIGNS, THIS PROJECT REQUIRES ONE (1) SCHEME C AND ONE (1) SCHEME E, SIGNS SHALL BE PAID FOR PER SQUARE FOOT INSTALLED AND ACCEPTED UNDER THE BID ITEM FOR PERMANENT CONSTRUCTION SIGNS.

NARRATIVE DESCRIPTION:

THE STORMWATER MANAGEMENT FOR THESE SIDEWALK IMPROVEMENTS INCLUDE MAINTAINING THE EXISTING STORM DRAINAGE COLLECTION AND CONVEYANCE SYSTEM DESIGNED TO ACCEPT STORM WATER RUNOFF FROM THE ROADWAY AND ADJACENT PROPERTIES ON A NETWORK OF INLETS AND CATCH BASINS AND CONVEY IT IN A CLOSED PIPE SYSTEM AND DISCHARGE IT INTO A MAINTAINED OUTFALL DITCH PERPENDICULAR TO SC-170.

THE TOPOGRAPHY OF THE SITE IS VERY FLAT AND PRIMARILY COMMERCIAL DEVELOPMENT WITH GRASSY LANDSCAPED AREAS. THIS PROJECT WILL NOT AFFECT THE EXISTING BUILDINGS BUT WILL ENCROACH ON THE LANDSCAPING.
WEB SOIL SURVEY WAS USED TO DETERMINE THE SOIL CONDITIONS AT THIS SITE. THE SOILS ARE PREDOMINANTLY

THE SEDIMENT CONTROL PLAN INCLUDES FOLLOWING THE EROSION CONTROL NOTES AND SEQUENCE OF CONSTRUCTION BY PLACING SILT FENCE AROUND THE PERIMETER, AND BY PLACING A COMBINATION OF TYPE A AND TYPE F INLET TUBES AT ADJACENT INLETS.

SEQUENCE OF CONSTRUCTION

1. OBTAIN NPDES COVERAGE FROM DHEC AND FINAL MS4 APPROVAL FROM THE CITY OF BEAUFORT DEPARTMENT OF PUBLIC WORKS.

2. NOTIFY SC DHEC REGIONAL OFFICE AND THE CITY OF BEAUFORT DEPARTMENT OF PUBLIC WORKS 48 HOURS PRIOR TO ANY LAND DISTRIBUNG ACTIVITIES

3. INSTALL TREE PROTECTION AND DELINEATE CLEARING LIMITS.

4. CLEARING & GRUBBING ONLY AS NECESSARY FOR INSTALLATION OF PERIMETER CONTROLS (E.G. SILT FENCE).

5. INSTALL PERIMETER CONTROLS (E.G. SILT FENCE).

6. PROVIDE SITE DRAINAGE WITH DIVERSION DITCHES, SWALES AND DRAINS.

7. CLEARING AND GRUBBING OF SITE (SEDIMENT & EROSION CONTROL MEASURES FOR THESE AREAS MUST ALREADY BE INSTALLED.

8. STRIP TOP SOIL AND STOCKPILE FOR LATER USE ON SHOULDERS AND SLOPES PER SECTION 209 OF THE STANDARD SPECIFICATIONS. "ALL DISTURBED AREA [ANY AREA OF LAND THAT WILL BE DISTURBED DURING CONSTRUCTION, THAT INCLUDES CLEARING, GRUBBING, STOCK PILING AND INSTALLATION OF ANY BMPS (SILT FENCE, SWALES, CHECK DAMS, ETC] MUST BE INCLUDED WITHIN THE LIMITS OF DISTURBANCE."

9. ROUGH GRADING.

10. INSTALL STORM DRAINAGE.

11. FINE GRADING.

12. CONSTRUCT CURB & GUTTER.

13 ASPHALT PAVING

14. CONSTRUCT SIDEWALK.

15. FINISH GRADING AND FINAL GRASSING AND LANDSCAPING.

16. MAINTAIN ALL SEDIMENT AND EROSION CONTROL DEVICES FOR THE EXTENT OF THE PROJECT.

17. REMOVAL OF SEDIMENT CONTROLS AFTER SITE HAS BEEN STABILIZED.

18. CONTACT THE BEAUFORT COUNTY CAPITAL PROJECTS DIRECTOR FOR FINAL PROJECT INSPECTION.

19. FILE NOTICE OF TERMINATION.

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CHECKE	D BY: <u>JCH</u>		DATE				SHEET
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BEAUFORT COUNTY CITY OF BEAUFORT

ROBERT SMALLS PKWY (SC-170) GENERAL CONSTRUCTION NOTES

SHEET 5 SCALE:

TEINFRAST	RUCTURE
CONSULTING	& ENGINEERING

GENERAL INFORMATION

CONTROL SURVEY SUMMARY

VERTICAL HORIZONTAL COORDINATES - NORTH AMERICAN VERTICAL DATUM 1988 (NAVD 88)

- NORTH AMERICAN DATUM 1983 (NAD 83) - SOUTH CAROLINA STATE PLANE COORDINATE SYSTEM


ALIGNMENT	CONTROL	POINTS	

CON	ITROL	NORTHING (Y)	EASTING (X)	
PI	= 10 + 00.00	220,006.826	2,090,194.824	
PI	= 16 + 00.00	220,428.124	2,090,622.033	

SURVEY CONTROL POINTS

-					
۱	CONTROL	NORTHING (Y)	EASTING (X)	ELEVATION	DESCRIPTION
-	BM 1	220,288.1904	2,090,426.214	15.117	X ON CROSS WALK CONC PAD VRS
-	BM 2	220,502.5017	2,090,588.869	15.977	RR SPIKE IN 11" OAK
۱	BM 3	220,011.5551	2,090,152.624	14.337	X IN TOP OF CONC CURB



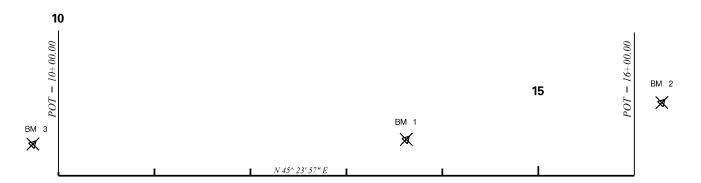








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BEAUFORT COUNTY CITY OF BEAUFORT


ROBERT SMALLS PKWY (SC-170) REFERENCE DATA SHEET

SCALE: 1" = 50"

150

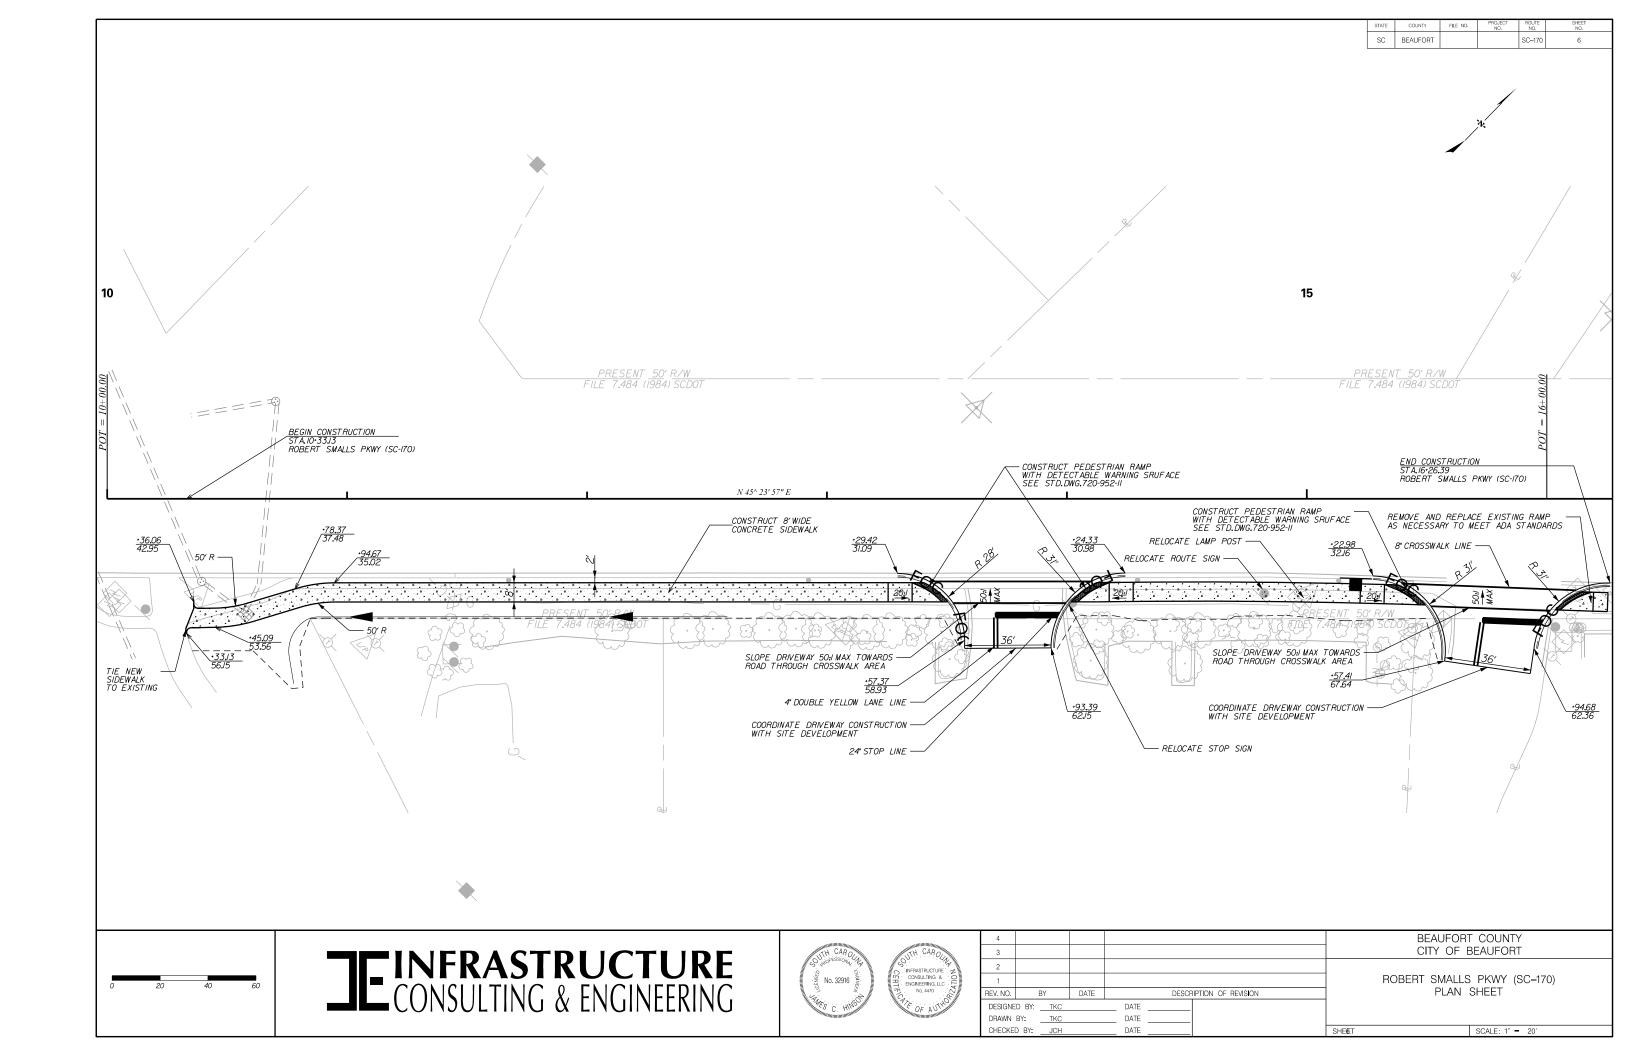

EROSION CONTROL DATA SHEET

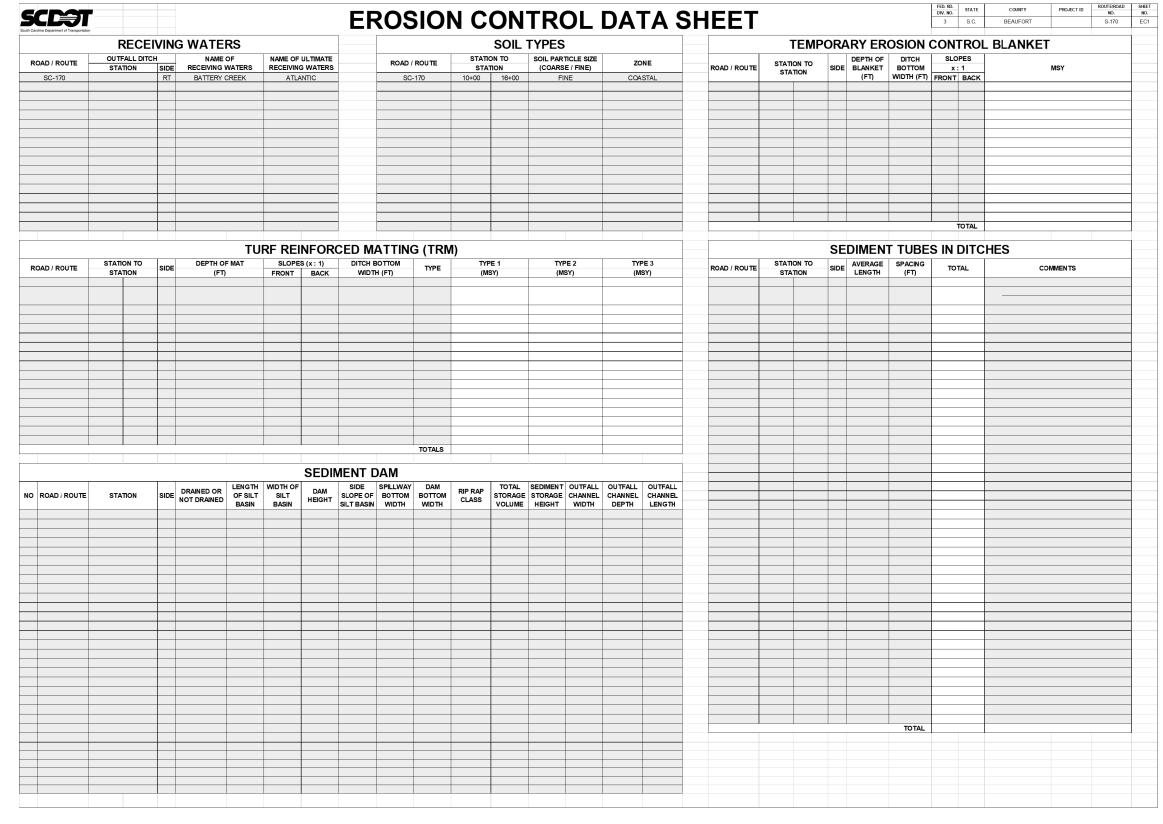








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BEAUFORT COUNTY CITY OF BEAUFORT

ROBERT SMALLS PKWY (SC-170) EROSION CONTROL DATA SHEET

ET EC1 SCALE: NTS

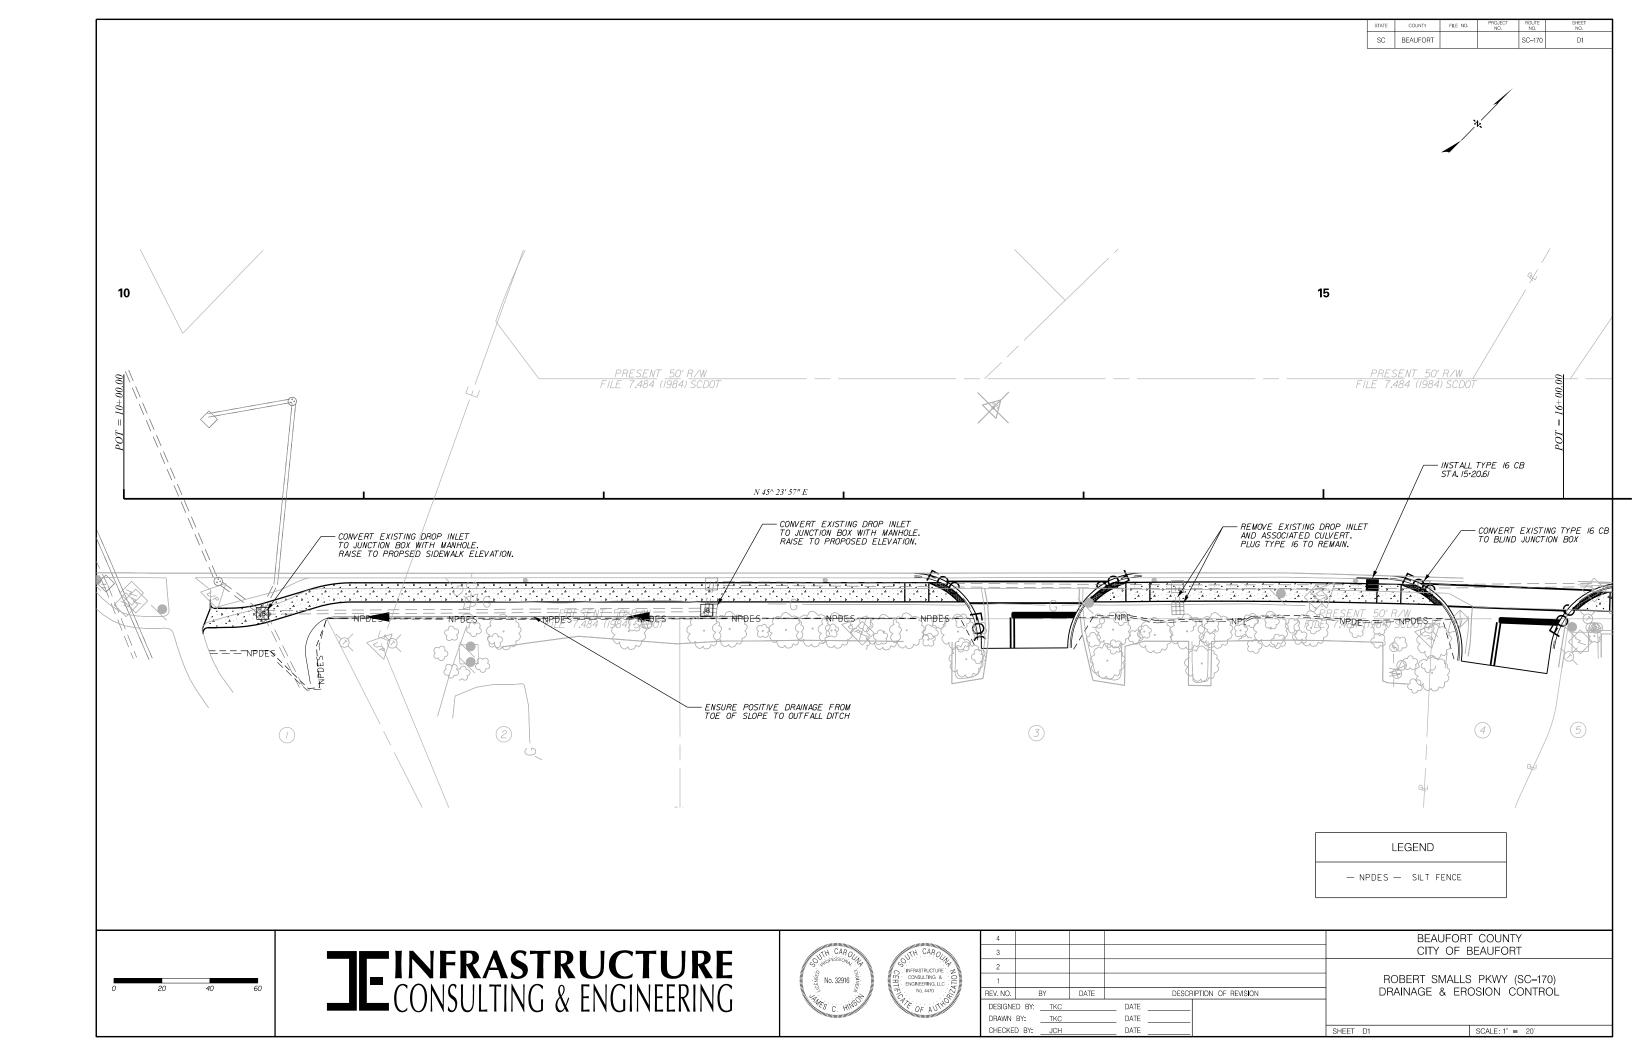

NOTES:

- 1. ALL WORK AND MATERIALS SHALL BE DONE IN ACCORDANCE WITH THE 2007 SOUTH CAROLINA DOT STANDARD SPECIFICATIONS FOR HIGHWAY CONSTRUCTION, SCDOT SUPPLEMENTAL SPECIFICATIONS ROADWAY LIGHTING, NATIONAL ELECTRICAL CODE AND NATIONAL ELECTRIC SAFETY CODE.
- 2. CONTACT TERRANCE HARRIS WITH DOMINION ENERGY FOR SERVICE POINT COORDINATION: TERRANCE.HARRIS@DOMINIONENERGY.COM: (843) 592-6728.
- 3. CONTRACTOR SHALL BE AWARE OF OVERHEAD POWER LINES DURING CONTRUCTION.
- 4. CONDUIT ACCESSORIES SUCH AS EXPANSION JOINTS, ELBOWS, LB'S, FLEXIBLE CONDUIT, ETC SHALL BE INCLUDED IN THE PRICE BID FOR CONDUIT.
- 5. LUMINAIRE MANUFACTURER SHALL PROVIDE A TEN YEAR WRITTEN WARRANTY FOR PARTS AND DEFECTIVE WORKMANSHIP ON LUMINAIRES.
- 6. ALL PITS USED FOR INSTALLED PUSHED (JACKED) CASINGS UNDER EXISTING ROADWAYS SHALL HAVE A MINIMUM OF FIVE FEET BETWEEN EDGE OF SHOULDER. LOCATIONS AS SHOWN ARE APPROXIMATE AND MAY BE SHIFTED AS NECESSARY TO MEET CLEARANCE REQUIREMENTS. CONTRACTOR SHALL FOLLOW MUTCD, SCDOT STANDARD DRAWINGS, AND SCDOT REQUIREMENTS FOR ALL TRAFFIC CONTROL RELATED WORK.
- 7. ALL ELECTRICAL CONNECTIONS SHALL BE MADE ABOVE GRADE INSIDE POLE BASES OR JUNCTION BOXES. NO UNDERGROUND SPLICING ALLOWED.
- 8. CONTRACTOR SHALL VERIFY THE LOCATION OF ALL UTILITIES PRIOR TO INSTALLATION. ANY DAMAGE TO EXISTING UTILITIES SHALL BE REPAIRED BY THE CONTRACTOR AT NO ADDITIONAL COST.
- 9. THE CONTRACTOR SHALL PROVIDE THE SERVICE POLE UNLESS OTHERWISE NOTED. THE SERVICE RISER AND LATERAL, WEATHERHEAD, WATERPROOF ENCLOSURES, CIRCUIT BREAKERS, LIGHTNING ARRESTER, AND THE NECESSARY WIRING FOR CONNECTING TO THE POWER SOURCE, SHALL BE INCLUDED UNDER THE "ELECTRICAL SERVICE CONNECTIONS" PAY ITEM.

POLE DATA TABLE

					Fixture				
			Center /	Sheet	Mounting	No. of	Arm		
Pole	Sta. No.	Offset	Base Line	No.	Height	Lum's	Length	Circuit	Installation Notes
P1	11+67.32	33.96' RT	ROBERT SMALLS PKWY	LL2	16'	1	N/A	EXISTING	
P2	12+92.33	33.98' RT	ROBERT SMALLS PKWY	LL2	16'	1	N/A	EXISTING	
P3	14+29.45	33.97' RT	ROBERT SMALLS PKWY	LL2	16'	1	N/A	EXISTING	
P4	15+13.21	34.32' RT	ROBERT SMALLS PKWY	LL2	EXISTING	1	N/A	EXISTING	RELOCATED LIGHT POLE



LEGEND:



PROPOSED DECORATIVE POLE, 14' POLE, 16' MOUNTING HEIGHT.

WITH LED LUMINAIRE.

LUMINAIRES SHALL BE (OR APPROVED EQUAL)

- HOLOPHANE MDLE2 P40 40K AS 3 BK RBK CH FBK PR12 (7280 LUMENS, 77 W, 4000K)
POLE SHALL BE (OR APPROVED EQUAL)

- HOLOPHANE CHA14F4J16P07ABGBK CH16 BRKWAY KIT FGIUS BK



RELOCATED LIGHT POLE



EXIST LIGHT POLE TO REMAIN



EXIST LIGHT POLE TO BE RELOCATED



PROPOSED PULL BOX. SEE CONSTRUCTION DETAILS ON SHEET LL6.



DIRECTIONAL BORE, SIZE AND TYPE AS SHOWN.

CONDUIT AND CABLE SCHEDULE

- (A) 2" SCH 80 PVC CONDUIT WITH 2 #8 AND 1 #8 GND, INSTALLED IN TRENCH.
- (STEEL OR HDPE), DIRECTIONALLY BORED.

	ELECTRICAL ITEMS						
6651091	SINGLE DECORATIVE LIGHT POLE	3	EA				
6888110	INSTALL STREET LIGHT LUMINAIRE	4	EA				
675027Y	4.0"SCHED80 PVC COND-DIR.BORED	120	LF				
6760020	2.0" SCHEDULE 80 PVC CONDUIT	540	LF				
6770319	#8Cu,1,600V,RHH,RHW,USE	1690	LF				
6800530	17X30X28D.ELEC.UNGRD.ENCLOS/HD	2	EA				






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ROBERT SMALLS PKWY (SC-170) LIGHTING PLAN SHEET

NO SCALE


BEAUFORT COUNTY CITY OF BEAUFORT

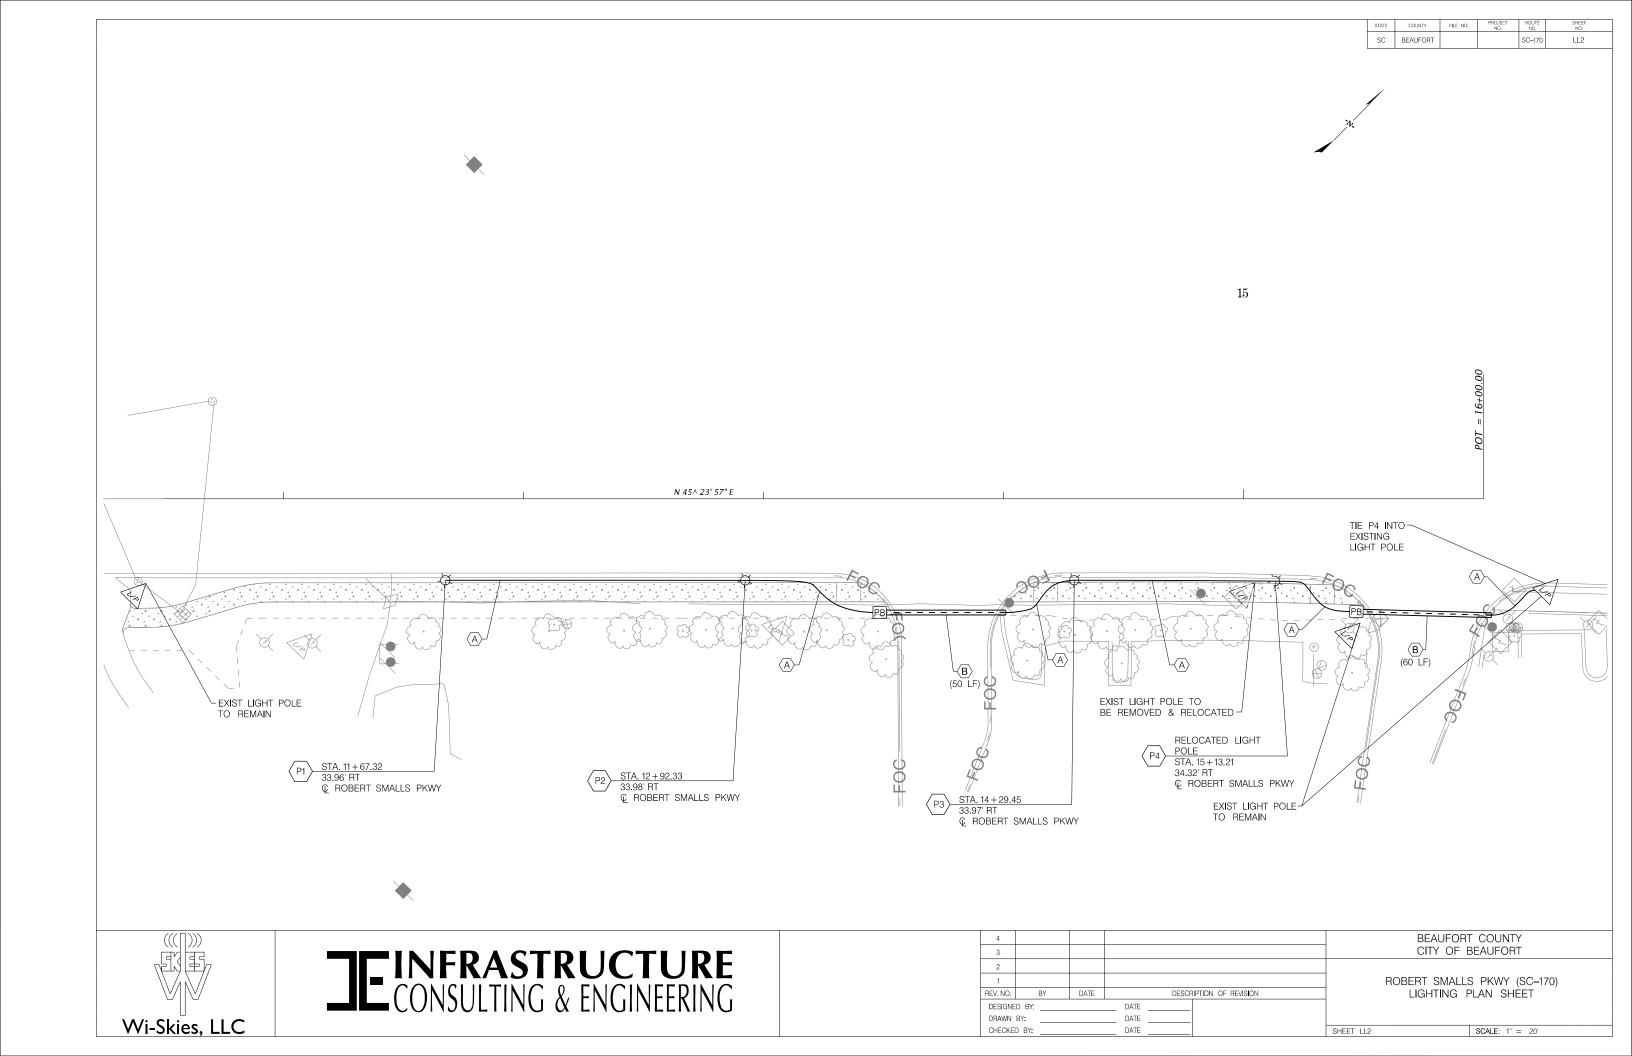

STATE	COUNTY	FILE NO.	PROJECT NO.	ROUTE NO.	SHEET NO.
SC	BEAUFORT			SC-170	LL3

NOTE:

- 1. CONTRACTOR SHALL UTILIZE EXISTING CIRCUIT BREAKER TO POWER RELOCATED AND NEW FIXTURES.
- 2. CONTRACTOR TO VERIFY AND NOTE ON DRAWINGS ALL CIRCUIT INFORMATION PRIOR TO BEGINNING WORK. THIS INCLUDES BUT NOT LIMITED TO, PANEL NAME, CIRCUIT NUMBER, CABLE SIZE AND NUMBER OF POLES.

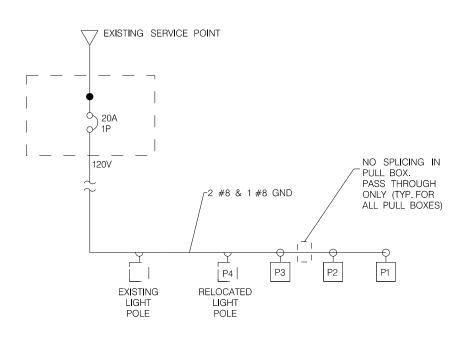

SYSTEM SINGLE LINE DIAGRAM



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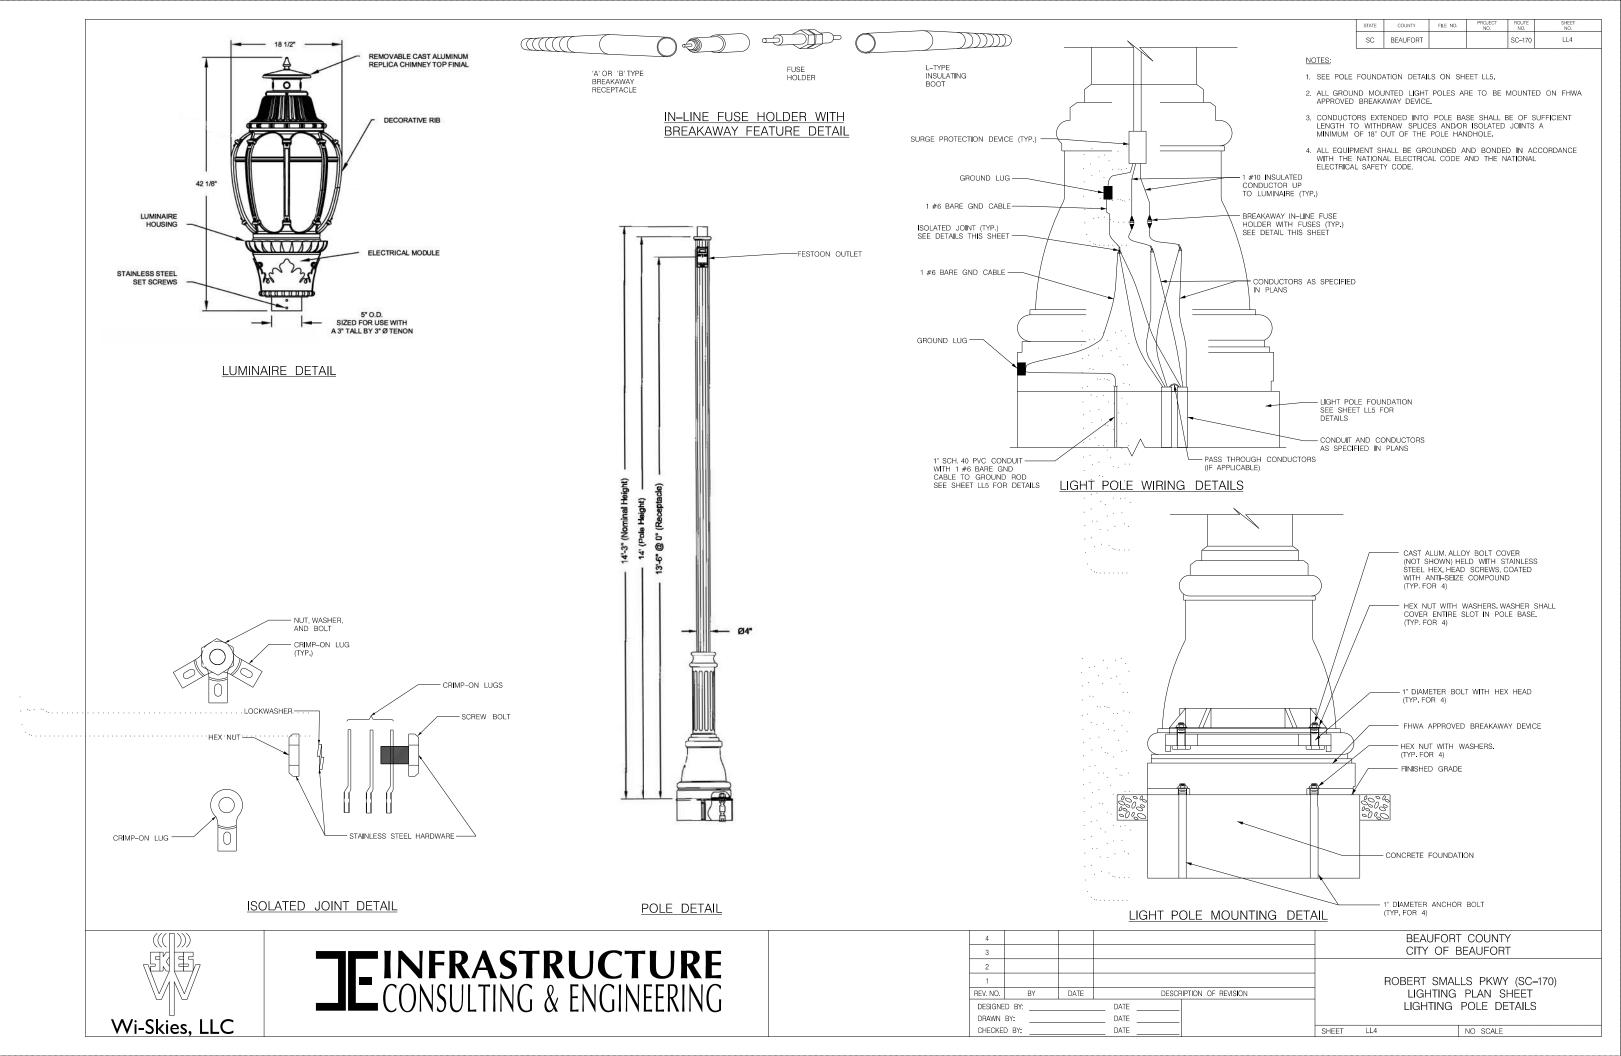
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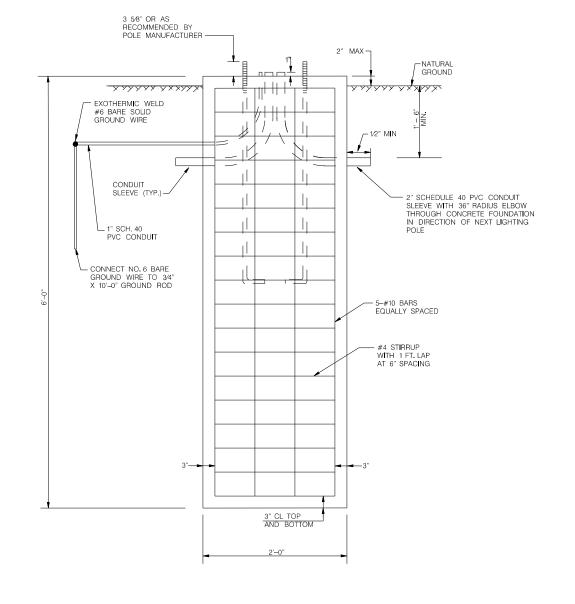
ROBERT SMALLS PKWY (SC-170)
LIGHTING PLAN SHEET
SERVICE POINT DETAILS


BEAUFORT COUNTY

SHEET LL3 NO SCALE




STATE COUNTY FILE NO. PROJECT NO. NO. SC—170 LL5



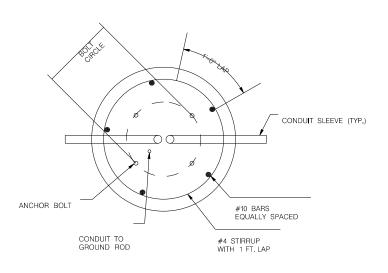

<u>PLAN</u>

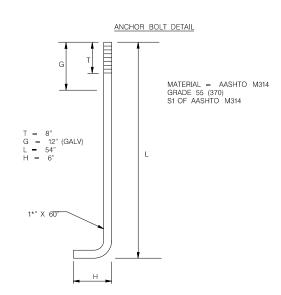

NOT

EACH 2'X 6' FOUNDATION REQUIRES: 0.70 CU.YDS. CLASS A CONCRETE AND 114 LBS OF BAR REINFORCING STEEL. THESE ARE CONSIDERED INCIDENTAL TO COST OF FOUNDATION.



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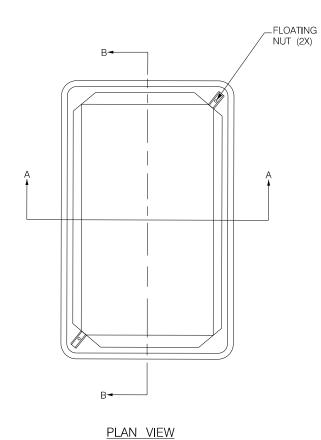
CITY OF BEAUFORT


ROBERT SMALLS PKWY (SC-170)
LIGHTING PLAN SHEET
POLE FOUNDATION DETAILS


BEAUFORT COUNTY

EET LL5 NO SCALE


STATE	COUNTY	FILE NO.	PROJECT NO.	ROUTE NO.	SHEET NO.
SC	BEAUFORT			SC-170	LL6




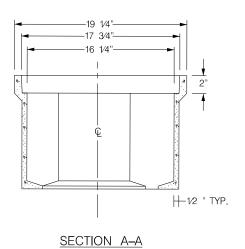

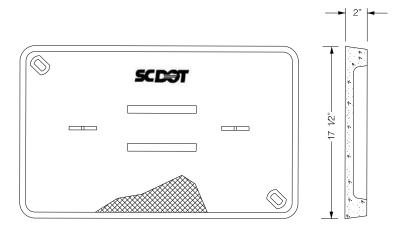

POLYMER CONCRETE COVER

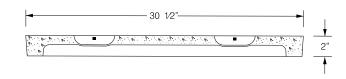

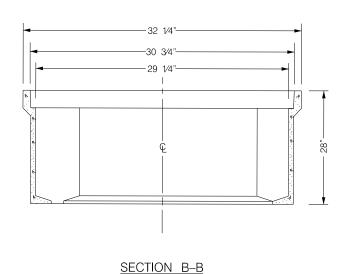

NOTES:

- 1) POLYMER BOX TOP AND FRAME MAY HAVE A DIFFERENT CROSS SECTION THAN WHAT IS SHOWN.
- 2) THERE SHALL BE NO CABLE SPLICING WITHIN PULL BOX. PULL BOX SHALL BE USED ONLY AS A CABLE PASS THROUGH.
- 3) ALL PULL BOXES SHALL HAVE SCDOT ELECTRIC LOGO CAST ON THE LID.

BEAUFORT COUNTY

CITY OF BEAUFORT



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ROBERT SMALLS PKWY (SC-170)
LIGHTING PLAN SHEET
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JUNCTION BOXPULL BOX DE

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