

ROOM FINISH SCHEDULE				
FLOOR	BASE	WALLS	CEILING	
1	CARPET MOWHAWK GROUP OR EQUAL, 24"x24" TILES. QUALITY, COLOR & PATTERN TO MATCH EXISTING IN ADJACENT AREAS	4" HIGH RUBBER COVE BASE ROPPE 700 SERIES COLOR TO MATCH EXISTING IN ADJACENT AREAS	NEW 5/8" TYPE "X" DRYWALL PAINTED 3 COATS (1 COAT PRIMER & 2 COATS FINISH) LATEX PAINT, EGGSHELL SHEEN COLOR BY OWNER	2' x 2' ACOUSTICAL TILE STYLE & HEIGHT TO MATCH EXISTING. CEILING HGT. @ +/-9'-0" SEE SHEET "E-1" FOR PROJECTED AREAS FOR NEW REQUIRED CEILING FINISH.
2	12"x12" VINYL COMPOSITE TILE (VCT) EXISTING TO REMAIN WHERE POSSIBLE.	4" HIGH RUBBER COVE BASE EXISTING TO REMAIN WHERE POSSIBLE.	EXISTING DRYWALL PAINTED 2 COATS (2 COATS FINISH) LATEX PAINT, EGGSHELL SHEEN COLOR BY OWNER	
			EXISTING CMU PAINTED 2 COATS (2 COATS FINISH) LATEX PAINT, EGGSHELL SHEEN COLOR BY OWNER	

NOTES:
 1. ALL FINISHES TO BE AS SPECIFIED, UNLESS OTHERWISE NOTED.
 2. FOR CLARITY, THE LETTERS "I, O, S, & Z" ARE NOT USED.
 3. SAMPLES OF ALL COLORS & PATTERNS FOR FINISHES TO BE SUBMITTED BY G.C. TO OWNER FOR FINAL SELECTION.

INTERIOR FINISH NOTES

QUALITY AND STYLES OF ALL NEW MATERIALS TO MATCH EXISTING IN ADJACENT AREAS, G.C. VERIFY ON SITE. SAMPLES OF ALL COLORS & PATTERNS FOR FINISHES TO BE SUBMITTED BY G.C. TO OWNER FOR FINAL SELECTION.

FLOORS:
 EXISTING CONCRETE, CLEAN, PATCH AND REPAIR AS REQUIRED FOR SMOOTH FINISH TO RECEIVE NEW CARPET.


CARPET:
 MOWHAWK GROUP OR EQUAL,
 24"x24" TILES

BASE:
 ROPPE 700 SERIES
 4" HIGH RUBBER COVE BASE

WALLS:
 PAINT - SHERWIN WILLIAMS OR EQUAL, SEMI-PERMEABLE EGGSHELL SHEEN
 ALL NEW AND EXISTING WALL SURFACES TO BE PREPARED AND PRIMED PER PAINT MANUF. SPECIFICATIONS.

CEILING:
 ARMSTRONG OR EQUAL, ACOUSTICAL LAY-IN SYSTEM
 TILES: 2' x 2' x 3/4", SQUARE EDGE, MINERAL FIBER
 GRID: 15/16" GRID SYSTEM.

INTERIOR WOOD DOORS & FRAMES:
 DOORS: VT INDUSTRIES, ARCHITECTURAL WOOD DOORS OR EQUAL, FACTORY STAINED & SEALED FINISH
 FRAMES: PRIMED AND PAINTED SEMI-GLOSS FINISH SHEEN

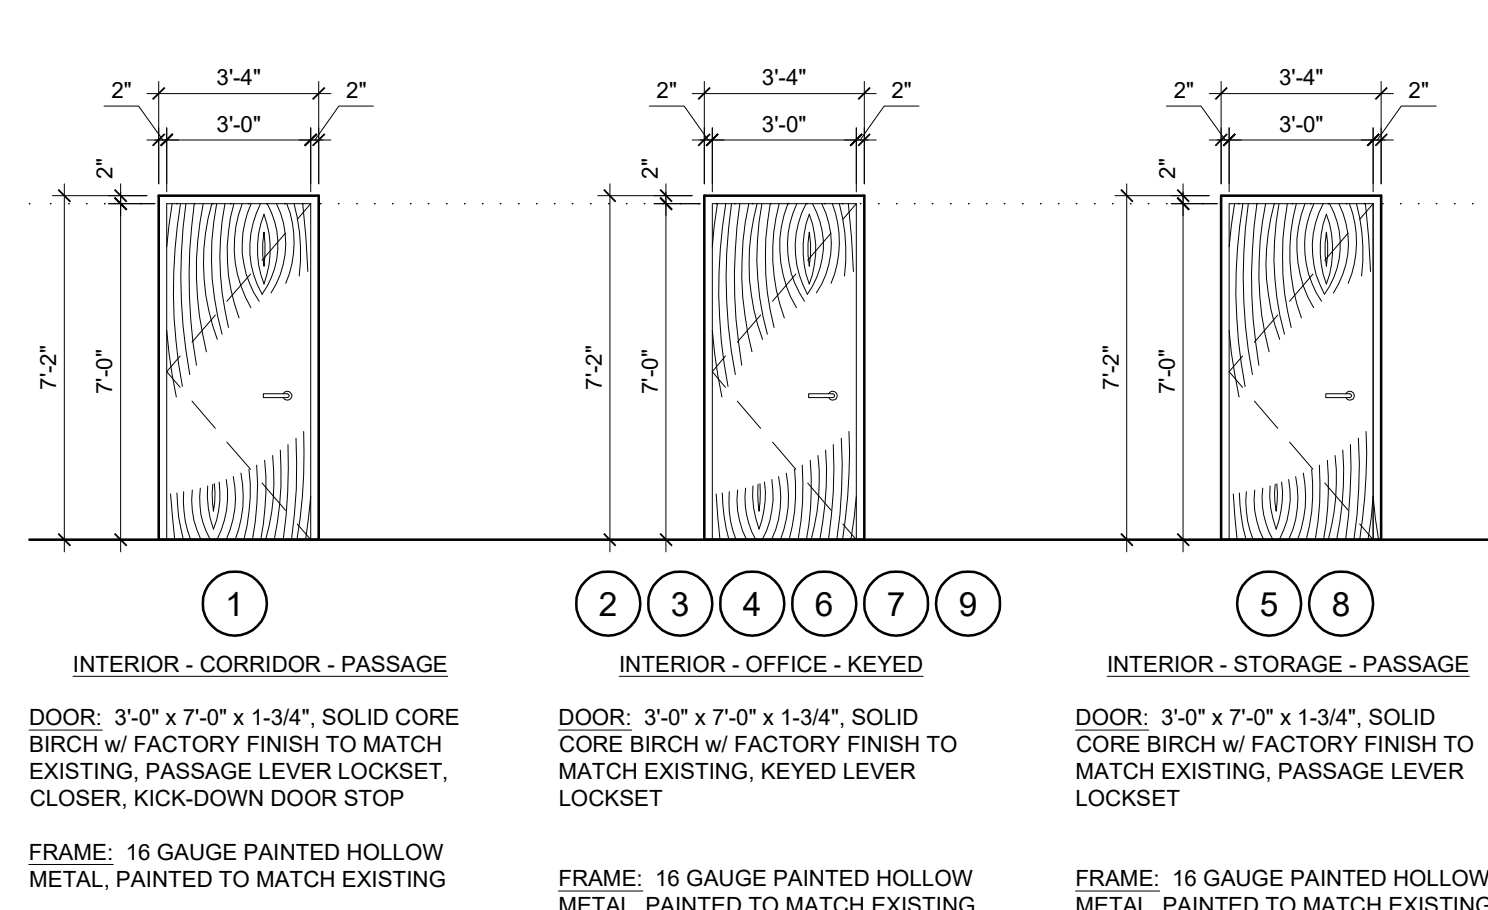

DOOR HARDWARE SCHEDULE

ALL HARDWARE TO HAVE "SATIN BRONZE" FINISH. BEFORE PURCHASING LOCKSET AND HARDWARE, G.C. TO VERIFY PRODUCTS TO MATCH EXISTING ARE CURRENTLY AVAILABLE FOR PURCHASE AND ARE NOT CURRENTLY DISCONTINUED.

LOCKSET:
 "CORBIN RUSSWIN, ASSY ABLOY" UT5200 SERIES UNIT LOCK

CLOSERS:
 "CORBIN RUSSWIN, ASSY ABLOY" DC3210 SERIES, PARALLEL ARM MOUNTING

INTERIOR DOOR HINGES:
 BALL BEARING HINGES, 3 PER DOOR

DOOR STOPS:
 "ASSY ABLOY" ROCKWOOD #403

PANIC EXIT DEVICE:
 NONE

KICK-DOWN DOOR STOP:
 "ASSY ABLOY" ROCKWOOD #460

MAGNETIC DOOR CATCH:
 NONE

NOTE: EACH DOOR TO HAVE DOOR STOPS, SEE HARDWARE SCHEDULE

NOTE: MANUFACTURER SHALL SUPPLY MASTER KEY TO FIT ALL DOORS - VERIFY KEYING SCHEMES w/ OWNER

T = TEMPERED GLASS
 TN = TINTED
 WG = WIRE GLASS
 SWG = SAFETY WIRE GLASS

DOOR & FRAME SCHEDULE

SCALE: 1/4" = 1'-0"


VERIFY ALL DOOR SWING DIRECTIONS ON FLOOR PLAN

WALL LEGEND

SYMBOL	DESCRIPTION
[Symbol]	EXISTING FRAMED WALLS - TO REMAIN. SEE FLOOR PLAN FOR LOCATIONS.
[Symbol]	EXISTING CMU WALLS - TO REMAIN. SEE FLOOR PLAN FOR LOCATIONS.
[Symbol]	DEMOLISHED: EXISTING METAL STUD FRAMED WALLS, OTHER STRUCTURES & FIXTURES TO BE DEMOLISHED.
[Symbol]	INTERIOR LOW HEIGHT WALL: LIGHT GAUGE METAL STUD FRAMED WALLS 10'-0" HIGH, w/ R-11 BATTS BETWEEN STUDS. 362S162-33 (3) STUDS SPACED @ 16" O.C. 362T125-33 TOP & BOTTOM TRACKS BRACING @ MID-POINT ALONG SPAN TYPICAL HEADER: (2) 362S162-43 (3) BOX HEADER 362T125-33 TOP & BOTTOM TRACK (1) 362S162-33 JACK STUD EACH END (1) 362S162-33 KING STUD EACH END MAX. CLEAR SPAN 3'-6" SEE FLOOR PLAN FOR LOCATIONS.

NOTES:
 1. ALL NEW INTERIOR METAL FRAMED WALLS TO HAVE SOUND BATT INSULATION.
 2. ALL NEW INTERIOR METAL FRAMED WALLS TO BE BRACED SECURELY ALONG TOP OF WALL TO EXISTING BUILDING STRUCTURE FRAME ABOVE AS REQUIRED.
 3. EXISTING WALL LOCATION & ASSEMBLY TYPE INFORMATION SHOWN OBTAINED FROM A COMBINATION OF BUILDING SURVEY AND ORIGINAL CONSTRUCTION DRAWINGS PROVIDED BY CLIENT.

- ### DEMOLITION NOTES
- REMOVE EXISTING ACOUSTICAL CEILING TILE AND GRID SYSTEM AS REQUIRED. A.C.T. MATERIALS THAT ARE SUITABLE FOR RE-USE ARE TO BE STORED ON SITE.
 - REMOVE EXISTING DOOR, FRAME AND ALL RELATED HARDWARE. PREPARE REMAINING WALL TO RECEIVE INFILL FRAMING.
 - REMOVE PORTION EXISTING METAL STUD FRAMED WALL AS SHOWN.
 - REMOVE ENTIRE OF EXISTING METAL STUD FRAMED WALL AS SHOWN.
 - CUT NEW OPENING IN EXISTING METAL STUD FRAMED WALL AS SHOWN.
 - REMOVE EXISTING FLOOR FINISH IN ROOM SHOWN ONLY UP TO DOOR OPENING. PREPARE REMAINING CONCRETE SLAB TO RECEIVE NEW FLOOR FINISH PER FINISH SCHEDULE.
- TYPICAL DEMOLITION NOTES:
- ALL MATERIALS RESULTING FROM DEMOLITION WORK TO BE DISPOSED OF PROPERLY.
 - BEFORE DEMOLISHING WALLS SEE PROPOSED FLOOR PLAN DRAWINGS FOR DIMENSIONS TO DETERMINE PORTIONS OF WALL REQUIRED TO BE REMOVED.
 - REPAIR OR REPLACE ALL STRUCTURAL MEMBERS THAT ARE DISCOVERED TO BE DAMAGED FROM WATER EXPOSURE, INSECT INFESTATION, ETC.
 - ALL STRUCTURAL FRAMING OF ROOFS AND FLOORS THAT ARE POSSIBLY SUPPORTED BY LOAD BEARING WALLS BENEATH THEM ARE TO BE SHORED UP WITH "TEMPORARY BRACING WALL" BEFORE REMOVING ANY FRAMING MEMBERS OF WALLS.
 - "TEMPORARY BRACING WALL" TO BE OF SIMILAR CONSTRUCTION OF LOAD BEARING WALL THAT IS BEING DEMOLISHED, AND IS TO BE LOCATED IN A MANNER TO PROVIDE AN ADEQUATE LOAD PATH DOWN TO FOUNDATION BELOW.
 - ALL EXISTING PIPING OF PLUMBING SYSTEMS BELOW CONCRETE SLAB AFFECTED BY DEMOLITION WORK TO BE PROPERLY CAPPED OFF BELOW FINISH FLOOR LEVEL.
 - ALL ELECTRICAL AND MECHANICAL SYSTEMS AFFECTED BY DEMOLITION WORK TO BE PROPERLY REMOVED. ABANDONMENT OF EXISTING ROUGH-IN WORK IS NOT ALLOWED.
 - REPORT ALL DISCREPANCIES TO DESIGNER IMMEDIATELY.

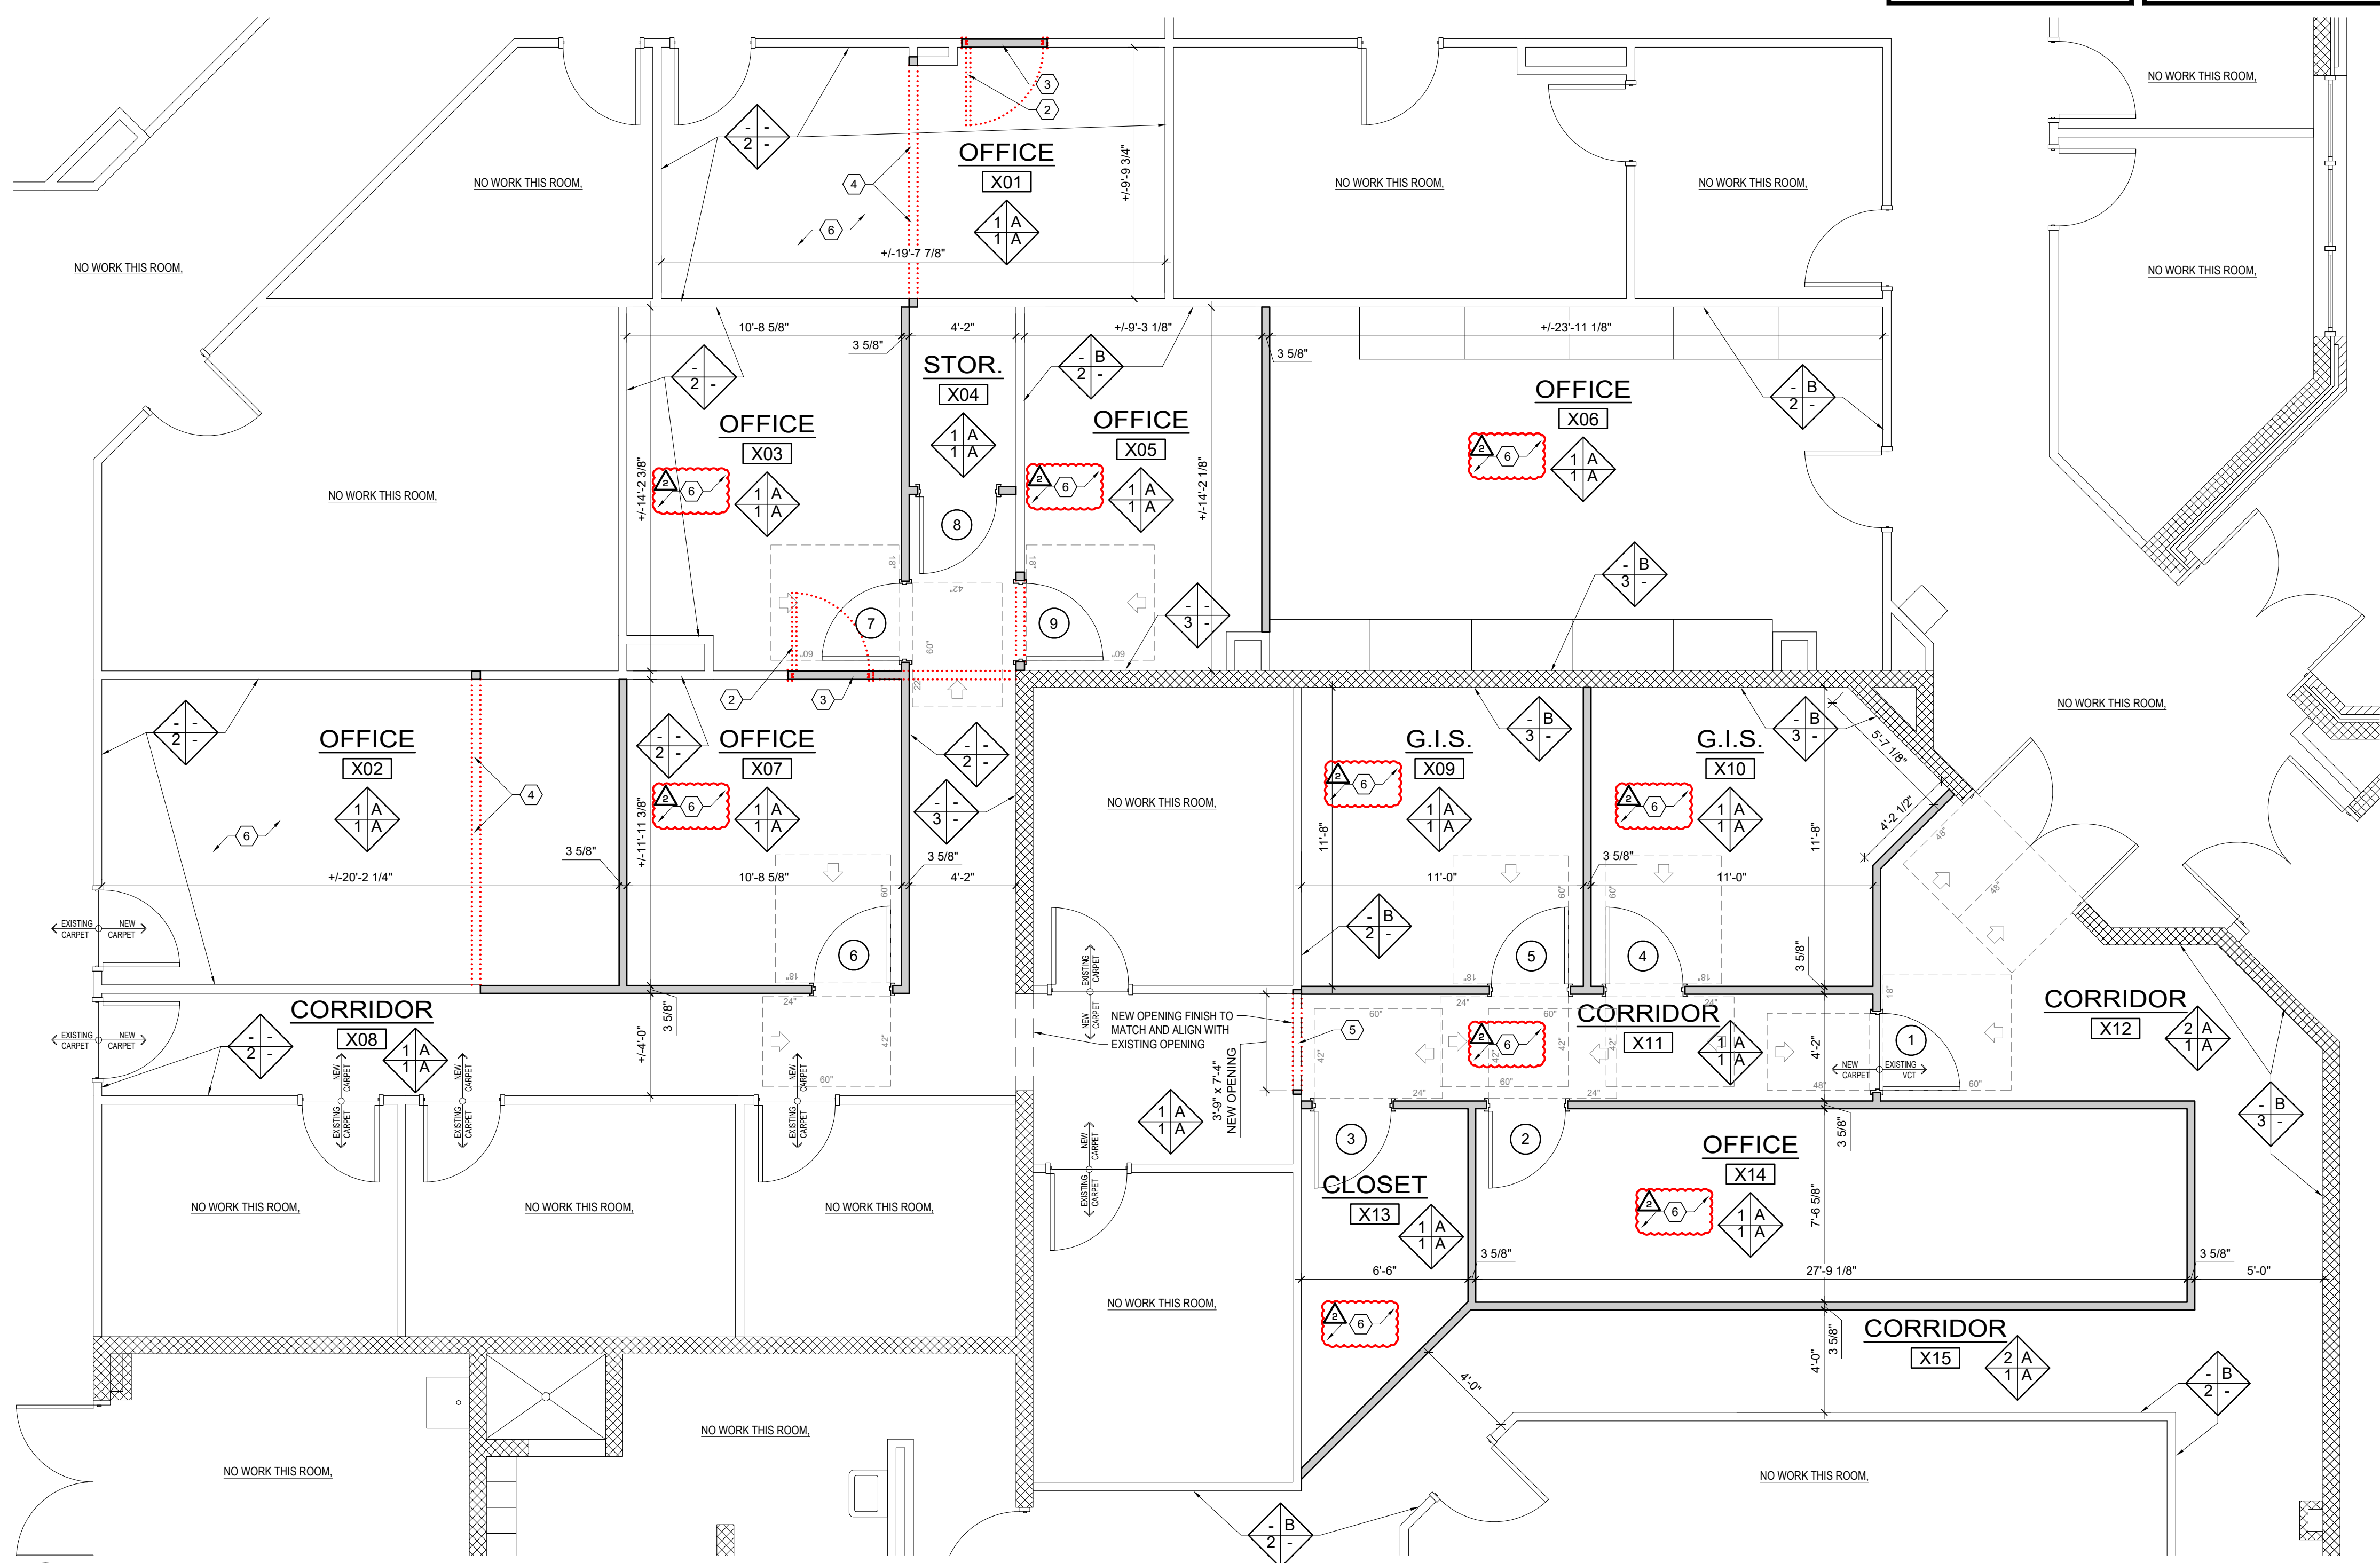

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B-2 FLOOR PLAN - DEMOLITION & NEW WORK

SCALE: 1/4" = 1'-0"

Owner: City of Wilson
 Operations Center
 Herring Ave. Wilson, NC 27789

Owner: BARTLETT
 ENGINEERING & SURVEYING, PC
 1400B North Street North
 Raleigh, NC 27601
 License # C-13551

Professional Engineer Seal: ROBERT S. BARTLETT, ENGINEER, No. 10278, State of North Carolina, expires 10-27-2010

Rev: [Table with revision details]

Title Sheet: FLOOR PLAN - NEW WORK
 Project: Office Alteration
 Operations Center City of Wilson
 Herring Ave. Wilson, NC 27789

Drawn by: M. Morgan
 Issue Date: 8-18-2021
 Project Number: 21-106
 Sheet: B-2