

ADDENDUM NO. 1

ORANGE BEACH FIRE STATION NO. 5 CITY OF ORANGE BEACH

ADDENDUM NO. ONE (1) - DATED November 30, 2021

This Addendum is directed to all bidders to whom the City of Orange Beach and Printing Pros has issued drawings and specifications. The following conditions, drawings, specification changes, etc., take precedence over any conflicting conditions in the Drawings and Specifications or other Contract and Bid Documents. Portions of the Contract Documents not changed by Addendum remain in effect.

SPECIFICATIONS

ITEM 1.01 SECTION 00 1113 – Advertisement for Bids (Attached)

Bid date has changed to January 13, 2022. Location and time remain the same.

DRAWINGS

ITEM 2.01 CIVIL DRAWINGS

Utility Service updated on all Civil drawings with new dated 2021.11.30 drawings. Remove and replace all drawings.

ATTACHMENTS:

Section 00 1113 – Advertisement for Bids Civil Drawing Package

NOTE: Receipt of all addenda must be acknowledged on the Bid Form in order for the proposal to be considered a conforming bid.

Stedmann B. McCollough McCollough Architecture, Inc.

END OF ADDENDUM #1

ADVERTISEMENT FOR BIDS

Sealed proposals will be received by the City of Orange Beach at the office of the City Clerk located at Orange Beach City Hall, 4099 Orange Beach Blvd, Orange Beach, AL 36561, on January 13, 2022, until 10:00 AM, CST for

PROJECT: ORANGE BEACH FIRE STATION NO.5 ORANGE BEACH, AL 36561

at which time and place they will be publicly opened and read. General Contractor's License number and type must be on the envelope.

A cashier's check or bid bond payable to City of Orange Beach in an amount not less than five (5) percent of the amount of the bid, but in no event more than \$10,000.00, must accompany the bidder's proposal. If awarded the bid and prior to beginning work, the Contractor is required to have a current City of Orange Beach Business License, furnish a Certificate of General Liability Insurance and Workers Compensation Insurance, and proof of Automobile General Liability Insurance. Insurance Certificate provided to the City shall name the City of Orange Beach as an additional insured. Performance and Payment Bonds must be executed upon award of the bid with a penalty equal to one hundred (100%) percent of the amount of the contract price.

<u>Bid Drawings and specifications will be available and can be examined at Printing Pros on and after November 1, 2021.</u>

Name of Architect: Sted McCollough Name of Company: McCollough Architecture Address: 4790 Wharf Pkwy Ste 209, Orange Beach, AL 36561 Phone No.: (251) 968-7222

General Contractor Bidders may obtain a digital copy of the documents from Printing Pros in Orange Beach, Alabama. Hard copy sets of drawings and specifications will be available to qualified General Contractors and others for the cost of printing and handling directly from the document's printer: Printing Pros (22660 Canal Rd, Orange Beach, AL 36561; phone 251/974-5006). Addenda and other bidding information will be issued only to holders of drawings and specifications <u>distributed by the Architect</u>. Release of the Bid Documents to the bidder does not imply acceptance of the bidder's qualifications by the Owner or Architect.

Bid Documents can also be reviewed at Printing Pros. Cost of printing plans and specifications are non-refundable.

Bids must be submitted on proposal forms furnished by the Architect or copies thereof. All bidders bidding in amounts exceeding that established by the State Licensing Board for General Contractors must be licensed under the provisions of Title 34, Chapter 8, Code of Alabama, 1975, and must show evidence of license before bidding or bid will not be received or considered by the Architect; the bidder shall show such evidence by clearly displaying his or her current license number on the outside of the sealed envelope in which the proposal is delivered. The Owner reserves the right to reject any or all proposals and to waive technical errors if, in the Owner's judgment, the best interests of the Owner will thereby be promoted.

Nonresident bidders must accompany any written Bid Documents with a written opinion of an attorney at law licensed to practice law in such nonresident bidder's state or domicile, as to the preferences, if any or none, granted by the law of that state to its own business entities whose principal places of business are in that state in the letting of any or all public contracts.

A Pre-Bid Conference will be held at the City of Orange Beach at the office of the City Clerk located at Orange Beach City Hall, 4099 Orange Beach Blvd Orange Beach, AL 36561 at 10:00 A.M. Thursday, December 2, 2021. Attendance by General Contractor Bidders at Pre-Bid Conference is mandatory.

Awarding Authority: City of Orange Beach,

Architect:

McCollough Architecture: Sted McCollough, President

ALL BIDS MUST BE RETURNED AS FOLLOWS:

All bidders must use the bid form provided in the bid documents and show on the envelope "SEALED BID", the bid title, the bidder's name, and the opening date and time.

Mailed Bids via U.S. Postal Service
City of Orange Beach
Attention: City Clerk
P.O. Box 458
Orange Beach, AL 36561


Hand Delivered Bids
City of Orange Beach
Attention: City Clerk
4099 Orange Beach Blvd.
Orange Beach, AL 36561

FIRE STATION NO. 5

CITY OF ORANGE BEACH

CIVIL CONSTRUCTION DRAWINGS



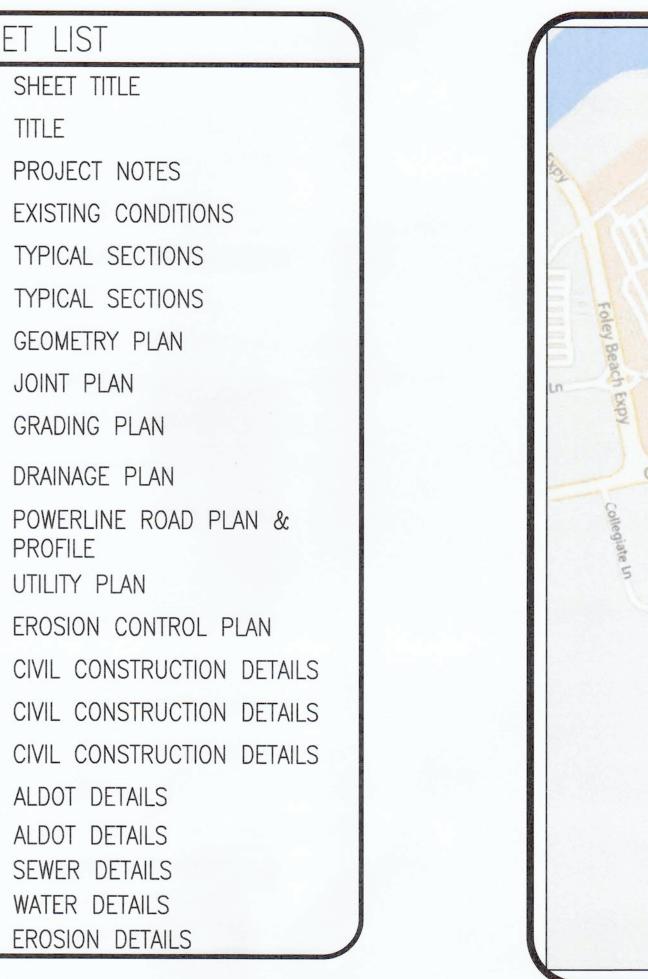

SHEET LIST

TITLE

SHEET NUMBER

SHEET TITLE

PROJECT NOTES

EXISTING CONDITIONS

TYPICAL SECTIONS

TYPICAL SECTIONS

GEOMETRY PLAN

GRADING PLAN

DRAINAGE PLAN

POWERLINE ROAD PLAN &

EROSION CONTROL PLAN

JOINT PLAN

PROFILE

UTILITY PLAN

ALDOT DETAILS

ALDOT DETAILS

SEWER DETAILS

WATER DETAILS

EROSION DETAILS



VICINITY MAP



UTILITY PROVIDERS

ORANGE BEACH GAS


SANITARY SEWER ORANGE BEACH SEWER ORANGE BEACH WATER WATER BALDWIN EMC POWER **TELEPHONE** CENTURYLINK





GAS

11-30-21 DATE

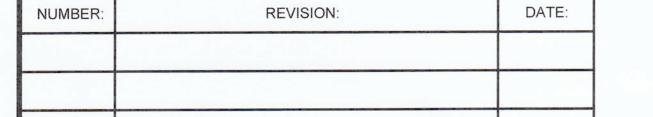

2. SILT FENCE MUST MEET THE REQUIREMENTS OF LOCAL JURISDICTIONAL AGENCY, SAID REQUIREMENTS AS SHOWN BY THESE PLANS.

- 3. DISTURBED AREAS SHALL BE VEGETATED AFTER CONSTRUCTION.
- 4. ADDITIONAL EROSION CONTROL MEASURES OR SILT BARRIERS TO BE PLACED AS SHOWN AND/OR DIRECTED BY THE PROJECT ENGINEER AND/OR LOCAL JURISDICTIONAL INSPECTOR.
- 5. WHEN ANY CONSTRUCTION BORDERS A DRAINAGE COURSE:

A. THE CONTRACTOR IS RESPONSIBLE FOR REMOVING ANY BUILDING OR OTHER EXCAVATION SPOIL DIRT, CONSTRUCTION TRASH OR DEBRIS, ETC., FROM THE DRAINAGE AREA SHOWN HEREON IN AN EXPEDITIOUS MANNER AS CONSTRUCTION PROGRESSES.

B. THE CONTRACTOR HEREBY AGREES TO STOP ALL WORK AND RESTORE THESE AREAS IMMEDIATELY UPON NOTIFICATION BY THE LOCAL JURISDICTIONAL INSPECTOR AND/OR PROFESSIONAL ENGINEER.

6. FOR ALL CONSTRUCTION ALONG AND/OR ACROSS WATERWAYS, BANK PROTECTION AND STABILIZATION SHALL BE REQUIRED AS PER LOCAL JURISDICTIONAL EROSION LAWS,

7. ALL EROSION CONTROL MEASURES SHALL BE IN PLACE PRIOR TO COMMENCING CONSTRUCTION AND SHALL BE MAINTAINED IN PROPER WORKING ORDER UNTIL ALL DISTURBED AREAS ARE STABILIZED. CONSTRUCTION ENTRANCE PADS SHALL BE INSTALLED BY THE CONTRACTOR AT CONSTRUCTION ACCESS POINTS PRIOR TO LAND DISTURBANCE.

8. A COPY OF THE APPROVED LAND DISTURBANCE PLAN SHALL BE PRESENT ON THE SITE WHENEVER LAND DISTURBING ACTIVITY IS IN PROGRESS.

9. CONSTRUCT SILT FENCE ALONG THE DOWNSTREAM SIDE OF ALL PROPOSED FILL CONSTRUCTION.

10. EROSION CONTROL DEVICES SHALL BE INSTALLED IMMEDIATELY AFTER GROUND DISTURBANCE OCCURS. THE LOCATION OF SOME OF THE EROSION CONTROL DEVICES MAY HAVE TO BE ALTERED FROM THAT SHOWN ON THE APPROVED PLANS IF DRAINAGE PATTERNS DURING CONSTRUCTION ARE DIFFERENT FROM THE FINAL PROPOSED DRAINAGE PATTERNS. IT IS THE CONTRACTOR'S RESPONSIBILITY TO ACCOMPLISH EROSION CONTROL FOR ALL DRAINAGE PATTERNS CREATED AT VARIOUS STAGES DURING CONSTRUCTION. ANY DIFFICULTY IN CONTROLLING EROSION DURING ANY PHASE OF CONSTRUCTION SHALL BE REPORTED TO THE ENGINEER IMMEDIATELY.

11. CONTRACTOR SHALL MAINTAIN ALL EROSION CONTROL MEASURES UNTIL PERMANENT VEGETATION HAS BEEN ESTABLISHED. CONTRACTOR SHALL CLEAN OUT ALL SEDIMENT PONDS WHEN REQUIRED BY THE ENGINEER OR LOCAL JURISDICTIONAL INSPECTOR. CONTRACTOR SHALL INSPECT EROSION CONTROL MEASURES AT THE END OF EACH WORKING DAY TO ENSURE MEASURES ARE FUNCTIONING PROPERLY.

12. THE CONTRACTOR SHALL REMOVE ACCUMULATED SILT WHEN THE SILT IS WITHIN 12" OF THE TOP OF THE SILT FENCE UTILIZED FOR EROSION CONTROL. IN THE DETENTION POND, SILT SHALL BE REMOVED WHEN A DEPTH OF 18" HAS ACCUMULATED AT THE WEIR.

13. ALL EASEMENTS DISTURBED MUST BE DRESSED AND GRASSED TO CONTROL EROSION IN ACCORDANCE WITH EASEMENT PLATS PRIOR ACCEPTANCE.

14. SILT BARRIERS TO BE PLACED AT DOWNSTREAM TOE OF ALL CUT AND FILL SLOPES.

15. THE CONTRACTOR SHALL FURNISH AND MAINTAIN ALL NECESSARY BARRICADES AROUND THE WORK AND SHALL PROVIDE PROTECTION AGAINST WATER DAMAGE AND SOIL EROSION.

16. TREE PROTECTION AND EROSION CONTROL MEASURES ARE TO BE ACCOMPLISHED PRIOR TO ANY OTHER CONSTRUCTION ON THE SITE AND MAINTAINED UNTIL PERMANENT GROUND COVER IS ESTABLISHED.

17. ALL SILT BARRIERS MUST BE PLACED AS ACCESS IS OBTAINED DURING CLEARING. NO GRADING SHALL BE DONE UNTIL SILT BARRIER AND DETENTION FACILITIES ARE CONSTRUCTED.

18. ALL SEDIMENT CONTROL DEVICES ARE TO BE CONSTRUCTED AND FULLY OPERATIONAL PRIOR TO ANY OTHER CONSTRUCTION OR GRADING.

19. ALL DISTURBED AREAS TO BE GRASSED AS SOON AS POSSIBLE.

20. ALL SLOPES SHALL BE STABILIZED AS SOON AS POSSIBLE.

21. GRASS AREAS DISTURBED DURING CONSTRUCTION SHALL BE REPLACED WITH GRASS IN KIND. IN AREAS OF INDECIPHERABLE GRASSES-USE FESCUE.

22. IT IS THE CONTRACTOR'S RESPONSIBILITY TO PERFORM REQUIRED MAINTENANCE OF ALL EROSION AND SEDIMENT CONTROL DEVICES TO ENSURE THEIR FUNCTION AT ALL TIMES.

23. LENGTH OF RIP RAP AREA SHALL BE 6(SIX) TIMES THE DIAMETER OF THE STORM DRAIN PIPE. WIDTH OF RIP RAP AREA SHALL BE THREE(3) TIMES THE DIAMETER AT THE MOUTH OF THE PIPE AND TWO(2) TIMES THE DIAMETER AT THE DOWNSTREAM END.

GENERAL NOTES

- 1. ALL SANITARY SEWER WORK ITEMS SHALL BE CONSTRUCTED IN ACCORDANCE WITH THE CITY OF ORANGE BEACH SEWER, CODE OF ORDINANCES, CHAPTER 74 UTILITIES AS AMENDED IN THE PROJECT SPECIFICATIONS AND CONTRACT PLANS. ALL CONSTRUCTION PERFORMED WITHIN THE EXISTING ALABAMA DEPARTMENT OF TRANSPORTATION (ALDOT) RIGHT-OF-WAYS SHALL BE IN ACCORDANCE WITH THE ALDOT STANDARDS FOR ACCOMMODATING UTILITIES ON HIGHWAY RIGHT-OF-WAY GUIDELINES IN ADDITION, THE CONTRACTOR SHALL PROVIDE TO THE ALDOT A PERFORMANCE BOND AND TRAFFIC CONTROL PLANS PRIOR TO THE START OF WORK IN THIS PROJECT. WHEN CONFLICTS OCCUR BETWEEN REQUIREMENTS SHOWN ON THESE DRAWINGS/SPECIFICATIONS AND REGULATORY CRITERIA, THE MORE STRINGENT REQUIREMENT SHALL PREVAIL. THE CONTRACTOR SHALL VERBALLY BRING ANY CONFLICT TO THE ATTENTION OF THE ENGINEER IMMEDIATELY, FOLLOWED BY AN OFFICIAL WRITTEN NOTIFICATION WITHIN 24 HOURS.
- 2. IF NECESSARY, USE TEMPORARY SHEETING OR TRENCH BOXES TO MINIMIZE THE SIZE OF THE EXCAVATIONS AND TO PROTECT ADJACENT EXISTING ROADWAYS, UTILITIES AND OTHER FACILITIES. THERE SHALL BE NO ADDITIONAL COST TO THE OWNER UNLESS THE CONTRACTOR IS DIRECTED TO LEAVE THE SHEETING IN PLACE.
- 3. REQUIRED SEWER LATERALS SHALL BE LAID TO THE EXISTING RIGHT OF WAY/PERMANENT EASEMENT LINE AND A CLEAN OUT INSTALLED.
- 4. WHERE WATER OR SEWER LINES ARE LAID IN LAWNS, MEDIAN STRIPS, ETC. IT SHALL BE THE CONTRACTORS RESPONSIBILITY TO REMOVE EXISTING SOD, PLANTS, SHRUBS, ETC. AND STORE IN SUCH A MANNER AS TO PRESERVE SAME. AFTER LAYING SEWER OR WATER LINE, THE CONTRACTOR SHALL REPLACE ALL SOD, SHRUBS, ETC. TO THEIR ORIGINAL POSITION. ANY SOD OR PLANTS LOST OR DAMAGED BY REMOVAL SHALL BE REPLACED IN KIND AT THE CONTRACTOR'S EXPENSE.
- 5. CONTRACTOR SHALL EXPLORE AHEAD A MINIMUM OF 200-FEET SO ADJUSTMENTS CAN BE MADE IN THE ALIGNMENT OF THE PIPE, IF NECESSARY, IN CASE OF UNKNOWN CONFLICTS WITH EXISTING STRUCTURES, UTILITIES AND/OR PIPING.
- 6. EXISTING UTILITIES ARE SHOWN FOR INFORMATIONAL PURPOSES ONLY. IT SHALL BE THE CONTRACTORS RESPONSIBILITY TO DETERMINE IF THE LOCATIONS SHOWN ARE CORRECT AND TO DETERMINE IF THERE ARE ADDITIONAL LINES THAT ARE NOT SHOWN ON THE PLANS. ALSO, IT WILL BE THE CONTRACTOR'S RESPONSIBILITY TO PROTECT ALL UTILITY LINES DURING CONSTRUCTION WITH NO ADDITIONAL COMPENSATION. THE CONTRACTOR SHALL NOTIFY THE RESPECTIVE UTILITY OWNER FOR ANY LINES THAT MAY CONFLICT WITH THE CONSTRUCTION AND THEY WILL MAKE THE ADJUSTMENTS NECESSARY (IN THE OPINION OF THE ENGINEER). IT SHALL BE THE CONTRACTOR'S RESPONSIBILITY TO COORDINATE ALL UTILITY ADJUSTMENTS. FOR UTILITY LOCATION SERVICE, THE CONTRACTOR SHALL CALL 1-800-292-8525 AT LEAST 48 HOURS BEFORE BEGINNING CONSTRUCTION. THE CONTRACTOR SHALL NOTIFY THE APPROPRIATE UTILITY OWNER FOR THE COORDINATION OF ANY UTILITIES REQUIRING RELOCATION. THE ENGINEER RESERVES THE RIGHT TO RELOCATE OR ADJUST REQUIRED SANITARY SEWER LINE LOCATIONS AND WATER MAINS TO AVOID EXISTING UTILITIES LOCATED BY THE CONTRACTOR.
- 7. THE CONTRACTOR SHALL EMPLOY THE SERVICES OF A PROFESSIONAL LAND SURVEYOR LICENSED IN THE STATE OF ALABAMA TO LOCATE PROPERTY CORNERS AND LAYOUT THE EASEMENTS AND SANITARY SEWER ALIGNMENT PRIOR TO BEGINNING CONSTRUCTION, THE CONTRACTOR SHALL COMPLY WITH ALL PROVISIONS TO THE EASEMENT DOCUMENTS OBTAINED BY THE OWNER, INCLUDING ALL ADDENDUMS, PROPERTY SPECIFIC ITEMS ARE LISTED ON THE PLANS FOR REFERENCE. HOWEVER IT IS THE CONTRACTOR S RESPONSIBILITY TO COMPLY WITH ALL EASEMENT AGREEMENTS.
- 8. ALL PROPERTY AND RIGHT-OF-WAY LINE LOCATIONS SHOWN ARE APPROXIMATE. PROJECT RIGHT-OF-WAY LINES SHALL BE SURVEYED AS NOTED ABOVE BY THE CONTRACTOR USING REFERENCES AS NECESSARY. PROJECT EASEMENTS SHALL BE LOCATED BY THE CONTRACTOR USING REFERENCES AS NOTED ON THE CONSTRUCTION PLANS.
- 9. ALL EXISTING BUILDINGS LOCATED WITHIN THE TEMPORARY OR PERMANENT EASEMENTS, EXCEPT THOSE NOTED ON THE PLANS TO BE REMOVED, SHALL BE LEFT IN PLACE. ANY DAMAGE TO THESE BUILDINGS BY THE CONTRACTOR'S OPERATIONS SHALL BE REMEDIED AT THE CONTRACTOR'S EXPENSE.
- 10. THE CONTRACTOR SHALL RESTORE ALL PRIVATE AND PUBLIC PROPERTY AFFECTED BY THIS WORK TO A CONDITION EQUAL TO OR BETTER THAN EXISTED BEFORE COMMENCING CONSTRUCTION WORK, UNLESS SPECIFICALLY EXEMPTED BY THE DRAWINGS. RESTORATION WORK INCLUDES, BUT IS NOT LIMITED TO PAVEMENT, BASE, SUB GRADE, CONCRETE CURBS, THERMOPLASTIC TRAFFIC MARKINGS, SIDEWALKS, STORM WATER PIPE, ETC. ALL RESTORATION WORK SHALL BE PER ALDOT STANDARDS AND SPECIFICATIONS AND ALDOT PERMIT REQUIREMENTS IF THERE IS A CONFLICT WITH ALDOT REQUIREMENTS AND THE CONTRACT DOCUMENTS, THE MORE STRINGENT REQUIREMENT SHALL GOVERN. IF ADDITIONAL TOPOGRAPHY OR ANY OTHER INFORMATION IS NECESSARY FOR THE CONTRACTOR TO RECONSTRUCT ALL FACILITIES TO PRE CONSTRUCTION DIMENSIONS, THE ACQUISITION OF SUCH ADDITIONAL INFORMATION SHALL BE THE CONTRACTOR'S RESPONSIBILITY AND AT HIS EXPENSE. THE CONTRACTOR SHALL RECONSTRUCT ALL FACILITIES TO PRE-CONSTRUCTION GRADES AND DIMENSIONS, UNLESS OTHERWISE NOTED. WATER, FERTILIZE AND SUPPLY ALL VEGETATION REMOVED AND REPLACED AT NOT EXPENSE TO THE OWNER, IN ACCORDANCE WITH THE CONTRACT DOCUMENTS.
- 11. ALL TREES, SHRUBS, ETC., ALONG THE LINES OF CONSTRUCTION SHALL BE PROTECTED WHERE POSSIBLE UNLESS NOTED OTHERWISE ON THE DRAWINGS. NO TREES LARGER THAN THREE INCHES (3") IN DIAMETER SHALL BE DESTROYED WITHOUT PRIOR APPROVAL OF THE ENGINEER AND OWNER.
- 12. ALL EXCESS MATERIAL FROM EXCAVATIONS AND BORING (INCLUDING REMOVAL OF EXISTING PAVEMENT, CURB AND GUTTER, AND SIDEWALKS) BELONG TO THE CONTRACTOR AND SHALL BE DISPOSED OF BY THE CONTRACTOR IN AN ACCEPTABLE MANNER. COST FOR SUCH REMOVAL AND DISPOSAL IS A SUBSIDIARY OBLIGATION OF THE VARIOUS PAY ITEMS AND WILL NOT BE PAID FOR SEPARATELY.
- 13. ALL PIPES 16 INCHES AND LARGER SHALL HAVE MINIMUM COVER OF 48 INCHES, AND PIPES SMALLER THAN 16 INCHES SHALL HAVE A MINIMUM COVER OF 30 INCHES, EXCEPT WHERE OTHERWISE NOTED ON THE PLANS, AT STREET INTERSECTIONS OR WHERE THE NEW PIPELINE CROSSES EXISTING OR PROPOSED UNDERGROUND LINES AT THE APPROXIMATE SAME DEPTH AS THE NEW LINE THE COVER SHALL BE INCREASED AND THE NEW LINE LAID BELOW THE EXISTING OR PROPOSED PIPELINES. WHERE THE NEW PIPELINE CROSSES EXISTING OR PROPOSED DITCHES, THE TOP OF THE PIPE SHALL BE A MINIMUM OF 36 INCHES BELOW THE EXISTING OR PROPOSED INVERT OF THE DITCH, WHICHEVER IS LOWER, EXCEPT WHERE NOTED ON THE PLANS.
- 14. THE CONTRACTOR SHALL BE RESPONSIBLE FOR PREVENTING PIPE FROM FLOATING. IF PIPE FLOATS DURING CONSTRUCTION, THE CONTRACTOR SHALL RELAY PIPE TO GRADE AT HIS EXPENSE
- 15. CONTRACTOR SHALL MAINTAIN ACCESS TO ADJACENT PROPERTY AT ALL TIMES. CONSTRUCTION ALONG THE ROUTE SHOULD BE DONE IN STAGES TO MINIMIZE INCONVENIENCE TO LOCAL TRAFFIC. ALL FLAG MEN AND TRAFFIC CONTROL DEVICES NECESSARY SHALL BE FURNISHED BY THE CONTRACTOR. DETOUR PLANS SHALL BE SUBMITTED TO THE CITY ENGINEER AND /OR ALDOT FOR APPROVAL TRAFFIC REGULATIONS ON THE PROJECT SHALL BE IN ACCORDANCE WITH ALDOT.
- 16. THE CONTRACTOR SHALL AT ALL TIMES, GAIN PERMISSION FROM THE ENGINEER FOR ANY PROPOSED CONSTRUCTION THAT WILL AFFECT TRAFFIC ON ANY STREET AFTER GAINING PERMISSION FROM THE ENGINEER. THE CONTRACTOR SHALL REQUEST IN WRITING TO THE ENGINEER, AT LEAST THREE (3) DAYS PRIOR TO THE START OF CONSTRUCTION, FOR PERMISSION TO PROCEED WITH THE CONSTRUCTION. THE CONTRACTOR SHALL NOT START SAID CONSTRUCTION UNTIL PERMISSION IS RECEIVED AND ALL WARNING SIGNS, BARRICADES AND OTHER REQUIRED CONVENIENCES AND SAFETY DEVICES REQUIRED BY THE MANUAL ON UNIFORM TRAFFIC CONTROL DEVICES, PART VI, LATEST EDITION HAVE BEEN INSTALLED AND APPROVED BY THE ENGINEER. THE CONTRACTOR SHALL AT ALL TIMES, MAINTAIN AT LEAST ONE LANE OF TRAFFIC ON THE STREET WHERE WATER MAINS AND SEWER LINES ARE BEING LAID. THE CONTRACTOR SHALL PROVIDE THE NECESSARY "EXPERIENCED FLAG MAN" TO DIRECT TRAFFIC.
- 17. AT NO TIME WILL A VALVE OF THE EXISTING WATER SYSTEM, BE OPERATED WITHOUT THE PRESENCE AND AUTHORIZATION OF AN AUTHORIZED EMPLOYEE OF THE CITY OF ORANGE BEACH OR ORANGE BEACH WATER AUTHORITY.
- 18. THE CONTRACTOR SHALL PROVIDE ANY TEMPORARY CONTROLS AND/OR STRUCTURES REQUIRED TO MAINTAIN SUITABLE AND SAFE WORKING CONDITIONS AT ALL TIMES. SUCH ITEMS SHALL BE REMOVED ONCE THAT PORTION OF WORK HAS BEEN COMPLETED.
- 19. SHOULD THE CONTRACTOR ELECT TO OBTAIN AREAS FOR THE PURPOSE OF STORING MATERIALS AND EQUIPMENT OR FOR CONDUCTING HIS WORK OPERATIONS, HE SHALL FURNISH THE OWNER AND ENGINEER A COPY OF THE AGREEMENT BETWEEN HIM AND THE OWNER OF THE PROPERTY PRIOR TO USING THE AREA (NO DIRECT PAYMENT). ANY CURB AND GUTTER, SIDEWALK, DRIVEWAY, ETC. DAMAGED BY THE CONTRACTOR WHEN HAULING MATERIALS OR MOVING EQUIPMENT IN OR OUT FROM THIS STORAGE AREA SHALL BE REPLACED IN KIND AT THE CONTRACTOR'S EXPENSE.
- 20. THE OWNER RESERVES THE RIGHT TO DELETE, REDUCE AND/OR INCREASE ANY BID ITEM OR ITEM OF WORK. NO ADJUSTMENT WILL BE MADE TO THE OTHER BID ITEM PRICES DUE TO THESE REVISIONS.
- 21. A MINIMUM HORIZONTAL DISTANCE OF FIVE (5) FEET SHALL BE MAINTAINED BETWEEN ALL WATER MAINS AND SANITARY SEWER LINES, UNLESS OTHERWISE UNAVAILABLE, IN LOCATIONS WHERE WATER MAINS MUST CROSS SANITARY SEWER TRUNK LINES, THE SEWER MAIN SHALL BE LAID AT SUCH ELEVATION THAT THE BOTTOM OF THE WATER MAIN IS 18 INCHES ABOVE THE TOP OF THE SANITARY SEWERS. THIS VERTICAL SEPARATION SHALL BE MAINTAINED FOR THAT PORTION OF THE WATER MAIN LOCATED WITHIN FIVE FEET HORIZONTALLY OF THE SEWER LINE.
- 22. THE CONTRACTOR SHALL NOTE THAT ALL WORK PERFORMED WITHIN PUBLIC OR PRIVATE RIGHT-OF-WAY OR EASEMENT AS ASSOCIATED WITH THE CONSTRUCTION OF THE NEW WATER AND/OR SEWER MAINS SHALL BE SUBJECT TO EROSION CONTROL PREVENTION TO PROTECT THE STABILITY OF ALL ROADS, STREETS, SIDEWALKS AND DRIVEWAYS. THE CONTRACTOR SHALL BE RESPONSIBLE FOR SECURING THE WORK AREA AT ALL TIMES DURING CONSTRUCTION. ALL WORK AND SITE RESTORATION SHALL BE GUARANTEED AS DEFINED IN THE SPECIFICATIONS. THE CONTRACTOR SHALL ALSO BE RESPONSIBLE FOR ANY DAMAGE WHICH OCCURS TO ALL ROADWAYS, STREETS, SIDEWALKS AND DRIVEWAYS WHICH ARE A RESULT OF CONSTRUCTION ACTIVITY ASSOCIATED WITH THIS PROJECT. THE CONTRACTOR SHALL NOT BE REIMBURSED FOR ANY ADDITIONAL WORK ASSOCIATED WITH RESTORATION AND MAINTENANCE OF THE WORK AREA DURING THE CONSTRUCTION AND/OR GUARANTEE PERIOD AS DEFINED IN THE SPECIFICATIONS.
- 23. SPECIAL EMPHASIS ON EXCAVATION SAFETY AND TRENCH CONSTRUCTION:
- A. OSHA'S EXCAVATION SAFETY STANDARDS 29, CFR PART 1926.650-652 SUBPART P. IS CONSIDERED AS COMPLIMENTARY TO THESE CONTRACT DOCUMENTS. IF THERE IS ANY DUPLICATION, REDUNDANCY OR CONFLICT BETWEEN THE STIPULATIONS OF THESE CONTRACT DOCUMENTS AND THOSE STANDARDS, THE MOST STRINGENT REQUIREMENT SHALL GOVERN.
- B. IT IS THE CONTRACTOR'S RESPONSIBILITY TO ENSURE THAT EXCAVATIONS DO NOT ENDANGER WORKMEN, EXISTING STRUCTURES, UTILITIES, OR OTHER FACILITIES. IF SUCH CONDITIONS OCCUR WHICH MAY ENDANGER WORKMEN, EXISTING STRUCTURES, UTILITIES, OR OTHER FACILITIES, IMMEDIATELY INSTALL AND MAINTAIN ADEQUATE SHEETING AND BRACING PER OSHA SPECIFICATIONS CEASE ALL WORK UNTIL THE SHEETING AND BRACING HAS BEEN PROPERLY AND COMPLETELY INSTALLED. INSTALL THE SHEETING AND BRACING IN A MANNER THAT WILL ALLOW REMOVAL WITHOUT INJURING OR ENDANGERING AND COMPLETELY FILL ALL VOIDS CAUSED BY THE WITHDRAWAL OF SHEETING WITH SAND AND COMPACT TO A DEGREE EQUAL TO THE SURROUNDING SOIL. REMOVE THE SHEETING AS THE WORK PROGRESSES OR, AT THE DISCRETION OF THE ENGINEER, CUT THE SHEETING OFF BELOW FINISHED GRADE AND LEAVE IN PLACE.
- 24. THE CONTRACTOR SHALL BE RESPONSIBLE FOR REMOVING AND TEMPORARILY RELOCATING ALL INFORMATION AND TRAFFIC SIGNS DURING CONSTRUCTION. SIGN SHOULD BE VISIBLE TO MOTORIZED VEHICLES; REPOSITION SIGNS IN A PRE-CONSTRUCTION LOCATION IMMEDIATELY AFTER CONSTRUCTION IS COMPLETED IN THESE AREAS. EXISTING STREET & ROAD NAMES SIGNS IN THE PROJECT AREAS SHALL BE KEPT VISIBLE AT ALL TIMES FOR THE FACILITATION OF ACCESS BY EMERGENCY VEHICLE TRAFFIC.
- 25. FOLLOWING FINAL ACCEPTANCE OF THIS PROJECT, THE CONTRACTOR SHALL FINALIZE AND SUBMIT TO THE ENGINEER A COMPLETE SET OF RECORD DRAWINGS SHOWING ACTUAL QUANTITIES, LOCATION AND VALVE REFERENCES. THE ENGINEER WILL FURNISH THE CONTRACTOR AN "ISSUED FOR CONSTRUCTION" SET OF DRAWINGS TO BE USED FOR THIS PURPOSE. THE CONTRACTOR IS RESPONSIBLE FOR MAINTAINING A RECORD DRAWING SET OF PLANS AS THE PROJECT PROGRESSES, PAY ESTIMATES SHALL NOT BE RECOMMENDED FOR PAYMENT UNTIL THE CONTRACTOR HAS DEMONSTRATED TO THE OWNER'S REPRESENTATIVE THAT THE RECORD DRAWINGS ARE BEING MAINTAINED.
- 26. THE CONTRACTOR SHALL BACKFILL ALL TRENCHES AT THE END OF EACH DAYS WORK NO TRENCH SHALL BE LEFT OPEN OVERNIGHT. THE ENDS OF ALL PIPE SHALL BE PLUGGED AT THE CLOSE OF EACH DAY'S WORK.

CITY OF ORANGE BEACH - FOR UTILITY CONSTRUCTION

- 1. THE CONTRACTOR WILL BE RESPONSIBLE FOR ANY DAMAGE DONE BY HIS EQUIPMENT TO EXISTING SANITARY SEWER LATERALS, UTILITIES, CROSS-DRAIN PIPES, BOX CULVERTS AND HEADWALLS ALL DISTRIBUTED OR BROKEN PIPES SHALL BE REPLACED BY THE CONTRACTOR AT NO ADDITIONAL COST TO THE OWNER.
- 2. THE CONTRACTOR SHALL BE RESPONSIBLE FOR MAINTAINING FLOWS THROUGH ANY EXISTING CULVERT, PIPE, CHANNELS AND STRUCTURES AND DIVERSION OF FLOWS IN THE CONSTRUCTION AREA AS NECESSARY DURING CONSTRUCTION WITH NO DIRECT PAYMENT. THE COST FOR THIS WORK SHALL BE INCLUDED IN THE VARIOUS CONTRACT PAY ITEMS.
- 3. ALL CONSTRUCTION ACTIVITIES SHALL INCORPORATE BEST MANAGEMENT PRACTICES AS REQUIRED BY ADEM AND EPA AND THE CONTRACT SPECIFICATIONS TO CONTROL EROSION, SEDIMENTATION AND THE POTENTIAL FOR DOWNSTREAM WATER QUALITY DEGRADATION CONSTRUCTION PRACTICES INCLUDE:
- 4. CONSTRUCT TEMPORARY SEDIMENTATION BASINS OR EARTHEN BERMS AT DOWN-GRADIENT ENDS OF NEWLY GRADED AREAS TO PROVIDE FOR SEDIMENT AND TURBIDITY REMOVAL
- 5. LIMIT SITE CLEARING TO THOSE AREAS REQUIRED FOR A PARTICULAR PHASE OF CONSTRUCTION EXISTING TREES AND VEGETATION TO REMAIN WHEREVER POSSIBLE.
- 6. TURBIDITY BARRIERS, HAY BALES AND OTHER EROSION CONTROL MEASURES SHALL REMAIN IN PLACE UNTIL CONSTRUCTION ACTIVITIES ARE COMPLETE AND THE POTENTIAL FOR EROSION IS ELIMINATED.
- 7. DO NOT EMPLOY SILT FENCES IN A MANNER TO CAUSE THEM TO ACT AS A DAM ACROSS PERMANENTLY FLOWING WATERCOURSES. USE SILT FENCES AT UPLAND LOCATIONS AND TURBIDITY BARRIERS IN PERMANENT WATER BODIES. REGARDLESS OF WATER DEPTH.
- 8. TURBIDITY BARRIERS FOR STREAMS AND CREEKS MAY BE EITHER FLOATING OR STAKED TYPE OR ANY COMBINATION OF TYPES THAT WILL SUIT SITE CONDITIONS, AND MEET EROSION CONTROL AND WATER QUALITY REQUIREMENTS. INSTALL POSTS IN STAKED TURBIDITY BARRIERS IN THE VERTICAL POSITION UNLESS OTHERWISE NOTED.
- 9. DISTURBED AREAS WITHIN PERMANENT AND TEMPORARY EASEMENTS AND RIGHTS-OF-WAYS SHALL BE RESTORED TO PRE-EXISTING CONDITIONS OR BETTER BY INSTALLING TOPSOIL AND SOLID SOD IN ACCORDANCE WITH THE PROJECT SPECIFICATIONS. THE TYPE OF SOLID SOD SHALL MATCH EXISTING SOD AS DETERMINED BY THE ENGINEER.
- 10. THE DEWATERING LIQUID SHALL BE TESTED FOR A TCLP AND FECAL AND RESULTS PROVIDED TO THE CITY FOR DISCHARGING INTO THE CITY'S STORM SEWER SYSTEM. ADDITIONALLY, THE CONTRACTOR SHALL NOT DISCHARGE TURBID DEWATERING LIQUID INTO THE CITY'S STORM WATER SYSTEM.

SITE NOTES

- 1. ALL CONCRETE SHALL BE CLASS A, 3,000 PSI AT 28 DAYS COMPRESSIVE STRENGTH WITH A MAXIMUM SLUMP OF 4" UNLESS NOTED OTHERWISE. ALL EXPOSED CONCRETE TO HAVE A FINE BROOM FINISH.
- 2. ALL MATERIALS SHALL BE NEW UNLESS USED OR SALVAGED MATERIALS ARE AUTHORIZED BY THE OWNER OR TENANT.
- 3. ALL DIMENSIONS ARE FACE OF CURB OR AS NOTED.
- 4. NECESSARY BARRICADES, SUFFICIENT LIGHTS, SIGNS AND OTHER TRAFFIC CONTROL METHODS AS MAY BE NECESSARY PER MANUAL ON UNIFORM TRAFFIC CONTROL DEVICES, PART VI, SHALL BE PROVIDED AND MAINTAINED THROUGHOUT CONSTRUCTION. THE PROJECT WILL REQUIRE ROAD CLOSURE/TRAFFIC CONTROL SCHEME.
- 5. SPECIAL CARE SHALL BE GIVEN WHILE WORKING NEAR PRIVATE RESIDENCES. ANY DAMAGES TO OR ADJACENT TO PRIVATE PROPERTY SHALL BE REPAIRED AT THE EXPENSE OF THE CONTRACTOR.

ENGINEER: JAYE H. ROBERTSON, P.E. SAWGRASS CONSULTING, LLC. (251) 544-7900

NUMBER: REVISION: DATE:



PROJECT NOTES

FIRE STATION NO. 5

CITY OF ORANGE BEACH




SCALE: N.T.S.


DATE: NOVEMBER, 2021


DRAWN BY: JNF

SHEET: 2 OF 20

CHECKED BY: JHR

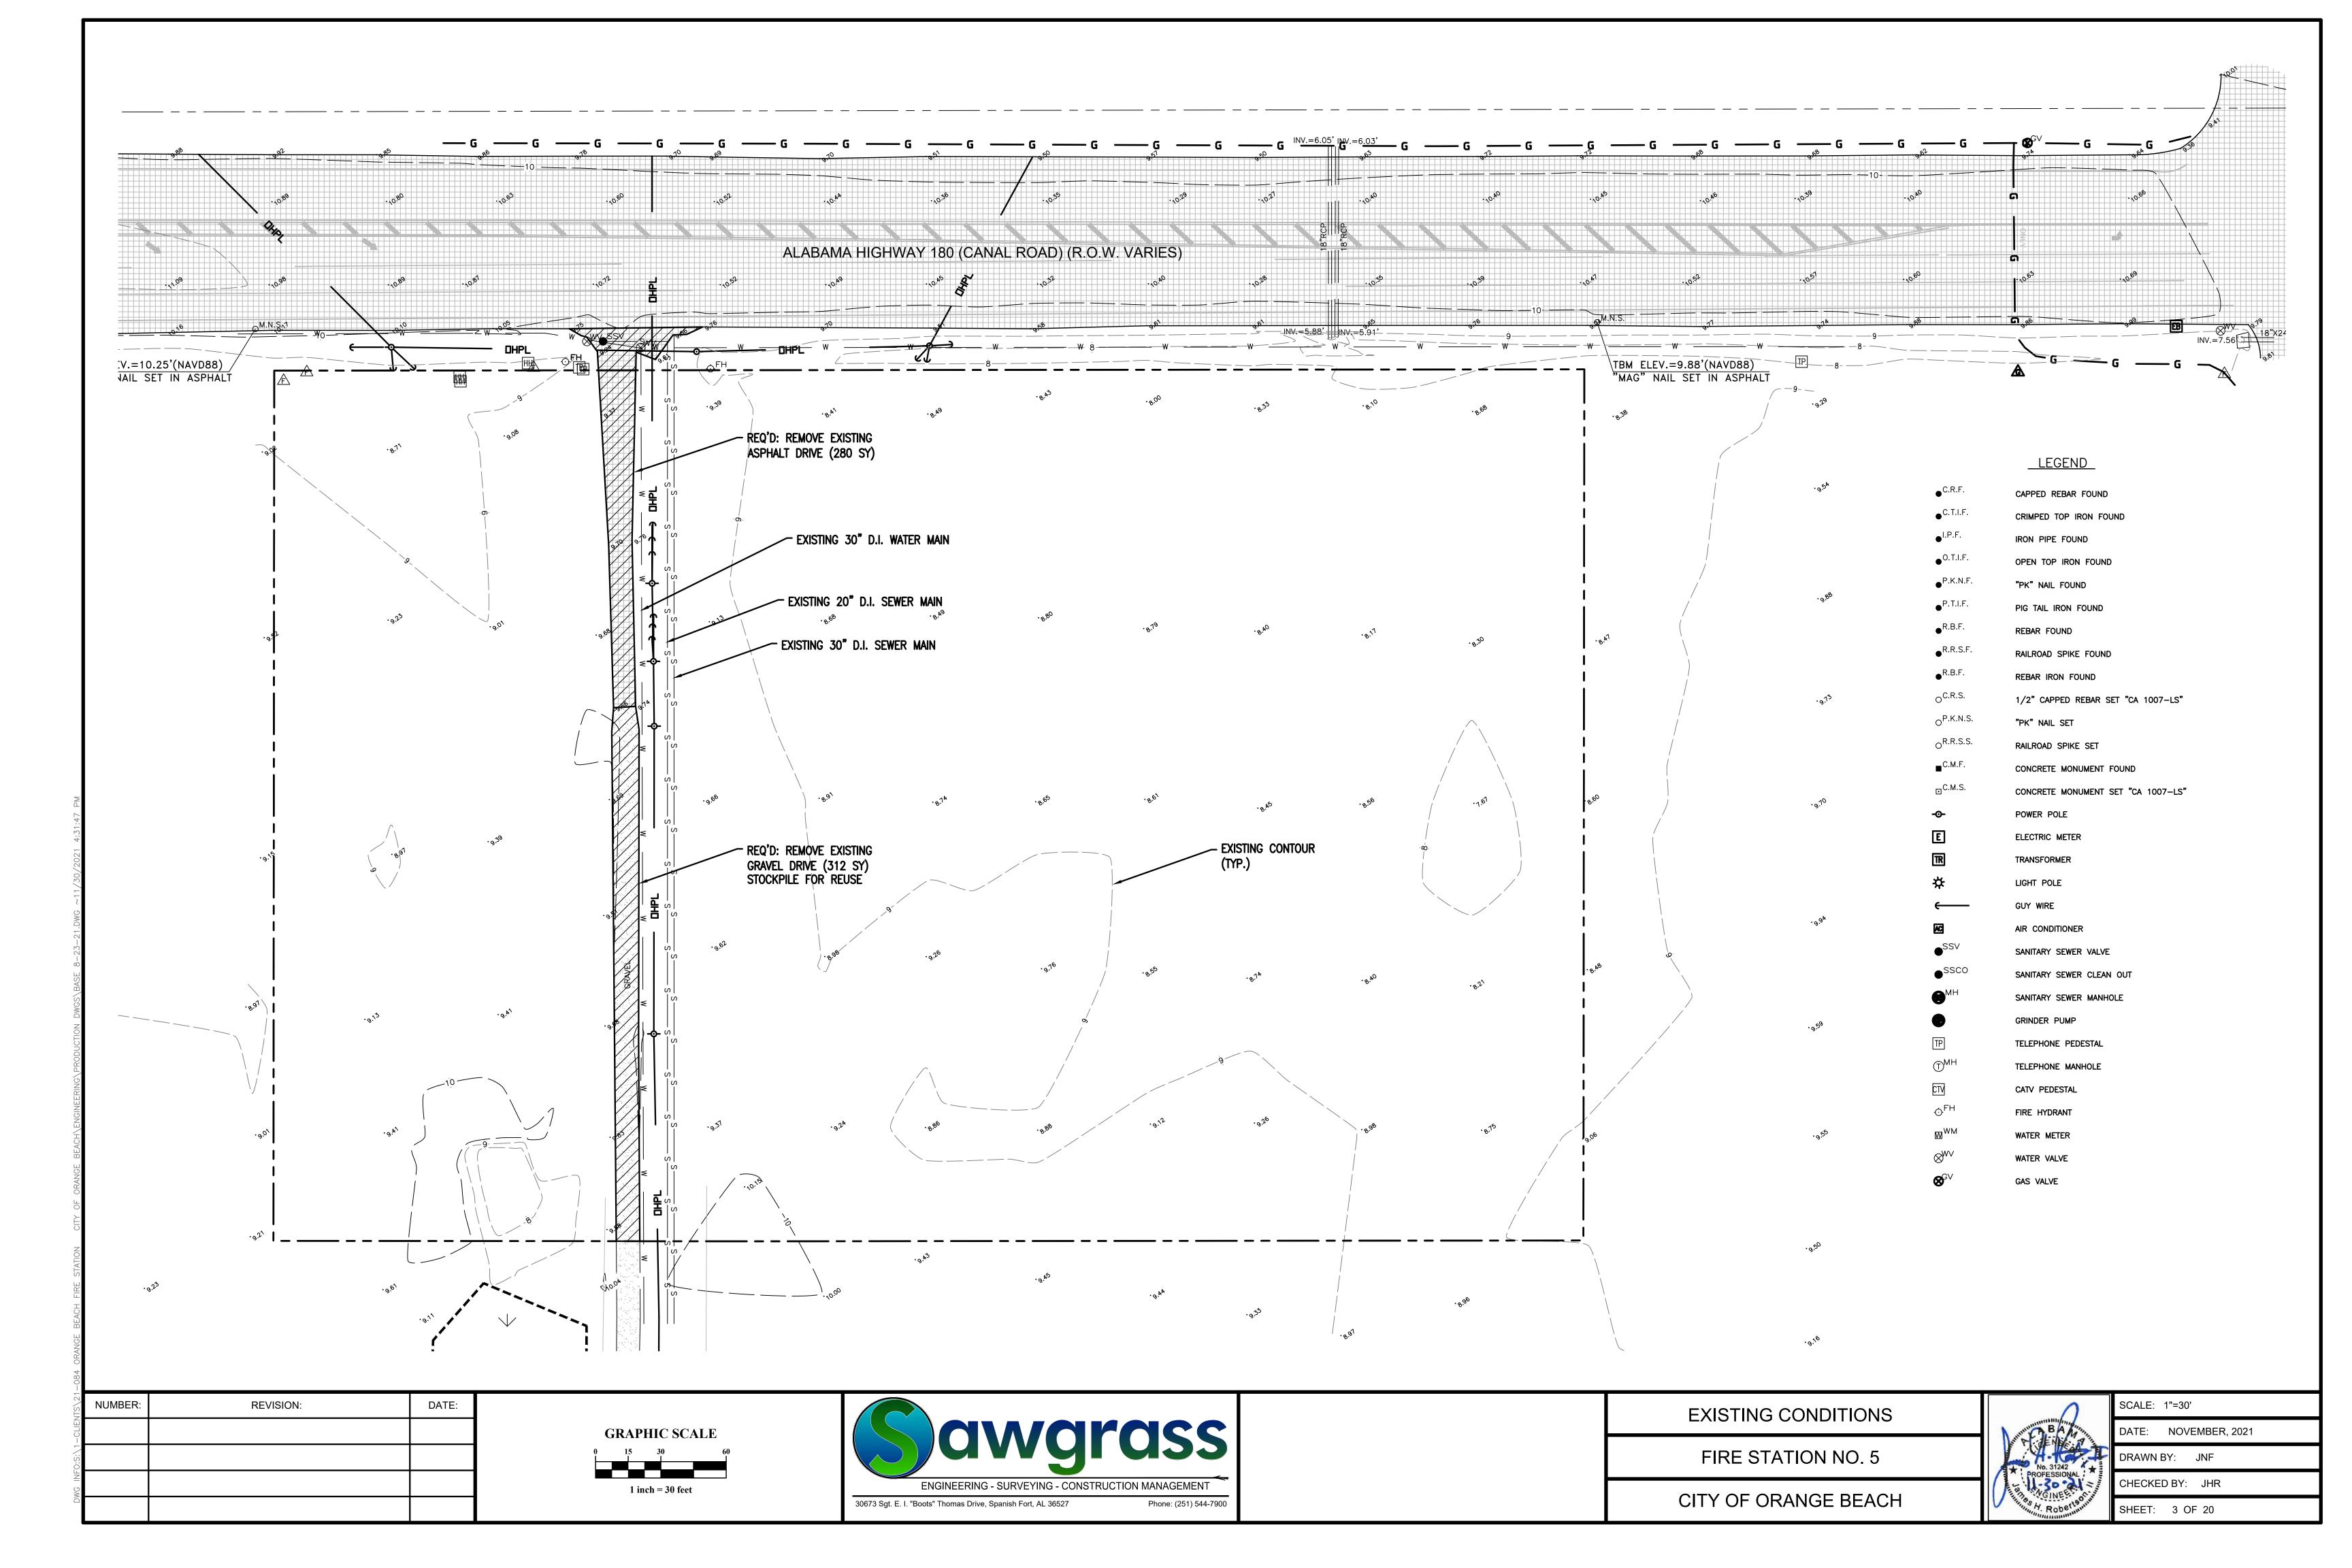

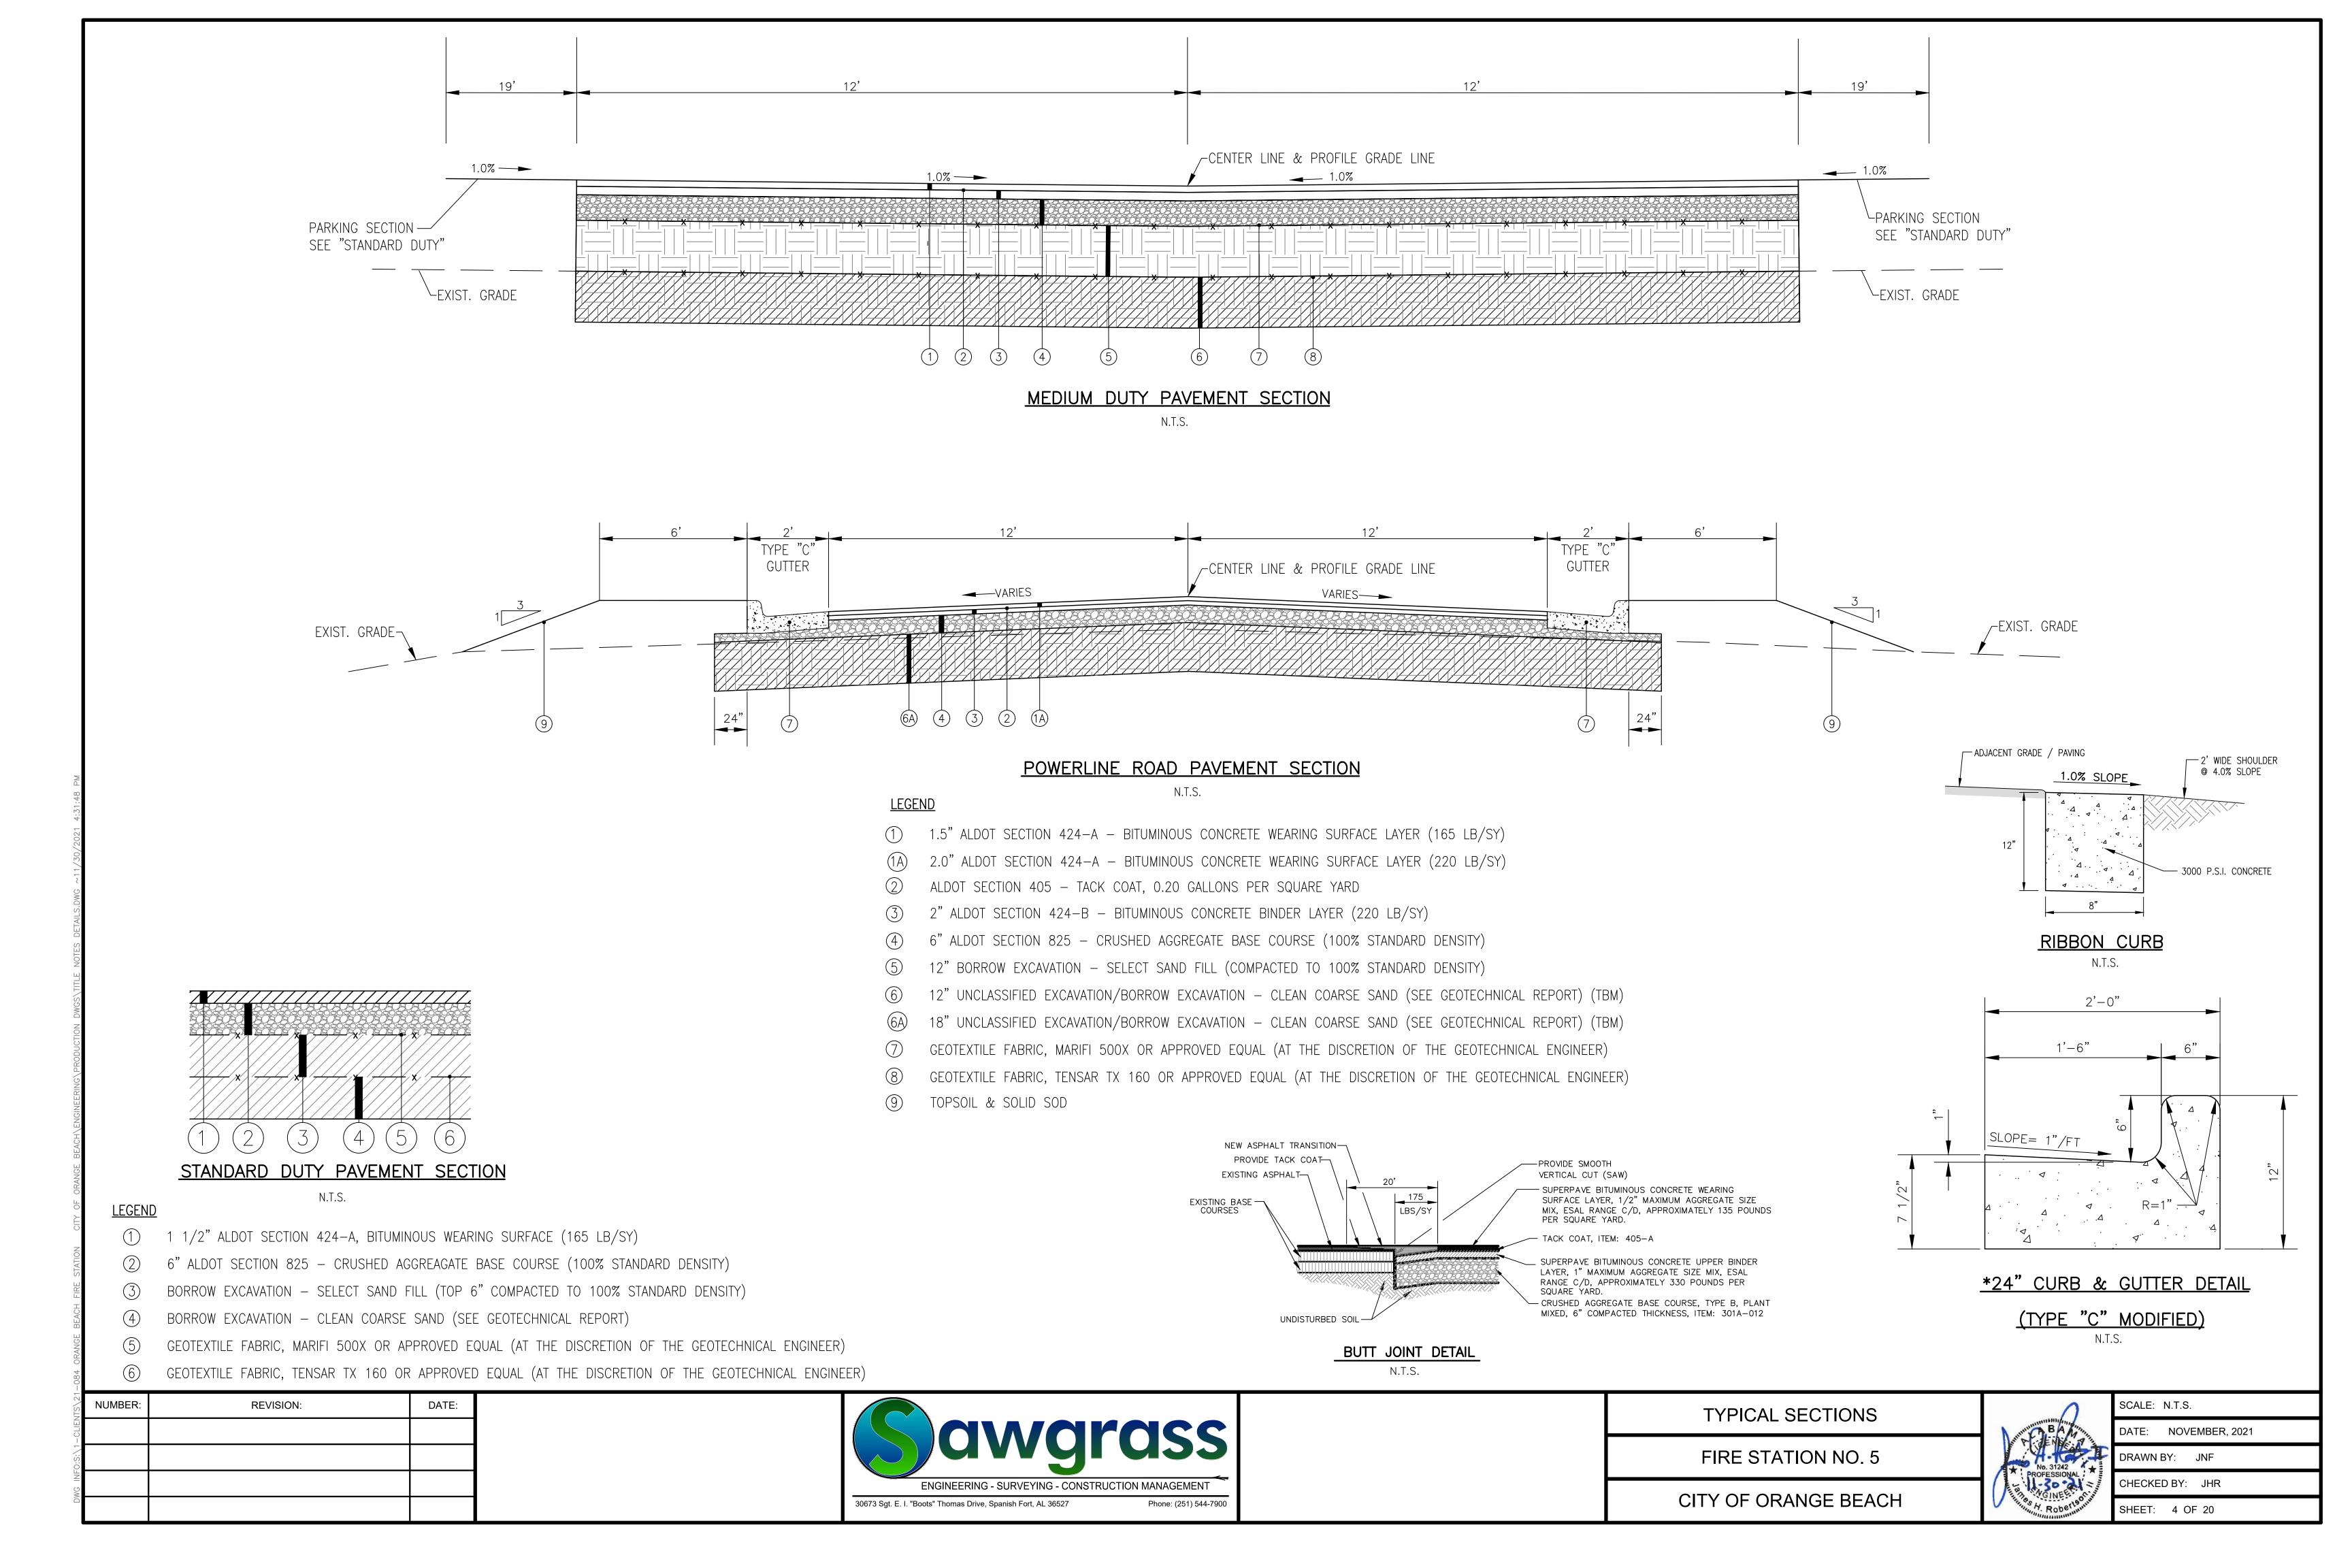

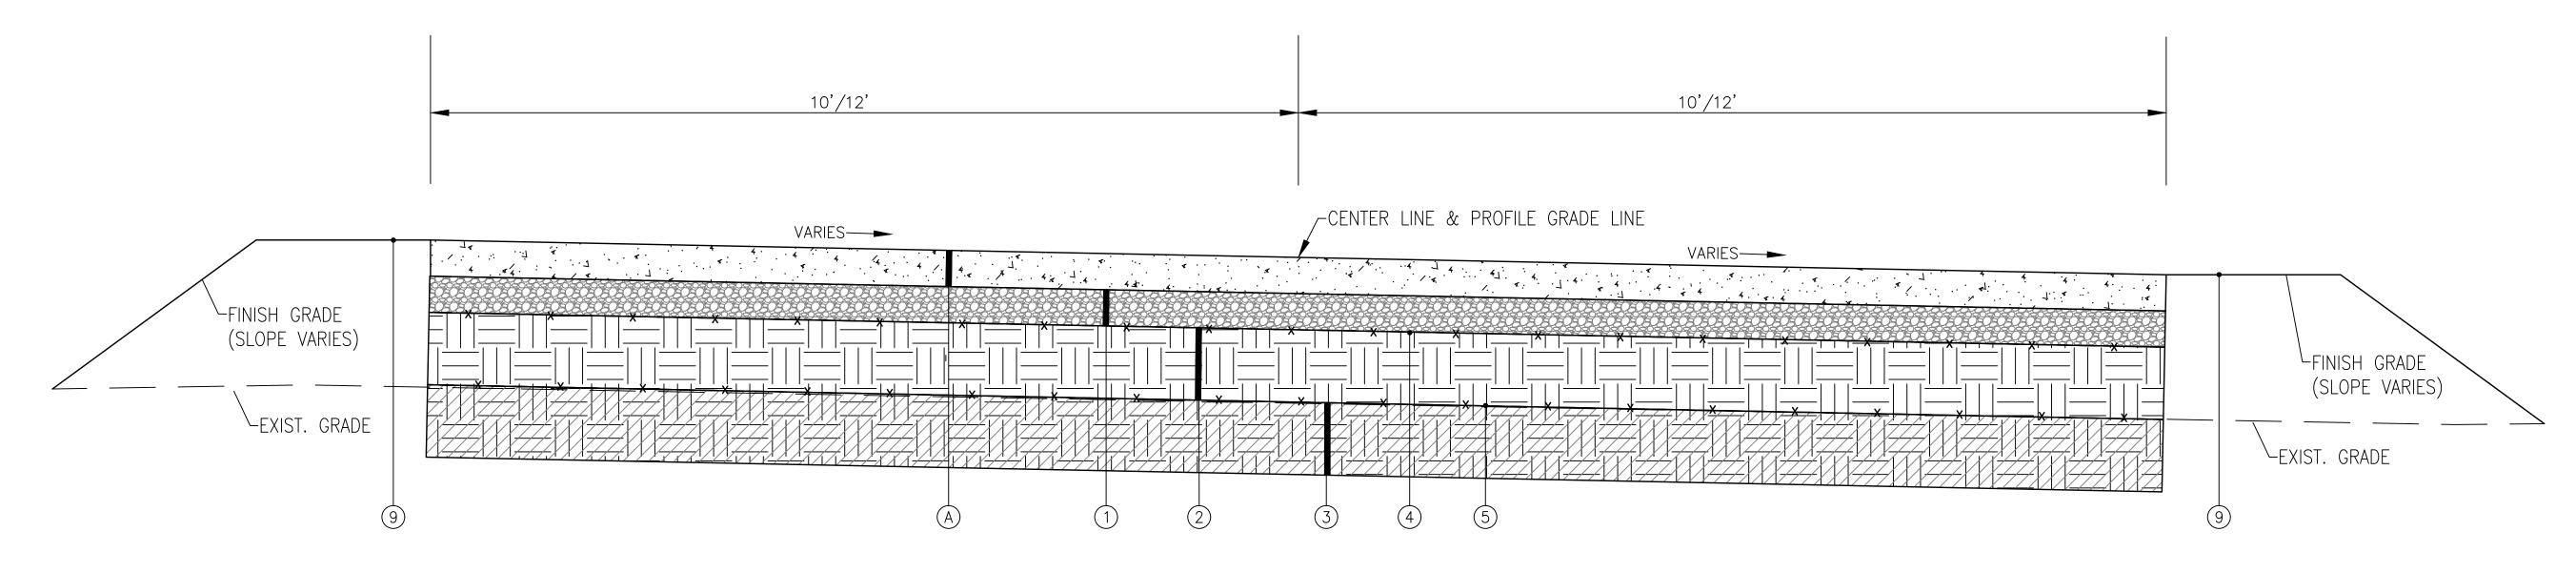

CONCRETE PAVEMENT SECTION


N.T.S.

* NOTE:

SEE SHEET 7 OF 12 FOR CONCRETE JOINT PLAN

<u>LEGEND</u>


- (A) 6" 4,000 PSI (500 PSI FLEXURAL STRENGTH) PORTLAND CEMENT CONCRETE
- 1) 6" ALDOT SECTION 825 CRUSHED AGGREGATE BASE COURSE (100% STANDARD DENSITY)
- \bigcirc 12" BORROW EXCAVATION SELECT SAND FILL (COMPACTED TO 100% STANDARD DENSITY)
- 3) 12" UNCLASSIFIED EXCAVATION/BORROW EXCAVATION CLEAN COARSE SAND (SEE GEOTECHNICAL REPORT) (TBM)
- 4) GEOTEXTILE FABRIC, MARIFI 500X OR APPROVED EQUAL (AT THE DISCRETION OF THE GEOTECHNICAL ENGINEER)
- 5 GEOTEXTILE FABRIC, TENSAR TX 160 OR APPROVED EQUAL (AT THE DISCRETION OF THE GEOTECHNICAL ENGINEER)
- 6 TOPSOIL & SOLID SOD

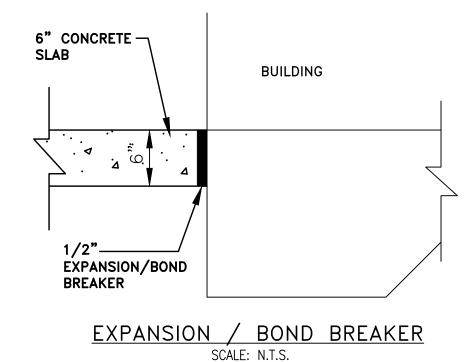

CONCRETE NOTES:

JOINTS SHOULD BE INSTALLED IN THE PCC PAVEMENTS TO LIMIT STRESSES RESULTING FROM EXPANSION AND CONTRACTION. CONTRACTION JOINTS SHOULD BE FORMED BY SAWING AS SOON AS THE CONCRETE HAS HARDENED ENOUGH TO PREVENT RAVELING. THESE JOINTS SHOULD EXTEND TO A DEPTH OF AT LEAST 1/4 OF THE PAVEMENT THICKNESS AND BE PLACED ON A 12 TO 15 FOOT SPACING. THE DESIGN AND LOCATION OF ALL PAVEMENT JOINTS SHOULD BE IN ACCORDANCE WITH RECOMMENDATIONS OF THE PORTLAND CEMENT ASSOCIATION (PCA) AND ACI 330.

ISOLATION JOINT MATERIAL SHOULD COMPLY WITH ACI STANDARDS. THE UPPER ONE INCH OF THE JOINT MATERIAL SHOULD BE REMOVED AND THE JOINT SEALED WITH A SELF—LEVELING ELASTOMERIC JOINT SEALANT IMMEDIATELY AFTER THE CURING PERIOD AND PRIOR TO OPENING TO TRAFFIC. CONSTRUCTION JOINTS SHOULD BE PROPERLY CLEANED AND SEALED WITH THE SAME TYPE OF JOINT SEALANT. DOWEL SIZING AND SPACING FOR CONSTRUCTION JOINTS SHOULD CONFORM TO THE RECOMMENDATIONS OF ACI 330.

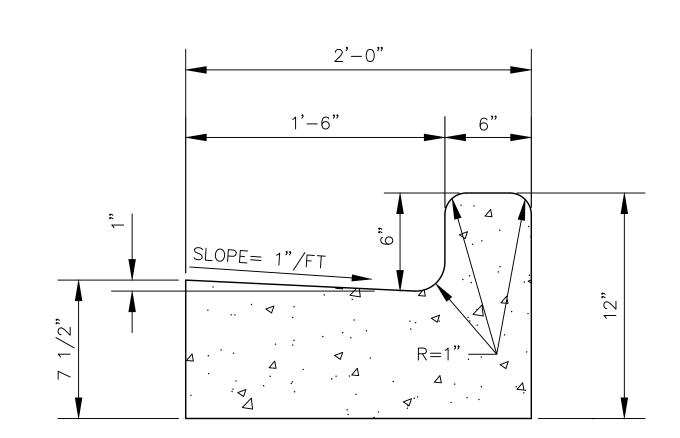

*24" CURB & GUTTER DETAIL

(TYPE "C" MODIFIED)

N.T.S.


NUMBER:	REVISION:	DATE:	

Savgi	'CISS
ENGINEERING - SURVEYING - CONSTRU	ICTION MANAGEMENT
30673 Sgt. E. I. "Boots" Thomas Drive, Spanish Fort, AL 36527	Phone: (251) 544-7900

TYPICAL SECTIONS

FIRE STATION NO. 5

CITY OF ORANGE BEACH

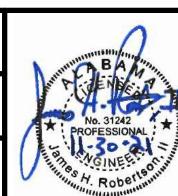



	SCALE:	N.T.S.
	DATE:	NOVEMBER, 2021
•		


DRAWN BY: JNF


CHECKED BY: JHR


SHEET: 5 OF 20

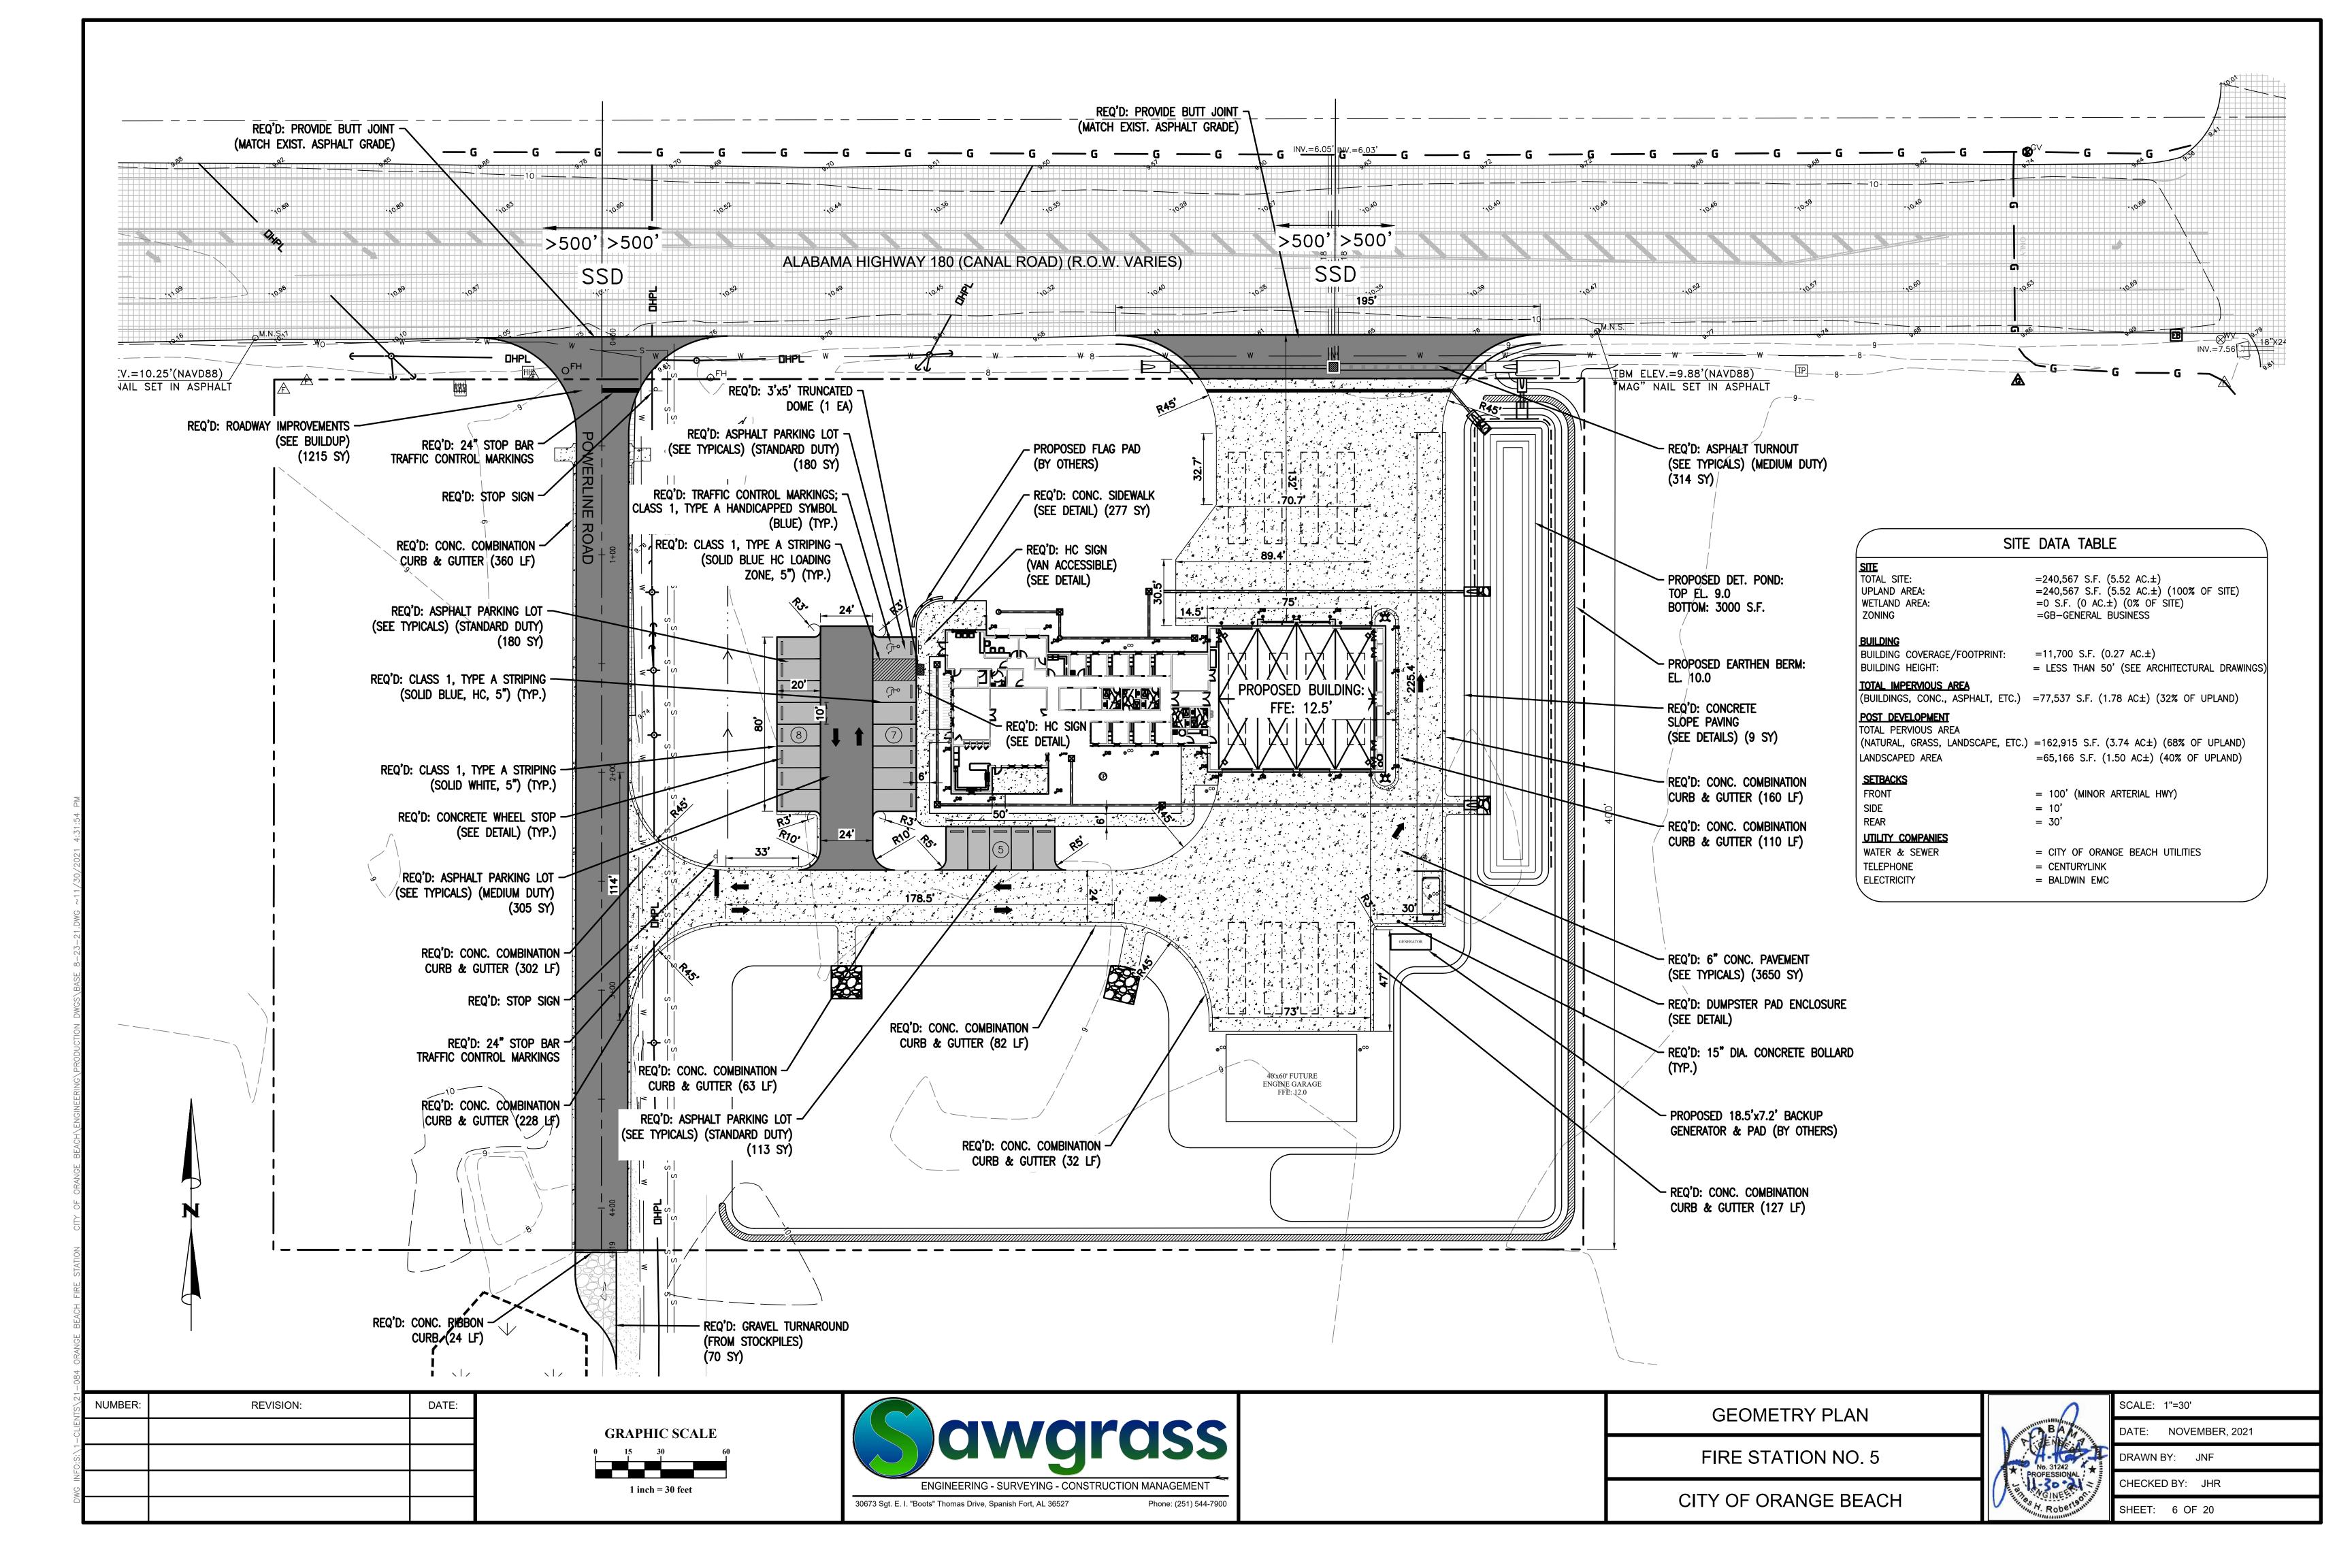


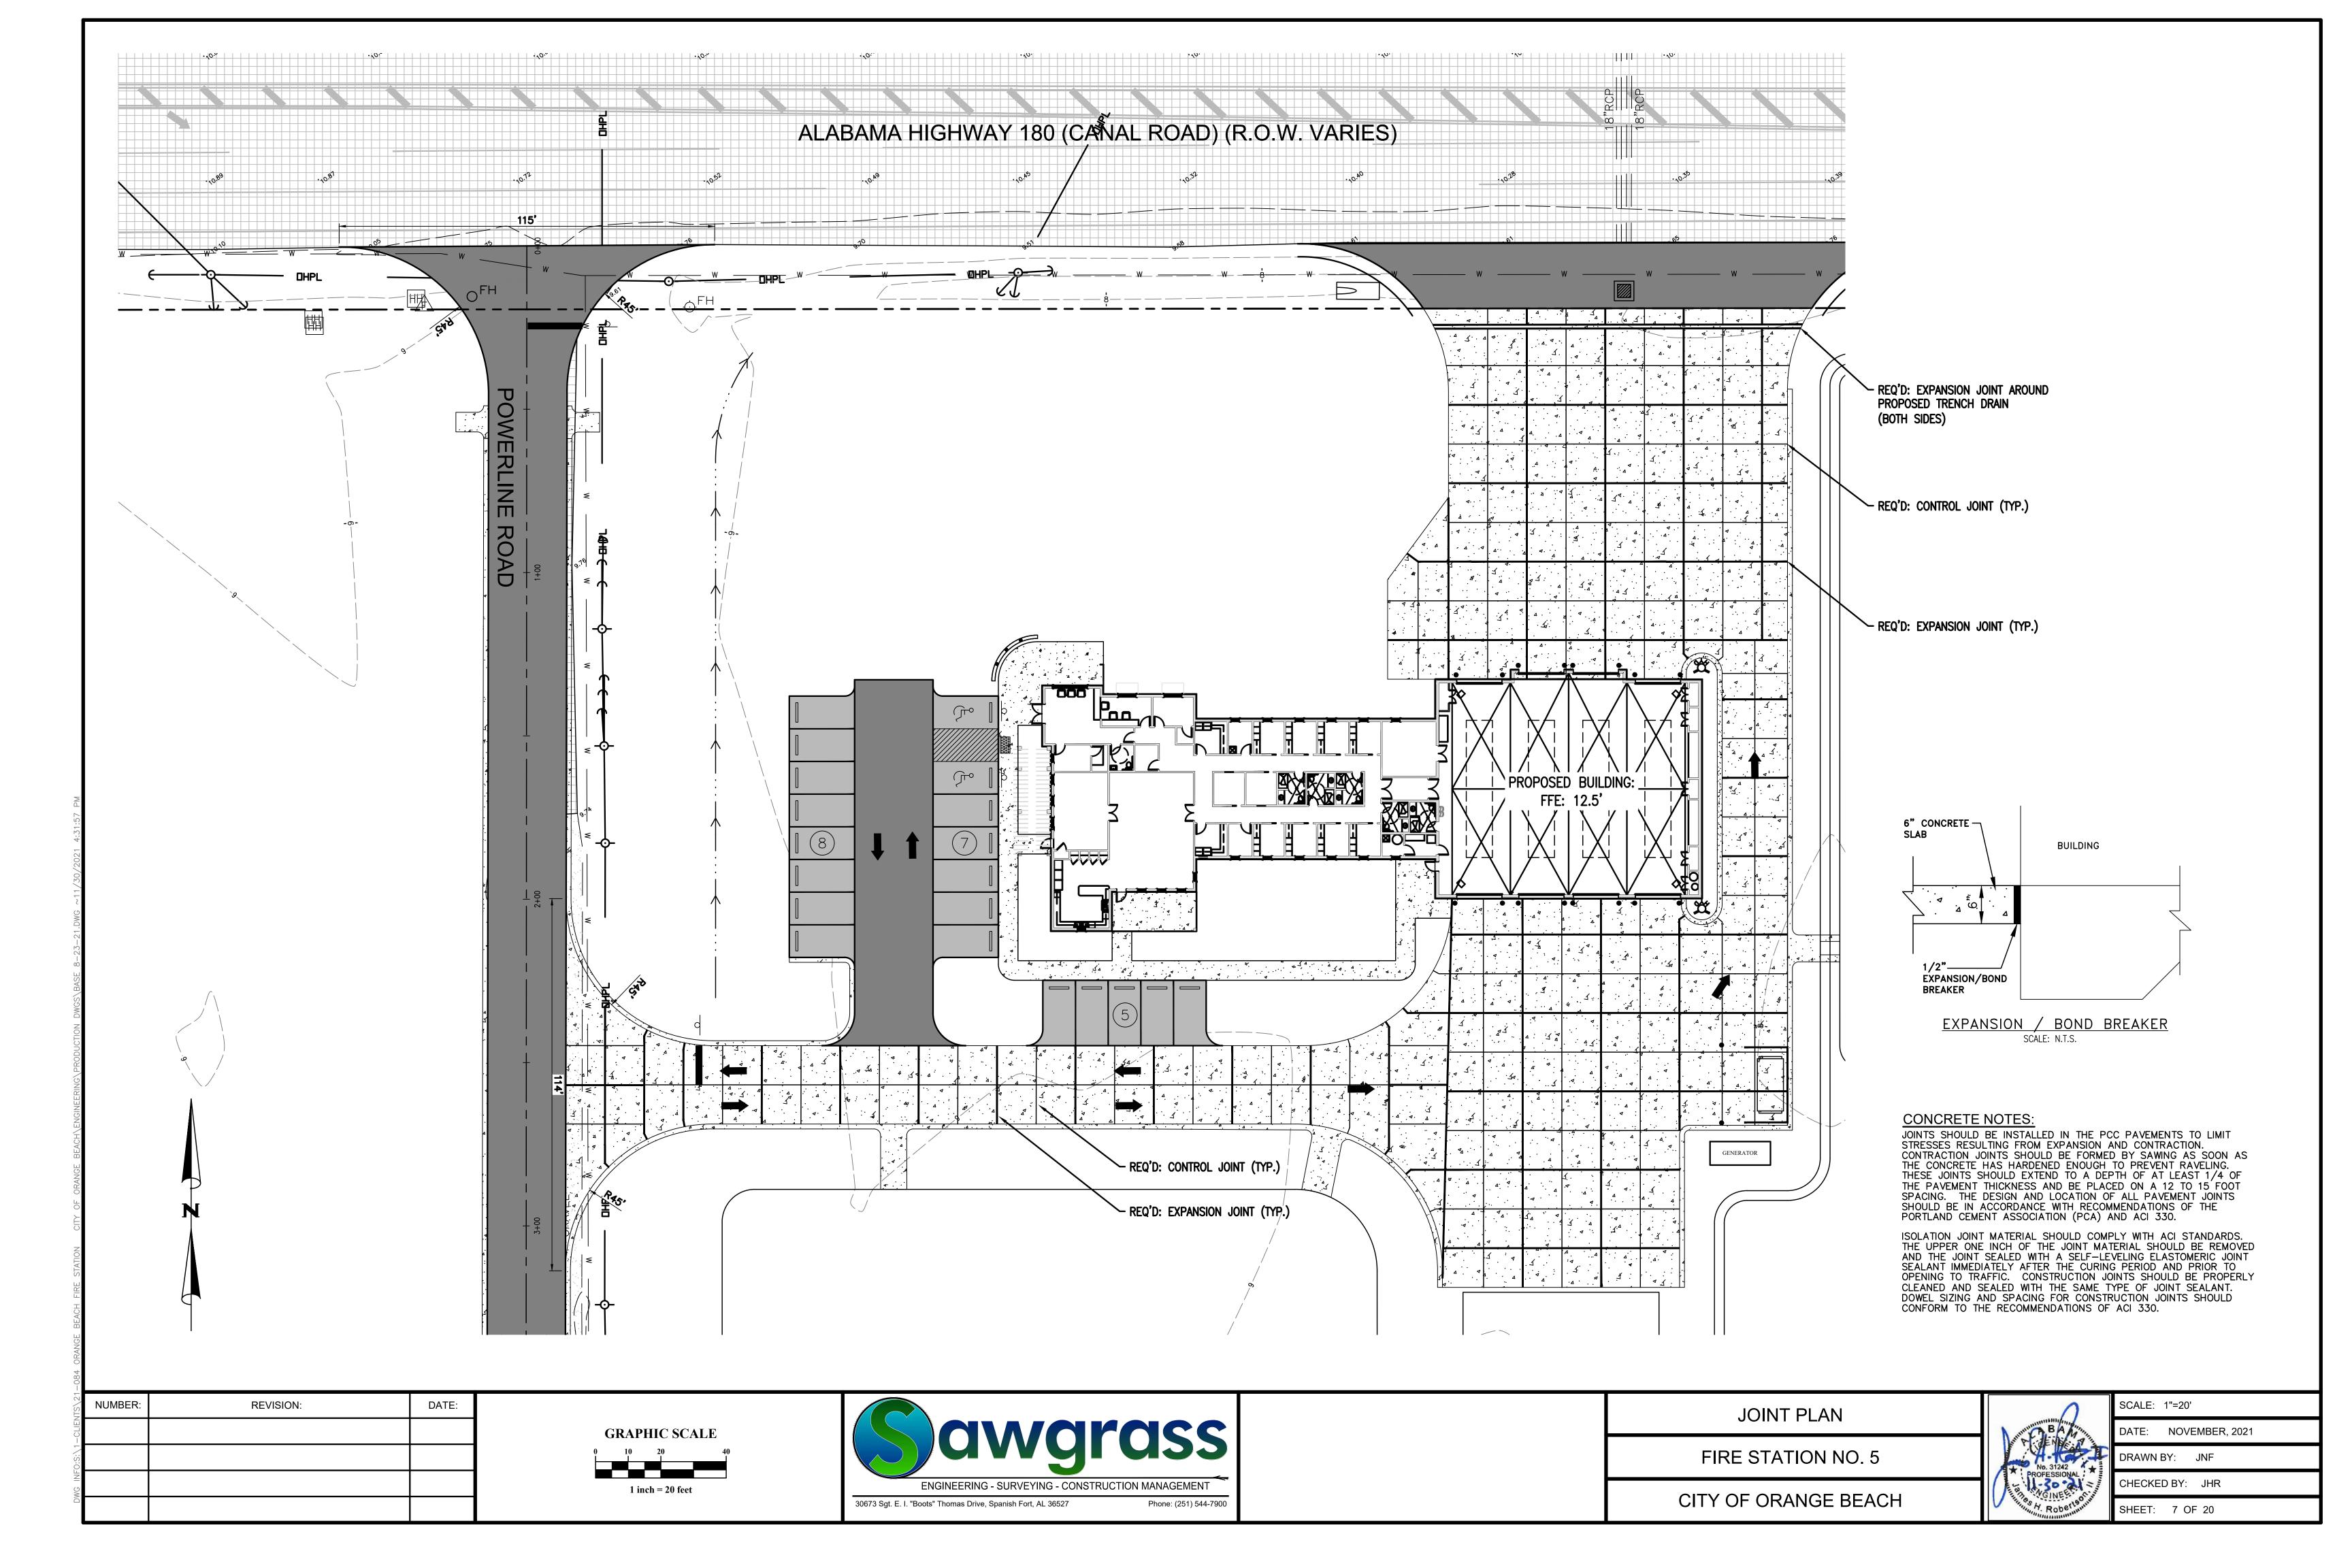


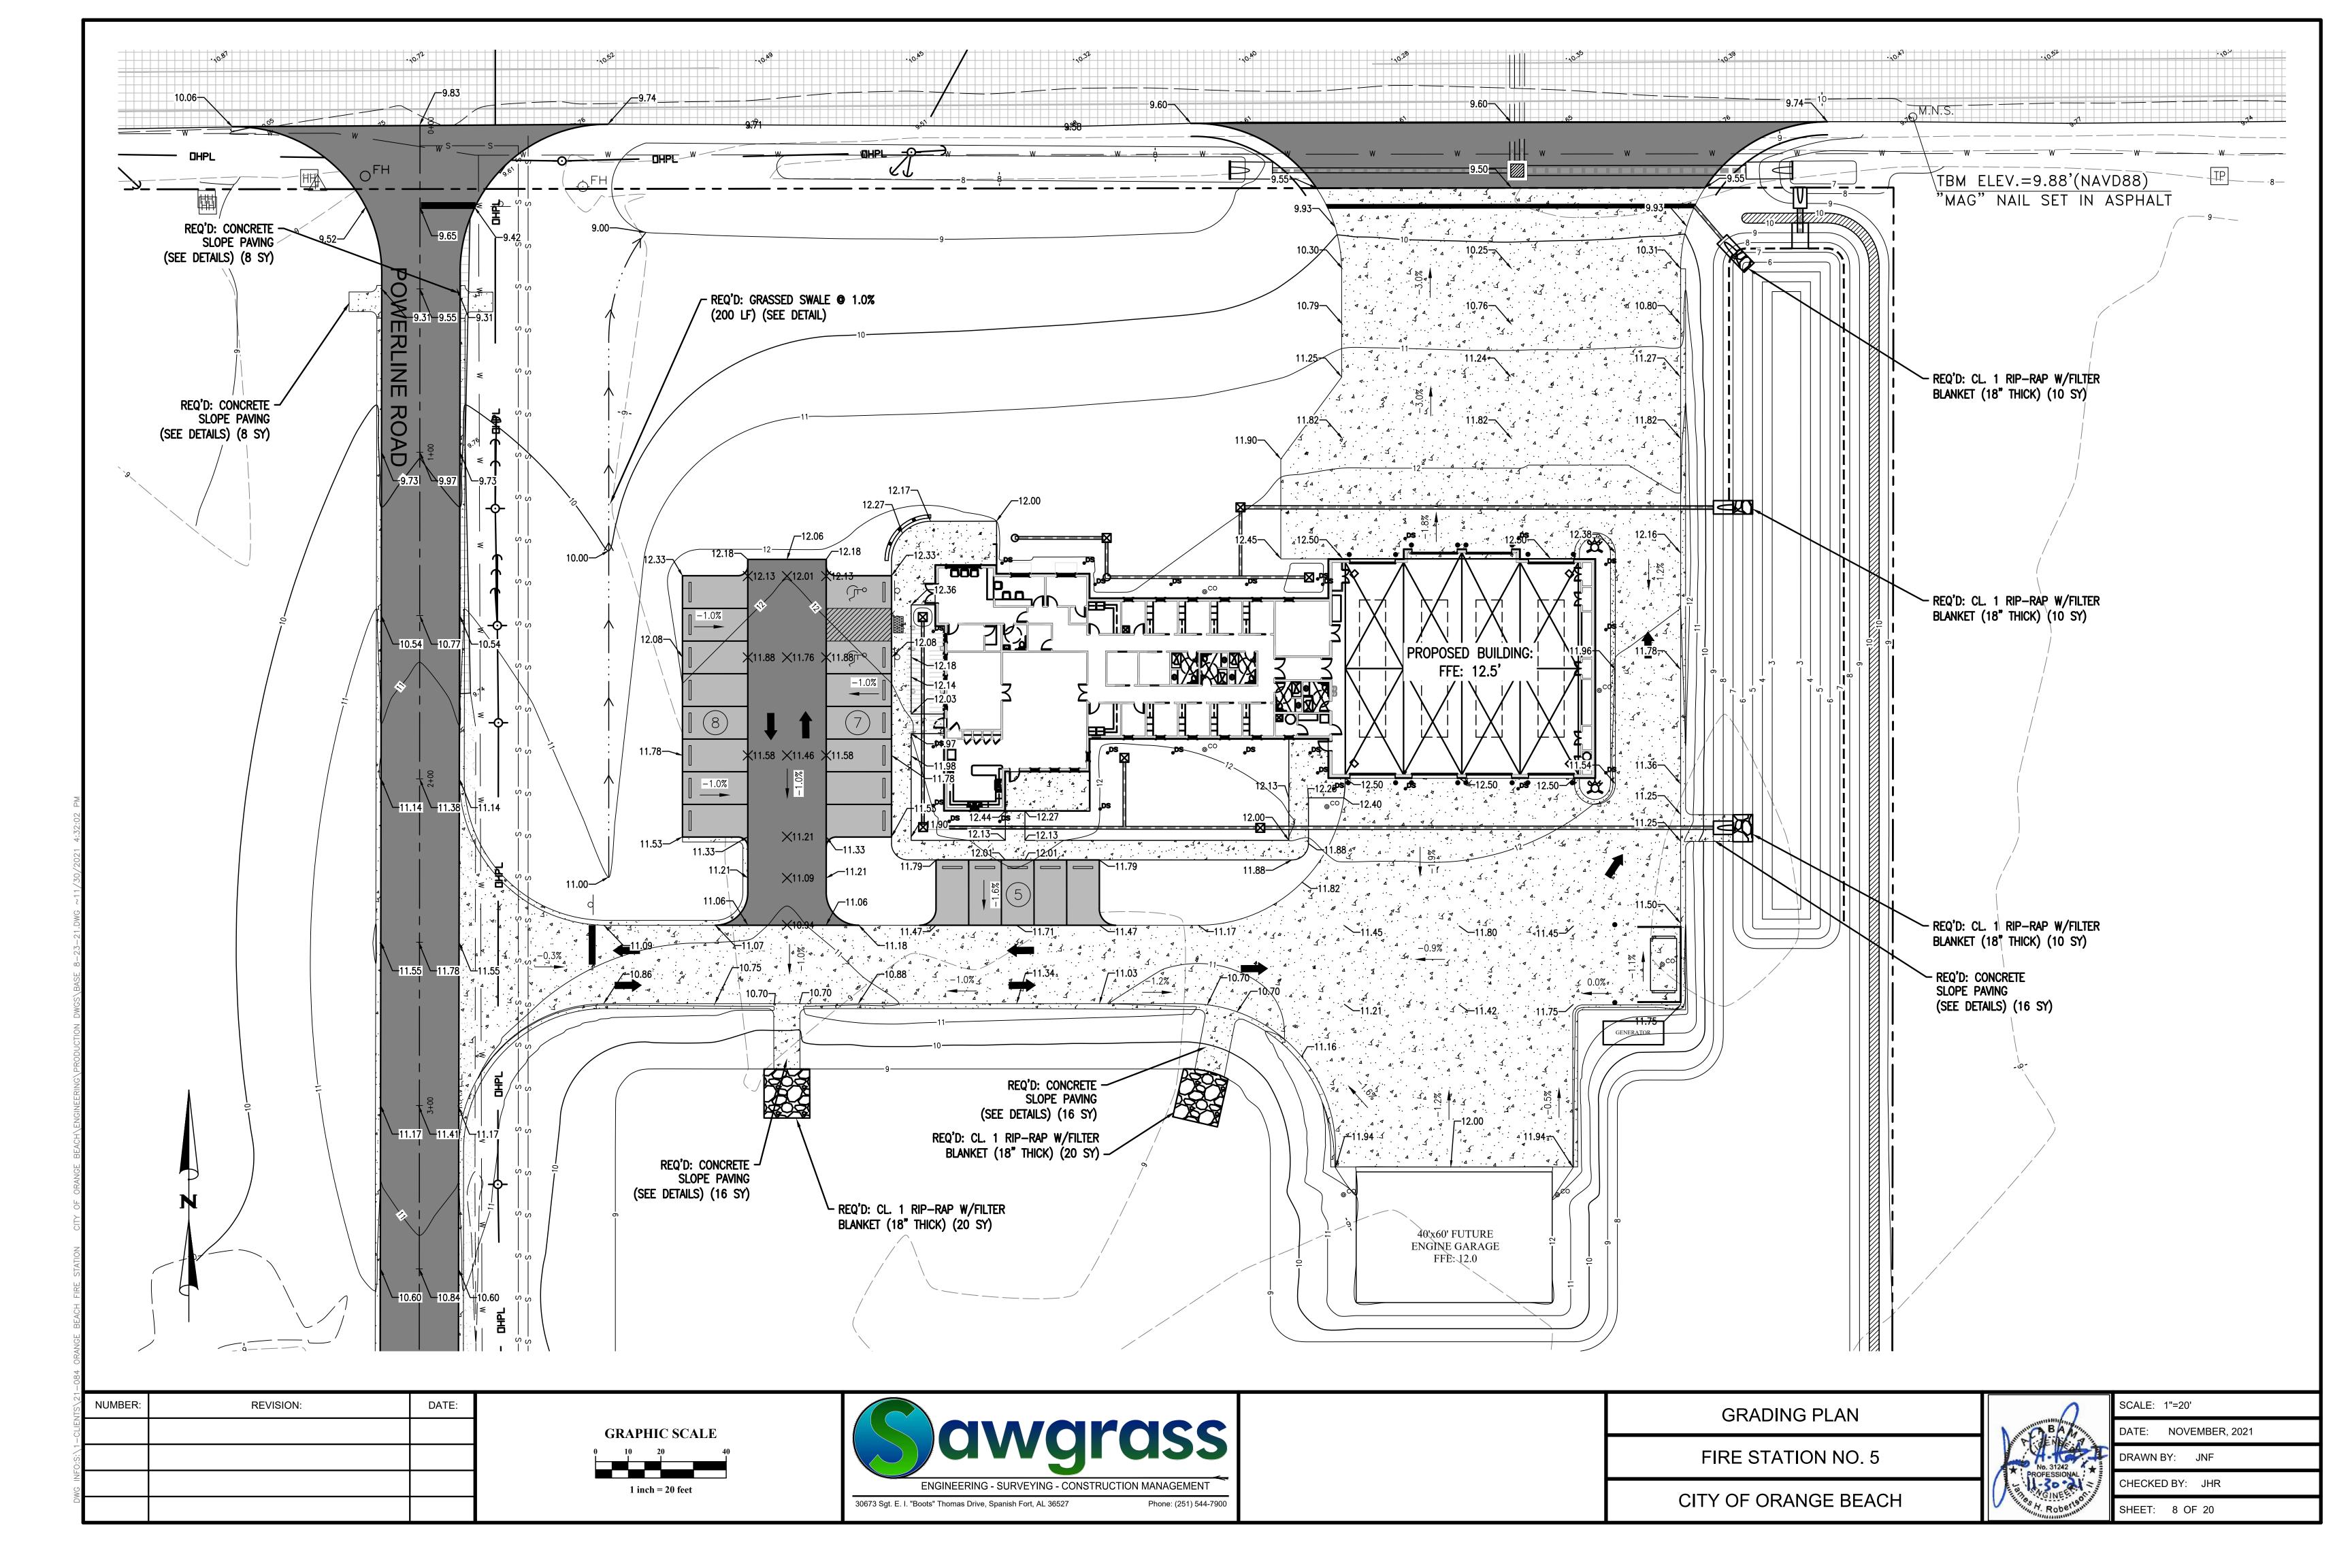


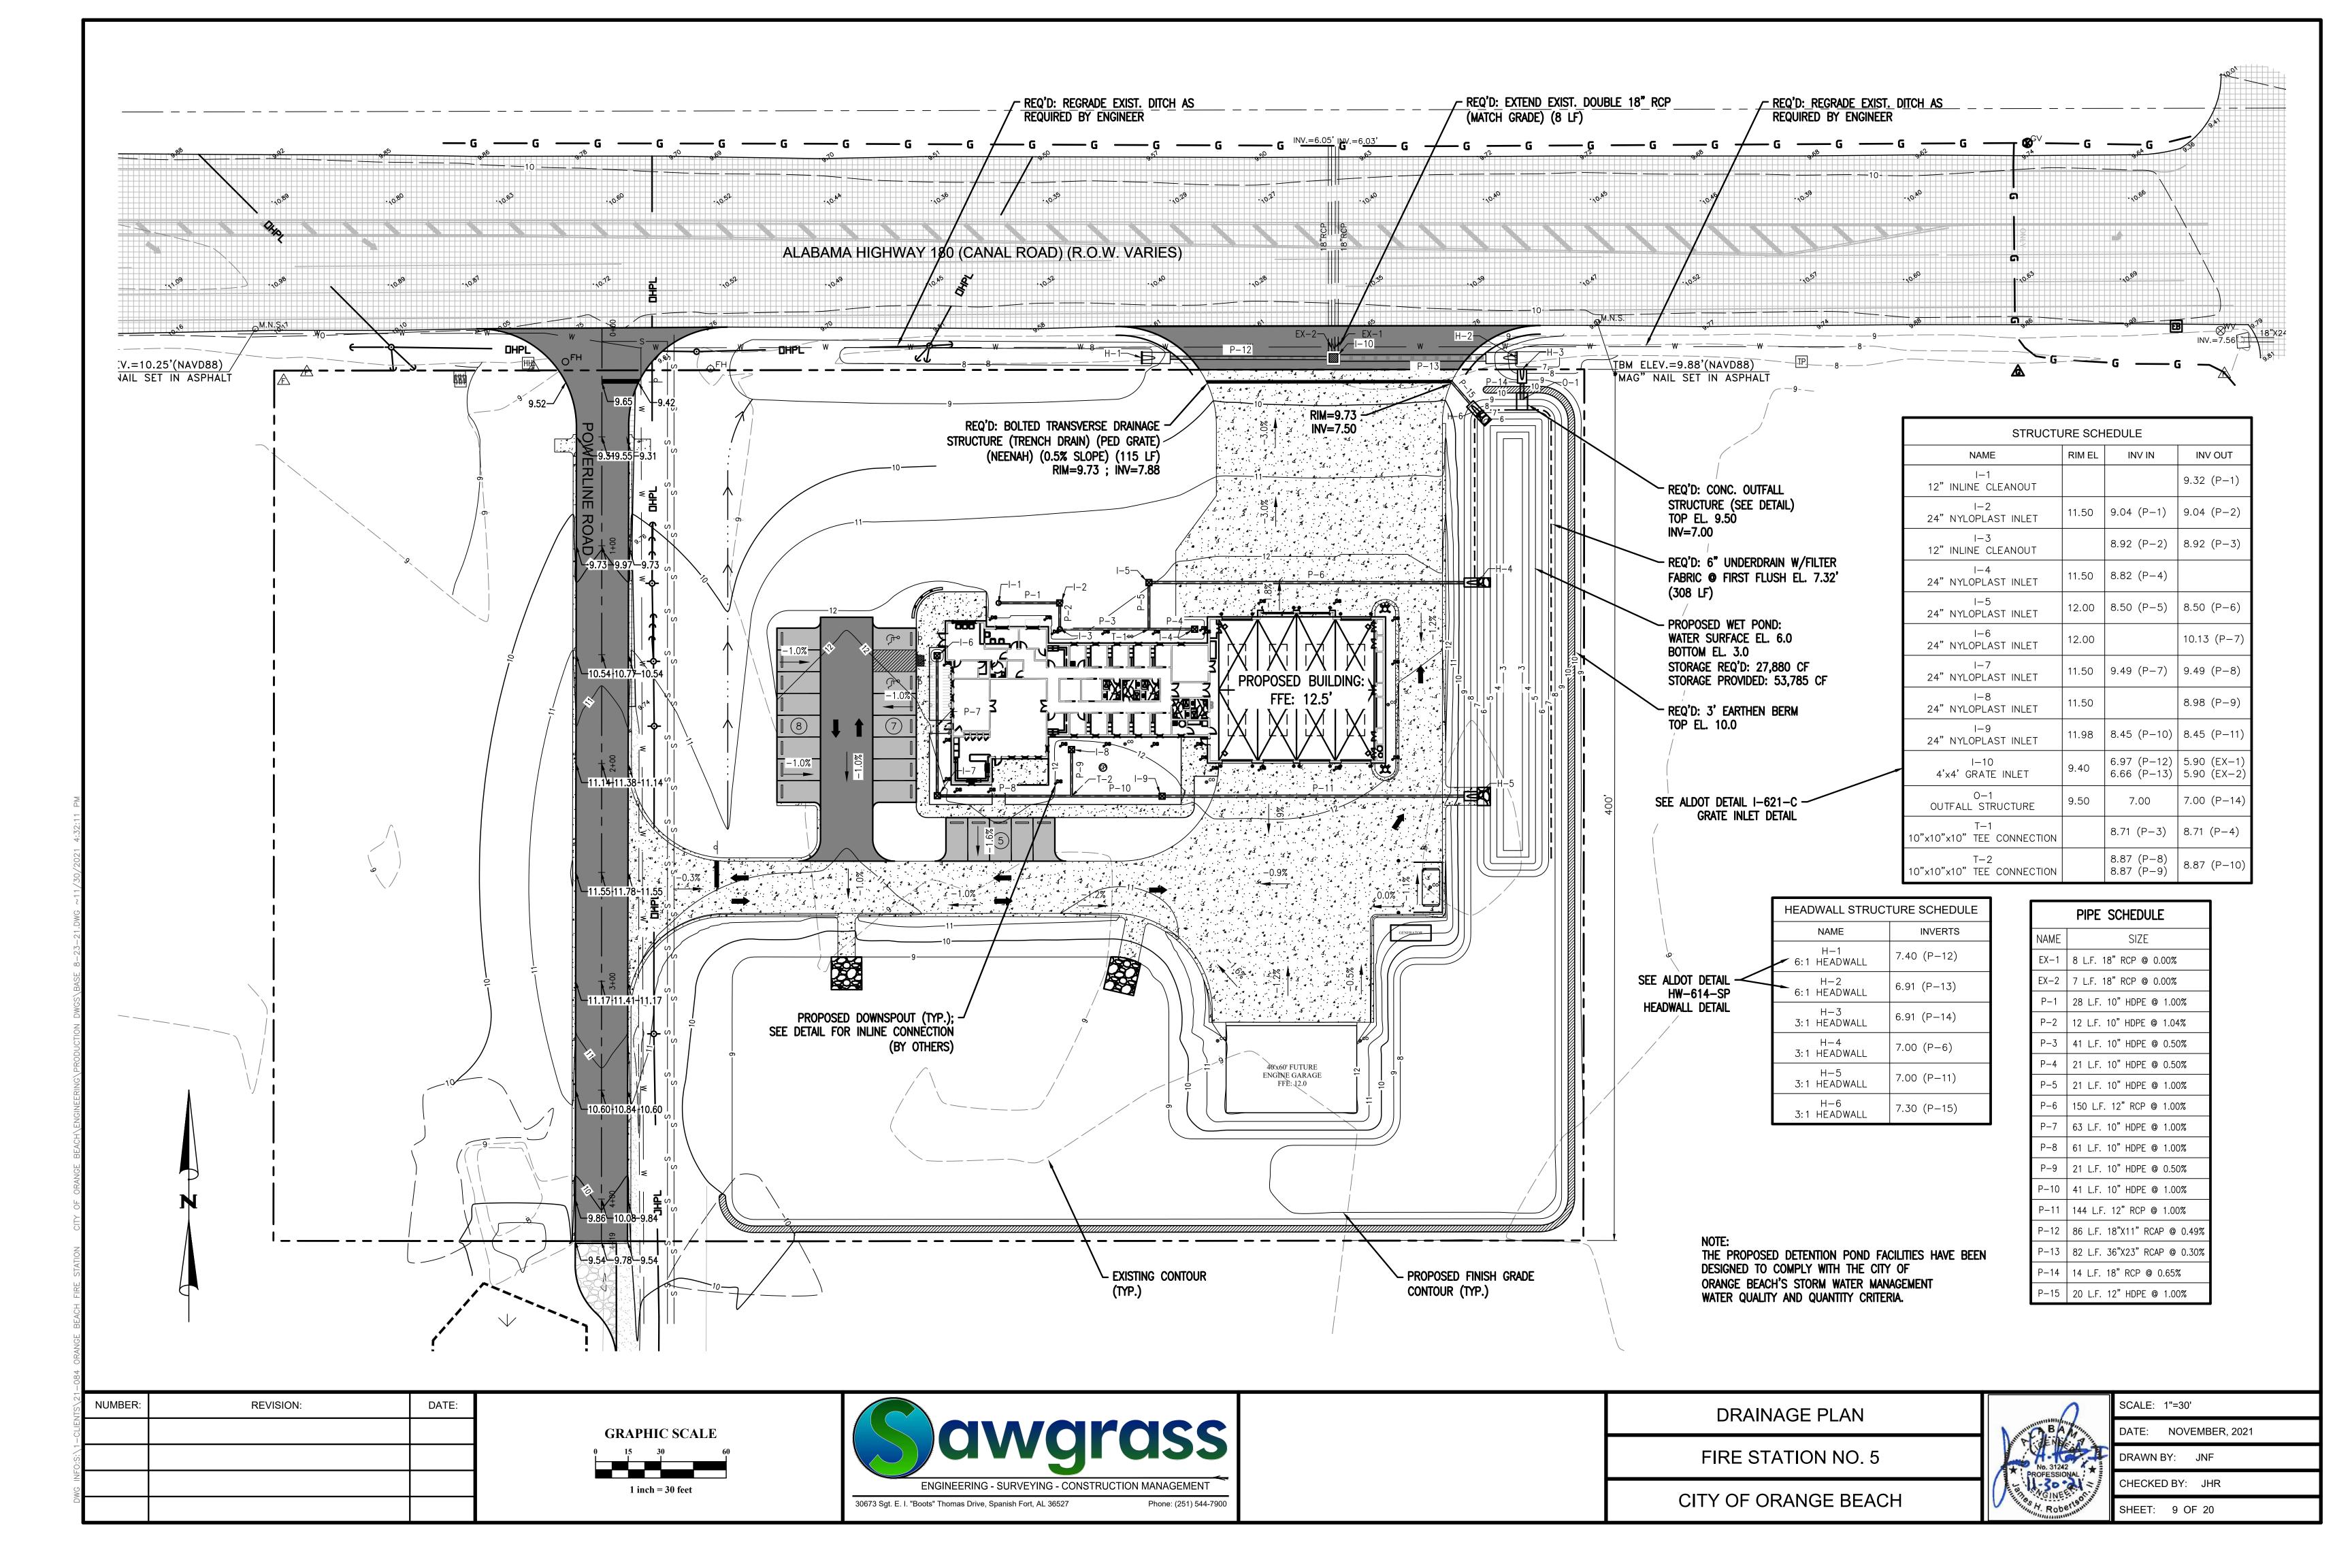


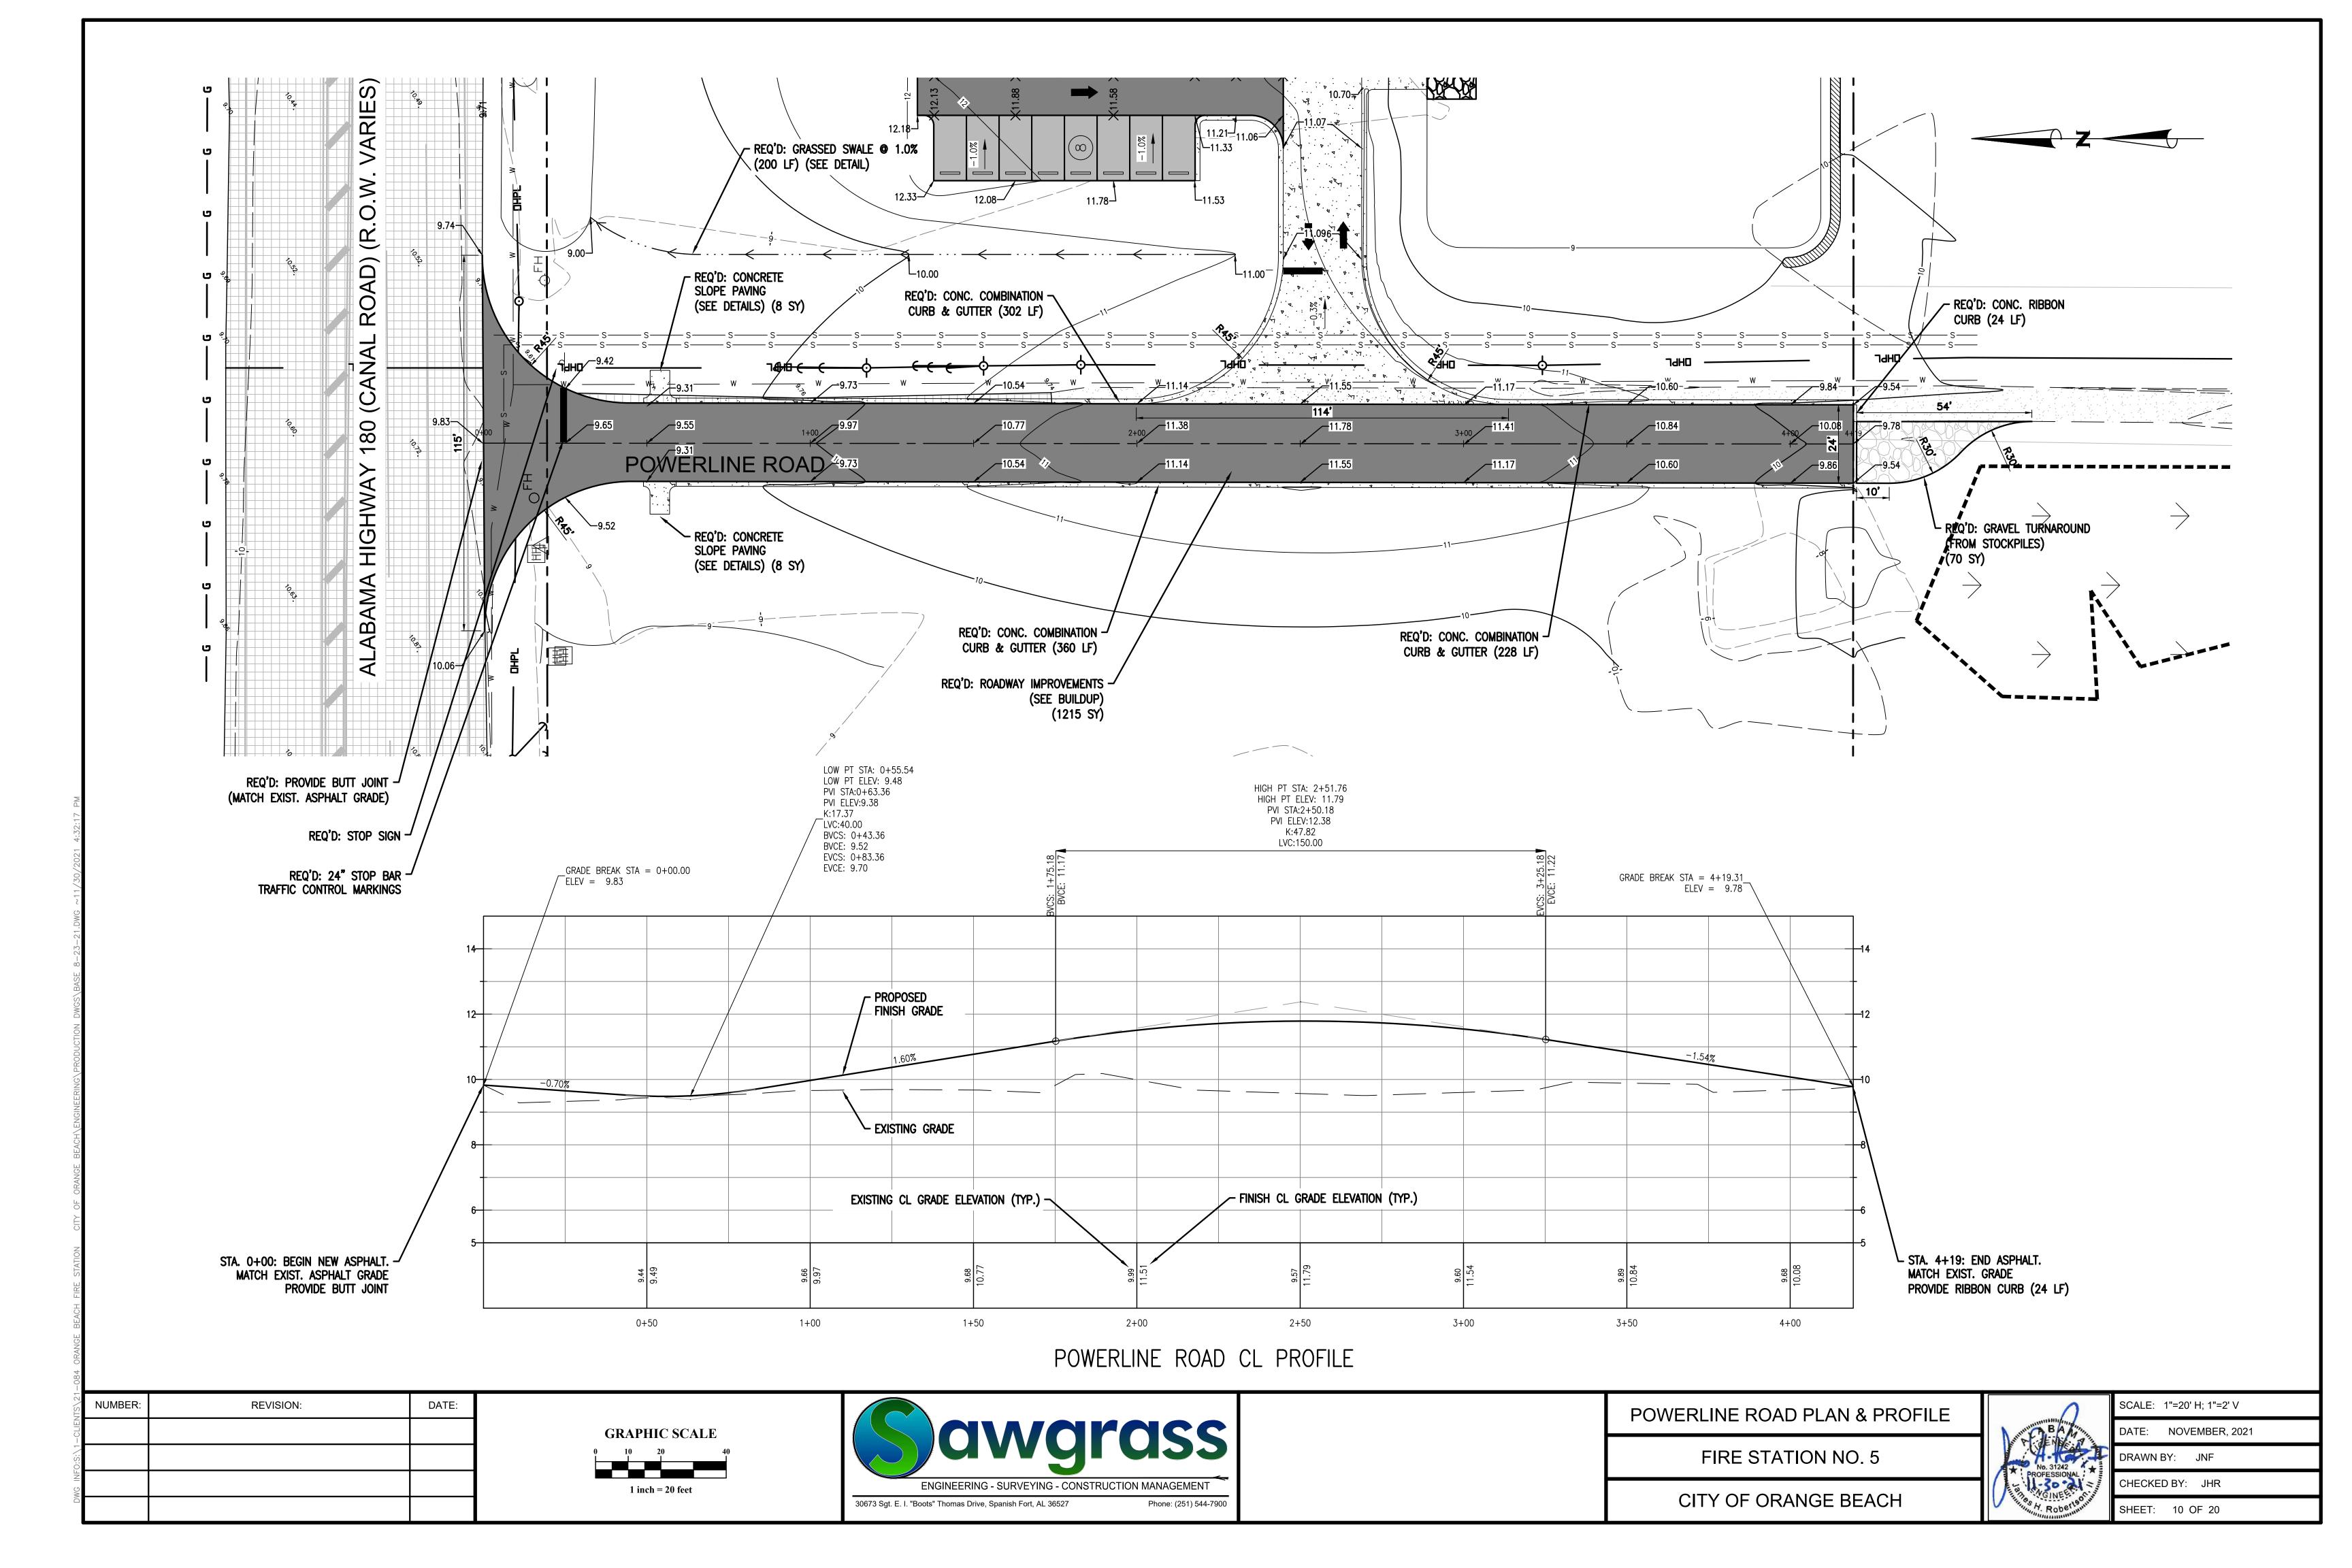


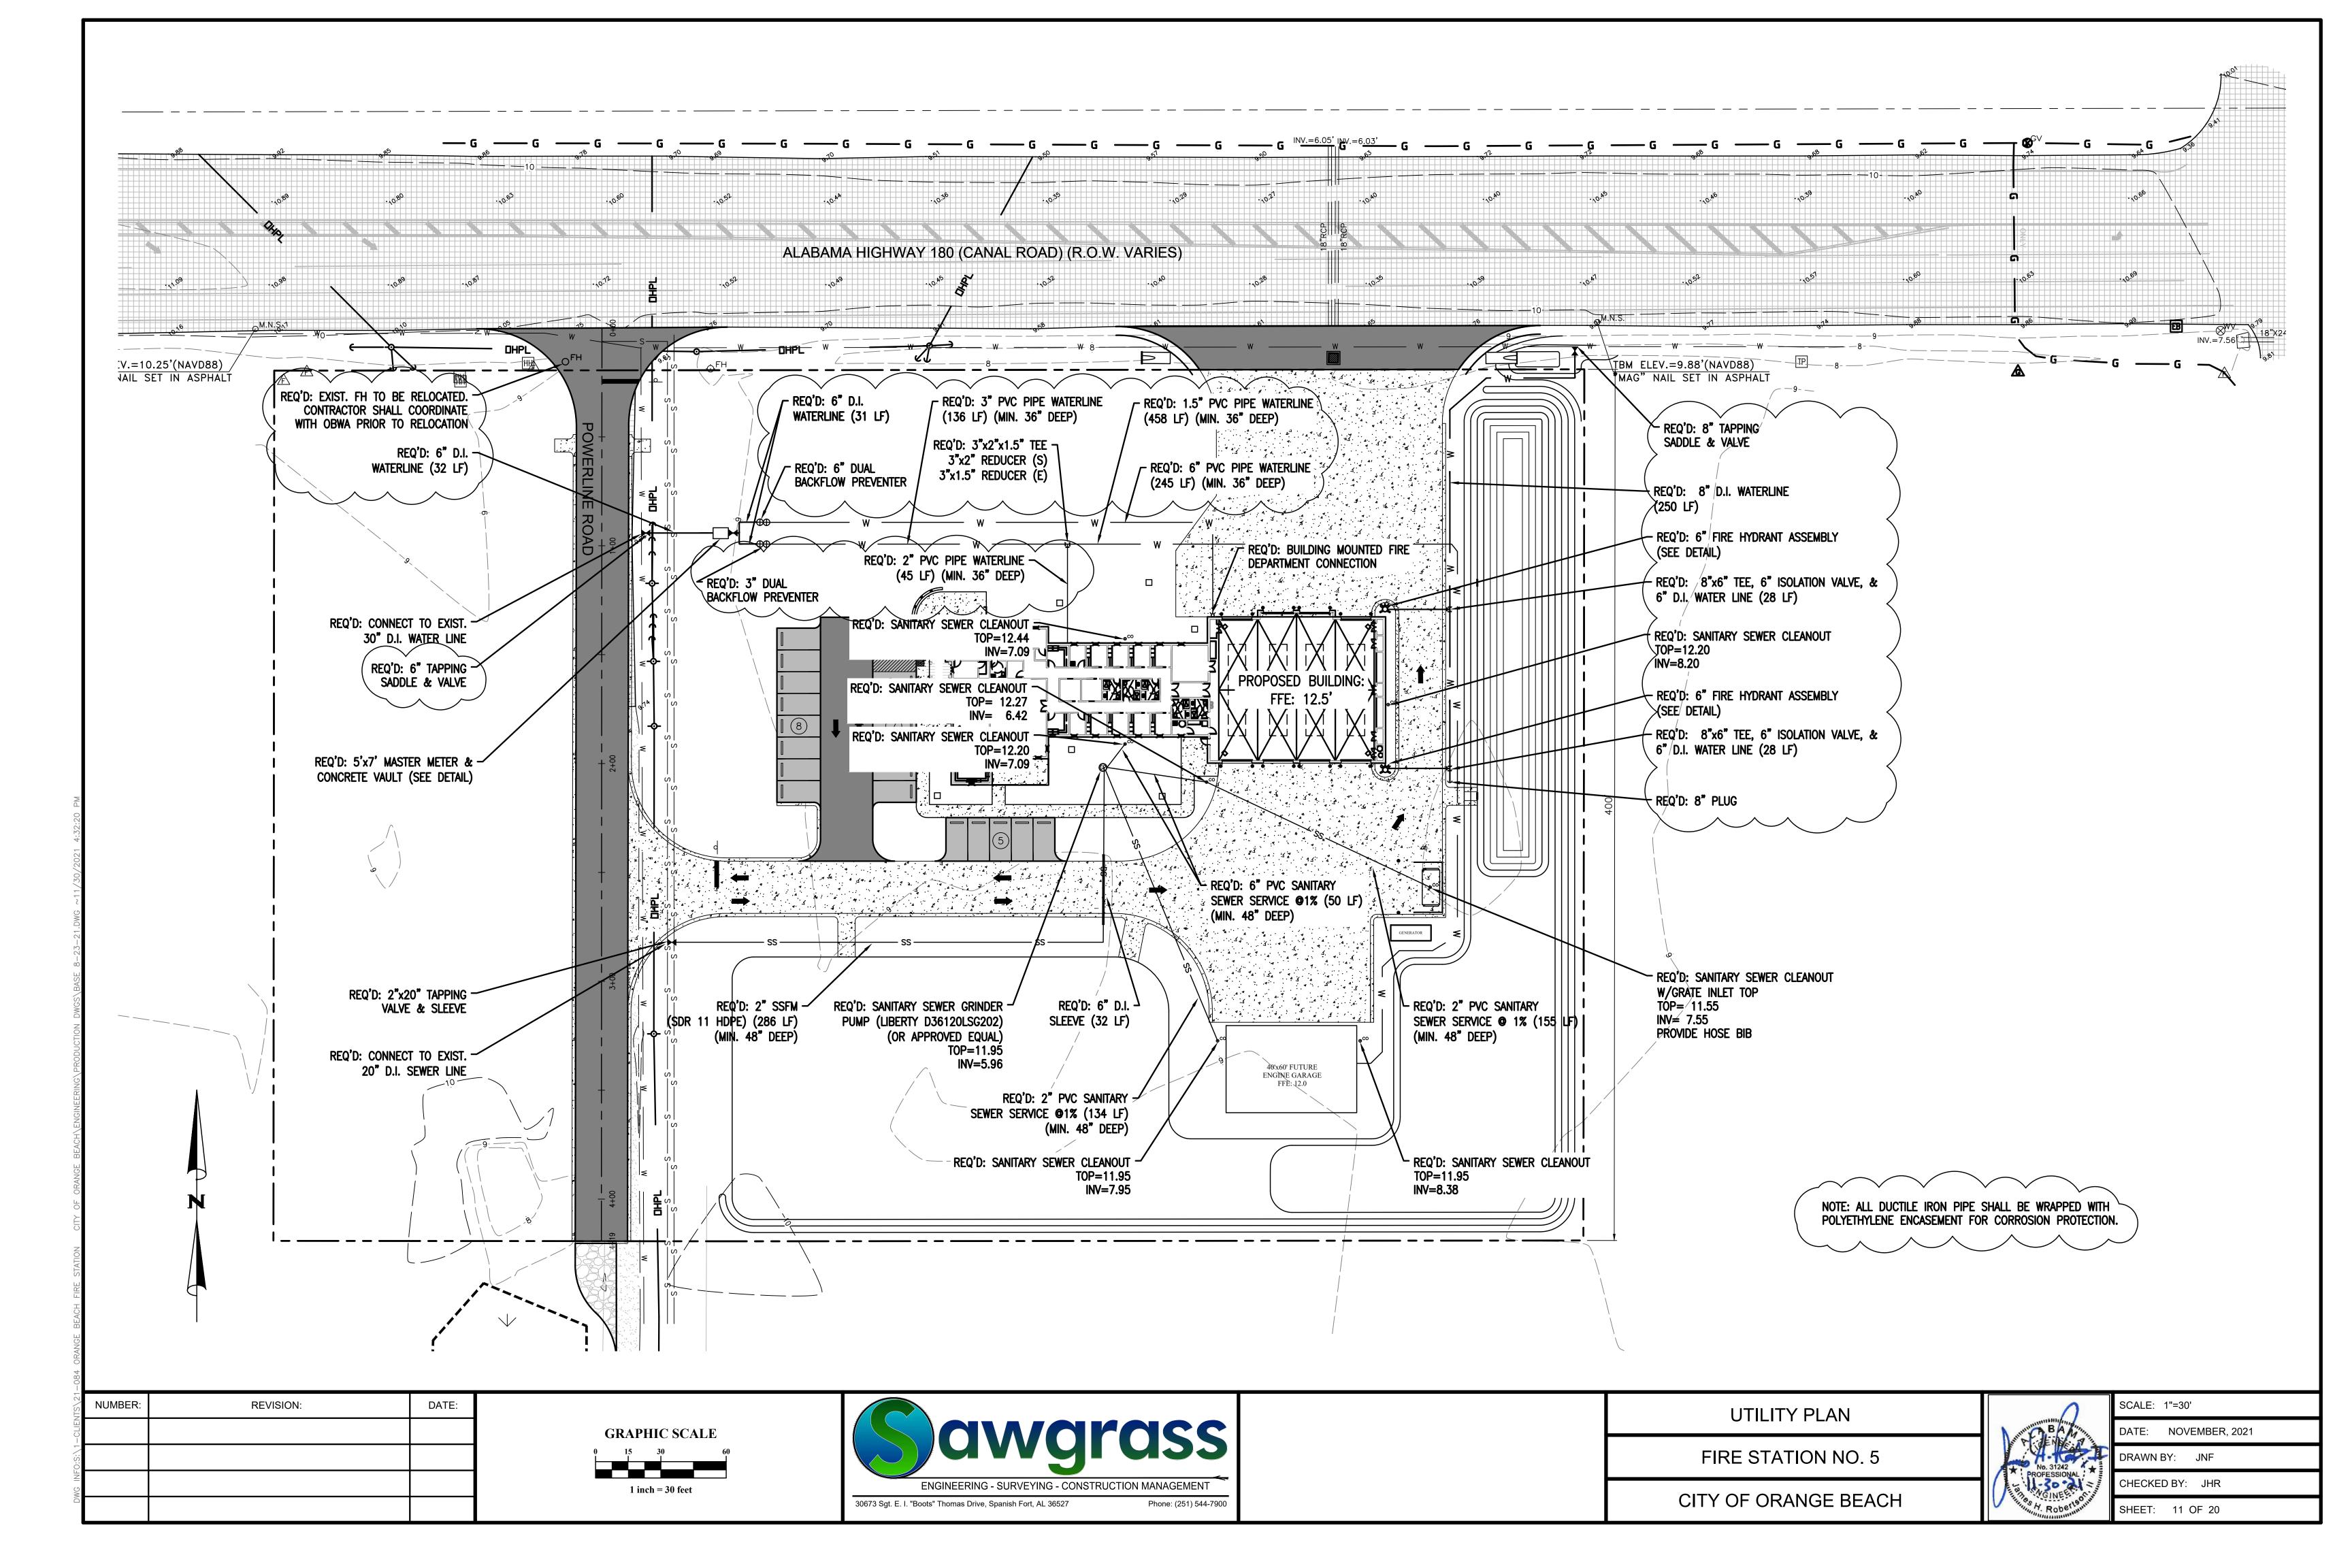

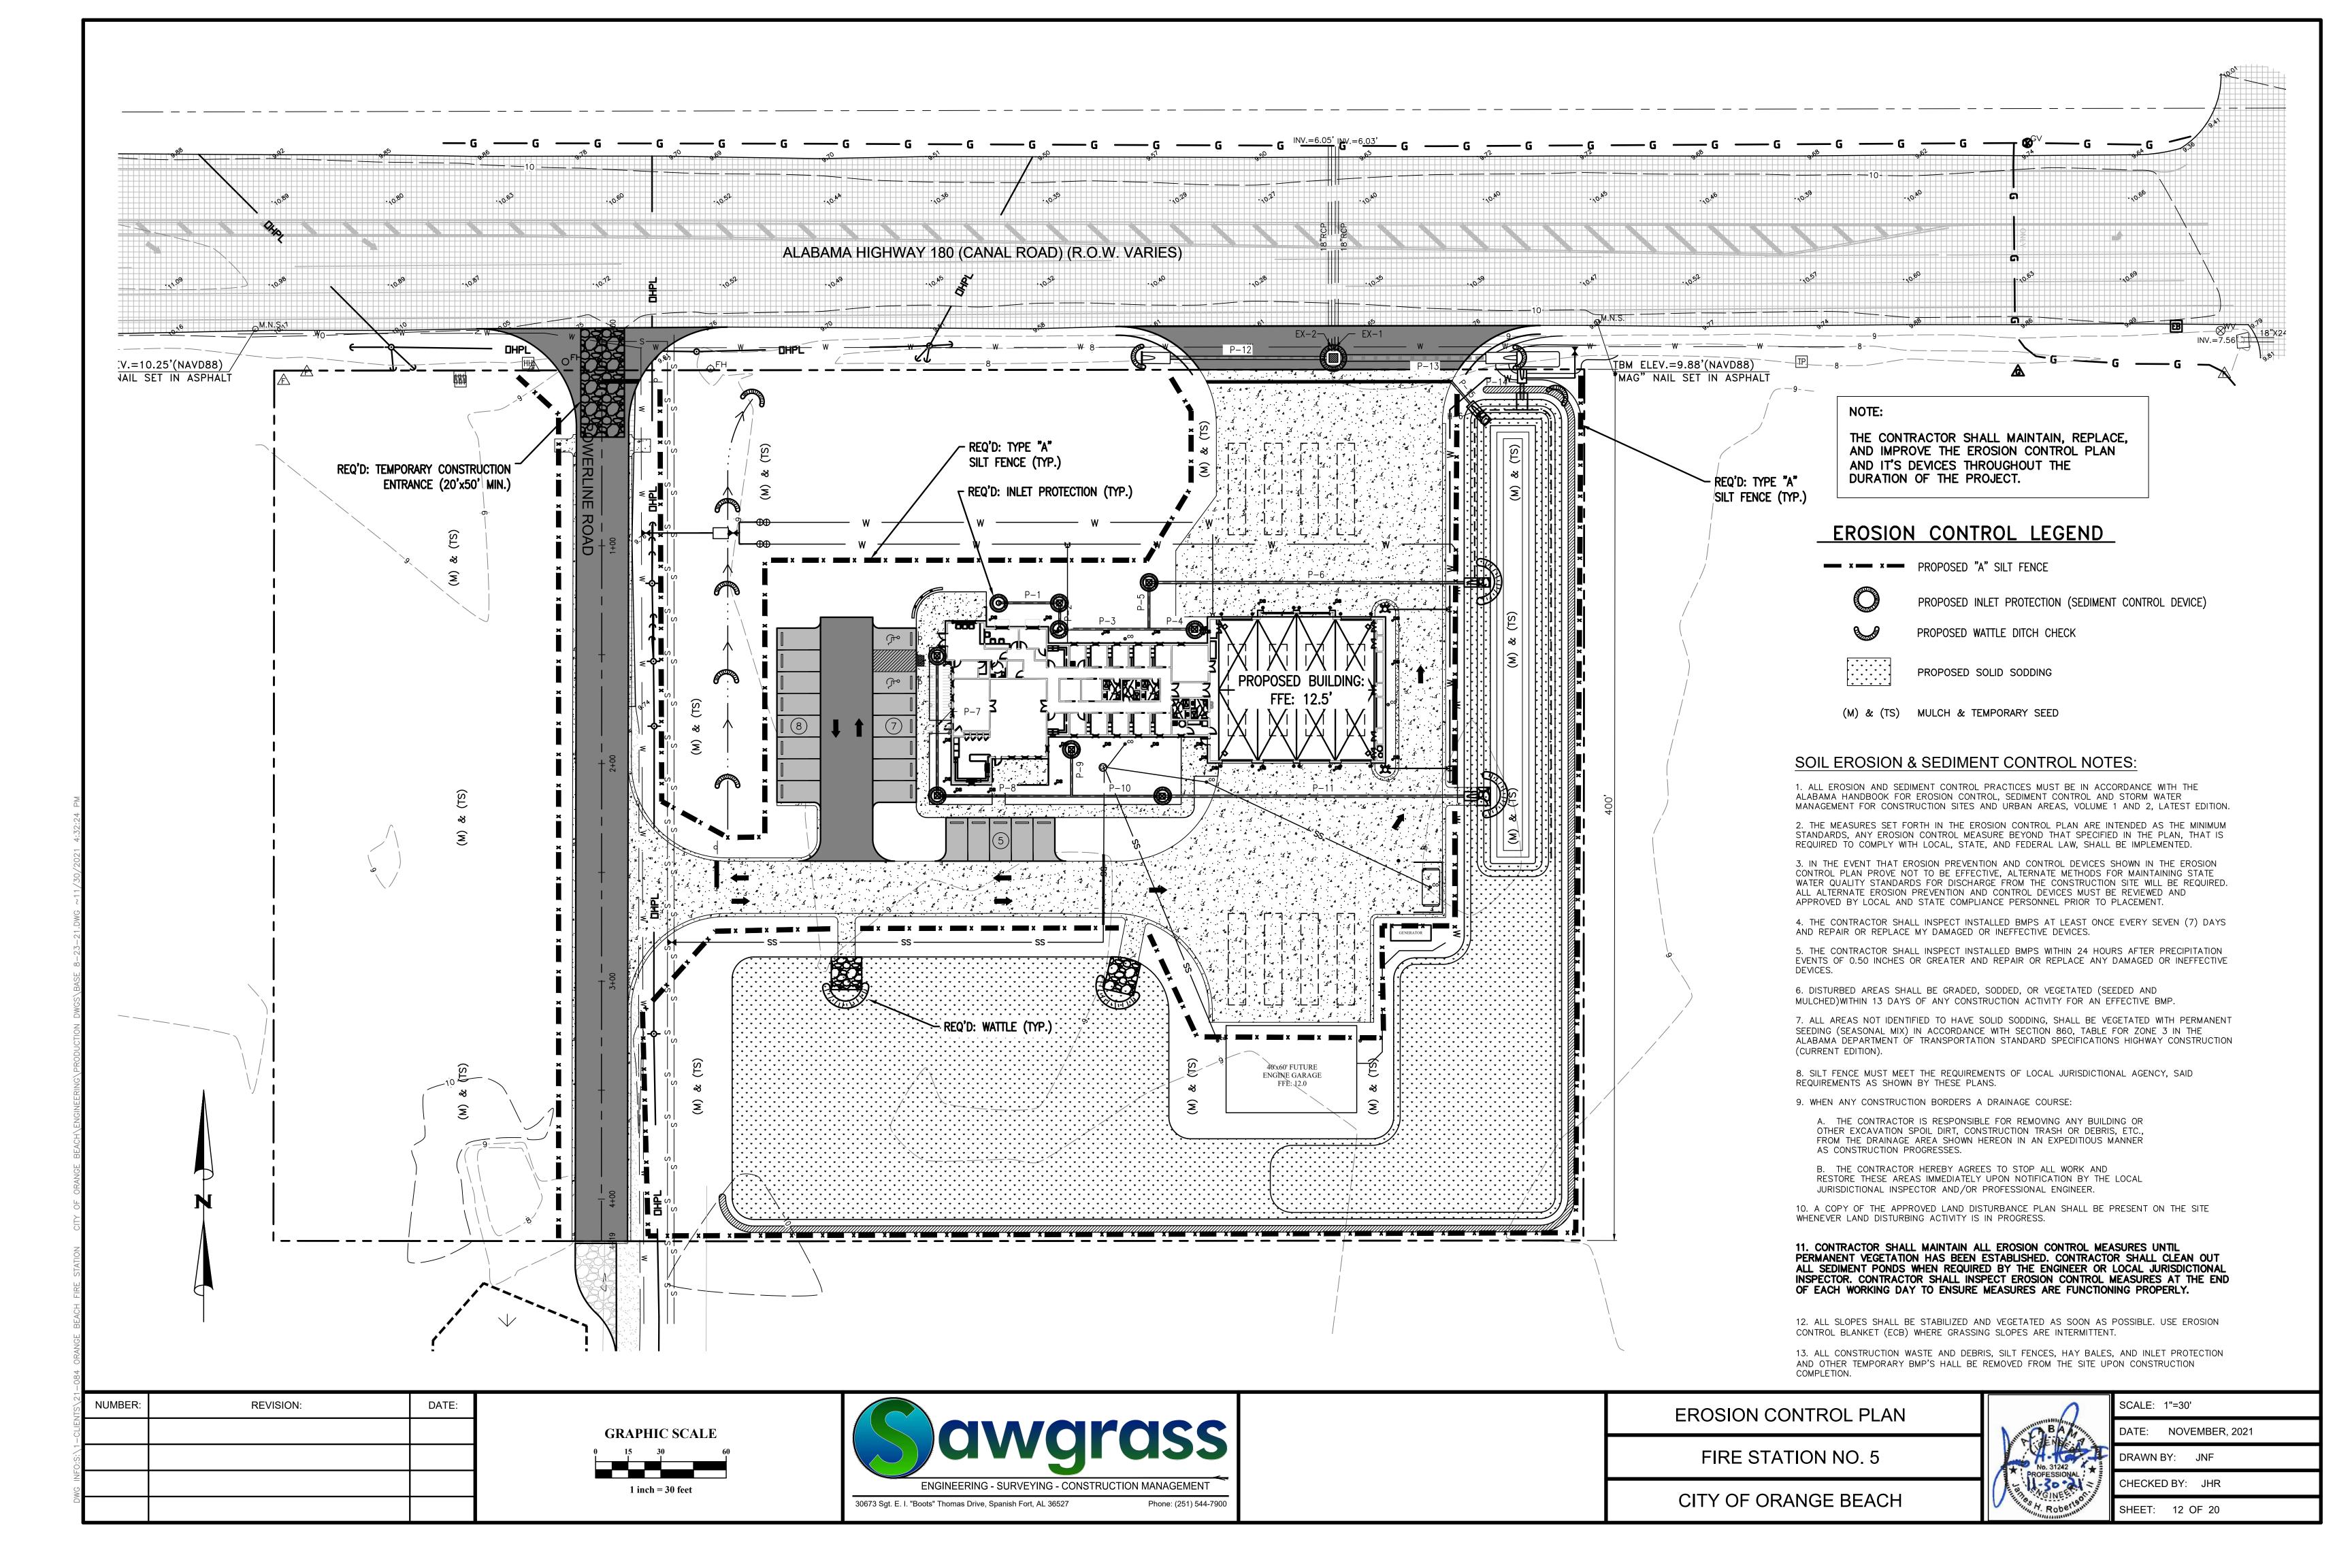

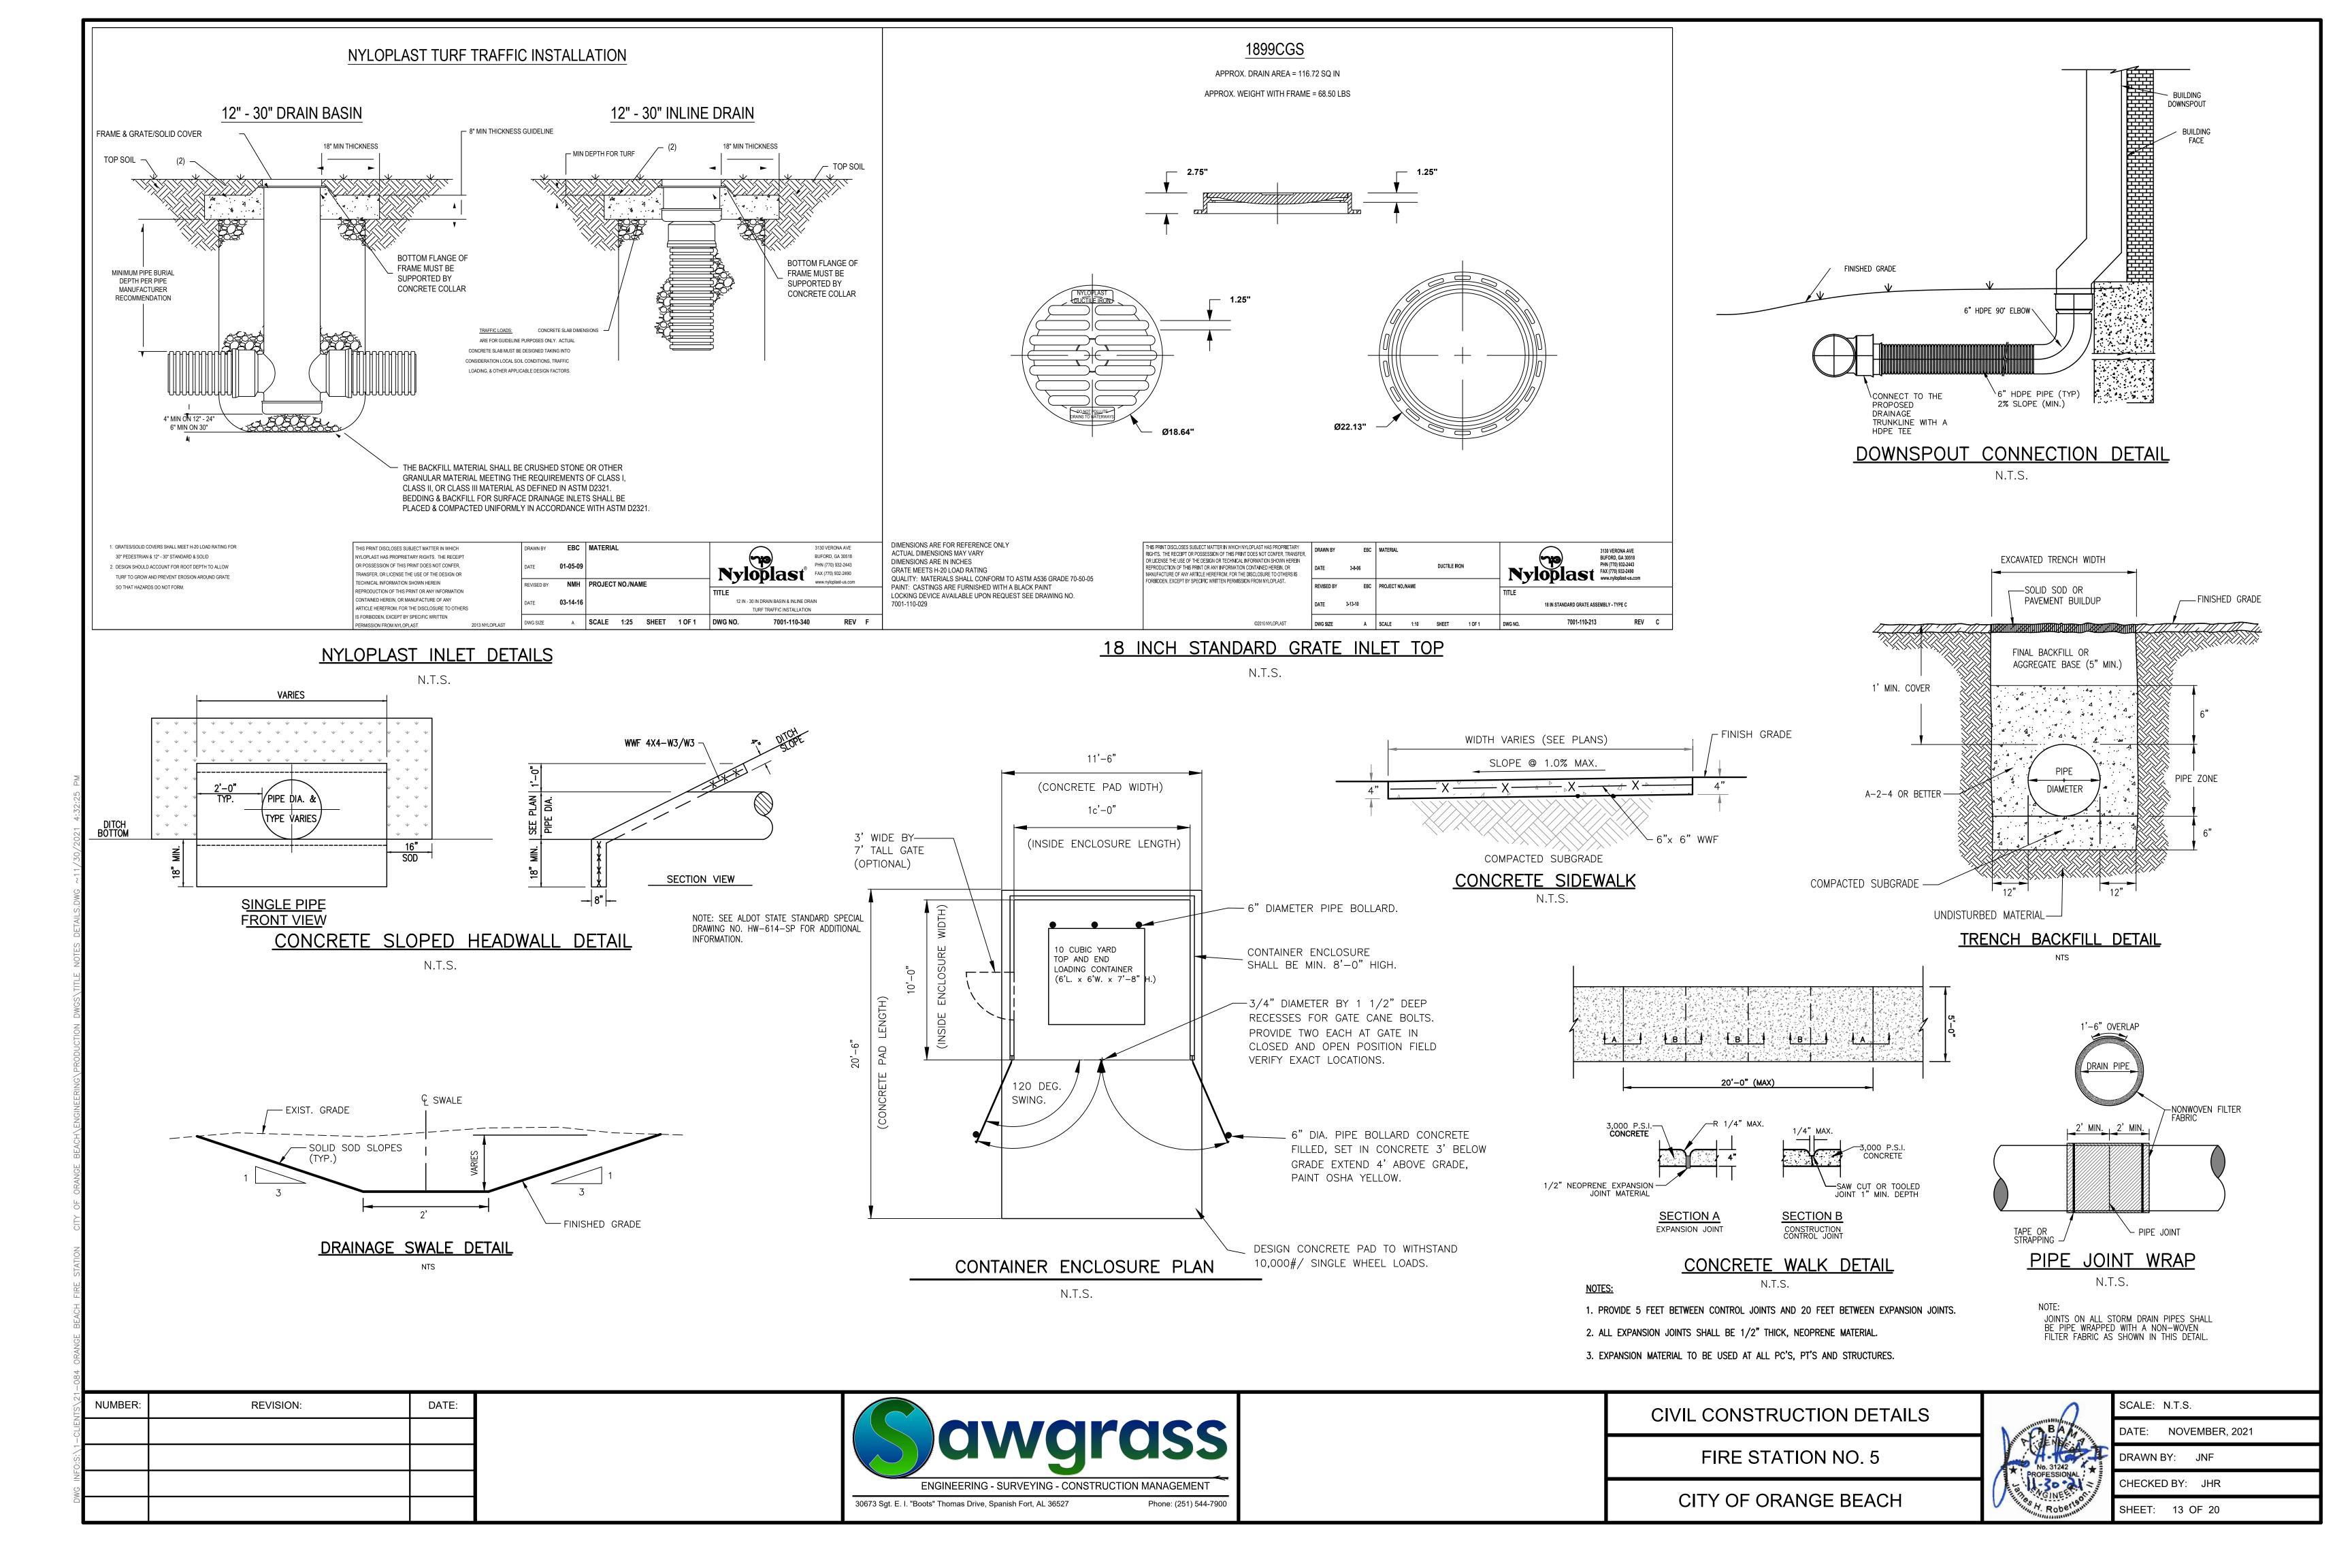

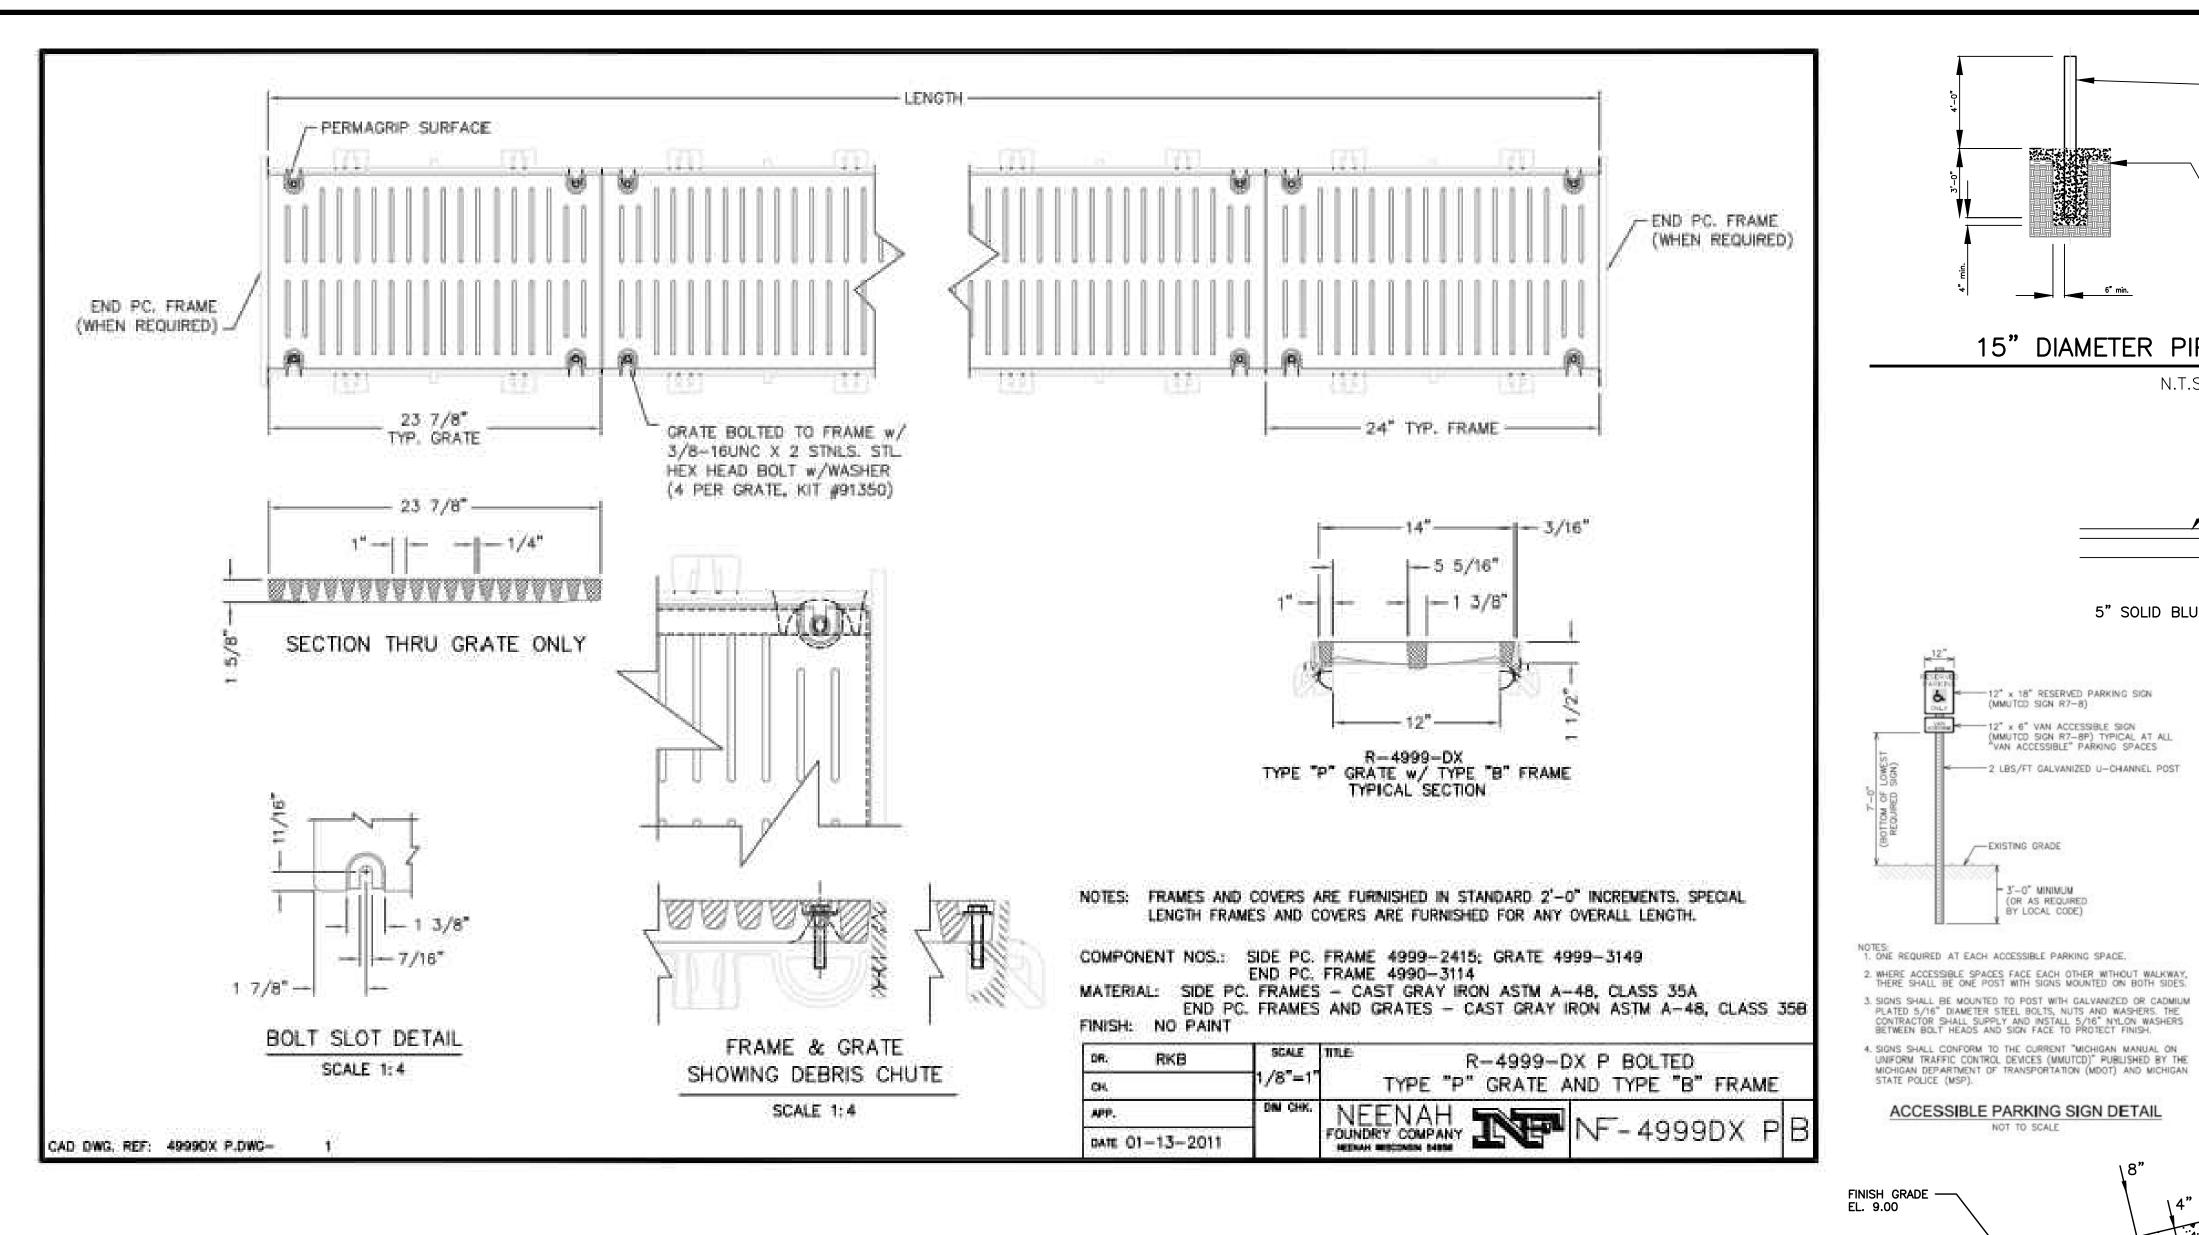

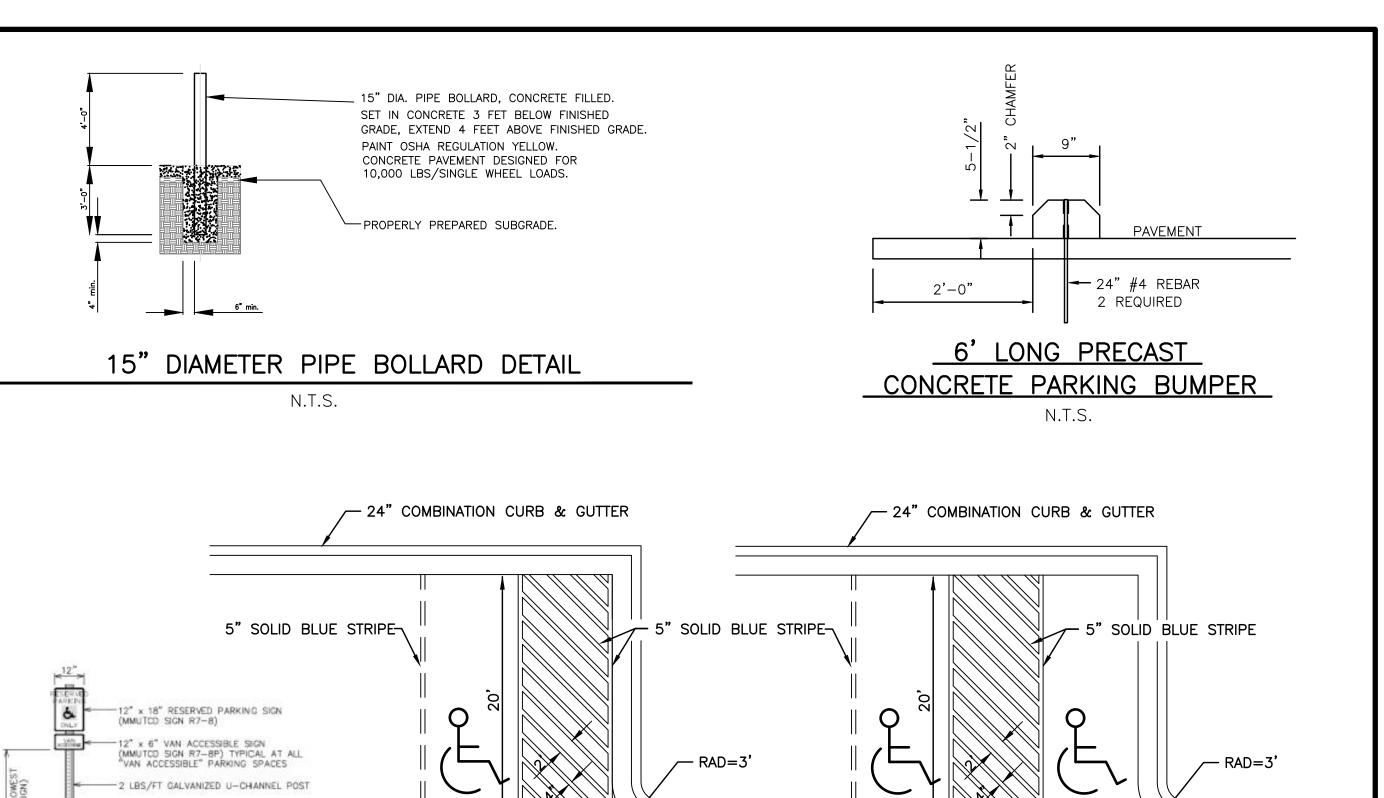

HANDICAPPED PARKING STRIPING DETAIL


PARKING STRIPING SHALL BE DONE PER THE REQUIREMENTS OF ALDOT ITEM

ACCESS AISLES STRIPED AT TWO FEET ON CENTER AND STANDARD HANDICAPPED

701-A SOLID WHITE CLASS 1, TYPE A, 5" WIDE STRIPES. MATERIALS AND

HANDICAPPED PARKING SPACES SHALL BE STRIPED IN SOLID BLUE, WITH

CONSTRUCTION REQUIREMENTS OF 701-A, SHALL BE ADHERED TO.

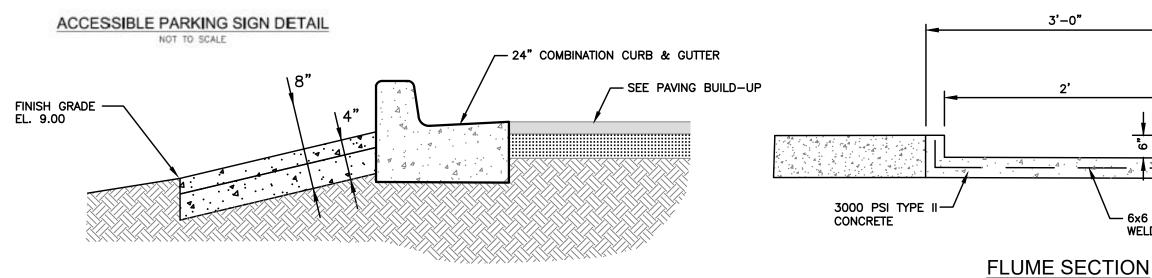

SYMBOLS.



EVENT PRE (CFS)			
2-YR	2.70	0.79	8.02
5-YR 3.25		1.01	8.13
10-YR	3.70	1.21	8.22
25-YR	4.38	1.52	8.35
50-YR	4.92	1.78	8.46

FLUME SIDE VIEW

FINISHED GRADE CRUSHED AGGREGATE — PEA GRAVEL OR CRUSHED STONE NON-WOVEN, 7 OZ. - 6" PERFORATED DRAIN PIPE W/ FILTER SOCK DETAIL OF

6" UNDERDRAIN PIPE

N.T.S.

TYPICAL FLUME DETAIL

N.T.S.

— 6x6 W1.4x W1.4 WELDED WIRE FABRIC

CITY OF ORANGE BEACH

<u>DETENTION POND CALCULATIONS</u>

-EXISTING GRADE

- 3'-0" MINIMUM

(OR AS REQUIRED BY LOCAL CODE)

CIVIL CONSTRUCTION DETAILS FIRE STATION NO. 5

0	SCALE: N.T.S.
BA A	DATE: NOVEMBER, 2021
No. 31242	DRAWN BY: JNF
PROFESSIONAL	CHECKED BY: JHR
A Roberts Structure	SHEET: 14 OF 20

NGINEERING \ PRODUCTION D	4'-0" ————————————————————————————————————	WEIR OPENING (ALL SIDES) WEIR OPENING (ALL SIDES) WEIR #3 (POND SIDE ONL) EL: 9.50
OF ORANGE BEACH LEN	EL=8.13 (5 YR) P-14 OUTFALL STRUCTURE INV=7.00 EL=7.00 BOTTOM OF POND	CONNECT 6" U.D. FOR CITY OF ORANGE BEACH
SIAIION CIIY	#4 BARS @ 12" O.C. — BOTH WAYS	WATER QUALITY SPECS 8" WEIR #1 EL: 7.00 CONNECT 6" U.D. FOR CITY OF ORANGE BEACH WATER QUALITY SPECS #4 BARS @ 12" O.C. BOTH WAYS
CH FIK	SIDE VIEW	FRONT VIEW


CONCRETE OUTFALL STRUCTURE N.T.S.

NUMBER:	REVISION:	DATE:	
			i

LID AND FRAME TOP EL: 10.50

Gawgr	dss
ENGINEERING - SURVEYING - CONSTRU	CTION MANAGEMENT
30673 Sgt. E. I. "Boots" Thomas Drive, Spanish Fort, AL 36527	Phone: (251) 544-7900

LID AND FRAME TOP EL: 10.50

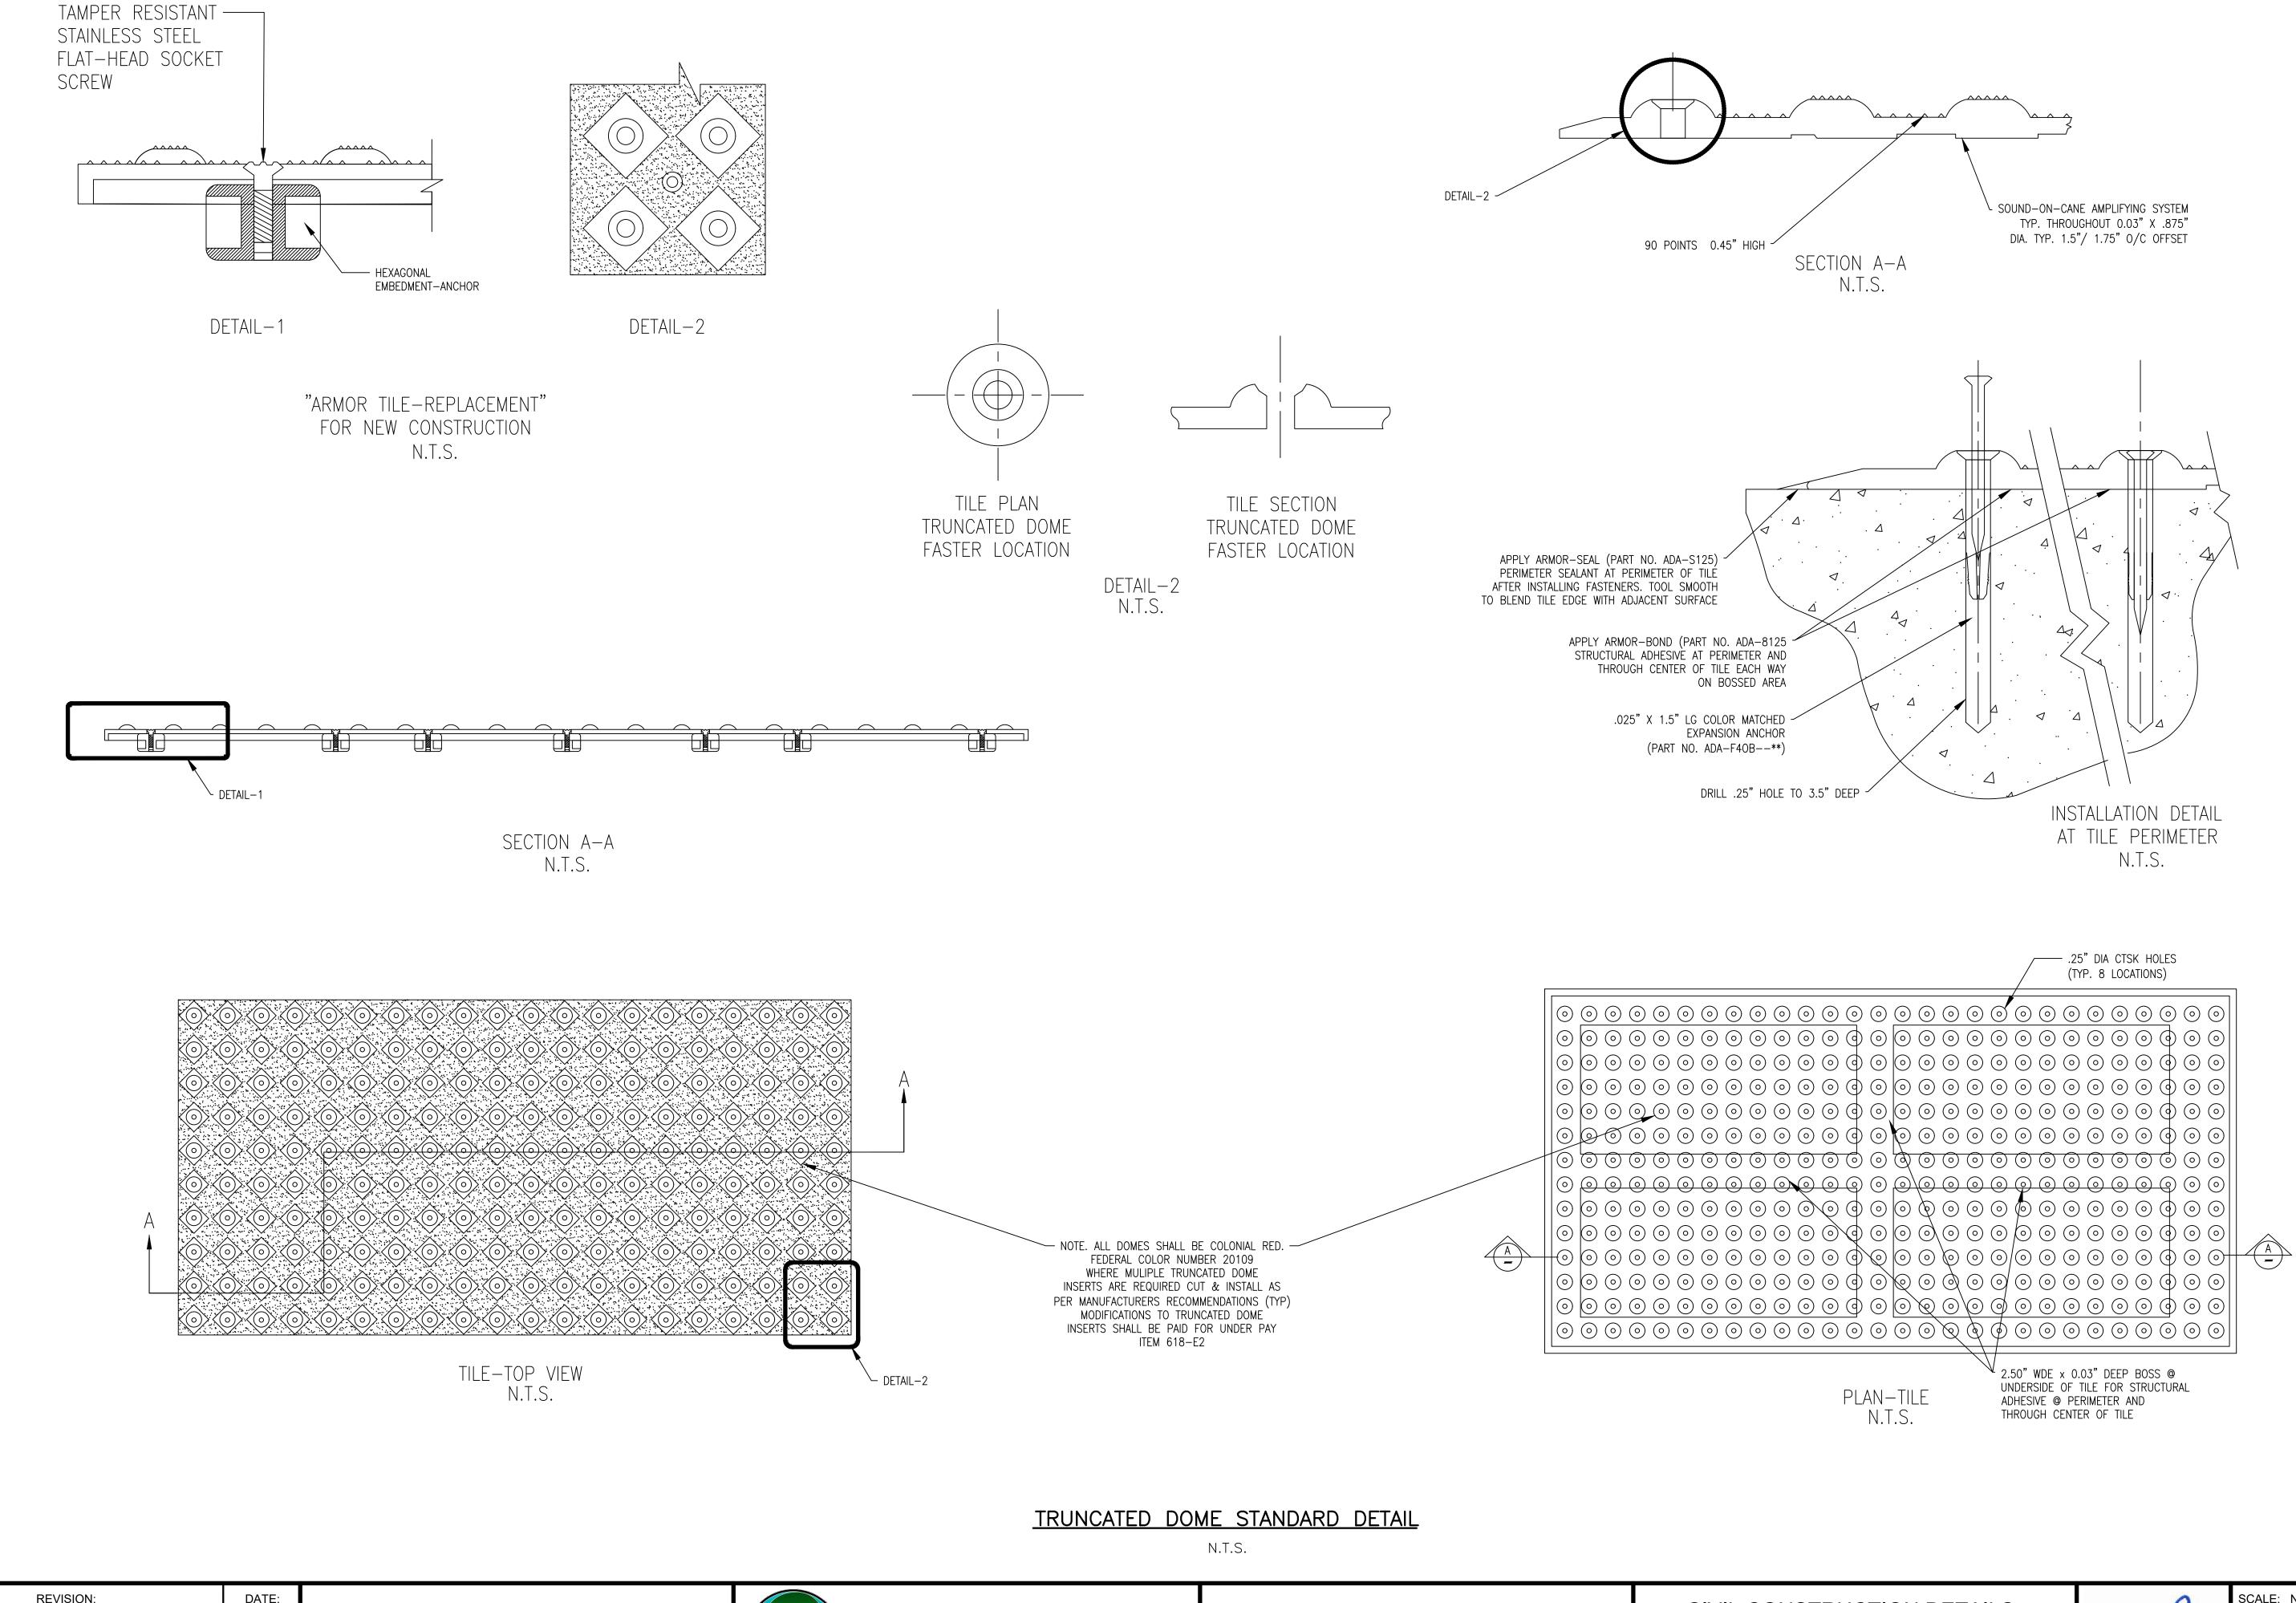

NUMBER: REVISION: DATE:

DATE:



CIVIL CONSTRUCTION DETAILS

FIRE STATION NO. 5

CITY OF ORANGE BEACH





DATE: NOVEMBER, 2021

DRAWN BY: JNF

CHECKED BY: JHR

SHEET: 15 OF 20

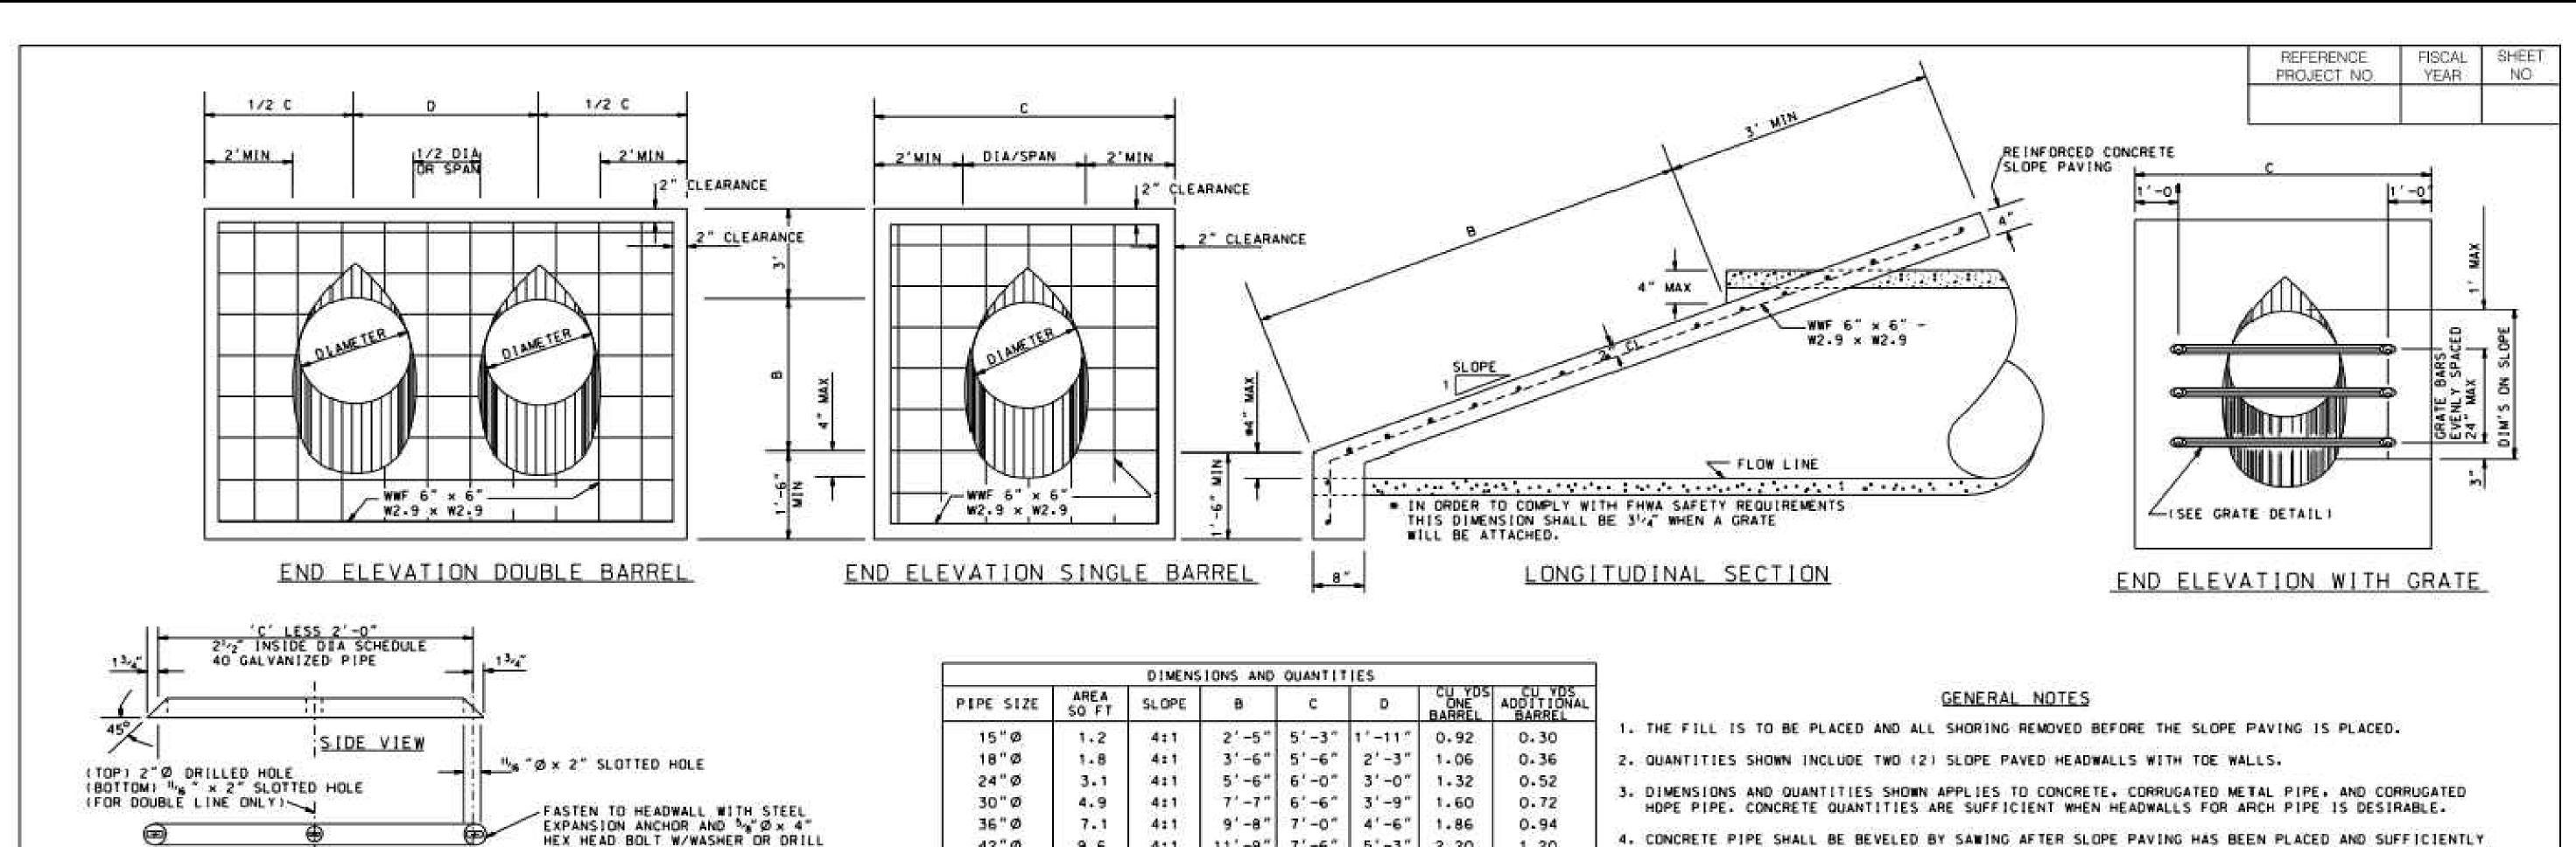

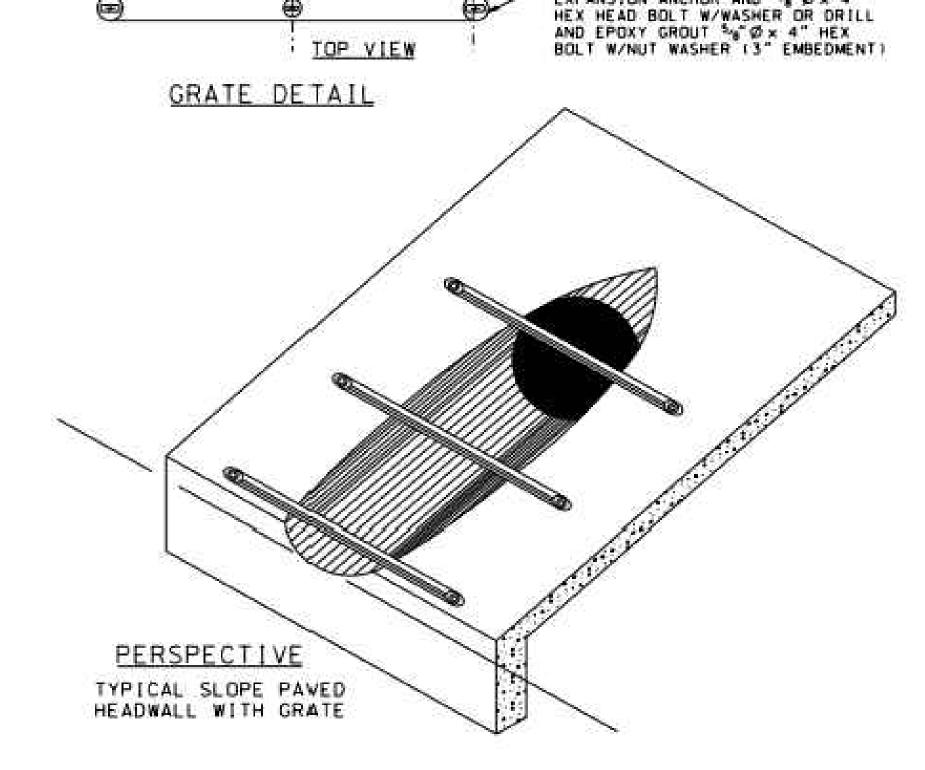

PIPE SIZE	AREA SO FT	SLOPE	SIONS AND B	C	D	CU YDS ONE BARREL	ADDITIONA BARREL
15"Ø	1.2	4:1	2'-5"	5'-3"	1*-117	0.92	0.30
18"Ø	1.8	4:1	3'-6"	5'-6"	2'-3"	1.06	0.36
24"Ø	3.1	4:1	5'-6"	6'-0"	3'-0"	1.32	0.52
30"Ø	4.9	4:1	7'-7"	6'-6"	3'-9"	1.60	0.72
36"∅	7.1	4:1	9'-8"	7'-0"	4"-6"	1.86	0.94
42"Ø	9.6	4:1	11'-9"	7'-6"	5'-3"	2.20	1.20
48 " Ø	12.6	4:1	13"-9"	8'-0"	6'-0"	2.40	1.46
54"Ø	15.9	4:1	15'-10"	8'-6"	6'-9"	2.60	1.76
15 "Ø	1.2	6:1	3'-7"	5'-3"	1"-11"	1.04	0.30
18"Ø	1.8	6:1	5'-1"	5'-6"	2'-3"	1.22	0.40
24"Ø	3.1	6:1	8'-1"	6'-0"	3'-0"	1.58	0.60
30"Ø	4.9	6:1	11'-2"	6'-6"	3'-9"	1.94	0.84
36"Ø	7.1	6:1	14'-2"	7'-0"	4"-6"	2.30	1.12
42"Ø	9.6	6:1	17'-3"	7'-6"	5'-3"	2.68	1.42
48 " Ø	12.6	6:1	20'-3"	B'-0"	6'-0"	3.04	1.78
54"Ø	15.9	6:1	23'-4"	8'-6"	6'-9"	3.40	2.18
15"Ø	1.2	10:1	5'-10"	5'-3"	1'-11"	1.24	0.32
18"∅	1.8	10:1	8'-4"	5'-6"	2"-3"	1.54	0.46
24"Ø	3.1	10:1	13'-5"	6'-0"	3"-0"	2.08	0.72
30"Ø	4.9	10:1	18'-5"	6'-6"	3'~9"	2.66	1.06
36"Ø	7.1	10:1	23"-5"	7'-0"	4"-6"	3.20	1.46
42"Ø	9.6	10:1	28'-6"	7'-6"	5'~3"	3.78	1.90
48 " Ø	12.6	10:1	33'-6"	8,-0,	6'-0"	4.32	2.42
54"Ø	15.9	10:1	38'-6"	8'-6"	6'-9"	4.88	3.02
15"Ø	1.2	20:1	11'-9"	5'-3"	1'-11"	1.84	0.42
18"Ø	1.8	20:1	16"-8"	5'-6"	2'-3"	2.40	0.62
24"Ø	3.1	20:1	261-8"	6,-0,	3'-0"	3.38	1.06

- 4. CONCRETE PIPE SHALL BE BEVELED BY SAWING AFTER SLOPE PAVING HAS BEEN PLACED AND SUFFICIENTLY CURED (SOME HAND FINISHING MAY BE NECESSARY.) WETAL PIPE SHALL BE SHOP CUT. CORRUGATED HDPE PIPE MAY BE FIELD BEVELED PRIOR TO PAVING OR SHOP CUT.
- 5. CONTRACTOR SHALL INSURE THROUGH MECHANICAL MEANS OR OTHER APPROVED DEVICES THAT CONNECTION BETWEEN BEVELED PIPE END AND CONCRETE WILL NOT BE DETACHED. CORRUGATED HOPE PIPE SHALL HAVE 12" Ø x 6" GALVANIZED HODK BOLTS WITH WASHERS LOCATED AT 30" OC FOR THE TOE AND "2" Ø x 6" GALVANIZED THREADED HEX HEAD BOLTS WITH WASHERS LOCATED ON 2'-0" CENTERS FOR SIDES. ANCHOR BOLTS INTO CONCRETE.
- 6. SLOPE PAVED HEADWALL WITHOUT GRATE SHALL BE CLASS 1. SLOPE PAVED HEADWALL WITH GRATE SHALL BE CLASS 2.
- 7. A 24" PIPE WITH GREATER THAN A 30" SKEW AND 30" OR GREATER IN DIAMETER SHALL HAVE A CLASS 2 END TREATMENT WHEN TERMINATED WITHIN THE CLEAR ZONE.
- 8. PIPE FOR GRATE SHALL BE SCHEDULE 40. GALVANIZED (ASTM A53) HARDWARE SHALL BE GALVANIZED ACCORDING TO SPECIFICATIONS.
- 9. RAW METAL EXPOSED BY CUTTING AND DRILLING OF PIPE FOR GRATE ASSEMBLY WILL REQUIRE A GALVANIZING REPAIR PAINT IN ACCORDANCE WITH SECTION 855.31 OF ALDOT SPECIFICATIONS.

--SPECIFICATIONS--

CURRENT ALABAMA DEPARTMENT OF TRANSPORTATION

THIS DRAWING REPRESENTS DESIGNS PREPARED FOR USE BY THE ALABAMA DEPARTMENT OF TRANSPORTATION AND IS NOT TO BE COPIED, REPRODUCED, ALTERED, OR USED BY ANYONE, OR ANY ORGANIZATION, WITHOUT THE EXPRESSED WRITTEN CONSENT OF THE ALABAMA DEPARTMENT OF TRANSPORTATION REPRESENTATIVE AUTHORIZED TO APPROVE THIS USE, ANYONE MAKING UNWITHORIZED USE OF THIS GRAWING MAY BE PROSECUTED TO THE FULLEST EXTENT OF THE LAW.

Changed notes 5, 4, 6, 5 to allow the use of 40% plac. 56-12-97 by C.J.S. Adjusted Note No. 7 requiring use of Grate on 01-02-05 by 8.8.4.

ALABAMA DEPARTMENT OF TRANSPORTATION 1409 COLISEUM BOULEVARD MONTGOMERY, AL 36/30-3050

DESIGN BUREAU SPECIAL DRAWING

CONCRETE SLOPE PAVED HEADWALL AND GRATE FOR SIDEDRAIN PIPE

Bureau Sta Engri D.J.W. DRAWN 81- DATE DRAWN 02-08-91

SPECIAL DRAWING NO HW-614-SP

61913

NOT TO SCALE


NUMBER:	REVISION:	DATE:	
			ĺ






FIRE STATION NO. 5


CITY OF ORANGE BEACH

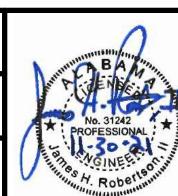


SCALE: N.T.S. DATE: NOVEMBER, 2021 DRAWN BY: JNF

CHECKED BY: JHR SHEET: 16 OF 20

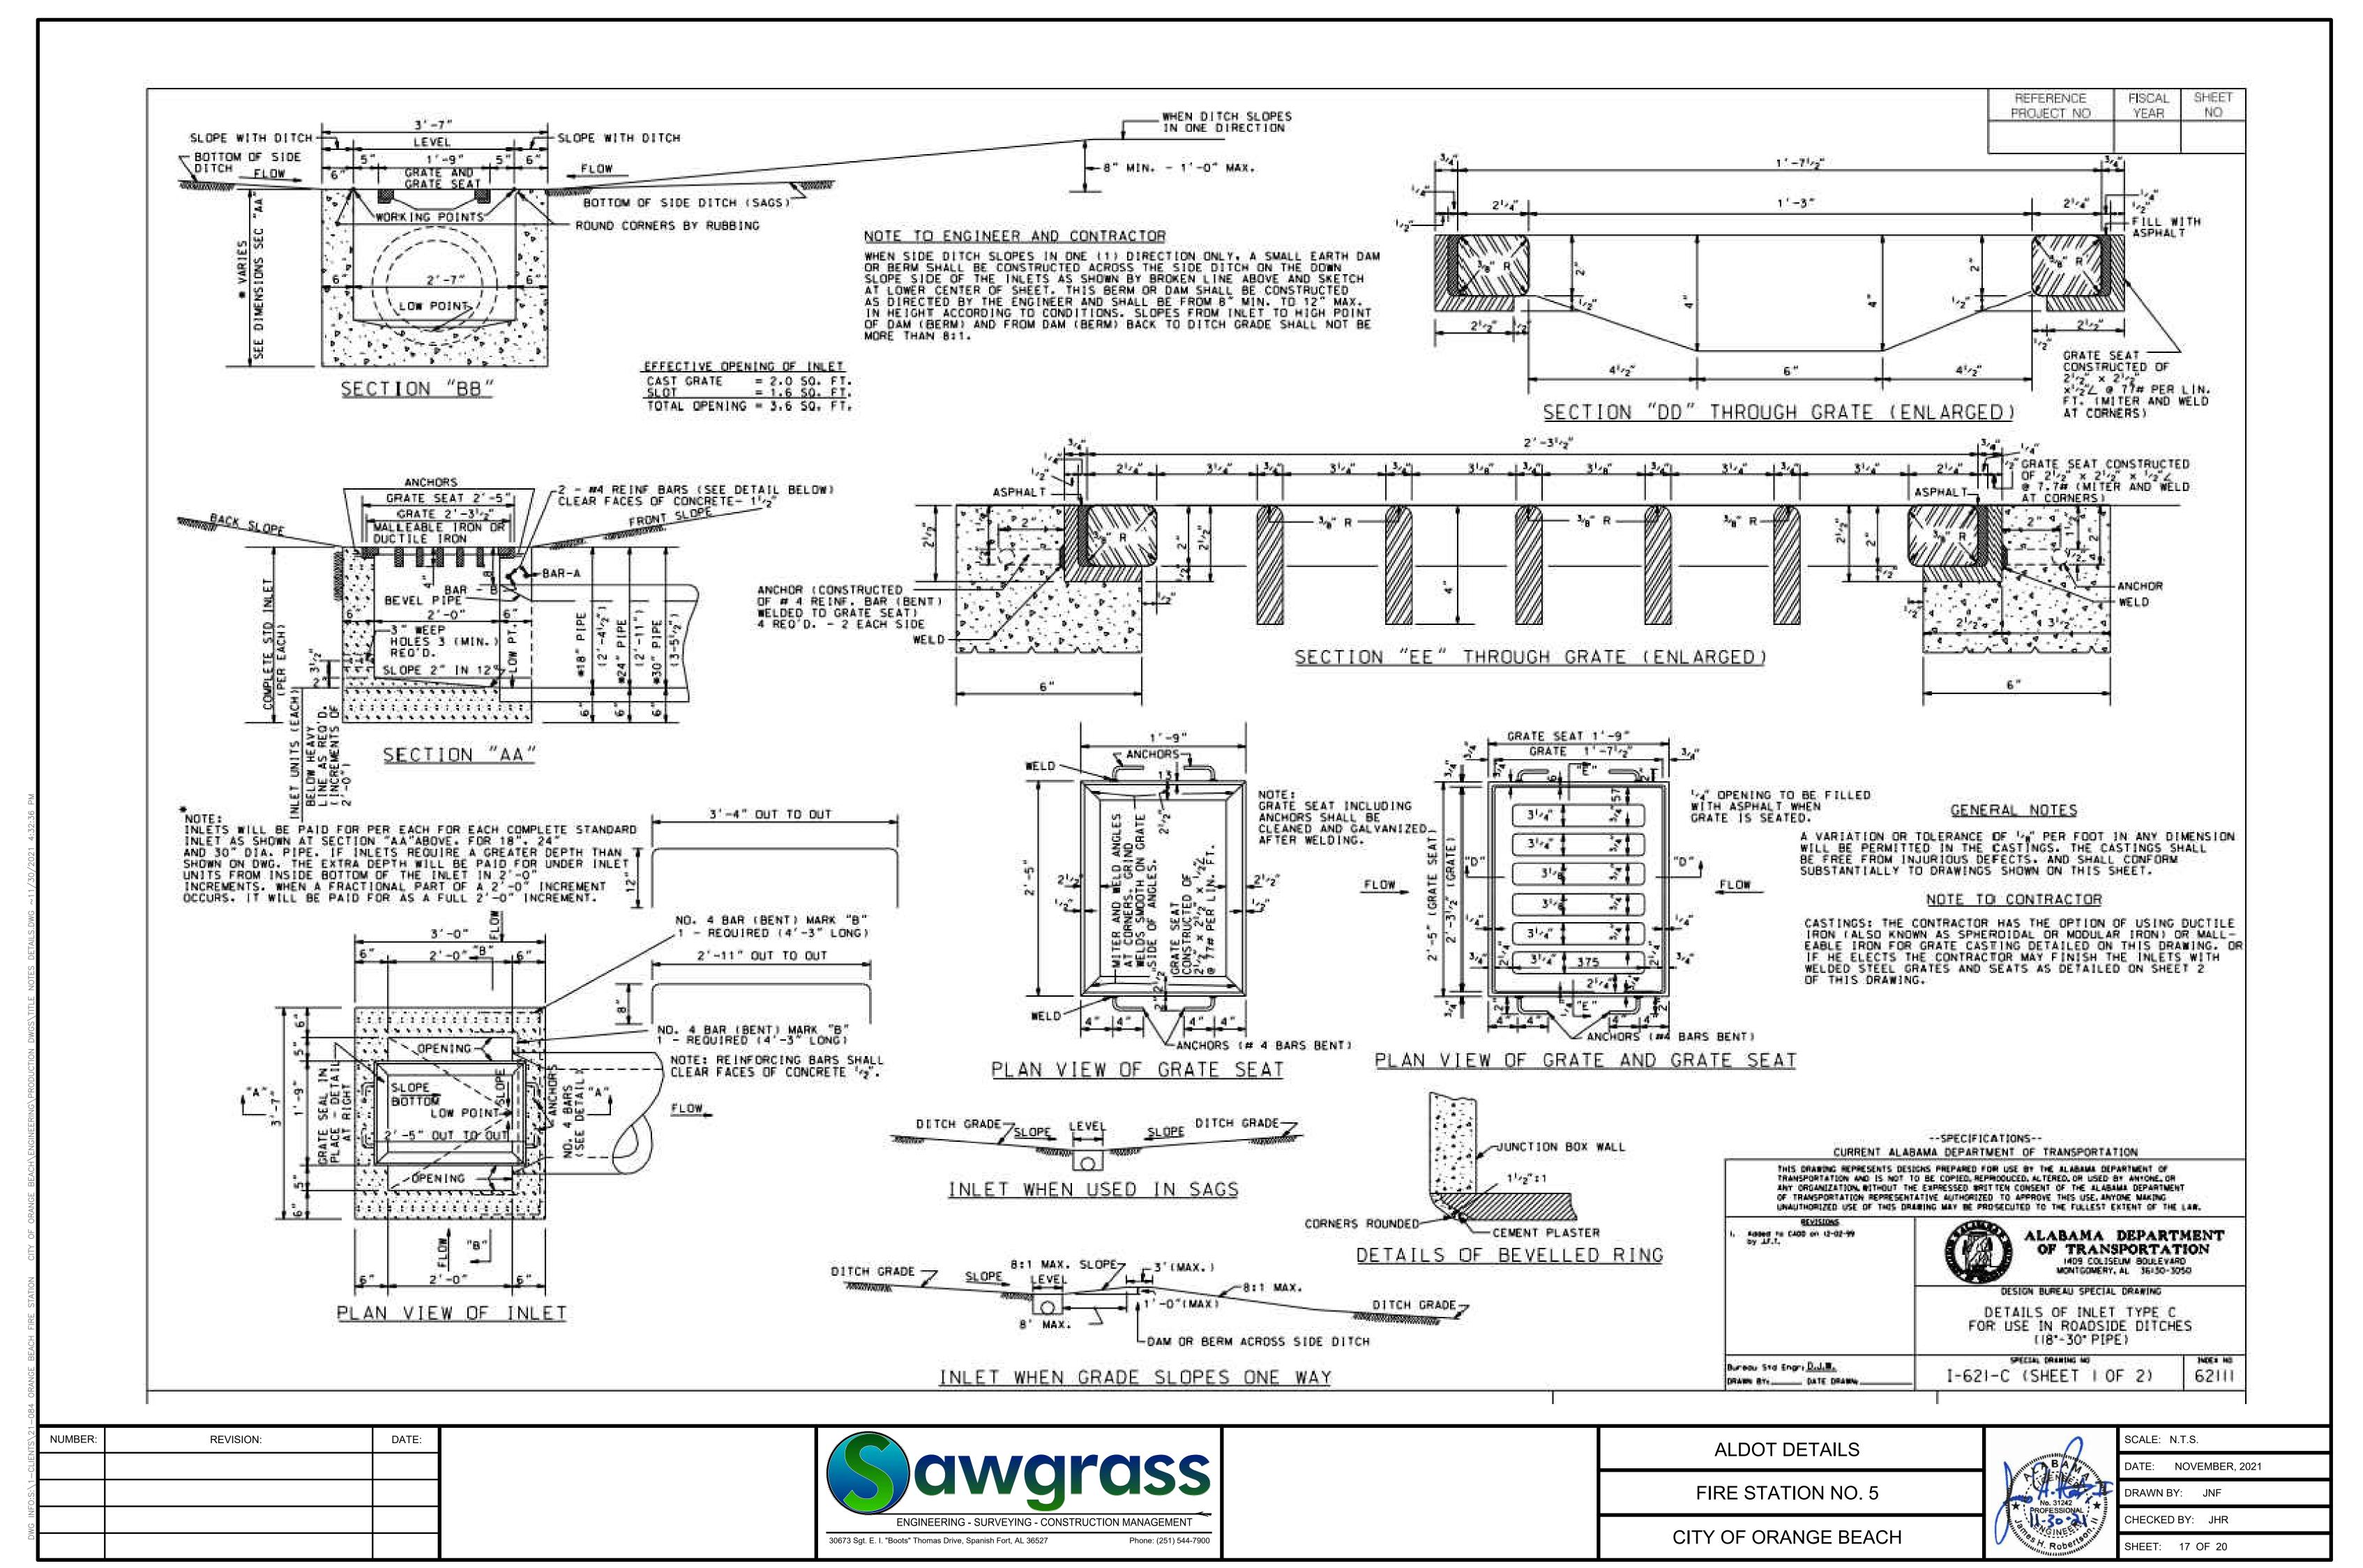

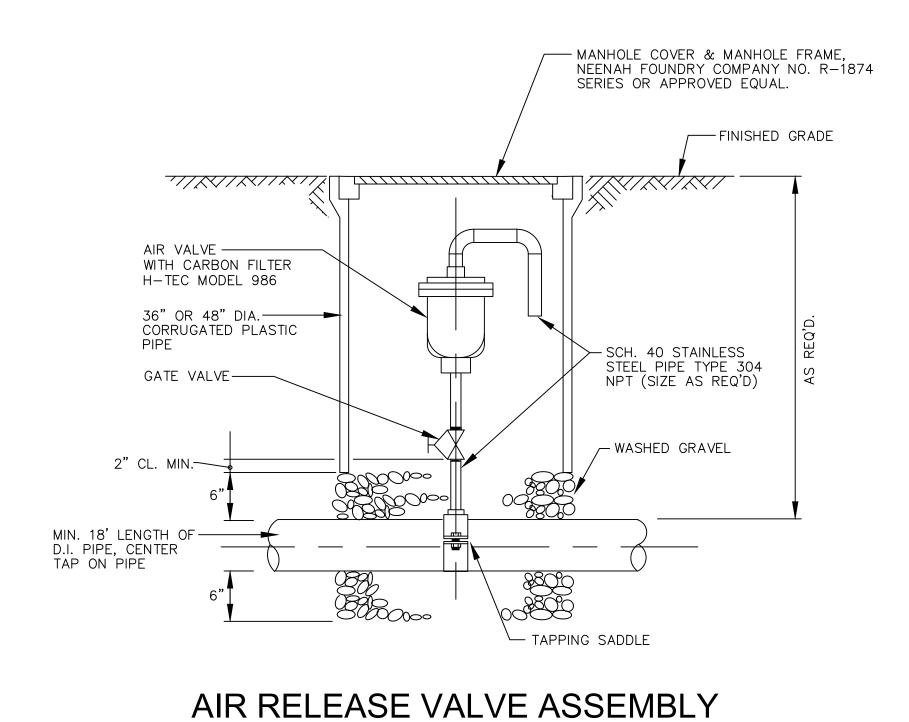


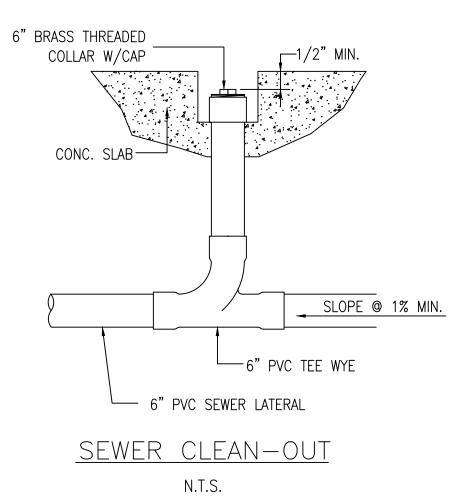

THRUST BLOCK BEARING AREAS (SQ.FT.)						VERTICAL ANCHOR BLOCK VOLUMES		
SIZE	PLUGGED END OR TEE	90° BEND	45° BEND	22-1/2° BEND	11-1/4° BEND	45° VERT. BEND	22-1/2° VERT. BEND	GATE VALVE
2" DIA. PIPE LINE	1.0	1.0	1.0	1.0	1.0	9.3 CU. FT.	4 CU. FT.	0.5 CU. FT.
4" DIA. PIPE LINE	1.9	2.6	1.4	1.0	1.0	21.1 CU. FT.	9.8 CU. FT.	0.8 CU. FT.
6" DIA. PIPE LINE	3.6	5.0	2.7	1.4	1.0	50 CU. FT.	16 CU. FT.	1.0 CU. FT.
8" DIA. PIPE LINE	5.8	8.2	4.4	2.25	1.2			1.5 CU. FT.

NOTE: THRUST BLOCK BEARING AREAS SHALL BE INCREASED IN POOR TRENCH CONDITIONS AS DIRECTED BY THE ENGINEER



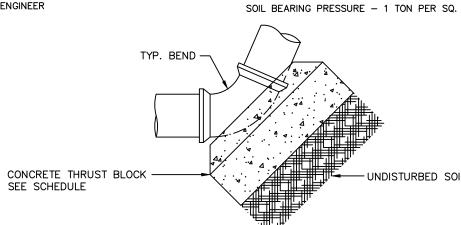

VERT. THRUST BLOCK DETAIL


THRUST BLOCK DETAIL

VERT. THRUST BLOCK DETAIL


UNDISTURBED SOIL-

CONCRETE THRUST BLOCK
SEE SCHEDULE


_ CONCRETE THRUST BLOCK SEE SCHEDULE

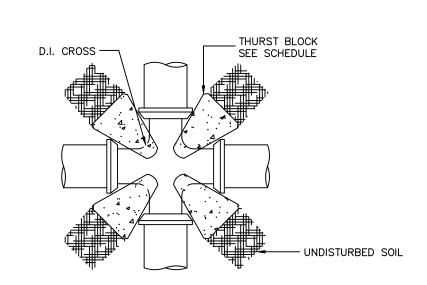


CROSS THRUST BLOCK DETAIL

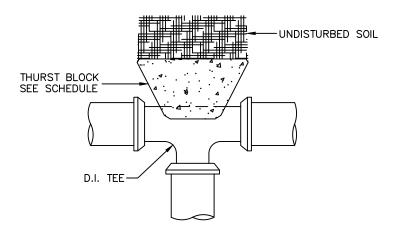



TEE THRUST BLOCK DETAIL

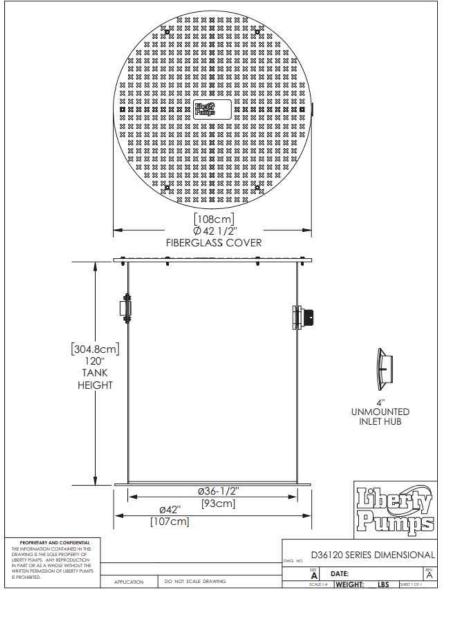

D36120LSG/LSGX-Series Dimensional Data

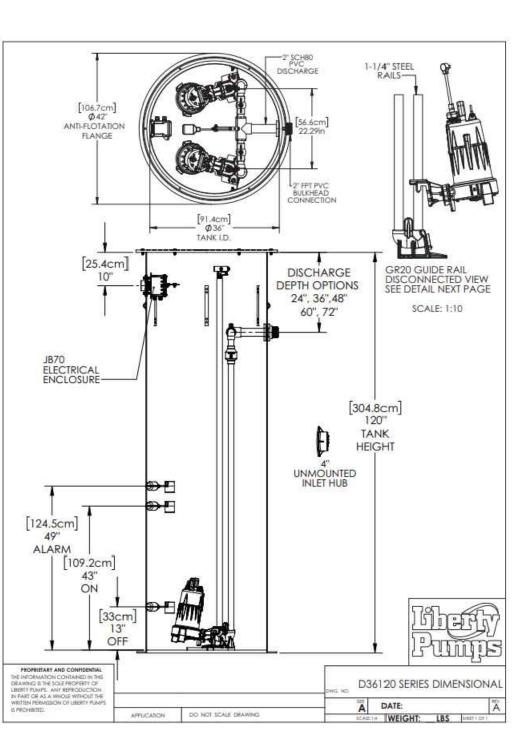

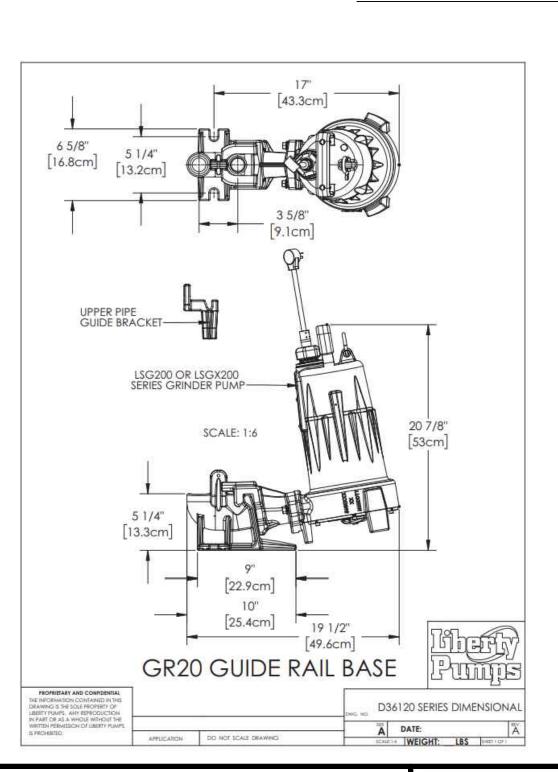


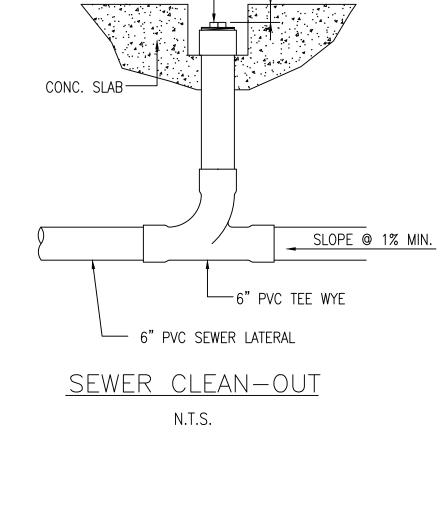


5/8 " DIA STEEL ROD -7

COVER OR PLUG -

__ LATERAL

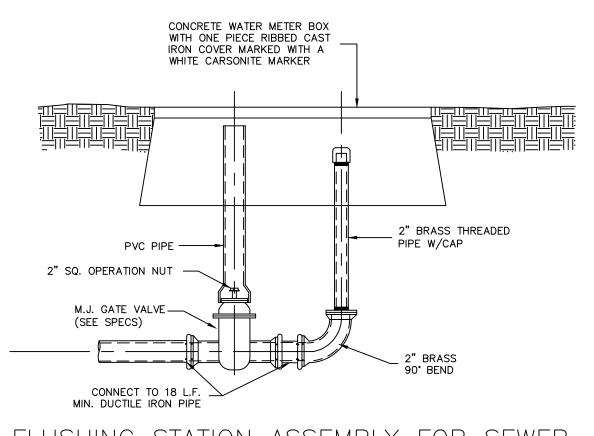


FLUSHING STATION ASSEMBLY FOR SEWER

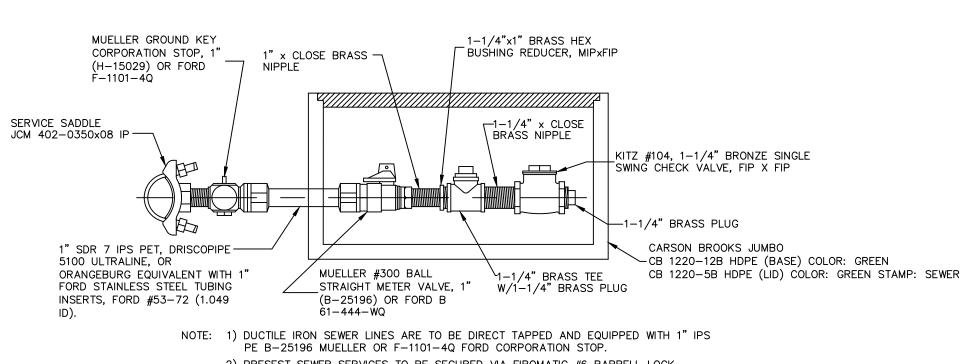

2) PRESEST SEWER SERVICES TO BE SECURED VIA FIROMATIC #6 BARRELL LOCK COMPLETE WITH NYLON DUST CAP. *SERVICE FITTINGS ARE I.P.S. PE CONDUCTIVE COMPRESSION AS INDICATED.

LOW PRESSURE SEWER SERVICE

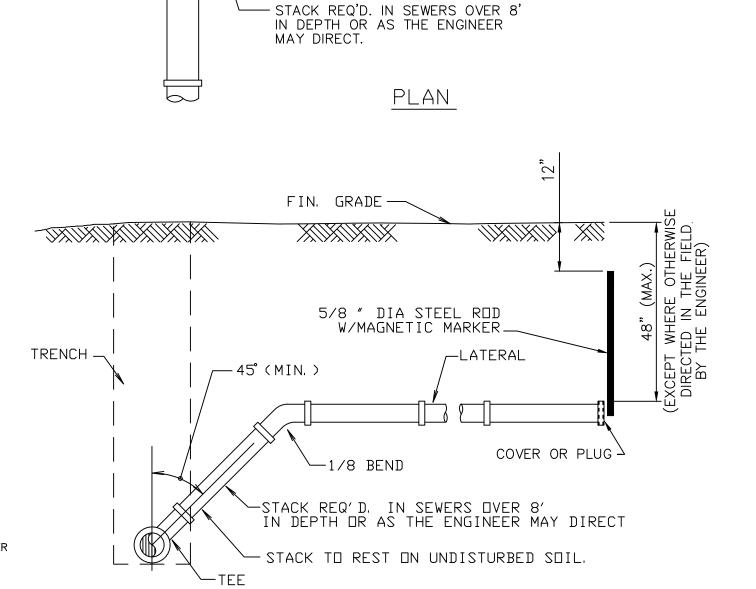

-SEWER MAIN

TYPICAL TEE & LATERAL INSTALLATION

ELEVATION

NUMBER: **REVISION:**




SEWER DETAILS

FIRE STATION NO. 5

CITY OF ORANGE BEACH



1	SCALE: N.T.S.
William X	DATE: NOVEMBER, 2021
	DRAWN BY: JNF
	CHECKED BY: JHR
	SHEET: 18 OF 20

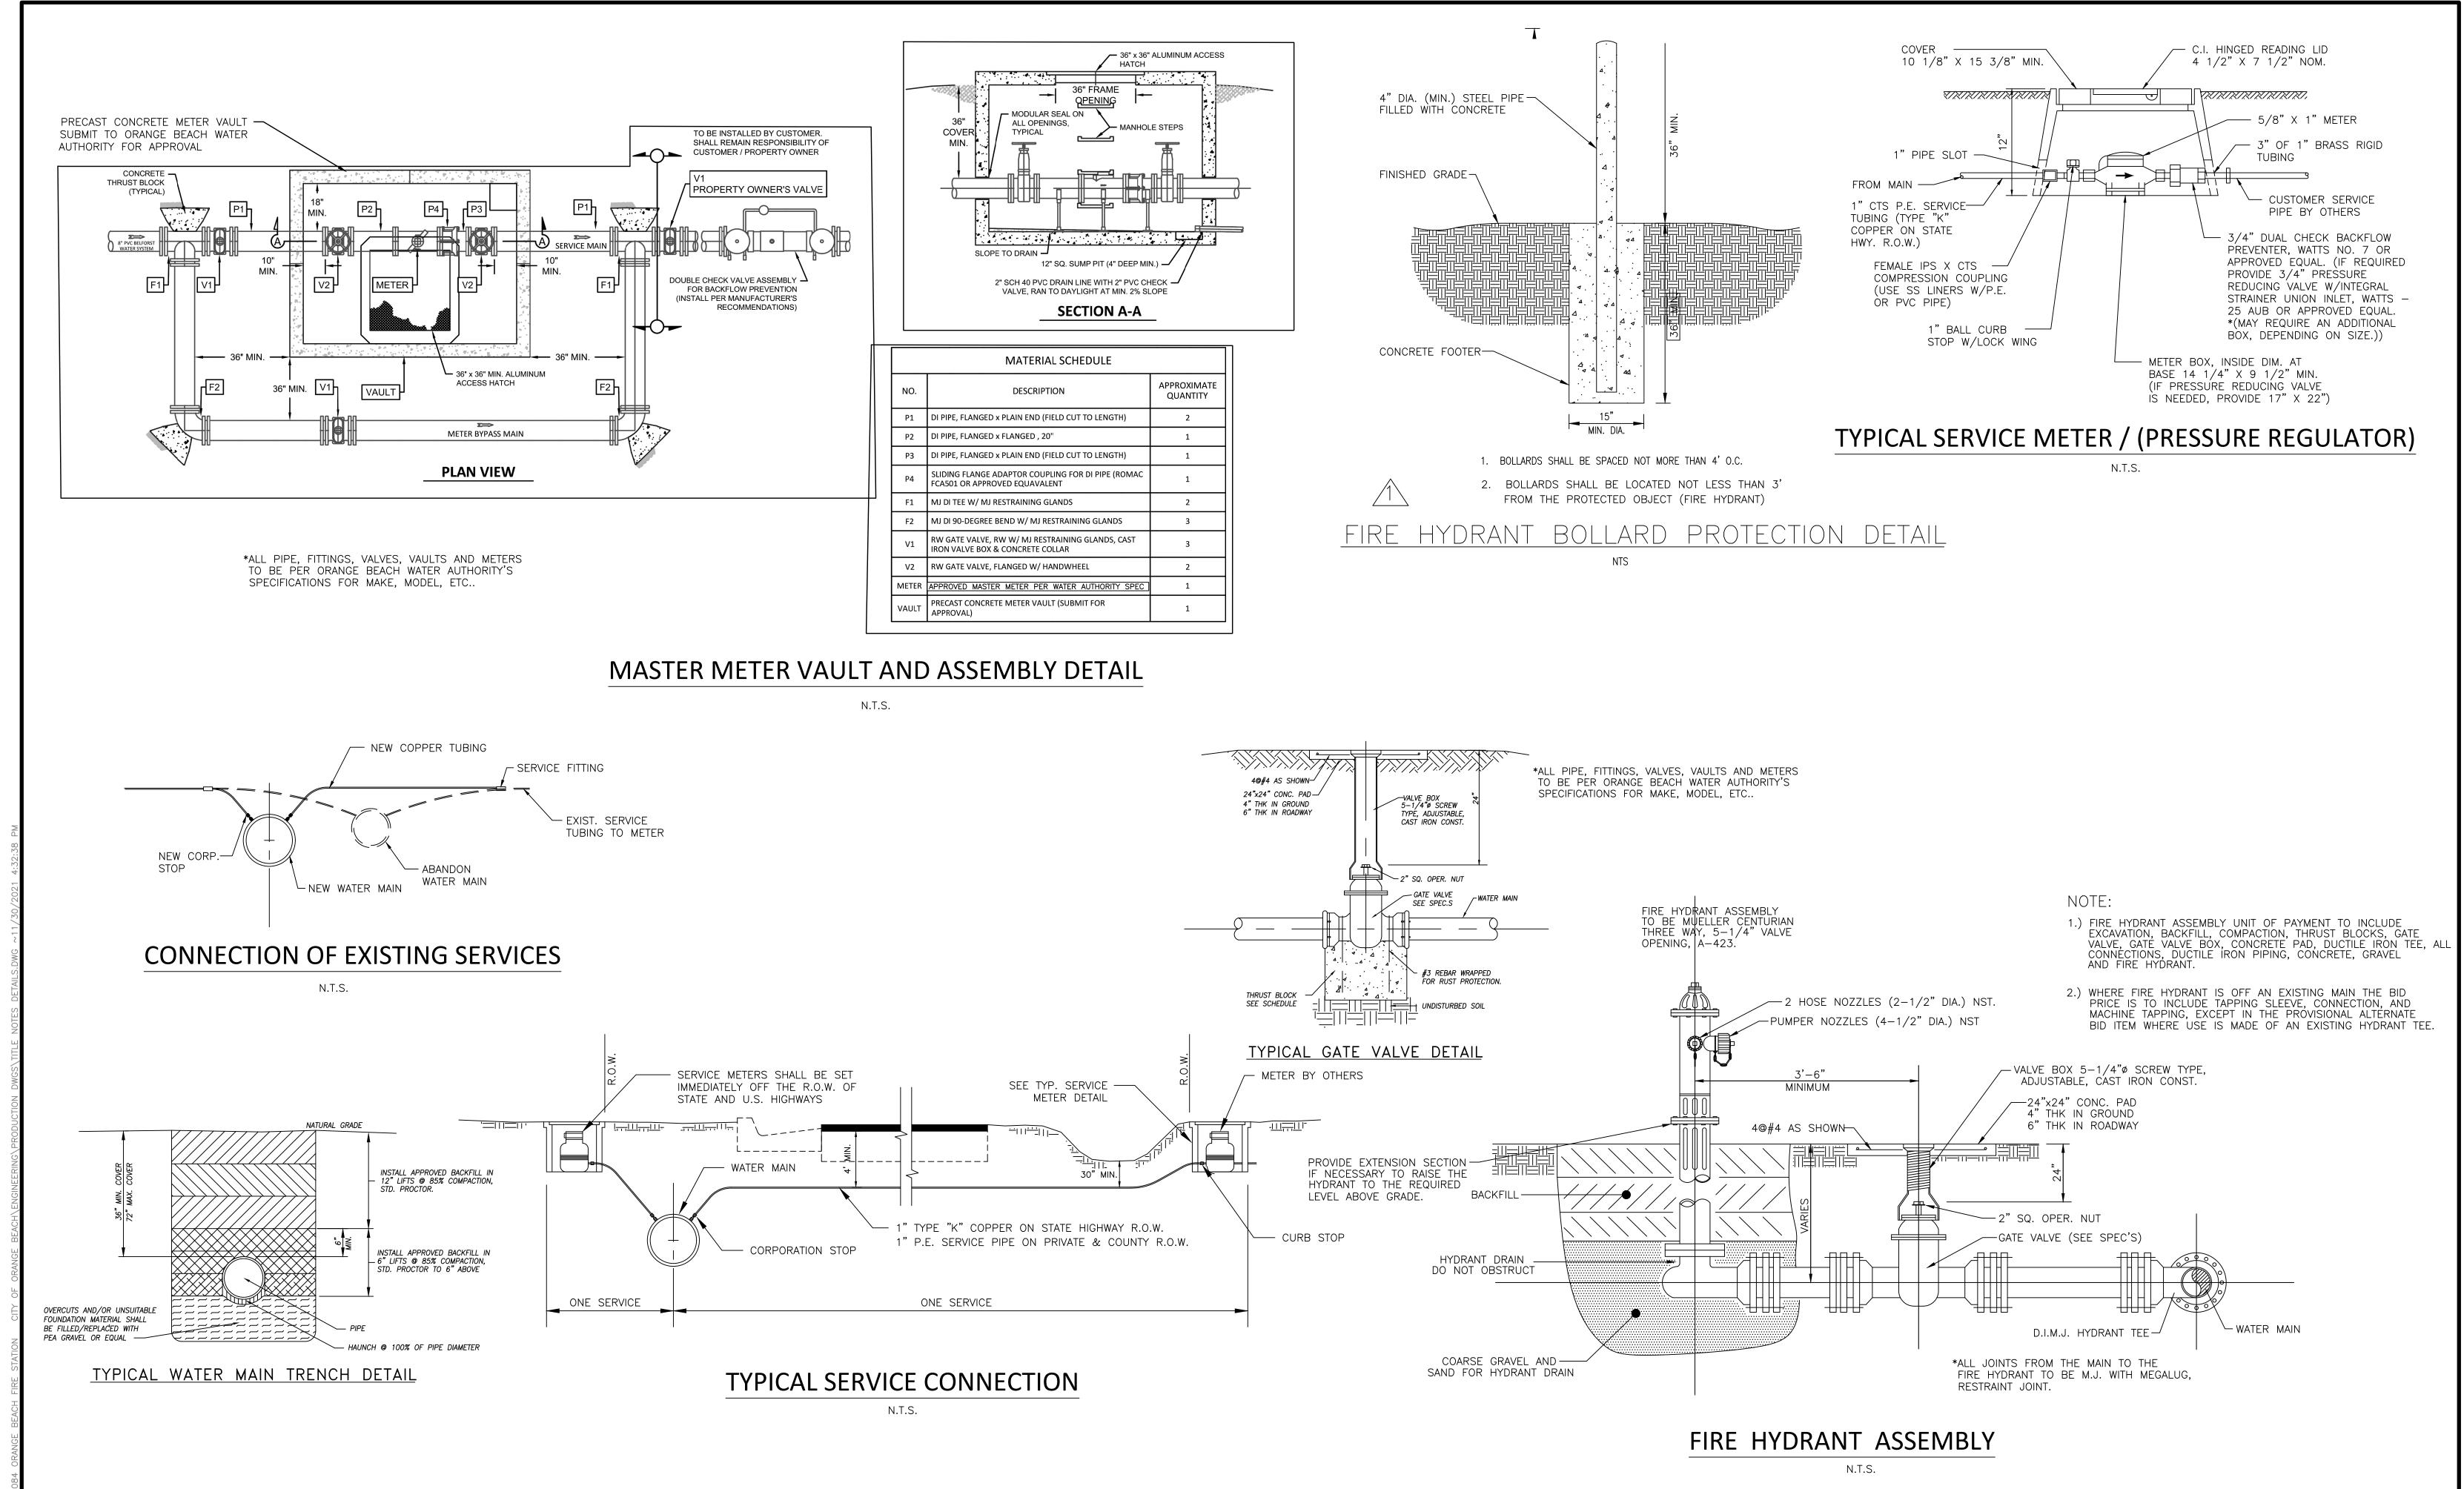

NUMBER: REVISION: DATE:

DATE:

DATE:

ENGINEERING - SURVEYING - CONSTRUCTION MANAGEMENT


30673 Sgt. E. I. "Boots" Thomas Drive, Spanish Fort, AL 36527

Phone: (251) 544-7900

WATER DETAILS

FIRE STATION NO. 5

CITY OF ORANGE BEACH

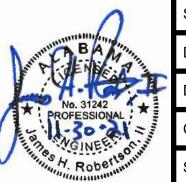


SCALE: N.T.S.

DATE: NOVEMBER, 2021

DRAWN BY: JNF

CHECKED BY: JHR

SHEET: 19 OF 20

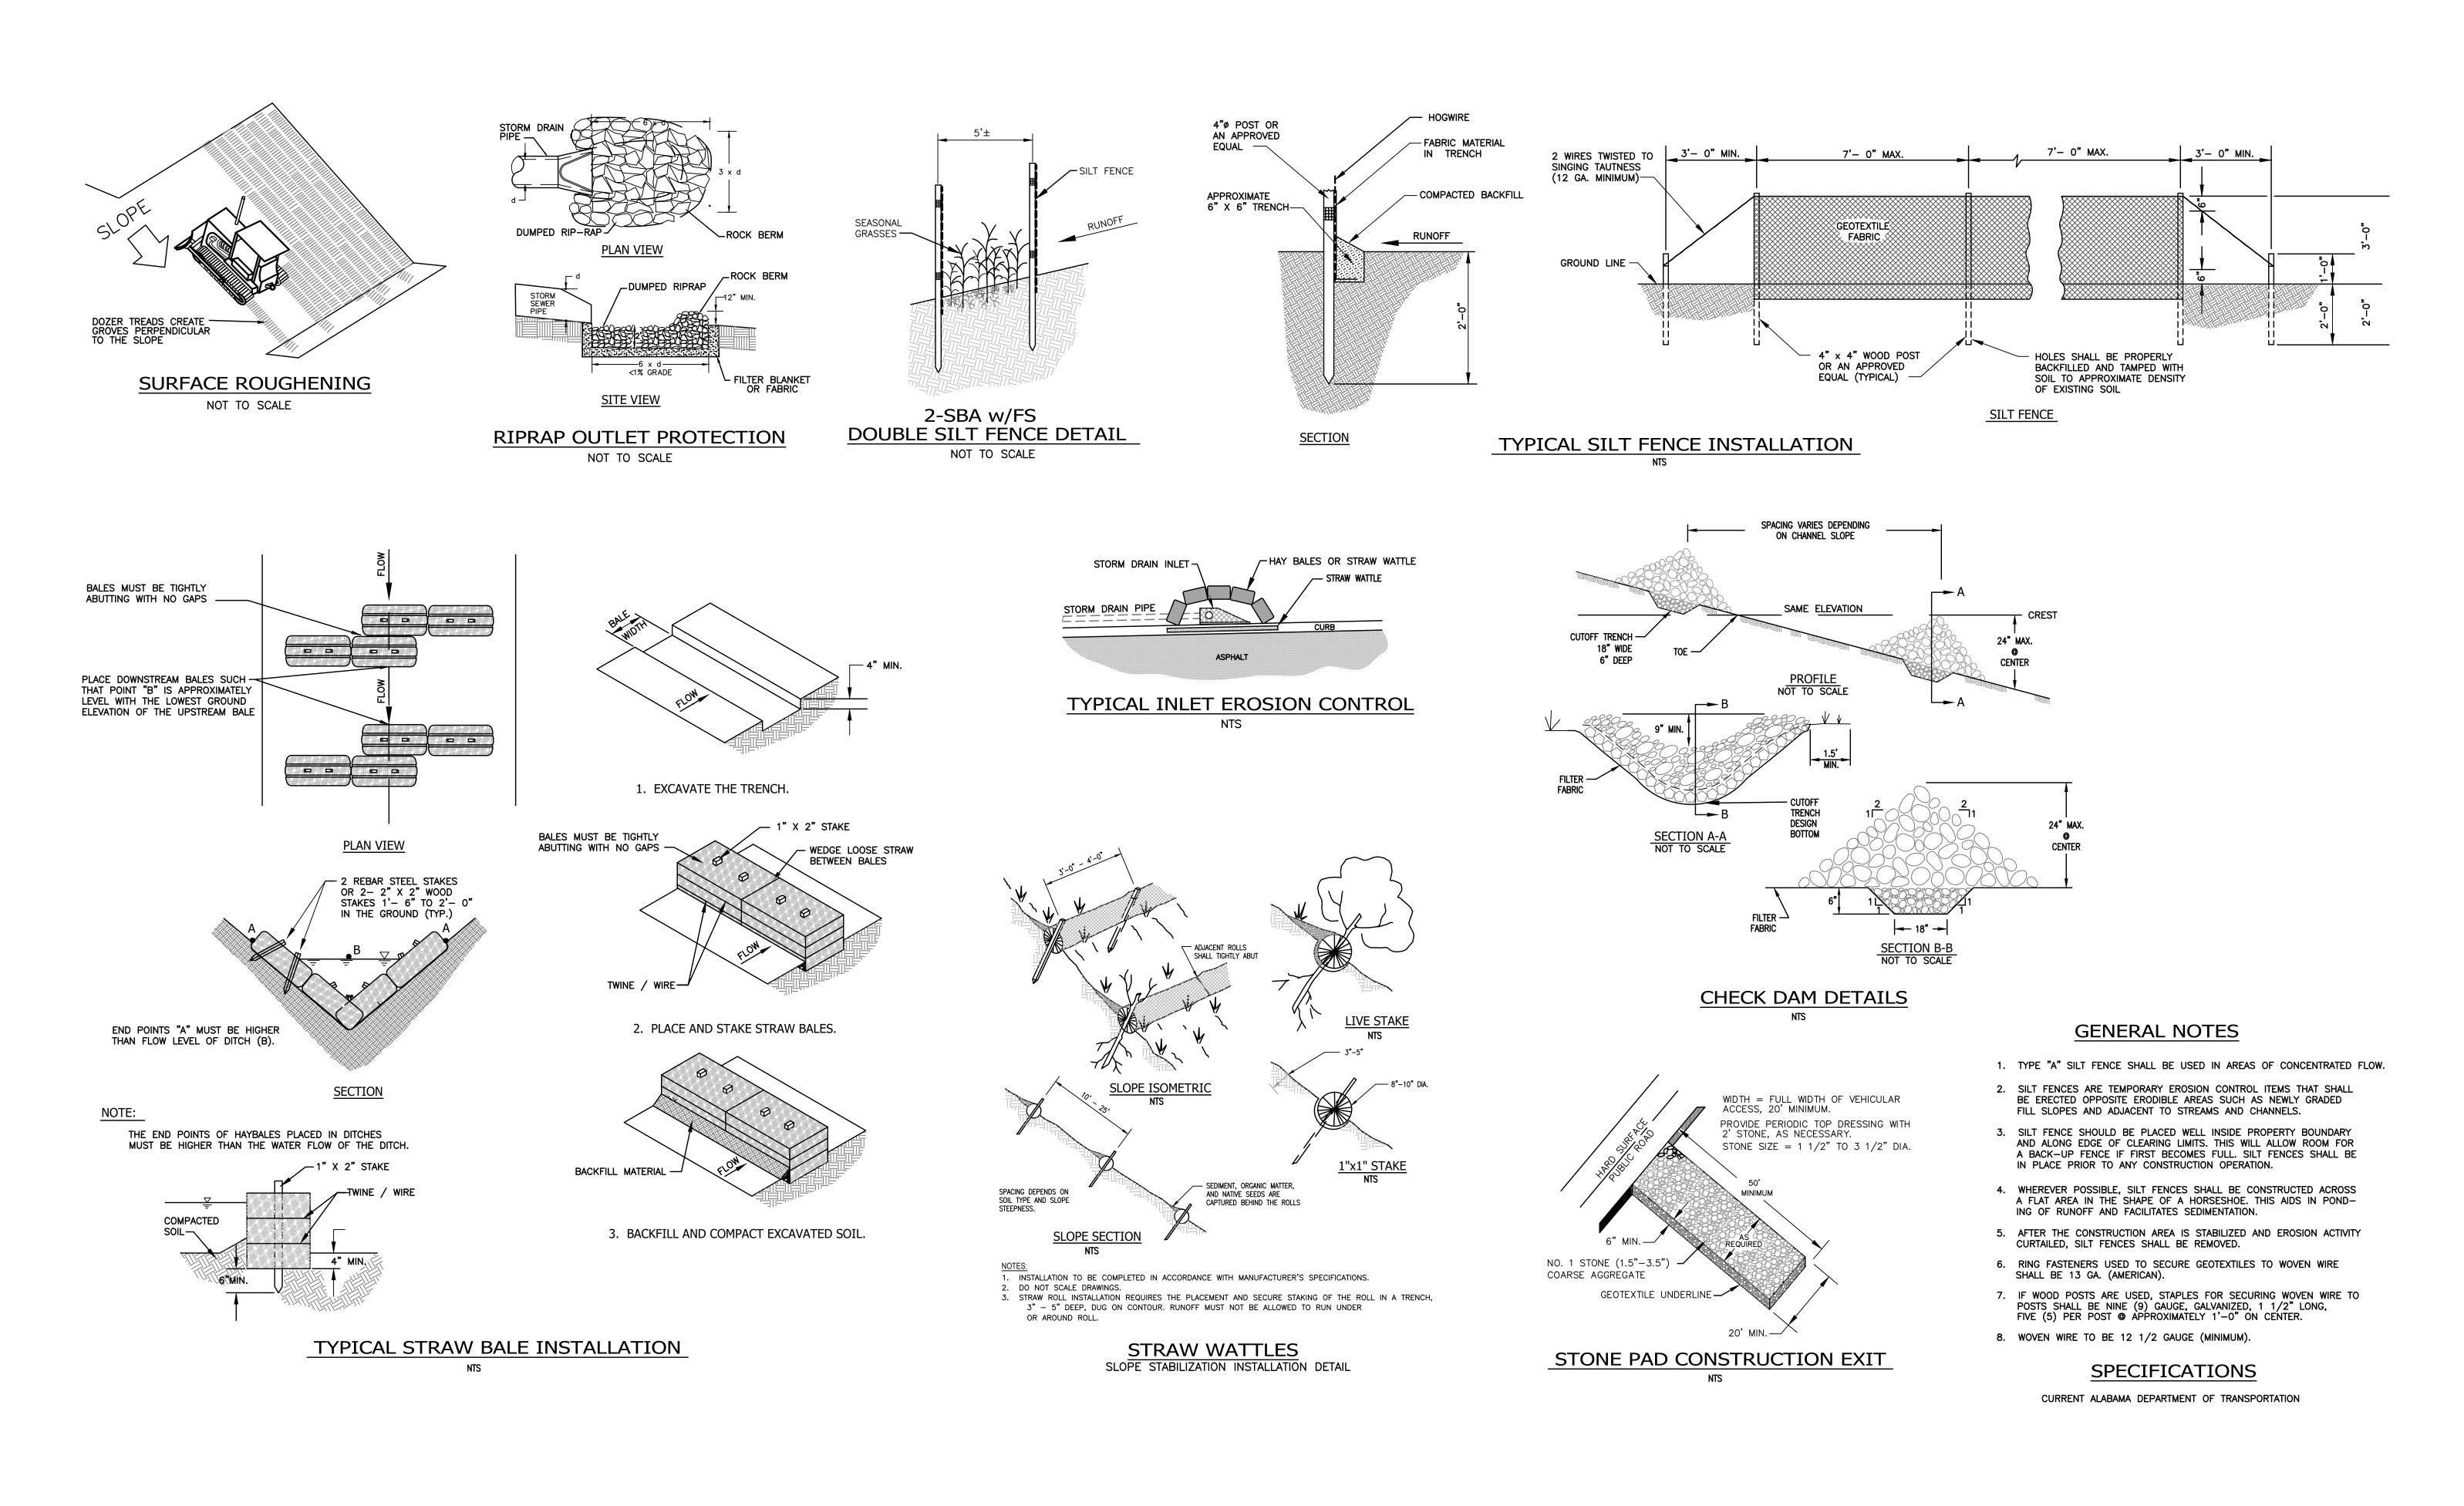


		DATE:	REVISION:	MBER:
awarass				
ENGINEERING - SURVEYING - CONSTRUCTION MANAGEM				
Sgt. E. I. "Boots" Thomas Drive, Spanish Fort, AL 36527 Phone: (251				

EROSION DETAILS

FIRE STATION NO. 5

CITY OF ORANGE BEACH

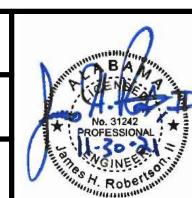

0	SCALE: N.T.S.
DBA A	DATE: NOVEMBER, 2021
No. 31242	DRAWN BY: JNF
PROFESSIONAL	CHECKED BY: JHR

SHEET: 20 OF 20