


1. PROVIDE DIRECT BIALURAL POWER SUPPLY FOR TYPE "P".
2. PROVIDE IT' X 30" COMPOSITE RIBBON WITH TIER 22 LID, LABELED "ELECTRIC."
3. 20' TALL, 6" DIAMETER STAINLESS STEEL, SHUNT UTILITY POLE WITH LIGHTING, SECURITY AND WIFI. 5 YEAR WARRANTY. FINISH TO BE SELECTED BY ARCHITECT. SEE FLOOR ELEVATIONS FOR DETAIL. ALL LIGHTING FIXTURE TYPES AND QUANTITIES PROVIDED FOR 4) FOUR UNIVERSAL YOKES AS SPARE FOR INSTALLATION OF CAMERAS, WIRELESS ACCESS POINTS AND OTHER MISCELLANEOUS EQUIPMENT. TO BE LINTENATED TO THE PRINSHANO / APLUPTI. PROVIDE ALL PARTS AND ACCESSORIES FOR A COMPLETE SYSTEM.
4. TYPE "H" REQUIRES POWER SUPPLY AND DXM MODULES. COORDINATE DISTANCE AND LENGTH RESTRICTIONS WITH FACTORY ENGINEER.
5. SEE MOUNTING DETAIL. THIS NOTE TYPICAL FOR THIS TYPE.
6. PROVIDE PIPE MOUNT DYNAMOX PLUS-IN STATION WITH IP 65 RATED COVER. PROVIDE REMOVABLE SOCCOPE BREAKOUT WITH 6 GROUNDING.
7. MAINTAIN EXISTING GLOBE LUMINAIRE MOUNT TO EXISTING MASONRY COLUMN. CURE EXISTING MASONRY COLUMN AND CONNECT 2" PVC SCHEDULE 40 CONDUIT BELOW GRADE.
8. LIGHT FIXTURE TYPE "H" IS INTEGRATED INTO HANDRAIL. SEE ARCHITECT DRAWINGS FOR CORRECT DIMENSIONS.
9. FIXTURE TYPE "H" AND "P" REQUIRE ONSITE SINGLE BAY MOCKUP PRIOR TO COMPLETE INSTALLATION TO CONFIRM MOUNTING DETAIL.
10. WIRE NEW STREET POLE LIGHTING TO EXISTING STREET LIGHTING BRACKET THROUGH THE WALL. MAXIMUM CURRENT SHALL BE A MAXIMUM 16 AMPERES LOAD ON 20 AMPERE BRACKET CIRCUIT.
11. RELOCATED PEDESTRIAN SIGNAL LIGHT. SEE CITY STANDARD PEDESTRIAN DETAILS ON DRAWING 02.05 FOR ADDITIONAL REQUIREMENTS. REPLACE CABLE PER COOT SPECIFICATIONS. CABLE WILL BE CONTINUOUS FROM PEDESTRIAN HEAD TO SIGNAL CABINET. NO SPLICES PERMITTED.
12. INSIGHT CDS-A NET DMX LIGHTING CONTROL BOX - SEE DRAWING 02.05 FOR DMX MIXING REQUIREMENTS.
13. ALL CONDUITS IN THE PAVILLION STRUCTURE SHALL BE ROUTED VERTICALLY UP EITHER OF THE STRUCTURAL COLUMNS BEHIND THE SCENE SCREEN AND THEN DISTRIBUTED HORIZONTALLY ALONG THE SCENE SCREEN ELEMENTS. USE THE SHUNT UTILITY POLE LINEAR LIGHT FIXTURES WHERE POSSIBLE. SEE "TYPE 'P' MOUNTING DETAIL" ON DRAWING 02.04 FOR REFERENCE PAVILLION CONNECTION. A MINIMUM OF TWO DMX CONTROL BOX LOCATIONS ALONG STRUCTURE MUST BE APPROVED BY ARCHITECT PRIOR TO ROUGH-IN. ALL CONDUITS AND JUNCTION BOXES MUST BE PAINTED TO MATCH PAVILLION STRUCTURE.
14. PROVIDE DIRECT BIALURAL POWER SUPPLY FOR TYPE "R".
15. EXISTING THIN HEAD CITY STANDARD INCANDESCENT LIGHTING POLE TO REMAIN. MAINTAIN AND PROTECT DURING CONSTRUCTION. RETROFIT EXISTING THIN HEADS WITH NEW LED SOURCES TO MATCH NEW LED CITY STANDARD POLES.

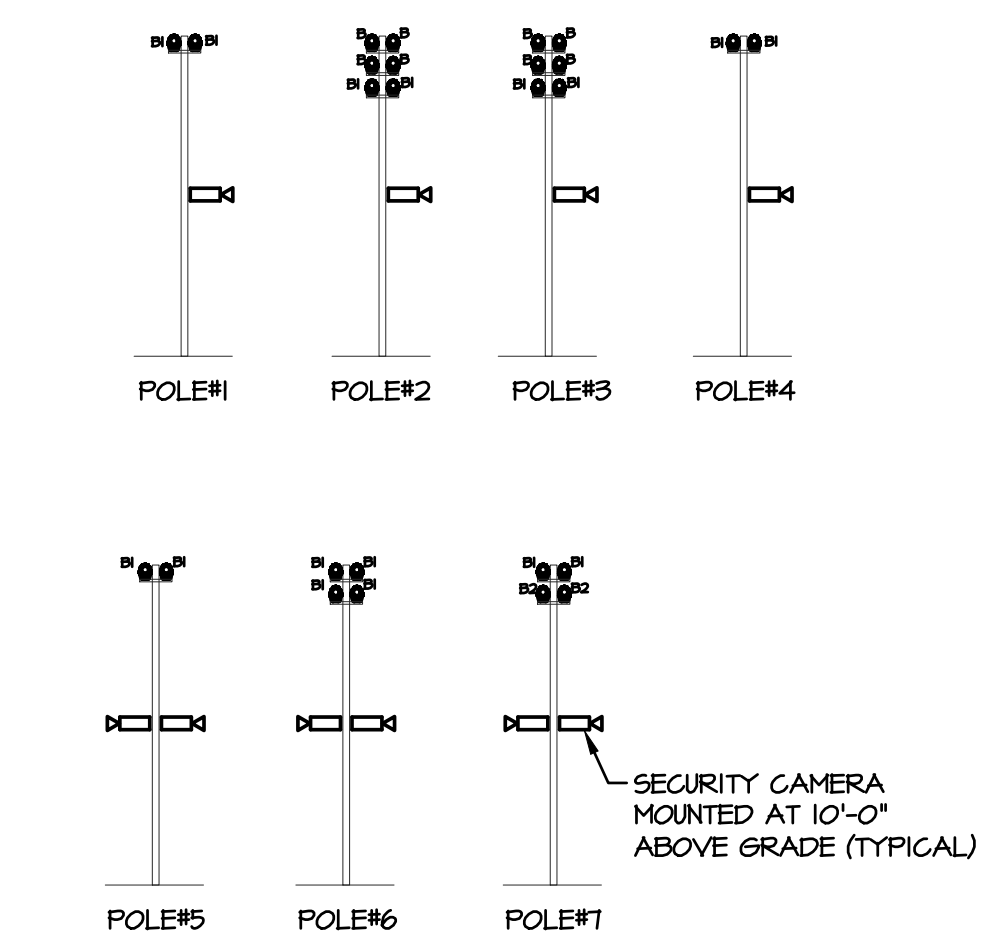

SCALE: 1" = 12'-0"

NOTE: SEE LIGHTING POLE BASE
DETAIL DRAWING EO.03.

Not For Construction

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issue date project number

sheet name

LIGHTING PLAN

sheet number

E2.01



LIGHTING PLAN
SCALE: 1" = 12'-0"

NOTE: ALL STREET LIGHTING POLES SHALL HAVE "CANTON CBD GREEN" COLOR.