

CENTENNIAL PLAZA

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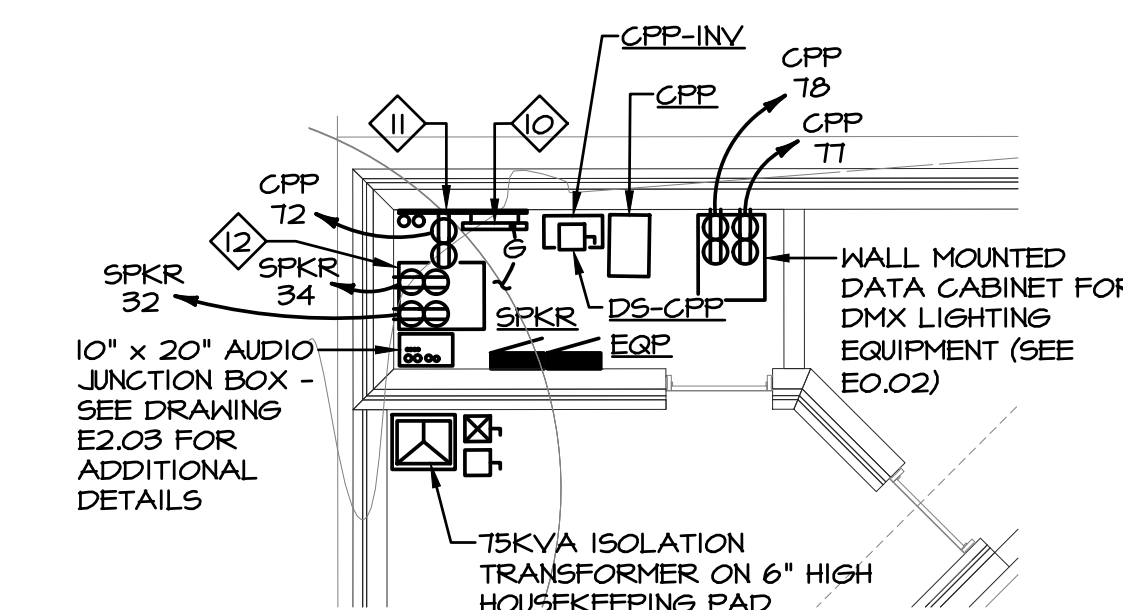
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ATWELL
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water feature

SOUTHERN AQUATICS, INC.
150 HILDEN RD
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PONTE VEDRA BEACH, FL 32081
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1. PROVIDE 120V POWER AT FIRE PIT LOCATION - 0.00K4 ASGUMED.
2. EXISTING 120/240V IN-GRADE VENDOR SERVICE VAULT TO REMAIN. MAINTAIN AND PROTECT DURING CONSTRUCTION.
3. PROVIDE VENDOR ELECTRICAL HANDLE WITH 200 AMPERE, 200/250V, 1 PHASE WEATHERPROOF DISTRIBUTION BLOCK. SEE ATTACHED DIAGRAM FOR ADDITIONAL DETAILS AND WIRING REQUIREMENTS.
4. PROVIDE 120V POWER AS INDICATED AND CAT6A DATA CABLE IN 1" PVC UNDERGROUND CONDUIT BACK TO DATA RACK FOR DIGITAL KIOSK LOCATION - 1.00K4 ASGUMED. PROVIDE INTEGRATED 15" X 15" W/ 16" DEPTH DIGITAL KIOSKS WITH (2) TWO COLUMNS OF (8) EIGHT 4" X 14" M" SCREENS IN CUSTOM ENCLOSURE BY DATAKRONICS. SEE ATTACHED DRAWING FOR DETAILS. KIOSK DATA EQUAL PRODUCTS MAY BE SUBMITTED FOR CONSIDERATION A MINIMUM OF 7 BUSINESS DAYS PRIOR TO BID DUE DATE.
5. PROVIDE 120V POWER AS INDICATED AND CAT6A DATA CABLE IN 1" PVC UNDERGROUND CONDUIT BACK TO DATA RACK FOR TRANSIT CENTER.
6. PROVIDE OUTDOOR WEATHERPROOF IN-USE GROUND BOX WITH TWO (2) DUPLEX 15 AMPERES NISSE GUSE TYPE 6P AND 1P60 RSTINGS - TO BE NIREMOLD. #XB8414/XB341C520B6. PROVIDE (3) THREE LOCK NUT TOOLS #XBLT TO THE CITY.
7. PROVIDE GFCI DUPLEX RECEPTACLE WITH WEATHERPROOF COVER. UNDERGROUND RECESSED IN 1/2" HIGH PRECAST SEATWALL OF TREE PLANTER.
8. 12" HIGH BY 30" WIDE VIDEO WALL - 200V, 3 PHASE, 24.6KV, 60.3 FLUX 1600-AMPERES. PROVIDE DATAKRONICS PDVX-6MM-60BXK536. EQUAL PRODUCTS MAY BE SUBMITTED FOR CONSIDERATION A MINIMUM OF 7 BUSINESS DAYS PRIOR TO BID DUE DATE. PROVIDE 100 AMPERE NON-FUSED WEATHERPROOF (NEMA 3R) 1/4" CONDUIT DISCONNECTED TO THE VIDEO WALL. 1-1/8" AHS GND 1-1/4" CONDUIT TO 40/3 CIRCUIT BREAKER IN MDP. 1" SEE ONE LINE DIAGRAM FOR DETAILS. PROVIDE 1 1/4" CONDUIT WITH FIBER OPTIC CABLE TO THE FIBER PATCH PANEL. PATCH PANEL PROVIDED UNDER PRODUCTION EQUIPMENT ALLOWANCE) IN CAFE ELECTRICAL CLOSET. COORDINATE CONDUIT ROUTING IN FAVILION STRUCTURE WITH ARCHITECT. COORDINATE MINOR CONNECTION REQUIREMENTS WITH EQUIPMENT SUPPLIER. PROVIDE ALL PARTS AND ACCESSORIES FOR A COMPLETE SYSTEM.
9. PROVIDE 120V POWER TO BE CAPPED AND LABELED IN SMART LIGHTING POLE BEHIND ACCESS PLATE FOR 120V WIRELESS. PROVIDE 5 ACCESS POINTS TO BE MOUNTED TO SMART LIGHTING POLES.
10. 24"x2"x1/4" CU GROUND BAR WITH INSULATED STAND-OFFS. INSTALL #4 AHS WIRE TO BUILDING GROUNDING ELECTRICAL SYSTEM.
11. 8"x4"x60/4" D/ND PAINTED TREATED PLYWOOD FOR WALL MOUNTED TELEDATA EQUIPMENT.
12. 4-POST RACK WITH 40MM SWITCHES, AUDIO AND VIDEO PROCESSORS. PROVIDE CONTENT SERVER - SEE RACK DRAWING AT I-10.0 ASGUMED.
13. PROVIDE 2-8 AHS 1/4" D/NO AHS GND - 3/4" UNDERGROUND PVC CONDUIT TO BRANCH CIRCUIT BREAKER INDICATED. WIRE IS SIZED TO ACCOMMODATE VOLTAGE DROP.
14. PROVIDE 120V POWER IN WEATHERPROOF JUNCTION BOX MOUNTED BEHIND STAGE SCREEN FOR FUTURE WIRELESS ACCESS POINTS. LABEL JUNCTION BOXES AS "120V POWER FOR WIRELESS ACCESS POINTS."
15. PROVIDE 120V POWER TO BE CAPPED AND LABELED IN CAFE FAVOR LIGHTING POLE BEHIND ACCESS PLATE FOR FUTURE WIRELESS ACCESS POINT TO BE MOUNTED TO POLE.



ENLARGED ELECTRICAL
CLOSET PLAN
SCALE: 1" = 6'-0"

Not For Construction

[illegible]

58



issue date project number

sheet name

POWER PLAN

sheet number

E2.02

