WIND LOAD INFO: Vasd = 124 mph Vut = 160 mph (3 sec. GUST) RISK CATEGORY I Exposure D

DUNE WALKOVER CONSTRUCTION

LOADS:

THE DUNE WALKOVER SUPER STRUCTURE (INCLUDING BENTS STRINGERS, AND DECKING) HAS BEEN DESIGNED FOR A VERTICAL LIVE LOAD OF 100 PSF, DEAD LOADS ASSOCIATED WITH THE STRUCTURE ITSELF, AND WIND LOADS PER CODE. THE STRUCTURE HAS NOT BEEN DESIGNED FOR SCOUR, OR HYDRODYNAMIC LOADS (INCLUDING BUT NOT LIMITED TO WAVE LOADS, CURRENT LOADS, ETC.).


ENGINEER MAKES NO WARRANTY OR CERTIFICATION REGARDING EXISTING STRUCTURES (INCLUDING EXISTING PILES) ONSITE,

ATLANTIC OCEAN FRONTAGE 570 OCEAN DRIVE TOWN OF JUNO BEACH PALM BEACH COUNTY, FLORIDA

CLIENT:

TOWN OF JUNO BEACH

NOVEMBER 2019

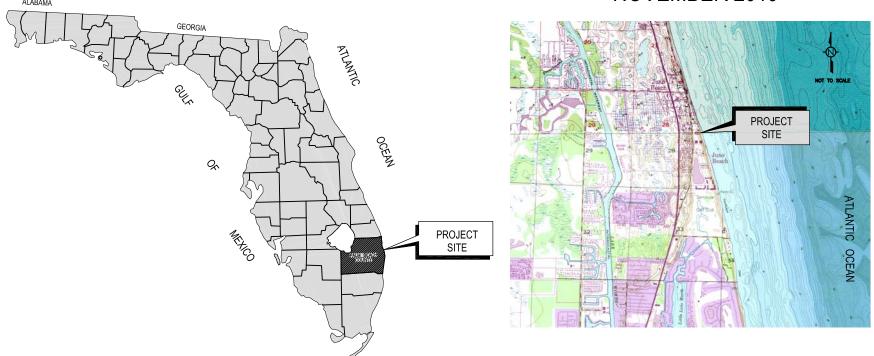

APPLICABLE PROVISION(S):

THE DUNE WALKOVER HAS BEEN DESIGNED IN ACCORDANCE WITH THE APPLICABLE SECTIONS OF THE 2017 FLORIDA BUILDING CODE.

THESE PLANS MUST BE USED IN CONJUNCTION WITH THE ATTACHED TECHNICAL SPECIFICATIONS.

This item has been electronically signed and sealed by Mark A. Powell, P.E. on November 18, 2019 using a Digital Signature.

Printed copies of this document are not considered signed and sealed and the signature must be verified on any electronic copies.

FOR BID PURPOSES ONLY. NOT FOR CONSTRUCTION.

INDEX TO DRAWINGS

SHEET NUMBER

TITLE

VICINITY MAP & TITLE SHEET DEMOLITION PLAN 3 SITE PLAN FRAMING PLAN SOUTH ELEVATION BENCH AND PLATFORM DETAILS DETAILS



REV 1 1 11/19 CLARIFY PAGE NUMBER

VICINITY MAP & TITLE SHEET


ISIMINGER & STUBBS Engineering, inc.

COASTAL • ENVIRONMENTAL • MARINE REGISTRY NUMBER: 8114 P.O. BOX 14702 - NORTH PALM BEACH, FL. 33408 - 561-881-0003

DUNE WALKOVER CONSTRUCTION ATLANTIC OCEAN FRONTAGE 570 OCEAN DRIVE

TOWN OF JUNO BEACH, PALM BEACH COUNTY, FL CLIENT: TOWN OF JUNO BEACH

	DATE 11/19		/19	DRAWN	PJK	CHKD	KI	DB	APPRVD	MAP
	DWG N	Э.	19123	3A1				SH	IEET	1
RING	COMPUTER FILE NO.			19123A			OF	7	1	

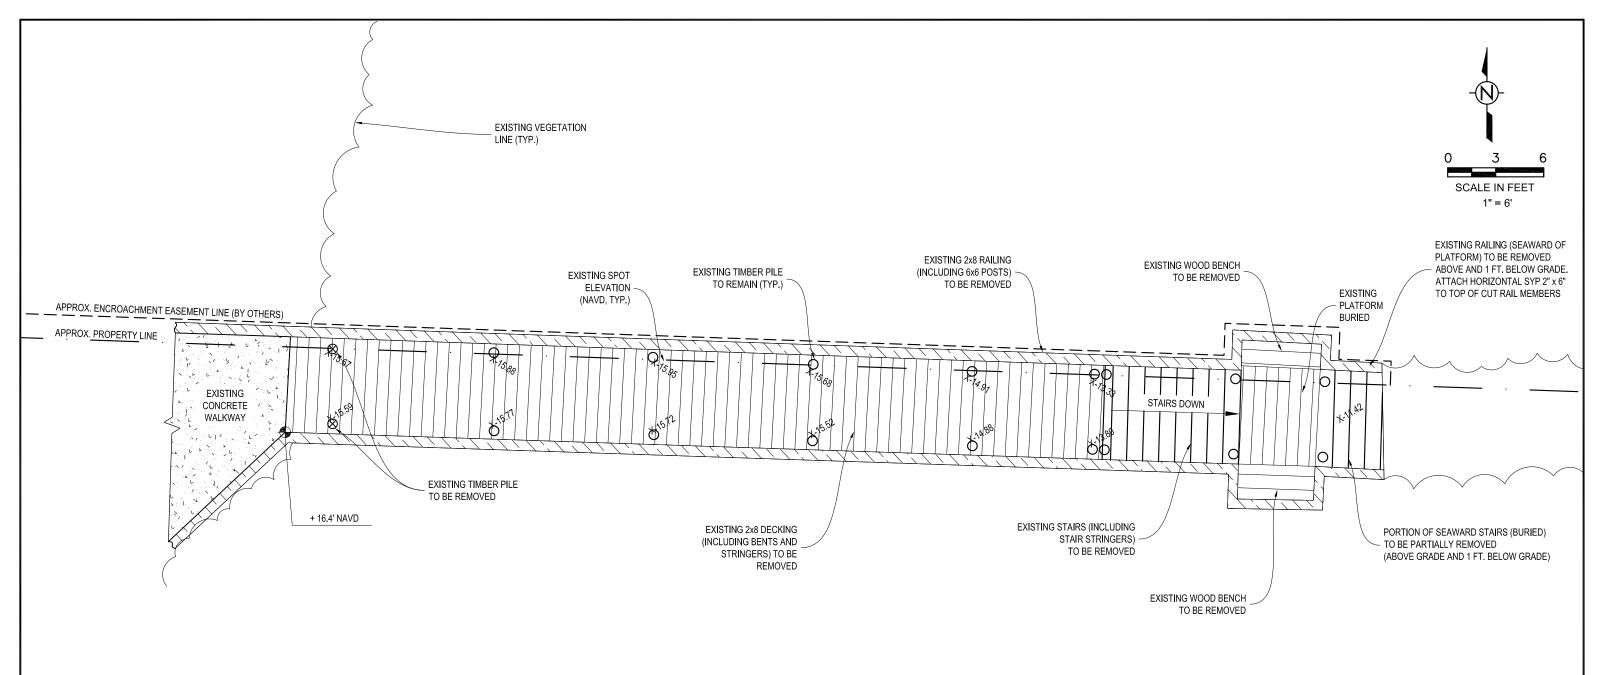




NOTES:

- 1. DATUM IS NAVD.
- 2. EXISTING CONDITIONS ARE APPROXIMATE BASED ON SURVEY BY MILLER LAND SURVEYING (REV. 10/24/19) AND ON-SITE OBSERVATIONS.
- 3. CONTRACTOR SHALL TAKE ALL STEPS NECESSARY TO PROTECT ALL EXISTING STRUCTURES ON-SITE AND ON NEIGHBORING PROPERTIES FROM DAMAGE. CONTRACTOR SHALL BE RESPONSIBLE FOR ALL REPAIRS TO EXISTING STRUCTURES AND VEGETATION SHOULD ANY DAMAGE OCCUR.

This item has been electronically signed and sealed by Mark A. Powell, P.E. on November 18, 2019 using a Digital Signature.

Printed copies of this document are not considered signed and sealed and the signature must be verified on any electronic copies.

FOR BID PURPOSES ONLY. NOT FOR CONSTRUCTION.

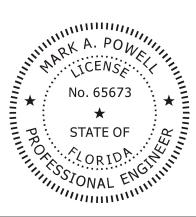

DEMOLITION PLAN



Isiminger & Stubbs Engineering, inc.


COASTAL • ENVIRONMENTAL • MARINE
REGISTRY NUMBER: 8114

REGISTRY NUMBER: 8114 P.O. BOX 14702 - NORTH PALM BEACH, FL. 33408 - 561-881-0003

DUNE WALKOVER CONSTRUCTION ATLANTIC OCEAN FRONTAGE

570 OCEAN DRIVE TOWN OF JUNO BEACH, PALM BEACH COUNTY, FL CLIENT: TOWN OF JUNO BEACH

DATE	11/19		DRAWN	PJK	CHKD	KI	ОВ	APPRVI)	MAP
DWG NO. 19123A2						SH	EET			
COMPUTER FILE NO.			19123A			OF	7		L	

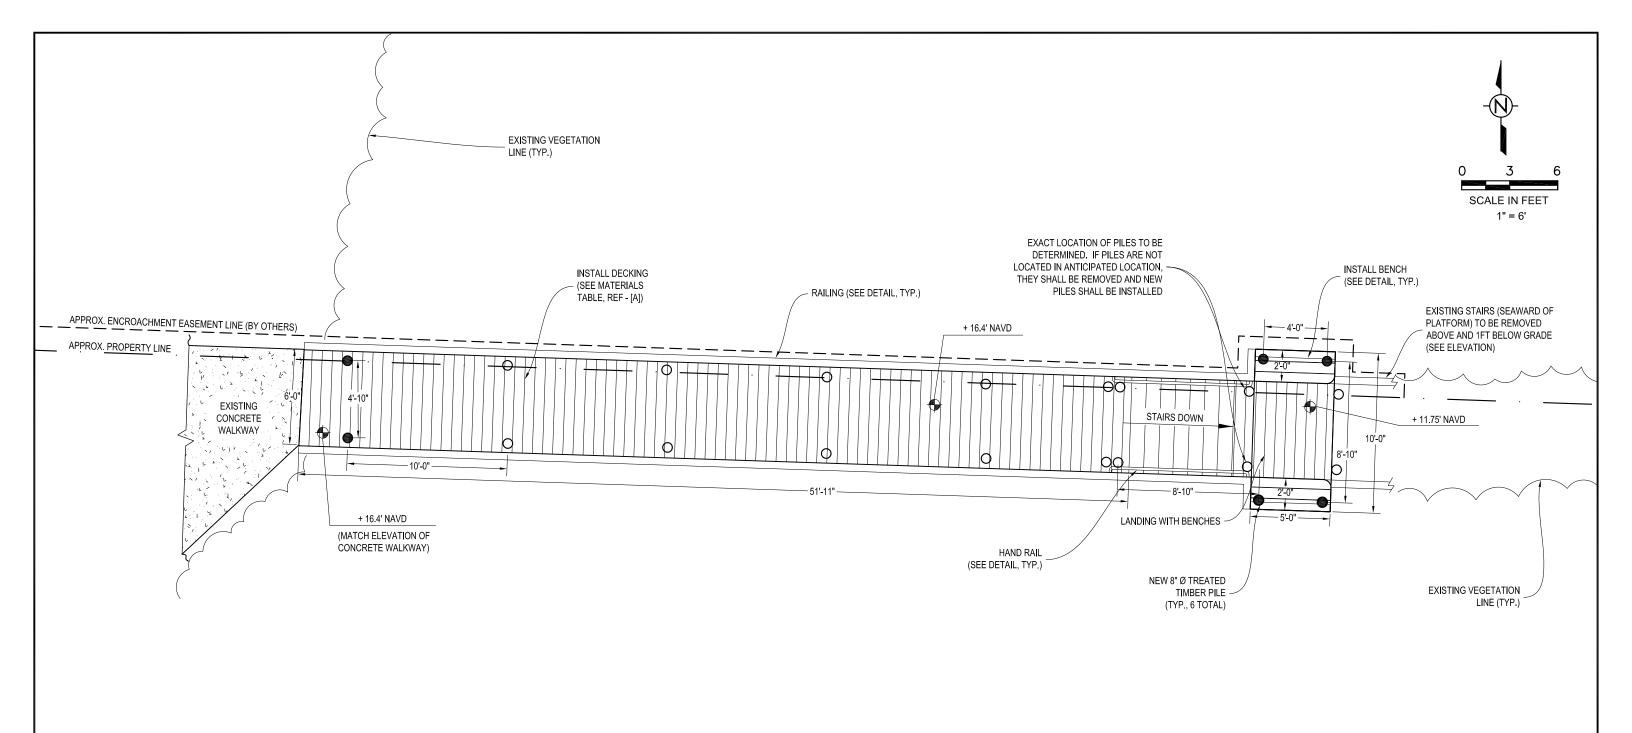


NOTES:

- DATUM IS NAVD.
- 2. EXISTING CONDITIONS ARE APPROXIMATE BASED ON SURVEY BY MILLER LAND SURVEYING (REV. 10/24/19) AND ON-SITE OBSERVATIONS.
- 3. CONTRACTOR SHALL TAKE ALL STEPS NECESSARY TO PROTECT ALL EXISTING STRUCTURES ON-SITE AND ON NEIGHBORING PROPERTIES FROM DAMAGE. CONTRACTOR SHALL BE RESPONSIBLE FOR ALL REPAIRS TO EXISTING STRUCTURES AND VEGETATION SHOULD ANY DAMAGE OCCUR.
- 4. SOME TRIM ELEMENTS NOT SHOWN. CONTRACTOR TO CONFIRM DETAILING OF TRIM ELEMENTS PRIOR TO COMMENCEMENT OF CONSTRUCTION.

This item has been electronically signed and sealed by Mark A. Powell, P.E. on November 18, 2019 using a Digital Signature.

Printed copies of this document are not considered signed and sealed and the signature must be verified on any electronic copies.

FOR BID PURPOSES ONLY. NOT FOR CONSTRUCTION.

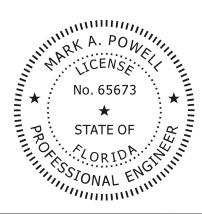

SITE PLAN

Isiminger & Stubbs Engineering, inc.


COASTAL • ENVIRONMENTAL • MARINE

REGISTRY NUMBER: 8114 P.O. BOX 14702 - NORTH PALM BEACH, FL. 33408 - 561-881-0003

DUNE WALKOVER CONSTRUCTION ATLANTIC OCEAN FRONTAGE 570 OCEAN DRIVE

TOWN OF JUNO BEACH, PALM BEACH COUNTY, FL CLIENT: TOWN OF JUNO BEACH

DATE 1	11/19 DRAWI		PJK	CHKD	KDB		APPRVD	MAP
DWG NO.	19123	3A3				SH	IEET	2
COMPUTER FILE NO.			19123A			OF	7	<u> </u>

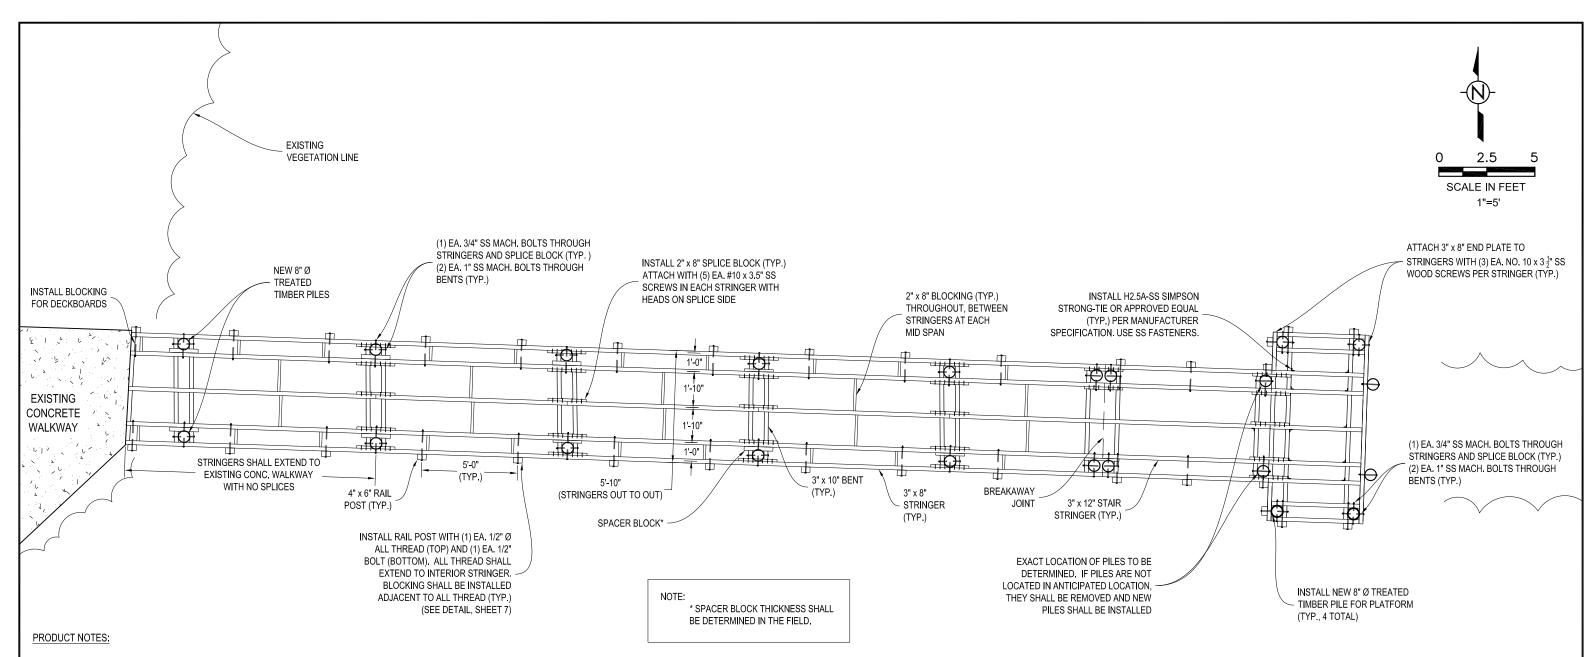

ALL STRUCTURAL MEMBERS SHALL BE PRESSURE TREATED ("GROUND CONTACT", AWPA CATEGORY UC4B MINIMUM EQUIVALENT) NO. 1 SOUTHERN YELLOW PINE OR BETTER.

HARDWARE:

ALL BOLTS, WASHERS, NUTS, SCREWS, NAILS, AND OTHER HARDWARE ITEMS SHALL BE 316 STAINLESS. THREADED ROD MAY BE USED IN PLACE OF HEX HEAD BOLTS FOR BOLTS LONGER THAN 7".

- 2. EXISTING CONDITIONS ARE APPROXIMATE BASED ON SURVEY BY MILLER LAND SURVEYING (REV. 10/24/19) AND ON-SITE OBSERVATIONS.
- 3. SOME TRIM ELEMENTS NOT SHOWN. CONTRACTOR TO CONFIRM DETAILING OF TRIM ELEMENTS PRIOR TO COMMENCEMENT OF CONSTRUCTION.

DECKING OPTIONS:

PINE: DECKING SHALL CONSIST OF 2" x 6" SUNBELT FOREST PRODUCTS (SEE PLAN SHEET 7) DECKING. END-TO-END JOINTS ARE NOT ALLOWED. DECKING SHALL BE INSTALLED WITH (2) EA. #10 X $3\frac{1}{2}$ " DECK SCREWS PER STRINGER CROSSING. GAP BOARDS 1/8" SIDE TO SIDE AND BETWEEN THE BOARDS AND OTHER SURFACES. THE TOP OF SCREWS ARE FLUSH WITH OR NO LOWER THAN $\frac{1}{32}$ " BELOW THE TOP OF DECKING.

COMPOSITE: DECKING SHALL CONSIST OF 2" x 6" EVERGRAIN® DECKING (COLOR: CAPE COD GREY). END-TO-END JOINTS ARE NOT ALLOWED. DECKING SHALL BE INSTALLED WITH (2) EA. #10 X 3 1/2" DECK SCREWS PER STRINGER CROSSING. GAP BOARDS 1/8" SIDE TO SIDE AND BETWEEN THE BOARDS AND OTHER SURFACES. PRE-DRILLING/COUNTERSINKING IS REQUIRED SUCH THAT THE TOP OF SCREWS ARE FLUSH WITH OR NO LOWER THAN $\frac{1}{32}$ " BELOW THE TOP OF DECKING. ALL OTHER MANUFACTURER INSTALLATION REQUIREMENTS (INCLUDING BOARD EDGE SPACING) SHALL BE FOLLOWED.

IPE: DECKING SHALL CONSIST OF 5/4" x 6" IPE DECKING. END-TO-END JOINTS ARE NOT ALLOWED. DECKING SHALL BE INSTALLED WITH (2) EA. #10 X 3 ½" DECK SCREWS PER STRINGER CROSSING. GAP BOARDS 1/8" SIDE TO SIDE AND BETWEEN THE BOARDS AND OTHER SURFACES. PRE-DRILLING/COUNTERSINKING IS REQUIRED SUCH THAT THE TOP OF SCREWS ARE FLUSH WITH OR NO LOWER THAN $\frac{1}{30}$ " BELOW THE TOP OF DECKING. ALL OTHER MANUFACTURER INSTALLATION REQUIREMENTS (INCLUDING BOARD EDGE SPACING) SHALL BE FOLLOWED.

This item has been electronically signed and sealed by Mark A. Powell, P.E. on November 18, 2019 using a Digital Signature.

Printed copies of this document are not considered signed and sealed and the signature must be verified on any electronic copies.



FRAMING PLAN

Isiminger & Stubbs Engineering, inc.

COASTAL • ENVIRONMENTAL • MARINE


REGISTRY NUMBER: 8114
P.O. BOX 14702 - NORTH PALM BEACH, FL. 33408 - 561-881-0003


DUNE WALKOVER CONSTRUCTION ATLANTIC OCEAN FRONTAGE 570 OCEAN DRIVE


TOWN OF JUNO BEACH, PALM BEACH COUNTY, FL CLIENT: TOWN OF JUNO BEACH


DATE 11/19 DRAWN PJK CHKD KDB APPRVD MAP DWG NO. 19123A4 COMPUTER FILE NO.

FOR BID PURPOSES ONLY. NOT FOR CONSTRUCTION.

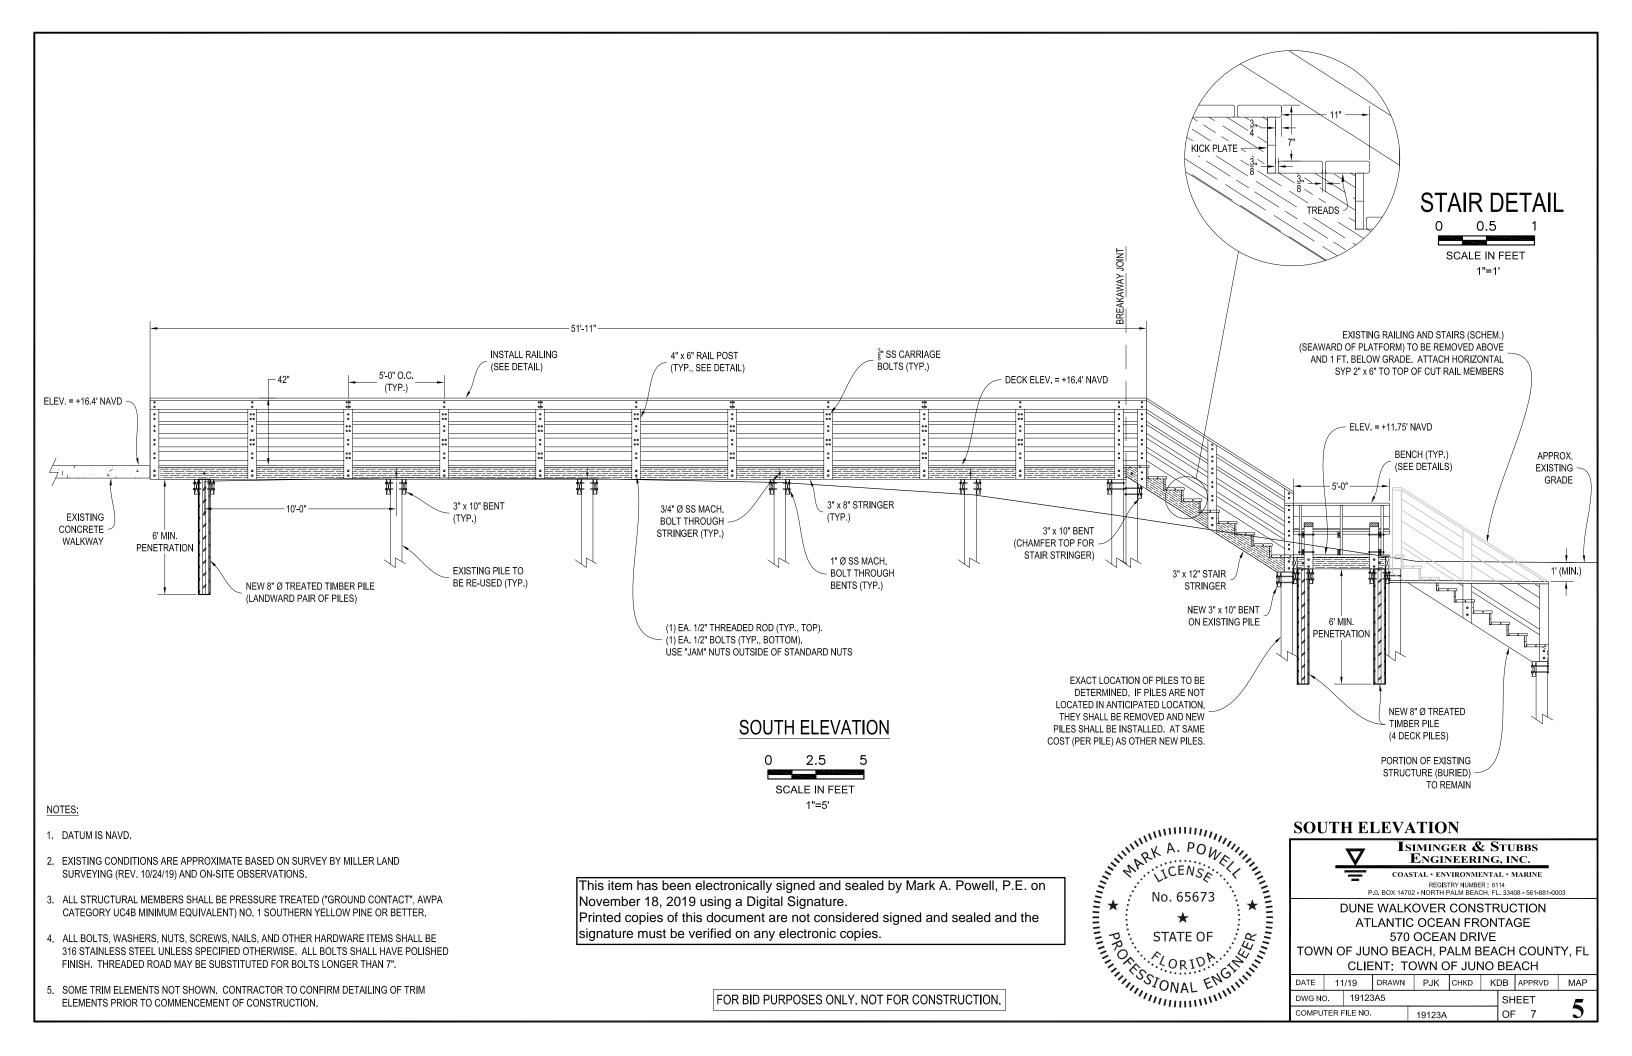


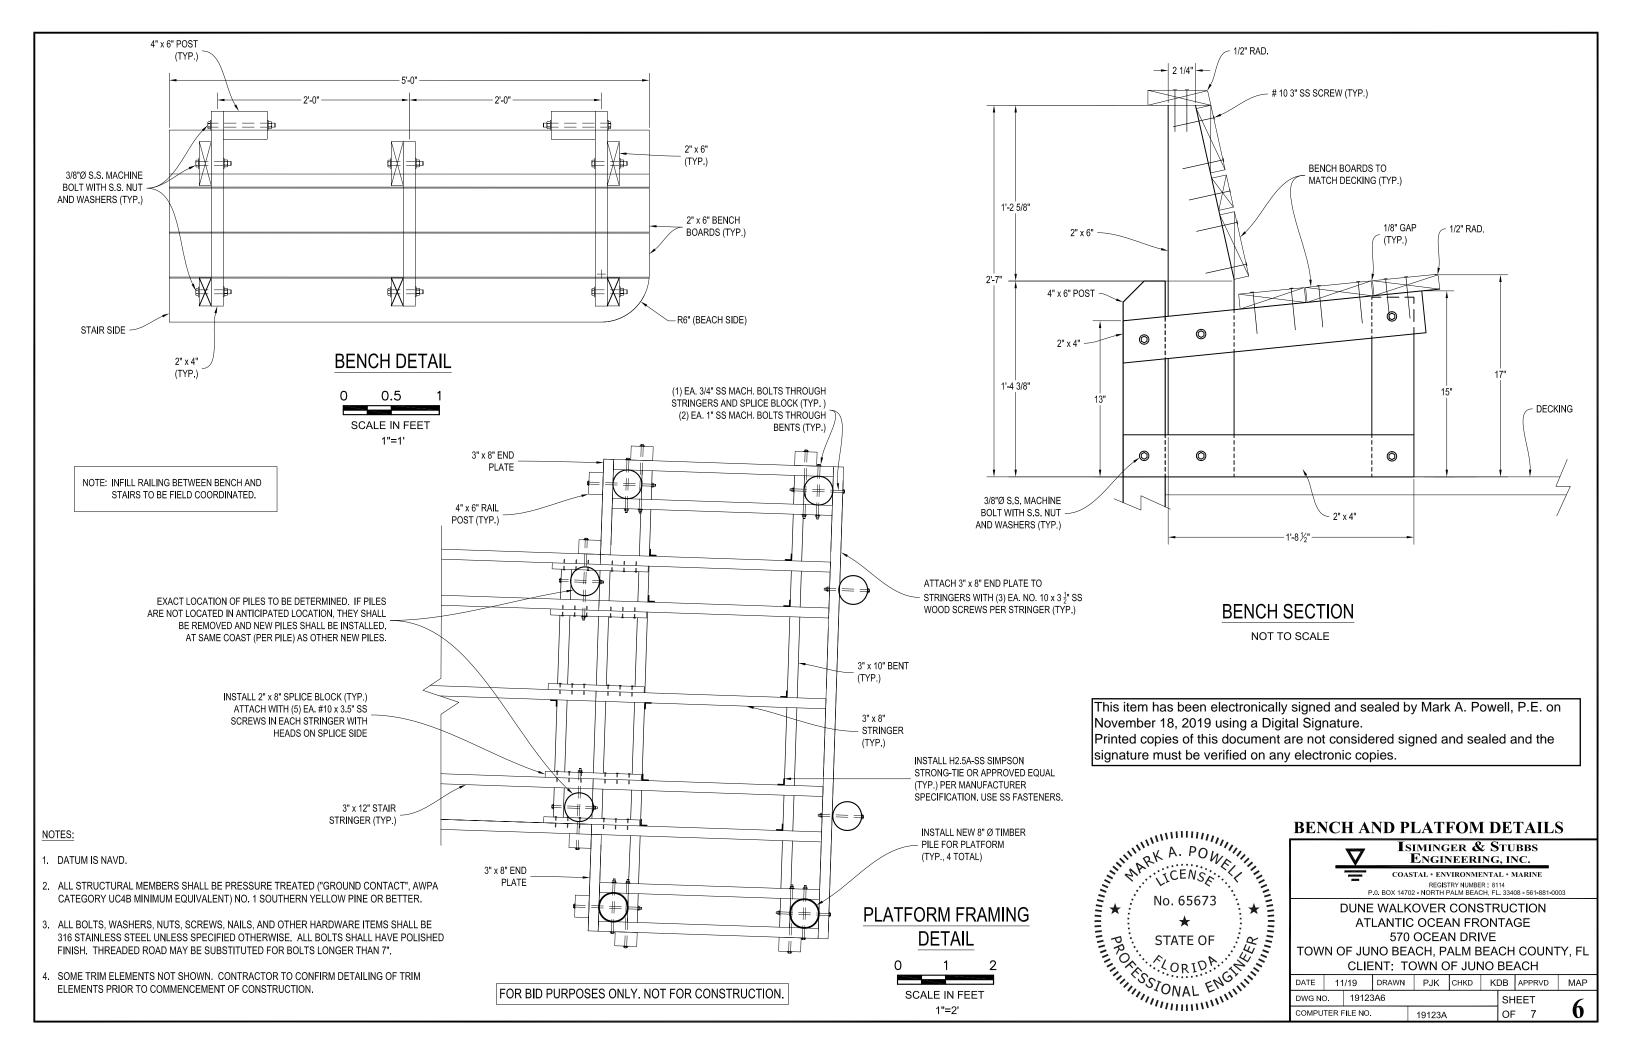


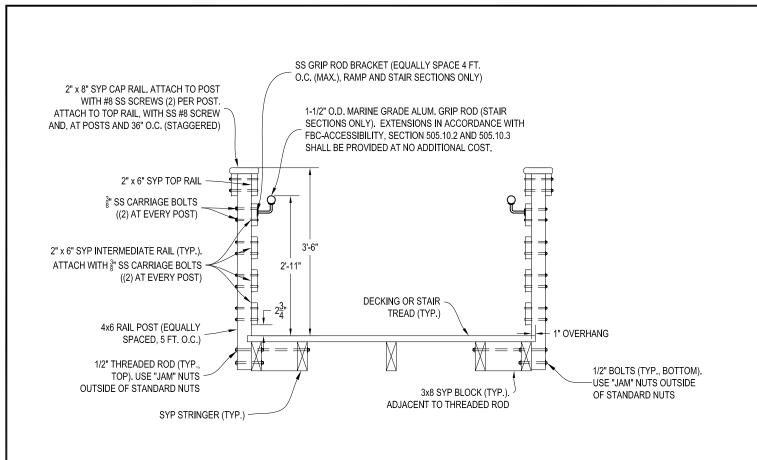

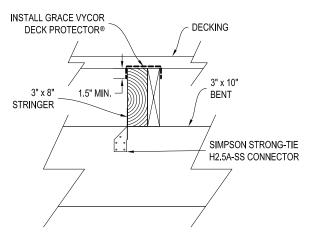

GRACE VYCOR DETAIL

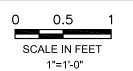

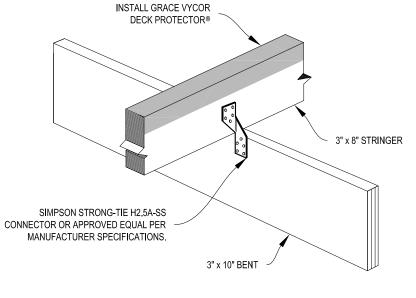

STRINGER/BENT DETAIL

NOT TO SCALE






MATERIALS TABLE

ITEM	BASE BID	ALT. 1	ALT. 2				
А	2" x 6" SYP *	2" x 6" > EVERGRAIN COMPOSITE > **	5/4" x 6" IPE				
В	2" x 6" SYP *	2" x 6" SYP *	5/4" x 6" IPE				
С	2" x 8" LUMBEROCK COMPOSITE **	2" x 8" LUMBEROCK COMPOSITE	2" x 6" IPE				


* SYP DECKING SHALL CONSIST OF 2" x 6" SUNBELT FOREST PRODUCTS SYP "TROPICAL PRESERVE PLUS" DECKING.

** CLIENT SHALL SELECT COLOR OF COMPOSITE AT NO ADDITIONAL COST.

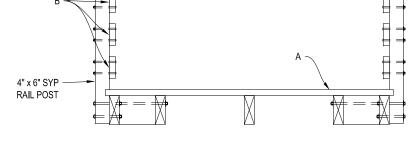

MATERIALS DETAIL

SCALE IN FEET 1"=2'-0"

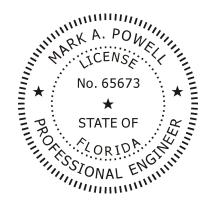

DETAILS

This item has been electronically signed and sealed by Mark A. Powell, P.E. on November 18, 2019 using a Digital Signature.

Printed copies of this document are not considered signed and sealed and the signature must be verified on any electronic copies.

REV 2 11/19 REVISE MATERIALS TABLE

REV 1 1/19 REVISE MATERIALS TABLE

Isiminger & Stubbs ENGINEERING, INC.

COASTAL • ENVIRONMENTAL • MARINE

REGISTRY NUMBER: 8114 P.O. BOX 14702 - NORTH PALM BEACH, FL. 33408 - 561-881-0003

DUNE WALKOVER CONSTRUCTION ATLANTIC OCEAN FRONTAGE 570 OCEAN DRIVE TOWN OF JUNO BEACH, PALM BEACH COUNTY, FL

CLIENT: TOWN OF JUNO BEACH

DATE 11/19 DRAWN PJK CHKD KDB APPRVD MAP DWG NO. 19123A7 SHEET COMPUTER FILE NO. 19123Ar2 OF 7

NOTES:

- 1. DATUM IS NAVD.
- 2. ALL STRUCTURAL MEMBERS SHALL BE PRESSURE TREATED ("GROUND CONTACT", AWPA CATEGORY UC4B MINIMUM EQUIVALENT) NO. 1 SOUTHERN YELLOW PINE OR BETTER.
- 3. ALL BOLTS, WASHERS, NUTS, SCREWS, NAILS, AND OTHER HARDWARE ITEMS SHALL BE 316 STAINLESS STEEL UNLESS SPECIFIED OTHERWISE. ALL BOLTS SHALL HAVE POLISHED FINISH. THREADED ROAD MAY BE SUBSTITUTED FOR BOLTS LONGER THAN 7". ALUMINUM HANDRAILS SHALL BE ALLOY 6061. CONTRACTOR TO PROVIDE CONNECTION DETAILS TO ENGINEER PRIOR TO ORDERING AND INSTALLING.
- SOME TRIM ELEMENTS NOT SHOWN. CONTRACTOR TO CONFIRM DETAILING OF TRIM ELEMENTS PRIOR TO COMMENCEMENT OF CONSTRUCTION.

FOR BID PURPOSES ONLY. NOT FOR CONSTRUCTION.