




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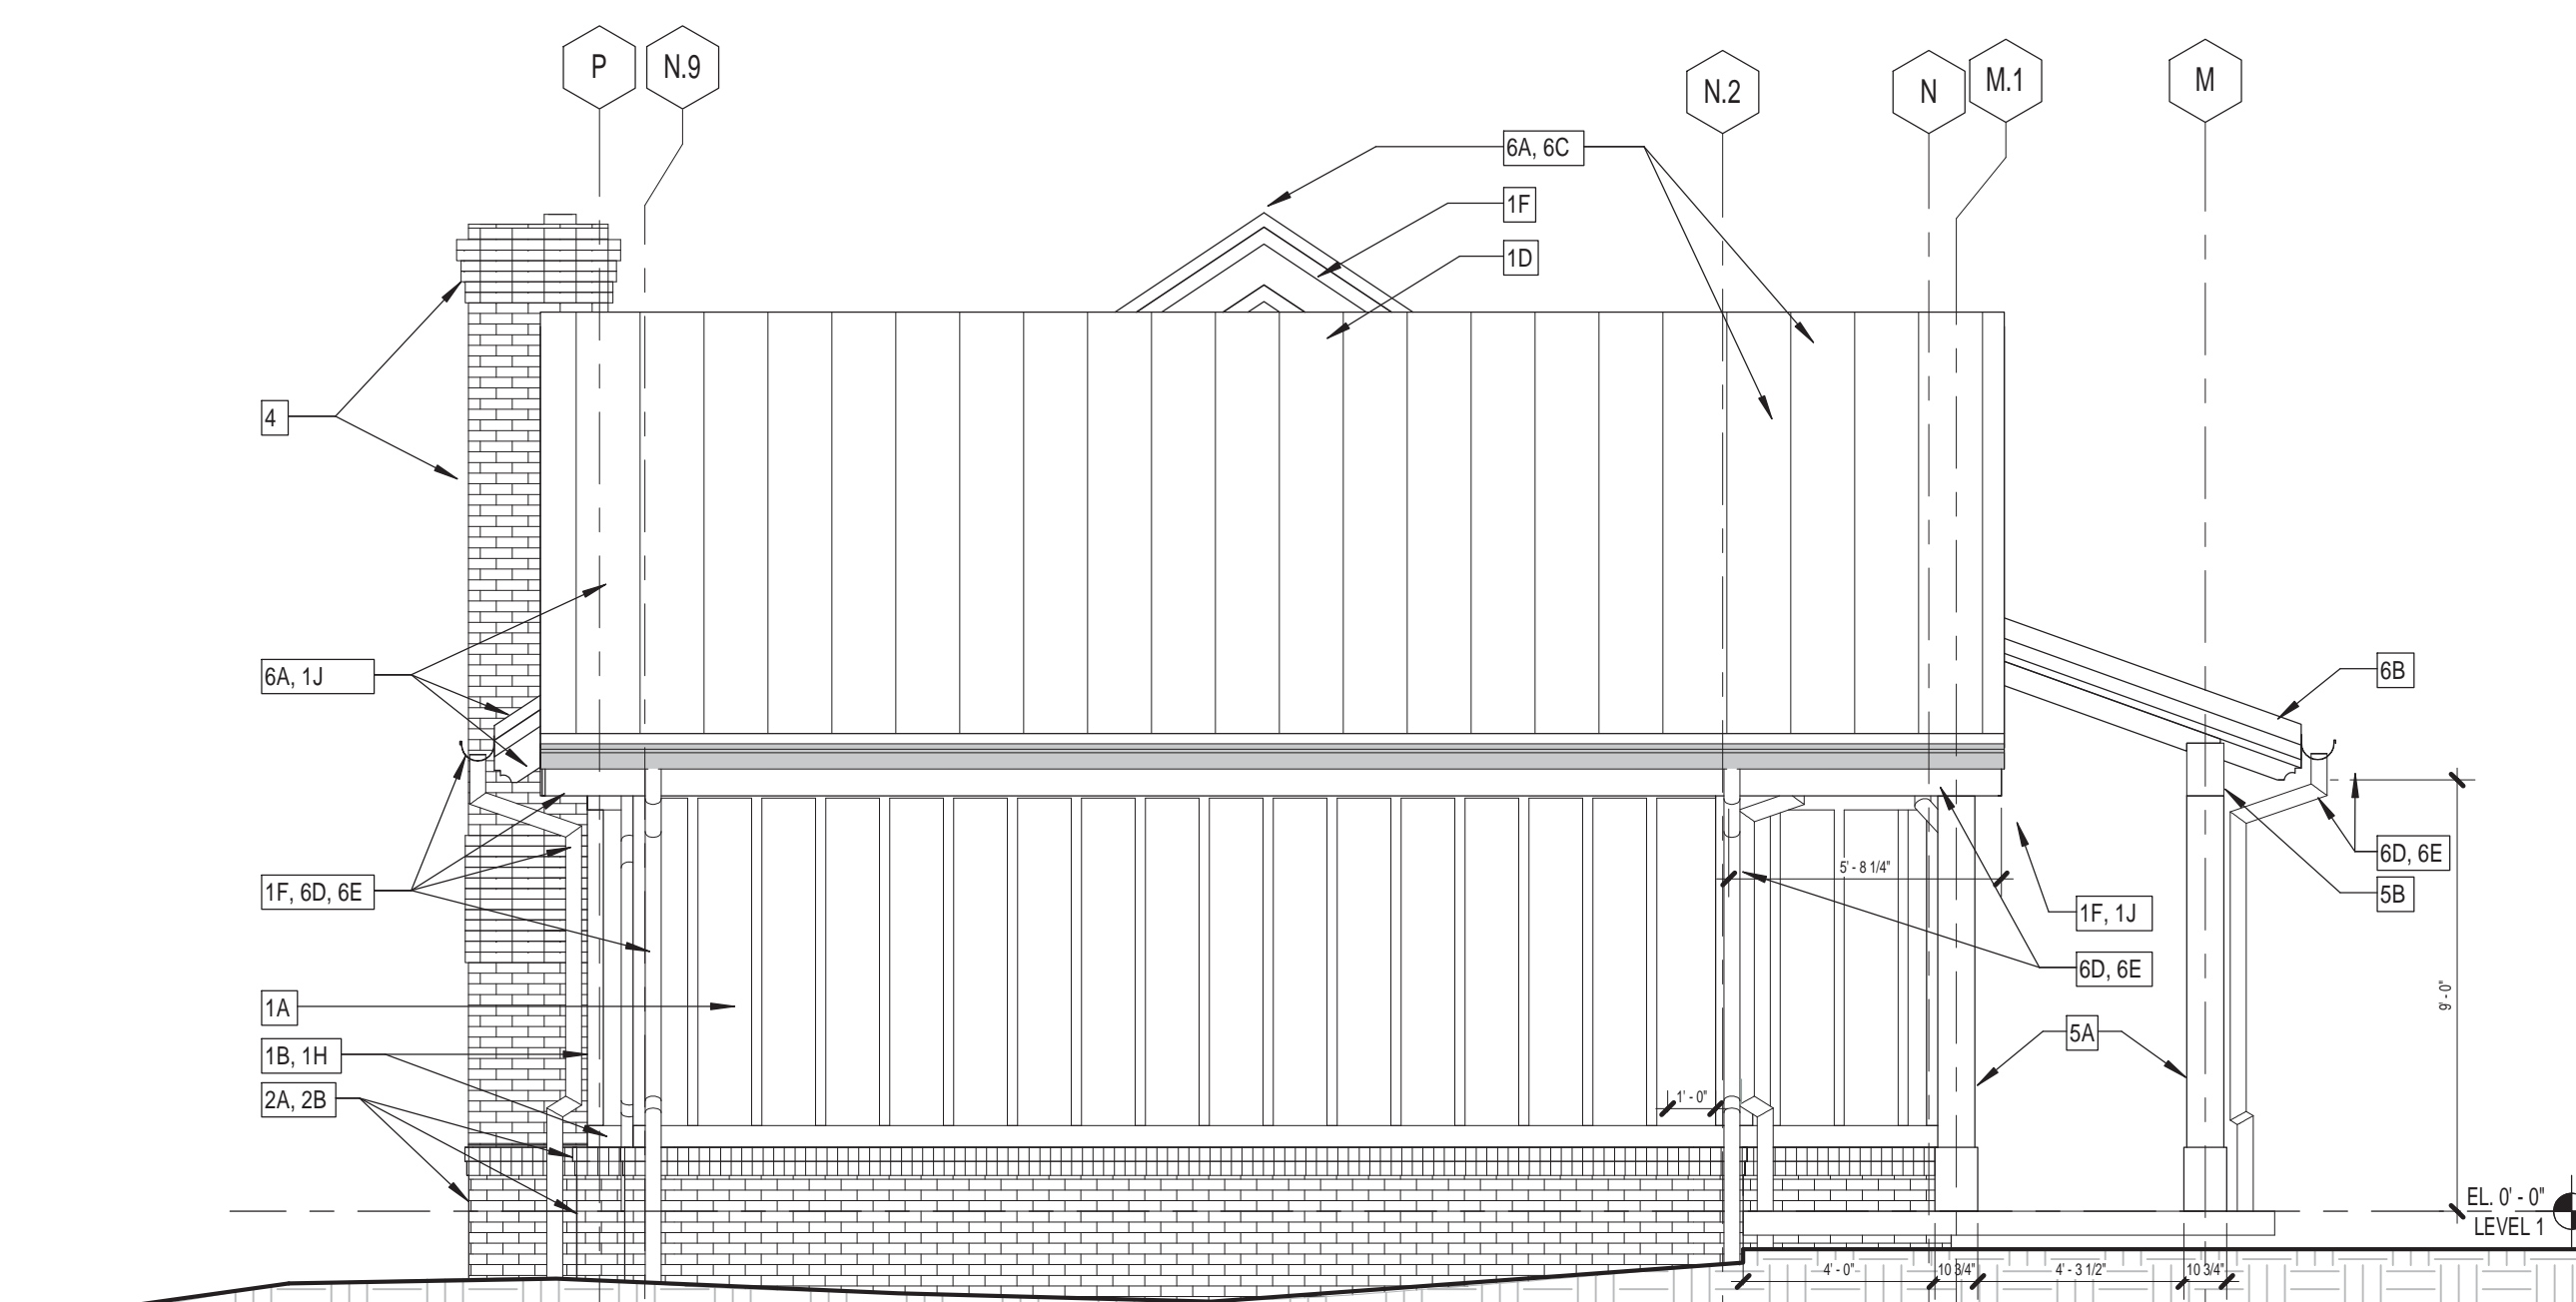
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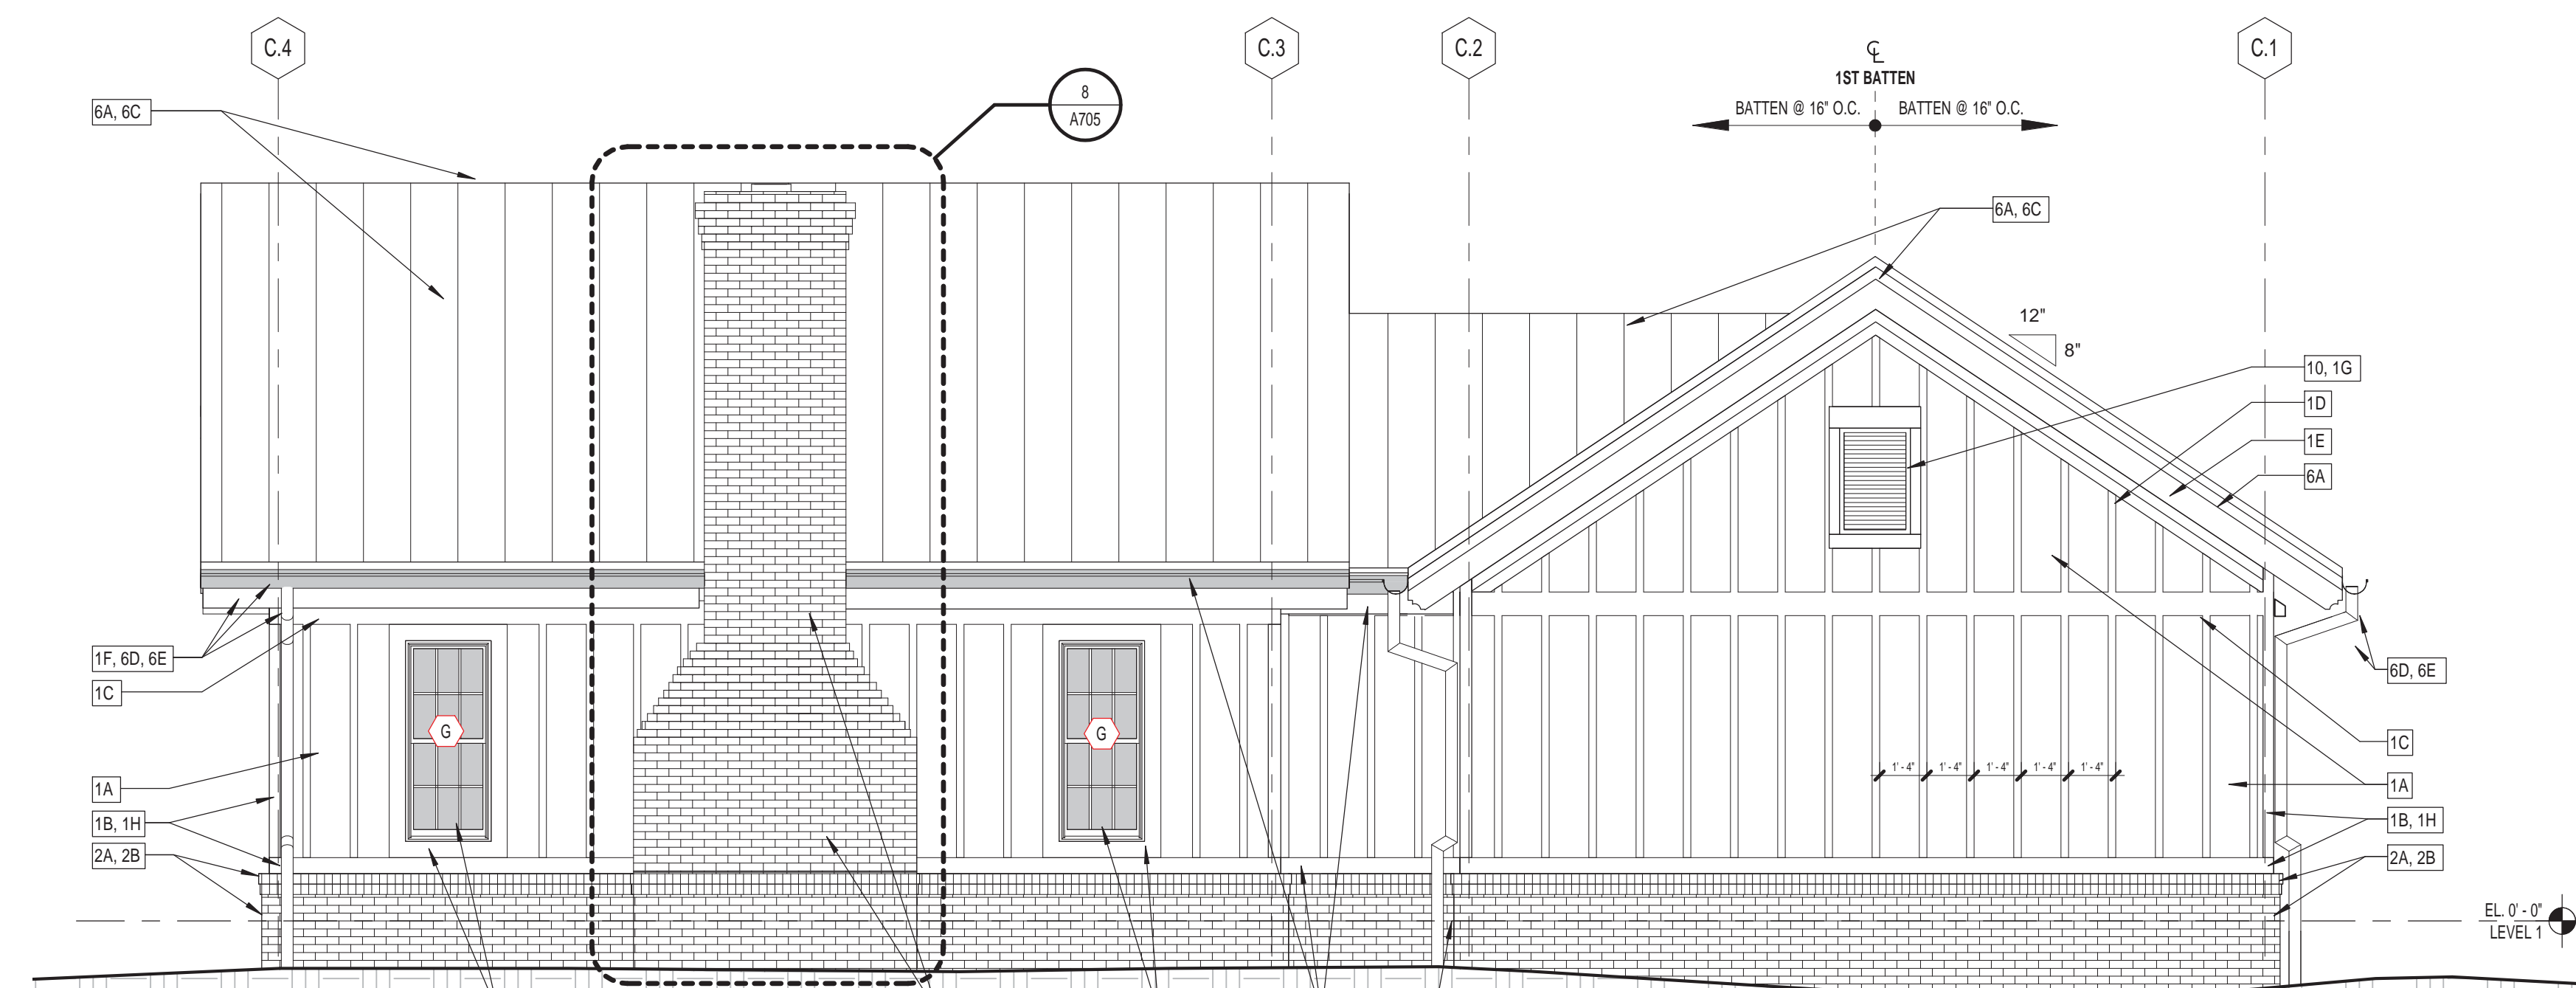
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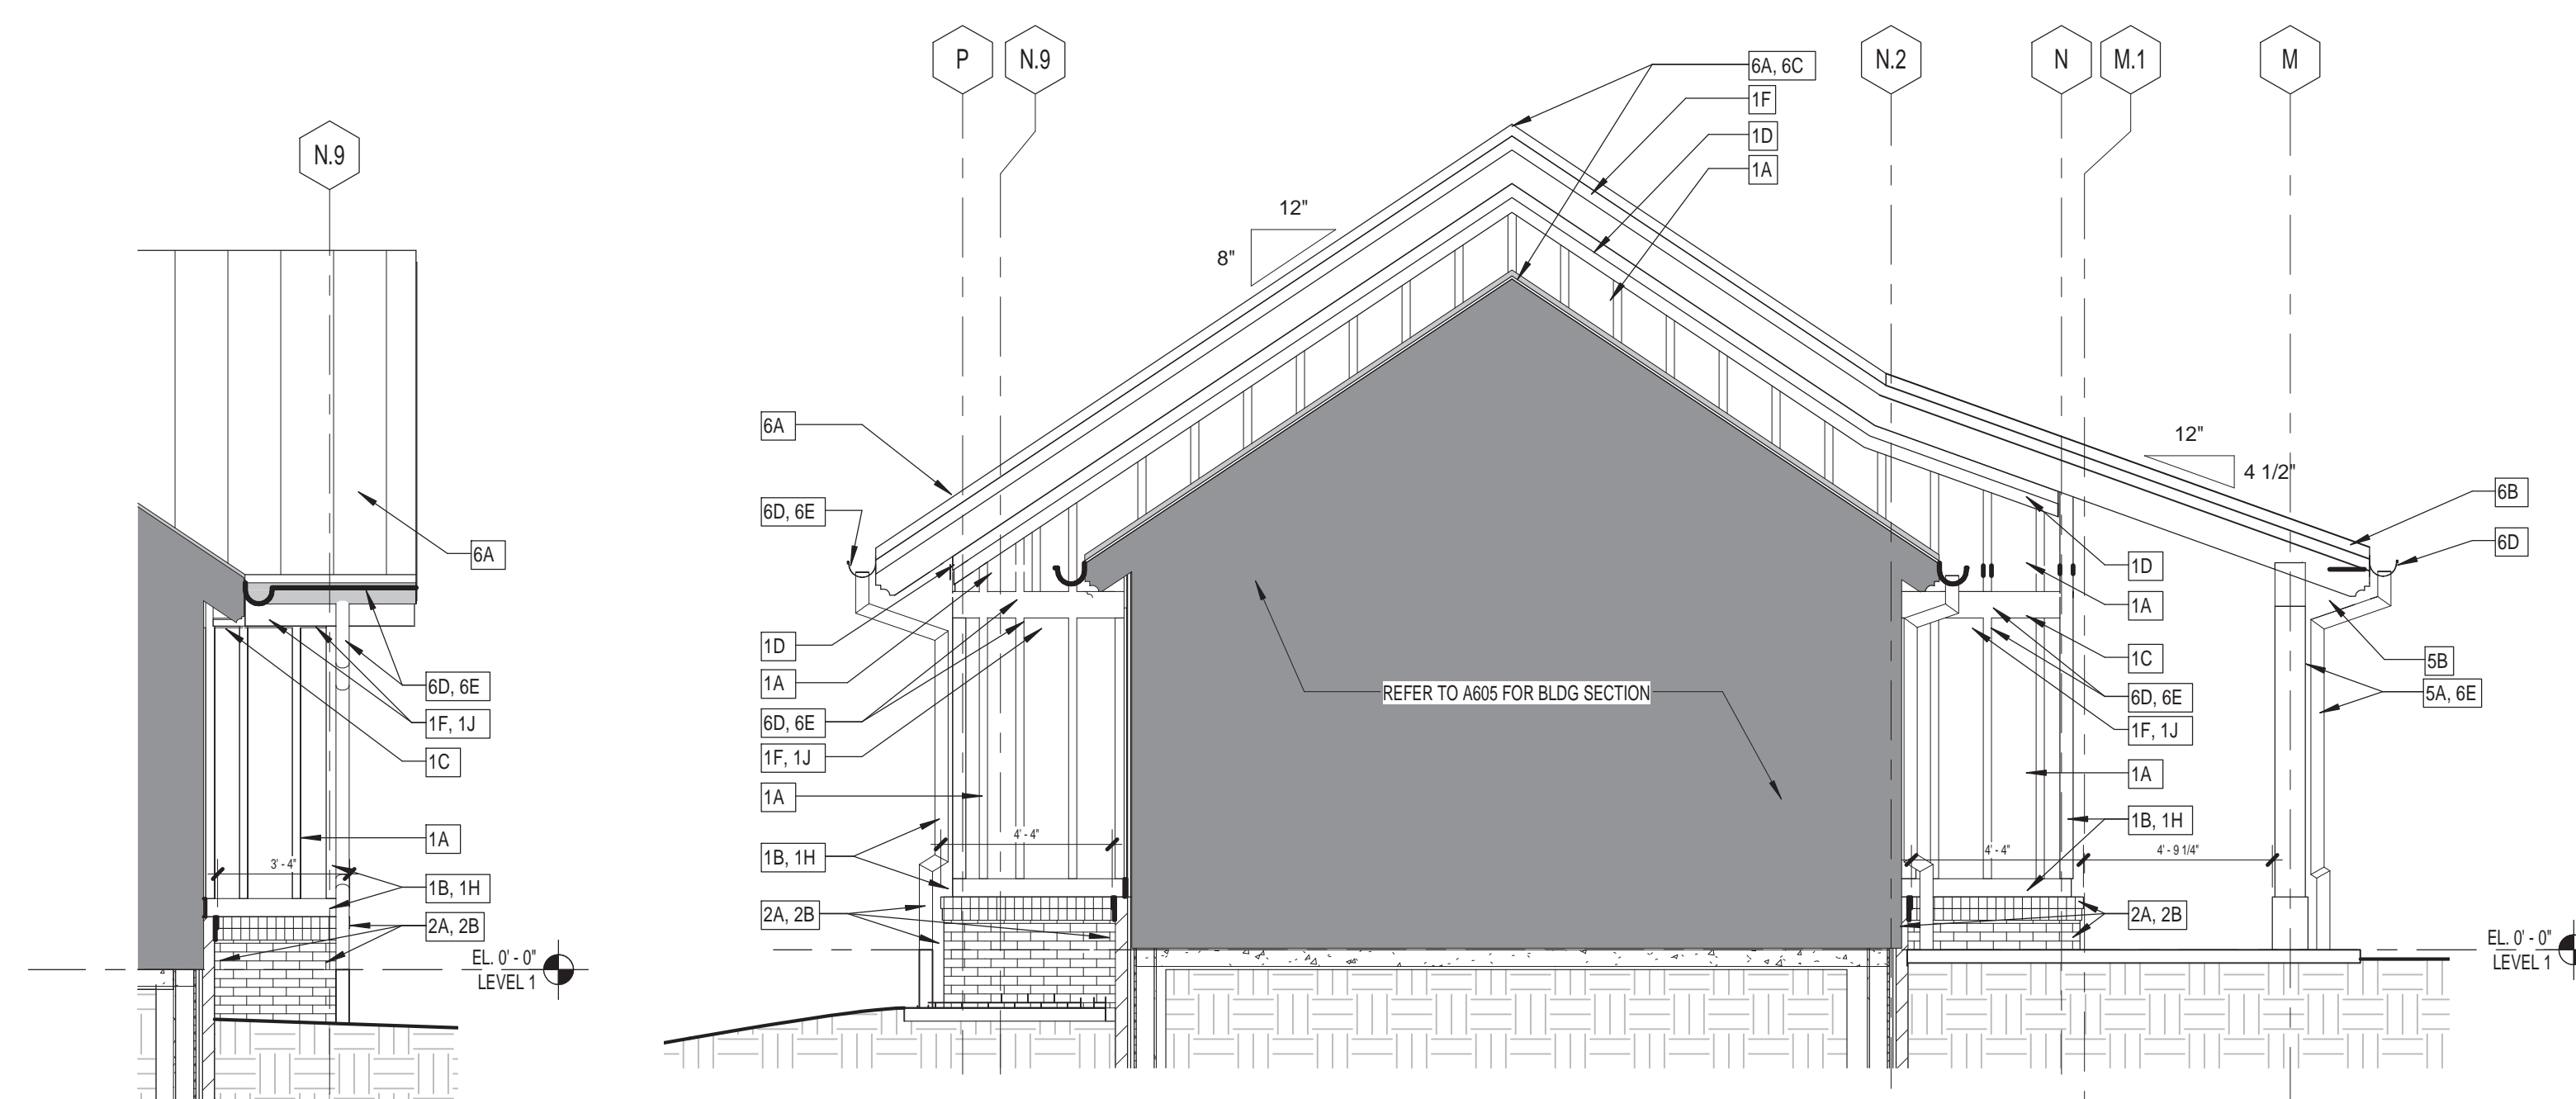
ISSUANCES		
No.	Drawing Issue Description	Date
1	ISSUED FOR DESIGN DEVELOPMENT	7/17/2015
2	ISSUED FOR CONSTRUCTION	12/14/15
3	ISSUED FOR CONSTRUCTION / CONFORMED	02/12/16




1 COMMUNITY BLDG - WEST ELEVATION  
A410 SCALE: 1/4" = 1'-0"

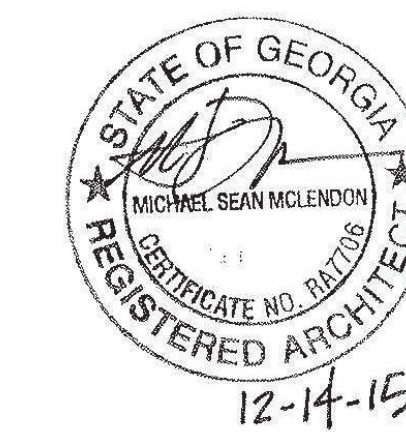


4 COMMUNITY BLDG - NORTH ELEVATION  
A410 SCALE: 1/4" = 1'-0"




5 COMM. BLDG - EAST (NICHE) ELEVATION  
A410 SCALE: 1/4" = 1'-0"

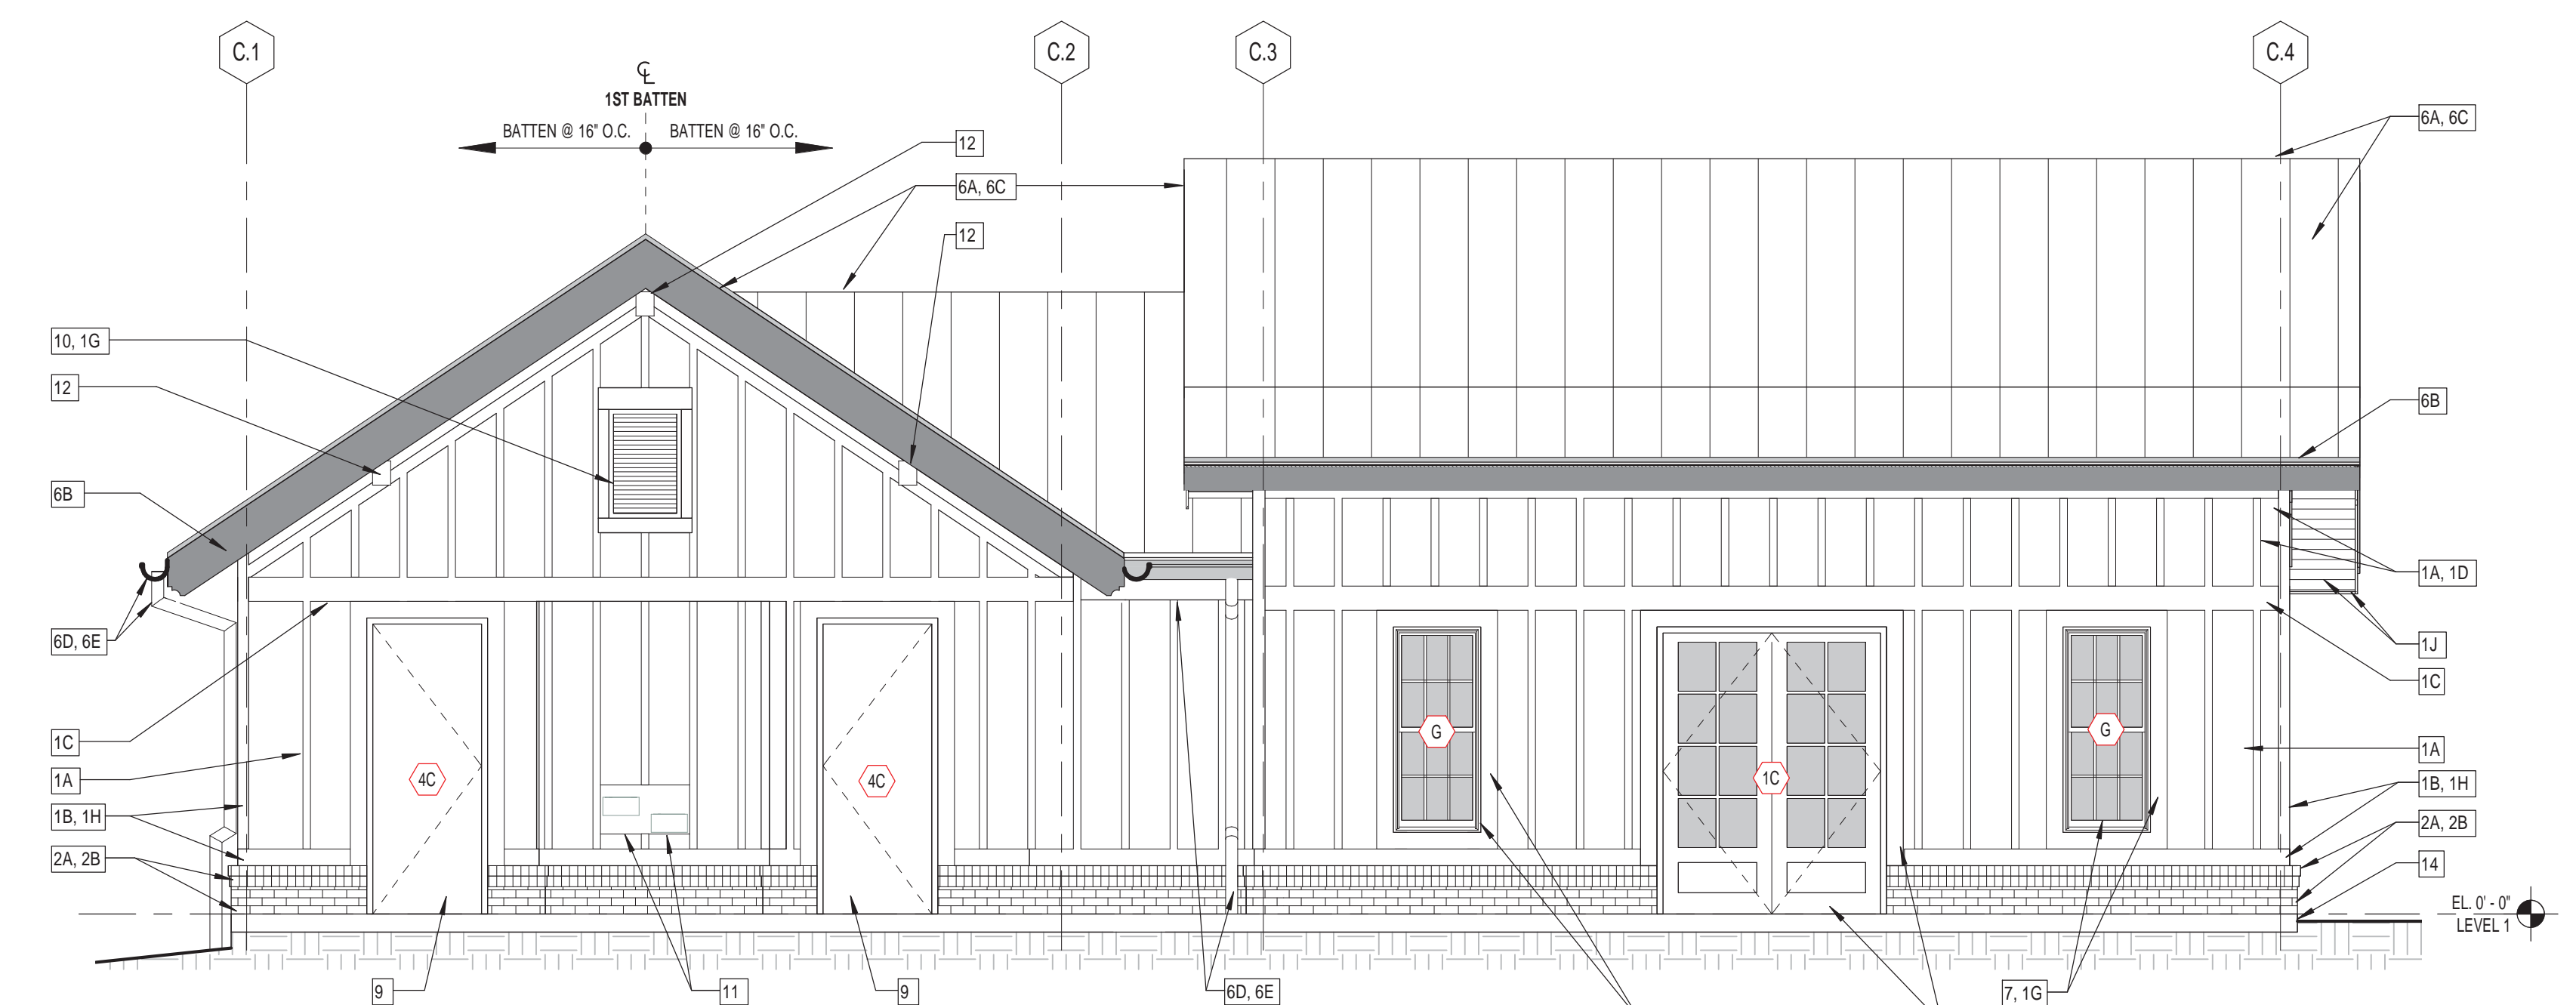


7 COMMUNITY BLDG - SOUTH ELEVATION AT VERTICAL WALL  
A410 SCALE: 1/4" = 1'-0"

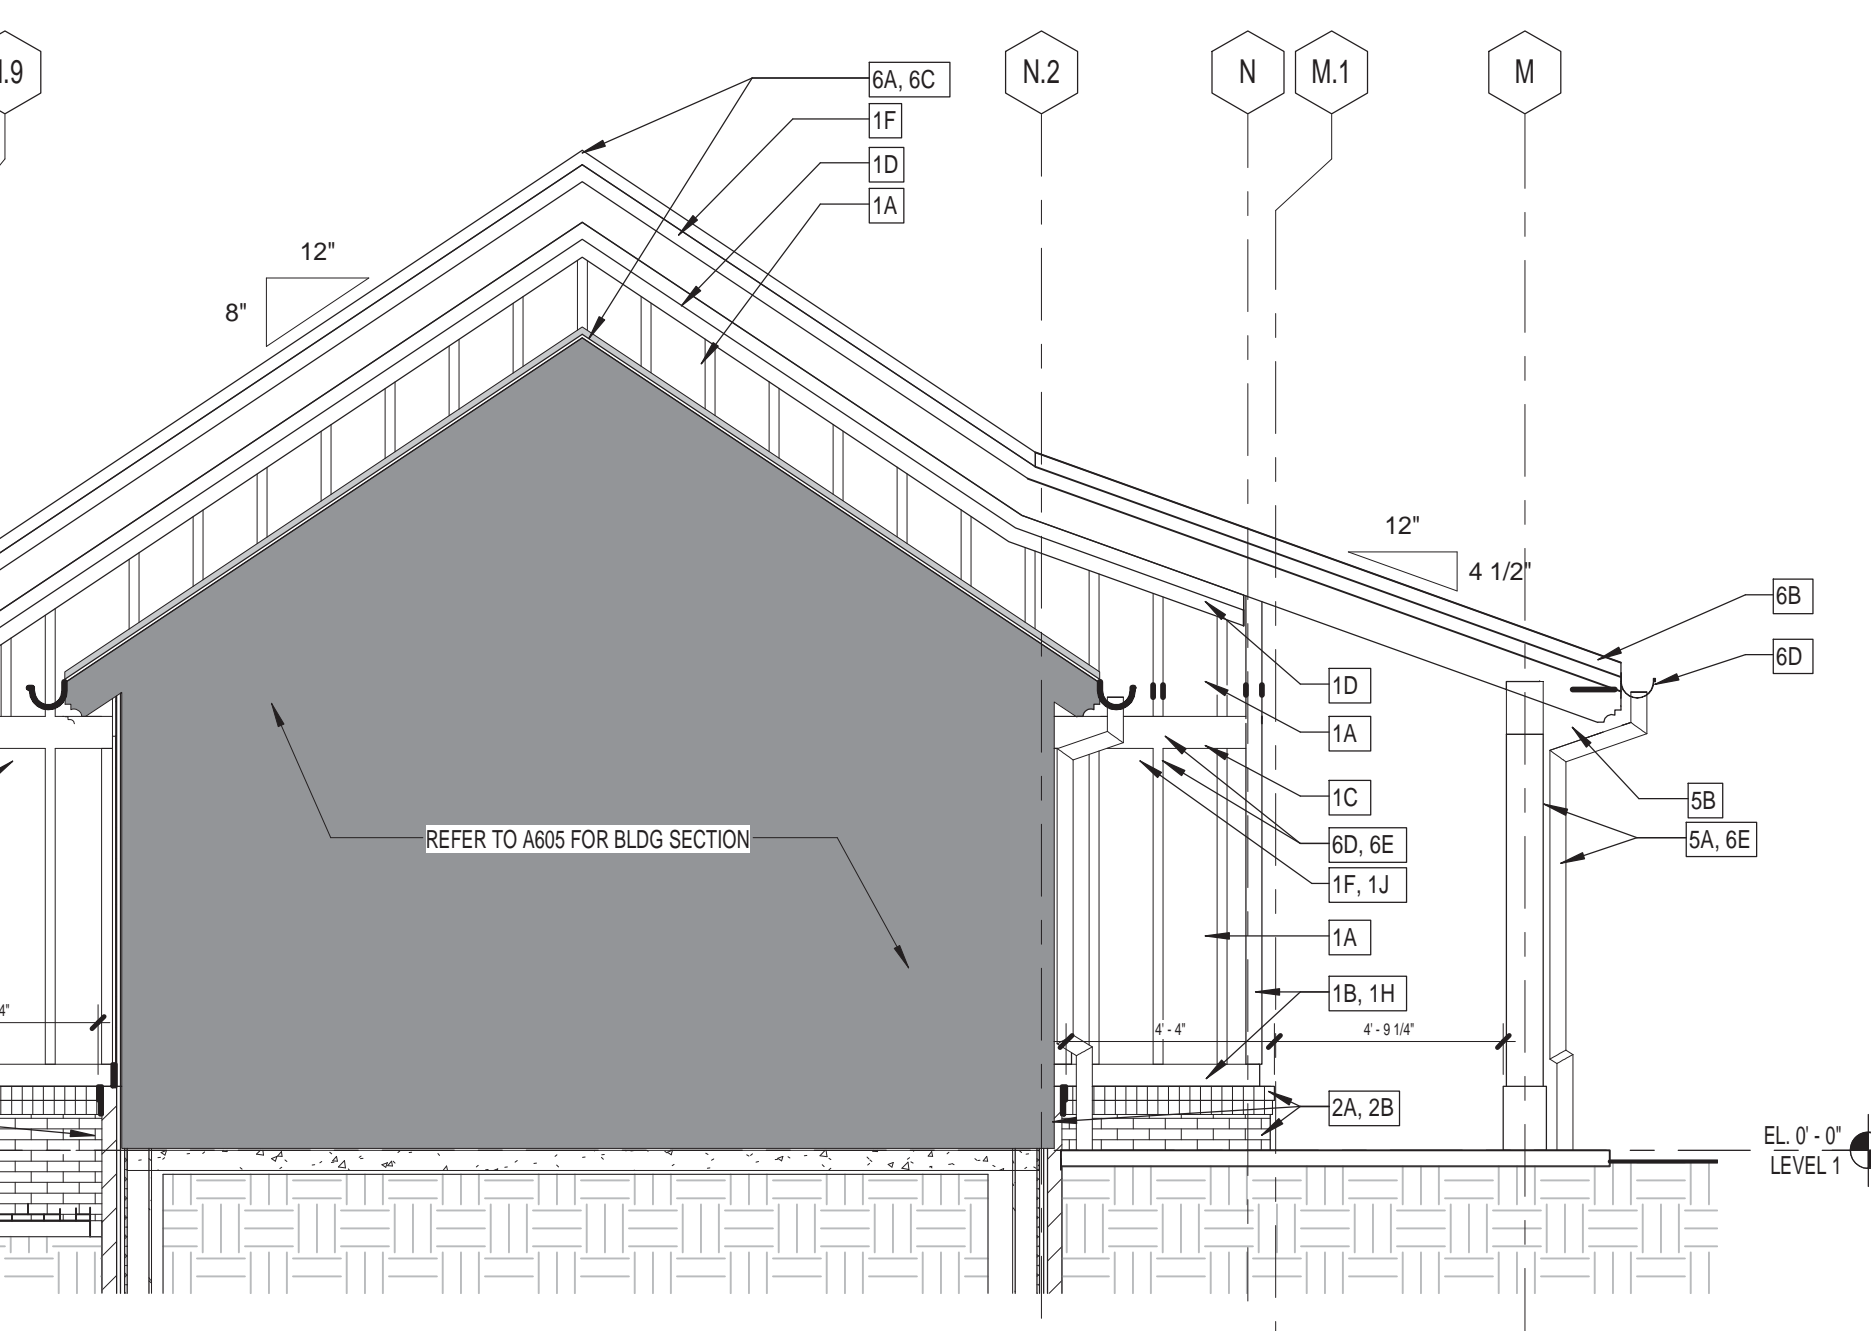

6 COMM. BLDG - WEST (NICHE) ELEVATION  
A410 SCALE: 1/4" = 1'-0"

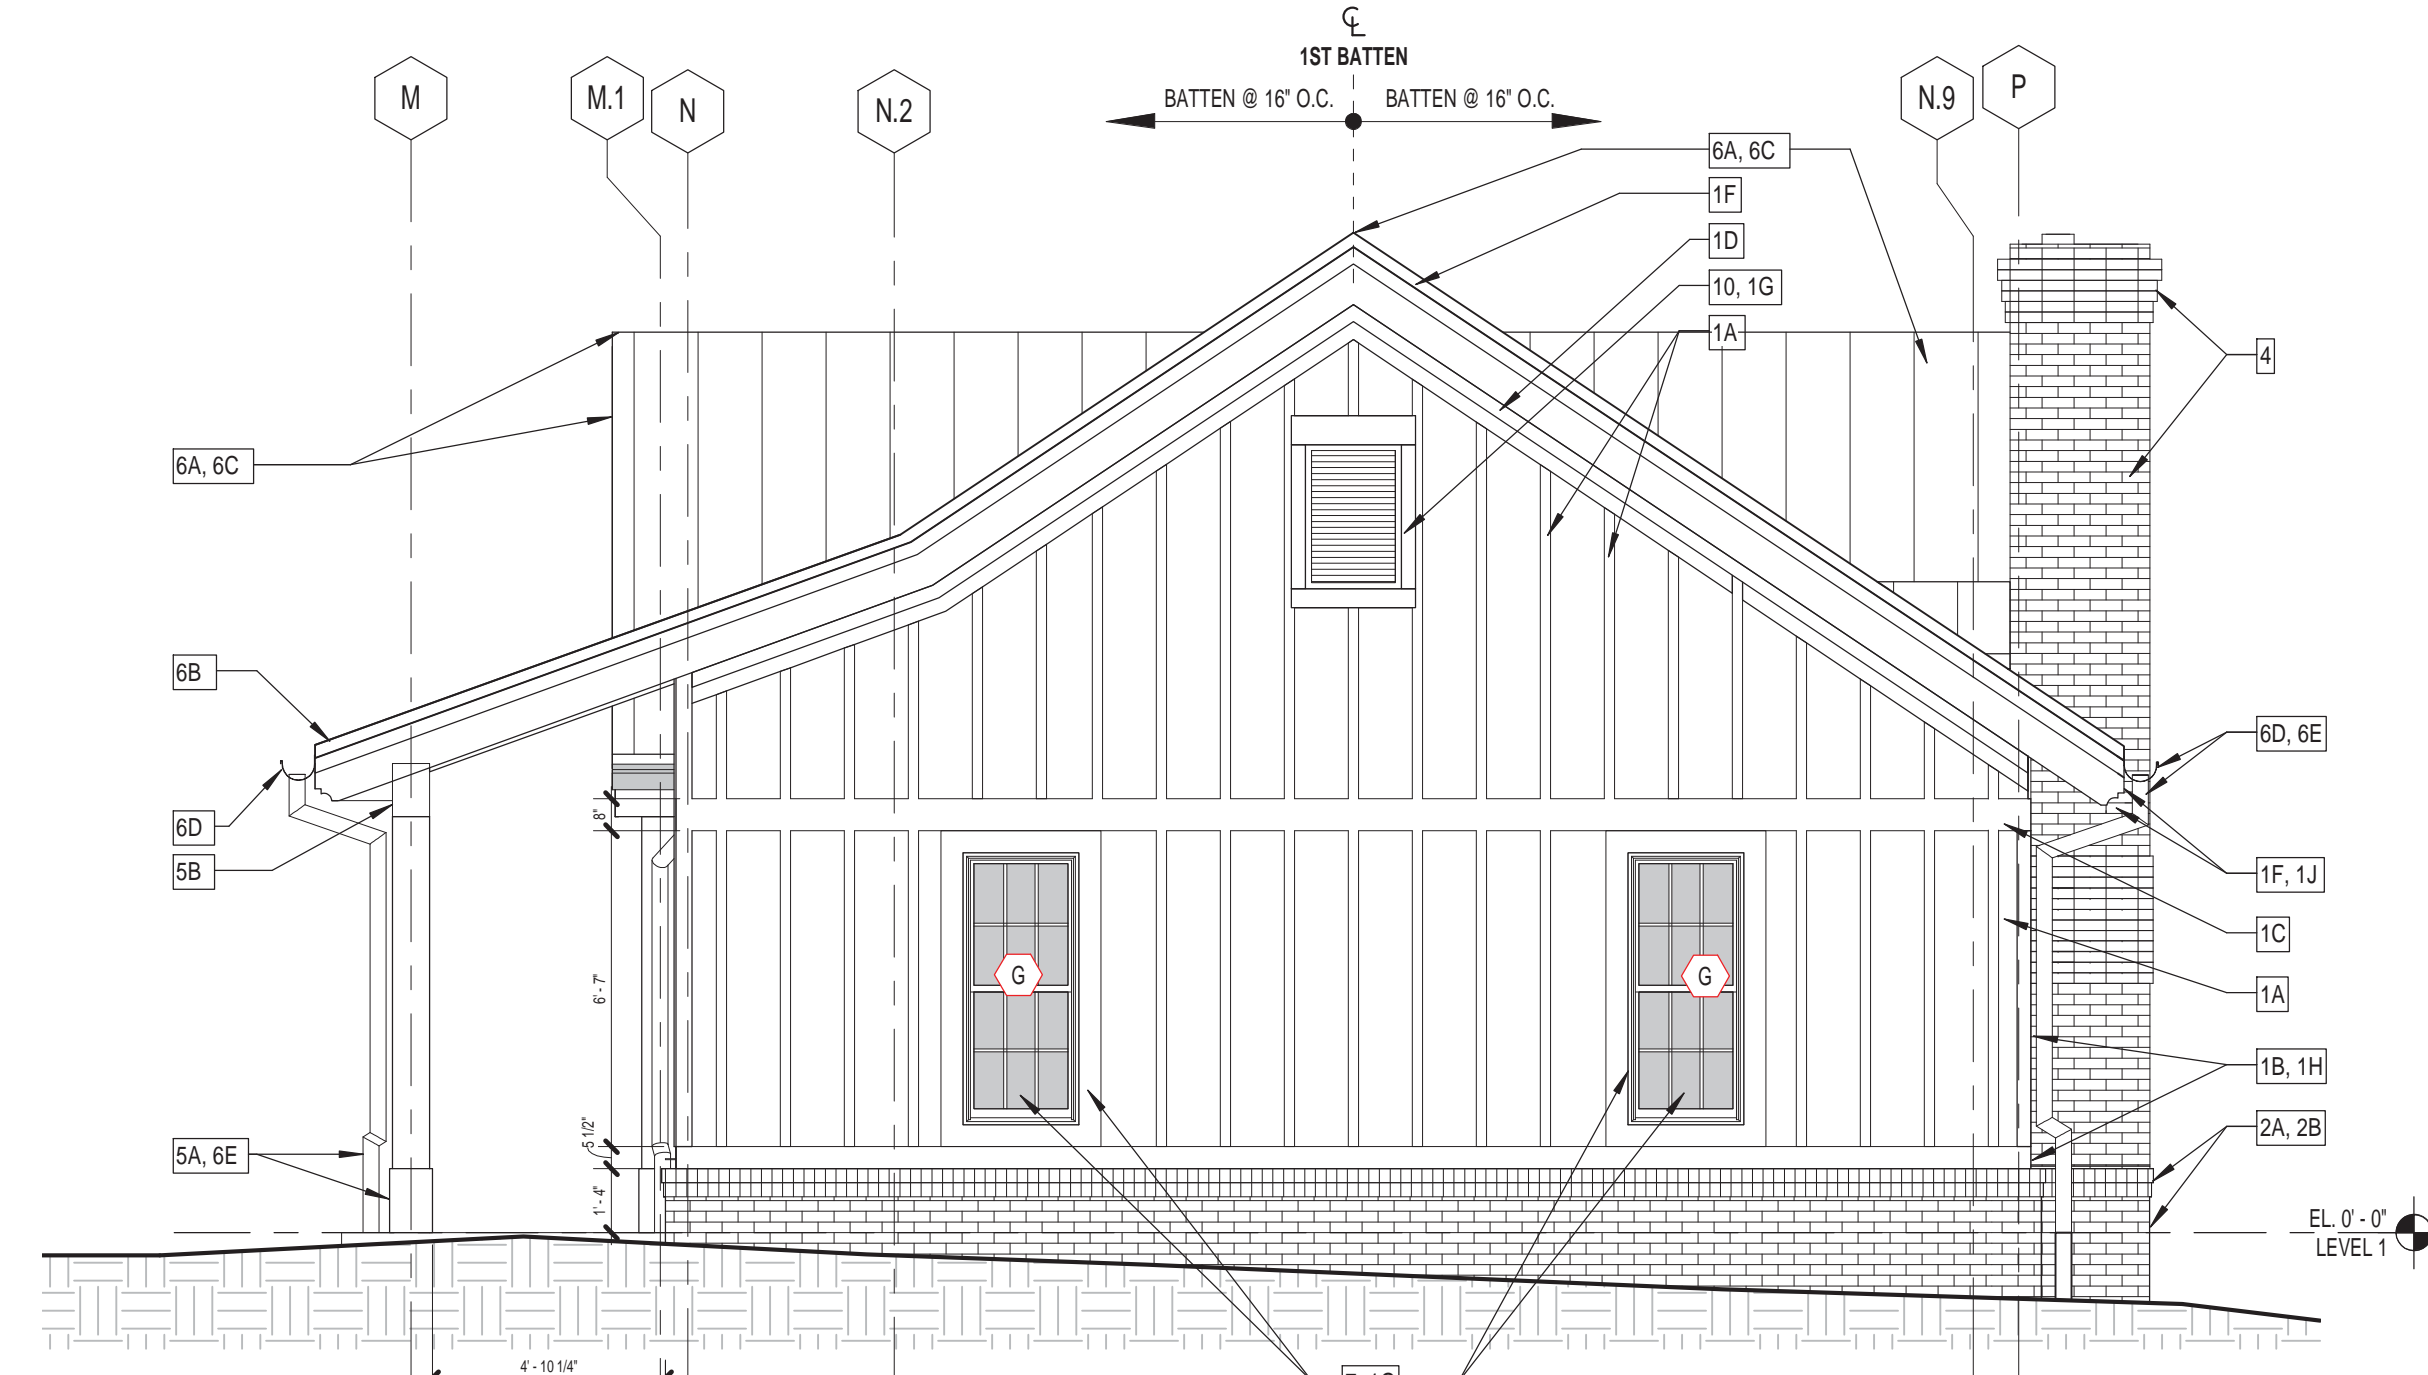

2 COMMUNITY BLDG - EAST ELEVATION  
A410 SCALE: 1/4" = 1'-0"

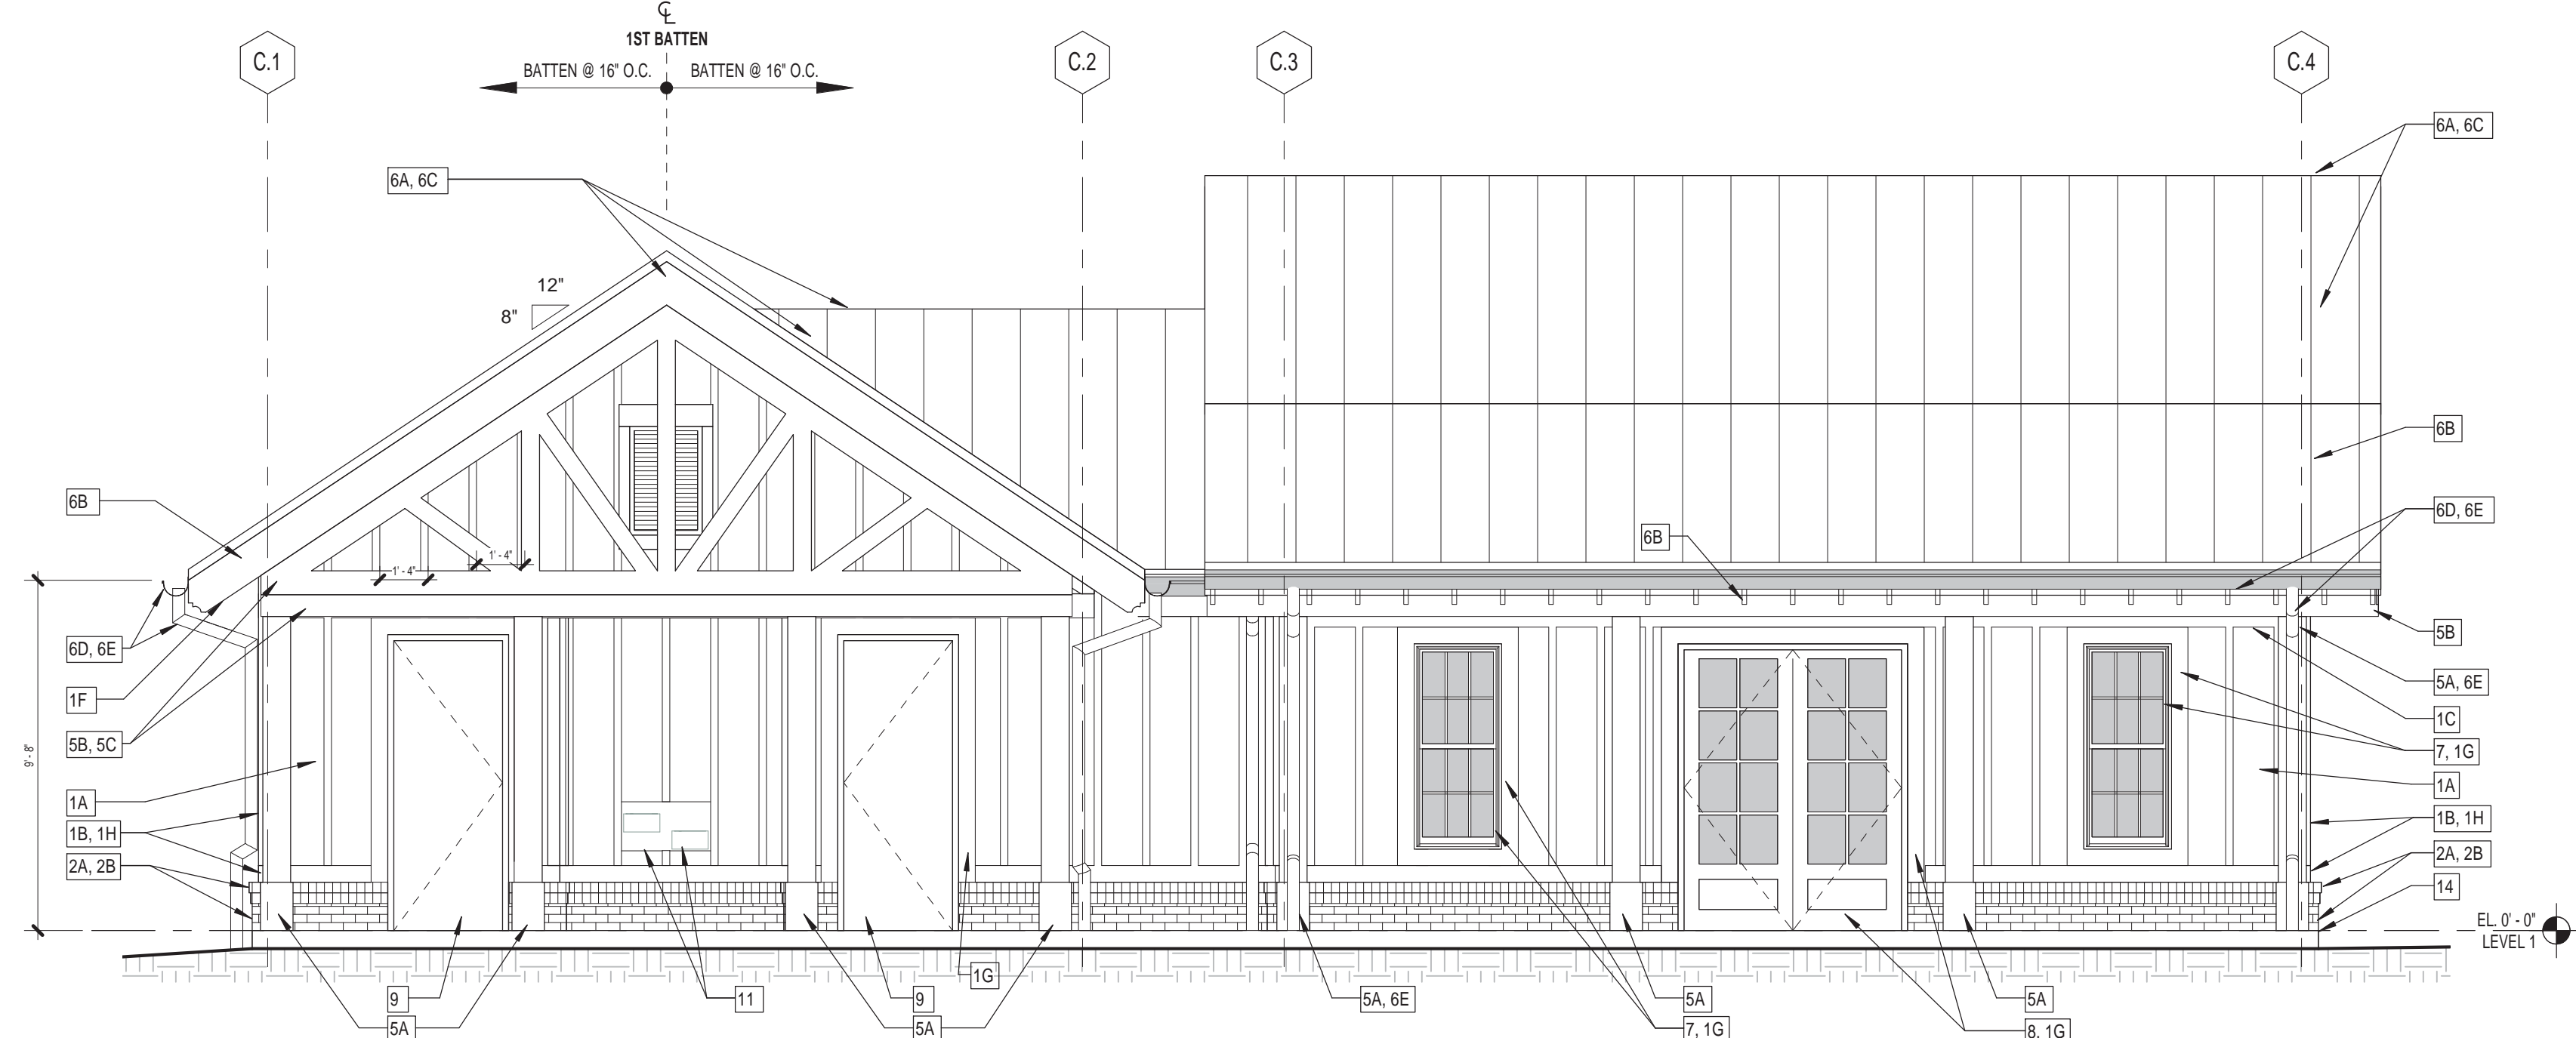

3 COMMUNITY BLDG - SOUTH ELEVATION  
A410 SCALE: 1/4" = 1'-0"

KEYNOTE LEGEND - ELEVATIONS (COMMUNITY BLDG)		ALSO REFER TO SHEETS A921 & A922 FOR ADD'L INFORMATION	
1A	FIBER CEMENT PANEL CLADDING w/ VERTICAL BATTEN STRIPS	4	CHIMNEY w/ SINGLE 8" FLUE - BRICK VENEER - TYPE 2, RUNNING BOND, CONCAVE MORTAR JOINTS - SEE A705
1B	FIBER CEMENT SKIRTBOARD, 5/4 (6")	5A	10" HEAVY TIMBER COLUMN w/ 1x TIMBER WRAP BASE (SEAL)
1C	FIBER CEMENT HORIZONTAL TRIM BAND, 5/4 (8")	5B	14" HEAVY TIMBER BEAM (SEAL)
1D	FIBER CEMENT RAKE TRIM, 5/4 (4" & 8")	5C	HEAVY TIMBER EXPOSED GABLE TRUSS (SEAL) w/PREFINISHED FASTENERS
1E	FIBER CEMENT FASCIA TRIM (GABLE FACE), 5/4 (4" & 8")	6A	STANDING SEAM METAL ROOF ASSEMBLY, GALVALUME, 2" OVERHANG TYP.
1F	FIBER CEMENT FASCIA TRIM (EAVE FACE), 5/4 (12")	6B	STANDING SEAM METAL CANOPY ASSEMBLY w/EXPOSED JOIST FRAMING, GALVALUME
1G	FIBER CEMENT TRIM, 5/4 (6") - TYP AT ALL WINDOW/ DOOR/ LOCATIONS AT FIBER CEMENT CLADDING. SEE 20/A921 FOR LOUVER TRIM	3	MASONRY EXPANSION JOINT
1H	FIBER CEMENT CORNER TRIM, 5/4 (4") - TYP AT ALL OUTSIDE & INSIDE CORNERS AT FIBER CEMENT CLADDING		
1J	FIBER CEMENT BEAD BD SOFFIT (PERPENDICULAR) w/VENTS		
1K	FIBER CEMENT BEAD BD SOFFIT (PERPENDICULAR) w/o VENTS		
2A	DOUBLE ROWLOCK BRICK WATERTABLE - TYPE 2, PROJECTED 1/2" EACH COURSE, CONCAVE MORTAR JOINTS		
2B	BASE BRICK VENEER - TYPE 2, RUNNING BOND, CONCAVE MORTAR JOINTS		
3	MASONRY EXPANSION JOINT		
4	CHIMNEY w/ SINGLE 8" FLUE - BRICK VENEER - TYPE 2, RUNNING BOND, CONCAVE MORTAR JOINTS - SEE A705		
5A	10" HEAVY TIMBER COLUMN w/ 1x TIMBER WRAP BASE (SEAL)		
5B	14" HEAVY TIMBER BEAM (SEAL)		
5C	HEAVY TIMBER EXPOSED GABLE TRUSS (SEAL) w/PREFINISHED FASTENERS		
6A	STANDING SEAM METAL ROOF ASSEMBLY, GALVALUME, 2" OVERHANG TYP.		
6B	STANDING SEAM METAL CANOPY ASSEMBLY w/EXPOSED JOIST FRAMING, GALVALUME		
6C	RIDGE VENT, GALVALUME		
6D	ALUMINUM GUTTER SYSTEM, GALVALUME (OGEE PROFILE)		
6E	ALUMINUM DOWNSPOUT, GALVALUME (ROUND PROFILE)		
7	ALUMINUM STOREFRONT THERMAL WINDOW SYSTEM (2' x 6'), 1" INSULATED GLAZING INFILL (FRONT SET)		
8	ALUMINUM STOREFRONT THERMAL ENTRANCE SYSTEM (2' x 6'), 1" INSULATED GLAZING INFILL (FRONT SET)		
9	HM DOOR /FRAME, PAINT PER SCHED.		
10	HM LOUVER (NON-FUNCTIONAL) / FRAME, PREFINISHED		
11	HI-LO DRINKING FOUNTAIN w/ REMOTE CHILLER; STAINLESS STEEL FINISH; CANE DETECTABLE ACCESSORY AT HI SIDE		
12	EXTERIOR LIGHTING		
13	BLDG SIGNAGE TBD - PROVIDE BLOCKING (NON-COMBUSTIBLE)		
14	PAVERS (REFER TO HARDSCAPE DWGS)		

MILTON CITY HALL



MILTON, GA

CITY OF MILTON

BUILDING ELEVATIONS -  
COMMUNITY BUILDING

Sean McLendon Principal-in-Charge	20140238 Project No.
Brian M. Parker, AIA Project Manager	12/14/15 Date
Venus Gerwin Project Architect	
SA, AJ, DY, AN Staff Architect	
	<b>A410</b>
	Drawing No.

PROJECT NUMBER: 20140238 PROJECT NAME: MILTON CITY HALL  
SHEET NUMBER: A410 - BUILDING ELEVATIONS - COMMUNITY BUILDING  
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