


| ISSUANCES |                                     |           |
|-----------|-------------------------------------|-----------|
| No.       | Drawing Issue Description           | Date      |
| 1         | ISSUED FOR DESIGN DEVELOPMENT       | 7/17/2015 |
| 2         | ISSUED FOR CONSTRUCTION             | 12/14/15  |
| 3         | ISSUED FOR CONSTRUCTION / CONFORMED | 02/12/16  |

## ADMIN BLDG - WEST ELEVATION

SCALE: 1/8" = 1'-0"


SCALE: 1/8" = 1'-0"

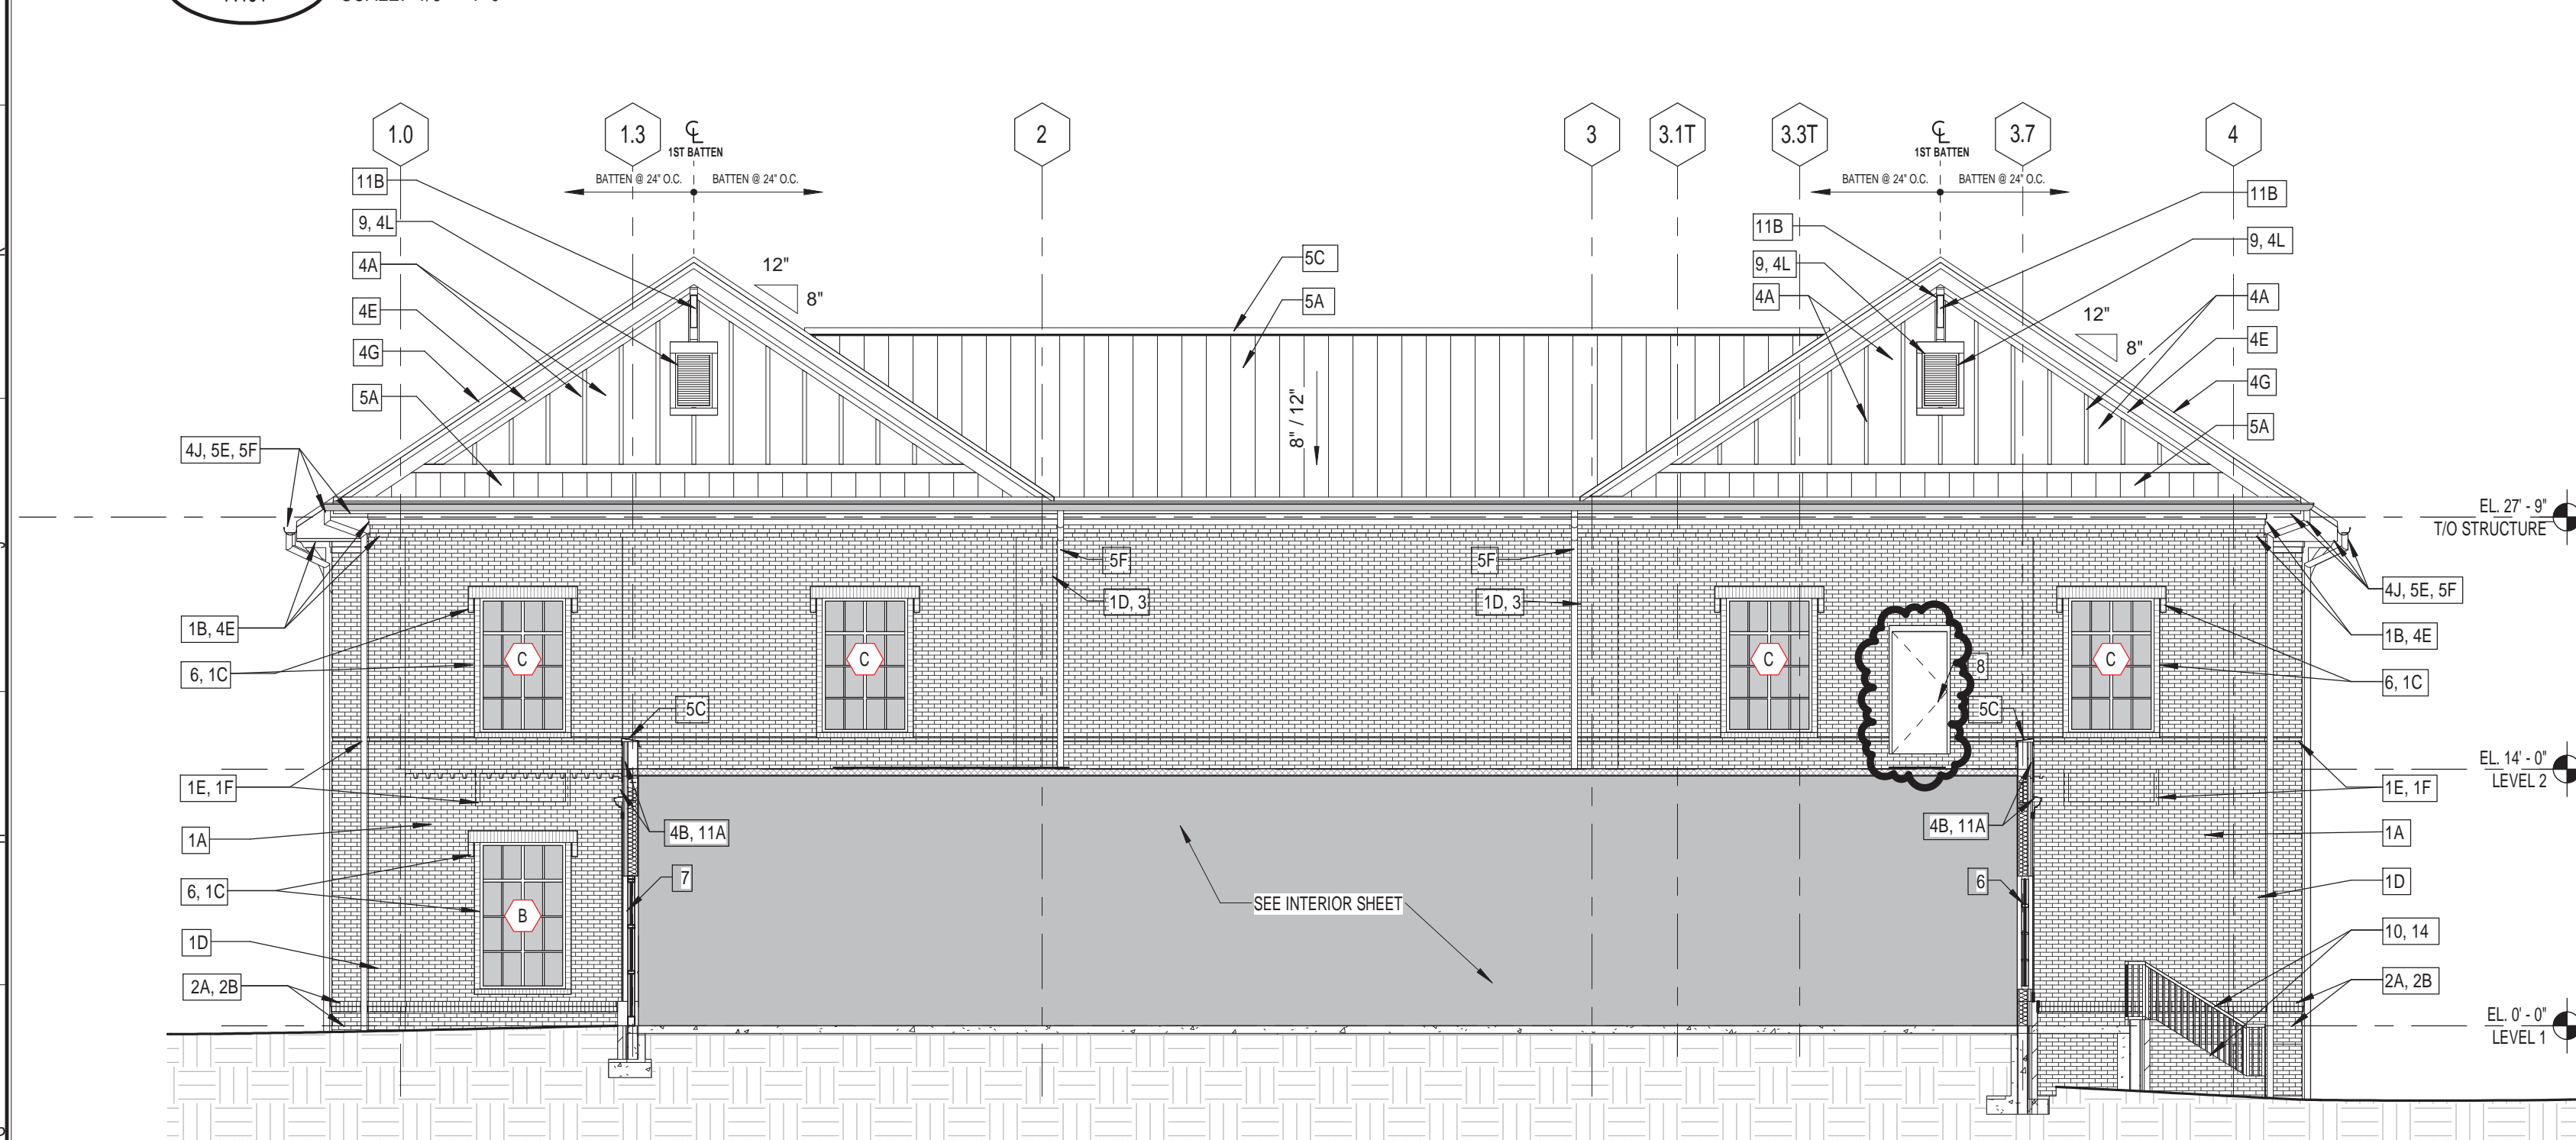

ADMIN BLDG - SOUTH ELEVATION

SCALE: 1:


SCALE: 1:

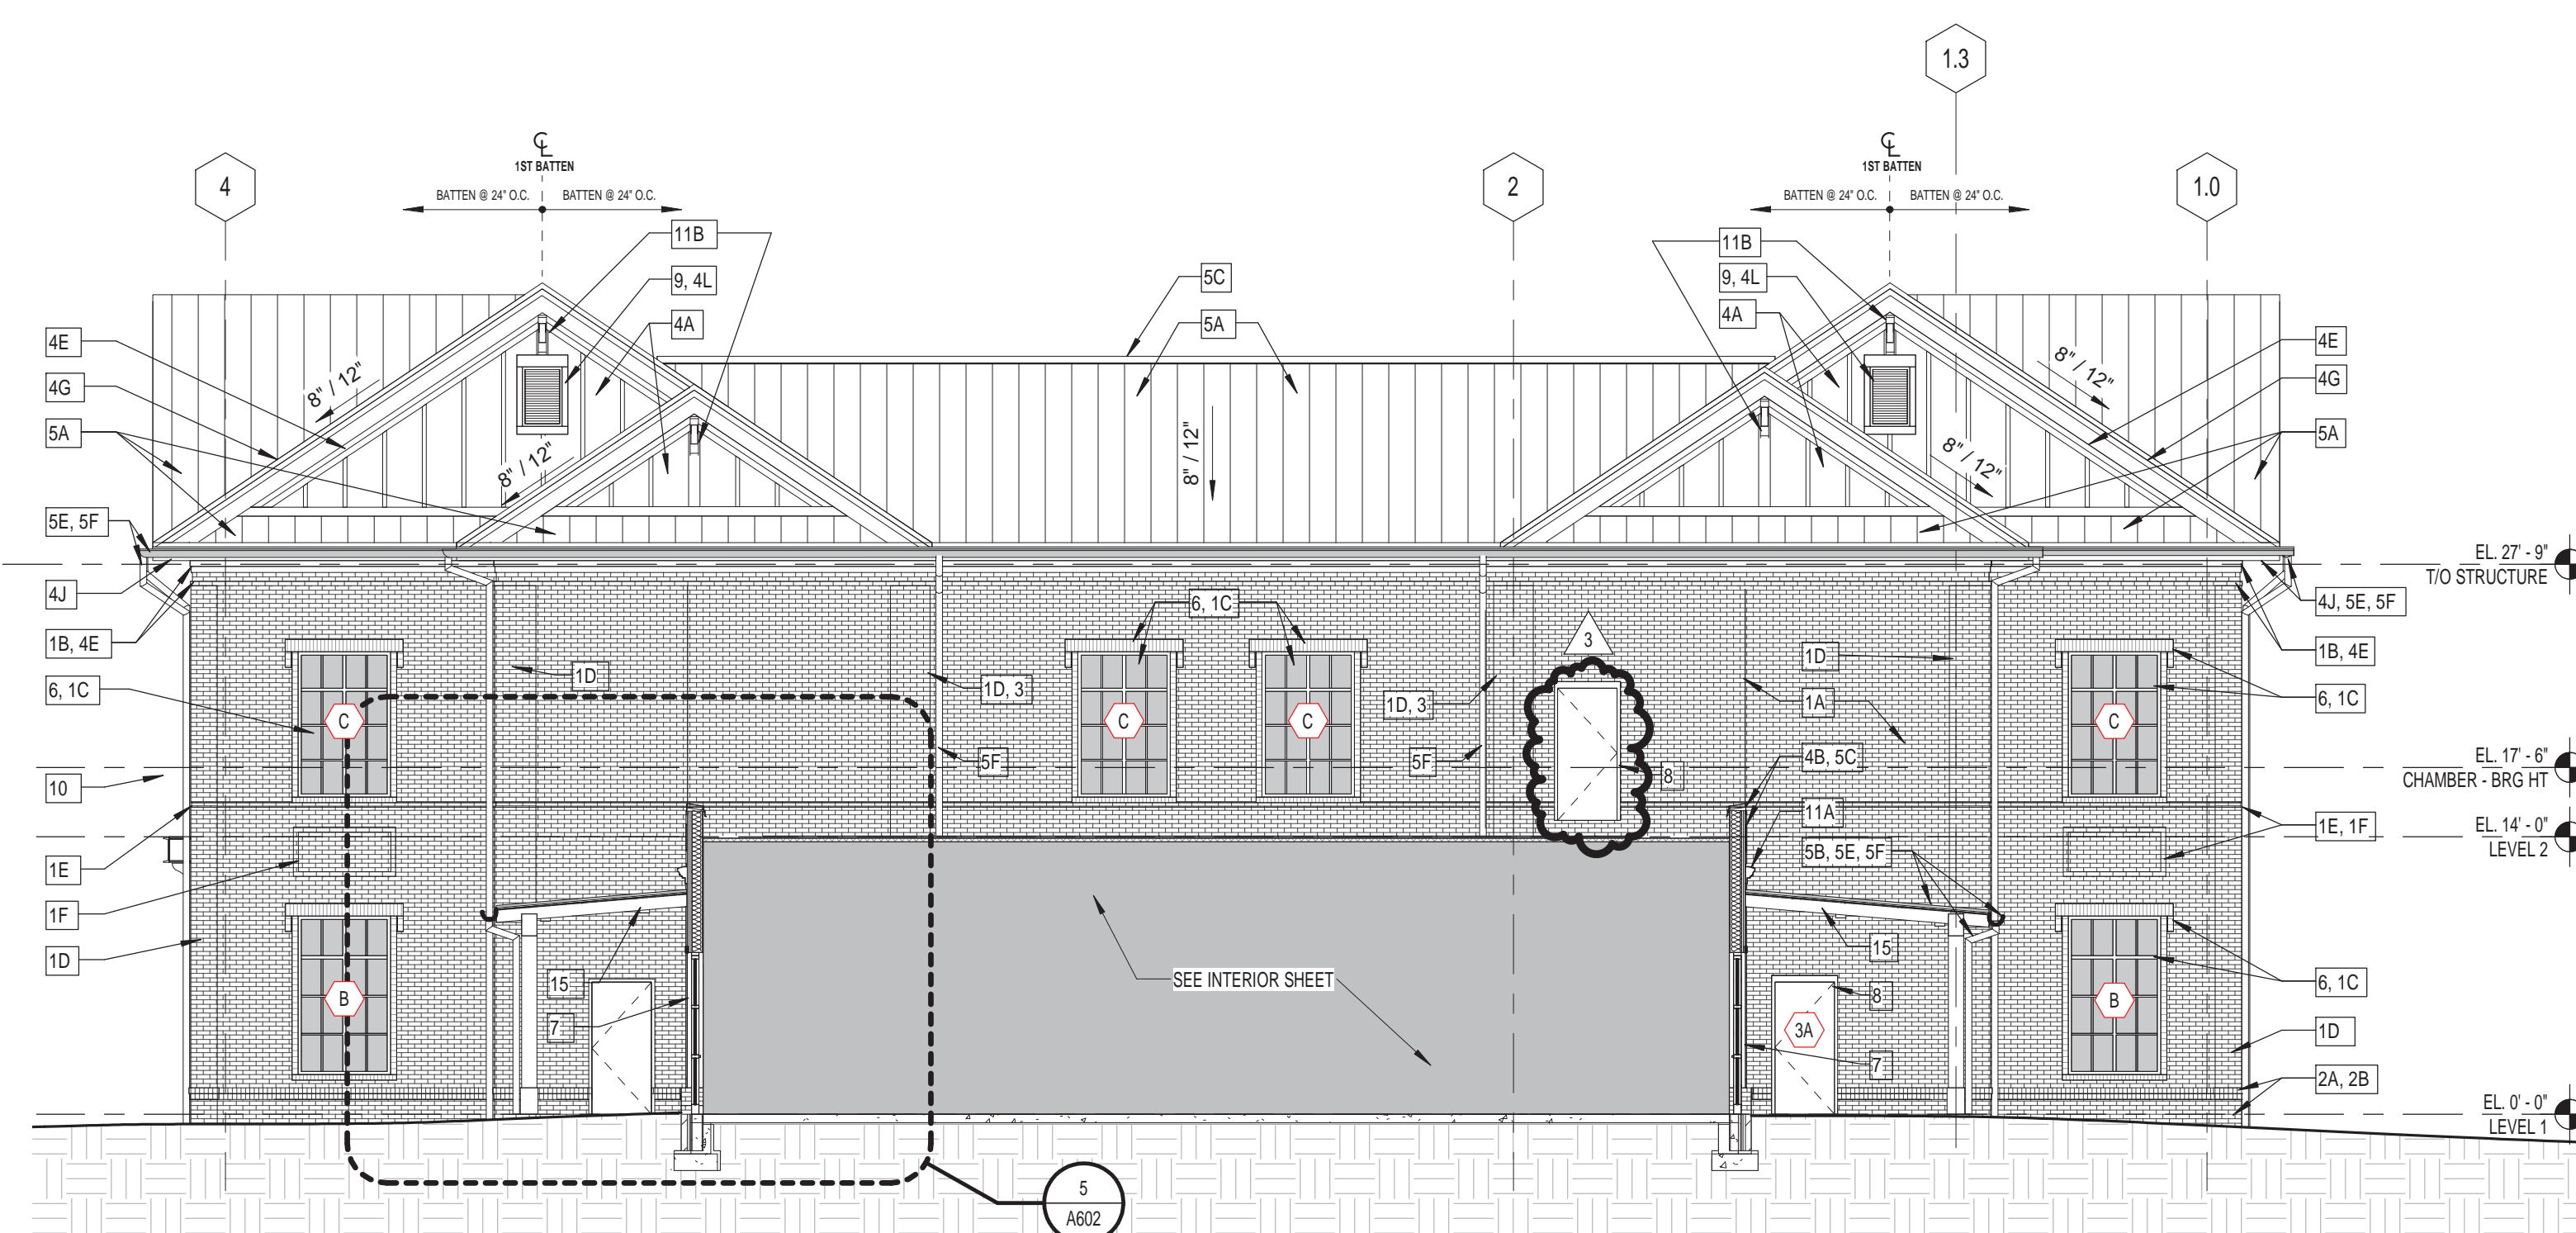

## ADMIN BLDG - NORTH ELEVATION

A401

SCALE: 1/8" = 1'-0"

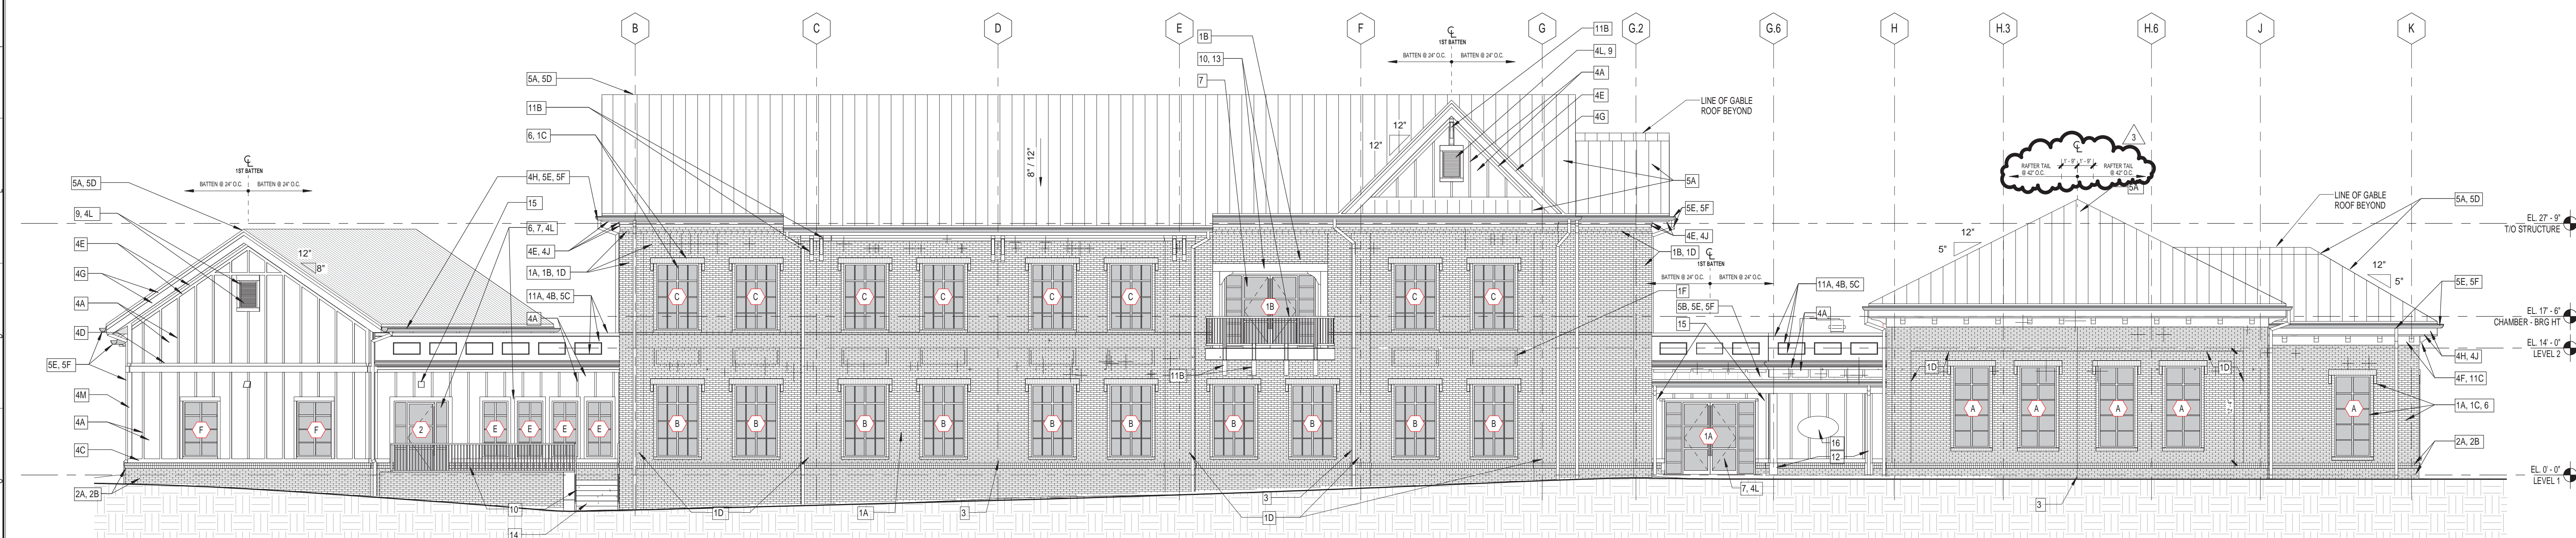

2 ADMIN BLDG - EAST ELEVATION

|      |     |
|------|-----|
| Z    | AL  |
| A401 | SCA |

|      |     |
|------|-----|
| Z    | AL  |
| A401 | SCA |

NOTE:  
WHERE FINAL EXTERIOR GRADE IS > 12" BELOW INTERIOR SLAB, ON, GRADE  
WATERPROOFING THROUGH - WALL FLASHING SHOULD DROP DOWN 3 COURSES (8")

| KEYNOTE LEGEND - ELEVATIONS (ADMIN BLDG) |   | ALSO REFER TO SHEETS A921 & A922 FOR ADD'L INFORMATION |   |
|--|---|--|---|
| 1A                                       | PRIMARY BRICK VENEER - TYPE 1, RUNNING BOND, CONCAVE MORTAR JOINTS  | 1F   | BRICK RECTANGULAR PROFILE - TYPE 1, STRETCHER HEAD & SILL COURSE, STACKED JAMB COURSE EACH SIDE, ALL PROJECTED 1/2" |
| 1B                                       | BRICK SOLDIER COURSE - TYPE 1, CONCAVE MORTAR JOINTS  | 2A   | DOUBLE ROWLOCK BRICK WATERTABLE - TYPE 2, PROJECTED 1/2" EACH COURSE, CONCAVE MORTAR JOINTS                         |
| 1C                                       | BRICK WINDOW/DOOR SURROUND - TYPE 1, SOLDIER HEAD COURSE w/ 2 COURSE OUTER SIDE CORBELS PROJECTING 1/2" EACH COURSE, STACKED JAMB COURSE EACH SIDE (FULL HT) PROJECTING 1/2" & ROWLOCK SILL COURSE (WINDOWS), PROJECTED 1" - TYP AT ALL MASONRY LOCATIONS | 2B   | BASE BRICK VENEER - TYPE 2, RUNNING BOND, CONCAVE MORTAR JOINTS   |
| 1D                                       | BRICK PILASTER PROJECTION (1") - TYPE 1, RUNNING BOND, CONCAVE MORTAR JOINTS  | 3  | MASONRY EXPANSION JOINT   |
| 1E                                       | BRICK RECESS COURSE - TYPE 1, 1/2"  | 4A   | FIBER CEMENT PANEL CLADDING w/ VERTICAL BATTEN STRIPS   |
|  |   | 4B   | FIBER CEMENT PANEL CLADDING / CUTOUT FEATURE  |
|  |   | 4C   | FIBER CEMENT SKIRTBOARD, 5/4 (6")   |
|  |   | 4D   | FIBER CEMENT HORIZONTAL TRIM BAND, 5/4 (8' & 12')   |
|  |   | 4E   | FIBER CEMENT RAKE TRIM (ADMIN), 5/4 (4' & 8')   |
|  |   | 4F   | FIBER CEMENT RAKE TRIM (CHAMBERS), 5/4 (12')  |
|  |   | 4G   | FIBER CEMENT FASCIA TRIM (GABLE FACE), 5/4 (4' & 8')  |
|  |   | 4H   | FIBER CEMENT FASCIA TRIM (EAVE FACE), 5/4 (12')   |
|  |   | 4J   | FIBER CEMENT BEAD BD SOFFIT (PERPENDICULAR) w/o VENTS   |
|  |   | 4K   | FIBER CEMENT BEAD BD SOFFIT (PERPENDICULAR) w/o VENTS   |
|  |   | 4L   | FIBER CEMENT TRIM, 5/4 (4") - TYP AT ALL WINDOW/ DOOR/ LOUVER LOCATIONS AT FIBER CEMENT CLADDING                    |
|  |   | 4M   | FIBER CEMENT CORNER TRIM, 5/4 (4") - TYP AT ALL OUTSIDE & INSIDE CORNERS AT FIBER CEMENT CLADDING                   |
|  |   | 5A   | STANDING SEAM METAL ROOF ASSEMBLY, GALVALUME, 2' OVERHANG TYP.  |
|  |   | 5B   | STANDING SEAM METAL CANOPY ASSEMBLY w/EXPOSED JOIST FRAMING, GALVALUME  |
|  |   | 5C   | STANDING SEAM METAL COPING, GALVALUME   |
|  |   | 5D   | RIDGE VENT, GALVALUME   |
|  |   | 5E   | ALUMINUM GUTTER SYSTEM, GALVALUME   |
|  |   | 5F   | ALUMINUM DOWNSPOUT, GALVALUME   |
|  |   | 6  | ALUMINUM STOREFRONT THERMAL WINDOW SYSTEM (2" & 6"). 1" INSULATED GLAZING INFILL (CENTER SET)                       |
|  |   | 7  | ALUMINUM STOREFRONT THERMAL ENTRANCE SYSTEM (2" x 4 1/2") w/SIDELITES, 1" INSULATED GLAZING INFILL (CENTER SET)     |
|  |   | 8  | HM DOOR /FRAME, PAINT PER SCHED.  |
|  |   | 9  | HM LOUVER (NON-FUNCTIONAL W/ BLANKOUT PLATE) / FRAME, PREFINISHED   |
|  |   | 10   | STEEL GUARDRAIL SYSTEM, PAINT PER SCHED.  |
|  |   | 11A  | FIBERGLASS CORNICE PROFILE  |
|  |   | 11B  | FIBERGLASS BRACKET PROFILE ( ADMIN BLDG.)   |
|  |   | 11C  | FIBERGLASS RAFTER TAIL PROFILE ( CHAMBER BLDG.)   |
|  |   | 12   | 10" HEAVY TIMBER COLUMN w/ 1x CEDAR WRAP BASE   |
|  |   | 13   | 10" HEAVY TIMBER BEAM & 10" HT COLUMNS AT BALCONY SURROUND w/BRACKET  |
|  |   | 14   | MONOLITHIC CONCRETE STEPS   |
|  |   | 15   | EXTERIOR LIGHTING FULL CUT OFF  |
|  |   | 16   | BLDG SIGNAGE TBD - PROVIDE BLOCKING (NON-COMBUSTIBLE)   |
|  |   | 17   | SHADING DEVICE (BAHAMA SHUTTERS) - PREFINISHED  |

MILTON CITY HALL

HOME OF "THE BEST QUALITY OF LIFE IN GEORGIA"

# MILTON

GEORGIA

MILTON, GA

CITY OF MILTON

BUILDING ELEVATIONS -  
ADMIN

|                      |             |
|----------------------|-------------|
| Sean McLendon        | 20140230    |
| Principal-in-Charge  | Project No. |
| Brian M. Parker, AIA | 12/14/15    |
| Project Manager      | Date        |
| Venuss Gervin        |             |
| Project Architect    |             |
| SA, AJ, DY, AN       |             |
| Staff Architect      |             |

A401

Drawing No. \_\_\_\_\_