
# ENGINEERING DEPARTMENT



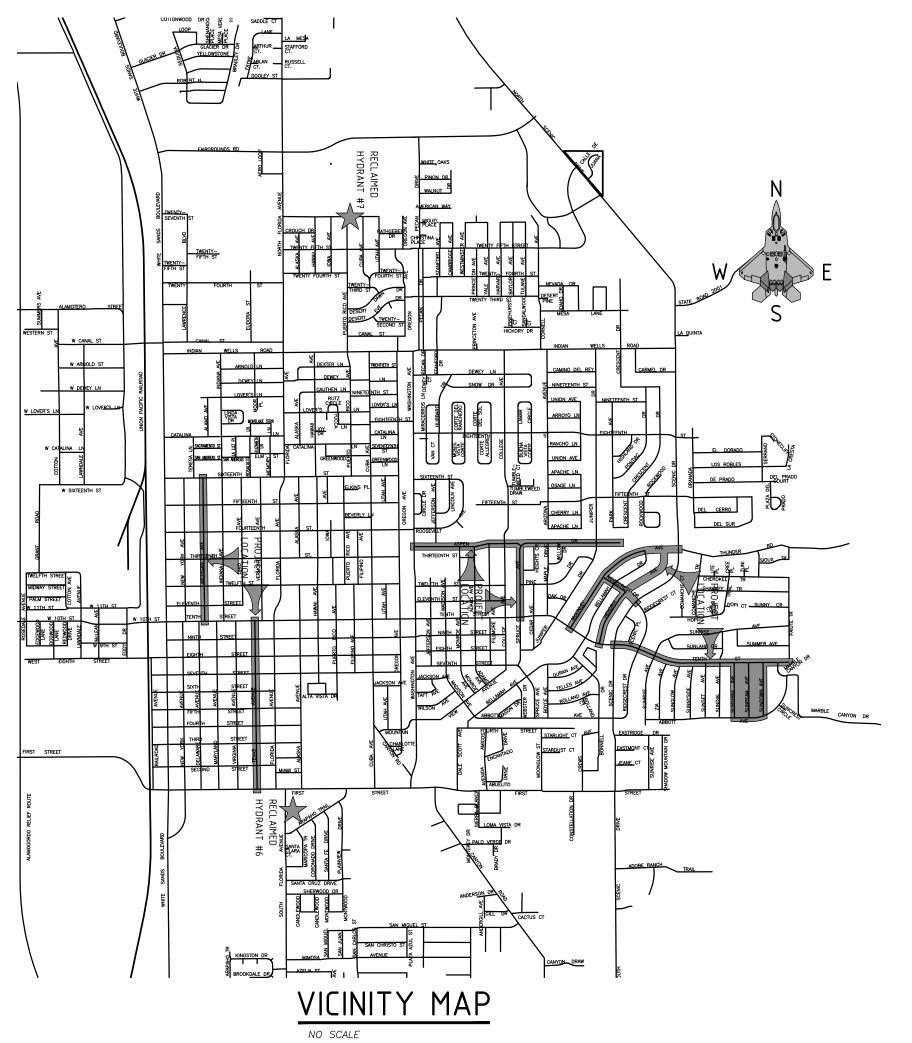

**IMPROVEMENT PLANS FOR** Street Maintenance Program FY 2017 Sheet Legend

Cover Sheet with Vicinity Map

General Sheets

Summary of Quantities

Survey Sheet and Control Points

Removal Plan Sheets

Roadway Construction Plans

Grading and Drainage Plans
Pavement Marking Plans and Details
Traffic Signing Plans and Details

Utility Plans and Details

Miscellaneous Detail Plan Sheets

NMDOT New Mexico Department of Transportation Standard Drawings

### **City Commissioners**

Richard A. Boss, Mayor at Large

Alfonso "Al" Hernandez, Mayor Pro-Tem

Jason Baldwin

Nadia Sikes

Susan L. Payne

Jenny Turnbull

Erica M. Martin

AGENCY	PLAN DATE		PLAN	DATE		REVISIONS	1	CTOPHER C	ENGINEEDING DEDT
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CENTURY LINK								09/07/2017	COVER SHEET
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OTERO COUNTY ELECTRIC COOPERATIVE								Engined Inc.	2017-010
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								LAS CRUCES, NEW MEXICO 88009 (575) 524-2007 (OFFICE)	<b>5 EN1701</b>
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ST1.0-2.0 ST3.0-4.0 ST5.0-6.0 ST7.0	Texas Avenue Striping Plan 10TH Street Striping Plan Michigan Avenue Striping Plan Aspen Drive Striping Plan
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Miscellaneous Details

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				Dial 811 or Professional Resources for Damage Prevention 1–800–321–2537
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### **Street Maintenance Program FY 2017**

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Designed By: GG Approved By: CA

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(575) 524-2007 (OFFICE) (575) 524-04.82 (FAX)

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Sheet 2 of 103 EN1701

CITY OF ALAMOGORDO, NEW MEXICO, ENGINEERING DEPARTMENT

#### **GENERAL NOTES:**

- <u>SPECIFICATIONS:</u> THE CITY OF ALAMOGORDO TECHNICAL SPECIFICATIONS, SPECIAL PROVISIONS AND SUPPLEMENTAL SPECIFICATIONS <u>AND THE NEW MEXICO STATE DEPARTMENT OF TRANSPORTATION (NMDOT)</u> STANDARD SPECIFICATIONS FOR HIGHWAY AND BRIDGE CONSTRUCTION 2007 EDITION (ORANGE BOOK) NMDOT SUPPLEMENTAL SPECIFICATIONS AND REVISIONS TO THE STANDARDS SPECIFICATION FOR HIGHWAY <u>AND BRIDGE CONSTRUCTION</u> SHALL GOVERN CONSTRUCTION OF THIS PROJECT. SEE BID DOCUMENT MANUAL, TECHNICAL SPECIFICATIONS FOR CONTRACT DOCUMENTS ORDER OF IMPORTANCE.
- <u>GENERAL NOTES:</u> GENERAL NOTES SHALL APPLY TO ALL SHEETS, EXCEPT WHERE MORE SPECIFIC INFORMATION IS PROVIDED. SEE INDIVIDUAL DRAWINGS FOR ADDITIONAL ABBREVIATIONS, SYMBOLS, LEGENDS, NOTES, DETAILS, AND OTHER REQUIREMENTS. IN ALL CASES, THE INFORMATION SHOWN ON INDIVIDUAL DRAWINGS SHALL GOVERN OVER ANY GENERAL INFORMATION. NOT ALL SPECIFIED ITEMS AND/OR STANDARD DETAILS SHOWN MAY BE APPLICABLE TO THIS PROJECT.
- MEANS, METHODS OR TECHNIQUES: THE OWNER AND ENGINEER ARE NOT RESPONSIBLE FOR THE CONSTRUCTION MEANS, METHODS OR TECHNIQUES, NOR FOR THE EXECUTION OF THE WORK AS SHOWN ON THESE DRAWINGS. THE OWNER AND ENGINEER SHALL NOT BE RESPONSIBLE FOR THE ACTS OR OMISSIONS OF THE CONTRACTOR, SUBCONTRACTORS, OR OTHER PERSONS PERFORMING ANY OF THE WORK, OR FOR THE FAILURE OF ANY OF THE CONTRACTORS OR SUBCONTRACTORS TO CARRY OUT THE WORK IN ACCORDANCE WITH THE CONTRACT DOCUMENTS.
- SAFETY REQUIREMENTS: THE CONTRACTOR IS RESPONSIBLE FOR MAINTAINING ALL WORK AREAS IN SAFE CONDITION FOR THE PUBLIC. THE CONTRACTOR SHALL BE RESPONSIBLE FOR COMPLIANCE FOR ALL CONTRACTOR PERSONNEL AND SUBCONTRACTOR PERSONNEL WITH APPLICABLE CURRENT FEDERAL, OSHA, STATE, COUNTY, AND CITY LAWS, ORDINANCES, RULES AND REGULATIONS CONCERNING SAFETY AND HEALTH. THE CONTRACTOR SHALL COMPLY WITH ALL OSHA TRENCH SAFETY RULES AND REGULATIONS APPLICABLE TO THIS PROJECT. THE CONTRACTOR SHALL INSTALL, AT A MINIMUM, SAFETY FENCING 48-INCHES IN HEIGHT AROUND THE PERIMETER OF OPEN TRENCHES AND REMOVAL AREAS. THIS WORK SHALL BE CONSIDERED INCIDENTAL TO THE COMPLETION OF THE PROJECT AND NO SEPARATE MEASUREMENT OR PAYMENT WILL BE MADE THEREFOR.
- <u>CONTRACTOR RESPONSIBILITY:</u> THE CONTRACTOR SHALL ASSUME SOLE AND COMPLETE RESPONSIBILITY FOR THE JOB SITE CONDITIONS DURING THE COURSE OF CONSTRUCTION OF THIS PROJECT INCLUDING SAFETY OF ALL PERSONS AND PROPERTY. THESE REQUIREMENTS SHALL APPLY CONTINUOUSLY AND SHALL NOT BE LIMITED TO NORMAL WORKING HOURS. THE CONTRACTOR SHALL DEFEND, INDEMNIFY AND HOLD THE OWNER AND ENGINEER HARMLESS FROM ANY AND ALL LIABILITY, REAL OR ALLEGED, IN CONNECTION WITH THE CONTRACTORS PERFORMANCE OF WORK ON THIS PROJECT.
- <u>Project deviations:</u> any proposed deviations from the contract documents by the contractor MUST BE ACCEPTED BY THE ENGINEER, IN WRITING, PRIOR TO THE WORK BEING DONE. ANY DEVIATIONS PERFORMED WITHOUT THE ENGINEER'S APPROVAL WILL NOT BE PAID FOR AND MAY BE REQUIRED TO BE RECONSTRUCTED OR REMOVED AT THE CONTRACTOR'S EXPENSE.
- <u>Public access to local businesses & residences:</u> The contractor shall provide ingress and EGRESS TO LOCAL BUSINESSES AND RESIDENCES FOR THE DURATION OF THE PROJECT. THE CONTRACTOR SHALL ADVISE PROPERTY OWNERS AND THE ENGINEER OF ANY ACCESS MODIFICATIONS, AT LEAST 24 HOURS IN ADVANCE. THIS WORK SHALL BE CONSIDERED INCIDENTAL TO THE COMPLETION OF THE PROJECT AND NO SEPARATE MEASUREMENT OR PAYMENT WILL BE MADE THEREFOR.
- PERMITTING: IT SHALL BE THE CONTRACTOR'S RESPONSIBILITY TO REQUEST AND OBTAIN ALL PERMITS NECESSARY FOR THIS PROJECT PRIOR TO COMMENCING CONSTRUCTION. CONTRACTOR SHALL COMPLY WITH ALL APPLICABLE CURRENT FEDERAL, OSHA, STATE, COUNTY, AND CITY LAWS, ORDINANCES, RULES AND REGULATIONS.
- <u>MAINTENANCE OF AS-BUILT PLANS:</u> THE CONTRACTOR SHALL MAINTAIN AN UP TO DATE SET OF AS-BUILT PLANS FOR THE PROJECT. THESE PLANS SHALL BE KEPT CURRENT, WITHIN ONE-WEEK, AT ALL TIMES AND SHALL BE SUBJECT TO REVIEW BY THE ENGINEER THROUGHOUT THE PROJECT AND WILL BE REVIEWED BY THE ENGINEER FOR ACCURACY AND COMPLETENESS AT LEAST ONCE EVERY 7-DAYS. THE FINAL AS-BUILT PLANS SHALL BE SUBMITTED TO THE ENGINEER PRIOR TO FINAL PAYMENT. FINAL AS-BUILT PLANS SHALL BE DELIVERED IN CLEAN HARD COPY. CONTRACTOR CERTIFICATION SHALL BE CLEARLY STATED ON THE COVER SHEET. THIS WORK SHALL BE CONSIDERED INCIDENTAL TO THE PROJECT AND NO SEPARATE MEASUREMENT OR PAYMENT WILL BE MADE THEREFOR.
- <u>WATER FOR CONSTRUCTION:</u> THE CONTRACTOR WILL BE RESPONSIBLE FOR PURCHASING ALL OF THE RECLAIMED WATER NEEDED FOR CONSTRUCTION FROM THE CITY OF ALAMOGORDO. THE COST WILL BE DETERMINED IN ACCORDANCE WITH THE CURRENT RECLAIMED WATER RATES. IT SHALL BE THE CONTRACTOR'S RESPONSIBILITY TO TRANSPORT AND APPLY THE RECLAIMED WATER AS SPECIFIED OR AS ORDERED BY THE ENGINEER. THE CONTRACTOR SHALL COORDINATE WITH THE ENGINEER FOR LOCATION OF SOURCES. THIS COST SHALL BE CONSIDERED INCIDENTAL TO THE PROJECT AND NO SEPARATE MEASUREMENT OF PAYMENT WILL BE MADE THEREFORE.
- <u>INTERRUPTION OF SERVICE:</u> CONTRACTOR MUST MAINTAIN WATER SERVICE AT ALL TIMES AS DIRECTED BY THE ENGINEER. IF AN INTERRUPTION OF SERVICE IS UNAVOIDABLE. THE CONTRACTOR SHALL NOTIFY ALL AFFECTED RESIDENTS ON A DOOR-TO-DOOR BASIS OR AS AGREED WITH THE ENGINEER. CONTRACTOR SHALL COORDINATE WITH THE ENGINEER FOR ALL WATER SHUT-OFFS.
- <u>EARTHWORK HAUL:</u> THE EARTHWORK HAUL ON THIS PROJECT WILL BE CONSIDERED AS INCLUDED IN THE CONTRACT PRICE FOR ITEMS "UNCLASSIFIED EXCAVATION", AND "BORROW", AS APPLICABLE, AND NO SEPARATE MEASUREMENT OR PAYMENT WILL BE MADE FOR HAUL.
- PAVEMENT DROP-OFF POLICY: IF A PAVEMENT DROP-OFF IS CREATED DURING CONSTRUCTION, THE CONTRACTOR SHALL INITIATE PROTECTIVE ACTION IN ACCORDANCE WITH THE NMDOT'S CURRENT "DROP-OFF POLICY". THE POLICY IS AVAILABLE FROM THE ENGINEER. THIS WORK SHALL BE CONSIDERED INCIDENTAL TO THE COMPLETION OF THE PROJECT AND NO SEPARATE MEASUREMENT OR PAYMENT WILL BE MADE THEREFOR.
- 14. <u>Warping of Slopes:</u> The contractor shall warp slopes where necessary to stay within the RIGHT OF WAY OR CONSTRUCTION EASEMENT LIMITS.
- 15. <u>Material Pits:</u> no material pits have been designated for this project. The contractor may OBTAIN SPECIFICATION BORROW OR SURFACING MATERIAL FROM ANY ACCEPTABLE SOURCE. ALL MATERIAL PITS SHALL BE GOVERNED BY SECTION 106 OF THE NMDOT STANDARD SPECIFICATIONS

- 16. <u>Construction equipment & material storage:</u> the contractor shall not store equipment or MATERIAL WITHIN 28 FEET FROM THE EDGE OF THE DRIVING LANE UNLESS THE EQUIPMENT OR MATERIAL IS PROPERLY SHIELDED UTILIZING CURRENT SAFETY DESIGN AND INSTALLATION METHODS. ALL EQUIPMENT AND MATERIAL STORED IN STAGING YARD SHALL BE PROPERLY SHIELDED UTILIZING CURRENT SAFETY DESIGN AND INSTALLATION METHODS. IN NO CASE SHALL THE CONTRACTOR STORE EQUIPMENT OR MATERIAL IN THE DRIVING LANE. THE SAFETY DESIGN FOR SHIELDING SHALL BE PROVIDED BY THE CONTRACTOR AND MUST BE APPROVED BY THE ENGINEER BEFORE IMPLEMENTING. THIS WORK, INCLUDING DESIGN, INSTALLATION AND REMOVAL OF THE SHIELDING, SHALL BE CONSIDERED INCIDENTAL TO THE COMPLETION OF THE PROJECT AND NO SEPARATE MEASUREMENT OR PAYMENT WILL BE MADE THEREFOR.
- 17. <u>Protection of Survey Monuments:</u> the contractor shall take precautions to protect HORIZONTAL AND VERTICAL CONTROL SURVEY MONUMENTS AND CONTROL POINTS FROM DAMAGE PRIOR TO INITIATING CONSTRUCTION. AN INVENTORY OF THE EXISTING MONUMENTS WILL BE TAKEN BY THE ENGINEER AND THE CONTRACTOR PRIOR TO START OF CONSTRUCTION. IF, DURING THE COURSE OF CONSTRUCTION OPERATIONS, THE CONTRACTOR DISTURBS OR DESTROYS A MARK, THE CONTRACTOR SHALL ESTABLISH A NEW MARK IN COMPLIANCE WITH THE STANDARDS AND PROCEDURES SET FORTH IN THE "GEODETIC MARK PRESERVATION GUIDEBOOK". NATIONAL GEODETIC SURVEY, MARCH 1990, CONTACT: NGS MARK PRESERVATION CENTER-NOAA, TELEPHONE (505) 768-3606.
- **18**. **R<u>emovals:</u>** the contractor shall be responsible for all removals required to complete the PROJECT. REMOVALS NOT SHOWN ON THE PLANS WILL BE DESIGNATED BY THE ENGINEER. THIS WORK WILL BE CONSIDERED AS INCLUDED IN THE CONTRACT PRICE FOR ITEM "REMOVAL OF STRUCTURES AND OBSTRUCTIONS" AND THE CONTRACTOR WILL NOT RECEIVE ADDITIONAL COMPENSATION FOR UNLISTED REMOVALS. <u>ITEMS THAT ARE SCHEDULED TO BE REMOVED AND REPLACED SHALL BE REPLACED WITH—IN</u> SEVEN (7) DAYS OF THEIR REMOVAL
- 19. <u>Saw Cutting:</u> contractor shall saw cut pavement, concrete sidewalk, concrete drive ways AND CURB AND GUTTER AT TIE-INS AS REQUIRED FOR A SMOOTH TRANSITION. THIS WORK WILL BE CONSIDERED INCIDENTAL TO THE COMPLETION OF THE PROJECT AND NO SEPARATE MEASUREMENT OR PAYMENT WILL BE MADE THEREFOR.
- **20.** <u>Salvageable materials</u>: salvageable materials from this project are to be hauled and stock PILED AT THE CITY YARD LOCATED AT 2600 N. FLORIDA AVENUE. HAUL OF SUCH MATERIAL SHALL BE PERFORMED DURING NORMAL WORKING HOURS AS DIRECTED BY THE ENGINEER. PAYMENT FOR THIS WORK SHALL BE INCLUDED IN THE CONTRACT PRICE FOR ITEM "REMOVAL OF STRUCTURES AND OBSTRUCTIONS.
- 21. <u>Waste materials</u>: waste material must be disposed of at a state approved site.
- 22. <u>Protection of existing utilities:</u> the contractor is responsible for locating and protecting ALL UNDERGROUND AND OVERHEAD UTILITIES AND SHALL COORDINATE ALL WORK WITH UTILITY OWNERS. ALL IMPROVEMENTS WHICH ARE DAMAGED BY THE CONTRACTOR'S OPERATIONS SHALL BE REPAIRED, RECONSTRUCTED OR REPLACED WITHIN 24 HOURS TO THE ENGINEER'S SATISFACTION AT THE CONTRACTOR'S EXPENSE WITHOUT ADDITIONAL COMPENSATION.
- 23. Contractor coordination with utilities: the contractor is hereby advised that utility RELOCATION WORK BY THE UTILITY OWNERS MAY BE PERFORMED CONCURRENT WITH CONSTRUCTION. THE CONTRACTOR SHALL PROVIDE FOR UTILITY WORK IN CONJUNCTION WITH CONSTRUCTION OPERATIONS AND SHALL BE REQUIRED TO COORDINATE THE SCHEDULING OF WORK WITH THE RESPECTIVE UTILITY OWNERS. ANY CLAIMS FOR DELAY SHALL BE CONTROLLED BY THE TERMS AND CONDITIONS OF THE NMDOT STANDARD SPECIFICATIONS FOR HIGHWAY AND BRIDGE CONSTRUCTION.
- 24. <u>VERIFY ELEVATIONS:</u> THE CONTRACTOR SHALL EMPLOY A LICENSED NEW MEXICO SURVEYOR AND SHALL FIELD VERIFY ALL ELEVATIONS, DIMENSIONS, AND RIGHT-OF-WAY PRIOR TO THE BEGINNING OF CONSTRUCTION. THE ELEVATIONS WERE BASED ON AS—BUILT AND FIELD SURVEY DATA. THE CONTRACTOR SHALL LIMIT ALL WORK ON THIS PROJECT TO WITHIN THE EXISTING RIGHT-OF-WAY AND EASEMENTS. THIS WORK WILL BE CONSIDERED INCIDENTAL TO CONSTRUCTION STAKING BID ITEM AND TO THE COMPLETION OF THE PROJECT, NO SEPARATE MEASUREMENT OR PAYMENT WILL BE MADE.
- 25. <u>Utility disclaimer:</u> utility locations shown hereon are based on the best available evidence INCLUDING PHYSICAL FEATURES SUCH AS VALVES, PEDESTALS, WARNING MARKERS AND SPOTS BY UTILITY LOCATING SERVICES. THERE IS NO GUARANTEE AS TO THE COMPLETENESS OR ACCURACY OF THE UTILITY DATA SHOWN ON THE PLANS. THE CONTRACTOR SHALL CONTACT ALL UTILITY OWNERS TO VERIFY THE HORIZONTAL AND VERTICAL LOCATIONS OF ALL UTILITIES. SHOULD A CONFLICT EXIST, THE CONTRACTOR SHALL NOTIFY THE ENGINEER OF THE CONFLICT WITH MINIMUM DELAY. EXCAVATION TO VERIFY LOCATIONS SHALL BE CONSIDERED INCIDENTAL TO THE COMPLETION OF THE PROJECT, NO SEPARATE MEASUREMENT OR PAYMENT WILL BE MADE.
- 26. <u>Traffic control:</u> the contractor shall maintain and control traffic as outlined in the "MUTCD, LATEST EDITION' DURING CONSTRUCTION. ANY NECESSARY DEVIATION FROM THE "MUTCD, LATEST EDITION" SHALL HAVE PRIOR APPROVAL OF THE ENGINEER. THE CONTRACTOR SHALL SUBMIT A COPY OF TRAFFIC CONTROL PLAN TO THE ENGINEER FOR APPROVAL, PRIOR TO START OF CONSTRUCTION.
- 23. TRUCK WEIGHT: MAXIMUM WEIGHT OF TRUCKS SHALL CONFORM TO N.M.D.O.T. STANDARDS. CONTRACTOR TO REPLACE ANY DAMAGED STREETS USED DURING CONSTRUCTION HAULING. REPLACEMENT OF DAMAGED STREETS SHALL BE CONSIDERED INCIDENTAL TO THE COMPLETION OF THE PROJECT, NO SEPARATE MEASUREMENT OR PAYMENT WILL BE MADE.
- **24**. <u>Work confinement:</u> the contractor shall be required to confine his work within the CONSTRUCTION LIMITS OR RIGHT-OF-WAY. PARKING OF EMPLOYEE'S PRIVATE VEHICLES SHALL NOT BE ALLOWED ALONG CONSTRUCTION AREAS THROUGHOUT CONSTRUCTION LIMITS. IT SHALL BE THE CONTRACTOR'S RESPONSIBILITY TO PROHIBIT ASPHALT VEHICLES AND EQUIPMENT, ROLLERS, CRANES, ETC., FROM DRIVING UPON, ACROSS, OR TURNING ON PRIVATE PROPERTY ADJACENT TO PROJECT WORK AREAS.
- 29. <u>Surface</u> <u>features:</u> contractor shall repair or replace fences, block walls, or surface FEATURES, DAMAGED BY CONTRACTOR'S OR SUBCONTRACTOR'S OPERATIONS, TO EXISTING OR BETTER CONDITION. REPAIR OR REPLACEMENT OF FENCES, BLOCK WALLS, OR SURFACE FEATURES SHALL BE CONSIDERED INCIDENTAL TO THE COMPLETION OF THE PROJECT AND NO SEPARATE MEASUREMENT OR PAYMENT WILL BE MADE THEREFOR.

- 30. <u>Project video:</u> Prior to initiating construction operations, contractor, shall perform digital VIDEO RECORDING OF THE ENTIRE PROJECT, ITS FULL LENGTH AND WIDTH. THE CONTRACTOR, SHALL ALSO INCLUDE OR ADD AS NECESSARY, ANY AREAS TO BE DISTURBED FOR MATERIAL STORAGE, EMPLOYEE PARKING OR EQUIPMENT STORAGE.
  - THE VIDEO DOCUMENTATION SHALL BE COMPLETED IN DIGITAL FORMAT; IT SHALL BE A MINIMUM RESOLUTION OF 1920 X 1080 PIXELS, AT 60 FPS (FRAME PER SECOND) AND IN COLOR. THE VIDEO DOCUMENTATION SHALL BE PERFORMED BETWEEN 10:00 A.M. AND 2:00 P.M. DURING PERIODS OF FULL SUN EXPOSURE. THE ACTUAL DATE OF RECORDING SHALL BE DATE—STAMPED WITHIN EACH FRAME OF THE VIDEO. APPROVAL OF THE VIDEO MUST BE OBTAINED FROM THE ENGINEER PRIOR TO THE COMMENCEMENT OF ANY CLEARING AND GRUBBING OPERATIONS.

A DVD COPY OF THE VIDEO RECORDING SHALL BE SUBMITTED TO THE ENGINEER, IN A FORMAT COMPATIBLE WITH STANDARD DVD PLAYERS.

ALL COST ASSOCIATED WITH THE VIDEO RECORDING SPECIFIED IN THIS ARTICLE SHALL BE CONSIDERED INCIDENTAL TO OTHER RELATED ITEMS OF WORK AND NO SEPARATE PAYMENT WILL BE MADE UNLESS SPECIFICALLY INDICATED ELSEWHERE IN THE SPECIAL PROVISIONS.

<u>SITE CLEAN UP:</u> PROJECT SITE(S) AND YARD(S) SHALL BE MAINTAINED BY CONTRACTOR AND KEPT IN A CLEAN AND ORDERLY MANNER TO THE SATISFACTION OF THE ENGINEER. THIS WORK SHALL BE CONSIDERED INCIDENTAL TO THE COMPLETION OF THE PROJECT AND NO SEPARATE MEASUREMENT OR PAYMENT WILL BE MADE THEREFOR.

#### <u>UTILITY COMPANY CONTACTS:</u>

CITY OF ALAMOGORDO:

WATER/SEWER: RONNIE BORUNDA — 575.439.4244 or 575.439.4132 FACILITY/FIBER OPTIC: LARRY GARNER - 575.439.4390 or 575.439.4391 PARK SUPERVISOR: ERIK MARION - 575.439.4139

(OFFICE) 575.443.6610

PNM ELECTRIC:

WILSON GUIN 575.430.2977 LORNE WOFFORD 575.430.8380

KELLY SANDERS

NEW MEXICO GAS COMPANY: NATURAL GAS (OFFICE) 1.888.664.2726

575.443.6424 TIM TURRI MARIO ESTRADA 575.430.8381

575.491.0766

TELEPHONE (CENTURY LINK): RAMON ROMAN (O) 575.525.5101 (C) 575.640.9152

CABLE TV:

BAJA CABLE (OFFICE) JONNNY RODRIGUEZ

(575) 524-04.82 (FAX)

575.439.3534 575.442.0259


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				New Mexico One Call, Inc. Call 2 days  Defore you dig!
				Dial 811 or Professional Resources for Damage Prevention 1–800–321–2537
REV. No.	DATE	DESCRIPTION	APPROVED	Professional Resources for Damage Prevention $1-800-321-253$ $f$



### **Street Maintenance Program FY 2017**

GENERAL NOTES AND UTILITY COMPANY CONTACTS

CITY OF ALAMOGORDO, NEW MEXICO, ENGINEERING DEPARTMENT

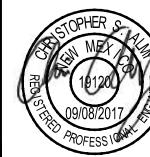

Occam Engineers Inc.
506 S MAIN ST. SUITE 600 LAS CRUCES, NEW MEXICO 88005 (575) 524-2007 (OFFICE)

^	Public Works Bid No.:
Occam Engineers	Drawn By: <b>GG</b>
Inc.	Checked By: CA
506 S MAIN ST. SUITE 600	Scale: Horiz.: n/a

2017-010 Designed By: **GG** Approved By: **CA** 

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Sheet 3 of 103

Sheet No.:

#### ROAD CONSTRUCTION PROJECT NOTES:

- 1. REFER TO DRAWING RC 1.0 FOR CENTERLINE ALIGNMENT DATA FOR ALL STREETS.
- 2. TARGET DESIGN SLOPE OF CURB RAMP RUNNING SLOPE IS 6.7% AS MEASURED AT THE BACK OF SIDEWALK. CONTRACTOR SHALL STRIVE TO ACHIEVE THIS DESIGN SLOPE AT EACH INSTALLATION. THE DESIGN SLOPE MAY NOT WORK IN ALL SCENARIOS. WHEN THE DESIGN SLOPE CANNOT BE ACHIEVED, CONTRACTOR SHALL ACHIEVE A SLOPE MAXIMUM OF 8.3%, MEASURED AT BACK OF SIDEWALK. THE LENGTH OF EACH RAMP SHALL NOT BE LESS THAN 5-FEET AND NOT GREATER THAN 15-FEET, MEASURED AT THE BACK OF SIDEWALK.
- 3. DIMENSIONS ARE RELATIVE TO BACK OF CURB AND BACK OF SIDEWALK, UNLESS SHOWN OTHERWISE.
- 4. NEW CURB RAMPS, ADA LANDINGS AND DRIVE PADS SHALL BE CONSTRUCTED OF 6-INCH THICK CONCRETE WITH REINFORCEMENT. NEW 4-INCH THICK CONCRETE SIDEWALK SHALL EXTEND 5-FEET FROM EACH NEW CURB RAMP TO TIE INTO EXISTING SIDEWALK.
- 5. MOST EXISTING UTILITIES HAVE NOT BEEN REFLECTED ON RC SERIES SHEETS FOR CLARITY. REFER TO U SERIES SHEETS TO SEE EXISTING UTILITIES.
- 6. EXISTING CURB AND GUTTER SHALL BE PROTECTED ALONG ALL MILL/INLAY CORRIDORS. ANY CURB AND GUTTER REPLACEMENT IS CALLED IN KEYED NOTES.
- 7. BID ITEM 203000 "UNCLASSIFIED EXCAVATION (OVER EXCAVATION)" HAS THE BID VOLUME COMPUTED FROM THE EXISTING GROUND ELEVATION DOWN TO THE NEW BASE COURSE BOTTOM ELEVATION IN AREAS OF COMPLETE PAVEMENT RECONSTRUCTION. THE COMPUTED VOLUME INCLUDES THE REMOVAL OF THE EXISTING SURFACING (ASPHALT OR CONCRETE) AND BASE COURSE. PROPER DISPOSAL IS REQUIRED PER GENERAL NOTE NO. 21.
- 8. PROJECT DESIGN GRADES ARE BASED ON REFERENCE POINTS AS NOTED ON PROJECT CONTROL SHEET SR 1.0.
- 9. NEW CURB & GUTTER, SIDEWALK, CURB-RAMPS WITH LANDING, AND SURFACING SHALL BE CONSTRUCTED AS SPECIFIED IN THE PLANS AND WILL REPLACE EXISTING ITEMS AS CALLED FOR. TRANSITION CURB STYLES AS SMOOTH AS POSSIBLE.
- 10. PAYMENT FOR VERTICAL CURBS BEHIND LANDINGS AND RAMPS, AS SPECIFIED, IS INCIDENTAL TO BID ITEM 608106 "6-INCH CONCRETE WITH REINFORCEMENT".
- 11. SLEEVES LOCATED AS PER MUTCD REGULATIONS FOR REMOVAL/RESETTING OF SIGNS FOR LATER RESETTING OF SIGNS MUST BE PROVIDED IN FRESH CONCRETÉ. RESET SIGNS TO PROVIDE MINIMUM ADA CLEARANCES.
- 12. NECESSARY TRANSITIONAL CUTS/FILLS BEHIND CURB/GUTTER, SIDEWALKS AND DRIVEWAYS ARE NOT QUANTIFIED AND ARE CONSIDERED INCIDENTAL TO THE ASSOCIATED BID ITEM.
- 13. REFERENCES TO PERCENT DENSITY SHALL BE INTERPRETED TO MEAN REQUIRED MINIMUM PERCENT OF OPTIMUM DRY DENSITY AS DETERMINED BY THE MODIFIED PROCTOR TEST (ASTM D-1557).
- 14. DETECTABLE WARNING SURFACES FOR ADA LANDINGS SHALL BE CAST IN PLACE REPLACEABLE UNITS. WARNING SURFACES SHALL BE PLACED IMMEDIATELY BEHIND THE BACK OF CURB, UNLESS SHOWN OTHERWISE. COLOR SHALL BE YELLOW.
- 15. TRANSITION CURBING AT DRIVE PADS AND ADA RAMPS IS PAYABLE AS THE ADJACENT CURB BID ITEM.
- 16. THE COMPACTION EQUIPMENT FOR THIS PROJECT IS LIMITED TO 35 TONS OR LESS.
- 17. SURFACING IS TO BE FEATHERED AT TURNOUTS AND INTERSECTIONS, SO THERE IS NO ABRUPT CHANGE IN RIDING SURFACE. COST FOR THIS WORK SHALL BE INCIDENTAL.

#### UTILITY CONSTRUCTION PROJECT NOTES:

- 1. WATERLINE CURVATURE SHALL BE ACCOMPLISHED USING PIPE FLEXURE IN ACCORDANCE WITH THE MANUFACTURERS RECOMMENDED PRACTICE. JOINTS ARE TO REMAIN FULLY SEATED. IN NO CASE SHALL ANY SINGLE DEFLECTION EXCEED 1.5' HORIZONTALLY OR VERTICALLY.
- 2. CONTRACTOR TO FIELD VERIFY LOCATION OF UTILITIES. LOCATIONS SHOWN TO BE CONSIDERED APPROXIMATE FOR DESIGN PURPOSE.
- 3. CONTRACTOR TO FIELD VERIFY LOCATION AND LENGTH OF WATER SERVICES. WATER SERVICE CONNECTIONS ARE PAID BY EACH AND NO ADDITIONAL PAYMENT OR CREDITS SHALL BE MADE TO THIS ITEM.
- 4. CONTRACTOR SHALL CUT AND CAP EXISTING WATERLINE ONCE PROPOSED WATERLINE IS IN SERVICE.
- 5. WHERE A WATER LINE PASSES LESS THAN 18-INCHES ABOVE OR BELOW AN EXISTING SANITARY SEWER LINE, THE WATER LINE SHALL BE ENCASED IN CONCRETE, 6-INCHES THICK MEASURED FROM THE OUTSIDE WALL OF THE PIPE FOR AT LEAST 10-FEET ON EACH SIDE OF THE CROSSING POINT.
- 6. ALL WATER MAIN TEES, BENDS, END CAPS, VALVES AND FIRE HYDRANTS SHALL BE FURNISHED WITH BOTH CONCRETE THRUST BLOCKS AND RESTRAINED JOINTS IN ACCORDANCE WITH THE DETAILS SHOWN FOR THESE ITEMS. CONCRETE THRUST BLOCKS AND MECHANICAL JOINT RESTRAINTS ARE INCIDENTAL TO THE ASSOCIATED ITEM.
- 7. EXISTING WATER MAINS WHICH ARE DESIGNATED TO BE REPLACED SHALL BE CAPPED OFF, BLOCKED WITH CONCRETE AND ABANDONED IN PLACE.
- 8. ALL WATER SYSTEM IMPROVEMENT MATERIALS SHALL COMPLY WITH THE LATEST EDITION OF AWWA

New Mexico One Call, Inc. Call 2 days EV. No. DATE APPROVED DESCRIPTION



### **Street Maintenance Program FY 2017**

**GENERAL NOTES AND UTILITY COMPANY CONTACTS** 

CITY OF ALAMOGORDO, NEW MEXICO, ENGINEERING DEPARTMENT



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506 S MAIN ST. SUITE 600


AS CRUCES, NEW MEXICO 8800 (575) 524-2007 (OFFICE) (575) 524-04.82 (FAX)

2017-010 ublic Works Bid No.: Designed By: **GG** GG Approved By: **CA** hecked By: CA

G2.1

Sheet No.:

Scale: Horiz.: n/a Vert.: n/a Sheet 4 of 103

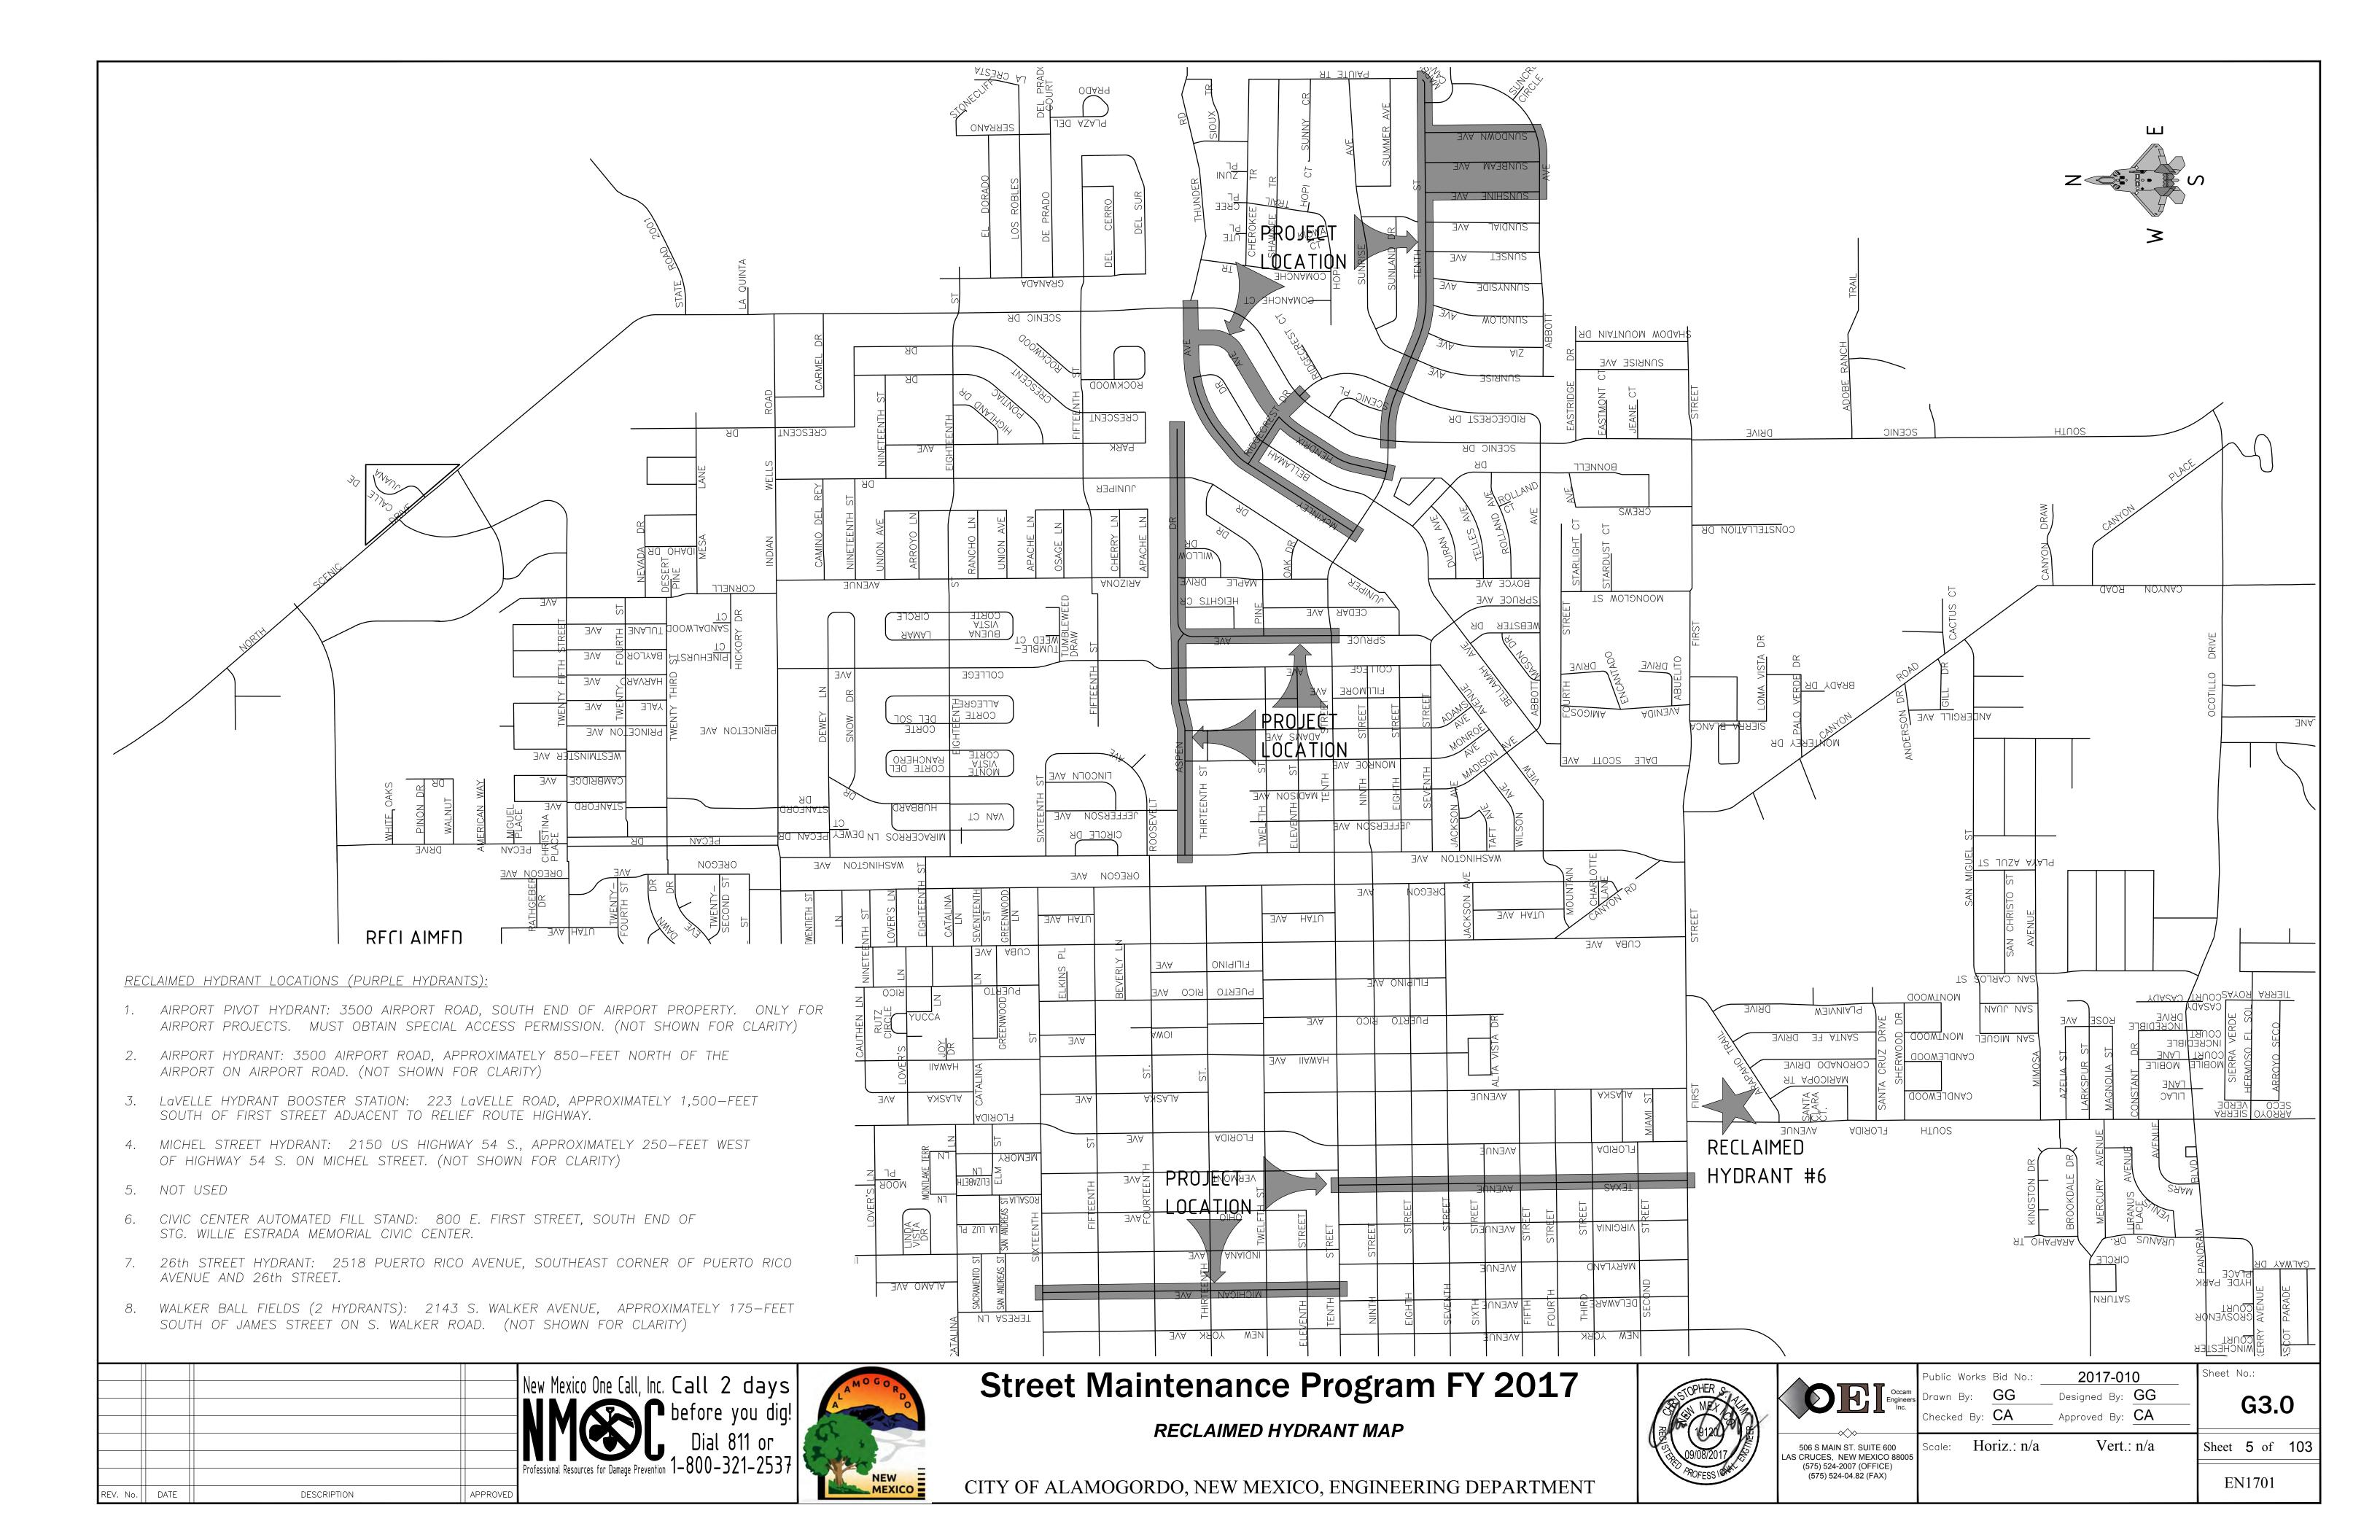

ITEM NO.	ITEM DESCRIPTION	UNIT	TOTAL PROJECT		
			ESTIMATE	FINAL	
203000	UNCLASSIFIED EXCAVATION (OVER EXCAVATION)	C.Y.	3,418		
207000	8" SUBGRADE PREPARATION (OVER EXCAVATION)	S.Y.	11,233		
303010	BASE COURSE (OVER EXCAVATION)	C.Y.	2,497		
414120	2" THICK HMA COLD MILLING	S.Y.	88,729		
417000	PAVEMENT PATCH	S.Y.	1,506		
423270	HMA SP-IV 2-INCHES THICK	S.Y.	90,459		
423271	HMA SP-IV 3-INCHES THICK (OVER EXCAVATION)	S.Y.	10,899		
450090	CONCRETE PAVEMENT 9-INCHES THICK	S.Y.	69		
608000	TACTILE WARNING SURFACE	S.F.	1,534		
608104	4-INCH THICK CONCRETE	S.Y.	906		
608106	6-INCH THICK CONCRETE WITH REINFORCEMENT	S.Y.	2,828		
609424	TYPE II CURB/GUTTER	L.F.	8,211		
614006	CONCRETE PIPE ENCASEMENT	L.F.	320		
618000	FURNISH & PROVIDE MUTCD PLAN	L.S.	1		
621000	MOBILIZATION	L.S.	1		
662400	ADJUST EXISTING MANHOLE TO FINAL GRADE	EA	41		
663100	NEW FIRE HYDRANT	EA	73		
663101	REMOVE & DISPOSE FIRE HYDRANT	EA	32		
663710	3/4-INCH SERVICE LINE REPLACEMENT	EA	544		
663711	1-INCH SERVICE LINE REPLACEMENT	EA	11		
663712	2-INCH SERVICE LINE REPLACEMENT	EA	6		
663724	4-INCH PVC WATERLINE	L.F.	50		
663726	6-INCH PVC WATERLINE	L.F.	15,570		
663728	8-INCH PVC WATERLINE	L.F.	4,441		
663730	10-INCH PVC WATERLINE	L.F.	7,393		
663772	DRY LATERAL WATERLINE CONNECTION	EA	31		
663856	REMOVE & DISPOSE EXISTING VALVE BOX	EA	96		
663887	WET LATERAL WATERLINE CONNECTION	EA	29		
663855	ADJUST EXISTING VALVE BOX TO GRADE	EA	13		
663896	6-INCH MAINLINE GATE VALVE	EA	71		
663898	8-INCH MAINLINE GATE VALVE	EA	34		
663899	10-INCH MAINLINE GATE VALVE	EA	28		
663944	EXISTING 4-INCH SEWER SERVICE REPAIR	LF	87		
663965	4" SEWER SERVICE CONNECTION AT EXISTING MAINLINE	EA	15		
704224	RETROREFLECTORIZED PLASTIC PAVEMENT STRIPE 24-INCHES WIDE	L.F.	1,003		
704330	RETROREFLECTORIZED PLASTIC LEFT ARROW	EA	1		
704440	RETROREFLECTORIZED PLASTIC WORD (ONLY)	EA	1		
704700	HOT THERMOPLASTIC PAVEMENT STRIPE 4-INCHES WIDE	L.F.	7,431		
704715	HOT THERMOPLASTIC PAVEMENT MARKING COMBINATION (THRU & RIGHT) ARROW	EA	1		
801000	CONSTRUCTION STAKING & SURVEYING	L.S.	1		


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REV. No.	DATE	DESCRIPTION	APPROVED	



## **Street Maintenance Program FY 2017**

SUMMARY OF QUANTITIES


CITY OF ALAMOGORDO, NEW MEXICO, ENGINEERING DEPARTMENT

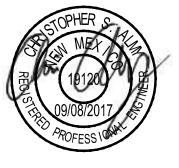

<b>^</b>	Public W	orks Bid No.:	2017-010	
Occam Engineers Inc.	Drawn B	y: <b>GG</b>	Designed By: <b>(</b>	GG
Inc.	Checked	Ву: СА	Approved By: $\overline{oldsymbol{\emptyset}}$	CA
~~				
506 S MAIN ST. SUITE 600 LAS CRUCES, NEW MEXICO 88005 (575) 524-2007 (OFFICE) (575) 524-04.82 (FAX)	Scale:	Horiz.: n/a	Vert.: 1	n/a

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Sheet 6 of 103 EN1701

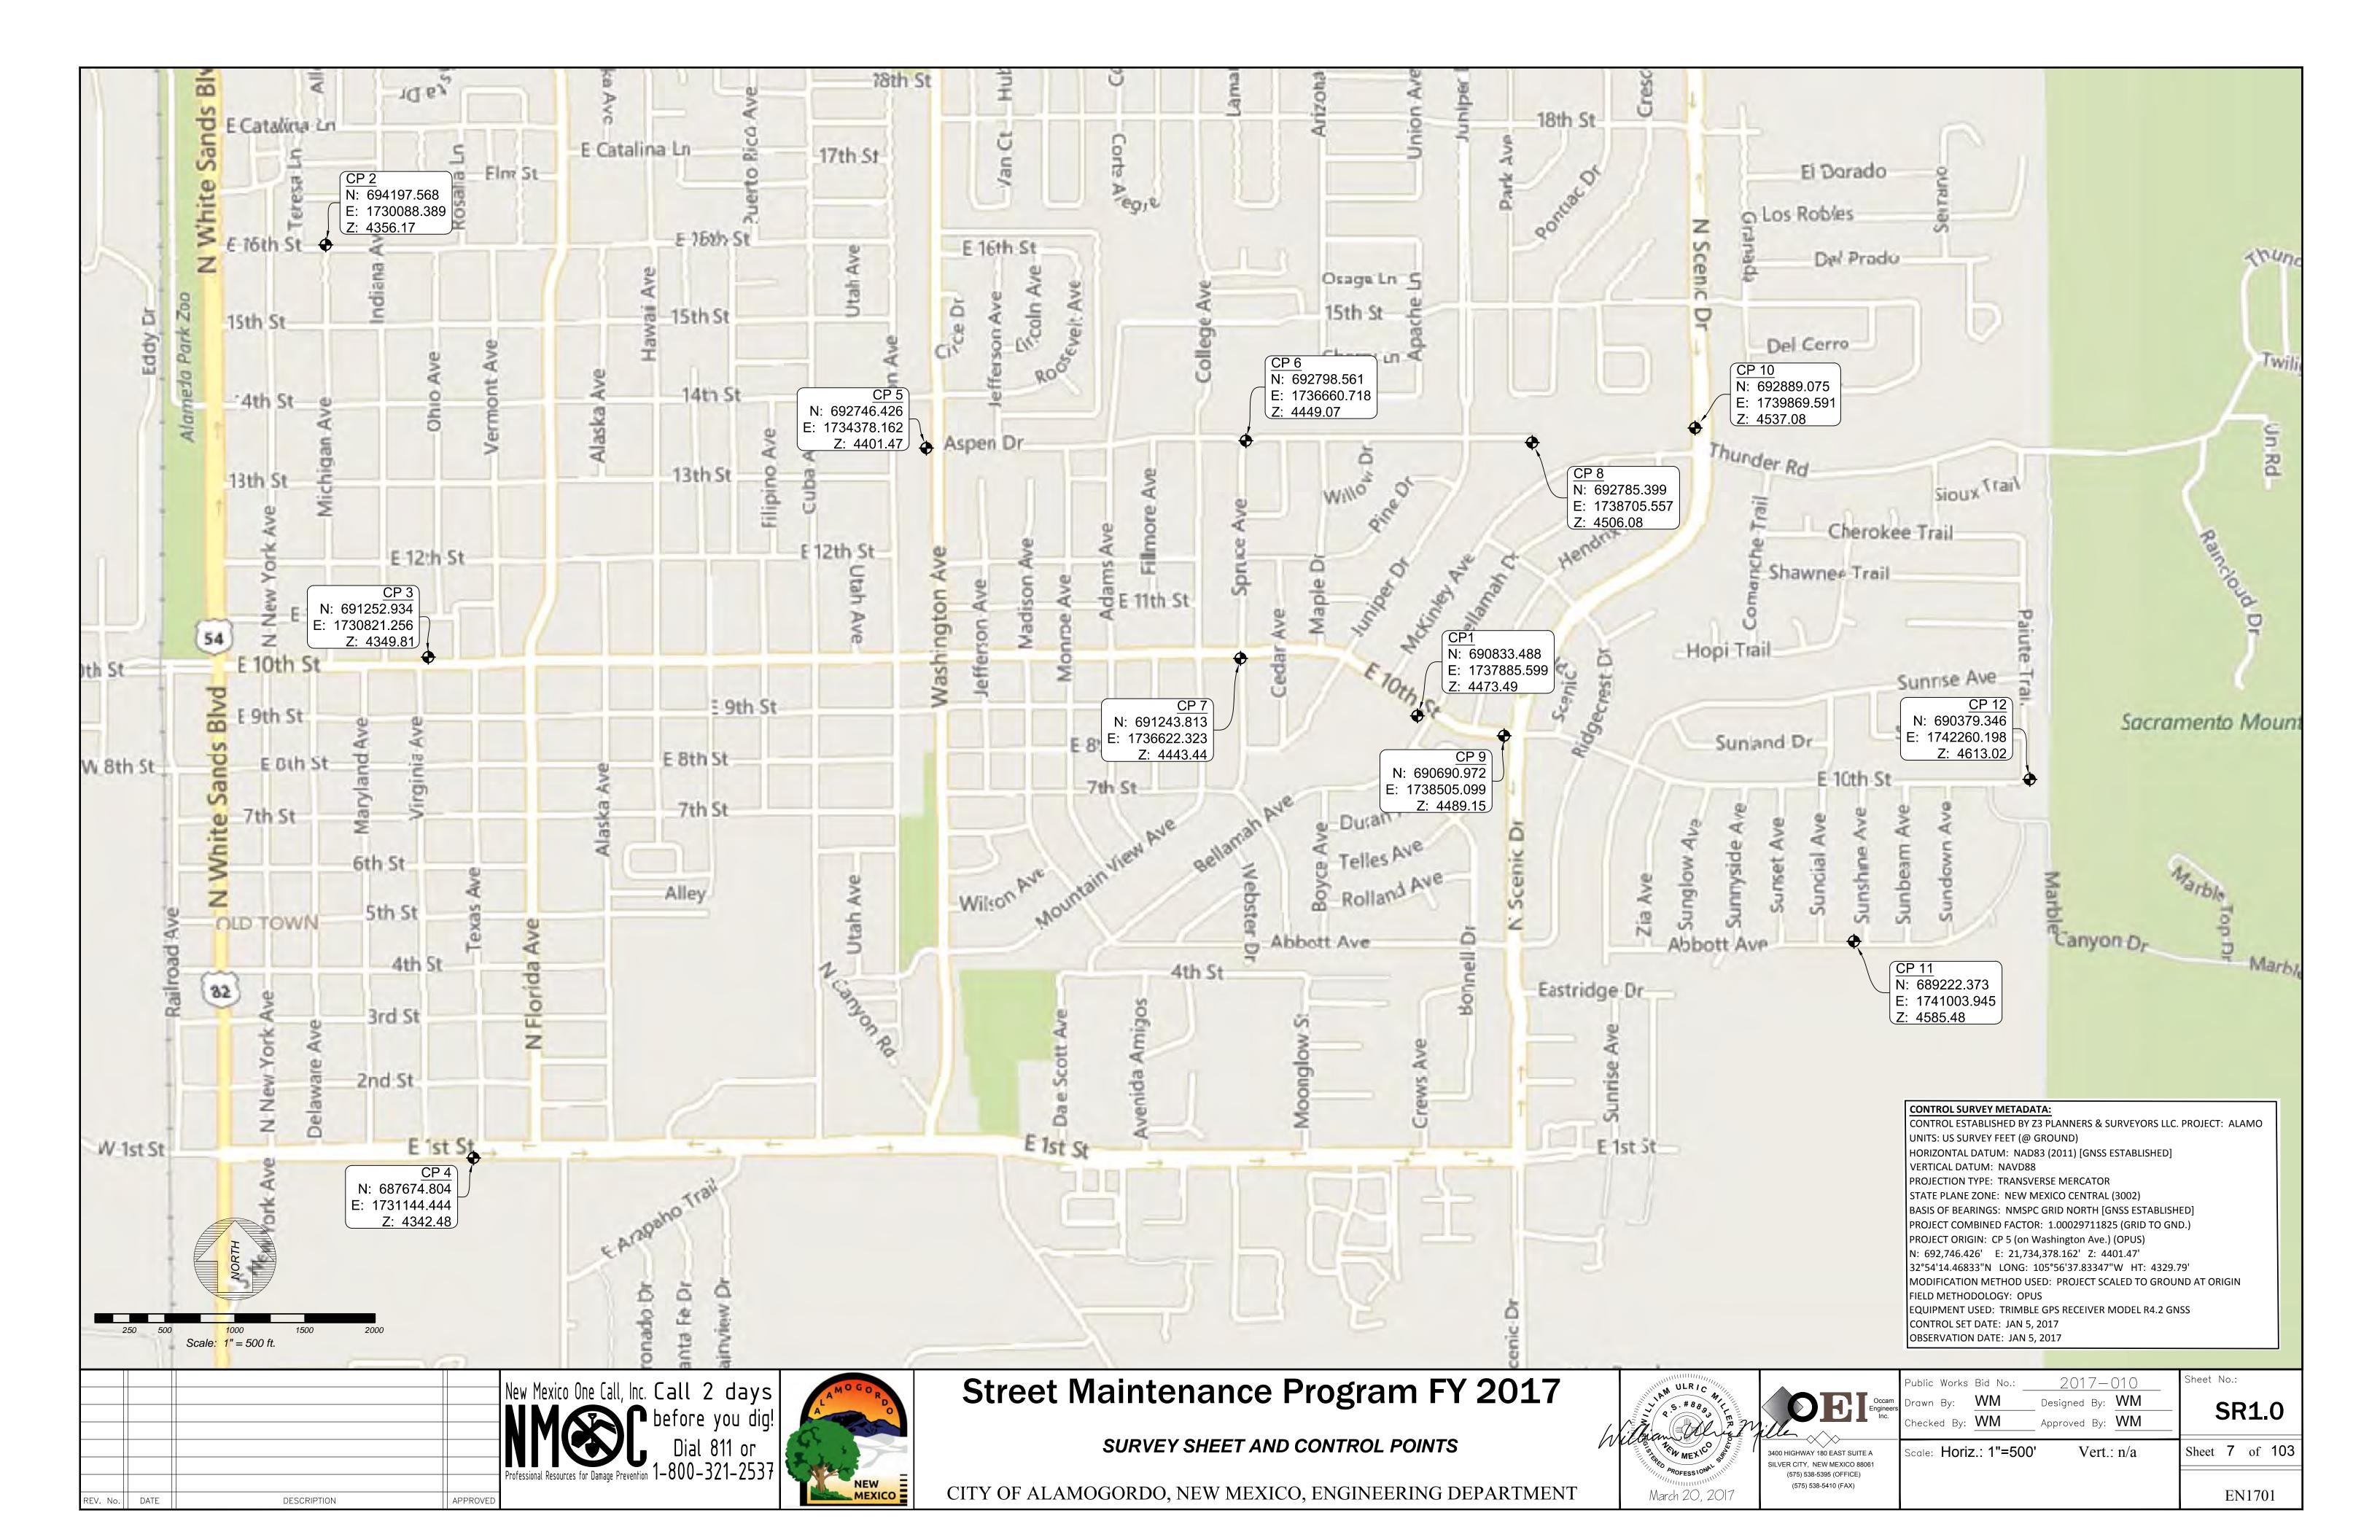

### TEXAS AVE. Number | Start Station | End Station | Radius | Length | Line/Chord Direction N0° 39' 19.89"W

	SUNSHINE AVE.							
Number	Number Start Station End Station Radius Length Line/Chord Direction							
L1	L1 0+00.00 11+41.56 1141.56 N0° 23' 03.05"W							

SUNBEAM AVE.						
Numbe	Start Station	End Station	Radius	Length	Line/Chord Direction	
L1	0+00.00	11+44.03		1144.03	S0° 22' 55.74"E	

	SUNDOWN AVE.							
Number	Start Station	End Station	Radius	Length	Line/Chord Direction			
L1	0+00.00	0+11.00		11.00	N20° 25' 07.95"W			
C1			65.91	14.61	N14° 04' 12.25"W			
L2	0+25.61	0+44.56		18.95	N7° 43' 16.55"W			
C2			65.91	8.46	N4° 02' 43.10"W			
L3	0+53.02	11+04.35		1051.33	N0° 22' 09.66"W			

	ABBOTT AVE.							
Number	Start Station	End Station	Radius	Length	Line/Chord Direction			
L1	0+00.00	2+34.49		234.49	S89° 43' 24.64"E			
C1			200.00	0.95	S89° 51' 36.01"E			
L2	2+35.45	3+16.66		81.21	S89° 59' 47.38"E			
C2			200.00	0.39	N89° 56' 50.24"E			
L3	3+17.05	4+14.86		97.81	N89° 53' 27.87"E			
C3			200.00	1.66	S89° 52' 17.79"E			
L4	4+16.51	4+66.55		50.03	S89° 38' 03.44"E			
C4			601.16	144.02	N85° 14' 23.90"E			
C5			653.14	234.75	N70° 00' 47.72"E			

TENTH ST.								
Number	Start Station	End Station	Radius	Length	Line/Chord Direction			
L1	0+00.00	1+22.62		122.62	S89° 18' 05.06"E			
C1			900.00	358.46	S77° 53' 28.52"E			
L2	4+81.08	8+39.95		358.88	S66° 28' 51.97"E			
L3	8+39.95	10+37.46		197.51	S66° 21' 58.39"E			
C2			1060.00	445.89	S78° 25' 01.15"E			
L4	14+83.35	16+52.76		169.41	N89° 31' 56.09"E			
L5	16+52.76	17+26.24		73.48	N89° 36' 59.47"E			
L6	17+26.24	19+14.96		188.72	N89° 38' 17.01"E			
L7	19+14.96	19+90.83		75.87	N89° 40' 05.38"E			
L8	19+90.83	22+83.93		293.10	N89° 34' 52.23"E			
L9	22+83.93	25+00.46		216.53	N89° 35' 51.92"E			
L10	25+00.46	25+81.00		80.54	N89° 36' 00.26"E			
L11	25+81.00	28+04.21		223.21	N89° 39' 44.67"E			
L12	28+04.21	28+81.05		76.84	N89° 38' 59.19"E			
L13	28+81.05	31+05.70		224.65	N89° 39' 04.27"E			
L14	31+05.70	31+82.66		76.96	N89° 25' 09.65"E			
L15	31+82.66	34+02.46		219.81	N89° 31' 22.23"E			
L16	34+02.46	34+82.99		80.52	N89° 37' 43.94"E			
L17	34+82.99	36+20.20		137.21	N89° 28' 05.77"E			
C3			70.00	109.31	N44° 44' 02.88"E			
L18	37+29.50	37+60.00		30.50	N0° 00' 00.00"E			

	MICHIGAN AVE.							
Number	Start Station	End Station	Radius	Length	Line/Chord Direction			
L1	0+00.00	2+89.54		289.54	N0° 50' 16.35"W			
L2	2+89.54	3+55.86		66.32	N0° 42' 24.77"W			
L3	3+55.86	6+96.28		340.43	N0° 39' 50.36"W			
L4	6+96.28	7+66.75		70.46	N0° 35' 52.17"W			
L5	7+66.75	12+58.78		492.03	N0° 39' 37.86"W			
L6	12+58.78	13+23.60		64.82	N0° 41' 18.29"W			
L7	13+23.60	18+17.09		493.49	N0° 40' 23.40"W			
L8	18+17.09	18+80.24		63.15	N0° 49' 08.15"W			
L9	18+80.24	23+77.84		497.60	N0° 39' 24.42"W			
L10	23+77.84	24+42.56		64.72	N0° 41' 20.18"W			
L11	24+42.56	29+73.79		531.23	N0° 39' 47.73"W			

ASPEN DR.							
Number	Start Station	End Station	Radius	Length	Line/Chord Direction		
L1	0+00.00	4+47.67		447.67	N89° 56' 07.35"E		
L2	4+47.67	9+40.12		492.46	N89° 52' 59.88"E		
L3	9+40.12	12+43.40		303.28	N89° 52' 05.58"E		
L4	12+43.40	12+80.81		37.41	N89° 43' 44.66"E		
L5	12+80.81	15+46.35		265.54	N76° 11' 20.90"E		
L6	15+46.35	15+57.70		11.35	N89° 00' 03.09"E		
L7	15+57.70	18+78.47		320.78	N89° 13' 45.15"E		
L8	18+78.47	19+18.48		40.01	S81° 58' 55.85"E		
L9	19+18.48	21+28.09		209.60	N89° 28' 07.80"E		
C1			73.75	50.01	S71° 06' 22.79"E		
L10	21+78.09	22+40.12		62.03	S51° 40' 53.91"E		
C2			149.25	134.69	N64° 10' 16.99"E		
L11	23+74.81	25+19.35		144.54	S89° 58' 32.10"E		
L12	25+19.35	28+14.67		295.31	S89° 59' 12.00"E		
L13	28+14.67	31+04.33		289.66	N89° 44' 58.51"E		
L14	31+04.33	38+20.16		715.83	N89° 46' 04.69"E		
L15	38+20.16	42+99.83		479.67	N89° 54' 52.34"E		


SPRUCE AVE.								
Number	Start Station	End Station	Radius	Length	Line/Chord Direction			
L1	0+00.00	6+79.87		679.87	N0° 15' 14.58"W			
L2	6+79.87	9+75.80		295.93	N0° 29' 28.94"W			
L3	9+75.80	13+85.79		409.99	N0° 47' 57.11"W			
C1			149.25	101.90	N18° 45' 34.49"E			

	RIDGECREST DR.								
Number	Start Station	End Station	Radius	Length	Line/Chord Direction				
L5	0+00.00	1+62.56		162.56	N43° 03' 39.39"W				
L4	1+62.56	2+97.14		134.58	N46° 51' 41.97"W				
L3	2+97.14	5+43.52		246.38	N56° 53' 42.94"W				
L2	5+43.52	8+56.77		313.25	N57° 12' 59.93"W				
L1	8+56.77	9+93.48		136.71	N53° 03' 12.77"W				

	MC KINLEY AVE.								
Number	Start Station	End Station	Radius	Length	Line/Chord Direction				
L1	0+00.00	12+78.70		1278.70	N32° 55' 59.79"E				
C1			450.00	135.41	N41° 33' 14.18"E				
L2	14+14.11	16+51.95		237.84	N50° 10' 28.56"E				
C2			1250.00	843.97	N69° 31' 01.31"E				
L3	24+95.93	29+92.43		496.50	N88° 51' 34.05"E				

	HENDRIX AVE.							
Number	Start Station	End Station	Radius	Length	Line/Chord Direction			
L1	0+00.00	3+25.30		325.30	N12° 41' 31.10"E			
C1			630.00	223.04	N22° 50' 02.65"E			
L2	5+48.34	9+62.89		414.55	N32° 58' 34.20"E			
C2			1175.00	538.16	N46° 05' 49.51"E			
L3	15+01.05	20+15.38		514.34	N59° 13' 04.83"E			
C3			280.00	291.76	N29° 21' 59.79"E			
L4	23+07.15	25+12.44		205.29	N0° 29' 05.24"W			

				New Mexico One Call, Inc. Call 2 days  Dial 811 or  Professional Resources for Damage Prevention 1-800-321-2537
REV. No.	DATE	DESCRIPTION	APPROVED	

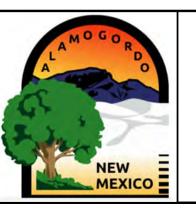

### **Street Maintenance Program FY 2017**

STREET ALIGNMENT CONTROL TABLES

CITY OF ALAMOGORDO, NEW MEXICO, ENGINEERING DEPARTMENT



Occam Engineers Inc.
506 S MAIN ST. SUITE 600 LAS CRUCES, NEW MEXICO 88005 (575) 524-2007 (OFFICE) (575) 524-04.82 (FAX)


Public Works Bid No.: 2017-010

Designed By: **GG** Approved By:  $\overline{\mathsf{CA}}$ 

Vert.: n/a Scale: Horiz.:

Sheet 8 of 103


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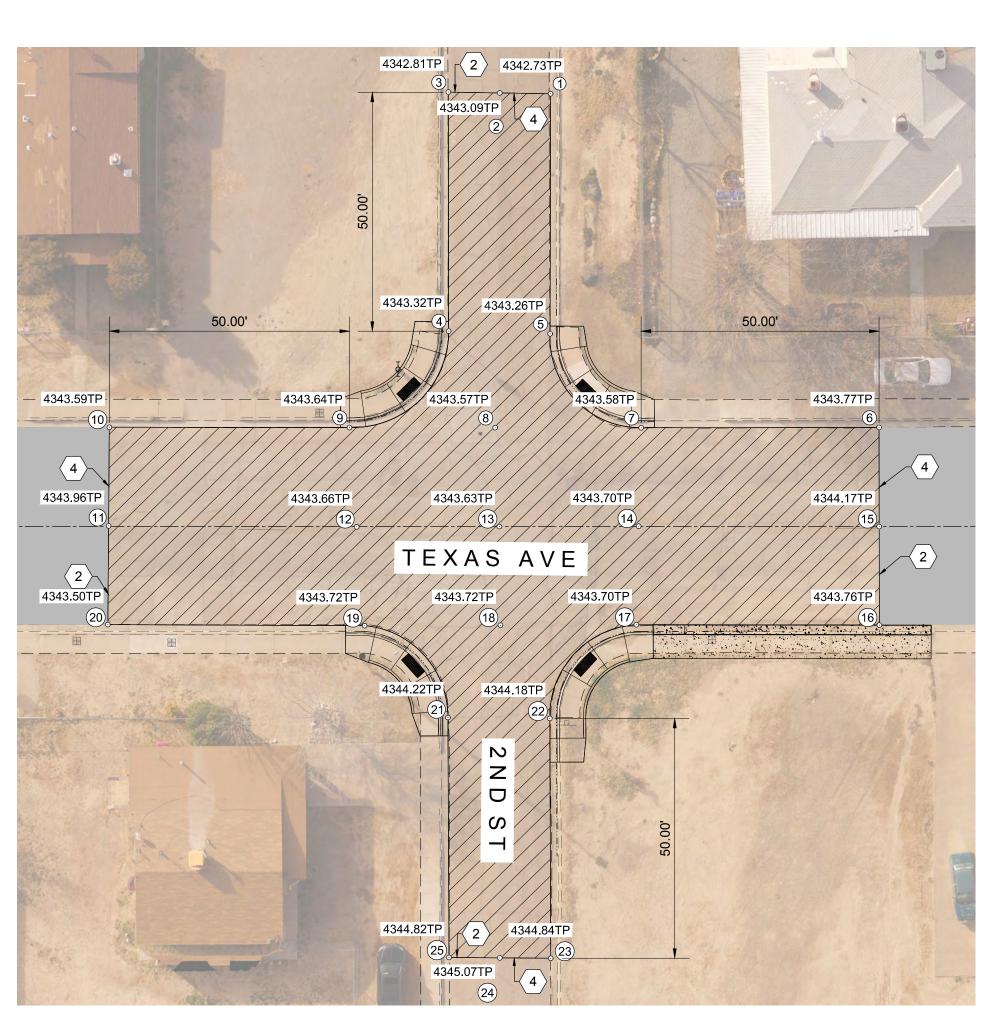


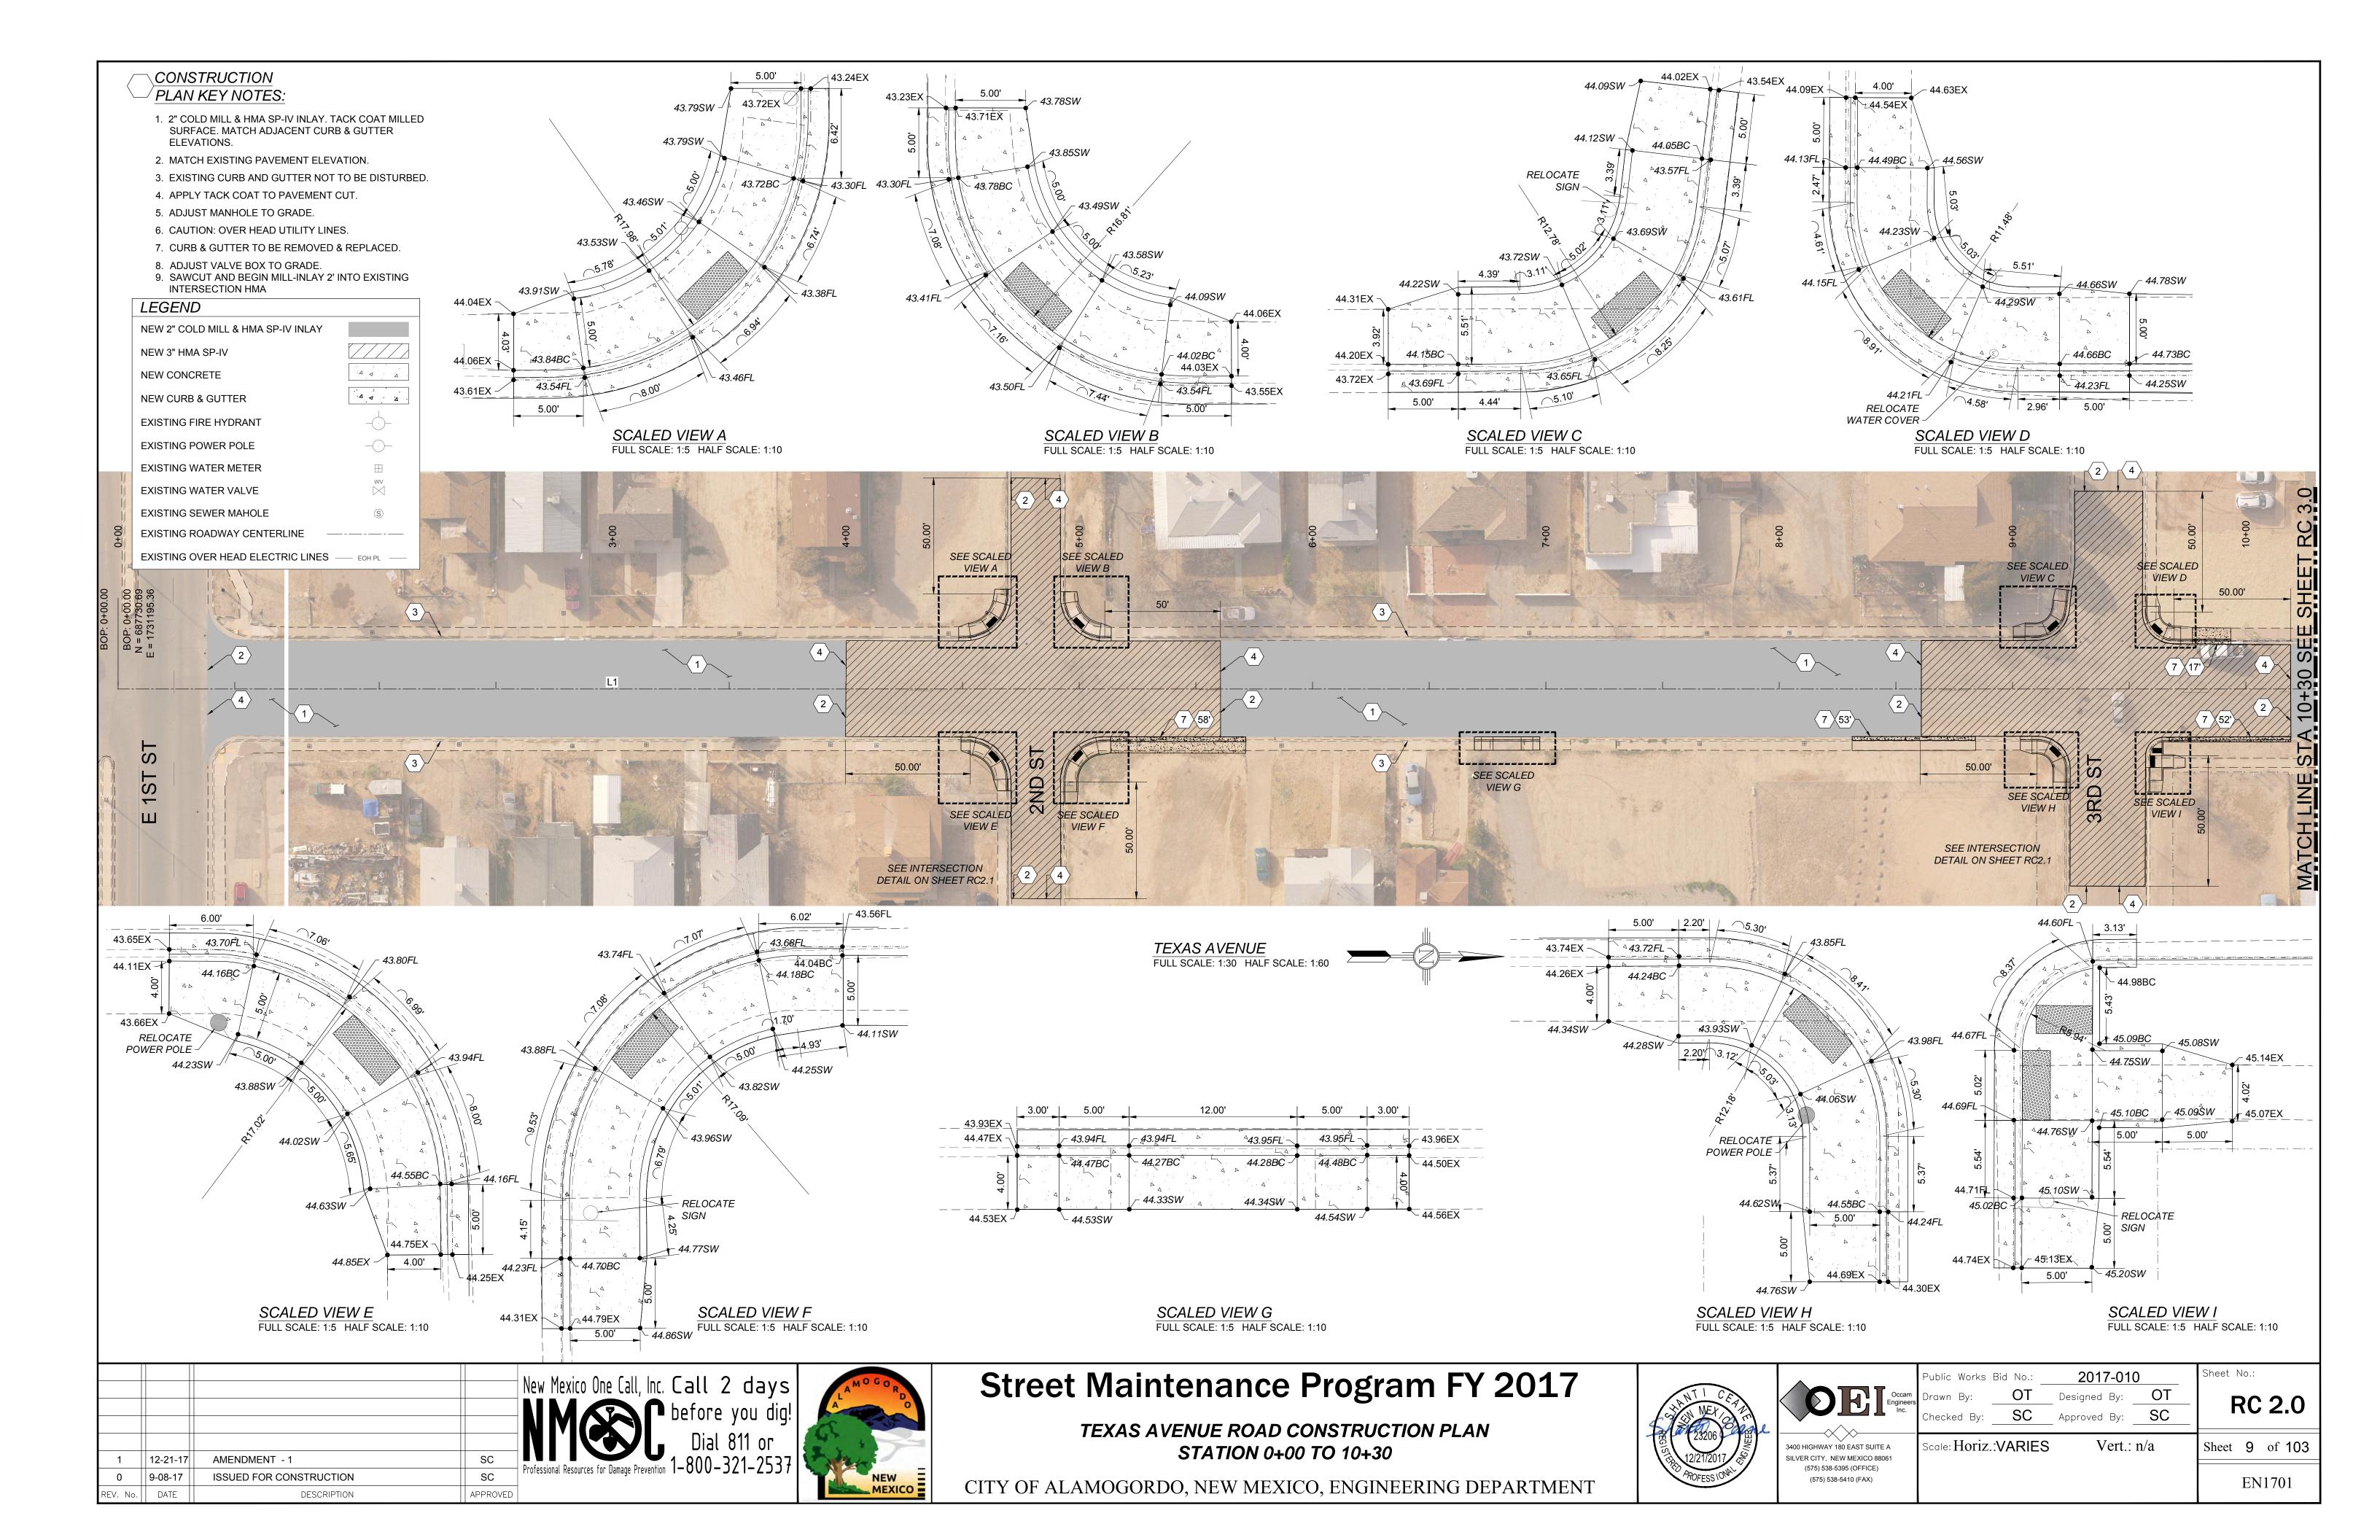PT#	Northing	Easting
1	688221.76	1731099.59
2	688211.17	1731099.53
3	688200.45	1731099.48
4	688201.08	1731149.25
5	688222.23	1731149.59
6	688290.97	1731168.30
7	688241.40	1731168.93
8	688211.02	1731169.26
9	688180.64	1731169.59
10	688130.64	1731170.10
11	688130.71	1731190.64
12	688182.41	1731190.26
13	688212.12	1731189.85
14	688241.14	1731189.45
15	688291.23	1731188.94
16	688291.50	1731209.47
17	688240.87	1731209.97
18	688212.57	1731210.39
19	688184.27	1731210.81
20	688130.79	1731211.20
21	688201.85	1731229.74
22	688223.08	1731229.69
23	688223.84	1731279.64
24	688213.23	1731279.68
25	688202.64	1731279.71


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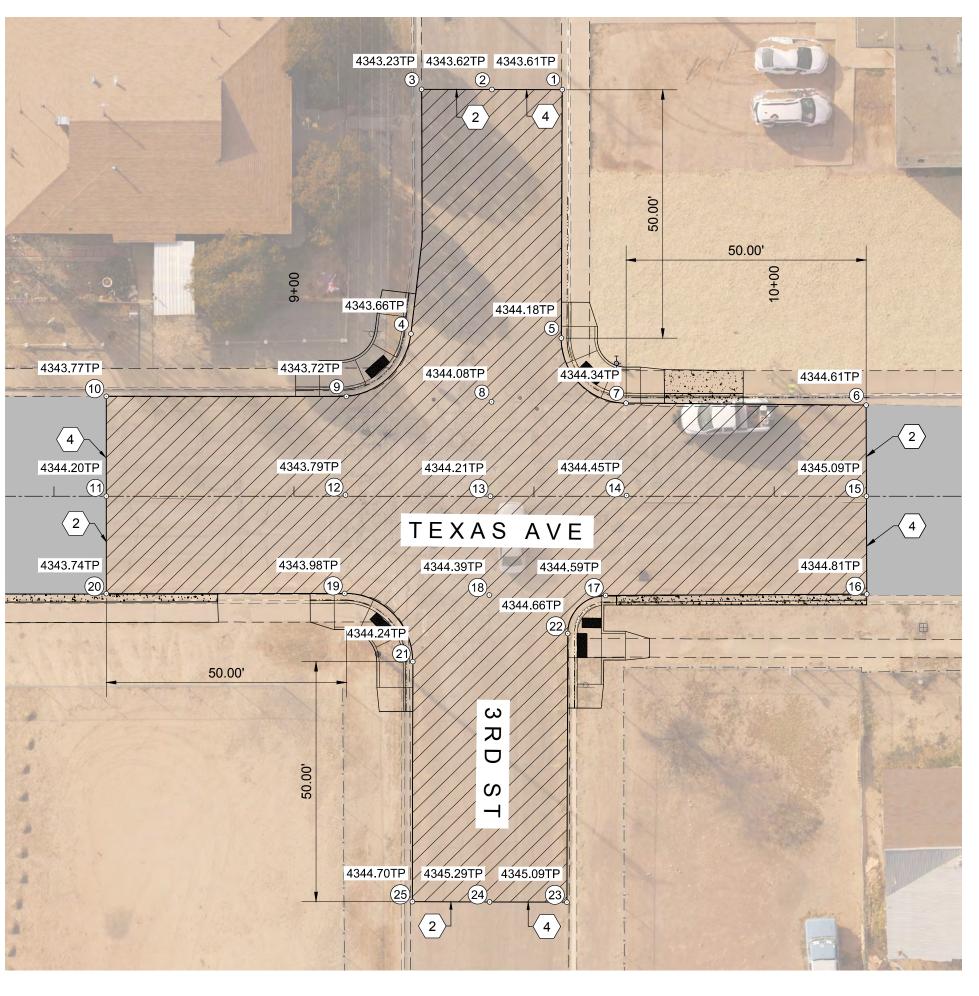
- 1. 2" COLD MILL & HMA SP-IV INLAY. TACK COAT MILLED SURFACE. MATCH ADJACENT CURB & GUTTER ELEVATIONS.
- 2. MATCH EXISTING PAVEMENT ELEVATION.
- 3. EXISTING CURB AND GUTTER NOT TO BE DISTURBED.
- 4. APPLY TACK COAT TO PAVEMENT CUT.
- 5. ADJUST MANHOLE TO GRADE.
- 6. CAUTION: OVER HEAD UTILITY LINES.
- 7. CURB & GUTTER TO BE REMOVED & REPLACED.
- 8. ADJUST VALVE BOX TO GRADE.9. SAWCUT AND BEGIN MILL-INLAY 2' INTO EXISTING INTERSECTION HMA





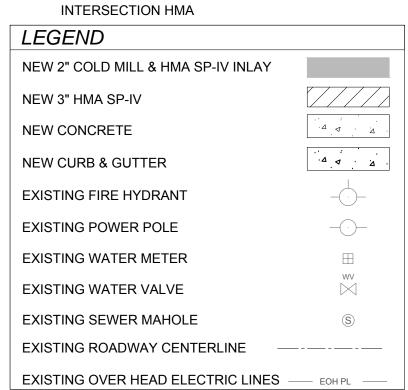




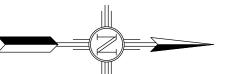


PT#	Northing	Easting
1	688685.53	1731099.74
2	688670.89	1731099.88
3	688656.24	1731100.02
4	688654.62	1731150.96
5	688685.94	1731151.48
6	688749.58	1731164.72
7	688699.58	1731164.88
8	688671.56	1731164.94
9	688641.31	1731164.16
10	688591.31	1731164.70
11	688591.55	1731185.49
12	688641.37	1731184.68
13	688671.56	1731184.59
14	688699.90	1731184.14
15	688749.86	1731183.70
16	688750.16	1731204.09
17	688695.77	1731204.99
18	688671.56	1731205.19
19	688641.44	1731205.21
20	688591.78	1731205.80
21	688655.78	1731219.23
22	688687.99	1731213.01
23	688688.44	1731268.97
24	688672.34	1731269.10
25	688656.25	1731269.23

GRADING PLAN - TEXAS AVENUE & 3RD FULL SCALE: 1:20 HALF SCALE: 1:40

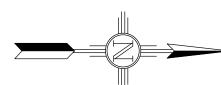

				New Mexico One Call, Inc. Call 2 days
				NMEDE before you dig Dial 811 or Professional Resources for Damage Prevention 1–800–321–2537
				Dial 811 or
				Professional Resources for Damage Prevention $1-800-321-2537$
REV. No.	DATE	DESCRIPTION	APPROVED	

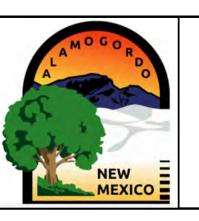

## **Street Maintenance Program FY 2017**

TEXAS AVENUE INTERSECTION RECONSTRUCTION 2ND STREET & 3RD STREET

l	Occam Engineers Inc.	
	3400 HIGHWAY 180 EAST SUITE A	
	SILVER CITY, NEW MEXICO 88061 (575) 538-5395 (OFFICE)	

(575) 538-5410 (FAX)


	Public Works	Bid No.:	2017-010	
am eers	Drawn By:	OT	Designed By:	ОТ
	Checked By:	SC	— Approved By:	SC

By: OT Designed By: OT SC RC 2

Scale: Horiz.: 1" = 20' Vert.: n/a Sheet 10 of 103

EN1701


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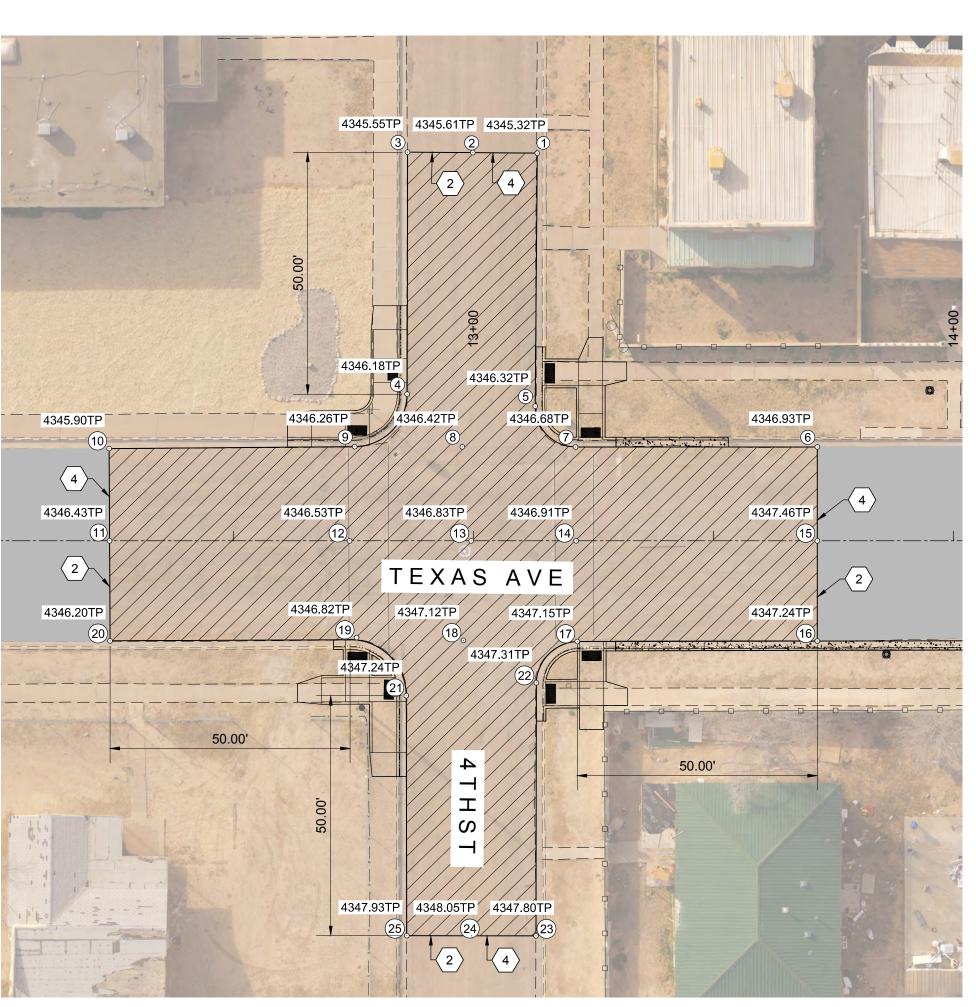


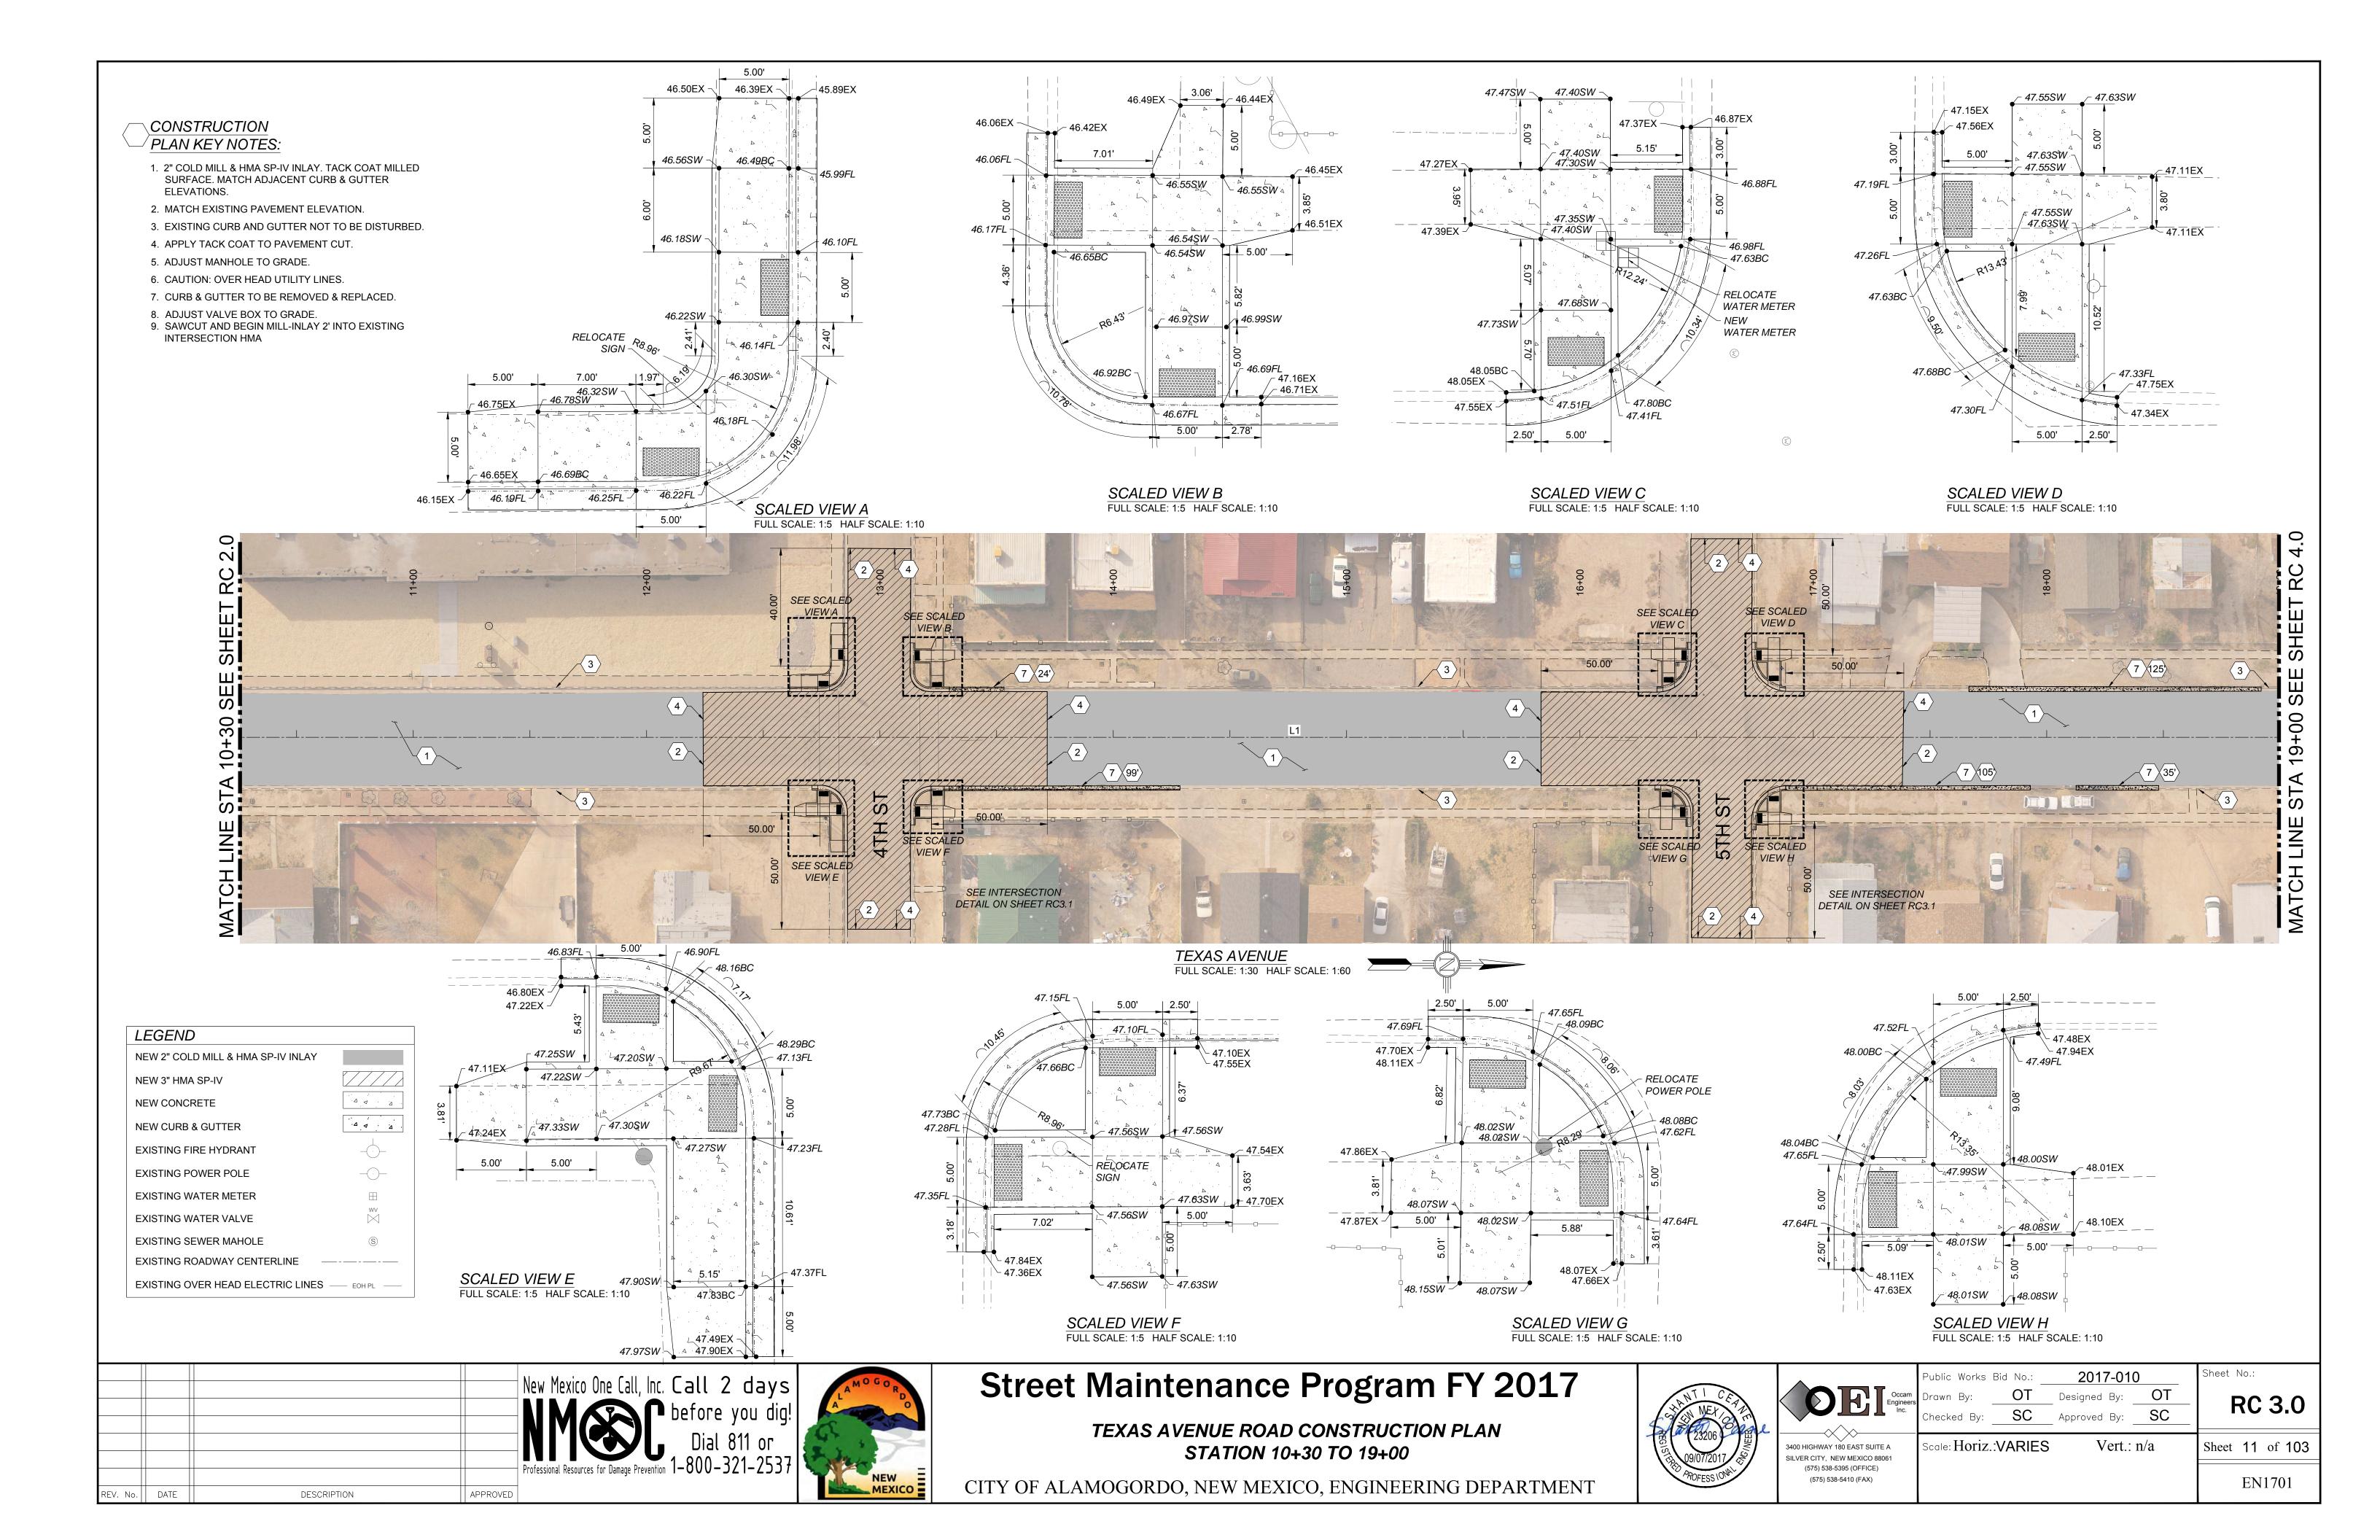PT#	Northing	Easting
1	689043.02	1731099.59
2	689029.58	1731099.64
3	689016.00	1731099.69
4	689016.48	1731150.09
5	689043.18	1731152.30
6	689102.06	1731160.11
7	689051.69	1731160.69
8	689028.11	1731160.93
9	689005.70	1731161.15
10	688954.53	1731162.13
11	688954.85	1731181.35
12	689004.84	1731180.78
13	689030.18	1731180.49
14	689052.05	1731180.23
15	689102.28	1731179.66
16	689102.52	1731200.53
17	689052.53	1731201.19
18	689028.80	1731201.25
19	689005.18	1731201.37
20	688955.18	1731202.18
21	689017.03	1731212.89
22	689044.08	1731209.91
23	689044.61	1731262.61
24	689031.20	1731262.75
25	689017.70	1731262.89


### CONSTRUCTION PLAN KEY NOTES:


- 1. 2" COLD MILL & HMA SP-IV INLAY. TACK COAT MILLED SURFACE. MATCH ADJACENT CURB & GUTTER
- 2. MATCH EXISTING PAVEMENT ELEVATION.
- 3. EXISTING CURB AND GUTTER NOT TO BE DISTURBED.
- 4. APPLY TACK COAT TO PAVEMENT CUT.
- 5. ADJUST MANHOLE TO GRADE.
- 6. CAUTION: OVER HEAD UTILITY LINES.
- 7. CURB & GUTTER TO BE REMOVED & REPLACED.
- 8 AD JUST VALVE BOX TO GRADE
- 8. ADJUST VALVE BOX TO GRADE.
  9. SAWCUT AND BEGIN MILL-INLAY 2' INTO EXISTING
  INTERSECTION HMA



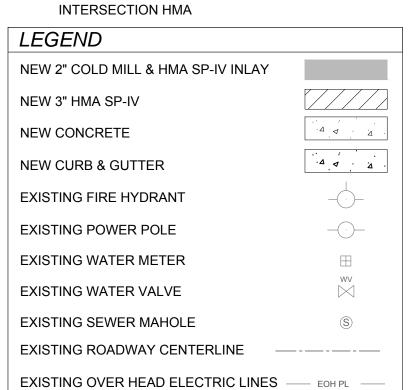



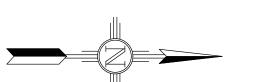

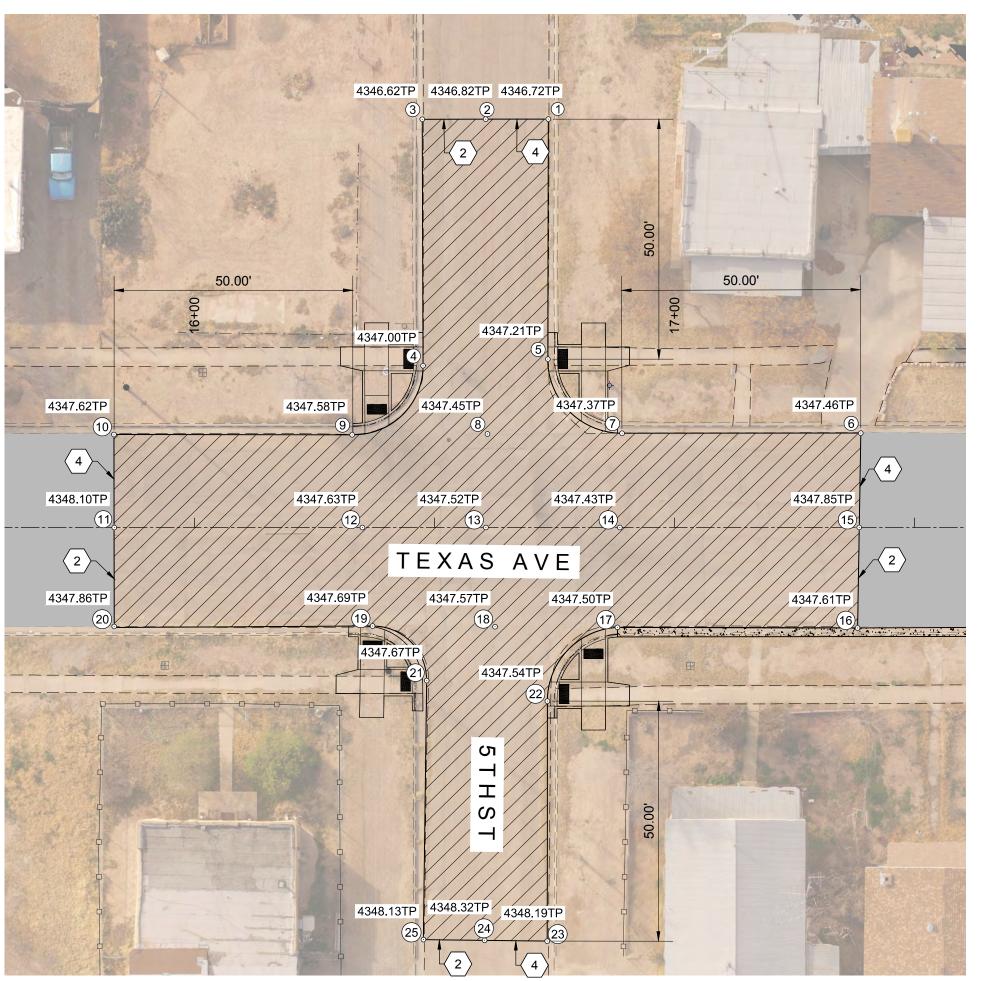

GRADING PLAN - TEXAS AVENUE & 5TH FULL SCALE: 1:20 HALF SCALE: 1:40



PT#	Northing	Easting
1	689403.34	1731091.14
2	689390.29	1731091.31
3	689377.09	1731091.47
4	689377.83	1731142.81
5	689403.81	1731141.14
6	689469.16	1731155.81
7	689419.44	1731156.40
8	689391.41	1731156.88
9	689363.22	1731157.36
10	689313.62	1731157.86
11	689313.90	1731177.24
12	689365.59	1731176.65
13	689391.30	1731176.36
14	689419.20	1731176.04
15	689469.05	1731175.45
16	689468.95	1731196.40
17	689418.95	1731196.84
18	689393.45	1731196.99
19	689367.95	1731197.14
20	689314.14	1731197.85
21	689379.34	1731208.38
22	689404.53	1731212.36
23	689405.06	1731262.35
24	689392.03	1731262.34
25	689379.28	1731262.33

J			
1	12-21-17	AMENDMENT - 1	SC
0	9-08-17	ISSUED FOR CONSTRUCTION	SC
REV. No.	DATE	DESCRIPTION	APPROVED
			•

New Mexico One Call, Inc. Call 2 days

Mexico One Call, Inc. Call 2 days

Dial 811 or

Professional Resources for Damage Prevention 1–800–321–2537



### Street Maintenance Program FY 2017

TEXAS AVENUE INTERSECTION RECONSTRUCTION 4TH STREET & 5TH STREET

CITY OF ALAMOGORDO, NEW MEXICO, ENGINEERING DEPARTMENT




٩	Occam Engineers Inc.	
	3400 HIGHWAY 180 EAST SUITE A	
	SILVER CITY, NEW MEXICO 88061	
	(575) 538-5395 (OFFICE)	ı

(575) 538-5410 (FAX)

	Public Works	Bid No.:	2017-010	)
Occam Engineers Inc.	Drawn By:	ОТ	Designed By:	ОТ
Inc.	Checked By:	SC	Approved By:	SC
^				
N 400 FAOT OUTE A	Carla Horiz	·1" - 20'	Vort	n/o

RC 3.1

Scale: Horiz.: 1" = 20' Vert.: n/a Sheet 12 of 103

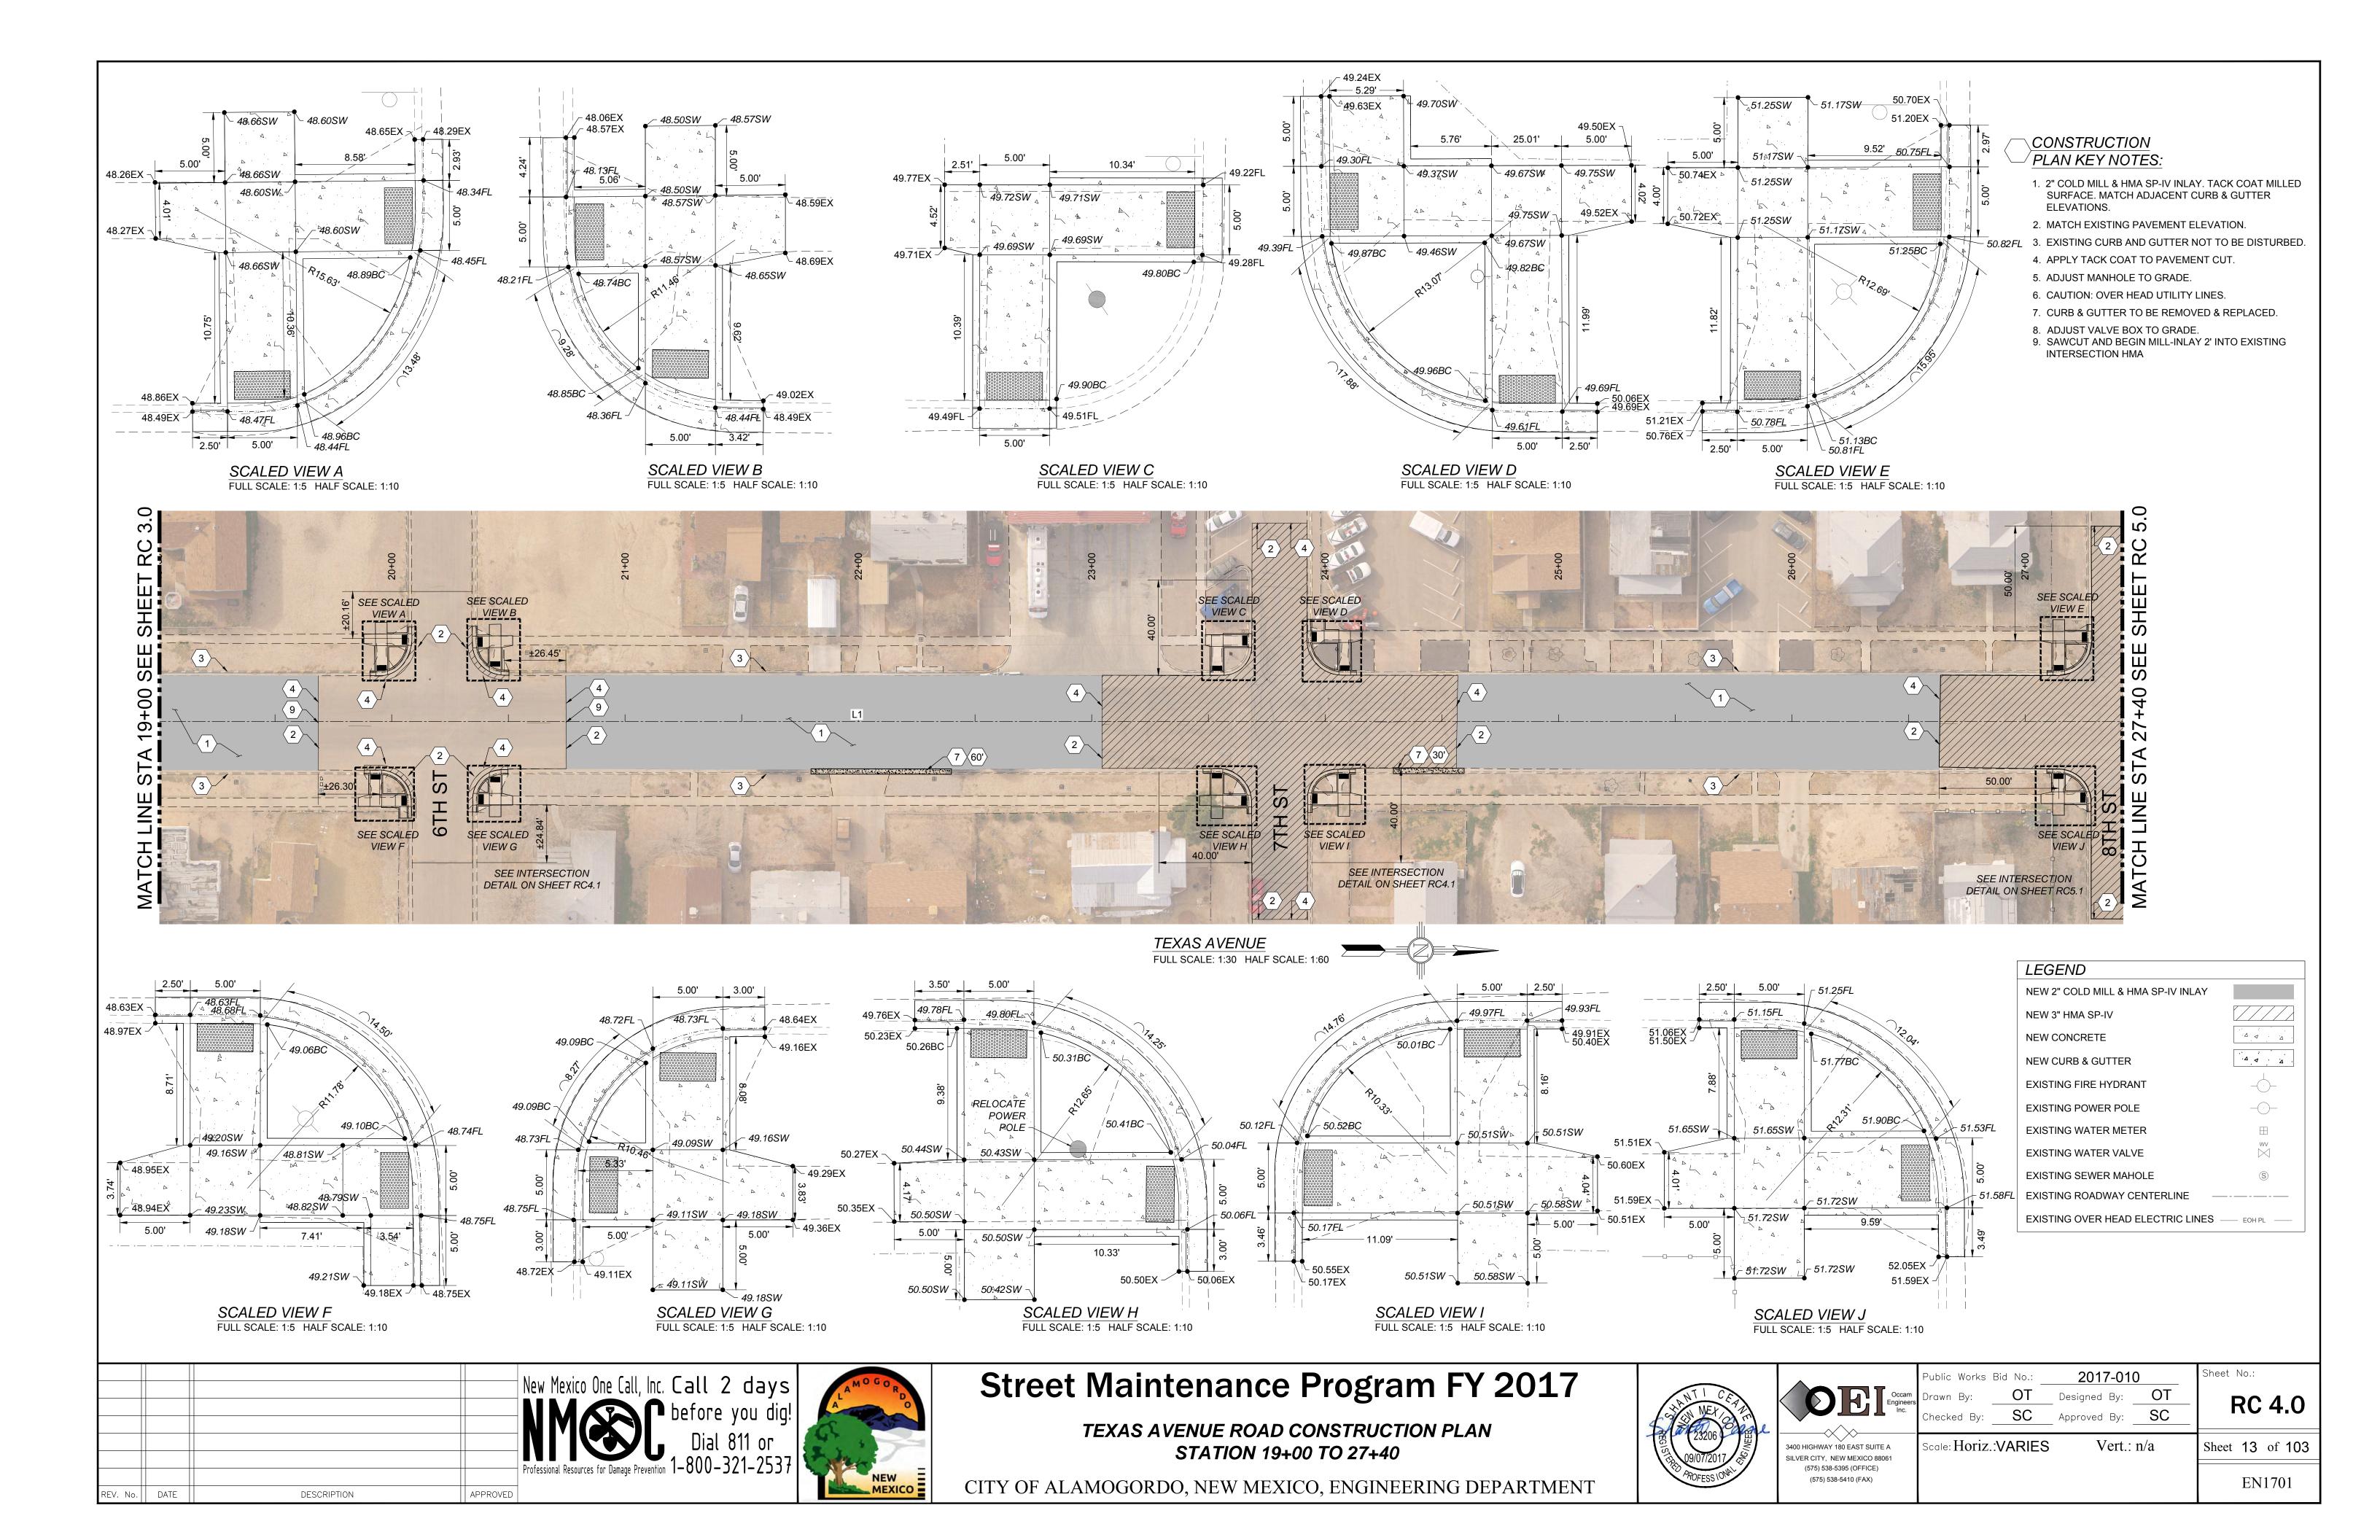

PT#	Northing	Easting
1	689804.92	1731151.95
2	689698.88	1731153.20
3	689699.05	1731172.84
4	689805.30	1731171.62
5	689805.69	1731191.80
6	689780.62	1731192.46
7	689777.63	1731192.51
8	689768.33	1731197.24
9	689765.66	1731205.18
10	689765.70	1731210.85
11	689699.22	1731193.60

\* 2' PATCH WITH NEW 3" HMA SP-IV AT NEW CURB AND **EXISTING PAVEMENT** 


#### CONSTRUCTION PLAN KEY NOTES:

- 1. 2" COLD MILL & HMA SP-IV INLAY. TACK COAT MILLED SURFACE. MATCH ADJACENT CURB & GUTTER ELEVATIONS.
- 2. MATCH EXISTING PAVEMENT ELEVATION.
- 3. EXISTING CURB AND GUTTER NOT TO BE DISTURBED.
- 4. APPLY TACK COAT TO PAVEMENT CUT.
- ADJUST MANHOLE TO GRADE.
- 6. CAUTION: OVER HEAD UTILITY LINES.
- 7. CURB & GUTTER TO BE REMOVED & REPLACED.
- 8. ADJUST VALVE BOX TO GRADE. 9. SAWCUT AND BEGIN MILL-INLAY 2' INTO EXISTING INTERSECTION HMA

### LEGEND


NEW 2" COLD MILL & HMA SP-IV INLAY NEW 3" HMA SP-IV NEW CONCRETE Δ Α Δ NEW CURB & GUTTER EXISTING FIRE HYDRANT **EXISTING POWER POLE EXISTING WATER METER** EXISTING WATER VALVE EXISTING SEWER MAHOLE EXISTING ROADWAY CENTERLINE

EXISTING OVER HEAD ELECTRIC LINES — EOH PL —

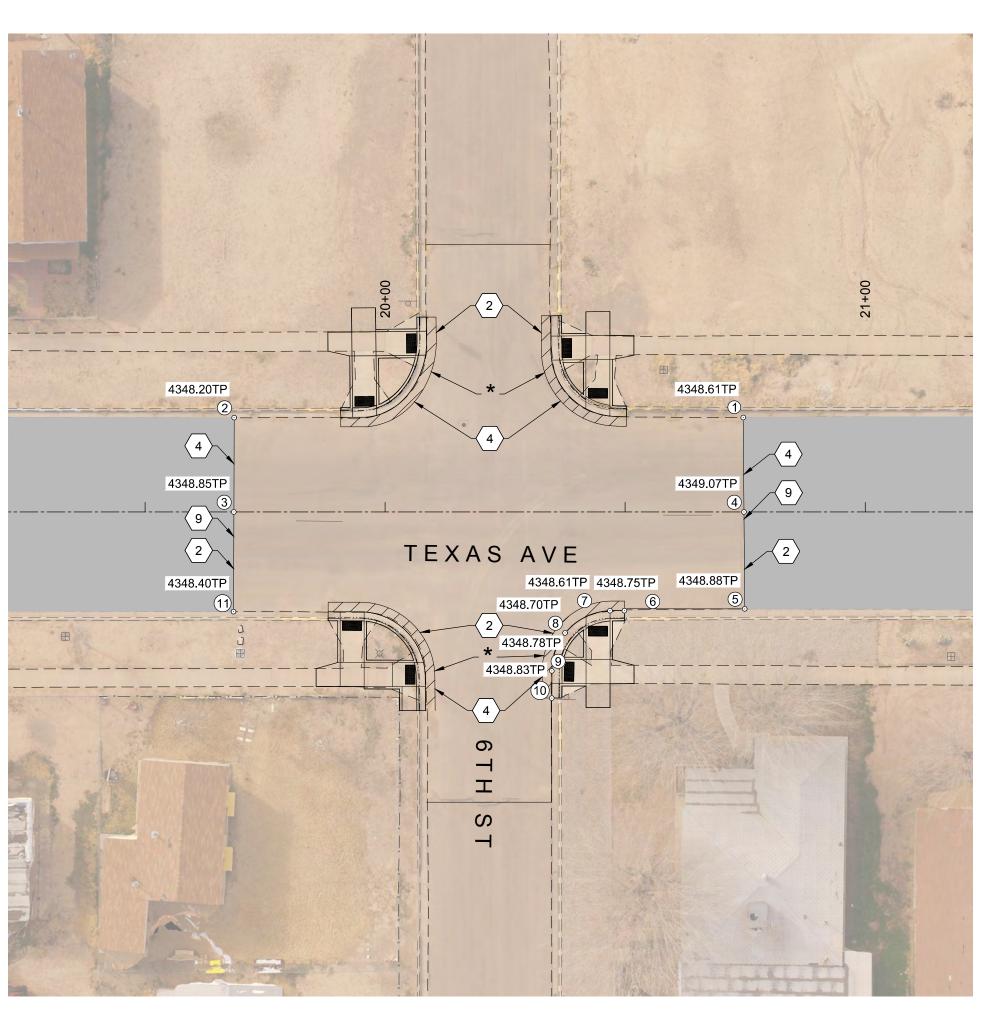


NO GRADING - TEXAS AVENUE & 6TH FULL SCALE: 1:20 HALF SCALE: 1:40



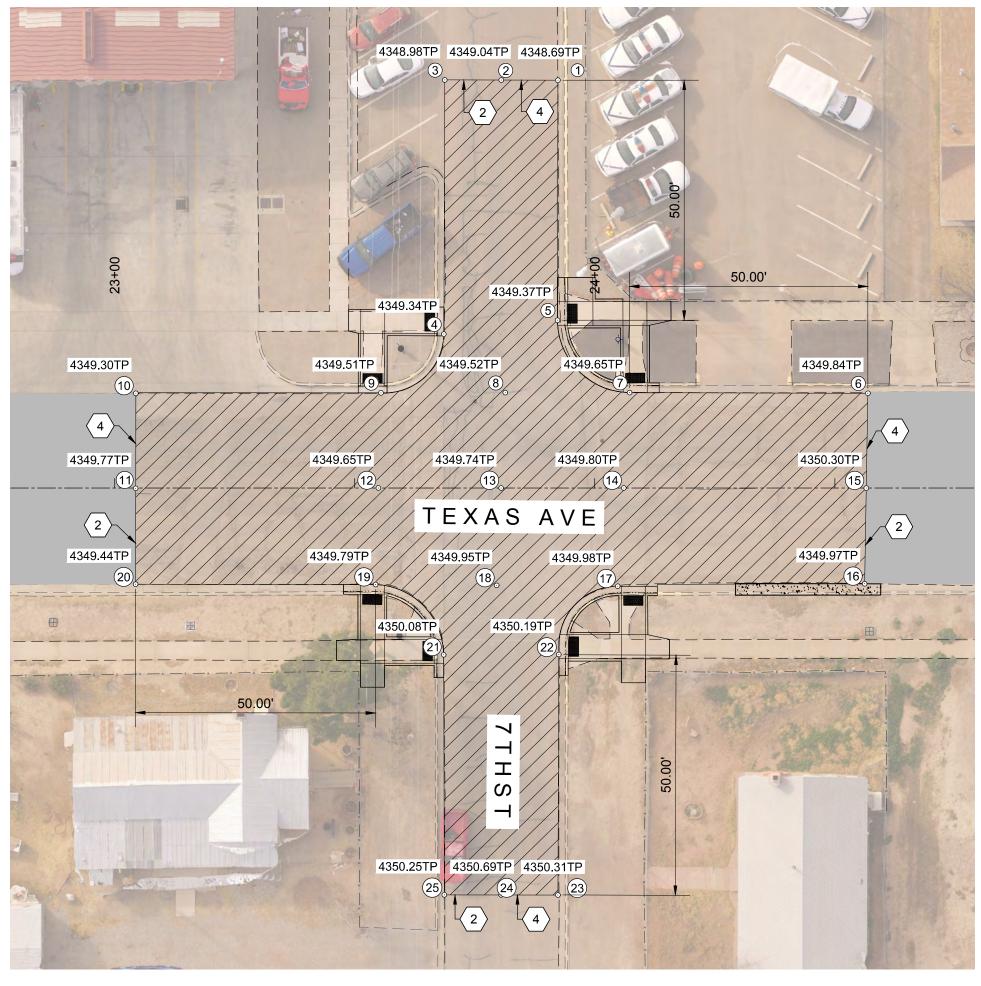


GRADING PLAN - TEXAS AVENUE & 7TH FULL SCALE: 1:20 HALF SCALE: 1:40

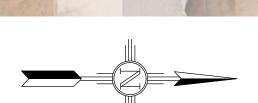

PT#	Northing	Easting
1	690121.88	1731083.02
2	690110.09	1731083.13
3	690098.31	1731083.23
4	690098.72	1731136.17
5	690122.38	1731133.02
6	690187.19	1731147.49
7	690137.57	1731147.93
8	690111.67	1731148.22
9	690085.77	1731148.57
10	690034.71	1731149.25
11	690034.91	1731169.04
12	690085.45	1731168.39
13	690111.03	1731168.10
14	690136.57	1731167.81
15	690187.08	1731167.25
16	690186.97	1731187.18
17	690135.54	1731188.28
18	690110.33	1731188.39
19	690085.12	1731188.51
20	690035.12	1731189.02
21	690099.45	1731202.99
22	690123.43	1731202.65
23	690123.83	1731252.76
24	690111.99	1731252.86
25	690100.16	1731252.98

1	12-21-17	AMENDMENT - 1	SC
0	9-08-17	ISSUED FOR CONSTRUCTION	SC
REV. No.	DATE	DESCRIPTION	APPROVED

New Mexico One Call, Inc. Call 2 days

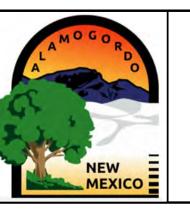

## **Street Maintenance Program FY 2017**

TEXAS AVENUE INTERSECTION RECONSTRUCTION 6TH STREET & 7TH STREET




١	Occam Engineers Inc.	
	3400 HIGHWAY 180 EAST SUITE A	,
	SILVER CITY, NEW MEXICO 88061	
	(575) 538-5395 (OFFICE)	ı

(575) 538-5410 (FAX)

	Public	Works	Bid	No.:	2017	7-0	
	Occam Engineers	Drawn	Ву:		OT	 Designed	Ву
Inc.	Checke			SC	 Approved	Ву	
							_

Sheet No.: RC 4.1

Scale: Horiz.: 1" = 20' Sheet 14 of 103 Vert.: n/a

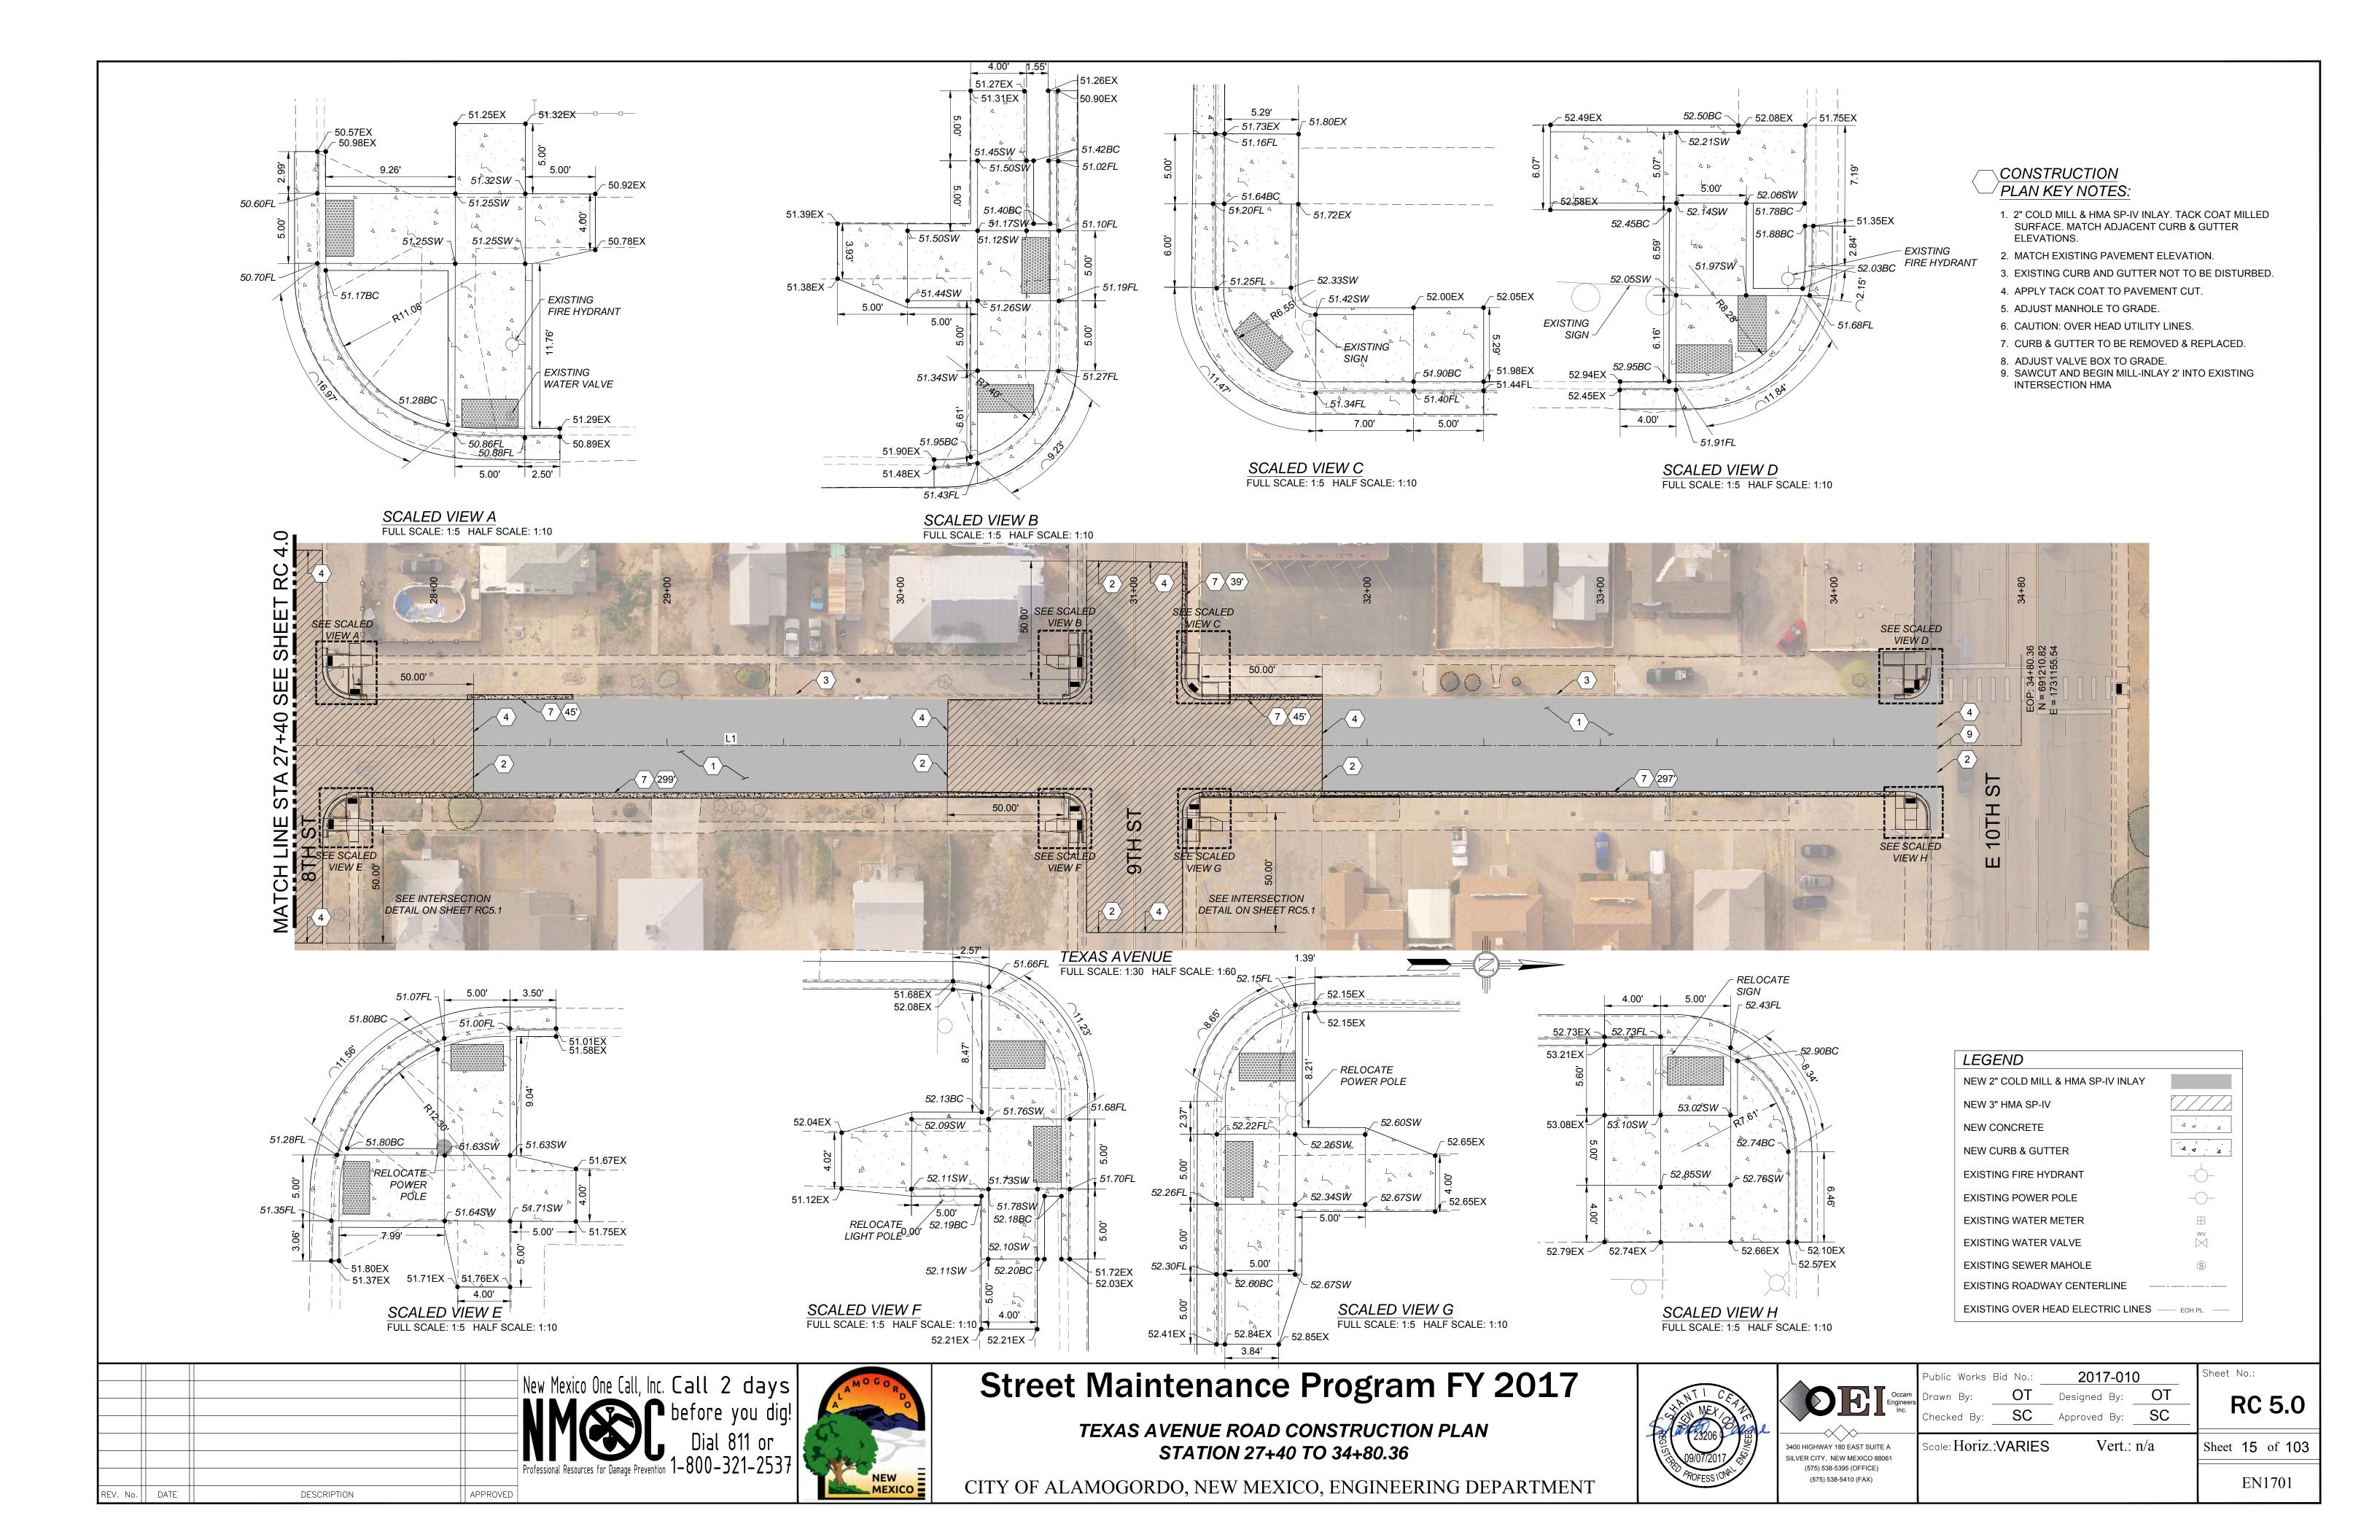


PT#         Northing         Easting           1         690457.88         1731080.45           2         690469.88         1731080.31           3         690481.88         1731080.17           4         690458.70         1731129.59           5         690482.48         1731130.82           6         690547.39         1731143.38           7         690495.91         1731143.96           8         690469.97         1731144.29           9         690444.04         1731144.62           10         690394.03         1731164.69           12         690444.56         1731164.31           13         690470.70         1731164.01           14         690496.83         1731163.71           15         690547.58         1731163.13           16         690547.77         1731183.26           17         690497.77         1731184.69           20         690393.89         1731184.69           20         690393.89         1731198.66           22         690483.41         1731198.30           23         690483.83         1731248.55           24         690471.80         1731248.55 <th></th> <th></th> <th></th>			
2       690469.88       1731080.31         3       690481.88       1731080.17         4       690458.70       1731129.59         5       690482.48       1731130.82         6       690547.39       1731143.38         7       690495.91       1731143.96         8       690469.97       1731144.29         9       690444.04       1731144.62         10       690394.03       1731164.69         12       690444.56       1731164.31         13       690470.70       1731163.71         14       690496.83       1731163.71         15       690547.58       1731183.26         17       690497.77       1731183.65         18       690471.44       1731184.17         19       690393.89       1731184.35         21       690483.41       1731198.30         23       690483.83       1731248.45         24       690471.80       1731248.55	PT#	Northing	Easting
3       690481.88       1731080.17         4       690458.70       1731129.59         5       690482.48       1731130.82         6       690547.39       1731143.38         7       690495.91       1731143.96         8       690469.97       1731144.29         9       690444.04       1731144.62         10       690394.03       1731164.69         12       690444.56       1731164.31         13       690470.70       1731164.01         14       690496.83       1731163.71         15       690547.58       1731183.26         17       690497.77       1731183.65         18       690471.44       1731184.69         20       690393.89       1731184.35         21       690459.16       1731198.30         22       690483.41       1731198.30         23       690483.83       1731248.45         24       690471.80       1731248.55	1	690457.88	1731080.45
4       690458.70       1731129.59         5       690482.48       1731130.82         6       690547.39       1731143.38         7       690495.91       1731143.96         8       690469.97       1731144.29         9       690444.04       1731145.03         11       690394.03       1731164.69         12       690444.56       1731164.31         13       690470.70       1731164.01         14       690496.83       1731163.71         15       690547.58       1731183.26         17       690497.77       1731183.65         18       690471.44       1731184.69         20       690393.89       1731184.35         21       690459.16       1731198.66         22       690483.41       1731198.30         23       690483.83       1731248.45         24       690471.80       1731248.55	2	690469.88	1731080.31
5       690482.48       1731130.82         6       690547.39       1731143.38         7       690495.91       1731143.96         8       690469.97       1731144.29         9       690444.04       1731144.62         10       690394.03       1731164.69         11       690393.96       1731164.31         13       690470.70       1731164.01         14       690496.83       1731163.71         15       690547.58       1731183.26         17       690497.77       1731183.65         18       690471.44       1731184.69         20       690393.89       1731184.35         21       690459.16       1731198.66         22       690483.41       1731198.30         23       690483.83       1731248.45         24       690471.80       1731248.55	3	690481.88	1731080.17
6       690547.39       1731143.38         7       690495.91       1731143.96         8       690469.97       1731144.29         9       690444.04       1731144.62         10       690394.03       1731164.03         11       690393.96       1731164.69         12       690444.56       1731164.01         13       690470.70       1731163.71         15       690547.58       1731163.13         16       690547.77       1731183.26         17       690497.77       1731183.65         18       690471.44       1731184.17         19       690393.89       1731184.35         20       690393.89       1731198.66         22       690483.41       1731198.30         23       690483.83       1731248.45         24       690471.80       1731248.55	4	690458.70	1731129.59
7       690495.91       1731143.96         8       690469.97       1731144.29         9       690444.04       1731144.62         10       690394.03       1731145.03         11       690393.96       1731164.69         12       690444.56       1731164.31         13       690470.70       1731163.71         15       690547.58       1731163.13         16       690547.77       1731183.26         17       690497.77       1731183.65         18       690471.44       1731184.17         19       690393.89       1731184.35         20       690393.89       1731198.66         22       690483.41       1731198.30         23       690483.83       1731248.45         24       690471.80       1731248.55	5	690482.48	1731130.82
8       690469.97       1731144.29         9       690444.04       1731144.62         10       690394.03       1731145.03         11       690393.96       1731164.69         12       690444.56       1731164.01         13       690470.70       1731163.71         14       690496.83       1731163.71         15       690547.58       1731183.26         17       690497.77       1731183.65         18       690471.44       1731184.69         20       690393.89       1731184.35         21       690459.16       1731198.66         22       690483.41       1731248.45         24       690471.80       1731248.55	6	690547.39	1731143.38
9       690444.04       1731144.62         10       690394.03       1731145.03         11       690393.96       1731164.69         12       690444.56       1731164.31         13       690470.70       1731164.01         14       690496.83       1731163.71         15       690547.58       1731183.26         17       690497.77       1731183.65         18       690471.44       1731184.69         20       690393.89       1731184.35         21       690459.16       1731198.66         22       690483.41       1731248.45         24       690471.80       1731248.55	7	690495.91	1731143.96
10       690394.03       1731145.03         11       690393.96       1731164.69         12       690444.56       1731164.01         13       690470.70       1731164.01         14       690496.83       1731163.71         15       690547.58       1731183.26         17       690497.77       1731183.65         18       690471.44       1731184.17         19       690445.11       1731184.69         20       690393.89       1731184.35         21       690459.16       1731198.66         22       690483.41       1731248.45         24       690471.80       1731248.55	8	690469.97	1731144.29
11       690393.96       1731164.69         12       690444.56       1731164.31         13       690470.70       1731164.01         14       690496.83       1731163.71         15       690547.58       1731183.26         17       690497.77       1731183.65         18       690471.44       1731184.17         19       690445.11       1731184.69         20       690393.89       1731184.35         21       690459.16       1731198.66         22       690483.41       1731248.45         24       690471.80       1731248.55	9	690444.04	1731144.62
12       690444.56       1731164.31         13       690470.70       1731164.01         14       690496.83       1731163.71         15       690547.58       1731163.13         16       690547.77       1731183.26         17       690497.77       1731183.65         18       690471.44       1731184.17         19       690445.11       1731184.69         20       690393.89       1731184.35         21       690459.16       1731198.66         22       690483.41       1731248.45         24       690471.80       1731248.55	10	690394.03	1731145.03
13       690470.70       1731164.01         14       690496.83       1731163.71         15       690547.58       1731163.13         16       690547.77       1731183.26         17       690497.77       1731183.65         18       690471.44       1731184.17         19       690445.11       1731184.69         20       690393.89       1731184.35         21       690459.16       1731198.66         22       690483.41       1731248.45         24       690471.80       1731248.55	11	690393.96	1731164.69
14       690496.83       1731163.71         15       690547.58       1731163.13         16       690547.77       1731183.26         17       690497.77       1731183.65         18       690471.44       1731184.17         19       690445.11       1731184.69         20       690393.89       1731184.35         21       690459.16       1731198.66         22       690483.41       1731198.30         23       690483.83       1731248.45         24       690471.80       1731248.55	12	690444.56	1731164.31
15       690547.58       1731163.13         16       690547.77       1731183.26         17       690497.77       1731183.65         18       690471.44       1731184.17         19       690445.11       1731184.69         20       690393.89       1731184.35         21       690459.16       1731198.66         22       690483.41       1731198.30         23       690483.83       1731248.45         24       690471.80       1731248.55	13	690470.70	1731164.01
16       690547.77       1731183.26         17       690497.77       1731183.65         18       690471.44       1731184.17         19       690445.11       1731184.69         20       690393.89       1731184.35         21       690459.16       1731198.66         22       690483.41       1731198.30         23       690483.83       1731248.45         24       690471.80       1731248.55	14	690496.83	1731163.71
17       690497.77       1731183.65         18       690471.44       1731184.17         19       690445.11       1731184.69         20       690393.89       1731184.35         21       690459.16       1731198.66         22       690483.41       1731198.30         23       690483.83       1731248.45         24       690471.80       1731248.55	15	690547.58	1731163.13
18       690471.44       1731184.17         19       690445.11       1731184.69         20       690393.89       1731184.35         21       690459.16       1731198.66         22       690483.41       1731198.30         23       690483.83       1731248.45         24       690471.80       1731248.55	16	690547.77	1731183.26
19       690445.11       1731184.69         20       690393.89       1731184.35         21       690459.16       1731198.66         22       690483.41       1731198.30         23       690483.83       1731248.45         24       690471.80       1731248.55	17	690497.77	1731183.65
20       690393.89       1731184.35         21       690459.16       1731198.66         22       690483.41       1731198.30         23       690483.83       1731248.45         24       690471.80       1731248.55	18	690471.44	1731184.17
21       690459.16       1731198.66         22       690483.41       1731198.30         23       690483.83       1731248.45         24       690471.80       1731248.55	19	690445.11	1731184.69
22       690483.41       1731198.30         23       690483.83       1731248.45         24       690471.80       1731248.55	20	690393.89	1731184.35
23       690483.83       1731248.45         24       690471.80       1731248.55	21	690459.16	1731198.66
24 690471.80 1731248.55	22	690483.41	1731198.30
	23	690483.83	1731248.45
25 690459.78 1731248.65	24	690471.80	1731248.55
	25	690459.78	1731248.65


#### CONSTRUCTION PLAN KEY NOTES:


- 1. 2" COLD MILL & HMA SP-IV INLAY. TACK COAT MILLED SURFACE. MATCH ADJACENT CURB & GUTTER ELEVATIONS.
- 2. MATCH EXISTING PAVEMENT ELEVATION.
- 3. EXISTING CURB AND GUTTER NOT TO BE DISTURBED.
- 4. APPLY TACK COAT TO PAVEMENT CUT.
- 5. ADJUST MANHOLE TO GRADE.
- 6. CAUTION: OVER HEAD UTILITY LINES.
- 7. CURB & GUTTER TO BE REMOVED & REPLACED.
- 8. ADJUST VALVE BOX TO GRADE.
- 9. SAWCUT AND BEGIN MILL-INLAY 2' INTO EXISTING INTERSECTION HMA



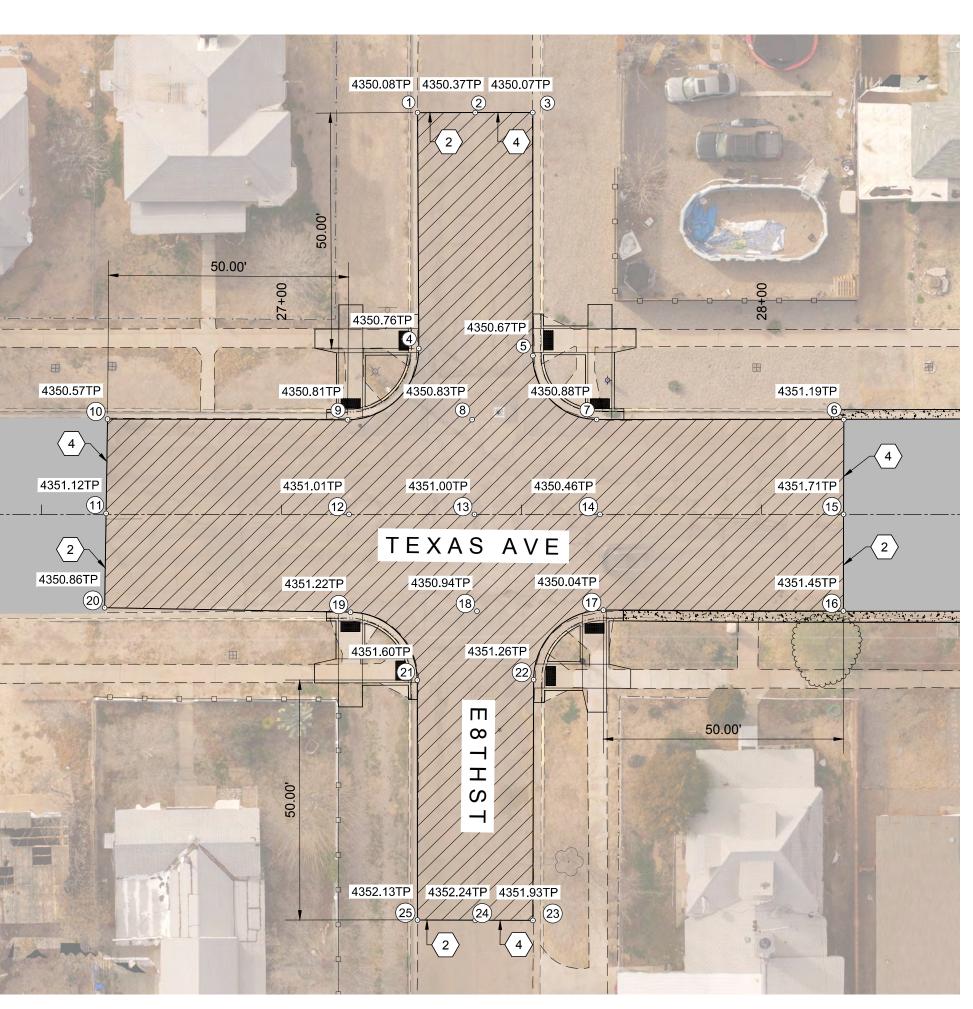




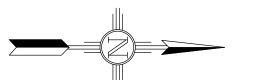

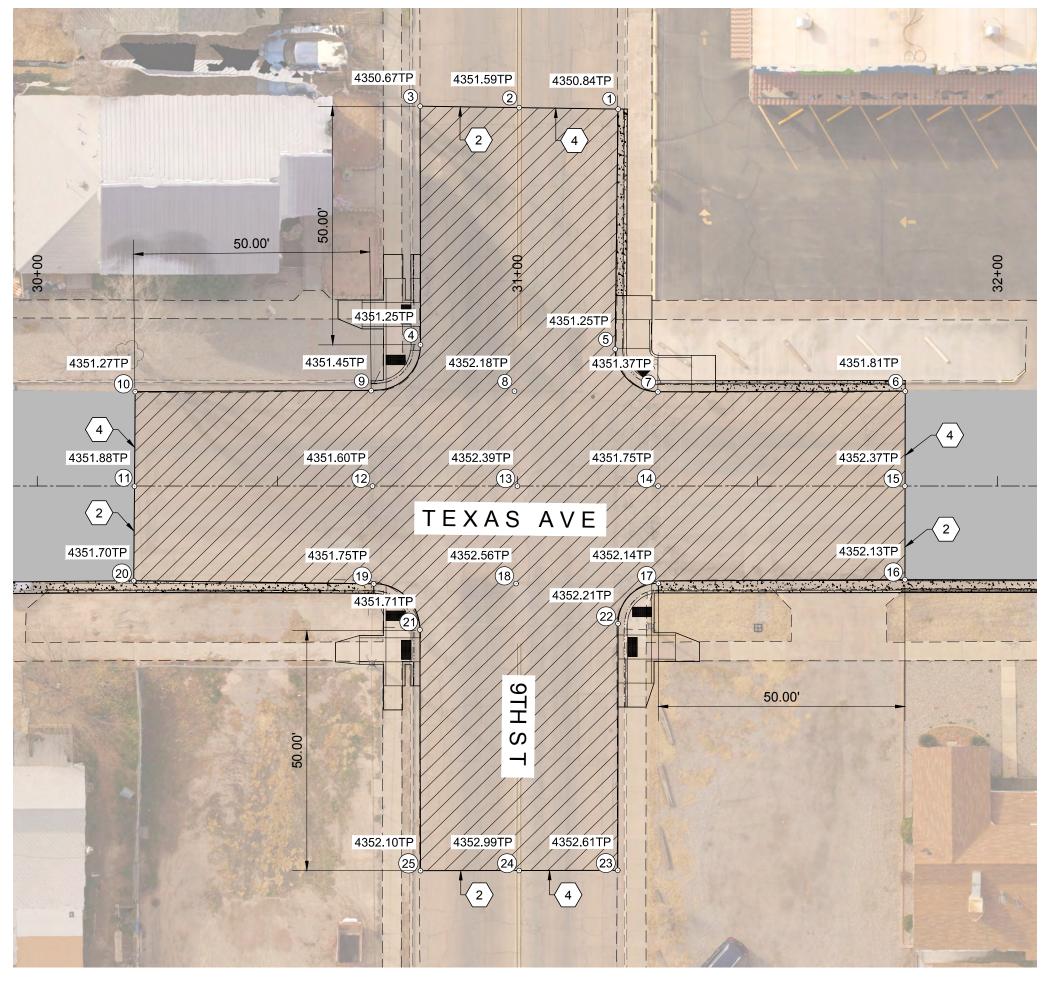

GRADING PLAN - TEXAS AVENUE & 9TH FULL SCALE: 1:20 HALF SCALE: 1:40

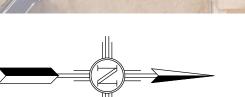

PT#	Northing	Easting
1	690850.57	1731081.12
2	690829.95	1731081.05
3	690809.33	1731080.98
4	690809.97	1731130.69
5	690850.54	1731131.12
6	690911.06	1731139.19
7	690859.52	1731139.92
8	690829.66	1731140.12
9	690799.80	1731140.37
10	690750.65	1731141.12
11	690750.73	1731160.83
12	690800.30	1731160.24
13	690830.49	1731159.89
14	690859.80	1731159.55
15	690911.20	1731158.97
16	690911.44	1731178.46
17	690860.09	1731179.81
18	690830.45	1731180.20
19	690800.80	1731180.59
20	690750.81	1731180.54
21	690810.53	1731190.07
22	690851.79	1731188.31
23	690852.31	1731239.69
24	690831.76	1731239.97
25	690811.21	1731240.24

	EXISTING C	OVER HEAD ELECTRIC LINES — EOH PL —	
1	12-21-17	AMENDMENT - 1	SC
0	9-08-17	ISSUED FOR CONSTRUCTION	SC
REV. No.	DATE	DESCRIPTION	APPROVED
			•

New Mexico One Call, Inc. Call 2 days



## **Street Maintenance Program FY 2017**

TEXAS AVENUE INTERSECTION RECONSTRUCTION 8TH STREET & 9TH STREET



٩	Occam Engineers Inc.	
	3400 HIGHWAY 180 EAST SUITE A	
	SILVER CITY, NEW MEXICO 88061	
	(575) 538-5395 (OFFICE)	
	(575) 538-5410 (FAX)	ı

	Public Wo	orks	Bid	No.:	2017-010	
am eers	Drawn By	<b>/</b> :		OT	Designed By:	ОТ
,	Checked			SC	Approved By:	SC

RC 5.1

| Scale: Horiz.:1" = 20' Vert.: n/a Sheet 16 of 103

EN1701


Sheet No.:





1. THE FOLLOWING INTERSECTIONS WITH MICHIGAN SHALL RECEIVE FULL RECONSTRUCTION: 12TH, 13TH, 14TH.


### CONSTRUCTION PLAN KEY NOTES:

- 2" COLD MILL & HMA SP-IV INLAY. TACK COAT MILLED SURFACE. MATCH ADJACENT CURB & GUTTER ELEVATIONS.
- 2. MATCH EXISTING PAVEMENT ELEVATION.
- 3. EXISTING CURB & GUTTER NOT TO BE DISTURBED.4. APPLY TACK COAT TO PAVEMENT CUT.
- 5. ADJUST MANHOLE TO GRADE.
- 6. CAUTION: OVERHEAD UTILITY LINES.
- 7. CURB & GUTTER TO BE REMOVED AND REPLACED.8. ADJUST VALVE BOX TO GRADE.
- 9. SAWCUT AND BEGIN MILL-INLAY, 2' INTO EXISTING INTERSECTION HMA.

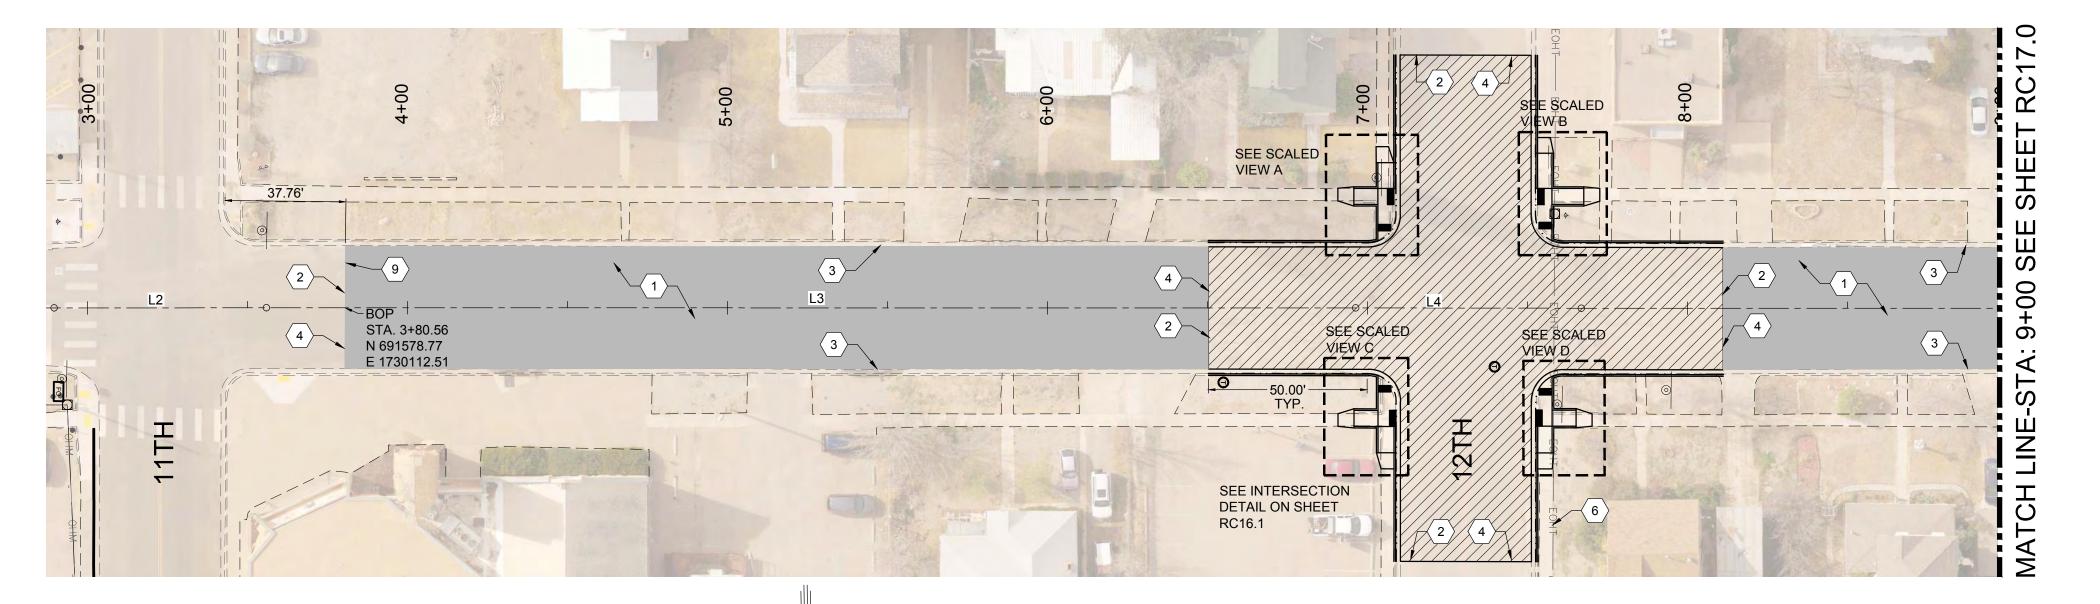

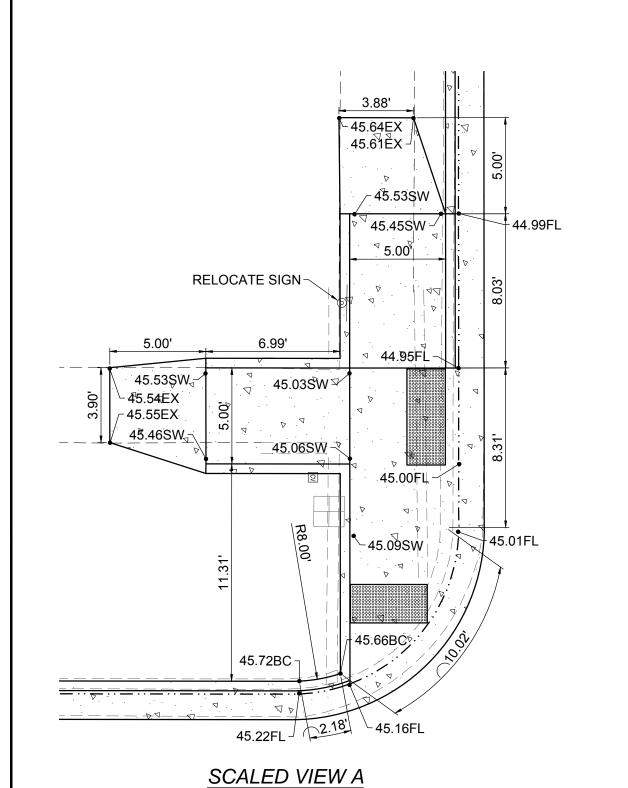


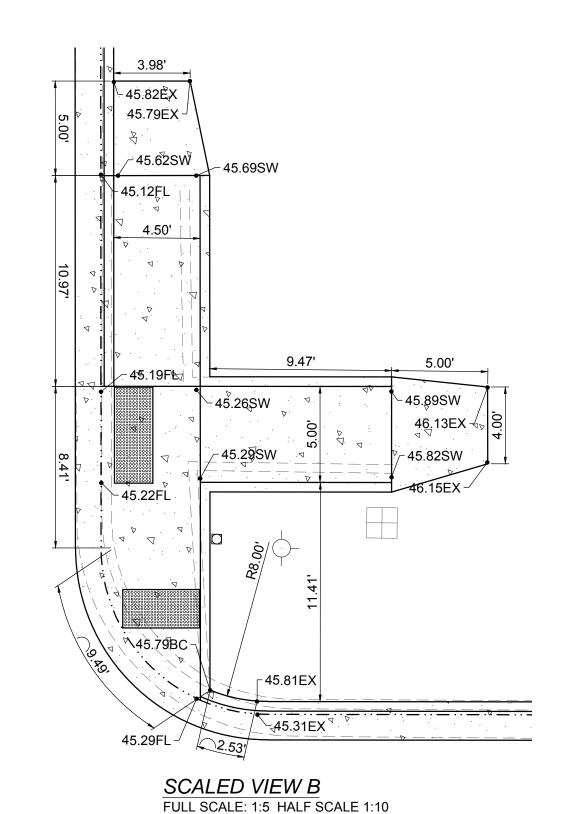

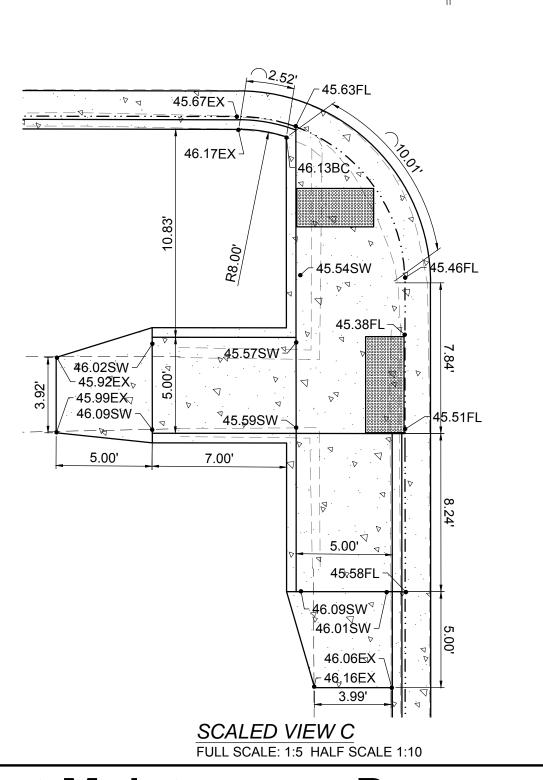

MICHIGAN AVENUE

FULL SCALE: 1:30 HALF SCALE 1:60

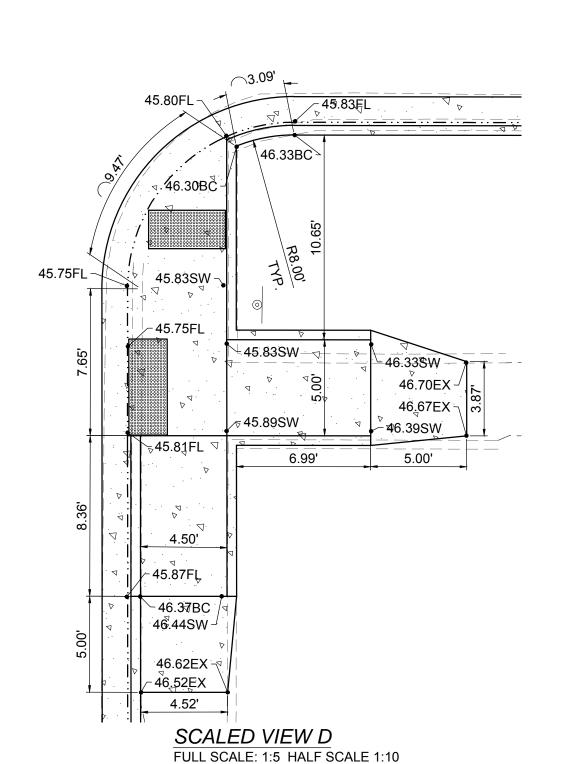

LEGEND	
NEW 2" COLD MILL & HMA SP-IV INLAY	
NEW 3" HMA SP-IV	
NEW CONCRETE	Δ Α . Δ .
NEW CURB & GUTTER	4 4 . 4
EXISTING FIRE HYDRANT	
EXISTING POWER POLE	<u> </u>
EXISTING WATER METER	
EXISTING WATER VALVE	wv  >>
EXISTING SEWER MAHOLE	<u>(S)</u>
EXISTING TELEPHONE MANHOLE	T
EXISTING ROADWAY CENTERLINE —	
EXISTING OVER HEAD ELECTRIC LINES	—— EOH PL ——


FULL SCALE: 1:5 HALF SCALE 1:10

New Mexico One Call, Inc. Call 2 days

New Mexico One Call, Inc. Call 2 days

Dial 811 or


Professional Resources for Damage Prevention 1 800-321-2537

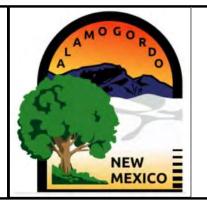

### Street Maintenance Program FY 2017

MICHIGAN AVENUE ROAD CONSTRUCTION PLAN STATION 3+80 TO 9+00

CITY OF ALAMOGORDO, NEW MEXICO, ENGINEERING DEPARTMENT

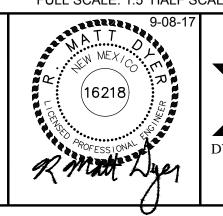


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Scale: Horiz	.: VARIES	Vert.:	n/a
Checked By:	MD	Approved By:	M
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Public Works	Bid No.: _	2017-010	


AD RC 16.0


(a Sheet 28 of 103

PT#	Northing	Easting
1	691907.52	1730029.78
2	691928.02	1730029.47
3	691948.40	1730029.30
4	691908.11	1730079.16
5	691948.93	1730079.18
6	691848.27	1730090.32
7	691897.81	1730089.85
8	691928.60	1730089.30
9	691959.24	1730089.19
10	692009.08	1730088.72
11	691848.43	1730109.40
12	691898.25	1730109.00
13	691928.70	1730108.23
14	691959.57	1730108.07
15	692009.32	1730107.78
16	691848.76	1730128.65
17	691898.39	1730128.05
18	691929.36	1730127.79
19	691960.12	1730127.42
20	692008.11	1730127.05
21	691908.79	1730137.64
22	691949.54	1730137.36
23	691909.49	1730187.97
24	691929.86	1730187.63
25	691950.34	1730187.59



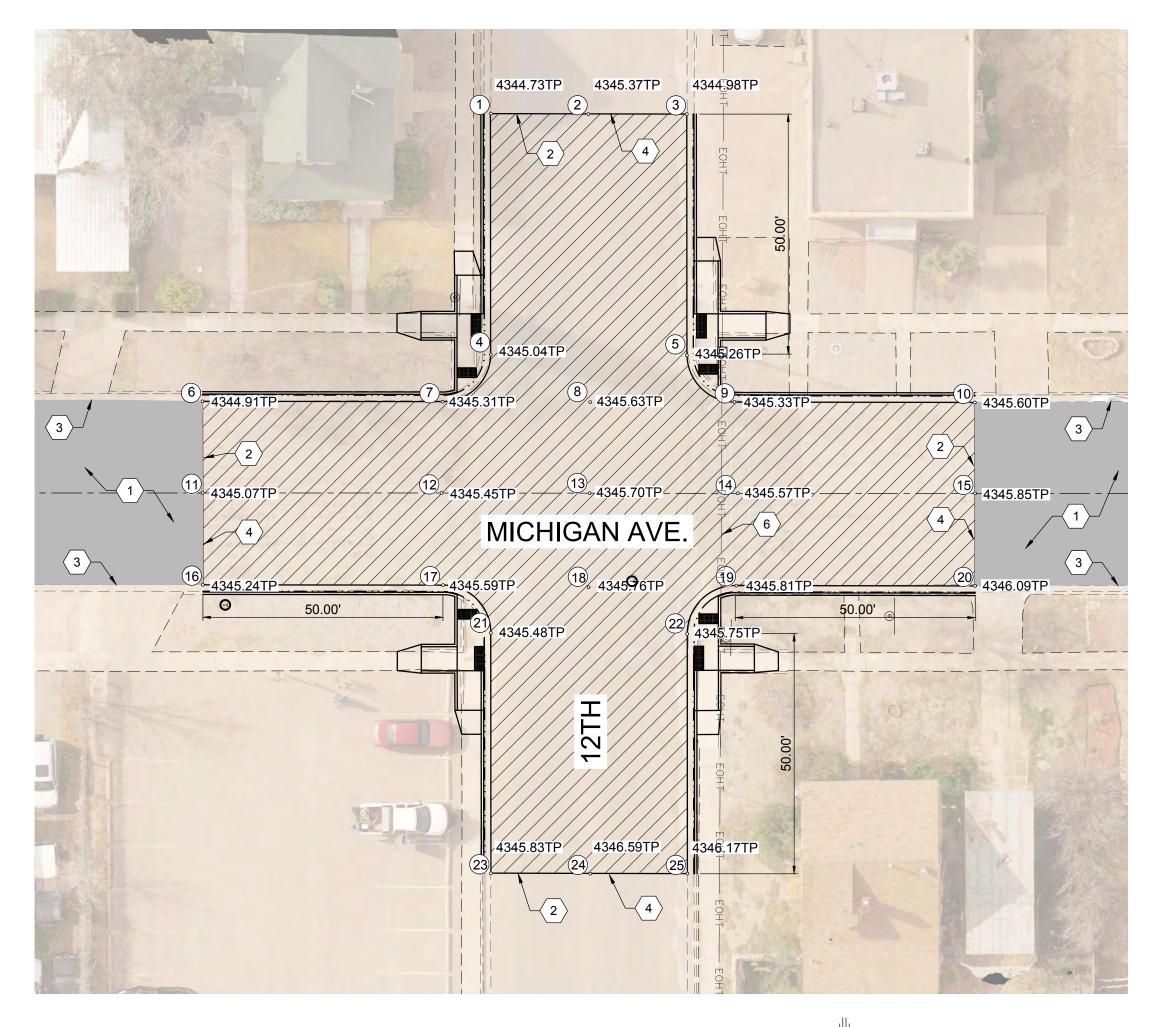

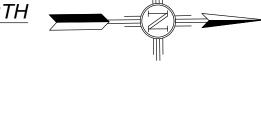

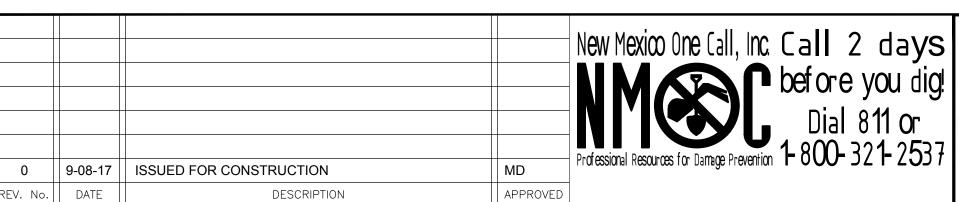




### **Street Maintenance Program FY 2017**

MICHIGAN AVENUE INTERSECTION RECONSTRUCTION PLAN 12TH STREET

CITY OF ALAMOGORDO, NEW MEXICO, ENGINEERING DEPARTMENT

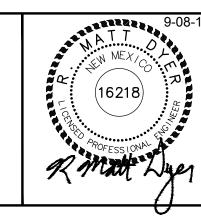

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RC 16.1

Vert.: n/a

CONSTRUCTION PLAN KEY NOTES:

ELEVATIONS.

LEGEND

NEW 3" HMA SP-IV

NEW CONCRETE

NEW CURB & GUTTER

EXISTING FIRE HYDRANT

EXISTING POWER POLE

EXISTING WATER METER

EXISTING WATER VALVE

**EXISTING SEWER MAHOLE** 

EXISTING TELEPHONE MANHOLE

EXISTING ROADWAY CENTERLINE

EXISTING OVER HEAD ELECTRIC LINES — EOH PL —

1. 2" COLD MILL & HMA SP-IV INLAY. TACK COAT MILLED SURFACE. MATCH ADJACENT CURB & GUTTER

3. EXISTING CURB & GUTTER NOT TO BE DISTURBED.

7. CURB & GUTTER TO BE REMOVED AND REPLACED.

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2. MATCH EXISTING PAVEMENT ELEVATION.


4. APPLY TACK COAT TO PAVEMENT CUT.

5. ADJUST MANHOLE TO GRADE. 6. CAUTION: OVERHEAD UTILITY LINES.


8. ADJUST VALVE BOX TO GRADE.

NEW 2" COLD MILL & HMA SP-IV INLAY

Sheet 29 of 103

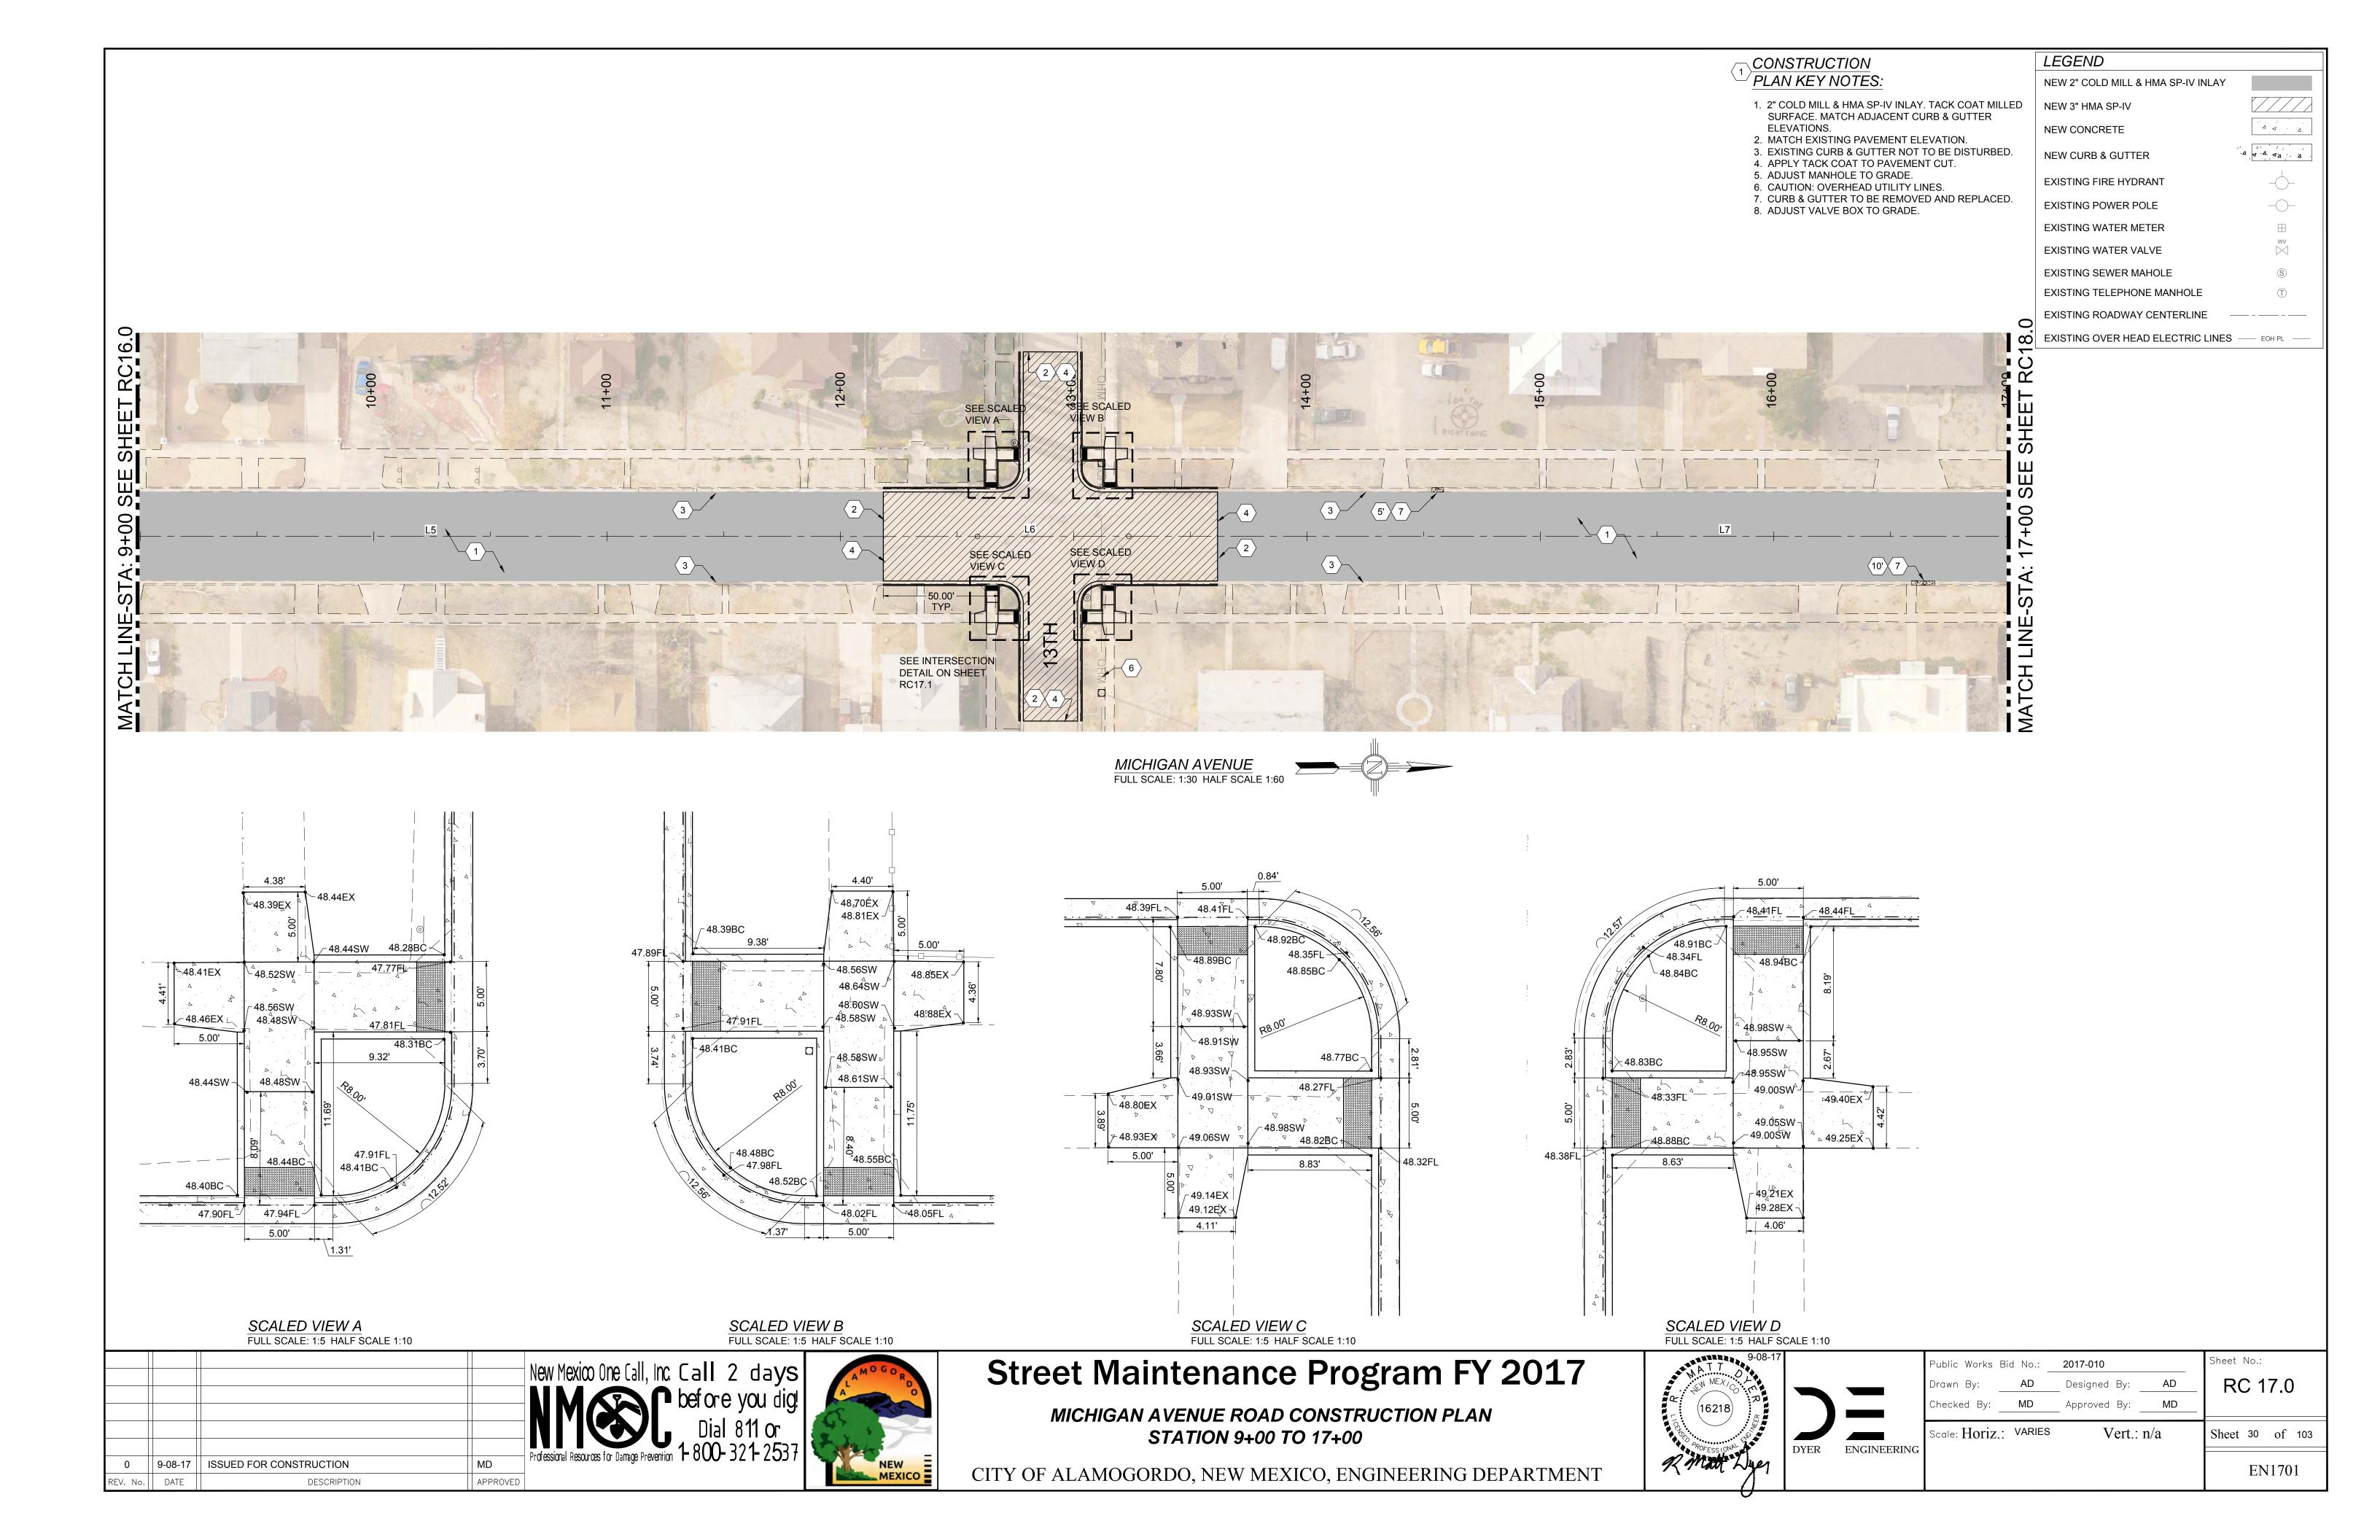

PT#	Northing	Easting
1	692475.73	1730023.17
2	692487.27	1730023.09
3	692498.86	1730023.02
4	692476.30	1730073.88
5	692499.55	1730073.30
6	692416.49	1730083.90
7	692467.09	1730083.30
8	692487.95	1730082.81
9	692508.92	1730082.86
10	692559.50	1730082.35
11	692416.54	1730102.96
12	692467.45	1730102.51
13	692488.37	1730102.41
14	692509.13	1730101.85
15	692559.57	1730101.25
16	692416.93	1730122.32
17	692467.37	1730121.26
18	692488.45	1730121.77
19	692509.20	1730121.07
20	692560.11	1730120.30
21	692477.02	1730131.29
22	692499.93	1730130.55
23	692477.64	1730178.93
24	692489.40	1730178.60
25	692500.77	1730178.56

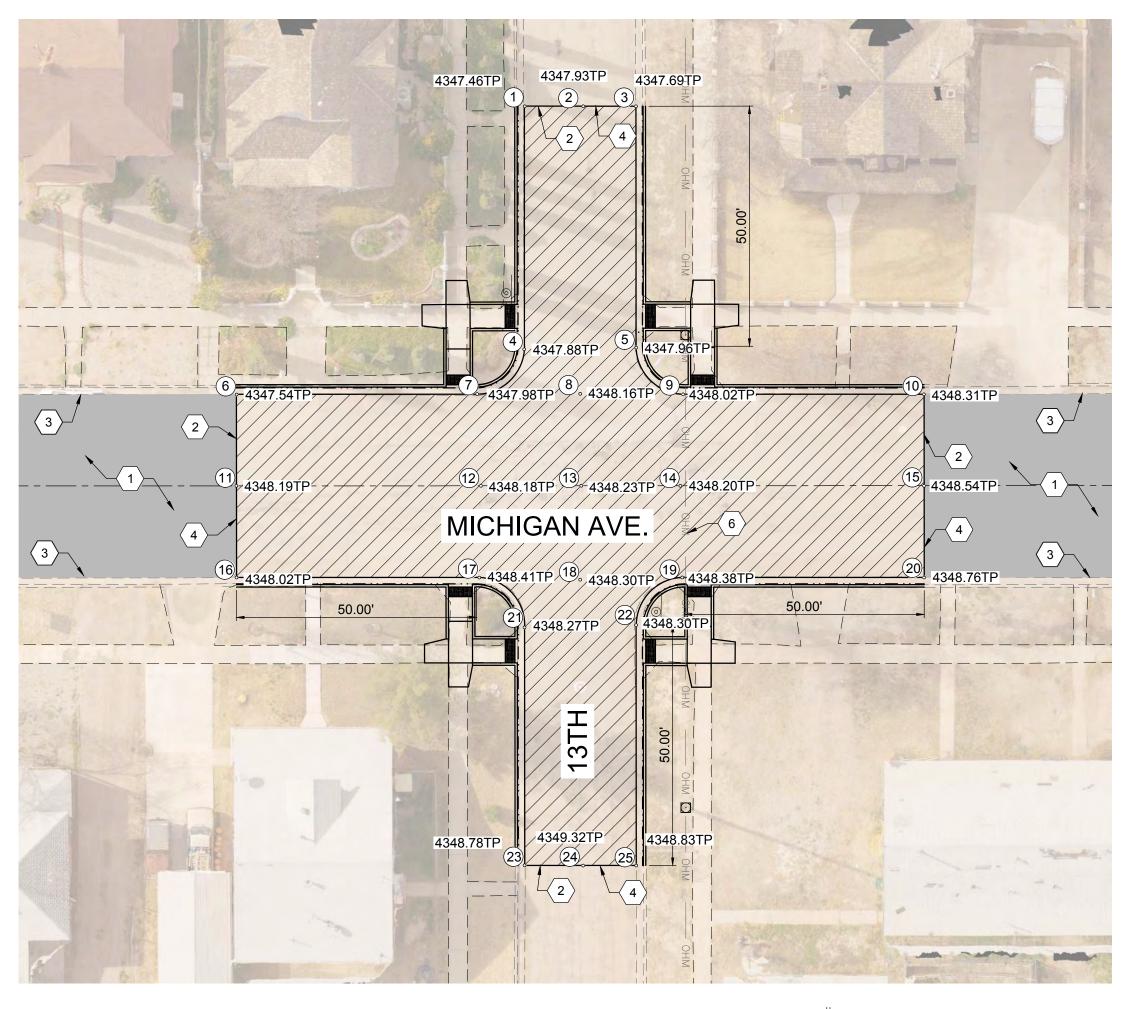





### ELEVATIONS.

CONSTRUCTION PLAN KEY NOTES:

- 1. 2" COLD MILL & HMA SP-IV INLAY. TACK COAT MILLED SURFACE. MATCH ADJACENT CURB & GUTTER
- 2. MATCH EXISTING PAVEMENT ELEVATION.
- 3. EXISTING CURB & GUTTER NOT TO BE DISTURBED. 4. APPLY TACK COAT TO PAVEMENT CUT.
- 5. ADJUST MANHOLE TO GRADE.
- 6. CAUTION: OVERHEAD UTILITY LINES.
- 7. CURB & GUTTER TO BE REMOVED AND REPLACED.
- 8. ADJUST VALVE BOX TO GRADE.

LEGEND	
NEW 2" COLD MILL & HMA SP-IV INLAY	
NEW 3" HMA SP-IV	
NEW CONCRETE	Δ Δ Δ
NEW CURB & GUTTER	Δ Δ Δ
EXISTING FIRE HYDRANT	
EXISTING POWER POLE	<u> </u>
EXISTING WATER METER	$\boxplus$
EXISTING WATER VALVE	WV 
EXISTING SEWER MAHOLE	<u>(S)</u>
EXISTING TELEPHONE MANHOLE	T
EXISTING ROADWAY CENTERLINE -	
EXISTING OVER HEAD ELECTRIC LINES	EOH PL

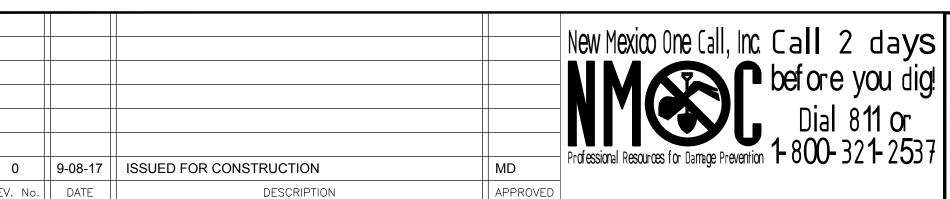


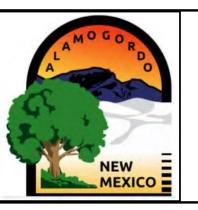

### **Street Maintenance Program FY 2017**

MICHIGAN AVENUE INTERSECTION RECONSTRUCTION PLAN 13TH STREET

CITY OF ALAMOGORDO, NEW MEXICO, ENGINEERING DEPARTMENT

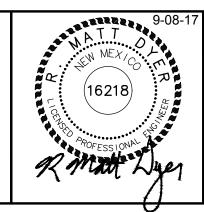

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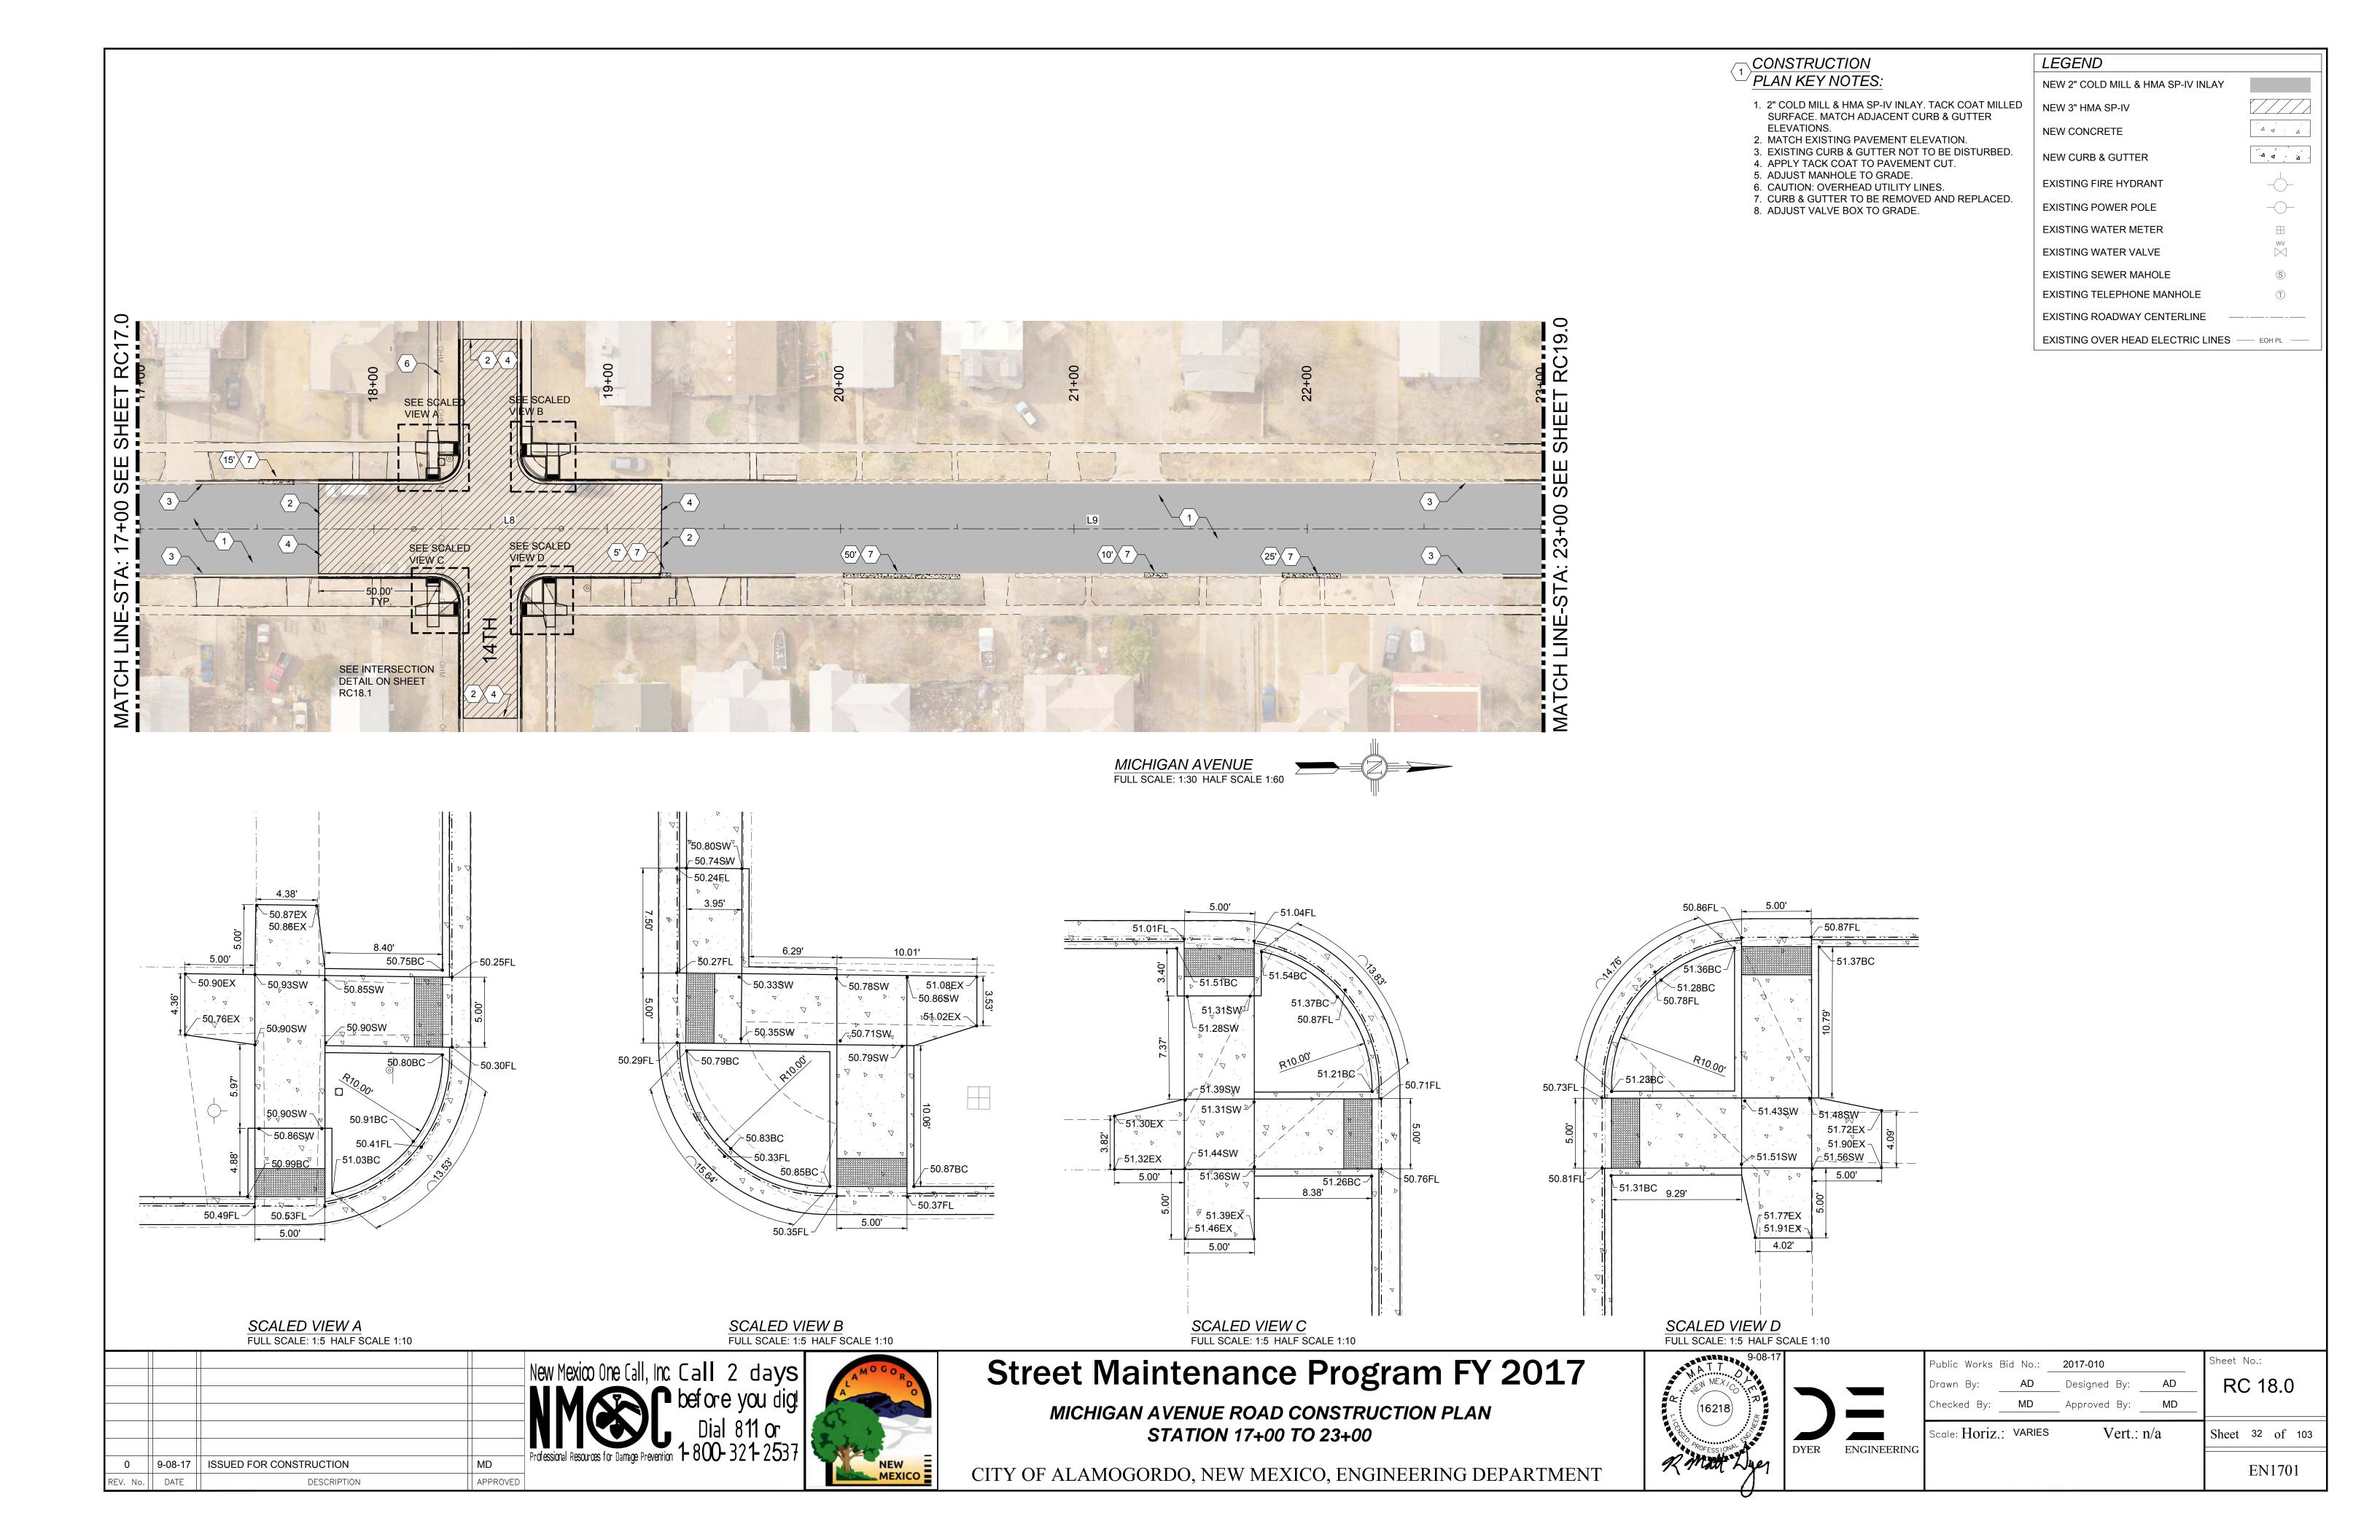
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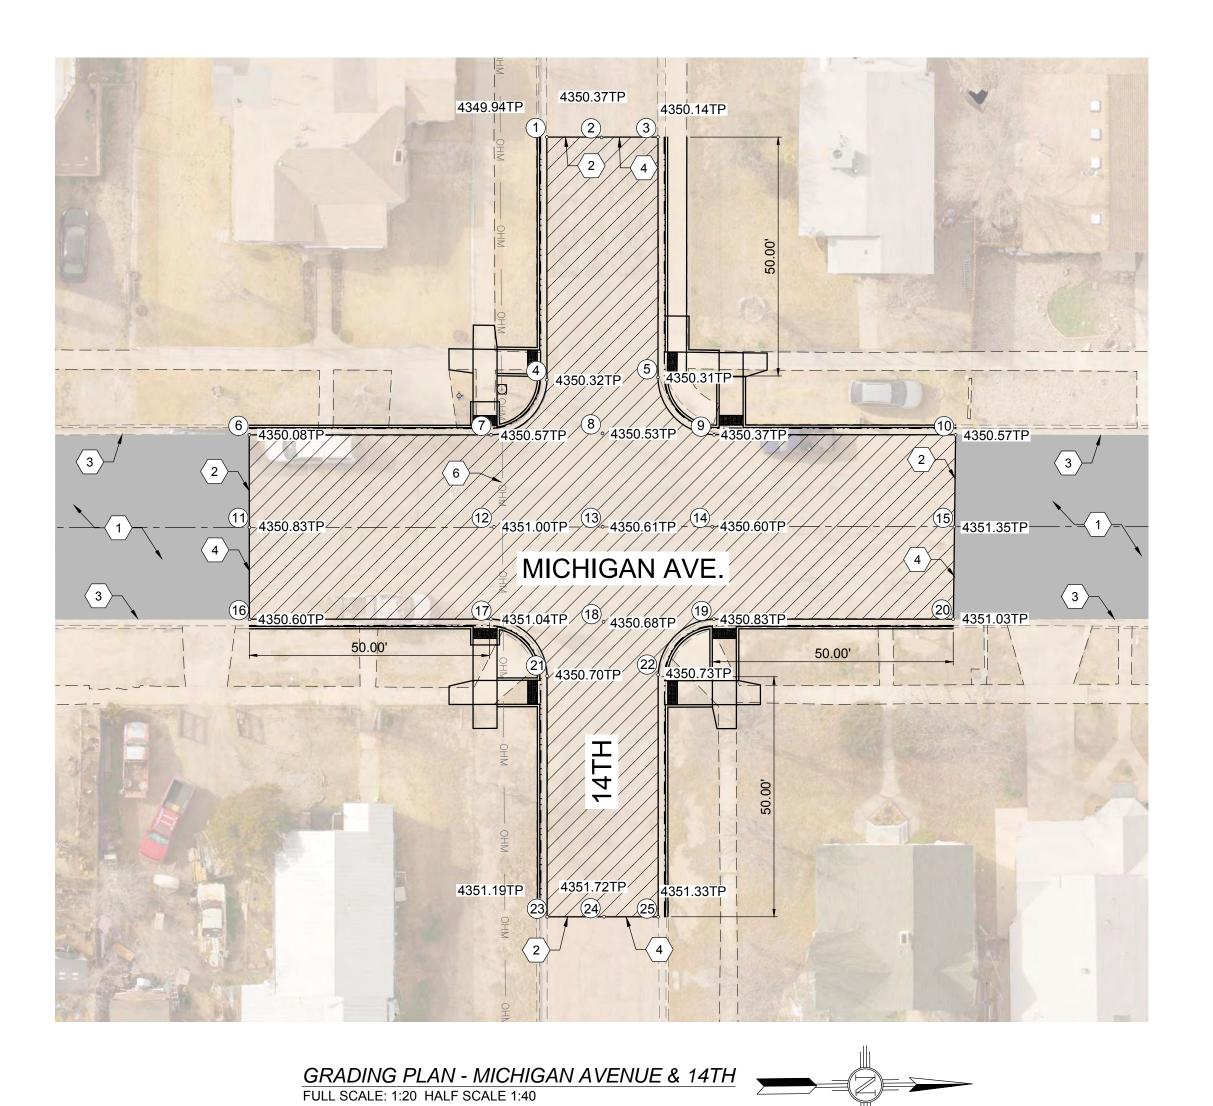
RC 17.1


EN1701

Sheet 31 of 103



DT //	N.L. all to		
PT#	Northing	Easting	
1	693035.40	1730014.24	
2	693047.16	1730014.31	
3	693058.49	1730014.18	
4	693036.11	1730064.95	
5	693059.09	1730064.14	
6	692974.37	1730077.07	
7	693024.80	1730076.57	
8	693047.68	1730075.98	
9	693070.67	1730075.92	
10	693121.25	1730075.42	
11	692974.62	1730096.15	
12	693025.27	1730095.65	
13	693047.83	1730095.38	
14	693070.71	1730095.00	
15	693121.14	1730094.61	
16	692974.75	1730115.53	
17	693025.50	1730114.92	
18	693048.07	1730115.39	
19	693070.95	1730114.38	
20	693121.37	1730113.67	
21	693036.76	1730126.33	
22	693059.74	1730125.73	
23	693037.57	1730176.98	
24	693048.80	1730176.74	
25	693060.35	1730176.71	



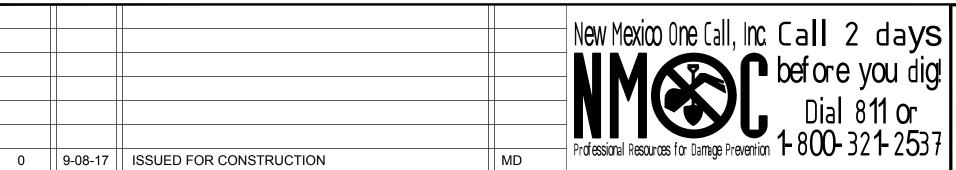


DESCRIPTION



### **Street Maintenance Program FY 2017**

MICHIGAN AVENUE INTERSECTION RECONSTRUCTION PLAN 14TH STREET

CITY OF ALAMOGORDO, NEW MEXICO, ENGINEERING DEPARTMENT

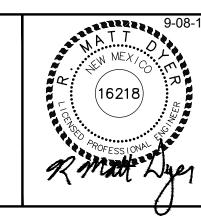

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Decima Dua AD Decimal Dua AD	Checked By:	MD	Approved By:	MD		' '
Public Works Bid No.: 2017-010	Drawn By:	AD	Designed By:	AD	l RC	18
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EN1701

CONSTRUCTION PLAN KEY NOTES:

ELEVATIONS.

LEGEND

NEW 3" HMA SP-IV

**NEW CONCRETE** 

NEW CURB & GUTTER

EXISTING FIRE HYDRANT

**EXISTING POWER POLE** 

EXISTING WATER METER

EXISTING WATER VALVE

EXISTING SEWER MAHOLE

EXISTING TELEPHONE MANHOLE

EXISTING ROADWAY CENTERLINE

EXISTING OVER HEAD ELECTRIC LINES — EOH PL —

1. 2" COLD MILL & HMA SP-IV INLAY. TACK COAT MILLED SURFACE. MATCH ADJACENT CURB & GUTTER

3. EXISTING CURB & GUTTER NOT TO BE DISTURBED.

7. CURB & GUTTER TO BE REMOVED AND REPLACED.

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2. MATCH EXISTING PAVEMENT ELEVATION.

4. APPLY TACK COAT TO PAVEMENT CUT.

5. ADJUST MANHOLE TO GRADE. 6. CAUTION: OVERHEAD UTILITY LINES.

8. ADJUST VALVE BOX TO GRADE.


NEW 2" COLD MILL & HMA SP-IV INLAY

NOTES:

- NOT USED
- 2. NOT USED
- 3. NO WORK INTERSECTION OF MICHIGAN AND 15TH.

CONSTRUCTION  $^{\prime}$  PLAN KEY NOTES:

- 1. 2" COLD MILL & HMA SP-IV INLAY. TACK COAT MILLED SURFACE. MATCH ADJACENT CURB & GUTTER ELEVATIONS.
- 2. MATCH EXISTING PAVEMENT ELEVATION.
- 3. EXISTING CURB & GUTTER NOT TO BE DISTURBED. 4. APPLY TACK COAT TO PAVEMENT CUT.
- 5. ADJUST MANHOLE TO GRADE. 6. CAUTION: OVERHEAD UTILITY LINES.
- 7. CURB & GUTTER TO BE REMOVED AND REPLACED.
- 8. ADJUST VALVE BOX TO GRADE.
- 9. SAWCUT AND BEGIN MILL-INLAY, 2' INTO EXISTING INTERSECTION HMA.

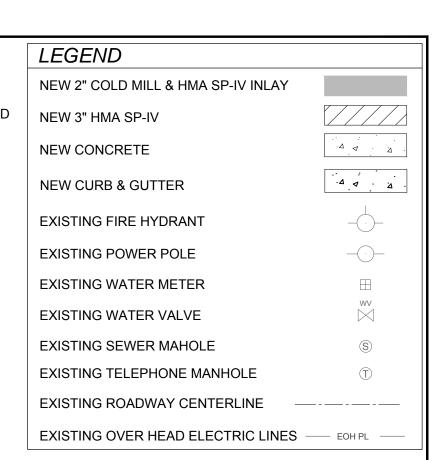



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MICHIGAN AVENUE	
FULL SCALE: 1:30 HALF SCALE 1:60	


0	9-08-17	ISSUED FOR CONSTRUCTION	MD	New Mexico One Call, Inc. Call 2 days  New Mexico One Call, Inc. Call 2 days  Dial 811 or Professional Resources for Damage Prevention 1-800-321-2537	
REV. No.	DATE	DESCRIPTION	APPROVED		



### **Street Maintenance Program FY 2017**

MICHIGAN AVENUE ROAD CONSTRUCTION PLAN STATION 23+00 TO 29+57

CITY OF ALAMOGORDO, NEW MEXICO, ENGINEERING DEPARTMENT

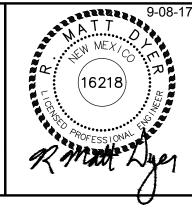

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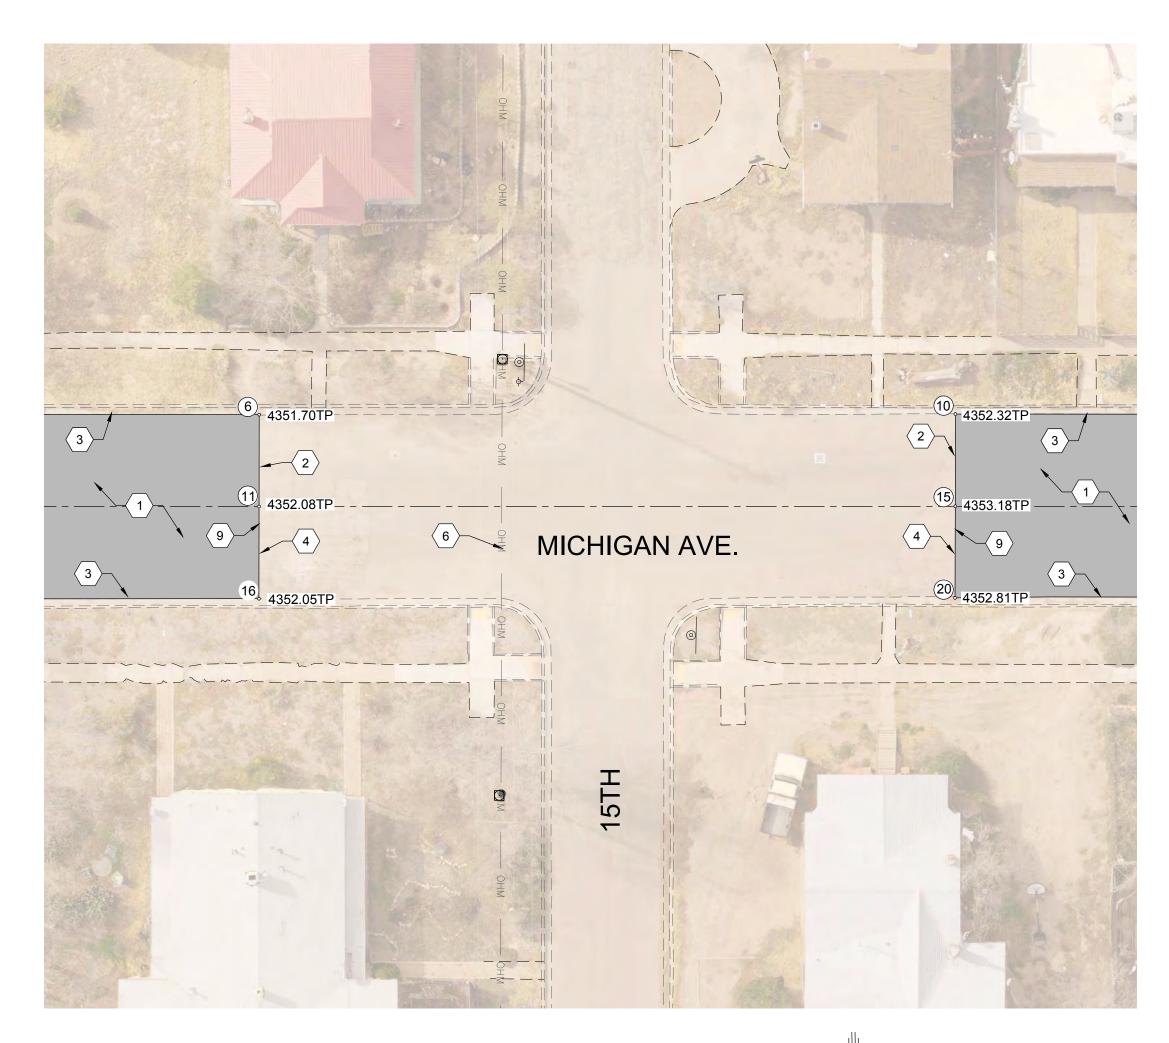
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Public Works	Bid No.:	2017-010		Sheet No.:
Drawn By:	AD	Designed By:	AD	RC 19.0
Checked By:	MD	Approved By:	MD	

PT#	Northing	Easting
6	602525 15	1730070.76
6	693535.15	1730070.76
10	693680.04	1730069.01
11	693535.37	1730089.29
15	693680.38	1730087.78
16	693535.82	1730109.03
20	693680.39	1730107.09
20	30000	

0 | 9-08-17 | ISSUED FOR CONSTRUCTION

DESCRIPTION








MICHIGAN AVENUE INTERSECTION RECONSTRUCTION PLAN 15TH STREET

CITY OF ALAMOGORDO, NEW MEXICO, ENGINEERING DEPARTMENT

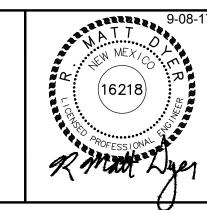

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Public	Works	Bid	No.:	2017-010
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Scale:	Horiz	1'	'=20'	

\_\_ | Sheet No.:
RC 19.1

1"=20' Vert.: n/a

CONSTRUCTION PLAN KEY NOTES:

ELEVATIONS.

 2" COLD MILL & HMA SP-IV INLAY. TACK COAT MILLED SURFACE. MATCH ADJACENT CURB & GUTTER

3. EXISTING CURB & GUTTER NOT TO BE DISTURBED.

7. CURB & GUTTER TO BE REMOVED AND REPLACED.

9. SAWCUT AND BEGIN MILL-INLAY, 2' INTO EXISTING

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2. MATCH EXISTING PAVEMENT ELEVATION.

4. APPLY TACK COAT TO PAVEMENT CUT.

6. CAUTION: OVERHEAD UTILITY LINES.

NEW 2" COLD MILL & HMA SP-IV INLAY

5. ADJUST MANHOLE TO GRADE.

8. ADJUST VALVE BOX TO GRADE.

INTERSECTION HMA.

LEGEND

NEW 3" HMA SP-IV

**NEW CONCRETE** 

**NEW CURB & GUTTER** 

EXISTING FIRE HYDRANT

EXISTING POWER POLE

EXISTING WATER METER

EXISTING WATER VALVE


EXISTING SEWER MAHOLE


EXISTING TELEPHONE MANHOLE


EXISTING ROADWAY CENTERLINE


EXISTING OVER HEAD ELECTRIC LINES — EOH PL —

Sheet 35 of 103 EN1701

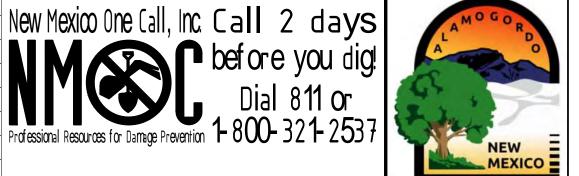

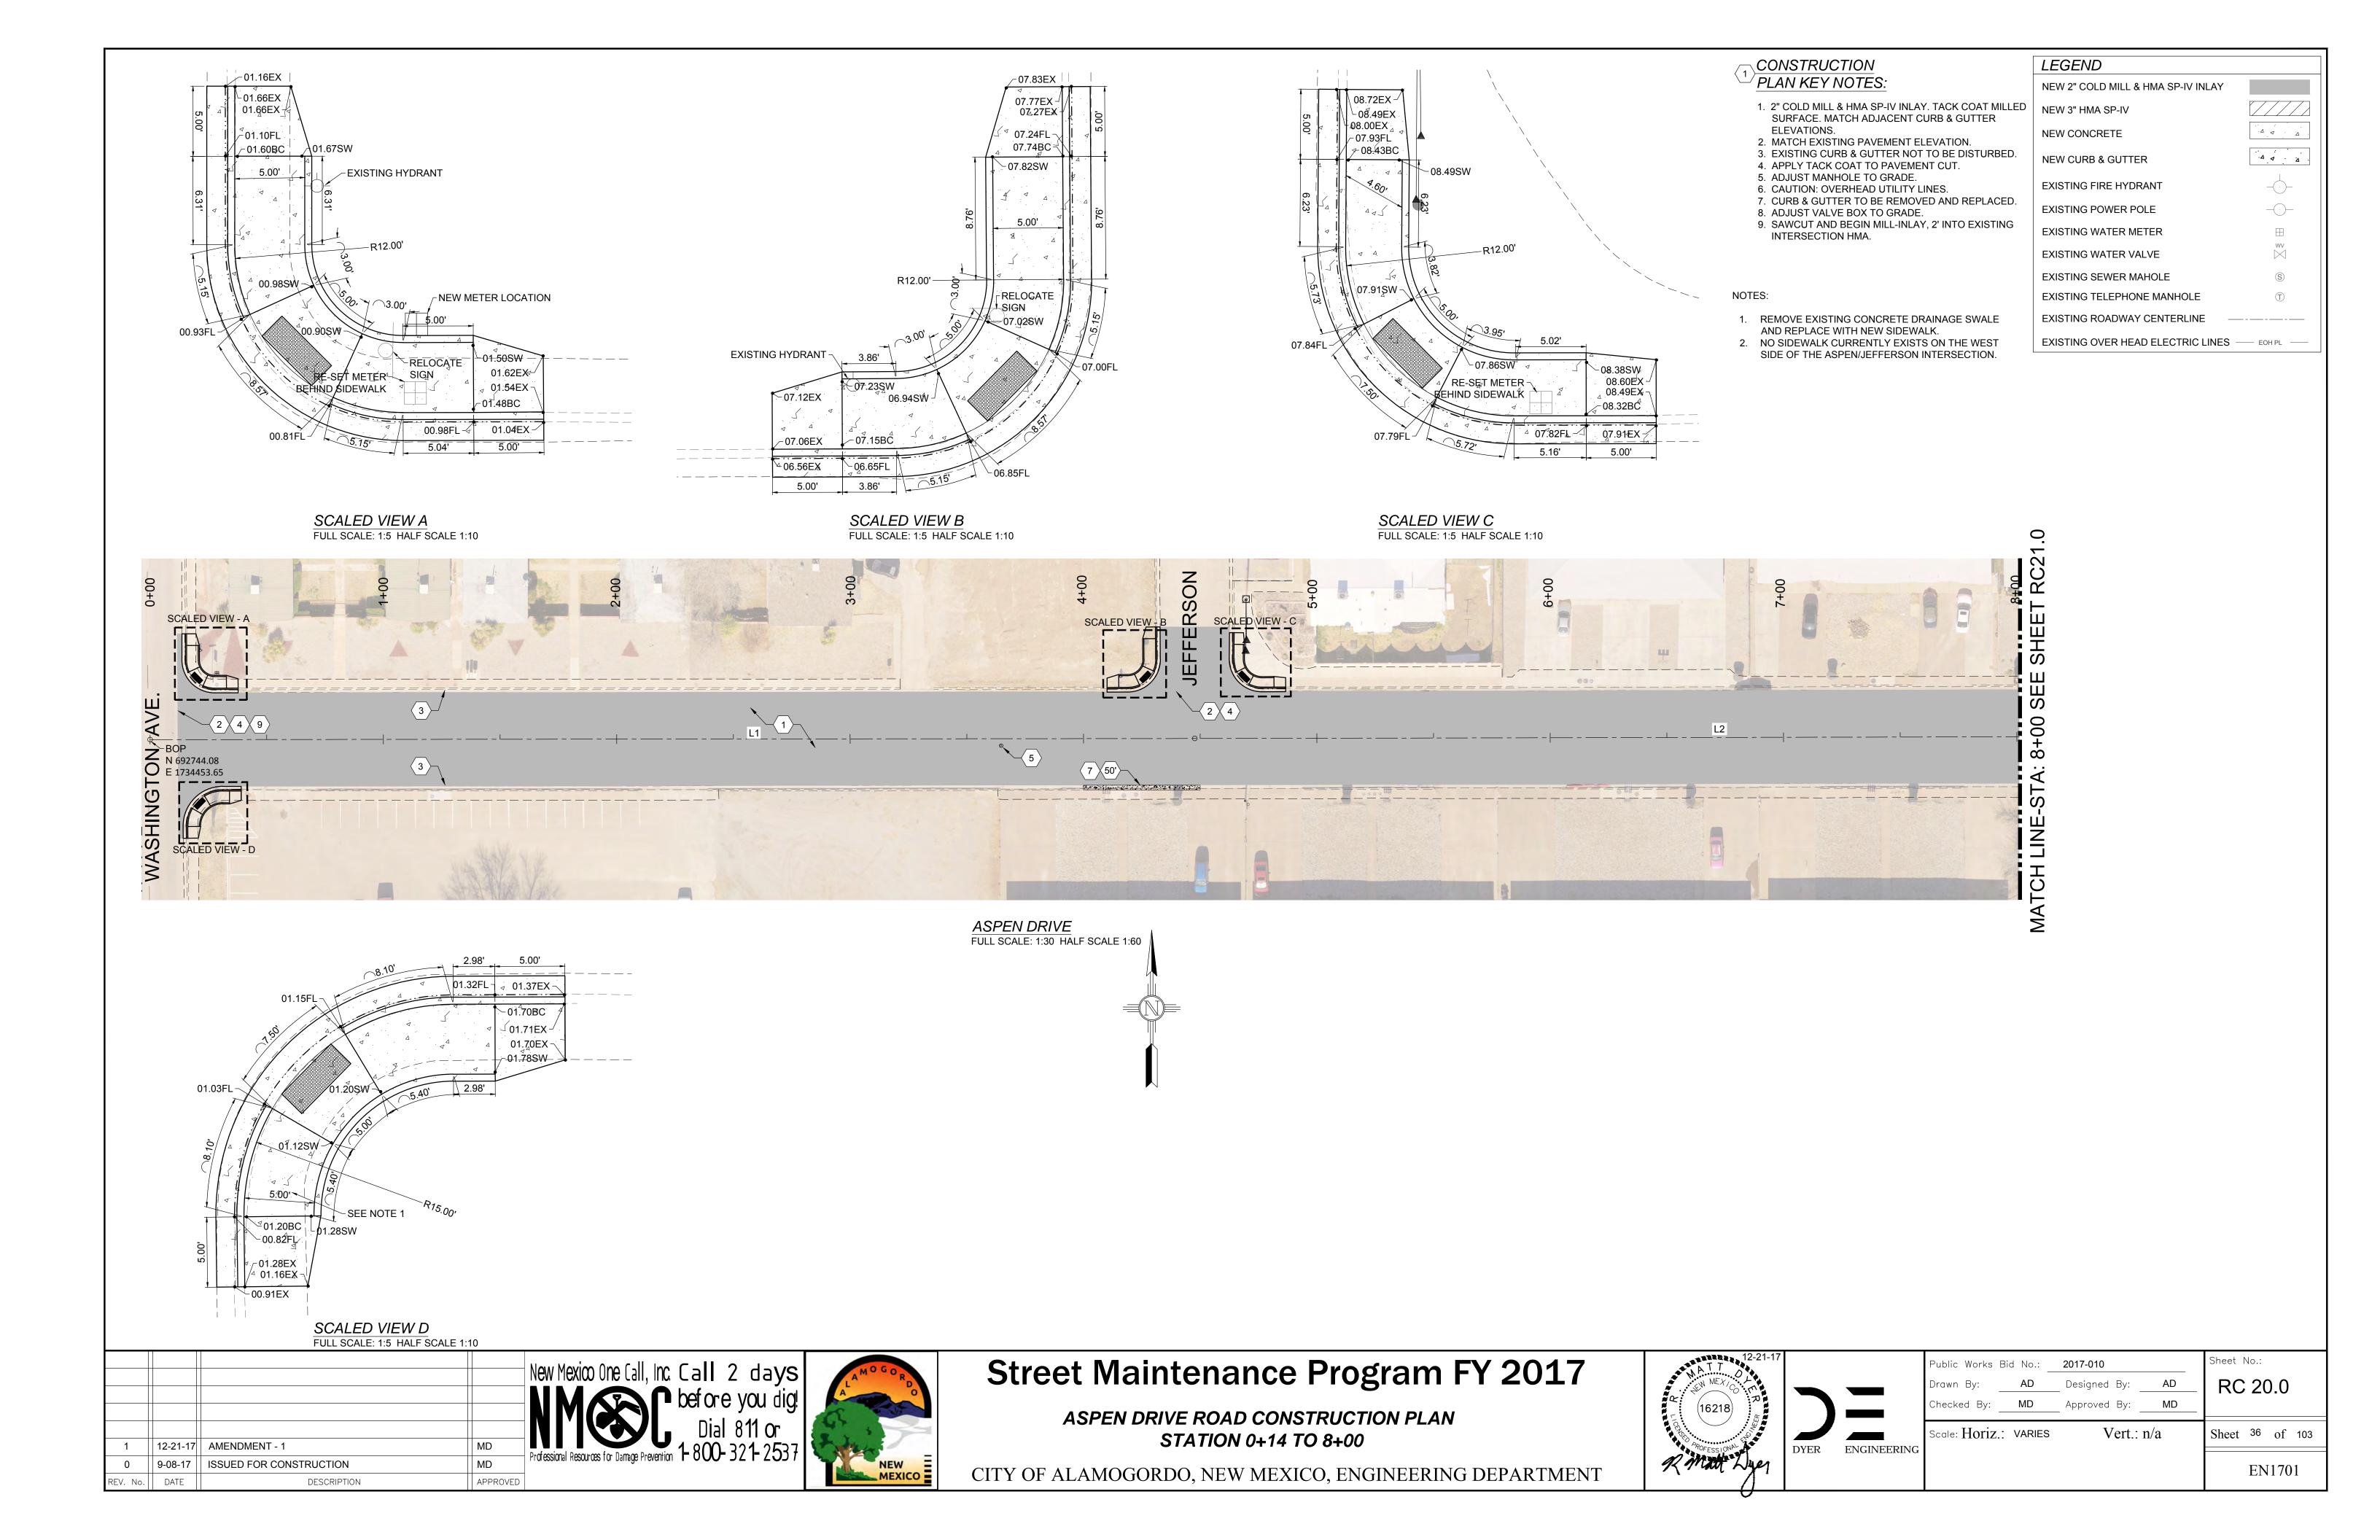

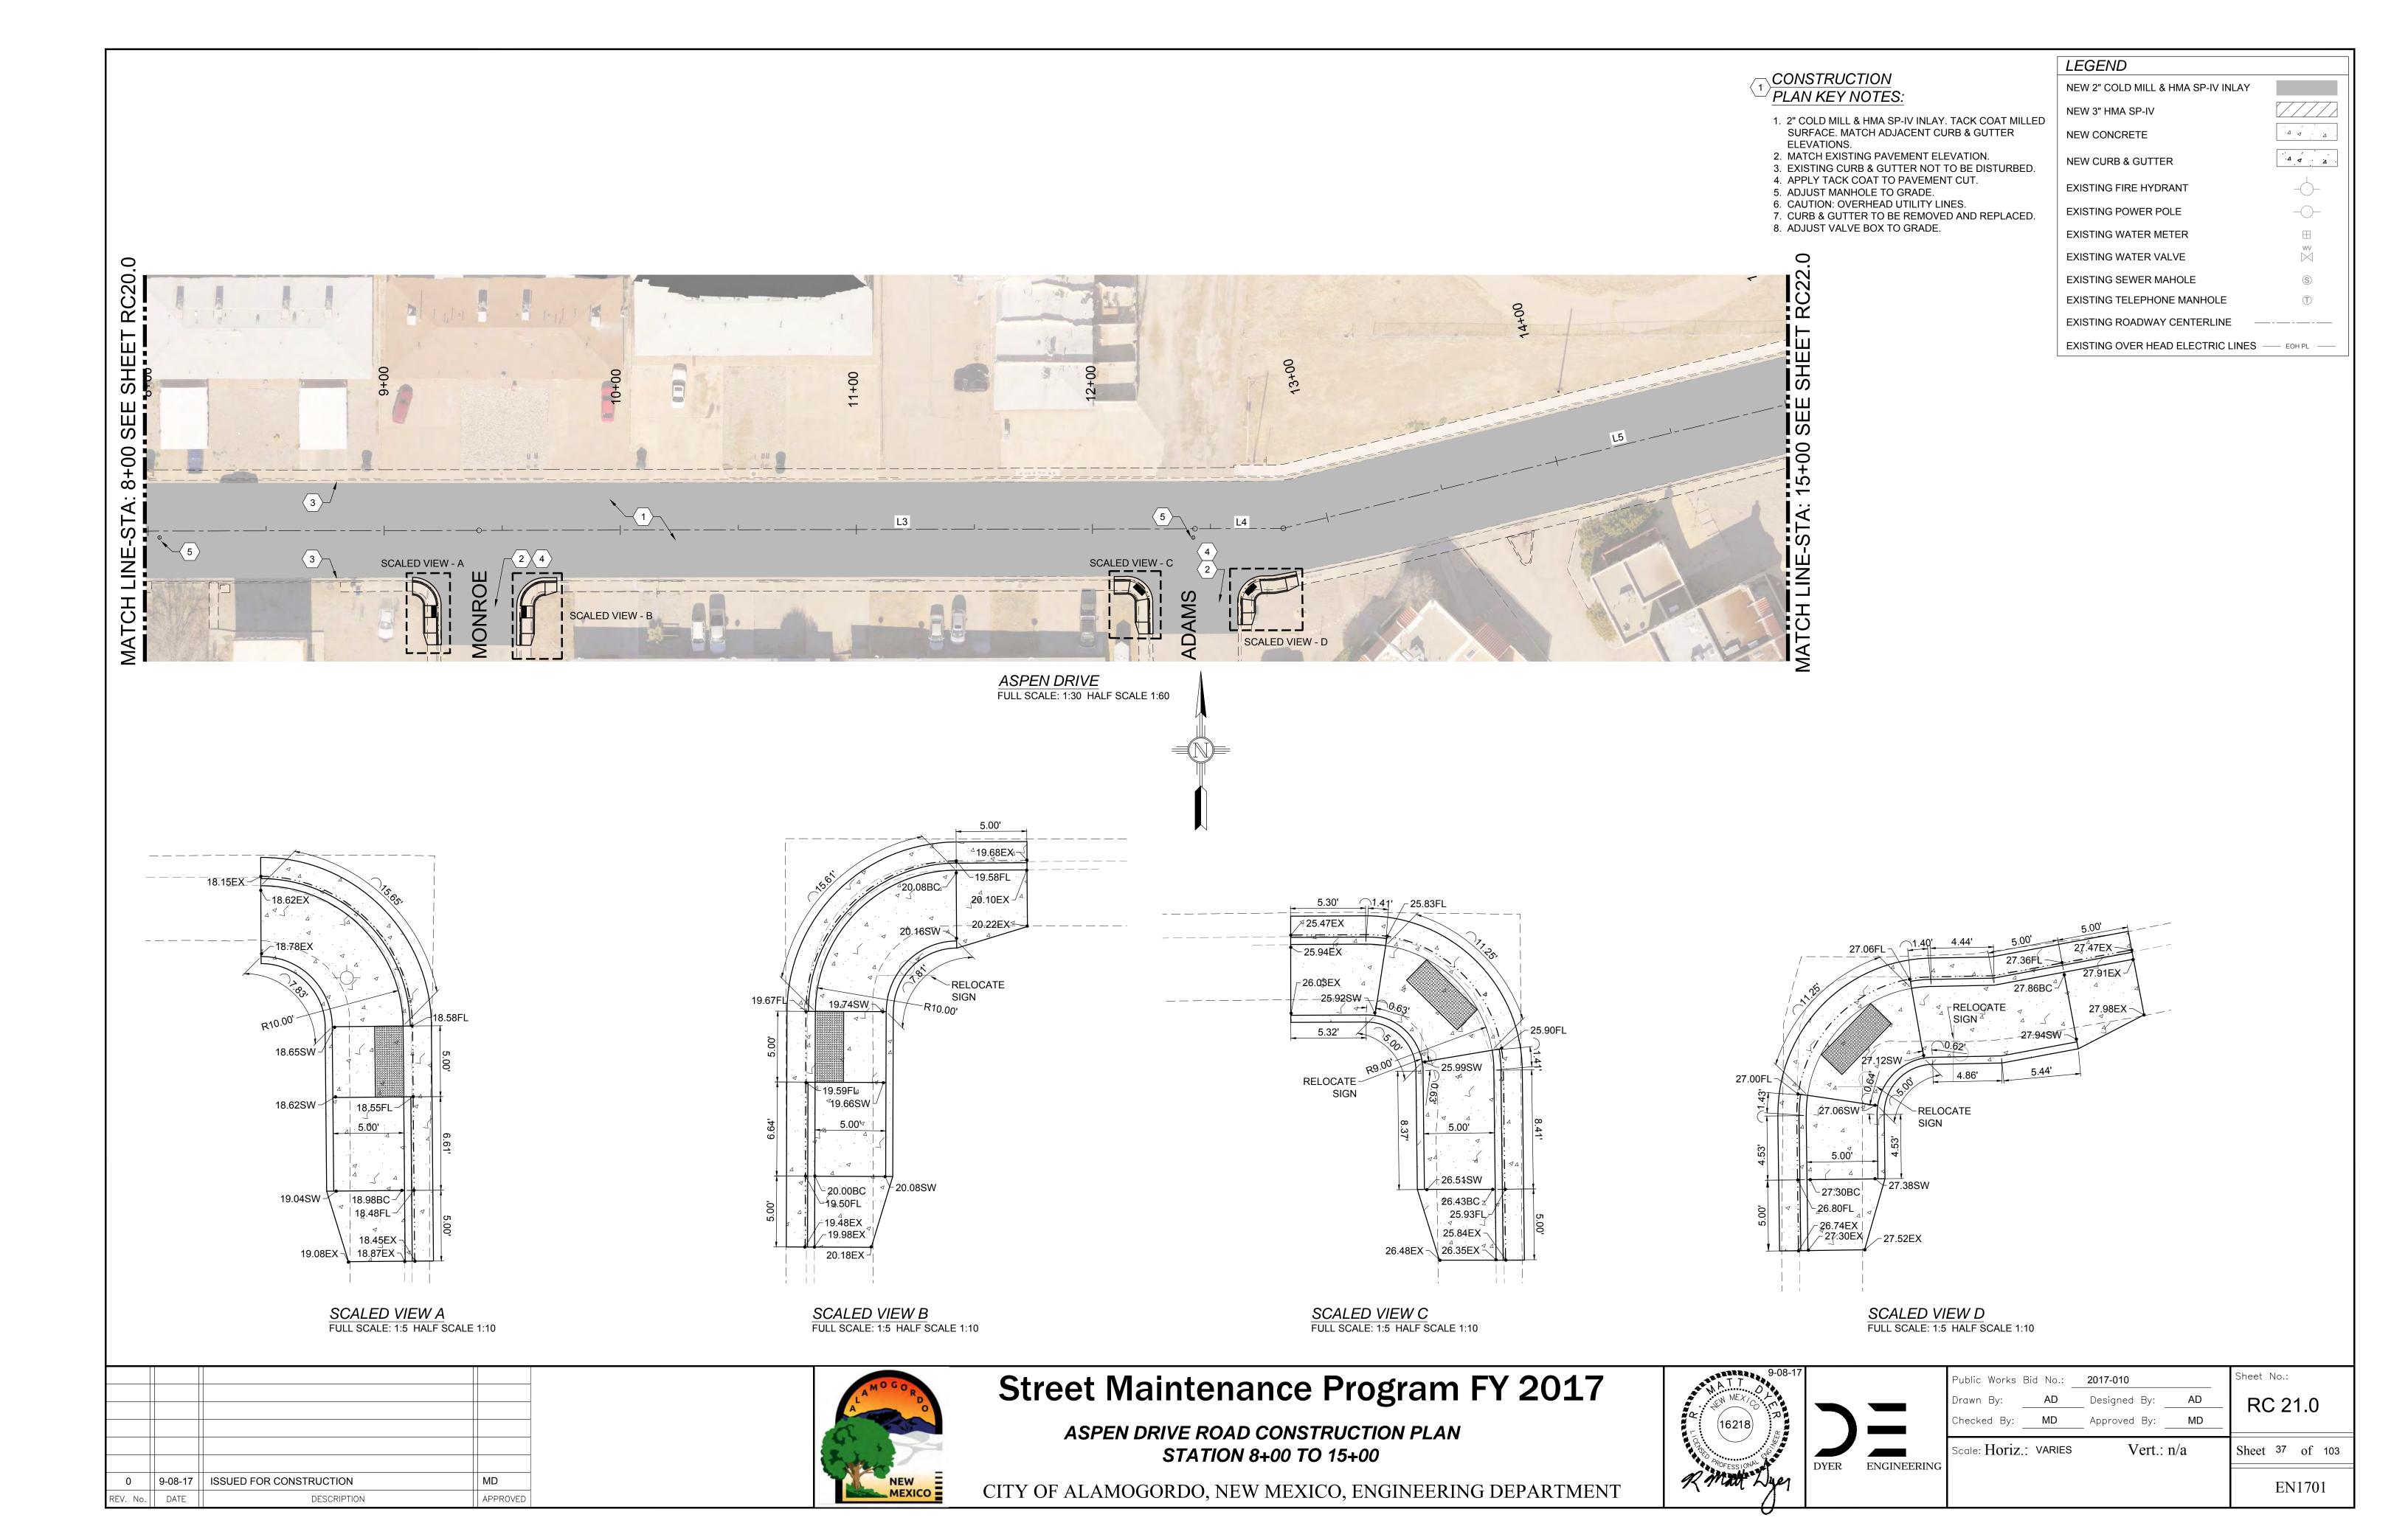

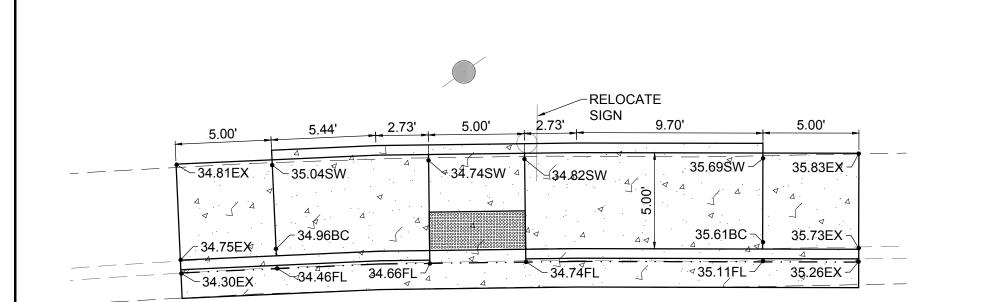



SCALED VIEW A FULL SCALE: 1:5 HALF SCALE 1:10


#### CONSTRUCTION PLAN KEY NOTES:

- 1. 2" COLD MILL & HMA SP-IV INLAY. TACK COAT MILLED SURFACE. MATCH ADJACENT CURB & GUTTER ELEVATIONS.
- 2. MATCH EXISTING PAVEMENT ELEVATION.
- 3. EXISTING CURB & GUTTER NOT TO BE DISTURBED.
- 4. APPLY TACK COAT TO PAVEMENT CUT.
- 5. ADJUST MANHOLE TO GRADE. 6. CAUTION: OVERHEAD UTILITY LINES.
- 7. CURB & GUTTER TO BE REMOVED AND REPLACED. 8. ADJUST VALVE BOX TO GRADE.

	LEGEND	
	NEW 2" COLD MILL & HMA SP-IV INLAY	
)	NEW 3" HMA SP-IV	
	NEW CONCRETE	.4 . 4
	NEW CURB & GUTTER	· · · · · · · · · · · · · · · · · · ·
	EXISTING FIRE HYDRANT	
	EXISTING POWER POLE	<u> </u>
	EXISTING WATER METER	
	EXISTING WATER VALVE	wv 
	EXISTING SEWER MAHOLE	(S)
	EXISTING TELEPHONE MANHOLE	T
	EXISTING ROADWAY CENTERLINE —	
	EXISTING OVER HEAD ELECTRIC LINES	EOH PL

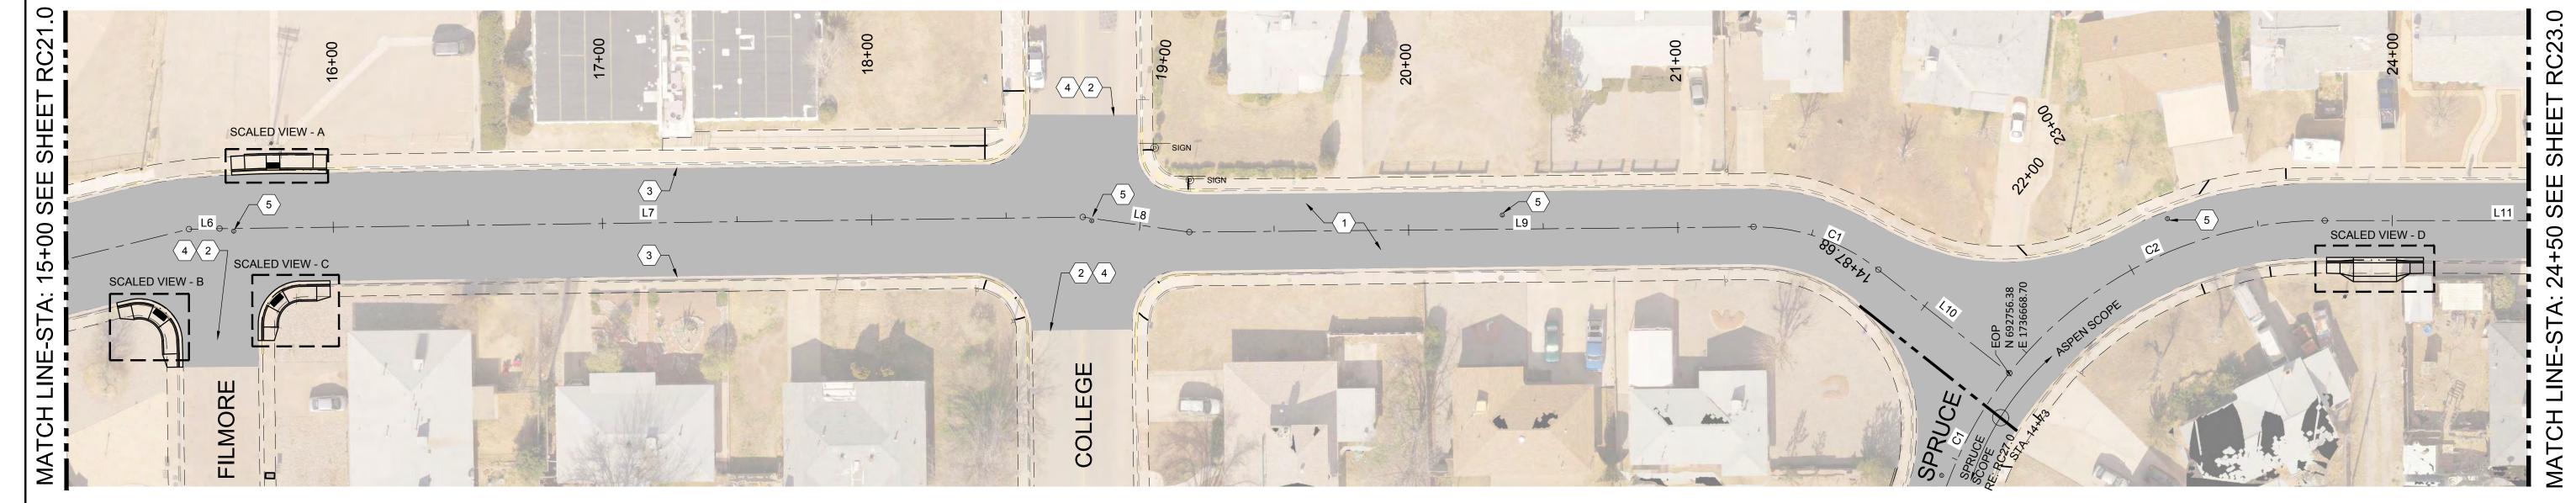

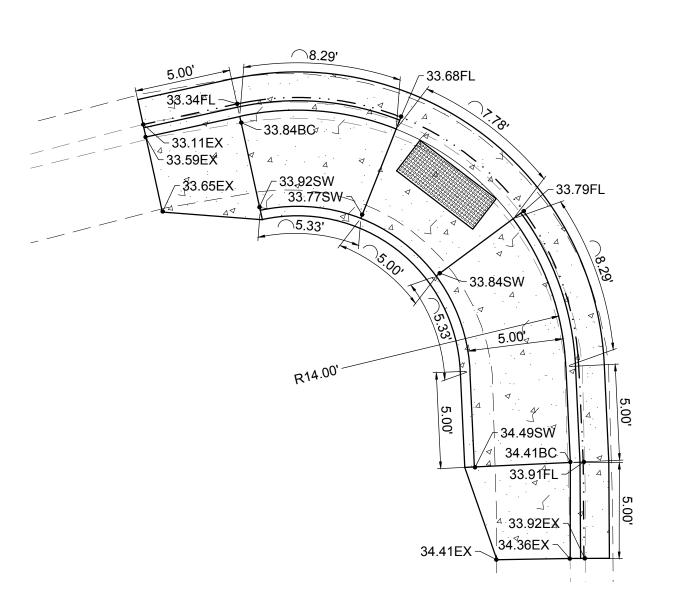

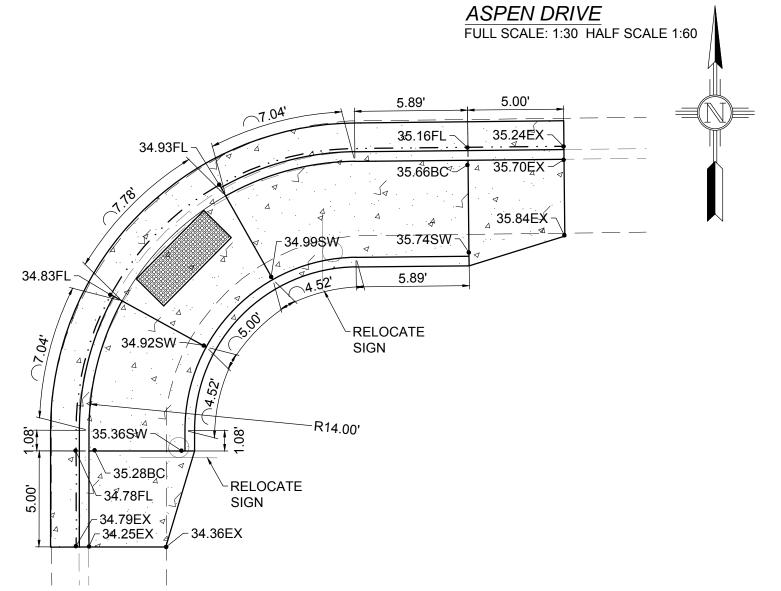

5.00'	5.00'	16.00'	5.00'	5.00'
52.85EX₄	53 <u>.02</u> FL	53.20FL MOUNTABLE CURB 53.74FL	53.92FL	<sup>4</sup> 54.09EX
53.28EX 88 7 53.42EX	53.52BC	53.53BC	54.42BC <sub>4</sub> 54.50SW	54.50EX

SCALED VIEW B
FULL SCALE: 1:5 HALF SCALE 1:10

SCALED VIEW C
FULL SCALE: 1:5 HALF SCALE 1:10

SCALED VIEW D
FULL SCALE: 1:5 HALF SCALE 1:10


				New Mexico One Call, Inc. Call 2 days  Set of the Call 2 days  Dial 811 or  Professional Resources for Damage Prevention 1-800-321-2537
0	9-08-17	ISSUED FOR CONSTRUCTION	MD	Professional Resources for Danlage Prevention 1 000 32 1 2037
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### **Street Maintenance Program FY 2017**

ASPEN DRIVE ROAD CONSTRUCTION PLAN STATION 15+00 TO 24+50


CITY OF ALAMOGORDO, NEW MEXICO, ENGINEERING DEPARTMENT





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Public Works	Bid No.:	2017-010		Sheet No.:
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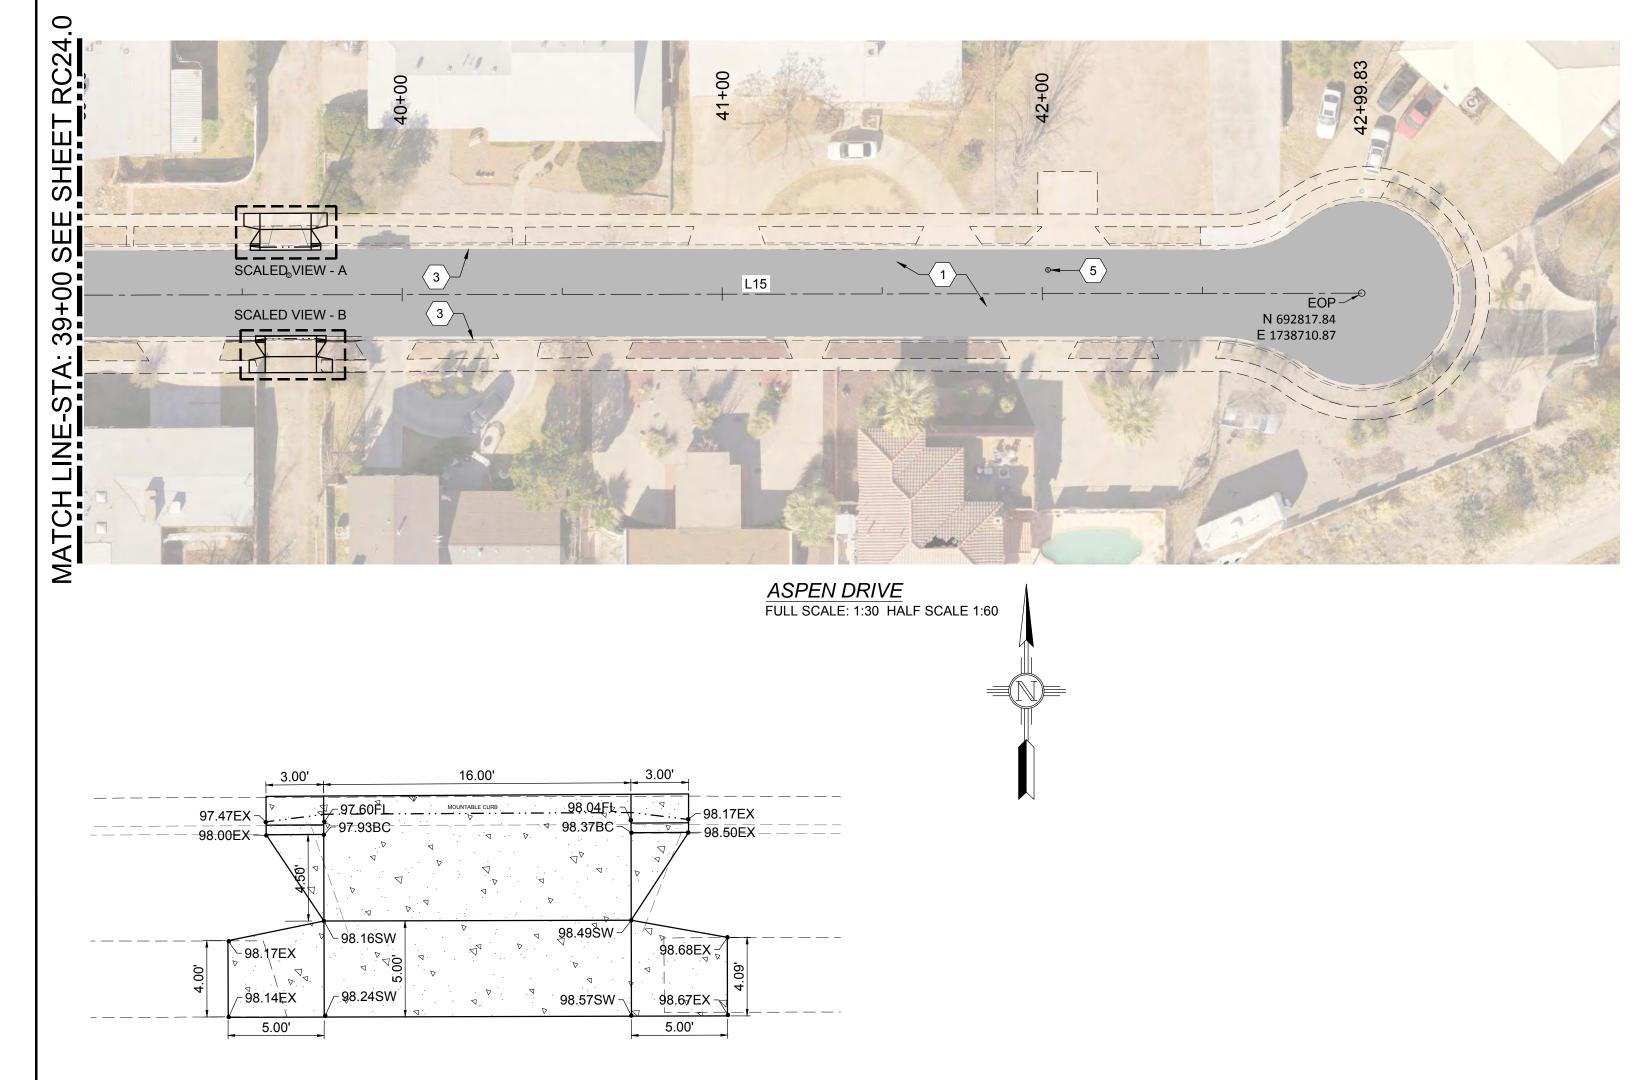
Scale: Horiz.: VARIES Sheet 38 of 103 EN1701

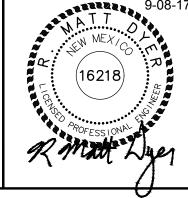



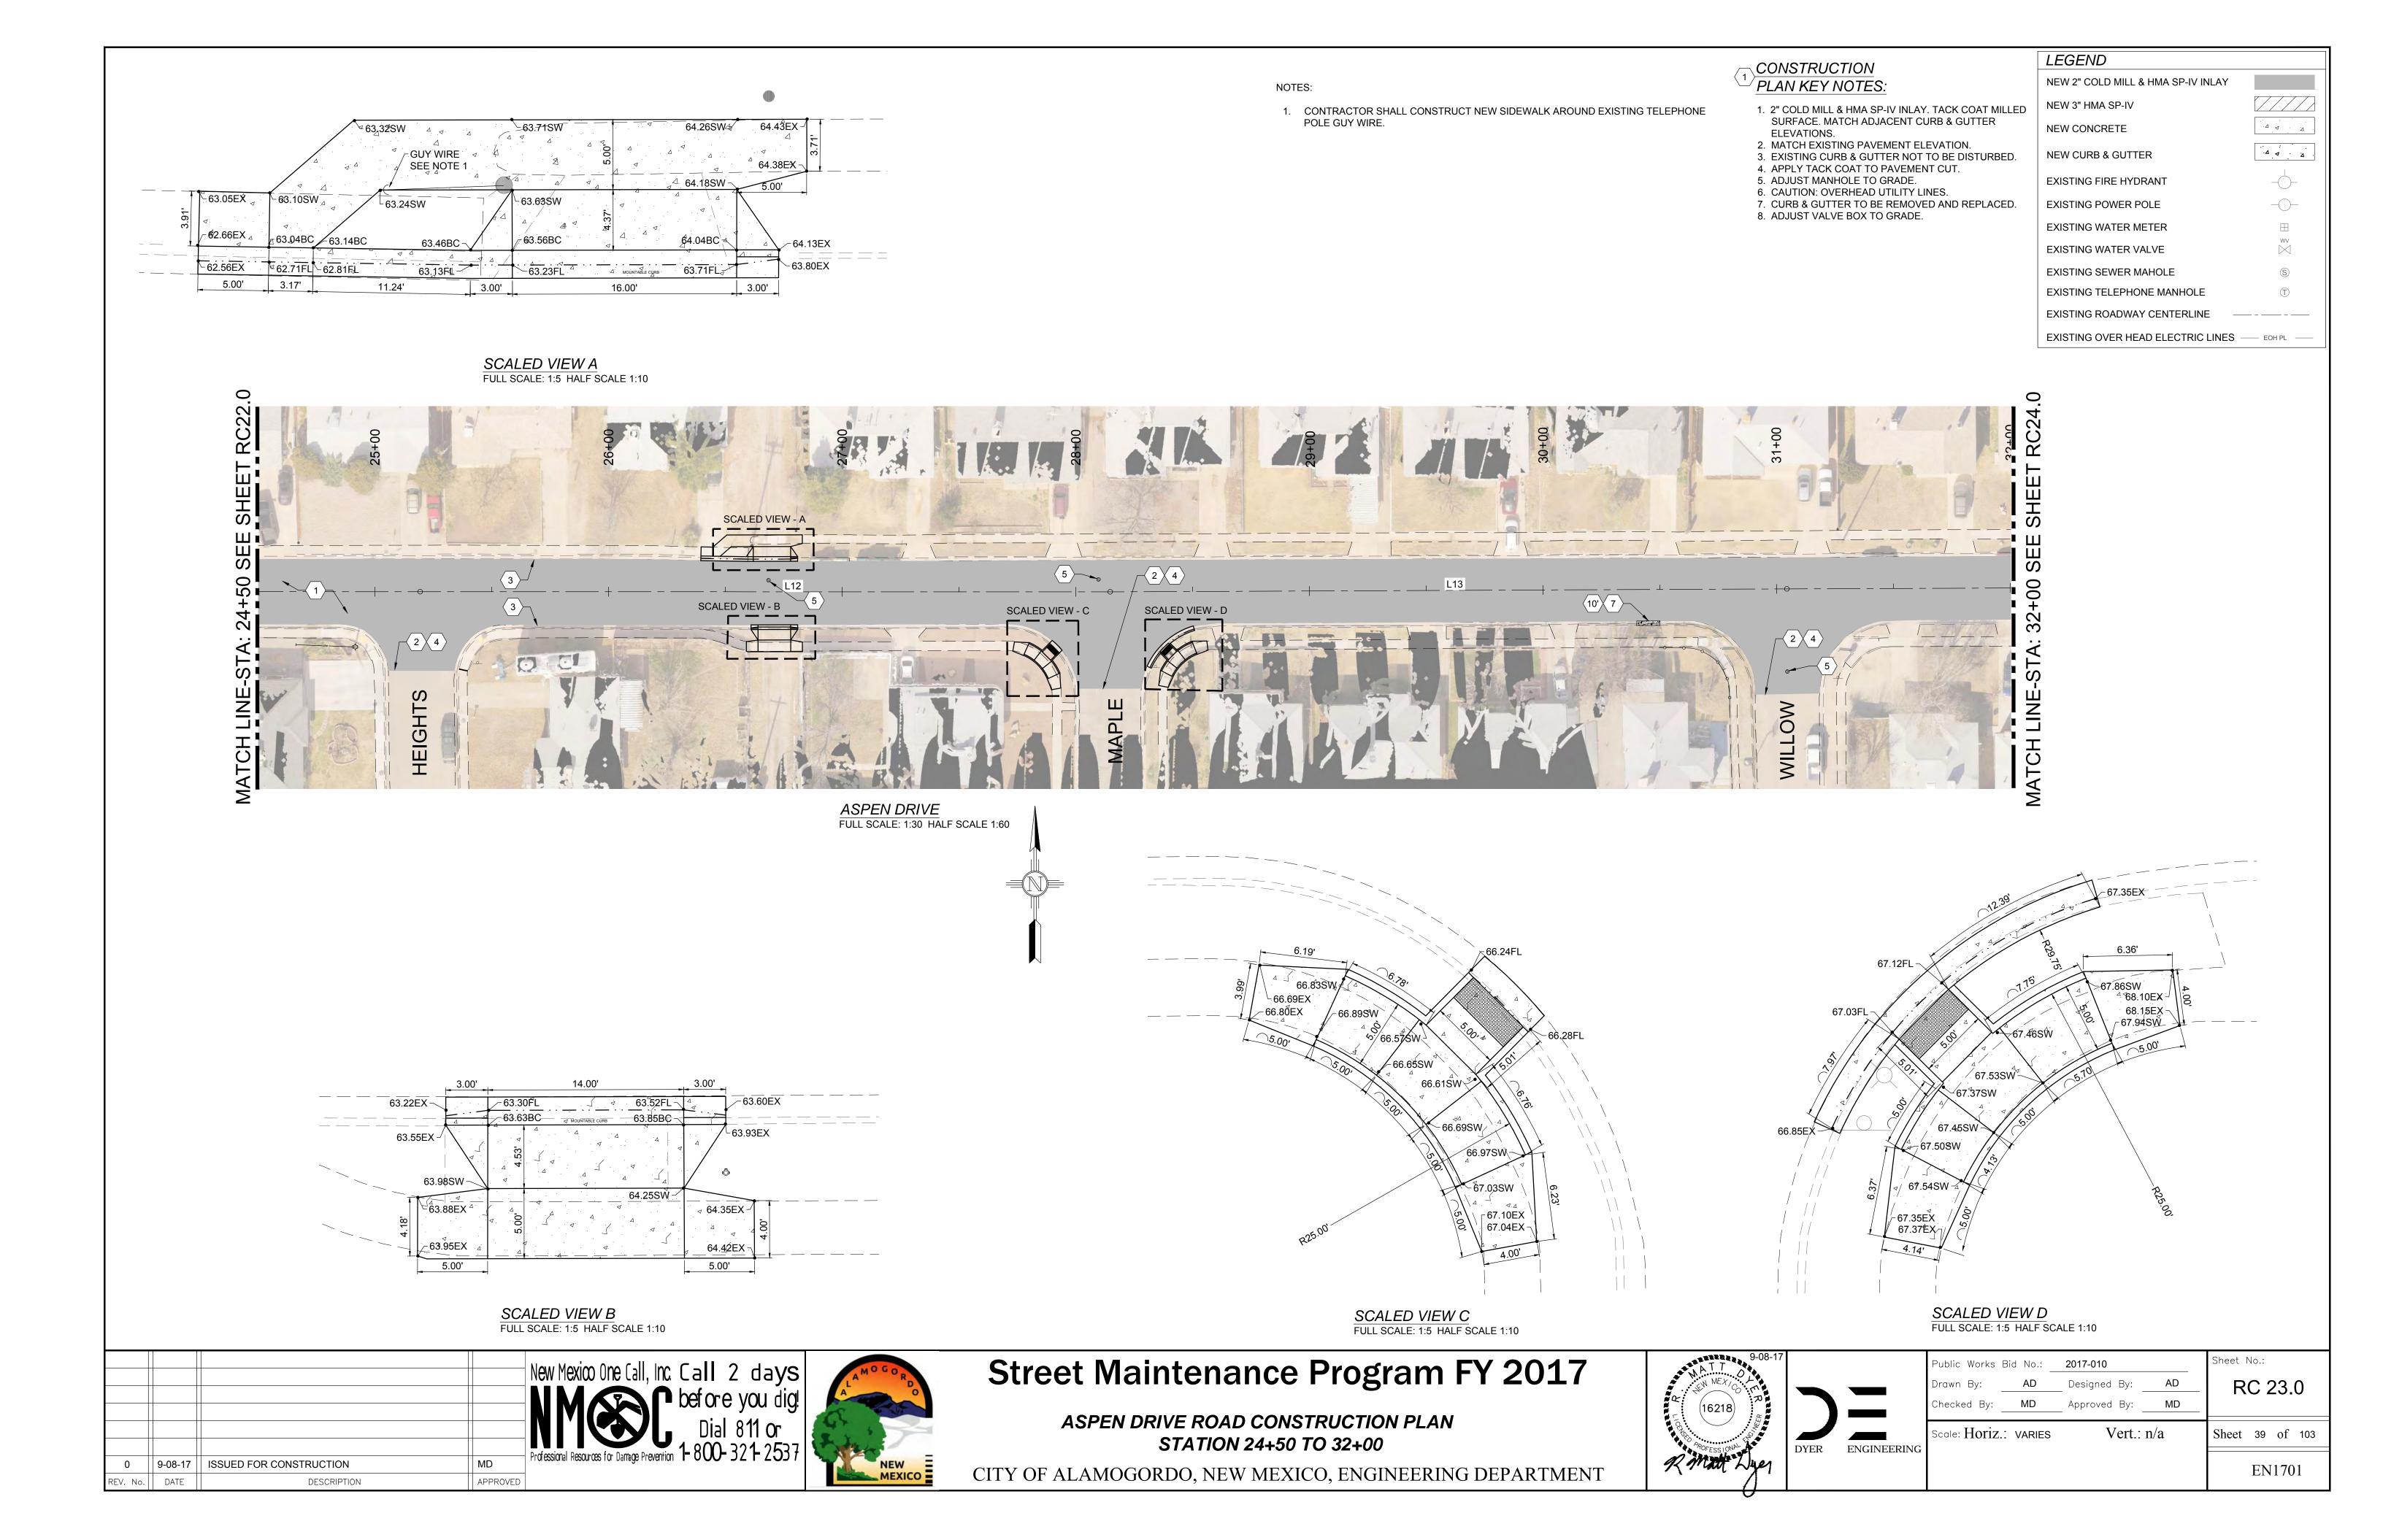

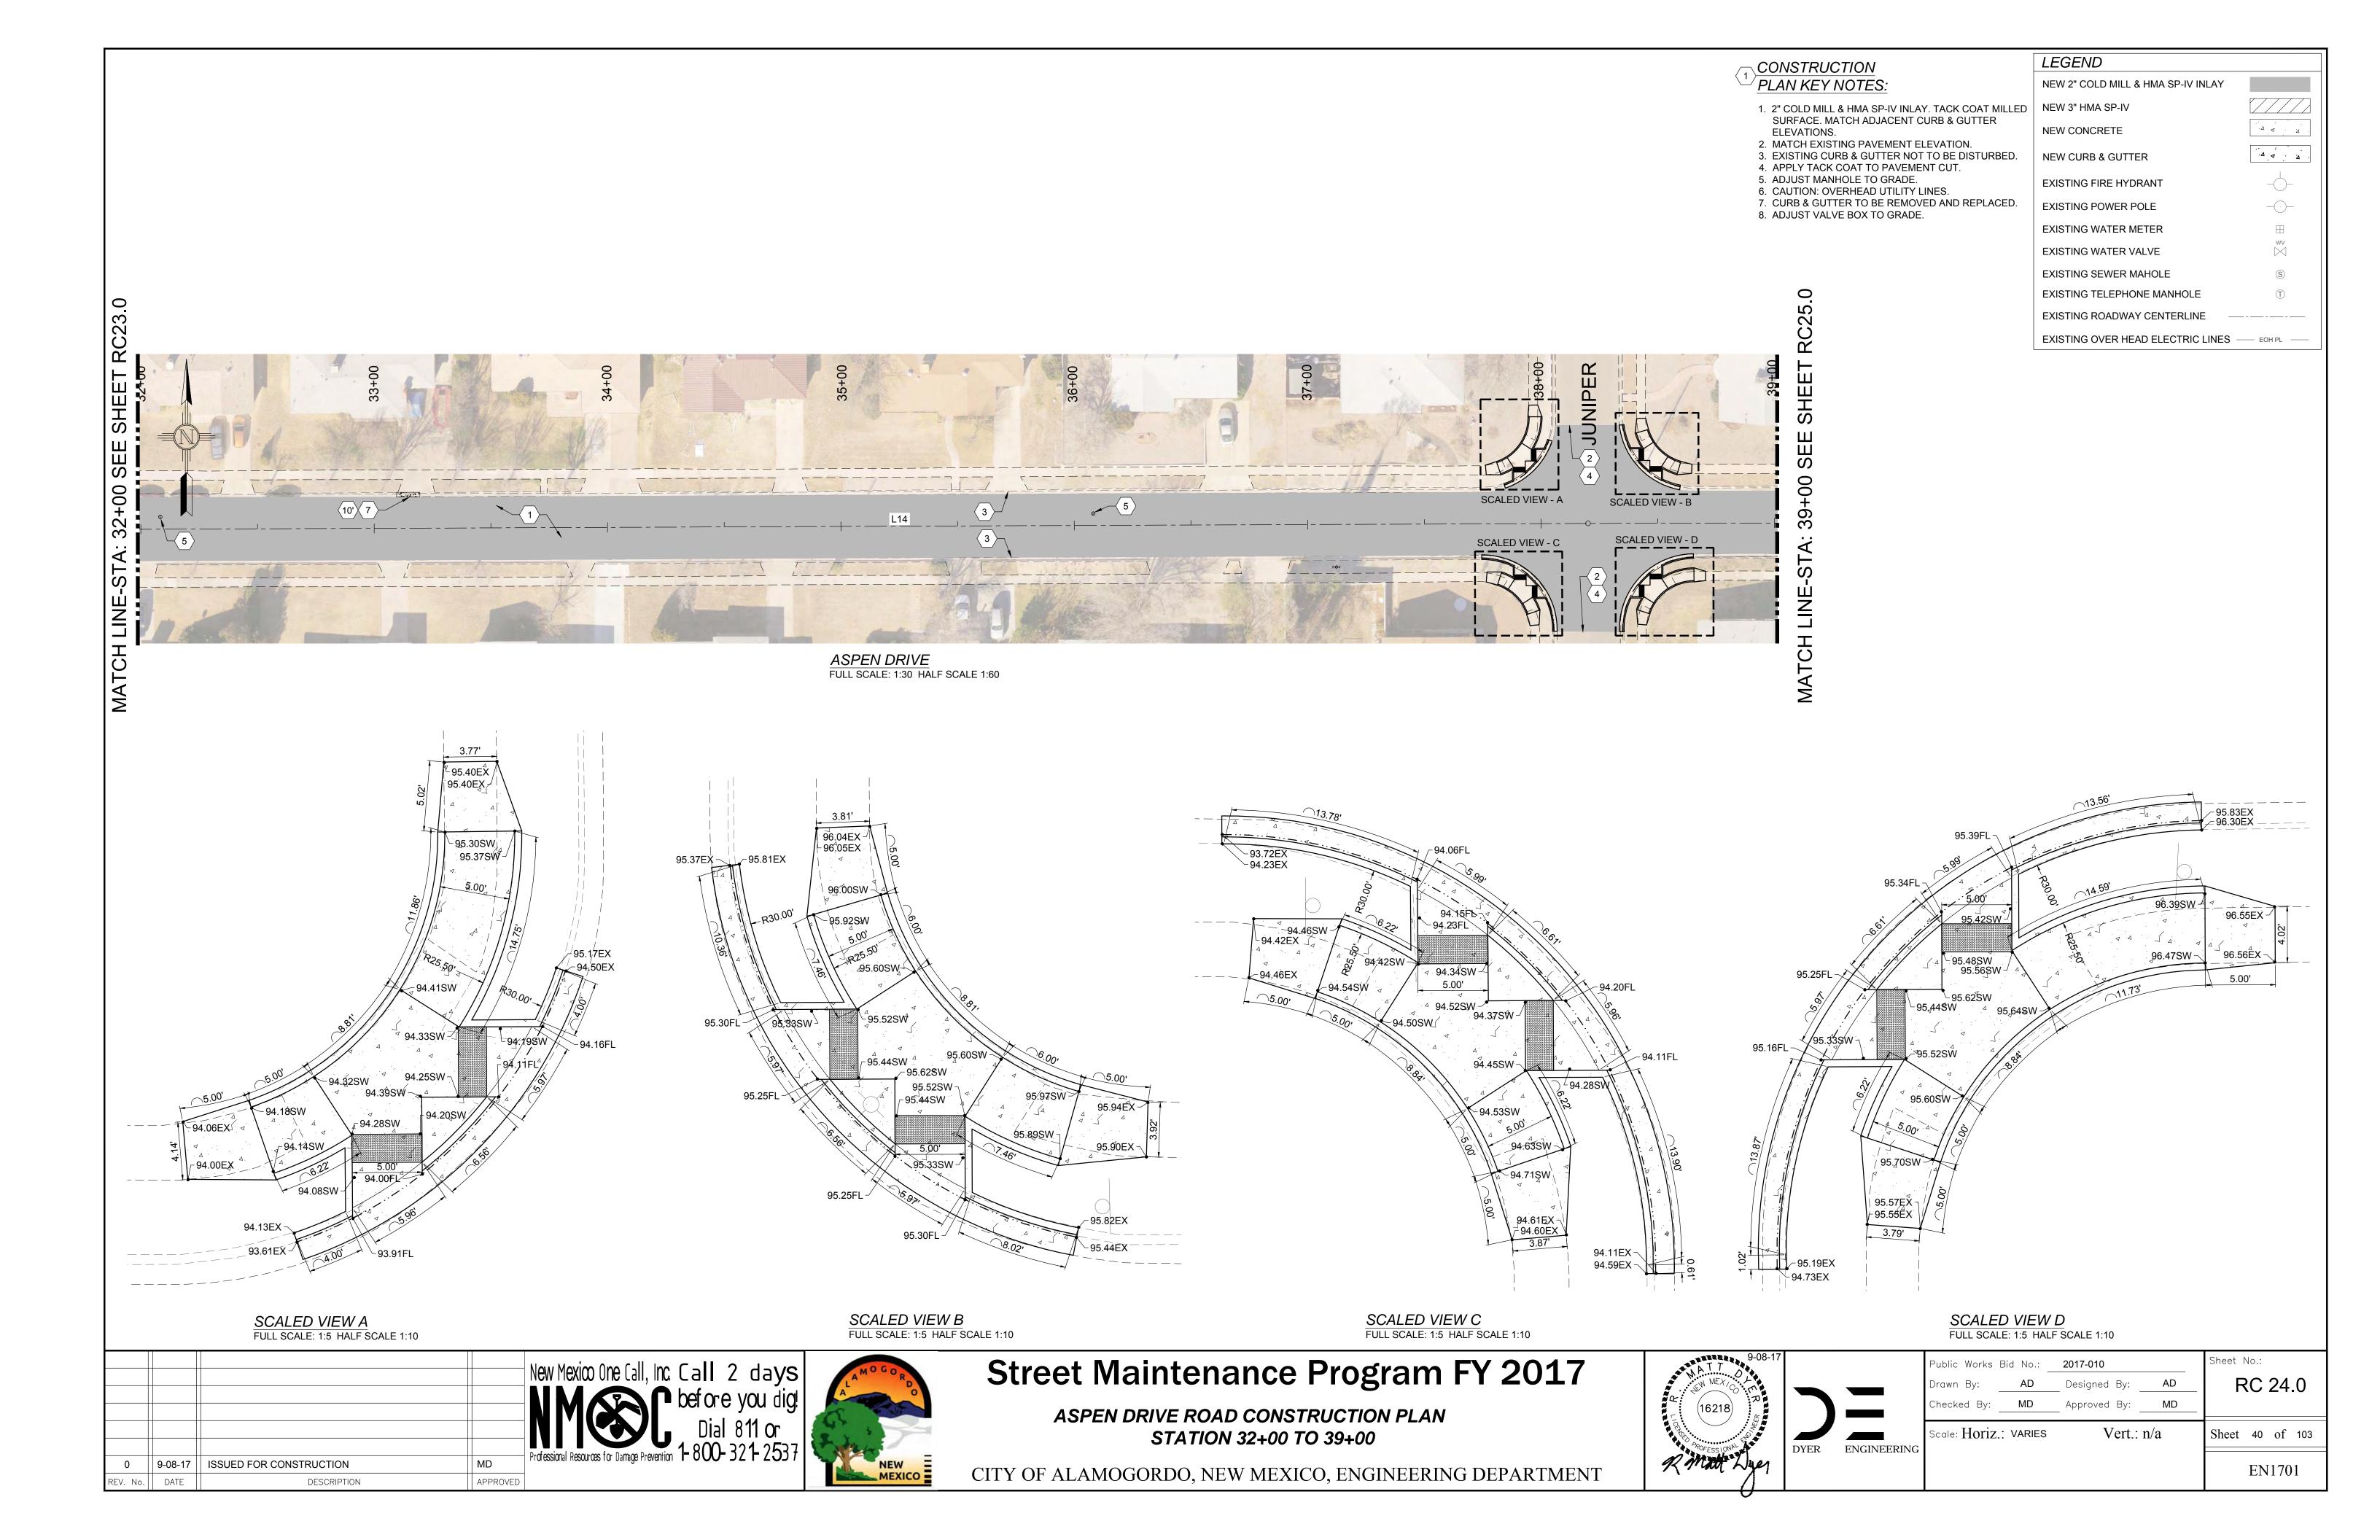SCALED VIEW A FULL SCALE: 1:5 HALF SCALE 1:10

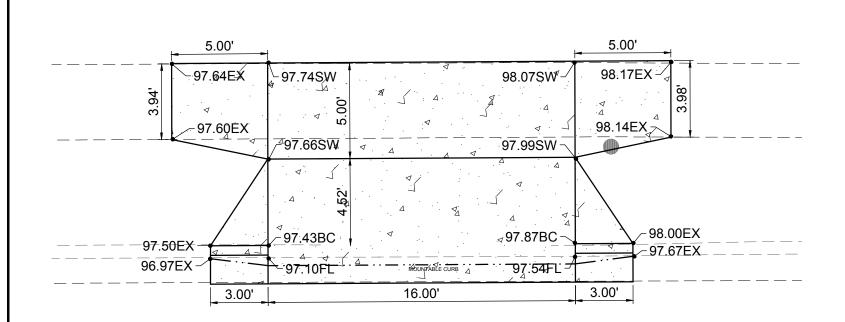

SCALED VIEW B
FULL SCALE: 1:5 HALF SCALE 1:10


	0.09.17	ISSUED FOR CONSTRUCTION	MD	New Mexico One Call, Inc. Call 2 days  Dial 811 or Professional Resources for Damage Prevention 1-800-321-2537
0	9-08-17	ISSUED FOR CONSTRUCTION	MD	
REV. No.	DATE	DESCRIPTION	APPROVED	



### **Street Maintenance Program FY 2017**

ASPEN DRIVE ROAD CONSTRUCTION PLAN STATION 39+00 TO 43+00

CITY OF ALAMOGORDO, NEW MEXICO, ENGINEERING DEPARTMENT

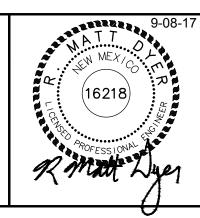

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Checked By:	MD	Approved By:	MD	

LEGEND

NEW 3" HMA SP-IV

**NEW CONCRETE** 

**NEW CURB & GUTTER** 

EXISTING FIRE HYDRANT

**EXISTING POWER POLE** 

EXISTING WATER METER

EXISTING WATER VALVE

EXISTING SEWER MAHOLE

EXISTING TELEPHONE MANHOLE

EXISTING ROADWAY CENTERLINE

EXISTING OVER HEAD ELECTRIC LINES — EOH PL —

NEW 2" COLD MILL & HMA SP-IV INLAY

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CONSTRUCTION

ELEVATIONS.

PLAN KEY NOTES:

1. 2" COLD MILL & HMA SP-IV INLAY. TACK COAT MILLED SURFACE. MATCH ADJACENT CURB & GUTTER

3. EXISTING CURB & GUTTER NOT TO BE DISTURBED.

6. CAUTION: OVERHEAD UTILITY LINES.7. CURB & GUTTER TO BE REMOVED AND REPLACED.


2. MATCH EXISTING PAVEMENT ELEVATION.


4. APPLY TACK COAT TO PAVEMENT CUT.

5. ADJUST MANHOLE TO GRADE.

8. ADJUST VALVE BOX TO GRADE.

Scale: Horiz.: VARIES Vert.: n/a Sheet 41 of 103 EN1701

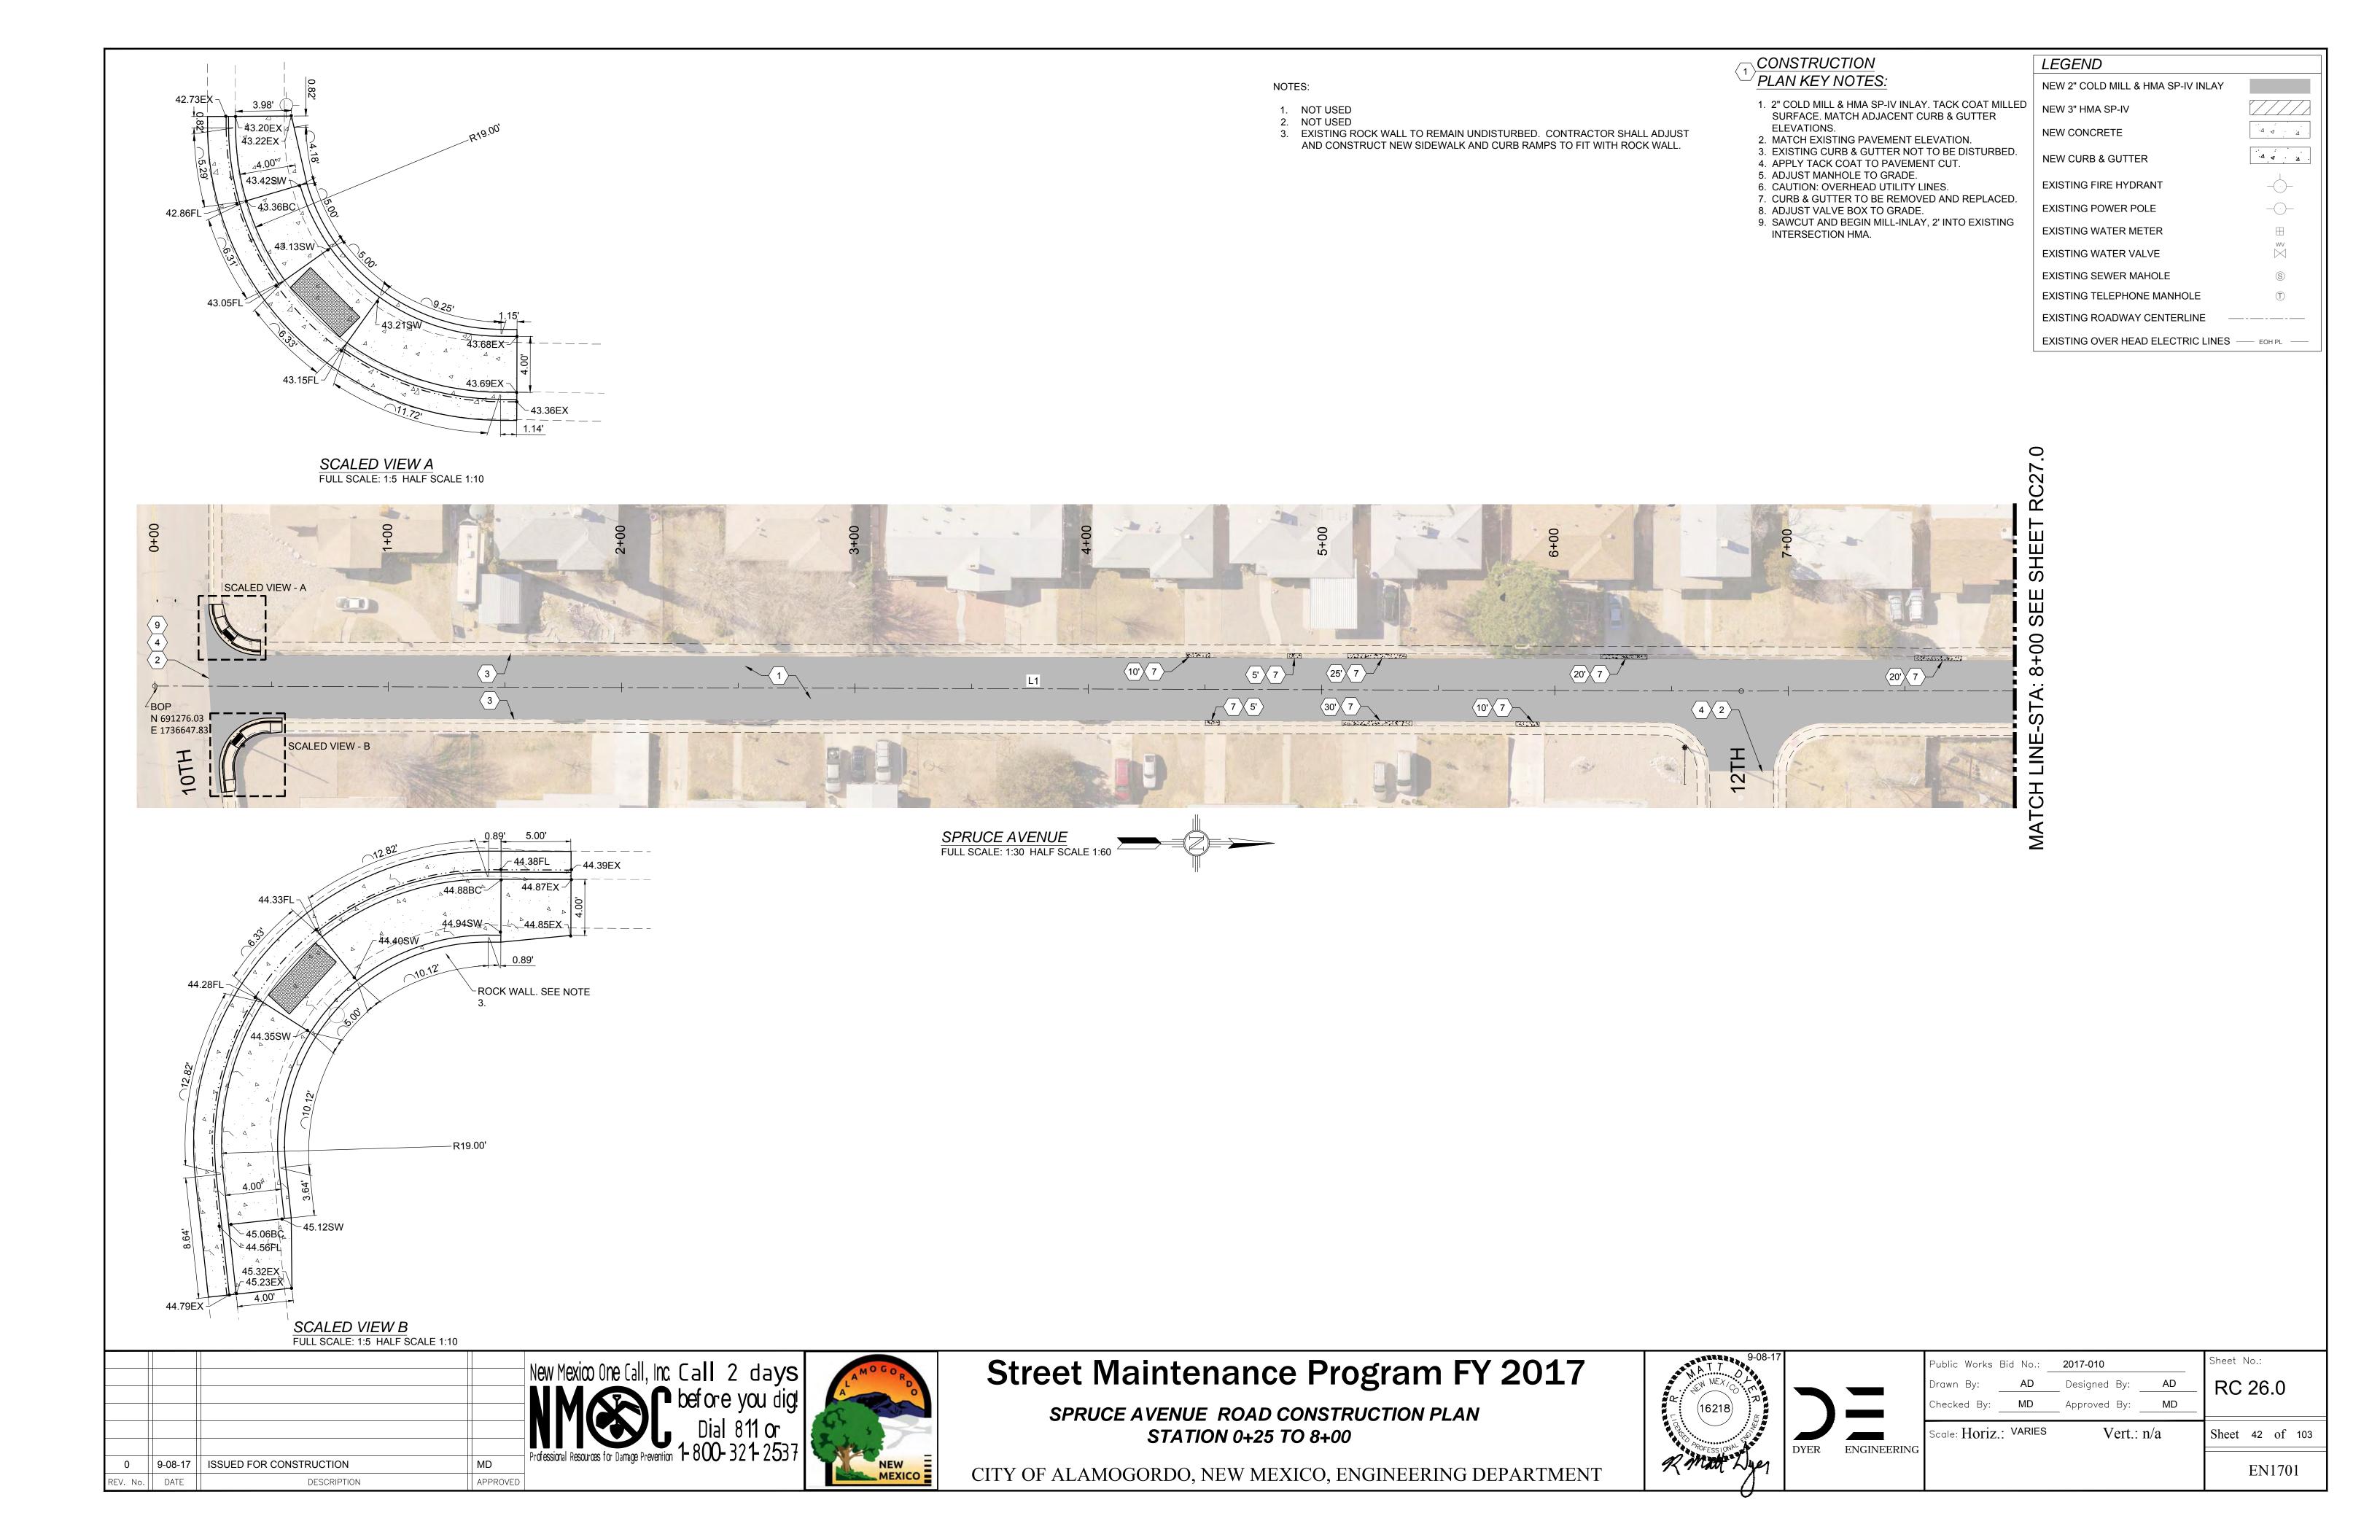

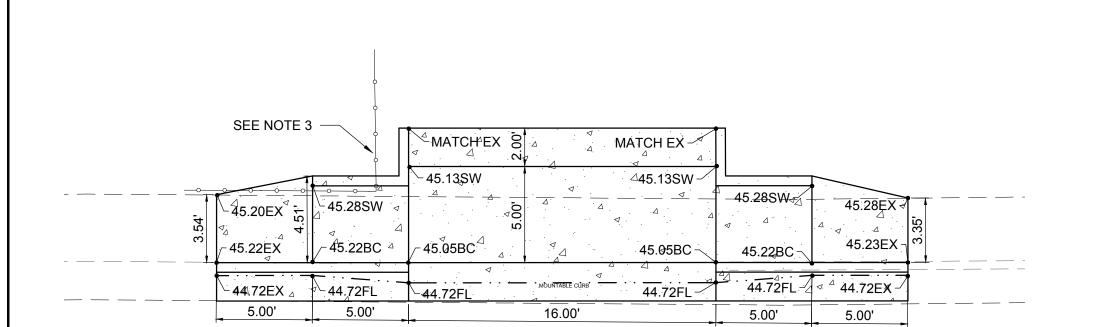

SCALED VIEW A FULL SCALE: 1:5 HALF SCALE 1:10


#### NOTES:


- NOT USED NOT USED
- 3. IF A CONFLICT WITH AN EXISTING FENCE EXISTS, CONTRACTOR SHALL MODIFY DRIVEPAD CURB TO CONFORM WITH EXISTING FENCE SO NO FENCE REPLACEMENT WILL BE REQUIRED.

#### CONSTRUCTION PLAN KEY NOTES:

- 2" COLD MILL & HMA SP-IV INLAY. TACK COAT MILLED SURFACE. MATCH ADJACENT CURB & GUTTER
- ELEVATIONS. 2. MATCH EXISTING PAVEMENT ELEVATION.
- 3. EXISTING CURB & GUTTER NOT TO BE DISTURBED.
- 4. APPLY TACK COAT TO PAVEMENT CUT. 5. ADJUST MANHOLE TO GRADE.
- 6. CAUTION: OVERHEAD UTILITY LINES.7. CURB & GUTTER TO BE REMOVED AND REPLACED.
- 8. ADJUST VALVE BOX TO GRADE.

	LEGEND	
	NEW 2" COLD MILL & HMA SP-IV INLAY	
ED	NEW 3" HMA SP-IV	
	NEW CONCRETE	Δ Δ Δ
).	NEW CURB & GUTTER	· A A · A
	EXISTING FIRE HYDRANT	
).	EXISTING POWER POLE	<u> </u>
	EXISTING WATER METER	
	EXISTING WATER VALVE	wv 
	EXISTING SEWER MAHOLE	<u>(S)</u>
	EXISTING TELEPHONE MANHOLE	T
	EXISTING ROADWAY CENTERLINE —	
	EXISTING OVER HEAD ELECTRIC LINES -	EOH PL

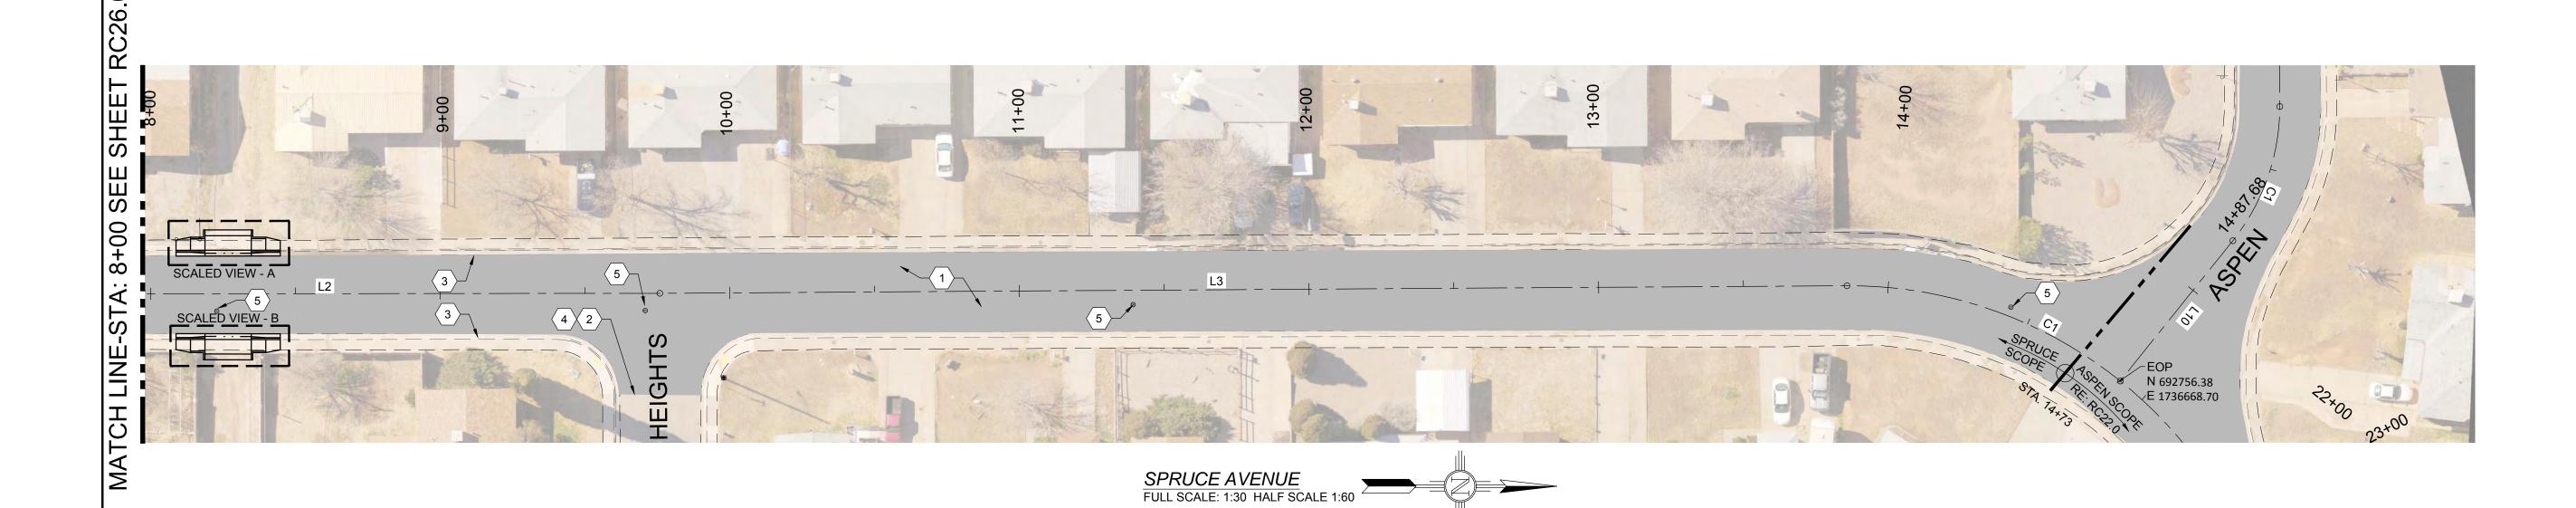

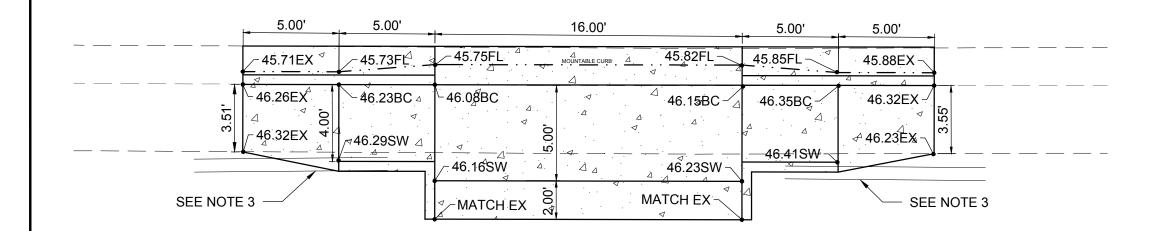

#### SCALED VIEW B FULL SCALE: 1:5 HALF SCALE 1:10


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REV. No.	DATE	DESCRIPTION	APPROVED		



### **Street Maintenance Program FY 2017**

SPRUCE AVENUE ROAD CONSTRUCTION PLAN STATION 8+00 TO 14+87

CITY OF ALAMOGORDO, NEW MEXICO, ENGINEERING DEPARTMENT

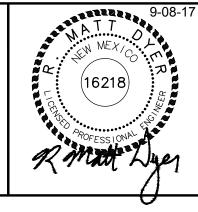



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Sheet 43 of 103 EN1701






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Sheet 45 of 103

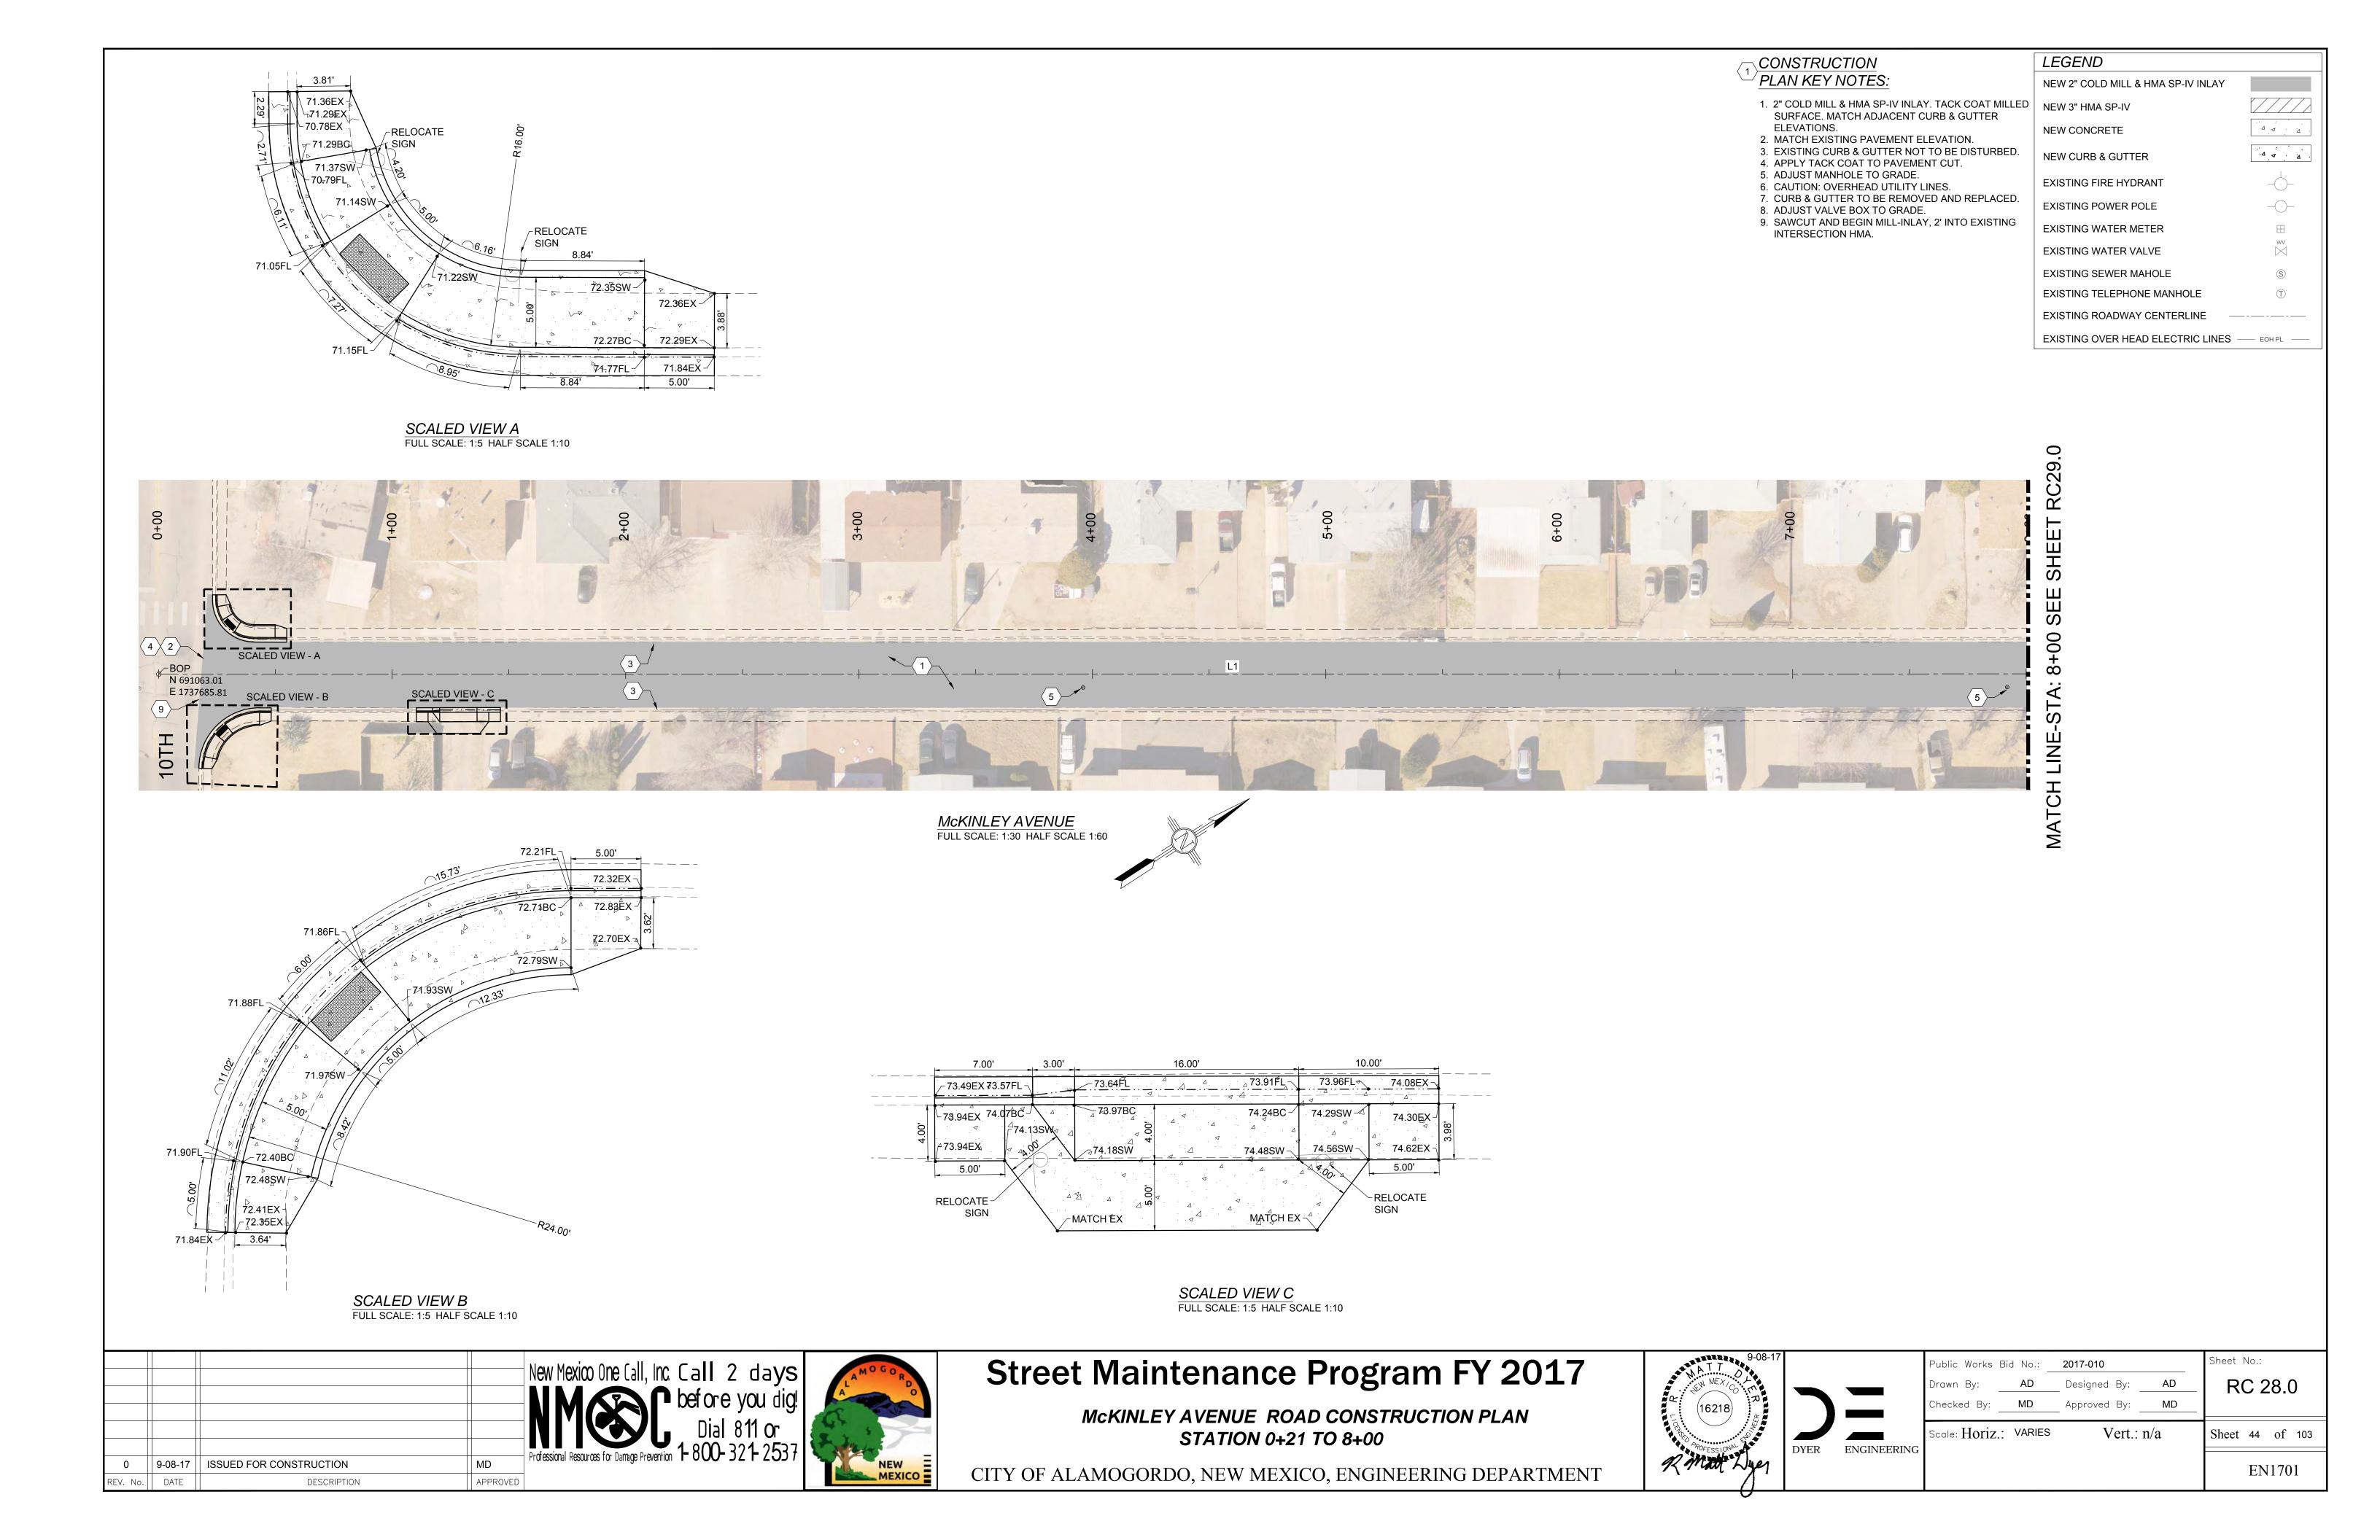

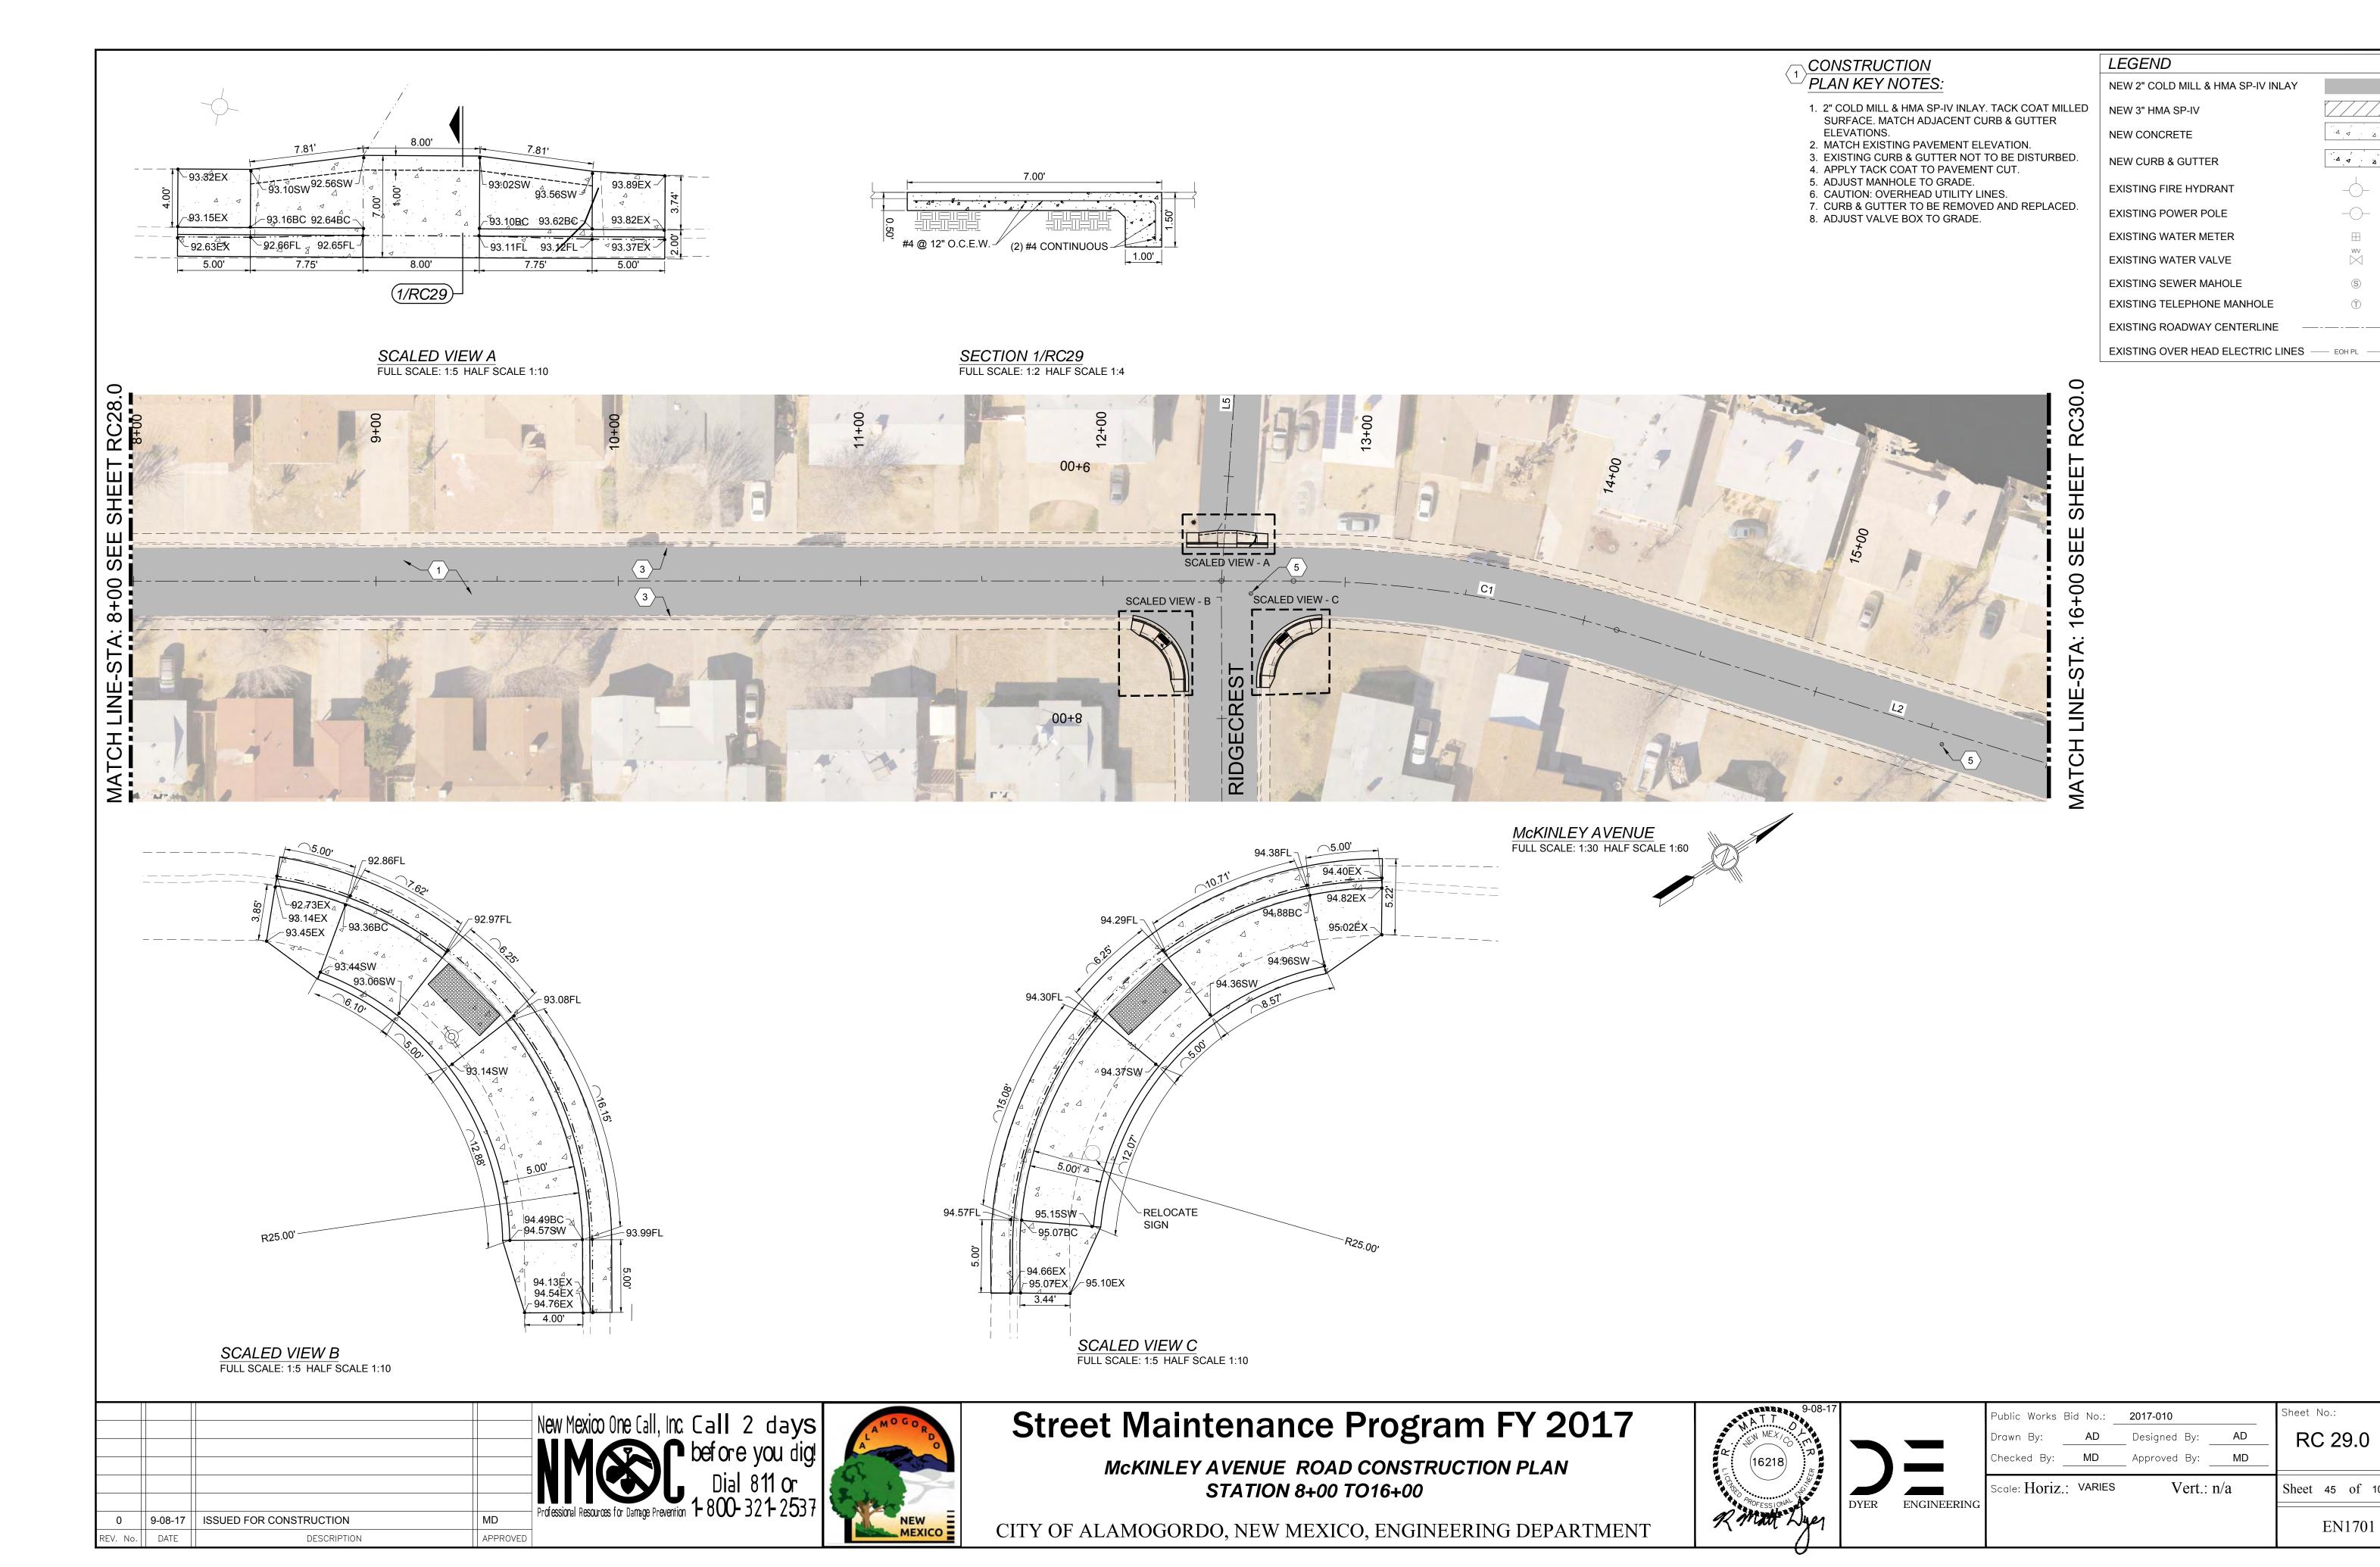
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### **Street Maintenance Program FY 2017**

McKINLEY AVENUE ROAD CONSTRUCTION PLAN STATION 16+00 TO24+00

CITY OF ALAMOGORDO, NEW MEXICO, ENGINEERING DEPARTMENT

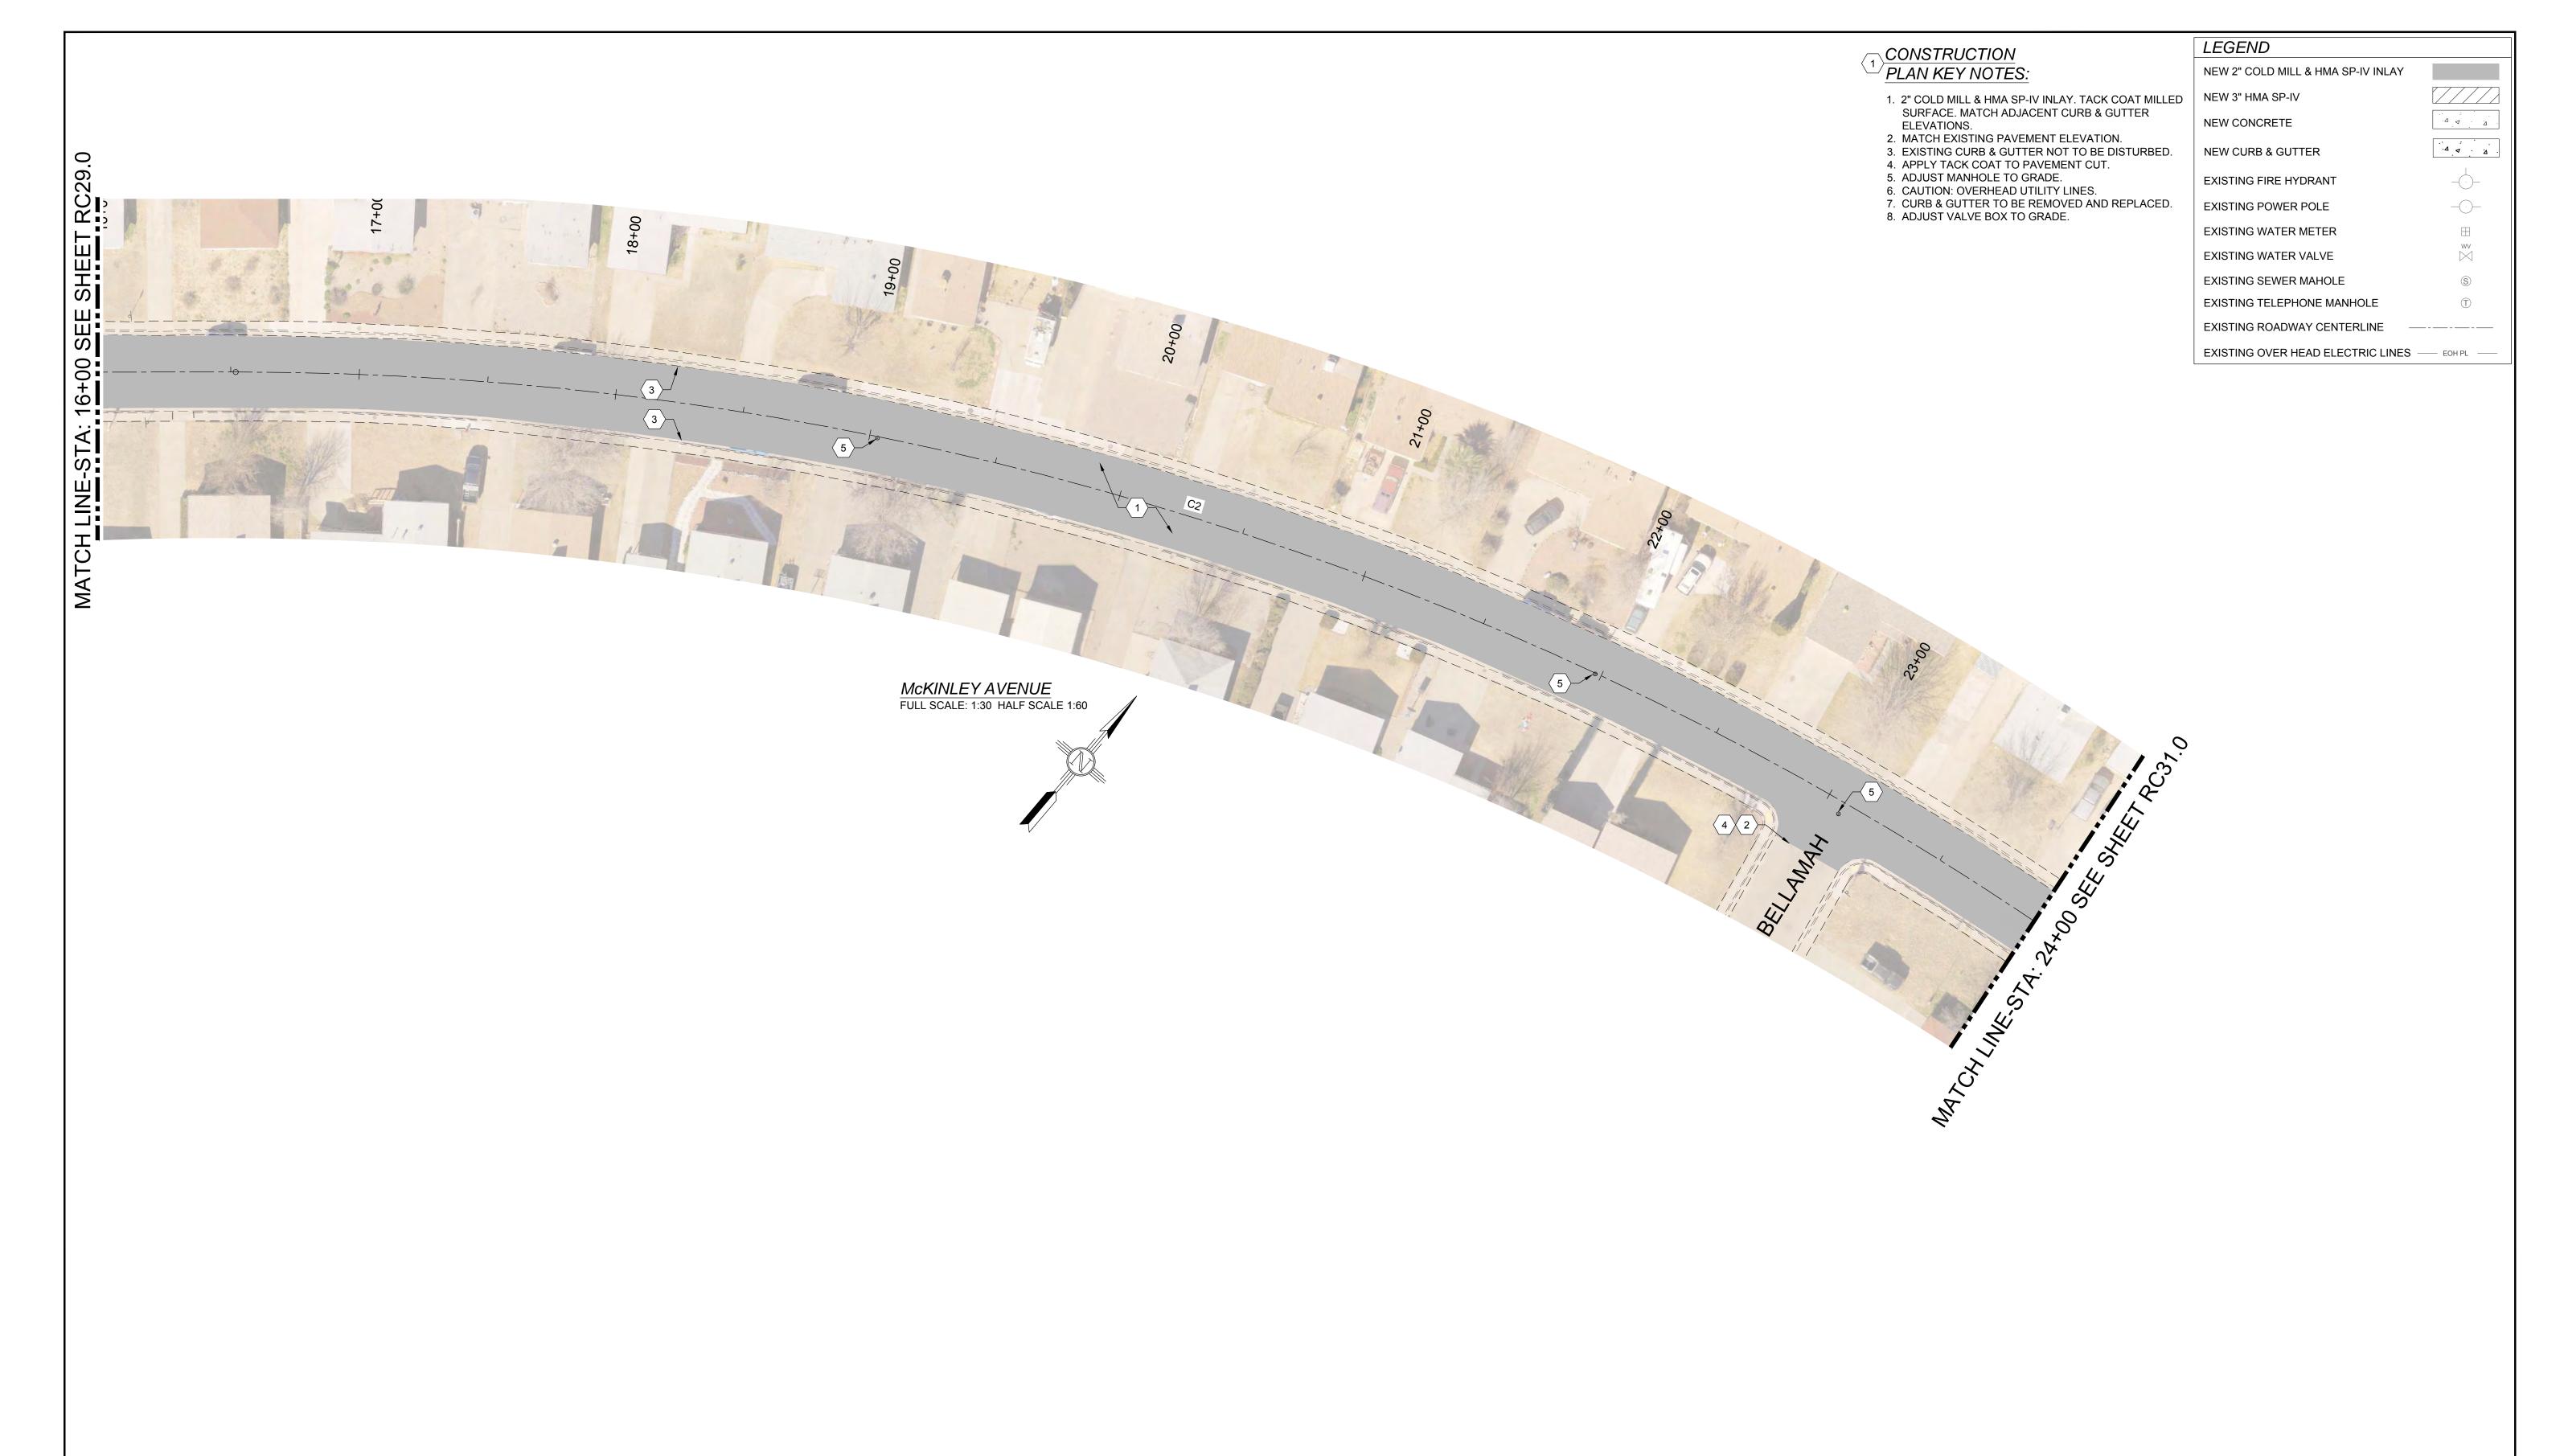


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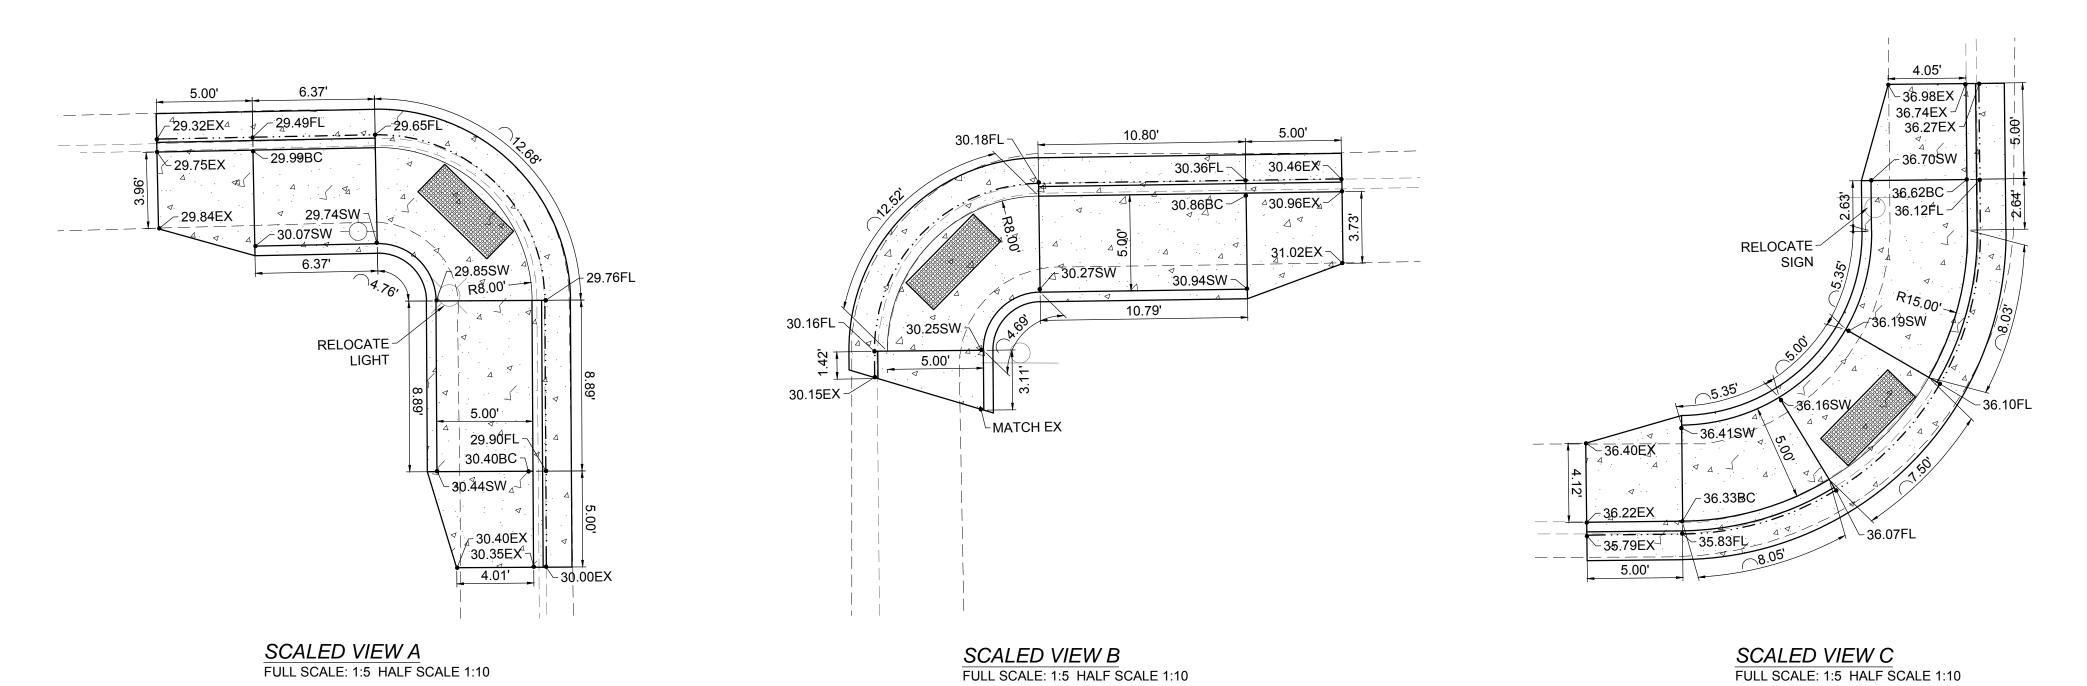
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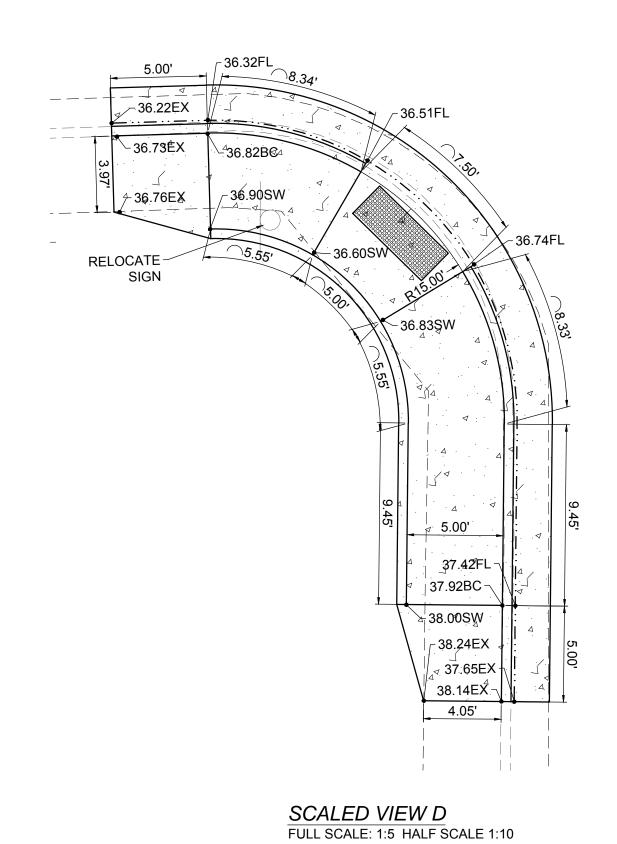
Sheet 46 of 10.

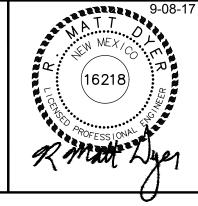EN1701





LEGEND NEW 2" COLD MILL & HMA SP-IV INLAY 1. 2" COLD MILL & HMA SP-IV INLAY. TACK COAT MILLED NEW 3" HMA SP-IV NEW CONCRETE Δ 4 . Δ 3. EXISTING CURB & GUTTER NOT TO BE DISTURBED. **NEW CURB & GUTTER** Δ 4 . Δ EXISTING FIRE HYDRANT 7. CURB & GUTTER TO BE REMOVED AND REPLACED. **EXISTING POWER POLE** 9. SAWCUT AND BEGIN MILL-INLAY, 2' INTO EXISTING **EXISTING WATER METER EXISTING WATER VALVE** EXISTING SEWER MAHOLE EXISTING TELEPHONE MANHOLE EXISTING ROADWAY CENTERLINE EXISTING OVER HEAD ELECTRIC LINES — EOH PL —

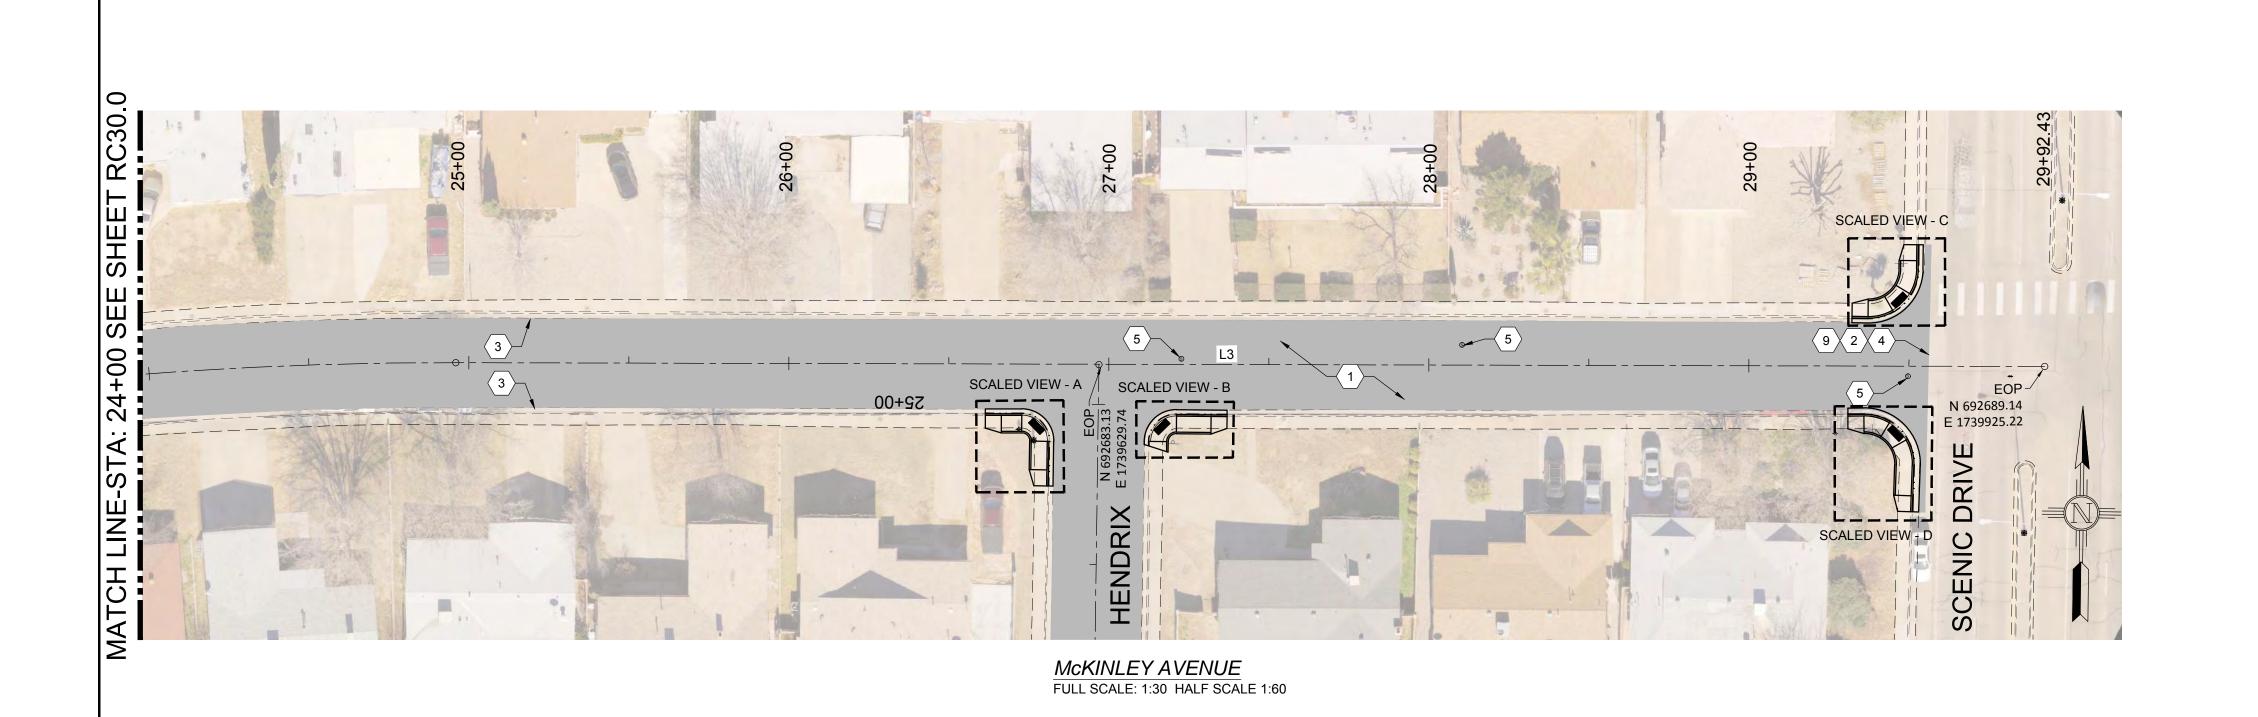

ENGINEERING

CONSTRUCTION

ELEVATIONS.

PLAN KEY NOTES:

SURFACE. MATCH ADJACENT CURB & GUTTER

2. MATCH EXISTING PAVEMENT ELEVATION.

4. APPLY TACK COAT TO PAVEMENT CUT.

6. CAUTION: OVERHEAD UTILITY LINES.

5. ADJUST MANHOLE TO GRADE.

8. ADJUST VALVE BOX TO GRADE.

INTERSECTION HMA.

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Sheet 47 of 103

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CITY OF ALAMOGORDO, NEW MEXICO, ENGINEERING DEPARTMENT


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## **Street Maintenance Program FY 2017**

McKINLEY AVENUE ROAD CONSTRUCTION PLAN STATION 24+00 TO29+54




### CONSTRUCTION PLAN KEY NOTES:

3. EXISTING FENCE TO REMAIN. CONTRACTOR SHALL COORDINATE TIE IN TO

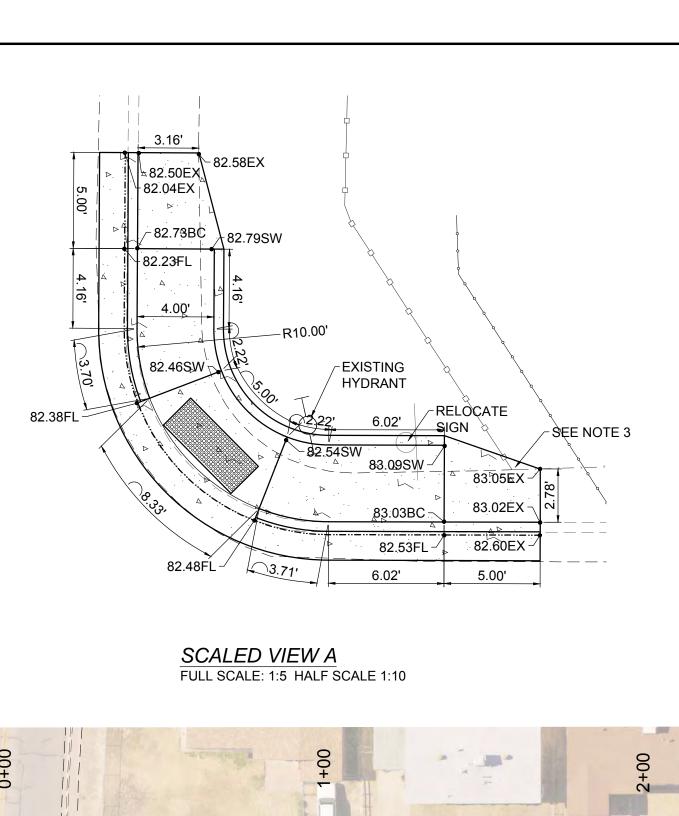EXISTING SIDEWALK SUCH THAT IT CONFORMS TO EXISTING FENCE.


- 1. 2" COLD MILL & HMA SP-IV INLAY. TACK COAT MILLED SURFACE. MATCH ADJACENT CURB & GUTTER ELEVATIONS.
- 2. MATCH EXISTING PAVEMENT ELEVATION.
- 3. EXISTING CURB & GUTTER NOT TO BE DISTURBED. 4. APPLY TACK COAT TO PAVEMENT CUT.
- 5. ADJUST MANHOLE TO GRADE.
- 6. CAUTION: OVERHEAD UTILITY LINES.
- 7. CURB & GUTTER TO BE REMOVED AND REPLACED. 8. ADJUST VALVE BOX TO GRADE.
- 9. SAWCUT AND BEGIN MILL-INLAY, 2' INTO EXISTING INTERSECTION HMA.

LEGEND NEW 2" COLD MILL & HMA SP-IV INLAY NEW 3" HMA SP-IV Δ Δ Δ **NEW CONCRETE** Δ 4 ... **NEW CURB & GUTTER** EXISTING FIRE HYDRANT EXISTING POWER POLE EXISTING WATER METER EXISTING WATER VALVE EXISTING SEWER MAHOLE EXISTING TELEPHONE MANHOLE EXISTING ROADWAY CENTERLINE EXISTING OVER HEAD ELECTRIC LINES — EOH PL —

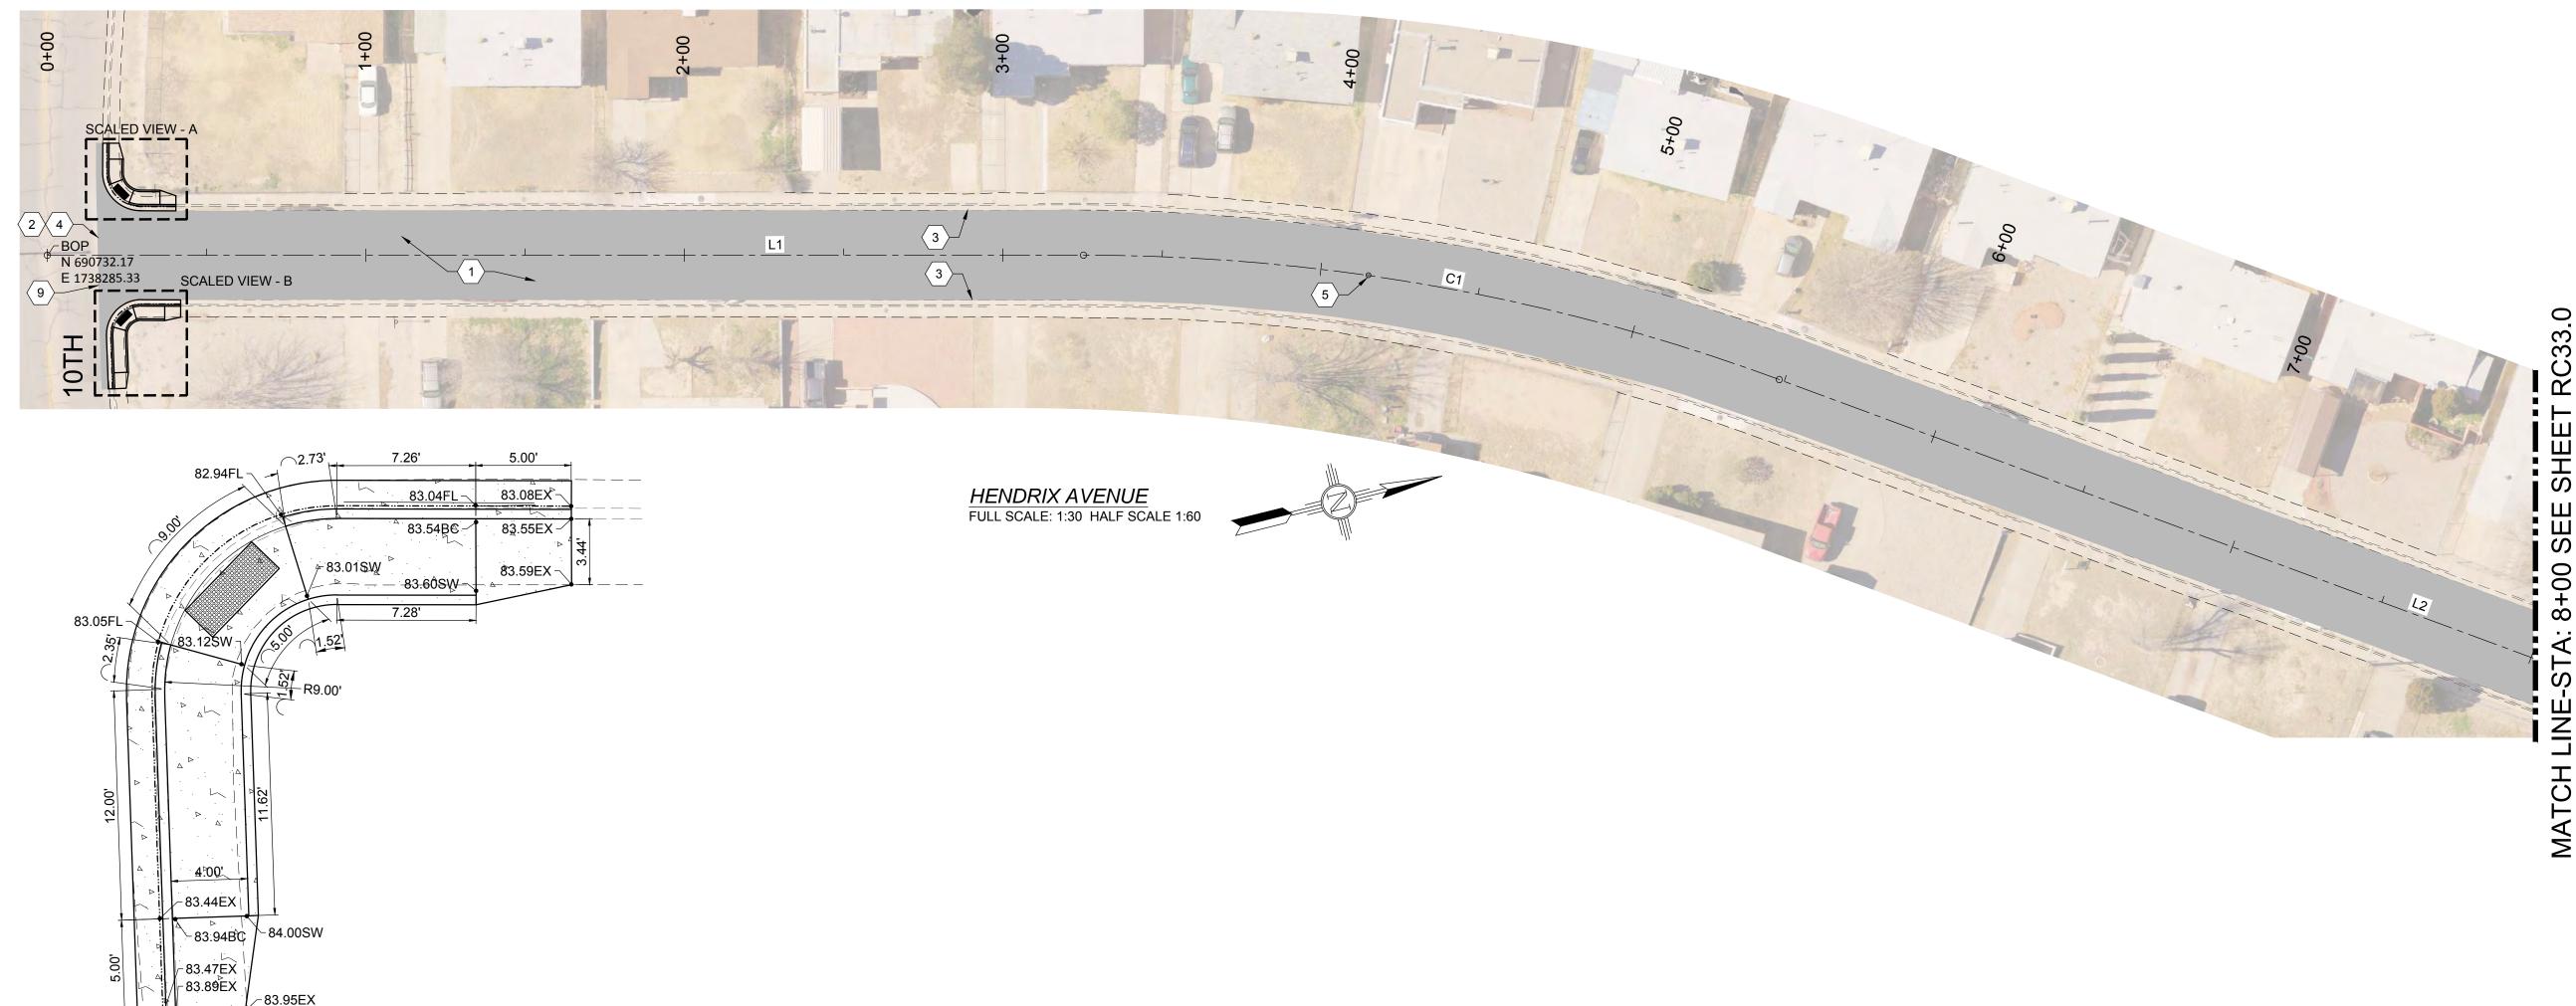

SCALED VIEW B
FULL SCALE: 1:5 HALF SCALE 1:10

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REV No	DATE	DESCRIPTION	APPROVED	

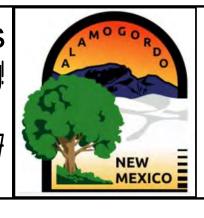

# **Street Maintenance Program FY 2017**


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HENDRIX AVENUE ROAD CONSTRUCTION PLAN STATION 0+18 TO 8+00

CITY OF ALAMOGORDO, NEW MEXICO, ENGINEERING DEPARTMENT



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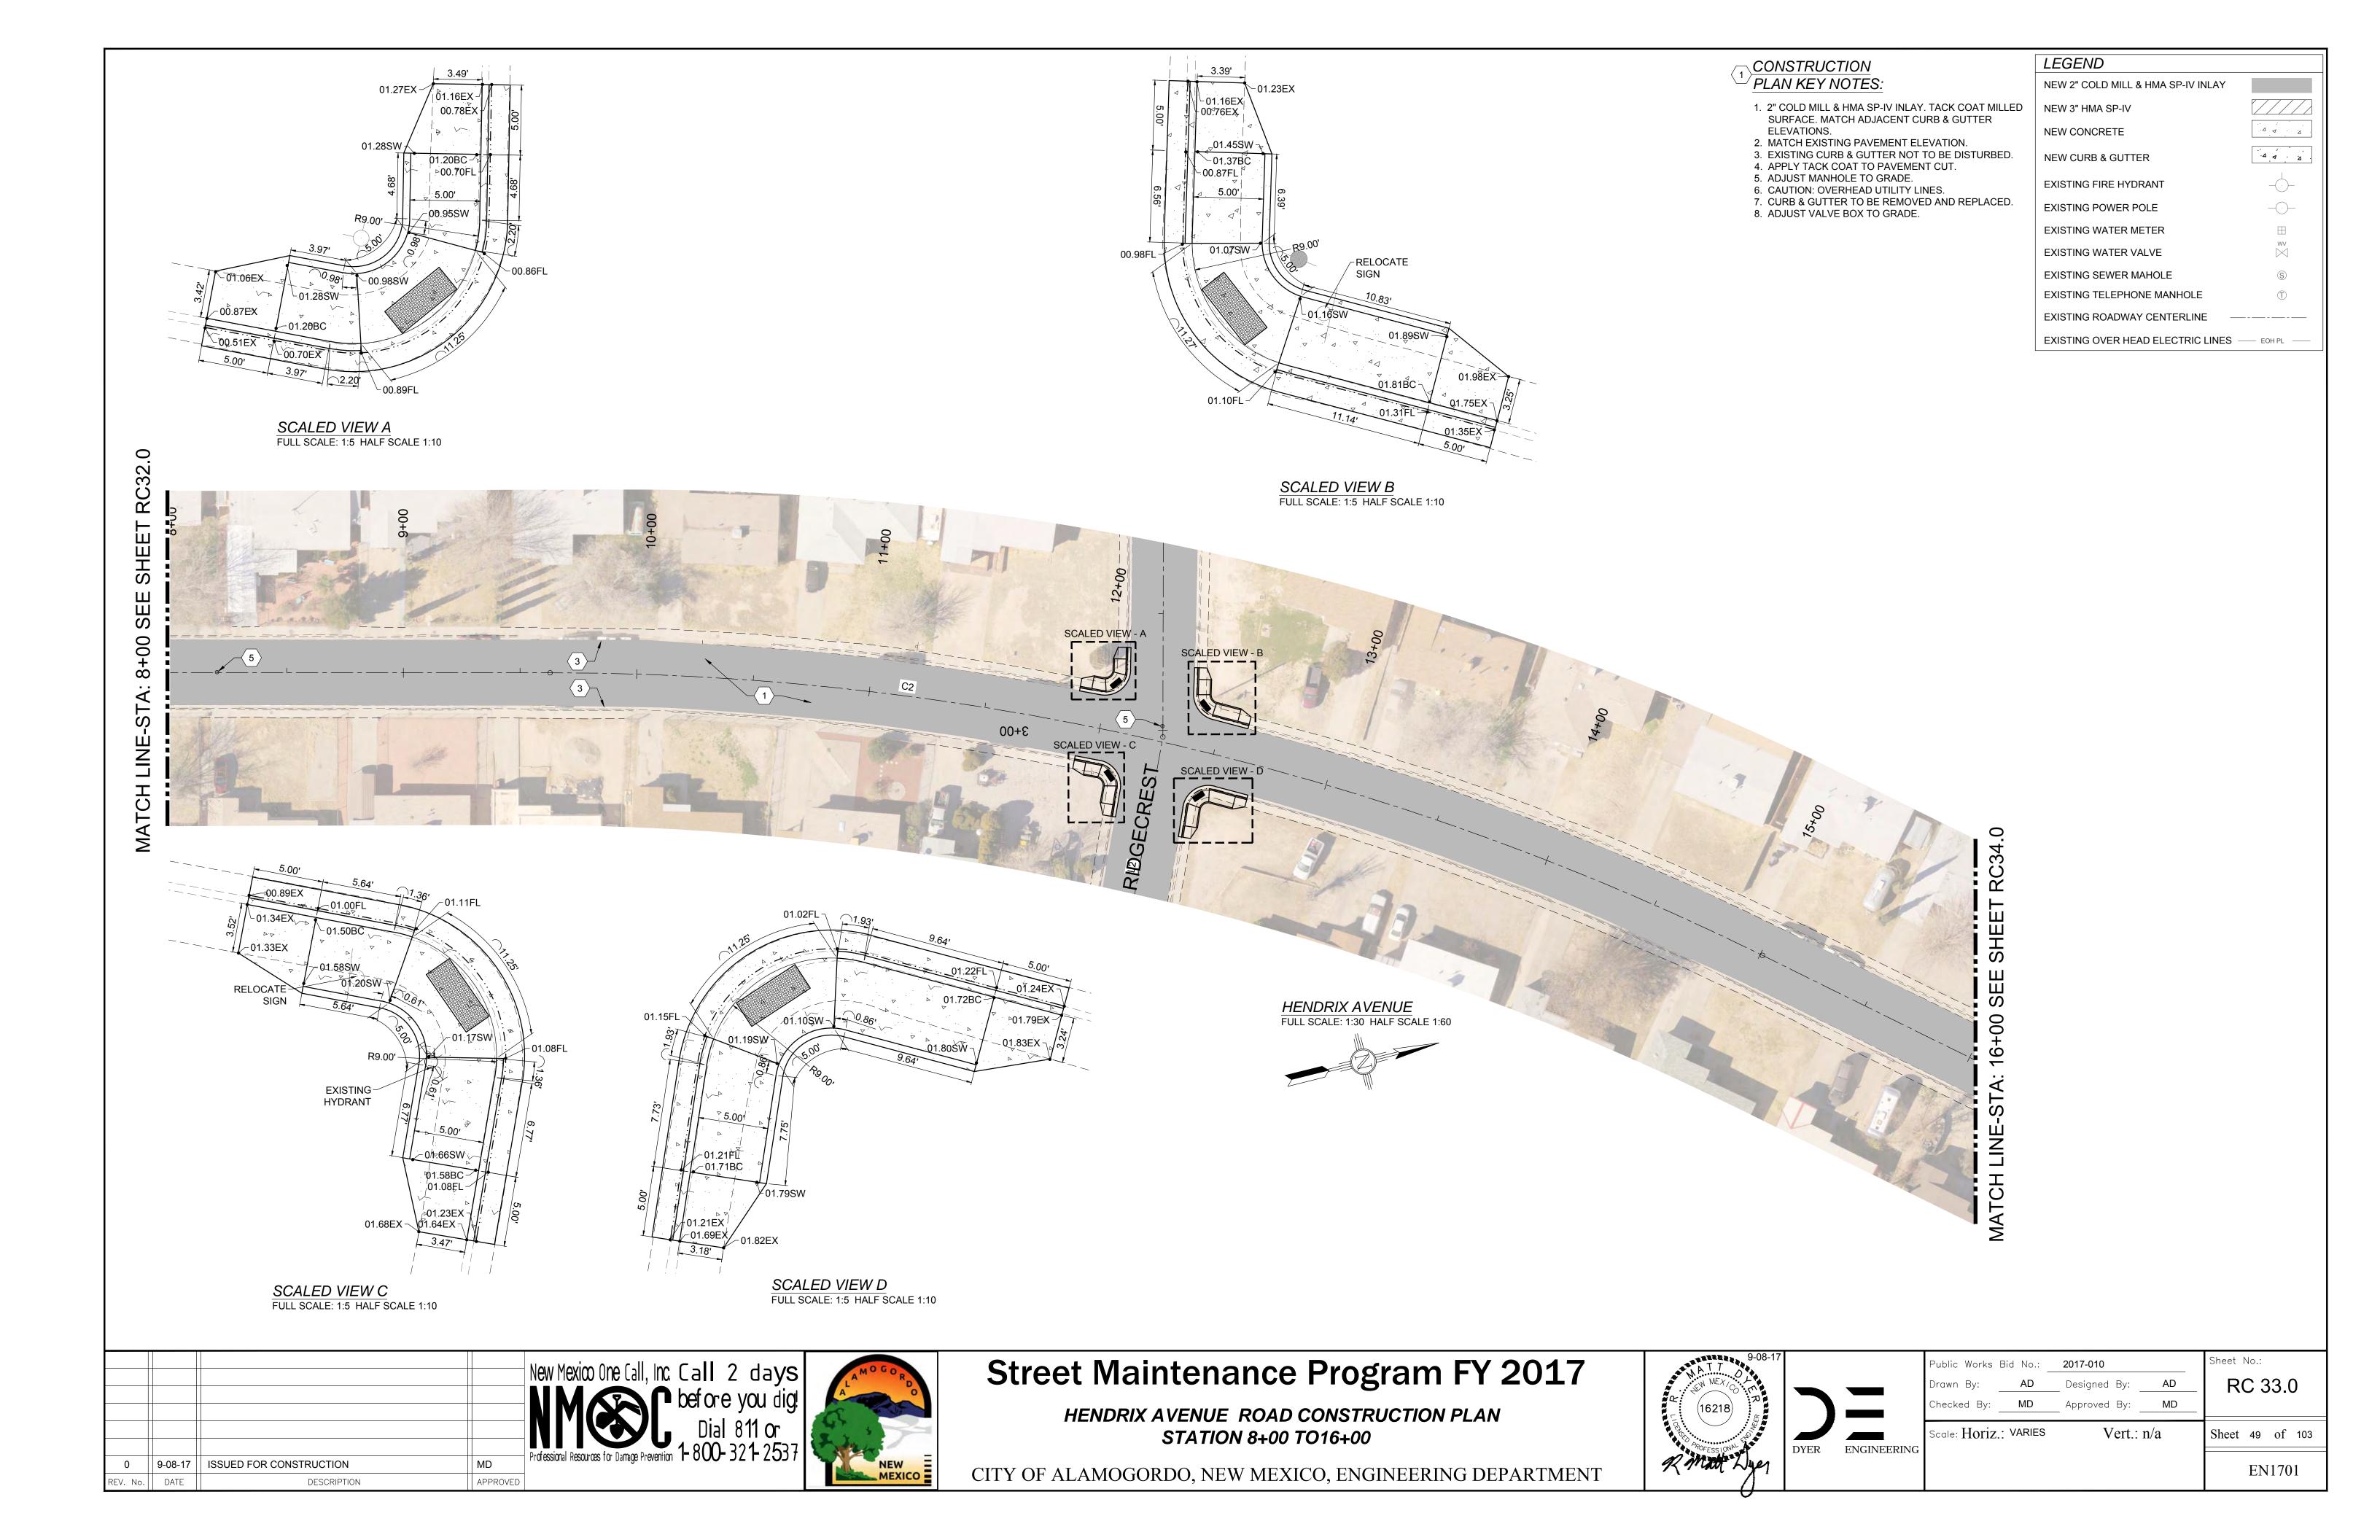
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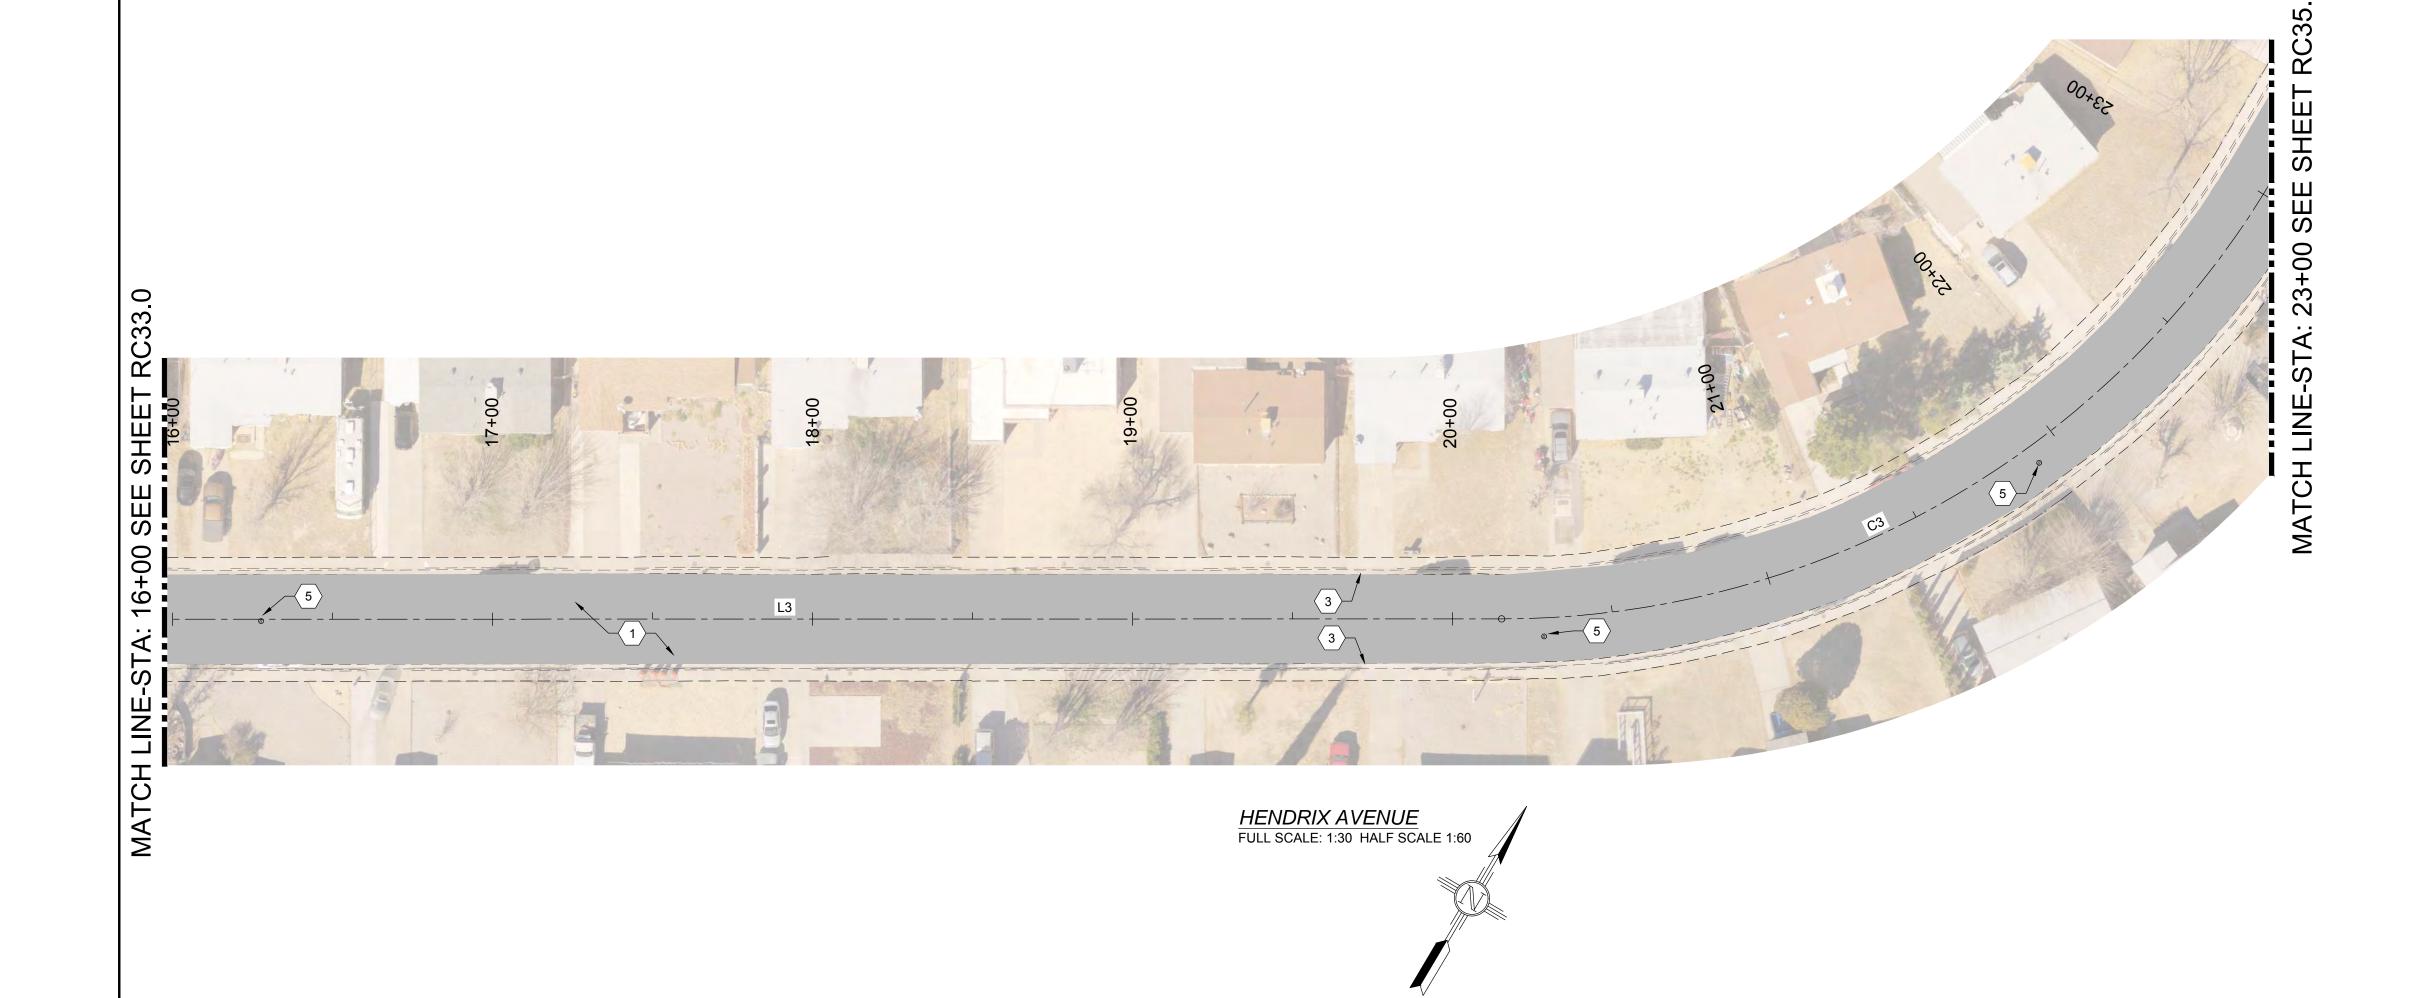
Sheet 48 of 103



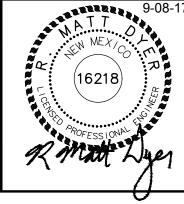


- 2" COLD MILL & HMA SP-IV INLAY. TACK COAT MILLED SURFACE. MATCH ADJACENT CURB & GUTTER ELEVATIONS.
   MATCH EXISTING PAVEMENT ELEVATION.
- 3. EXISTING CURB & GUTTER NOT TO BE DISTURBED. 4. APPLY TACK COAT TO PAVEMENT CUT.
- 5. ADJUST MANHOLE TO GRADE.
- 6. CAUTION: OVERHEAD UTILITY LINES.
- 7. CURB & GUTTER TO BE REMOVED AND REPLACED. 8. ADJUST VALVE BOX TO GRADE.

	LEGEND	
	NEW 2" COLD MILL & HMA SP-IV INLAY	
.ED	NEW 3" HMA SP-IV	
	NEW CONCRETE	Δ Δ Δ
).	NEW CURB & GUTTER	Δ Δ . Δ .
	EXISTING FIRE HYDRANT	
).	EXISTING POWER POLE	<u> </u>
	EXISTING WATER METER	$\boxplus$
	EXISTING WATER VALVE	wv 
	EXISTING SEWER MAHOLE	<u>s</u>
	EXISTING TELEPHONE MANHOLE	T
	EXISTING ROADWAY CENTERLINE —	
	EXISTING OVER HEAD ELECTRIC LINES -	EOH PL



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# **Street Maintenance Program FY 2017**

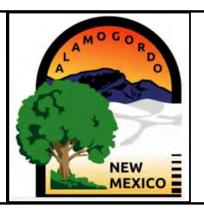HENDRIX AVENUE ROAD CONSTRUCTION PLAN STATION 16+00 TO23+00

CITY OF ALAMOGORDO, NEW MEXICO, ENGINEERING DEPARTMENT


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SCALED VIEW A

FULL SCALE: 1:5 HALF SCALE 1:10

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3.13	31.47EX √31.68EX <sub>△</sub> ⊲	-31.51SW△ _	31,21BC 31,21BC 31,21BC 31,321BC 31,34SW 31,29SW 31,34SW 31,29SW 31,34SW 31,29SW 31,34SW 31,29SW 31,34SW 31,29SW 31,34SW 31,34	31.43SW	31.27EX	3.32'
	5.00'	5.00'	16.00'	5.00'	5.00'	

SCALED VIEW B
FULL SCALE: 1:5 HALF SCALE 1:10

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SCALED VIEW A \_\_\_\_\_\_
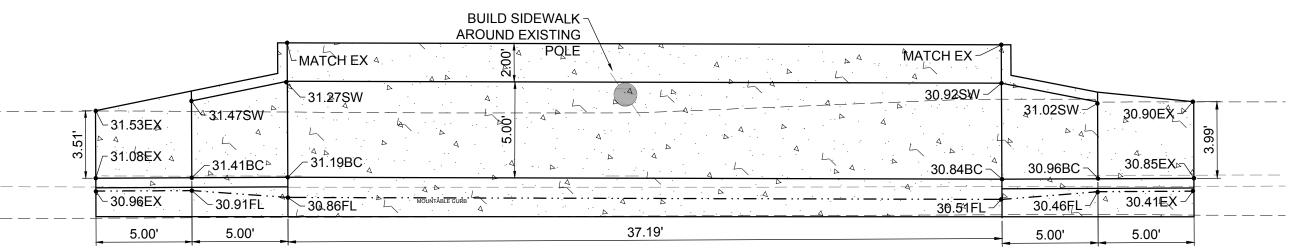
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HENDRIX AVENUE
FULL SCALE: 1:30 HALF SCALE 1:60


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# **Street Maintenance Program FY 2017**

HENDRIX AVENUE ROAD CONSTRUCTION PLAN STATION 23+00 TO 24+99

CITY OF ALAMOGORDO, NEW MEXICO, ENGINEERING DEPARTMENT



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LEGEND

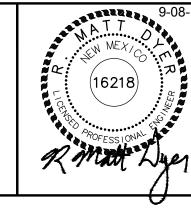NEW CONCRETE

NEW CURB & GUTTER

EXISTING FIRE HYDRANT

**EXISTING POWER POLE** 

EXISTING WATER METER

EXISTING WATER VALVE

EXISTING SEWER MAHOLE

EXISTING TELEPHONE MANHOLE

EXISTING ROADWAY CENTERLINE

EXISTING OVER HEAD ELECTRIC LINES — EOH PL —

1. 2" COLD MILL & HMA SP-IV INLAY. TACK COAT MILLED NEW 3" HMA SP-IV

SURFACE. MATCH ADJACENT CURB & GUTTER

3. EXISTING CURB & GUTTER NOT TO BE DISTURBED.

7. CURB & GUTTER TO BE REMOVED AND REPLACED.

2. MATCH EXISTING PAVEMENT ELEVATION.

4. APPLY TACK COAT TO PAVEMENT CUT.

6. CAUTION: OVERHEAD UTILITY LINES.

5. ADJUST MANHOLE TO GRADE.

8. ADJUST VALVE BOX TO GRADE.


NEW 2" COLD MILL & HMA SP-IV INLAY


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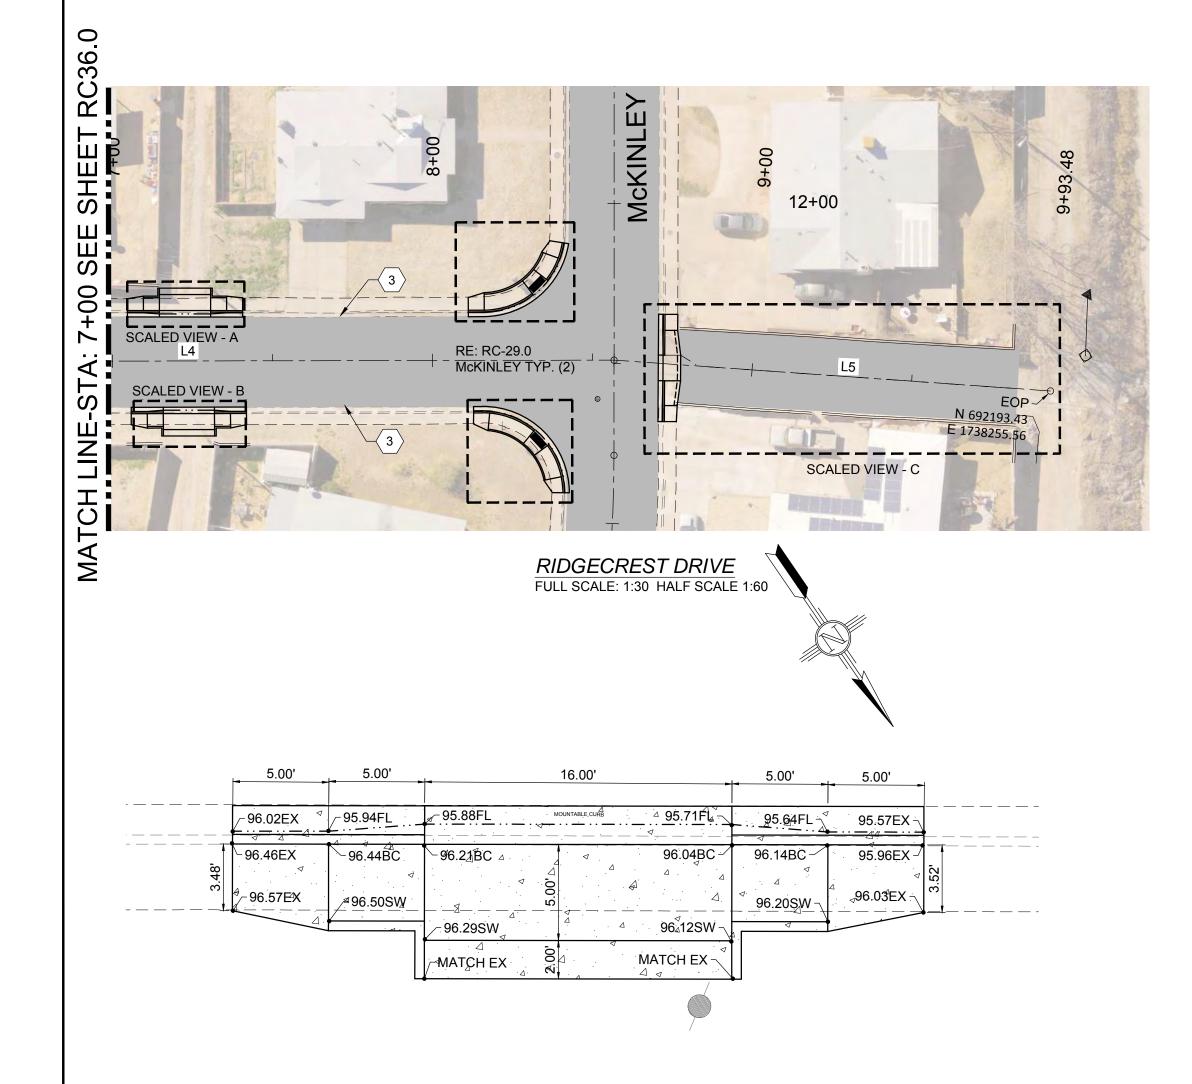
CONSTRUCTION PLAN KEY NOTES:

ELEVATIONS.



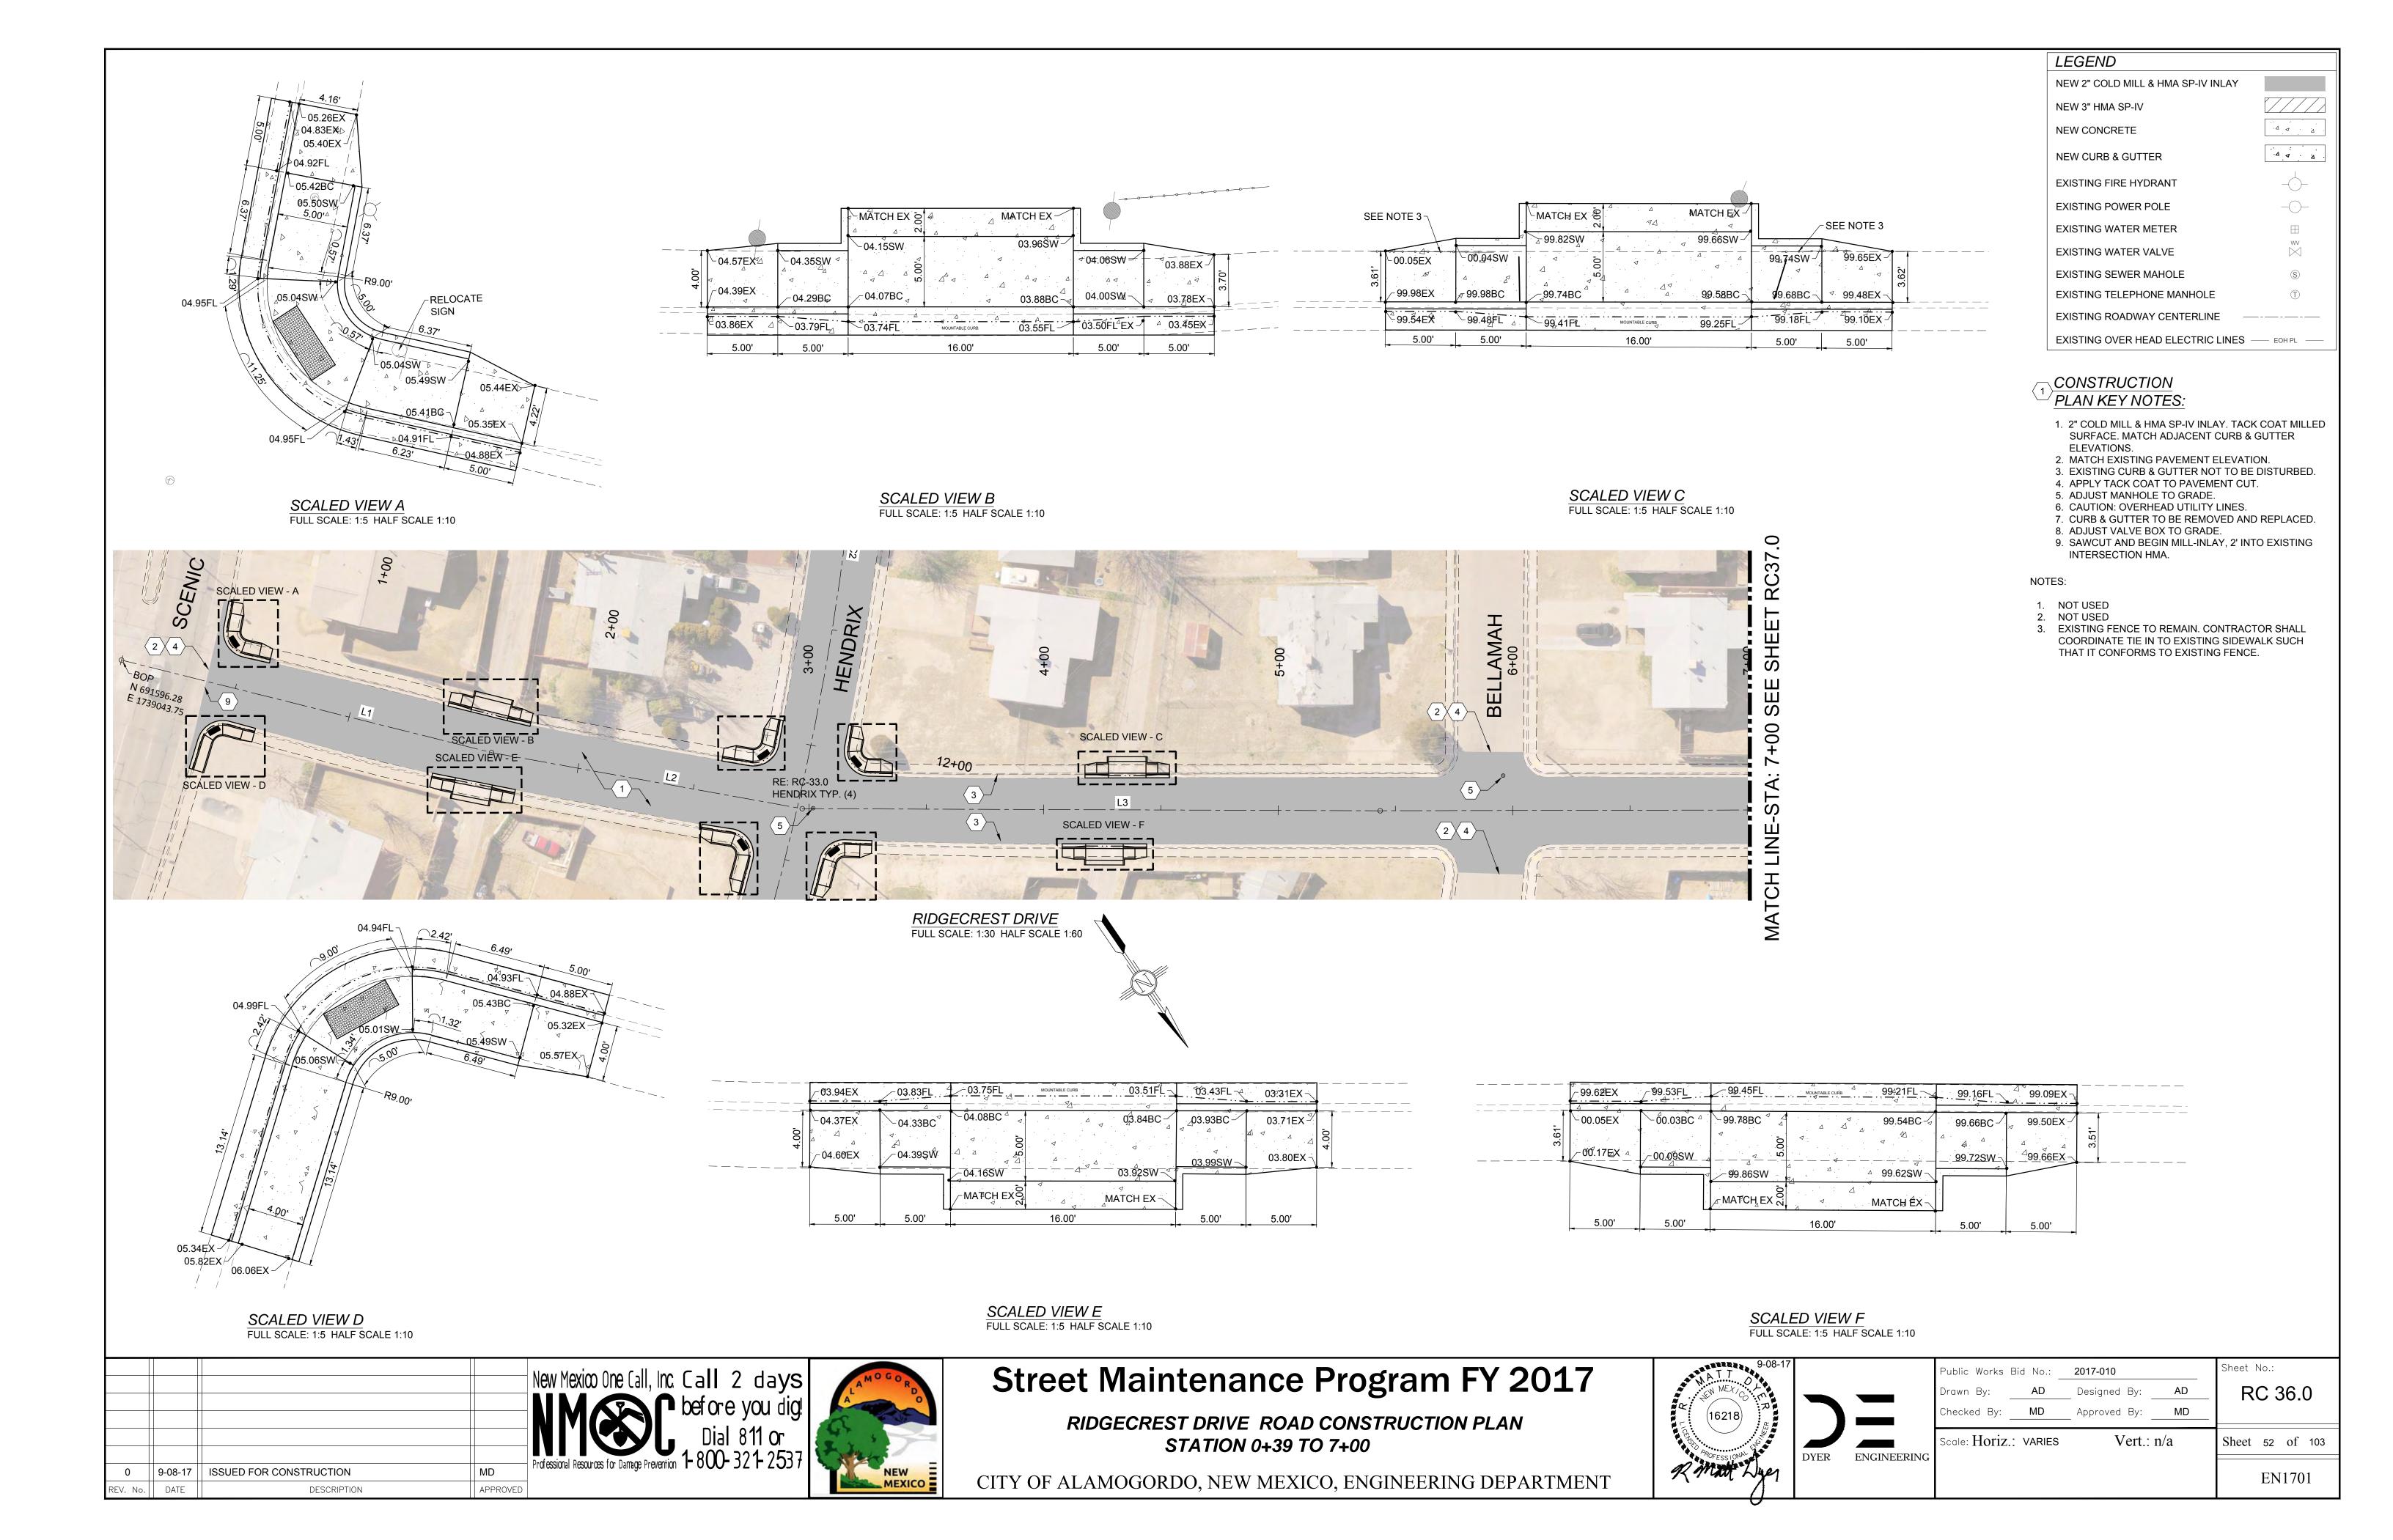

SCALED VIEW A FULL SCALE: 1:5 HALF SCALE 1:10

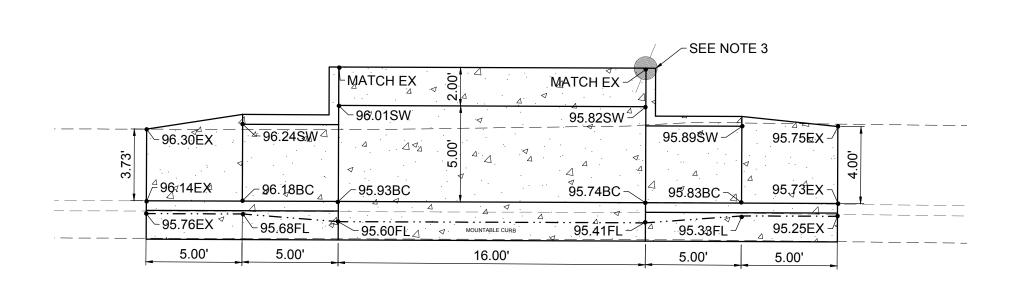

SCALED VIEW B FULL SCALE: 1:5 HALF SCALE 1:10

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DESCRIPTION



# **Street Maintenance Program FY 2017**

NOTES:

1. NOT USED

NOT USED

DRAINAGE CHANNEL INLET.

3. CONTRACTOR TO MODIFY RETAINING CURB TO INCORPORATE EXISTING POLE.

5. SEE DRAWING RC-29 FOR DETAILS AND SECTION VIEWS OF THE CONCRETE

4. SEE DETAIL "CHANNEL PAVEMENT SECTION" ON SHEET D3.0 FOR THE PAVEMENT

CROSS SECTION TO BE USED FOR THE DRAINAGE CHANNEL BETWEEN MCKINLEY


RIDGECREST DRIVE ROAD CONSTRUCTION PLAN **STATION 7+00 TO 9+93** 

CITY OF ALAMOGORDO, NEW MEXICO, ENGINEERING DEPARTMENT


### CONSTRUCTION PLAN KEY NOTES:

- 1. 2" COLD MILL & HMA SP-IV INLAY. TACK COAT MILLED SURFACE. MATCH ADJACENT CURB & GUTTER ELEVATIONS.
- 2. MATCH EXISTING PAVEMENT ELEVATION.
- 3. EXISTING CURB & GUTTER NOT TO BE DISTURBED. 4. APPLY TACK COAT TO PAVEMENT CUT.
- 5. ADJUST MANHOLE TO GRADE.
- 6. CAUTION: OVERHEAD UTILITY LINES. 7. CURB & GUTTER TO BE REMOVED AND REPLACED.
- 8. ADJUST VALVE BOX TO GRADE.

	LEGEND	
	NEW 2" COLD MILL & HMA SP-IV INLAY	
)	NEW 3" HMA SP-IV	
	NEW CONCRETE	· Δ · Δ ·
	NEW CURB & GUTTER	Δ Δ Δ
	EXISTING FIRE HYDRANT	<u> </u>
	EXISTING POWER POLE	<del>-</del>
	EXISTING WATER METER	
	EXISTING WATER VALVE	wv 
	EXISTING SEWER MAHOLE	S
	EXISTING TELEPHONE MANHOLE	T
	EXISTING ROADWAY CENTERLINE —	
	EXISTING OVER HEAD ELECTRIC LINES	—— EOH PL ——

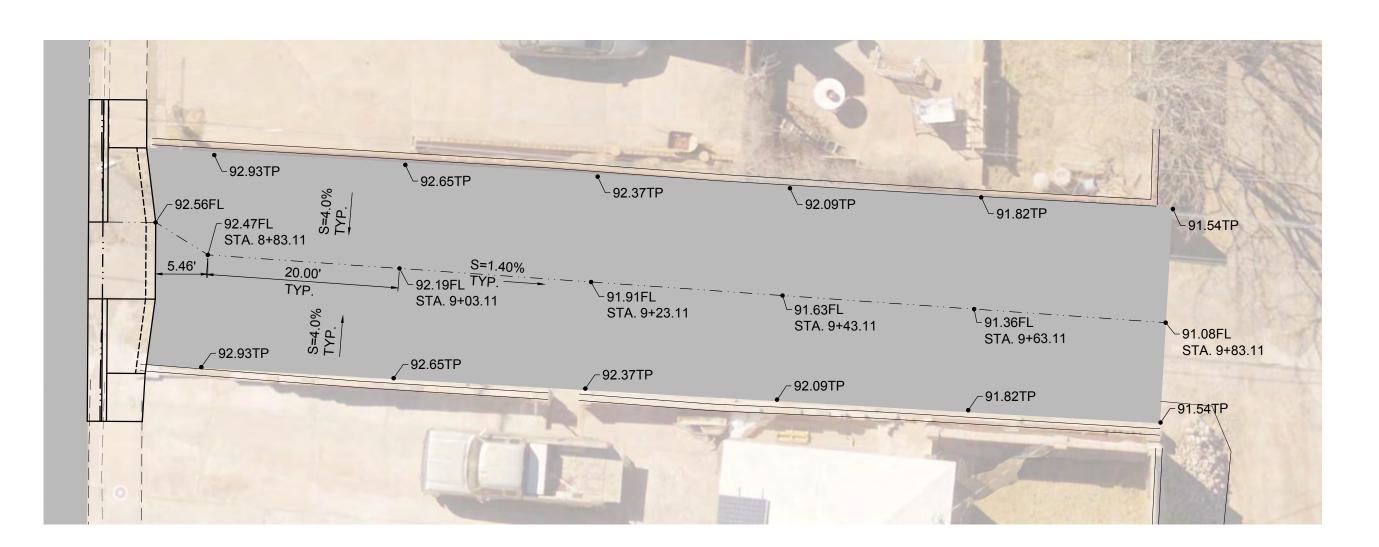

SCALED VIEW C FULL SCALE: 1:10 HALF SCALE 1:20

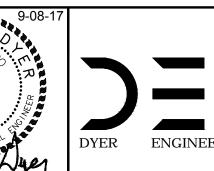


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Sheet 53 of 103 EN1701



# CONSTRUCTION PLAN KEY NOTES:

- 1. NEW 4" SOLID WHITE LINE.
- WHITE LANE USAGE ARROW LEFT
   WHITE LANE USAGE ARROW STRAIGHT RIGHT
- 4. WHITE LANE USAGE "ONLY".
- 5. 24" SOLID WHITE STOP BAR 4' FROM CROSSWALK
- 6. 24" SOLID WHITE CROSSWALK
- 7. DOUBLE 4" WIDE, SOLID YELLOW LINES.
- 8. 4" CENTERLINE DASHED YELLOW LINE.

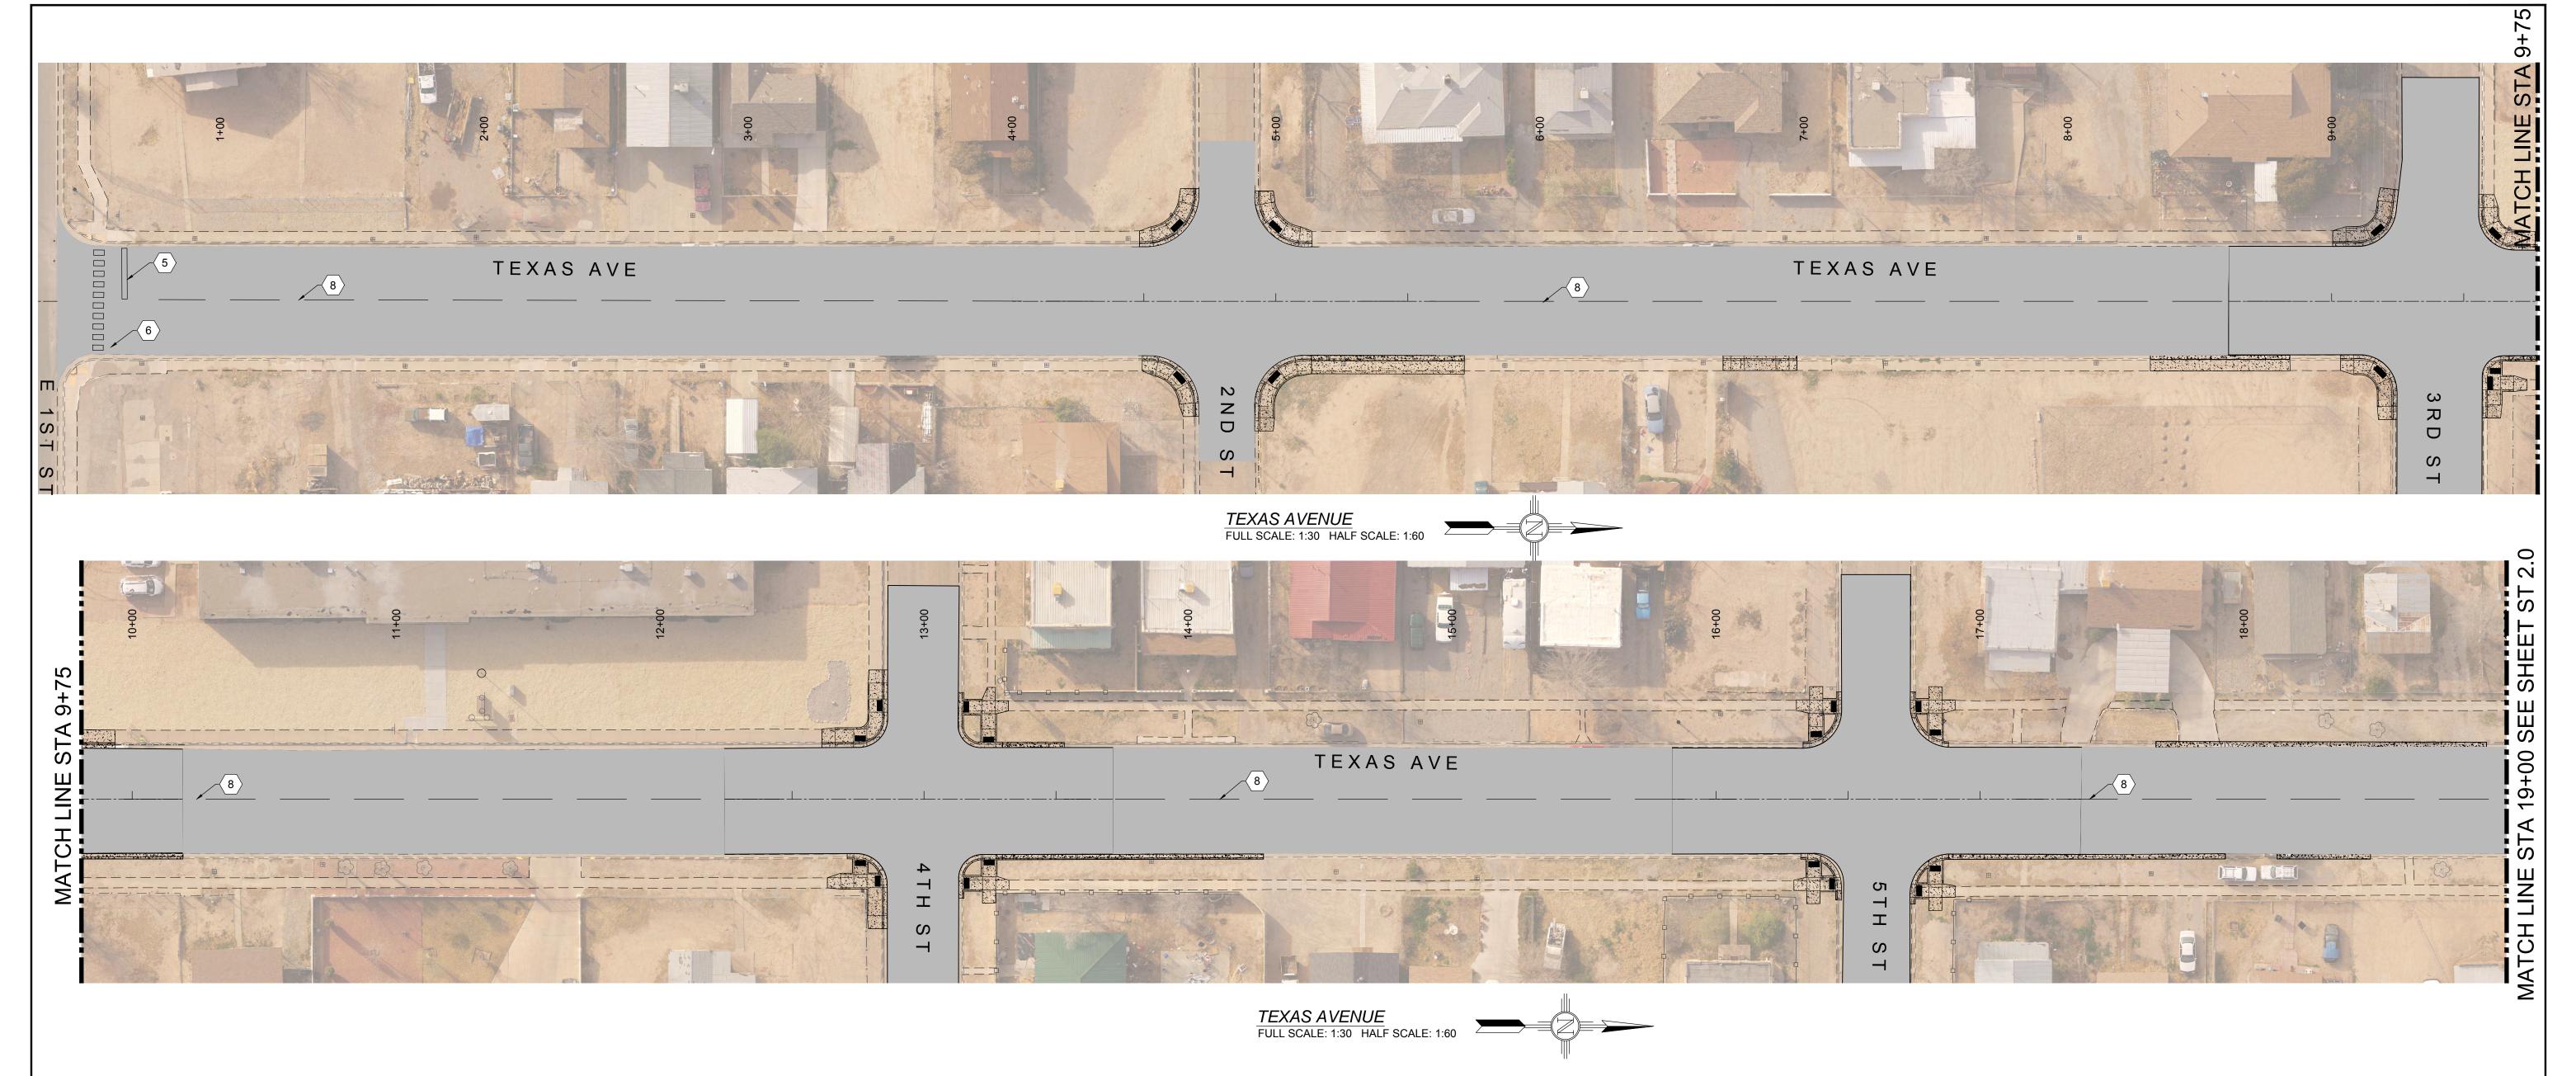LEGEND	
NEW 2" COLD MILL & HMA SP-IV INLAY	
NEW 3" HMA SP-IV	
NEW CONCRETE	Δ Δ Δ
NEW CURB & GUTTER	Δ Δ Δ
EXISTING FIRE HYDRANT	
EXISTING POWER POLE	<u> </u>
EXISTING WATER METER	
EXISTING WATER VALVE	WV 
EXISTING SEWER MAHOLE	<u>(S)</u>
EXISTING ROADWAY CENTERLINE —	
EXISTING OVER HEAD ELECTRIC LINES -	EOH PL

# XISTING FIRE HYDRANT XISTING POWER POLE XISTING WATER METER XISTING WATER VALVE XISTING SEWER MAHOLE XISTING ROADWAY CENTERLINE XISTING OVER HEAD ELECTRIC LINES — EOH PL

1	12-21-17	AMENDMENT - 1	SC
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# Street Maintenance Program FY 2017

TEXAS AVENUE STRIPING PLAN STATION 0+00 TO 19+00

CITY OF ALAMOGORDO, NEW MEXICO, ENGINEERING DEPARTMENT

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l	Occam Engineers Inc.	F
	3400 HIGHWAY 180 EAST SUITE A SILVER CITY, NEW MEXICO 88061 (575) 538-5395 (OFFICE)	S

(575) 538-5410 (FAX)

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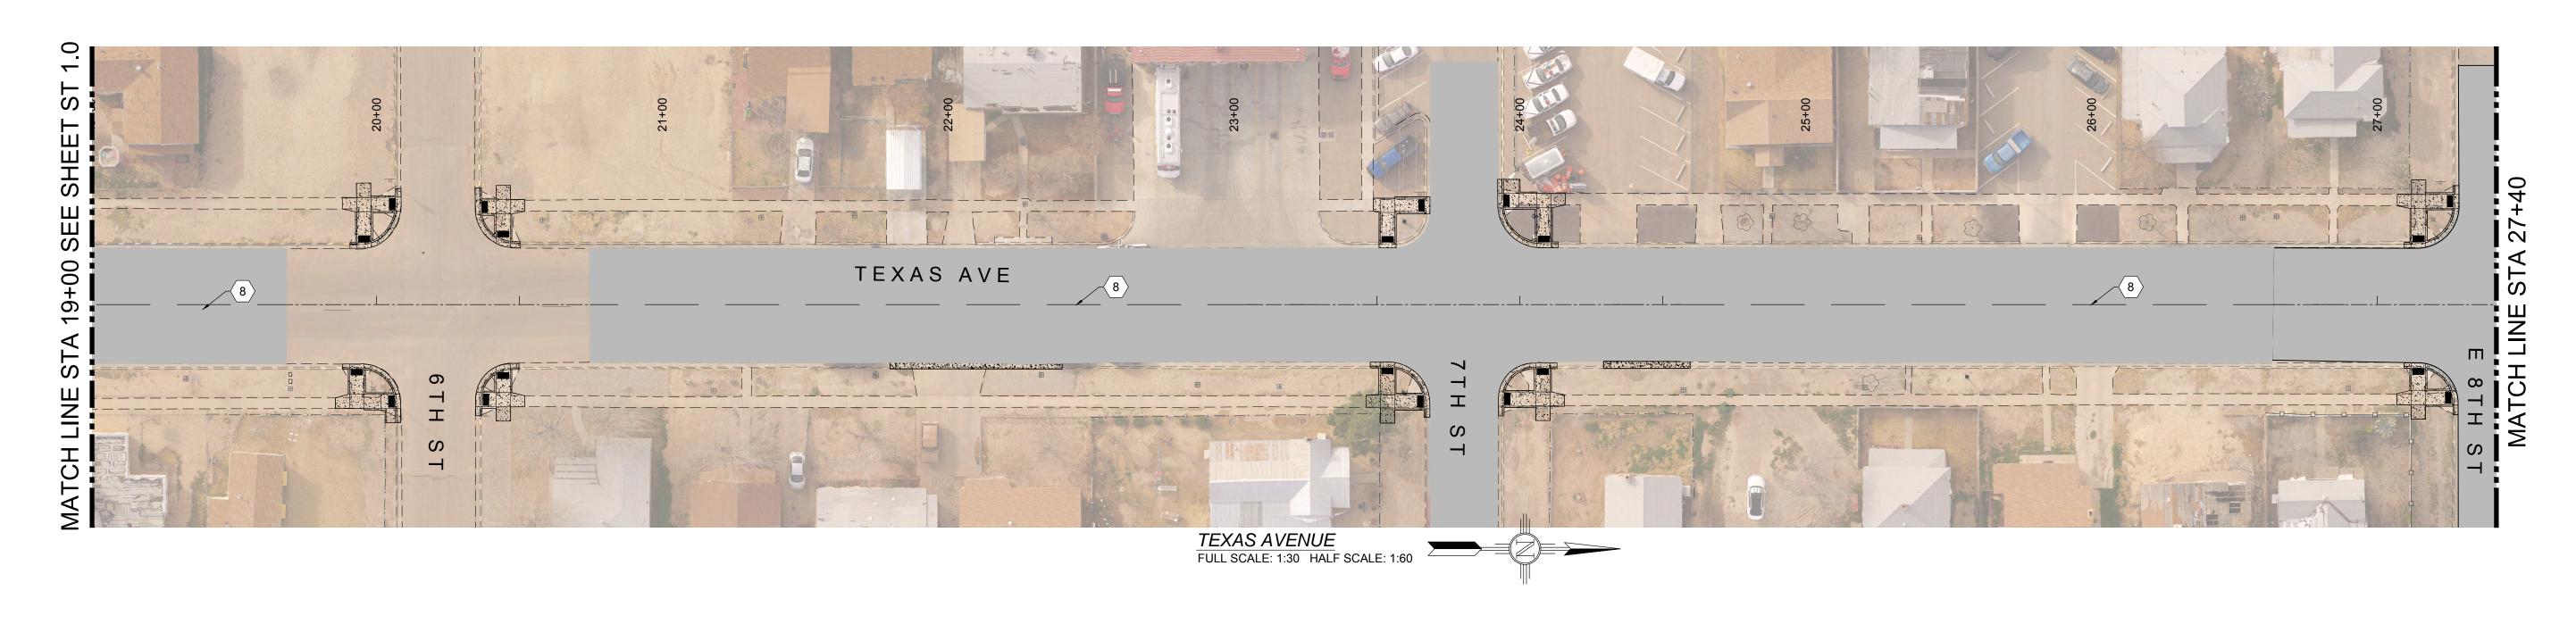
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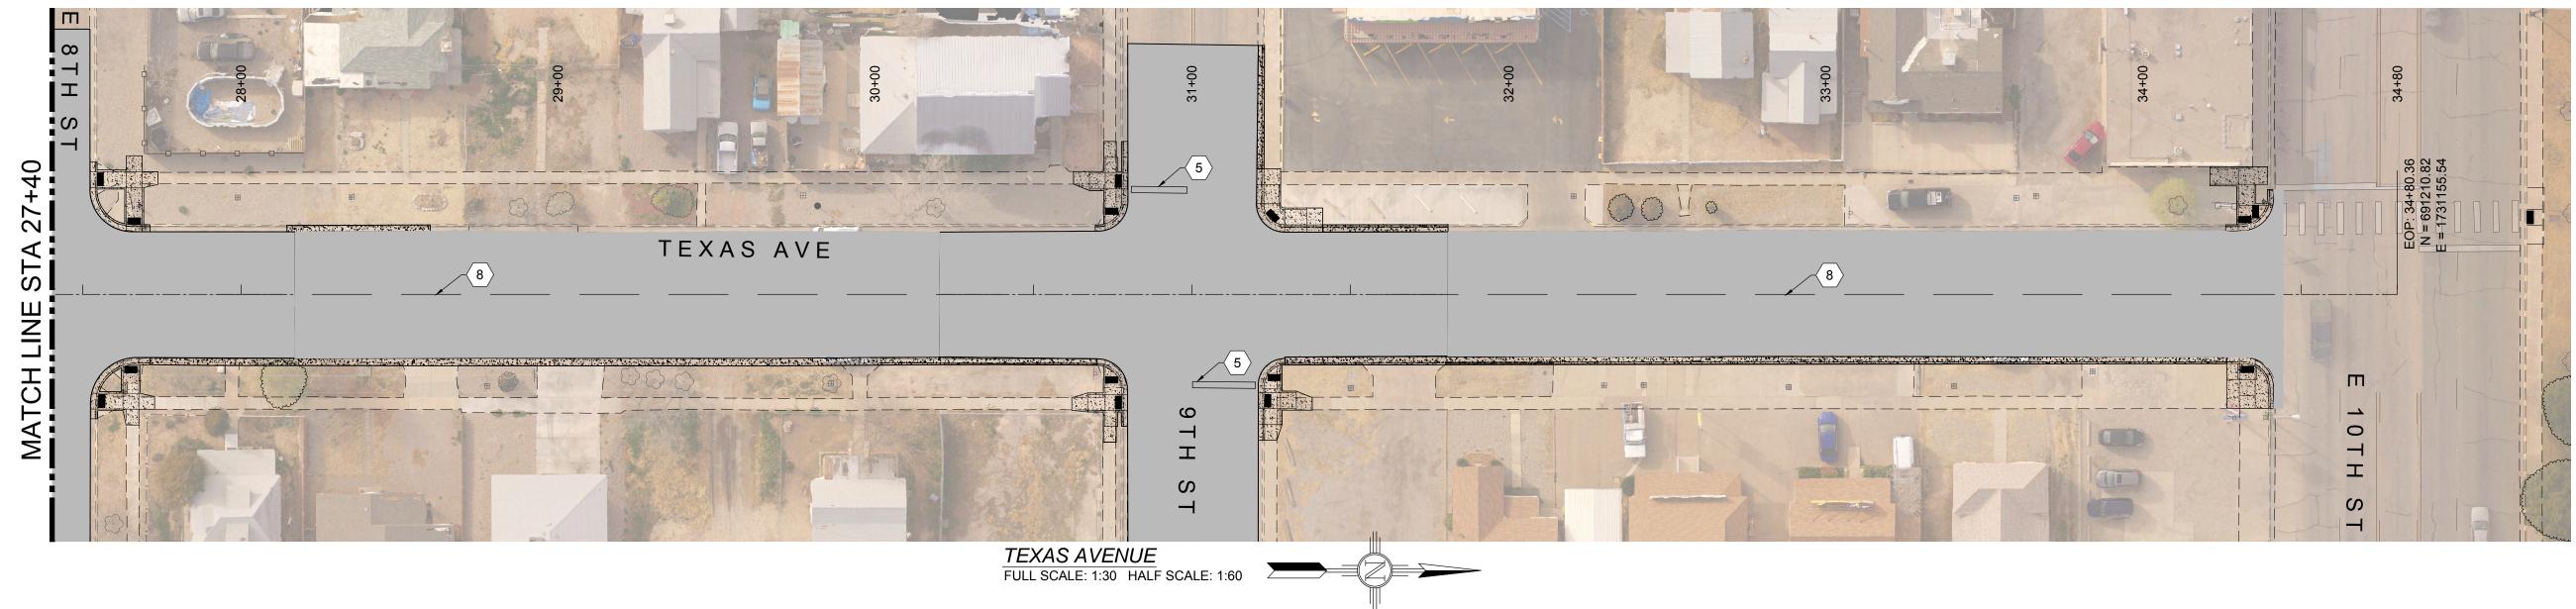
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EN1701

Sheet **54** of **103** 





### CONSTRUCTION PLAN KEY NOTES:

- 1. NEW 4" SOLID WHITE LINE.
- 2. WHITE LANE USAGE ARROW LEFT
- 3. WHITE LANE USAGE ARROW STRAIGHT RIGHT
- 4. WHITE LANE USAGE "ONLY".
- 5. 24" SOLID WHITE STOP BAR 4' FROM CROSSWALK
- 6. 24" SOLID WHITE CROSSWALK
- 7. DOUBLE 4" WIDE, SOLID YELLOW LINES.
- 8. 4" CENTERLINE DASHED YELLOW LINE.

NEW 2" COLD MILL & HMA SP-IV INLAY	
NEW 3" HMA SP-IV	
NEW CONCRETE	Δ Δ Δ
NEW CURB & GUTTER	Δ Δ Δ
EXISTING FIRE HYDRANT	
EXISTING POWER POLE	<u> </u>
EXISTING WATER METER	$\blacksquare$
EXISTING WATER VALVE	wv  >>
EXISTING SEWER MAHOLE	(\$)
EXISTING ROADWAY CENTERLINE -	
EXISTING OVER HEAD ELECTRIC LINES	—— EOH PL ——

				Nov Movice One Call Inc
				New Mexico One Call, Inc
				Professional Resources for Damage Preventio
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# **Street Maintenance Program FY 2017**

TEXAS AVENUE STRIPING PLAN STATION 19+00 TO 34+80

CITY OF ALAMOGORDO, NEW MEXICO, ENGINEERING DEPARTMENT

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Occam Engineers Inc.	Pu Dr Ch
3400 HIGHWAY 180 EAST SUITE A SILVER CITY, NEW MEXICO 88061 (575) 538-5395 (OFFICE)	Sc


(575) 538-5410 (FAX)


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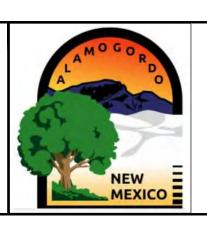
CONSTRUCTION PLAN KEY NOTES:

- 1. NEW 4" SOLID WHITE LINE
- 2. WHITE LANE USAGE ARROW LEFT 3. WHITE LANE USAGE ARROW - STRAIGHT - RIGHT
- 4. WHITE LANE USAGE "ONLY"
- 5. 24" SOLID WHITE STOP BAR 4' FROM CROSSWALK
- 6. 24" SOLID WHITE CROSSWALK 7. DOUBLE 4" WIDE, SOLID YELLOW LINES

8. 4" CENTERLINE DASHED YELLOW LINE

NEW 2" COLD MILL & HMA SP-IV INLAY		
NEW 3" HMA SP-IV		
NEW CONCRETE	Δ Δ Δ .	
NEW CURB & GUTTER	Δ Δ .	
EXISTING FIRE HYDRANT		
EXISTING POWER POLE	<u> </u>	
EXISTING WATER METER	⊞	
EXISTING WATER VALVE	wv 	
EXISTING SEWER MAHOLE	(S)	
EXISTING TELEPHONE MANHOLE	T	
EXISTING ROADWAY CENTERLINE -		
EXISTING OVER HEAD ELECTRIC LINES	—— EOH PL ——	

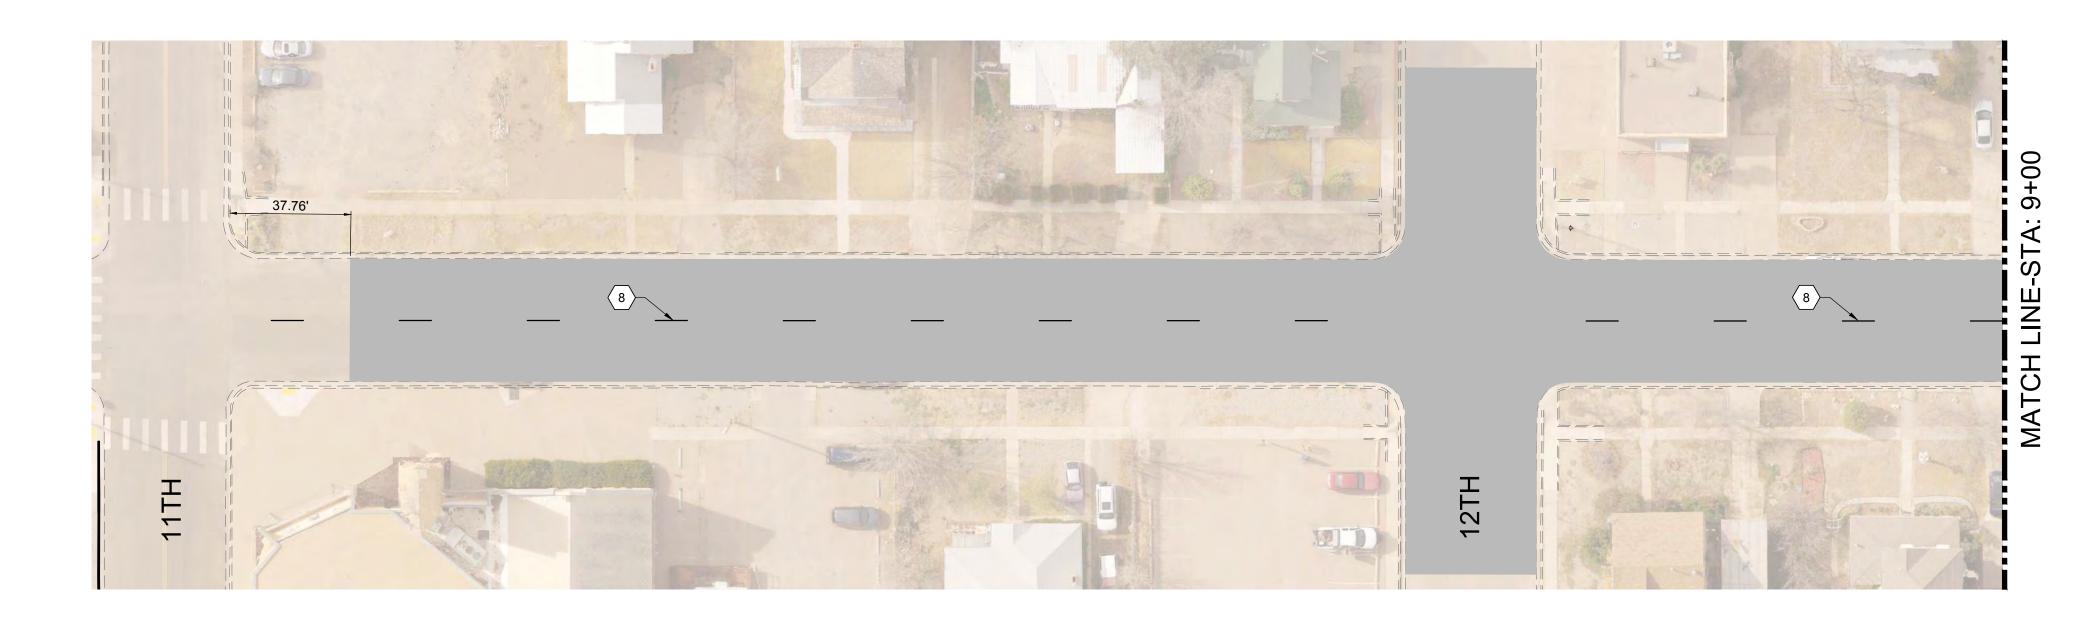
				New Mexico One Call, Inc. Call 2 days
				N before you dig!
				Professional Resources for Damage Prevention 1-800-321-2537
0	9-08-17	ISSUED FOR CONSTRUCTION	MD	Fidesidal Results to ballage rievalled   1 000 32   203
REV No	DATE	DESCRIPTION	APPROVED.	

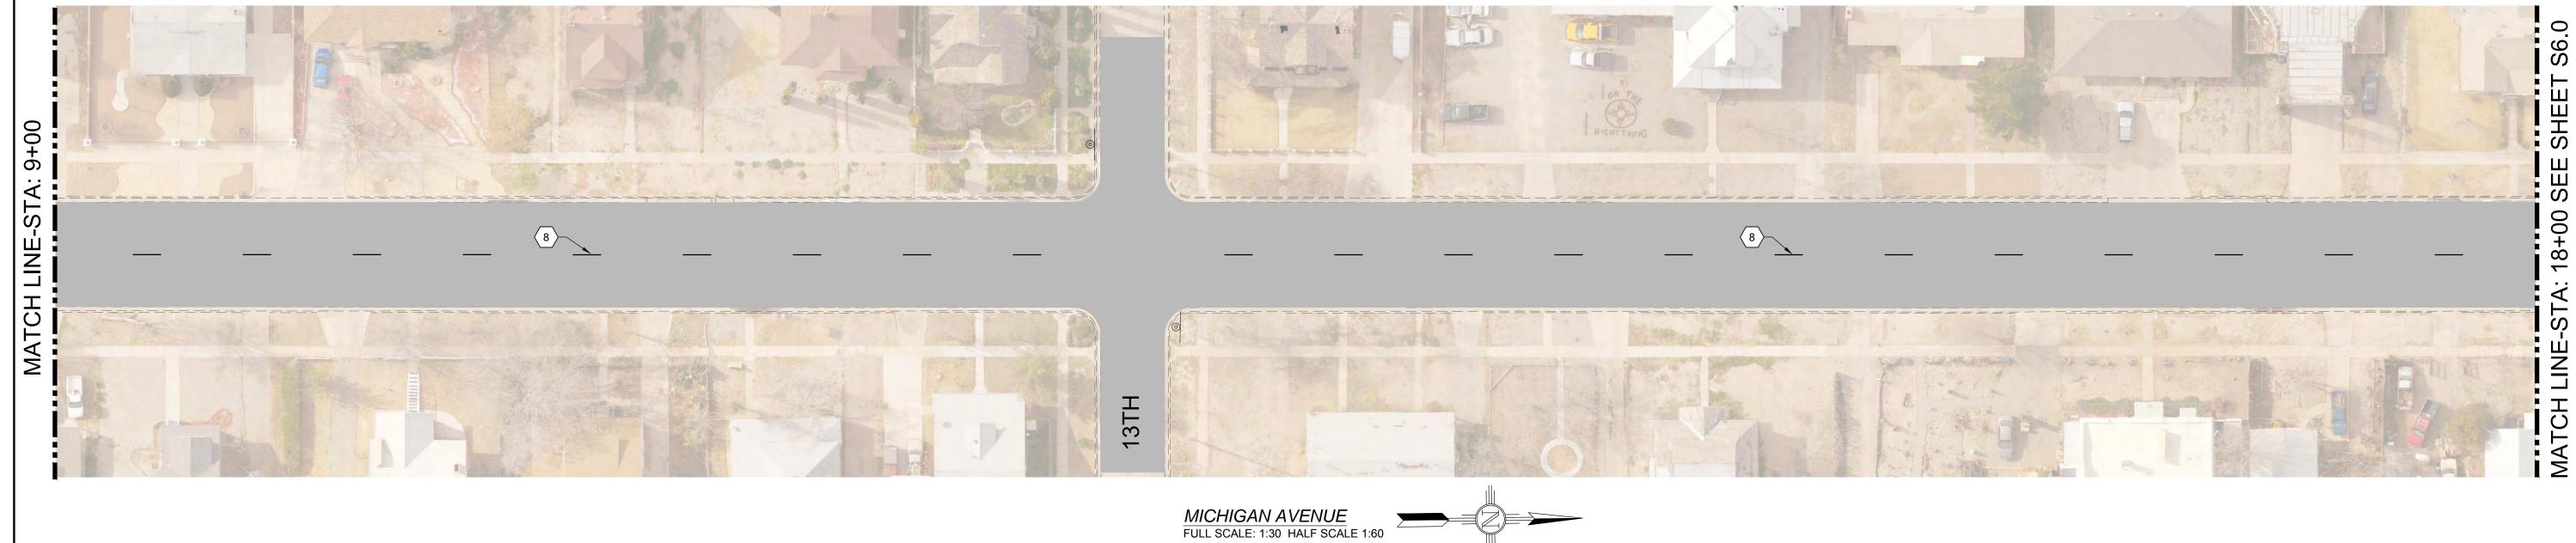

# **Street Maintenance Program FY 2017**

MICHIGAN AVENUE STRIPING PLAN STATION 0+41 TO 18+00

CITY OF ALAMOGORDO, NEW MEXICO, ENGINEERING DEPARTMENT

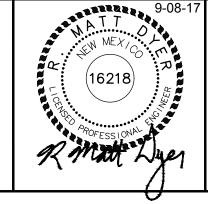

DYER	ENGINEERIN

Sheet No.:		2017-010	Bid No.:	Public Works	
S 5.0	AD	Designed By: _	AD	Drawn By:	
] 33.0	MD	_ Approved By: _	MD	Checked By:	

LEGEND

Scale: Horiz.: 1"=30' Vert.: n/a

Sheet 58 of 103 EN1701

S 5.0







# CONSTRUCTION PLAN KEY NOTES:

- NEW 4" SOLID WHITE LINE
   WHITE LANE USAGE ARROW LEFT
- WHITE LANE USAGE ARROW LEFT
   WHITE LANE USAGE ARROW STRAIGHT RIGHT
- 4. WHITE LANE USAGE "ONLY"
- 5. 24" SOLID WHITE STOP BAR 4' FROM CROSSWALK6. 24" SOLID WHITE CROSSWALK
- 7. DOUBLE 4" WIDE, SOLID YELLOW LINES8. 4" CENTERLINE DASHED YELLOW LINE

LEGEND	
NEW 2" COLD MILL & HMA SP-IV INLAY	
NEW 3" HMA SP-IV	
NEW CONCRETE	Δ Δ . Δ
NEW CURB & GUTTER	.4 .4
EXISTING FIRE HYDRANT	
EXISTING POWER POLE	<u> </u>
EXISTING WATER METER	
EXISTING WATER VALVE	wv 
EXISTING SEWER MAHOLE	S
EXISTING TELEPHONE MANHOLE	$\bigcirc$
EXISTING ROADWAY CENTERLINE —	
EXISTING OVER HEAD ELECTRIC LINES	EOH PL


0	9-08-17	ISSUED FOR CONSTRUCTION	MD	New Mexico One Call, Inc. Call 2 days  New Mexico One Call, Inc. Call 2 days  Dial 811 or  Professional Resources for Damage Prevention 1-800-321-2537
REV. No.	DATE	DESCRIPTION	APPROVED	
■ I\		DESCRIPTION		



# **Street Maintenance Program FY 2017**

MICHIGAN AVENUE STRIPING PLAN STATION 18+00 TO 29+57

CITY OF ALAMOGORDO, NEW MEXICO, ENGINEERING DEPARTMENT

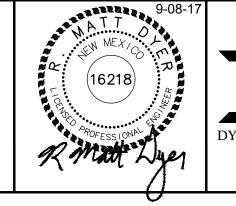


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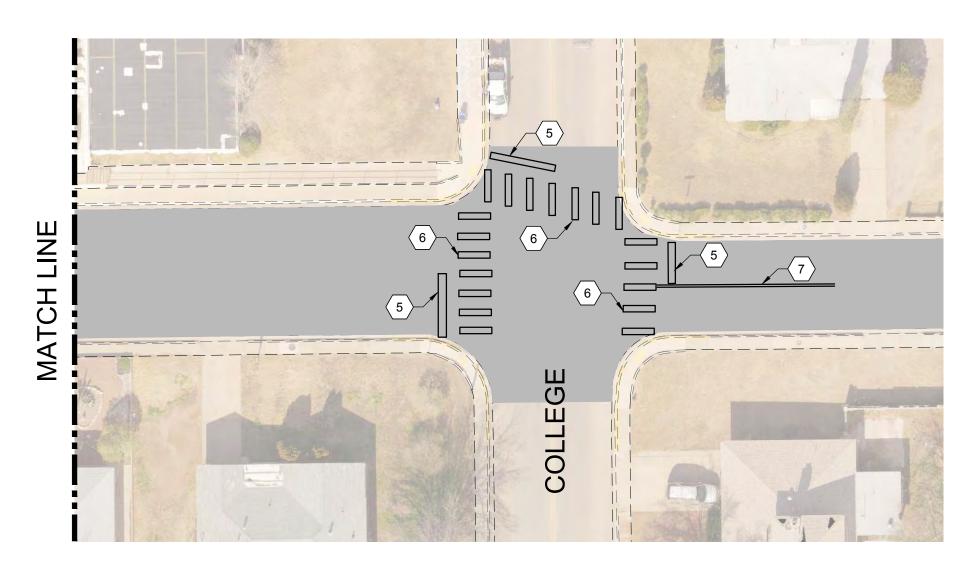
Public Works	Bid No.:	2017-010		Sheet No.:
Drawn By:	AD	Designed By:	AD	S 6.0
Checked By:	MD	Approved By: _	MD	0.0.0
Scale: <b>Horiz</b>	1"=30'	Vert ·	n/a	Sheet 59 (


Vert.: n/a

Sheet 59 of 10

EN1701



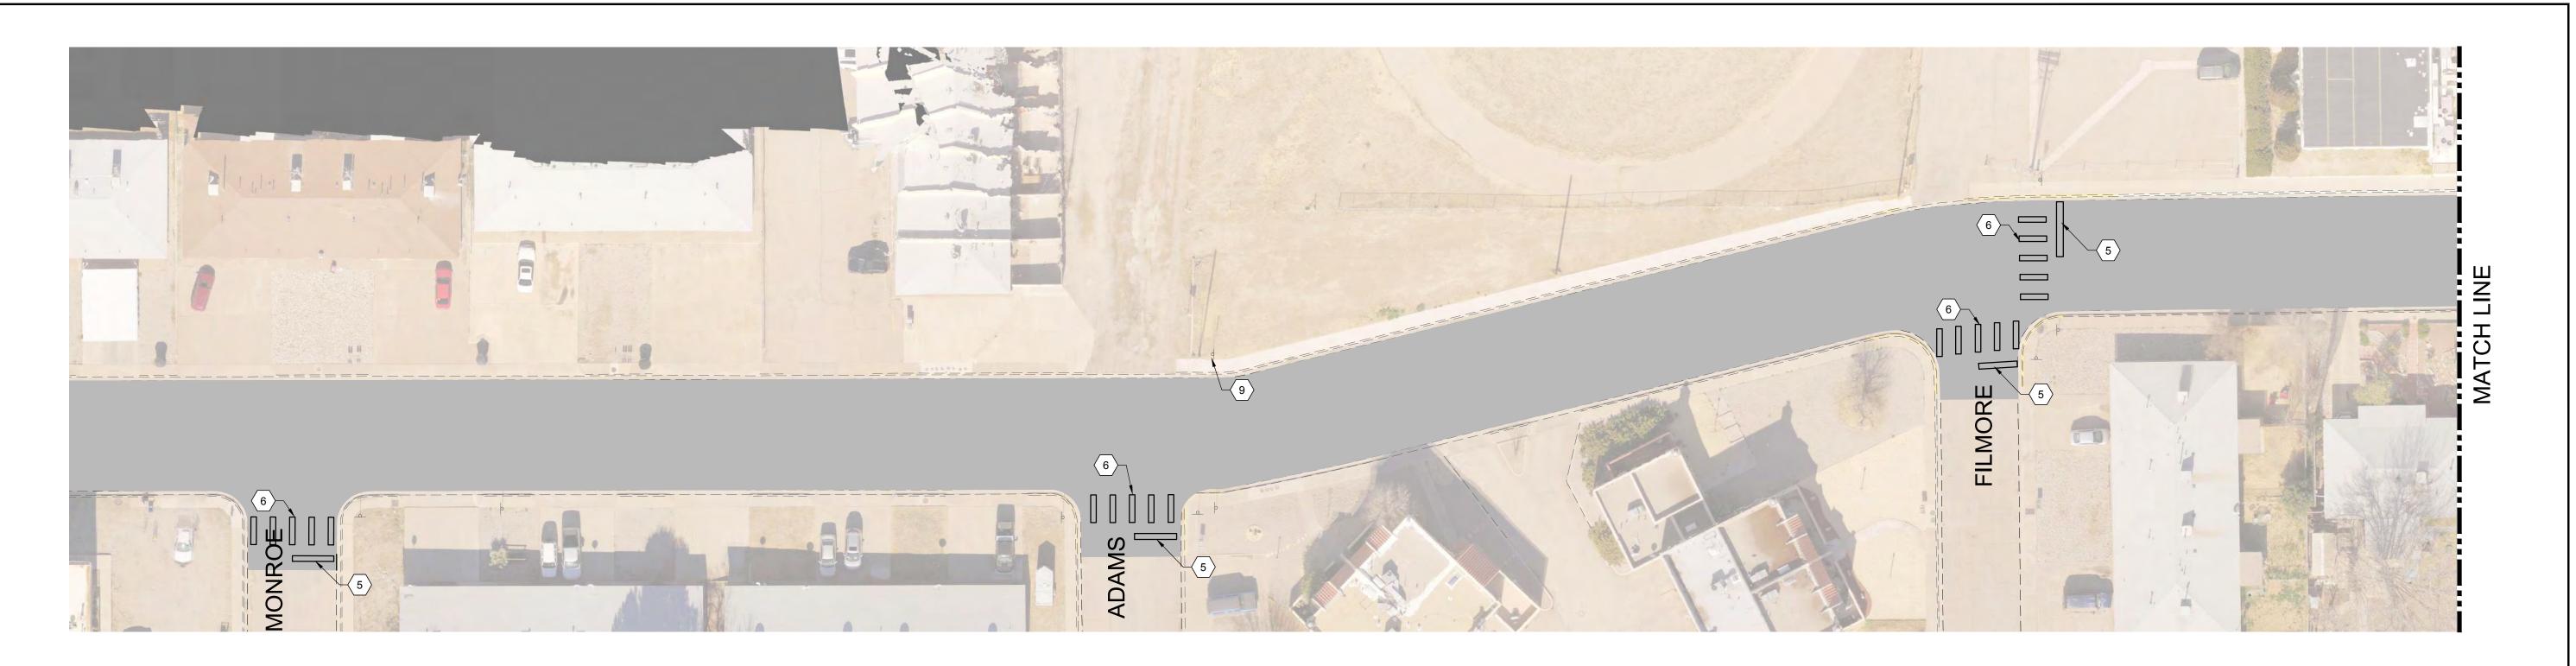

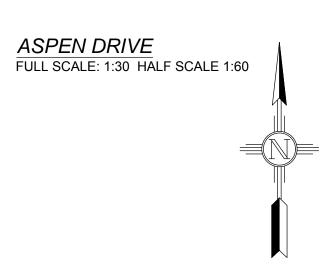

### CONSTRUCTION PLAN KEY NOTES:

- NEW 4" SOLID WHITE LINE
   WHITE LANE USAGE ARROW LEFT
- 3. WHITE LANE USAGE ARROW STRAIGHT RIGHT
- 4. WHITE LANE USAGE "ONLY" 5. 24" SOLID WHITE STOP BAR - 4' FROM CROSSWALK
- 6. 24" SOLID WHITE CROSSWALK 7. DOUBLE 4" WIDE, SOLID YELLOW LINES
- 8. 4" CENTERLINE DASHED YELLOW LINE
- 9. REMOVE EXISTING PEDESTRIAN CROSSWALK SIGN

LEGEND	
NEW 2" COLD MILL & HMA SP-IV INLAY	
NEW 3" HMA SP-IV	
NEW CONCRETE	Δ Δ Δ
NEW CURB & GUTTER	· 4 · 4 ·
EXISTING FIRE HYDRANT	
EXISTING POWER POLE	<u> </u>
EXISTING WATER METER	
EXISTING WATER VALVE	wv 
EXISTING SEWER MAHOLE	<u>(S)</u>
EXISTING TELEPHONE MANHOLE	T
EXISTING ROADWAY CENTERLINE —	
EXISTING OVER HEAD ELECTRIC LINES	EOH PL


	T			
				New Mexico One Call, Inc. Call 2 days  New Mexico One Call, Inc. Call 2 days  Dial 811 or  Professional Resources for Damage Prevention 1-800-321-2537
0	9-08-17	ISSUED FOR CONSTRUCTION	MD	ridessidial resource for ballage rievalitat 1 000 32 1 2031
REV. No.	DATE	DESCRIPTION	APPROVED	




# **Street Maintenance Program FY 2017**

ASPEN DRIVE STRIPING PLAN STATION 9+00 TO 20+00


CITY OF ALAMOGORDO, NEW MEXICO, ENGINEERING DEPARTMENT

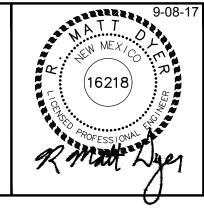

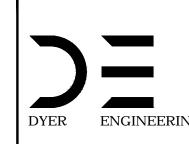

	Public Works	Bid No.:	2017-01
	Drawn By:	AD	Design
	Checked By:	MD	 Approv
nia	Scale: <b>Horiz</b>	.: 1"=30'	


ublic Works	Bid No.:	2017-010		Sheet No.:	
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hecked By:	MD	Approved By: _	MD		
ogle: Horiz	1"=30'	Vert	n/a	Sheet 60 of	- F

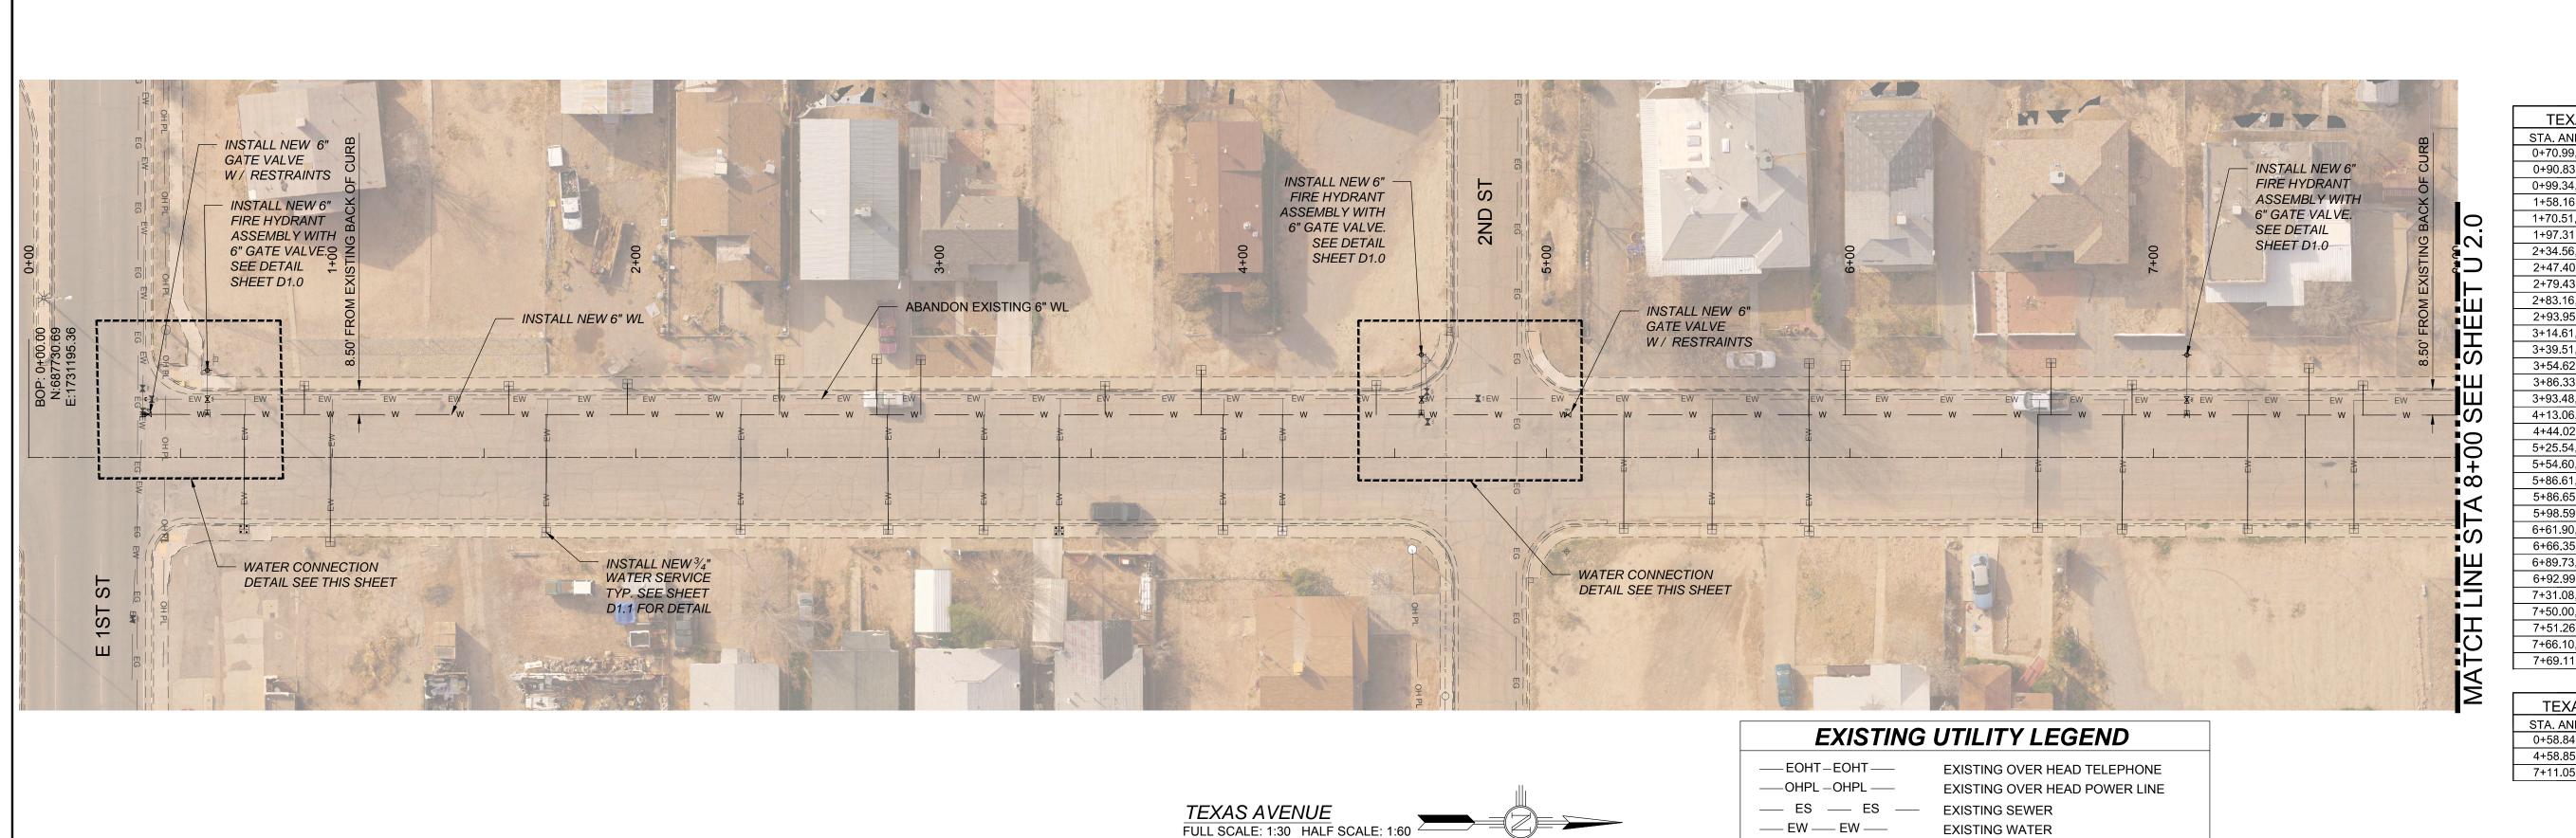

TEXAS AVE. V	VATER SE	RVICES
STA. AND OFFSET	SIZE	LENGTH
0+70.99, 23.61 RT	3/4"	37.80'
0+90.83, 23.66 LT	3/4"	9.47'
0+99.34, 27.84 RT	3/4"	42.03'
1+58.16, 23.58 LT	3/4"	9.41'
1+70.51, 24.66 RT	3/4"	38.83'
1+97.31, 24.29 LT	3/4"	10.13'
2+34.56, 23.79 RT	3/4"	37.93'
2+47.40, 32.17 LT	3/4"	18.03'
2+79.43, 32.44 LT	3/4"	18.30'
2+83.16, 23.80 RT	3/4"	37.94'
2+93.95, 32.14 LT	3/4"	18.01'
3+14.61, 23.88 RT	3/4"	38.00'
3+39.51, 24.20 RT	3/4"	38.32'
3+54.62, 23.60 LT	3/4"	9.50'
3+86.33, 28.85 LT	3/4"	14.75'
3+93.48, 23.91 RT	3/4"	38.00'
4+13.06, 24.22 RT	3/4"	38.31'
4+44.02, 23.85 LT	3/4"	8.81'
5+25.54, 23.38 RT	3/4"	37.44'
5+54.60, 23.65 RT	3/4"	37.70'
5+86.61, 24.34 RT	3/4"	38.39'
5+86.65, 31.04 LT	3/4"	17.00'
5+98.59, 30.34 LT	3/4"	16.30'
6+61.90, 23.20 RT	3/4"	37.23'
6+66.35, 31.15 LT	3/4"	17.13'
6+89.73, 23.67 RT	3/4"	37.69'
6+92.99, 23.97 LT	3/4"	9.96'
7+31.08, 23.50 RT	3/4"	37.50'
7+50.00, 29.50 RT	6"	42.25'
7+51.26, 29.50 LT	3/4"	15.51'
7+66.10, 23.44 RT	3/4"	37.44'
7+69.11, 23.70 LT	3/4"	9.71'

IT ASSEMBLY
ENGTH
4.55'
9.78'
9.78'



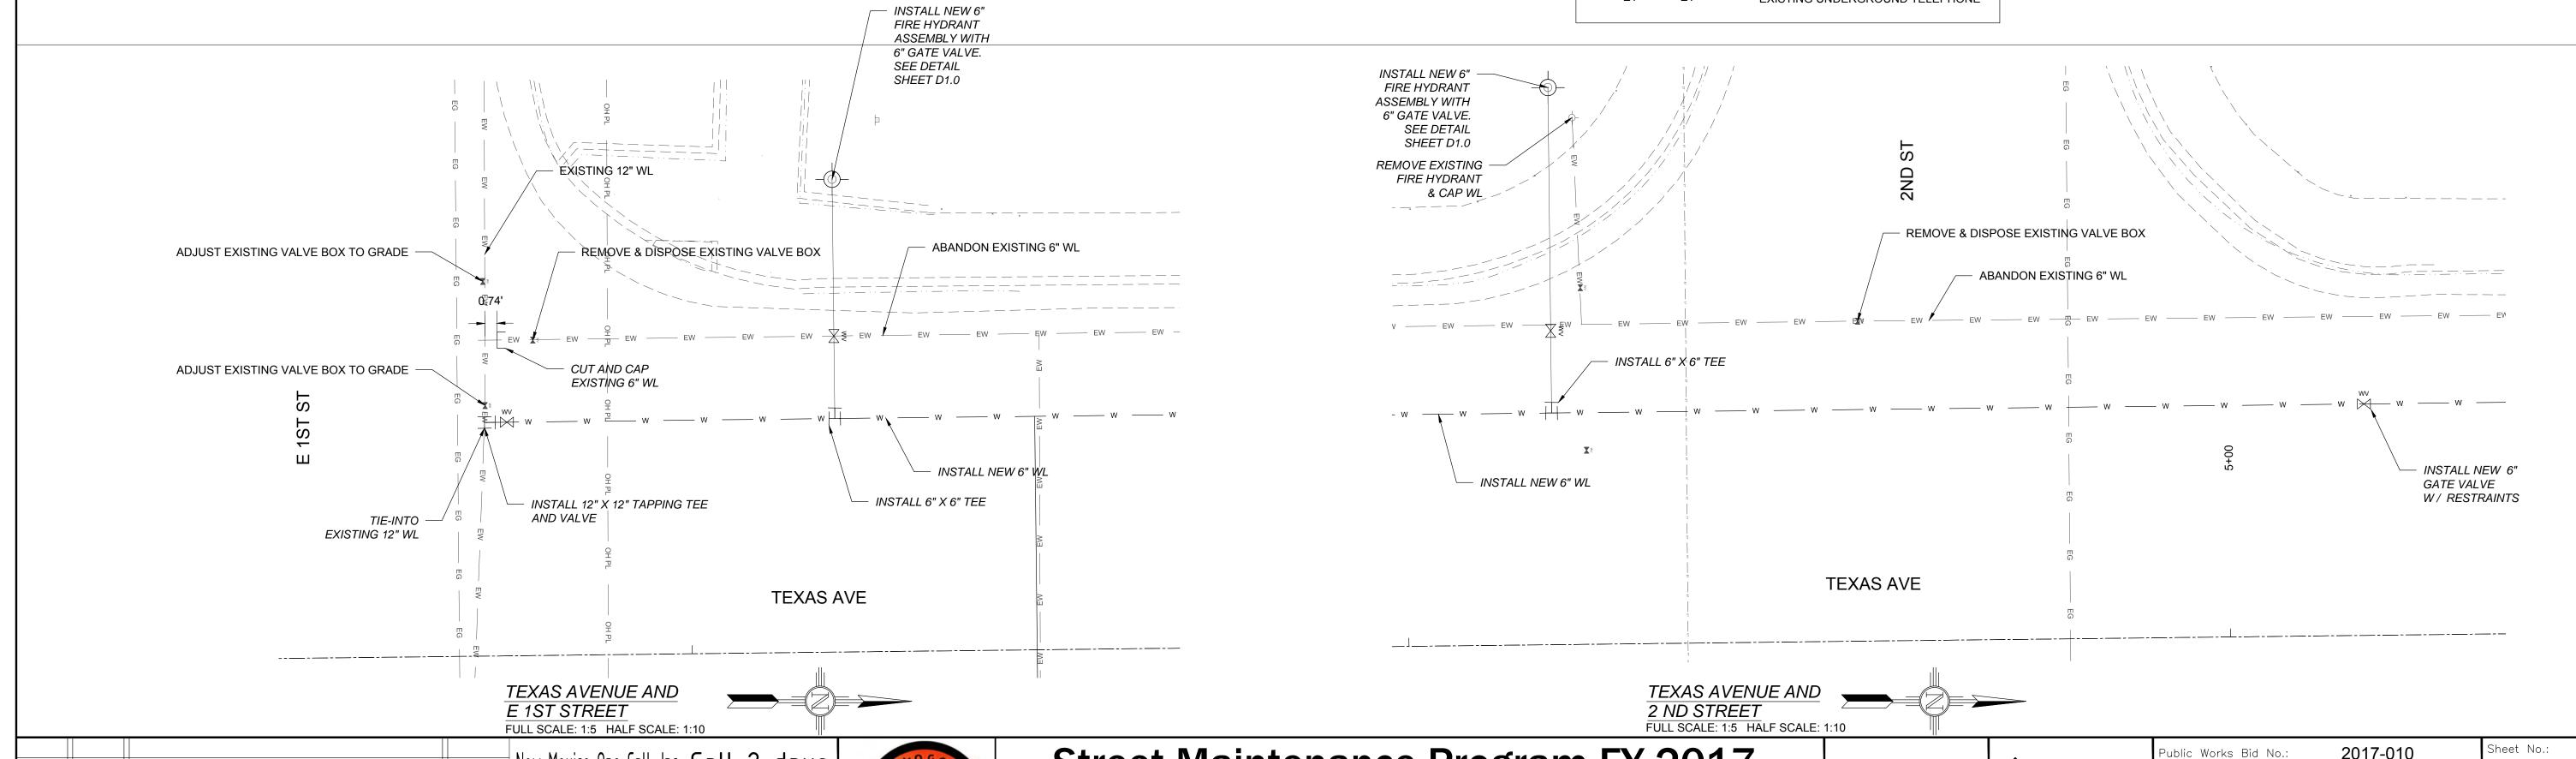

New Mexico One Call, Inc. Call 2 days AMENDMENT - 1 | 12-21-17 09-08-17 ISSUED FOR CONSTRUCTION DESCRIPTION

# **Street Maintenance Program FY 2017**

TEXAS AVENUE WATER LINE REPLACEMENT PLAN STATION 0+00 TO 8+00



<b>A</b> -	F
Occam Engineers	
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V V V	
3400 HIGHWAY 180 EAST SUITE A	S
SILVER CITY, NEW MEXICO 88061	l

(575) 538-5395 (OFFICE)


(575) 538-5410 (FAX)


Public Works	Bid No.:	2017-010	
Drawn By:	TM	Designed By:	TM
Checked By:	SC	— Approved By:	SC

Sheet 61 of 103

Scale: Horiz.:VARIES Vert.: n/a EN1701

CITY OF ALAMOGORDO, NEW MEXICO, ENGINEERING DEPARTMENT

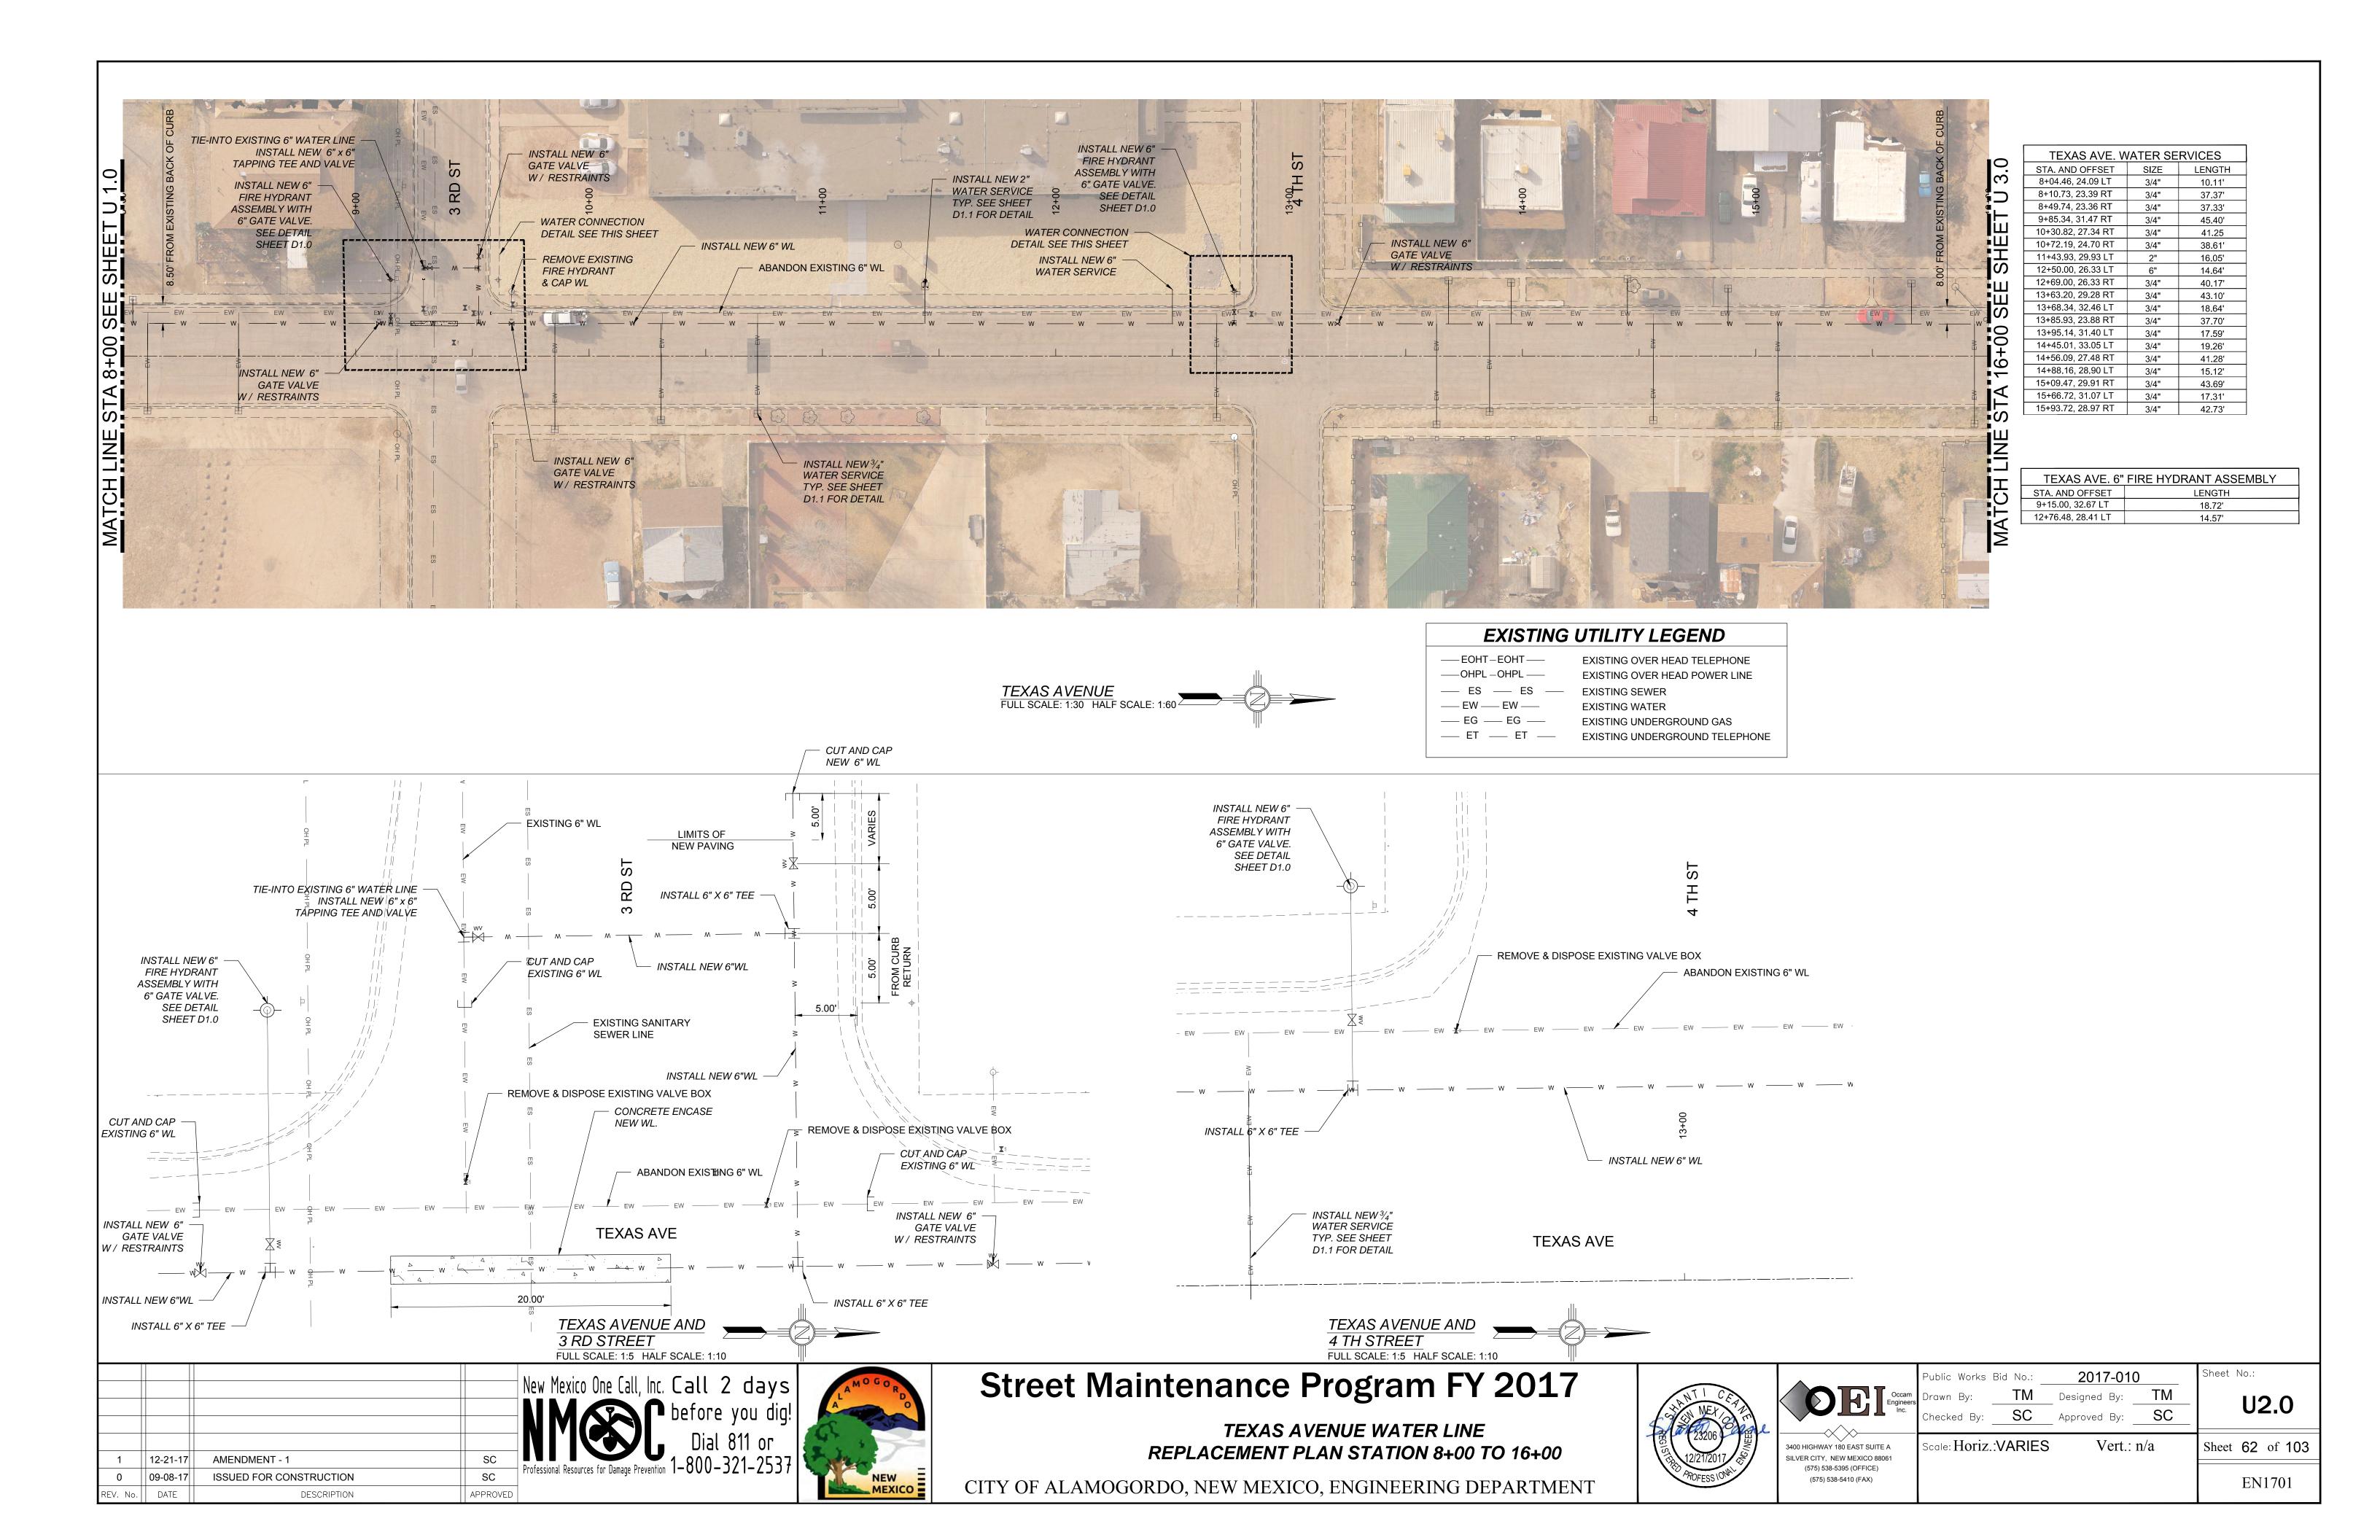

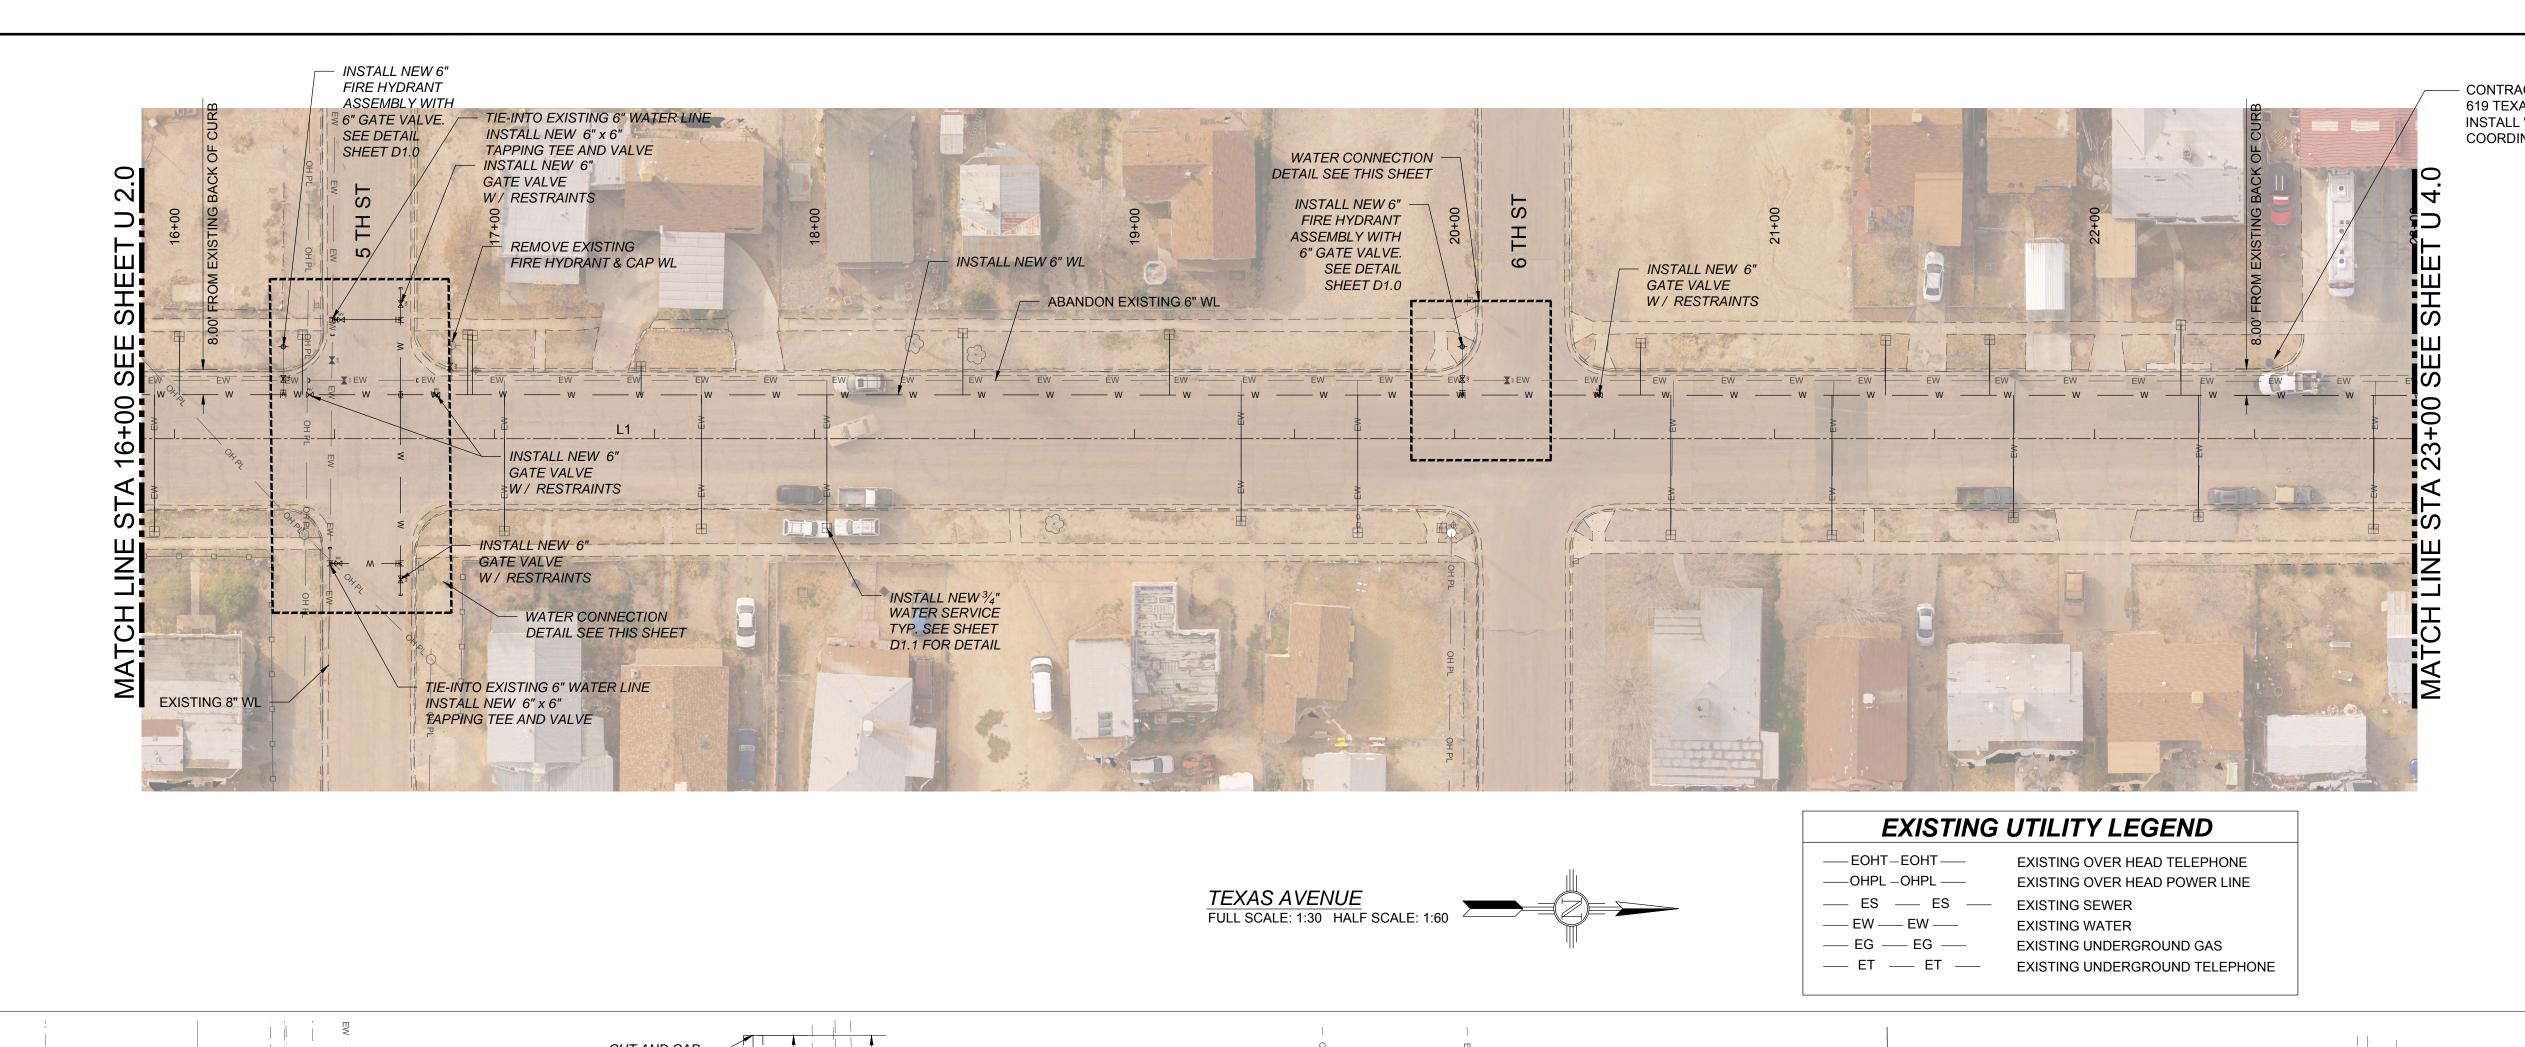

CONTRACTOR NOTE:
 619 TEXAS AVENUE
 INSTALL WATER SAMPLING STATION.
 COORDINATE LOCATION WITH OWNER.

TEXAS AVE. WATER SERVICES			
STA. AND OFFSET	SIZE	LENGTH	
16+01.46, 31.91 LT	3/4"	18.15'	
16+40.01, 32.53 LT	3/4"	18.80'	
16+91.61, 32.62 LT	3/4"	18.90'	
16+93.13, 32.28 LT	3/4"	18.56'	
17+03.08, 28.83 RT	3/4"	42.57'	
17+45.76, 22.63 LT	3/4"	8.92'	
17+64.66, 28.14 RT	3/4"	41.85'	
18+03.83, 27.92 RT	3/4"	41.61'	
18+46.32, 33.00 LT	3/4"	19.32'	
19+10.97, 32.62 LT	3/4"	18.96'	
19+33.25, 25.72 RT	3/4"	39.37'	
19+69.72, 29.39 RT	3/4"	43.04'	
20+58.18, 29.89 LT	3/4"	15.17'	
20+67.55, 30.04 RT	3/4"	43.66'	
21+17.88, 30.06 RT	3/4"	43.66'	
21+34.70, 30.76 LT	3/4"	17.15'	
21+67.22, 30.88 LT	3/4"	17.29'	
21+74.59, 24.59 RT	3/4"	38.18'	
22+26.97, 35.52 LT	3/4"	21.94'	
22+32.39, 24.44 RT	3/4"	38.01'	
22+87.15, 28.15 RT	3/4"	41.71'	

TEXAS AVE. 6" FIRE HYDRANT ASSEMBLY		
STA. AND OFFSET	LENGTH	
16+33.95, 28.74 LT	15.00'	
20+02.42. 28.74 LT	15 11'	

CUT AND CAP NEW 8" WL LIMITS OF INSTALL NEW 6" **TEXAS AVE NEW PAVING** FIRE HYDRANT ASSEMBLY WITH INSTALL NEW 8" INSTALL NEW 8" WL / 6" GATE VALVE. TIE-INTO EXISTING 8' WATER LINE GATE VALVE SEE DETAIL INSTALĒNEW 8" x 8" W / RESTRAINTS SHEET D1.0 INSTALL NEW 8" WL -TAPPING TEE AND VALVE - INSTALL NEW 6 FIRE HYDRANT ASSEMBLY WITH INSTALL 8" X 8" TEE 6" GATE VAL√E. SEE DETAIL CUT AND CAP SHEET D1.0 ABANDON EXISTING 6" WL EXISTING 8" WL REMOVE & DISPOSE EXISTING VALVE BOX INSTALL 6" X 6" TEE CUT AND CAP EXISTING 8" WL REMOVE & DISPOSE EXISTING VALVE BOX INSTALL NEW 8" WL INSTALL NEW 8" WL ABANDON EXISTING 6" WL REMOVE & DISPOSE EXISTING VALVE BOX CUT AND CAP - CUT AND CAP INSTALL NEW 6" WL EXISTING 6" WL EXISTING 6" WL INSTALL 8" X 8" TEE TIE-INTO EXISTING 6" WATER LINE INSTALL NEW 8" INSTALL NEW 6" x 6" GATE VALVE **TEXAS AVE** TAPPING TEE AND VALVE W / RESTRAINTS LIMITS OF **NEW PAVING** INSTALL NEW 6" CUT AND CAP - INSTALL NEW 6" TEXAS AVE INSTALL NEW 6" WL GATE VALVE NEW 8" WL INSTALL 6" X 6" T∉E GATE VALVE INSTALL NEW 8" WL -W / RESTRAINTS W / RESTRAINTS TEXAS AVENUE AND TEXAS AVENUE AND TEXAS AVENUE AND 6 TH STREET 5 TH STREET EAST SIDE 5 TH STREET WEST SIDE FULL SCALE: 1:5 HALF SCALE: 1:10 FULL SCALE: 1:5 HALF SCALE: 1:10 FULL SCALE: 1:5 HALF SCALE: 1:10



# **Street Maintenance Program FY 2017**

TEXAS AVENUE WATER LINE REPLACEMENT PLAN STATION 16+00 TO 23+00

CITY OF ALAMOGORDO, NEW MEXICO, ENGINEERING DEPARTMENT



	F
Occam Engineers Inc.	C
	_
3400 HIGHWAY 180 EAST SUITE A	S
SILVED CITY NEW MEVICO 99061	

(575) 538-5395 (OFFICE)

(575) 538-5410 (FAX)

Occam Engineers Inc.

Public Works Bid No.:

TM Designed By:

Checked By:

SC Approved By:


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Sheet No.:

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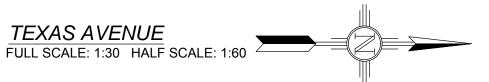
Sheet 63 of 103

Scale: Horiz.:VARIES Vert.: n/a



TEXAS AVE. WATER SERVICES			
STA. AND OFFSET	SIZE	LENGTH	
23+15.74, 28.81 RT	3/4"	42.36'	
24+57.18, 29.82 RT	3/4"	43.32'	
24+88.20, 30.92 LT	3/4"	17.42'	
25+20.62, 29.16 RT	3/4"	42.64'	
25+39.68, 23.43 LT	3/4"	9.95'	
25+67.75, 29.37 RT	3/4"	42.84'	
26+36.71, 30.65 RT	3/4"	44.10'	
26+52.78, 30.47 LT	3/4"	17.02'	
26+64.49, 30.81 LT	3/4"	17.36'	
26+89.83, 29.35 RT	3/4"	42.79'	
27+98.74, 30.54 LT	3/4"	13.70'	
28+07.03, 29.64 RT	3/4"	45.70'	
28+35.02, 30.35 LT	3/4"	14.34'	
28+43.98, 29.15 RT	3/4"	45.13'	
28+77.85, 29.05 RT	3/4"	44.97'	
29+43.23, 31.06 LT	3/4"	15.27'	
29+58.37, 28.00 RT	3/4"	43.77'	
29+77.30, 31.18 LT	3/4"	15.45'	

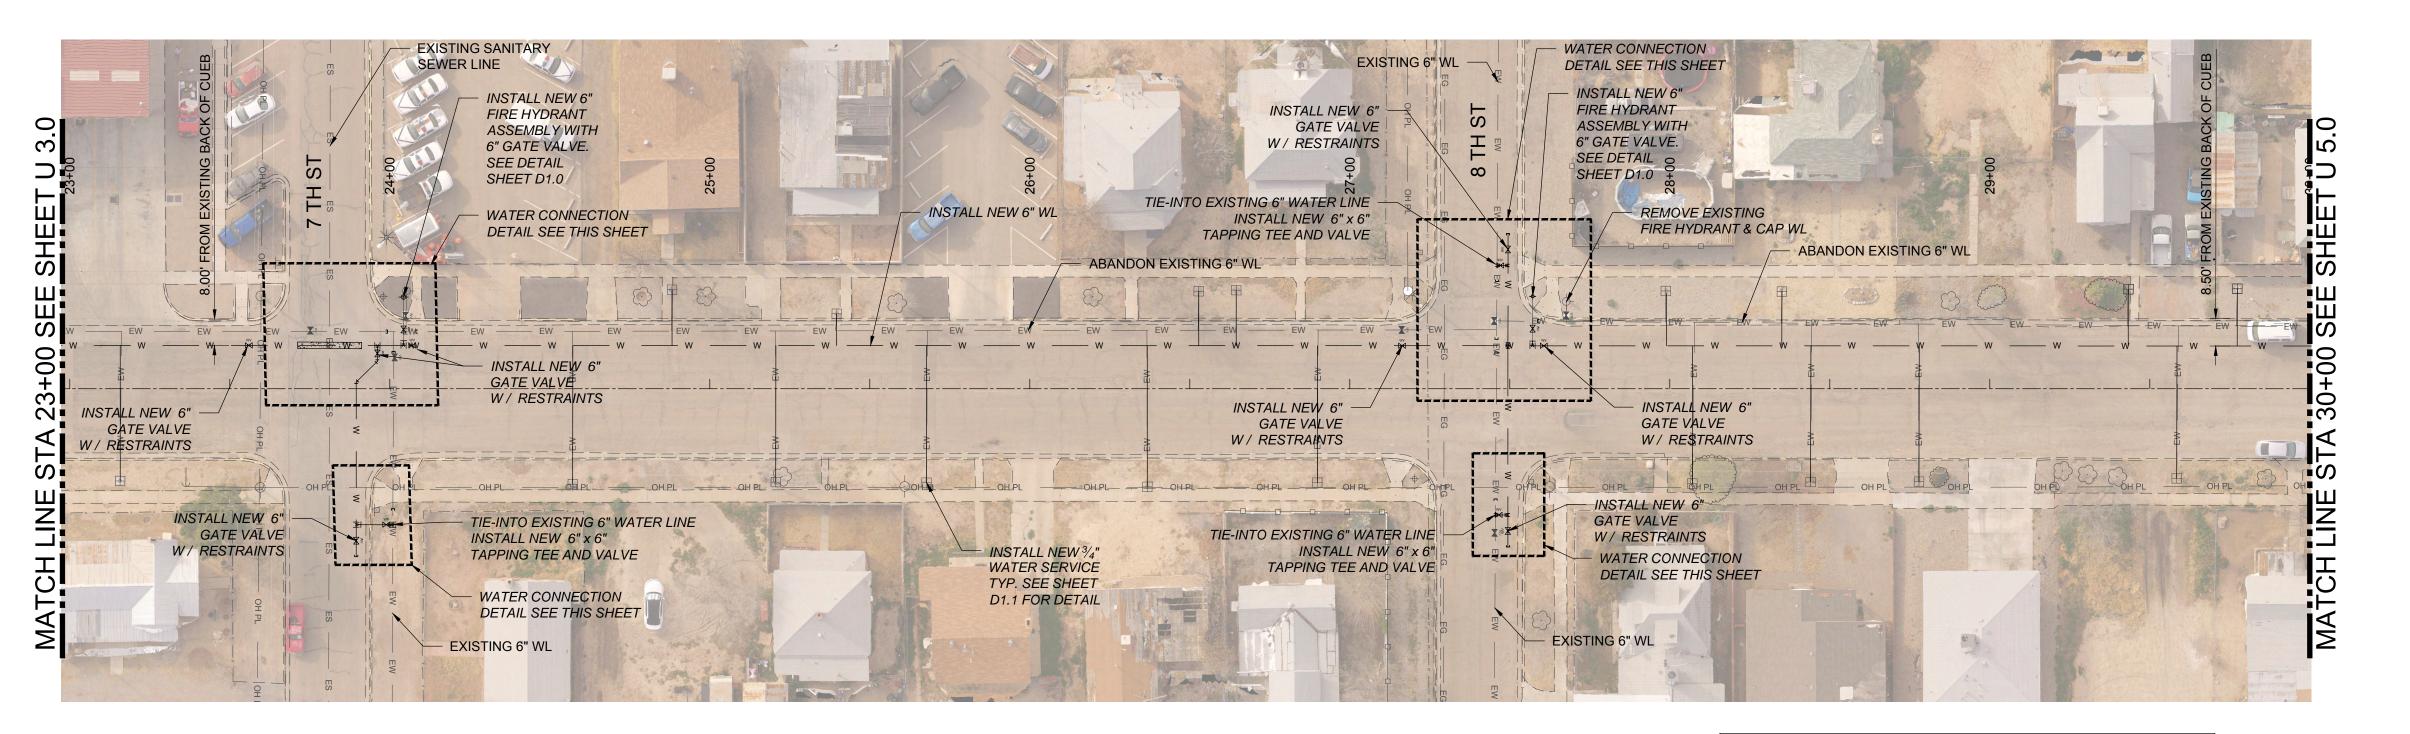TEXAS AVE. 6" FIRE HYDRANT ASSEMBLY			
STA. AND OFFSET	LENGTH		
24+04.30, 28.74 LT	15.22'		
27+57.12, 28.83 LT	15.40'		



# **EXISTING UTILITY LEGEND**

——EOHT-EOHT-EXISTING OVER HEAD TELEPHONE ——OHPL —OHPL —— EXISTING OVER HEAD POWER LINE **EXISTING SEWER** — ES — ES —

— ET — ET — EXISTING UNDERGROUND TELEPHONE

—— EW —— EW —— EXISTING WATER —— EG —— EG —— EXISTING UNDERGROUND GAS

ABANDON EXISTING 6" WL CUT AND CAP INSTALĻ/NEW 6" — NEW 6" WL FIRE/HYDRANT AŞŞÉMBLY WITH **EXISTING SANITARY** REMOVE EXISTING CUT AND CAP LIMITS OF √6" GATE VALVE. SEWER LINE FIRE HYDRANT & CAP WL EXISTING 6" WL NEW PAVING SEE DETAIL INSTALL NEW 6" ∖SHEET D1.0 GATE VALVE — TIE-INTO EXISTING 6" WATER LINE W / RESTRAINTS INSTALL NEW 6" x 6" TAPPING TEE AND VALVE EXISTING 6" WL ក្ល TIE-INTO EXISTING 6" WATER LINE INSTALL 6" X 6" TEE INSTALL NEW 6" x 6" INSTALL NEW 6" WL TAPPING TEE AND VALVE CUT AND CAP EXISTING 6" WL INSTALL 6" X 6" TEE ABANDON EXISTING 6" WL CUT AND CAP INSTALL NEW 6" REMOVE & DISPOSE EXISTING 6" WL GATE VALVE ABANDON EXISTING 6" WL EXISTING VALVE BOX JNSTALL NEW 6" CUT AND CAP W / RESTRAINTS FIRE HYDRANT EXISTING 6" WL ABANDON EXISTING 6" WL ASSEMBLY WITH 6" GATE VALVE. SEE DETAIL CUT AND CAP SHEET D1.0 INSTALL 6" X 6" TEE NEW 6" WL EXISTING 6" WL — **CUT AND CAP** INSTALL NEW 6" WL EXISTING 6" WL INSTALL NEW 6" TEXAS AVENUE AND GATE VALVE 7 TH STREET EAST SIDE W / RESTRAINTS INSTALL NEW 6" WL FULL SCALE: 1:5 HALF SCALE: 1:10 INSTALL 6" TEE EXISTING 6" WL ABANDON EXISTING 6" WL TIE-INTO EXISTING 6" WATER LINE REMOVE & DISPOSE INSTALL NEW 6" INSTALL NEW 6" INSTALL NEW 6" x 6" CONCRETE ENCASE EXISTING VALVE BOX GATE VALVE GATE VALVE TAPPING TEE AND VALVE REMOVE & DISPOSE W / RESTRAIÑTS W / RESTRAINTS **EXISTING VALVE BOX** CUT AND CAP INSTALL 6" EXISTING 6" WL CUT AND CAP CUT AND CAP 45° BEND TYP. NEW 6" ₩L INSTALL NEW 6' EXISTING 6" WL GATE VALVE W / RESTRAINTS INSTALL NEW 6" WL — **TEXAS AVE TEXAS AVE** INSTALL 6" X 6" TEE TEXAS AVENUE AND TEXAS AVENUE AND TEXAS AVENUE AND 8 TH STREET EAST SIDE 7 TH STREET 8 TH STREET WEST SIDE FULL SCALE: 1:5 HALF SCALE: 1:10 FULL SCALE: 1:5 HALF SCALE: 1:10 FULL SCALE: 1:5 HALF SCALE: 1: Sheet No.: 2017-010

New Mexico One Call, Inc. Call 2 days AMENDMENT - 1 12-21-17 | 09-08-17 ISSUED FOR CONSTRUCTION DESCRIPTION



# **Street Maintenance Program FY 2017**

TEXAS AVENUE WATER LINE REPLACEMENT PLAN STATION 23+00 TO 30+00

CITY OF ALAMOGORDO, NEW MEXICO, ENGINEERING DEPARTMENT




Occam Engineers Inc.	P D
<b>▼</b>	
3400 HIGHWAY 180 EAST SUITE A	S
SILVER CITY, NEW MEXICO 88061	
(575) 538-5395 (OFFICE)	

(575) 538-5410 (FAX)

SC Approved By: SC Scale: Horiz.:VARIES

U4.0

Vert.: n/a Sheet 64 of 103

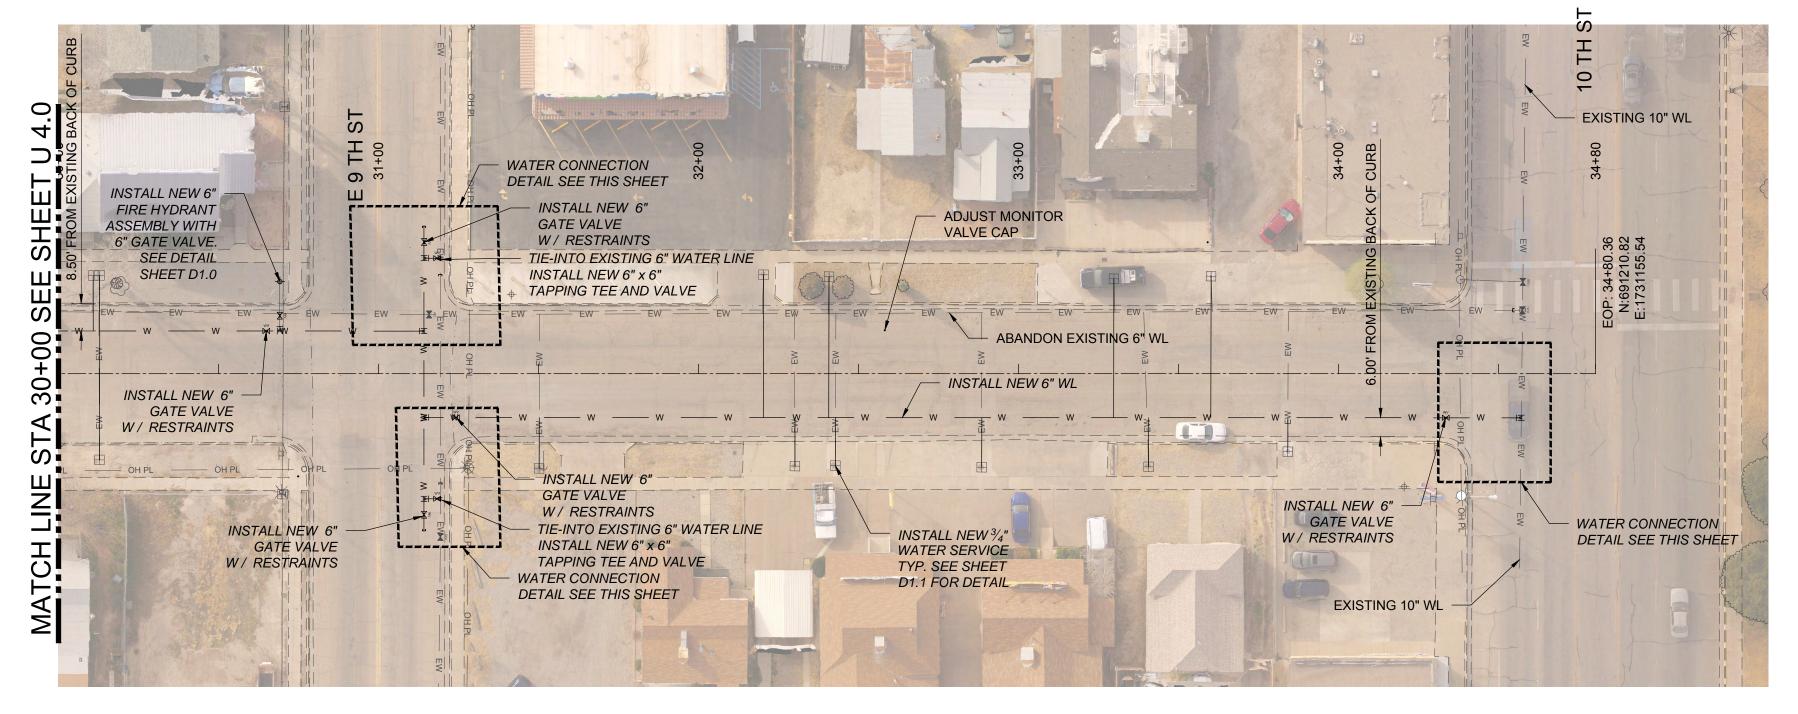

AMENDMENT - 1

ISSUED FOR CONSTRUCTION

DESCRIPTION

| 12-21-17

09-08-17

TEXAS AVE. WATER SERVICES				
STA. AND OFFSET	SIZE	LENGTH		
30+10.93, 30.65 LT	3/4"	14.98'		
30+12.87, 26.93 RT	3/4"	42.60'		
30+12.89, 30.70 LT	3/4"	15.03'		
31+50.25, 29.58 RT	3/4"	15.88'		
32+20.37, 30.93 LT	3/4"	44.65'		
32+30.17, 28.89 RT	3/4"	15.17'		
32+40.83, 30.31 LT	3/4"	44.03'		
32+42.79, 28.72 RT	3/4"	15.00'		
32+88.53, 29.23 RT	3/4"	15.50'		
33+29.83, 29.66 LT	3/4"	43.41		
33+40.66, 29.10 RT	3/4"	15.35		
33+60.19, 30.47 LT	3/4"	44.23'		
33+84.17, 24.36 RT	3/4"	10.60'		

TEXAS AVE. 6" FIRE HYDRANT ASSEMBLY

STA. AND OFFSET LENGTH

30+69.23, 28.74 LT 15.41'

Scale: Horiz.:VARIES

400 HIGHWAY 180 EAST SUITE A

SILVER CITY, NEW MEXICO 88061

(575) 538-5395 (OFFICE)

(575) 538-5410 (FAX)


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Sheet 65 of 103

EN1701


# TEXAS AVENUE FULL SCALE: 1:30 HALF SCALE: 1:60

### 

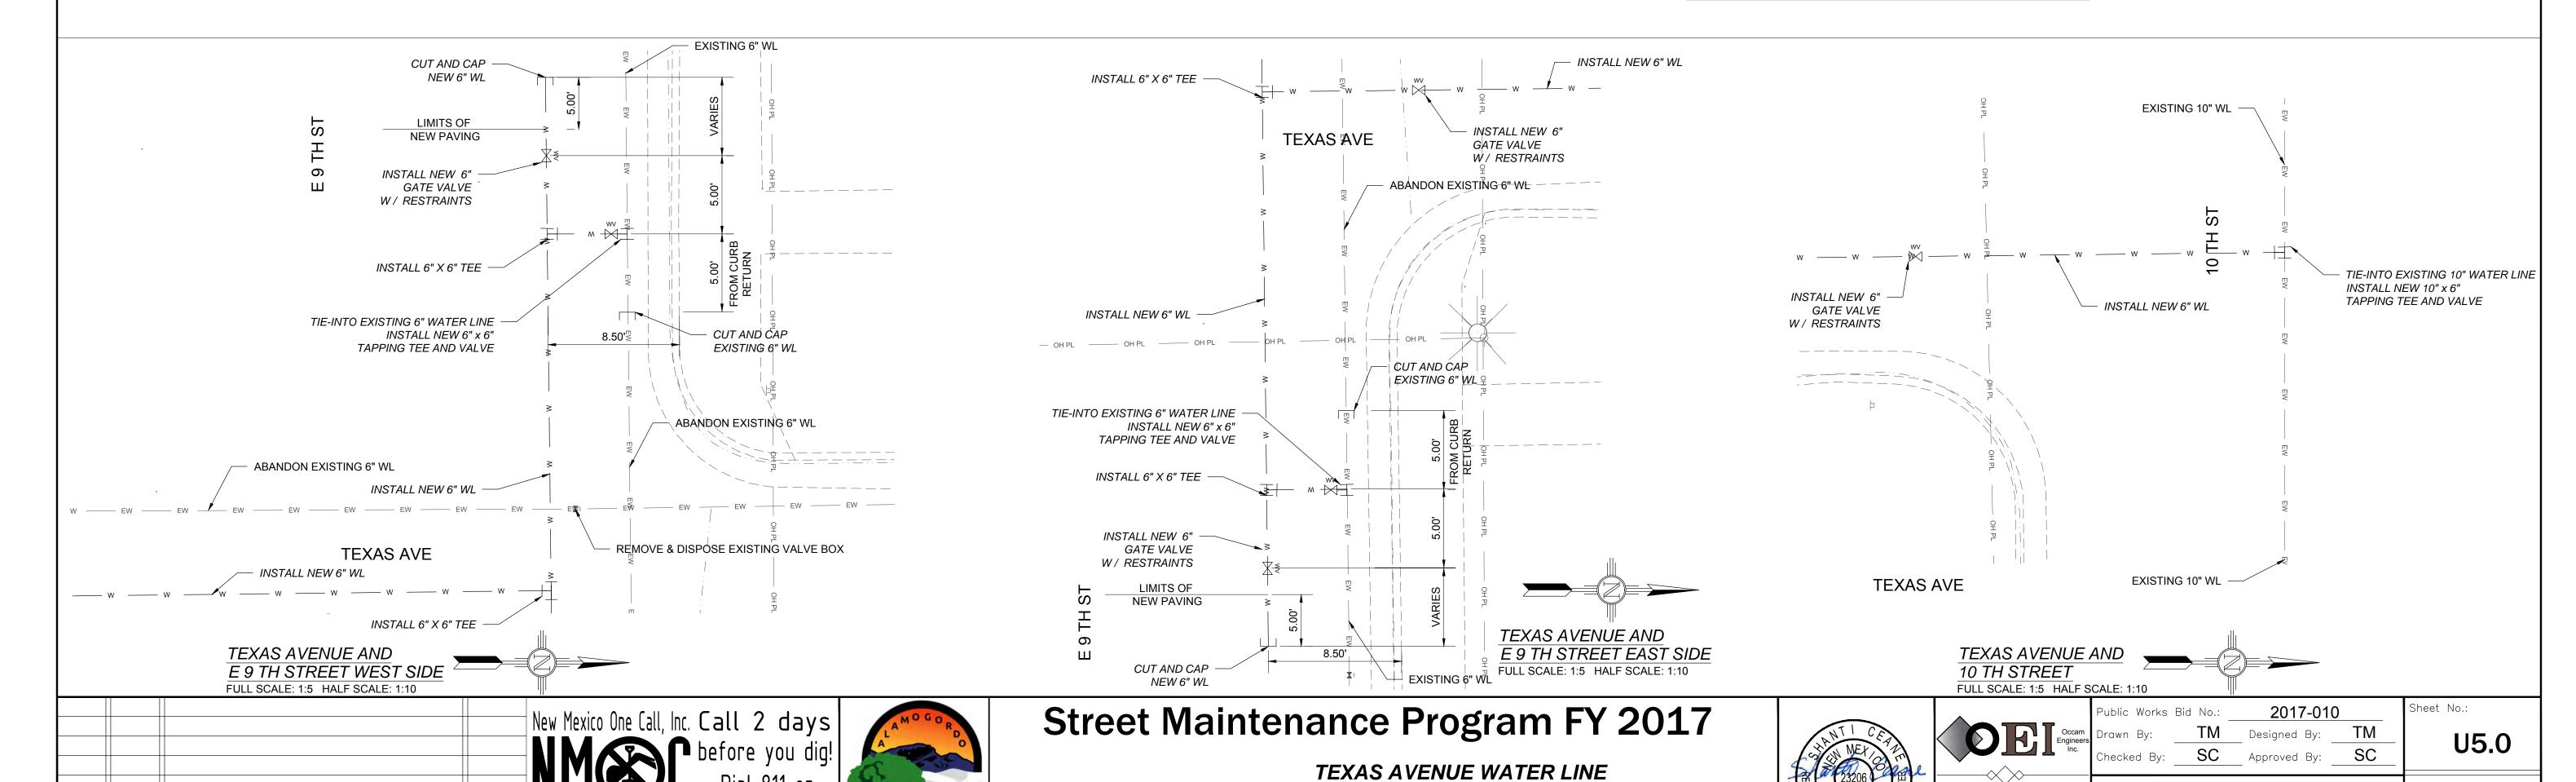

REPLACEMENT PLAN STATION 30+00 TO 34+80.36

CITY OF ALAMOGORDO, NEW MEXICO, ENGINEERING DEPARTMENT

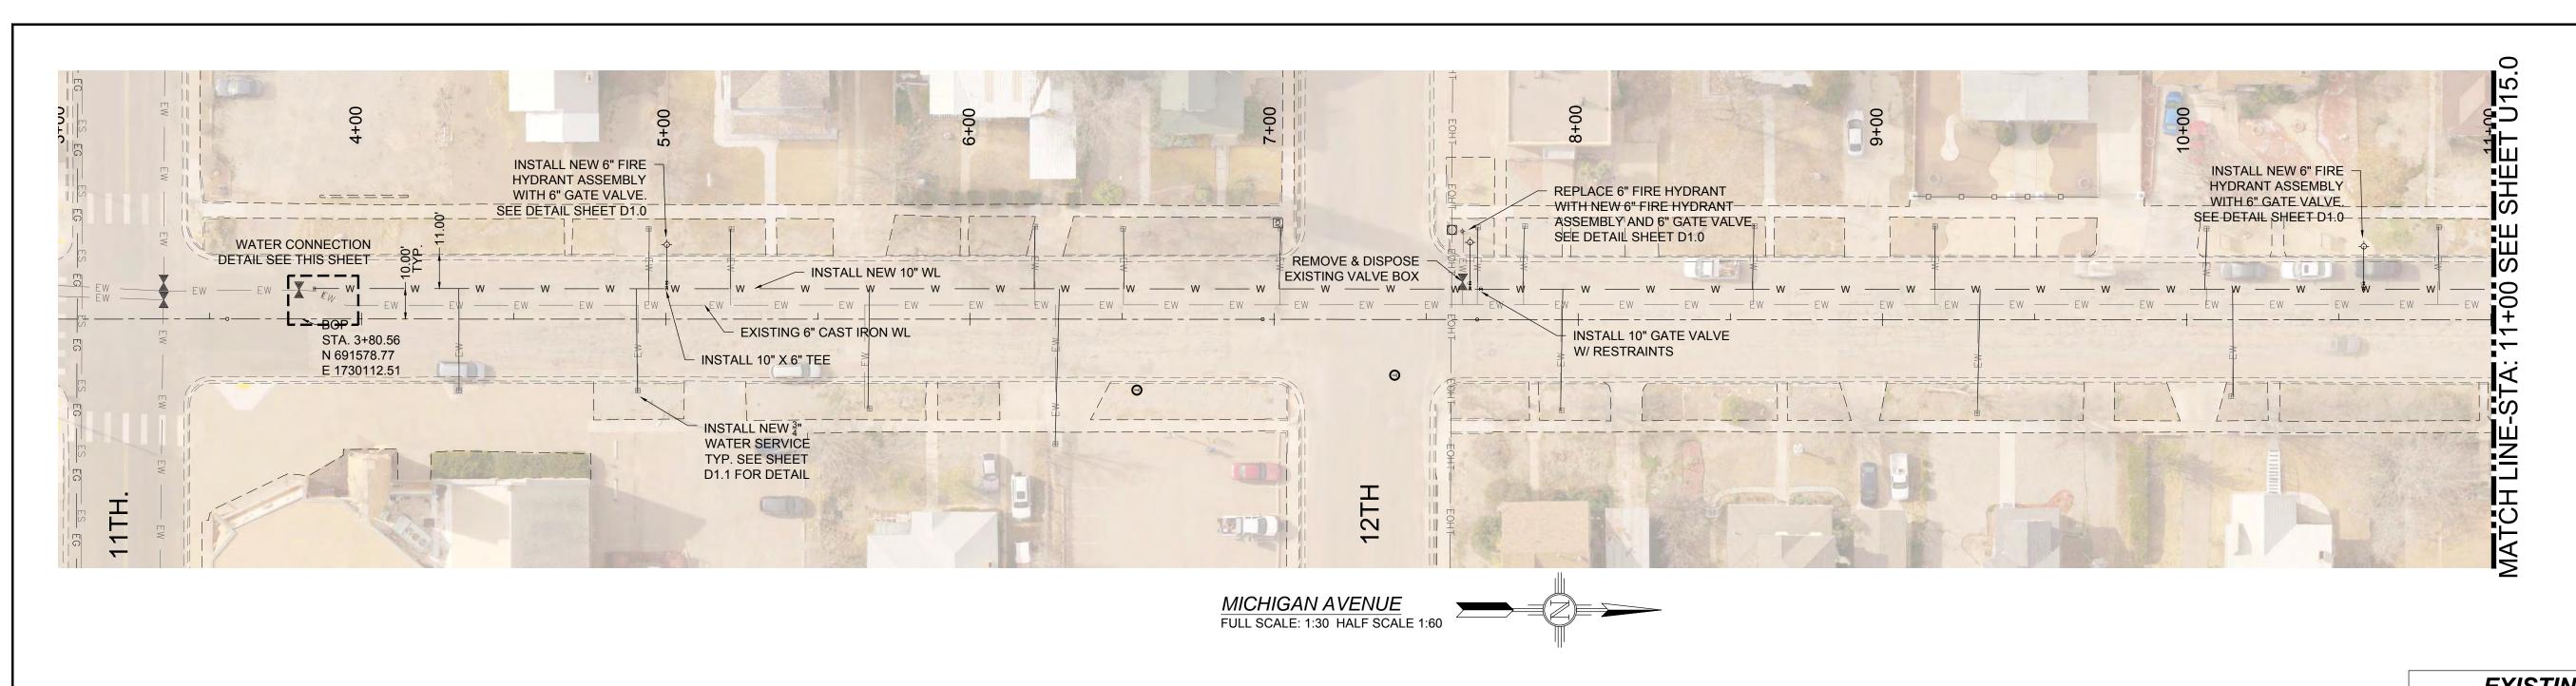



——EOHT-EOHT-EXISTING OVER HEAD TELEPHONE ——OHPL —OHPL —— EXISTING OVER HEAD POWER LINE — ES — ES — EXISTING SEWER —— EW —— EW —— **EXISTING WATER** EXISTING UNDERGROUND GAS — ET — ET — EXISTING UNDERGROUND TELEPHONE — OHM — OHM — EXISTING OVER HEAD MULTIPLE

MICHIGAN AVE. WATER SERVICES

3/4"

LENGTH


33.41'

33.71'

STA. AND OFFSET

4+32.04, 23.41 RT

4+90.76, 23.71 RT

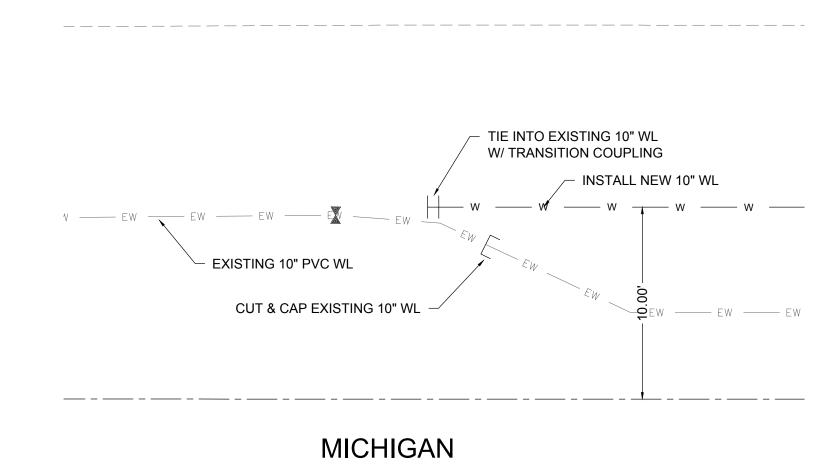

MICHIGAN / 11TH TIE-IN DETAIL FULL SCALE: 1:5 HALF SCALE 1:10	

0 9-08-17 SSUED FOR CONSTRUCTION

DESCRIPTION

	New Mexico One Call, Inc. Call 2 days    New Mexico One Call, Inc. Call 2 days   Dial 811 or	AMOGO
MD	Professional Resources for Damage Prevention 1 000 32 1 2037	
APPROVED		MEX


# **Street Maintenance Program FY 2017**

MICHIGAN AVENUE WATER LINE REPLACEMENT **PLAN STATION 3+85 TO 11+00** 

CITY OF ALAMOGORDO, NEW MEXICO, ENGINEERING DEPARTMENT

	0, 1	00.7
4+94.35, 29.70 LT	3/4"	19.7'
5+21.40, 29.52 LT	3/4"	19.52'
5+66.70, 29.46 RT	3/4"	39.46'
6+21.48, 30.50 LT	3/4"	20.5'
6+28.03, 41.12 RT	1"	51.12'
6+50.54. 29.46 LT	3/4"	19.46'
7+01.98, 29.93 LT	3/4"	19.93'
7+66.80, 29.93 LT	3/4"	19.93'
7+82.60, 30.13 LT	3/4"	20.13'
7+94.29, 30.04 RT	3/4"	40.04'
8+57.54, 30.59 LT	3/4"	20.59'
9+17.07, 30.28 LT	3/4"	20.28'
9+31.22, 30.29 RT	3/4"	40.29'
10+06.49, 29.83 LT	3/4"	19.83'
10+14.81, 24.97 RT	3/4"	34.97'
10+82.97, 30.29 LT	3/4"	20.29'


MICHIGAN AVE. 6" FIRE HYDRANT ASSEMBLY		
STA. AND OFFSET	LENGTH	
5+00.44, 24.44 LT	14.44'	
7+62.31, 29.64 LT	19.64'	
10+58.27, 24.10 LT	14.10'	

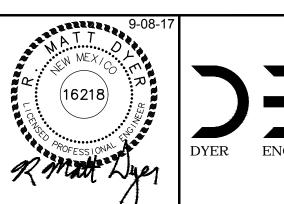

-17		
	DYER	ENGINEERIN

Public Works	Bid No.:	2017-010		Sheet No.:
Drawn By:	AD	Designed By:	AD	U14.0
Checked By:	MD	Approved By:	MD	
**		<b>*</b> * * .		

Sheet 74 of 103 Scale: **Horiz.**: Vert.: n/a EN1701

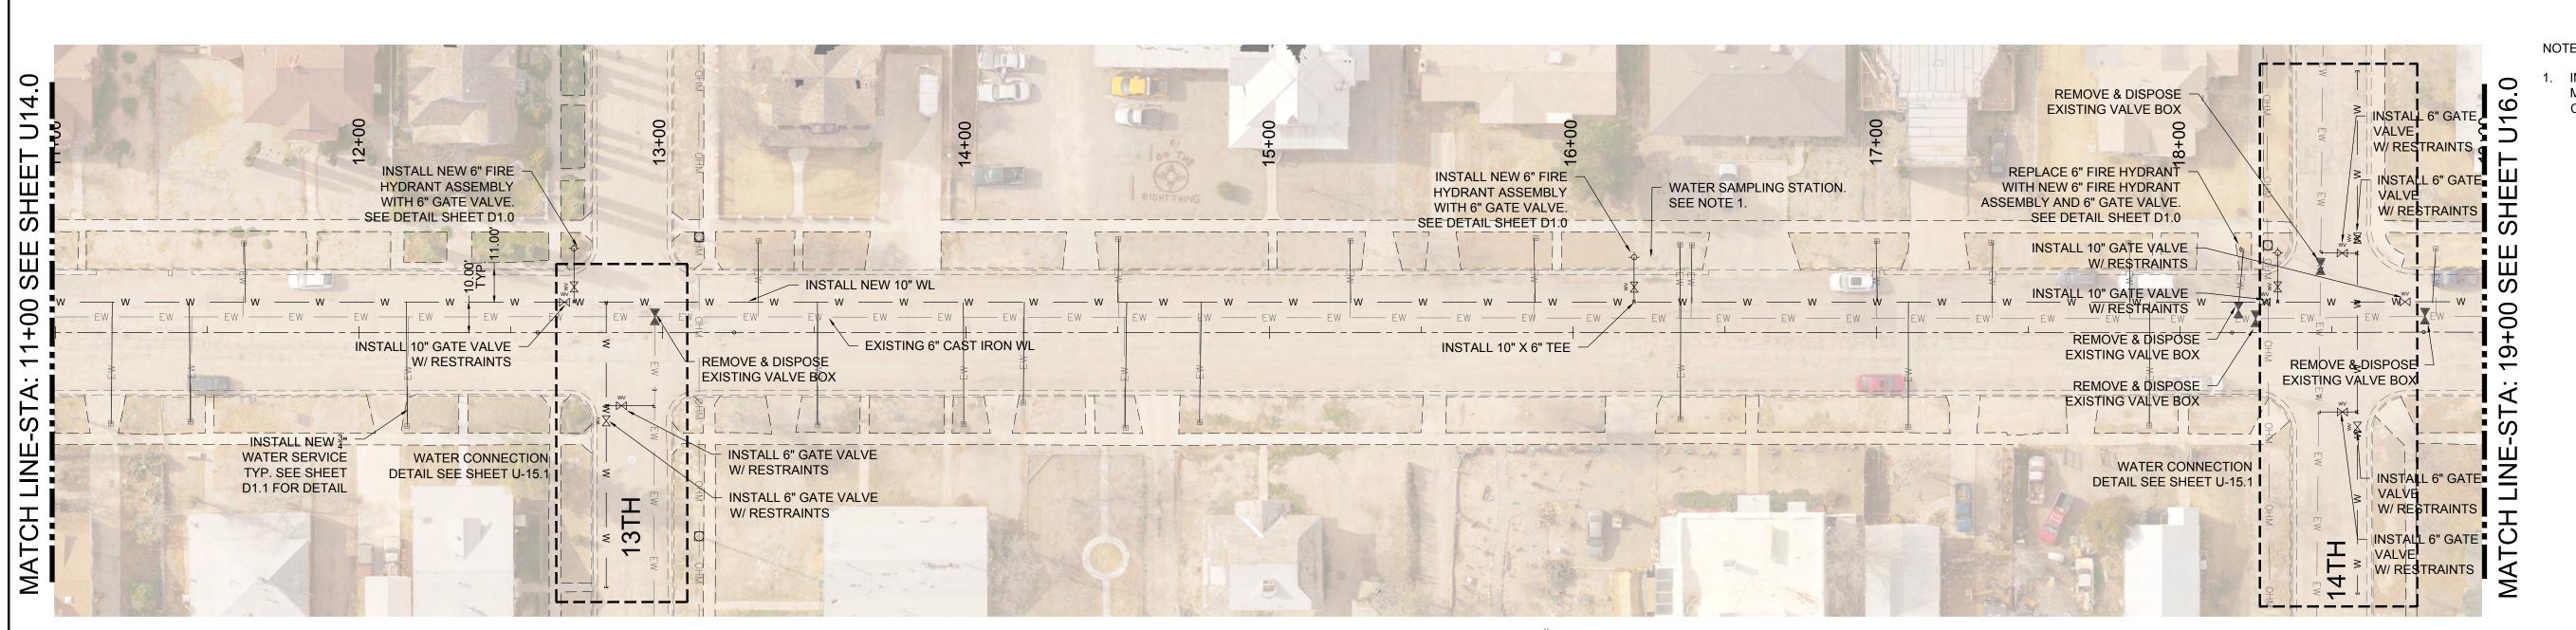

MICHIGAN AVENUE

FULL SCALE: 1:30 HALF SCALE 1:60

1. INSTALL WATER SAMPLING STATION AT 1311 MICHIGAN AVENUE. CONTRACTOR SHALL COORDINATE LOCATION WITH OWNER.

## **EXISTING UTILITY LEGEND**

EXISTING OVER HEAD TELEPHONE ——OHPL —OHPL —— EXISTING OVER HEAD POWER LINE — ES — ES — EXISTING SEWER **EXISTING WATER** EXISTING UNDERGROUND GAS EXISTING UNDERGROUND TELEPHONE —— OHM —— OHM —— EXISTING OVER HEAD MULTIPLE

STA. AND OFFSET	SIZE	LENGTH
11+18.38, 29.98 RT	3/4"	39.98'
11+44.48, 29.32 RT	3/4"	39.32'
11+61.91, 29.17 LT	3/4"	19.17'
12+15.93, 30.61 RT	3/4"	40.61'
13+31.45, 30.05 LT	3/4"	20.05'
13+51.25, 30.05 RT	3/4"	40.05'
13+99.24, 30.25 RT	3/4"	40.25'
14+18.75, 22.85 RT	3/4"	32.85'
14+50.34, 30.93 LT	3/4"	20.93'
14+52.35, 30.88 RT	3/4"	40.88'
14+76.81, 29.26 RT	3/4"	39.26'
15+26.57, 30.63 LT	3/4"	20.63'
15+87.37, 30.76 LT	3/4"	20.76'
16+35.02, 29.12 LT	3/4"	19.12'
16+35.42, 28.37 RT	1"	38.37'
16+38.95, 28.84 LT	3/4"	18.84'
16+99.88, 29.91 LT	3/4"	19.91'
17+10.25, 31.16 RT	3/4"	41.16'
17+38.07, 29.58 LT	3/4"	19.58'
17+83.30, 30.12 LT	3/4"	20.12'
17+89.75, 30.19 RT	3/4"	40.19'
18+83.90, 27.35 LT	3/4"	17.35'

MICHIGAN AVE. 6" FIRE HYDRANT ASSEMBL		
STA. AND OFFSET	LENGTH	
12+70.88, 27.72 LT	17.72'	
16+20.02, 24.79 LT	14.79'	
18+20.80, 27.00 LT	17.00'	

				New
				N
1	12-21-17	AMENDMENT - 1	MD	D=of ood
0	9-08-17	ISSUED FOR CONSTRUCTION	MD	Profess
REV. No.	DATE	DESCRIPTION	APPROVED	



# **Street Maintenance Program FY 2017**

MICHIGAN AVENUE WATER LINE REPLACEMENT **PLAN STATION 11+00 TO 19+00** 


CITY OF ALAMOGORDO, NEW MEXICO, ENGINEERING DEPARTMENT

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DYER	ENGINEERI

Public Works	Bid No.:	2017-010		Sheet No.:
Drawn By:	AD	Designed By:	AD	U15.0
Checked By:	MD	Approved By: _	MD	

Scale: Horiz.: Vert.: n/a Sheet 75 of 103 EN1701

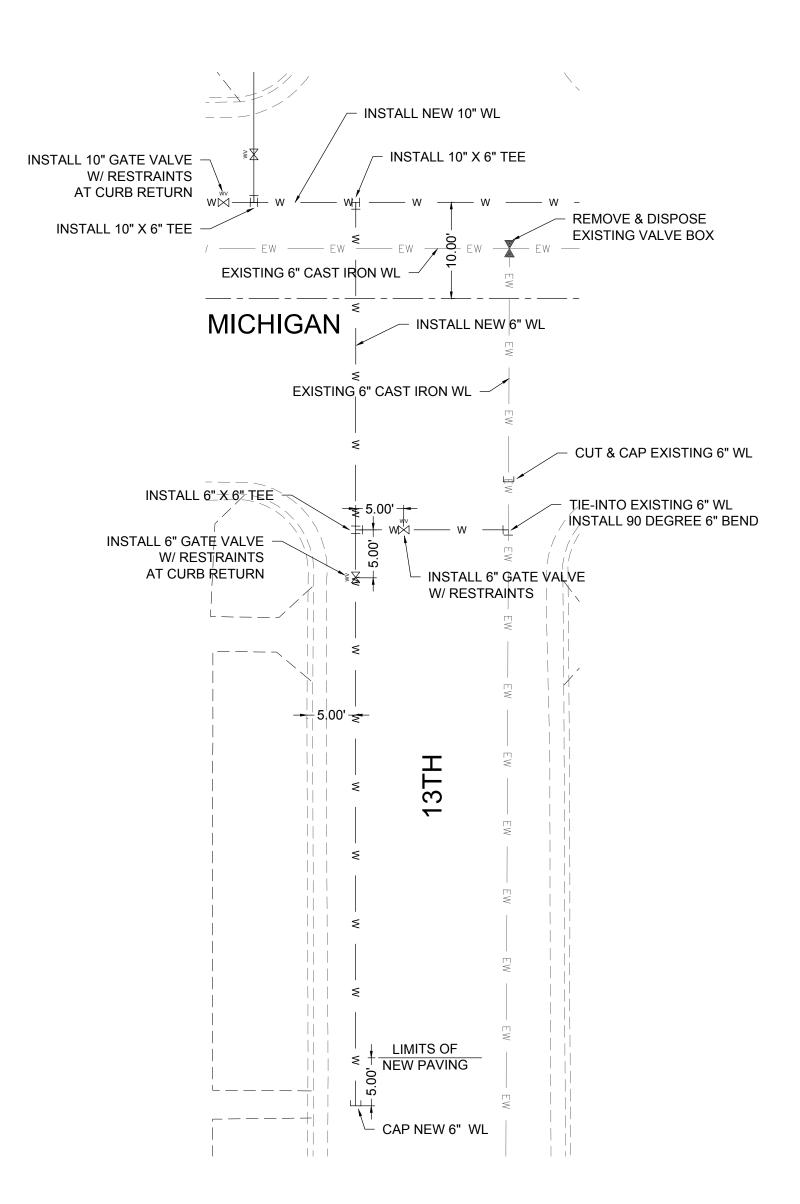

### EVICTING LITH ITY I FORMS



EXISTING	UTILITY LEGEND
——EOHT—EOHT—	EXISTING OVER HEAD TELEPHONE
——OHPL —OHPL ——	EXISTING OVER HEAD POWER LINE
ES ES	EXISTING SEWER
—— EW —— EW ——	EXISTING WATER
—— EG —— EG ——	EXISTING UNDERGROUND GAS
ET ET	EXISTING UNDERGROUND TELEPHONE
—— OHM —— OHM ——	EXISTING OVER HEAD MULTIPLE




				New Mexico One Call, Inc. Call 2 days    New Mexico One Call, Inc. Call 2 days   Dial 811 or
1	12-21-17	AMENDMENT - 1	MD	Professional Personal for Personal Properties 1-800-321-2537
0	9-08-17	ISSUED FOR CONSTRUCTION	MD	Professional Resources for Datinge Prevention 1 000 32 1 2037
REV. No.	DATE	DESCRIPTION	APPROVED	



# **Street Maintenance Program FY 2017**

MICHIGAN AVENUE WATER LINE TIE IN DETAILS

CITY OF ALAMOGORDO, NEW MEXICO, ENGINEERING DEPARTMENT

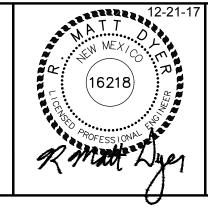

MICHIGAN / 14TH TIE-IN DETAIL
FULL SCALE: 1:10 HALF SCALE 1:20

LIMITS OF NEW PAVING

	_
DYER	ENGINEERING

		F
		( )
DYER I	ENGINEERING	

CAP NEW 6" WL

+ CAP NEW 6" WL

<del>---</del> 5.00' <del>|---</del>

- INSTALL NEW 6" WL

\_\_\_ x \_\_\_ x \_\_\_ x \_\_\_ x

INSTALL 10" GATE VALVE

W/ RESTRAINTS

AT CURB RETURN

INSTALL 6" GATE VALVE W/ RESTRAINTS

AT CURB RETURN

**MICHIGAN** 

INSTALL 6" GATE VALVE
W/ RESTRAINTS

AT CURB RETURN

INSTALL NEW 6" WL

 $\perp$  5.00'  $\stackrel{1}{\downarrow}$  INSTALL 6" X 6" TEE

REMOVE & DISPOSE

EXISTING ¥ALVE BOX

LIMITS OF NEW PAVING

INSTALL 6" GATE VALVE

TIE-INTO EXISTING 6" WL

INSTALL 90 DEGREE 6" BEND

CUT & CAP EXISTING 6" WL

ABANDON EXISTING 6" WL

CUT-&-CAP EXISTING 6" WL -

TIĘ-IŅTO EXĮSTING 6" WL -INSTALL 90 DEGREE 6" BEND

INSTALL 10" GATE VALVE -

W/ RESTRAINTS

AT CURB RETURN

W/ RESTRAINTS

INSTALL 10"X6" CROSS

- INSTALL NEW 1҈9" WL

NSTALL 6" GATE VALVE W/ RESTRAINTS


EXISTING 6" CAST IRON WL

Drawn By: AD Designed By: AD  Checked By: MD Approved By: MD	
Public Works Bid No.: 2017-010	

Sheet No.:


U15.1

Sheet 76 of 103

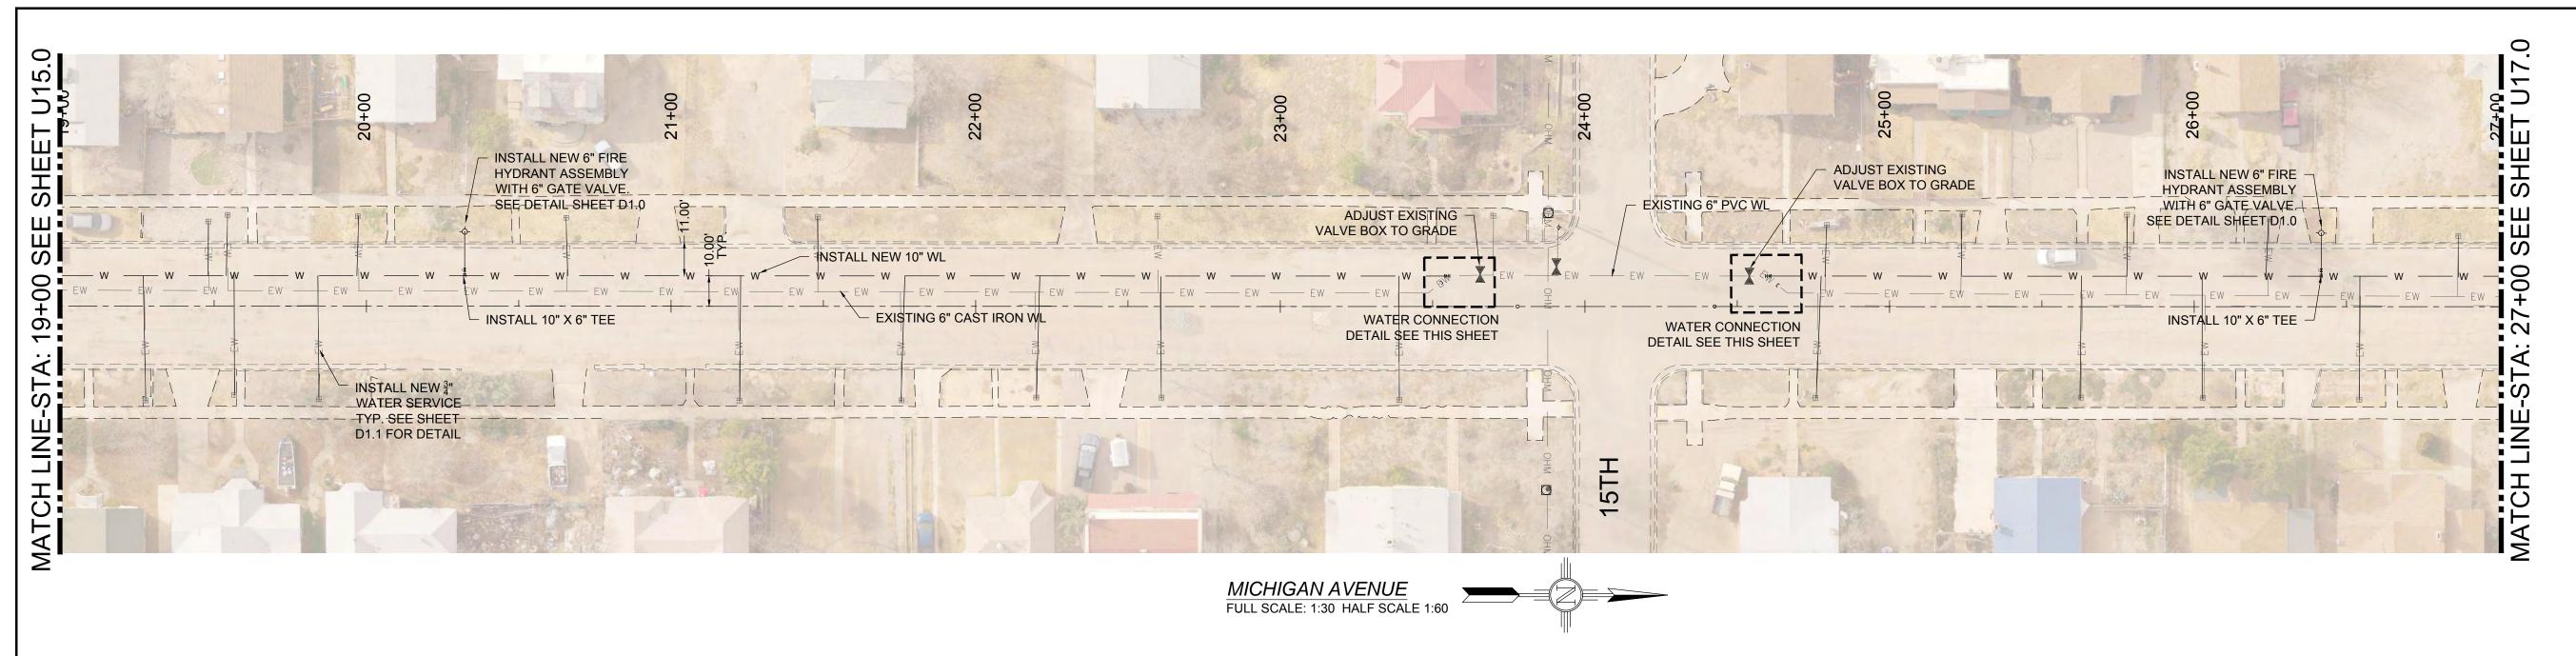

### EXISTING UTILITY LEGEND


——EOHT-EOHT-EXISTING OVER HEAD TELEPHONE ——OHPL —OHPL —— EXISTING OVER HEAD POWER LINE — ES — ES — EXISTING SEWER **EXISTING WATER** EXISTING UNDERGROUND GAS — ET — ET — EXISTING UNDERGROUND TELEPHONE —— OHM —— OHM —— EXISTING OVER HEAD MULTIPLE

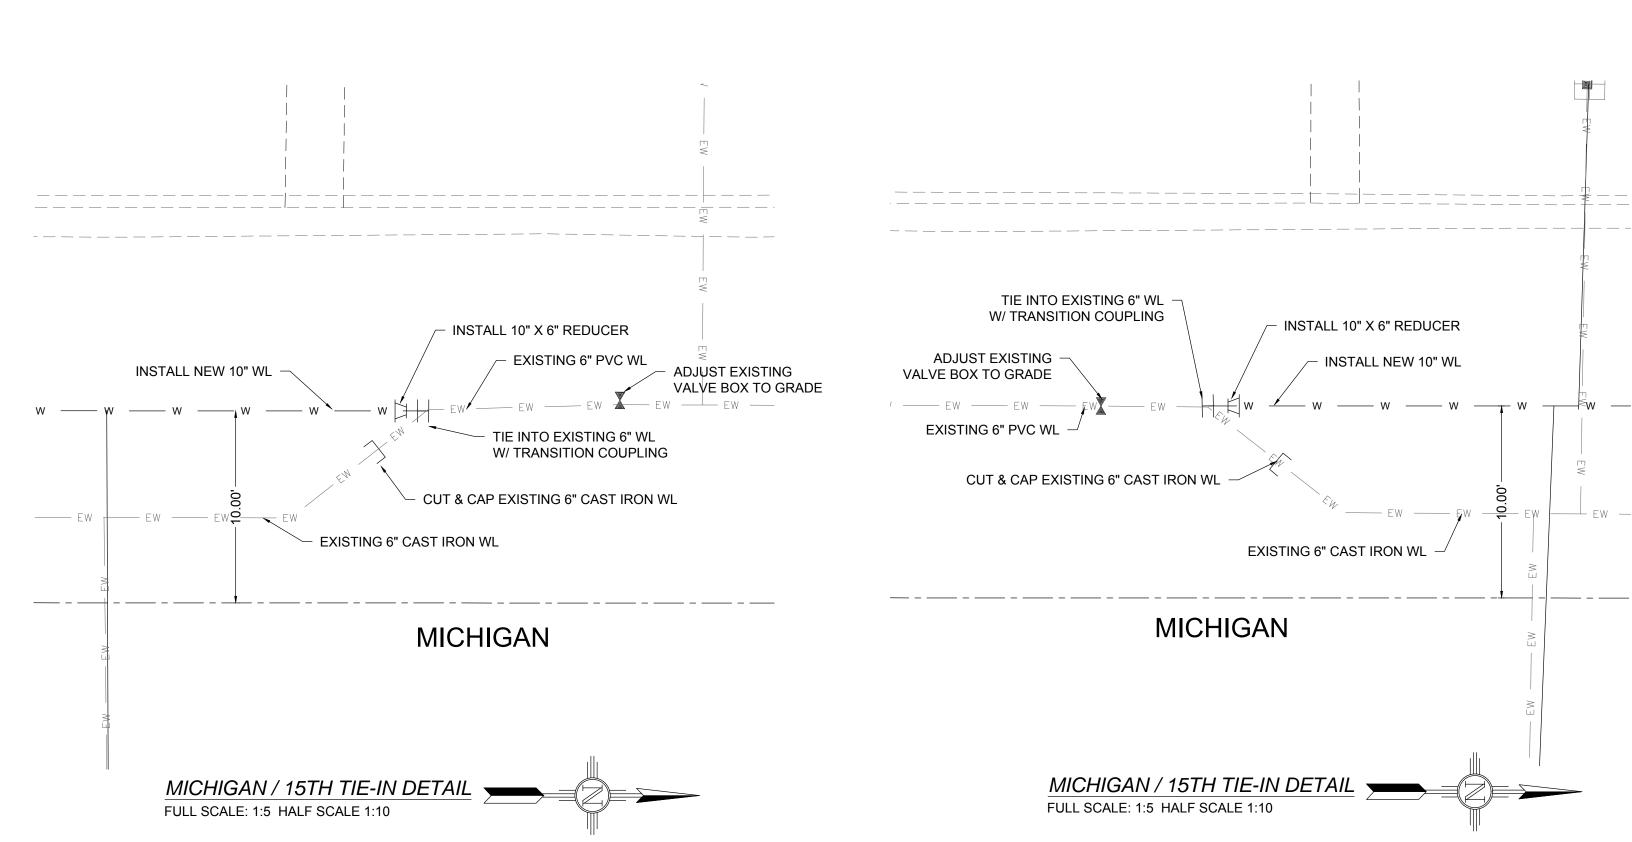

STA. AND OFFSET	SIZE	LENGTH
19+27.38, 31.01 RT	3/4"	41.01'
19+48.08, 27.80 LT	3/4"	17.80'
19+54.07, 30.11 LT	3/4"	20.11'
19+56.85, 29.08 RT	3/4"	39.08'
19+84.29, 30.34 RT	3/4"	40.34'
19+97.06, 29.99 LT	3/4"	19.99'
20+65.44, 28.97 LT	3/4"	18.97'
21+22.27, 30.61 RT	3/4"	40.61'
21+47.92, 29.45 LT	3/4"	19.45'
21+75.71, 30.98 RT	3/4"	40.98'
22+19.89, 30.06 RT	3/4"	40.06'
22+59.49, 29.72 LT	3/4"	19.72'
22+60.83, 30.05 RT	3/4"	40.05'
23+39.15, 30.60 RT	3/4"	40.60'
24+75.93, 29.82 RT	3/4"	39.82'
24+79.21, 26.80 LT	3/4"	16.80'
25+23.65, 30.34 LT	3/4"	20.34'
25+62.53, 29.87 RT	3/4"	39.87'
25+77.94, 29.71 LT	3/4"	19.71'
26+03.00, 29.62 RT	3/4"	39.62'
26+24.48, 28.70 LT	3/4"	18.70'
26+54.07, 30.33 RT	3/4"	40.33'
26+86.57, 23.09 LT	3/4"	13.09'

MICHIGAN AVE. 6" FIRE HYDRANT ASSEMBLY		
STA. AND OFFSET	LENGTH	
20+32.22, 24.37 LT	14.37'	
26+41.66, 24.04 LT	14.04'	


				'll'
0	9-08-17	ISSUED FOR CONSTRUCTION	MD	New Mexico One Call, Inc. Call 2 days  New Mexico One Call, Inc. Call 2 days  Dial 811 or  Professional Resources for Damage Prevention 1-800-321-2537
REV. No.	DATE	DESCRIPTION	APPROVED	
INLV. INO.	DATE	DESCRIPTION	AFFROVED	

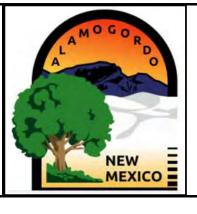

# **Street Maintenance Program FY 2017**

MICHIGAN AVENUE WATER LINE REPLACEMENT PLAN STATION 19+00 TO 27+00

CITY OF ALAMOGORDO, NEW MEXICO, ENGINEERING DEPARTMENT

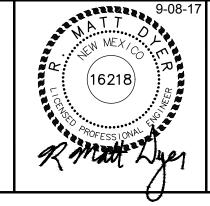


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DYER	ENGINEERIN

Sheet No.:		2017-010	Bid No.:	Public Works	
U16.0	AD	Designed By:	AD	Drawn By:	
	MD	Approved By:	MD	Checked By:	
				1	

Vert.: Scale: Horiz.:


n/a	Sheet	77	of	103
		EN	170	1

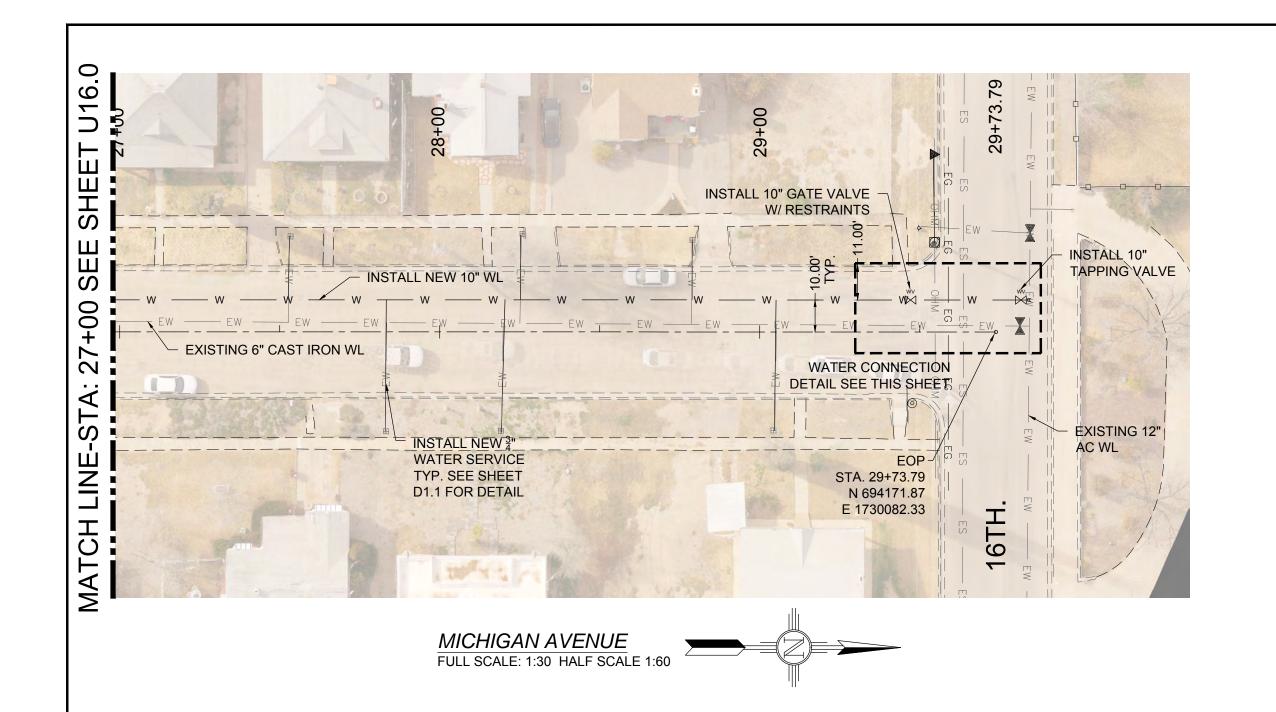

### EXISTING UTILITY LEGEND


— EOHT—EOHT— EXISTING OVER HEAD TELEPHONE
— OHPL—OHPL— EXISTING OVER HEAD POWER LINE
— ES — ES — EXISTING SEWER
— EW — EW — EXISTING WATER
— EG — EG — EXISTING UNDERGROUND GAS

— ET — ET — EXISTING UNDERGROUND TELEPHONE
— OHM — OHM — EXISTING OVER HEAD MULTIPLE

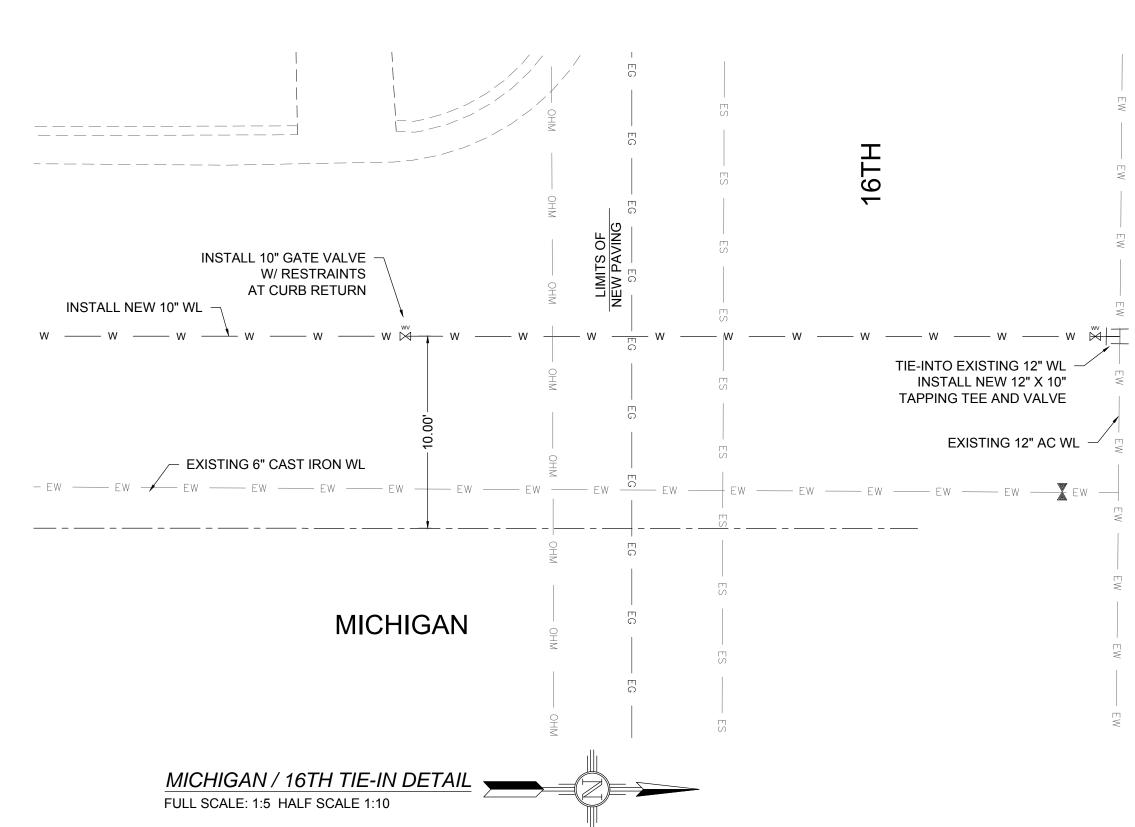

MICHIGAN AVE.	WATER SE	RVICES
STA. AND OFFSET	SIZE	LENGTH
27+53.03, 29.96 LT	3/4"	19.96'
27+82.89, 30.75 RT	3/4"	40.75'
28+19.41, 31.18 RT	3/4"	41.18'
28+25.48, 30.30 LT	3/4"	20.30'
28+79.07, 28.86 LT	3/4"	18.86'
29+04.60, 30.72 RT	3/4"	40.72'


				II
				New Mexico One Call, Inc. Call 2 days  New Mexico One Call, Inc. Call 2 days  before you dig!  Dial 811 or  Professional Resources for Damage Prevention 1-800-321-2537
1	12-21-17	AMENDMENT - 1	MD	Defension   Description 1 - 800 - 321 - 2537
0	9-08-17	ISSUED FOR CONSTRUCTION	MD	Professional Resources for Damage Prevention 1 000 J2 1 200 1
REV. No.	DATE	DESCRIPTION	APPROVED	

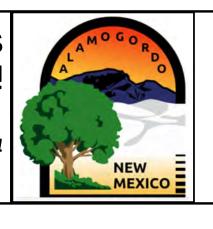

# Street Maintenance Program FY 2017

MICHIGAN AVENUE WATER LINE REPLACEMENT PLAN STATION 27+00 TO 29+50

CITY OF ALAMOGORDO, NEW MEXICO, ENGINEERING DEPARTMENT

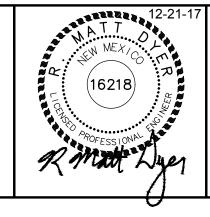



DYER	ENGINEERIN

Public Works	Bid No.:	2017-010		Sheet No.:
Drawn By:	AD	Designed By:	AD	U17.0
Checked By:	MD	Approved By:	MD	

Checked By: MD Approved By: MD Scale: Horiz.: Vert.: n/a

Sheet 78 of 103 EN1701

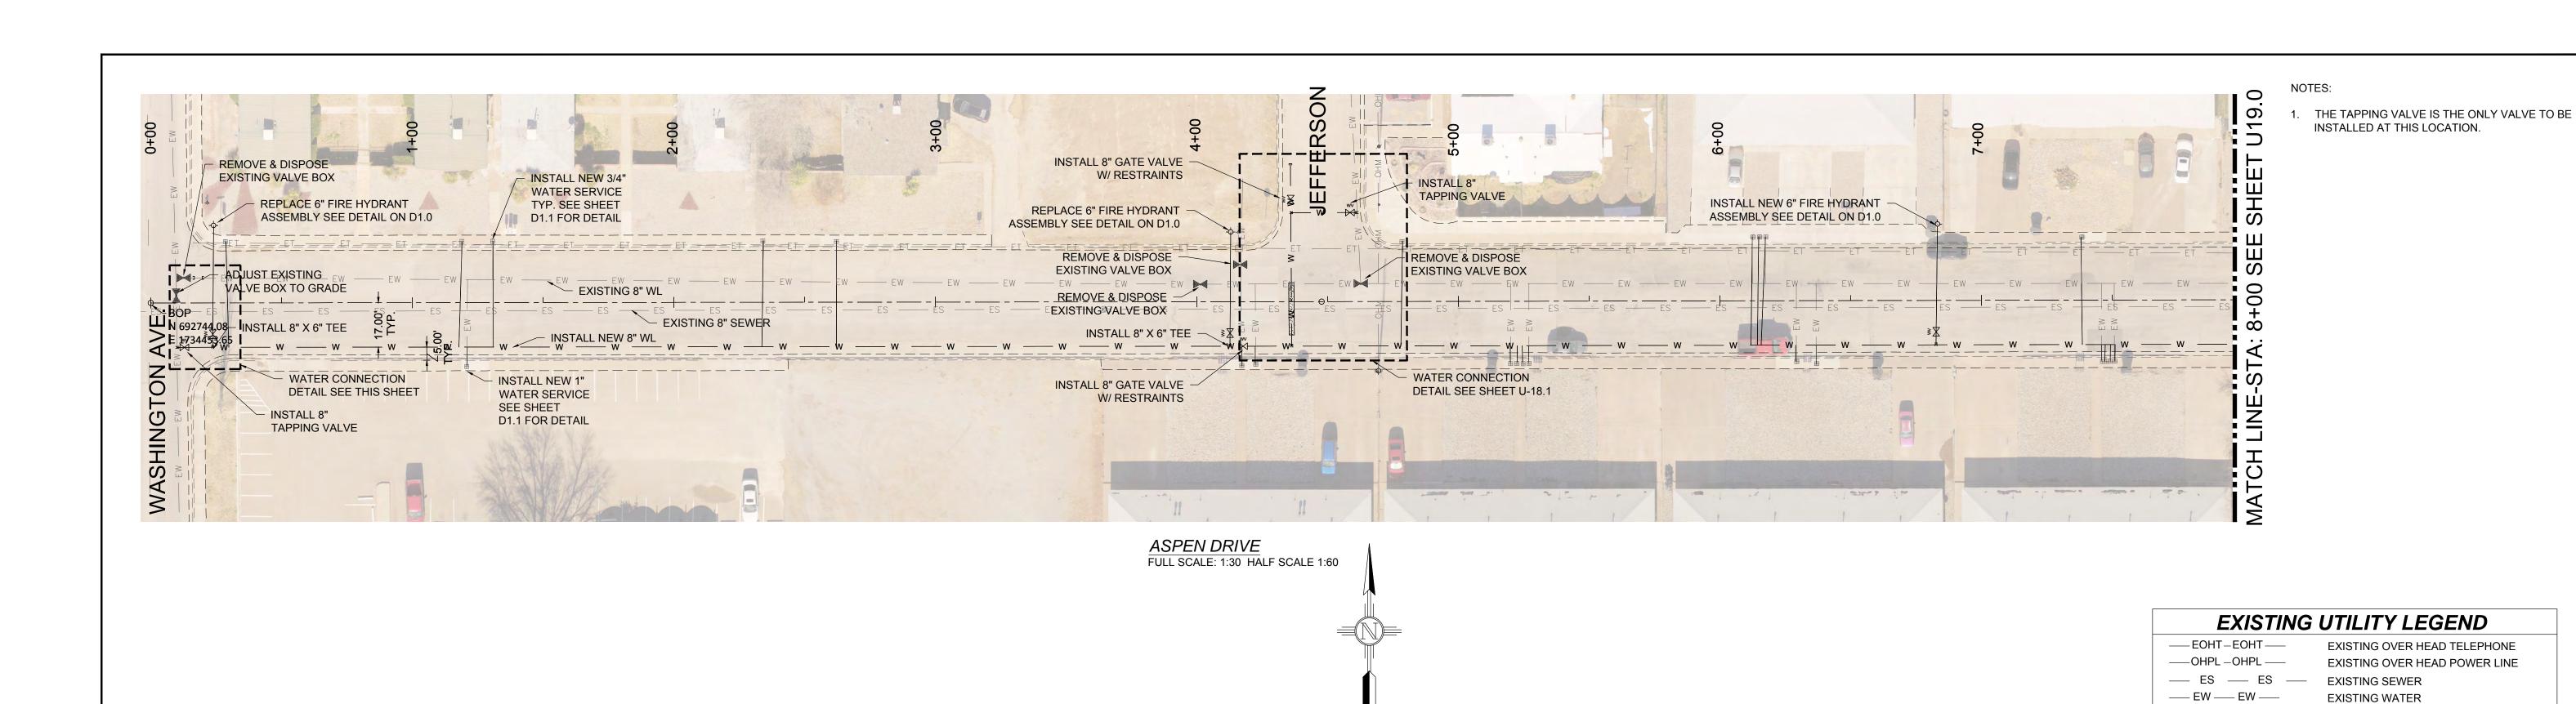

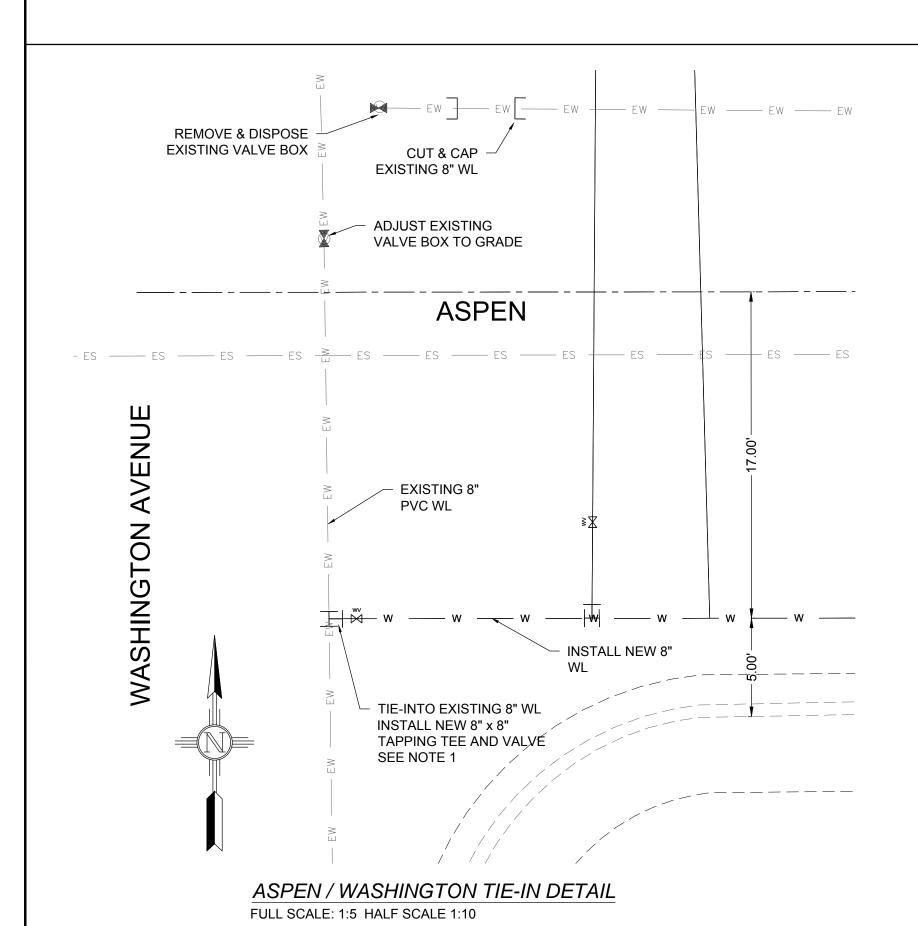

				New Mexico One Call, Inc. Call 2 days  Dial 811 or
1	12-21-17	AMENDMENT - 1	MD	Professional Resources for Damage Prevention 1-800-321-2537
^	0.00.17	ISSUED FOR CONSTRUCTION	MD	The content of the co

APPROVED

0 | 9-08-17 | ISSUED FOR CONSTRUCTION


DESCRIPTION



# Street Maintenance Program FY 2017

ASPEN DRIVE WATER LINE REPLACEMENT PLAN STATION 0+18 TO 8+00

CITY OF ALAMOGORDO, NEW MEXICO, ENGINEERING DEPARTMENT

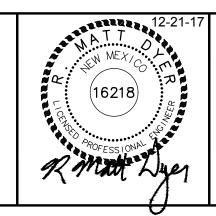

. 1-17		
'elere'		
	DYER	ENGINEERI
4		

STA. AND OFFSET	LENGTH	
0+23.82, 29.80 LT	46.60'	
4+15.65, 26.50 LT	43.28'	
6+83.09, 28.69 LT	46.37'	
Public Works Bid No.: 20	17-010	Sheet No.:

Public Works	Bid No.:	2017-010		Sheet No.:
Drawn By:	AD	Designed By:	AD	U18.0
Checked By:	MD	Approved By:	MD	

ASPEN DR. 6" FIRE HYDRANT ASSEMBLY

EXISTING UNDERGROUND GAS

EXISTING OVER HEAD MULTIPLE

ASPEN DR. WATER SERVICES

3/4"

3/4"

3/4"

3/4"

3/4"

3/4"

3/4"

3/4"

1 1/2"

STA. AND OFFSET

0+28.64, 23.23 LT

1+18.88, 23.45 LT

1+21.04, 24.25 RT

1+30.77, 23.44 LT

2+34.25, 23.47 LT

2+62.32, 23.12 LT

4+17.27, 24.12 RT

4+22.35, 23.81 RT

4+78.40, 23.16 LT

5+19.81, 23.70 RT

5+22.49, 23.71 RT

5+24.78, 23.71 RT

5+26.97, 23.82 RT

6+12.49, 24.48 LT

6+15.08, 24.47 LT

6+17.46, 24.27 LT

6+29.29, 23.03 RT

6+36.85, 24.14 RT

7+38.21, 24.03 LT

7+45.86, 23.47 RT

7+47.55, 23.47 RT

7+49.14, 23.37 RT

7+50.83, 23.38 RT

EXISTING UNDERGROUND TELEPHONE

LENGTH

40.23'

40.45'

7.25'

40.44'

40.47'

40.12'

7.12'

6.81'

40.16'

6.71'

6.71'

6.72'

6.82'

41.48'

41.47'

41.27'

6.03'

7.14'

41.02'

6.47'

6.47'


6.38'

6.38'

Scale: Horiz.: Vert.: n/a

EN1701

Sheet 79 of 103

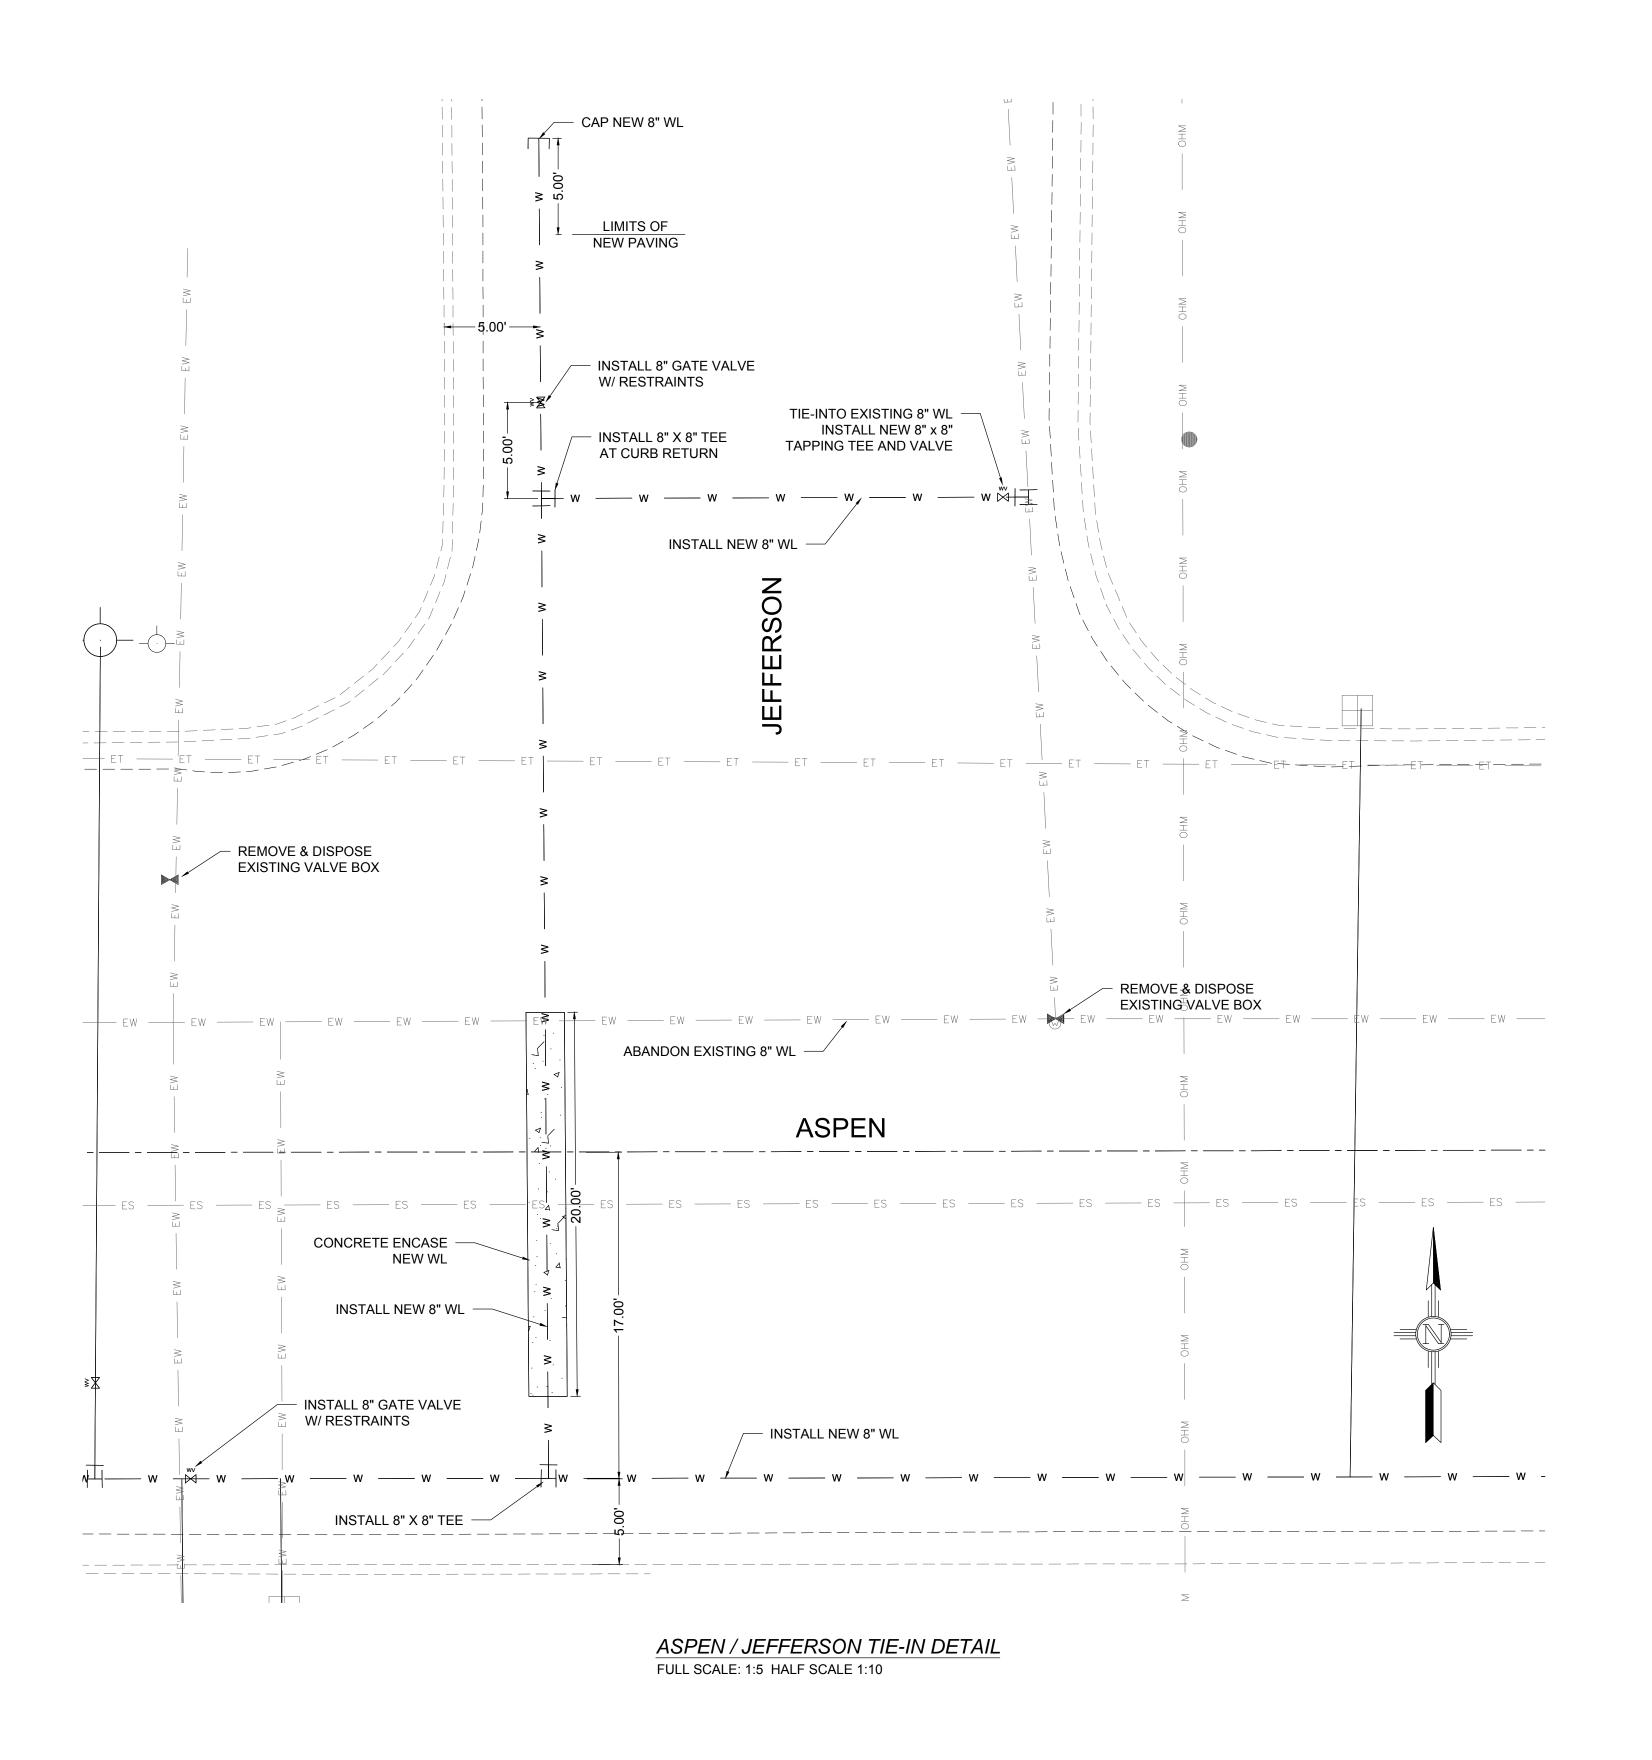

### **EXISTING UTILITY LEGEND**

EXISTING OVER HEAD TELEPHONE ——OHPL —— EXISTING OVER HEAD POWER LINE — ES — ES — EXISTING SEWER **EXISTING WATER** 

—— EG —— EG —— EXISTING UNDERGROUND GAS — ET — ET — EXISTING UNDERGROUND TELEPHONE

—— OHM —— OHM —— EXISTING OVER HEAD MULTIPLE


New Mexico One Call, Inc. Call 2 days 12-21-17 | AMENDMENT - 1 9-08-17 SSUED FOR CONSTRUCTION



# **Street Maintenance Program FY 2017**

ASPEN / JEFFERSON WATER LINE TIE IN DETAILS

CITY OF ALAMOGORDO, NEW MEXICO, ENGINEERING DEPARTMENT

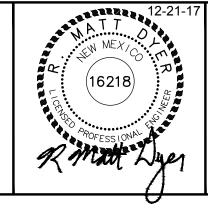



DYER	ENGINEERIN

Public Works	Bid No.:	2017-010		Sheet No.:
Drawn By:	AD	Designed By:	AD	U18.
Checked By:	MD	Approved By:	MD	

Scale: Horiz.:

Vert.: n/a

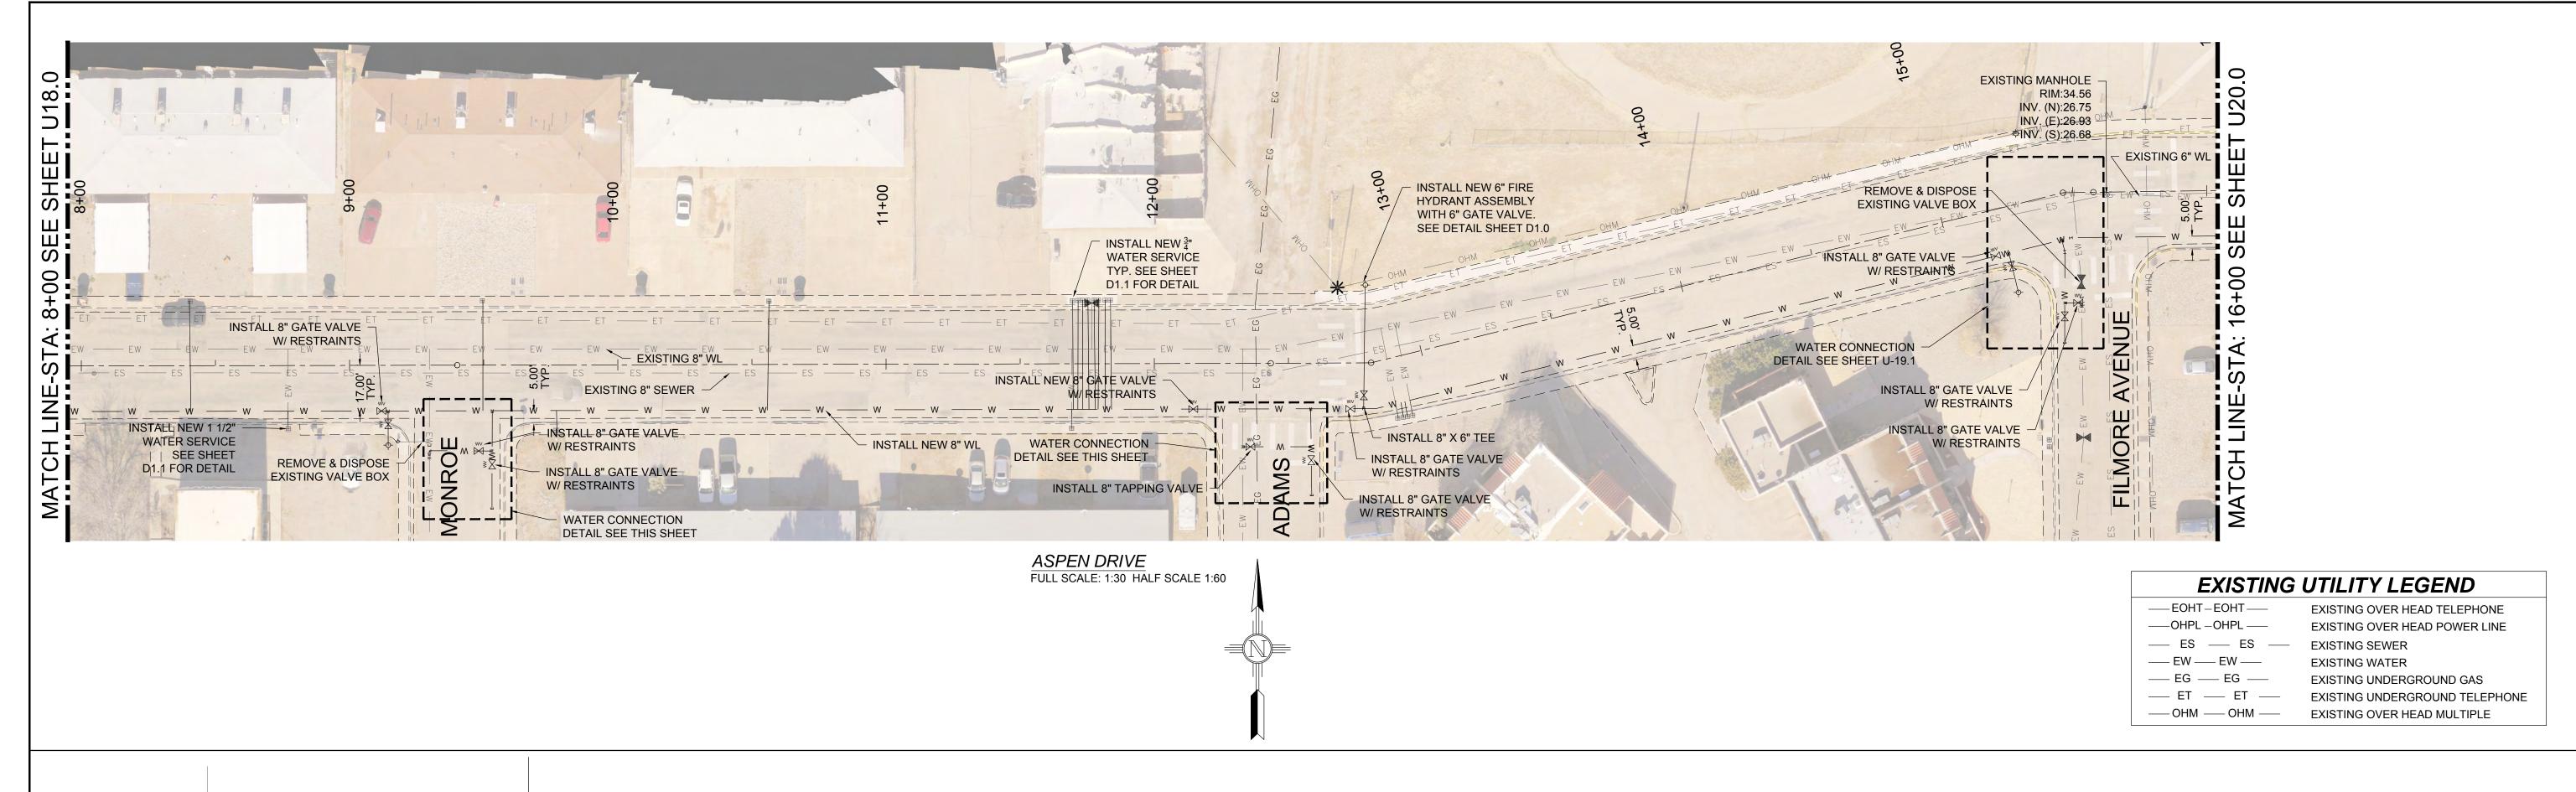


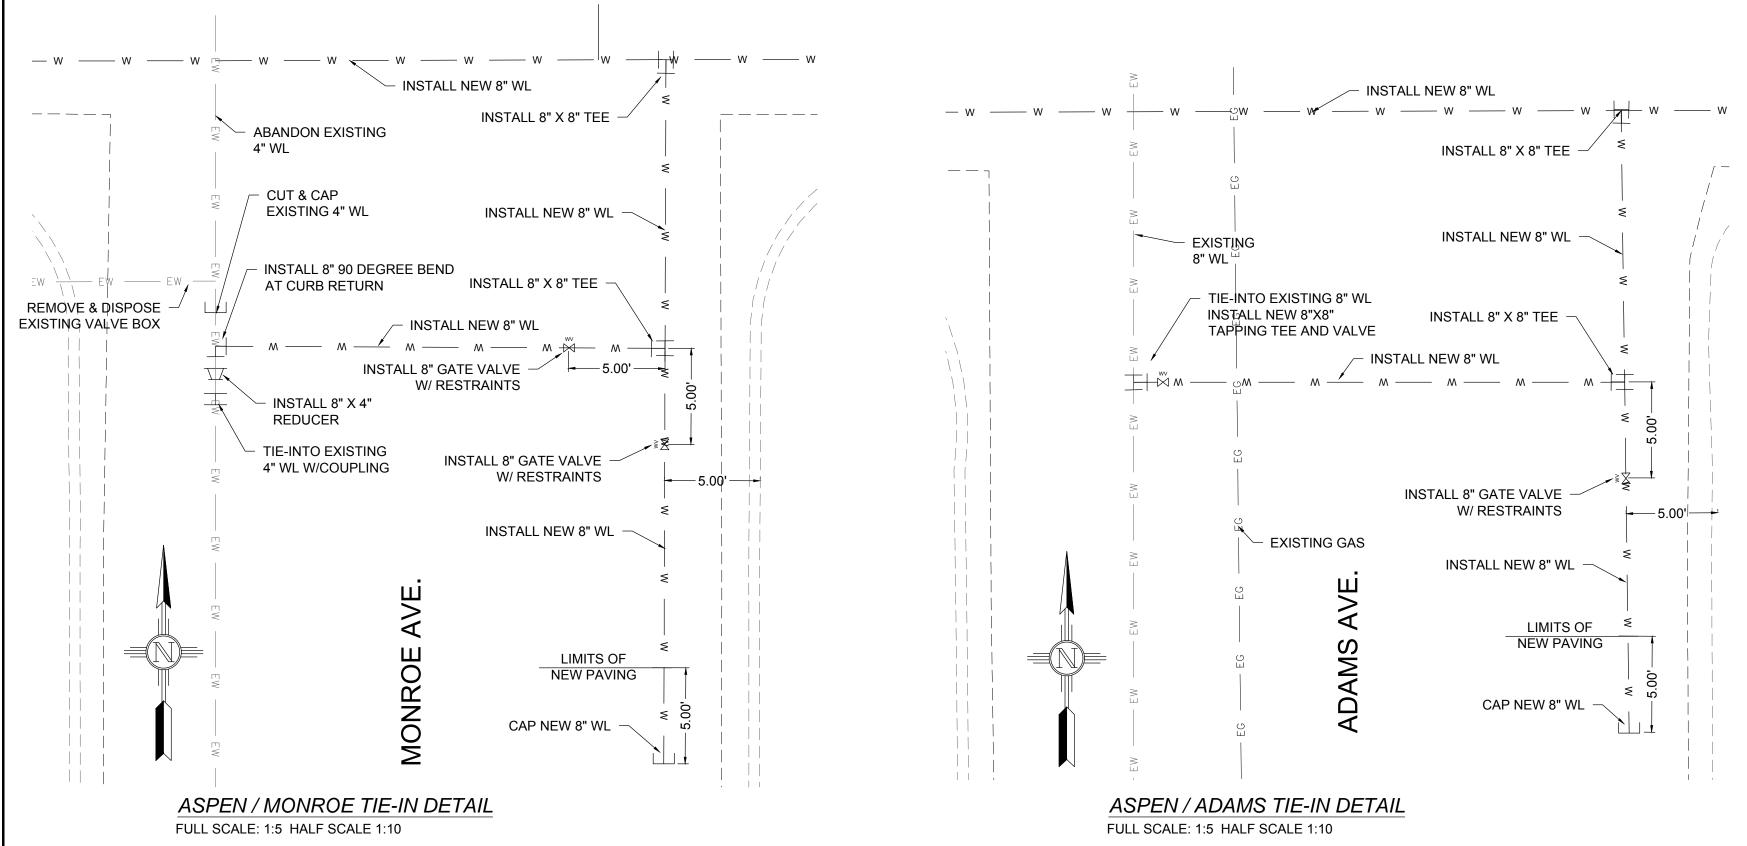

7.6. 2 2	. WATER SERVI	
STA. AND OFFSET	SIZE	LENGTH
8+40.62, 24.12 LT	1"	41.12'
8+77.03, 23.43 RT	1 1/2"	6.44'
9+49.64, 24.19 LT	1 1/2"	41.19'
9+77.36, 24.35 RT	1"	7.35'
10+56.44, 23.55 LT	1 1/2"	40.55'
11+69.12, 23.89 RT	1"	6.89'
11+69.53, 23.59 LT	3/4"	40.59'
11+71.71, 23.68 LT	3/4"	40.68'
11+73.24, 23.71 LT	3/4"	40.71'
11+75.30, 23.75 LT	3/4"	40.75'
11+77.55, 23.85 LT	3/4"	40.85'
11+79.37, 23.89 LT	3/4"	40.89'
11+81.74, 23.52 LT	3/4"	40.52'
11+83.72, 23.66 LT	3/4"	40.66'
12+85.71, 22.66 RT	3/4"	5.66'
12+87.78, 22.66 RT	3/4"	5.66'
12+89.46, 22.55 RT	3/4"	5.55'
12+91.60, 22.67 RT	3/4"	5.67'

ASPEN DR. 6" FII	ASPEN DR. 6" FIRE HYDRANT ASSEMBLY		
STA. AND OFFSET	LENGTH		
9+14.22, 29.68 RT	12.76'		
12+78.18, 28.90 LT	46.05'		
15+27.83, 33.20 RT	15.10'		


				New Mexico One Call, Inc. Call 2 d
				NM before you
1	12-21-17	AMENDMENT - 1	MD	Professional Resources for Damage Prevention 1-800-321-
0	9-08-17	ISSUED FOR CONSTRUCTION	MD	Professional Resources for Damage Prevention FOOG JZ F
REV. No.	DATE	DESCRIPTION	APPROVED	

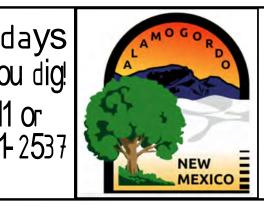

# Street Maintenance Program FY 2017


ASPEN DRIVE WATER LINE REPLACEMENT PLAN STATION 8+00 TO 16+00

CITY OF ALAMOGORDO, NEW MEXICO, ENGINEERING DEPARTMENT

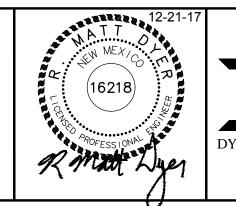

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Public Works	Bid No.:	2017-010		Sheet No.:
Drawn By:	AD	Designed By: _	AD	U19.0
Checked By:	MD	Approved By: _	MD	
Scale: Horiz	·:	Vert.: 1	n/a	Sheet 81 of 103

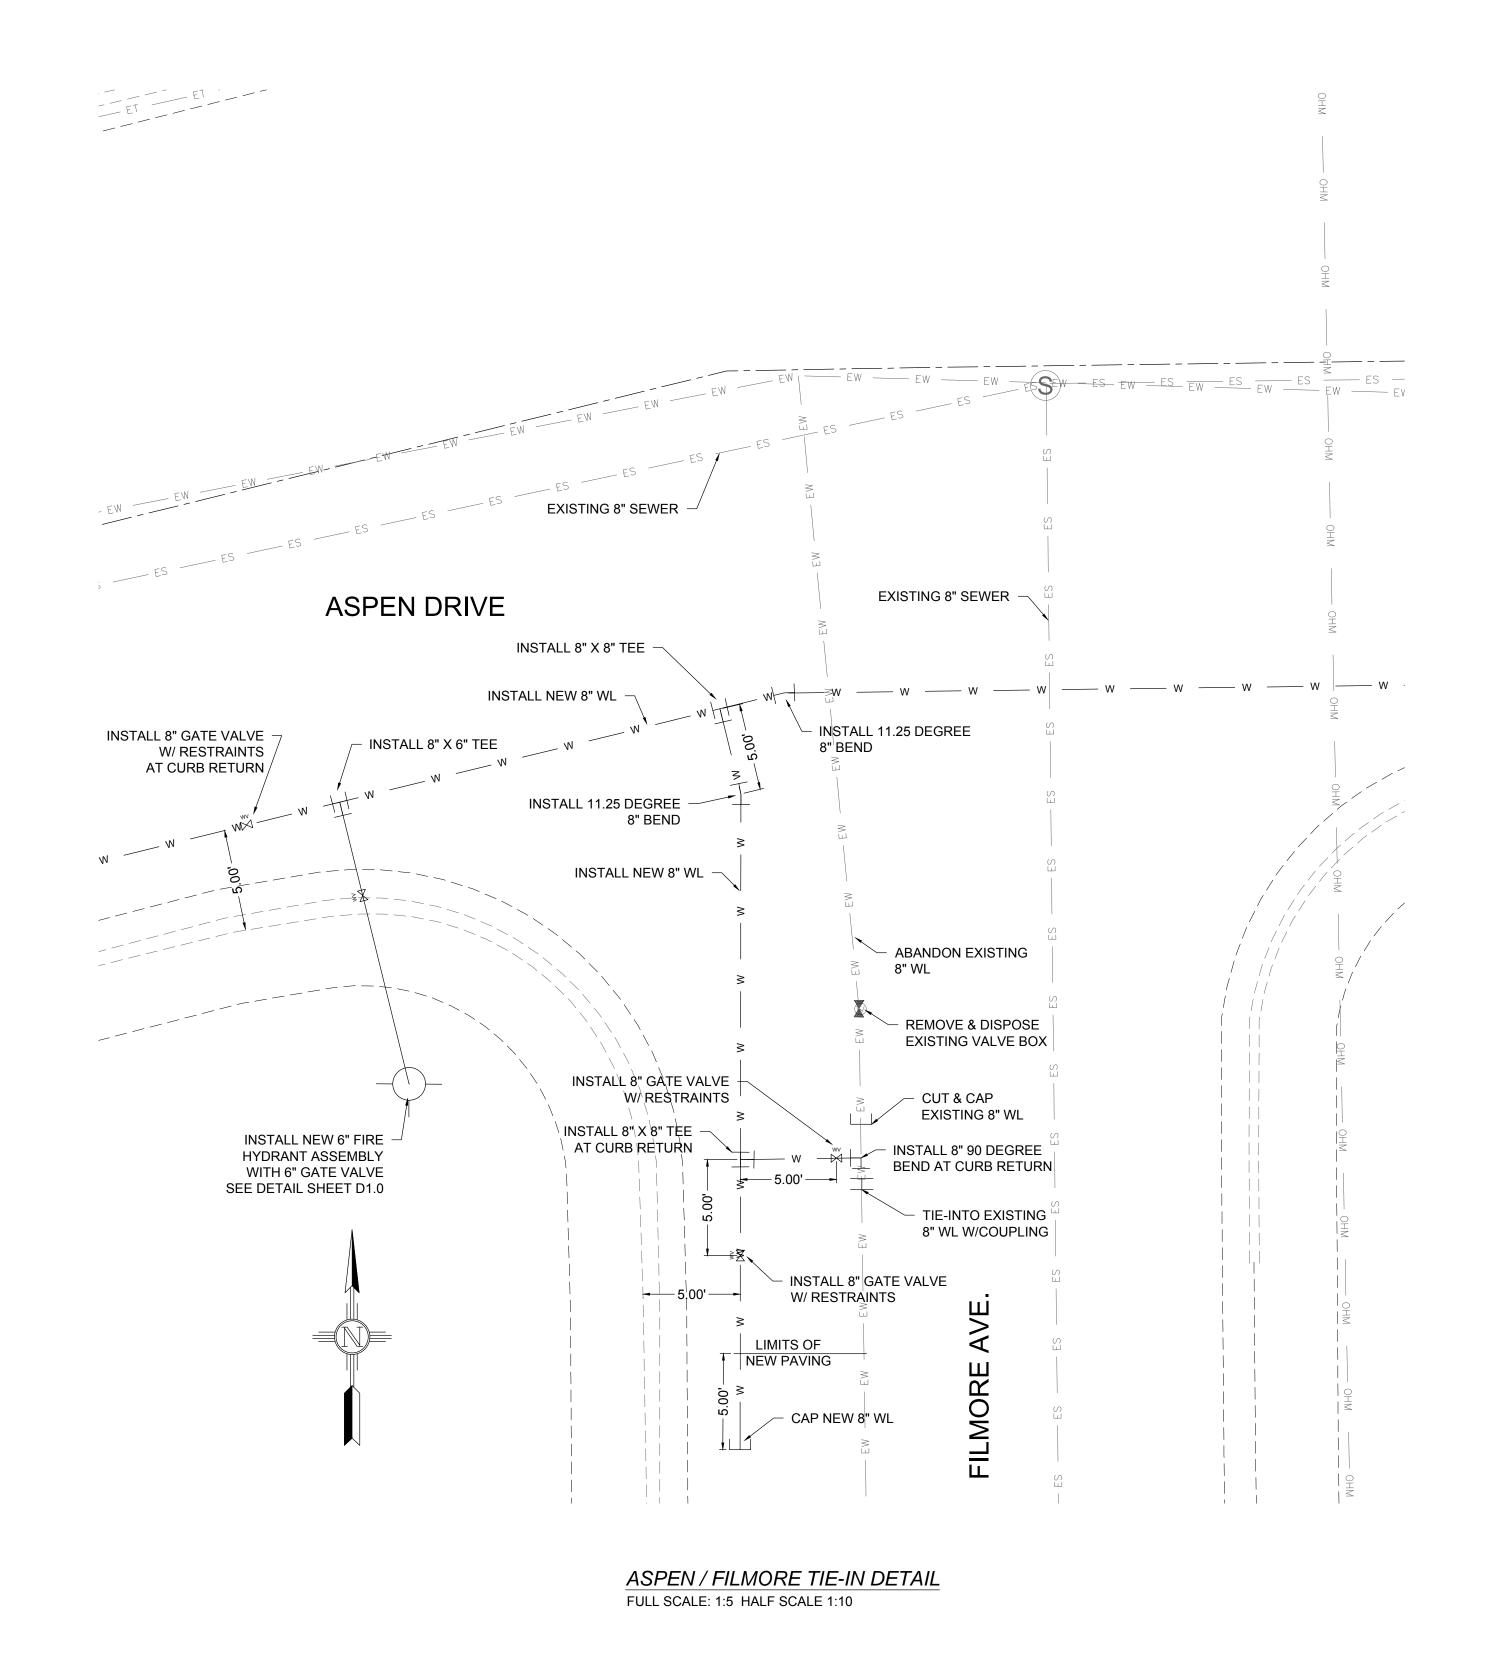


EXISTING	UTILITY LEGEND
——EOHT—EOHT——	EXISTING OVER HEAD TELEPHONE
——OHPL —OHPL ——	EXISTING OVER HEAD POWER LINE
ES ES	EXISTING SEWER
EW EW	EXISTING WATER
—— EG —— EG ——	EXISTING UNDERGROUND GAS
ET ET	EXISTING UNDERGROUND TELEPHONE
—— OHM —— OHM ——	EXISTING OVER HEAD MULTIPLE



# Street Maintenance Program FY 2017

ASPEN DRIVE WATER LINE REPLACEMENT PLAN STATION 8+00 TO 16+00

CITY OF ALAMOGORDO, NEW MEXICO, ENGINEERING DEPARTMENT

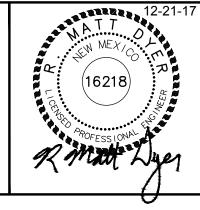



DYER	ENGINEERIN
	DYER

Public Works	Bid No.:	2017-010		Sheet No.:
Drawn By:	AD	Designed By:	AD	U19.1
Checked By:	MD	Approved By:	MD	

Scale: Horiz.: Vert.: n/a

Sheet 82 of 103 EN1701

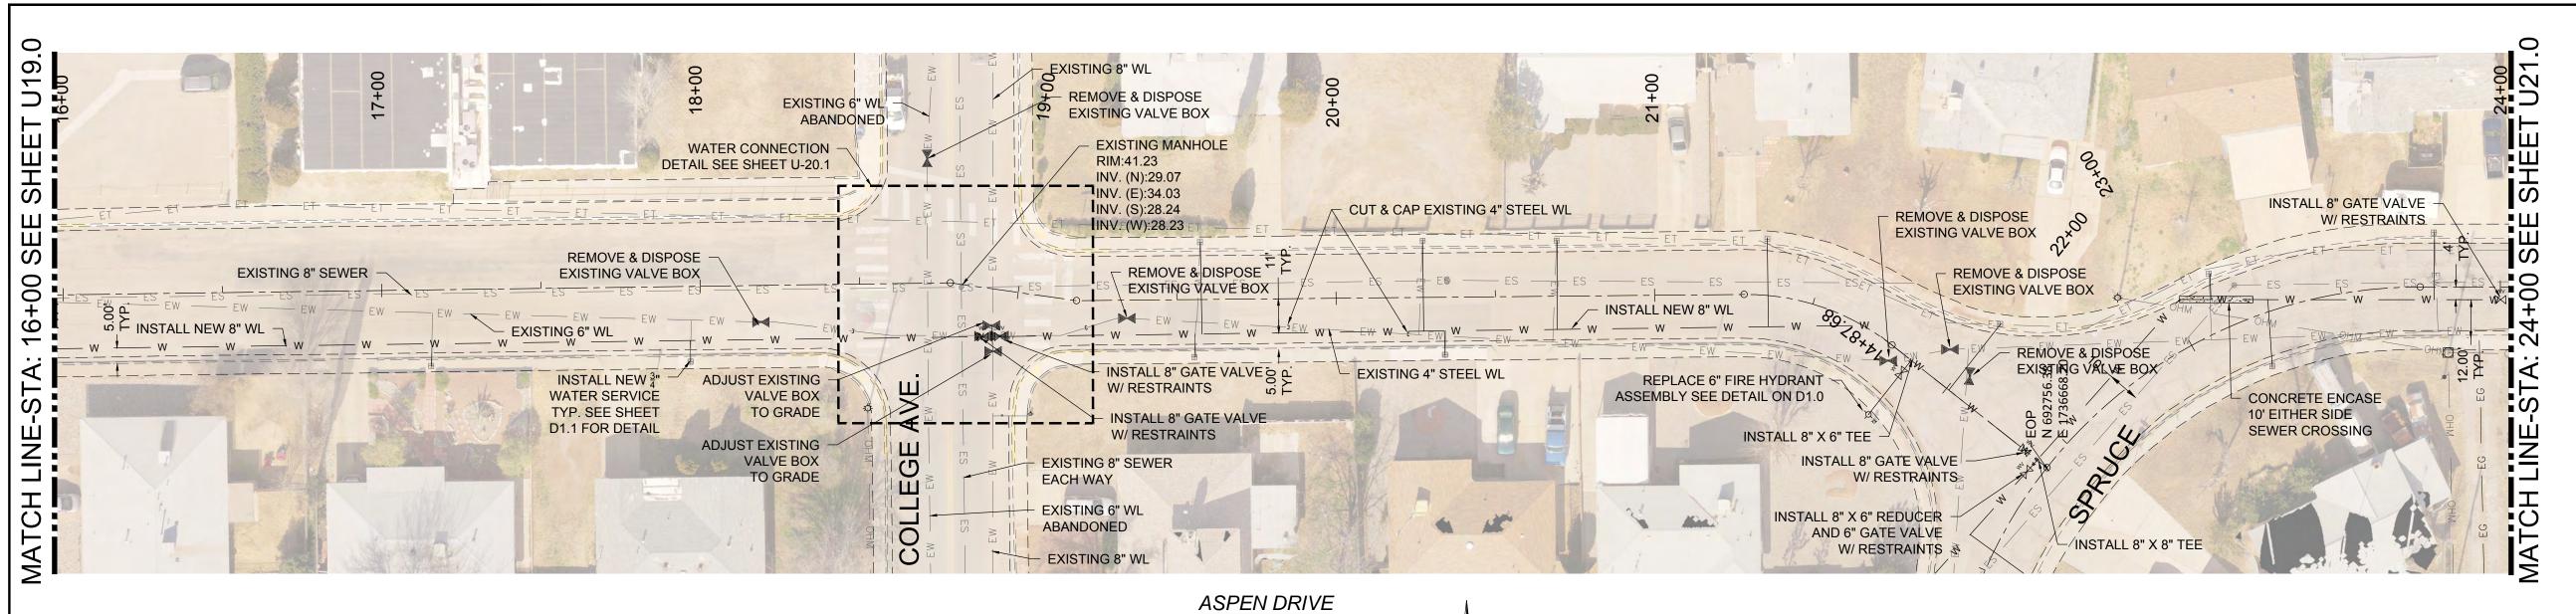

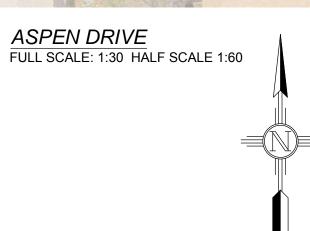

### EXISTING UTILITY LEGEND

	ASPEN DR. WATER SERVICES				
Ī	STA. AND OFFSET	SIZE	LENGTH		
	17+15.18, 23.59 RT	3/4"	6.80'		
	17+96.52, 23.56 RT	3/4"	6.70'		
	19+55.38, 17.98 RT	3/4"	7.46'		
	19+57.47, 17.88 LT	3/4"	29.00'		
	20+27.20, 17.72 LT	3/4"	28.00'		
	20+33.92, 18.23 RT	3/4"	8.00'		
	20+69.57, 17.48 LT	3/4"	28.10'		
	21+34.02, 17.61 LT	3/4"	27.50'		
	22+00.82, 26.10 LT	3/4"	26.10'		
	23+13.99, 17.63 LT	3/4"	7.96'		
	23+21.97, 16.76 RT	3/4"	20.98'		
	23+79.23, 16.74 LT	3/4"	20.74'		

ASPEN DR. 6" FIRE HYDRANT ASSEMBLY		
STA. AND OFFSET	LENGTH	
21+88.56, 21.90 RT	21.90'	


				New Mexico One Call, Inc. Ca
1	12-21-17	AMENDMENT - 1	MD	
0	9-08-17	ISSUED FOR CONSTRUCTION	MD	Professional Resources for Damage Prevention 1-8
REV. No.	DATE	DESCRIPTION	APPROVED	



# Street Maintenance Program FY 2017

ASPEN DRIVE WATER LINE REPLACEMENT PLAN STATION 16+00 TO 24+00

CITY OF ALAMOGORDO, NEW MEXICO, ENGINEERING DEPARTMENT

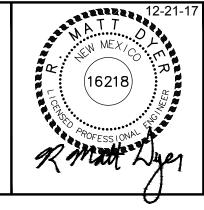


DYER	ENGINEERIN

Public Works	Bid No.:	2017-010		Sheet No.:
Drawn By:	AD	Designed By:	AD	U20.0
Checked By:	MD	_ Approved By:	MD	

Scale: Horiz.: Vert.: n/a

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EN1701

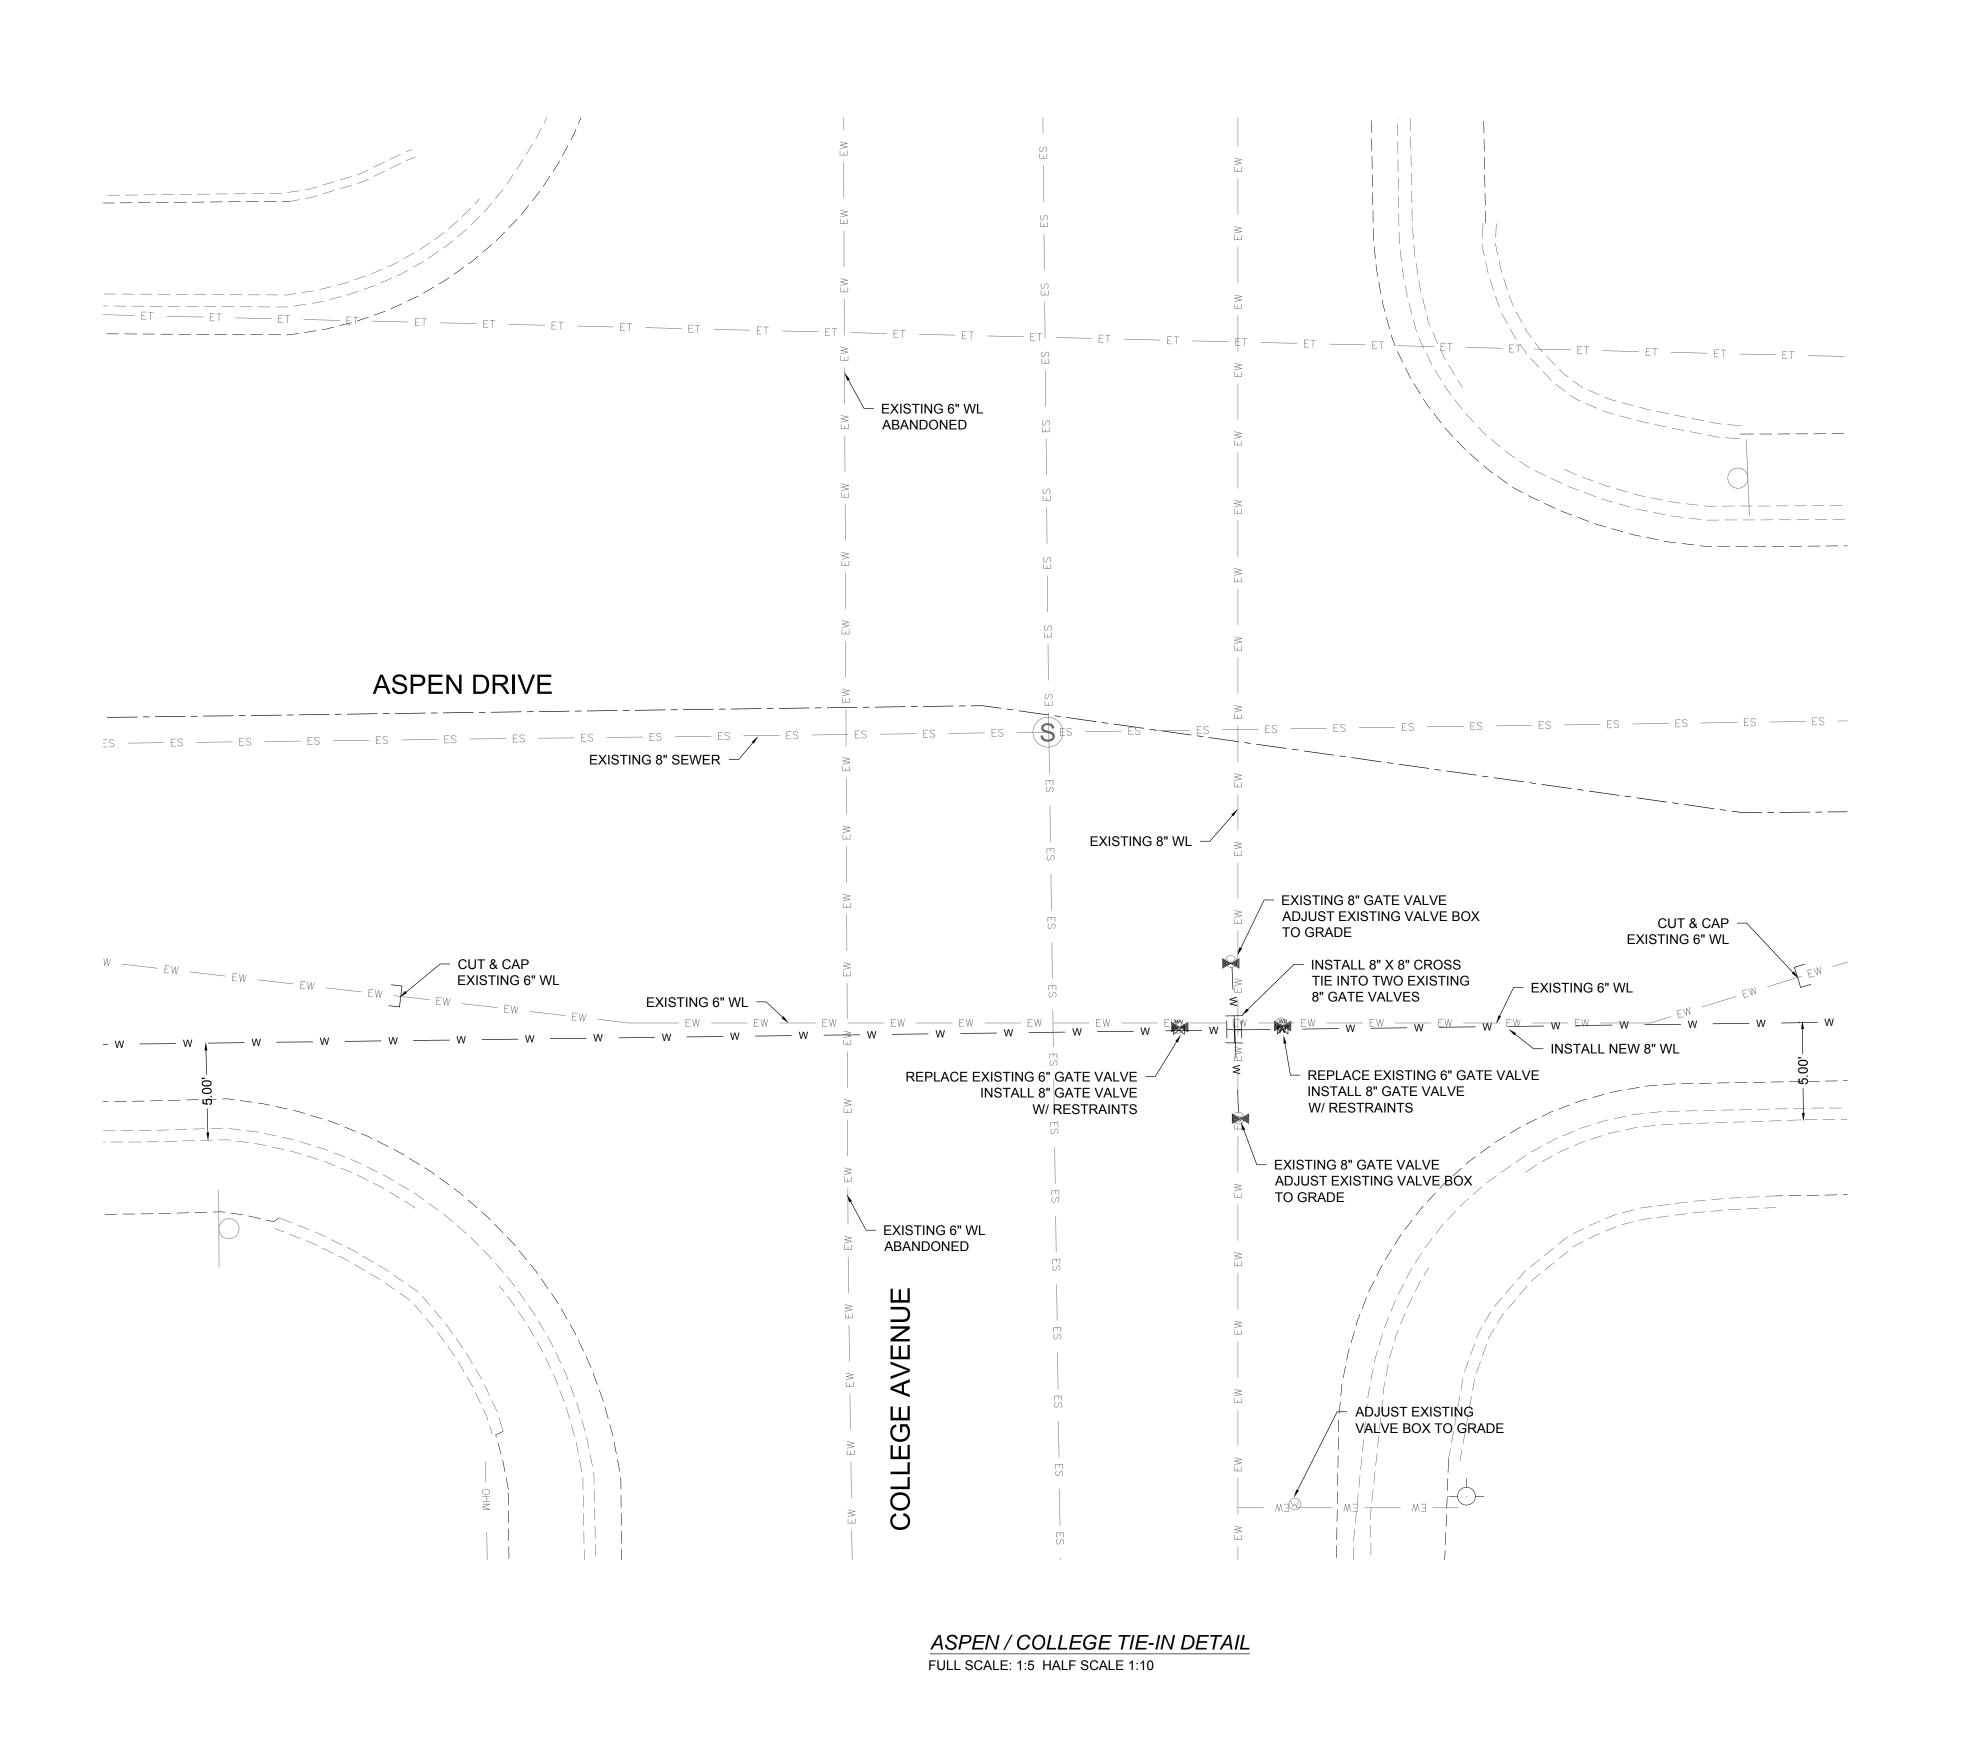


New Mexico One Call, Inc. Call 2 days

Dial 811 or

No 9-08-17 ISSUED FOR CONSTRUCTION


REV. No. DATE DESCRIPTION APPROVED

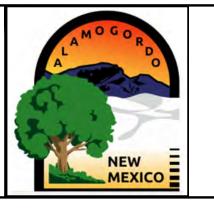

# Street Maintenance Program FY 2017

ASPEN DRIVE WATER LINE REPLACEMENT PLAN STATION 16+00 TO 24+00


CITY OF ALAMOGORDO, NEW MEXICO, ENGINEERING DEPARTMENT

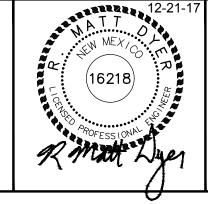

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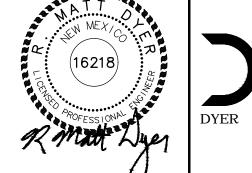
Public Works	Bid No.:	2017-010		Sheet No.:
Drawn By:	AD	Designed By:	AD	U20.1
Checked By:	MD	Approved By:	MD	

Scale: Horiz.: Vert.: n/a

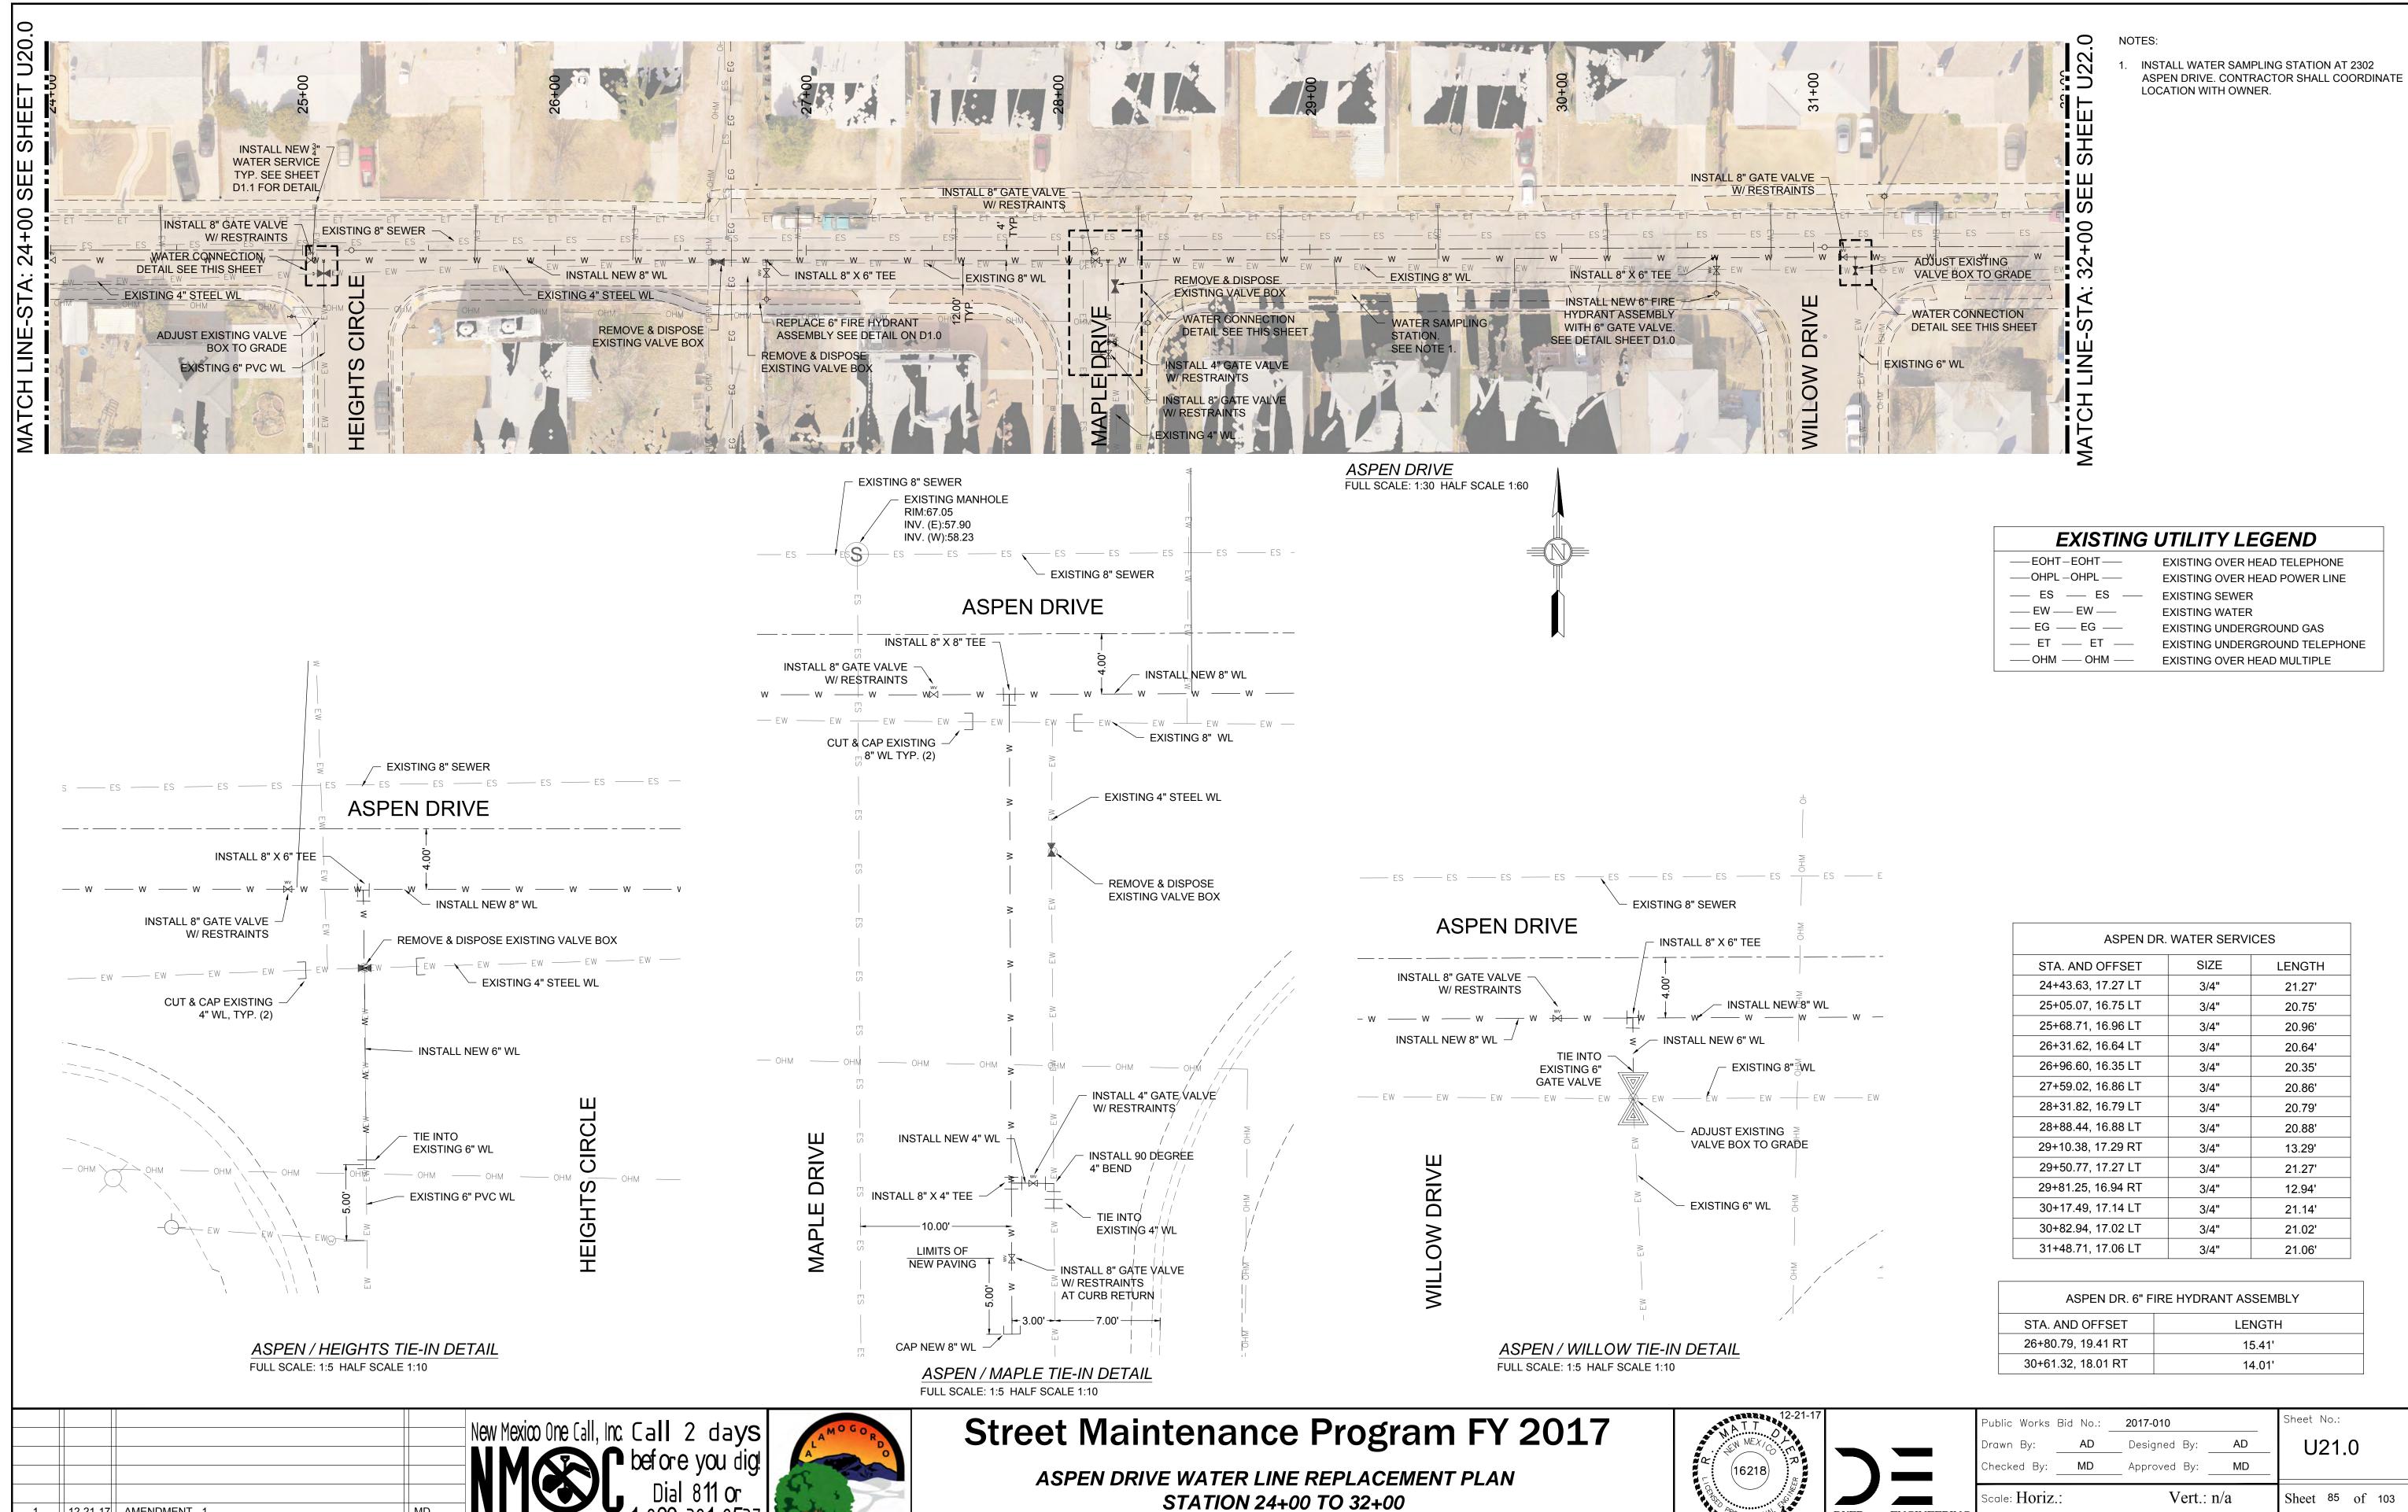


12-21-17 | AMENDMENT - 1 | 9-08-17 | ISSUED FOR CONSTRUCTION DESCRIPTION

CITY OF ALAMOGORDO, NEW MEXICO, ENGINEERING DEPARTMENT
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 CONTRACTOR SHALL INSTALL NEW 2" IRRIGATION SERVICE LINE APPROXIMATELY 210 LF TO THE SOUTH DOWN THE ALLEY. THE NEW SERVICE IS FOR 1302 JUNIPER DRIVE.

### EXISTING UTILITY LEGEND

— EOHT—EOHT— EXISTING OVER HEAD TELEPHONE
— OHPL—OHPL— EXISTING OVER HEAD POWER LINE
— ES — ES — EXISTING SEWER
— EW — EW — EXISTING WATER
— EG — EG — EXISTING UNDERGROUND GAS
— ET — ET — EXISTING UNDERGROUND TELEPHONE
— OHM — OHM — EXISTING OVER HEAD MULTIPLE

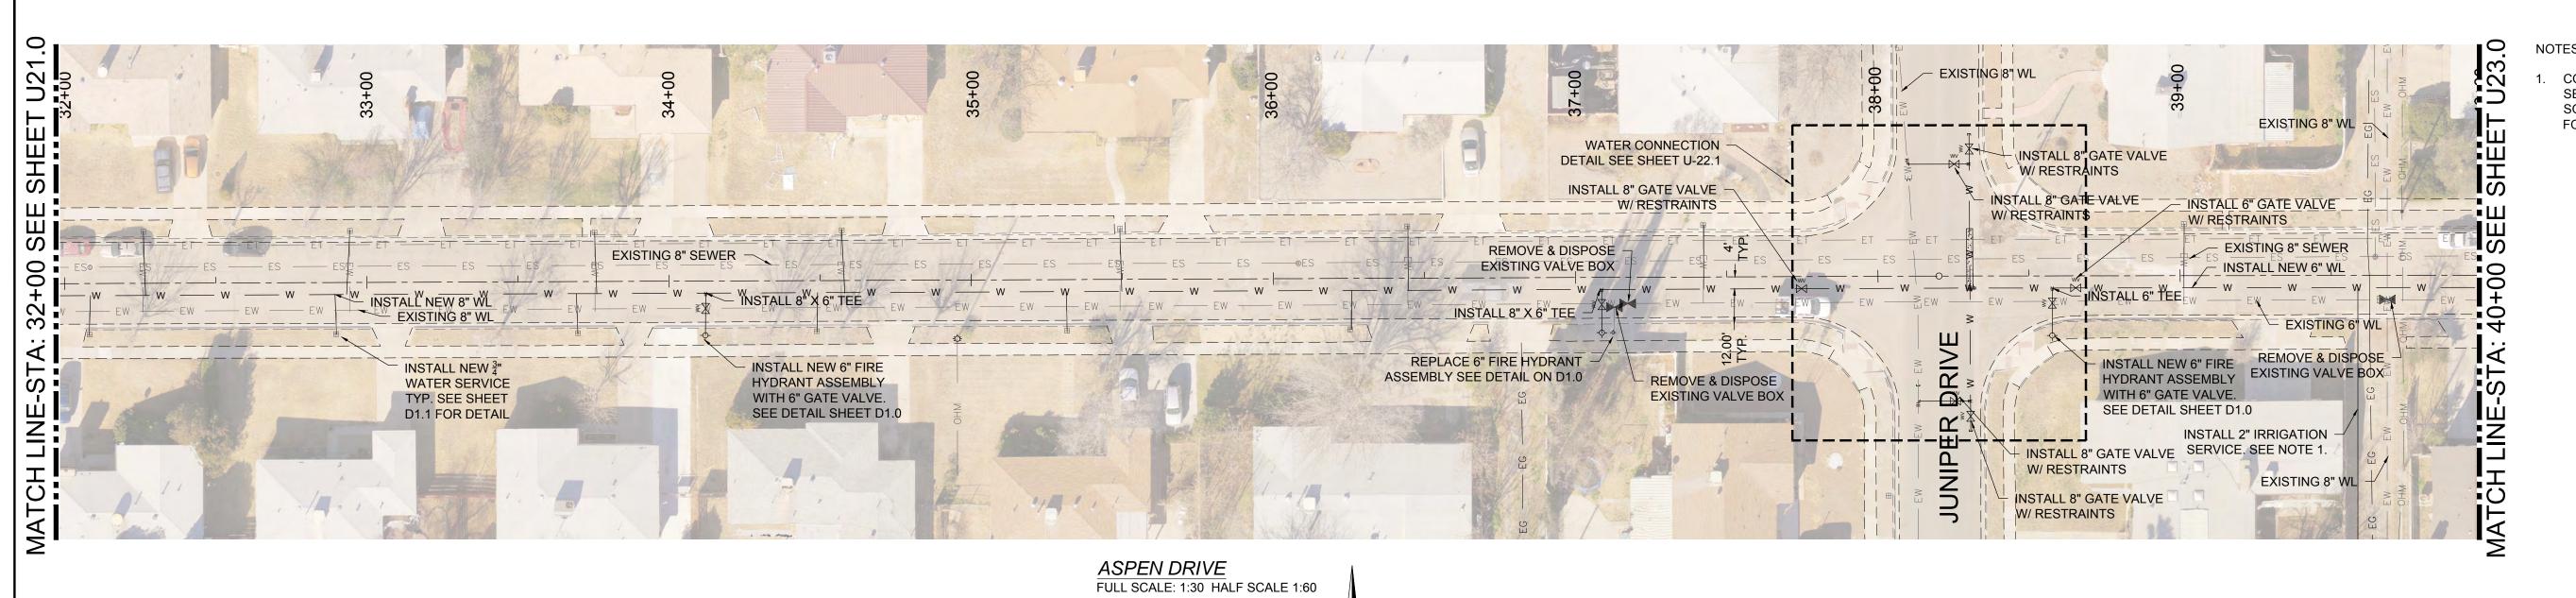STA. AND OFFSET	SIZE	LENGTH
32+08.18, 16.59 RT	3/4"	12.59'
32+26.06, 17.10 LT	3/4"	21.10'
32+89.66, 17.07 RT	3/4"	13.07'
32+94.27, 16.99 LT	3/4"	20.99'
33+69.55, 17.24 RT	3/4"	13.24'
33+75.48, 16.32 LT	3/4"	20.32'
34+48.85, 16.90 RT	3/4"	12.90'
34+56.93, 16.65 LT	3/4"	20.65'
35+31.53, 16.90 RT	3/4"	12.90'
35+49.22, 16.44 LT	3/4"	20.44'
36+25.47, 16.62 RT	3/4"	12.62'
36+44.32, 17.05 LT	3/4"	21.05'
37+42.22, 17.15 LT	3/4"	21.15'
39+01.37, 17.05 LT	3/4"	21.05'

ASPEN DR. 6" FIRE HYDRANT ASSEMBLY  STA. AND OFFSET LENGTH				
				34+11.80, 17.90 RT
37+12.50, 18.37 RT	14.37'			
38+57.54, 19.54 RT	15.54'			

				New Mexico
1	12-21-17	AMENDMENT - 1	MD	
0	9-08-17	ISSUED FOR CONSTRUCTION	MD	Professional Resources
REV. No.	DATE	DESCRIPTION	APPROVED	



# **Street Maintenance Program FY 2017**

ASPEN DRIVE WATER LINE REPLACEMENT PLAN STATION 32+00 TO 40+00

CITY OF ALAMOGORDO, NEW MEXICO, ENGINEERING DEPARTMENT


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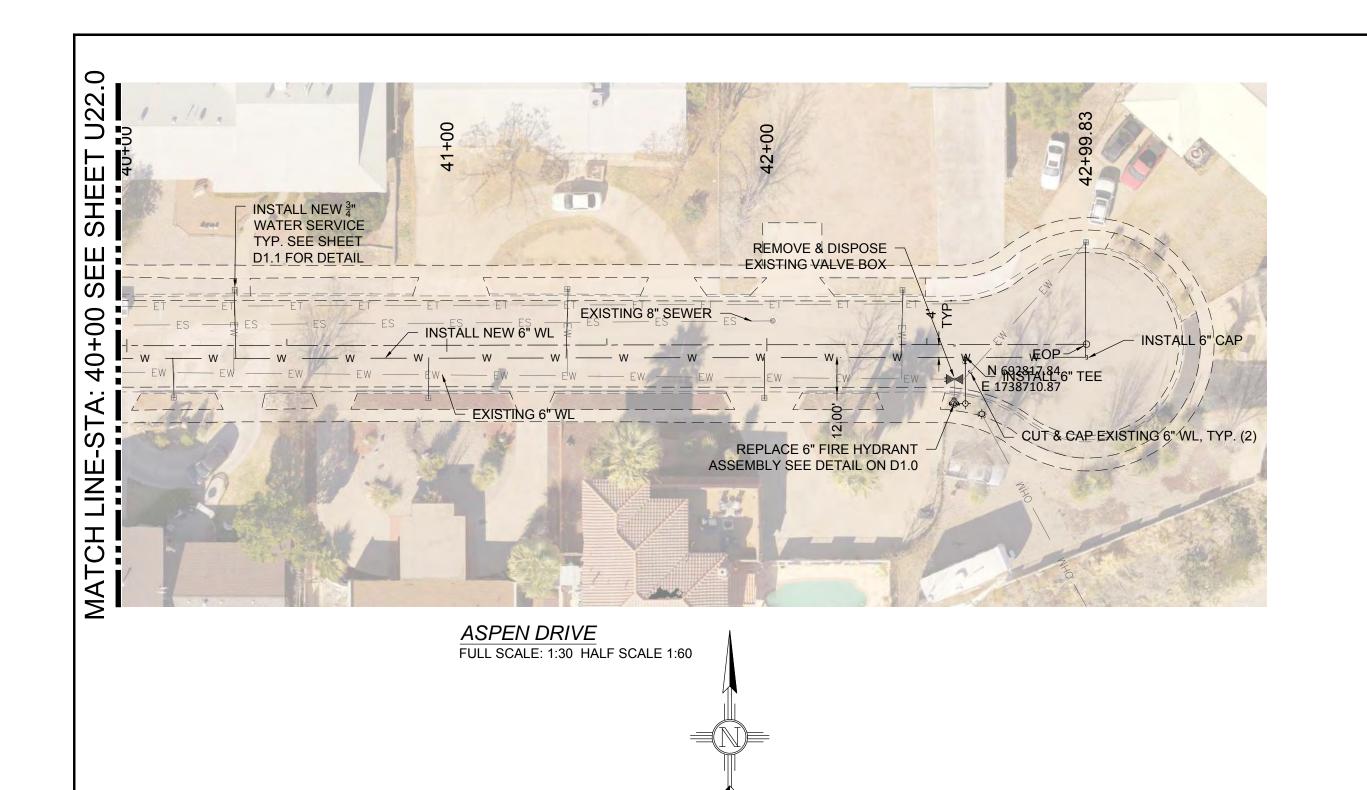
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Public Works	Bid No.:	2017-010		Sheet No.:
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Checked By:	MD	Approved By: _	MD	

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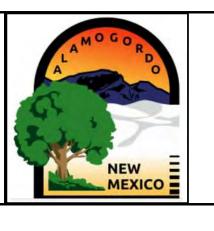
### EXISTING UTILITY LEGEND

——EOHT-EOHT-EXISTING OVER HEAD TELEPHONE EXISTING OVER HEAD POWER LINE ——OHPL —OHPL —— — ES — ES — EXISTING SEWER —— EW —— EW —— **EXISTING WATER** — EG — EG — EXISTING UNDERGROUND GAS — ET — ET — EXISTING UNDERGROUND TELEPHONE — OHM — OHM — EXISTING OVER HEAD MULTIPLE

ASPEN DR. \	WATER SERVIC	CES
STA. AND OFFSET	SIZE	LENGTH
40+14.61, 16.37 RT	1"	12.37'
40+33.87, 17.18 LT	3/4"	21.18'
40+94.25, 16.66 RT	3/4"	12.66'
41+37.91, 17.36 LT	3/4"	21.36'
41+99.11, 16.64 RT	3/4"	12.64'
42+42.21, 17.21 LT	3/4"	21.21'
42+99.83, 31.67 LT	1"	35.67'

ASPEN DR. 6"	FIRE HYDRANT ASSEMBLY
STA. AND OFFSET	LENGTH
42+58.64, 18.49 RT	14.49'

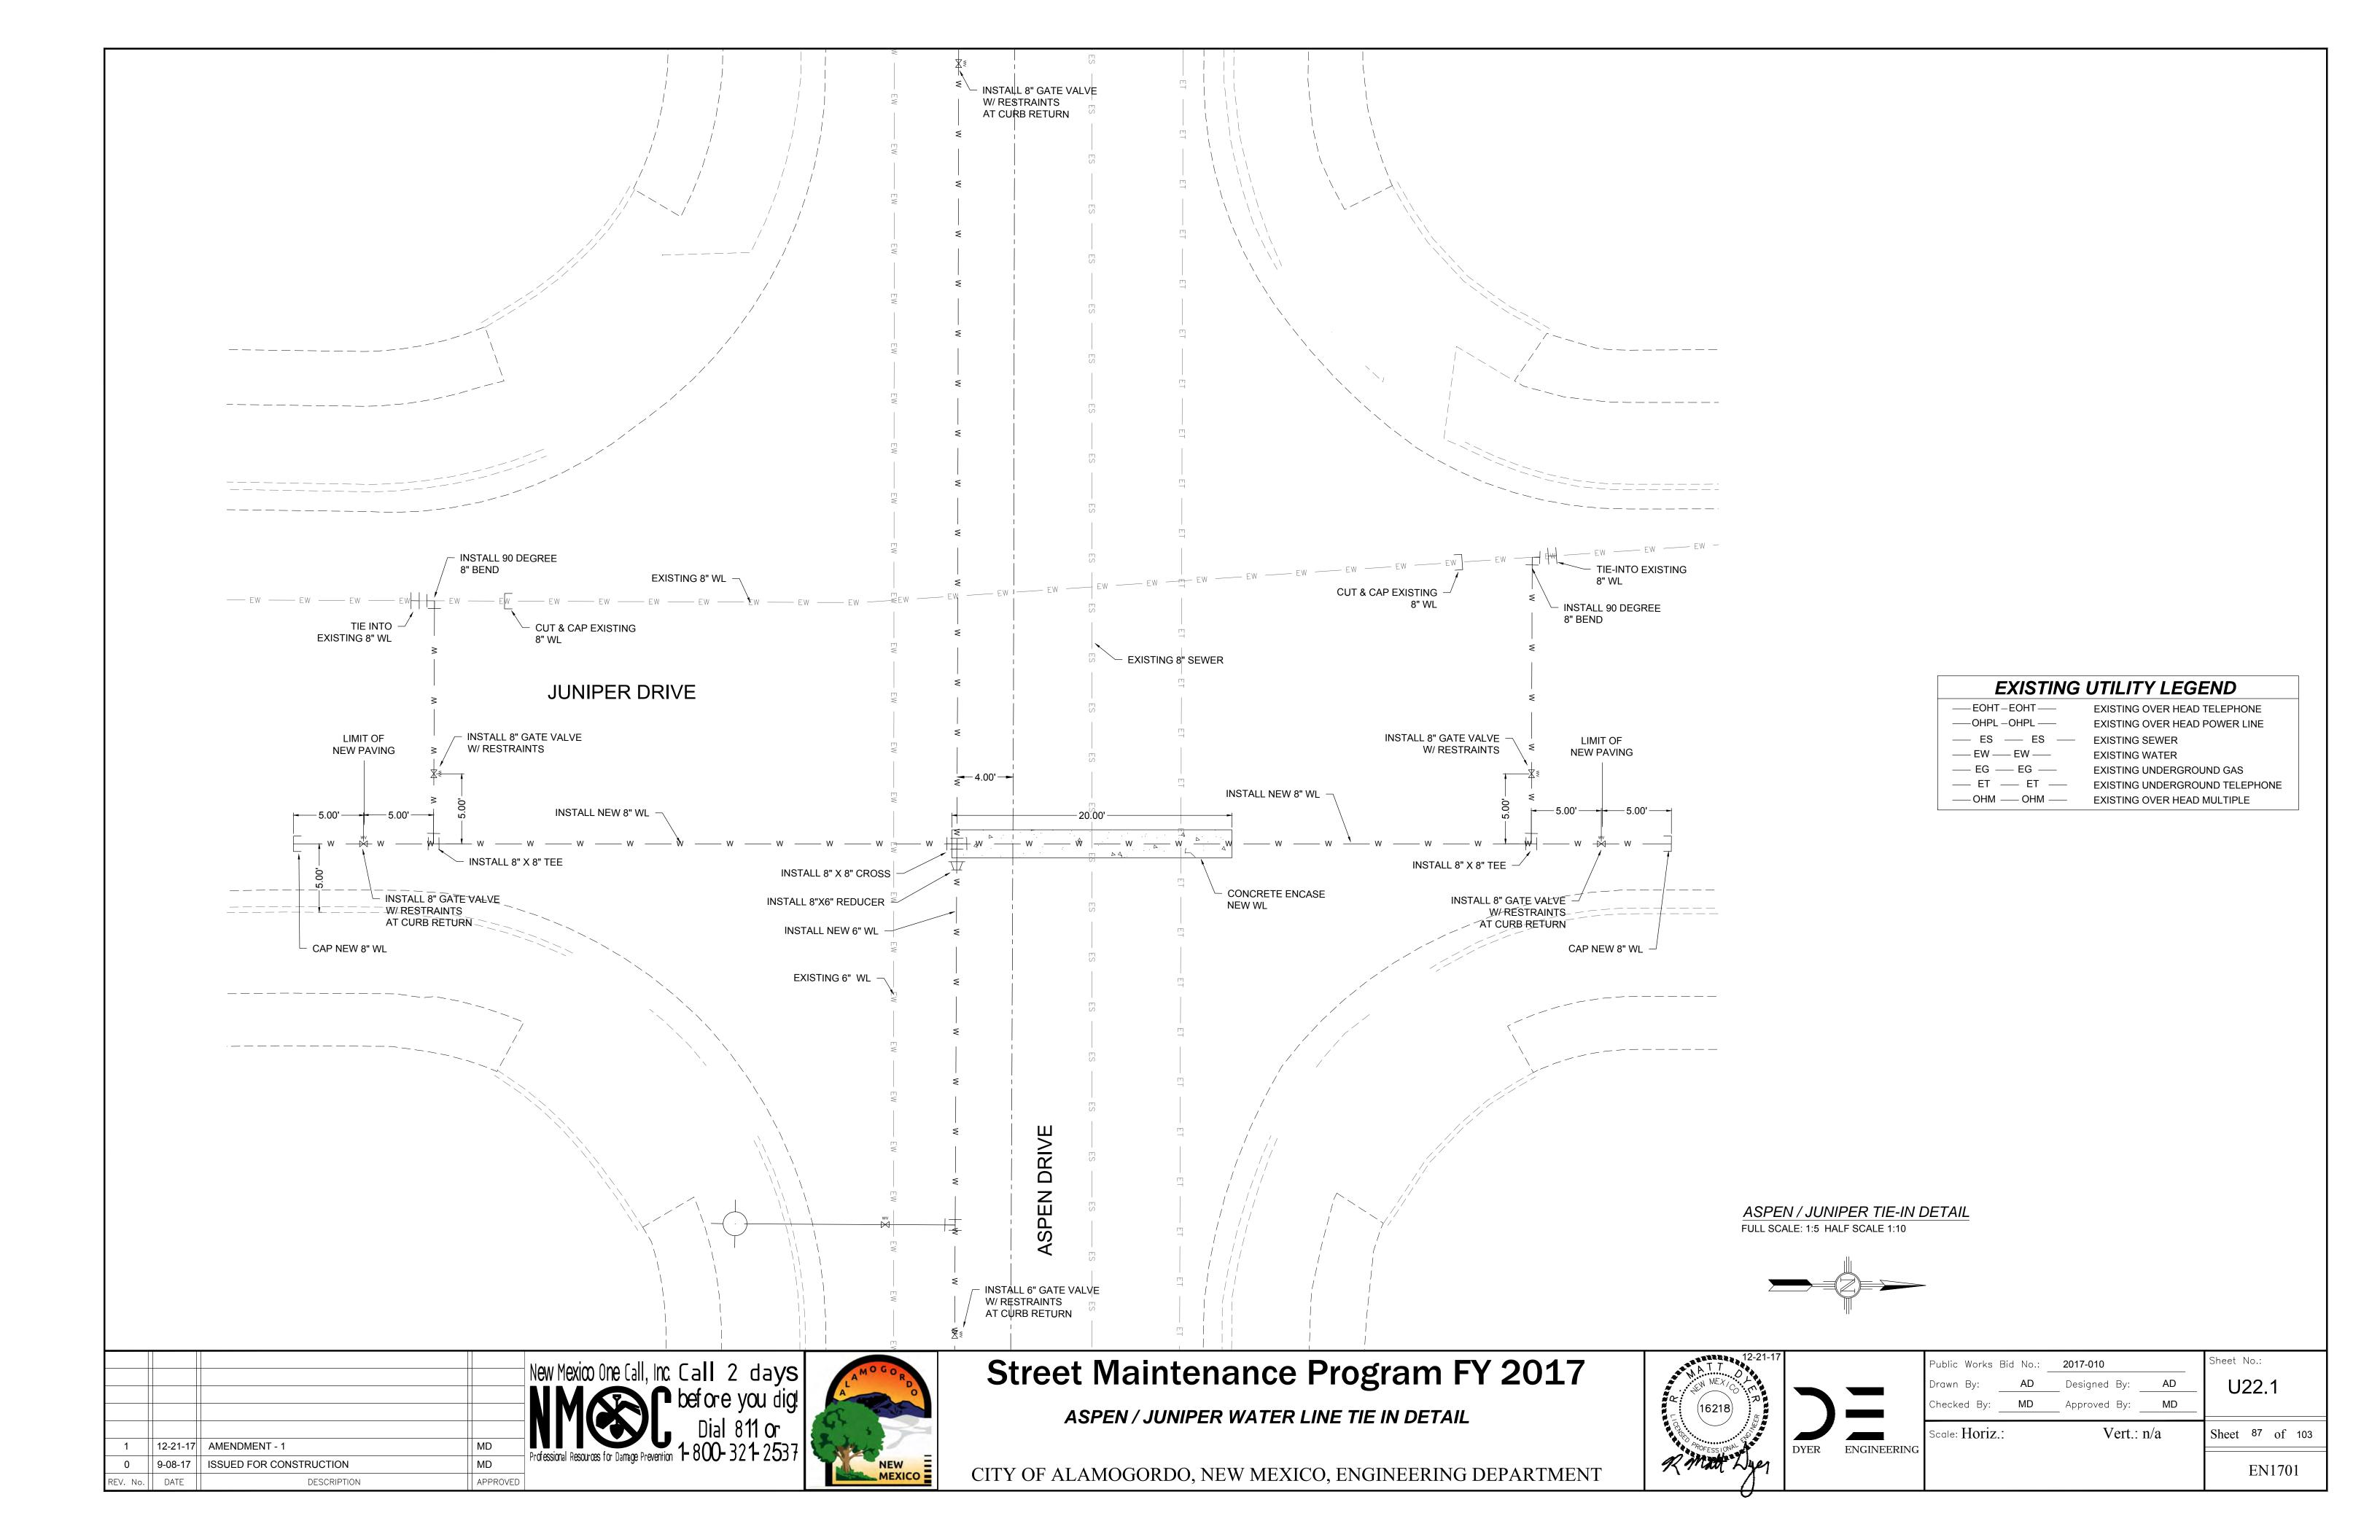
O 9-08-17 ISSUED FOR CONSTRUCTION MD Professional Resources for Damage Prevention 1-800-32					
DEV. N. DATE DESCRIPTION APPROVED	0	9-08-17	ISSUED FOR CONSTRUCTION	MD	New Mexico One Call, Inc. Call 2 days  New Mexico One Call, Inc. Call 2 days  Dial 811 or  Professional Resources for Damage Prevention 1-800-321-2537
TREV. NO.   DATE   DATE   DESCRIPTION   APPROVED	REV. No.	DATE	DESCRIPTION	APPROVED	



# **Street Maintenance Program FY 2017**

ASPEN DRIVE WATER LINE REPLACEMENT PLAN STATION 40+00 TO 42+99

CITY OF ALAMOGORDO, NEW MEXICO, ENGINEERING DEPARTMENT

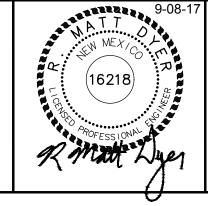


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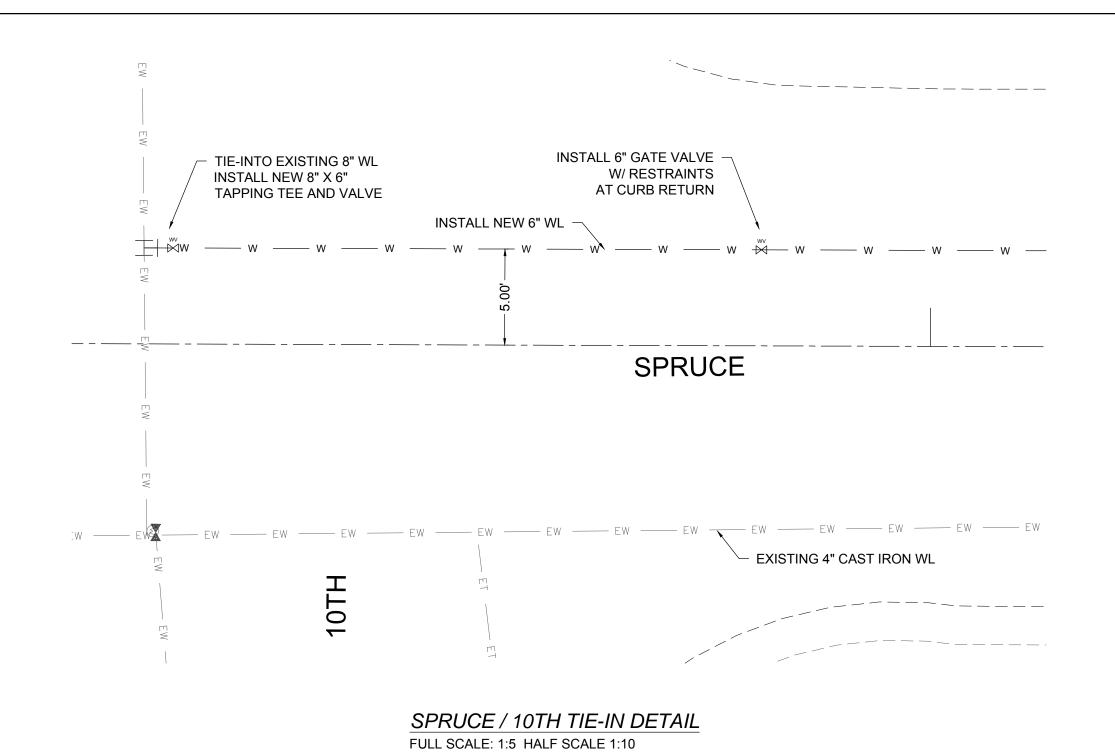
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Checked By:	MD	Approved By: _	MD
Drawn By:	AD	Designed By: _	AD
Public Works	Bid No.:	2017-010	


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Vert.: n/a



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SPRUCE AVE.	WATER SE	RVICES
STA. AND OFFSET	SIZE	LENGTH
0+66.77, 16.67 LT	3/4"	11.67'
0+91.74, 16.68 RT	3/4"	21.68'
1+74.25, 16.97 RT	3/4"	21.97'
1+87.85, 16.45 LT	3/4"	11.45'
2+48.53, 16.97 RT	3/4"	21.97'
3+07.01, 16.76 LT	3/4"	11.76'
3+22.50, 16.80 RT	3/4"	21.80'
3+63.14, 16.85 LT	3/4"	11.85'
3+97.62, 17.12 RT	3/4"	22.12'
4+28.03, 16.73 LT	3/4"	11.73'
4+72.94, 16.62 RT	3/4"	21.62'
4+87.88, 16.80 LT	3/4"	11.80'
5+47.06, 17.21 LT	3/4"	12.21'
5+47.75, 16.61 RT	3/4"	21.61'
6+07.01, 16.78 LT	3/4"	11.78'
6+15.27, 16.40 RT	3/4"	21.40'
6+67.29, 16.69 LT	3/4"	11.69'
7+27.17, 16.40 LT	3/4"	11.40'
7+86.69, 16.56 LT	3/4"	11.56'

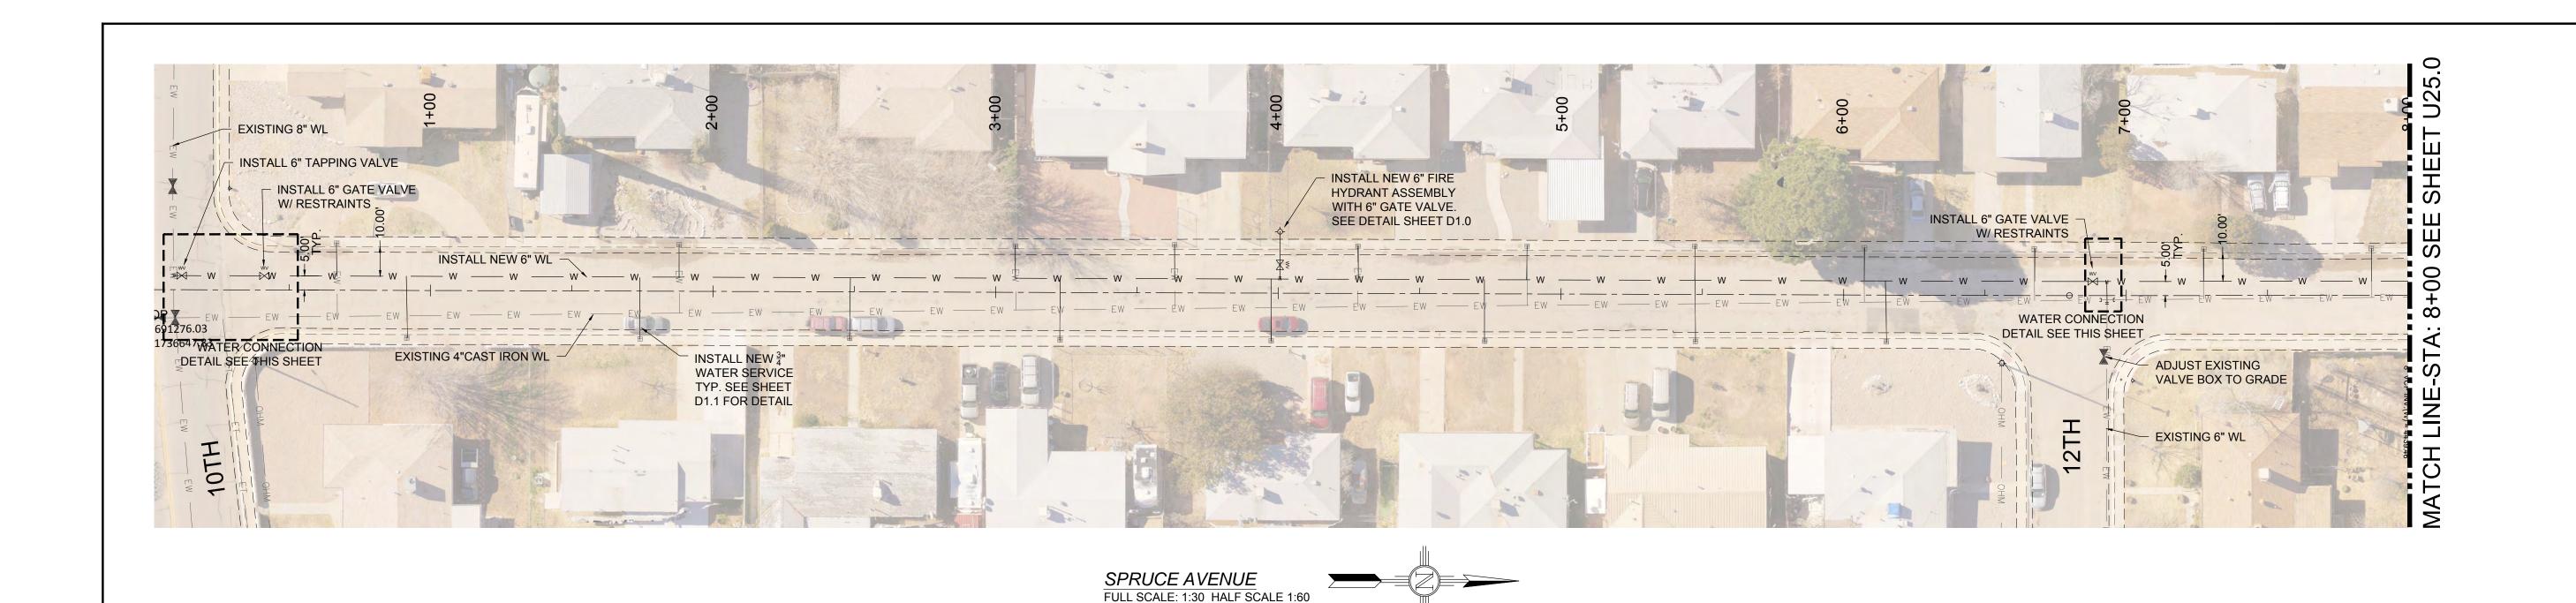SPRUCE AVE. 6" FIRE HYDRANT ASSEMBLY	
STA. AND OFFSET	LENGTH
4+00.50, 21.72 LT	16.72'

				New Mexico One Call, Inc. Call 2 days  New Mexico One Call, Inc. Call 2 days  Dial 811 or  Professional Resources for Damage Prevention 1-800-321-2537
1	12-21-17	AMENDMENT - 1	MD	Defended Region to Remon Deputition 1-800-321-2537
0	9-08-17	ISSUED FOR CONSTRUCTION	MD	Professional Resources for Dailage Prevention 1 000 32 1 2007
REV. No.	DATE	DESCRIPTION	APPROVED	

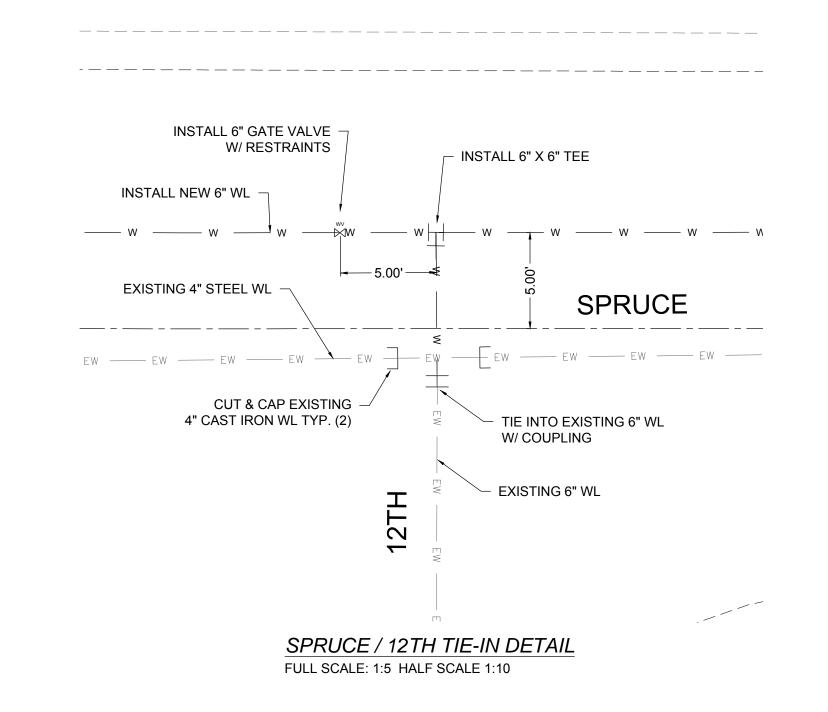

# Street Maintenance Program FY 2017

SPRUCE AVENUE WATER LINE REPLACEMENT PLAN STATION 0+09 TO 8+00

CITY OF ALAMOGORDO, NEW MEXICO, ENGINEERING DEPARTMENT

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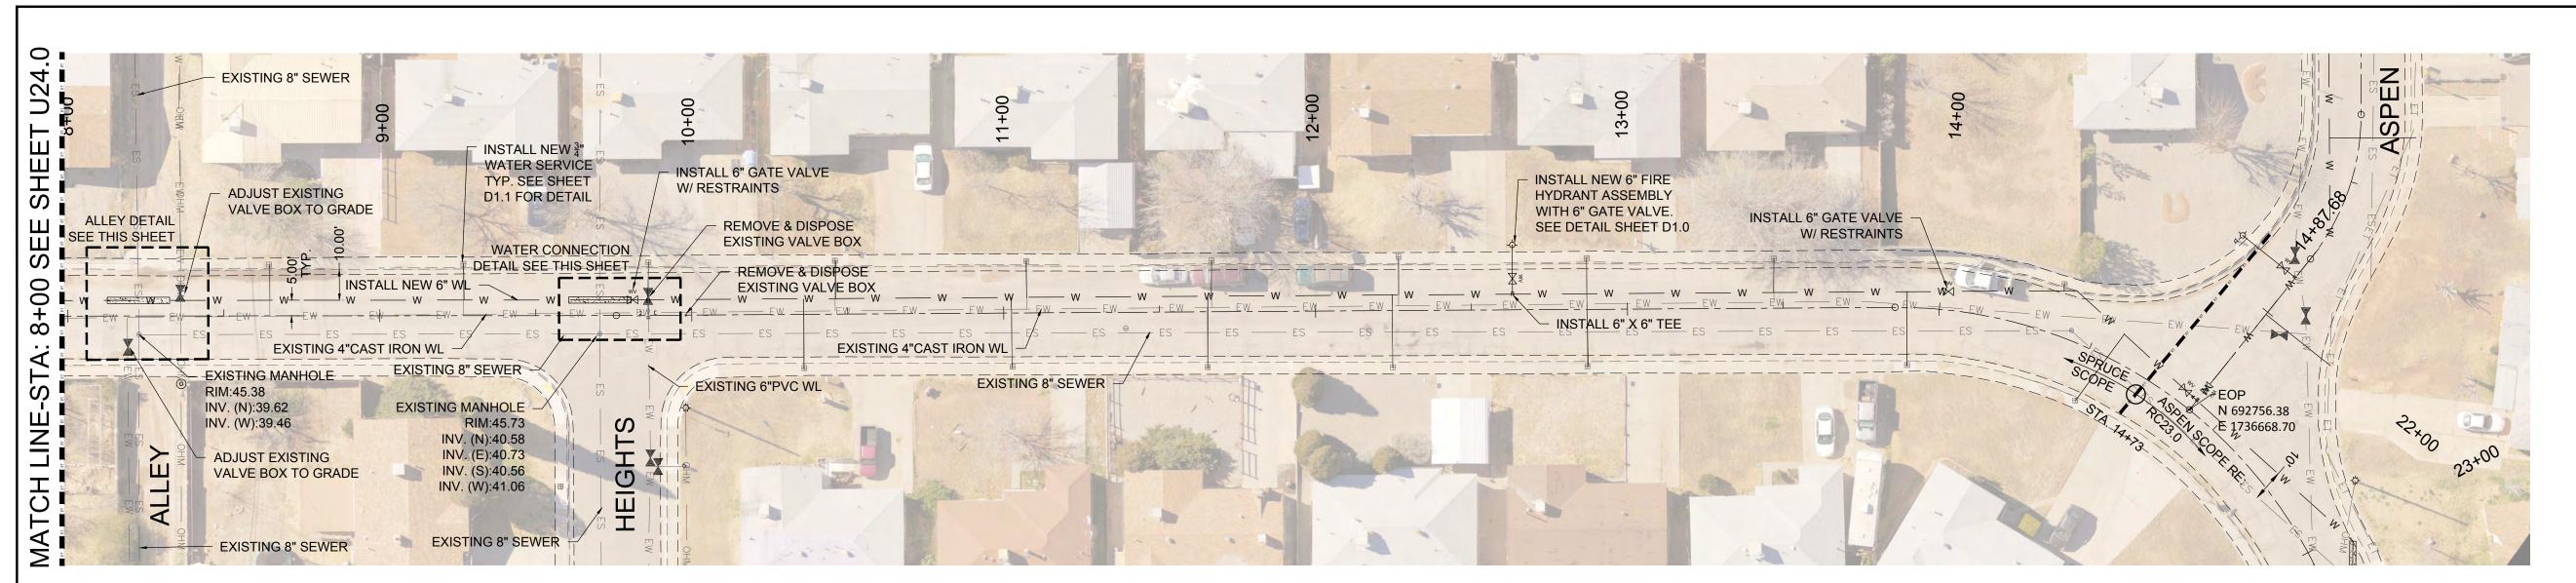
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Public Works	Bid No.:	2017-010
Drawn By:	AD	Designed By
Checked By:	MD	Approved By

2017-010		Sheet No.:
Designed By:	AD	U24.0
Approved By:	MD	<b>02</b> ∓.0
	Designed By:	Designed By: AD


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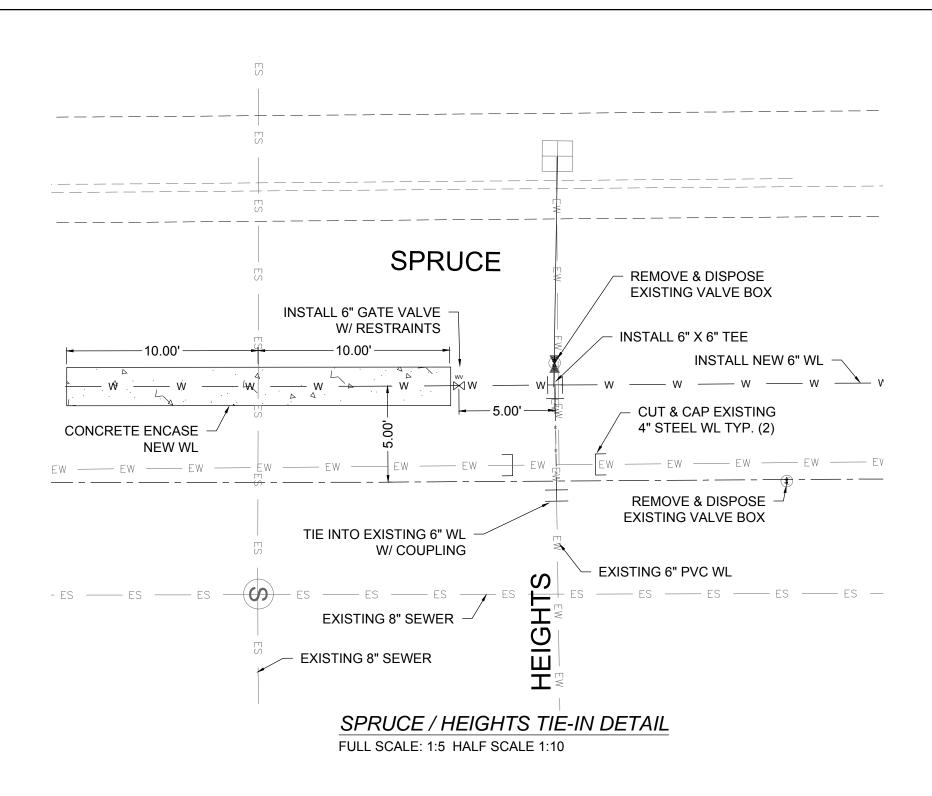
Sheet 89 of 103 EN1701





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SPRUCE AVE. WATER SERVICES				
STA. AND OFFSET	SIZE	LENGTH		
8+64.69, 16.39 LT	3/4"	11.39'		
9+26.73, 16.86 LT	3/4"	11.86'		
9+85.81, 16.81 LT	3/4"	11.81'		
10+36.02, 17.54 RT	3/4"	22.54'		
10+45.91, 16.99 LT	3/4"	11.99'		
11+02.52, 17.12 RT	3/4"	22.12'		
11+07.20, 16.80 LT	3/4"	11.80'		
11+65.31, 17.71 RT	3/4"	22.71'		
11+66.62, 16.19 LT	3/4"	11.19'		
12+24.47, 18.36 RT	3/4"	23.36'		
12+26.64, 16.53 LT	3/4"	11.53'		
12+87.15, 18.39 RT	3/4"	23.39'		
12+86.96, 16.20 LT	3/4"	11.20'		
13+46.72, 15.87 LT	3/4"	10.87'		
13+89.99, 18.59 RT	3/4"	23.64'		
14+36.03, 16.26 LT	3/4"	1.97'		
14+53.39, 17.03 RT	3/4"	26.22'		

SPRUCE AVE. 6" F	TRE HYDRANT ASSEMBLY
STA. AND OFFSET	LENGTH
12+63.27, 20.88 LT	15.88'

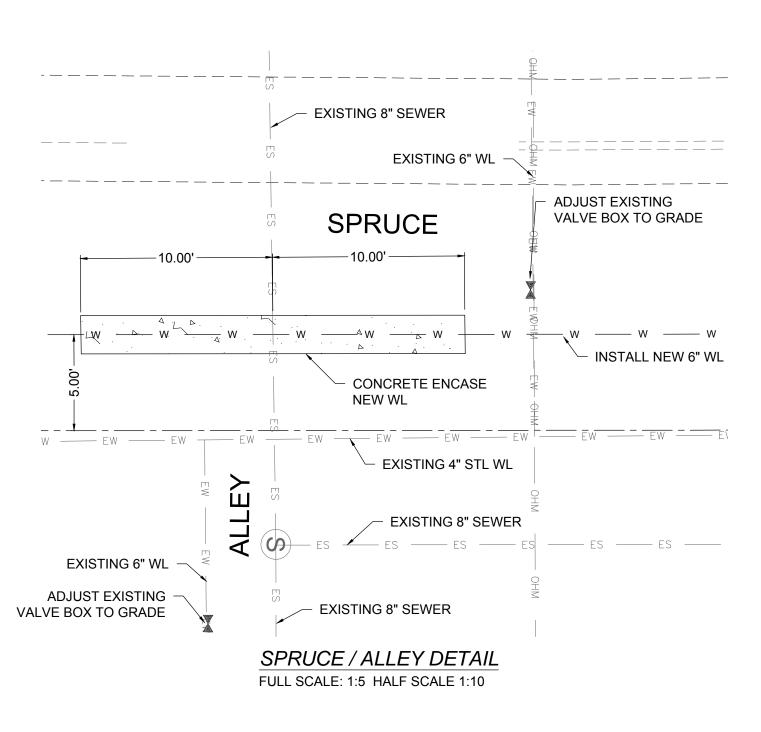				New Mexico One Call, Inc. Call 2 day
				NM P before you d
	10.01.15			Professional Resources for Damage Prevention 1-800-321-25
1	12-21-17	AMENDMENT - 1	MD	Professional Possings for Damon Provincian 1-800-321-25
0	9-08-17	ISSUED FOR CONSTRUCTION	MD	Trucondi rocurco la parigo ricadilla i 1 000 32 i 20
REV. No.	DATE	DESCRIPTION	APPROVED	



# Street Maintenance Program FY 2017

SPRUCE AVENUE WATER LINE REPLACEMENT PLAN STATION 8+00 TO 14+87

CITY OF ALAMOGORDO, NEW MEXICO, ENGINEERING DEPARTMENT


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Public Works	Bid No.:	2017-010		Sheet No.:
Drawn By:	AD	Designed By: _	AD	U25.0
Checked By:	MD	Approved By:	MD	020.0

Scale: Horiz.: Vert.: n/a

Sheet 90 of 103 EN1701



McKINLEY AVENUE
FULL SCALE: 1:30 HALF SCALE 1:60
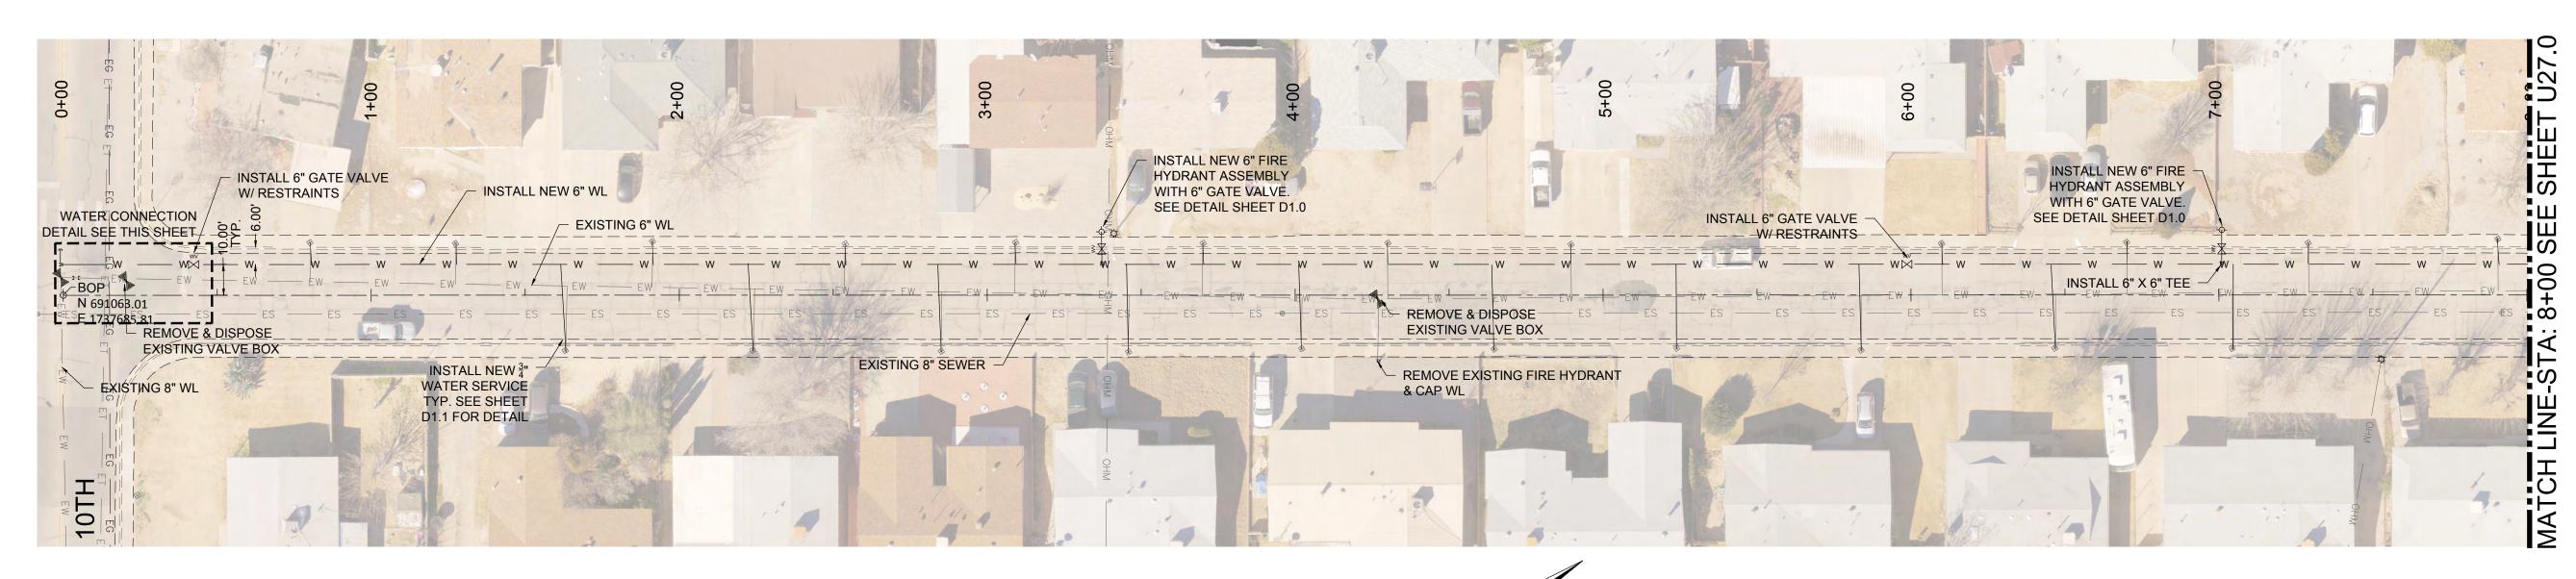
### EXISTING UTILITY LEGEND

— EOHT—EOHT— EXISTING OVER HEAD TELEPHONE
— OHPL—OHPL— EXISTING OVER HEAD POWER LINE
— ES — ES — EXISTING SEWER
— EW — EW — EXISTING WATER
— EG — EG — EXISTING UNDERGROUND GAS
— ET — ET — EXISTING UNDERGROUND TELEPHONE
— OHM — OHM — EXISTING OVER HEAD MULTIPLE

STA. AND OFFSET	SIZE	LENGTH
0+80.29, 17.30 LT	3/4"	7.30'
1+27.33, 16.91 LT	3/4"	6.91'
1+63.14, 18.21 RT	3/4"	28.21'
1+91.47, 17.36 LT	3/4"	7.36'
2+24.24, 17.91 RT	3/4"	27.91'
2+53.53, 16.76 LT	3/4"	6.76'
2+84.91, 18.36 RT	3/4"	28.36'
3+09.30, 17.27 LT	3/4"	7.27'
3+45.90, 18.66 RT	3/4"	28.66'
3+69.78, 16.69 LT	3/4"	6.69'
4+01.84, 17.47 RT	3/4"	27.47'
4+30.04, 16.90 LT	3/4"	6.90'
4+64.55, 17.62 RT	3/4"	27.62'
4+89.57, 16.64 LT	3/4"	6.64'
5+23.71, 17.30 RT	3/4"	27.3'
5+84.00, 17.71 RT	3/4"	27.71'
6+10.10, 16.93 LT	3/4"	6.93'
6+46.92, 17.09 RT	3/4"	27.09'
6+70.22, 17.55 LT	3/4"	7.55'
7+04.42, 17.50 RT	3/4"	27.5'
7+29.17, 16.92 LT	3/4"	6.92'
7+90.44, 18.29 LT	3/4"	8.29'

McKINLEY AVE. 6"	McKINLEY AVE. 6" FIRE HYDRANT ASSEMBLY		
STA. AND OFFSET	LENGTH		
3+37.68, 20.62 LT	11.15'		
7+00.00, 21.74 LT	11.16'		

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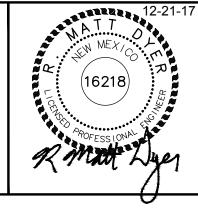
				New Mexico One Call, Inc. Call 2 days  Set on Damage Prevention 1-800-321-2537	4
1	12-21-17	AMENDMENT - 1	MD	Defension   Description 1 - 800 - 321 - 2537	1
0	9-08-17	ISSUED FOR CONSTRUCTION	MD		7
REV. No.	DATE	DESCRIPTION	APPROVED		



# **Street Maintenance Program FY 2017**

McKINLEY AVENUE WATER LINE REPLACEMENT
PLAN STATION 0+00 TO 8+00

CITY OF ALAMOGORDO, NEW MEXICO, ENGINEERING DEPARTMENT




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	Checke	ed By:		MC
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Public Works	Bid No.:	2017-010		Sheet No.:
Drawn By:	AD	Designed By:	AD	U26.0
Checked By:	MD	Approved By: _	MD	020.0

Horiz.: Vert.: n/a

Sheet 91 of 103 EN1701



**EXISTING UTILITY LEGEND** 

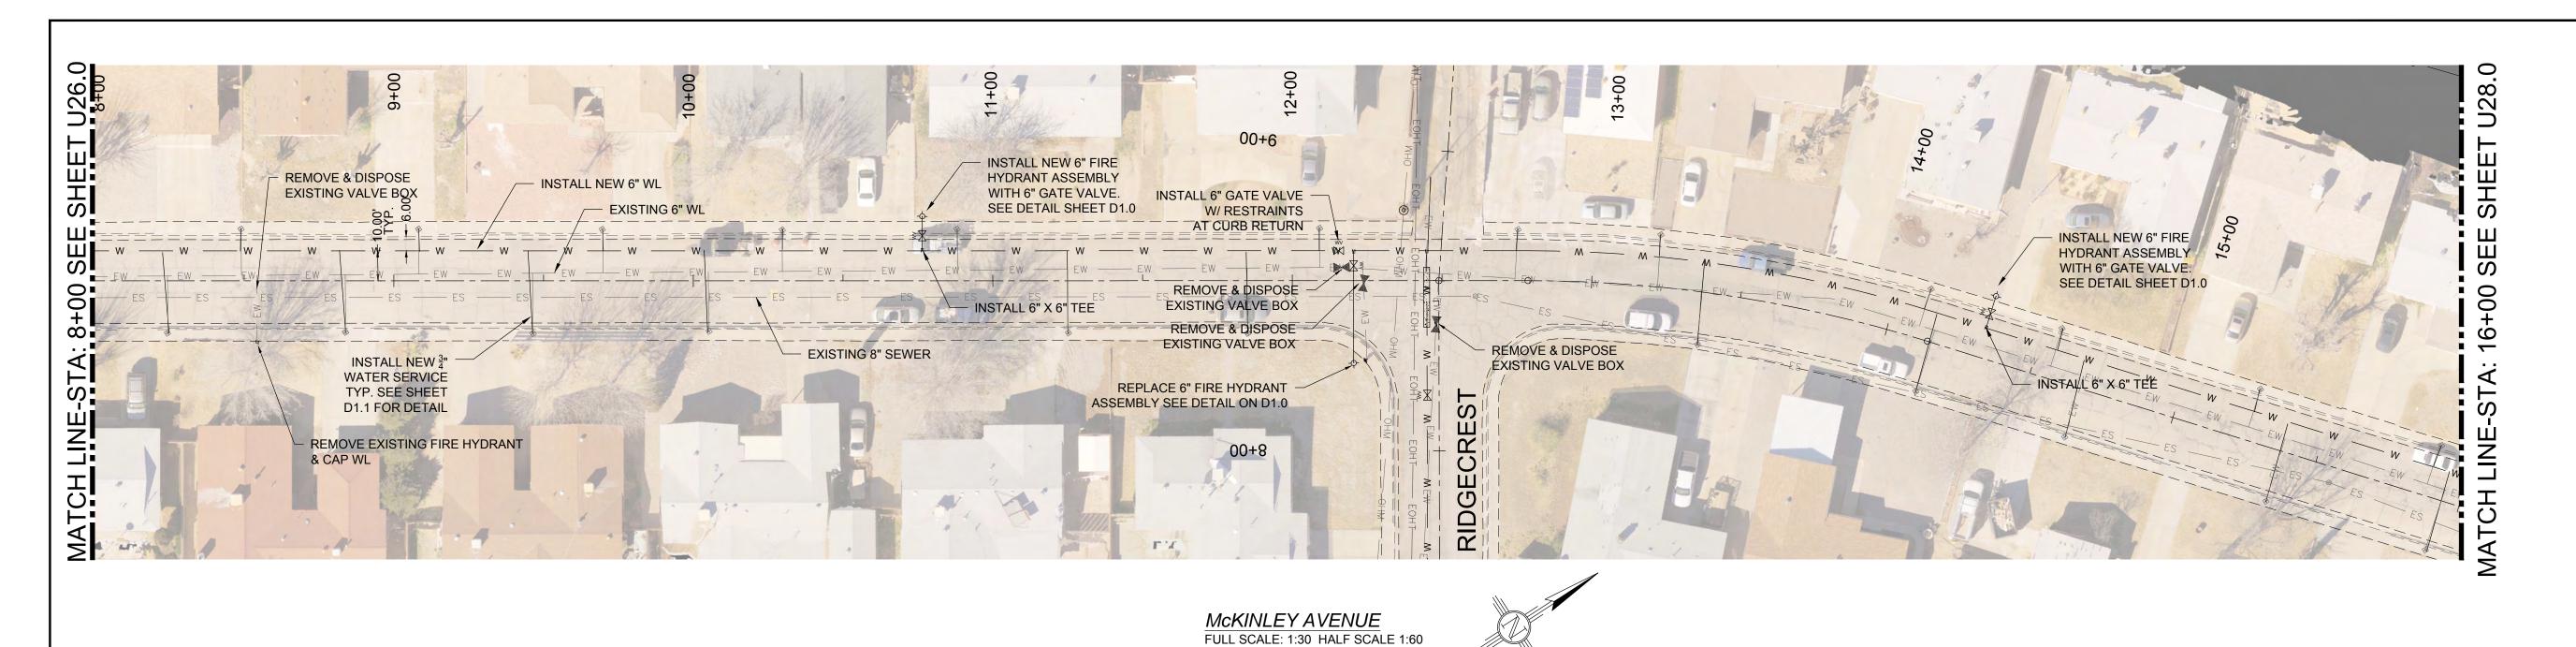——EOHT-EOHT-— ES — ES — EXISTING SEWER

EXISTING OVER HEAD TELEPHONE EXISTING OVER HEAD POWER LINE

**EXISTING WATER** EXISTING UNDERGROUND GAS — ET — ET — EXISTING UNDERGROUND TELEPHONE

— OHM — OHM — EXISTING OVER HEAD MULTIPLE

STA. AND OFFSET	SIZE	LENGTH
8+24.36, 17.60 RT	3/4"	27.60'
8+48.96, 17.38 LT	3/4"	7.38'
8+83.85, 17.22RT	3/4"	27.22'
9+08.26, 17.35 RT	3/4"	7.35'
9+46.40, 17.45 RT	3/4"	27.45'
9+69.57, 17.13 LT	3/4"	7.13'
10+05.20, 16.98 RT	3/4"	26.98'
10+29.58, 17.14 LT	3/4"	7.14'
10+88.29, 17.13 LT	3/4"	7.13'
11+25.03, 17.41 RT	3/4"	27.41'
11+84.94, 17.66 RT	3/4"	27.66'
12+09.08, 17.48 LT	3/4"	7.48'
12+46.42, 34.88 LT	3/4"	24.88'
12+75.23, 17.18 LT	3/4"	7.18'
13+21.43, 17.52 LT	3/4"	7.52'
13+37.73, 17.39 RT	3/4"	27.39'
14+10.23, 17.13 LT	3/4"	7.13'
14+15.46, 17.15 RT	3/4"	27.15'
14+55.87, 17.62 LT	3/4"	7.62'
14+67.61, 17.25 RT	3/4"	27.25'
15+25.03, 17.58 LT	3/4"	7.58'
15+37.94, 17.18 RT	3/4"	27.18'
15+87.98, 17.86 LT	3/4"	7.86'
15+93.45, 17.38 RT	3/4"	27.38'

McKINLEY AVE. 6" F	FIRE HYDRANT ASSEMBLY
STA. AND OFFSET	LENGTH
10+76.71, 21.31 LT	11.53'
12+20.61, 27.64 RT	37.01'
14+32.23, 21.22 LT	11.38'

1	12-21-17	AMENDMENT - 1	MD
0	9-08-17	ISSUED FOR CONSTRUCTION	MD
REV. No	DATE	DESCRIPTION	APPROVED






# **Street Maintenance Program FY 2017**

McKINLEY AVENUE WATER LINE REPLACEMENT **PLAN STATION 8+00 TO 16+00** 

CITY OF ALAMOGORDO, NEW MEXICO, ENGINEERING DEPARTMENT

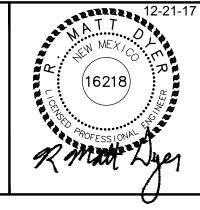


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Public	Works	Bid No.:	2017-010		Sheet No.:
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Scale: Horiz.: Vert.: n/a

Sheet 92 of 103 EN1701



<b>EXISTING</b>	UTILITY LEGEND
——EOHT-EOHT—	EXISTING OVER HEAD TELEPHONE
——OHPL —OHPL —	EXISTING OVER HEAD POWER LINE
— ES — ES —	EXISTING SEWER
—— EW —— EW ——	EXISTING WATER
—— EG —— EG ——	EXISTING UNDERGROUND GAS
— ET — ET —	EXISTING UNDERGROUND TELEPHONE
—— OHM —— OHM ——	EXISTING OVER HEAD MULTIPLE

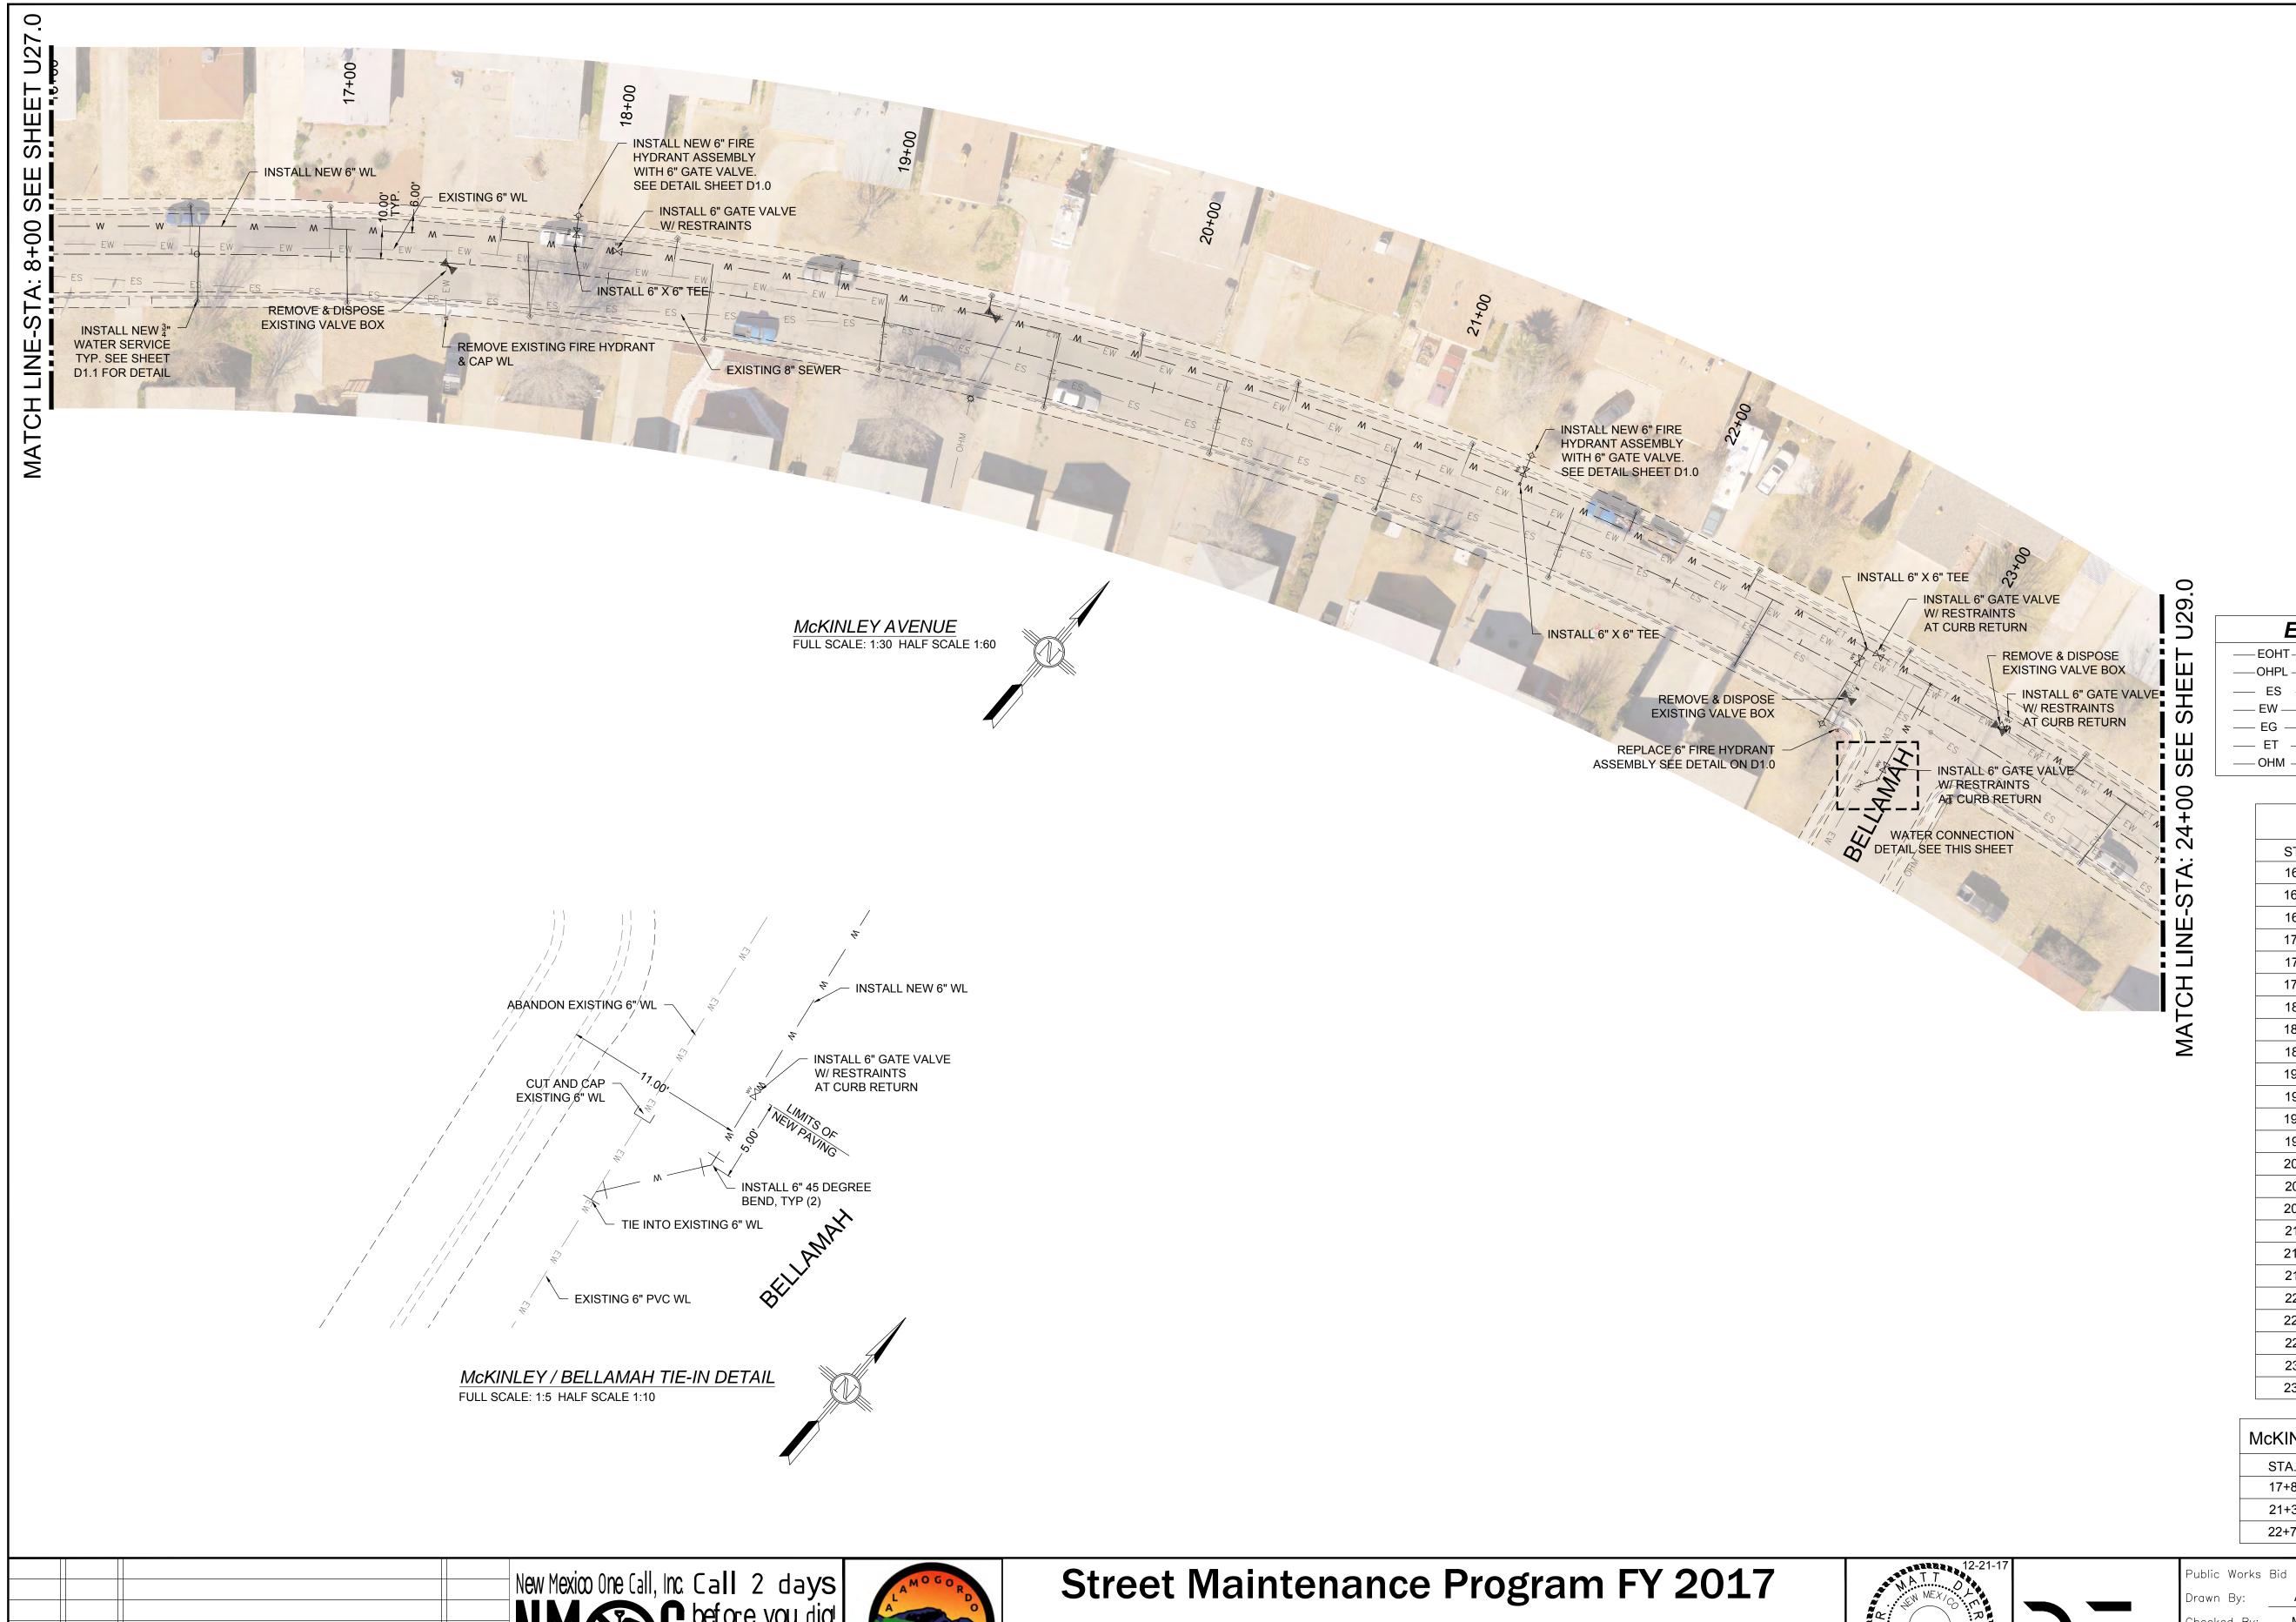McKINLEY AVE	E. WATER SE	ERVICES
STA. AND OFFSET	SIZE	LENGTH
16+49.67, 17.74 LT	3/4"	7.74'
16+51.91, 16.61 RT	3/4"	26.61'
16+99.18, 17.95 LT	3/4"	7.95'
17+06.27, 16.32 RT	3/4"	26.32'
17+60.46, 17.48 LT	3/4"	7.48'
17+73.34, 16.64 RT	3/4"	26.64'
18+22.81, 17.51 LT	3/4"	7.51'
18+37.41, 17.22 RT	3/4"	27.22'
18+81.62, 17.38 LT	3/4"	7.38'
19+01.92, 17.06 RT	3/4"	27.06'
19+35.90, 17.42 LT	3/4"	7.42'
19+63.68, 17.24 RT	3/4"	27.24'
19+91.17, 17.44 LT	3/4"	7.44'
20+26.40, 17.05 RT	3/4"	27.05'
20+48.70, 17.12 LT	3/4"	7.12'
20+89.75, 17.07 RT	3/4"	27.07'
21+14.58, 17.35 LT	3/4"	7.35'
21+57.42, 16.78 RT	3/4"	26.78'
21+76.72, 17.30 LT	3/4"	7.30'
22+25.37, 17.29 LT	3/4"	7.29'
22+32.30, 17.12 RT	3/4"	27.12'
22+86.02, 17.13 LT	3/4"	7.13'
23+58.56, 17.18 LT	3/4"	7.18'
23+77.56, 16.99 RT	3/4"	26.99'

McKINLEY AVE. 6" FIRE HYDRANT ASSEMBLY			
STA. AND OFFSET	LENGTH		
17+87.06, 21.26 LT	12.18'		
21+35.86, 21.46 LT	10.89'		
22+74.51, 21.16 RT	31.16'		

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EN1701


1	12-21-17	AMENDMENT - 1	MD
0	9-08-17	ISSUED FOR CONSTRUCTION	MD
REV. No.	DATE	DESCRIPTION	APPROVED
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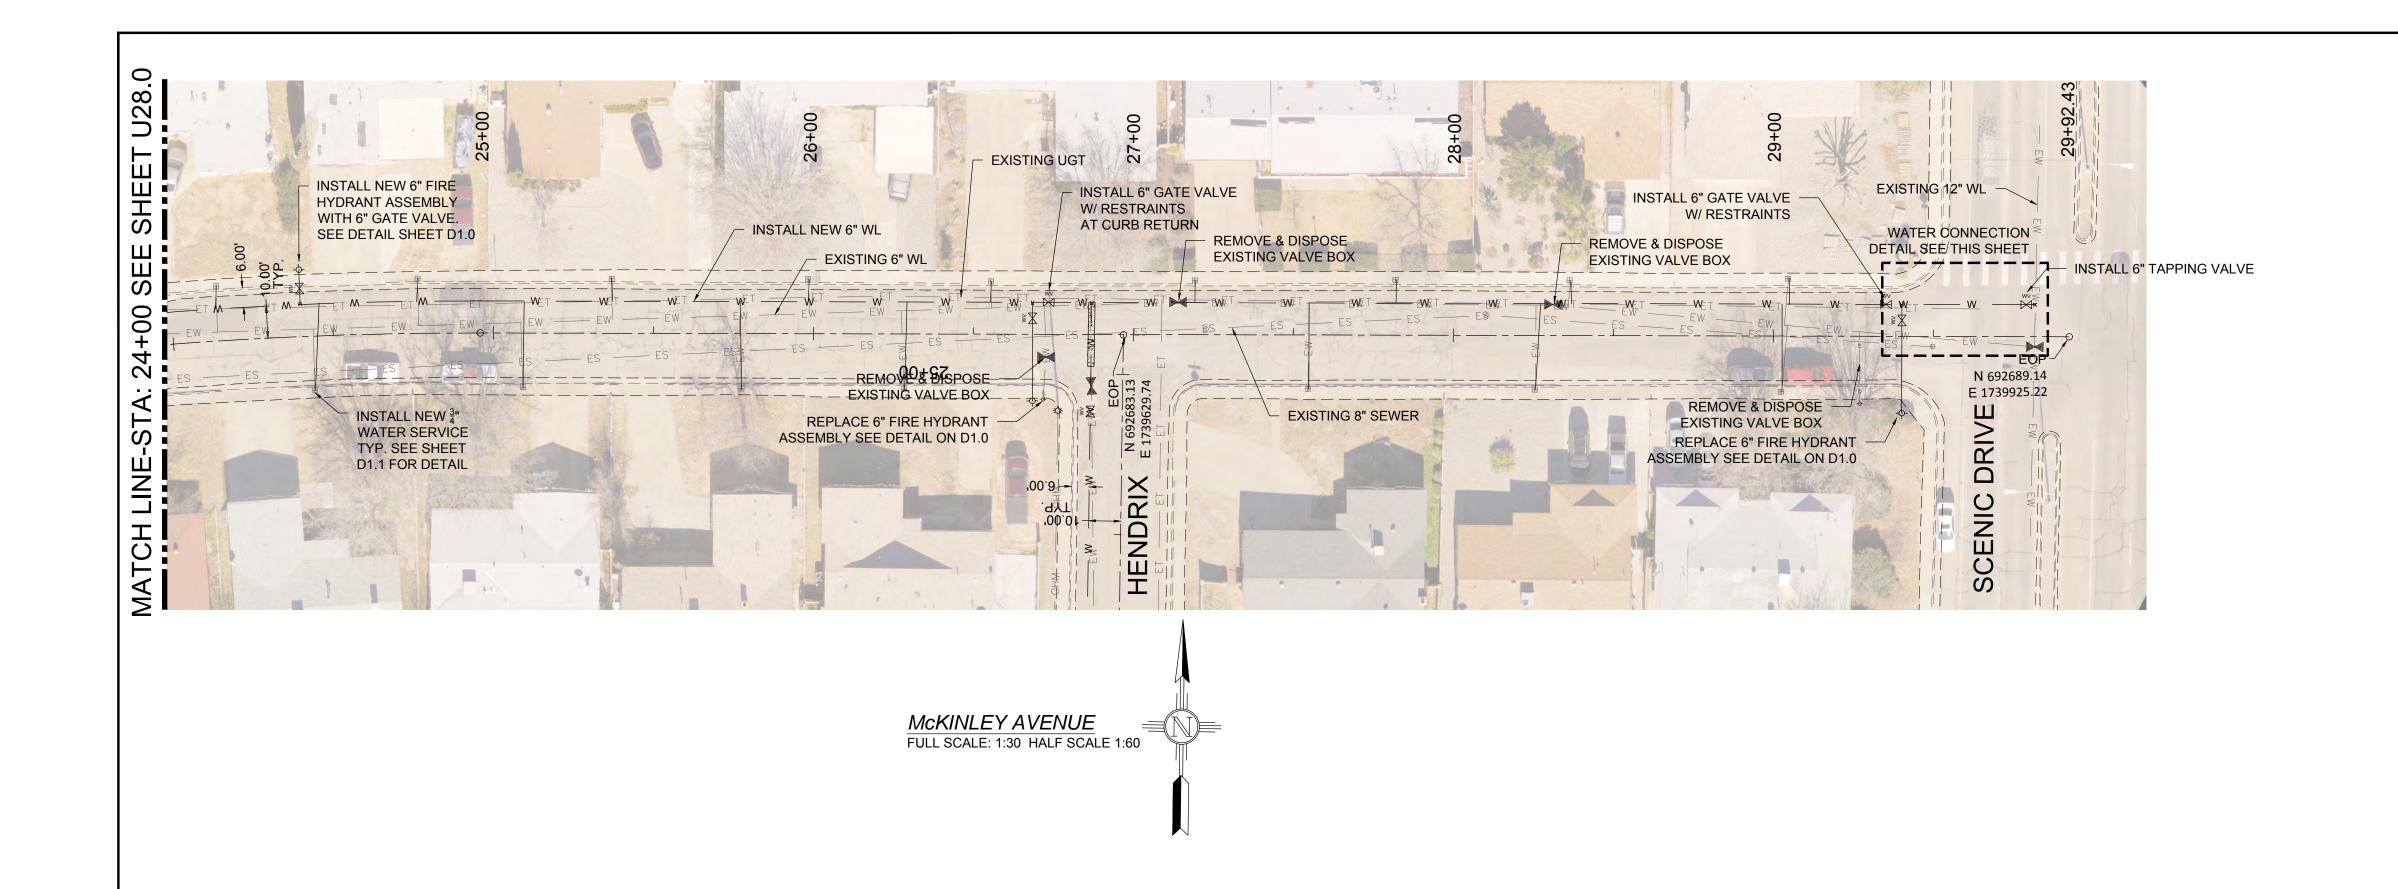
McKINLEY AVENUE WATER LINE REPLACEMENT PLAN STATION 16+00 TO 24+00


CITY OF ALAMOGORDO, NEW MEXICO, ENGINEERING DEPARTMENT



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Public Works	Bid No.:	2017-010		Sheet N	lo.:
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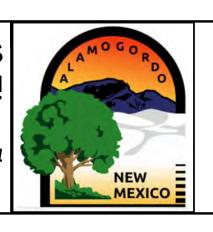
# EXISTING UTILITY LEGEND

— EOHT – EOHT — EXISTING OVER HEAD TELEPHONE
— OHPL – OHPL — EXISTING OVER HEAD POWER LINE
— ES — ES — EXISTING SEWER
— EW — EW — EXISTING WATER
— EG — EG — EXISTING UNDERGROUND GAS
— ET — ET — EXISTING UNDERGROUND TELEPHONE
— OHM — OHM — EXISTING OVER HEAD MULTIPLE

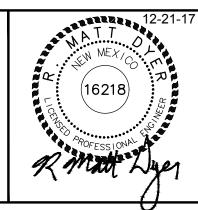STA. AND OFFSET	SIZE	LENGTH
24+14.43, 17.07 LT	3/4"	7.07'
24+43.64, 16.91 RT	3/4"	26.91'
24+76.41, 17.44 LT	3/4"	7.44'
25+09.37, 16.93 RT	3/4"	26.93'
25+36.83, 17.32 LT	3/4"	7.32'
25+77.35, 17.03 RT	3/4"	27.03'
25+98.42, 17.07 LT	3/4"	7.07'
26+28.20, 17.22 RT	3/4"	27.22'
26+55.24, 16.90 LT	3/4"	6.90'
27+19.09, 16.75 LT	3/4"	6.75'
27+54.63, 16.67 RT	3/4"	26.67'
27+81.95, 17.16 LT	3/4"	7.16'
28+25.72, 17.12 RT	3/4"	27.12'
28+36.53, 17.04 LT	3/4"	7.04'
29+04.71, 18.04 LT	3/4"	8.04'
29+02.75, 17.27 RT	3/4"	27.27'

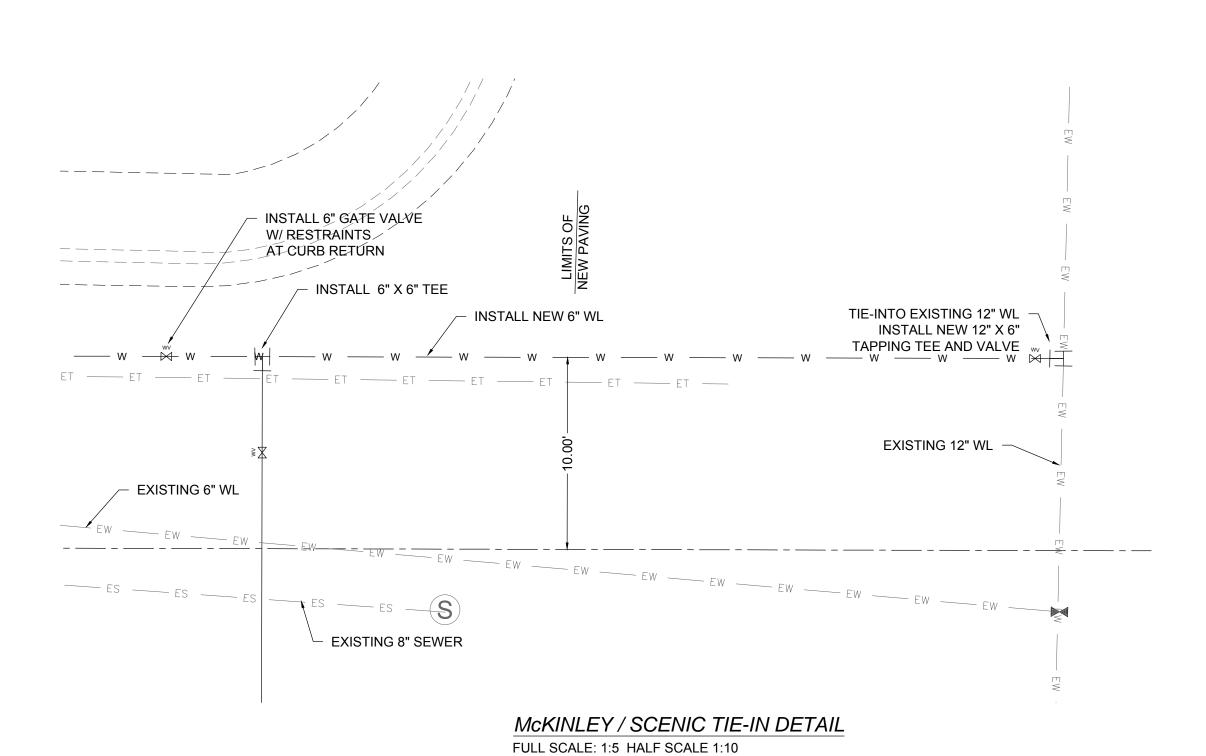McKINLEY AVE. 6" F	McKINLEY AVE. 6" FIRE HYDRANT ASSEMBLY					
STA. AND OFFSET	LENGTH					
24+39.19, 20.90 LT	11.24'					
26+71.89, 19.04 RT	29.04'					
29+27.10, 20.91 RT	30.91'					

				New Mexico One Call, Inc. Call 2 days  New Mexico One Call, Inc. Call 2 days  Dial 811 or  Professional Resources for Damage Prevention 1-800-321-2537
1	12-21-17	AMENDMENT - 1	MD	Defension   Description for Demon Description 1 800- 321-253
0	9-08-17	ISSUED FOR CONSTRUCTION	MD	Professional Resources for Daffage Prevention 1 000 JZ 1 Z 0 J 1
REV. No.	DATE	DESCRIPTION	APPROVED	



# Street Maintenance Program FY 2017


McKINLEY AVENUE WATER LINE REPLACEMENT PLAN STATION 24+00 TO 29+83

CITY OF ALAMOGORDO, NEW MEXICO, ENGINEERING DEPARTMENT


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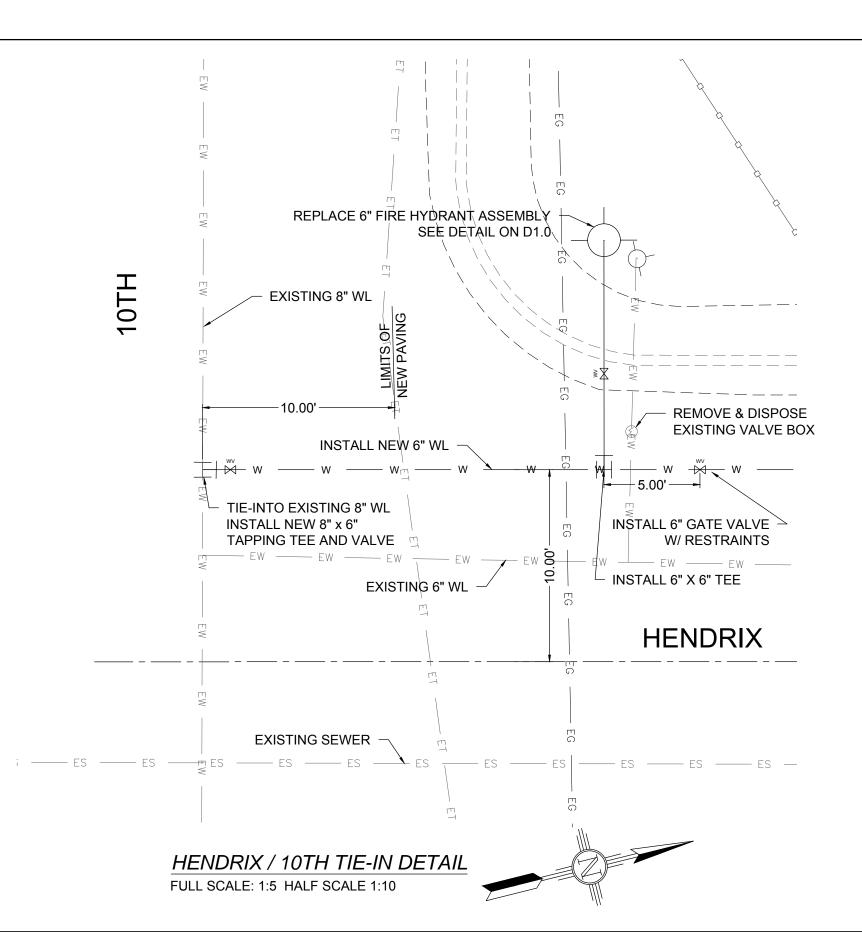
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Public Works Bid No.:		2017-010		Sheet No.:		
Drawn By:	AD	Designed By:	AD	U29.0		
Checked By: MD		Approved By:	MD	020.0		
Scale: Horiz.: Vert.: n/a		Sheet 94 of 103				





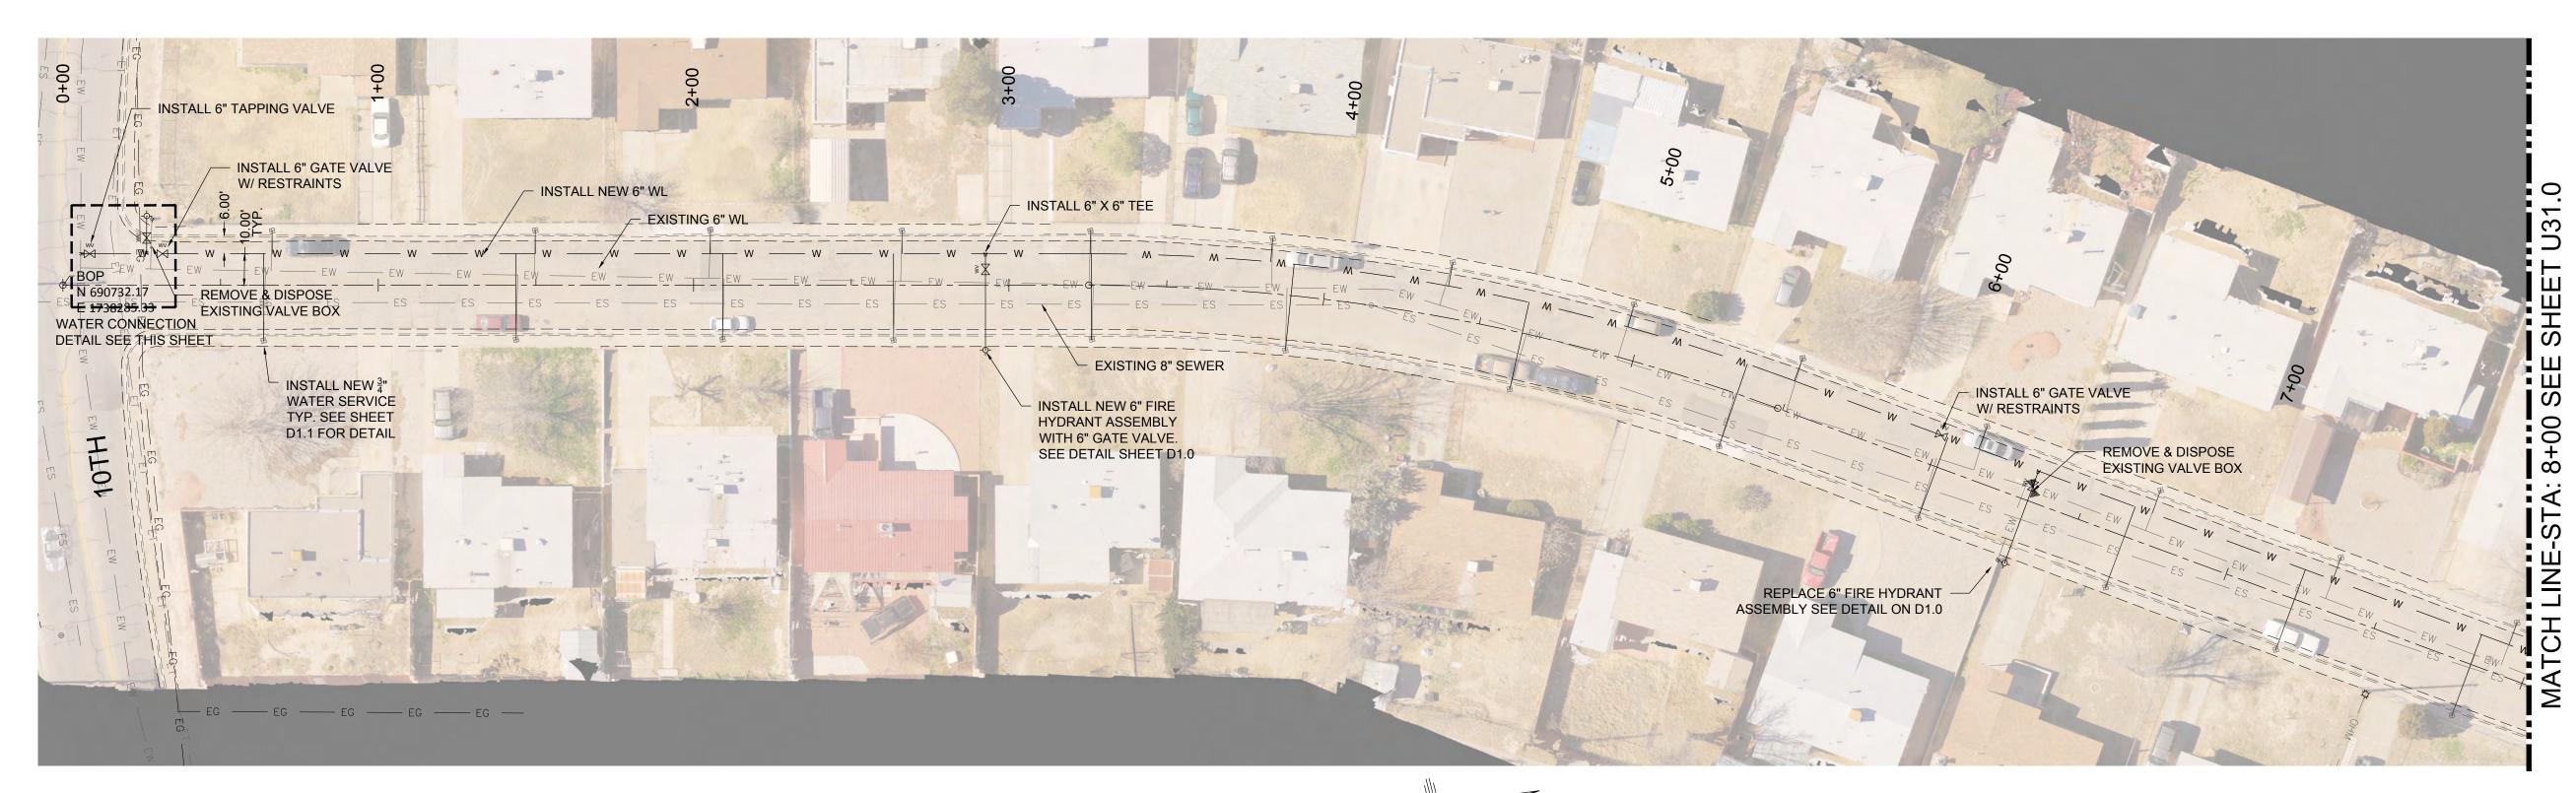

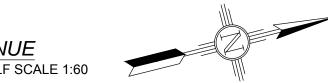

EXISTING	UTILITY LEGEND
——EOHT—EOHT——	EXISTING OVER HEAD TELEPHONE
——OHPL —OHPL ——	EXISTING OVER HEAD POWER LINE
ES ES	EXISTING SEWER
—— EW —— EW ——	EXISTING WATER
—— EG —— EG ——	EXISTING UNDERGROUND GAS
ET ET	EXISTING UNDERGROUND TELEPHONE
—— OHM —— OHM ——	EXISTING OVER HEAD MULTIPLE

HENDRIX AVE. WATER SERVICES						
STA. AND OFFSET	SIZE	LENGTH				
0+69.49, 20.46 RT	3/4"	30.46'				
0+71.97, 14.45 LT	3/4"	4.45'				
1+49.33, 19.88 RT	3/4"	29.88'				
1+55.30, 14.87 LT	3/4"	4.87'				
2+10.36, 15.18 LT	3/4"	5.18'				
2+14.19, 19.45 RT	3/4"	29.45'				
2+68.06, 19.84 RT	3/4"	29.84'				
2+70.54, 14.88 LT	3/4"	4.88'				
3+29.88, 15.18 LT	3/4"	5.18'				
3+30.57, 19.33 RT	3/4"	29.33'				
3+85.80, 15.85 LT	3/4"	5.85'				
3+93.71, 18.93 RT	3/4"	28.93'				
4+41.82, 16.39 LT	3/4"	6.39'				
4+67.44, 19.02 RT	3/4"	29.02'				
4+98.84, 16.66 LT	3/4"	6.66'				
5+37.90, 18.32 RT	3/4"	28.32'				
5+53.24, 16.84 LT	3/4"	6.84'				
6+04.95, 17.76 RT	3/4"	27.76'				
6+15.28, 17.34 LT	3/4"	7.34'				
6+67.75, 17.63 RT	3/4"	27.63'				
6+73.47, 17.08 LT	3/4"	7.08'				
7+25.02, 17.67 RT	3/4"	27.67'				
7+34.16, 17.03 LT	3/4"	7.03'				
7+84.35, 17.72 RT	3/4"	27.72'				
7+93.29, 17.02 LT	3/4"	7.02'				

HENDRIX AVE. 6" FIRE HYDRANT ASSEMBLY					
STA. AND OFFSET	LENGTH				
0+28.29, 21.00 LT	11.00'				
2+92.58, 21.19 RT	31.23'				
6+30.38, 20.96 RT	30.96'				

1 0	12-21-17 9-08-17	AMENDMENT - 1 ISSUED FOR CONSTRUCTION	MD MD	New Mexico One Call, Inc. Ca  New Mexico One Call, Inc. Ca  Professional Resources for Damage Prevention 1-8
REV. No.	DATE	DESCRIPTION	APPROVED	



# **Street Maintenance Program FY 2017**

HENDRIX AVENUE WATER LINE REPLACEMENT PLAN STATION 0+10 TO 8+00

CITY OF ALAMOGORDO, NEW MEXICO, ENGINEERING DEPARTMENT


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Public Works	Bid No.:	2017-010				Sheet No.
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Sheet 95 of 103 EN1701



FULL SCALE: 1:30 HALF SCALE 1:60

 PULL PIPE JOINTS WITHIN MANUFACTURER'S TOLERANCE TO ACHIEVE PROPER ALIGNMENT FOR CROSS.

EXISTING UTILITY LEGEND

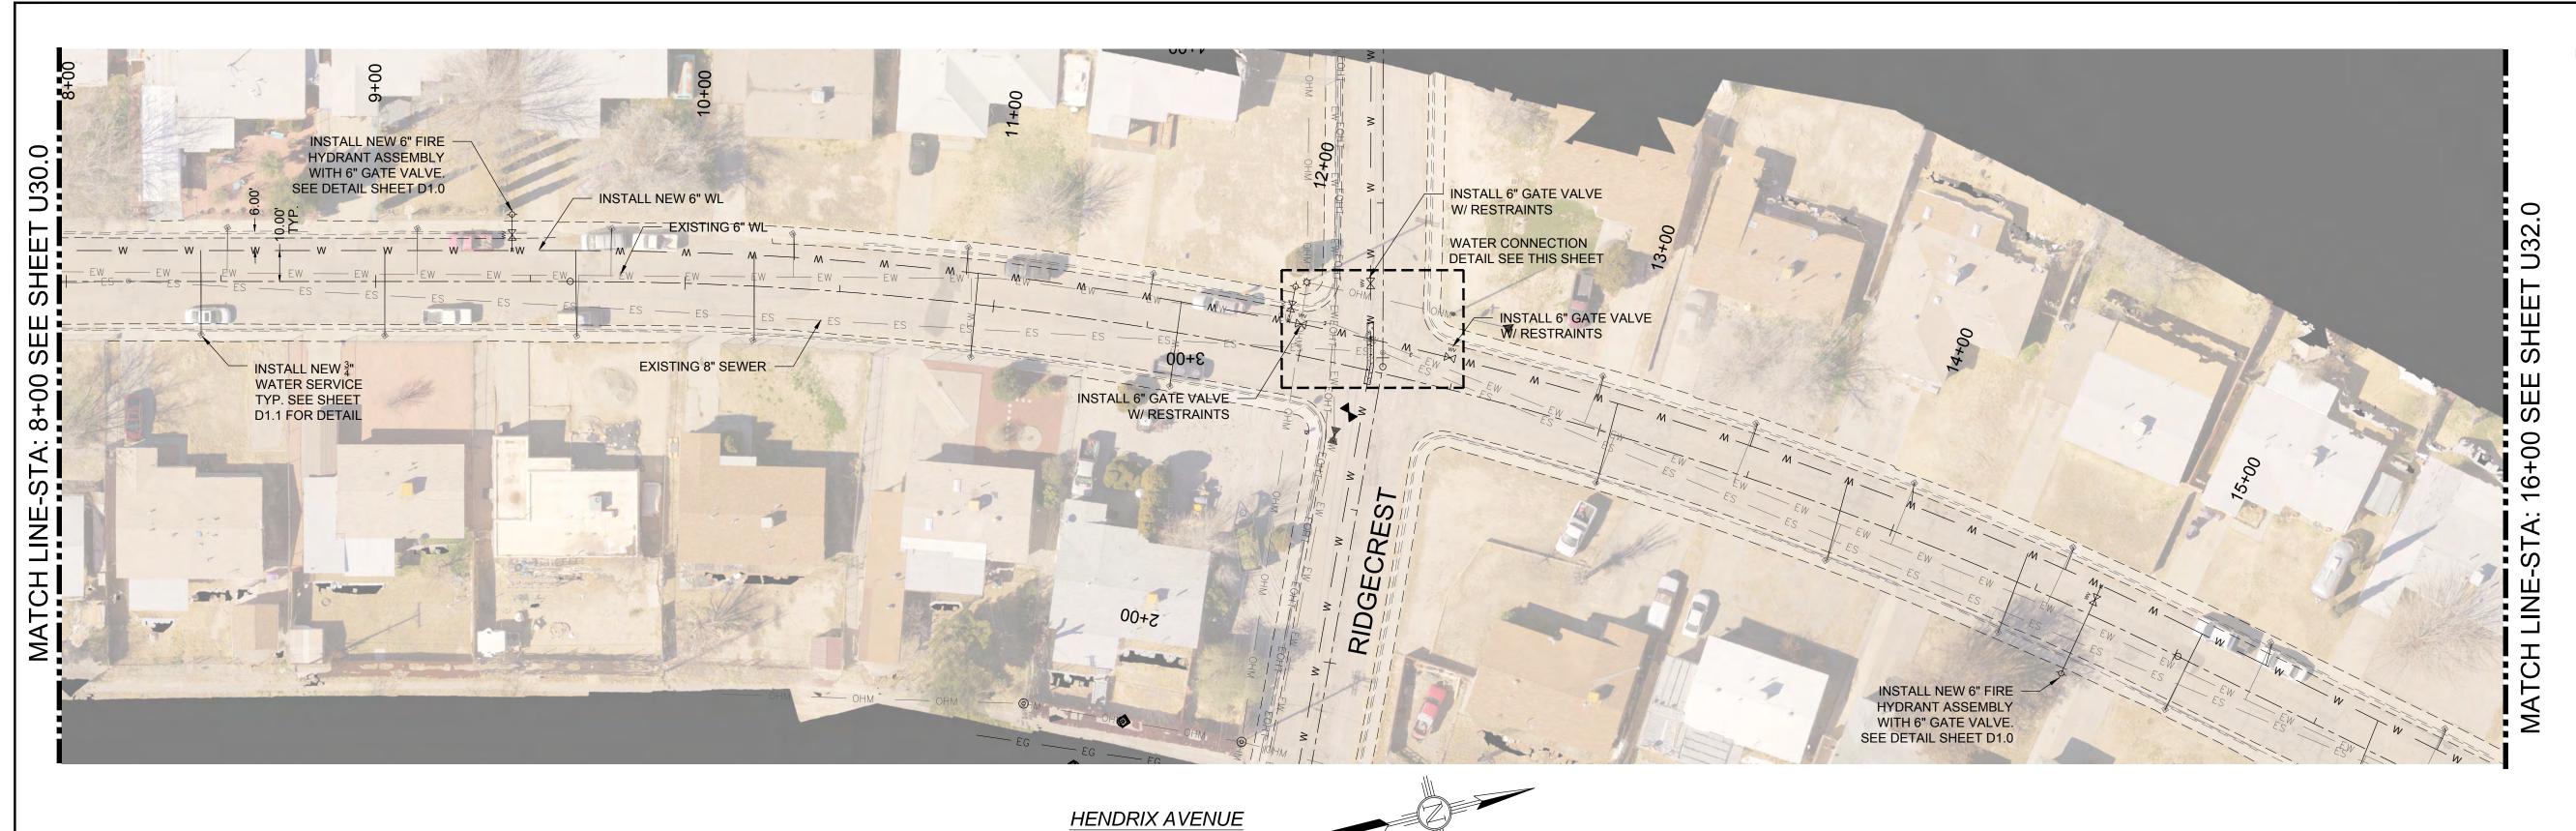**EXISTING OVER HEAD TELEPHONE** ——OHPL —— EXISTING OVER HEAD POWER LINE — ES — ES — **EXISTING SEWER** 

— OHM — OHM — EXISTING OVER HEAD MULTIPLE

EXISTING WATER EXISTING UNDERGROUND GAS EXISTING UNDERGROUND TELEPHONE

HENDRIX AVE. WATER SERVICES				
STA. AND OFFSET	SIZE	LENGTH		
8+44.84, 17.20 RT	3/4"	27.20'		
8+53.13, 16.95 LT	3/4"	6.95'		
9+04.00, 17.54 RT	3/4"	27.54'		
9+14.21, 16.83 LT	3/4"	6.83'		
9+65.71, 17.78 RT	3/4"	27.78'		
9+76.02, 17.21 LT	3/4"	7.21'		
10+23.29, 17.52 RT	3/4"	27.52'		
10+34.15, 17.48 LT	3/4"	7.48'		
10+89.55, 18.18 LT	3/4"	8.18'		
10+94.49, 17.12 RT	3/4"	27.12'		
11+49.47, 17.70 LT	3/4"	7.70'		
11+60.35, 17.48 RT	3/4"	27.48'		
12+96.18, 16.92 LT	3/4"	6.92'		
13+03.79, 16.81 RT	3/4"	26.81'		
13+47.68, 17.44 LT	3/4"	7.44'		
13+83.60, 16.70 RT	3/4"	26.70'		
14+01.33, 16.63 LT	3/4"	6.63'		
14+44.64, 17.24 RT	3/4"	27.24'		
14+55.76, 17.52 LT	3/4"	7.52'		
15+05.27, 16.86 RT	3/4"	26.86'		
15+26.38, 17.18 LT	3/4"	7.18'		
15+70.22, 17.29 RT	3/4"	27.29'		
15+88.91, 17.10 LT	3/4"	7.10'		

HENDRIX AVE. 6" F	IRE HYDRANT ASSEMBLY
STA. AND OFFSET	LENGTH
9+44.08, 21.61 LT	11.61'
11+95.41, 22.73 LT	11.81'
14+69.24, 21.19 RT	31.79'

New Mexico One Call, Inc. Call 2 days before you dig! 12-21-17 | AMENDMENT - 1 9-08-17 SSUED FOR CONSTRUCTION

HENDRIX / RIDGECREST TIE-IN DETAIL

FULL SCALE: 1:5 HALF SCALE 1:10

SINSTALL 6" GATE VALVE OHW/ RESTRAINTS AT CURB RETURN

INSTALL NEW 6" WL -

SEE U-34

EXISTING 6" WL

**INSTALL NEW 6" WL** 

SEE NOTE 1

CONCRETE ENCASE

INSTALL NEW 6" WL SEE U-34

INSTALL NEW 6" FIRE

HYDRANT ASSEMBLY WITH 6" GATE VALVE.

— INSTALL 6" X 6" TEE

SEE DETAIL SHEET D1.0

INSTALL 6" GATE VALVE W/ RESTRAINTS AT CURB RETURN



INSTALL 6" GATE VALVE

CUT & CAP EXISTING

W/ RESTRAINTS.

# **Street Maintenance Program FY 2017**

HENDRIX AVENUE WATER LINE REPLACEMENT **PLAN STATION 8+00 TO 16+00** 

CITY OF ALAMOGORDO, NEW MEXICO, ENGINEERING DEPARTMENT


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Sheet 96 of 103 t∴ n/a



HENDRIX AVENUE
FULL SCALE: 1:30 HALF SCALE 1:60

### **EXISTING UTILITY LEGEND**

EXISTING OVER HEAD TELEPHONE ——OHPL —OHPL —— EXISTING OVER HEAD POWER LINE

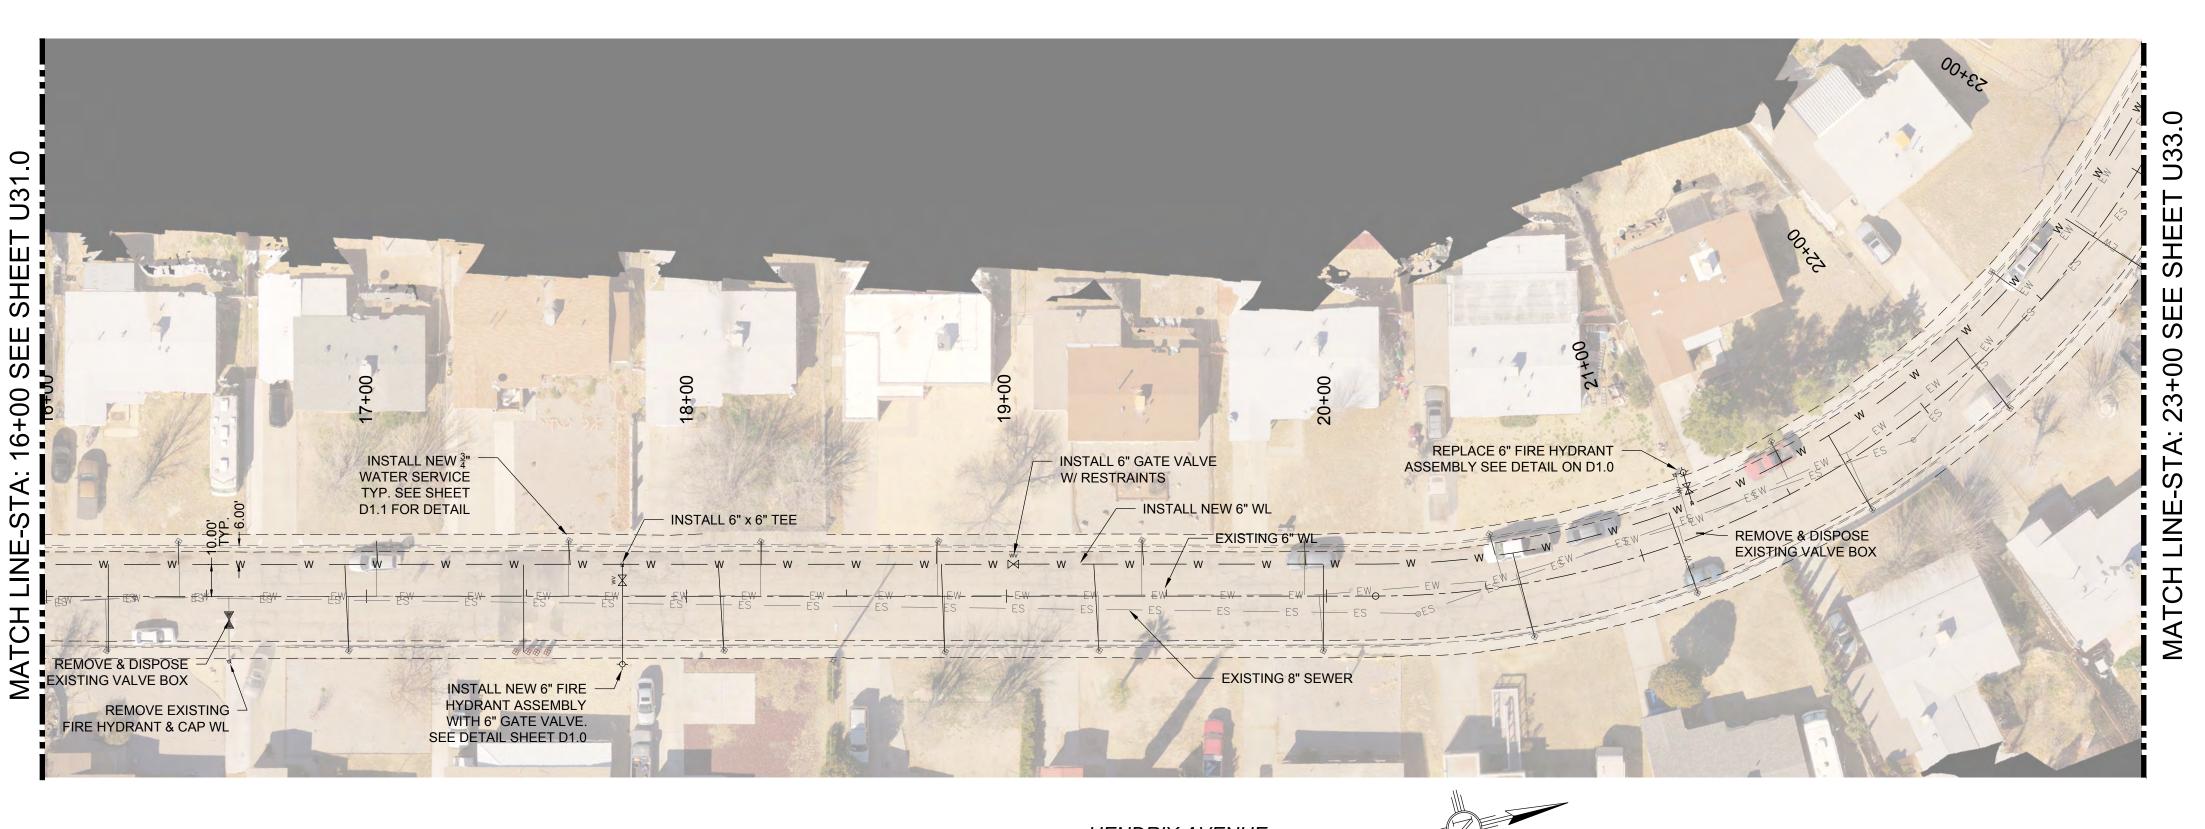— ES — ES — EXISTING SEWER

EXISTING WATER

EXISTING UNDERGROUND GAS EXISTING UNDERGROUND TELEPHONE

— OHM — OHM — EXISTING OVER HEAD MULTIPLE

HENDRIX AVE. WATER SERVICES STA. AND OFFSET LENGTH 16+18.81, 16.92 RT 3/4" 26.92' 16+41.32, 17.18 LT 3/4" 7.18' 16+94.54, 17.00 RT 3/4" 27.00' 17+03.22, 16.93 LT 3/4" 6.93' 17+46.71, 17.27 RT 27.27' 17+50.56, 17.20 RT 3/4" 27.20' 17+53.19, 17.52 RT 3/4" 27.52' 17+56.59, 17.45 RT 3/4" 27.45' 17+63.24, 17.15 LT 3/4" 7.15' 18+11.67, 16.82 RT 3/4" 26.82' 18+23.30, 17.00 LT 3/4" 7.00' 18+78.29, 17.08 LT 3/4" 7.08' 18+80.76, 17.15 RT 3/4" 27.15' 19+28.69, 16.93 RT 3/4" 26.93' 19+42.26, 17.15 LT 3/4" 7.15' 19+93.14, 17.17 LT 3/4" 7.17' 19+99.19, 17.08 RT 3/4" 27.08' 20+53.27, 17.02 LT 3/4" 7.02' 20+62.25, 16.92 RT 3/4" 26.92' 21+12.29, 16.79 RT 3/4" 26.79' 21+52.50, 17.35 LT 3/4" 7.35' 21+69.38, 16.67 RT 3/4" 26.67' 22+19.78, 17.16 RT 3/4" 27.16' 22+45.54, 17.29 LT 3/4" 7.29' 22+76.81, 17.70 RT 3/4" 27.70'

HENDRIX AVE. 6" FIRE HYDRANT ASSEMBLY		
STA. AND OFFSET	LENGTH	
17+79.57, 22.47 RT	31.39'	
21+18.75, 20.22 LT	10.22'	


12-21-17 | AMENDMENT - 1 9-08-17 | ISSUED FOR CONSTRUCTION DESCRIPTION



# **Street Maintenance Program FY 2017**

HENDRIX AVENUE WATER LINE REPLACEMENT **PLAN STATION 16+00 TO 23+00** 

CITY OF ALAMOGORDO, NEW MEXICO, ENGINEERING DEPARTMENT

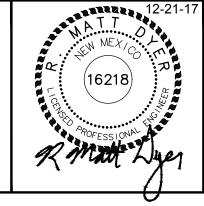


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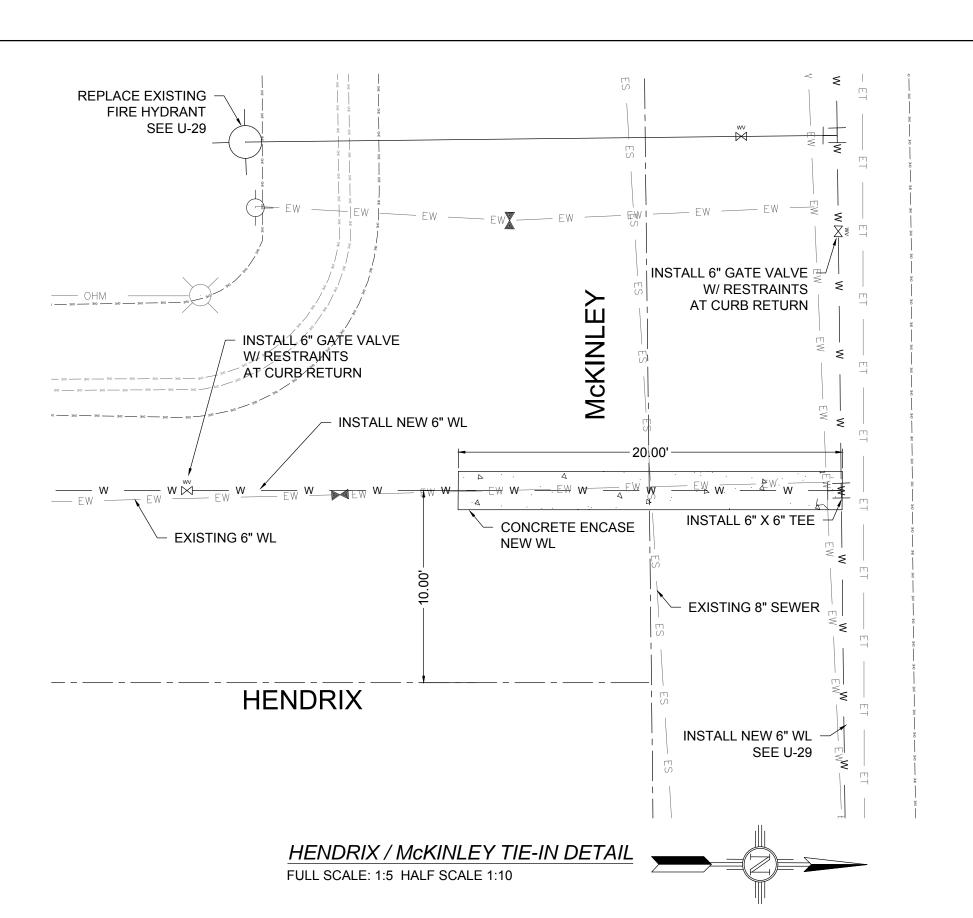
Public Works	Bid No.:	2017-010	
Drawn By:	AD	Designed By:	AD
Checked By:	MD	Approved By:	MD

U32.0

Scale: **Horiz.**: Vert.: n/a


Sheet 97 of 103 EN1701



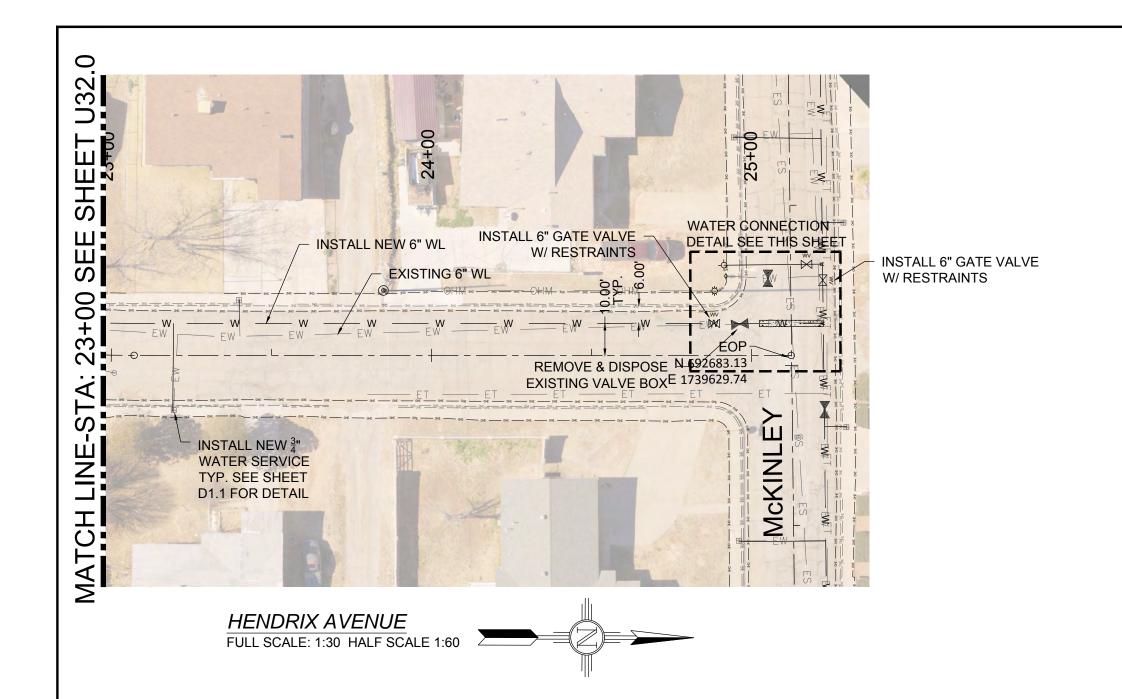

EXISTING UTILITY LEGEND			
——EOHT—EOHT——	EXISTING OVER HEAD TELEPHONE		
——OHPL —OHPL ——	EXISTING OVER HEAD POWER LINE		
ES ES	EXISTING SEWER		
EW EW	EXISTING WATER		
—— EG —— EG ——	EXISTING UNDERGROUND GAS		
ET ET	EXISTING UNDERGROUND TELEPHONE		
—— ОНМ —— ОНМ ——	EXISTING OVER HEAD MULTIPLE		


HENDRIX AVE. WATER SERVICES			
STA. AND OFFSET	SIZE	LENGTH	
23+19.55, 16.91 RT	3/4"	26.91'	
23+39.72, 17.63 LT	3/4"	7.63'	

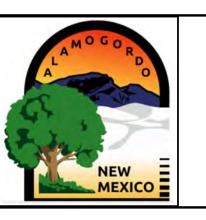

# Street Maintenance Program FY 2017

HENDRIX AVENUE WATER LINE REPLACEMENT PLAN STATION 23+00 TO 25+23

CITY OF ALAMOGORDO, NEW MEXICO, ENGINEERING DEPARTMENT

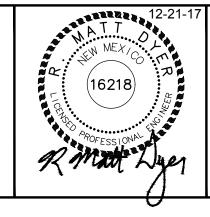


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Sheet 98 of 103


EN1701




RIDGECREST DRIVE
FULL SCALE: 1:30 HALF SCALE 1:60

### EXISTING UTILITY LEGEND

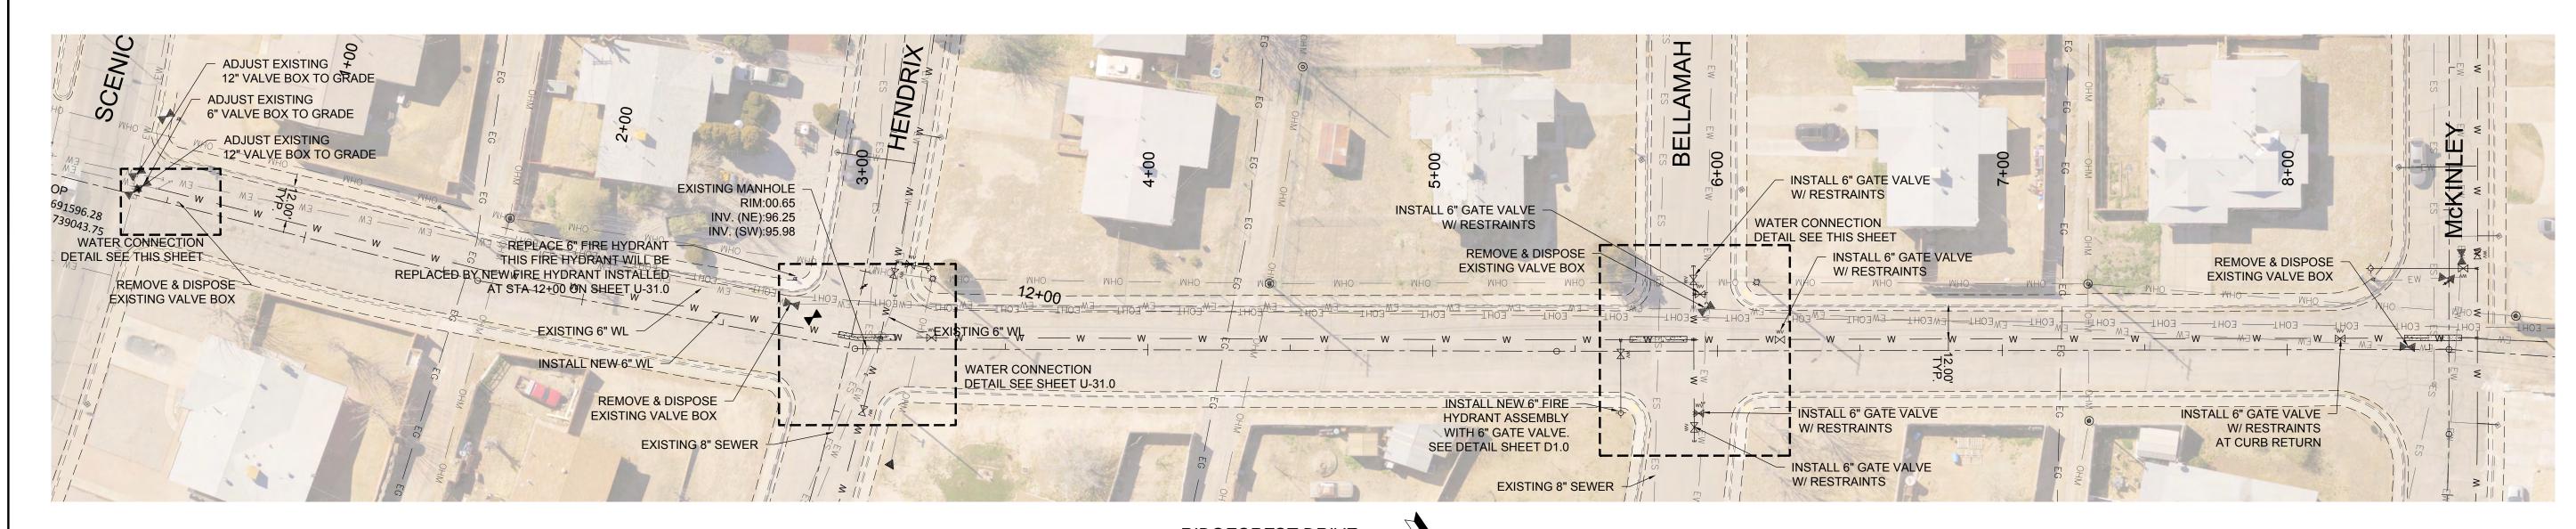— EOHT – EOHT — EXISTING OVER HEAD TELEPHONE
— OHPL – OHPL — EXISTING OVER HEAD POWER LINE
— ES — ES — EXISTING SEWER
— EW — EW — EXISTING WATER
— EG — EG — EXISTING UNDERGROUND GAS
— ET — ET — EXISTING UNDERGROUND TELEPHONE
— OHM — OHM — EXISTING OVER HEAD MULTIPLE

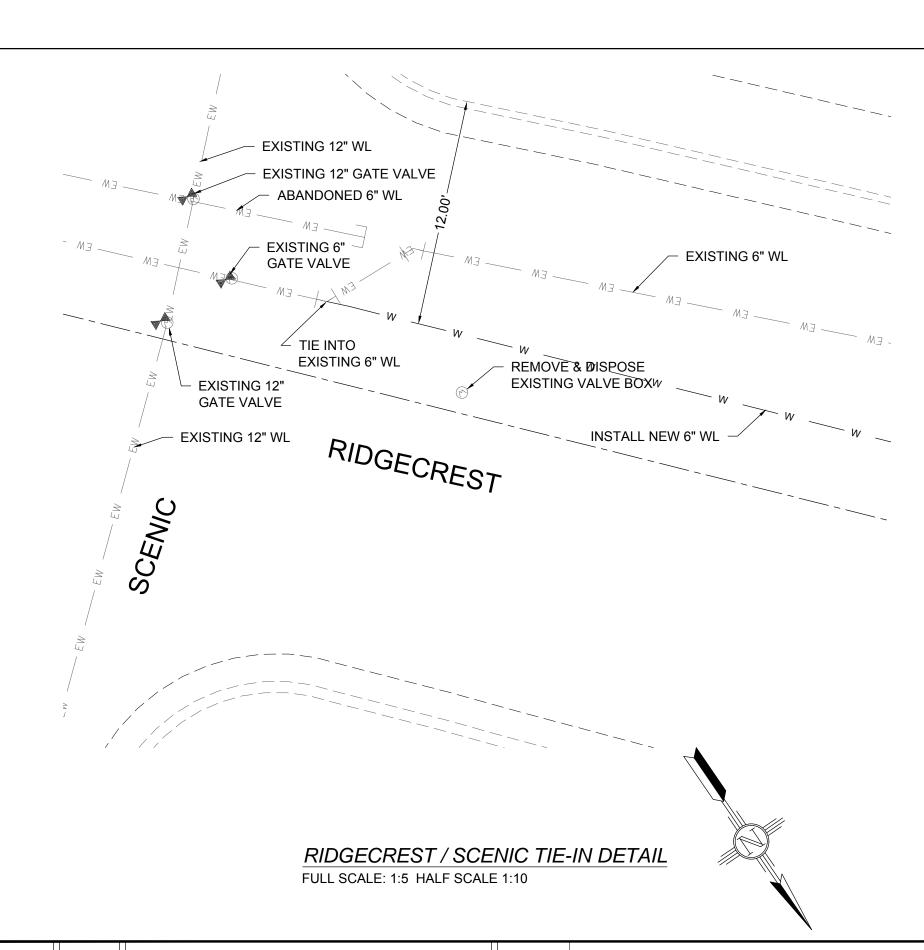

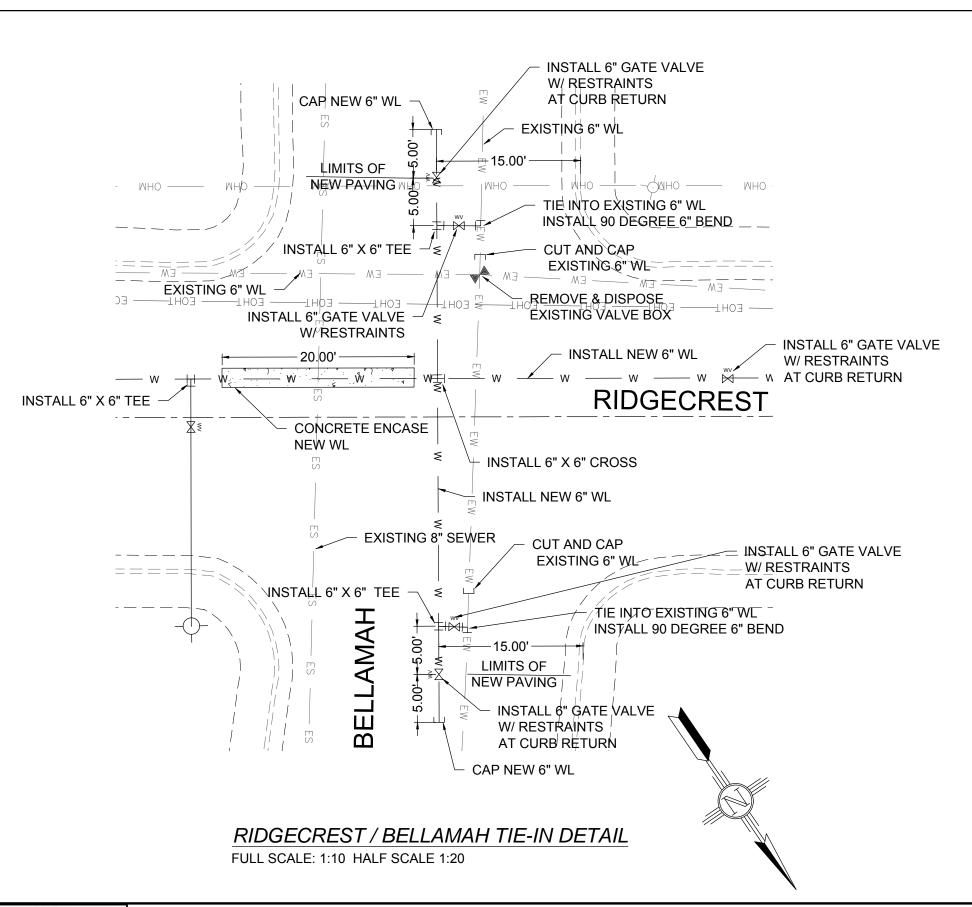

F	RIDGECREST DR. 6"	FIRE HYDRANT ASSEMBLY
	STA. AND OFFSET	LENGTH
	5+65.85, 21.75 RT	25.75'


				New Mexico One Call, Inc. Call 2 days
				Dial 811 or Professional Resources for Damage Prevention 1-800-321-2537
1	12-21-17	AMENDMENT - 1	MD	1.800 321 2537
0	9-08-17	ISSUED FOR CONSTRUCTION	MD	Professional Resources for Damage Prevention FOOO JZ FZOJ /
REV. No.	DATE	DESCRIPTION	APPROVED	



# **Street Maintenance Program FY 2017**


RIDGECREST DRIVE WATER LINE REPLACEMENT PLAN STATION 0+38 TO 8+67

CITY OF ALAMOGORDO, NEW MEXICO, ENGINEERING DEPARTMENT

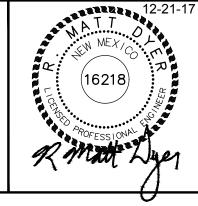


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Public Works	Bid No.:	2017-010		Sheet No.:
Drawn By:	AD	Designed By:	AD	U34.0
Checked By:	MD	Approved By: _	MD	
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# #4 REBAR @ 12" O.C. TYPICAL #4 REBAR 1'-6" LONG TYP. OF 4 #4 REBAR PERIMETER TYPICAL

# Valve Box Concrete Collar Detail

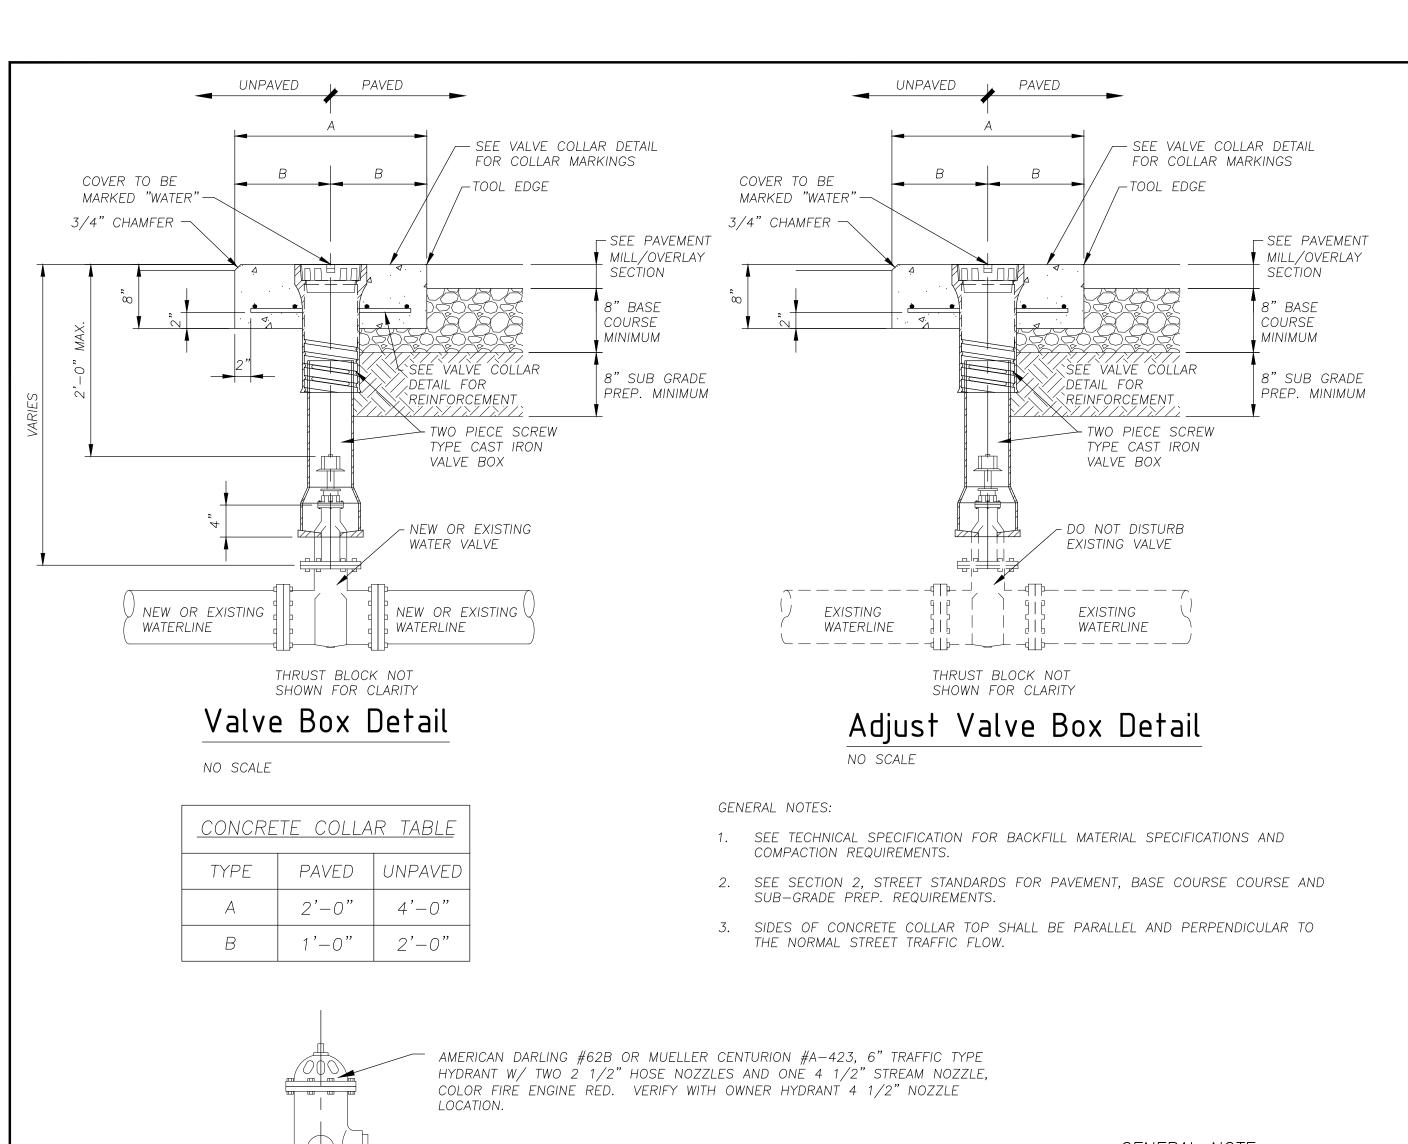

# Valve Box Collar Marking Detail

NO SCALE
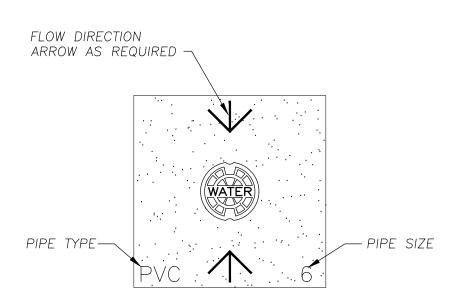
### GENERAL NOTES:

- 1. SIDES OF CONCRETE COLLAR TOP SHALL BE PARALLEL AND PERPENDICULAR TO THE NORMAL STREET TRAFFIC FLOW.
- 2. SCRIBE CONCRETE WITH LINE DIRECTIONAL ARROWS, PIPE SIZE AND PIPE TYPE.
- 3. TEXT SIZE SHALL BE 4-INCHES TALL AND SCORED 3/8" DEEP IN A NEAT AND CONSISTENT MANNER, TYPICAL.



Utility Trench Cross-Section

SEE TECHNICAL SPECIFICATIONS FOR MIN. & MAX. TRENCH WIDTH

— SEE PAVEMENT MILL/OVERLAY SECTION

6" MIN. (W) DETECTABLE

WARNING MARKING TAPE,

COLOR COORDINATED AND

IMPRINTED W/ INSTALLED

-BACKFILL

\_\_\_\_HAUNCH\_

UNCOMPACTED BEDDING REGION-

No Scale

NOT REQUIRED FOR PIPE

THAN 4-INCH DIAMETER. -

OR CONDUIT SMALLER

-SPRINGLINE

UNDISTURBED EARTH

—FINAL BACKFİLL:

95% COMPACTION

INSI<u>DE V</u>ALVE BOX

95% COMPACTION

TYPE II AGGREGATE,—

=BEDDING: 6" MAXIMUM,

95% COMPACTION —

 $\begin{bmatrix} \\ \end{bmatrix}$ TYPE II AGGREGATE,

UNCOMPACTED BEDDING REGION

-WIDTH=D/3 (D=PIPE O.D.) OR

INITIAL BACKFILL:

HAUNCH ZONE:

-TYPE I OR II AGGRE<del>G</del>ATE,

PROVIDE 14 GA. SOLID COPPER

TRACER WIRE FOR NON-METAL PIPE.

USE APWA COLOR CODE. TERMINATE

SIEVE SIZE	PERCENT OF DRY WEIGHT PASSING SIEVE
1—INCH	100
3/4-INCH	85 – 95
No. 4	40 - 70
No. 10	35 – 45
No. 16	25 – 35
No. 200	6 – 18
PLASTIC INDEX	12 MAXIMUM
LIQUID LIMITS	35 MAXIMUM
FRACTURED FACES	70% MINIMUM
TOTAL AVAILABLE WATER SOLUBLE SULFATES	35 MAXIMUM

### GENERAL NOTE:

SEE CONCRETE THRUST

BLOCK DETAIL


- 1. FIRE HYDRANT SHALL BE INSTALLED 6-FEET FROM BACK OF CURB TO CENTER OF
- HYDRANT OR AS SPECIFIED BY ENGINEER. . ALL FITTINGS FROM WATER MAIN LINE TO FIRE HYDRANT SHALL BE M.J. FITTINGS.
- GRIP RING PIPE RESTRAINED, OR PRE—APPROVED EQUAL, SHALL BE INSTALLED ON PIPE FROM HYDRANT VALVE TO HYDRANT BOOT WHEN VALVE IS LOCATED WITH—IN THE 5—FEET MINIMUM SEPARATION THIS INSTALLATION MUST BE APPROVED BY ENGINEER
- MINIMUM SEPARATION, THIS INSTALLATION MUST BE PRE—APPROVED BY ENGINEER.
  4. FIRE HYDRANT VALVE SHALL NOT BE LOCATED IN THE CURB OR THE GUTTER.

# 6" BLUE UTILITY MARKING TAPE (DETECTABLE) PROVIDE 14 GA. SOLID COPPER TRACER WIRE FOR NON-METAL PIPE. USE APWA COLOR CODE. TERMINATE INSIDE VALVE BOX ENCAPSULATE PIPE IN 3000 PSI CONCRETE PIPE - SIZE VARIES IN AREAS WHERE SOIL IS UNSUITABLE, CONTRACTOR SHALL REMOVE UNSUITABLE SOIL AND REPLACE WITH 3/4" CRUSHED ROCK (DENSIFIED)

# Pipe Concrete Encasement

### GENERAL NOTES:

- 1. SEE TECHNICAL SPECIFICATIONS FOR BACKFILL MATERIAL SPECIFICATIONS AND COMPACTION REQUIREMENTS.
- 2. NATIVE SOIL SHALL NOT BE USED AS BACKFILL MATERIAL WITHIN THE LIMITS OF ANY ROADWAY.
- 3. COMPACTION OF THE PIPE BEDDING MAY BE ACCOMPLISHED USING MECHANICAL TAMPING DEVICES PRIOR TO PLACEMENT OF THE PIPE OR CONDUIT. MINIMUM EXCAVATION FOR PIPE BELLS MAY BE ACCOMPLISHED AS NECESSARY TO ALLOW PROPER ALIGNMENT AND ELEVATION OF THE PIPE OR CONDUIT.
- 4. COMPACTION IN THE HAUNCH ZONE SHALL BE COMPLETED BY HAND WITH TAMPERS OR SUITABLE POWER COMPACTORS IN MAXIMUM LIFTS OF SIX (6) INCHES. TAMPERS SHALL NOT CONTACT THE PIPE OR CONDUITS DURING THE TAMPING PROCESS.
- 5. THE CONTRACTOR SHALL NOT EMPLOY THE USE OF IMPACT TAMPERS DIRECTLY ABOVE THE PIPE OR CONDUIT UNTIL THE FULL LOOSE LAYER BACKFILL DEPTH ABOVE THE PIPE IS OBTAINED
- 6. TRENCHING AND EXCAVATION OPERATIONS SHALL CONFORM TO THE CURRENT FEDERAL, STATE AND LOCAL SAFETY ORDINANCES INCLUDING ALL O.S.H.A. REGULATIONS.

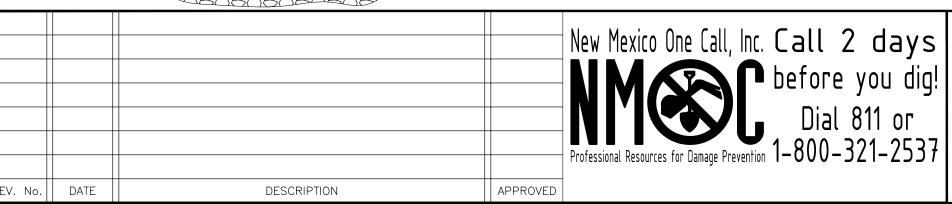

6" WATER LINE, MINIMUM

5'-0" MINIMUM

SEE VALVE BOX DETAIL -

DRAINAGE PIT - 3/4" CLEAN

CRUSHED ROCK, 2/3 CUBIC YARD

FINAL FINIAL GRADE

MIN. MAX

CONCRETE THRUST BLOCK

5 CUBIC FEET MINIMUM —



D.I. M.J. TEE

- VALVE COLLAR SHALL NOT

SEE CONCRETE VALVE

WATER LINE, MINIMUM

SEE GATE VALVE ANCHOR DETAIL

Fire Hydrant Detail

COLLAR DETAIL

BE INSTALLED IN SIDEWALK

OR ACCESSIBLE (ADA) RAMPS

# Street Maintenance Program FY2017

### **Miscellaneous Details**

ENGINEERING DEPARTMENT CITY OF ALAMOGORDO NEW MEXICO



<u> </u>	Public Works	Bid No.:	2017-01	0
Occam Engineers	Drawn By:	GG	Designed By:	GG
Inc.	Drawn By: Checked By:	CA	Approved By:	CA
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506 S MAIN ST. SUITE 600 S CRUCES, NEW MEXICO 88005 (575) 524-2007 (OFFICE) (575) 524-04.82 (FAX)	Scale: H	Ioriz.: 1" = .2	2154' Vert.:	N/A

2017-010


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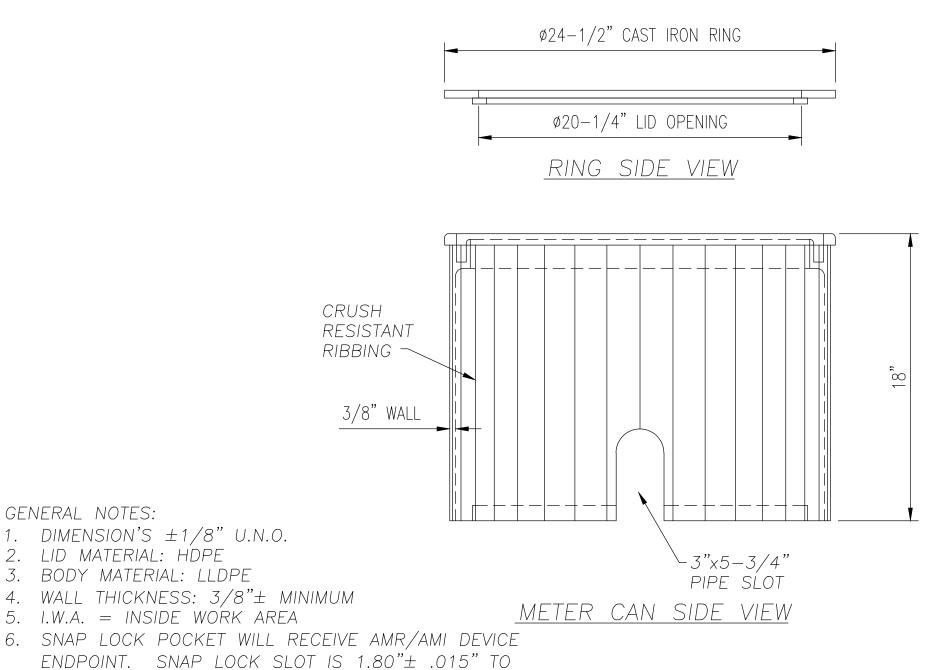
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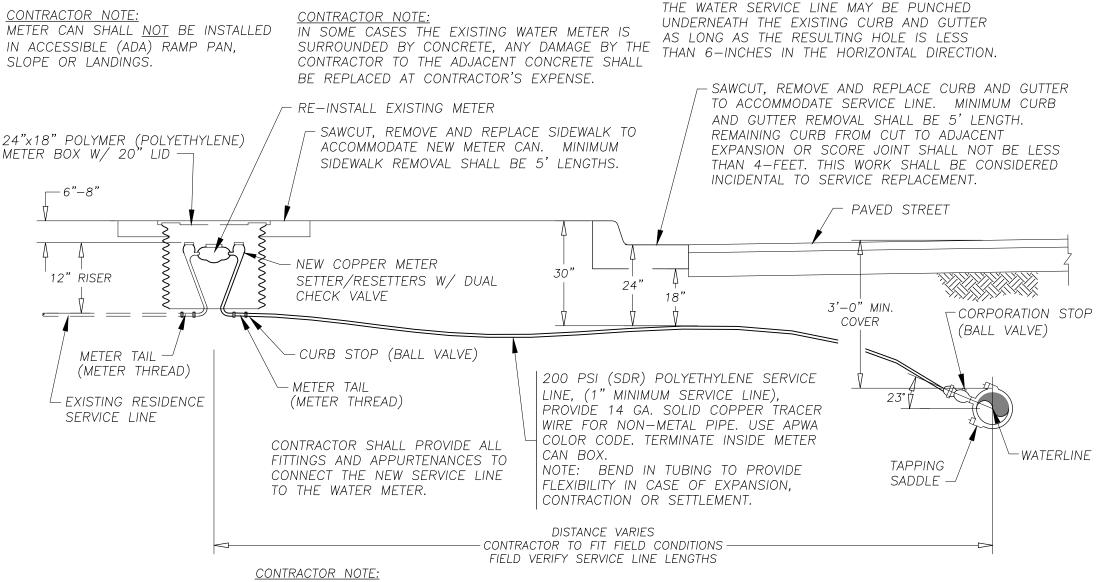
Sheet 100 of 103 EN1701



PIPE SIZE	TEE, CAP, PLUG, ELBOW ANGLE	Α	В	С	D	PIPE SIZE	TEE, CAP, PLUG, ELBOW ANGLE	Α	В	С	D
4"	TEE OR CAP/PLUG	2'	1'	_	_	10"	TEE OR CAP/PLUG	3'	3'	_	_
4"	90° 45°	_	_	2'	2'	10"	90°	_	_	3'-6"	3'-6"
4"	22 1/2° 11 1/4°	_	_	2'	2'	10"	45°	_	_	3'	3'
6"	TEE OR CAP/PLUG	2'	2'	_	_	10"	22 1/2° 11 1/4°	_	_	2'	2'
6"	90° 45°	_	_	2'	2'	12"	TEE OR CAP/PLUG	3'-6"	3'-6"	_	_
6"	22 1/2° 11 1/4°	_	_	2'	2'	12"	90°	_	_	4'	4'
8"	TEE OR CAP/PLUG	3'	3'	_	_	12"	45°	_	_	3'-6"	3'-6"
8"	90°	_	_	3'	3'	12"	22 1/2° 11 1/4°	_	_	2'	2'
8"	45°	_	_	2'	2'	14"	TEE OR CAP/PLUG	4'	4'	_	_
8"	22 1/2° 11 1/4°			2'	2'	14"	90°	_		5'	5'
	THE DIMENSIONS ON THE TABLE ARE FOR DIDE					14"	45°	_		3'-6"	3'-6"
1175	THE DIMENSIONS ON THE TABLE ARE FOR PIPE BEING TESTED UP TO 150 P.S.I.						22 1/2° 11 1/4°	_	_	3'	3'



CONTRACTOR SHALL INSCRIBE A 'W' ON TOP OF CONCRETE CURB (IN-LINE W/ NEW WATER SERVICE) TO INDICATE THE LOCATION OF THE NEW WATER SERVICE LINE.

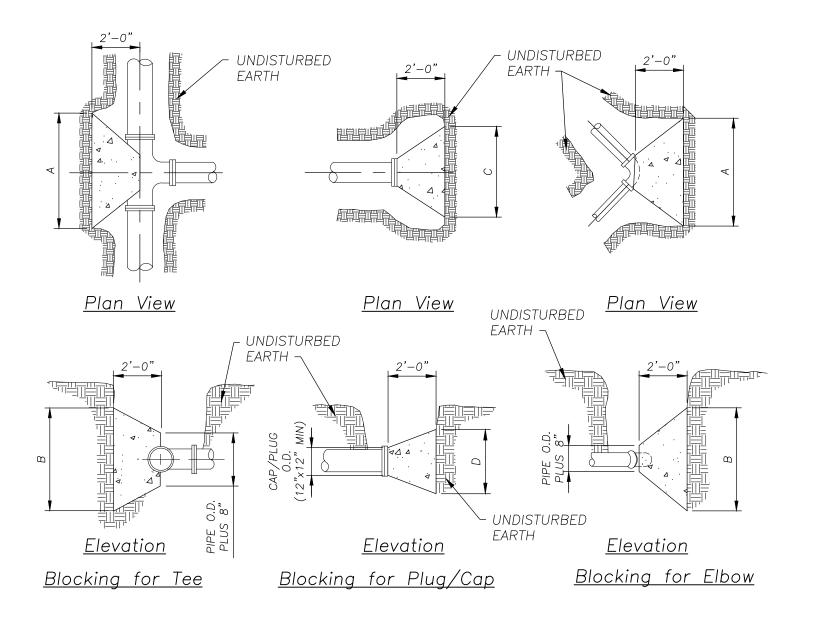


METER CAN SHALL BE INSTALLED IN SIDEWALKS OR LANDSCAPE AREA (BETWEEN SIDEWALK AND BACK OF CURB) WITHIN RIGHT OF WAY. METER CANS SHALL NOT BE INSTALLED IN DRIVEWAYS OR VEHICULAR TRAFFIC FLOWS UNLESS LOCATION(S) AND METER CAN TYPE(S) HAVE BEEN PRE-APPROVED BY THE PUBLIC WORKS DEPARTMENT AND COMMUNITY DEVELOPMENT DEPARTMENT PRIOR TO INSTALLATION.

THE CITY OF ALAMOGORDO RESERVES THE RIGHT TO CHANGE AND/OR MODIFY ANY ITEM(S) EITHER DETAILED OR SPECIFIED ON THIS DRAWING.

### Typical City of Alamogordo Water Service Detail

WATER SERVICE DETAIL AND WATER SERVICE INSTALLATION MATERIAL LISTING ARE TYPICAL FOR 3/4" WATER SERVICE. ADJUSTMENTS SHALL BE MADE TO FITTINGS, CONNECTIONS, SERVICE LINE, ECT. SIZE AS REQUIRED FOR WATER SERVICES LARGER THAN 3/4". ALL FITTING, CONNECTIONS, SERVICE LINE, ETC. SHALL BE RATED FOR 150 P.S.I. (MINIMUM) WORKING PRESSURE.

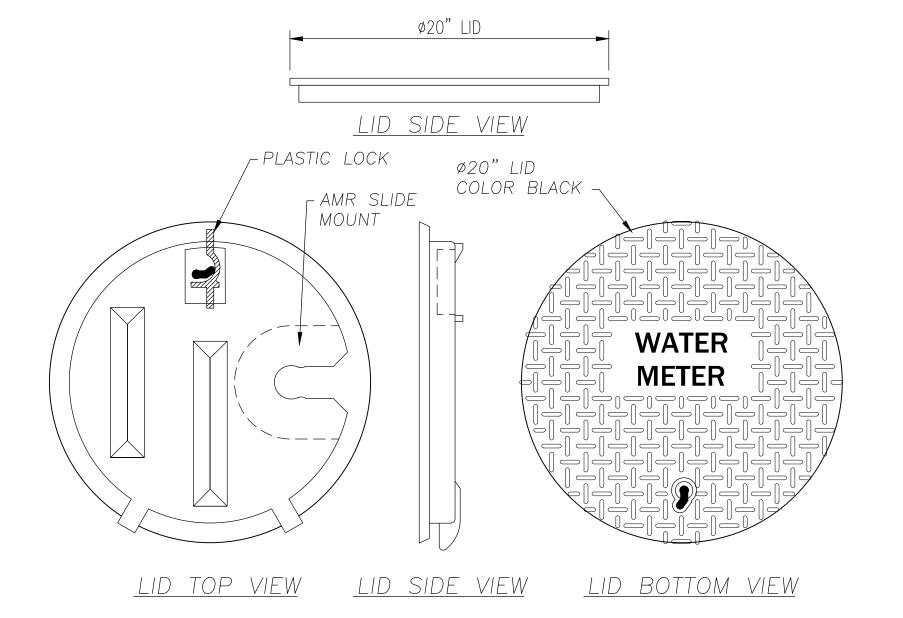

### TYPICAL WATER SERVICE INSTALLATION MATERIAL LISTING.

COLD WATER METER: WATER METERS SHALL BE MULTIJET, READING IN CUBIC FEET AND ACCEPTABLE FOR USE WITH ZENNER STEALTH READER MIU SYSTEM. NO SUBSTITUTIONS. REFER TO ARTICLE 02-026.1 WATER SUPPLY SYSTEM FOR THE LIST OF COMPATIBLE WATER METERS. WATER METERS LARGER THAN 2-INCHES SHALL BE POSITIVE DISPLACEMENT

SERVICE (TAPPING) SADDLE:TAPPING SADDLES REQUIRE THE PRE-APPROVAL BY PUBLIC WORKS DEPARTMENT AND ENGINEERING DEPARTMENT PRIOR TO INSTALLATION. ACCEPTABLE SADDLES SHALL HAVE DOUBLE STRAPS STRAP SECURED BY FOUR BOLTS. SADDLES SHALL ALSO HAVE 1" IP THREADED OUTLET AND BE MADE OF THE FOLLOWING ACCEPTED

BODY - DUCTILE IRON BODY, CONFORMING TO ASTM A-536, WITH 10-12 MIL FUSSION EPOXY COATING OR NYLON

STRAPS - TYPE 304 (18-8) HEAVY GRADE STAINLESS STEEL, CONFORMING TO ASTM A-240.

NUTS & WASHERS - UNC ROLL THREAD TYPE 304 (18-8) STAINLESS STELL BOLTS WITH HEAVY HEX NUTS. ROD FOR BOLTS, CONFORMING TO ASTM A-240, AND NUTS, CONFORMING TO ASTM A-194. ALL WELDS FULLY PASSIVATED FOR ENHANCED CORROSION RESISTANCE. NUTS COATED TO PREVENT GALLING.

GASKET - NITRILE BUTADIENE RUBBER (NBR), ASTM D-2000 MBC-610 OR HD EDPM O-RING.

NOTE: <u>SADDLE WITH SLENDER SINGLE STRAPS SECURED BY TWO BOLTS, CAST IRON BODY AND STEEL STRAPS</u>

 ${\color{blue} { t CORPORATION}}$  CORPORATION STOP SHALL BE BALL VALVE TYPE AND RATED FOR 150 P.S.I. (MINIMUM) WORKING PRESSURE. CORPORATION STOP SHALL HAVE A 1" IP THREADED INLET WITH A PACK JOINT CONNECTION FITTING OR MUELLER INSTA-TITE CONNECTION FOR 1" PVC SERVICE LINE.

SERVICE LINE: SERVICE LINE SHALL BE 1" BLUE SDR POLYETHYLENE, 200 PSI, CONFORMING TO ASTM D2737 AND SPECIFIED FOR

<u>CURB STOP:</u> CURB STOP SHALL BE BALL VALVE TYPE AND RATED FOR 150 P.S.I. (MINIMUM) WORKING PRESSURE.

COPPER METER RESETTER: COPPER METER RESETTER (METER YOKE) SHALL BE HORIZONTAL STYLE, 5/8"x3/4" (METER YOKE) BRASS/COPPER WITH LOCK WING STYLE ANGLE METER VALVE ON INLET AND TOP ENTRY ANGLE DUAL CHECK VALVE ON OUTLET WITH BRASS SUPPORT BAR. THE CONNECTIONS FOR METER SHALL BE BRAS SWIREL NUT WITH WIRE SEAL HOLE AND METER SUPPORT LIP. INLET AND OUTLET THREADS SHALL BE METER THREAD. THE CONNECTION TO THE 1" SERVICE LINE SHALL BE MADE WITH AN AY McDONALD 76102 O.A.E. CTS MAC-PAC JOINTxFNPT CURB STOP AND A 3/4"x1" BRASS METER BUSHING. IF A THERMAL-COIL BOX IS UTILIZED THE FOLLOWING MATERIALS SHALL BE USED VERSUS THE

-POLYBUTYLENE TUBING -A LOCK WING METER STOP (INLET 3/4") -A DUAL CHECK VALVE (OUTLET 3/4") -A 3/4" OUTSIDE METER THREADED INLET -A 3/4" OUTSIDE METER THREADED OUTLET

METER BOXES: SPECIFICATION IS BASED ON USE OF "DFW PLASTICS, INC." BY DFW PLASTICS, INC., 901 E INDUSTRIAL AVENUE, SAGINAW TX 76131, WITH ATTRIBUTES AS DESCRIBED BELOW. EQUAL PRODUCTS OF OTHER WATER METER CAN MANUFACTURES MAY BE ACCEPTABLE WHEN PRE-APPROVED BY OWNER. PRE-APPROVED EQUAL, SUBSTITUTIONS UNDER ARTICLE 01-002.4.

THIS PRODUCT IS DESIGNED TO WITHSTAND LOADING IN NON-DELIBERATE AND INCIDENTAL TRAFFIC. NOT TO BE INSTALLED IN ROADWAY. METER PIT LID SHALL BE BLACK AND CONSTRUCTED OUT OF MODIFIED POLYETHYLENE MATERIAL FOR MAXIMUM DURABILITY AND CORROSION RESISTANCE. THE BLACK MATERIAL IS FOR MAXIMUM UV PROTECTION. THE BLACK MATERIAL SHALL BE UNIFORM THROUGHOUT THE METER PIT LID FOR MAXIMUM LONGEVITY AND NOT HAVE A FOAMING AGENT THAT CREATES AIR POCKETS WITHIN THE POLYMER LID.

### VERTICAL AND LATERAL LOAD RATING:

- COMPLIANT WITH AASHTO, DESIGN LOAD OF H-10; ASTM C857-16, DESIGN LOAD OF A-8, 8,000 LBS. TRANSFERRED THROUGH A 10" X 10" STEEL PLATE CENTERED IN THE COVER AND BODY.
- COMPLIANT WITH AASHTO, DESIGN LOAD OF H-20; ASTM C857-16, DESIGN LOAD OF A-16, 16,000 LBS. TRANSFERRED THROUGH A 10" X 20" STEEL PLATE CENTERED ON THE COVER AND BODY.
- THIS PRODUCT IS DESIGNED TO WITHSTAND H-10 AND H-20 LOADING IN NON-DELIBERATE OR INCIDENTAL TRAFFIC AREAS.

NOT INTENDED TO BE INSTALLED IN ROADWAYS.

### POLYMER LID

- THE POLYMER LID SHALL HAVE A MOLDED KEY HOLE AND PLASTIC LOCK UNDERNEATH LID AS ILLUSTRATED.
- THE POLYMER LID SHALL HAVE ONE (1) MOLDED SLIDE MOUNT FOR PLACEMENT OF AMR/AMI DEVICE AS ILLUSTRATED.
- THE POLYMER LID SHALL SEAT SECURELY AND EVENLY INSIDE THE METER PIT AND SHALL NOT OVERLAP THE TOP EDGE OF THE METER PIT. THE POLYMER LID SHALL HAVE MOLDED TREAD-PATTERN FOR SKID RESISTANCE - TREAD DIMENSIONS SHALL BE 0.188" X
- THE POLYMER LID SHALL HAVE "WATER METER" MOLDED INTO THE LID FONT SHALL BE STD FADAL CNC FONT WITH 1" CHARACTERS X 0.150" DEEP.
- THE POLYMER LID SHALL BE BLACK AND HAVE A MOLDED RECYCLED EMBLEM WITH A MINIMUM OF 50% POST CONSUMER RECYCLED AND 50% POST INDUSTRIAL/ PRE CONSUMER RECYCLED CONTENT- VERIFIED WITH A LEED PRODUCT DOCUMENTATION.


- THE POLYMER BODY SHALL BE BLACK AND HAVE A MINIMUM OF 3/8" WALL THICKNESS AS ILLUSTRATED.
- THE POLYMER BODY SHALL HAVE MINIMUM INSIDE WORKING ROOM OF (23-1/4") AS ILLUSTRATED.

CONSUMER RECYCLED CONTENT - VERIFIED WITH A LEED PRODUCT DOCUMENTATION.

- THE POLYMER BODY SHALL HAVE CRUSH RESISTANT RIBBING ALONG THE OUTSIDE OF THE BOX WITH 1-5/8" BASE FOOTING LOCATED AT THE BOTTOM OF THE METER PIT TO HELP ELIMINATE SINKING OR FLOATING ONCE INSTALLED.
- THE POLYMER BODY SHALL HAVE A STRAIGHT WALL DESIGN AND NOT BE FLARED AS TO ALLOW FOR ADJUSTMENT TO GRADE AFTER INSTALLATION.
- THE POLYMER BODY SHALL HAVE ONE PIPE SLOT MOLDED ON EACH END OF THE BODY THAT MEASURES (3" X 5-3/4"). • THE POLYMER BODY SHALL HAVE A MOLDED RECYCLED EMBLEM WITH A MINIMUM OF 35% POST INDUSTRIAL/ PRE

WHENEVER IN THE SPECIFICATIONS, ANY PARTICULAR MATERIALS, PROCESS AND/OR EQUIPMENT IS INDICATED OR SPECIFIED B' PATENT. PROPRIETARY. OR BRAND NAME. OR BY NAME OF MANUFACTURER, SUCH WORDING SHALL BE DEEMED TO BE USED FOR THE PURPOSE OF FACILITATING DESCRIPTION OF THE MATERIAL, PROCESS, AND/OR EQUIPMENT DESIRED, AND SHALL BE DEEMED TO BE FOLLOWED BY THE WORDS "OR EQUAL". THE LISTS OF ACCEPTABLE MATERIAL ARE NOT INTENDED TO BE COMPREHENSIVI LISTS, OR IN ANY ORDER OF PREFERENCE. THE BIDDER MAY OFFER ANY MATERIAL, PROCESS, AND/OR EQUIPMENT WHICH COMPL WITH THE GOVERNING SPECIFICATIONS WHICH THE BIDDER CONSIDERS TO BE EQUIVALENT TO THAT WHICH IS INDICATED OF

THE NOTED METER BOX SIZE IS FOR A TYPICAL FOR 3/4" AND 1" WATER SERVICES. METER BOXES FOR WATER SERVICES LARGER THAN 1 1/2" SHALL BE PRE-APPROVED BY THE PUBLIC WORKS DEPARTMENT.

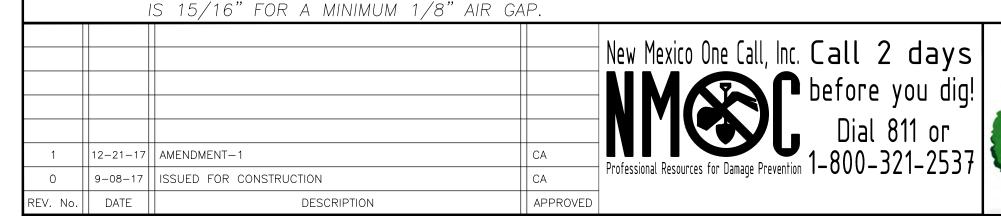

ALLOW FOR A FINGER FORCE INSTALL. POCKET HEIGHT

GENERAL NOTES:

2. LID MATERIAL: HDPE

3. BODY MATERIAL: LLDPE



# **Street Maintenance Program FY2017**

### **Miscellaneous Details**

ENGINEERING DEPARTMENT CITY OF ALAMOGORDO






(575) 524-04.82 (FAX)


	Public Works Bid No.:	2017-010
Occam Engineers	Drawn By: <b>GG</b>	Designed By: <b>GG</b>
Occam Engineers Inc.	Checked By: CA	Approved By: $\overline{CA}$
S MAIN ST. SUITE 600	Scale: Horiz.: 1" =	.2154' Vert.: N/A

**D1.1** 

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**NEW MEXICO** 



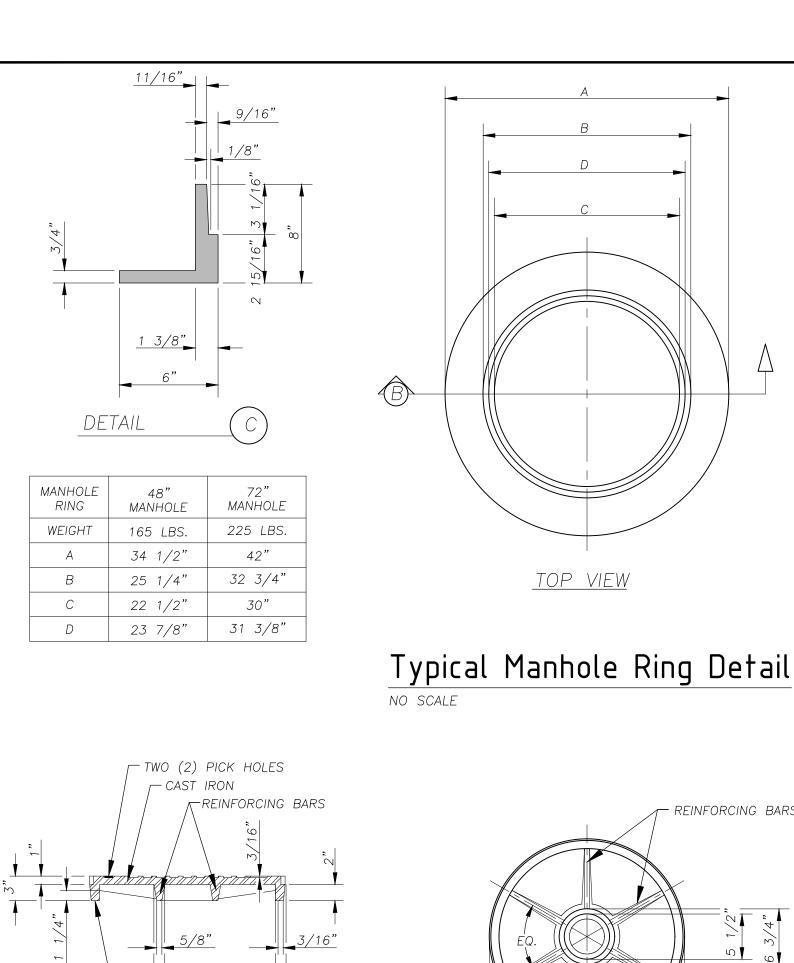

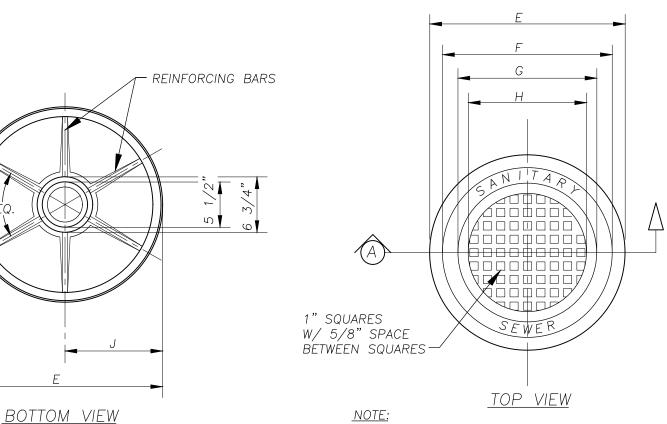M.H. COVER

SECTION

SNUG FIT.

GENERAL NOTES:

APPROPRIATE UTILITY.

✓ LMF —

CAST IRON -

1. MATCHING SURFACES MARKED "MF" TO BE MACHINE FINISHED OF ANY IRREG-ULARITIES THAT WOULD PREVENT A

CASTING TO BE SMOOTH AND FREE OF

MATCHING SURFACES MARKED "MF" TO BE MACHINE FINISHED AND BE FREE OF


MANHOLE RING AND LID SHALL BE DESIGNED FOR H-20 WHEEL LOADING.


TOP OF LID MAY VARY FROM DETAIL SHOWN. LID SHALL BE MARKED FOR

ANY IRREGULARITIES THAT WOULD PREVENT A SNUG FIT.

MINIMUM TOTAL WEIGHT (RING AND LID) SHALL BE 300 LBS.

CASTING TO BE SMOOTH AND FREE OF AIR VOIDS.

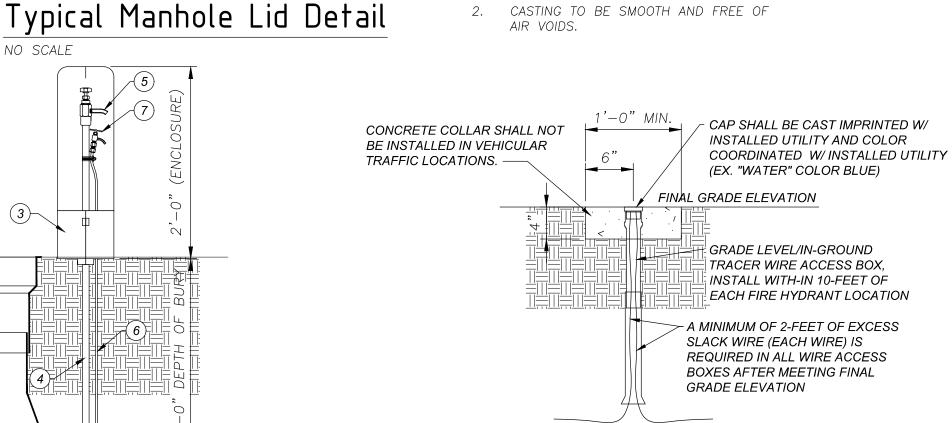

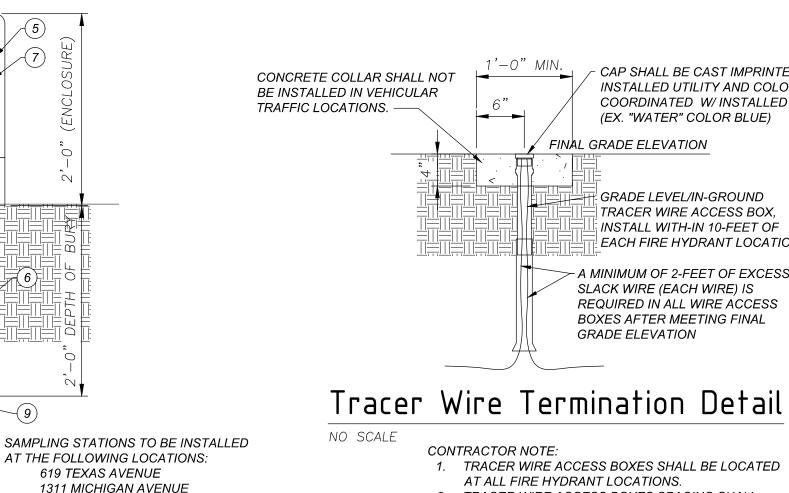



1. MATCHING SURFACES MARKED "MF" TO BE MACHINE FINISHED OF ANY IRREG-

2. CASTING TO BE SMOOTH AND FREE OF

THAT WOULD PREVENT A



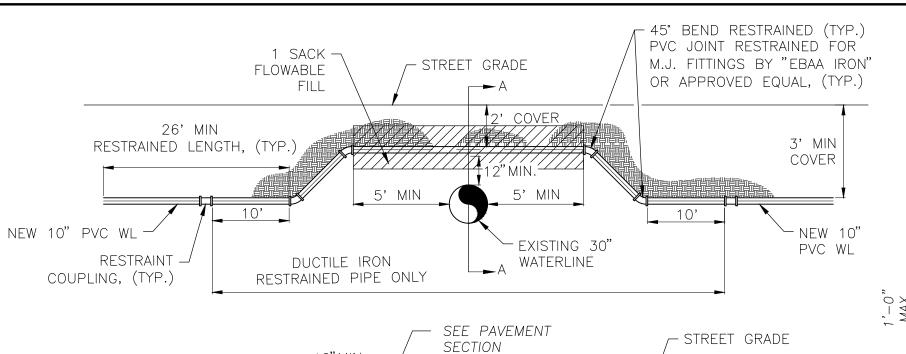

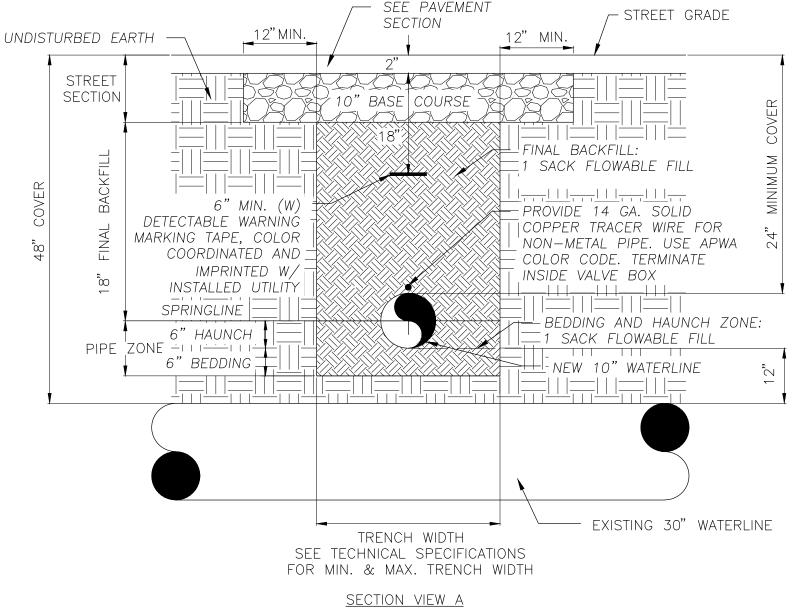

# 30" Waterline Crossing Detail


NO SCALE

A — SQUARE

– 7-#5 REBAR EQ. SPACED, EACH WAY CONCRETE COLLAR TABLE 48"/60" | 72" & LARGER MANHOLE MANHOLE 48" MIN. 60" MIN. 12" MIN. 12" MIN.

4-#5 REBAR

### Manhole Concrete Collar Detail NO SCALE SEE MANHOLE RING AND LID DETAIL 7-#5 REBAR EQ. SPACED, EACH WAY SECTION

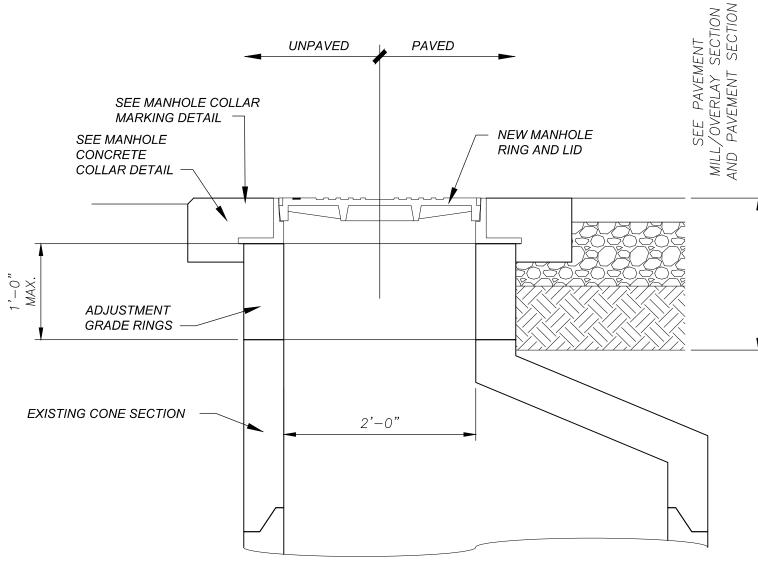

# Manhole Ring and Lid Adjustment Detail

### **GENERAL NOTES:**

- SIDES OF CONCRETE COLLAR TOP SHALL BE PARALLEL AND PERPENDICULAR TO THE NORMAL STREET
- 2. USE 3,000 P.S.I. CONCRETE FOR CONCRETE COLLARS.
- SCRIBE CONCRETE WITH LINE DIRECTIONAL ARROWS, PIPE SIZE AND PIPE TYPE.
- 4. TEXT SIZE SHALL BE 4-INCHES TALL AND SCORED 3/8" DEEP IN A NEAT AND CONSISTENT MANNER,

# – PIPE SIZE FLOW DIRECTION ARROW AS REQUIRED - PIPE TYPE

# Manhole Collar Marking Detail

### NO SCALE

### GENERAL NOTES:

- 1. SIDES OF CONCRETE COLLAR TOP SHALL BE PARALLEL AND PERPENDICULAR TO THE NORMAL STREET TRAFFIC FLOW.
- 2. USE 3,000 P.S.I. CONCRETE FOR CONCRETE COLLAR.
- 3. SCRIBE CONCRETE WITH LINE DIRECTIONAL ARROWS, PIPE SIZE AND PIPE TYPE.
- 4. TEXT SIZE SHALL BE 4-INCHES TALL AND SCORED 3/8" DEEP IN A NEAT AND CONSISTENT MANNER, TYPICAL.

2	1-05-18	AMENDMENT-2	CA
1	12-21-17	AMENDMENT-1	CA
0	9-08-17	ISSUED FOR CONSTRUCTION	CA
REV. No.	DATE	DESCRIPTION	APPROVED

Typical Sampling Station

SECTION

MANHOLE

175 LBS.

23 3/4"

20 5/8"

16 7/8"

11 7/8"

ITEM / DESCRIPTION

1/2" S.S. WATERWAY

8 LOCKING HOLE

10 VALVE BOX

9 3/4" S.S. NIPPLI

5 BLOW OFF & SAMPLING BIBB
6 1/4" S.S. TUBING

88 FRONT DOOR ( COVER A )
88 REAR DOOR ( COVER B )
88 BASE (2-PIECES)

MANHOLE

310 LBS.

31 1/4"

28 1/8"

24 3/8"

15 5/8"

14 3/8" 21 7/8"

MANHOLE

RING

WEIGHT

New Mexico One Call, Inc. Call 2 days

AT THE FOLLOWING LOCATIONS:

1311 MICHIGAN AVENUE

605 SUNDOWN AVENUE

VERIFY WITH OWNER FINAL LOCATION(S).

619 TEXAS AVENUE

2302 ASPEN DRIVE

# **Street Maintenance Program FY2017**

### **Miscellaneous Details**

ENGINEERING DEPARTMENT CITY OF ALAMOGORDO




50 LAS CF (!

<b>^</b>		ks Bid No.:	20	)17-01	0	
Occam Engineers	Drawn By:	GG	Design	ed By:	GG	
Inc.	Drawn By: Checked By	y: CA	Approv	ed By:	CA	
506 S MAIN ST. SUITE 600 S CRUCES, NEW MEXICO 88005 (575) 524-2007 (OFFICE) (575) 524-04.82 (FAX)	Scale:	Horiz.: 1" =	.2154'	Vert.:	N/A	

Sheet No.: D2.0


Sheet 102 of 103 EN1701

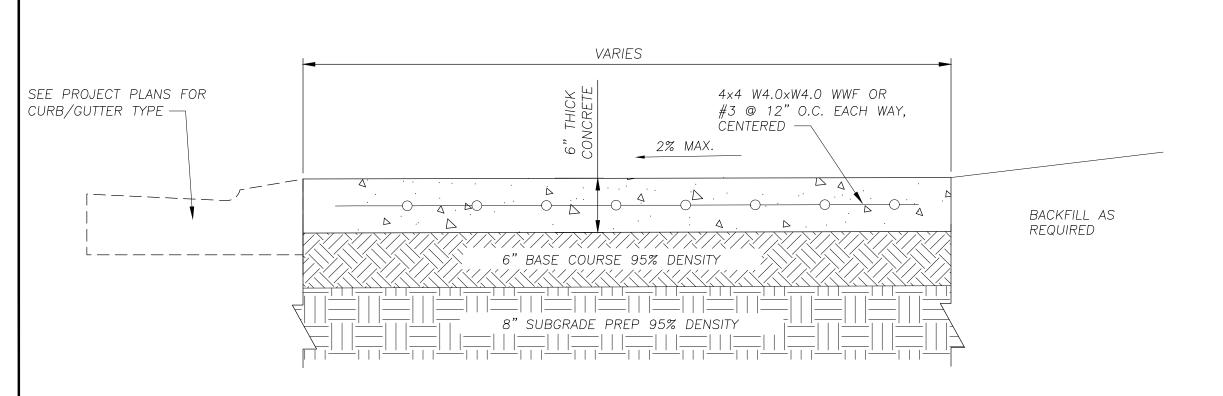


### Thick Reinforced Concrete No Scale

### **GENERAL NOTES:**


- 1. CROSS SLOPE SHALL NOT EXCEED 2% MAXIMUM.
- 2. RAMP SLOPE SHALL NOT EXCEED 8.3% MAXIMUM.
- CONTRACTOR SHALL FIELD VERIFY CROSS SLOPE AND RAMP SLOPE AND COORDINATE WITH ENGINEER ITEMS THAT MAY EXCEED THESE MAXIMUM REQUIREMENTS.
- 4. COORDINATE WITH OWNER/ENGINEER LIMITS OF REMOVAL
- 5. COORDINATE WITH OWNER/ENGINEER LIMITS OF BACKFILL REQUIREMENTS.

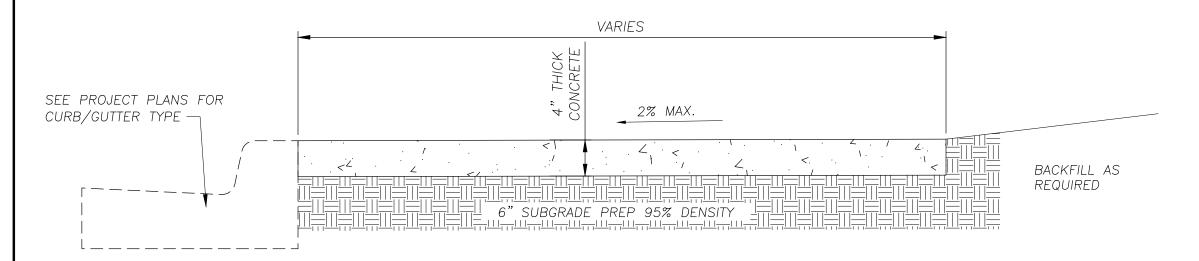


Thick Concrete

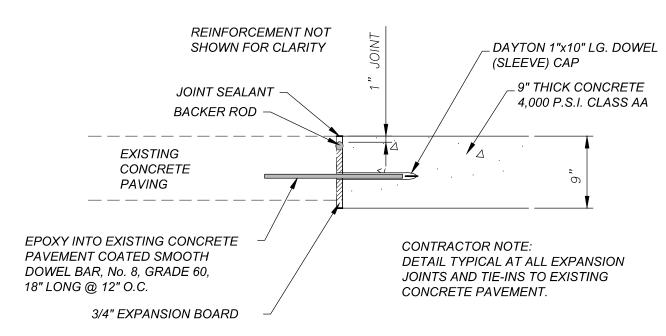

# Doweled Expansion Joint Detail

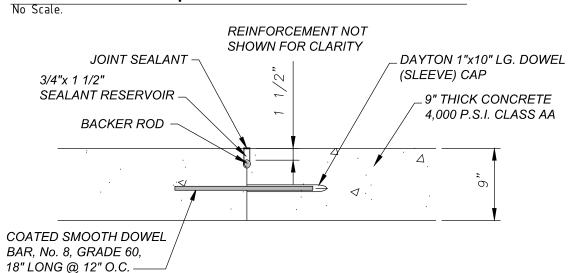


Doweled Construction Joint Detail

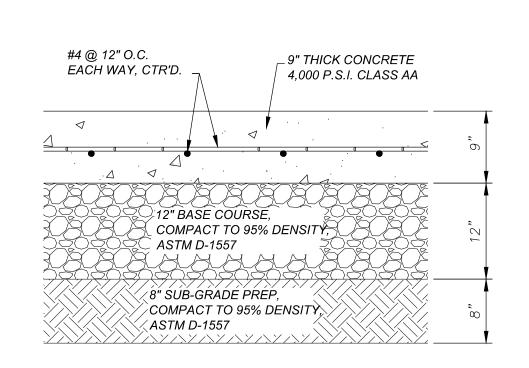


9" Concrete Pavement Section


# SEE PAVEMENT SECTION

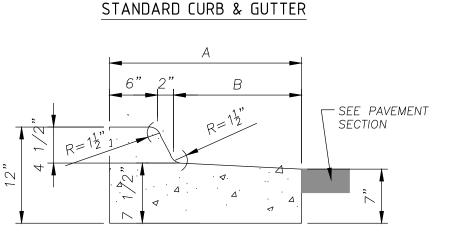

### REVERSE SLOPE CURB & GUTTER

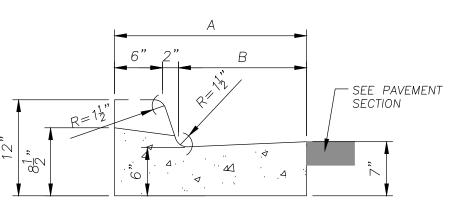

LAY-DOWN CURB & GUTTER

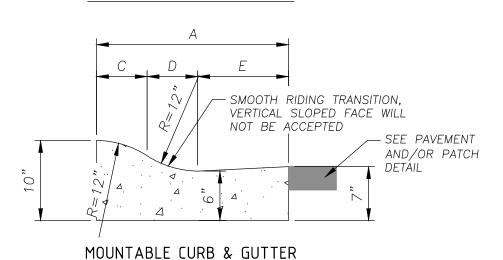


CURB & GUTTER LEGEND 11 18" | 24" | 30" 10" 16" 22" C | 5 5/8" | 5 5/8" | 5 5/8" 7" 5" E 7 3/8" | 11 3/8" | 17 3/8"

### TYPICAL CURB AND GUTTER DETAIL

### **GENERAL NOTES:**

- 1. NEW CURB/GUTTER PROFILE SHALL MATCH EXISTING ADJACENT CURB AND GUTTER AND/OR STREET PROFILE.
- 2. NEW CURB/GUTTER SHALL INCLUDE 8-INCH SUB-GRADE PREP.
- 3. NEW CURB/GUTTER SHALL INCLUDE 6-INCH BASE COURSE.
- 4. EDGES OF CURB/GUTTER NOT SPECIFICALLY DIMENSIONED SHALL BE EDGED WITH A 3/8" EDGING TOOL.
- 5. DIMENSIONS AT ROUNDED CORNERS MEASURED TO INTERSECTION OF STRAIGHT LINES.
- 6. PROVIDE CONTROL JOINTS EVERY 5'-0". CONTROL JOINT SHALL BE TOOL JOINTED WITH TOP ROUND EDGE OF 1/8-INCH RADIUS, DEPTH OF 1-INCH. THE FINISH JOINT OPENING EXCLUDING RADII SHALL NOT BE WIDER THAT 1/8-INCH.
- 7. PROVIDE 1/2" EXPANSION JOINTS EVERY 50'-0", ALONG CURB AND GUTTER.
- 8. TACK COAT EDGE OF GUTTER PRIOR TO PLACEMENT OF NEW PAVEMENT/PAVEMENT PATCH.
- 9. THE CONSTRUCTION OF CURB & GUTTER AND/OR PAVEMENT SHALL BE CONSTRUCTED SO THAT THE GUTTER FLOW WILL BE CONSTANT (NO PONDING AREAS WILL BE ACCEPTED)

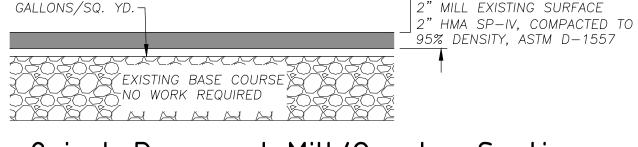

# 2-inch Pavement Mill/Overlay Section

PRIME COAT 0.15 GALLONS/SQ. YD. 3" HMA SP-IV, COMPACTED TO 95% DENSITY, ASTM D-15578" BASE COURSE, COMPACTED TO 95% DENSITY, ASTM D-1557 8" SUB-GRADE PREP,


COMPACTED TO 95%

DENSITY, ASTM D-1557

### Typical Pavement Section


PRIME COAT 0.15

No Scale

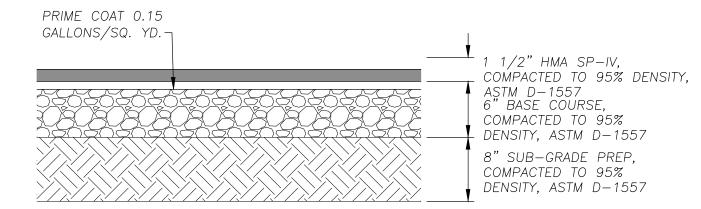


### Channel Pavement Section


No Scale

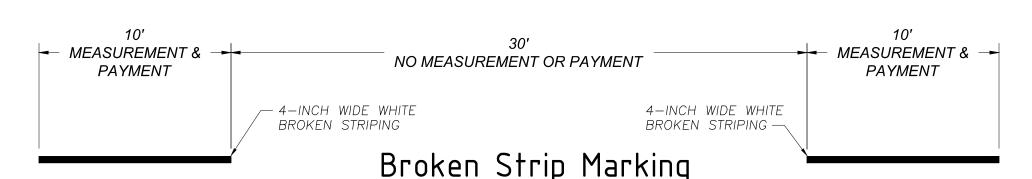

- CROSSWALK AND STOP BARS SHALL BE 3M-N380 PREFORMED PATTERNED MARKING OR APPROVED EQUAL (O.A.E.).
- ALIGN CROSSWALK WITH CENTERLINE OF WHEEL PATH, COORDINATE WITH OWNER PRIOR TO INSTALLATION.
- SYMBOLS AND LEGENDS SHALL BE 3M-380IES PREFORMED PATTERNED MARKING O.A.E. BROKEN STRIPING, DOUBLE STRIPING AND SINGLE STRIPING
- SHALL BE 90 MIL HOT THERMOPLASTIC PAVEMENT STRIPING.
- MEASUREMENT AND PAYMENT FOR BROKEN STRIPING (10 LF) SHALL BE CALCULATED BY MATERIAL USED.

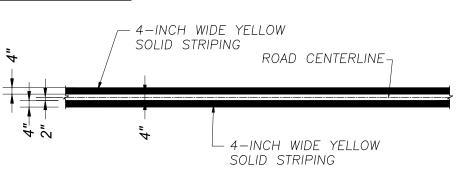


Double Yellow Marking

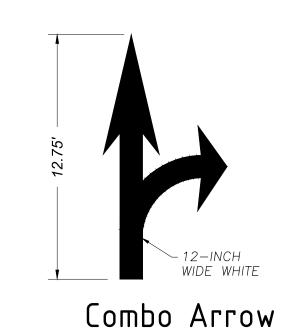

Turn Arrow

4—INCH WIDE WHITE LETTERING-**→** 5.90′ → Word "ONLY "

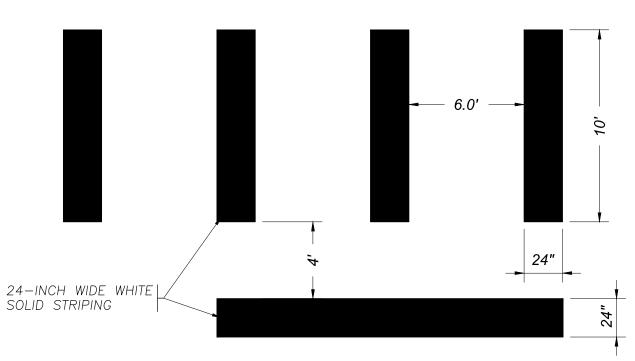

# Crosswalk and Stop Bar

				New
1	12-21-17	AMENDMENT-1	CA	Destauria
0	9-08-17	ISSUED FOR CONSTRUCTION	CA	Professio
REV No	DATE	DESCRIPTION	ADDROVED	1

Mexico One Call, Inc. Call 2 days


# **Street Maintenance Program FY2017**

### **Miscellaneous Details**

12-INCH WIDE WHITE

CITY OF ALAMOGORDO ENGINEERING DEPARTMENT

NEW MEXICO

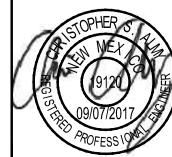

Occam Engineers	Public Works Drawn By:	Bid No
Inc.	Checked By:	CA
506 S MAIN ST. SUITE 600 AS CRUCES, NEW MEXICO 88005 (575) 524-2007 (OFFICE)	Scale: H	oriz.: 1

(575) 524-04.82 (FAX)

2017-010 Designed By: **GG** Approved By: **CA** 1'' = .2154' Vert.: N/A

D3.0

Sheet No.:

Sheet 103 of 103