

PURCHASING AND MATERIALS MANAGEMENT (843) 918-2170 FAX: (843) 918-2182 www.cityofmyrtlebeach.com

Addendum 02 October 27, 2020 IFB 21-B0013 Broadway Theater Exterior Demolition

The purpose of this Addendum 02 to IFB 21-B0013 for Broadway Theater Exterior Demolition, dated October 12, 2020, and previously amended on October 21, 2020, is to provide the façade demolition drawings that have been submitted for permitting. Permit drawings are attached and are hereby made part of this addendum.

Bids will be received until 2:00PM (local time) on Wednesday, November 4, 2020. No electronic submissions will be accepted. The City is not responsible for late or misdirected mail.

Please send in your sealed bid to the address below: City of Myrtle Beach 3231 Mr. Joe White Avenue Myrtle Beach, SC 29577 Attn: Purchasing Division/Ann Sowers

If you have any questions, please don't hesitate to call to the undersigned below. Thank-you,
City of Myrtle Beach
Ann Sowers/Procurement Office/Buyer
Email: asowers@cityofmyrtlebeach.com

BROADWAY THEATRE

811 MAIN STREET MYRTLE BEACH, SC 29577

PHASE 1 HISTORIC REVELATION 10/26/20 4701-193011




BROADWAY
THEATRE
PHASE 1 HISTORIC
REVELATION


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INDEX OF DRAWINGS SHEET NO. SHEET NAME SHT REV SHT REV NO. DATE REVISION DESCRI	PROJECT GOAL THE PROJECT GOAL IS THE REMOVAL OF EXISTING FAÇADE FINISHES TO REV	EAL ORIGINAL HISTORIC FINISHES BELOW. THE ORIGINAL FINISH MATERIALS MUST BE	E EXPOSED TO EVALUATE THEIR CONDITION	MATERIAL LEGEND	N.T.S.
### PACKET PROPERTY P	AND DETERMINE IF THE ORIGINAL EXTERIOR FAÇADES STILL RETAIN THEIR HI THE STATE HISTORIC PRESERVATION OFFICE (SHPO) AND THE NATIONAL PAR THE FUTURE ADAPTIVE RENOVATION PROJECT PLANNED FOR THESE BUILDIN	STORIC CHARACTERS. THIS PROJECT SCOPE IS THE PREPARATORY WORK NECESSA RK SERVICE (NPS) FOR THEIR REVIEWS. THIS WORK IS A NECESSARY STEP TOWARDS	ARY TO FORMULATE THE PART 1 SUBMITTAL TO S ACHIEVING HISTORIC TAX CREDITS DURING	(NOT ALL MATERIALS APPLICABLE) PLAN AND SECTION PLASTER, CEMENT, SPRAY-ON SAND, GROUT SPRAY-ON FIREPROOF	ELEVATION N DFING BRICK
	807 MAIN STREET (FORMERLY HELEN MATES)	809 MAIN STREET (FORMERLY J&J DRUG CO.)	811 MAIN STREET (FORMERLY BROADWAY THEATER)	POROUS FILL STEEL, IRON BATT/LOOS INSULATION	OSE FILL CERAMIC TILE
	SCOPE SUMMARY	SCOPE SUMMARY	SCOPE SUMMARY	ROCK ALUMINUM EXTRUDED POLYSTYR	D CONCRETE / PLASTER / RENE STUCCO
	SCOPE OF WORK IS EXTERIOR AND INCLUDES REMOVAL OF EXISTING EIFS FACADE FINISH FROM FRONT FACADE AND SMALL PORTION WRAPPING FRONT CORNERS ONTO DEMISING WALLS AS WELL AS REMOVAL AND BOARDING UP OF EXISTING 2ND FLOOR WINDOWS IN FRONT AND REAR FACADES.	SCOPE OF WORK IS EXTERIOR AND INCLUDES REMOVAL OF AN EXISTING FABRIC AWNING AND REMOVAL OF EXISTING SHEATHING OVER ORIGINAL WOOD FRAMED WINDOWS THAT WILL BE RECOVERED (FOR PROTECTION) AFTER BEING OBSERVED AND DOCUMENTED.	SCOPE OF WORK IS EXTERIOR AND INCLUDES REMOVAL OF EXISTING FACADE FINISHES AND WOOD FRAMING OVER EXISTING FRONT BRICK FACADE AS WELL AS BOARDING-UP FIVE ORIGINAL FACADE OPENINGS WITHIN THE ORIGINAL BRICK WALL.	LIGHTWEIGHT CONCRETE (OR CONCRETE FILL) STRUCTURAL CONCRETE (CAST IN PLACE, ETC.) WOOD (FINISH) WOOD (ROUGH) GYPSUM E	BOARD SHINGLES/SIDING
	NOTE: BUILDING IS CURRENTLY UNOCCUPIED AND IS NOT PLANNED TO BE OCCUPIED WITHOUT FUTURE PERMITTED WORK.	NOTE: BUILDING IS CURRENTLY UNOCCUPIED AND IS NOT PLANNED TO BE OCCUPIED WITHOUT FUTURE PERMITTED WORK.	NOTE: BUILDING IS CURRENTLY UNOCCUPIED AND IS NOT PLANNED TO BE OCCUPIED WITHOUT FUTURE PERMITTED WORK.	BRICK (COMMON OR FACE) WOOD BLOCKING CARPET A CONC. MASONRY UNITS PLYWOOD	
	CODE INFORMATION	CODE INFORMATION	CODE INFORMATION	GRAPHIC SYMBOL LEGEND	N.T.S.
	APPLICABLE BUILDING CODE & EDITION 2018 IEBC; 2018 IBC W/ SC MODIFICATIONS, 2018 IFC W/ SC MODIFICATIONS, 2018 IPC W/ SC MODIFICATIONS, 2018 IMC W/ SC MODIFICATIONS, 2017 NEC W/ SC MODIFICATIONS, ANSI A117.1 - 2009	APPLICABLE BUILDING CODE & EDITION 2018 IEBC; 2018 IBC W/ SC MODIFICATIONS, 2018 IFC W/ SC MODIFICATIONS, 2018 IPC W/ SC MODIFICATIONS, 2018 IMC W/ SC MODIFICATIONS, 2017 NEC W/ SC MODIFICATIONS, ANSI A117.1 - 2009	APPLICABLE BUILDING CODE & EDITION 2018 IEBC; 2018 IBC W/ SC MODIFICATIONS, 2018 IFC W/ SC MODIFICATIONS, 2018 IPC W/ SC MODIFICATIONS, 2018 IMC W/ SC MODIFICATIONS, 2017 NEC W/ SC MODIFICATIONS, ANSI A117.1 - 2009	DRAWING TITLE TO SOLUTION THE EXERTSE REVISION NUMBER EXERTSE AREA REVISED TYPICAL DIMENSION INDICATOR	SECTION KEYS DIRECTION OF SECTION BUILDING SECTION LOCATION ON SHEET GRID 3067 DEVILLE STREET MYRTLE BEACH, SOUTH CAROLINA 2957 TEL. 843.872.0360 FAX 843.722.4789 WWW.LS3P.COM
	BASIC BUILDING CODE INFORMATION CONSTRUCTION CLASSIFICATION TYPE (IBC 602) TYPE IIIB OCCUPANCY GROUP (indicate all) NO CHANGE; NO INTERIOR WORK OCCUPANCY GROUP (indicate most restrictive) (IBC Table 504.3, 504.4, 506.2) NO CHANGE' NO INTERIOR WORK Incidental Use Area Separation? Incidental Use Area Separation? (IBC 509.4) Accessory Occupancy (ies)? What percent of story is the sum of all accessory occupancies? (IBC 508.2) IT no □ yes SF %	BASIC BUILDING CODE INFORMATION CONSTRUCTION CLASSIFICATION TYPE (IBC 602) OCCUPANCY GROUP (indicate all) (IBC 302) (Note IBC 506.2.2, 506.2.4) OCCUPANCY GROUP (indicate most restrictive) (IBC Table 504.3, 504.4, 506.2) Incidental Use Area Separation? (IBC 509.4) Accessory Occupancy (ies)? What percent of story is the sum of all accessory occupancies? (IBC 508.2) TYPE IIIB NO CHANGE; NO INTERIOR WORK NO CHANGE' NO INTERIOR WORK Incidental Use Area Separation? Incidental Use Area Separation?	BASIC BUILDING CODE INFORMATION CONSTRUCTION CLASSIFICATION TYPE (IBC 602) OCCUPANCY GROUP (indicate all) (IBC 302) (Note IBC 506.2.2, 506.2.4) OCCUPANCY GROUP (indicate most restrictive) (IBC Table 504.3, 504.4, 506.2) Incidental Use Area Separation? (IBC 509.4) Accessory Occupancy (ies)? What percent of story is the sum of all accessory occupancies? (IBC 508.2) TYPE IIIB NO CHANGE; NO INTERIOR WORK IN INCIDENTAL IN	DRAWING LOCATION ON SHEET GRID DRAWING NAME PLAN DOOR NUMBER FLOOR ELEVATION DRAWING SCALE DRAWING LOCATION ON SHEET GRID DRAWING LOCATION ON SHEET GRID DRAWING NAME PLAN DRAWING SCALE GLASS TYPE SUBSYSTEM ROOM NAME ROOM NAME 2201 150 SF	SHEET IDENTIFIER FOR LOCATION OF SECTION DIRECTION OF SECTION WALL SECTION LOCATION ON SHEET GRID TERMINATION OF SECTION SHEET IDENTIFIER FOR LOCATION OF SECTION SHEET IDENTIFIER FOR LOCATION OF SECTION ELEVATION KEY
	Mixed Occupancy – Separated? (IBC 508.4, 506.2.2, 506.2.4) Mixed Occupancy - Non separated? (IBC 508.3) □ no ▼ yes □ no ▼ yes □ no ▼ yes	Mixed Occupancy – Separated? (IBC 508.4, 506.2.2, 506.2.4) Mixed Occupancy - Non separated? (IBC 508.3) OTHER FIRE PROTECTION SYSTEMS, DEVICES or FEATURES If the building has any special or notable fire protection or safety feature or hazard the designers should list them here, describe the performance characteristics and refer to locations in construction documents. (e.g. fire extinguishers, smoke evacuation/control/compartments. Note IBC 414.1.3.)	Mixed Occupancy – Separated? (IBC 508.4, 506.2.2, 506.2.4) Mixed Occupancy - Non separated? (IBC 508.3) □ no ▼ yes □ no ▼ yes □ no ▼ yes	SHEET NUMBER WHERE DETAIL IS REFERENCED DETAIL LOCATION ON SHEET GRID TERMINATION OF SECTION SHEET IDENTIFIER FOR LOCATION OF DETAIL SHEET IDENTIFIER FOR LOCATION OF DETAIL	SHEET IDENTIFIER FOR LOCATION OF ELEVATION DIRECTION OF ELEVATION DIRECTION OF ELEVATION Myrile Beach, SC 9666 10/26/20
				GENERAL PROJECT NOTES	MEMBERS OF THE AMERICAN INSTITUTE OF ARCH
				 THE CITY OF MYRTLE BEACH WILL SUBMIT FOR DHEC DEMOLITION PERMIT. THE GENERAL CONTRACTOR SHALL COORDINATE MAINTENANCE OF TRAFFIC (M.O.T.) AT SIDEWALK AND ROADWAY WITH CITY STAFF PRIOR TO M.O.T. INSTALLATION AND BEFORE START OF WORK. THE GENERAL CONTRACTOR SHII ERECT BARRICADES, FENCES OR OTHER SECURABLE MEANS TO PREVENT UNAUTHORIZED ACCESS INTO CONSTRUCTION ZONES. 	COPYRIGHT 2020 ALL RIGHTS RESERVED PRINTED OR ELECTRONIC DRAWINGS AND DOCUMENTATION MAY NOT BE REPRODU IN ANY FORM WITHOUT WRITTEN PERMISS FROM LS3P ASSOCIATES LTD.
					REVISIONS: No. Description Date
				VICINITY MAP AR	PROJECT: 4701-193011 DATE: 10/26/20 DRAWN BY: Author CHECKED BY: Checker
					PROJECT INFORMATION
					R-001

M 360://4XXX-XXXXX MYR Arts District/Arch_Theater

PERMIT SET

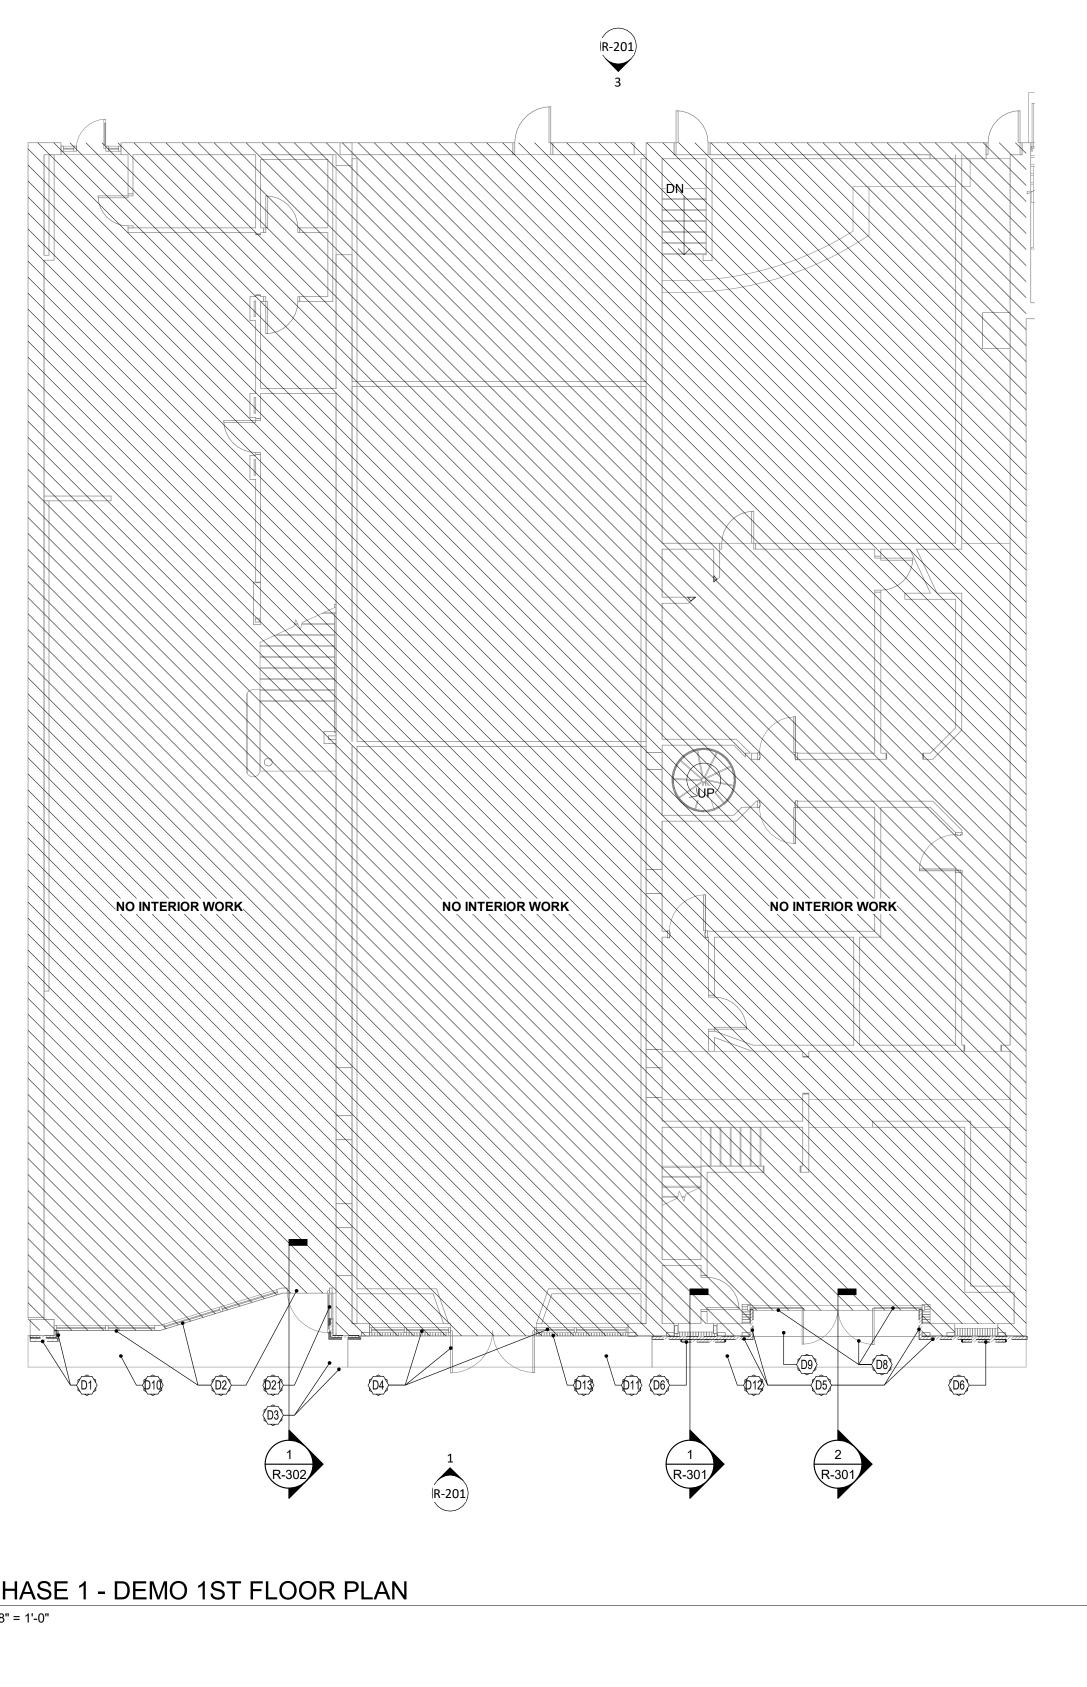


PHASE 1 - DEMO 1ST FLOOR PLAN

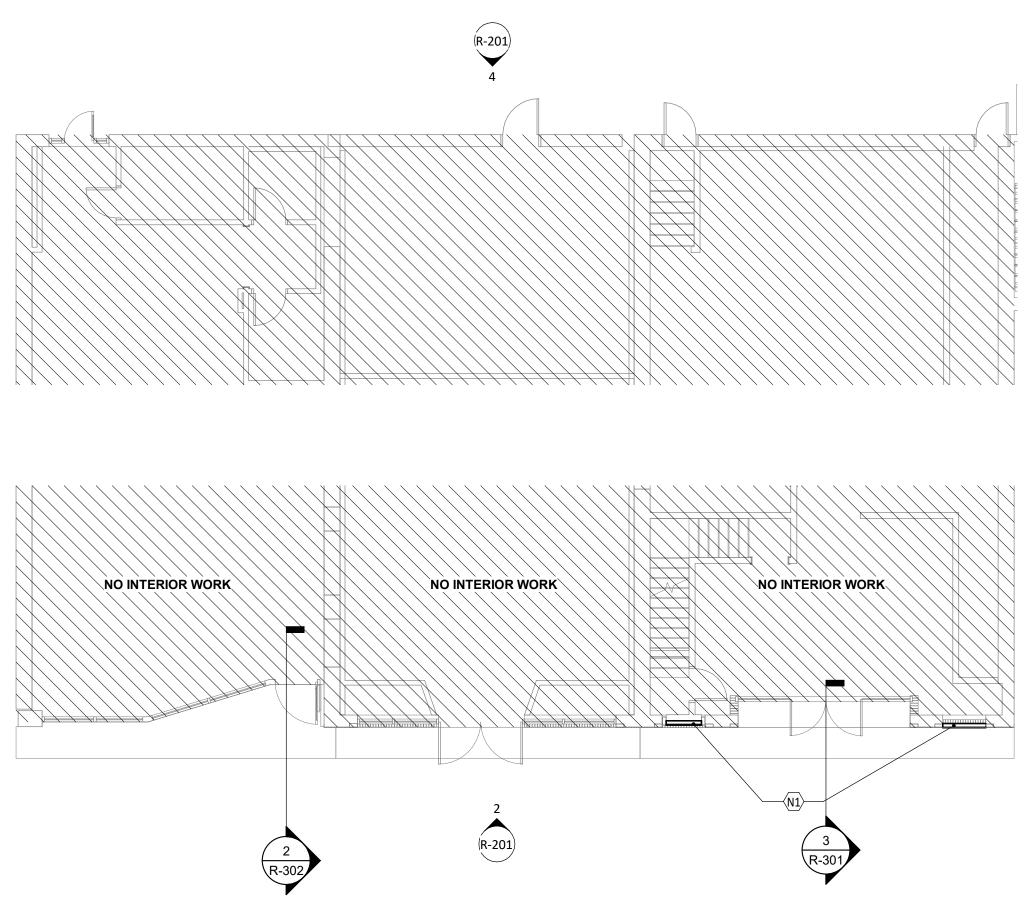

3 PHASE 1 - NEW 1ST FLOOR PLAN
1/8" = 1'-0"



PHASE 1 - DEMO 2ND FLOOR PLAN

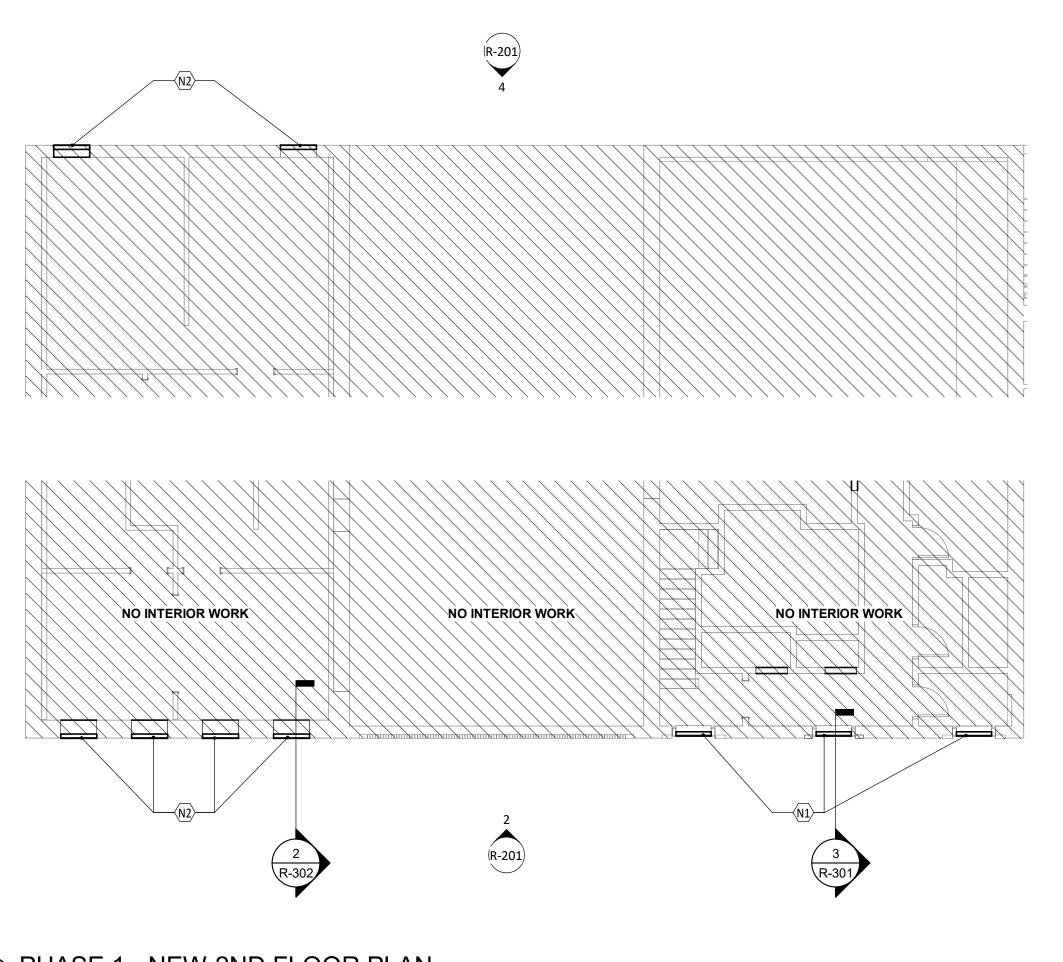

PHASE 1 - NEW 2ND FLOOR PLAN

1/8" = 1'-0"

PHASE 1 - DEMOLITION NOTES BY NUMBER NOTE

EXISTING WOOD PANELING AND FURRING TO BE REMOVED. ORIGINAL BRICK SUBSTRATE TO REMAIN. EXISTING METAL AND GLASS SIGNAGE CABINET/DESK TO BE REMOVED. EXISTING BRICK TO REMAIN EXISTING STOREFRONT TO REMAIN

CITY OF MYRTLE

BEACH

BROADWAY

REVELATION

PHASE 1 HISTORIC

3067 DEVILLE STREE I

MYRTLE BEACH, SOUTH CAROLINA 29577

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THEATRE

EXISTING EXTERIOR TILE FINISH TO REMAIN EXISTING CONCRETE SIDWALK FINISH TO REMAIN EXISTING STUCCO FINISHED (WEDGE SHAPED) FRAMING AND THEATER SIGN TO BE REMOVED. ORIGINAL BRICK SUBSTRATE TO REMAIN.

EXISTING LIGHT FIXTURE TO BE REMOVED. EXISTING EXTERIOR TILED FLOORING TO REMAIN EXISTING THEATER SIGNAGE TO BE REMOVED

EXISTING STONE COPING TO REMAIN EXISTING BRICK HEADER FOR ORIGINAL THEATER OPENING TO REMAIN. LINEAR INTERLOCKING METAL PANELS TO BE REMOVED.

EXISTING FLAGSTONE SIDWALK FINISH TO REMAIN

NUMBER

EXISTING EIFS TO BE REMOVED. ORIGINAL STONE SUBSTRATE TO REMAIN. EXISTING STOREFRONT TO REMAIN EXISTING EIFS TO BE REMOVED. ORIGINAL STUCCO OVER BRICK SUBSTRATE TO

EXISTING WINDOWS AND EIFS TRIM TO BE REMOVED. ORIGINAL STUCCO OVER BRICK SUBSTRATE TO REMAIN. ALUMINUM DISPLAY CASE AND WOOD PANELING ON SIDE WALL ADJACENT TO DOOR TO REMAIN. WOODEN SOFFIT TRIM AND STUCCO CEILING TO REMAIN.

EXISTING EIFS EXTENSIONS ON SIDE OF DEMISING WALL TO BE REMOVED. ENTIRETY OF WALL IS NOT EIFS. EXISTING WINDOWS TO BE REMOVED. WINDOW TRIM TO REMAIN.

EXISTING STOREFRONT TO REMAIN EXISTING CONCRETE SIDEWALK FINISH TO REMAIN ALL EXISTING BRICK TO REMAIN

> EXISTING STONE CAP TO REMAIN EXISTING FABRIC AWNING AND STRUCTURAL FRAME TO BE REMOVED EXISTING OSB PANELS OVER WOOD FRAMED VERTICAL WINDOWS TO BE REMOVED. GC TO NOTIFY OWNER ARCHITECT WHEN THESE PANELS ARE TO BE

PHASE 1 - NEW WORK NOTES BY NUMBER

NOTE# NOTE

BROADWAY

INFILL EXISTING OPENING PER BOARD-UP PROCEDURES EXISTING BRICK HEADER FOR ORIGINAL THEATER OPENING TO REMAIN. EXISTING STEEL BEAM TO REMAIN (APPROXIMATE LOCATION)

GC TO REVIEW EXISTING CONDITIONS WITH OWNER/ARCHITECT FOR DIRECTION

REGARDING WEATHERIZATION OF EXPOSED SOFFIT AREA. EXISTING STOREFRONT TO REMAIN EXISTING BRICK TO REMAIN EXISTING STONE COPING TO REMAIN

EXISTING EXTERIOR TILED FLOORING TO REMAIN EXISTING CONCRETE TO REMAIN EXISTING STONE KEYSTONE AND TRIM BLOCKS TO REMAIN ASSUMED LOCATION WHERE ORIGINAL STRUCTURAL SUPPORT FOR ORIGINAL MARQUEE

PASSED THROUGH WALL. ASSUMED LOCATION OF ORIGINAL MARQUEE TENSION ROD MOUNTING PLATE, TO

REMAIN IF FOUND. ASSUMED LOCATION OF ORIGINAL WALL BOLT. TO REMAIN IF FOUND.

HELEN MATES

INFILL EXISTING OPENING PER BOARD-UP PROCEDURES

CROSSHATCH DENOTES AREA OVER EXISTING WINDOWS/OPENING TO BE COVERED WITH NEW PRIMED AND PAINTED 3/4" PLYWOOD. GC TO SEAL PLYWOOD AT ALL EDGES TO EXISTING FACADE.

DEMOLITION PLAN SHEET NOTES

THIS PROJECT IS SEEKING HISTORIC TAX CREDITS; THEREFORE, THE GENERAL CONTRACTOR SHALL UTILIZE MEANS AND METHODS THAT ARE NON-DESTRUCTIVE TO THE ORIGINAL FINISHES AND FEATURES OF THE

NUMBERED KEY NOTES DO NOT IMPLY SEQUENCE. CONTRACTOR TO PERFORM DEMOLITION WORK AS REQUIRED PER WORK SEQUENCE. DEMOLITION DRAWINGS ARE INTENDED TO SHOW GENERAL AREAS OF DEMOLITION AS WELL AS GENERAL EXISTING CONDITIONS. THEY DO NOT SHOW ALL WORK WHICH MAY BE NECESSARY. COMPARE WITH DRAWINGS

INDICATING NEW CONSTRUCTION, 4. REFER TO OTHER DRAWINGS AND SPECIFICATIONS FOR ADDITIONAL

INFORMATION ON DEMOLITION. VERIFY FIELD CONDITIONS PRIOR TO START OF DEMOLITION/CONSTRUCTION AND NOTIFY THE ARCHITECT OF ANY DISCREPANCIES.

THE GENERAL CONTRACTOR SHALL NOTIFY THE ARCHITECT IF CONDITIONS DISCOVERED DURING THE DEMOLITION PROCESS REVEAL ANY UNFORESEEN DISCREPANCIES OR ADDITIONAL HISTORIC FEATURES. DO NOT ALLOW MATERIAL AND DEBRIS GENERATED BY DEMOLITION ACTIVITIES TO ACCUMULATE ON THE JOB SITE. REMOVE DAILY AND DISPOSE OF IN A LEGAL MANNER. NO ON-SITE SALE OR BURNING OF REMOVED ITEMS

8. TERMINATE AND CAP ANY UTILITY IN WALLS CEILINGS AND FLOORS TO BE REMOVED AND NOT INTENDED FOR REUSE.

FLOOR PLAN SHEET NOTES

I. EXTERIOR DIMENSIONS ARE FACE OF FINISH TO FACE OF FINISH. FOR BOARD-UP PROCEDURES, REFER TO SHEET R-102 "PHASE 1 - BOARD-UP PROCEDURES"

> 809 MAIN ST. 807 MAIN ST.

> > **KEYPLAN**

PLANS

R-101

PERMIT SET

PHASE 1 -HISTORIC **RESTORATION**

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IAAI/USFA Abandoned Building Project USFA National Arson Prevention Initiative Board Up Procedures



Materials List and Specifications

Security Measures

- 1. All openings in the basement, first floor doors and windows, and any point of entry accessible from a porch, fire escape or other potential climbing point shall be barricaded with plywood, 2x4 braces, carriage bolt sets, and nails. Particle board, wafer board, Masonite, or other similar material shall not be used for purposes of boarding-up a building.
- 2. Openings that are at least 10' from ground level which are not accessible from a porch, fire escape, roof, or other climbing point can be secured with nails in each brace, and every 12" around the perimeter. For all openings, the plywood should be fitted so that it rests snugly against the exterior frame, butting up to the siding on wood frame buildings and up to the brick molding edge on brick buildings. It may be necessary to remove the staff bead so this fit can be flush and tight.
- 3. The structure shall be posted with a NO TRESPASSING sign at the completion of the board-up.

Materials


- 1. Plywood, 1/2" (4 ply) exterior grade CDX
- 2. Braces 2" by 4" by 8' construction grade lumber
- 3. 3/8" (coarse thread) by 12" carriage bolts (rounded head on weather side)
- 4. 3/8" (coarse thread) construction grade nuts
- 5. 1/2" (USS Standard) Flat washers with an inside diameter large enough to bypass the wrench neck inside the carriage bolt head so no lift edge is available beneath an installed carriage bolt head.
- 6. 3/8" (USS Standard) diameter flat washers for installation beneath the nut inside the building
 1 3/4"
 7. 1-5/8" (6d) galvanized or stainless steel ring-shank nails or comparable deck
- -nails. screws.


Barrier Assembly

- 1. Applying barriers is accomplished with a inside and outside carpenter with appropriate tools and supplies. The inside carpenter will need a light. Exit is made over a ladder when the last window is boarded.
- 2. Plywood shall be cut to fit over the window and door openings, flush with outside of the molding/trimmer stud. Application of barriers shall be completed so that all lift or pry points are avoided.
- 3. The 2x4 braces shall be cut to fit the horizontal dimension of the plywood. Two exterior and two interior 2x4 braces shall be provided for each window and three sets for each door.
- 4. Window Assembly Braces are located horizontally approximately 1/3 of the distance from the top and the bottom of the window. Bolt holes are located 1/3 of the length of the brace from the outside edge of the window jams. Prior to installation, the assembly should be pre-assembled and 3/8" holes drilled through all of the components.
- 5. Door Assembly Door braces will be placed horizontally; one in the center of the doorway and one 1/2 the distance from the center to the top and one 1/2 distance from the center to the bottom of the doorway. Bolt holes are located 1/3 of the length of the brace from the outside edge of the door frame. Prior to installation, the assembly should be pre-assembled and 3/8" holes drilled through all of the components.
- 6. Plywood used to cover exterior openings shall be nailed every 12" along the perimeter to the window or door frame.
- 7. The 2x4 braces on the interior and exterior of the assemblies shall be secured using 3/8" by 12" carriage bolt assemblies. Bolts shall be inserted through the predrilled holes from the exterior with a 1/2" washer place against the exterior brace, a 3/8" washer is placed against the interior brace. The bolt is tightened from the inside so that it slightly compresses the interior brace.
- 8. The exterior surfaces of barriers shall be painted or stained the same color as the structure to minimize the appearance.

Should the through-bolt compression method be impossible due to the size or condition of the opening, the opening shall be covered with plywood and secured with a minimum of 3-inch-long deck or wood screws installed on 4-inch centers around the circumference of the opening.

For buildings that require access by authorized personnel, a single door that is visible from the street may be secured using a solid core wood or steel door. There shall be no windows or other openings in this door. The door shall be securely locked using a padlock and hasp assembly that is bolted through the door. The lock loop portion of the hasp is attached to the door frame using a minimum of 3-inch-long wood screws.

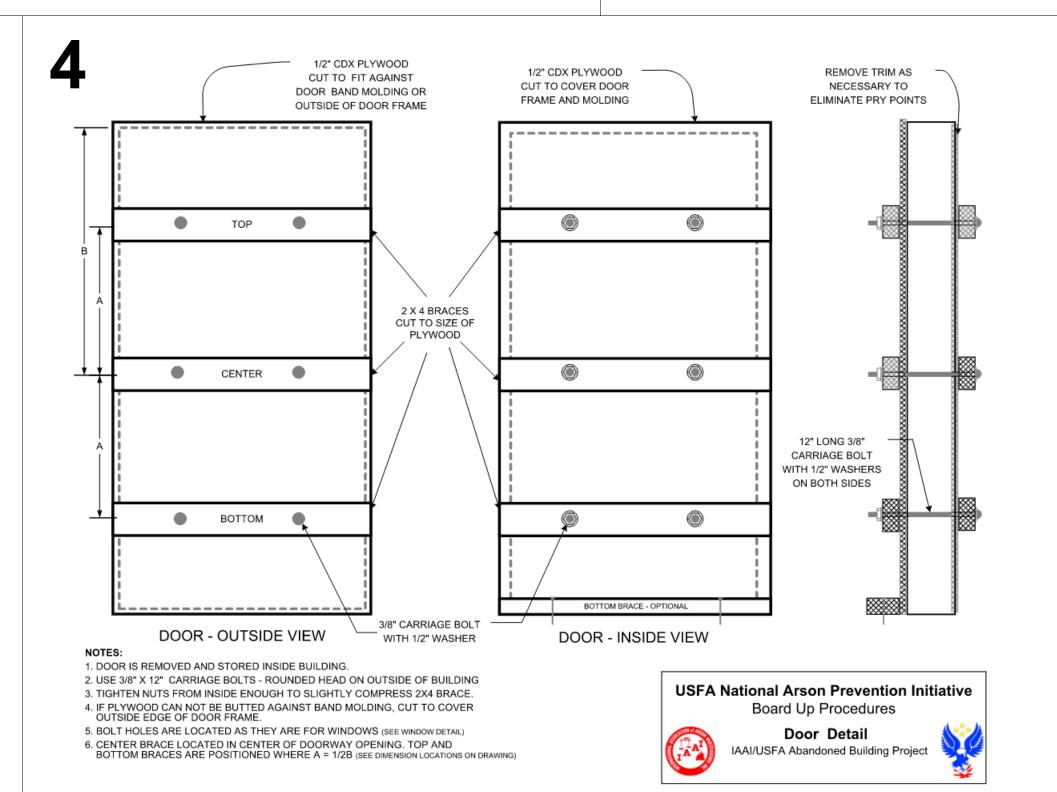

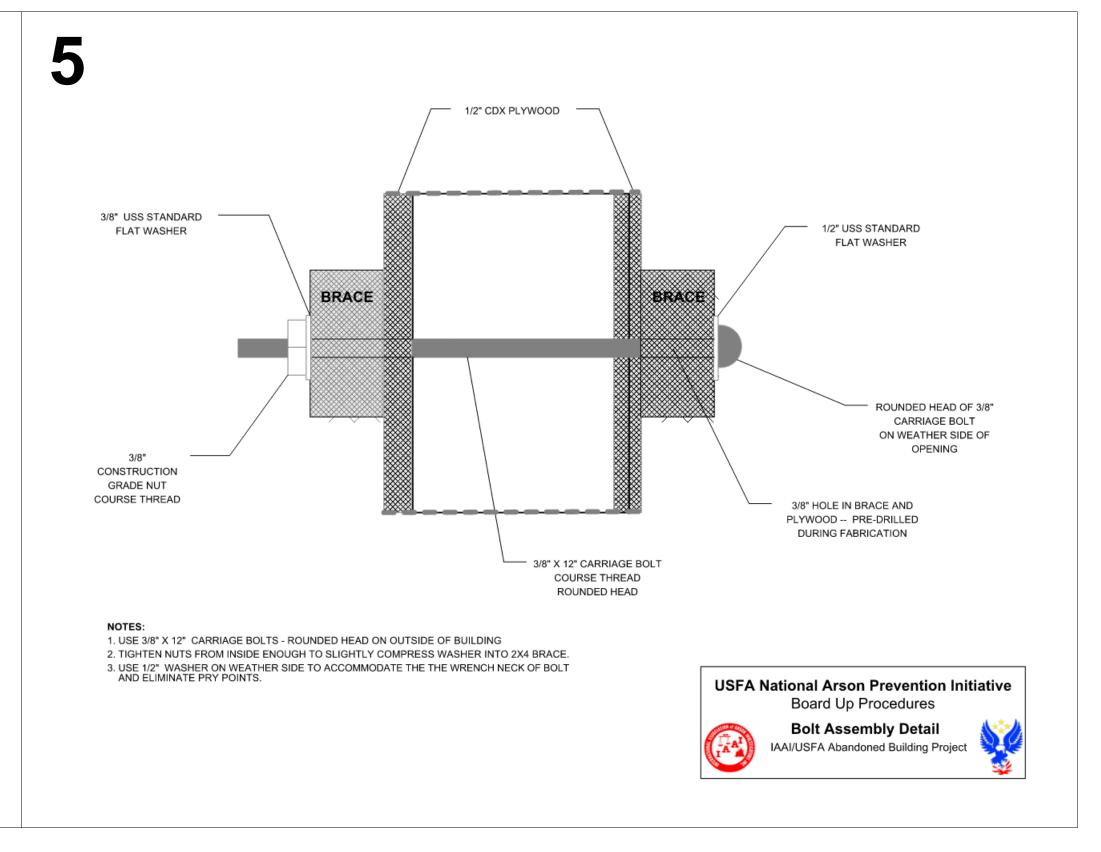

1/2" CDX PLYWOOD CUT TO TO COVER WINDOW OPENING -----SECURE TO STRUCTURE WITH 1-5/8" (6D) GALVANIZED NAILS -----------2 X 4 BRACE CUT TO OUTSIDE DIMENSION OF WINDOW TRIM 2 X 4 BRACE CUT TO SIZE OF PLYWOOD 3/8" CARRIAGE BOLT 12" LONG/COURSE THREAD -----NUT TO MATCH, WASHERS INSTALLED

WINDOW - OUTSIDE VIEW

1. FOR DOUBLE HUNG WINDOWS, SLIDE SASH TO CENTER OF UNIT AND PASS BOLTS THROUGH OPENINGS AT TOP AND BOTTOM. 2. STORM WINDOWS SHOULD BE REMOVED AND STORED INSIDE STRUCTURE.

3. OUTSIDE TRIM MAY HAVE TO BE REMOVED TO ACCOMMODATE A FLUSH AND 4. TIGHTEN NUTS FROM INSIDE ENOUGH TO SLIGHTLY COMPRESS 2X4 BRACE.

5. BRACE LOCATIONS: A = 1/3 B (SEE DIMENSION LOCATIONS ON DRAWING) 6. LOCATION OF BOLT HOLES: C = 1/3D (SEE DIMENSION LOCATIONS ON DRAWING)

ON BOTH SIDES ROUNDED HEAD OF BOLT ON OUTSIDE **USFA National Arson Prevention Initiative** Board Up Procedures Window Detail IAAI/USFA Abandoned Building Project

WINDOW ASSEMBLY MATERIALS REQUIRED PER WINDOW


- 1 1/2" CDX PLYWOOD SHEET CUT TO DIMENSIONS OF WINDOW FRAME (WEATHER SIDE
- 4 2X4 BRACES CUT TO WIDTH OF PLYWOOD


4 CARRIAGE BOLT ASSEMBLIES

- DOOR ASSEMBLIES MATERIALS REQUIRED PER DOOR 1 1/2" CDX PLYWOOD SHEET - CUT TO DIMENSIONS
- OF DOOR FRAME (WEATHER SIDE) 1 1/2" CDX PLYWOOD SHEET - CUT TO OUTSIDE
- DIMENSIONS OF DOOR FRAME TRIM (INSIDE) 6 2X4 BRACES - 3 CUT TO WIDTH OF OUTSIDE
- PLYWOOD, 3 CUT TO WIDTH OF INSIDE PLYWOOD
- 1 2X4 BOTTOM BRACE CUT TO WIDTH OF DOOR TRIM (OPTIONAL)

6 CARRIAGE BOLT ASSEMBLIES

- 1 12' X 3/8" CARRIAGE BOLT COURSE THREAD
- 1 1/2" USS STANDARD FLAT WASHER (WEATHER SIDE)
- 1 3/8" USS STANDARD FLAT WASHER (INSIDE) 1 3/8" CONSTRUCTION GRADE NUT - COURSE THREAD

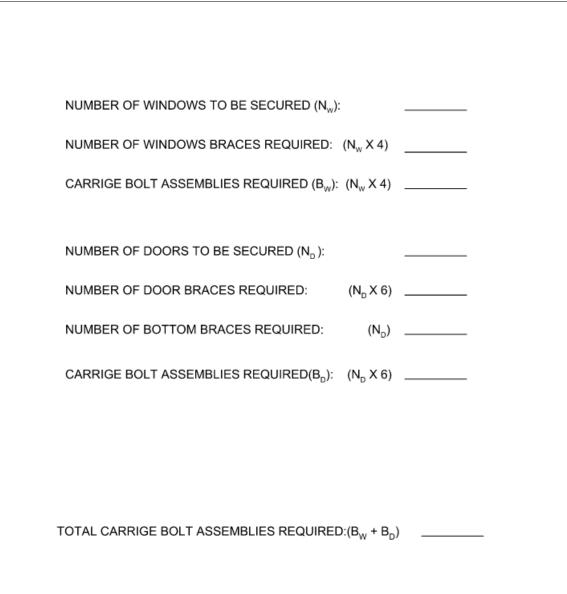

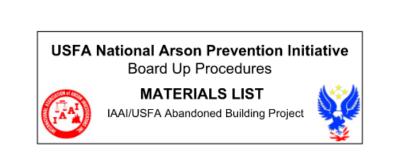

PHASE 1 -**BOARD-UP PROCEDURES**

CITY OF MYRTLE **BEACH**

BROADWAY THEATRE PHASE 1 HISTORIC **REVELATION**

3067 DEVILLE STREET

MYRTLE BEACH, SOUTH CAROLINA 29577 TEL. 843.872.0360 FAX 843.722.4789 WWW.LS3P.COM





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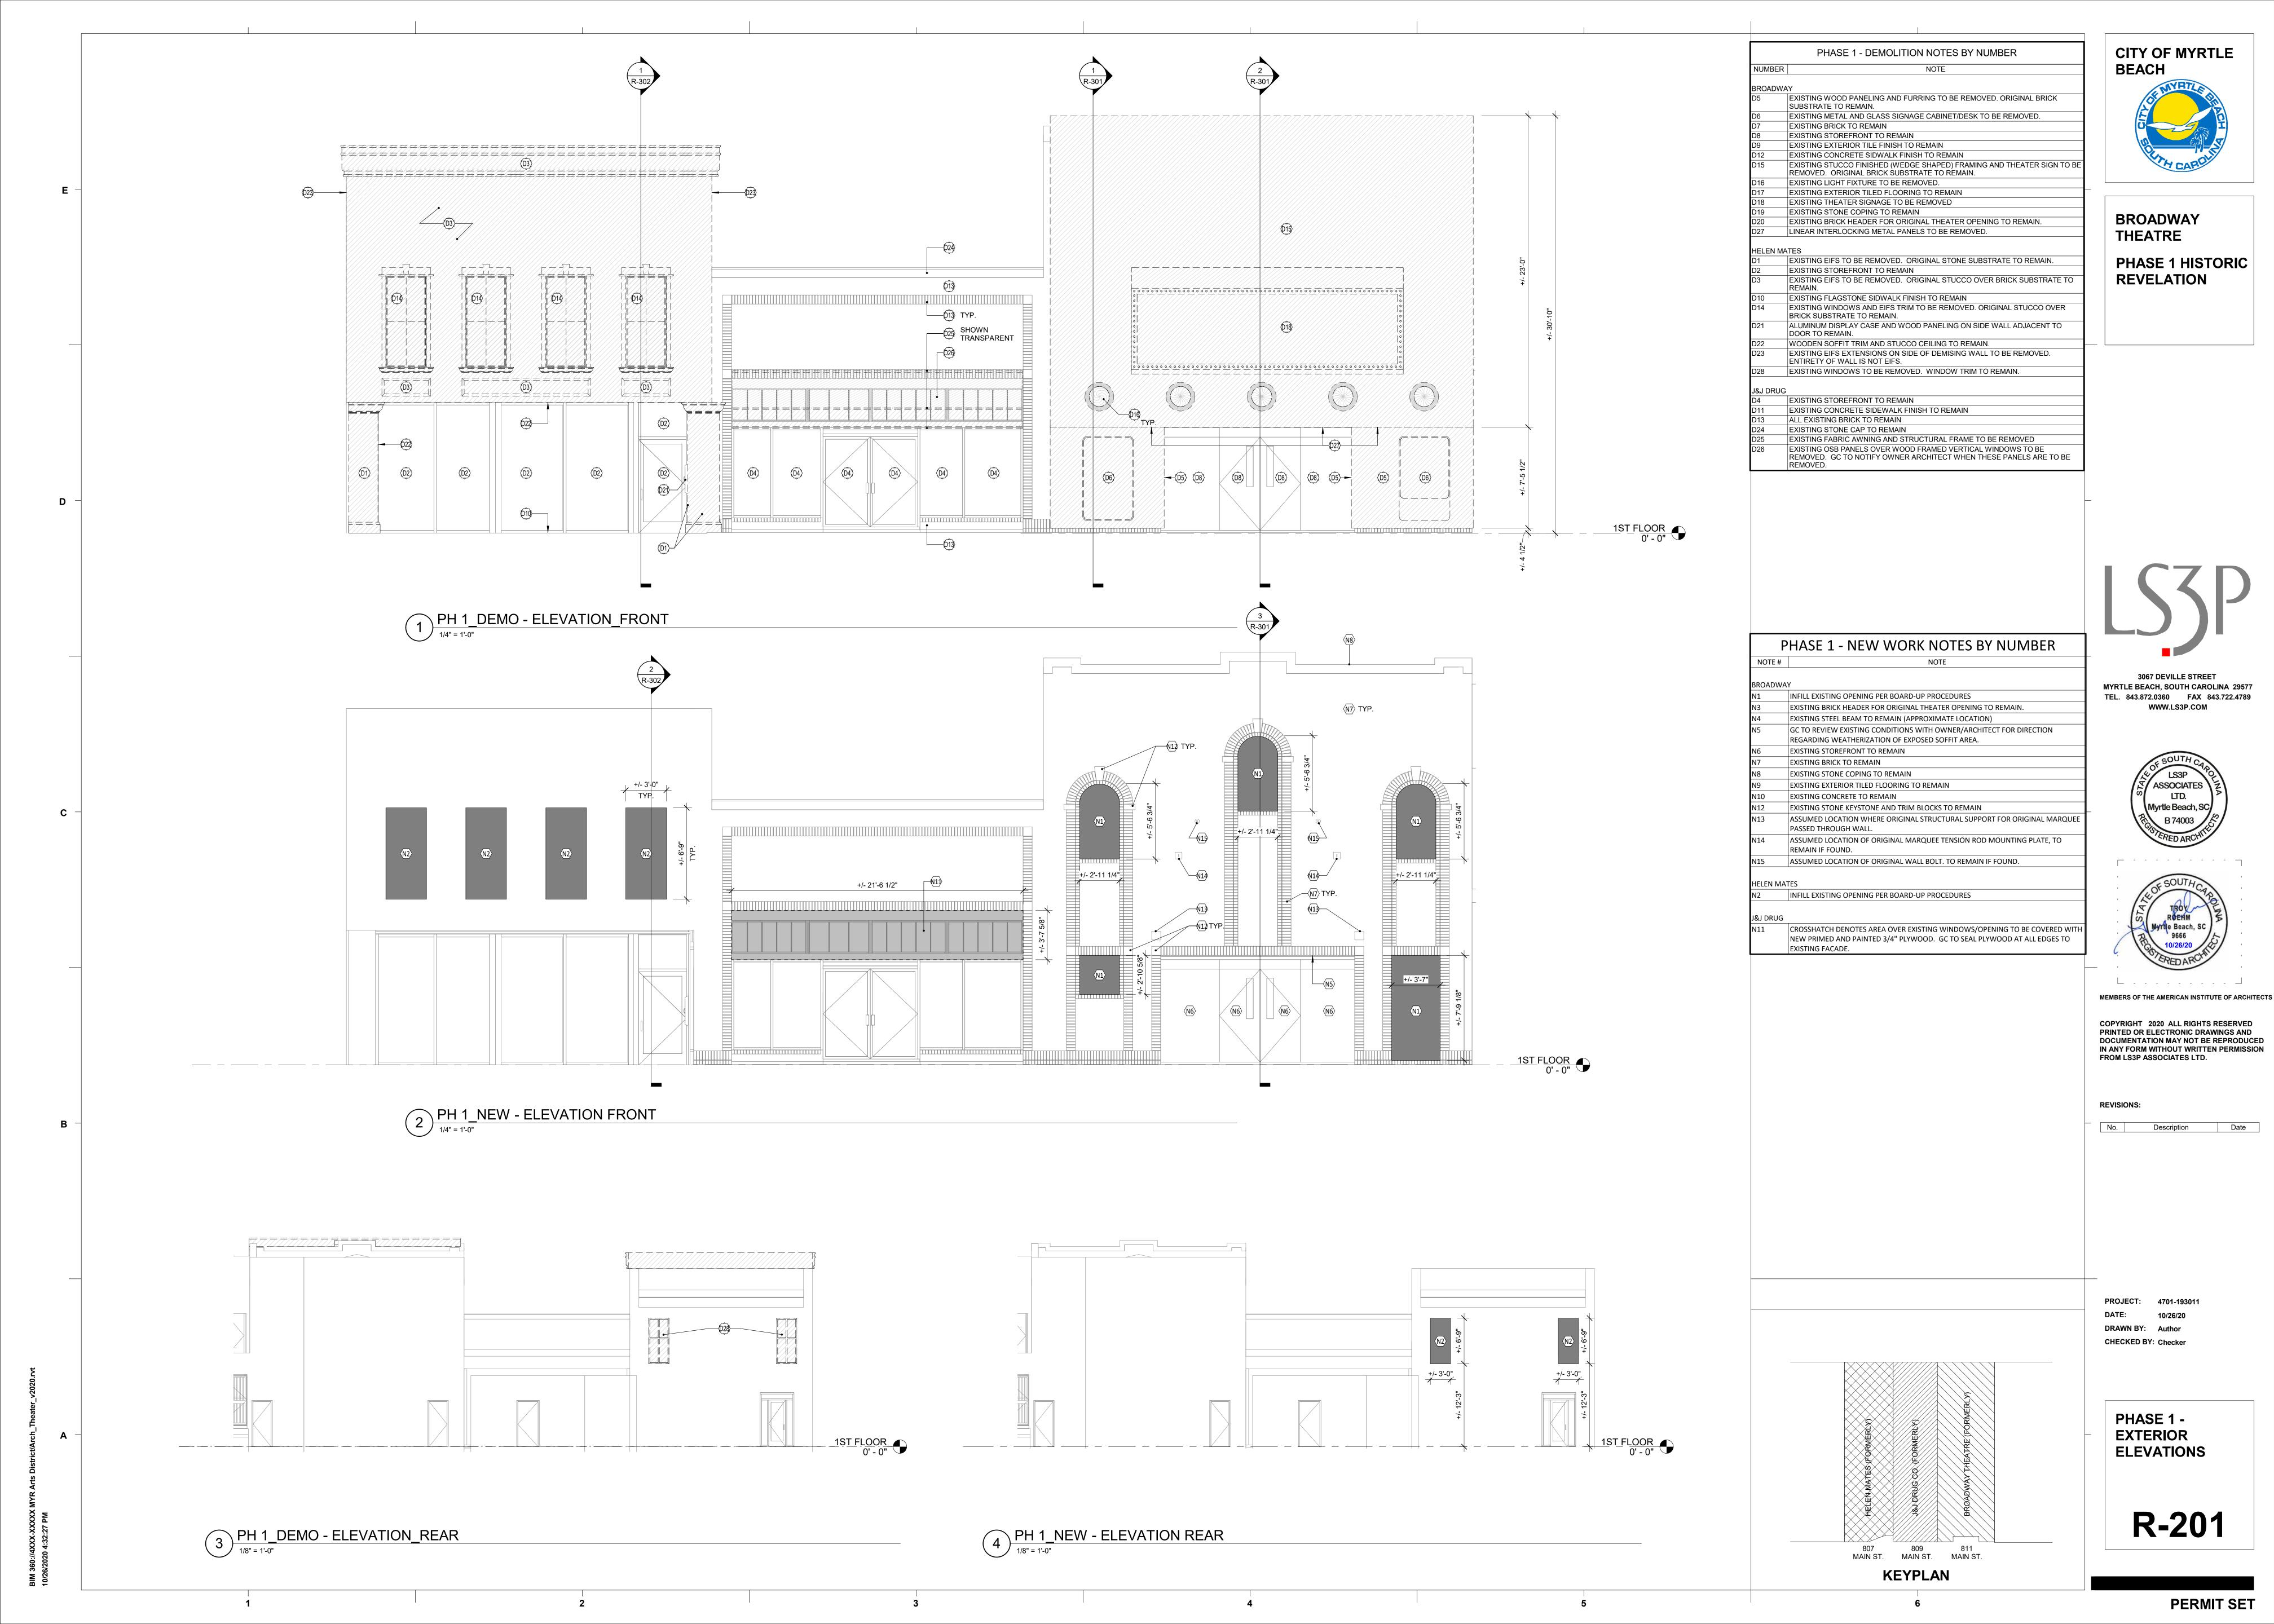
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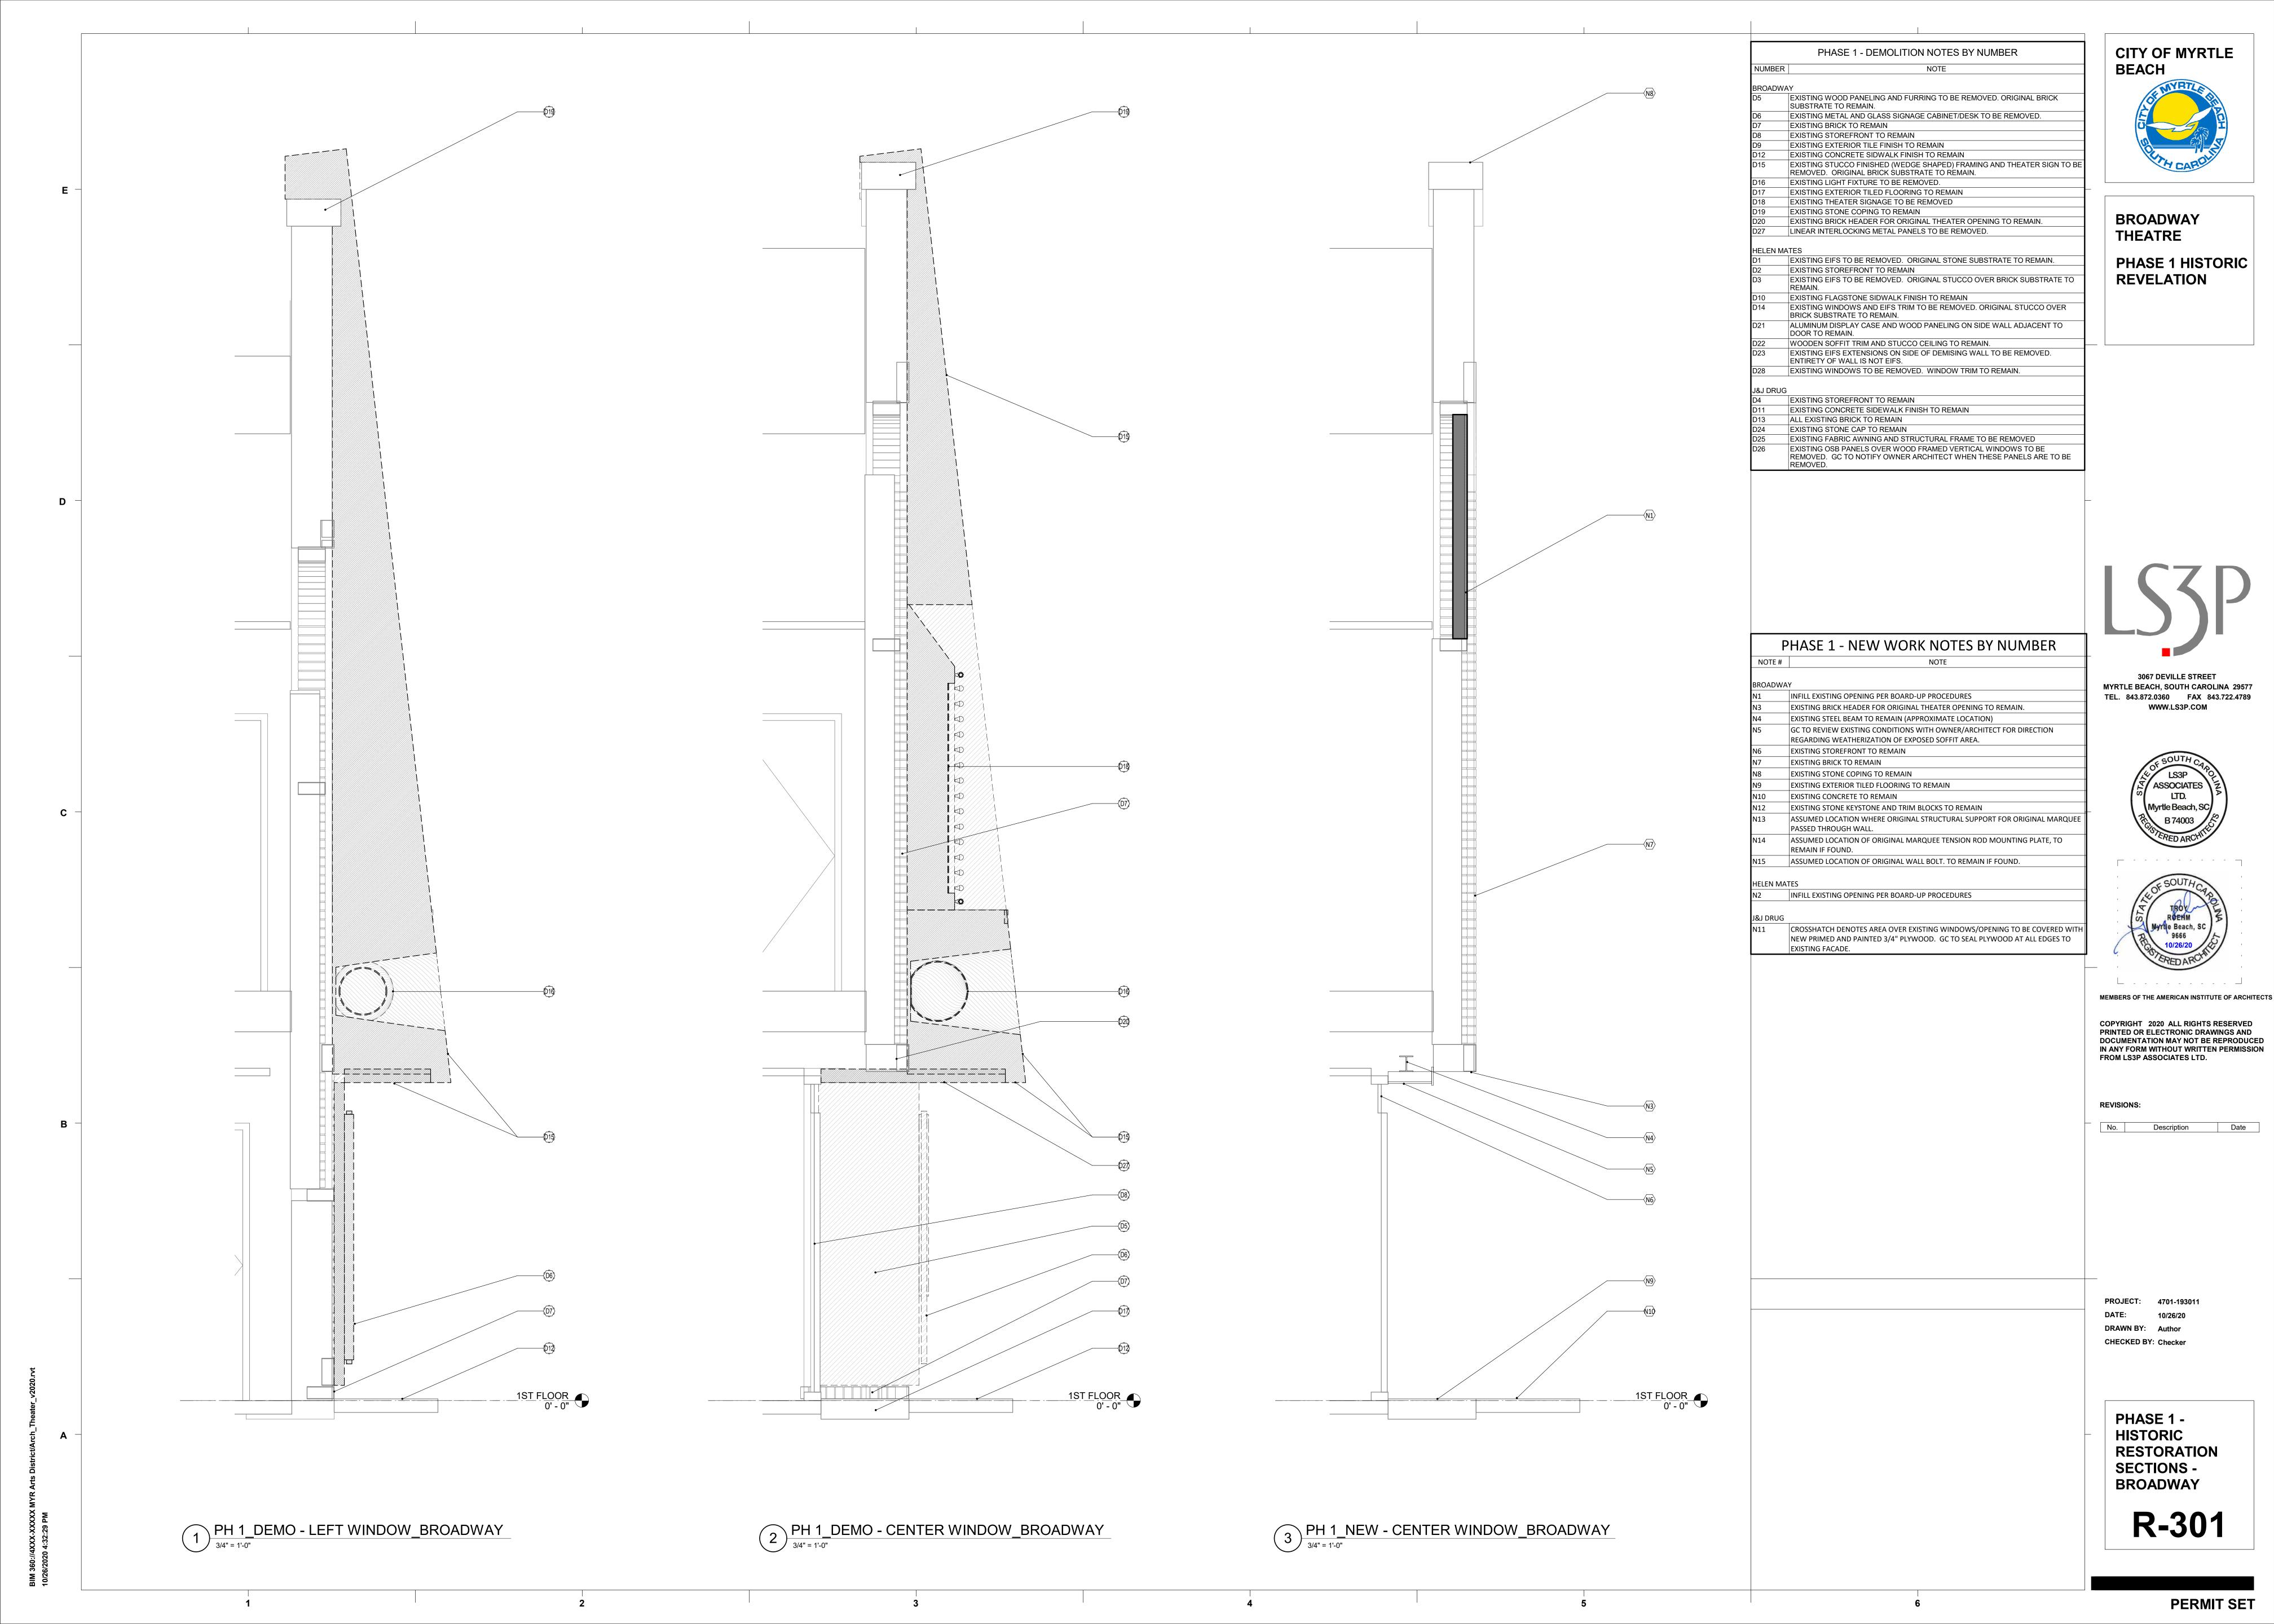
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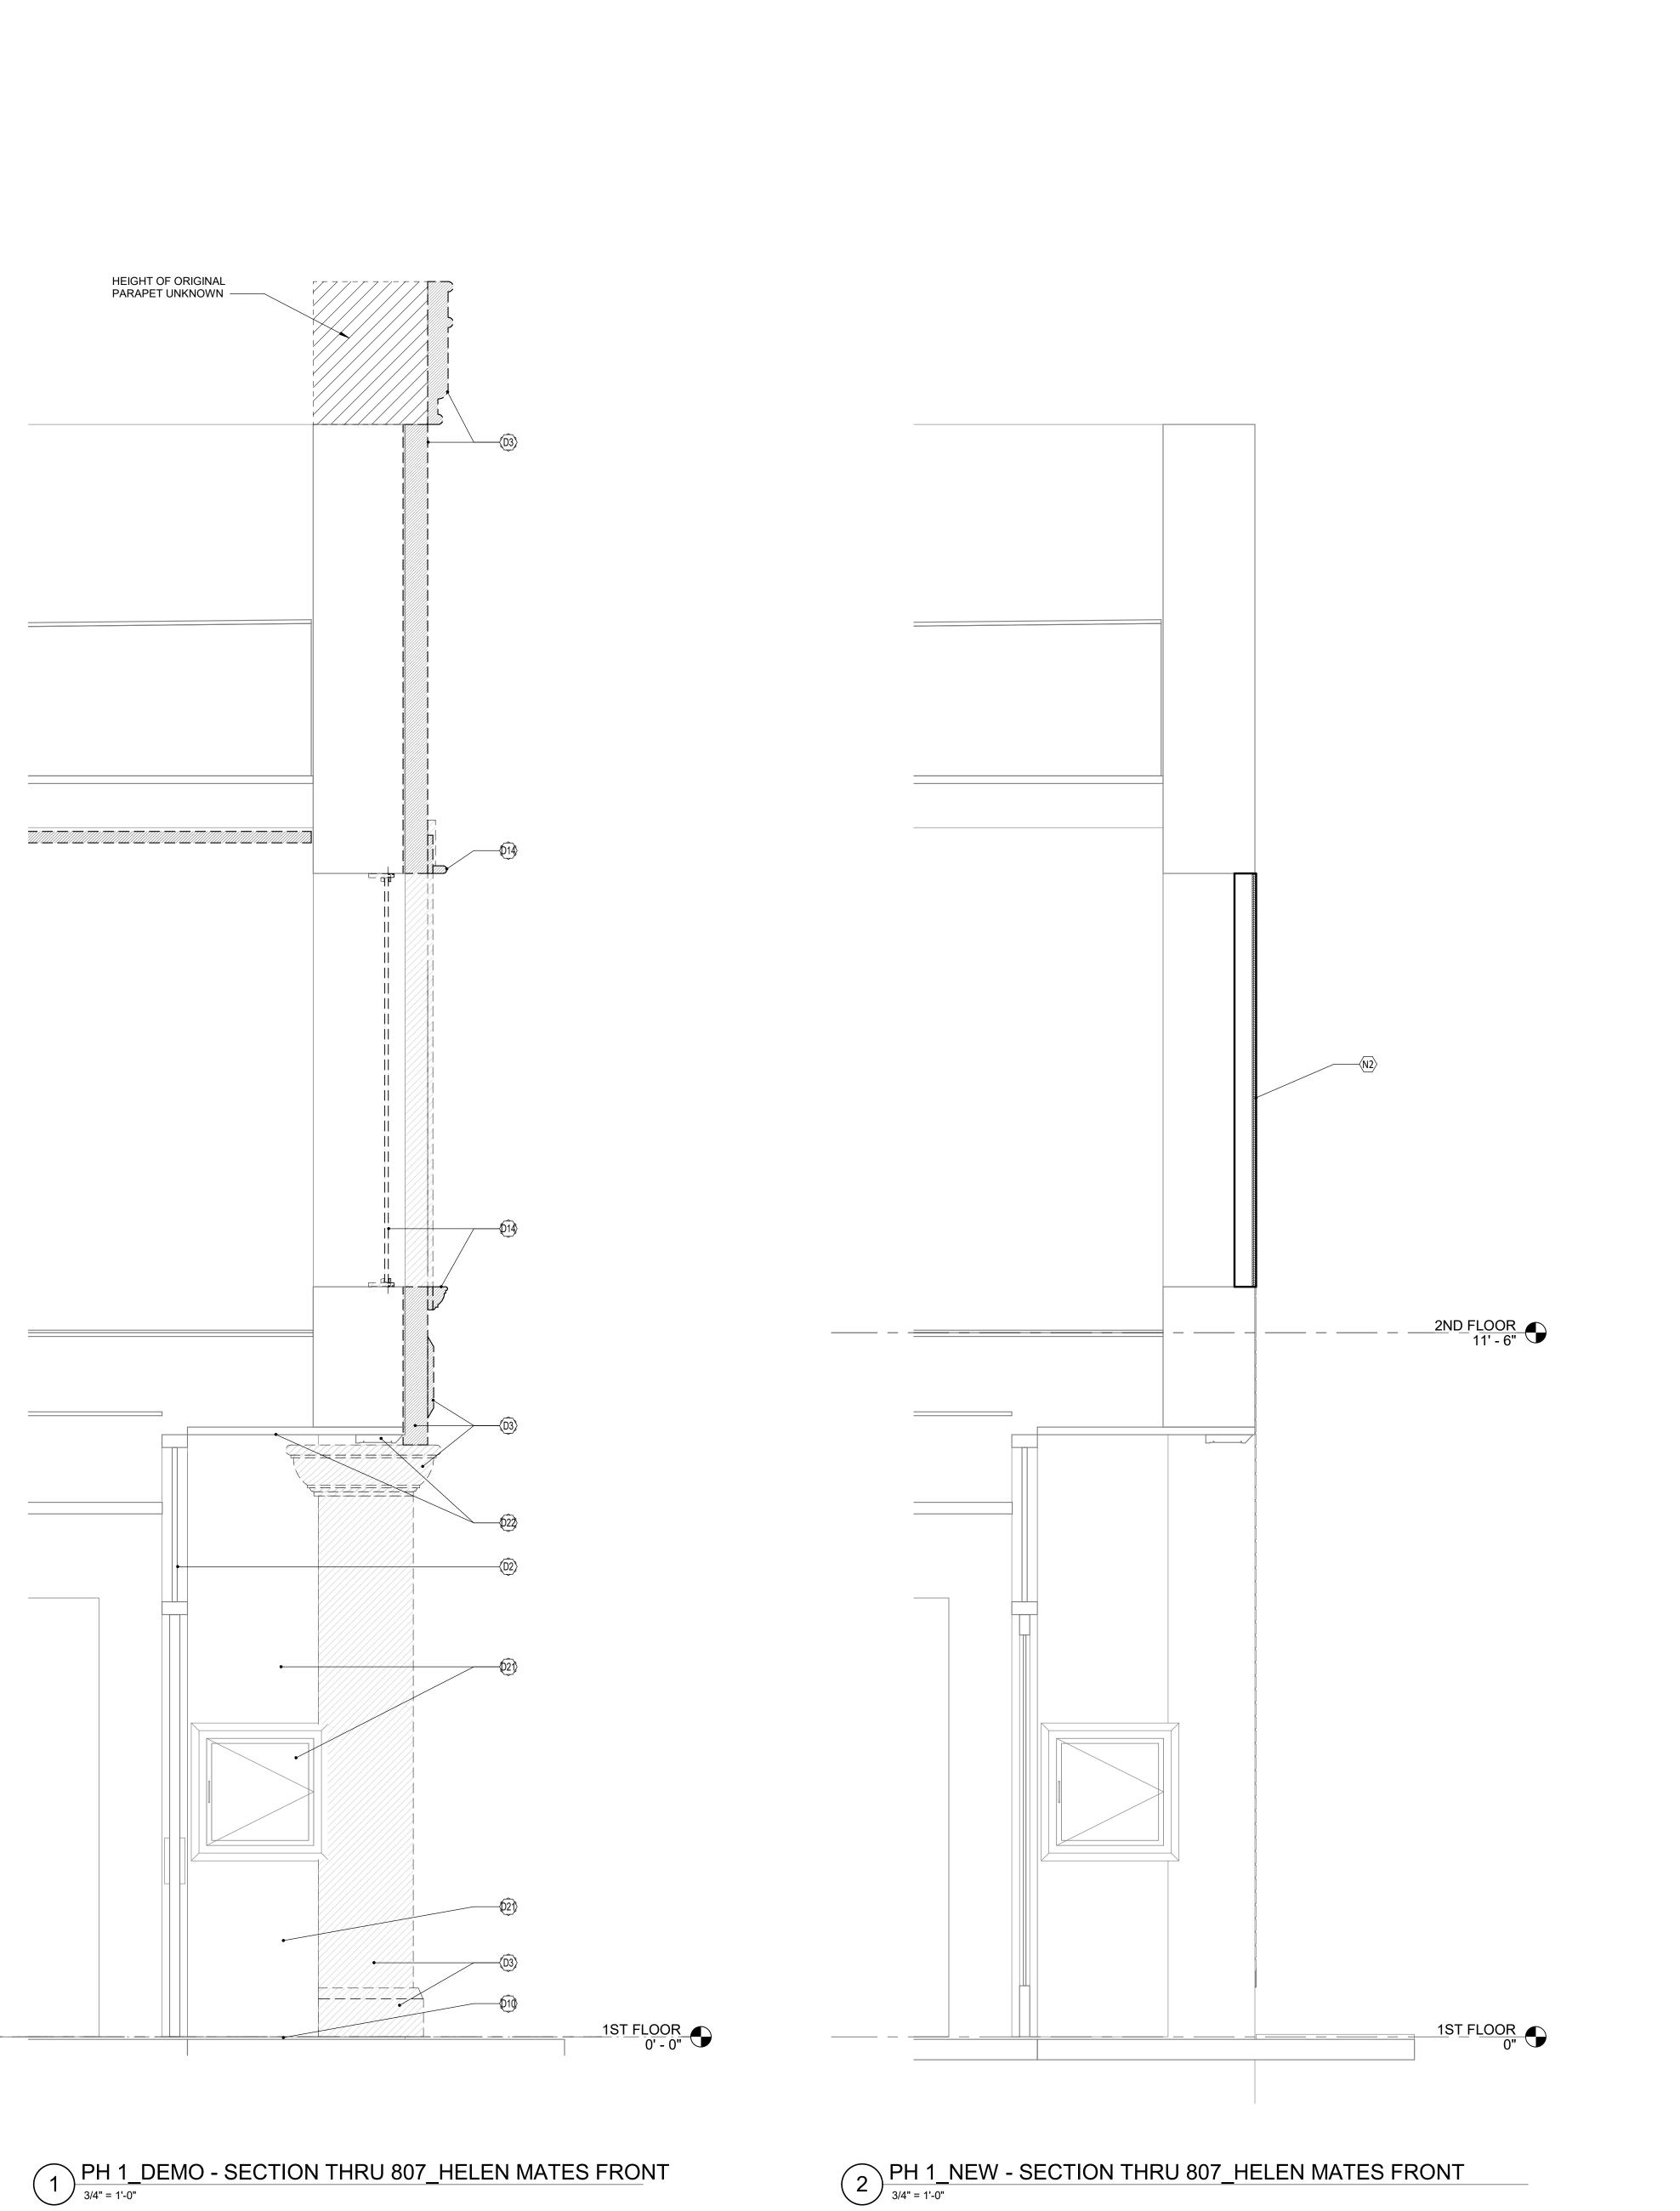
Description

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R-102







CITY OF MYRTLE PHASE 1 - DEMOLITION NOTES BY NUMBER **BEACH** NOTE NUMBER EXISTING WOOD PANELING AND FURRING TO BE REMOVED. ORIGINAL BRICK SUBSTRATE TO REMAIN. EXISTING METAL AND GLASS SIGNAGE CABINET/DESK TO BE REMOVED. EXISTING BRICK TO REMAIN EXISTING STOREFRONT TO REMAIN EXISTING EXTERIOR TILE FINISH TO REMAIN EXISTING CONCRETE SIDWALK FINISH TO REMAIN EXISTING STUCCO FINISHED (WEDGE SHAPED) FRAMING AND THEATER SIGN TO BE REMOVED. ORIGINAL BRICK SUBSTRATE TO REMAIN. EXISTING LIGHT FIXTURE TO BE REMOVED. EXISTING EXTERIOR TILED FLOORING TO REMAIN EXISTING THEATER SIGNAGE TO BE REMOVED EXISTING STONE COPING TO REMAIN **BROADWAY** EXISTING BRICK HEADER FOR ORIGINAL THEATER OPENING TO REMAIN. **THEATRE** LINEAR INTERLOCKING METAL PANELS TO BE REMOVED. PHASE 1 HISTORIC EXISTING EIFS TO BE REMOVED. ORIGINAL STONE SUBSTRATE TO REMAIN. EXISTING STOREFRONT TO REMAIN **REVELATION** EXISTING EIFS TO BE REMOVED. ORIGINAL STUCCO OVER BRICK SUBSTRATE TO EXISTING FLAGSTONE SIDWALK FINISH TO REMAIN EXISTING WINDOWS AND EIFS TRIM TO BE REMOVED. ORIGINAL STUCCO OVER BRICK SUBSTRATE TO REMAIN. ALUMINUM DISPLAY CASE AND WOOD PANELING ON SIDE WALL ADJACENT TO DOOR TO REMAIN. WOODEN SOFFIT TRIM AND STUCCO CEILING TO REMAIN. EXISTING EIFS EXTENSIONS ON SIDE OF DEMISING WALL TO BE REMOVED. ENTIRETY OF WALL IS NOT EIFS. EXISTING WINDOWS TO BE REMOVED. WINDOW TRIM TO REMAIN. EXISTING STOREFRONT TO REMAIN EXISTING CONCRETE SIDEWALK FINISH TO REMAIN ALL EXISTING BRICK TO REMAIN EXISTING STONE CAP TO REMAIN EXISTING FABRIC AWNING AND STRUCTURAL FRAME TO BE REMOVED EXISTING OSB PANELS OVER WOOD FRAMED VERTICAL WINDOWS TO BE REMOVED. GC TO NOTIFY OWNER ARCHITECT WHEN THESE PANELS ARE TO BE REMOVED.

PHASE 1 - NEW WORK NOTES BY NUMBER

EXISTING BRICK HEADER FOR ORIGINAL THEATER OPENING TO REMAIN.

GC TO REVIEW EXISTING CONDITIONS WITH OWNER/ARCHITECT FOR DIRECTION

ASSUMED LOCATION WHERE ORIGINAL STRUCTURAL SUPPORT FOR ORIGINAL MARQUEE

CROSSHATCH DENOTES AREA OVER EXISTING WINDOWS/OPENING TO BE COVERED WITH NEW PRIMED AND PAINTED 3/4" PLYWOOD. GC TO SEAL PLYWOOD AT ALL EDGES TO

ASSUMED LOCATION OF ORIGINAL MARQUEE TENSION ROD MOUNTING PLATE, TO

INFILL EXISTING OPENING PER BOARD-UP PROCEDURES

EXISTING STEEL BEAM TO REMAIN (APPROXIMATE LOCATION)

REGARDING WEATHERIZATION OF EXPOSED SOFFIT AREA.

EXISTING STONE KEYSTONE AND TRIM BLOCKS TO REMAIN

INFILL EXISTING OPENING PER BOARD-UP PROCEDURES

ASSUMED LOCATION OF ORIGINAL WALL BOLT. TO REMAIN IF FOUND.

EXISTING STOREFRONT TO REMAIN

EXISTING STONE COPING TO REMAIN

EXISTING CONCRETE TO REMAIN

EXISTING EXTERIOR TILED FLOORING TO REMAIN

EXISTING BRICK TO REMAIN

PASSED THROUGH WALL.

REMAIN IF FOUND.


EXISTING FACADE.

NOTE #

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MEMBERS OF THE AMERICAN INSTITUTE OF ARCHITECTS

VISIONS:

o. Description Da

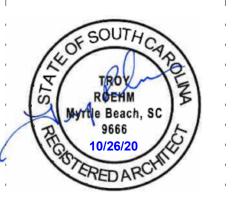PROJECT: 4701-193011
DATE: 10/26/20
DRAWN BY: Author
CHECKED BY: Checker

PHASE 1 RESTORATION
WALL
SECTIONS HELEN MATES

R-302

PERMIT SET