

GENERAL NOTES:

- POWER DISTRIBUTION: IT IS THE RESPONSIBILITY OF THE ELECTRICAL CONTRACTOR TO AS-BUILT EXISTING POWER PANELS AND MARK-UP (TYPE WRITTEN) PANEL DOOR DIRECTORY SCHEDULES TO REFLECT MODIFICATIONS MADE AS PART OF THIS PROJECT. FOR NEW PANELS: PROVIDE TYPE WRITTEN PANEL DIRECTORIES AND SCHEDULES REFLECTING AS-BUILT CONDITIONS.
- ALL ELECTRICAL EQUIPMENT SHALL BE INSTALLED IN ACCORDANCE WITH APPLICABLE LOCAL AND STATE CODES AND WITH THE LATEST EDITION OF THE NATIONAL ELECTRICAL CODE.
- PROVIDE ADDITIONAL SUPPORT FOR SWITCHES, STARTERS, FIXTURES, RACEWAYS AND OTHER ELECTRICAL EQUIPMENT WHEREVER THE BUILDING STRUCTURE IS NOT SUITABLE FOR DIRECT MOUNTING.
- DO NOT INSTALL MATERIALS OTHER THAN SPECIFIED EXCEPT FOR ALTERNATES ACCEPTED BY OWNER.
- FIRESTOP, DRAFT STOP AND/OR PROTECT THE ANNULAR SPACE AROUND ALL PIPE, TUBE, CONDUIT, WIRE, CABLE, VENT AND DUCT PENETRATION THROUGH WALLS, PARTITIONS, FLOORS, CEILINGS AND ROOFS IN ACCORDANCE WITH THE REQUIREMENTS OF THE NATIONAL ELECTRICAL CODE AND UL LISTING REQUIREMENTS. ALL OPENINGS SHALL BE SEALED TO MATCH FIRE OR SMOKE RATING OF WALL PENETRATIONS.
- VERIFY CEILING SUSPENSION SYSTEMS IN THE VARIOUS AREAS AND PROVIDE THE PROPER MOUNTING ACCESSORIES, TRIMS, ETC., TO SUIT THE PARTICULAR AREA.
- SYMBOLS IN THE LEGENDS ARE APPLICABLE GENERALLY. FOR EXACT REQUIREMENTS REFER TO THE SCHEDULES, LAYOUTS, DETAILS AND TO THE SPECIFICATIONS SINCE THE APPEARANCE OF A PARTICULAR SYMBOL IN THE LEGEND DOES NOT NECESSARILY IMPLY THAT THE ITEM IS INCLUDED IN THE CONTRACT.
- EXCEPT WHERE NOTED OTHERWISE, LIMIT LIGHTING AND RECEPTACLE BRANCH CIRCUIT HOMERUNS TO 7 CONDUCTORS. 3 PHASE WIRES, 3 NEUTRAL AND 1 GROUND.
- PROVIDE INDEPENDENT NEUTRALS FOR ALL NEW LIGHTING AND RECEPTACLE CIRCUITS.
- ALL POWER CIRCUITS SHALL CONTAIN AN EQUIPMENT GROUNDING CONDUCTOR (GREEN COLOR INSULATION) ROUTED IN CONDUIT AND SIZED AS INDICATED ON DRAWINGS (MINIMUM SIZE - #12AWG).
- ALL WORK SHALL BE DONE IN ACCORDANCE WITH THE AMERICANS WITH DISABILITIES ACT (ADA).
- ROUTE CONDUITS CONCEALED IN FINISHED SPACES, UNLESS NOTED OTHERWISE ON PLANS. INSTALL ALL DEVICES RECESSED FLUSH IN WALL, UNLESS NOTED OTHERWISE ON PLANS.
- PROVIDE EXPANSION JOINT FITTINGS FOR ALL RACEWAYS CROSSING EXPANSION JOINTS.
- FOR ALL RECEPTACLES: PROVIDE AN EQUIPMENT BONDING JUMPER FROM THE GROUNDING TERMINAL OF THE RECEPTACLE TO THE METAL BOX.
- DO NOT INSTALL DEVICE OUTLET BOXES BACK-TO-BACK IN COMMON WALL. OFFSET 6". ALTERNATE CIRCUITS TO ADJACENT DEVICES IN MULTI-OUTLET RACEWAY.
- LABEL ALL RECEPTACLE FACEPLATES WITH PANEL NAME AND CIRCUIT NUMBER FEEDING THAT RECEPTACLE.
- COORDINATE ALL WORK AND POWER OUTAGES WITH OWNER.
- PROVIDE STRIPING ON THE FLOOR AROUND ELECTRICAL PANELS TO IDENTIFY THE CODE REQUIRED WORKING CLEARANCE.
- PHASE IDENTIFICATION FOR CIRCUITS SHALL BE ACCOMPLISHED BY COLOR CODE AS FOLLOWS:

CIRCUITS RATED (480/277V):	CIRCUITS RATED (240/120V):
PHASE "A" = BROWN	PHASE "A" = BLACK
PHASE "B" = ORANGE	PHASE "B" = RED
PHASE "C" = YELLOW	PHASE "C" = BLUE
NEUTRAL = GRAY	NEUTRAL = WHITE
- ALL WIRING CONDUCTORS SHALL BE COPPER (CU) WITH THWN INSULATION AS A MINIMUM REQUIREMENT.

TYPICAL DEVICE MOUNTING HEIGHT

RECEPTACLES	_____	18" AFF
LIGHT SWITCHES	_____	48" AFF

NOTE: DIMENSIONS ARE TO DEVICE CENTERLINE UNLESS NOTED OTHERWISE.

ELECTRICAL LEGENDS & ABBREVIATIONS

NOTE: ALL SYMBOL DESCRIPTIONS ARE SUBJECT TO MODIFICATION ON THE DRAWINGS. ALL SYMBOLS NOT NECESSARILY USED ON THIS PROJECT.

GENERAL SYMBOLS:

- POINT OF CONNECTION
- POINT OF REMOVAL
- KEY NOTE
- DEMOLITION NOTE
- CONSTRUCTION NOTE
- REVISION
- DETAIL BUBBLE
- SECTION BUBBLE

ELECTRICAL SYMBOLS:

- 237 CART INDICATES ROOM NUMBER
- DISCONNECT SWITCH. REFER TO PLANS FOR ADDITIONAL INFORMATION. "30" INDICATES AMPACITY, "3" INDICATES PHASES, "3R" INDICATES NEMA CLASSIFICATION. WHERE USED ON A MOTOR CIRCUIT, SWITCH SHALL BE HORSEPOWER RATED GREATER THAN THE HORSEPOWER.
- 2' x 4' LED LIGHT FIXTURE. SEE LIGHT FIXTURE SCHEDULE. 'a,b' LOWER CASE LETTERS INDICATES BI-LEVEL SWITCHING SCHEME. 'A' INDICATES FIXTURE TYPE, REFER TO FIXTURE SCHEDULE. 'N' INDICATES NIGHT LIGHT (PERMANENTLY ENERGIZED.) "H1/1" INDICATES FEEDER CIRCUIT, I.E. FROM PANEL "H1" CKT. NO. "1"
- 4' LED LIGHT FIXTURE. SEE LIGHT FIXTURE SCHEDULE. SAME AS ABOVE.
- 4' LED HI BAY LIGHT FIXTURE. SEE LIGHT FIXTURE SCHEDULE. SAME AS ABOVE.
- 2' x 2' LED LIGHT FIXTURE. SEE LIGHT FIXTURE SCHEDULE. SAME AS ABOVE.
- LED EXIT SIGN WITH BATTERY PACK EMERGENCY LIGHTING UNIT WITH NUMBER OF HEADS INDICATED. SEE LIGHT FIXTURE SCHEDULE. CONNECT TO UN-SWITCHED ROOM LIGHTING CIRCUIT.
- EMERGENCY LED EXIT LIGHT FIXTURE (CEILING OR WALL MOUNT). SEE LIGHTING FIXTURE SCHEDULE. ARROW INDICATES EGRESS DIRECTION. CONNECT TO UN-SWITCHED ROOM LIGHTING CIRCUIT.
- RECESSED DOWNLIGHT LED FIXTURE. "H" INDICATES FIXTURE TYPE, REFER TO FIXTURE SCHEDULE.
- LED WALLPACK LIGHT FIXTURE, "W" INDICATED FIXTURE TYPE, SEE LIGHT FIXTURE SCHEDULE.
- TOGGLE TYPE LIGHT SWITCH, 120V/20A. MOUNTED 48" A.F.F. (UNLESS NOTED OTHERWISE). NONE INDICATES SINGLE-POLE, SINGLE-THROW. "3" INDICATES THREE WAY. 'a' LOWER CASE LETTER INDICATES SWITCHING SCHEME. "D" INDICATES DIMMER TYPE SWITCH. (1000 WATTS UNLESS NOTED OTHERWISE) COORDINATE SWITCH TYPE WITH FIXTURE TO BE DIMMED. "OS" INDICATES PIR OCCUPANCY/SENSOR. MATCH OCCUPANCY SENSOR WITH TYPE OF LIGHTING TO BE CONTROLLED. "M" INDICATES TO PROVIDE MOTOR-RATED SWITCH WITH OVERLOADS IF REQUIRED
- CEILING MOUNT OCCUPANCY SENSOR. "b" LOWER CASE LETTER INDICATES SWITCHING SCHEME.
- CEILING MOUNT DAYLIGHT SENSOR. "b" LOWER CASE LETTER INDICATES SWITCHING SCHEME.
- WALL MOUNT OCCUPANCY SENSOR.
- 120V/20A DUPLEX RECEPTACLE. MOUNTED 18" A.F.F. (UNLESS NOTED OTHERWISE). "GF" INDICATES SELF-TEST GROUND FAULT CIRCUIT INTERRUPTER TYPE. "WP" INDICATES WEATHER PROOF WHILE IN USE COVER WITH WEATHER RESISTANT RECEPTACLE "C" COUNTER TOP, MOUNTED 42" UP OR 6" ABOVE COUNTER. USE GFCI TYPE. "DW" DISHWASHER RECEPTACLE, MOUNTED INSIDE CABINET UNDER SINK, GFCI TYPE. "M" MICROWAVE RECEPTACLE, COORDINATE MOUNTING HGT. WITH CABINET INSTALLER. "P1/1" INDICATES FEEDER CIRCUIT, I.E. FROM PANEL "P1" CKT. NO. "1"
- 220V/30A DUPLEX RECEPTACLE. MOUNTED 18" A.F.F. (UNLESS NOTED OTHERWISE).
- 120V/20A DUPLEX RECEPTACLE. MOUNTED 6" ABOVE COUNTER-TOP (UNLESS NOTED OTHERWISE).
- 120V/20A QUAD RECEPTACLE. MOUNTED 18" A.F.F. (UNLESS NOTED OTHERWISE).
- COMBINATION TELEPHONE/DATA OUTLET MOUNTED 18" A.F.F (UNLESS NOTED OTHERWISE) PROVIDE AND INSTALL 4"x4"x1 1/2" BOX WITH SINGLE GANG EXTENSION RING AND 3/4" EMPTY CONDUIT WITH PULLWIRE.
- TELEPHONE/TV OUTLET MOUNTED 18" A.F.F (UNLESS NOTED OTHERWISE) PROVIDE AND INSTALL 4"x4"x1 1/2" BOX WITH SINGLE GANG EXTENSION RING AND 3/4" EMPTY CONDUIT WITH PULLWIRE. "TV" INDICATES TV OUTLET.
- ELECTRIC MOTOR
- BRANCH CIRCUIT RACEWAY - CONCEALED IN WALL OR CEILING
- POWER PANEL "P1"
- TELEPHONE BACKBOARD (FIRE RESISTANT)
- DRY TYPE TRANSFORMER
- SPECIAL PURPOSE RECEPTACLES

ELECTRICAL ABBREVIATIONS:

- A AMPERES
- AFCI ARC FAULT CIRCUIT INTERRUPTER
- AFF ABOVE FINISHED FLOOR
- AFG ABOVE FINISHED GRADE
- AHU AIR HANDLING UNIT
- AIC AMPS INTERRUPTING CAPACITY
- ATS AUTOMATIC TRANSFER SWITCH
- AWG AMERICAN WIRE GAUGE
- BOF BOTTOM OF FIXTURE
- BOS BOTTOM OF STEEL
- C CONDUIT
- CAT CATALOG
- CB CIRCUIT BREAKER
- CKT CIRCUIT
- CT CURRENT TRANSFORMER
- CWA CONSTANT WATTAGE AUTOTRANSFORMER
- DTT DOUBLE TWIN TUBE
- DWG(S) DRAWING(S)
- EB ELECTRONIC BALLAST
- EC EMPTY CONDUIT
- ECB ENCLOSED CIRCUIT BREAKER
- EF EXHAUST FAN
- EFF ENERGY EFFICIENT
- EJ EXPANSION JOINT
- EM EMERGENCY
- EMT ELECTRICAL METALLIC TUBING
- EQUIP EQUIPMENT
- EWC ELECTRIC WATER COOLER
- EWH ELECTRIC WATER HEATER
- EXIST EXISTING
- ER EXISTING TO REMAIN
- EXP EXPLOSION PROOF
- FAAP FIRE ALARM ANNUNCIATOR PANEL
- FACU FIRE ALARM CONTROL UNIT
- FBO FURNISHED BY OTHERS
- FCU FAN COIL UNIT
- FMS FACILITY MANAGEMENT SYSTEM
- FVNR FULL VOLTAGE NON-REVERSING FURNISHED WITH EQUIPMENT
- GFCI/GF GROUND FAULT CIRCUIT INTERRUPTER
- G/GND GROUND
- HP HORSEPOWER
- HPF HIGH POWER FACTOR
- HACR HEATING/AIR CONDITIONING RATED
- INCAN INCANDESCENT
- JB JUNCTION BOX
- KW KILOWATTS
- LTG LIGHTING
- MAG MAGNETIC
- MCB MAIN CIRCUIT BREAKER
- MCC MOTOR CONTROL CENTER
- MCCB MOLDED CASE CIRCUIT BREAKER
- MCS MOLDED CASE SWITCH
- MLO MAIN LUGS ONLY
- MTD MOUNTED
- MTG MOUNTING
- N NEUTRAL
- NEC NATIONAL ELECTRICAL CODE
- NF NON-FUSED
- NIC NOT IN CONTRACT
- NTS NOT TO SCALE
- NWR NO WORK REQUIRED
- OF OWNER FURNISHED
- OFCI OWNER FURNISHED, CONTRACTOR INSTALLED
- OFOI OWNER FURNISHED, OWNER INSTALLED
- PB PUSH BUTTON
- PMT PAD MOUNTED TRANSFORMER
- PNL(S) PANEL(S)
- RECEPT RECEPTACLE
- REQD REQUIRED
- RM ROOM
- RGS RIGID GALVANIZED STEEL CONDUIT
- SMR SURFACE MOUNTED RACEWAY
- ST SHUNT TRIP
- RTU ROOF TOP UNIT
- STP SHIELDED TWISTED PAIR
- SPST SINGLE-POLE, SINGLE-THROW
- TBB TELEPHONE BACKBOARD
- TEL TELEPHONE
- TOC TOP OF CONCRETE
- TOF TOP OF FIXTURE
- TVSS TRANSIENT VOLTAGE SURGE SUPPRESSION
- TYP TYPICAL
- UH UNIT HEATER
- UNO UNLESS NOTED OTHERWISE
- UG UNDERGROUND
- UP UNDERGROUND POWER
- UT UNDERGROUND TELEPHONE
- UTP UNSHIELDED TWISTED PAIR
- V VOLTS
- VA VOLT-AMPERES
- VFD VARIABLE FREQUENCY DRIVE
- W WATTS
- WP WEATHERPROOF
- XFMR TRANSFORMER
- 2S1W 2 SPEED, 1 WINDING

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 Project #: 2006158

New Recreation Building for:
HANAHAN CITY PARK
 City of Hanahan
 Hanahan, South Carolina

SOUTH CAROLINA
 LIVE OAK CONSULTANTS, LLC
 No. 3886
 STATE OF SOUTH CAROLINA
 PROFESSIONAL ENGINEER
 No. 15521
 03/11/21
 ROBERT N. BAIRD

BID SET

Rev.	Date	Description
0	03.11.2021	BID SET

DRAWN BY: D. GRANGER
 CHECKED BY: R. BAIRD
 PROJECT NUMBER: 19006
 DATE: 09.21.2020

SHEET TITLE:
ELECTRICAL NOTES, LEGEND, & ABBREVIATIONS
 SHEET NUMBER:
E001


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GENERAL NOTES:

1. REFER TO DRAWING E001 FOR ELECTRICAL GENERAL NOTES, LEGENDS, & ABBREVIATIONS.
2. REFER TO DRAWING E501 FOR ELECTRICAL LIGHTING SCHEDULE.

KEYED NOTES:

1 -

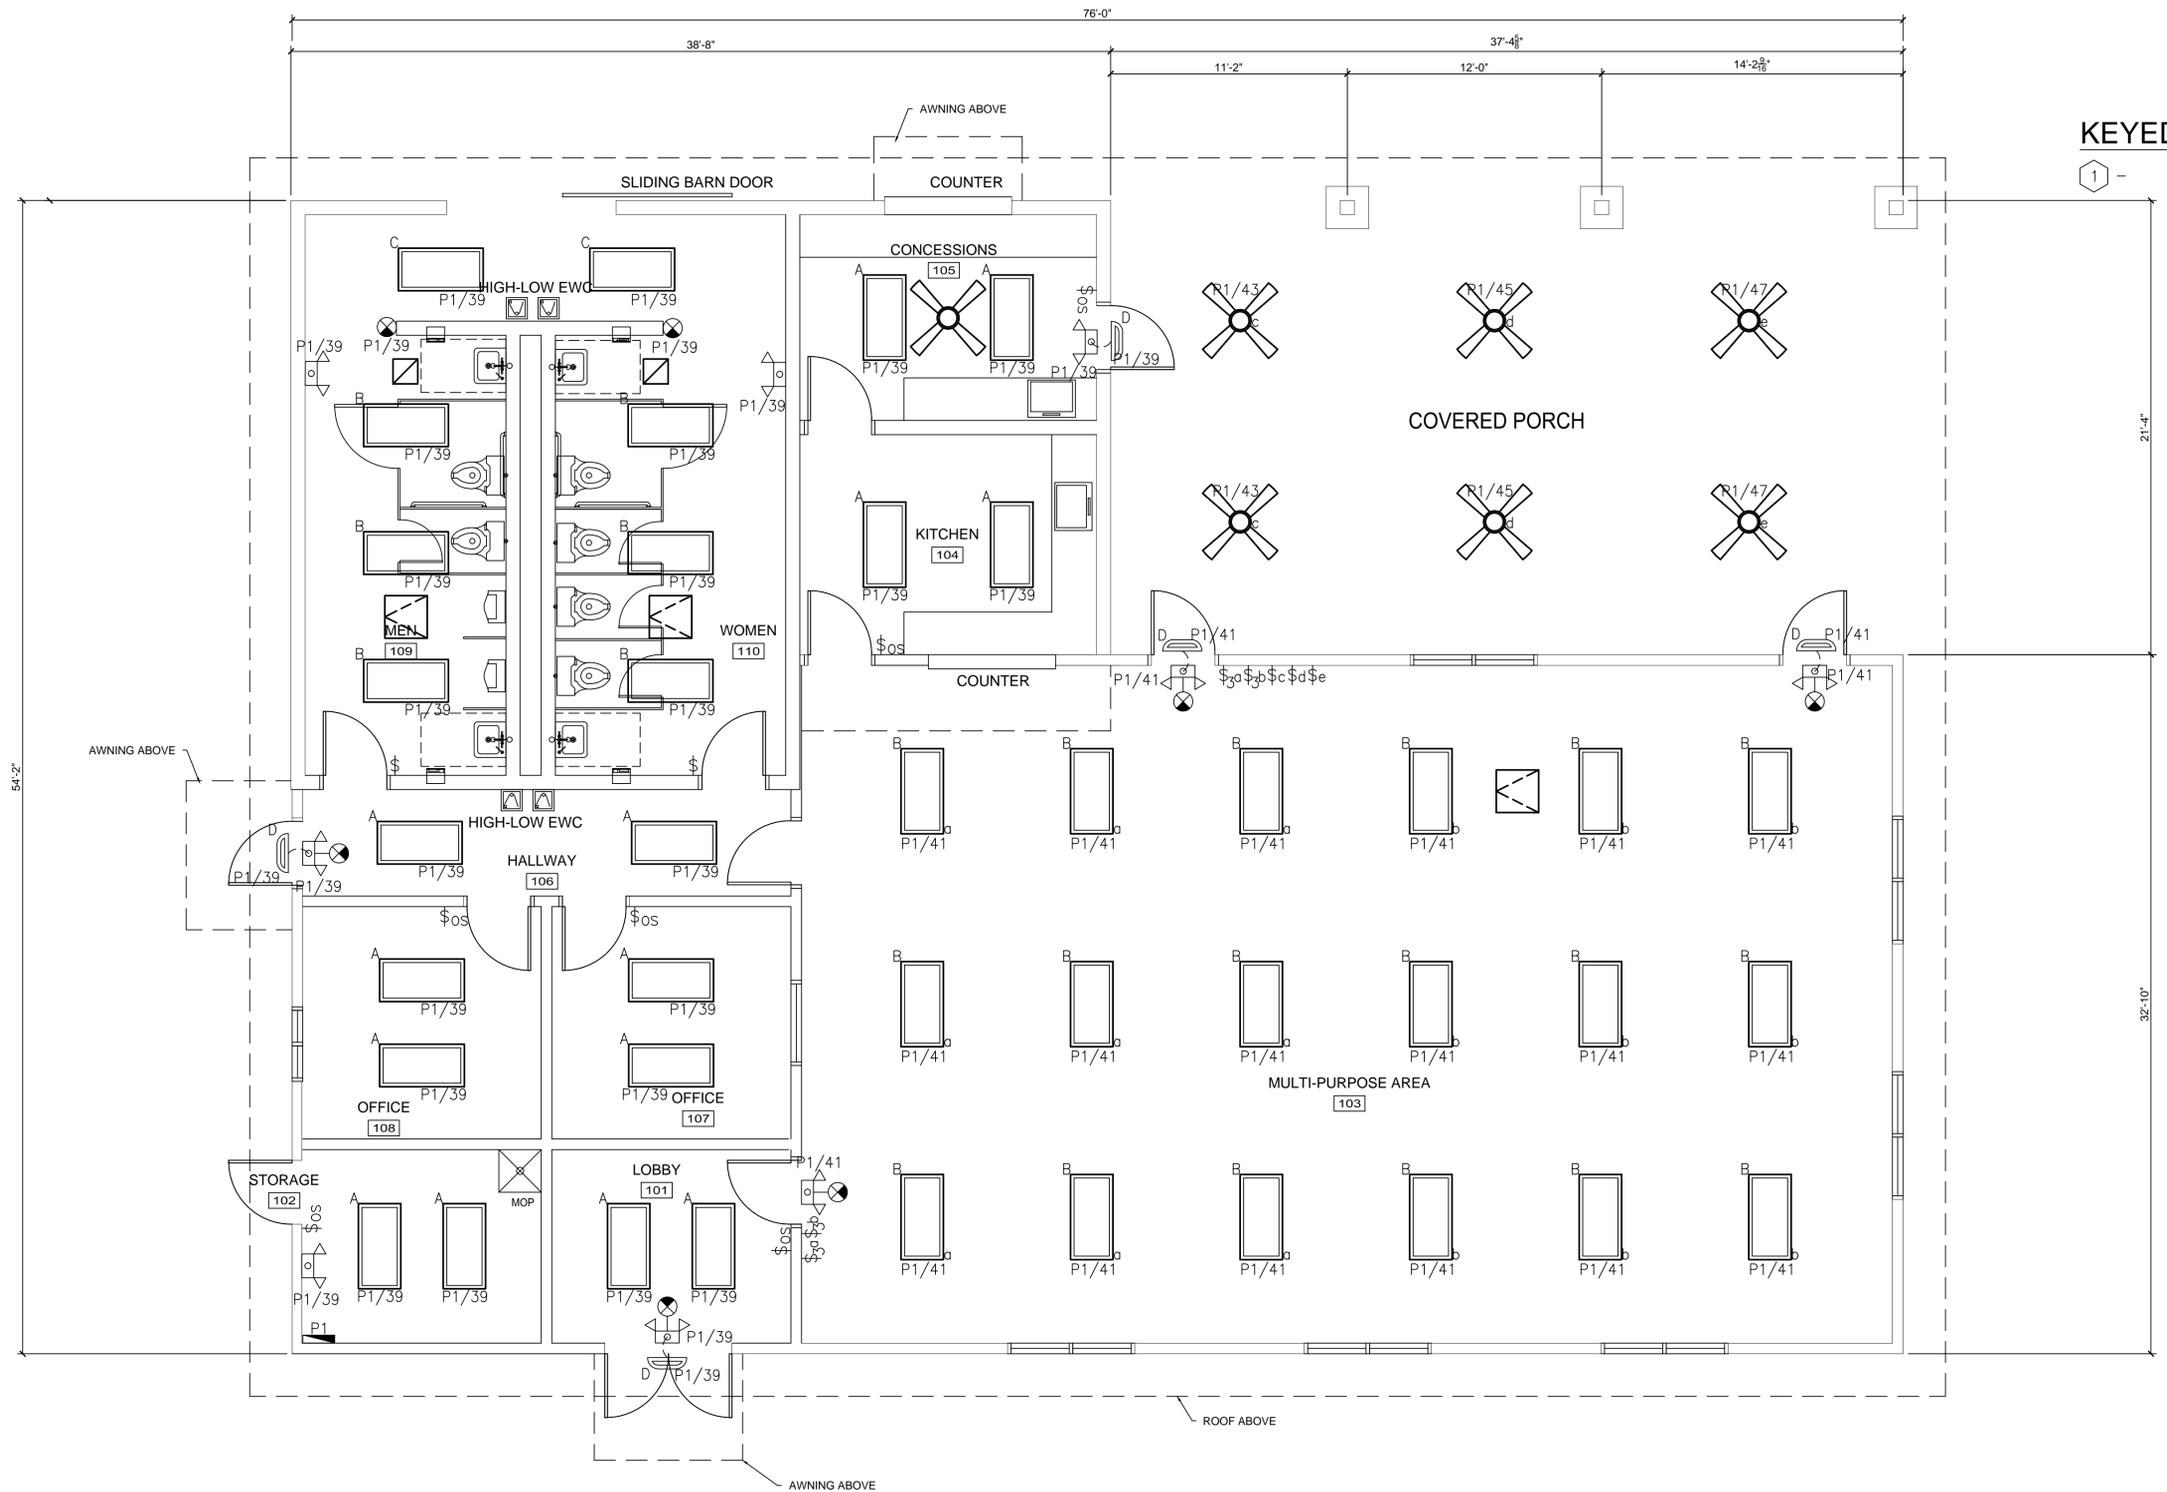

E1 REC. CENTER ELECTRICAL LIGHTING PLAN
SCALE: 1/4"=1'-0"

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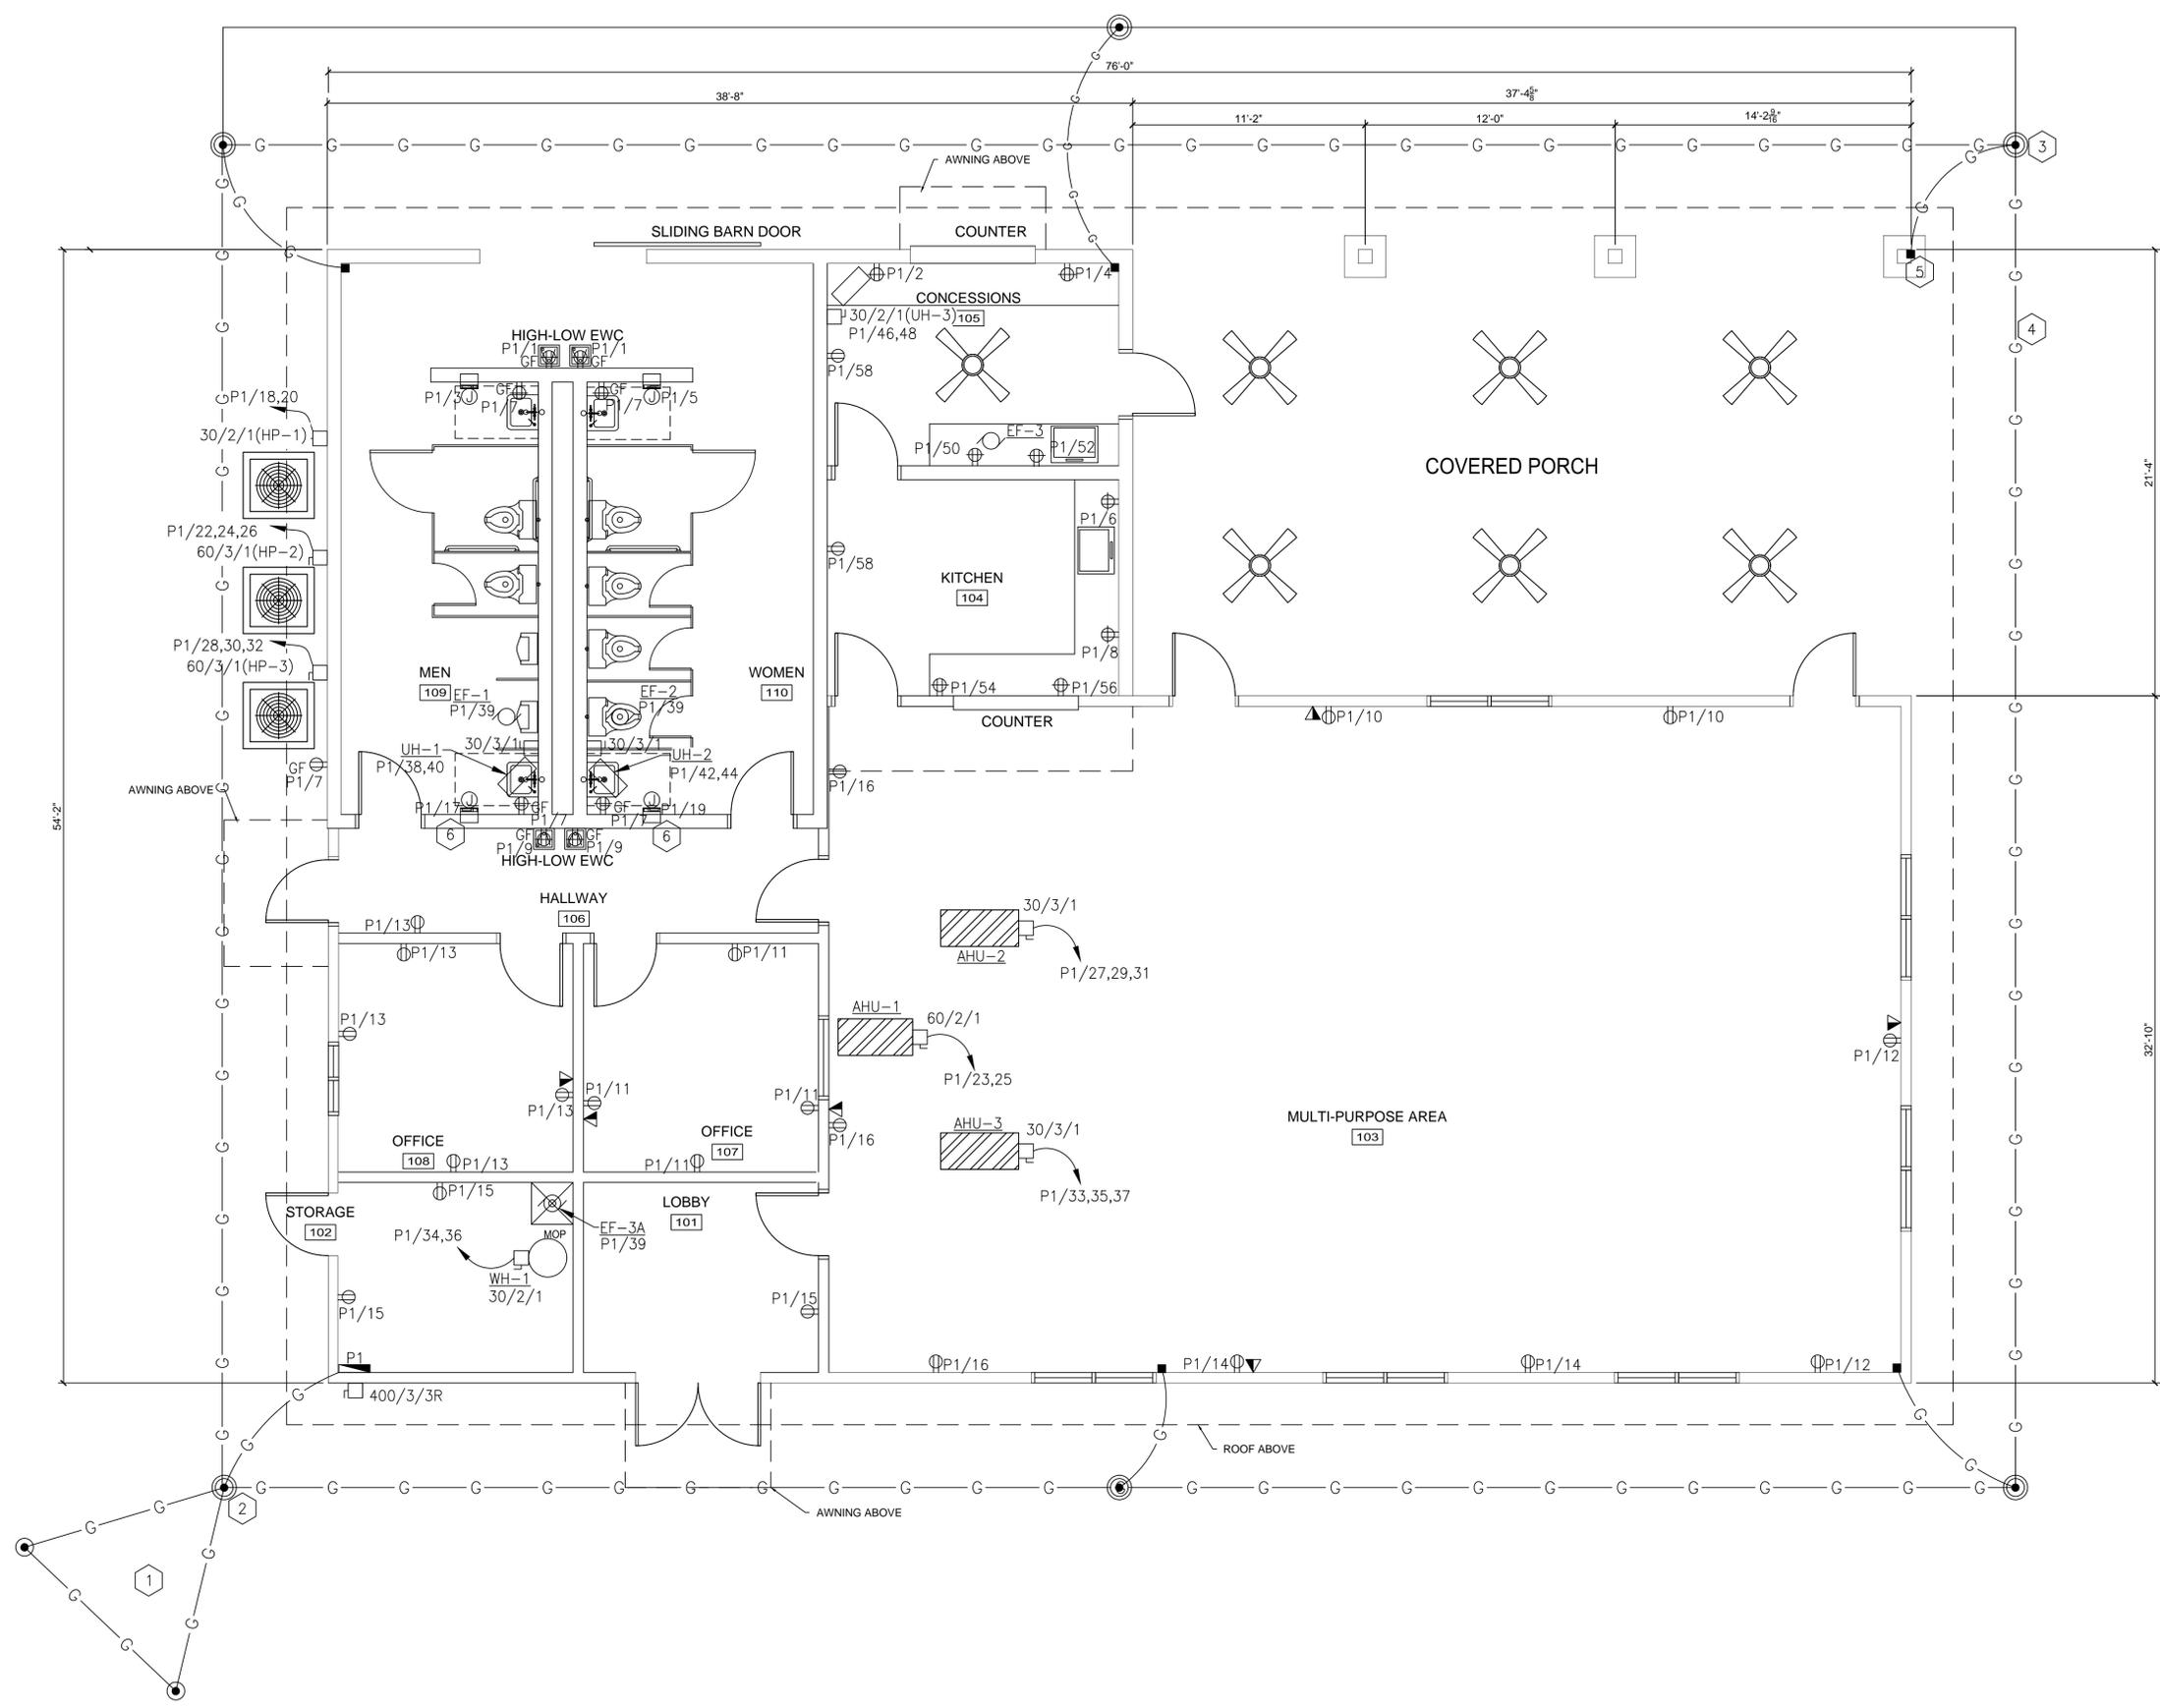
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Rev.	Date	Description
0	03.11.2021	BID SET

DRAWN BY: D. GRANGER
CHECKED BY: R. BAIRD
PROJECT NUMBER: 19006
DATE: 09.21.2020

SHEET TITLE:
**REC. CENTER BLDG.
ELECTRICAL
LIGHTING PLAN**
SHEET NUMBER:
E101

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GENERAL NOTES:

1. REFER TO DRAWING E001 FOR ELECTRICAL GENERAL NOTES, LEGENDS, & ABBREVIATIONS.
2. REFER TO DRAWING E501 FOR ELECTRICAL SCHEDULES.
3. CONTRACTOR SHALL TIE BATHROOM LIGHT SWITCHES AND EXHAUST FANS TOGETHER.
4. CONTRACTOR SHALL TIE LIGHT SWITCH AND EXHAUST FAN TOGETHER IN STORAGE 102.

KEYED NOTES:

- 1 GROUNDING TRIAD, SEE DETAIL DWG E501.
- 2 GROUND TEST WELL, SEE DETAIL DWG E501.
- 3 GROUND ROD, SEE DETAIL DWG E501.
- 4 GROUND CONDUCTOR, SEE DETAIL DWG E501.
- 5 EXOTHERMIC WELD CABLE TO STEEL COLUMN, SEE DETAIL DWG E501.
- 6 HAND DRYER.

E1 REC. CENTER ELECTRICAL POWER PLAN
SCALE: 1/4"=1'-0"

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Project #: 20200158

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Hanahan, South Carolina




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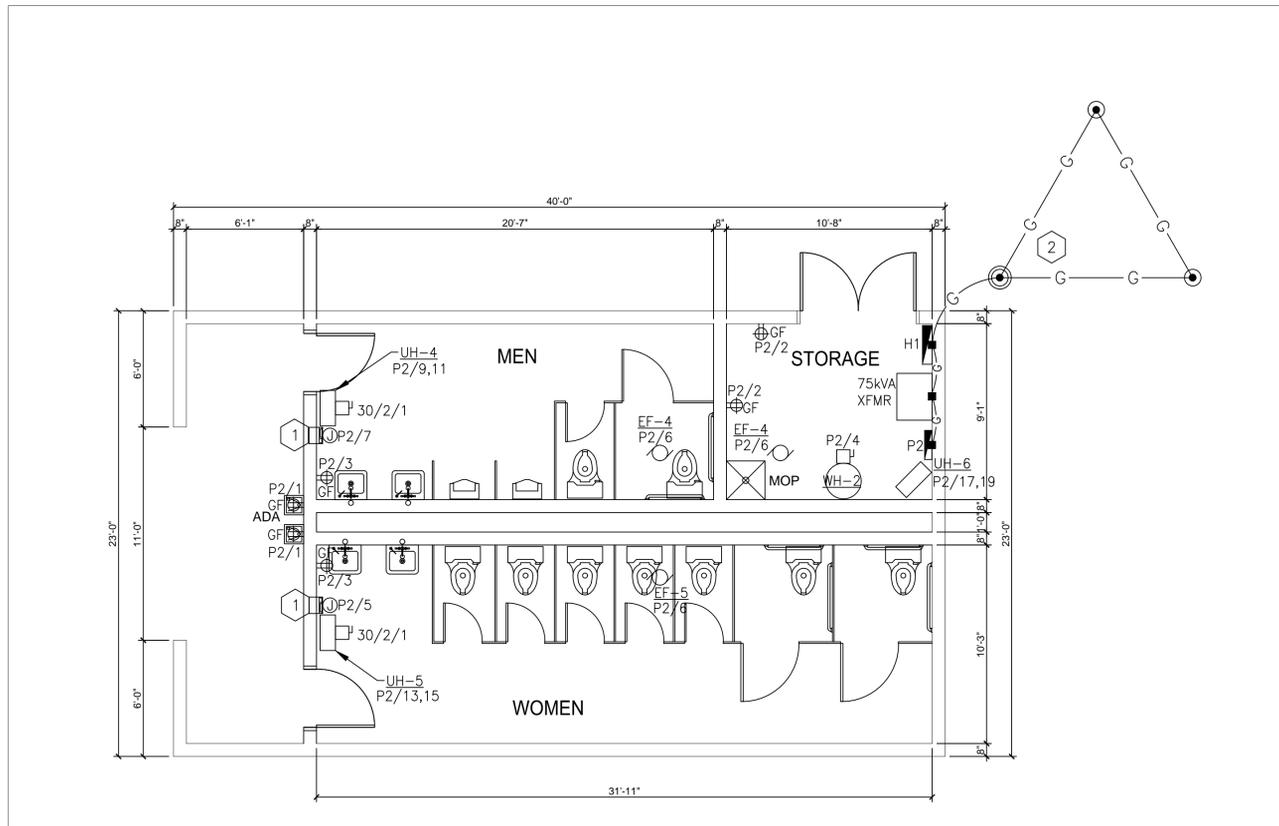
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SHEET TITLE:
**REC. CENTER BLDG.
ELECTRICAL
POWER PLAN**
SHEET NUMBER:
E102



E1 RESTROOMS ELECTRICAL LIGHTING PLAN
SCALE: 1/4"=1'-0"

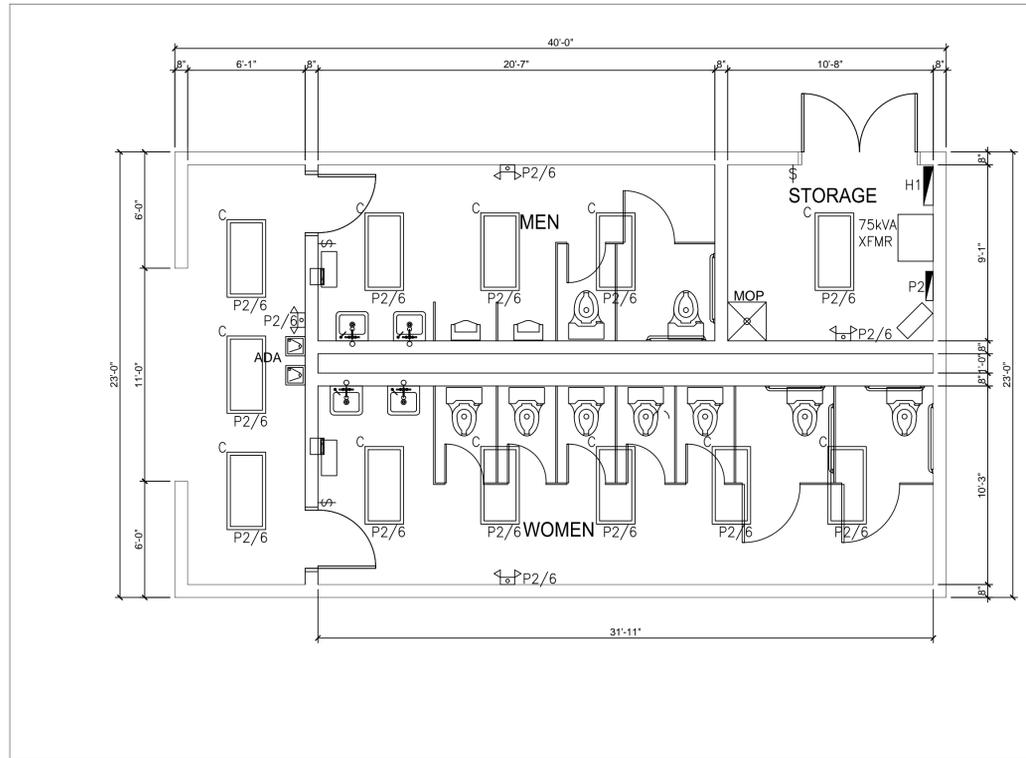

E1 RESTROOMS ELECTRICAL POWER PLAN
SCALE: 1/4"=1'-0"

GENERAL NOTES:

1. REFER TO DRAWING E001 FOR ELECTRICAL GENERAL NOTES, LEGENDS, & ABBREVIATIONS.
2. REFER TO DRAWING E501 FOR ELECTRICAL SCHEDULES.

KEYED NOTES:

- 1 HAND DRYER.
- 2 CONTRACTOR SHALL INSTALL GROUNDING TRIAD AND CONNECT NEW POWER PANEL & DISCONNECT SWITCH TO GROUND.



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City of Hanahan
Hanahan, South Carolina



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SHEET TITLE:
**RESTROOM BLDG.
ELECTRICAL
PLAN**
SHEET NUMBER:
E103


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GENERAL NOTES:


- REFER TO DRAWING E001 FOR ELECTRICAL GENERAL NOTES, LEGENDS, & ABBREVIATIONS.
- REFER TO DRAWING E501 FOR ELECTRICAL LIGHTING SCHEDULE.
- ALL SWITCHES ARE TO BE INSTALLED IN NEMA 3R WEATHERPROOF ENCLOSURE.

KEYED NOTES:

- SWITCHES FOR CEILING FAN POWER. TWO (2) FANS PER SWITCH.
- SWITCHES FOR PAVILION LIGHTS.

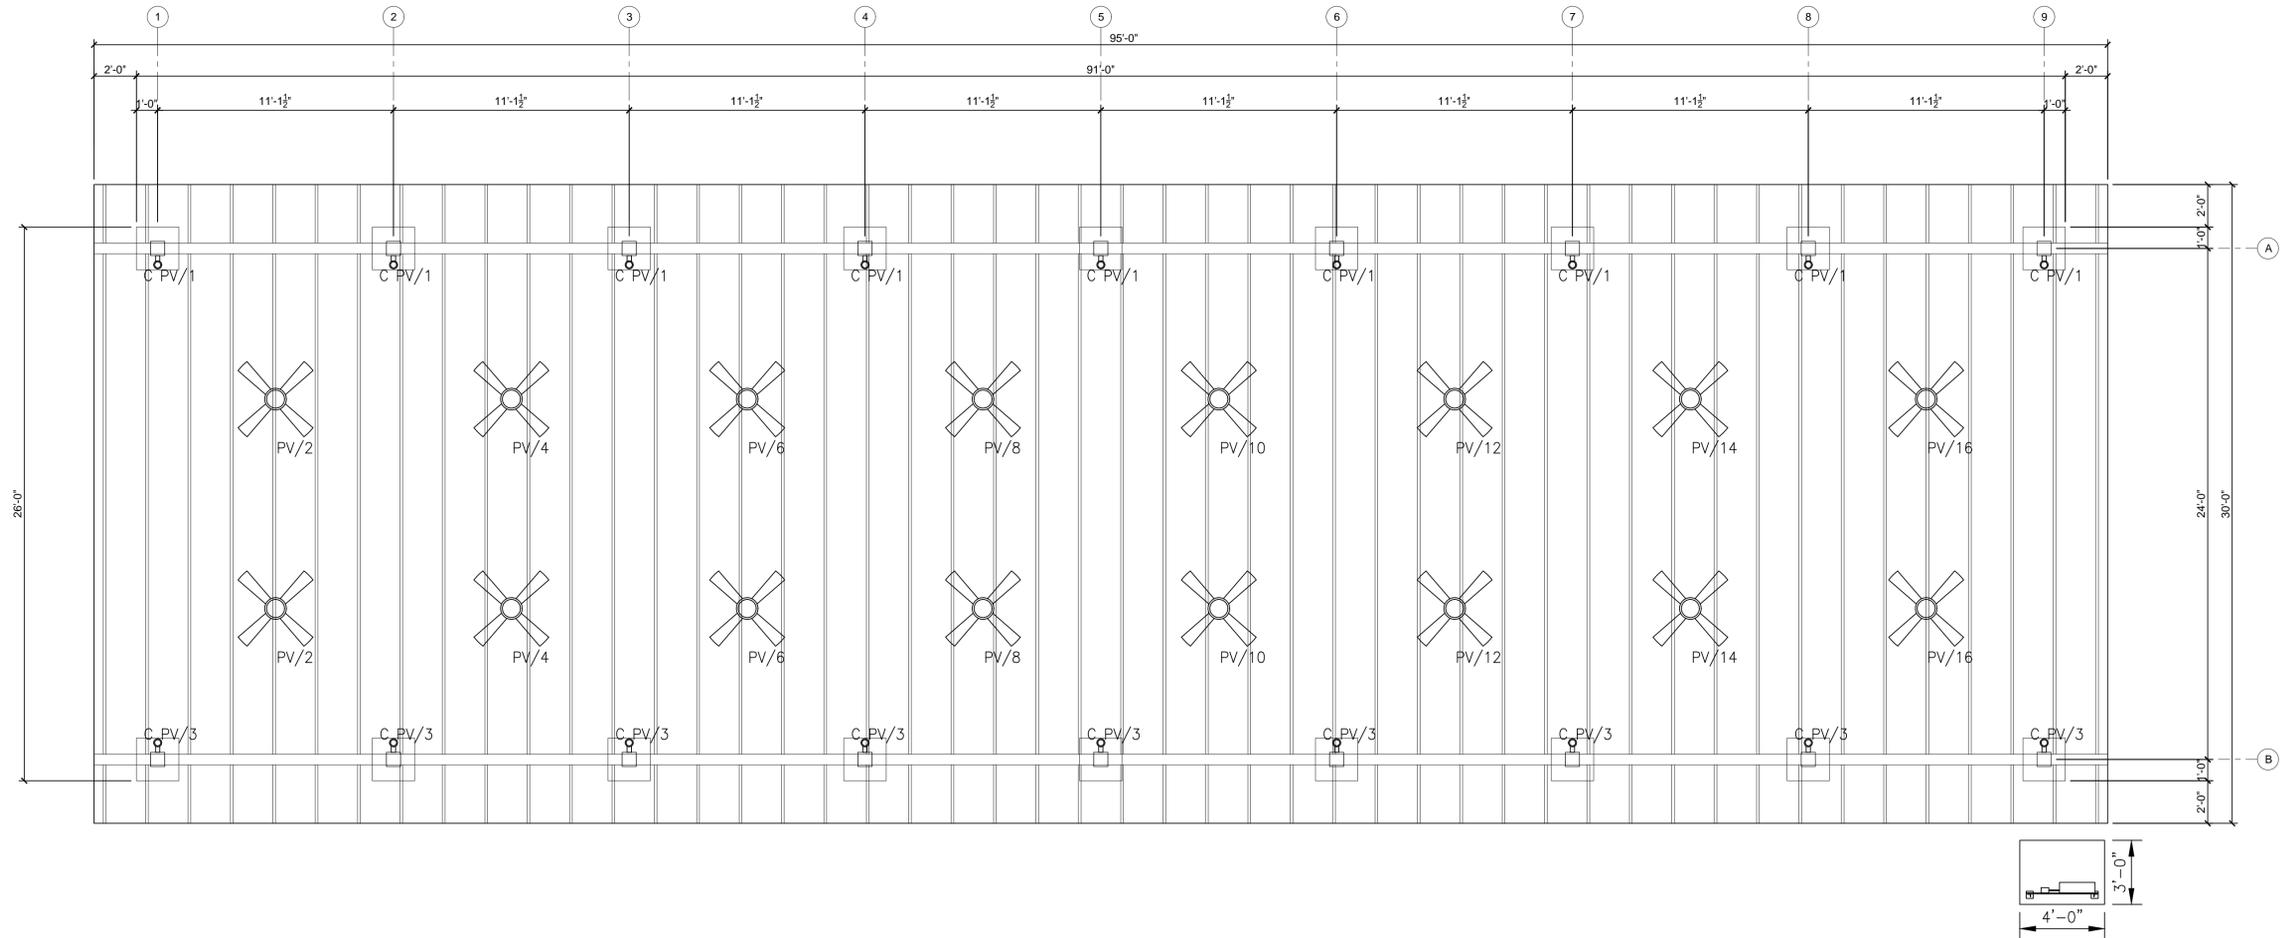

E1 PAVILION ELECTRICAL PLAN
SCALE: 1/4"=1'-0"

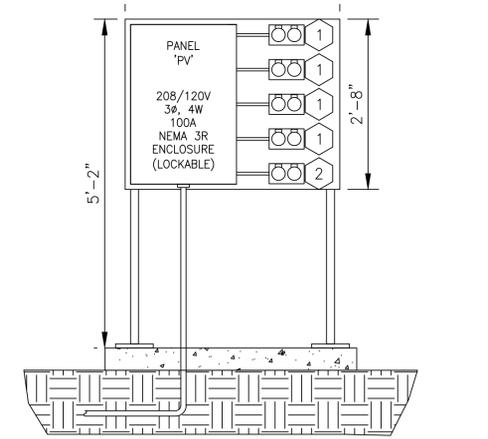

E1 PAVILION ELECTRICAL EQUIPMENT LAYOUT
SCALE: 3/4"=1'-0"

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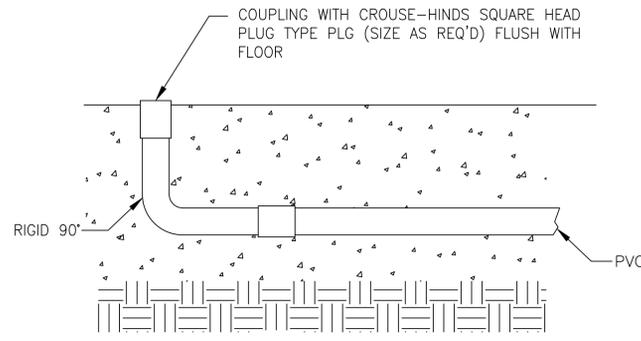


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0	03.11.2021	BID SET

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SHEET TITLE:
PAVILION ELECTRICAL PLAN
SHEET NUMBER:
E104




TYPICAL CONDUIT CONNECTION
1 **DETAIL**
 E501 N.T.S.

- NOTES:**
- TMGB - TELECOMMUNICATIONS MAIN GROUNDING BUS.
 - GB - INTERSYSTEM BONDING TERMINAL.
 - BC - BONDING CONDUCTOR.
 - MBJ - MAIN BONDING JUMPER
 - EGB - EQUIPMENT GROUNDING BUS
 - MS - MAIN SERVICE EQUIPMENT
 - CT - CT / METERING CABINET (IF APPLICABLE)


- NOTES:**
- ① SIZE PER NEC 250.66.
 - ② PROVIDE GROUNDING/BONDING SYSTEM CONNECTIONS TO MAIN ELECTRICAL SERVICE AT THE LOCATION OF THE THE MAIN SERVICE DISCONNECT.

BC CONDUCTOR SIZE

≤ 25' - #4 CU
≤ 50' - #1 CU
≤ 75' - #2/0 CU
> 75' - #3/0 CU

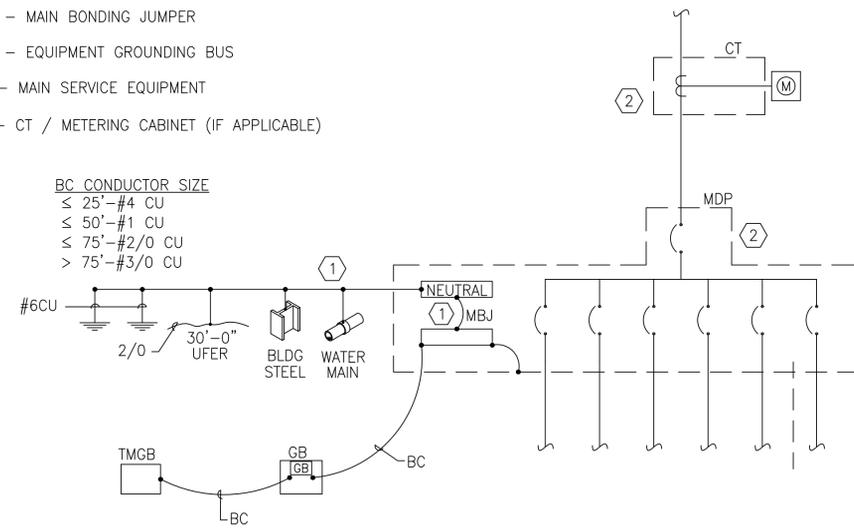


TYPICAL ELECTRICAL SERVICE GROUNDING/BONDING
2 **DETAIL**
 E5-01 N.T.S.

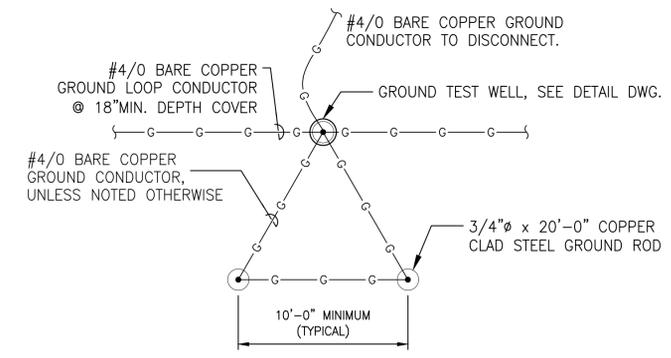


GROUNDING TRIAD
3 **DETAIL**
 E5-01 N.T.S.

LIGHTING FIXTURE SCHEDULE

SYMBOL	DESCRIPTION	MANUFACTURER	CATALOG NUMBER	VOLTAGE	LAMPS	FIXTURE WATTAGE	NOTES
A	RECESSED	LITHONIA LIGHTING	BLC 2X4 4000LM 80CRI 35K ADSN MIN10 ZT	120V	LED	36W	2X4 TROFFER
B	SURFACE MOUNTED	LITHONIA LIGHTING	2BLTX4 40L ADP EZ1 LP840	120V	LED	34W	2X4 TROFFER
C	WALL MOUNT	CONTECH LIGHTING	CY3T 3 40K W X WF BZ RD	120V	LED	20W	UP/DOWN LIGHT
D	WALL MOUNT	DUAL LITE	PG Z	120V	LED	3W	CONNECTED TO BATTERY BACK-UP
-	-	-	-	-	-	-	-

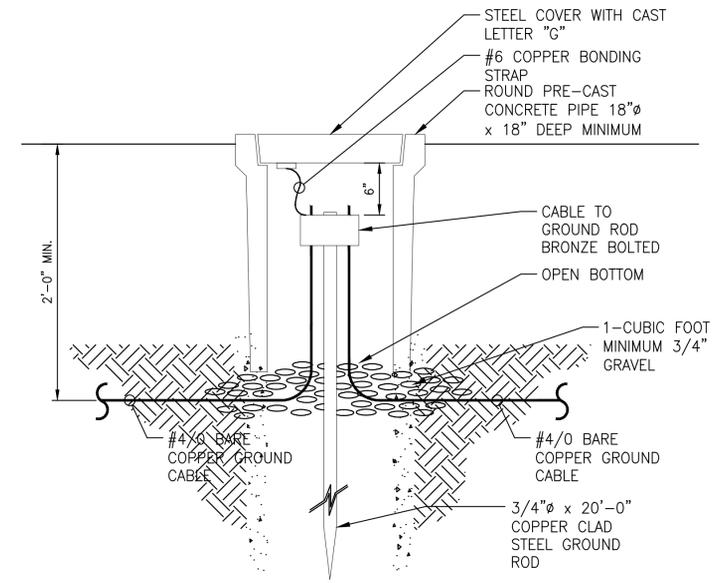

GROUNDING TEST WELL, TRAFFICE RATED
4 **DETAIL**
 E5-01 N.T.S.

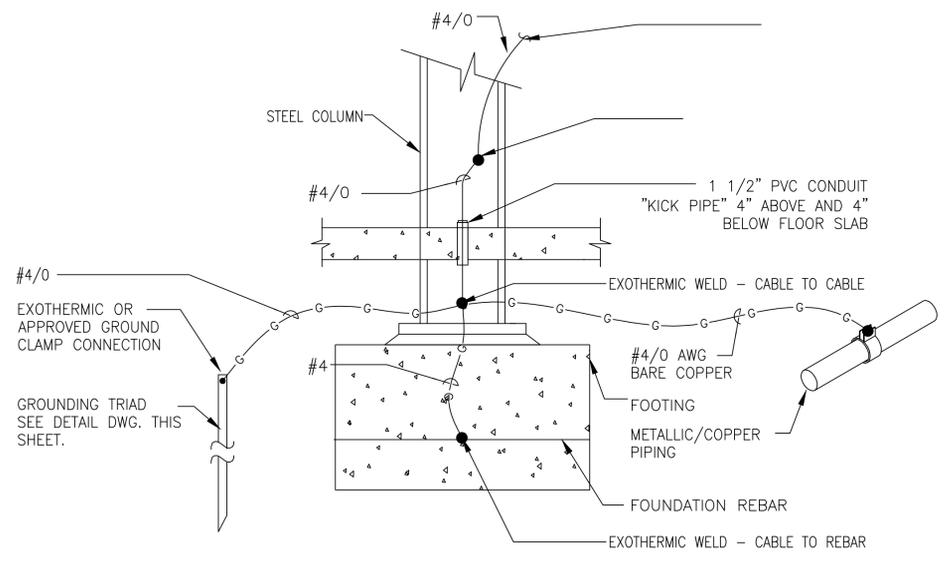

TYPICAL GROUNDING CONNECTION AT BUILDING STEEL
5 **DETAIL**
 E5-01 N.T.S.

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SHEET TITLE:
ELECTRICAL DETAILS, & SCHEDULES
 SHEET NUMBER:
E501

PANEL NAME:		H1		LOCATION:		RESTROOM STORAGE ROOM															
VOLTAGE:		480 480/277V - 3PH 4W		AIC:		22,000															
AMP RATING:		400A		FEEDER CONDUCTOR SIZE:		SEE SINGLE LINE DIAGRAM															
MLO / MAIN BREAKER:		400A MCB		FED FROM:		UTILITY															
LOAD NAME	WIRE SIZE	CONDUIT SIZE	BREAKER SIZE	POLES	CIRCUIT NUMBER	DEMAND FACTOR	LOAD TYPE	PHASE A LOAD (VA)	PHASE A LOAD (VA)	PHASE B LOAD (VA)	PHASE B LOAD (VA)	PHASE C LOAD (VA)	PHASE C LOAD (VA)	LOAD TYPE	DEMAND FACTOR	CIRCUIT NUMBER	POLES	BREAKER SIZE	CONDUIT SIZE	WIRE SIZE	LOAD NAME
SPARE			20	3	1	1.00	C							C	1.00	2		125	1-1/4"	3#2, #6G	75KVA TRANSFORMER (PANEL P2)
					3	1.00	C							C	1.00	4					
					5	1.00	C							C	1.00	6					
SPARE			50	3	7	1.00	C							C	1.00	8					
					9	1.00	C							C	1.00	10					
					11	1.00	C							C	1.00	12					
SPARE			30	3	13	1.00	C							C	1.00	14					
					15	1.00	C							C	1.00	16					
					17	1.00	C							C	1.00	18					
SPARE			20	1	19	1.00	C							C	1.00	20					
SPARE			20	1	21	1.00	C							C	1.00	22					
SPARE			20	1	23	1.00	C							C	1.00	24					
SPACE					25	1.00	C							C	1.00	26					
SPACE					27	1.00	C							C	1.00	28					
SPACE					29	1.00	C							C	1.00	30					
CONNECTED LOAD PER PHASE								0	0	0	CONNECTED AMPS AT 480V								0.0		
TOTAL CONNECTED LOAD VA								0									0.0				
DEMAND LOAD PER PHASE								0	0	0	CONNECTED AMPS AT 208V								81.0		
TOTAL DEMAND LOAD VA								0									0.0				
DIVERSITY								1.0	CONNECTED AMPS AT 480V								0.0				
DEMAND VOLT AMP (VA) CONTINUOUS								0	DEMAND AMPS AT 208V								81.0				
DEMAND AMPS CONTINUOUS								0.0													
DEMAND VOLT AMP (VA) NON-CONTINUOUS								0	CONNECTED AMPS AT 208V								81.0				
DEMAND AMPS NON-CONTINUOUS								0.0	DEMAND FEEDER AMPS = [(1.25 X CONTINUOUS) + NON-CONTINUOUS]												

PANEL NAME:		P1 RECREATION CENTER		LOCATION:		STORAGE ROOM																
VOLTAGE:		208 208/120V - 3PH 4W		AIC:		14,000																
AMP RATING:		400A		FEEDER CONDUCTOR SIZE:		SEE SINGLE LINE DIAGRAM																
MLO / MAIN BREAKER:		400A MCB		FED FROM:		UTILITY TRANSFORMER #2																
LOAD NAME	WIRE SIZE	CONDUIT SIZE	BREAKER SIZE	POLES	CIRCUIT NUMBER	DEMAND FACTOR	LOAD TYPE	PHASE A LOAD (VA)	PHASE A LOAD (VA)	PHASE B LOAD (VA)	PHASE B LOAD (VA)	PHASE C LOAD (VA)	PHASE C LOAD (VA)	LOAD TYPE	DEMAND FACTOR	CIRCUIT NUMBER	POLES	BREAKER SIZE	CONDUIT SIZE	WIRE SIZE	LOAD NAME	
WATER COOLER	2#12, #12G	1/2"	20	1	1	1.00	N	600	180					N	1.00	2		20	1/2"	2#12, #12G	RECEPTACLE - CONCESSIONS	
MENS ROOM HAND DRYER	2#12, #12G	1/2"	20	1	3	1.00	N			1400	360			N	1.00	4		20	1/2"	2#12, #12G	RECEPTACLE - CONCESSIONS	
WOMENS ROOM HAND DRYER	2#12, #12G	1/2"	20	1	5	1.00	N					1400	180	N	1.00	6		20	1/2"	2#12, #12G	RECEPTACLE - KITCHEN	
MENS & WOMENS ROOM RECEPTACLES - EXTERIOR	2#12, #12G	1/2"	20	1	7	1.00	N	900	180					N	1.00	8		20	1/2"	2#12, #12G	RECEPTACLE - KITCHEN	
WATER COOLER	2#12, #12G	1/2"	20	1	9	1.00	N			600	360			N	1.00	10		20	1/2"	2#12, #12G	RECEPTACLE - MULTI-PURPOSE AREA	
RECEPTACLES - OFFICE 107	2#12, #12G	1/2"	20	1	11	1.00	N						360	N	1.00	12		20	1/2"	2#12, #12G	RECEPTACLE - MULTI-PURPOSE AREA	
RECEPTACLES - OFFICE 108, HALLWAY	2#12, #12G	1/2"	20	1	13	1.00	N	900	360					N	1.00	14		20	1/2"	2#12, #12G	RECEPTACLE - MULTI-PURPOSE AREA	
RECEPTACLES - STORAGE LOBBY	2#12, #12G	1/2"	20	1	15	1.00	N			540	540			N	1.00	16		20	1/2"	2#12, #12G	RECEPTACLE - MULTI-PURPOSE AREA	
MENS ROOM HAND DRYER	2#12, #12G	1/2"	20	1	17	1.00	N					1400	1500	C	1.00	18						HP-1
WOMENS ROOM HAND DRYER	2#12, #12G	1/2"	20	1	19	1.00	N	1400	1500					C	1.00	20		2	25	3/4"	2#10, #10G	HP-1
SPARE			20	1	21	1.00	N			0	2521			C	1.00	22						
AHU-1	2#8, #10G	3/4"	40	2	23	1.00	N					4056	2521	C	1.00	24		3	35	3/4"	3#6, #10G	HP-2
					25	1.00	N	4056	2521					C	1.00	26						
					27	1.00	N			3482	2521			C	1.00	28						
AHU-2	3#10, #10G	3/4"	30	3	29	1.00	N					3482	2521	C	1.00	30		3	35	3/4"	3#6, #10G	HP-3
					31	1.00	N	3482	2521					C	1.00	32						
					33	1.00	N			3482	2250			N	1.00	34		2	25	3/4"	2#10, #10G	WH-1
					35	1.00	N					3482	2250	N	1.00	36						
					37	1.00	N	3482	1500					C	1.00	38						
LIGHTS - OFFICES, KITCHEN, RESTRMS	2#12, #12G	1/2"	20	1	39	1.00	C			900	1500			C	1.00	40						
LIGHTS - MULTI-PURPOSE AREA	2#12, #12G	1/2"	20	1	41	1.00	C					700	1500	C	1.00	42						
PORCH FANS	2#12, #12G	1/2"	20	1	43	1.00	N	1800	1500					C	1.00	44						
PORCH FANS	2#12, #12G	1/2"	20	1	45	1.00	N			1800	1500			C	1.00	46						
PORCH FANS	2#12, #12G	1/2"	20	1	47	1.00	N					1800	1500	C	1.00	48						
SPARE			20	1	49	1.00	N			180				N	1.00	50		1	20	1/2"	2#12, #12G	RECEPTACLE - CONCESSIONS
SPARE			20	1	51	1.00	N				180			N	1.00	52		1	20	1/2"	2#12, #12G	RECEPTACLE - CONCESSIONS
SPARE			20	1	53	1.00	C						180	N	1.00	54		1	20	1/2"	2#12, #12G	RECEPTACLE - KITCHEN
SPARE			20	1	55	1.00	C			180				N	1.00	56		1	20	1/2"	2#12, #12G	RECEPTACLE - KITCHEN
SPARE			20	1	57	1.00	C				360			N	1.00	58		1	20	1/2"	2#12, #12G	RECEPTACLE - KITCHEN
SPARE			20	1	59	1.00	C							N	1.00	60		1	20	1/2"	2#12, #12G	FIRE ALARM CONTROL UNIT
CONNECTED LOAD PER PHASE								27302	24296	28892	CONNECTED AMPS AT 208V								223.4			
TOTAL CONNECTED LOAD VA								80490									223.4					
DEMAND LOAD PER PHASE								27302	24296	28892	CONNECTED AMPS AT 208V								223.4			
TOTAL DEMAND LOAD VA								80490									223.4					
DIVERSITY								1.0	CONNECTED AMPS AT 208V								223.4					
DEMAND VOLT AMP (VA) CONTINUOUS								28846	DEMAND AMPS AT 208V								223.4					
DEMAND AMPS CONTINUOUS								80.1														
DEMAND VOLT AMP (VA) NON-CONTINUOUS								51844	CONNECTED AMPS AT 208V								223.4					
DEMAND AMPS NON-CONTINUOUS								143.3	DEMAND FEEDER AMPS = [(1.25 X CONTINUOUS) + NON-CONTINUOUS]													

PANEL NAME:		P2 RESTROOM		LOCATION:		RESTROOM STORAGE ROOM																
VOLTAGE:		208 208/120V - 3PH 4W		AIC:		14,000																
AMP RATING:		250A		FEEDER CONDUCTOR SIZE:		SEE SINGLE LINE DIAGRAM																
MLO / MAIN BREAKER:		250A MLO		FED FROM:		H1 VIA XFMR T-P																
LOAD NAME	WIRE SIZE	CONDUIT SIZE	BREAKER SIZE	POLES	CIRCUIT NUMBER	DEMAND FACTOR	LOAD TYPE	PHASE A LOAD (VA)	PHASE A LOAD (VA)	PHASE B LOAD (VA)	PHASE B LOAD (VA)	PHASE C LOAD (VA)	PHASE C LOAD (VA)	LOAD TYPE	DEMAND FACTOR	CIRCUIT NUMBER	POLES	BREAKER SIZE	CONDUIT SIZE	WIRE SIZE	LOAD NAME	
WATER COOLER	2#12, #12G	1/2"	20	1	1	1.00	N	600	360					N	1.00	2		20	1/2"	2#12, #12G	RECEPTACLE - STORAGE	
WOMENS & MENS RECEPTACLES	2#12, #12G	1/2"	20	1	3	1.00	N			360	1500			N	1.00	4		20	1/2"	2#12, #12G	WH-2	
WOMENS ROOM HAND DRYER	2#12, #12G	1/2"	20	1	5	1.00	N					1400	600	C	1.00	6		20	1/2"	2#12, #12G	LIGHTS	
MENS ROOM HAND DRYER	2#12, #12G	1/2"	20	1	7	1.00	N	1400						N	1.00	8		20	1/2"	2#12, #12G	SMOKE DETECTORS	
UH-4	2#12, #12G	1/2"	20	2	9	1.00	C			1500				N	1.00	10						SPARE
					11	1.00	C					1500		N	1.00	12						SPARE
UH-5	2#12, #12G	1/2"	20	2	13	1.00	C	1500						N	1.00	14						SPARE
					15	1.00	C			1500				N	1.00	16						SPARE
UH-6	2#12, #12G	1/2"	20	2	17	1.00	C					1100		N	1.00	18						SPARE
					19	1.00	C	1100						N	1.00	20						SPACE
SPARE			20	1	21	1.00	N							N	1.00	22						SPACE
SPARE			20	1	23	1.00	N							N	1.00	24						SPACE
SPARE					25	1.00	N			5580				N	1.00	26						
SPARE					27	1.00																

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FAULT CURRENT CALCULATION

PER NEC 110.24, LIVE OAK CONSULTANTS HAS PERFORMED A FAULT CURRENT CALCULATION ON THIS PROJECT. CALCULATION IS BASED ON THE FOLLOWING:

ESTIMATED 300 KVA PAD-MOUNTED (UTILITY PROVIDED) TRANSFORMER WITH A SECONDARY VOLTAGE OF 208/120, SINGLE-PHASE, THREE-WIRE. ASSUMED IMPEDANCE IS 5%.

THE ESTIMATED 300 KVA TRANSFORMER IS LOCATED APPROXIMATELY 65' AWAY FROM THE METER BASE MOUNTED ON THE BUILDING.


SERVICE ENTRANCE CONDUCTORS ARE COMPRISED OF TWO SETS OF 4#3/0 COPPER CONDUCTORS OR EQUAL.

BASED ON THE ABOVE DESIGN AND ASSUMPTIONS, WE CALCULATE THE MAXIMUM FAULT CURRENT AT THE SERVICE EQUIPMENT TO BE 16,154 AMPS AT THE METER BASE MOUNTED ON THE BUILDING.

THE ELECTRICAL GEAR SHALL BE RATED FOR 22,000 AMPS OF FAULT CURRENT.

CONTRACTOR SHALL PROVIDE A FIELD MARKING OF SUFFICIENT DURABILITY AND IS SUBJECT TO AUTHORITY HAVING JURISDICTION'S APPROVAL LOCATED AT THE EXTERIOR DISCONNECT SWITCH (SERVICE EQUIPMENT). MARKING SHALL READ AS FOLLOWS:

"MAXIMUM AVAILABLE FAULT CURRENT 16,154 AMPS, CALCULATED 03/01/2021"

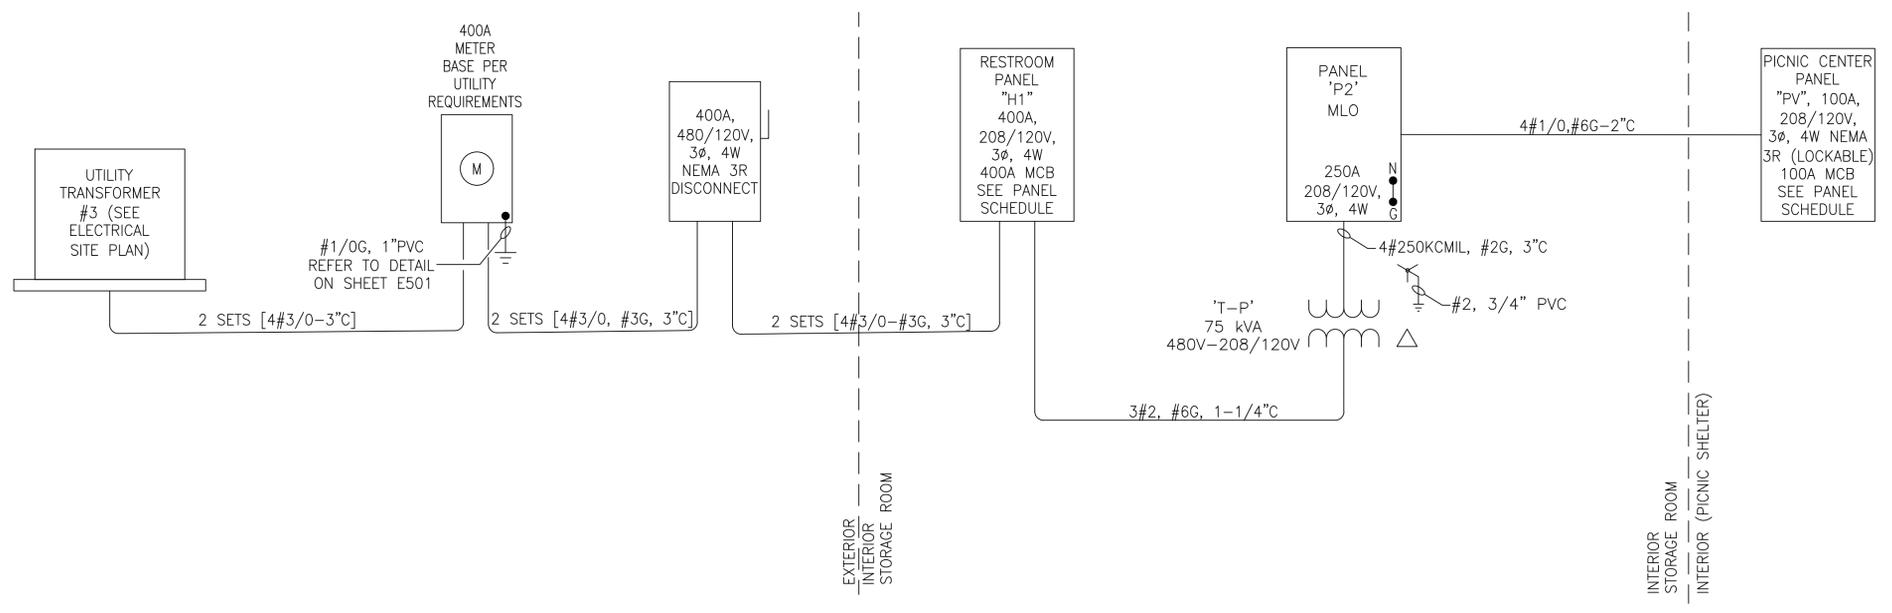

SINGLE LINE DIAGRAM
RESTROOM & PICNIC SHELTER
 SCALE: N.T.S.

FAULT CURRENT CALCULATION

PER NEC 110.24, LIVE OAK CONSULTANTS HAS PERFORMED A FAULT CURRENT CALCULATION ON THIS PROJECT. CALCULATION IS BASED ON THE FOLLOWING:

ESTIMATED 112.5 KVA PAD-MOUNTED (UTILITY PROVIDED) TRANSFORMER WITH A SECONDARY VOLTAGE OF 208/120, SINGLE-PHASE, THREE-WIRE. ASSUMED IMPEDANCE IS 5%.

THE ESTIMATED 112.5 KVA TRANSFORMER IS LOCATED APPROXIMATELY 65' AWAY FROM THE METER BASE MOUNTED ON THE BUILDING.


SERVICE ENTRANCE CONDUCTORS ARE COMPRISED OF TWO SETS OF 4#3/0 COPPER CONDUCTORS OR EQUAL.

BASED ON THE ABOVE DESIGN AND ASSUMPTIONS, WE CALCULATE THE MAXIMUM FAULT CURRENT AT THE SERVICE EQUIPMENT TO BE 10,644 AMPS AT THE METER BASE MOUNTED ON THE BUILDING.

THE ELECTRICAL GEAR SHALL BE RATED FOR 14,000 AMPS OF FAULT CURRENT.

CONTRACTOR SHALL PROVIDE A FIELD MARKING OF SUFFICIENT DURABILITY AND IS SUBJECT TO AUTHORITY HAVING JURISDICTION'S APPROVAL LOCATED AT THE EXTERIOR DISCONNECT SWITCH (SERVICE EQUIPMENT). MARKING SHALL READ AS FOLLOWS:

"MAXIMUM AVAILABLE FAULT CURRENT 10,644 AMPS, CALCULATED 03/01/2021"

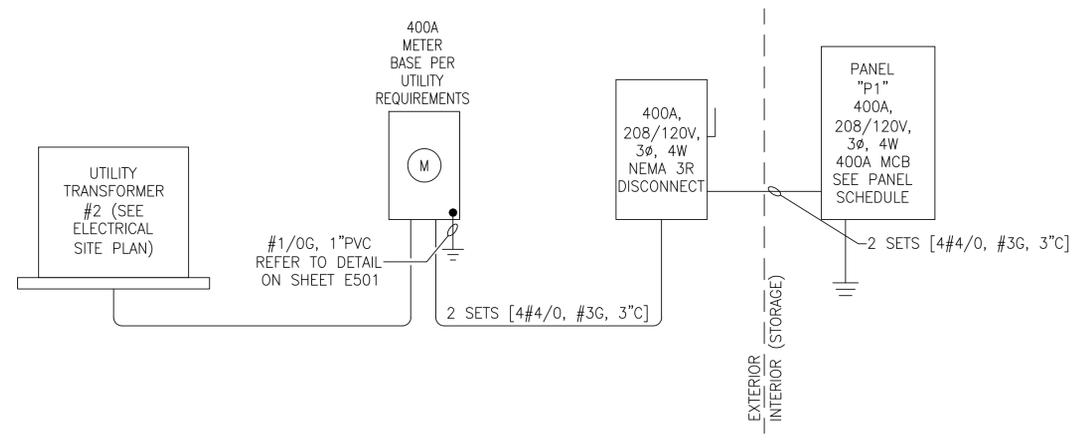

SINGLE LINE DIAGRAM
RECREATION CENTER
 SCALE: N.T.S.




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New Recreation Building for:
HANAHAN CITY PARK
 City of Hanahan
 Hanahan, South Carolina



BID SET

Rev.	Date	Description
0	03.11.2021	BID SET

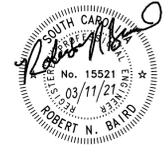DRAWN BY: D. GRANGER
 CHECKED BY: R. BAIRD
 PROJECT NUMBER: 19006
 DATE: 02.24.2021

SHEET TITLE:
ELECTRICAL SINGLE LINE DIAGRAM
 SHEET NUMBER:
E701

FIRE ALARM AND SMOKE DETECTION SYSTEM SPECIFICATIONS:

PART 1 GENERAL

1.1 REFERENCES:

2013 NFPA 72—NATIONAL FIRE ALARM CODE

2012 INTERNATIONAL BUILDING CODE

NFPA 90A STANDARD FOR THE INSTALLATION OF AIR CONDITIONING AND VENTILATING SYSTEMS

STATE AND LOCAL CODES

1.2 QUALIFICATIONS OF INSTALLER: INDIVIDUAL WITH THREE OR MORE YEARS RECENT EXPERIENCE IN THE INSTALLATION OF SMOKE DETECTION AND FIRE ALARM SYSTEMS. INSTALLER SHALL BE UL CERTIFIED. FIRE ALARM SYSTEM SHALL BE UL CERTIFICATED.

1.3 SUBMITTALS:

1.3.1 MAKE SUBMITTALS UNDER PROVISIONS OF THIS SECTION.

1.3.2 SUBMITTALS ARE REQUIRED FOR:

- A. FIRE ALARM AND SMOKE DETECTION SYSTEM
- B. MANUFACTURER'S STATEMENT OF COMPLIANCE
- C. AUTHORIZED DISTRIBUTOR AND SERVICE FACILITY
- D. MANUFACTURER'S CERTIFICATION
- E. OPERATING AND MAINTENANCE MANUAL

1.3.3 PROVIDE PRODUCT DATA SHEETS WHICH SHOW EQUIPMENT RATINGS, FEATURES, DIMENSIONS, AND FINISHES.

1.3.4 PROVIDE SHOP DRAWINGS WHICH SHOW SYSTEM LAYOUT AND DEVICE INTERCONNECTIONS.

1.3.5 PROVIDE UPDATED BATTERY CALCULATION SHOWING THAT BATTERY HAS THE CAPACITY TO OPERATE SYSTEM IN STANDBY AND IN ALARM MODES FOR TIMES SPECIFIED. ADD CELLS AS NECESSARY.

1.3.6 SUBMIT MANUFACTURER'S STATEMENT OF COMPLIANCE THAT INTEGRATED SYSTEM MEETS OR EXCEEDS SPECIFIED REQUIREMENTS AND CODE REQUIREMENTS.

1.3.7 SUBMIT NAME, ADDRESS AND TELEPHONE NUMBER OF AUTHORIZED DISTRIBUTOR AND SERVICE FACILITY.

1.4 EXTRA MATERIALS: PROVIDE THREE KEYS OF EACH TYPE.

PART 2 PRODUCTS

2.1 MANUFACTURERS:

- A. EST
- B. NOTIFIER
- C. SIMPLEX
- D. SECUTRON

2.2 SUPPLIER: AUTHORIZED DISTRIBUTOR OF MANUFACTURER WITH SERVICE FACILITIES WITHIN 100 MILES OF PROJECT SITE.

2.3 SYSTEM DESCRIPTION:

2.3.1 FIRE ALARM SYSTEM: NFPA 72; AUTOMATIC INTELLIGENT ADDRESSABLE FIRE ALARM SYSTEM. INTEGRATED SYSTEM SHALL BE UL LISTED.

2.3.2 SYSTEM SUPERVISION: PROVIDE ELECTRICALLY—SUPERVISED SYSTEM, WITH SUPERVISED ALARM INITIATING AND ALARM SIGNALING CIRCUITS. OCCURRENCE OF SINGLE GROUND OR OPEN CONDITION IN INITIATING OR SIGNALING CIRCUIT PLACES CIRCUIT IN TROUBLE MODE. COMPONENT OR POWER SUPPLY FAILURE PLACES SYSTEM IN TROUBLE MODE.

2.3.3 TROUBLE SEQUENCE OF OPERATION: SYSTEM TROUBLE, INCLUDING GROUNDING OR OPEN CIRCUIT OF SUPERVISED CIRCUITS, OR POWER OR SYSTEM FAILURE CAUSES SYSTEM TO ENTER TROUBLE MODE, WHICH INCLUDES THE FOLLOWING OPERATIONS:

- A. VISUAL AND AUDIBLE TROUBLE ALARM AT CONTROL PANEL.
- B. MANUAL ACKNOWLEDGE FUNCTION AT CONTROL PANEL SILENCES AUDIBLE TROUBLE ALARM; VISUAL ALARM IS DISPLAYED UNTIL INITIATING TROUBLE IS CLEARED.
- C. TRANSMIT TROUBLE SIGNAL TO REMOTE STATION.

2.3.4 ALARM SEQUENCE OF OPERATION: ACTUATION OF MANUAL FIRE ALARM STATION OR AUTOMATIC INITIATING DEVICE CAUSES SYSTEM TO ENTER ALARM, WHICH INCLUDES THE FOLLOWING OPERATIONS:

- A. SOUND AND DISPLAY LOCAL FIRE ALARM SIGNALING DEVICES WITH NON—CODED SIGNAL.
- B. TRANSMIT NON—CODED SIGNAL TO REMOTE STATION EQUIPMENT.
- C. INDICATE LOCATION OF ALARM ON FIRE ALARM CONTROL PANEL AND ON REMOTE ANNUNCIATOR PANEL.
- D. TRANSMIT SIGNAL TO BUILDING MECHANICAL SYSTEMS TO INITIATE SHUTDOWN OF FANS AND DAMPER OPERATION.

2.3.5 DRILL SEQUENCE OF OPERATION: MANUAL DRILL FUNCTION CAUSES ALARM MODE OPERATION TO:

- A. SOUND AND DISPLAY LOCAL FIRE ALARM SIGNALING DEVICES.
- B. INDICATE LOCATION OF ALARM ON FIRE ALARM CONTROL PANEL AND ON REMOTE ANNUNCIATOR PANEL.

2.3.6 ALARM RESET: KEY—ACCESSIBLE RESET FUNCTION RESETS ALARM SYSTEM OUT OF ALARM IF ALARM INITIATING CIRCUITS HAVE CLEARED.

2.4 FIRE ALARM CONTROL PANEL:

2.4.1 CONTROL PANEL: MODULAR CONSTRUCTION. SYSTEM SHALL INCLUDE PROVISIONS FOR DETECTING AND REPORTING FAILURES OF MICROPROCESSOR CIRCUITS, MEMORY, OR SOFTWARE.

2.4.2 POWER SUPPLY: SHALL BE ADEQUATE TO POWER ALL FIRE ALARM SYSTEM DEVICES INCLUDING CONTROL PANEL MODULES, REMOTE DETECTORS, REMOTE ANNUNCIATORS, DOOR HOLDERS, RELAYS, AND ALARM SIGNALING DEVICES. INCLUDE BATTERY—OPERATED EMERGENCY POWER SUPPLY WITH CAPACITY FOR OPERATING SYSTEM IN STANDBY MODE FOR 24 HOURS FOLLOWED BY ALARM MODE FOR 5 MINUTES.

2.4.3 PROVIDE TROUBLE ACKNOWLEDGE, DRILL, AND ALARM SILENCE SWITCHES.

2.4.4 ANNUNCIATOR: PROVIDE SUPERVISED ANNUNCIATOR INCLUDING AUDIBLE AND VISUAL INDICATION OF FIRE ALARM AND AUDIBLE AND VISUAL INDICATION OF SYSTEM TROUBLE.

2.5 INITIATING DEVICES: EACH INTELLIGENT DEVICE SHALL HAVE ITS OWN ADDRESS. INFORMATION STORED IN THE ADDRESS SHALL INCLUDE DEVICE TYPE (SMOKE SENSOR, PULL STATION, ETC.), AND THE ROOM NUMBER OF THE SPACE IN WHICH IT IS LOCATED.

2.5.1 MANUAL STATION: SEMI—RECESSED MOUNTED, DOUBLE ACTION MANUAL STATION.

2.5.2 CEILING MOUNTED SMOKE DETECTOR: NFPA 72; PHOTOELECTRIC TYPE, 900 SQUARE FOOT COVERAGE MINIMUM, PLUG—IN BASE, VISUAL INDICATION THAT DETECTOR IS OPERATIONAL, SUITABLE FOR MOUNTING ON 4 INCH OUTLET BOX.

2.5.3 HEAT DETECTOR: NFPA 72; FIXED TEMPERATURE TYPE WITH NOMINAL RATING OF 135 DEGREES F, 900 SQUARE FOOT COVERAGE MINIMUM, PLUG—IN BASE, REPLACEABLE AND INTERCHANGEABLE FUSIBLE ELEMENT, SUITABLE FOR MOUNTING ON A 4—INCH OUTLET BOX.

2.5.4 DUCT TYPE SMOKE DETECTOR: NFPA 72, PHOTOELECTRIC TYPE, VISUAL INDICATION THAT DETECTOR IS OPERATIONAL, SUITABLE FOR MOUNTING ON DUCTS PROVIDED UNDER DIVISION 15. PROVIDE REMOTE INDICATOR WITH DETECTOR. REMOTE INDICATOR SHALL HAVE ALARM LED AND KEY TEST SWITCH. DETECTOR IS FURNISHED BY DIVISION 16, INSTALLED BY DIVISION 15, AND WIRED BY DIVISION 16. REMOTE INDICATOR IS FURNISHED, INSTALLED AND WIRED BY DIVISION 16.

2.6 SIGNALING DEVICES:

2.6.1 ALARM HORN: NFPA 72; SURFACE TYPE FIRE ALARM HORN. SOUND RATING: 90 DB AT 10 FEET. PROVIDE INTEGRAL STROBE LAMP AND FLASHER WITH RED LETTERED FIRE ON WHITE LENS TO MEET ADA REQUIREMENTS.

2.6.2 STROBE FLASHER: NFPA 72; SURFACE TYPE FIRE ALARM STROBE FLASHER WITH RED LETTERED FIRE ON WHITE LENS TO MEET ADA REQUIREMENTS.

2.6.3 REMOTE ANNUNCIATOR: PROVIDE SUPERVISED REMOTE ANNUNCIATOR INCLUDING AUDIBLE AND VISUAL INDICATION OF FIRE ALARM BY ZONE, AND AUDIBLE AND VISUAL INDICATION OF SYSTEM TROUBLE. INSTALL IN FLUSH WALL—MOUNTED ENCLOSURE.

2.6.4 SYNCHRONIZATION OF FLASHERS: ALL STROBE FLASHERS SHALL BE SYNCHRONIZED.

2.7 FIRE ALARM WIRE AND CABLE:

2.7.1 FIRE ALARM POWER BRANCH CIRCUITS: BUILDING WIRE IN CONDUIT AS SPECIFIED IN ELECTRICAL DRAWINGS.

2.7.2 INITIATING AND SIGNAL CIRCUITS: BUILDING WIRE IN CONDUIT AS SPECIFIED IN ELECTRICAL DRAWINGS.

PART 3 EXECUTION

3.1 INSTALLATION:

3.1.1 DEVICES ARE SHOWN GENERALLY. INSTALL SYSTEM IN ACCORDANCE WITH NFPA 72 AND MANUFACTURER'S INSTRUCTIONS. ALL FIRE ALARM SYSTEM DEVICES AND CIRCUITS SHALL BE POWERED AND SUPERVISED BY THE FIRE ALARM CONTROL PANEL.

3.1.2 INSTALL MANUAL STATION WITH OPERATING HANDLE 48 INCHES ABOVE FLOOR. INSTALL AUDIBLE AND VISUAL SIGNAL DEVICES 12 INCHES BELOW CEILING BUT NO HIGHER THAN 80 INCHES ABOVE FINISHED FLOOR, OR AS SHOWN ON DRAWINGS.

3.1.3 USE #16 AWG MINIMUM SIZE CONDUCTORS FOR FIRE ALARM DETECTION AND SIGNAL CIRCUIT CONDUCTORS. INSTALL WIRING IN CONDUIT.

3.1.3.1 INSTALL FIRE ALARM CIRCUIT CONDUCTORS WITH COLOR CODED INSULATION, OR USE COLOR CODED TAPE AT EACH CONDUCTOR TERMINATION AND IN EACH JUNCTION BOX AS FOLLOWS:

- A. POWER BRANCH CIRCUIT CONDUCTORS: BLACK, RED, WHITE
- B. INITIATING DEVICE CIRCUIT: BLACK, RED
- C. SIGNAL DEVICE CIRCUIT: BLUE (POSITIVE), WHITE (NEGATIVE)

3.1.4 INITIATION DEVICE INSTALLATION: INITIATION DEVICES (I.E. MANUAL STATIONS, SMOKE DETECTORS AND HEAT DETECTORS) SHALL BE CONNECTED IN A MANNER THAT ENSURES ELECTRICAL SUPERVISION TO THE DEVICE. SMOKE DETECTOR BASES SHALL BE CONNECTED INTO THE CIRCUIT IN A WAY WHICH ASSURES THAT REMOVAL OF THE DETECTOR HEAD WILL CAUSE THE CIRCUIT TO OPEN.

3.1.4.1 AUTOMATIC DETECTOR INSTALLATION: NFPA 72 AND NFPA 90A. ADJUST DETECTOR LOCATIONS TO AVOID CONFLICTS WITH LIGHT FIXTURES, DIFFUSERS, ETC. AND TO COMPLY WITH NFPA AND STATE REQUIREMENTS.

A. CEILING MOUNTED DETECTORS SHALL NOT BE LOCATED IN A DIRECT AIR FLOW OR CLOSER THAN 3 FEET FROM AN AIR SUPPLY DIFFUSER.

3.1.4.2 INSTALL REMOTE INDICATOR FOR DUCT TYPE SMOKE DETECTOR IN READILY ACCESSIBLE LOCATION NEAR ASSOCIATED DETECTOR. (SEE NFPA 70 FOR DEFINITION OF READILY ACCESSIBLE. CEILINGS NOT HIGHER THAN 10 FEET IN FINISHED SPACES WILL BE CONSIDERED READILY ACCESSIBLE).

3.2 FIELD QUALITY CONTROL: TEST EACH DEVICE AND TEST INTEGRATED SYSTEM IN ACCORDANCE WITH NFPA 72 AND LOCAL FIRE DEPARTMENT REQUIREMENTS. THESE TESTS SHALL BE CONDUCTED BY A TECHNICIAN CERTIFIED BY THE MANUFACTURER.

3.3 MANUFACTURER'S FIELD SERVICES:

3.3.1 PROVIDE MANUFACTURER'S FIELD SERVICES TO INCLUDE SERVICES OF A TECHNICIAN CERTIFIED BY THE MANUFACTURER TO SUPERVISE INSTALLATION, ADJUSTMENTS, AND FINAL CONNECTIONS, AND TO CONDUCT SYSTEM AND DEVICE TESTING AS REQUIRED IN PARAGRAPH 3.2.

3.3.2 PROVIDE MANUFACTURER'S CERTIFICATION THAT THE INSTALLED SYSTEM HAS BEEN FULLY TESTED AS SPECIFIED, MEETS OR EXCEEDS SPECIFICATIONS AND CODE REQUIREMENTS, AND IS OPERATING PROPERLY.

3.4 OPERATING AND MAINTENANCE MANUAL:

3.4.1 PROVIDE TWO (2) BOUND OPERATING AND MAINTENANCE MANUALS AT PROJECT COMPLETION. MANUALS SHALL CONTAIN:

- A. NAME, ADDRESS, AND TELEPHONE NUMBER OF AUTHORIZED DISTRIBUTOR AND SERVICE FACILITY
- B. SHOP DRAWINGS
- C. PRODUCT DATA
- D. OPERATING AND MAINTENANCE INSTRUCTIONS
- E. MANUFACTURER'S WARRANTIES
- F. MANUFACTURER'S CERTIFICATIONS
- G. AS—BUILT RECORD DRAWINGS (SHOW END OF LINE DEVICES)

END OF SECTION

FIRE ALARM LEGEND:

[FACP] FIRE ALARM CONTROL PANEL

[FAA] FIRE ALARM REMOTE ANNUNCIATOR

[F<] FIRE ALARM HORN WITH STROBE FLASHER

[F+] FIRE ALARM STROBE FLASHER

[F] FIRE ALARM MANUAL PULL STATION


[S] FIRE ALARM SMOKE DETECTOR

[D] FIRE ALARM DUCT SMOKE DETECTOR

[T] FIRE ALARM TAMPER SWITCH FOR SPRINKLER, PROVIDED AS A PART OF SPRINKLER SYSTEM, (WIRED UNDER DIVISION 16)

[F<] FIRE ALARM FLOW SWITCH FOR SPRINKLER, PROVIDED AS A PART OF SPRINKLER SYSTEM, (WIRED UNDER DIVISION 16)

[D] DOOR RELEASE/HOLDER

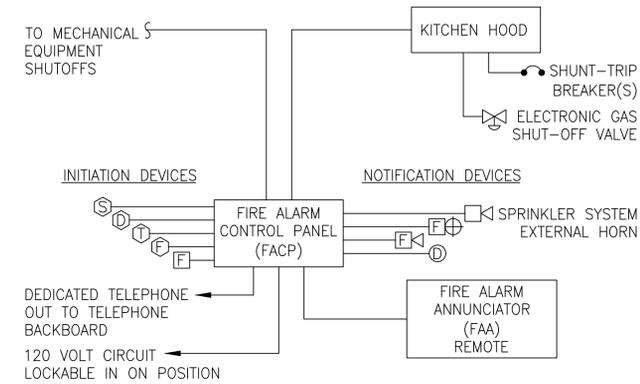

NOTES:

1. SEE FLOOR PLANS FOR NUMBER AND TYPE OF INITIATION DEVICES (I.E. SMOKE DETECTORS, HEAT DETECTORS, PULL STATIONS, ETC.).
2. SEE FLOOR PLANS FOR NUMBER AND TYPE OF NOTIFICATION DEVICES (I.E. HORNS, STROBES, ETC.).



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 Project #: 2006158

New Recreation Building for:
HANAHAN CITY PARK
 City of Hanahan
 Hanahan, South Carolina



BID SET
 Rev. 0 Date 03.11.2021 Description BID SET


DRAWN BY: D. GRANGER
 CHECKED BY: R. BAIRD
 PROJECT NUMBER: 19006
 DATE: 10.01.2020

SHEET TITLE:

FIRE ALARM SPECIFICATIONS

SHEET NUMBER:
FA001

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GENERAL NOTES:
 1. REFER TO DRAWING FA001 FOR FIRE ALARM GENERAL NOTES, LEGENDS, & ABBREVIATIONS.

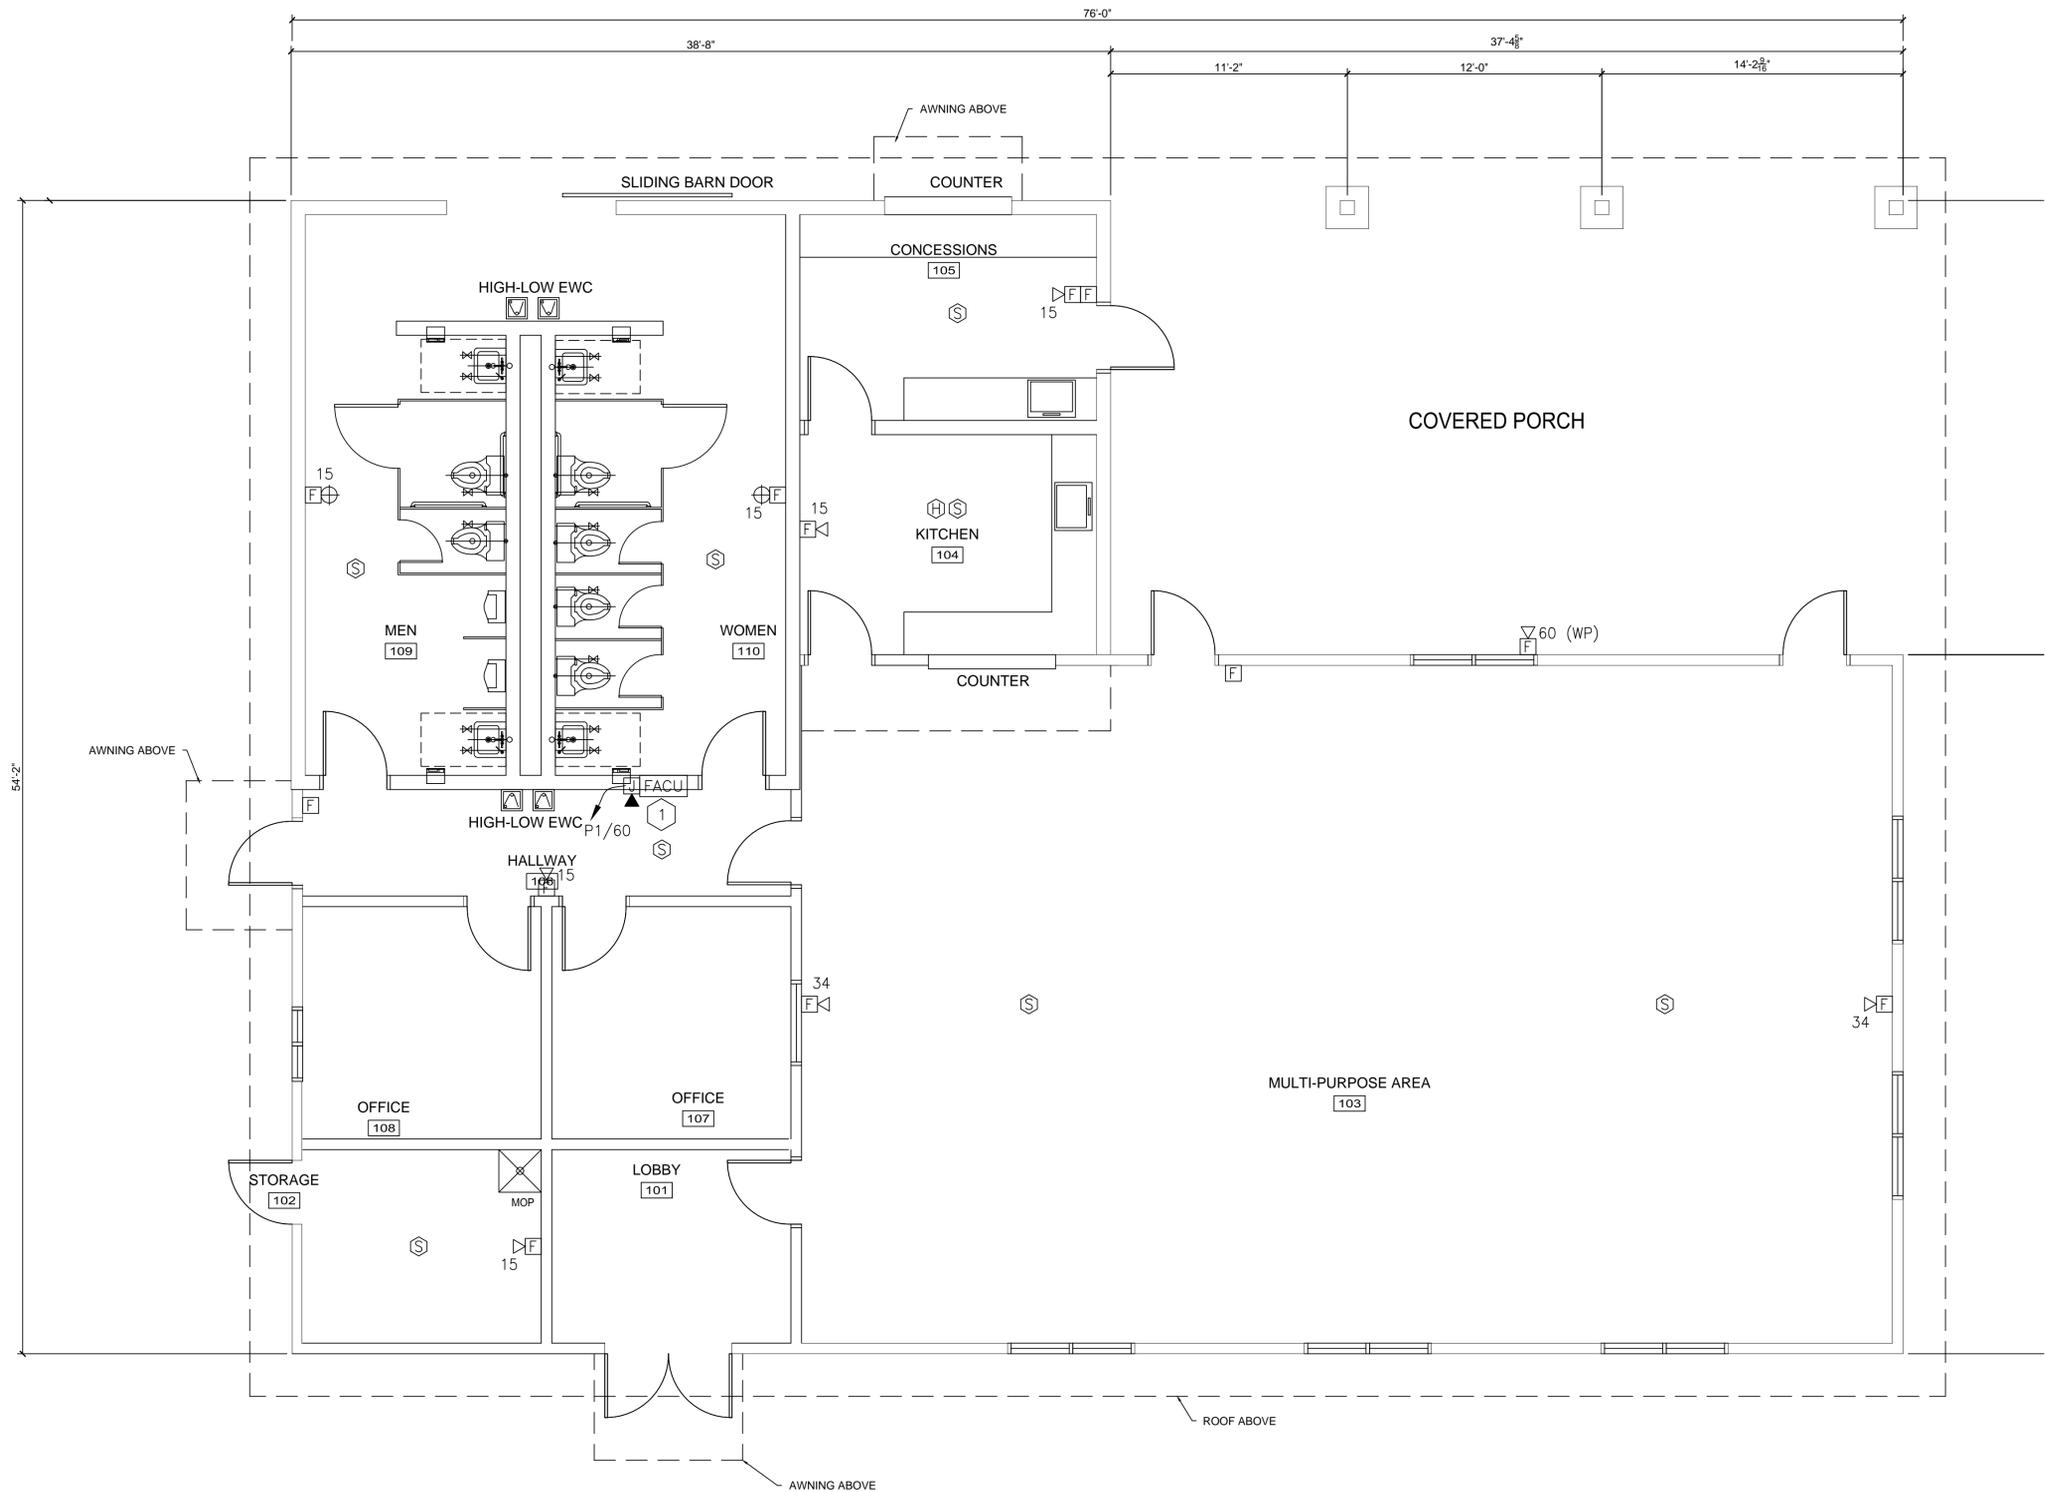KEYED NOTES:
 1 FIRE ALARM CONTROL UNIT (FACU), PROVIDE ONE (1) DEDICATED TELEPHONE LINE FOR MONITORING.

FA1 REC. CENTER FIRE ALARM PLAN
 SCALE: 1/4"=1'-0"



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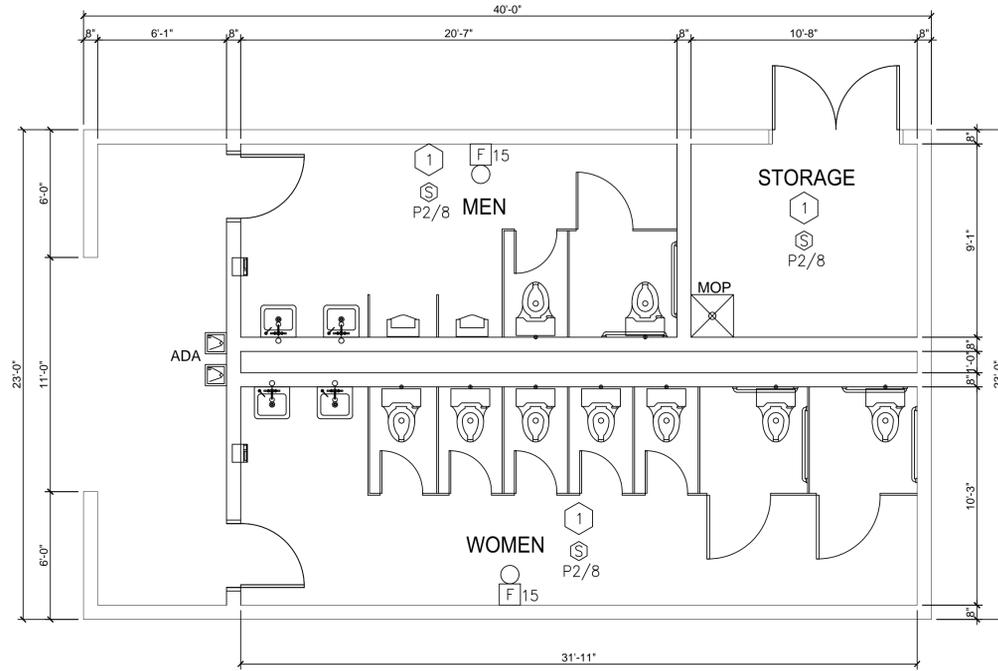
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DRAWN BY: D. GRANGER
CHECKED BY: R. BAIRD
PROJECT NUMBER: 19006
DATE: 10.01.2020

SHEET TITLE:

REC. CENTER BLDG. FIRE ALARM PLAN

SHEET NUMBER:
FA101



E1 RESTROOMS ELECTRICAL FIRE ALARM PLAN
SCALE: 1/4"=1'-0"

GENERAL NOTES:

1. REFER TO DRAWING E001 FOR ELECTRICAL GENERAL NOTES, LEGENDS, & ABBREVIATIONS.
2. REFER TO DRAWING E601 FOR ELECTRICAL SCHEDULES.

KEYED NOTES:

- 1 120V WITH BACK-UP BATTERY PHOTOELECTRIC SMOKE DETECTOR WITH LOW FREQUENCY AUDIBLE BASE, PROVIDE AUDIO/VISUAL SYSTEM SMOKE DETECTORS IN THE HEARING IMPAIRED UNITS. CONNECT IN TANDEM WHERE MORE THAN ONE IN THE SAME UNIT.



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SHEET TITLE:

RESTROOMS BLDG.
FIRE ALARM PLAN

SHEET NUMBER:

FA102