





ENGINEER
 DEPARTMENT OF ENVIRONMENTAL SERVICES
 FACILITIES & ENGINEERING DIVISION
 ENGINEERING BUREAU
 2100 CLARENDON BOULEVARD, SUITE 813
 ARLINGTON, VA 22201
 PHONE: 703.228.3629 FAX: 703.228.3606
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OWNER
 ARLINGTON COUNTY
 DES - TRANSIT BUREAU
 2100 CLARENDON BOULEVARD,
 SUITE 900 ARLINGTON, VA 22201

CONSULTANT
 TO BE DETERMINED

CONTRACTOR
 TO BE DETERMINED

LOCATION MAP

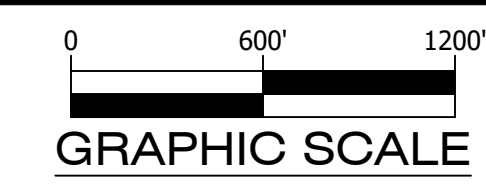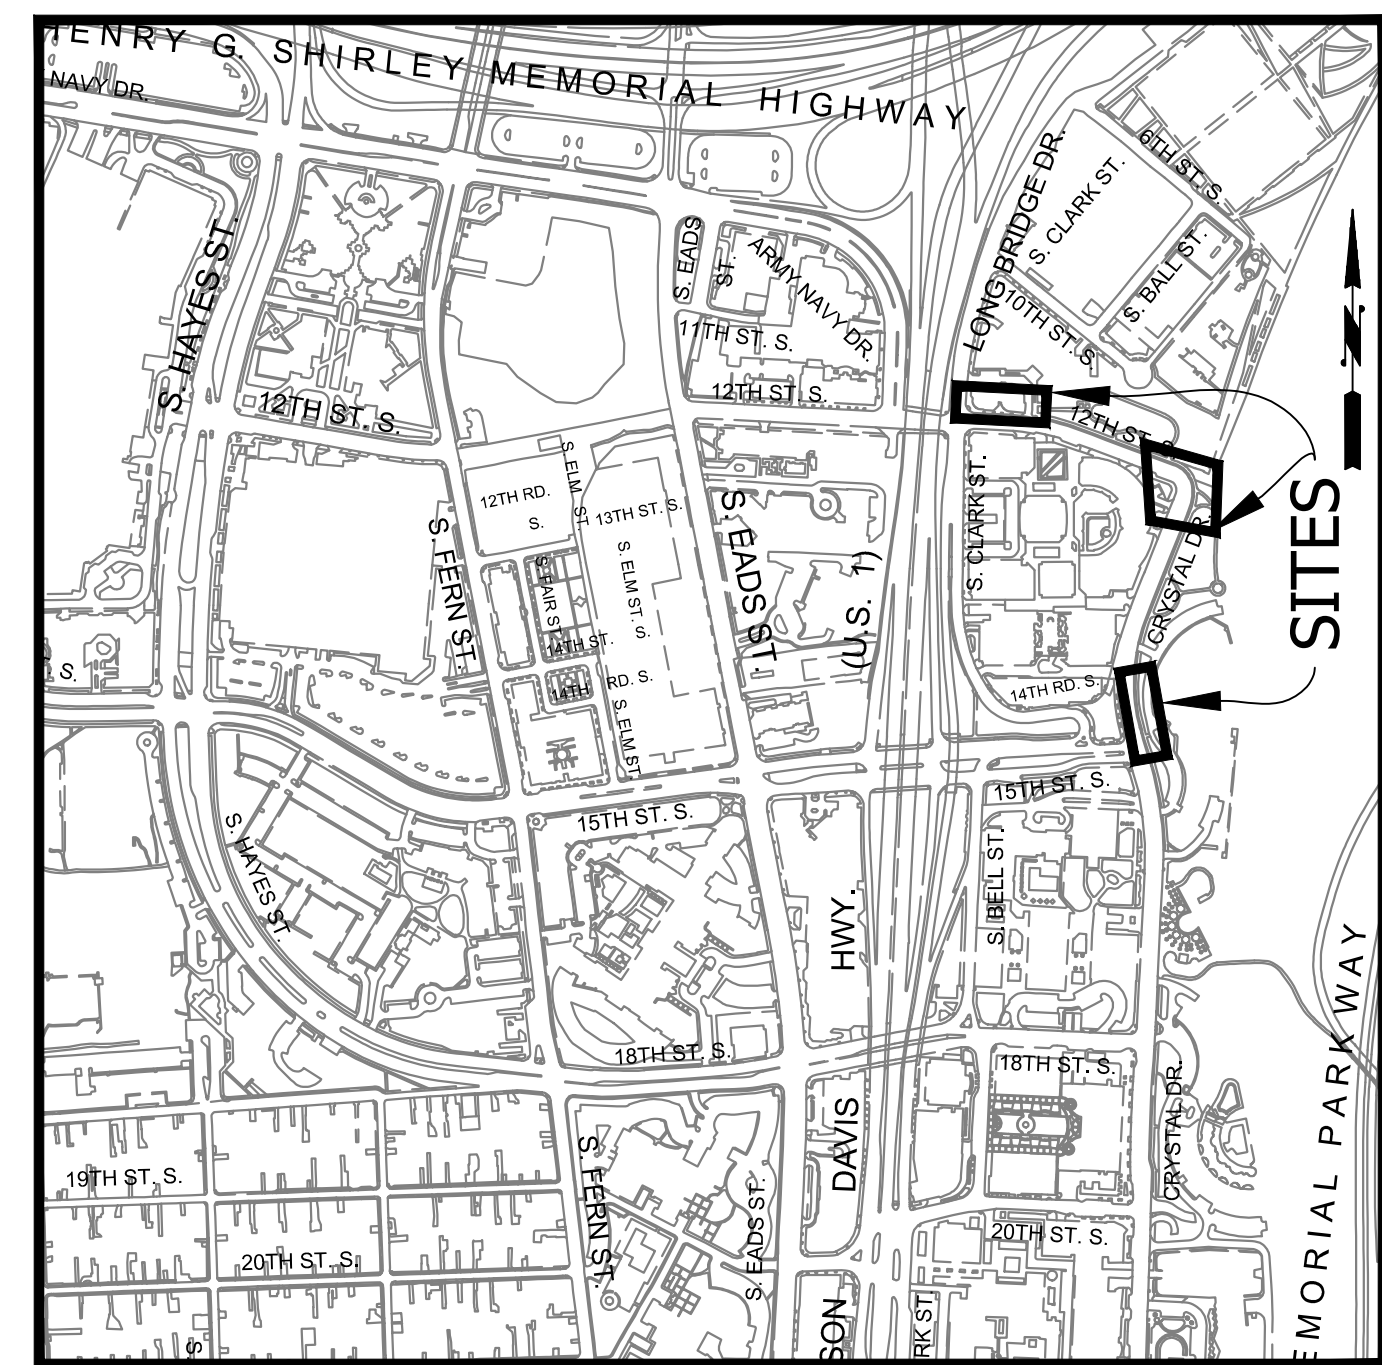

CONSTRUCTION DRAWINGS FOR: TRANSITWAY EXTENSION TO PENTAGON CITY CRYSTAL DR & 12TH ST S (CIVIL SITE WORK)

PROJECT CODE: MA13 - SEGMENT I

ARLINGTON VIRGINIA

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 FACILITIES & ENGINEERING DIVISION
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APPROVALS	DATE
<i>[Signature]</i>	3/29/21
QUALITY CONTROL ENGINEER <i>Ramal Takbar</i>	3.24.21
CONSTRUCTION MANAGEMENT SUPERVISOR <i>[Signature]</i>	03.04.2021
WATER, SEWER, STREETS BUREAU CHIEF <i>Dennis M. Leach</i>	03/17/21
TRANSPORTATION DIRECTOR <i>[Signature]</i>	3/2/21
PROJECT MANAGER	

REVISIONS DATE

GENERAL NOTES:

GENERAL CONSTRUCTION NOTES

- ALL CONSTRUCTION WORK FOR THIS PROJECT SHALL CONFORM TO THE ARLINGTON COUNTY DEPARTMENT OF ENVIRONMENTAL SERVICES, CONSTRUCTION STANDARDS AND SPECIFICATIONS, AND WHERE APPLICABLE THE VIRGINIA DEPARTMENT OF TRANSPORTATION (VDOT) ROAD AND BRIDGE SPECIFICATIONS, AND ROAD AND BRIDGE STANDARDS. THE LATEST EDITIONS OF EACH RELEVANT MANUAL SHALL BE USED.
- ALL CONSTRUCTION AND WORK ACTIVITIES SHALL COMPLY WITH THE VIRGINIA WORK AREA PROTECTION MANUAL AND ALL OTHER RELEVANT WORK SAFETY REQUIREMENTS, LATEST EDITIONS.
- THE CONTRACTOR SHALL IMMEDIATELY NOTIFY THE PROJECT OFFICER OF ANY DISCREPANCIES BETWEEN ACTUAL FIELD CONDITIONS AND THE APPROVED PLANS.
- THE CONTRACTOR SHALL CONTACT "MISS UTILITY" AT 811 FOR MARKING THE LOCATIONS OF EXISTING UNDERGROUND UTILITIES (i.e. WATER, SEWER, GAS, TELEPHONE, ELECTRIC, AND CABLE TV) AT LEAST 72 HOURS PRIOR TO ANY EXCAVATION OR CONSTRUCTION. THE CONTRACTOR IS REQUIRED TO IDENTIFY AND PROTECT ALL OTHER UTILITY LINES FOUND IN THE WORK SITE AREA BELONGING TO OTHER OWNERS THAT ARE NOT MEMBERS OF "MISS UTILITY". PRIVATE WATER, SEWER AND GAS LATERALS WILL NOT BE MARKED BY MISS UTILITY OR THE COUNTY. THE CONTRACTOR SHALL LOCATE AND PROTECT THESE SERVICES DURING CONSTRUCTION.
- THE CONTRACTOR SHALL BE RESPONSIBLE FOR LAYING OUT THE WORK AND SHALL RETAIN A PROFESSIONAL LAND SURVEYOR LICENSED IN THE COMMONWEALTH OF VIRGINIA TO PROVIDE ALL NECESSARY CONSTRUCTION LAYOUTS AND ESTABLISH ALL CONTROL LINES, GRADES, AND ELEVATION DURING CONSTRUCTION. THE CONTRACTOR SHALL SUBMIT A COPY OF ALL CUT SHEETS FOR REVIEW, PER THE SPECIFICATIONS. THE COST OF ALL NECESSARY SURVEYING SERVICES SHALL BE CONSIDERED INCIDENTAL TO THE WORK AND, UNLESS OTHERWISE SPECIFIED, THE COST SHALL BE INCORPORATED INTO THE COSTS FOR RELEVANT ITEMS.
- THE LOCATION OF ALL EXISTING UTILITIES SHOWN ON THESE PLANS ARE FROM BEST AVAILABLE RECORDS AND SHALL BE CONSIDERED TO BE APPROXIMATE. WHEN CONSTRUCTION ACTIVITY REACHES IN PROXIMITY TO EXISTING UTILITIES, THE TRENCH(ES) SHALL BE OPENED A SUFFICIENT DISTANCE AHEAD OF THE WORK OR TEST PITS SHALL BE MADE TO VERIFY THE EXACT LOCATION AND INVERTS OF THE UTILITY TO ALLOW FOR POSSIBLE CHANGES IN THE LINE OR GRADE AS DIRECTED BY OFFICER. THE CONTRACTOR SHALL BE RESPONSIBLE FOR ANY DAMAGE TO THE EXISTING UTILITIES AND THE RELATED STRUCTURES. ALL EXISTING UTILITY SYSTEMS SHALL BE PROTECTED TO PREVENT DAMAGE DURING THE CONTRACTOR'S OPERATIONS. ANY SYSTEM DAMAGED SHALL BE PROMPTLY REPAIRED AT NO COST TO THE OWNER.
- EXISTING MANHOLE FRAMES, COVERS, VALVE BOXES, AND OTHER APPURTENANCES SHALL BE ADJUSTED TO THE FINAL GRADE OR REPLACED, AS NECESSARY. UNLESS OTHERWISE SPECIFIED, THE COST FOR THIS SHALL BE CONSIDERED INCIDENTAL TO THE WORK, AND SHALL BE INCORPORATED INTO THE COSTS FOR RELEVANT ITEMS.
- THE CONTRACTOR SHALL PROVIDE ADA COMPLIANT ACCESS THROUGH OR AROUND THE SITE AT ALL TIMES AND SHALL ENSURE THE SAFETY OF ALL THOSE PASSING THROUGH OR ADJACENT TO THE SITE.
- ALL SIDEWALK AND CURB AND GUTTER DEMOLITION SHALL BEGIN AND END AT THE CONSTRUCTION JOINT NEAREST TO THE DEPICTED DEMOLITION EXTENTS WITH A NEAT SAWCUT LINE TO FULL DEPTH OF PAVEMENT SECTION.

STORMWATER AND ENVIRONMENTAL PROTECTION

- THE CONTRACTOR SHALL CONFINE ALL ACTIVITIES AT THE SITE ASSOCIATED WITH CONSTRUCTION ACTIVITIES, TO INCLUDE STORAGE OF EQUIPMENT AND OR MATERIALS, ACCESS TO THE WORK, FORMWORK, ETC. TO WITHIN THE DESIGNATED LIMITS OF DISTURBANCE (LOD).

TREE PROTECTION

- TREES SHALL BE PROTECTED PER THE REQUIREMENTS OF ARLINGTON PARKS & RECREATION STANDARD.

TRAFFIC CONTROL

- CONTRACTOR SHALL NOTIFY THE PROJECT OFFICER AT LEAST 3 WORKING DAYS PRIOR TO DISTURBING ANY EXISTING, OR INSTALLING ANY NEW, TRAFFIC SIGNS, SIGNALS, OR OTHER TRAFFIC CONTROL DEVICES.
- THE CONTRACTOR SHALL PREMARK THE LAYOUT OF ANY PERMANENT TRAFFIC CONTROL STRIPING, INDICATING THE PROPOSED LOCATION AND TYPE OF MARKING TO BE INSTALLED. THE PREMARKING MAY CONSIST OF TYPE D TAPE, CHALK, OR LUMBER CRAYONS. THE CONTRACTOR SHALL ALLOW 3 WORKING DAYS FOR THE INSPECTION AND APPROVAL OF THE PREMARKINGS PRIOR TO PLACING THE PERMANENT MARKINGS.
- THE CONTRACTOR SHALL SUBMIT ANY REQUESTS FOR TEMPORARY "NO PARKING" RESTRICTIONS TO THE PROJECT OFFICER AT LEAST 5 BUSINESS DAYS PRIOR TO THE DESIRED ONSET OF RESTRICTIONS. PRIOR TO A REQUEST FOR THE REMOVAL OF ACCESS TO ANY ADA PARKING SPACE THE CONTRACTOR MUST HAVE MADE PROVISION FOR ALTERNATIVE ADA PARKING AS INDICATED ON THE APPROVED PLAN OR AS DIRECTED BY THE PROJECT OFFICER.
- WHEN THE APPROVED PLAN CALLS FOR THE REMOVAL OF ANY PARKING METER THE CONTRACTOR MUST MAKE A REQUEST TO THE PROJECT OFFICER AT LEAST ONE WEEK IN ADVANCE OF THE DESIRED REMOVAL. THE PROJECT OFFICER WILL THEN COORDINATE THE PARKING METER REMOVAL WITH TRAFFIC ENGINEERING AND OPERATIONS.
- THE CONTRACTOR SHALL PRESERVE ALL BUS STOPS, INCLUDING MAINTAINING ADEQUATE ACCESSIBILITY THROUGH AND ADJACENT TO THE CONSTRUCTION FOR BUSES AND THEIR PASSENGERS. THE CONTRACTOR SHALL NOT CLOSE, RELOCATE, OR OTHERWISE MODIFY A BUS STOP WITHOUT PRIOR REQUEST OF THE PROJECT OFFICER. ANY RELOCATION OR CLOSURE OF A BUS STOP SHALL REQUIRE AT LEAST FOUR WEEKS ADVANCE NOTICE FOR COORDINATION WITH THE COUNTY'S BUS STOP COORDINATOR - 703-228-3049.
- WHEN CONDITIONS WARRANT DUE TO TRAFFIC VOLUMES, PATTERNS, OR SPECIAL EVENTS, THE COUNTY MAY SUSPEND OR OTHERWISE DIRECT THE CONTRACTOR'S ACTIVITIES TO PROTECT THE PUBLIC AND OR THE COUNTY'S TRANSPORTATION NETWORK.

WATER DISTRIBUTION, STORM AND SANITARY SEWER SYSTEMS

- UNLESS OTHERWISE DIRECTED, CONTRACTORS ARE EXPRESSLY PROHIBITED FROM OPERATING ANY WATER VALVES OR APPURTENANCES. CONTRACTORS SHALL SUBMIT ALL REQUESTS FOR VALVE OPERATIONS TO THE PROJECT OFFICER AT LEAST 1 WEEK IN ADVANCE OF THE REQUIRED OPERATION.
- IN THE EVENT OF A WATER OR SEWER EMERGENCY, THE CONTRACTOR SHALL IMMEDIATELY NOTIFY THE COUNTY'S WATER CONTROL CENTER AT 703-228-6555 AND THE PROJECT OFFICER.
- THE CONTRACTOR SHALL COORDINATE ALL UTILITY SHUTOFFS, DISCONNECTS, AND/OR ABANDONMENT WITH UTILITY OWNER AND PROJECT OFFICER AT LEAST 1 WEEK IN ADVANCE OF THE REQUIRED INTERRUPTION.

FIRE DEPARTMENT NOTES:

- ALL EXISTING FIRE HYDRANTS AND FIRE DEPARTMENT CONNECTIONS SHALL BE MAINTAINED UNOBSTRUCTED AND ACCESSIBLE AT ALL TIMES IN ACCORDANCE WITH SECTIONS 508.5.4 AND 508.5.5 OF THE ARLINGTON COUNTY FIRE PREVENTION CODE.
- ACCESS TO BUILDINGS FOR FIREFIGHTING SHALL BE MAINTAINED AT ALL TIMES. EXISTING FIRE APPARATUS ACCESS ROADS (FIRE LANES) SHALL BE KEPT CLEAR OF OBSTRUCTIONS IN ACCORDANCE WITH SECTION 503.4 OF THE ARLINGTON COUNTY FIRE PREVENTION CODE. ACCESS TO CONSTRUCTION SITES SHALL BE PROVIDED AND MAINTAINED IN ACCORDANCE WITH SECTION 1410 OF THE ARLINGTON COUNTY FIRE PREVENTION CODE.
- IN THE EVENT THAT EXISTING FIRE DEPARTMENT CONNECTIONS OR FIRE APPARATUS ACCESS ROADS (FIRE LANES) MUST BE OBSTRUCTED TO FACILITATE CONSTRUCTION ACTIVITIES, CONTACT THE ARLINGTON COUNTY FIRE DEPARTMENT FIRE PREVENTION OFFICE AT 703-228-4644 TO COORDINATE REVIEW AND APPROVAL OF TEMPORARY FIRE DEPARTMENT CONNECTIONS AND/OR FIRE APPARATUS ACCESS ROADS PRIOR TO CREATING THE OBSTRUCTION.

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04	SECTION DETAILS	35	TEST HOLE PIT LOGS
05	SITE DETAILS	T1	SIGNAGE AND STRIPING PLAN
06	BRASCO DETAILS	T2	SIGNAGE AND STRIPING PLAN
07	BRASCO DETAILS	T3	SIGNAGE AND STRIPING PLAN
08	BRASCO DETAILS		
09	BRASCO & FURNISHING DETAILS		
10	EXISTING CONDITIONS		
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25	UTILITY PLAN		
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SWM18-0167

ADT

15,000 VPD - 15TH ST S BETWEEN US ROUTE 1 AND CRYSTAL DR - 2018 - VDOT
 5,200 VPD - CRYSTAL DR BETWEEN 26TH ST S AND 12TH ST S - 2018 - VDOT
 5,300 VPD - 12TH ST S BETWEEN CRYSTAL DR AND 5 EADS ST - 2018 - VDOT

STREET CLASSIFICATION

MINOR ARTERIAL - CRYSTAL DR AND 15TH ST S AND 12TH ST S

POSTED SPEED


30 MPH - CRYSTAL DR (OBTAINED FROM GIS DATA)
 25 MPH - 12TH ST S (OBTAINED FROM GIS DATA)

PROJECT NAME AND LOCATION
 TRANSITWAY EXTENSION TO PENTAGON CITY
 COVER SHEET
 CRYSTAL DR & 12TH ST S
 MA13 - SEGMENT I

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 CHECKED: TL
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 PLOTTED: AUGUST 4 2021
 PLOTTED BY: NSHARP

SCALE: H: 1" = 600'

SHEET 01 OF 35

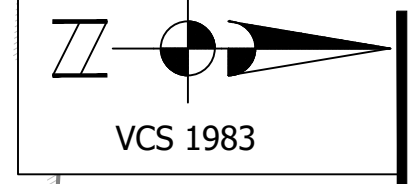

APPROVALS	DATE
<i>Kamell</i>	3/29/21
QUALITY CONTROL ENGINEER <i>Kamal Takar</i>	3.24.21
CONSTRUCTION MANAGEMENT SUPERVISOR <i>John</i>	03.04.2021
WATER, SEWER, STREETS BUREAU CHIEF <i>Dennis M. Leach</i>	03/17/21
TRANSPORTATION DIRECTOR <i>Diana Izzo</i>	3/2/21
PROJECT MANAGER	

REVISIONS	DATE

PROJECT NAME AND LOCATION
TRANSITWAY EXTENSION TO PENTAGON CITY


OVERALL PLAN
CRYSTAL DR & 12TH ST S

MA13 - SEGMENT I

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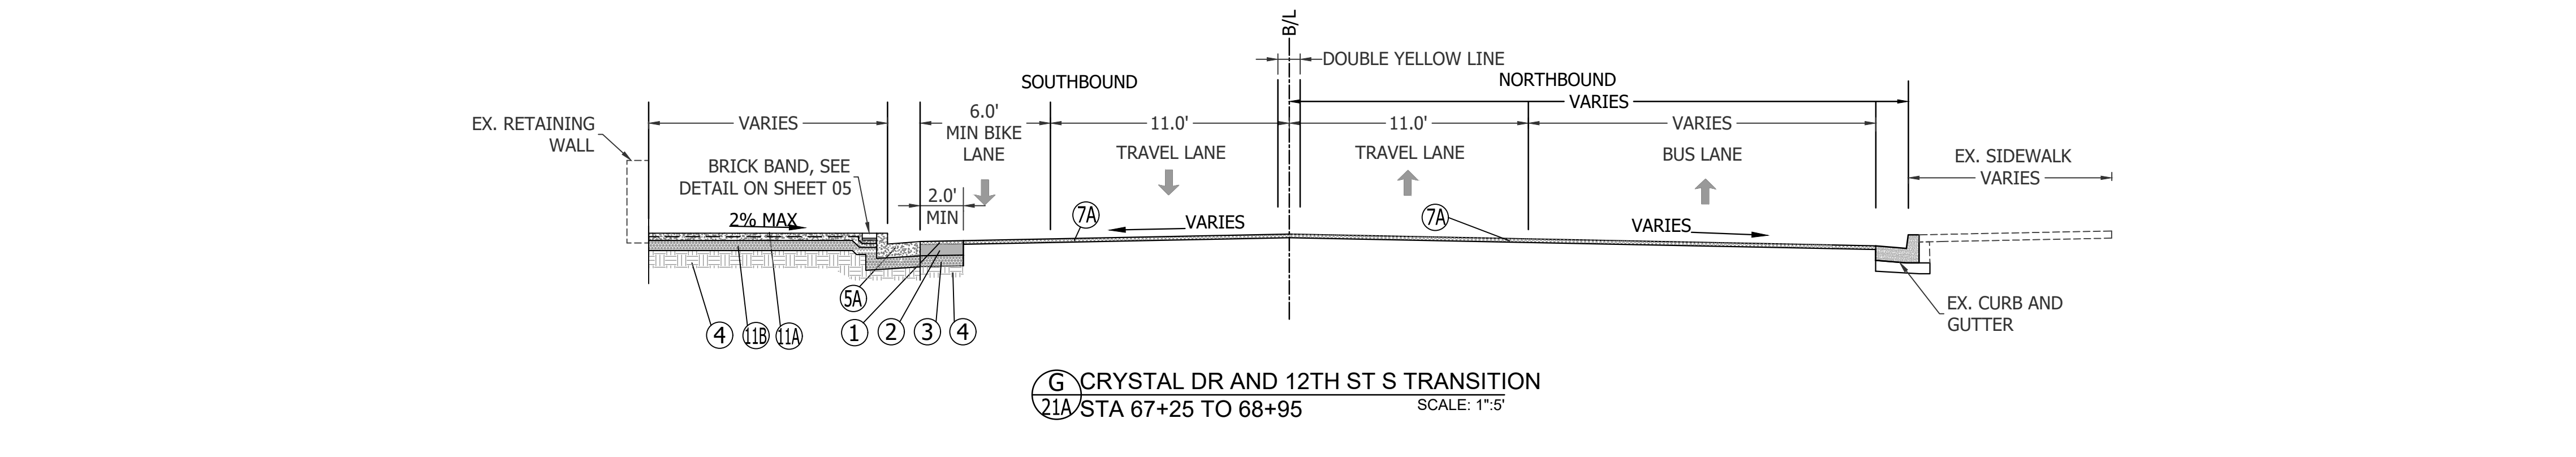
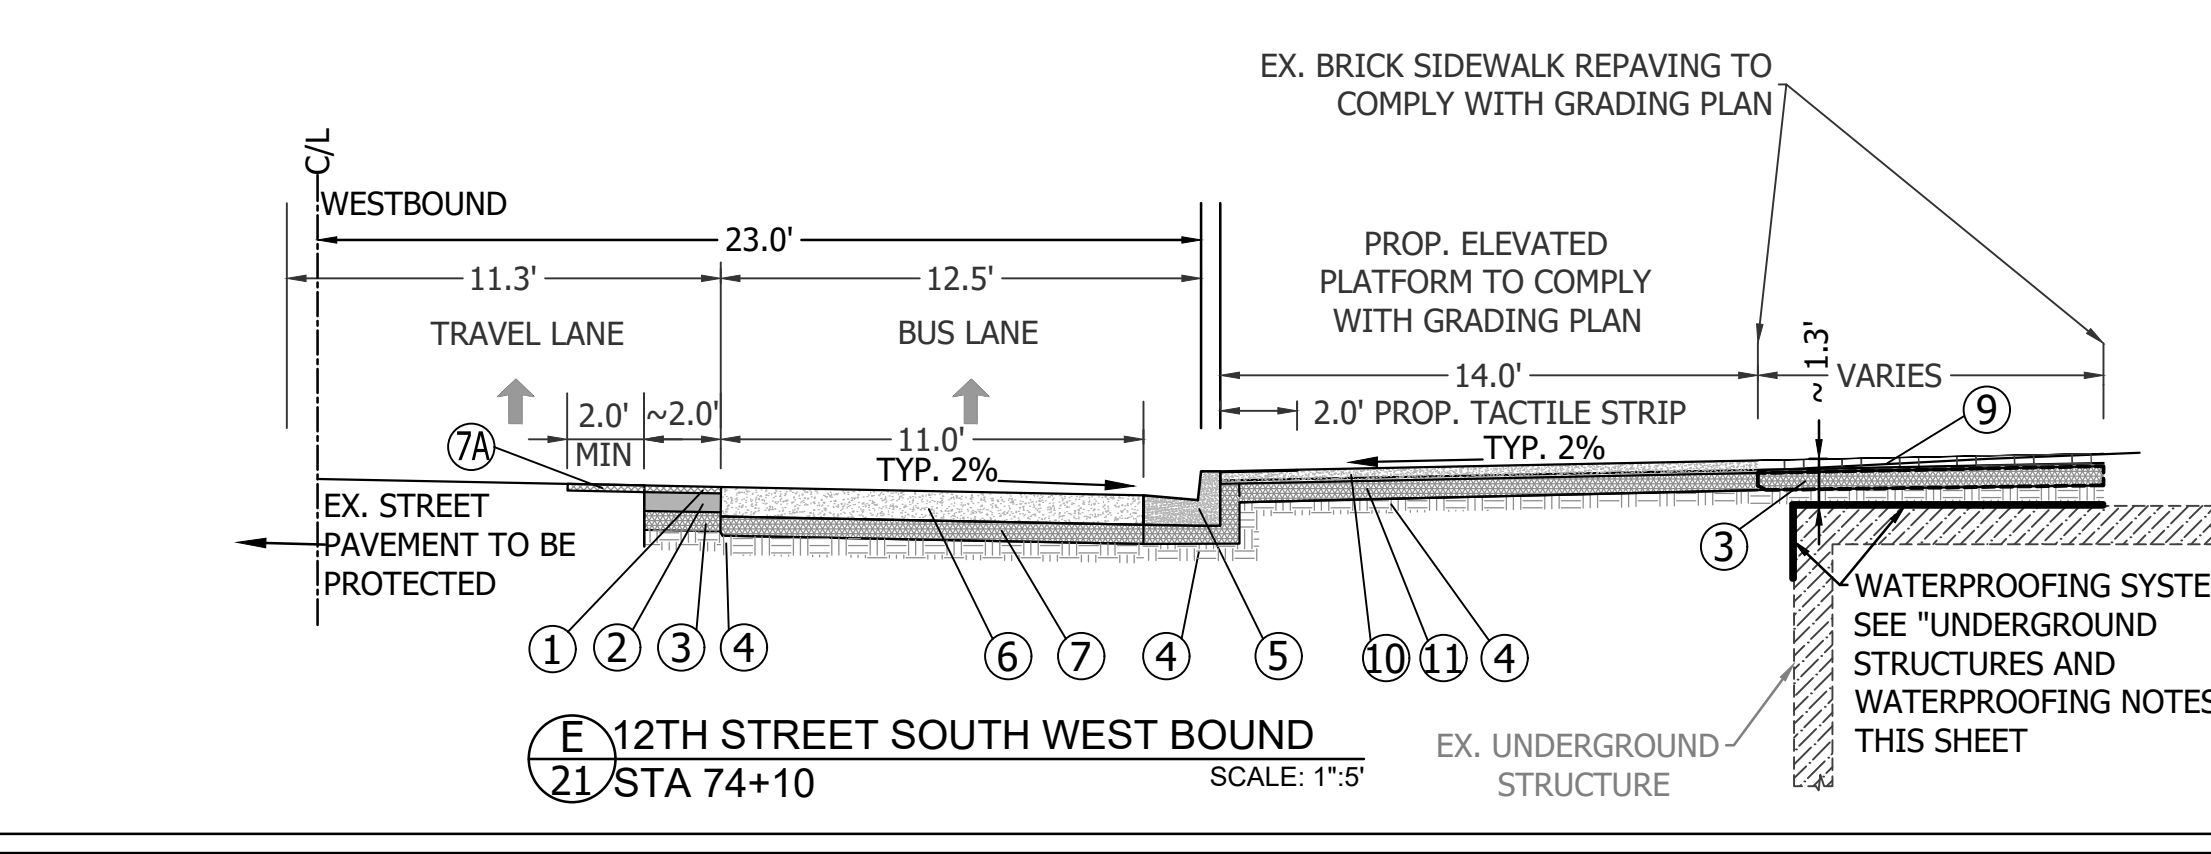
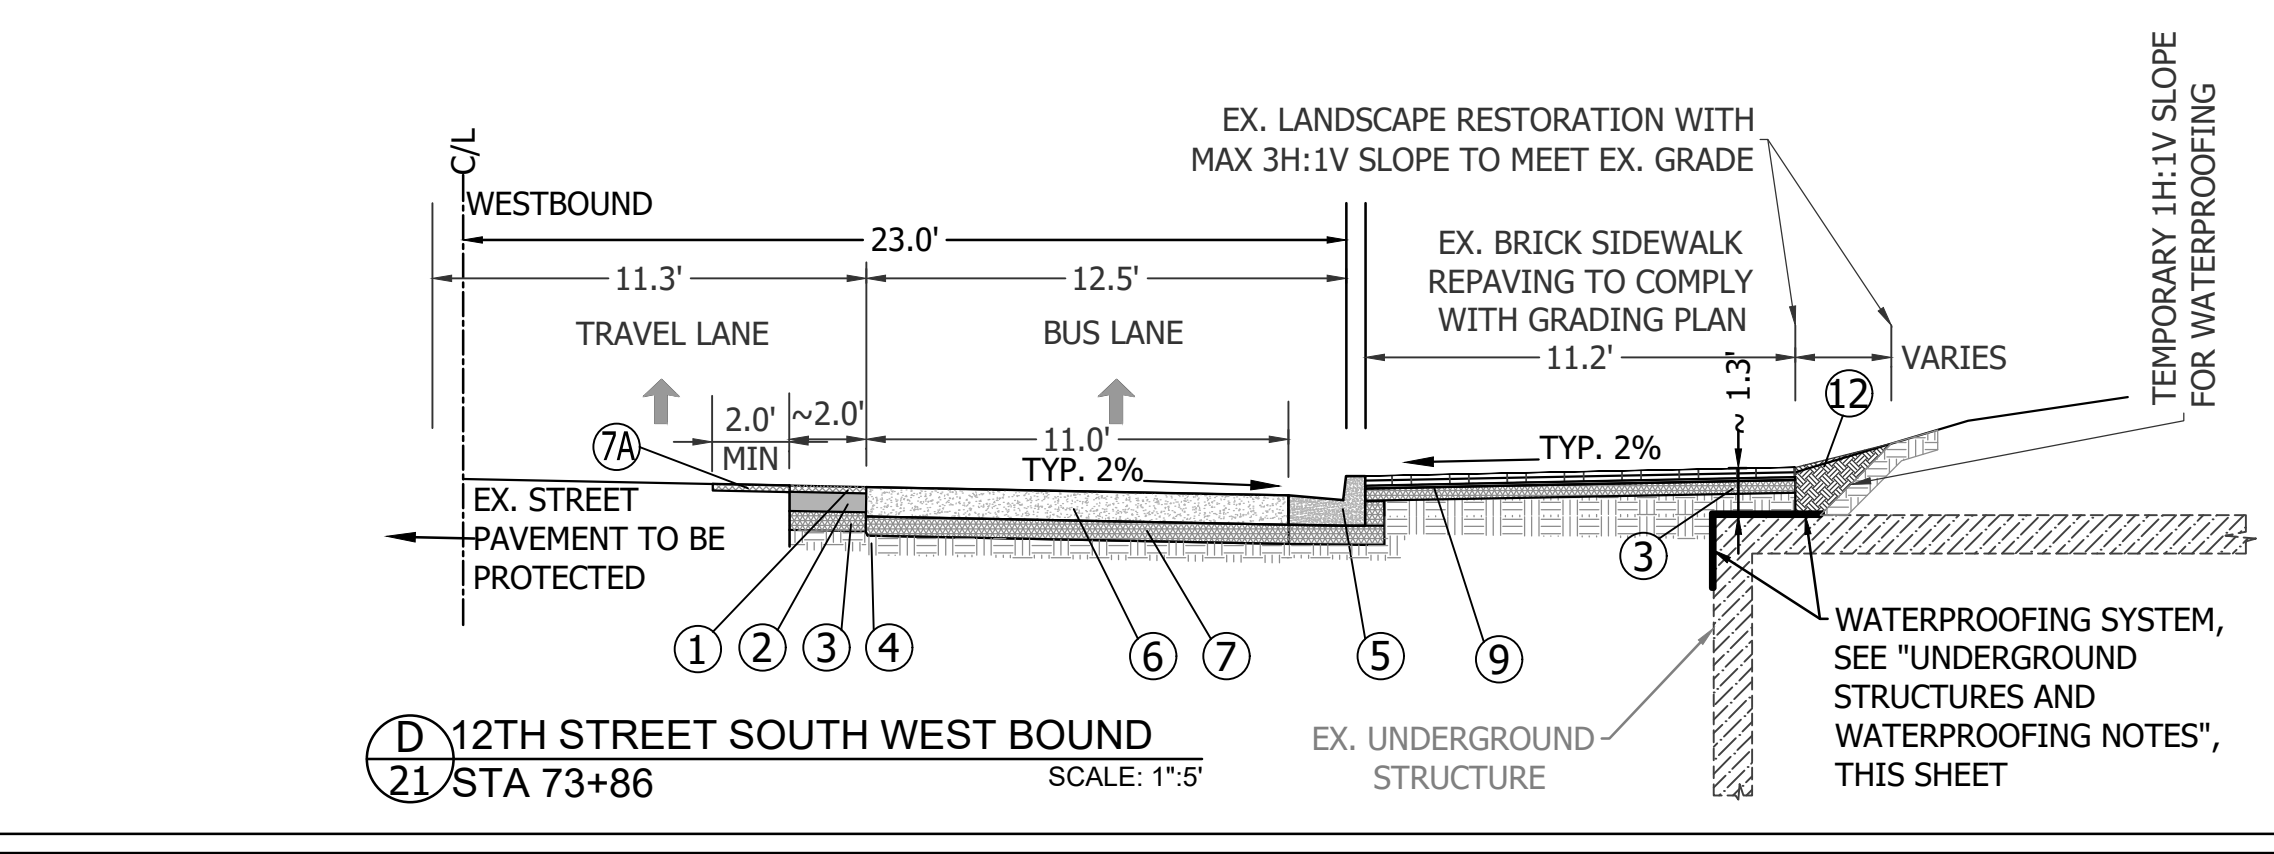
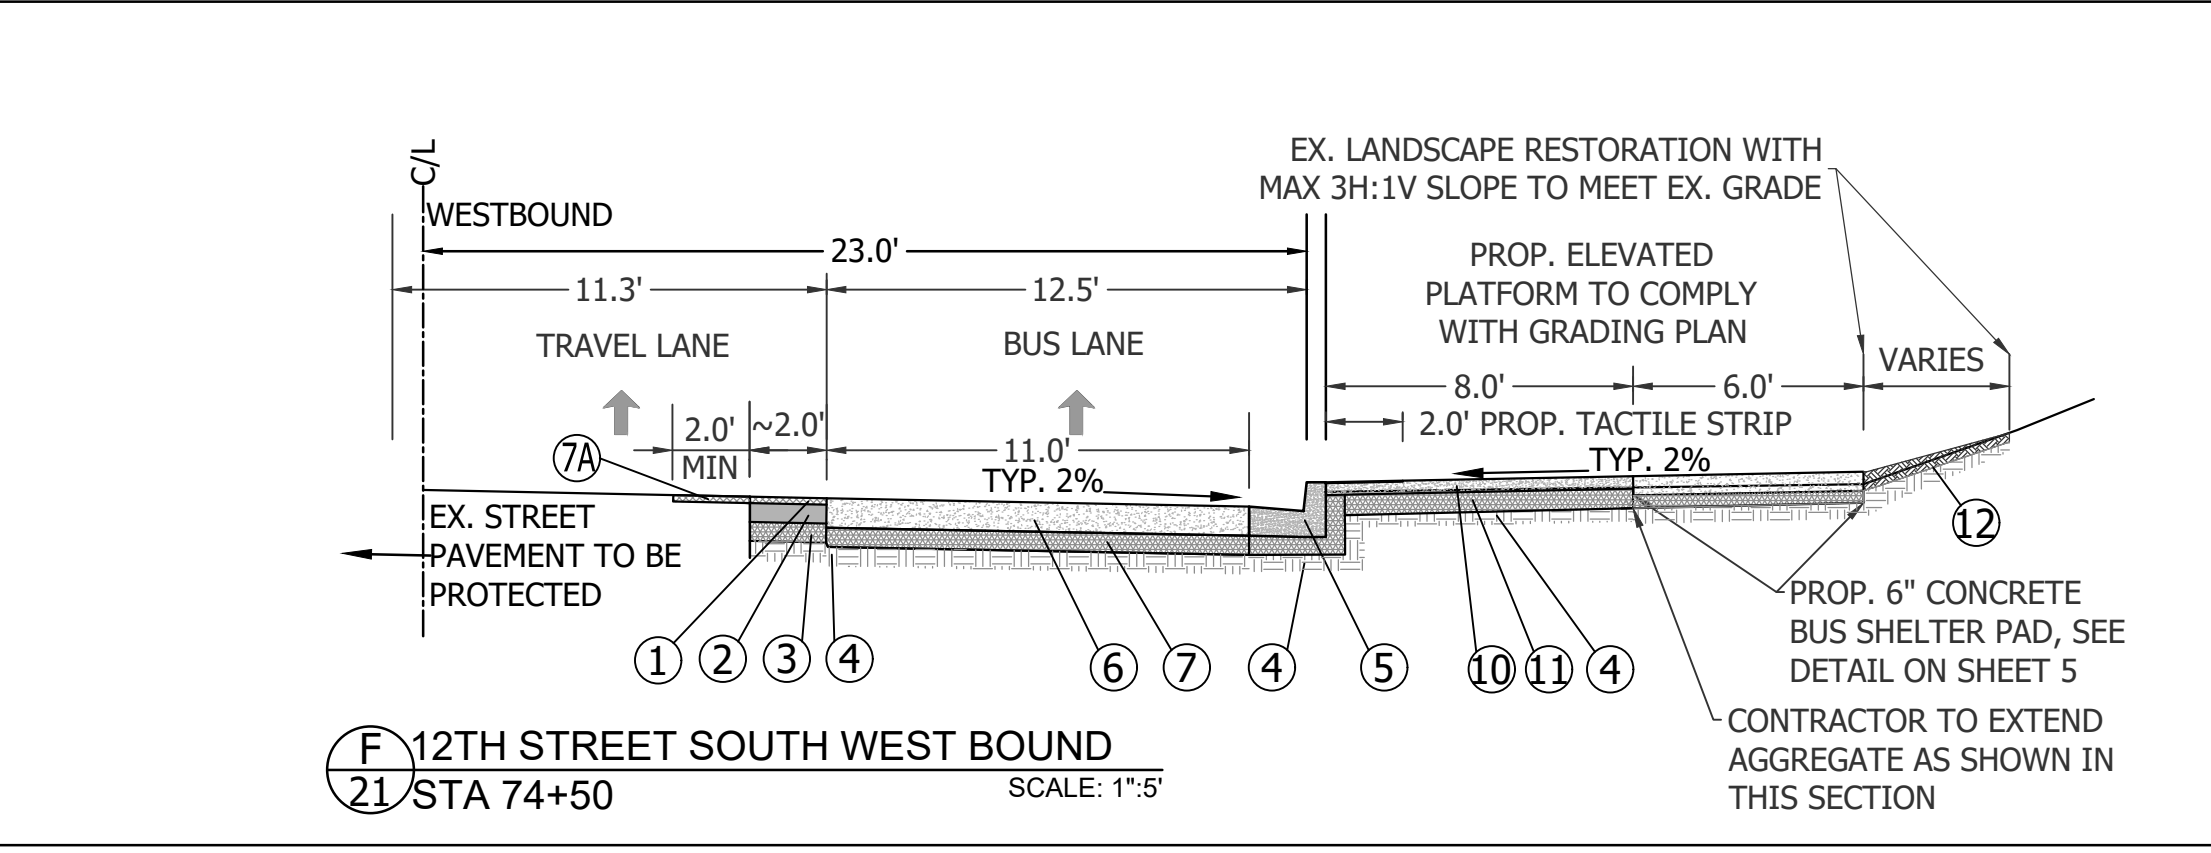
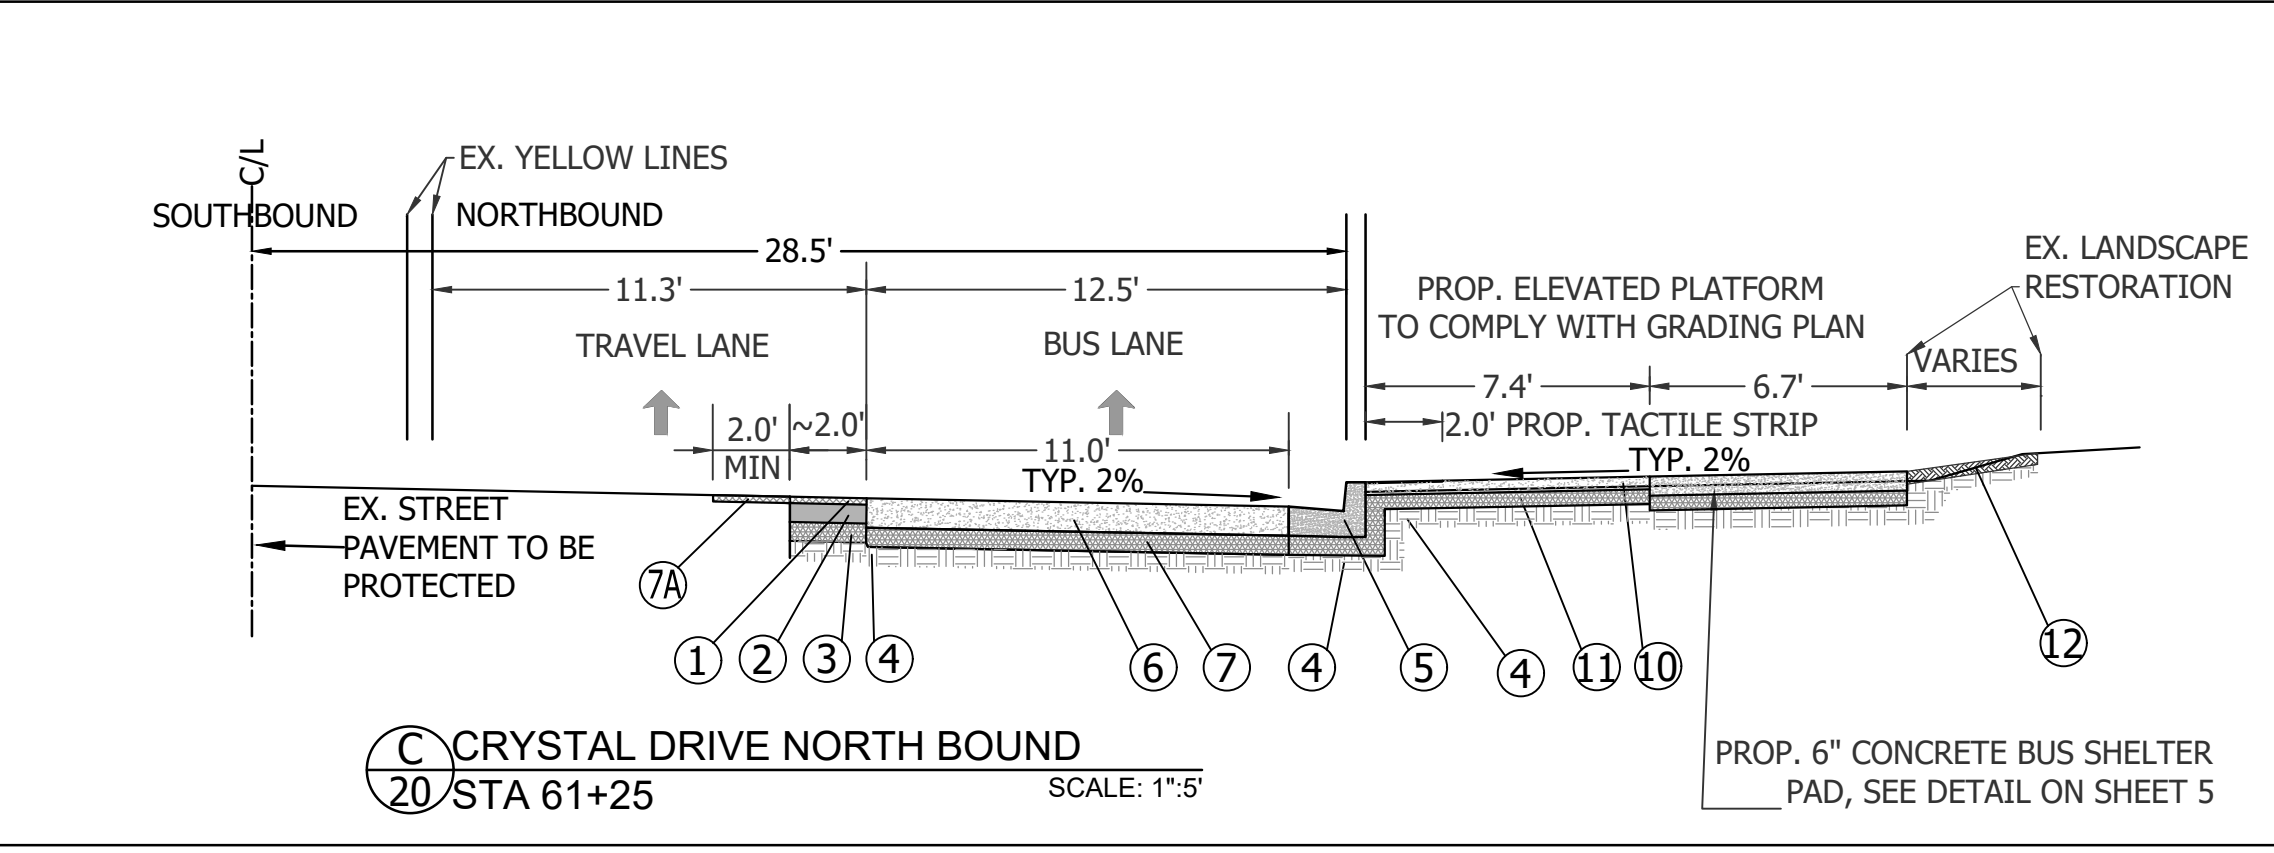
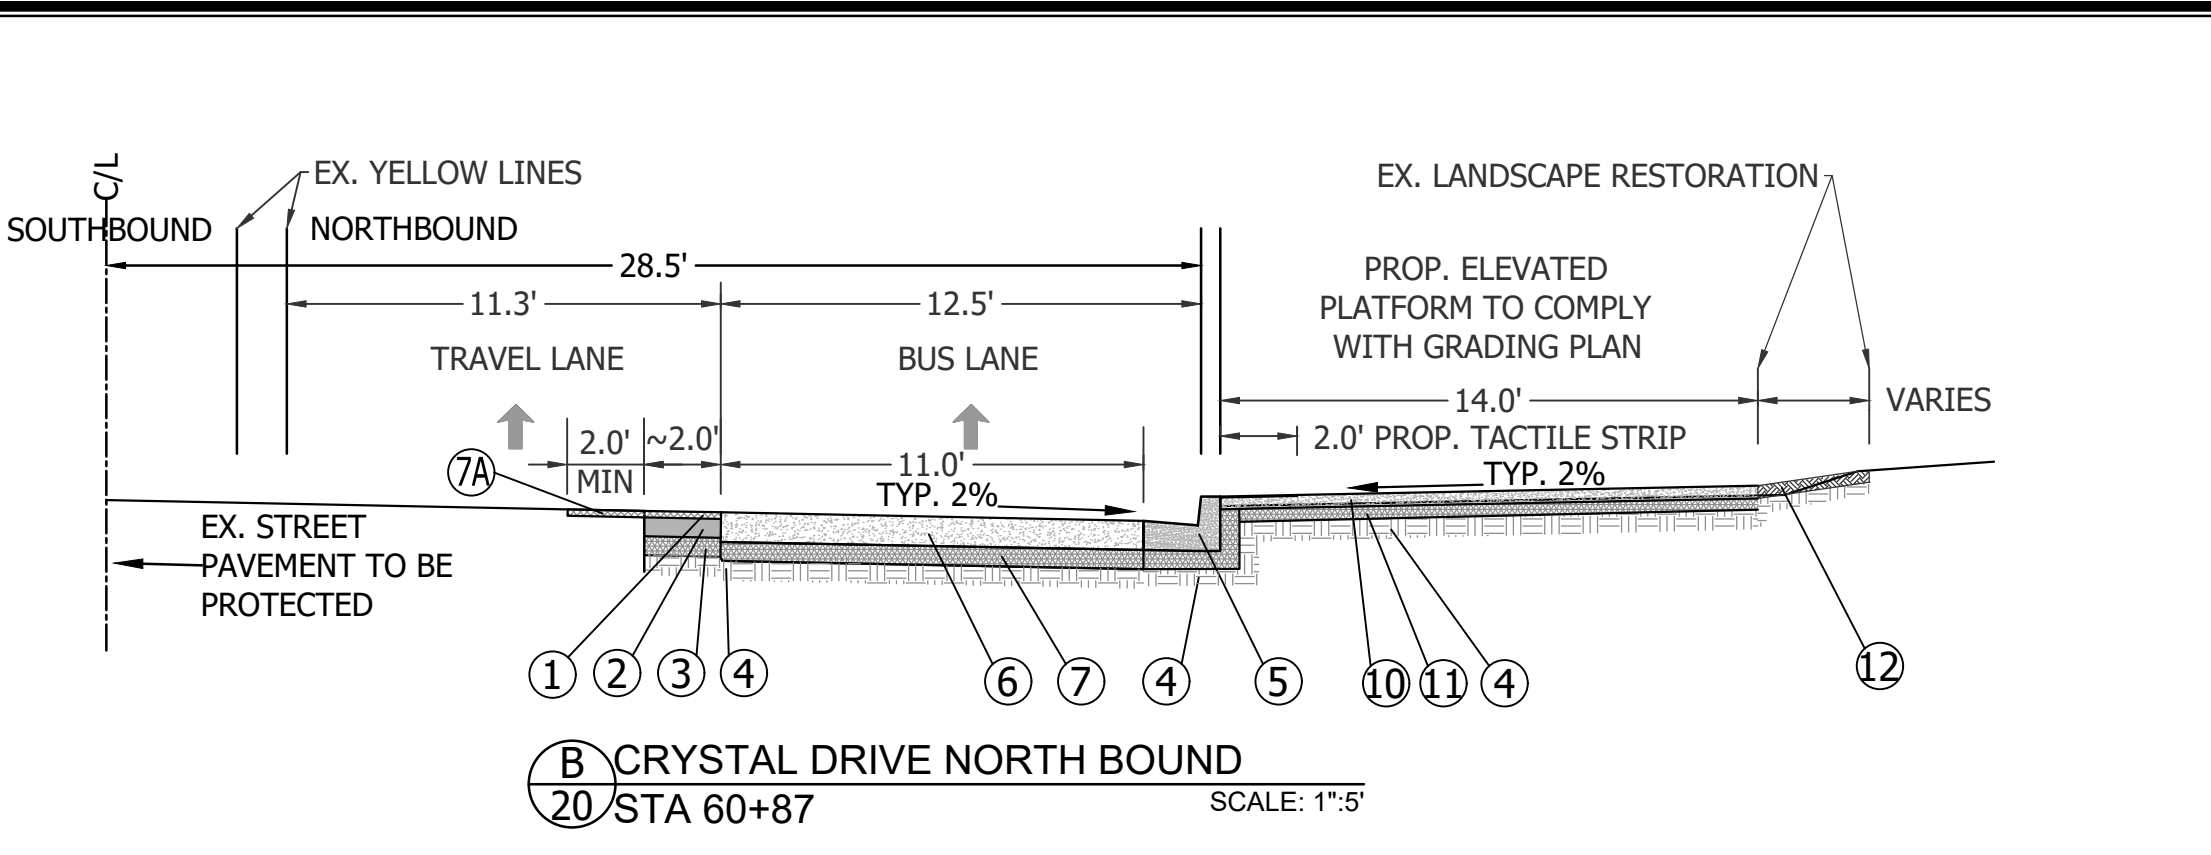
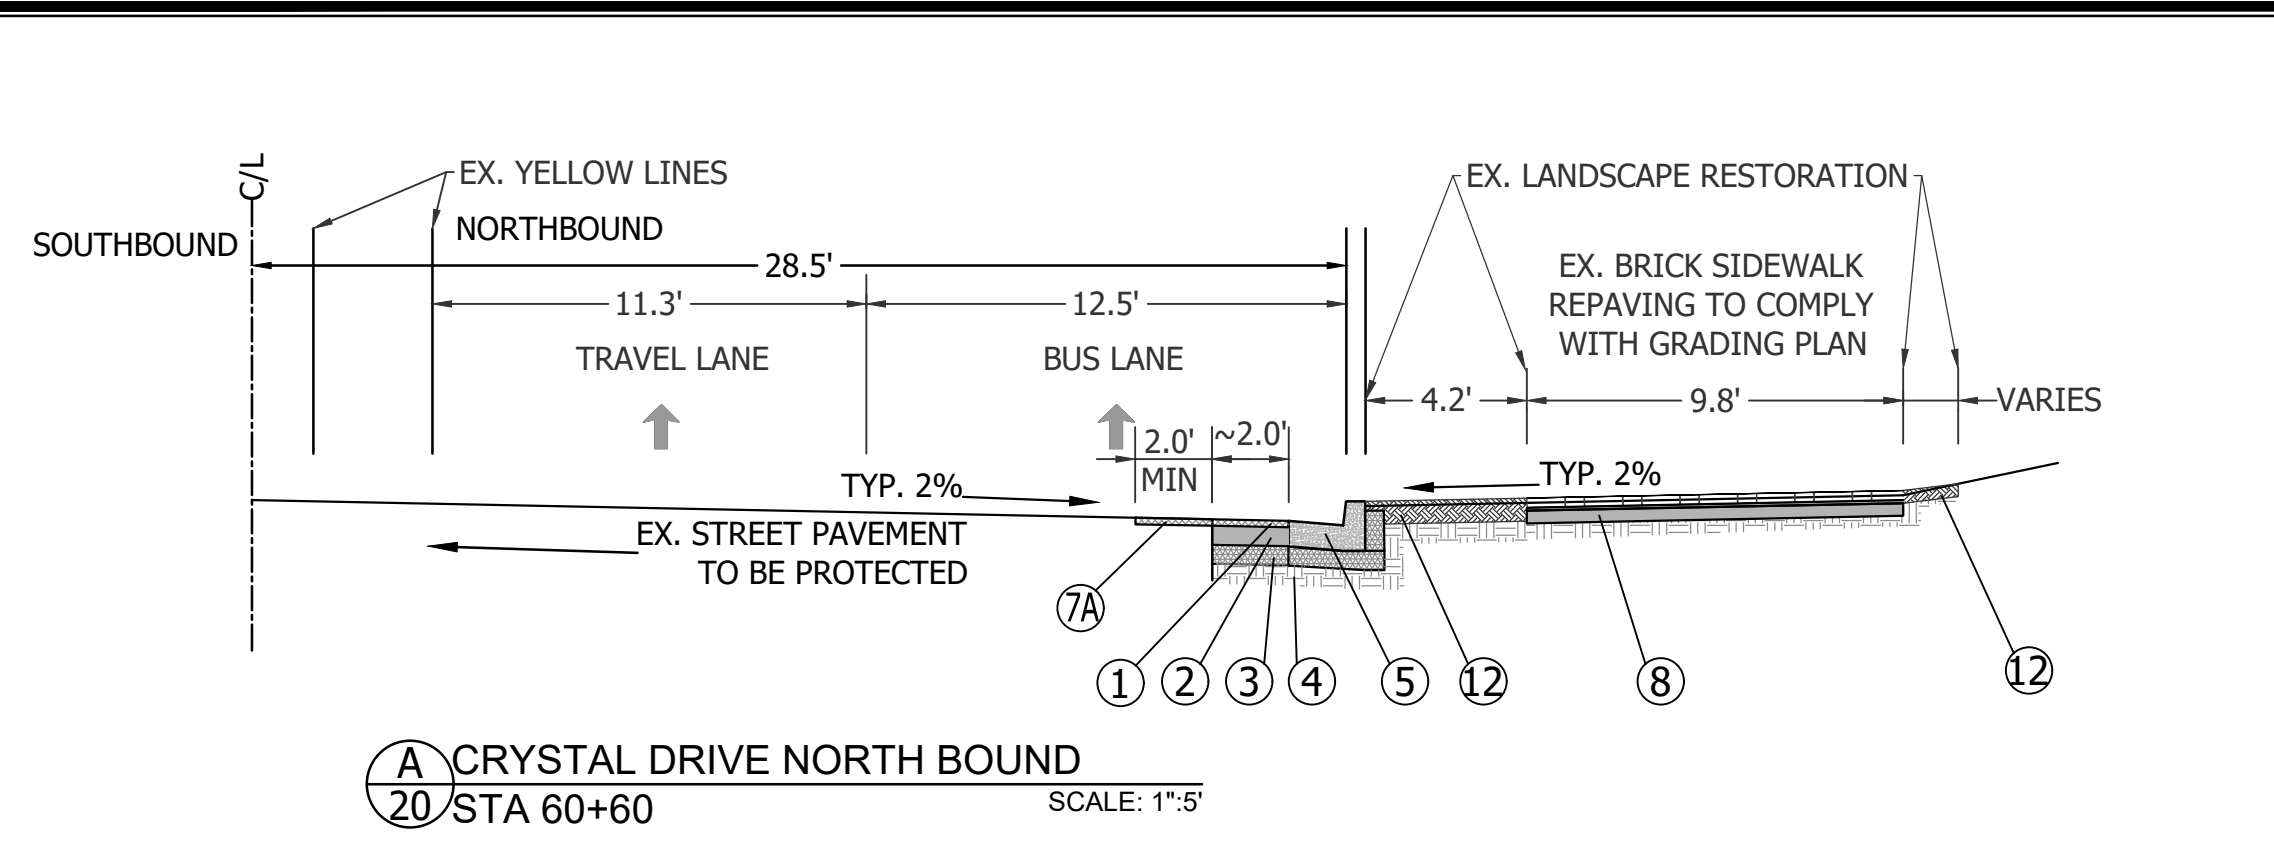


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OVERALL PLAN

THIS SHEET FOR INFORMATIONAL PURPOSES ONLY!

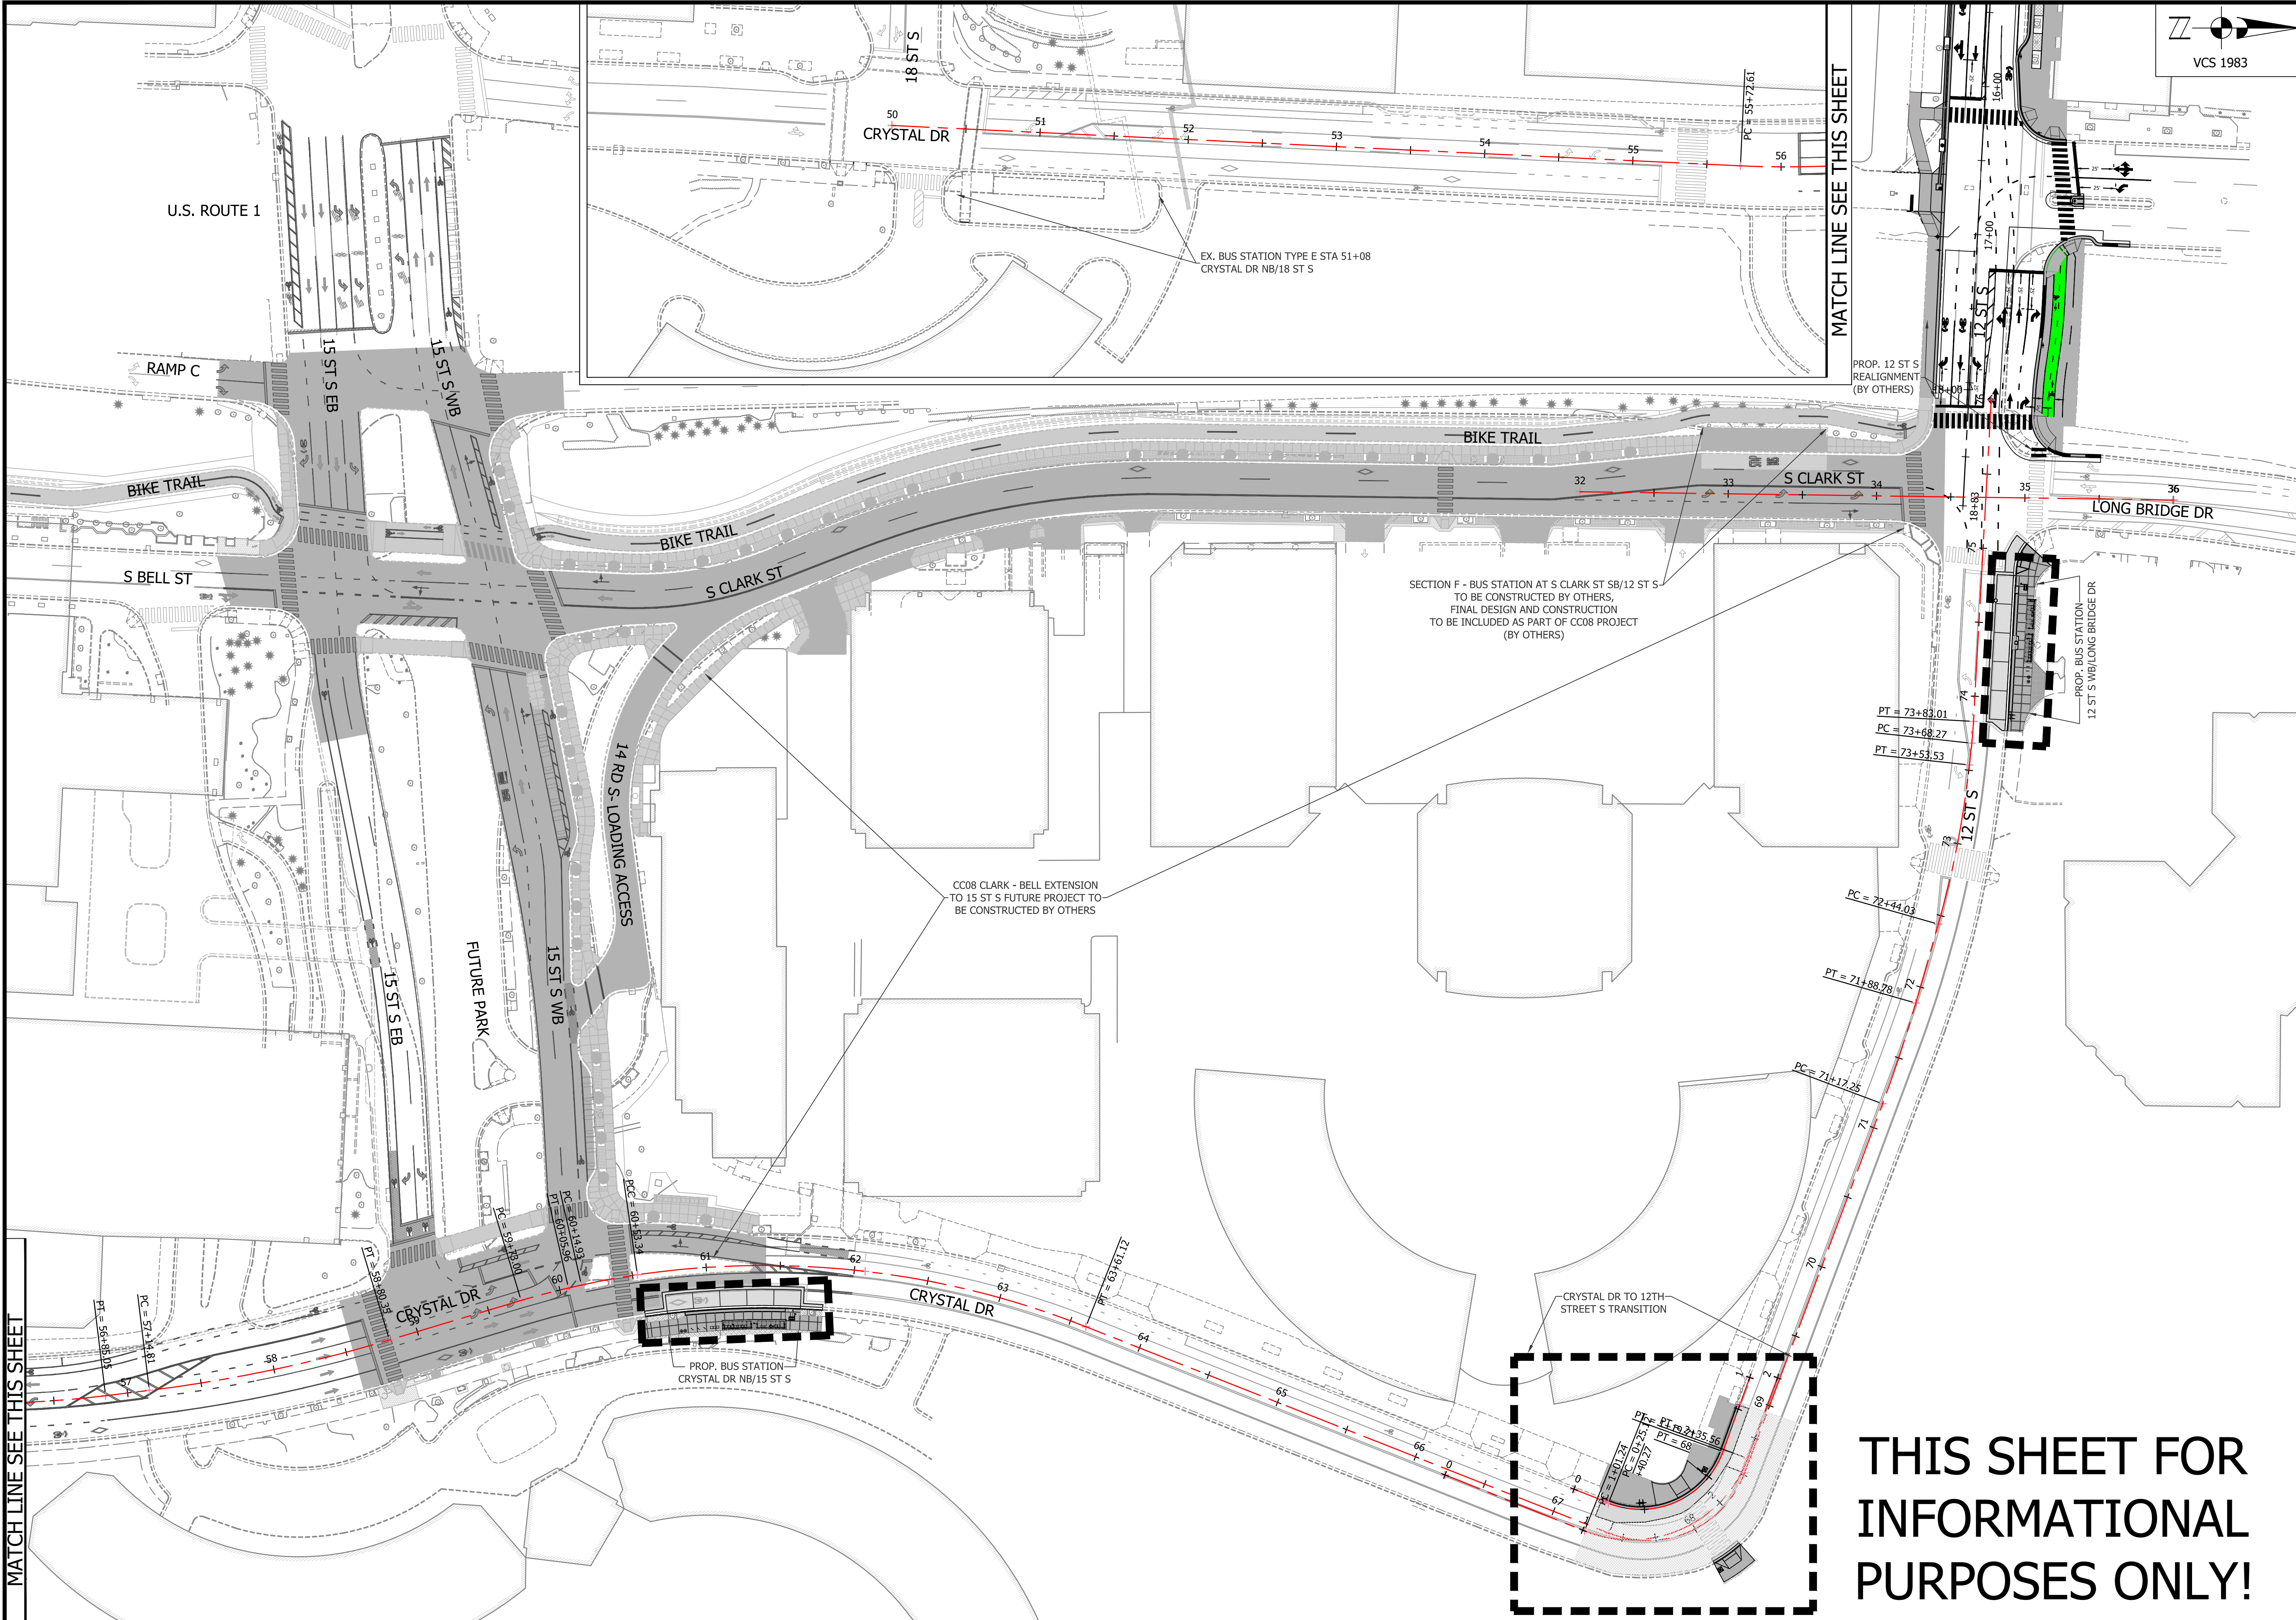

- UNDERGROUND STRUCTURES AND WATERPROOFING NOTES:**
- THERE IS AN EXISTING UNDERGROUND ("UG") STRUCTURE (PARKING GARAGE) AT THE 12TH STREET S AND CLARK BELL STREET STATION. AS PER TEST HOLE INFORMATION, THE TOP OF UG STRUCTURE RANGES APPROXIMATELY 1' BELOW THE SIDEWALK SURFACE. CONTRACTOR IS RESPONSIBLE FOR THE MEANS AND METHODS OF CONSTRUCTION TO ENSURE THAT NO DAMAGE WILL OCCUR TO THE UG STRUCTURE.
 - IT IS ANTICIPATED THAT THERE WILL BE EXISTING WATERPROOFING ON TOP OF THE UG STRUCTURE WHICH MAY BE DISTURBED DURING THE EXCAVATION. CONTRACTOR SHALL RESTORE OR INSTALL NEW WATERPROOFING ON AREAS DISTURBED DURING EXCAVATION PRIOR TO INSTALLING ANY CONCRETE OR OTHER MATERIALS. CONTRACTOR SHALL USE HOT FLUID - APPLIED RUBBERIZED ASPHALT WATERPROOFING OR AN APPROVED EQUAL.
 - CONTRACTOR SHALL PERFORM A PRE-CONSTRUCTION DOCUMENTATIONS/INVENTORIES OF EXISTING UNDERGROUND & ABOVE STRUCTURES AND ANY OTHER FEATURES THAT MAY BE IMPACTED DURING CONSTRUCTION. EXISTING DAMAGES, DEFECTS, OR CRACKS DISCOVERED DURING THE PRE-CONSTRUCTION INVENTORY SHALL BE DOCUMENTED (USING PHOTOS, VIDEOS, ETC.) AND SHALL BE MONITORED DURING AND AFTER CONSTRUCTION.

ARLINGTON VIRGINIA

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SEAL
COMMONWEALTH OF VIRGINIA
TREVOR M. LANTZY
Lic. No. 0402050508
8/4/2021
PROFESSIONAL ENGINEER

APPROVALS	DATE
<i>Kamal Takat</i> QUALITY CONTROL ENGINEER	3/29/21
<i>Ramal Takat</i> CONSTRUCTION MANAGEMENT SUPERVISOR	3.24.21
<i>Dennis M. Leach</i> WATER, SEWER, STREETS BUREAU CHIEF	03.04.2021
<i>Diana Iazza</i> TRANSPORTATION DIRECTOR	03/17/21
<i>Diana Iazza</i> PROJECT MANAGER	3/2/21

REVISIONS	DATE

PROJECT NAME AND LOCATION
TRANSITWAY EXTENSION TO PENTAGON CITY

SECTION DETAILS
CRYSTAL DR & 12TH ST S

MA13 - SEGMENT I

- NOTES:**
- LANE, SIDEWALK, PLATFORM WIDTH MAY VARY.
 - PLAN CROSS SLOPES MAY VARY, SEE CROSS SECTIONS SHEET.
 - CONTRACTOR TO TIE PROPOSED FULL DEPTH ASPHALT TO EXISTING PAVEMENT USING THE VDOT WP-2 DETAIL.


- PAVEMENT SCHEDULE:**
- PROP. SURFACE - 2" ASPHALT CONCRETE (TYPE SM-9.5D) PER ARLINGTON COUNTY SPECS
 - PROP. BASE - 6" ASPHALT CONCRETE (TYPE BM-25.D) PER ARLINGTON COUNTY SPECS
 - PROP. COMPACTED SUBBASE - 6" AGGREGATE BASE MATERIAL PER ARLINGTON COUNTY SPECS
 - UNDISTURBED SUBGRADE OR BACKFILL & STANDARD COMPACTION REQUIRED PER ARLINGTON COUNTY SPECS
 - PROP. C-2 CURB & GUTTER PER ARL STD R-2.0 WITH MODIFIED 6" TO 9.5" HIGH CURB & 10" THICK GUTTER
 - PROP. C-2 CURB & GUTTER PER ARL STD R-2.0
 - PROP. 10" THICK REINFORCED CONCRETE BUS PAD (SEE DETAIL ON SHEET 5)
 - PROP. 6" AGGREGATE BASE MATERIAL PER ARLINGTON COUNTY SPECS (VDOT 21A)
 - PROP. MILL AND OVERLAY (2' WIDE MINIMUM)



- SALVAGED BRICKS SHALL BE INSTALLED OVER 1" SAND, AND 4" CONCRETE BASE TO COMPLY WITH ARL STD R-2.1. BRICK SIDEWALK WIDENING/REPAVING SHALL MATCH EX. MATERIAL, COLOR & PATTERN
- SALVAGED BRICKS SHALL BE INSTALLED OVER 1" SAND, AND 6" MIN AGGREGATE BASE TO COMPLY WITH ARL STD R-2.1. BRICK SIDEWALK WIDENING/REPAVING SHALL MATCH EX. MATERIAL, COLOR & PATTERN
- PROP. BROOM FINISHED 4" CONCRETE SIDEWALK PER ARL STD R-2.0, TYP. SCORED IN 6' X 6' MODULE
- PROP. 3" MIN. AGGREGATE BASE MATERIAL PER ARL STD R-2.0 UNDER SIDEWALK
- PROP. BROOM FINISHED 4" REINFORCED CONCRETE SIDEWALK, SCORED IN 6' X 6' MODULE. SEE DETAIL ON SHEET 05
- PROP. 4" MIN. AGGREGATE BASE MATERIAL PER ARL STD R-2.0 UNDER SIDEWALK
- PROP. TYP. 4"-6" TOPSOIL AND SEED OR MULCH PER ARLINGTON COUNTY SPECS

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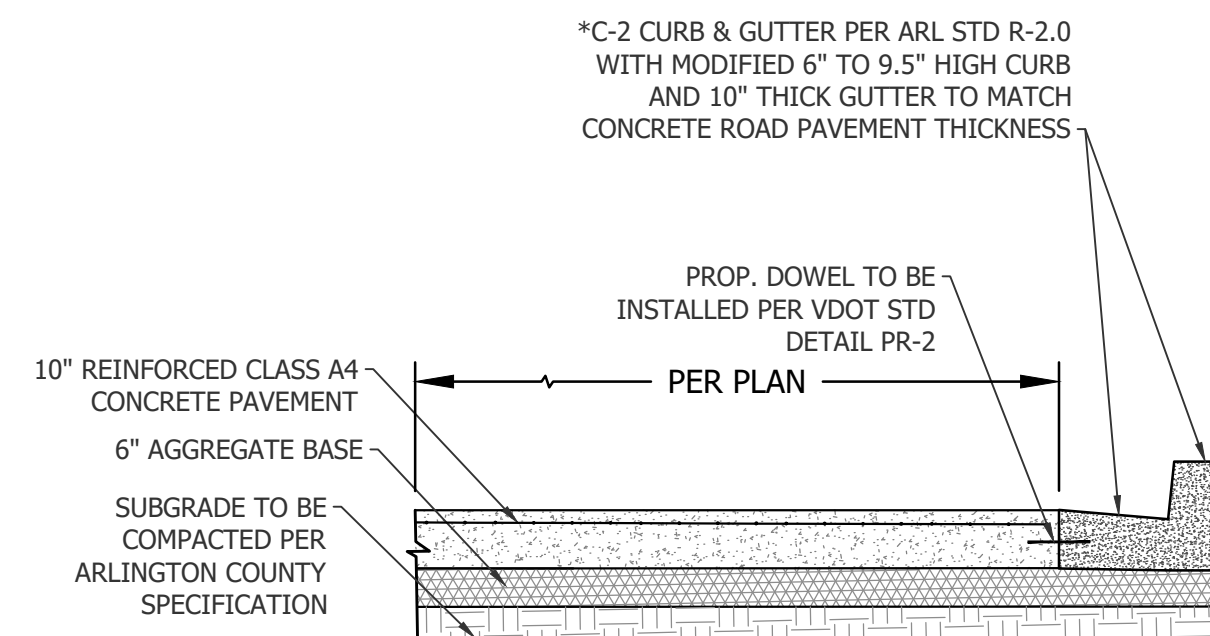
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PLOTTED BY: NSHARP



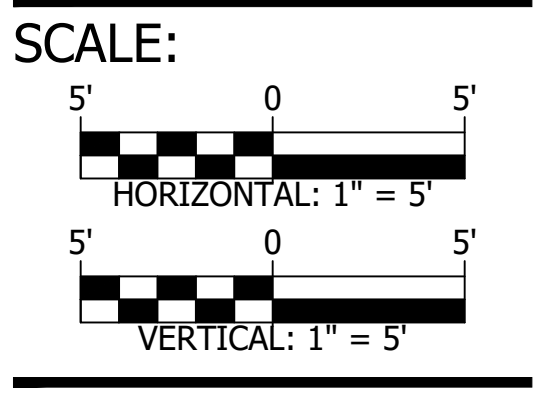


10" REINFORCED CONCRETE BUS PAD
N.T.S.

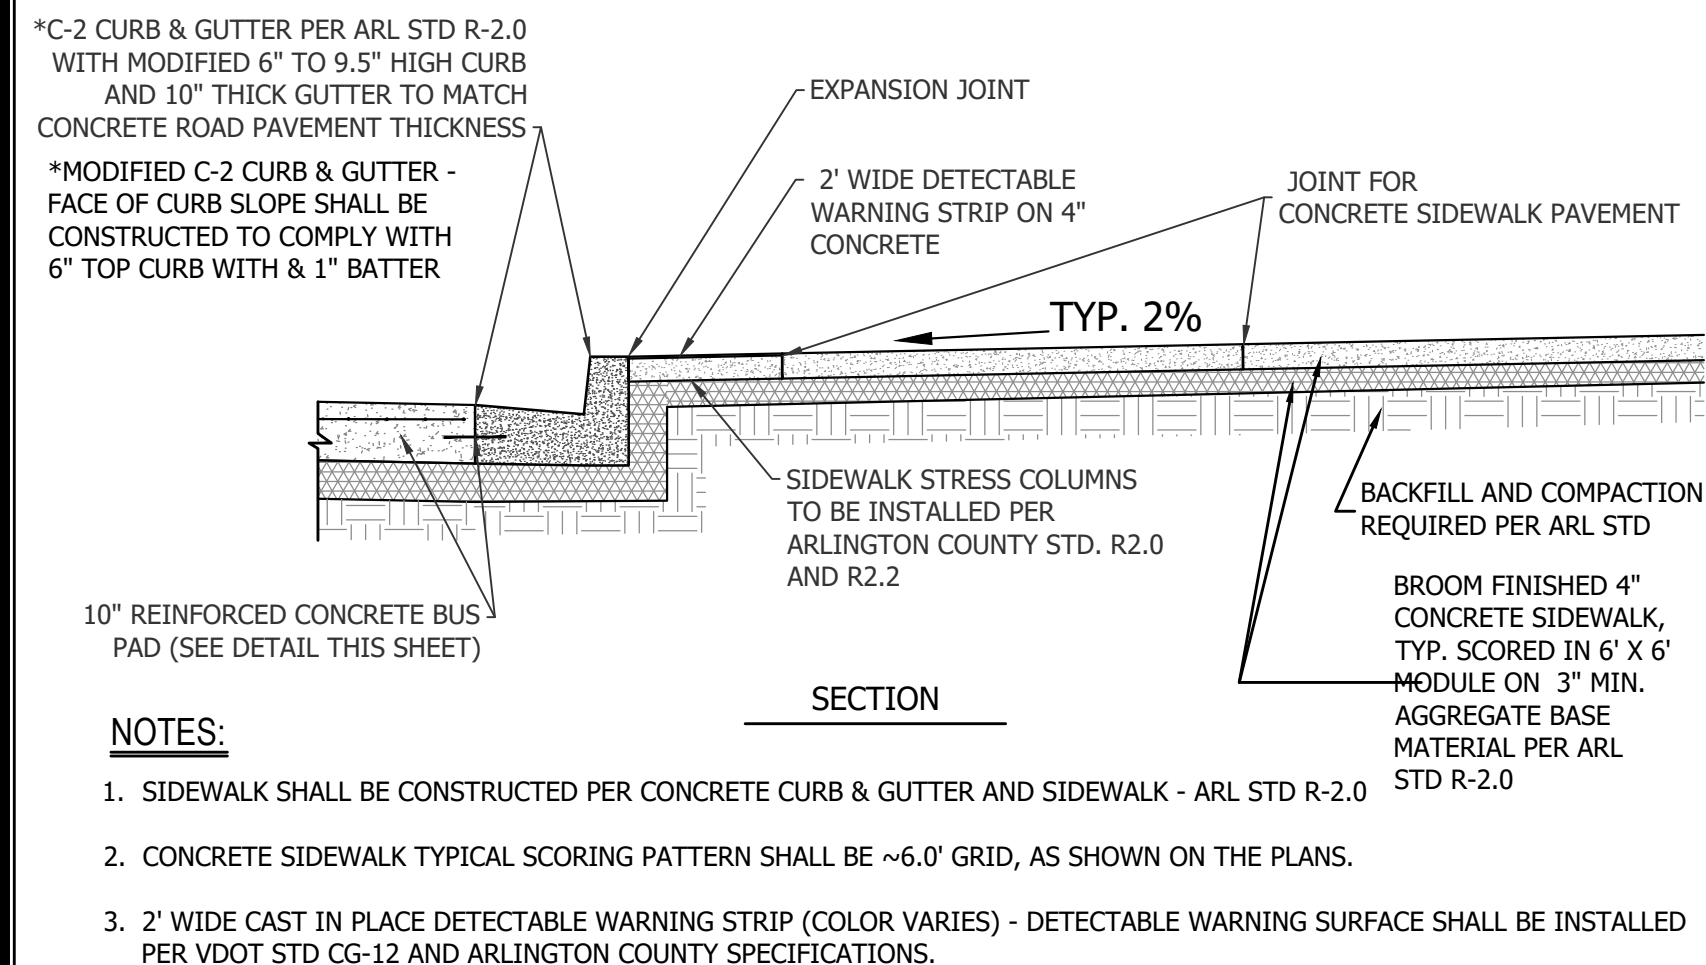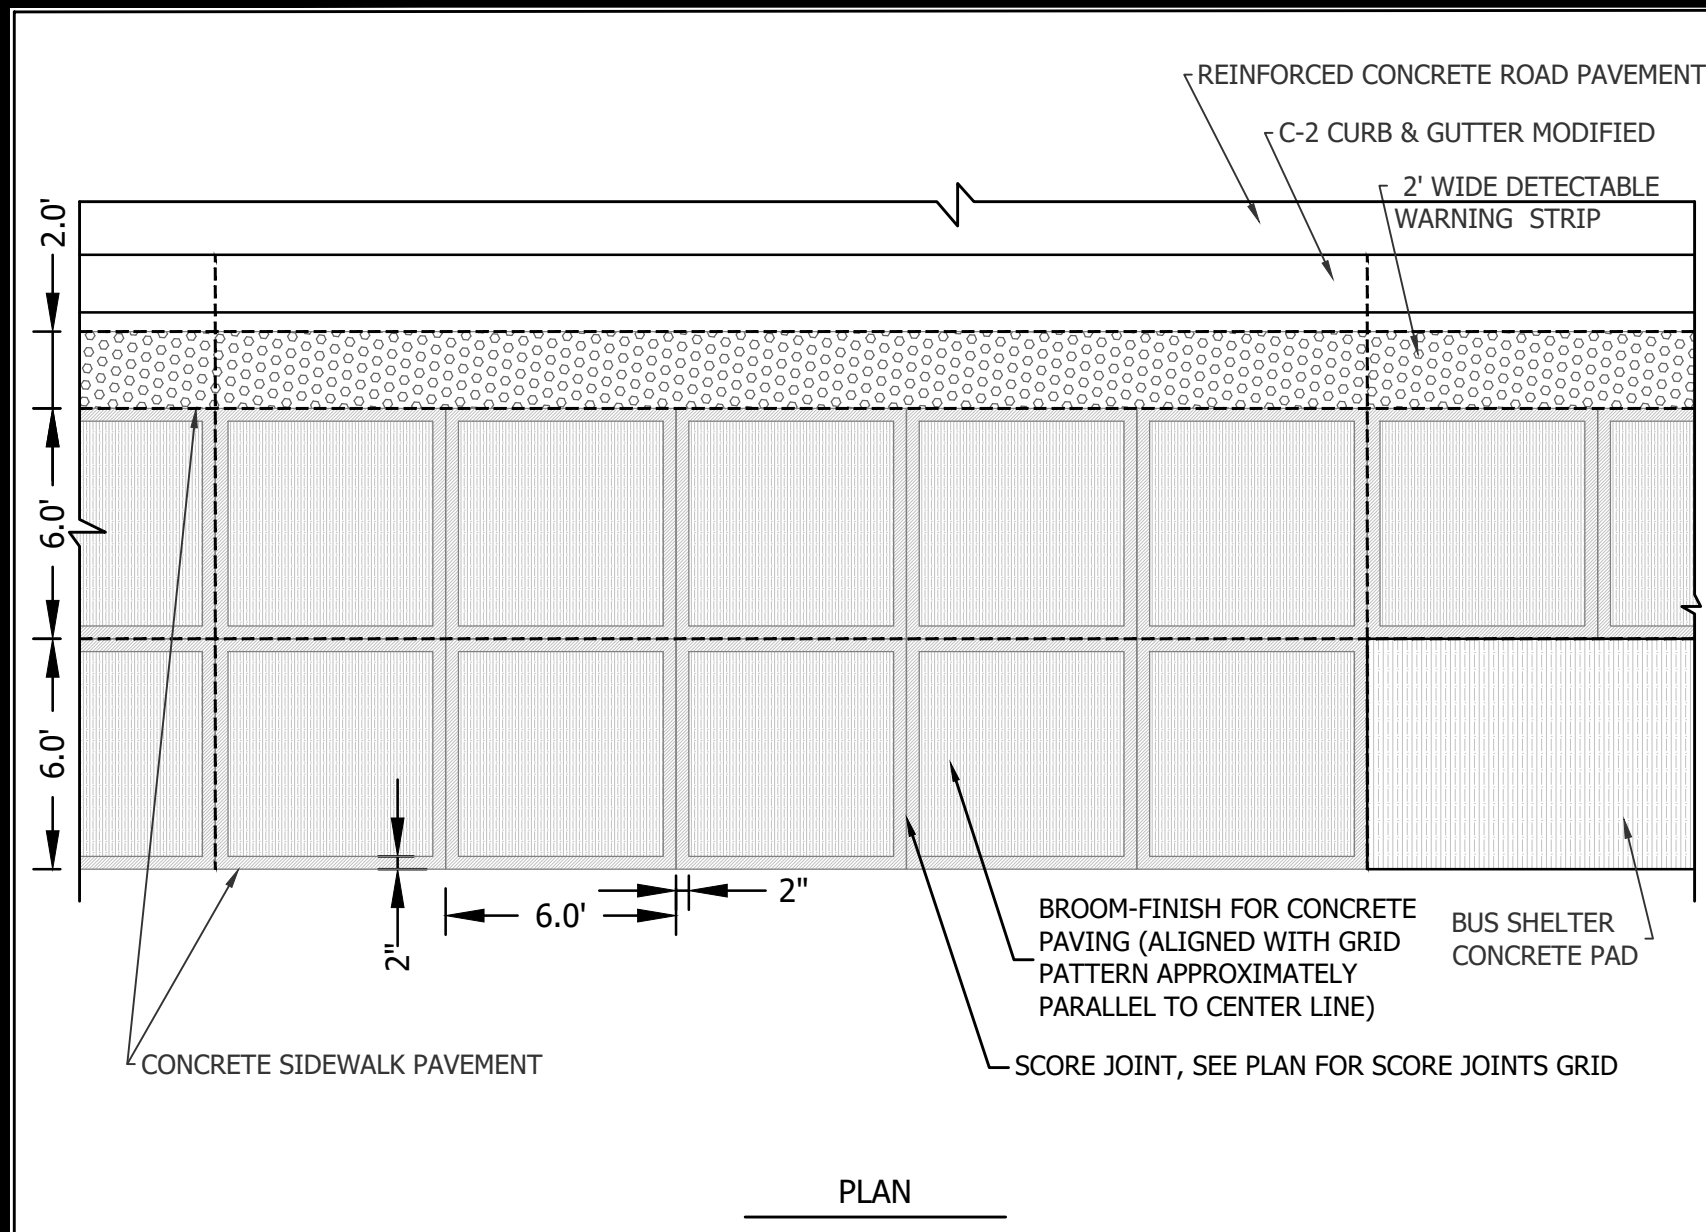


- NOTES:
1. CONCRETE, REINFORCEMENT AND DOWELS SHALL BE PROVIDED PER VDOT STD DETAILS PR-2 AND PR-6 AND ARLINGTON COUNTY SPECIFICATIONS.
2. EXPANSION, CONTRACTION AND LONGITUDINAL JOINTS TO BE PROVIDED PER VDOT STD DETAIL PR-2 AND ARLINGTON COUNTY SPECIFICATIONS.


10" REINFORCED CONCRETE BUS PAD
N.T.S.

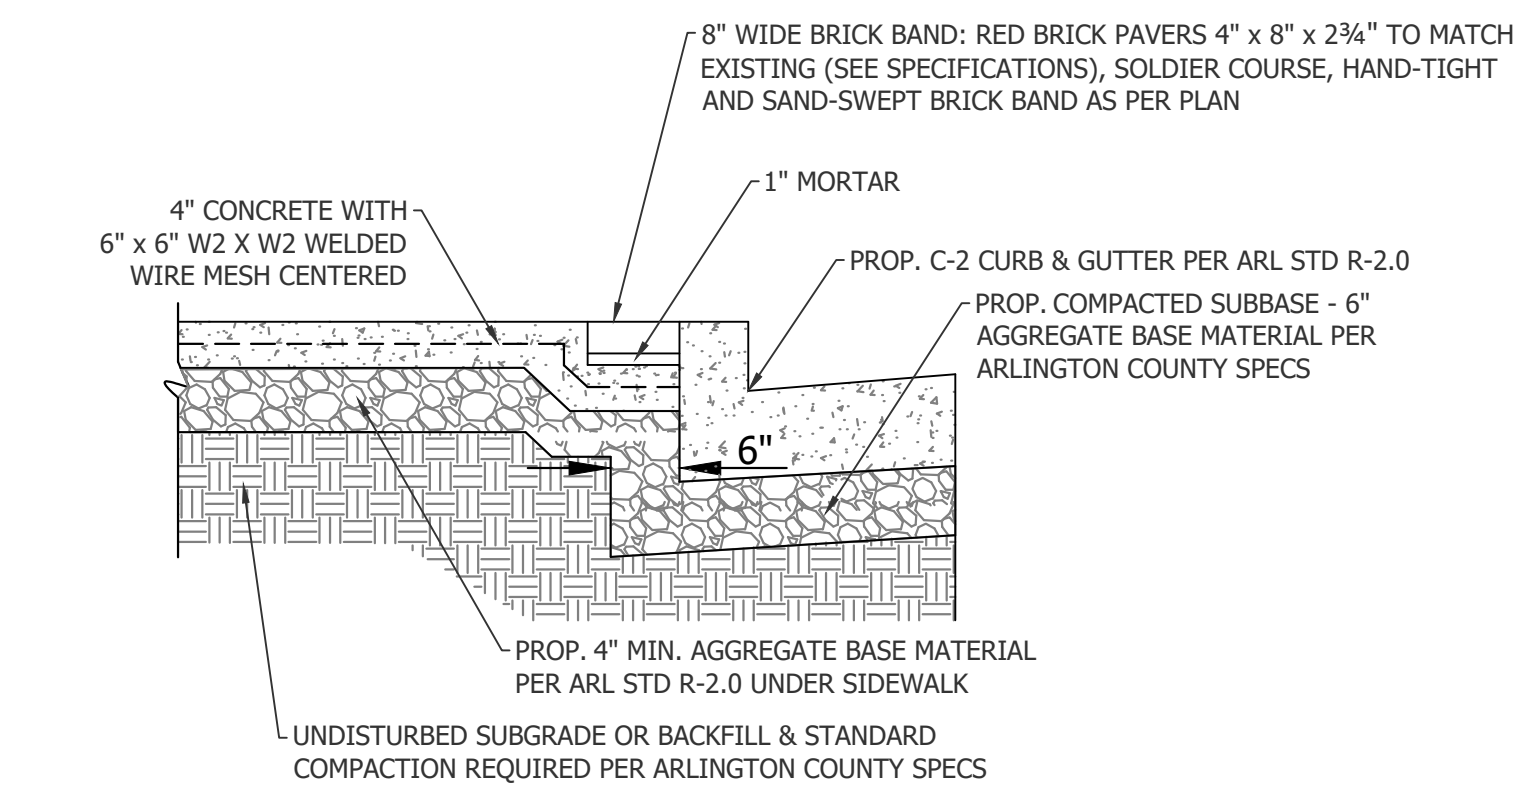

REINFORCED CONCRETE SIDEWALK AND BRICK PAVER BAND DETAIL
N.T.S.

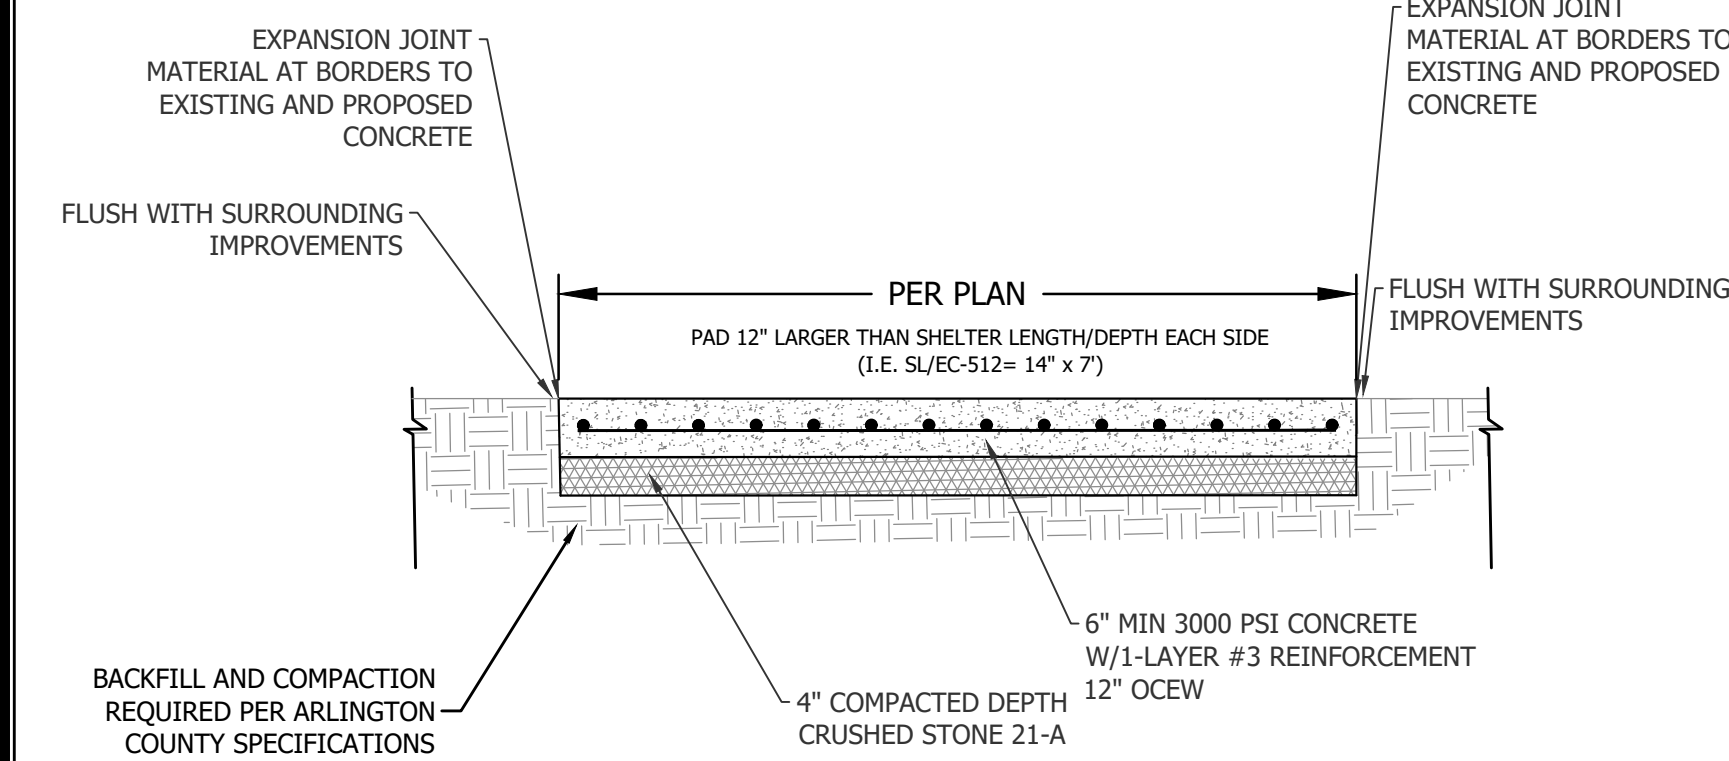


6" CONCRETE BUS SHELTER PAD
N.T.S.

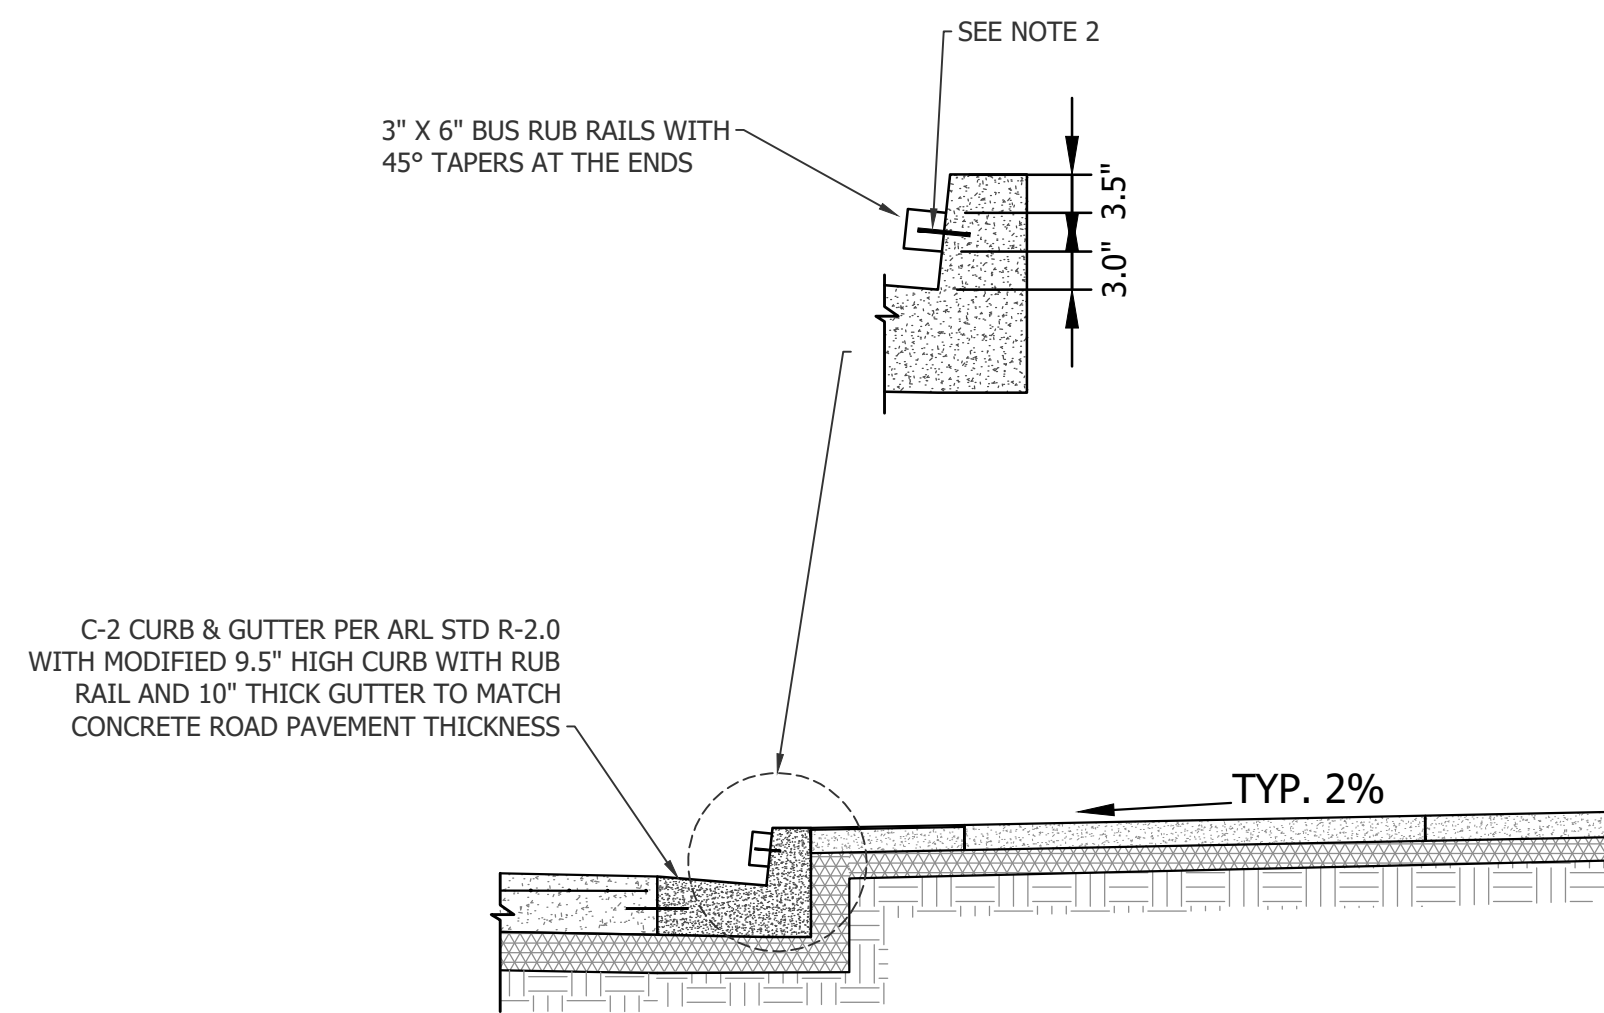


- NOTES:
1. RUB RAILS WILL BE PROVIDED BY ARLINGTON COUNTY FOR THE CONTRACTOR TO INSTALL. AT THAT TIME ADDITIONAL PLACEMENT INFORMATION WILL BE PROVIDED.
2. CONTRACTOR TO COORDINATE WITH FASTENER SUPPLIER FOR APPROPRIATE CONNECTION TO CONCRETE. SHOP DRAWINGS SHALL BE SUBMITTED TO THE PROJECT MANAGER.

9.5" CONCRETE CURB WITH RUB RAIL
N.T.S.

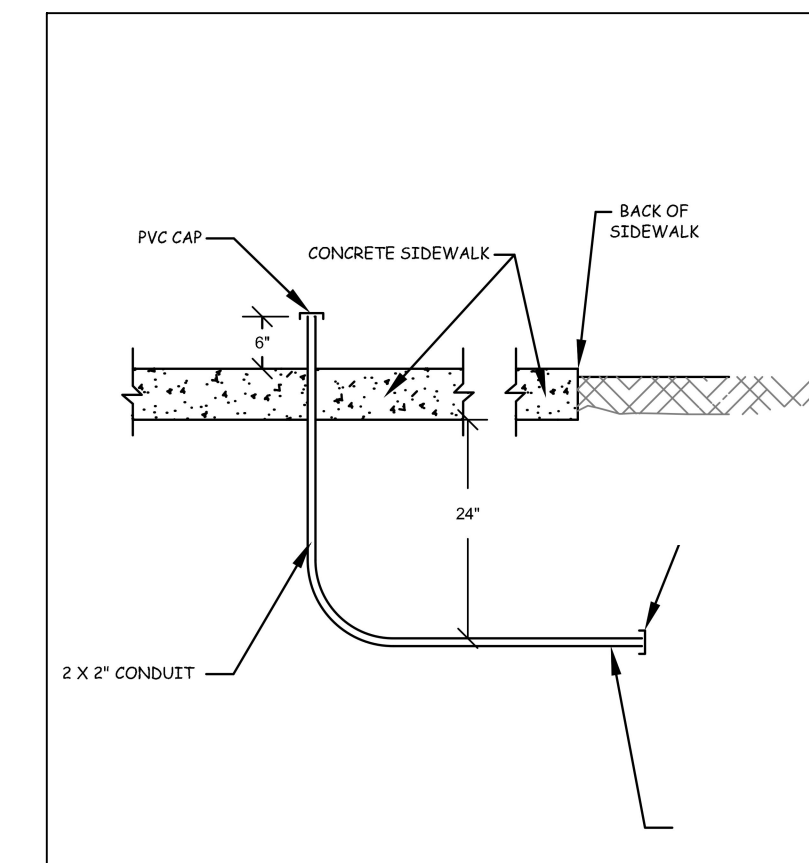

FARE MACHINE CONDUIT STUB OUTS
N.T.S.

FARE MACHINE CONDUIT STUB OUTS
N.T.S.

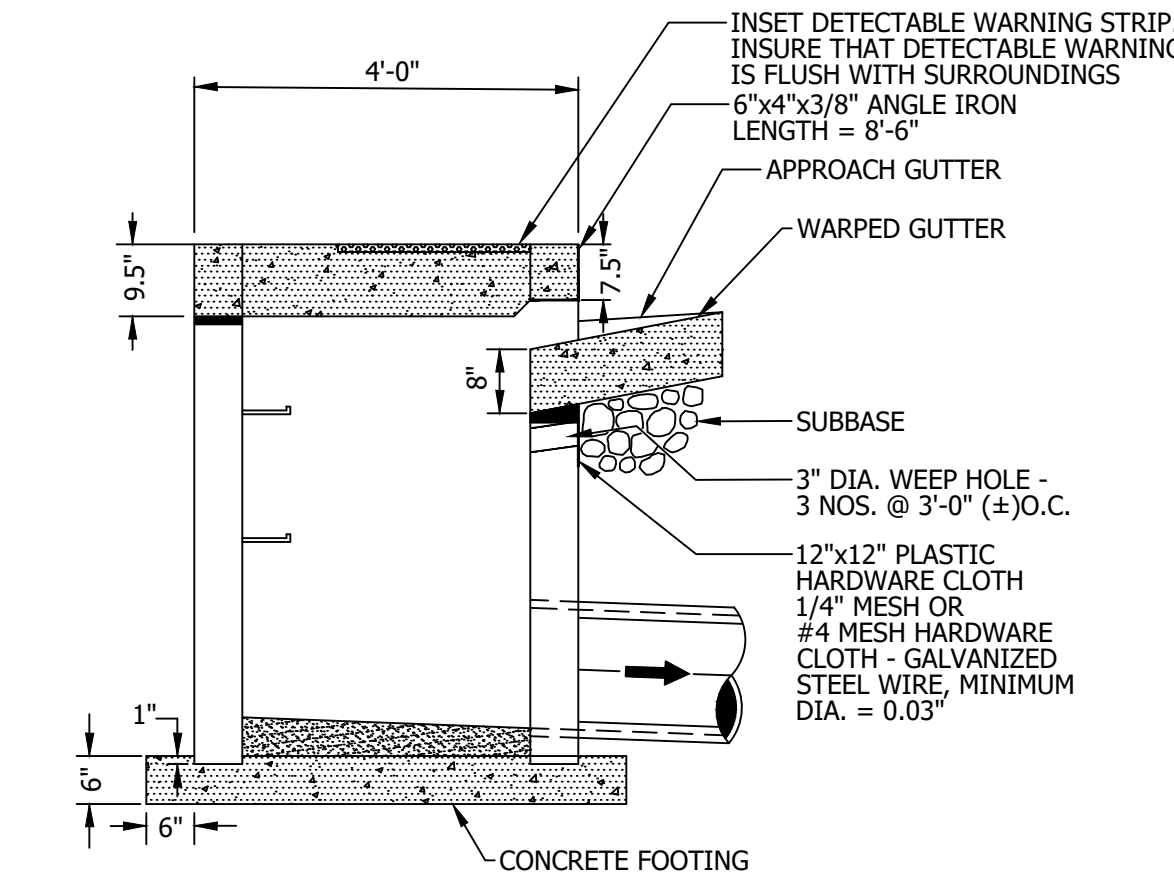

MODIFIED 9.5" ARLINGTON COUNTY CB-2A CATCH BASIN
N.T.S.




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<i>[Signature]</i> Kamal Takat	3.24.21
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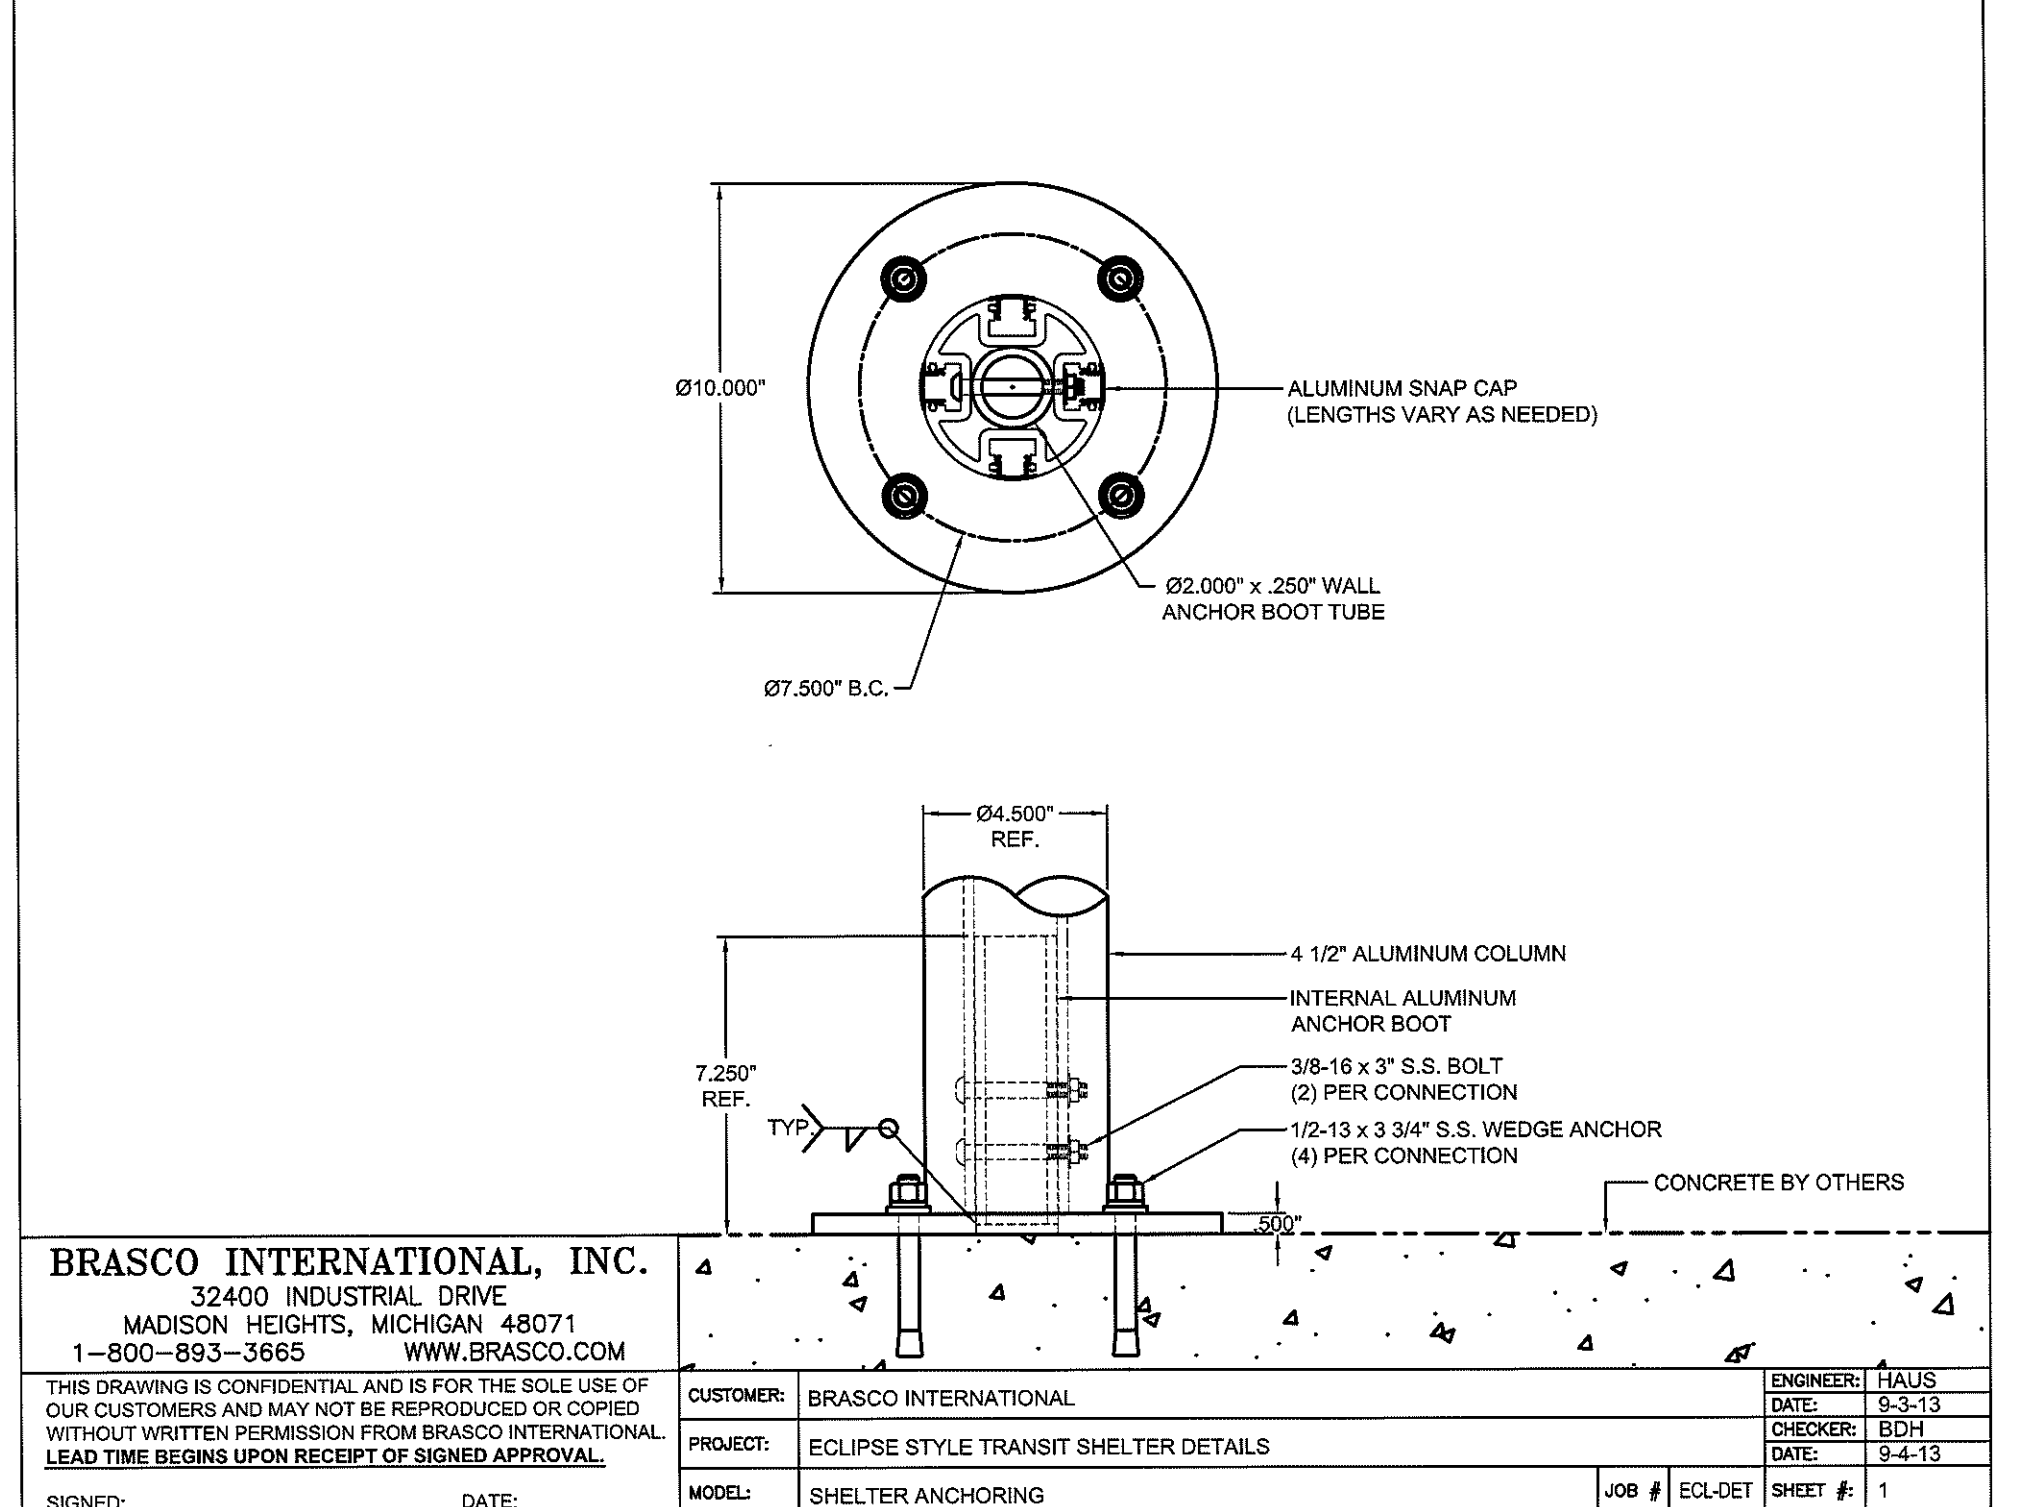
PROJECT NAME AND LOCATION
TRANSITWAY EXTENSION TO PENTAGON CITY
SITE DETAILS
CRYSTAL DR & 12TH ST S
MA13 - SEGMENT I

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DRAWN: NS
CHECKED: TL
MISS UTILITY TRANSMITTAL #: N/A
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PLOTTED: AUGUST 4 2021
PLOTTED BY: NSHARP

SCALE: N/A




BRASCO SHELTER N.T.S.

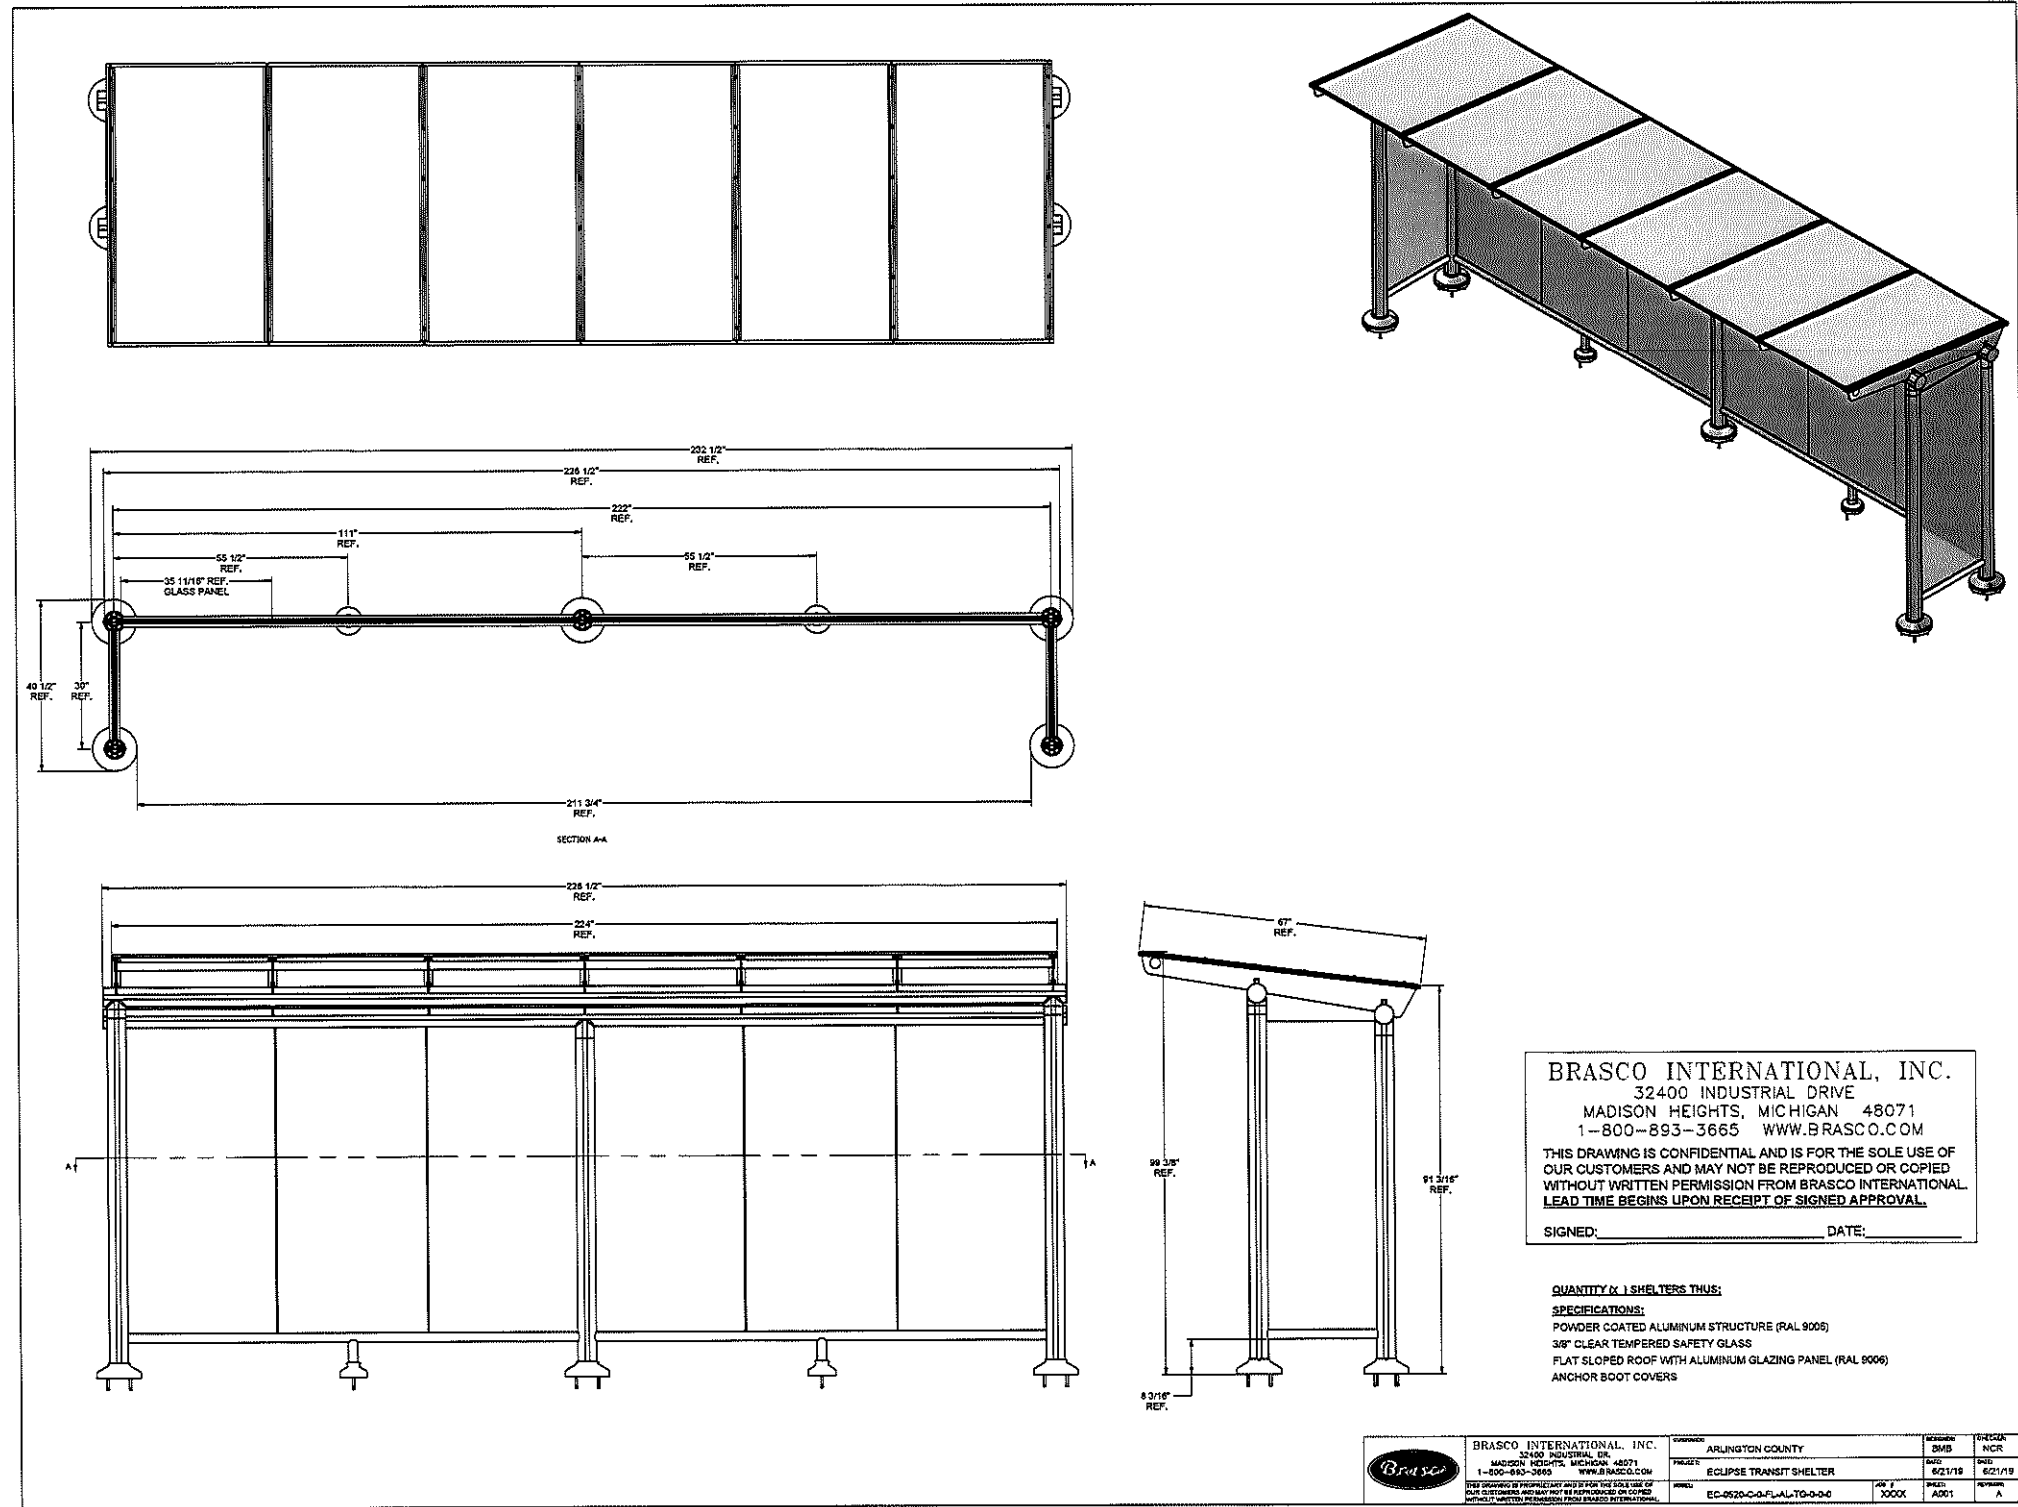


SHELTER ANCHORING N.T.S.


NOTE:
1. CONTRACTOR TO UTILIZE THESE DETAILS
2. SHELTER LOCATION SHALL BE INSTALLED PER SHEET 21
3. CONTRACTOR TO REFER TO BRASCO INSTALLATION GUIDE FOR INSTALLATION INFORMATION

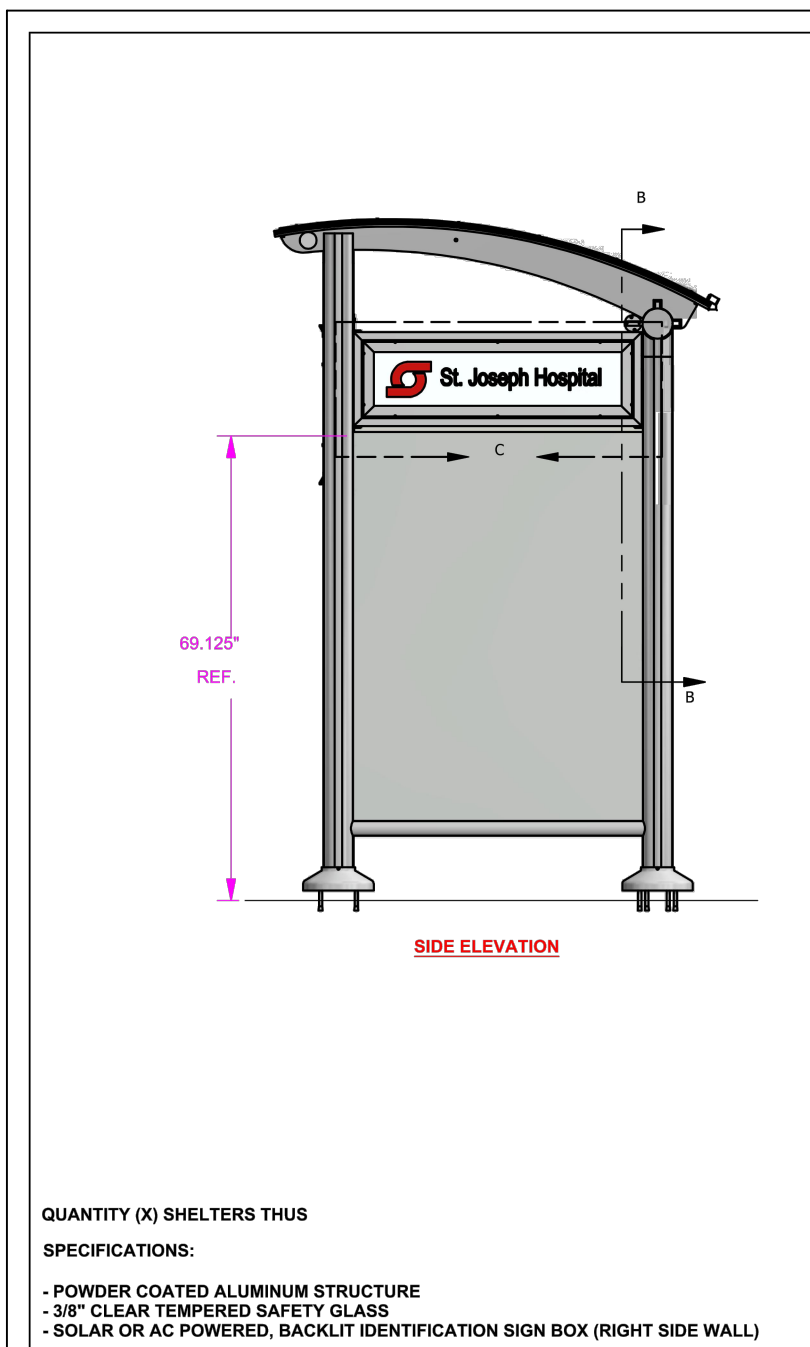


SHELTER NAME SIGNAGE N.T.S.

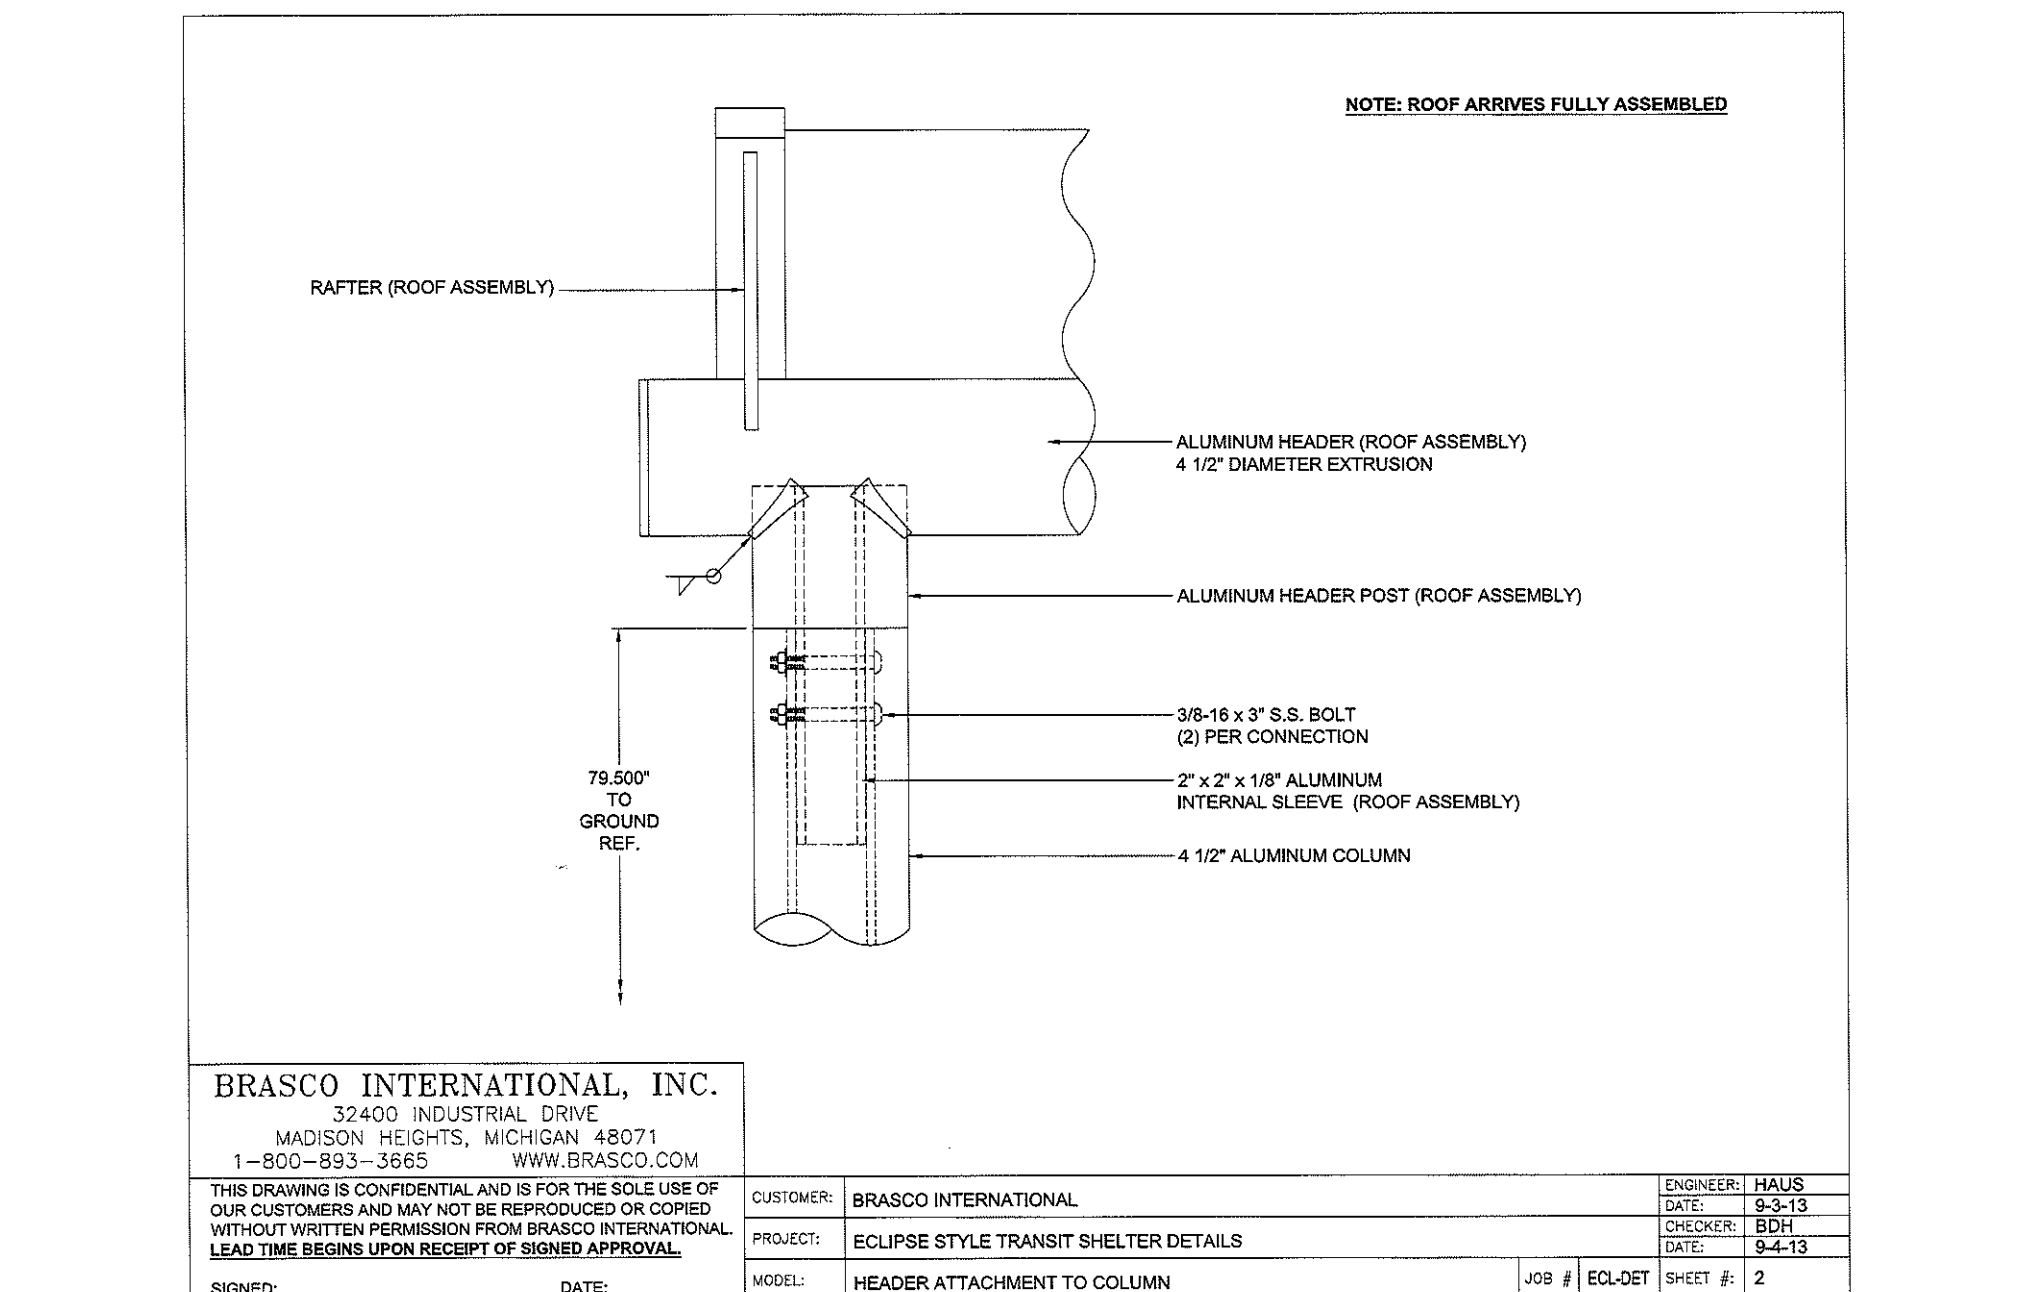

HEADER ATTACHMENT TO COLUMN N.T.S.

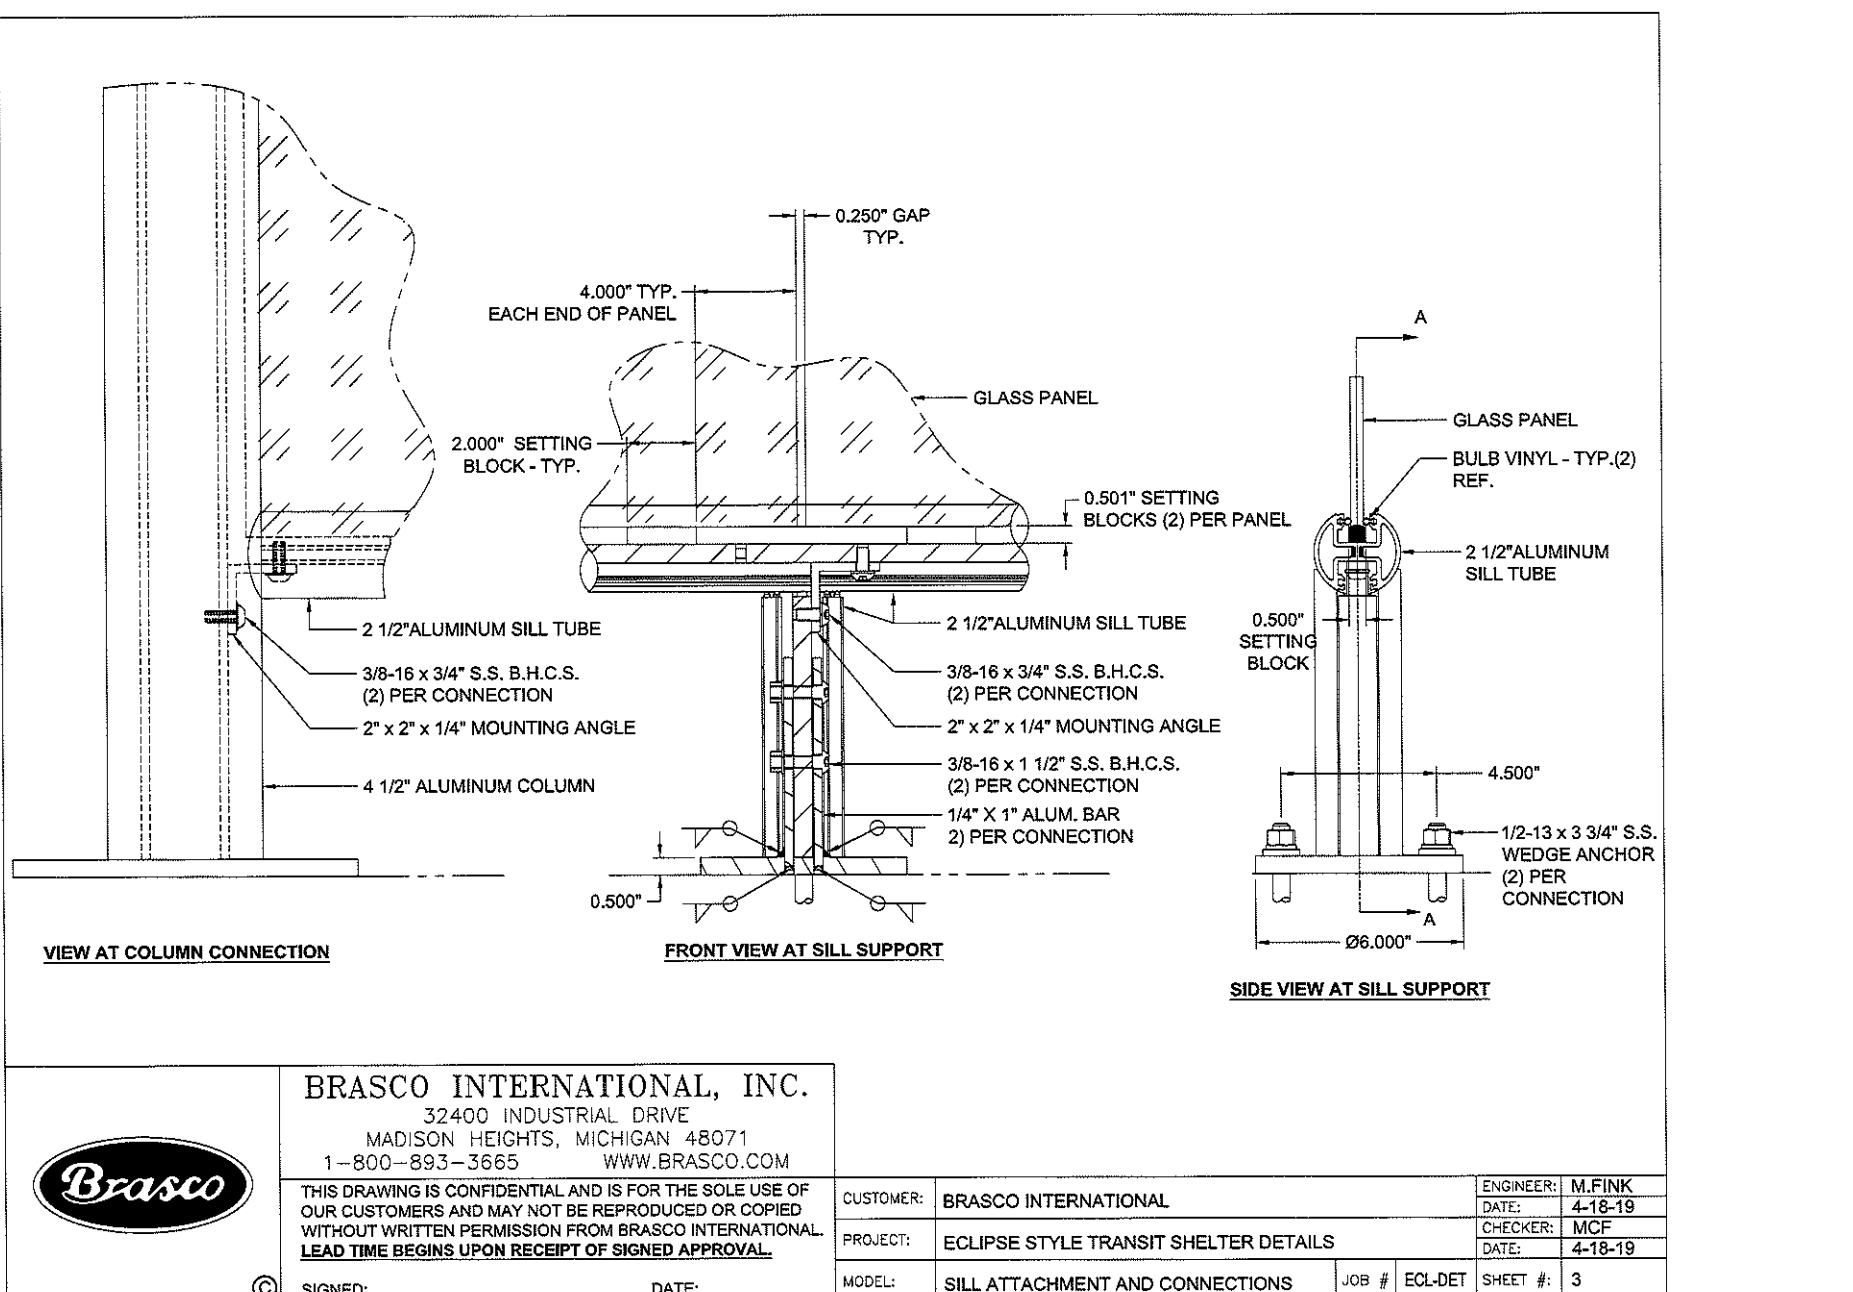

SILL ATTACHMENT AND CONNECTION N.T.S.

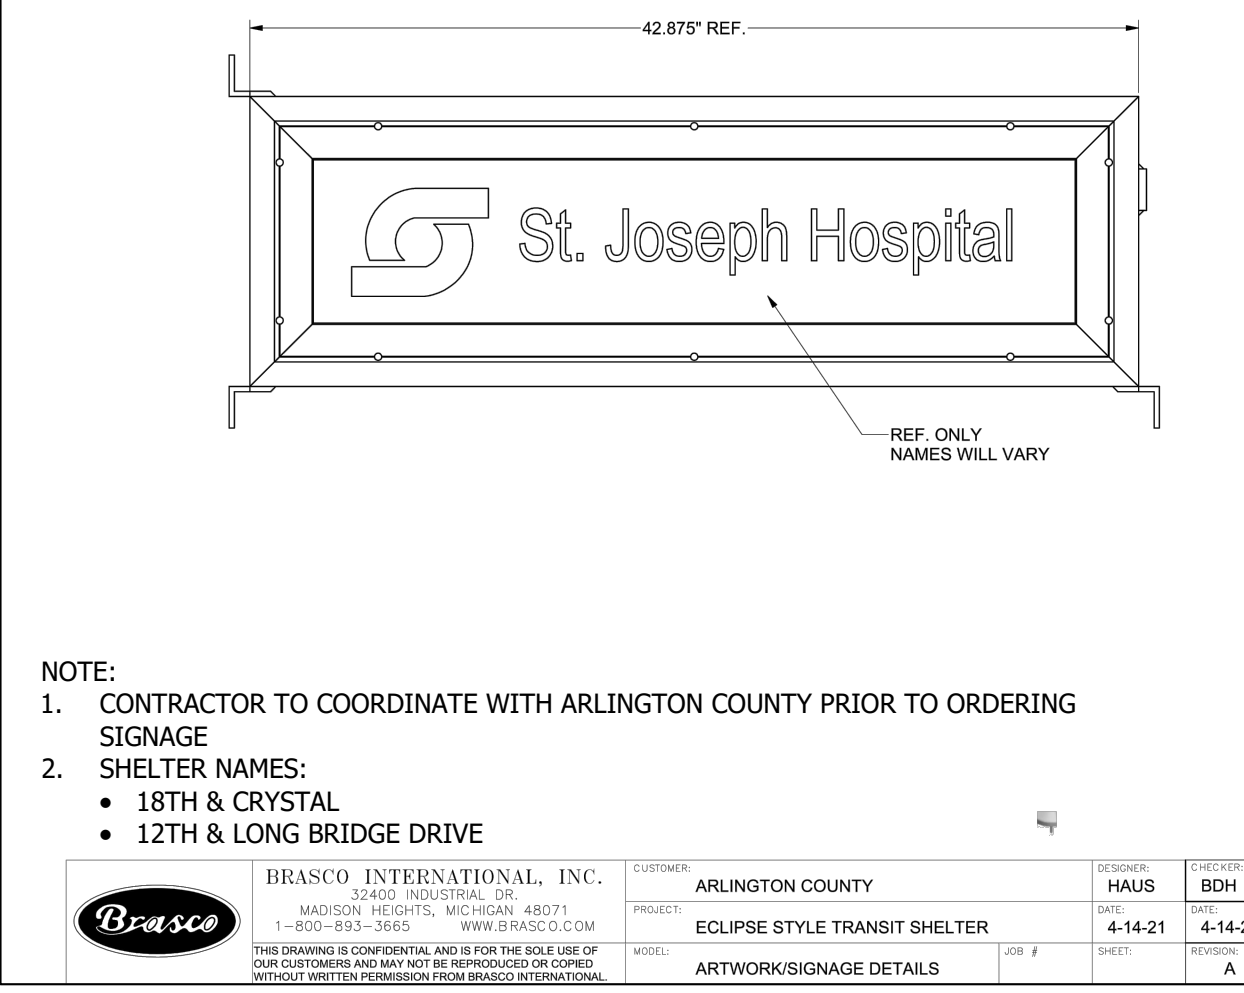

SHELTER NAME SIGNAGE N.T.S.

DEPARTMENT OF ENVIRONMENTAL SERVICES
FACILITIES & ENGINEERING DIVISION
ENGINEERING BUREAU
2100 CLARENDON BOULEVARD, SUITE 813
ARLINGTON, VA 22201
PHONE: 703.228.3629
FAX: 703.228.3606

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APPROVALS	DATE
<i>Kamell</i>	3/29/21
QUALITY CONTROL ENGINEER <i>Kamal Takat</i>	3.24.21
CONSTRUCTION MANAGEMENT SUPERVISOR <i>Diana</i>	03.04.2021
WATER, SEWER, STREETS BUREAU CHIEF <i>Dennis M. Leach</i>	03/17/21
TRANSPORTATION DIRECTOR <i>Diana Iaza</i>	3/21

REVISIONS	DATE

PROJECT NAME AND LOCATION
TRANSITWAY EXTENSION TO PENTAGON CITY

STATION DETAILS
CRYSTAL DR & 12TH ST S

MA13 - SEGMENT 1

DESIGNED: PB
DRAWN: NS
CHECKED: TL
MISS UTILITY TRANSMITTAL #: N/A

FILENAME:
PATH: \\DES-CAD-S2\ENGINEERING_DATA\DATA\MA13

PLOTTED: AUGUST 4 2021
PLOTTED BY: NSHARP

SCALE: N/A



APPROVALS DATE
 [Signature] 3/29/21
 QUALITY CONTROL ENGINEER
 [Signature] 3.24.21
 CONSTRUCTION MANAGEMENT SUPERVISOR
 [Signature] 03.04.2021
 WATER, SEWER, STREETS BUREAU CHIEF
 [Signature] 03/17/21
 TRANSPORTATION DIRECTOR
 [Signature] 3/2/21
 PROJECT MANAGER

REVISIONS DATE

PROJECT NAME AND LOCATION
TRANSITWAY EXTENSION TO PENTAGON CITY
STATION DETAILS
CRYSTAL DR & 12TH ST S
 MA13 - SEGMENT I

DESIGNED: PB
 DRAWN: NS
 CHECKED: TL
 MISS UTILITY TRANSMITTAL #: N/A
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 PATH: \\DES-CAD-S2\ENGINEERING_DATA\DA\MA13
 PLOTTED: AUGUST 4 2021
 PLOTTED BY: NSHARP

SCALE: N/A

LED Illumination

UL Listed Outdoor Rated LED Light

The PLS-Series' UL Listed, outdoor rated LED light outperforms most any other single solar powered light on the market. It is both rated as one of the safest LED lights for outdoor / damp locations as well as one of the highest luminaire outputs.



- Highlights:
- 3.60 foot candles at 2 ft.
 - 8.00 foot candles at 4 ft.
 - 30.1 foot candles at 6 ft.

PLS-SERIES PV PANEL HIGHLIGHTS

Qualifications	UL Listed
Wattage	5W LED Light
Manufacturer's Warranty	5 Years


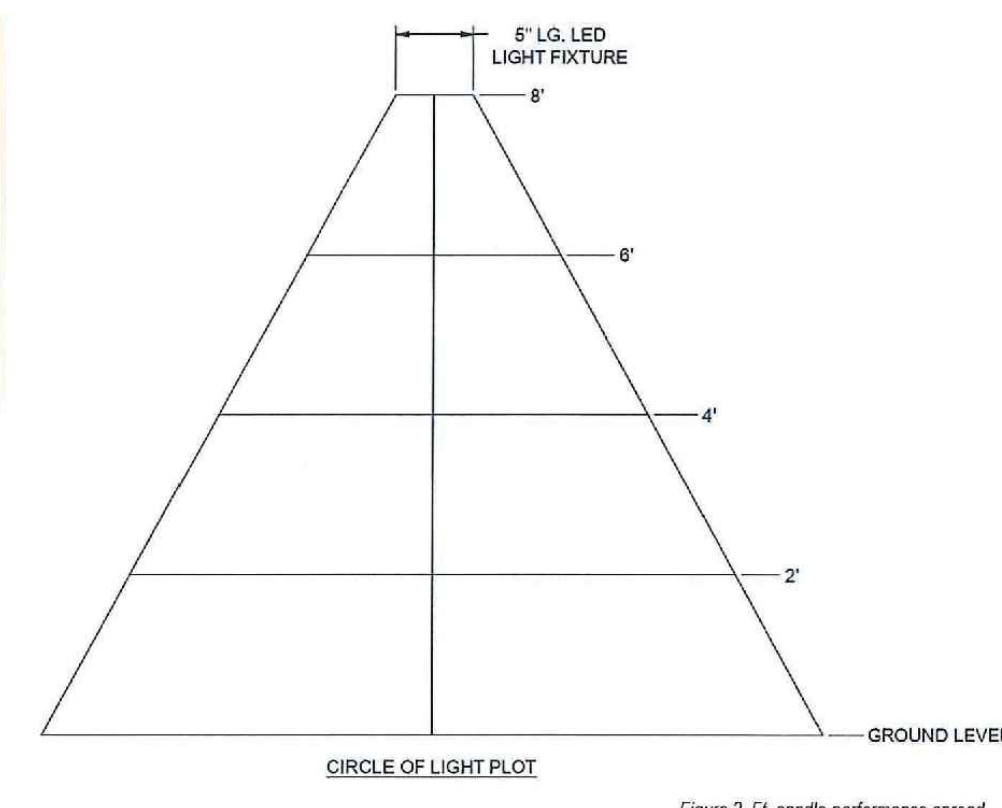


Figure 1. Performance Metrics

Figure 2. Ft. candle performance spread

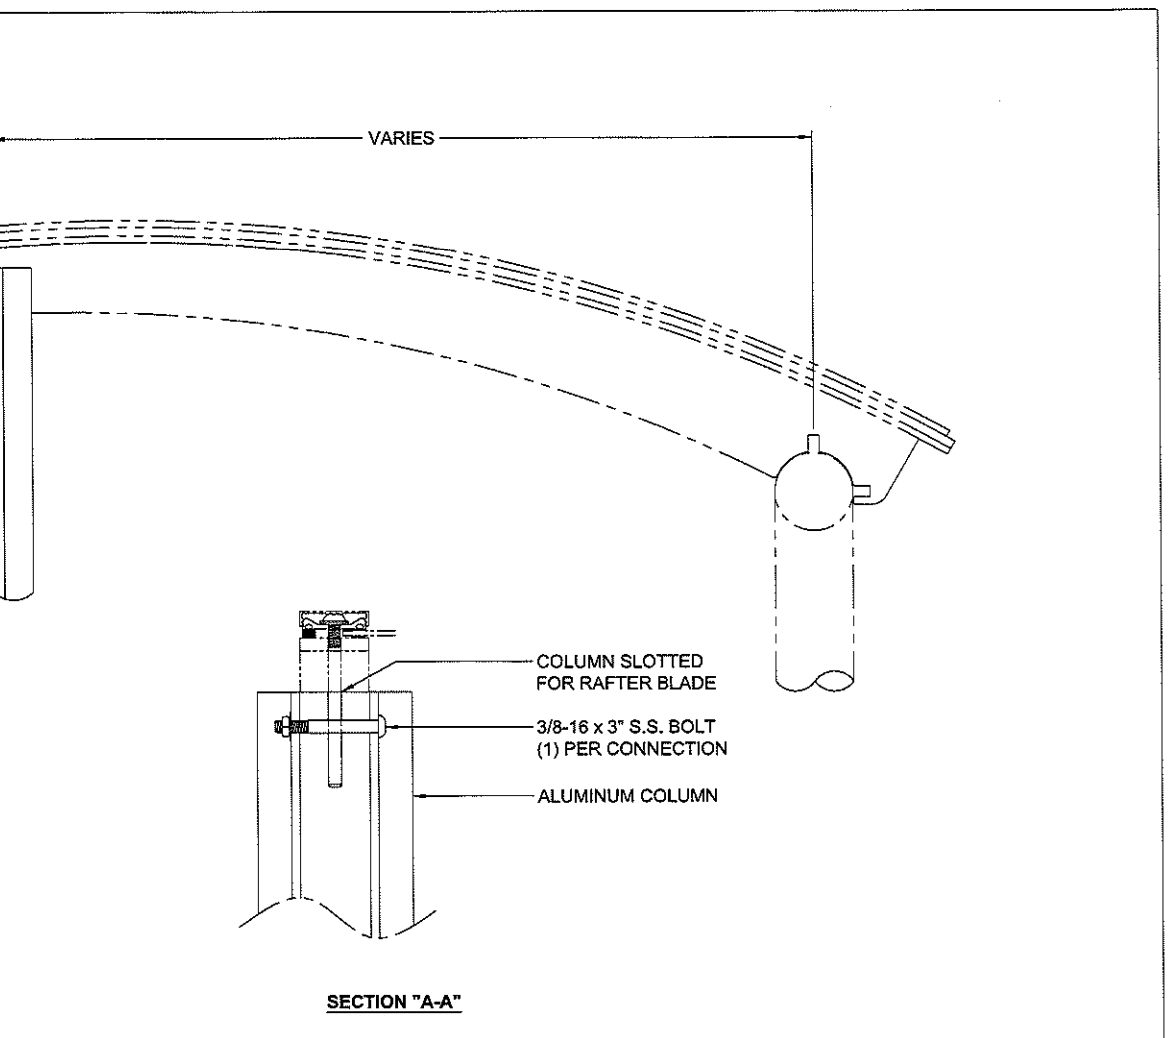


BRASCO INTERNATIONAL, INC.
 32400 INDUSTRIAL DRIVE
 MADISON HEIGHTS, MICHIGAN 48071
 1-800-893-3665 WWW.BRASCO.COM

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CUSTOMER:	BRASCO INTERNATIONAL	ENGINEER:	HAUS
PROJECT:	ECLIPSE STYLE TRANSIT SHELTER DETAILS	DATE:	8-3-13
MODEL:	FRONT COLUMN TO RAFTER ATTACHMENT	CHECKED:	SOH
		DATE:	9-4-13
SIGNED:		JOB #	EQ-DET
DATE:		SHEET #	5

FRONT COLUMN TO RAFTER ATTACHMENT
 N.T.S.

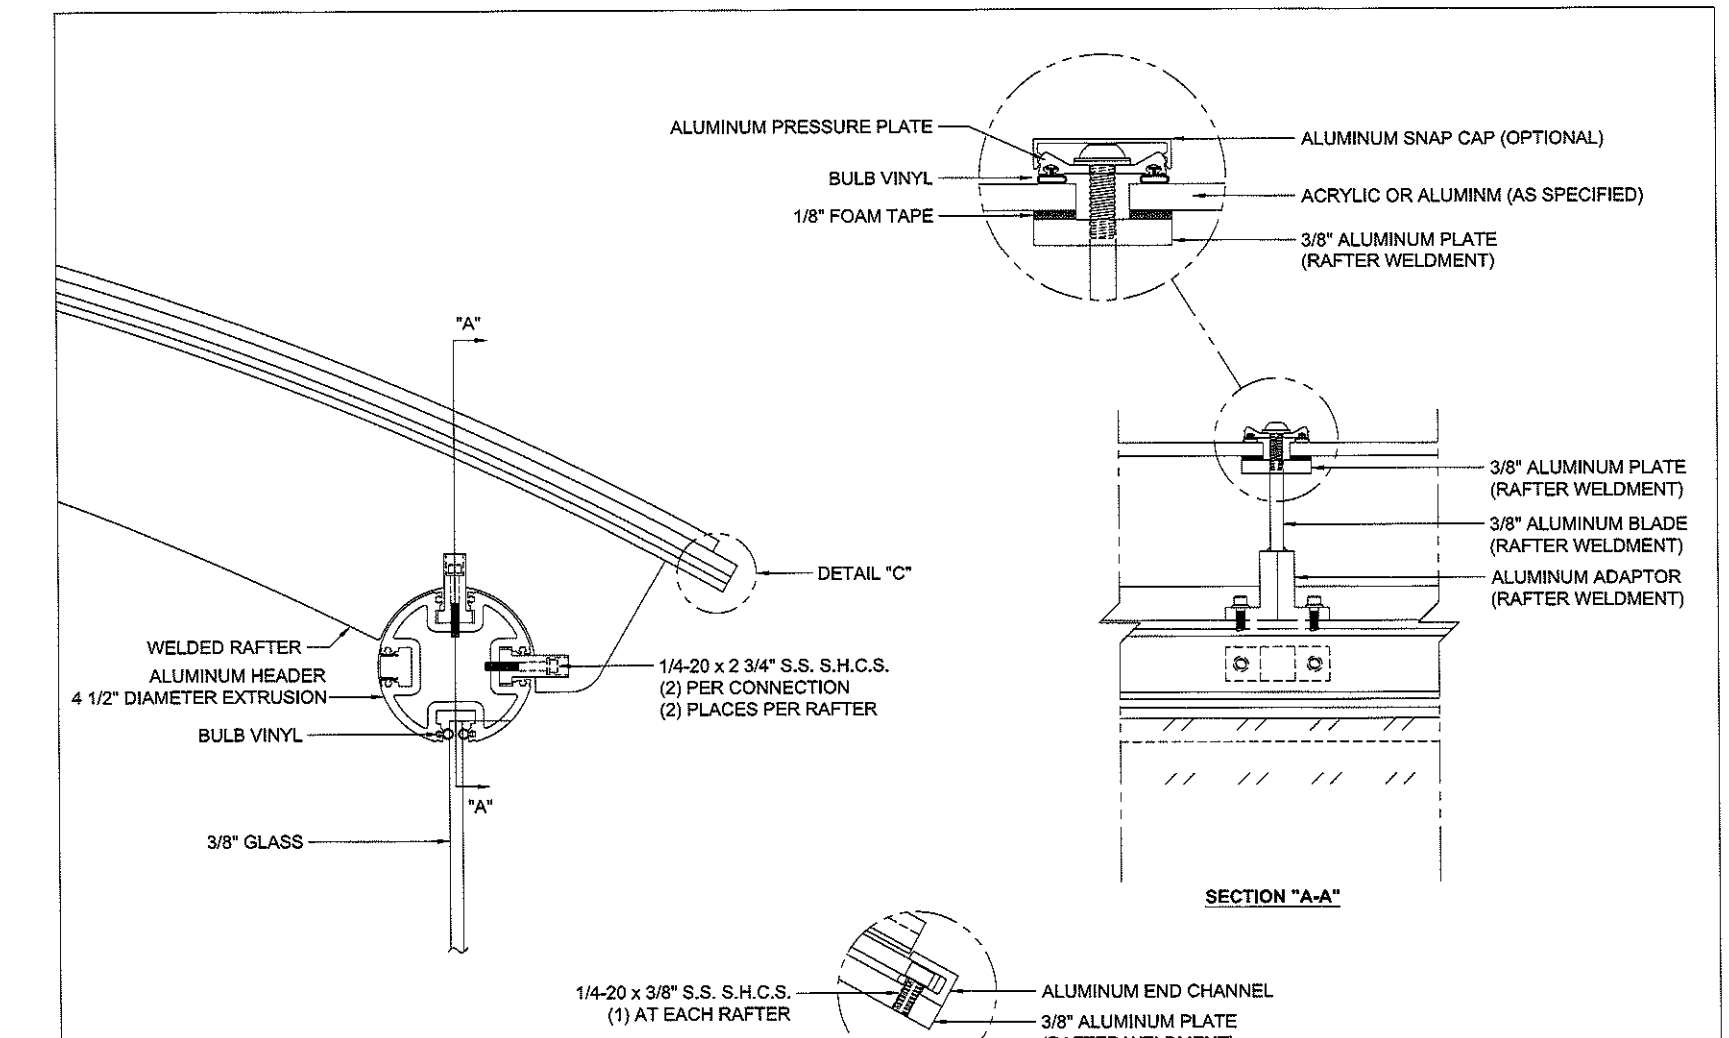


BRASCO INTERNATIONAL, INC.
 32400 INDUSTRIAL DRIVE
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CUSTOMER:	BRASCO INTERNATIONAL	ENGINEER:	HAUS
PROJECT:	ECLIPSE STYLE TRANSIT SHELTER DETAILS	DATE:	8-3-13
MODEL:	RAFTER AND ROOF ATTACHMENTS	CHECKED:	SOH
		DATE:	9-4-13
SIGNED:		JOB #	EQ-DET
DATE:		SHEET #	4

RAFTER AND ROOF ATTACHMENTS
 N.T.S.


Installing Expansion Anchors



Setting information	Symbol	Units	Nominal anchor diameter, d _a				
			3/8	1/2	5/8	3/4	1
Nominal bit diameter	d _b	in.	3/8	1/2	5/8	3/4	1
Minimum nominal embedment	e _{min}	in.	2-5/16 (69)	2-3/8 (80)	3-5/8 (91)	3-9/16 (91)	4-7/16 (119)
Effective minimum embedment	e _{eff}	in.	2 (51)	2 (51)	3-1/4 (83)	3-1/8 (79)	4 (102)
Min. hole depth	h _i	in.	2-5/8 (67)	2-5/8 (67)	4 (102)	3-3/4 (95)	4-5/8 (117)
Min. thickness of fixture	t _{min}	in.	3/8 (9)	3/8 (9)	n/a (3)	1/8 (3)	n/a (3)
Max. thickness of fixture	t _{max}	in.	2-1/4 (57)	4 (101)	2-3/4 (70)	5-5/8 (143)	4-3/4 (121)
Installation torque	T _{inst}	ft-lb (Nm)	25 (34)	40 (54)	60 (81)	110 (149)	110 (149)
Fixture hole diameter	d _i	in.	7/16 (11.1)	9/16 (14.3)	11/16 (17.5)	13/16 (20.6)	1 1/2 (25.4)
Available anchor lengths	e _{max}	in.	3 (76)	3-3/4 (90)	4 (102)	5-1/2 (140)	6 (152)
Threaded length including dog point	e _{thread}	in.	7/8 (22)	1-5/8 (41)	2-3/8 (60)	3-3/8 (88)	4-7/8 (125)
Unthreaded length	e _{unthr}	in.	2-1/8 (54)	2-1/8 (54)	3-1/4 (83)	4 (102)	4 (102)

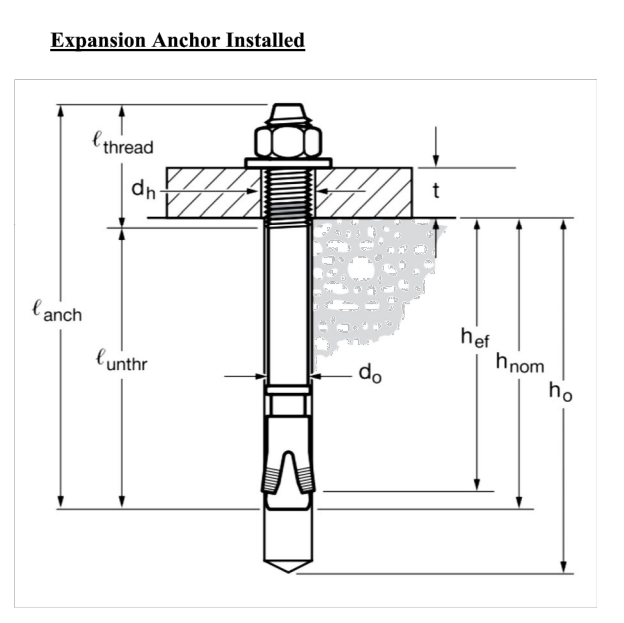Expansion Anchor Technical Chart
 Minimum thickness of fixture is a concern only when the anchor is installed at the minimum nominal embedment. When WWS Bolt 1Z anchors are installed at this embedment, the anchor threading ends near the surface of the concrete. If the fixture is sufficiently thin, it could be possible to run the nut to the bottom of the threading during application of the installation torque. If fixtures are thin, it is recommended that embedment be increased accordingly.

- Step 1. Prepping the Concrete**
 Using anchor boot as a template, mark hole locations and move anchor boot out of the way. Drill a hole the same diameter as the expansion anchor to a minimum depth of 1/2" deeper than the anchor will penetrate to allow debris to fall during installation.
- Step 2. Prepping the Hole**
 Clean debris from holes using a wire brush, vacuum, or compressed air.
- Step 3. Anchor Installation**
 Replace the anchor boot and align with holes in the concrete. Make sure the nut on the expansion anchor is threaded to the top of the threaded rod to prevent damage to the threads. Insert the expansion anchor through the base plate and into the hole in the concrete. Hit the expansion anchor with sharp blows until the washers are snug against the base plates.
- Step 4. Securing the Anchor Boot**
 Tighten the nut to the recommended installation torque.

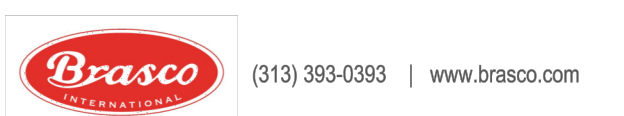

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Standard Brasco Anchoring Guidelines



Expansion Anchor Installed

1. Locating proper column locations is critical. Care must be taken to keep columns plumb and walls square to each other.
2. Shelter should be sloped slightly to the rear for proper drainage. Approximately 1/4 inch slope per ft. from front to rear of shelter is recommended. Columns should be shimmed as necessary.
3. Anchors to be installed in conjunction with manufacturers recommendations only. (See Expansion Anchor Technical Chart on previous page.)
4. Anchors need to be installed a minimum of 6 inches from the edge of the concrete pad. See below for reference.

Standard Concrete Pad Overview

NOTE: This visual is for reference only. Brasco is not liable for concrete installation instructions unless structural concrete calculations are included with an order. Consult your local building codes for specific concrete pad requirements.

RECOMMENDED: Brasco recommends a minimum 4 inch thick, 3000 PSI concrete pad for areas with wind speeds lower than 110 MPH. The concrete pad should allow a minimum of 6 inches around the shelter's perimeter to prevent concrete breakage when anchoring. Concrete may or may not require additional reinforcement.

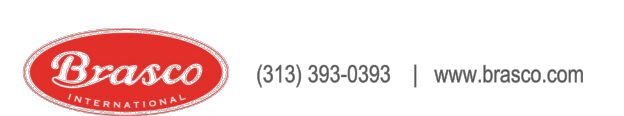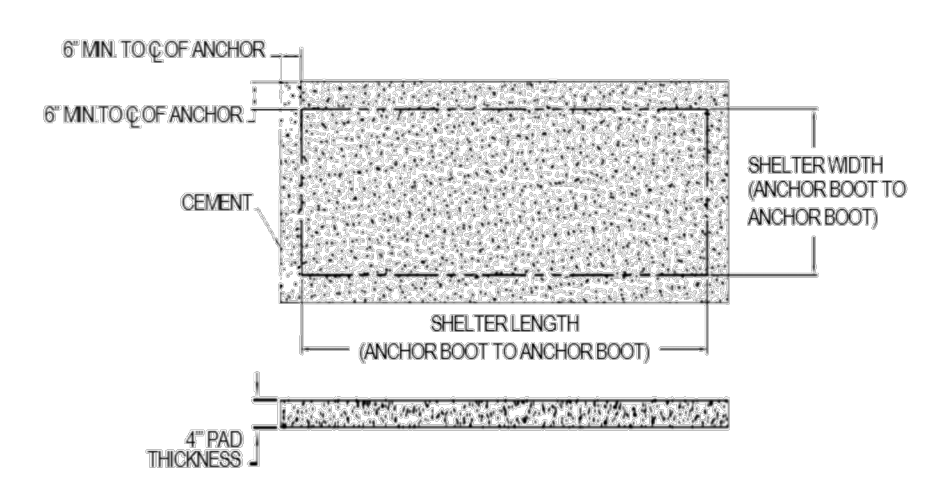

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INSTALLING EXPANSION ANCHORS
 N.T.S.

ANCHORING GUIDELINES
 N.T.S.


STORAGE AND TOOLS
 N.T.S.

Storage

1. Products stored outside must be fully tarped. Wooden crates, cardboard boxes and identifying labels are not weatherproof and will deteriorate in the elements.
2. If your order includes solar lighting, be cautious when handling batteries as they are capable of generating hazardous short-circuit currents. Remove all jewelry (bracelets, metal watches, rings) before attempting to handle or disassemble batteries.
3. Batteries should be stored indoors at a recommended 68 degrees Fahrenheit for max shelf life.
4. Batteries should be installed no later than 3 months from delivery or battery warranties will be void.

TOOLS NEEDED


<input type="checkbox"/> Drill Motor / Impact Driver	<input type="checkbox"/> Cordless Drill	<input type="checkbox"/> Chalk Line
<input type="checkbox"/> 3/8" Drill Bit (min. 6" lg.)	<input type="checkbox"/> Air Compressor	<input type="checkbox"/> Tape Measure
<input type="checkbox"/> Ply Bar (Leveling)	<input type="checkbox"/> Steel Hammer	<input type="checkbox"/> Torque Wrench
<input type="checkbox"/> 8" Long Masonry Drill Bits	<input type="checkbox"/> Dead Blow Hammer or Mallet	<input type="checkbox"/> Hex Key Set
<input type="checkbox"/> 5/8" and 3/4" Socket and Wrench	<input type="checkbox"/> Bubble Level, Line / String Level	<input type="checkbox"/> Generator or Other Power Source
<input type="checkbox"/> HD Drill Motor or Hammer Drill	<input type="checkbox"/> Min. 6ft. Step Ladder	<input type="checkbox"/> Shop Vac or Blower for Clean Up

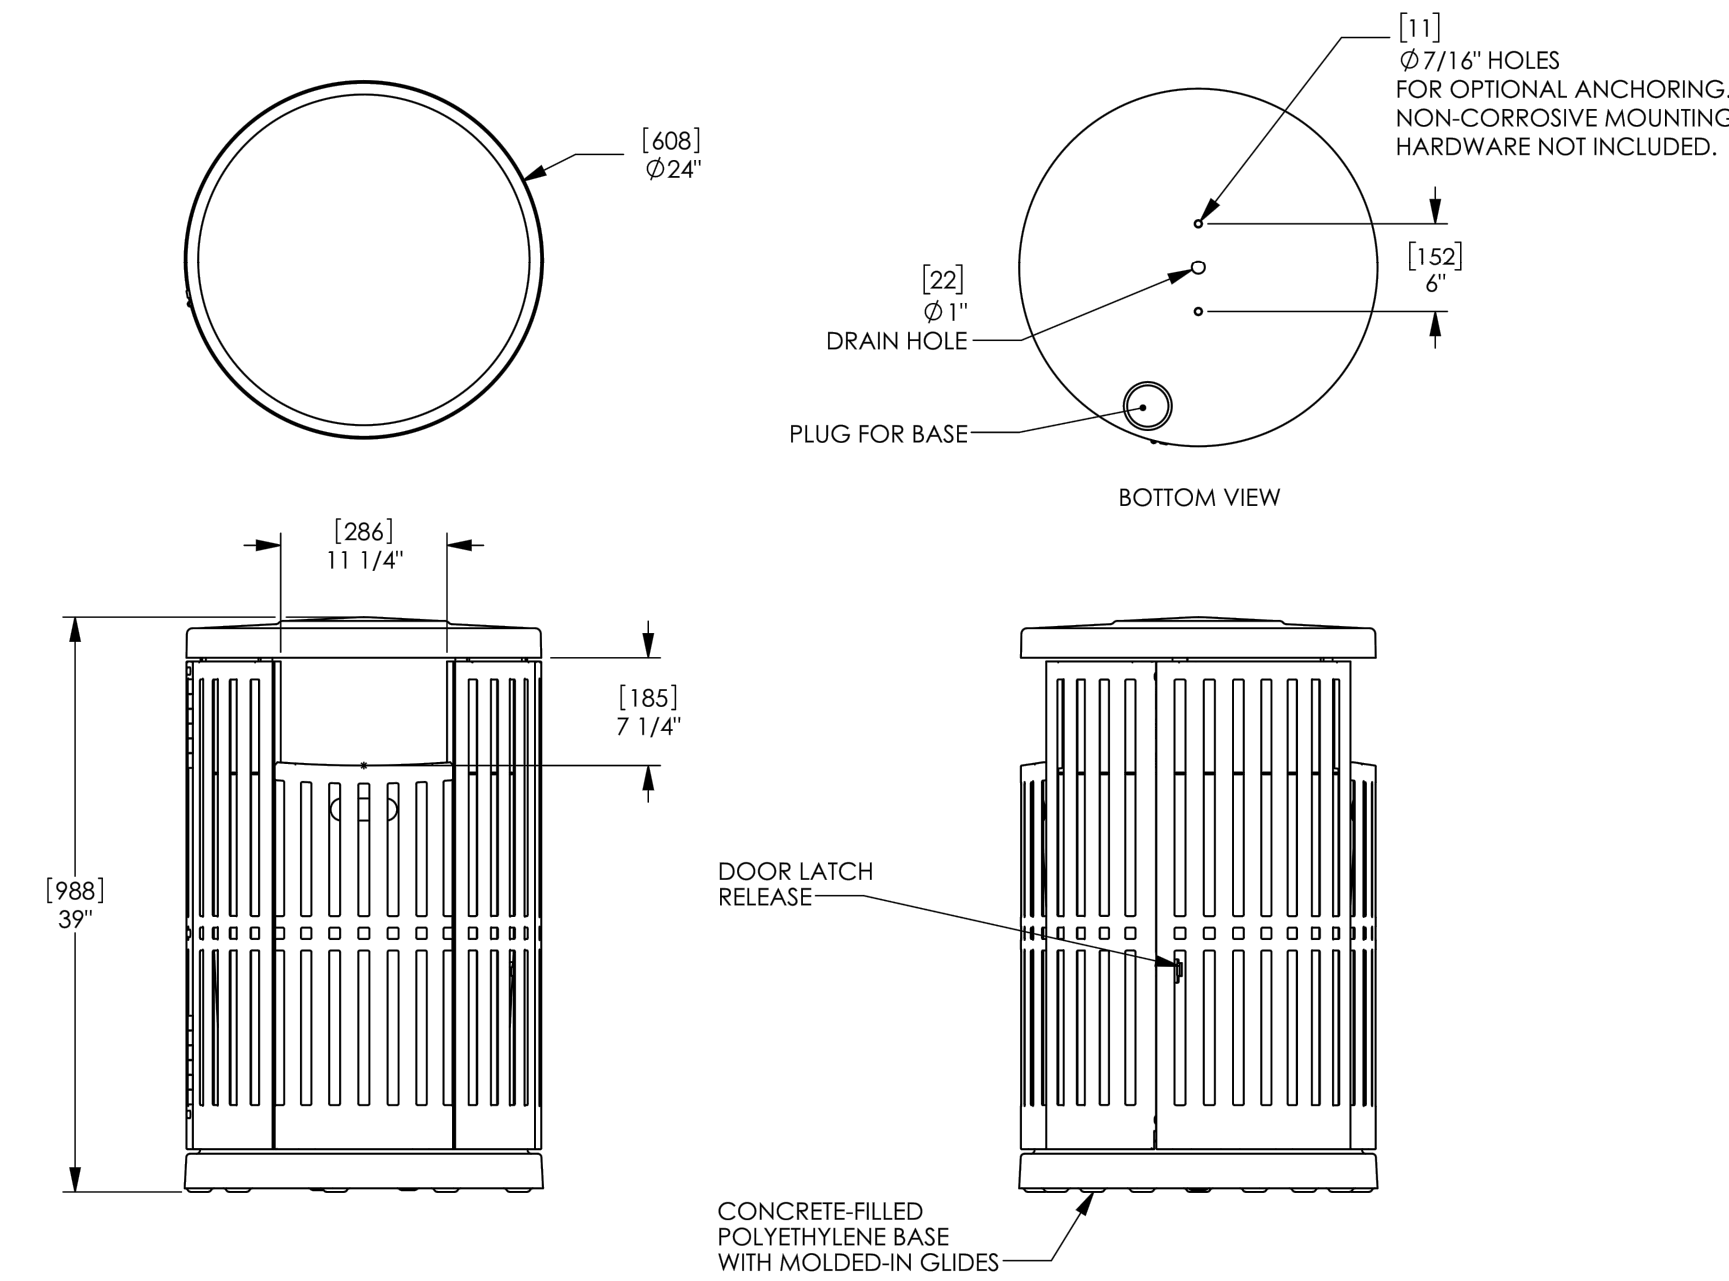

landscapiforms Drawing: CP363-01
Dimensions are in inches [mm]

- NOTE:
1. CONTRACTOR TO UTILIZE THESE DETAILS OR APPROVED EQUAL
2. POWDER COATED METAL: BLACK
3. AMENITIES SHALL BE INSTALLED PER SHEET 21


LITTER RECEPTACLE, 36 GALLON, SIDE OPENING N.T.S.

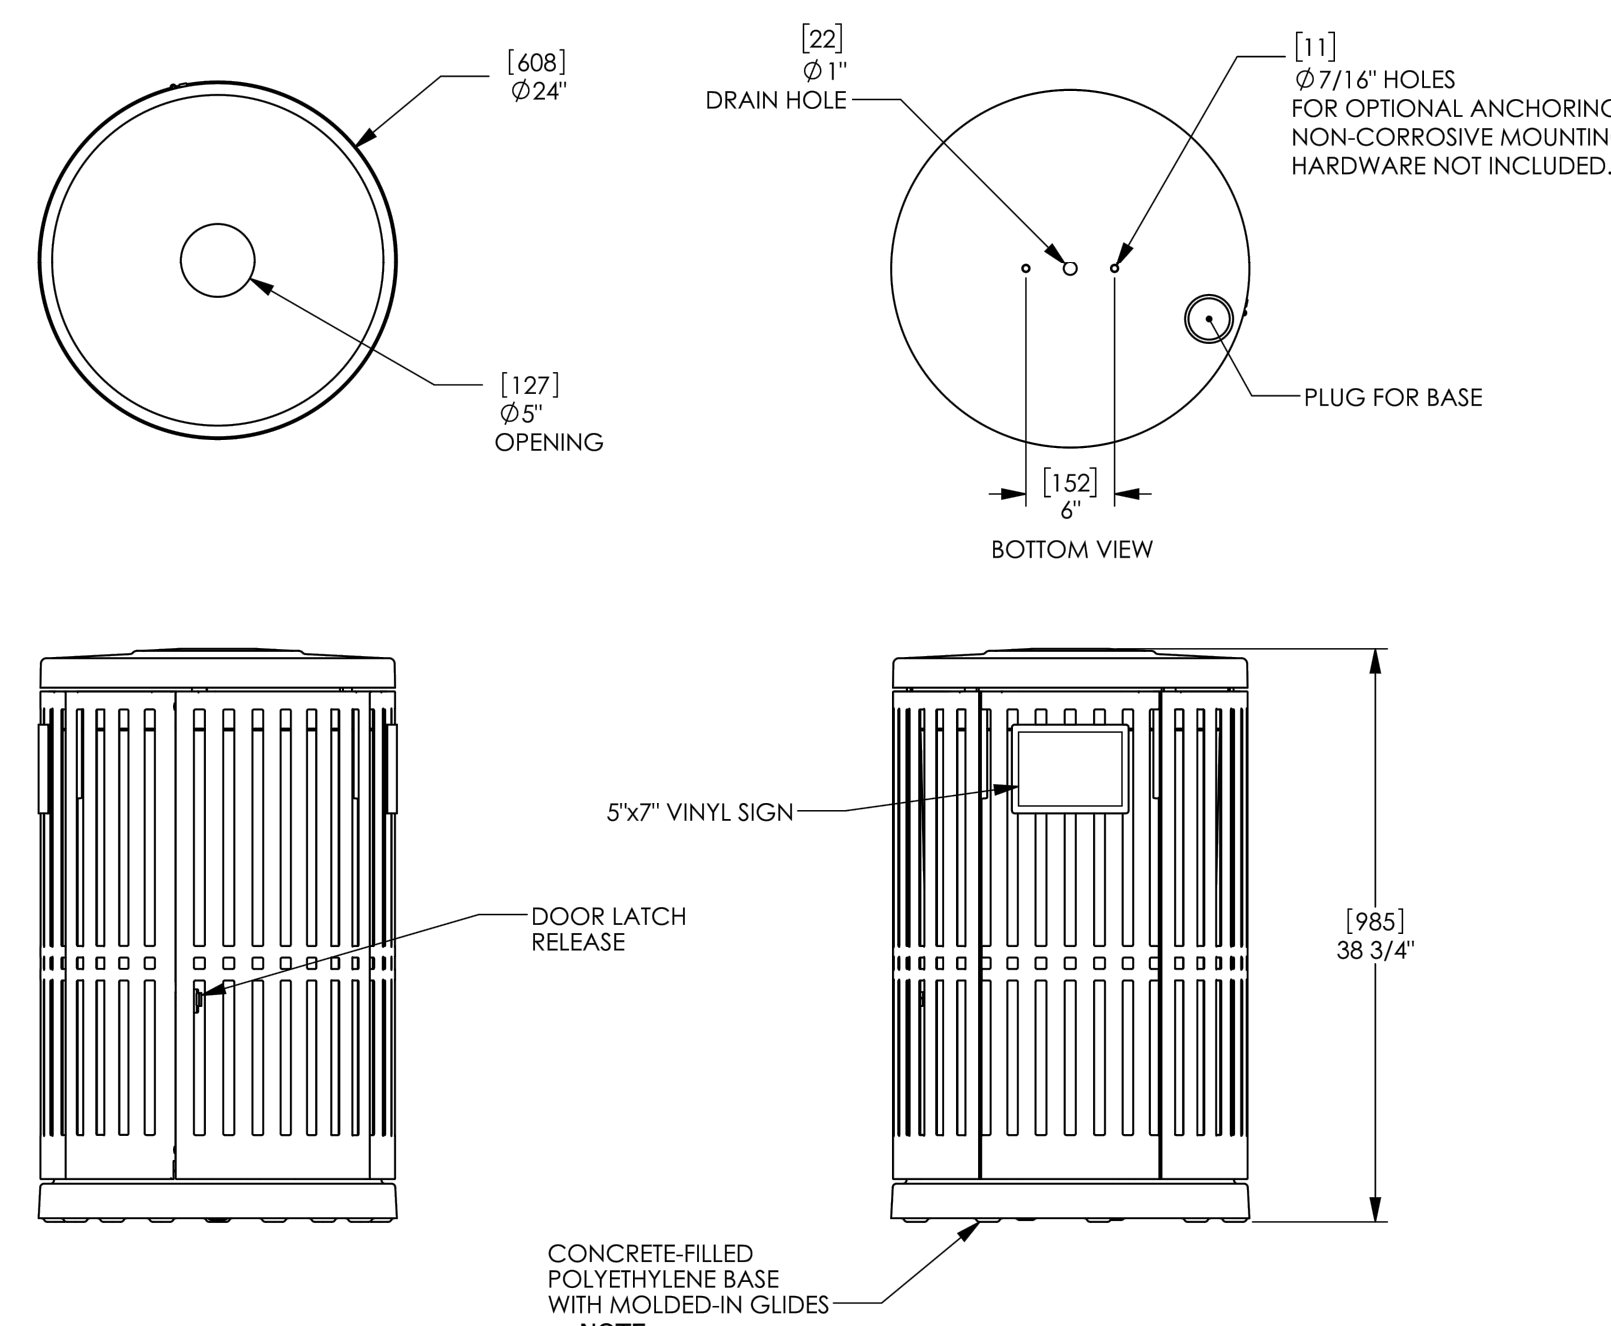

landscapiforms Drawing: CP363-01-HCL
Dimensions are in inches [mm]

- NOTE:
1. CONTRACTOR TO UTILIZE THESE DETAILS OR APPROVED EQUAL
2. POWDER COATED METAL: BLUE
3. AMENITIES SHALL BE INSTALLED PER SHEET 21


RECYCLING STATION, 40 GALLON, TOP OPENING N.T.S.

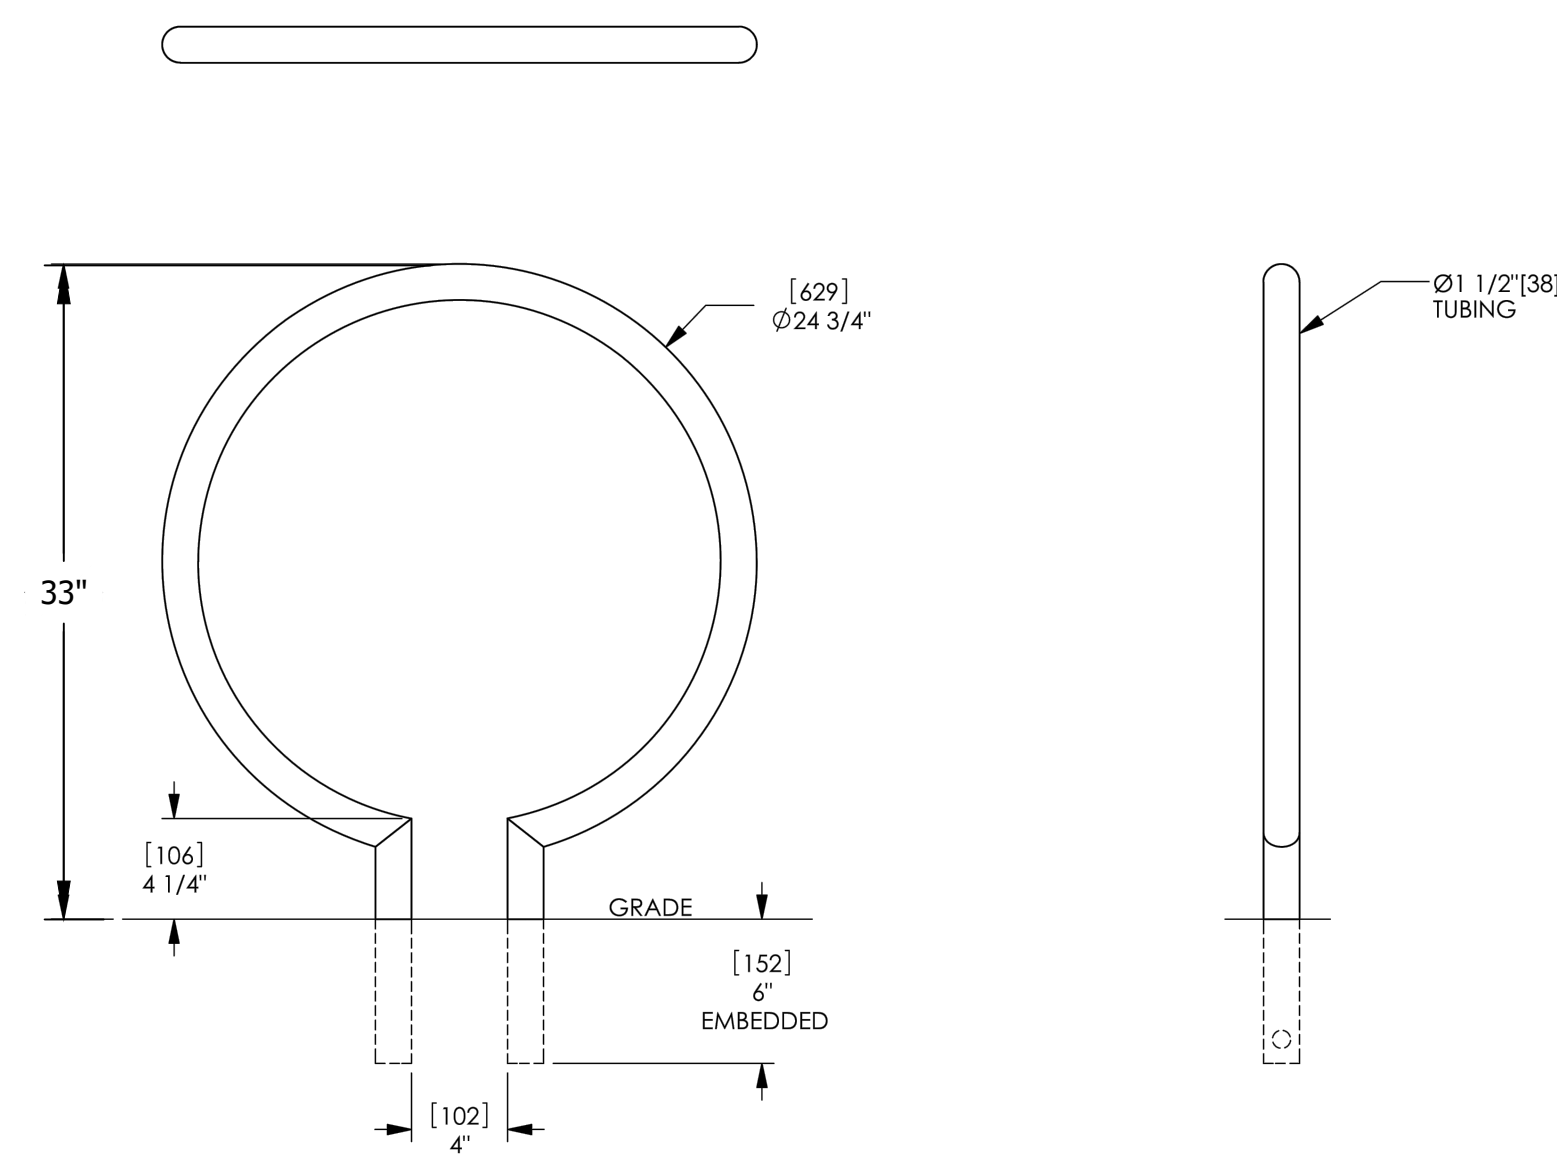

landscapiforms Drawing: RG263-01
Dimensions are in inches [mm]

- NOTE:
1. CONTRACTOR TO UTILIZE THESE DETAILS OR APPROVED EQUAL
2. POWDER COATED METAL: SILVER
3. AMENITIES SHALL BE INSTALLED PER SHEET 21
4. CONTRACTOR SHALL SPECIAL ORDER BIKE RACKS TO ENSURE THE INSTALLED HEIGHT OF 33"

BIKE RACK, EMBEDDED N.T.S.

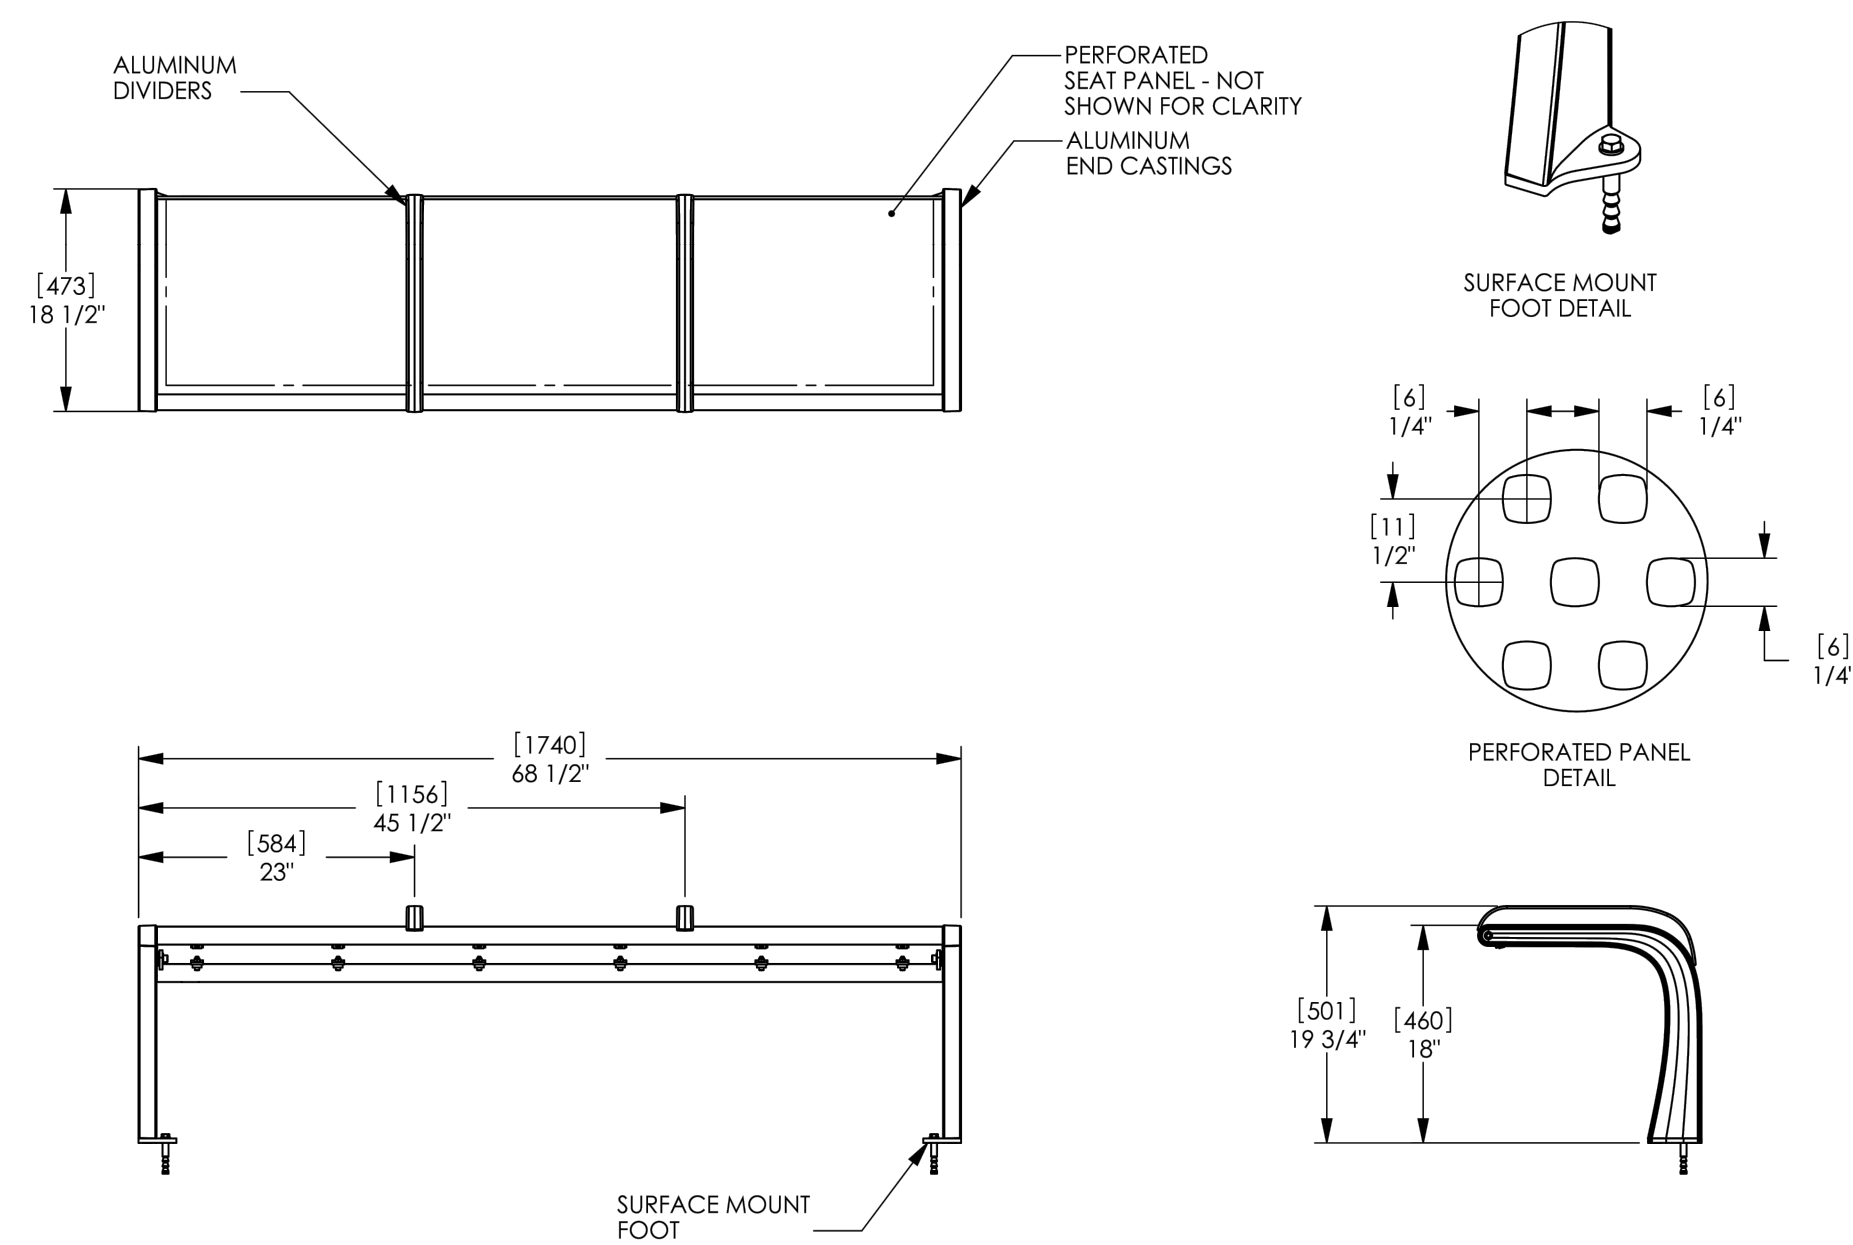

landscapiforms Drawing: SA476-03
Dimensions are in inches [mm]
U.S. Patent No.: D507,420

- NOTE:
1. CONTRACTOR TO UTILIZE THESE DETAILS OR APPROVED EQUAL
2. POWDER COATED METAL: SILVER
3. AMENITIES SHALL BE INSTALLED PER SHEET 21
4. CONTRACTOR SHALL SPECIAL ORDER BENCHES TO ENSURE THE INSTALLED WIDTH OF 4 FEET OR 6 FEET

BENCH, STRAIGHT, BACKLESS, DIVIDERS, SURFACE MOUNTED N.T.S.



APPROVALS	DATE
<i>[Signature]</i>	3/29/21
QUALITY CONTROL ENGINEER <i>Ramal Taktak</i>	3.24.21
CONSTRUCTION MANAGEMENT SUPERVISOR <i>[Signature]</i>	03.04.2021
WATER, SEWER, STREETS BUREAU CHIEF <i>Dennis M. Leach</i>	03/17/21
TRANSPORTATION DIRECTOR <i>Diana Iaza</i>	3/2/21
PROJECT MANAGER	

REVISIONS	DATE

PROJECT NAME AND LOCATION
TRANSITWAY EXTENSION TO PENTAGON CITY
STATION DETAILS
CRYSTAL DR & 12TH ST S
MA13 - SEGMENT I

DESIGNED: PB
DRAWN: NS
CHECKED: TL
MISS UTILITY TRANSMITTAL #: N/A
FILENAME: MA13-204-DETAILS.DWG
PATH: \\DES-CAD-S2\ENGINEERING_DATA\DATA\MA13
PLOTTED: AUGUST 4 2021
PLOTTED BY: NSHARP

SCALE: N/A

DEPARTMENT OF
ENVIRONMENTAL SERVICES
FACILITIES & ENGINEERING DIVISION
ENGINEERING BUREAU
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FAX: 703.228.3606

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APPROVALS	DATE
<i>[Signature]</i> QUALITY CONTROL ENGINEER	3/29/21
<i>[Signature]</i> Kamal Takrar	3.24.21
<i>[Signature]</i> CONSTRUCTION MANAGEMENT SUPERVISOR	03.04.2021
<i>[Signature]</i> WATER, SEWER, STREETS BUREAU CHIEF	03/17/21
<i>[Signature]</i> Dennis M. Leach TRANSPORTATION DIRECTOR	3/2/21
<i>[Signature]</i> Diana Laza PROJECT MANAGER	


REVISIONS	DATE

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PROJECT NAME AND LOCATION
TRANSITWAY EXTENSION TO
PENTAGON CITY
STATION DETAILS
CRYSTAL DR & 12TH ST S
MA13 - SEGMENT I

DESIGNED: PB
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PATH: \\DES-CAD-S2\ENGINEERING_DATA\DA\MA13
PLOTTED: AUGUST 4 2021
PLOTTED BY: NSHARP

SCALE: N/A

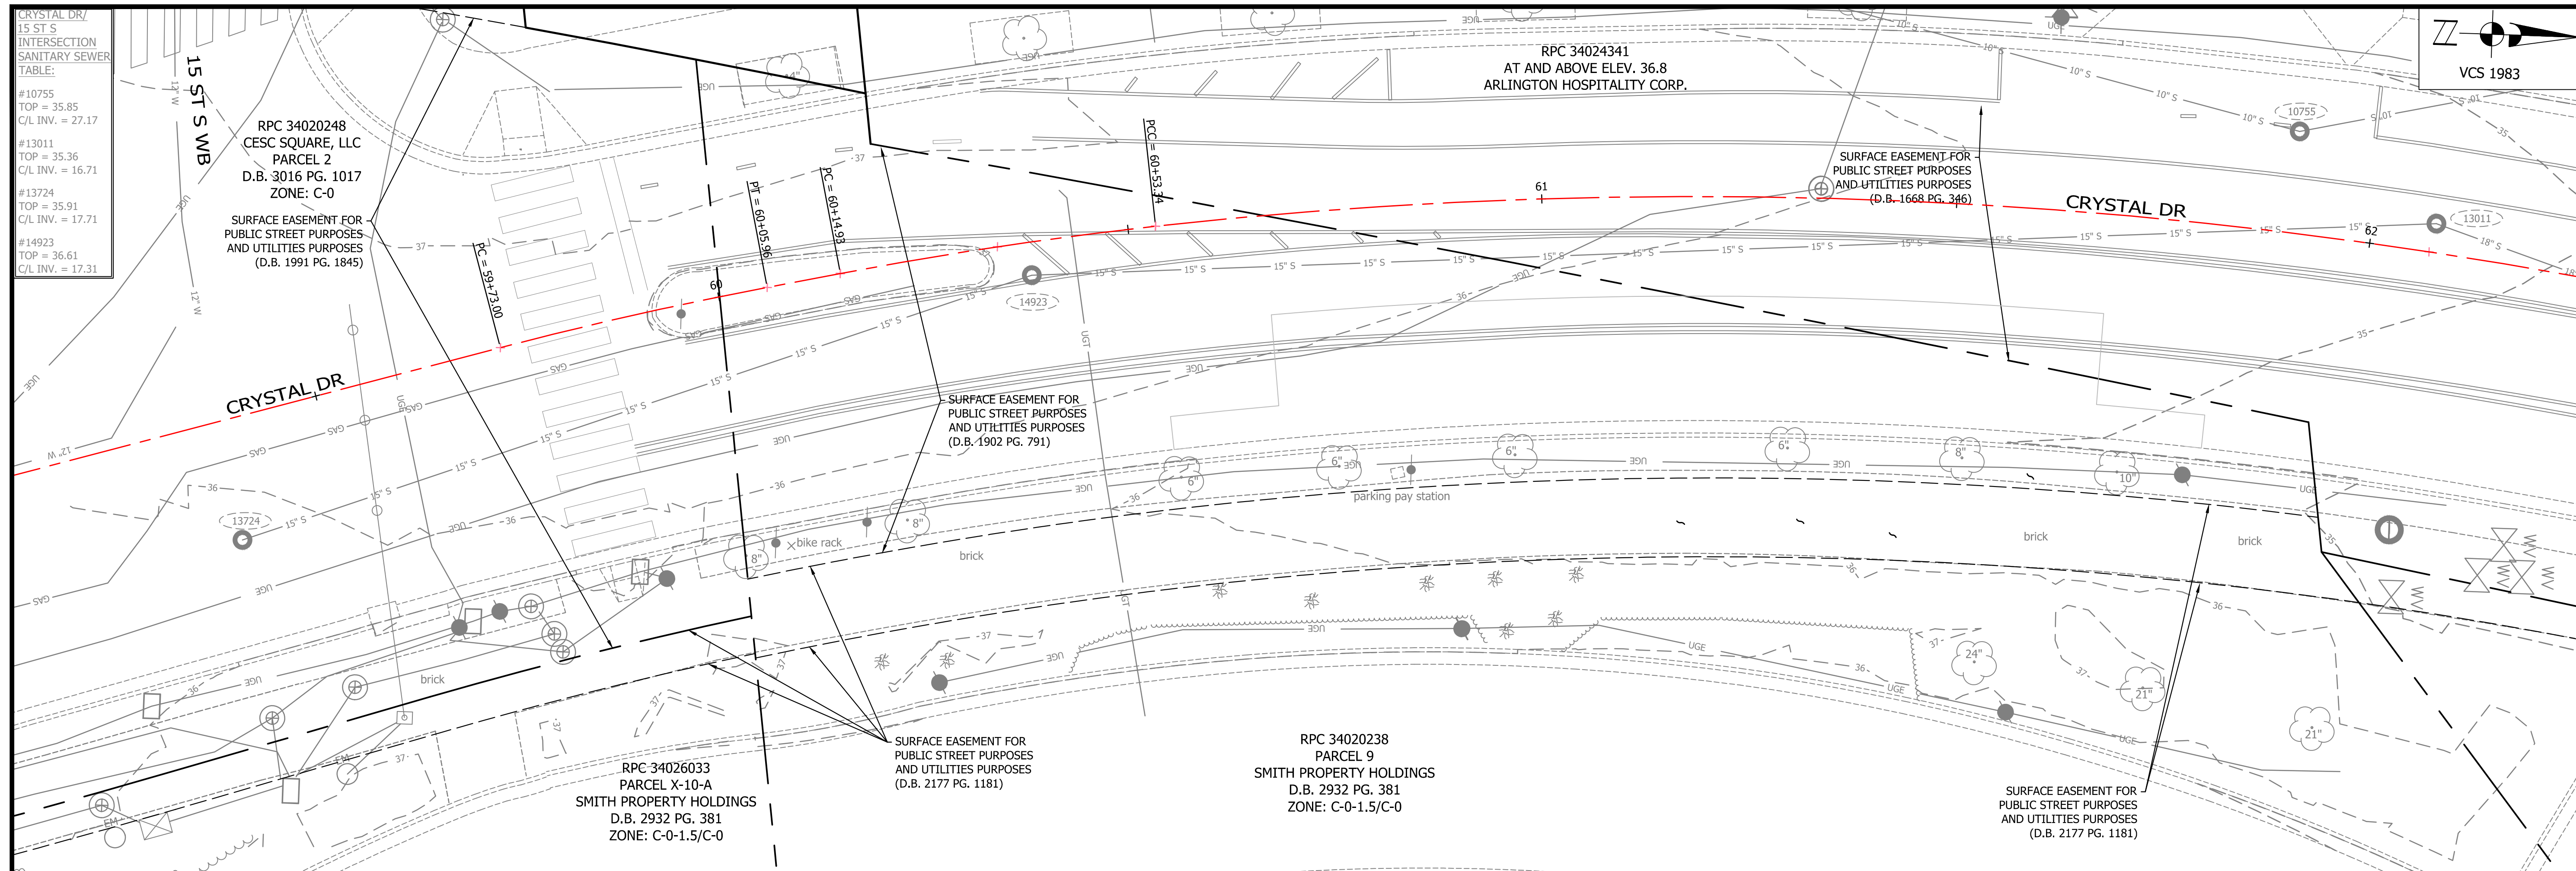

APPROVALS	DATE
<i>T. Lantzy</i>	3/29/21
QUALITY CONTROL ENGINEER <i>Ramal Takat</i>	3.24.21
CONSTRUCTION MANAGEMENT SUPERVISOR <i>Quinn</i>	03.04.2021
WATER, SEWER, STREETS BUREAU CHIEF <i>Dennis M. Leach</i>	03/17/21
TRANSPORTATION DIRECTOR <i>Diana Iaza</i>	3/2/21
PROJECT MANAGER	

REVISIONS	DATE

GENERAL NOTES

- CRYSTAL DRIVE - THIS TOPOGRAPHIC SURVEY WAS COMPLETED UNDER THE DIRECT AND RESPONSIBLE CHARGE OF JOSHUA M. BROCK, L.S. FROM AN ACTUAL GROUND SURVEY MADE UNDER MY SUPERVISION; THAT THE IMAGERY AND/OR ORIGINAL DATA WAS OBTAINED FROM IN OCTOBER 2017; AND THAT THIS PLAT, MAP OR DIGITAL GEOSPATIAL DATA INCLUDING METADATA MEETS MINIMUM ACCURACY STANDARDS UNLESS OTHERWISE NOTED.
- 12 STREET SOUTH - THIS TOPOGRAPHIC SURVEY WAS COMPLETED UNDER THE DIRECT AND RESPONSIBLE CHARGE OF NATHAN A. ORR, L.S. FROM AN ACTUAL GROUND SURVEY MADE UNDER MY SUPERVISION; THAT THE IMAGERY AND/OR ORIGINAL DATA WAS OBTAINED FROM 01/29/2015 TO 03/10/2015; AND THAT THIS PLAT, MAP OR DIGITAL GEOSPATIAL DATA INCLUDING METADATA MEETS MINIMUM ACCURACY STANDARDS UNLESS OTHERWISE NOTED.
- HORIZONTAL DATUM: VIRGINIA COORDINATE SYSTEM 1983.
- VERTICAL DATUM: NORTH AMERICAN VERTICAL DATUM 1988.
- CONTOUR INTERVAL: 1'
- BOUNDARY INFORMATION SHOWN HEREON WAS COMPILED FROM EXISTING LAND RECORDS AND DOES NOT REPRESENT A FIELD RUN BOUNDARY SURVEY. PROP C/L PROVIDED FOR REFERENCE ONLY.


12 ST S/LONG BRIDGE DRIVE INTERSECTION STORM SEWER TABLE:

#15391	TOP = 27.98
15" RCP INV. OUT =	24.79 (15417)
#15417	TOP = 27.97
15" RCP INV. IN = NO ACCESS (15429)	
15" RCP INV. IN = NO ACCESS (15391)	
15" RCP INV. OUT = NO ACCESS (15413)	
#15429	TOP = 27.91
15" RCP INV. OUT =	24.41 (15417)
12 ST S/LONG BRIDGE DRIVE INTERSECTION SANITARY SEWER TABLE:	
#11648	TOP = 28.62
C/L INV. =	16.57
#13005	TOP = 27.99
C/L INV. =	12.91
#14034	TOP = 28.37
INV. IN =	13.96 (SOUTH)
C/L INV. =	13.06

NATHAN A. ORR
 Lic. No. 3178
 LAND SURVEYOR

JOSHUA M. BROCK
 Lic. No. 3122
 LAND SURVEYOR

CRYSTAL DR NB & 15TH ST S INTERSECTION

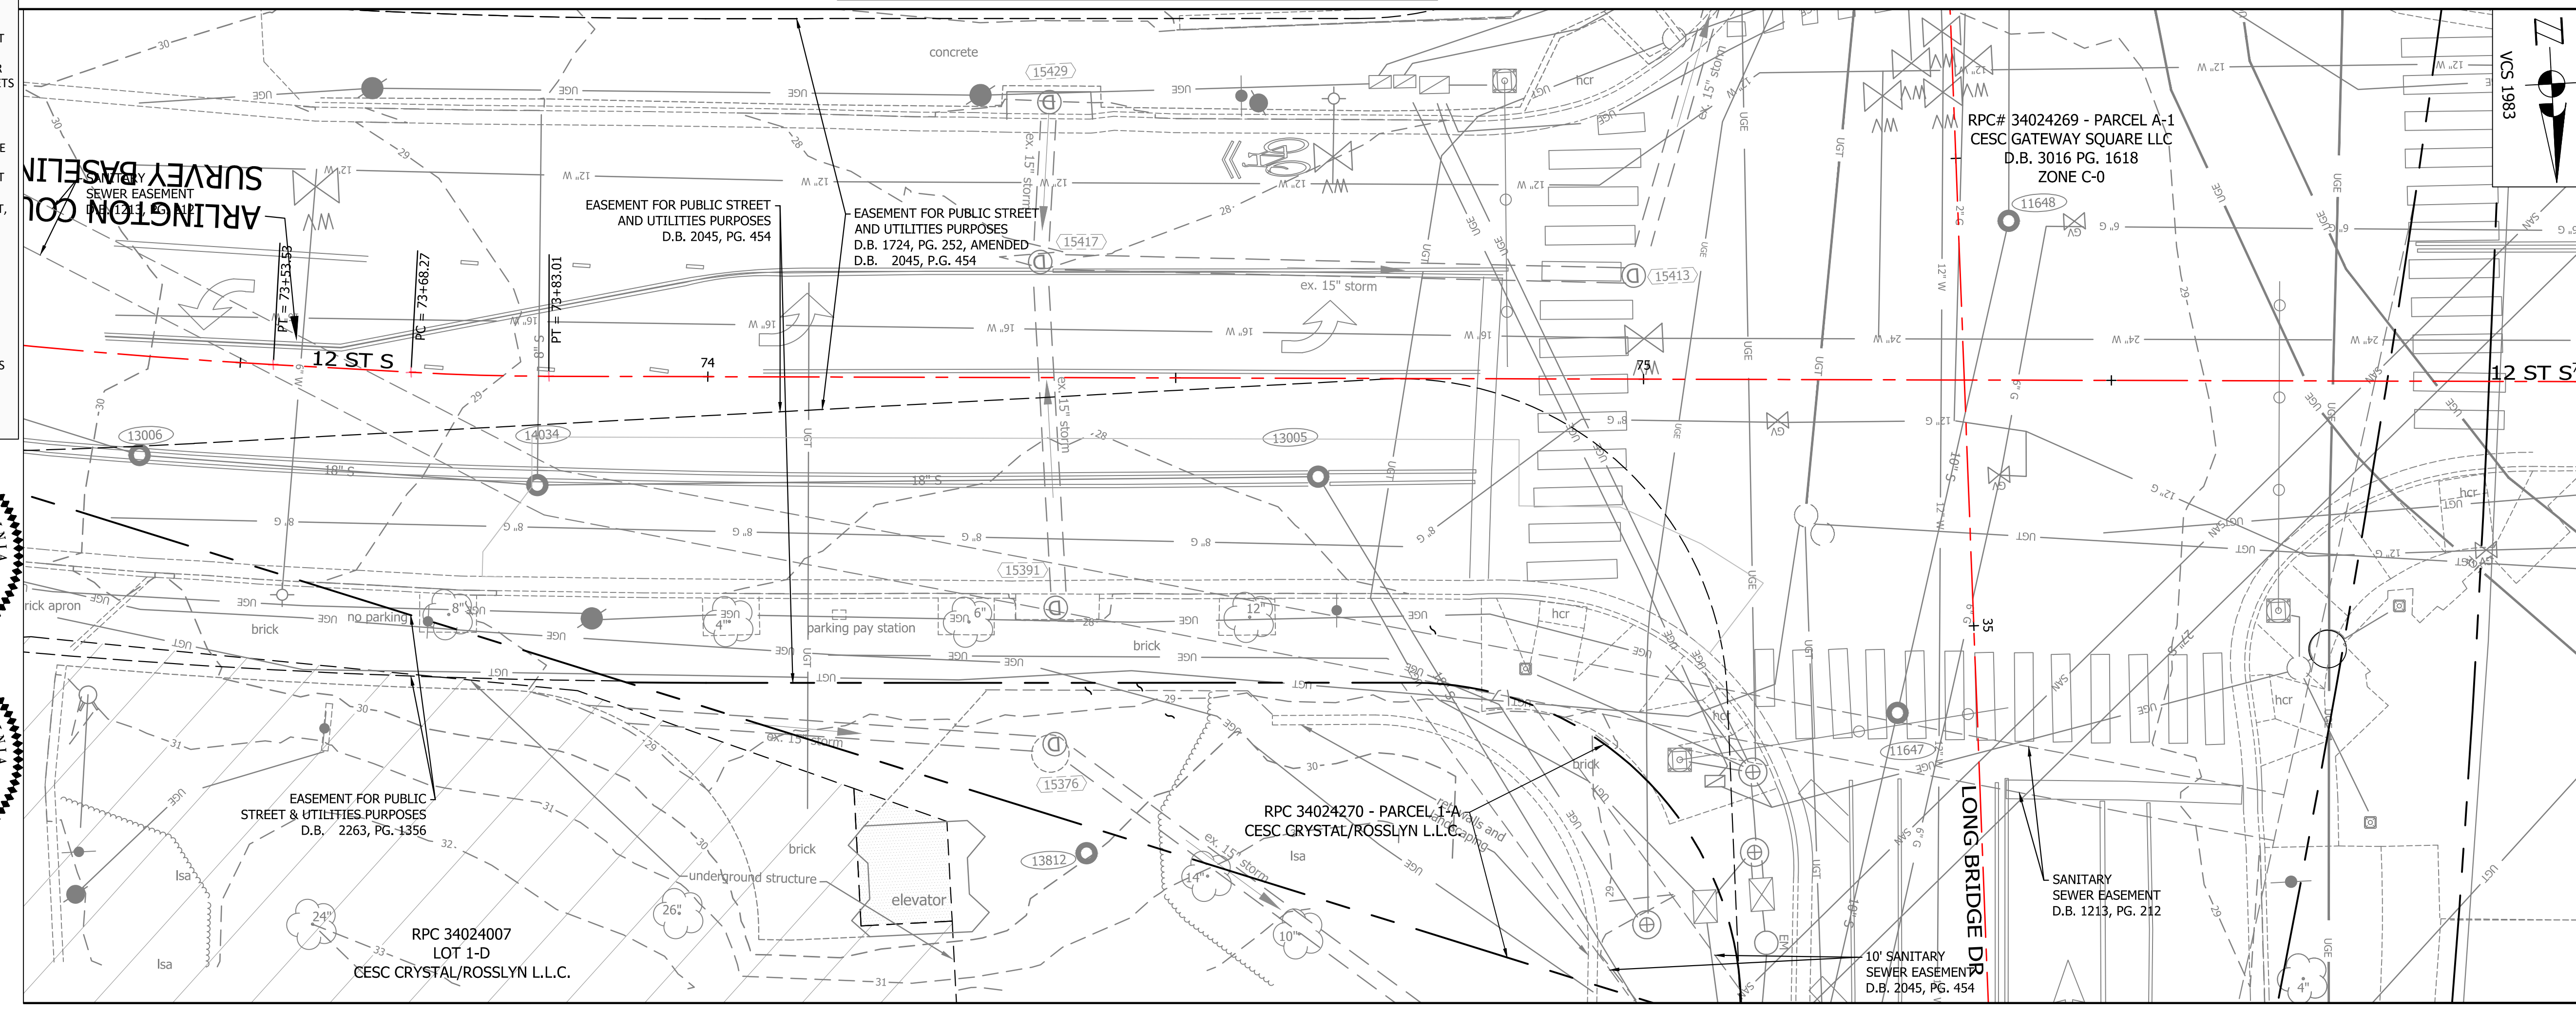

12TH ST S WB & LONG BRIDGE DR INTERSECTION


PROJECT NAME AND LOCATION
 TRANSITWAY EXTENSION TO PENTAGON CITY
 EXISTING CONDITIONS
 CRYSTAL DR & 12TH ST S
 MA13 - SEGMENT 1

DESIGNED: PB
 DRAWN: NS
 CHECKED: TL
 MISS UTILITY TRANSMITTAL #: N/A

FILENAME:
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 PATH: \\DES-CAD-S2\ENGINEERING_DATA\DATA\MA13

PLOTTED: AUGUST 4 2021
 PLOTTED BY: NSHARP



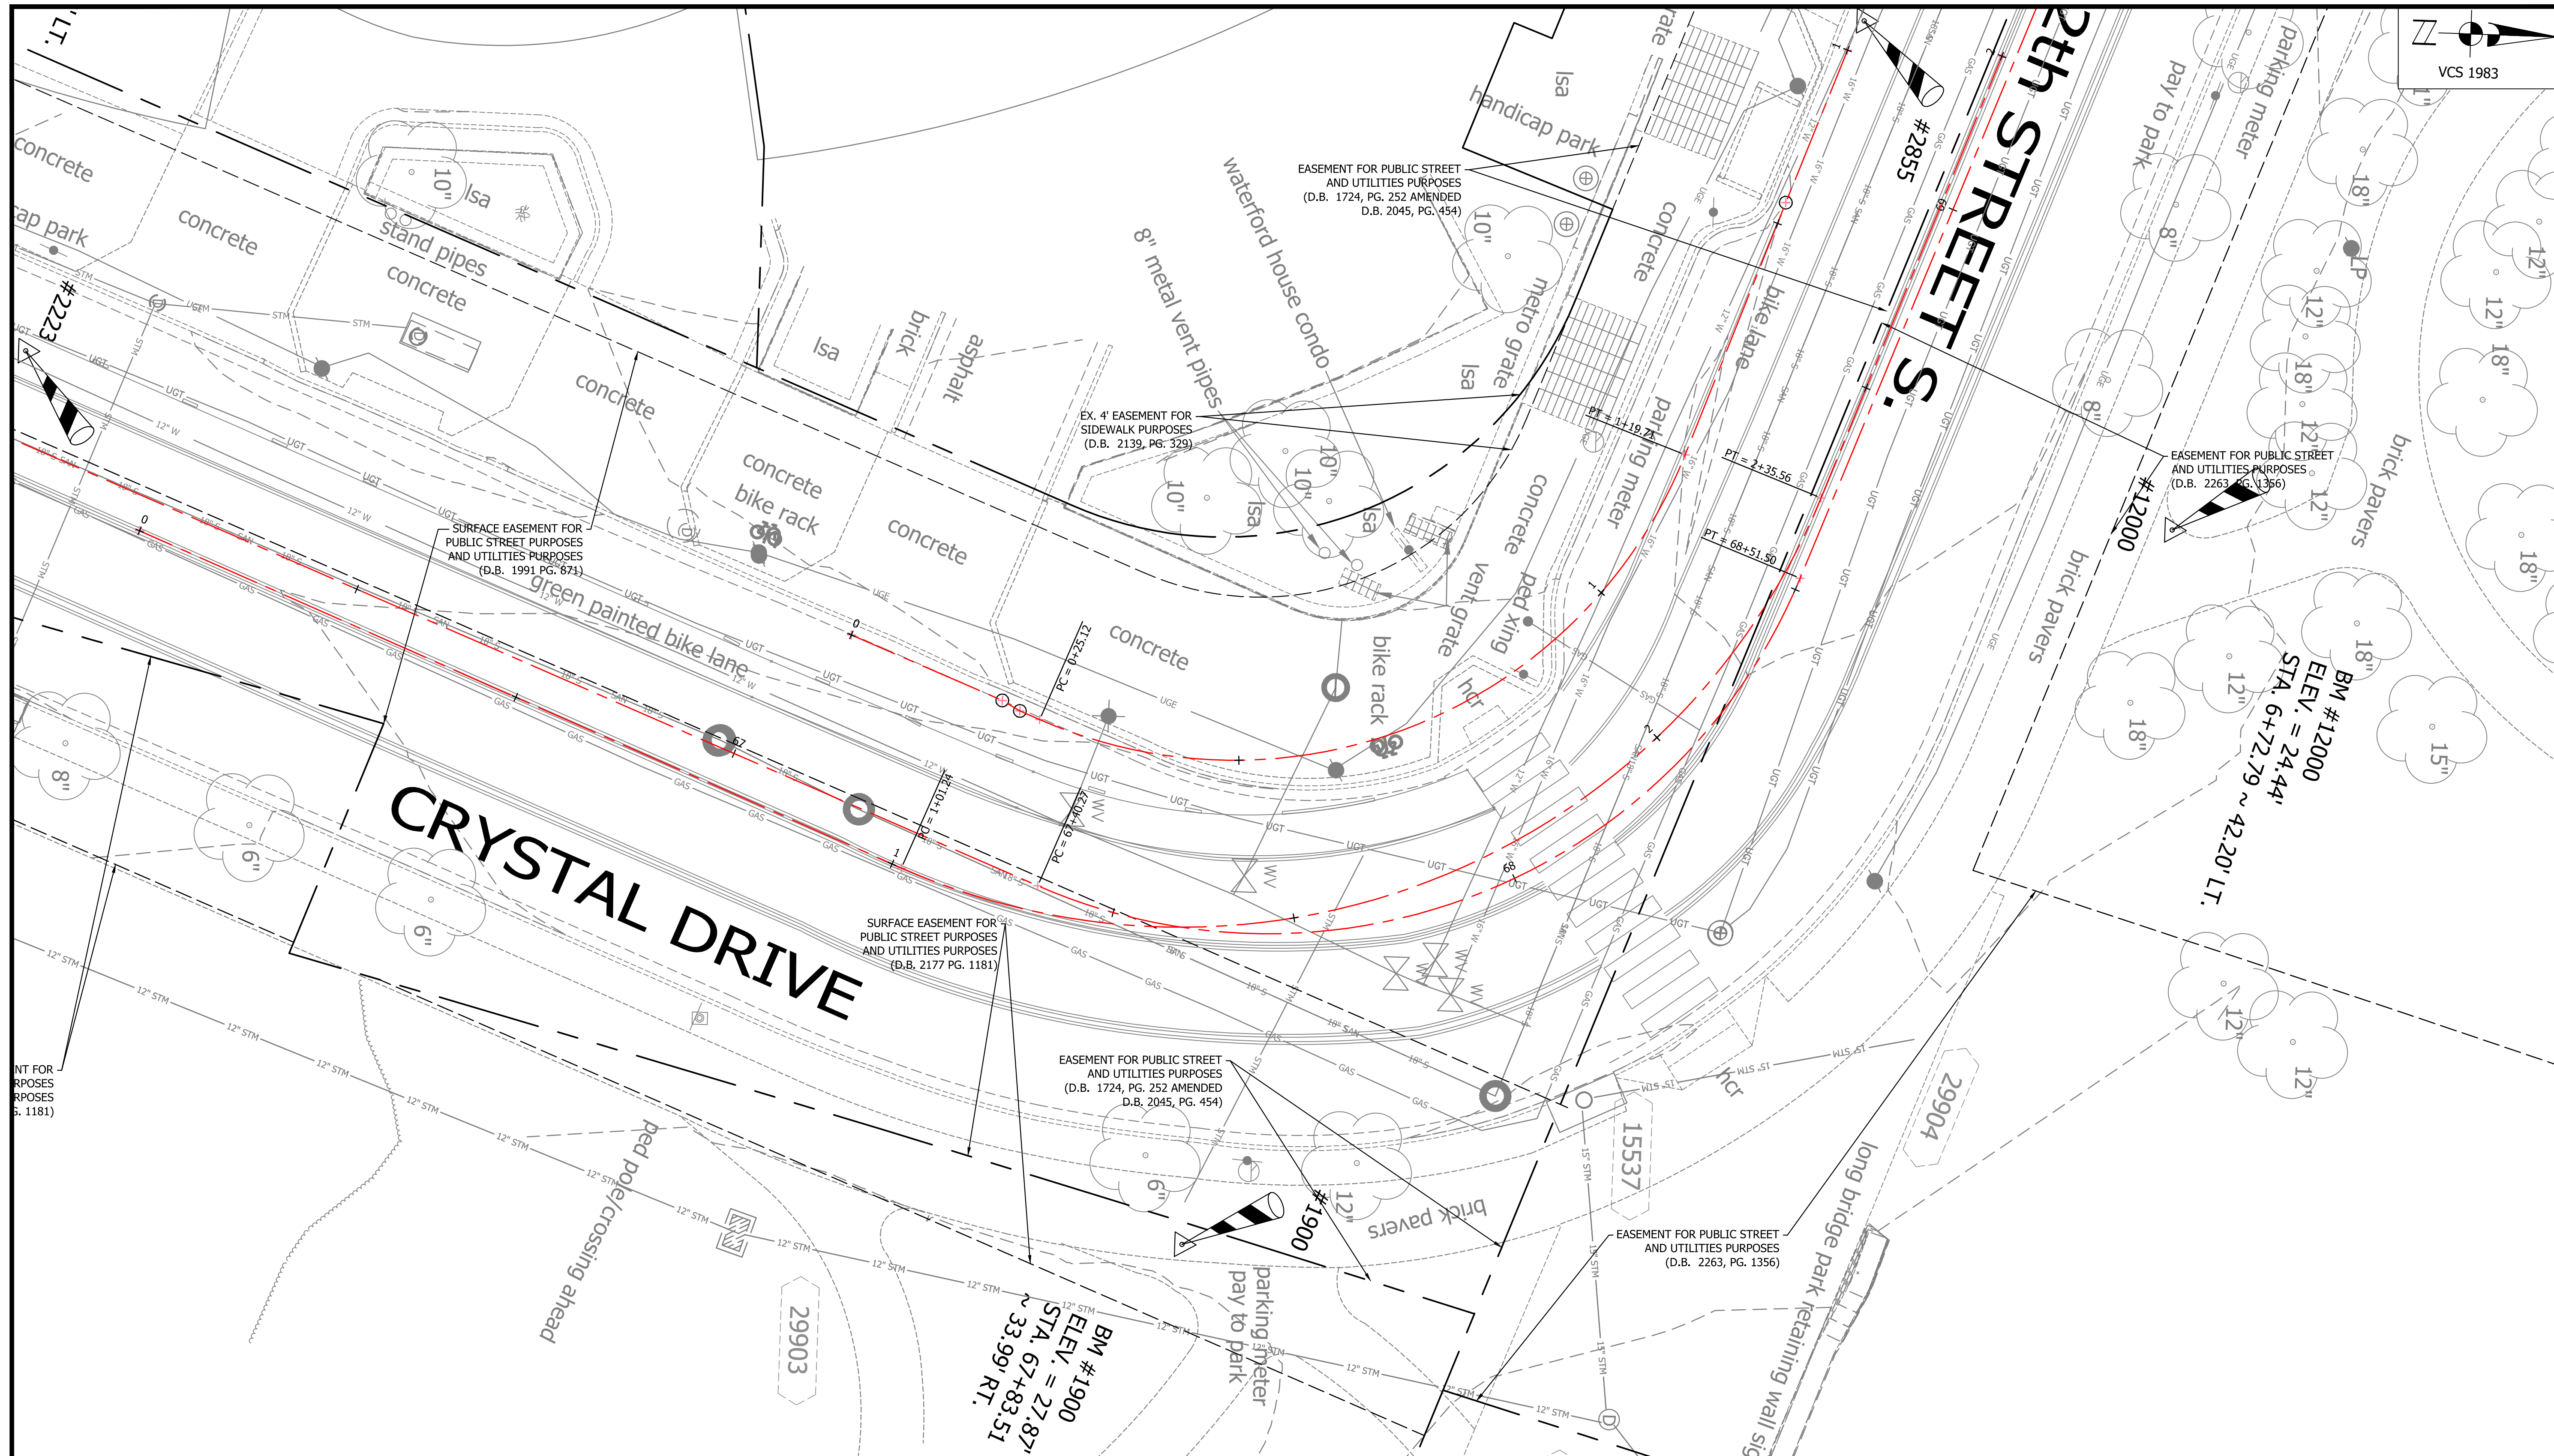

CRYSTAL DR & 12TH STREET S INTERSECTION TRANSITION

SANITARY TABULATION		STORM TABULATION	
#13007 TOP = 29.63 C/L INV. = 13.85	#14064 TOP = 29.00 C/L INV. = 14.05	#15476 TOP = 27.27 12" RCP INV. IN = 20.57 (15436) 15" RCP INV. OUT = 20.42 (15537)	#15691 TOP = 26.26 15" RCP INV. IN = 20.94 (15714) 15" RCP INV. IN = 21.02 (15664) 18" RCP INV. OUT = 20.93 (15762)
#13008 TOP = 27.12 C/L INV. = 15.11	#41516 TOP = 27.51 C/L INV. = 15.31	#15531 TOP = 26.64 15" RCP INV. IN = 18.18 (15537) 12" HDPE INV. IN = 18.13 (29903) 18" RCP INV. OUT = 12.30 (29905)	#15714 TOP = 26.54 15" RCP OUT = 22.53 (15691)
#13009 TOP = 27.44 C/L INV. = 15.29		#15537 TOP = 27.30 15" RCP INV. IN = 19.60 (29904) 15" RCP INV. OUT = 19.57 (15531)	#22902 12" HDPE INV. OUT = 22.38 (29903)
		#15762 TOP = 27.38 18" RCP INV. IN = 20.09 (15691) 18" RCP INV. OUT = UNKNOWN (15866)	#22903 12" HDPE INV. IN = 20.69 (29902) 12" HDPE INV. OUT = 20.64 (15531)

D12S CONTROL POINTS				
Point #	Northing	Easting	Elevation	Description
1900	7000331.2346	11896177.7398	27.87	PK NAIL
1901	6999949.3759	11896034.8111	32.69	TRV
1902	6999534.2721	11896027.3892	35.92	TRV

PROJECT CONTROL POINTS				
Point #	Northing	Easting	Elevation	Description
2223	7000187.0355	11896074.1141	26.72	PK NAIL
2855	7000408.8949	11896026.2349	28.27	PK NAIL
12000	7000448.4622	11896086.7766	28.44	PK NAIL

- NOTE:**
- UNDERGROUND UTILITIES WERE DESIGNATED BY MID-ATLANTIC UTILITY LOCATING ON 10/28/19 & LOCATED BY ARLINGTON COUNTY SURVEYORS ON 11/6/19.
 - WATER LINE & SANITARY SEWER PIPE SIZES ARE PER ARLINGTON COUNTY RECORDS.
 - THE IMAGERY AND/OR ORIGINAL DATA WAS OBTAINED FROM 09/2019 TO 11/2019; AND THAT THIS PLAT, MAP OR DIGITAL GEOSPATIAL DATA INCLUDING METADATA MEETS MINIMUM ACCURACY STANDARDS UNLESS OTHERWISE NOTED.
- CONTROL DATA**
- CONTROL POINTS DATA TAKEN FROM THE CRYSTAL DRIVE PROJECT IN D12S.
 - HORIZONTAL DATUM: VIRGINIA COORDINATE SYSTEM 1983 - NORTH ZONE.
 - VERTICAL DATUM: NORTH AMERICAN VERTICAL DATUM 1988.
 - BOUNDARY INFORMATION SHOWN HEREON WAS COMPILED FROM EXISTING LAND RECORDS AND DOES NOT REPRESENT A FIELD RUN BOUNDARY SURVEY.



APPROVALS	DATE
<i>Kamell</i>	3/29/21
QUALITY CONTROL ENGINEER <i>Kamal Takat</i>	3.24.21
CONSTRUCTION MANAGEMENT SUPERVISOR <i>John</i>	03.04.2021
WATER, SEWER, STREETS BUREAU CHIEF <i>Dennis M. Leach</i>	03/17/21
TRANSPORTATION DIRECTOR <i>Diana Iaza</i>	3/2/21

REVISIONS	DATE

PROJECT NAME AND LOCATION
TRANSITWAY EXTENSION TO PENTAGON CITY

EXISTING CONDITIONS
CRYSTAL DR & 12TH ST


MA13 - SEGMENT 1

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PLOTTED: AUGUST 4 2021
PLOTTED BY: NSHARP





CRYSTAL DR NB & 15TH ST S INTERSECTION

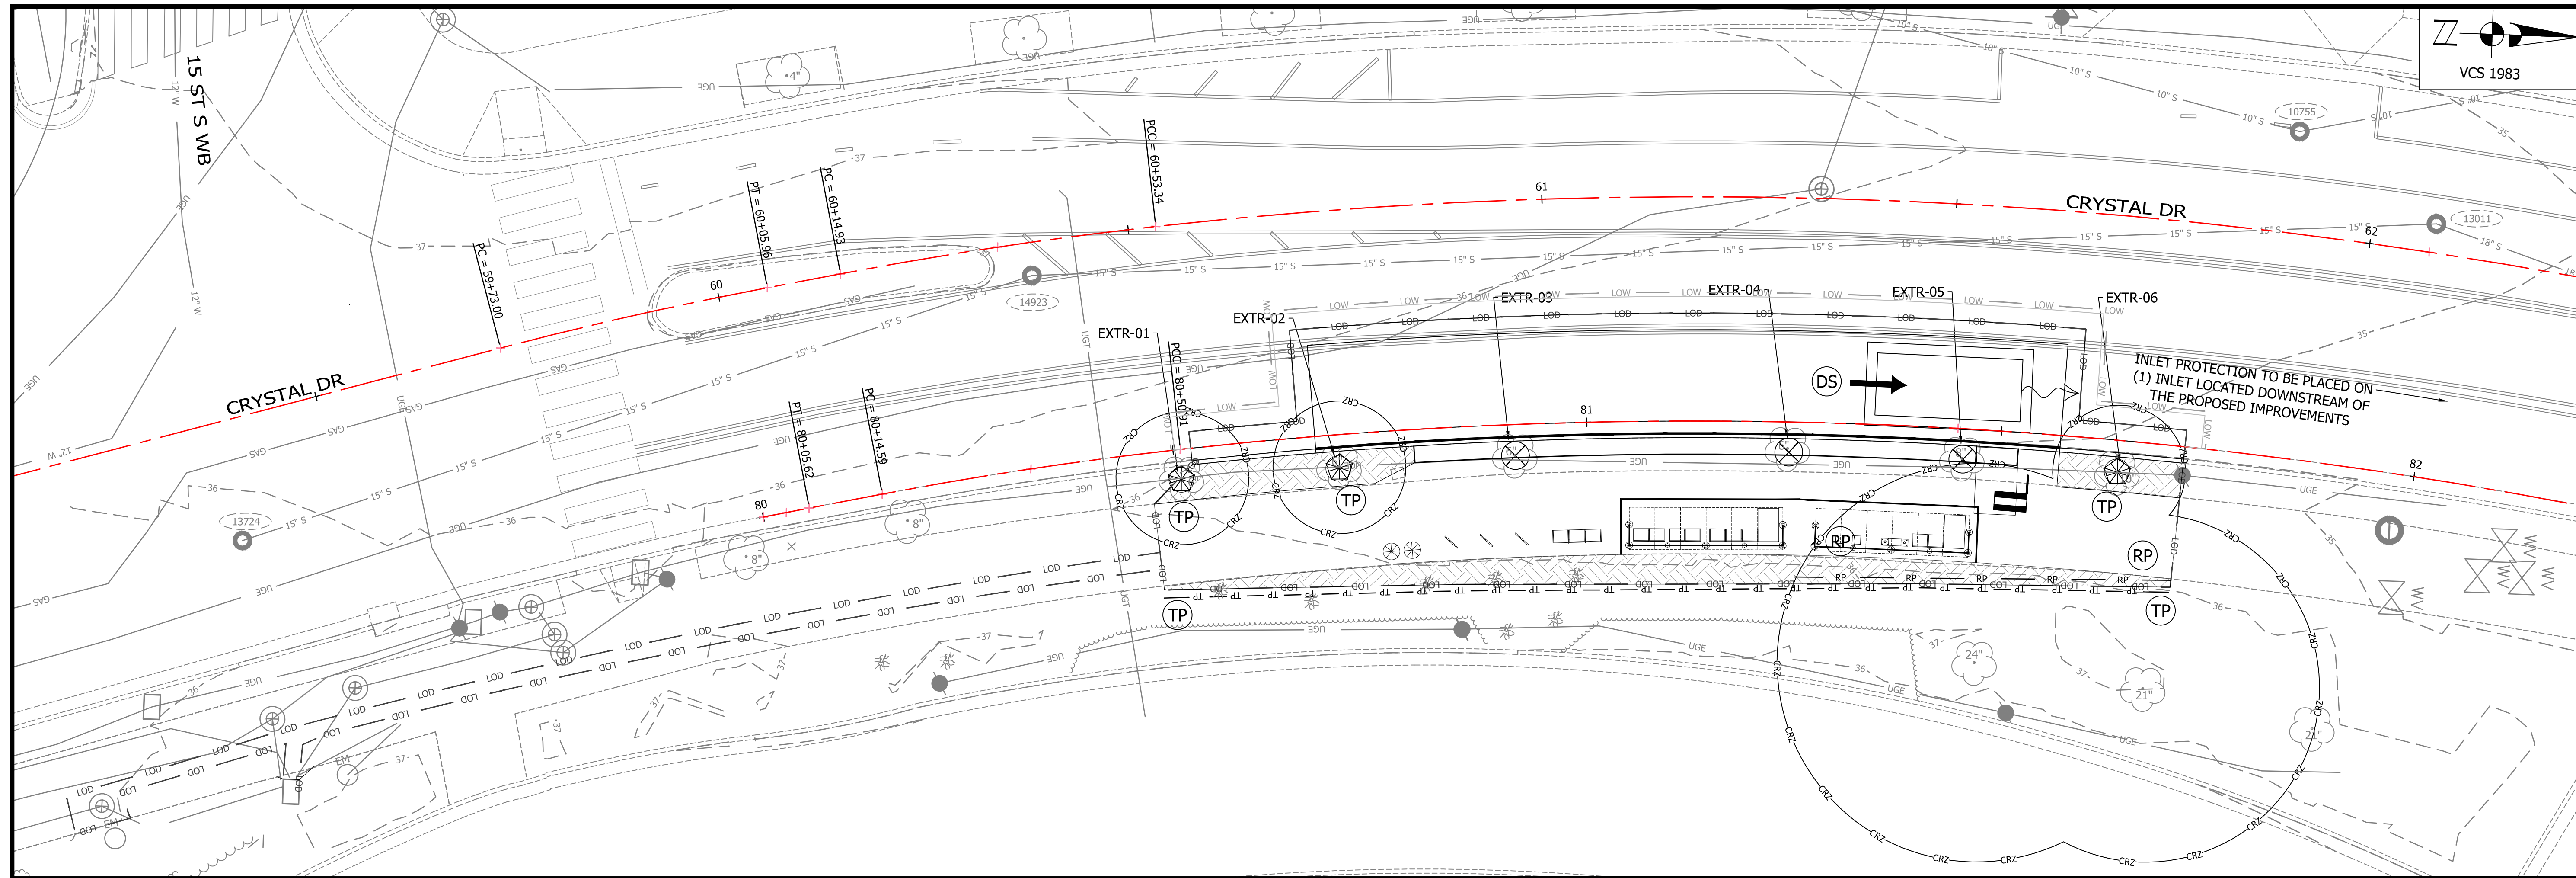

APPROVALS	DATE
<i>[Signature]</i>	3/29/21
QUALITY CONTROL ENGINEER <i>Ramal Takar</i>	3.24.21
CONSTRUCTION MANAGEMENT SUPERVISOR <i>[Signature]</i>	03.04.2021
WATER, SEWER, STREETS BUREAU CHIEF <i>Dennis M. Leach</i>	03/17/21
TRANSPORTATION DIRECTOR <i>[Signature]</i>	3/2/21


REVISIONS	DATE

PROJECT NAME AND LOCATION
TRANSITWAY EXTENSION TO PENTAGON CITY
E&S CONTROL PLAN
CRYSTAL DR & 12TH ST S
 MA13 - SEGMENT 1

DESIGNED: PB
 DRAWN: NS
 CHECKED: TL
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 PLOTTED: AUGUST 4 2021
 PLOTTED BY: NSHARP




EROSION AND SEDIMENT CONTROL LEGEND			
3.07	STORM DRAIN INLET PROTECTION	IP	
3.26	DEWATERING STRUCTURE	DS	
3.38	TREE PROTECTION	TP	
	CRITICAL ROOT ZONE	CRZ	
	ROOT PRUNING	RP	
	TREE TO BE REMOVED		
	EX. TREE NUMBER (SEE SHEET 24 FOR TREE INVENTORY)		
	LIMITS OF DISTURBANCE	LOD	
	LIMITS OF WORK	LOW	

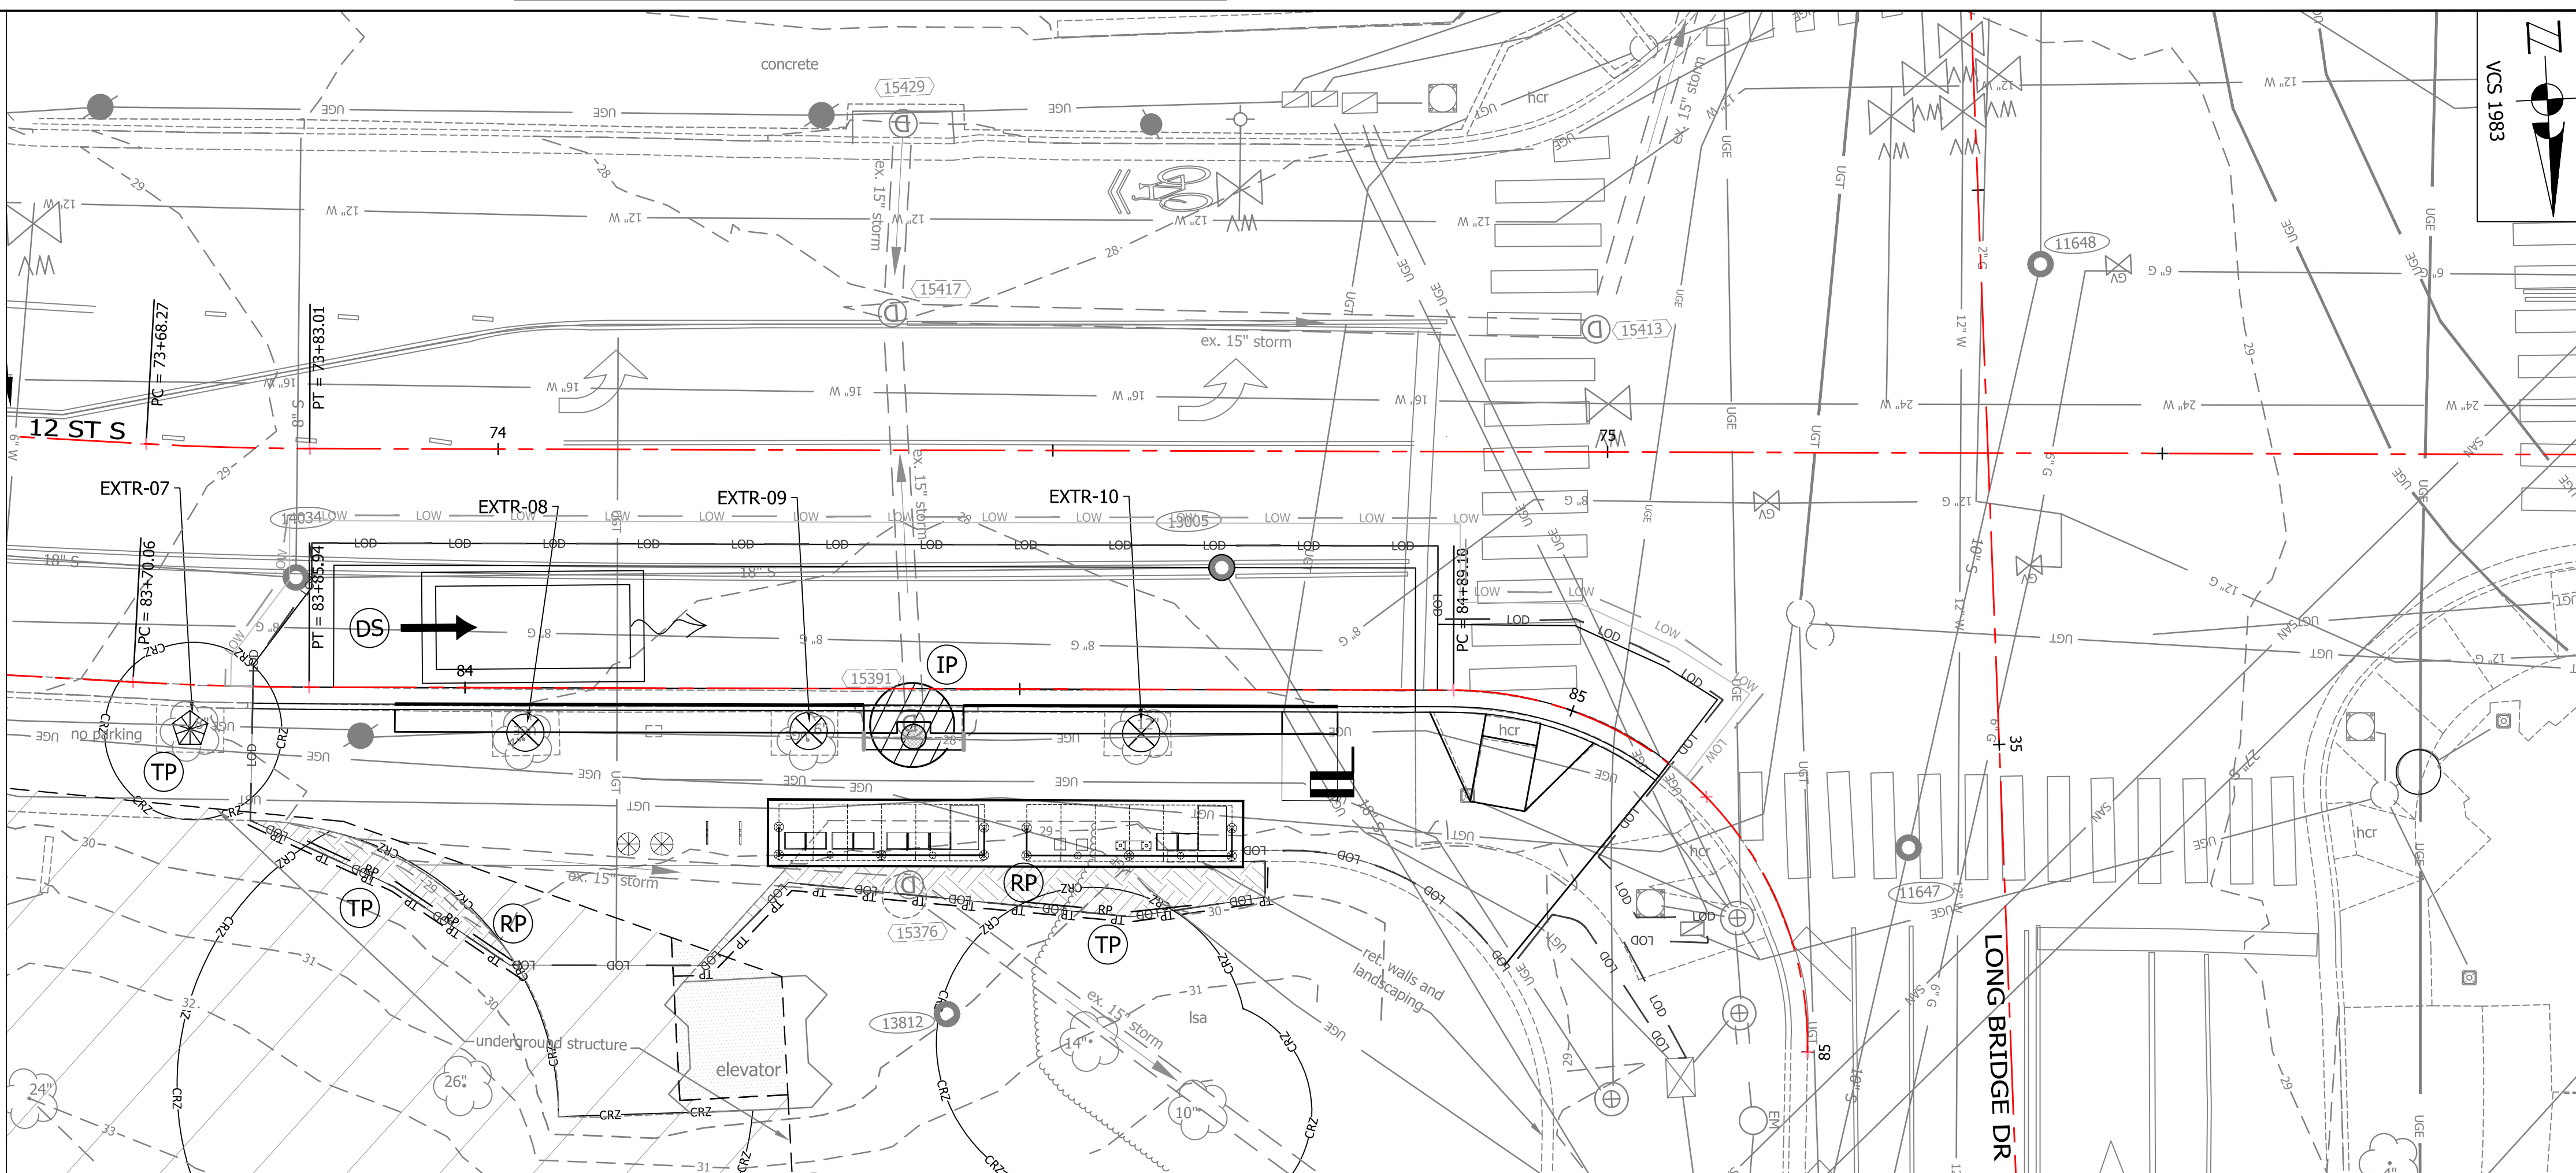

12TH ST S WB & LONG BRIDGE DR INTERSECTION

THIS SHEET IS FOR EROSION AND SEDIMENT CONTROL USE ONLY
 FOR ALL DETAILS AND SPECIFICATIONS, SEE THE VIRGINIA
 EROSION & SEDIMENT CONTROL HANDBOOK
 REVISED ON 11/08/2016

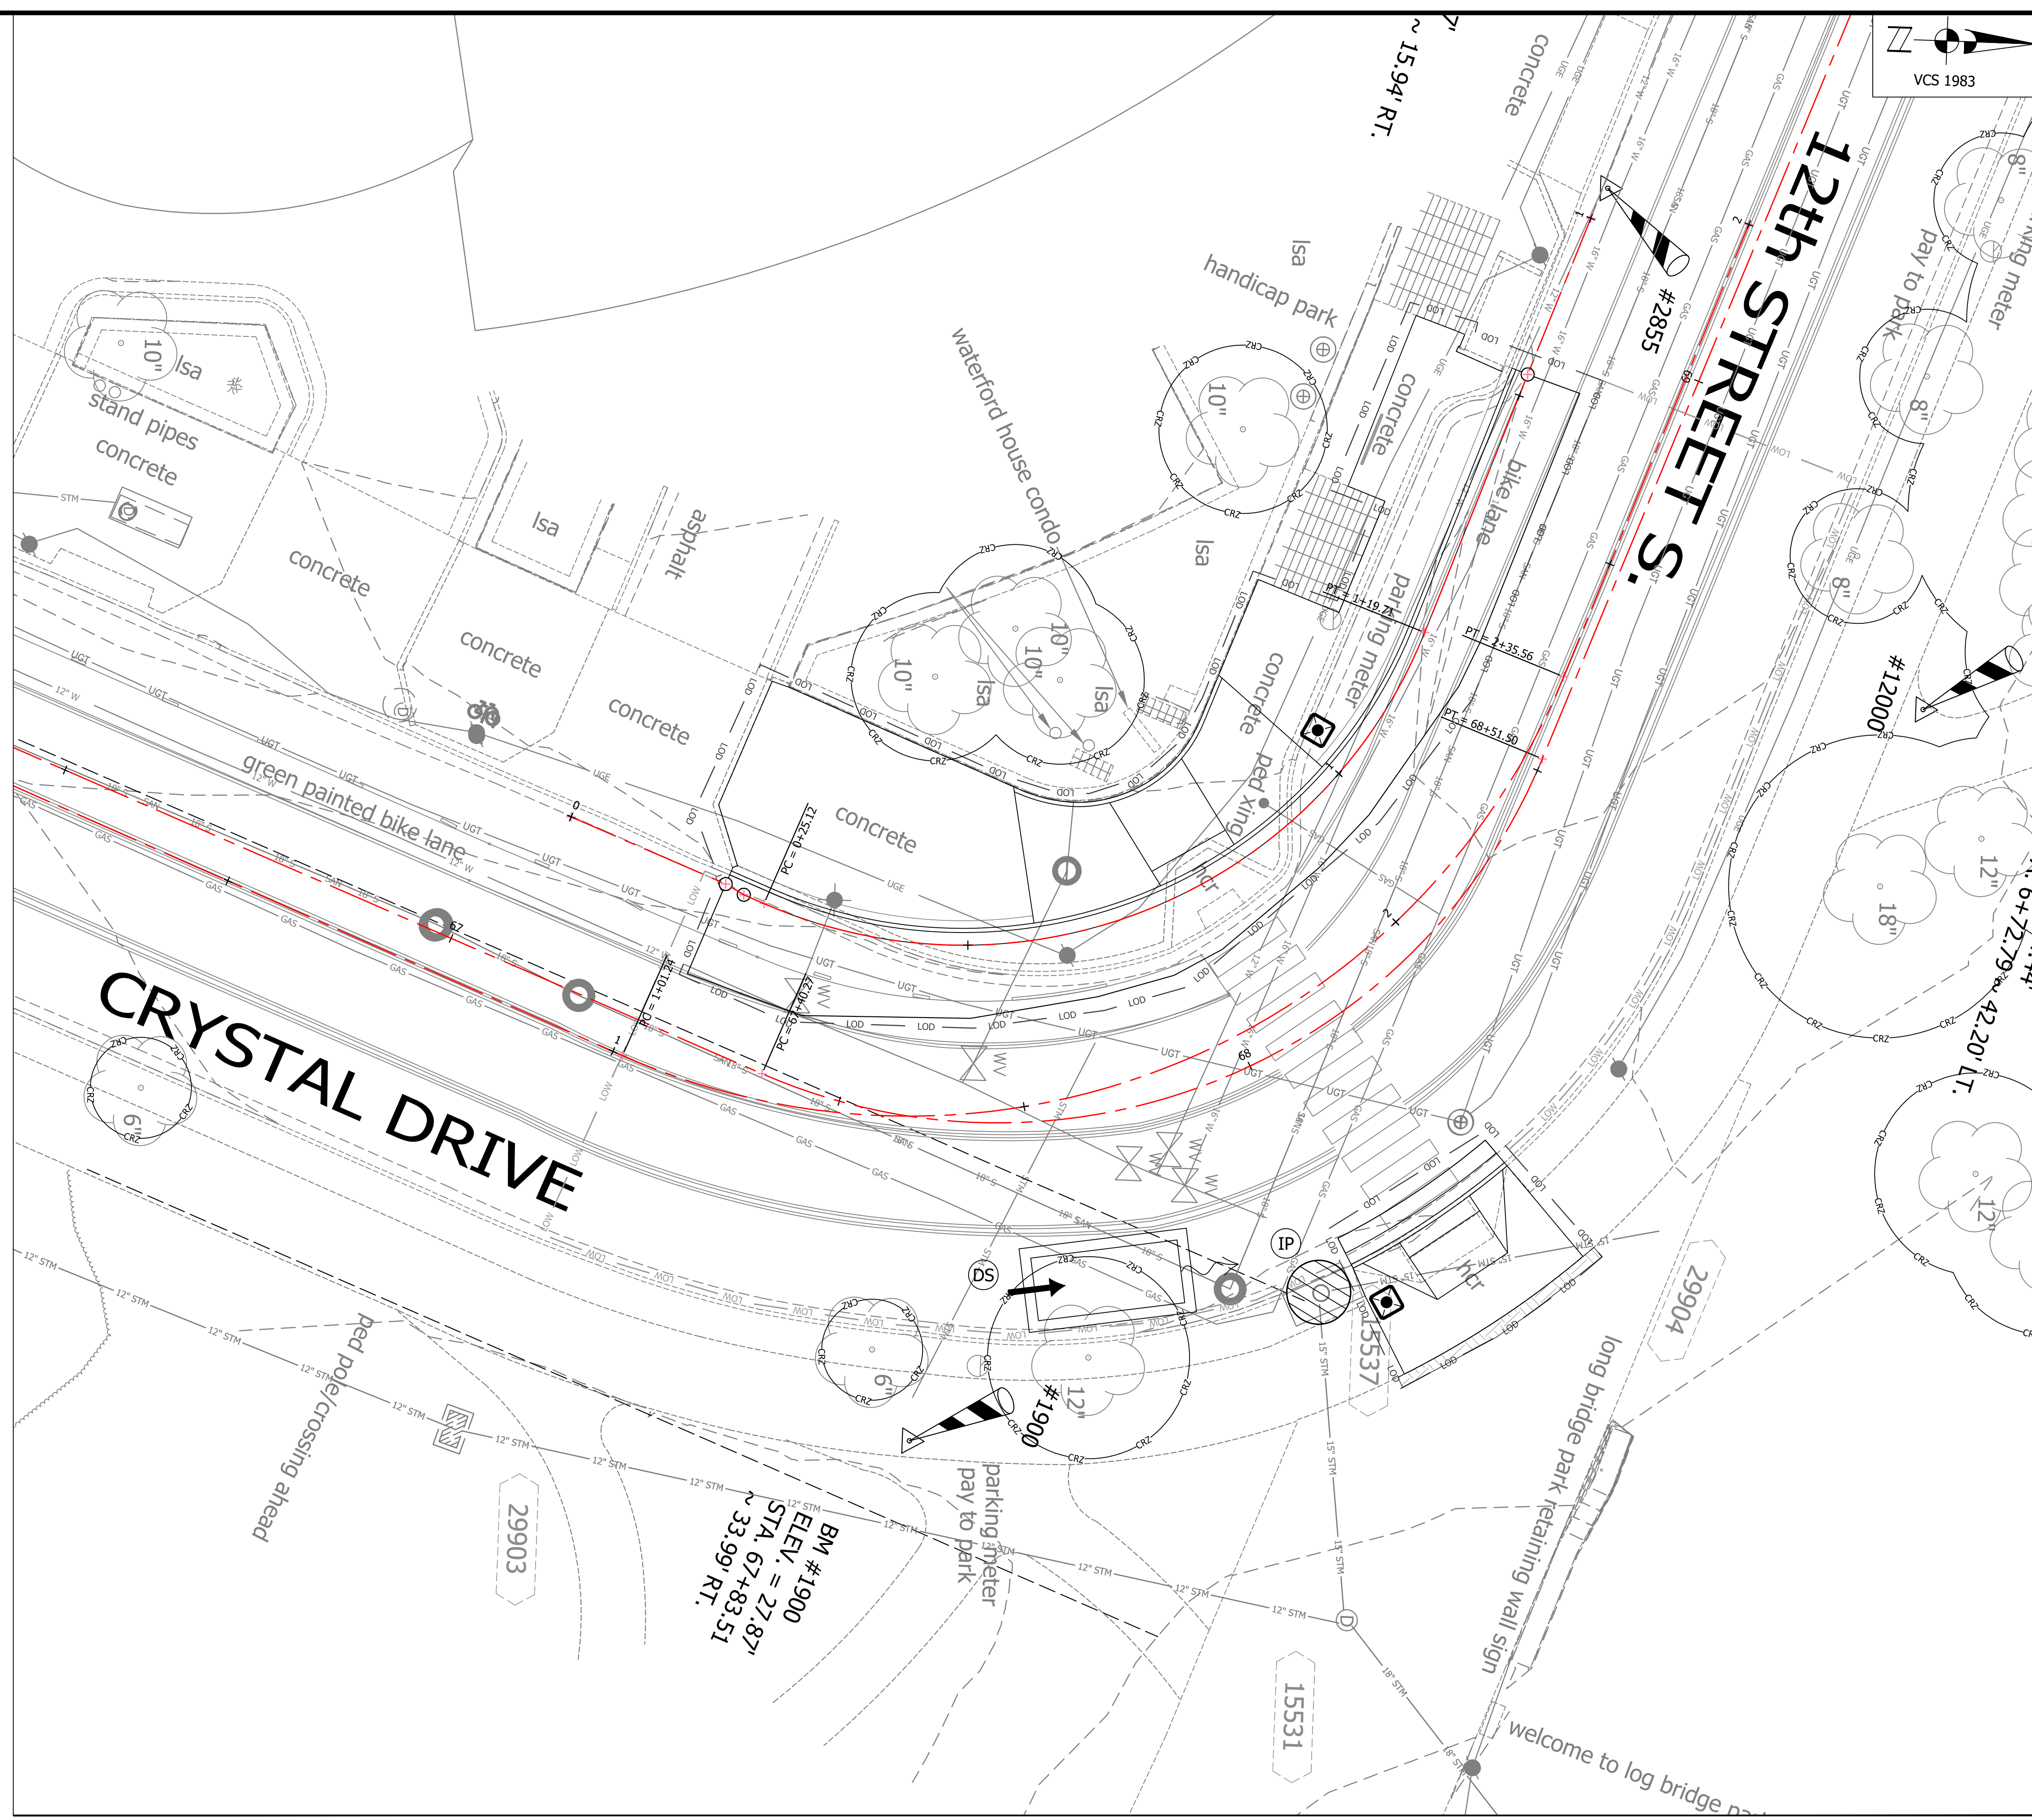

APPROVALS	DATE
<i>Kamell</i>	3/29/21
QUALITY CONTROL ENGINEER <i>Kamal Takak</i>	3.24.21
CONSTRUCTION MANAGEMENT SUPERVISOR <i>Quinn</i>	03.04.2021
WATER, SEWER, STREETS BUREAU CHIEF <i>Dennis M. Leach</i>	03/17/21
TRANSPORTATION DIRECTOR <i>Diana Ivasz</i>	3/2/21
PROJECT MANAGER	

REVISIONS	DATE

PROJECT NAME AND LOCATION
TRANSITWAY EXTENSION TO PENTAGON CITY
E&S CONTROL PLAN
CRYSTAL DR & 12TH ST S
 MA13 - SEGMENT 1

DESIGNED: PB
 DRAWN: NS
 CHECKED: TL
 MISS UTILITY TRANSMITTAL #: N/A
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 PLOTTED: AUGUST 4 2021
 PLOTTED BY: NSHARP




EROSION AND SEDIMENT CONTROL LEGEND

3.07	STORM DRAIN INLET PROTECTION	IP	
3.26	DEWATERING STRUCTURE	DS	
3.38	TREE PROTECTION	TP	
	CRITICAL ROOT ZONE	CRZ	
	ROOT PRUNING	RP	
	TREE TO BE REMOVED		
	EX. TREE NUMBER (SEE SHEET 24 FOR TREE INVENTORY)		-EXTR-01
	LIMITS OF DISTURBANCE		-LOD-
	LIMITS OF WORK		-LOW-

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 REVISED ON 11/08/2016

CRYSTAL DR & 12TH STREET S TRANSITION

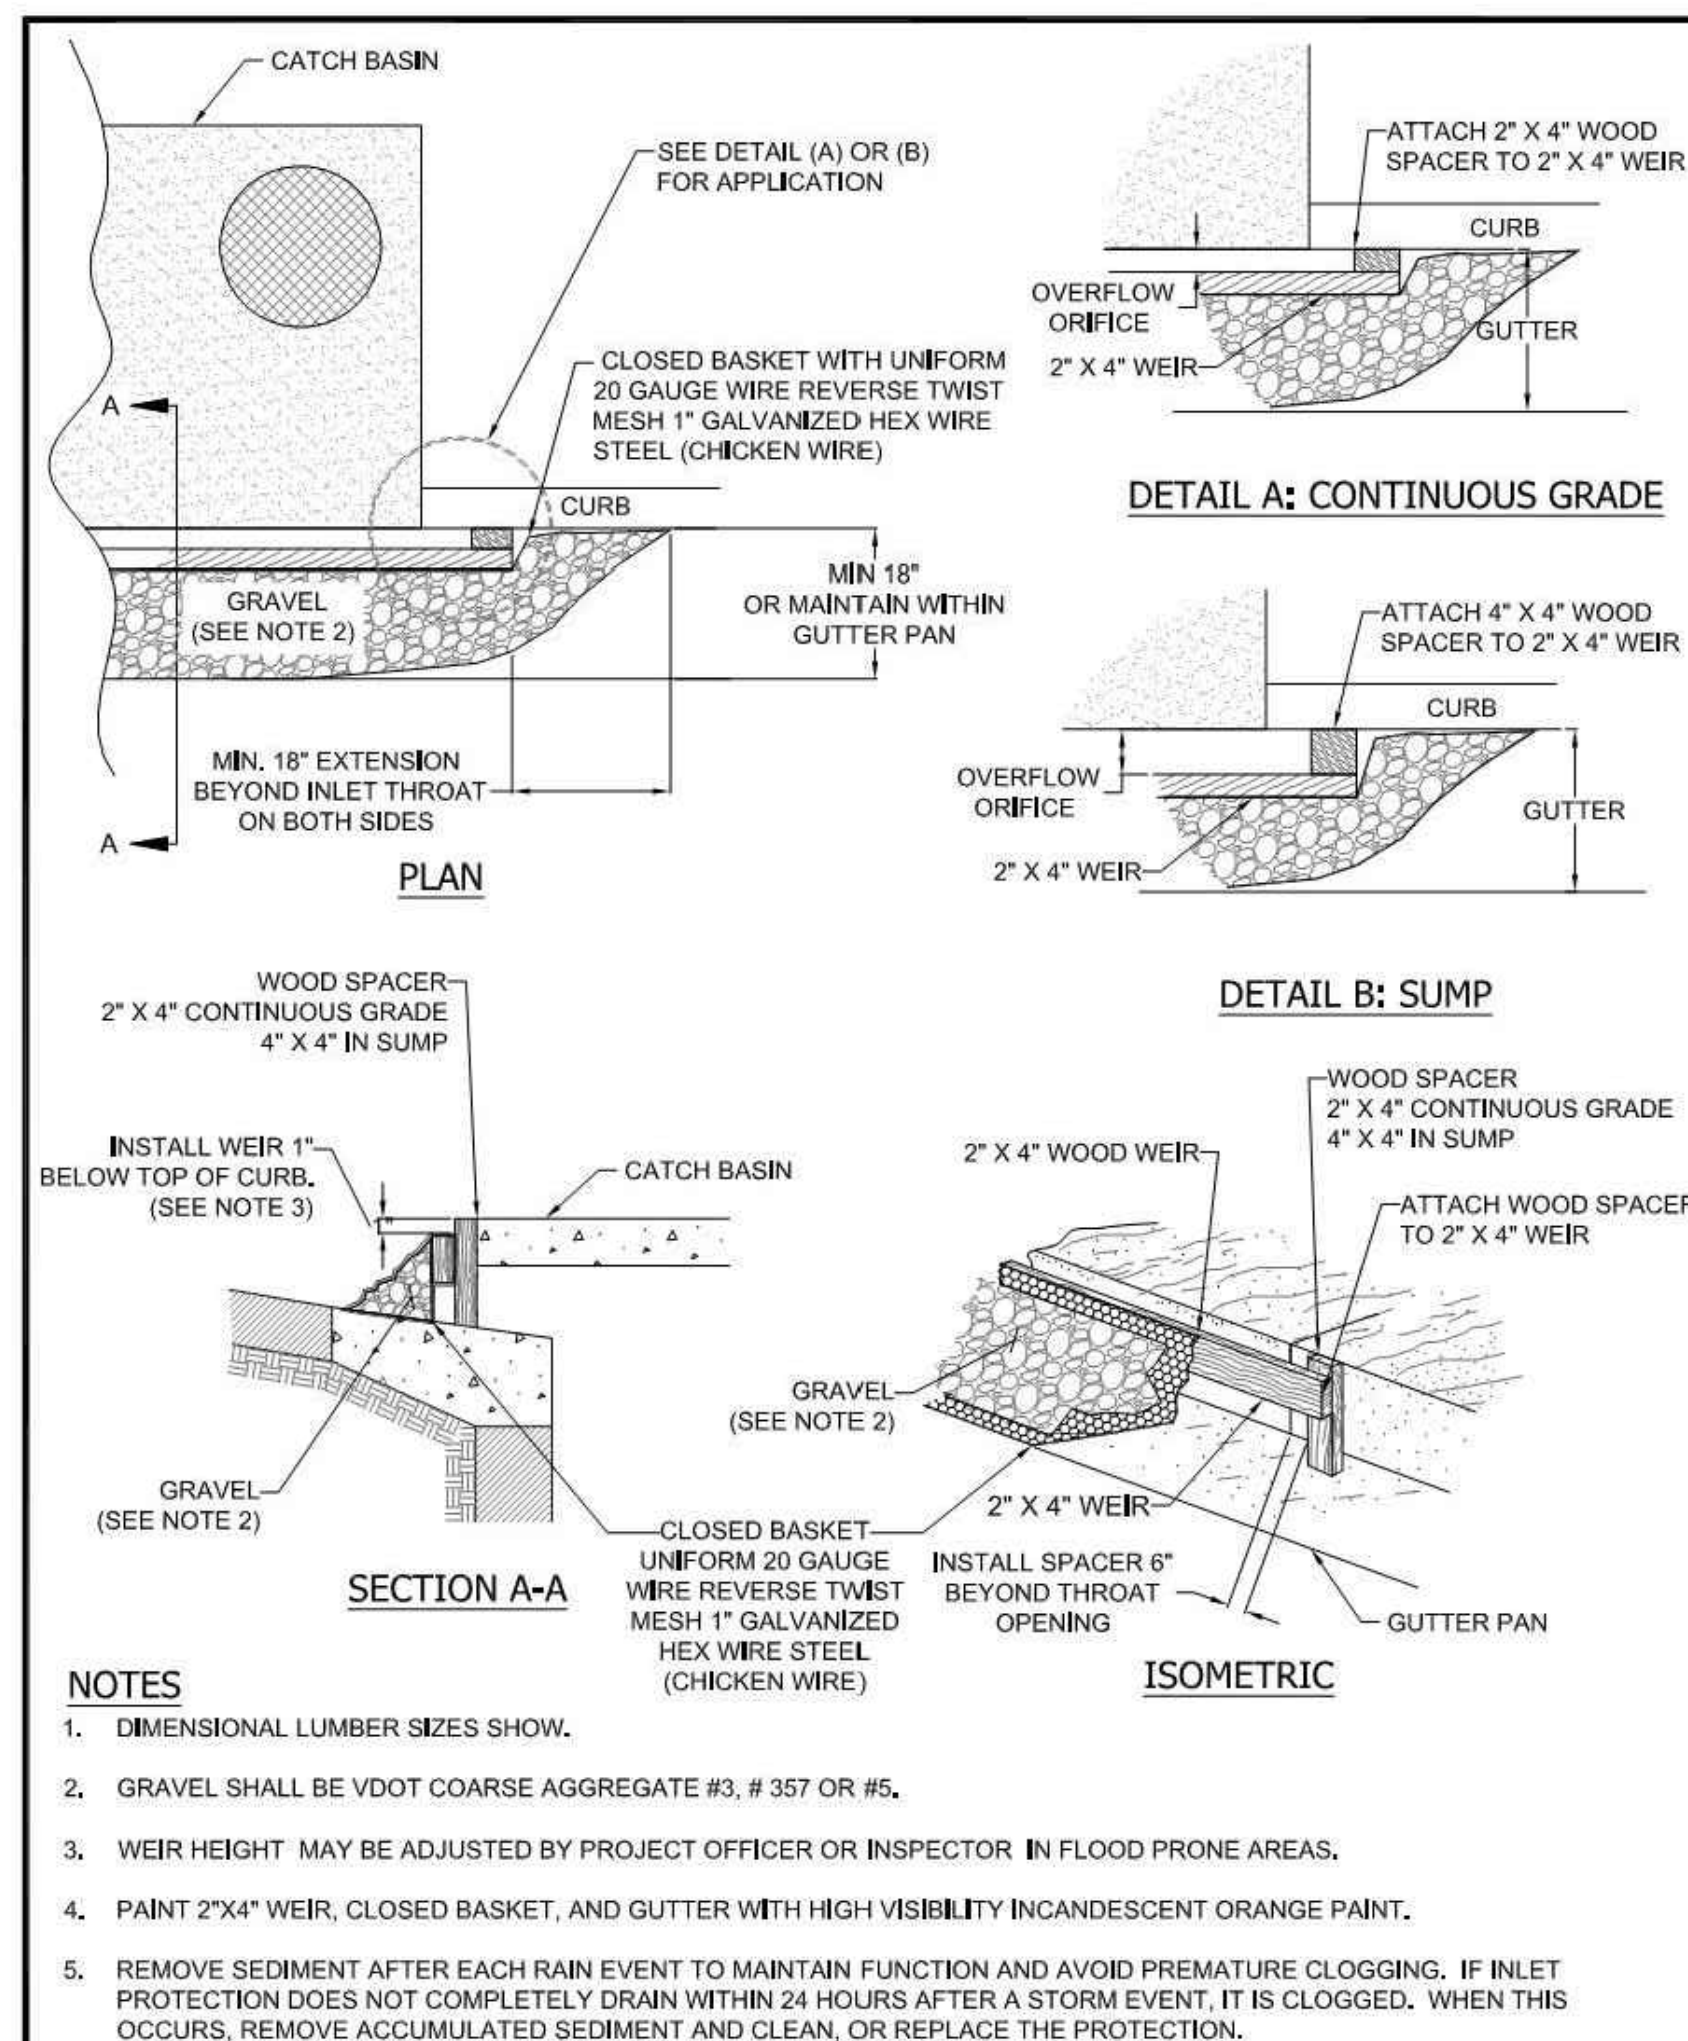


- NOTES**
1. DIMENSIONAL LUMBER SIZES SHOW.
 2. GRAVEL SHALL BE VDOT COARSE AGGREGATE #3, # 357 OR #5.
 3. WEIR HEIGHT MAY BE ADJUSTED BY PROJECT OFFICER OR INSPECTOR IN FLOOD PRONE AREAS.
 4. PAINT 2"x4" WEIR, CLOSED BASKET, AND GUTTER WITH HIGH VISIBLE INCANDESCENT ORANGE PAINT.
 5. REMOVE SEDIMENT AFTER EACH RAIN EVENT TO MAINTAIN FUNCTION AND AVOID PREMATURE CLOGGING. IF INLET PROTECTION DOES NOT COMPLETELY DRAIN WITHIN 24 HOURS AFTER A STORM EVENT, IT IS CLOGGED. WHEN THIS OCCURS, REMOVE ACCUMULATED SEDIMENT AND CLEAN, OR REPLACE THE PROTECTION.

ES1 11 CURB INLET PROTECTION

ARLINGTON COUNTY, VIRGINIA
DEPARTMENT OF ENVIRONMENTAL SERVICES


DRAWING NO. 3.07-7 (ACG)

REVISION & DATE

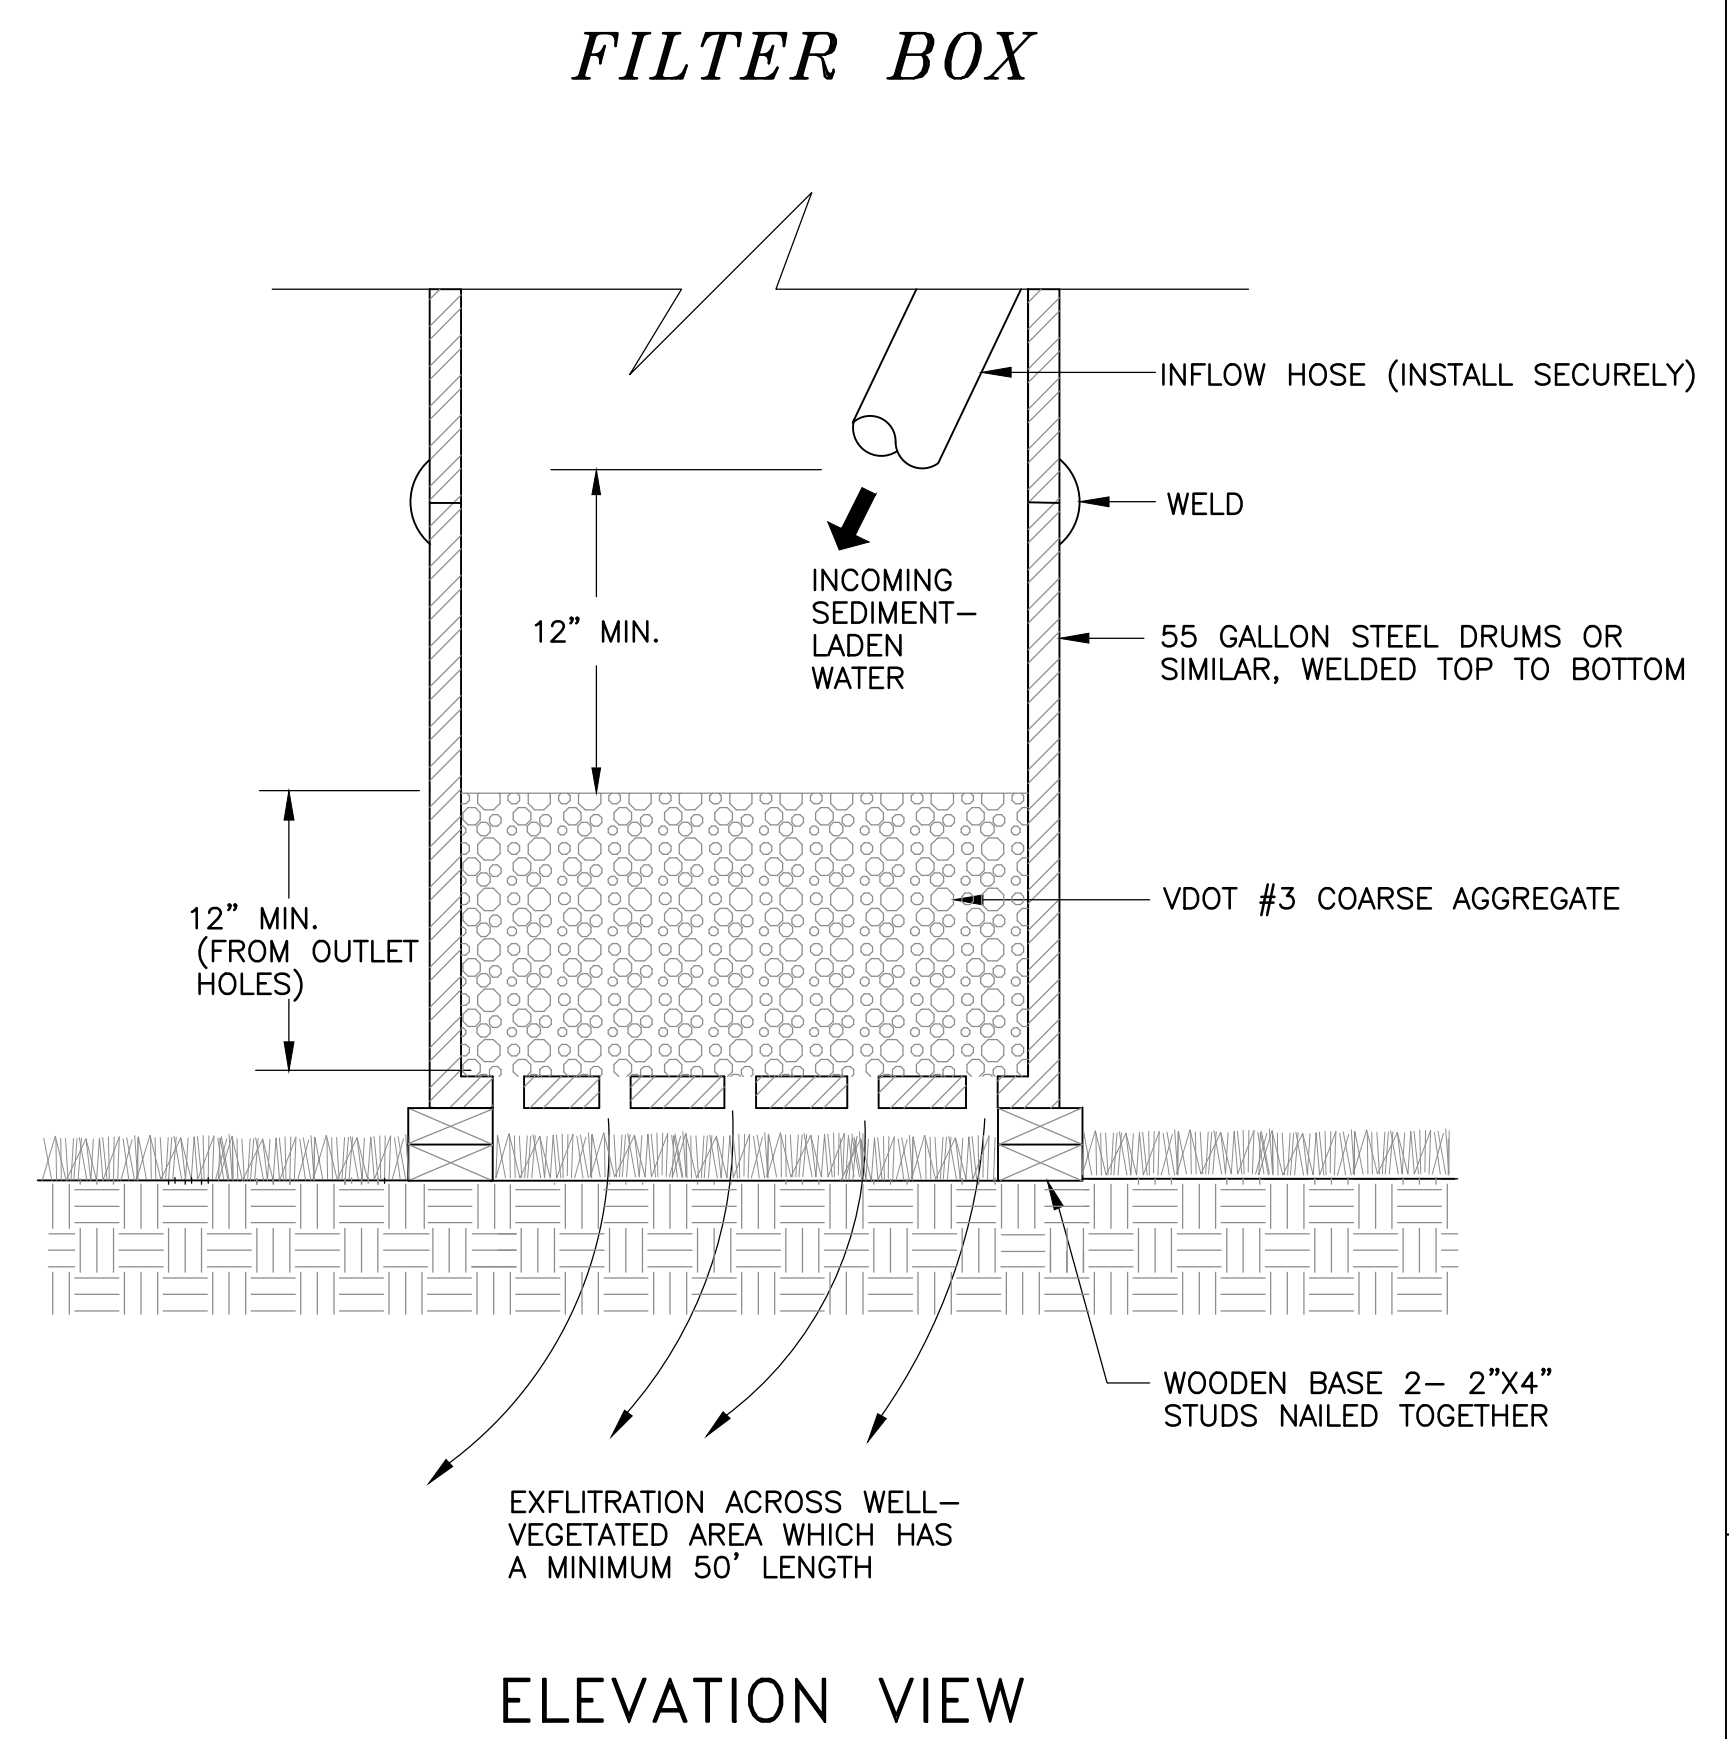

ES2 11 DEWATERING DEVICE


SOURCE: VA. DSWC PLATE: 3.26-2

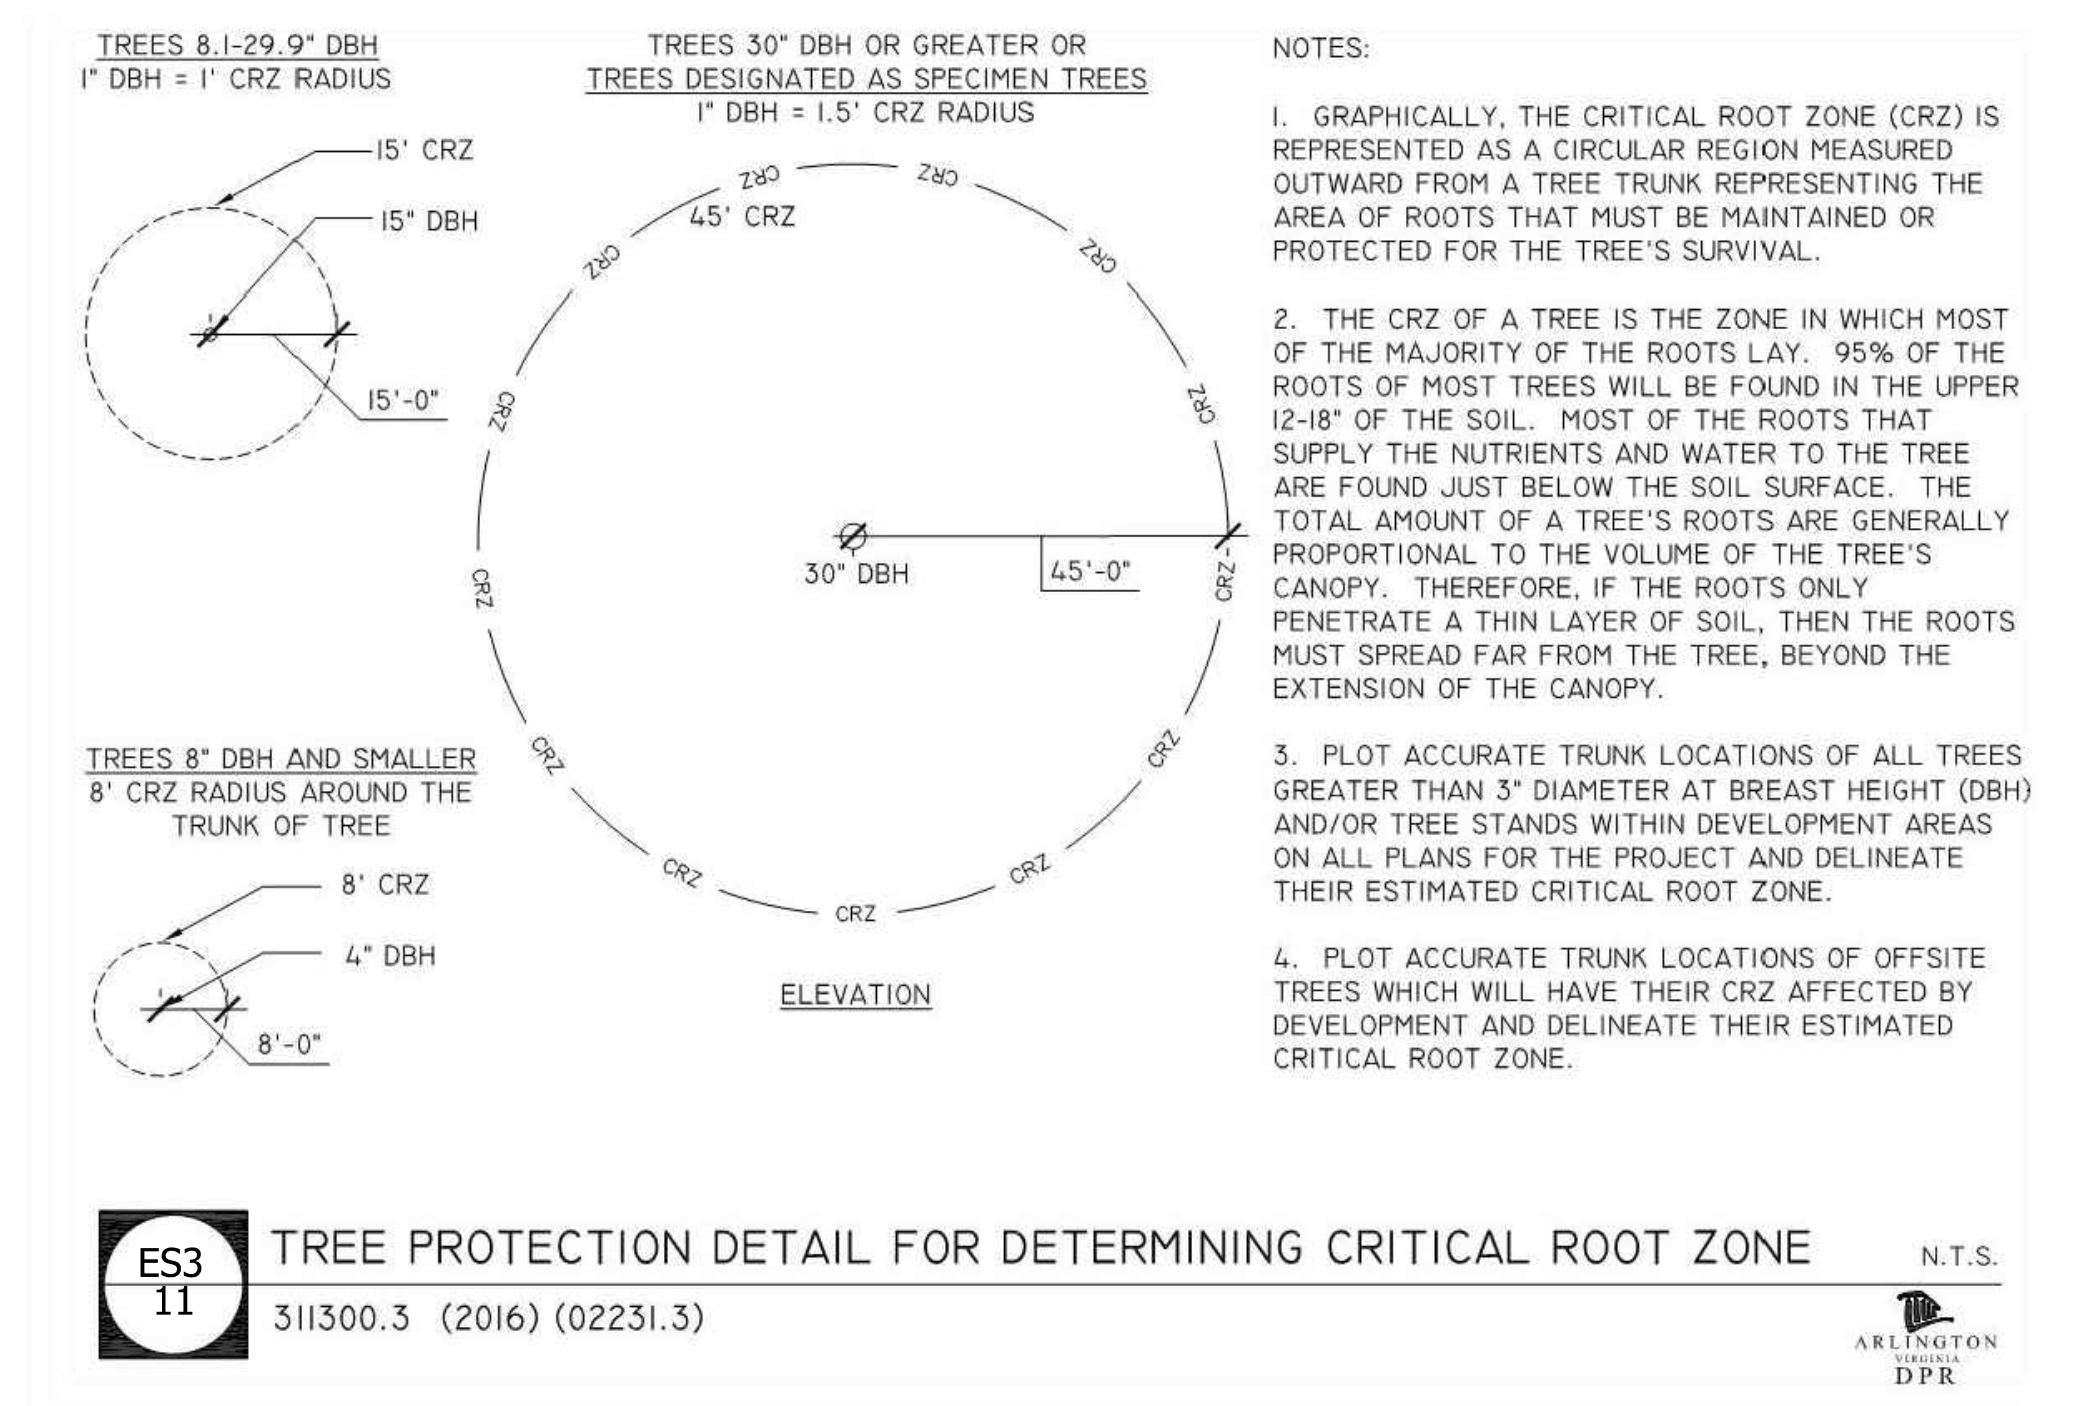

ES3 11 TREE PROTECTION DETAIL FOR DETERMINING CRITICAL ROOT ZONE

311300.3 (2016) (02231.3)


N.T.S. ARLINGTON DPR

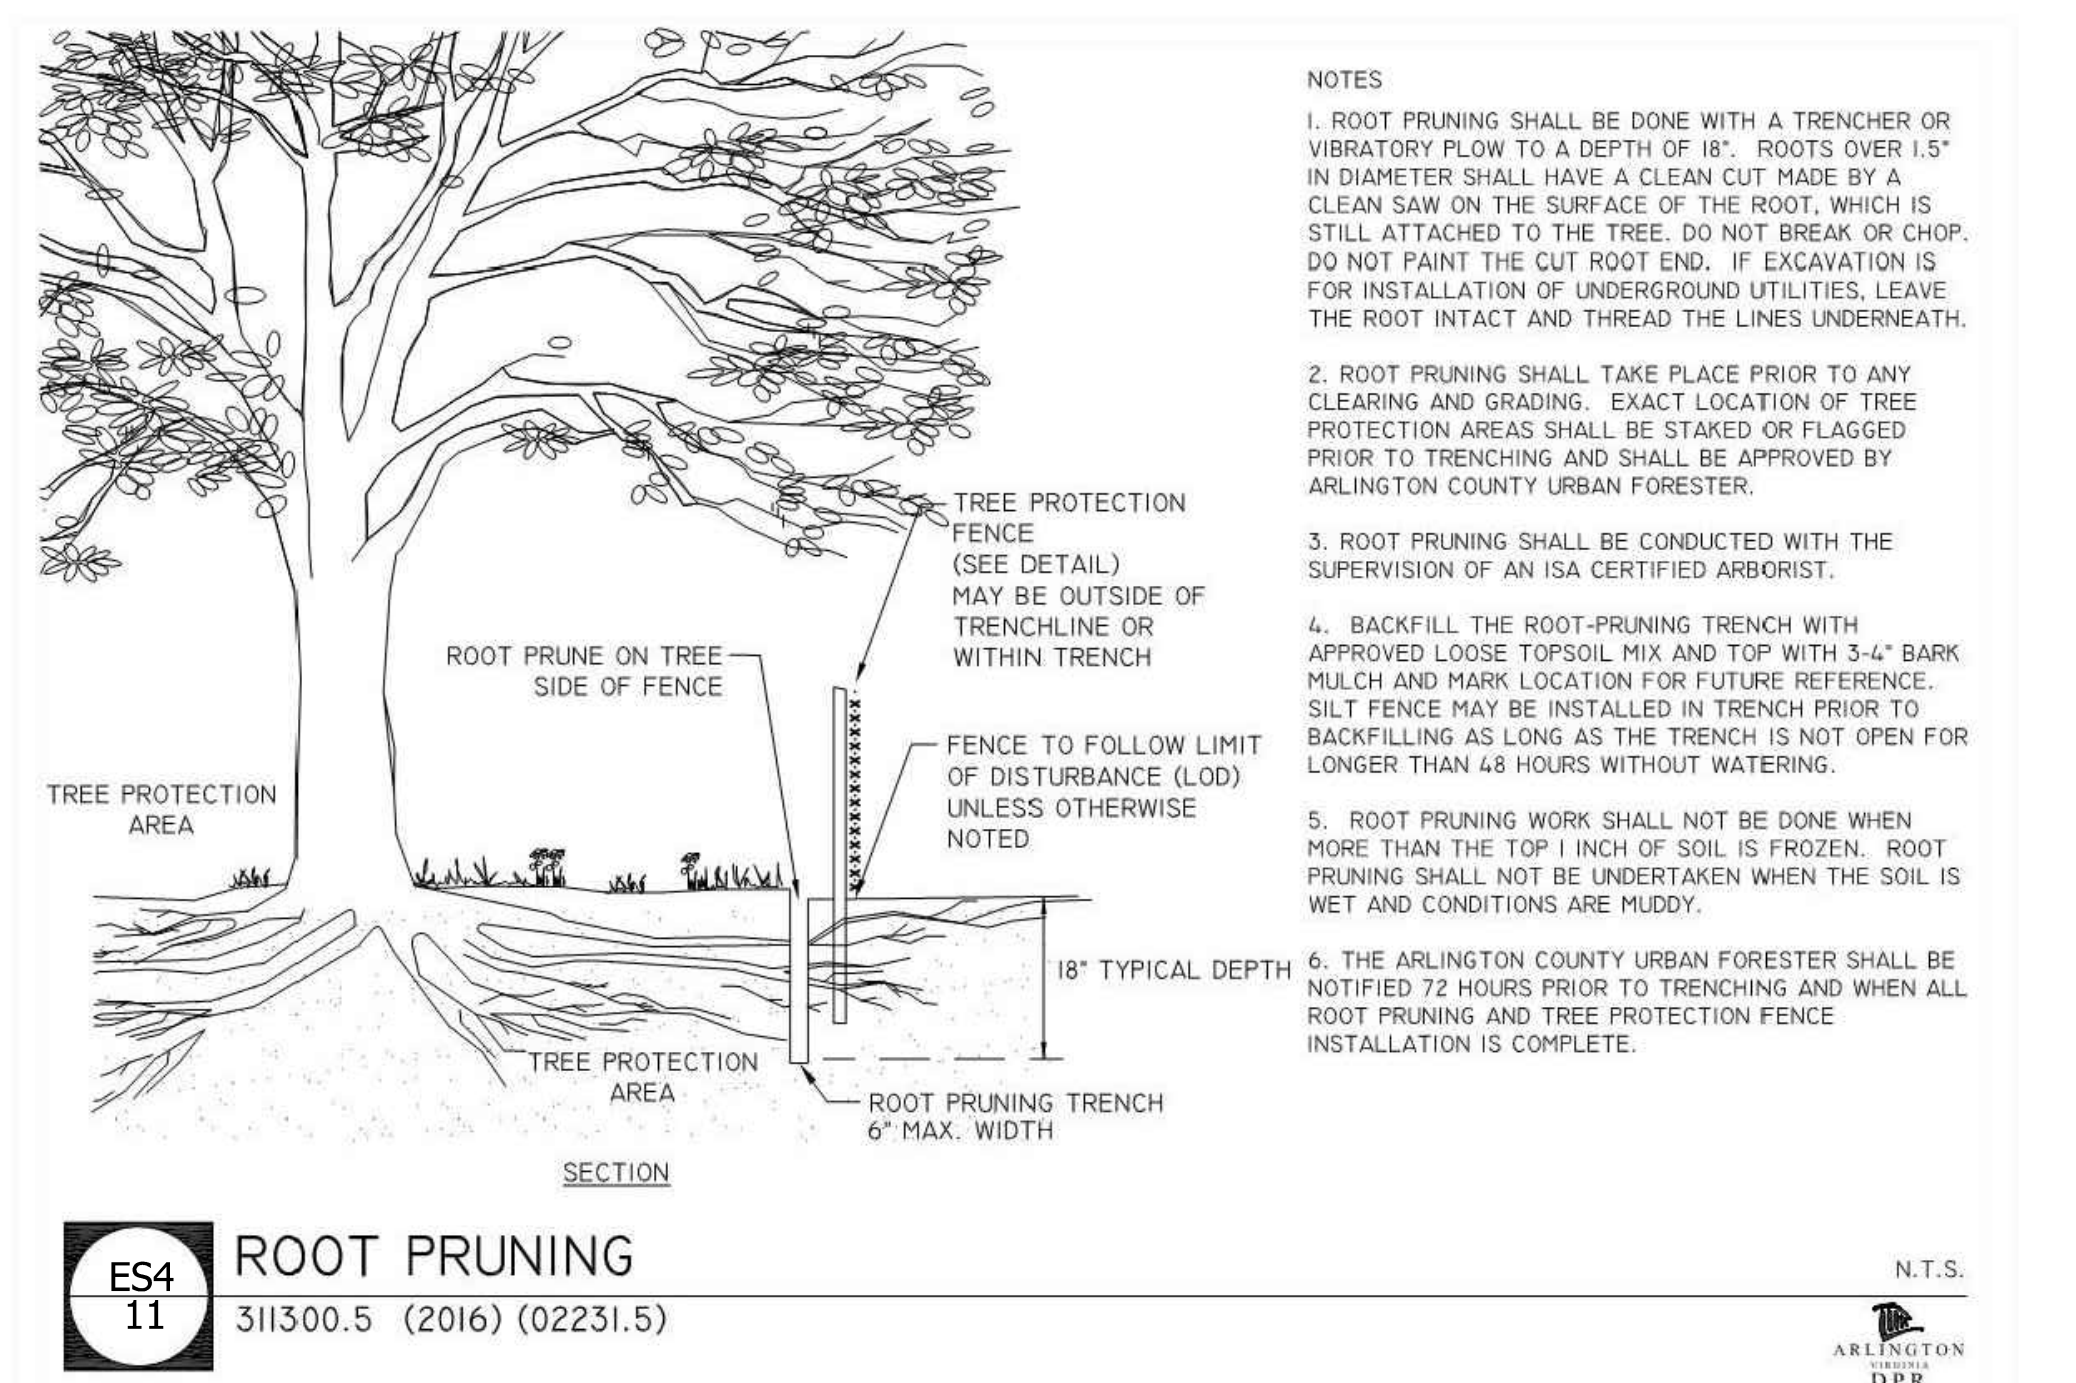

ES4 11 ROOT PRUNING

311300.5 (2016) (02231.5)

N.T.S. ARLINGTON DPR

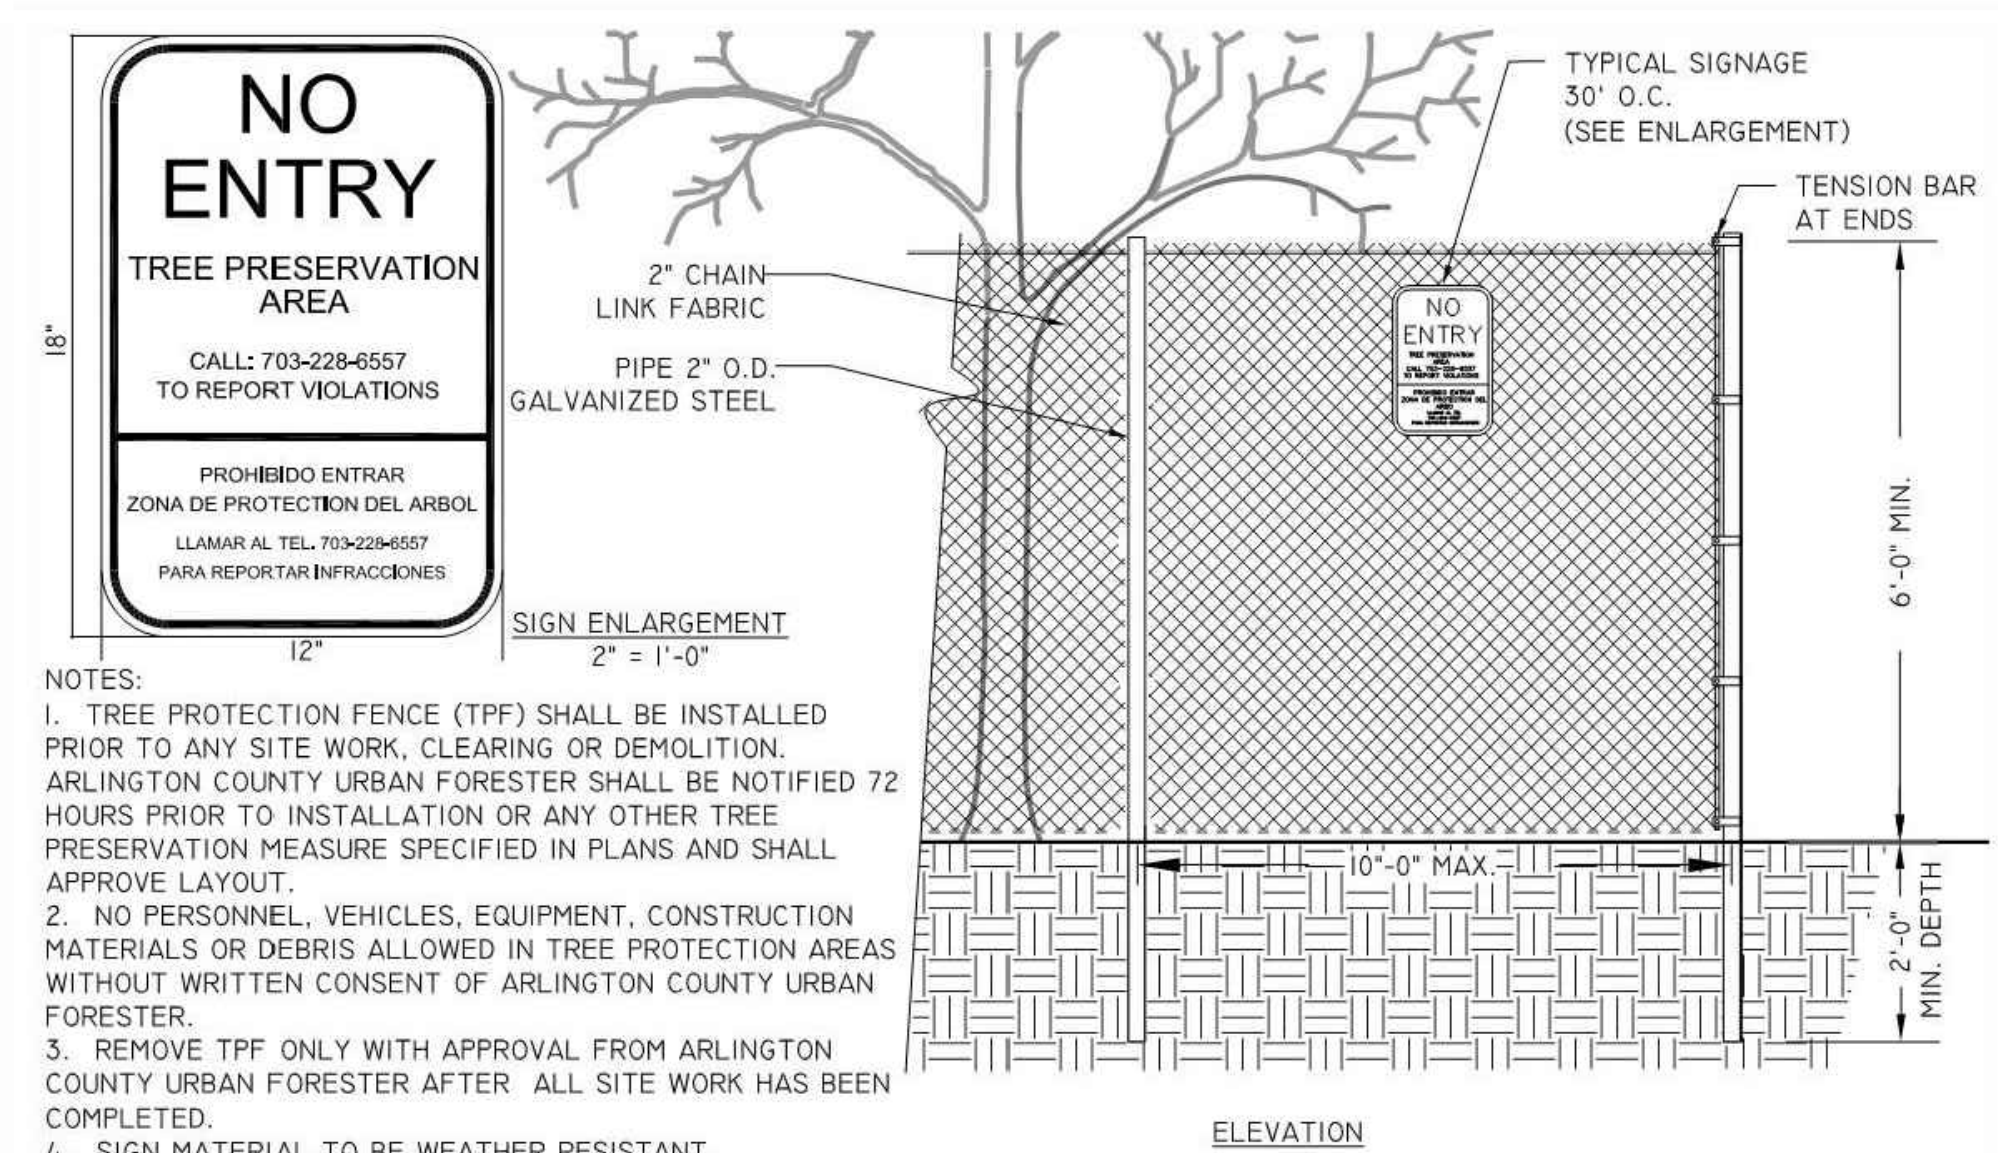

ES5 11 6' CHAIN LINK TREE PROTECTION FENCE

311300.1 (2016) (02231.1)

1/2" = 1'-0" ARLINGTON DPR

CBPO / BMP NARRATIVE:

THIS PROJECT IS A PUBLIC ROAD PROJECT AND IS THEREFORE EXEMPT FROM THE REQUIREMENTS OF THE CHESAPEAKE BAY PRESERVATION ORDINANCE UNDER 61-15 OF THE ARLINGTON COUNTY CODE.

SWM / ADEQUATE OUTFALL NARRATIVE:

THE SUBJECT SITE IS LOCATED IN ZONE X ON FEMA FIRM # 51013C0081C AND IS NOT LOCATED IN THE RPA. THE PROJECT SITE (CRYSTAL DRIVE AND 12TH STREET SOUTH) HAS NO HISTORY OF RECORDED FLOODING AND/OR PONDING ON THE STREETS DURING HEAVY RAIN EVENTS.

THE REHABILITATION SITE HAS 2 (TWO) OUTFALL AREAS. STORM COMPUTATIONS HAS BEEN PROVIDED TO DEMONSTRATE THE ADEQUATE CAPACITY OF THE EXISTING STORM SYSTEMS. THE RESULTS SHOWED EXISTING STORM DRAINAGE SYSTEMS AND PROPOSED INLETS RELOCATION ARE ADEQUATE. SEE SHEETS XX - XX.

STORM WATER RUNOFF CONSIDERATIONS:

EXISTING STORMWATER SYSTEM WILL BE USED TO DRAIN OUT THE STORMWATER RUNOFF DURING CONSTRUCTION. RUNOFF SHALL BE TREATED WITH INLET PROTECTION PRIOR TO ENTERING MAJOR STORM SEWER SYSTEMS. THERE IS NO ANTICIPATED CHANGE IN STORM WATER RUNOFF AFTER COMPLETION OF THE PROJECT.

STORM DRAIN INLET PROTECTION:

INLET PROTECTION WILL BE INSTALLED AS SHOWN. ALL STORM SEWER INLETS SHALL BE PROTECTED DURING CONSTRUCTION. SEDIMENT-LADEN WATER SHALL BE FILTERED BEFORE ENTERING THE STORM SEWER INLETS.

STORM DRAIN INLET PROTECTION: ALL EXISTING & PROPOSED STORM SEWER INLETS IN AND AROUND THE PROJECT LIMITS SHALL BE PROTECTED DURING CONSTRUCTION. SEDIMENT-LADEN WATER SHALL BE FILTERED BEFORE ENTERING THE STORM SEWER INLETS.

DEWATERING STRUCTURE: SEDIMENT LADEN OR TURBID WATER SHALL BE FILTERED, SETTLED OR SIMILARLY TREATED PRIOR TO DISCHARGE.

VIRGINIA DEPARTMENT OF ENVIRONMENTAL QUALITY (DEQ) MUNICIPAL SEPARATE STORM SEWER SYSTEM (MS4) NOTE:

ONLY THE FOLLOWING NON-STORMWATER DISCHARGES ARE AUTHORIZED BY ARLINGTON COUNTY'S MS4 PERMIT, UNLESS THE STATE WATER CONTROL BOARD, THE VIRGINIA SOIL AND WATER CONSERVATION BOARD (BOARD), OR ARLINGTON COUNTY DETERMINES THE DISCHARGE TO BE A SIGNIFICANT SOURCE OF POLLUTANTS TO SURFACE WATERS:

WATER LINE FLUSHING; LANDSCAPE IRRIGATION; DIVERTED STREAM FLOWS; RISING GROUND WATERS; UNCONTAMINATED GROUND WATER INFILTRATION (AS DEFINED AT 40 CFR 35.2005(20)); UNCONTAMINATED PUMPED GROUND WATER; DISCHARGES FROM POTABLE WATER SOURCES; FOUNDATION DRAINS; AIR CONDITIONING CONDENSATION; IRRIGATION WATER; SPRINGS; WATER FROM CRAWLSPACE PUMPS; FOOTING DRAINS; LAWN WATERING; INDIVIDUAL RESIDENTIAL CAR WASHING; FLOWS FROM RIPARIAN HABITATS AND WETLANDS; DECHLORINATED SWIMMING POOL DISCHARGES; DISCHARGES OR FLOWS FROM FIRE FIGHTING; AND, OTHER ACTIVITIES GENERATING DISCHARGES IDENTIFIED BY THE DEPARTMENT OF ENVIRONMENTAL QUALITY AS NOT REQUIRING VPOES AUTHORIZATION.

APPROPRIATE CONTROLS MUST BE IMPLEMENTED TO PREVENT ANY NON-STORMWATER DISCHARGES NOT INCLUDED ON THE ABOVE LIST (E.G., CONCRETE WASH WATER, PAINT WASH WATER, VEHICLE WASH WATER, DETERGENT WASH WATER, ETC.) FROM BEING DISCHARGED INTO ARLINGTON COUNTY'S MS4 SYSTEM, WHICH INCLUDES THE CURB AND GUTTER SYSTEM, AS WELL AS CATCH BASINS AND OTHER STORM DRAIN INLETS, OR STREAM NETWORK.

PER CHAPTER 26 OF THE ARLINGTON COUNTY CODE, IT SHALL BE UNLAWFUL FOR ANY PERSON TO DISCHARGE DIRECTLY OR INDIRECTLY INTO THE STORM SEWER SYSTEM OR STATE WATERS, ANY SUBSTANCE LIKELY, IN THE OPINION OF THE COUNTY MANAGER, TO HAVE AN ADVERSE EFFECT ON THE STORM SEWER SYSTEM.

- TREE PROTECTION:**
1. CONTRACTOR TO CONTACT THE ARLINGTON FORESTER TO SCHEDULE A PRE-CONSTRUCTION INSPECTION OF TREE PROTECTION MEASURES BEFORE ANY WORK NEAR THE CRITICAL ROOT ZONES OF TREES. TO SCHEDULE THE PRE-CONSTRUCTION MEETING CALL 703-228-1863.
 2. CONTRACTOR TO PROTECT TREES PER THE PLAN ACCORDING TO THE ARLINGTON COUNTY DPR DESIGN STANDARD DETAIL 02231.1.
 3. CONTRACTOR TO ROOT PRUNE TREES PER THE PLAN ACCORDING TO THE ARLINGTON COUNTY DPR DESIGN STANDARD DETAIL 02231.5, WHERE CALLED OUT ON THE PLAN.
 4. CONTRACTOR TO CALL THE URBAN FORESTER AT 703-228-1863, 72 HOURS BEFORE PLANTING, TO SCHEDULE INSPECTION OF THE TREES TO BE PLANTED. WARRANTY FOR 1 YEAR AFTER PLANTING SHALL BE THE CONTRACTOR'S RESPONSIBILITY. THE URBAN FORESTER AND DPR IS RESPONSIBLE FOR INSPECTION.
 5. CONTRACTOR TO PREPARE TREE PLANTING STRIPS FOR THE REPLACEMENT TREES ACCORDING TO ARLINGTON COUNTY DPR DESIGN STANDARD DETAIL 02930.4A AND 02930.4B.
 6. CONTRACTOR TO PREPARE STREET TREE PLANTING PITS ACCORDING TO THE ARLINGTON COUNTY DPR DESIGN STANDARD DETAIL 02930.3A, 02930.3B, AND 02930.11C.
 7. CONTRACTOR TO PLANT THE TREES ACCORDING TO ARLINGTON COUNTY DPR DESIGN STANDARD DETAIL 02930.1 (ON FLAT LAND) OR 02930.2 (ON SLOPES).

THIS SHEET IS FOR EROSION AND SEDIMENT CONTROL USE ONLY FOR ALL DETAILS AND SPECIFICATIONS, SEE THE VIRGINIA EROSION & SEDIMENT CONTROL HANDBOOK

DEPARTMENT OF ENVIRONMENTAL SERVICES
FACILITIES & ENGINEERING DIVISION
ENGINEERING BUREAU
2100 CLARENDON BOULEVARD, SUITE 813
ARLINGTON, VA 22201
PHONE: 703.228.3629
FAX: 703.228.3606

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APPROVALS	DATE
<i>Trevor M. Lantz</i>	3/29/21
QUALITY CONTROL ENGINEER <i>Kamal Takat</i>	3.24.21
CONSTRUCTION MANAGEMENT SUPERVISOR <i>Debra</i>	03.04.2021
WATER, SEWER, STREETS BUREAU CHIEF <i>Dennis M. Leach</i>	03/17/21
TRANSPORTATION DIRECTOR <i>Diana Izzo</i>	3/2/21

REVISIONS	DATE

PROJECT NAME AND LOCATION
TRANSITWAY EXTENSION TO PENTAGON CITY
E&S CONTROL DETAILS
CRYSTAL DR & 12TH ST S
MAL3 - SEGMENT 1

DESIGNED: PB
DRAWN: NS
CHECKED: TL
MISS UTILITY TRANSMITTAL #: N/A
FILENAME: MAL3-224-E_AND_S_PLAN.DWG
PATH: \\DES-CAD-S2\ENGINEERING_DATA\DATA\MAL3
PLOTTED: AUGUST 4 2021
PLOTTED BY: NSHARP

SCALE: N/A

EROSION AND SEDIMENT CONTROL NARRATIVE

PROJECT DESCRIPTION
TWO STATIONS ARE PROPOSED TO BE CONSTRUCTED FOR THE SEGMENT F OF THE CRYSTAL CITY POTOMAC YARD TRANSITWAY (TRANSITWAY). PROPOSED IMPROVEMENTS ARE ALSO PROPOSED AT THE TRANSITION FROM CRYSTAL DRIVE TO 12TH STREET S.

THE TRANSITWAY STATION AT CRYSTAL DRIVE NORTH BOUND AND 15TH STREET SOUTH INTERSECTION (STA 61+18) CONSIST OF CURBSIDE 9.5" HIGH PLATFORM AND TWO CUSTOM BUS SHELTERS SIMILAR TO THE BUS SHELTERS INSTALLED AT CRYSTAL DRIVE NORTH BOUND AND 18TH STREET SOUTH INTERSECTION.

THE TRANSITWAY STATION AT 12TH STREET SOUTH NORTH BOUND AND LONG BRIDGE DRIVE INTERSECTION (STA 74+54) CONSIST OF CURBSIDE 9.5" HIGH PLATFORM AND ONE BUS SHELTER PREFABRICATED AND PROVIDED BY BRASCO.

THE CRYSTAL DRIVE TO 12TH STREET S TRANSITION IMPROVEMENTS WILL INCLUDE THE INSTALLATION OF TWO CURB RAMPS, CURB AND GUTTER, SIDEWALK AND ASPHALT.

THE TRANSITWAY STATION AT CRYSTAL DRIVE NORTH BOUND AND 15TH STREET SOUTH INTERSECTION (STA 61+18) INCLUDES:

- ROAD ASPHALT DEMOLITION AND REPAVING WITH 10" REINFORCED CONCRETE BUS PAD;
- CURB & GUTTER DEMOLITION AND CONSTRUCTION OF NEW MODIFIED CURB & GUTTER WITH 9.5" CURB HIGH AND TWO TRANSITIONS FROM 6" TO 9.5";
- SIDEWALK BRICK PAVEMENT DEMOLITION AND CONSTRUCTION OF NEW ELEVATED CONCRETE BUS PLATFORM, FOUNDATION FOR BUS SHELTERS AND TWO RAMPS WITH BRICK PAVEMENT;
- TREE/LANDSCAPING STRIP AND TREE REMOVAL ASSOCIATED WITH CONCRETE BUS PLATFORM CONSTRUCTION;
- EXISTING STREET LANDSCAPING SHALL BE RESTORED AND EXISTING TREES SHALL BE PROTECTED.

THE TRANSITWAY STATION AT 12TH STREET SOUTH NORTH BOUND AND LONG BRIDGE DRIVE INTERSECTION (STA 74+54) INCLUDES:

- ROAD ASPHALT DEMOLITION AND REPAVING WITH 10" REINFORCED CONCRETE BUS PAD;
- CURB & GUTTER DEMOLITION AND CONSTRUCTION OF NEW MODIFIED CURB & GUTTER WITH 9.5" CURB HIGH AND TWO TRANSITIONS FROM 6" TO 9.5";
- SIDEWALK BRICK PAVEMENT DEMOLITION AND CONSTRUCTION OF NEW ELEVATED CONCRETE BUS PLATFORM, FOUNDATION FOR BUS SHELTERS AND TWO RAMPS WITH BRICK PAVEMENT;
- TREE REMOVAL ASSOCIATED WITH CONCRETE BUS PLATFORM CONSTRUCTION;
- EXISTING STREET LANDSCAPING SHALL BE RESTORED;
- CATCH BASIN SHALL BE REPLACED WITH MODIFIED CATCH BASIN TO ACCOMMODATE ELEVATED PLATFORM 9.5" HIGH.

THE CRYSTAL DRIVE TO 12TH STREET SOUTH TRANSITION (STA 67+00 TO STA 69+00) INCLUDES:

- ROAD ASPHALT DEMOLITION AND REPAVING;
- CURB & GUTTER DEMOLITION AND CONSTRUCTION OF NEW CURB & GUTTER;
- SIDEWALK DEMOLITION AND CONSTRUCTION OF NEW SIDEWALK WITH BRICK BAND;
- RAMP DEMOLITION AND CONSTRUCTION OF TWO NEW RAMPS;
- EXISTING STREET LANDSCAPING AND/OR GRASS AREAS SHALL BE RESTORED;

DISTURBED AREA, PRE DEVELOPED AND POST DEVELOPED IMPERVIOUS CONDITIONS PROVIDED IN THE TABLE - SEE THIS SHEET.

THIS PROJECT DOES NOT IMPACT VDOT RIGHT-OF-WAY.

EXISTING SITE CONDITIONS

THE PROJECT SITES ARE LOCATED IN BUSINESS AREAS AND CONSIST ENTIRELY OF IMPERVIOUS AREA (ASPHALT ROADWAY AND CONCRETE/BRICK PAYER SIDEWALK). SUFFICIENT STORM DRAINAGE SYSTEM IS IN PLACE AND THERE IS NO KNOWN RECORD OF FLOODING IN THE AREA.

WATERSHED

THE PROJECT LIMITS ARE LOCATED WITHIN THE ROACHES RUN WATERSHED.

ADJACENT PROPERTIES

COMMERCIAL PROPERTIES ARE LOCATED BEHIND PROPOSED TRANSITWAY STATIONS, AND THE PROPOSED TRANSITION IMPROVEMENTS.

OFF-SITE AREAS

THE EXTENT OF OFFSITE CONSTRUCTION IS LIMITED TO CONNECTING TO EXISTING STREETS ADJACENT TO THIS PARCELS, AND CONNECTING PROPOSED UTILITIES TO EXISTING UTILITIES.

CRITICAL AREAS

AS THE PROJECT AREA IS WITHIN THE EXISTING ROADWAY, THERE ARE NO EXISTING EROSION PROBLEMS IDENTIFIED.

SOILS

COMPLEX: URBAN LAND-UDORTHENTS COMPLEX

SLOPE: 2 TO 15 PERCENT

URBAN: 85-100

SOIL HYDRAULIC GROUP: D

THE SOILS IN CONSTRUCTION AREA ARE DISTURBED BY URBANIZATION DEVELOPMENT WITH ROAD/SIDEWALK PAVEMENT OVER SAND/GRAVEL BASE. SOIL HYDRAULIC GROUP FOR THE PROJECT AREA IS D.

PERMANENT STABILIZATION

ALL OF THE AREA DISTURBED WITH THIS PLAN WILL BE RESTORED TO A SIMILAR EXISTING CONDITION. ALL AREA NOT STABILIZED WITH PAVEMENT WILL BE STABILIZED WITH GRASS, MULCH, OR SOD.

VEGETATIVE PRACTICES

THE EROSION AND SEDIMENT CONTROL INSPECTOR SHALL HAVE THE AUTHORITY TO ADD OR DELETE EROSION AND SEDIMENT CONTROLS AS NEEDED IN THE FIELD OR AS SITE CONDITIONS WARRANT. IN ADDITION, NO SEDIMENT TRAPS OR BASINS MAY BE REMOVED WITHOUT PRIOR APPROVAL OF THE INSPECTOR.

LANDSCAPE / TREE PRESERVATION NOTES

PRIOR TO ANY LAND DISTURBING ACTIVITY THE CONTRACTOR SHALL CONTACT THE ARLINGTON COUNTY ARBORIST TO SCHEDULE AN INSPECTION.

STORMWATER RUNOFF CONSIDERATIONS:

EXISTING STORMWATER SYSTEM WILL BE USED TO DRAIN THE STORMWATER RUNOFF. THE IMPERVIOUS AREA WITHIN THE PROJECT LIMIT IS INCREASED BY 420 SF (0.0096 AC), THEREFORE THERE IS NO SIGNIFICANT CHANGE IN STORM WATER QUANTITY RESULTING FROM THIS PROJECT.

EROSION AND SEDIMENT CONTROL MEASURES

THE EROSION AND SEDIMENT CONTROL MEASURES FOR THIS PROJECT AREA INCLUDES INLET PROTECTION. INLET PROTECTION MAY BE REQUIRED OUTSIDE THE PROJECT LIMITS WHEN WATER FROM DISTURBED AREA WILL FLOW OFFSITE.

UNLESS OTHERWISE INDICATED, ALL VEGETATIVE AND STRUCTURAL EROSION AND SEDIMENT CONTROL PRACTICES SHALL BE CONSTRUCTED AND MAINTAINED ACCORDING TO THE MINIMUM STANDARDS AND SPECIFICATIONS OF THE VIRGINIA EROSION AND SEDIMENT CONTROL HANDBOOK (VESCH) AND THE ARLINGTON COUNTY EROSION AND SEDIMENT CONTROL ORDINANCE. THE MINIMUM STANDARDS OF THE VIRGINIA EROSION AND SEDIMENT CONTROL REGULATIONS (VESCR) SHALL BE ADHERED TO UNLESS WAIVED OR APPROVED BY VARIANCE.

RUNOFF REDUCTION SPREADSHEET INFORMATION:

THE RUNOFF REDUCTION SPREADSHEET INFORMATION ON THIS PLAN IS FOR DATA TRACKING PURPOSES TO DOCUMENT THE AREA OF LAND DISTURBANCE AND TO CHARACTERIZE PRE- AND POST-DEVELOPMENT LAND USE CONDITIONS.

IN ACCORDANCE WITH ARLINGTON COUNTY'S CHESAPEAKE BAY TOTAL MAXIMUM DAILY LOAD (TMDL) ACTION PLAN, APPROVED BY THE VIRGINIA DEPARTMENT OF ENVIRONMENTAL QUALITY (DEQ) ON SEPTEMBER 1, 2015, LINEAR DEVELOPMENT PROJECTS CONDUCTED BY THE COUNTY ARE ADMINISTERED AND TRACKED AS FOLLOWS CONSISTENT WITH 9VAC25-870-69.A.4, 9VAC25-870-76, AND 9VAC25-870-92:

- POLLUTANT LOAD CHANGES WILL BE COMPUTED AS DESCRIBED IN SECTION 3.A OF THE ACTION PLAN.
- RETROFIT OPPORTUNITIES WILL BE EVALUATED FOR EACH PROJECT, USING THE SCREENING AND SELECTION CRITERIA APPLIED AND DESCRIBED IN THE ADOPTED STORMWATER MASTER PLAN.
- RETROFIT PROJECTS THAT MEET THE SCREENING CRITERIA AND ARE DETERMINED BY ARLINGTON TO BE FEASIBLE AND COST-EFFECTIVE WILL BE IMPLEMENTED WITH SPECIFIC LINEAR DEVELOPMENT PROJECTS. POLLUTANT LOAD REDUCTIONS FROM RETROFIT PROJECTS WILL BE COMPUTED AS DESCRIBED IN SECTION 5 OF THE ACTION PLAN.
- IN CASES WHERE RETROFIT PROJECTS ARE NOT FEASIBLE AND COST-EFFECTIVE FOR A PARTICULAR LINEAR PROJECT, ANY POLLUTANT OF CONCERN (POC) LOAD INCREASES THAT MIGHT OCCUR FOR THAT PROJECT WILL BE ADDRESSED BY LARGER OVERALL POC LOAD REDUCTIONS IN PLACE OR ADDED THROUGH TMDL ACTION PLAN IMPLEMENTATION.

IN THE ABOVE MANNER ARLINGTON, AS THE M&A OPERATOR AND THE CONSTRUCTION SITE OPERATOR FOR ITS LINEAR DEVELOPMENT PROJECTS, IMPLEMENTS LINEAR PROJECTS AND RETROFIT PROJECTS IN A MANNER THAT ACHIEVES THE MOST TMDL POC REDUCTION FOR THE LEAST COST, WHILE FULLY ACCOUNTING FOR LOAD CHANGES THAT OCCUR WITH LINEAR DEVELOPMENT PROJECT ACTIVITY CONSISTENT WITH THE DEQ CHESAPEAKE BAY TMDL REPORT DATED 06/21/2010 AND 01/2015.

DESIGNED BY: [Signature]

GENERAL EROSION & SEDIMENT CONTROL NOTES

1. UNLESS OTHERWISE INDICATED, ALL VEGETATIVE AND STRUCTURAL EROSION AND SEDIMENT CONTROL PRACTICES SHALL BE CONSTRUCTED AND MAINTAINED ACCORDING TO THE LATEST EDITIONS OF THE VIRGINIA EROSION AND SEDIMENT CONTROL HANDBOOK (VESCH) AND THE ARLINGTON COUNTY EROSION AND SEDIMENT CONTROL ORDINANCE.

2. THE PLAN APPROVING AUTHORITY MUST BE NOTIFIED ONE WEEK PRIOR TO THE PRE-CONSTRUCTION CONFERENCE, ONE WEEK PRIOR TO THE COMMENCEMENT OF LAND DISTURBING ACTIVITY AND ONE WEEK PRIOR TO THE FINAL INSPECTION.

3. ALL EROSION AND SEDIMENT CONTROL MEASURES ARE TO BE PLACED PRIOR TO OR AS A FIRST STEP IN CLEARING.

4. A COPY OF THE APPROVED EROSION AND SEDIMENT CONTROL PLANS SHALL BE MAINTAINED ON THE SITE AT ALL TIMES.

5. PRIOR TO COMMENCING LAND DISTURBING ACTIVITIES IN AREAS OTHER THAN INDICATED ON THESE PLANS (INCLUDING BUT NOT LIMITED TO OFF-SITE BORROW OR WASTE AREAS), THE CONTRACTOR SHALL SUBMIT A SUPPLEMENTARY EROSION CONTROL PLAN TO THE OWNER FOR REVIEW AND APPROVAL BY THE PLAN APPROVING AUTHORITY.

6. THE CONTRACTOR IS RESPONSIBLE FOR INSTALLATION OF ANY ADDITIONAL EROSION CONTROL MEASURES NECESSARY TO PREVENT EROSION SEDIMENTATION AS DETERMINED BY THE PLAN APPROVING AUTHORITY.

7. ALL DISTURBED AREAS ARE TO DRAIN TO APPROVED SEDIMENT CONTROL MEASURES AT ALL TIMES DURING LAND DISTURBING ACTIVITIES DURING SITE DEVELOPMENT UNTIL FINAL STABILIZATION IS ACHIEVED.

8. DURING DENATURING OPERATIONS, WATER WILL BE PUMPED INTO AN APPROVED FILTERING DEVICE.

GENERAL LAND CONSERVATION NOTES

1. NO DISTURBED AREA WHICH IS NOT ACTIVELY BEING WORKED SHALL REMAIN DENUDED FOR MORE THAN 7 CALENDAR DAYS UNLESS OTHERWISE AUTHORIZED BY THE DIRECTOR OR HIS AGENT.

2. ALL E&S CONTROL MEASURES APPROVED WITH THE E&S CONTROL PLAN SHALL BE PLACED AS THE FIRST STEP IN GRADING.

3. ALL STORM AND SANITARY SEWER LINES NOT IN STREETS SHALL BE SEEDED AND MULCHED WITHIN 5 DAYS AFTER BACKFILL. NO MORE THAN 500' (150M) SHALL BE OPEN AT ANY TIME.

4. ELECTRIC POWER, TELEPHONE AND GAS SUPPLY TRENCHES SHALL BE COMPACTED, SEEDED AND MULCHED WITHIN 5 DAYS AFTER BACKFILL.

5. ALL TEMPORARY EARTH BERMS, DIVERSIONS AND SEDIMENT CONTROL DAMS SHALL BE SEEDED AND MULCHED FOR TEMPORARY VEGETATIVE COVER IMMEDIATELY AFTER. STRAW OR HAY MULCH IS REQUIRED. ALL SOIL STOCKPILES SHALL BE SEEDED AND MULCHED IMMEDIATELY AFTER GRADING.

6. DURING CONSTRUCTION, ALL STORM SEWER INLETS SHALL BE PROTECTED BY SEDIMENT TRAPS, MAINTAINED AND MODIFIED DURING CONSTRUCTION PROGRESS AS REQUIRED.

7. ANY DISTURBED AREA NOT COVERED BY NOTE 1 ABOVE AND NOT PAVED, SODDED OR BUILT UPON BY NOV. 1, OR DISTURBED AFTER THAT DATE, SHALL BE MULCHED IMMEDIATELY WITH HAY OR STRAW MULCH AT THE RATE OF 2 TONS/ACRE AND OVER-SEEDED BY APRIL 15.

8. AT THE COMPLETION OF ANY PROJECT CONSTRUCTION AND PRIOR TO BOND RELEASE, ALL TEMPORARY SEDIMENT CONTROLS SHALL BE REMOVED AND ALL DENUDED AREAS SHALL BE STABILIZED.

UTILITY INSTALLATION

UNDERGROUND UTILITY LINES SHALL BE INSTALLED IN ACCORDANCE WITH THE FOLLOWING STANDARDS IN ADDITION TO OTHER APPLICABLE CRITERIA:

1. NO MORE THAN 500 LINEAR FEET OF TRENCH MAY BE OPENED AT ONE TIME.

2. EXCAVATED MATERIAL SHALL BE PLACED ON THE UPHILL SIDE OF TRENCHES.

3. EFFLUENT FROM DEWATERING OPERATIONS SHALL BE FILTERED OR PASSED THROUGH AN APPROVED SEDIMENT TRAPPING DEVICE, OR BOTH, AND DISCHARGED IN A MANNER THAT DOES NOT ADVERSELY AFFECT FLOWING STREAMS OR OFF-SITE PROPERTY.

4. MATERIAL USED FOR BACKFILLING TRENCHES SHALL BE PROPERLY COMPACTED IN ORDER TO MINIMIZE EROSION AND PROMOTE STABILIZATION.

5. RESTABILIZATION SHALL BE ACCOMPLISHED IN ACCORDANCE WITH THESE REGULATIONS.

6. APPLICABLE SAFETY REGULATIONS SHALL BE COMPLIED WITH.

TEMPORARY SEEDING:

SEE SHEET III-288 OF THE VIRGINIA EROSION AND SEDIMENT CONTROL HANDBOOK (VESCH) FOR ALLOWABLE PLANTING MATERIAL, SEEDING RATES, AND DATES. THE REQUIREMENTS OF THE "SOUTH" PLANTING REQUIREMENTS SHALL BE FOLLOWED. LIMING SHALL BE BASED ON TABLE 3.31-A OF VESCH. FERTILIZERS SHALL BE APPLIED AS 600 LB/ACRE. THE FERTILIZER SHALL BE INCORPORATED INTO THE TOP 2-4" OF SOIL. SEED SHALL BE EVENLY APPLIED AND SMALL GRAINS SHALL BE PLANTED NO MORE THAN 1.5" DEEP. SEEDING MADE IN FALL FOR WINTER COVER AND DURING HOT SUMMER MONTHS SHALL BE MULCHED.

PERMANENT SEEDING:

THE SUBJECT SITE IS LOCATED IN THE COASTAL PLAIN AREA OF VIRGINIA, SO SHEET III-304 OF THE VIRGINIA EROSION AND SEDIMENT CONTROL HANDBOOK SHALL BE FOLLOWED FOR FINAL SEEDING MATERIAL, SEEDING RATES, AND DATES OF APPLICATION.

SODDING:

SODDED AREAS SHALL BE BROUGHT TO FINAL GRADE IN ACCORDANCE WITH THE APPROVED PLANS. SOIL TEST SHOULD BE MADE TO DETERMINE THE EXACT REQUIREMENTS FOR LIME AND FERTILIZER. PRIOR TO LAYING SOD, SOIL SURFACE SHALL BE CLEAR OF TRASH, DEBRIS AND LARGE OBJECTS. QUALITY OF SOD SHALL BE STATE CERTIFIED AND ENSURE GENETIC PURITY AND HIGH QUALITY. SOD SHALL NOT BE LAID IN EXCESSIVELY WET OR DRY WEATHER AND BE DELIVERED AND INSTALLED WITHIN 36 HOURS. SOD SHOULD NOT BE LAID ON FROZEN SOIL SURFACE AND SHALL BE INSTALLED PER PAGE III-339 OF VESCH.

DUST CONTROL:

DUST SHALL BE CONTROLLED USING A VARIETY OF METHODS TO INCLUDE VEGETATIVE COVER, MULCH, TILLAGE, IRRIGATION, SPRAY-ON ADHESIVES, STONE, BARRIERS, AND CALCIUM CHLORIDE. THE IMPLEMENTATION OF THE DUST CONTROL METHODS SHALL BE INSTALLED PER SECTION 3.39 OF VESCH.

MAINTENANCE PROGRAM:

THE FOLLOWING IS A PROGRAM OF MAINTENANCE FOR THE MECHANICAL CONTROLS SPECIFIED IN THIS NARRATIVE AND ON THE PLAN:

- THE SITE SUPERINTENDENT OR HIS/HER REPRESENTATIVE SHALL MAKE A VISUAL INSPECTION OF ALL MECHANICAL CONTROLS AND NEWLY STABILIZED AREA (I.E. SEEDED AND MULCHED AND/OR SODDED AREAS) ON A DAILY BASIS; ESPECIALLY AFTER A HEAVY RAINFALL EVENT TO INSURE THAT ALL CONTROLS ARE MAINTAINED AND PROPERLY FUNCTIONING. ANY DAMAGED CONTROLS SHALL BE REPAIRED PRIOR TO THE END OF THE WORK DAY INCLUDING RE-SEEDING AND MULCHING OR RE-SODDING IF NECESSARY.
- ALL SEDIMENT TRAPPING DEVICES SHALL BE CLEARED OUT AT 50% TRAP CAPACITY AND THE SEDIMENT SHALL BE DISPOSED OF BY SPREADING ON THE SITE OR IF NOT SUITABLE FOR FILL, HAULING AWAY AND DEPOSITING AT AN ACCEPTABLE DUMP SITE.
- THE CONTRACTOR SHALL TAKE SPECIAL CARE TO PREVENT MUD AND/OR OTHER DEBRIS FROM BEING ENTERED ONTO EXISTING SWM/BMP FACILITIES OR DOWN STREAM WATER WAYS. SHOULD OFF SITE AREAS BECOME POLLUTED BY CONSTRUCTION ACTIVITIES, THE CONTRACTOR SHALL BE RESPONSIBLE FOR CLEANING THE EFFECTED AREAS TO THE SATISFACTION OF THE INSPECTOR.
- AT THE COMPLETION OF CONSTRUCTION AND PRIOR TO BOND RELEASE, ALL TEMPORARY SEDIMENT CONTROLS SHALL BE REMOVED AND ANY REMAINING DENUDED AREAS SHALL BE STABILIZED. CERTAIN DEVICES MAY BE REMOVED PRIOR TO CONSTRUCTION COMPLETION BUT ONLY WITH THE APPROVAL OF THE COUNTY INSPECTOR.
- AFTER CONSTRUCTION OPERATIONS HAVE ENDED, ALL DISTURBED AREAS SHALL BE STABILIZED. UPON APPROVAL OF THE COUNTY INSPECTOR, MECHANICAL SEDIMENT CONTROLS SHALL BE REMOVED AND THE GROUND PERMANENTLY STABILIZED WITH VEGETATION WITHIN 30 DAYS.

1. THE SITE SUPERINTENDENT OR HIS/HER REPRESENTATIVE SHALL MAKE A VISUAL INSPECTION OF ALL MECHANICAL CONTROLS AND NEWLY STABILIZED AREA (I.E. SEEDED AND MULCHED AND/OR SODDED AREAS) ON A DAILY BASIS; ESPECIALLY AFTER A HEAVY RAINFALL EVENT TO INSURE THAT ALL CONTROLS ARE MAINTAINED AND PROPERLY FUNCTIONING. ANY DAMAGED CONTROLS SHALL BE REPAIRED PRIOR TO THE END OF THE WORK DAY INCLUDING RE-SEEDING AND MULCHING OR RE-SODDING IF NECESSARY.

2. ALL SEDIMENT TRAPPING DEVICES SHALL BE CLEARED OUT AT 50% TRAP CAPACITY AND THE SEDIMENT SHALL BE DISPOSED OF BY SPREADING ON THE SITE OR IF NOT SUITABLE FOR FILL, HAULING AWAY AND DEPOSITING AT AN ACCEPTABLE DUMP SITE.

3. THE CONTRACTOR SHALL TAKE SPECIAL CARE TO PREVENT MUD AND/OR OTHER DEBRIS FROM BEING ENTERED ONTO EXISTING SWM/BMP FACILITIES OR DOWN STREAM WATER WAYS. SHOULD OFF SITE AREAS BECOME POLLUTED BY CONSTRUCTION ACTIVITIES, THE CONTRACTOR SHALL BE RESPONSIBLE FOR CLEANING THE EFFECTED AREAS TO THE SATISFACTION OF THE INSPECTOR.

4. AT THE COMPLETION OF CONSTRUCTION AND PRIOR TO BOND RELEASE, ALL TEMPORARY SEDIMENT CONTROLS SHALL BE REMOVED AND ANY REMAINING DENUDED AREAS SHALL BE STABILIZED. CERTAIN DEVICES MAY BE REMOVED PRIOR TO CONSTRUCTION COMPLETION BUT ONLY WITH THE APPROVAL OF THE COUNTY INSPECTOR.

5. AFTER CONSTRUCTION OPERATIONS HAVE ENDED, ALL DISTURBED AREAS SHALL BE STABILIZED. UPON APPROVAL OF THE COUNTY INSPECTOR, MECHANICAL SEDIMENT CONTROLS SHALL BE REMOVED AND THE GROUND PERMANENTLY STABILIZED WITH VEGETATION WITHIN 30 DAYS.

6. DURING CONSTRUCTION, ALL STORM SEWER INLETS SHALL BE PROTECTED BY SEDIMENT TRAPS, MAINTAINED AND MODIFIED DURING CONSTRUCTION PROGRESS AS REQUIRED.

7. ANY DISTURBED AREA NOT COVERED BY NOTE 1 ABOVE AND NOT PAVED, SODDED OR BUILT UPON BY NOV. 1, OR DISTURBED AFTER THAT DATE, SHALL BE MULCHED IMMEDIATELY WITH HAY OR STRAW MULCH AT THE RATE OF 2 TONS/ACRE AND OVER-SEEDED BY APRIL 15.

8. AT THE COMPLETION OF ANY PROJECT CONSTRUCTION AND PRIOR TO BOND RELEASE, ALL TEMPORARY SEDIMENT CONTROLS SHALL BE REMOVED AND ALL DENUDED AREAS SHALL BE STABILIZED.

9. EFFLUENT FROM DEWATERING OPERATIONS SHALL BE FILTERED OR PASSED THROUGH AN APPROVED SEDIMENT TRAPPING DEVICE, OR BOTH, AND DISCHARGED IN A MANNER THAT DOES NOT ADVERSELY AFFECT FLOWING STREAMS OR OFF-SITE PROPERTY.

10. EXCAVATED MATERIAL SHALL BE PLACED ON THE UPHILL SIDE OF TRENCHES.

11. NO MORE THAN 500 LINEAR FEET OF TRENCH MAY BE OPENED AT ONE TIME.

12. EXCAVATED MATERIAL SHALL BE PLACED ON THE UPHILL SIDE OF TRENCHES.

13. EFFLUENT FROM DEWATERING OPERATIONS SHALL BE FILTERED OR PASSED THROUGH AN APPROVED SEDIMENT TRAPPING DEVICE, OR BOTH, AND DISCHARGED IN A MANNER THAT DOES NOT ADVERSELY AFFECT FLOWING STREAMS OR OFF-SITE PROPERTY.

14. MATERIAL USED FOR BACKFILLING TRENCHES SHALL BE PROPERLY COMPACTED IN ORDER TO MINIMIZE EROSION AND PROMOTE STABILIZATION.

15. RESTABILIZATION SHALL BE ACCOMPLISHED IN ACCORDANCE WITH THESE REGULATIONS.

16. APPLICABLE SAFETY REGULATIONS SHALL BE COMPLIED WITH.

TABLE 3.31-B
(Revised June 2003)
TEMPORARY SEEDING SPECIFICATIONS
QUICK REFERENCE FOR ALL REGIONS

SEED		
APPLICATION DATES	SPECIES	APPLICATION RATES
Sept. 1 - Feb. 15	50/50 Mix of Annual Ryegrass (lolium multi-florum) & Cereal (Winter) Rye (Secale cereale)	50 -100 (lbs/acre)
Feb. 16 - Apr. 30	Annual Ryegrass (lolium multi-florum)	60 - 100 (lbs/acre)
May 1 - Aug. 31	German Millet	50 (lbs/acre)

FERTILIZER & LIME

- Apply 10-10-10 fertilizer at a rate of 450 lbs. / acre (or 10 lbs. / 1,000 sq. ft.)
- Apply Pulverized Agricultural Limestone at a rate of 2 tons/acre (or 90 lbs. / 1,000 sq. ft.)

NOTE:
1 - A soil test is necessary to determine the actual amount of lime required to adjust the soil pH of site.
2 - Incorporate the lime and fertilizer into the top 4 – 6 inches of the soil by disking or by other means.
3 - When applying Slowly Available Nitrogen, use rates available in [Erosion & Sediment Control Technical Bulletin # 4, 2003 Nutrient Management for Development Sites](#) at <http://www.dcr.state.va.us/sw/e&s.htm#pubs>

TABLE 3.32-D
(Revised June 2003)
PERMANENT SEEDING SPECIFICATIONS FOR PIEDMONT AREA

SEED ¹		
LAND USE	SPECIES	APPLICATION PER ACRE
<u>Minimum Care Lawn</u> (Commercial or Residential)	Tall Fescue ¹	95-100%
	Perennial Ryegrass	0-5%
	Kentucky Bluegrass ¹	0-5%
		TOTAL: 175-200 lbs.
<u>High-Maintenance Lawn</u>	Tall Fescue ¹	128 lbs.
	Red Top Grass or Creeping Red Fescue	2 lbs.
	Seasonal Nurse Crop ²	20 lbs.
		TOTAL: 150 lbs.
<u>General Slope (3:1 or less)</u>	Tall Fescue ¹	108 lbs.
	Red Top Grass or Creeping Red Fescue	2 lbs.
	Seasonal Nurse Crop ²	20 lbs.
	Crownvetch ³	20 lbs.
		TOTAL: 150 lbs.

1 - When selecting varieties of turfgrass, use the Virginia Crop Improvement Association (VCIA) recommended turfgrass variety list. Quality seed will bear a label indicating that they are approved by VCIA. A current turfgrass variety list is available at the local County Extension office or through VCIA at 804-746-4884 or at <http://sudan.cses.vt.edu/html/Turf/turf/publications/publications2.html>

2 - Use seasonal nurse crop in accordance with seeding dates as stated below:

February 16 th - April	Annual Rye
May 1 st - August 15 th	Foxtail Millet
August 16 th - October	Annual Rye
November - February 15 th	Winter Rye

3 - Substitute Sericea lespedeza for Crownvetch east of Farmville, VA (May through September use hulled seed, all other periods, use unhulled Sericea). If Flatpea is used, increase rate to 30 lbs./acre. If Weeping Lovegrass is used, include in any slope or low maintenance mixture during warmer seeding periods, increase to 30 -40

FERTILIZER & LIME

- Apply 10-20-10 fertilizer at a rate of 500 lbs. / acre (or 12 lbs. / 1,000 sq. ft.)
- Apply Pulverized Agricultural Limestone at a rate of 2 tons/acre (or 90 lbs. / 1,000 sq. ft.)

NOTE:
- A soil test is necessary to determine the actual amount of lime required to adjust the soil pH of site.
- Incorporate the lime and fertilizer into the top 4 – 6 inches of the soil by disking or by other means.
- When applying Slowly Available Nitrogen, use rates available in [Erosion & Sediment Control Technical Bulletin # 4, 2003 Nutrient Management for Development Sites](#) at <http://www.dcr.state.va.us/sw/e&s.htm#pubs>

Pre-Storm Erosion and Sediment Control Checklist

Per Erosion and Sediment Control General Note 6, the Contractor is responsible for the installation and maintenance of any additional erosion and sediment control (ESC) measures necessary to prevent erosion and sedimentation as determined by the County. These supplementary practices are in addition to those shown in an ESC plan. ESC practices shall be modified as needed to ensure only clear water is discharged from the site.

The following actions shall be taken prior to storm events with predicted heavy and/or large volume rainfall to prevent sediment discharge from a construction site. A typical summer thunderstorm is an example of a storm event with predicted heavy and/or large volume rainfall.

Perimeter controls

- Silt fence shall be checked for undermining, holes, or deterioration of the fabric. Fencing shall be replaced immediately if the fabric is damaged or worn. Silt fence must be trenched into the ground per state specifications (Std & Spec 3.09).
- Wooden stakes or steel posts shall be properly secured upright into the ground. Damaged posts or stakes must be replaced.
- Sediment that has accumulated against the silt fence should be removed. Accumulated sediment must be removed when the level reaches one-half the height of the fencing.
- Hay bales or a stone berm should be placed across the construction entrance to prevent sediment from leaving the construction site.

Exposed slopes and soil

- Exposed slopes not at the final stabilization phase shall be covered with tarps, plastic sheeting, or erosion control matting. Covering material shall be properly secured/anchored.
- Controls shall be installed to prevent concentrated flow down an exposed slope. Berms or diversion dikes shall be installed at the top of cut / exposed slopes to direct storm flow around the disturbed area.
- Exposed slopes at the final stabilization phase shall be stabilized using slope stabilization practices such as soil stabilization blankets or matting as specified in the Virginia Erosion and Sediment Control Handbook (VESCH) Std & Spec 3.36. Blankets or mats must be properly secured and anchored to the slope using staples, pins, or stakes.
- Seeded areas shall be checked and reseeded as necessary to cover exposed soil. Recently seeded areas shall be protected by straw or soil stabilization blankets to prevent seeding from being washed away.

Stockpiles

- Stockpiled soil and other loose materials that can be washed away shall be covered with a tarp, plastic sheeting, or other stabilization matting. The cover must be properly secured / anchored down to prevent it from being blown off and exposing materials to rain. Controls such as hay bales or booms should be placed along the perimeter of the stock pile (downhill side).

Inlet protection

- Inlet protection controls shall be inspected to ensure they are functioning properly and flooding will not occur. Clogged or damaged controls must be replaced immediately. Ensure controls allow for overflow / bypass of stormwater runoff during significant storm events.

In addition to these pre-storm actions, all erosion and sediment control (ESC) measures must be checked daily and after each significant rainfall.

MA13 SEGMENT (PRE AND POST DEVELOPMENT LAND COVER CALCULATIONS)

TOTAL PROJECT AREA					
LIMITS OF WORK (LOW)			0.4798	20900	AC/SF
LIMITS OF DISTURBANCE (LOD)			0.3076	13400	AC/SF
	PRE DEV [AC/SF]	POST DEV [AC/SF]	NET CHANGE [AC/SF]		
(LOD) IMPERVIOUS AREA	0.2801	12200	0.2897	12620	0.0096 420
(LOD) PEROVIOUS AREA	0.0275	1200	0.0179	780	-0.0096 -420

MA13 - SEGMENT I

TRANSITWAY EXTENSION TO PENTAGON CITY

E&S CONTROL NOTES

CRYSTAL DR & 12TH ST S

DESIGNED: PB
DRAWN: NS
CHECKED: TL
MISS UTILITY TRANSMITTAL #: N/A

FILENAME: MA13-224-E_AND_S_PLAN.DWG
PATH: \\DES-CAD-S2\ENGINEERING_DATA\DA\MA13

PLOTTED: AUGUST 4 2021
PLOTTED BY: NSHARP

SCALE: N/A

2011 BMP Standards and Specifications 2013 Draft BMP Standards and Specs

Project Name: **MA13 - Crystal City Transitway Extension**
 Date: **11/7/2019**
 Linear Development Project? **Yes**

CLEAR ALL

data input cells
 constant values
 calculation cells
 final results

Site Information

Post-Development Project (Treatment Volume and Loads)

Enter Total Disturbed Area (acres) → **0.3076**

Maximum reduction required: **20%**
 The site's net increase in impervious cover (acres) is: **0.0096**
 Post-Development TP Load Reduction for Site (lb/yr): **0.1398**

Check:
 BMP Design Specifications List: **2013 Draft Stds & Specs**
 Linear project? **Yes**
 Land cover areas entered correctly? **✓**
 Total disturbed area entered? **✓**

Pre-ReDevelopment Land Cover (acres)

	A Soils	B Soils	C Soils	D Soils	Totals
Forest/Open Space (acres) -- undisturbed forest/open space					0.0000
Managed Turf (acres) -- disturbed, graded for yards or other turf to be mowed/managed				0.0275	0.0275
Impervious Cover (acres)				0.2801	0.2801
Totals					0.3076

Post-Development Land Cover (acres)

	A Soils	B Soils	C Soils	D Soils	Totals
Forest/Open Space (acres) -- undisturbed, protected forest/open space or reforested land					0.0000
Managed Turf (acres) -- disturbed, graded for yards or other turf to be mowed/managed				0.0179	0.0179
Impervious Cover (acres)				0.2897	0.2897
Totals					0.3076

Constants

Annual Rainfall (inches)	43
Target Rainfall Event (inches)	1.00
Total Phosphorus (TP) EMC (mg/L)	0.26
Total Nitrogen (TN) EMC (mg/L)	1.86
Target TP Load (lb/acre/yr)	0.41
Pj (unless correction factor)	0.90

Runoff Coefficients (Rv)

	A Soils	B Soils	C Soils	D Soils
Forest/Open Space	0.02	0.03	0.04	0.05
Managed Turf	0.15	0.20	0.22	0.25
Impervious Cover	0.95	0.95	0.95	0.95

LAND COVER SUMMARY -- PRE-REDEVELOPMENT

Pre-ReDevelopment	Land Cover Summary-Pre	
	Listed	Adjusted ¹
Forest/Open Space Cover (acres)	0.0000	0.0000
Weighted Rv(forest)	0.0000	0.0000
% Forest	0%	0%
Managed Turf Cover (acres)	0.0275	0.0179
Weighted Rv(turf)	0.2500	0.2500
% Managed Turf	9%	6%
Impervious Cover (acres)	0.2801	0.2801
Rv(impervious)	0.9500	0.9500
% Impervious	91%	94%
Total Site Area (acres)	0.3076	0.2980
Site Rv	0.8874	0.9080

Treatment Volume and Nutrient Load

Pre-ReDevelopment	Listed	Adjusted ¹
Pre-ReDevelopment Treatment Volume (acre-ft)	0.0227	0.0225
Pre-ReDevelopment Treatment Volume (cubic feet)	990.8811	982.1691
Pre-ReDevelopment TP Load (lb/yr)	0.6226	0.6171
Pre-ReDevelopment TP Load per acre (lb/acre/yr)	2.0200	2.0700
Baseline TP Load (lb/yr)	0.1222 <small>(0.41 lbs/acre/yr applied to pre-redevelopment area excluding pervious land proposed for new impervious cover)</small>	

¹Adjusted Land Cover Summary:
 Pre ReDevelopment land cover minus pervious land cover (forest/open space or managed turf) acreage proposed for new impervious cover.
 Adjusted total acreage is consistent with Post-ReDevelopment acreage (minus acreage of new impervious cover).
 Column I shows load reduction requirement for new impervious cover (based on new development load limit, 0.41 lbs/acre/year).

LAND COVER SUMMARY -- POST DEVELOPMENT

Land Cover Summary-Post (Final)		Land Cover Summary-Post		Land Cover Summary-Post	
Post ReDev. & New Impervious		Post-ReDevelopment		Post-Development New Impervious	
Forest/Open Space Cover (acres)	0.0000	Forest/Open Space Cover (acres)	0.0000	New Impervious Cover (acres)	0.0096
Weighted Rv(forest)	0.0000	Weighted Rv(forest)	0.0000	Rv(impervious)	0.9500
% Forest	0%	% Forest	0%	% Impervious	94%
Managed Turf Cover (acres)	0.0179	Managed Turf Cover (acres)	0.0179	Total ReDev. Site Area (acres)	0.2980
Weighted Rv (turf)	0.2500	Weighted Rv (turf)	0.2500	ReDev Site Rv	0.9080
% Managed Turf	6%	% Managed Turf	6%		
Impervious Cover (acres)	0.2897	ReDev. Impervious Cover (acres)	0.2801		
Rv(impervious)	0.9500	Rv(impervious)	0.9500		
% Impervious	94%	% Impervious	94%		
Final Site Area (acres)	0.3076	Total ReDev. Site Area (acres)	0.2980		
Final Post Dev Site Rv	0.9093	ReDev Site Rv	0.9080		

Treatment Volume and Nutrient Load

Final Post-Development	Post-ReDevelopment	Post-Development
Final Post-Development Treatment Volume (acre-ft)	Post-ReDevelopment Treatment Volume (acre-ft)	Post-Development Treatment Volume (acre-ft)
0.0233	0.0225	0.0008
Final Post-Development Treatment Volume (cubic feet)	Post-ReDevelopment Treatment Volume (cubic feet)	Post-Development Treatment Volume (cubic feet)
1,015,274.7	982,169.1	33,105.6
Final Post-Development TP Load (lb/yr)	Post-ReDevelopment TP Load (lb/yr)*	Post-Development TP Load (lb/yr)
0.6379	0.6171	0.0208
Final Post-Development TP Load per acre (lb/acre/yr)	Post-ReDevelopment TP Load per acre (lb/acre/yr)	
2.0700	2.0700	
	Max. Reduction Required (Below Pre-ReDevelopment Load)	
	20%	
	TP Load Reduction Required for Redeveloped Area (lb/yr)	TP Load Reduction Required for New Impervious Area (lb/yr)
	0.1234	0.0169

Post-Development Requirement for Site Area

TP Load Reduction Required (lb/yr) **0.1403**
 Linear Project TP Load Reduction Required (lb/yr): **0.1398**

Nitrogen Loads (Informational Purposes Only)

Pre-ReDevelopment TN Load (lb/yr)	4.4538	Final Post-Development TN Load (Post-ReDevelopment & New Impervious) (lb/yr)	4.5634
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08/01/2018

date

Qianqian Li, P.E.
 ESC Program Administrator
 Department of Environmental Services
 2100 Clarendon Boulevard, Suite 813
 Arlington, Virginia 22201

Re: Erosion and Sediment Control Permit Application for:
MA13 - Crystal City Transitway Extension

street address
Crystal Dr/18 St S & 12 St S/Long Bridge Dr
 lot, block, section subdivision

permit number

Dear Mrs. Li:

I hereby certify that I accept the responsibilities of Responsible Land Disturber for the above referenced project. I understand that these responsibilities include:

1. Reviewing the erosion and sedimentation (E&S) plan for the project.
2. Walking the site prior to construction to identify critical areas.
3. Conducting a pre-construction briefing with earth moving and site contractors to present the E&S plan and highlight the presence of critical areas, the limits of clearing and the required E&S controls and tree protection measures to be installed. Call 703-228-0760 to schedule pre-construction meeting.
4. Regularly inspecting the site during construction to ensure that all E&S controls are functioning and are adequate to address erosion and sedimentation. Inspect the site 48 hours after a runoff-generating storm, and provide a copy of the inspection findings to the county.
5. Reporting to the owner the presence inadequate or non functioning E&S controls when they are observed.
6. Ensuring that temporary soil stabilization is applied within 7 days to areas denuded that will remain undisturbed for longer than 14 days. Permanent stabilization shall be applied to areas that are to be left dormant for more than one year.
7. Calling (703) 228-0760 at least 80 hours before demolishing any structure.

I may be reached at **703-228-0596** with questions about this plan or my execution of the duties of

Responsible Land Disturber.

Sincerely,

Trevor M. Lantzy
 signed
TREVOR LANTZY
 name printed
PE, 0402050508
 professional registration (type and number)

RESPONSIBLE LAND DISTURBER (RLD) NOTE

UPON AWARD OF COUNTY'S CONSTRUCTION CONTRACT, CONTRACTOR IS RESPONSIBLE FOR APPLYING AND TRANSFERRING THE OWNERSHIP OF RESPONSIBLE LAND DISTURBER PRIOR TO STARTING ANY LAND DISTURBANCE WITHIN THE PROJECT SITE. FOR THIS PERMIT APPLICATION, A SIGNED COPY OF THE RESPONSIBLE LAND DISTURBER WILL BE SUBMITTED SEPARATELY.

POLLUTION PREVENTION PLAN NOTES

ONLY THE FOLLOWING NON-STORMWATER DISCHARGES ARE AUTHORIZED BY ARLINGTON COUNTY'S M54 PERMIT, UNLESS THE STATE WATER CONTROL BOARD, THE VIRGINIA SOIL AND WATER CONSERVATION BOARD (BOARD), OR ARLINGTON COUNTY DETERMINES THE DISCHARGE TO BE A SIGNIFICANT SOURCE OF POLLUTANTS TO SURFACE WATERS:

WATER LINE FLUSHING; LANDSCAPE IRRIGATION; DIVERTED STREAM FLOWS; RISING GROUND WATERS; UNCONTAMINATED GROUND WATER INFILTRATION (AS DEFINED AT 40 CFR 35.2005(20)); UNCONTAMINATED PUMPED GROUND WATER; DISCHARGES FROM POTABLE WATER SOURCES; FOUNDATION DRAINS; AIR CONDITIONING CONDENSATION; IRRIGATION WATER; SPRINGS; WATER FROM CRAWL SPACE PUMPS; FOOTING DRAINS; LAWN WATERING; INDIVIDUAL RESIDENTIAL CAR WASHING; FLOWS FROM RIPARIAN HABITATS AND WETLANDS; DECHLORINATED SWIMMING POOL DISCHARGES; DISCHARGES OR FLOWS FROM FIRE FIGHTING; AND, OTHER ACTIVITIES GENERATING DISCHARGES IDENTIFIED BY THE DEPARTMENT OF ENVIRONMENTAL QUALITY AS NOT REQUIRING VPDES AUTHORIZATION.

APPROPRIATE CONTROLS MUST BE IMPLEMENTED TO PREVENT ANY NON-STORMWATER DISCHARGES NOT INCLUDED ON THE ABOVE LIST (E.G., CONCRETE WASH WATER, PAINT WASH WATER, VEHICLE WASH WATER, DETERGENT WASH WATER, ETC.) FROM BEING DISCHARGED INTO ARLINGTON COUNTY'S M54 SYSTEM, WHICH INCLUDES THE CURB AND GUTTER SYSTEM, AS WELL AS CATCH BASINS AND OTHER STORM DRAIN INLETS, OR STREAM NETWORK.

PER CHAPTER 26 OF THE ARLINGTON COUNTY CODE, IT SHALL BE UNLAWFUL FOR ANY PERSON TO DISCHARGE DIRECTLY OR INDIRECTLY INTO THE STORM SEWER SYSTEM OR STATE WATERS, ANY SUBSTANCE LIKELY, IN THE OPINION OF THE COUNTY MANAGER, TO HAVE AN ADVERSE EFFECT ON THE STORM SEWER SYSTEM OR STATE WATERS.

STORMWATER POLLUTION PREVENTION PLAN
 MA13 - Crystal City Transitway Extension

STORMWATER POLLUTION PREVENTION PLAN (SWPPP)
 Arlington County Projects
 (Roadway Improvement)

For Construction Activities At:

MA13 - Crystal City Transitway Extension
 Crystal Dr/18 St S and 12th St S/Long Bridge Dr Intersections
 Arlington, VA 22202

Crystal Dr
 Latitude: 38.8607 N (decimal degrees)
 Longitude: 77.0493 W (decimal degrees)
 12th St S
 Latitude: 38.8630 N (decimal degrees)
 Longitude: 77.0509 W (decimal degrees)

Construction Activity Operator:

Insert Company/Organization Name
 Insert Name
 Insert Address
 Insert City, State, Zip Code
 Insert Telephone Number
 Insert Email Address
 Insert 24-hour Emergency Contact

SWPPP Preparation Date:

August 01, 2018

CERTIFICATION

I certify under penalty of law that I have read and understand this document and that this document and all attachments were prepared in accordance with a system designed to assure that qualified personnel properly gathered and evaluated the information submitted. Based on my inquiry of the person or persons who manage the system, or those persons directly responsible for gathering the information, the information submitted is, to the best of my knowledge and belief, true, accurate, and complete. I am aware that there are significant penalties for submitting false information, including the possibility of fine and imprisonment for knowing violators.

Operator Name:

Title:

Signature:

Date:

Arlington County SWPPP 12/2016

STORMWATER POLLUTION PREVENTION PLAN
 MA13 - Crystal City Transitway Extension

1.0 SWPPP Documents Located Onsite & Available for Review

SWPPP Document Type Located Onsite & Available for Review?

Registration Statement	<input type="checkbox"/> Yes	<input type="checkbox"/> NA
Notice of Coverage Letter	<input type="checkbox"/> Yes	<input type="checkbox"/> NA
Construction General Permit	<input type="checkbox"/> Yes	<input type="checkbox"/> NA
Pollution Prevention Plan	<input checked="" type="checkbox"/> Yes	<input type="checkbox"/> NA
Erosion & Sediment Control Plan	<input checked="" type="checkbox"/> Yes	<input type="checkbox"/> NA
Stormwater Management Plan	<input type="checkbox"/> Yes	<input type="checkbox"/> NA
LDA Permit	<input type="checkbox"/> Yes	<input type="checkbox"/> NA

Required documents must be kept at a centralized location on the project site (i.e. in a mail box or other container)

2.0 Authorized Non-Stormwater Discharges

Type of Authorized Non-Stormwater Discharges Likely Present at Your Project Site?

Uncontaminated excavation dewatering	<input checked="" type="checkbox"/> Yes	<input type="checkbox"/> No
Landscape irrigation	<input type="checkbox"/> Yes	<input checked="" type="checkbox"/> No
Others [describe]	<input type="checkbox"/> Yes	<input type="checkbox"/> No

3.0 Pollution Prevention Awareness

Employees will be given a "walk through" of the site identifying areas of possible pollution and will be shown Erosion and Sediment Controls and Pollution Prevention Practices (identified in Sections 4.0 and 5.0 of this SWPPP) that are applicable to their assigned job duties. A refresher meeting and "walk through" will be conducted on an as needed basis.

4.0 Erosion & Sediment Controls

Select all that apply	Erosion & Sediment Control	Estimated Installation Date	Estimated Removal Date	Responsible Party (Name, Contact Phone Number)
<input type="checkbox"/>	Construction Entrance (Std. & Spec. 3.02)			
<input type="checkbox"/>	Silt Fence (Std. & Spec. 3.05)			
<input type="checkbox"/>	Culvert Inlet Protection (Std. & Spec. 3.08)			
<input type="checkbox"/>	Outlet Protection (Std. & Spec. 3.18)		NA	
<input checked="" type="checkbox"/>	Temporary Seeding (Std. & Spec. 3.31)	As required	NA	
<input checked="" type="checkbox"/>	Permanent Seeding (Std. & Spec. 3.32)		NA	
<input type="checkbox"/>	Sodding (Std. & Spec. 3.33)		NA	
<input type="checkbox"/>	Mulching (Std. & Spec. 3.35)		NA	
<input type="checkbox"/>	Safety Fence (Std. & Spec. 3.01)			
<input checked="" type="checkbox"/>	Storm Drain Inlet Protection			

Arlington County SWPPP 12/2016

ARLINGTON VIRGINIA

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APPROVALS DATE

<i>Kamal</i>	3/29/21
QUALITY CONTROL ENGINEER <i>Kamal Tabak</i>	3.24.21
CONSTRUCTION MANAGEMENT SUPERVISOR <i>Donna M. Leach</i>	03.04.2021
WATER, SEWER, STREETS BUREAU CHIEF <i>Donna M. Leach</i>	03/17/21
TRANSPORTATION DIRECTOR <i>Diana Iazza</i>	3/2/21
PROJECT MANAGER	

REVISIONS DATE

REVISIONS	DATE

PROJECT NAME AND LOCATION
TRANSITWAY EXTENSION TO PENTAGON CITY
SW POLLUTION PREVENTION PLAN
CRYSTAL DR & 12TH ST S
 MA13 - SEGMENT I

DESIGNED: PB
 DRAWN: NS
 CHECKED: TL
 MISS UTILITY TRANSMITTAL #: N/A
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 PATH: \\DES-CAD-S2\ENGINEERING_DATA\DA\MA13
 PLOTTED: AUGUST 4 2021
 PLOTTED BY: NSHARP

SCALE: N/A

STORMWATER POLLUTION PREVENTION PLAN
MA13 - Crystal City Transitway Extension

<input type="checkbox"/>	(Std. & Spec 3.08 and/or Arlington County Std. & Spec from approved ESC plan)			
<input checked="" type="checkbox"/>	Dewatering (Std. & Spec 3.25 and/or Arlington County Std. & Spec from approved ESC plan)			
<input type="checkbox"/>	Turbidity Curtain (Std. & Spec 3.27 and/or Arlington County Std. & Spec from approved ESC plan)			
<input checked="" type="checkbox"/>	Tree Protection (Arlington County Std. & Spec from approved ESC plan)			
<input type="checkbox"/>	Stream Crossing / Cofferdams (Std. & Spec 3.25 or on plan)			
<input type="checkbox"/>	Pump Around System (detail on approved plan)			
<input type="checkbox"/>	Rip Rap (Std. & Spec. 3-19)			
<input type="checkbox"/>	Other(s) [describe]			

Pre-Storm Erosion and Sediment Control Checklist

The following actions shall be taken prior to storm events with predicted heavy and/or large volume rainfall to prevent predicted discharges from a construction site. A typical summer thunderstorm is an example of a storm event with predicted heavy and/or large volume rainfall.

- Perimeter controls (silt fence, hay bales, stone berms) used to prevent sediment from leaving the site shall be checked for undermining, holes, or deterioration and repaired/replaced if needed.
- Sediment that has accumulated against perimeter controls shall be removed if the depth exceeds more than 1/2 of the silt fence height.
- Exposed soil or slopes shall be covered with straw, tarps, plastic sheeting, or erosion control matting. Covering material shall be properly secured/anchored.
- Stockpiled soil and other loose materials that can be washed away shall be covered with a tarp, plastic sheeting, or other stabilization matting. The cover must be properly secured / anchored down to prevent it from being blown off and exposing materials to rain. Controls such as hay bales or berms should be placed along the perimeter of the stock pile (downhill side). Stockpiled materials should not obstruct flow along the curb line.
- Inlet protection controls shall be inspected to ensure they are installed per approved ESC plan, are functioning properly, and maintained as needed.

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STORMWATER POLLUTION PREVENTION PLAN

5.0 Potential Sources of Pollution & Pollution Prevention Practices

Pollutant-Generating Activity	Likely Present at your Project Site?	Pollutants									Pollution Prevention Practice	Responsible Party (Name, Contact Phone Number)
		Sediment	Nutrients	Heavy Metals	pH (acids and bases)	Pesticides & Herbicides	Oil & Grease	Bacteria & Viruses	Trash, Debris, Solids	Other Toxic Chemicals		
Clearing, grading, excavating, and un-stabilized areas	<input checked="" type="checkbox"/> Yes <input type="checkbox"/> No	X	X							X	(1)	
Paving and saw cutting operations	<input checked="" type="checkbox"/> Yes <input type="checkbox"/> No	X							X	X	(2)	
Concrete operations, washout, and cement waste	<input checked="" type="checkbox"/> Yes <input type="checkbox"/> No			X	X				X		(3)	
Washing / cleaning	<input checked="" type="checkbox"/> Yes <input type="checkbox"/> No	X	X	X	X			X	X	X	(4)	
Dewatering operations	<input checked="" type="checkbox"/> Yes <input type="checkbox"/> No	X	X						X		(5)	
Material / chemical use and storage	<input checked="" type="checkbox"/> Yes <input type="checkbox"/> No	X	X	X	X	X	X	X	X	X	(6)	
Equipment and vehicle maintenance	<input checked="" type="checkbox"/> Yes <input type="checkbox"/> No				X	X		X	X		(7)	
Waste management / disposal	<input type="checkbox"/> Yes <input checked="" type="checkbox"/> No								X	X	(8)	
Sanitary waste	<input checked="" type="checkbox"/> Yes <input type="checkbox"/> No		X	X				X			(9)	
Nutrient management	<input type="checkbox"/> Yes <input checked="" type="checkbox"/> No	X	X						X	X	(10)	

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STORMWATER POLLUTION PREVENTION PLAN

Pollution Prevention Practices:


- (1) **Clearing, grading, excavating, and un-stabilized areas** – Maintain as much existing vegetation as practicable. Utilize erosion and sediment controls to prevent sediment from leaving the construction site. Dispose of clearing debris at acceptable disposal sites. Apply permanent or temporary stabilization, sodding and/or mulching to denuded areas in accordance with the erosion and sediment control specifications and the general VPDES permit for discharges of stormwater from construction activities. Plastic sheeting, tarps, 2" deep straw cover, and/or erosion matting can be used for temporary slope stabilization.
- (2) **Paving and saw cutting operations** – Cover storm drain inlets during paving and saw cutting operations. Use pollution prevention materials such as drip pans and absorbent/dry for all paving machines to limit leaks and spills of paving materials and fluids. Slurry from saw cutting operations may not enter a storm drain; it must be captured and disposed of properly.

Temporary controls (i.e. tarp and block, sand berms, booms, and/or filter fabric) shall be used to cover storm drains during paving and saw cutting operations to prevent any discharges from entering the storm drain. These temporary controls SHALL BE REMOVED AT THE END OF EACH DAY. Inlet protection specified in the approved ESC plan shall be installed or reinstalled following the completion of paving or saw cutting work.

<input checked="" type="checkbox"/>	Method of covering / protecting storm drains:
<input checked="" type="checkbox"/>	Method for containment, collection, disposal of saw cut slurry:


- (3) **Concrete operations, washout, and cement waste** – Direct concrete wash water into a leak-proof container or leak-proof settling basin that is designed so that no overflows can occur due to inadequate sizing or precipitation. Hardened concrete wastes shall be removed and disposed of in a manner consistent with the handling of other construction wastes.
 - Washouts must be sized appropriately for the needs of the project.
 - Do not locate washouts near storm drains. Concrete wash water is not allowed to enter a storm drain.
 - Concrete washout areas cannot be used for the purpose of dewatering.
 - Get up and operate small mixers on top of plywood that is covered by tarps or heavy plastic drop cloths.
 - Wash out mixers and truck chutes in designated contained washout areas.
 - No tracking from washout areas may occur.
 - Place plastic sheeting, boards, or tarps under concrete truck chutes during pouring.

The selected concrete wash out facility will be used:

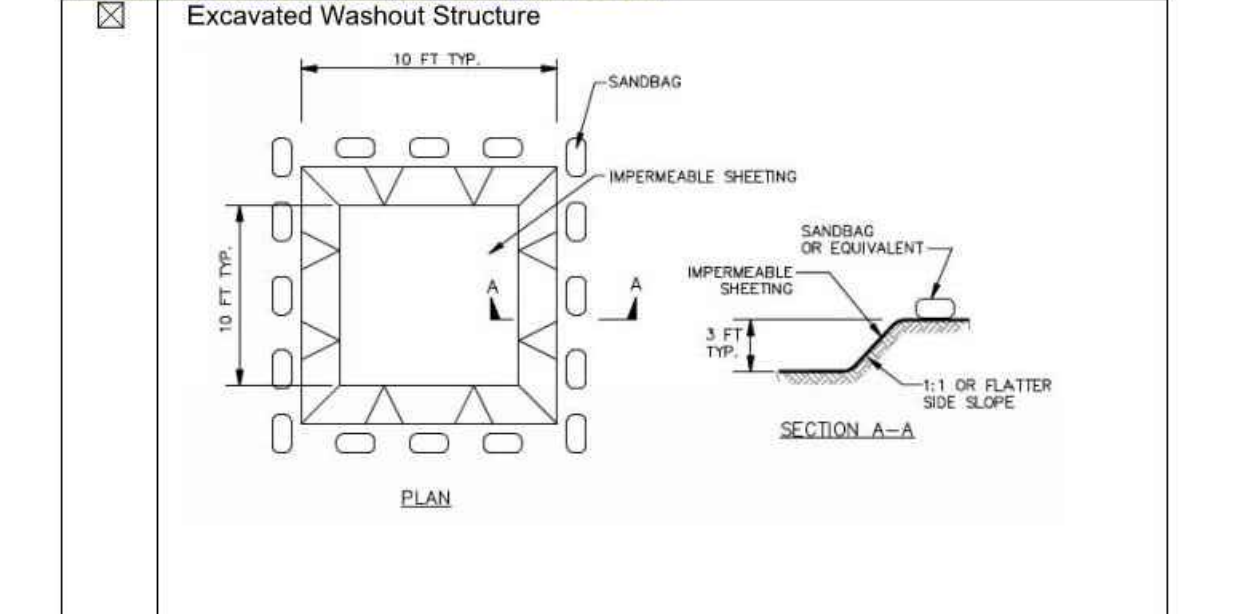

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STORMWATER POLLUTION PREVENTION PLAN

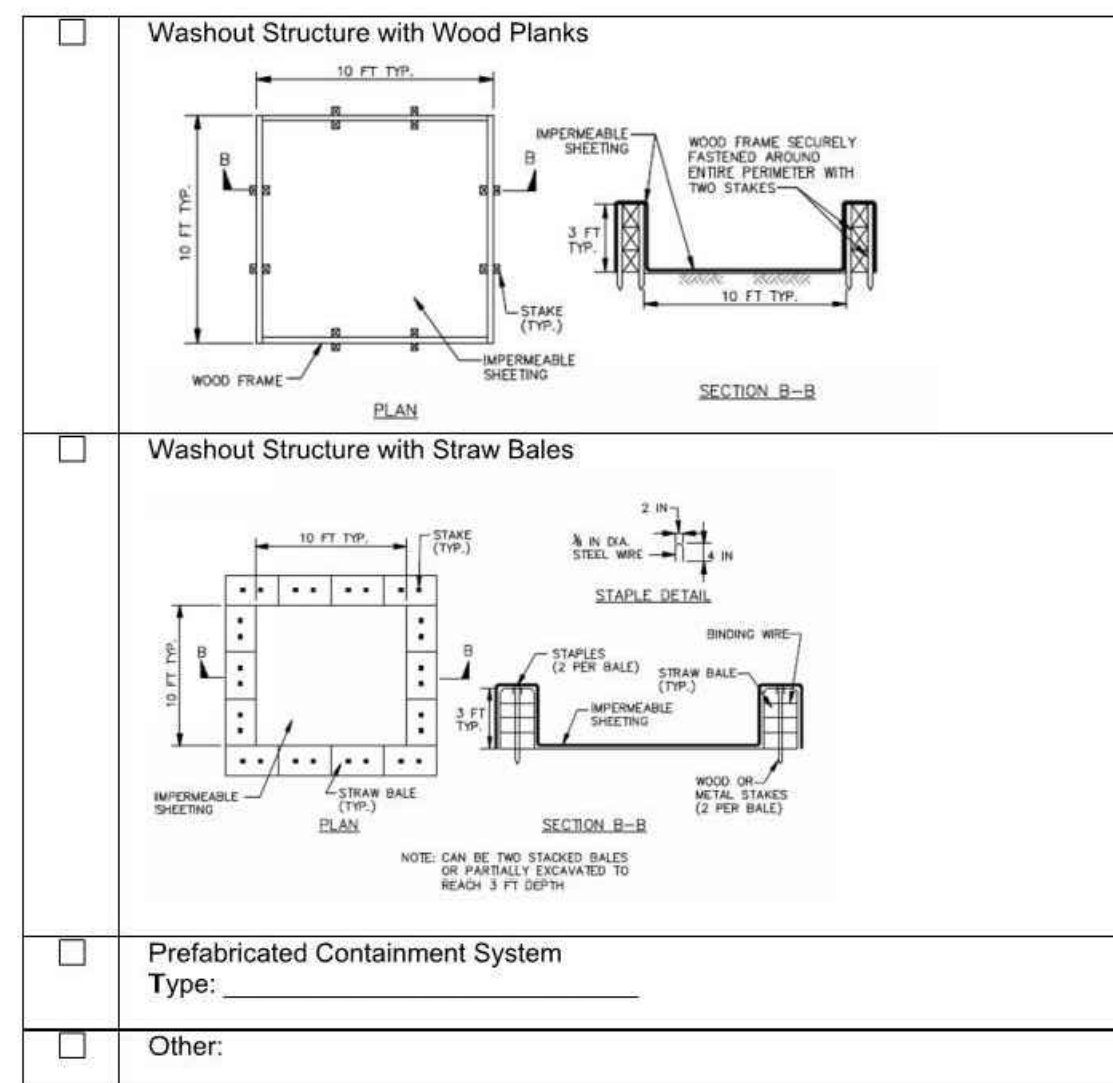

- (4) **Washing / cleaning** – Prevent the discharge of wash water to the storm drain system or surface waters.
 - Wash water or liquid wastes may not enter a storm drain or surface waters.
 - Provide a suitable containment system for cleaning equipment such as a drum, prefabricated system, lined container, or portable wash pad.
 - The wash / containment area must be sized appropriately for the needs of the project.
 - Locate wash / containment areas away from storm drains.
- (5) **Dewatering operations** – Construction site dewatering may not be discharged without treatment. Sediment laden or turbid water shall be filtered, settled or similarly treated prior to discharge.
 - Dewatering detail on approved ESC plan will be used.
 - Dewatering option from Planning & Field Guide for Pollution Prevention (P2):
 - Filter Box
 - Straw Bale/Silt Fence Pit
 - Portable Sediment Tank
 - Filter Bag

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STORMWATER POLLUTION PREVENTION PLAN

- Pump from Settling Pit
 - Manufactured System: _____
 - Other: _____
- (6) **Material / chemical use and storage** – Designate areas of the construction site for material delivery and storage. Locate these areas near construction entrances and away from waterways and storm drains. Enclose, cover or berm construction material storage areas if susceptible to stormwater.
 - Stockpiled soil and other loose materials that can be washed away shall be covered with a tarp, plastic sheeting, or other stabilization matting. The cover must be properly secured / anchored down to prevent it from being blown off and exposing materials to rain. Controls such as hay bales or berms should be placed along the perimeter of the stock pile (downhill side).

Stockpiled materials located on the edge of roadways should not obstruct flow along the curb line (gutter). Leave at least a one (1) foot space away from the curb to allow stormwater to flow along the curb line. Boards with cinder blocks and/or bricks may be used to create the flow through space.

 - Method used to ensure flow through: _____
 - Provide secondary containment for paint, pesticides, cleaners, solvents, and/or other chemicals and keep these items secured and covered when not in use.
 - Regularly inspect containers.
 - (7) **Equipment and vehicle maintenance** – Use a designated area, away from storm drains and surface waters, to refuel vehicle or equipment or perform maintenance.
 - Regularly inspect vehicles and equipment for leaks. Clean up all spills and leaks upon discovery.
 - Use containment measures when conducting fueling (e.g. place spill pad, board, plastic sheeting on ground)
 - Regularly inspect fuel containers.
 - Provide secondary containment and secure storage for fuel, oil, and/or lubricants
 - Keep drip pans, sheeting, and/or absorbent pads under heavy equipment when not in use (i.e. overnight) to capture leaks.
 - (8) **Waste management / disposal** – Designate a waste collection area on the construction site that does not receive a substantial amount of runoff from upland areas and does not drain directly to a waterway. Ensure that waste containers have lids so they can be covered before periods of rain. Schedule waste collection to prevent the containers from overflowing.
 - A sufficient number of waste containers must be kept on a site to handle the quantity of waste produced.
 - Keep roll off containers covered and/or dumpster / trash lids closed.
 - Check waste containers frequently for damage / leaks and clean using DRY methods when necessary. Never clean out a dumpster by power washing or hosing it out.
 - Replace containers that are leaking, cracked, corroded, or otherwise deteriorating.
 - Do not bury waste material. Dispose of excess dry concrete, grout and mortar in the trash.

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STORMWATER POLLUTION PREVENTION PLAN

- (9) **Sanitary waste** – Prevent the discharge of sanitary waste by providing convenient and well-maintained portable sanitary facilities.
 - Locate portable lavatories away from storm drains and surface waters.
 - Keep portable lavatories level and provide secondary containment (i.e. trays)
 - Regularly inspect facilities for leaks
 - Schedule routine maintenance

- (10) **Nutrient management** – Apply nutrients in accordance with manufacturer's recommendations. Do not apply during rainfall events or windy conditions. Provide secondary containment and keep fertilizer properly secured when not being used.

Additional information and details can be found in the Arlington County Planning & Field Guide for Pollution Prevention (P2).

Select all that apply	Stormwater Management Control	Estimated Installation Date	Responsible Party
<input type="checkbox"/>	Exempted – stormwater management retrofit facility or stream restoration project	NA	NA
<input type="checkbox"/>	Linear development project per Arlington County Chesapeake Bay Total Maximum Daily Load (TMDL) Action Plan ¹	NA	NA
<input type="checkbox"/>	Post-development Stormwater Management Controls provided by a Larger Common Plan of Development or Sale	NA	Common Plan Construction Activity Operator
<input type="checkbox"/>	Rooftop Disconnection		Construction Activity Operator

¹ In accordance with Arlington County's Chesapeake Bay Total Maximum Daily Load (TMDL) Action Plan, approved by the Virginia Department of Environmental Quality (DEQ) on September 1, 2015, linear development projects conducted by the County are administered and tracked as follows consistent with 9VAC25-870-69 A.4, 9VAC25-870-76, and 9VAC25-870-82:

- Pollutant load changes will be computed as described in Section 3.A of the Action Plan.
- Retrofit opportunities will be evaluated for each project, using the screening and selection criteria applied and described in the adopted Stormwater Master Plan.
- Retrofit projects that meet the screening criteria and are determined by Arlington to be feasible and cost-effective will be implemented with specific linear development projects. Pollutant load reductions from retrofit projects will be computed as described in Section 5 of the Action Plan.
- In cases where retrofit projects are not feasible and cost-effective for a particular linear project, any POC load increases that might occur for that project will be addressed by larger overall POC load reductions in place or added through TMDL action plan implementation.

In the above manner Arlington, as the MS4 operator and the construction site operator for its linear development projects, implements linear projects and retrofit projects in a manner that achieves the most TMDL POC reduction for the least cost, while fully accounting for load changes that occur with linear development project activity consistent with the DEQ Chesapeake Bay TMDL Special Condition Guidance.

Arlington County SWPPP 12/2016

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APPROVALS	DATE
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<i>Ramal Taktak</i> CONSTRUCTION MANAGEMENT SUPERVISOR	3.24.21
<i>Oliver</i> WATER, SEWER, STREETS BUREAU CHIEF	03.04.2021
<i>Dennis M. Leach</i> TRANSPORTATION DIRECTOR	03/17/21
<i>Diana Izzo</i> PROJECT MANAGER	3/2/21

REVISIONS DATE

REVISIONS	DATE

PROJECT NAME AND LOCATION
TRANSITWAY EXTENSION TO PENTAGON CITY
SW POLLUTION PREVENTION PLAN
CRYSTAL DR & 12TH ST S
 MA13 - SEGMENT I

DESIGNED: PB
DRAWN: NS
CHECKED: TL
MISS UTILITY TRANSMITTAL #: N/A

FILENAME:
MA13-224-E_AND_S_PLAN.DWG
PATH: \\DES-CAD-S2\ENGINEERING_DATA\DA\MA13

PLOTTED: AUGUST 4 2021
PLOTTED BY: NSHARP

SCALE: N/A



APPROVALS	DATE
<i>[Signature]</i> QUALITY CONTROL ENGINEER	3/29/21
<i>[Signature]</i> CONSTRUCTION MANAGEMENT SUPERVISOR	3.24.21
<i>[Signature]</i> WATER, SEWER, STREETS BUREAU CHIEF	03.04.2021
<i>[Signature]</i> TRANSPORTATION DIRECTOR	03/17/21
<i>[Signature]</i> PROJECT MANAGER	3/2/21

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 PLOTTED: AUGUST 4 2021
 PLOTTED BY: NSHARP

SCALE: N/A

STORMWATER POLLUTION PREVENTION PLAN

8.0 Self Inspection Report & Corrective Action Log (make additional copies as necessary)

Company/Organization: _____
 Name of Inspector: _____
 Telephone Number: _____
 Qualifications: _____

Inspection Schedule
 Discharges to impaired waters, surface waters within a TMDL watershed, or exceptional waters:

Once every 4 business days

Inspection Date: _____
 Describe phase of construction: _____

Is a copy of the SWPPP available on site? Yes No Is the SWPPP complete? Yes No

Erosion & Sediment Controls/ Pollution Prevention Practices	In Compliance?	Corrective Action Needed & Notes	Date Corrective Action Taken
Are controls in place to prevent sediment from being tracked off site or onto the street?	<input type="checkbox"/> Yes <input type="checkbox"/> No <input type="checkbox"/> NA		
Are perimeter controls adequately installed and properly maintained?	<input type="checkbox"/> Yes <input type="checkbox"/> No <input type="checkbox"/> NA		
Are storm drains properly protected / approved inlet protection is in place?	<input type="checkbox"/> Yes <input type="checkbox"/> No <input type="checkbox"/> NA		
Are all slopes and disturbed areas, including stockpiles, not actively being worked properly stabilized?	<input type="checkbox"/> Yes <input type="checkbox"/> No <input type="checkbox"/> NA		
Are dewatering operations working properly?	<input type="checkbox"/> Yes <input type="checkbox"/> No <input type="checkbox"/> NA		
Is construction dust properly controlled?	<input type="checkbox"/> Yes <input type="checkbox"/> No <input type="checkbox"/> NA		
Are mature trees and/or natural areas properly protected?	<input type="checkbox"/> Yes <input type="checkbox"/> No <input type="checkbox"/> NA		

Arlington County SWPPP 12/2016

STORMWATER POLLUTION PREVENTION PLAN

7.0 Spill Prevention & Response

Most spills can be cleaned up using a spill kit. Absorbent/oil dry, sealable containers, plastic bags, and shovels/brooms are suggested minimum spill response items that should be available at the project site.

- 1st Priority: Protect all people
 2nd Priority: Protect equipment and property
 3rd Priority: Protect the environment

- Check for hazards (flammable material, noxious fumes, cause of spill) – if flammable liquid, turn off engines and nearby electrical equipment. **If serious hazards are present leave the area and call 911. LARGE SPILLS ARE LIKELY TO PRESENT A HAZARD.**
- Ensure the spill area is safe to enter and that it does not pose an immediate threat to health or safety of any person.
- Stop the spill source.
- Call co-workers and supervisor for assistance and to make them aware of the spill and potential dangers.
- If possible, stop spill from spreading and/or entering storm drains (use absorbent or other materials as necessary).
- If spilled material has entered a storm drain; contact Arlington County Fire Department and project manager.
- Clean up spilled material according to manufacturer specifications, for liquid spills use absorbent materials and do not flush area with water.
- Properly dispose of cleanup materials and used absorbent material according to manufacturer specifications.

Emergency Contacts:
Local Contacts
 Arlington County Fire & Police 703-558-2222
 DES Water, Sewer, Streets 24-Hour Emergency 703-228-6555
 Washington Gas Emergency 703-750-1400
Nights, Holidays & Weekends
 VA Dept. of Emergency Management 804-674-2400
 24 Hour Reporting Service

Spill kit on site: Yes No
 Location(s) of spill kit: _____

Arlington County SWPPP 12/2016

INSTRUCTIONS for COMPLETING the SINGLE FAMILY RESIDENCE, COMMON PLAN of DEVELOPMENT or SALE STORMWATER POLLUTION PREVENTION PLAN (SWPPP)

General
 A Stormwater Pollution Prevention Plan (SWPPP) must be developed prior to obtaining locality (e.g., City, County, Town) authorization to commence land disturbance.

SWPPP Cover Page
 For a construction activity, enter the project/site name and physical address (if available), including city (or town), state and zip code. Enter the latitude and longitude in decimal degrees of the construction activity.

Enter the Construction Activity Operator's company/organization name, the Operator's name and mailing address, including city (or town), state, and zip code, telephone number, email address (if available), and a 24-hour emergency contact.

Enter the SWPPP preparation date.

The Construction Activity Operator identified on the cover page of the SWPPP is responsible for certifying the information contained therein. **Please sign the certification in blue.** Please note that state statutes require the SWPPP to be signed as follows:

- For a corporation, by a responsible corporate officer;
- For a partnership or sole proprietorship, by a general partner or the proprietor, respectively;
- For a municipality, state, federal, or other public agency, by either a principal executive officer or ranking elected official.

Section 1.0 SWPPP Documents Located Onsite & Available for Review
 Utilize the provided checklist to ensure that the required SWPPP documents are located onsite and are available for review, if applicable.

Section 2.0 Authorized Non-Stormwater Discharges
 Identify the authorized non-stormwater discharges likely to be present at the project site. If an unlisted authorized non-stormwater discharge is likely to be present at the project site, provide it here.

Section 3.0 Pollution Prevention Awareness
 Provide employees with a "walk through" of the project site and identify areas of possible pollution, erosion and sediment controls, and pollution prevention practices which are applicable to their assigned job duties. Conduct refresher meetings and perform additional "walk throughs" on an as needed basis.

Section 4.0 Erosion & Sediment Controls
 Identify the erosion and sediment controls to be implemented at the project site. For each erosion and sediment control, enter the estimated installation date and estimated removal date. If an unlisted erosion and sediment control will be implemented at the project site, provide the applicable information here.

Section 5.0 Potential Sources of Pollution & Pollution Prevention Practices
 Identify the pollutant-generating activities likely to be present at the project site; implement and maintain the corresponding pollution prevention practices. If an unlisted pollutant-generating activity is likely to be present at the project site, describe it, identify the associated pollutant(s), and provide the corresponding pollution prevention practice(s) to be implemented and maintained.

Section 6.0 Stormwater Management Controls
 Identify the stormwater management controls to be implemented at the project site, if applicable. For each stormwater management control, enter the estimated installation date. If an unlisted stormwater management control will be implemented at the project site, provide the applicable information here.

Section 7.0 Spill Prevention & Response
 Most spills can be cleaned up following manufacturer specifications. The priority should be to protect all people, equipment, property, and the environment. Enter the telephone number of your local fire and police departments.

Section 8.0 Inspections & Corrective Action Log
 Enter the qualified inspector's company/organization name, the inspector's name, telephone number, and qualifications. Select the applicable inspection schedule, enter the construction activity inspection date, and enter the date and rainfall amount of the last measurable storm event (if applicable). Identify if the implemented best management practices are in compliance with the SWPPP. Enter corrective actions needed; the party responsible for implementing the corrective actions, and the date corrective actions were taken, if applicable. Make additional copies of the inspection and corrective action log as necessary.

Section 9.0 Grading & Stabilization Activities Log
 Enter the date grading activities were initiated, a description of the grading activities including location, the date grading activities ceased, the date stabilization measures were initiated, and a description of the stabilization measures including location.

Section 10.0 SWPPP Modification & Update Log
 Enter the SWPPP modification date, description of the SWPPP modification/update, and the name and title of the SWPPP modification preparer, if applicable.

Arlington County SWPPP 12/2016

STORMWATER POLLUTION PREVENTION PLAN

9.0 Grading & Stabilization Activities Log

Date Grading Activity Initiated	Description of the Grading Activity (including location)	Date Grading Activity Ceased	Date Stabilization Measures Initiated	Description of the Stabilization Measure (including location)

10.0 SWPPP Modification & Update Log

Modification Date	Description of the Modification / Update	Modification Prepared By (name & title)

Arlington County SWPPP 12/2016

STORMWATER POLLUTION PREVENTION PLAN

		(See Cover Page of this SWPPP)
<input type="checkbox"/>	Sheet flow to Vegetated Filter (1 or 2)	
<input type="checkbox"/>	Grass Channel	
<input type="checkbox"/>	Rainwater Harvesting	
<input type="checkbox"/>	Permeable Pavement (1 or 2)	
<input type="checkbox"/>	Infiltration (1 or 2)	
<input type="checkbox"/>	Bio-retention (1 or 2)	
<input type="checkbox"/>	Others [describe]	

Arlington County SWPPP 12/2016

STORMWATER POLLUTION PREVENTION PLAN

Are washout facilities (concrete, paint) available, labeled, and properly maintained?	<input type="checkbox"/> Yes <input type="checkbox"/> No <input type="checkbox"/> NA		
Are trash and waste materials properly managed and disposed of?	<input type="checkbox"/> Yes <input type="checkbox"/> No <input type="checkbox"/> NA		
Are trash receptacles covered and not leaking?	<input type="checkbox"/> Yes <input type="checkbox"/> No <input type="checkbox"/> NA		
Are non-stormwater discharges (i.e. wash water, saw cut slurry) properly managed?	<input type="checkbox"/> Yes <input type="checkbox"/> No <input type="checkbox"/> NA		
Are vehicle and equipment fueling, maintenance, and/or staging areas free of spills and leaks?	<input type="checkbox"/> Yes <input type="checkbox"/> No <input type="checkbox"/> NA		
Are materials that are potential stormwater contaminants stored properly (covered / have secondary containment)?	<input type="checkbox"/> Yes <input type="checkbox"/> No <input type="checkbox"/> NA		
Are portable lavatories level, in good condition, and located away from storm drains?	<input type="checkbox"/> Yes <input type="checkbox"/> No <input type="checkbox"/> NA		
Is a spill kit accessible onsite?	<input type="checkbox"/> Yes <input type="checkbox"/> No <input type="checkbox"/> NA		


Are there any unauthorized discharges at the time of this inspection? Yes No
 If yes, describe: _____
 Has any unauthorized discharge occurred since the last inspection? Yes No
 If yes, describe: _____

Non - Compliance Issues
 Describe any incidents of non-compliance not described above (use another page if necessary)

Certification
 "I certify under penalty of law that I have read and understand this document and that this document and all attachments were prepared in accordance with a system designed to assure that qualified personnel properly gathered and evaluated the information submitted. Based on my inquiry of the person or persons who manage the system, or those persons directly responsible for gathering the information, the information submitted is, to the best of my knowledge and belief, true, accurate, and complete. I am aware that there are significant penalties for submitting false information, including the possibility of fine and imprisonment for knowing violations."

Operator or Assigned Qualified Personnel Name: _____
 Signature: _____
 Date: _____

Arlington County SWPPP 12/2016

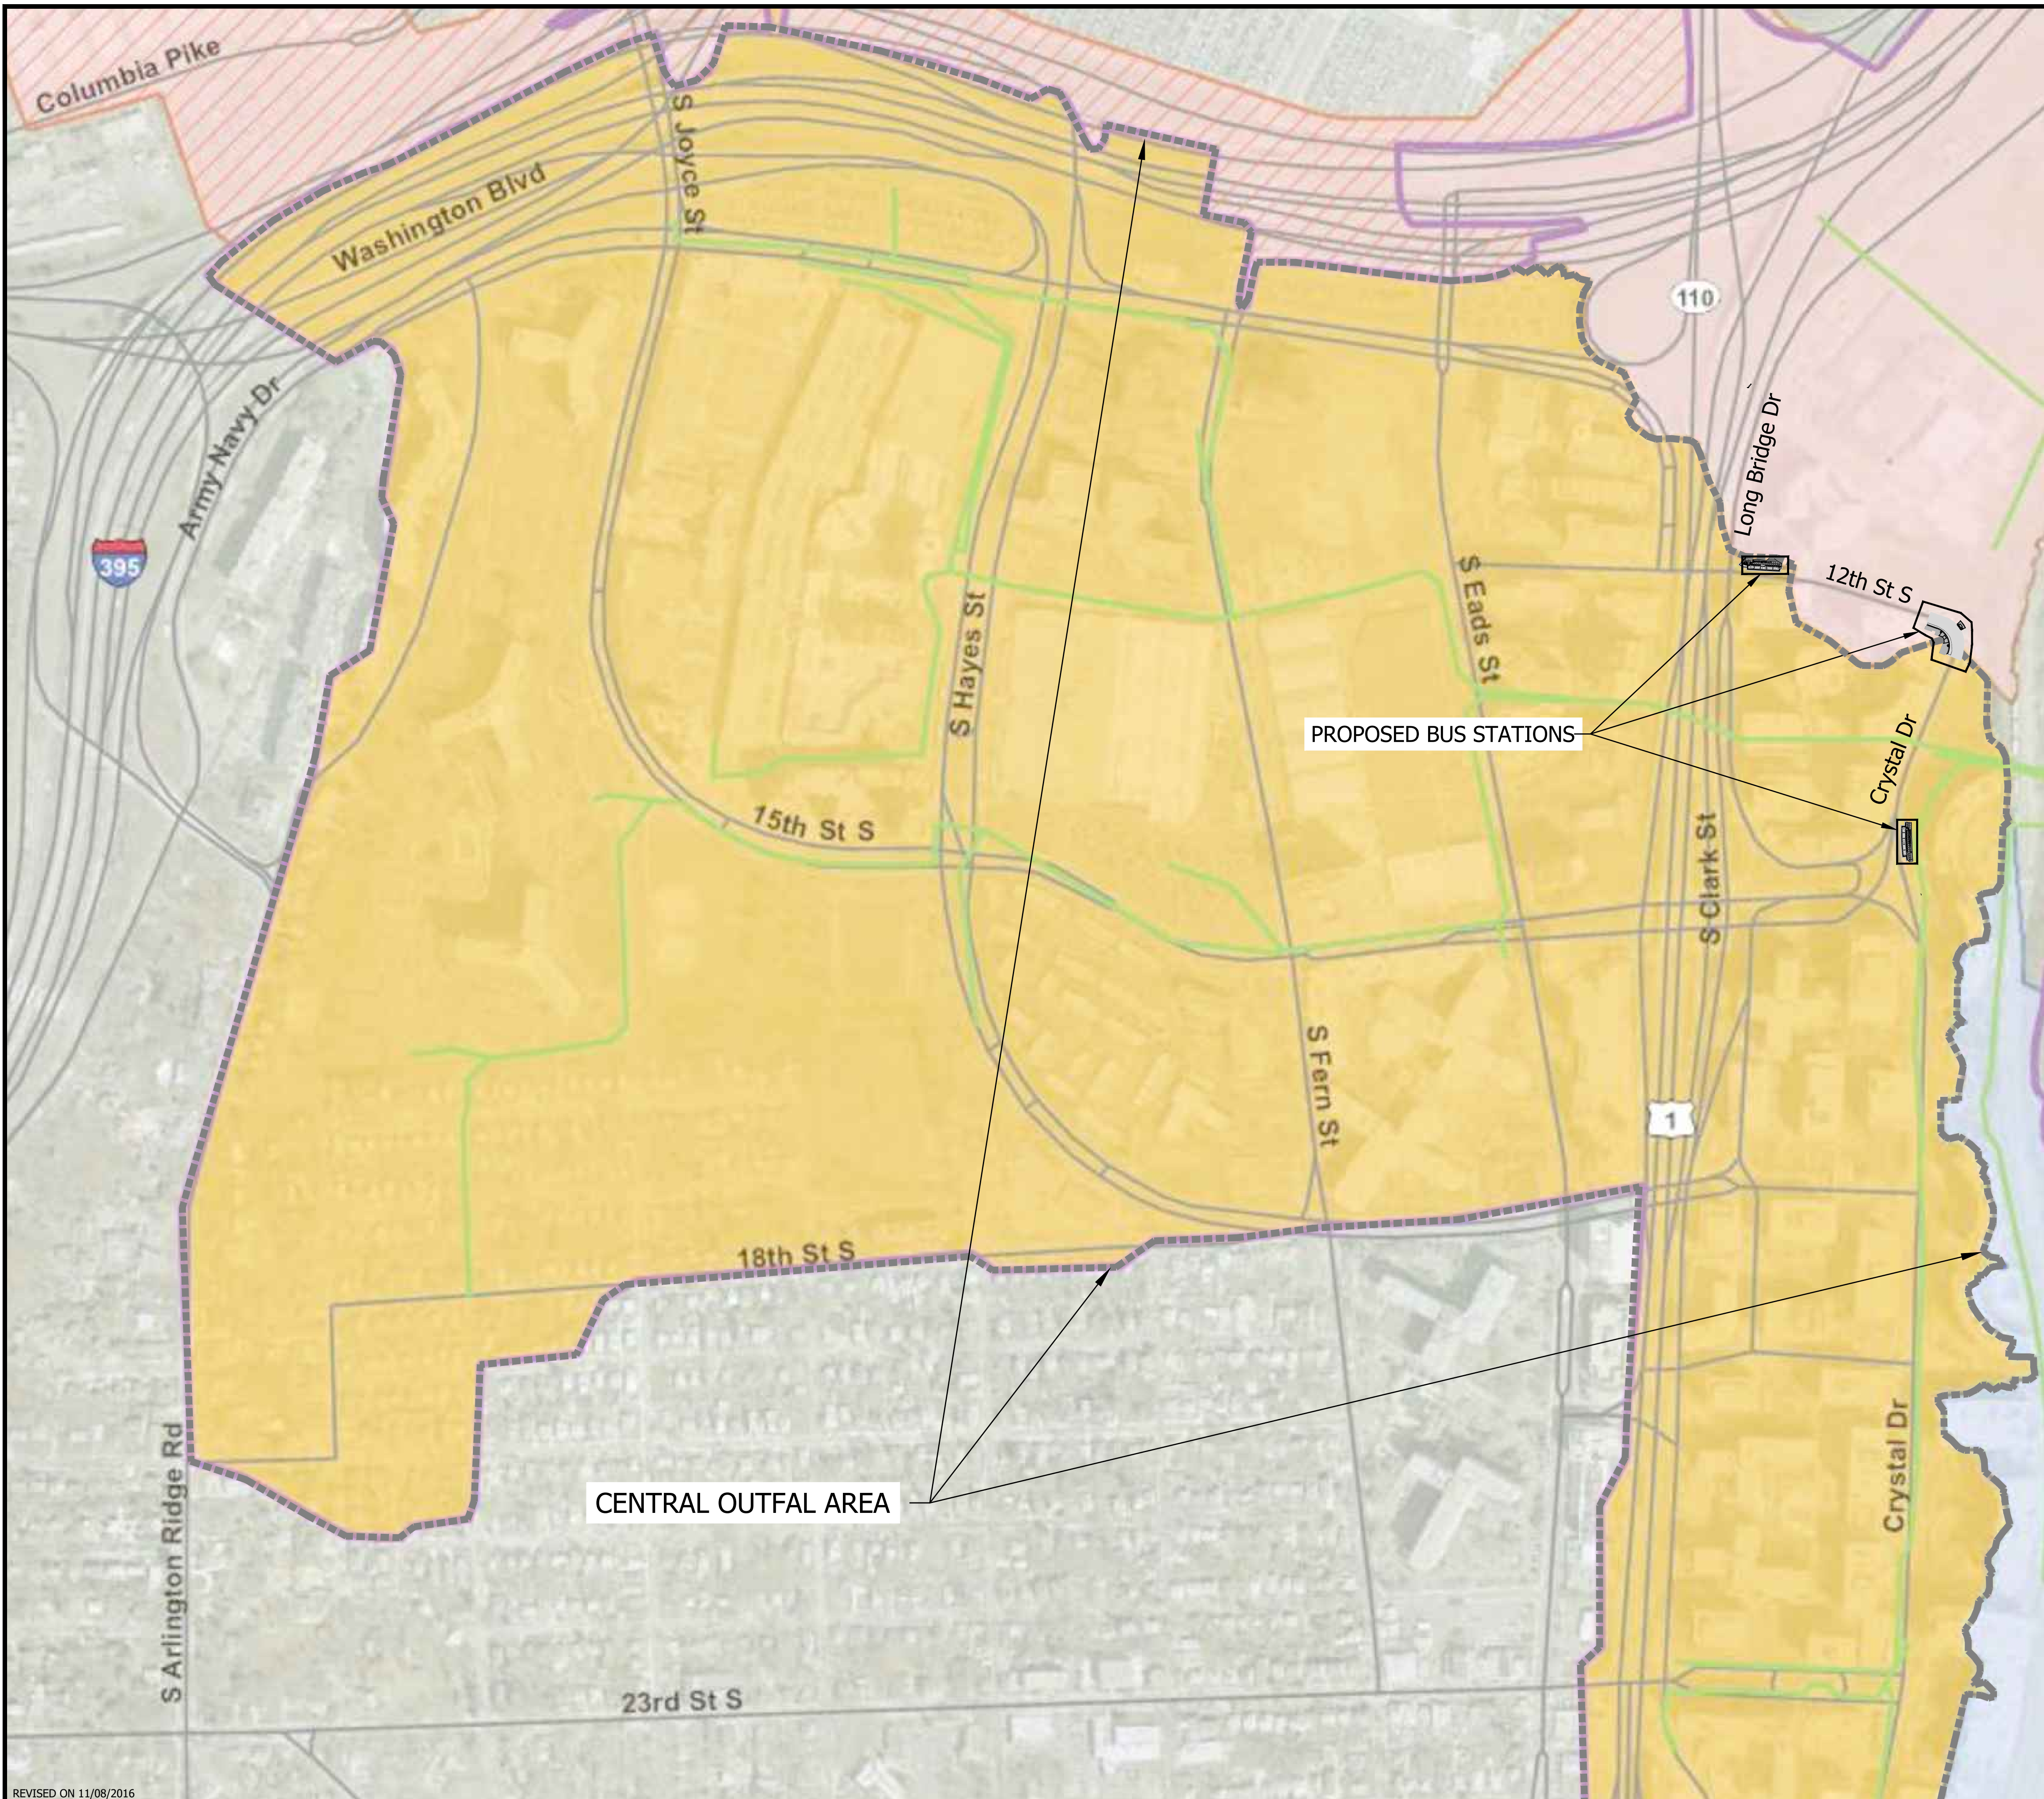

**STORMWATER MANAGEMENT PLAN
(CHANNEL AND FLOOD PROTECTION)**

CHANNEL PROTECTION
THE CHANNEL PROTECTION ANALYSIS FOR THE OUTFALL WAS PERFORMED TO THE 1% BASED ON THE PROPOSED LIMITS OF DISTURBANCE (LOD).


PROPOSED BUS STATION/PROJECT LOD = 0.3076 ACRES
TOTAL DRAINAGE AREA TO CENTRAL OUTFALL AREA = 461 ACRES

SINCE 0.3076 AC / 461 AC < 1%, THE ANALYSIS COMPLIES WITH THE 1% RULE.

GIVEN THAT THE 1% POINT IS LOCATED WITHIN A PIPE SYSTEM, NO EROSION WILL OCCUR AT THIS POINT. THEREFORE, THE CHANNEL PROTECTION REQUIREMENT HAS BEEN SATISFIED.

FLOOD PROTECTION
THERE IS CURRENTLY NO DATA TO DETERMINE IF THIS AREA CONTAINS LOCALIZED FLOODING. THEREFORE, LOCALIZED FLOODING IN THIS AREA IS UNKNOWN. BASED ON THIS INFORMATION, THE FLOOD PROTECTION CRITERIA HAS BEEN SATISFIED.

DISCHARGE TO WATER FLOW - EX. 144" PIPE & 84" PIPE

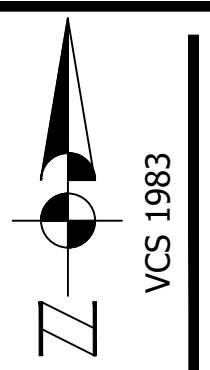



APPROVALS	DATE
<i>[Signature]</i> QUALITY CONTROL ENGINEER	3/29/21
<i>[Signature]</i> QUALITY CONTROL ENGINEER	3.24.21
<i>[Signature]</i> CONSTRUCTION MANAGEMENT SUPERVISOR	03.04.2021
<i>[Signature]</i> WATER, SEWER, STREETS BUREAU CHIEF	03/17/21
<i>[Signature]</i> TRANSPORTATION DIRECTOR	
<i>[Signature]</i> PROJECT MANAGER	3/2/21

REVISIONS	DATE

PROJECT NAME AND LOCATION
TRANSITWAY EXTENSION TO PENTAGON CITY
STORMWATER MANAGEMENT PLAN
CRYSTAL DR & 12TH ST S
MA13 - SEGMENT 1

DESIGNED: PB
DRAWN: NS
CHECKED: TL
MISS UTILITY TRANSMITTAL #: N/A
FILENAME: MA13-250-DRAINAGE_DEVIDES.DWG
PATH: \\DES-CAD-S2\ENGINEERING_DATA\DATA\MA13
PLOTTED: AUGUST 4 2021
PLOTTED BY: NSHARP

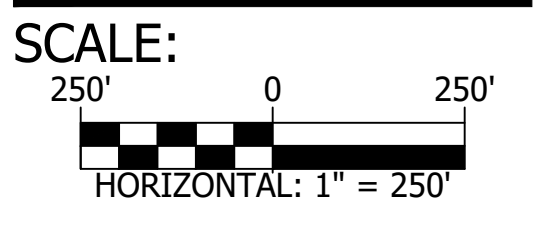

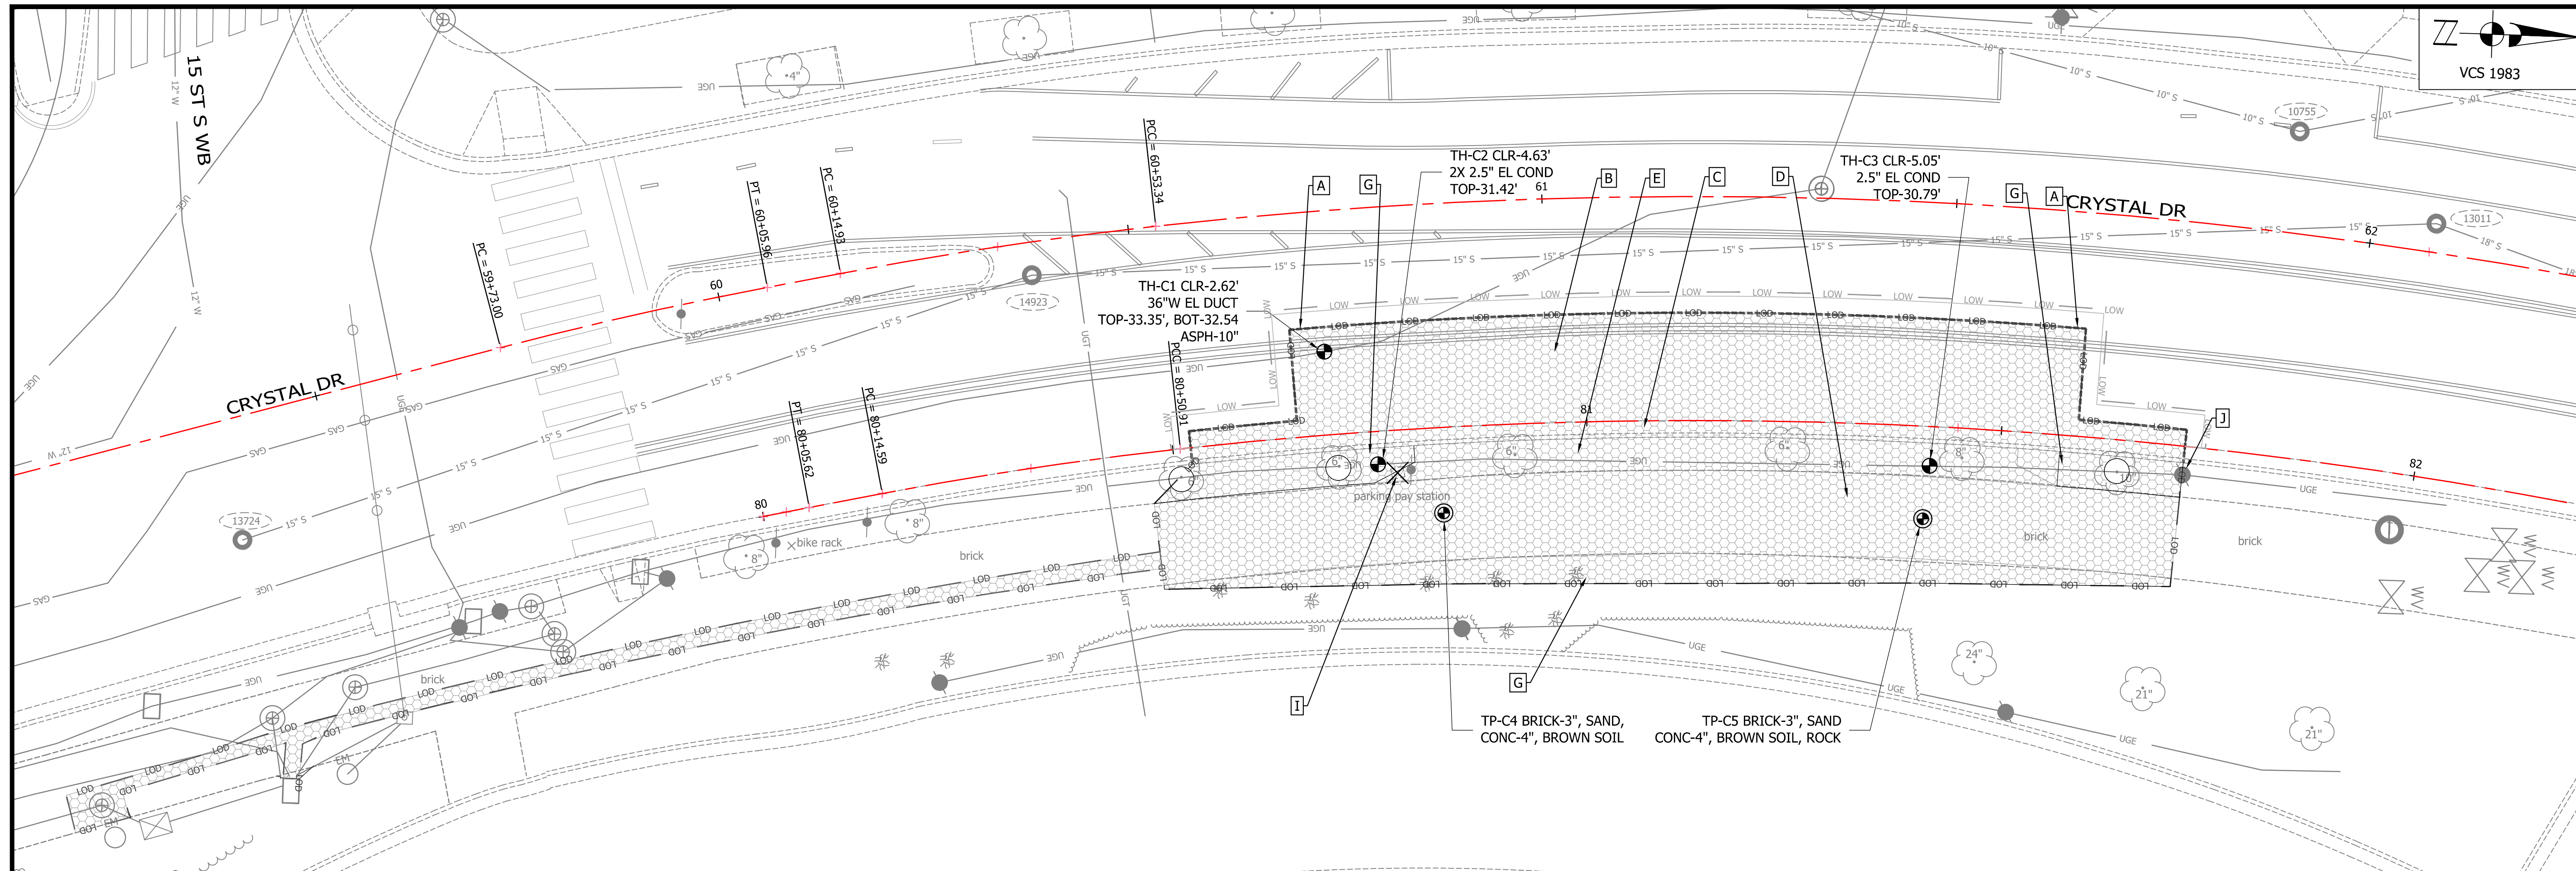


APPROVALS	DATE
<i>[Signature]</i>	3/29/21
QUALITY CONTROL ENGINEER <i>Ramal Takar</i>	3.24.21
CONSTRUCTION MANAGEMENT SUPERVISOR <i>[Signature]</i>	03.04.2021
WATER, SEWER, STREETS BUREAU CHIEF <i>Dennis M. Leach</i>	03/17/21
TRANSPORTATION DIRECTOR <i>[Signature]</i>	3/2/21
PROJECT MANAGER	

REVISIONS	DATE

- DEMOLITION KEY NOTES:**
- CAUTION: POTENTIAL UNDERGROUND UTILITY CONFLICT. THE PROVIDED TEST HOLE/PIT DATA IS APPROXIMATE. THE CONTRACTOR, IF NECESSARY, SHALL FIELD VERIFY (TEST PIT) EXACT LOCATIONS AND DEPTHS OF EXISTING UTILITY.
- USE OF LARGE EQUIPMENT (HOE RAMS, VIBRATORY ROLLERS, ETC.) SHALL NOT BE PERMITTED WITHIN 5 FEET OF UNDERGROUND STRUCTURES.
- A** CONTRACTOR SHALL MAKE A NEAT LINE SAWCUT EXISTING PAVEMENT (AT NEAREST JOINT WHERE POSSIBLE).
 - B** CONTRACTOR SHALL REMOVE/DEMOLISH/DISPOSE STREET PAVEMENT.
 - C** CONTRACTOR SHALL REMOVE/DEMOLISH/DISPOSE CURB AND GUTTER.
 - D** CONTRACTOR SHALL REMOVE EXISTING BRICK PAVEMENT WITH CAUTION IN ORDER TO RESTORE BRICK SIDEWALK PAVEMENT WITH SALVAGED BRICKS. REST OF SALVAGED BRICKS SHALL BE RETURNED TO ARLINGTON COUNTY. CONTACT ARLINGTON COUNTY DIVISION OF TRANSPORTATION AT 703-228-6570. CONTRACTOR SHALL EXCAVATE/REMOVE AGGREGATES/DIRT UNDER BRICK SIDEWALK IN ORDER TO COMPLY WITH NEW PROPOSED PAVEMENT.
 - E** CONTRACTOR SHALL REMOVE/EXCAVATE/DISPOSE OF EXISTING TREES AND DIRT IN ORDER TO COMPLY WITH NEW PROPOSED PAVEMENT.
 - F** CONTRACTOR SHALL REMOVE/DEMOLISH/DISPOSE EXISTING CATCH BASIN AND MAKE AN EXCAVATION IN ORDER TO COMPLY WITH NEW PROPOSED CATCH BASIN INSTALLATION. EXISTING 15" RCP & UTILITY CONDUITS SHALL BE PROTECTED.
 - G** CONTRACTOR SHALL REMOVE/EXCAVATE/DISPOSE OF EXISTING SHRUBS AND DIRT IN ORDER TO COMPLY WITH PROPOSED LANDSCAPING RESTORATION.
 - H** CONTRACTOR SHALL COORDINATE STREETLIGHT REMOVAL WITH DOMINION ENERGY. CONTRACTOR TO REMOVE THE EXISTING FOUNDATION IN ORDER TO COMPLY WITH NEW PROPOSED STREET LIGHT INSTALLATION. EXISTING ELECTRICAL POWER CONNECTION TO THE REMAINING STREET LIGHTS TO REMAIN IN SERVICE. CONTACT ARLINGTON COUNTY DIVISION OF TRANSPORTATION AT 703-228-6570.
 - I** CONTRACTOR SHALL REMOVE EXISTING PARKING PAY STATIONS, INCLUDING FOUNDATION AND TRAFFIC SIGNS. CONTRACTOR SHALL RETURN REMOVED PARKING PAY STATIONS AND SIGNS TO ARLINGTON COUNTY. PARKING PAY STATIONS AND SIGNS REMOVAL SHALL BE COORDINATED WITH TE&O (TEL. 703-228-7952).
 - J** CONTRACTOR SHALL PROTECT EXISTING POLE, UTILITY, STRUCTURE, FROM DAMAGE.
 - K** CONTRACTOR SHALL PROVIDE A WATERPROOFING RESTORATION OVER EXISTING UNDERGROUND STRUCTURES PER SPECIFICATIONS. SEE DETAILS AND NOTES - SHEET 04.
 - L** EXISTING RETAINING WALL TO REMAIN
- DEMOLITION GENERAL NOTES:**
- TEMPORARY EDGE RESTRAINTS SHALL BE PLACED AT THE PERIMETER OF THE EXPOSED AREA TO MINIMIZE CREEPING OF THE EX. BRICK PAVEMENT. VEHICULAR TRAFFIC SHOULD BE KEPT AT LEAST 6' FROM THE WORK EDGES.
 - EXISTING STAND PIPE/FIRE HYDRANT TO REMAIN IN SERVICE. THE CONTRACTOR SHALL MAINTAIN UNIMPEDED ACCESS TO THE STAND PIPE/FIRE HYDRANT DURING CONSTRUCTION. THE CONTRACTOR SHALL ERECT SIGNS THAT CLEARLY IDENTIFY THE LOCATION OF THE STAND PIPE/FIRE HYDRANT.
 - EXISTING UNDERGROUND UTILITIES ARE TO REMAIN UNLESS OTHERWISE NOTED. CONTRACTOR SHALL ADJUST ALL STRUCTURES TOP TO NEW GRADES PER ARL STD S-2.3.
 - ALL EXISTING SIDEWALK, PAVEMENT, DAMAGED BRICKS, ASPHALT, AND/OR SIDEWALK WITHIN THE LIMITS SHOWN SHALL BE REMOVED AND HAULED TO WASTE.
 - EXISTING TREE REMOVAL AND PROTECTION SHALL COMPLY WITH E&S CONTROL PLAN.
 - ALL EXISTING STRUCTURES TO REMAIN WITHIN THE PROJECT AREA SHALL BE BROUGHT TO PROPOSED GRADE DURING CONSTRUCTION.

CRYSTAL DR NB & 15TH ST S INTERSECTION

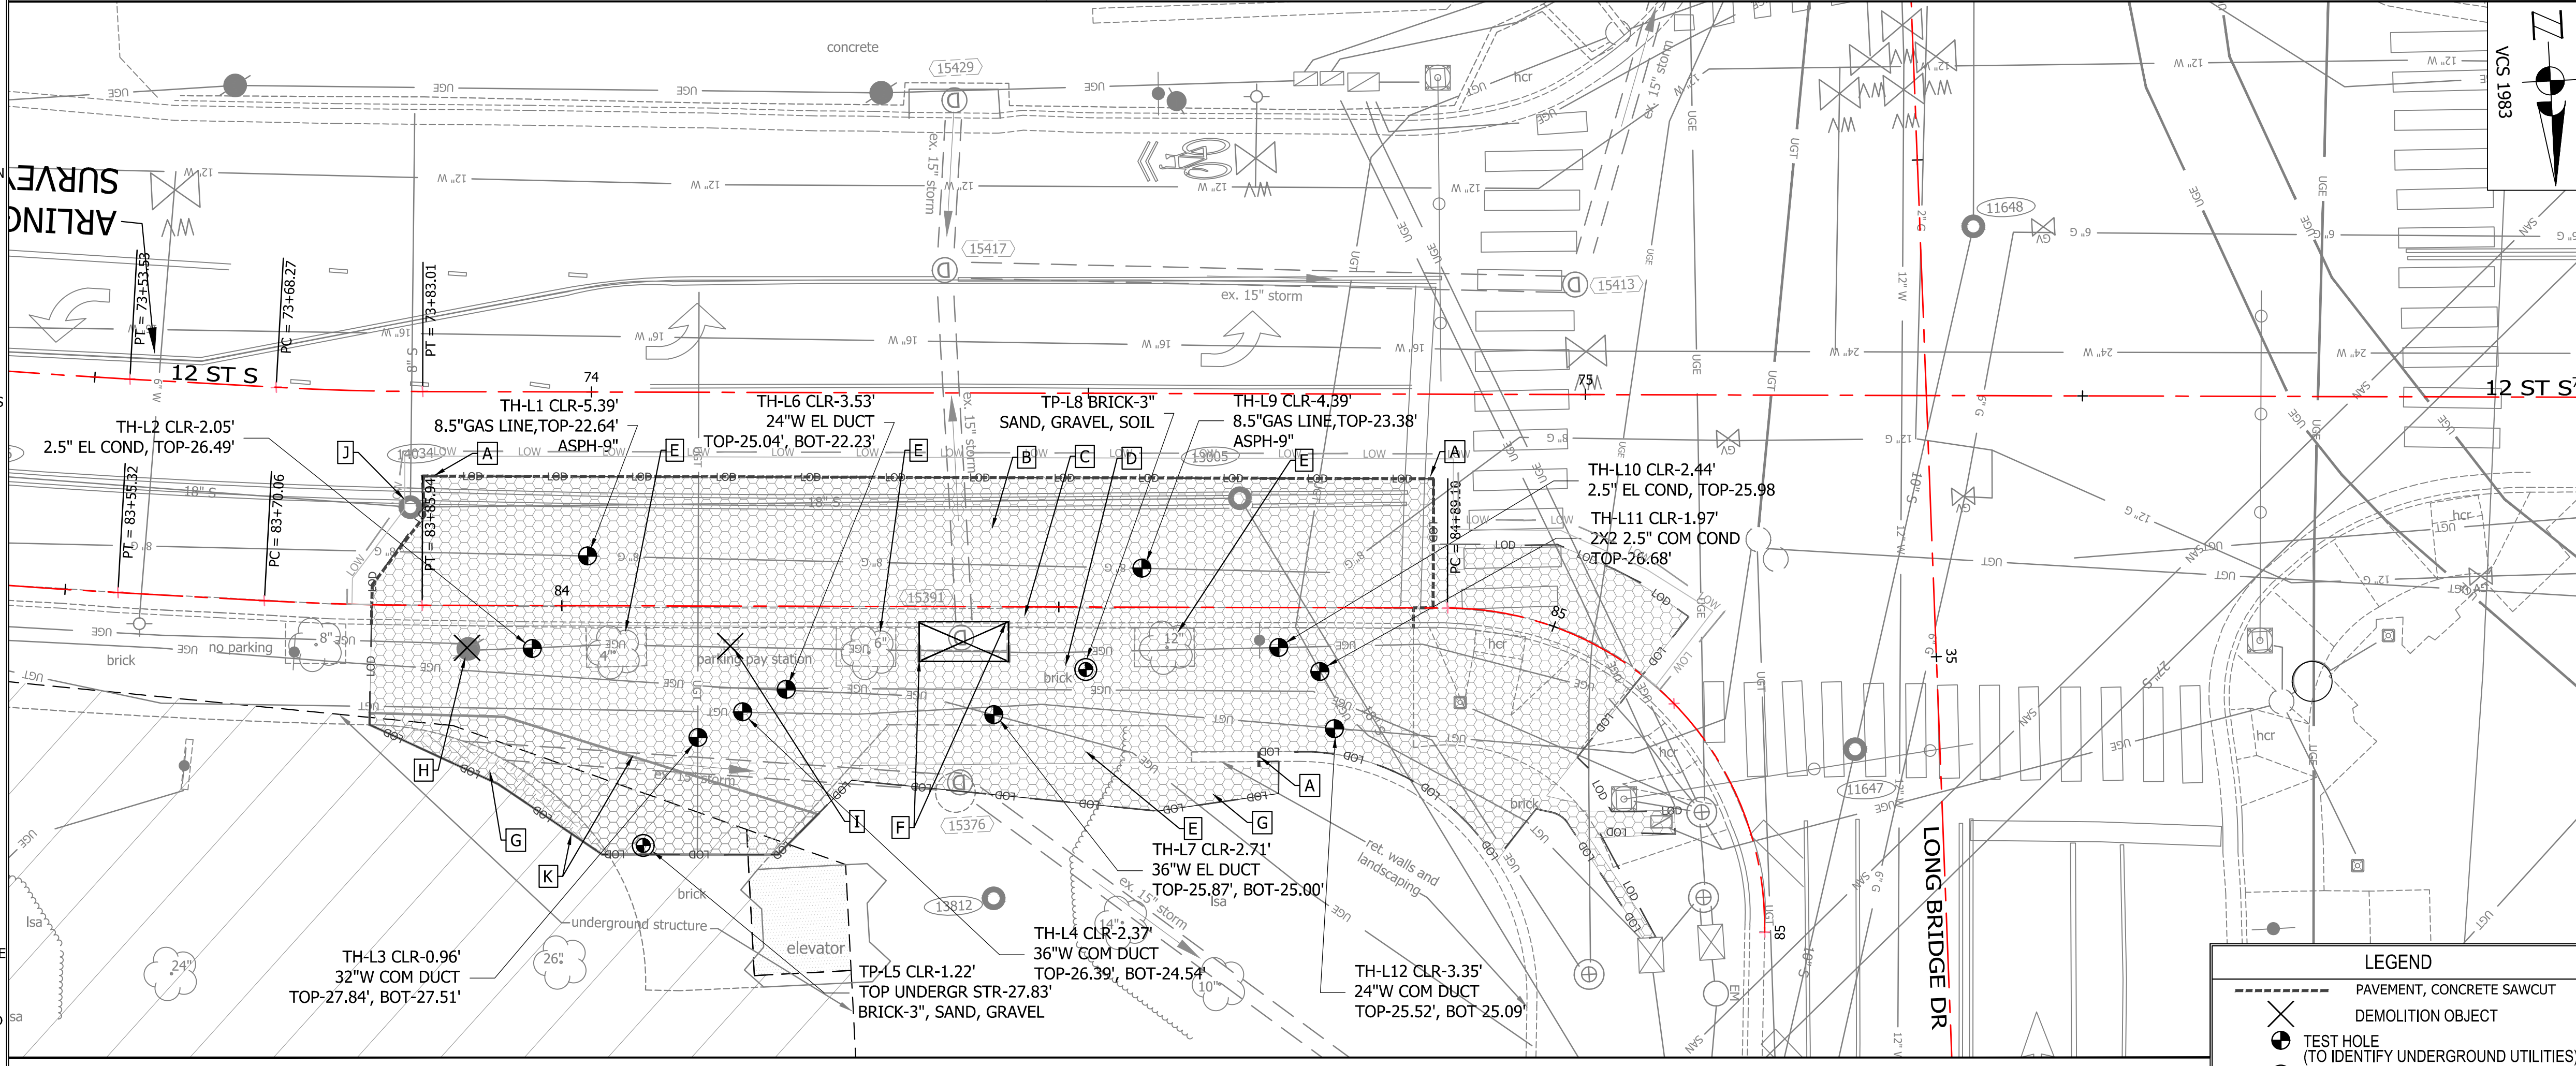

12TH ST S WB & LONG BRIDGE DR INTERSECTION

PROJECT NAME AND LOCATION
TRANSITWAY EXTENSION TO PENTAGON CITY
 DEMOLITION PLAN
CRYSTAL DR & 12TH ST S
 MA13 - SEGMENT 1

DESIGNED: PB
 DRAWN: NS
 CHECKED: TL
 MISS UTILITY TRANSMITTAL #: N/A
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 PATH: \\DES-CAD-S2\ENGINEERING_DATA\DATA\MA13

PLOTTED: AUGUST 4 2021
 PLOTTED BY: NSHARP

SCALE:
 10' = 10'
 HORIZONTAL: 1" = 10'

LEGEND

- PAVEMENT, CONCRETE SAWCUT
- DEMOLITION OBJECT
- ⊗ TEST HOLE (TO IDENTIFY UNDERGROUND UTILITIES)
- ⊙ TEST PIT (TO IDENTIFY PAVEMENT LAYERS)



NOTE: SEE SHEETS 33-35 FOR TEST HOLE/PIT LOGS

DEMOLITION KEY NOTES:
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L EXISTING RETAINING WALL TO REMAIN

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CRYSTAL DR NB & 12TH STREET S TRANSITION

ARLINGTON VIRGINIA

DEPARTMENT OF ENVIRONMENTAL SERVICES
 FACILITIES & ENGINEERING DIVISION
 ENGINEERING BUREAU
 2100 CLARENDON BOULEVARD, SUITE 813
 ARLINGTON, VA 22201
 PHONE: 703.228.3629
 FAX: 703.228.3606
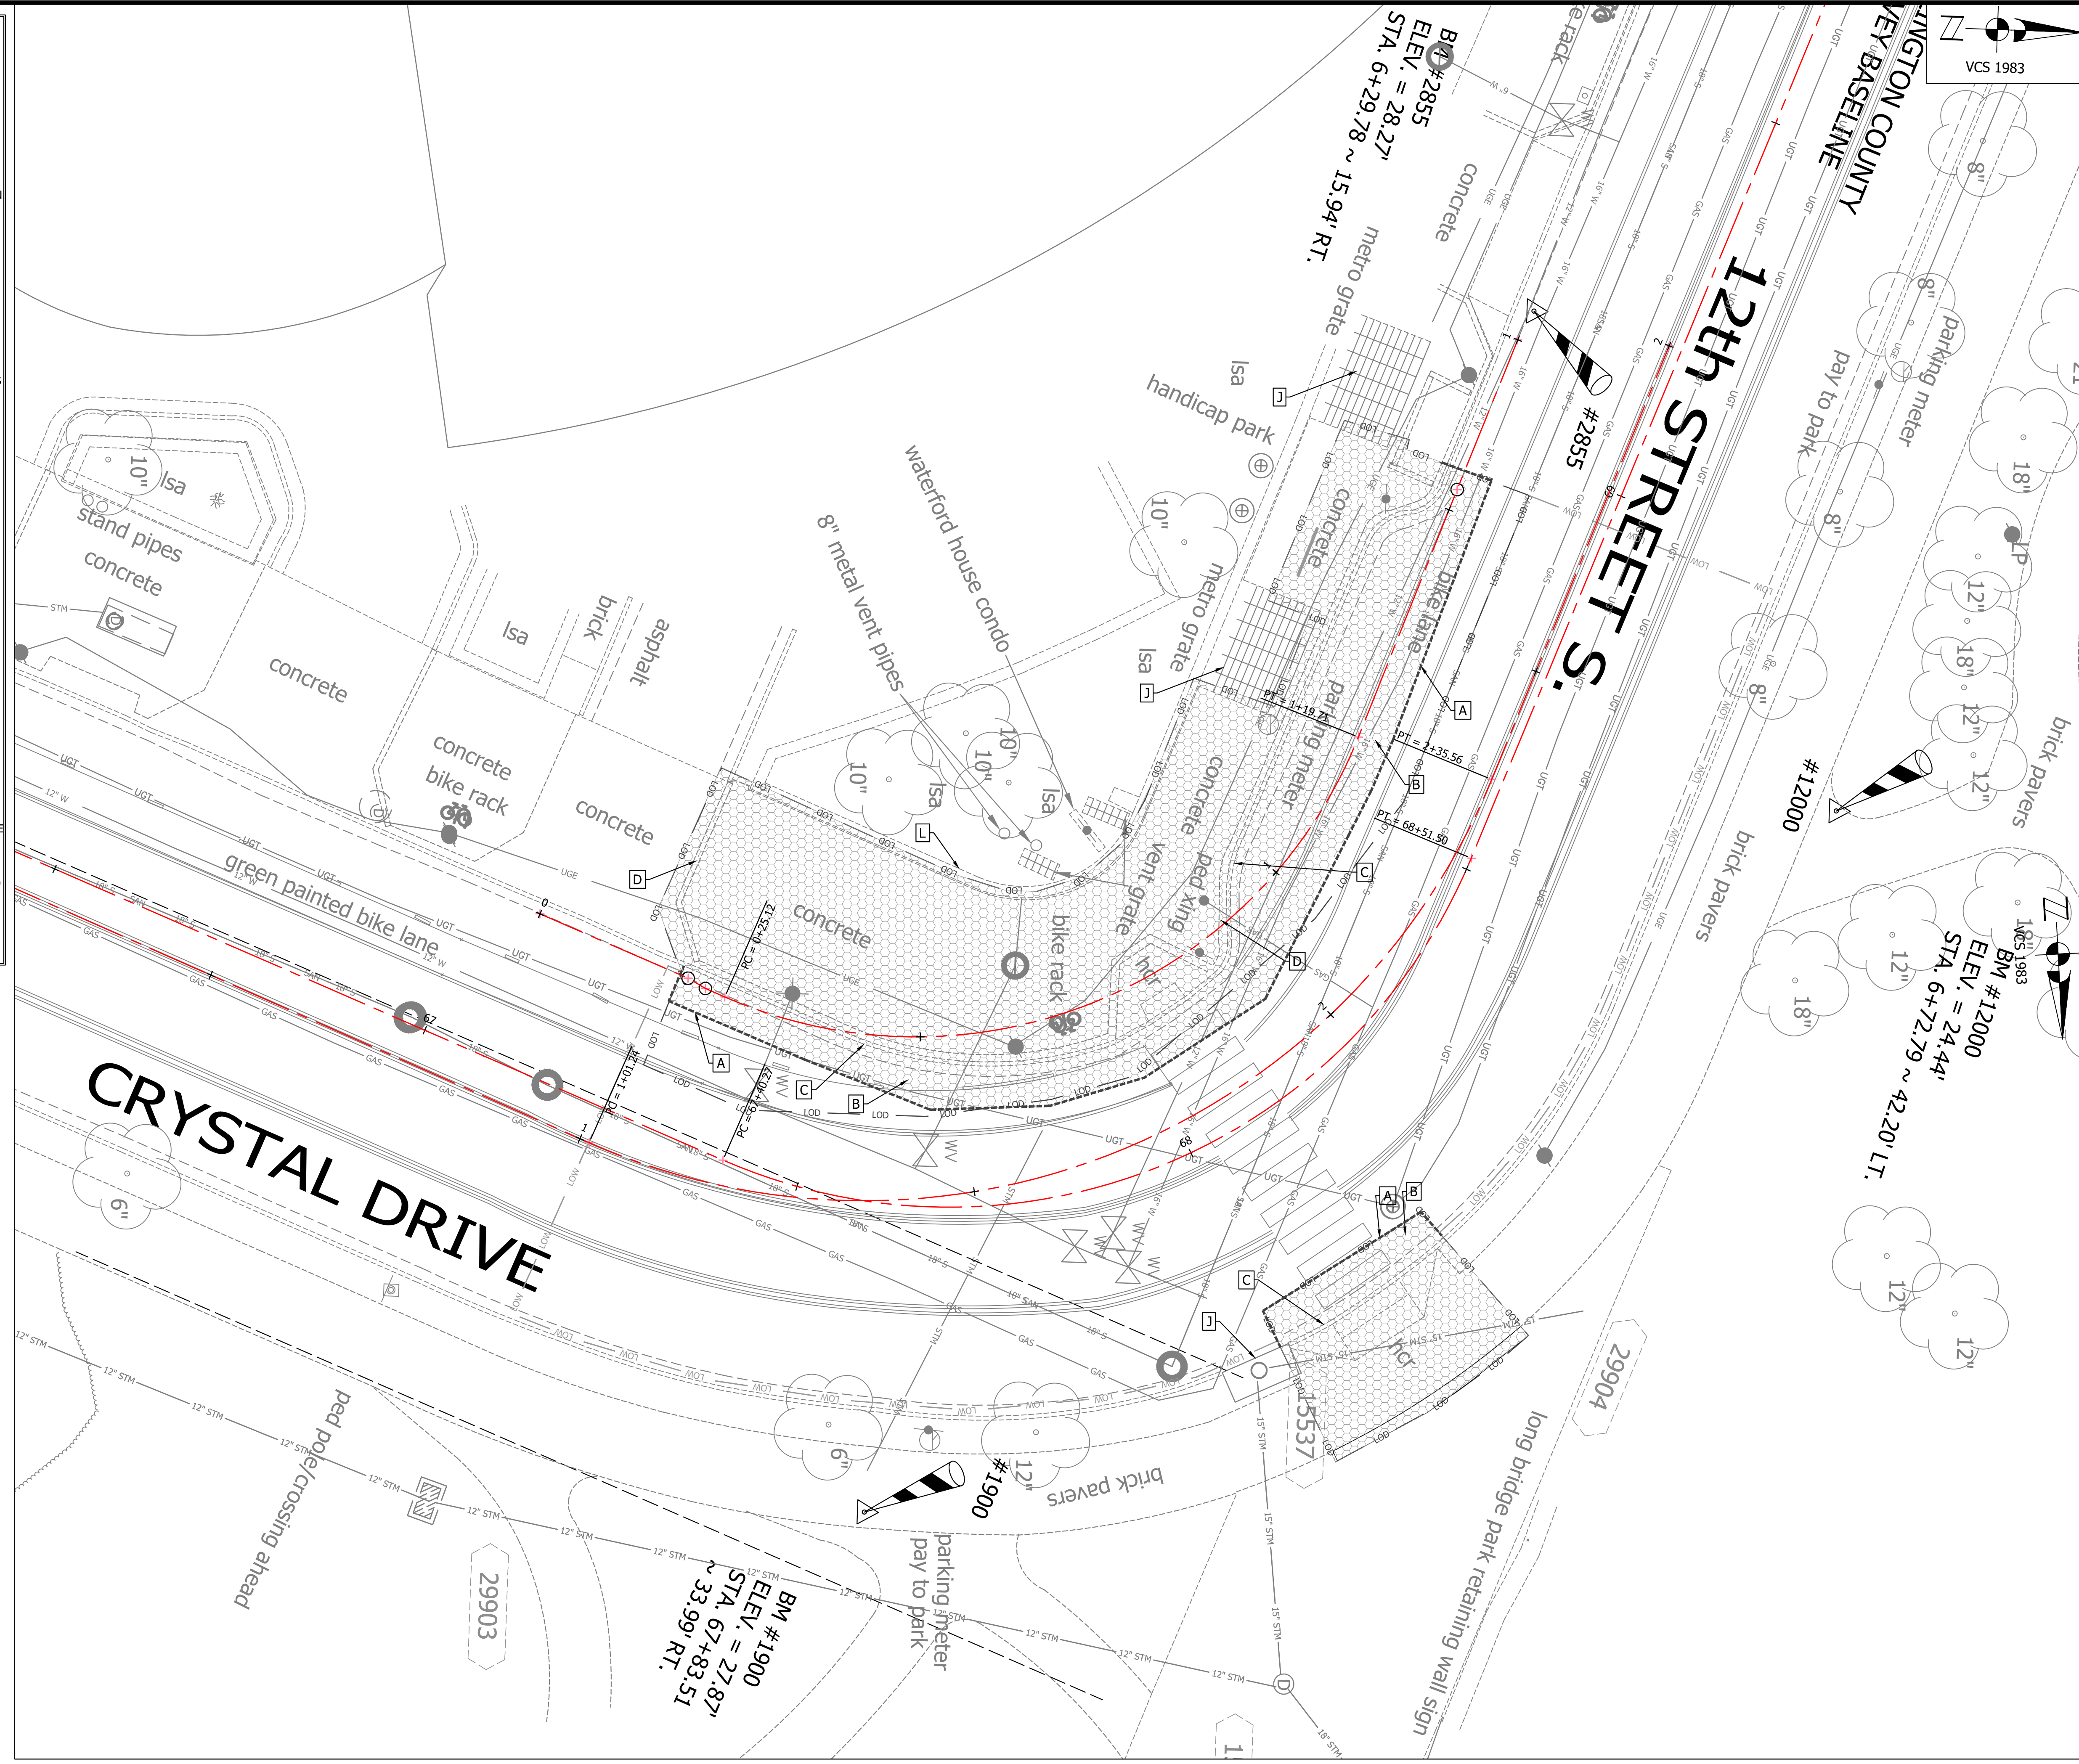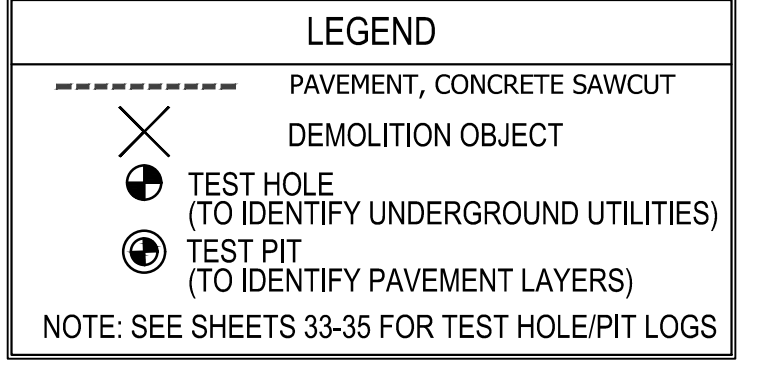
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APPROVALS	DATE
<i>Kamell</i>	3/29/21
QUALITY CONTROL ENGINEER <i>Kamal Takbar</i>	3.24.21
CONSTRUCTION MANAGEMENT SUPERVISOR <i>Quinn</i>	03.04.2021
WATER, SEWER, STREETS BUREAU CHIEF <i>Dennis M. Leach</i>	03/17/21
TRANSPORTATION DIRECTOR <i>Diana Izzo</i>	3/2/21
PROJECT MANAGER	

REVISIONS	DATE

PROJECT NAME AND LOCATION
TRANSITWAY EXTENSION TO PENTAGON CITY

DEMOLITION PLAN
CRYSTAL DR & 12TH ST S


MA13 - SEGMENT 1

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 CHECKED: TL
 MISS UTILITY TRANSMITTAL #: N/A

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PLOTTED: AUGUST 4 2021
 PLOTTED BY: NSHARP




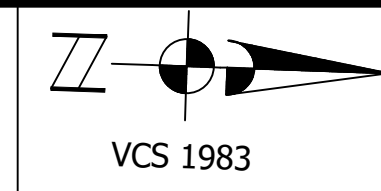


APPROVALS	DATE
<i>[Signature]</i>	3/29/21
QUALITY CONTROL ENGINEER <i>[Signature]</i>	3.24.21
CONSTRUCTION MANAGEMENT SUPERVISOR <i>[Signature]</i>	03.04.2021
WATER, SEWER, STREETS BUREAU CHIEF <i>[Signature]</i>	03/17/21
TRANSPORTATION DIRECTOR <i>[Signature]</i>	3/2/21
PROJECT MANAGER	


REVISIONS	DATE

PROJECT NAME AND LOCATION
TRANSITWAY EXTENSION TO PENTAGON CITY
GEOMETRIC CONTROL PLAN
CRYSTAL DR & 12TH ST S
 MA13 - SEGMENT I

DESIGNED: PB
 DRAWN: NS
 CHECKED: TL
 MISS UTILITY TRANSMITTAL #: N/A
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 PLOTTED: AUGUST 4 2021
 PLOTTED BY: NSHARP

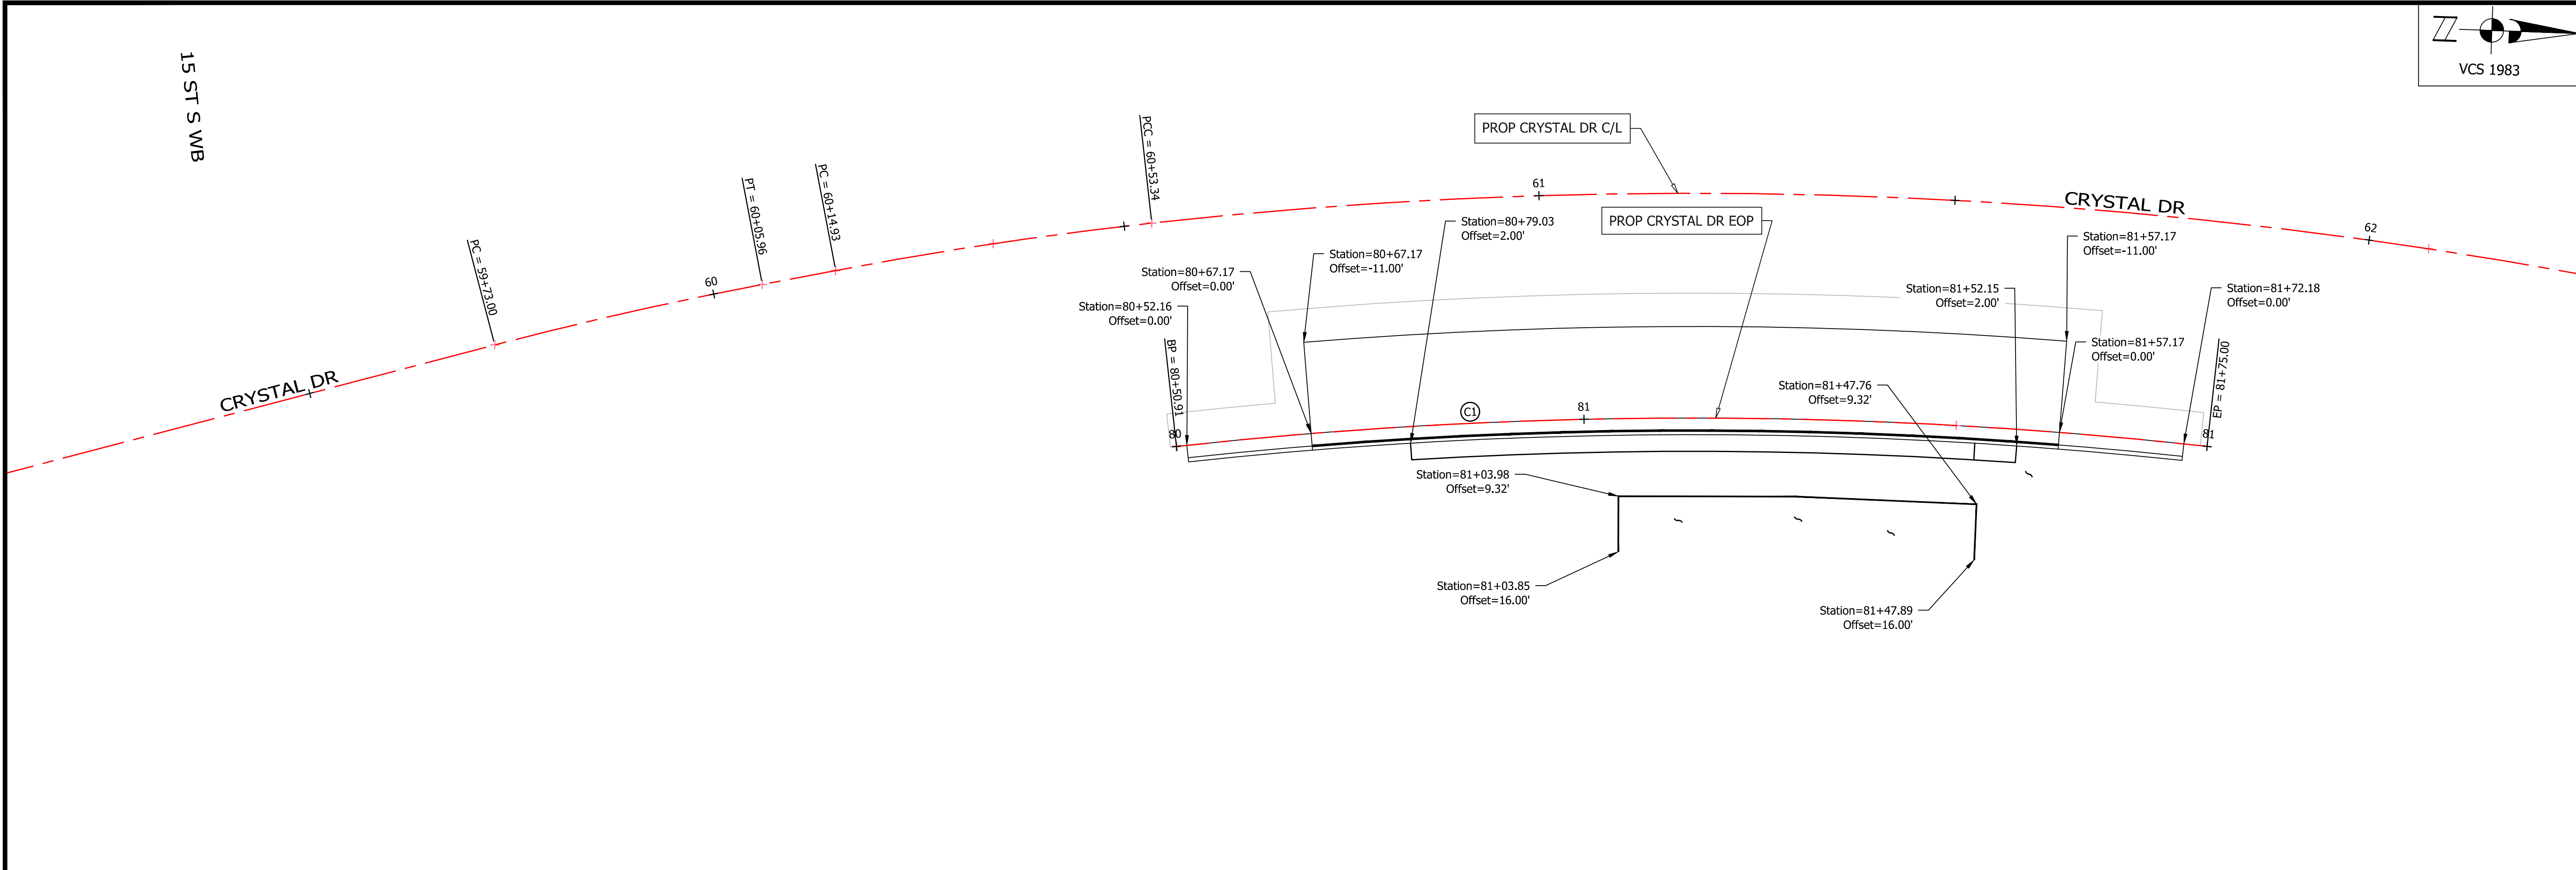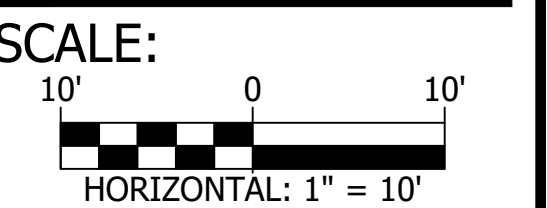

CRYSTAL DR NB & 15TH ST S INTERSECTION

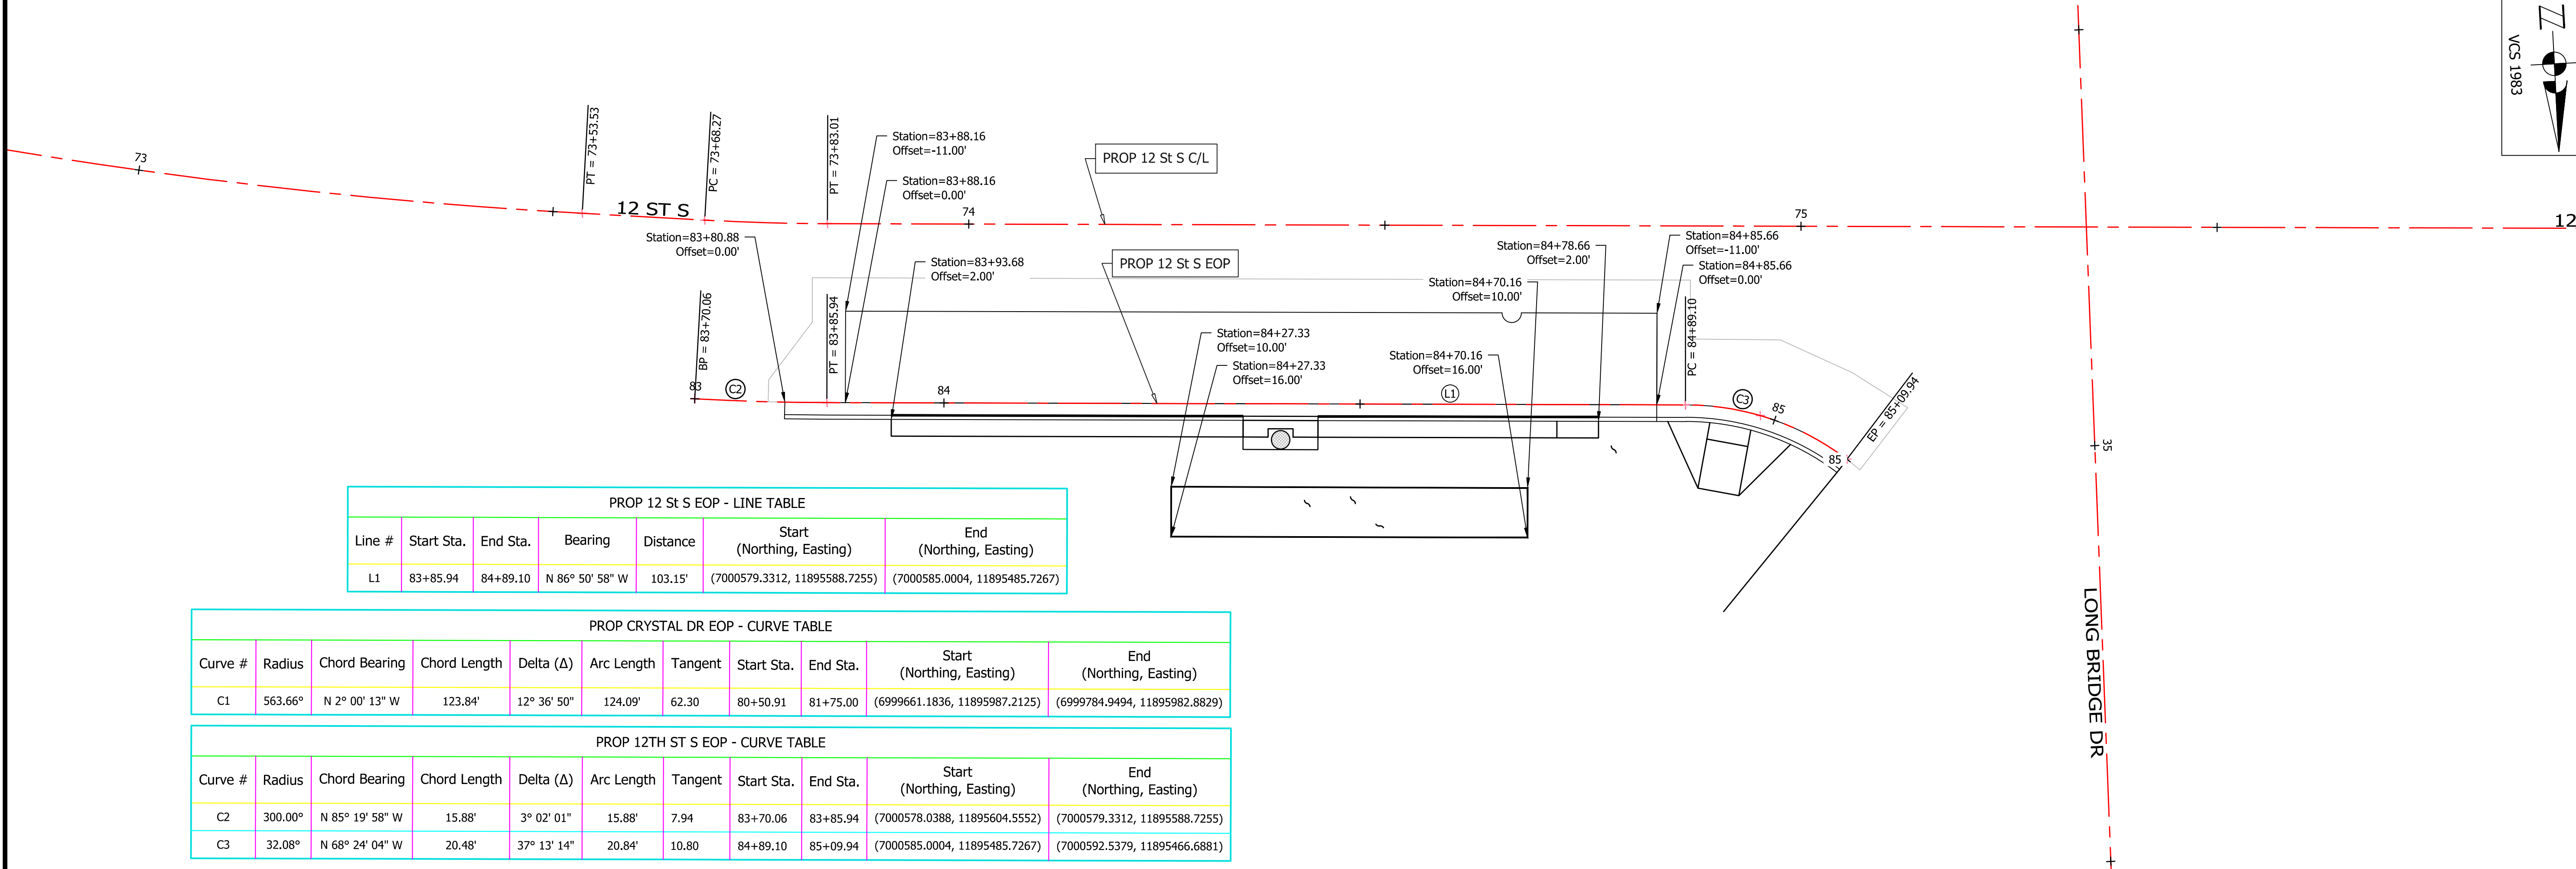

12TH ST S WB & LONG BRIDGE DR INTERSECTION

Line #	Start Sta.	End Sta.	Bearing	Distance	Start (Northing, Easting)	End (Northing, Easting)
L1	83+85.94	84+89.10	N 86° 50' 58" W	103.15'	(7000579.3312, 11895588.7255)	(7000585.0004, 11895485.7267)

Curve #	Radius	Chord Bearing	Chord Length	Delta (Δ)	Arc Length	Tangent	Start Sta.	End Sta.	Start (Northing, Easting)	End (Northing, Easting)
C1	563.66'	N 2° 00' 13" W	123.84'	12° 36' 50"	124.09'	62.30'	80+50.91	81+75.00	(6999661.1836, 11895987.2125)	(6999784.9494, 11895982.8829)

Curve #	Radius	Chord Bearing	Chord Length	Delta (Δ)	Arc Length	Tangent	Start Sta.	End Sta.	Start (Northing, Easting)	End (Northing, Easting)
C2	300.00'	N 85° 19' 58" W	15.88'	3° 02' 01"	15.88'	7.94'	83+70.06	83+85.94	(7000578.0388, 11895604.5552)	(7000579.3312, 11895588.7255)
C3	32.08'	N 68° 24' 04" W	20.48'	37° 13' 14"	20.84'	10.80'	84+89.10	85+09.94	(7000585.0004, 11895485.7267)	(7000592.5379, 11895466.6881)





APPROVALS	DATE
<i>[Signature]</i>	3/29/21
QUALITY CONTROL ENGINEER <i>Ramal Taktak</i>	3.24.21
CONSTRUCTION MANAGEMENT SUPERVISOR <i>[Signature]</i>	03.04.2021
WATER, SEWER, STREETS BUREAU CHIEF <i>Dennis M. Leach</i>	03/17/21
TRANSPORTATION DIRECTOR <i>[Signature]</i>	3/2/21
PROJECT MANAGER <i>[Signature]</i>	

REVISIONS	DATE

PROJECT NAME AND LOCATION
TRANSITWAY EXTENSION TO PENTAGON CITY
GEOMETRIC CONTROL PLAN
CRYSTAL DR & 12TH ST S
 MA13 - SEGMENT I

DESIGNED: PB
 DRAWN: NS
 CHECKED: TL
 MISS UTILITY TRANSMITTAL #: N/A
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 PLOTTED: AUGUST 4 2021
 PLOTTED BY: NSHARP

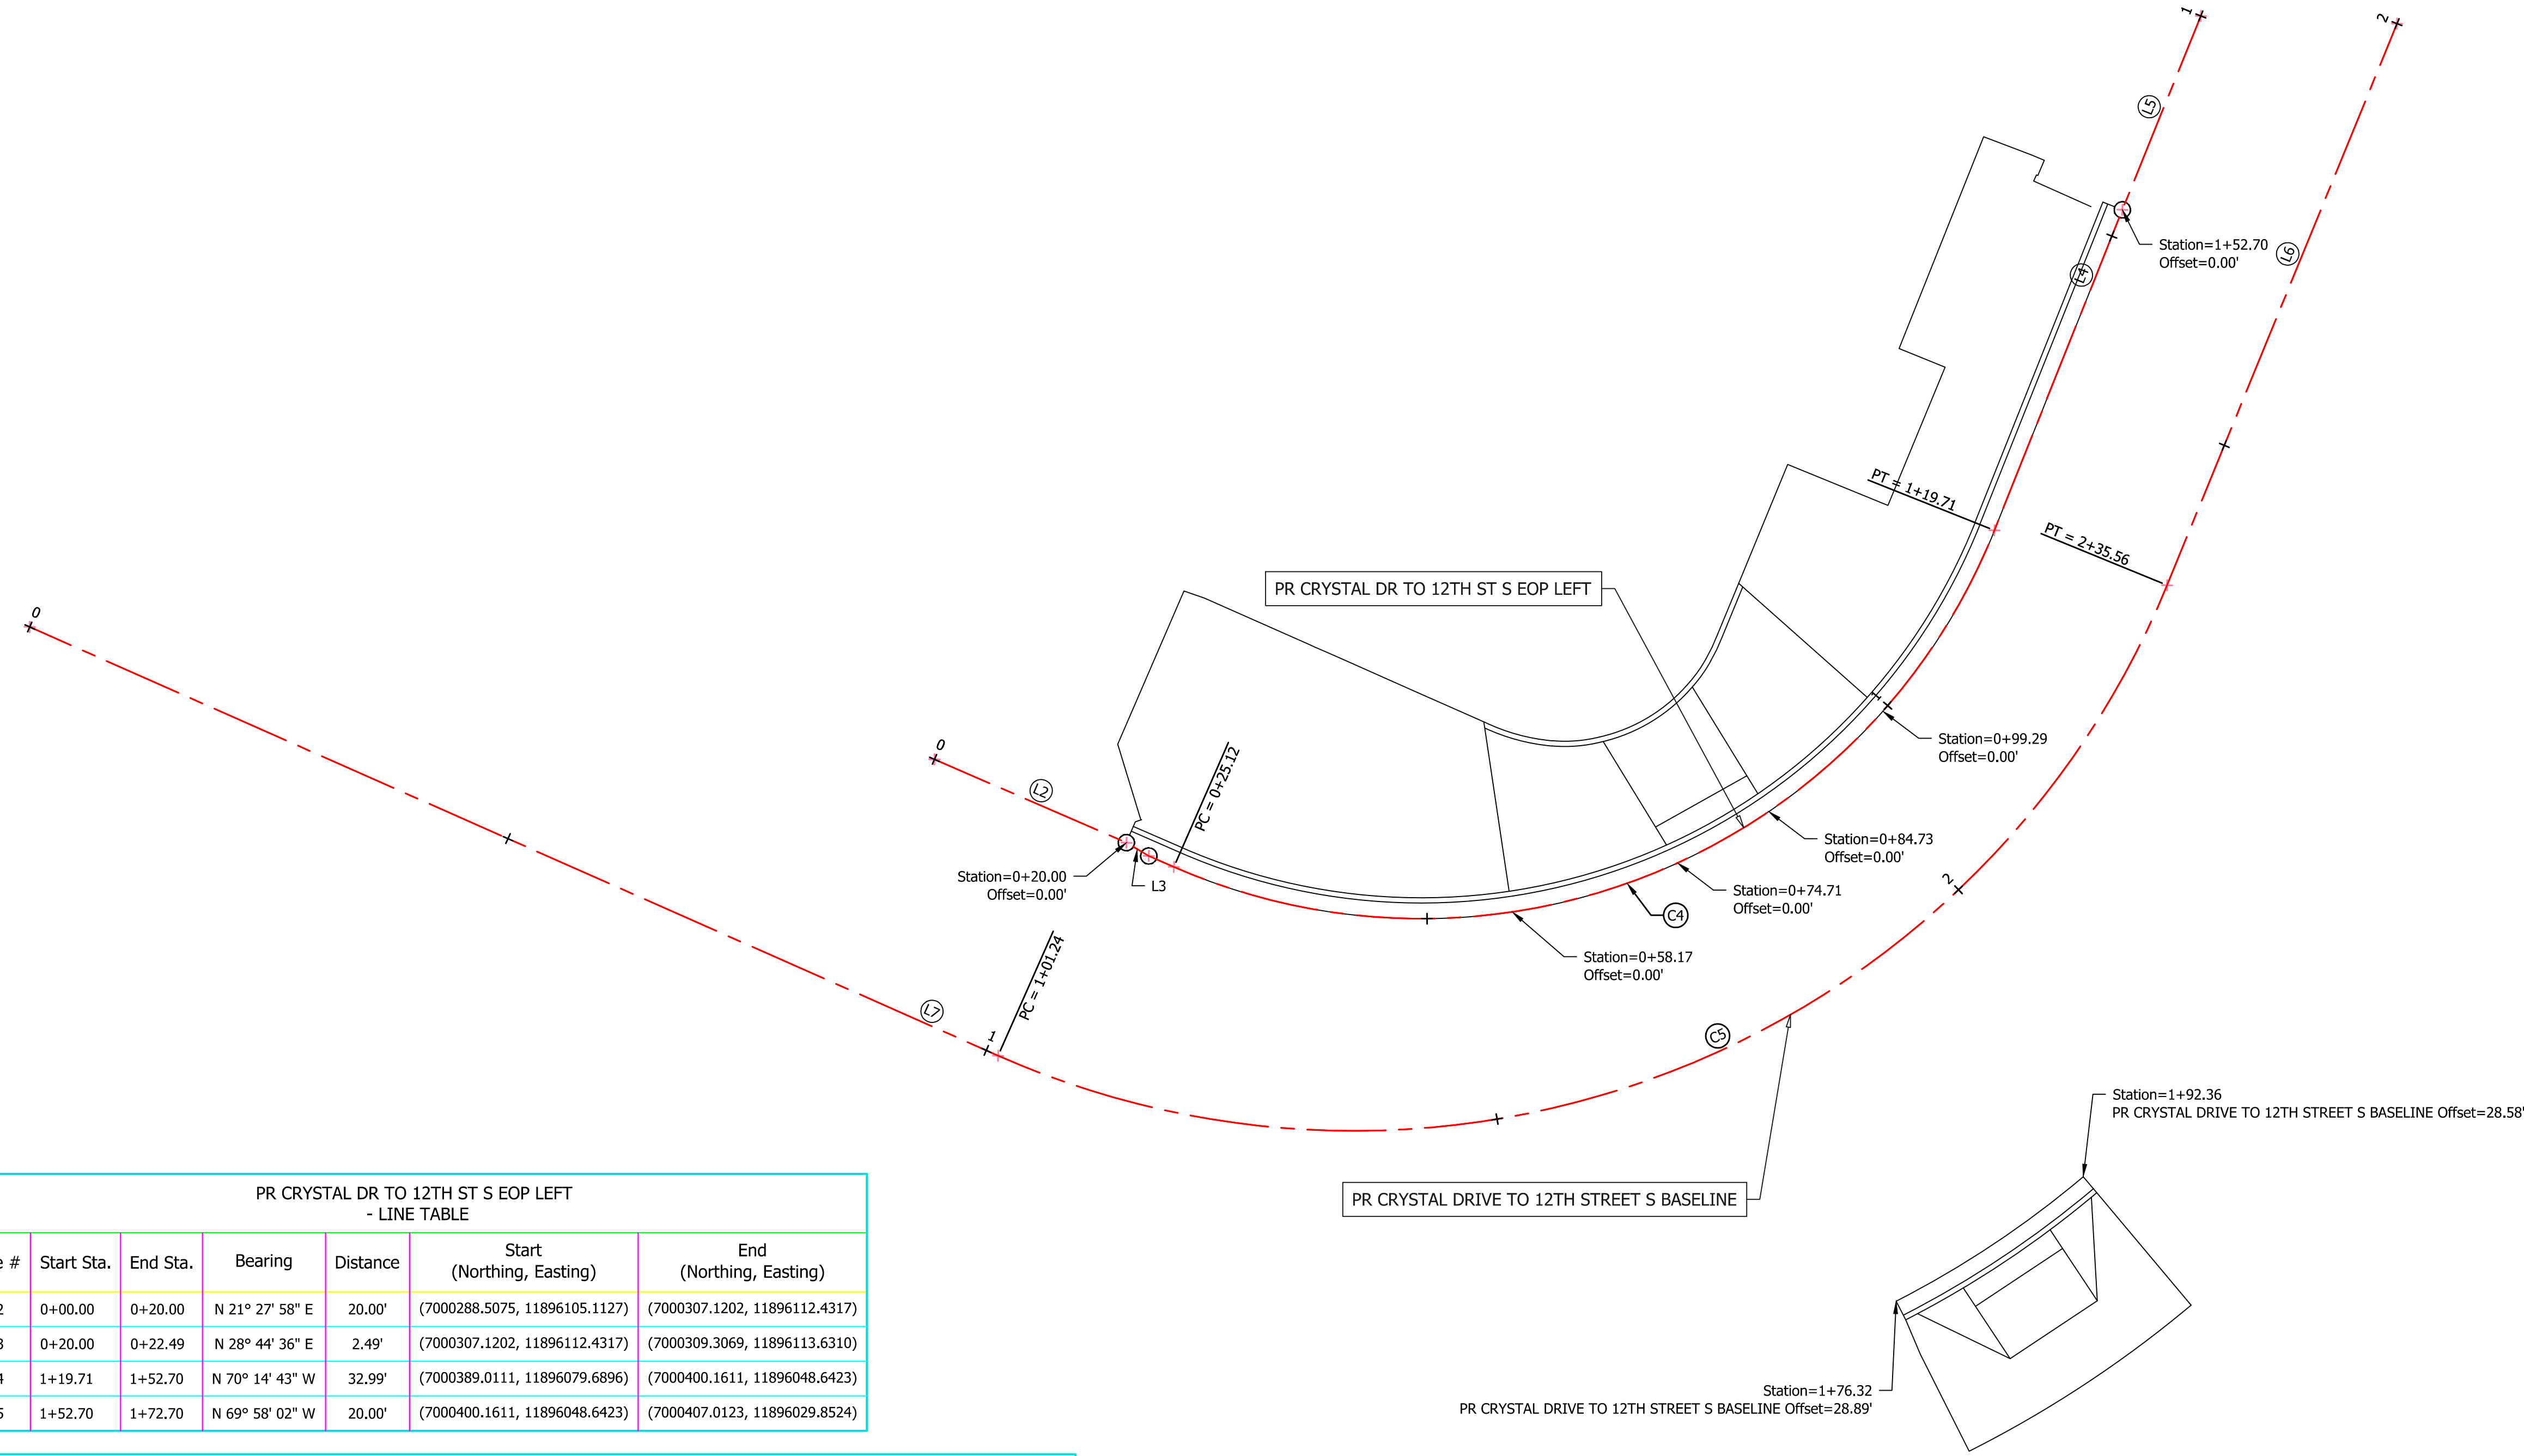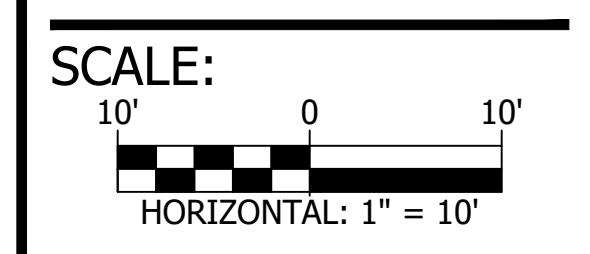


Line #	Start Sta.	End Sta.	Bearing	Distance	Start (Northing, Easting)	End (Northing, Easting)
L2	0+00.00	0+20.00	N 21° 27' 58" E	20.00'	(7000288.5075, 11896105.1127)	(7000307.1202, 11896112.4317)
L3	0+20.00	0+22.49	N 28° 44' 36" E	2.49'	(7000307.1202, 11896112.4317)	(7000309.3069, 11896113.6310)
L4	1+19.71	1+52.70	N 70° 14' 43" W	32.99'	(7000389.0111, 11896079.6896)	(7000400.1611, 11896048.6423)
L5	1+52.70	1+72.70	N 69° 58' 02" W	20.00'	(7000400.1611, 11896048.6423)	(7000407.0123, 11896029.8524)

Curve #	Radius	Chord Bearing	Chord Length	Delta (Δ)	Arc Length	Tangent	Start Sta.	End Sta.	Start (Northing, Easting)	End (Northing, Easting)
C4	59.00'	N 24° 18' 49" W	84.78'	91° 51' 47"	94.60'	60.95	0+25.12	1+19.71	(7000311.7468, 11896114.5979)	(7000389.0111, 11896079.6896)

Line #	Start Sta.	End Sta.	Bearing	Distance	Start (Northing, Easting)	End (Northing, Easting)
L6	2+35.56	2+93.57	N 69° 44' 00" W	58.02'	(7000405.6858, 11896084.3605)	(7000425.7832, 11896029.9330)
L7	0+00.00	1+01.24	N 21° 52' 48" E	101.24'	(7000201.6323, 11896095.4833)	(7000295.5824, 11896133.2129)

Curve #	Radius	Chord Bearing	Chord Length	Delta (Δ)	Arc Length	Tangent	Start Sta.	End Sta.	Start (Northing, Easting)	End (Northing, Easting)
C5	84.00'	N 23° 55' 36" W	120.45'	91° 36' 48"	134.31'	86.40	1+01.24	2+35.56	(7000295.5824, 11896133.2129)	(7000405.6858, 11896084.3605)

CRYSTAL DR & 12TH ST S TRANSITION

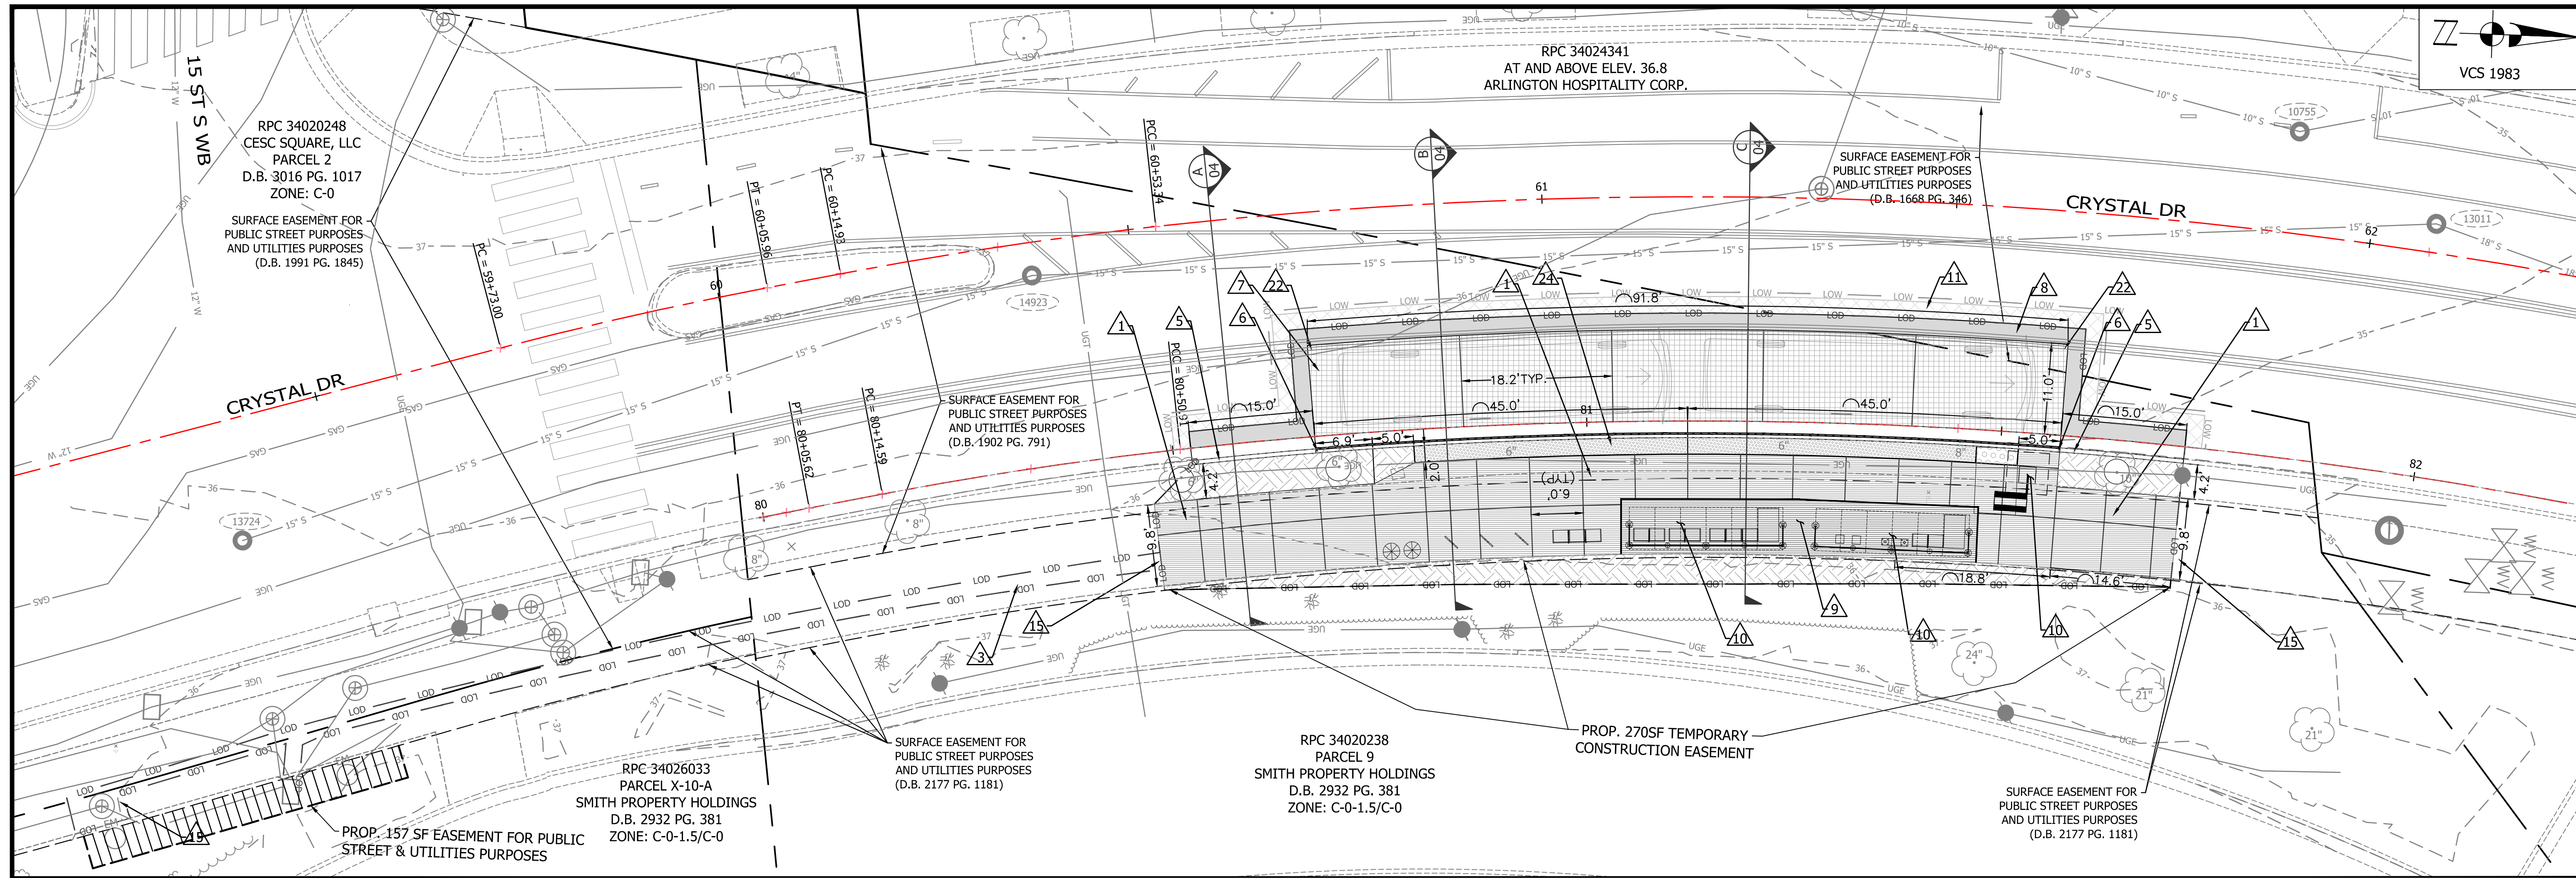

CRYSTAL DR NB & 15TH ST S INTERSECTION - STATION PLAN




APPROVALS	DATE
<i>Samuel</i>	3/29/21
QUALITY CONTROL ENGINEER <i>Ramal Takar</i>	3.24.21
CONSTRUCTION MANAGEMENT SUPERVISOR <i>Quinn</i>	03.04.2021
WATER, SEWER, STREETS BUREAU CHIEF <i>Dennis M. Leach</i>	03/17/21
TRANSPORTATION DIRECTOR <i>Diana Izzo</i>	3/2/21
PROJECT MANAGER	

REVISIONS	DATE

- CONSTRUCTION NOTES:**
- CAUTION: POTENTIAL UTILITY CONFLICT. CONTRACTOR TO FIELD VERIFY EXACT LOCATION AND DEPTH OF EXISTING UTILITY. SEE DEMOLITION PLAN FOR EX. TEST HOLES/PITS.
- USE OF LARGE EQUIPMENT (HOE RAMS, VIBRATORY ROLLERS, ETC.) SHALL NOT BE PERMITTED WITHIN 5 FEET OF UNDERGROUND STRUCTURES. ALL COMPACTION OPERATIONS OVER EXISTING UNDERGROUND STRUCTURE SHALL BE PERFORMED WITH APPROPRIATE SMALL VIBRATORY PLATES TO ELIMINATE ANY DAMAGES TO THE STRUCTURE.
- CONTRACTOR SHALL CONSTRUCT NEW BROOM FINISHED 4" THICK CONCRETE SIDEWALK, SCORED IN 6" X6" MODULE. SIDEWALK PAVEMENT SHALL COMPLY WITH ARL STD R-2.0 & R-2.1.
 - CONTRACTOR TO INSTALL CG-12 TYPE A PER VDOT ROAD AND BRIDGE STANDARDS
 - CONTRACTOR SHALL RESTORE FULL DEPTH SIDEWALK PAVEMENT WITH SALVAGED BRICKS ON FLEXIBLE AGGREGATE BASE AND MATCH EXISTING MATERIAL, COLOR, PATTERN AND PROPOSED GRADE. SEE PROPOSED RAMP DETAILS & STREET CROSS SECTIONS SHEET. SIDEWALK PAVEMENT RESTORATION SHALL COMPLY WITH ARL STD R-2.1.
 - CONTRACTOR SHALL INSTALL NEW 2' WIDE DETECTABLE WARNING SURFACE ON TOP OF RIGID CONCRETE BASE TO COMPLY WITH STANDARD CONCRETE SIDEWALK RAMP CG-12 TYPE A PER VDOT ROAD AND BRIDGE STANDARDS DRAWING.
 - CONTRACTOR SHALL CONSTRUCT NEW C-2 CURB & GUTTER PER ARL STD R-2.0 WITH MODIFIED 6" TO 9.5" HIGH CURB TRANSITION AND 10" THICK GUTTER. SEE EOP PROFILE AND DETAILS ON SHEET 05.
 - CONTRACTOR SHALL CONSTRUCT NEW C-2 CURB & GUTTER PER ARL STD R-2.0 WITH MODIFIED 9.5" HIGH CURB, 10" THICK GUTTER AND RUB RAIL. SEE EOP PROFILE AND DETAILS ON SHEET 5.
 - CONTRACTOR SHALL CONSTRUCT 10" REINFORCED CONCRETE BUS PAD PER DETAIL ON SHEET 5 AND VDOT DETAIL PR-2.
 - CONTRACTOR SHALL INSTALL FULL DEPTH ASPHALT ROAD PAVEMENT. PER ARLINGTON COUNTY NOTES ON DETAIL R-1.4. FOR ASPHALT PAVEMENT LAYERS SEE TYPICAL STREET CROSS SECTIONS SHEET.
 - CONTRACTOR SHALL CONSTRUCT 6" CONCRETE BUS SHELTER PAD. SEE DETAIL ON SHEET 5.
 - REFER TO SHEETS 21A AND 21B FOR STATION DETAILS, FURNISHINGS AND LAYOUT.
 - PROP. MILL AND OVERLAY
 - CONTRACTOR SHALL CONSTRUCT NEW C-2 CURB & GUTTER PER ARL STD R-2.0
 - CONTRACTOR TO INSTALL CB-2A CATCH BASIN 9' LENGTH FOR SAGS PER ARL STD D-1.3 MODIFIED FOR A 9.5" CURB HEIGHT (PER SHEET 5). CONTRACTOR TO PROVIDE SHOP DRAWINGS THAT ARE SIGNED & SEALED BY A VIRGINIA REGISTERED STRUCTURAL ENGINEER.

- CONTRACTOR SHALL FURNISH AND INSTALL STREETLIGHT FOUNDATION AND LED TWIN CARLYLE FIXTURE ON 16' POLE PER ARLINGTON COUNTY LIGHTING STANDARDS. SERVICE DISCONNECTS AND CONNECTIONS TO BE COORDINATED WITH UTILITY PROVIDER. CONTACT ARLINGTON COUNTY DIVISION OF TRANSPORTATION AT 703-228-6570.
- RESTORE CONCRETE PAVEMENT AND/OR BRICK PAVERS AFTER UTILITY AND CONCRETE INSTALLATION.
- CONTRACTOR TO INSTALL MODIFIED CG-12 TYPE B PER VDOT ROAD AND BRIDGE STANDARDS
- BRICK BAND PER DETAIL ON SHEET 05
- INSTALL DOUBLE SIDED SOLAR RECTANGULAR RAPID FLASHING BEACON (RFB) WITH PUSH BUTTON AND PEDESTAL FOUNDATION PER ARLINGTON STANDARD (DWG. 66.04). SEE DETAIL ON SHEET T3.
- EXISTING FIRE HYDRANT TO REMAIN
- RELOCATE EXISTING BIKE RACK
- CONTRACTOR SHALL FURNISH AND INSTALL 1-2" DIAMETER ELECTRICAL CONDUIT, AND ELECTRICAL CONNECTION PER ARLINGTON COUNTY STREETLIGHT STANDARDS
- CONCRETE BUS PAD SHALL HAVE 2' 45" CORNERS
- ADJUST WATER METER ACCORDINGLY
- CONTRACTOR SHALL INSTALL NEW 2' WIDE CAST IN PLACE DETECTABLE WARNING SURFACE (REFER TO SHEETS 21A AND 21B FOR COLORS) - TO BE INSTALLED PER VDOT ROAD AND BRIDGE STANDARDS DRAWING AND ARLINGTON COUNTY SPECIFICATIONS.

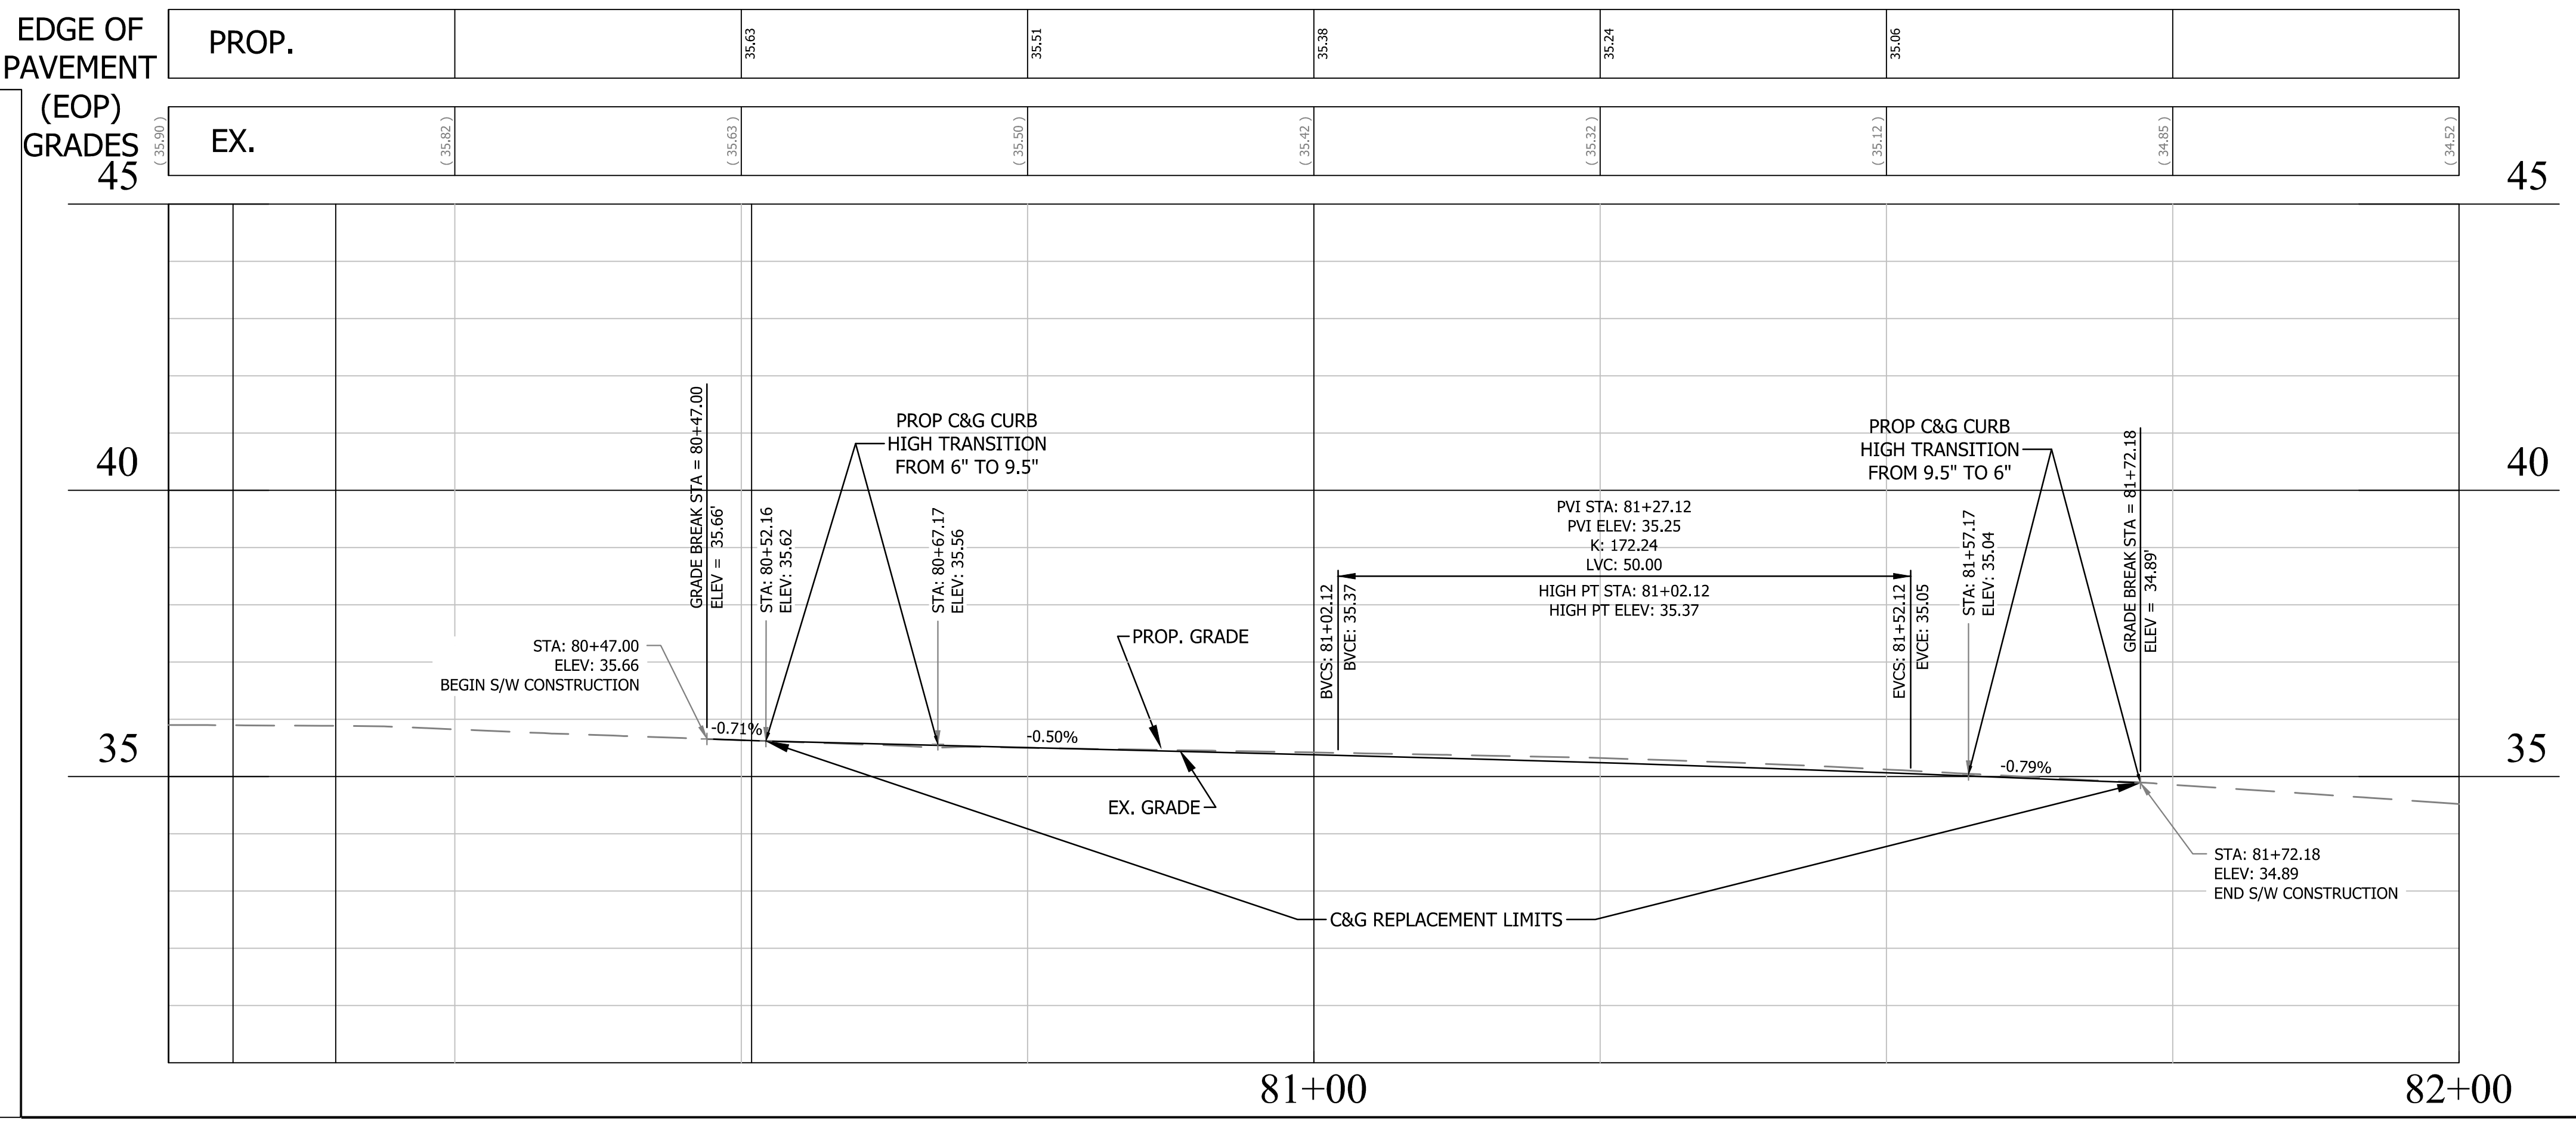


CRYSTAL DR NB & 15TH ST S INTERSECTION - EOP PROFILE

PROJECT NAME AND LOCATION
TRANSITWAY EXTENSION TO PENTAGON CITY
 SITE PLAN & PROFILE
CRYSTAL DR & 12TH ST S
 MA13 - SEGMENT 1

DESIGNED: PB
 DRAWN: NS
 CHECKED: TL
 MISS UTILITY TRANSMITTAL #: N/A


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PLOTTED: AUGUST 4 2021
 PLOTTED BY: NSHARP

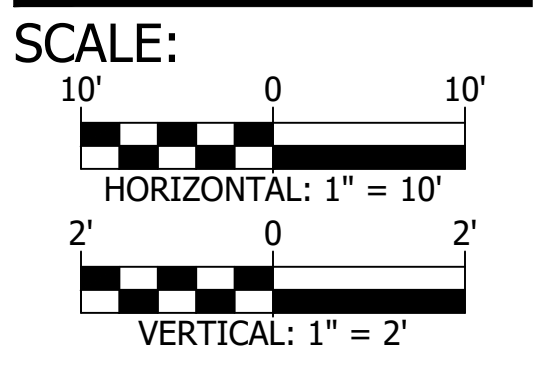


CONSTRUCTION NOTES:

- CAUTION: POTENTIAL UTILITY CONFLICT. CONTRACTOR TO FIELD VERIFY EXACT LOCATION AND DEPTH OF EXISTING UTILITY, SEE DEMOLITION PLAN FOR EX. TEST HOLES/PITS.
- USE OF LARGE EQUIPMENT (HOE RAMS, VIBRATORY ROLLERS, ETC.) SHALL NOT BE PERMITTED WITHIN 5 FEET OF UNDERGROUND STRUCTURES. ALL COMPACTION OPERATIONS OVER EXISTING UNDERGROUND STRUCTURE SHALL BE PERFORMED WITH APPROPRIATE SMALL VIBRATORY PLATES TO ELIMINATE ANY DAMAGES TO THE STRUCTURE.
- CONTRACTOR SHALL CONSTRUCT NEW BROOM FINISHED 4" THICK CONCRETE SIDEWALK, SCORED IN 6" X6" MODULE. SIDEWALK PAVEMENT SHALL COMPLY WITH ARL STD R-2.0 & R-2.1.
- CONTRACTOR TO INSTALL CG-12 TYPE A PER VDOT ROAD AND BRIDGE STANDARDS
- CONTRACTOR SHALL RESTORE FULL DEPTH SIDEWALK PAVEMENT WITH SALVAGED BRICKS ON FLEXIBLE AGGREGATE BASE AND MATCH EXISTING MATERIAL, COLOR, PATTERN AND PROPOSED GRADE. SEE PROPOSED RAMP DETAILS & STREET CROSS SECTIONS SHEET. SIDEWALK PAVEMENT RESTORATION SHALL COMPLY WITH ARL STD R-2.1.
- CONTRACTOR SHALL INSTALL NEW 2" WIDE DETECTABLE WARNING SURFACE ON TOP OF RIGID CONCRETE BASE TO COMPLY WITH STANDARD CONCRETE SIDEWALK RAMP CG-12 TYPE A PER VDOT ROAD AND BRIDGE STANDARDS DRAWING.
- CONTRACTOR SHALL CONSTRUCT NEW C-2 CURB & GUTTER PER ARL STD R-2.0 WITH MODIFIED 6" TO 9.5" HIGH CURB TRANSITION AND 10" THICK GUTTER. SEE EOP PROFILE AND DETAILS ON SHEET 05.
- CONTRACTOR SHALL CONSTRUCT NEW C-2 CURB & GUTTER PER ARL STD R-2.0 WITH MODIFIED 9.5" HIGH CURB, 10" THICK GUTTER AND RUB RAIL. SEE EOP PROFILE AND DETAILS ON SHEET 5.
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- CONTRACTOR SHALL INSTALL FULL DEPTH ASPHALT ROAD PAVEMENT. PER ARLINGTON COUNTY NOTES ON DETAIL R-1.4. FOR ASPHALT PAVEMENT LAYERS SEE TYPICAL STREET CROSS SECTIONS SHEET.
- CONTRACTOR SHALL CONSTRUCT 6" CONCRETE BUS SHELTER PAD. SEE DETAIL ON SHEET 5.
- REFER TO SHEETS 21A AND 21B FOR STATION DETAILS, FURNISHINGS AND LAYOUT.
- PROP. MILL AND OVERLAY
- CONTRACTOR SHALL CONSTRUCT NEW C-2 CURB & GUTTER PER ARL STD R-2.0
- CONTRACTOR TO INSTALL CB-2A CATCH BASIN 9' LENGTH FOR SAGS PER ARL STD D-1.3 MODIFIED FOR A 9.5" CURB HEIGHT (PER SHEET 5). CONTRACTOR TO PROVIDE SHOP DRAWINGS THAT ARE SIGNED & SEALED BY A VIRGINIA REGISTERED STRUCTURAL ENGINEER.
- CONTRACTOR SHALL FURNISH AND INSTALL STREETLIGHT FOUNDATION AND LED TWIN CARLYLE FIXTURE ON 16' POLE PER ARLINGTON COUNTY LIGHTING STANDARDS. SERVICE DISCONNECTS AND CONNECTIONS TO BE COORDINATED WITH UTILITY PROVIDER. CONTACT ARLINGTON COUNTY DIVISION OF TRANSPORTATION AT 703-228-6570.
- RESTORE CONCRETE PAVEMENT AND/OR BRICK PAVERS AFTER UTILITY AND CONCRETE INSTALLATION.
- CONTRACTOR TO INSTALL MODIFIED CG-12 TYPE B PER VDOT ROAD AND BRIDGE STANDARDS
- BRICK BAND PER DETAIL ON SHEET 05
- INSTALL DOUBLE SIDED SOLAR RECTANGULAR RAPID FLASHING BEACON (RFB) WITH PUSH BUTTON AND PEDESTRIAN WARNING SIGNS (SPEC. 83-01). INSTALL PEDESTAL FOUNDATION PER ARLINGTON STANDARD (DWG. 66.04). SEE DETAIL ON SHEET T3.
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- RELOCATE EXISTING BIKE RACK
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12TH ST S WB & LONG BRIDGE DR INTERSECTION - STATION PLAN

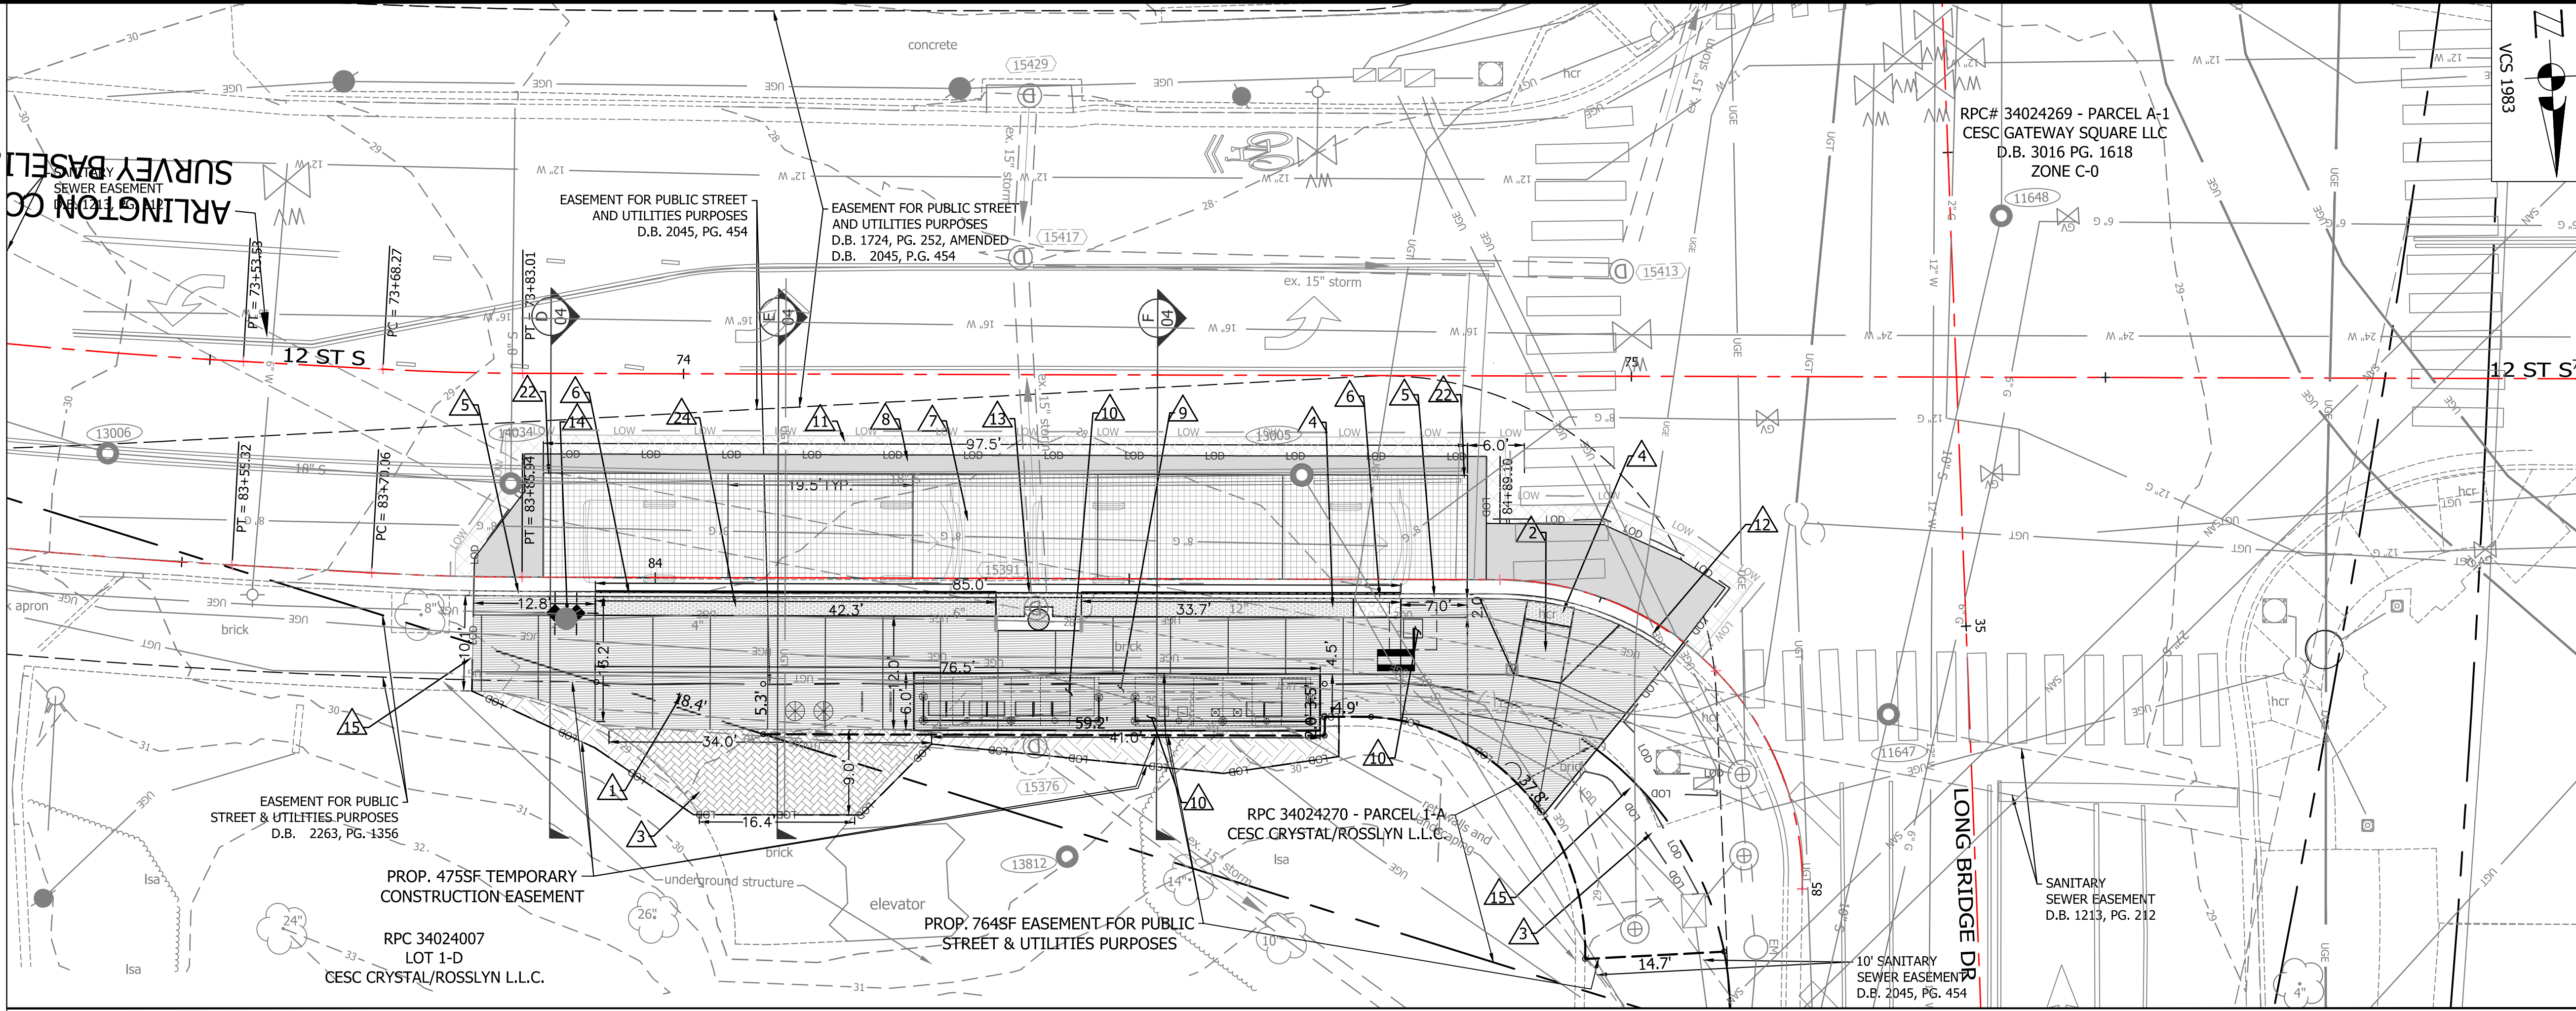

12TH ST S WB & LONG BRIDGE DR INTERSECTION - EOP PROFILE

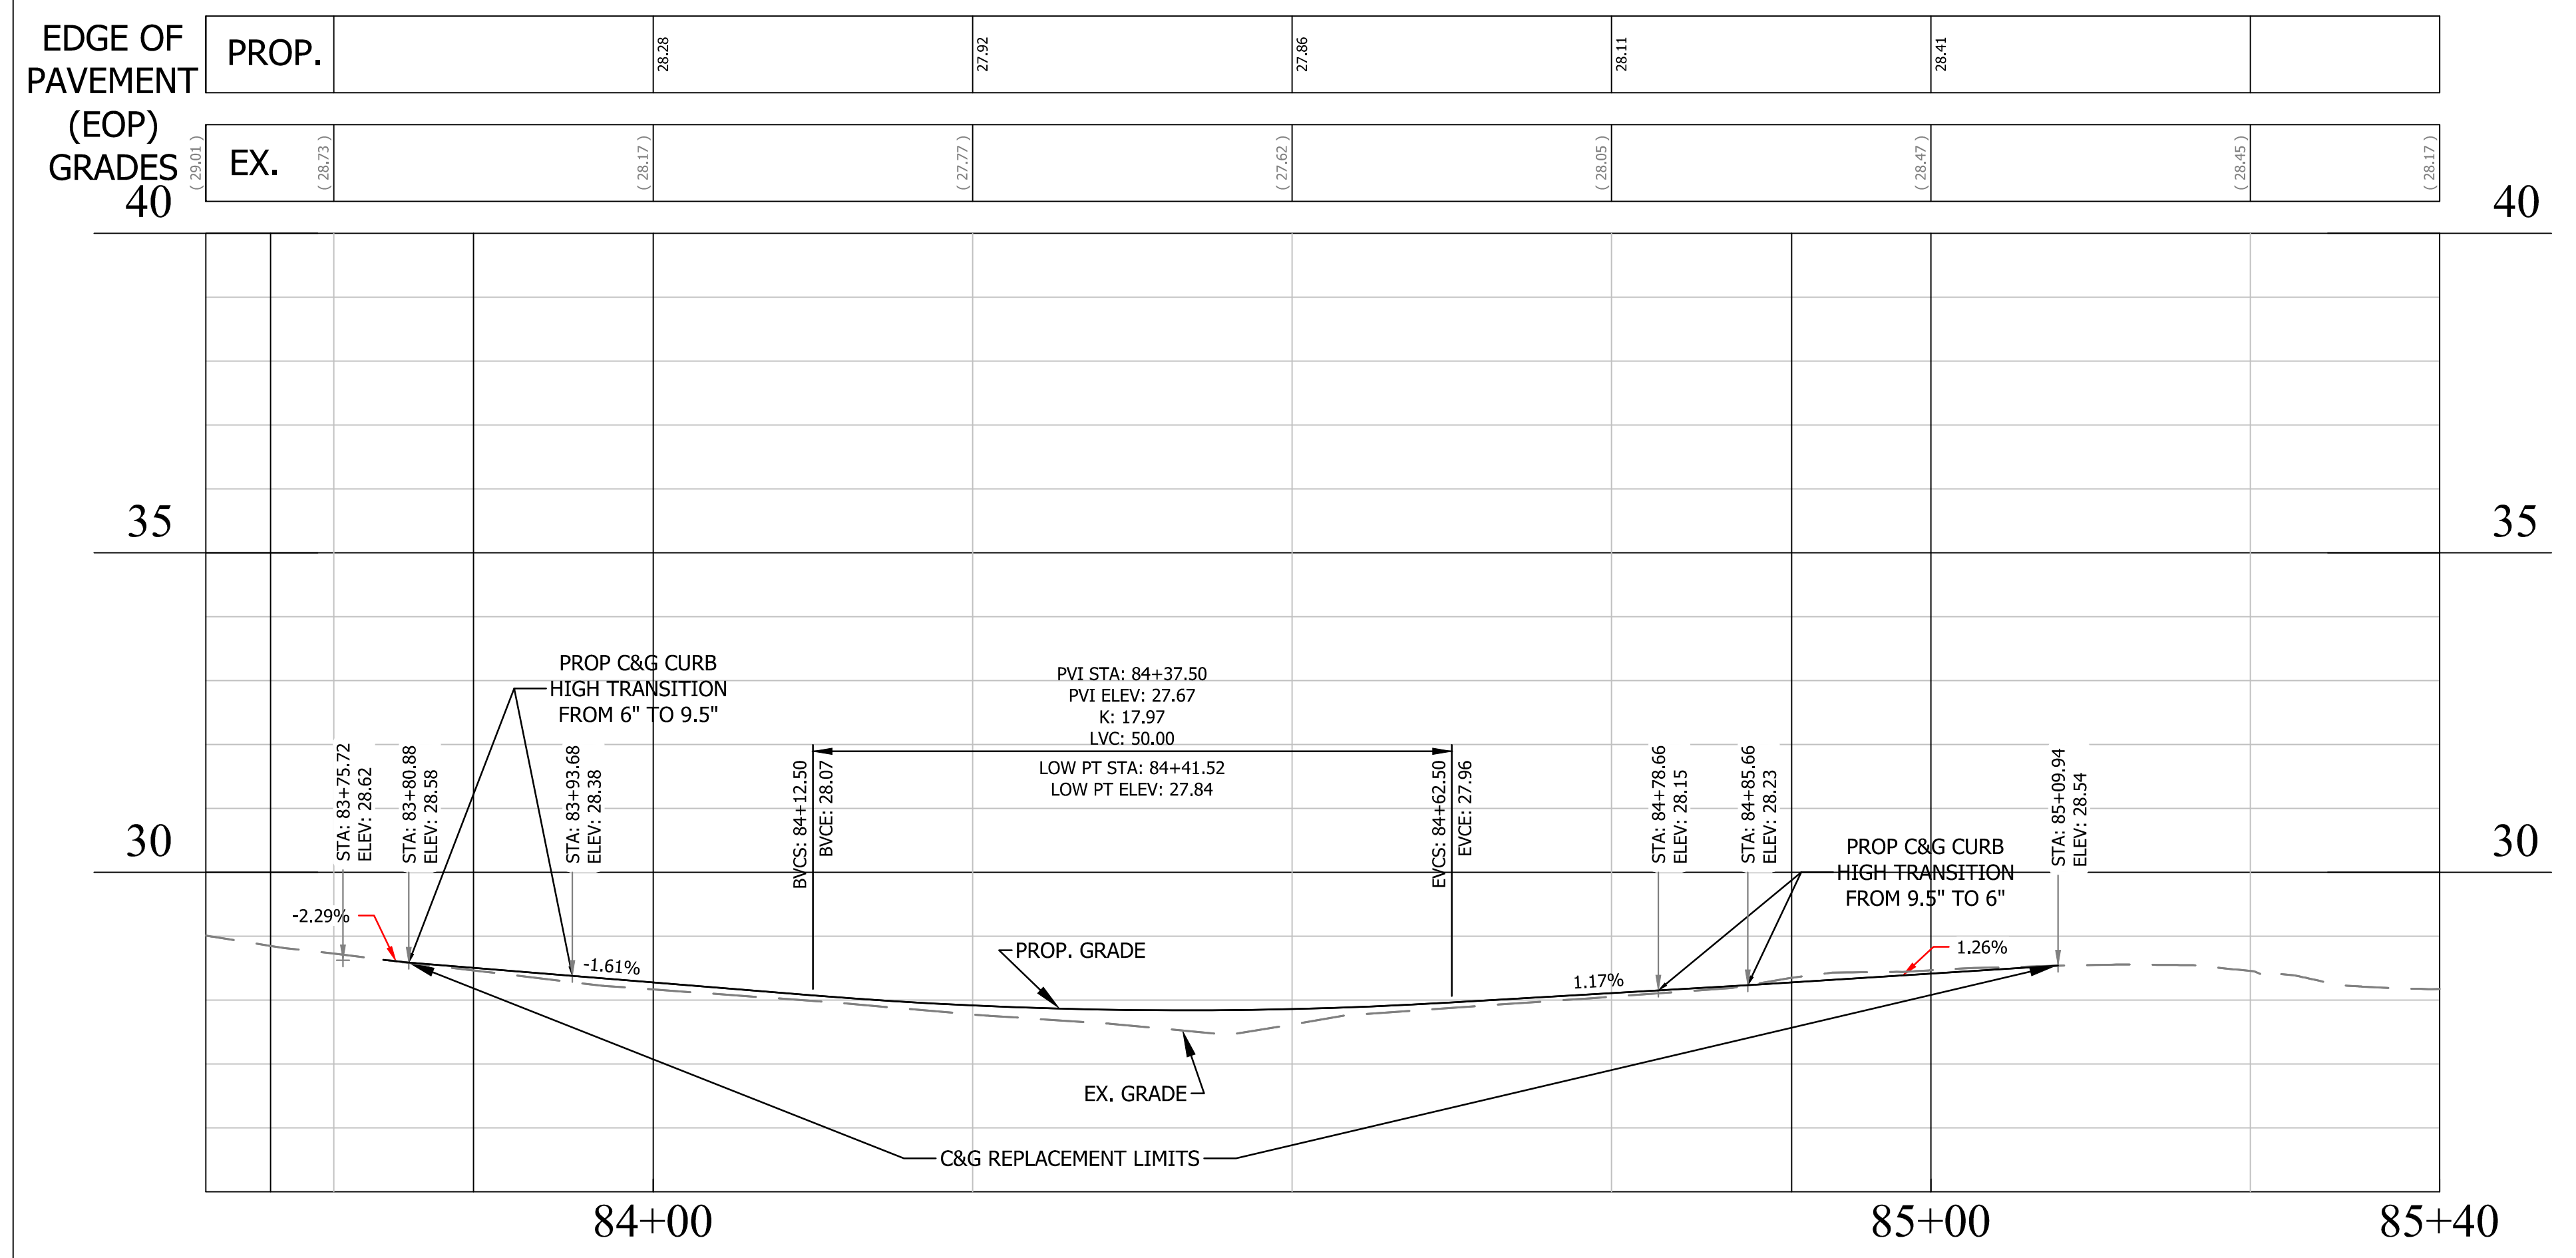

APPROVALS	DATE
<i>[Signature]</i> QUALITY CONTROL ENGINEER	3/29/21
<i>[Signature]</i> Kamal Takat CONSTRUCTION MANAGEMENT SUPERVISOR	3.24.21
<i>[Signature]</i> Dennis M. Leach WATER, SEWER, STREETS BUREAU CHIEF	03.04.2021
<i>[Signature]</i> TRANSPORTATION DIRECTOR	03/17/21
<i>[Signature]</i> PROJECT MANAGER	3/2/21

REVISIONS	DATE

PROJECT NAME AND LOCATION
TRANSITWAY EXTENSION TO PENTAGON CITY


SITE PLAN & PROFILE
CRYSTAL DR & 12TH ST S

MA13 - SEGMENT 1


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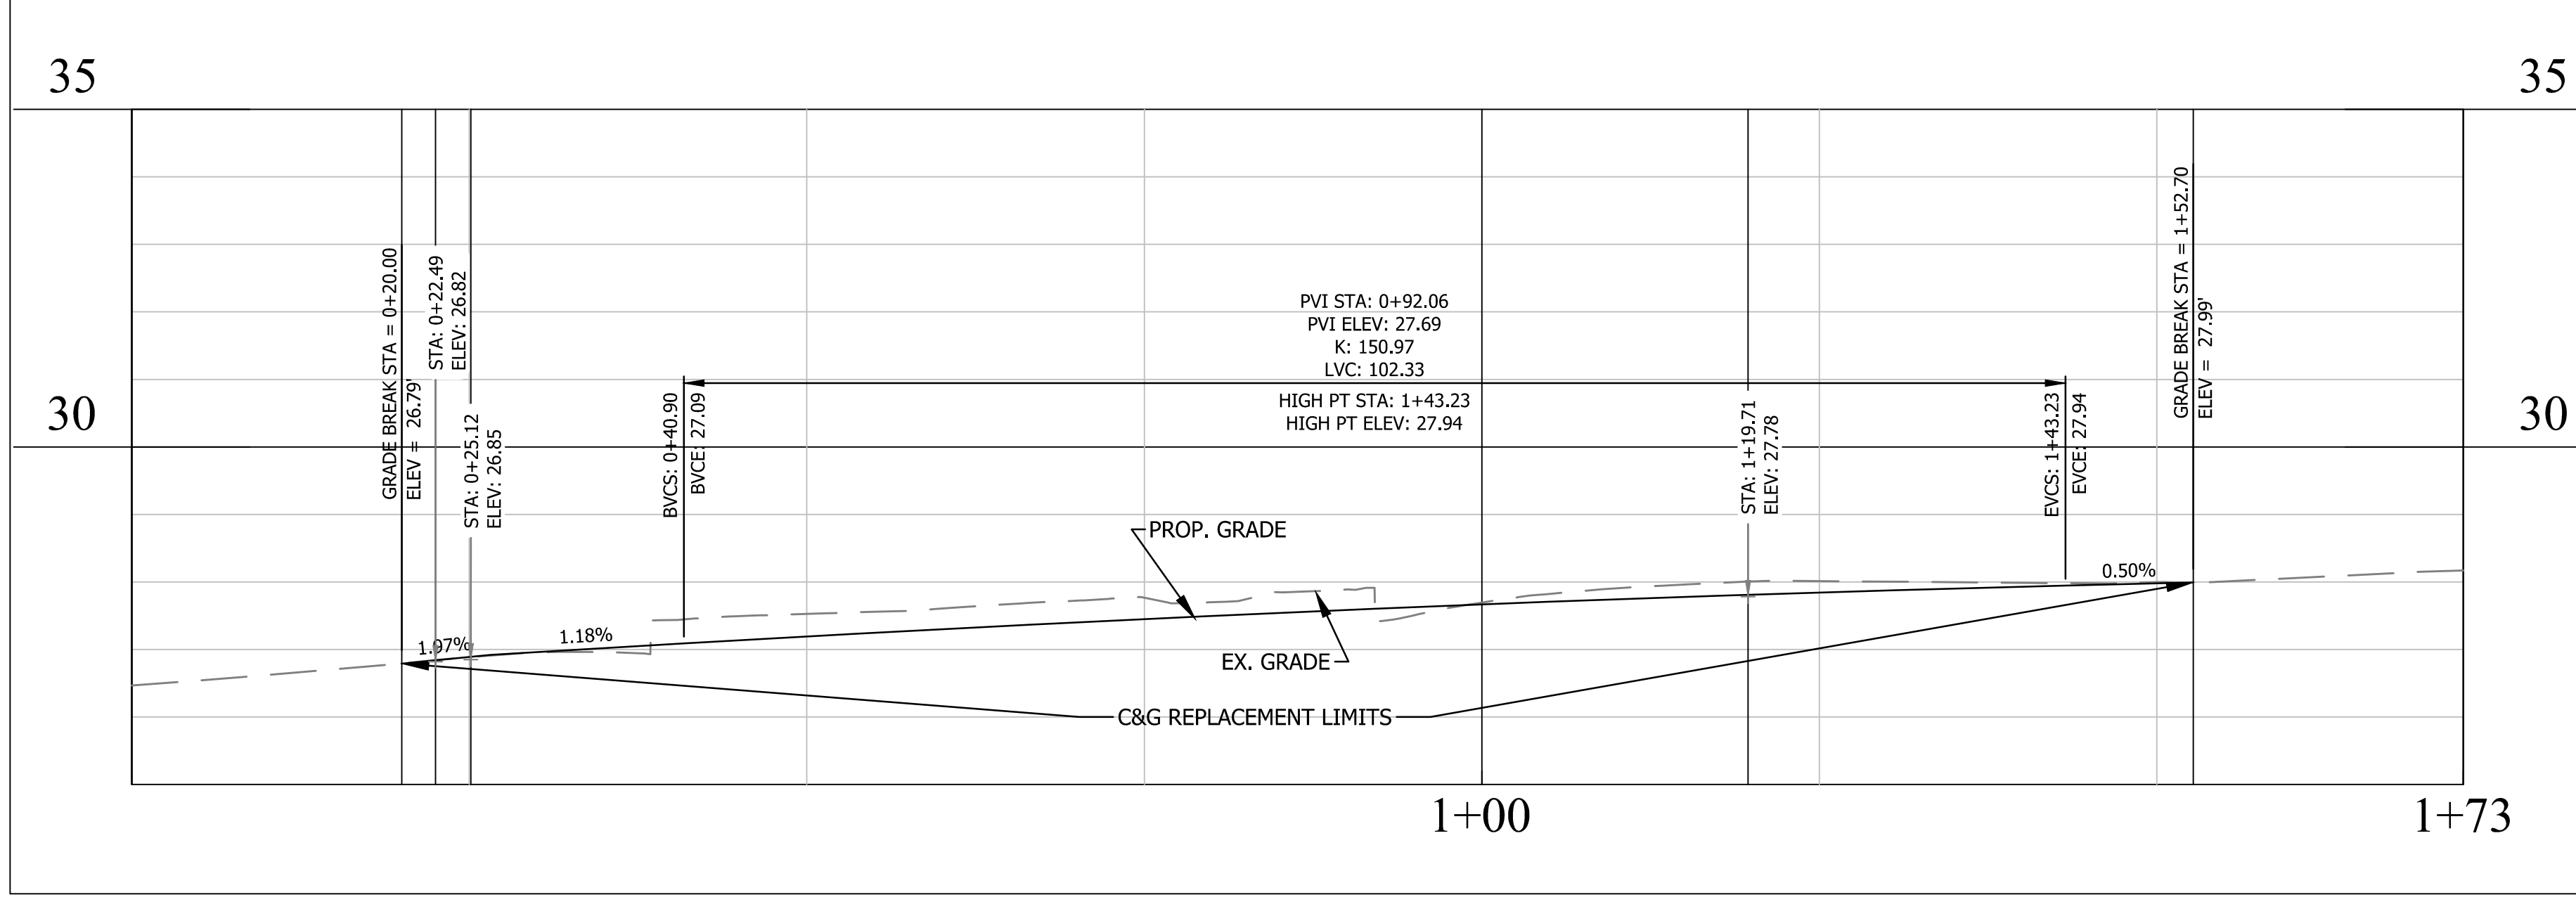
PLOTTED: AUGUST 4 2021
 PLOTTED BY: NSHARP



- CONSTRUCTION NOTES:**
- CAUTION: POTENTIAL UTILITY CONFLICT. CONTRACTOR TO FIELD VERIFY EXACT LOCATION AND DEPTH OF EXISTING UTILITY, SEE DEMOLITION PLAN FOR EX. TEST HOLES/PITS.
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CRYSTAL DR NB & 12TH ST S TRANSITION PLAN

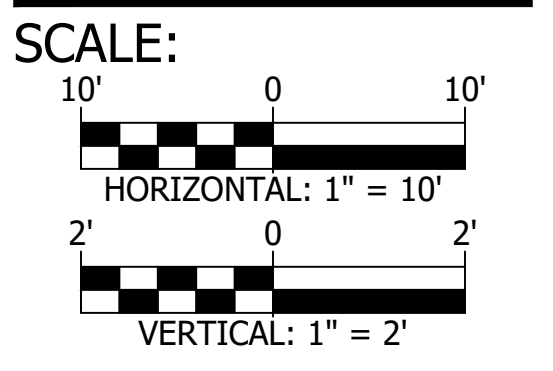

CRYSTAL DR NB & 12TH ST S TRANSITION PLAN - EOP LEFT PROFILE

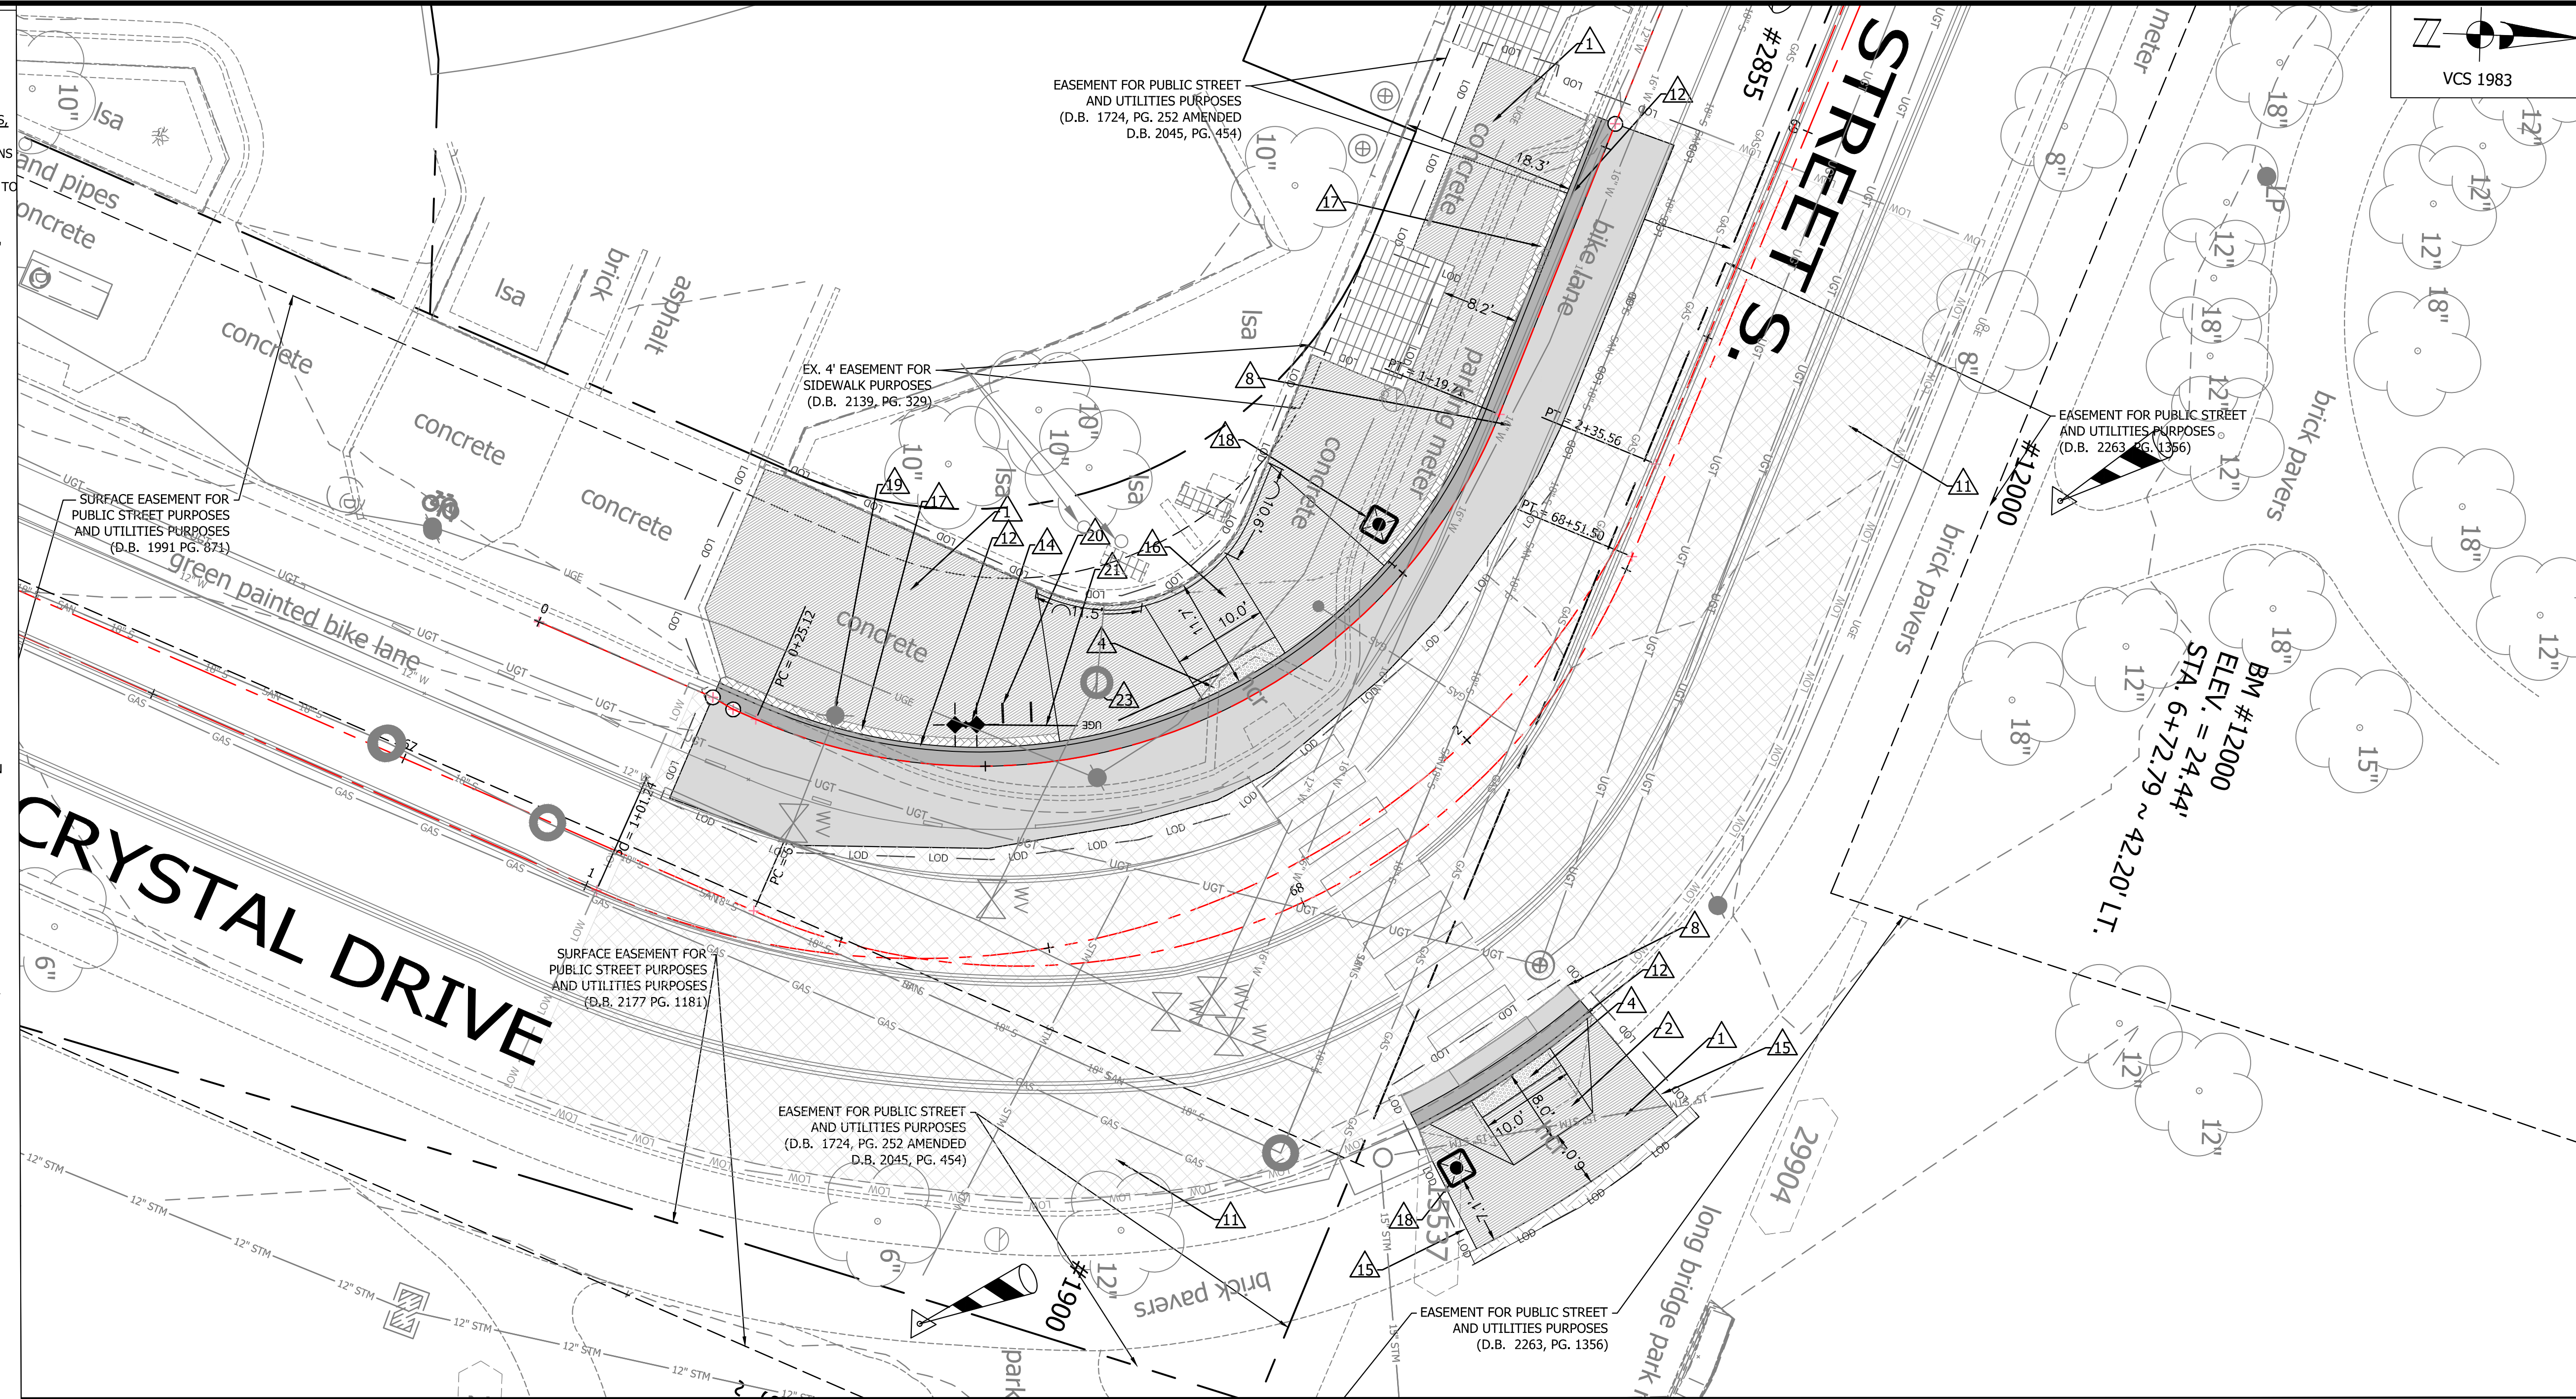



APPROVALS	DATE
<i>Kamell</i>	3/29/21
QUALITY CONTROL ENGINEER <i>Kamal Takat</i>	3.24.21
CONSTRUCTION MANAGEMENT SUPERVISOR <i>John</i>	03.04.2021
WATER, SEWER, STREETS BUREAU CHIEF <i>Dennis M. Leach</i>	03/17/21
TRANSPORTATION DIRECTOR <i>Diana Izzo</i>	3/2/21
PROJECT MANAGER	

REVISIONS	DATE


PROJECT NAME AND LOCATION
TRANSITWAY EXTENSION TO PENTAGON CITY
SITE PLAN & PROFILE
CRYSTAL DR & 12TH ST S
 MA13 - SEGMENT 1

DESIGNED: PB
 DRAWN: NS
 CHECKED: TL
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 PLOTTED: AUGUST 4 2021
 PLOTTED BY: NSHARP

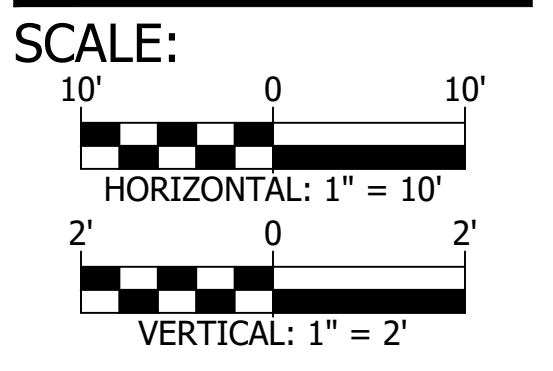

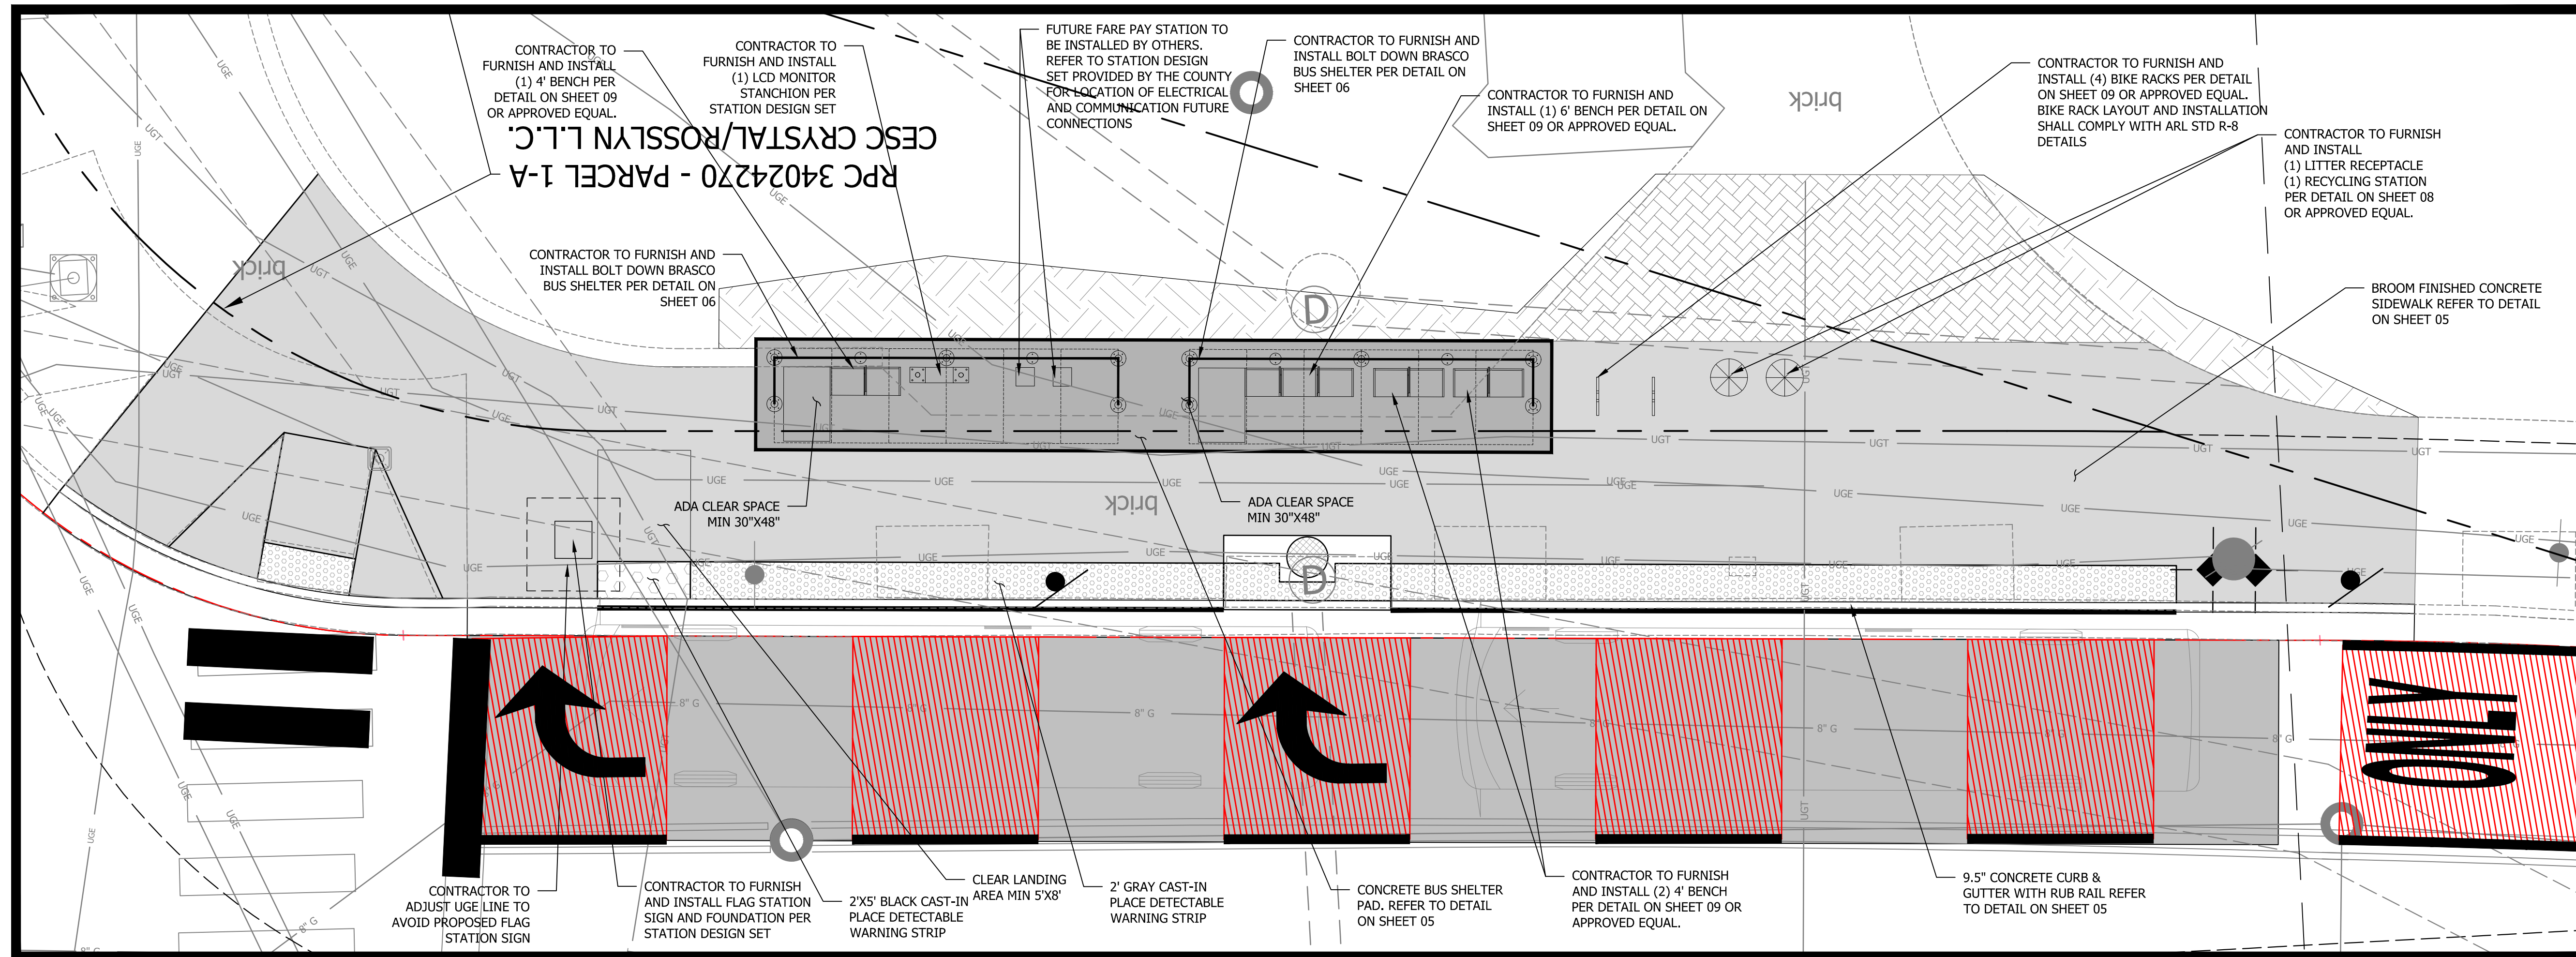

NOTES VIEW

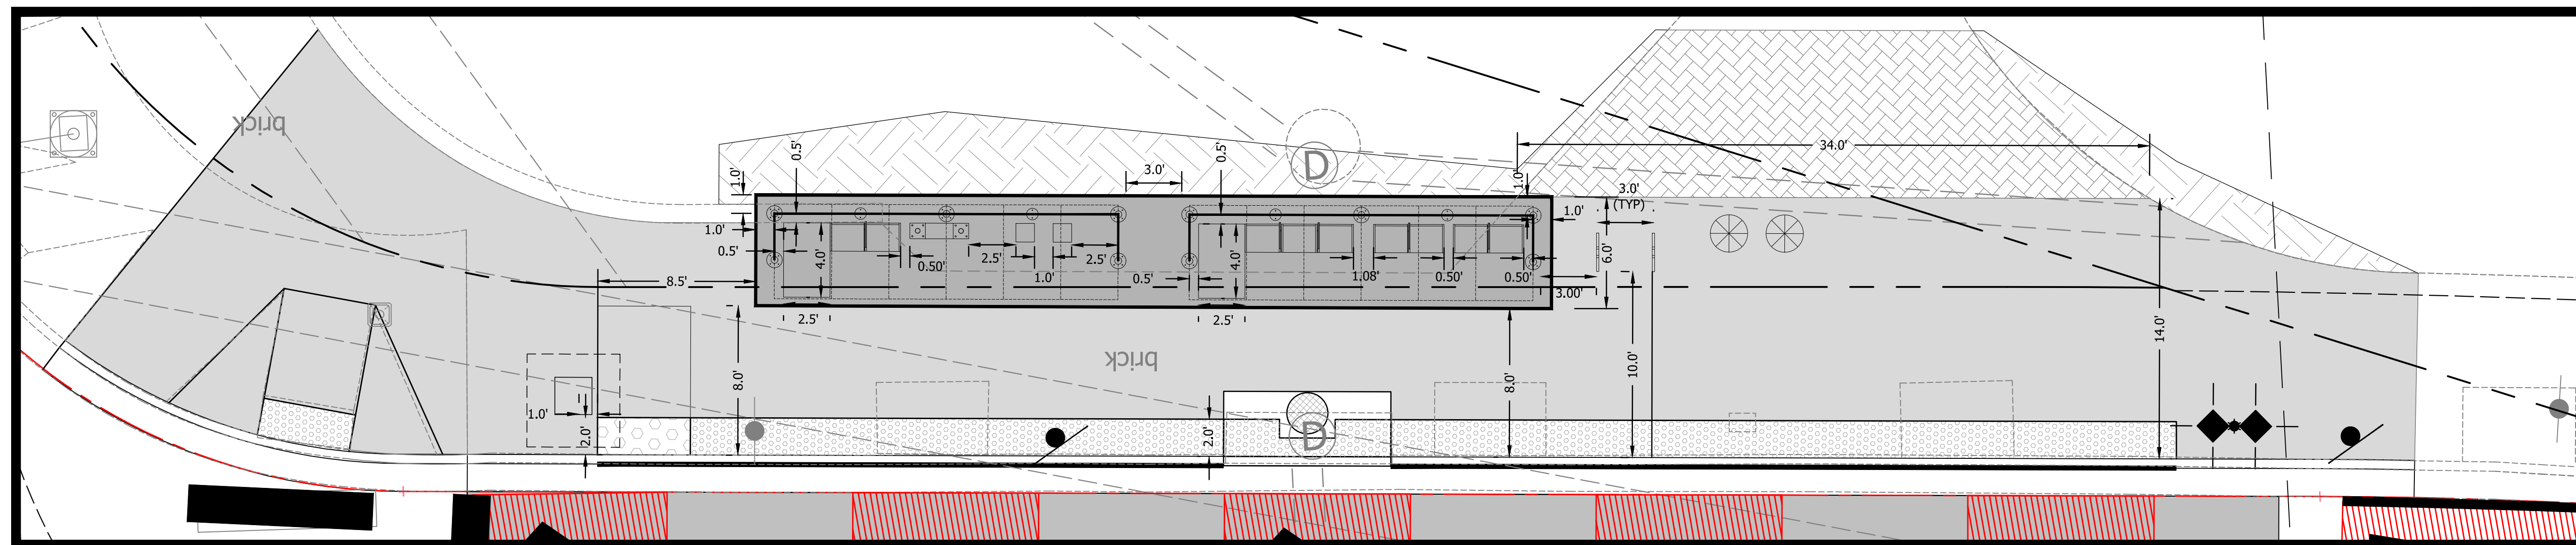

GEOMETRIC VIEW

- NOTES:
1. FLAG STATION SIGN AND LCD MONITOR DETAILS WILL NOT BE INCLUDED ON THESE PLANS. ARLINGTON COUNTY SHALL PROVIDE SIGNED AND SEALED BUILDING PLANS TO THE CONTRACTOR FOR CONSTRUCTION.
 2. CONTRACTOR TO CONFIRM LOCATION OF ALL STATION FURNISHINGS WITH ARLINGTON COUNTY PRIOR TO INSTALLATION.

12TH ST & LONG BRIDGE DR STATION LAYOUT
215 12TH ST S 1"=5'





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<i>[Signature]</i> QUALITY CONTROL ENGINEER	3/29/21
<i>[Signature]</i> QUALITY CONTROL ENGINEER	3.24.21
<i>[Signature]</i> CONSTRUCTION MANAGEMENT SUPERVISOR	03.04.2021
<i>[Signature]</i> WATER, SEWER, STREETS BUREAU CHIEF	03/17/21
<i>[Signature]</i> TRANSPORTATION DIRECTOR	3/2/21
<i>[Signature]</i> PROJECT MANAGER	

REVISIONS	DATE

PROJECT NAME AND LOCATION
TRANSITWAY EXTENSION TO PENTAGON CITY
STATION DETAIL
CRYSTAL DR & 12TH ST S
MA13 - SEGMENT I

DESIGNED: PB
DRAWN: NS
CHECKED: TL
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PLOTTED: AUGUST 4 2021
PLOTTED BY: NSHARP

SCALE:
AS SHOWN

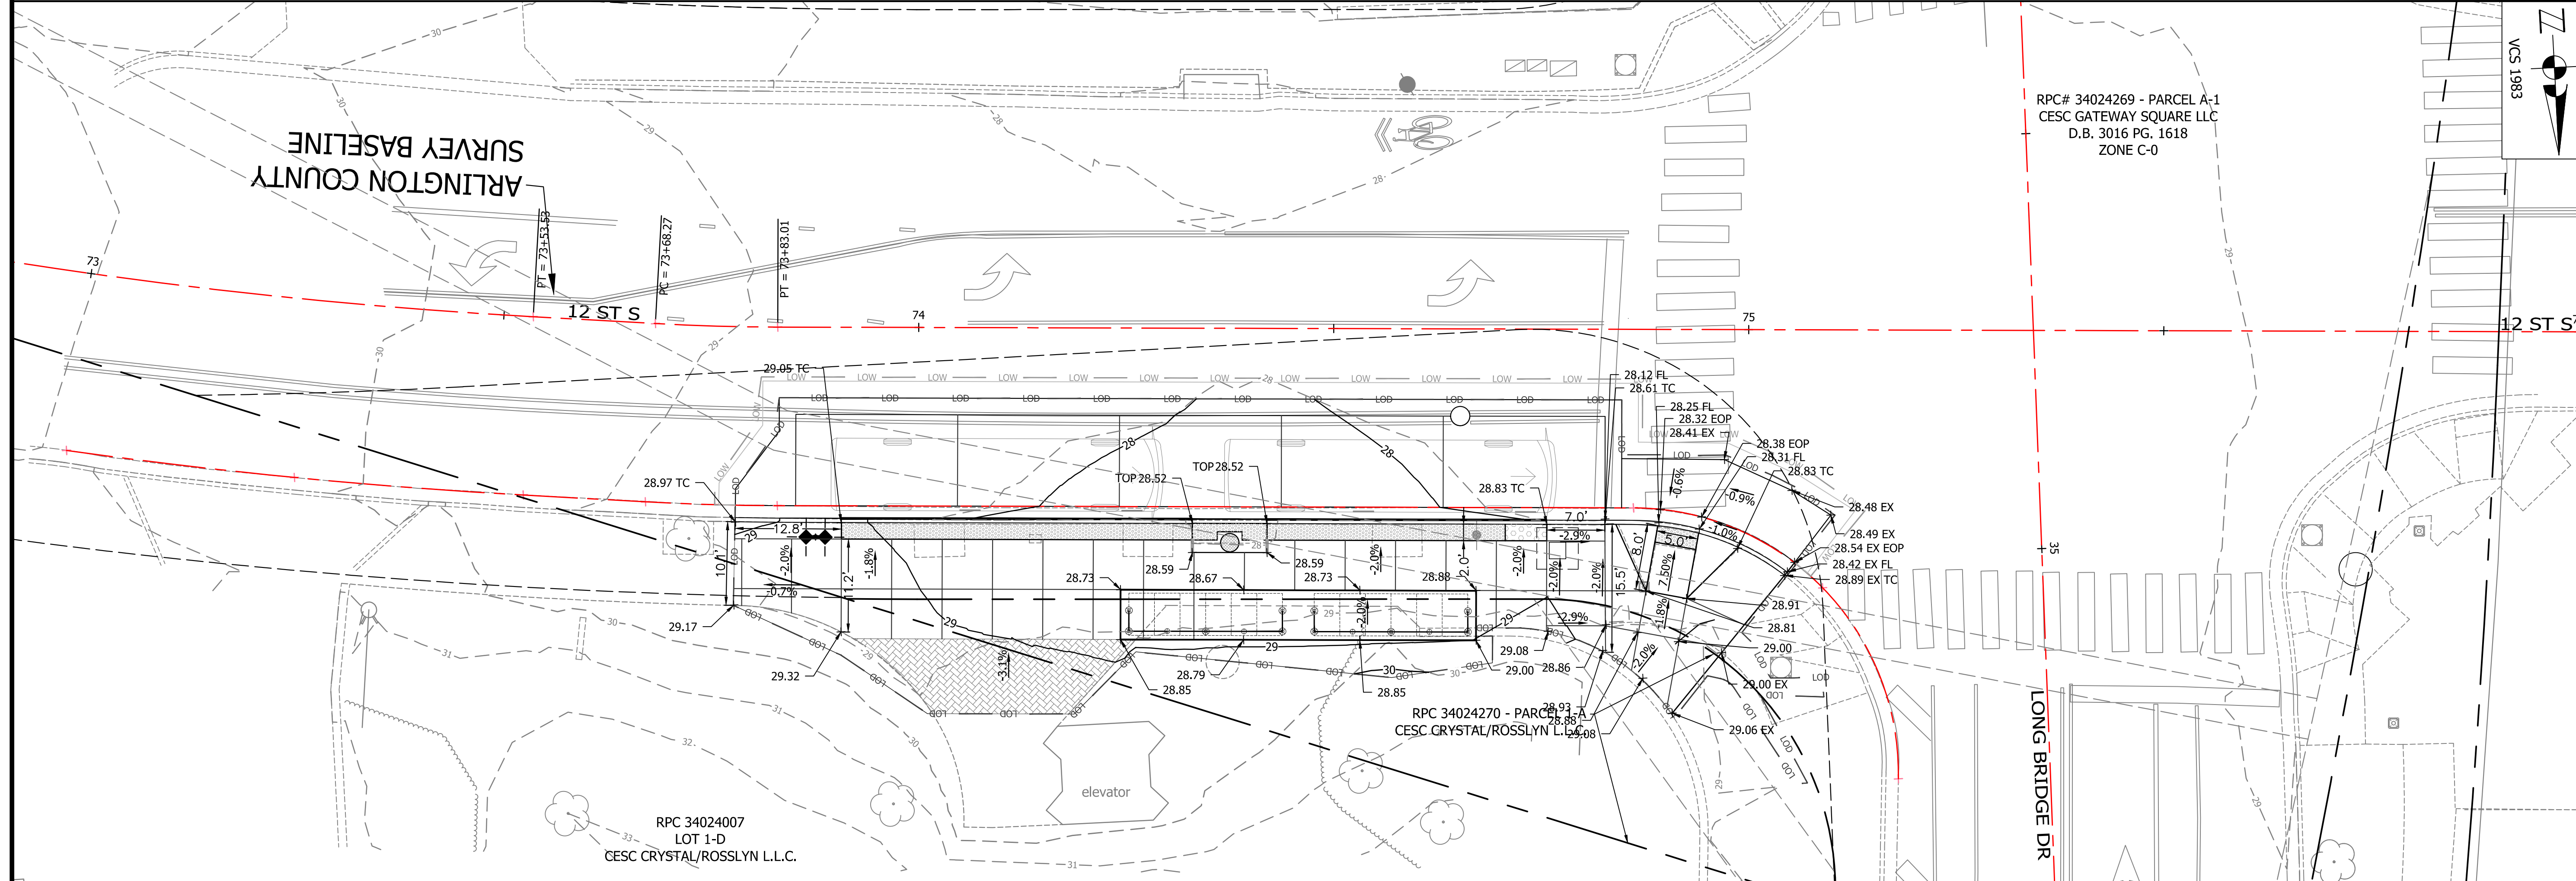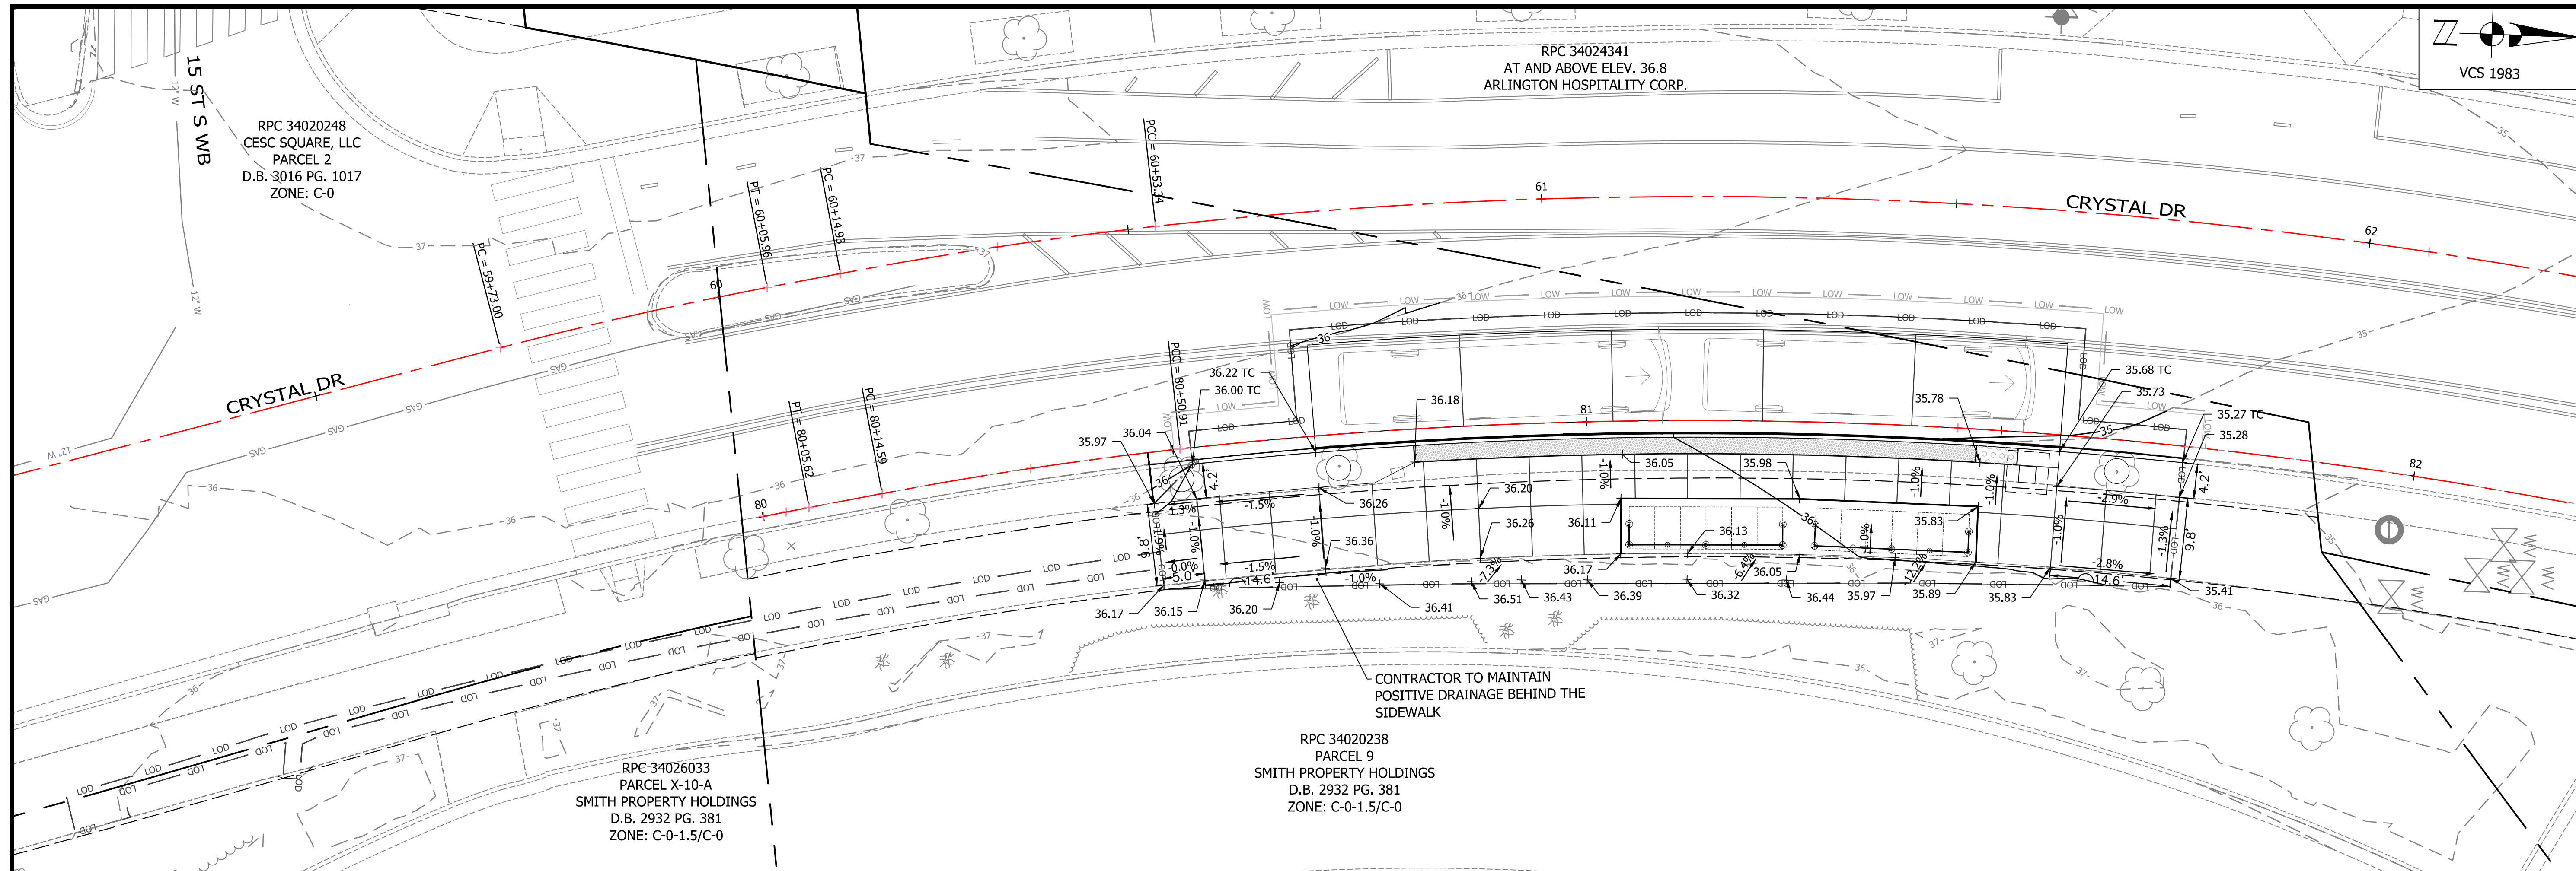

ARLINGTON VIRGINIA

DEPARTMENT OF ENVIRONMENTAL SERVICES
 FACILITIES & ENGINEERING DIVISION
 ENGINEERING BUREAU
 2100 CLARENDON BOULEVARD, SUITE 813
 ARLINGTON, VA 22201
 PHONE: 703.228.3629
 FAX: 703.228.3606

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SEAL
 COMMONWEALTH OF VIRGINIA
 TREVOR M. LANTZY
 Lic. No. 0402050508
 8/4/2021
 PROFESSIONAL ENGINEER

APPROVALS	DATE
<i>[Signature]</i>	3/29/21
QUALITY CONTROL ENGINEER <i>Ramal Takar</i>	3.24.21
CONSTRUCTION MANAGEMENT SUPERVISOR <i>[Signature]</i>	03.04.2021
WATER, SEWER, STREETS BUREAU CHIEF <i>Dennis M. Leach</i>	03/17/21
TRANSPORTATION DIRECTOR <i>[Signature]</i>	3/2/21
PROJECT MANAGER <i>[Signature]</i>	

REVISIONS	DATE


PROJECT NAME AND LOCATION
TRANSITWAY EXTENSION TO PENTAGON CITY
RAMP DETAILS - GRADING PLAN
CRYSTAL DR & 12TH ST S
 MA13 - SEGMENT 1

DESIGNED: PB
 DRAWN: NS
 CHECKED: TL
 MISS UTILITY TRANSMITTAL #: N/A

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PLOTTED: AUGUST 4 2021
 PLOTTED BY: NSHARP



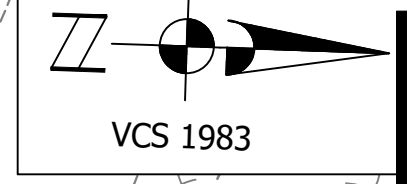

APPROVALS	DATE
<i>[Signature]</i> QUALITY CONTROL ENGINEER	3/29/21
<i>[Signature]</i> CONSTRUCTION MANAGEMENT SUPERVISOR	3.24.21
<i>[Signature]</i> WATER, SEWER, STREETS BUREAU CHIEF	03.04.2021
<i>[Signature]</i> TRANSPORTATION DIRECTOR	03/17/21
<i>[Signature]</i> PROJECT MANAGER	3/2/21

REVISIONS	DATE

PROJECT NAME AND LOCATION
TRANSITWAY EXTENSION TO PENTAGON CITY



RAMP DETAILS - GRADING PLAN
CRYSTAL DR & 12TH ST S

MA13 - SEGMENT 1

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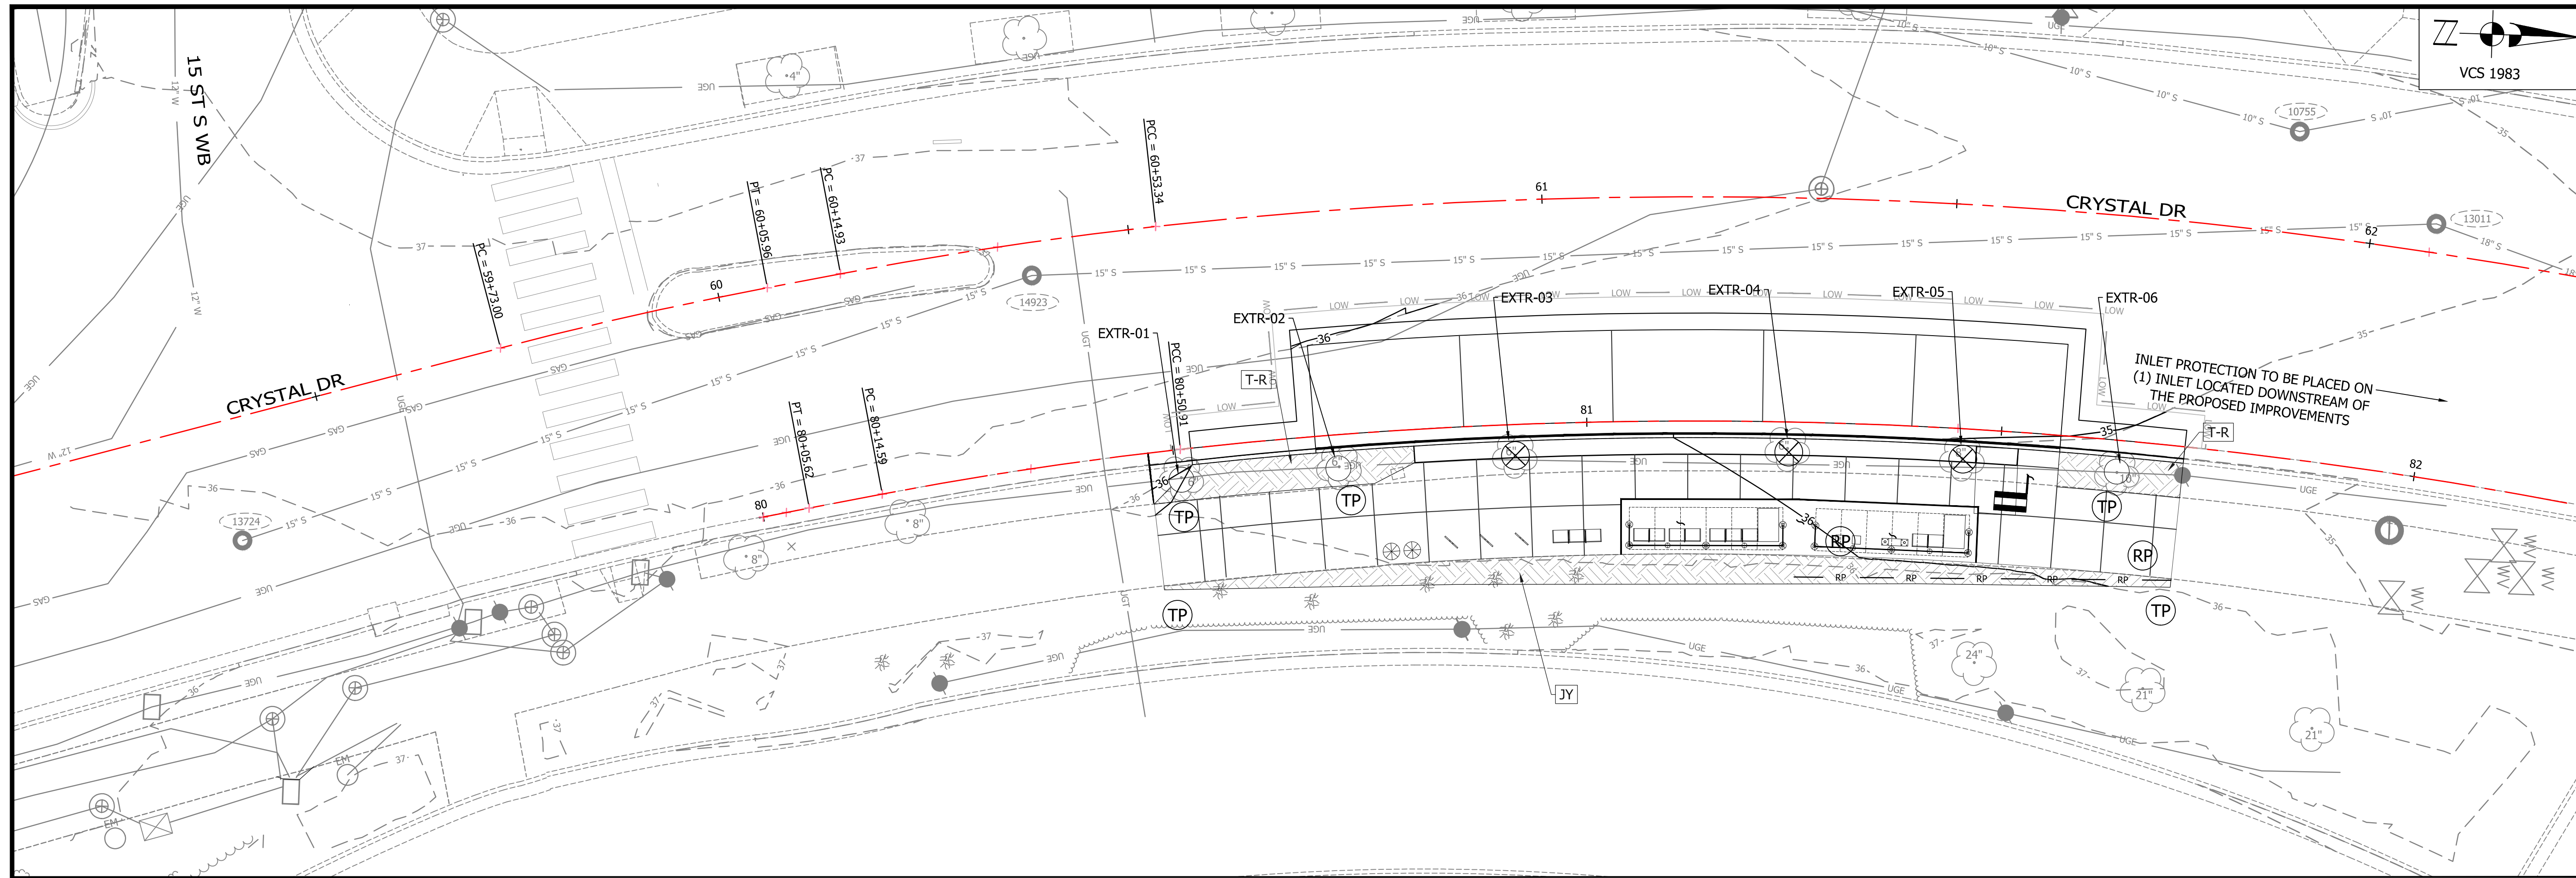
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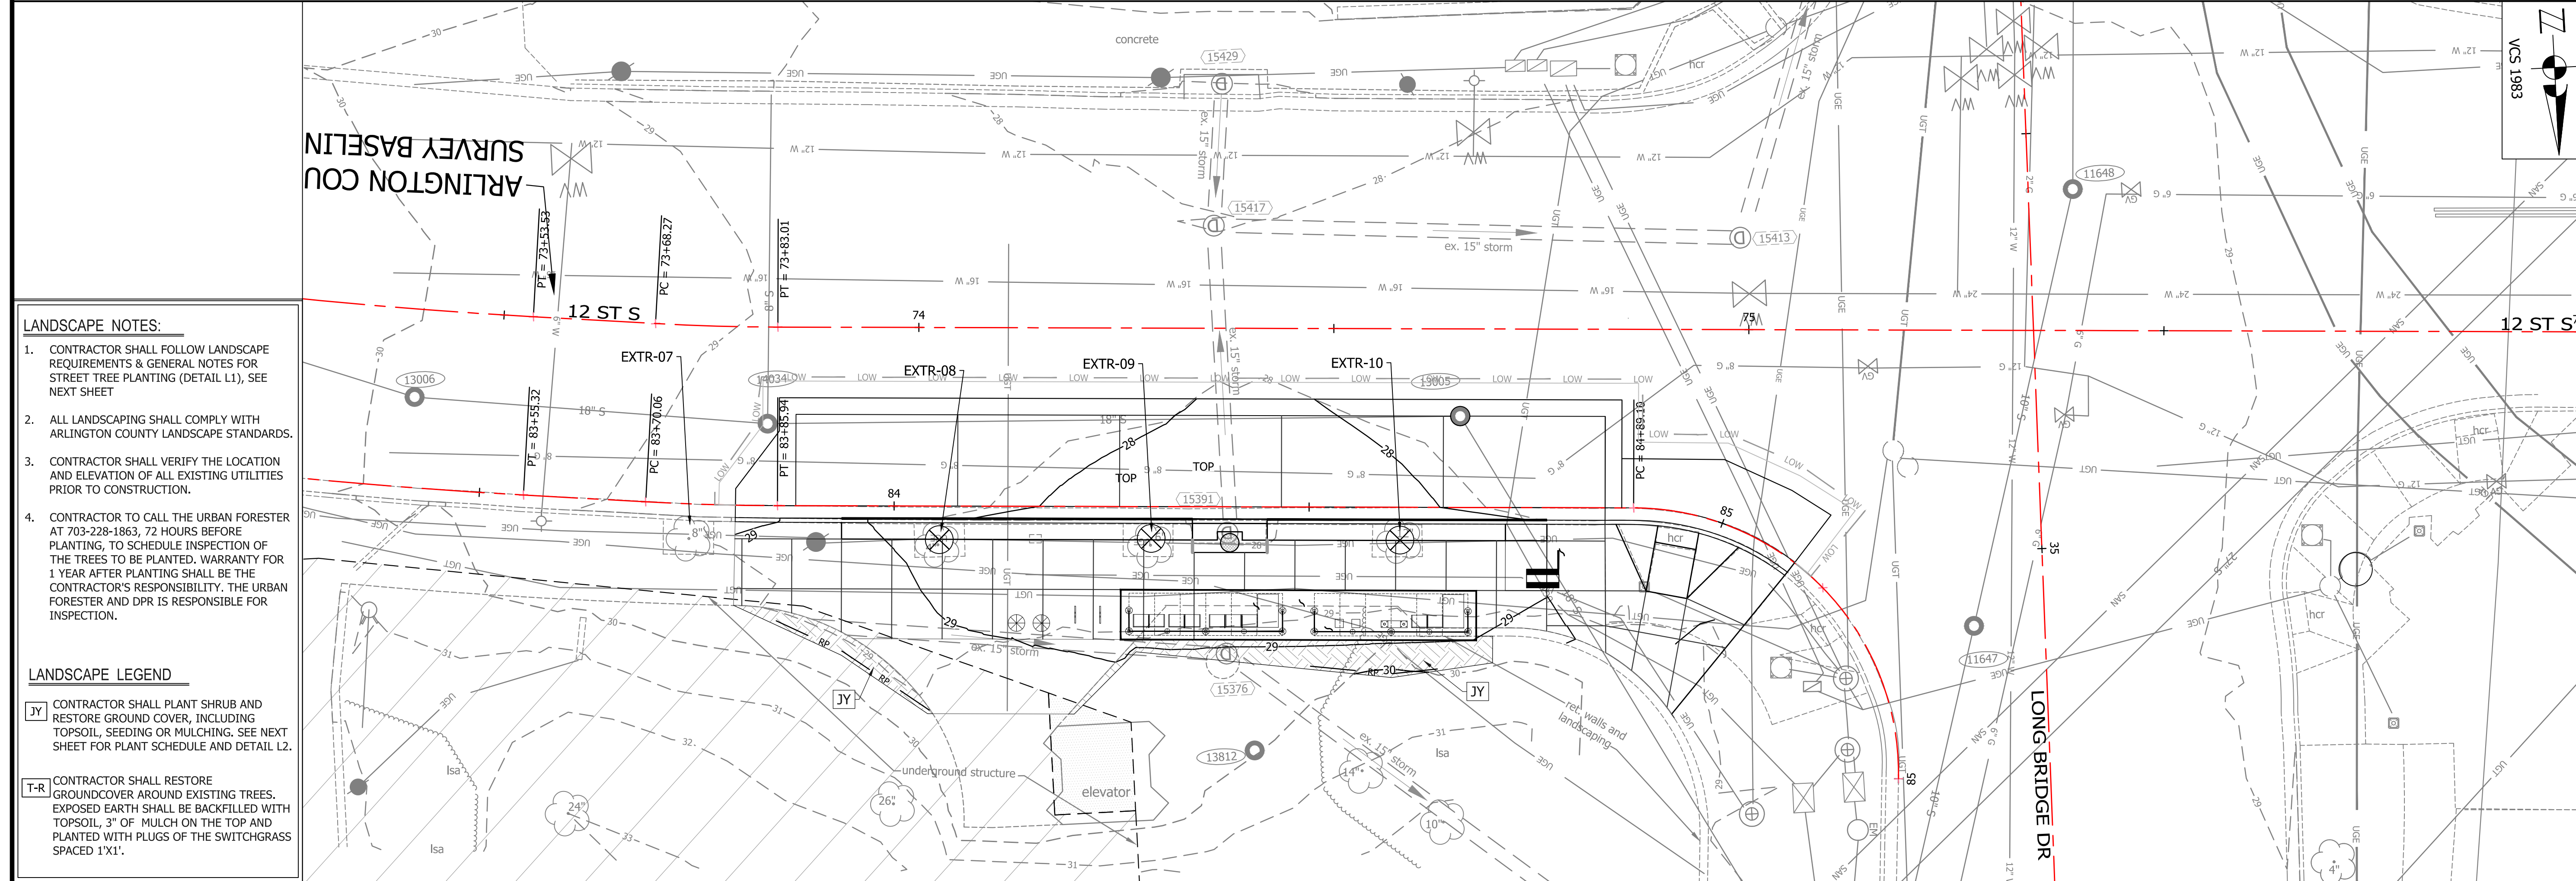


CRYSTAL DR & 12TH STREET S TRANSITION

NOTE: SEE SHEETS 20 & 21A FOR EOP PROFILE, SEE SHEETS 26 - 29A FOR CROSS SECTIONS

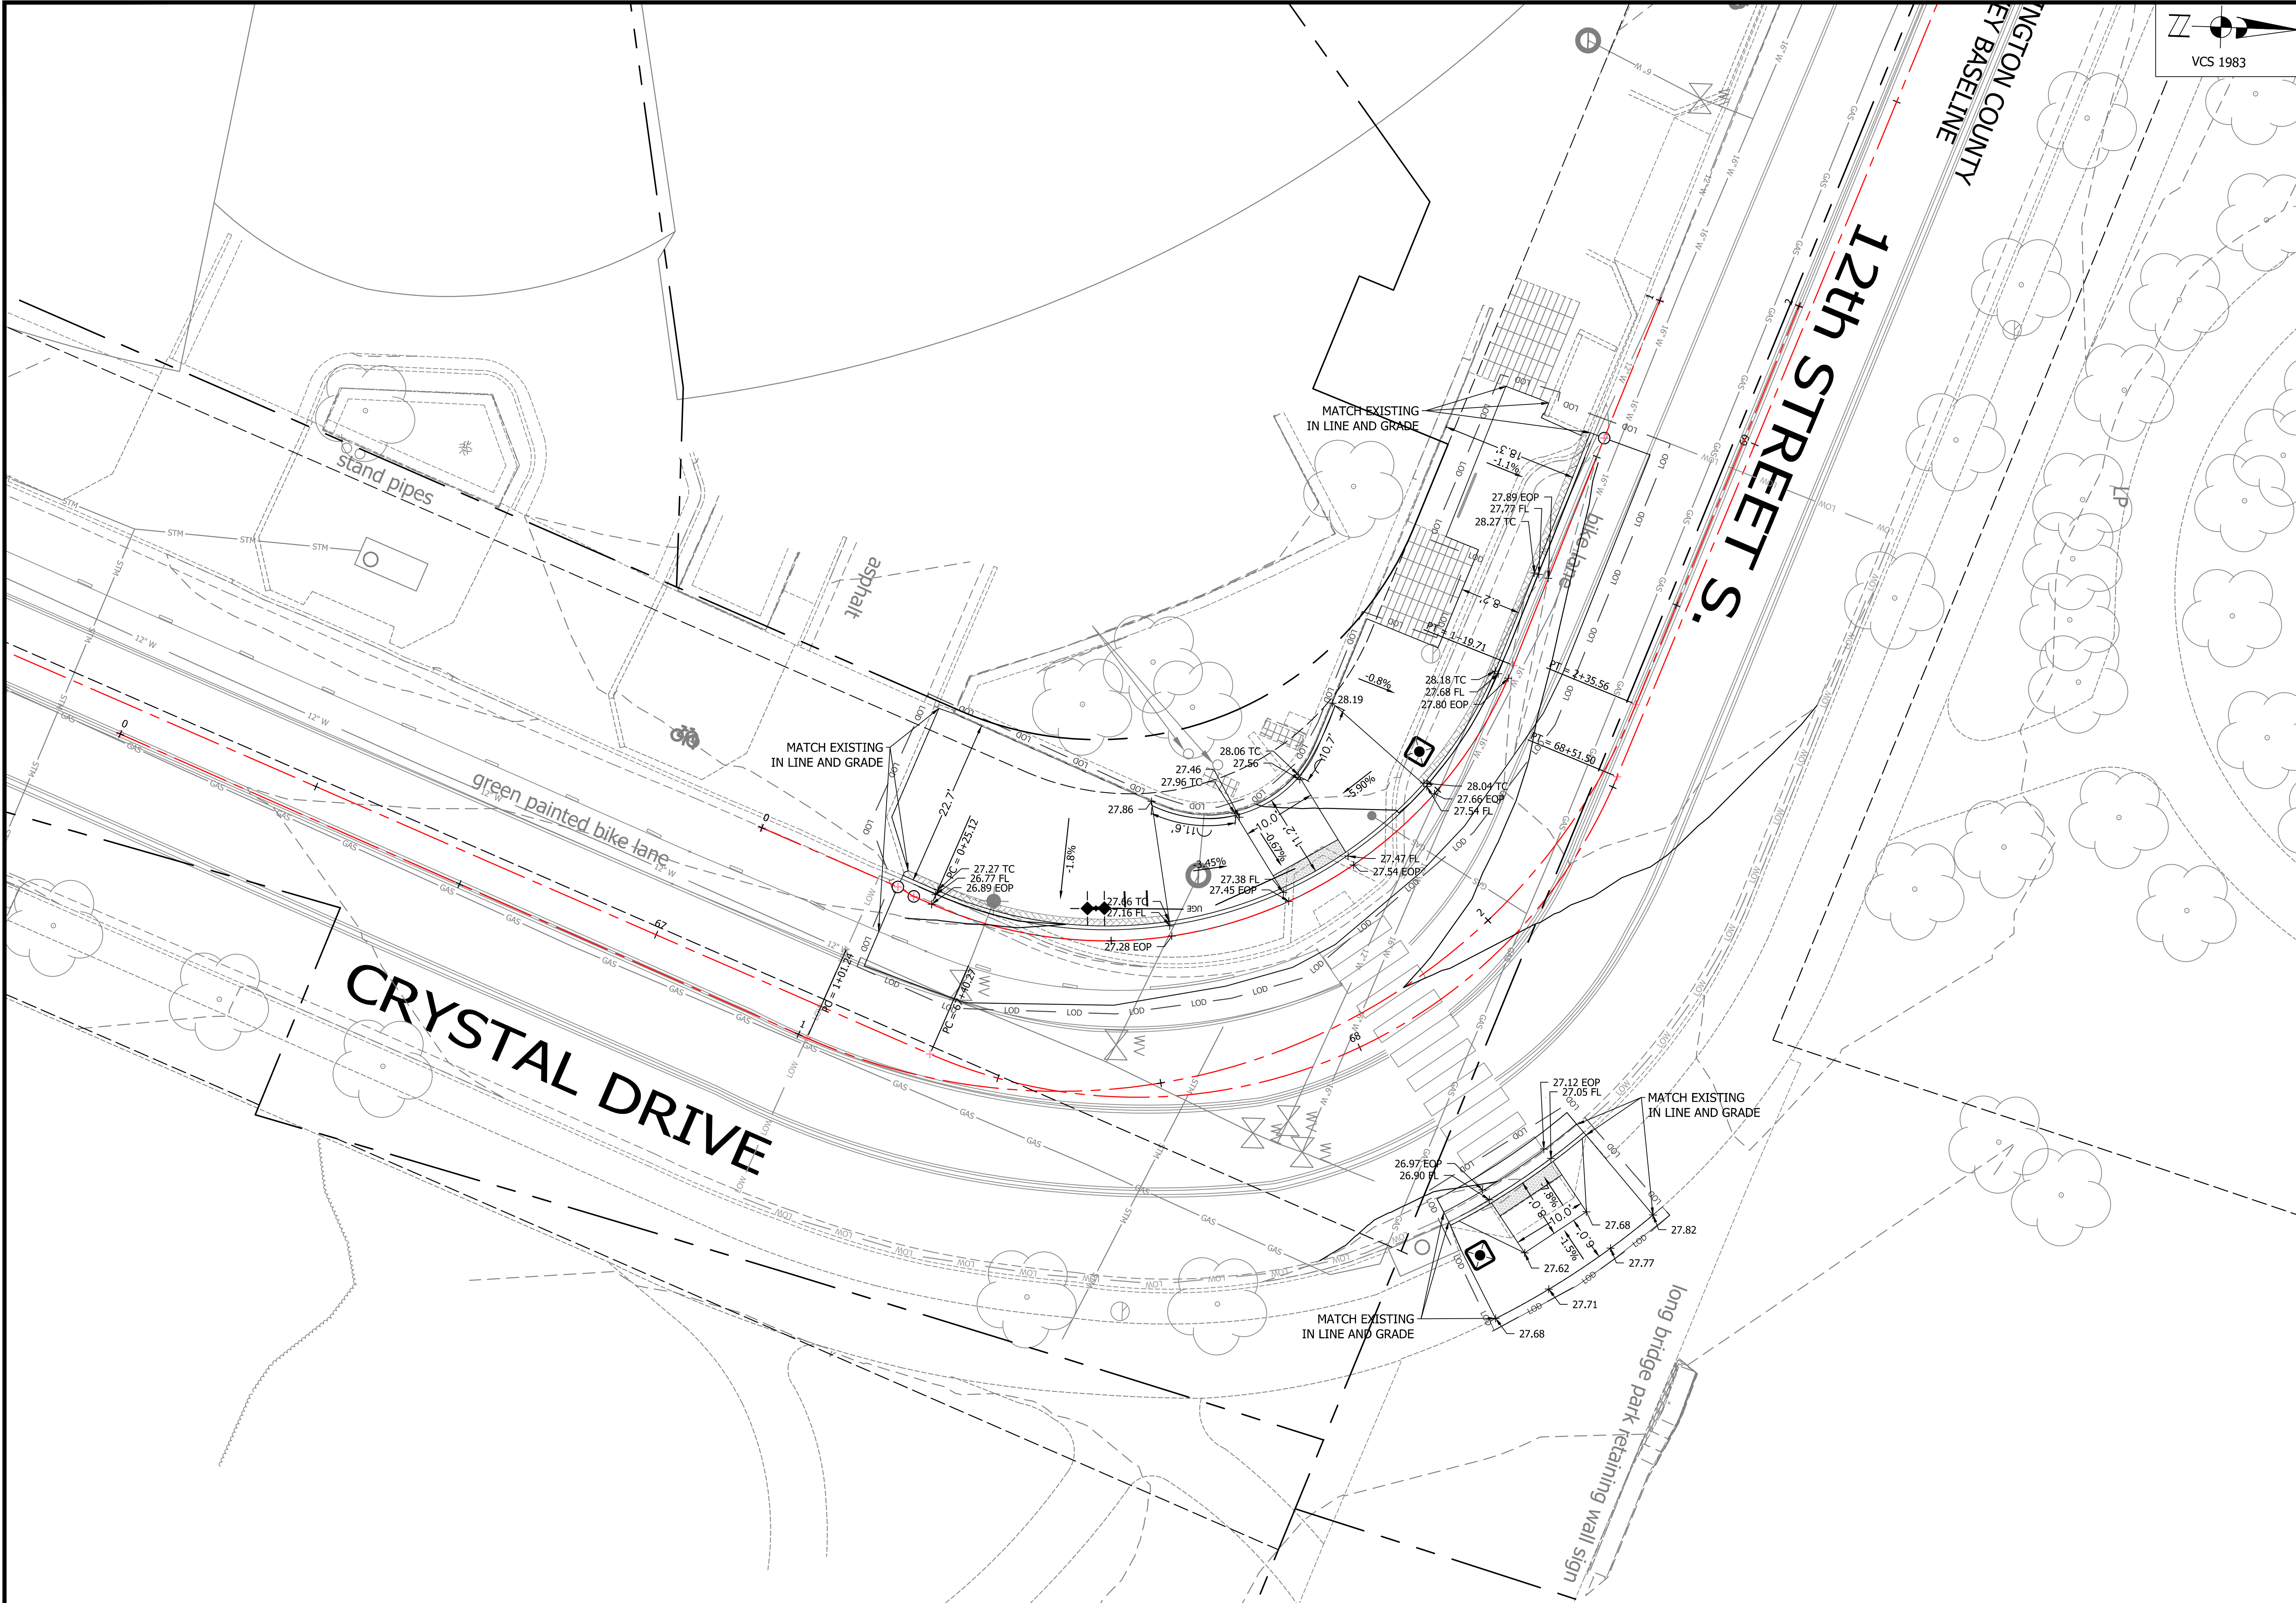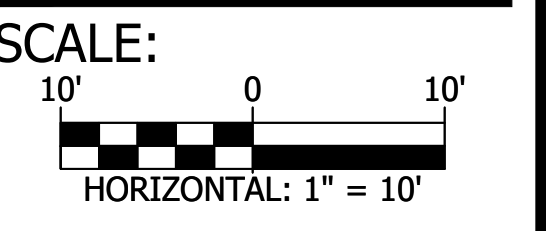

CRYSTAL DR NB & 15TH ST S INTERSECTION



12TH ST S WB & LONG BRIDGE DR INTERSECTION

LANDSCAPE NOTES:

1. CONTRACTOR SHALL FOLLOW LANDSCAPE REQUIREMENTS & GENERAL NOTES FOR STREET TREE PLANTING (DETAIL L1), SEE NEXT SHEET
2. ALL LANDSCAPING SHALL COMPLY WITH ARLINGTON COUNTY LANDSCAPE STANDARDS.
3. CONTRACTOR SHALL VERIFY THE LOCATION AND ELEVATION OF ALL EXISTING UTILITIES PRIOR TO CONSTRUCTION.
4. CONTRACTOR TO CALL THE URBAN FORESTER AT 703-228-1863, 72 HOURS BEFORE PLANTING, TO SCHEDULE INSPECTION OF THE TREES TO BE PLANTED. WARRANTY FOR 1 YEAR AFTER PLANTING SHALL BE THE CONTRACTOR'S RESPONSIBILITY. THE URBAN FORESTER AND DPR IS RESPONSIBLE FOR INSPECTION.

LANDSCAPE LEGEND

JY CONTRACTOR SHALL PLANT SHRUB AND RESTORE GROUND COVER, INCLUDING TOPSOIL, SEEDING OR MULCHING. SEE NEXT SHEET FOR PLANT SCHEDULE AND DETAIL L2.

T-R CONTRACTOR SHALL RESTORE GROUND COVER AROUND EXISTING TREES. EXPOSED EARTH SHALL BE BACKFILLED WITH TOPSOIL, 3" OF MULCH ON THE TOP AND PLANTED WITH PLUGS OF THE SWITCHGRASS SPACED 1'X1'.



APPROVALS	DATE
<i>Trevor M. Lantzy</i> QUALITY CONTROL ENGINEER	3/29/21
<i>Ramal Takbar</i> CONSTRUCTION MANAGEMENT SUPERVISOR	3.24.21
<i>Quinn</i> WATER, SEWER, STREETS BUREAU CHIEF	03.04.2021
<i>Dennis M. Leach</i> TRANSPORTATION DIRECTOR	03/17/21
<i>Diana Izzo</i> PROJECT MANAGER	3/2/21

REVISIONS	DATE

PROJECT NAME AND LOCATION
TRANSITWAY EXTENSION TO PENTAGON CITY
 LANDSCAPE PLAN
CRYSTAL DR & 12TH ST S
 MA13 - SEGMENT 1

DESIGNED: PB
 DRAWN: NS
 CHECKED: TL
 MISS UTILITY TRANSMITTAL #: N/A
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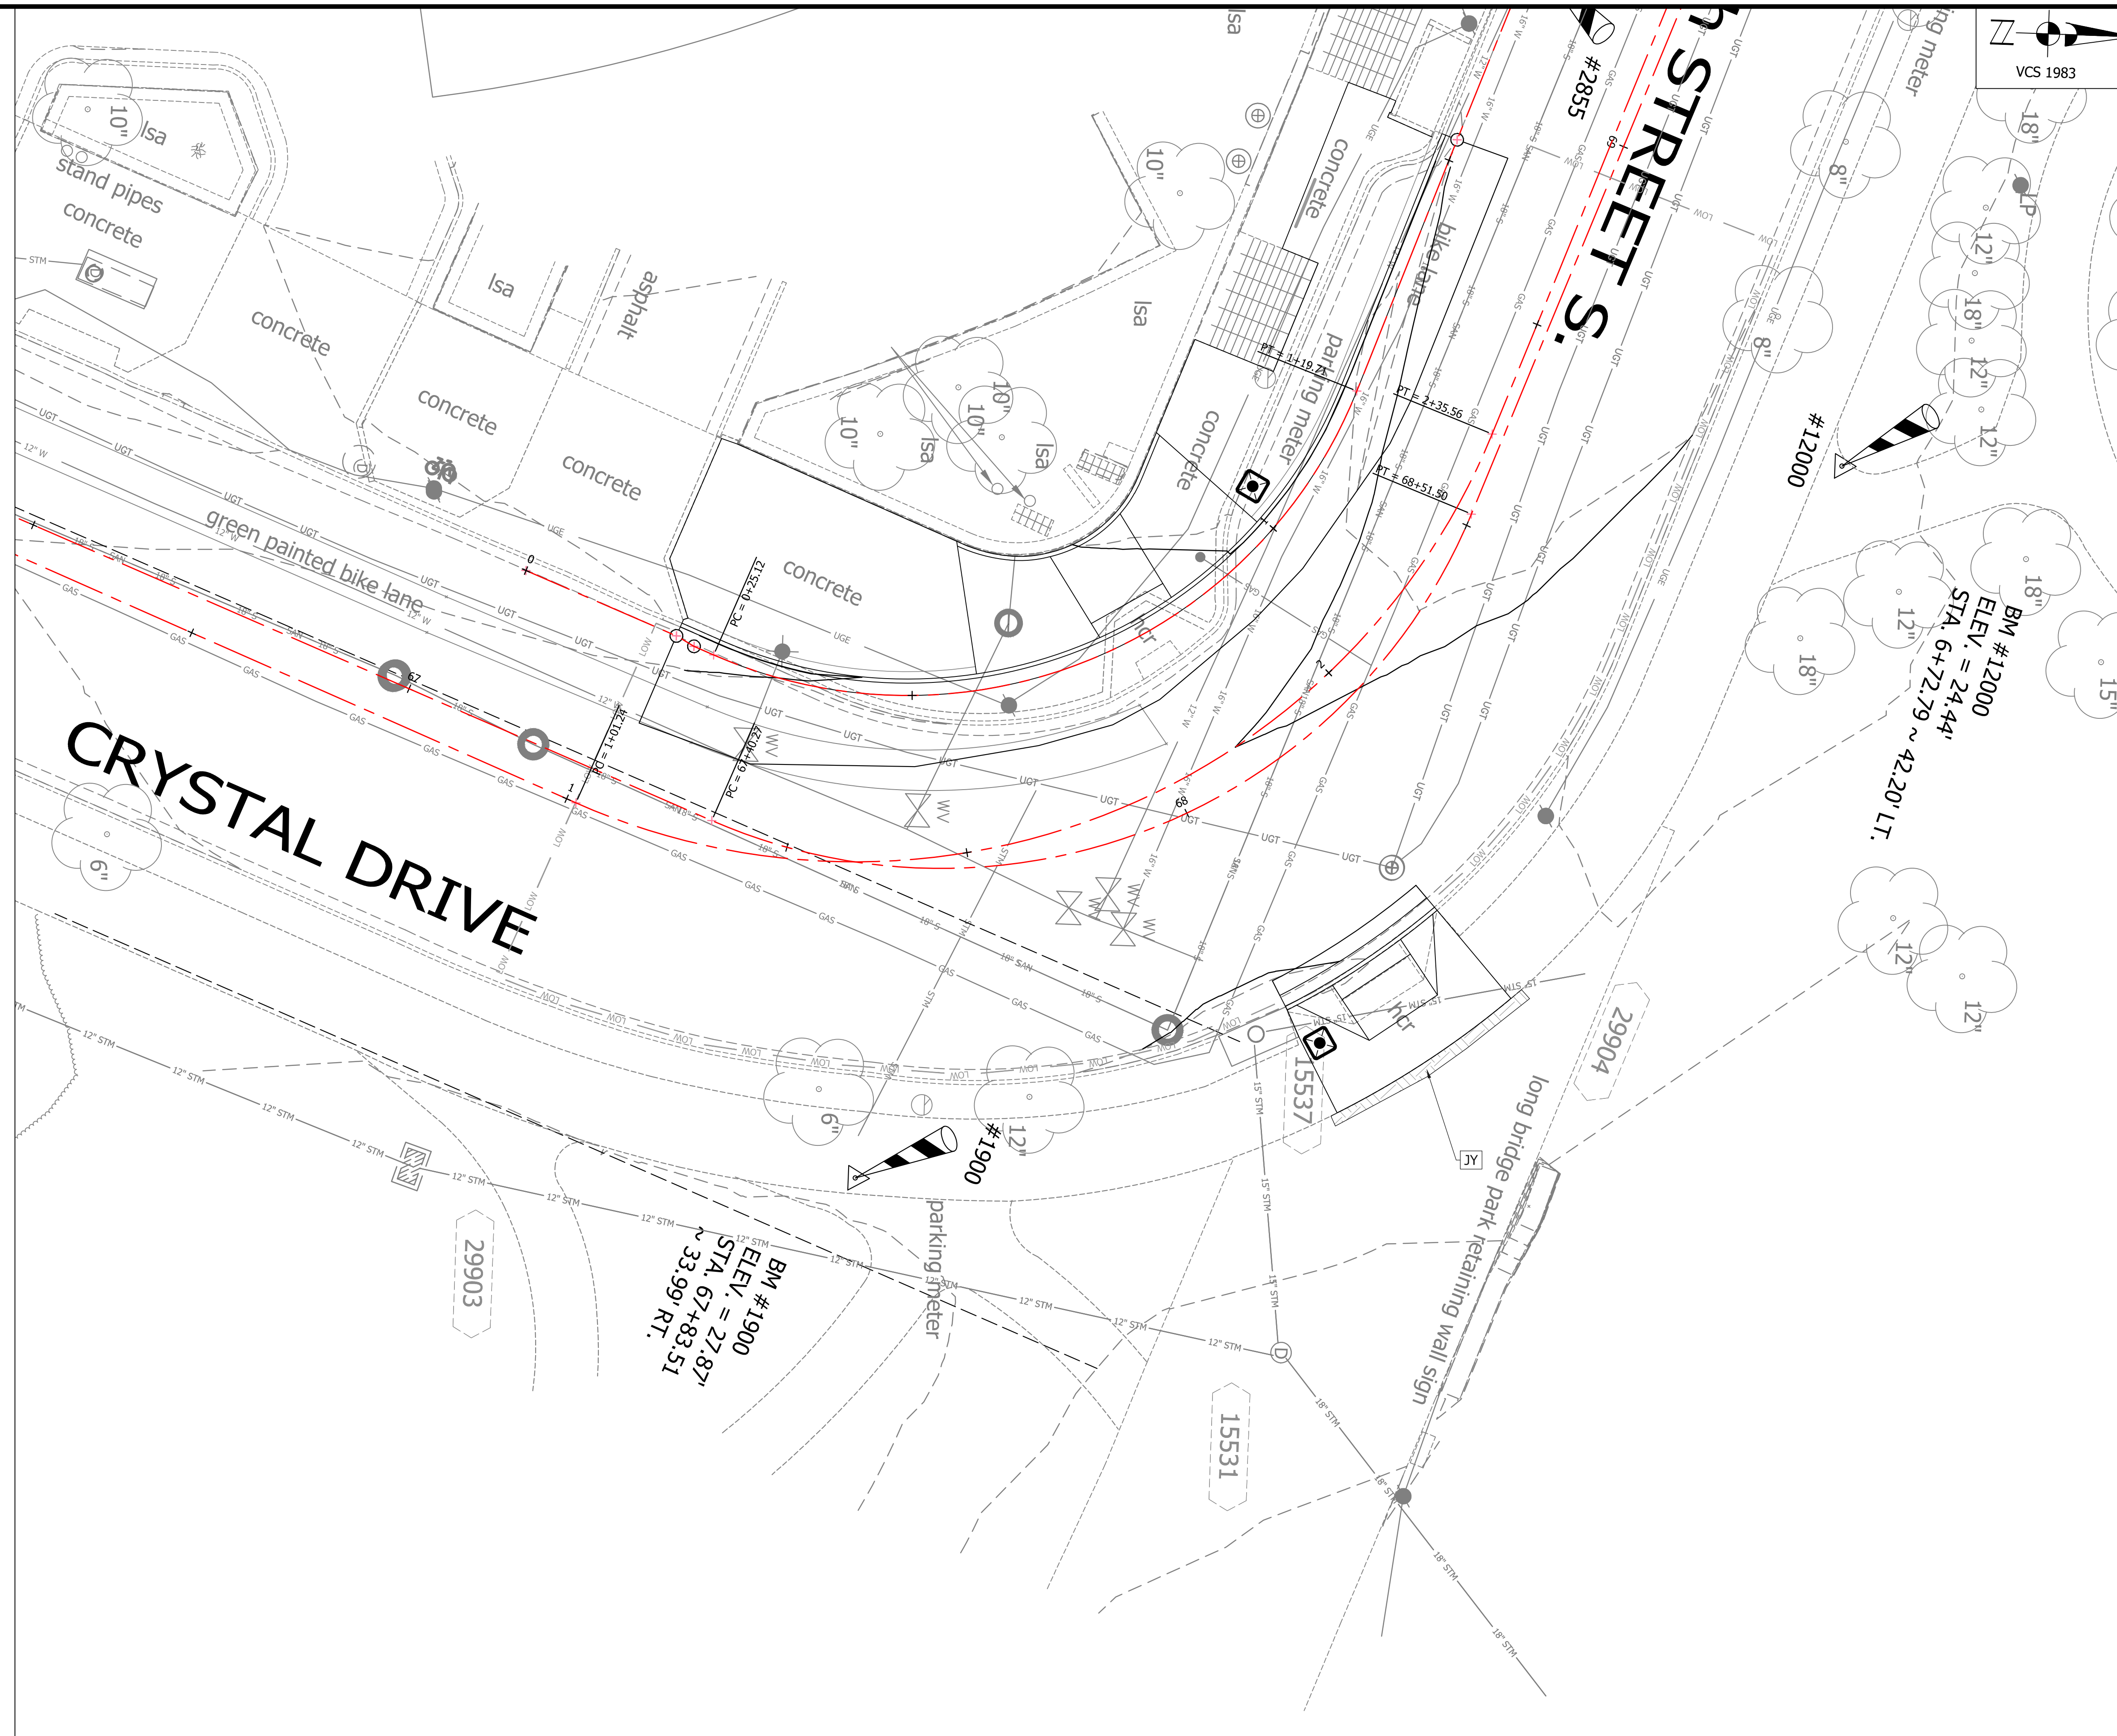


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CRYSTAL DR NB & 12TH ST S TRANSITION

DEPARTMENT OF ENVIRONMENTAL SERVICES
 FACILITIES & ENGINEERING DIVISION
 ENGINEERING BUREAU
 2100 CLARENDON BOULEVARD, SUITE 813
 ARLINGTON, VA 22201
 PHONE: 703.228.3629
 FAX: 703.228.3606

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APPROVALS	DATE
<i>Kamal</i>	3/29/21
QUALITY CONTROL ENGINEER <i>Kamal Takat</i>	3.24.21
CONSTRUCTION MANAGEMENT SUPERVISOR <i>Quinn</i>	03.04.2021
WATER, SEWER, STREETS BUREAU CHIEF <i>Dennis M. Leach</i>	03/17/21
TRANSPORTATION DIRECTOR <i>Shawn Lizza</i>	3/2/21
PROJECT MANAGER	

REVISIONS	DATE

PROJECT NAME AND LOCATION
TRANSITWAY EXTENSION TO PENTAGON CITY
LANDSCAPE PLAN
CRYSTAL DR & 12TH ST S
 MA13 - SEGMENT 1

DESIGNED: PB
 DRAWN: NS
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 MISS UTILITY TRANSMITTAL #: N/A
 FILENAME: MA13-260-LANDSCAPE_PLAN.DWG
 PATH: Q:\DATA\MA13\CAD\ACTIVE
 PLOTTED: AUGUST 4 2021
 PLOTTED BY: NSHARP



LANDSCAPE REQUIREMENTS:

- BEFORE ANY GRADING, DEMOLITION, OR OTHER DISTURBANCE, TREE PROTECTION NEEDS TO BE INSTALLED PER PLAN, AND INSPECTED BY AN ARLINGTON COUNTY PARKS AND RECREATION URBAN FORESTER. EROSION AND SEDIMENT CONTROLS ARE INSPECTED BY THE DEPARTMENT OF ENVIRONMENTAL SERVICES.
- PLANTS SHALL BE FURNISHED AND INSTALLED AS INDICATED, INCLUDING ALL PLANTS, MATERIALS, AND EQUIPMENT.
- PLANTS SHALL BE TYPICAL OF THEIR SPECIES AND VARIETY; HAVE NORMAL GROWTH HABITS, WELL-DEVELOPED DENSELY FOLIATED BRANCHES, AND VIGOROUS ROOT SYSTEMS; AND BE FREE FROM DEFECTS AND INJURIES.
- PLANTS SHALL BE PLANTED ON THE DAY OF DELIVERY IF/WHEN PRACTICAL. IN THE EVENT THAT THIS IS NOT POSSIBLE, THE CONTRACTOR SHALL PROTECT STOCK NOT PLANTED. PLANTS SHALL NOT REMAIN UNPLANTED FOR LONGER THAN A THREE-DAY PERIOD AFTER DELIVERY. ANY PLANTS NOT INSTALLED DURING THIS PERIOD SHALL BE REJECTED, UNLESS OWNER AND CONTRACTOR PROVIDE OTHERWISE BY WRITTEN AGREEMENT. ALL PLANTS KEPT ON SITE FOR ANY PERIOD OF TIME SHOULD BE WATERED AND CARED FOR USING ANSI A300 STANDARDS.
- PLANTS SHALL NOT BE BOUND WITH WIRE OR ROPE AT ANY TIME SO AS TO DAMAGE THE BARK OR BREAK BRANCHES. PLANTS SHALL BE HANDLED FROM THE BOTTOM OF THE ROOT BALL ONLY.
- PLANTING OPERATIONS SHALL BE PERFORMED DURING PERIODS WITHIN THE PLANTING SEASON WHEN WEATHER AND SOIL CONDITIONS ARE SUITABLE AND IN ACCORDANCE WITH ACCEPTED LOCAL PRACTICE. PLANTS SHALL NOT BE INSTALLED IN TOP SOIL THAT IS IN MUDDY OR FROZEN CONDITION. LAWNS, TREES AND SHRUBS SHALL BE INSTALLED BETWEEN 03/15 AND 06/15 OR BETWEEN 09/15 AND 12/01. IF A PROJECT COMPLETION IS OUTSIDE OF THIS PLANTING PERIOD, CONTACT THE ARLINGTON COUNTY URBAN FORESTER TO OBTAIN A DEFERRAL OR APPROVAL FOR PLANTING OUT OF SEASON.
- NO PLANT, EXCEPT GROUNDCOVERS, SHALL BE PLANTED WITHIN TWO FEET OF A SIDEWALK.
- TREES AND SHRUBS SHALL BE PLANTED IN HOLES TWO TO THREE TIMES AS WIDE AND TO THE DEPTH OF THE ROOT BALL.
- PLANTS SHALL BE PLANTED IN IN SITU SOIL THAT IS THOROUGHLY WATERED.
- SET ALL PLANTS PLUMB AND STRAIGHT SET AT SUCH LEVEL THAT NORMAL OR NATURAL RELATIONSHIP BETWEEN THE PLANT AND THE GROUND SURFACE WILL BE ESTABLISHED. LOCATE THE PLANT IN THE CENTER OF THE PIT.
- INJURED ROOTS SHALL BE PRUNED TO CLEAN ENDS BEFORE PLANTING WITH CLEAN, SHARP TOOLS. THE LEADER OF TREES SHALL NOT BE CUT BACK.
- PRESERVED AND PLANTED TREES MUST BE INSPECTED AND APPROVED BY A DEPARTMENT OF PARKS AND RECREATION URBAN FORESTER.
- ALL DISTURBED AREAS SHALL BE TREATED WITH 4" TOP SOIL OR COMPOST AND SEEDED IN ACCORDANCE WITH PERMANENT STABILIZATION METHODS INDICATED ON SOIL EROSION AND SEDIMENT CONTROL SHEET AND/OR LANDSCAPE PLAN.

NOTES

- A PERMIT IS REQUIRED WHEN TREES ARE PLANTED IN PUBLIC RIGHT-OF-WAY OR IN A PUBLIC EASEMENT. THE DEPARTMENT OF ENVIRONMENTAL SERVICES SHALL ISSUE THE PERMIT ACCORDING TO THE PROVISIONS OF THE CURRENT ARLINGTON COUNTY ADMINISTRATIVE REGULATION 4.3.
- TREE SPECIES SHALL BE SELECTED FROM THE "ARLINGTON COUNTY STREET TREE LIST" OR PER SECTOR PLAN REQUIREMENTS.
- TREES SHALL BE NURSERY GROWN SPECIMENS THAT MEET THE LATEST EDITION OF THE AMERICAN STANDARDS FOR NURSERY STOCK (ANSI Z60). BALLED AND BURLAPPED TREES SHALL BE SECURELY HELD IN PLACE BY UNTREATED BURLAP AND STOUT ROPE (NYLON ROPE IS NOT ACCEPTABLE). LOOSE, BROKEN OR MANUFACTURED BALLS ARE UNACCEPTABLE.
- CALL MISS UTILITY AT (800) 552-7001 FOR UTILITY LOCATIONS PRIOR TO EXCAVATION.
- AT TIME OF PLANTING PRUNE ONLY CROSSING LIMBS, BROKEN OR DEAD BRANCHES, AND ANY BRANCHES THAT POSE A HAZARD TO PEDESTRIANS. DO NOT PRUNE INTO OLD WOOD ON EVERGREENS.
- TREE PIT AND TREE STRIP PLANTING AREA DIMENSIONS:
(A) 5' X 12' OR LARGER IS STANDARD
(B) 4' X 15' MINIMUM IS ALLOWED PER SITE CONDITIONS AND COUNTY URBAN FORESTER'S APPROVAL.
- SPACE TREES 25'-30' APART OR PER SECTOR PLAN REQUIREMENTS OR SITE CONDITIONS.
- SITE CHARACTERISTICS, SUCH AS OVERHEAD POWER LINES, EXISTING VEGETATION, AND INFRASTRUCTURE ITEMS SUCH AS CURBS, SIDEWALKS, AND UTILITIES SHALL BE CONSIDERED. TREES THAT GROW TALLER THAN 25 FEET SHOULD NOT BE PLANTED DIRECTLY UNDER POWER LINES. WHEN POSSIBLE THE TREE LEADER SHALL BE OFFSET FROM POWER LINES.
- BACKFILL SOIL MIXTURE SHALL BE 3/4 EXISTING SOIL CLEANED OF DEBRIS (GRAVEL, ROCKS, STICKS, TRASH, ETC.) AND MIXED WITH 1/4 ORGANIC MATERIAL (COMPOSTED BARK, LEAF MOLD, OR OTHER PLANT DEBRIS PROCESSED TO A POINT OF DECAY AND APPROVED BY THE COUNTY URBAN FORESTER. PEAT MOSS MAY NOT BE USED).
- IF THE QUANTITY OF ACCEPTABLE EXISTING SOIL IS INSUFFICIENT FOR THE PLANTING REQUIREMENTS, THE CONTRACTOR MAY USE TOPSOIL. SOIL TEST REPORT RESULTS FOR THE TOPSOIL WILL BE MADE AVAILABLE TO THE COUNTY URBAN FORESTER UPON REQUEST. CONTRACTOR SHALL SUBMIT TOPSOIL FOR APPROVAL TO COUNTY URBAN FORESTER THAT MEETS THE FOLLOWING SPECIFICATIONS:
(A.) TOPSOIL CONSISTS OF A SANDY LOAM WITH UNIFORM COMPOSITION AND IS FREE OF STONES, LUMPS, PLANTS, ROOTS, AND OTHER DEBRIS OVER 1/2" IN LENGTH.
(B.) TOPSOIL HAS A PH RANGE OF 5.5 TO 6.5 AND A MINIMUM CONTENT OF 1.0% ORGANIC MATTER
(C.) TOPSOIL DOES NOT CONTAIN TOXIC SUBSTANCES HARMFUL TO PLANT GROWTH. SOLUBLE SALT LEVEL SHALL NOT EXCEED 3 MILLIOMHS PER CENTIMETER.
- TREES PLANTED WITHOUT THE TRUNK FLARE VISIBLE WILL BE REJECTED.
- TREES MAY ONLY BE STAKED IF REQUIRED BY THE COUNTY URBAN FORESTER. REFER TO ARLINGTON COUNTY STANDARD STAKING DETAILS.
- MULCH SHALL BE CLEAN, SCREENED, DOUBLE-HAMMERED HARDWOOD BARK MULCH, UNIFORM IN SIZE AND FREE OF STONES, CLODS, NON-ORGANIC DEBRIS AND OTHER FOREIGN MATERIAL.
- ALL PLANTS SHALL BE WATERED TWICE: ONCE AT INSTALLATION AND AGAIN WITHIN 48-HOURS OF INSTALLATION. EACH WATERING WILL CONSIST OF 20 GALLONS PER TREE.
- CONTRACTOR SHALL LEGALLY REMOVE EXCESS SOIL & DEBRIS FROM SITE.

GENERAL NOTES FOR STREET TREE PLANTINGS

FOR TREES PLANTED IN RIGHT-OF-WAY
329300.5 (2016) (02930.5)



NOTES


- AT PLANTING PRUNE ONLY BROKEN OR DEAD BRANCHES PER ANSI 300 STANDARD.
- PLANTING PIT/TRENCH SHALL BE DUG DEEP ENOUGH TO ALLOW AT LEAST 1/8TH OF ROOT BALL TO SET ABOVE EXISTING GRADE.
- SET PLANTS IN ERECT, STABLE, AND UNIFORM POSITIONS IN THE CENTER OF THE PLANTING PIT. ORIENT BEST FACE OF PLANT TO BE THE MOST VISIBLE.
- UNLESS OTHERWISE DIRECTED BY COUNTY URBAN FORESTER, BACKFILL SOIL MIXTURE WILL BE 3/4 EXISTING SOIL CLEANED OF DEBRIS (GRAVEL, ROCKS, STICKS, TRASH, ETC.) AND MIXED WITH 1/4 ORGANIC MATERIAL (COMPOSTED BARK, LEAF MOLD, OR OTHER PLANT DEBRIS PROCESSED TO A POINT OF DECAY AND APPROVED BY THE COUNTY URBAN FORESTER. PEAT MOSS MAY NOT BE USED).
- CONTRACTOR SHALL REMOVE EXCESS SOIL & DEBRIS FROM SITE.
- DO NOT PLACE MULCH IN CONTACT WITH STEM OF SHRUBS

THIS DETAIL SUPERSEDES ALL OTHER SHRUB PLANTING DETAILS IN ARLINGTON COUNTY.

ALL PLANTS MUST BE WATERED TWICE: ONCE AT INSTALLATION AND AGAIN WITHIN 48-HOURS OF INSTALLATION, PER THE SPECIFICATIONS.

SHRUB PLANTING

ELEVATION
329300.8 (2016) (02930.8)

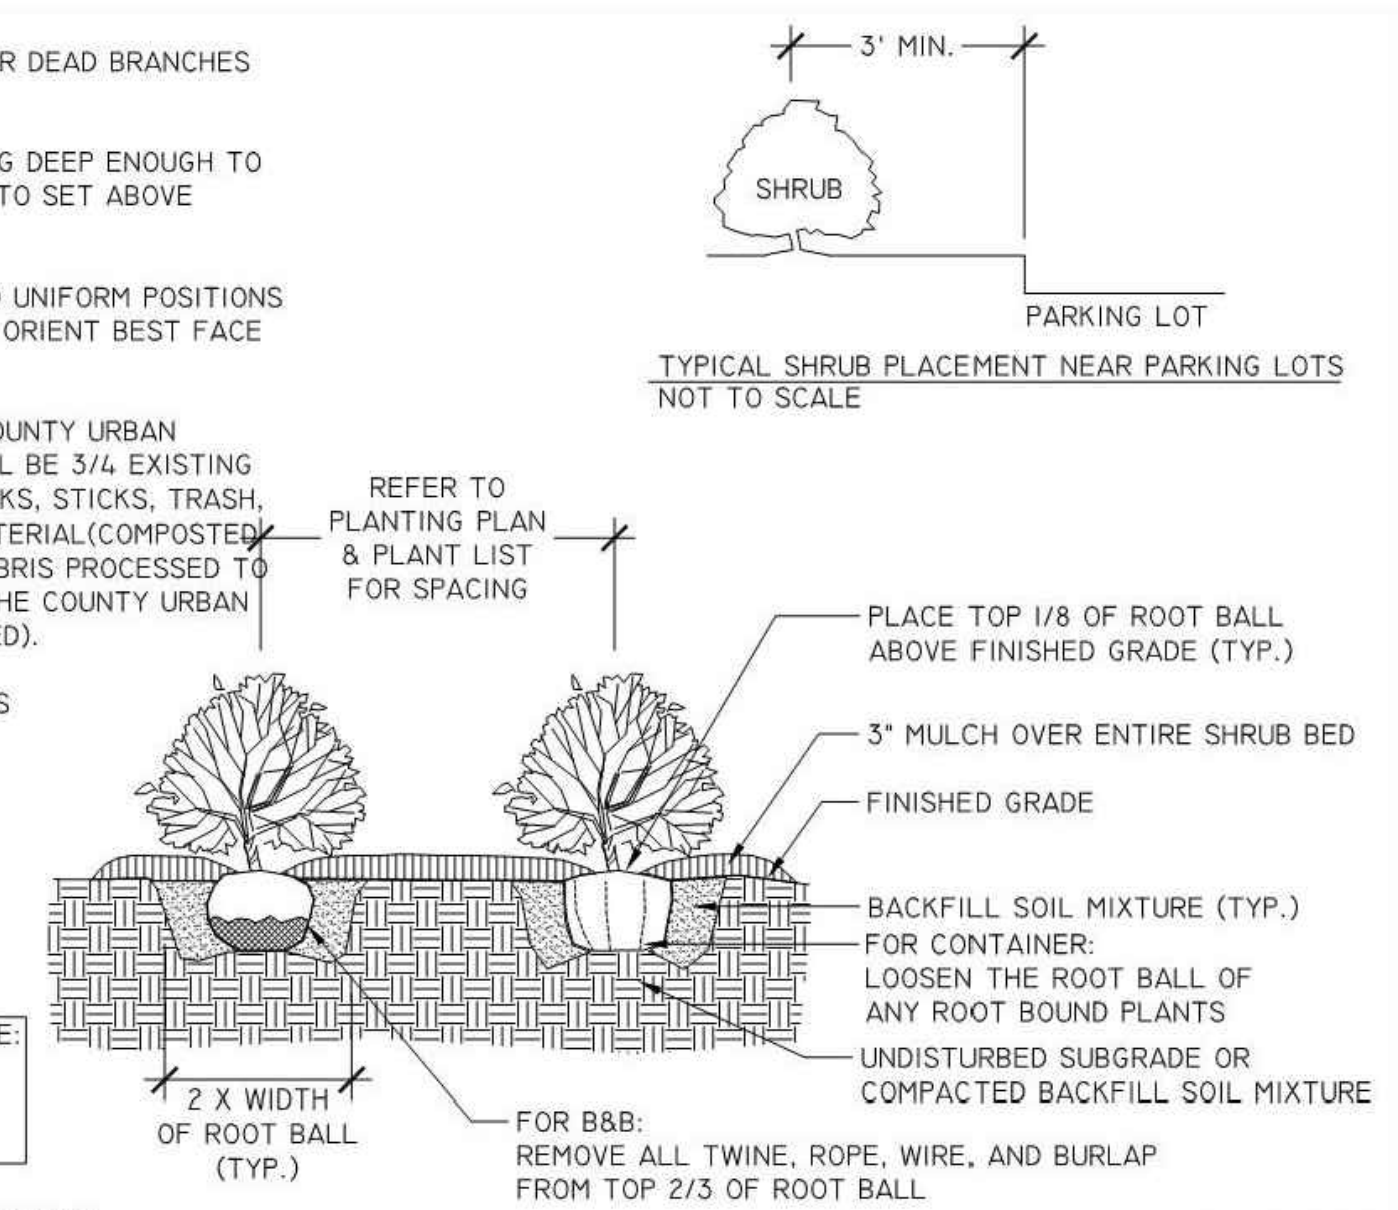

MA13 - Crystal City Transitway Extension PLANT SCHEDULE

QTY	KEY	BOTANICAL NAME	COMMON NAME	SIZE	SPACING	REMARKS
SHRUBS						
60	JY	SHENANDOAH SWITCHGRASS	PANICUM VIRGATUM	12"-18" Tall	3.0' O.C.	CONTAINER

MA13 - Crystal City Transitway Extension TREE INVENTORY AND REPLACEMENT SCHEDULE

Ex Tree #	To Be Removed	DBH	Condition	Species	Common name	Species Rating	Replacement value	Replacements	Comments
01		6"	70	<i>Zelkova serrata</i>	Japanese Zelkova	75			Protect
02		6"	70	<i>Zelkova serrata</i>	Japanese Zelkova	75			Protect
03	X	8"	70	<i>Zelkova serrata</i>	Japanese Zelkova	75	1	1	
04	X	8"	70	<i>Zelkova serrata</i>	Japanese Zelkova	75	1	1	
05	X	8"	70	<i>Zelkova serrata</i>	Japanese Zelkova	75	1	1	
06		10"	60	<i>Zelkova serrata</i>	Japanese Zelkova	75			Protect
07		7"	30	<i>Zelkova serrata</i>	Japanese Zelkova	75			Protect
08	X	5"	80	<i>Zelkova serrata</i>	Japanese Zelkova	75	1	1	
09	X	7"	40	<i>Zelkova serrata</i>	Japanese Zelkova	75	1	1	
10	X	12"	70	<i>Zelkova serrata</i>	Japanese Zelkova	75	6.3	2	
Total:							7*		

*TREES REPLACEMENT TO BE INCLUDED IN CC08 CLARK-BELL EXTENSION TO 15TH STREET SOUTH PROJECT

DEPARTMENT OF ENVIRONMENTAL SERVICES
FACILITIES & ENGINEERING DIVISION
ENGINEERING BUREAU
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APPROVALS	DATE
<i>Kamell</i> QUALITY CONTROL ENGINEER	3/29/21
<i>Kamal Taktae</i> CONSTRUCTION MANAGEMENT SUPERVISOR	3.24.21
<i>Oliver</i> WATER, SEWER, STREETS BUREAU CHIEF	03.04.2021
<i>Dennis M. Leach</i> TRANSPORTATION DIRECTOR	03/17/21
<i>Diana Izzo</i> PROJECT MANAGER	3/2/21

REVISIONS DATE

NO.	DESCRIPTION	DATE

PROJECT NAME AND LOCATION
TRANSITWAY EXTENSION TO PENTAGON CITY

LANDSCAPE DETAILS
CRYSTAL DR & 12TH ST S


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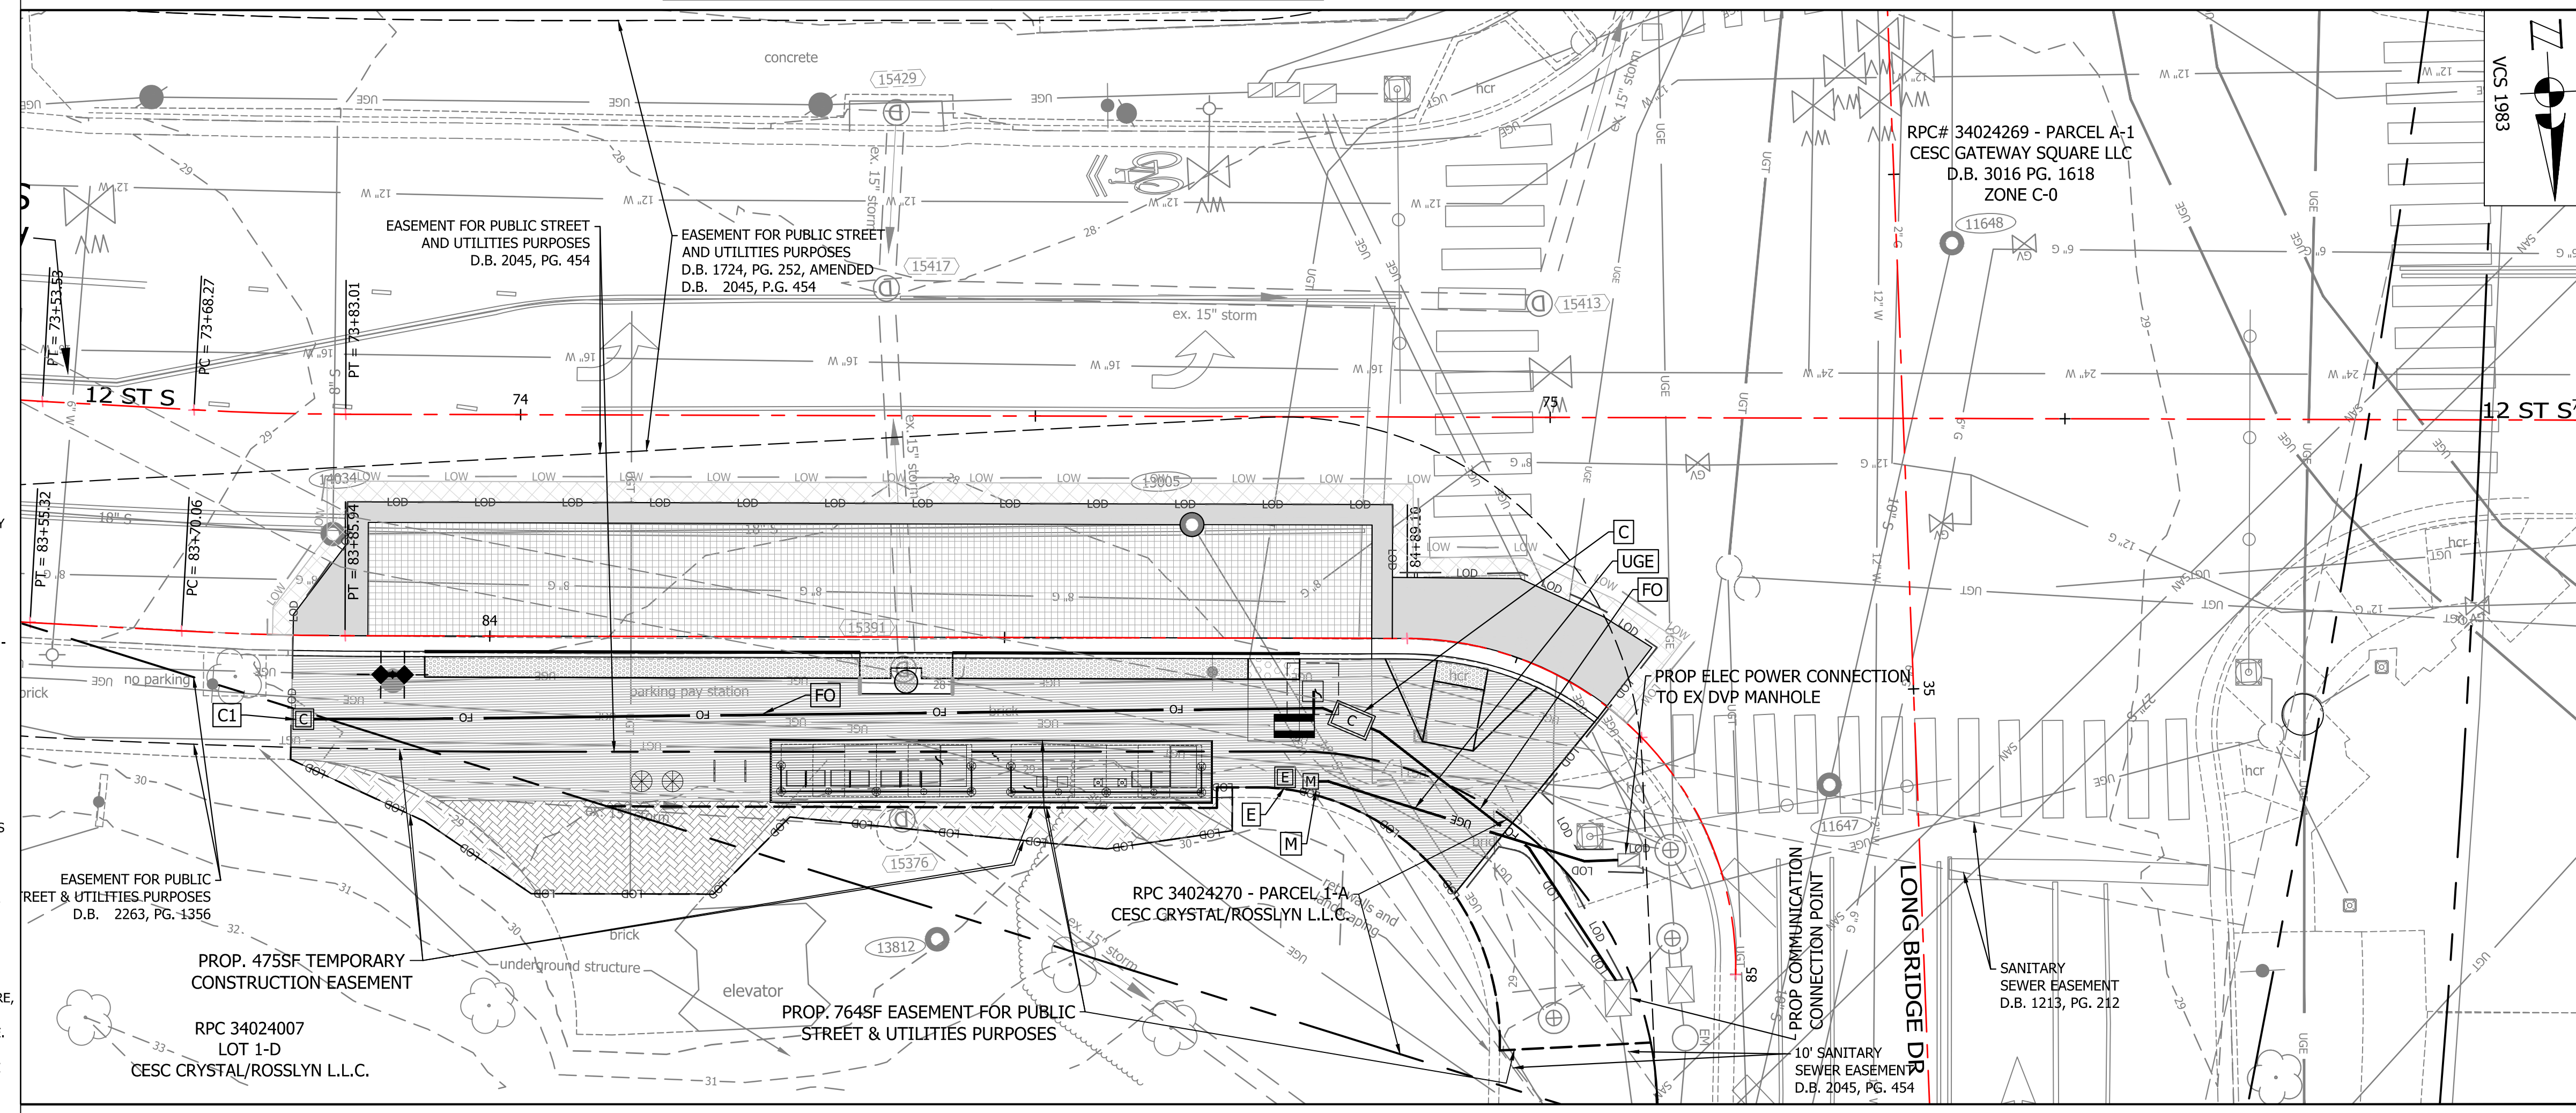
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PLOTTED: AUGUST 4 2021
PLOTTED BY: NSHARP

SCALE: N/A



CRYSTAL DR NB & 15TH ST S INTERSECTION

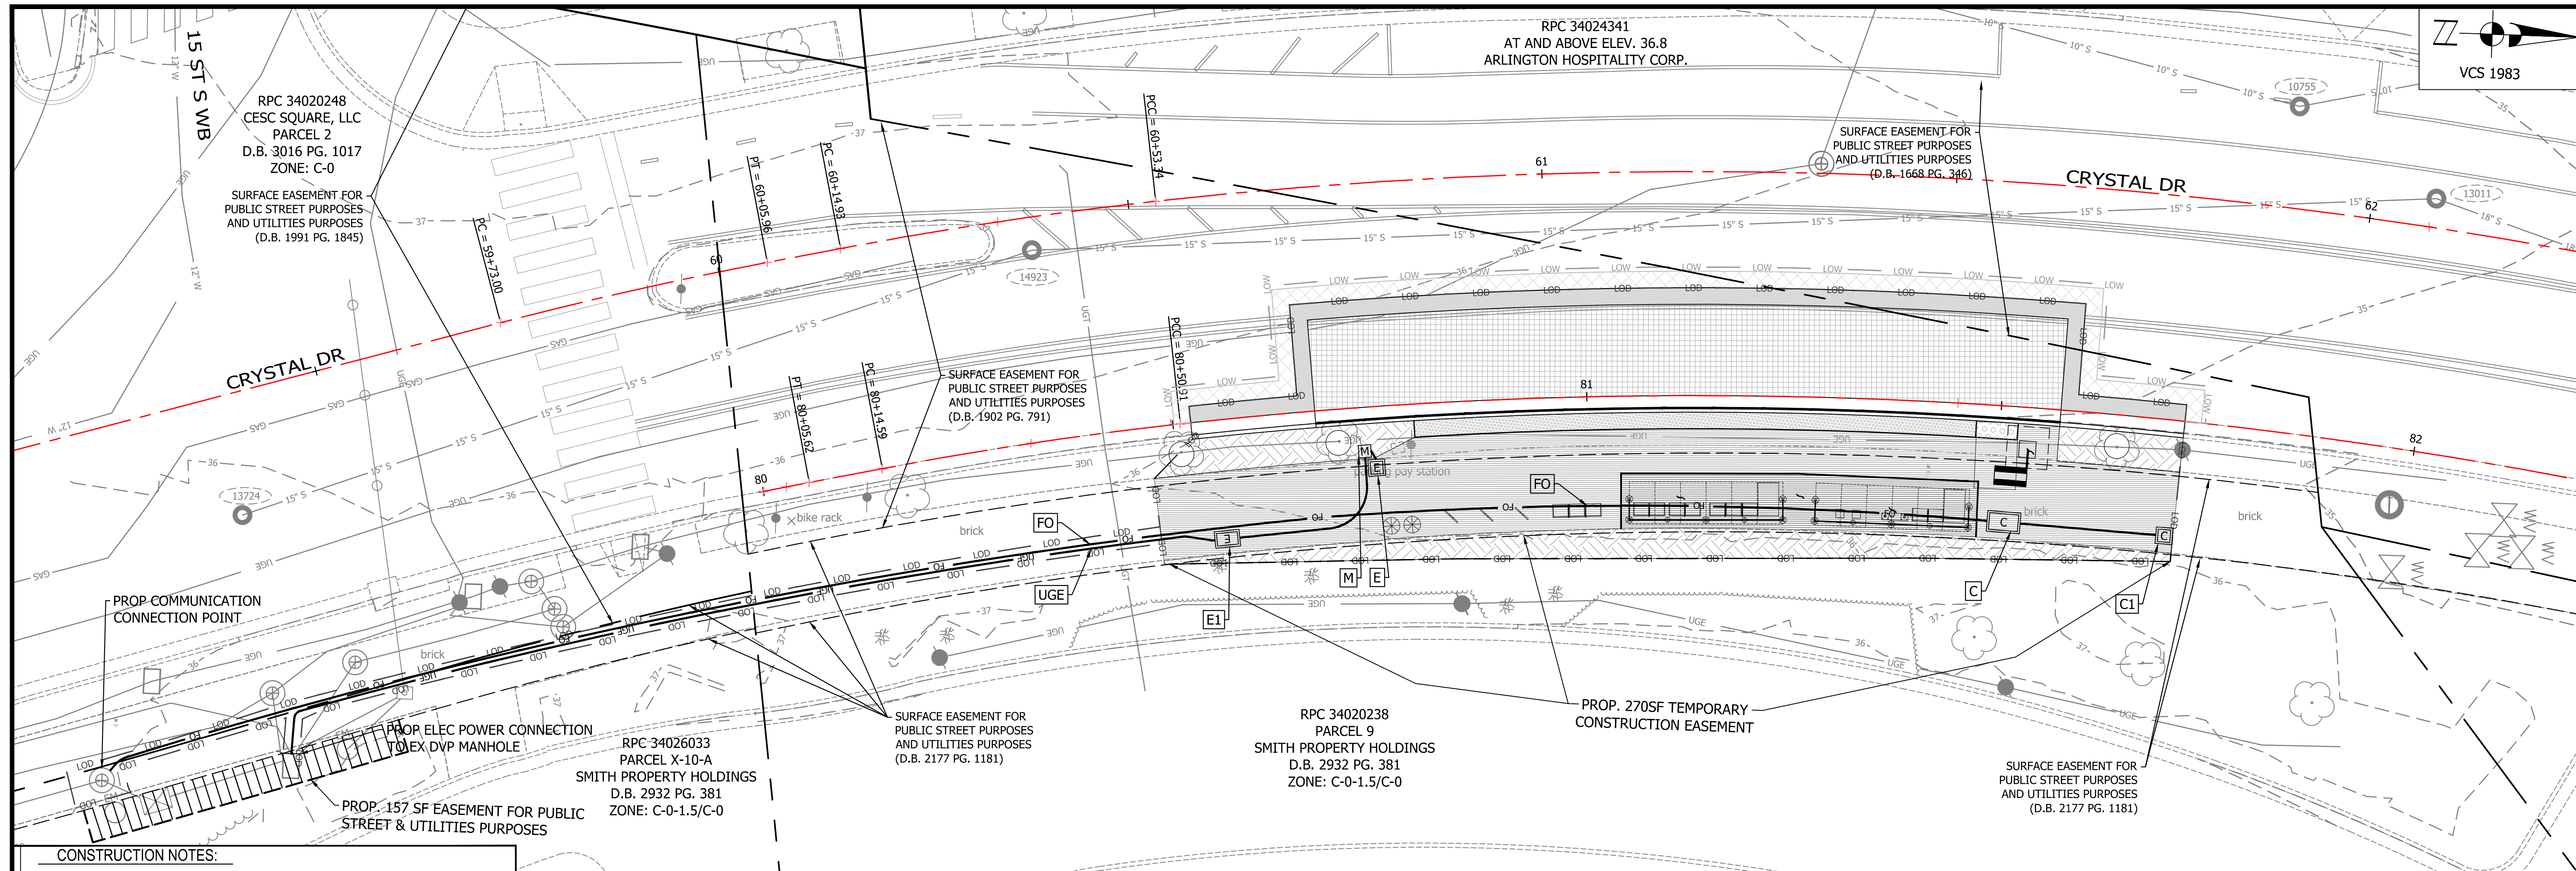

12TH ST S WB & LONG BRIDGE DR INTERSECTION

CONSTRUCTION NOTES:

CAUTION: POTENTIAL UTILITY CONFLICT. CONTRACTOR TO FIELD VERIFY EXACT LOCATION AND DEPTH OF EXISTING UTILITY, SEE DEMOLITION PLAN FOR EXISTING TEST HOLES/PITS.

UGE CONTRACTOR SHALL FURNISH AND INSTALL 1-2" DIAMETER PVC OR HDPE ELECTRICAL CONDUIT PER ARLINGTON COUNTY TRAFFIC SIGNAL SPECIFICATIONS.

FO CONTRACTOR SHALL FURNISH AND INSTALL 4-2" DIAMETER PVC OR HDPE COMMUNICATION CONDUIT PER ARLINGTON COUNTY TRAFFIC SIGNAL SPECIFICATIONS.

E CONTRACTOR SHALL INSTALL ELECTRICAL JUNCTION BOX - SMALL PER ARL STD 14040-01.

EI CONTRACTOR SHALL INSTALL ELECTRICAL JUNCTION BOX - TYPE 3 PER ARL STD 61-04.

C CONTRACTOR SHALL INSTALL COMMUNICATION JUNCTION BOX - TYPE 4 PER ARL STD 61-04.

CI CONTRACTOR SHALL INSTALL COMMUNICATION JUNCTION BOX PER ARL STD 61-01. TO BE INSTALLED IN BRICK SECTION WITH CONDUIT ENDS TO BE TURNED UP AND CAPPED.

M METERED SERVICE PEDESTAL (METER TO BE PROVIDED BY DEV)

GENERAL NOTES:

- SERVICE CONDUIT MUST BE INSTALLED WITH AT LEAST A 24" COVER BELOW FINAL GRADE. PRIMARY CONDUIT MUST BE INSTALLED WITH AT LEAST A 30" COVER BELOW FINAL GRADE (MAXIMUM 48" DEPTH). ALL CONDUITS, INCLUDING SPARES TERMINATING NEAR POLES OR AT BUILDINGS OR OTHER STRUCTURES SHALL BE PLUGGED TO PREVENT ENTRANCE OF FOREIGN MATERIAL. ALL CONDUITS SHALL BE SEALED TO PREVENT WATER FROM ENTERING.
- WHEN USING PLASTIC CONDUIT, CONTRACTOR TO FOLLOW ARLINGTON COUNTY SPECIFICATIONS.
- CONDUIT INSTALLATION MUST BE INSPECTED BY DOMINION ENERGY AND ARLINGTON COUNTY DTS PERSONNEL PRIOR TO BACKFILLING. NOTIFICATION FORTY-EIGHT (48) HOURS PRIOR TO CONSTRUCTION IS REQUIRED.
- PROPOSED CONDUIT RUNS, METER AND JUNCTION BOX LOCATIONS SHOWN AS APPROXIMATE. CONTRACTOR SHALL FIELD LOCATE CONDUIT ALIGNMENT, AND PLACE METER AND JUNCTION BOXES ACCORDINGLY.
- CONTRACTOR SHALL RESTORE SIDEWALK PAVEMENT ASSOCIATED WITH UTILITY CUTS TO COMPLY WITH ARL STD M-6.0 AND PLAN CONSTRUCTION NOTES 2 OR 3 FOR BRICK PAVEMENT - SHEET 20.

COMMUNICATIONS/FIBER NOTES:

- ANY WORK TOUCHING EXISTING COUNTY FIBER INFRASTRUCTURE, INCLUDING CONDUIT RELOCATION AND OPENING OR ENTERING HANDHOLES SHALL BE PERFORMED BY ANY ONE OF THREE (3) COUNTY FIBER CONTRACTORS.
- CONTRACTOR TO CONTACT THE Communications Team at 703-228-7726 FOR A LIST OF AUTHORIZED CONTRACTORS, AND TO SCHEDULE FIBER CONSTRUCTION AND RELATED INSPECTION OF HANDHOLES FOR CONDUIT INSTALLATION. CONTACT ARLINGTON COUNTY PROJECT OFFICER FOR FIBER OPTIC CABLE REMOVAL OR INSTALLATION AT LEAST 10 BUSINESS DAYS IN ADVANCE.
- ALL FIBER-OPTIC CABLE INSTALLATION, REMOVAL, SPLICING, AND TESTING SHALL BE PERFORMED BY ARLINGTON COUNTY'S FIBER-OPTIC CONTRACTOR.
- CONTRACTOR SHALL FURNISH FIBER PATCH PANEL FOR INSTALLATION BY THE COUNTY. FIBER PATCH PANEL SHALL BE APPROPRIATE LENGTH TO ALLOW FOR 50" SLACK IN EACH INTERMEDIATE JUNCTION BOX. CONTRACTOR SHALL SUBMIT A SHOP DRAWING OF THE PATCH PANEL (INDICATING THE TAIL LENGTH) TO THE PROJECT OFFICER FOR COUNTY REVIEW PRIOR TO ORDERING.
- THE CONTRACTOR SHALL BE RESPONSIBLE FOR THE INSTALLATION OF PROPOSED JUNCTION BOXES AND CONDUITS INCLUDING ALL APPURTENANCES SUCH AS GROUND RODS, TRACER WIRE, PULL TAPE, ETC.
- FIBER OPTIC CONDUIT MUST BE INSTALLED WITH AT LEAST A 36" COVER BELOW FINAL GRADE.
- ALL NEW CONDUITS SHALL HAVE PULL TAPE INSTALLED BETWEEN JUNCTION BOXES AND TRACER WIRE INSTALLED WITHIN OR BESIDE AT LEAST ONE OF THE CONDUITS. TRACER WIRE SHALL BE CONNECTED TO THE GROUND RODS INSTALLED IN THE ADJACENT JUNCTION BOXES.
- DO NOT SPLICE TRACER WIRE.

REFER TO THE APPROVED BUILDING PLANS FOR ELECTRICAL CONDUIT TO THE STATION AND ITS FURNISHINGS

ARLINGTON VIRGINIA

DEPARTMENT OF ENVIRONMENTAL SERVICES
 FACILITIES & ENGINEERING DIVISION
 ENGINEERING BUREAU
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APPROVALS	DATE
<i>Kamal</i>	3/29/21
QUALITY CONTROL ENGINEER <i>Kamal Takkar</i>	3.24.21
CONSTRUCTION MANAGEMENT SUPERVISOR <i>John</i>	03.04.2021
WATER, SEWER, STREETS BUREAU CHIEF <i>Dennis M. Leach</i>	03/17/21
TRANSPORTATION DIRECTOR <i>Diana Izzo</i>	3/2/21
PROJECT MANAGER	

REVISIONS	DATE

PROJECT NAME AND LOCATION
TRANSITWAY EXTENSION TO PENTAGON CITY

UTILITY PLAN
CRYSTAL DR & 12TH ST S

MAIL3 - SEGMENT 1

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 CHECKED: TL
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 PLOTTED BY: NSHARP


















APPROVALS	DATE
<i>[Signature]</i>	3/29/21
QUALITY CONTROL ENGINEER	
<i>[Signature]</i>	3.24.21
CONSTRUCTION MANAGEMENT SUPERVISOR	
<i>[Signature]</i>	03.04.2021
WATER, SEWER, STREETS BUREAU CHIEF	
<i>[Signature]</i>	03/17/21
TRANSPORTATION DIRECTOR	
<i>[Signature]</i>	3/2/21
PROJECT MANAGER	

REVISIONS	DATE

PROJECT NAME AND LOCATION
**TRANSITWAY EXTENSION TO
PENTAGON CITY**
**CROSS SECTIONS
CRYSTAL DR & 12TH ST S**
MA13 - SEGMENT I

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DRAWN: NS
CHECKED: TL
MISS UTILITY TRANSMITTAL #: N/A
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PLOTTED: AUGUST 4 2021
PLOTTED BY: NSHARP

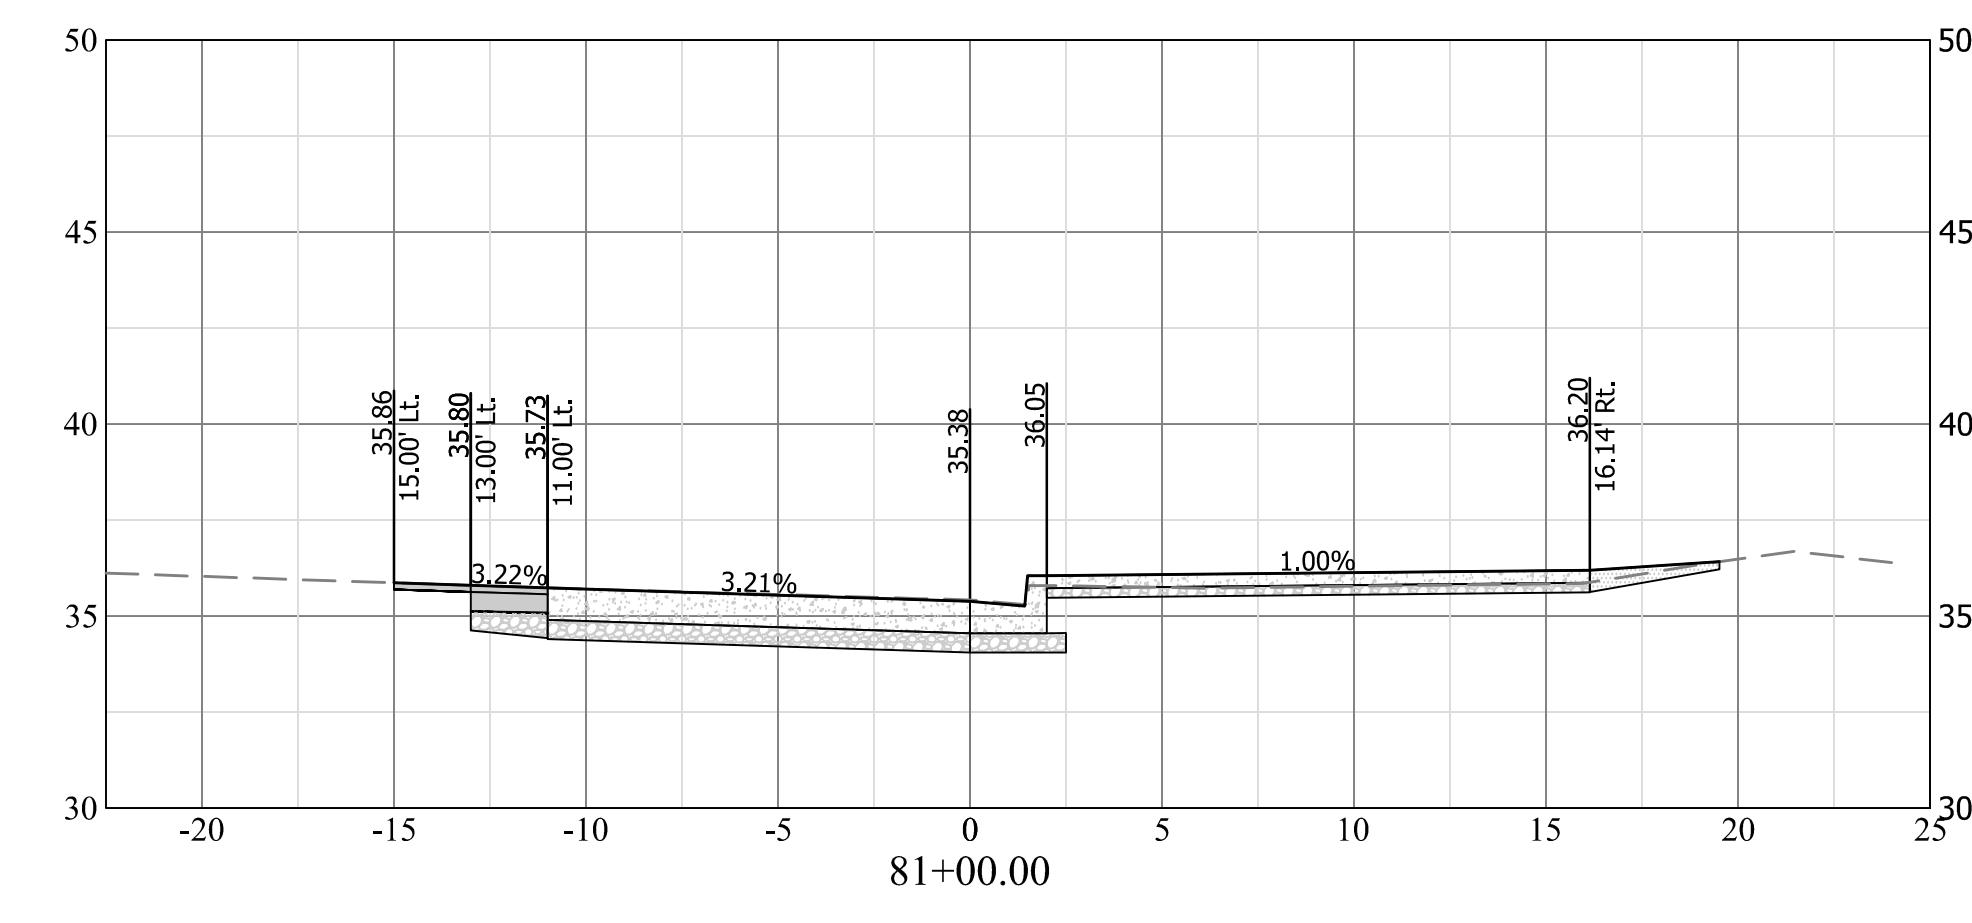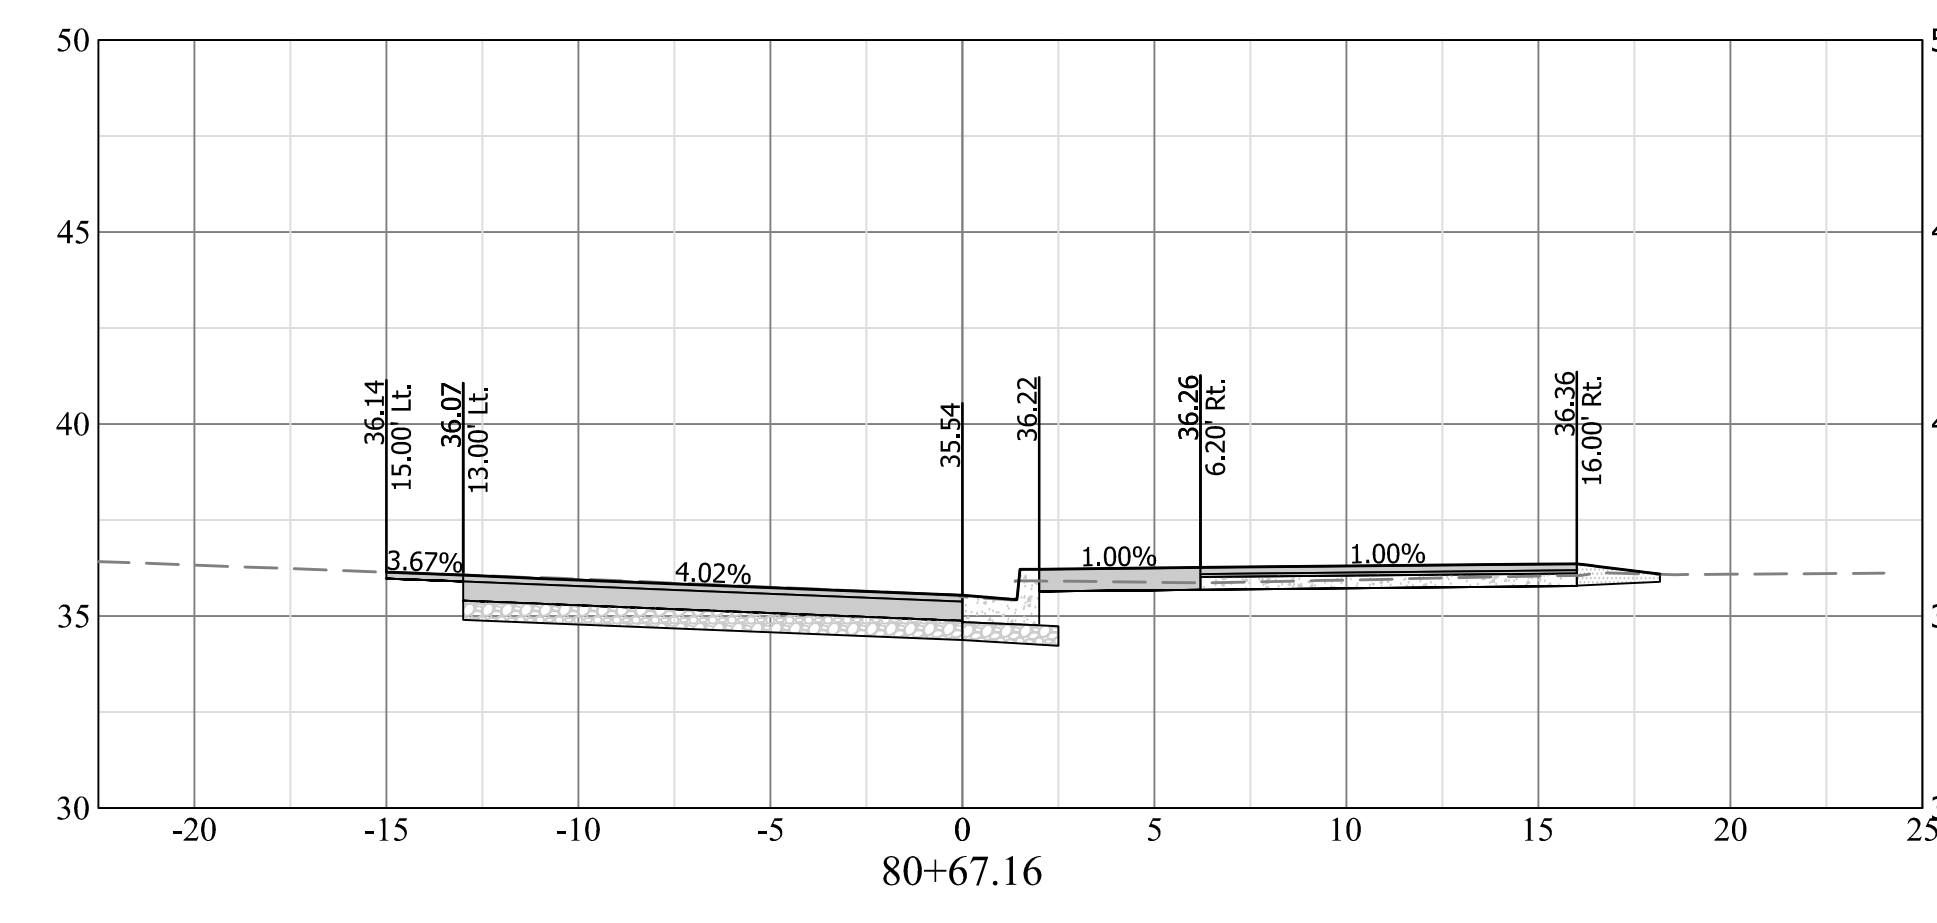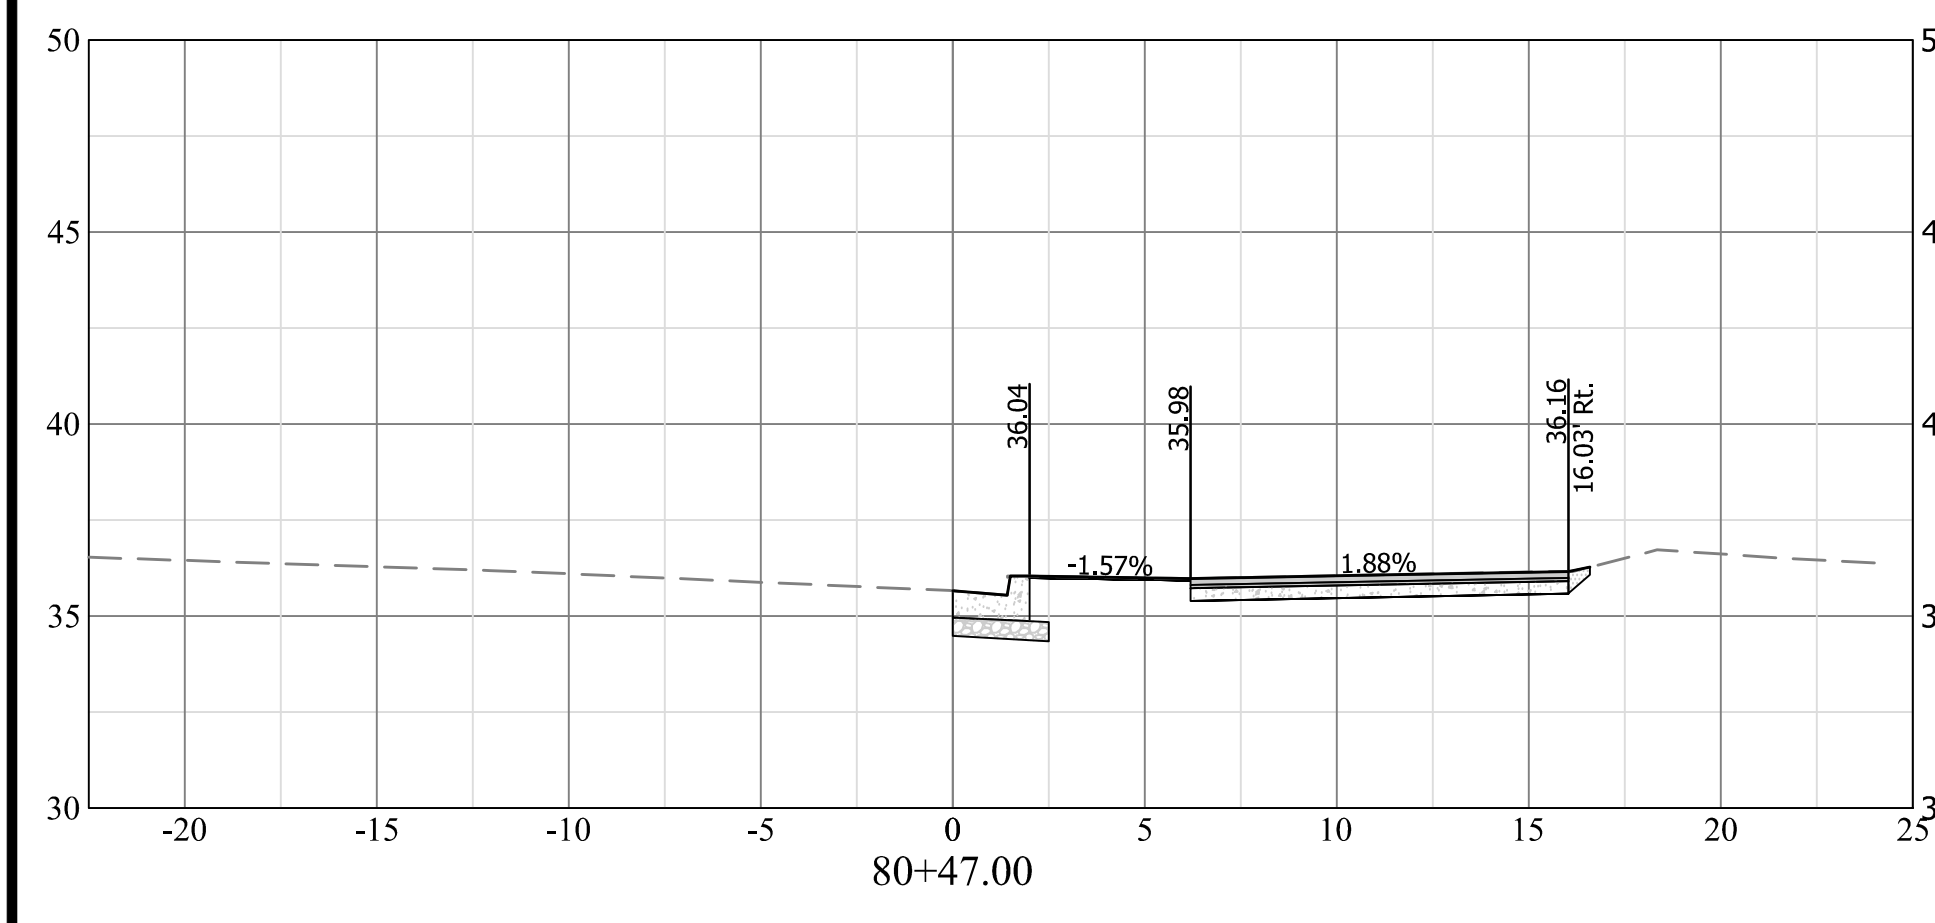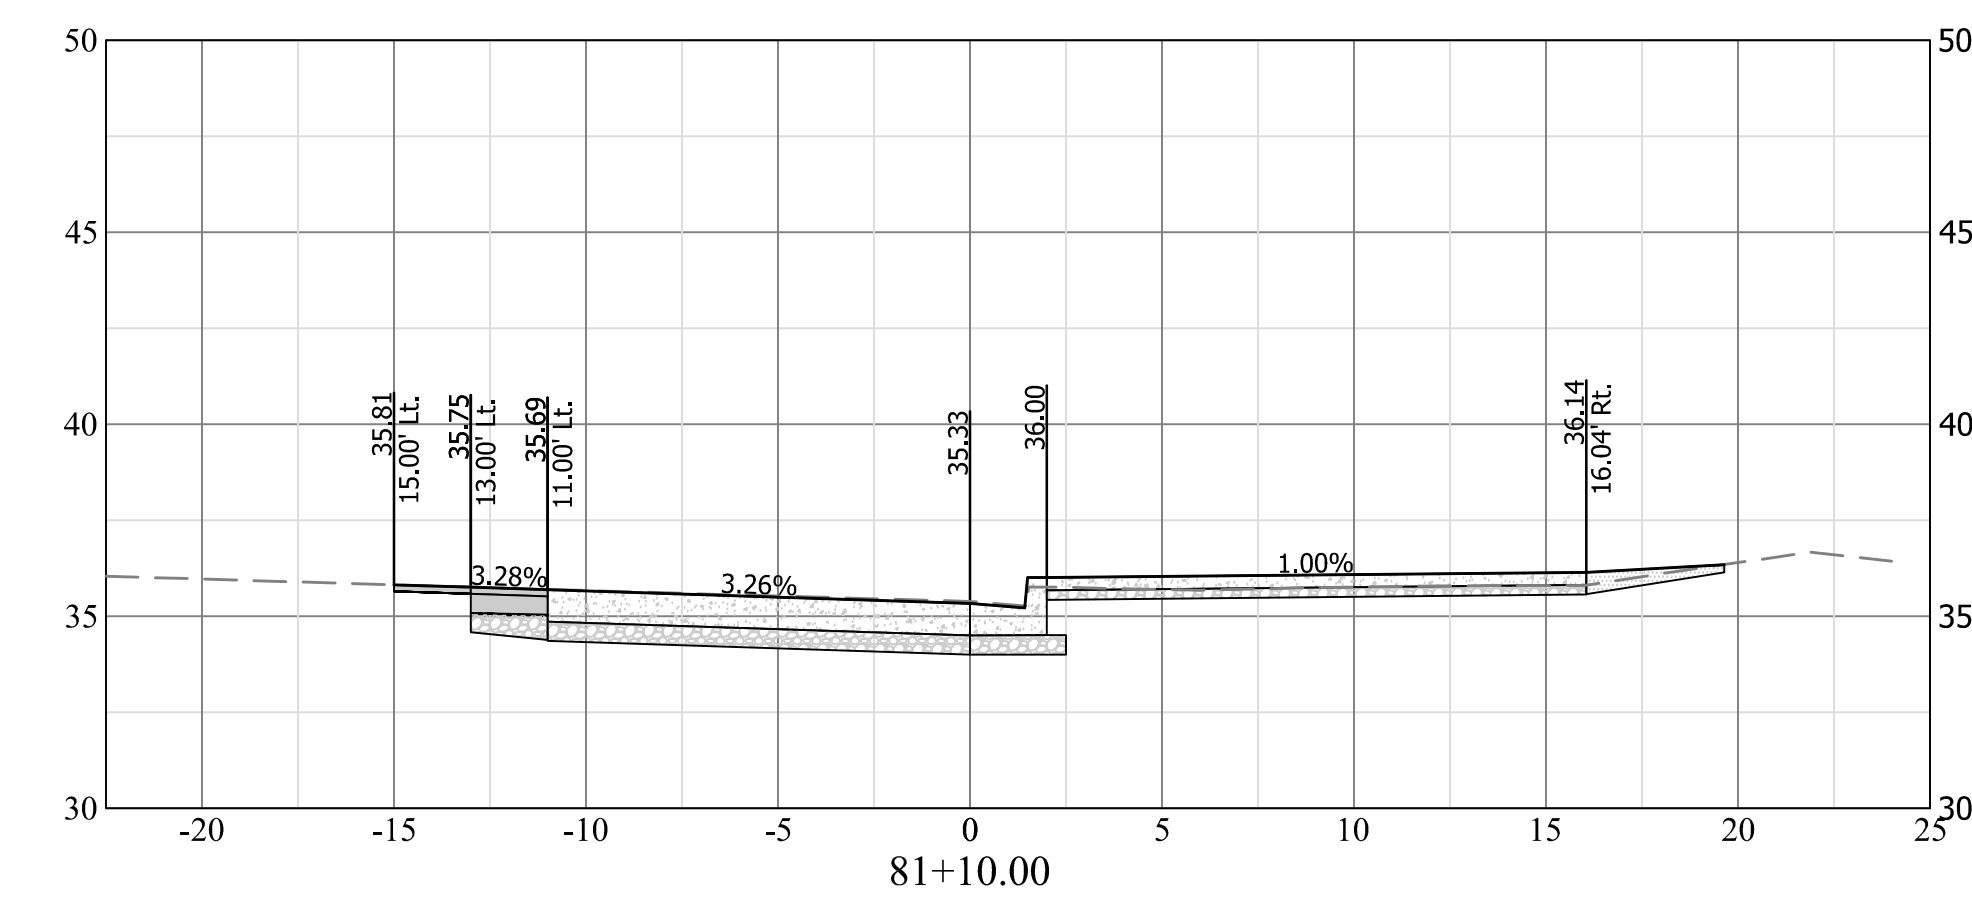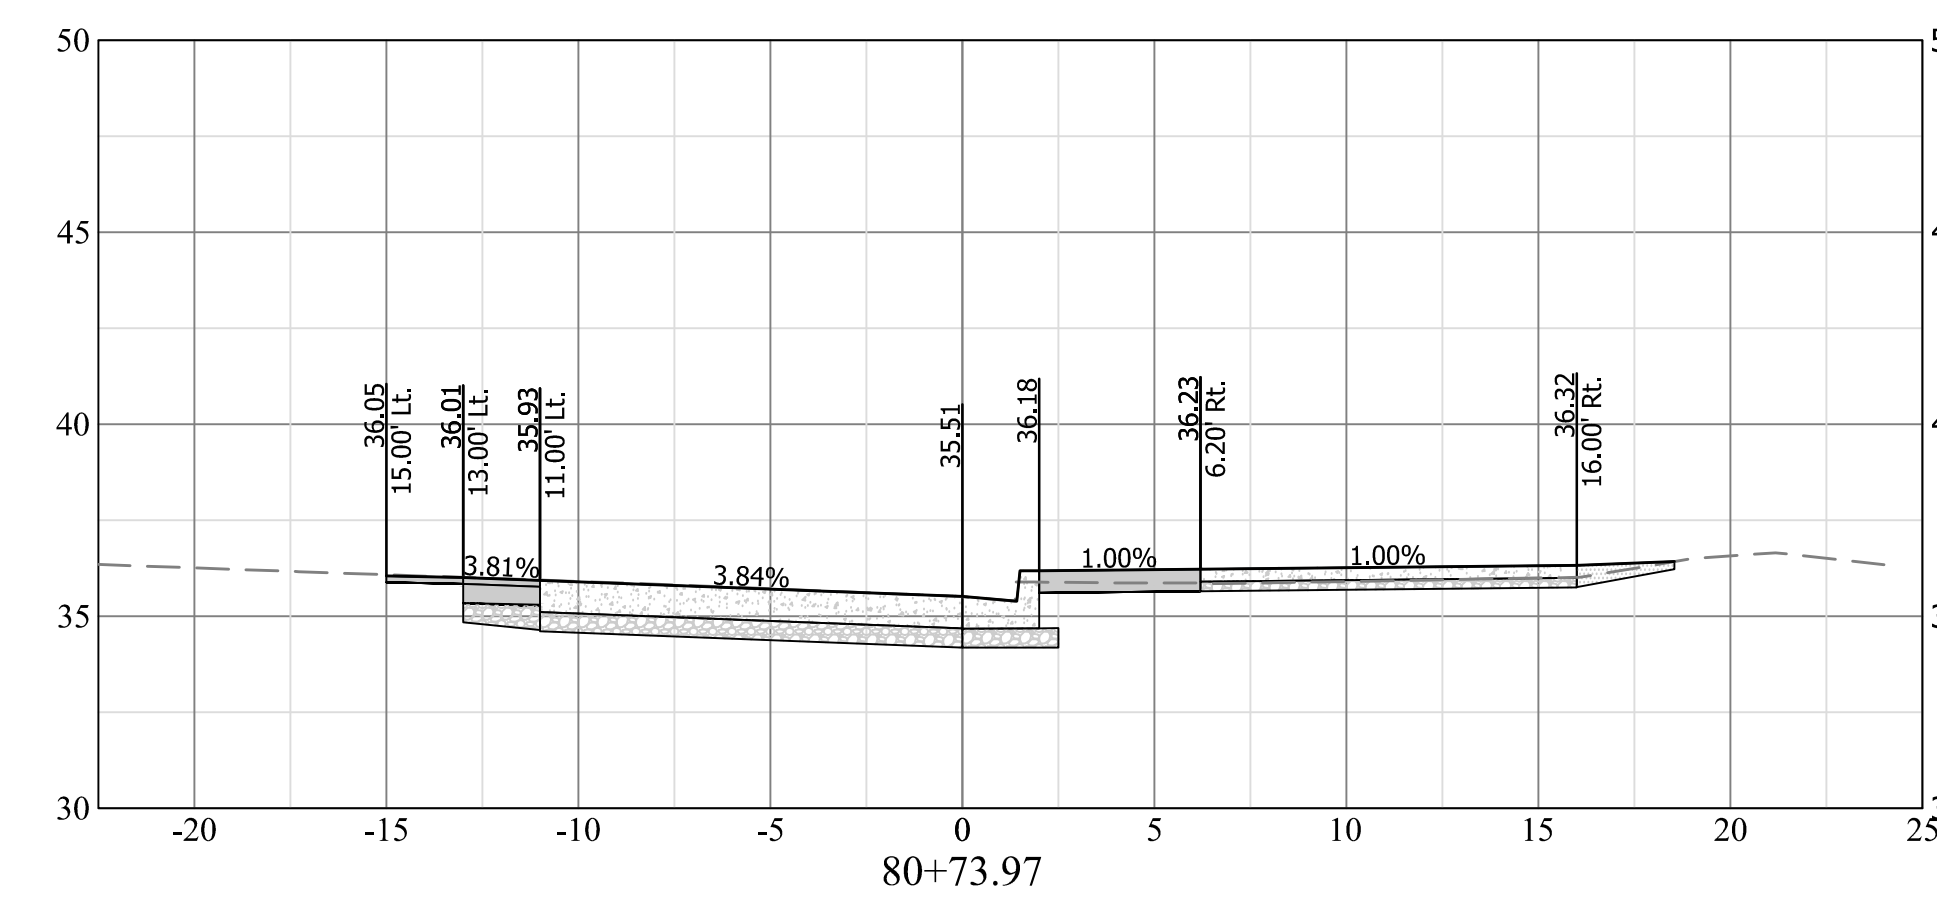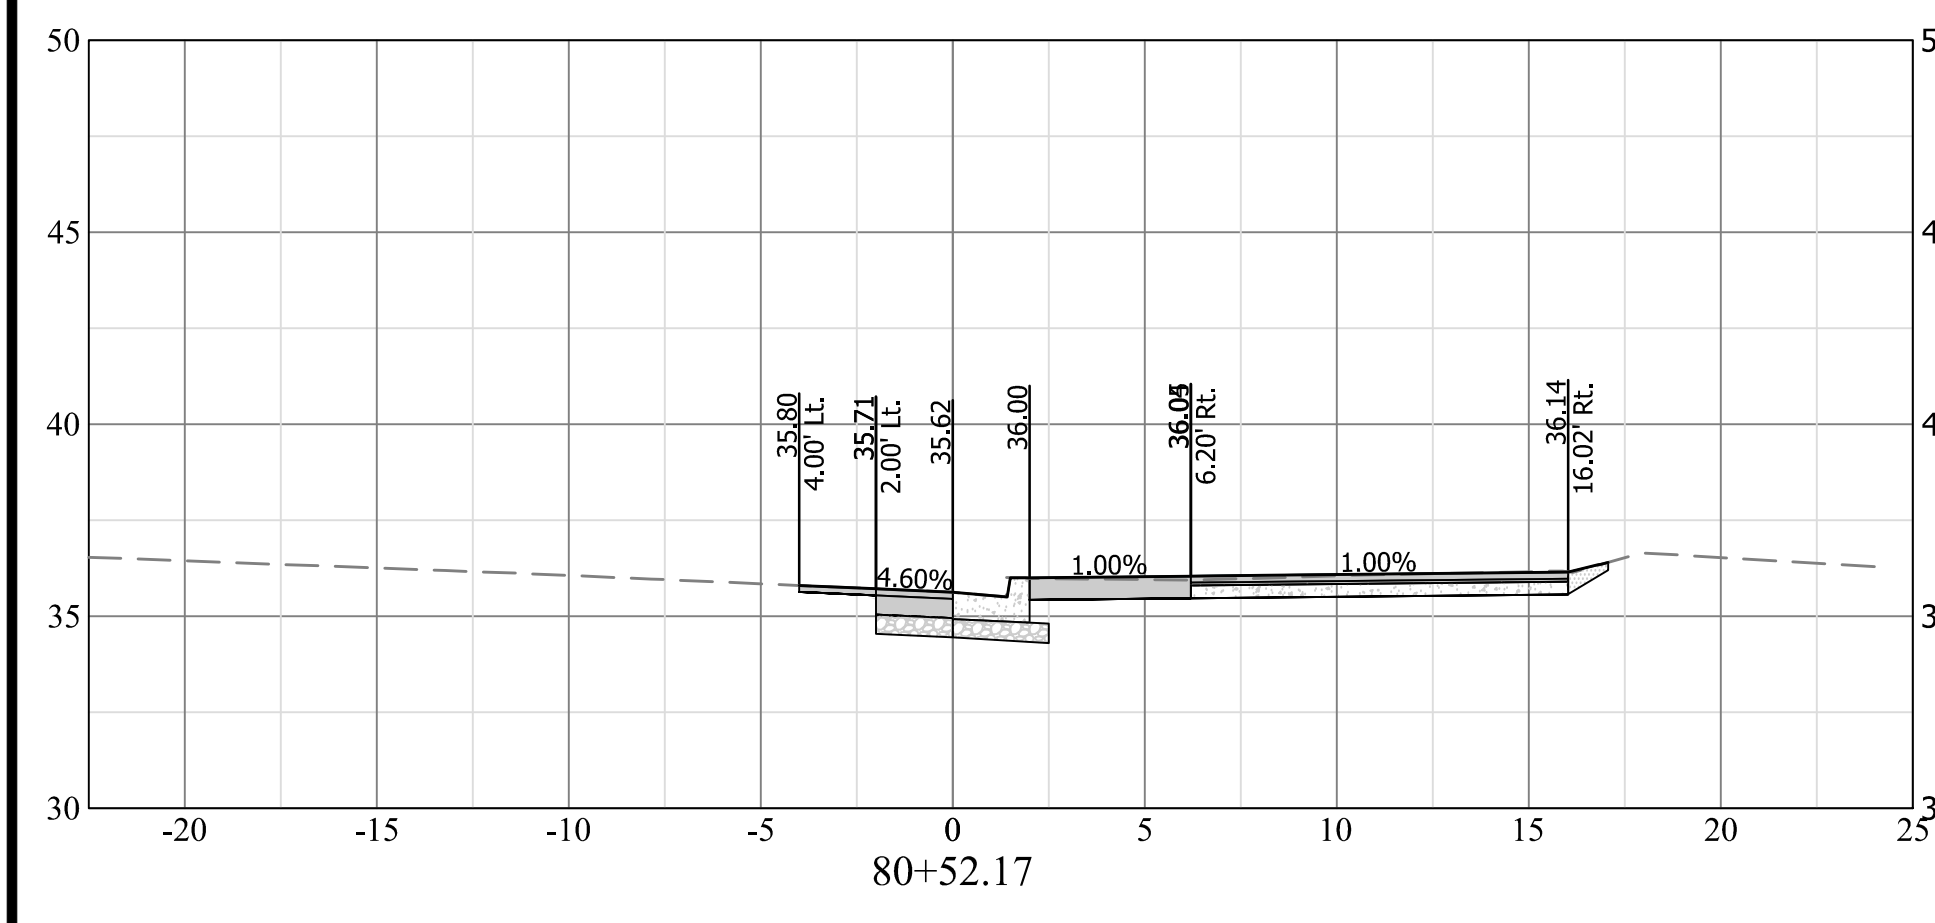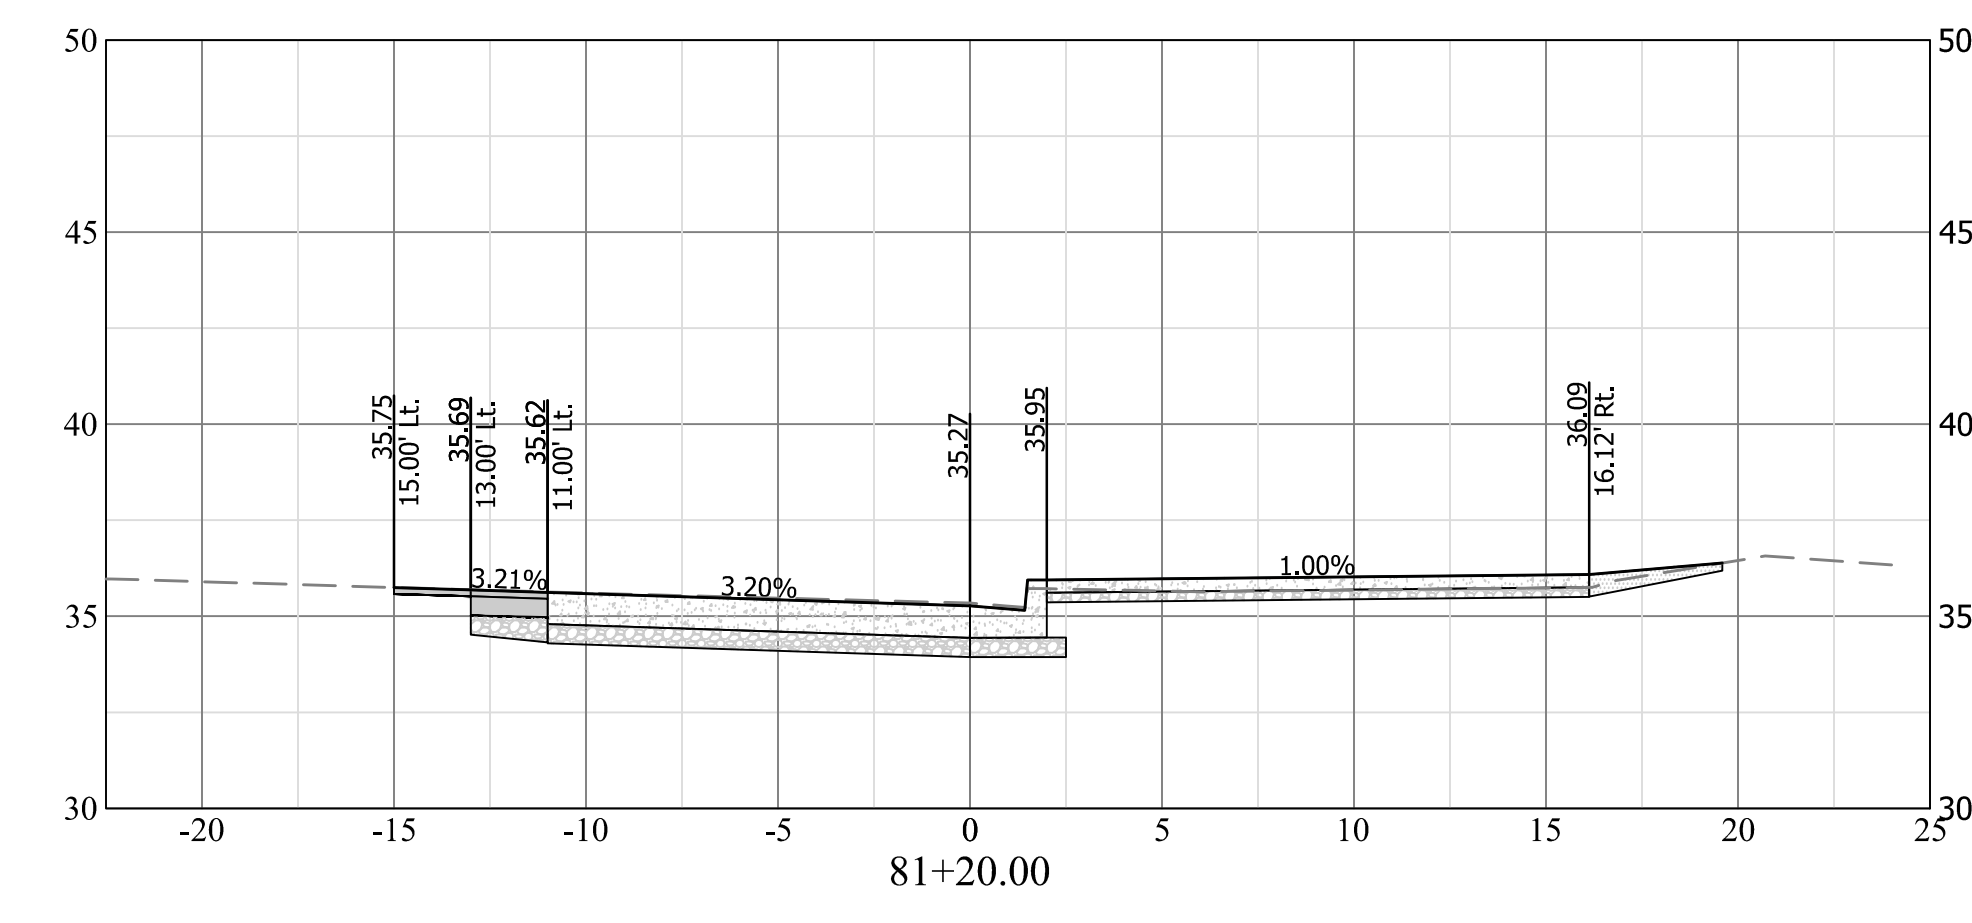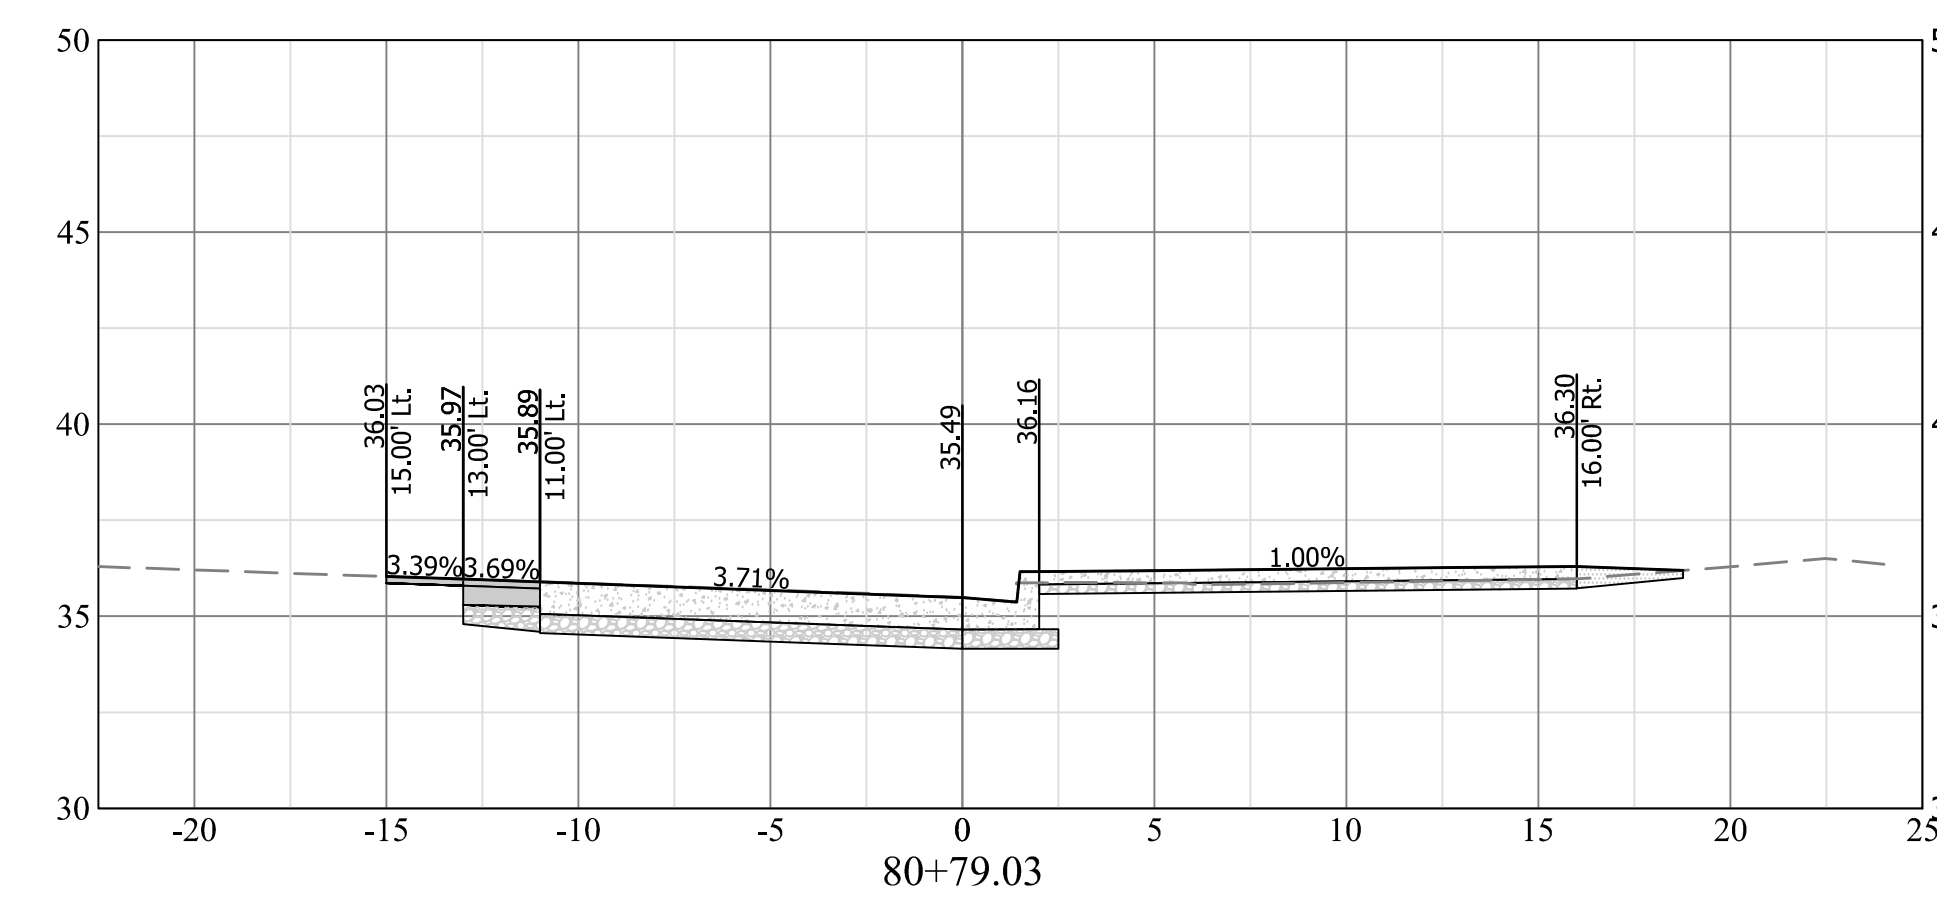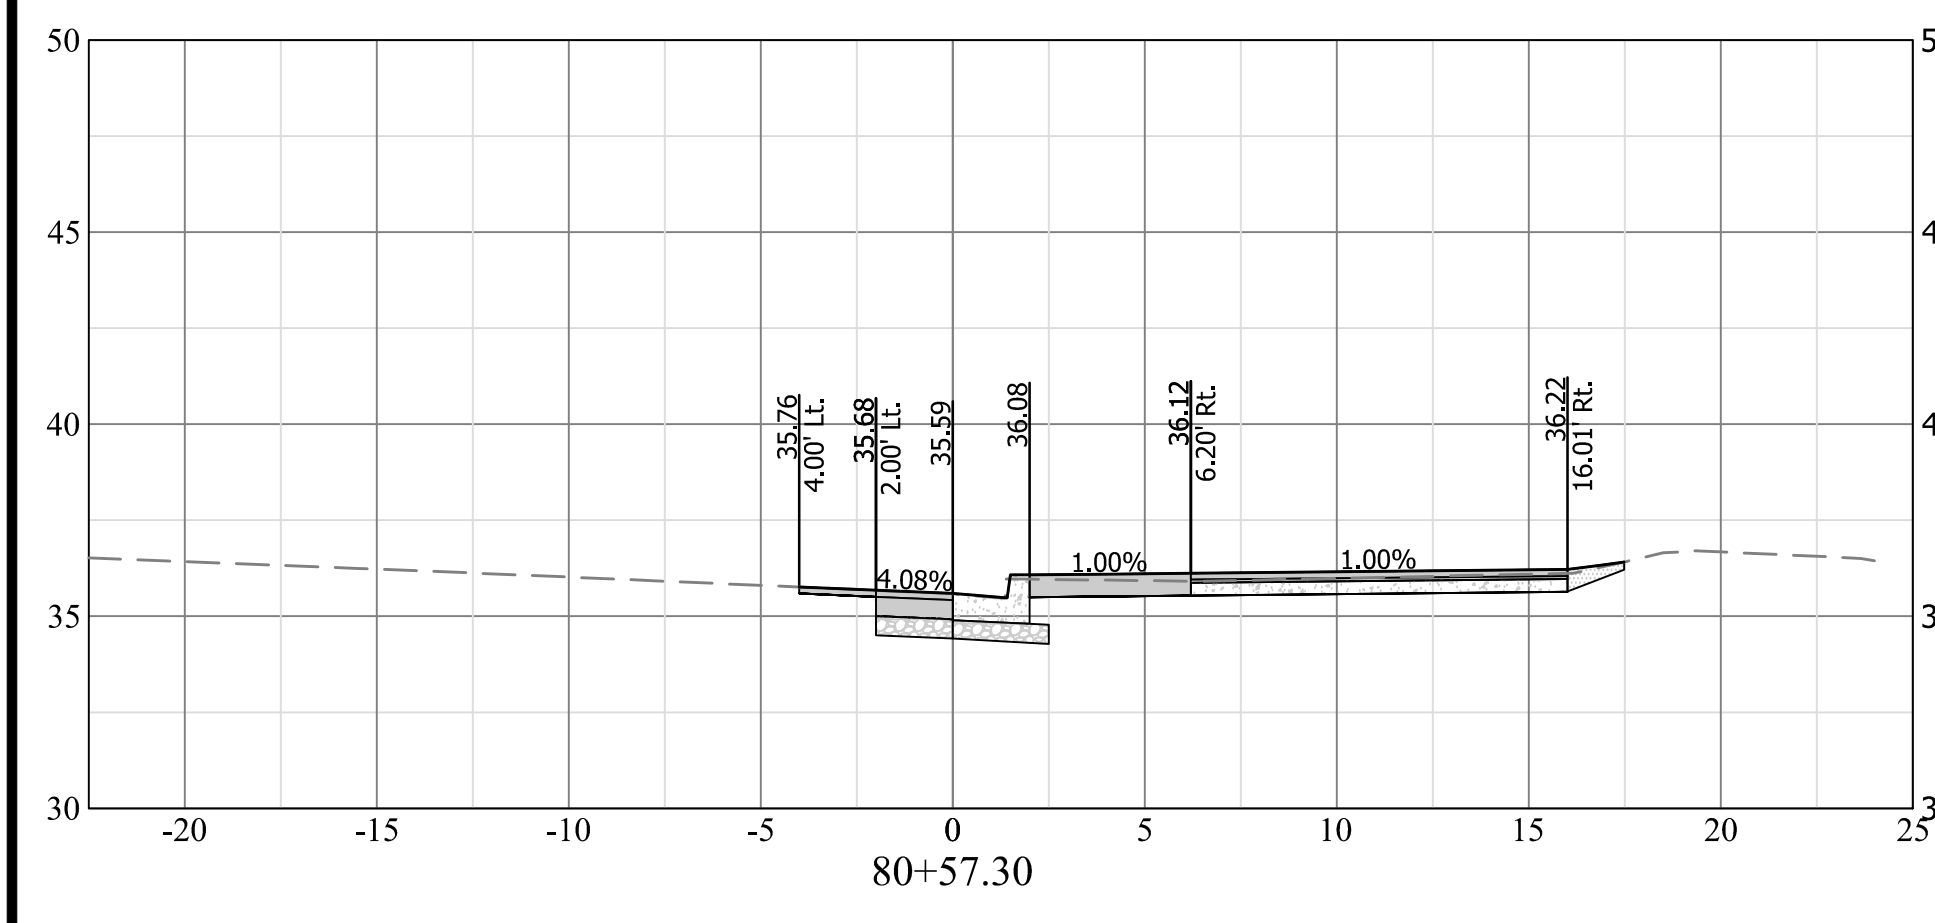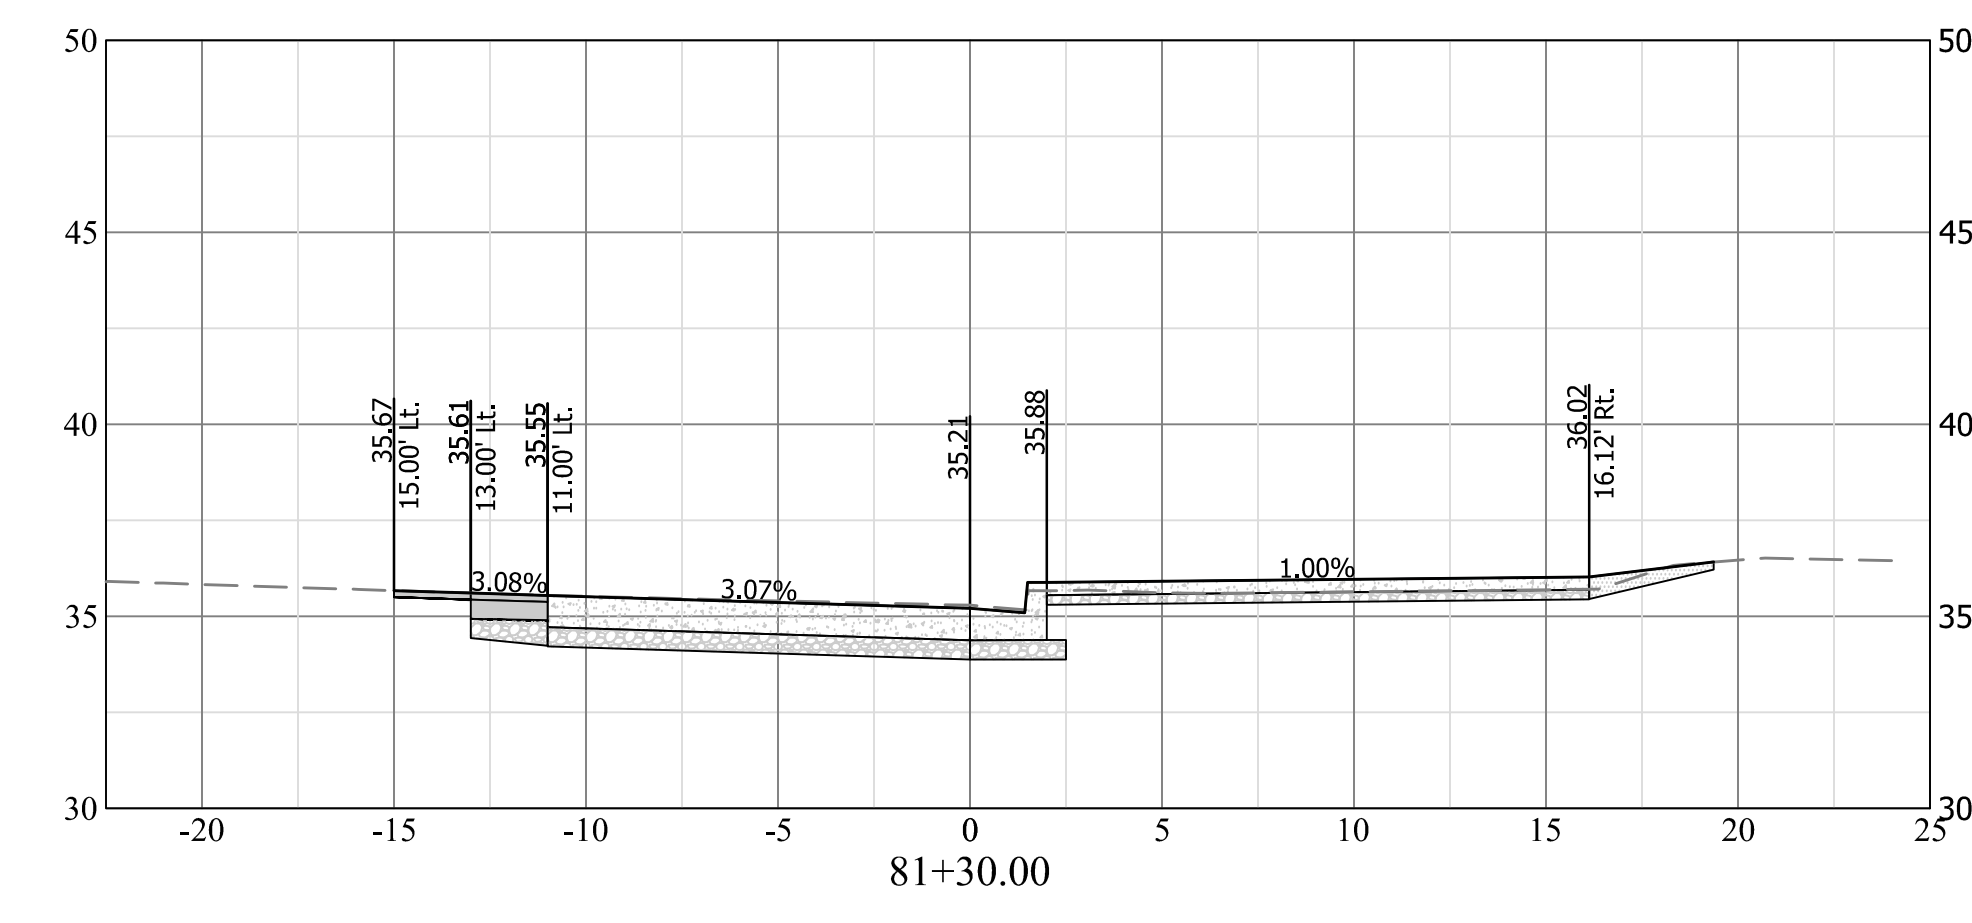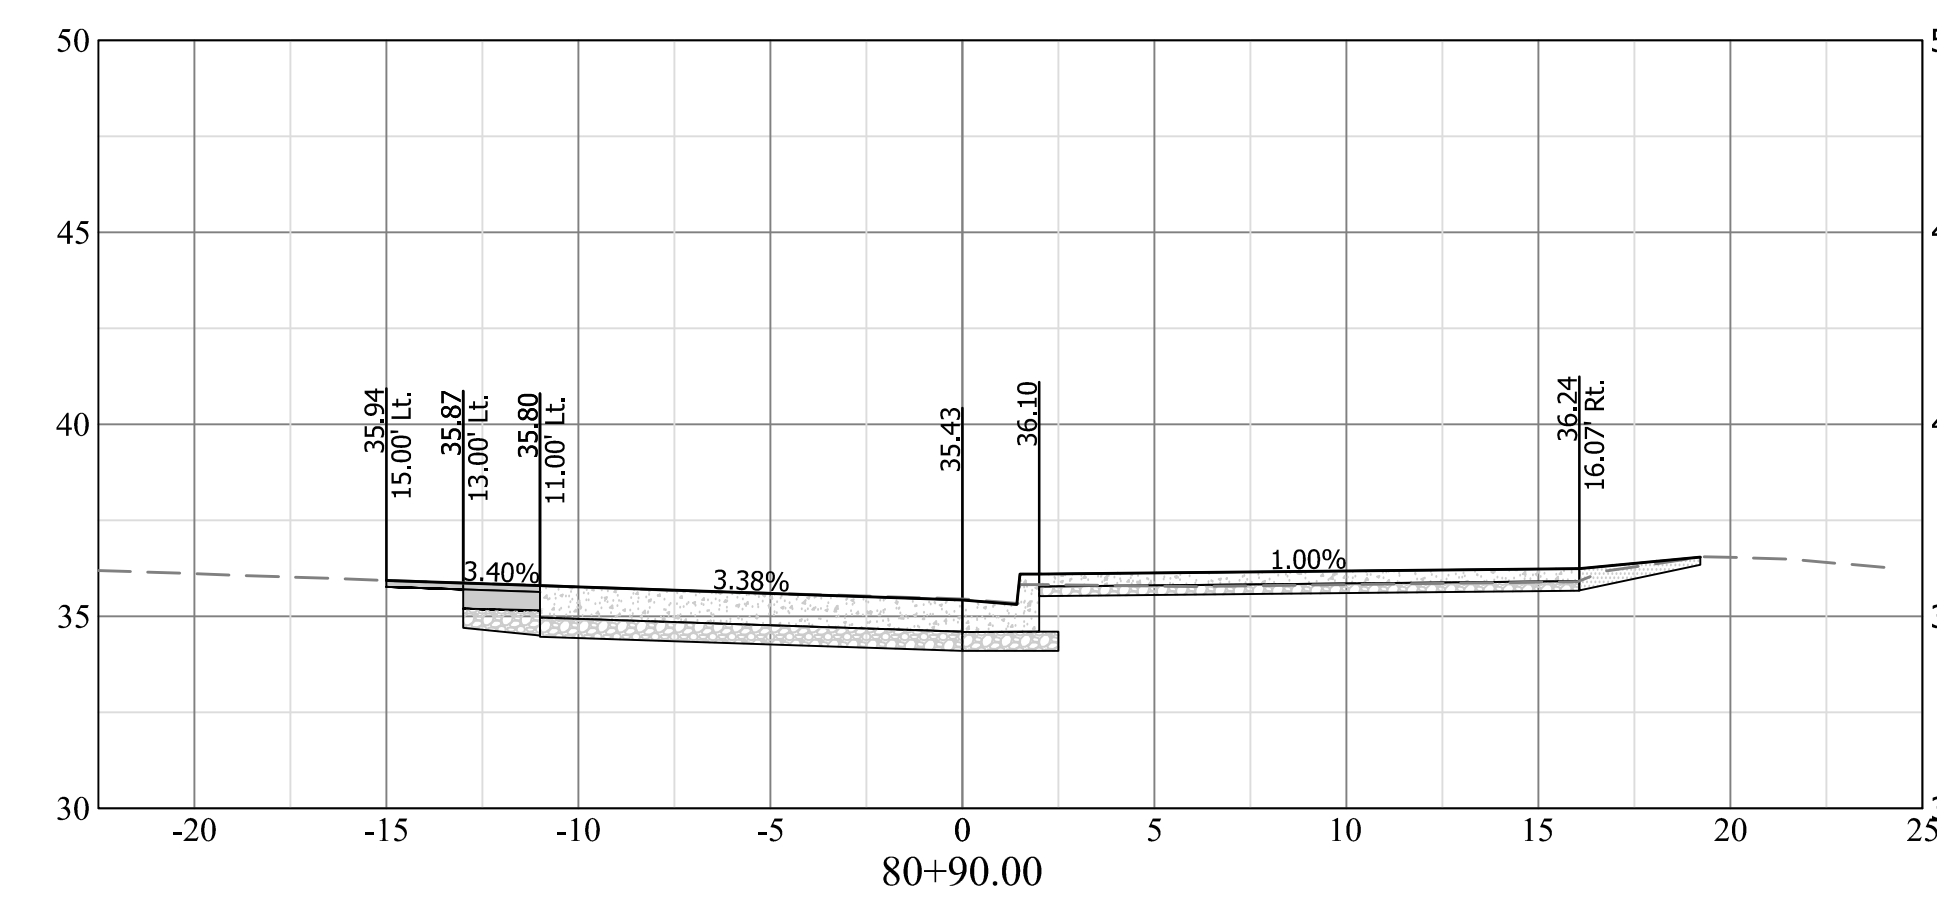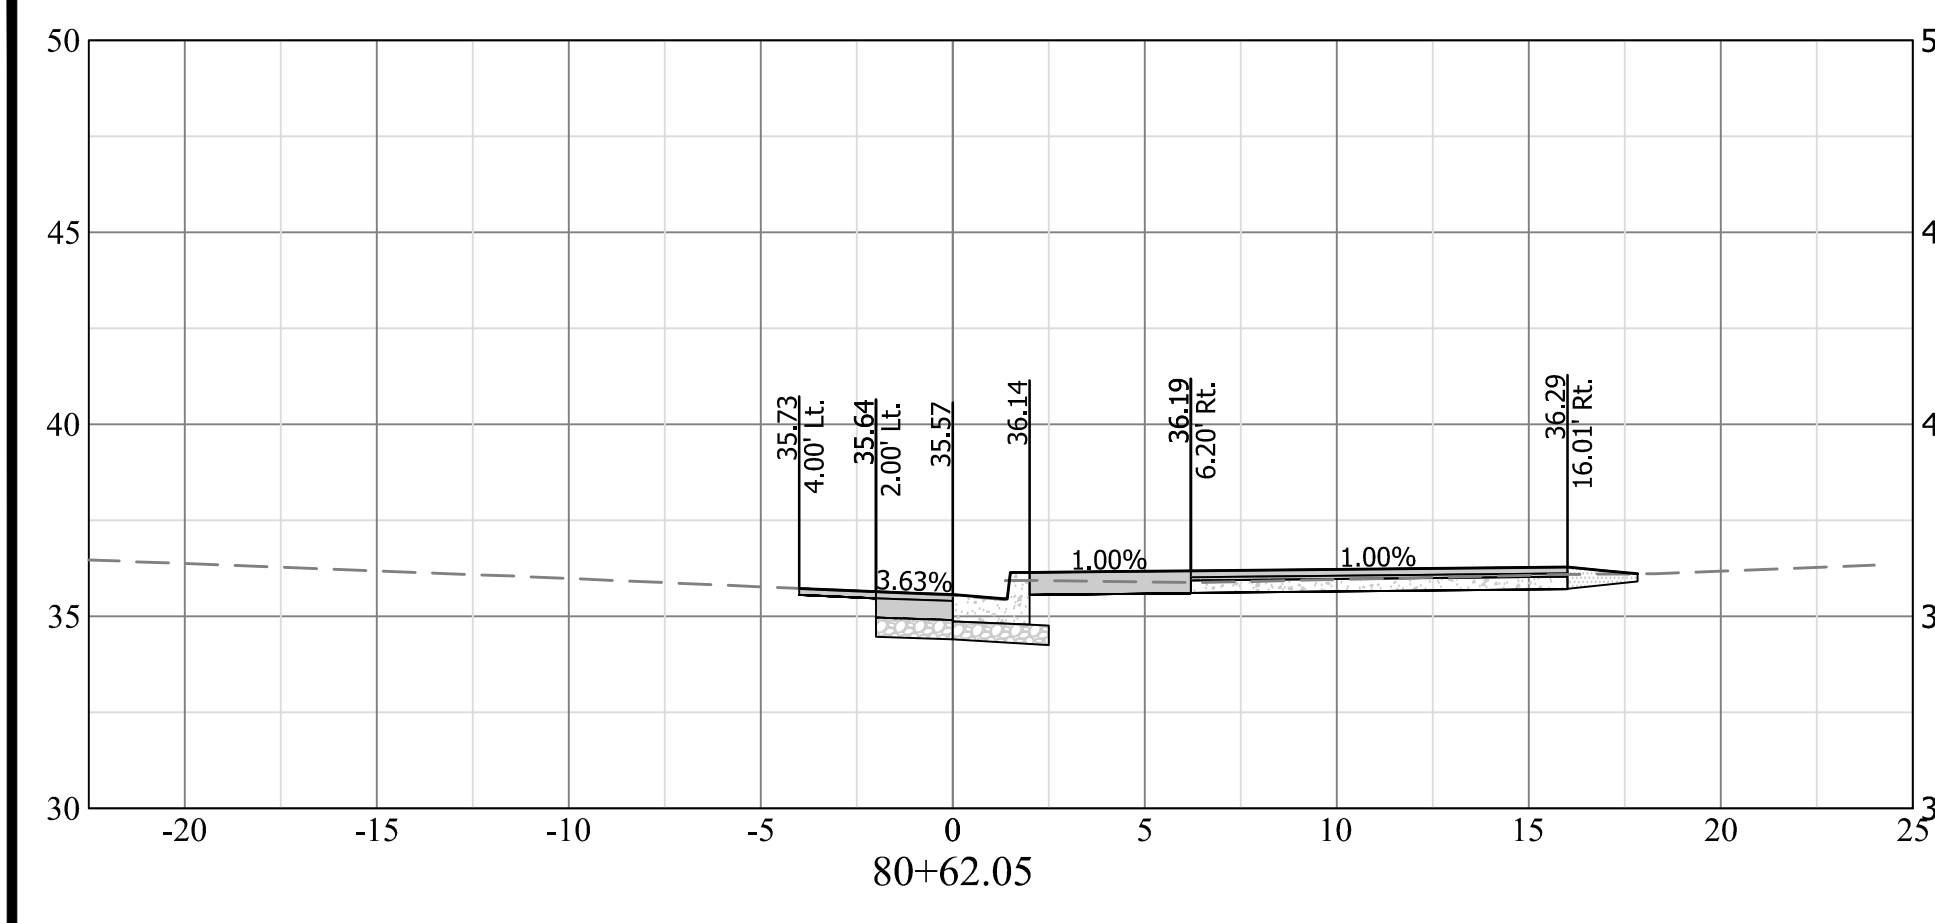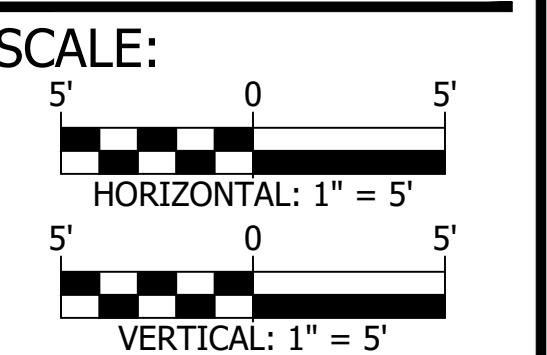

CRYSTAL DR NB & 15TH ST S INTERSECTION

NOTE: PAVEMENT AND SIDEWALK SECTIONS ARE SHOWN ON THIS SHEET FOR INFORMATIONAL PURPOSES ONLY. SEE SHEET 04 FOR PAVEMENT AND SIDEWALK TYPICAL SECTIONS. SEE PLAN AND PROFILE SHEETS FOR EXTENTS OF PROPOSED PAVEMENT AND SIDEWALK.










APPROVALS	DATE
<i>[Signature]</i> QUALITY CONTROL ENGINEER	3/29/21
<i>[Signature]</i> CONSTRUCTION MANAGEMENT SUPERVISOR	3.24.21
<i>[Signature]</i> WATER, SEWER, STREETS BUREAU CHIEF	03.04.2021
<i>[Signature]</i> TRANSPORTATION DIRECTOR	03/17/21
<i>[Signature]</i> PROJECT MANAGER	3/2/21

REVISIONS	DATE

PROJECT NAME AND LOCATION
**TRANSITWAY EXTENSION TO
PENTAGON CITY**
**CROSS SECTIONS
CRYSTAL DR & 12TH ST S**
MA13 - SEGMENT I

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PLOTTED BY: NSHARP

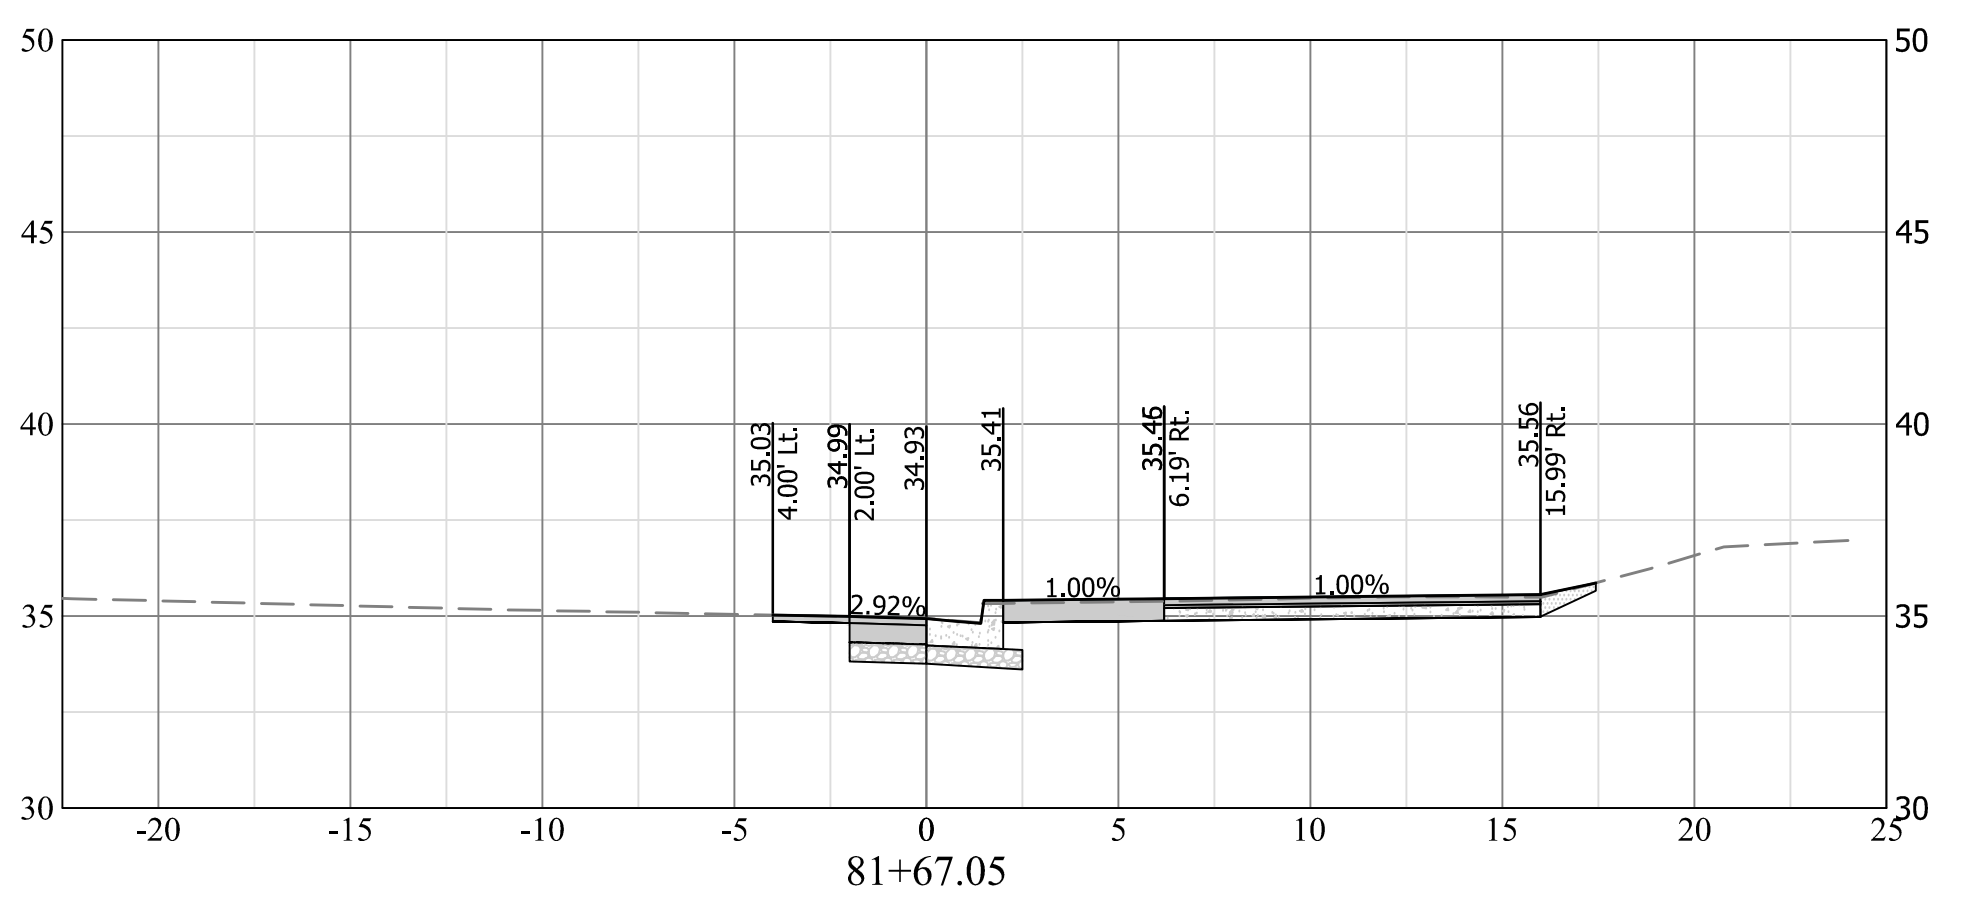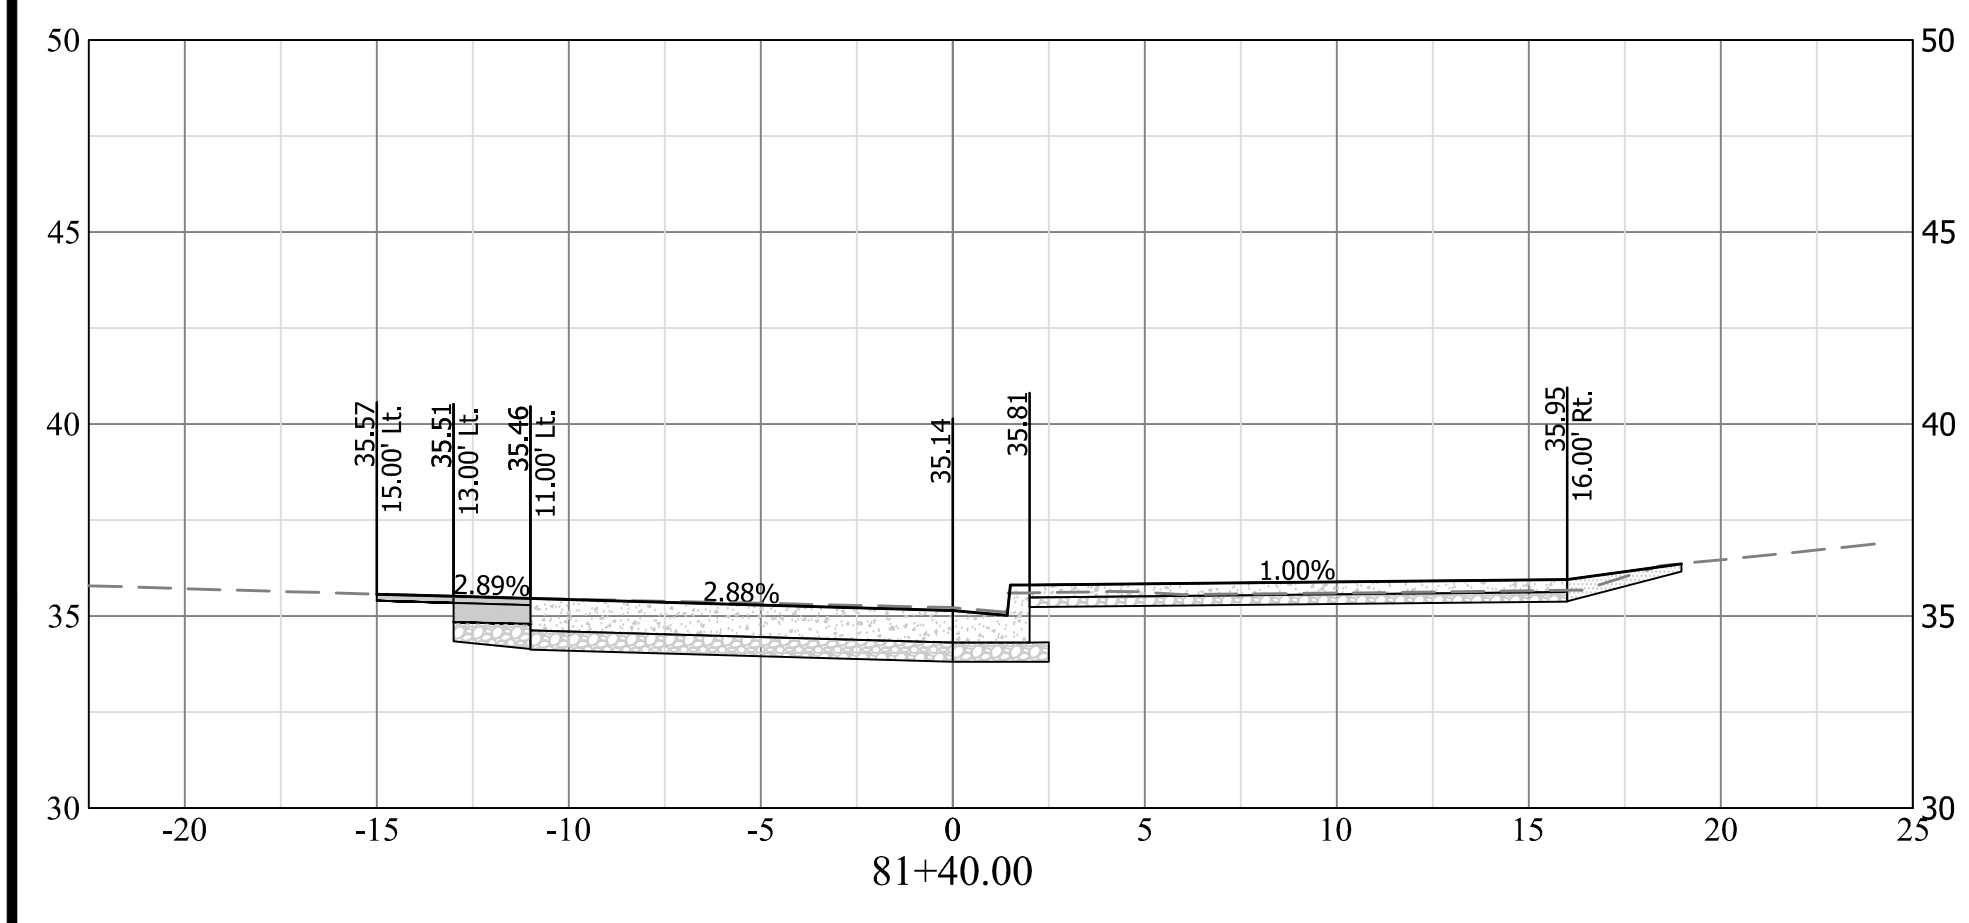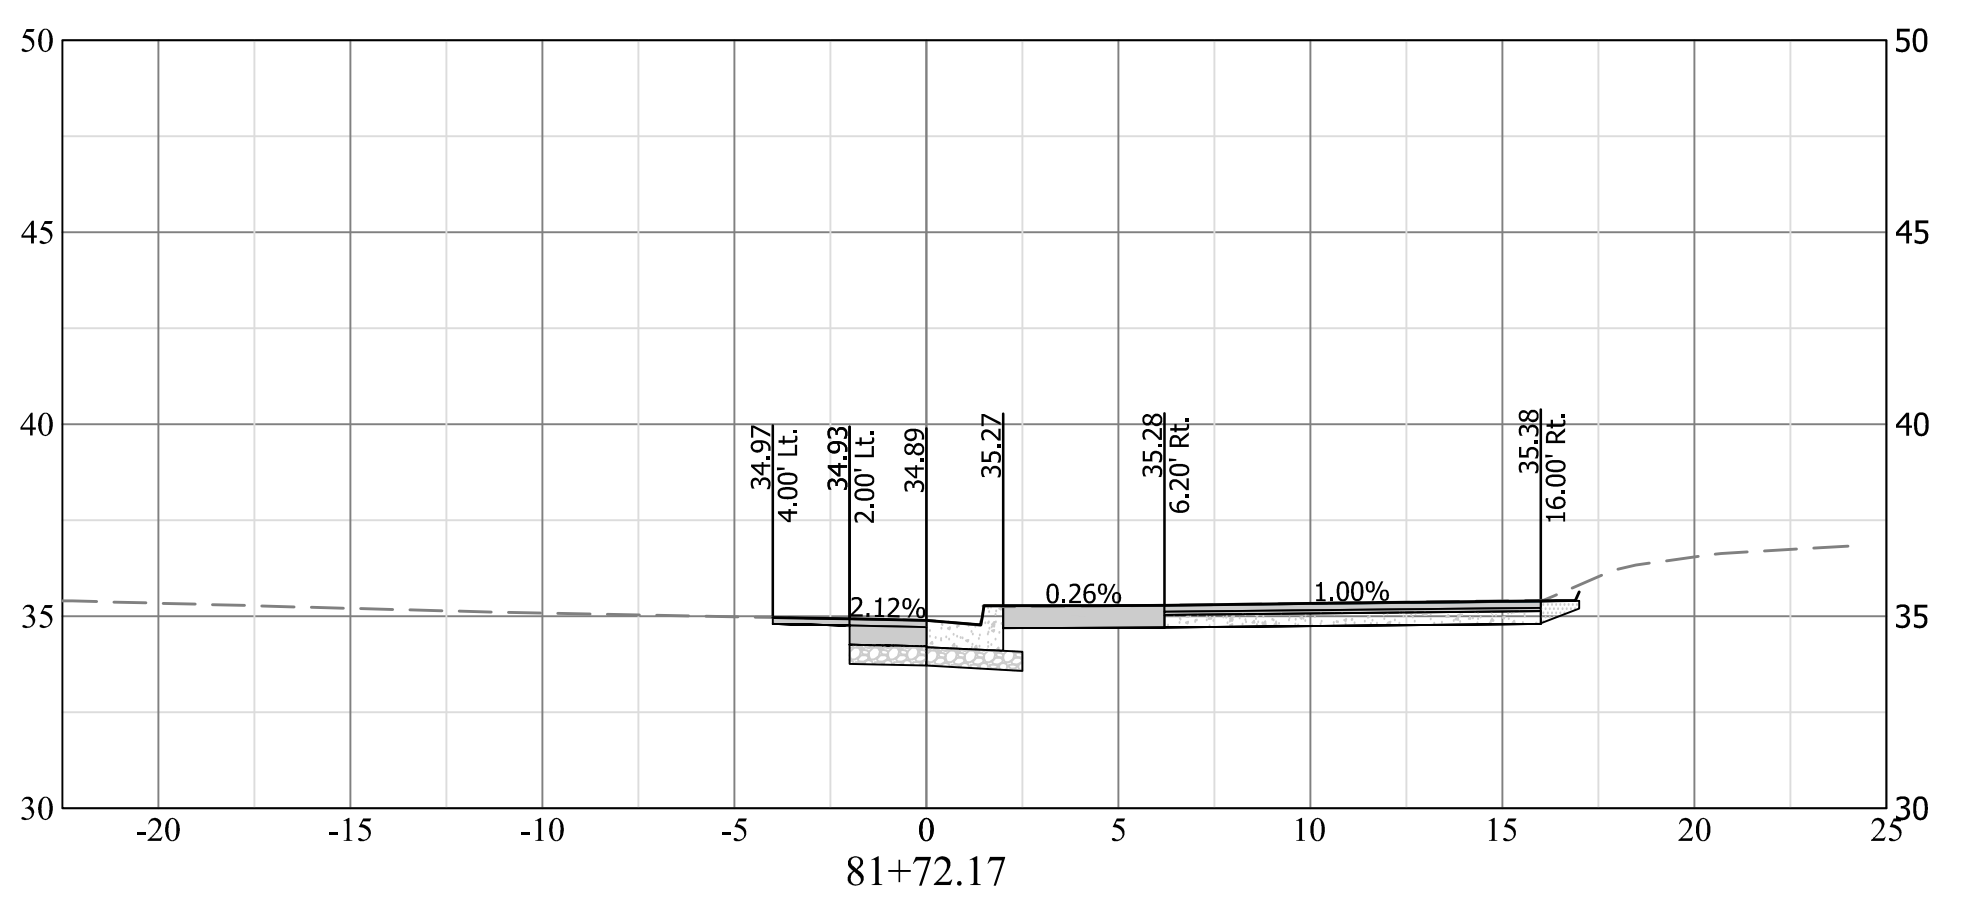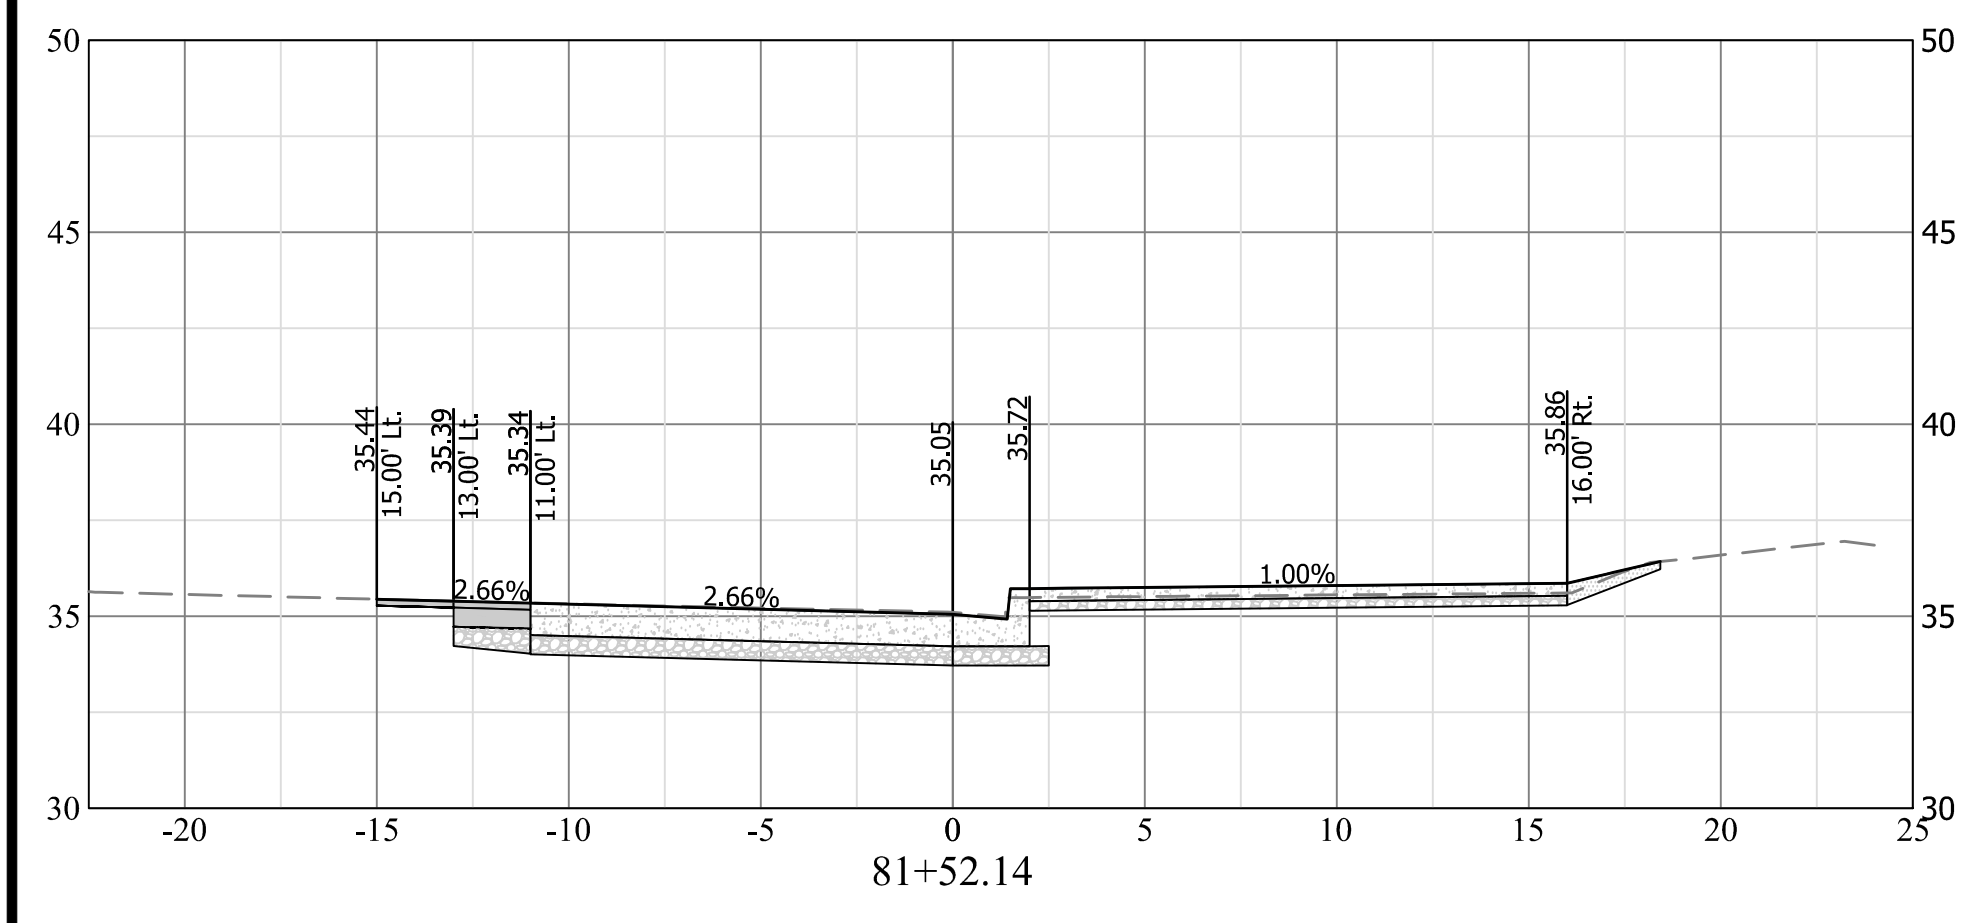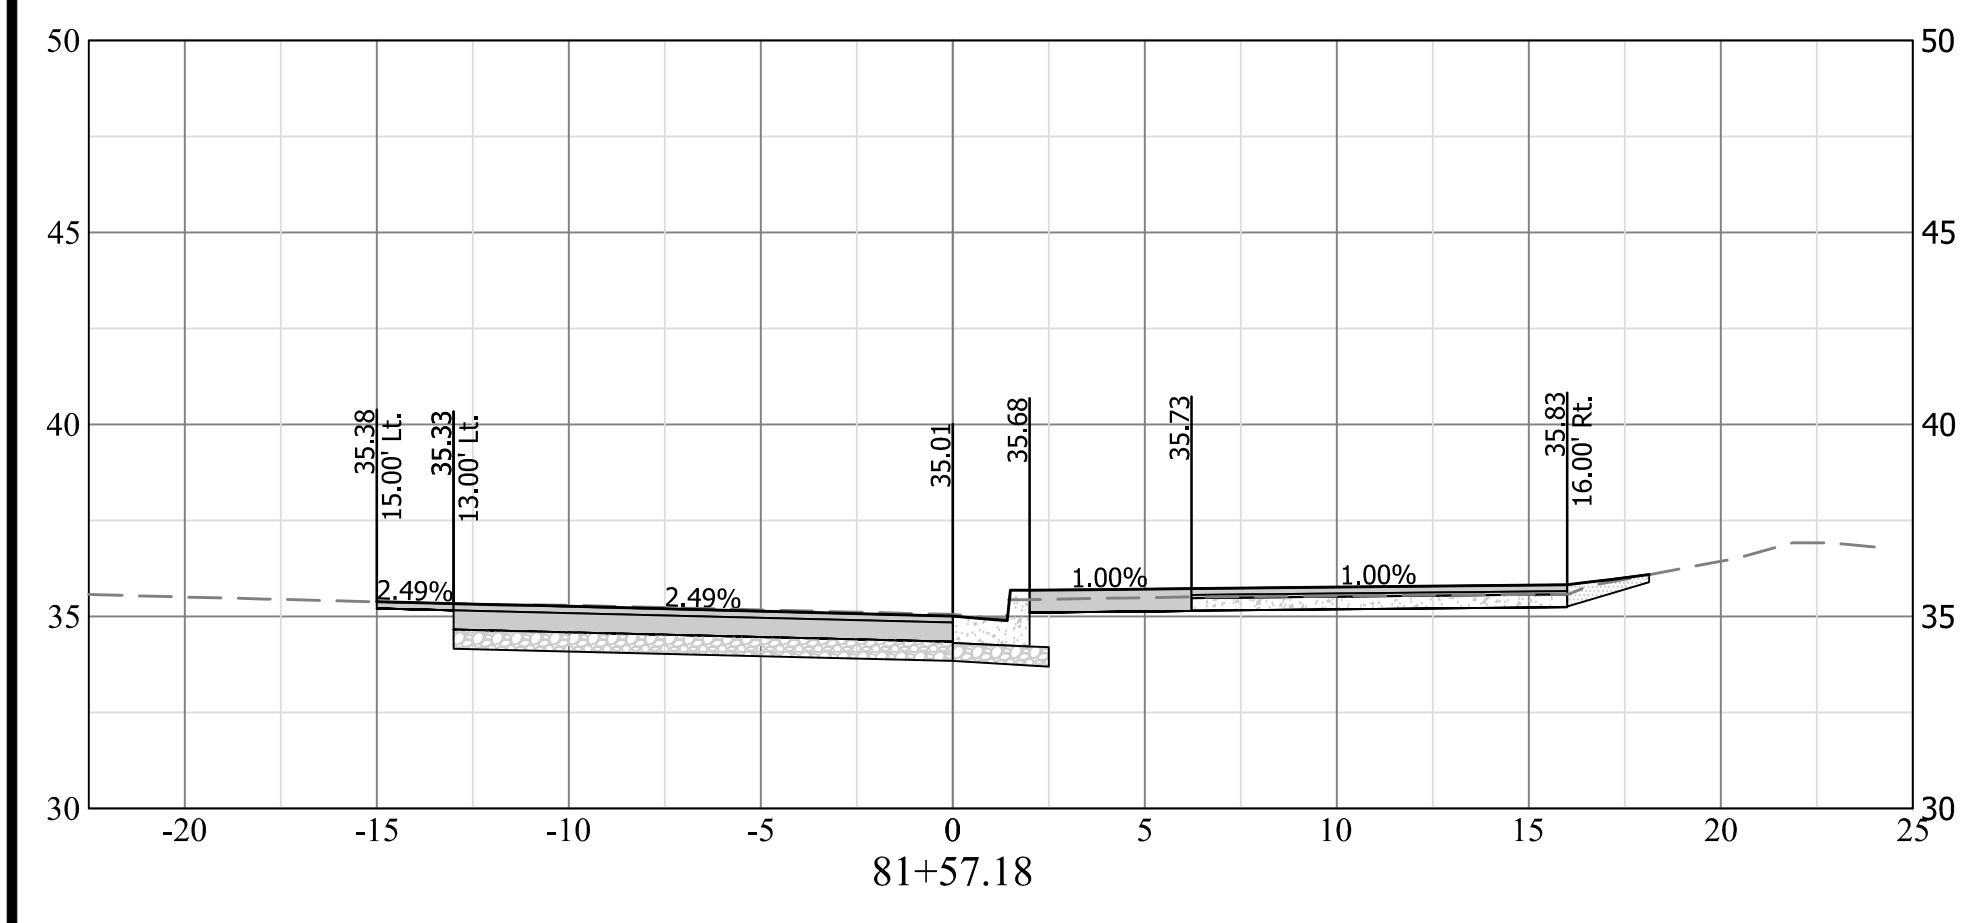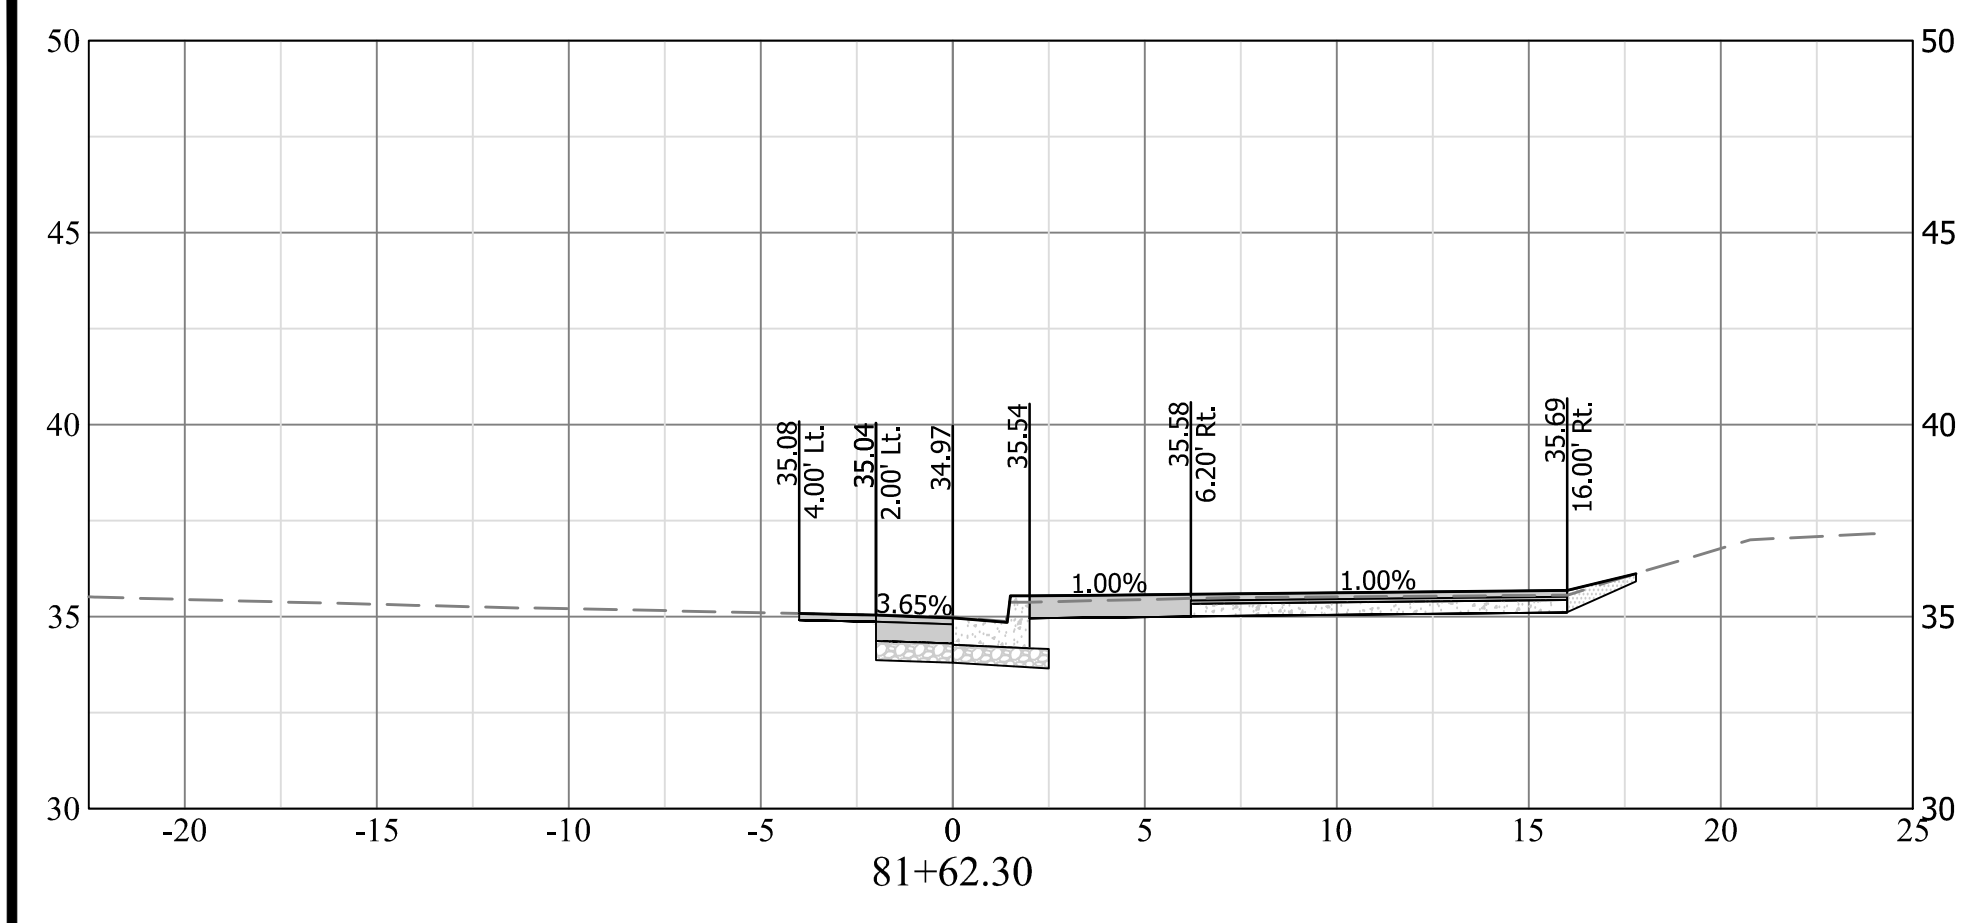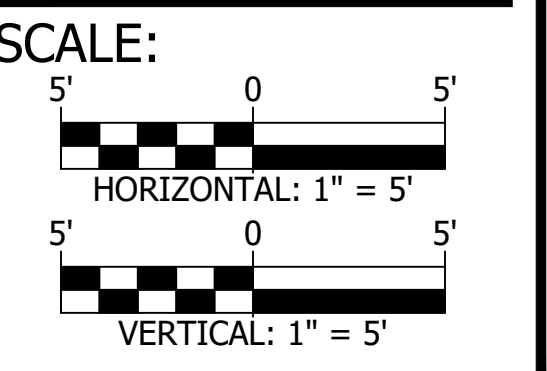

CRYSTAL DR NB & 15TH ST S INTERSECTION

NOTE: PAVEMENT AND SIDEWALK SECTIONS ARE SHOWN ON THIS SHEET FOR INFORMATIONAL PURPOSES ONLY. SEE SHEET 04 FOR PAVEMENT AND SIDEWALK TYPICAL SECTIONS. SEE PLAN AND PROFILE SHEETS FOR EXTENTS OF PROPOSED PAVEMENT AND SIDEWALK.
















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<i>[Signature]</i> QUALITY CONTROL ENGINEER	3/29/21
<i>[Signature]</i> CONSTRUCTION MANAGEMENT SUPERVISOR	3.24.21
<i>[Signature]</i> WATER, SEWER, STREETS BUREAU CHIEF	03.04.2021
<i>[Signature]</i> TRANSPORTATION DIRECTOR	03/17/21
<i>[Signature]</i> PROJECT MANAGER	3/2/21

REVISIONS	DATE

PROJECT NAME AND LOCATION
**TRANSITWAY EXTENSION TO
PENTAGON CITY**
**CROSS SECTIONS
CRYSTAL DR & 12TH ST S**
MA13 - SEGMENT I

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12TH ST S WB & LONG BRIDGE DR INTERSECTION

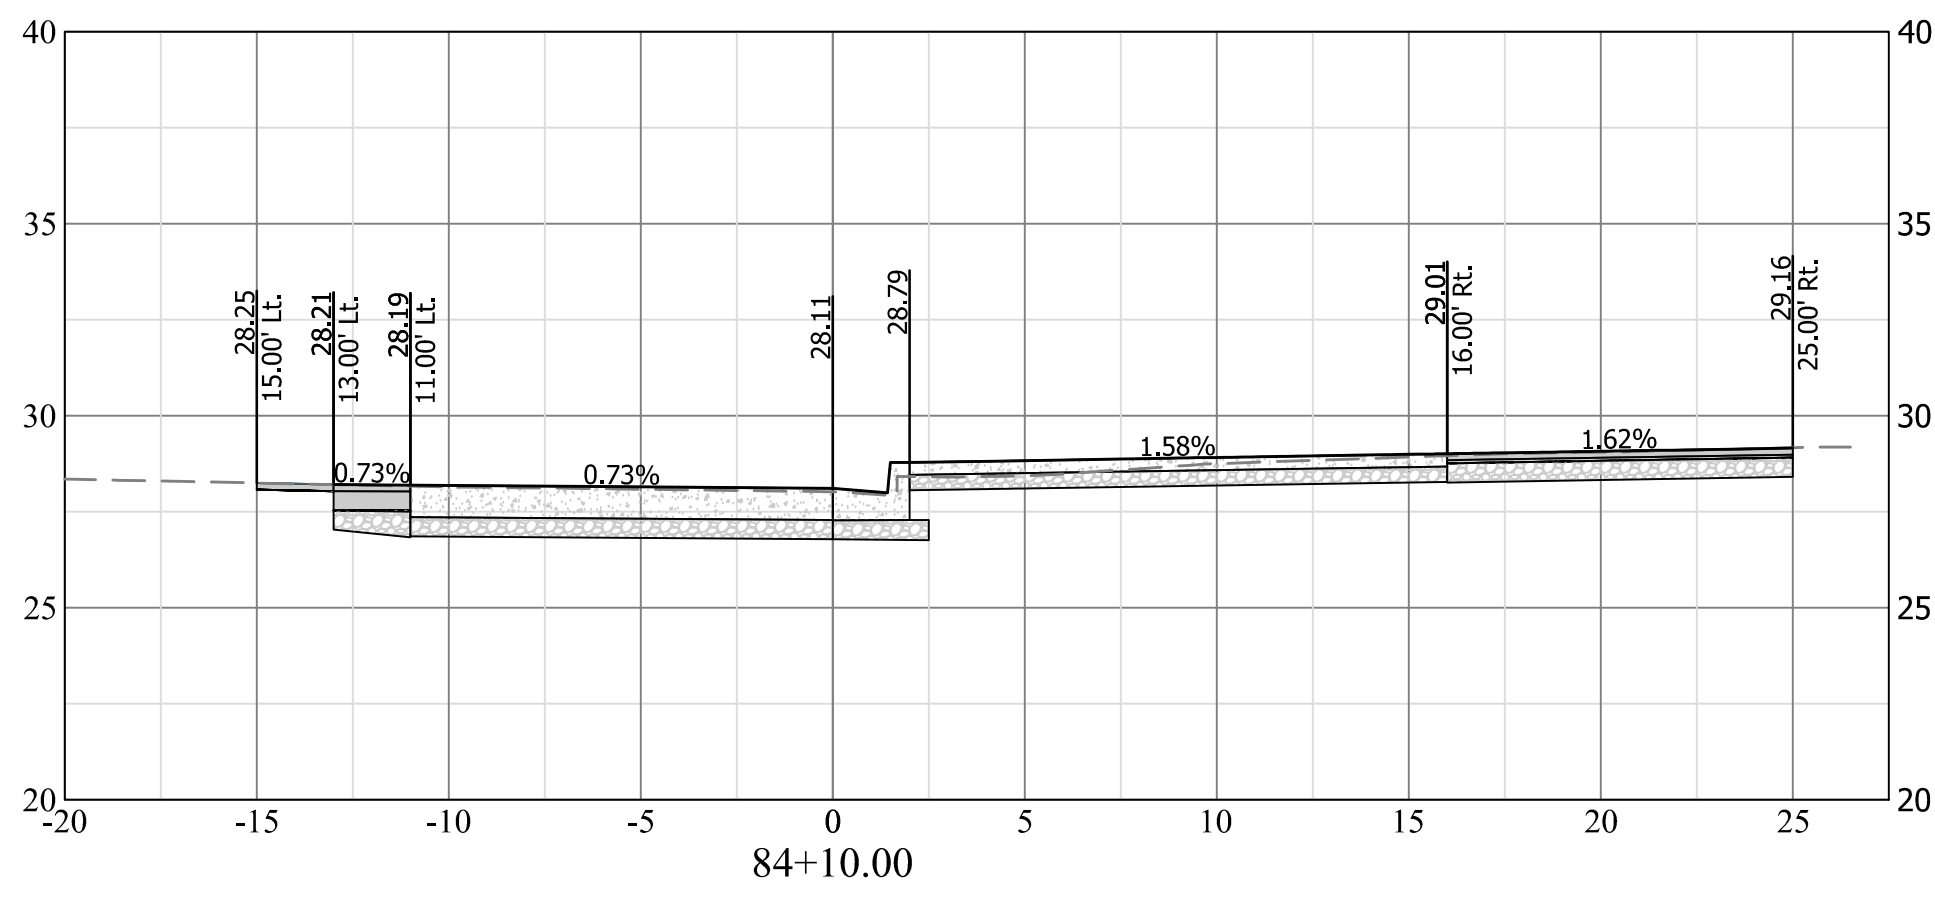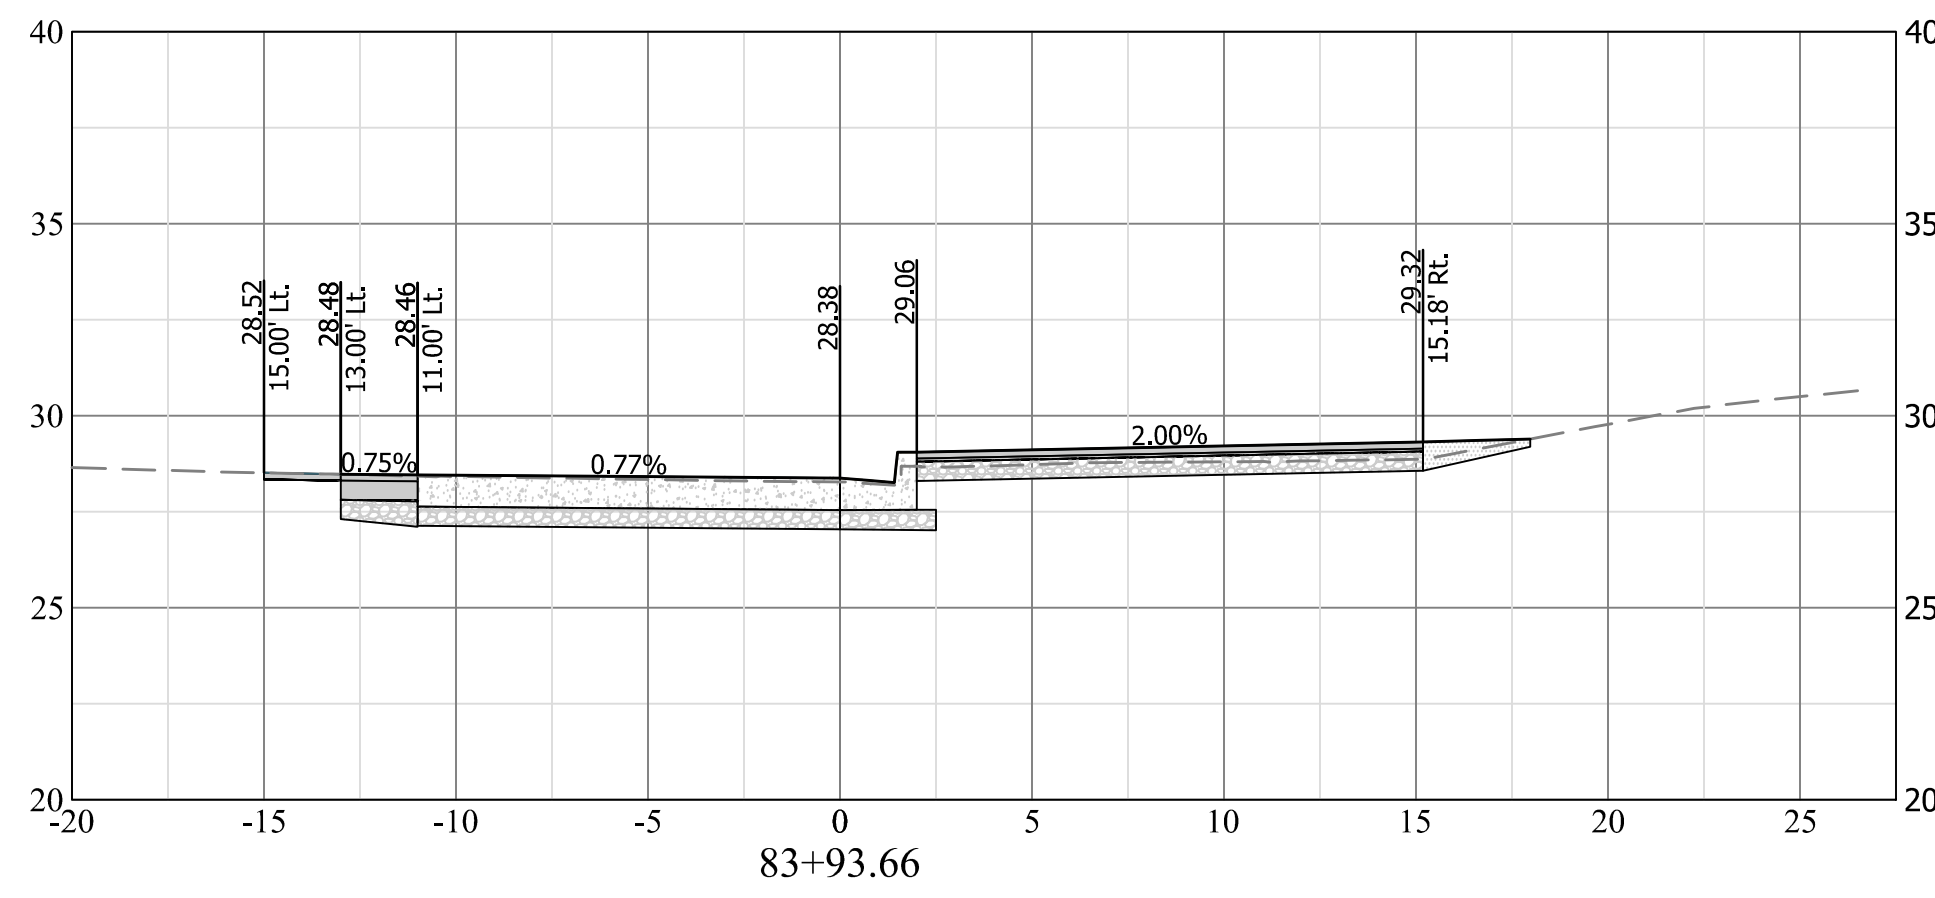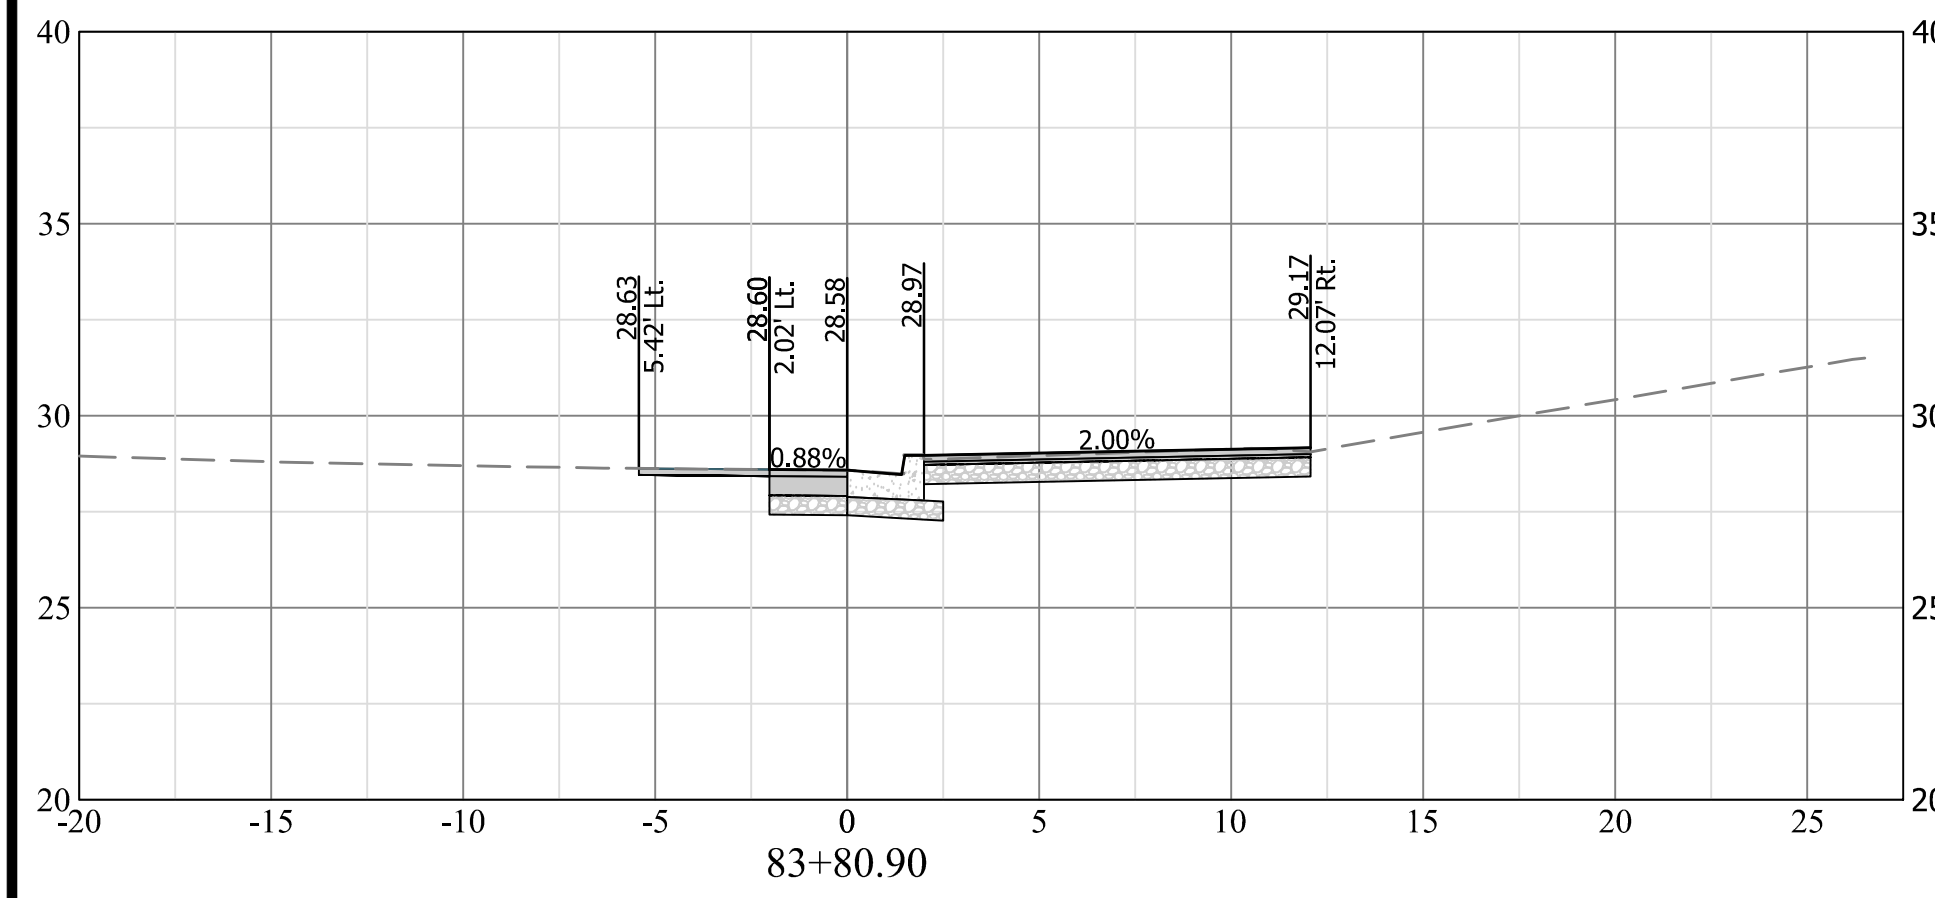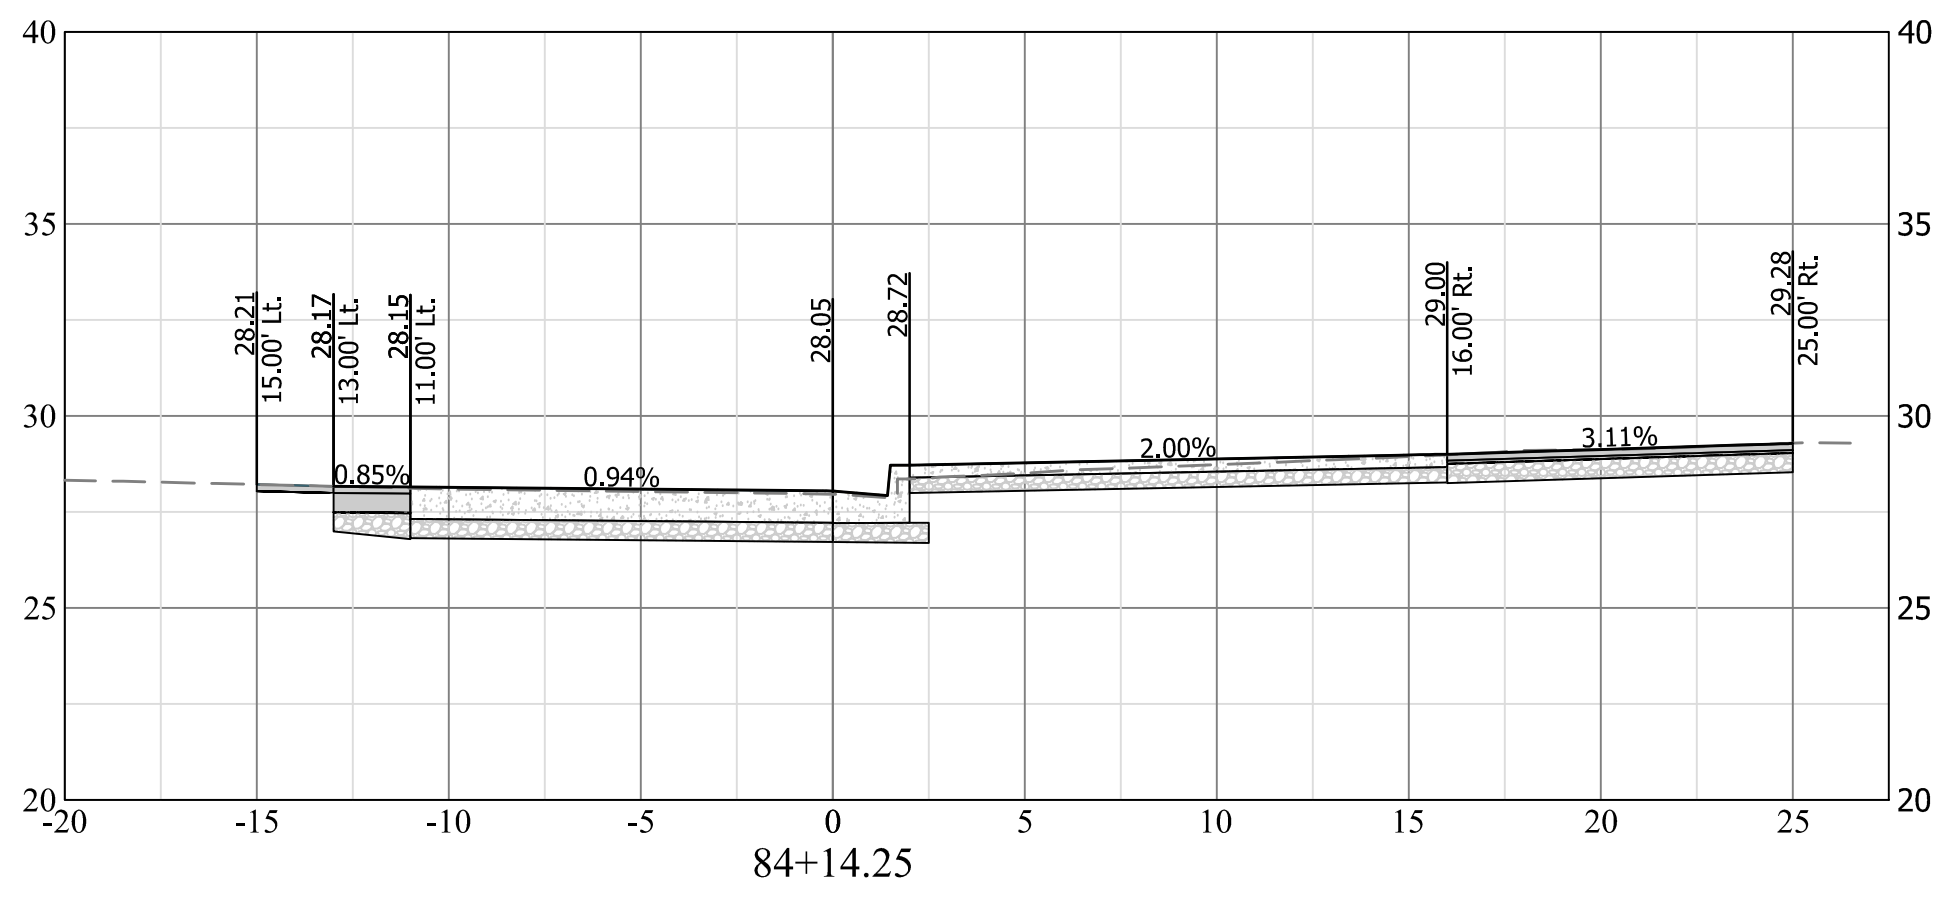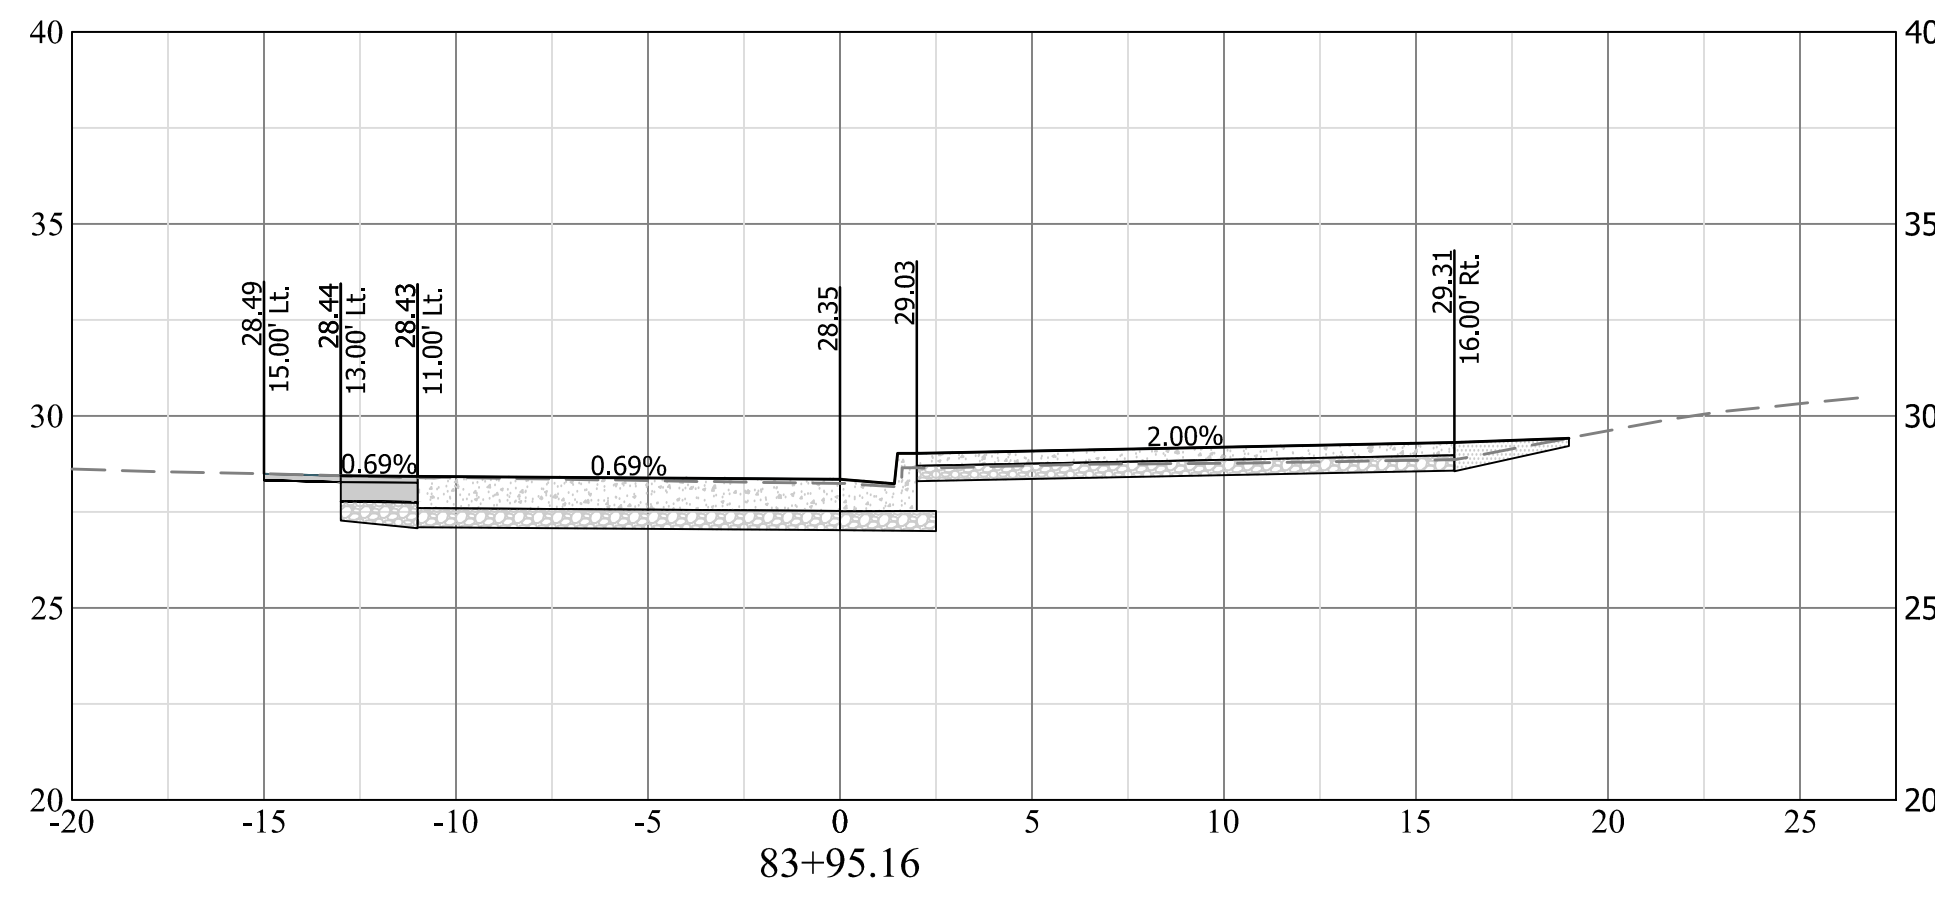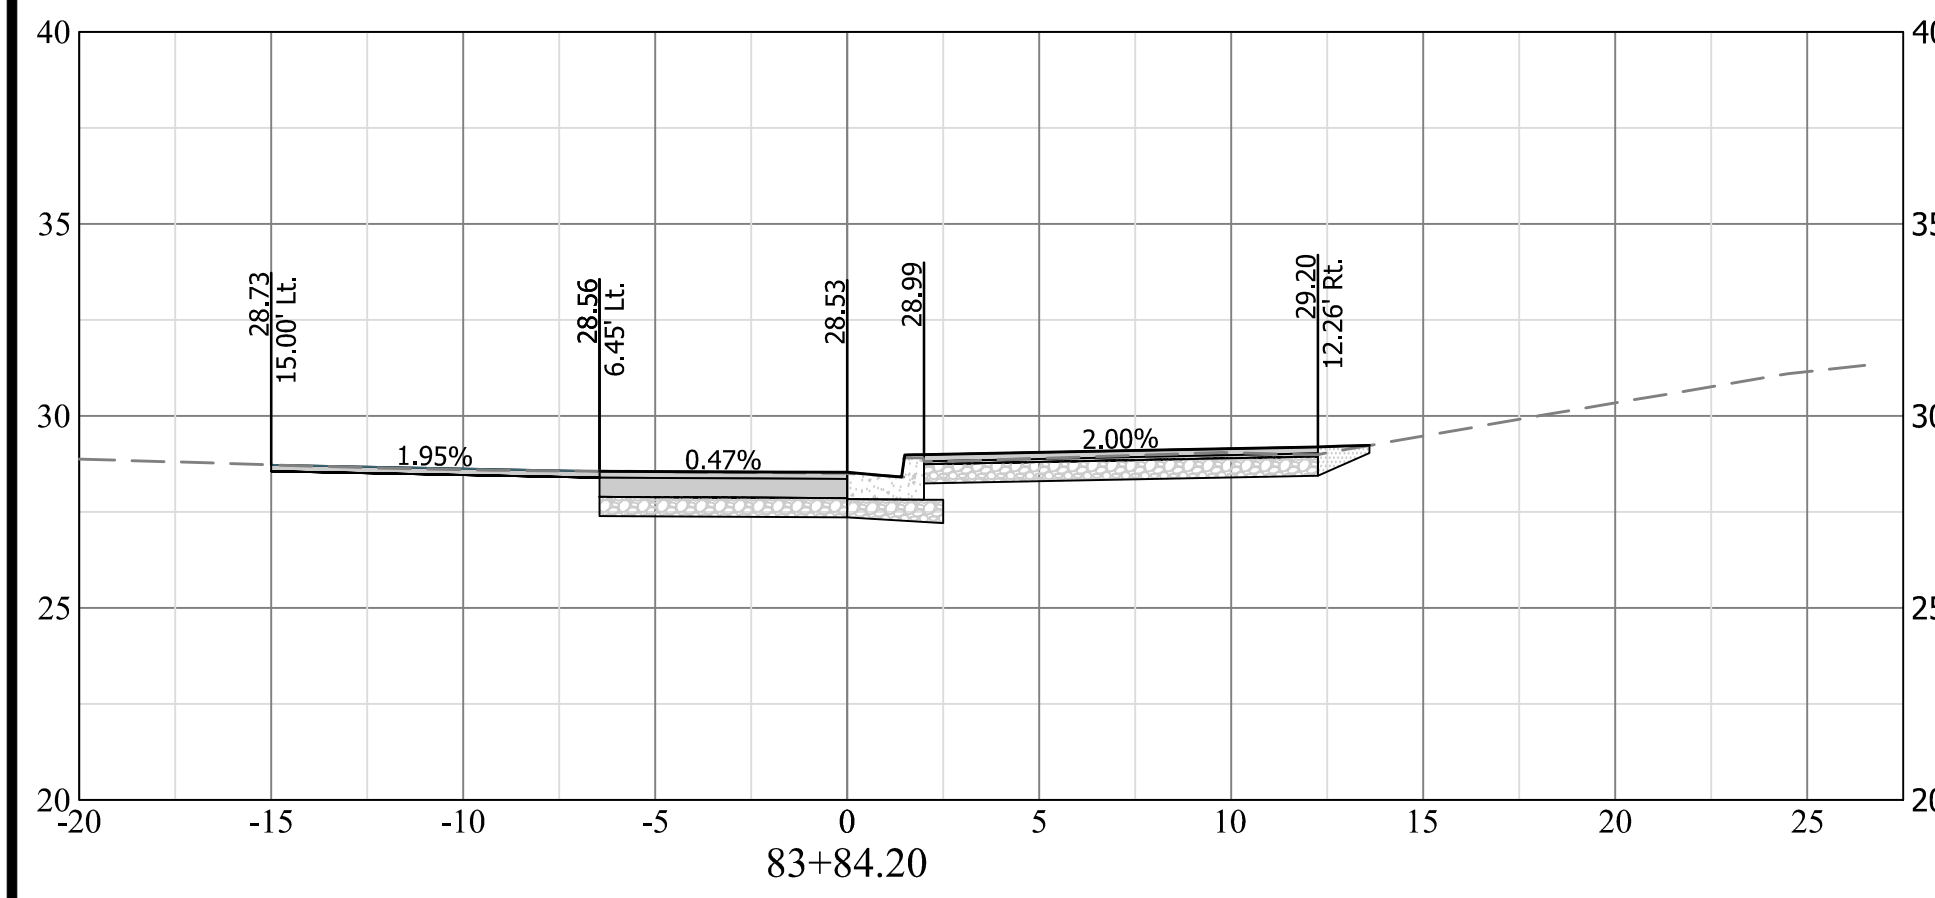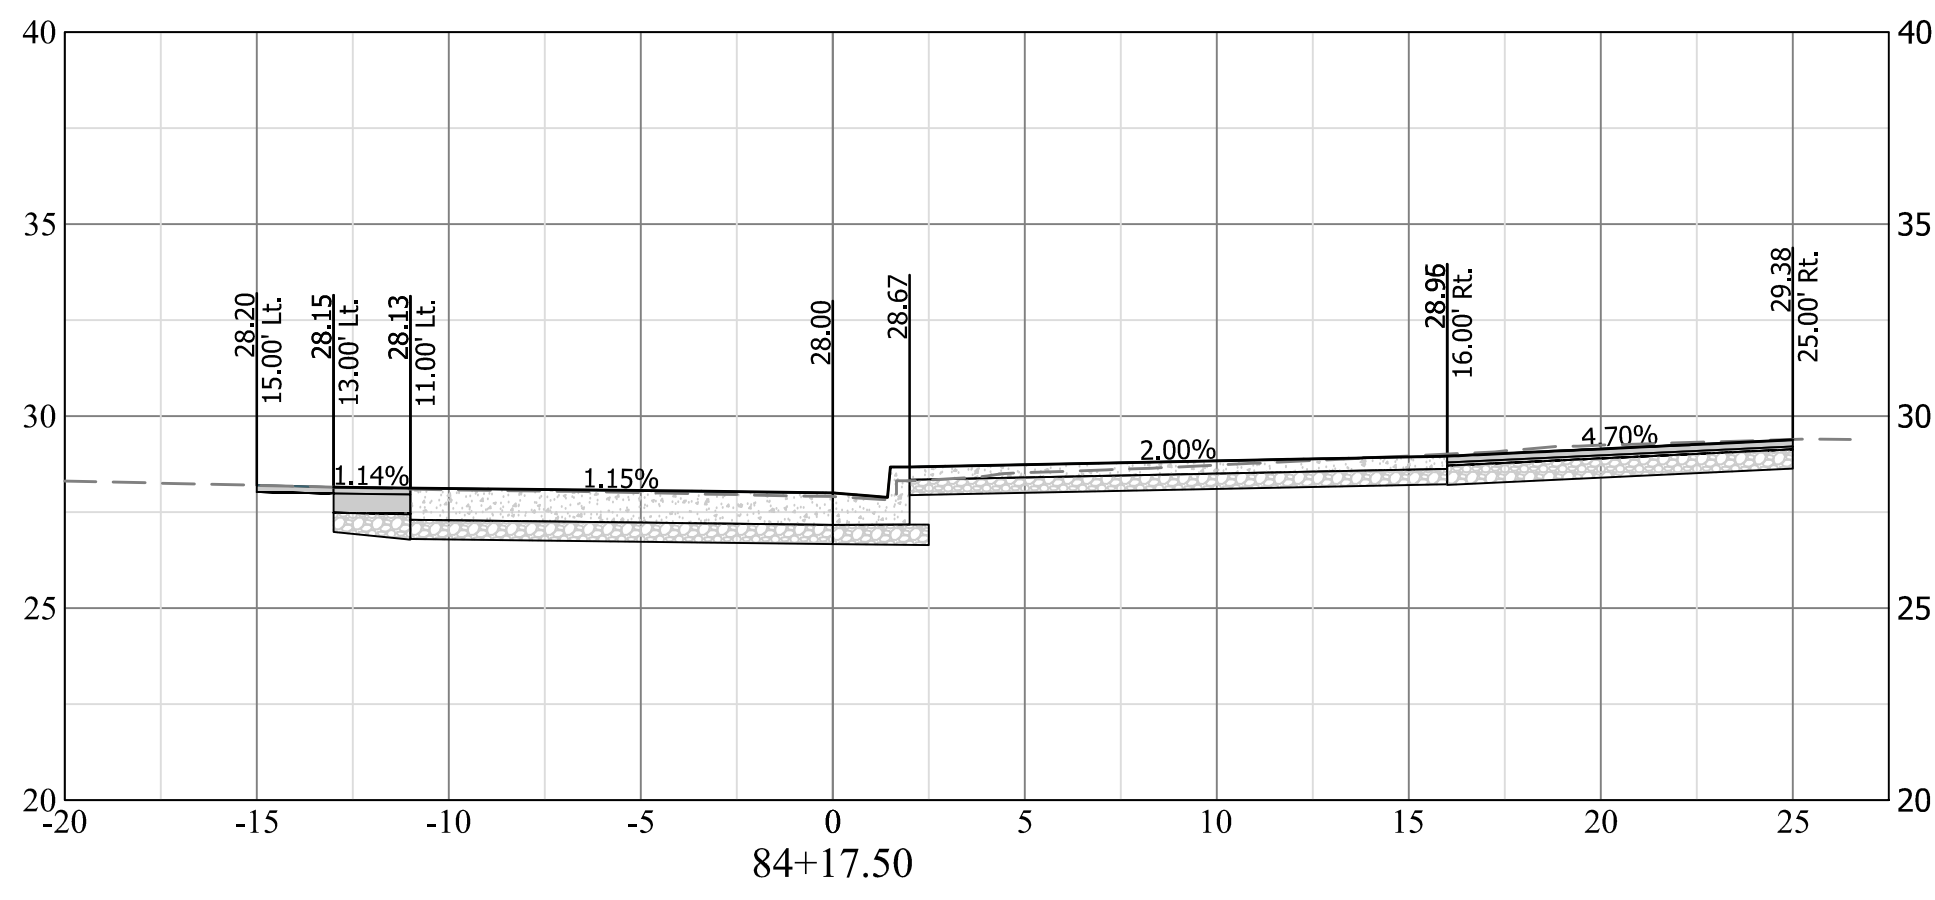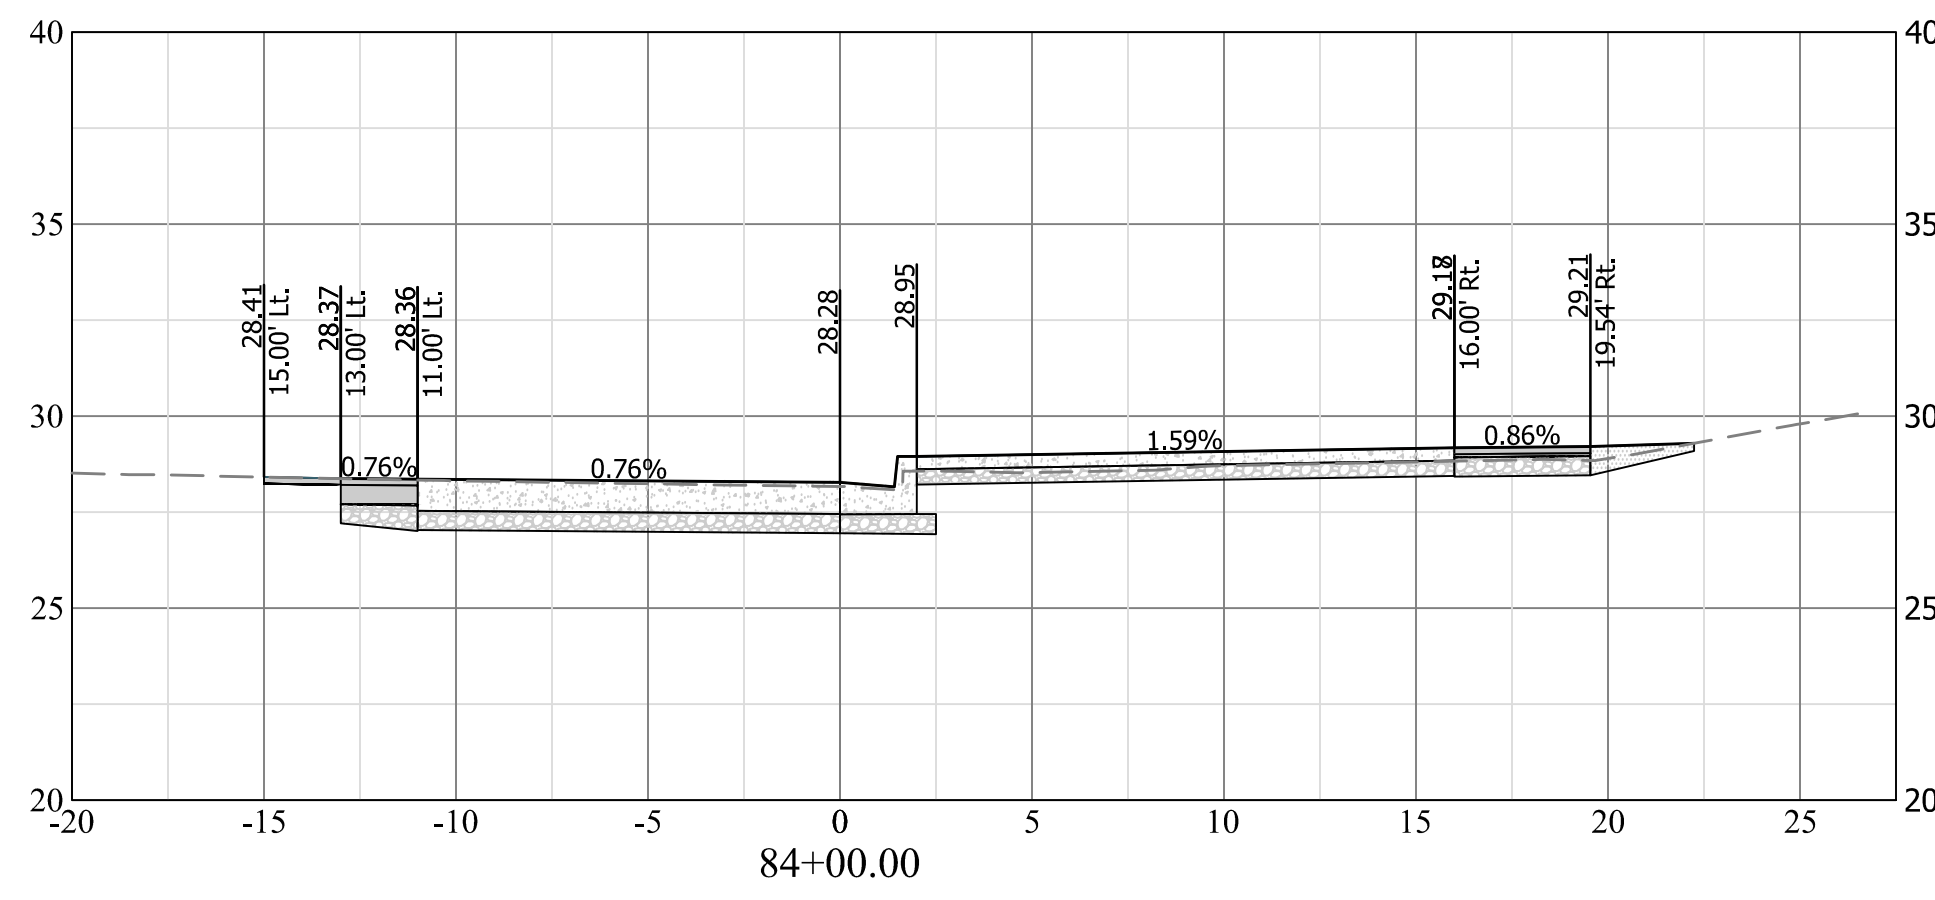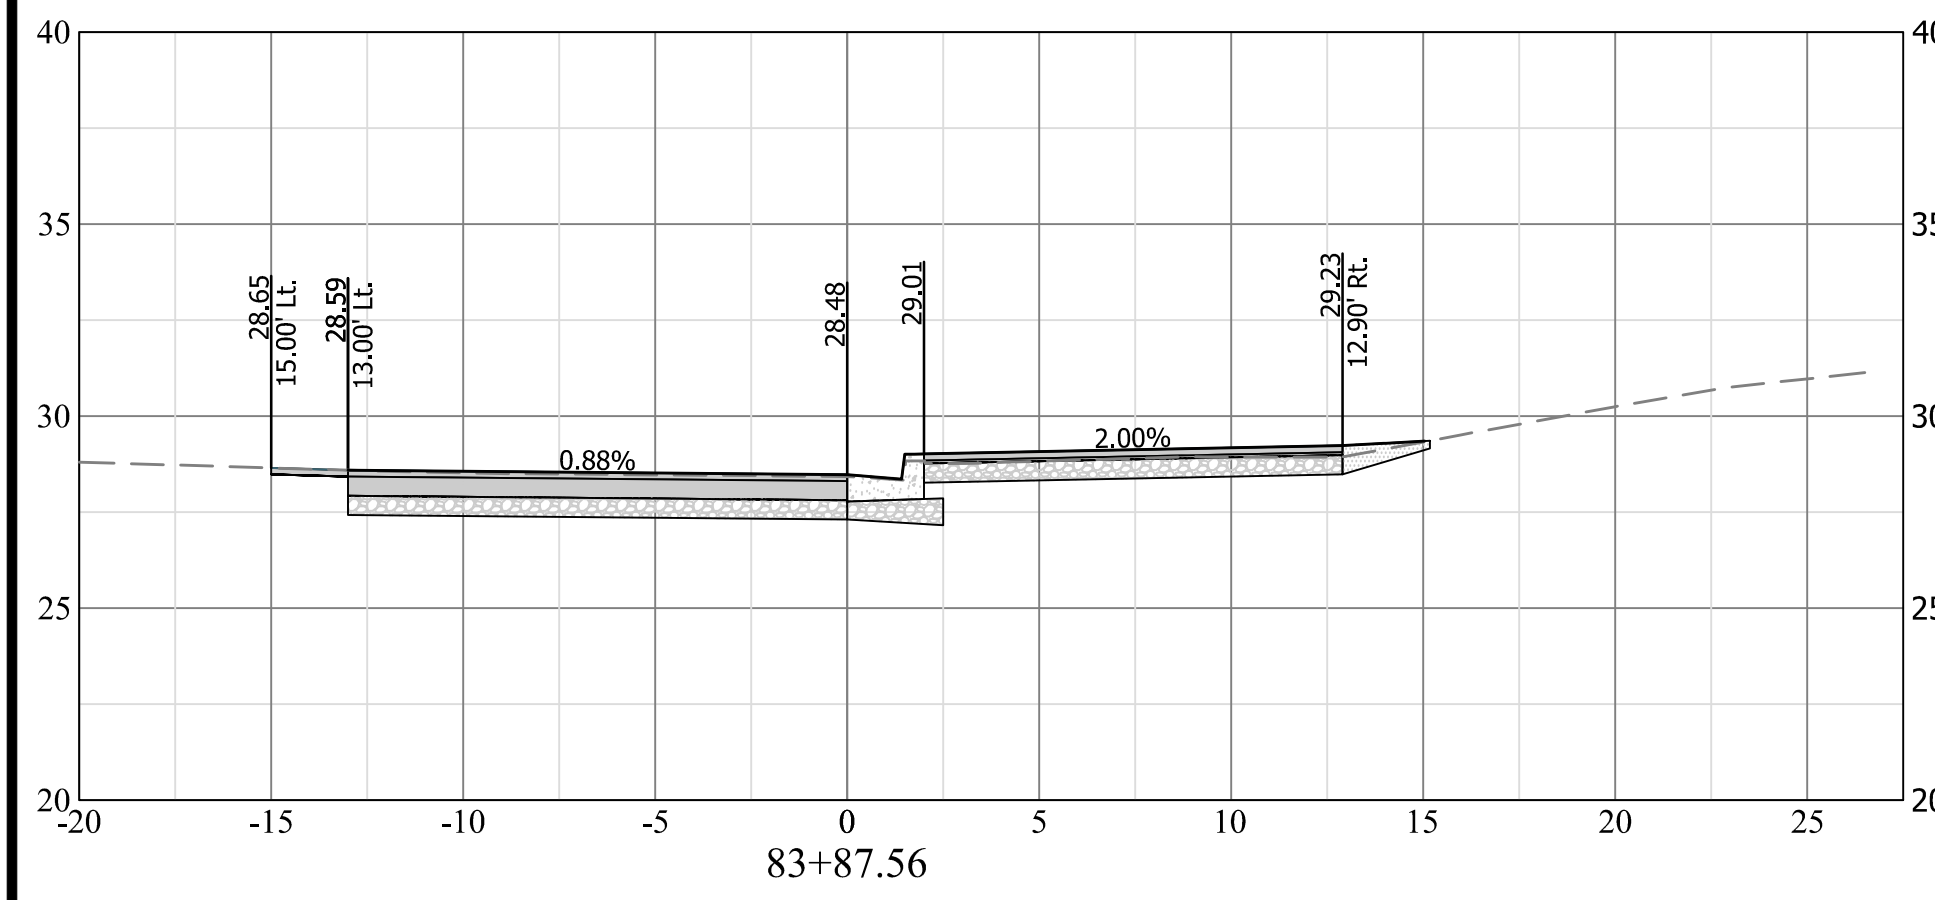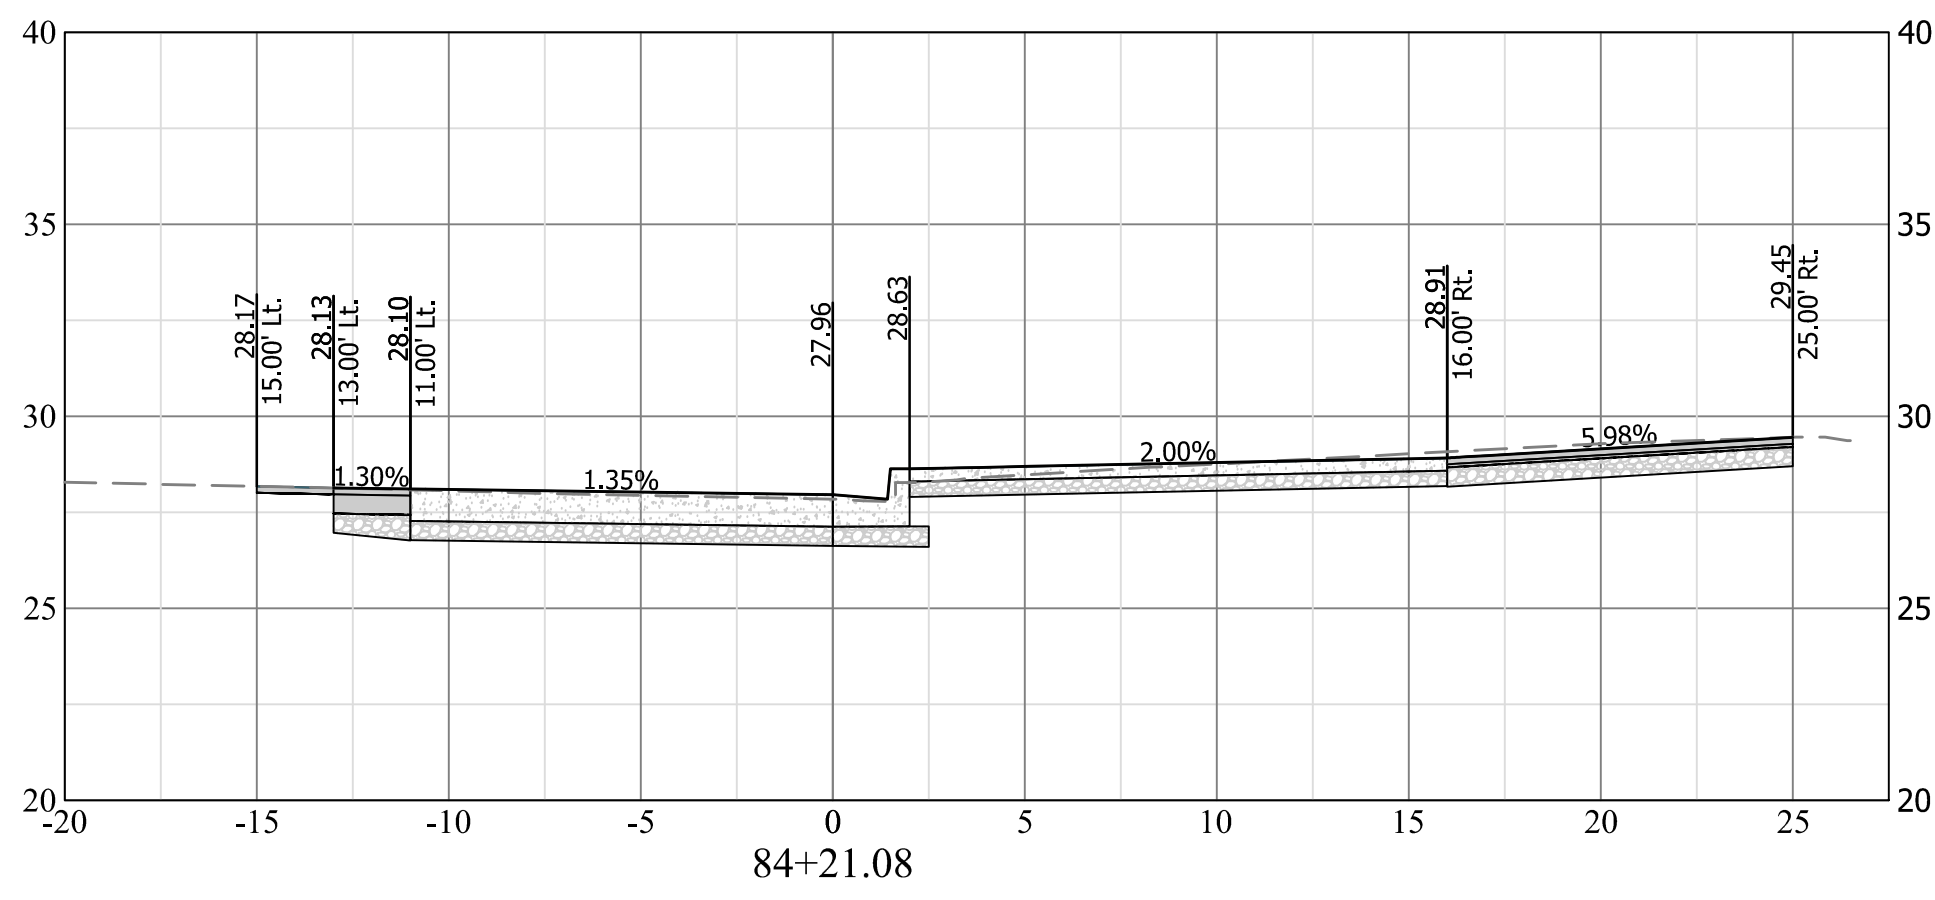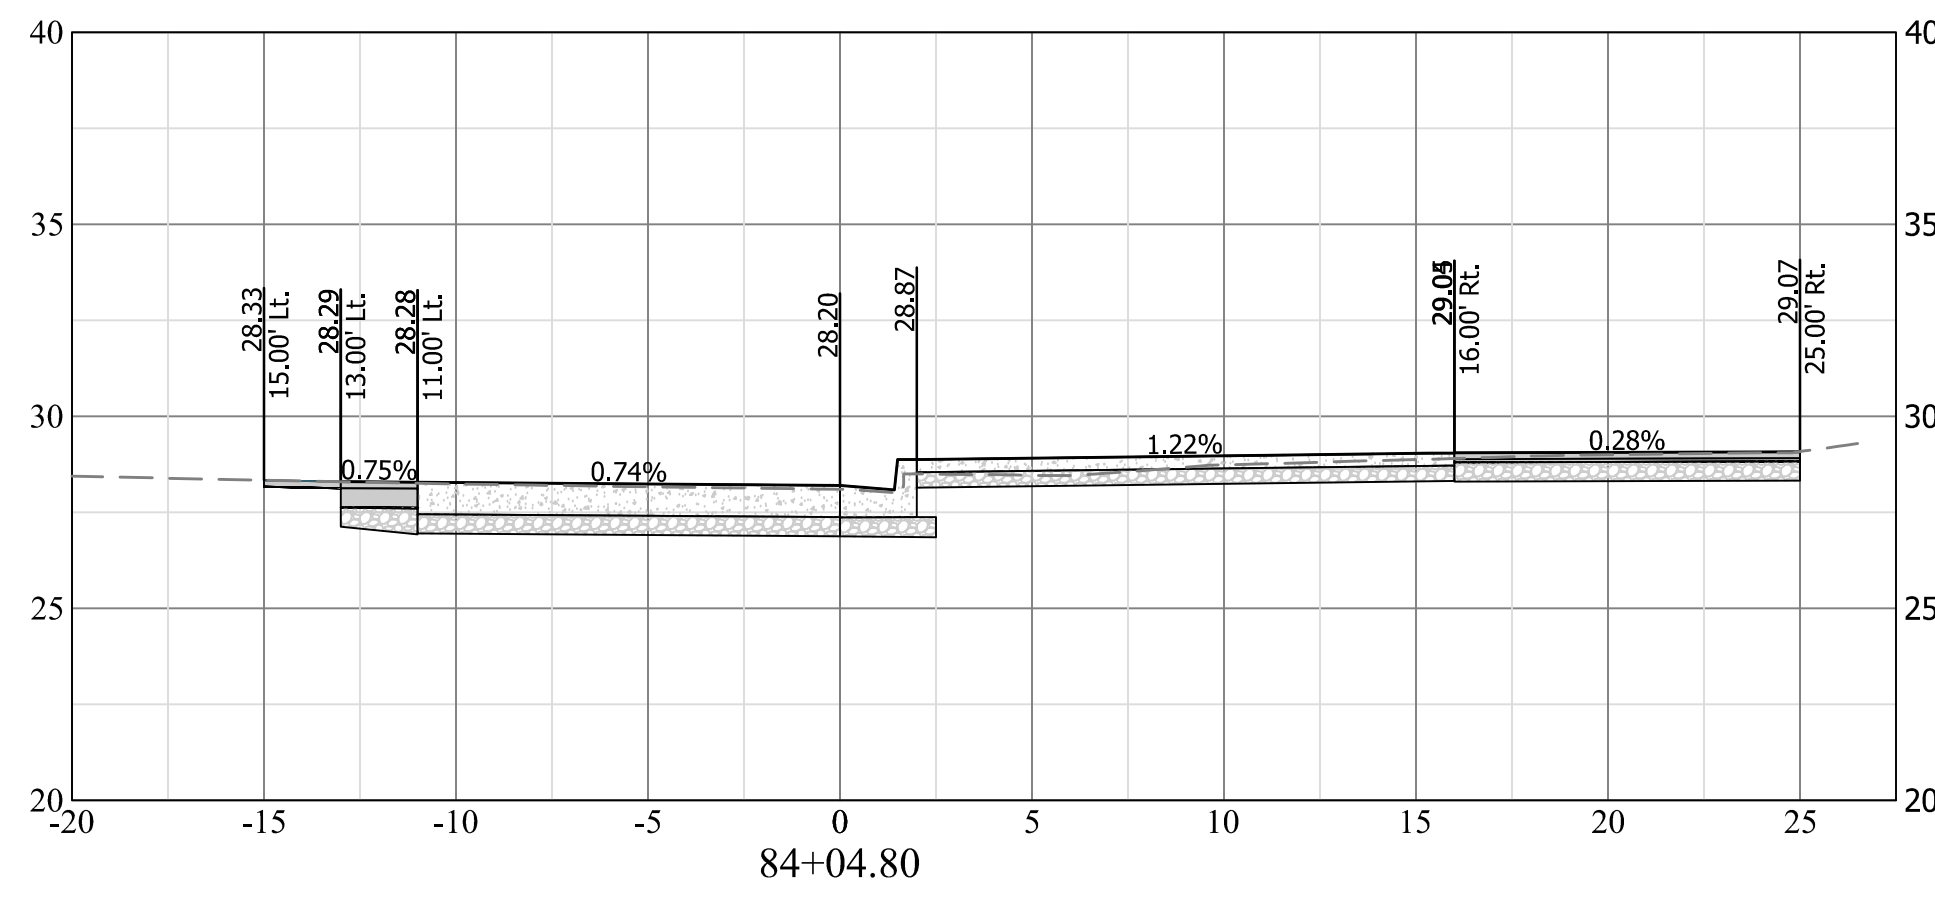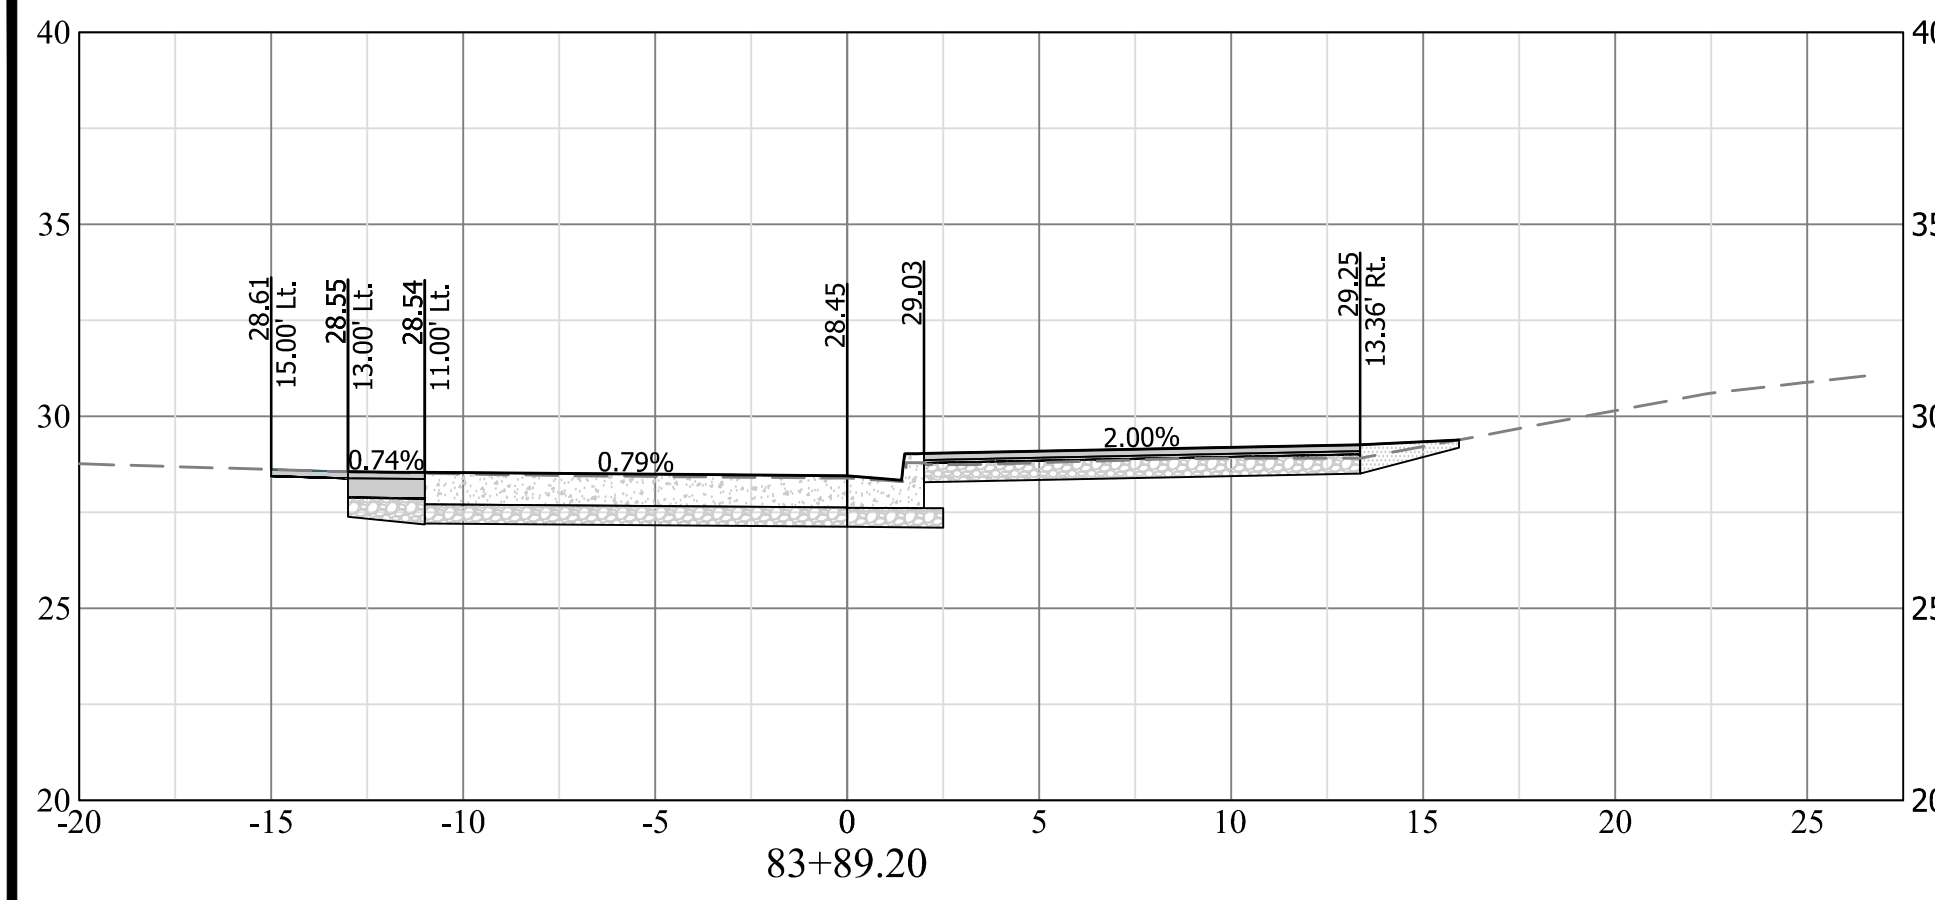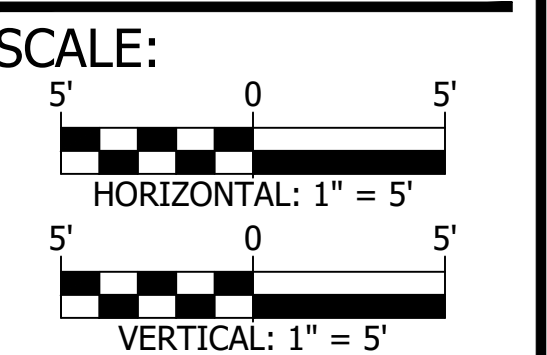NOTE: PAVEMENT AND SIDEWALK SECTIONS ARE SHOWN ON THIS SHEET FOR INFORMATIONAL PURPOSES ONLY. SEE SHEET 04 FOR PAVEMENT AND SIDEWALK TYPICAL SECTIONS. SEE PLAN AND PROFILE SHEETS FOR EXTENTS OF PROPOSED PAVEMENT AND SIDEWALK.















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<i>[Signature]</i> QUALITY CONTROL ENGINEER	3/29/21
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<i>[Signature]</i> TRANSPORTATION DIRECTOR	03/17/21
<i>[Signature]</i> PROJECT MANAGER	3/2/21

REVISIONS	DATE

PROJECT NAME AND LOCATION
**TRANSITWAY EXTENSION TO
PENTAGON CITY**
**CROSS SECTIONS
CRYSTAL DR & 12TH ST S**
MA13 - SEGMENT I

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12TH ST S WB & LONG BRIDGE DR INTERSECTION

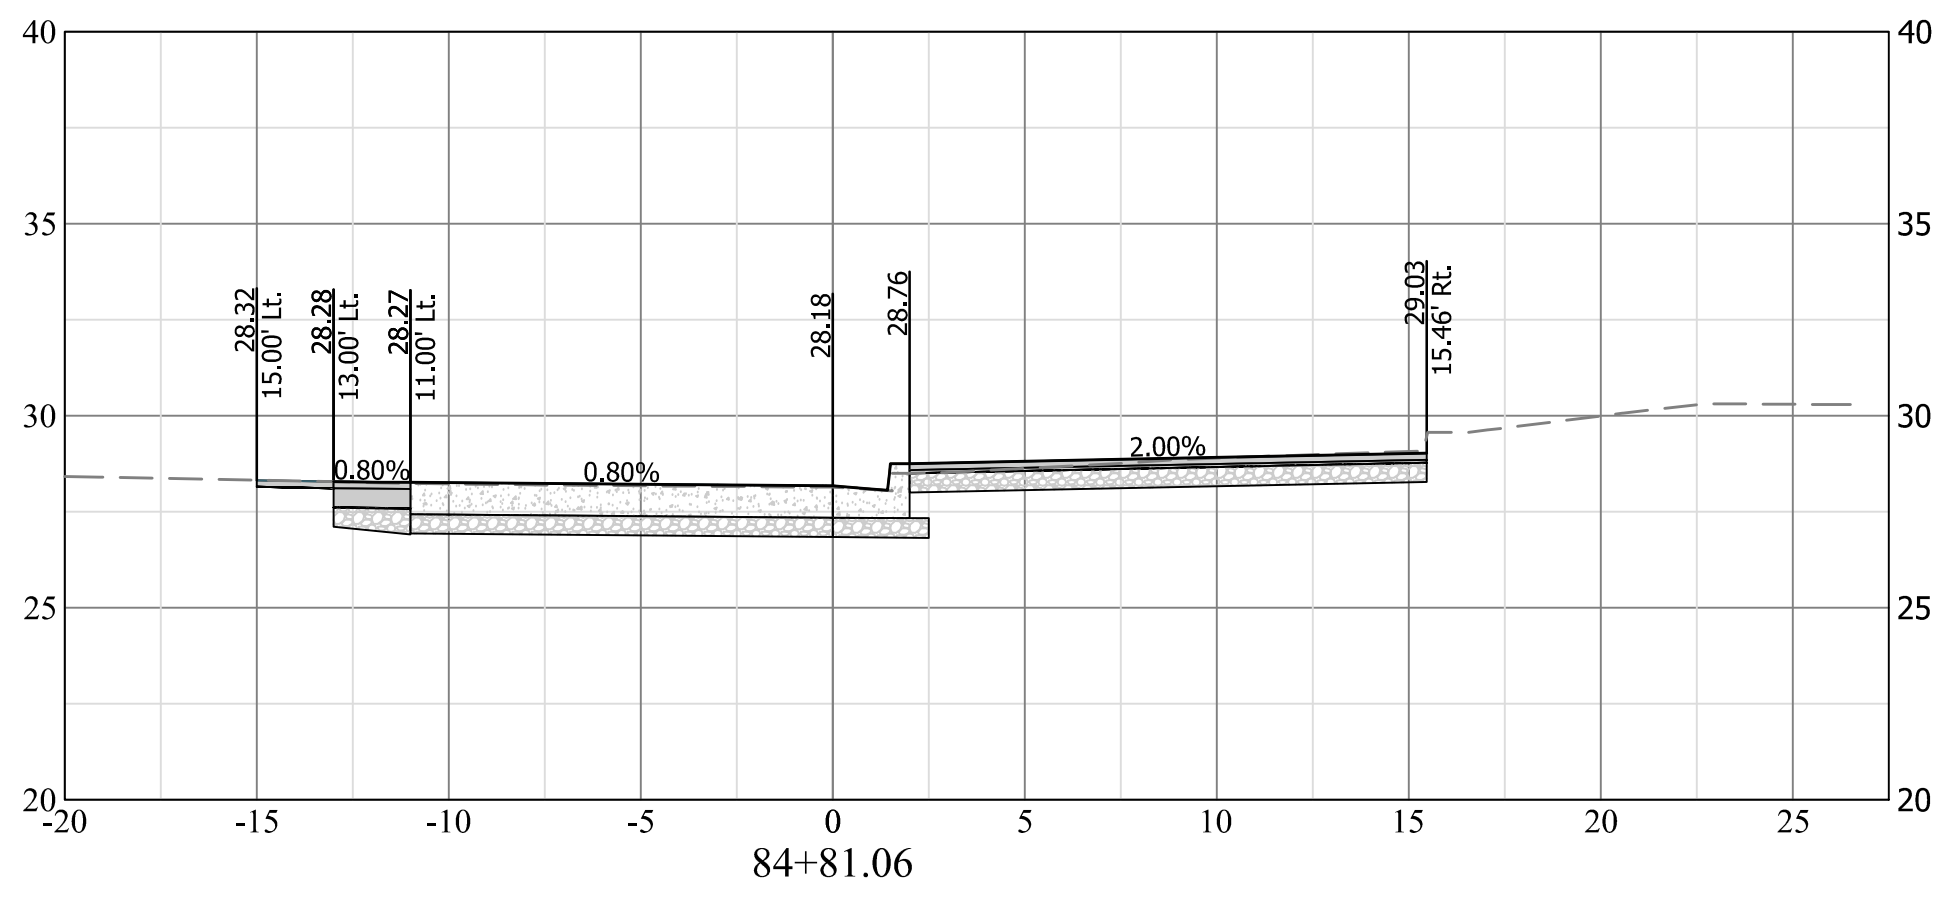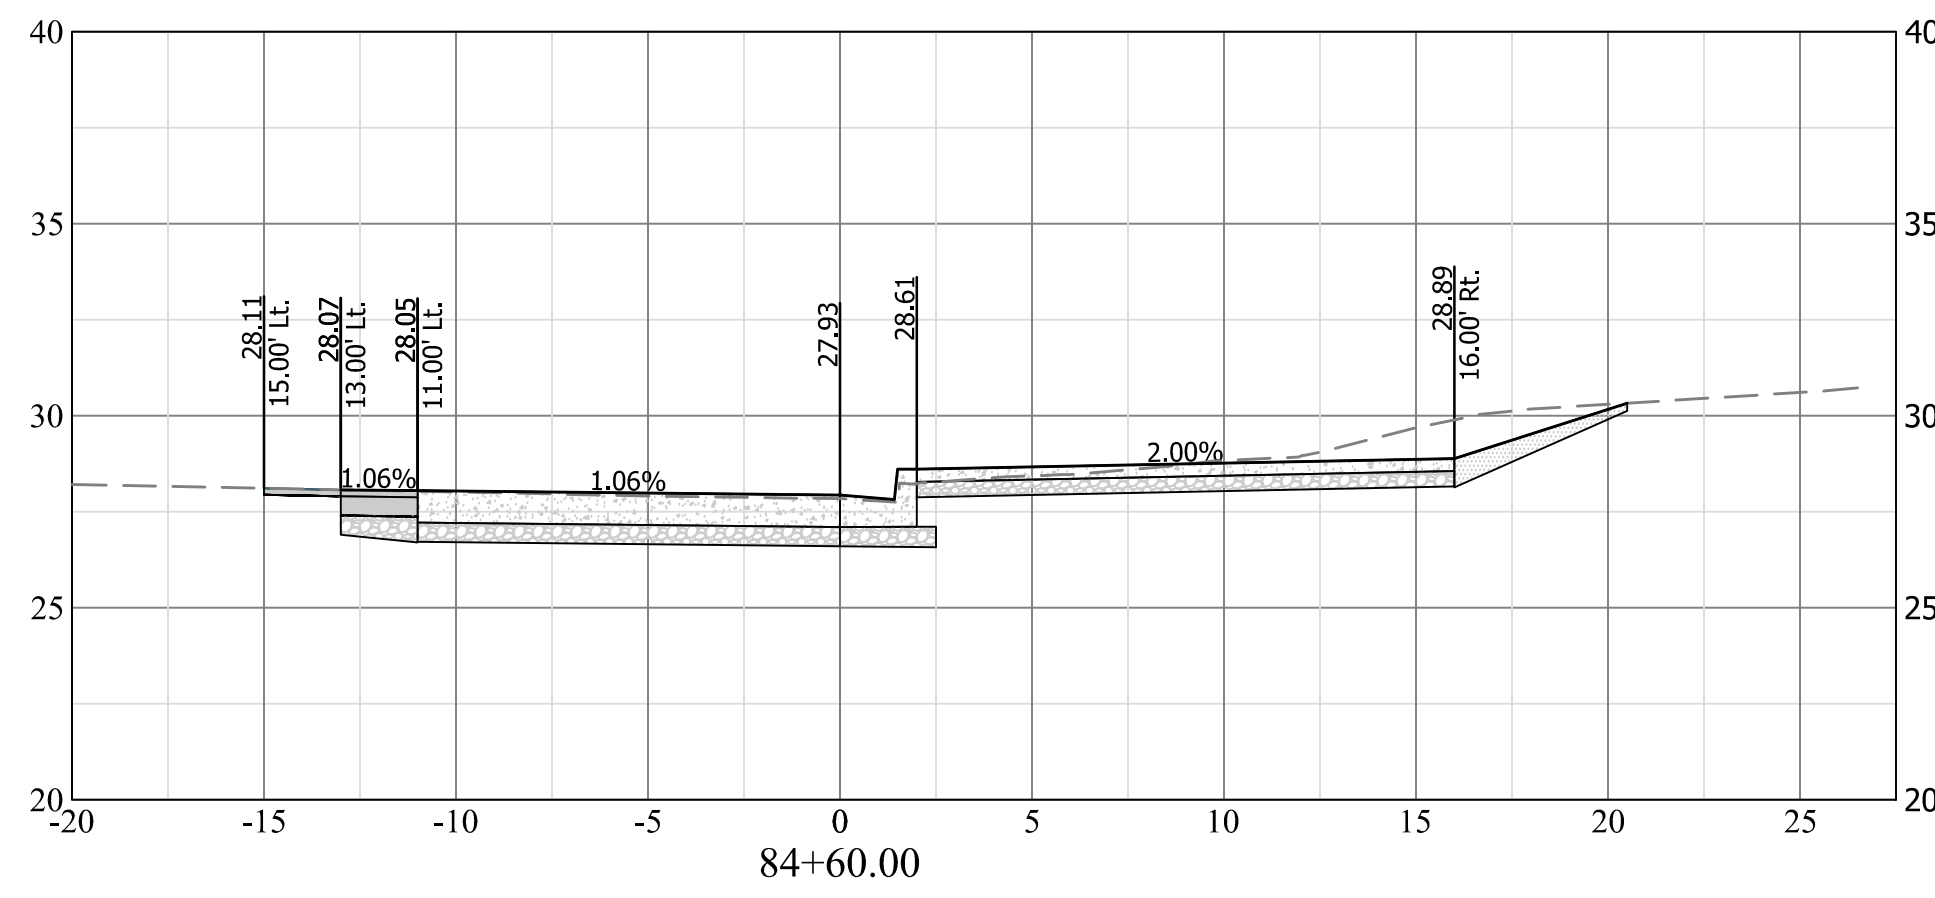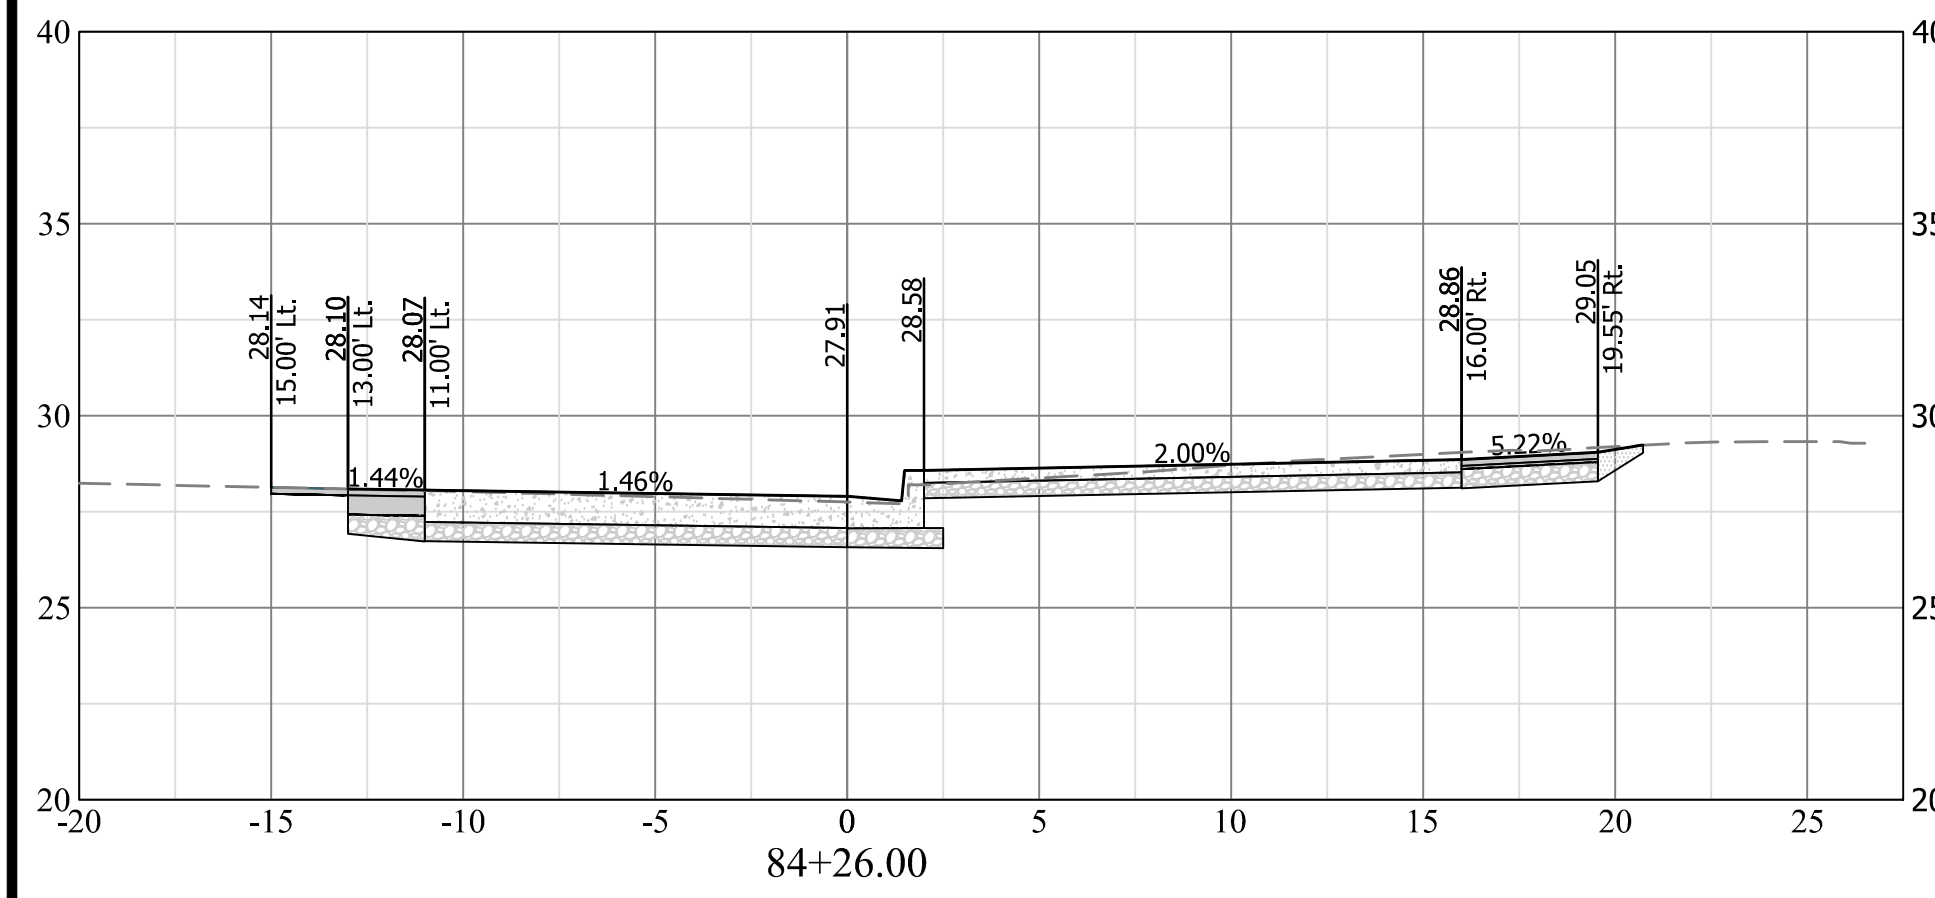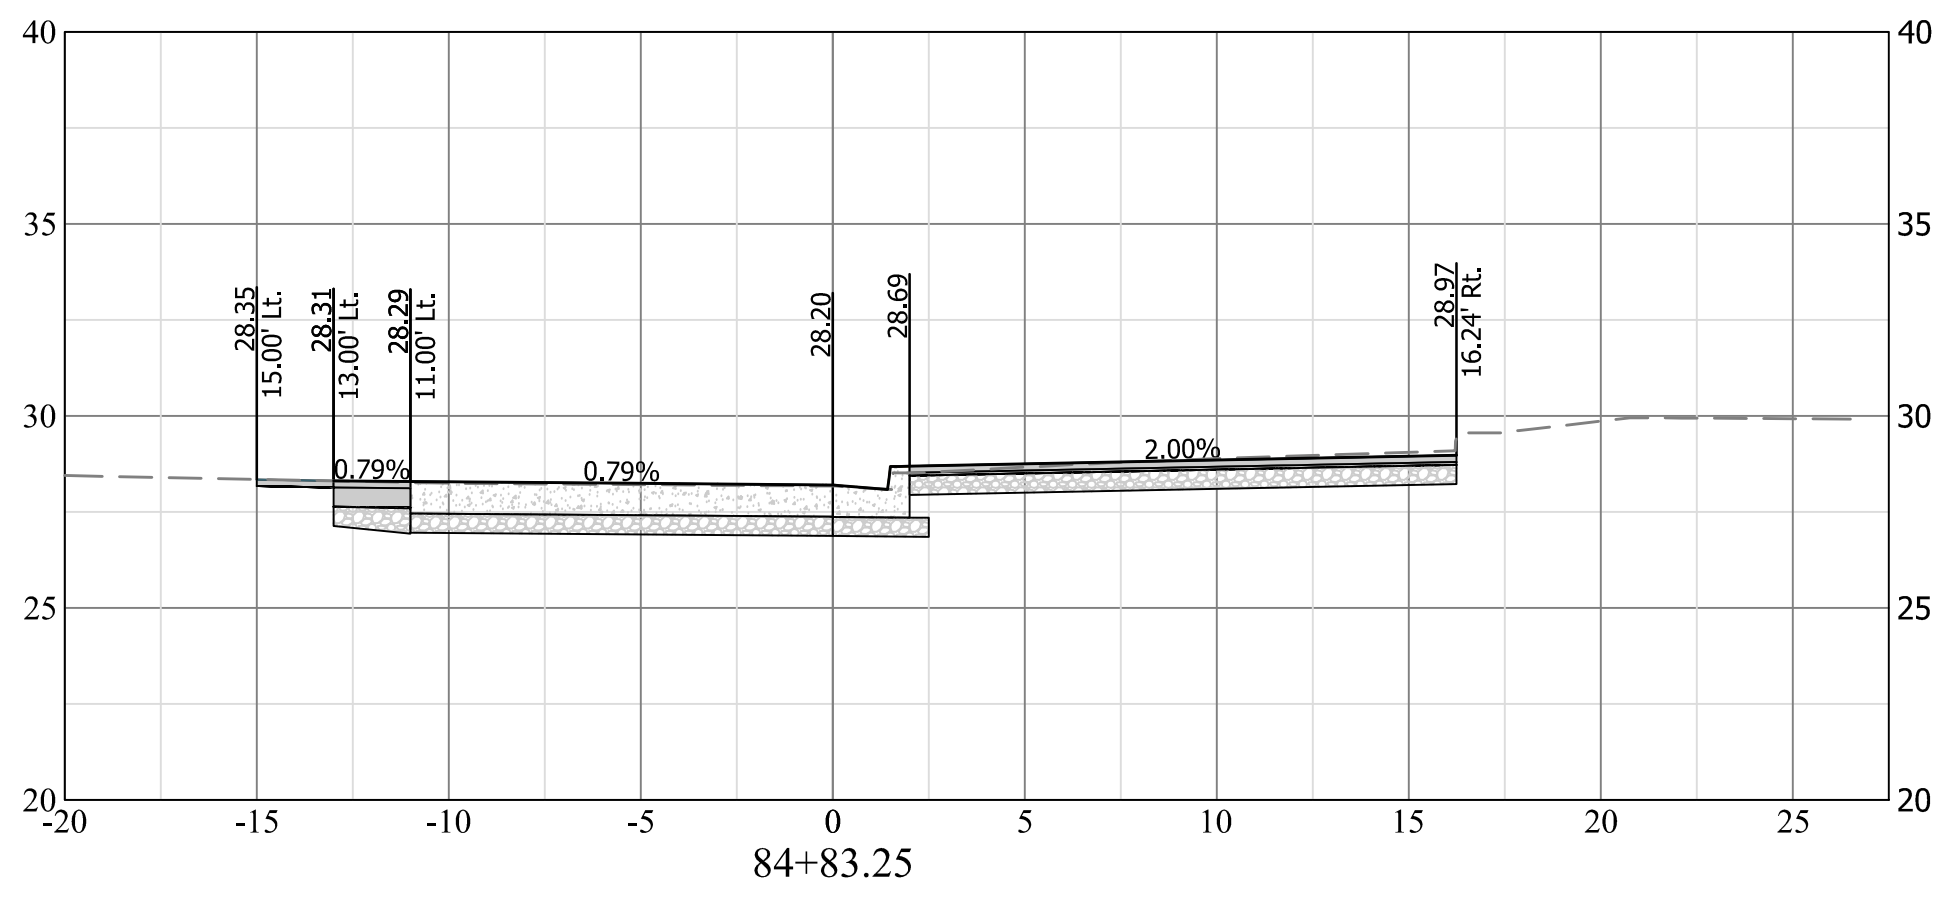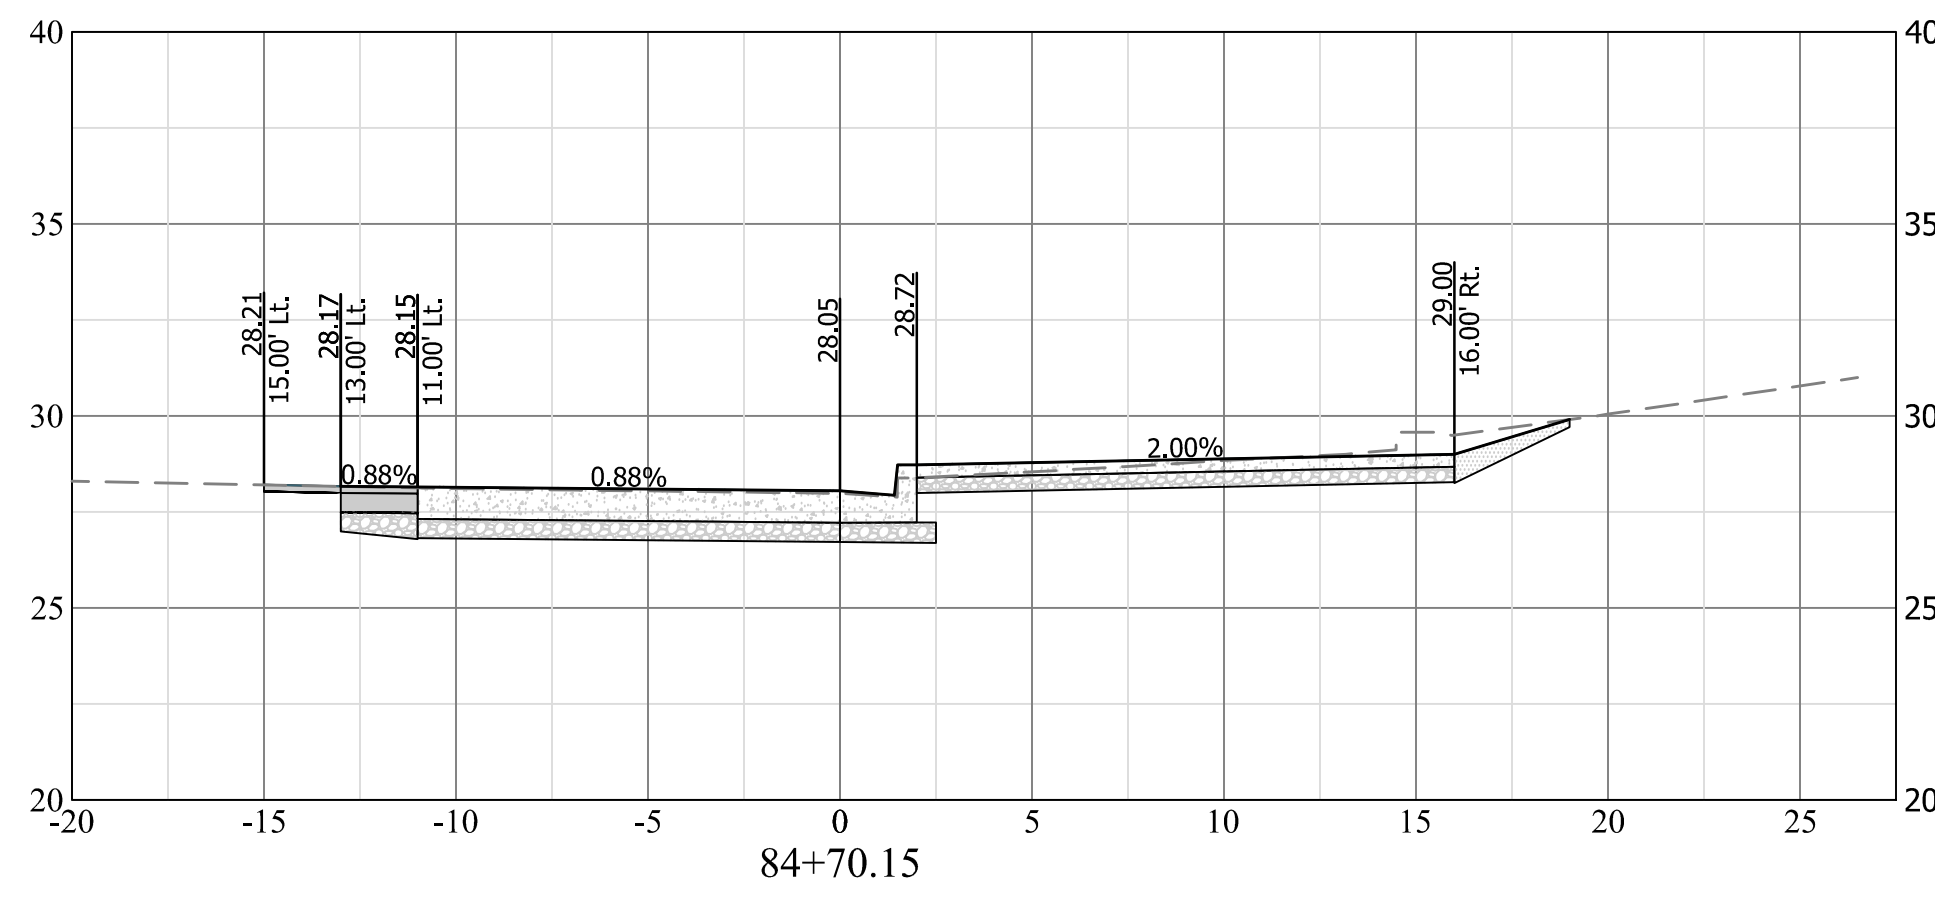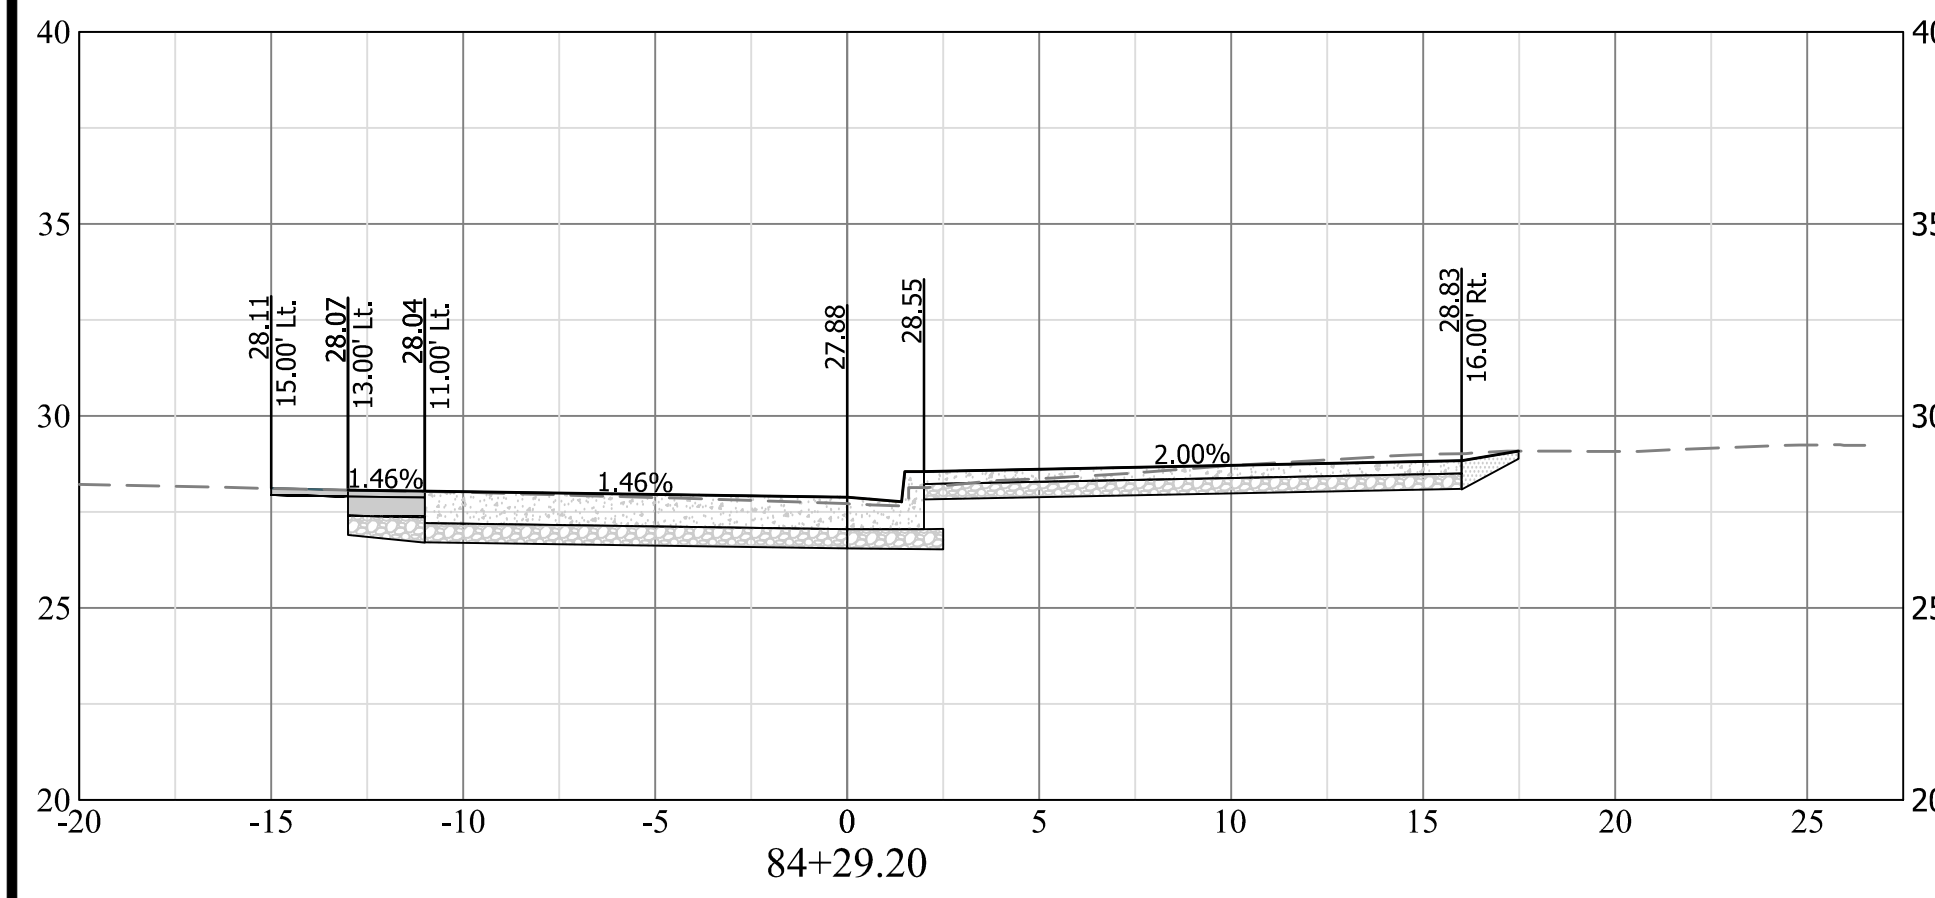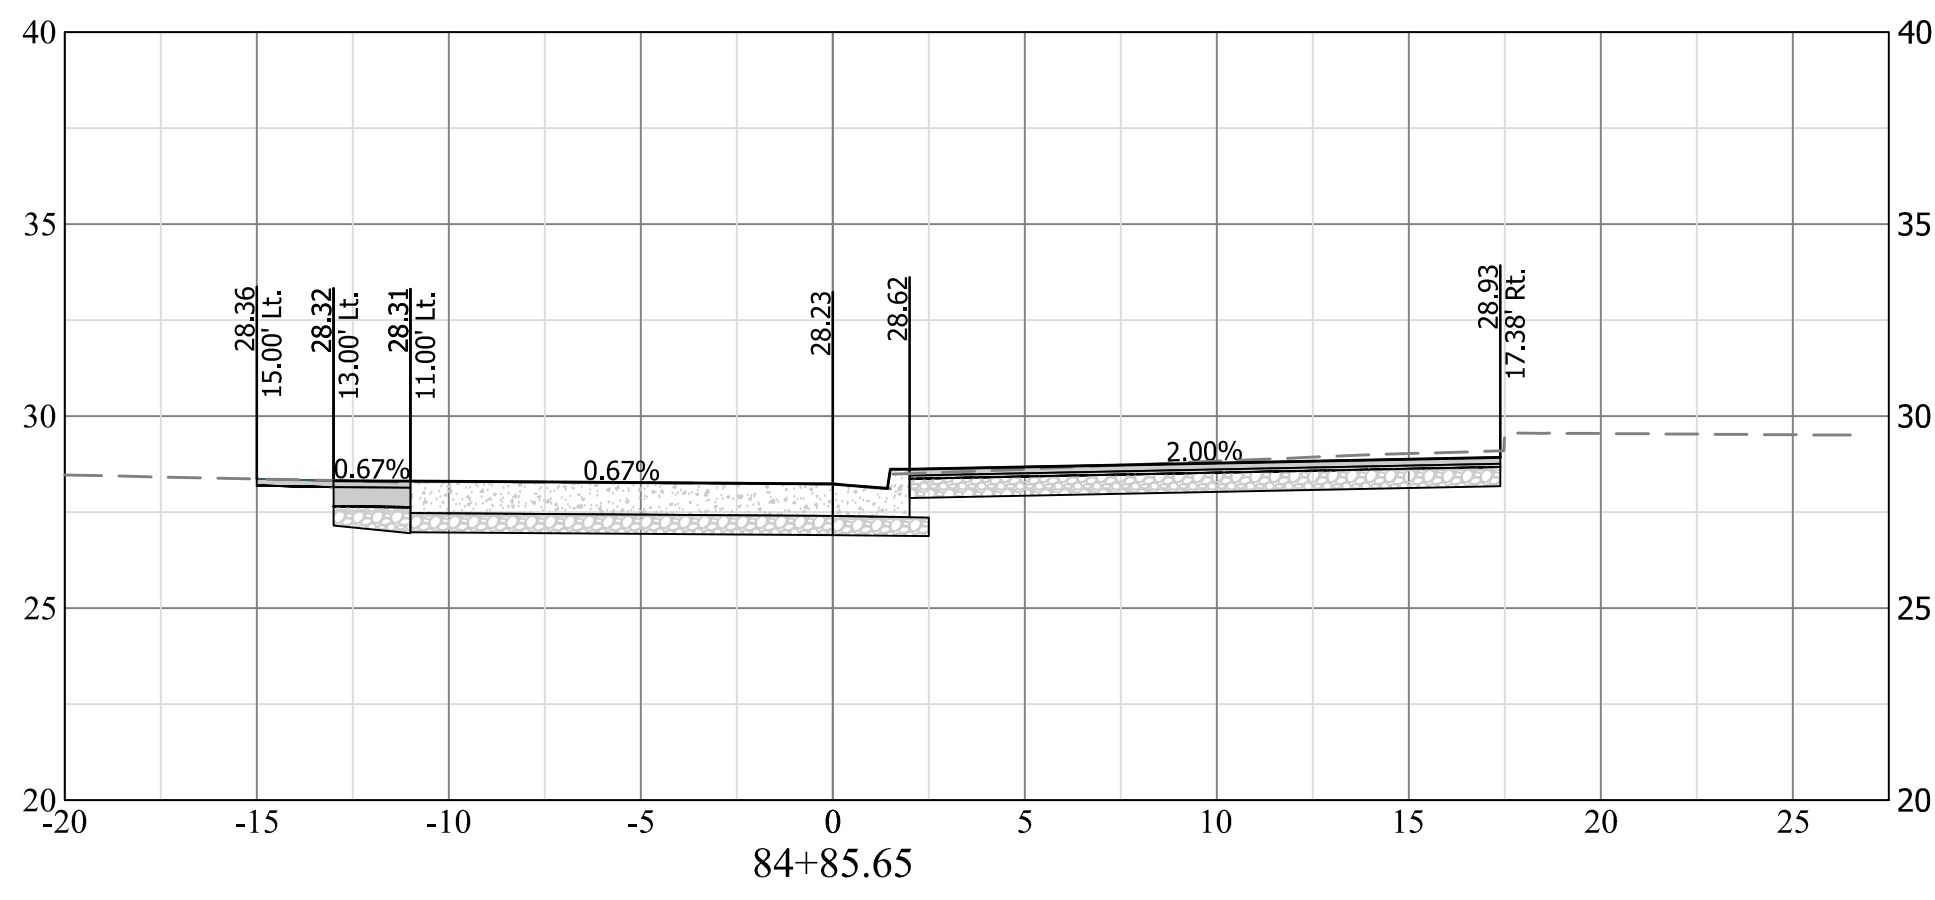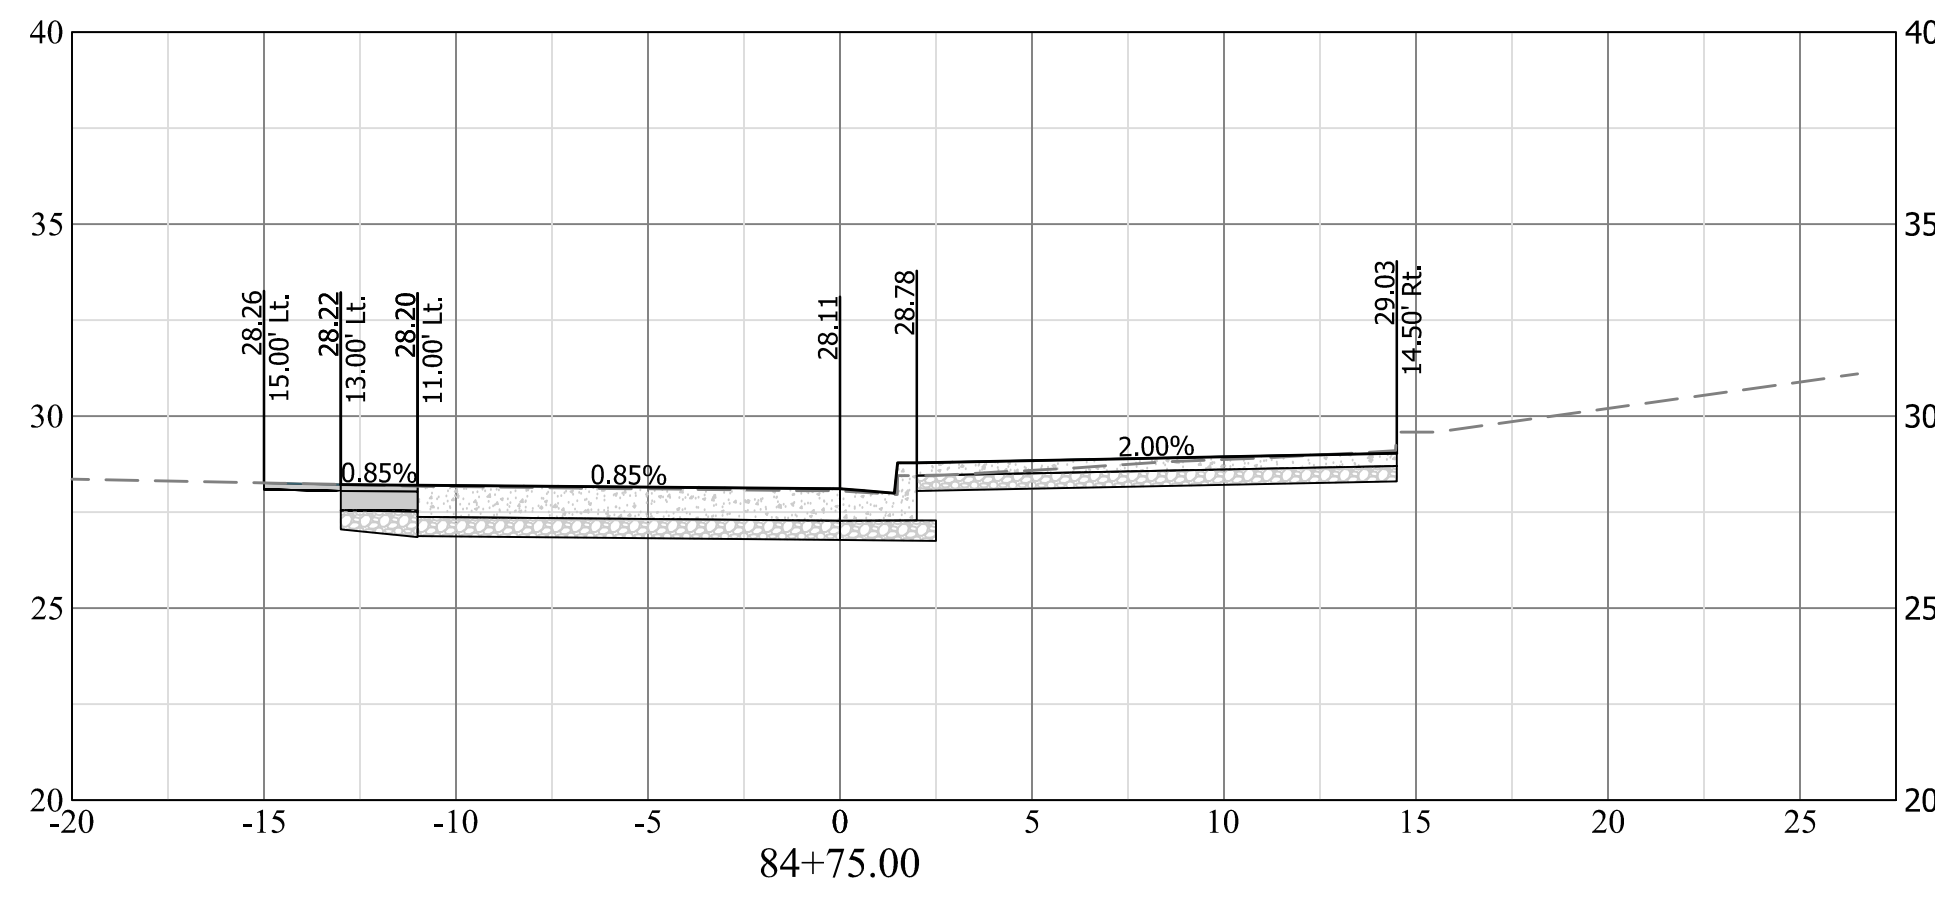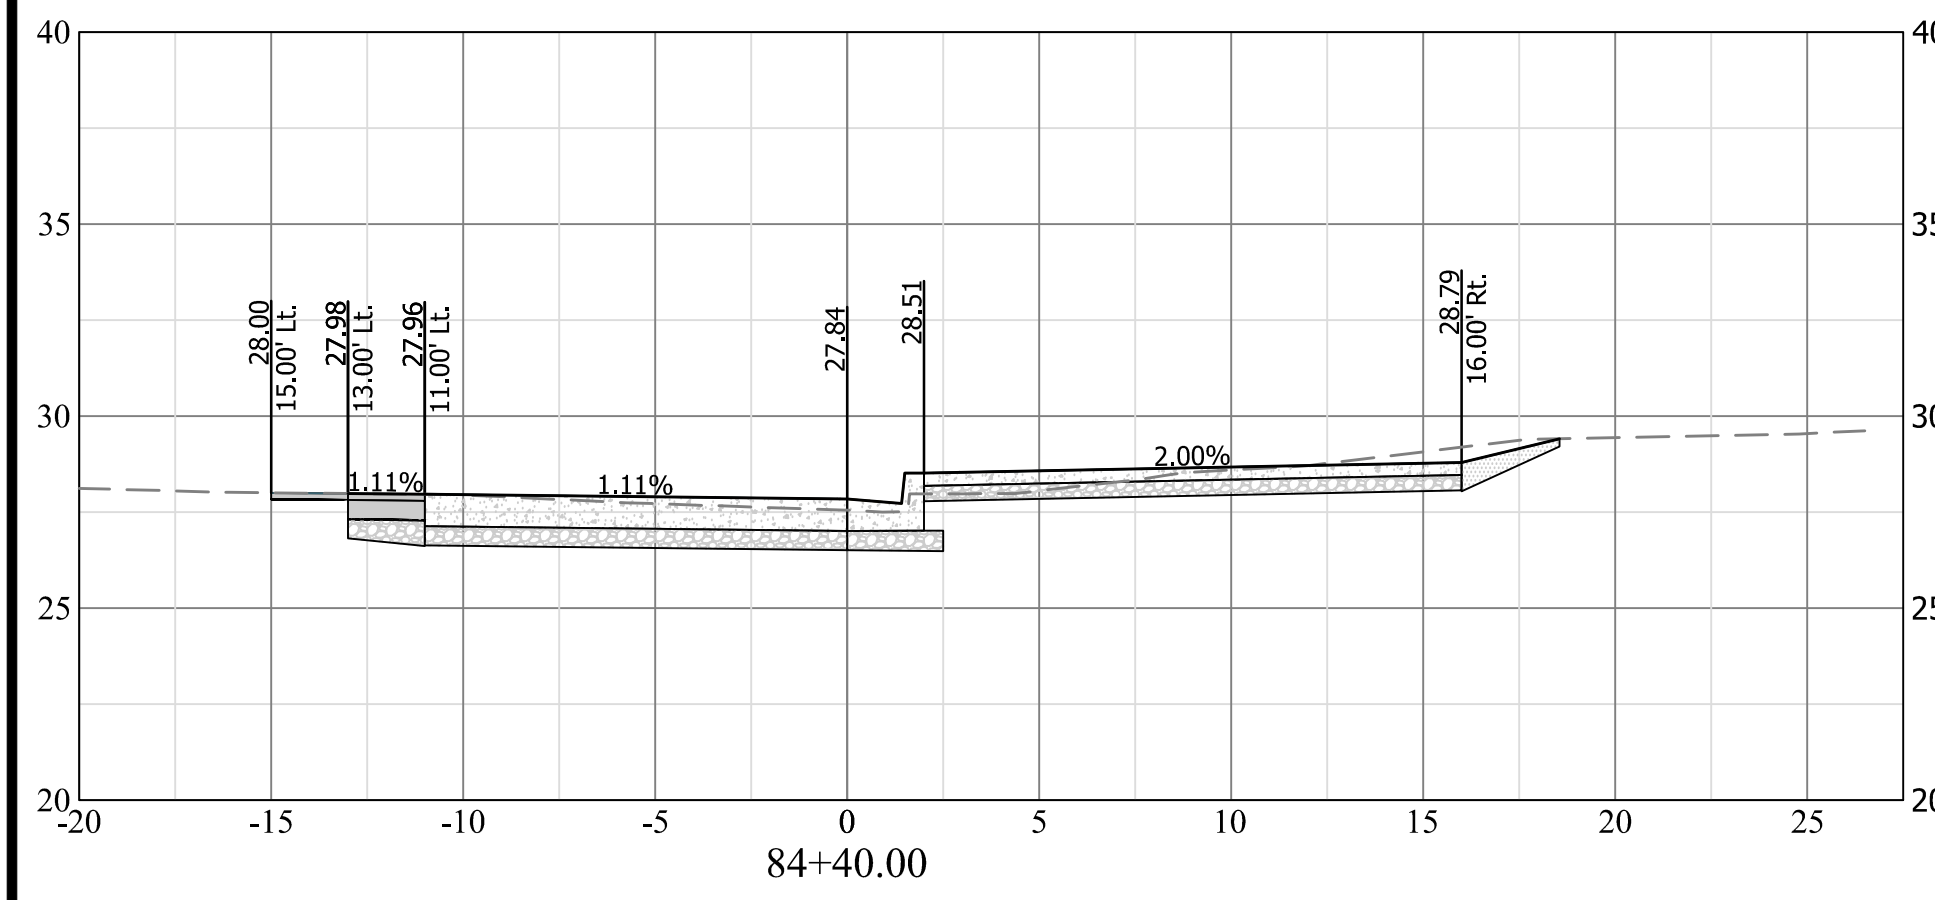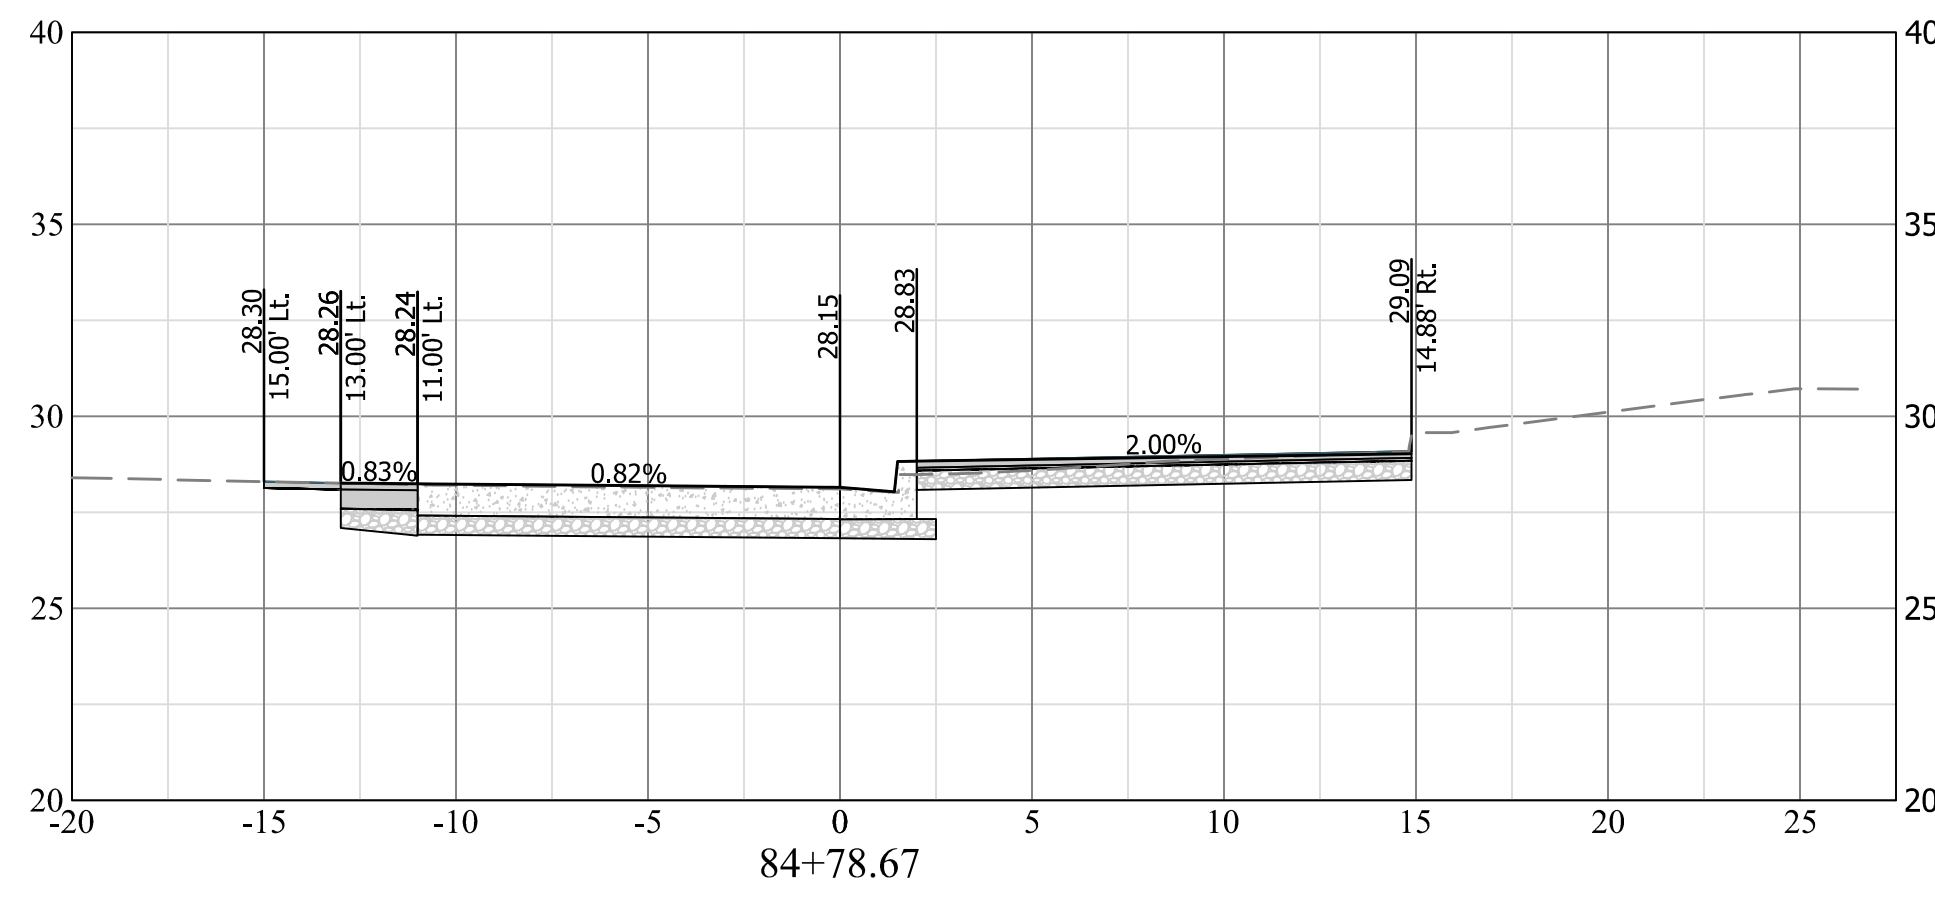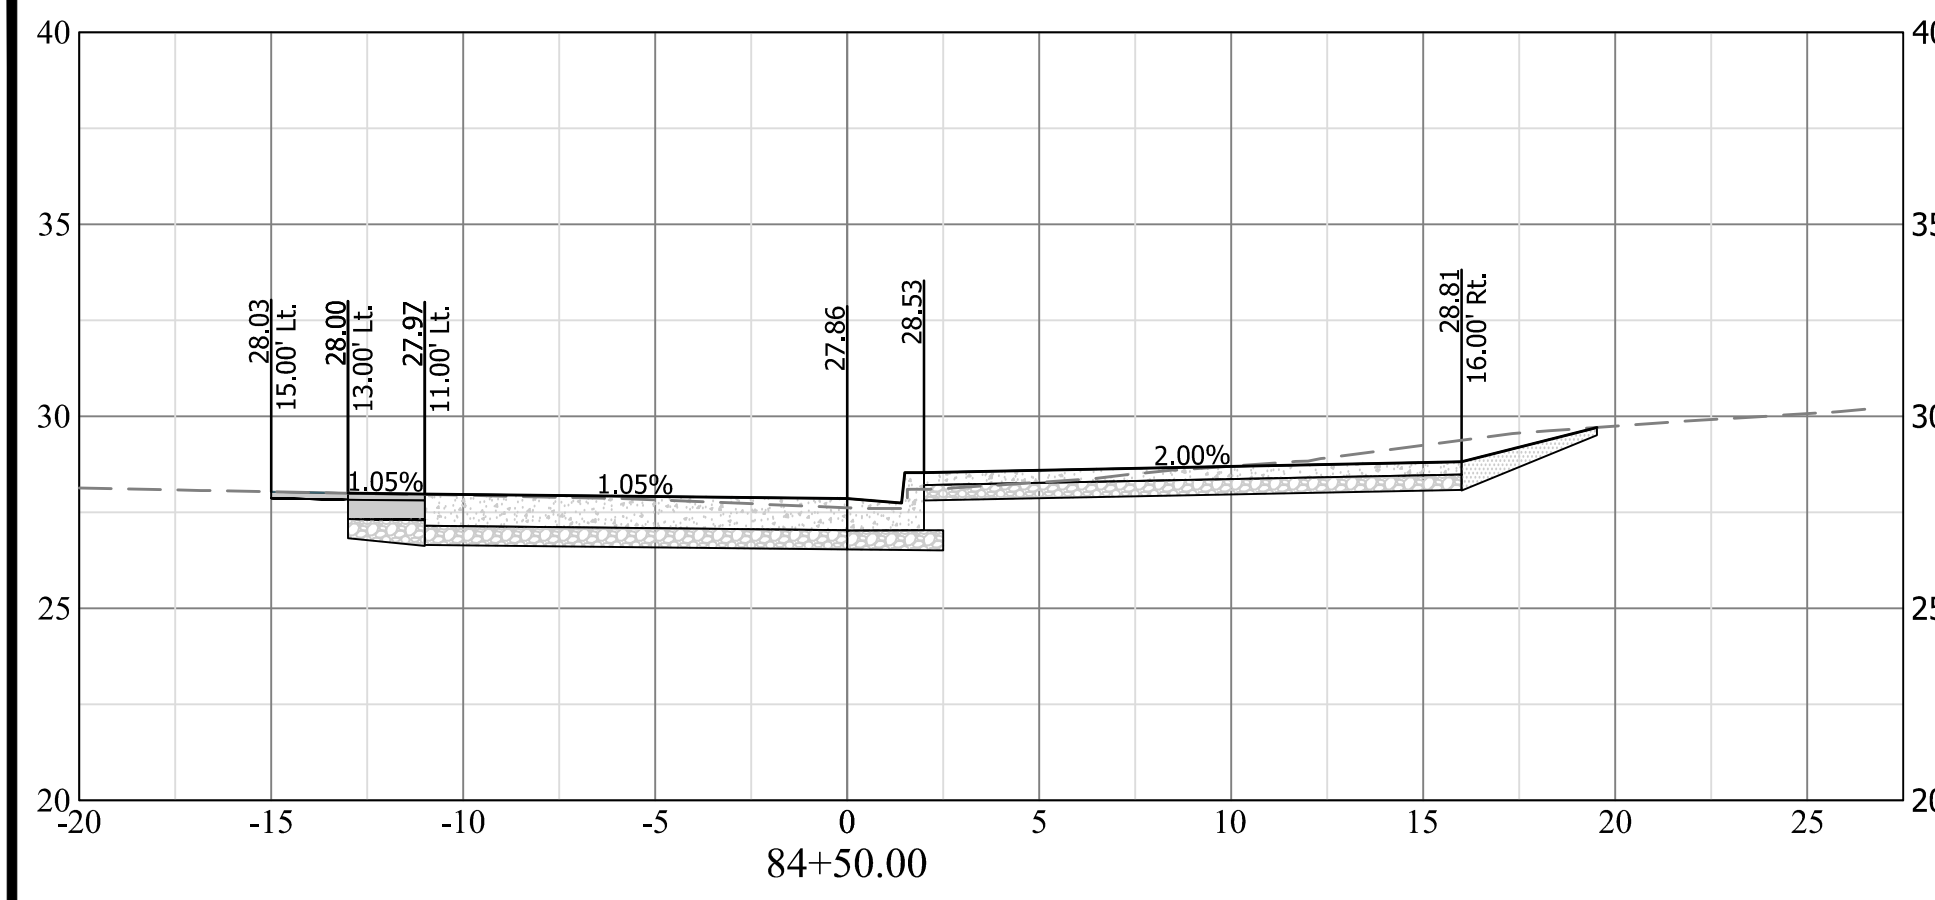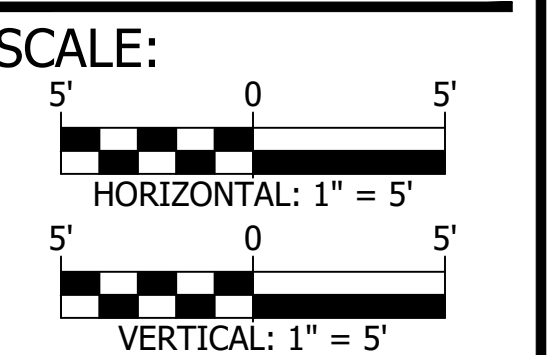NOTE: PAVEMENT AND SIDEWALK SECTIONS ARE SHOWN ON THIS SHEET FOR INFORMATIONAL PURPOSES ONLY. SEE SHEET 04 FOR PAVEMENT AND SIDEWALK TYPICAL SECTIONS. SEE PLAN AND PROFILE SHEETS FOR EXTENTS OF PROPOSED PAVEMENT AND SIDEWALK.



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PROJECT NAME AND LOCATION
**TRANSITWAY EXTENSION TO
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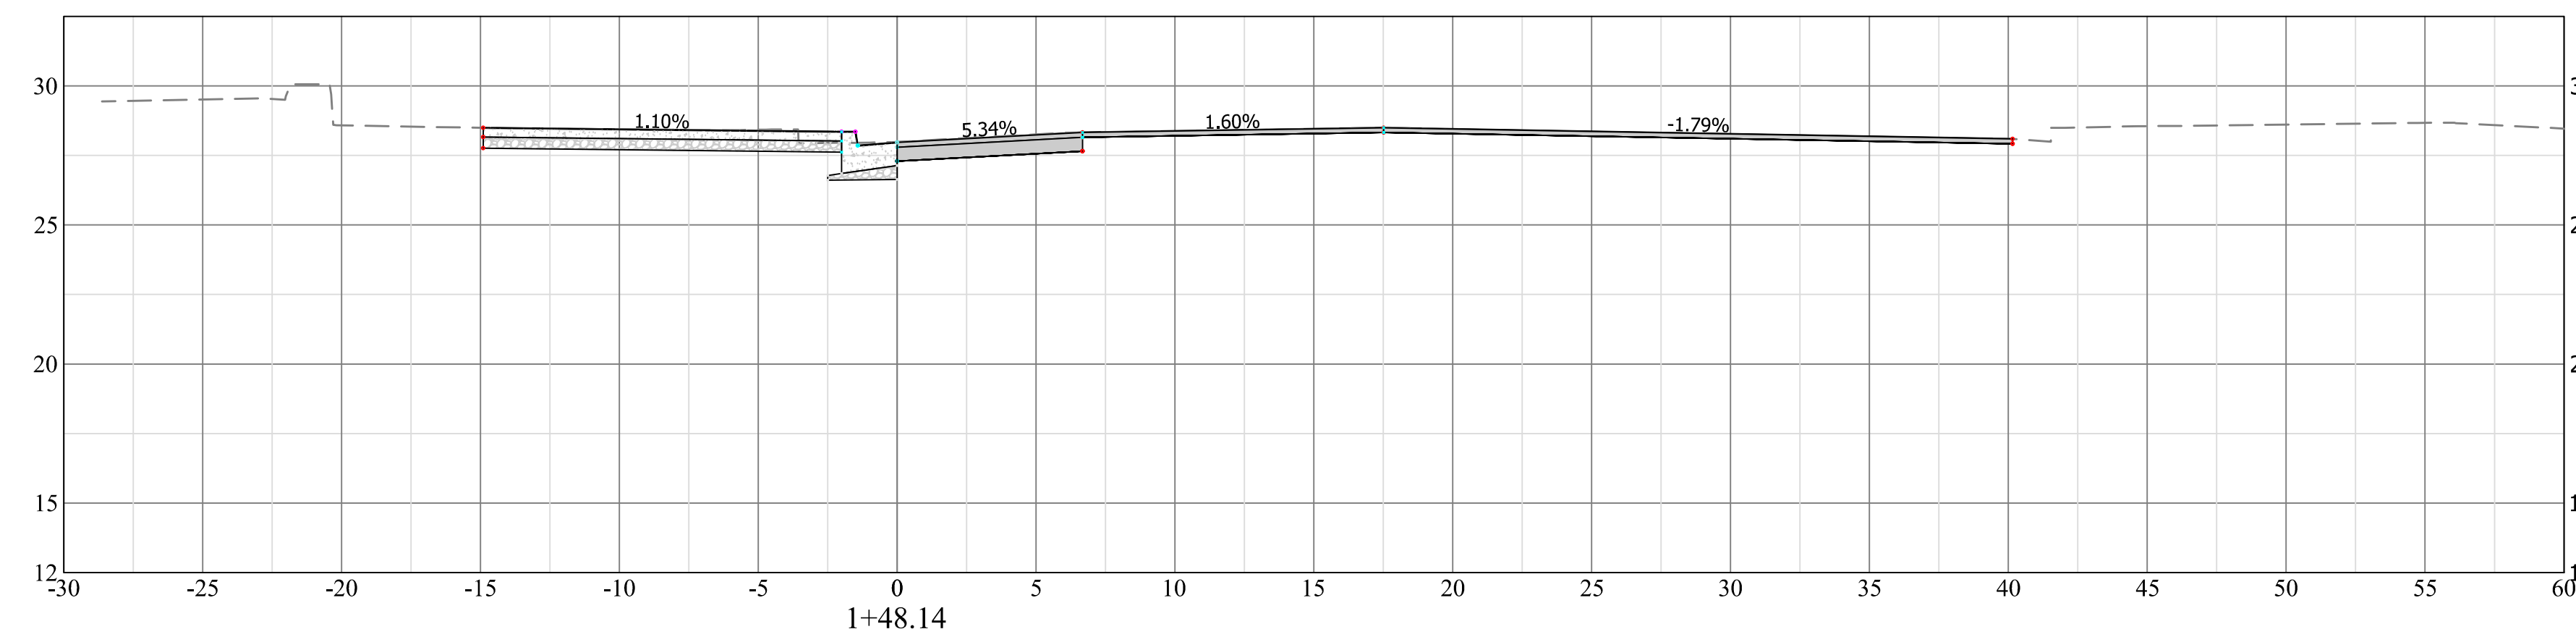
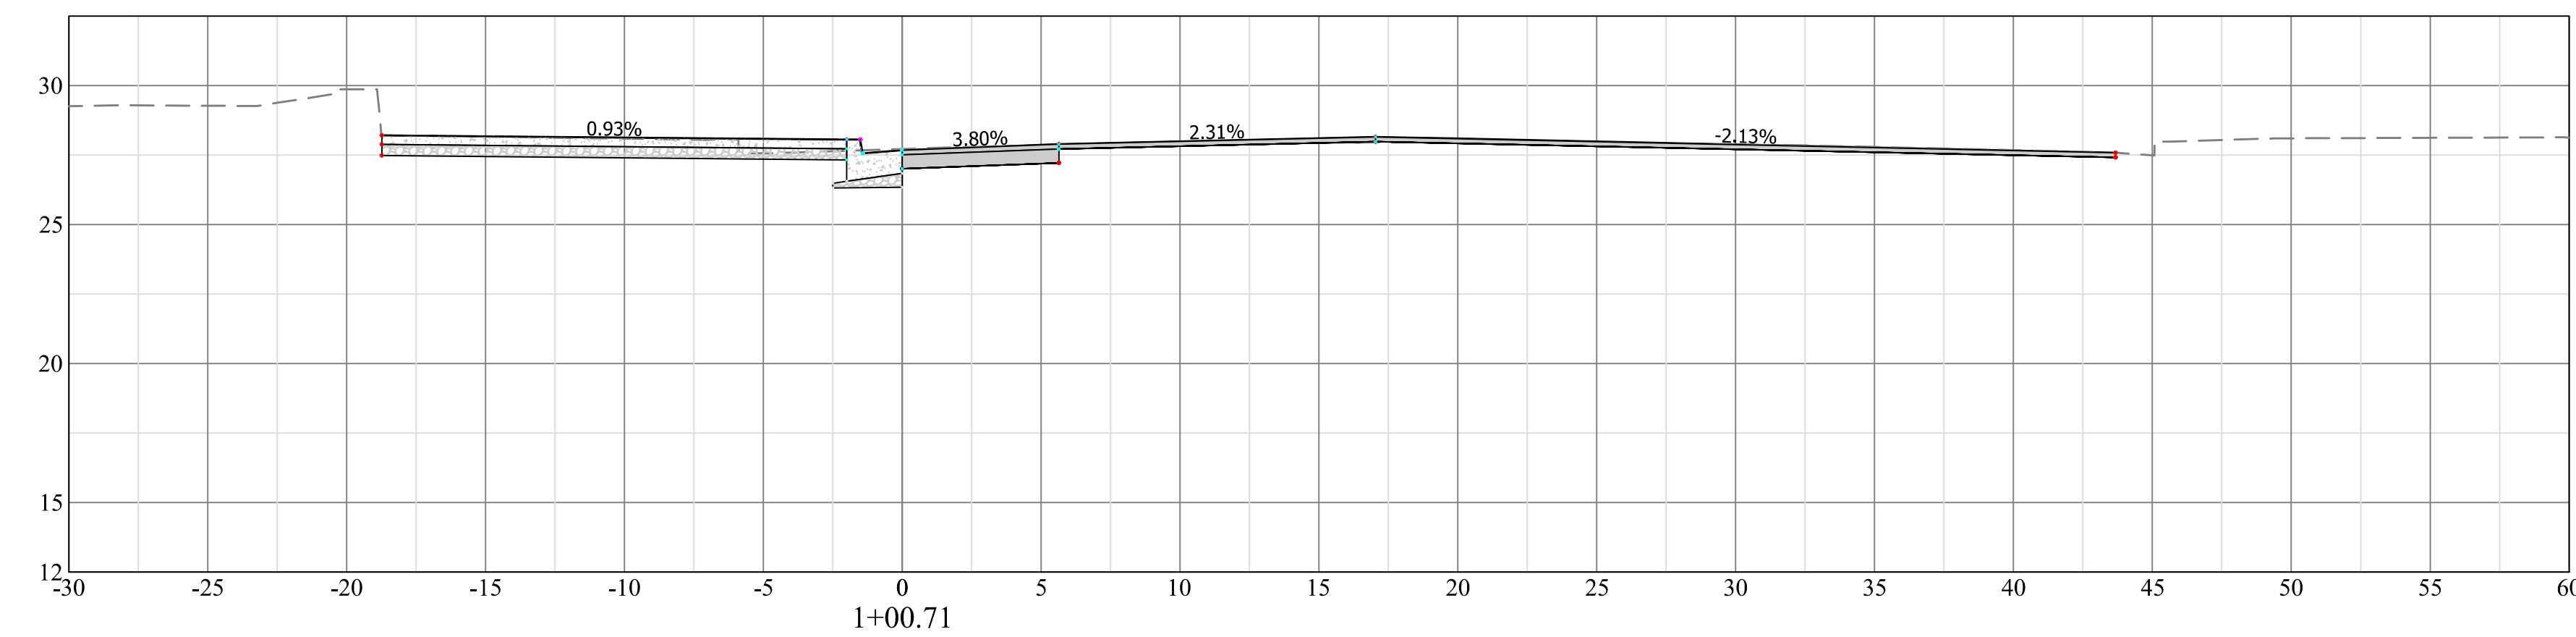
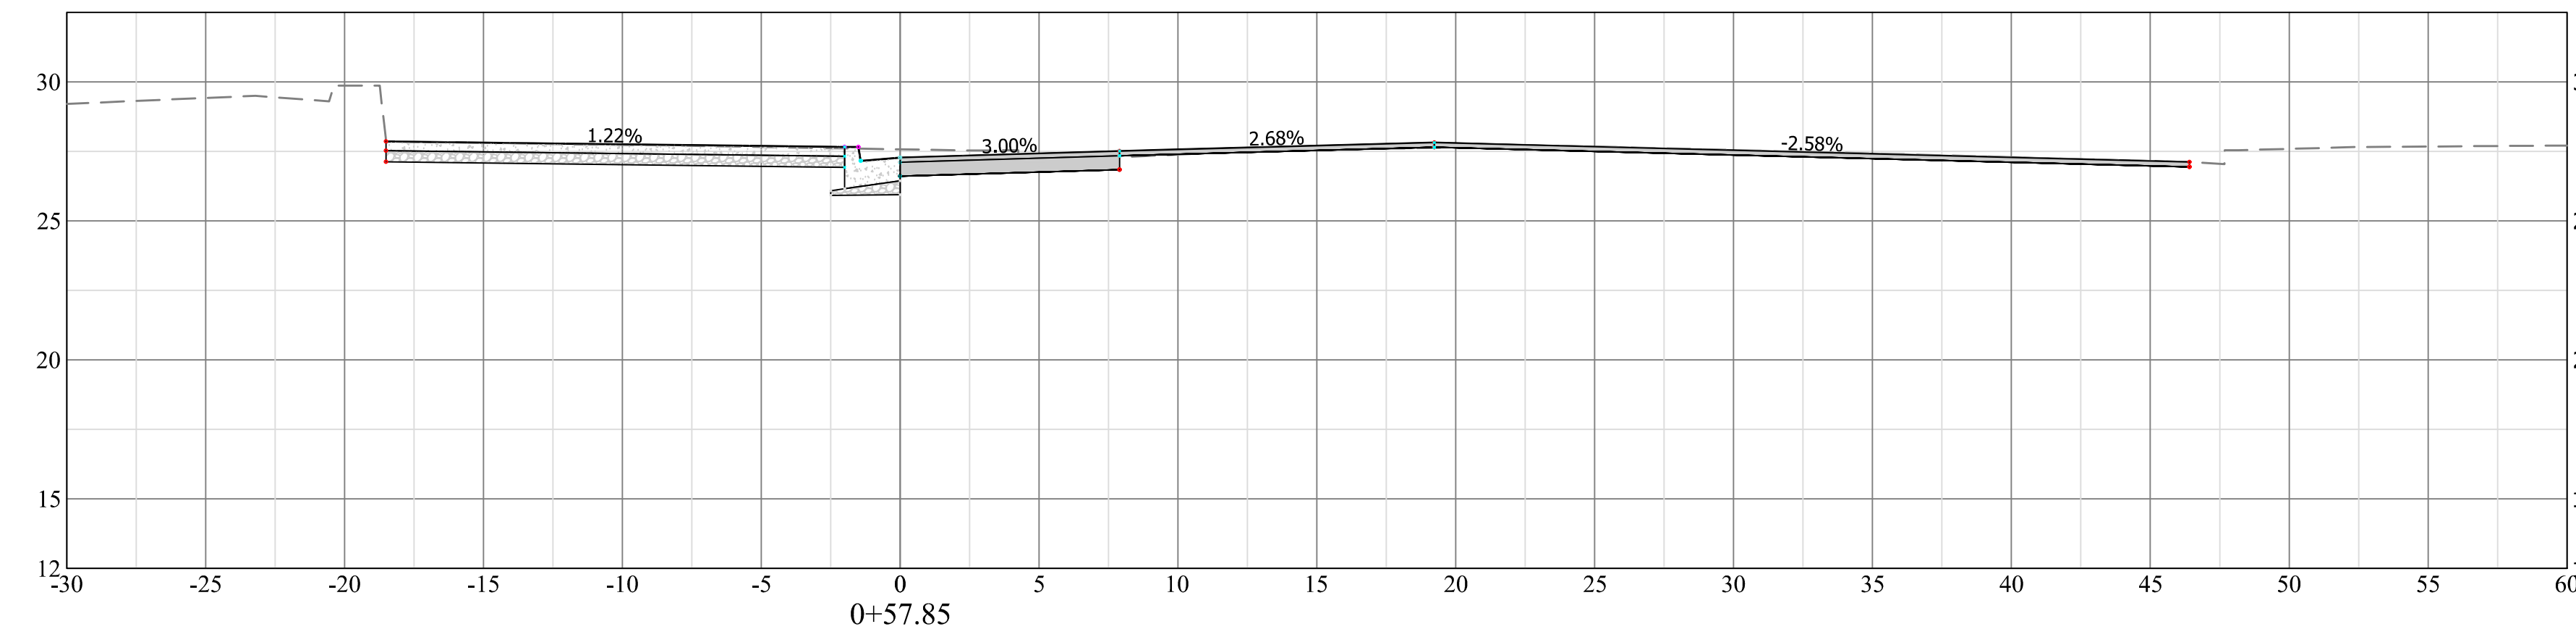
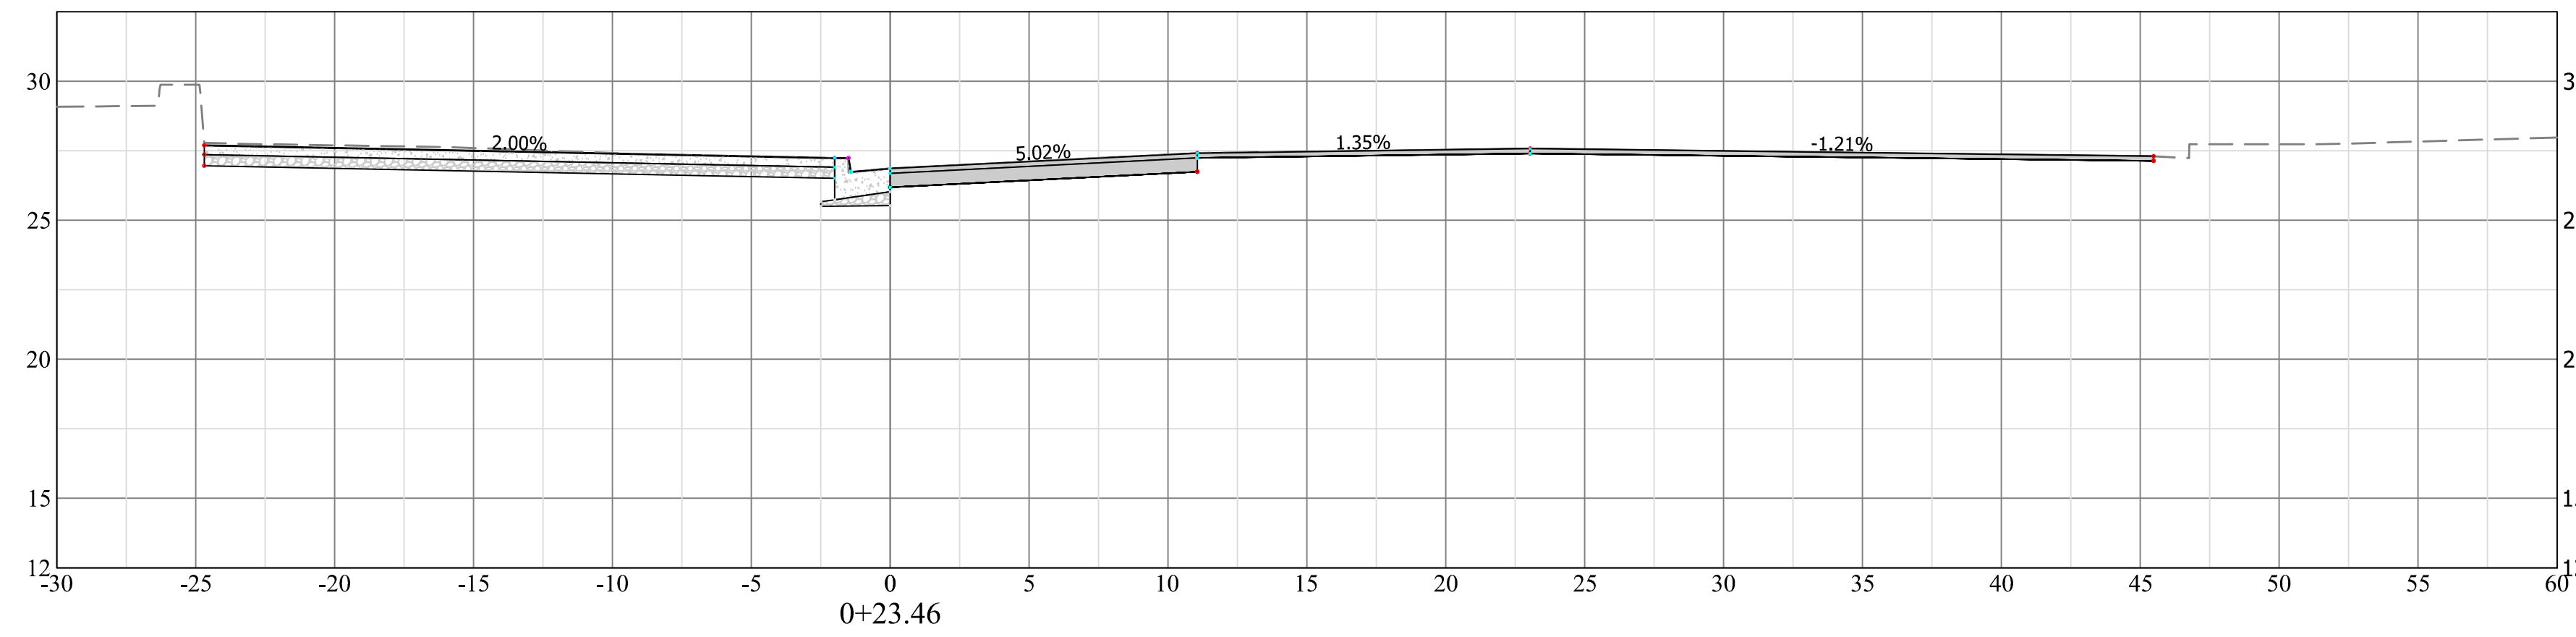
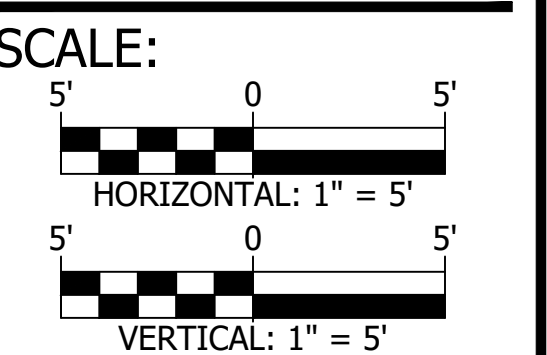
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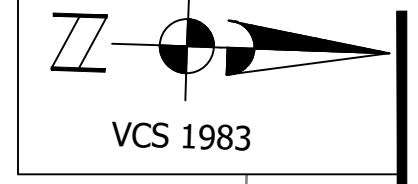
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12TH ST S & CRYSTAL DRIVE TRANSITION

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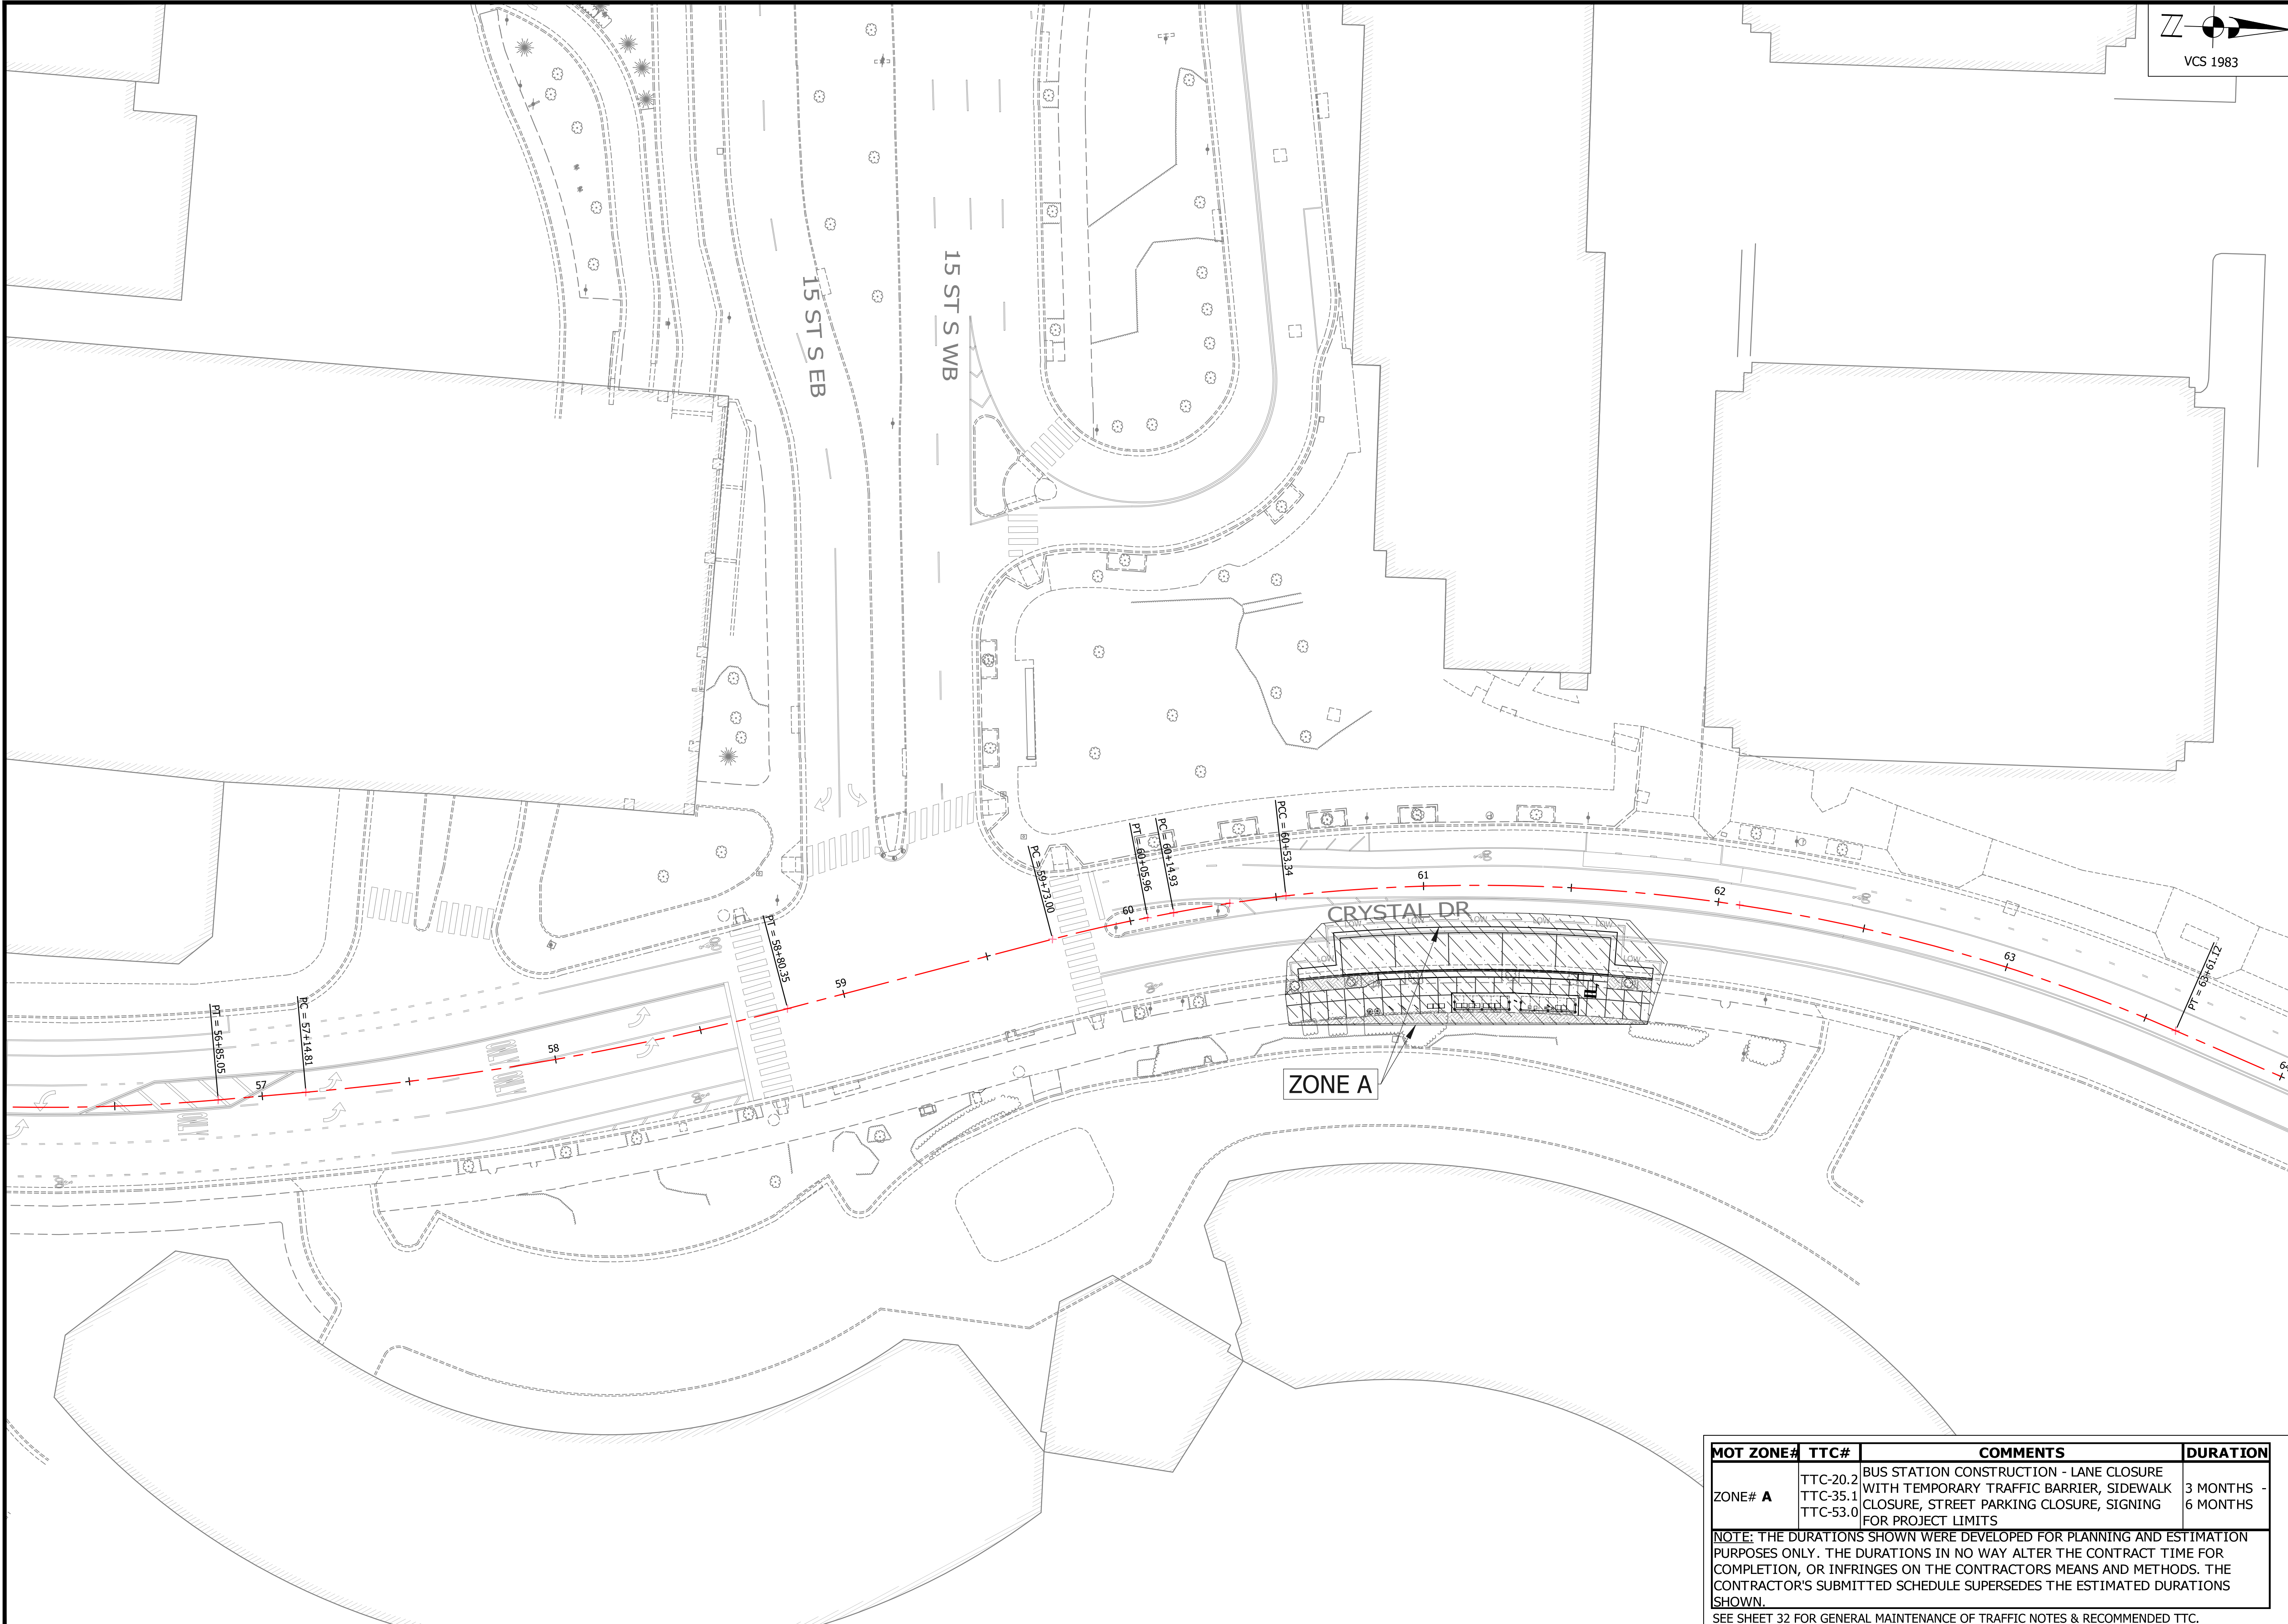
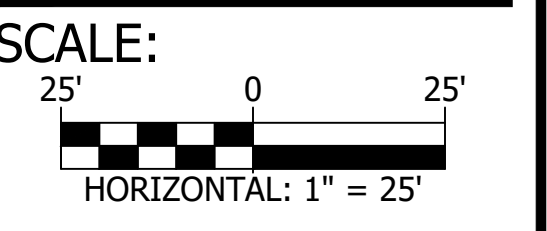
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<i>[Signature]</i> WATER, SEWER, STREETS BUREAU CHIEF	03.04.2021
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<i>[Signature]</i> PROJECT MANAGER	3/2/21

REVISIONS DATE

REVISIONS	DATE

PROJECT NAME AND LOCATION
TRANSITWAY EXTENSION TO PENTAGON CITY
MOT PLAN
CRYSTAL DR & 12TH ST S
 MA13 - SEGMENT I


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MOT ZONE#	TTC#	COMMENTS	DURATION
ZONE# A	TTC-20.2 TTC-35.1 TTC-53.0	BUS STATION CONSTRUCTION - LANE CLOSURE WITH TEMPORARY TRAFFIC BARRIER, SIDEWALK CLOSURE, STREET PARKING CLOSURE, SIGNING FOR PROJECT LIMITS	3 MONTHS - 6 MONTHS

NOTE: THE DURATIONS SHOWN WERE DEVELOPED FOR PLANNING AND ESTIMATION PURPOSES ONLY. THE DURATIONS IN NO WAY ALTER THE CONTRACT TIME FOR COMPLETION, OR INFRINGES ON THE CONTRACTORS MEANS AND METHODS. THE CONTRACTOR'S SUBMITTED SCHEDULE SUPERSEDES THE ESTIMATED DURATIONS SHOWN.
 SEE SHEET 32 FOR GENERAL MAINTENANCE OF TRAFFIC NOTES & RECOMMENDED TTC.

CRYSTAL DR NB & 15TH ST S INTERSECTION



DEPARTMENT OF ENVIRONMENTAL SERVICES
FACILITIES & ENGINEERING DIVISION
ENGINEERING BUREAU
2100 CLARENDON BOULEVARD, SUITE 813
ARLINGTON, VA 22201
PHONE: 703.228.3629
FAX: 703.228.3606
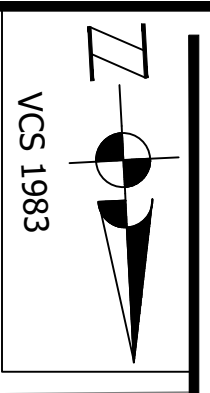
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APPROVALS	DATE
<i>[Signature]</i> QUALITY CONTROL ENGINEER	3/29/21
<i>[Signature]</i> CONSTRUCTION MANAGEMENT SUPERVISOR	3.24.21
<i>[Signature]</i> WATER, SEWER, STREETS BUREAU CHIEF	03.04.2021
<i>[Signature]</i> TRANSPORTATION DIRECTOR	03/17/21
<i>[Signature]</i> PROJECT MANAGER	3/2/21

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PROJECT NAME AND LOCATION
TRANSITWAY EXTENSION TO PENTAGON CITY


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CRYSTAL DR & 12TH ST S

MA13 - SEGMENT I

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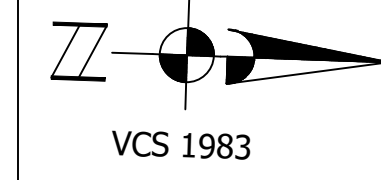
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MOT ZONE#	TTC#	COMMENTS	DURATION
ZONE# B	TTC-20.2 TTC-35.1 TTC-53.0	BUS STATION CONSTRUCTION - LANE CLOSURE WITH TEMPORARY TRAFFIC BARRIER, SIDEWALK CLOSURE, STREET PARKING CLOSURE, SIGNING FOR PROJECT LIMITS, SIDEWALK ACCESS TO EXISTING ELEVATOR WITH PEDESTRIAN LONGITUDINAL CHANNELIZING DEVICES AND SHALL BE SEPARATED FROM CONSTRUCTION AREA WITH 6' FENCE	3 MONTHS - 6 MONTHS

NOTE: THE DURATIONS SHOWN WERE DEVELOPED FOR PLANNING AND ESTIMATION PURPOSES ONLY. THE DURATIONS IN NO WAY ALTER THE CONTRACT TIME FOR COMPLETION, OR INFRINGES ON THE CONTRACTORS MEANS AND METHODS. THE CONTRACTOR'S SUBMITTED SCHEDULE SUPERSEDES THE ESTIMATED DURATIONS SHOWN.
SEE SHEET 32 FOR GENERAL MAINTENANCE OF TRAFFIC NOTES & RECOMMENDED TTC.

12TH ST S WB & LONG BRIDGE DR INTERSECTION

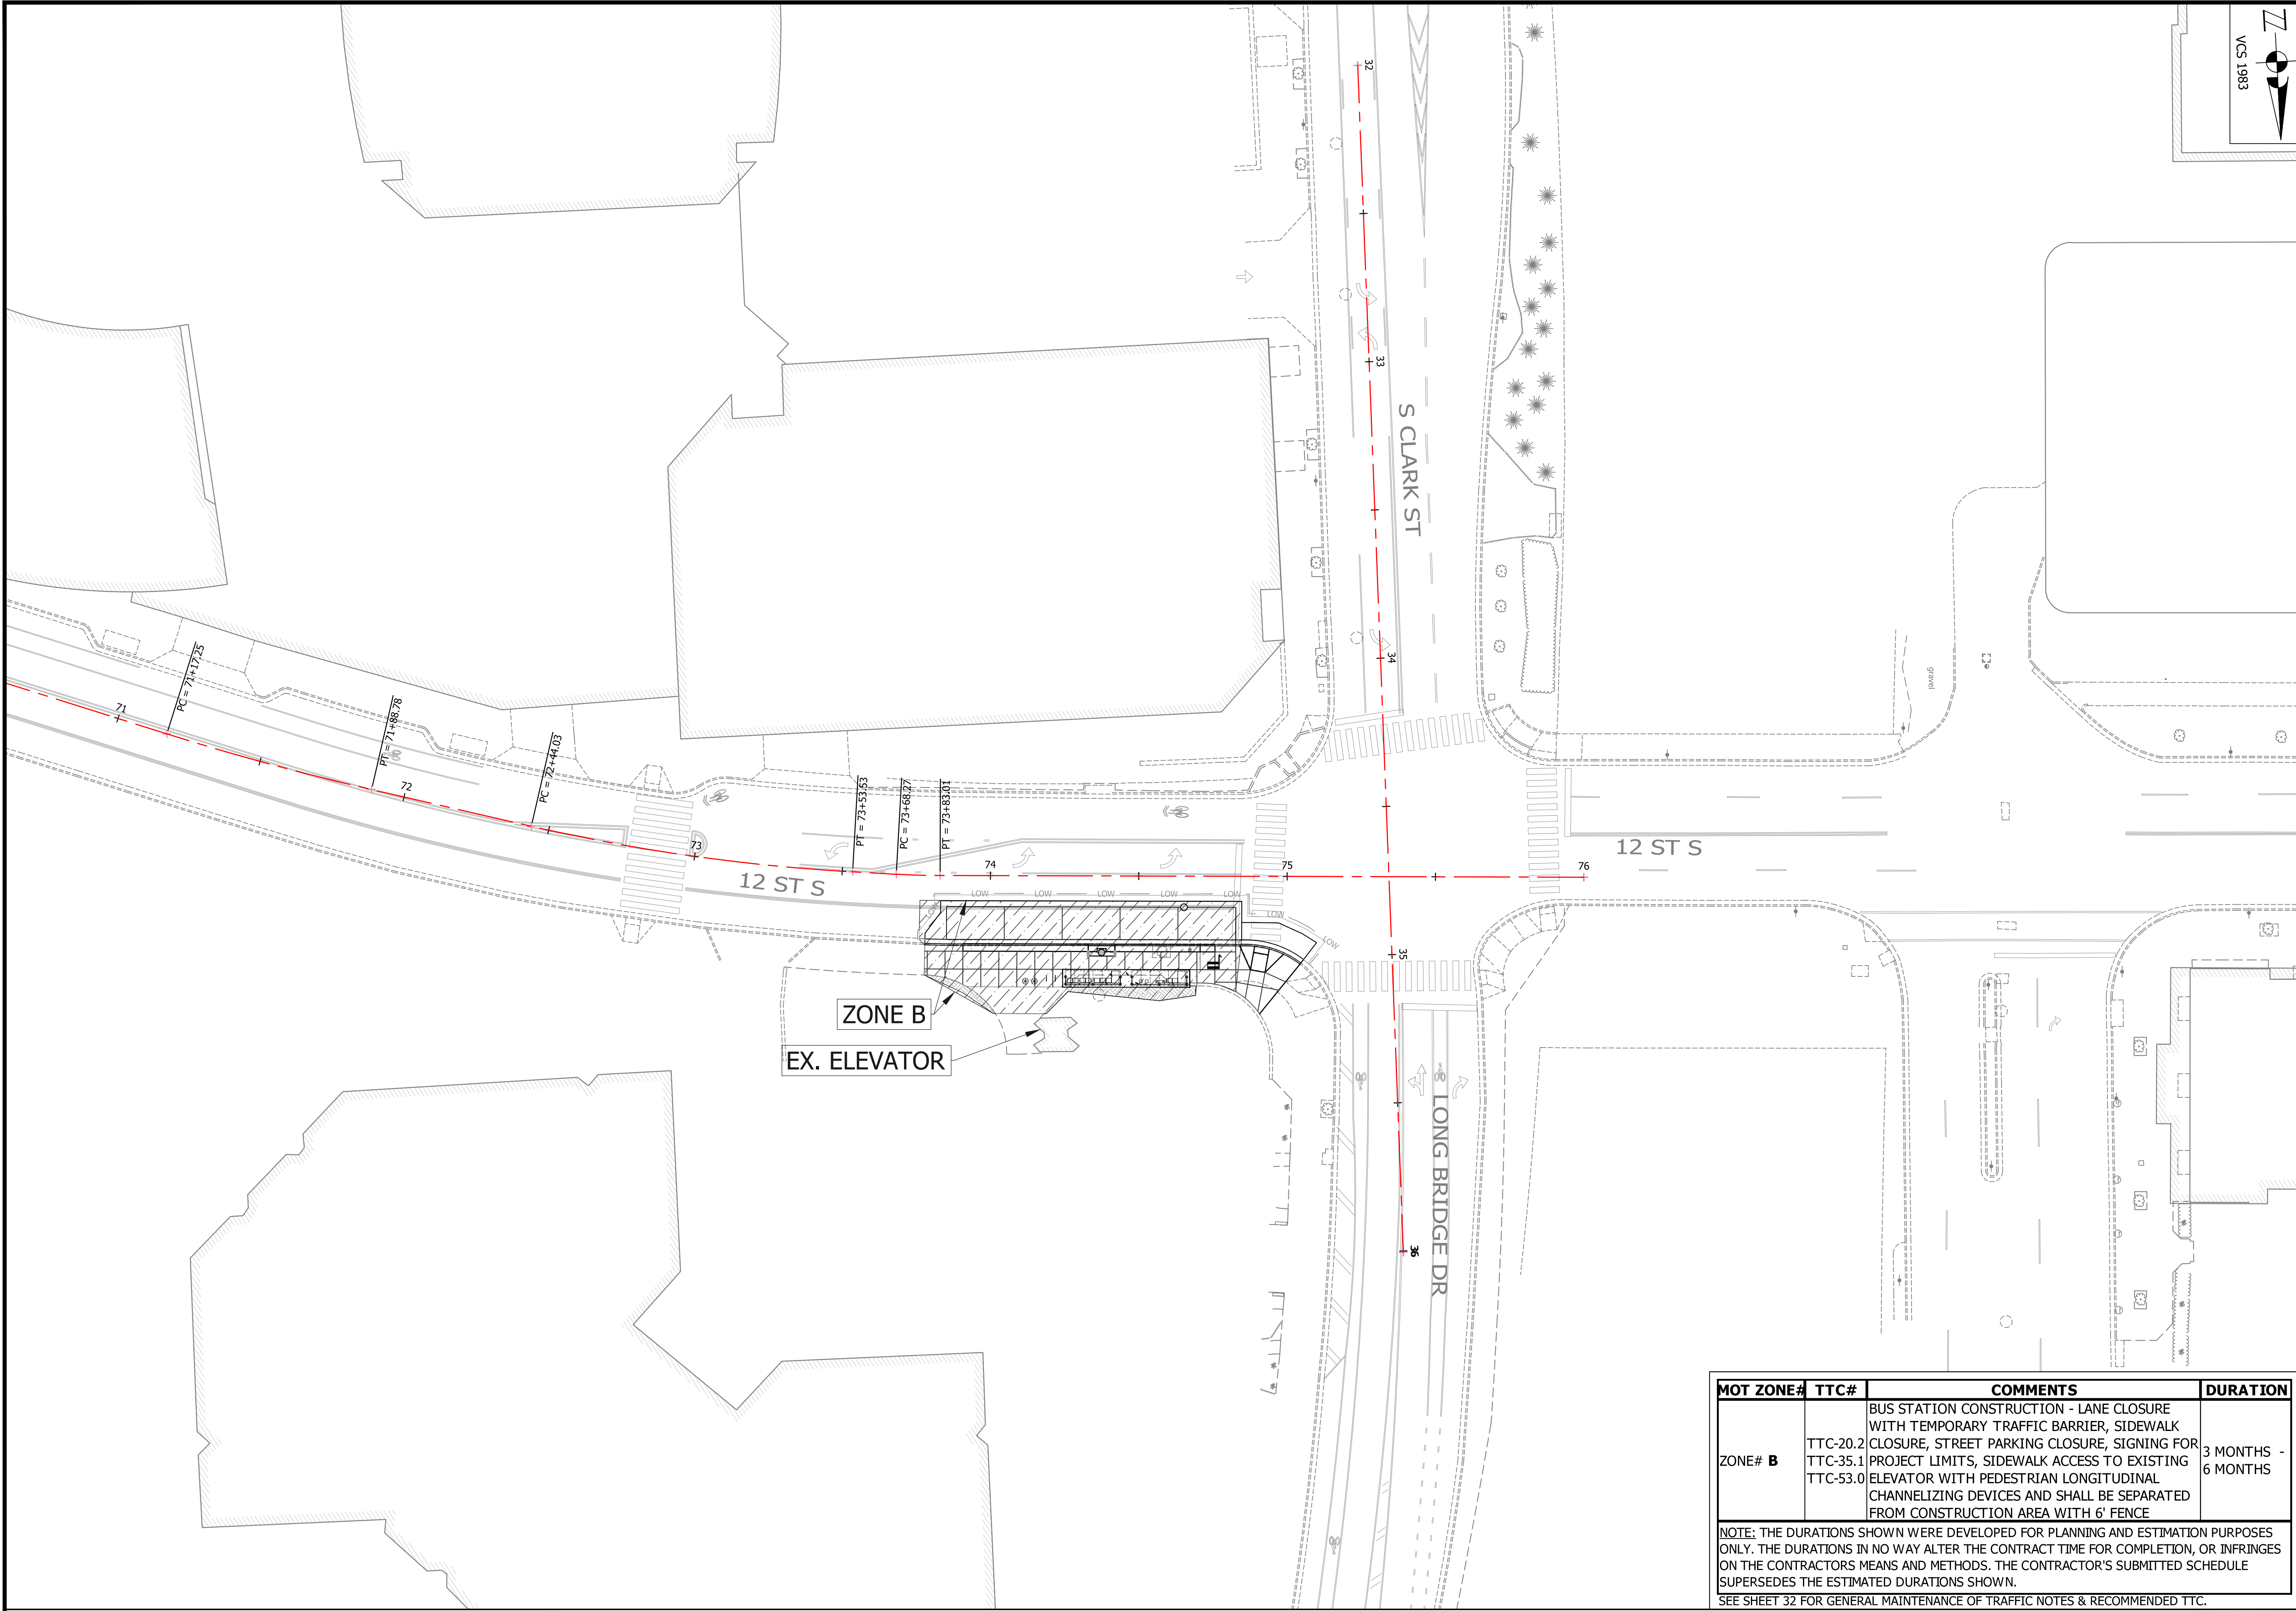

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FACILITIES & ENGINEERING DIVISION
ENGINEERING BUREAU
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ARLINGTON, VA 22201
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APPROVALS	DATE
<i>[Signature]</i> QUALITY CONTROL ENGINEER	3/29/21
<i>[Signature]</i> Kamal Takrar	3.24.21
<i>[Signature]</i> CONSTRUCTION MANAGEMENT SUPERVISOR	03.04.2021
<i>[Signature]</i> WATER, SEWER, STREETS BUREAU CHIEF	03/17/21
<i>[Signature]</i> TRANSPORTATION DIRECTOR	
<i>[Signature]</i> PROJECT MANAGER	3/2/21



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PROJECT NAME AND LOCATION
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MOT PLAN
CRYSTAL DR & 12TH ST S
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ZONE C

MOT ZONE#	TTC#	COMMENTS	DURATION
ZONE# B	TTC-20.2	BUS STATION CONSTRUCTION - LANE CLOSURE WITH TEMPORARY TRAFFIC BARRIER, SIDEWALK CLOSURE, STREET PARKING CLOSURE, SIGNING FOR PROJECT LIMITS, SIDEWALK ACCESS TO EXISTING ELEVATOR WITH PEDESTRIAN LONGITUDINAL CHANNELIZING DEVICES AND SHALL BE SEPARATED FROM CONSTRUCTION AREA WITH 6' FENCE	3 MONTHS - 6 MONTHS
	TTC-35.1		
	TTC-53.0		

NOTE: THE DURATIONS SHOWN WERE DEVELOPED FOR PLANNING AND ESTIMATION PURPOSES ONLY. THE DURATIONS IN NO WAY ALTER THE CONTRACT TIME FOR COMPLETION, OR INFRINGES ON THE CONTRACTORS MEANS AND METHODS. THE CONTRACTOR'S SUBMITTED SCHEDULE SUPERSEDES THE ESTIMATED DURATIONS SHOWN.
SEE SHEET 32 FOR GENERAL MAINTENANCE OF TRAFFIC NOTES & RECOMMENDED TTC.

GENERAL MAINTENANCE OF TRAFFIC NOTES:

- TRAFFIC CONTROL DEVICES AND SAFETY MEASURES SHALL COMPLY WITH THE VIRGINIA WORK AREA PROTECTION MANUAL, VDOT'S GUIDELINES FOR TEMPORARY TRAFFIC CONTROL, FEDERAL HIGHWAY ADMINISTRATION MANUAL ON UNIFORM TRAFFIC CONTROL DEVICES, ARLINGTON COUNTY STANDARDS, THE TRAFFIC CONTROL PLANS INCLUDED IN THE CONSTRUCTION DRAWINGS, AND/OR AS DIRECTED BY THE PROJECT OFFICER.
- THE CONTRACTOR SHALL SUBMIT A DETAILED SCHEDULE WHICH INDICATES START AND FINISH DATES FOR EACH SEGMENT OF THE WORK. THE SCHEDULE SHALL INDICATE THE DURATION OF ALL LANE OR SHOULDER CLOSURES. THE CONTRACTOR SHALL NOTIFY THE PROJECT OFFICER A MINIMUM OF 3 BUSINESS DAYS IN ADVANCE OF PROCEEDING TO THE NEXT WORK SEGMENT.
- THE CONTRACTOR SHALL NOTIFY THE PROJECT OFFICER OF PARKING RESTRICTION NEEDS A MINIMUM OF 3 BUSINESS DAYS PRIOR TO COMMENCEMENT OF WORK FOR EACH SEGMENT. COUNTY PROJECT OFFICER SHALL RESTRICT PARKING BY CONTACTING DES - PERMITTING SECTION, 703-228-4798.
- DURING CONSTRUCTION, THE CONTRACTOR SHALL EITHER MAINTAIN APPROPRIATE SIGHT DISTANCE TO ALL TRAFFIC SIGNS OR PROVIDE FOR TEMPORARY SIGNAGE OR FLAGGERS TO GUIDE TRAFFIC THROUGH WORK ZONES.
- THE CONTRACTOR SHALL MINIMIZE THE DURATION OF ANY BLOCKAGE TO PRIVATE ENTRANCES AND DRIVEWAYS. THE CONTRACTOR SHALL SUBMIT A SCHEDULE OF DRIVEWAY CLOSURE FOR APPROVAL BY THE PROJECT OFFICER. THE PROJECT OFFICER SHALL BE NOTIFIED A MINIMUM OF 3 BUSINESS DAYS IN ADVANCE OF SUCH ACTIVITIES. THE CONTRACTOR SHALL NOTIFY THE PROPERTY OWNER AT LEAST 24 HOURS IN ADVANCE OF THE START OF ANY WORK THAT WILL REQUIRE TEMPORARY CLOSURE OF ACCESS TO THE PROPERTY. THE CONTRACTOR SHALL MAKE ALL PRIVATE ENTRANCES AND DRIVEWAYS ACCESSIBLE AT THE CONCLUSION OF EACH WORKDAY.
- ANY EXCAVATIONS WHICH ARE SPECIFICALLY APPROVED BY THE PROJECT OFFICER TO REMAIN OPEN PAST NORMAL WORKING HOURS SHALL BE THE RESPONSIBILITY OF THE CONTRACTOR AND SHALL BE PROTECTED IN ACCORDANCE WITH THE VIRGINIA WORK AREA PROTECTION MANUAL AND AS APPROVED BY THE PROJECT OFFICER.
- PEDESTRIAN TRAFFIC SHALL BE MAINTAINED AT ALL TIMES, INCLUDING ACCESS TO BUS STOP SHELTERS, UNLESS OTHERWISE APPROVED IN THE PLANS.
- PEDESTRIAN TRAFFIC SHALL BE SEPARATED FROM WORK ZONES WITH APPROPRIATE MEASURES IN ACCORDANCE WITH MUTCD.
- ADEQUATE PROVISIONS FOR PERSONS WITH DISABILITIES SHALL BE PROVIDED AT ALL TIMES PER ADA REQUIREMENTS.
- WHEN NECESSARY, PEDESTRIANS SHALL BE APPROPRIATELY DIRECTED WITH ADVANCED WARNING SIGNS PLACED AT INTERSECTIONS, TO CROSS TO THE OPPOSITE SIDE OF THE ROADWAY IN ORDER TO PREVENT CONFLICT WITH MIDBLOCK WORK SITES.
- PEDESTRIANS SHALL NOT BE LED INTO CONFLICT WITH WORK SITE EQUIPMENT, OPERATIONS, AND/OR VEHICLES MOVING THROUGH OR AROUND THE WORK SITE.
- ALL EXISTING FIRE HYDRANTS AND FIRE DEPARTMENT CONNECTIONS SHALL BE MAINTAINED UNOBSTRUCTED AND ACCESSIBLE AT ALL TIMES IN ACCORDANCE WITH SECTIONS 508.5.4 AND 508.5.5 OF THE ARLINGTON COUNTY FIRE PREVENTION CODE.
- ACCESS TO BUILDINGS FOR FIREFIGHTING SHALL BE MAINTAINED AT ALL TIMES. EXISTING FIRE APPARATUS ACCESS ROADS (FIRE LANES) SHALL BE KEPT CLEAR OF OBSTRUCTIONS IN ACCORDANCE WITH SECTION 503.4 OF THE ARLINGTON COUNTY FIRE PREVENTION CODE. ACCESS TO CONSTRUCTION SITES SHALL BE PROVIDED AND MAINTAINED IN ACCORDANCE WITH SECTION 1410 OF THE ARLINGTON COUNTY FIRE PREVENTION CODE.
- IN THE EVENT THAT EXISTING FIRE DEPARTMENT CONNECTIONS OR FIRE APPARATUS ACCESS ROADS (FIRE LANES) MUST BE OBSTRUCTED TO FACILITATE CONSTRUCTION ACTIVITIES, CONTACT THE ARLINGTON COUNTY FIRED DEPARTMENT FIRE PREVENTION OFFICE AT 703-228-4644 TO COORDINATE REVIEW AND APPROVAL OF TEMPORARY FIRE DEPARTMENT CONNECTIONS AND/OR FIRE APPARATUS ACCESS ROADS PRIOR TO CREATING THE OBSTRUCTION.
- AT SIGNALIZED INTERSECTIONS, THE CONTRACTOR SHALL BE RESPONSIBLE FOR MAINTAINING VEHICLE DETECTION AT ALL TIMES DURING THE PROJECT. TRAFFIC SENSORS SHALL BE RESTORED TO THEIR PRE-CONSTRUCTION STATE PRIOR TO THE COMPLETION OF THIS PROJECT.
- IN ARLINGTON COUNTY RIGHT-OF-WAY, WORK HOURS ARE RESTRICTED TO 9 AM TO 4 PM (MON-FRI).
- IN VDOT RIGHT-OF-WAY, WORK HOURS ARE RESTRICTED TO 9:30 AM TO 3 PM (MON-THUR.) AND 9:30 AM TO 2 PM (FRI.).
- ALL LANES SHALL BE FULLY OPEN TO TRAFFIC OUTSIDE THE ABOVE HOURS UNLESS SPECIFIED OTHERWISE IN THE MAINTENANCE OF TRAFFIC PLANS.
- CONTRACTOR SHALL COVER ANY EXISTING SIGNS WHICH ARE NOT APPLICABLE OR ARE IN CONFLICT WITH THIS MOT PLAN.
- CONTRACTOR SHALL ERADICATE AND RE-STRIP AS NECESSARY ANY EXISTING PAVEMENT MARKINGS THAT ARE IN CONFLICT WITH OR DO NOT ALIGN WITH THE TEMPORARY PAVEMENT MARKINGS OR NEW TRAFFIC PATTERNS.
- CONTRACTOR SHALL ERADICATE ALL TEMPORARY PAVEMENT MARKING, INCLUDING TEMPORARY MARKED CROSSWALKS ONCE THE WORK AREA(S) ASSOCIATED WITH THE MARKINGS HAS BEEN COMPLETED.
- TEMPORARY SIGNS AND BARRIERS ARE NOT TO BE PLACED WHERE THEY WOULD OBSTRUCT PEDESTRIAN PASSAGE ON SIDEWALKS, UNLESS SUCH SIGNAGE OR BARRIER IS INTENDED TO CLOSE THE SIDEWALK SEGMENT.
- SIDEWALK AND BIKE LANE CLOSURES ARE TO BE COORDINATED WITH THE CONSTRUCTION MANAGER AND T&E PRIOR TO IMPLEMENTATION.
- ACCESS TO LONG BRIDGE PARK ESPLANADE IS TO BE MAINTAINED AT ALL TIMES.

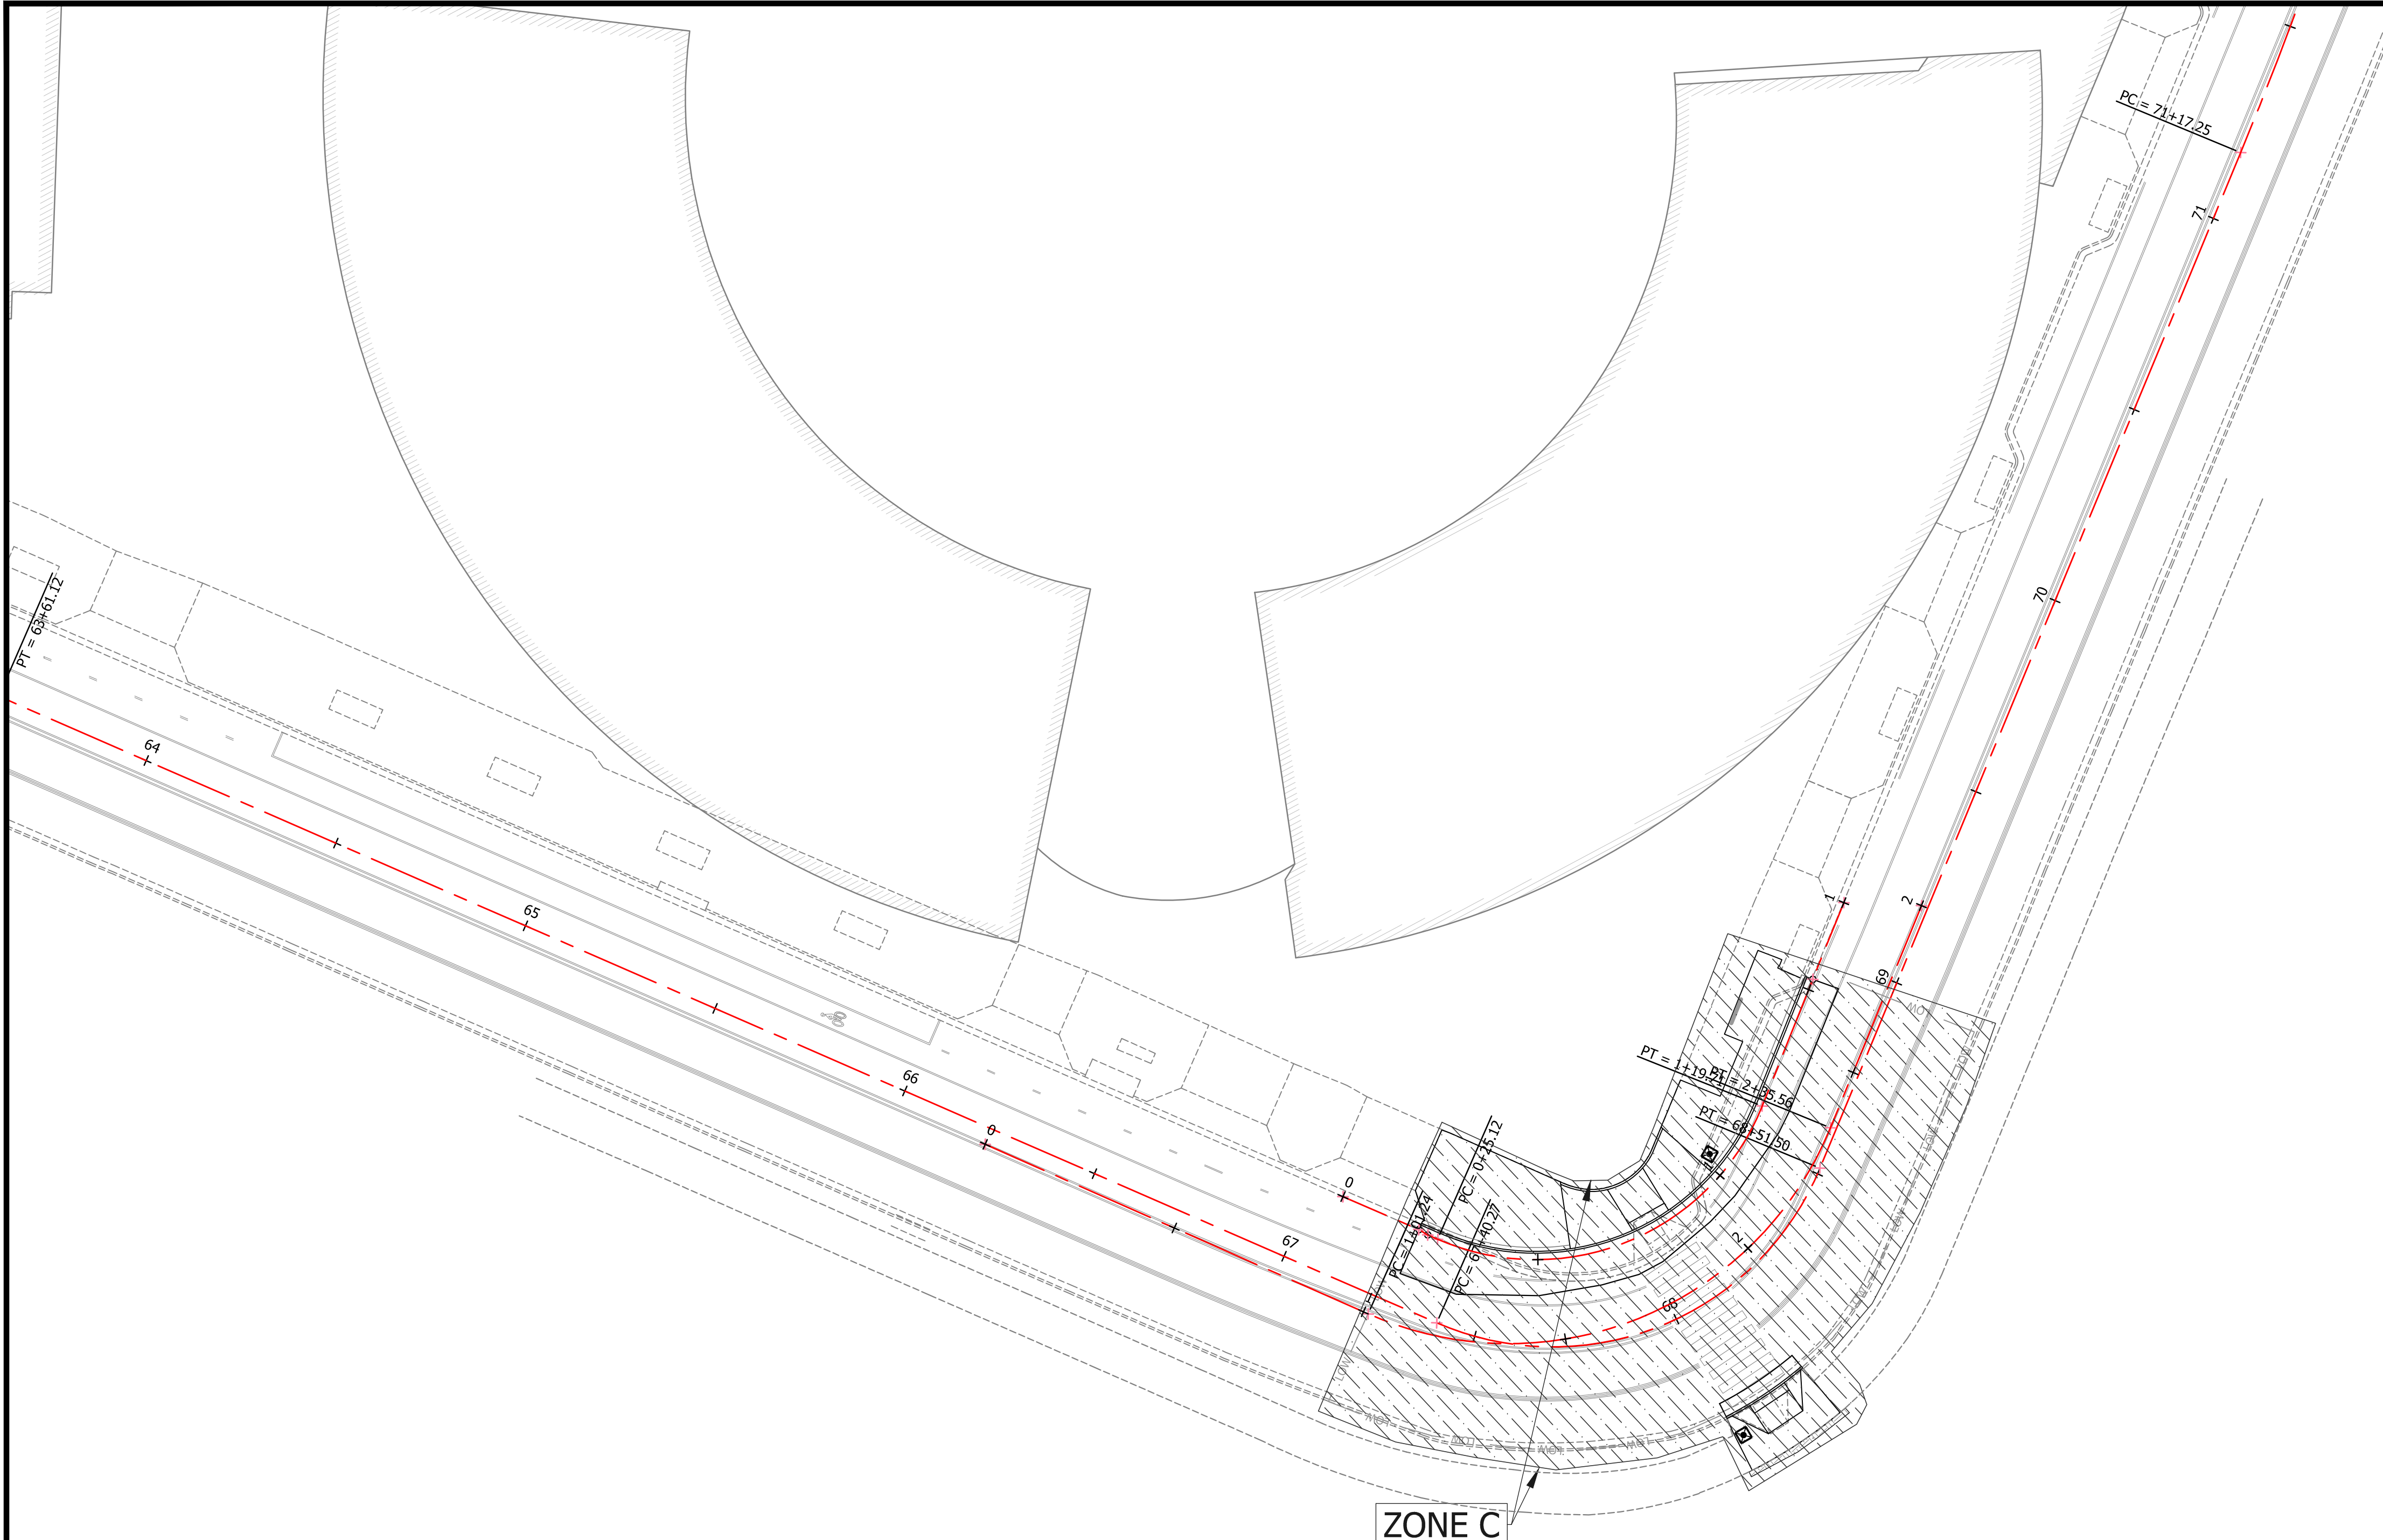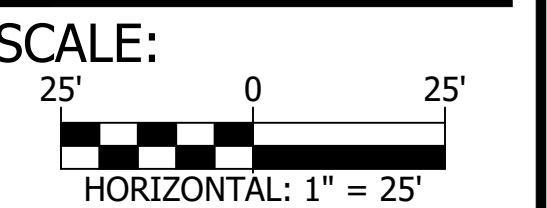ALL AND ANY TEMPORARY STRIPING DUE TO MAINTENANCE OF TRAFFIC OPERATIONS PART OF THIS PROJECT SHALL BE INCLUDED AS PART OF THE PROJECT COST.

SEE SHEET 30-31A FOR CONSTRUCTION ZONES.


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September 2019

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Lane Closure Operation with Temporary Traffic Barrier¹
(Figure TTC-20.2)



1: Revision 1 - 4/1/2015
2: Revision 2 - 7/1/2018

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September 2019

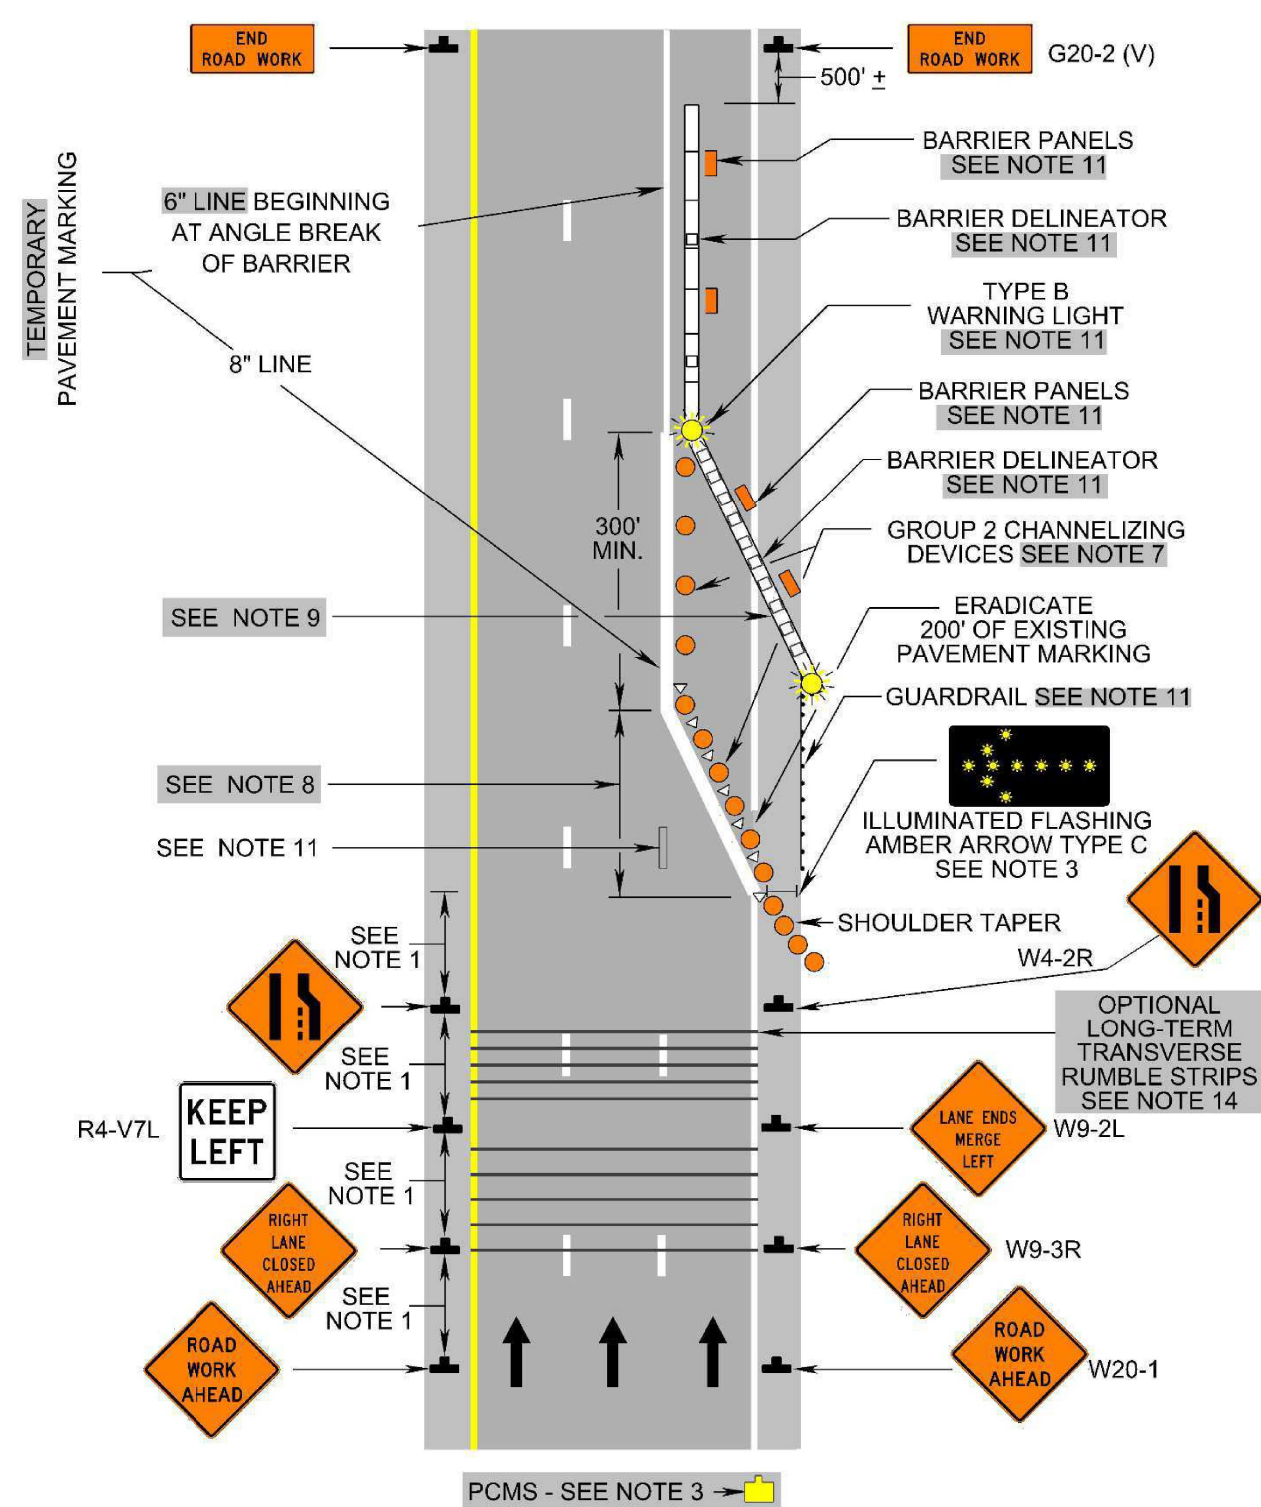Typical Traffic Control
Lane Closure Operation with Temporary Traffic Barrier¹
(Figure TTC-20.2)
NOTES


- Guidance:**
- See Table 6H-5, page 6H-6, for recommended spacing of advance warning signs.
 - SHOULDER CLOSED (W21-5a) signs should be used on Limited-Access Highways where there is no opportunity for disabled vehicles to pull off the roadway (see Figure TTC-6).
 - When closing a lane, a PCMS should be used in advance of the first warning sign if all of the left side signs cannot be installed.
 - If drivers cannot see a pull-off area beyond the closed shoulder, information regarding the length of the shoulder closure should be provided in feet or miles, as appropriate.
 - An emergency pull-off area should be provided per Section 6G.18 and Temporary Traffic Control Figure TTC-8.
- Standard:**
- On divided highways having a median wider than 8', right and left sign assemblies shall be required.
 - Group 2 channelizing device spacing shall be at the following:
- | Group 2 Channelizing Device Spacing | | | | | |
|-------------------------------------|-------------------|------------------|-------------------|---------------------|-------------------|
| Location Spacing | Speed Limit (mph) | Location Spacing | Speed Limit (mph) | Location Spacing | Speed Limit (mph) |
| Transition | 0-35 36+ | Travelway | 0-35 36+ | Construction Access | 0-35 36+ |
| | 20' 40' | | 40' 80' | | 80' 120' |
- Construction access spacing may be increased to this distance, but shall not exceed one access per ¼ mile.
- For taper lengths, see TTC-19.2.
 - See Table 6H-6 for barrier transition flare rate.² When the barrier transition flare¹ is on a horizontal alignment, the total offset shall be prorated around the curve in lieu of a straight-line flare.
 - End treatment of a barrier in order of preference:
 - Where guardrail exists, attach to barrier with appropriate fixed object attachment.
 - Where cut slope exists, bury barrier into cut slope and provide for drainage as needed.
 - Extend end of barrier until it is beyond the established clear zone (see Figure 2 on Page A-4 of Appendix A for clear zone values).
 - When barrier end is inside the established clear zone, attenuator service Type I or Type II shall be used. Refer to L&D special design drawings.
 - Barrier panels 8 inches in width and 12 inches in height shall be placed on top of the concrete barrier and spaced on 40' centers along the transition or taper sections and spaced on 80' centers along the parallel or tangent sections. Reflectorized surface shall be fluorescent orange prismatic lens sheeting. The light at the beginning of the barrier run and at the breakpoint where the barrier becomes parallel to the roadway shall be a Type B flashing light. Barrier delineators shall be spaced on 20' centers along the transition or taper sections and spaced on 80' centers and centered² in-between the barrier panels along the parallel or tangent sections² approximately 24 inches up from the roadway surface.
- Guidance:**
- Eradication of existing pavement markings should be as shown in Figure TTC-55.
- Option:**
- The barrier shown in this typical application is an example of one method that may be used to close a shoulder and lane² on a long-term project.
 - Long-term transverse rumble strips may be installed to enhance the work zone see Chapter 6F, Section 6F-99 paragraph 12 and 13 for installation guidance and spacing.²

1: Revision 1 - 4/1/2015
2: Revision 2 - 7/1/2018

September 2019

Page 6H-79

Sidewalk Closure and Bypass Sidewalk Operation
(Figure TTC-35.1)

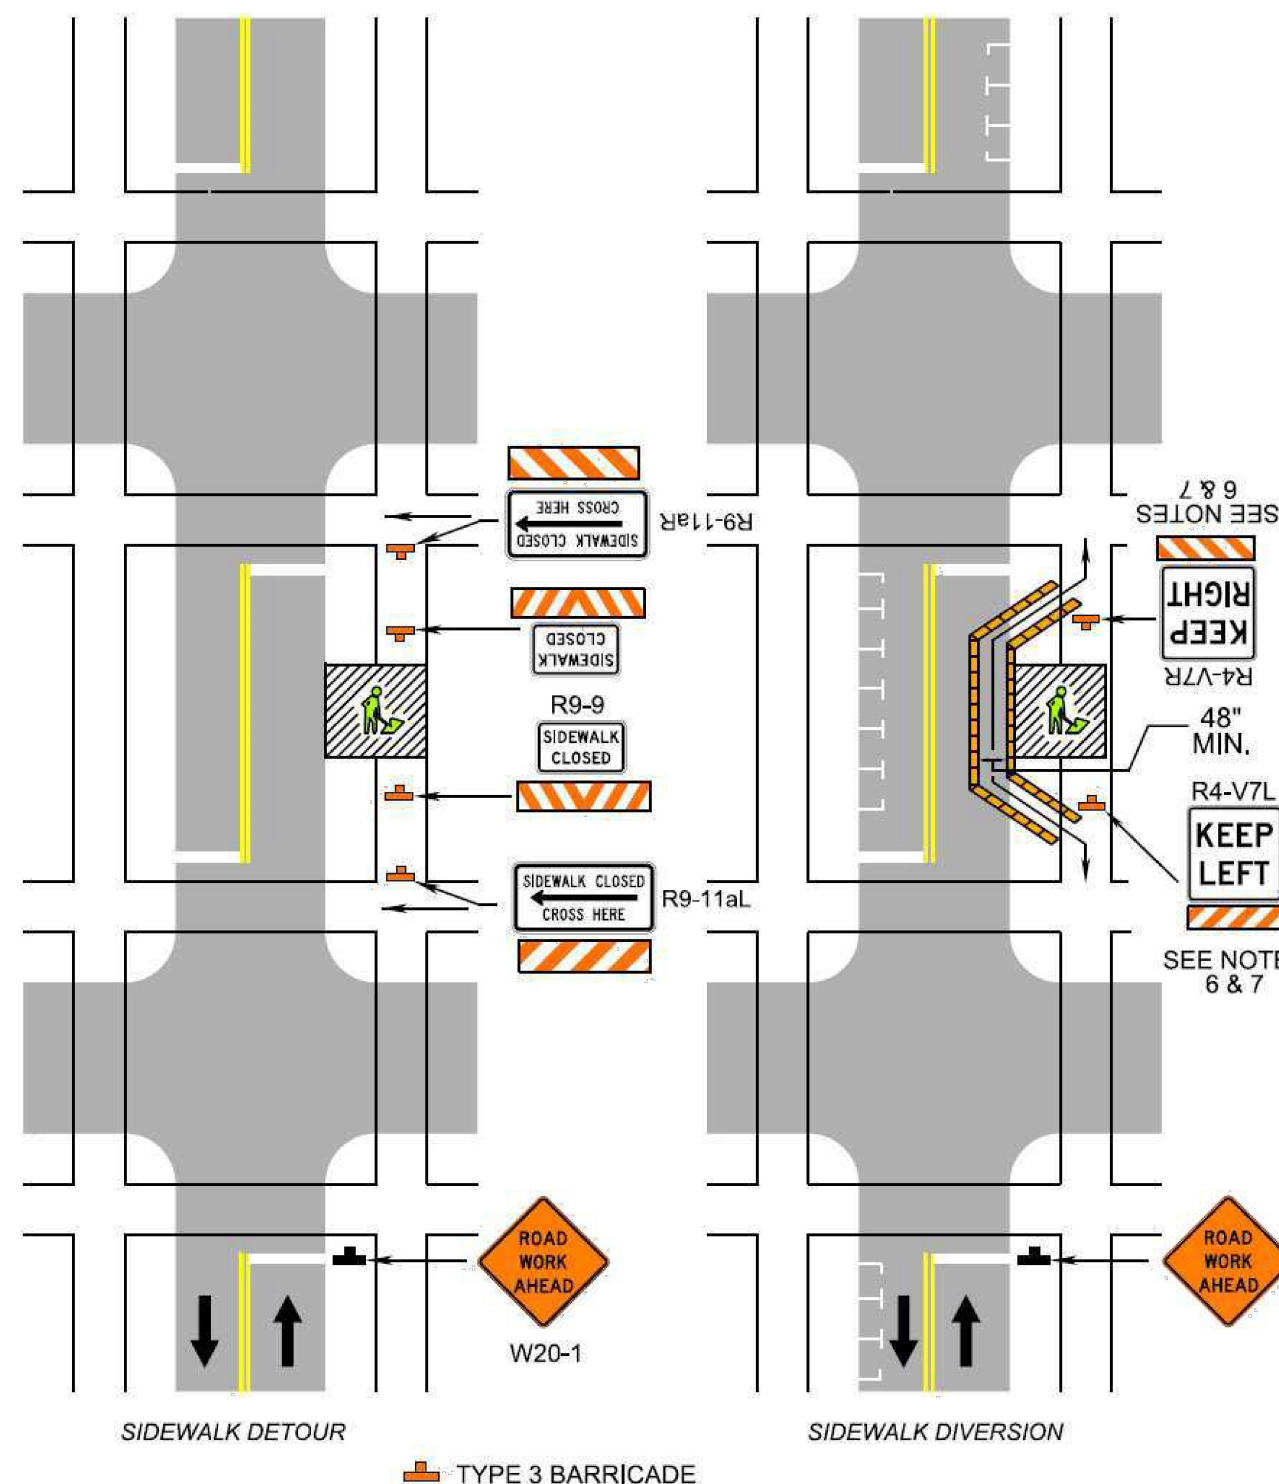

2: Revision 2 - 9/1/2019

Page 6H-78

September 2019

Typical Traffic Control
Sidewalk Closure and Bypass Sidewalk Operation
(Figure TTC-35.1)
NOTES


- Standard:**
- When crosswalks or other pedestrian facilities are closed or relocated, temporary facilities shall be detectable and shall include accessibility features consistent with the features present in the existing pedestrian facility.
- Guidance:**
- Where high speeds are anticipated, a temporary traffic barrier and, if necessary, a crash cushion should be used to separate the temporary sidewalks from vehicular traffic.
 - Audible information devices should be considered where midblock closings and changed crosswalk areas cause inadequate communication to be provided to pedestrians who have visual disabilities.
 - Temporary markings should be considered for operations exceeding three days in duration.
- Option:**
- Only the TTC devices related to pedestrians are shown. Other devices, such as lane closure signing or ROAD NARROWS (W5-1) signs, may be used to control vehicular traffic.
 - For nighttime closures, Type A Flashing warning lights may be used on barricades that support signs and close sidewalks.
 - Signs, such as KEEP RIGHT (R4-V7R) and KEEP LEFT (R4-V7L), may be placed along a temporary sidewalk to guide or direct pedestrians.
- Standard:**
- All sidewalk closures shall be closed with Type 3 Barricades. The SIDEWALK CLOSED (R9-9) sign and the SIDEWALK CROSS HERE (R9-11) sign shall be installed above the Type 3 barricade. The KEEP RIGHT sign can cover the top rail of the Type 3 Barricade.²

2: Revision 2 - 9/1/2019

August 2011

Page 6H-113

Signing for Project Limits
(Figure TTC-53.0)

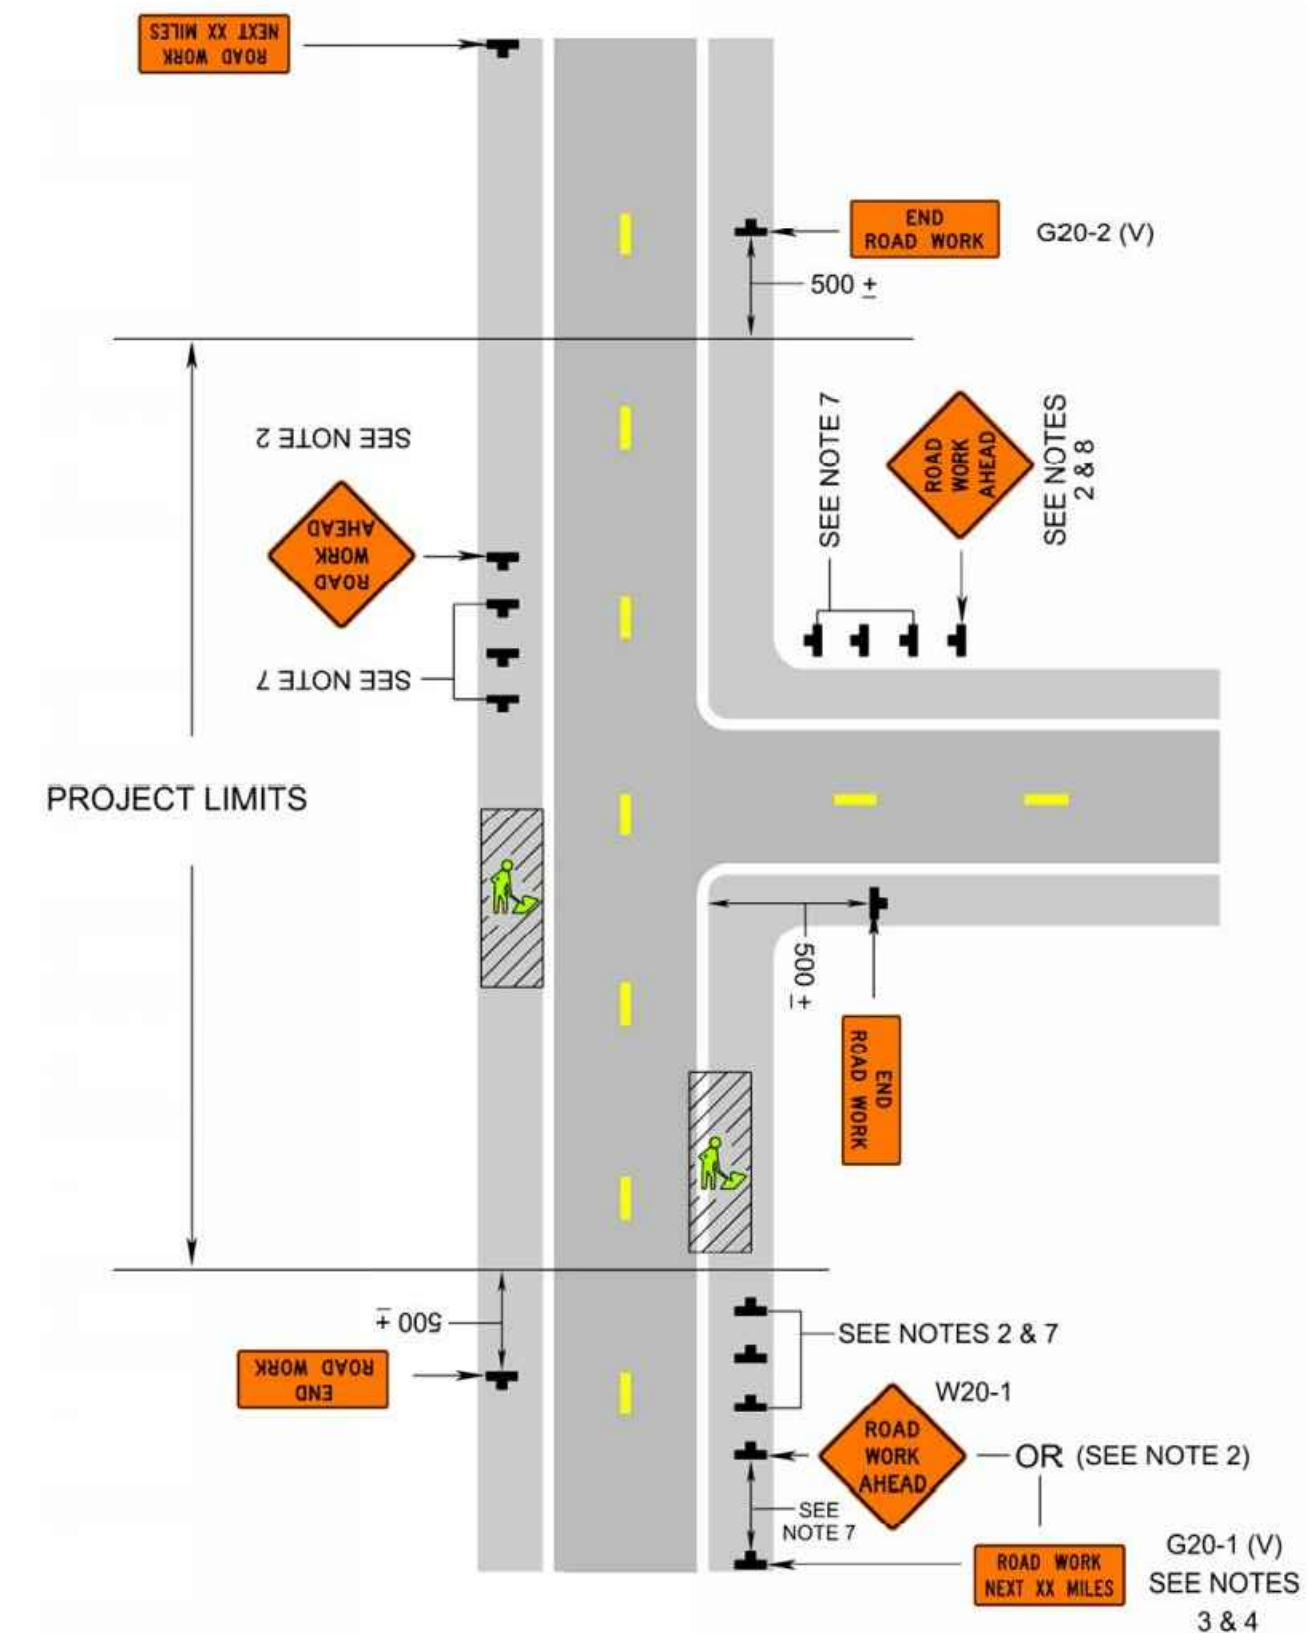

Page 6H-112

August 2011

Typical Traffic Control
Signing for Project Limits
(Figure TTC-53.0)
NOTES

- Support:**
- This layout depicts signing requirements for notifying motorist when they are entering and exiting a potential construction/maintenance area with a duration equal to or greater than 60 days.
- Standard:**
- The ROAD WORK AHEAD (W20-1) sign or the ROAD WORK NEXT XX MILES (G20-1 (V)) sign shall be placed far enough in advance of the project limits so that other warning signs in a series may be adequately placed prior to the condition they are warning about.
 - The ROAD WORK NEXT XX MILES sign shall be used for projects with activity areas greater than 2 miles in length, or when multiple work activities (such as pavement patching, guardrail installations, shoulder restoration, etc.) occur along a highway.
 - The distance displayed on the ROAD WORK NEXT XX MILES sign shall be stated to the nearest whole mile from the point of installation to the END ROAD WORK (G20-2 (V)) sign.
 - On divided highways having a median wider than 8', right and left sign assemblies shall be required.
- Guidance:**
- For projects with activity areas 2 miles or less in length, the ROAD WORK AHEAD sign should be the first sign motorist encounter.
 - Sign spacing should be 1300'-1500' for Limited Access highways. For all other roadways, the sign spacing should be 500'-800' where the posted speed limit is greater than 45 mph, and 350'-500' where the posted speed limit is 45 mph or less.
 - All connections within the project limits should be identified with signs indicating to motorist they are entering or exiting a potential construction/maintenance area.

ARLINGTON
VIRGINIA

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John P. ... 03.04.2021
WATER, SEWER, STREETS BUREAU CHIEF

Dennis M. Leach 03/17/21
TRANSPORTATION DIRECTOR

Diana Iazze 3/2/21
PROJECT MANAGER

REVISIONS **DATE**

PROJECT NAME AND LOCATION
**TRANSITWAY EXTENSION TO
PENTAGON CITY**

MOT DETAILS
CRYSTAL DR & 12TH ST S
MAL13 - SEGMENT 1

DESIGNED: PB
DRAWN: NS
CHECKED: TL
MISS UTILITY TRANSMITTAL #: N/A

FILENAME:
MAL13-286-MOT.DWG
PATH: \\DES-CAD-S2\ENGINEERING_DATA\DA\A\MAL13

PLOTTED: AUGUST 4 2021
PLOTTED BY: NSHARP

SCALE: N/A

SHEET 32 OF 35

CRYSTAL CITY TRANSITWAY EXTENSION - CRYSTAL DR & 12TH ST S

TEST HOLE FORM		
<small>4501 DALY DRIVE CHANTILLY, VA 20151 703.378.0100 WWW.MIDATLANTICLOCATING.COM</small>		
Project: M-0618-0201-5323 (Crystal City Trans.)	Prepared By: Stephen Russell	Date: 2018-02-05
City: Arlington	State: VA	Test Hole: TH C1 of
General Location: 1501 Crystal Dr.		
UTILITY INFORMATION		
Utility Size: 36"	Material: Concrete Cover	Good Condition: YES
Utility Type: Electric Ductbank	Utility Owner: Dominion	
ADDITIONAL UTILITY INFORMATION		
Utility Size:	Material:	See Test Hole No.:
Utility Type: None	Utility Owner:	
SITE CONDITIONS		
Field Condition: Asphalt Road	Pavement Thickness: 10"	
Ground Condition: Brown Soil/ Rock		
FIRST & SECOND BENCHMARK INFORMATION		
1st Elevation:	1st Benchmark Description:	
BM Check:		
2nd Elevation:	2nd Benchmark Description:	
Elevation Datum:		
FIELD MARKER INFORMATION		
Type set: Mag Nail	Elevation: 35.97'	
Offset Direction: Nail is set C/L of the Utility.		
PROFILE VIEW		
Top of utility field measurement: 2.62'		Elevation: 33.35'
Bottom of utility field measurement: 3.43'		Elevation: 32.54'
Facing: North	Utility Width/Spacing:	
PLAN VIEW		
COORDINATES		
Northing:	Easting:	
COMMENTS/NOTES		

TEST HOLE FORM		
<small>4501 DALY DRIVE CHANTILLY, VA 20151 703.378.0100 WWW.MIDATLANTICLOCATING.COM</small>		
Project: M-0618-0201-5323 (Crystal City Trans.)	Prepared By: Stephen Russell	Date: 2018-02-02
City: Arlington	State: VA	Test Hole: TH C2 of
General Location: 1501 Crystal Drive.		
UTILITY INFORMATION		
Utility Size: (2) 2 1/2"	Material: Steel	Good Condition: YES
Utility Type: Electric Conduits	Utility Owner:	
ADDITIONAL UTILITY INFORMATION		
Utility Size:	Material:	See Test Hole No.:
Utility Type: None	Utility Owner:	
SITE CONDITIONS		
Field Condition: Grass	Pavement Thickness:	
Ground Condition: Brown Soil/ Rock		
FIRST & SECOND BENCHMARK INFORMATION		
1st Elevation:	1st Benchmark Description:	
BM Check:		
2nd Elevation:	2nd Benchmark Description:	
Elevation Datum:		
FIELD MARKER INFORMATION		
Type set: Wooden Hub	Elevation: 36.05'	
Offset Direction: Hub is set C/L of the Utility.		
PROFILE VIEW		
Top of utility field measurement: 4.63'		Elevation: 31.42'
Bottom of utility field measurement: None		Elevation: None
Facing: North	Utility Width/Spacing: 6"	
PLAN VIEW		
COORDINATES		
Northing:	Easting:	
COMMENTS/NOTES		

TEST HOLE FORM		
<small>4501 DALY DRIVE CHANTILLY, VA 20151 703.378.0100 WWW.MIDATLANTICLOCATING.COM</small>		
Project: M-0618-0201-5323 (Crystal City Trans.)	Prepared By: Stephen Russell	Date: 2018-02-02
City: Arlington	State: VA	Test Hole: TH C3 of
General Location: 1501 Crystal Drive.		
UTILITY INFORMATION		
Utility Size: 2 1/2"	Material: Metal	Good Condition: YES
Utility Type: Electric Conduits	Utility Owner:	
ADDITIONAL UTILITY INFORMATION		
Utility Size:	Material:	See Test Hole No.:
Utility Type: None	Utility Owner:	
SITE CONDITIONS		
Field Condition: Grass	Pavement Thickness:	
Ground Condition: Brown Soil/ Rock/ Roots		
FIRST & SECOND BENCHMARK INFORMATION		
1st Elevation:	1st Benchmark Description:	
BM Check:		
2nd Elevation:	2nd Benchmark Description:	
Elevation Datum:		
FIELD MARKER INFORMATION		
Type set: Wooden Hub	Elevation: 35.84'	
Offset Direction: Hub is set C/L of the Utility.		
PROFILE VIEW		
Top of utility field measurement: 5.05'		Elevation: 30.79'
Bottom of utility field measurement: None		Elevation: None
Facing: North	Utility Width/Spacing:	
PLAN VIEW		
COORDINATES		
Northing:	Easting:	
COMMENTS/NOTES		

TEST HOLE FORM		
<small>4501 DALY DRIVE CHANTILLY, VA 20151 703.378.0100 WWW.MIDATLANTICLOCATING.COM</small>		
Project: M-0618-0201-5323 (Crystal City Trans.)	Prepared By: Stephen Russell	Date: 2018-02-02
City: Arlington	State: VA	Test Hole: TH C4 of
General Location: 1501 Crystal Drive.		
UTILITY INFORMATION		
Utility Size: Clear Hole	Material:	Good Condition: YES
Utility Type: None	Utility Owner:	
ADDITIONAL UTILITY INFORMATION		
Utility Size:	Material:	See Test Hole No.:
Utility Type: None	Utility Owner:	
SITE CONDITIONS		
Field Condition: Brick Sidewalk	Pavement Thickness: 4" 4" Concrete	
Ground Condition: Sand/ Concrete/ Brown Soil		
FIRST & SECOND BENCHMARK INFORMATION		
1st Elevation:	1st Benchmark Description:	
BM Check:		
2nd Elevation:	2nd Benchmark Description:	
Elevation Datum:		
FIELD MARKER INFORMATION		
Type set: Chiseled "X"	Elevation: 35.93'	
Offset Direction: Chiseled "X" is set C/L of the Utility.		
PROFILE VIEW		
Top of utility field measurement: 3.00'		Elevation: 32.93'
Bottom of utility field measurement: None		Elevation: None
Facing: North	Utility Width/Spacing:	
PLAN VIEW		
COORDINATES		
Northing:	Easting:	
COMMENTS/NOTES		

TEST HOLE FORM		
<small>4501 DALY DRIVE CHANTILLY, VA 20151 703.378.0100 WWW.MIDATLANTICLOCATING.COM</small>		
Project: M-0618-0201-5323 (Crystal City Trans.)	Prepared By: Stephen Russell	Date: 2018-02-05
City: Arlington	State: VA	Test Hole: TH C5 of
General Location: 1501 Crystal Dr.		
UTILITY INFORMATION		
Utility Size: Clear Hole	Material:	Good Condition: YES
Utility Type: None	Utility Owner:	
ADDITIONAL UTILITY INFORMATION		
Utility Size:	Material:	See Test Hole No.:
Utility Type: None	Utility Owner:	
SITE CONDITIONS		
Field Condition: Brick Sidewalk	Pavement Thickness: 4" Brick/ 4" Concrete	
Ground Condition: Sand/ Concrete/ Brown Soil/ Rock		
FIRST & SECOND BENCHMARK INFORMATION		
1st Elevation:	1st Benchmark Description:	
BM Check:		
2nd Elevation:	2nd Benchmark Description:	
Elevation Datum:		
FIELD MARKER INFORMATION		
Type set: Chiseled "X"	Elevation: 35.72'	
Offset Direction: Chiseled "X" is set C/L of the Utility.		
PROFILE VIEW		
Top of utility field measurement: 3.00'		Elevation: 32.72'
Bottom of utility field measurement: None		Elevation: None
Facing: North	Utility Width/Spacing:	
PLAN VIEW		
COORDINATES		
Northing:	Easting:	
COMMENTS/NOTES		

NOTE: SEE SHEET 18 FOR TEST HOLE/PIT LOCATIONS

DEPARTMENT OF ENVIRONMENTAL SERVICES
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Samuel 3/29/21
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Kamal Takat 3.24.21
 CONSTRUCTION MANAGEMENT SUPERVISOR
Debra 03.04.2021
 WATER, SEWER, STREETS BUREAU CHIEF
Dennis M. Leach 03/17/21
 TRANSPORTATION DIRECTOR
Diana Izzo 3/2/21
 PROJECT MANAGER

REVISIONS DATE

PROJECT NAME AND LOCATION
TRANSITWAY EXTENSION TO PENTAGON CITY
TEST HOLE PIT LOGS
CRYSTAL DR & 12TH ST S
 MA13 - SEGMENT I

DESIGNED: PB
 DRAWN: NS
 CHECKED: TL
 MISS UTILITY TRANSMITTAL #: N/A
 FILENAME:
 MA13-229-TESTHOLES.DWG
 PATH: \\DES-CAD-S2\ENGINEERING_DATA\DATA\MA13-229-TESTHOLES.DWG
 PLOTTED: AUGUST 4 2021
 PLOTTED BY: NSHARP

SCALE: N/A

TEST HOLE FORM		
4501 DALY DRIVE CHANTILLY, VA 20151 703.378.0100 WWW.MIDATLANTICLOCATING.COM		
Project: M-0618-0201-5323 (Crystal City Trans.)	Prepared By: Stephen Russell	Date: 2018-01-15
City: Arlington	State: VA	Test Hole: TH L1 of
General Location: 201 12th St. S.		
UTILITY INFORMATION		
Utility Size: 8 1/2"	Material: Epoxy Coated Steel	Good Condition: YES
Utility Type: Gas Line	Utility Owner: WGL	
ADDITIONAL UTILITY INFORMATION		
Utility Size:	Material:	See Test Hole No.:
Utility Type: None	Utility Owner:	
SITE CONDITIONS		
Field Condition: Asphalt Road	Pavement Thickness: 9"	
Ground Condition: 21A/ Brown Soil/ Rock/ Clay		
FIRST & SECOND BENCHMARK INFORMATION		
1st Elevation: 28.37'	1st Benchmark Description: 14034	
BM Check: +0.04'		
2nd Elevation: 27.99'	2nd Benchmark Description: 13005	
Elevation Datum:		
FIELD MARKER INFORMATION		
Type set: Mag Nail	Elevation: 28.03'	
Offset Direction: Nail is set C/L of the Utility.		
PROFILE VIEW		
Top of utility field measurement: 5.39'		Elevation: 22.64'
Bottom of utility field measurement: None		Elevation: None
Facing: East	Utility Width/Spacing:	
PLAN VIEW		
COORDINATES		
Northing:	Easting:	
COMMENTS/NOTES		

TEST HOLE FORM		
4501 DALY DRIVE CHANTILLY, VA 20151 703.378.0100 WWW.MIDATLANTICLOCATING.COM		
Project: M-0618-0201-5323 (Crystal City Trans.)	Prepared By: Yassin Aloumouati	Date: 2018-02-06
City: Crystal City	State: VA	Test Hole: TH L2 of
General Location: 12 St. S. & S. Clark St.		
UTILITY INFORMATION		
Utility Size: 2 1/2"	Material: Steel	Good Condition: YES
Utility Type: Electric Conduit	Utility Owner:	
ADDITIONAL UTILITY INFORMATION		
Utility Size:	Material:	See Test Hole No.:
Utility Type: None	Utility Owner:	
SITE CONDITIONS		
Field Condition: Brick	Pavement Thickness: 3"	
Ground Condition: Sand Gravel Brown Soil		
FIRST & SECOND BENCHMARK INFORMATION		
1st Elevation: 28.37'	1st Benchmark Description: 14034	
BM Check: +0.04'		
2nd Elevation: 27.99'	2nd Benchmark Description: 13005	
Elevation Datum:		
FIELD MARKER INFORMATION		
Type set: Mag Nail	Elevation: 28.54'	
Offset Direction: Nail is set C/L of the Utility.		
PROFILE VIEW		
Top of utility field measurement: 2.05'		Elevation: 28.49'
Bottom of utility field measurement: None		Elevation: None
Facing: East	Utility Width/Spacing:	
PLAN VIEW		
COORDINATES		
Northing:	Easting:	
COMMENTS/NOTES		

TEST HOLE FORM		
4501 DALY DRIVE CHANTILLY, VA 20151 703.378.0100 WWW.MIDATLANTICLOCATING.COM		
Project: M-0618-0201-5323 (Crystal City Trans.)	Prepared By: Yassin Aloumouati	Date: 2018-02-09
City: Crystal City	State: VA	Test Hole: TH L3 of
General Location: 12 St. S. & S. Clark St.		
UTILITY INFORMATION		
Utility Size: 32"	Material: Smooth Pour Concrete	Good Condition: YES
Utility Type: Communication Ductbank	Utility Owner:	
ADDITIONAL UTILITY INFORMATION		
Utility Size:	Material:	See Test Hole No.:
Utility Type: None	Utility Owner:	
SITE CONDITIONS		
Field Condition: Brick	Pavement Thickness: 3"	
Ground Condition: Sand, Gravel, Brown Soil		
FIRST & SECOND BENCHMARK INFORMATION		
1st Elevation: 28.37'	1st Benchmark Description: 14034	
BM Check: +0.04'		
2nd Elevation: 27.99'	2nd Benchmark Description: 13005	
Elevation Datum:		
FIELD MARKER INFORMATION		
Type set: Mag Nail	Elevation: 28.80'	
Offset Direction: Nail is set C/L of the Utility.		
PROFILE VIEW		
Top of utility field measurement: 0.96'		Elevation: 27.84'
Bottom of utility field measurement: 1.29'		Elevation: 27.51'
Facing: Northwest	Utility Width/Spacing:	
PLAN VIEW		
COORDINATES		
Northing:	Easting:	
COMMENTS/NOTES		

TEST HOLE FORM		
4501 DALY DRIVE CHANTILLY, VA 20151 703.378.0100 WWW.MIDATLANTICLOCATING.COM		
Project: M-0618-0201-5323 (Crystal City Trans.)	Prepared By: Yassin Aloumouati	Date: 2018-02-09
City: Crystal City	State: VA	Test Hole: TH L4 of
General Location: 12 St. S. & S. Clark St.		
UTILITY INFORMATION		
Utility Size: 36"	Material: Rough Pour Concrete	Good Condition: YES
Utility Type: Communication Ductbank	Utility Owner:	
ADDITIONAL UTILITY INFORMATION		
Utility Size:	Material:	See Test Hole No.:
Utility Type: None	Utility Owner:	
SITE CONDITIONS		
Field Condition: Brick	Pavement Thickness: 3"	
Ground Condition: Sand, Gravel, and Brown Soil		
FIRST & SECOND BENCHMARK INFORMATION		
1st Elevation: 28.37'	1st Benchmark Description: 14034	
BM Check: +0.04'		
2nd Elevation: 27.99'	2nd Benchmark Description: 13005	
Elevation Datum:		
FIELD MARKER INFORMATION		
Type set: Mag Nail	Elevation: 28.76'	
Offset Direction: Nail is set C/L of the Utility.		
PROFILE VIEW		
Top of utility field measurement: 2.37'		Elevation: 28.99'
Bottom of utility field measurement: 4.22'		Elevation: 24.54'
Facing: East	Utility Width/Spacing:	
PLAN VIEW		
COORDINATES		
Northing:	Easting:	
COMMENTS/NOTES		

TEST HOLE FORM		
4501 DALY DRIVE CHANTILLY, VA 20151 703.378.0100 WWW.MIDATLANTICLOCATING.COM		
Project: M-0618-0201-5323 (Crystal City Trans.)	Prepared By: Yassin Aloumouati	Date: 2018-02-12
City: Crystal City	State: VA	Test Hole: TP-L5
General Location: 12 St. S. & S. Clark St.		
UTILITY INFORMATION		
Utility Size: N/A	Material: Tar Coated Concrete	Good Condition: YES
Utility Type: Top of Parking Garage	Utility Owner:	
ADDITIONAL UTILITY INFORMATION		
Utility Size:	Material:	See Test Hole No.:
Utility Type: None	Utility Owner:	
SITE CONDITIONS		
Field Condition: Brick	Pavement Thickness: 3"	
Ground Condition: Sand, Gravel		
FIRST & SECOND BENCHMARK INFORMATION		
1st Elevation: 28.37'	1st Benchmark Description: 14034	
BM Check: +0.04'		
2nd Elevation: 27.99'	2nd Benchmark Description: 13005	
Elevation Datum:		
FIELD MARKER INFORMATION		
Type set: Mag Nail	Elevation: 29.05'	
Offset Direction: Nail is set C/L of the Test Hole.		
PROFILE VIEW		
Top of utility field measurement: 1.22'		Elevation: 27.83'
Bottom of utility field measurement: None		Elevation: None
Facing: West	Utility Width/Spacing:	
PLAN VIEW		
COORDINATES		
Northing:	Easting:	
COMMENTS/NOTES		

TEST HOLE FORM		
4501 DALY DRIVE CHANTILLY, VA 20151 703.378.0100 WWW.MIDATLANTICLOCATING.COM		
Project: M-0618-0201-5323 (Crystal City Trans.)	Prepared By: Yassin Aloumouati	Date: 2018-02-06
City: Crystal City	State: VA	Test Hole: TH L6 of
General Location: 12 St. S. & S. Clark St.		
UTILITY INFORMATION		
Utility Size: 24"	Material: Rough Pour Concrete	Good Condition: YES
Utility Type: Electric Ductbank	Utility Owner:	
ADDITIONAL UTILITY INFORMATION		
Utility Size:	Material:	See Test Hole No.:
Utility Type: None	Utility Owner:	
SITE CONDITIONS		
Field Condition: Brick	Pavement Thickness: 3"	
Ground Condition: Gravel, Brown Soil		
FIRST & SECOND BENCHMARK INFORMATION		
1st Elevation: 28.37'	1st Benchmark Description: 14034	
BM Check: +0.04'		
2nd Elevation: 27.99'	2nd Benchmark Description: 13005	
Elevation Datum:		
FIELD MARKER INFORMATION		
Type set: Mag Nail	Elevation: 28.57'	
Offset Direction: Nail is set C/L of the Utility.		
PROFILE VIEW		
Top of utility field measurement: 3.53'		Elevation: 25.04'
Bottom of utility field measurement: 6.34'		Elevation: 22.23'
Facing: East	Utility Width/Spacing:	
PLAN VIEW		
COORDINATES		
Northing:	Easting:	
COMMENTS/NOTES		

NOTE: SEE SHEET 18 FOR TEST HOLE/PIT LOCATIONS

DEPARTMENT OF ENVIRONMENTAL SERVICES
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 PHONE: 703.228.3629
 FAX: 703.228.3606

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



APPROVALS DATE
 [Signature] 3/29/21
 QUALITY CONTROL ENGINEER
 [Signature] 3.24.21
 CONSTRUCTION MANAGEMENT SUPERVISOR
 [Signature] 03.04.2021
 WATER, SEWER, STREETS BUREAU CHIEF
 [Signature] 03/17/21
 TRANSPORTATION DIRECTOR
 [Signature] 3/2/21
 PROJECT MANAGER





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



PROJECT NAME AND LOCATION
 TRANSITWAY EXTENSION TO PENTAGON CITY
 TEST HOLE PIT LOGS
 CRYSTAL DR & 12TH ST S
 MA13 - SEGMENT I

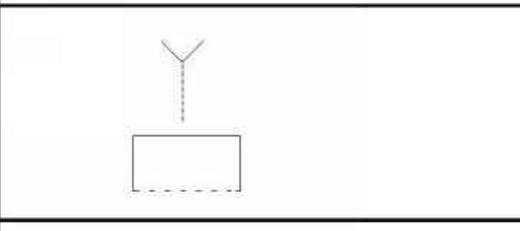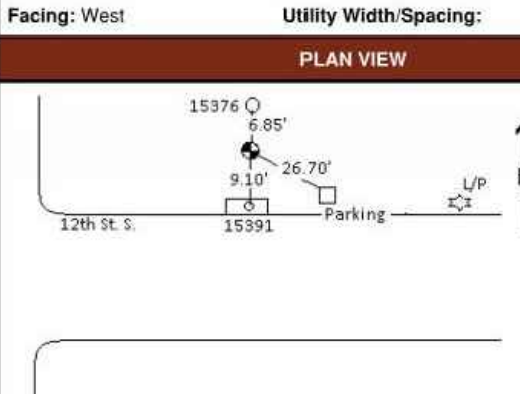



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 PLOTTED: AUGUST 4 2021
 PLOTTED BY: NSHARP

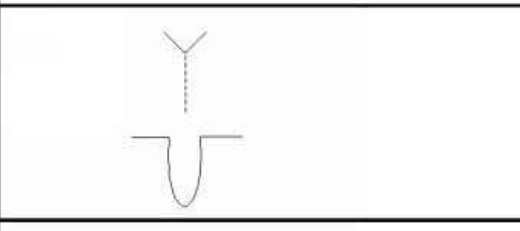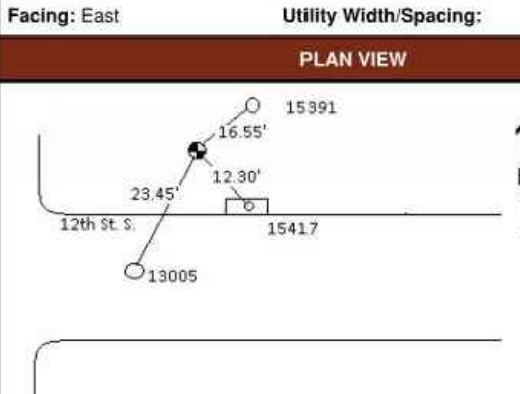



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

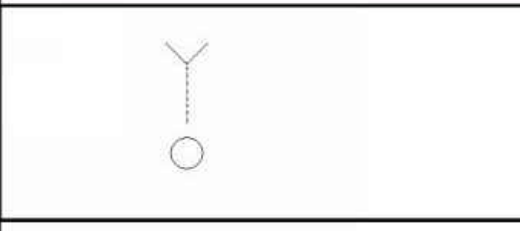
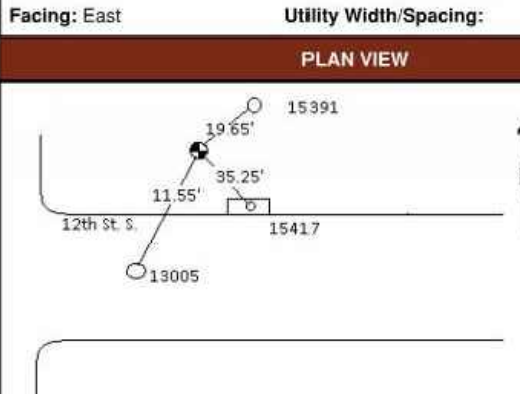
 TEST HOLE FORM 		
4501 DALY DRIVE CHANTILLY, VA 20151 703.378.0100 WWW.MIDATLANTICLOCATING.COM		
Project: M-0618-0201-5323 (Crystal City Trans.)	Prepared By: Yassin Aloumouali	Date: 2018-02-13
City: Crystal City	State: VA	Test Hole: TH L7 of
General Location: 12 St. S. & S. Clark St.		
UTILITY INFORMATION		
Utility Size: 36"	Material: RCP	Good Condition: YES
Utility Type: Electric Ductbank	Utility Owner:	
ADDITIONAL UTILITY INFORMATION		
Utility Size:	Material:	See Test Hole No.:
Utility Type: None	Utility Owner:	
SITE CONDITIONS		
Field Condition: Brick	Pavement thickness: 3"	
Ground Condition: Sand, Gravel, Brown Soil		
FIRST & SECOND BENCHMARK INFORMATION		
1st Elevation: 28.37'	1st Benchmark Description: 14034	
BM Check: +0.04		
2nd Elevation: 27.99'	2nd Benchmark Description: 13005	
Elevation Datum:		
FIELD MARKER INFORMATION		
Type set: Mag Nail	Elevation: 28.58'	
Offset Direction: Nail is set C/L of the Utility.		
PROFILE VIEW		
		
Top of utility field measurement: 2.71'		Elevation: 28.87'
Bottom of utility field measurement: 3.58'		Elevation: 25.00'
Facing: West	Utility Width/Spacing:	
PLAN VIEW		
		
COORDINATES		
Northing:	Easting:	
COMMENTS/NOTES		

 TEST HOLE FORM 		
4501 DALY DRIVE CHANTILLY, VA 20151 703.378.0100 WWW.MIDATLANTICLOCATING.COM		
Project: M-0618-0201-5323 (Crystal City Trans.)	Prepared By: Tommy Lockhart	Date: 2018-02-06
City: Crystal City	State: VA	Test Hole: TP-L8
General Location: 12 St. S. & S. Clark St.		
UTILITY INFORMATION		
Utility Size: Clear Hole	Material:	Good Condition: YES
Utility Type: None	Utility Owner:	
ADDITIONAL UTILITY INFORMATION		
Utility Size:	Material:	See Test Hole No.:
Utility Type: None	Utility Owner:	
SITE CONDITIONS		
Field Condition: Brick	Pavement thickness: 3"	
Ground Condition: Sand, Gravel, Brown Soil		
FIRST & SECOND BENCHMARK INFORMATION		
1st Elevation: 28.37'	1st Benchmark Description: 14034	
BM Check: +0.04		
2nd Elevation: 27.99'	2nd Benchmark Description: 13005	
Elevation Datum:		
FIELD MARKER INFORMATION		
Type set: Chiseled "X"	Elevation: 28.33'	
Offset Direction: Nail is set C/L of the Hole.		
PROFILE VIEW		
		
Top of utility field measurement: 3.00'		Elevation: 25.33'
Bottom of utility field measurement: None		Elevation: None
Facing: East	Utility Width/Spacing:	
PLAN VIEW		
		
COORDINATES		
Northing:	Easting:	
COMMENTS/NOTES		

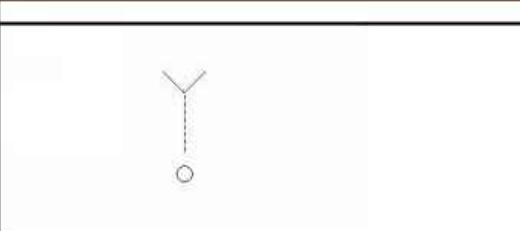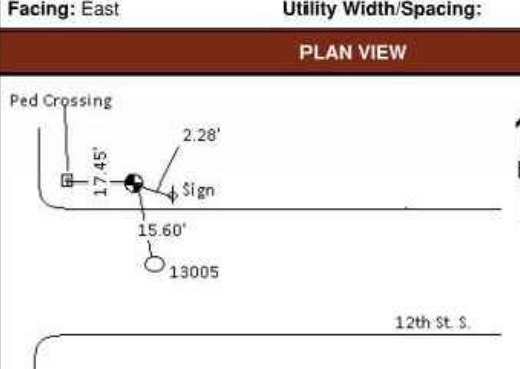 TEST HOLE FORM 		
4501 DALY DRIVE CHANTILLY, VA 20151 703.378.0100 WWW.MIDATLANTICLOCATING.COM		
Project: M-0618-0201-5323 (Crystal City Trans.)	Prepared By: Stephen Russell	Date: 2018-02-05
City: Arlington	State: VA	Test Hole: TH L9 of
General Location: 12th St. and Long Bridge Drive		
UTILITY INFORMATION		
Utility Size: 8 1/2"	Material: Epoxy Coated Steel	Good Condition: YES
Utility Type: Gas Line	Utility Owner: WGL	
ADDITIONAL UTILITY INFORMATION		
Utility Size:	Material:	See Test Hole No.:
Utility Type: None	Utility Owner:	
SITE CONDITIONS		
Field Condition: Asphalt Road	Pavement thickness: 9"	
Ground Condition: Brown Soil, Rock		
FIRST & SECOND BENCHMARK INFORMATION		
1st Elevation: 14034	1st Benchmark Description: 28.37'	
BM Check: +0.04		
2nd Elevation: 27.99'	2nd Benchmark Description: 13005	
Elevation Datum:		
FIELD MARKER INFORMATION		
Type set: Mag Nail	Elevation: 27.77'	
Offset Direction: Nail is set C/L of the Utility.		
PROFILE VIEW		
		
Top of utility field measurement: 4.39'		Elevation: 23.38'
Bottom of utility field measurement: None		Elevation: None
Facing: East	Utility Width/Spacing:	
PLAN VIEW		
		
COORDINATES		
Northing:	Easting:	
COMMENTS/NOTES		

 TEST HOLE FORM 		
4501 DALY DRIVE CHANTILLY, VA 20151 703.378.0100 WWW.MIDATLANTICLOCATING.COM		
Project: M-0618-0201-5323 (Crystal City Trans.)	Prepared By: Tommy Lockhart	Date: 2018-02-06
City: Crystal City	State: VA	Test Hole: TH L10 of
General Location: 12 St. S. & S. Clark St.		
UTILITY INFORMATION		
Utility Size: 2 1/2"	Material: Steel	Good Condition: YES
Utility Type: Electric Conduit	Utility Owner:	
ADDITIONAL UTILITY INFORMATION		
Utility Size:	Material:	See Test Hole No.:
Utility Type: None	Utility Owner:	
SITE CONDITIONS		
Field Condition: Brick	Pavement thickness: 3"	
Ground Condition: Sand, Gravel, Brown Soil		
FIRST & SECOND BENCHMARK INFORMATION		
1st Elevation: 28.37'	1st Benchmark Description: 14034	
BM Check: +0.04		
2nd Elevation: 27.99'	2nd Benchmark Description: 13005	
Elevation Datum:		
FIELD MARKER INFORMATION		
Type set: Chiseled "X"	Elevation: 28.42'	
Offset Direction: Nail is set C/L of the Utility.		
PROFILE VIEW		
		
Top of utility field measurement: 2.44'		Elevation: 25.98'
Bottom of utility field measurement: None		Elevation: None
Facing: East	Utility Width/Spacing:	
PLAN VIEW		
		
COORDINATES		
Northing:	Easting:	
COMMENTS/NOTES		

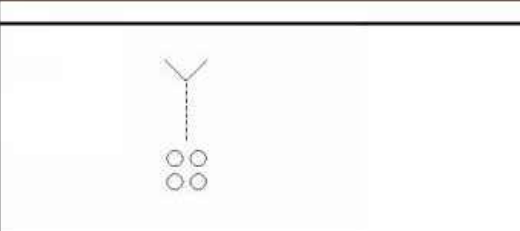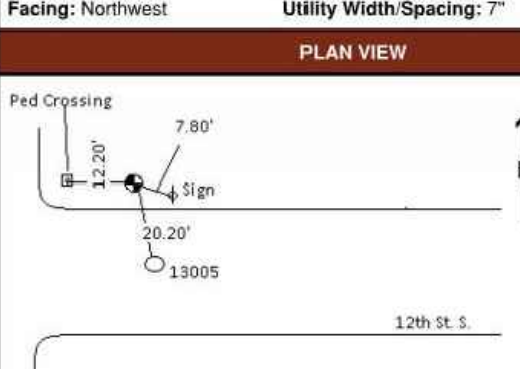 TEST HOLE FORM 		
4501 DALY DRIVE CHANTILLY, VA 20151 703.378.0100 WWW.MIDATLANTICLOCATING.COM		
Project: M-0618-0201-5323 (Crystal City Trans.)	Prepared By: Tommy Lockhart	Date: 2018-02-06
City: Crystal City	State: VA	Test Hole: TH L11 of
General Location: 12 St. S. & S. Clark St.		
UTILITY INFORMATION		
Utility Size: (4) 2 1/2"	Material: P.E.	Good Condition: YES
Utility Type: Communication Conduit	Utility Owner:	
ADDITIONAL UTILITY INFORMATION		
Utility Size:	Material:	See Test Hole No.:
Utility Type: None	Utility Owner:	
SITE CONDITIONS		
Field Condition: Brick	Pavement thickness: 3"	
Ground Condition: Sand, Gravel, Brown Soil, Rocks		
FIRST & SECOND BENCHMARK INFORMATION		
1st Elevation: 28.37'	1st Benchmark Description: 14034	
BM Check: +0.04		
2nd Elevation: 27.99'	2nd Benchmark Description: 13005	
Elevation Datum:		
FIELD MARKER INFORMATION		
Type set: Chiseled "X"	Elevation: 28.65'	
Offset Direction: Nail is set C/L of the Utility.		
PROFILE VIEW		
		
Top of utility field measurement: 1.97'		Elevation: 26.68'
Bottom of utility field measurement: None		Elevation: None
Facing: Northwest	Utility Width/Spacing: 7"	
PLAN VIEW		
		
COORDINATES		
Northing:	Easting:	
COMMENTS/NOTES		

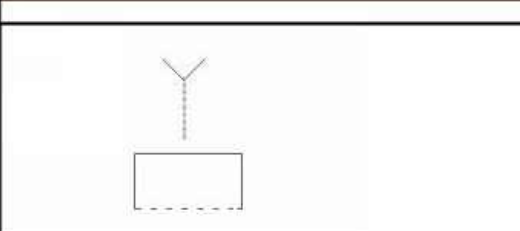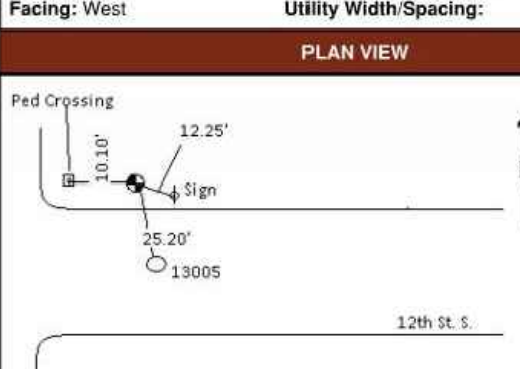 TEST HOLE FORM 		
4501 DALY DRIVE CHANTILLY, VA 20151 703.378.0100 WWW.MIDATLANTICLOCATING.COM		
Project: M-0618-0201-5323 (Crystal City Trans.)	Prepared By: Yassin Aloumouali	Date: 2018-02-08
City: Arlington	State: VA	Test Hole: TH L12 of
General Location: 12th St S. and S. Clark St.		
UTILITY INFORMATION		
Utility Size: 24"	Material: Rough Pour Concrete	Good Condition: YES
Utility Type: Communication Ductbank	Utility Owner:	
ADDITIONAL UTILITY INFORMATION		
Utility Size:	Material:	See Test Hole No.:
Utility Type: None	Utility Owner:	
SITE CONDITIONS		
Field Condition: Brick Sidewalk	Pavement thickness: 3"	
Ground Condition: Sand, Gravel, Brown Soil		
FIRST & SECOND BENCHMARK INFORMATION		
1st Elevation: 28.37'	1st Benchmark Description: 14034	
BM Check: +0.04		
2nd Elevation: 27.99'	2nd Benchmark Description: 13005	
Elevation Datum:		
FIELD MARKER INFORMATION		
Type set: Chiseled "X"	Elevation: 28.87'	
Offset Direction: Chiseled "X" is set C/L of the Utility.		
PROFILE VIEW		
		
Top of utility field measurement: 3.35'		Elevation: 25.52'
Bottom of utility field measurement: 3.78'		Elevation: 25.09'
Facing: West	Utility Width/Spacing:	
PLAN VIEW		
		
COORDINATES		
Northing:	Easting:	
COMMENTS/NOTES		

NOTE: SEE SHEET 18 FOR TEST HOLE/PIT LOCATIONS

DEPARTMENT OF ENVIRONMENTAL SERVICES
 FACILITIES & ENGINEERING DIVISION
 ENGINEERING BUREAU
 2100 CLARENDON BOULEVARD, SUITE 813
 ARLINGTON, VA 22201
 PHONE: 703.228.3629
 FAX: 703.228.3606

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APPROVALS DATE
 [Signature] 3/29/21
 QUALITY CONTROL ENGINEER
 [Signature] 3.24.21
 CONSTRUCTION MANAGEMENT SUPERVISOR
 [Signature] 03.04.2021
 WATER, SEWER, STREETS BUREAU CHIEF
 [Signature] 03/17/21
 TRANSPORTATION DIRECTOR
 [Signature] 3/2/21
 PROJECT MANAGER

REVISIONS DATE

PROJECT NAME AND LOCATION
 TRANSITWAY EXTENSION TO PENTAGON CITY
 TEST HOLE PIT LOGS
 CRYSTAL DR & 12TH ST S
 MA13 - SEGMENT I

DESIGNED: PB
 DRAWN: NS
 CHECKED: TL
 MISS UTILITY TRANSMITTAL #: N/A
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 PLOTTED BY: NSHARP

SCALE: N/A




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<i>Camell</i> QUALITY CONTROL ENGINEER	3/29/21
<i>Kamal Takar</i> CONSTRUCTION MANAGEMENT SUPERVISOR	3.24.21
<i>Quinn</i> WATER, SEWER, STREETS BUREAU CHIEF	03.04.2021
<i>Dennis M. Leach</i> TRANSPORTATION DIRECTOR	03/17/21
<i>Dianna Izzo</i> PROJECT MANAGER	3/2/21

REVISIONS	DATE

PROJECT NAME AND LOCATION
**TRANSITWAY EXTENSION TO PENTAGON CITY
SIGNAGE AND STRIPING PLAN
CRYSTAL DR & 12TH ST S
MA13 - SEGMENT 1**

DESIGNED: PB
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CHECKED: TL
MISS UTILITY TRANSMITTAL #: N/A
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PLOTTED: AUGUST 4 2021
PLOTTED BY: NSHARP

SCALE: Hor: 1" = 25'
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SCALE: 1" = 25'

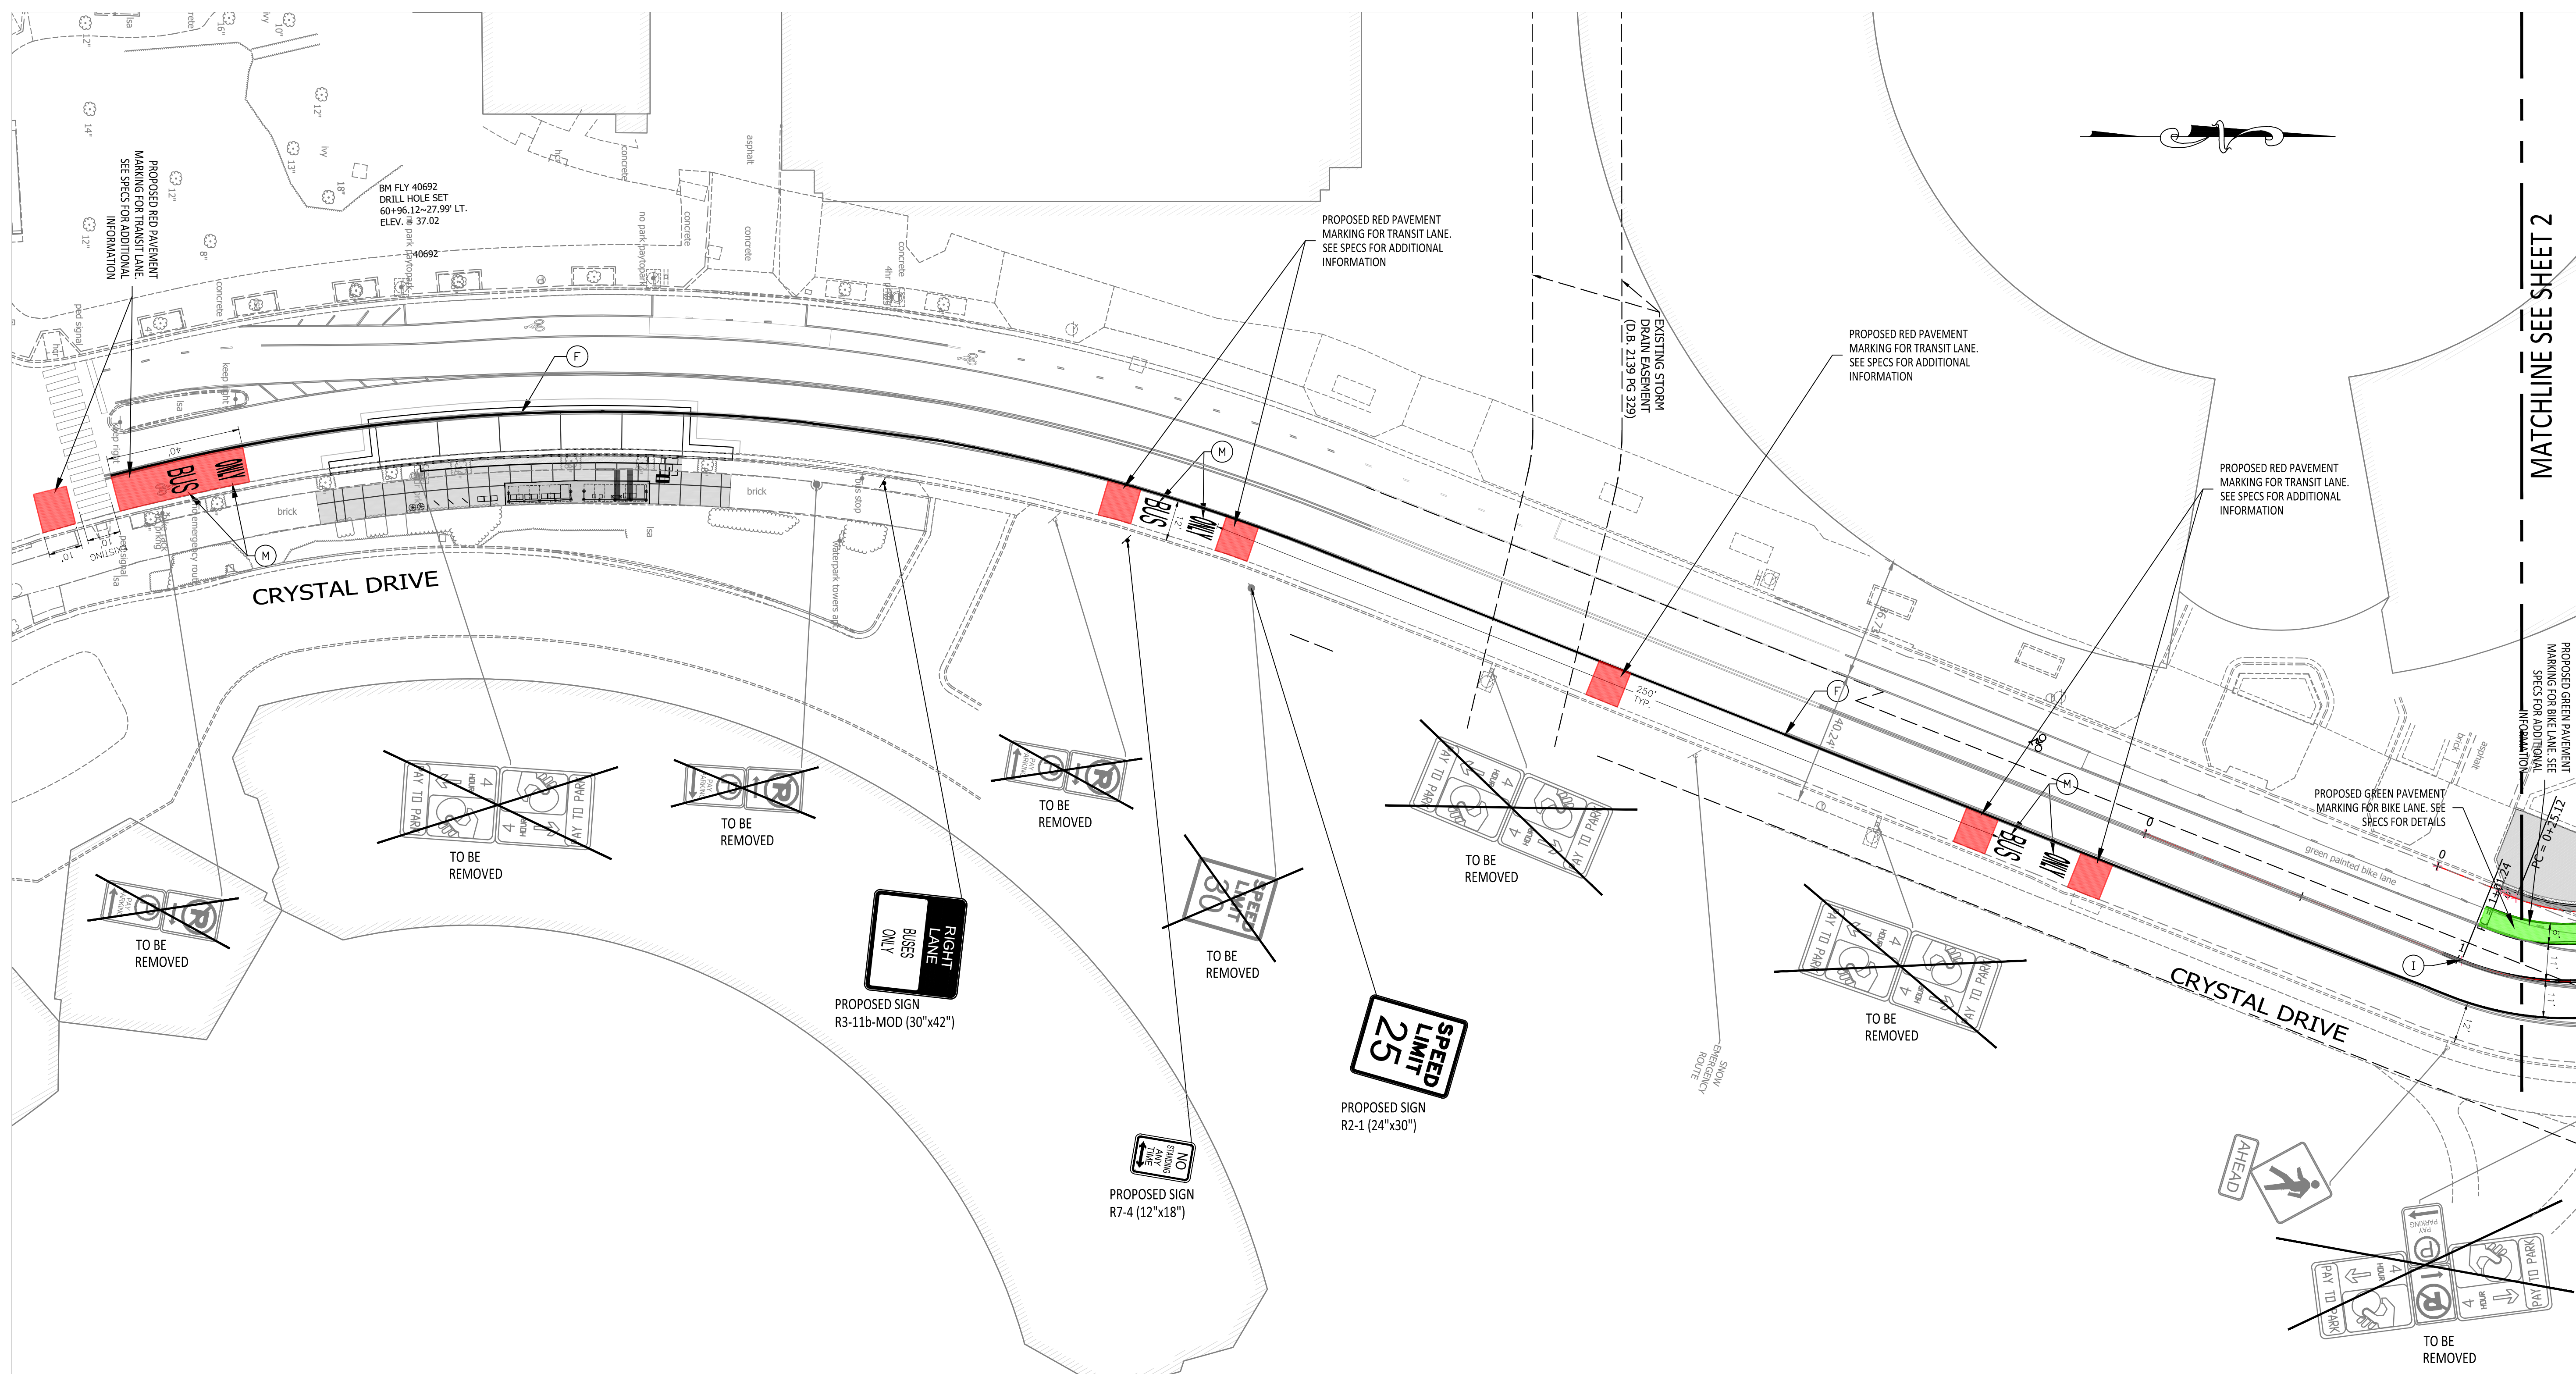

STANDARD PAVEMENT MARKING LEGEND

(A)	TYPE B CLASS 1	WHITE 4" WIDTH	PARKING LANES, EDGE LINES, LANE LINES
(B)	TYPE B CLASS 1	WHITE 4" WIDTH, 10' LONG, 30' SPACING	DASHED LANE LINES
(C)	TYPE B CLASS 1	WHITE 4" WIDTH, 2' LONG 10' SPACING	LANE TRANSITIONS, TURN LANE SKIPS
(D)	TYPE B CLASS 1	WHITE 18" WIDTH	STOP BARS
(E)	TYPE B CLASS 1	WHITE 24" WIDTH	CONTINENTAL CROSS WALKS
(F)	TYPE B CLASS 1	WHITE 6" WIDTH	TURN LANES, TRANSVERSE CROSS WALKS, BIKE LANES
(G)	TYPE B CLASS 1	YELLOW 4" WIDTH, 10' LONG, 30' SPACING	DIVIDED TRAFFIC, TWO WAY TURN LANES
(H)	TYPE B CLASS 1	YELLOW 4" WIDTH	EDGE LINES
(I)	TYPE B CLASS 1	YELLOW 4" WIDTH, DOUBLE LINE, 4" SPACING	CENTERLINES
(J)	TYPE B CLASS 1	WHITE 6" WIDTH, 10' SPACING @45 DEGREE	HATCH LINES, SAFETY ZONES
(K)	TYPE B CLASS 1	WHITE SINGLE ARROW	TURN LANES
(L)	TYPE B CLASS 1	WHITE COMBINATION ARROW	TURN LANES
(M)	TYPE B CLASS 1	WHITE 8" LETTERS	PAVEMENT LETTERS (STOP, YIELD, BUS, ONLY, etc.)
(N)	TYPE B CLASS 1	WHITE 6" WIDTH, 2' LONG, 10' SPACING	LANE TRANSITIONS, TURN LANE SKIPS
(O)	TYPE B CLASS 1	WHITE 12" WIDTH, 20' SPACING @45 DEGREE	GORE MARKINGS
(P)	TYPE B CLASS 1	YELLOW 8" WIDTH @45 DEGREE	GORE MARKINGS
(Q)	TYPE B CLASS 1	WHITE 6" WIDTH, 2' LONG, 4' SPACING	LANE TRANSITIONS
(R)	TYPE B CLASS 1	WHITE 4" WIDTH, DOUBLE LINE, 4' SPACING	CURB EXTENSIONS
(S)	TYPE B CLASS 1	WHITE 24" WIDTH	VDOT - STOP BARS
(T)	TYPE B CLASS 1	YELLOW 6" WIDTH, 2' LONG, 4' SPACING	LANE TRANSITIONS

PAVEMENT MARKING NOTES:



- STREET WIDTH MEASUREMENTS ARE FROM FACE OF CURB TO FACE OF CURB. LANES ARE MEASURED FROM CENTER OF MARKING TO CENTER OF MARKING.
- CONTACT TE&O CONSTRUCTION MANAGER OR HIS DESIGNEE AT 703-228-6598 OR (571) 437-1077 TO APPROVE MARKING LAYOUT 48 HRS. PRIOR TO INSTALLATION OF MARKING.
- PAVEMENT MARKINGS TO BE IN ACCORDANCE WITH THE FOLLOWING:
 - A.) THE MANUAL ON UNIFORM TRAFFIC CONTROL DEVICES.
 - B.) ARLINGTON COUNTY PAVEMENT MARKING SPECIFICATIONS.
- ALL MARKINGS SHALL BE THERMOPLASTIC PER ARLINGTON COUNTY MARKING STANDARDS UNLESS OTHERWISE NOTED.
- SHARED LANE MARKINGS SHALL BE PLACED IN CENTER OF TRAVEL LANE.
- FOR DETAILS SEE ARLINGTON COUNTY PAVEMENT MARKING SPECIFICATIONS.

SIGN NOTES:

- FOR ALL SIGN POSTS PLACED IN CONCRETE USE 7 GAUGE HEAVY DUTY ANCHOR (30"x2.50") WITH HARDWARE FOR 2" POST. USE 1/2" CORNER BOLT WITH FLANGED NUT AND 3/8" DRIVER RIVET WITH WASHER.
- CONTACT TE&O CONSTRUCTION MANAGER OR HIS DESIGNEE AT 703-228-6598 OR 571-437-1077 48 HRS PRIOR TO POURING CONCRETE. ALTERNATIVE CONTACT AT 703-228-3788 OR 571-414-7497.

LEGEND

EXISTING	PROPOSED

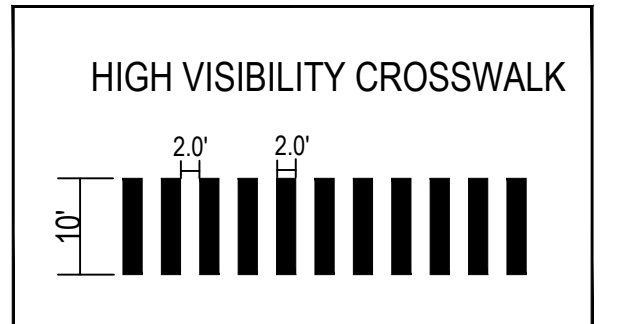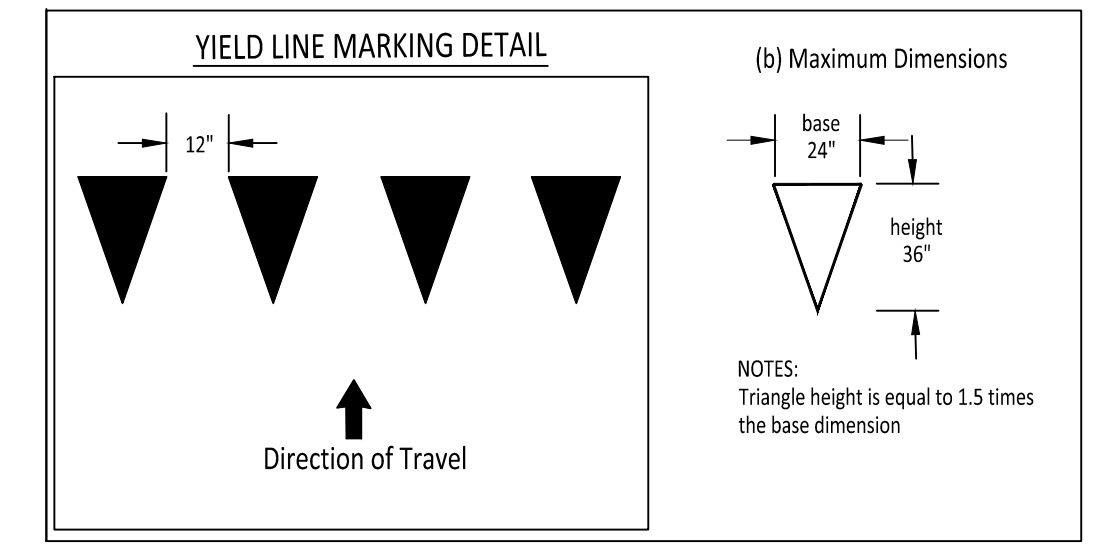



APPROVALS	DATE
<i>[Signature]</i> QUALITY CONTROL ENGINEER	3/29/21
<i>[Signature]</i> CONSTRUCTION MANAGEMENT SUPERVISOR	3.24.21
<i>[Signature]</i> WATER, SEWER, STREETS BUREAU CHIEF	03.04.2021
<i>[Signature]</i> TRANSPORTATION DIRECTOR	03/17/21
<i>[Signature]</i> PROJECT MANAGER	3/2/21

REVISIONS	DATE



PROJECT NAME AND LOCATION
TRANSITWAY EXTENSION TO PENTAGON CITY
SIGNAGE AND STRIPING PLAN
CRYSTAL DR & 12TH ST S
 MA13 - SEGMENT 1

DESIGNED: PB
 DRAWN: NS
 CHECKED: TL
 MISS UTILITY TRANSMITTAL #: N/A

FILENAME:
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PLOTTED: AUGUST 4 2021
 PLOTTED BY: NSHARP

SCALE: Hor: 1" = 25'
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 SCALE: 1" = 25'

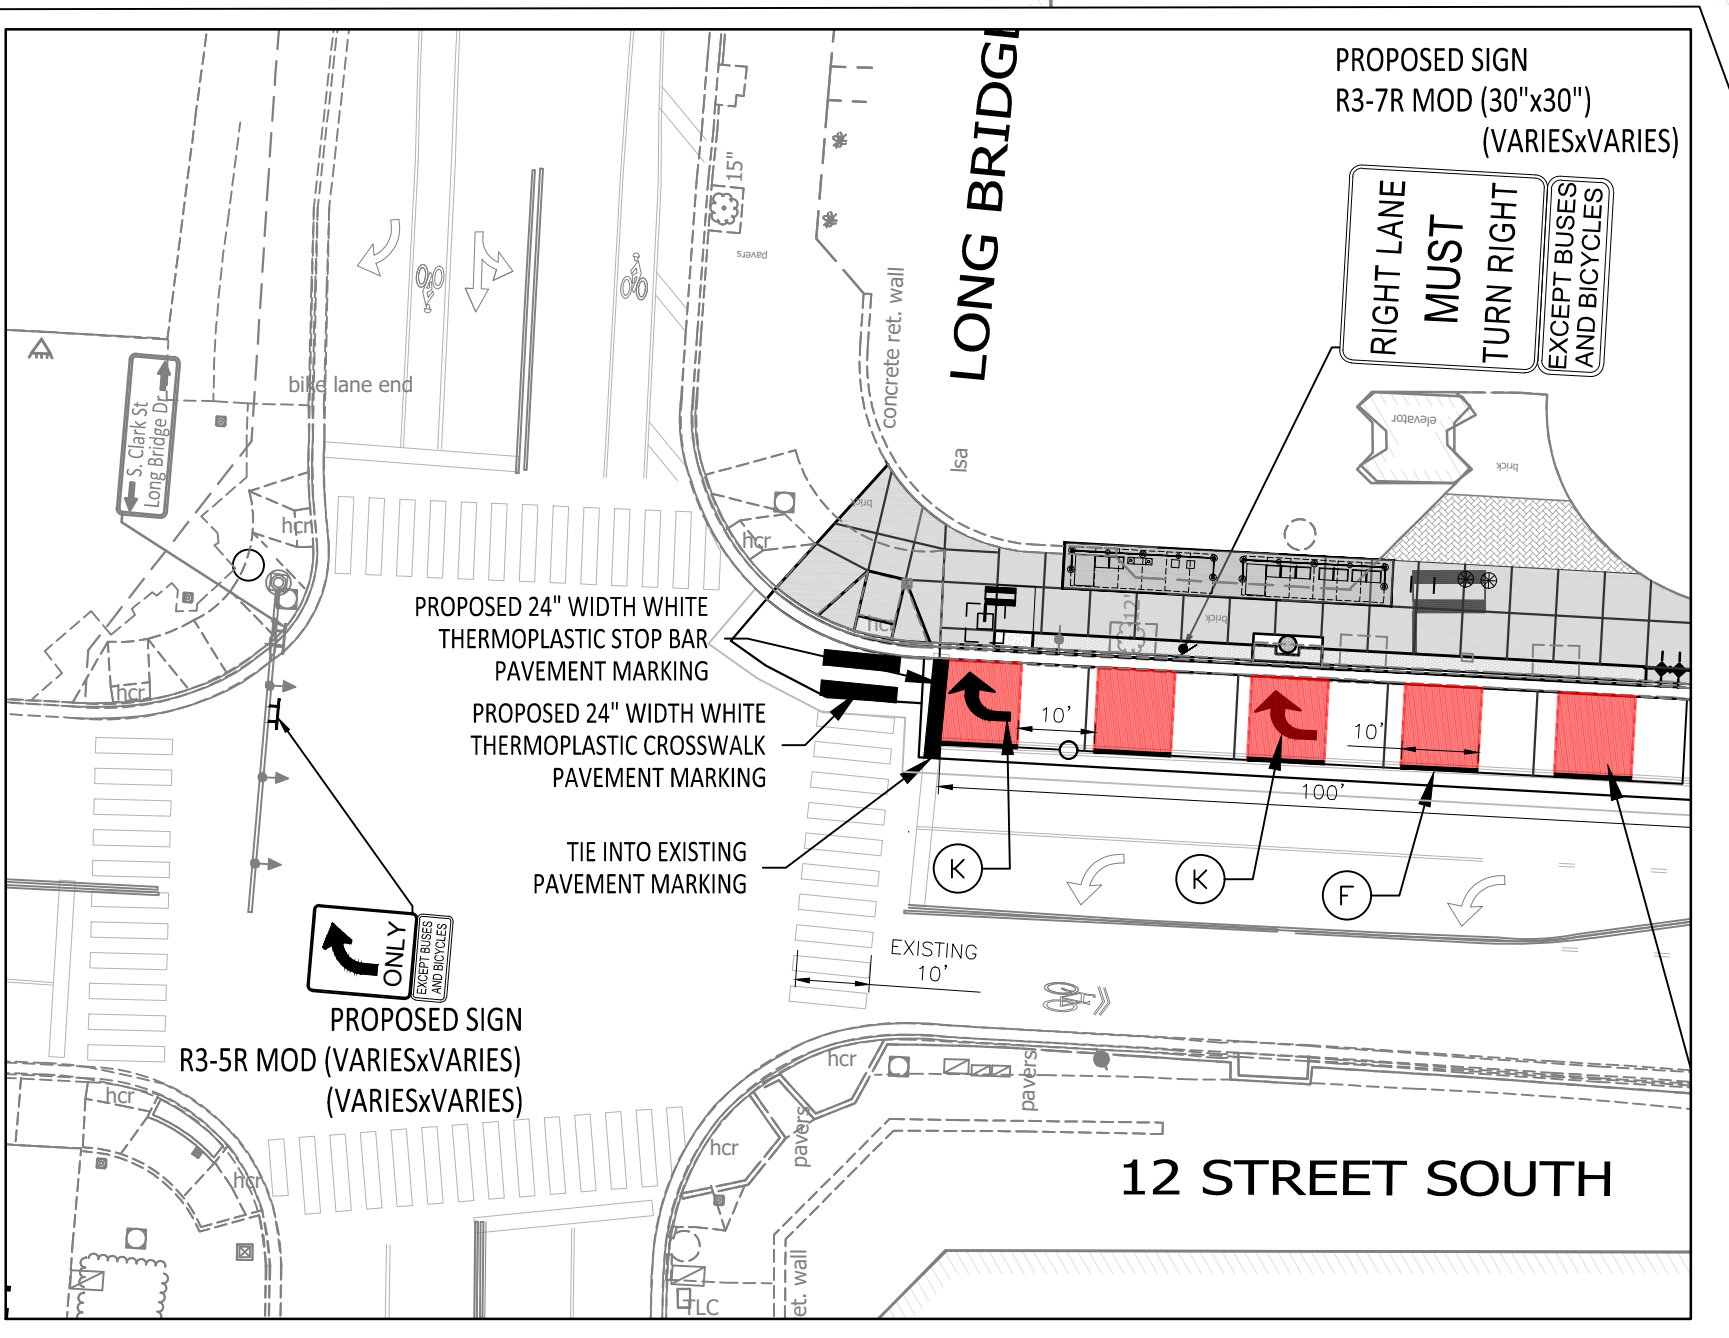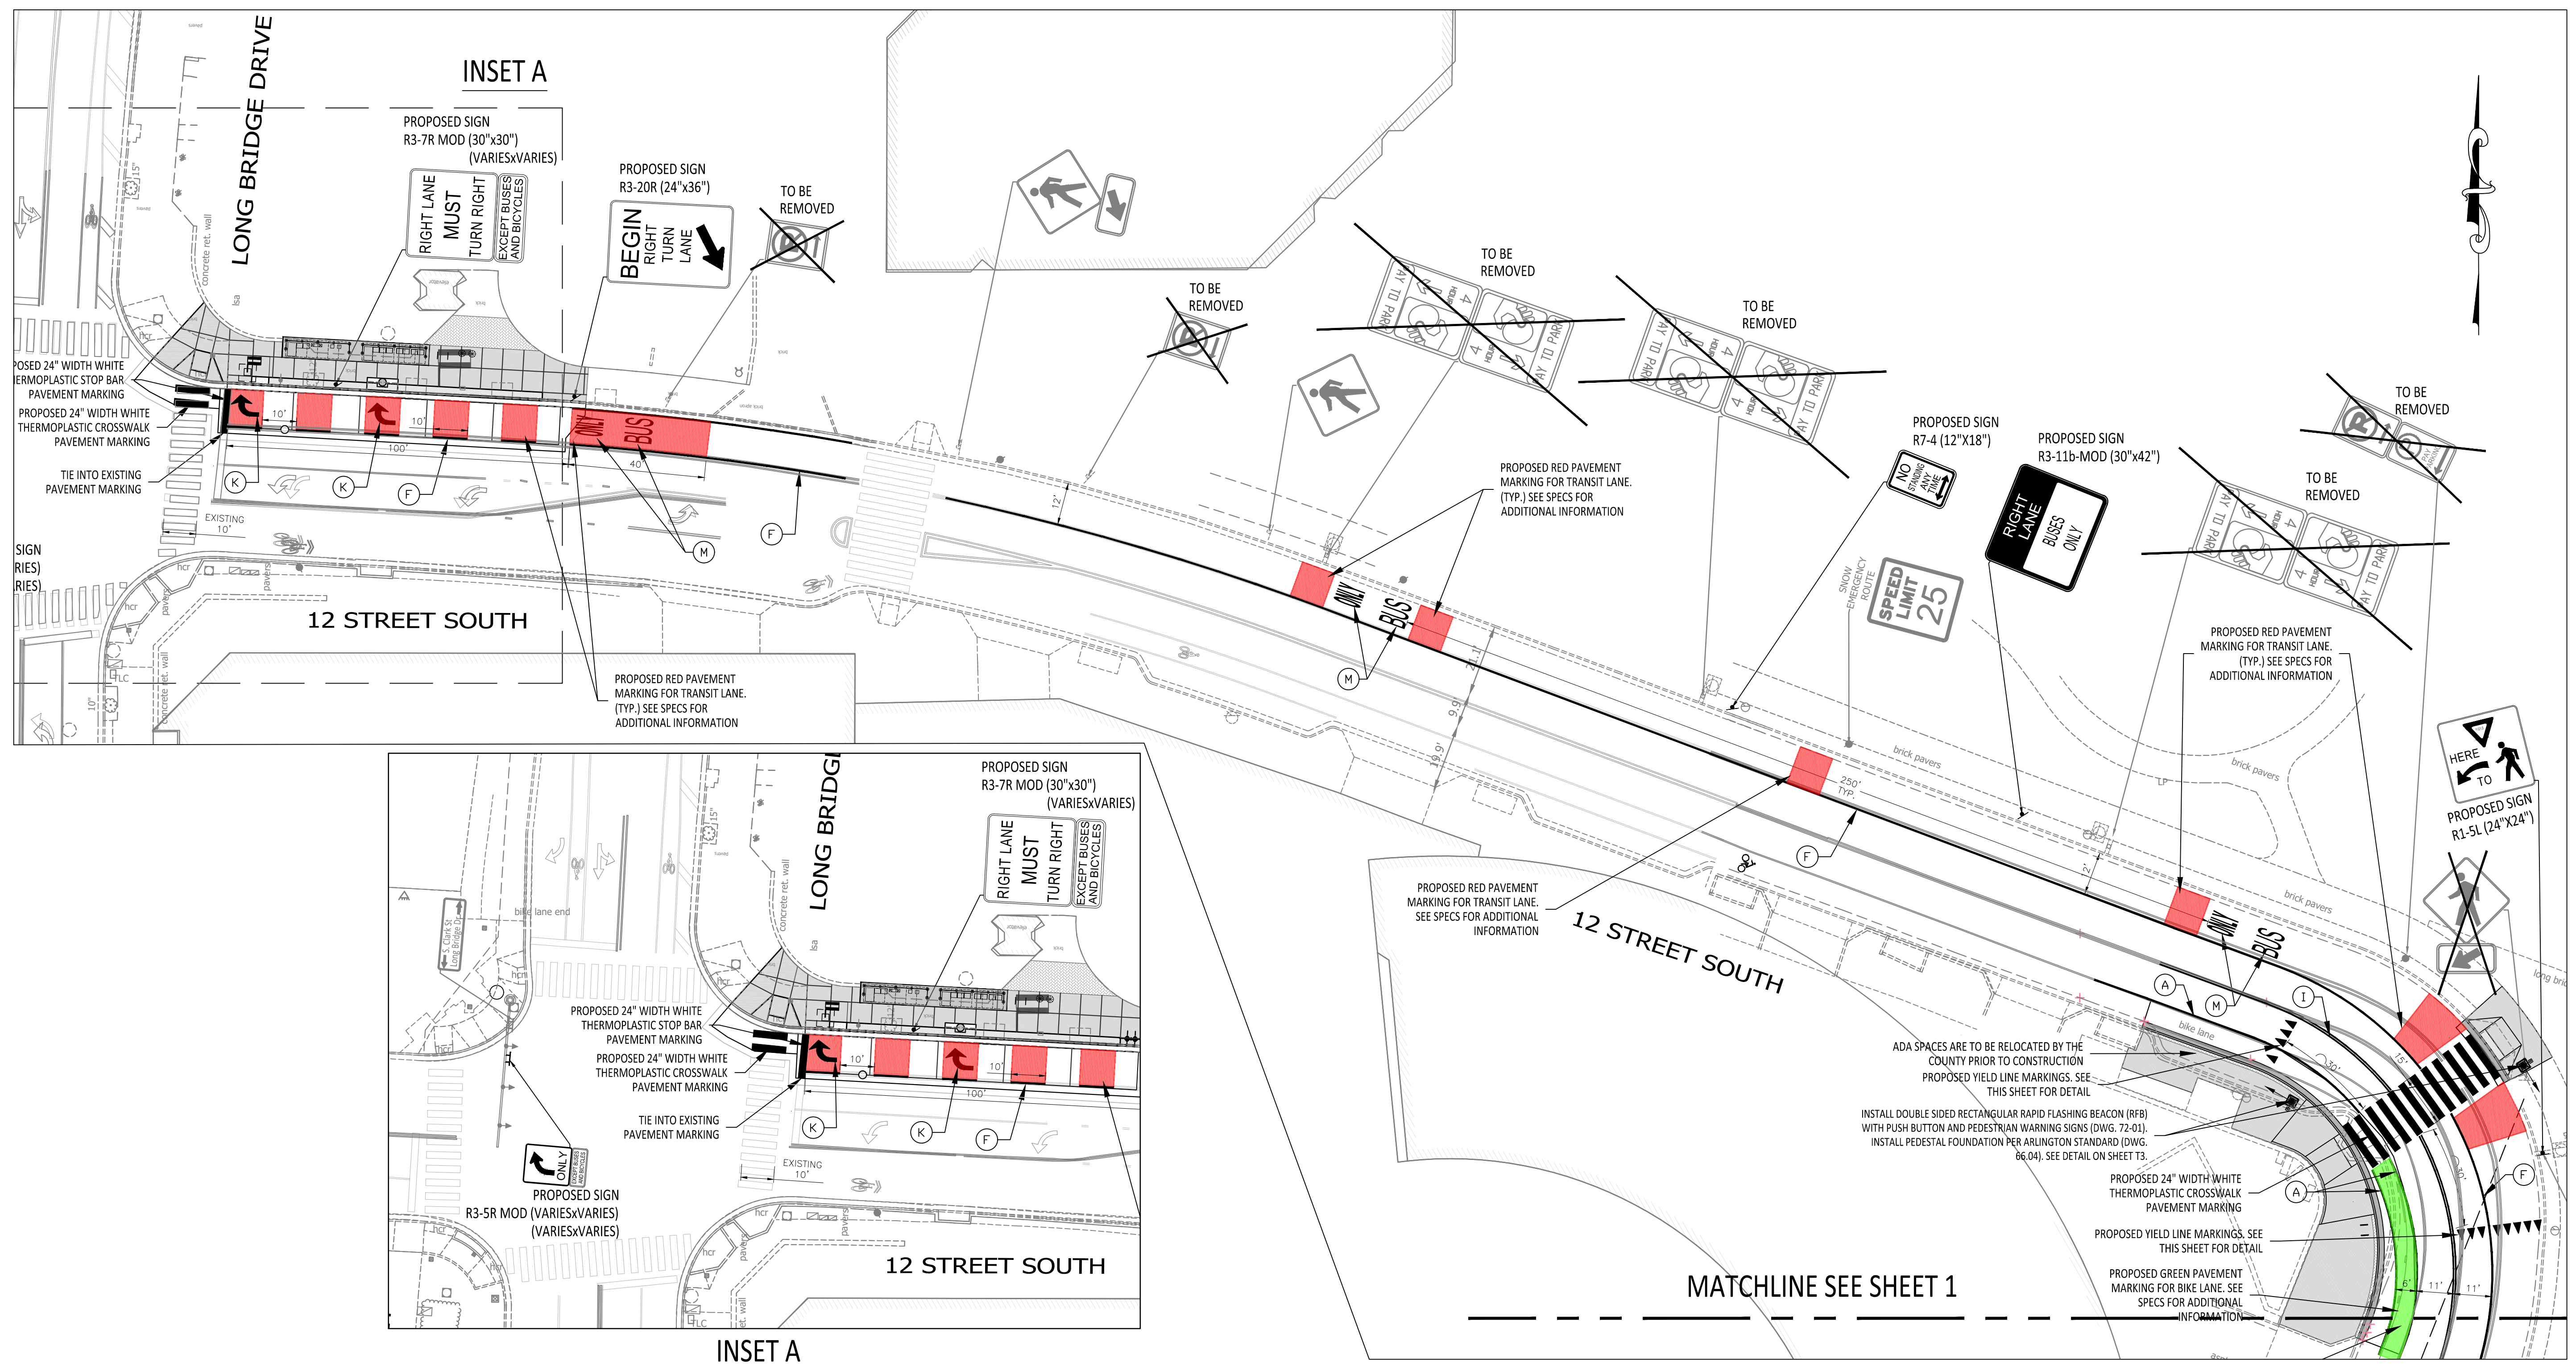

STANDARD PAVEMENT MARKING LEGEND




Symbol	Type	Description
(A)	TYPE B CLASS 1	WHITE 4" WIDTH
(B)	TYPE B CLASS 1	WHITE 4" WIDTH, 10' LONG, 30' SPACING
(C)	TYPE B CLASS 1	WHITE 4" WIDTH, 2' LONG 10' SPACING
(D)	TYPE B CLASS 1	WHITE 18" WIDTH
(E)	TYPE B CLASS 1	WHITE 24" WIDTH
(F)	TYPE B CLASS 1	WHITE 6" WIDTH
(G)	TYPE B CLASS 1	YELLOW 4" WIDTH, 10' LONG, 30' SPACING
(H)	TYPE B CLASS 1	YELLOW 4" WIDTH
(I)	TYPE B CLASS 1	YELLOW 4" WIDTH, DOUBLE LINE, 4" SPACING
(J)	TYPE B CLASS 1	WHITE 6" WIDTH, 10' SPACING @45 DEGREE
(K)	TYPE B CLASS 1	WHITE SINGLE ARROW
(L)	TYPE B CLASS 1	WHITE COMBINATION ARROW
(M)	TYPE B CLASS 1	WHITE 8" LETTERS
(N)	TYPE B CLASS 1	WHITE 6" WIDTH, 2' LONG, 10' SPACING
(O)	TYPE B CLASS 1	WHITE 12" WIDTH, 20' SPACING @45 DEGREE
(P)	TYPE B CLASS 1	YELLOW 8" WIDTH @45 DEGREE
(Q)	TYPE B CLASS 1	WHITE 6" WIDTH, 2' LONG, 4' SPACING
(R)	TYPE B CLASS 1	WHITE 4" WIDTH, DOUBLE LINE, 4' SPACING
(S)	TYPE B CLASS 1	WHITE 24" WIDTH
(T)	TYPE B CLASS 1	YELLOW 6" WIDTH, 2' LONG, 4' SPACING
(A)	TYPE B CLASS 1	PARKING LANES, EDGE LINES, LANE LINES
(B)	TYPE B CLASS 1	DASHED LANE LINES
(C)	TYPE B CLASS 1	LANE TRANSITIONS, TURN LANE SKIPS
(D)	TYPE B CLASS 1	STOP BARS
(E)	TYPE B CLASS 1	CONTINENTAL CROSS WALKS
(F)	TYPE B CLASS 1	TURN LANES, TRANSVERSE CROSS WALKS, BIKE LANES
(G)	TYPE B CLASS 1	DIVIDED TRAFFIC, TWO WAY TURN LANES
(H)	TYPE B CLASS 1	EDGE LINES
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(J)	TYPE B CLASS 1	HATCH LINES, SAFETY ZONES
(K)	TYPE B CLASS 1	TURN LANES
(L)	TYPE B CLASS 1	TURN LANES
(M)	TYPE B CLASS 1	PAVEMENT LETTERS (STOP, YIELD, BUS, ONLY, etc.)
(N)	TYPE B CLASS 1	LANE TRANSITIONS, TURN LANE SKIPS
(O)	TYPE B CLASS 1	GORE MARKINGS
(P)	TYPE B CLASS 1	GORE MARKINGS
(Q)	TYPE B CLASS 1	LANE TRANSITIONS
(R)	TYPE B CLASS 1	CURB EXTENSIONS
(S)	TYPE B CLASS 1	VDOT - STOP BARS
(T)	TYPE B CLASS 1	LANE TRANSITIONS

- PAVEMENT MARKING NOTES:**
- STREET WIDTH MEASUREMENTS ARE FROM FACE OF CURB TO FACE OF CURB. LANES ARE MEASURED FROM CENTER OF MARKING TO CENTER OF MARKING.
 - CONTACT TE&O CONSTRUCTION MANAGER OR HIS DESIGNEE AT 703-228-6598 OR (571) 437-1077 TO APPROVE MARKING LAYOUT 48 HRS. PRIOR TO INSTALLATION OF MARKING.
 - PAVEMENT MARKINGS TO BE IN ACCORDANCE WITH THE FOLLOWING:
 A.) THE MANUAL ON UNIFORM TRAFFIC CONTROL DEVICES.
 B.) ARLINGTON COUNTY PAVEMENT MARKING SPECIFICATIONS.
 - ALL MARKINGS SHALL BE THERMOPLASTIC PER ARLINGTON COUNTY MARKING STANDARDS UNLESS OTHERWISE NOTED.
 - SHARED LANE MARKINGS SHALL BE PLACED IN CENTER OF TRAVEL LANE.
 - FOR DETAILS SEE ARLINGTON COUNTY PAVEMENT MARKING SPECIFICATIONS.


- SIGN NOTES:**
- FOR ALL SIGN POSTS PLACED IN CONCRETE USE 7 GAUGE HEAVY DUTY ANCHOR (30"x2.50") WITH HARDWARE FOR 2" POST. USE 5/8" CORNER BOLT WITH FLANGED NUT AND 3/8" DRIVER RIVET WITH WASHER.
 - CONTACT TE&O CONSTRUCTION MANAGER OR HIS DESIGNEE AT 703-228-6598 OR 571-437-1077 48 HRS PRIOR TO POURING CONCRETE. ALTERNATIVE CONTACT AT 703-228-3788 OR 571-414-7497.

LEGEND


EXISTING	PROPOSED
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[Symbol]	[Symbol]
[Symbol]	[Symbol]

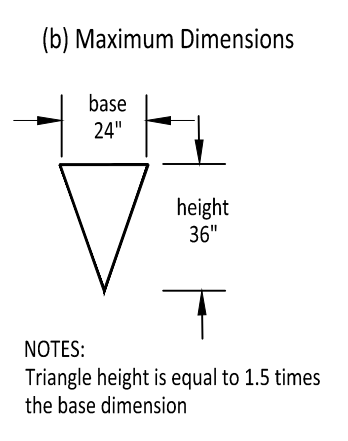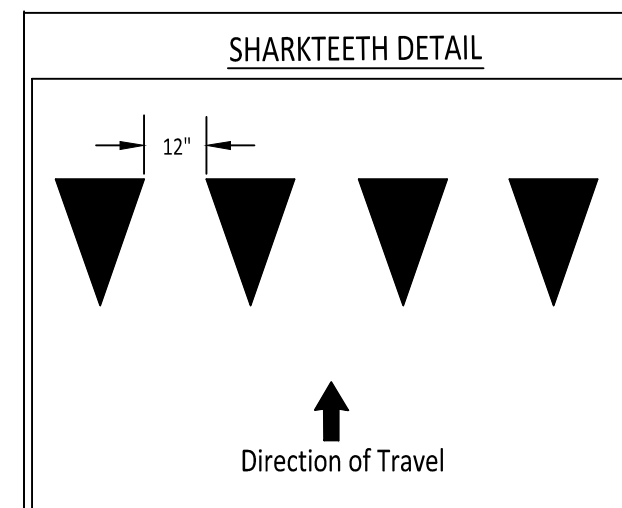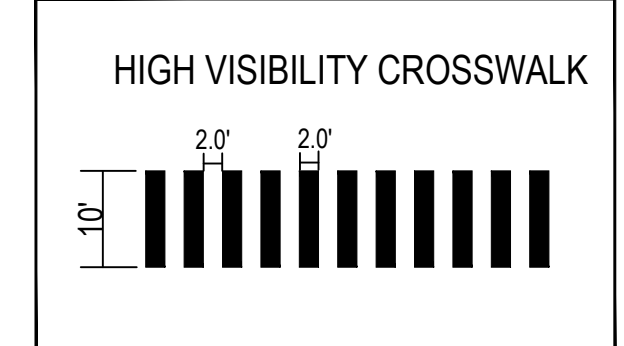

NOTES:
 Triangle height is equal to 1.5 times the base dimension

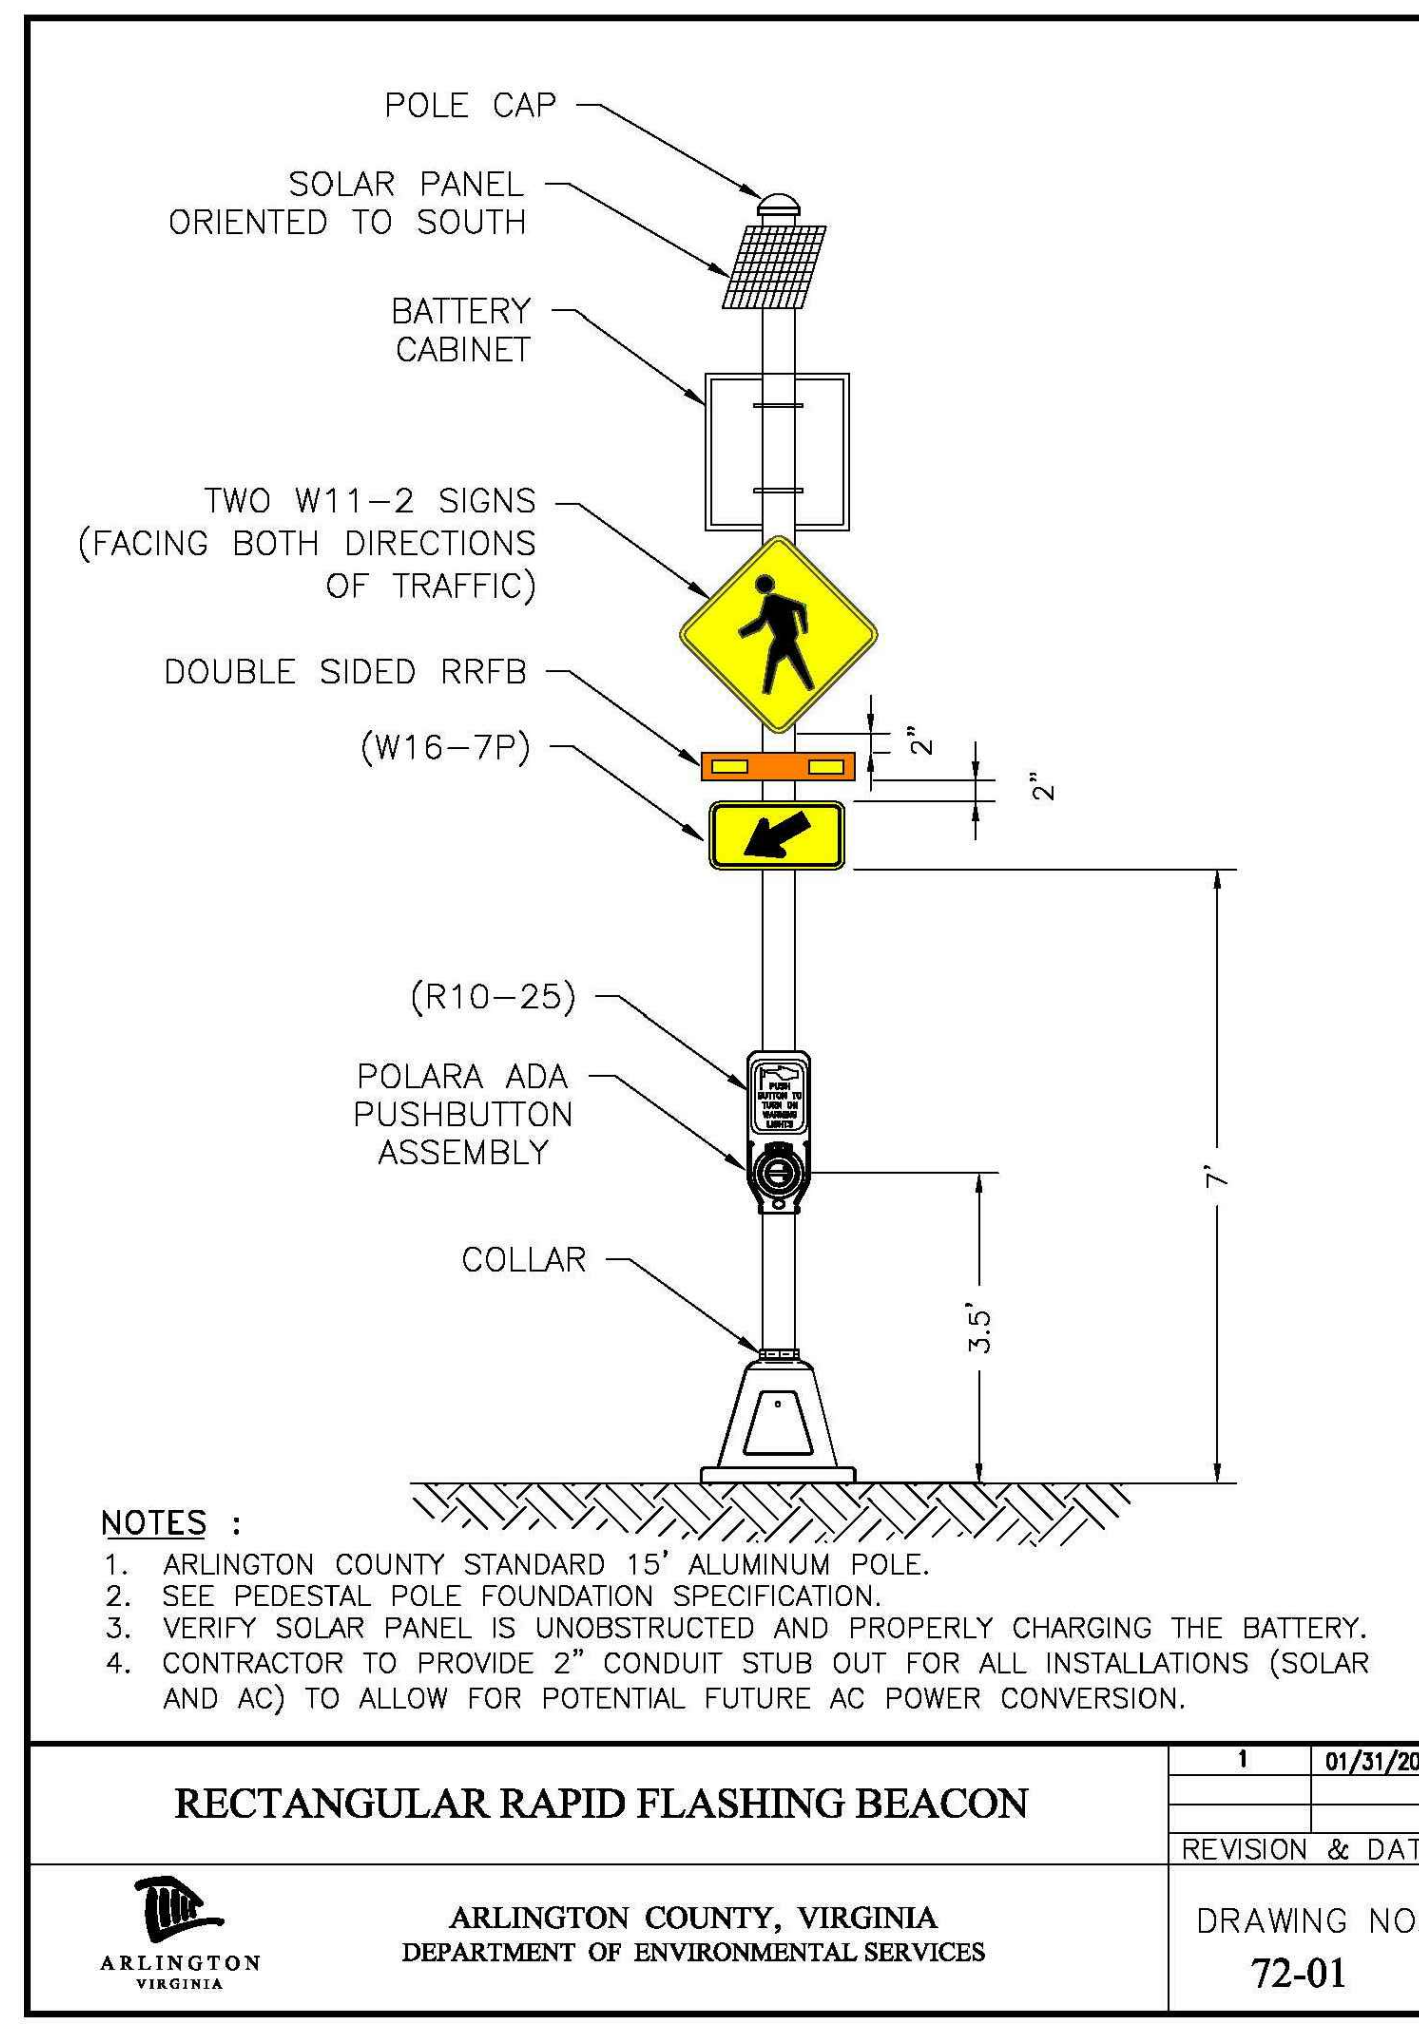

RECTANGULAR RAPID FLASHING BEACON		1	01/31/2019
		REVISION & DATE	
ARLINGTON COUNTY, VIRGINIA DEPARTMENT OF ENVIRONMENTAL SERVICES		DRAWING NO. 72-01	

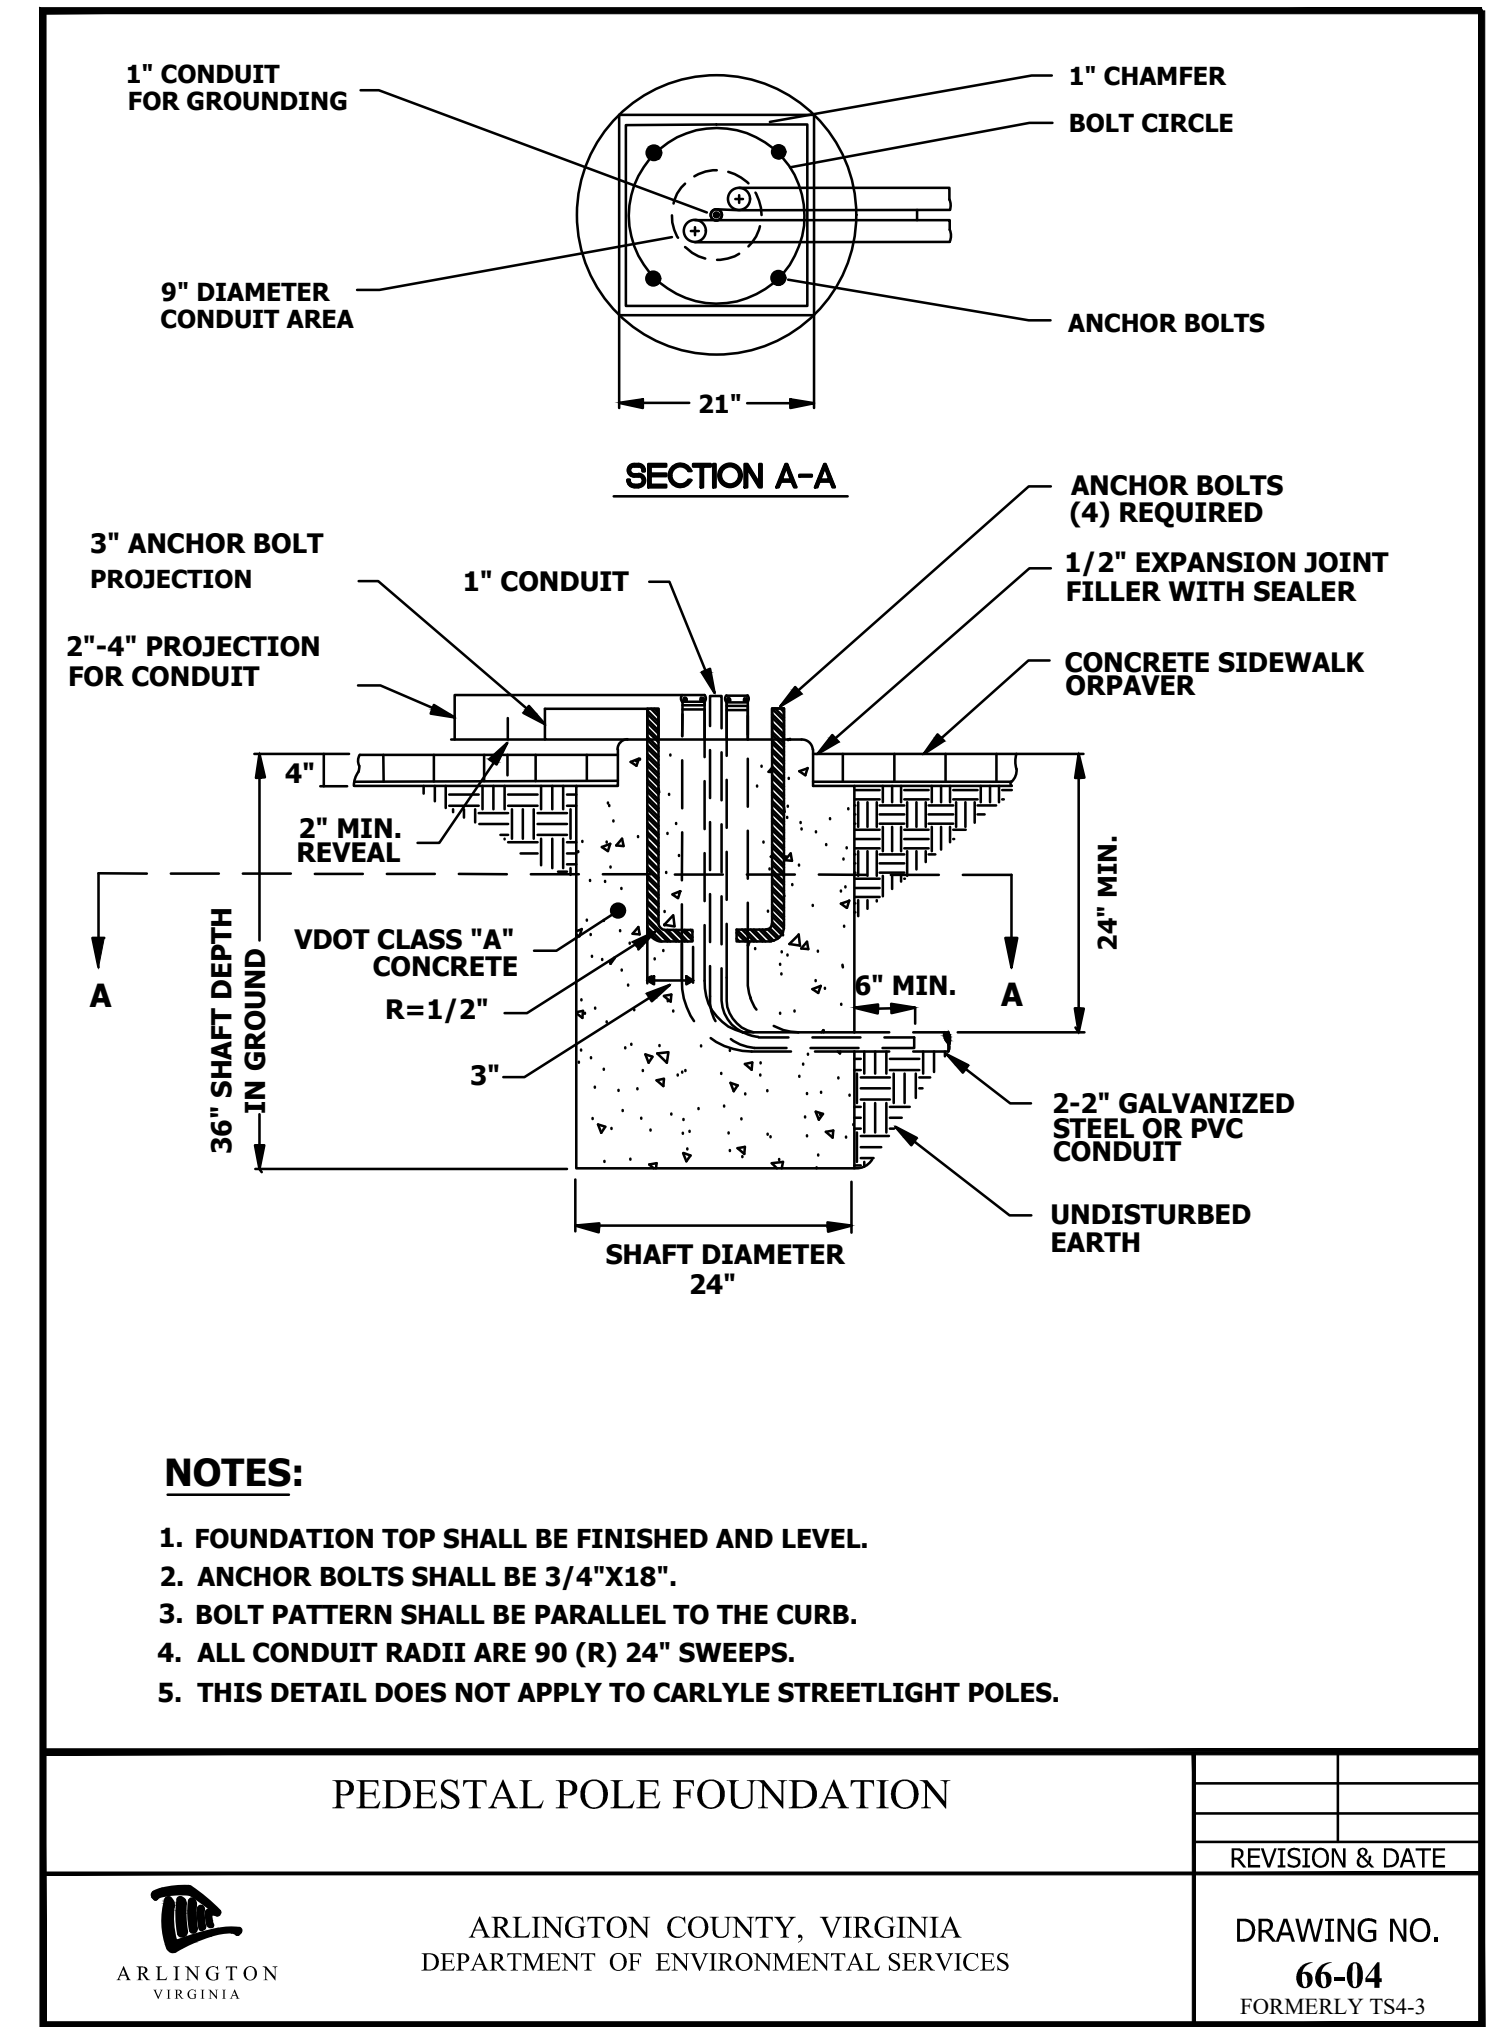

PEDESTAL POLE FOUNDATION			
		REVISION & DATE	
ARLINGTON COUNTY, VIRGINIA DEPARTMENT OF ENVIRONMENTAL SERVICES		DRAWING NO. 66-04 FORMERLY TS4-3	

DEPARTMENT OF ENVIRONMENTAL SERVICES
 FACILITIES & ENGINEERING DIVISION
 ENGINEERING BUREAU
 2100 CLARENDON BOULEVARD, SUITE 813
 ARLINGTON, VA 22201
 PHONE: 703.228.3629
 FAX: 703.228.3606

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APPROVALS	DATE
<i>[Signature]</i> QUALITY CONTROL ENGINEER	3/29/21
<i>[Signature]</i> CONSTRUCTION MANAGEMENT SUPERVISOR	3.24.21
<i>[Signature]</i> WATER, SEWER, STREETS BUREAU CHIEF	03.04.2021
<i>[Signature]</i> TRANSPORTATION DIRECTOR	03/17/21
<i>[Signature]</i> PROJECT MANAGER	3/2/21

REVISIONS	DATE

PROJECT NAME AND LOCATION
TRANSITWAY EXTENSION TO PENTAGON CITY
SIGNAGE AND STRIPING PLAN
CRYSTAL DR & 12TH ST S
 MA13 - SEGMENT I

DESIGNED: PB
 DRAWN: NS
 CHECKED: TL
 MISS UTILITY TRANSMITTAL #: N/A
 FILENAME:
 CC08-281-SIGNAGE_AND_STRIPING-CRYSTAL DRIVE.D
 PATH: Q:\DATA\MA13\CAD\ACTIVE\MA13-PARKING
 PLOTTED: AUGUST 4 2021
 PLOTTED BY: NSHARP

SCALE: