FANTASY HARBOUR BUS FACILITY

FOR

HORRY COUNTY SCHOOLS

SITE LOCATION INVESTORS BOULEVARD MYRTLE BEACH, SC 29579

LOCATION MAP / VICINITY MAP SCALE N.T.S.

SHEET INDEX

MYSTLE BEACH INTL AIPPORT

THIS PROPERTY IS LOCATED IN FLOOD ZONE "X" AS SCALED FROM F.I.R.M. No. 45051C0704 K, DATED DECEMBER 16, 2021, THIS PLAT IS NOT THE BASIS FOR FLOOD ZONE DETERMINATION OR FLOOD ZONE RELATED ISSUES.

CONTRACTOR SHALL BE KNOWLEDGEABLE WITH LOCAL, CITY, COUNTY, STATE, AND FEDERAL REGULATIONS AS THEY MAY PERTAIN TO THIS PROJECT AND SHALL ADHERE TO THESE REGULATIONS.

INFORMATION REGARDING THE PRESENCE, SIZE, CHARACTER, AND LOCATION OF ANY UNDERGROUND UTILITY AND/OR STRUCTURE SHOWN ON THIS PLAN IS APPROXIMATE. IT IS THE CONTRACTOR'S RESPONSIBILITY TO HAVE ALL UNDERGROUND UTILITIES LOCATED.

DESCRIPTION SHEET COVER SHEET C1.0 **GENERAL NOTES** C2.0 OVERALL & KEY PLAN C3.0 **EXISTING CONDITIONS** C4.0 - C4.1 C5.0 - C5.1 HORIZONTAL CONTROL STRIPING PLAN C5.2 C6.0 - C6.2 **GRADING PLAN COMPENSATORY STORAGE** C6.3 DRAINAGE PLAN C7.0 - C7.2 C7.3 - C7.8 STORM PROFILES UTILITY PLAN C8.0 - C8.1 C9.0 - C9.2 **EROSION & SEDIMENT CONTROL DETAILS** C10.0 - C10.5 SCDOT DETAILS C10.6



Know what's below.

Call before you dig.

- THERE ARE NO KNOWN COVENANTS OR RESTRICTIONS ON THIS SITE
- THERE ARE NO 24" DBH OR GREATER LIVE OAKS ON THIS SITE
- FINAL INSPECTIONS WILL NOT BE CONDUCTED UNTIL A FINAL AS-BUILT IS SUBMITTED TO HORRY COUNTY.
- LIGHT FIXTURES SHALL BE FULL-CUTOFF AND MEET
 ILLUMINATING ENGINEERING SOCIETY OF NORTH AMERICA
 (IESNA) CRITERIA. LIGHTING SHALL BE AIMED STRAIGHT DOWN.
 LIGHTING SHALL NOT PRODUCE AN ILLUMINATION THAT

EXCEEDS 1 FOOTCANDLE BEYOND ANY RESIDENTILA LINE

DEVELOPMENT RESOURCE GROUP LLC



MYRTLE BEACH, SC 29577



COVER SHEET

COVER SHEET

FANTASY HARBOUR BUS FACILITY

PLANS FOR

PLANS FOR

CONSTRUCTION

CONWAY, SC 29526

JOE BURCH

JOB NO: 21.148
SCALE: NTS
DRAWN BY: PJC
CHECKED BY: WAG
APPROVED BY: WAG
DATE: 03/15/2023

SHEET NUMBER:

C1.0

426-00-00-0012 PARCEL PIN #'(S): **CURRENT ZONING: BUS LOT** PROPOSED LAND USE: TOTAL PROJECT AREA = 38.10 ACRES 35.60 ACRES LAND DISTURBANCE AREA = IMPERVIOUS AREAS = 12.00 ACRES CONCRETE OR HEAVY DUTY ASPHALT = 10.34 ACRES 1.66 ACRES ASPHALT LOT/DRIVE = 23.60 ACRES PERVIOUS AREAS = GRAVEL DRIVE = 0.52 ACRES 0.88 ACRES FUTURE TRAINING PAD = FUTURE MAINTENANCE AREA = 5.65 ACRES 16.55 ACRES GRASS/OPEN SPACE = PARKING REQUIRED: 1 SPACE PER VEHICLE STORED ON SITE 1 SPACE PER EMPLOYEE ON LARGEST SHIFT 1 SPACE PER STORED VEHICLE * 215 BUSES = 215 BUS SPACES 1 SPACE PER EMPLOYEE * 227 PEAK EMPLOYEES = 227 SPACES 227 CAR - 215 BUS PARKING PROVIDED: CAR PARKING = 221 STALLS ADA VAN ACCESSIBLE = 4 STALLS 2 STALLS ADA ACCESSIBLE = BUS PARKING = 215 STALLS SETBACKS: FRONT = 50 FT SIDE = 10 FT REAR =15 FT MAX BUILDING HEIGHT = 120 FT NONE WETLAND AREA =

POND AREA =

NONE

PROJECT SUMMARY

HORIZONTAL DATUM: NAD 83

VERTICAL DATUM: NAVD 88

BENCHMARK: 1/2" IRON PIPE FOUND (SEE SHEET C3.0 & C3.1)


NPDES PERMIT: XX

SCDHEC WATER PERMIT: N/A

SCDHEC SEWER PERMIT: N/A

(34%)

(66%)

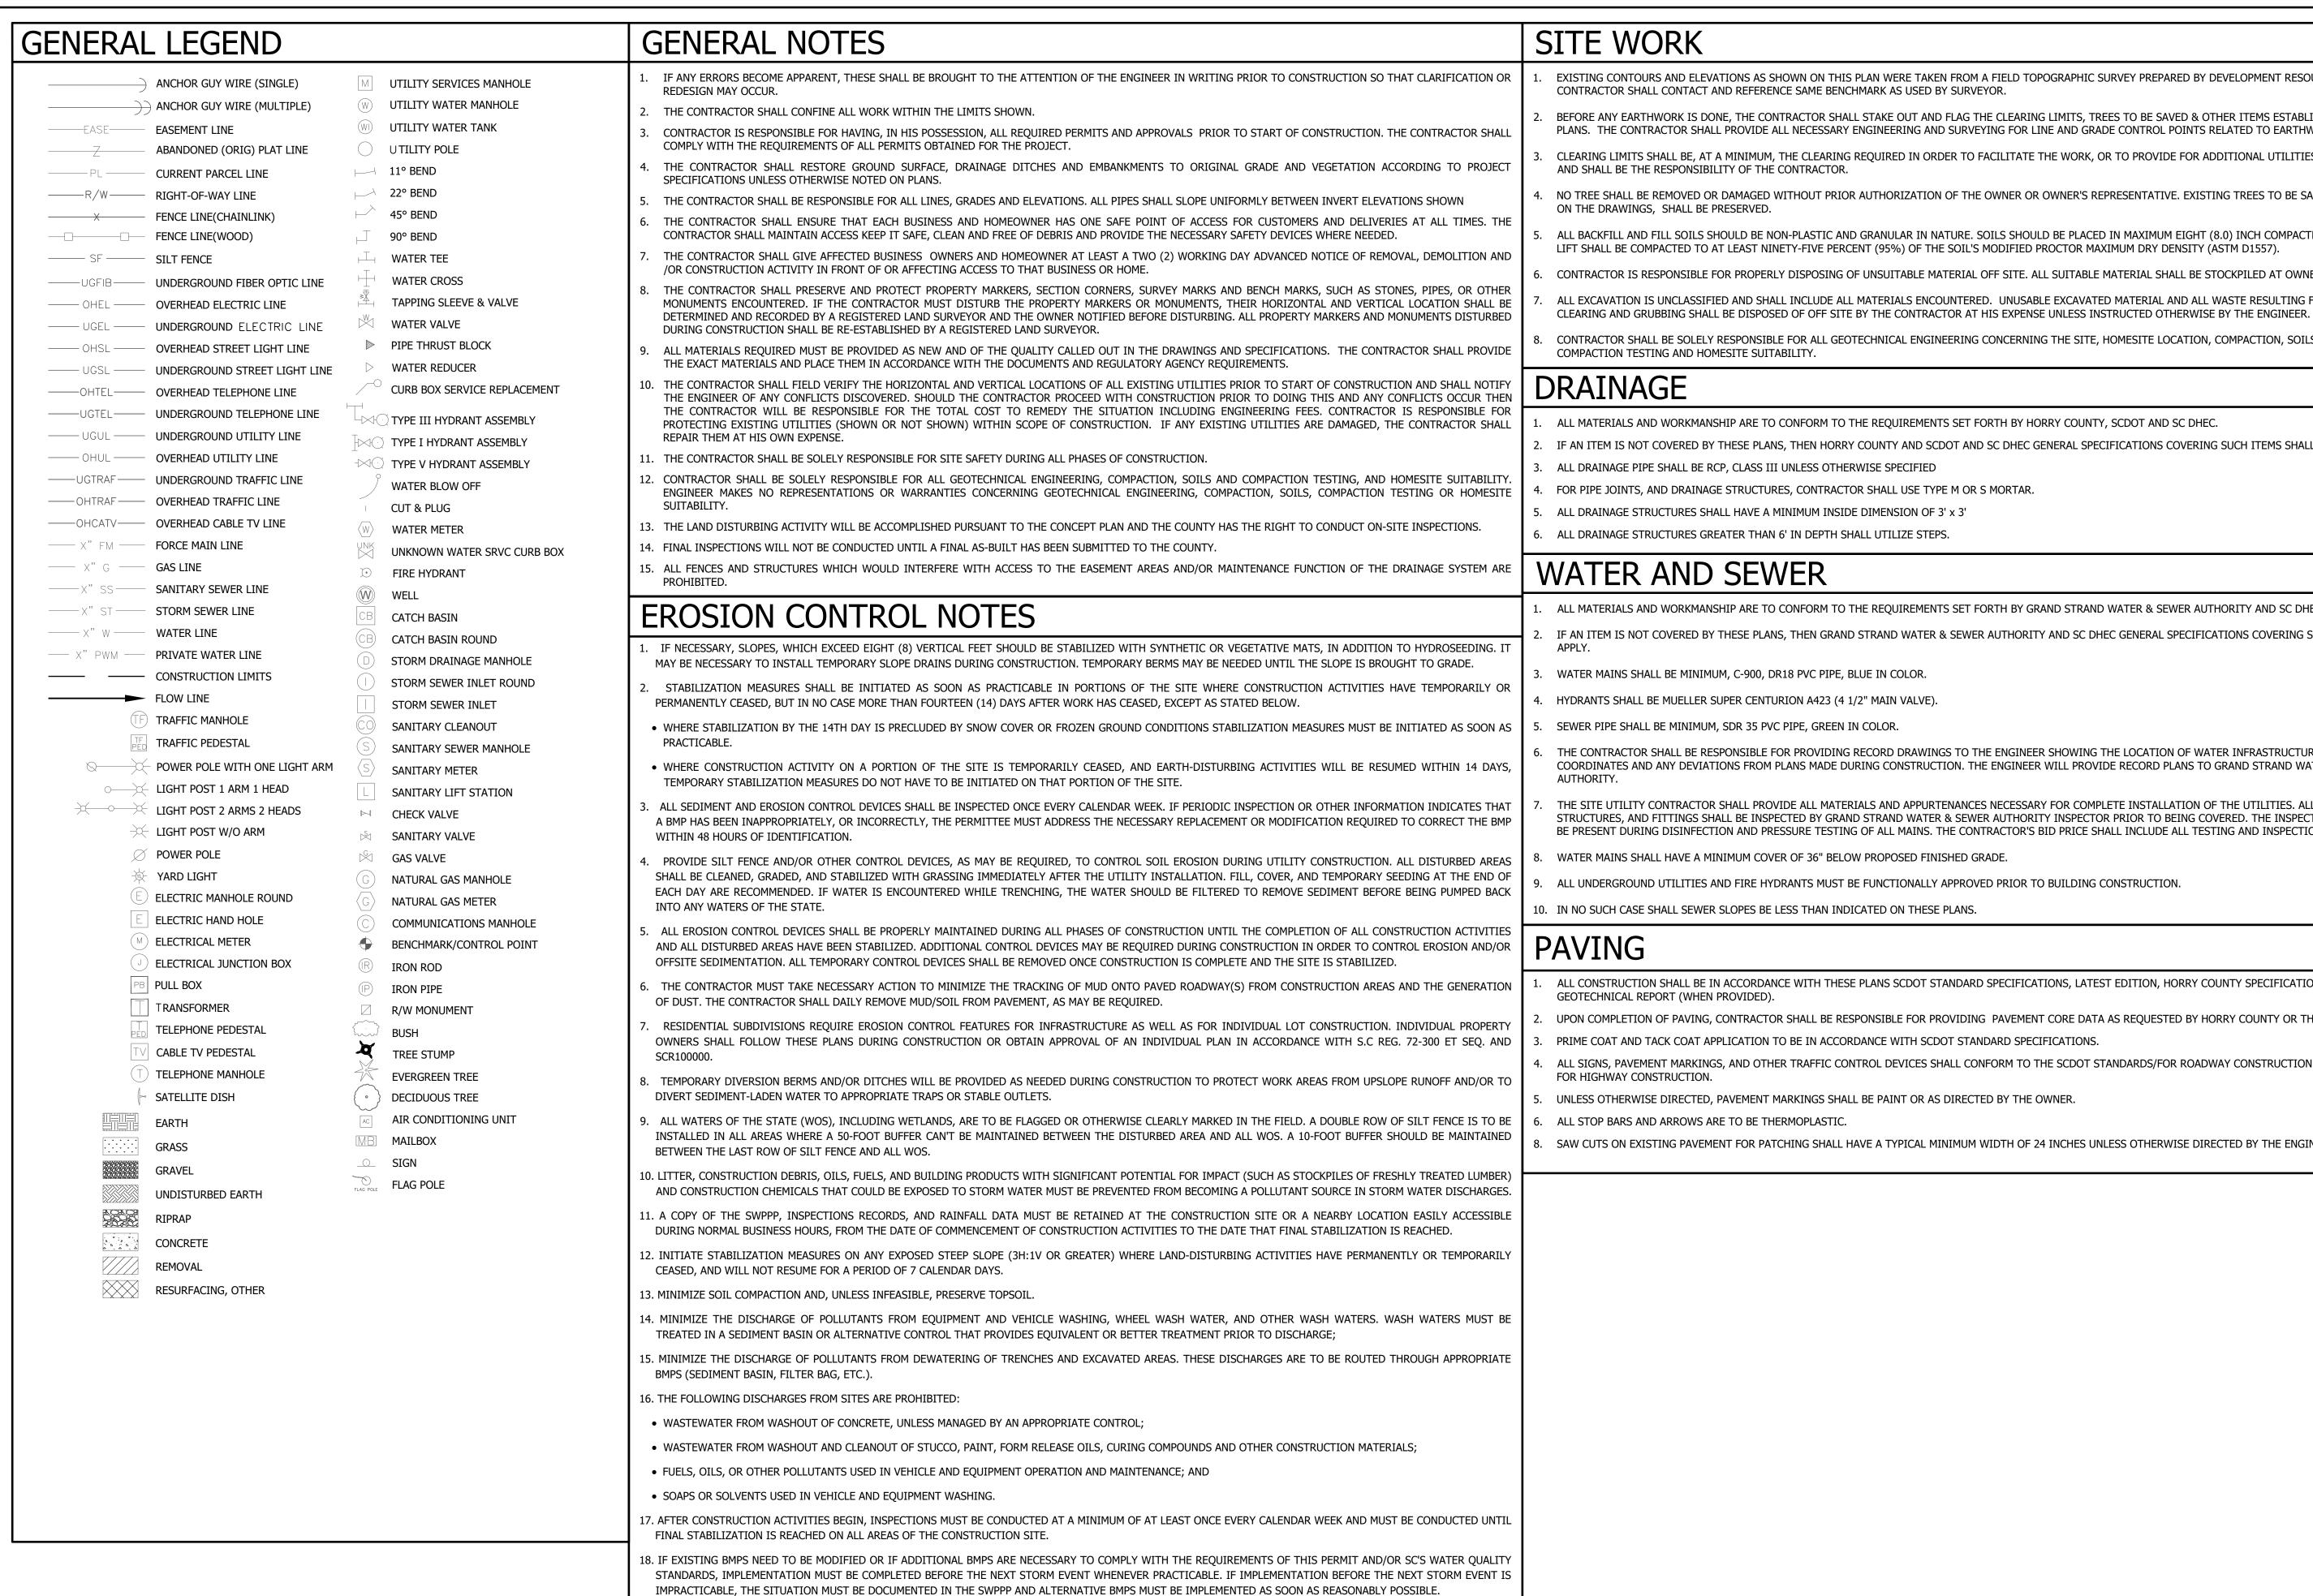

APPROVED OTHERWISE.

19. A PRE-CONSTRUCTION CONFERENCE MUST BE HELD FOR EACH CONSTRUCTION SITE WITH AN APPROVED ON-SITE SWPPP PRIOR TO THE IMPLEMENTATION OF

CONSTRUCTION ACTIVITIES. FOR NON-LINEAR PROJECTS THAT DISTURB 10 ACRES OR MORE THIS CONFERENCE MUST BE HELD ON-SITE UNLESS THE DEPARTMENT HAS

SITE WORK

- EXISTING CONTOURS AND ELEVATIONS AS SHOWN ON THIS PLAN WERE TAKEN FROM A FIELD TOPOGRAPHIC SURVEY PREPARED BY DEVELOPMENT RESOURCE GROUP, LLO CONTRACTOR SHALL CONTACT AND REFERENCE SAME BENCHMARK AS USED BY SURVEYOR
- BEFORE ANY EARTHWORK IS DONE, THE CONTRACTOR SHALL STAKE OUT AND FLAG THE CLEARING LIMITS, TREES TO BE SAVED & OTHER ITEMS ESTABLISHED BY THE PLANS. THE CONTRACTOR SHALL PROVIDE ALL NECESSARY ENGINEERING AND SURVEYING FOR LINE AND GRADE CONTROL POINTS RELATED TO EARTHWORK.
- CLEARING LIMITS SHALL BE, AT A MINIMUM, THE CLEARING REQUIRED IN ORDER TO FACILITATE THE WORK, OR TO PROVIDE FOR ADDITIONAL UTILITIES OR EASEMENTS AND SHALL BE THE RESPONSIBILITY OF THE CONTRACTOR.
- NO TREE SHALL BE REMOVED OR DAMAGED WITHOUT PRIOR AUTHORIZATION OF THE OWNER OR OWNER'S REPRESENTATIVE. EXISTING TREES TO BE SAVED, AS SHOWN ON THE DRAWINGS, SHALL BE PRESERVED.
- ALL BACKFILL AND FILL SOILS SHOULD BE NON-PLASTIC AND GRANULAR IN NATURE. SOILS SHOULD BE PLACED IN MAXIMUM EIGHT (8.0) INCH COMPACTED LIFTS. EACH
- CONTRACTOR IS RESPONSIBLE FOR PROPERLY DISPOSING OF UNSUITABLE MATERIAL OFF SITE. ALL SUITABLE MATERIAL SHALL BE STOCKPILED AT OWNERS DIRECTION.
- ALL EXCAVATION IS UNCLASSIFIED AND SHALL INCLUDE ALL MATERIALS ENCOUNTERED. UNUSABLE EXCAVATED MATERIAL AND ALL WASTE RESULTING FROM SITE
- CONTRACTOR SHALL BE SOLELY RESPONSIBLE FOR ALL GEOTECHNICAL ENGINEERING CONCERNING THE SITE, HOMESITE LOCATION, COMPACTION, SOILS AND COMPACTION TESTING AND HOMESITE SUITABILITY.

- ALL MATERIALS AND WORKMANSHIP ARE TO CONFORM TO THE REQUIREMENTS SET FORTH BY HORRY COUNTY, SCDOT AND SC DHEC.
- IF AN ITEM IS NOT COVERED BY THESE PLANS, THEN HORRY COUNTY AND SCDOT AND SC DHEC GENERAL SPECIFICATIONS COVERING SUCH ITEMS SHALL APPLY.
- ALL DRAINAGE PIPE SHALL BE RCP, CLASS III UNLESS OTHERWISE SPECIFIED
- FOR PIPE JOINTS, AND DRAINAGE STRUCTURES, CONTRACTOR SHALL USE TYPE M OR S MORTAR
- 5. ALL DRAINAGE STRUCTURES SHALL HAVE A MINIMUM INSIDE DIMENSION OF 3' imes 3'
- ALL DRAINAGE STRUCTURES GREATER THAN 6' IN DEPTH SHALL UTILIZE STEPS

WATER AND SEWER


- ALL MATERIALS AND WORKMANSHIP ARE TO CONFORM TO THE REQUIREMENTS SET FORTH BY GRAND STRAND WATER & SEWER AUTHORITY AND SC DHEC.
- IF AN ITEM IS NOT COVERED BY THESE PLANS, THEN GRAND STRAND WATER & SEWER AUTHORITY AND SC DHEC GENERAL SPECIFICATIONS COVERING SUCH ITEMS SHALL
- WATER MAINS SHALL BE MINIMUM, C-900, DR18 PVC PIPE, BLUE IN COLOR.
- HYDRANTS SHALL BE MUELLER SUPER CENTURION A423 (4 1/2" MAIN VALVE).
- SEWER PIPE SHALL BE MINIMUM, SDR 35 PVC PIPE, GREEN IN COLOR.
- THE CONTRACTOR SHALL BE RESPONSIBLE FOR PROVIDING RECORD DRAWINGS TO THE ENGINEER SHOWING THE LOCATION OF WATER INFRASTRUCTURE IN STATE PLANE COORDINATES AND ANY DEVIATIONS FROM PLANS MADE DURING CONSTRUCTION. THE ENGINEER WILL PROVIDE RECORD PLANS TO GRAND STRAND WATER & SEWER AUTHORITY.
- THE SITE UTILITY CONTRACTOR SHALL PROVIDE ALL MATERIALS AND APPURTENANCES NECESSARY FOR COMPLETE INSTALLATION OF THE UTILITIES. ALL PUBLIC PIPE STRUCTURES, AND FITTINGS SHALL BE INSPECTED BY GRAND STRAND WATER & SEWER AUTHORITY INSPECTOR PRIOR TO BEING COVERED, THE INSPECTOR MUST ALSO BE PRESENT DURING DISINFECTION AND PRESSURE TESTING OF ALL MAINS. THE CONTRACTOR'S BID PRICE SHALL INCLUDE ALL TESTING AND INSPECTION FEES.
- WATER MAINS SHALL HAVE A MINIMUM COVER OF 36" BELOW PROPOSED FINISHED GRADE.
- ALL UNDERGROUND UTILITIES AND FIRE HYDRANTS MUST BE FUNCTIONALLY APPROVED PRIOR TO BUILDING CONSTRUCTION.
- IN NO SUCH CASE SHALL SEWER SLOPES BE LESS THAN INDICATED ON THESE PLANS.

PAVING

- ALL CONSTRUCTION SHALL BE IN ACCORDANCE WITH THESE PLANS SCDOT STANDARD SPECIFICATIONS, LATEST EDITION, HORRY COUNTY SPECIFICATIONS, AND GEOTECHNICAL REPORT (WHEN PROVIDED).
- UPON COMPLETION OF PAVING, CONTRACTOR SHALL BE RESPONSIBLE FOR PROVIDING PAVEMENT CORE DATA AS REQUESTED BY HORRY COUNTY OR THE ENGINEER. PRIME COAT AND TACK COAT APPLICATION TO BE IN ACCORDANCE WITH SCDOT STANDARD SPECIFICATIONS.
- ALL SIGNS, PAVEMENT MARKINGS, AND OTHER TRAFFIC CONTROL DEVICES SHALL CONFORM TO THE SCDOT STANDARDS/FOR ROADWAY CONSTRUCTION AND THE MUTCD FOR HIGHWAY CONSTRUCTION.
- UNLESS OTHERWISE DIRECTED, PAVEMENT MARKINGS SHALL BE PAINT OR AS DIRECTED BY THE OWNER.
- ALL STOP BARS AND ARROWS ARE TO BE THERMOPLASTIC.
- SAW CUTS ON EXISTING PAVEMENT FOR PATCHING SHALL HAVE A TYPICAL MINIMUM WIDTH OF 24 INCHES UNLESS OTHERWISE DIRECTED BY THE ENGINEER.



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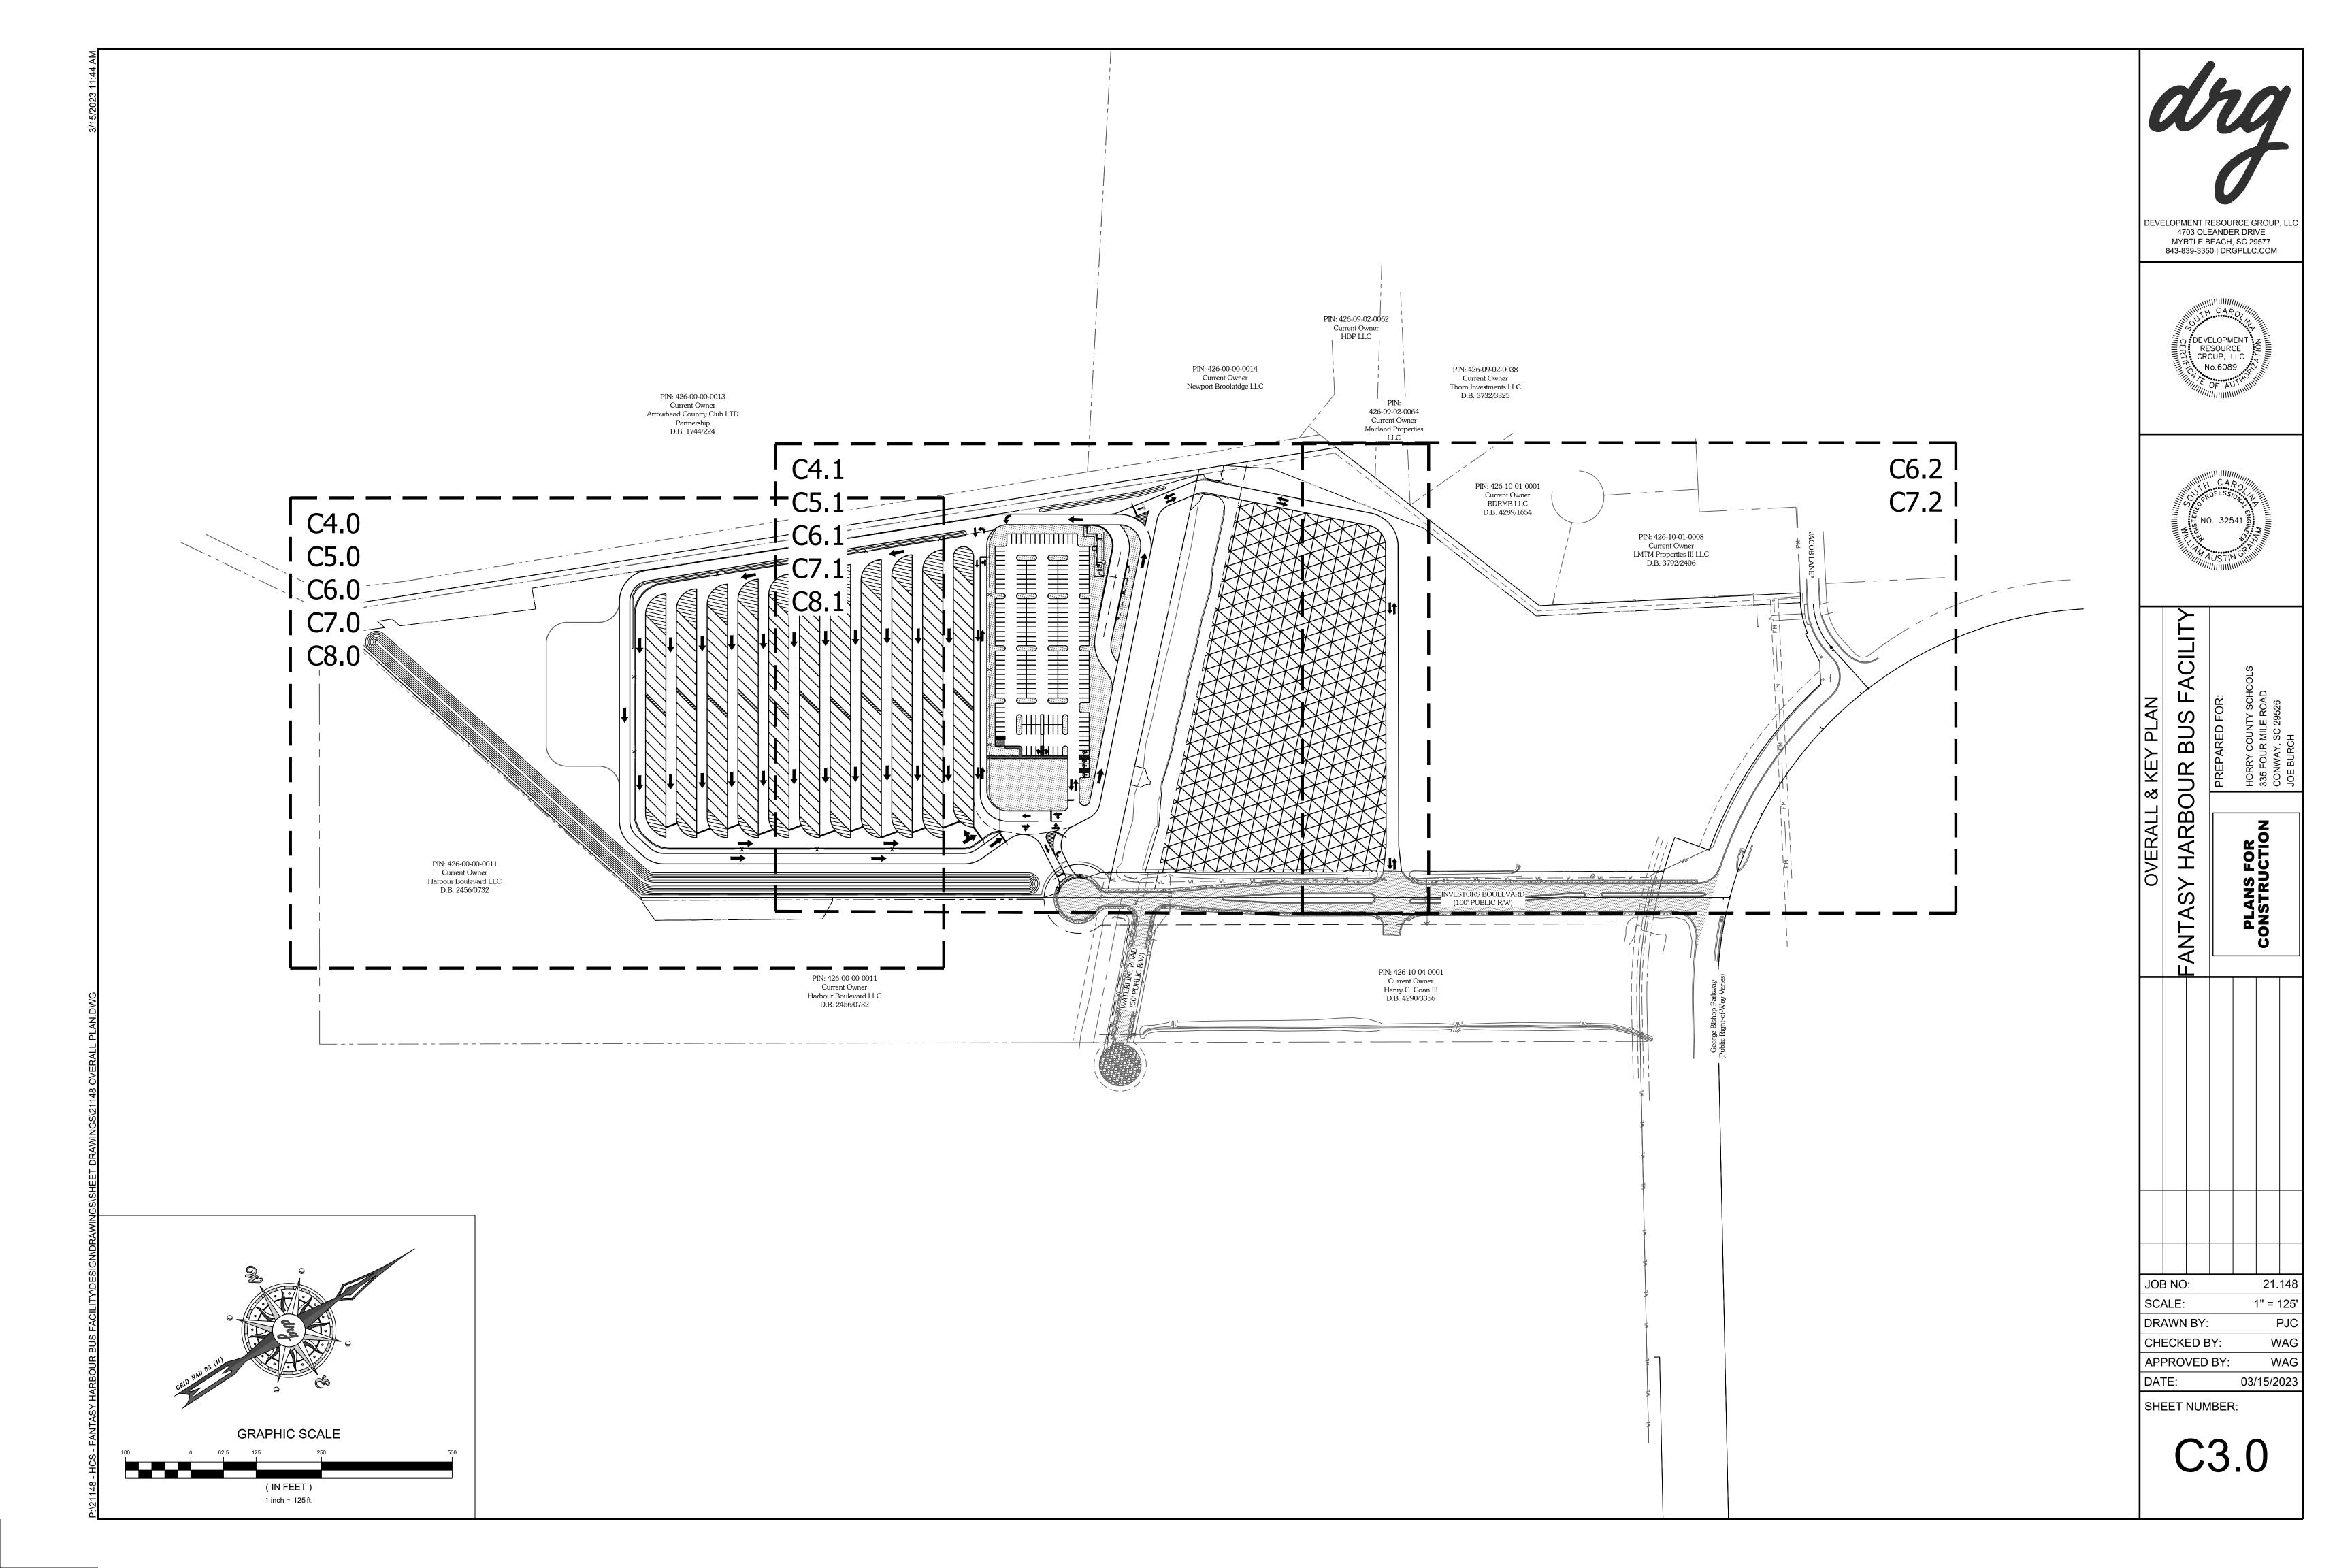
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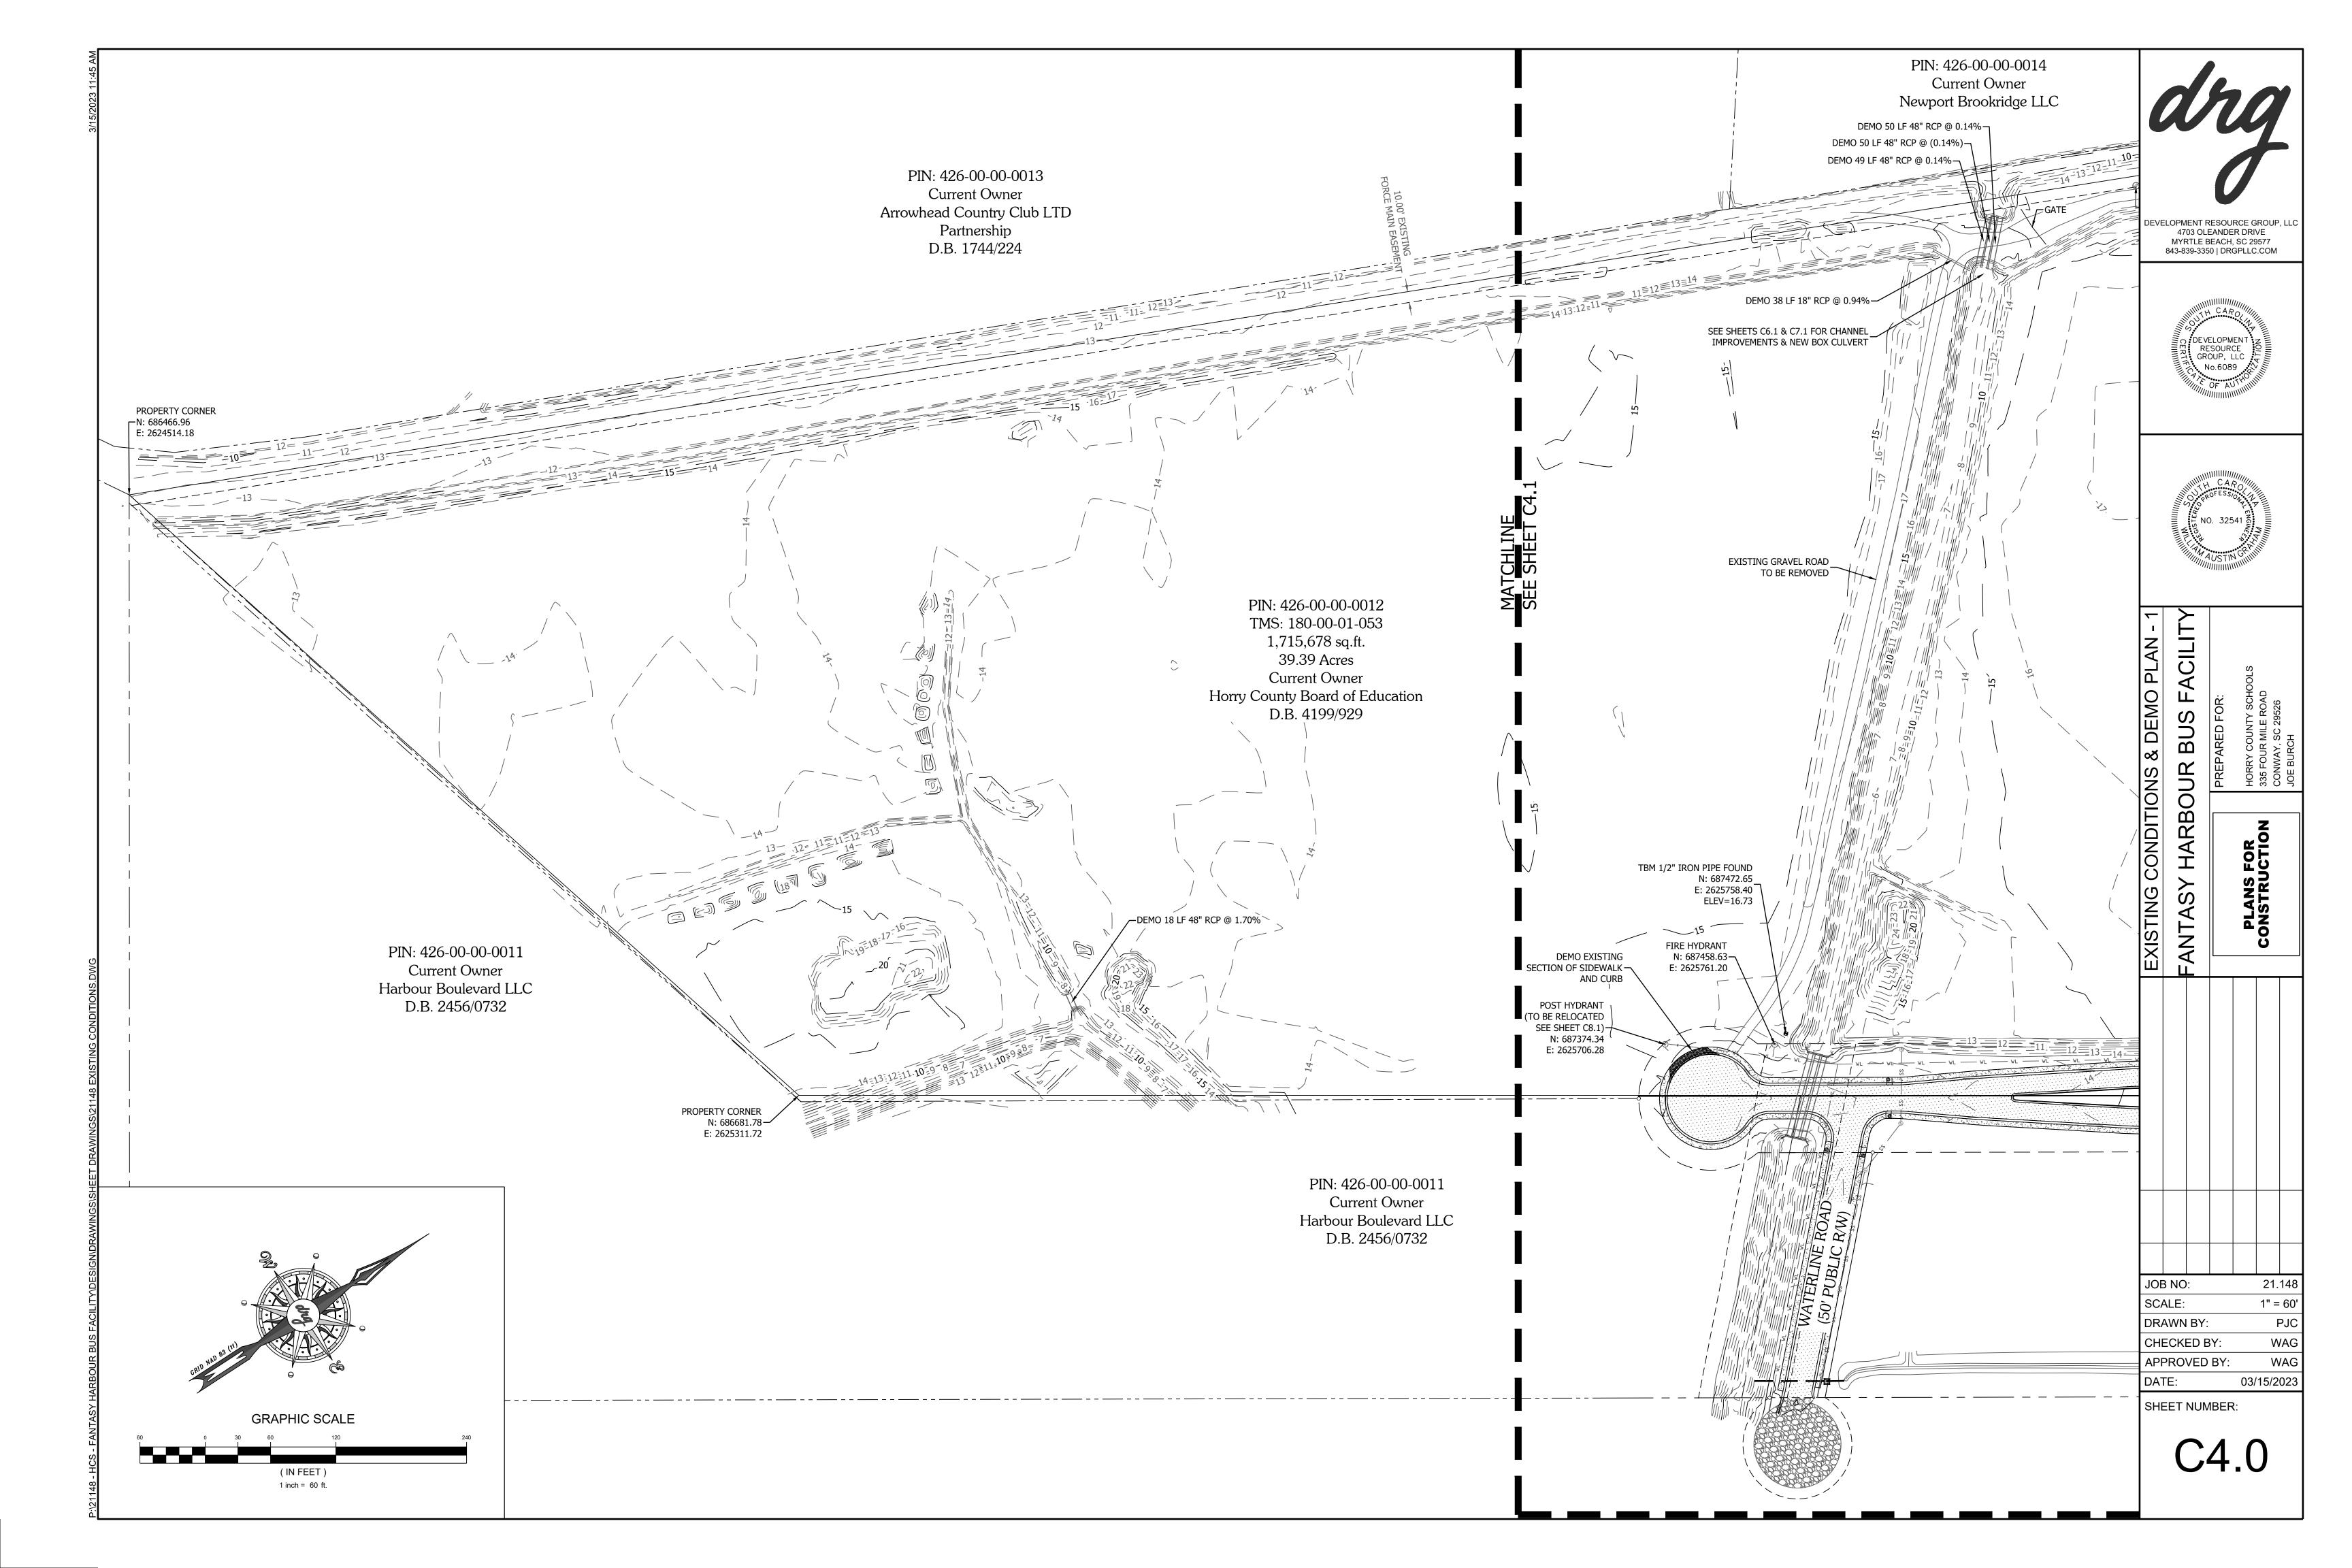
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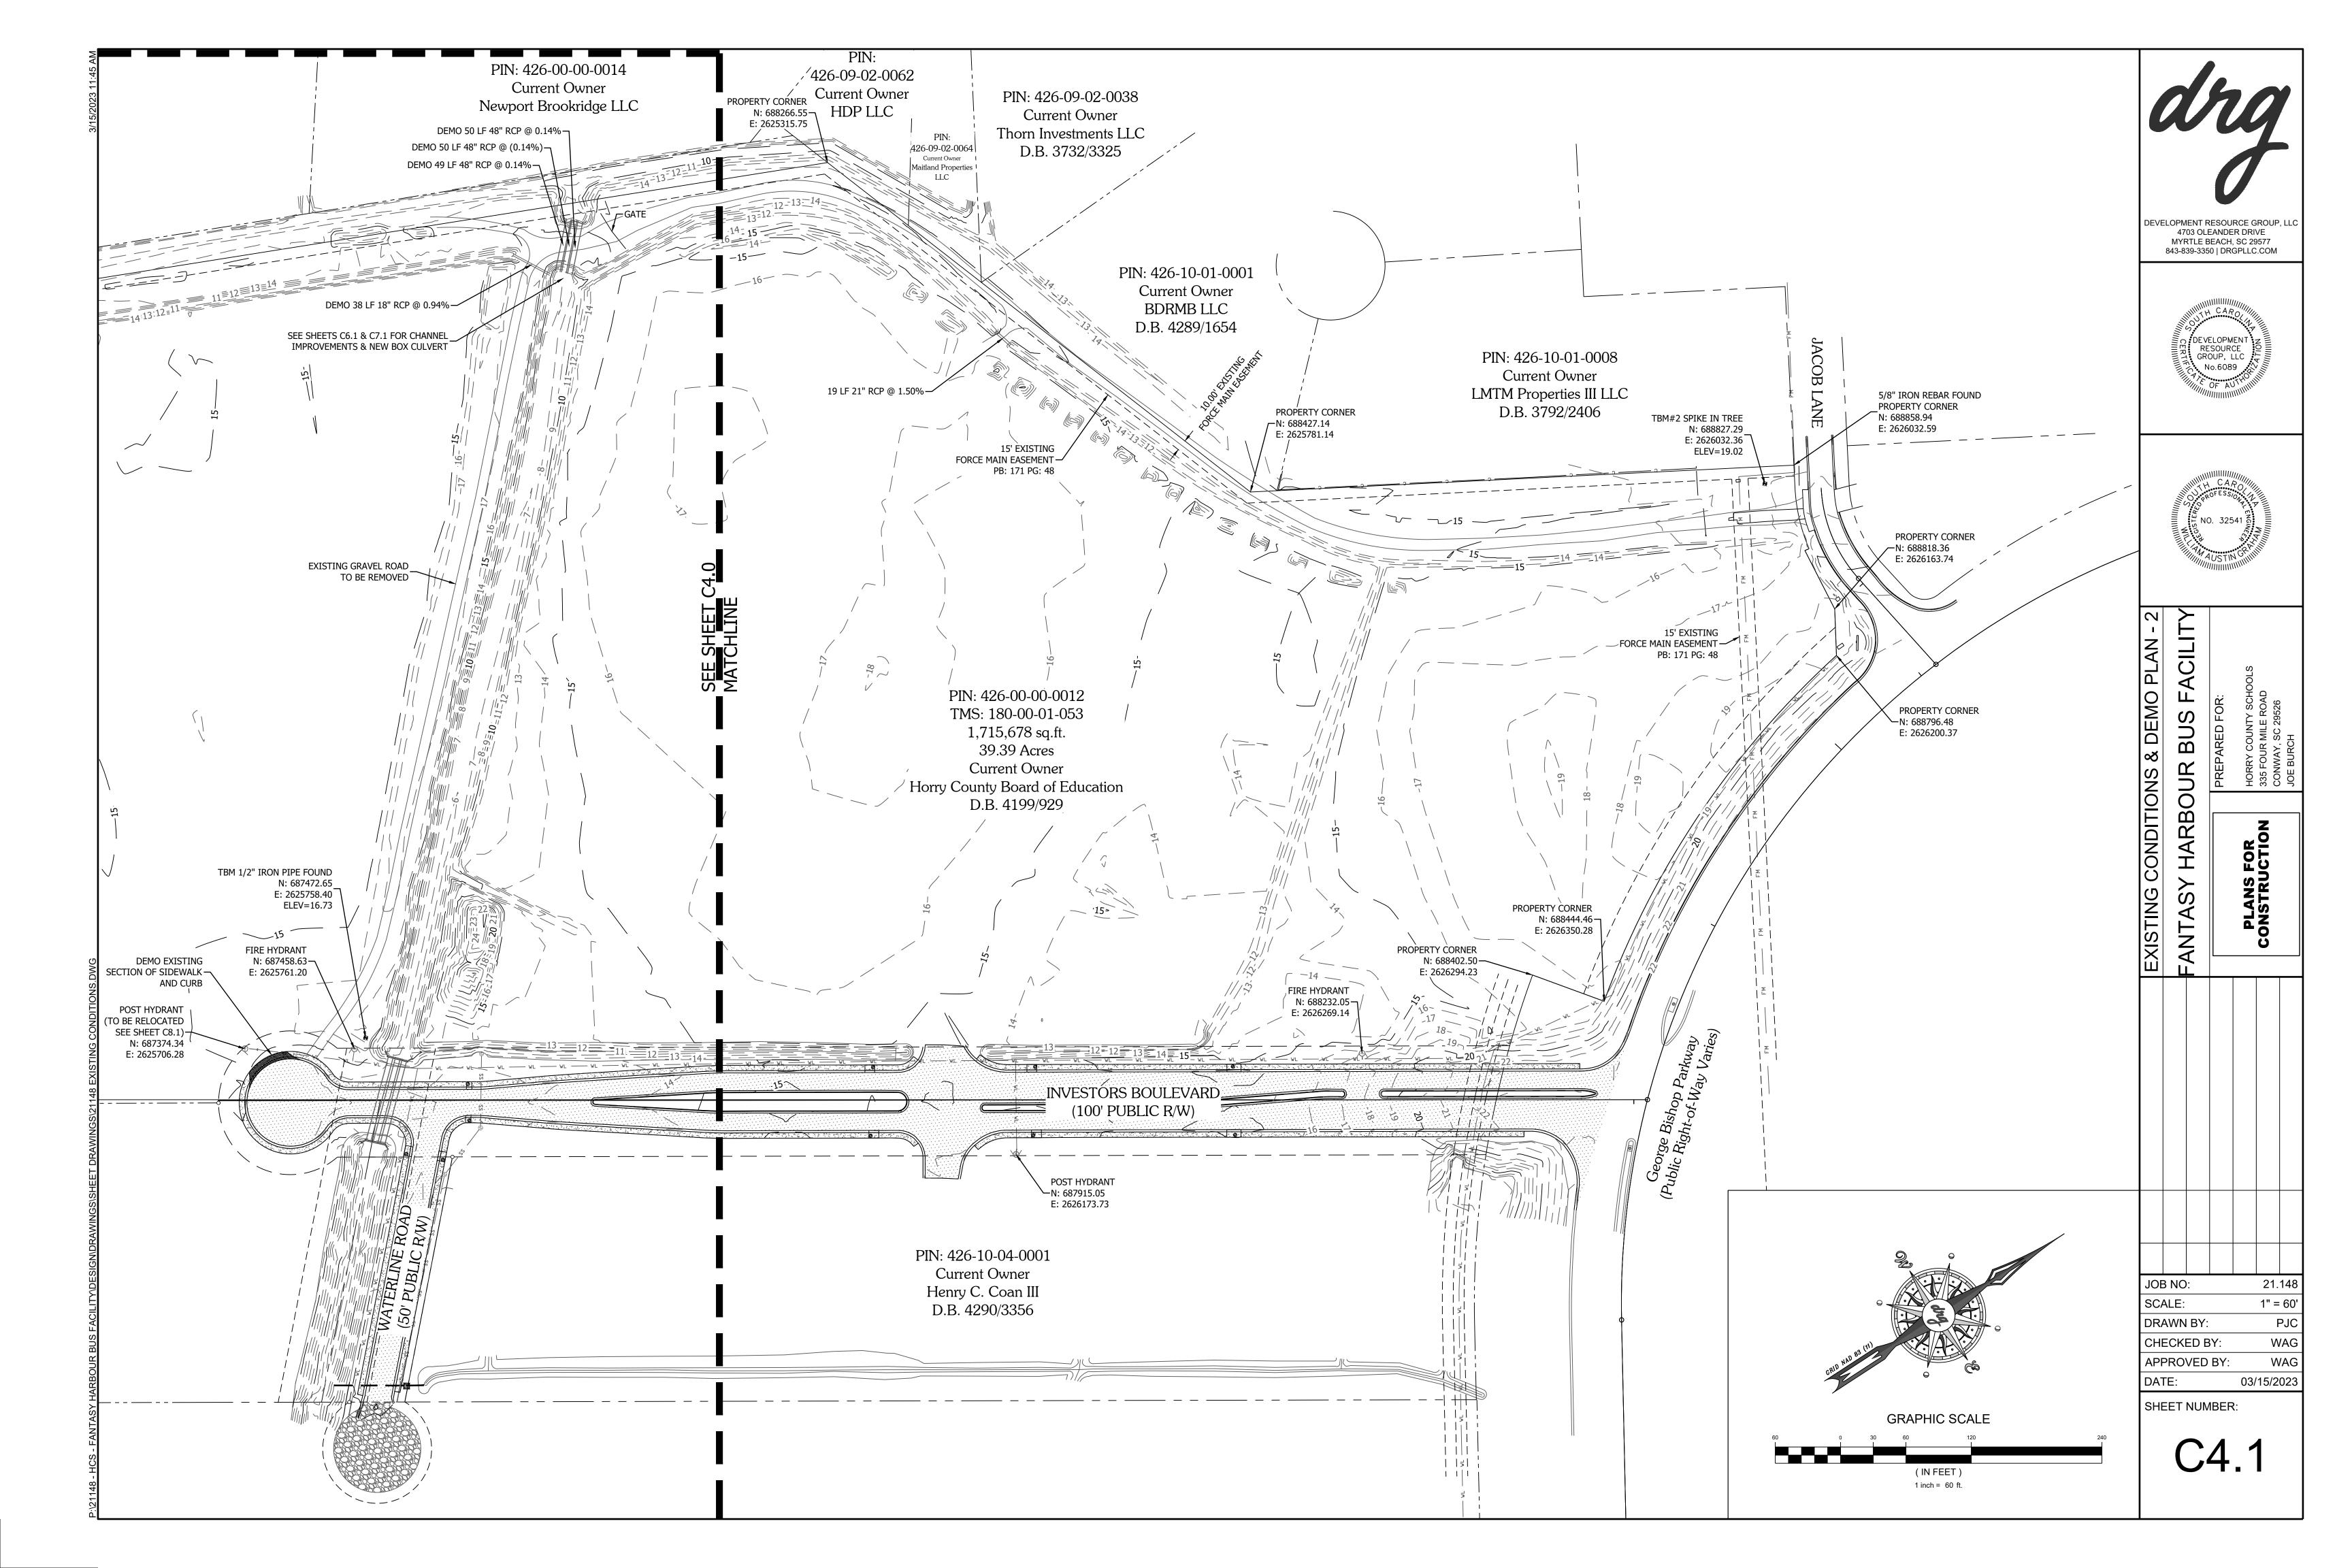
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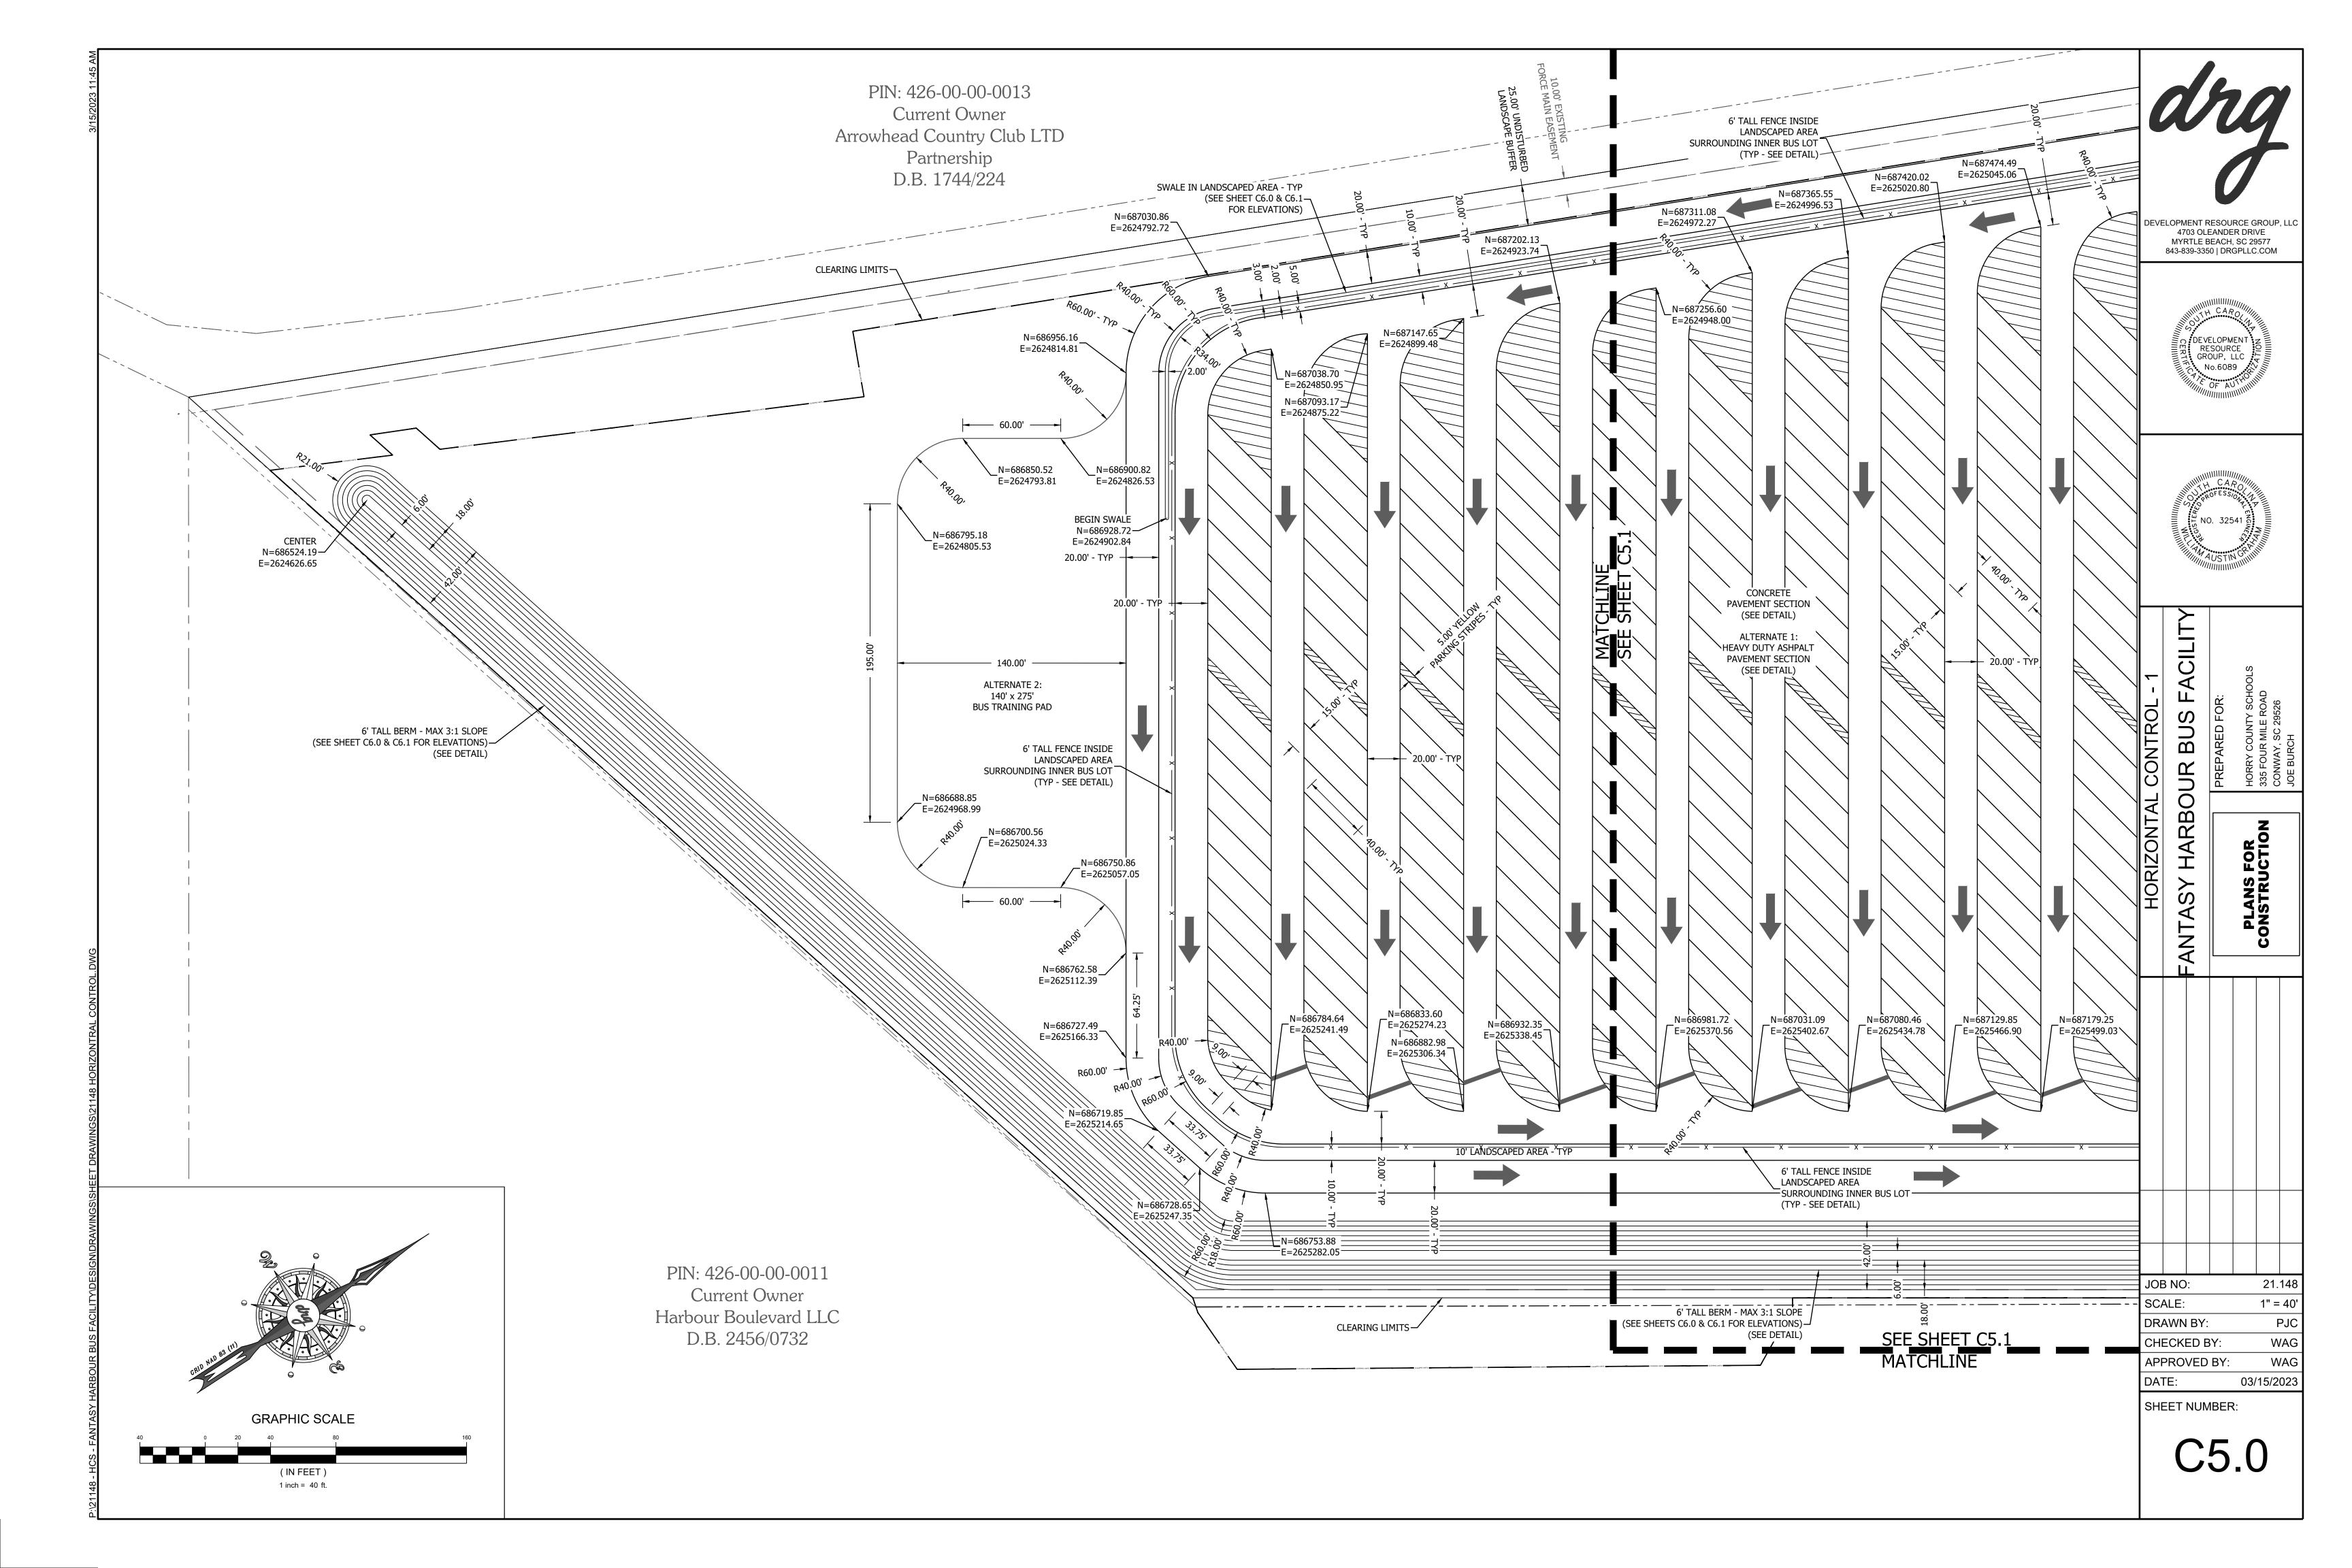
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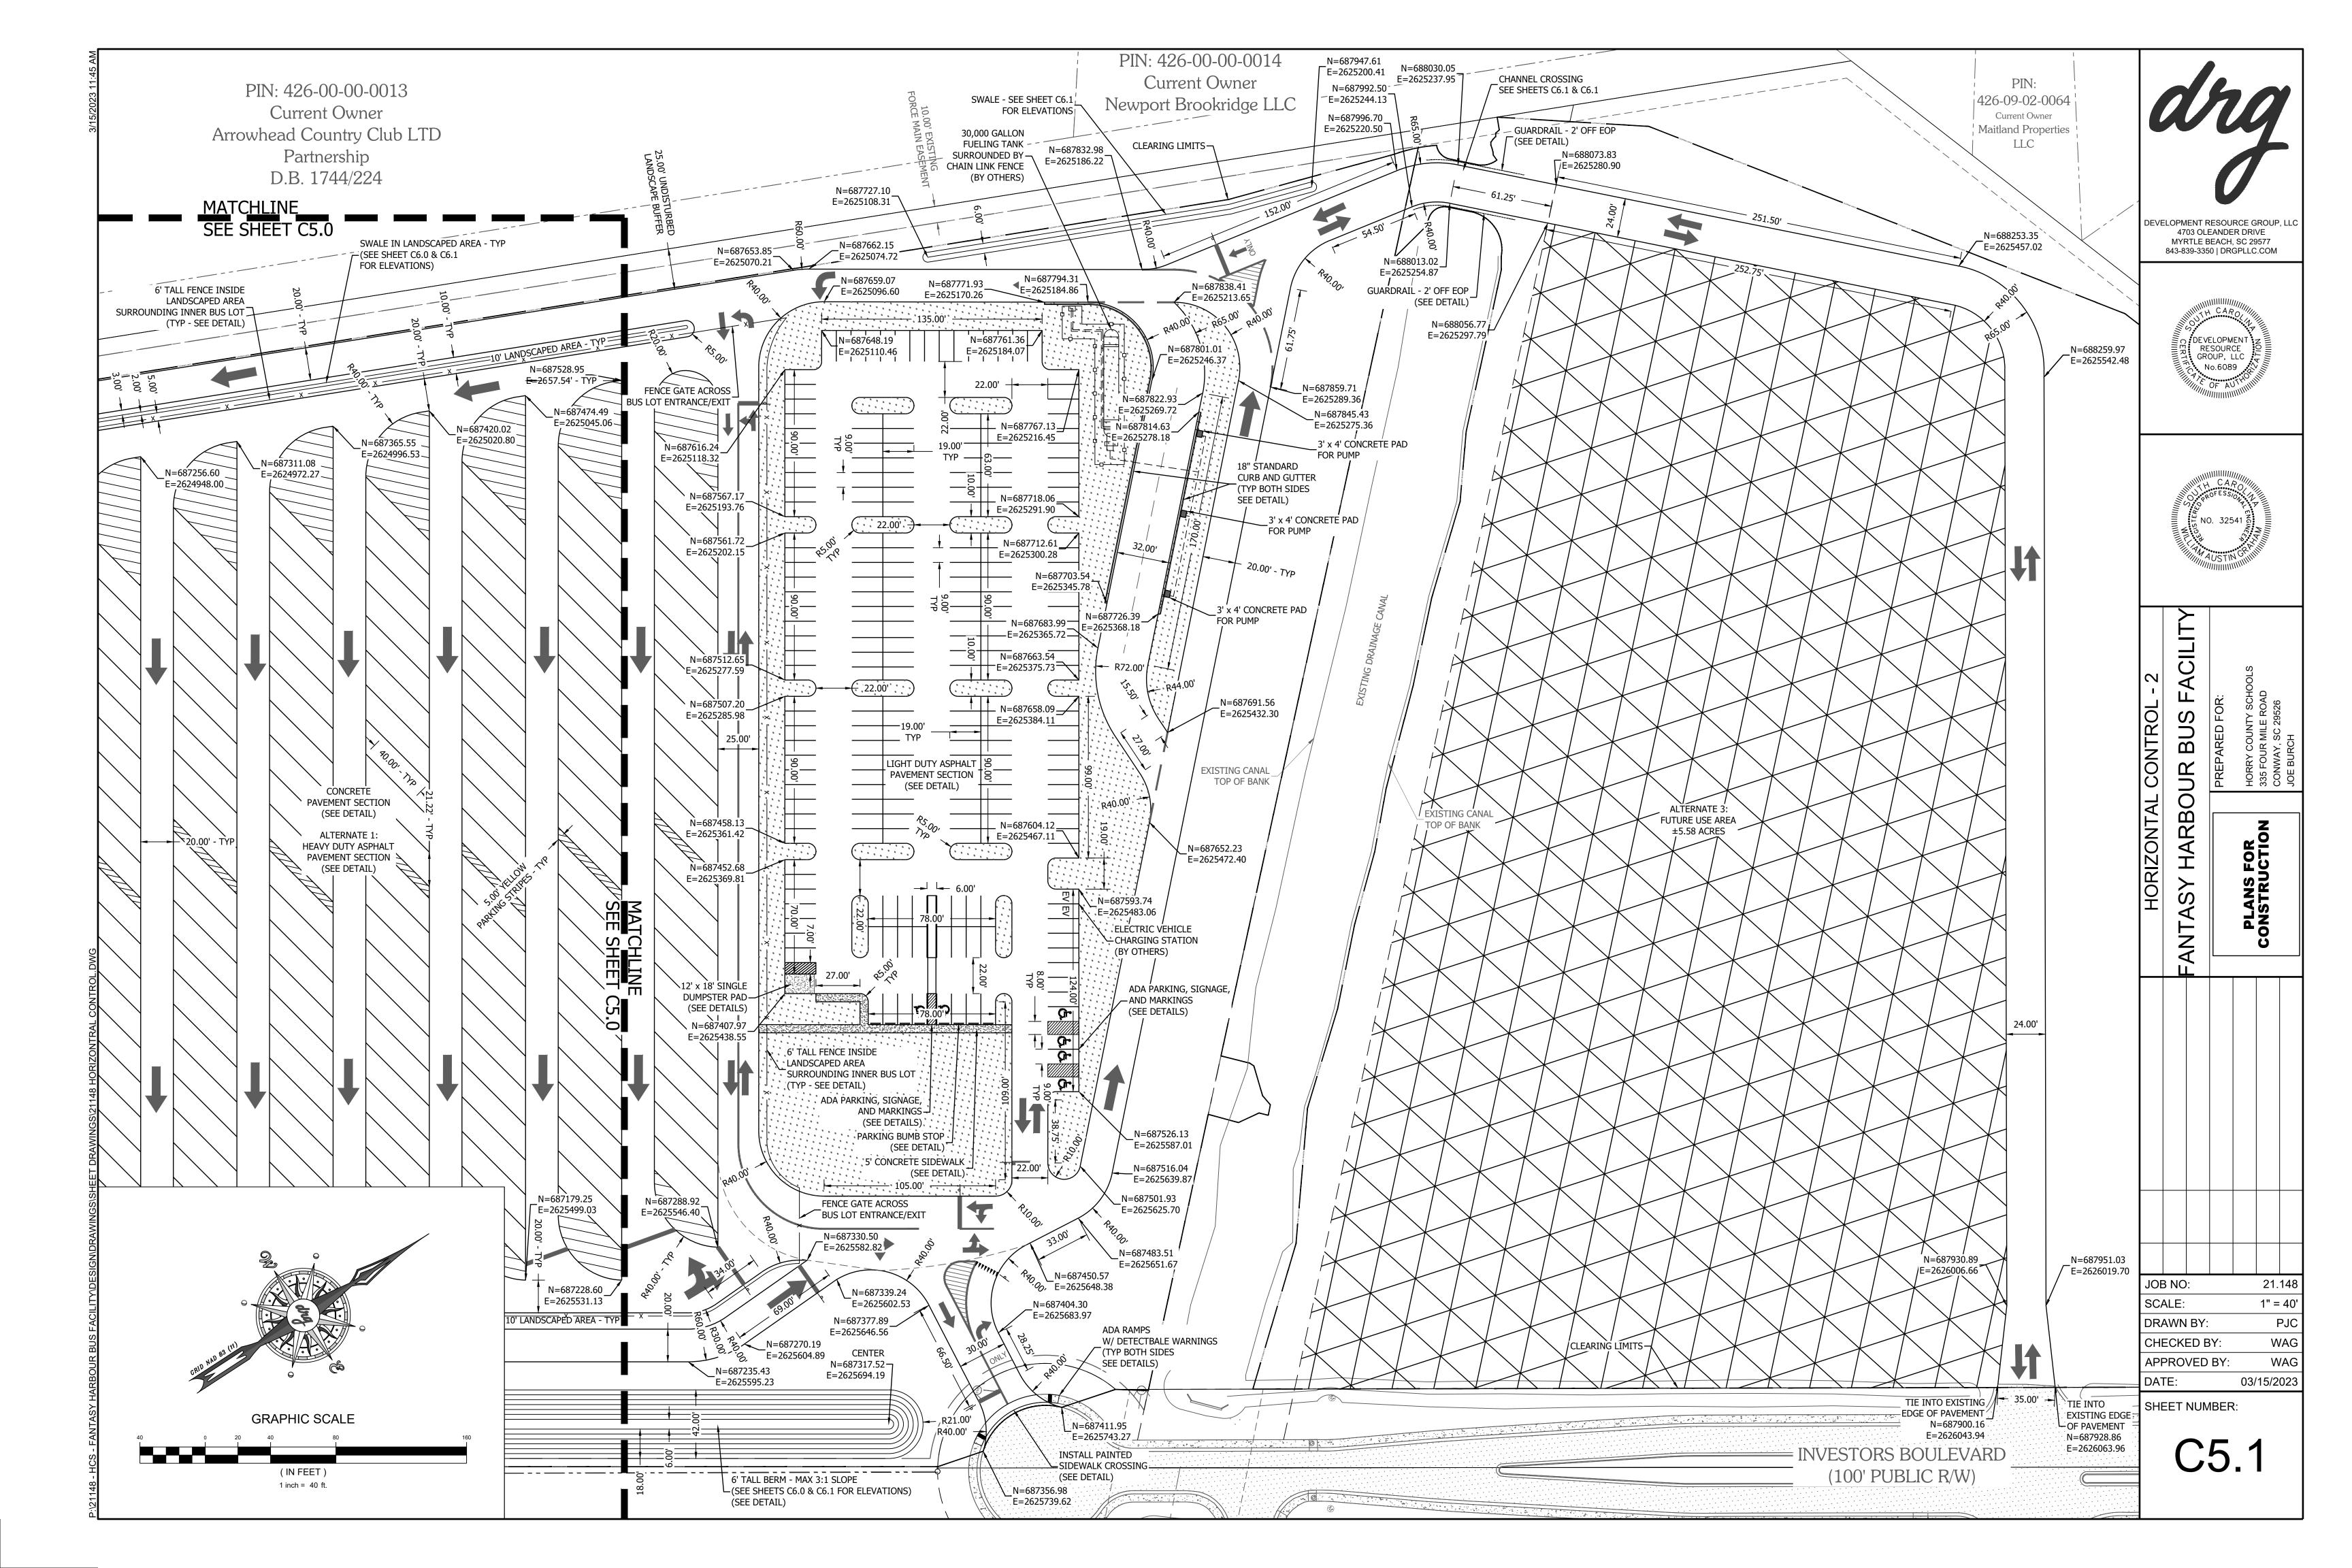
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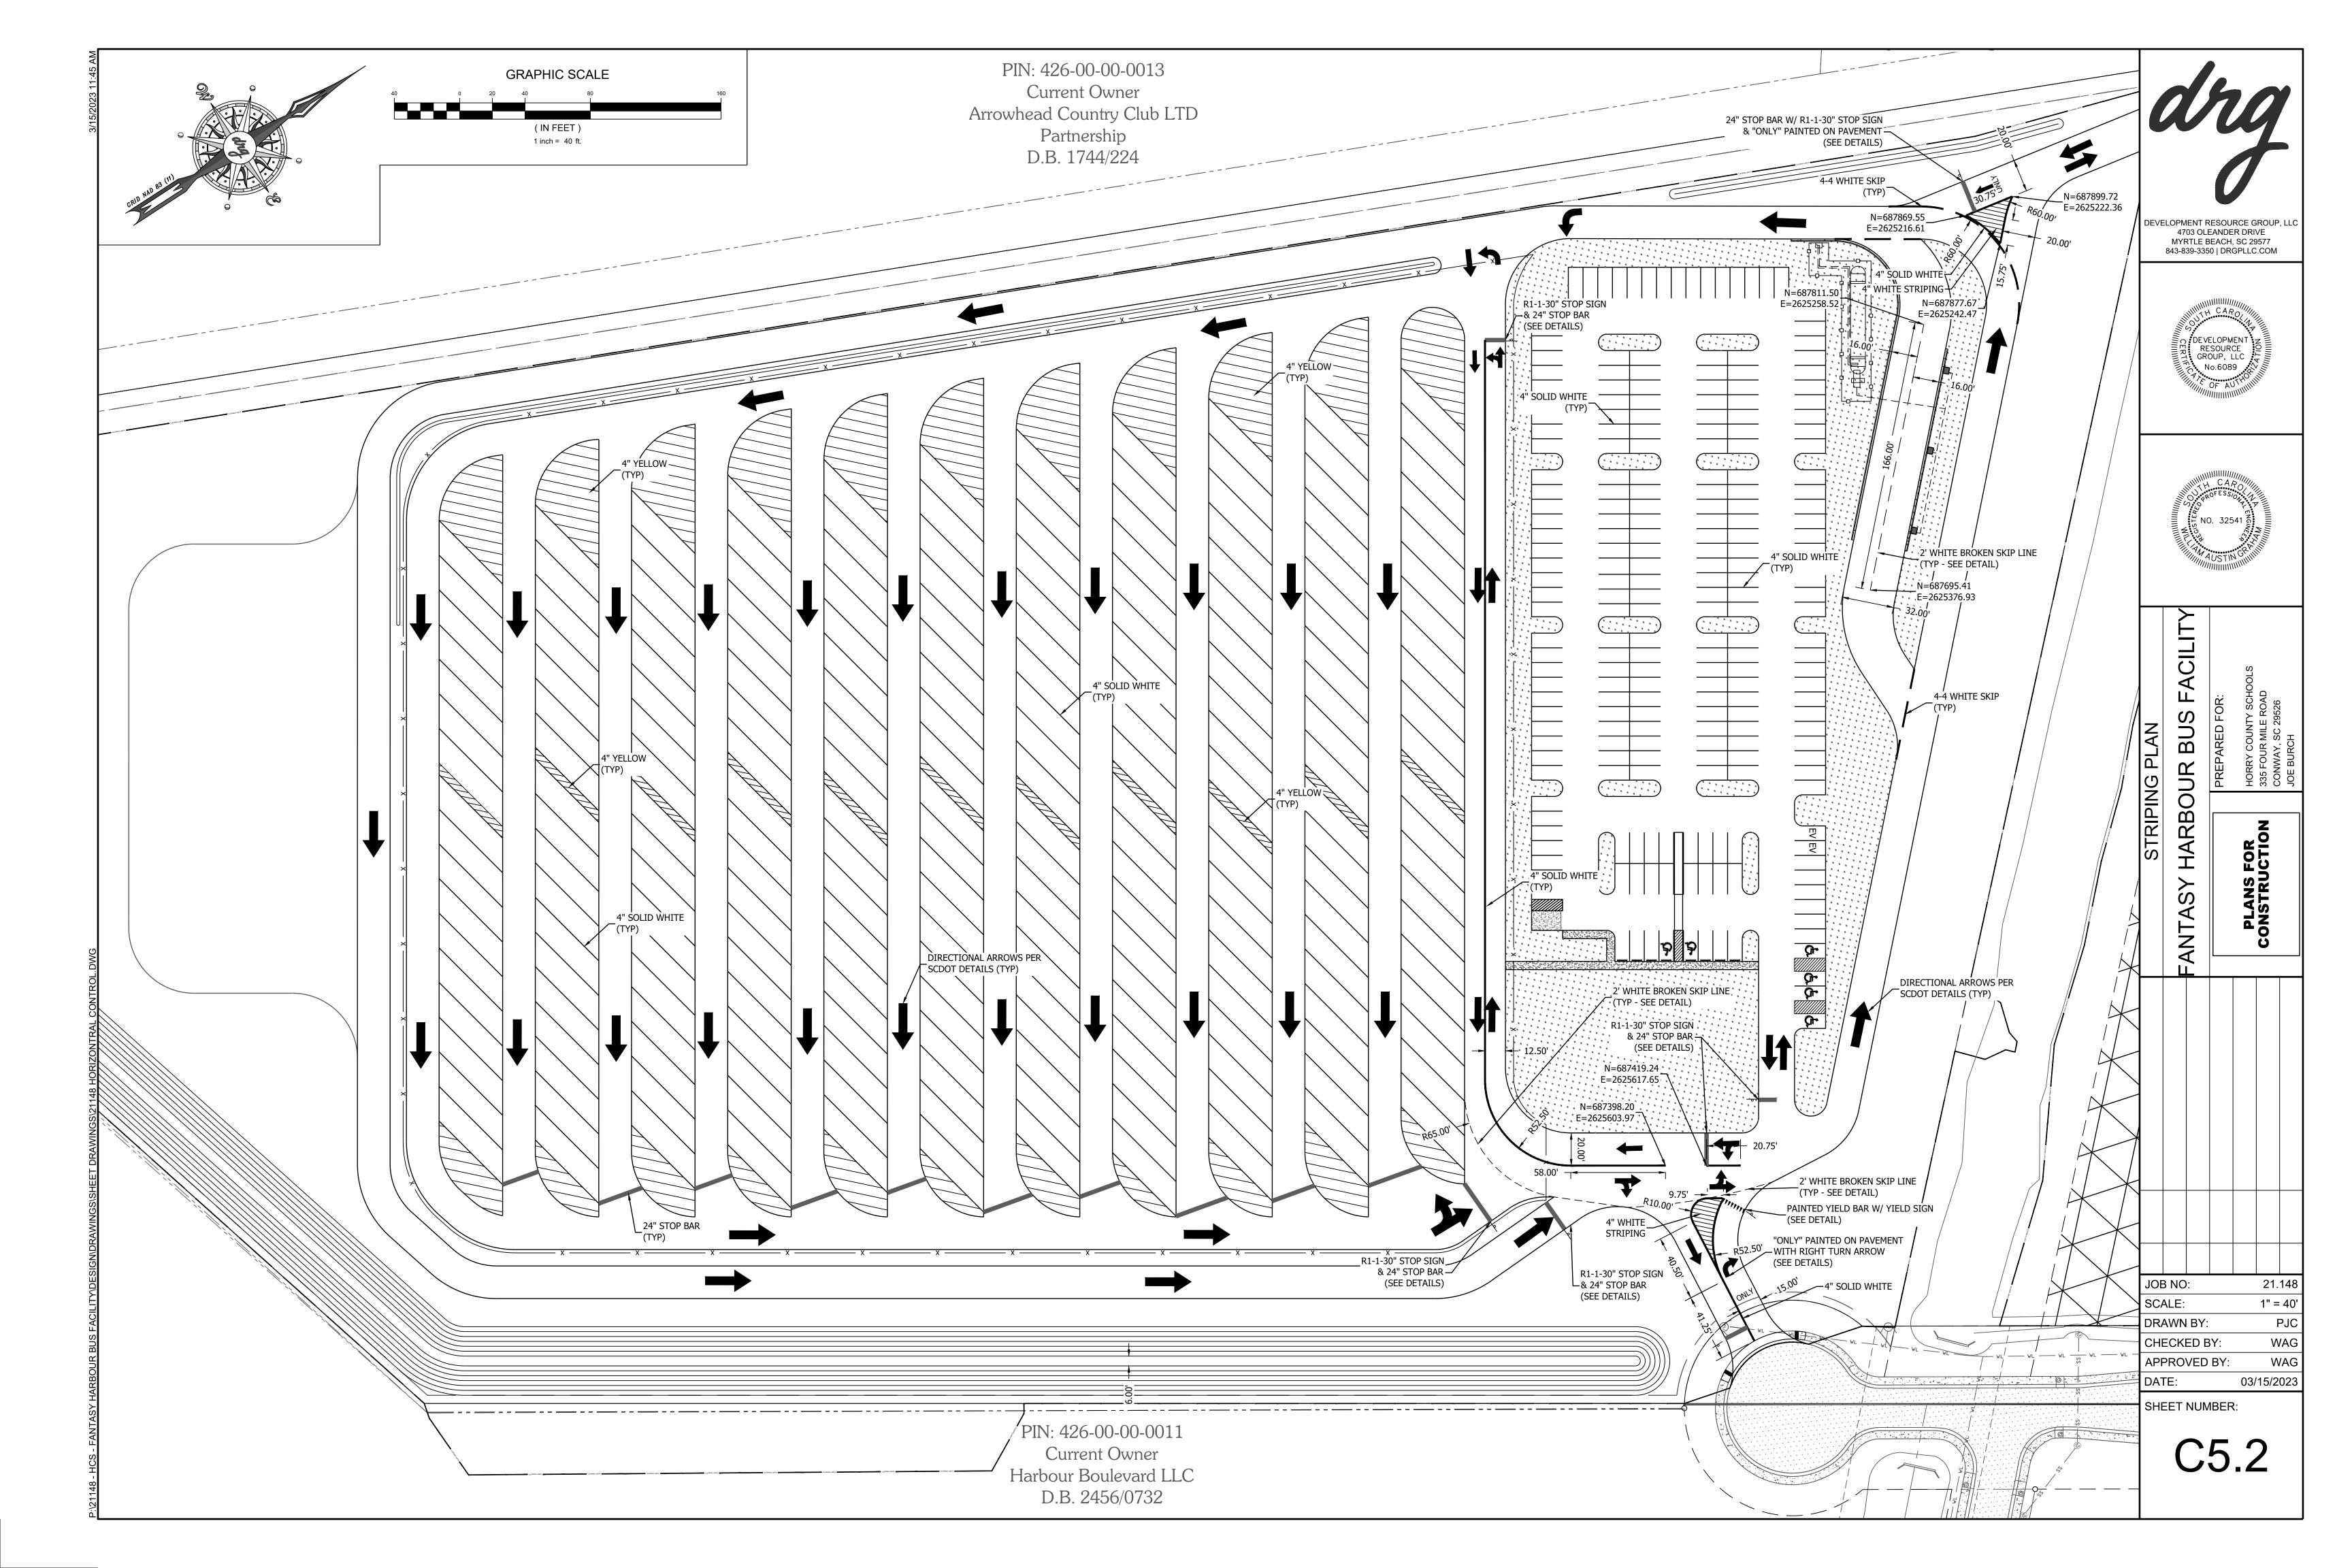


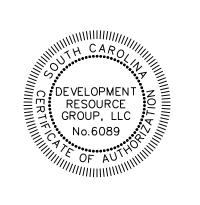














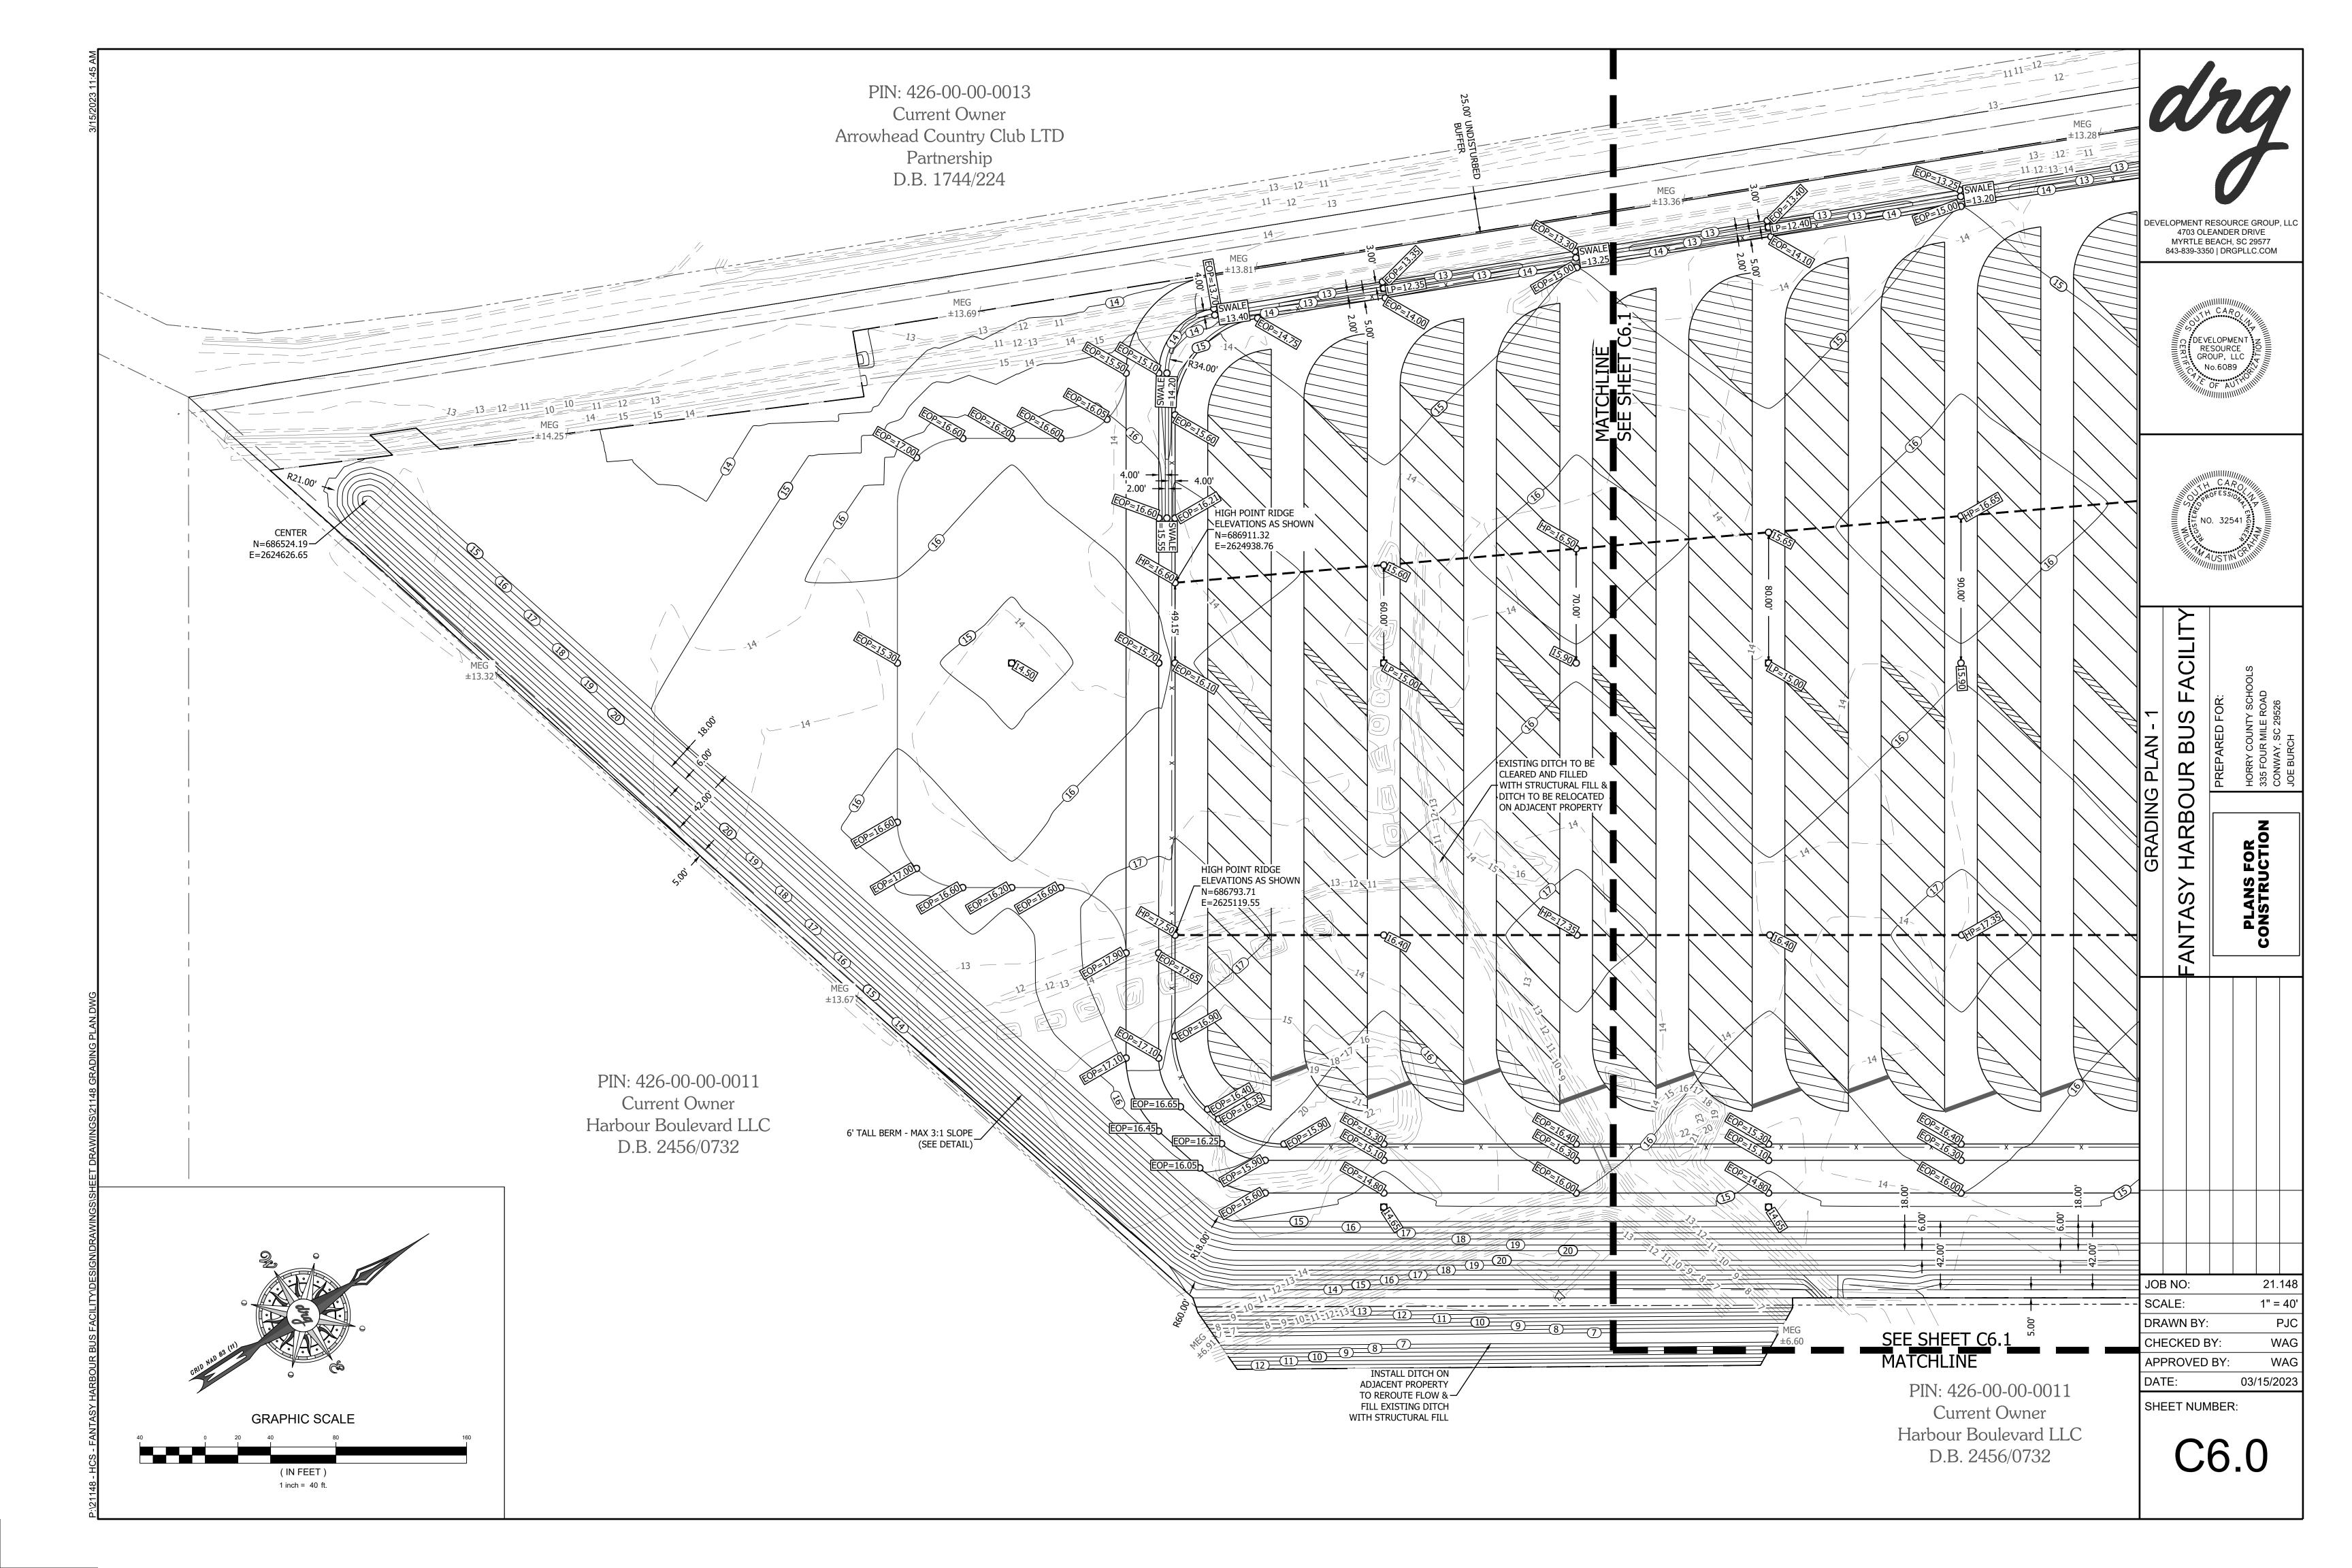


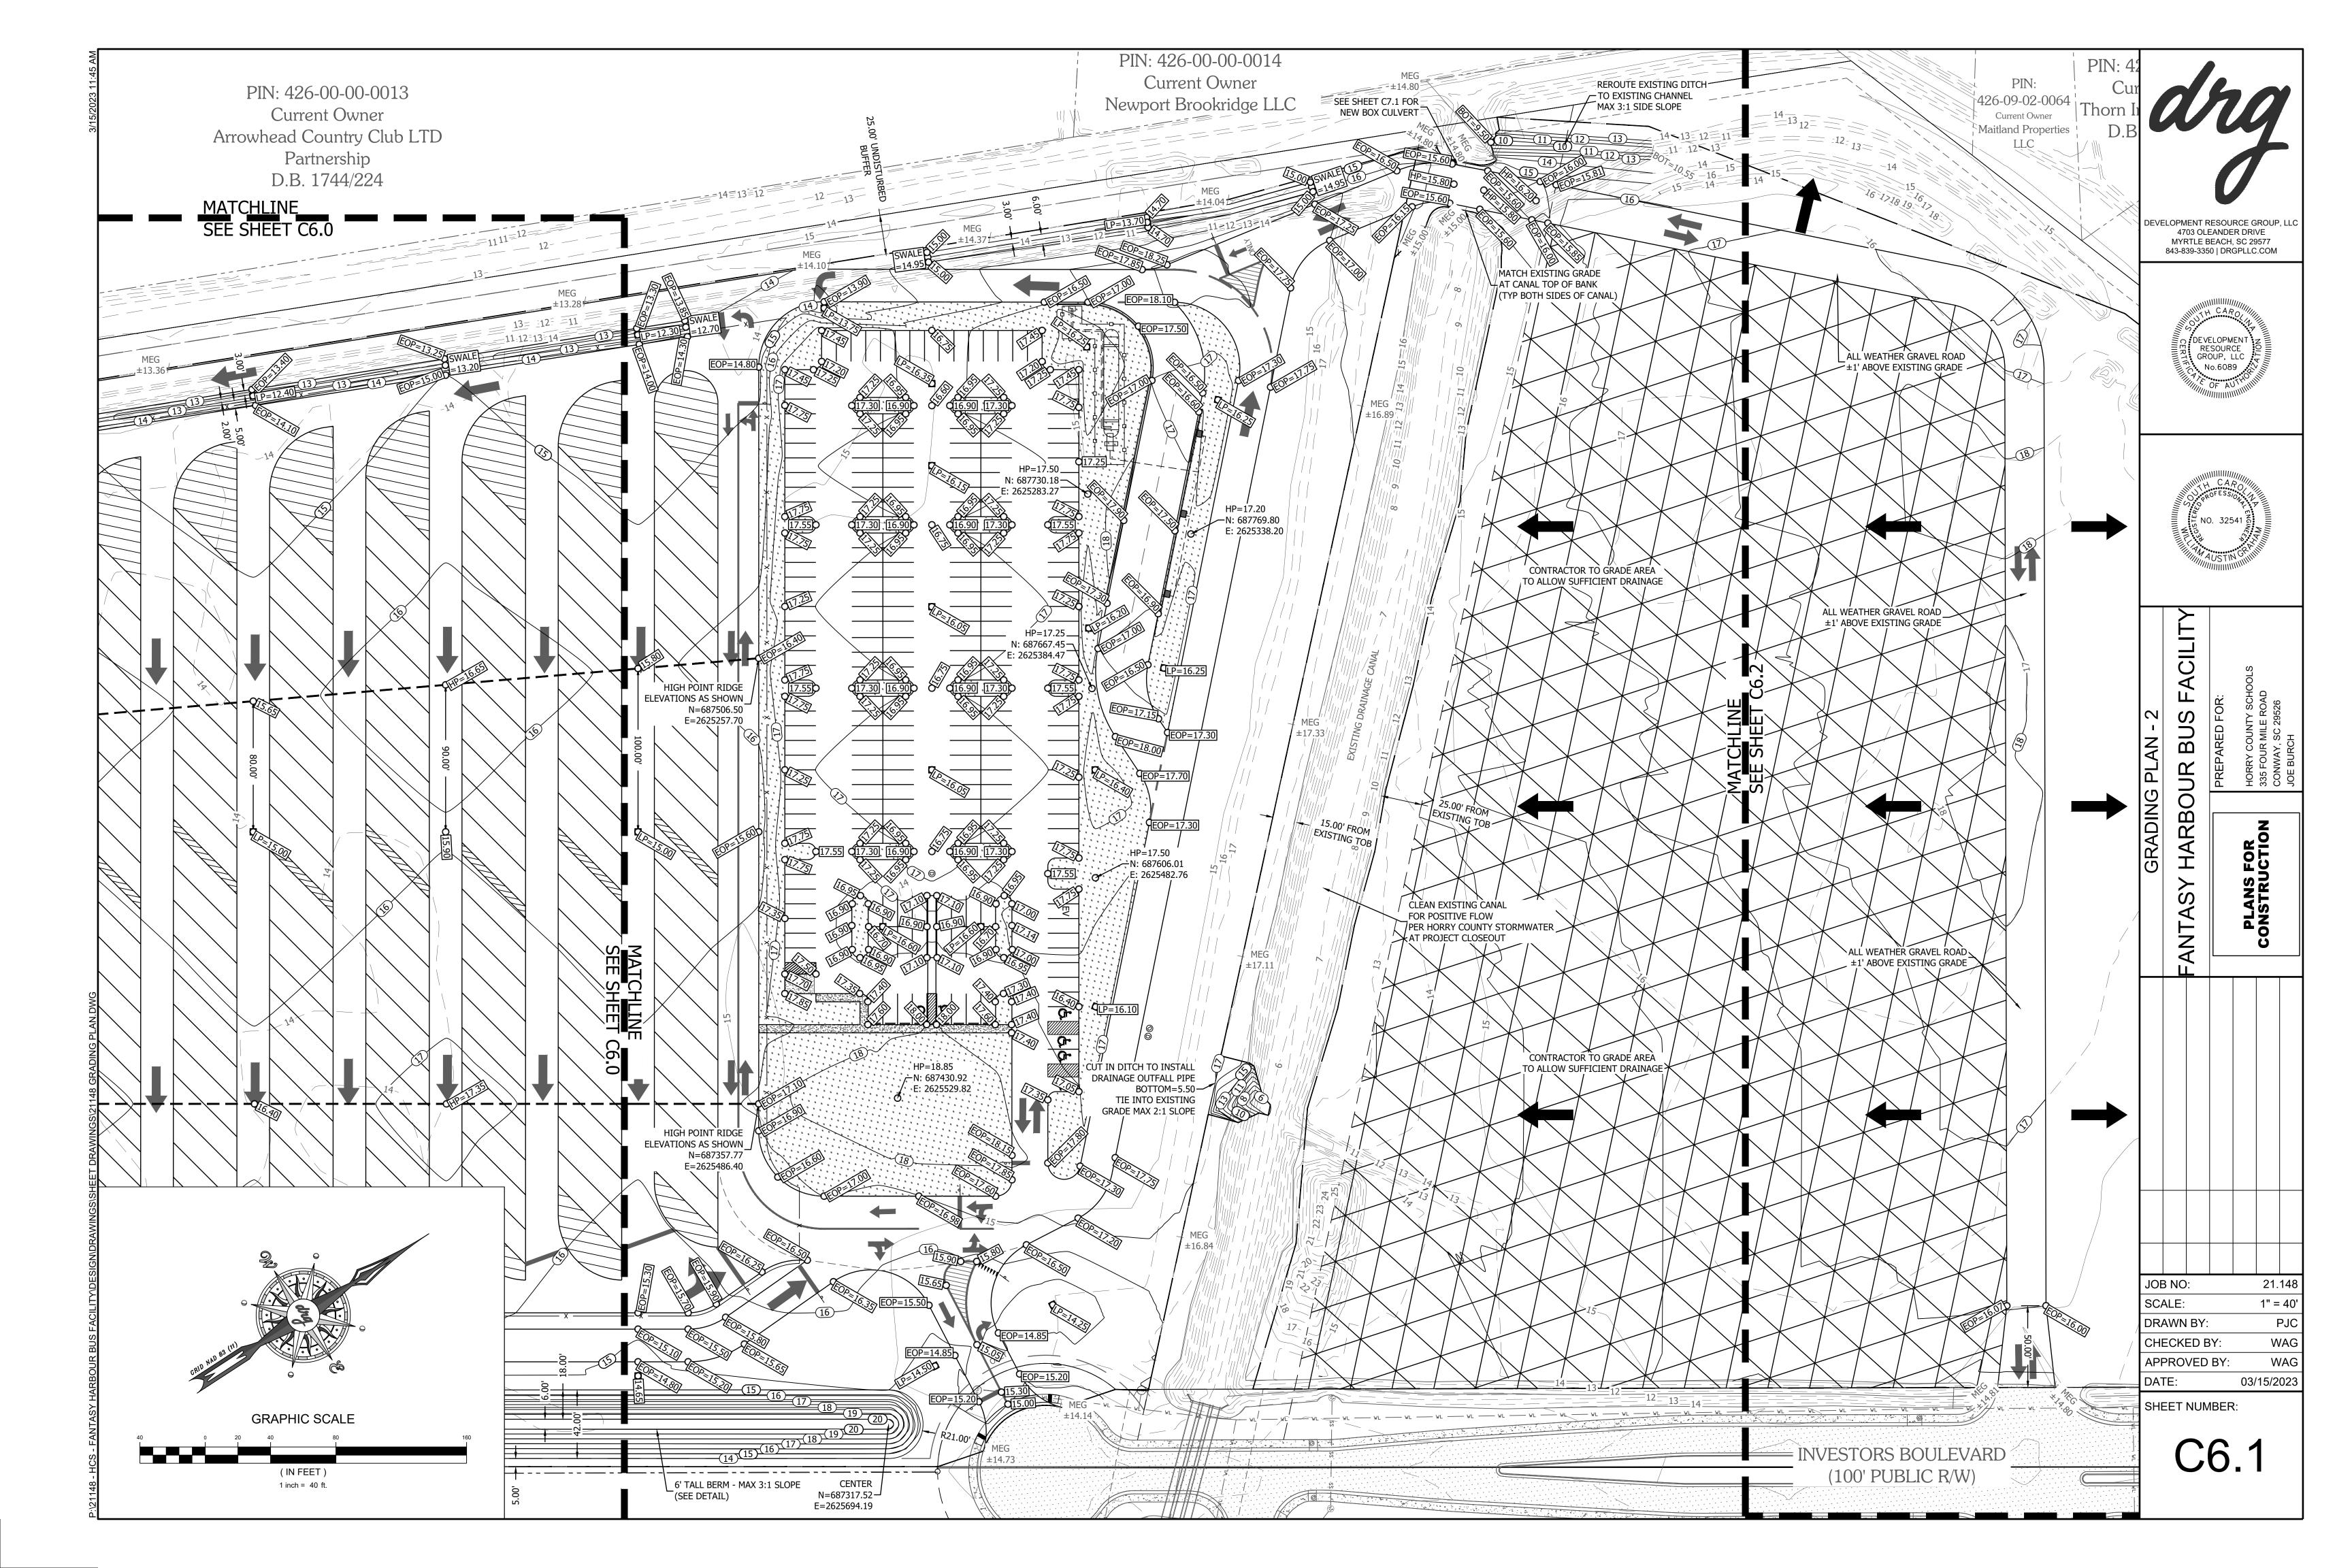


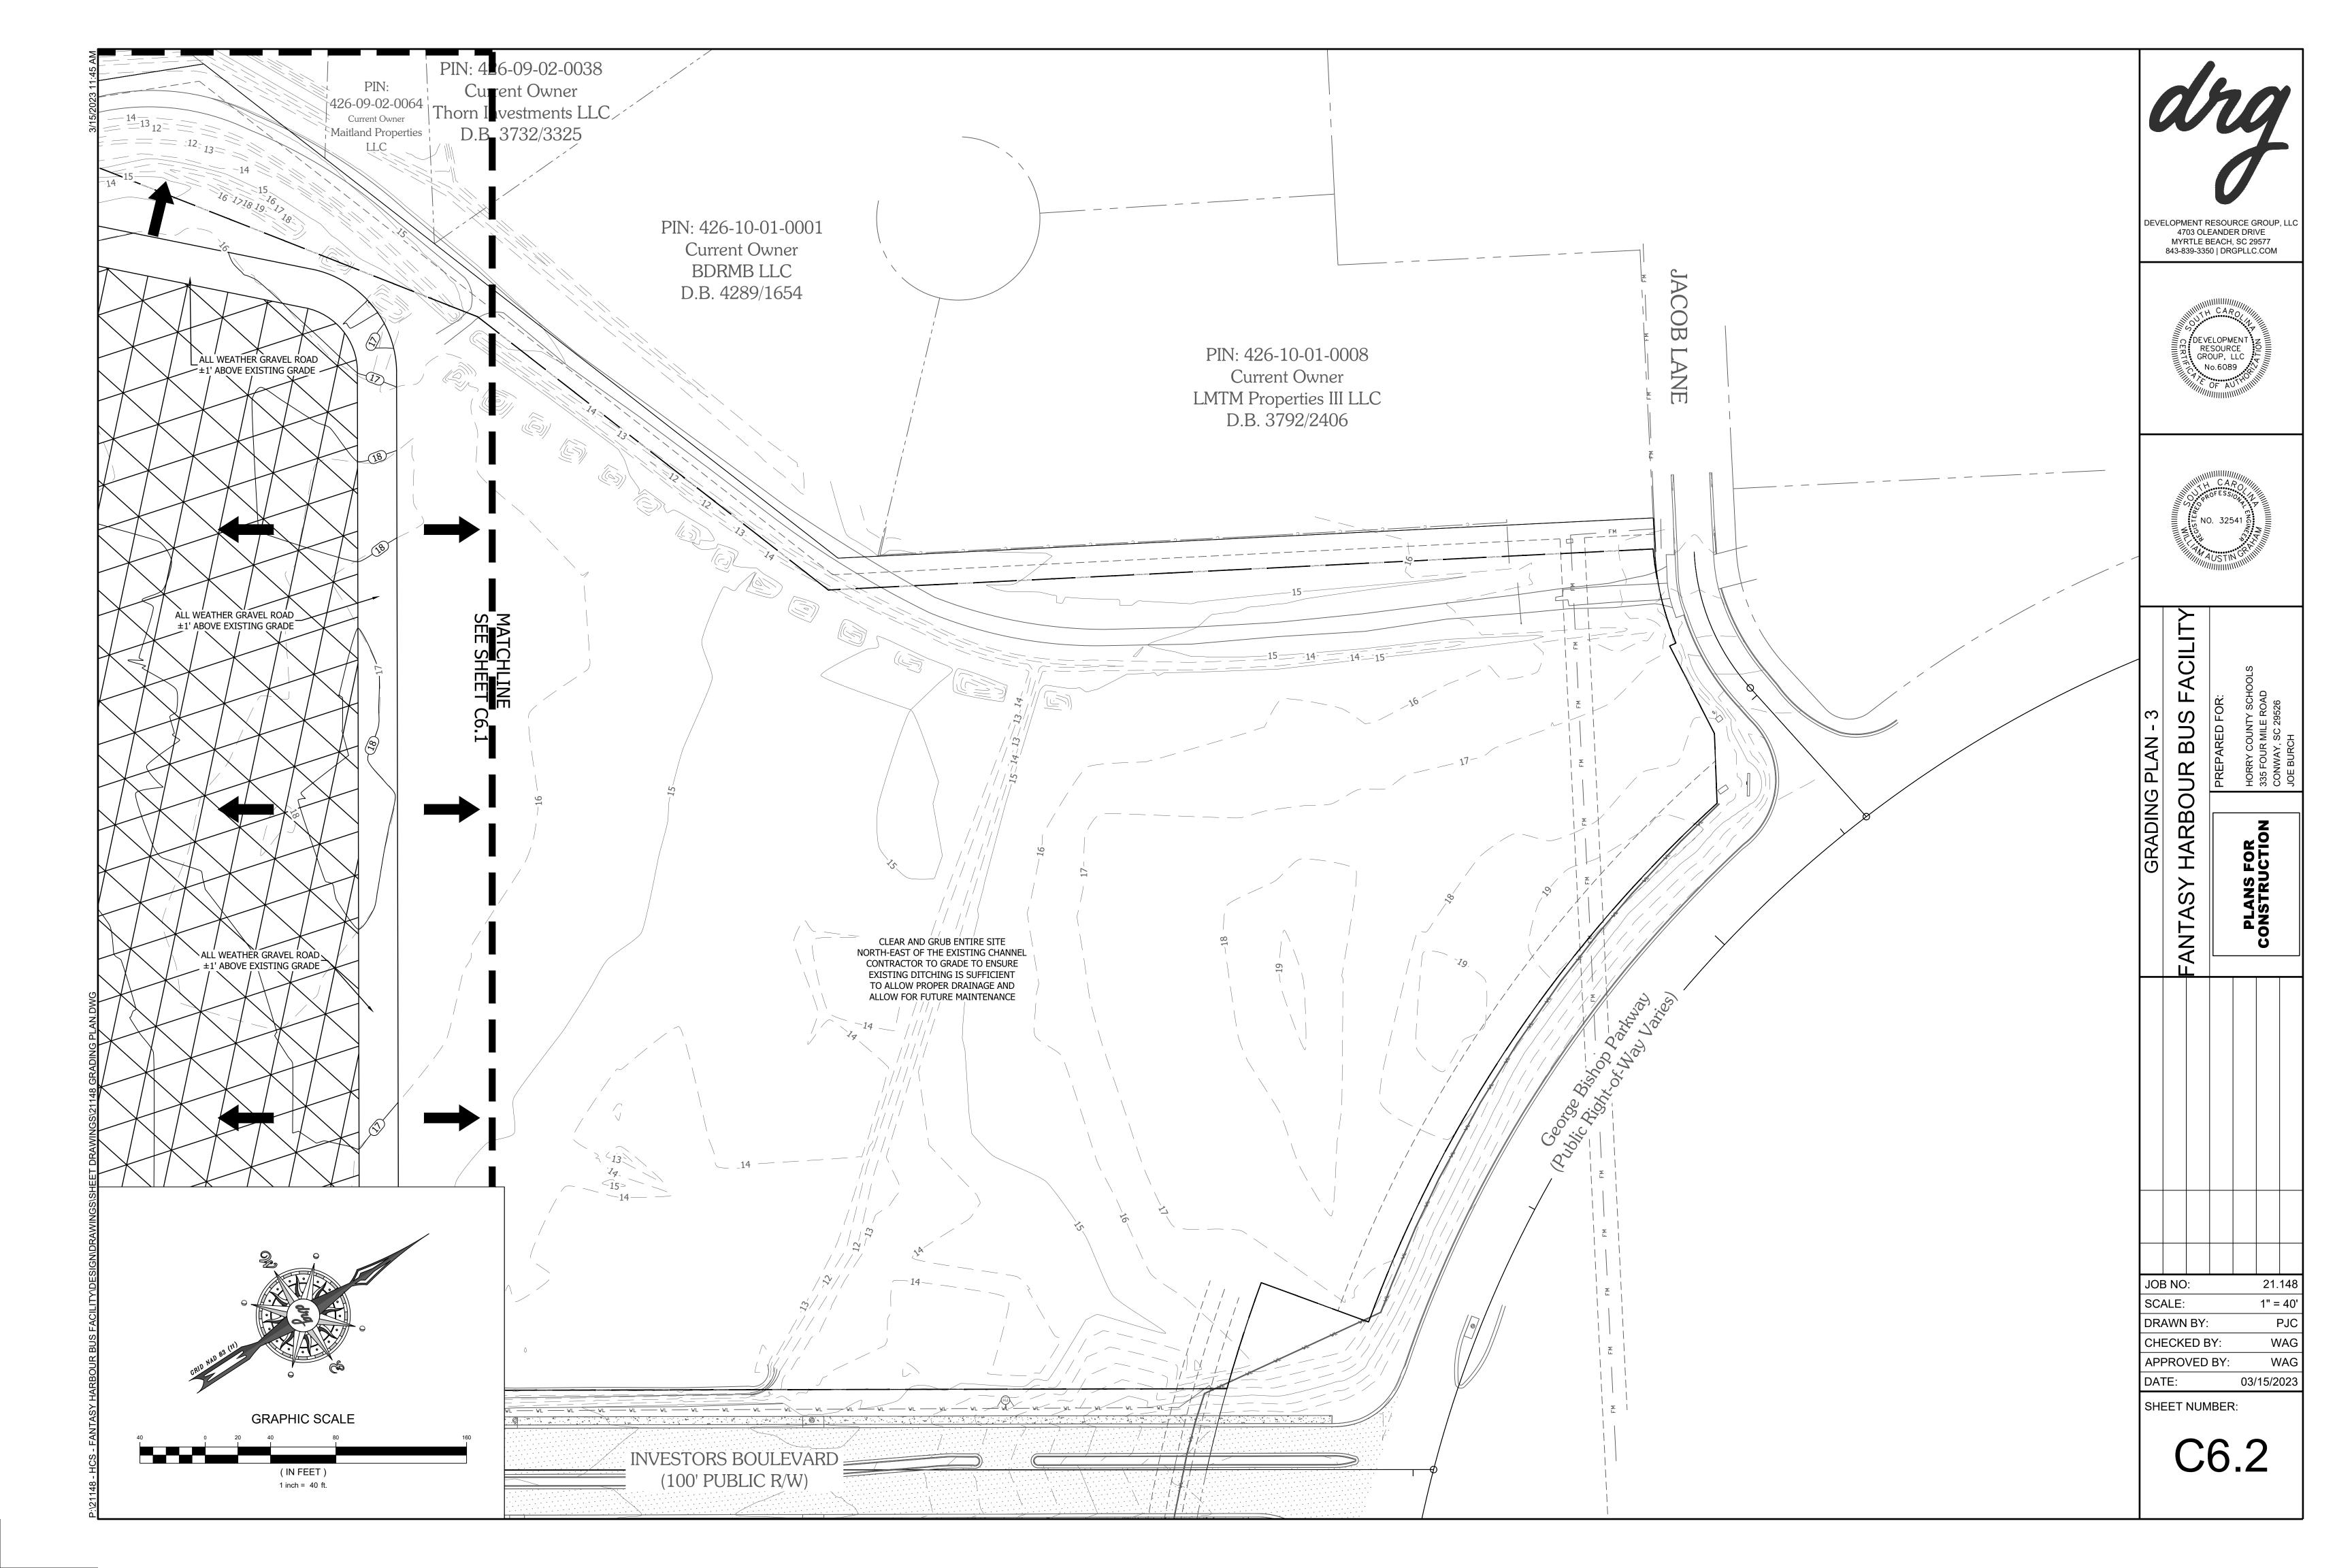


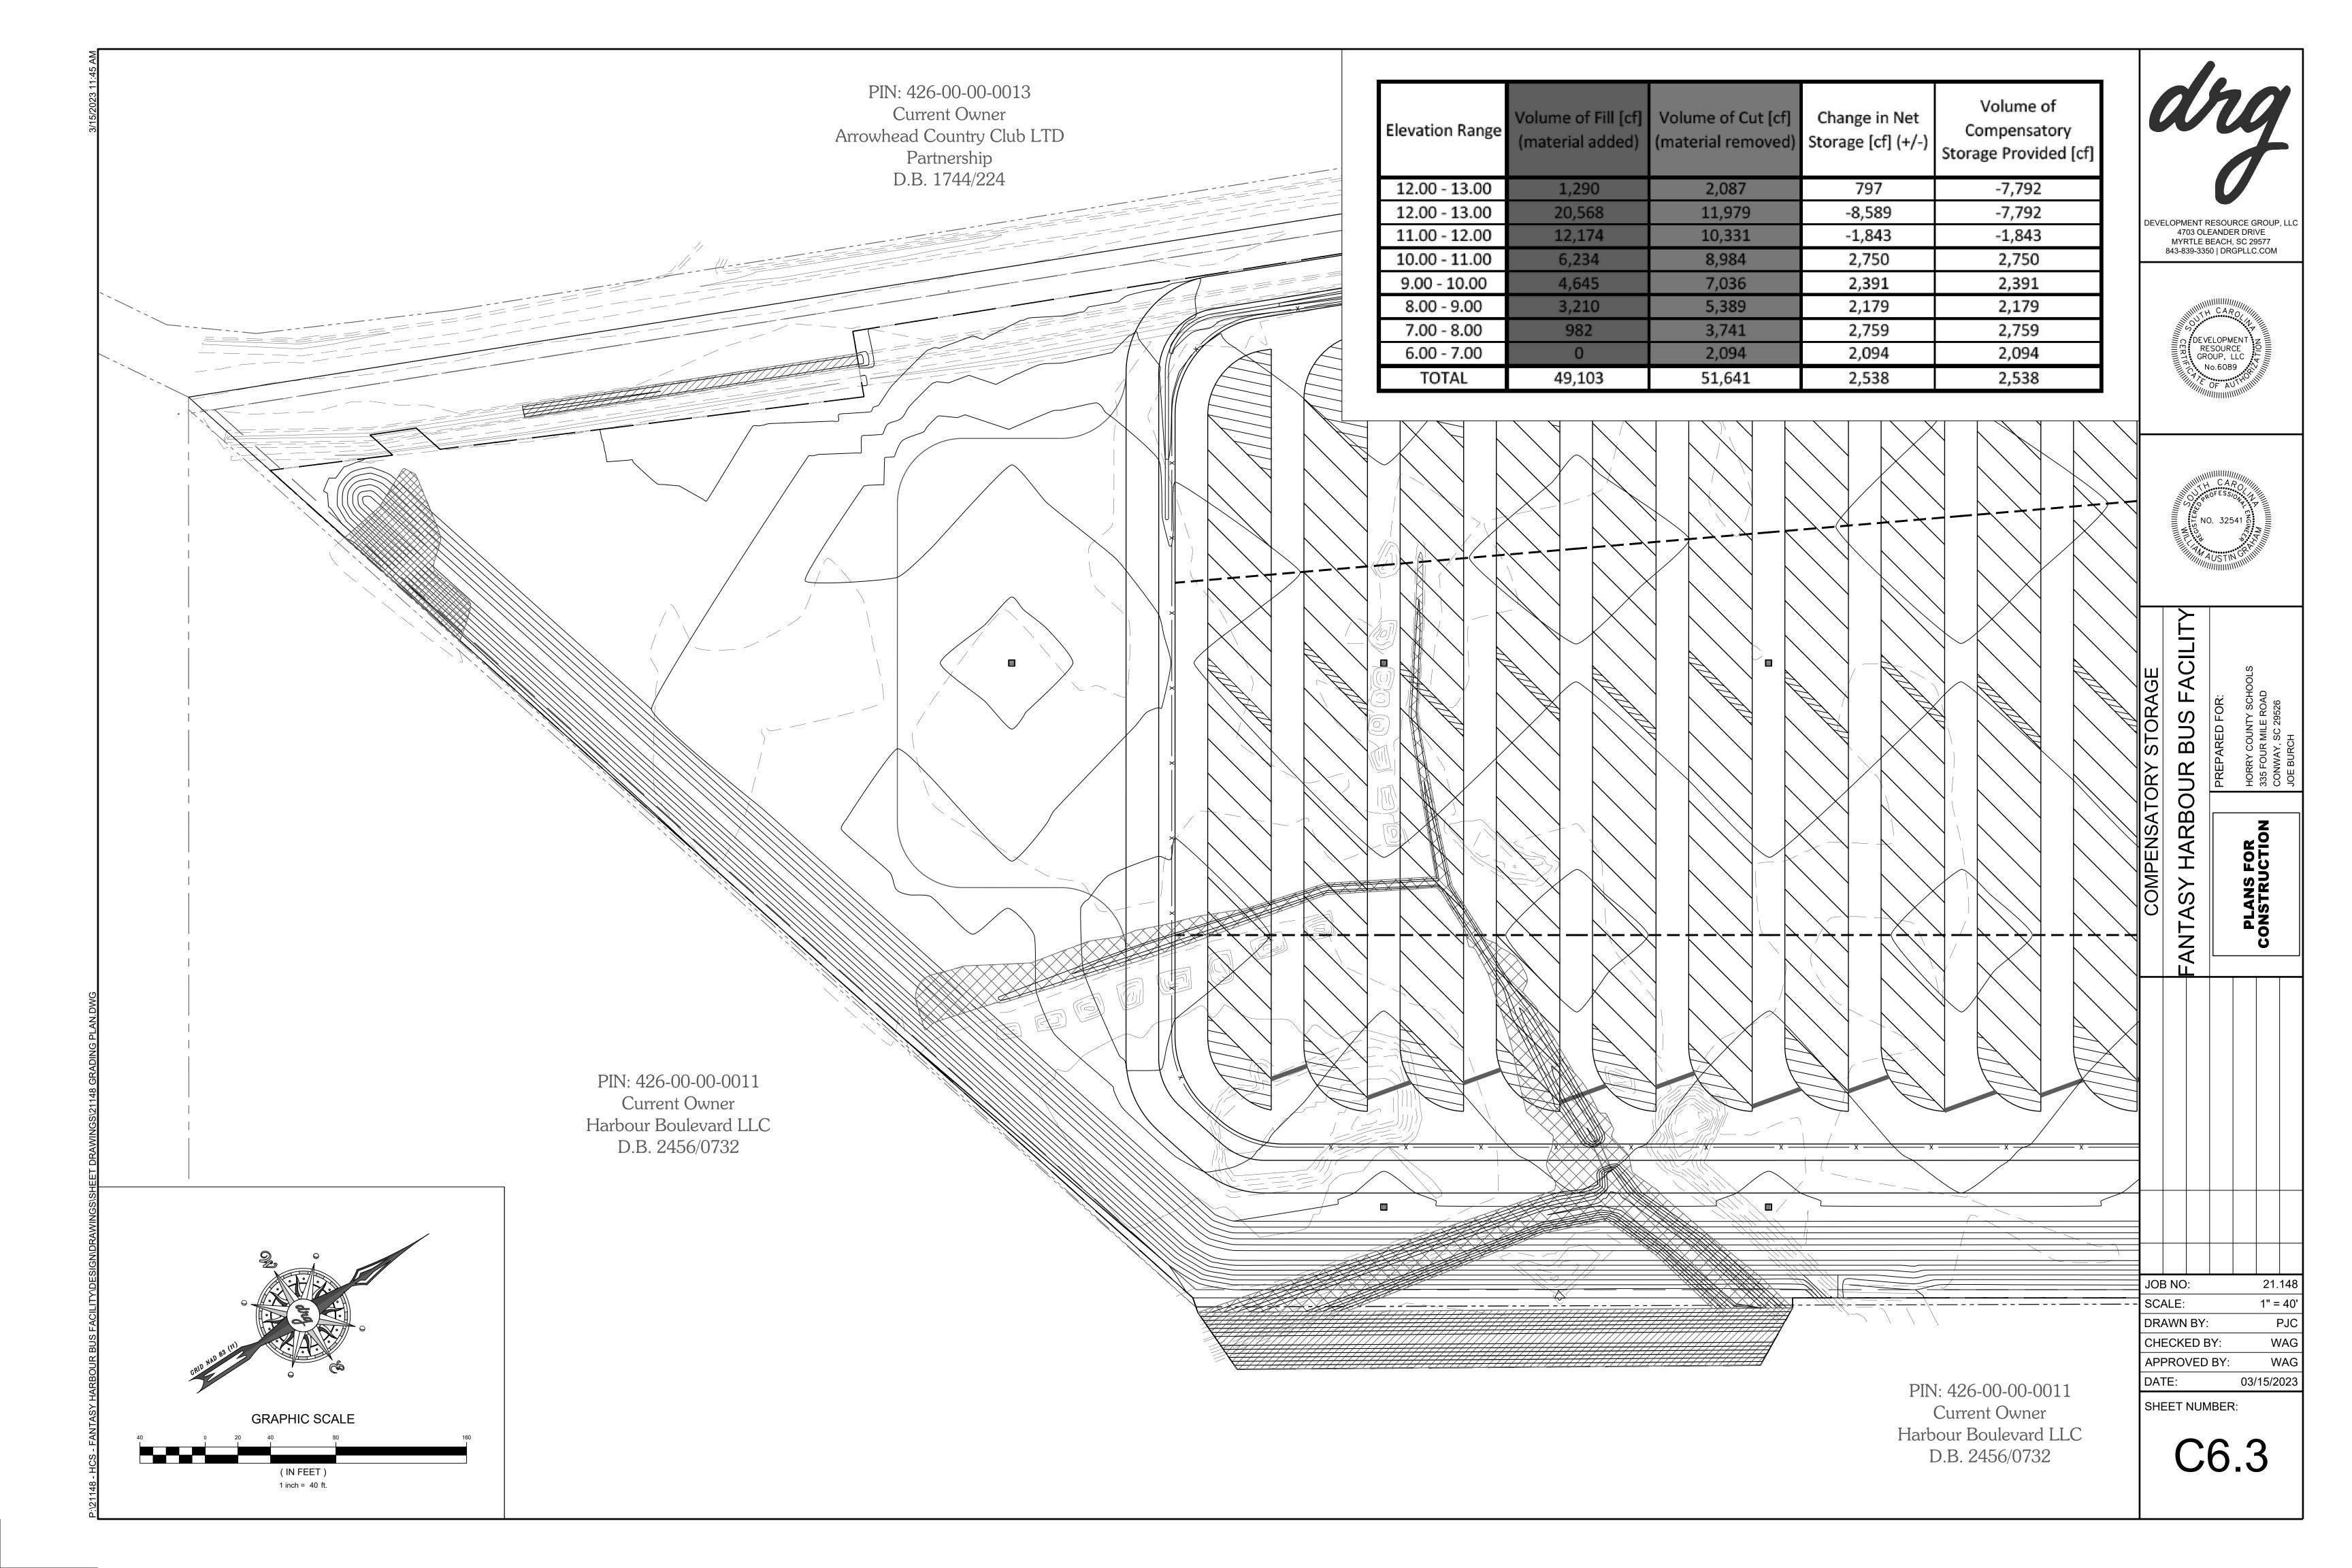


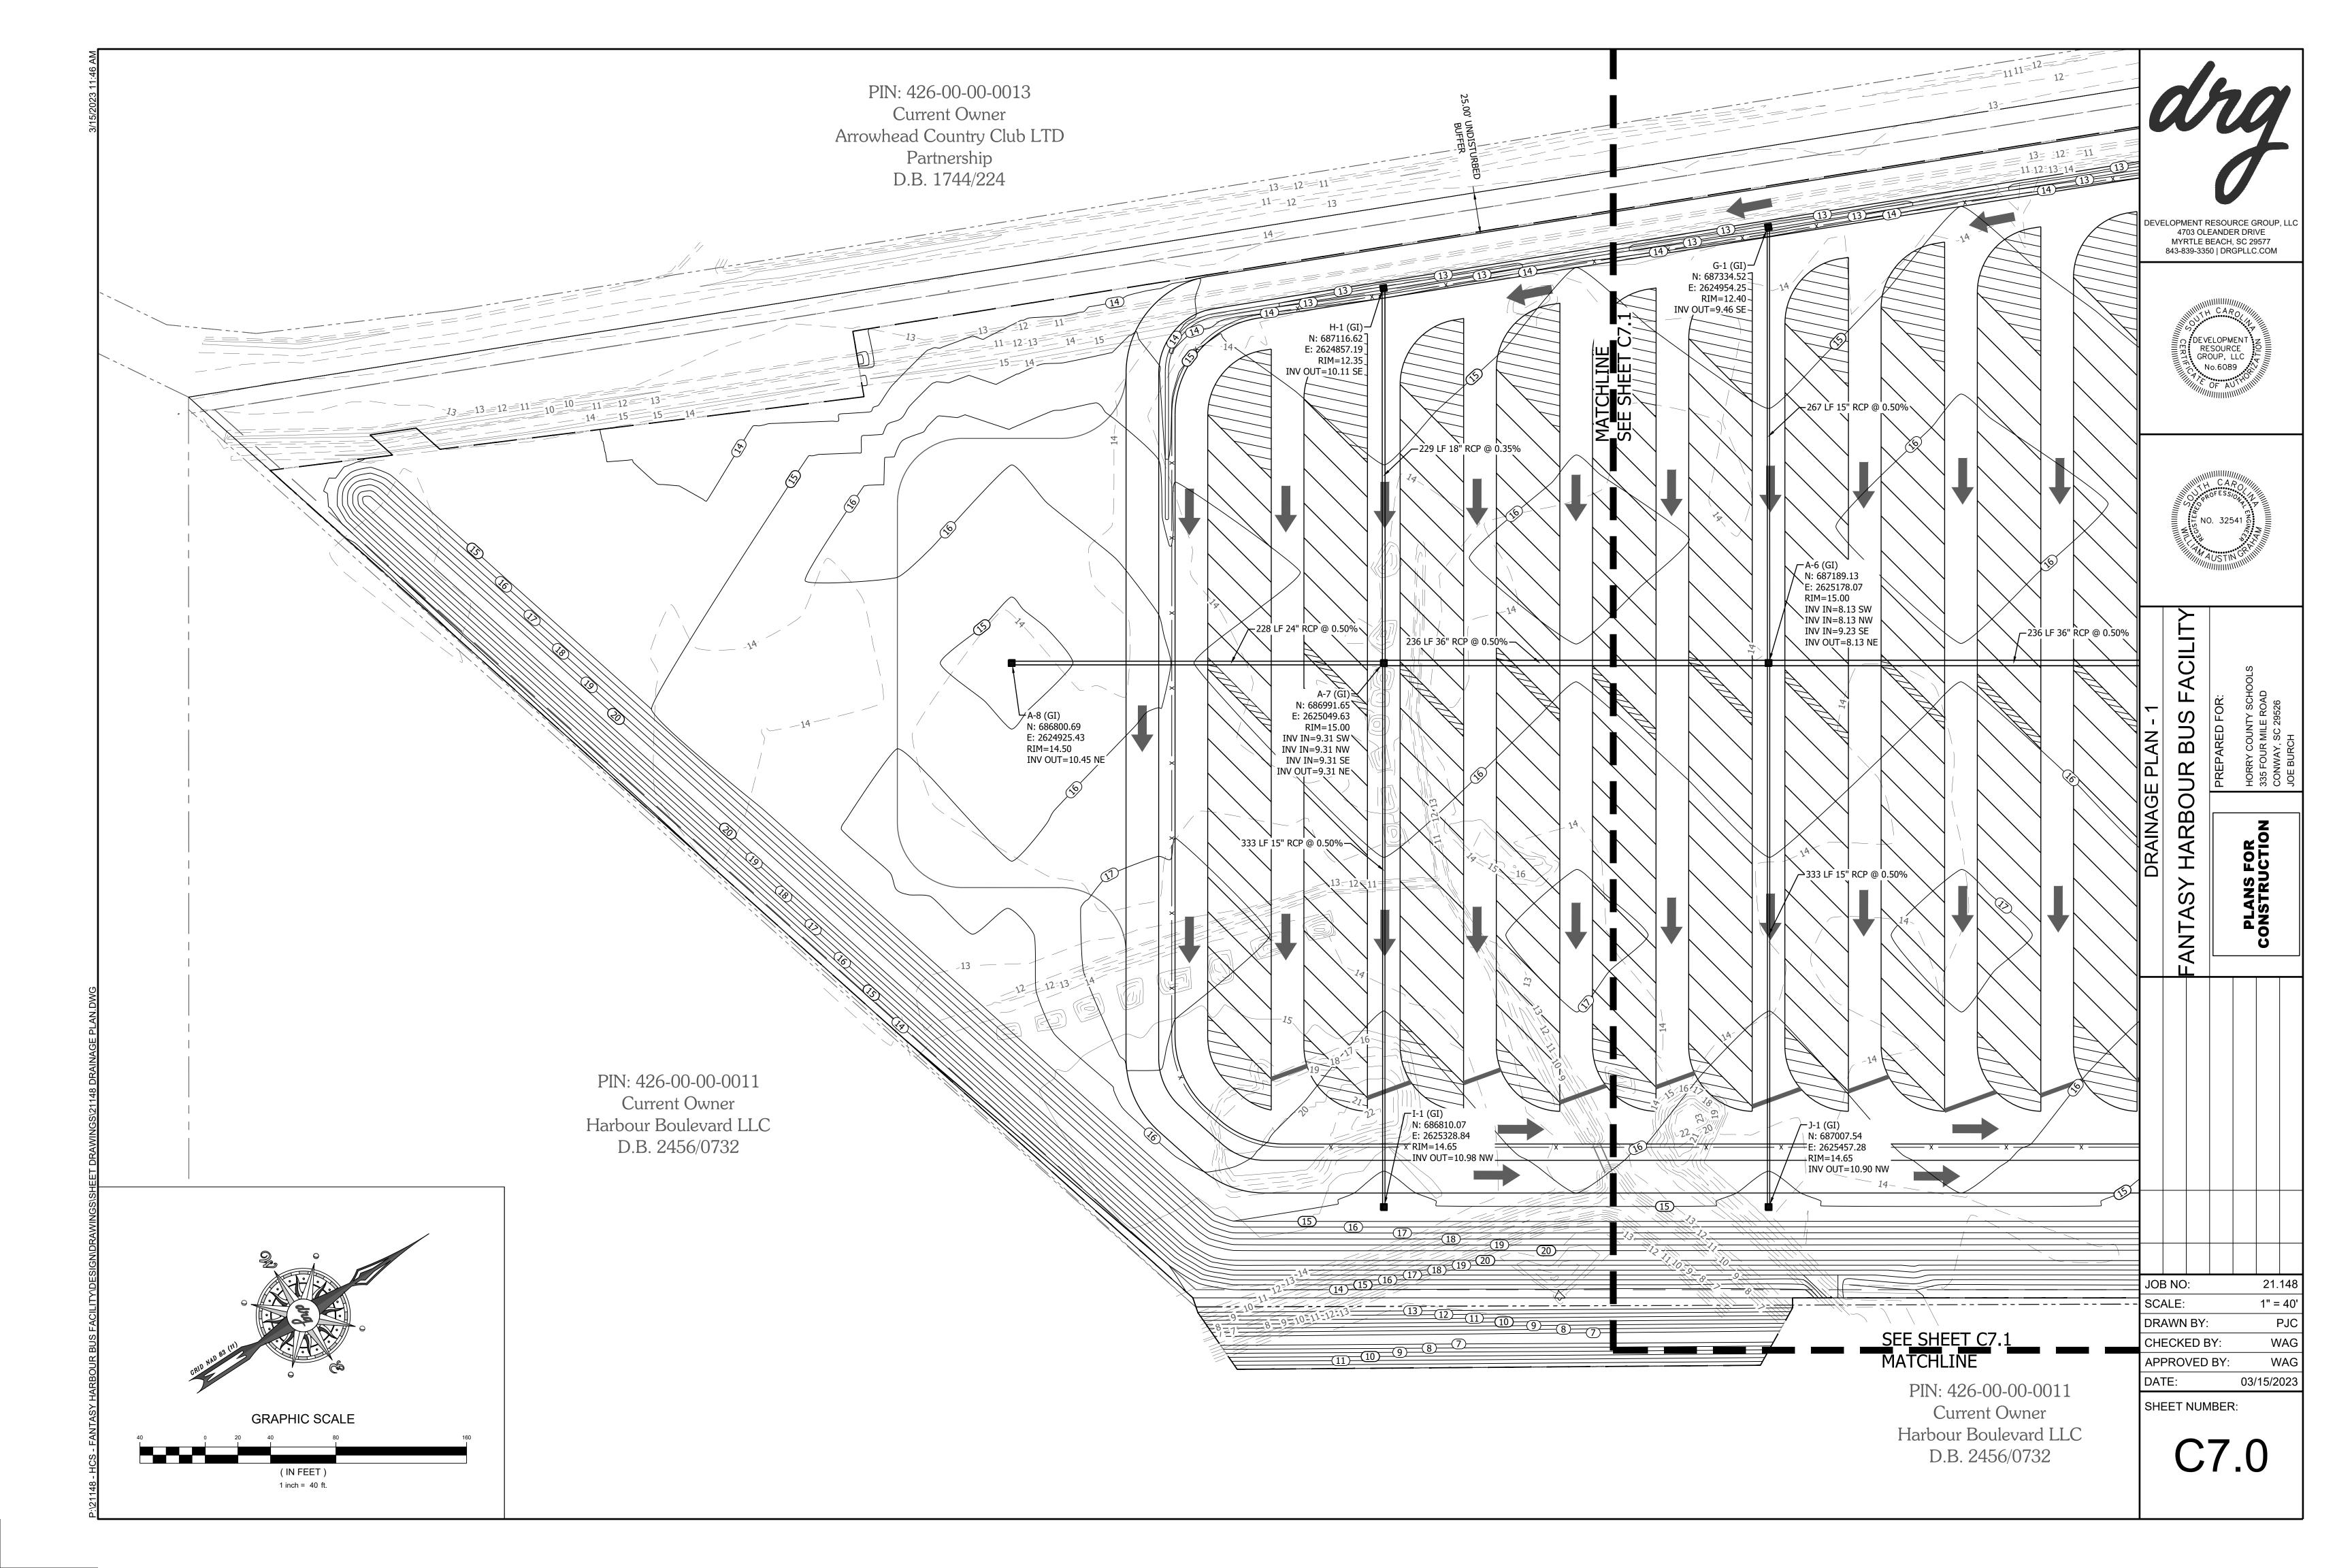

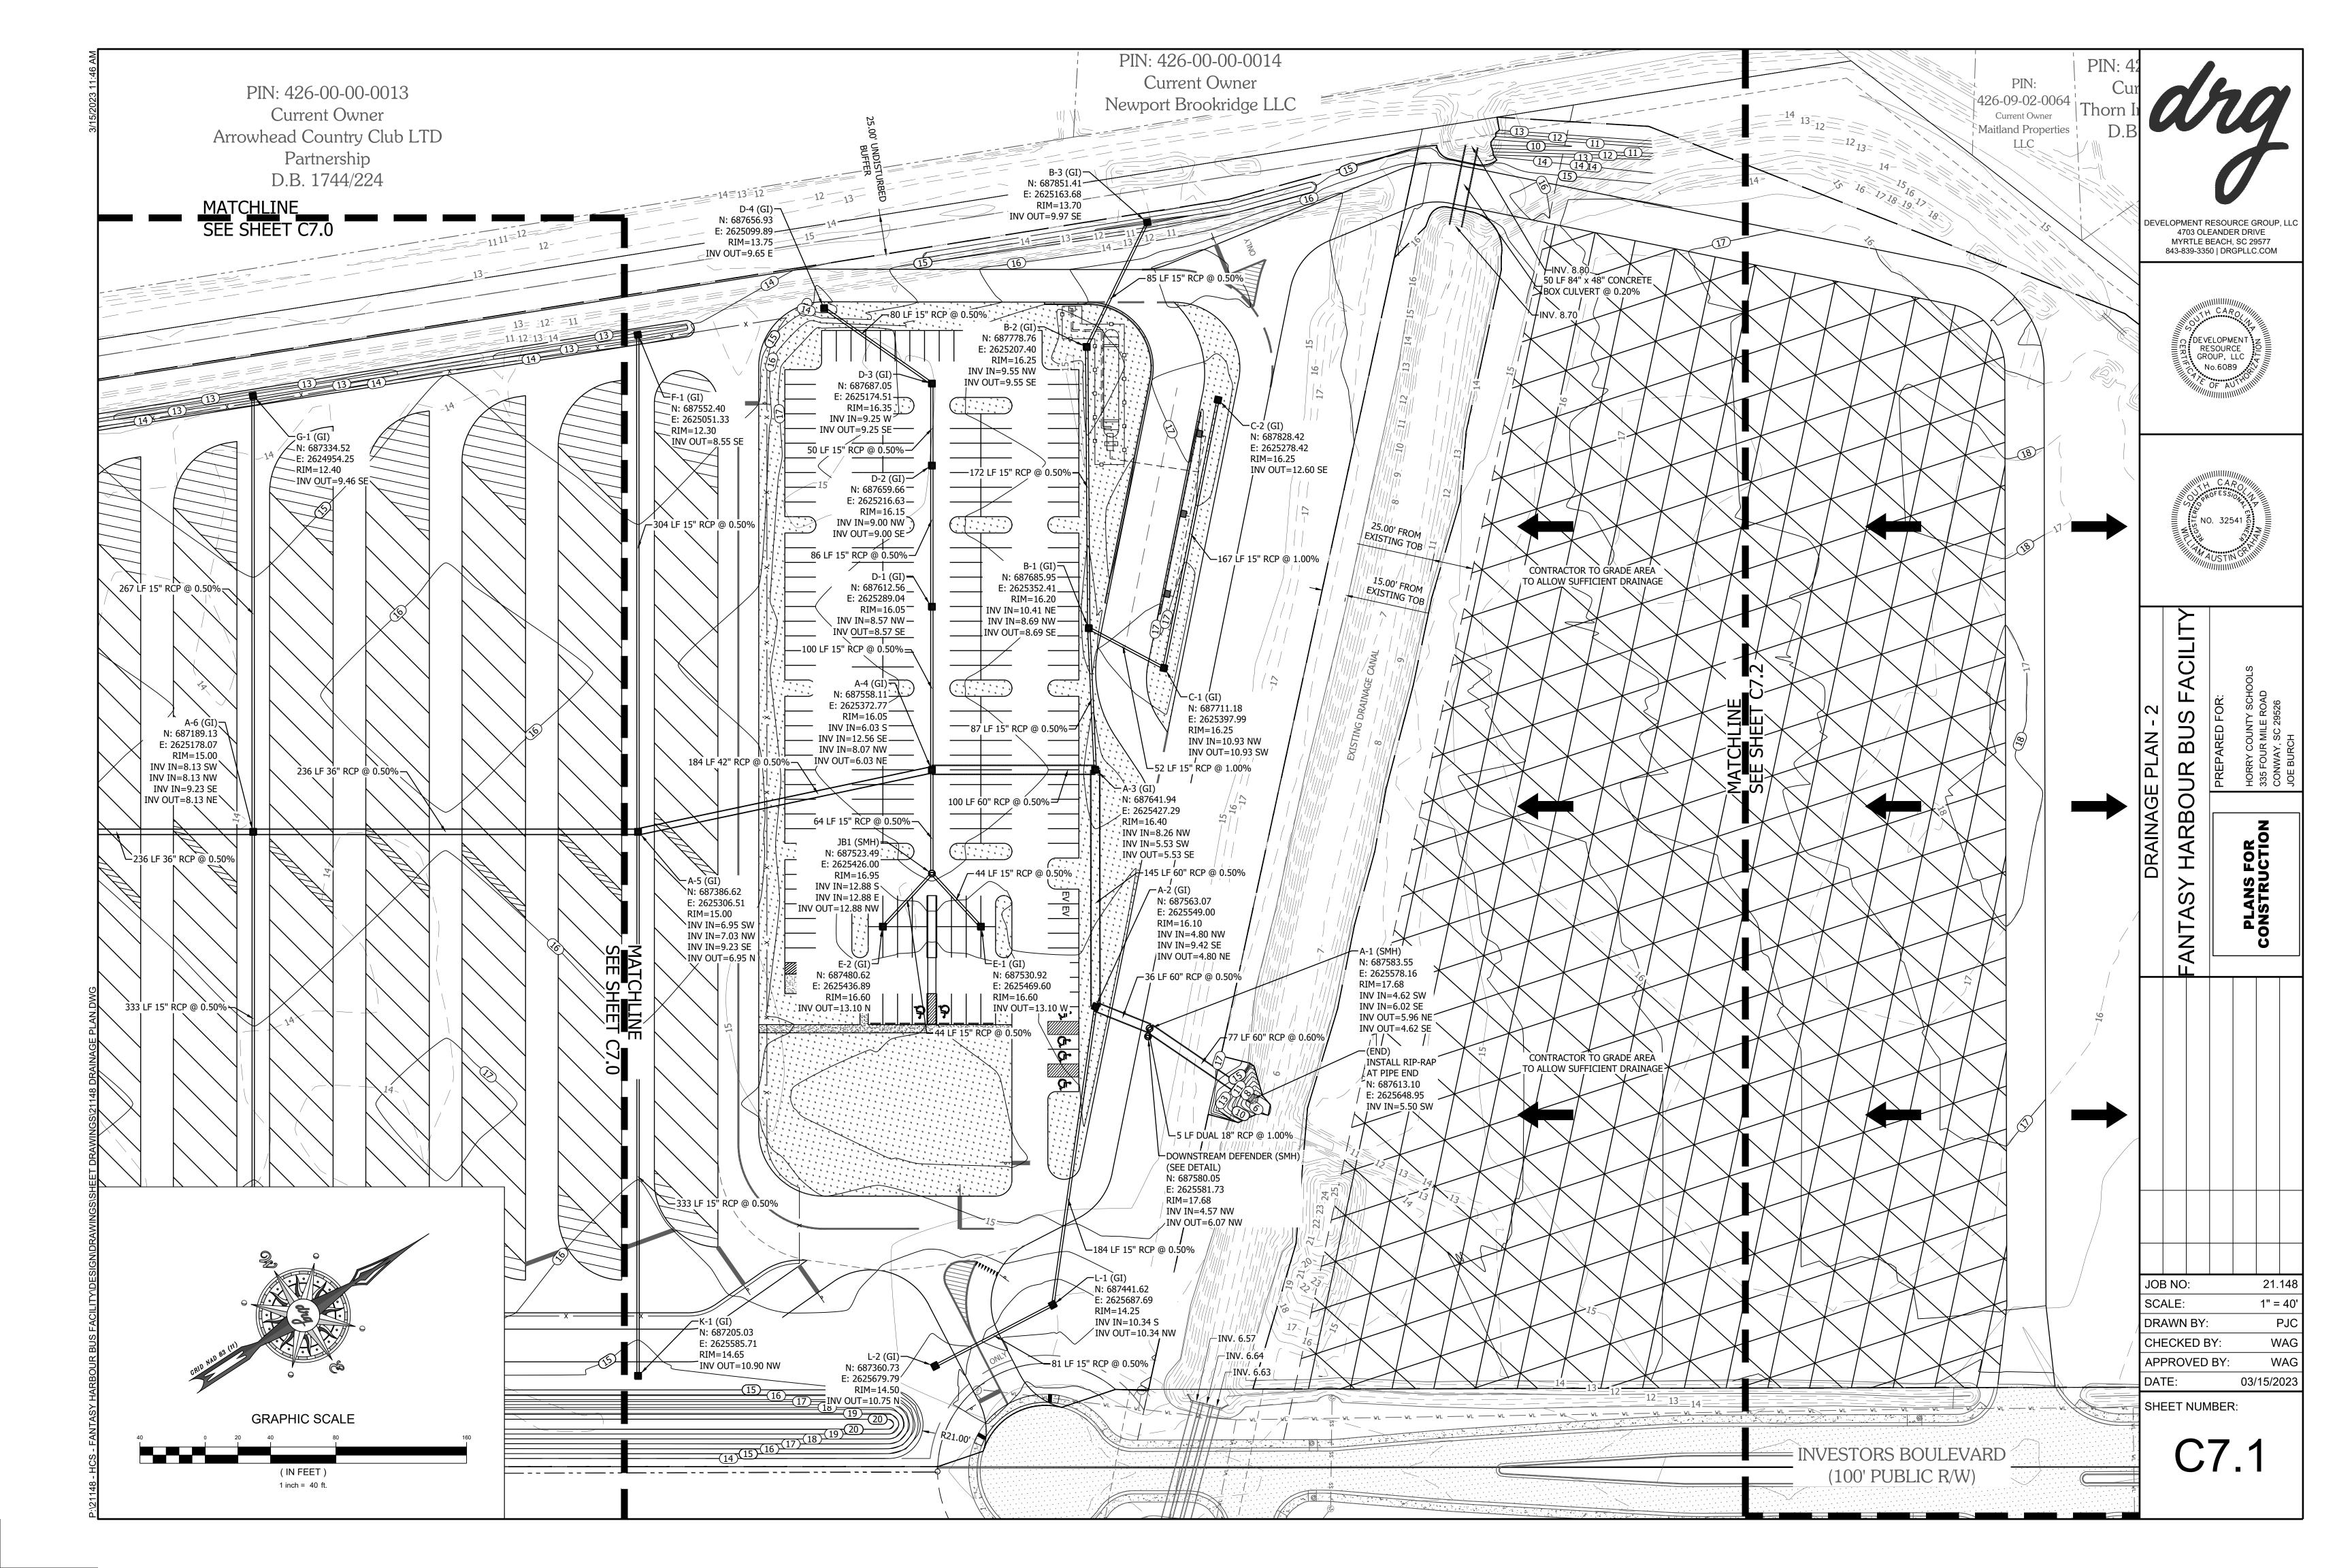

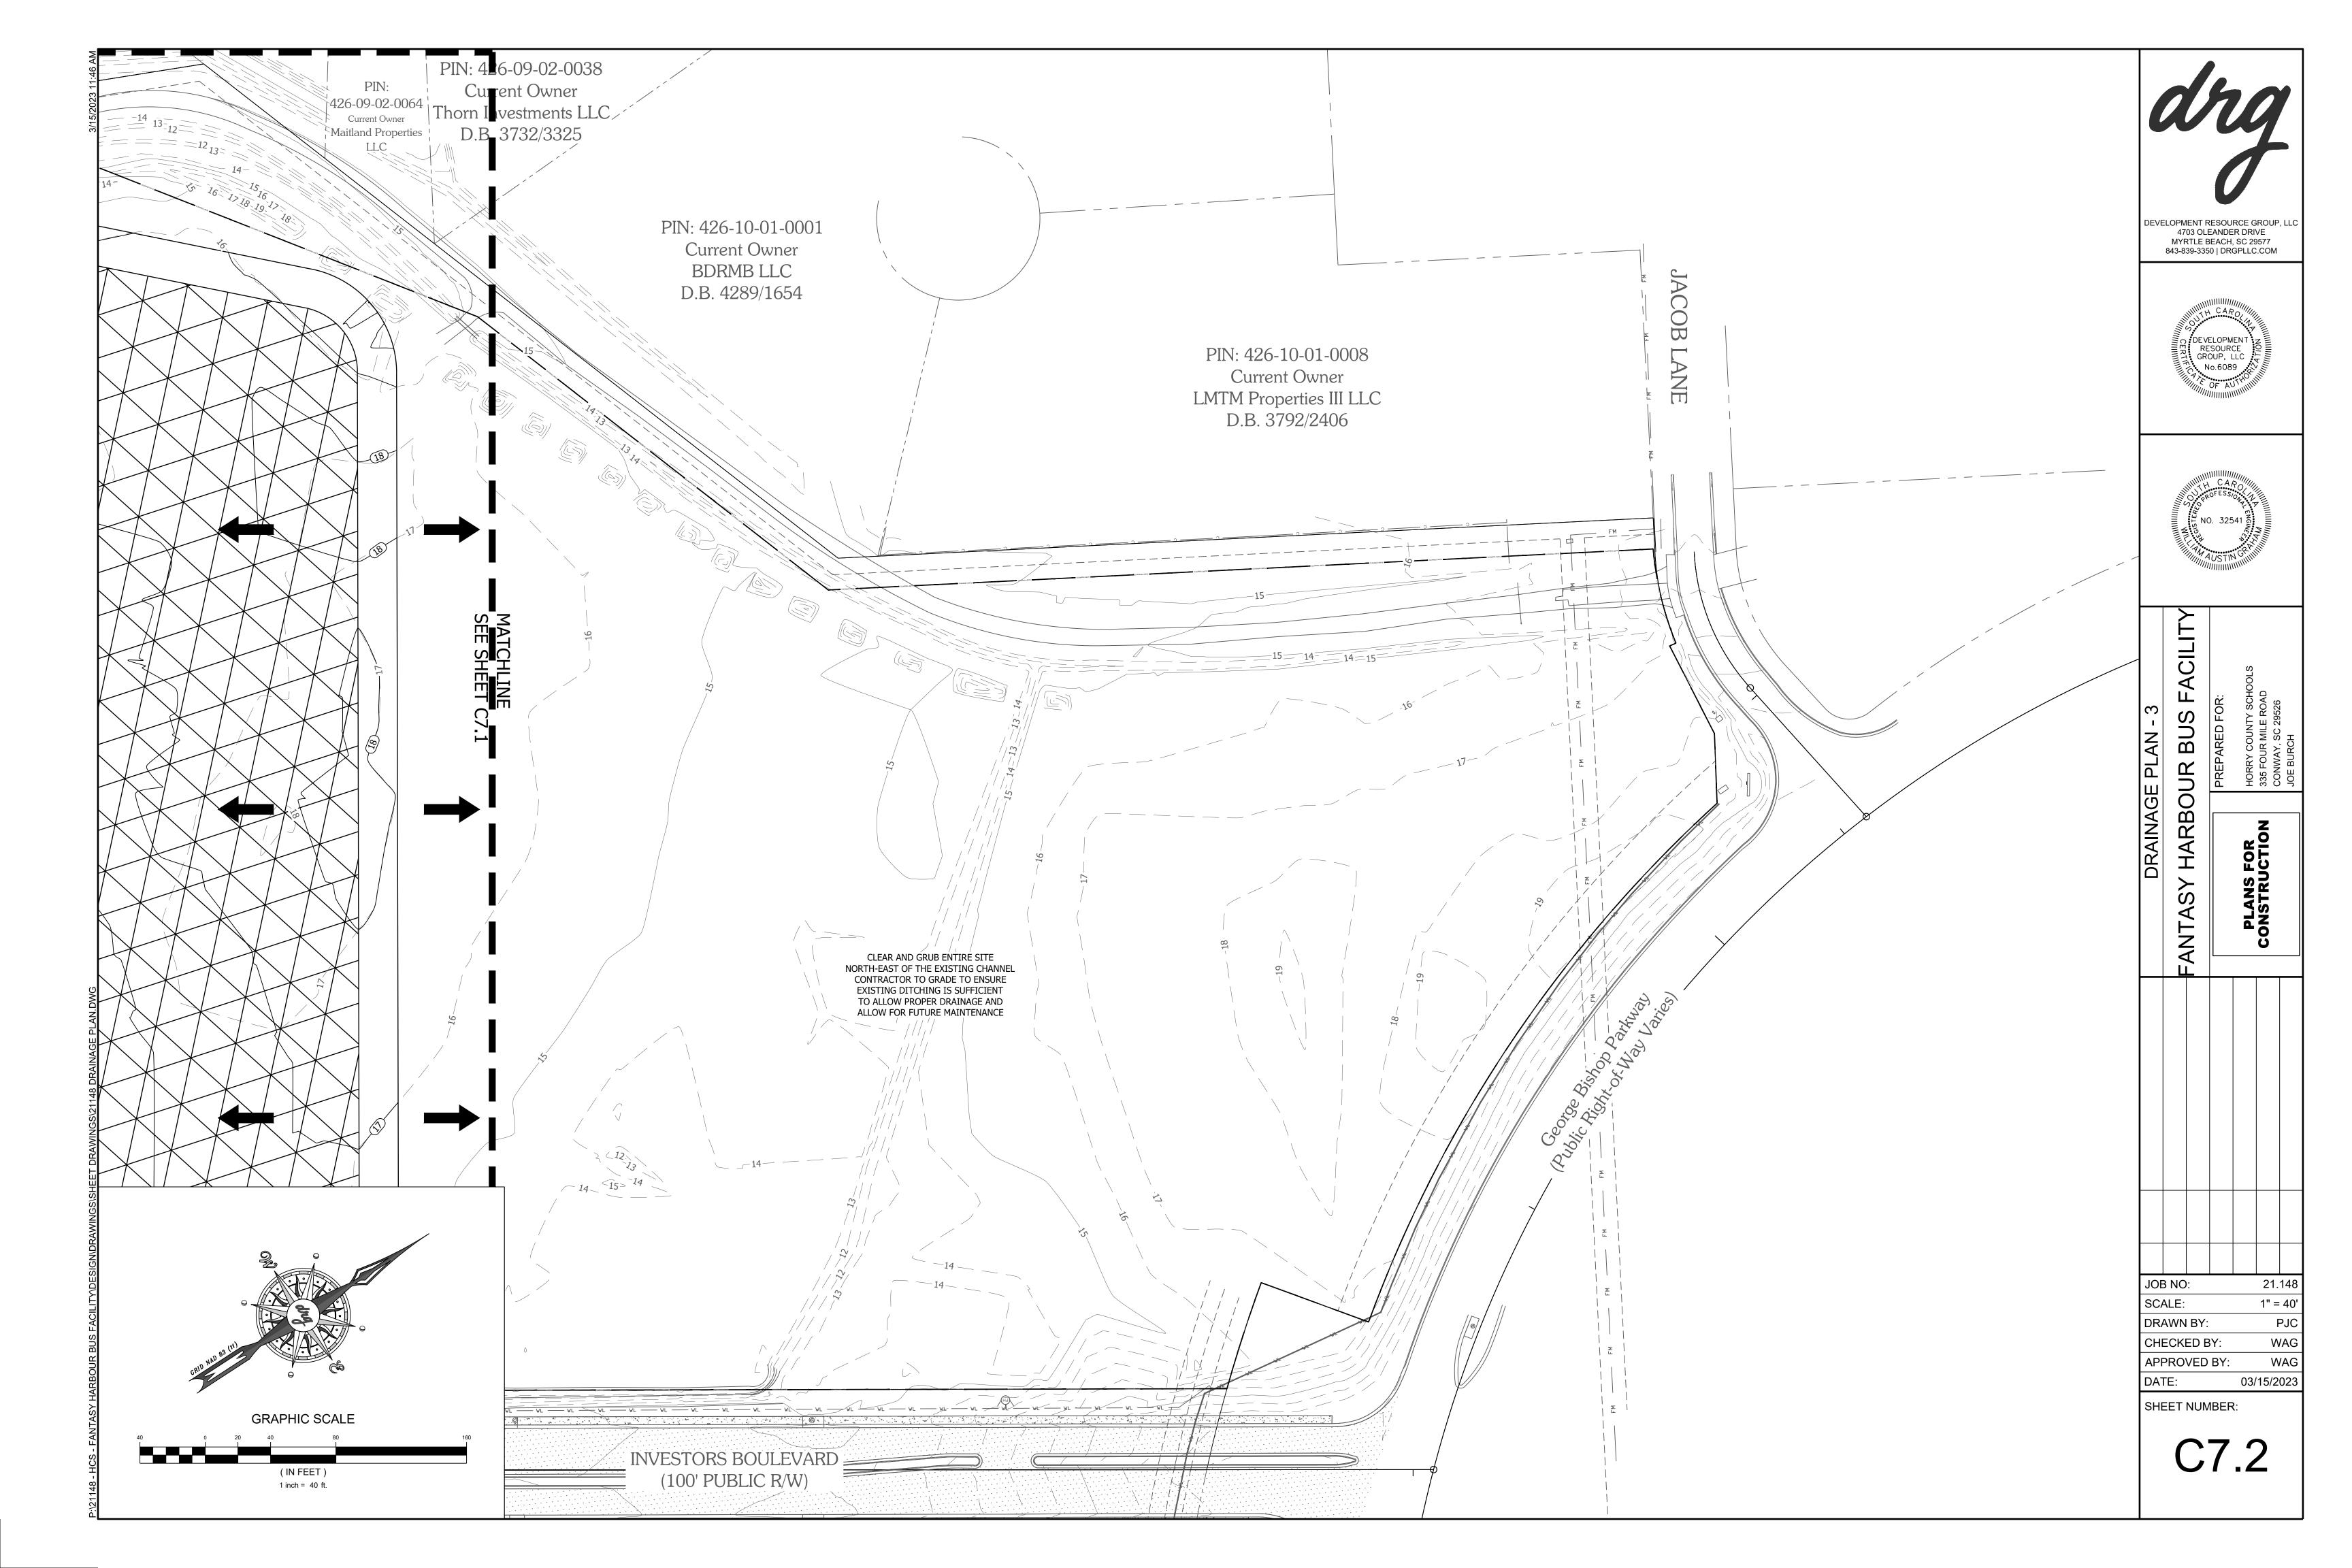

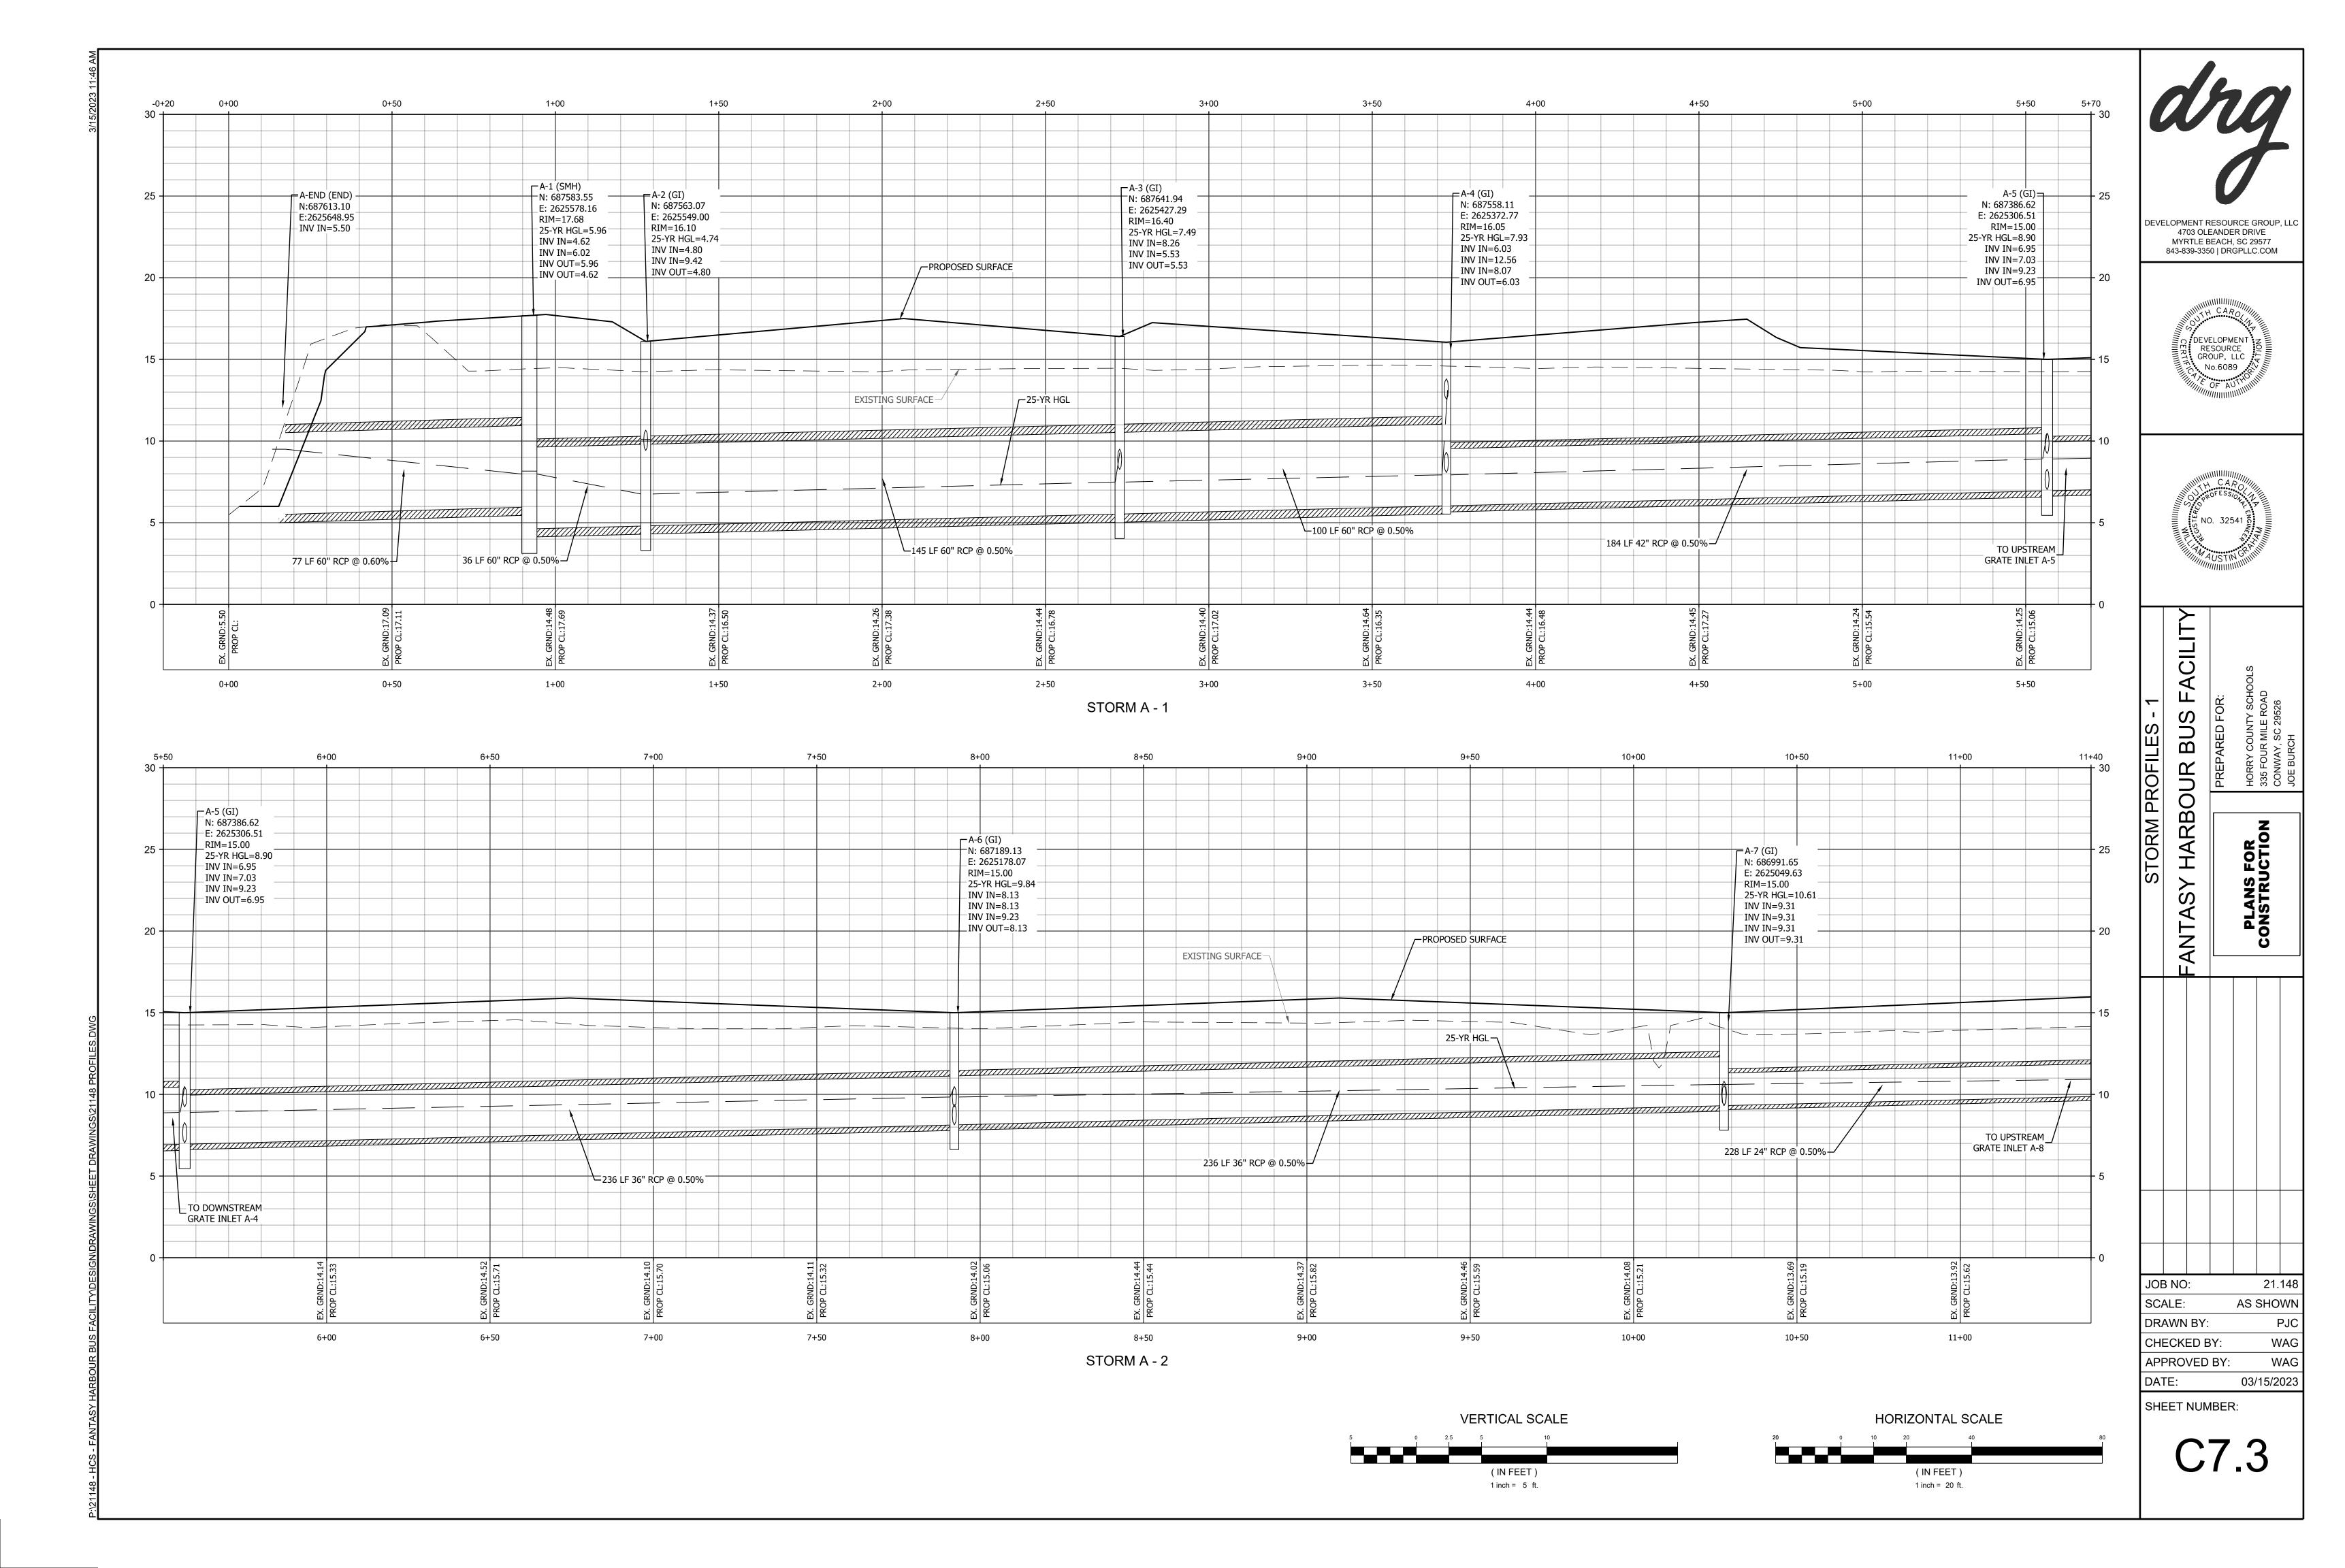

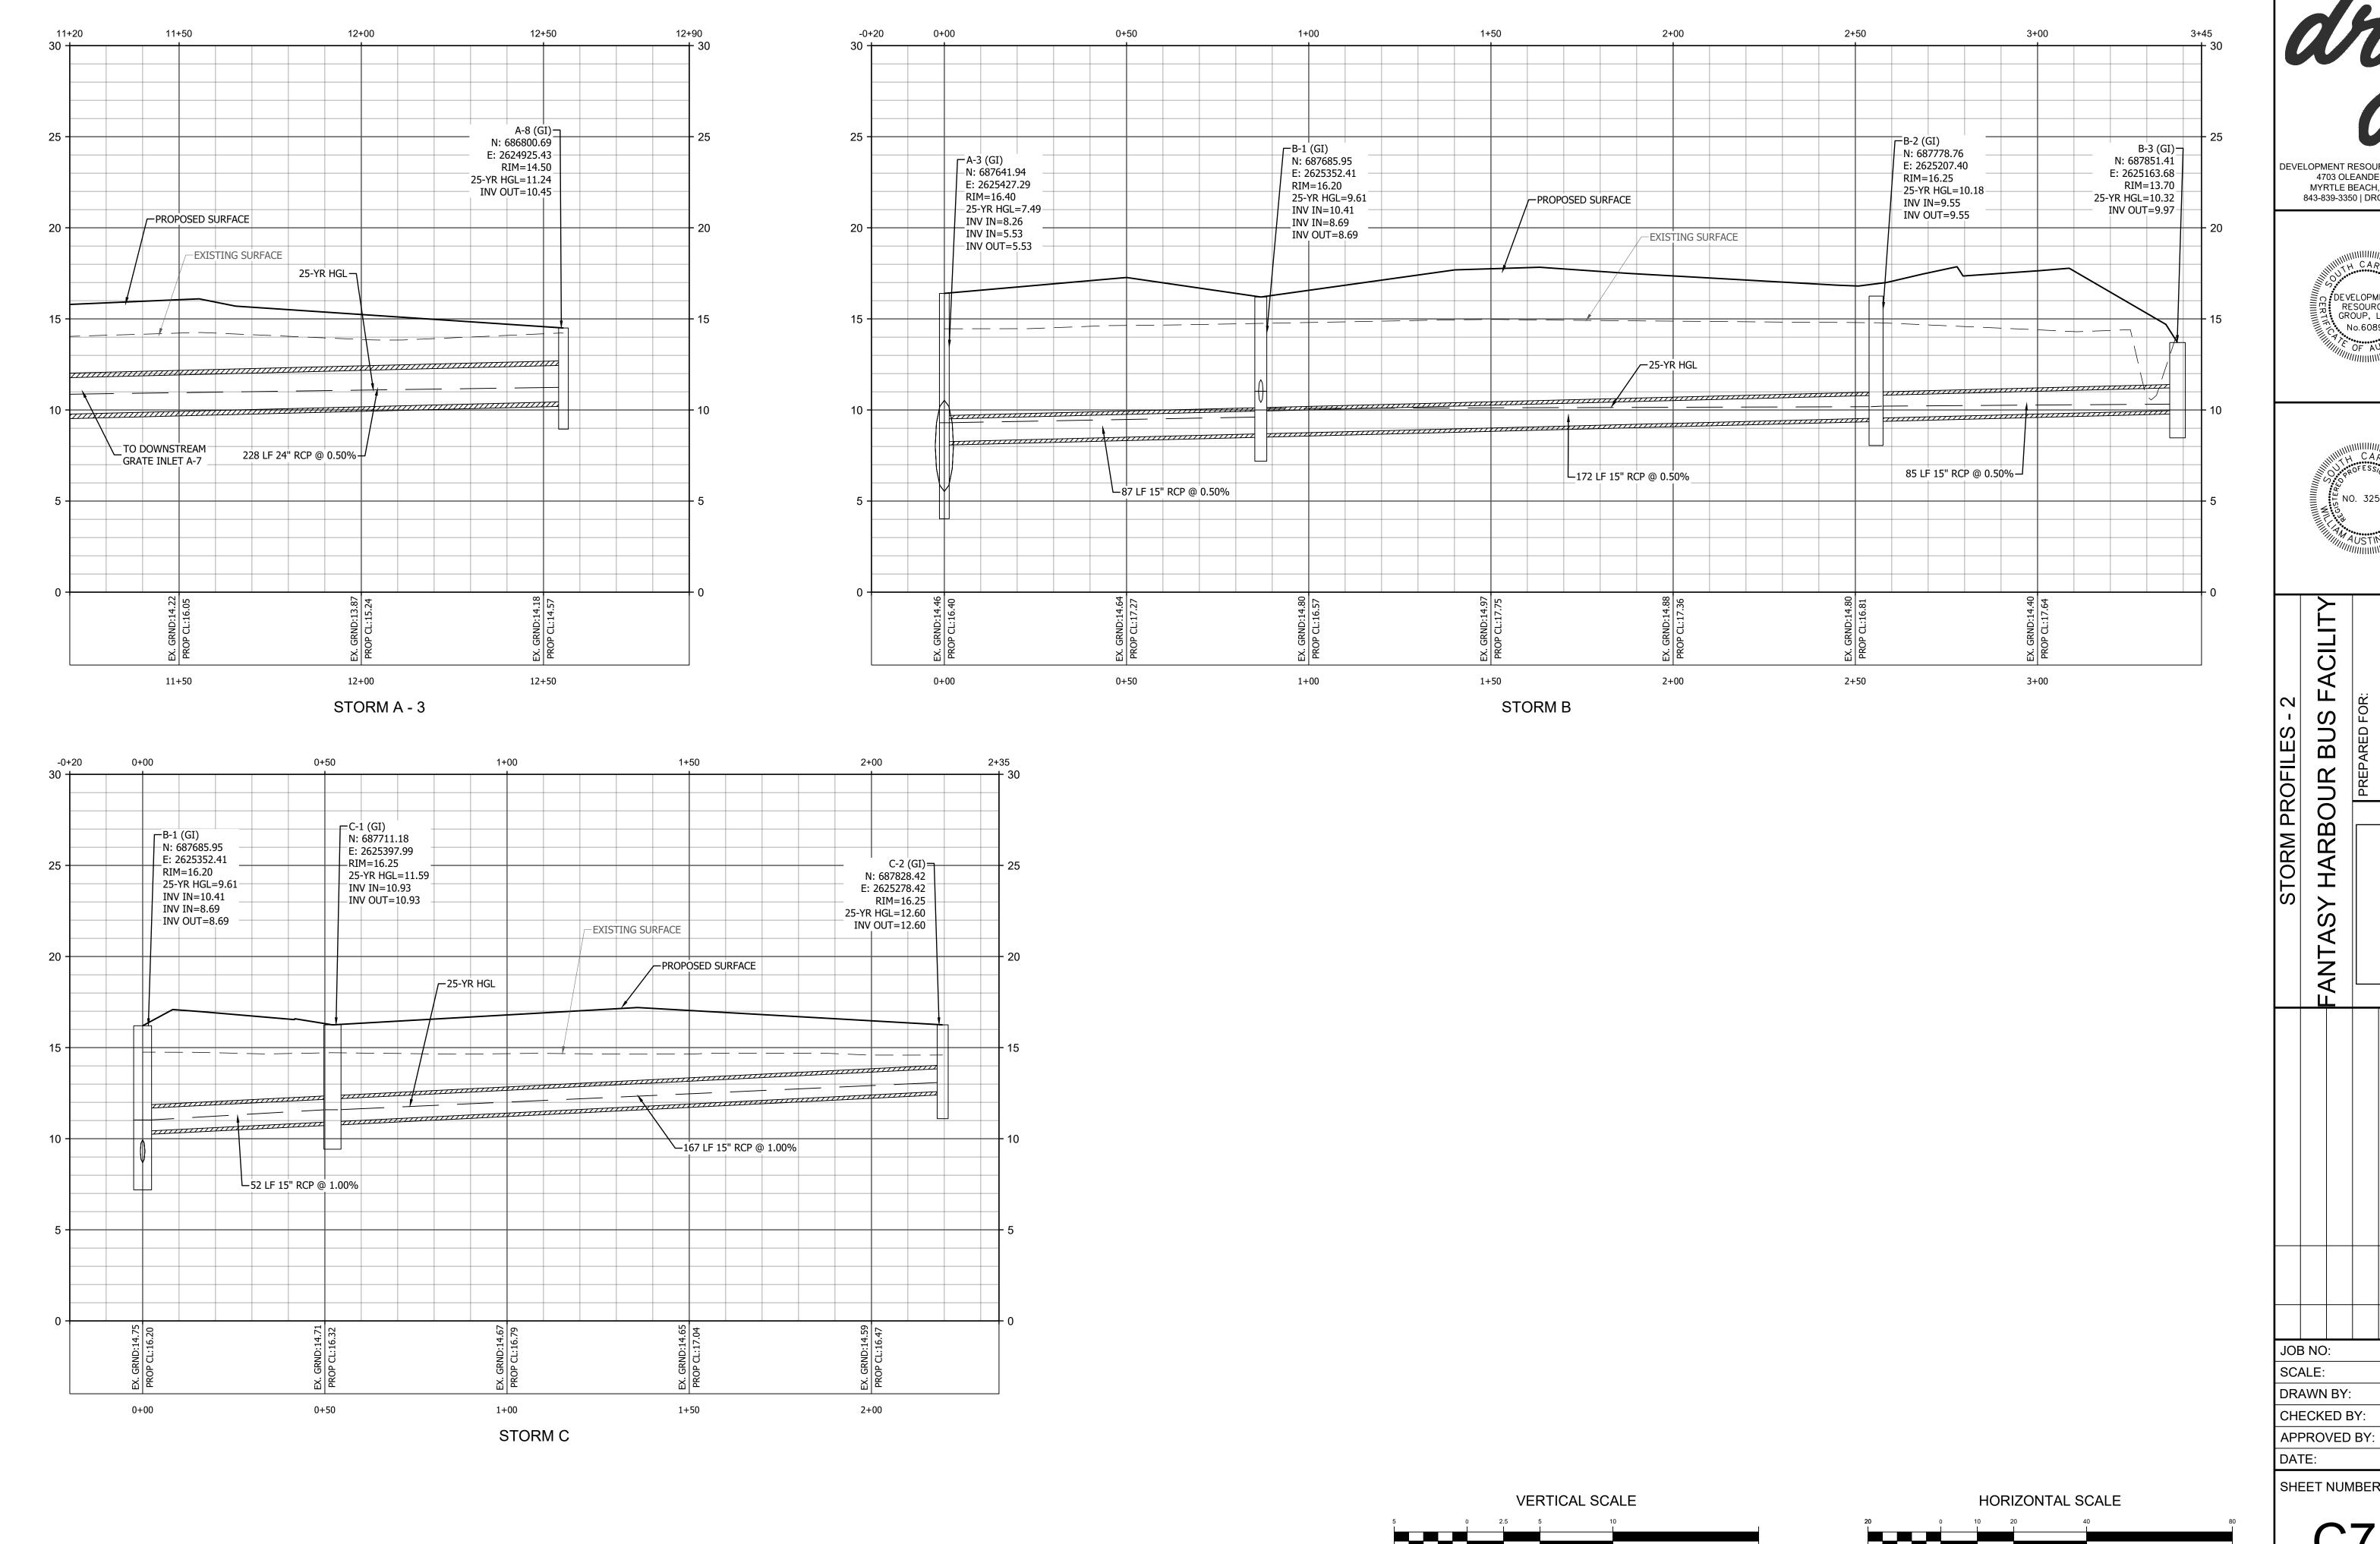


(IN FEET)

1 inch = 5 ft.

DEVELOPMENT RESOURCE GROUP, LL

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ACILIT HARBOUR BUS F PLANS FOR CONSTRUCTION FANTASY JOB NO: 21.148 SCALE: AS SHOWN DRAWN BY:

SHEET NUMBER:

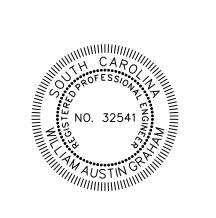
(IN FEET)

1 inch = 20 ft.

WAG

WAG

03/15/2023

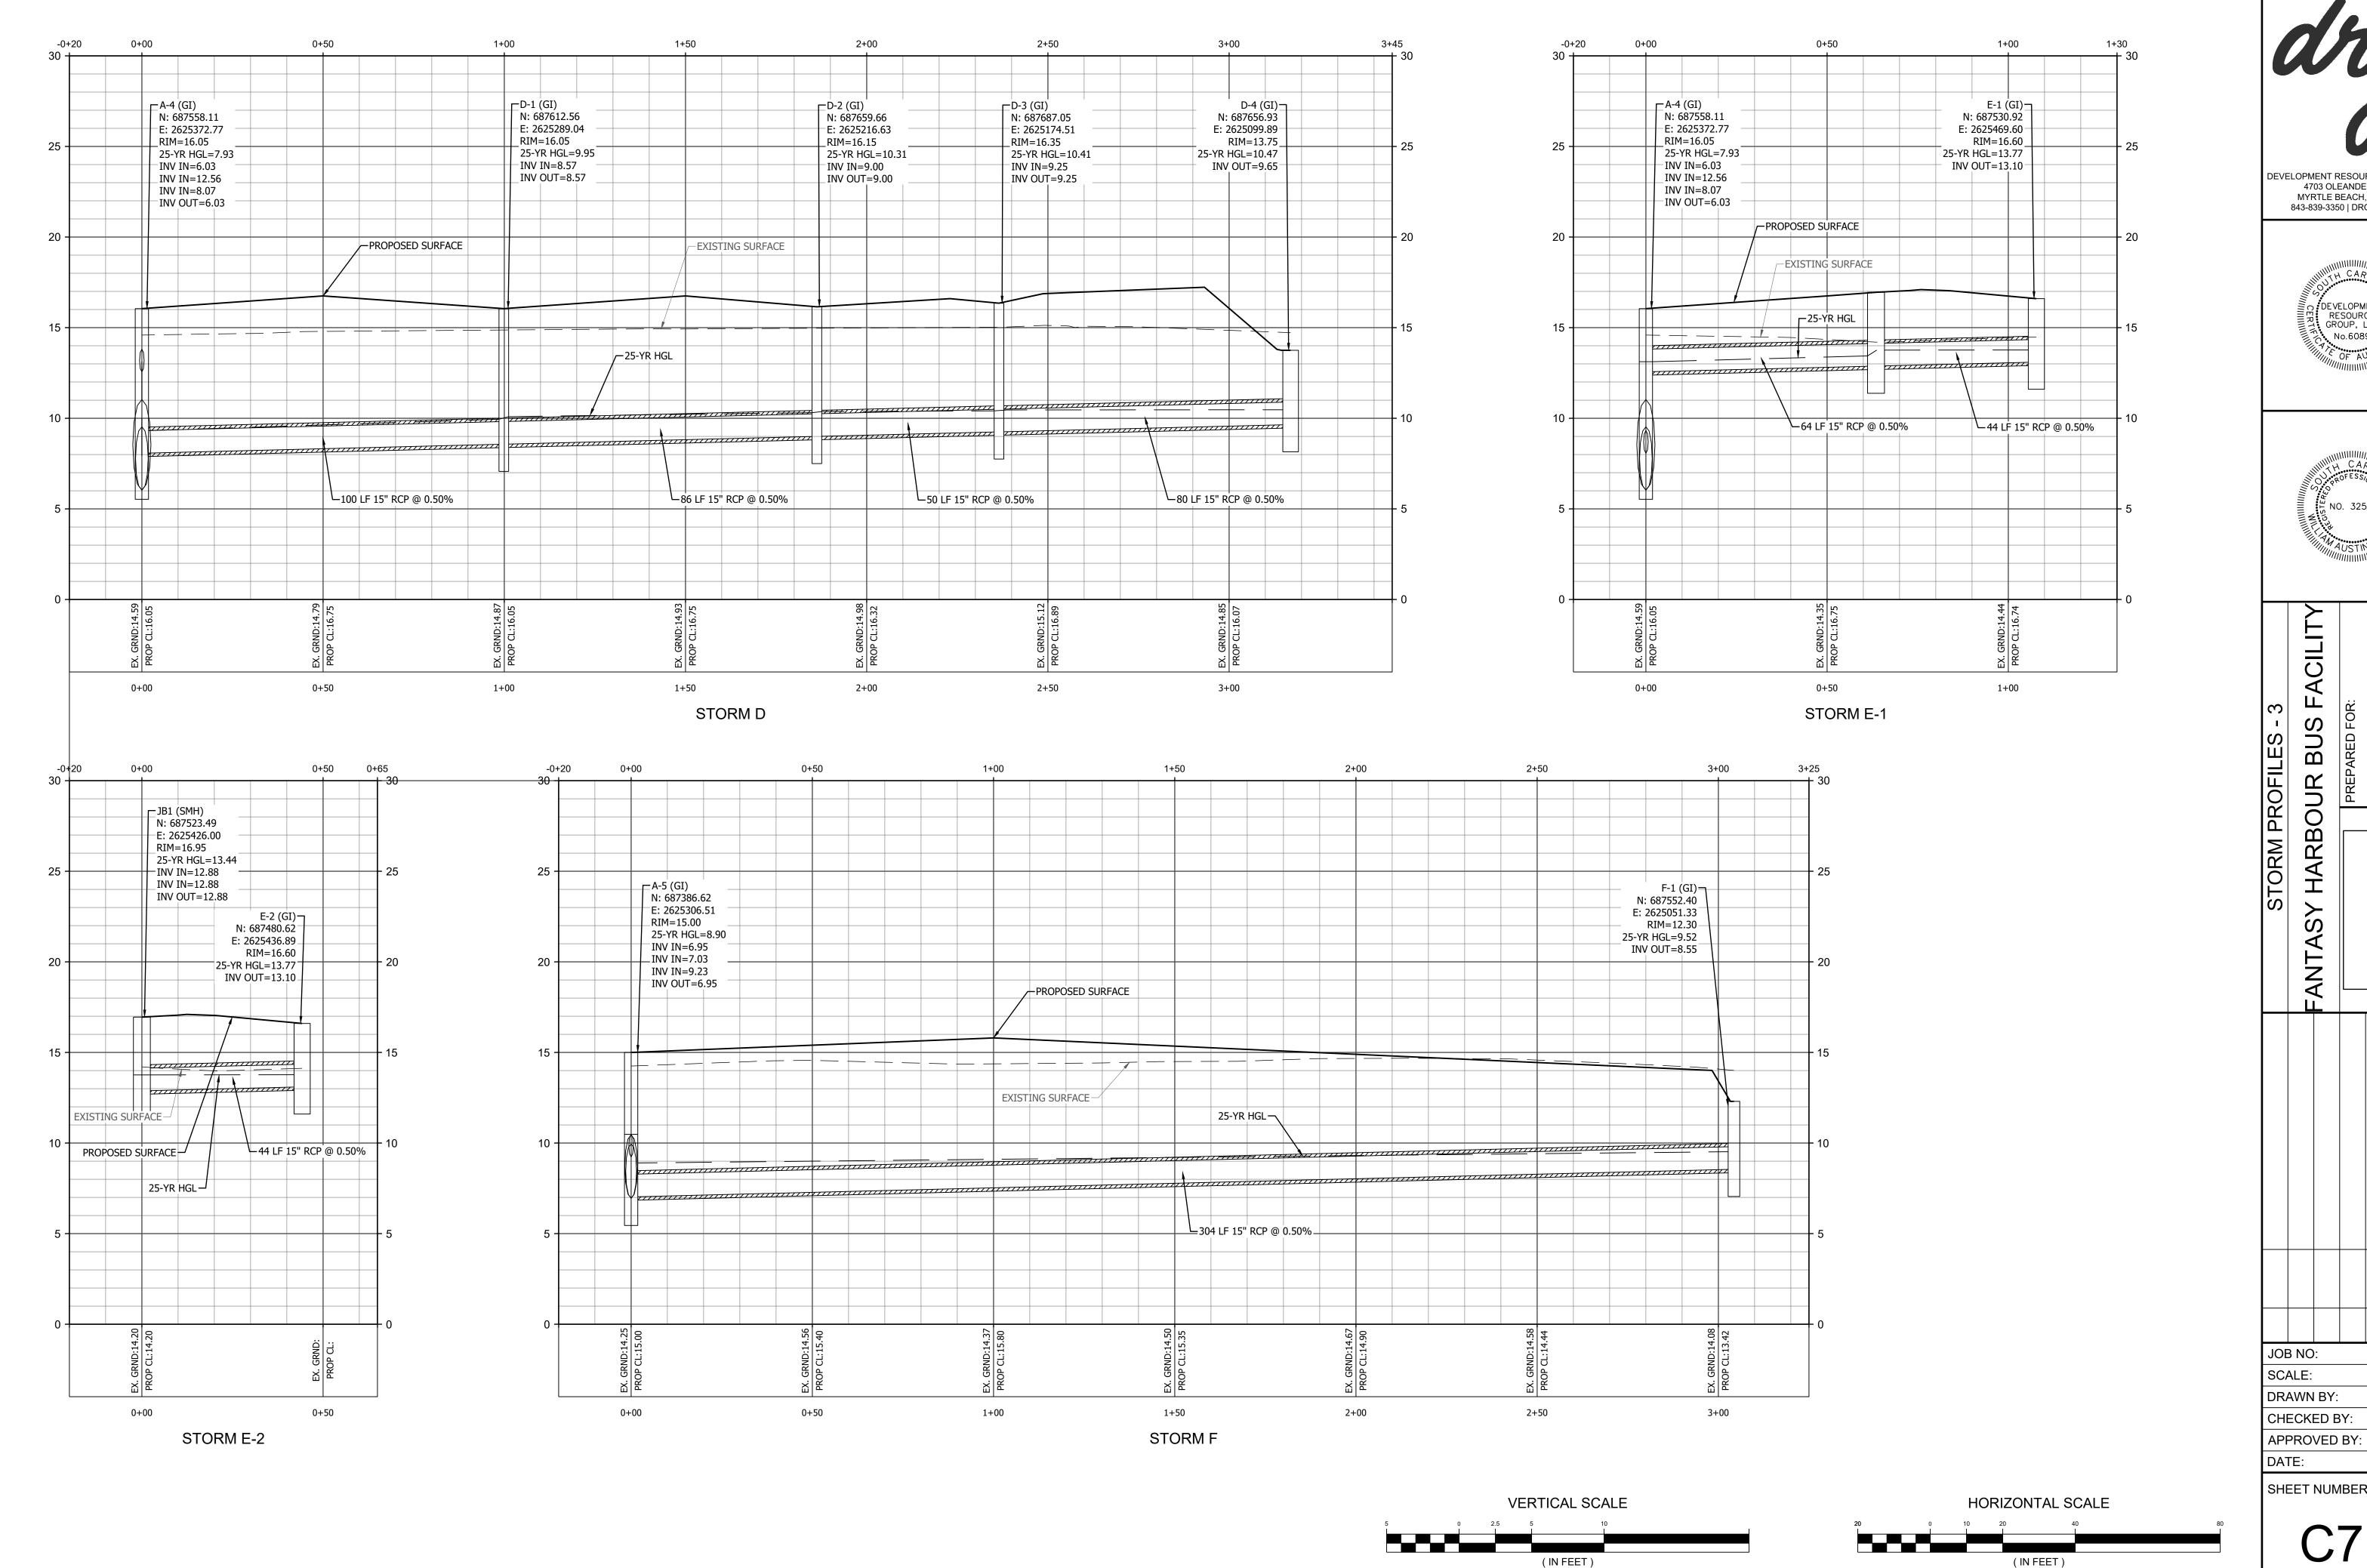

1 inch = 5 ft.

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ACILIT HARBOUR BUS

JOB NO: 21.148


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1 inch = 20 ft.

AS SHOWN

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FANTASY HARBOUR BUS FACILITY

PLANS FOR CONSTRUCTION

JOB NO: 21.148 SCALE: AS SHOWN DRAWN BY: PJC WAG

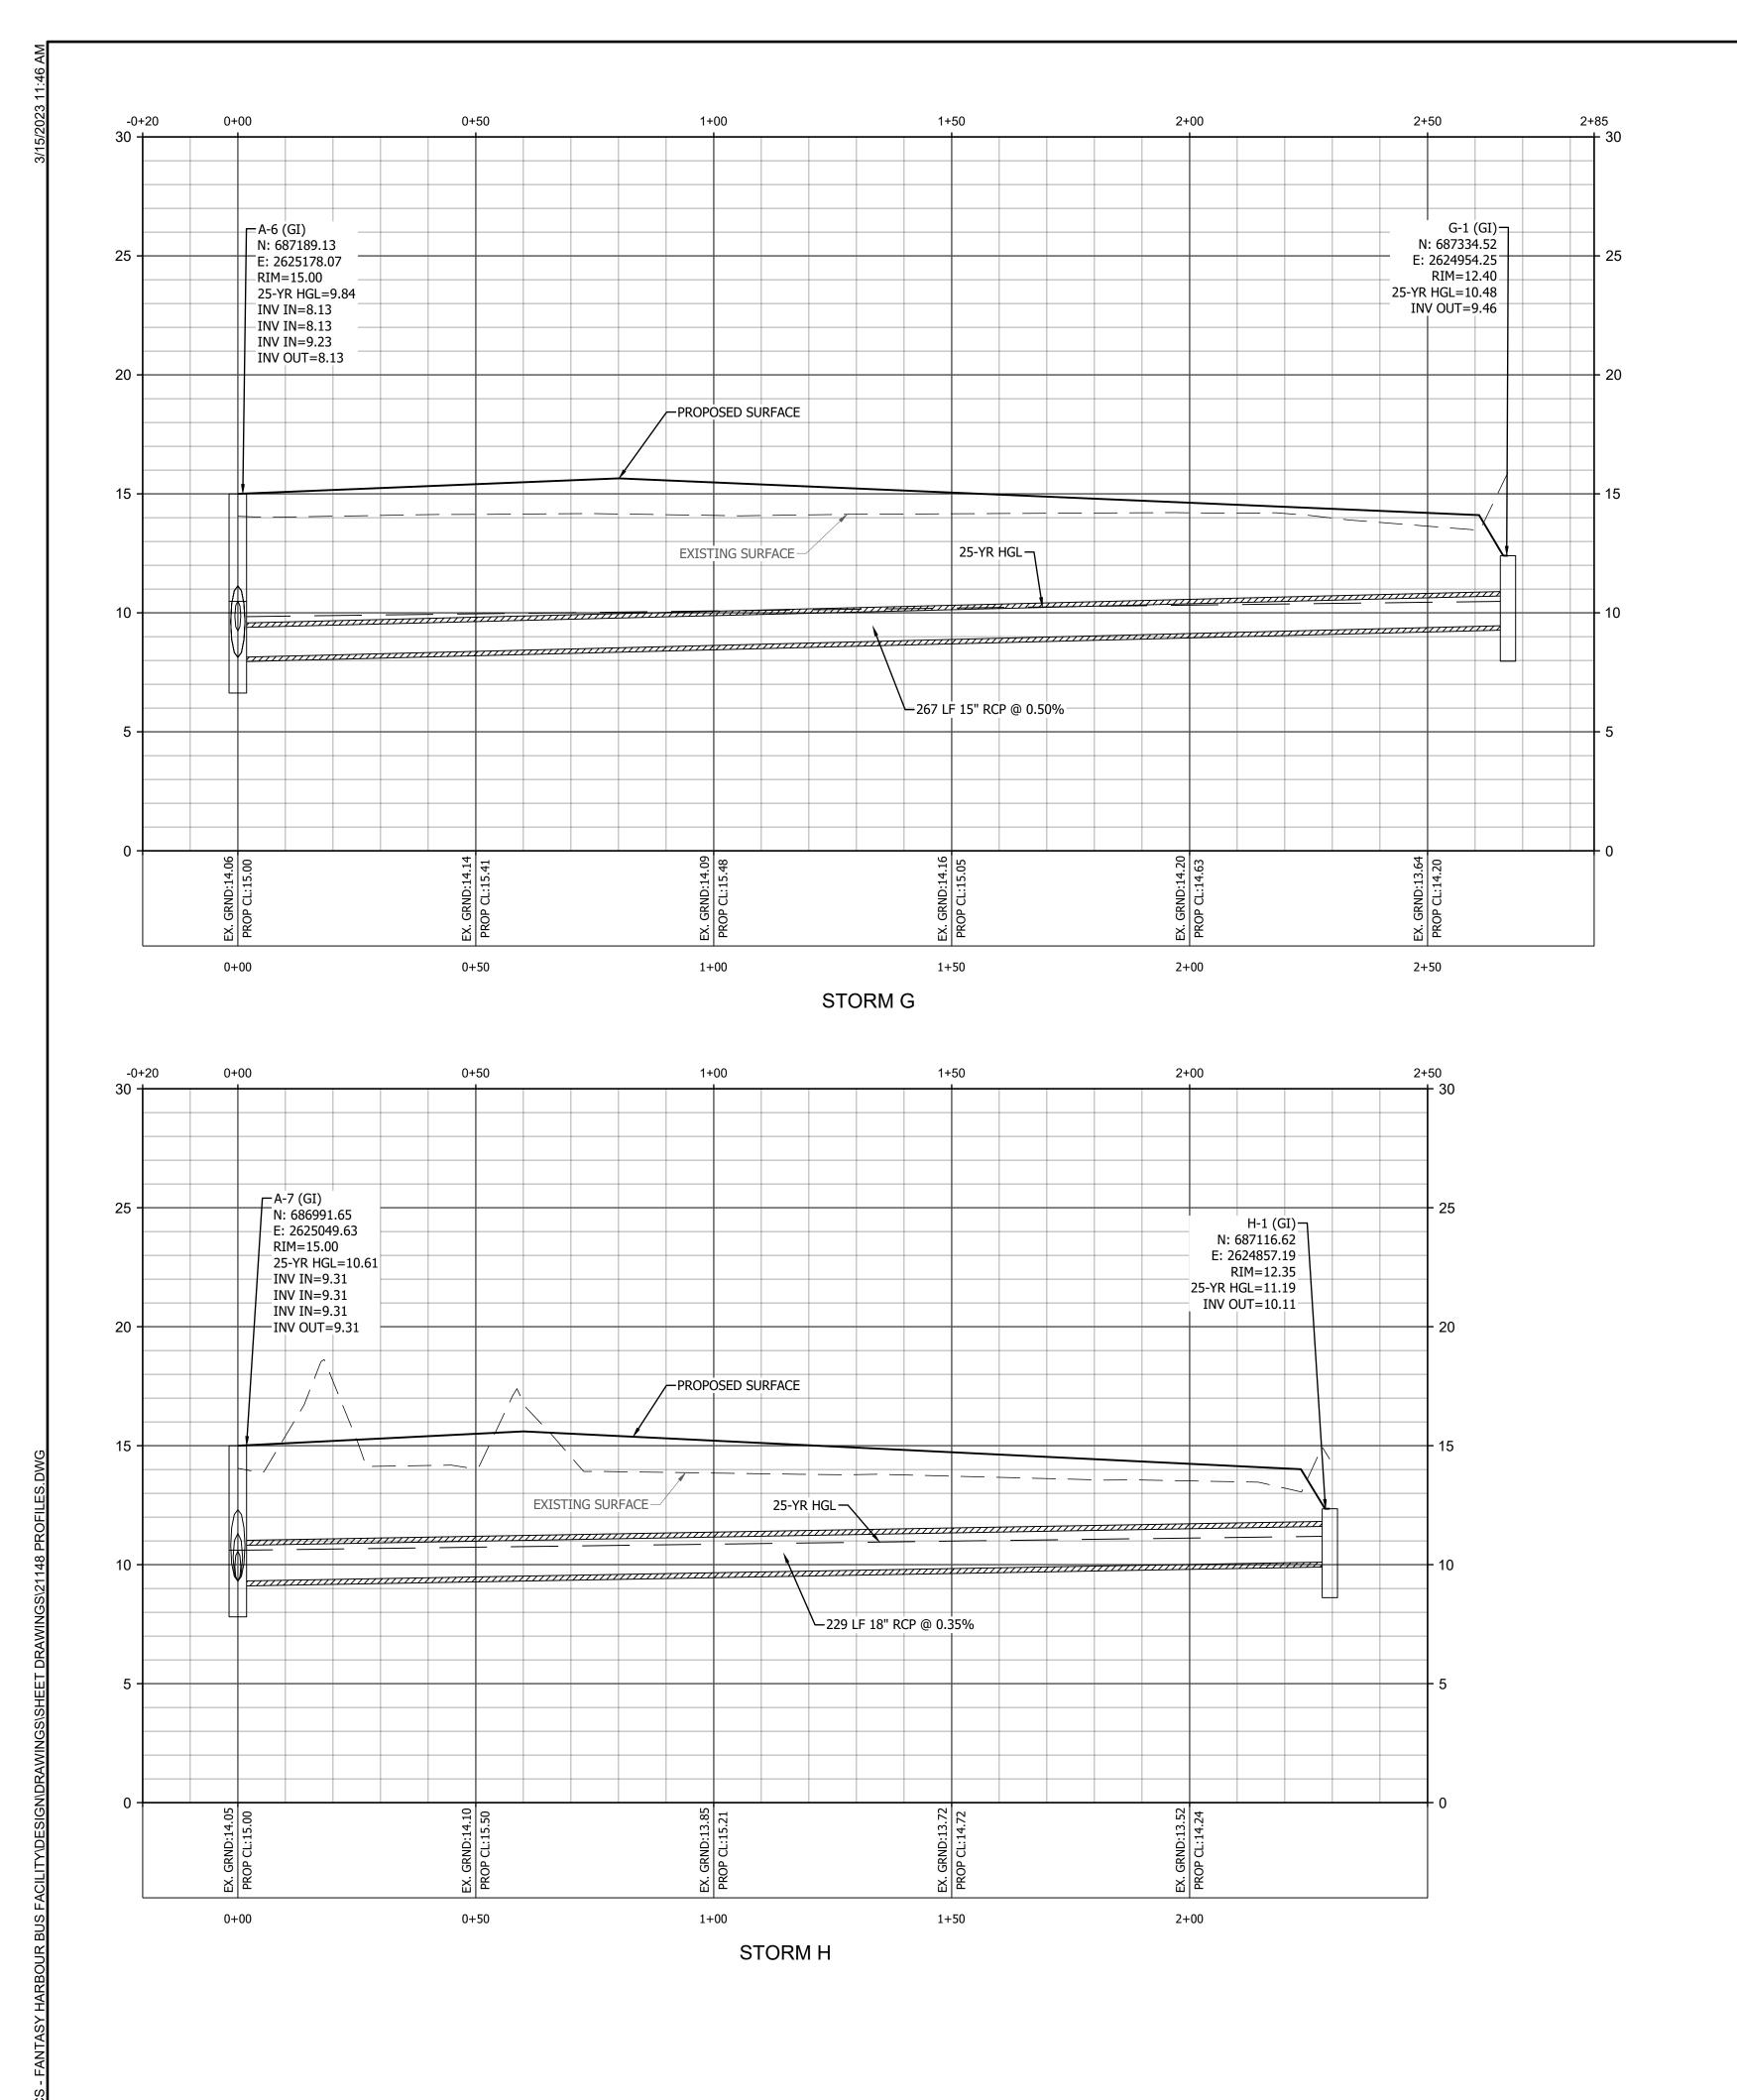CHECKED BY: WAG APPROVED BY:

DATE:


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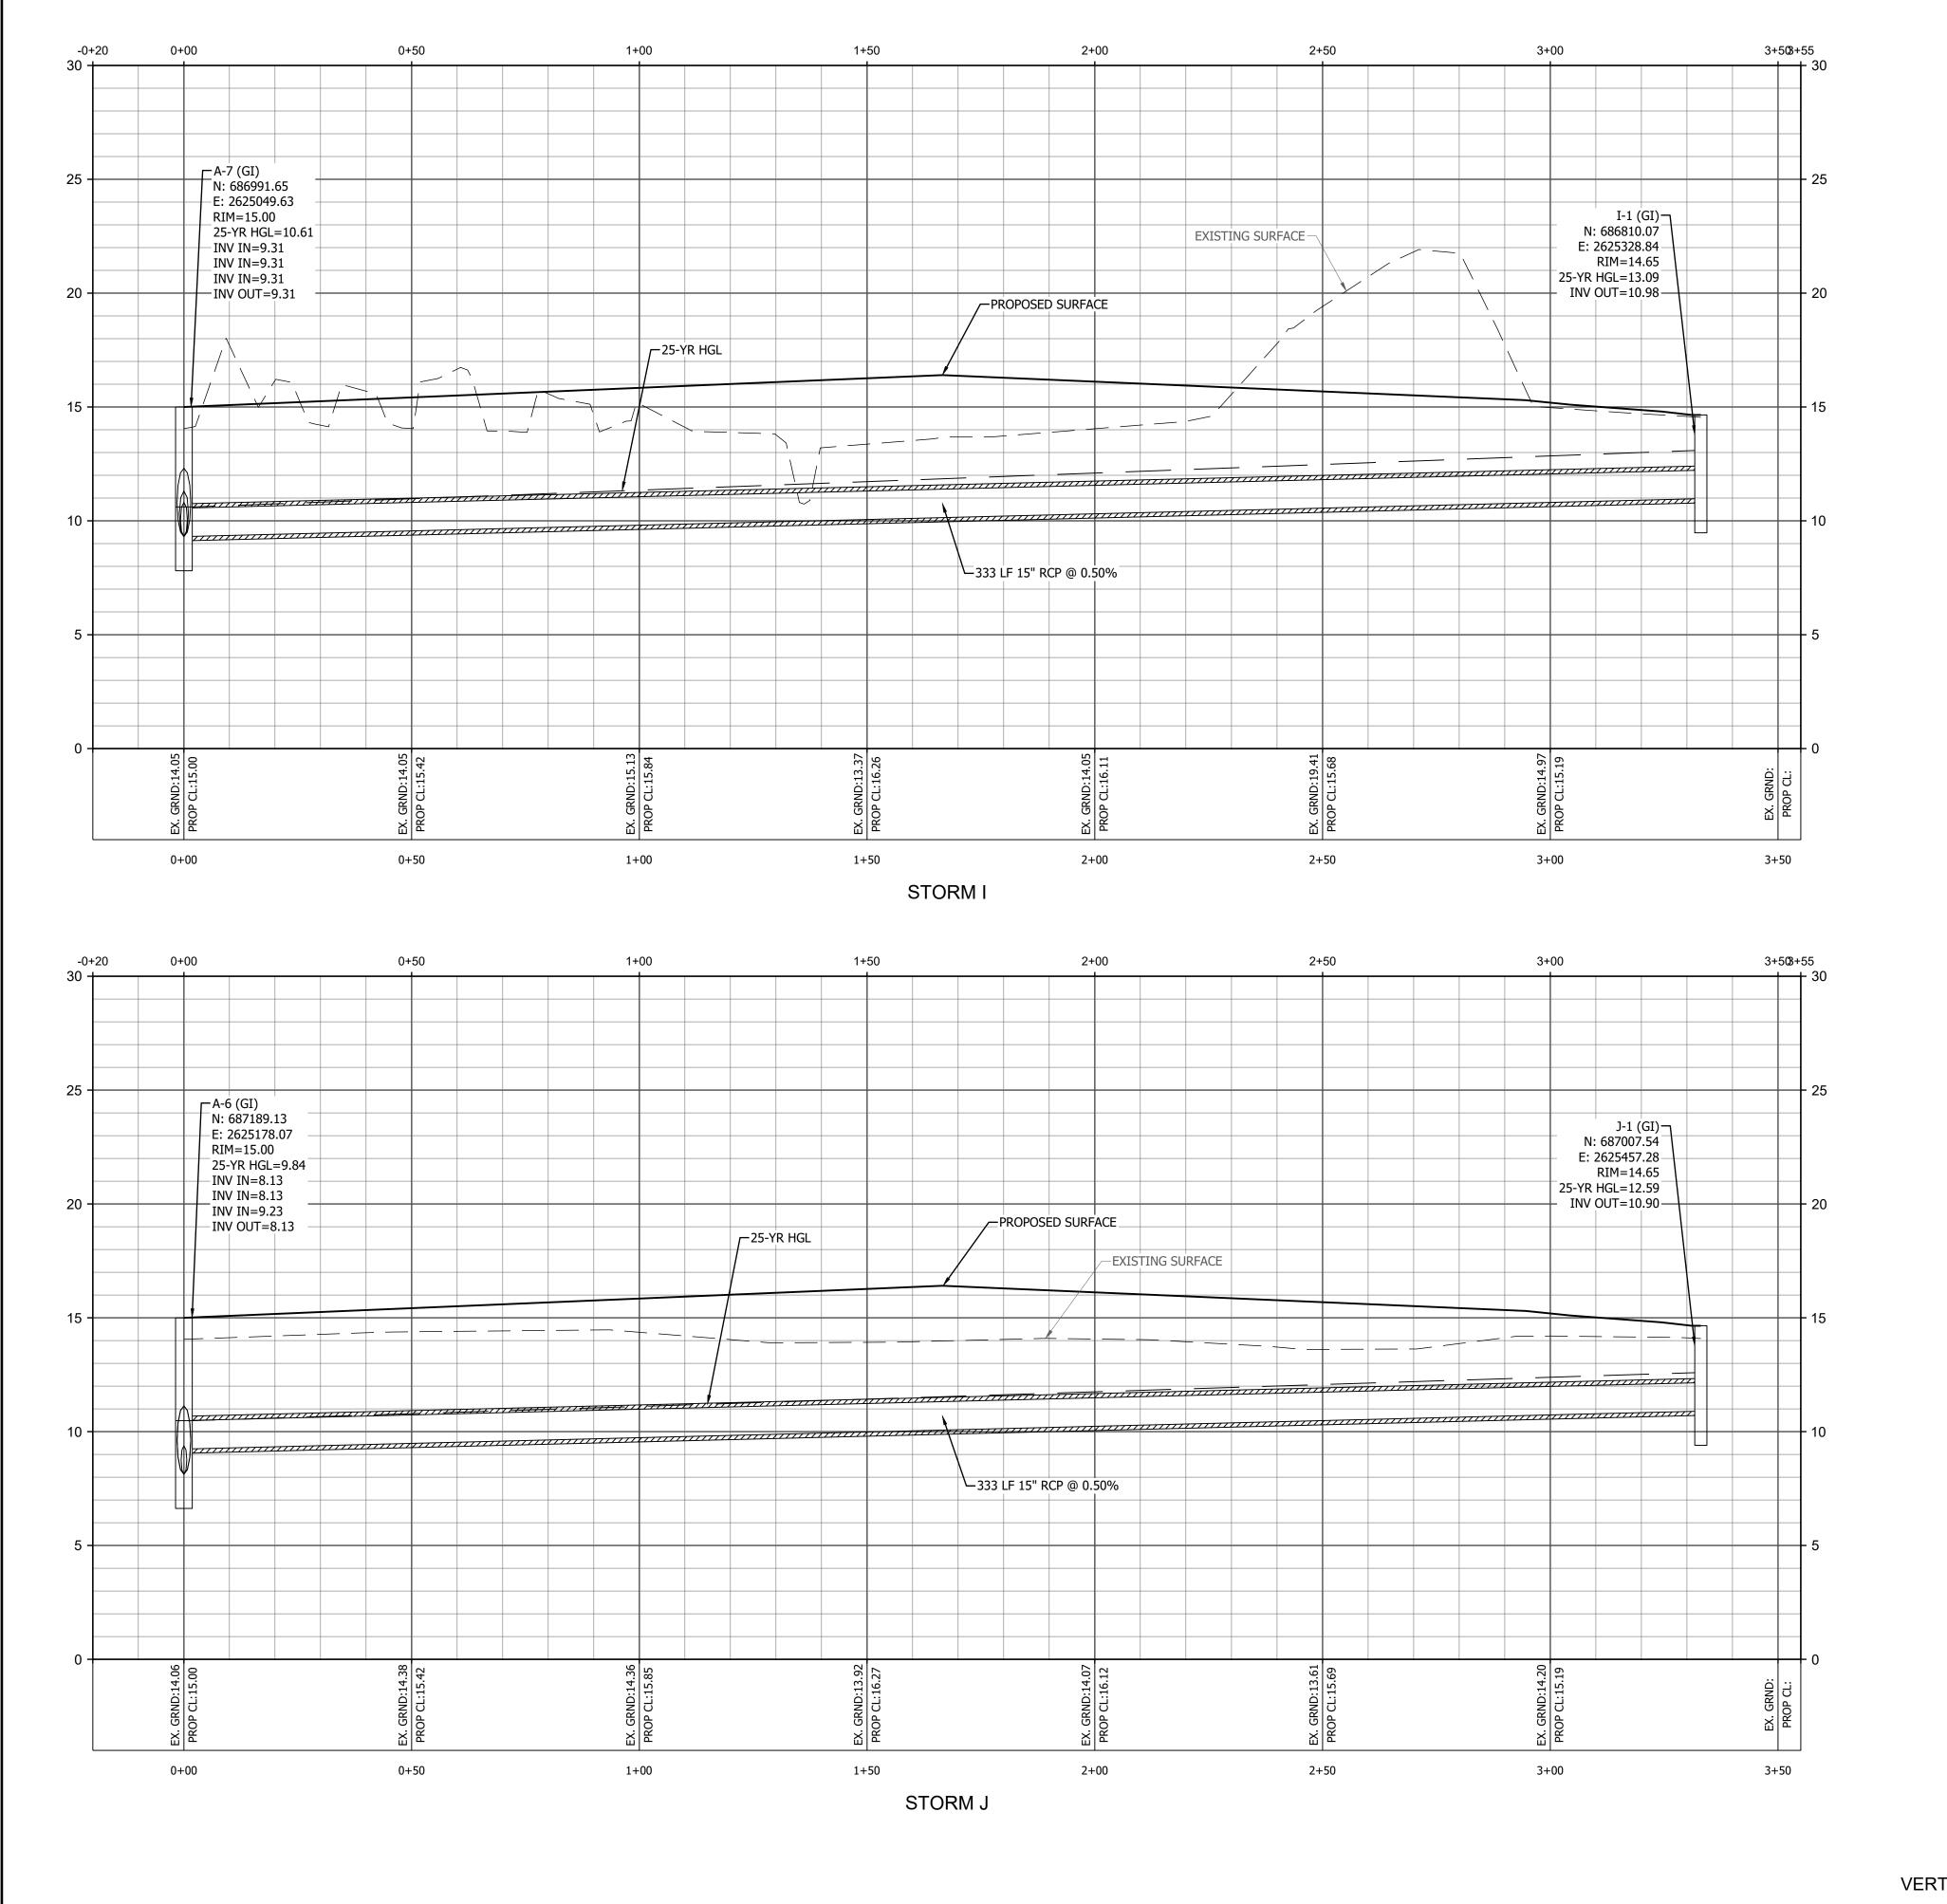
(IN FEET)

1 inch = 20 ft.

SHEET NUMBER:


03/15/2023



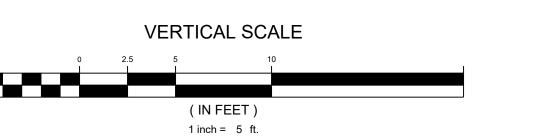



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HARBOUR BUS FACILITY

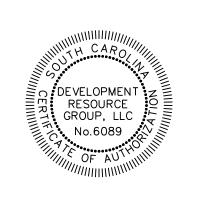PLANS FOR CONSTRUCTION

FANTASY I

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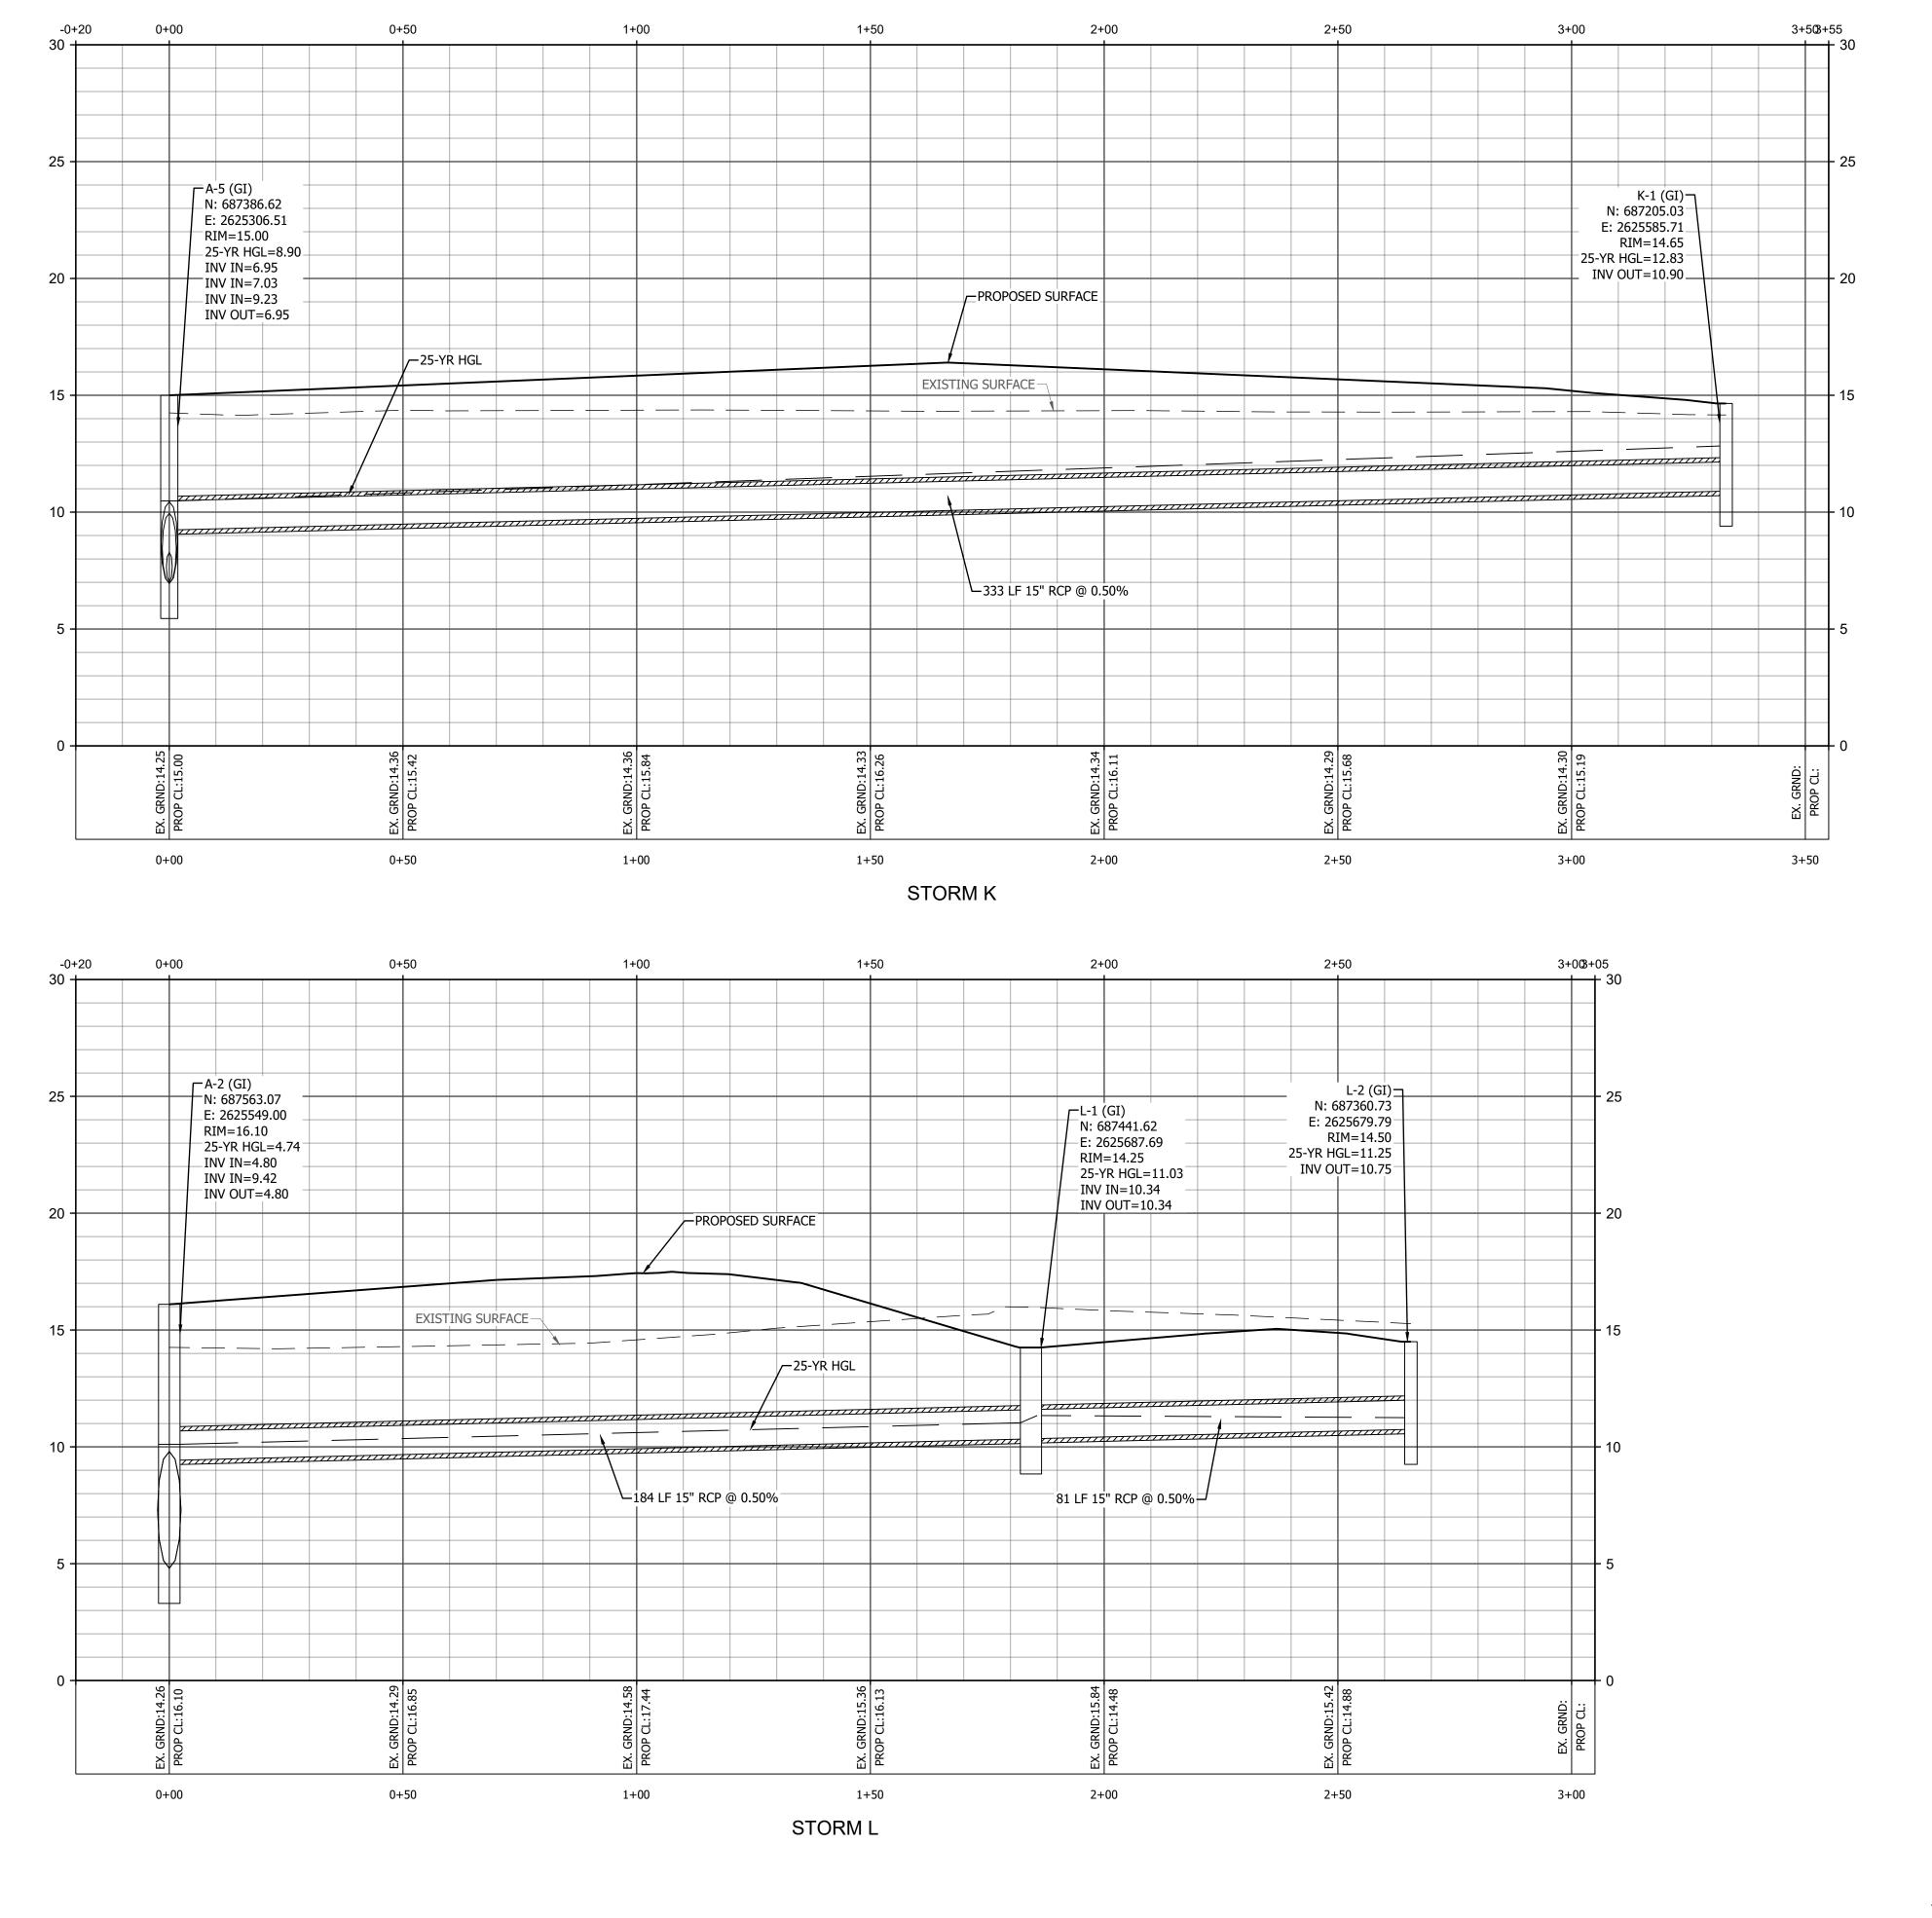
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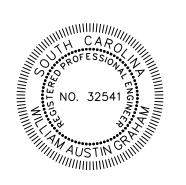
VERTICAL SCALE HORIZONTAL SCALE (IN FEET) (IN FEET) 1 inch = 5 ft. 1 inch = 20 ft.





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HARBOUR BUS FACILITY

FANTASY I

JOB NO: 21.148 AS SHOWN SCALE:

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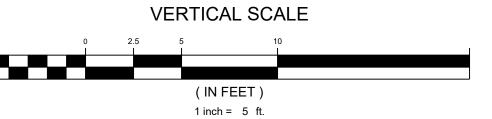
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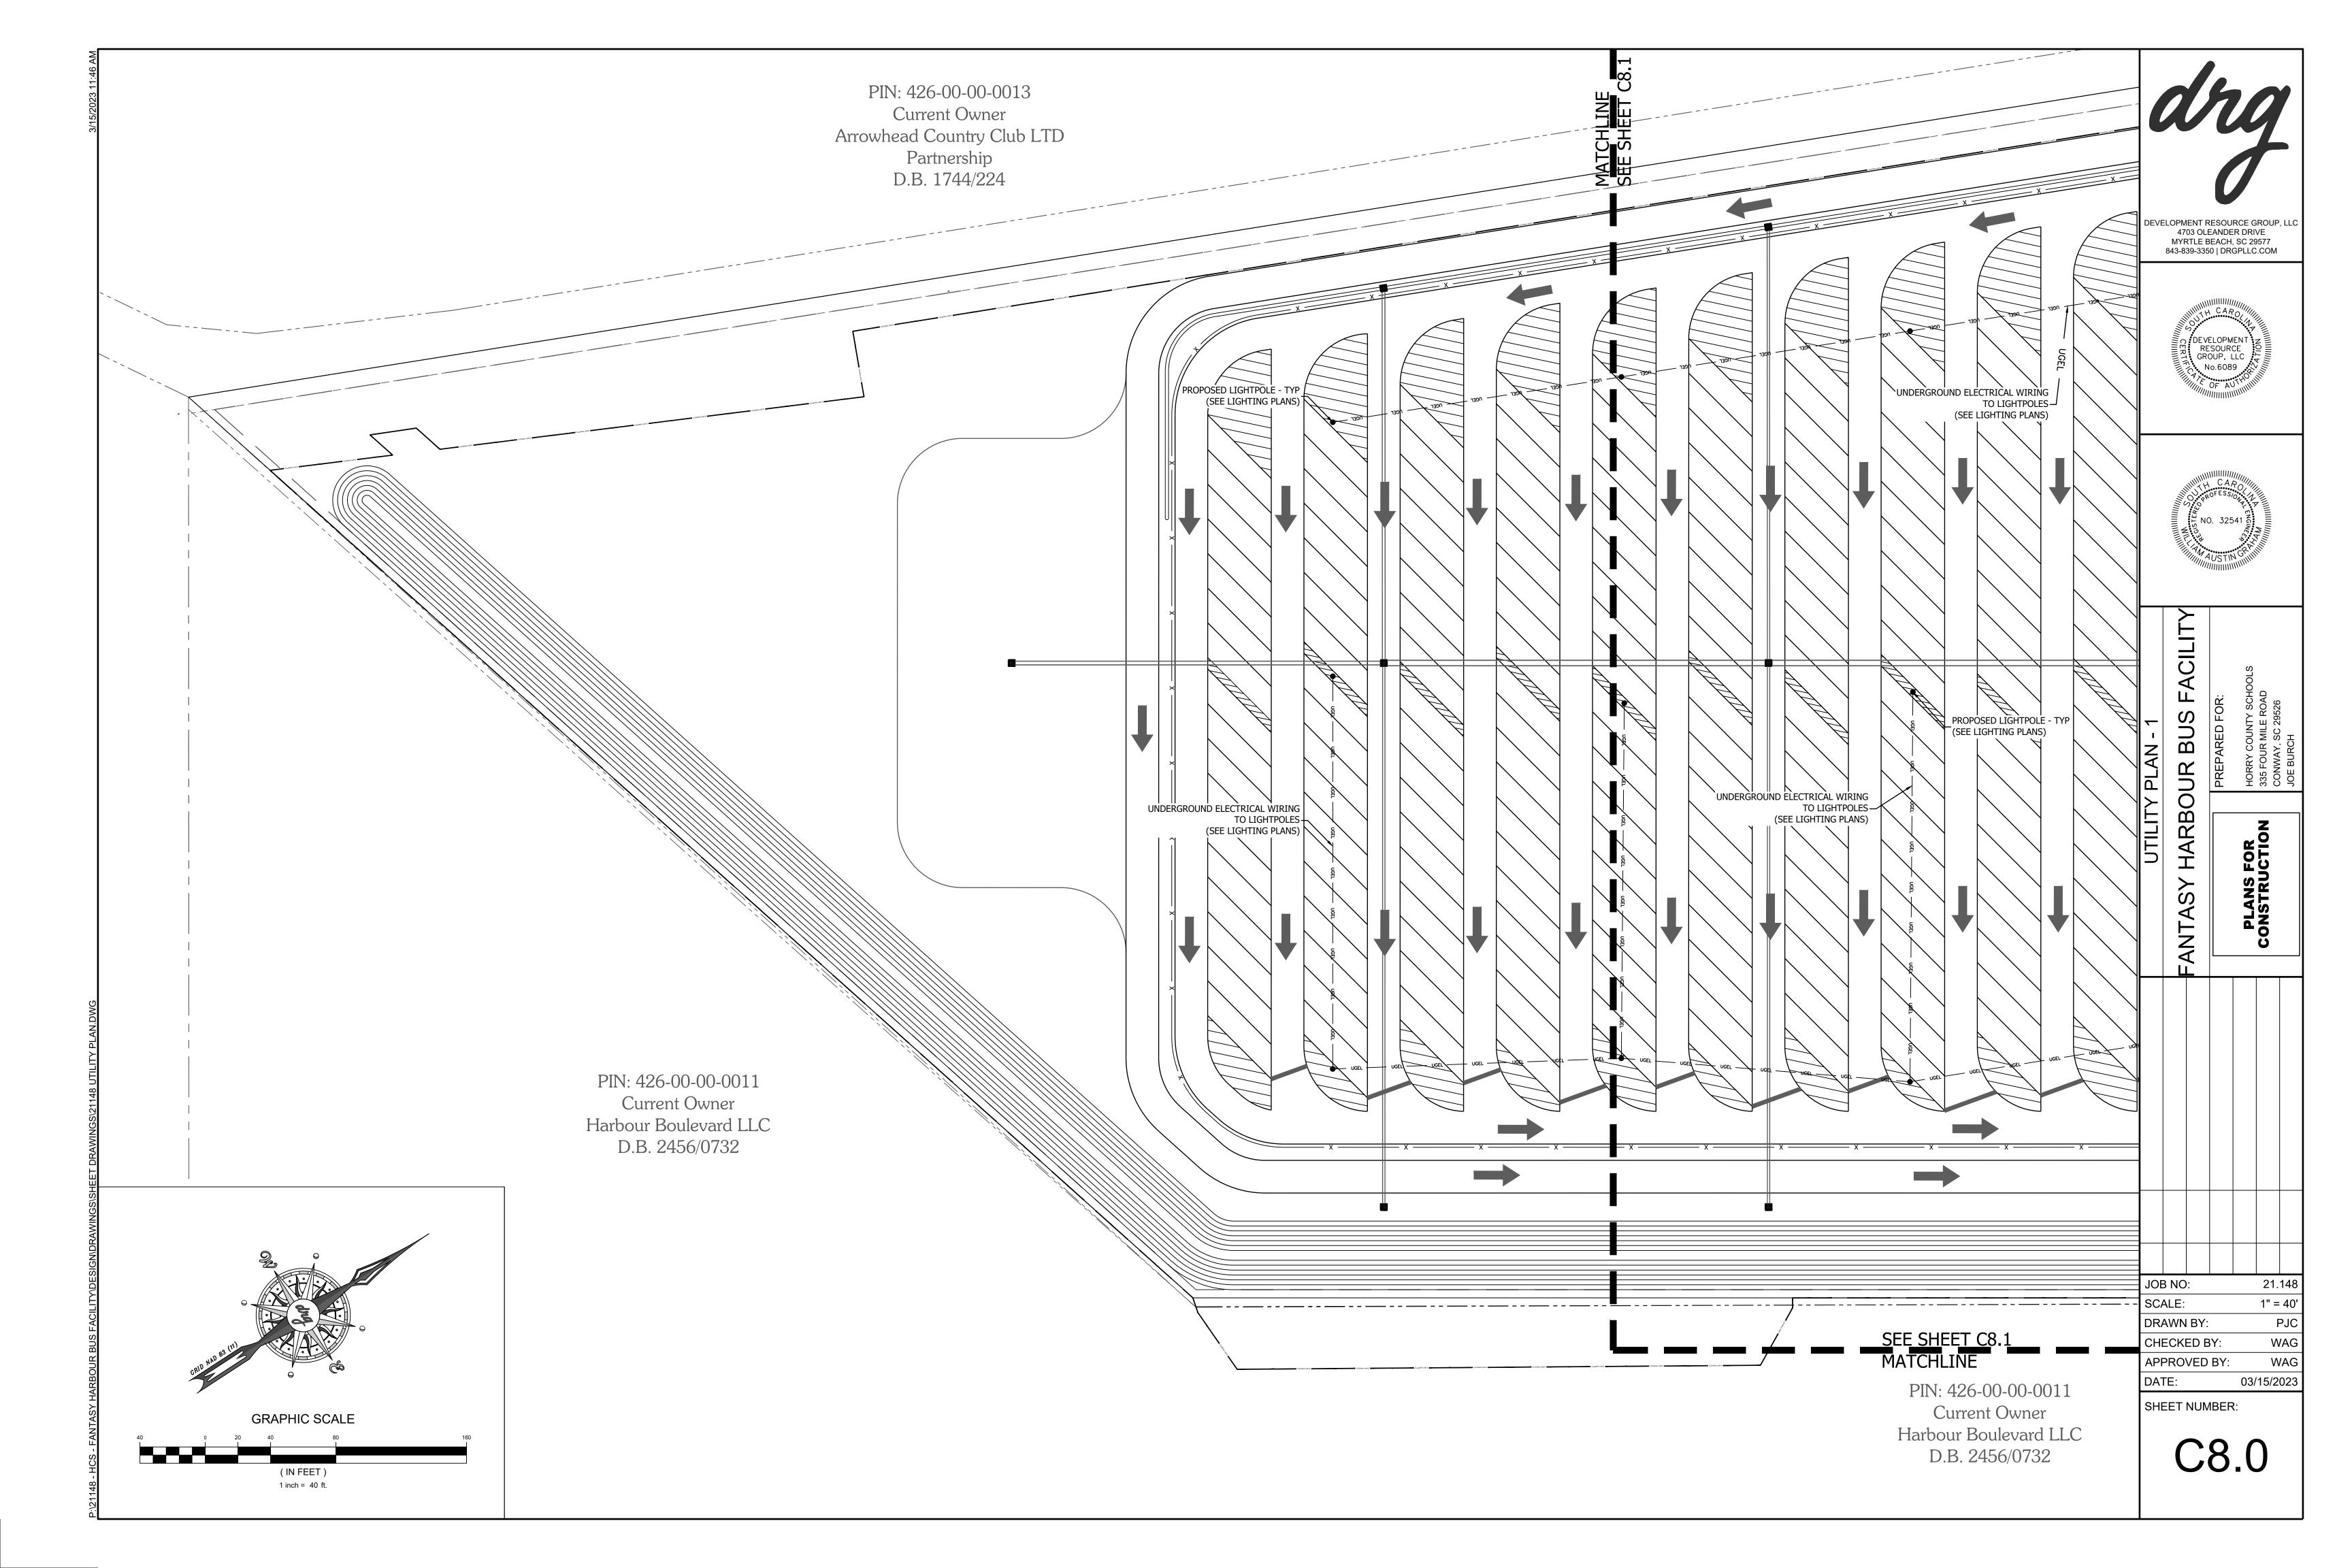
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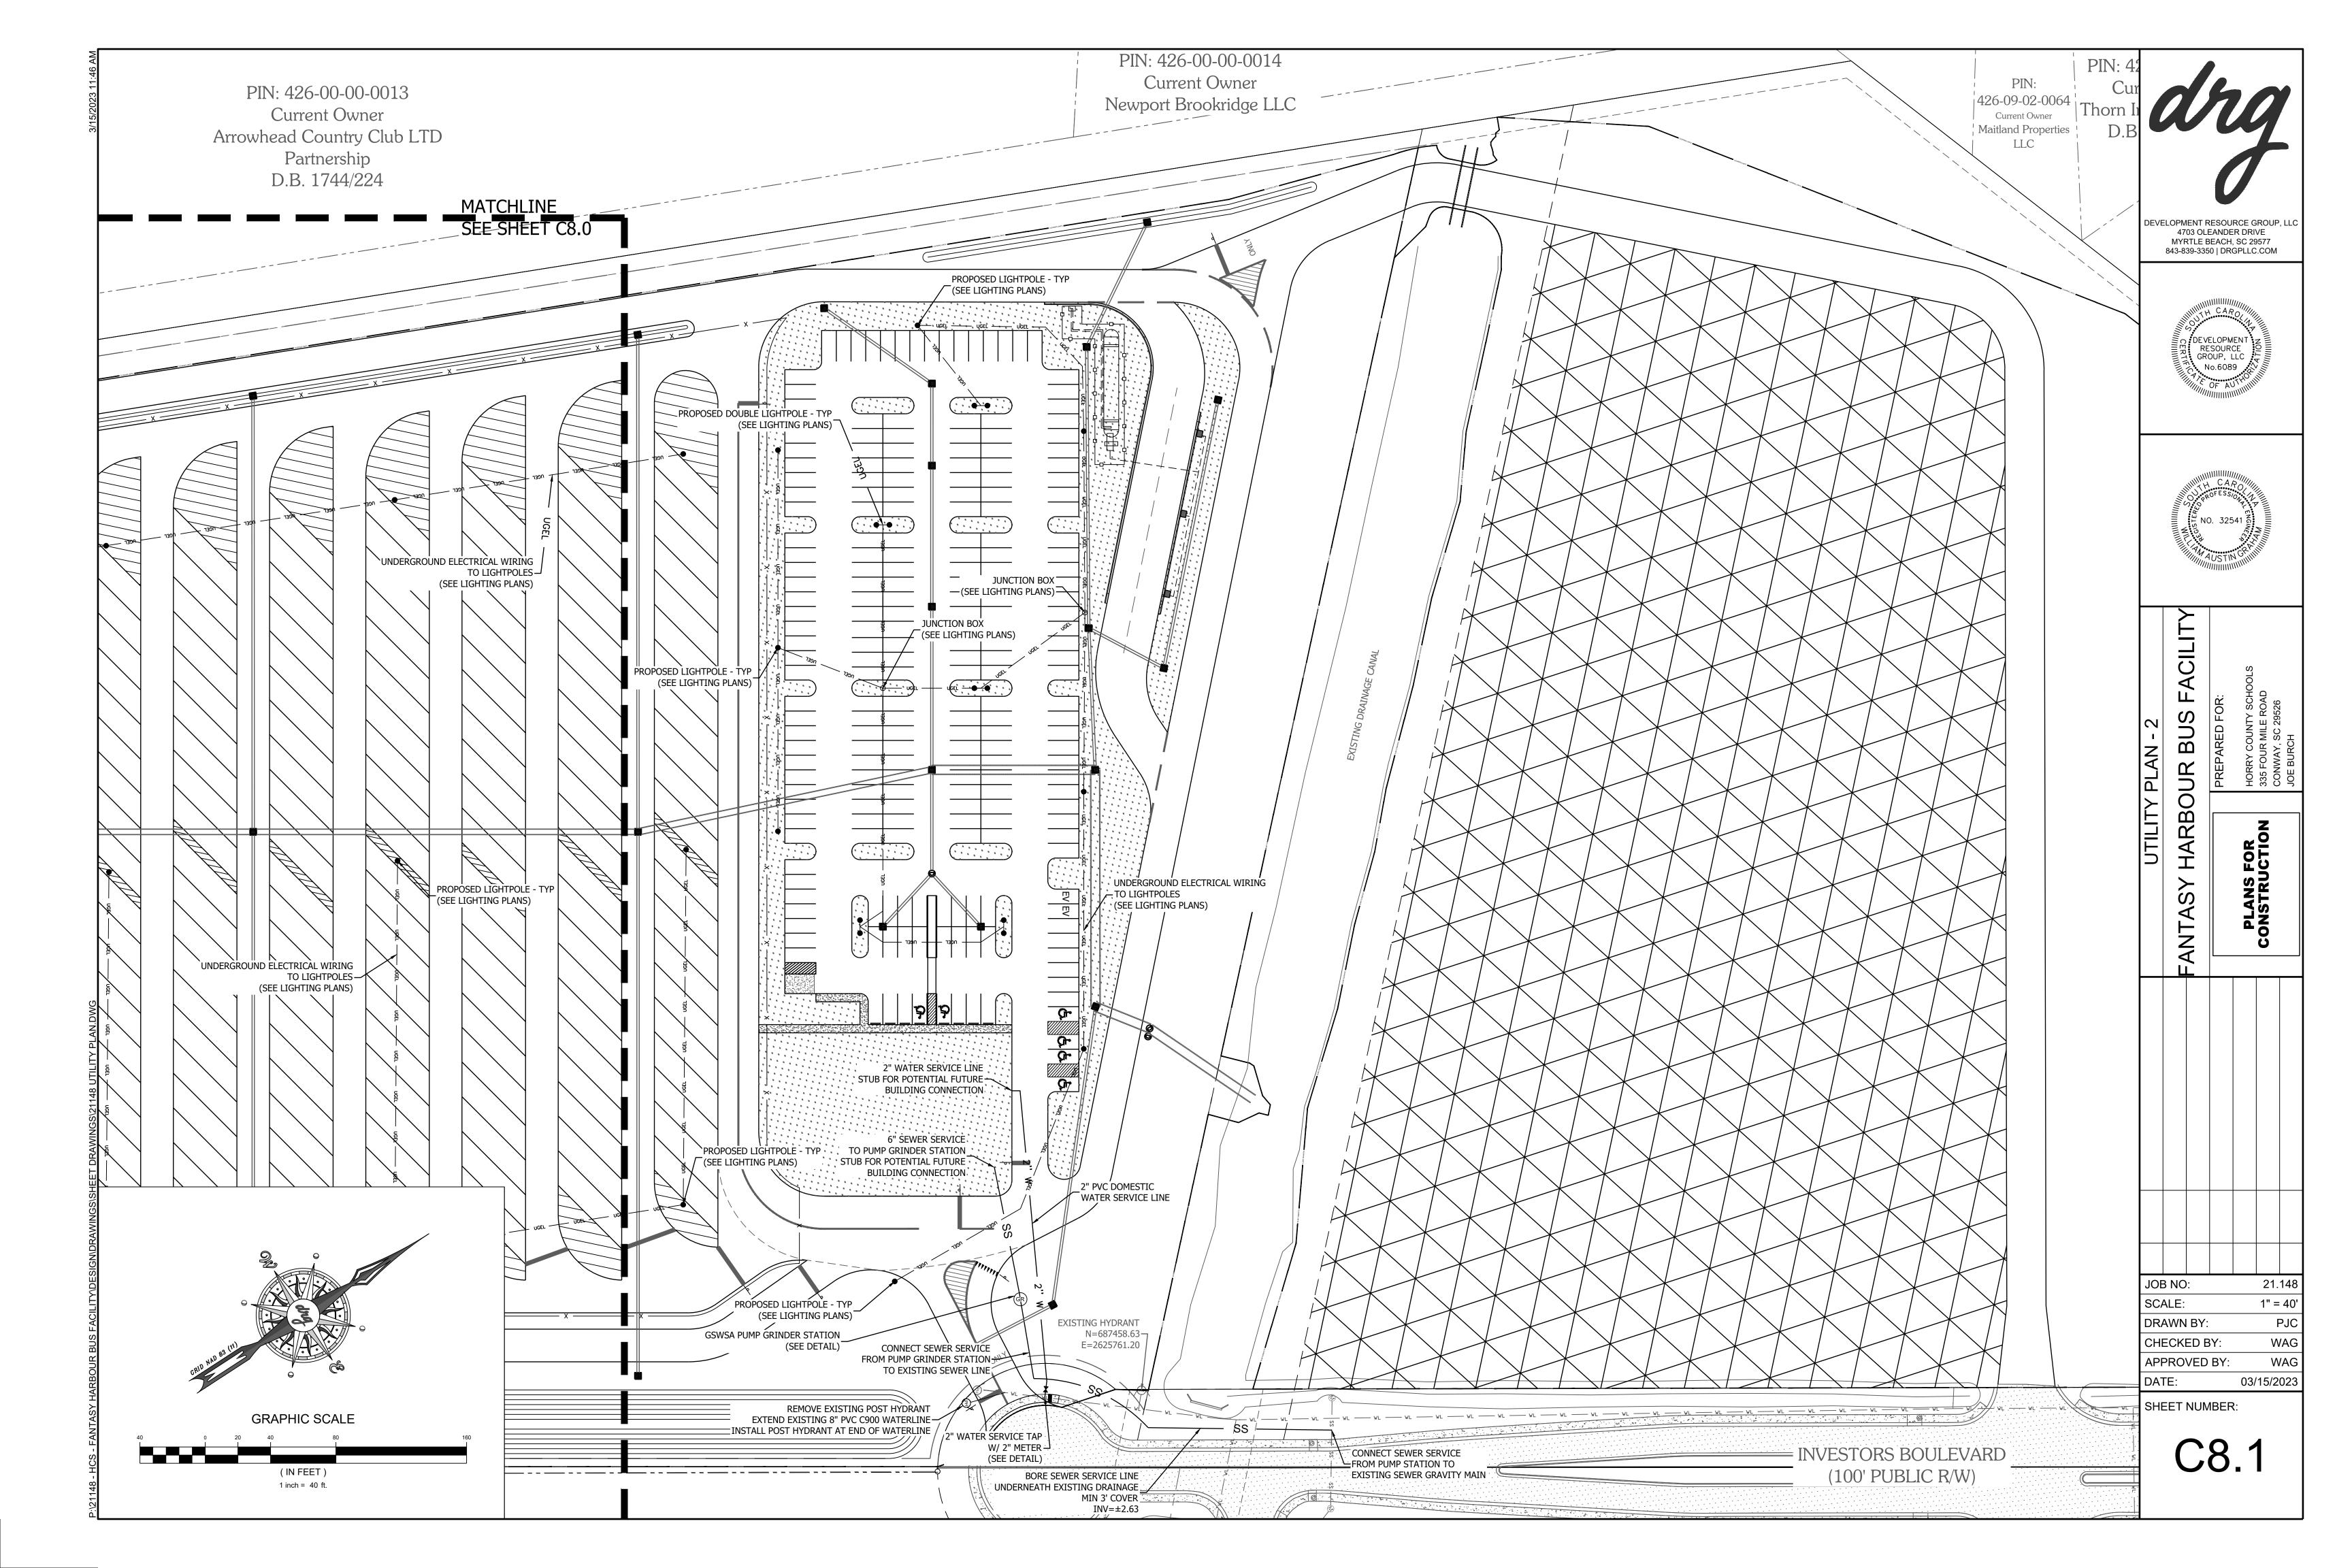
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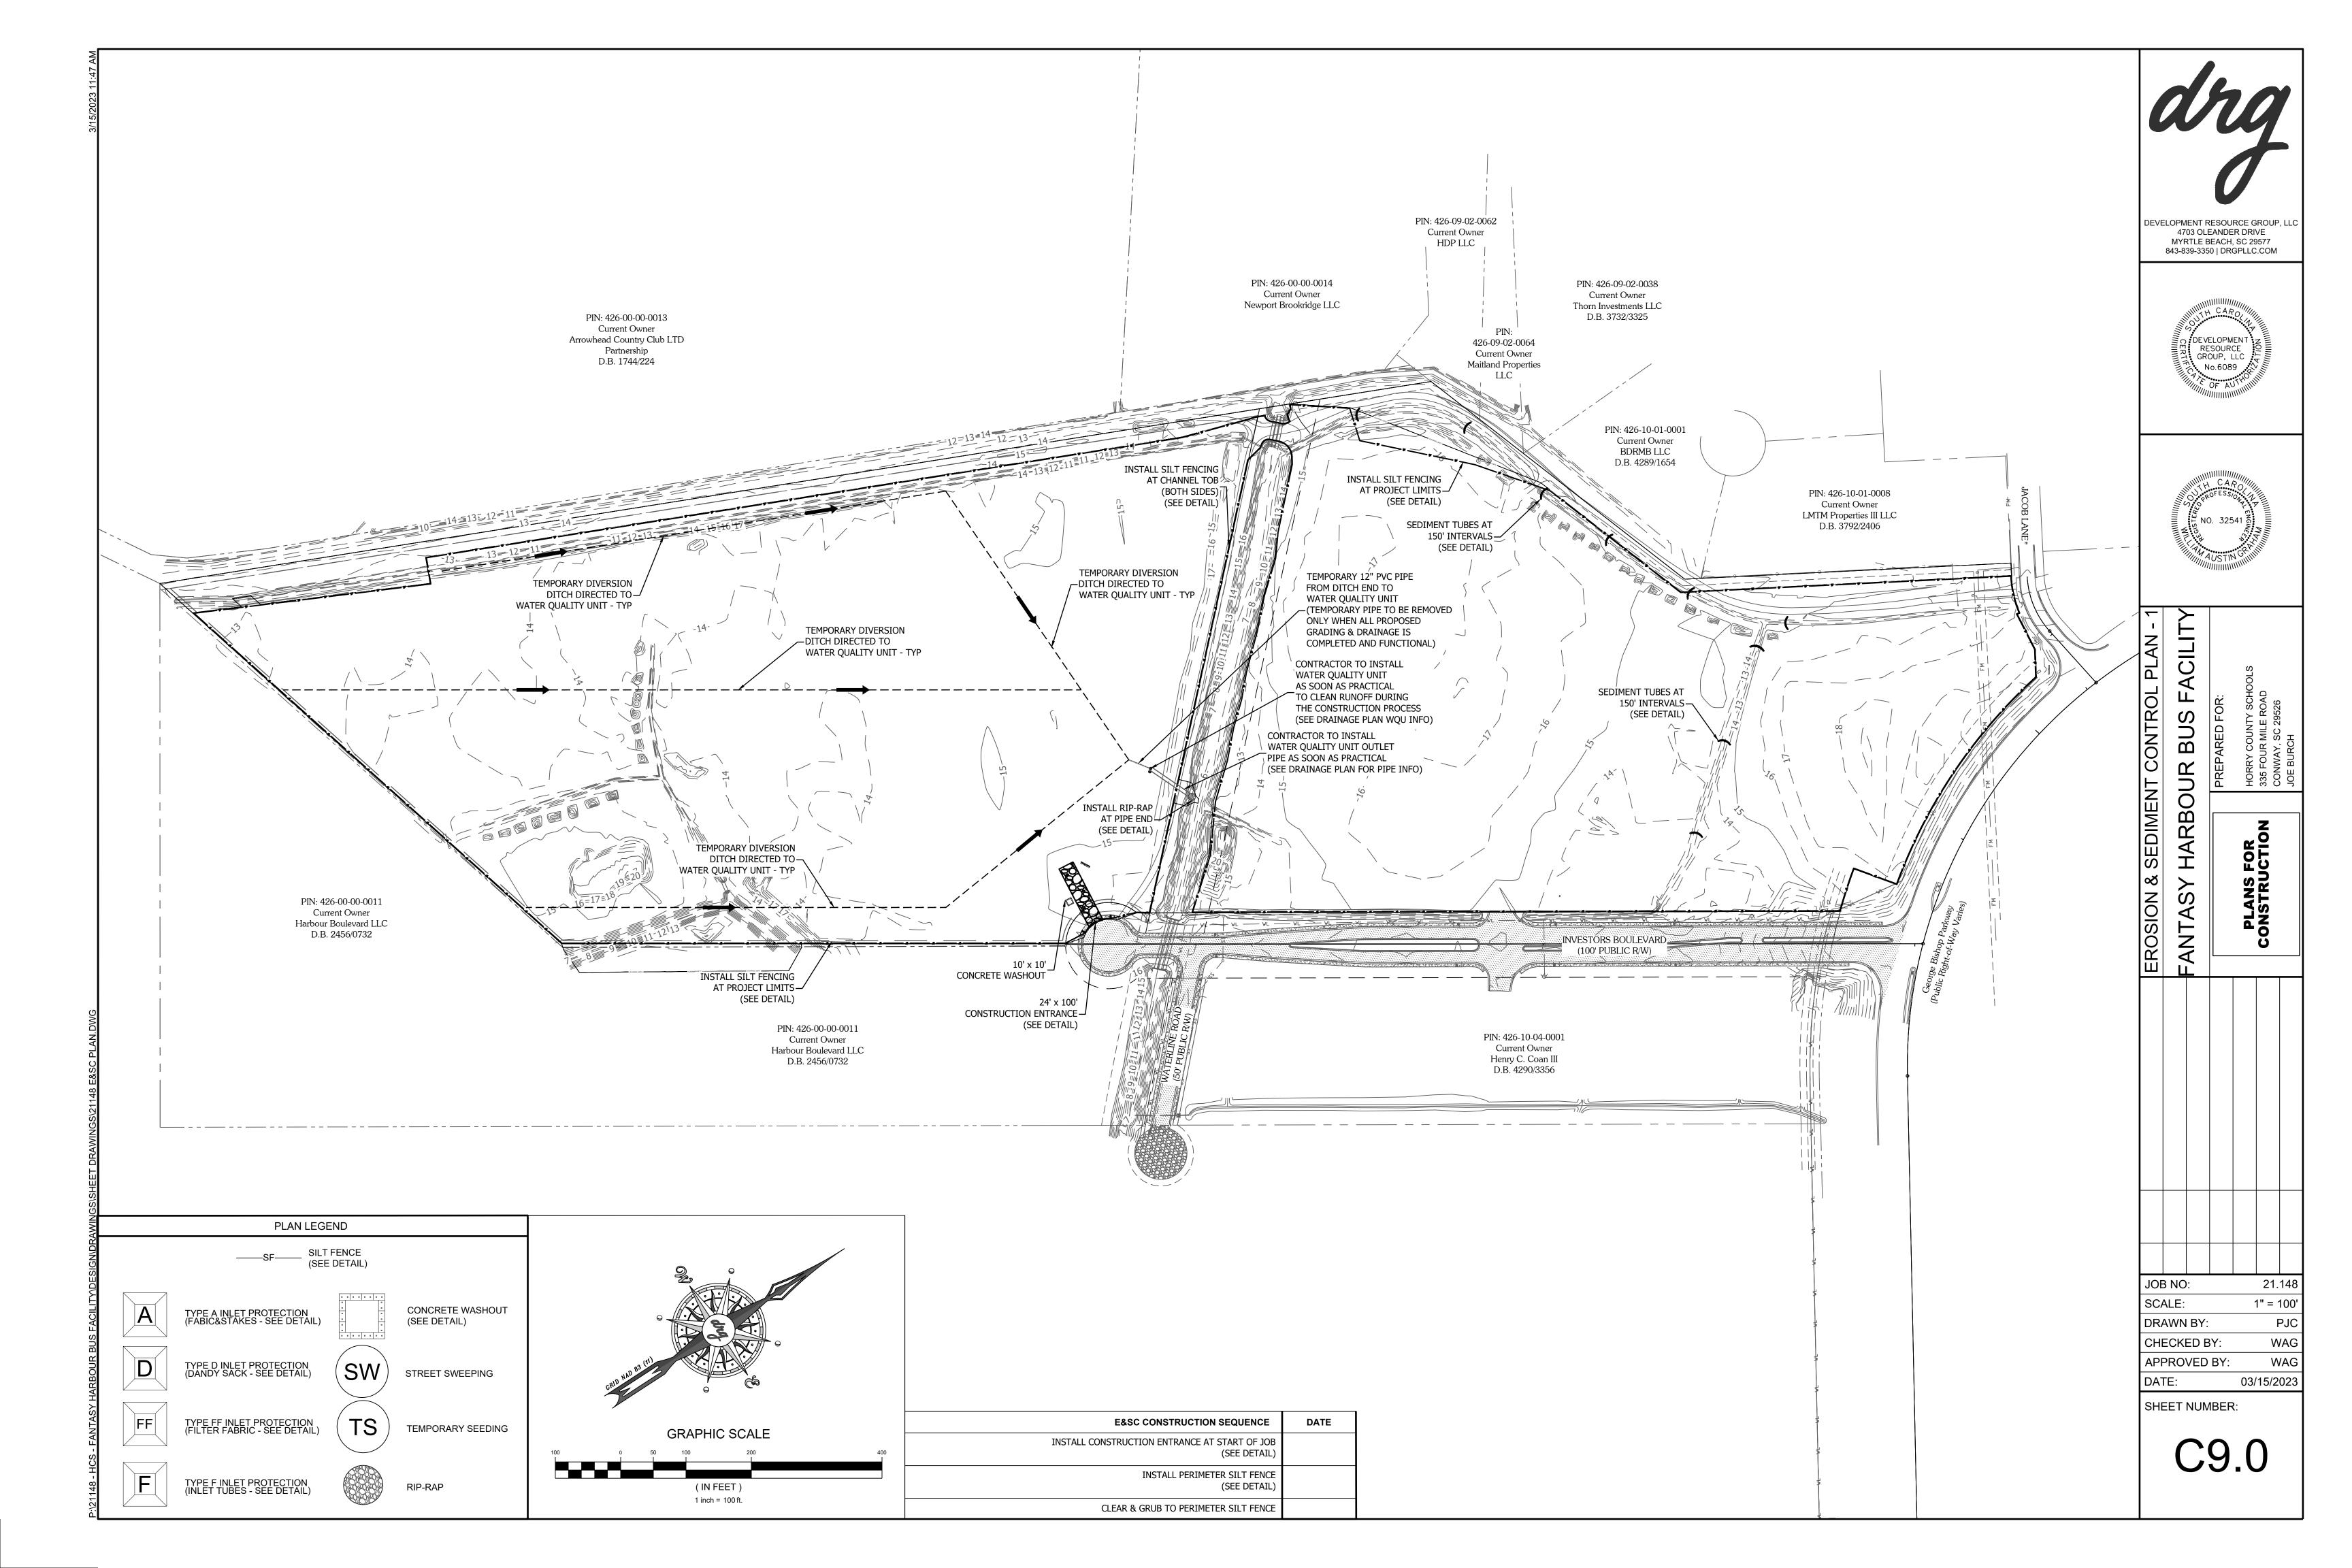
(IN FEET)


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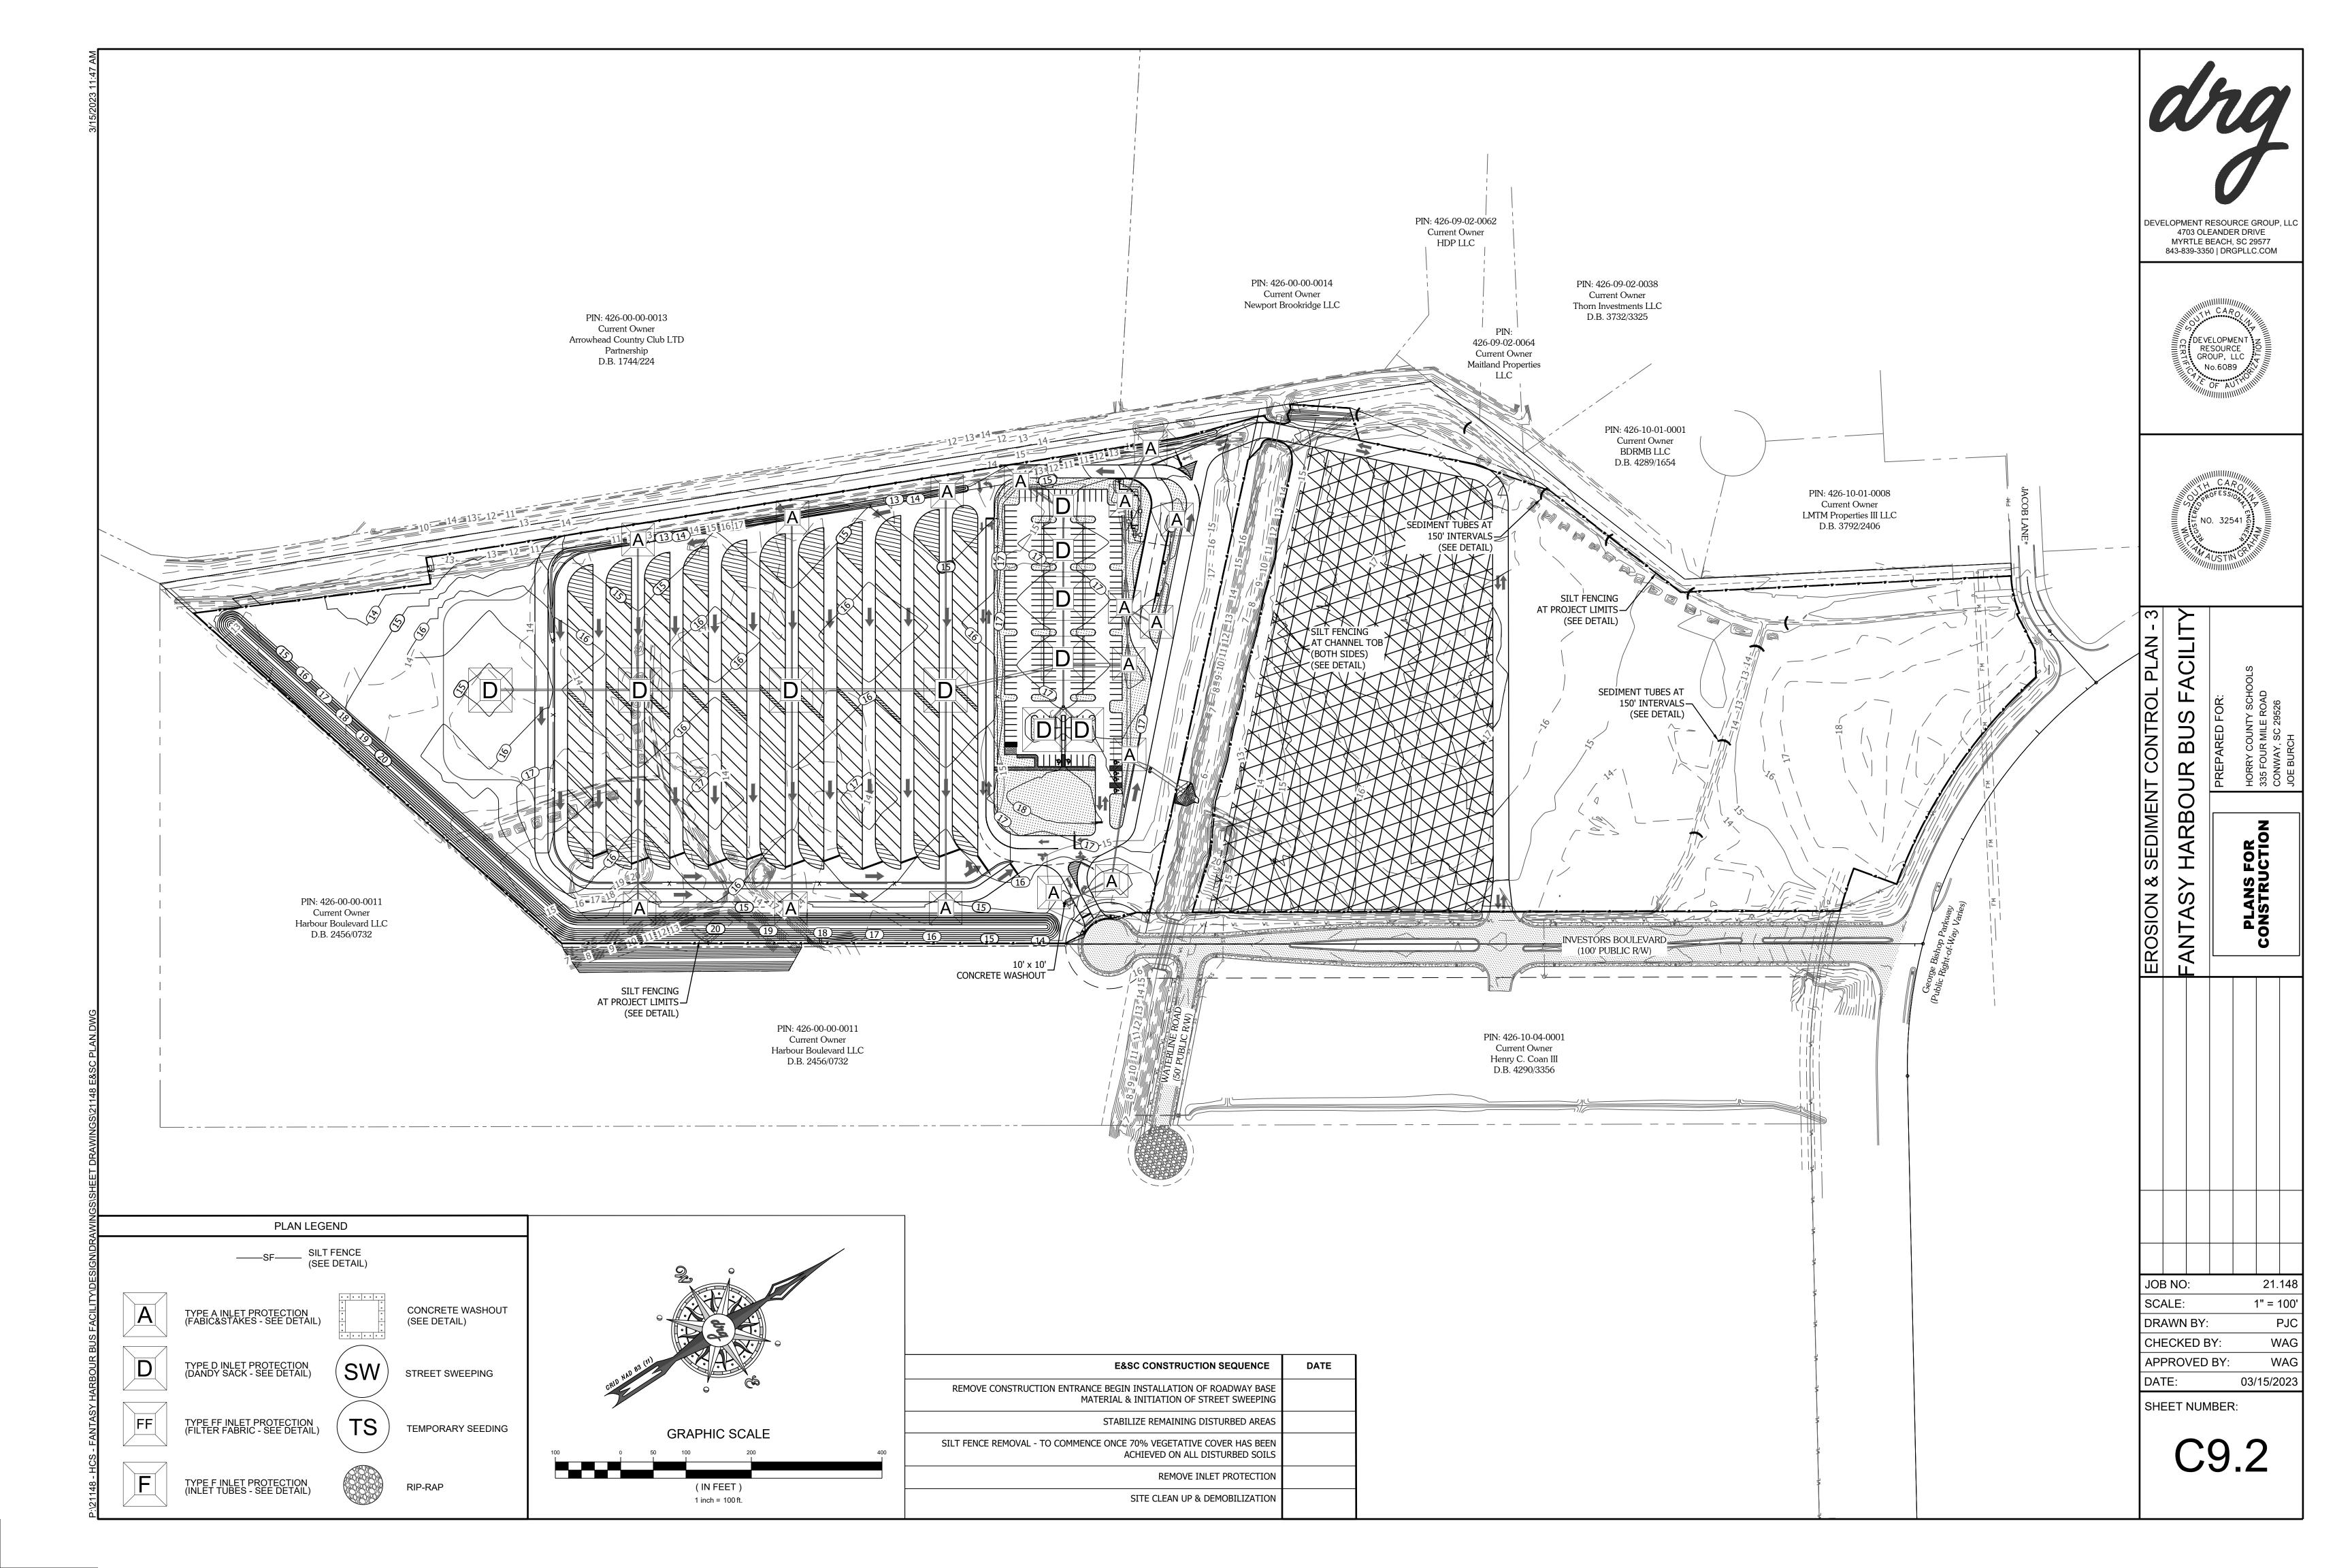











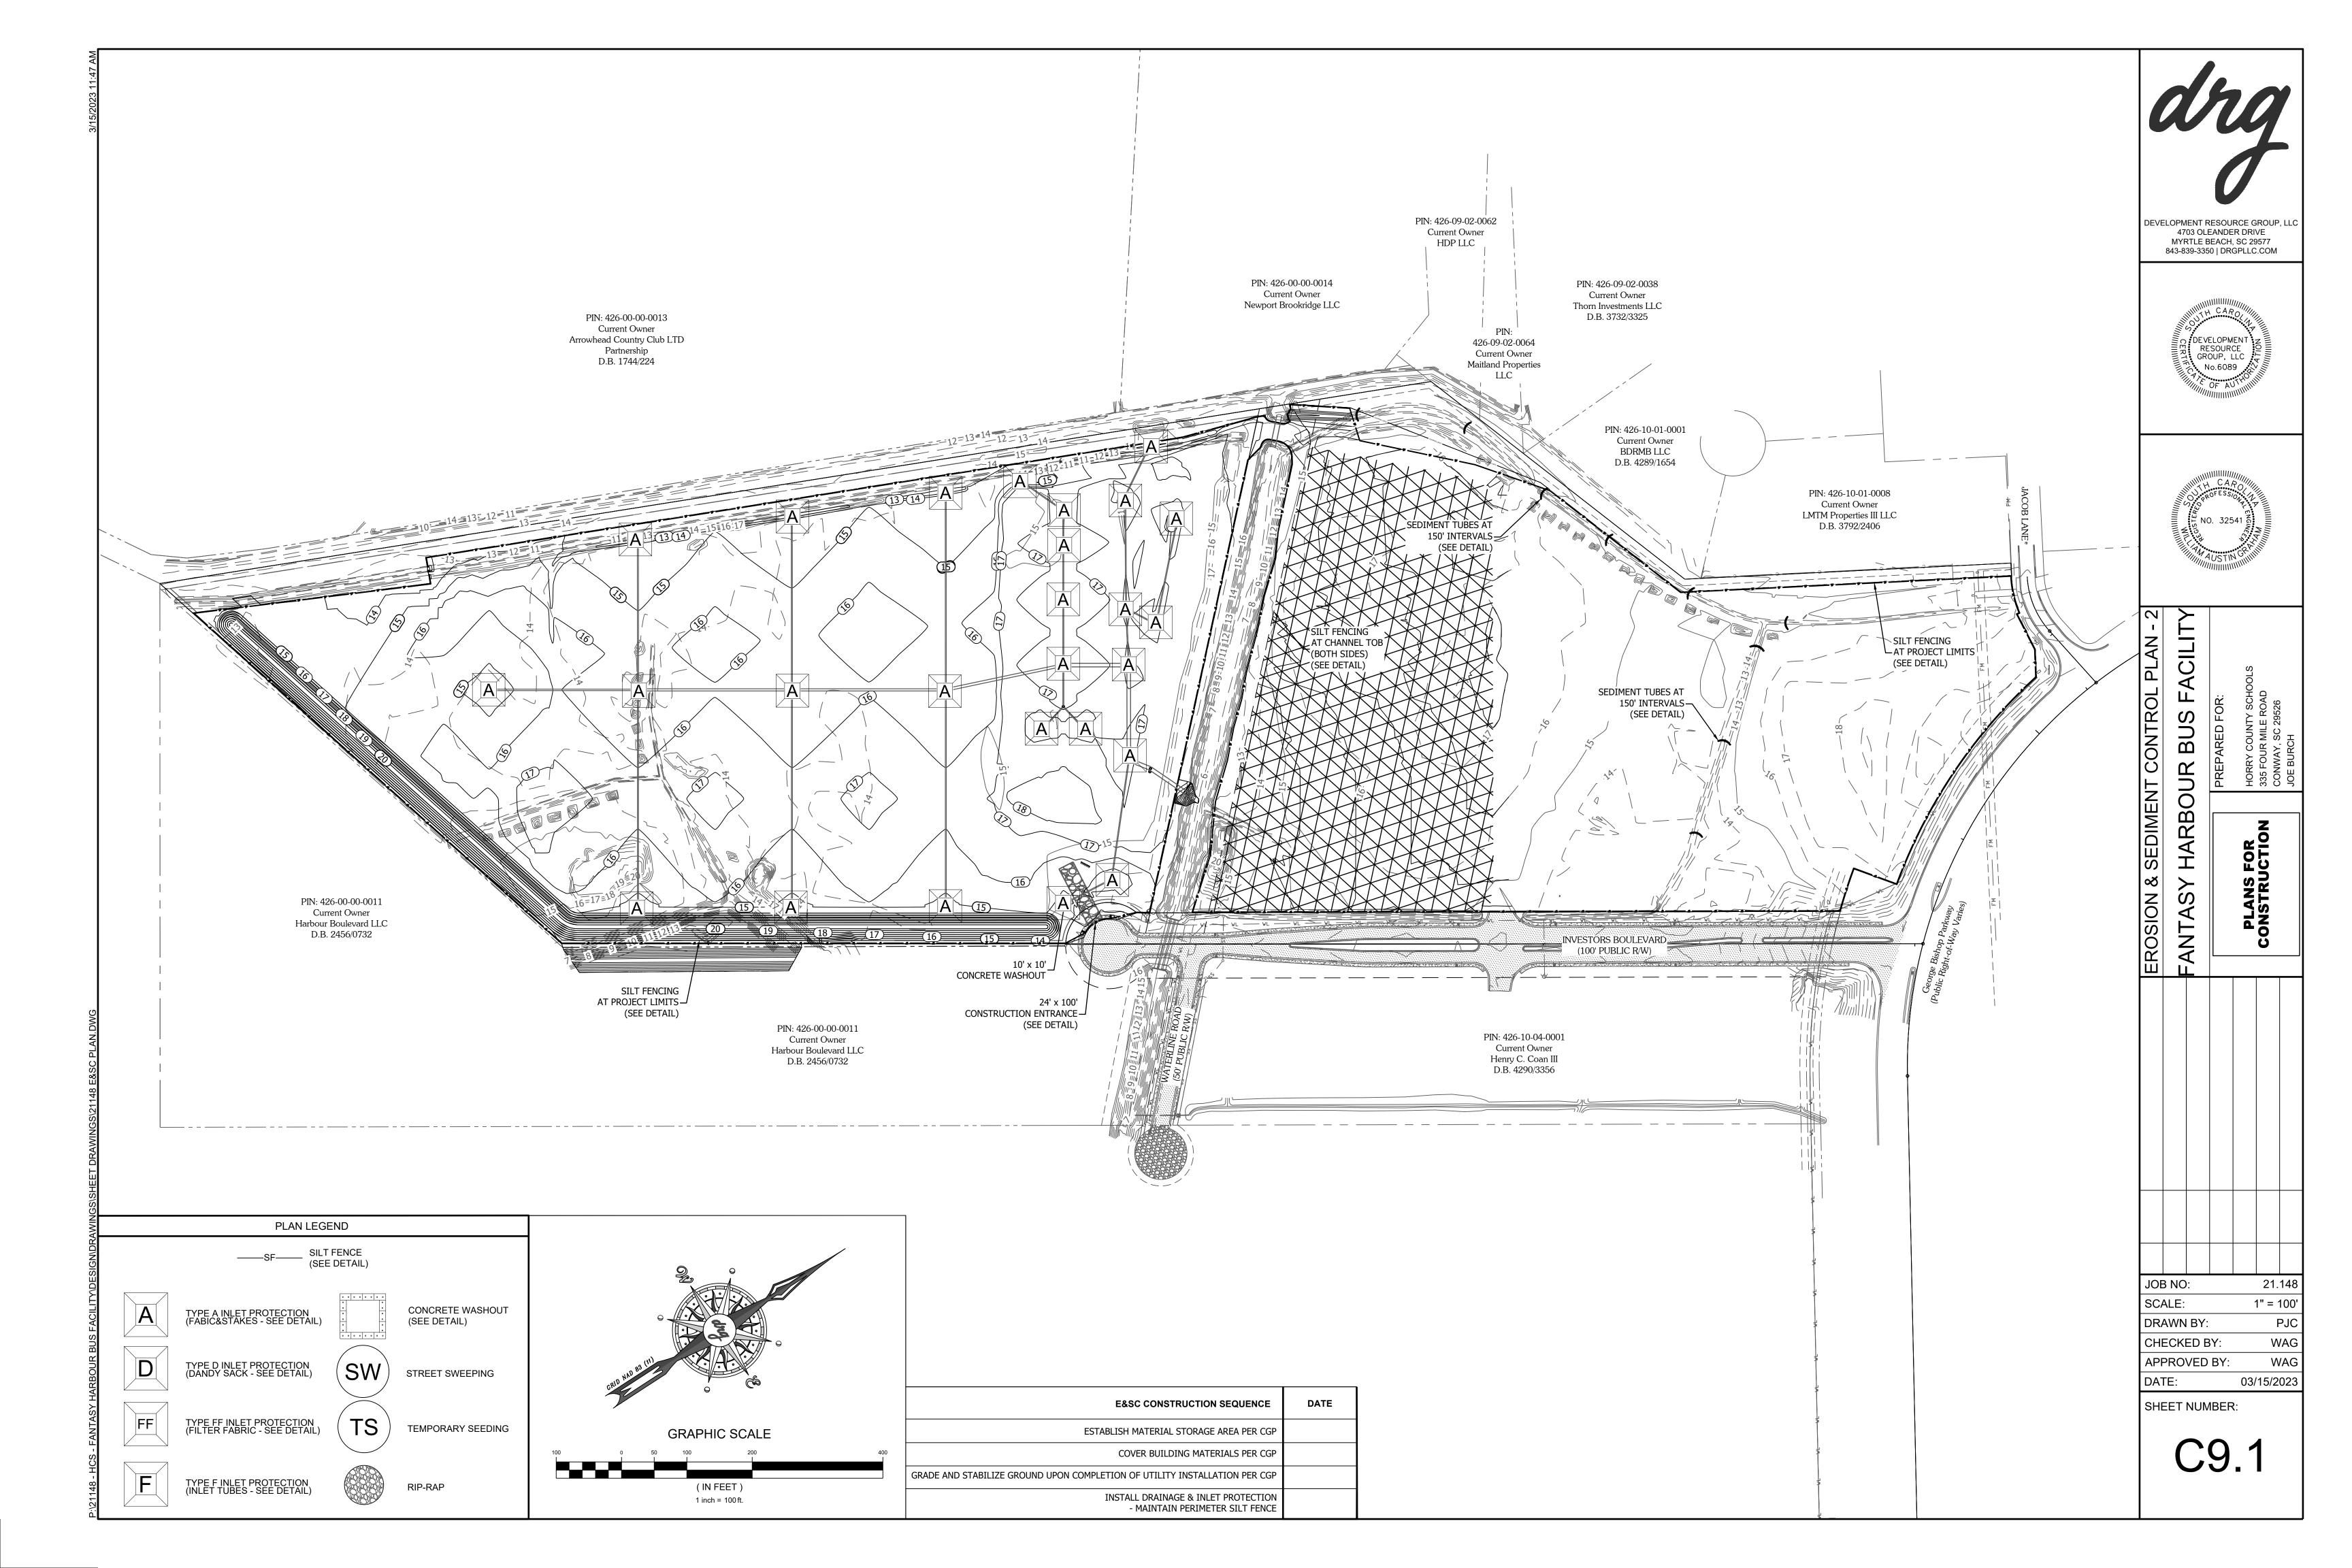

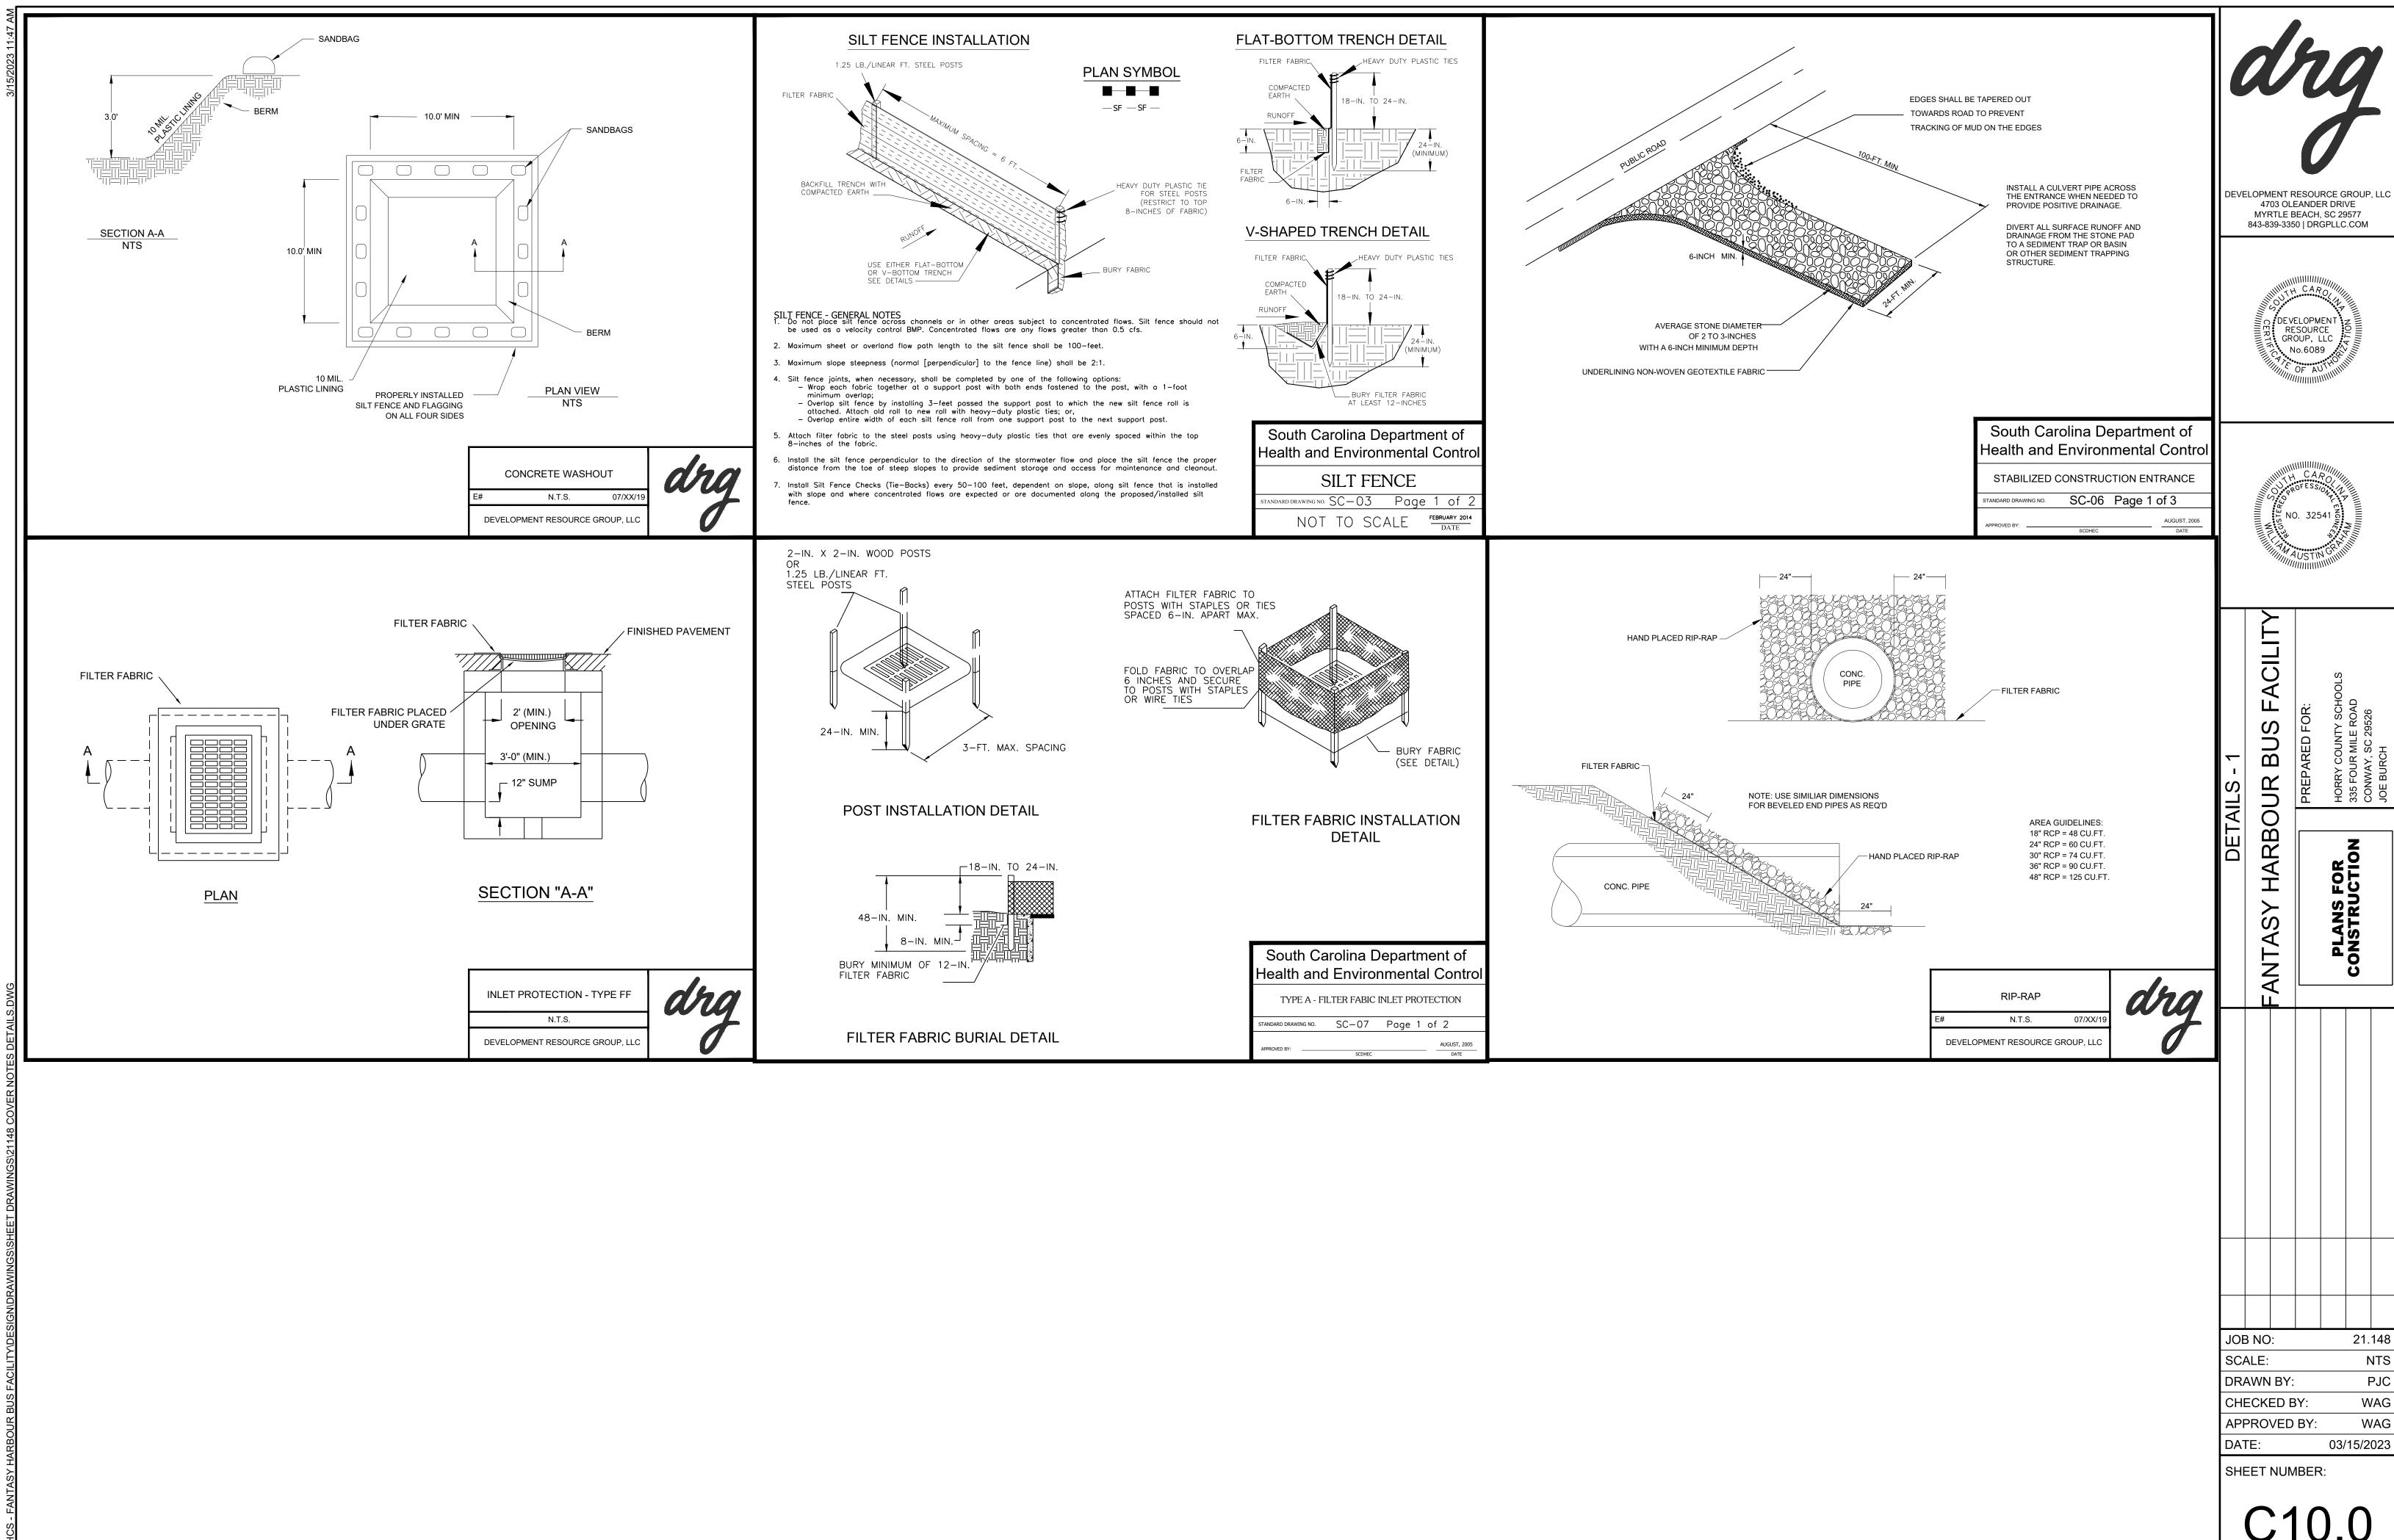



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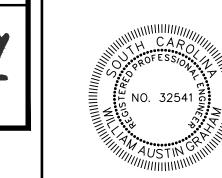




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DETAILS - 3

DETAILS - 3

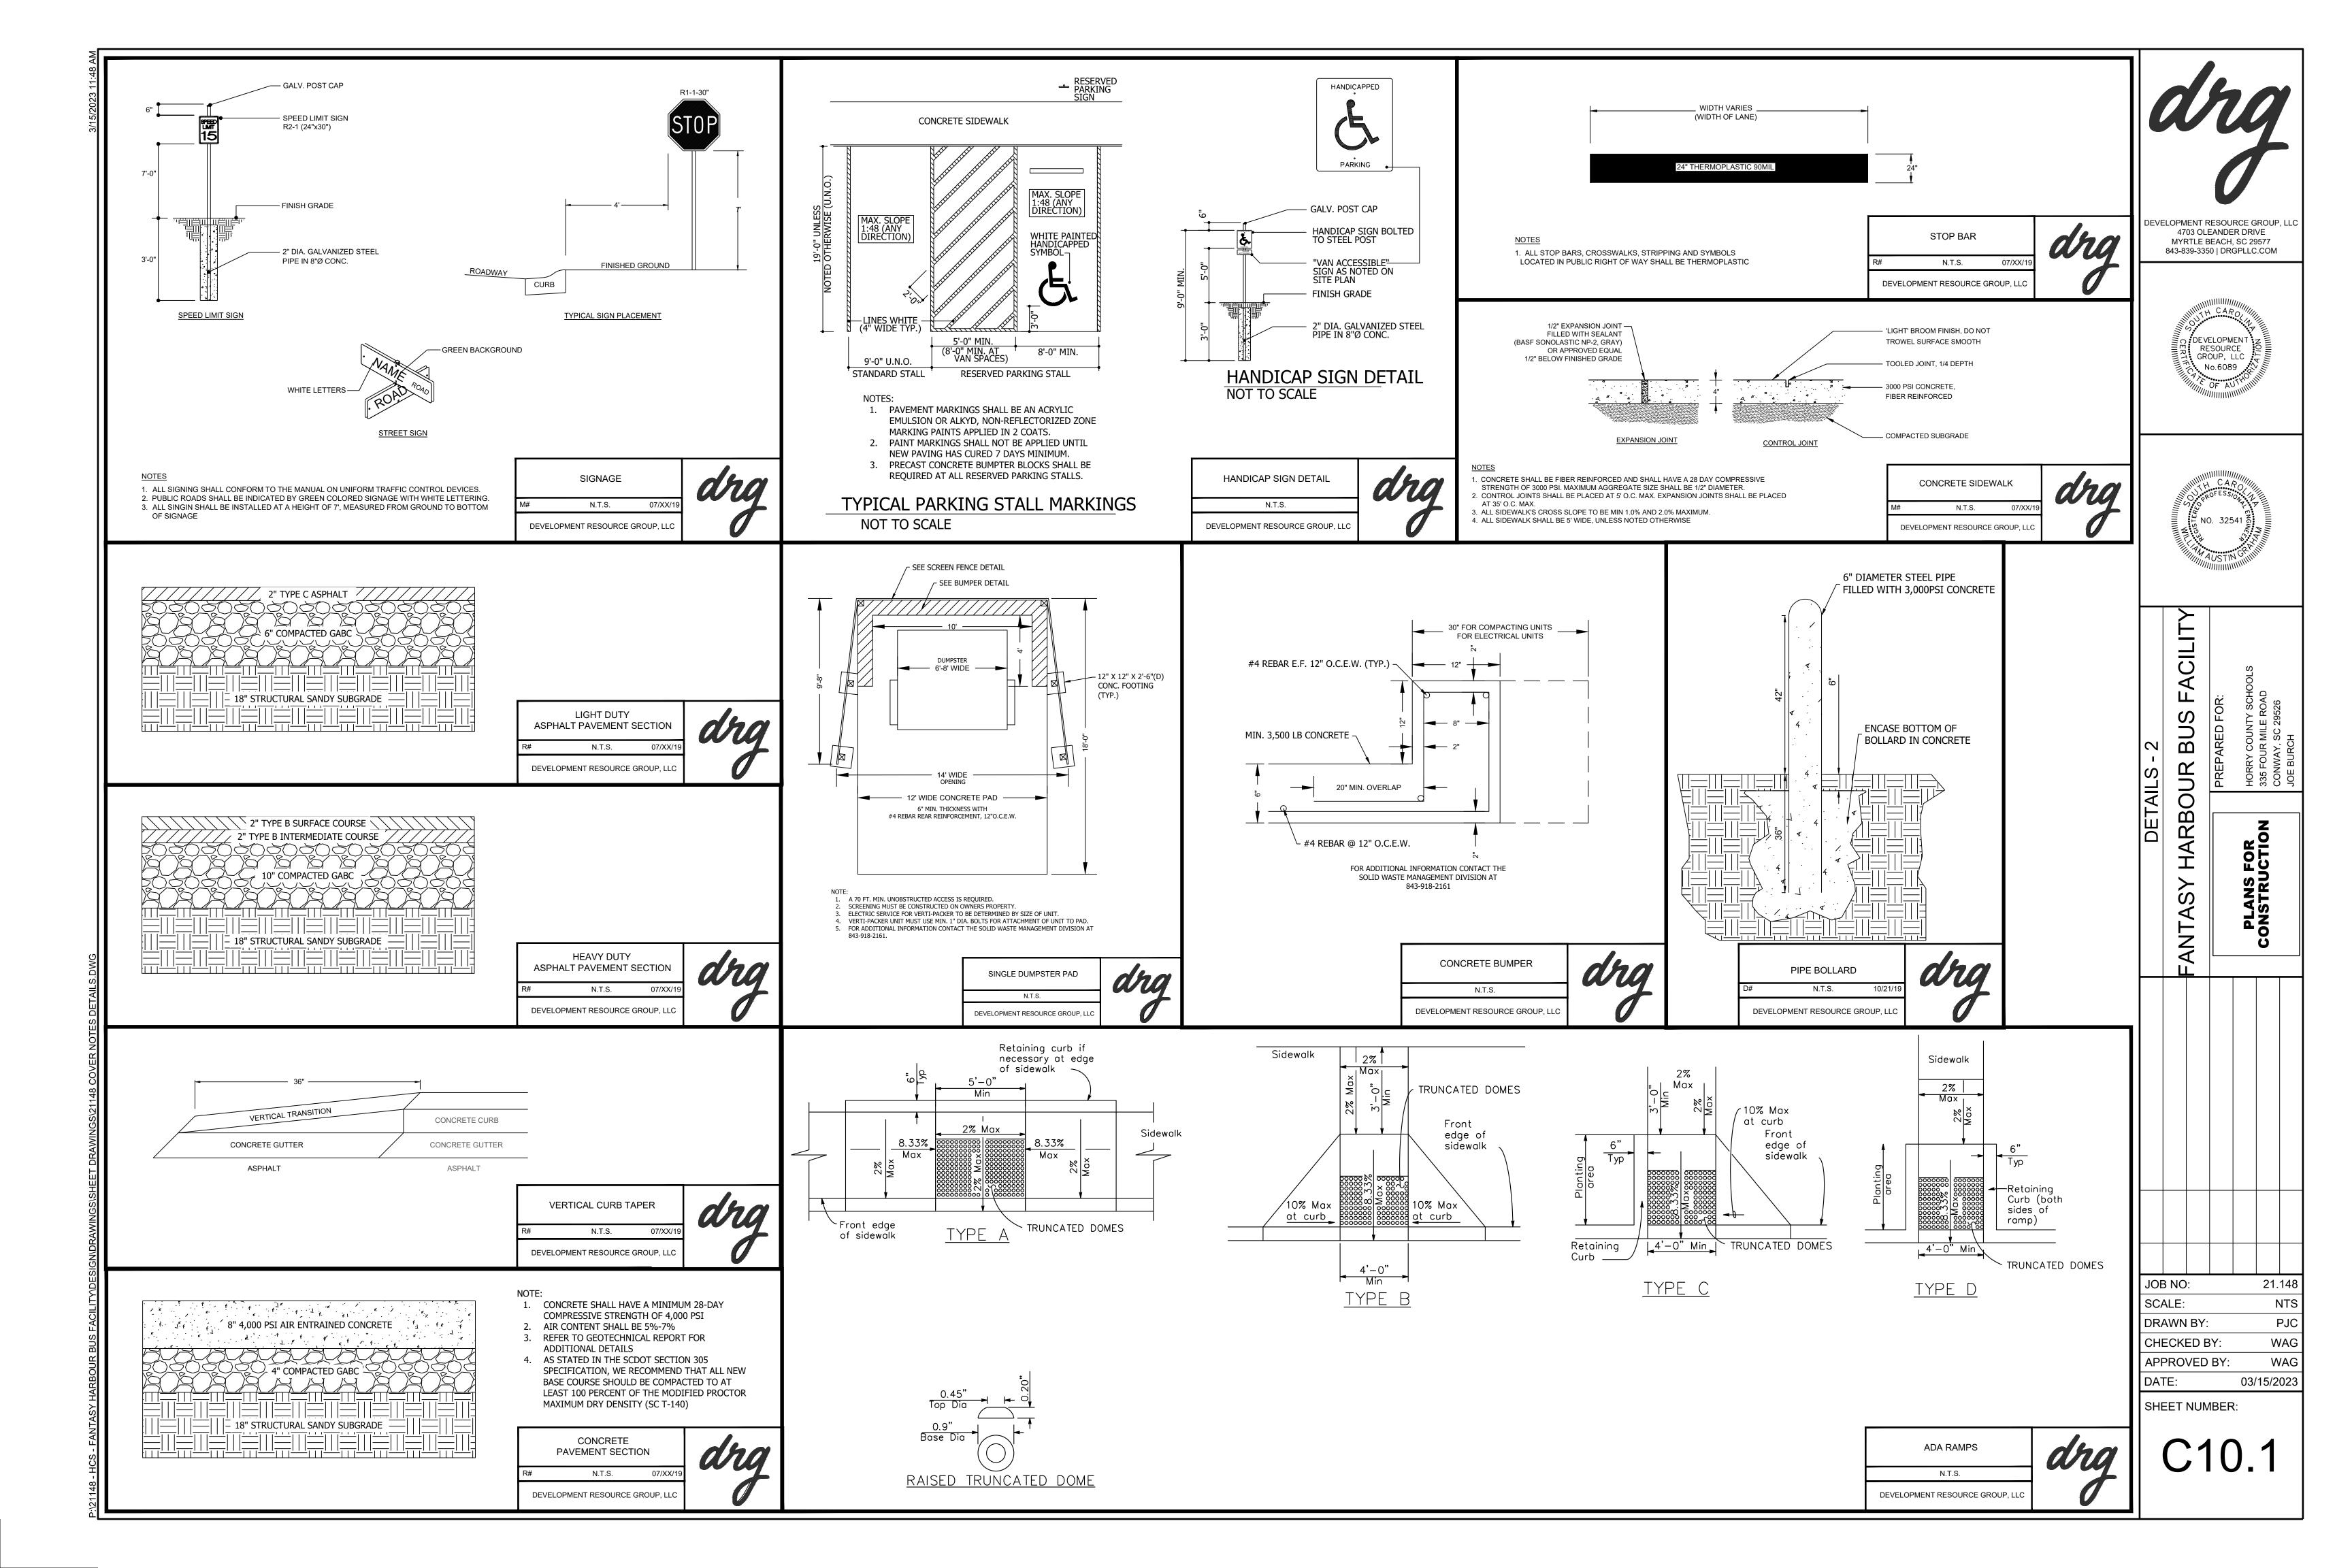SAN TASY HARBOUR BUS FACILITY

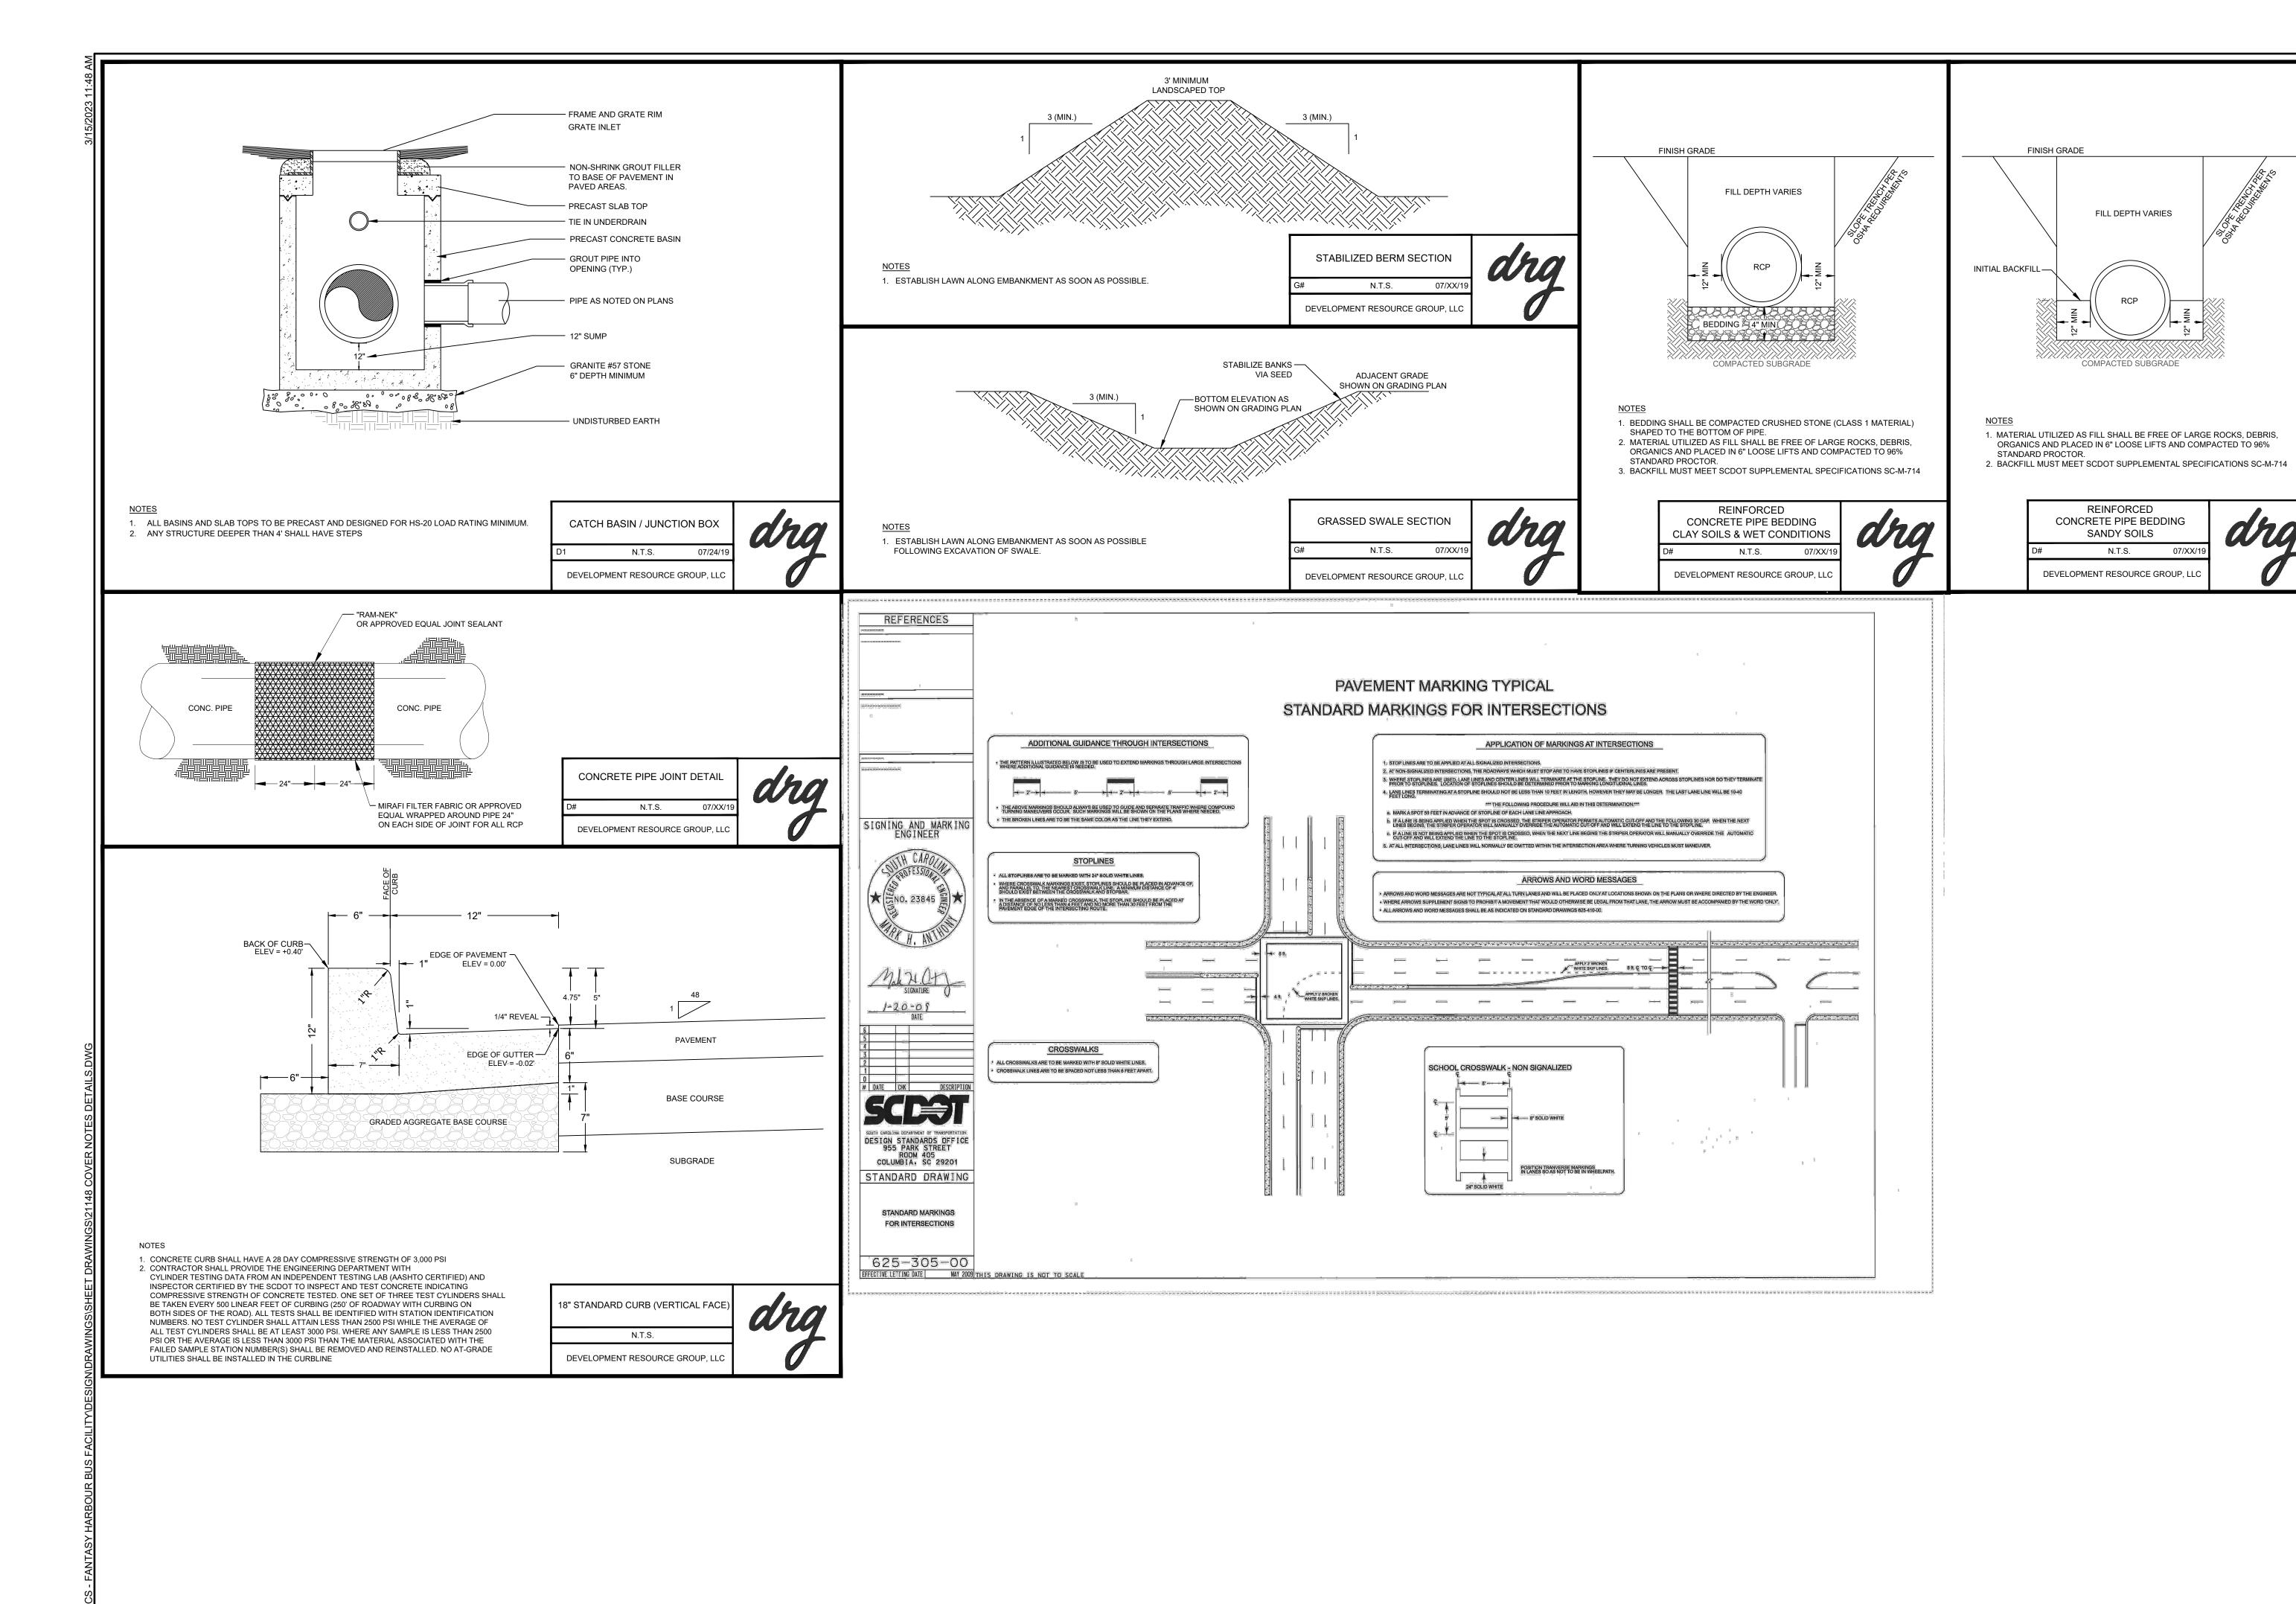HORRY COUNTY SCHOOLS

CONSTRUCTION

LONWAY, SC 29526

LONWAY, S


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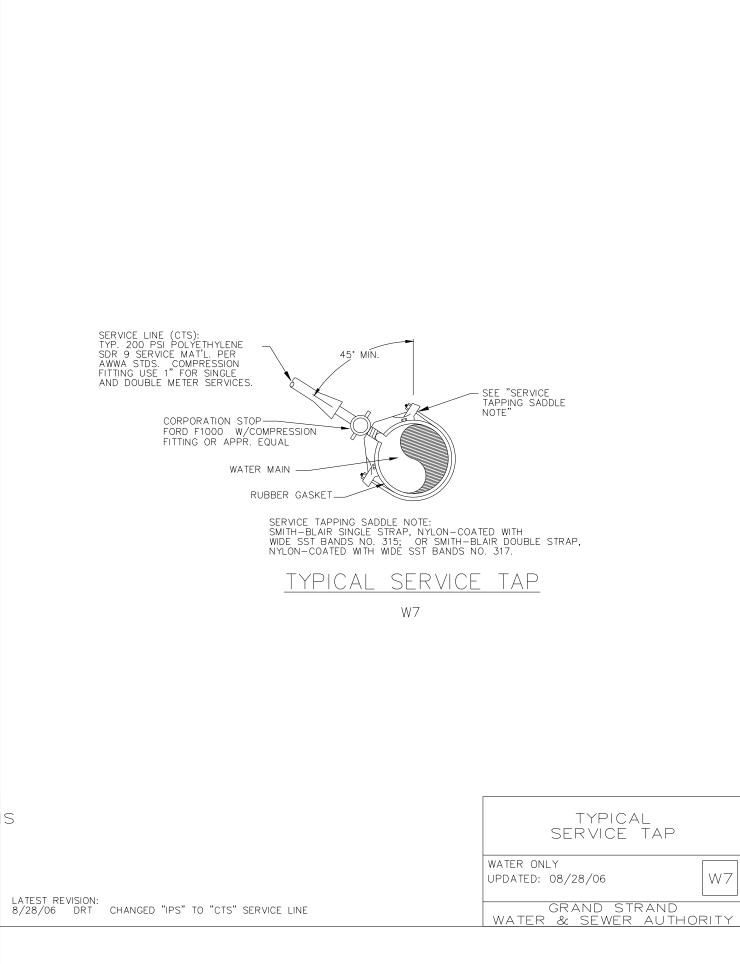
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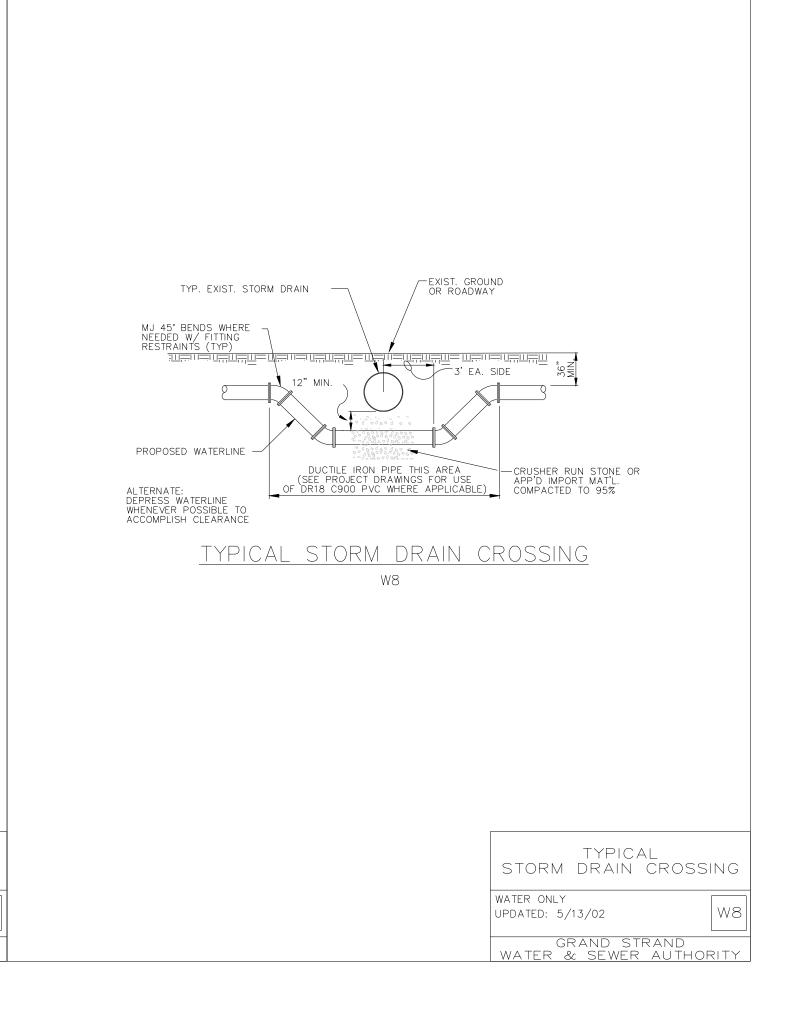
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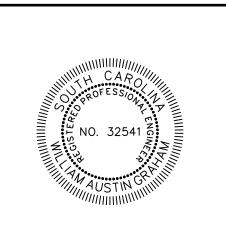






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V 0 =	DETAILS - 4	FANTASY HARBOUR BUS FACILITY		PREPARED FOR:	HORRY COUNTY SCHOOLS	335 FOUR MILE ROAD	JOE BURCH		
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				PLANS FOR CONSTRUCTION					
J	21.	148							
S	C	ALE: NTS							

C10.3
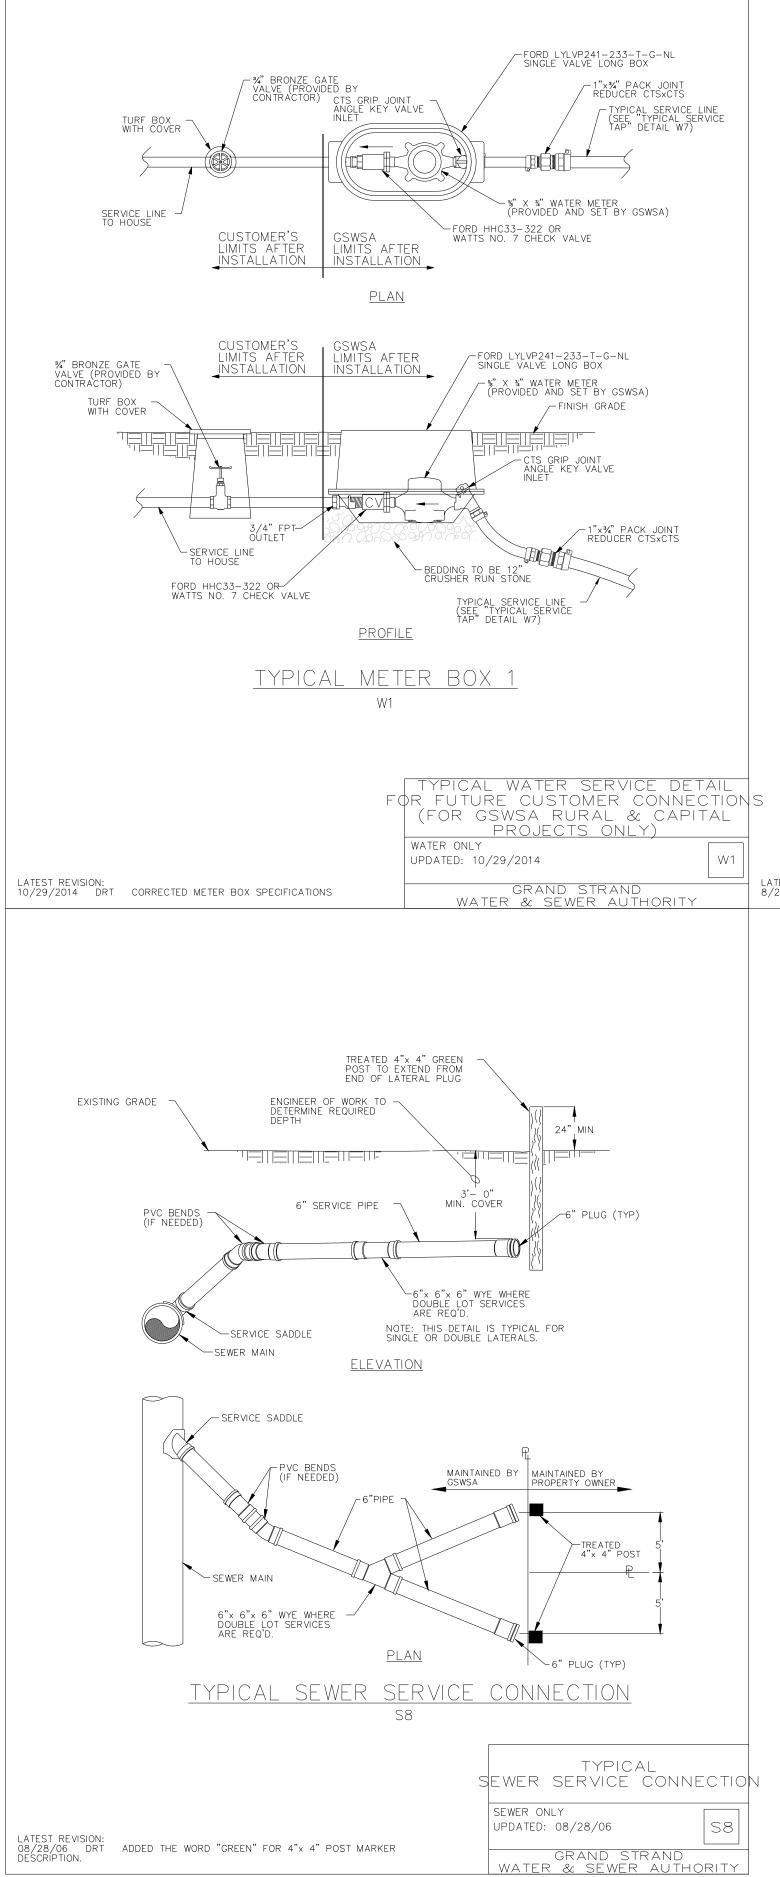
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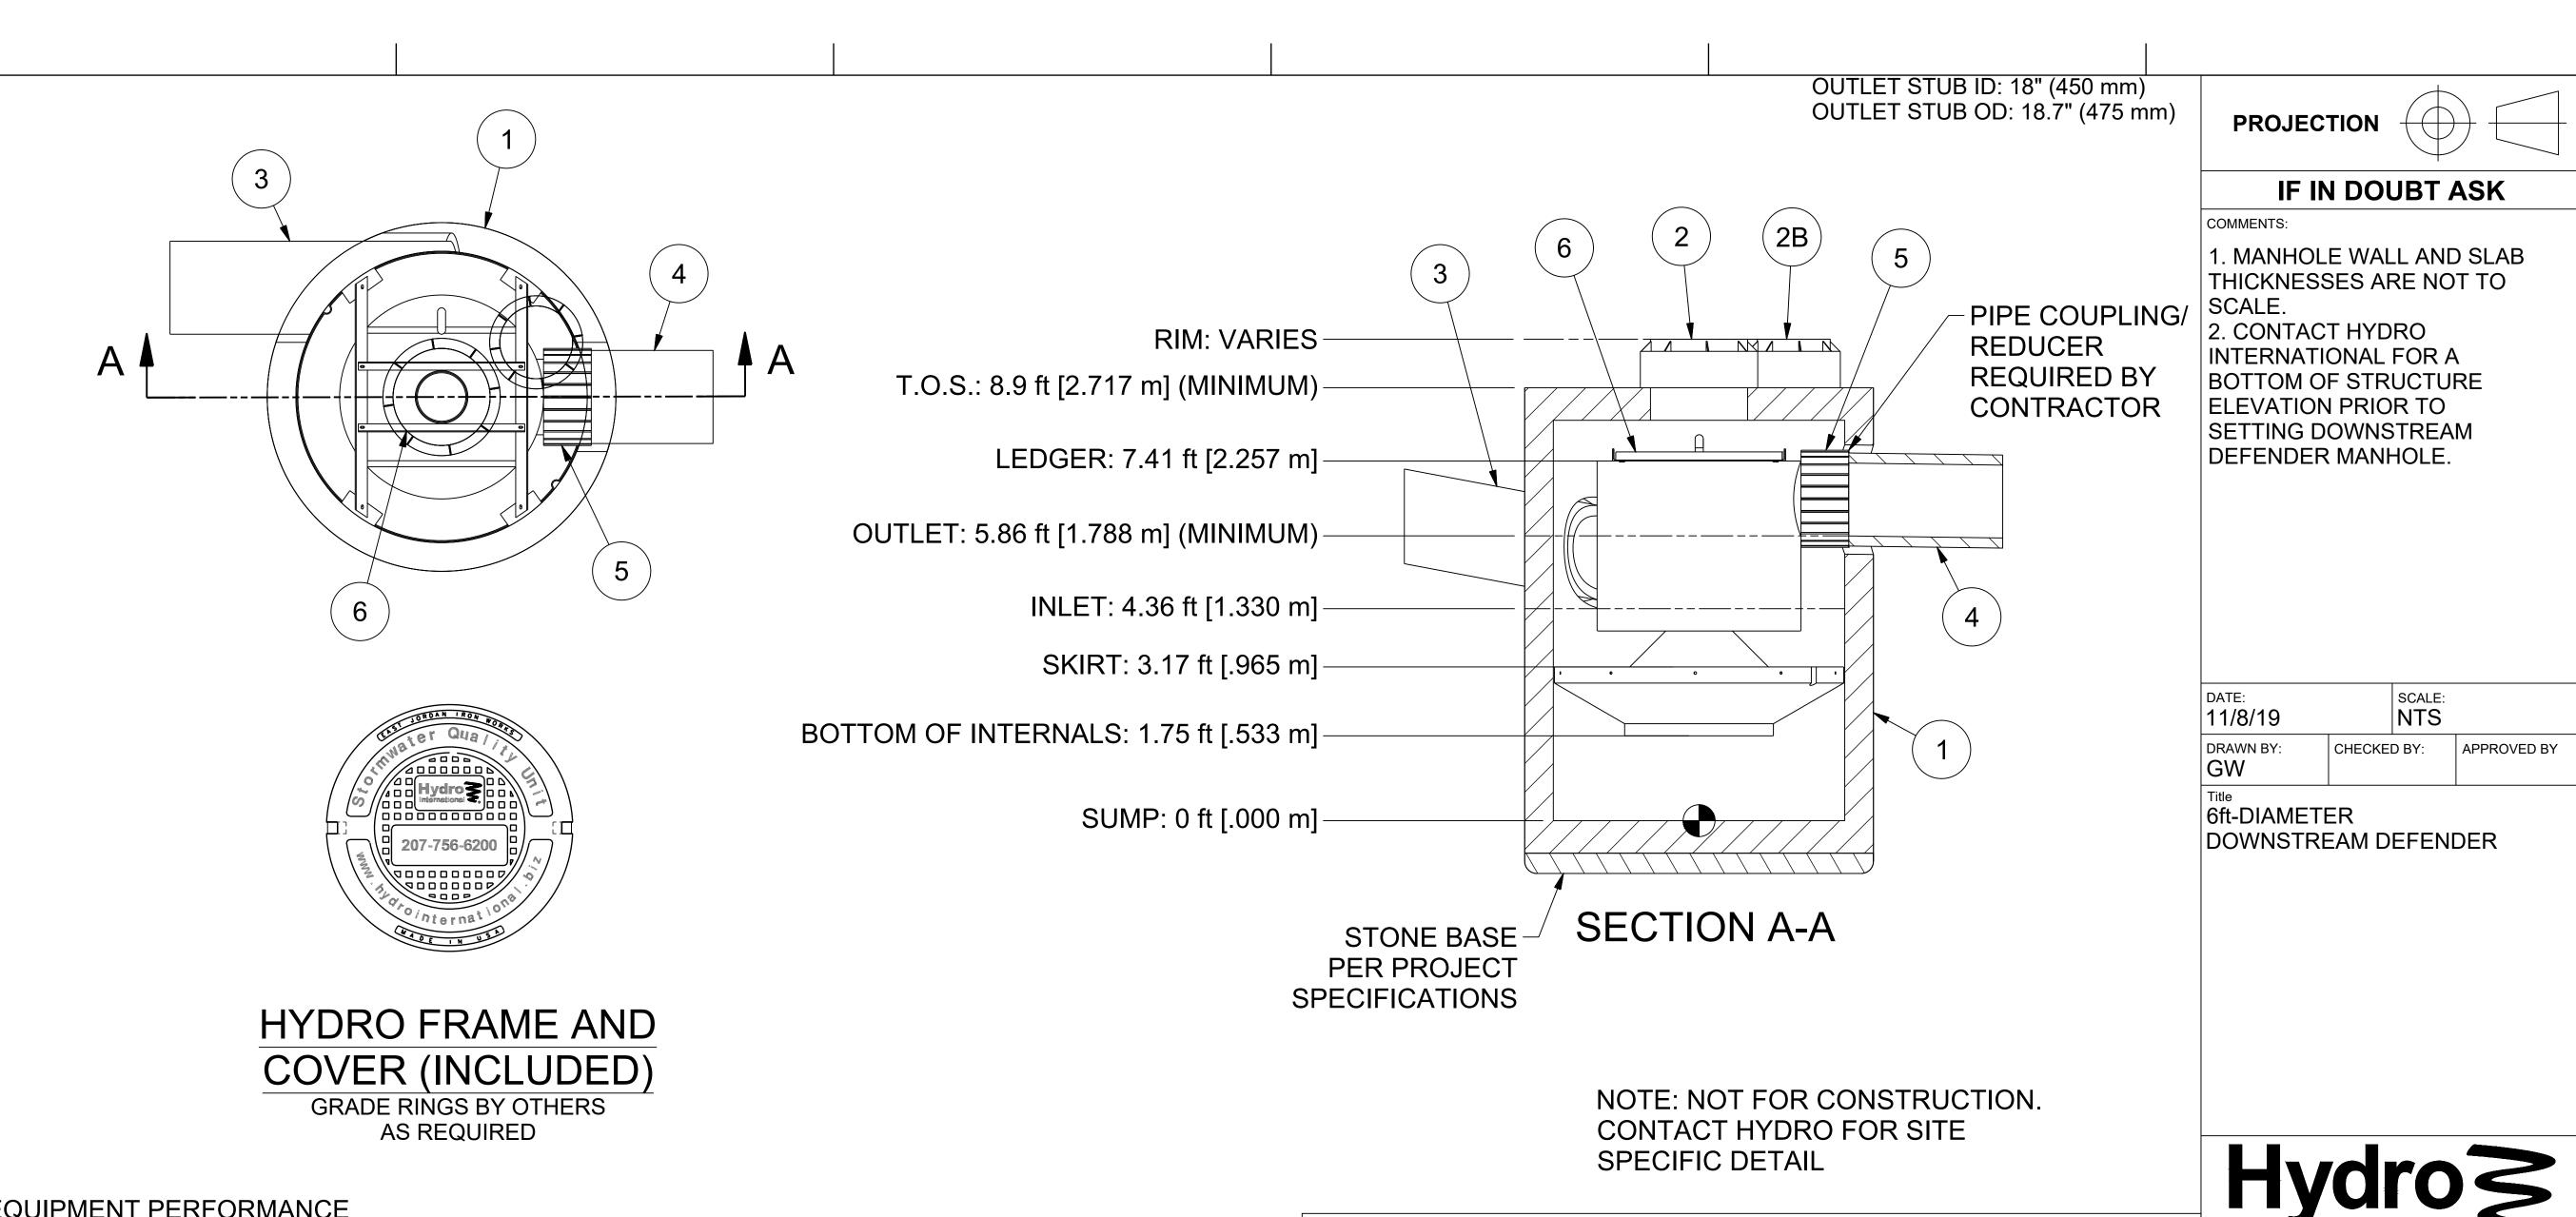
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EQUIPMENT PERFORMANCE


The stormwater treatment unit shall adhere to the hydraulic parameters given in the chart below and provide the removal efficiencies and storage capacities as follows:

- The treatment system shall use an induced vortex to separate pollutants from stormwater runoff.
- Peak Hydraulic Capacity: 8.0 cfs (227 l/s)
- Sediment Storage Capacity: 2.10 cu. yd. (1.59 cu. m)
- Continuous Oil Storage Capacity: 216 gal. (818 liters)
- Sediment shall be stored in a zone that is isolated from the main flow path and protected from reintrainment by a benching skirt.
- For more product information including regulatory acceptances, please visit https://hydro-int.com/en/products/downstream-defender

			International 2 ®					
ITEM	QTY	SIZE (in)	SIZE (mm)	DESCRIPTION	hydro-int.com <company></company>			
1	1	72	1800	PRECAST MANHOLE (BY	DO NOT SCALE DR	AWING		
				HYDRO VIA PRECASTER)	STEEL FABRICATION UNLESS OTHERWISE	SPECIFIED,		
2	3	24	600	FRAME AND COVER	DIMENSIONS ARE IN LINEAR	INCHES.		
2B	1	18	450	FRAME AND COVER	000 - 012in = ±0.04in 012 - 024in = ±0.06in	ANGULAR 000 - 120in = ±1° 120 - 240in = ±0.5° 240in >>>> = ±0.25°		
3	1	18 (MAX)	450 (MAX)	MAX INLET PIPE (BY OTHERS)	024 - 048in = ±0.08in 048 - 120in = ±0.12in 120in >>> = ±0.20in			
4	1	18 (MAX)	450 (MAX)	MAX OUTLET PIPE (BY OTHERS)	WEIGHT:	MATERIAL:		
5	1			PIPE COUPLING (BY OTHERS)		17W 11 E1 W 1E.		
6	1			INTERNAL COMPONENTS	REFERENCE NUMBER:			
				(PRE-INSTALLED)	DRAWING NO.:			
RFORMANCE (OF ITS EQU	MENT, (OR THE PERF	SHEET SIZE: SHEET: Rev.					

ANY WARRANTY GIVEN BY HYDRO INTERNATIONAL WILL APPLY ONLY TO THOSE ITEMS SUPPLIED BY IT. ACCORDINGLY HYDRO INTERNATIONAL CANNOT ACCEPT ANY RESPONSIBILITY FOR ANY STRUCT INTERNATIONAL

4703 OLEANDER DRIVE MYRTLE BEACH, SC 29577

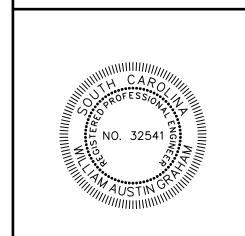

FANTASY HARBOUR BUS FACILITY

21.148

SCALE: **DRAWN BY:** CHECKED BY: APPROVED BY: 03/15/2023


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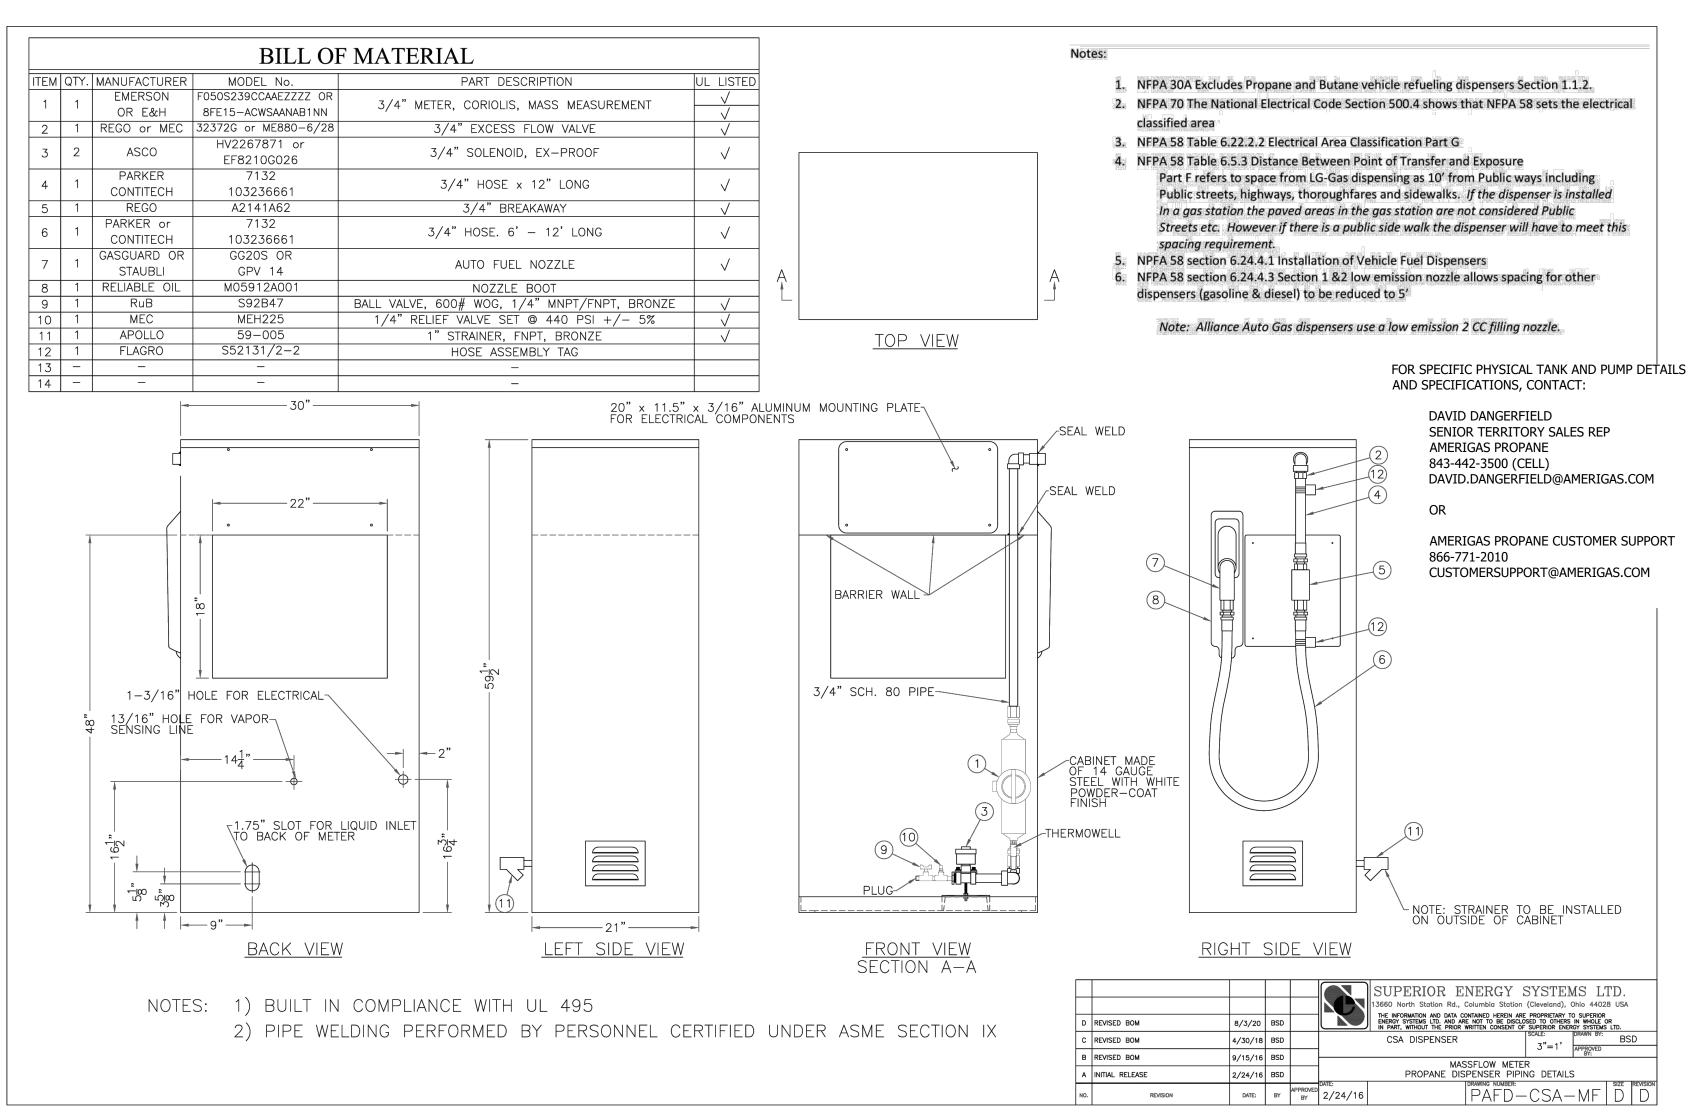
C10.4

FOR SPECIFIC PHYSICAL TANK AND PUMP DETAILS AND SPECIFICATIONS, CONTACT:

DAVID DANGERFIELD
SENIOR TERRITORY SALES REP
AMERIGAS PROPANE
843-442-3500 (CELL)
DAVID.DANGERFIELD@AMERIGAS.COM

AMERIGAS PROPANE CUSTOMER SUPPORT 866-771-2010 CUSTOMERSUPPORT@AMERIGAS.COM




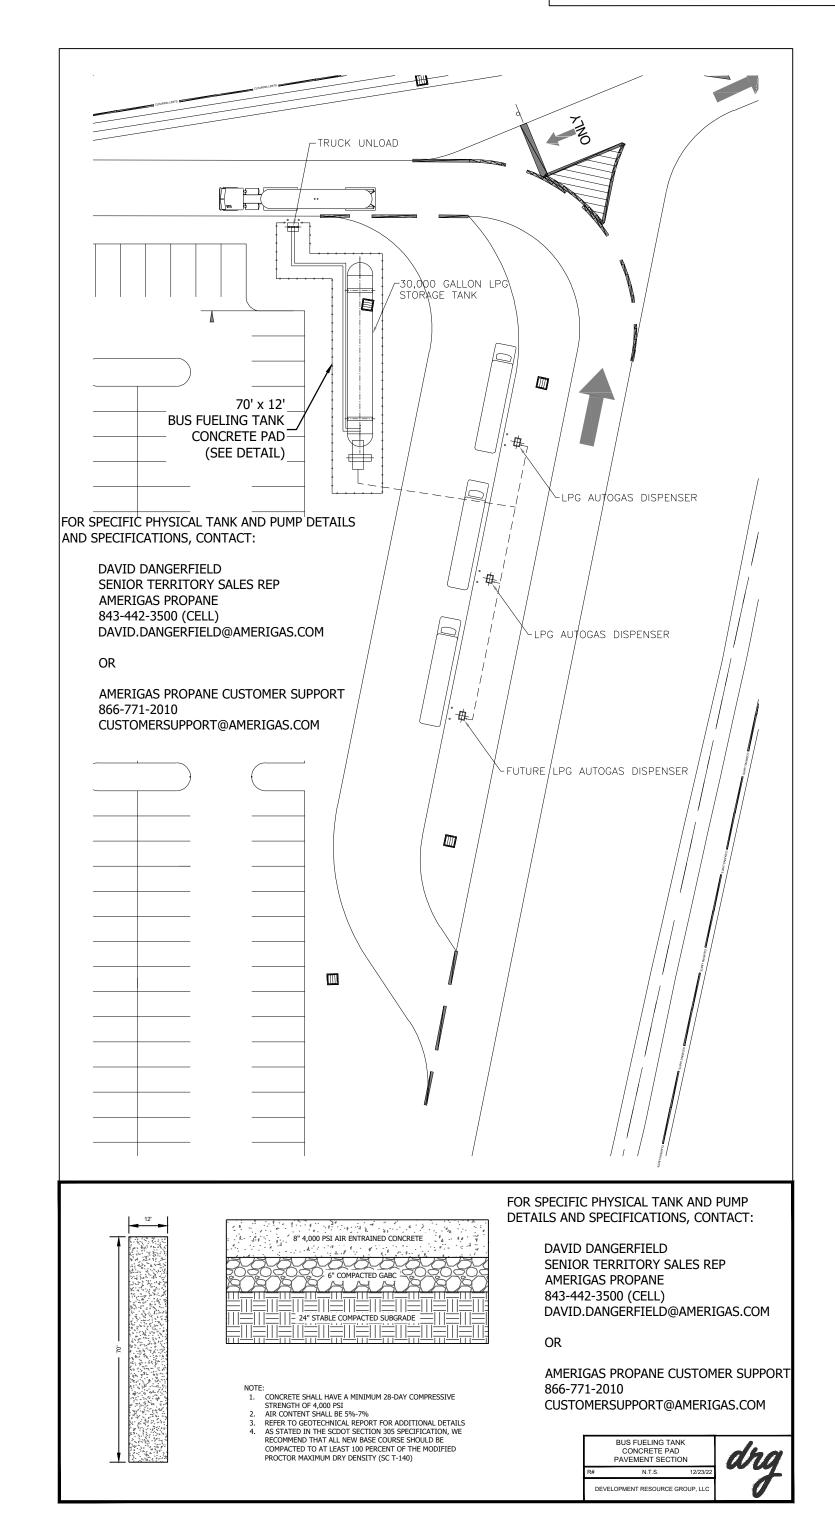



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HARBOUR BUS FACILITY
PREPARED FOR:
HORRY COUNTY SCHOOLS
335 FOUR MILE ROAD

PLANS FOR CONSTRUCTION TO THE CONSTRUCTION TO

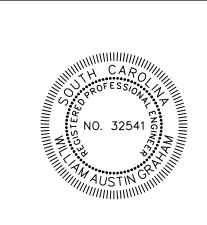JOB NO: 21.148

SCALE: NTS

DRAWN BY: PJC

CHECKED BY: WAG


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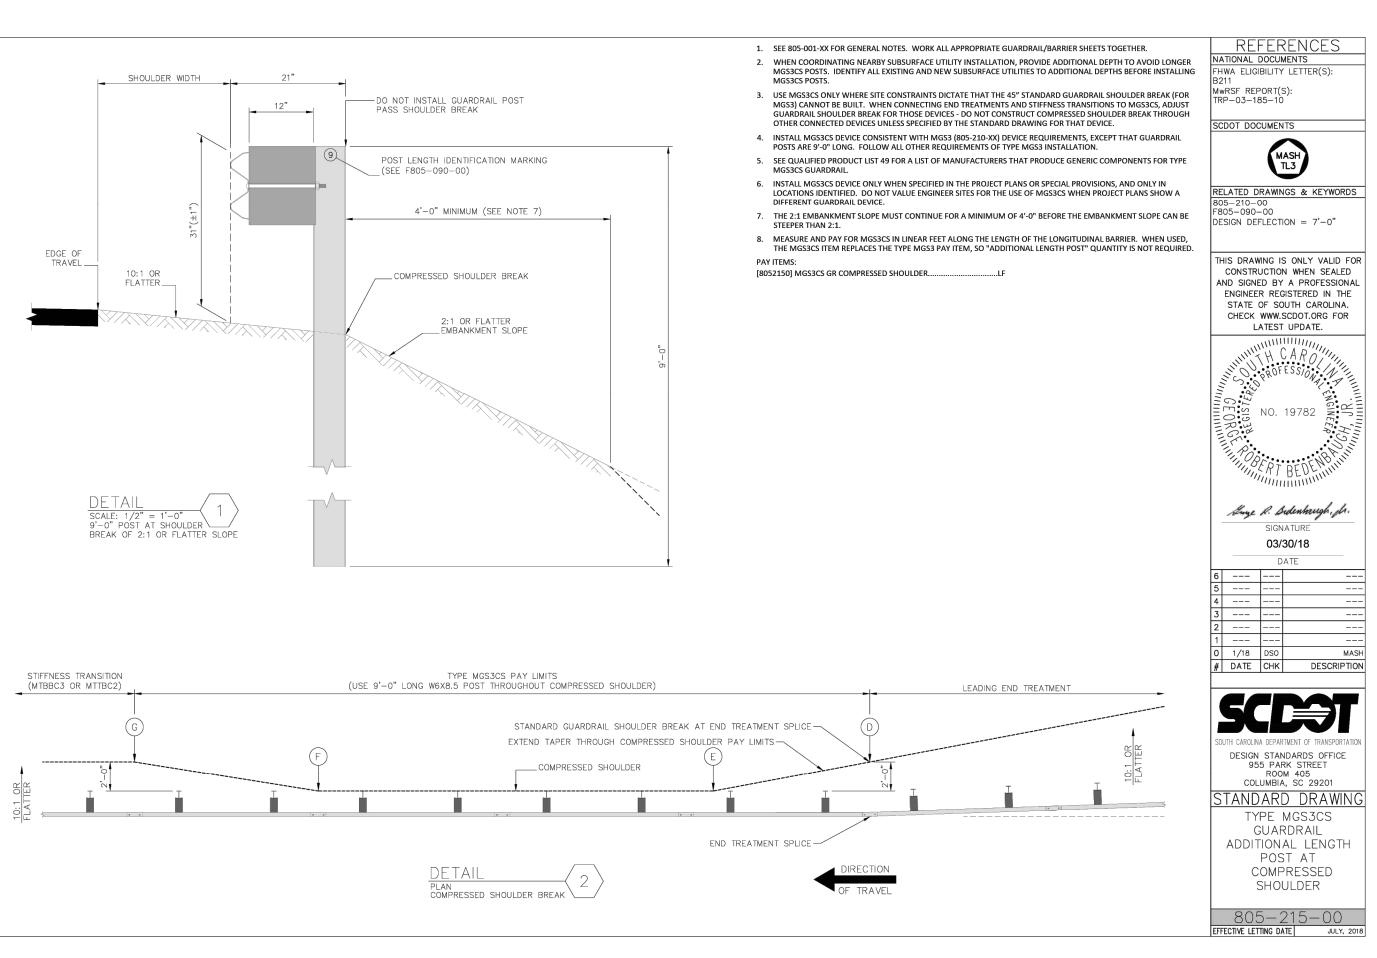
DATE: 03/15/2023


SHEET NUMBER:


APPROVED BY:

C10.5



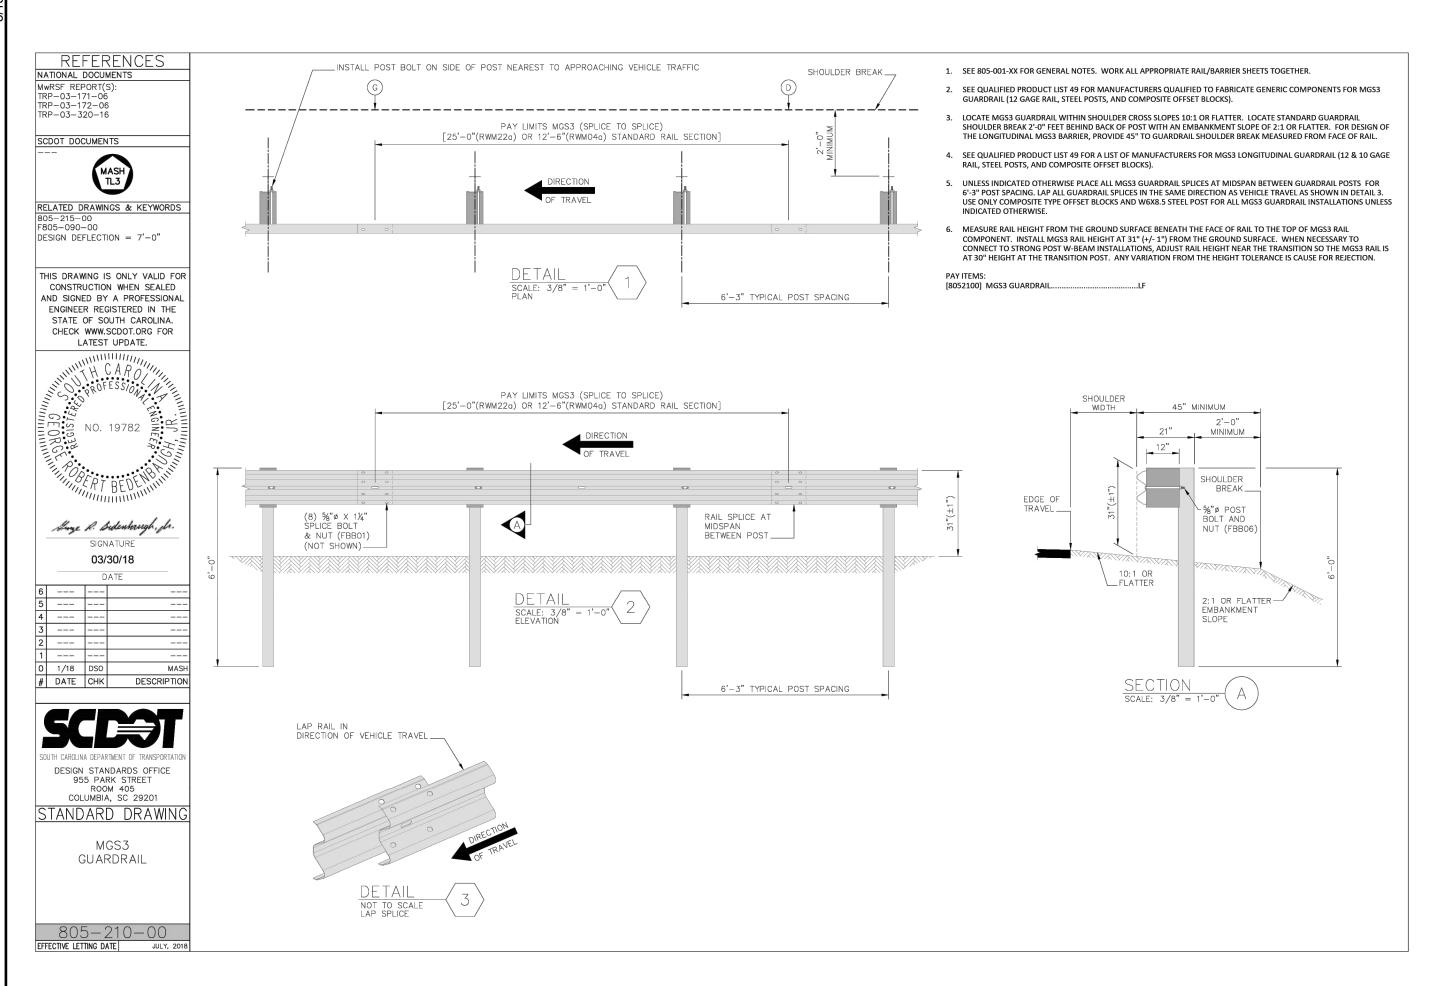

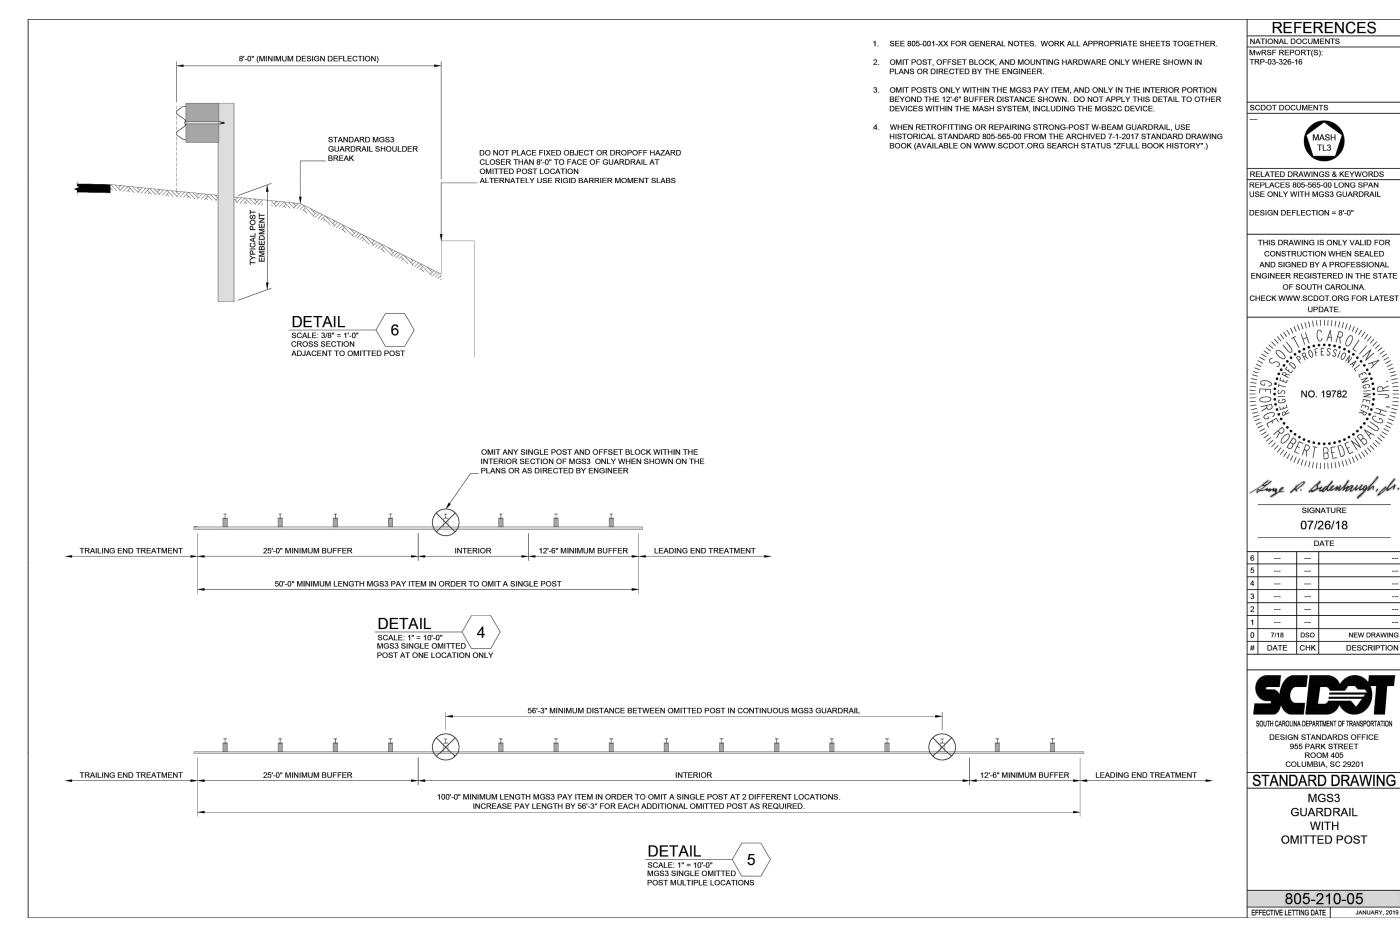


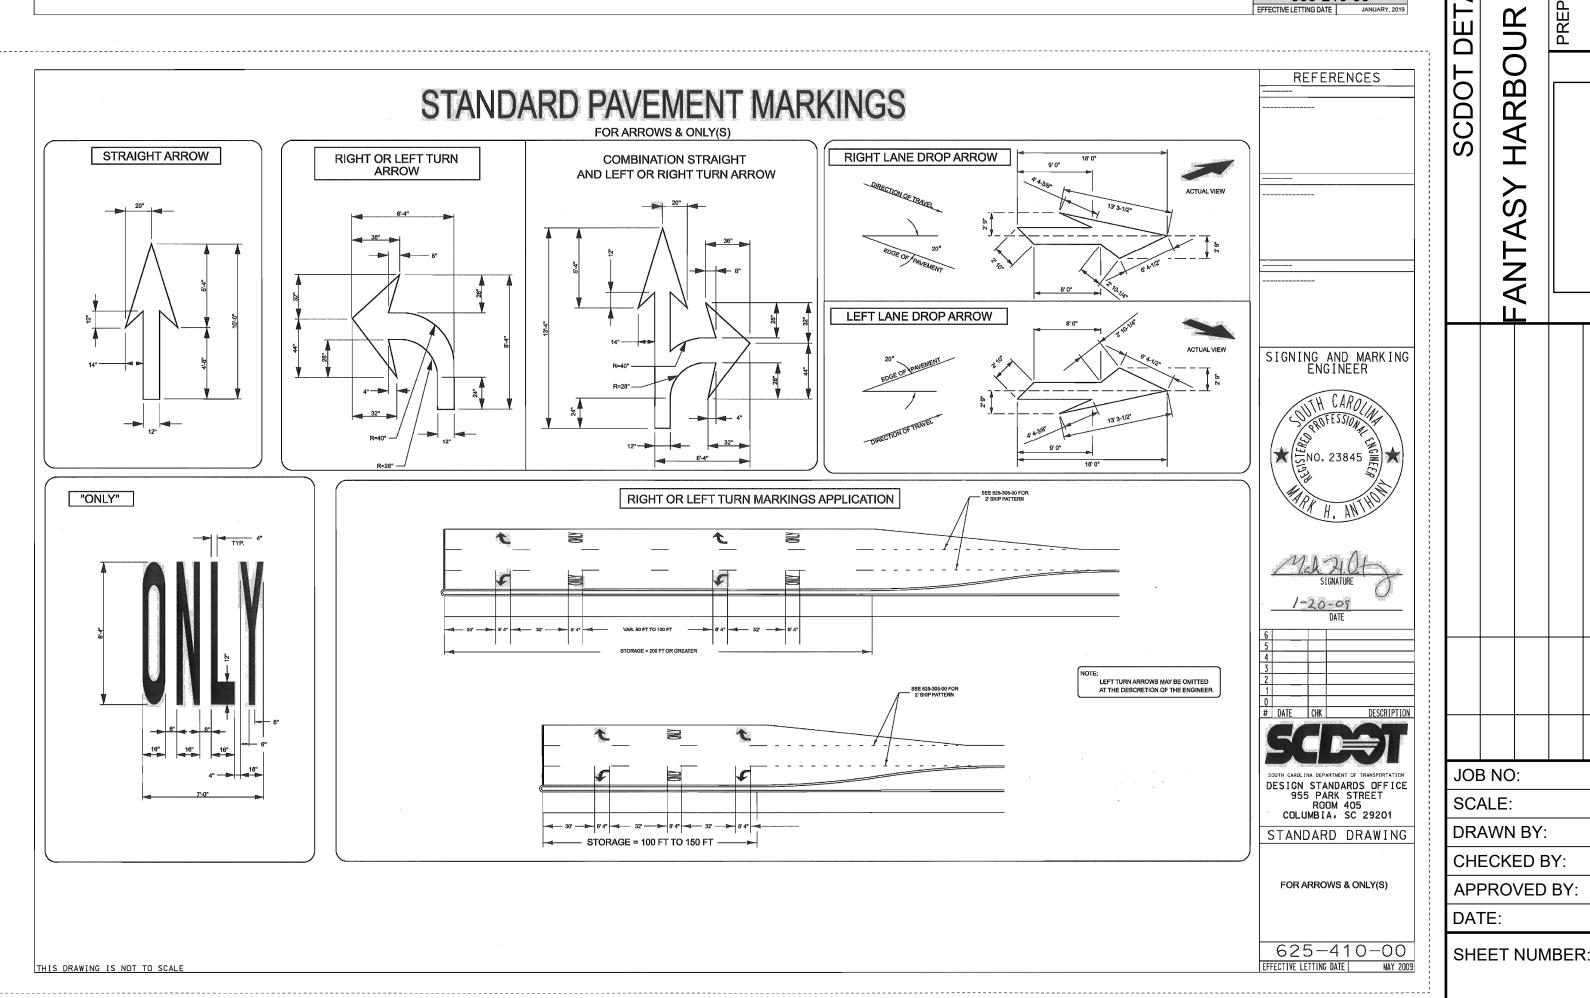




DEVELOPMENT RESOURCE GROUP, LL 4703 OLEANDER DRIVE MYRTLE BEACH, SC 29577 843-839-3350 | DRGPLLC.COM



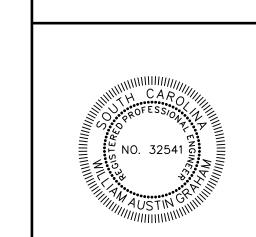


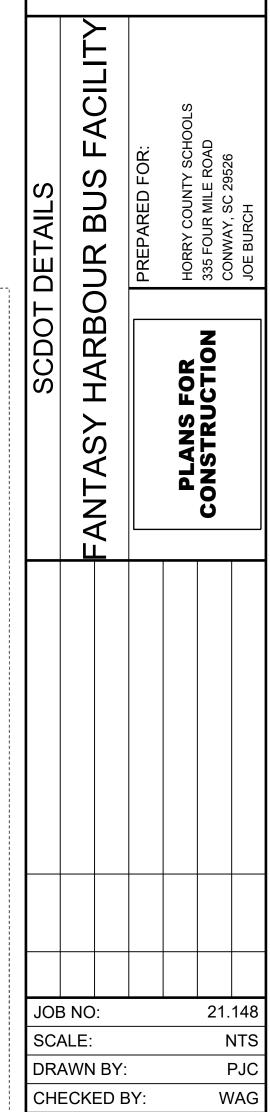

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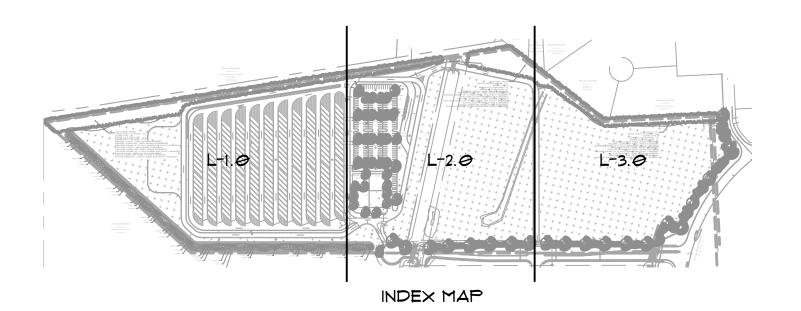
PIN: 426-09-02-0064 Current Owner Maitland Properties UNDISTURBED BUFFER LINEAR LENGTH OF BUFFER- 1,161 BUFFER TYPE: A BUFFER WIDTH PROPOSED : 25' BUFFER WIDTH PROVIDED -: 25' REQUIRED CANOPY TREES: 35(50% EVERGREEN) REQUIRED UNDERSTORY TREES: 35(50% EVERGREEN) REQUIRED SHRUBS: 28" HT SOLID SCREEN (85% OPACITY REQUIRED) PROVIDED CANOPY TREES: 35(50% EVERGREEN) PROVIDED UNDERSTORY TREES: 35(50% EVERGREEN) PROVIDED SHRUBS: 28" HT SOLID SCREEN (85% OPACITY REQUIRED) EXISTING CANOPY TREES: 35 (50% EVERGREEN) EXISTING UNDERSTORY TREES: 35 (50% EVERGREEN) EXISTING SHRUBS: 28" HT SOLID SCREEN (85% OPACITY REQUIRED) ___ 44,185/ SF - SEED 251,633 SF - SEED ___ 40,91\$ SF/- SOD

TYPE C PERIMETER BUFFER LINEAR LENGTH OF PROPERTY/USE LINE: 589'


REQUIRED CANOPY TREES: 18 (50 % EVERGREEN)
REQUIRED UNDERSTORY TREES: 18 (50% EVERGREEN)

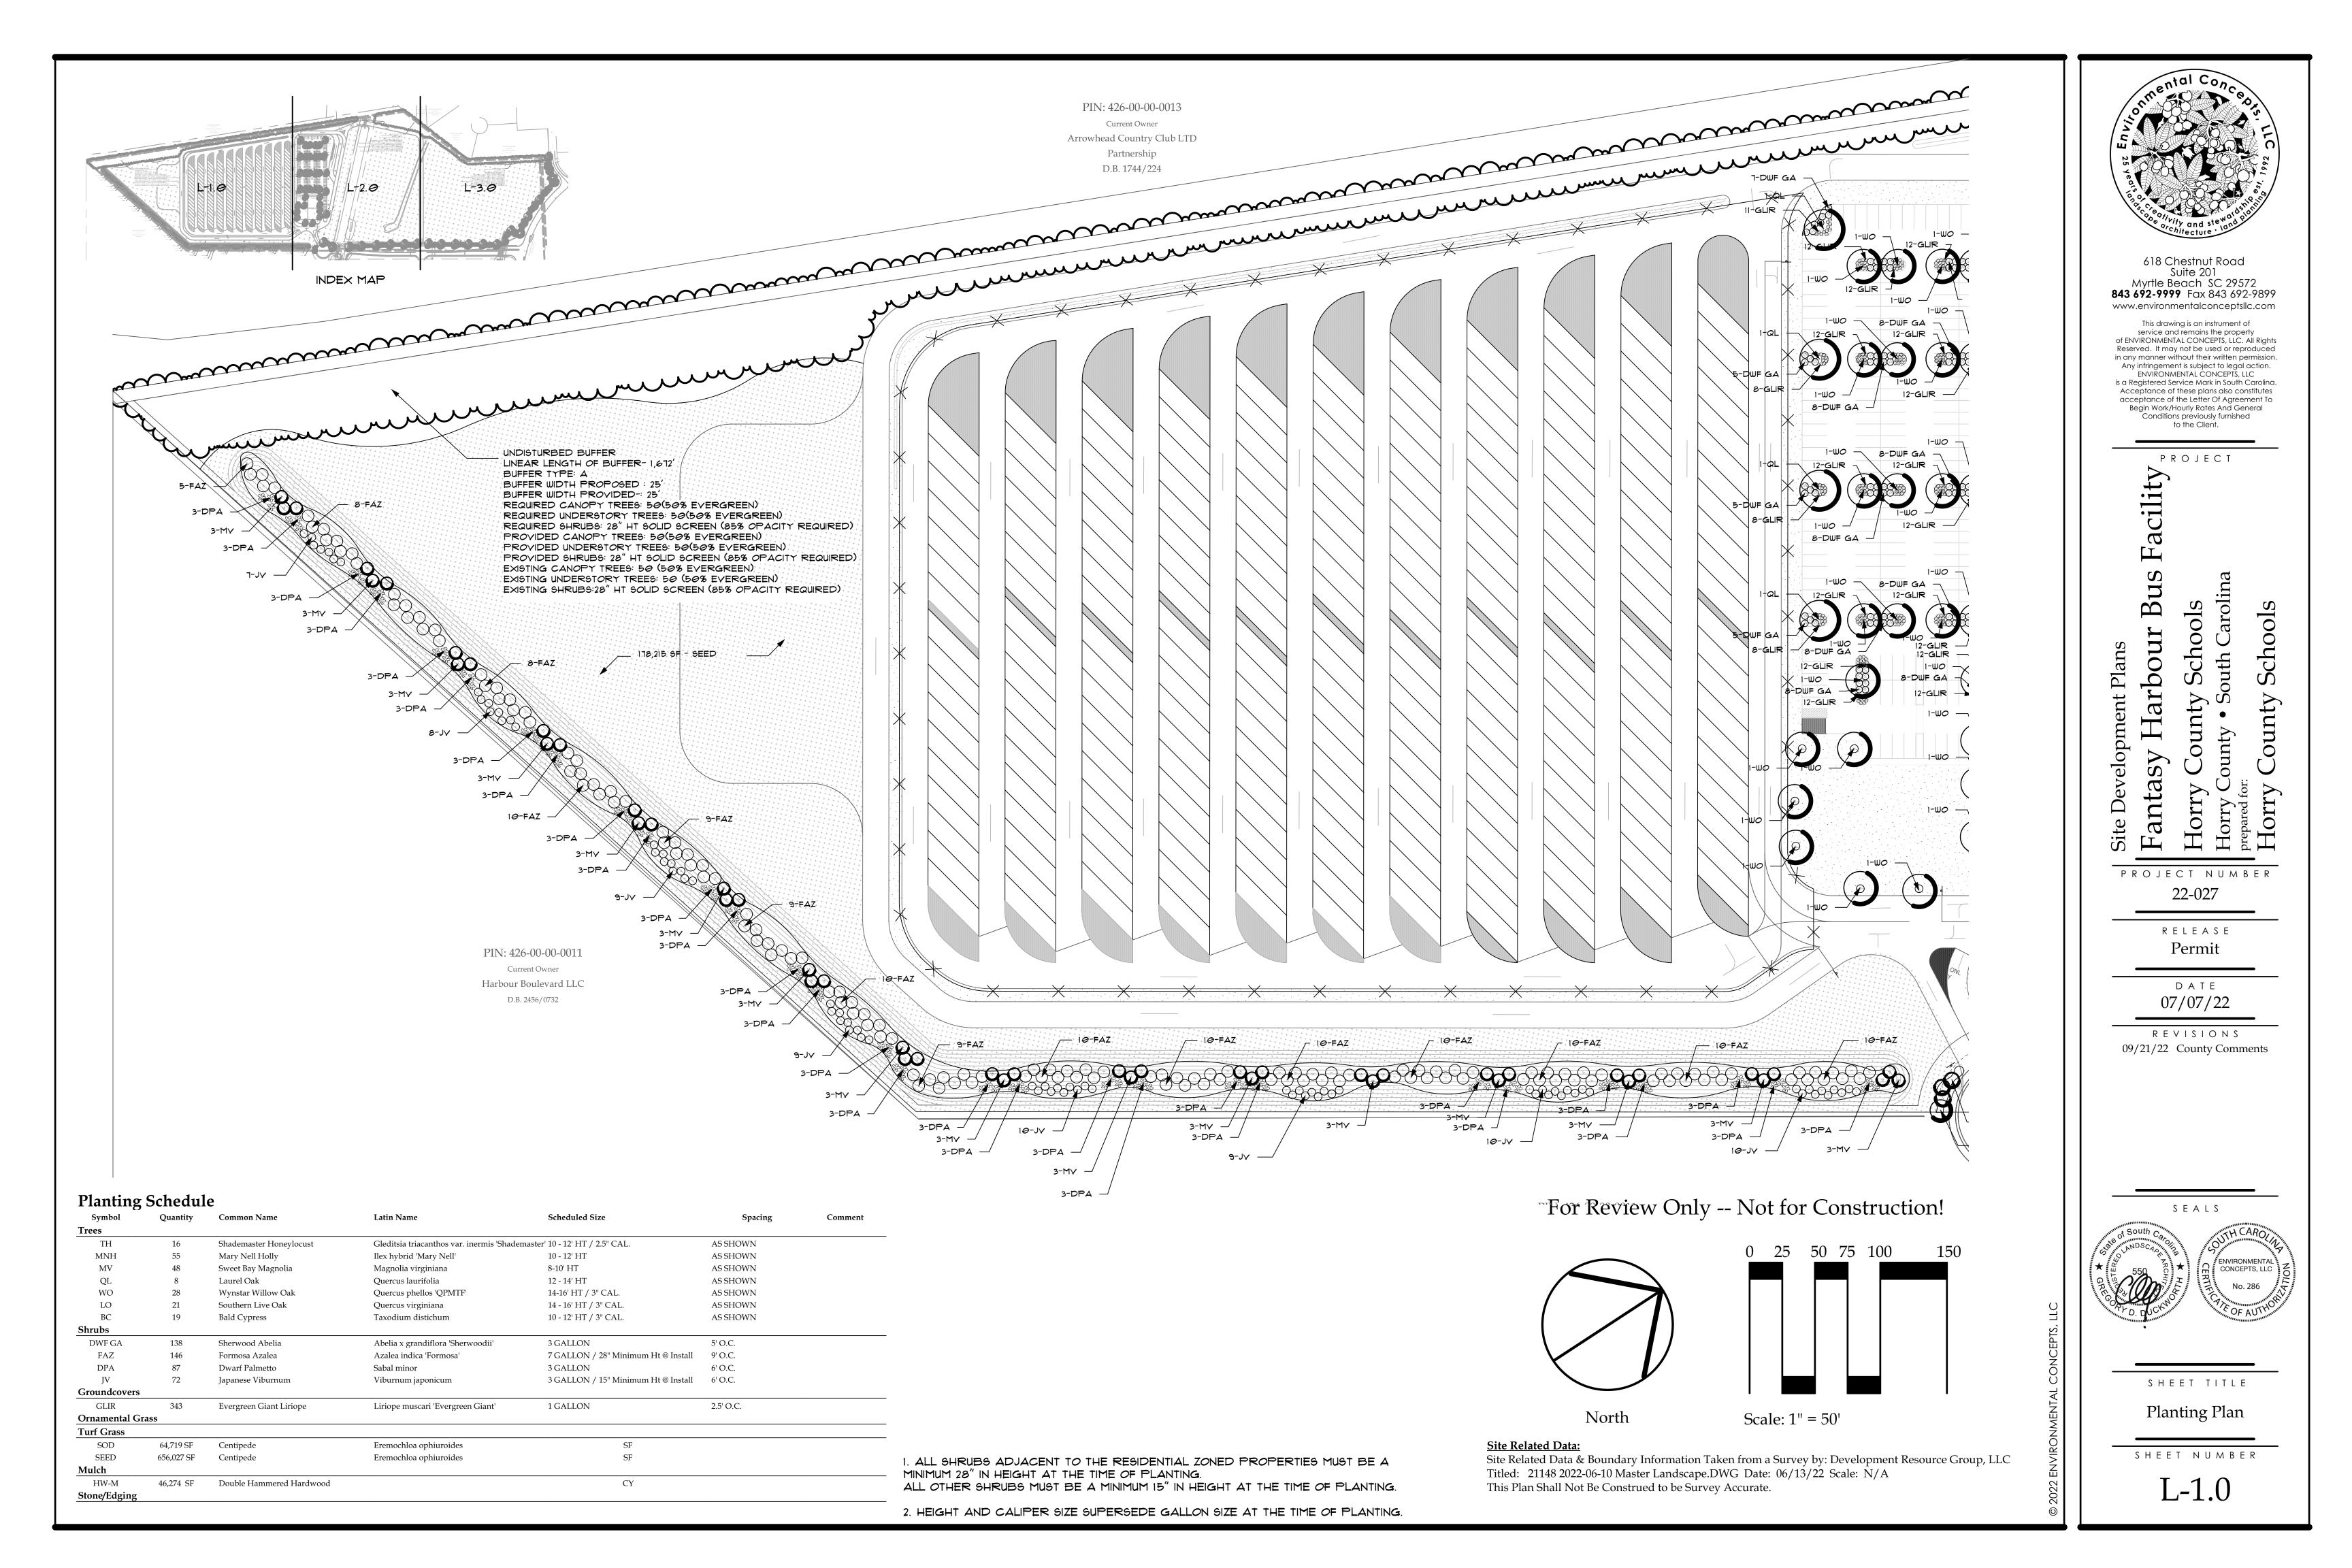REQUIRED SHRUBS: NONE

* SEE SHEET L-1.0 FOR PLANTING SCHEDULE



For Review Only -- Not for Construction!

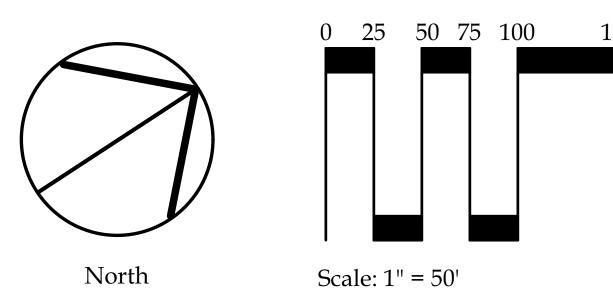

Site Related Data & Boundary Information Taken from a Survey by: Development Resource Group, LLC Titled: 21148 2022-06-10 Master Landscape.DWG Date: 06/13/22 Scale: N/A This Plan Shall Not Be Construed to be Survey Accurate.



618 Chestnut Road Suite 201 Myrtle Beach SC 29572 **843 692-9999** Fax 843 692-9899 www.environmentalconceptsllc.com

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PROJECT

Facility arbour

Schools


22-027

RELEASE

Permit

07/07/22 REVISIONS

09/21/22 County Comments

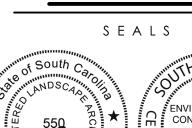



SHEET TITLE

Planting Plan

SHEET NUMBER

L-2.0

* SEE SHEET L-1.0 FOR PLANTING SCHEDULE PIN: 426-10-01-0001 INDEX MAP Current Owner BDRMB LLC D.B. 4289/1654 PIN: 426-10-01-0008 Current Owner LMTM Properties III LLC D.B. 3792/2406 TYPE C PERIMETER BUFFER LINEAR LENGTH OF PROPERTY/USE LINE: 184' REQUIRED CANOPY TREES: 6 (50 % EVERGREEN) REQUIRED UNDERSTORY TREES: 6 (50% EVERGREEN) REQUIRED SHRUBS: NONE UNDISTURBED BUFFER LINEAR LENGTH OF BUFFER-1,161' BUFFER TYPE: A BUFFER WIDTH PROPOSED: 25' BUFFER WIDTH PROVIDED- 25 REQUIRED CANOPY TREES: 35(50% EVERGREEN) REQUIRED UNDERSTORY TREES: 35(50% EVERGREEN) REQUIRED SHRUBS: 28" HT SOLID SCREEN (85% OPACITY REQUIRED) PROVIDED CANOPY TREES: 35(50% EVERGREEN) PROVIDED UNDERSTORY TREES: 35(50% EVERGREEN) PROVIDED SHRUBS: 28" HT SOLID SCREEN (85% OPACITY REQUIRED) EXISTING CANOPY TREES: 35 (50% EVERGREEN) EXISTING UNDERSTORY TREES: 35 (50% EVERGREEN) EXISTING SHRUBS 28" HT SOLID SCREEN (85% OPACITY REQUIRED) ___ 386,800 SF - SEED -WATER EASEMENT TYPE C PERIMETER BUFFER LINEAR LENGTH OF PROPERTY/USE LINE: 542' REQUIRED CANOPY TREES: 16 (50 % EVERGREEN) REQUIRED UNDERSTORY TREES: 16 (50% EVERGREEN) REQUIRED SHRUBS: NONE For Review Only -- Not for Construction! 0 25 50 75 100 North Scale: 1'' = 50'TYPE C PERIMETER BUFFER LINEAR LENGTH OF PROPERTY/USE LINE: 482' REQUIRED CANOPY TREES: 15 (50 % EVERGREEN) REQUIRED UNDERSTORY TREES: 15 (50% EVERGREEN) Site Related Data & Boundary Information Taken from a Survey by: Development Resource Group, LLC Titled: 21148 2022-06-10 Master Landscape.DWG Date: 06/13/22 Scale: N/A REQUIRED SHRUBS: NONE This Plan Shall Not Be Construed to be Survey Accurate.



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Acceptance of these plans also constitutes acceptance of the Letter Of Agreement To Begin Work/Hourly Rates And General

Conditions previously furnished

PROJECT

Facility

Schools


22-027

RELEASE

Permit

07/07/22

REVISIONS 09/21/22 County Comments

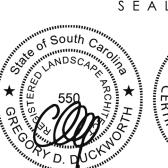


SHEET TITLE

Planting Plan

SHEET NUMBER

L-3.0

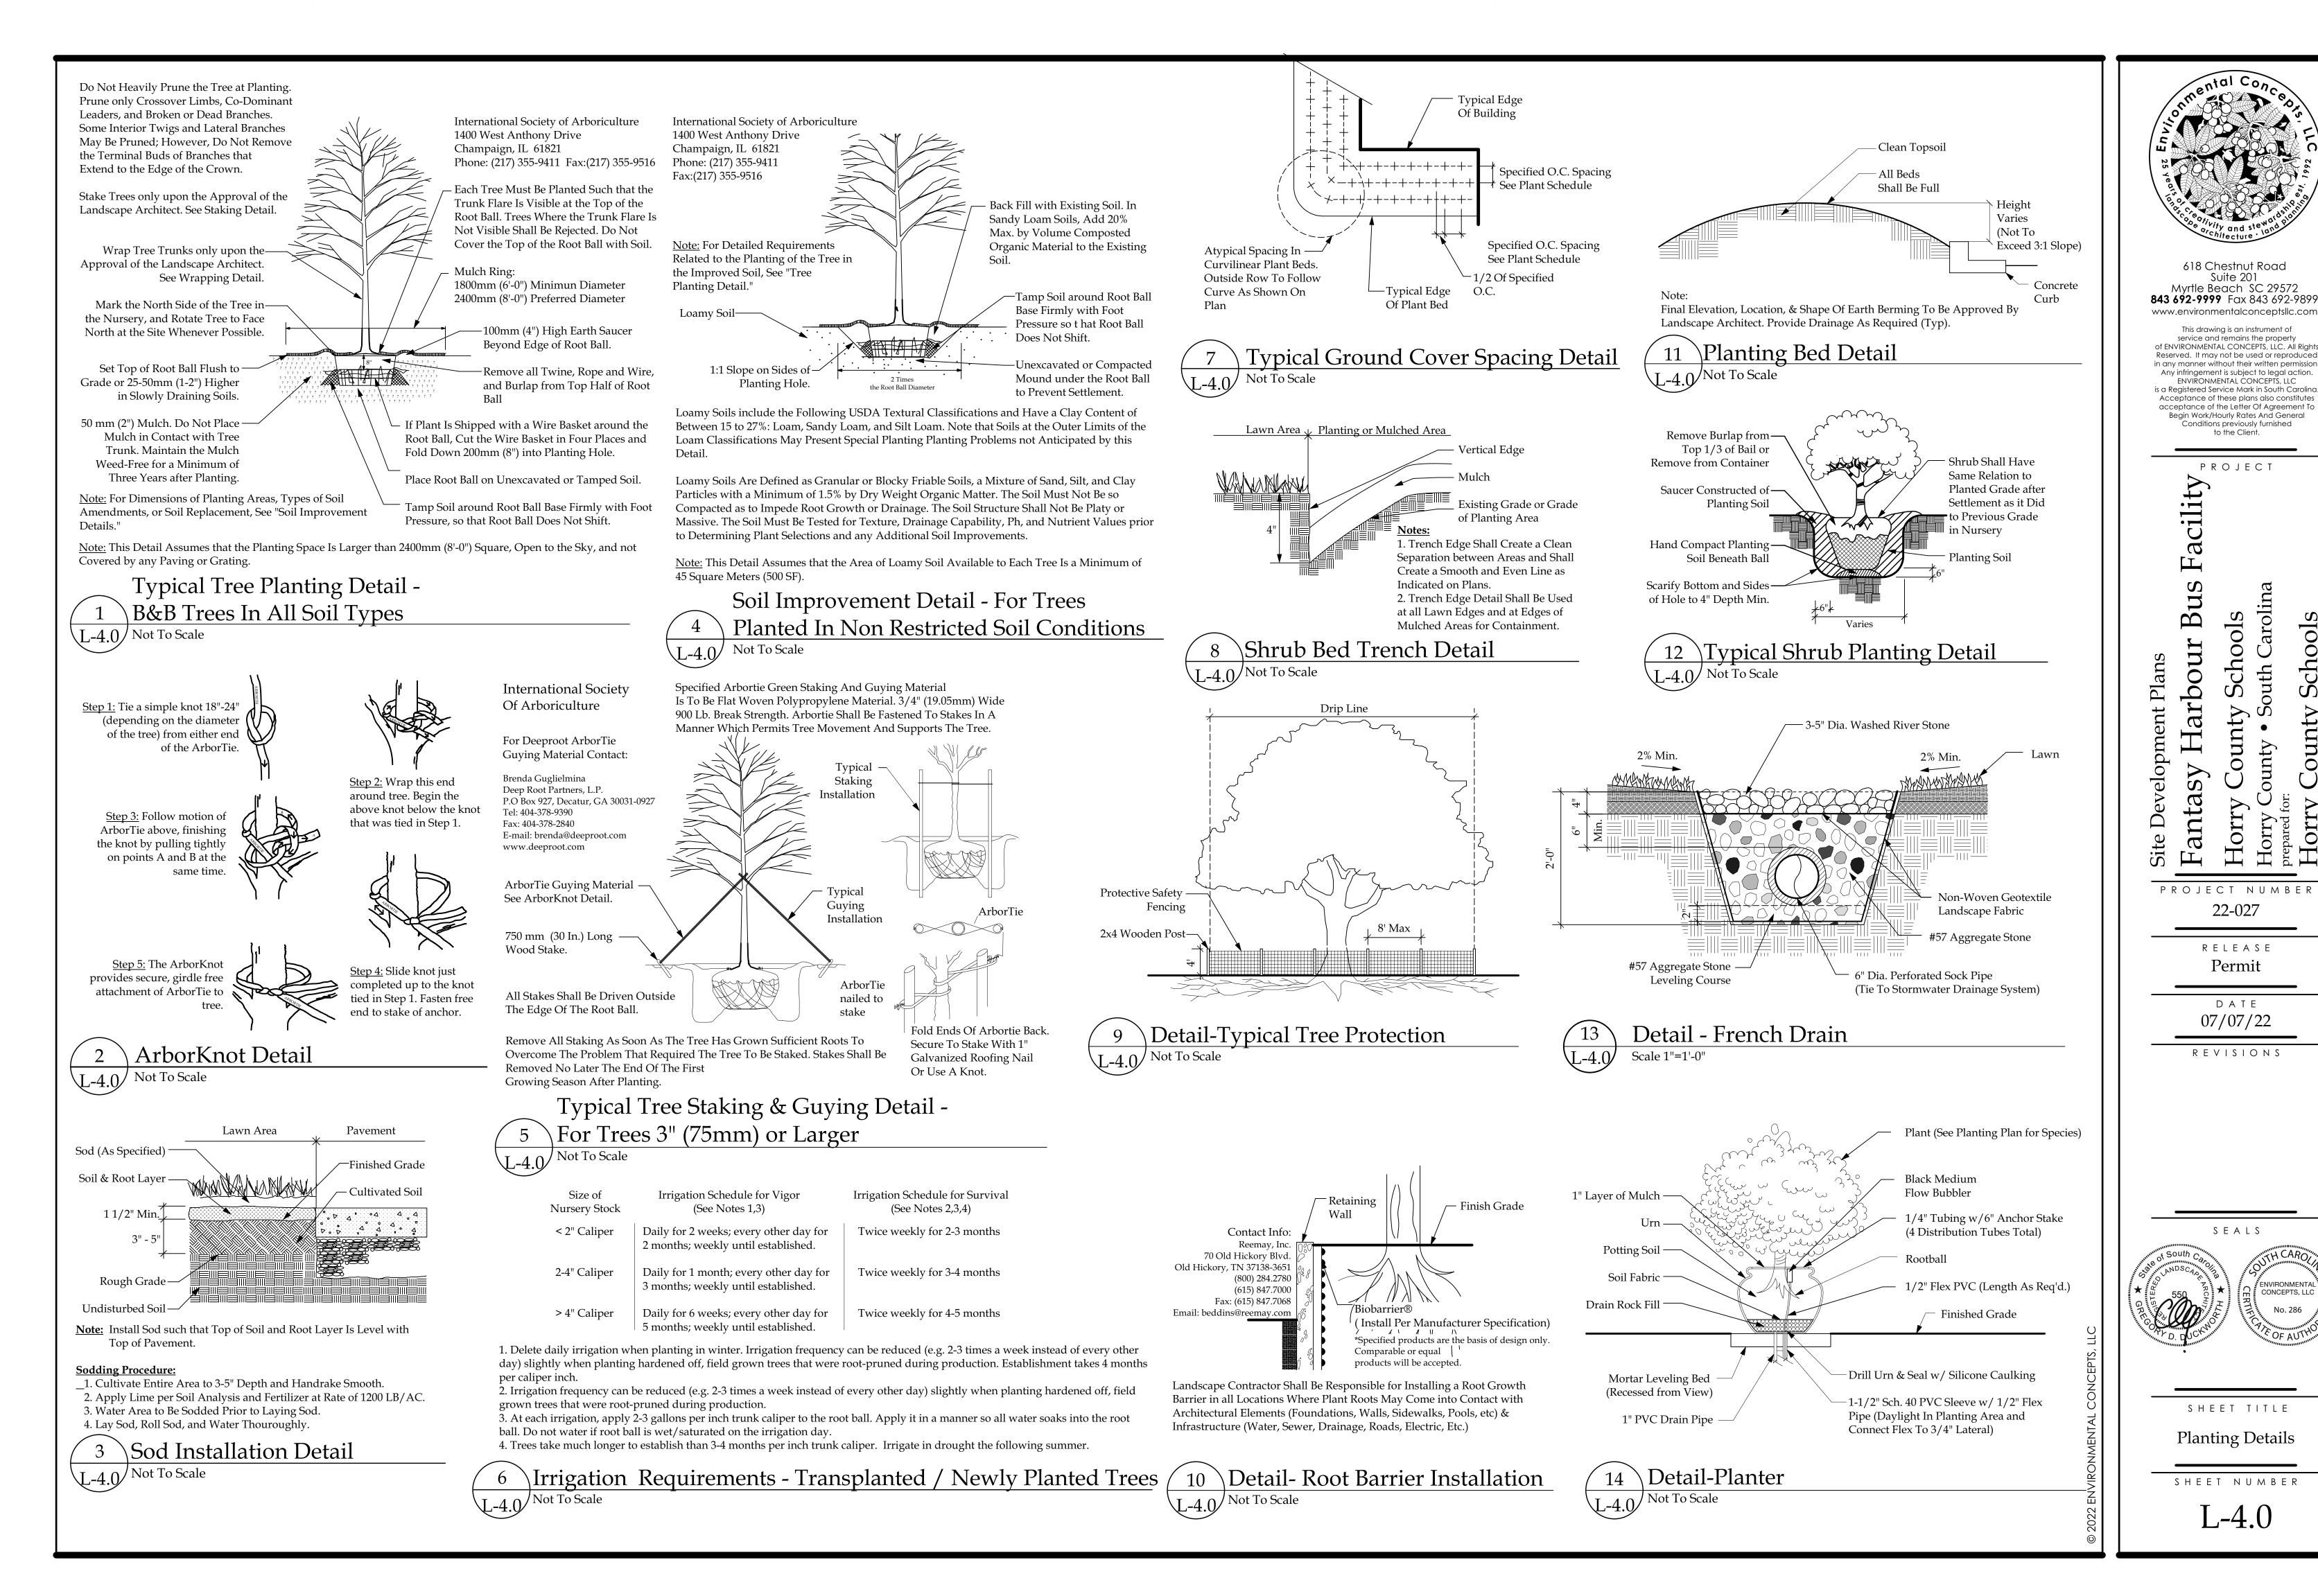

Schools

CONCEPTS, LLC

SITE WORK

General:

1.1 DIMENSIONS: ± Indicates Check Dimension Only; Contact Landscape Architect for Field Adjustments if Field Conditions Vary.

1.2 STRUCTURAL: Contractor Responsible for the Structural Integrity of all Elements. 1.3 LUMBER: Contractor Shall Use at minimum Pressure-Treated Lumber for all Exterior Construction unless alternative is specified.

Contractor/Owner Should be Aware of Fasteners Recommended by Lumber Manufacturers in Construction Involving Pressure-Treated Lumber. Pressure-Treated Lumber Can be Chemically Corrosive to Certain Types of Fasteners. All Edges Should be Sanded Smooth. Handrails and Decking Should be Cup Side Down.

1.4 COMPLIANCE: Contractor Responsible for Verifying Compliance with all Setback and Zoning Requirements.

1.5 PERMITS: The Contractor is Responsible for Acquiring all Necessary Permits Prior to Construction

1.6 UTILITIES: Contractor Responsible for Locating all Underground Utilities Prior to Construction. Contractor to Secure a Responsible Utility Locate Service, Such as Palmetto Utility Protection Service (PUPS), Prior to any Excavation or Installation: A. PRE-CONSTRUCTION NOTICE:

South Carolina 811

Anyone Proposing To Excavate, Dig, Bore, Tunnel, Blast, Or Disturb The Earth In Any Manner In Which Buried

Utilities May Be Damaged Is Required To Adhere To The South Carolina Underground Facility Damage Prevention Act.

Please Call 811 or The Toll-Free Number (1-888-721-7877) Between The Hours Of 7:30 AM EST. And 5:30 PM EST,

Monday Through Friday, 72 Hours Before Starting The Proposed Work. The South Carolina State Law Requires That Excavators Give A 3 Full Working Days

Notice (Not Including The Day Of The Call) Excluding Weekends And Holidays, For The Locators To Get Out To Mark The Area.

After A Notice Has Been Processed You Will Know When You Are Legally Free To Proceed With The Digging Work And Which Utilities In The Area

SC811 Will Be Notifying For You. Any Utilities That SC811 Does Not Notify, You Will Be Responsible For Notifying Directly.

The Utility Companies Ask That You Leave A 2 1/2 Feet Margin On Each Side Of A Marked Utility Line. Also Note

That Your Request Is Good For 10 Working Days After It Has Been Processed By Our

1.7 SAFETY: Contractor Responsible for Security Fencing and Signage to Prevent Injury to the Public During Construction.

1.8 MAINTENANCE: Owner Shall Consider the Future Maintenance Requirements of This Project to Prevent Injury to the Public.

1.9 DRAINAGE: Contractor Shall Maintain Positive Drainage Away from Structures. 1.10 HAZARDOUS MATERIALS/UXO/ARCHAEOLOGICAL: - Environmental

Concepts, LLC Shall have No Duty or Responsibility for the Discovery, Determination, Location, Presence, Handling, Removal, Disposal or Exposure of Anyone or Anything to: Hazardous Waste Materials in any Form or of any Type at the Project Site, Including, but Not Limited to: Asbestos, Asbestos Related Products, Polychlorinated Biphenyl (PCBs), or Any Other Substances, Whether Now or at Some Later Date Considered to be Toxic; as well as Unexploded Ordnance (UXO) and Unexpected Archaeological Finds at the Project Site.

1.11 DEER OR OTHER FAUNA : - Environmental Concepts, LLC Shall Have No Duty Or Responsibility For The Knowledge, Discovery, Or Determination To The Presence Of Deer, Rabbits, Moles, Or Other Fauna Which May Cause Damage At The Site. It Is The Owner/Responsible Agent"s Obligation To Inform Environmental Concepts, LLC In Writing, Prior To Design, Of Any Known Deer Or Other Fauna Which May Be Present Which May Cause Damage At The Site. When Informed, Environmental Concepts, LLC Will Specify Deer Resistant Plants For The Project. 1.12 REVIEW & APPROVAL: These Plans have Been Reviewed and Approved by the Owner/Responsible Agent Who Understands That any Changes, Substitutions, or Deletions May Require Review and Approval by the Responsible Reviewing Authority.

Tree Protection:

2.1 DRIPLINE: Tree dieback, decline, and even tree death can be caused by the disturbance of roots due to trenching, vibratory plowing, or earth sawing operations. During construction, none of the above actions are be performed within the dripline

2.2 PROTECTION: Protect designated trees scheduled to remain from:

- Unnecessary cutting, breaking, or skinning of roots

- Skinning and bruising of bark - Smothering of trees by stockpiling construction or excavation materials within dripline

- Excess foot or vehicular traffic

- Parking of vehicles within drip line

- Cleaning of equipment, solvents and gasoline within dripline

2.3 FENCING: Erect temporary barricades around trees shown to remain before commencement of any site clearing or grading. Fence to be 4' high with 2x4 posts. All fencing should be placed at drip line of tree, fully enclosing all trees scheduled to remain. Nothing shall be placed inside of protective barricades, including but not limited to construction material, machinery, chemicals, or temporary soil deposits. When paving, excavation, or hardscape must be done within barricades, barricades shall be moved back to a secondary location at the edge of work. Extra care must be taken at this time by the contractor to insure that no damage to a tree occurs. 2.4 GRADES: No grade changes are to be made within the barricades without prior approval of the owner or his designated representative.

D. Interfering branches may be removed at the direction of the owner or his designated representative by a qualified tree surgeon.

2.5 HEALTH: Provide water to trees as required to maintain their health during construction work.

2.6 RESPONSIBILITY: General contractor shall be responsible for any damage done to trees designated to remain. Damage or removal of protected trees shall be subject to replacement or fine based on initial agreement with owner or his designated representative.

LANDSCAPING

Part 1 - General

1.1 DESCRIPTION:

A. This landscape plan has been reviewed and approved by the owner/responsible agent who understands that any changes, substitutions, or deletions may require review and approval by the responsible reviewing

B. The scope of work for the Landscape Contractor shall include the furnishing and installation of all grassing, all landscape planting work, and any irrigation work as called for as part of this Contract.

C. The Landscape Contractor shall coordinate with the General Contractor for the installation of all the noted earth berms within the landscaped areas. The berming fill and installation of all topsoil shall be the responsibility of the General Contractor. Final grading and contouring of the berms shall be the responsibility of the Landscape Contractor.

D. Prior to installation, all clearing, aesthetic earth mounding, and final plant locations is to be approved by Landscape Architect.

E. Landscape Contractor is to inform Landscape Architect of any concerns with plant material specified prior to installation and, at such time, alternate plant material may be specified by Landscape Architect. Landscape Contractor assumes all risk in installing plant material indicated on planting schedule.

F. Deer Or Other Fauna - Environmental Concepts, LLC Shall Have No Duty Or Responsibility For The Knowledge, Discovery, Or Determination To The Presence Of Deer, Rabbits, Moles, Or Other Fauna Which May Cause Damage At The Site. It Is The Owner/Responsible Agent"s Obligation To Inform Environmental Concepts, LLC In Writing, Prior To Design, Of Any Known Deer Or Other Fauna Which May Be Present Which May Cause Damage At The Site. When Informed, Environmental Concepts, LLC Will Specify Deer Resistant Plants For The Project.

G. Landscape Contractor shall estimate quantity of all plant materials, sod and mulch. Plant quantities are estimates only and are subject to field verification by the Landscape Contractor. The planting schedule shall override plant labels. H. The Owner / Responsible agent shall notify the Landscape Architect of any special requirements of the planting plan, such as deer resistant planting etc...

1.2 COORDINATION OF CONDITIONS:

A. The Landscape Contractor shall be responsible for coordinating the work of his crew and his subcontractors concerning performance of the landscape work The Landscape Contractor shall also be responsible for the proper workmen as well as all subcontractors and their employees who perform on this project. B. Coordination with the Landscape Architect: The Landscape Contractor will pay close attention to conditions and circumstances for which the Landscape Architect is to inspect and approve. Failure of a timely notification to Landscape Architect regarding any variances in said conditions and circumstances will result in work being removed and reinstalled at the Landscape Contractors

C. Landscape Contractor is responsible for locating all utilities prior to installation and/or Construction.

D. Landscape Contractor shall not alter or damage any structure or existing plant material to remain on property during installation.

1.3 EXAMINATION AND VERIFICATION OF DRAWINGS AND SITE:

A. It shall be the Landscape Contractor's responsibility to report to the Landscape Architect any deviations between drawings, specifications and the site. Failure to do so prior to the installation of materials will result in replacing and/or relocating materials and shall be done at the Landscape Contractor's

1.4 CLEAN-UP:

A. At reasonable regular intervals during the installation of the work, the Landscape Contractor shall clean up the site and dispose of waste materials, rubbish, and debris caused by their operations.

B. When site work involves movement of soil or other materials that could stair or discolor walks and pavements, then the Landscape Contractor shall clean up daily before leaving job site and remove all materials that may stain or discolor.

1.5 SOIL SAMPLES:

A. The Landscape Contractor shall collect soil samples of the areas to be landscaped, submit samples to an appropriate testing agency, obtain results and deliver same to the Landscape Architect. Soil sample boxes may be obtained from the County Agent's office. Location and quantity of samples to be taken are

1. Two samples of areas to be grassed, taken after the areas are prepared for

2. Two samples of planting beds taken after the beds are prepared for planting. B. The same lab shall be used for all samples to ensure accurate results.

Part 2 - Products

2.1 RELATED LANDSCAPING MATERIAL:

E. STAKING AND GUYING MATERIALS:

A. DESCRIPTION: This section covers the furnishing and installation of all items associated with the landscaping as called for in this contract.

B. FERTILIZER: Tree and shrub fertilization shall be carried out according to ANSI A300 Part 2 - Tree, Shrub, And Other Woody Plant Maintenance - Standard 2. Plant Beds for Herbaceous Flowers: Areas to be planted with herbaceous Practices (Fertilization). Fertilizer for perennials and annuals shall be in the form of a complete fertilizer (10-10-10). Verify all plant nutrient requirements through soil test.

C. TOPSOIL: Topsoil to be used for backfilling plant pits shall consist of fertile friable soil and shall contain a normal amount of organic matter. It shall be reasonably free from subsoil, refuse, heavy or stiff clay, stones larger than one inch in size, coarse sand, and noxious substances. Topsoil shall be free from toxic amounts of either acid or alkaline elements and shall be capable of sustaining healthy plant growth.

D. MULCH: Industry standard mulch as specified by the Plant Schedule. All mulch must be clean and free of trash and debris.

1. Specified DeepRoot ArborTie green staking and guying material is to be flat woven polypropylene material. 3/4" (19.05mm) wide with a 900 lb. break strength. ArborTie shall be fastened to stakes in a manner which permits tree movement and supports the tree.

2. The ArborTie material shall be secured with an ArborKnot according to

3. Guy Stakes: Sound, durable lumber with minimum uniform cross-section above point 2"x 2" nominal dimensions; capable of withstanding above ground and underground conditions until final inspection; or steel rod, minimum of 1/2" diameter.

F. ROOT BARRIER

1. Guaranteed, any existing trees and new trees (required to meet code) have the ability to damage everything - including sidewalks, driveways, parking lots, curbing, patios, swimming pools, pool decks, building foundations – guaranteed.

2. That is why we have Root Barrier called-out in our specifications. 3. Tree Root Barriers shall be required to prevent roots from coming into contact with all man-made architectural elements and utilities (install per manufacturers

specifications). 4. Everyone - including ARBs and government agencies - desires the "estate look" on lots that are, in many cases, too small to support the structures and

"required" vegetation. G. SOIL AMENDMENTS OR CONDITIONING MATERIALS: 1. Aluminum Sulfate: Unadulterated, in manufacturer's original, unopened container labeled with analysis and net weight. Use to acidify soil (lower pH) if

necessary. 2. Limestone: Raw, ground agricultural limestone, containing at least 90 percent calcium carbonate; 90 percent shall pass No. 10 sieve and 50 percent shall pass No. 50 sieve. Use to decrease acidity of soil (raise pH if necessary). 3. Shredded Bark: Commercial horticultural preparation finely ground, free of

extraneous and harmful matter. 4. Peat: Shall be peat moss finely shredded, consisting of 90 percent organic moss peat, be brown in color and suitable for horticultural purposes.

2.2 LANDSCAPING PLANT MATERIALS:

A. DESCRIPTION: This section covers the quantities, sizes, and other specifications for plant material to be furnished and installed as a part of this Contract.

B. DEER RESISTANT PLANTS: Some Of The Plants Indicated On This Plan May Have A Resistance To Deer. However, If The Deer Are Present In Large Enough Numbers Or Are Hungry Enough They Will Eat Whatever May Be

C. PLANT SIZES: Plant sizes specified for plants in this contract are as recommended by the American Association of Nurserymen. Plants will be specified as 12"-15" plants, 18"-24" plants, etc.

D. MEASUREMENT: Plants are not to be stretched in order to obtain a measurement. Measurements will be taken from plants in their natural state and planted. Height of plants will not be measured to the tip of the tallest terminal, but will be measured as average height of plant. Spread of plants shall be measured as average spread.

E. AVERAGE SIZE: If a bed or group of plants is specified to be 18"-24", then the entire group of plants shall average 21" in spread or height (whichever is applicable). A group of plants just slightly meeting an average of 18" would be

rejected. F. DEVIATION: The Landscape Contractor may, upon approval of the Landscape Architect, install plants larger than specified, but no additional payment will be granted for such deviation. Under no conditions, except as stated above, will plants smaller than specified be installed under this Contract. G. NOMENCLATURE: Names of plants required for use as trees, shrubs, vines, groundcovers, etc., conform generally with names accepted in nursery trade. In the event of dispute, authority will be Standardized Plant Names, Second Edition, American Joint Committee of Horticulture, 1942, J. Horace McFarland Co., Harrisburg, Penn.

H. SUBSTITUTIONS: Plants in the variety and/or sizes specified that are unobtainable must be substituted only through a request and approval method. If a specified plant cannot be located, then the Landscape Contractor shall contact the Landscape Architect and notify them of which plants are unavailable The Landscape Architect, if unable to locate said plant, will approve an appropriate substitution.

I. SPECIFICATIONS: Except when stated otherwise, specifications for measurements, quality and grade in Materials List (see Drawings) refer to USA Standards for Nursery Stock (USA Standards Institute of Nurserymen). In case of conflict of stated measurements, use greater requirements. All plant material shall comply with the American Standard For Nursery Stock (ANSI Z60.1-1996) J. CONDITION OF PLANTS SUPPLIED: Well-shaped within normal habit of growth, sound, healthy, vigorous, of proper color, and free from insect pests, disease of physical injury.

Part 3 - Execution

3.1 PREPARING PLANT PITS AND BEDS:

A. All plant pits and beds are to be prepared as follows: 1. Plant Pits: Holes dug for planting plants are to be at least 10" wider and at

least 6" deeper than the plant container or root ball.

flowers (pansy, kale or cabbage) are to have a minimum of 6" of quality topsoil over the entire area. Two inches of cow manure shall be spread over the entire area and thoroughly incorporated and mixed with the top 6" of topsoil with a power tiller.

3. Plant Beds for Grassing: See Grassing Specifications.

4. Landscape Contractor shall be responsible for installing a root growth barrier in all locations where plant roots may come into contact with architectural elements (Foundations, Walls, Sidewalks, Pools...etc) or utilities.

5. All planted areas will be pre-emerged to inhibit weed germination.

6. All ericaceae family plants shall be planted in raised beds, minimum 4" height with 50% organic humus, 30% soil, and 20% sand.

3.2 PLANTING:

A. All Plants shall be planted according to the latest accepted techniques for planting plant materials as recommended by the American Association of Nurserymen and as shown on the planting details in the Drawings. B. All plant material shall comply with the American Standard For Nursery Stock (ANSI Z60.1-1996)

C. See planting details sheet for proper method of installing plant material. A copy of the planting details sheet will be provided by the Landscape Architect if not a part of this plan set.

3.3 FERTILIZATION:

A. Trees and shrubs are to be fertilized according to ANSI A300 Part 2 - Tree, Shrub, And Other Woody Plant Maintenance - Standard Practices (Fertilization) B. Annual and Perennial Fertilization should occur at the rate of 1 pound per 100 square feet of bed area or a complete slow-release fertilizer following label

C. Grass: See Grassing Specifications.

3.4 BACKFILL OR PLANTING MIXTURE:

A. The backfill or planting mixture to be placed in plant pits around trees and shrubs shall contain a mixture of two (2) parts topsoil to one (1) part of soil conditioner, which shall be peat moss or humus, shredded hardwood or softwood bark mulch. These materials may be hand mixed as planting is installed

3.5 CONSTRUCTION OF BASINS OR SAUCERS:

A. Basins with a depth of 2" shall be constructed around all plant bed or individual planted trees or shrubs.

A. All plantings shall be thoroughly watered by the Landscape Contractor at the time of the planting.

B. If in contract: irrigation system shall cover 100% of all lawn and planting bed areas. Irrigation water shall not come in contact with any building, structure or

3.7 PLANT ROOT PROTECTION:

A. All balled and burlapped plants are subject to be opened and inspected by the Landscape Architect. Any undersized, broken, or dried-out balls will be reason for rejection.

3.8 MULCHING:

A. All planting beds and areas designated as mulch to have 2"- 3" depth of mulch. All liriope and mondo grass areas shall be mulched with 1"- 2" of mulch. See planting schedule for mulch type.

B. All trees located in sod areas shall have a mulch ring around them.

3.9 SEEDING /SOD:

A. The Landscape Contractor shall be responsible for furnishing and installing all grassing/sod as shown on the plans or called for as a part of these specifications. B. The areas to receive grass are to be brought to the grades as shown on the grading plans and approved by the Landscape Architect prior to grassing. The sod bed should be loose and friable just prior to applying sod.

C. Areas to receive seed / sod shall be clean of debris and weed free. D. Soil shall be amended per soil test recommendations prior to seed / sod

E. All seed shall be applied per manufacturers specifications.

F. All sod placed on slopes shall be pinned in place to prevent sliding. G . After Installation sod surface should be smooth and flat with no gaps.

3.10 MAINTENANCE:

A. The height of any plant materials within the sight triangle shall be maintained as required per

applicable City/County codes. B. Owner shall consider the maintenance requirements of all plant materials for

C. Trees and shrubs shall be maintained according to ANSI A300 and the companion Best Management Practices.

3.11 WARRANTY:

A. The Landscape Contractor shall warrant all work (including plants and trees) for a period of 1 year, replacing all dead or non-functional items at no cost to the

B. Understanding that there is a one (1) year warranty period on all installed plant material, it is incumbent upon the Landscape Contractor to inform the Landscape Architect immediately of defficiencies in perscribed plant material. You are also hereby informed that the Owner/Landscape Architect reserves the right to inspect installed plant material at any time within the one (1) year warranty period and call for replacements where deficiences are present. C. Landscape Contractor shall remove tree stakes and guying after 1-year warranty period has ended.

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PROJECT

acility Ц Bu

Harbour ounty Snta

Schools

County

Fai Ho Site PROJECT NUMBER 22-027

> RELEASE Permit

DATE 07/07/22

REVISIONS

CONCEPTS, LLC

SHEET TITLE

Specifications

SHEET NUMBER

L-5.0

SYMBOL SCHEDULE

2009 SOUTH CAROLINA ENERGY CONSERVATION CODE

COMMERCIAL ENERGY EFFICIENCY - ELECTRICAL SUMMARY

C401 METHOD OF COMPLIANCE

2009 NCECC CHAPTER 4 SC SPECIFIC COMCHECK PROVIDED N/A BASED ON PROJECT SCOPE ☐ ASHRAE 90.1-2013

C406 ADDITIONAL EFFICIENCY PACKAGE OPTIONS

☐ C406.2 EFFICIENT MECH EQUIPMENT ☐ C406.5 ON—SITE RENEWABLE ENERGY C406.6 DEDICATED OA SYSTEM C406.3 REDUCED LTG DENSITY ☐ C406.4 ENHANCED DIGITAL LTG CNTLS ☐ C406.7 HI-EFF SERVICE WTR HTG ☐ NOT APPLICABLE BASED ON PROJECT ☐ C406.7.1 WTR HTG LOAD FRACTION

C408 - SYSTEM COMMISSIONING:

BUILDING IS LESS THAN 10,000 SQUARE FEET AND IS EXEMPT FROM THE SYSTEM COMMISSIONING REQUIREMENTS OF SECTION C408.

BUILDING IS GREATER THAN 10,000 SQUARE FEET AND REQUIRES SYSTEM COMMISSIONING PER SECTION C408.

C405.2 - LIGHTING CONTROLS (MANDATORY REQUIREMENTS):

LIGHTING SYSTEMS ARE PROVIDED WITH CONTROLS AS REQUIRED PER SECTION C405.2, EXCEPT WHERE EXEMPT. ☐ NOT APPLICABLE

C405.3 - EXIT SIGNS (MANDATORY REQUIREMENTS):

INTERNALLY ILLUMINATED EXIT SIGNS DO NOT EXCEED 5 WATTS PER SIDE. □ NOT APPLICABLE

C405.4 - INTERIOR LIGHTING POWER REQUIREMENTS (PRESCRIPTIVE) (NON-EXEMPT): NOT APPLICABLE PER 2009 NCECC C503.1, EXCEPTION 2.G.

C405.4.1 - TOTAL <u>CONNECTED</u> INTERIOR LIGHTING POWER: XXX,XXX WATTS SPECIFIED

XX % REDUCTION OF SPECIFIED VS. ALLOWED (APPLICABLE IF C406.1.2 IS SELECTED)

C405.4.2 - TOTAL <u>ALLOWABLE</u> INTERIOR LIGHTING POWER: METHOD OF COMPLIANCE:

☐ BUILDING AREA METHOD ☐ SPACE-BY-SPACE METHOD XXX,XXX WATTS ALLOWED

C405.5.1 - EXTERIOR BUILDING LIGHTING POWER (NON-EXEMPT): ☐ NOT APPLICABLE

TOTAL CONNECTED EXTERIOR LIGHTING POWER:

10,672 WATTS SPECIFIED TOTAL ALLOWABLE EXTERIOR LIGHTING POWER:

31,675 WATTS ALLOWED

C405.6 - ELECTRICAL ENERGY CONSUMPTION (DWELLING UNITS): SEPARATE ELECTRICAL METERING HAS BEEN PROVIDED FOR EACH DWELLING UNIT IN GROUP R-2 BUILDINGS.

NOT APPLICABLE

C405.7 - ELECTRICAL TRANSFORMERS (MANDATORY REQUIREMENTS):

ELECTRICAL TRANSFORMERS HAVE BEEN SPECIFIED TO MEET MINIMUM EFFICIENCY REQUIREMENTS PER C405.7, EXCEPT WHERE EXEMPT.

☐ NOT APPLICABLE

C405.8 - ELECTRICAL MOTORS (MANDATORY REQUIREMENTS):

ELECTRICAL MOTORS HAVE BEEN SPECIFIED TO MEET MINIMUM EFFICIENCY REQUIREMENTS PER C405.8, EXCEPT WHERE EXEMPT.

☐ NOT APPLICABLE

ABBREVIATIONS

DIMENSION INDICATES HEIGHT ABOVE FINISHED FLOOR AT WHICH CENTER OF DEVICE IS TO MOUNTED. SEE PLANS.

NEMA 3R ABOVE FINISHED FLOOR

AFF AUTHORITY HAVING JURISDICTION AHJ AIR HANDLER UNIT

CIRCUIT BREAKER EMPTY CONDUIT WITH PULL CORD

ELECTRICAL CONTRACTOR ELECTRIC WATER COOLER ELECTRIC WATER HEATER

FACP FIRE ALARM CONTROL PANEL FUSE PER NAMEPLATE

LIGHTING CONTACTOR

MECHANICAL CONTRACTOR P.C. PLUMBING CONTRACTOR

UNDERGROUND WEATHERPROOF

SERVICE ENTRANCE EMERGENCY FIXTURE WITH BATTERY OR GEN. BACK-UP

EXISTING ITEM RELOCATED TO THIS LOCATION.

EXISTING ITEM TO BE RELOCATED. EXISTING ITEM TO REMAIN.

EXISTING ITEM TO BE REPLACED. EXISTING ITEM TO BE REMOVED.

RMS SYMMETRICAL SHORT CIRCUIT CURRENT AMPERE INTERRUPTING CAPACITY (EQUIPMENT RATING)

DEVICES AND PATHWAYS

WRING SYSTEM CONCEALED IN WALL OR CEILING. WHEN SHOWN, CROSS EXIT LIGHT WITH ARROWS AND NUMBERS OF FACES AS INDICATED ON PLANS. 90 MIN BATTERY BACKUP. SEE LIGHTING FIXTURE SCHEDULE. LINES INDICATE NUMBER OF WIRES. (GROUND WIRES ARE NOT SHOWN)

WIRING SYSTEM CONCEALED IN OR UNDER SLAB OR UNDERGROUND.

WIRING SYSTEM EXPOSED

CONDUIT TURNED UP TO FLOOR ABOVE.

CONDUIT TURNED DOWN TO FLOOR BELOW.

BRANCH CIRCUIT HOMERUN TO PANEL.

JUNCTION BOX WITH CONNECTION TO EQUIPMENT SERVED. 4" SQUARE BOX WITH A SINGLE-GANG OPENING AND PLASTER RING.

DUPLEX RECEPTACLE, 20 AMP, 120 VOLT. HUBBELL 5352, OR

DUPLEX RECEPTACLE MOUNTED ABOVE COUNTER BACKSPLASH, OR

GROUND FAULT RECEPTACLE. NEMA 5-20R DUPLEX. ALL RECEPTACLES INSTALLED OUTSIDE SHALL BE GFCI. WEATHERPROOF RECEPTACLE. NEMA 5-20R GFI DUPLEX. COVER SHALL BE

PANELS, DISCONNECTS

INTERMATIC #WP1020 (CLEAR) OR SPECIFICATION EQUAL.

CONNECTION TO MOTOR. STARTER PROVIDED BY OTHERS UNLESS OTHERWISE NOTED.

FRACTIONAL HORSEPOWER MANUAL MOTOR STARTER, WITH OVERLOAD PROTECTION

NON-FUSED HEAVY DUTY DISCONNECT SWITCH. NUMERALS INDICATE SWITCH RATING. NEMA 1 ENCLOSURE, UNLESS OTHERWISE

FUSED HEAVY DUTY DISCONNECT SWITCH. NUMERALS INDICATE SWITCH RATING/FUSE SIZE. NEMA 1 ENCLOSURE, UNLESS OTHERWISE

PANELBOARD. SEE SCHEDULE FOR MOUNTING. TOP OF PANEL AT 6'-6" AFF.

LIGHTING (SEE FIXTURE SCH.)

EXTERIOR EMERGENCY FIXTURE WITH EMERGENCY BALLAST OR DRIVER. PROVIDE 1100 LUMEN INVERTER RATED FOR 90 MINUTE OPERATION. SEE FIXTURE

SCHEDULE FOR FIXTURE TYPE, EMERGENCY DEVICE SHALL SUPPLEMENT FIXTURE.

SINGLE HEAD POLE FIXTURE. SEE FIXTURE SCHEDULE. 180 DEGREE DOUBLE HEAD POLE FIXTURE. SEE FIXTURE SCHEDULE.

90 DEGREE DOUBLE HEAD POLE FIXTURE. SEE FIXTURE SCHEDULE.

90 DEGREE FOUR HEAD POLE FIXTURE. SEE FIXTURE SCHEDULE.

KEY OPERATED SWITCH 2-HR TIMER SWITCH, 20 AMP, 120/277 VOLT, EQUAL TO INTERMATIC FF SERIES

PHOTO CONTROL, EXTERIOR, MOUNT FACING NORTH.

PLAN NUMBER PLAN NAME

ELECTRICAL SCHEDULES & RISER

ELECTRICAL SHEET INDEX

ELECTRICAL NOTES & LEGENDS ELECTRICAL SPECIFICATIONS

SITE PLAN — ELECTRICAL SITE PLAN — ELECTRICAL LIGHTING PHOTOMETRICS

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09-20-22

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REV # DATE DESCRIPTION

XX-XX-2022 DATE: 22-0269 PROJECT #: DRAWN BY: hm DESIGNED BY: zk CHECKED BY:

SHEET TITLE: ELECTRICAL NOTES & LEGENDS

SHEET NO: 1 of 5

Optima Engineering

Mechanical Electrical Plumbing Fire Protection Lighting Design

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09-20-22

Fantasy Harbour Bus Horry County Schools

REV # DATE DESCRIPTION

DATE: XX-XX-2022
PROJECT #: 22-0269
DRAWN BY: hm
DESIGNED BY: zk
CHECKED BY: zk


SHEET TITLE:

ELECTRICAL

SPECIFICATIONS

EO.2

SHEET NO: 2 of 5

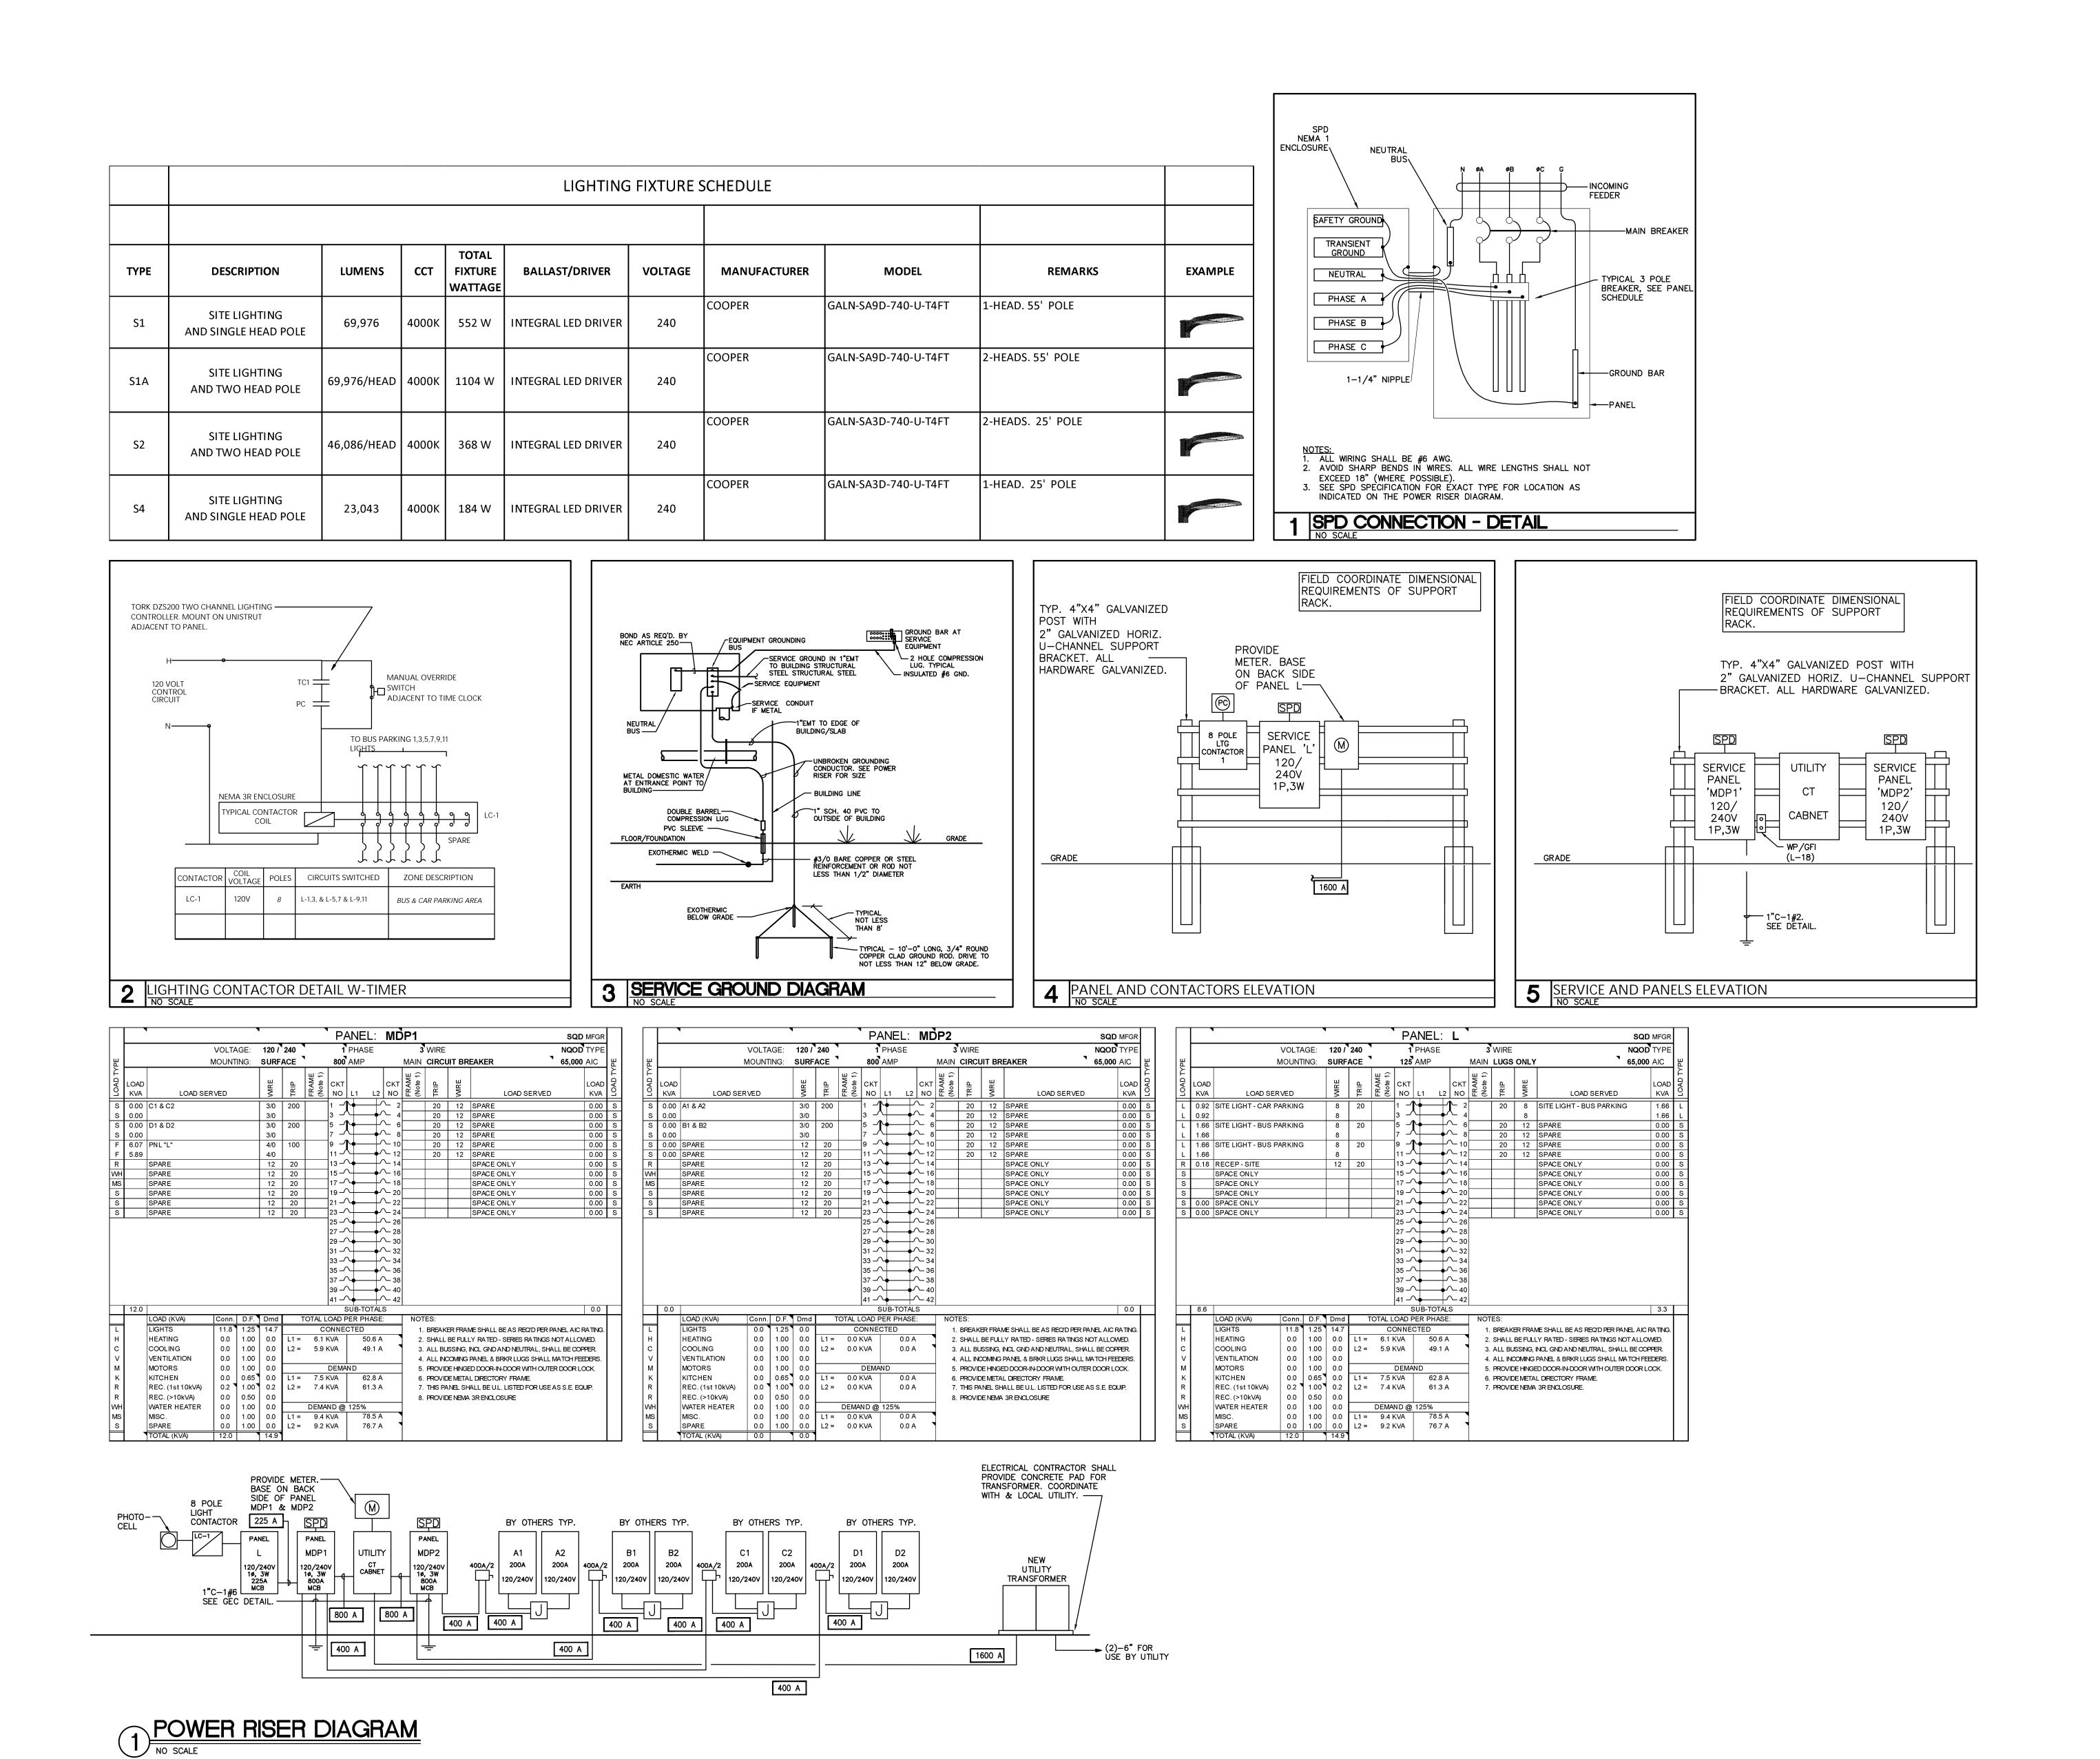

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Fantasy Harbour Bus Horry County Schools

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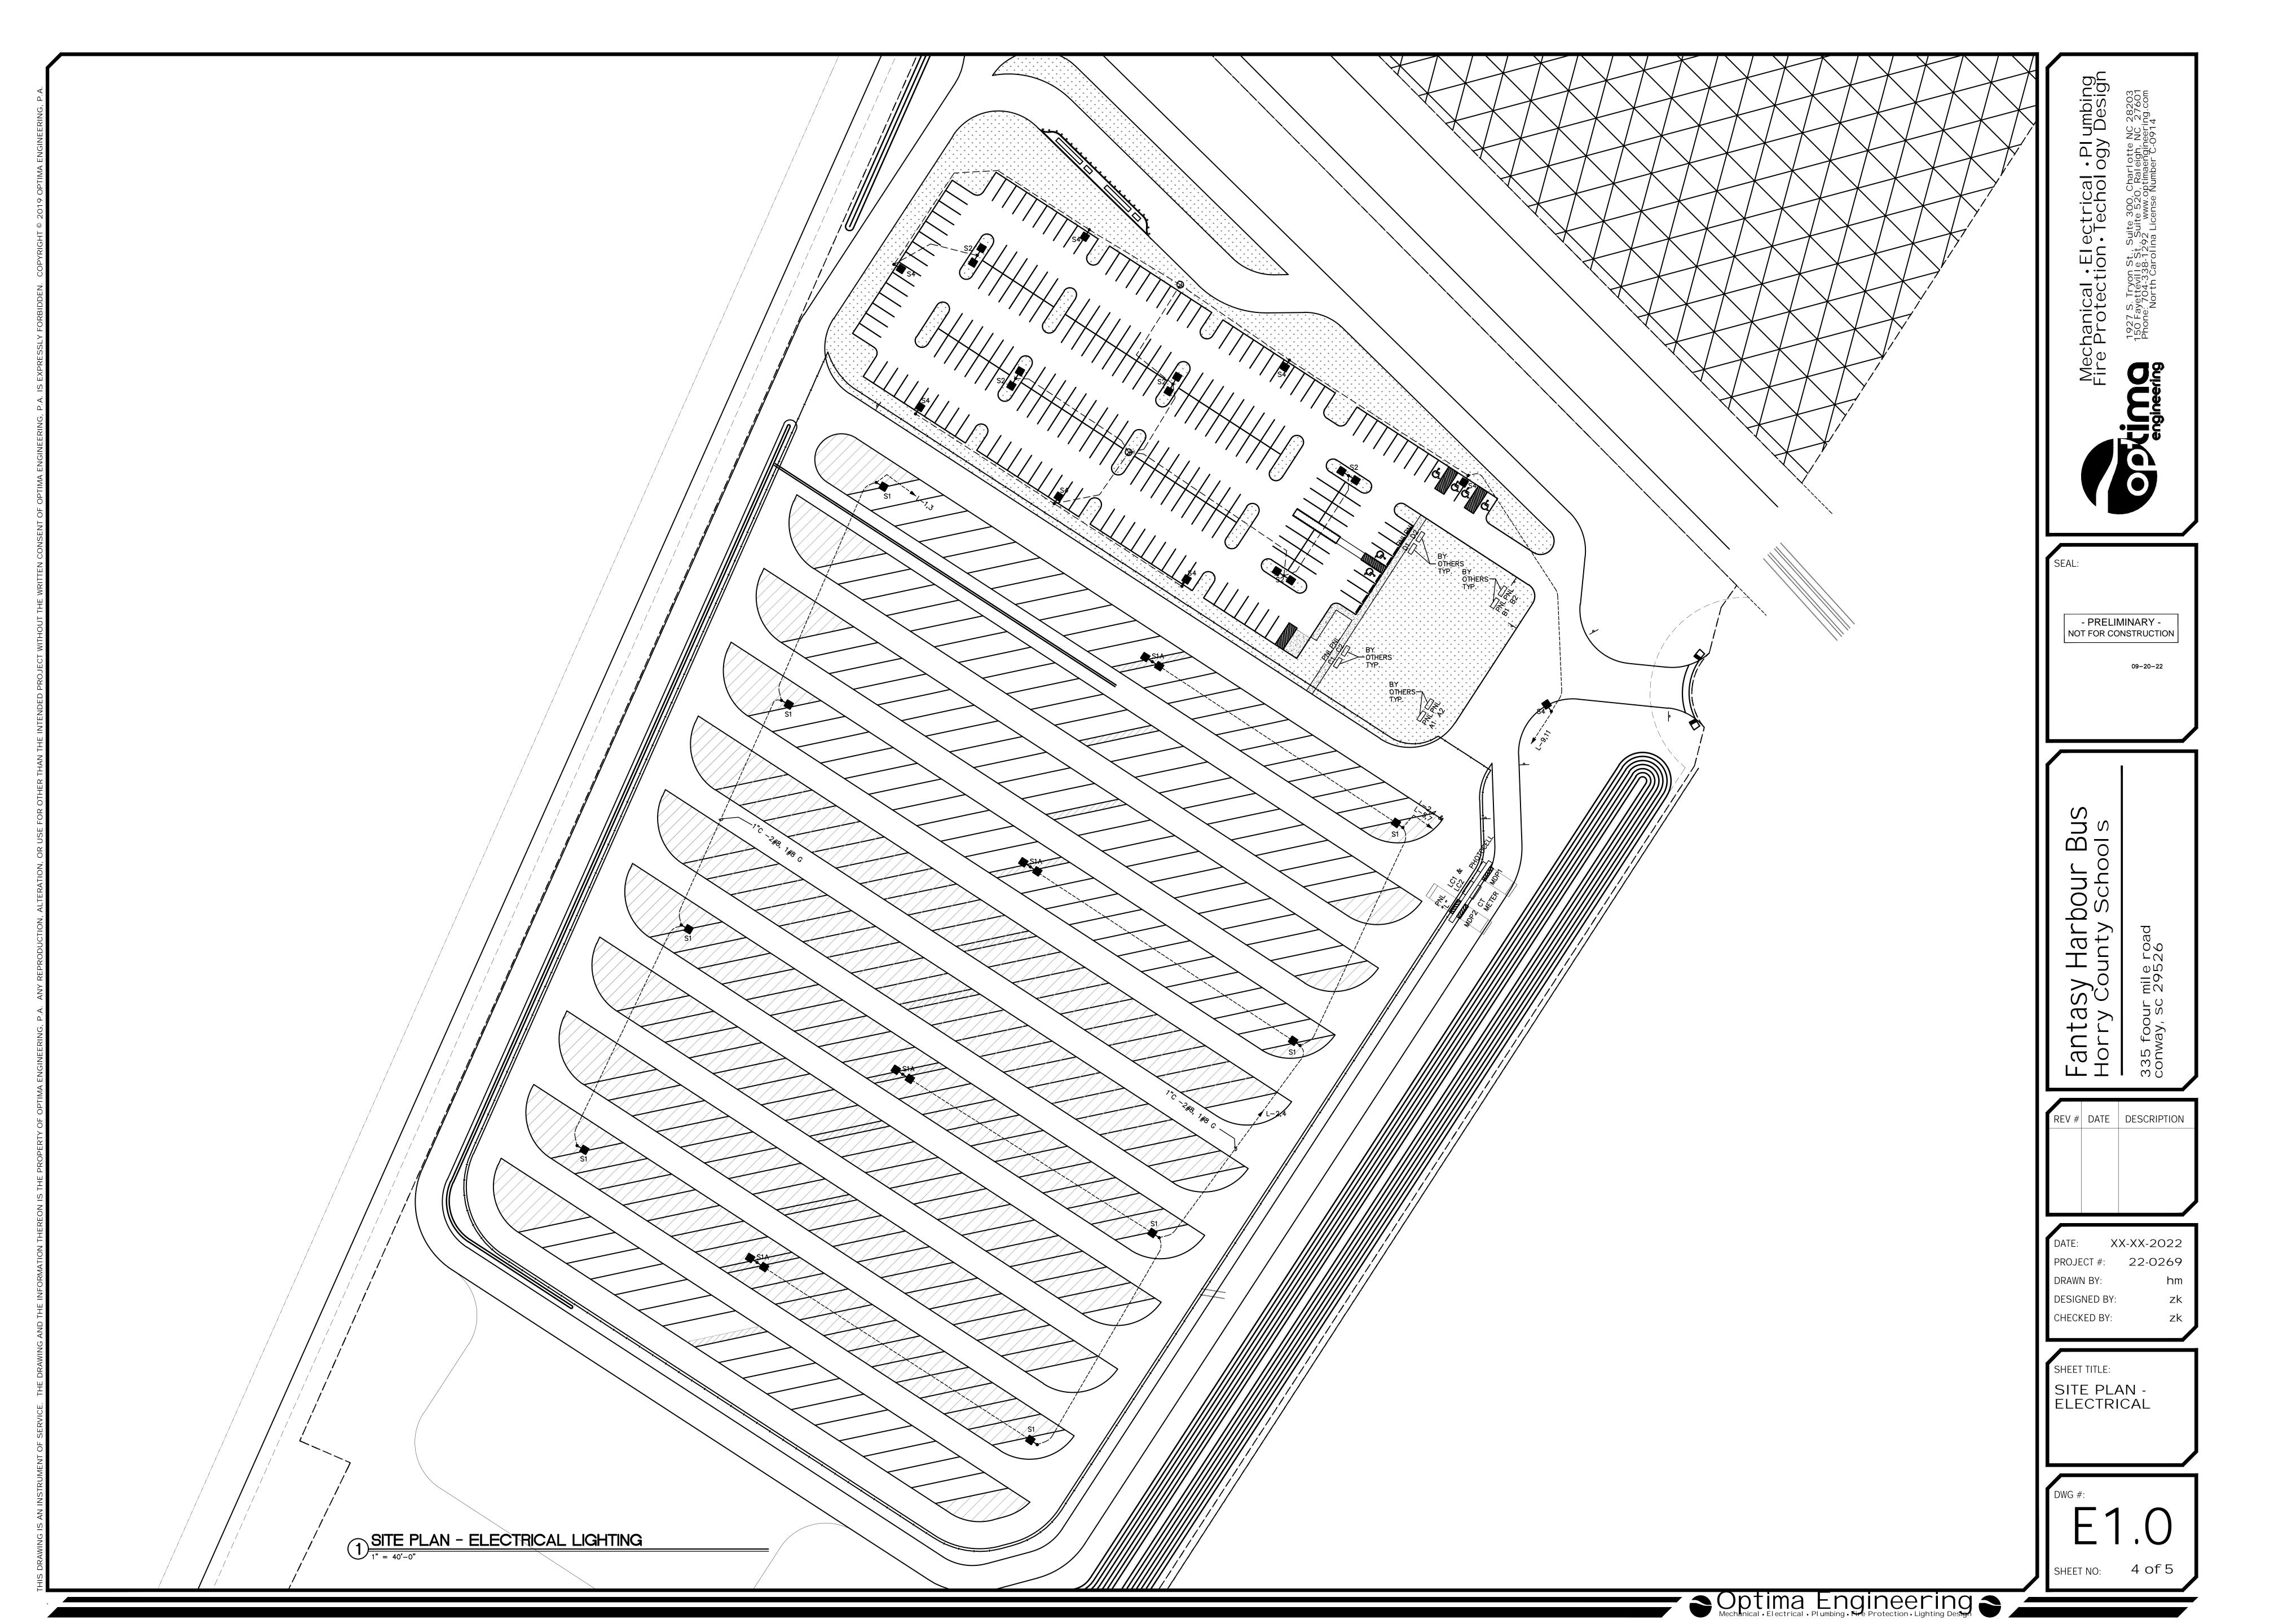
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DESIGNED BY: zk
CHECKED BY: zk


SHEET TITLE:

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SCHEDULES
& RISER

EO.3

SHEET NO: 3 of 5



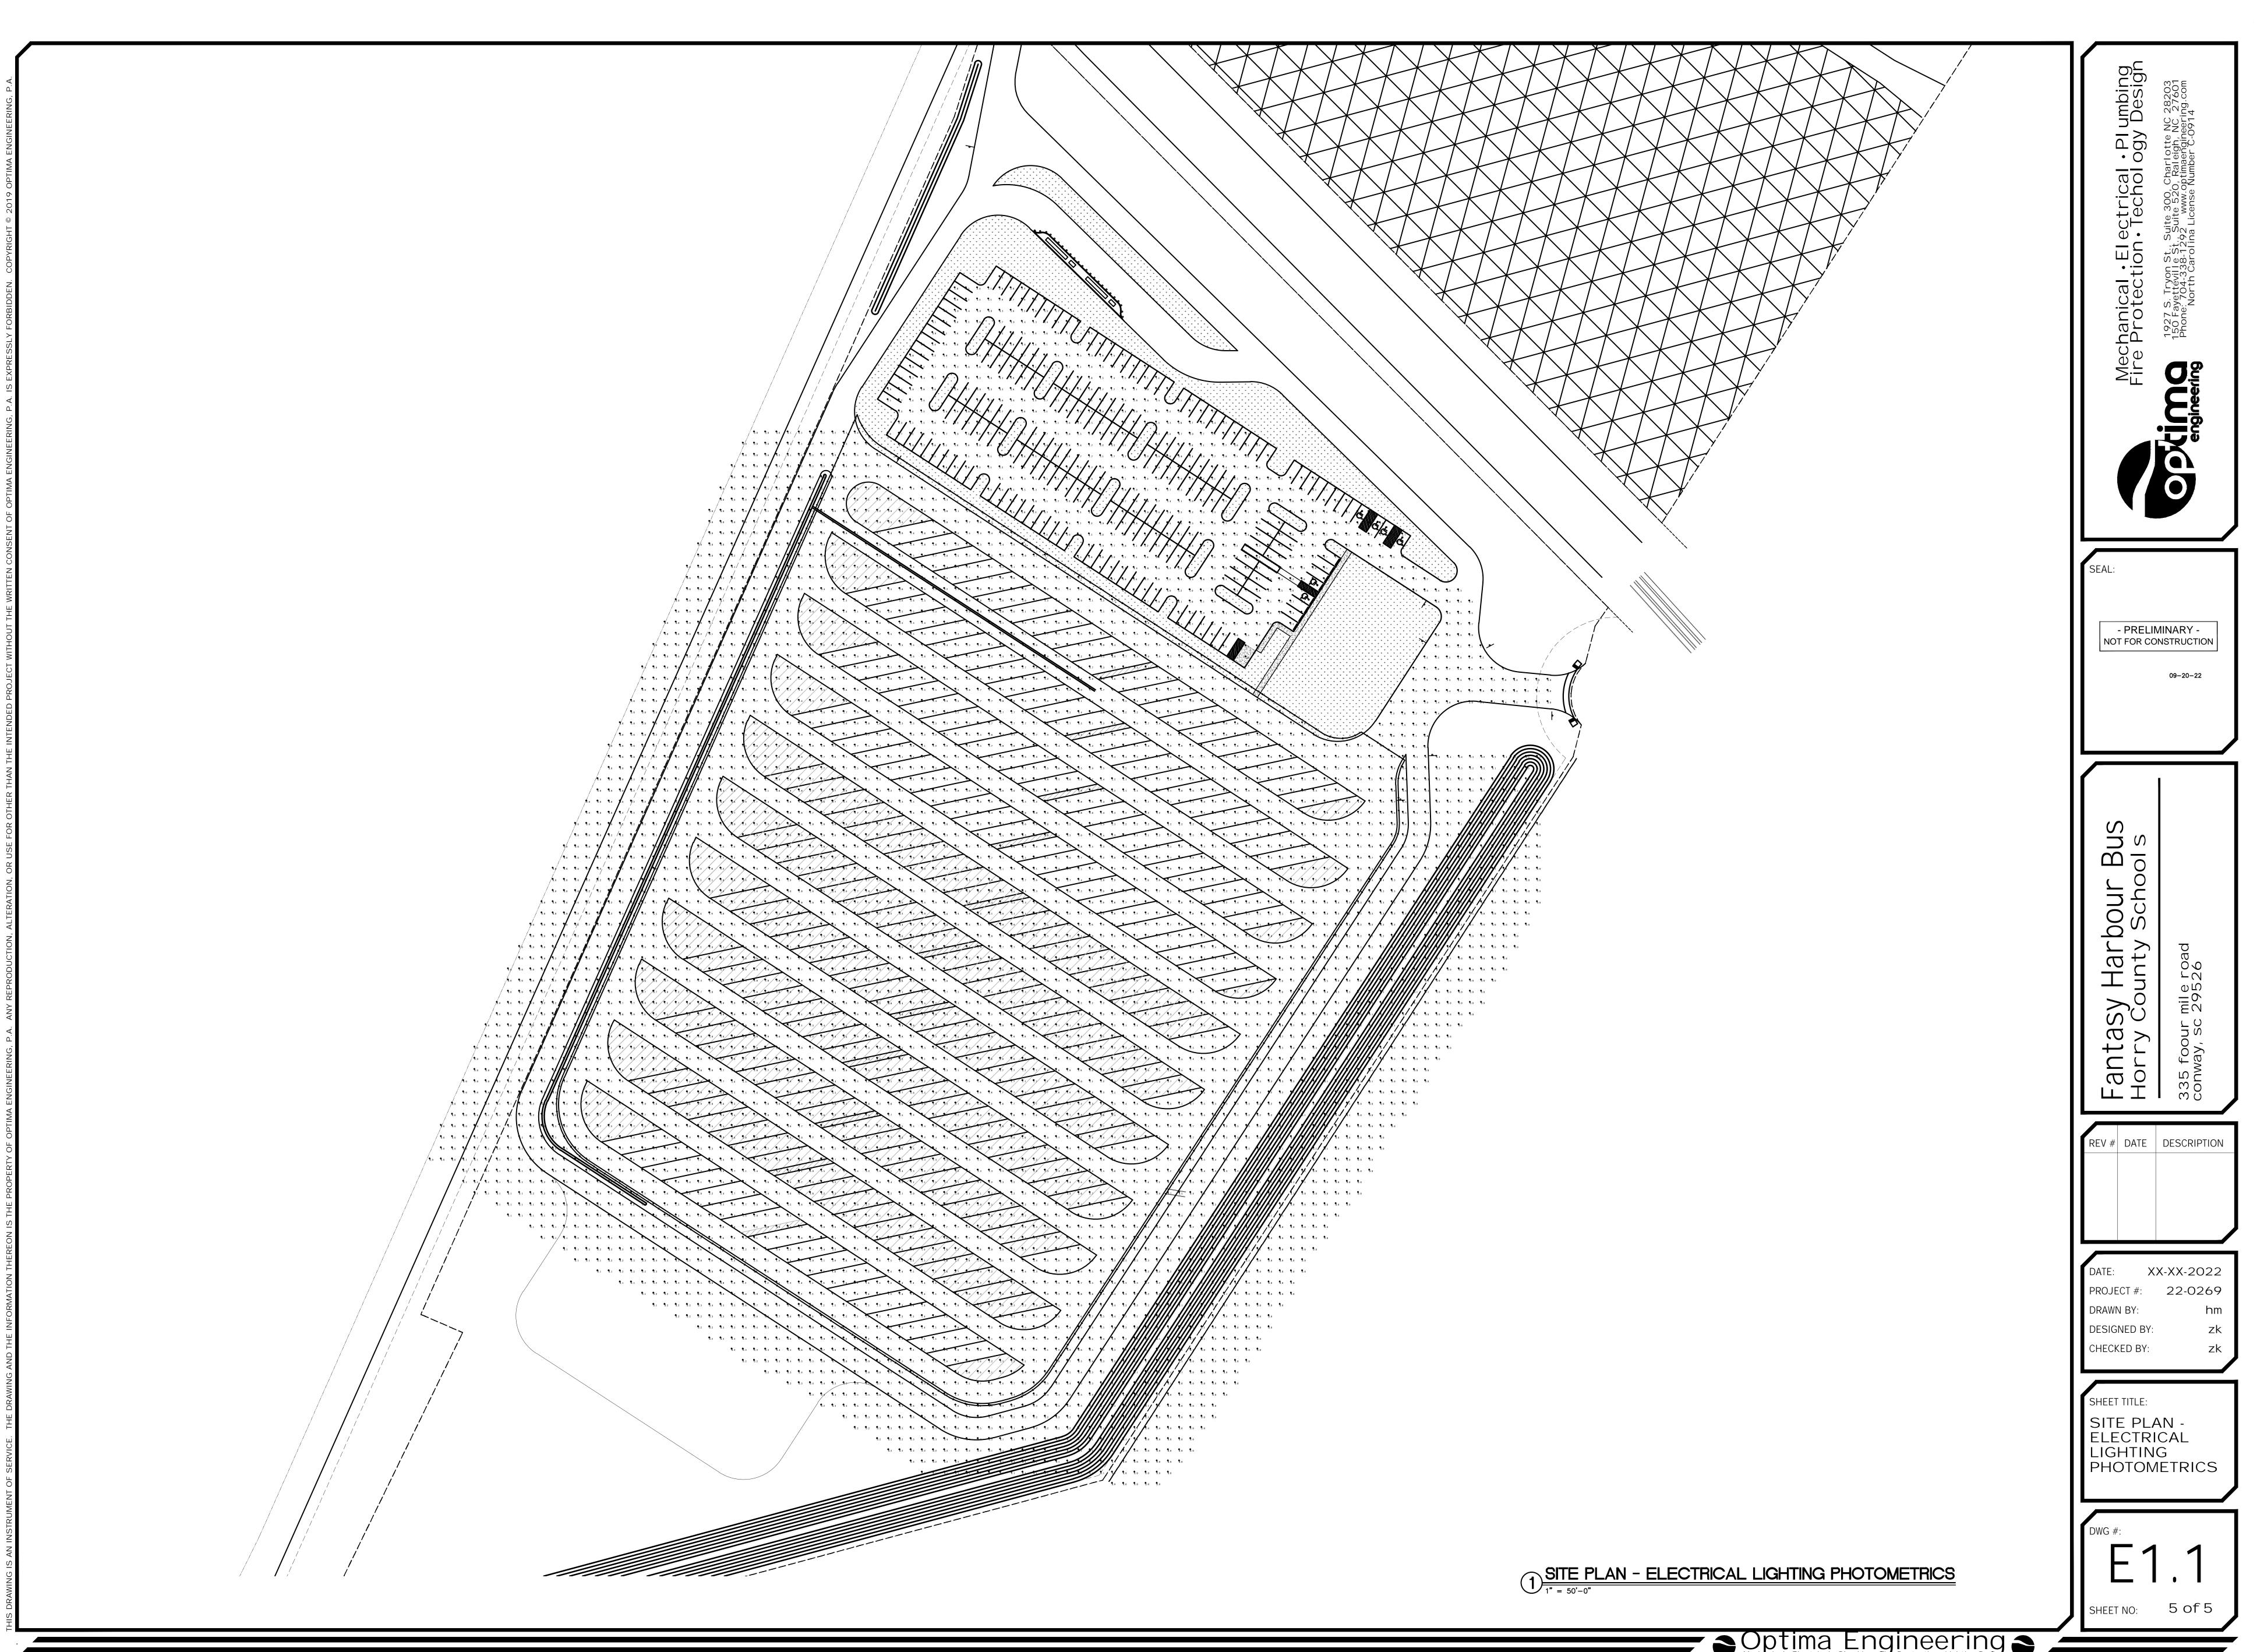

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