STRATION CAPERS 2 GRAVITY SEWER IMPROVEMENTS

DORCHESTER COUNTY, SOUTH CAROLINA

CONTACTS:


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DORCHESTER COUNTY WATER AND SEWER
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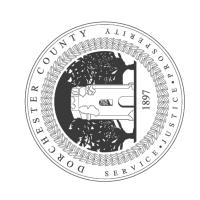
N.T.S.

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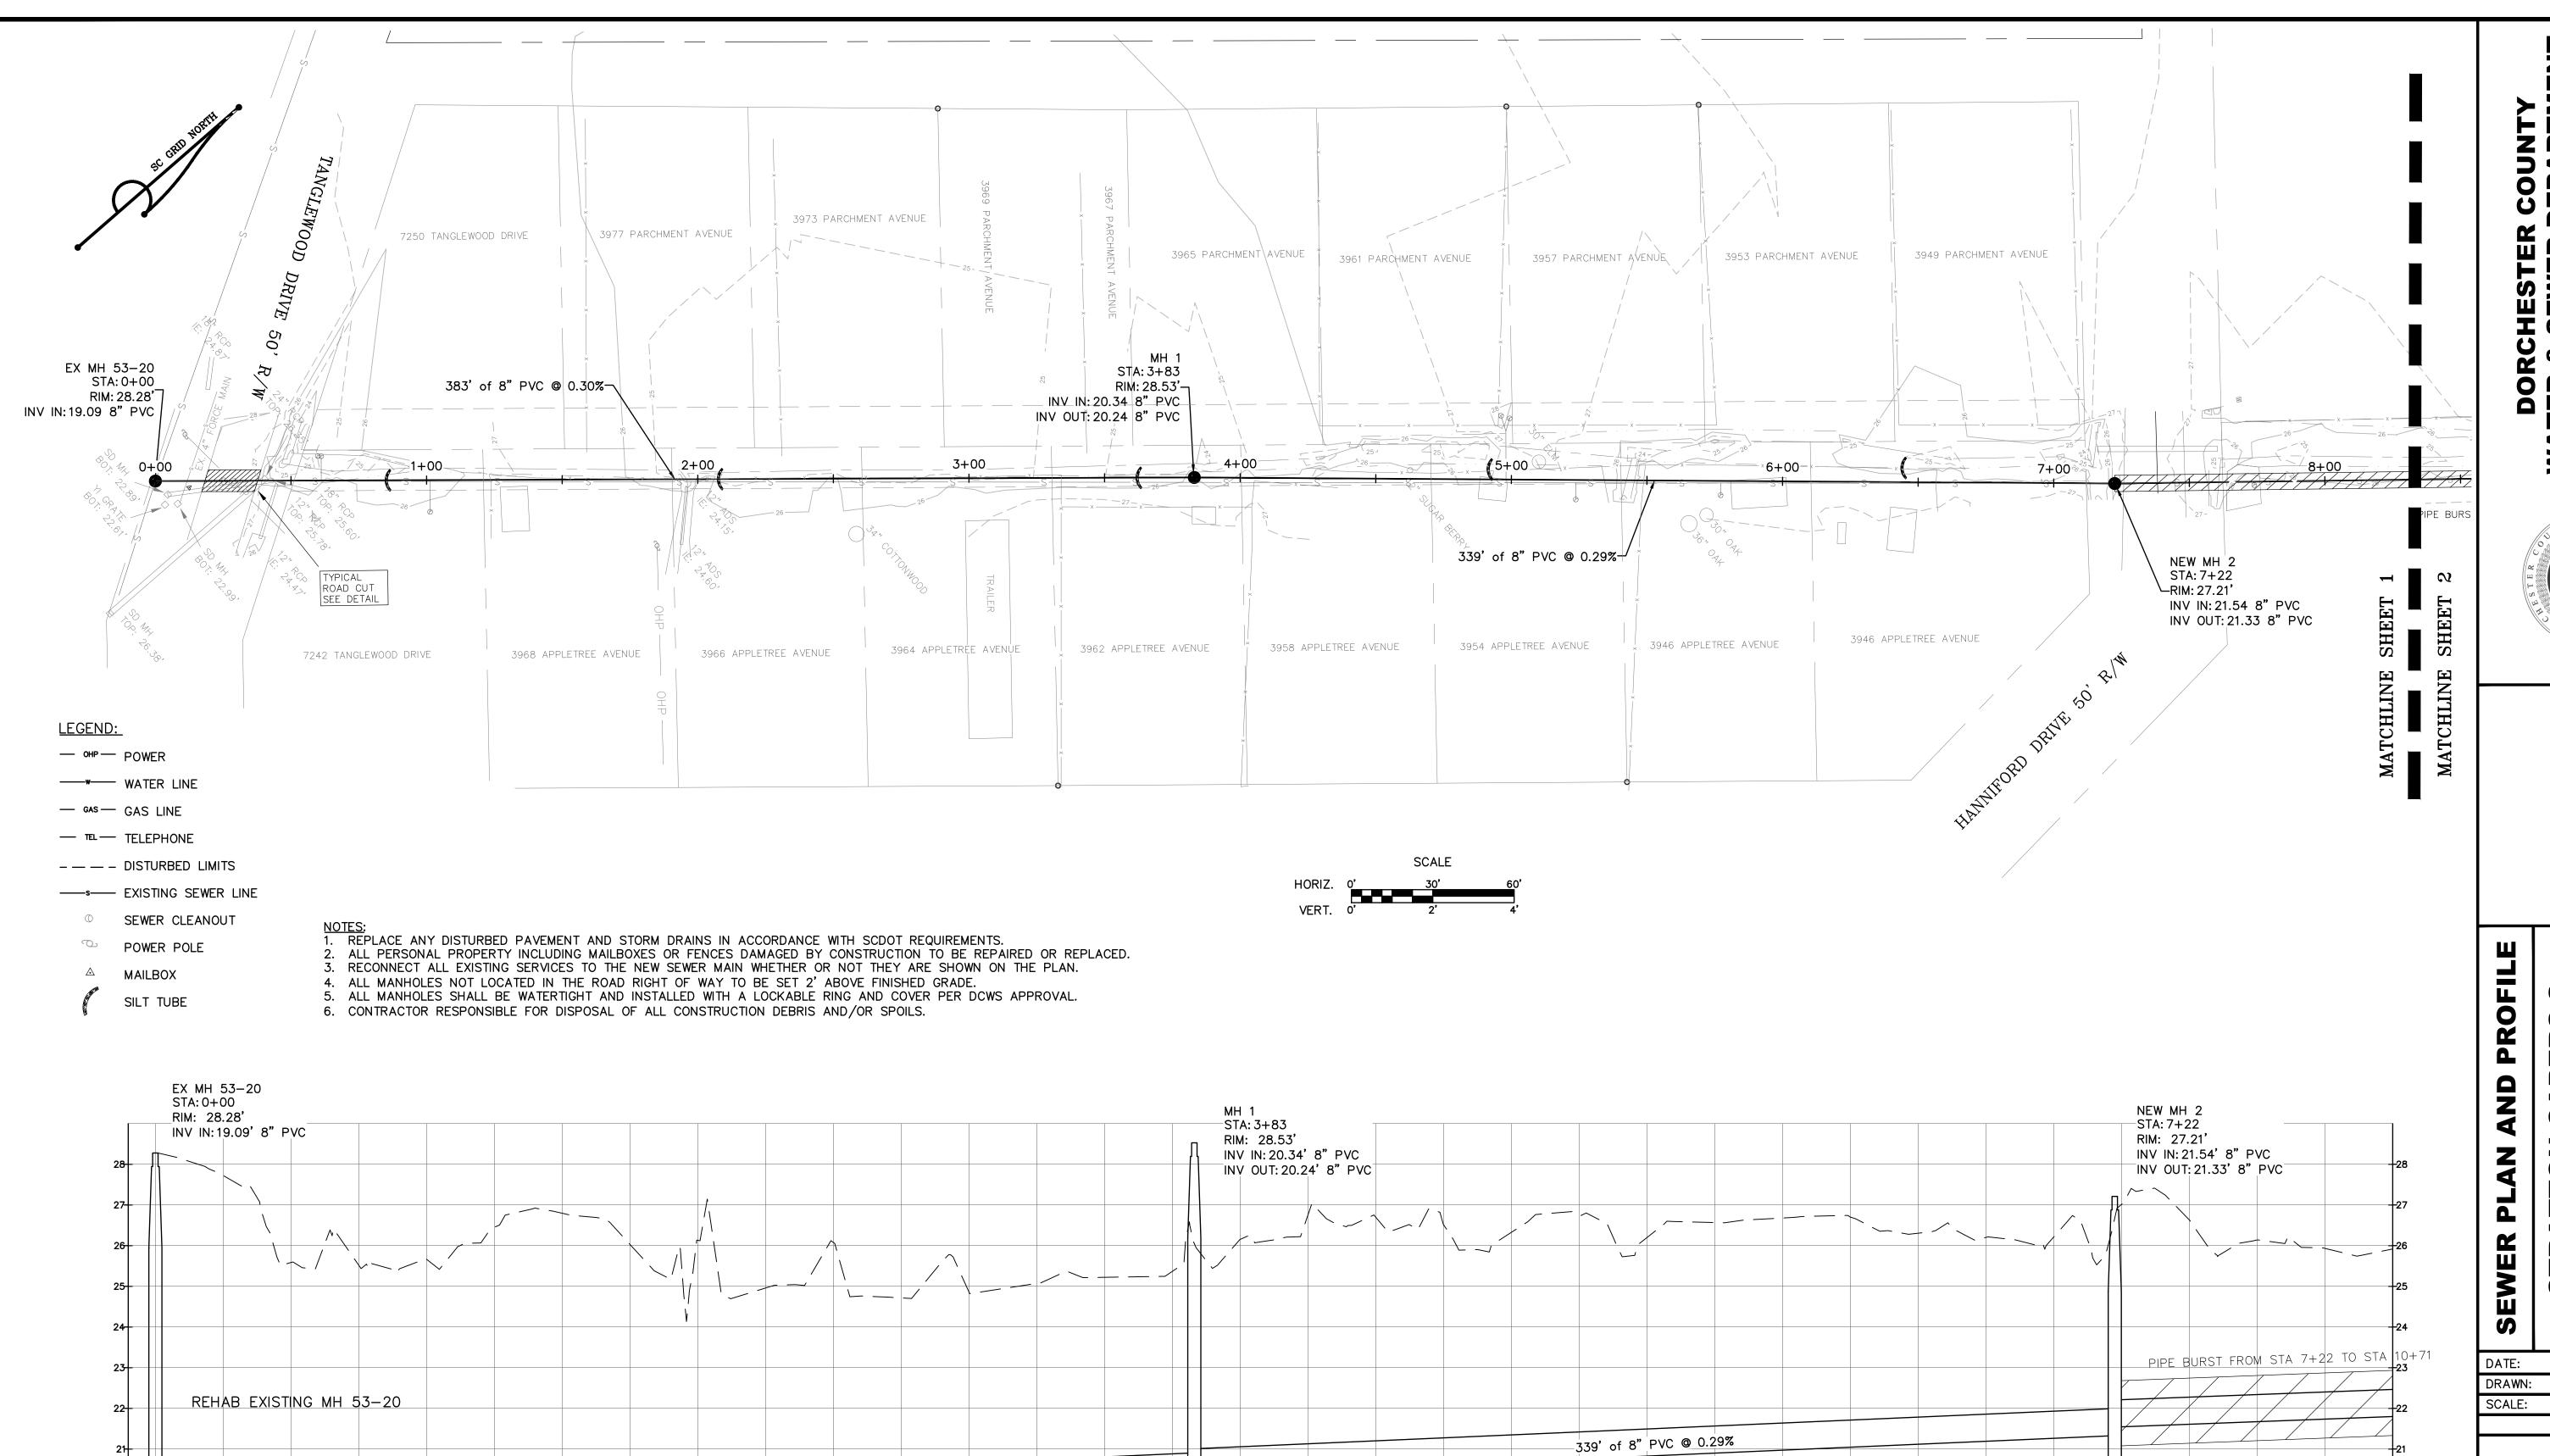
Know what's below.
Call before you dig.



3-27-19

REVISIONS

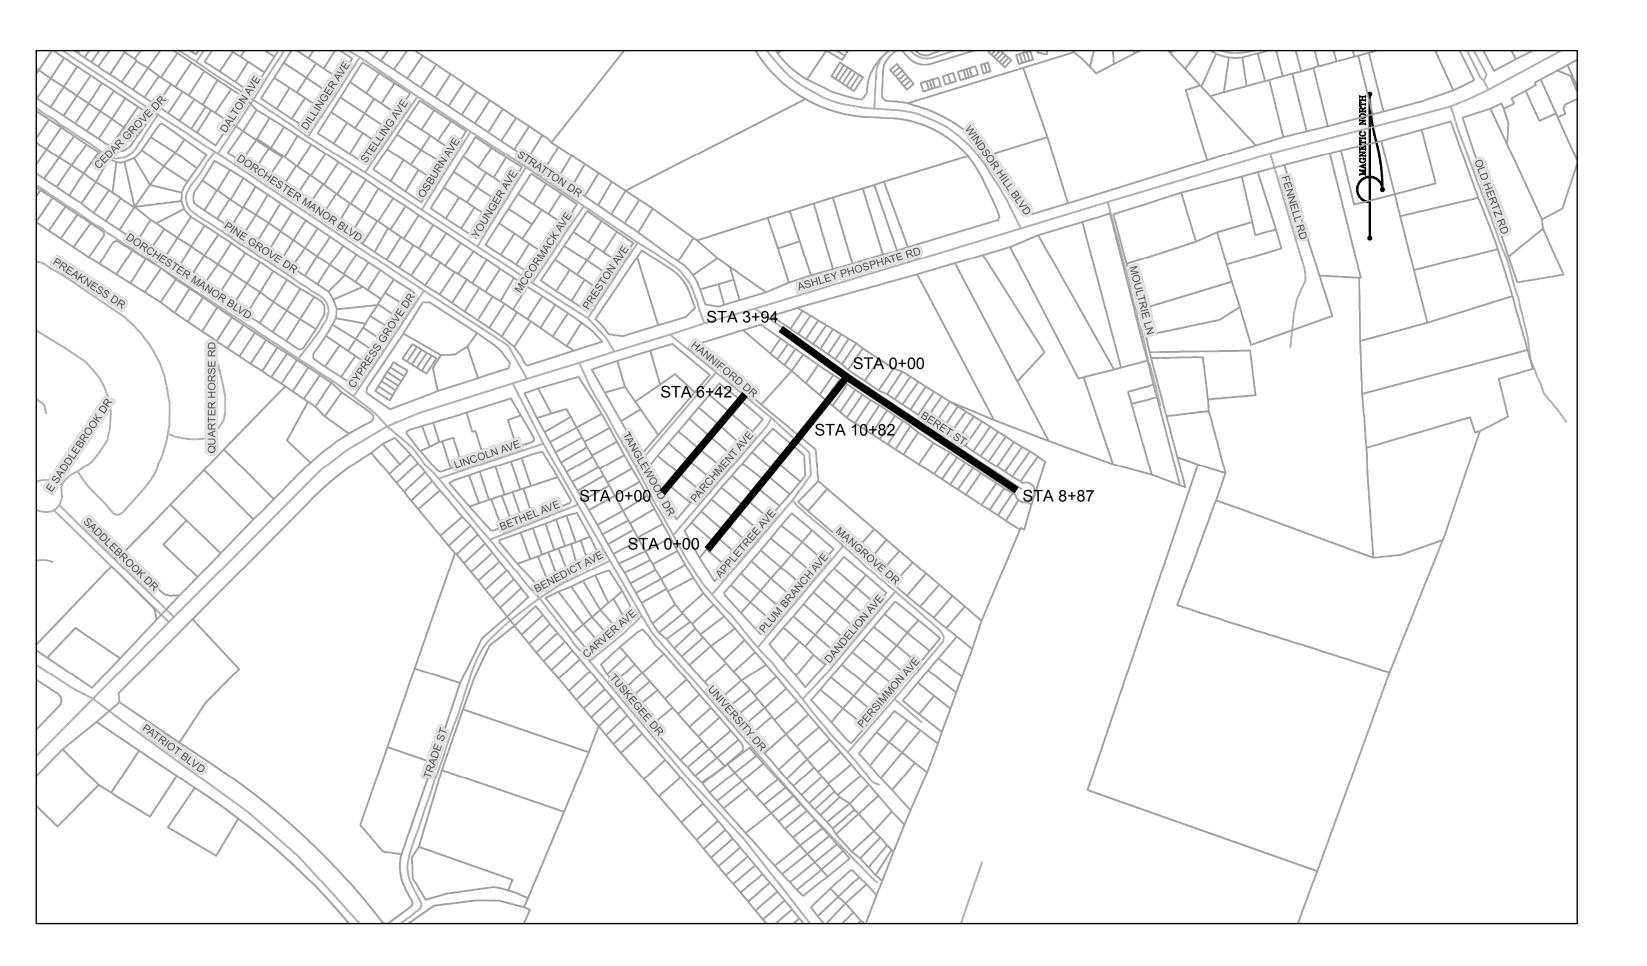COVER SHEET



EX MH 53-20 TO EX MH 53-21 STA -0+10 TO 8+25

2+25 2+50 2+75 3+00 3+25 3+50 3+75 4+00 4+25 4+50 4+75 5+00 5+25 5+50 5+75 6+00 6+25 6+50 6+75 7+00

383' of 8" PVC @ 0.30%-

1+25 1+50 1+75 2+00




STRATTON


3-27-1 HORIZ 1"=30

VERT. 1'=2 REVISIONS

SHEET 1

7+25 7+50 7+75 8+00 8+25

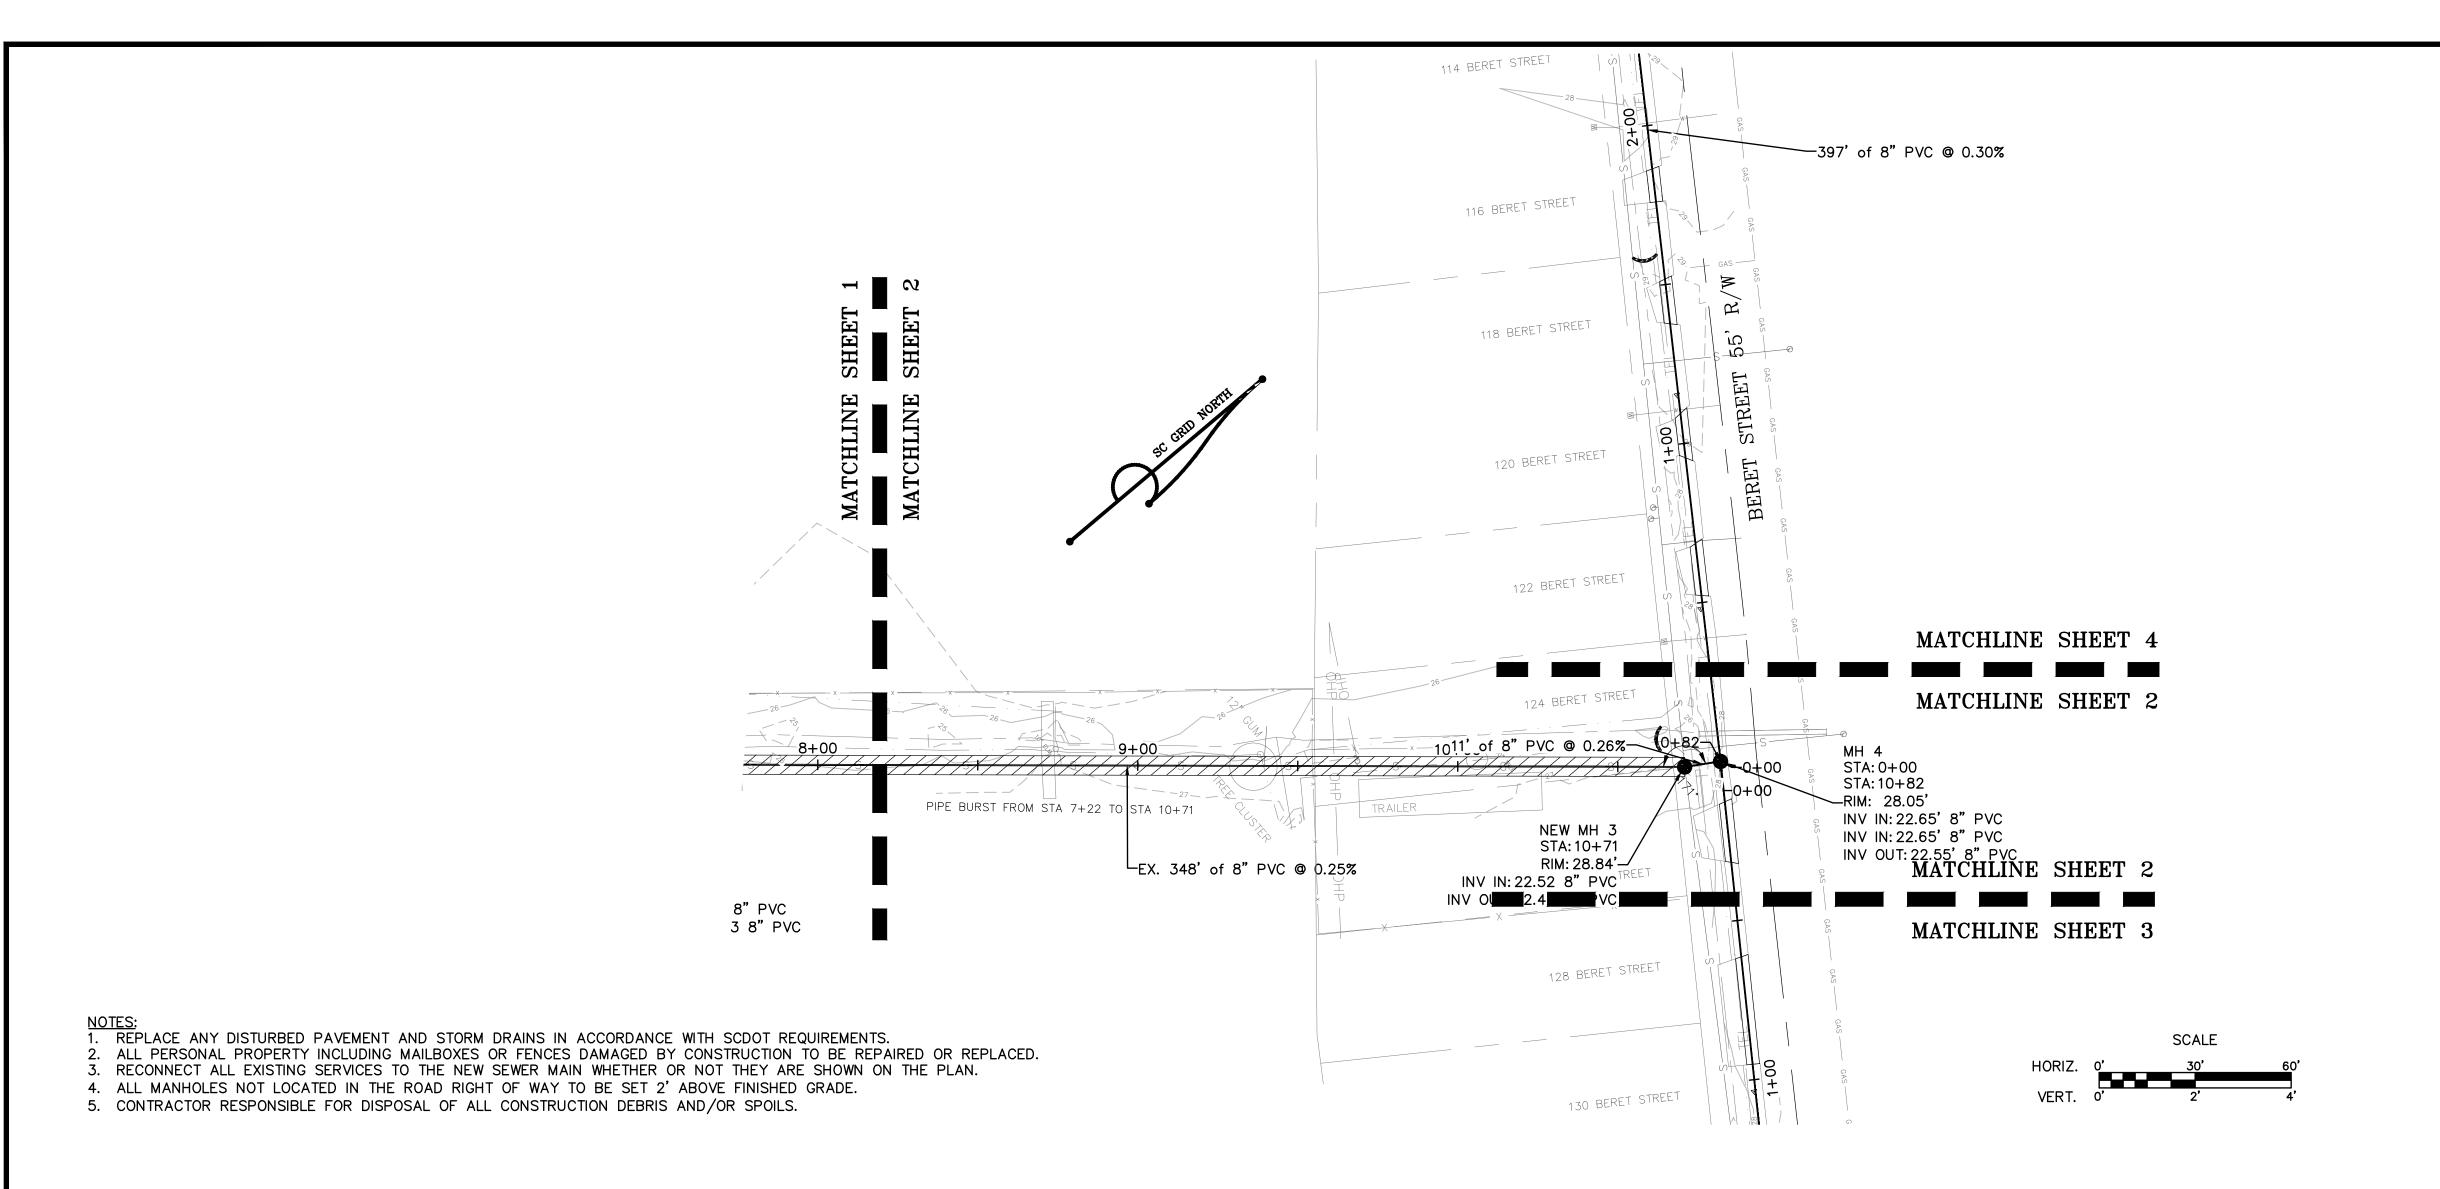

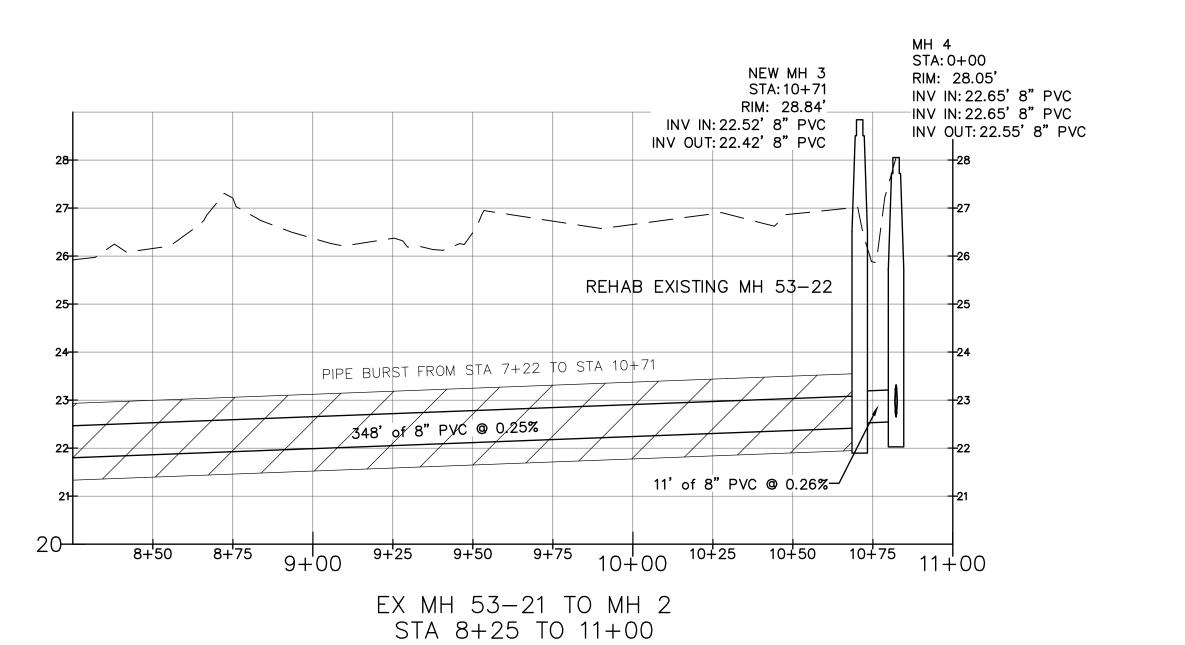

SILT TUBE

DORCHESTER
WATER & SEWER I
235 DEMING

A SERVICE STERVICE ST

DORCHESTER COUNTY

TER & SEWER DEPARTMENT
235 DEMING WAY
SUMMERVILLE, SC 29483
PHONE; (843) 832-0075
FAX: (843) 832-0073

SEWER PLAN AND PROFIL STRATTON CAPERS 2

STRATT GRAV IMPR


DATE: 3-27-19


DRAWN: STL

SCALE: HORIZ 1"=30'

VERT. 1'=2'

VERT REVISIONS

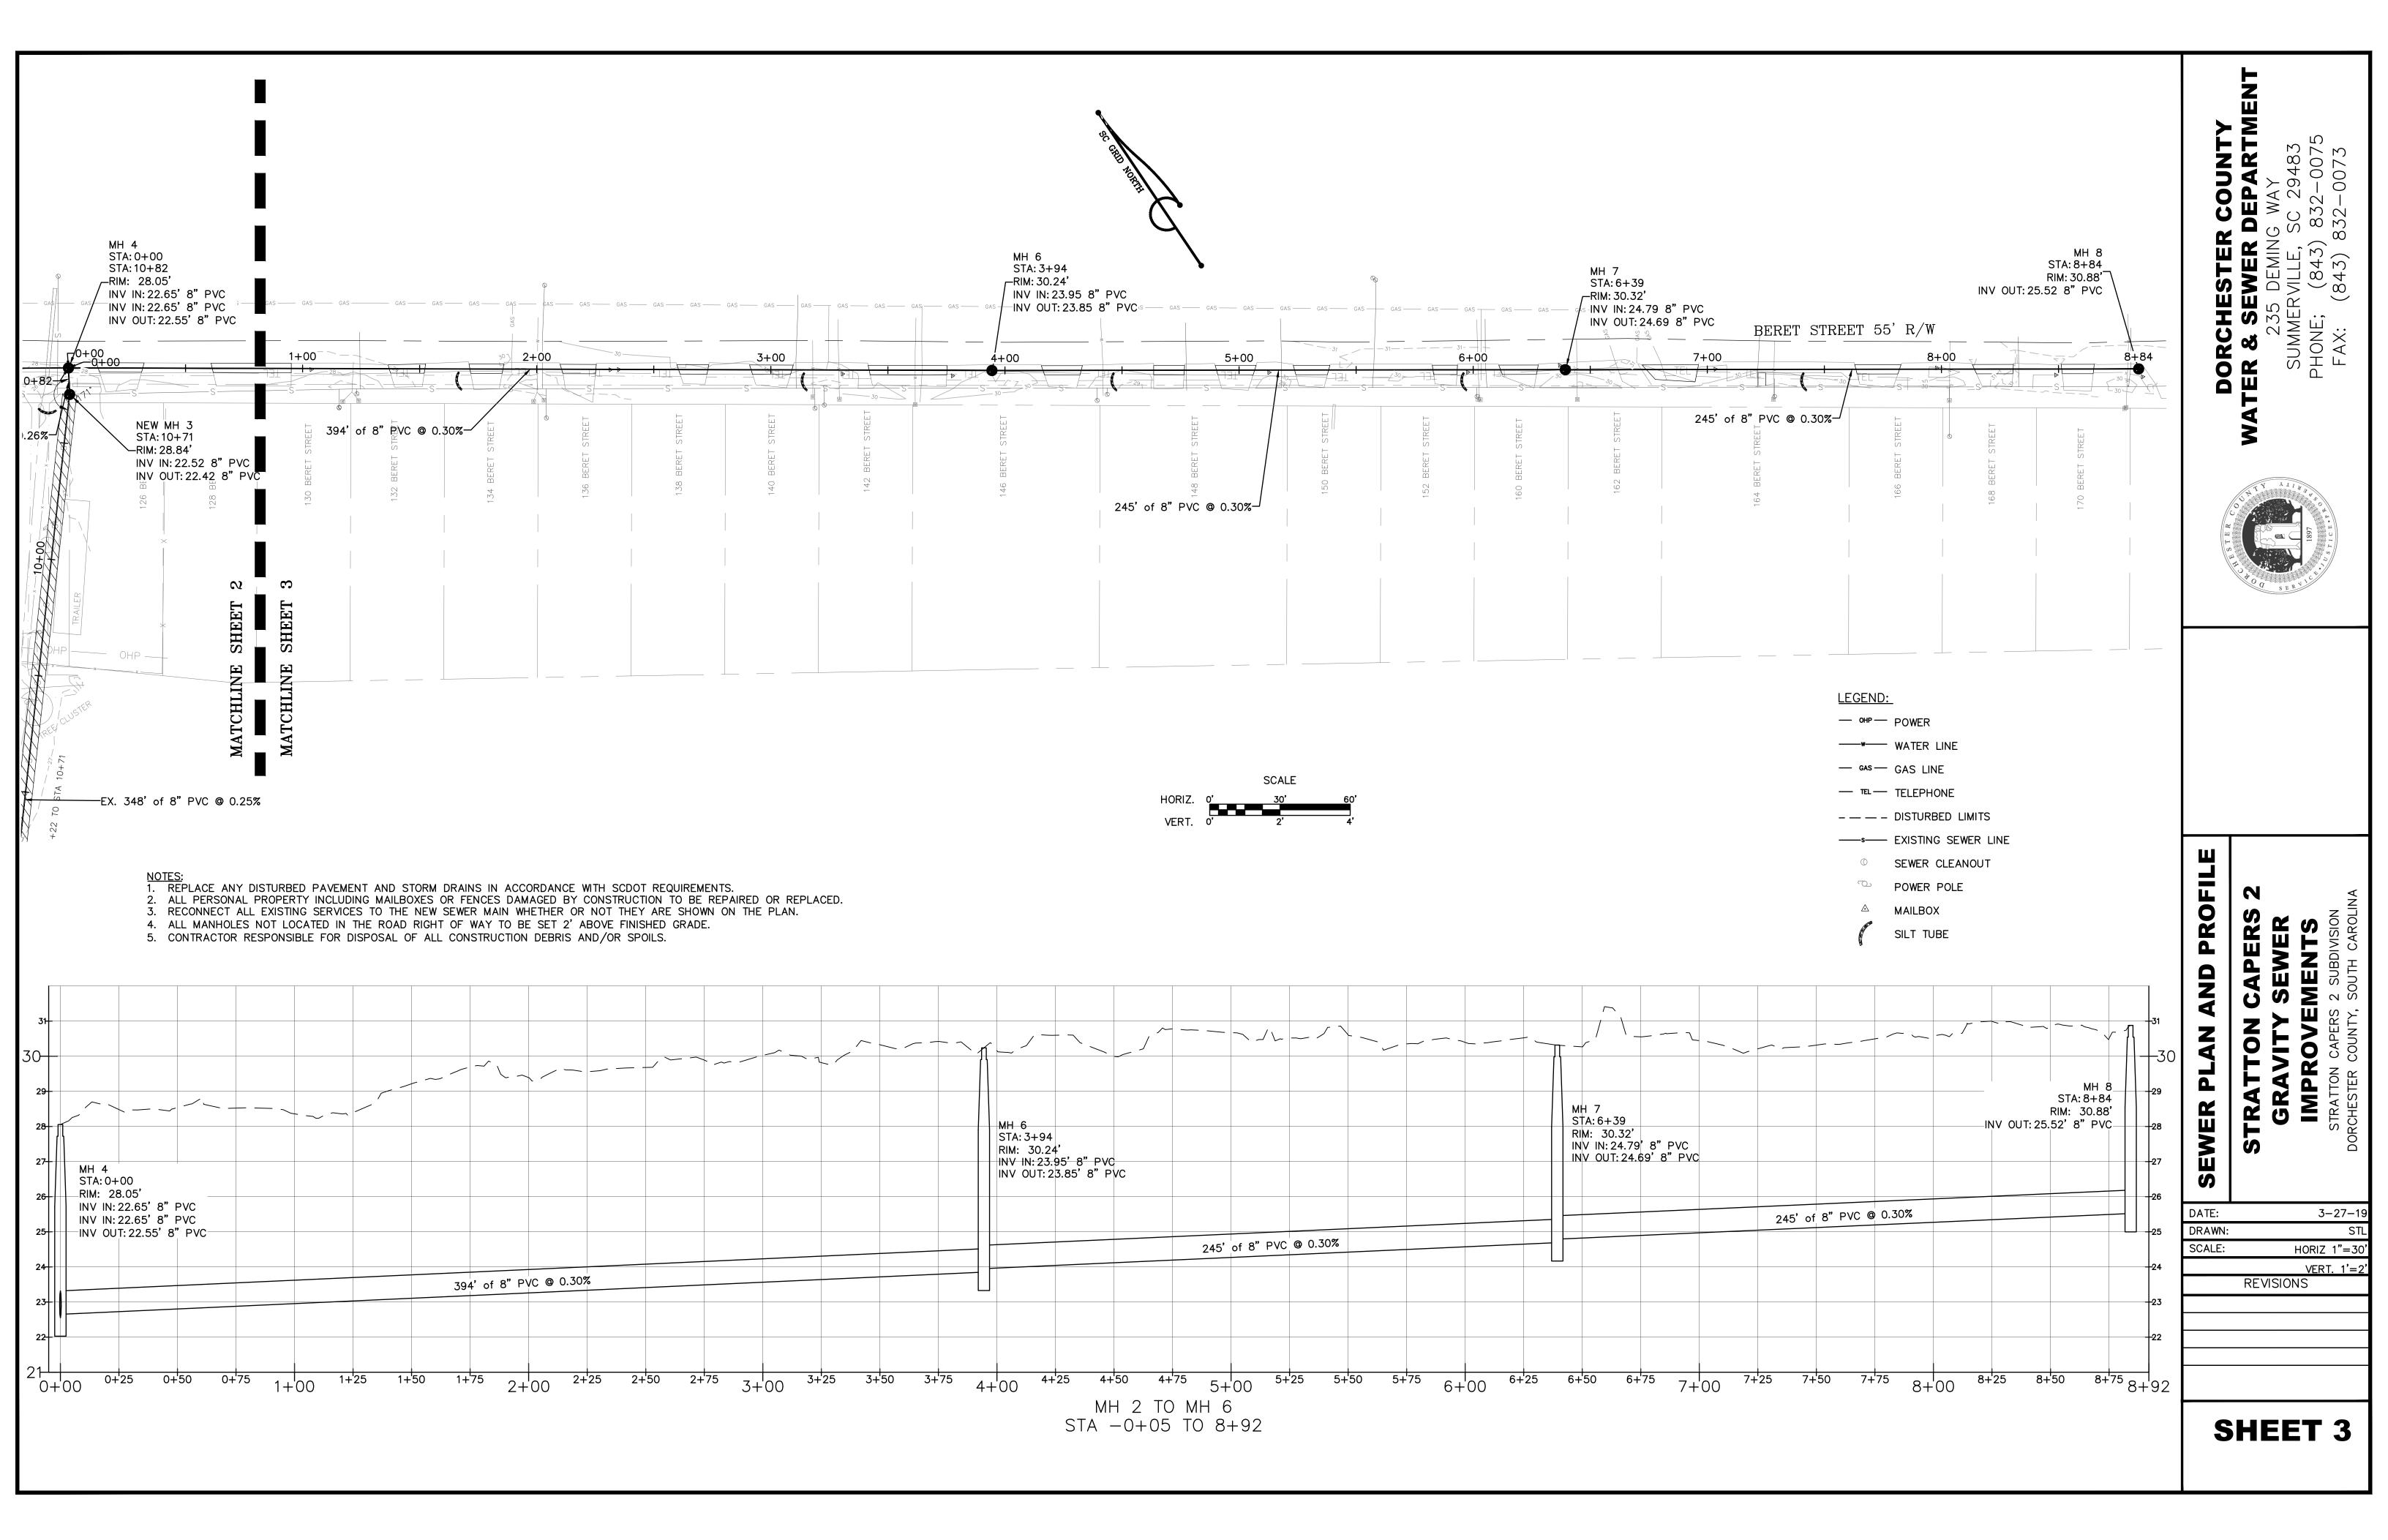

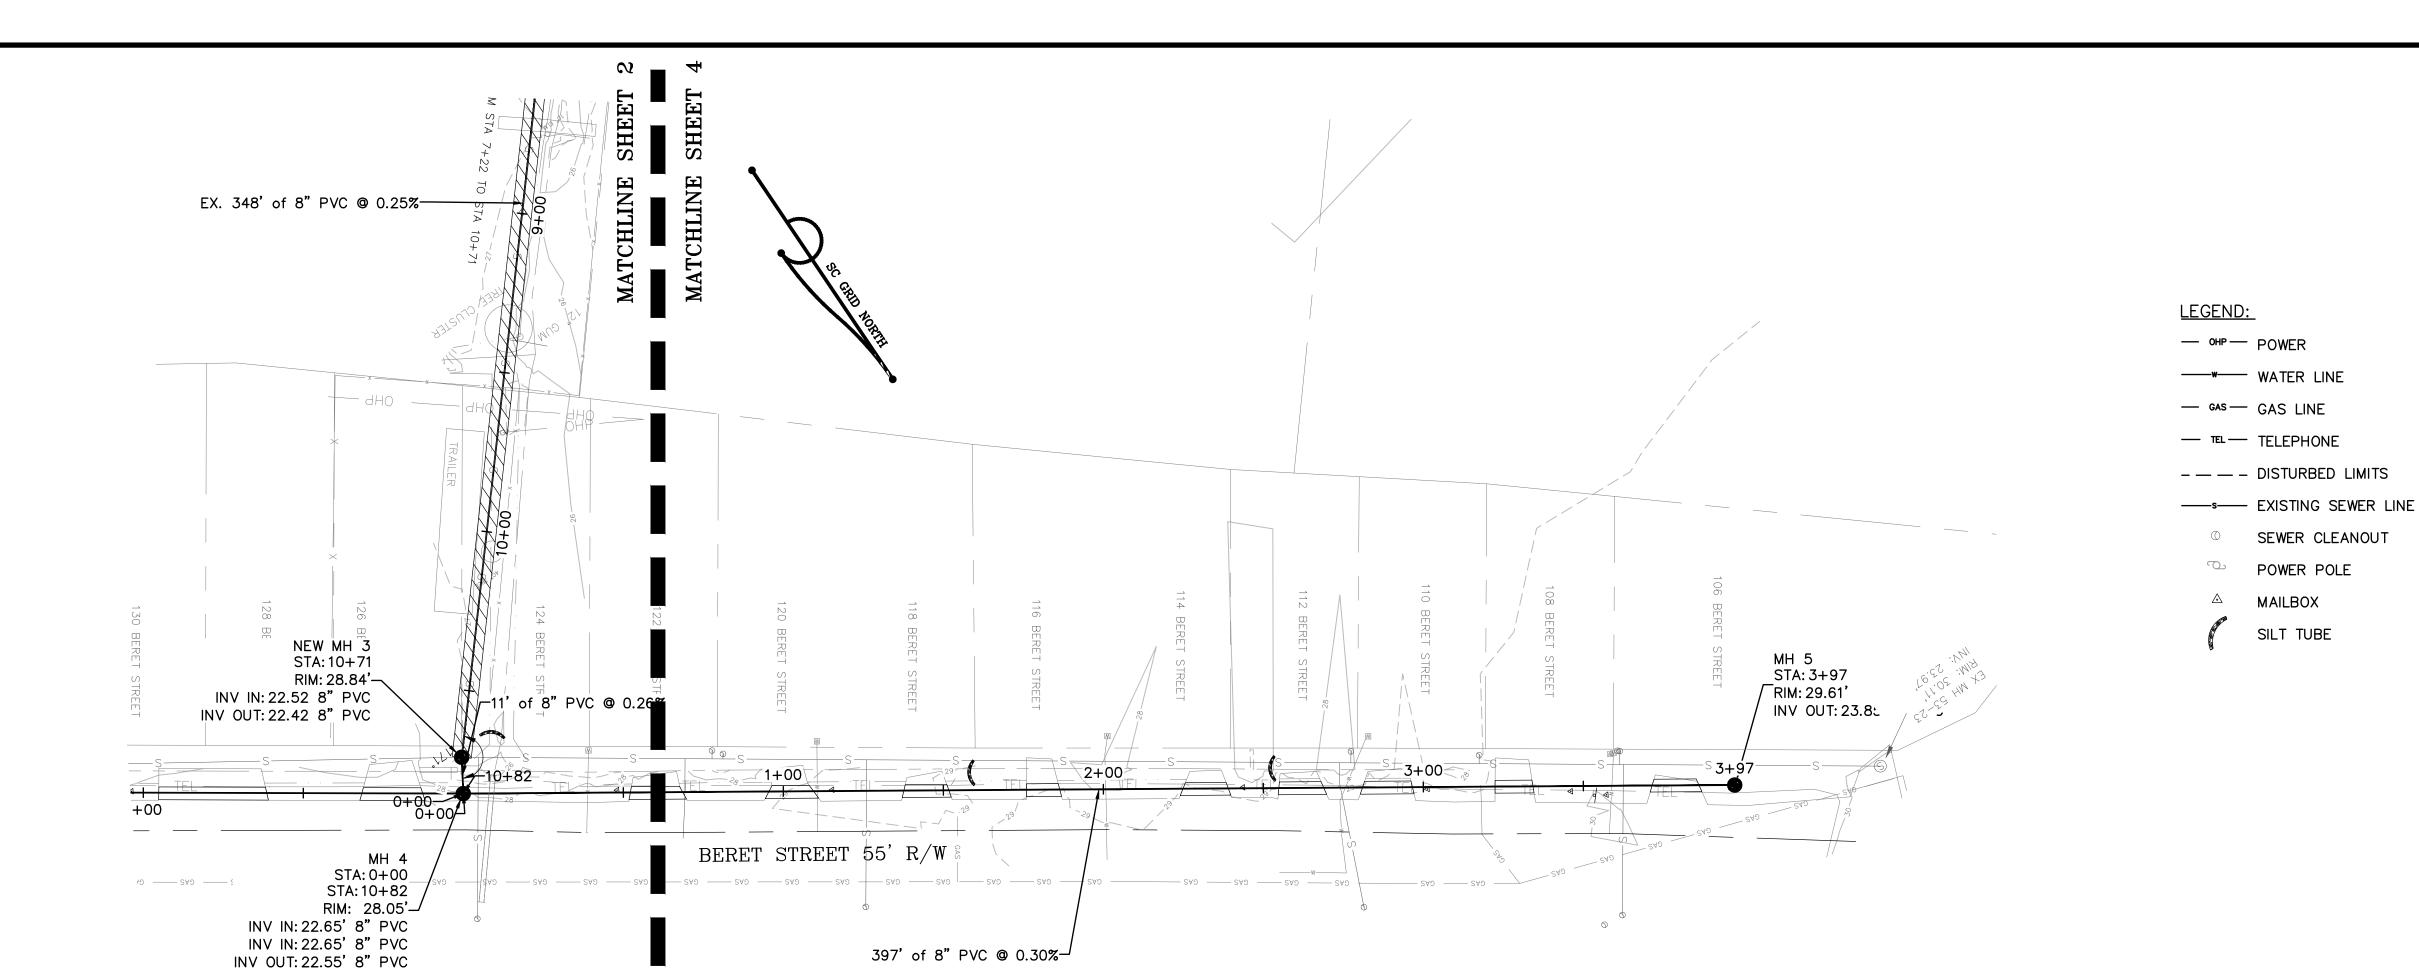

NOTES:

1. REPLACE ANY DISTURBED PAVEMENT AND STORM DRAINS IN ACCORDANCE WITH SCDOT REQUIREMENTS.

2. ALL PERSONAL PROPERTY INCLUDING MAILBOXES OR FENCES DAMAGED BY CONSTRUCTION TO BE REPAIRED OR REPLACED.

3. RECONNECT ALL EXISTING SERVICES TO THE NEW SEWER MAIN WHETHER OR NOT THEY ARE SHOWN ON THE PLAN.


4. ALL MANHOLES NOT LOCATED IN THE ROAD RIGHT OF WAY TO BE SET 2' ABOVE FINISHED GRADE.

5. CONTRACTOR RESPONSIBLE FOR DISPOSAL OF ALL CONSTRUCTION DEBRIS AND/OR SPOILS.

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SCALE

397' of 8" PVC @ 0.30%[→]




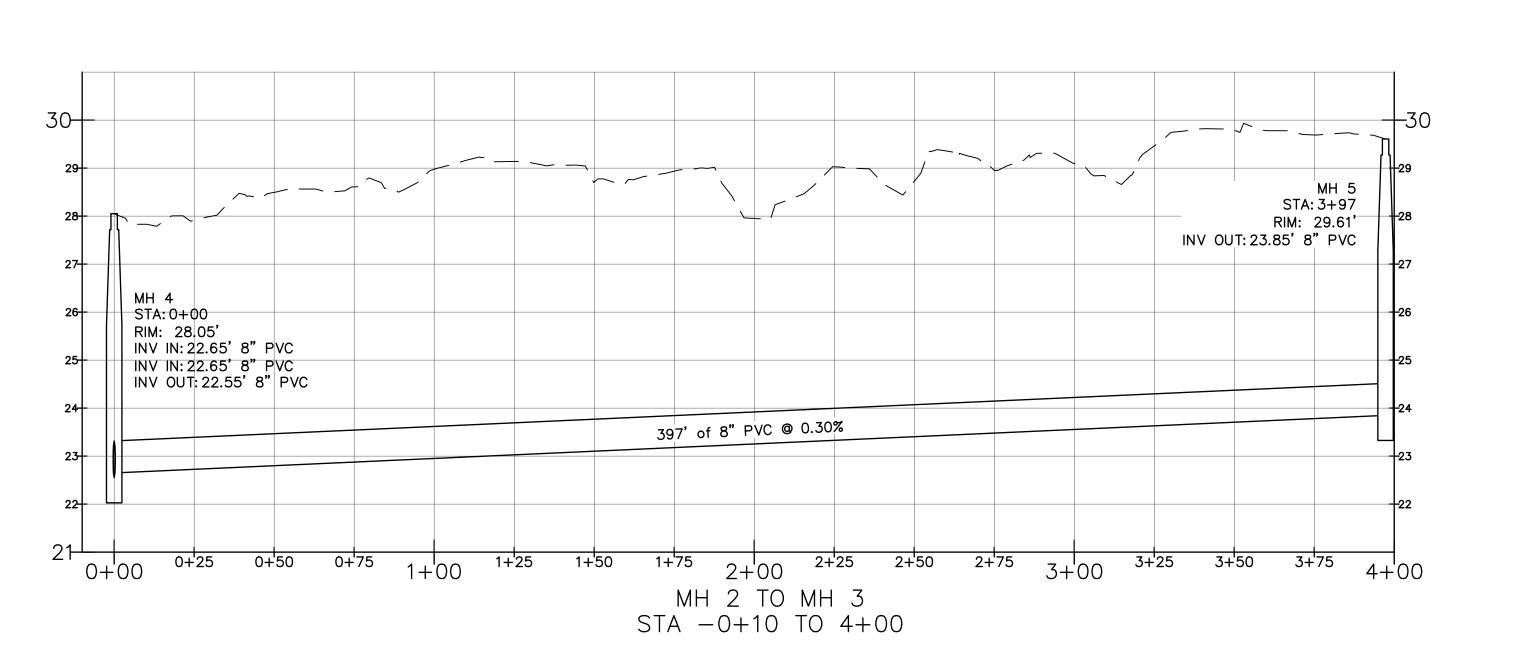




3-27-1

DATE: DRAWN: SCALE: HORIZ 1"=30 VERT. 1'= REVISIONS

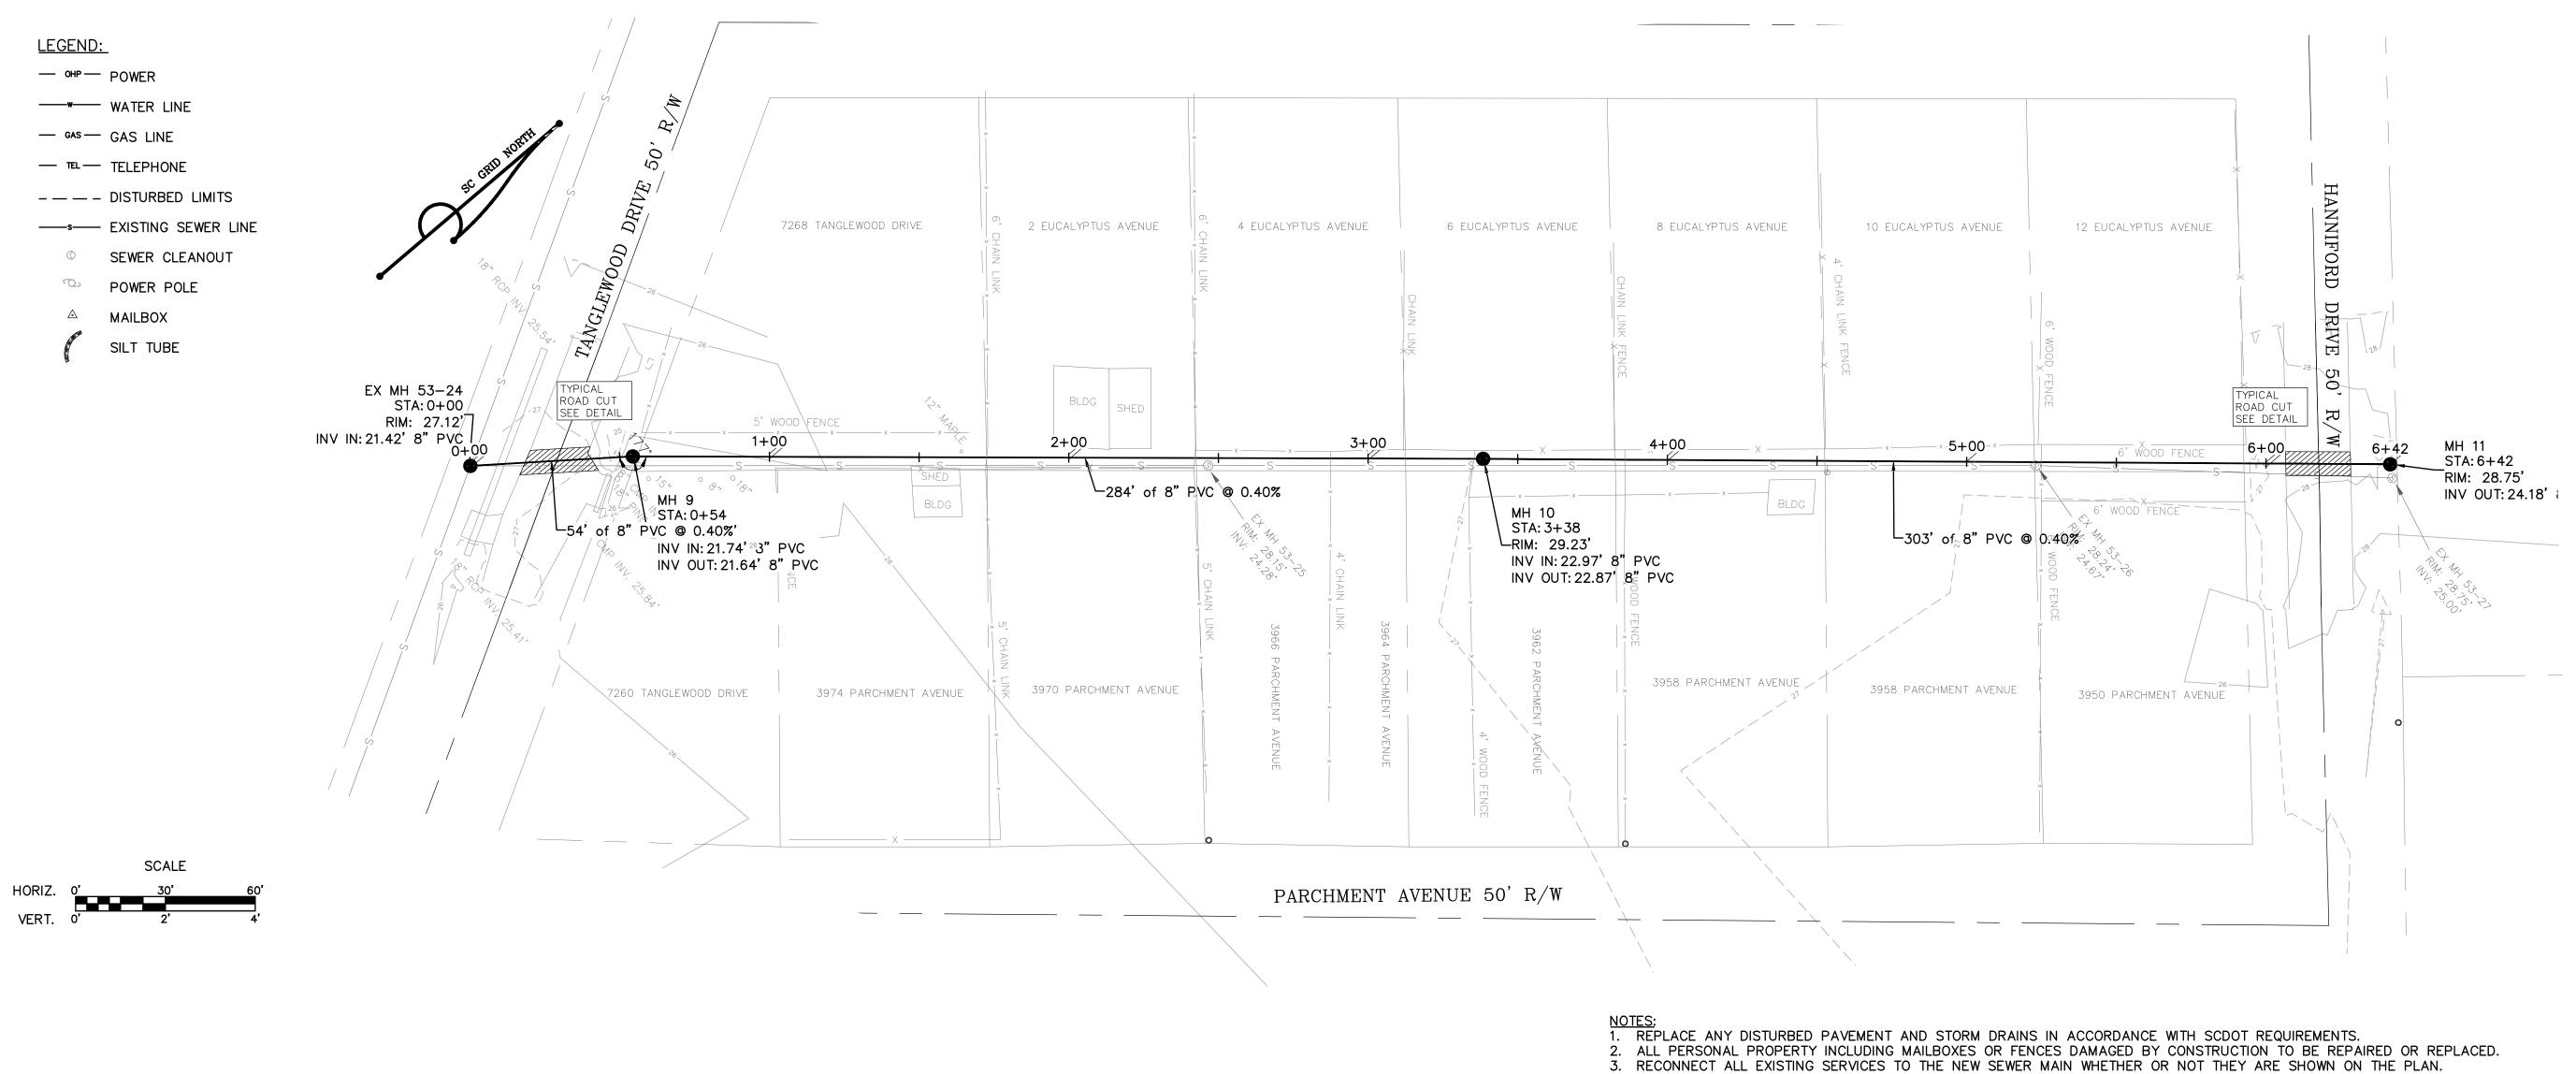

4. ALL MANHOLES NOT LOCATED IN THE ROAD RIGHT OF WAY TO BE SET 2' ABOVE FINISHED GRADE.

5. CONTRACTOR RESPONSIBLE FOR DISPOSAL OF ALL CONSTRUCTION DEBRIS AND/OR SPOILS.

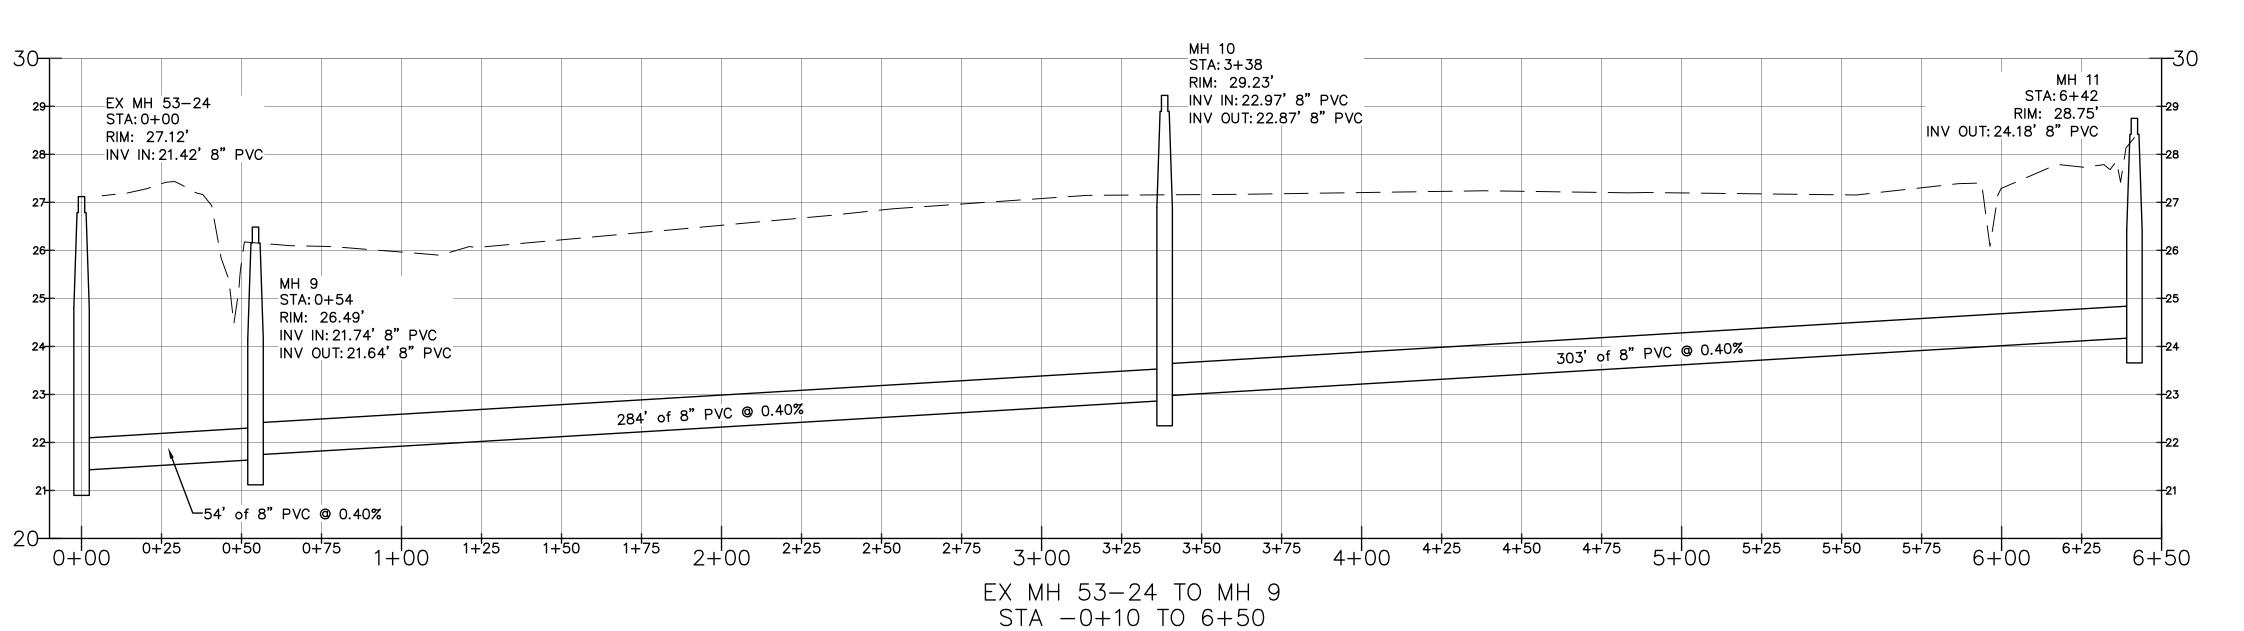

DORCHEST WATER & SEWE

7 APERS

DATE: 3-27-1 DRAWN: HORIZ 1"=30 SCALE: VERT. 1'=:

SEWER

REVISIONS



NOTE:

REHAB THE FOLLOWING 8 MANHOLES CIRCLED ON THE MAP WITHIN STRATTON CAPERS 2:

53-4

53-20 53-24 53-7

53-9

53-11 53-13 53-15





2 MANHOLE REHAB


STRATTON CAPERS 2
GRAVITY SEWER
IMPROVEMENTS
STRATTON CAPERS 2 SUBDIVISION
DORCHESTER COUNTY, SOUTH CAROLINA


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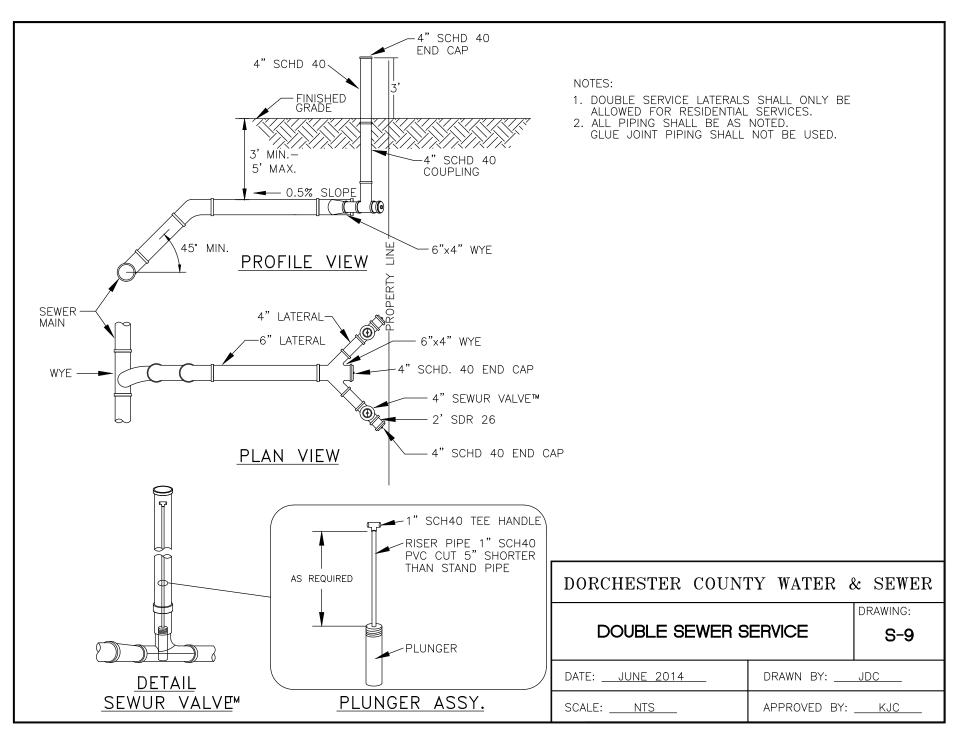
REVISIONS




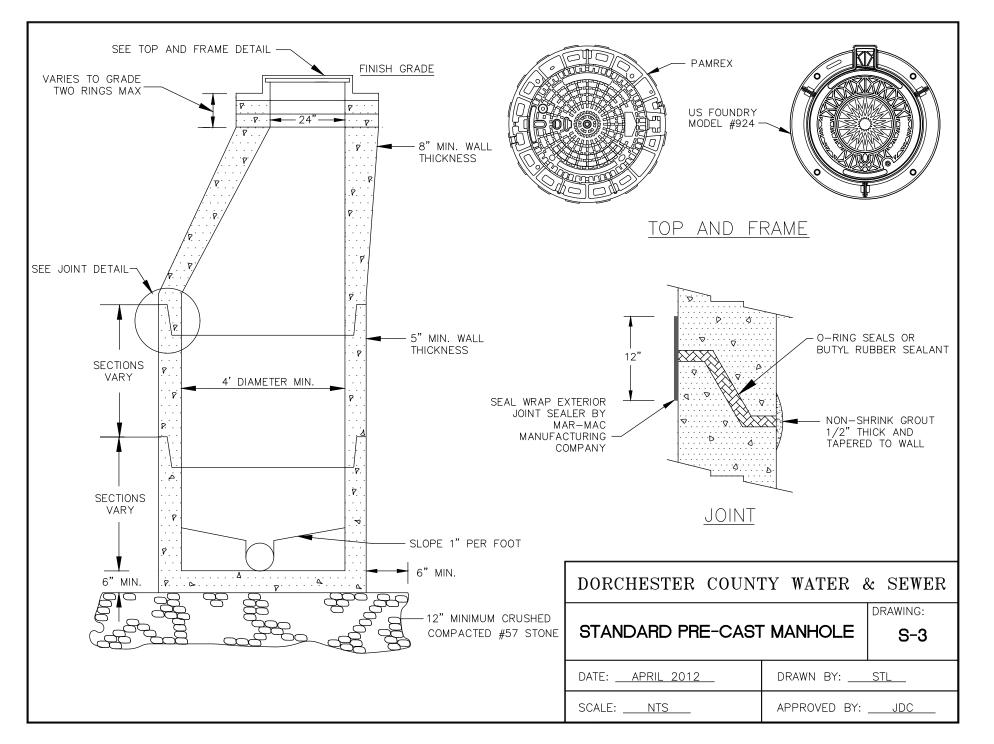

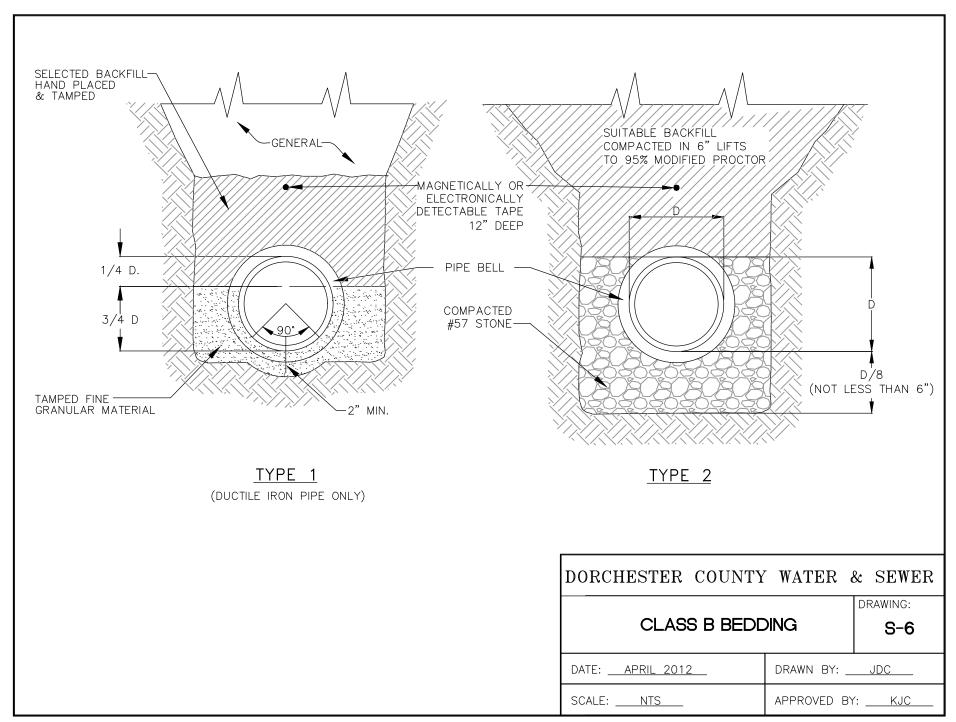

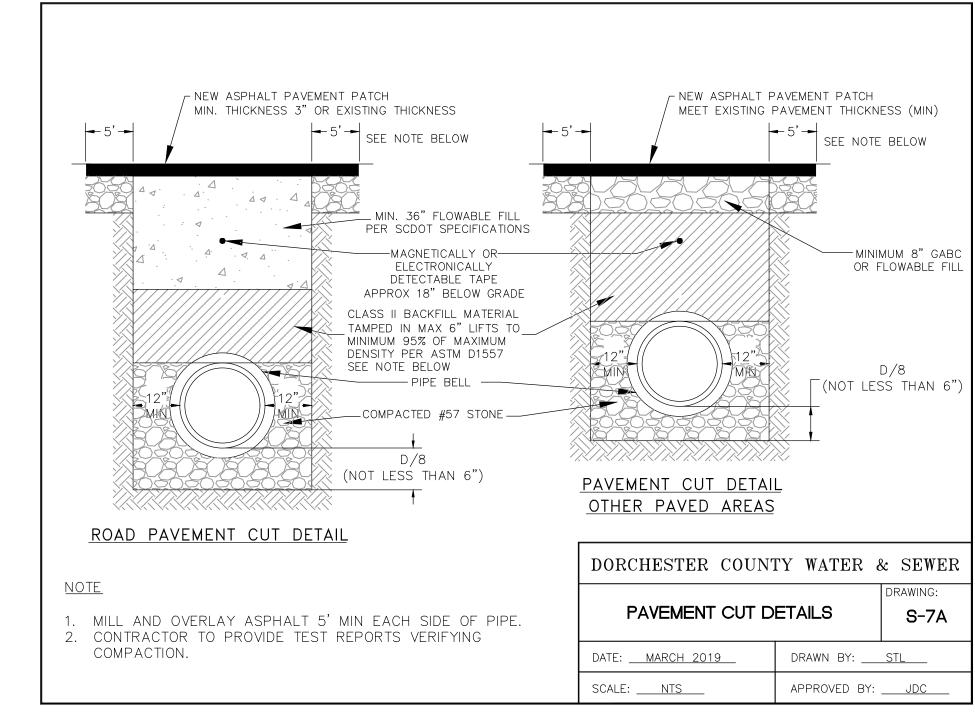

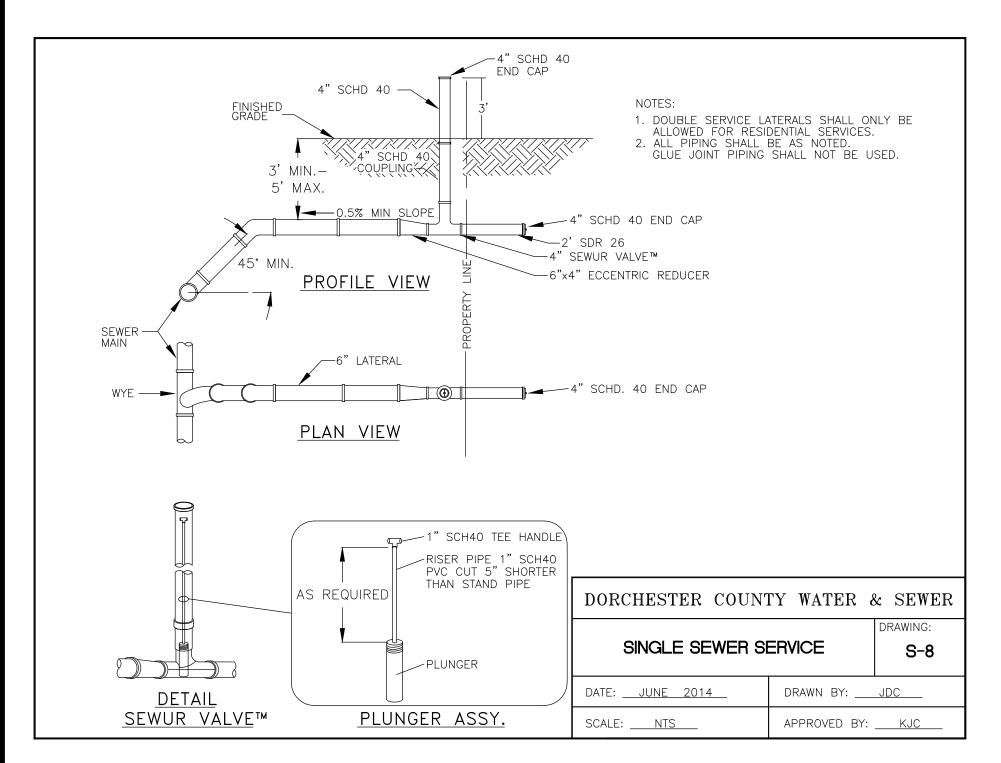

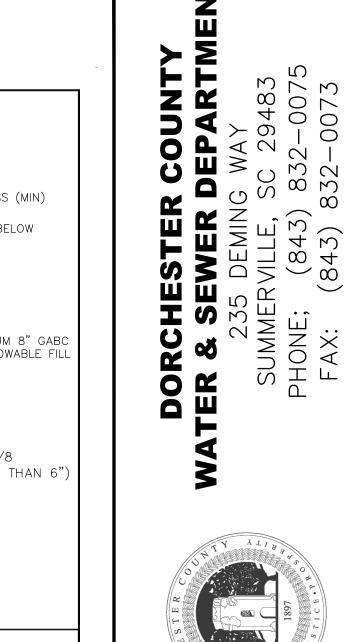

STRAT

SHE


SEWER

3-27-19 DATE: DRAWN: N.T.S. SCALE:

REVISIONS

DETAIL SHEET 1

SEDIMENT TUBE INSTALLATION

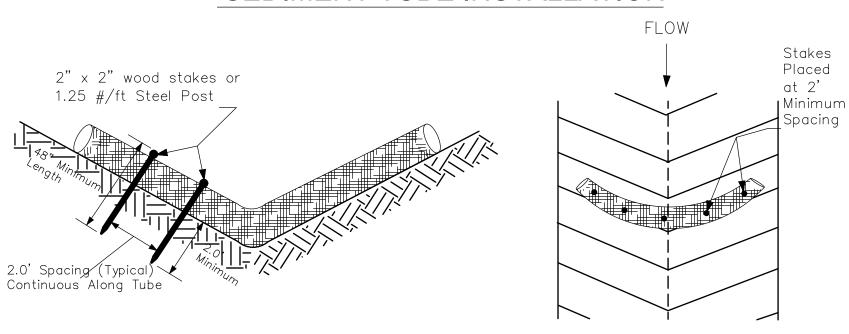

SEDIMENT TUBE SPACING

	SLOPE	MAX. SEDIMENT TUBE SPACING
	LESS THAN 2%	150-FEET
	2%	100-FEET
	3%	75-FEET
	4%	50-FEET
	5%	40-FEET
	6%	30-FEET
	GREATER THAN 6%	25-FEET


SEDIMENT TUBES - GENERAL NOTES

- Sediment tubes may be installed along contours, in drainage conveyance channels, and around inlets to help prevent off—site discharge of sediment—laden stormwater runoff.
- 2. Sediment tubes are elongated tubes of compacted geotextiles, curled excelsior wood, natural coconut fiber. or hardwood mulch. Straw, pine needle, and leaf mulch-filled sediment tubes are not permitted.
- 3. The outer netting of the sediment tube should consist of seamless, high-density polyethylene photodegradable materials treated with ultraviolet stabilizers or a seamless, high-density polyethylene non-degradable material.
- 4. Sediment tubes, when used as checks within channels, should range between 18-inches and 24-inches depending on channel dimensions. Diameters outside this range may be allowed where necessary when approved.
- 5. Curled excelsior wood, or natural coconut products that are rolled up to create a sediment tube are not allowed.
- 6. Sediment tubes should be staked using wooden stakes (2—inch X 2-inch) or steel posts (standard "U" or "T" sections with a minimum weight of 1.25 pounds per foot) at a minimum of 48—inches in length placed on 2—foot centers.
- 7. Install all sediment tubes to ensure that no gaps exist between the soil and the bottom of the tube. Manufacturer's recommendations should always be consulted before
- 8. The ends of adjacent sediment tubes should be overlapped 6-inches to prevent flow and sediment from passing through
- 9. Sediment tubes should not be stacked on top of one another, unless recommended by manufacturer.
- 10. Each sediment tube should be installed in a trench with a depth equal to 1/5 the diameter of the sediment tube.
- 11. Sediment tubes should continue up the side slopes a minimum of 1—foot above the design flow depth of the channel.
- 12. Install stakes at a diagonal facing incoming runoff.

- SEDIMENT TUBES INSPECTION & MAINTENANCE
- 1. The key to functional sediment tubes is weekly inspections, routine maintenance, and regular sediment removal.
- 2. Regular inspections of sediment tubes shall be conducted once every calendar week and, as recommended, within 24-hours after each rainfall even that produces 1/2-inch or more of
- 3. Attention to sediment accumulations in front of the sediment tube is extremely important. Accumulated sediment should be continually monitored and removed when necessary.
- 4. Remove accumulated sediment when it reaches 1/3 the height of the sediment tube.
- 5. Removed sediment shall be placed in stockpile storage areas or spread thinly across disturbed area. Stabilize the removed sediment after it is relocated.
- 6. Large debris, trash, and leaves should be removed from in front of tubes when found.
- 7. If erosion causes the edges to fall to a height equal to or below the height of the sediment tube, repairs should be made immediately to prevent runoff from bypassing tube.
- 8. Sediment tubes should be removed after the contributing drainage area has been completely stabilized. Permanent vegetation should replace areas from which sediment tubes have been removed.

1.25 LB./LINEAR FT. WOOD POSTS -FILTER FABRIC -HEAVY DUTY PLASTIC TIES BACKFILL TRENCH WITH COMPACTED EARTH -USE EITHER FLAT-BOTTOM - BURY FABRIC OR V-BOTTOM TRENCH SHOWN BELOW

SILT FENCE INSTALLATION

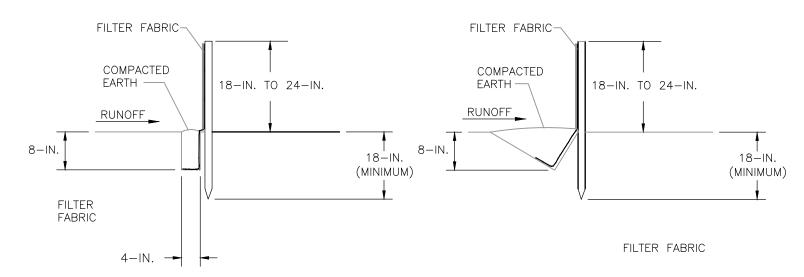

FLAT-BOTTOM TRENCH DETAIL

V-SHAPED TRENCH DETAIL

SEDIMENT AND EROSION CONTROL PROCEDURES

- 1. DURING CLEARING AND EARTHWORK ACTIVITIES THE CONTRACTOR SHALL INSTALL ALL EROSION CONTROL DEVICES SPECIFIED AND AS INDICATED ON THE DRAWINGS. DURING EACH PHASE OF SITE CONSTRUCTION THE CONTRACTOR SHALL ADJUST, RELOCATE AND/OR REINSTALL AS APPLICABLE ALL EROSION CONTROL DEVICES AND MEASURES NECESSARY TO PREVENT SOIL EROSION AND SEDIMENT DISCHARGE FROM THE SITE.
- 2. IN ADDITION TO SPECIFIED TEMPORARY GRASSING AND STANDARD PROTECTION AS DETAILED. ALL DRAINAGE STRUCTURES SHALL HAVE GEOTEXTILE FABRIC PLACED OVER ALL FRAMES AND GRATES TO PREVENT SEDIMENT ENTRY INTO NEW STRUCTURES AND CONDUITS. ALL SEDIMENT SHALL BE CLEANED OUT OF STRUCTURES AND CONDUITS REGULARLY.
- 3. SILT FENCE SHALL BE MAINTAINED AROUND THE DOWNSTREAM PERIMETER OF ALL ACTIVE EARTHWORK AREAS TO PREVENT SEDIMENT TRANSPORT ONTO ADJACENT PROPERTIES.
- 4. TEMPORARY GRASSING AND SILT FENCE FILTER BARRIERS SHALL BE INSTALLED AND MAINTAINED UNTIL CONSTRUCTION IS COMPLETE AND LANDSCAPING IS INSTALLED.
- 5. THE CONTRACTOR SHALL IMMEDIATELY CLEANUP AND REPAIR ALL EROSION DAMAGE AFTER DISCOVERY AND REINSTALL ADEQUATE CONTROL MEASURES AS NECESSARY TO PREVENT REOCCURRENCE OF DAMAGE.



UTILITY NOTICE

PRIOR TO EXCAVATION AND INSTALLATION OF SEWER UTILITIES, THE CONTRACTOR SHALL CONTACT THE PALMETTO UTILITY PROTECTION SERVICE (P.U.P.S.) AT 811. THE CONTRACTOR SHALL ALSO BE REQUIRED TO COORDINATE DIRECTLY (AS NECESSARY) WITH EACH APPLICABLE UTILITY AGENCIES FOR APPROPRIATE FIELD LOCATION MARKING. THE CONTRACTOR SHALL BE RESPONSIBLE TO ASSURE THAT ALL EXISTING UTILITIES HAVE BEEN LOCATED & MARKED TO PERFORM THE WORK IN A SAFE MANNER WITHOUT DAMAGE TO EXISTING UTILITIES.


DHEC-OCRM STANDARD EROSION CONTROL NOTES

(LATEST REVISED STANDARD SC DHEC NOTES - DECEMBER 2012)

- 1. If necessary, slopes, which exceed eight (8) vertical feet should be stabilized with synthetic or vegetative mats, in addition to hydroseeding. It may be necessary to install temporary slope drains during construction.
- 2. Temporary berms may be needed until the slope is brought to grade. Stabilization measures shall be initiated as soon as practicable in portions of the site where construction activities have temporarily or permanently ceased, but in no case more than fourteen (14) days after work has ceased, except as stated below.
- Where stabilization by the 14th day is precluded by snow cover or frozen ground conditions stabilization measures must be initiated as soon
- Where construction activity on a portion of the Site is temporarily ceased, and earth—disturbing activities will be resumed within 14 days, temporary stabilization measures do not have to be initiated on that portion of the Site.
- 3. All sediment and erosion control devices shall be inspected once calendar every week. If periodic inspection or other information indicates that a BMP has been inappropriately, or incorrectly, the Permittee must address the necessary replacement or modification required to correct the BMP 14. Minimize the discharge of pollutants from equipment and vehicle washing, wheel wash water, and other wash waters. Wash waters must be within 48 hours of identification.
- 4. Provide silt fence and/or other control devices, as may be required, to control soil erosion during utility construction. All disturbed areas shall be cleaned, graded, and stabilized with grassing immediately after the utility installation. Fill, cover, and temporary seeding at the end of each day are recommended. If water is encountered while trenching, the water should be filtered to remove sediment before being pumped back into any waters of the State.
- 5. All erosion control devices shall be properly maintained during all phases of construction until the completion of all construction activities and all disturbed areas have been stabilized. Additional control devices may be required during construction in order to control erosion and/or offsite sedimentation. All temporary control devices shall be removed once construction is complete and the site is stabilized.
- 6. The contractor must take necessary action to minimize the tracking of mud onto paved roadway(s) from construction areas and the generation of dust. The contractor shall daily remove mud/soil from pavement, as may be required.
- follow these plans during construction or obtain approval of an individual plan in accordance with S.C Reg. 72—300 et seq. and SCR100000.
- 8. Temporary diversion berms and/or ditches will be provided as needed during construction to protect work areas from upslope runoff and/or to divert sediment—laden water to appropriate traps or stable outlets.
- 9. All waters of the State (WoS), including wetlands, are to be flagged or otherwise clearly marked in the field. A double row of silt fence is to installed in all areas where a 50-foot buffer can't be maintained between the disturbed area and all WoS. A 10-foot buffer should be maintained between the last row of silt fence and all WoS.

- 10. Litter, construction debris, oils, fuels, and building products with significant potential for impact (such as stockpiles of freshly treated lumber) and construction chemicals that could be exposed to storm water must be prevented from becoming a pollutant source in storm water
- 11. A copy of the SWPPP, inspections records, and rainfall data must be retained at the construction site or a nearby location easily accessible during normal business hours, from the date of commencement of construction activities to the date that final stabilization is reached.
- 12. Initiate stabilization measures on any exposed steep slope (3H:1V or greater) where land— disturbing activities have permanently or temporarily ceased, and will not resume for a period of 7 calendar days.
- 13. Minimize soil compaction and, unless infeasible, preserve topsoil.
- treated in a sediment basin or alternative control that provides equivalent or better treatment prior to discharge.
- 15. Minimize the discharge of pollutants from dewatering of trenches and excavated areas. These discharges are to be routed through appropriate BMPs (sediment basin, filter bag, etc.)
- 16. The following discharges from sites are prohibited:
- Wastewater from washout of concrete, unless managed by an appropriate control;
- Wastewater from washout and cleanout of stucco, paint, form release oils, curing compounds and other construction materials; Fuels, oils, or other pollutants used in vehicle and equipment operation and maintenance;
- Soaps or solvents used in vehicle and equipment washing.
- 17. After construction activities begin, inspections must be conducted at a minimum of at least once every calendar week and must be conducted until final stabilization is reached on all areas of the construction site.
- 7. Residential subdivisions require erosion control features for infrastructure as well as for individual lot construction. Individual property owners shall 18. If existing BMPs need to be modified or if additional BMPs are necessary to comply with the requirements of this permit and/or SC's Water Quality Standards, implementation must be completed before the next storm event whenever practicable. If implementation before the next storm event is impracticable, the situation must be documented in the SWPPP and alternative BMPs must be implemented as soon as reasonably possible.
 - 19. A Pre-Construction Conference must be held for each construction site with an approved On-Site SWPPP prior to the implementation of construction activities. For non-linear projects that disturb 10 acres or more this conference must be held on-site unless the Department has approved otherwise.

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DATE: 3-27-19 DRAWN: SCALE: N.T.S.
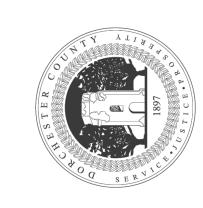
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REVISIONS

DETAIL