Colleton County MS Mechanical Replacement 1379 Tuskegeee Airmen Drive

CONSTRUCTION DOCUMENTS 04-30-2024 1201-230265

EXTERIOR ELEVATION MARKER

INTERIOR ELEVATION MARKER

REVISION NUMBER

REFER TO DETAIL VIEW AND SHEET INDICATED FOR ITEMS ON REFERENCED

GLAZING



Colleton County School District



CHARLESTON, SOUTH CAROLINA 29401 TEL. 843.577.4444 FAX. 843.722.4789





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△ DATE DESCRIPTION 1 05/09/2024 REV. 001 - OSF

SHEET NAME: COVER SHEET

ORIG SUBMISSION: 04-30-2024

Walterboro, SC 29488



ARCHITECTURE LS3P


205 1/2 KING STREET CHARLESTON, SC 29401 (843) 577-4444 KAMERON QUICK KAMERON QUICK@LS3P.COM

MEP/FP **DULOHERY WEEKS**

10 CHATHAM CENTER SOUTH SUITE 200 SAVANNAH, GA 31405 - (912) 341-6831 ROBERT LAFOND RLAFOND@DULOHERY.COM


STRUCTURAL MMSA, INC.

30 PATEWOOD DRIVE SUITE 100 GREENVILLE, SC 29615 (864) 331-1201 TONY LAND TLAND@MMSAINC.COM

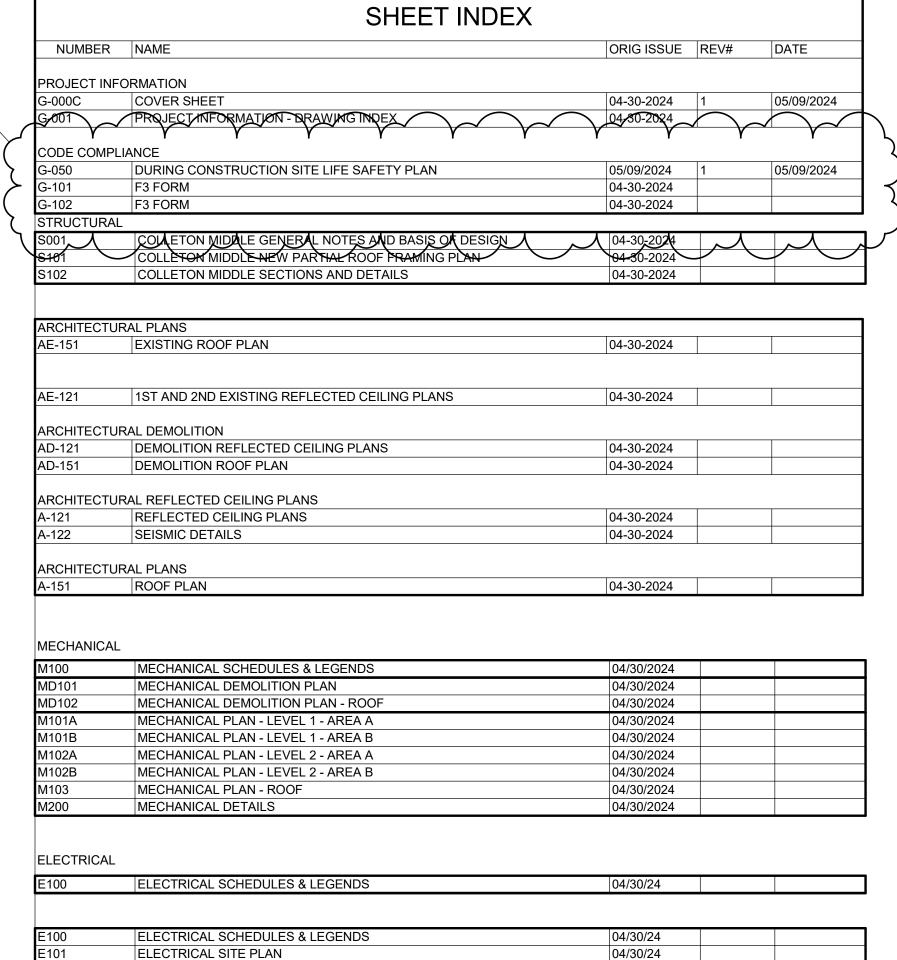

MECHANICAL POWER PLAN - LEVEL 2 - AREA A

PROJECT ABBREVIATIONS							DRAWING TITLES		
A/C	AIR CONDITION(ING)	INSUL	INSULATION	TOW	TOP OF WALL				
	ADMINISTRATION	INT	INTERIOR	TRTD	TREATED			DETAIL NUM	BER
	ABOVE FINISHED FLOOR	JAN CLO	JANITOR CLOSET	TV	TELEVISION			VIEW TITLE	
	ALTERNATE	KIT	KITCHEN	TYP	TYPICAL				\
	ALUMINUM APPROXIMATE(LY)	KO LAB	KNOCKOUT LABORATORY	UL	UNDERWRITERS LABORATORIES			FLOOR PLAN- LE	VEL 1
	ARCHITECT(URAL)	LAB	LAMINATE	UNO	UNLESS NOTED OTHERWISE			$(A1)^{1/4"=1'-0"}$	
	AUTOMATIC	LAU	LAUNDRY	VERT	VERTICAL			DRAWING SO	CALE
	AUXILIARY	LAV	LAVATORY	VEST	VESTIBULE			DIAWING St	CALL
	AUDIOVISUAL	LF	LINEAR FEET	VIF	VERIFY IN FIELD				
	BITUMINOUS BUILDING LINE	LVR MAINT	LOUVER MAINTENANCE	W W/	WEST, WIDE WITH				
	BUILDING LINE	MATL	MATERIAL MATERIAL	W/O	WITHOUT				_
	BULL NOSE	MAX	MAXIMUM	W/W	WALL TO WALL			VIEW MARKERS	
	BOTTOM OF STEEL	MECH	MECHANICAL	WC	WATER CLOSET				
BOT	ВОТТОМ	MEZZ	MEZZANINE	WD	WOOD			DDAMMAC NUMBER (TVD)	
	CABINET	MFG	MANUFACTURING	WP	WORKING POINT, WATERPROOFING			DRAWING NUMBER (TYP) REFERENCE TYPE (SIM, OH)	
	CONTROL JOINT CENTER LINE	MFR MIN	MANUFACTURER MINIMUM	WR	WATER REPELLENT			Ref	
	CEILING	MISC	MISCELLANEOUS	WT	WEIGHT			BUILDING SE	ECTION MARKER
	CEILING HEIGHT	MO	MASONRY OPENING	WWF	WELDED WIRE FABRIC			A101	
CLO	CLOSET	MR	MOISTURE RESISTANT	YD	YARD			DRAWING SHEET (TYP)	
	CLEAR(ANCE)	MTD	MOUNTED					▲ Ref	
	CONCRETE MASONRY UNIT COLUMN	MTG MTL	MOUNTING METAL					WALL SECTION	ON MARKER
	CONCRETE	N N	NORTH					(A1U1)	
	CONFERENCE	NIC	NOT IN CONTRACT						
CONT	CONTINUE. CONTINUOUS	NOM	NOMINAL					Ref ■ DETAIL SEC	TION MARKER
CORR	CORRIDOR	NON	NON-COMBUSTIBLE			ITEM TAGS		A101	
	CUBIC FOOT CUBIC YARD	COMB NTS	NOT TO SCALE			II EIVI IAGS			
	DEMOLISH	OC	ON CENTER					DRAWING NUMBER	
	DEPARTMENT	OD	OUTSIDE DIAMETER					REFERENCE TYPE (SIM, OH)	
DET	DETAIL	OPP	OPPOSITE			()a/4	—CONSTRUCTION SUBSYSTEM TYPE	1Ref	
DF	DRINKING FOUNTAIN	OPT	OPTION(AL)			₩4] -	F# - FLOOR	EXTERIOR E	LEVATION MARKE
	DIAMETER	PCF PLAM	POUNDS PER CUBIC FEET PLASTIC LAMINATE				R# - ROOF	A101	
	DIAGONAL DIMENSION	PLAW	POUNDS PER LINEAR FEET				S# - SLAB ON GRADE W# - WALL	DRAWING SHEET	
	DIVISION	PLYWD	PLYWOOD				VV# - VVALL		
	DOWNSPOUT	PNL	PANEL			(101A) -	—DOOR MARK	DRAWING NUMBER	
Е	EAST	PR	PAIR				DOOR MARK WILL TYPICALLY CORRESPOND WITH ROOM NUMBER	88 (A101) 88 INTERIOR EL	_EVATION MARKE
EA	EACH	PREFAB PREFIN	PREFABRICATED PREFINISH			UB •	—UNIT DOOR TYPE	DRAWING DIRECTION	
	EXTERIOR INSULATION & FINISH SYSTEM	PRKG	PARKING					DRAWING SHEET	
	EXPANSION JOINT	PSF	POUNDS PER SQUARE FOOT			Room	ROOM IDENTIFICATION		
	ELEVATION	PSI	POUNDS PER SQUARE INCH			name	NAME	DRAWING NUMBER	
ELEC	ELECTRIC(AL)	PT	PAINT, POST-TENSIONED, PRE-TREATED			101	NUMBER	REFERENCE TYPE (SIM, OH)	
ELEV ENCL	ELEVATOR ENCLOSE(D)	PVC	POLYVINYL CHLORIDE			150 SF	—AREA (IF INDICATED)	Ref	
EOS	EDGE OF SLAB	1 00	(PLASTIC)					DETAIL CALL	LOUT
EQ	EQUAL	QTR	QUARTER			(A)	WINDOW, STOREFRONT, OR	A3.888	
EQUIP	EQUIPMENT	QTY	QUANTITY				CURTAINWALL TYPE	1 / `	
EWC	ELECTRIC WATER COOLER	R RCP	RADIUS, RISER REFLECTED CEILING PLAN			?	—MATERIAL MARK	VIEW EXTENTS	
EXIST EXP JT	EXISTING EXPANSION JOINT	RD	ROOF DRAIN				CASEWORK	DRAWING SHEET	
EXT	EXTERIOR	REF	REFRIGERATOR, REFERENCE				—CASEWORK TYPE		
	FACE TO FACE	REQD	REQUIRED			B12A 18X34X20A	—CASEWORK SIZE		
	FLOOR DRAIN	RL	ROOF LEADER						
	FIRE EXTINGUISHER	RM RO	ROOM ROUGH OPENING						
	FIRE EXTINGUISHER CABINET FINISH FLOOR ELEVATION	ROW	RIGHT OF WAY				CEILINGS		
	FIRE HOSE CABINET	S	SOUTH			ACT1 9'-8"	5	DRAWING SYMBOLS	
	FINISHED FLOOR	SC	SOLID CORE			\ \ •	—ELEVATION ABOVE TOP OF		
FLR	FLOOR, FILLER	SD	STORM DRAIN SECTION				SLAB ELEVATION		
	FACE OF CURB	SECT SF	SECTION SQUARE FEET				—CEILING TYPE	REFERENCE GRID LINES CENTERLINE	<u>GLAZ</u>
	FACE OF FINISH FACE OF MASONRY	SIM	SIMILAR					Ę .	///
	FACE OF SLAB	SPEC	SPECIFICATION					(AA.88) (AA.88)	.//
	FACE OF WALL	SPKR	SPEAKER			STUD/CMU SIZE		REVISIONS	
FT	FOOT, FEET	SQ	SQUARE			PARTITION TYPE			-REVISION NUMB
	FOOTING	SS STD	STAINLESS STEEL STANDARD						
	FURNISH, FURNITURE	STOR	STANDARD STORAGE			J3A1S	PARTITION IDENTIFICATION TAG		-AREA REVISED
	GAGE GALVANIZED	SUSP	SUSPENDED			ADDITIONAL DESIGNATOR*			
	GENERAL CONTRACTOR	SYS	SYSTEM			FIRE RATING*			
GYP BD	GYPSUM BOARD	T	TREAD			(* = IF REQUIRED)		FLOOR LEVEL IDENTIFICATIONS BUILDING OF	<u>RIENTATION</u>
	GYPSUM PLASTER	TEL TEMP	TELEPHONE TEMPORARY						
	HANDICAP HEAVY DUTY	TEMP	TOP OF FINISH FLOOR				LIGHT FIXTURE IDENTIFICATION TAG	Name Elevation	
	HEAVY DUTY HARDWOOD	THK	THICKNESS			FIXTURE TYPE	LIGHT INTOILE IDENTIFICATION TAG		
	HARDWARE	THRU	THROUGH					TRUE PR	
	HOLLOW METAL	TO	TOP OF			18	01.005.74.0	Name NORTH N	NORTH
HORIZ	HORIZONTAL	TOB	TOP OF BEAM			, iv	SLOPE TAG	Elevation	
	HEIGHT	TOC TOF	TOP OF CONCRETE, CURB TOP OF FOOTING			RISE PER 12" RUN		MATCHI INE	
	HEATING, VENTILATION & AIR CONDITIONING	TOF	TOP OF FOOTING TOP OF JOIST					MATCHLINE REFER TO	DETAIL VIEW ANI
	INSIDE DIAMETER	TOM	TOP OF MASONRY					/ INDICATED	FOR ITEMS ON F
	INCLUDE(D), (ING)	TOP	TOP OF PARAPET			⟨N⟩ -	—SEE NOTE BY NUMBER	DETAIL SIDE OF M	ATCHLINE
INCL	* * * *	TOS	TOP OF SLAB				SCHEDULE ON SHEET	NUMBER———SHEET NU	MBER
	INFORMATION								
	INFORMATION					EQ02	—ITEM TAG: FURNITURE, EQUIPMENT		

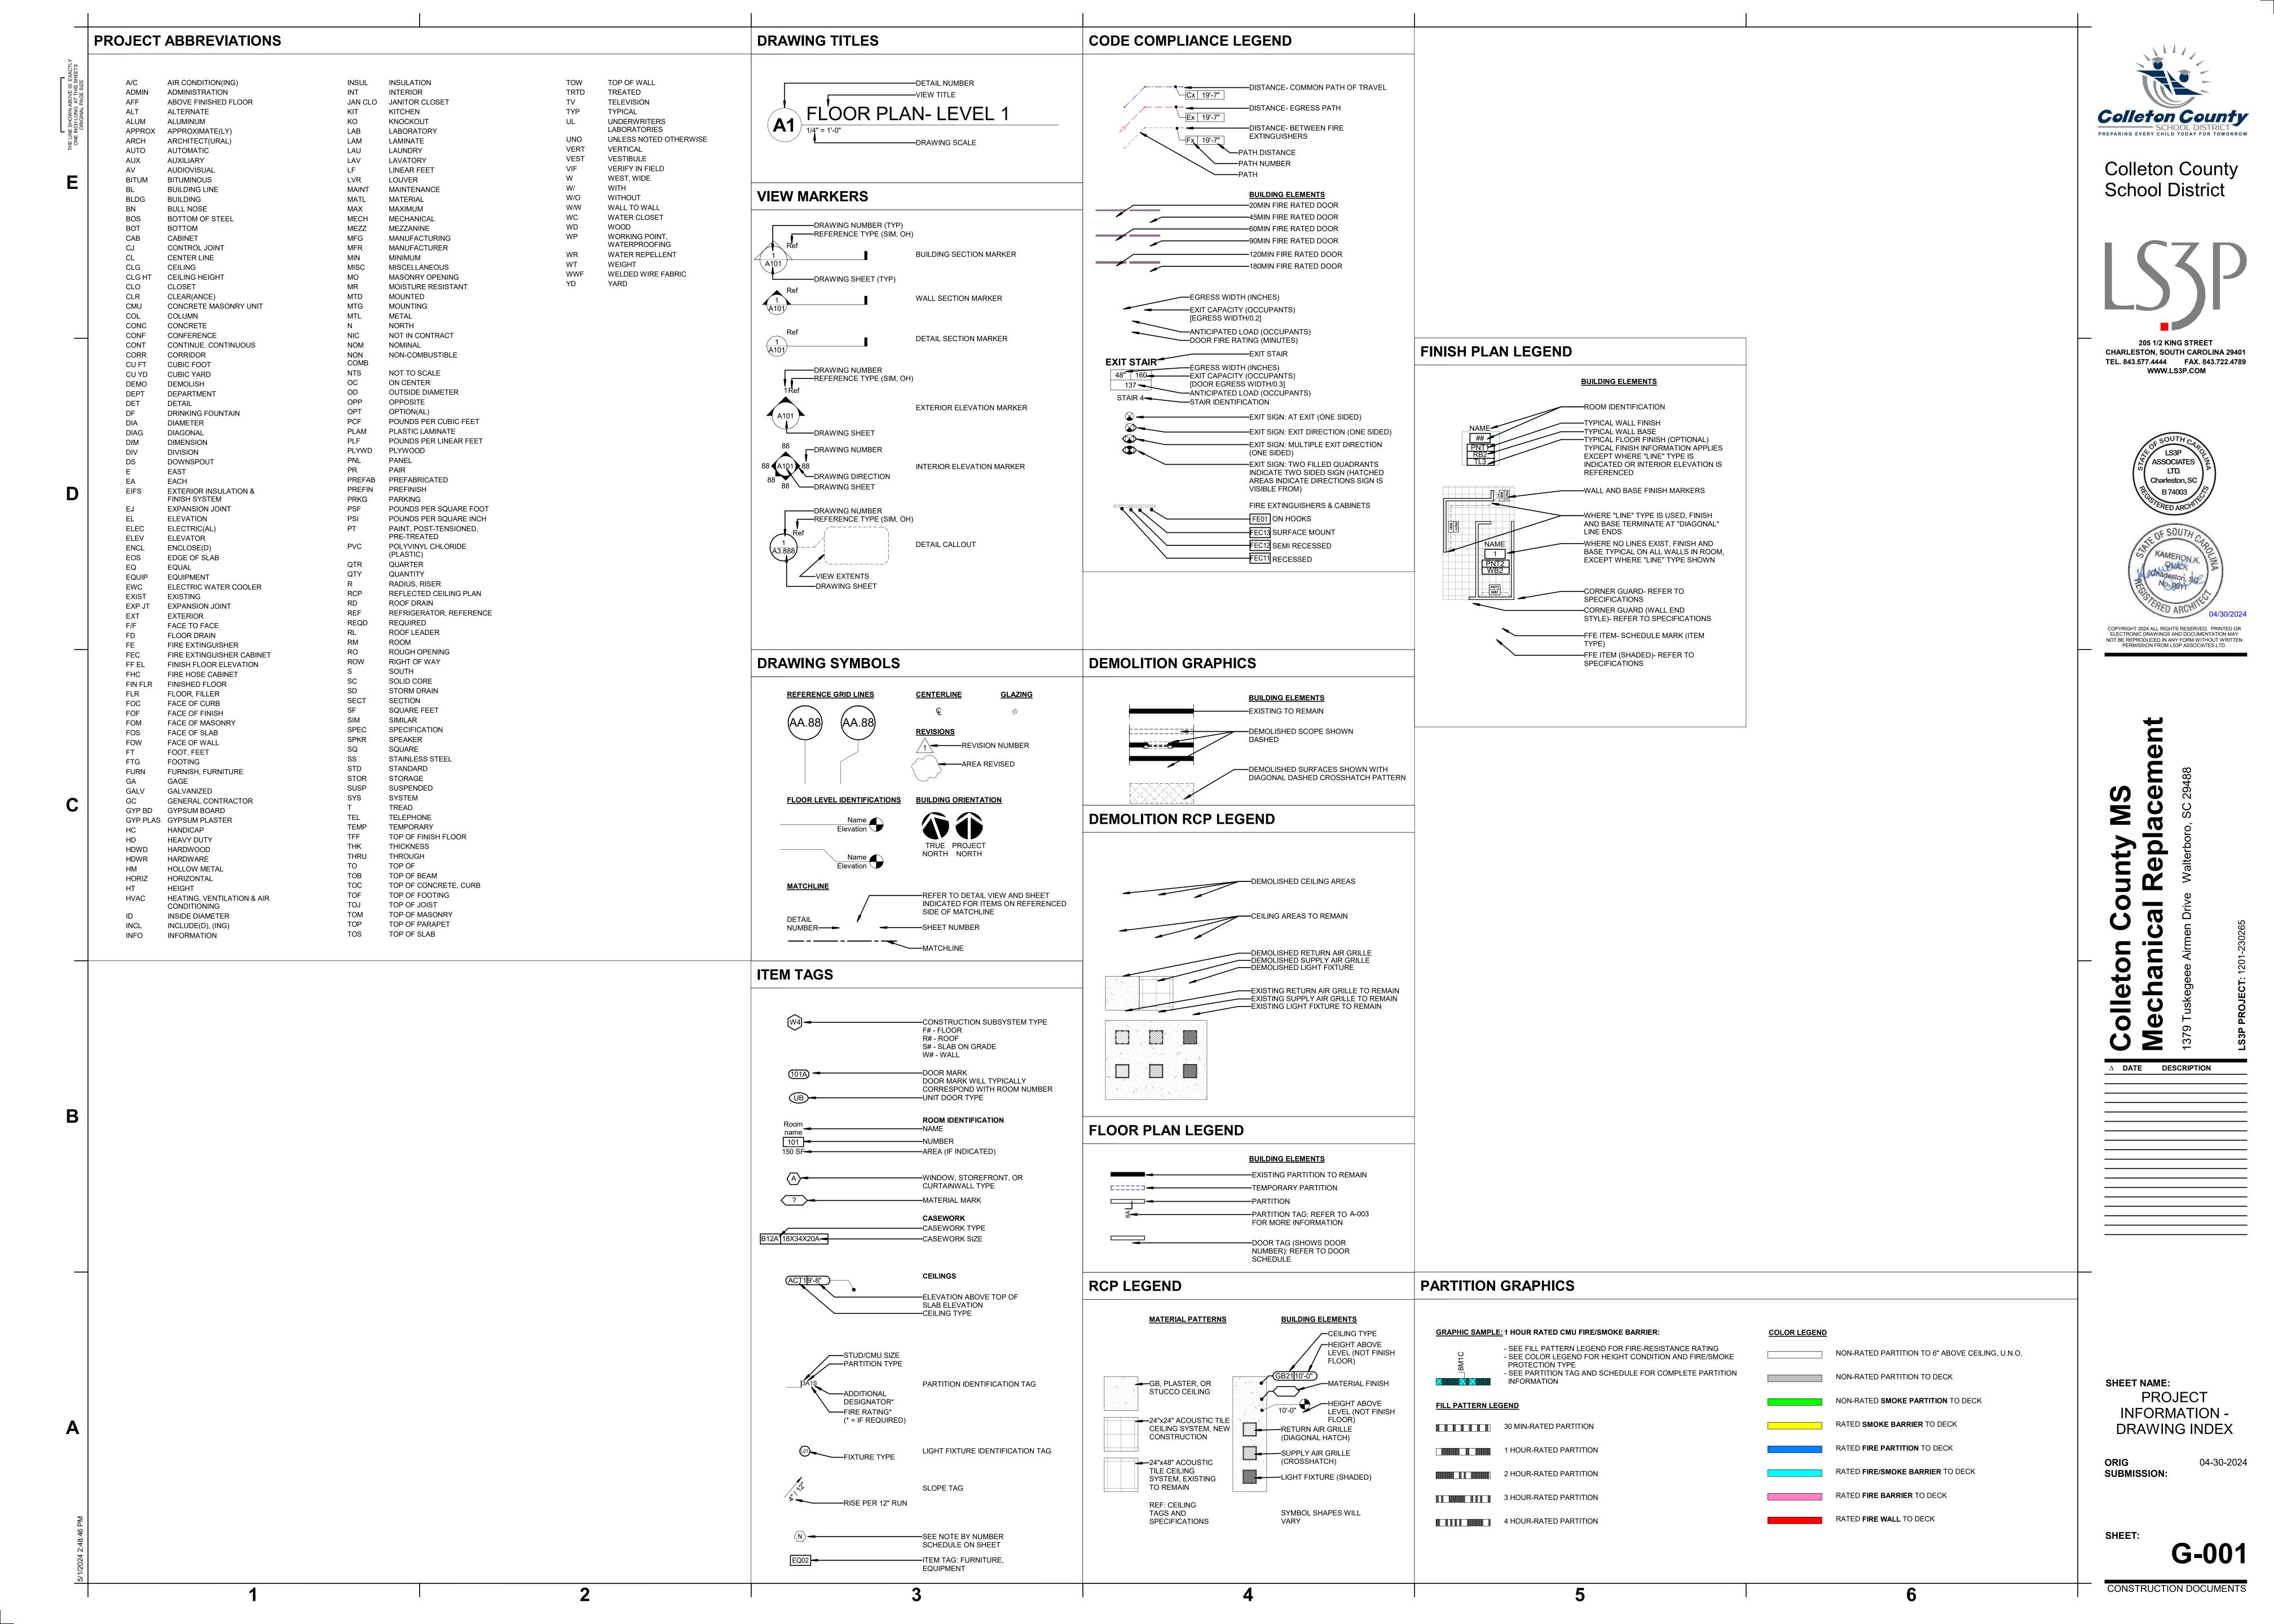

NOTE: THE INTENT IS FOR THE WORK TO BE COMPLETED OVER THE SUMMER BREAK TO MINIMIZE DISRUPTIONS TO THE SCHOOL DAY. IF WORK IS NOT COMPLETE BY THE START OF THE SCHOOL YEAR, THEN INTERIOR WORK WILL BE DONE AFTER HOURS AND ON WEEKENDS.

SITE LIFE SAFETY LEGEND EGRESS POINTS, TYP. AREA OF WORK AREA, TYP. FIRE TRUCK ACCESS

CONSTRUCTION LAYDOWN AREA

SHEET NAME: DURING CONSTRUCTION SITE LIFE SAFETY PLAN 05/09/2024 ORIG SUBMISSION:

Δ **DATE DESCRIPTION**1 05/09/2024 REV. 001 - OSF COMMENTS

Colleton County
SCHOOL DISTRICT

Colleton County School District

205 1/2 KING STREET CHARLESTON, SOUTH CAROLINA 29401 TEL. 843.577.4444 FAX. 843.722.4789 WWW.LS3P.COM

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G-050

School District

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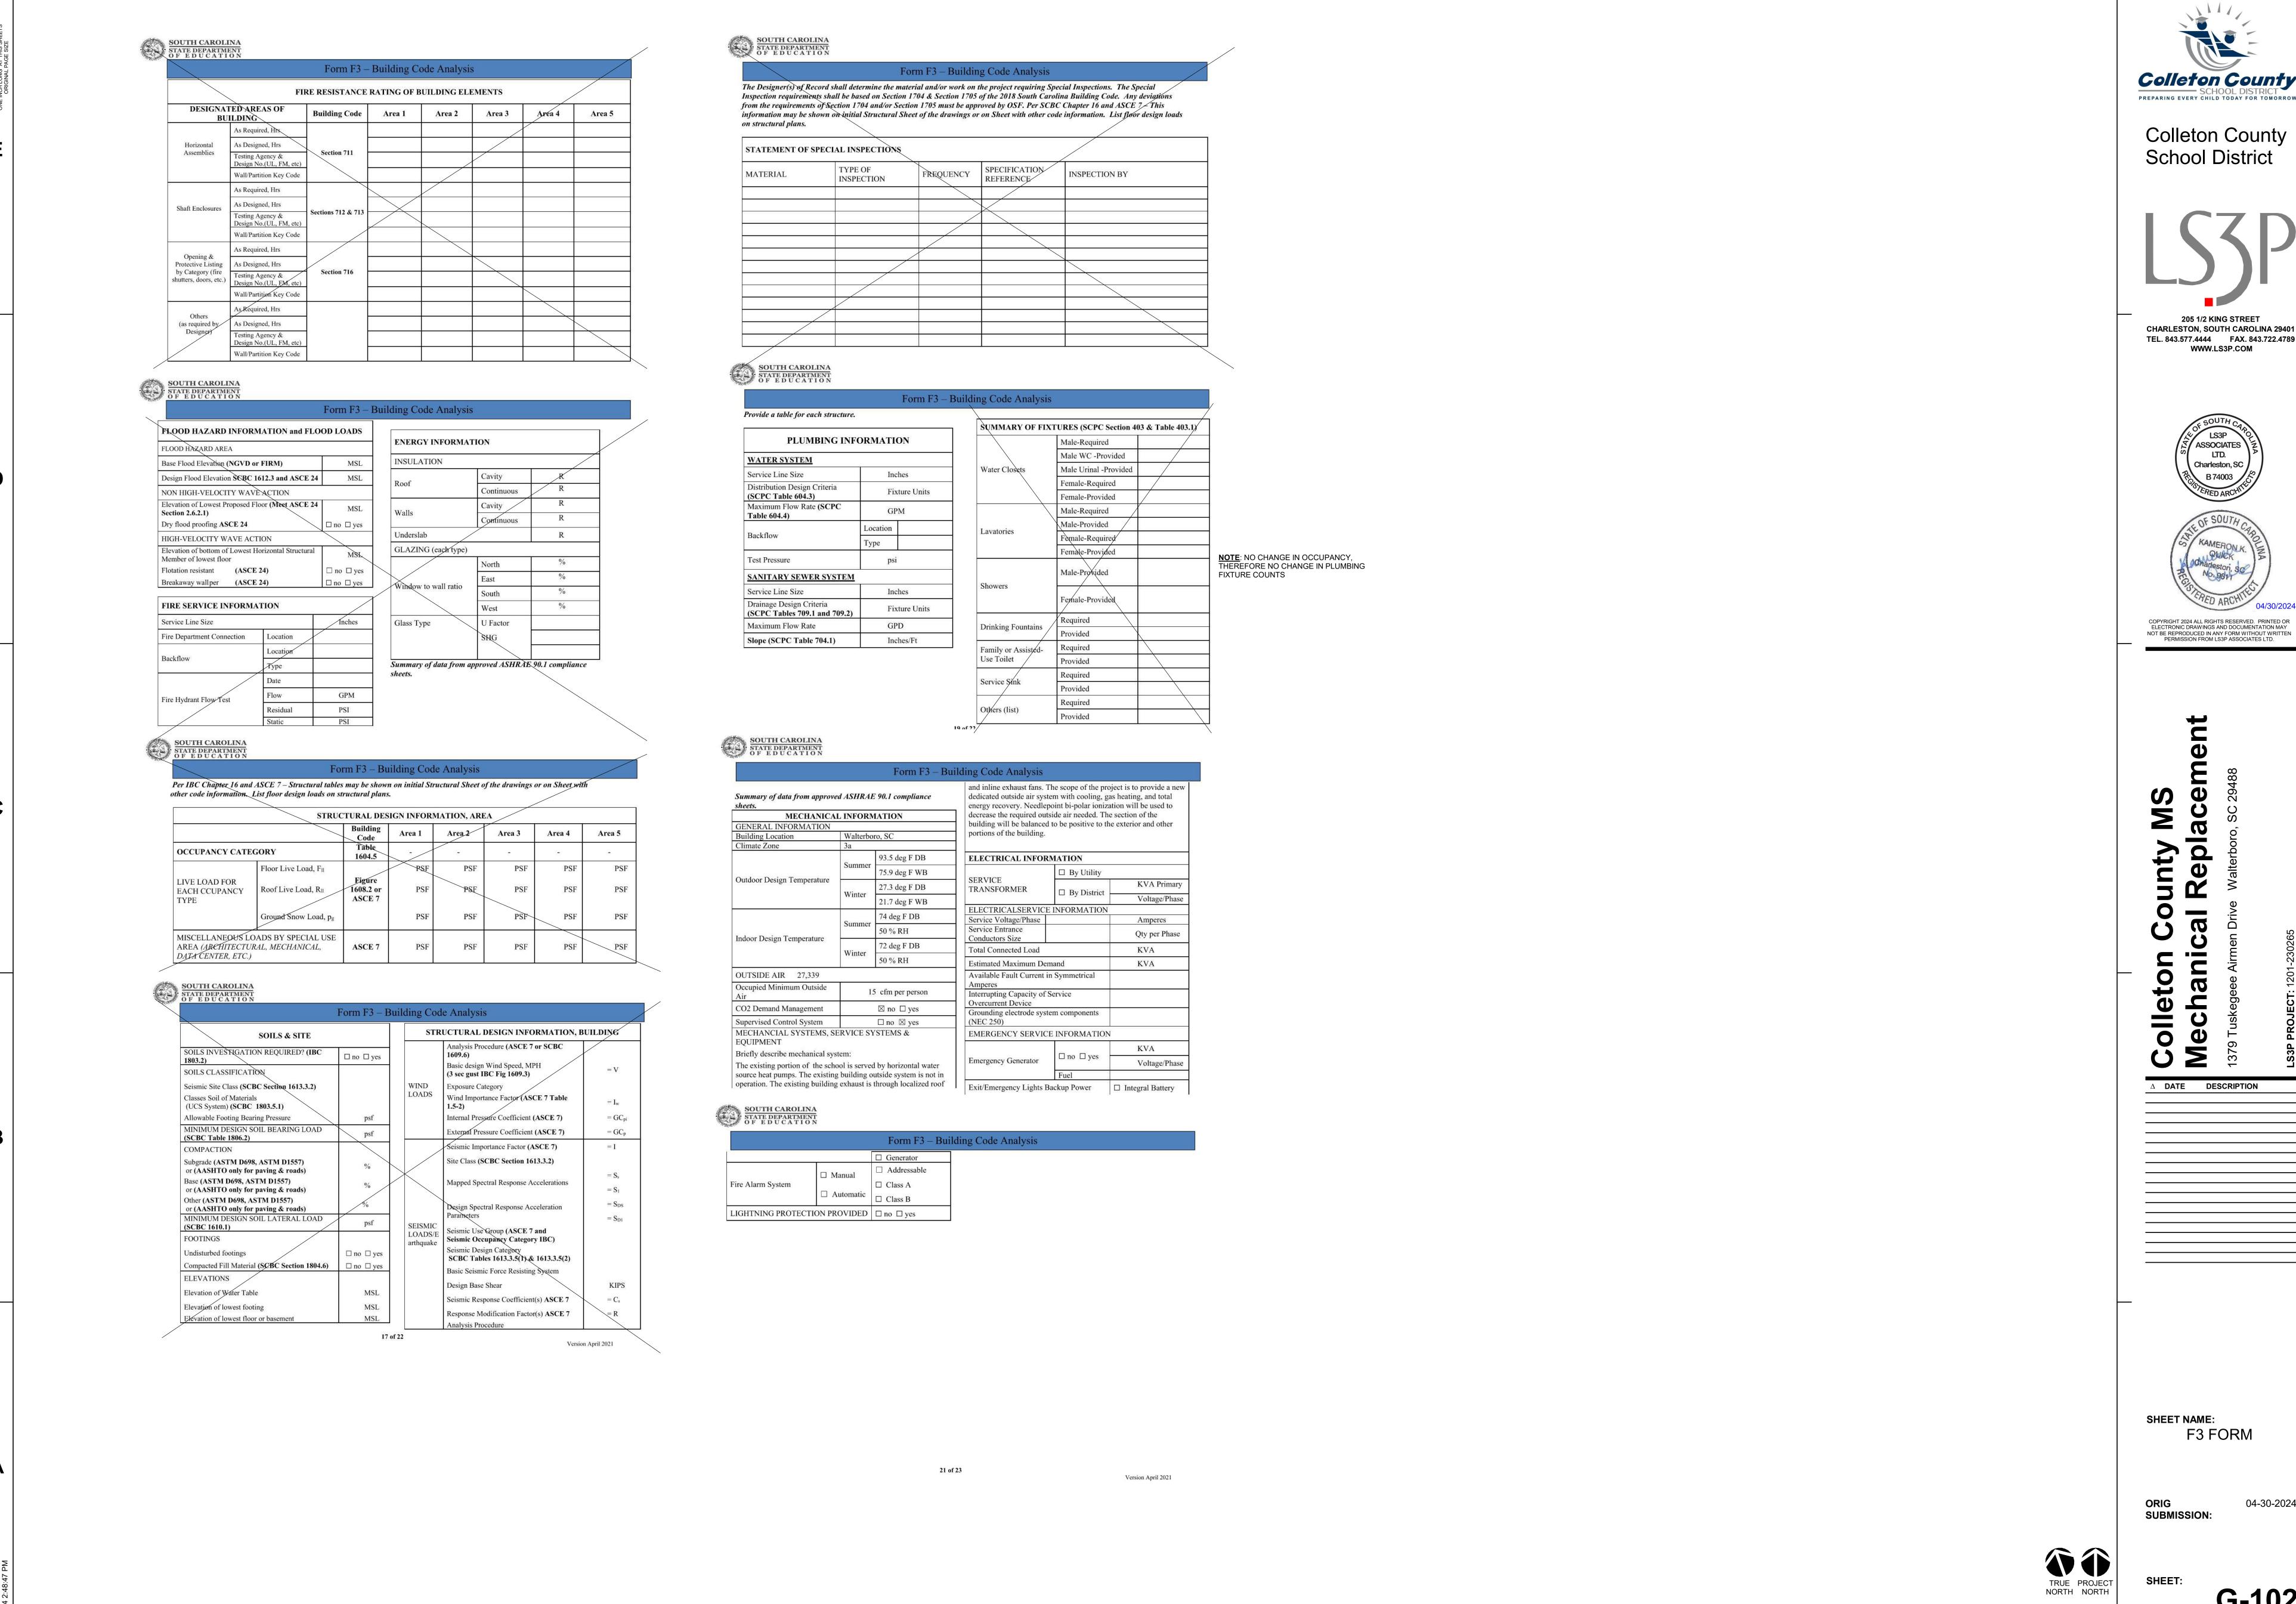
SHEET NAME: F3 FORM

SUBMISSION:

SHEET:

CONSTRUCTION DOCUMENTS

G-101



CHARLESTON, SOUTH CAROLINA 29401

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 Δ DATE DESCRIPTION

SHEET NAME: F3 FORM

SUBMISSION:

G-102

- 1.1 THE CONTRACTOR IS RESPONSIBLE FOR COMPLYING WITH ALL OSHA REGULATIONS ON THE PROJECT SITE. CONTRACTOR SHALL VERIFY EXISTING CONDITIONS AND DIMENSIONS SHOWN AND NOTIFY ENGINEER OF ANY DISCREPANCIES PRIOR TO FABRICATION AND CONSTRUCTION.
- 1.2 CONTRACTOR TO PROVIDE ADEQUATE BRACING FOR THE STRUCTURE SO THAT IT WILL BE STABLE DURING ALL STAGES OF CONSTRUCTION. THE STRUCTURE IS DESIGNED FOR A COMPLETED CONDITION ONLY AND THERE-FORE REQUIRES ADDITIONAL SUPPORT TO MAINTAIN STABILITY DURING CONSTRUCTION.
- 1.3 THE ENGINEER SHALL NOT BE RESPONSIBLE FOR THE MEANS, METHODS, TECHNIQUES. SEQUENCES OR PROCEDURES OF CONSTRUCTION SELECTED BY THE CONTRACTOR OR THE SAFETY PRECAUTIONS AND PROGRAMS INCIDENTAL TO THE WORK OF THE CONTRACTOR. THE ENGINEER SHALL NOT BE RESPONSIBLE FOR THE FAILURE OF THE CONTRACTOR TO PERFORM THE CONSTRUCTION WORK IN ACCORDANCE WITH DRAWINGS. THE COST OF ANY TESTS OR WORK REQUIRED BECAUSE OF CONTRACTOR'S FAILURE TO PERFORM IN ACCORDANCE WITH THE DRAWINGS SHALL BE BORNE BY THE CONTRACTOR.
- 1.4 COORDINATE THESE DRAWINGS WITH ARCHITECTURAL, ELECTRICAL, MECHANICAL, AND PLUMBING DRAWINGS.
- 2.0 CONCRETE
- 2.1 CONCRETE SHALL HAVE THE UNIT WEIGHT AND THE MINIMUM COMPRESSIVE STRENGTHS (f'c) AT 28 DAYS AS SHOWN ON THE CONCRETE MATERIALS SCHEDULE, THIS DRAWING.
- 2.2 GROUT FOR BASE PLATES SHALL BE NON-SHRINKABLE GROUT AND SHALL HAVE A MINIMUM SPECIFIED COMPRESSIVE STRENGTH AT 28 DAYS OF 5000 PSI, U.N.O.
- 2.3 NO CALCIUM CHLORIDE SHALL BE USED IN ANY CONCRETE.
- 2.4 MIXING, TRANSPORTING AND PLACING OF CONCRETE SHALL CONFORM TO ACI-301.
- 2.5 ALL CONCRETE WORK SHALL CONFORM TO THE REQUIREMENTS OF ACI-318, "BUILDING CODE REQUIRMENTS FOR REINFORCED CONCRETE".
- 2.6 CHAMFER ALL EXPOSED EXTERNAL CORNERS OF CONCRETE WITH 3/4" X 45 DEGREE CHAMFER U.N.O.
- 2.7 CONCRETE REINFORCEMENT BARS SHALL CONFORM TO ASTM A615, GRADE 60. REINFORCING BARS SHALL NOT BE TACK WELDED, WELDED, HEATED OR CUT, UNLESS INDICATED ON THE CONTRACT DOCUMENTS. ALL LAP SPLICES SHALL BE CLASS "B" U.N.O.
- 2.8 SLAB-ON-GRADE SHALL HAVE CONSTRUCTION JOINTS OR CRACK CONTROL JOINTS AS SHOWN ON THE DRAWINGS. CONSTRUCTION JOINTS CAN BE USED AT CONTROL JOINT LOCATIONS AT CONTRACTORS OPTION. SEE SLAB PLANS & JOINT DETAILS FOR ADDITIONAL INFORMATION.
- 2.9 ALL CONCRETE REINFORCEMENT SHALL BE DETAILED, FABRICATED, LABELED, SUPPORTED, AND SPACED IN FORMS AND SECURED IN PLACE IN ACCORDANCE WITH THE PROCEDURES AND REQUIREMENTS OUTLINED IN THE LATEST EDITION OF THE "BUILDING CODE REQUIREMENTS FOR REINFORCED CONCRETE", ACI 318, AND THE "MANUAL OF STANDARD PRACTICE FOR DETAILING REINFORCED CONCRETE STRUCTURES", ACI 315, LATEST EDITION.
- 2.10 CONCRETE MIX MAXIMUM W/C RATIO: 0.50.
- 3.0 STRUCTURAL STEEL
- 3.1 STRUCTURAL STEEL ROLLED SHAPES AND PLATES SHALL CONFORM TO THE MATERIAL INFORMATION SCHEDULE BELOW. DIMENSIONS AND PROPERTIES SHALL BE IN ACCORDANCE TO ASTM A6.

STEEL MATERIALS SCHEDULE				
STRUCTURAL ELEMENT	FY YIELD STRENGTH (KSI)	REMARKS		
BEAMS	50	ASTM A992		
CONNECTIONS, PLATES, & ALL OTHERS	36	ASTM A36		
TUBING	46	ASTM A500 GRADE B		

- 3.2 STRUCTURAL STEEL DETAILING, FABRICATION AND ERECTION SHALL CONFORM TO THE AISC "SPECIFICATION FOR STRUCTURAL STEEL BUILDINGS - ALLOWABLE STRESS DESIGN AND PLASTIC DESIGN" (LATEST EDITION), AND THE AISC "CODE OF STANDARD PRACTICE FOR STEEL BUILDINGS AND BRIDGES" (LATEST EDITION)
- 3.3 CONNECTION BOLTS FOR STRUCTURAL STEEL MEMBERS SHALL BE 3/4" DIA A325-N, UNO, AND SHALL CONFORM TO ASTM A325; NUTS SHALL CONFORM TO ASTM A563: WASHERS SHALL CONFORM TO ASTM F436, CONNECTION BOLTS SHALL HAVE A HARDENED WASHER PLACED UNDER THE ELEMENT TO BE TIGHTENED.
- 3.4 DETAILING OF STRUCTURAL STEEL CONNECTIONS MUST BE CONSISTENT WITH RECOGNIZED. PUBLISHED METHODS SUCH AS IN THE AISC "MANUAL OF STEEL CONSTRUCTION", 15th EDITION; "ENGINEERING FOR STEEL CONSTRUCTION", OR "VOLUME II CONNECTIONS MANUAL OF STEEL CONSTRUCTION".
- 3.5 WELDING SHALL CONFORM TO THE AMERICAN WELDING SOCIETY STRUCTURAL WELDING CODE AWS D1.1. ELECTRODES FOR SHOP AND FIELD WELDS SHALL BE CLASS E70XX. ALL WELDING SHALL BE DONE BY QUALIFIED, CERTIFIED WELDERS PER THE ABOVE STANDARD.
- 3.6 ALL WELDS NOT INDICATED SHALL BE A MINIMUM OF 3/16" ALL AROUND UNLESS NOTED OTHERWISE.
- 3.7 THERE SHALL BE NO FIELD CUTTING OF STRUCTURAL STEEL MEMBERS FOR THE WORK OF OTHER TRADES WITHOUT PRIOR APPROVAL OF THE STRUCTURAL ENGINEER.
- 3.8 ALL STEEL TO BE PRIMED PER THE SPECIFICATIONS..
- 3.9 FOR FLOOR AND ROOF OPENINGS, THE FABRICATOR SHALL VERIFY OPENING LOCATIONS WITH EQUIPMENT SELECTED AND MAKE ANY NECESSARY MODIFICATIONS AT NO ADDITIONAL COST. THE CONTRACTOR SHALL COORDINATE MECHANICAL UNITS AND OPENINGS & ARCHITECTURAL ITEMS REQUIRED FOR COMPLETE INSTALLATION OF WORK. IT IS THE RESPONSIBILITY OF FABRICATOR TO RECEIVE ALL NECESSARY INFORMATION PRIOR TO FABRICATION OF THE STEEL.
- 3.10 SEE MECHANICAL DRAWINGS FOR ADDITIONAL OPENINGS NOT SHOWN.

- 4.0 STEEL DECK
- 4.1 STEEL DECK SHALL BE ASTM A446 HAVING A MINIMUM YIELD STRENGTH OF 33,000 PSI AS PER THE STEEL DECK INSTITUTE DESIGN MANUAL.
- 4.2 STEEL DECK SHALL BE ERECTED IN ACCORDANCE WITH THE MANUFACTURER'S SPECIFICATIONS AND ERECTION LAYOUTS AND CONNECTED TO SUPPORTING MEMBERS AS INDICATED BELOW.
- 4.3 ROOF DECK
- 4.3.1 STEEL ROOF DECK SHALL BE 1 1/2", 18 GAGE GALVANIZED WIDE RIB (S.D.I. TYPE WR) UNO.
- 4.3.2 ROOF DECK SHALL HAVE THE FOLLOWING MINIMUM PROPERTIES:

	18 GAGE 1 1/2" DEC
MOMENT OF INERTIA, In	0.295 IN/FT ⁴ WIDTH
MOMENT OF INERTIA, Ip	0.289 IN/FT ⁴ WIDTH
SECTION MODULUS (TOP OF DECK), Sn	0.327 IN/FT ³ WIDTH
SECTION MODULUS (BOT. OF DECK) Sp	0.318 IN/FT ³ WIDTH

IN ADDITION TO MEETING THE MINIMUM REQUIREMENTS ABOVE, THE DECK MANUFACTURER SHALL DESIGN THE ROOF DECK AND ATTACHMENTS TO STEEL FOR THE ROOF LOADS, INCLUDING DECK UPLIFT. ALL ROOF DECK SHALL HAVE A MINIMUM 1-SPAN CONDITION.

- 4.3.3 1 1/2" ROOF DECK SHALL BE CONNECTED TO SUPPORTS WITH #12 TEK SCREWS IN THE BOTTOM OF THE FLUTES USING A S.D.I. 36/5 PATTERN (UNO). DECK SIDELAPS SHALL BE FASTENED USING #10 SCREWS WITH MINIMUM 5-SIDE LAPS CONNECTIONS PER SPAN. ALL ENDLAPS SHALL BE A MINIMUM OF 2" AND SHALL OCCUR OVER SUPPORTS. MINIMUM DIAPHRAGM SHEAR STRENGTH Q = 396 PLF (WORKING, UNO).
- 4.3.4 DO NOT SUSPEND PIPES, DUCTS, OR CEILING FROM ROOF DECK.

CONCRETE MATERIALS SCHEDULE				
	f'c	REMARKS		
STRUCTURAL ELEMENT	CONCRETE COMPRESSIVE STRENGTH @ 28 DAYS (PSI)			

SLAB-ON-GRADE

- 1. ALL CONCRETE SHALL BE NORMAL WEIGHT CONCRETE. (150 PCF)
- 3500

STRUCTURAL DESIGN CRITERIA (NEW ROOF TOP UNIT ONLY)

ALL NEW DESIGNS SHALL CONFORM TO THE PROVISIONS OF THE **INTERNATIONAL BUILDING CODE 2021**

- 1.0 DESIGN LOADS
- 1.1 DEAD LOADS:
- SUPPORT STRUCTURE: SELF WEIGHT
- 1.2 LIVE LOADS:
- 20 PSF

1.3 WIND LOAD: (PER IBC 2021 / ASCE 7-16)

BASIC WIND SPEED = 146 MPH (ult)

EXPOSURE C; RISK CATEGORY III

BASIC SEISMIC RESISTING SYSTEM

1.4 SEISMIC LOAD (PER IBC 2021)

(TABLE 12.2-1)

MASONRY SHEAR WALLS

III (TABLE 1604.5)

1.4.1 RISK CATEGORY:

1.4.2 SEISMIC IMPORTANCE FACTOR: Ip = 1.25Ss = 0.84gS1 = 0.251g

1.4.3 SPECTRAL ACCELERATION COEFFICIENTS: 1.4.4 SPECTRAL RESPONSE COEFFICIENTS

 $S_{DS} = 0.652g$ $S_{D1} = 0.318g$

1.4.6 COMPONENT TYPE

AIR HANDLING UNIT

1.4.7 DESIGN BASE SHEAR ANALYSIS PROCEDURE

V = 0.125W**EQUIVALENT LATERAL FORCE** PROCEDURE

AS-BUILT ORDINARY REINFORCED

1.4.8 SEISMIC DESIGN CATEGORY D (TABLE 1613.2.5 (1) & 1613.2.5 (2)

1.4.9 RESPONSE MODIFICATION FACTOR, R R = 2

1.5 DESIGN WIND PRESSURE - UPLIFT PRESSURE

TRIBUTARY	UPLIFT PRESSURE psf			
AREA	ALL ZONES (+) (PSF)	ALL ZONES (-) (PSF)		
A < 10ft ²	20.5	105		
A = 50ft ²	17.5	89.5		
A ≥ 100ft ²	16.5	83		
-	-	-	-	

"+" = PRESSURES ACTING TOWARD SURFACES

"-" = PRESSURES ACTING AWAY FROM SURFACES


Colleton County


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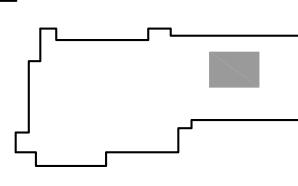
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SHEET NAME: **GENERAL NOTES** AND BASIS OF DESIGN

04-30-2024

ORIG SUBMISSION:


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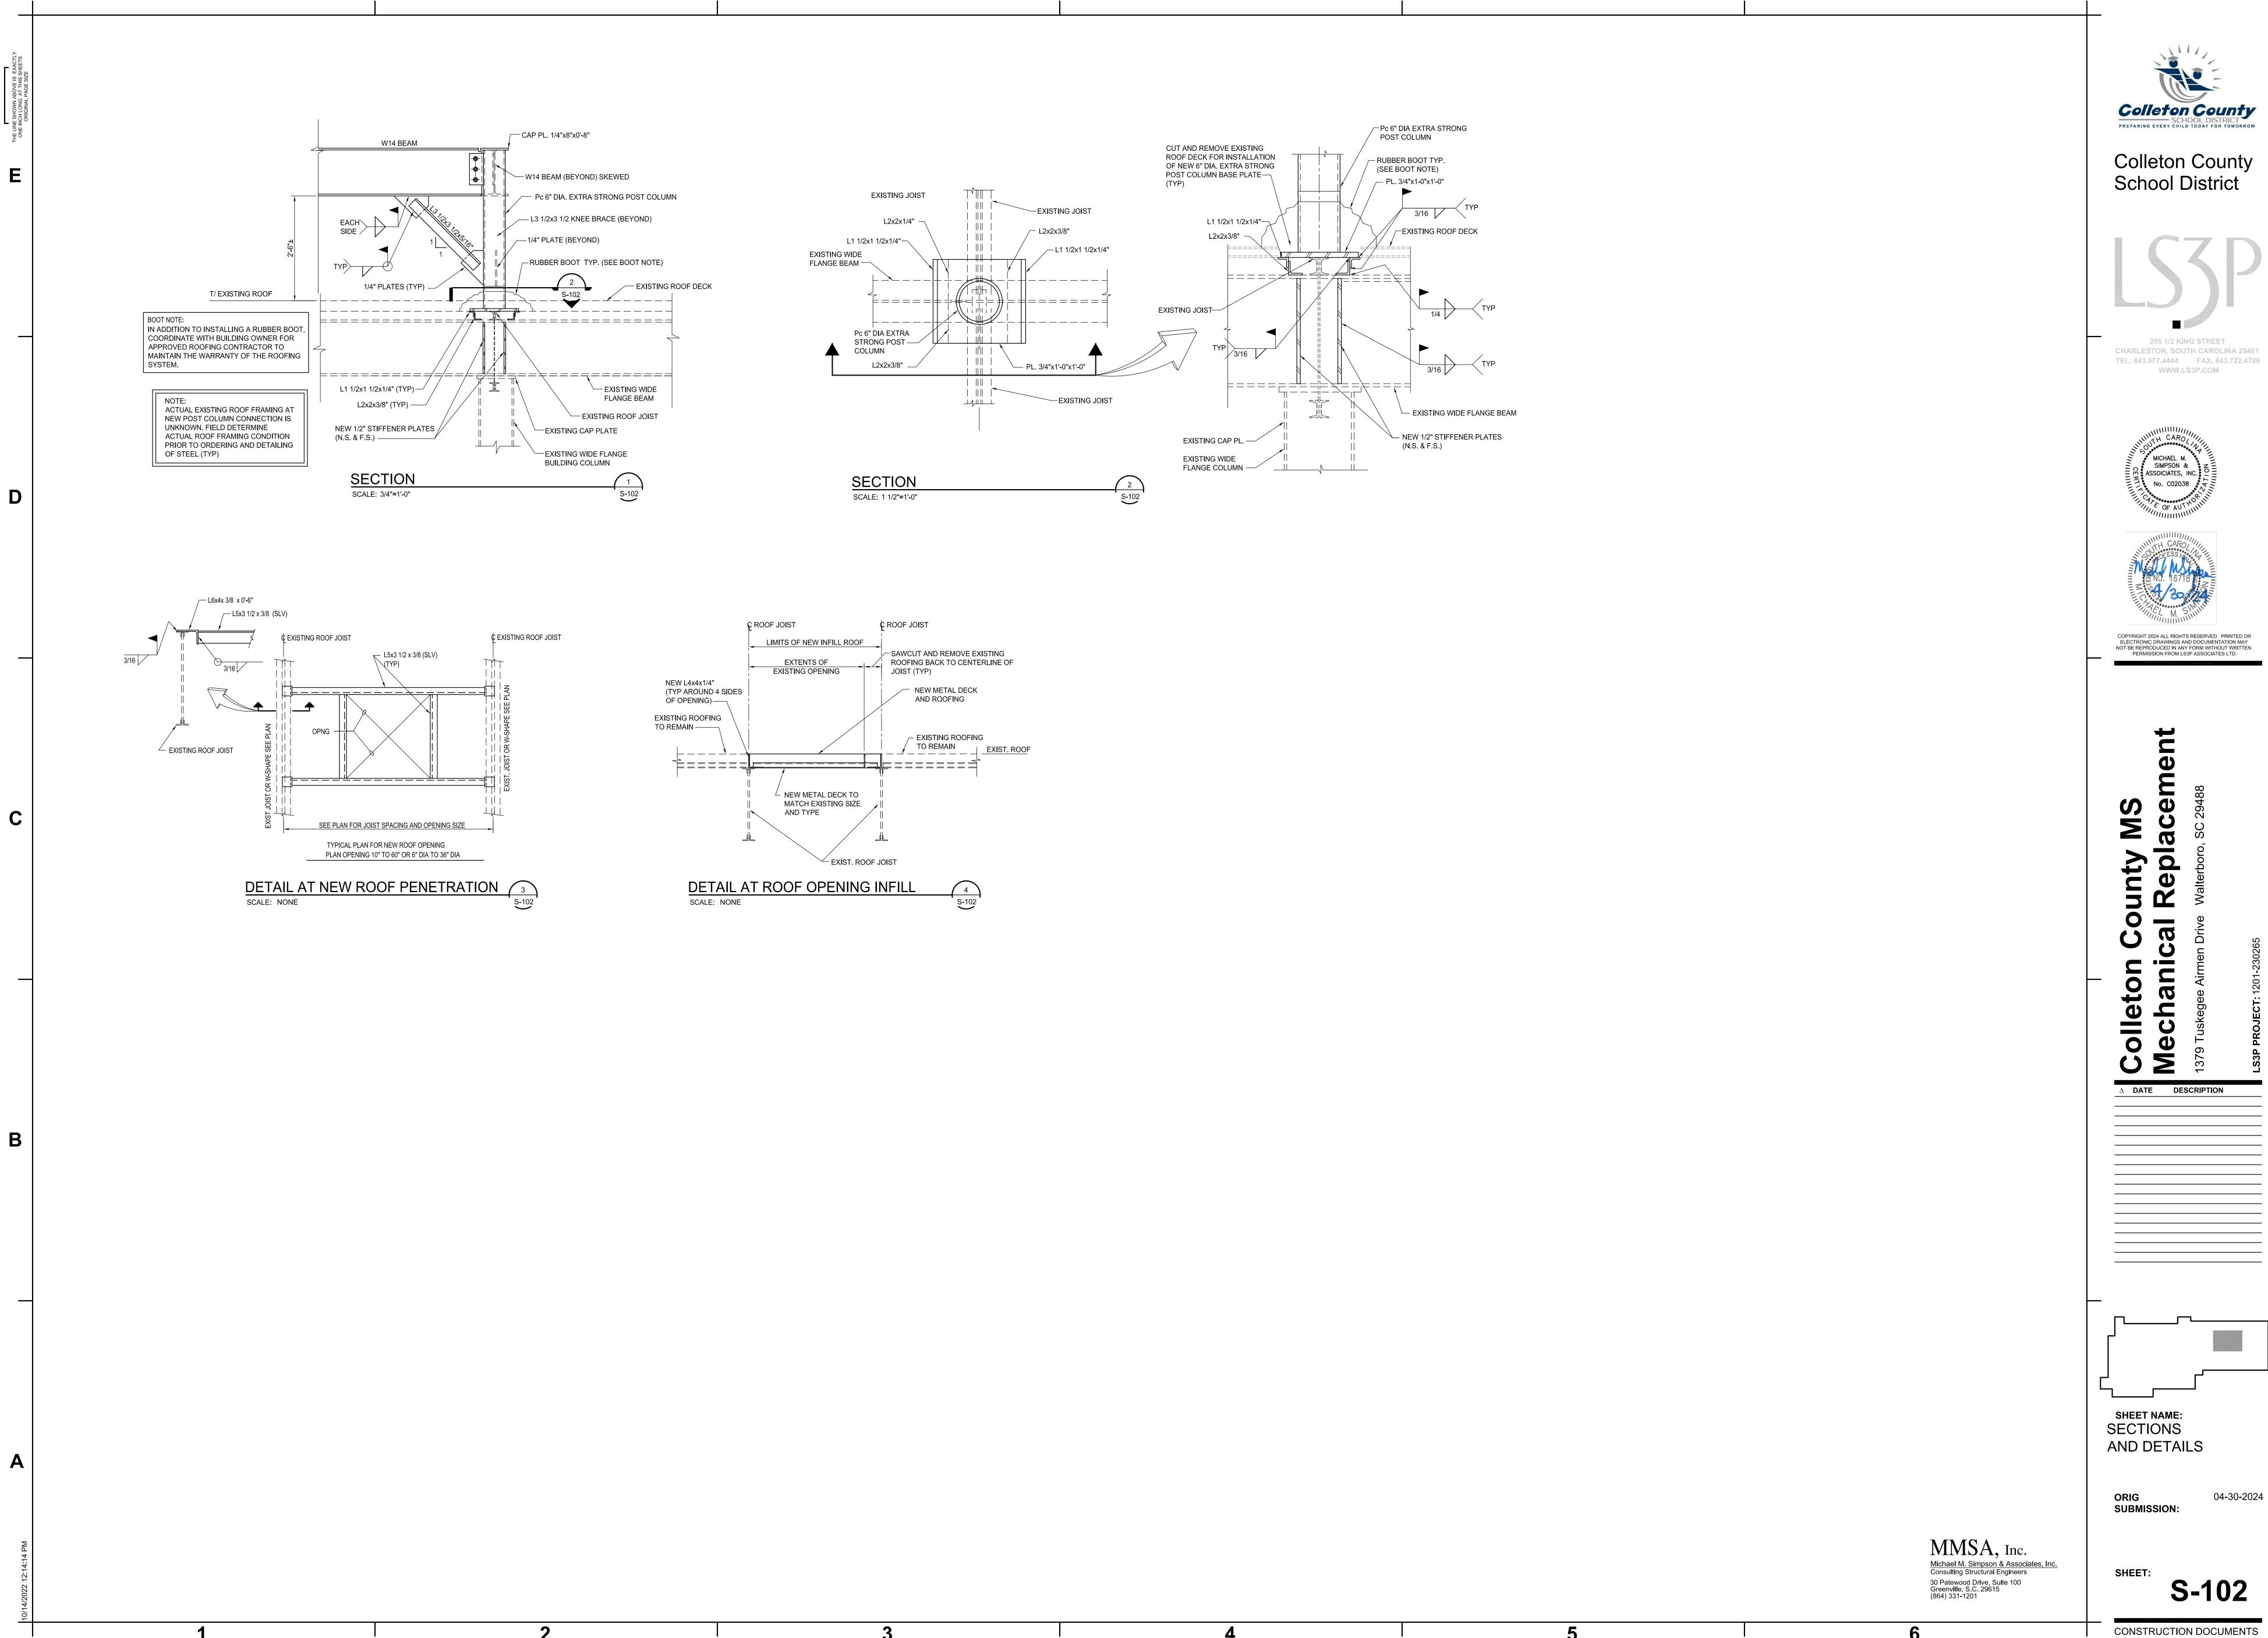
MMSA, Inc.

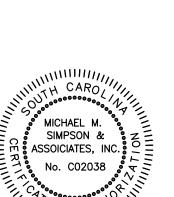30 Patewood Drive, Suite 100 Greenville, S.C. 29615

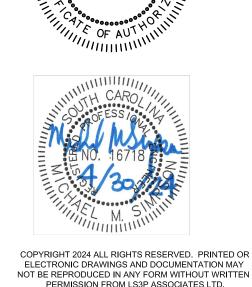(864) 331-1201

Michael M. Simpson & Associates, Inc.
Consulting Structural Engineers




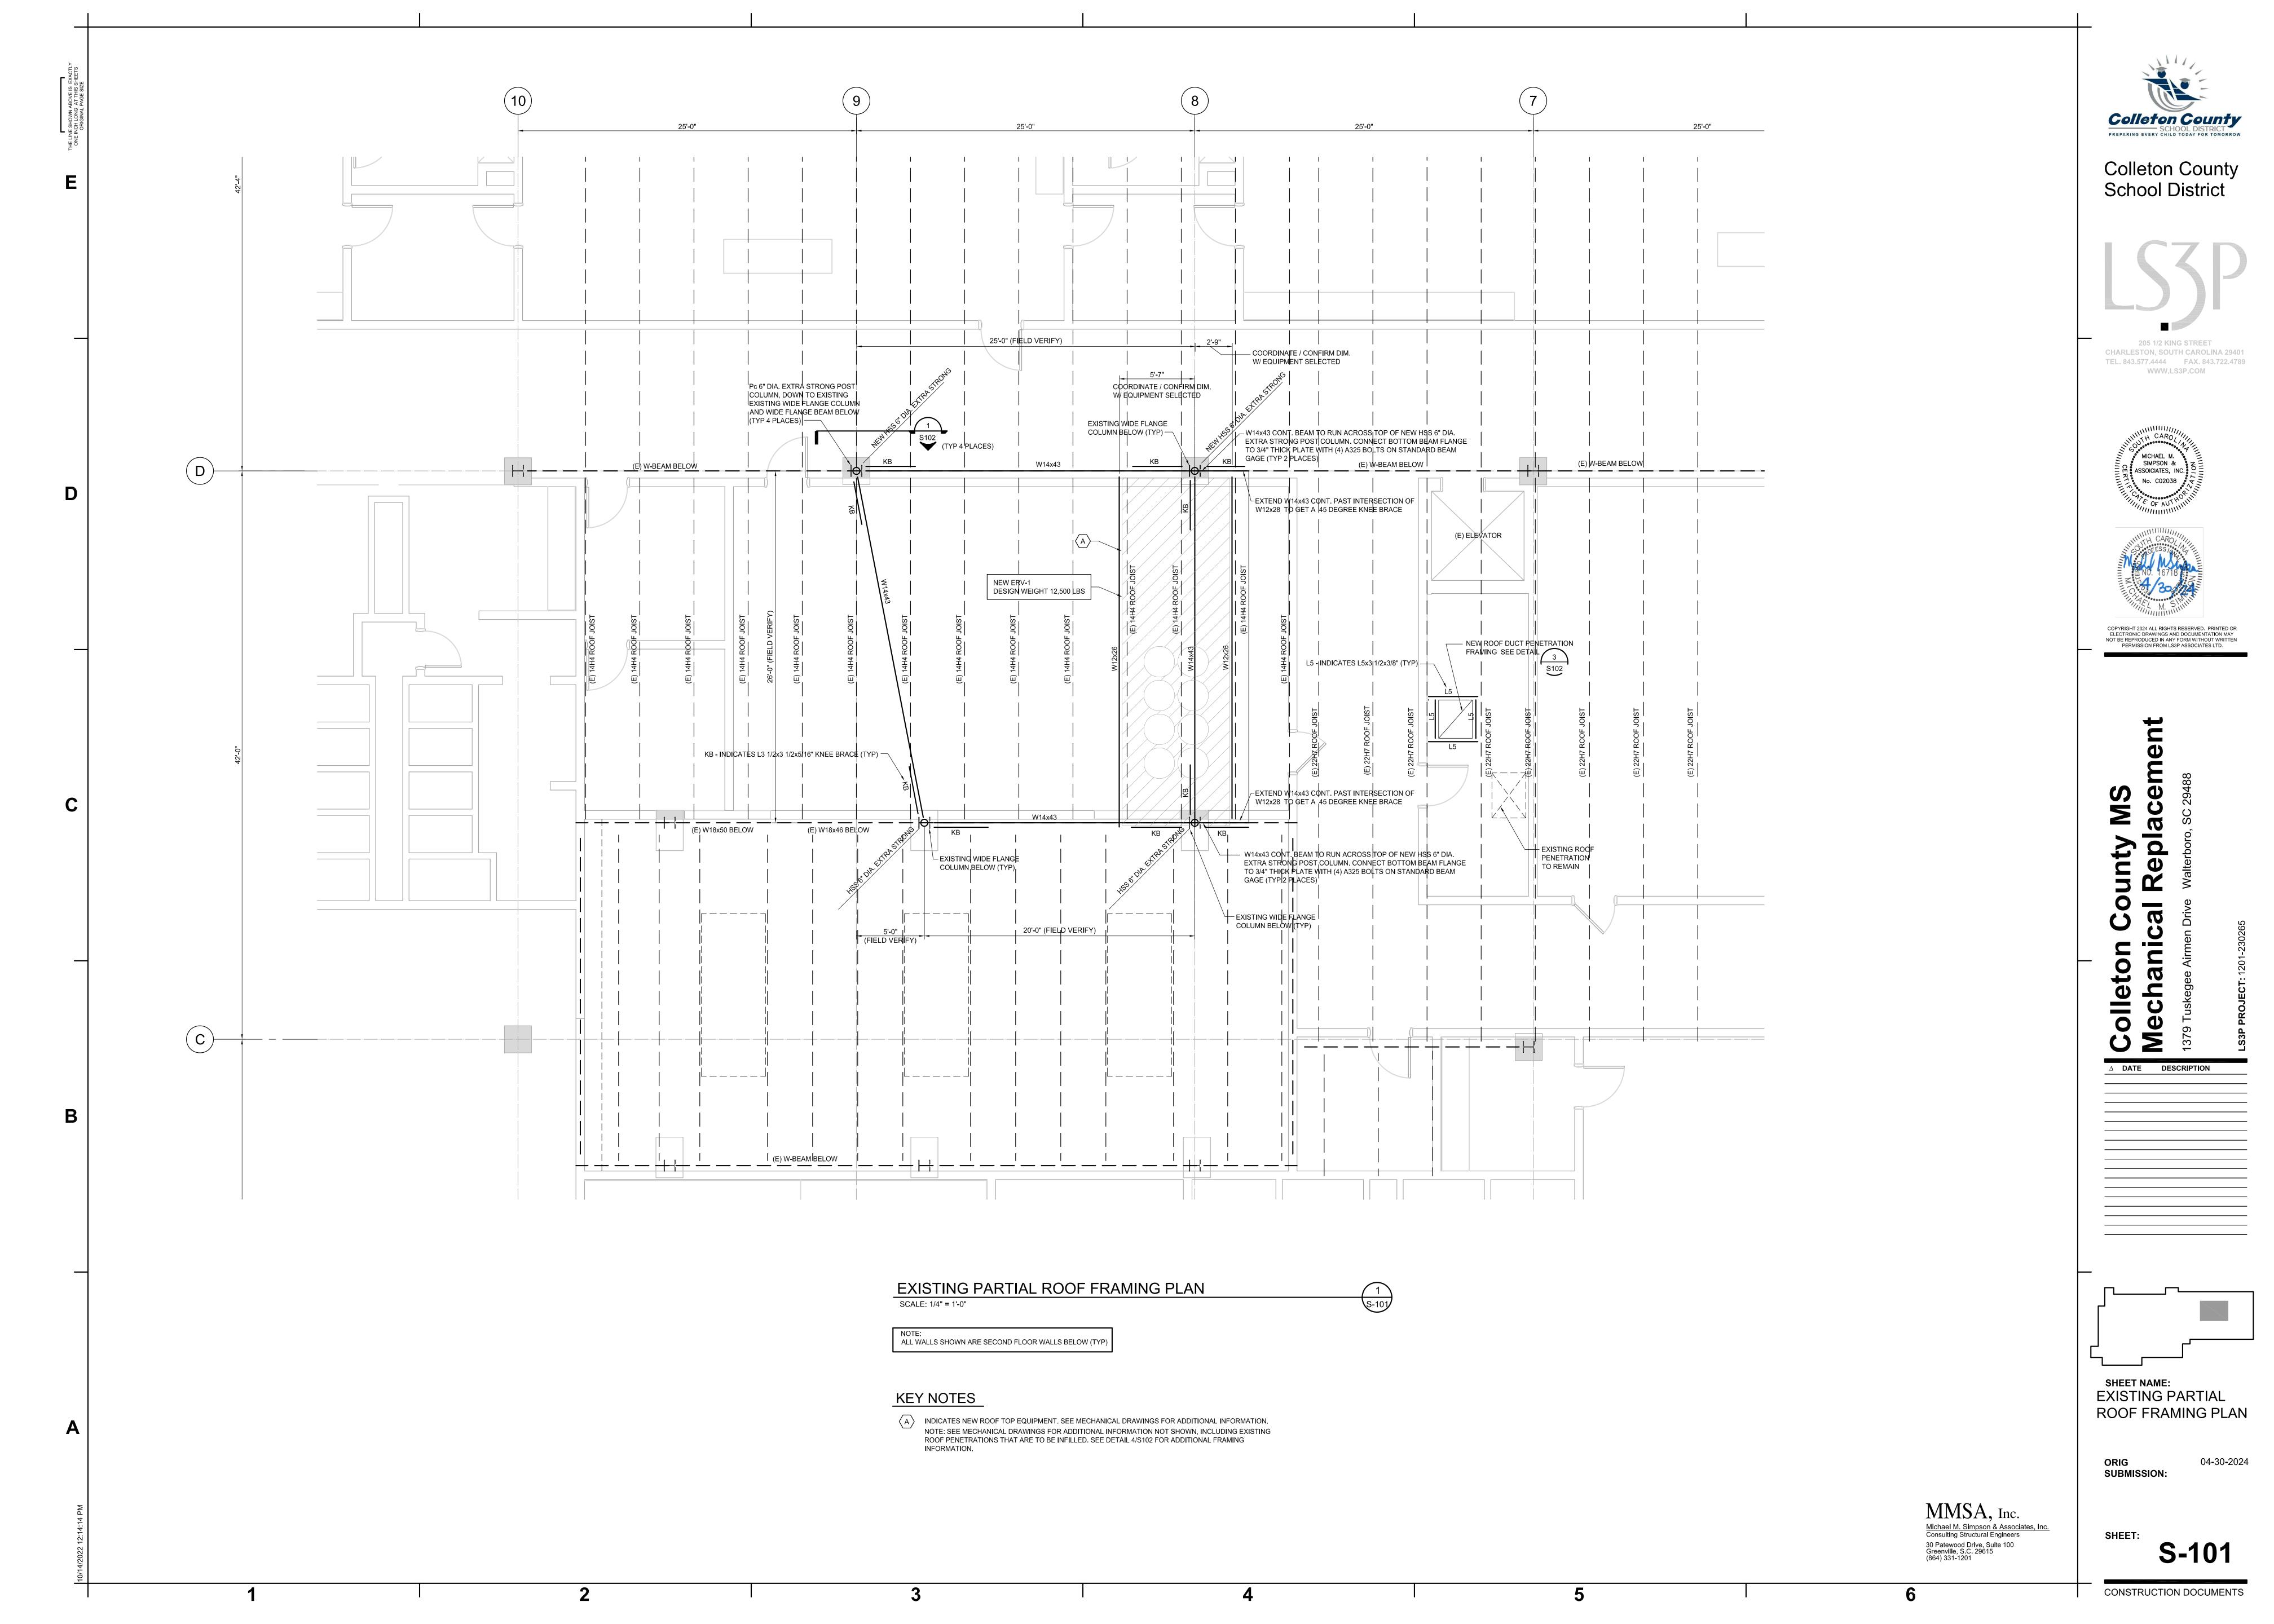


Colleton County

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CHARLESTON, SOUTH CAROLINA 29401



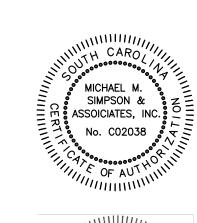

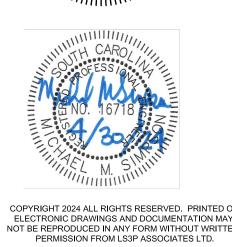
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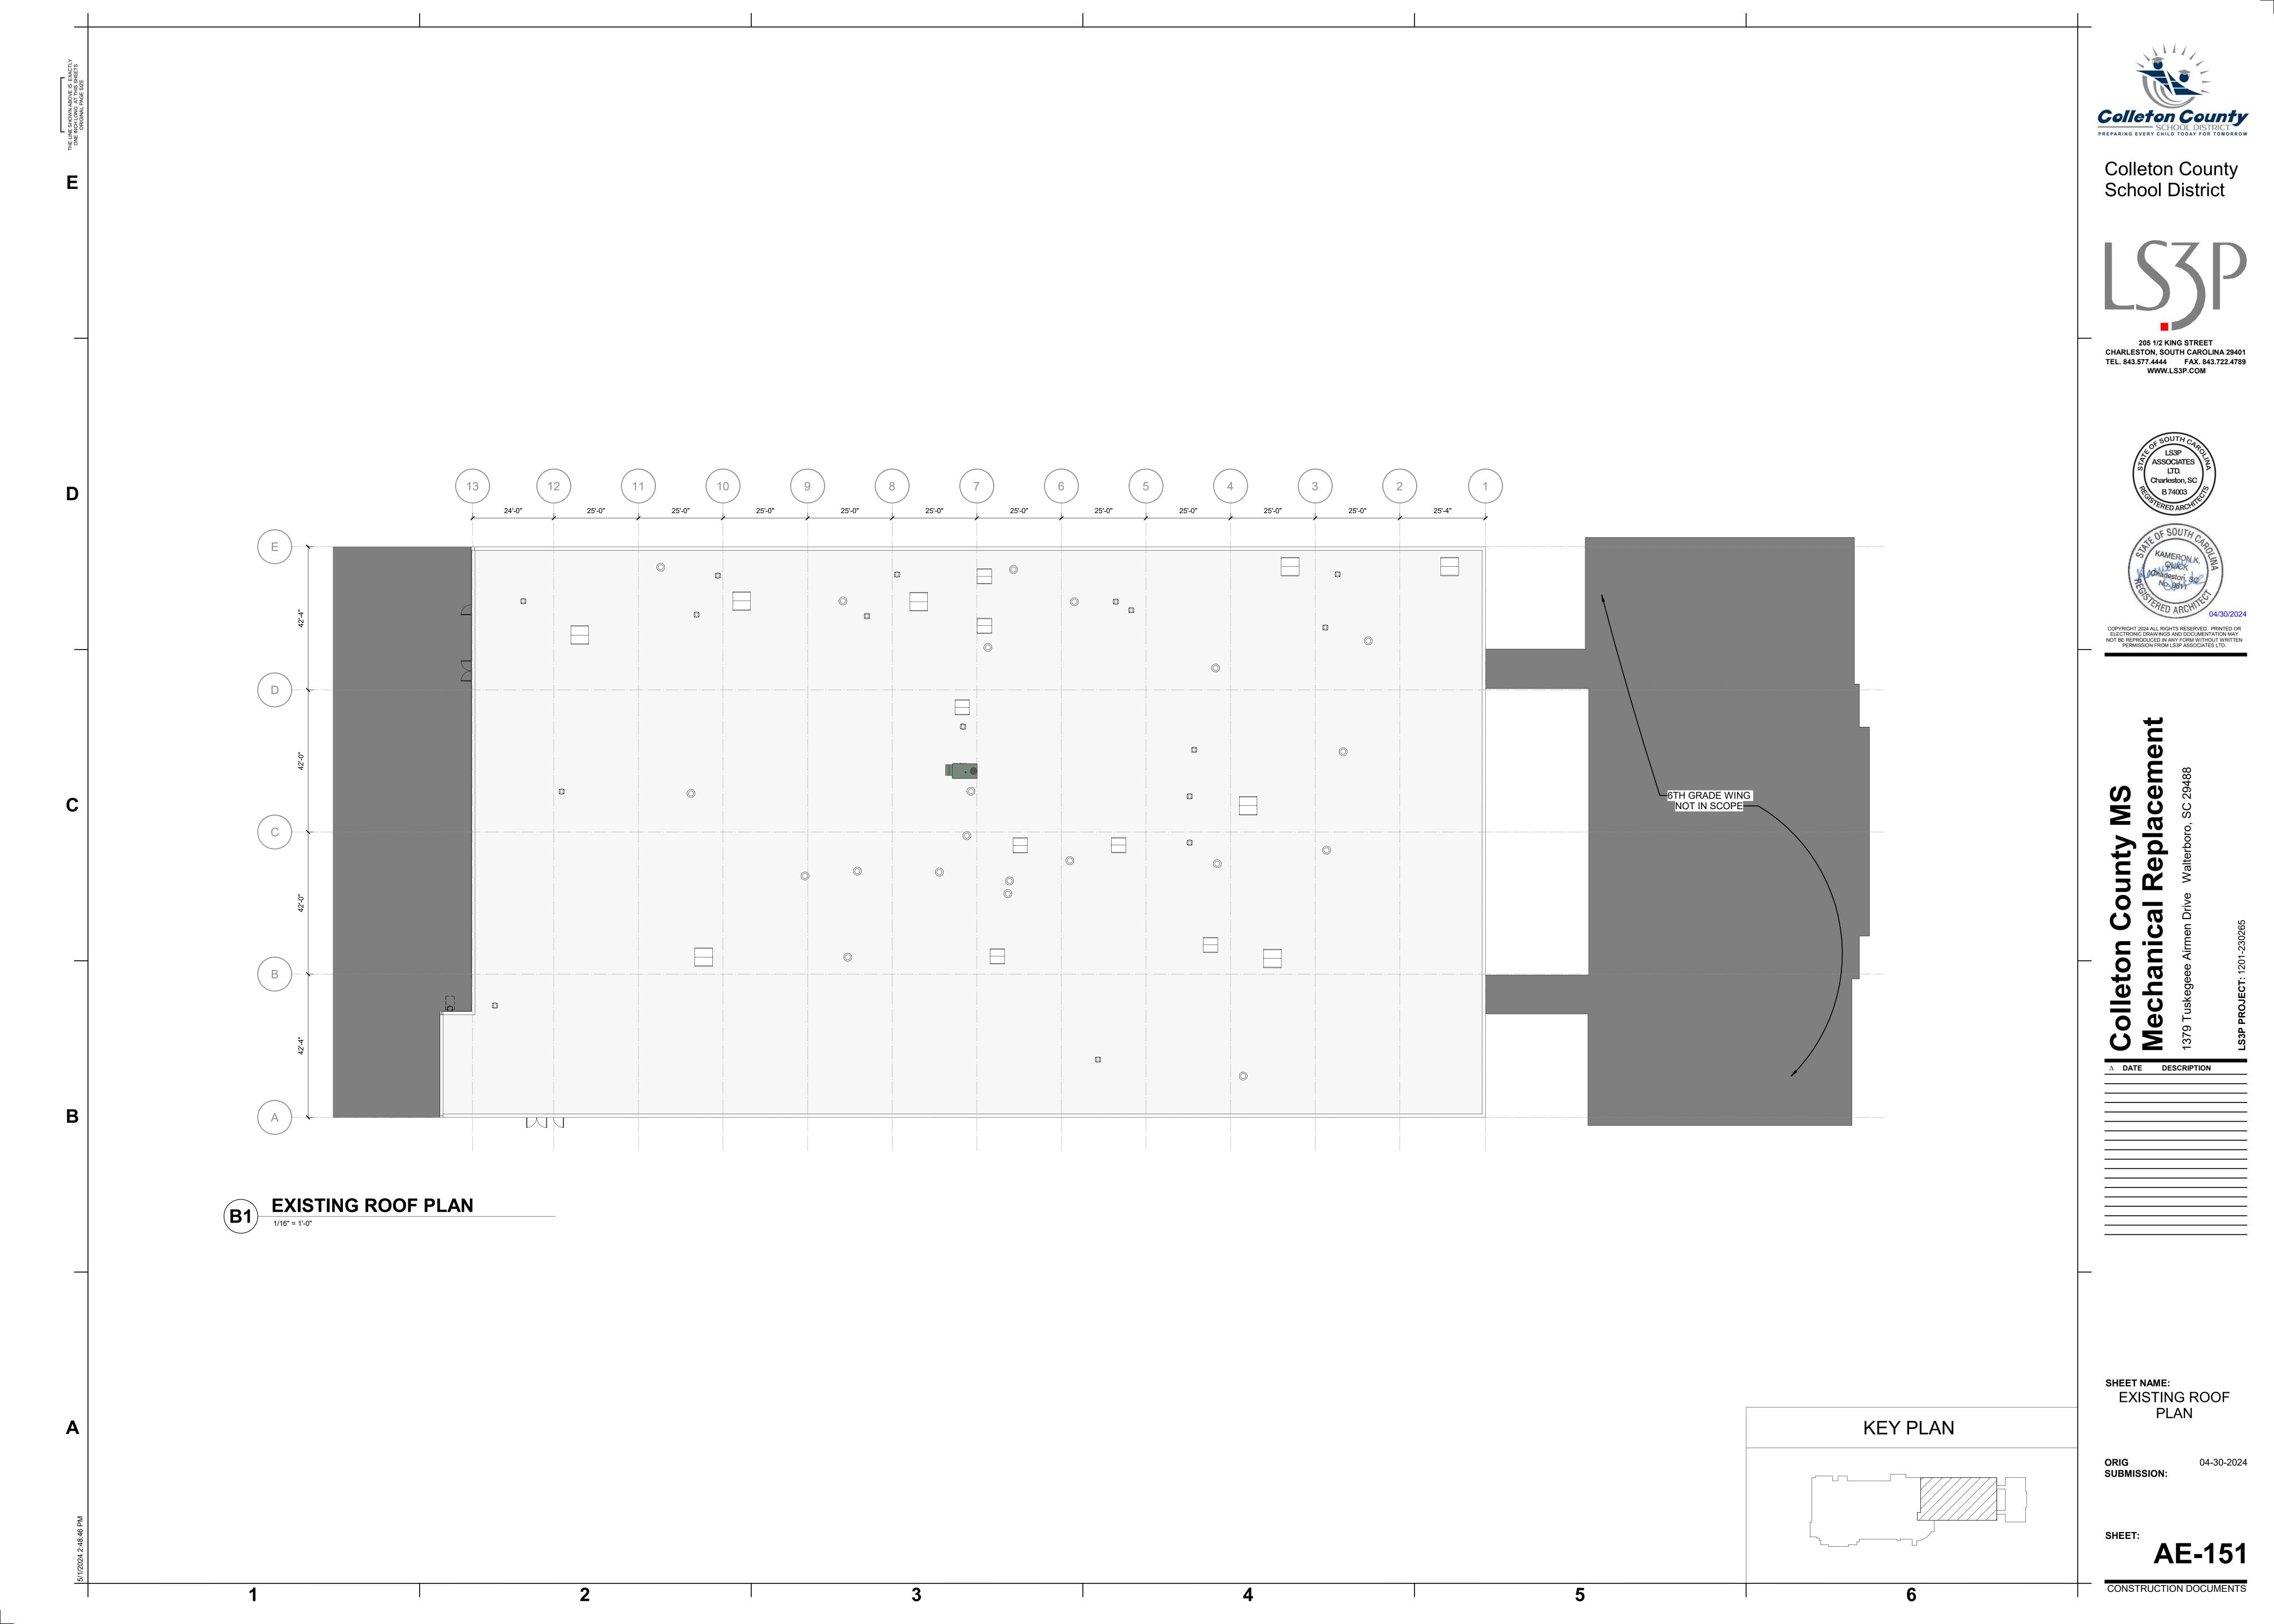
 Δ DATE DESCRIPTION

SHEET NAME: SECTIONS AND DETAILS

04-30-2024

S-102



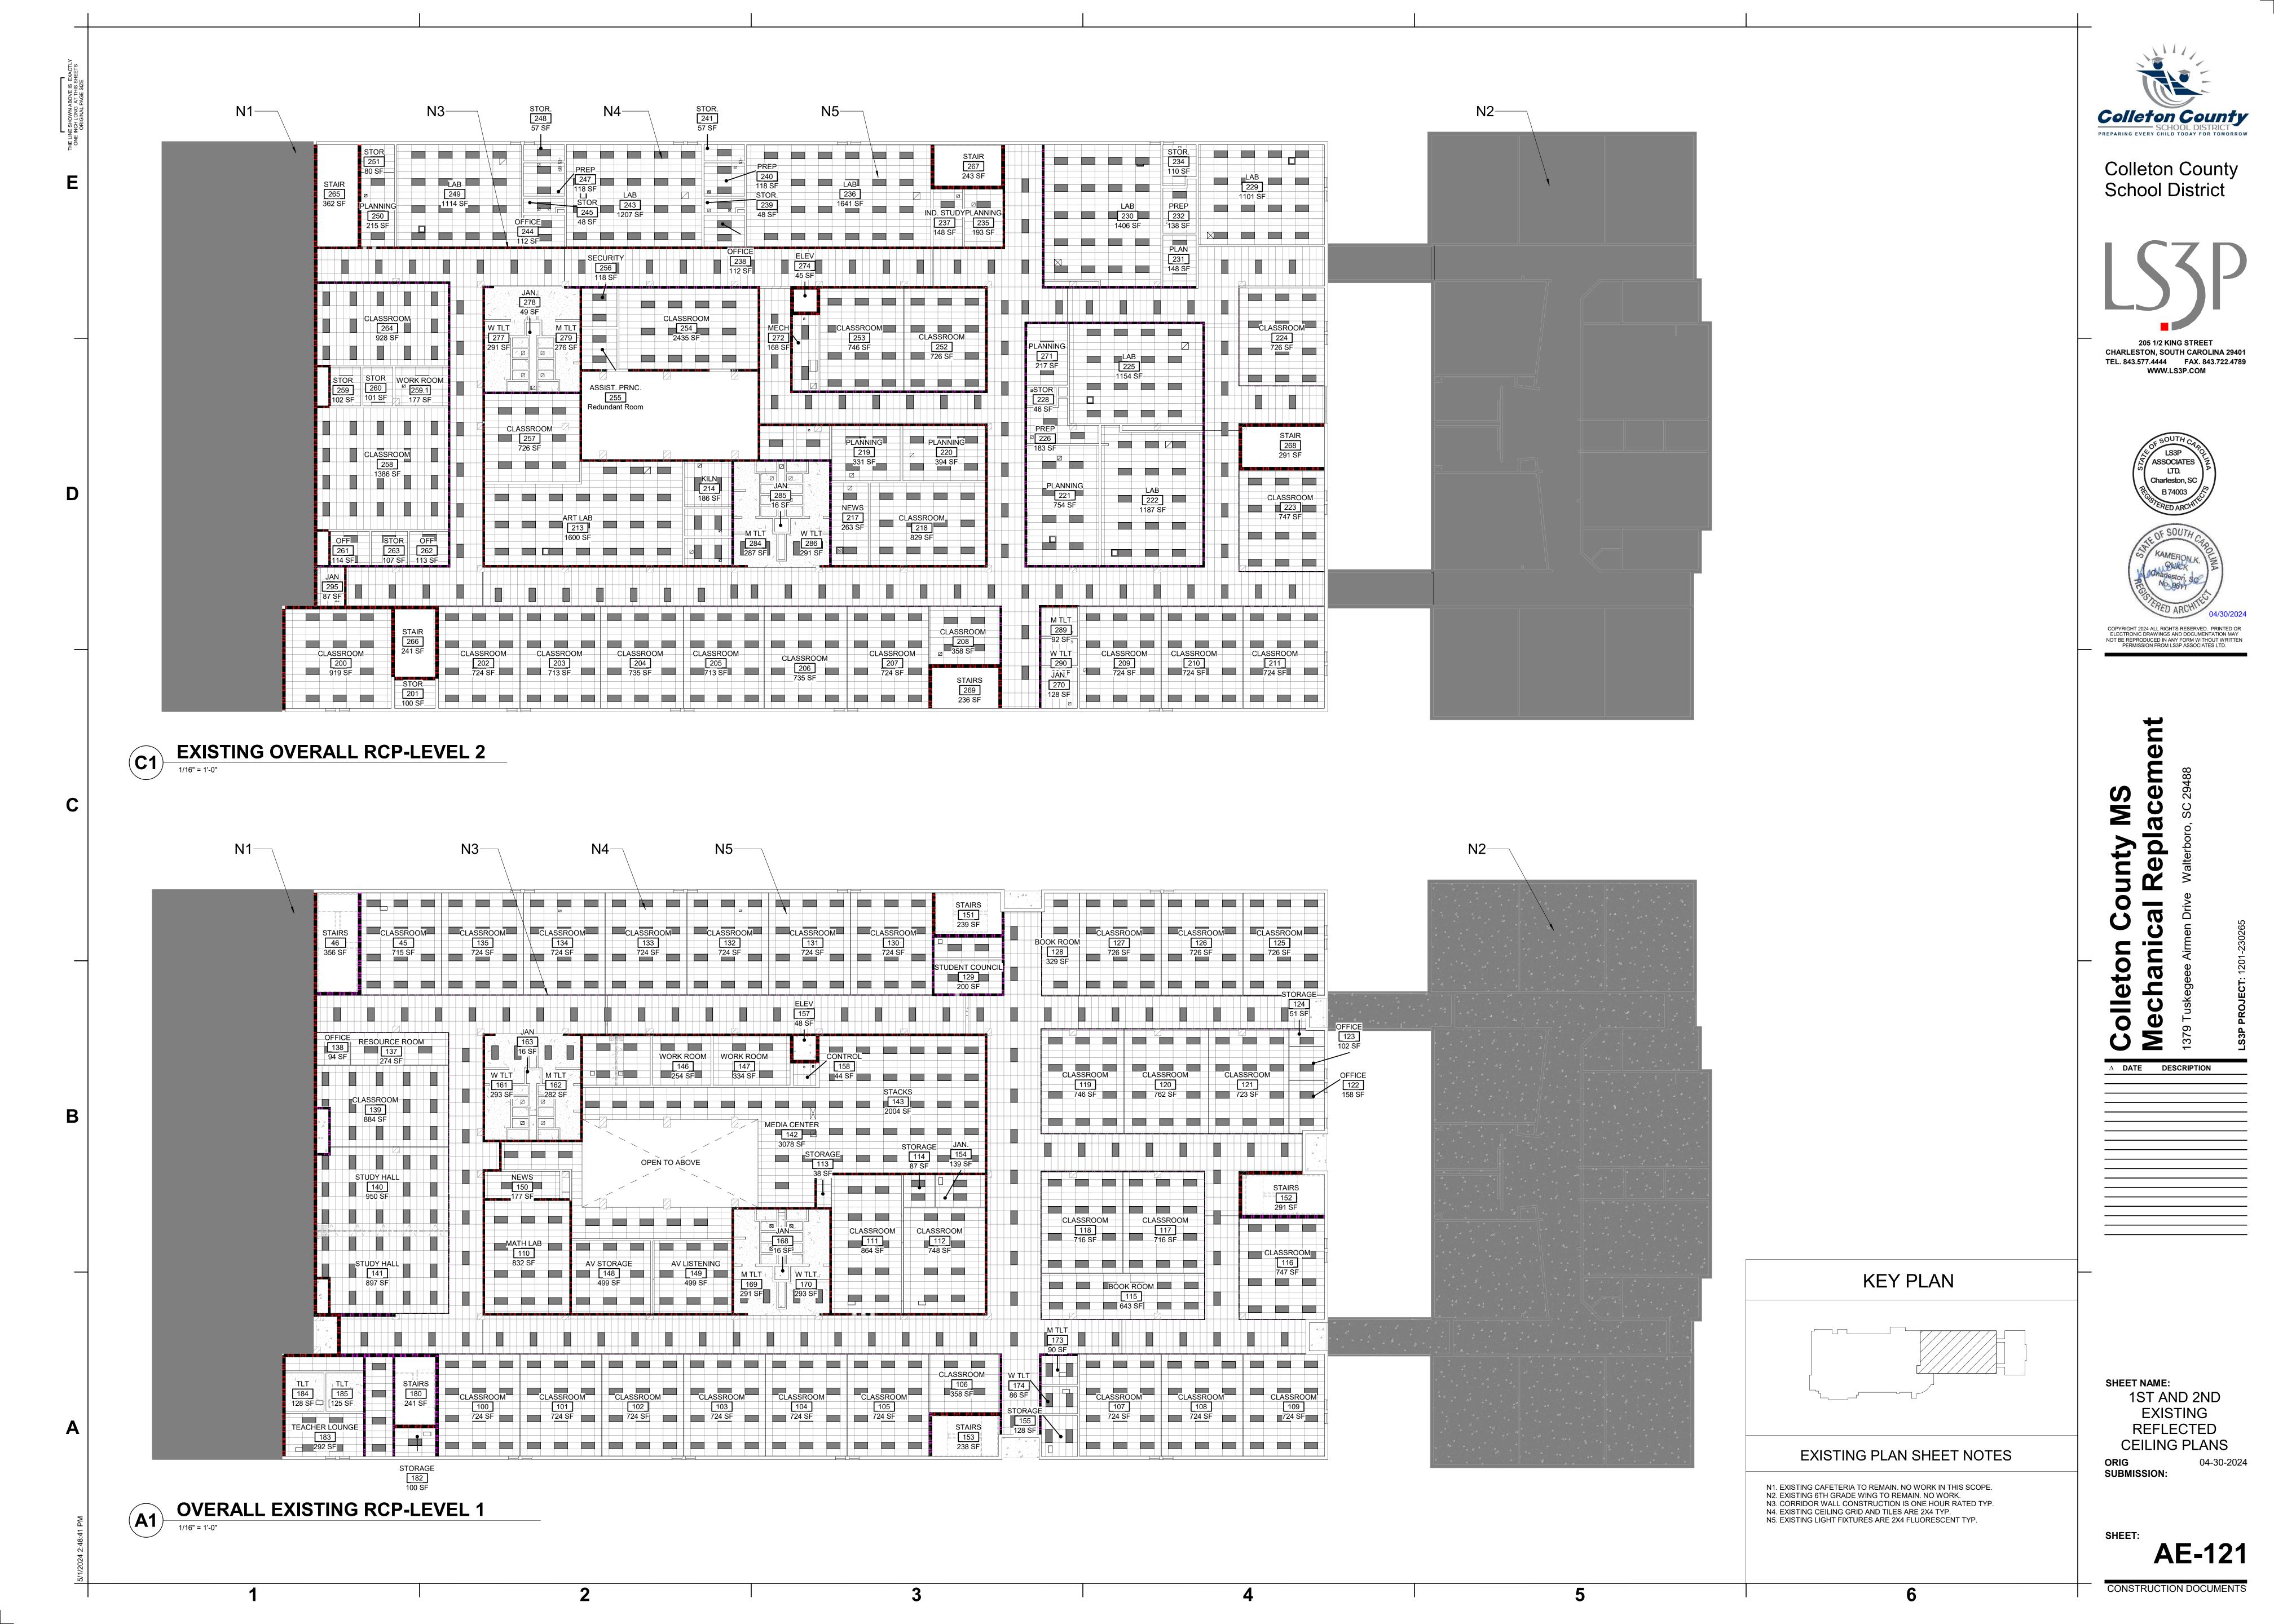

Colleton County **School District**

205 1/2 KING STREET

CHARLESTON, SOUTH CAROLINA 29401 TEL. 843.577.4444 FAX. 843.722.4789 WWW.LS3P.COM

ASSOCIATES LTD. Charleston, SC

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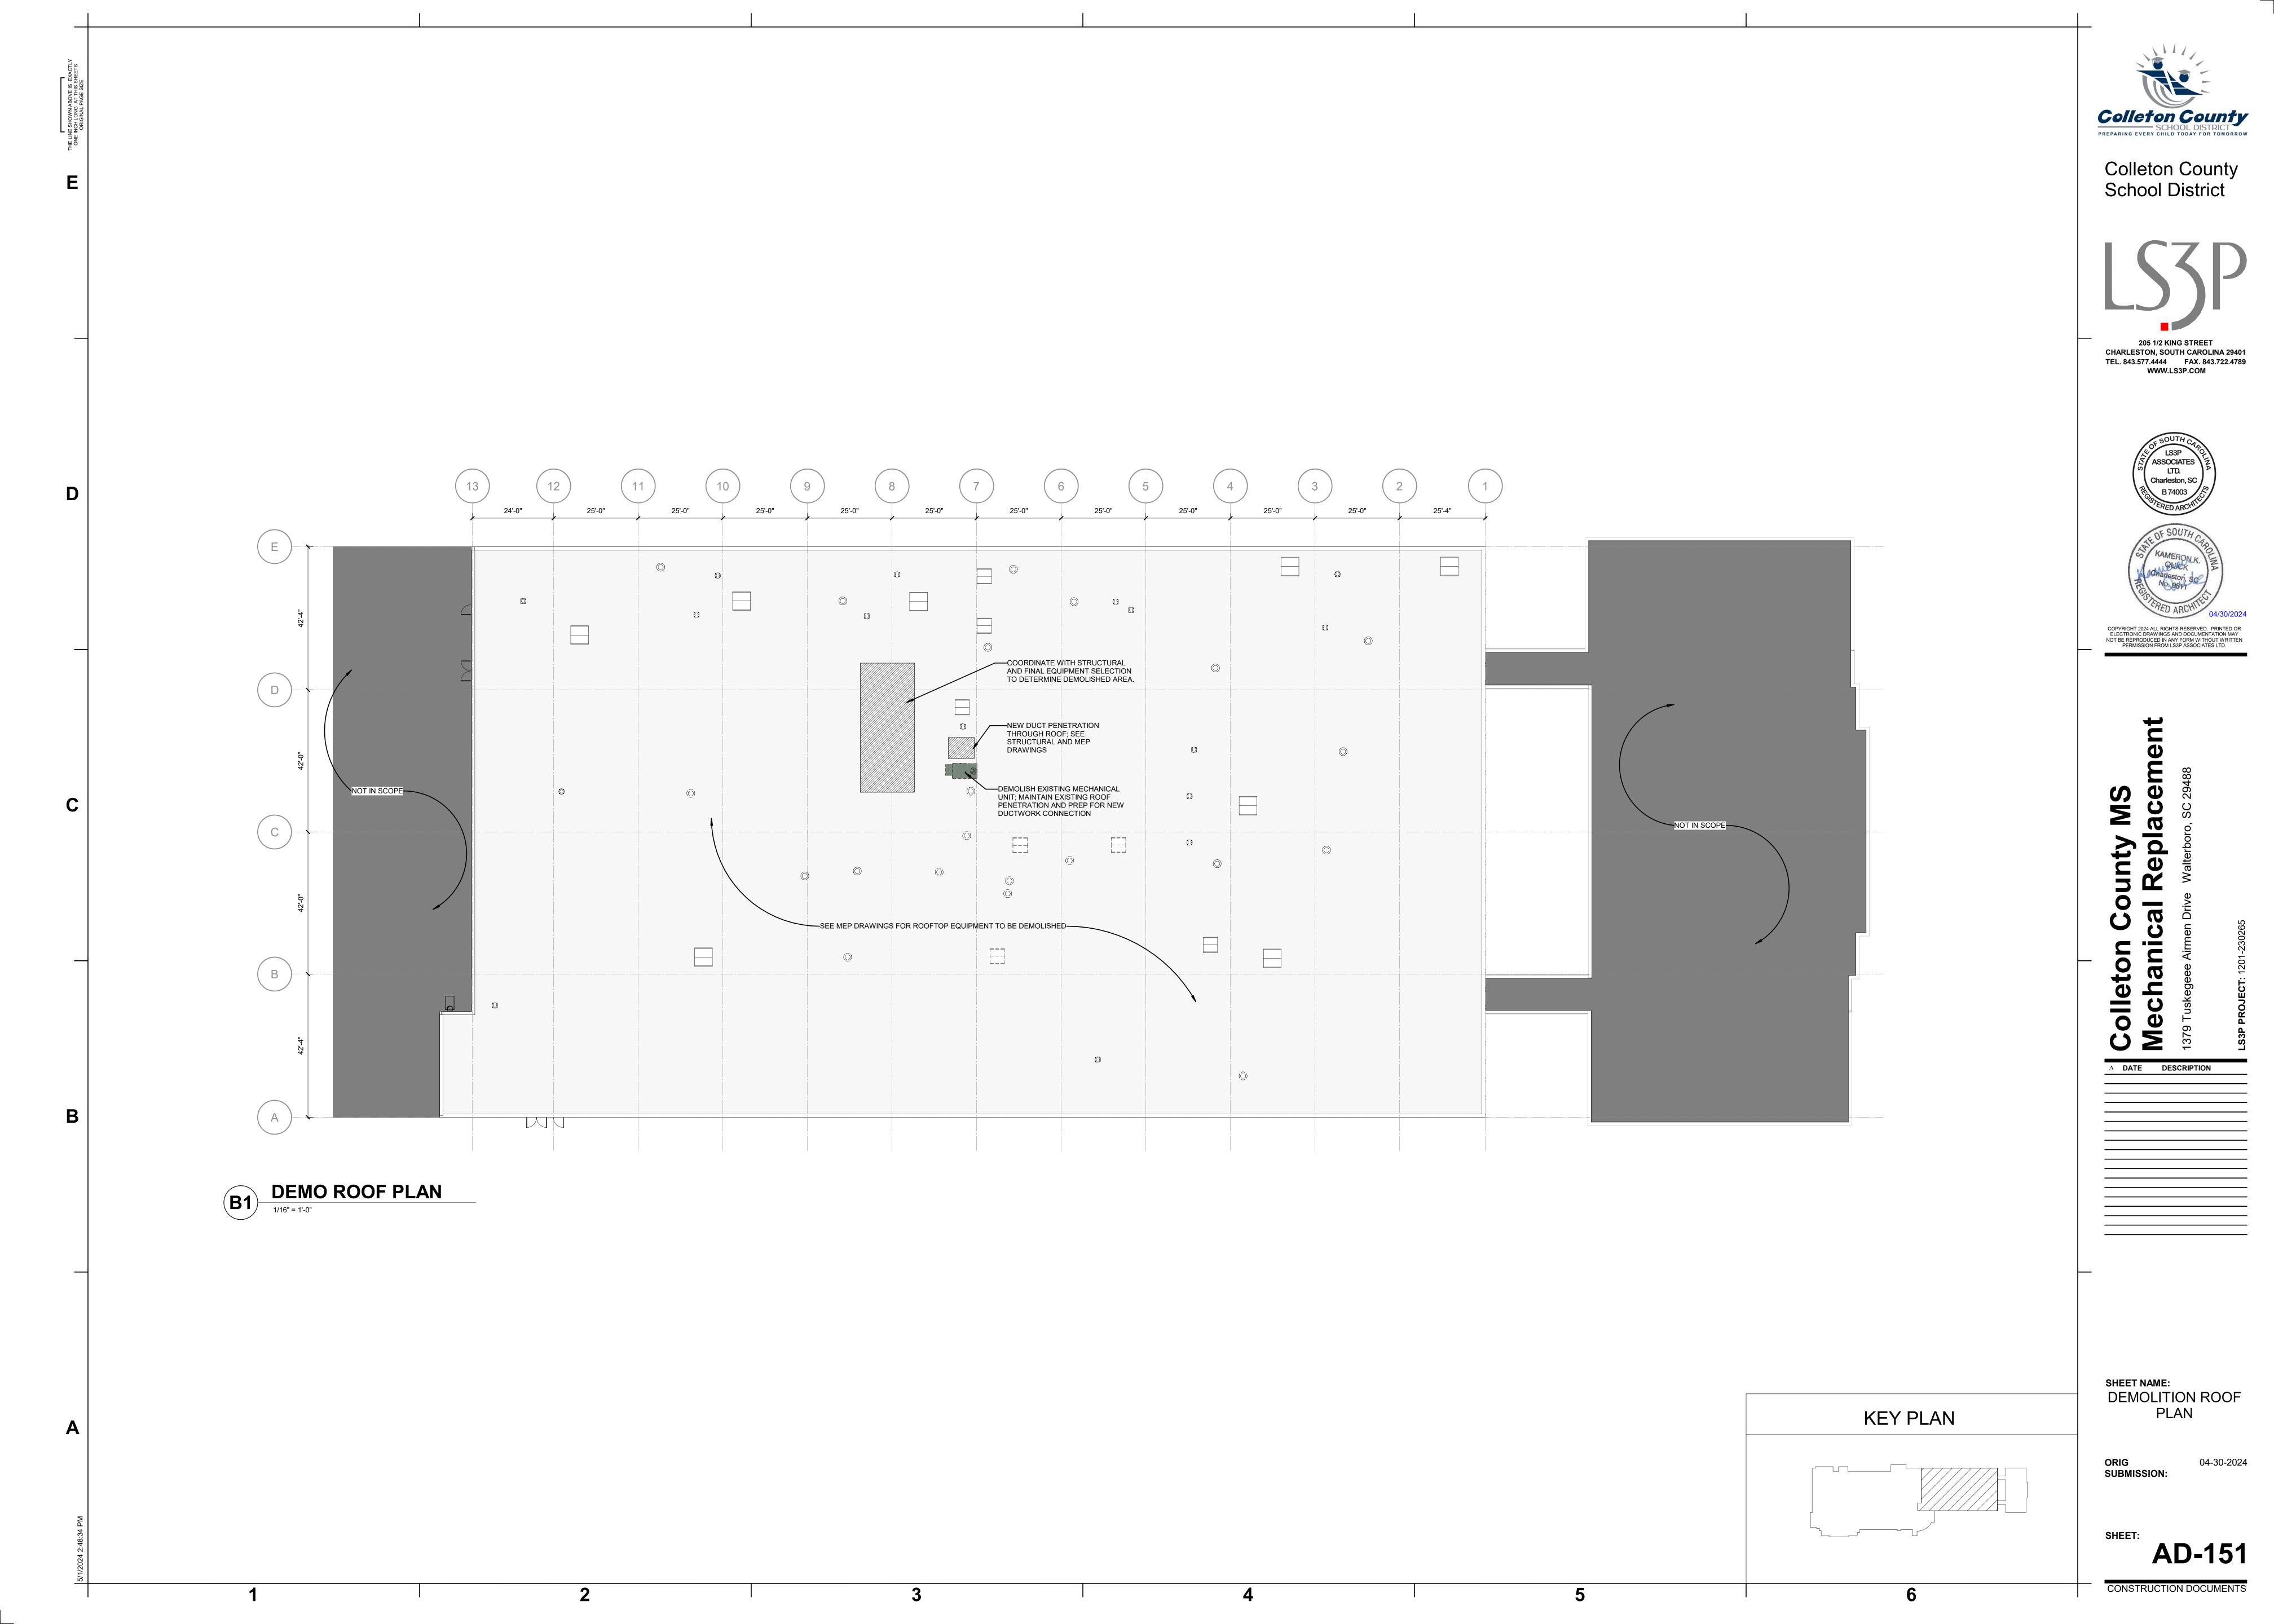
SHEET NAME: DEMOLITION REFLECTED **CEILING PLANS**

SUBMISSION:


NOTE: NOT ALL ELEMENTS ARE SHOWN IN PLAN


04-30-2024


SHEET: **AD-121**





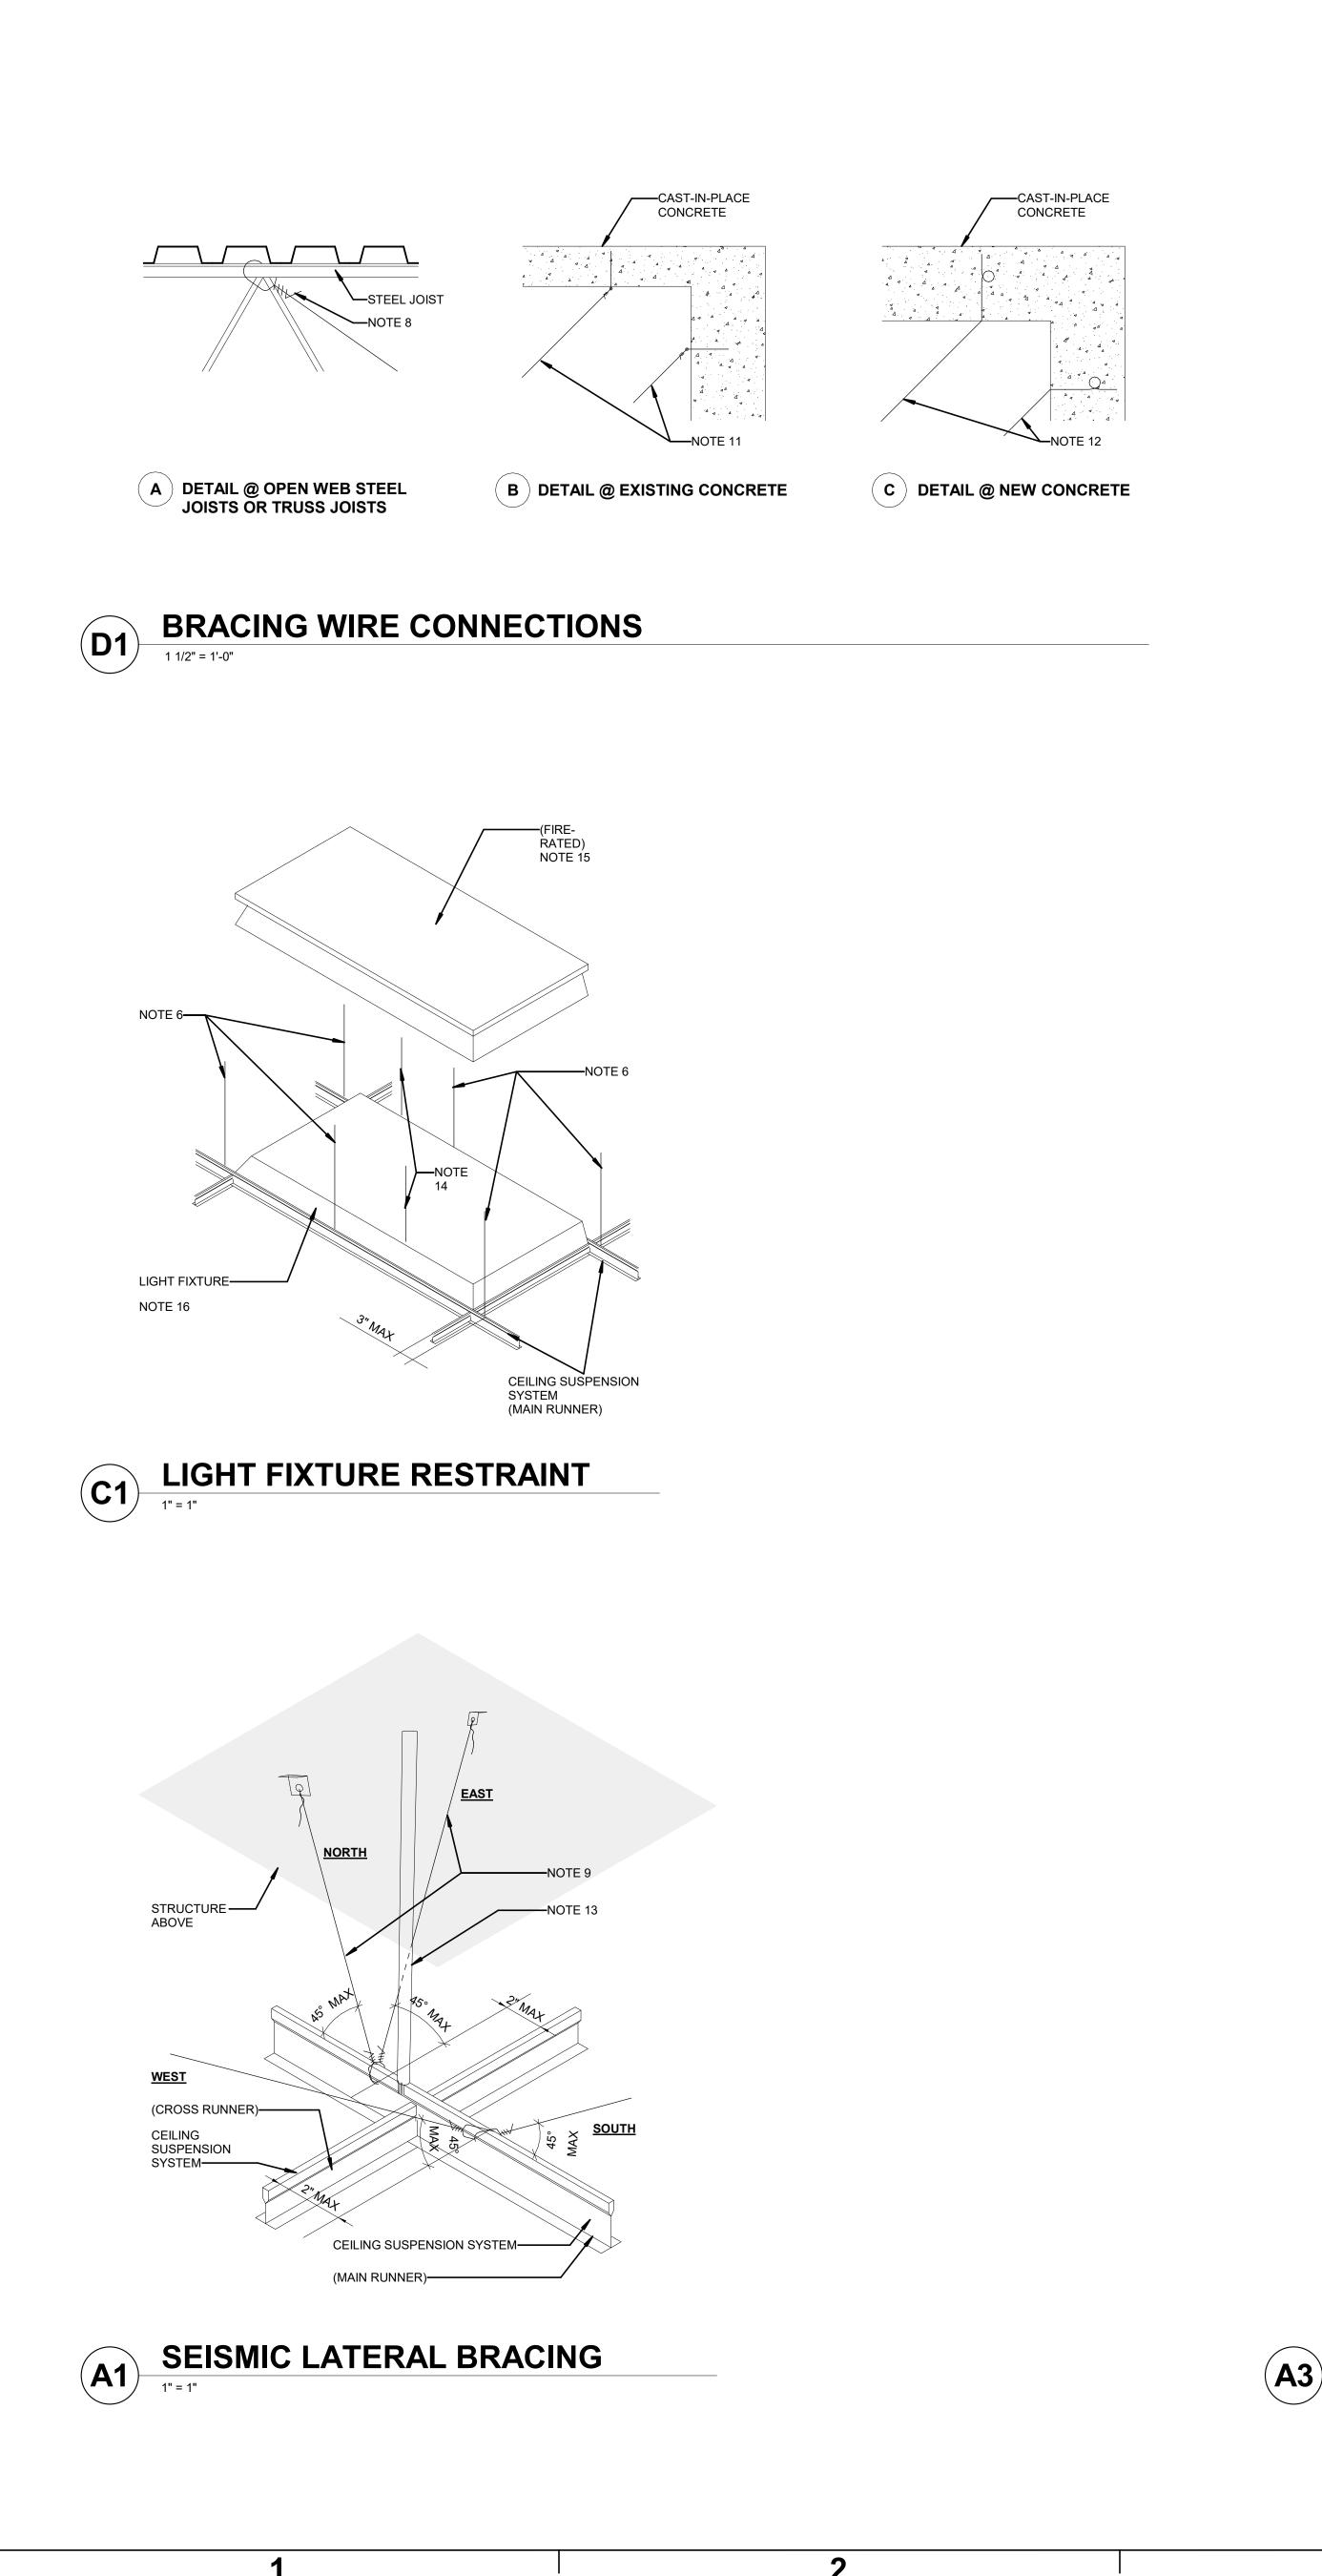


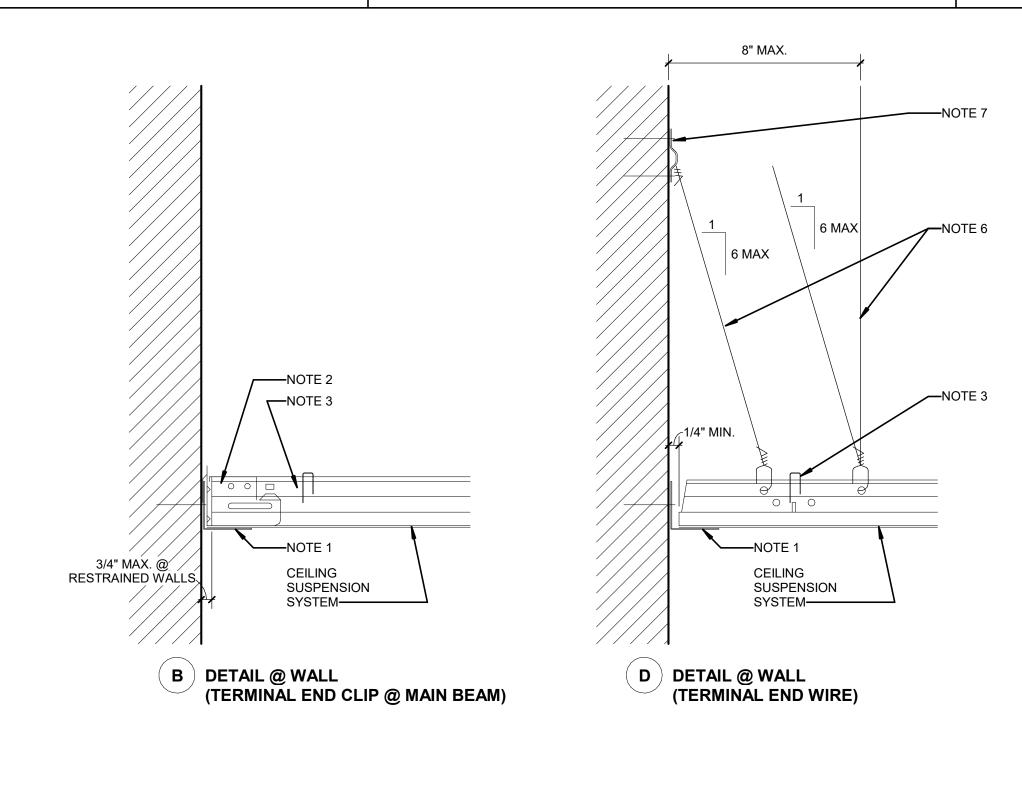

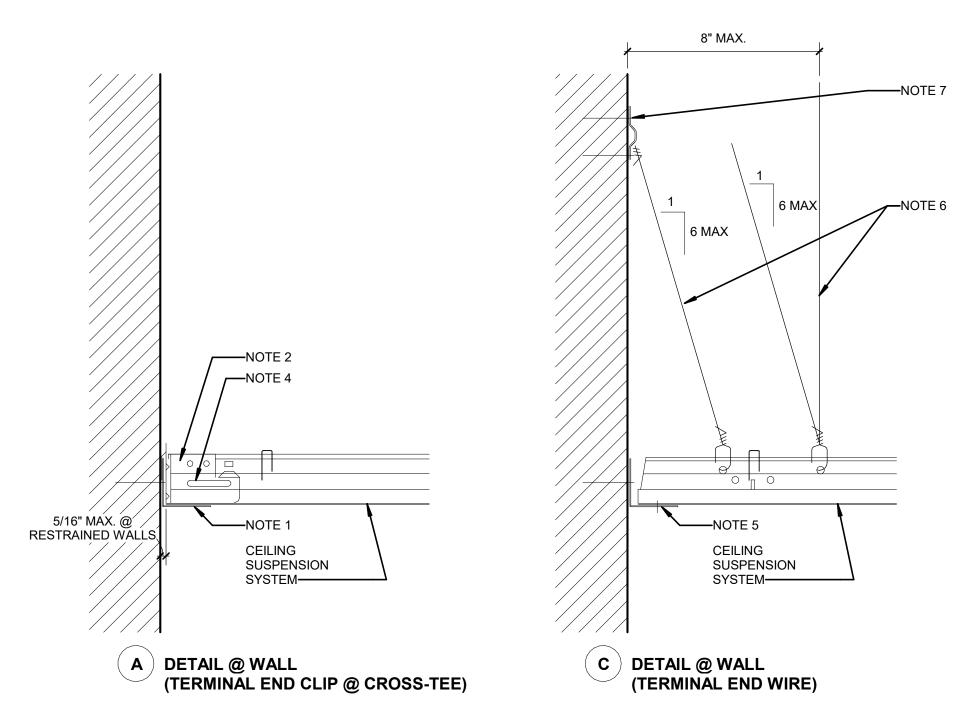

C3 CEILING GRID SEISMIC DETAILS @ WALL

TYPICAL SEISMIC CEILING PLAN

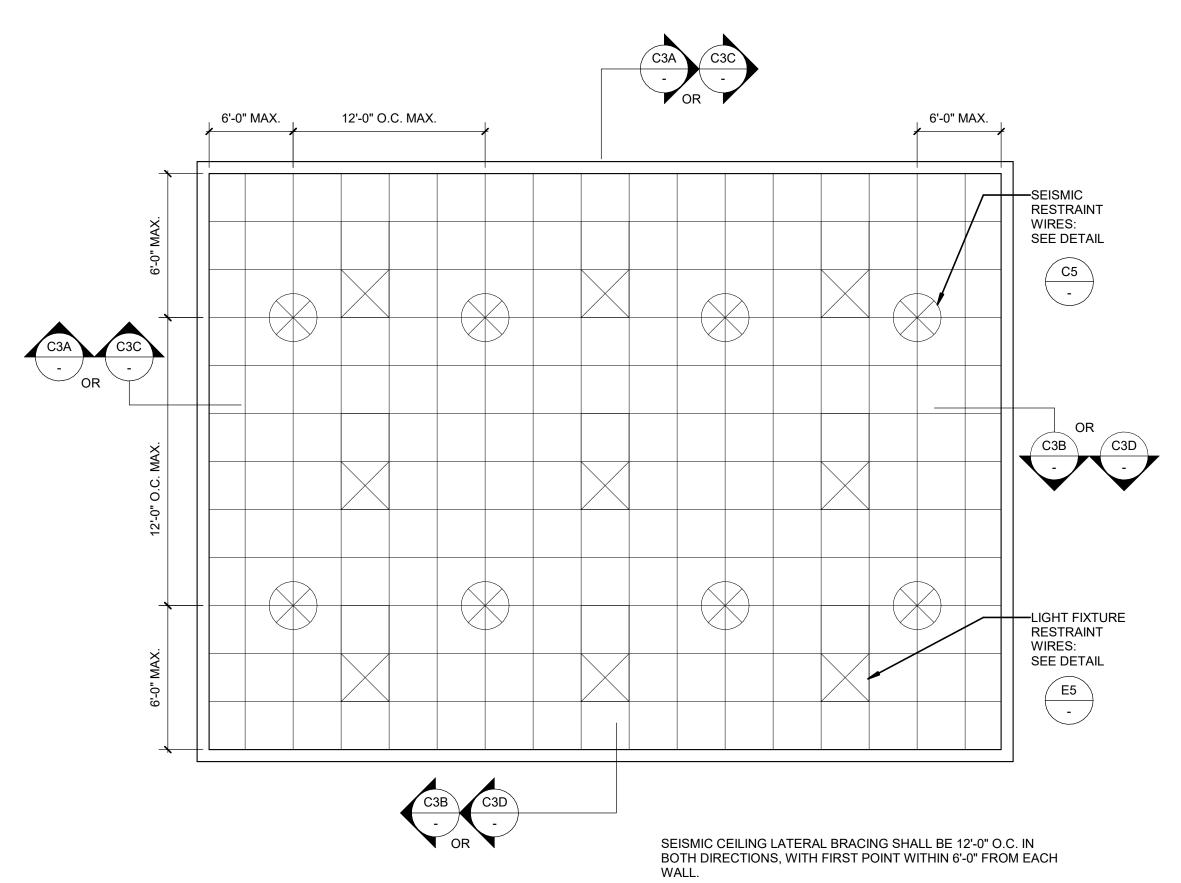

CEILING SEISMIC DESIGN GENERAL NOTES

FOR DESIGN CATEGORY D, E, & F

- A. CEILING SEISMIC DETAILS ARE PROVIDED TO ILLUSTRATE THE GENERAL REQUIREMENTS OF CISCA'S "GUIDELINES FOR SEISMIC RESTRAINT, SEISMIC DESIGN CATEGORY DESIGN D, E, & F AND THE IBC, CHAPTER 16.

 CONTRACTOR IS RESPONSIBLE FOR MEETING ALL APPLICABLE PROVISIONS OF THESE STANDARDS. IN CASE OF CONFLICT, THE MORE STRINGENT
- REQUIREMENT WILL BE ENFORCED.

 B. CEILING SEISMIC DETAILS SHOWN FOR CEILING SYSTEMS (INCLUDING ALL DEVICES SUPPORTED BY THE SYSTEM) WITH A COMBINED AVERAGE WEIGHT
- OF OVER 2.5 LBS/SF PER ASTM-E580-06

 C. DETAILS SHOWN ARE GENERAL DETAILS NOT SPECIFIC TO A MANUFACTURER. PROPRIETARY SEISMIC DETAILS NOT SHOWN MUST BE SUBMITTED BY CONTRACTOR DURING CONSTRUCTION FOR ARCHITECT'S REVIEW ACCORDING TO THE LATEST APPLICABLE ESR REPORT.

CEILING SEISMIC DESIGN SHEET NOTES

FOR DESIGN CATEGORY D, E, & F

- WALL ANGLE 2"x2". ATTACH TO WALL ONLY.
 BEAM END RETAINING CLIP.
- 3. STABILIZER BAR.
- 1/2" DIA S-12 SCREW.
 WALL ANGLE 2"x2". ATTACH TO RUNNER/TEE & WALL.
- WALL ANGLE 2 X2 : ATTACH TO ROUNGLIVILL & WALL.
 12 GA HANGER WIRE AT 48" O.C. AT MAIN GRIDS. INSTALL EITHER SLOPED OR VERTICALLY W/ MAX SLOPE TO BE 1 IN 6 (10°).
- 18 GA x 3/4" METAL STRAP. ANCHOR TO MASONRY WALL W/ HILTI SDF 22-7/8" LONG (OR EQUAL). ANCHOR TO STUD WALL WITH 20 GA S-12 SCREWS.
 12 GA SEISMIC RESTRAINT WIRES. WRAP & TIE @ TOP OF WEB MEMBERS.
 12 GA SEISMIC RESTRAINT WIRES. TIE TO METAL STRAP.
- 10. NOT USED
 11. 12 GA SEISMIC RESTRAINT WIRE. ANCHOR TO EXISTING STRUCTURE WITH
- 3/16" POWER DRIVEN EYE PIN.
 12. 12 GA SEISMIC RESTRAINT WIRE. PROVIDE PIG-TAILED LOOPS IN
- CONCRETE.

 13. PROVIDE COMPRESSION POST (BY CLG MANUF.) ANCHORED TO MAIN RUNNER & TO STRUCTURE ABOVE.
- 14. 12 GA HANGER WIRE. CONNECT TO LIGHT FIXTURE & STRUCTURE ABOVE. PROVIDE 2 MIN PER FIXTURE. WIRES MAY BE LEFT SLACK.
- 15. WIRE TO STRUCTURE ABOVE.16. ATTACH FIXTURE TO SUSPENDED GRID SYSTEM OR INDEPENDENTLY SUPPORT FIXTURE FROM STRUCTURE ABOVE.



Colleton County School District



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Colleton County MS Mechanical Replacement

Δ DATE DESCRIPTION

SHEET NAME: SEISMIC DETAILS

ORIG SUBMISSION:


SHEET:

A-122

CONSTRUCTION DOCUMENTS

3

USE THIS DETAIL FOR ROOM OVER 1,000 SF

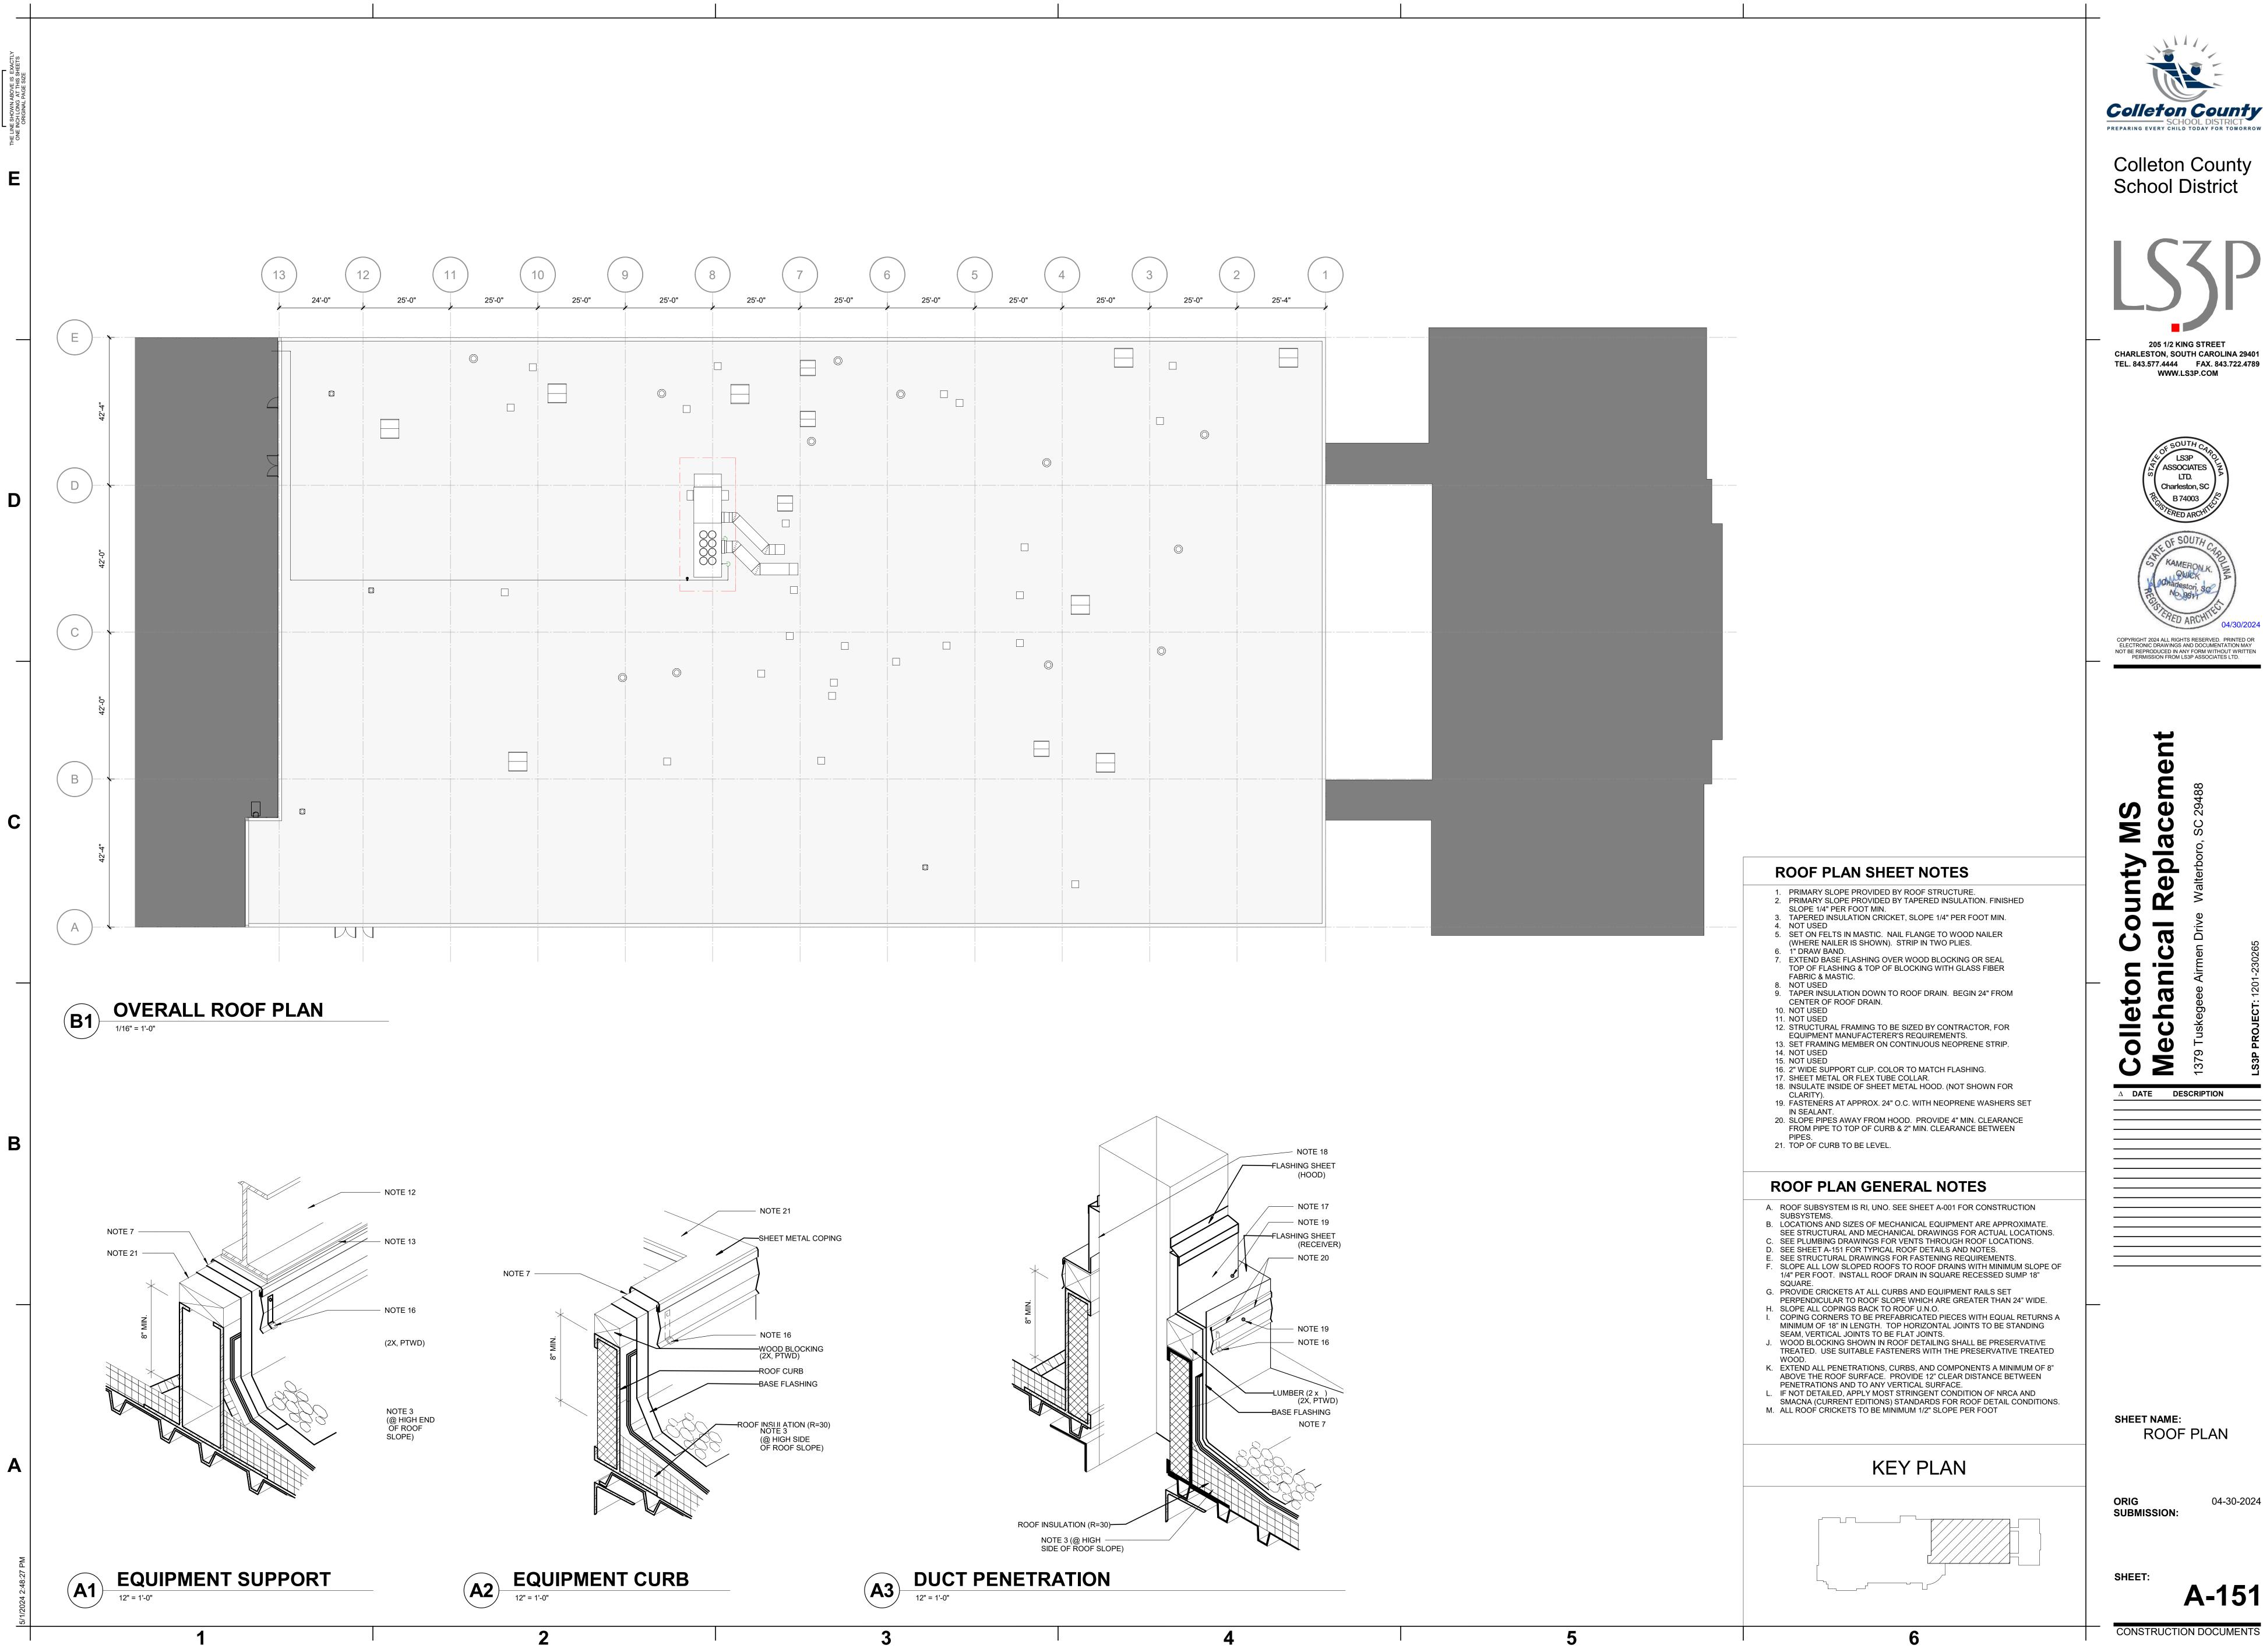


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Q

 Δ **DATE DESCRIPTION**

SHEET NAME: **ROOF PLAN**

04-30-2024 SUBMISSION:

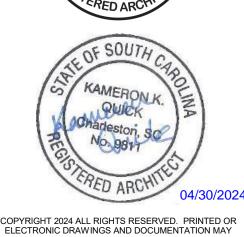A-151

GENERAL NOTES

- 1. THE DRAWINGS SHOW THE GENERAL ARRANGEMENT AND LOCATIONS OF THE MECHANICAL WORK. THE CONTRACTOR SHALL COORDINATE THE MECHANICAL INSTALLATION WITH THE STRUCTURE AND ALL OTHER TRADES. PERFORM ALL WORK IN ACCORDANCE WITH 2021
- 2. REFER TO THE ARCHITECTURAL REFLECTED CEILING PLANS FOR EXACT LOCATIONS OF THE CEILING MOUNTED DEVICES.
- 3. DUCTWORK SHOWN ON THE PLANS IS SIZED AND ROUTED BASED ON INFORMATION AVAILABLE DURING DESIGN PHASE FOR CEILING HEIGHTS, STRUCTURAL MEMBERS, ETC. ALL DUCTS SIZES AND ROUTINGS MUST BE CONFIRMED IN THE FIELD BY THE CONTRACTOR PRIOR TO FABRICATION AND INSTALLATION. WHERE CONFLICTS ARISE. REFER TO THE
- 4. REFER TO SENSOR MOUNTING DETAIL FOR MOUNTING HEIGHT.

INTERNATIONAL MECHANICAL CODE (IMC) WITH SC AMENDMENTS.

- 5. ALL CONCEALED SUPPLY AIR AND RETURN AIR DUCTWORK SHALL HAVE ONE LAYER OF TYPE 'A' DUCT WRAP. ALL LINED DUCTWORK CALLED OUT ON PLANS SHALL HAVE ONE LAYER OF TYPE 'A' DUCT LINER. ALL EXPOSED RECTANGULAR DUCTWORK SHALL HAVE ONE LAYER OF TYPE 'A' DUCT LINER AND SHALL HAVE PAINT GRIP FINISH WITH COLOR SELECTED BY ARCHITECT. GENERAL EXHAUST AIR DUCTWORK SHALL NOT BE INSULATED. (SEE SECTION
- 6. ROOF MOUNTED EQUIPMENT SHALL BE LOCATED 10 FEET MINIMUM FROM ROOF EDGE.
- 7. DEVICES REQUIRED TO BE ACCESSIBLE SHALL NOT BE INSTALLED ABOVE DRYWALL CEILINGS. REFER TO ARCHITECTURAL REFLECTED CEILING PLANS FOR LOCATIONS OF HARD CEILINGS.
- 8. SMOKE DAMPERS SHALL BE ACTUATED BY CEILING MOUNTED SMOKE DETECTORS FURNISHED AND INSTALLED BY DIV. 26/27.
- 9. ALL FIRE DAMPERS AND SMOKE DAMPERS (AS APPLICABLE) SHALL BE INSTALLED IN ACCORDANCE WITH THE MANUFACTURER'S UL LISTED DETAILS.
- 10. CONNECT NEW EQUIPMENT TO THE EXISTING INTEGRATED SOLUTIONS CAMPUS CONTROL SYSTEM. UPDATE BUILDING GRAPHICS WITH THE NEW EQUIPMENT.

DEMOLITION NOTES

REMARKS

GREENHECK RVE

HORIZONTAL DISCHARGE

- 1. THE DRAWINGS SHOW THE GENERAL ARRANGEMENT AND LOCATIONS OF EXISTING MECHANICAL WORK. THE CONTRACTOR SHALL FIELD-VERIFY LOCATIONS PRIOR TO PERFORMING DEMOLITION WORK AND SHALL NOTIFY THE ENGINEER OF ANY CONFLICTS OR DISCREPANCIES. DUCTWORK ROUTES WERE ESTIMATED FROM ORIGINAL PLANS. THIS INFORMATION WAS SUPPLEMENTED BY LIMITED FIELD OBSERVATION. DETAILED ABOVE-CEILING VERIFICATION OF DUCTWORK HAS NOT BEEN PERFORMED.
- 2. HATCHING INDICATES ITEMS TO BE DEMOLISHED, UNLESS NOTED OTHERWISE. DEMOLISHED ITEMS SHALL BE REMOVED FROM THE SITE AND DISPOSED OF BY THE CONTRACTOR. DEMOLITION OF AN ITEM SHALL INCLUDE ASSOCIATED DUCTWORK, AIR DISTRIBUTION DEVICES, HANGERS, SUPPORTS, BRACKETS, ROOF CURB, PIPING, CONDUIT, WIRING, CONTROLS, ETC. UNLESS NOTED OTHERWISE. IN EXPOSED AREAS, BUILDING SURFACES AFFECTED BY DEMOLITION SHALL BE REPAIRED AND REFINISHED TO MATCH EXISTING.
- 3. AT LOCATIONS WHERE MECHANICAL DEMOLITION RESULTS IN WALL OPENINGS, ALL SUCH OPENINGS SHALL BE CLOSED OFF WITH WALL MATERIALS AND FINISH TO MATCH SURROUNDING WALL. IF ANY SUCH WALLS ARE FIRE-RATED, THE FIRE RATING MUST BE MAINTAINED. ENSURE THAT EXISTING WALL OPENINGS WILL NOT BE REUSED IN THE NEW WORK PLANS BEFORE SEALING WALL PENETRATIONS. COORDINATE WITH ARCHITECTURAL DRAWINGS FOR ADDITIONAL INSTRUCTIONS/DETAILS FOR OPENING REPAIRS.
- 4. AT LOCATIONS WHERE MECHANICAL DEMOLITION RESULTS IN CEILING OPENINGS, ALL SUCH OPENINGS SHALL BE CLOSED OFF WITH MATERIALS AND FINISH TO MATCH SURROUNDING CEILING. REPLACE ALL DAMAGED ACOUSTICAL CEILING TILES AND REPAIR DAMAGED CEILING GRIDS FOR ALL SUCH AREAS AFFECTED BY DEMOLITION. IF ANY SUCH CEILINGS ARE RATED, THE RATING MUST BE MAINTAINED. COORDINATE WITH ARCHITECTURAL DRAWINGS FOR ADDITIONAL INSTRUCTIONS/DETAILS FOR OPENING REPAIRS.
- 5. AT LOCATIONS WHERE MECHANICAL DEMOLITION RESULTS IN ROOF OPENINGS, ALL SUCH OPENINGS SHALL BE ADEQUATELY CAPPED AND SEALED. ENSURE THAT EXISTING ROOF PENETRATIONS WILL NOT BE REUSED IN THE NEW WORK PLANS BEFORE SEALING ROOF PENETRATIONS. COORDINATE WITH ARCHITECTURAL DRAWINGS FOR ADDITIONAL INSTRUCTIONS/DETAILS FOR OPENING REPAIRS.
- 6. COORDINATE THE DEMOLITION OF EQUIPMENT AND ALL ASSOCIATED ITEMS WITH PHASING AS DIRECTED BY THE OWNER. IT IS THE CONTRACTOR'S RESPONSIBILITY TO ENSURE THAT DEMOLITION OF AN ITEM DOES NOT AFFECT THE HVAC OPERATION IN A DIFFERENT PHASE. ALL DEMOLISHED ITEMS SHALL BE OFFERED BACK TO THE OWNER FOR FIRST REFUSAL. CONTRACTOR IS THEN RESPONSIBLE FOR PROPER DISPOSAL OF ALL REMOVED MATERIALS
- 7. REFER TO ARCHITECTURAL DETAILS FOR WEATHER TIGHT AND FLASHING DETAILS.

		SUPPLY AIR DUCT
		RETURN AIR DUCT OR EXHAUST DUCT
		DUCT TRANSITION
		EXTERIOR DUCT
		SINGLE WALL SPIRAL SEAM DUCT
		DOUBLE WALL SPIRAL SEAM DUCT
		LINED DUCT
		EXISTING DUCT
	i 	— X = DIFFUSER TYPE / Y = THROW
<u> </u>		— Z = AIRFLOW, CFM
	MD	MANUAL DAMPER
	MD	MOTORIZED DAMPER
<u> </u>	VAVD	VARIABLE AIR VOLUME DAMPER
╩ █ █	FD	FIRE DAMPER
	SD	SMOKE DAMPER
」 [¬] Ţ	FSD	FIRE / SMOKE DAMPER
7_1	CRD	CEILING RADIATION DAMPER
	-	SINGLE WALL TURNING VANES
<u>⊬</u> ↓		FLEXIBLE DUCT CONNECTION
 	AD	ACCESS DOOR
	SDR	SUBDUCT RISER
	ABD	
	AHU	AIR HANDLING UNIT
	TU	TERMINAL UNIT
	FCU	FAN COIL UNIT
	CH	CHILLER
	В	BOILER
		COOLING TOWER
	P	PUMP
	PHE	PLATE HEAT EXCHANGER
	HP	SPLIT SYSTEM HEAT PUMP
	AH	SPLIT SYSTEM AIR HANDLER
	DHP	DUCTLESS HEAT PUMP
	DAH	DUCTLESS AIR HANDLER
	WHP	WALL MOUNT HEAT PUMP
	THP	THRU WALL HEAT PUMP
	RHP	ROOF HEAT PUMP
	WSHP	WATER SOURCE HEAT PUMP
	HPWH	HEAT PUMP WATER HEATER
	VRF	VARIABLE REFRIGERANT FLOW
	VAH	VRF AIR HANDLER
	VHP	VRF HEAT PUMP
	HRC	MAIN HEAT RECOVERY CONTROLLER
	SUB	SUB HEAT RECOVERY CONTROLLER
	AC	SPLIT SYSTEM AIR CONDITIONER
	СС	SPLIT SYSTEM COOLING COIL
	WAC	WALL MOUNT AIR CONDITIONER
	RAC	ROOF AIR CONDITIONER
	DOAS	DEDICATED OUTDOOR AIR SYSTEM
	ERV	ENERGY RECOVERY VENTILATOR
	EF	EXHAUST FAN
D		THERMOSTAT / TEMPERATURE SENSOR
)		HUMIDISTAT / HUMIDITY SENSOR



School District

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 Δ DATE DESCRIPTION

SHEET NAME: **MECHANICAL** SCHEDULES & LEGENDS

04/30/2024 SUBMISSION:

SHEET:

M100

CONSTRUCTION DOCUMENTS

DULOHERY WEEKS & ENGINEERS

DIAMETER

AFF ABOVE FINISH FLOOR

UNDERGROUND


CONNECT TO EXISTING

OA OUTDOOR AIR

W/ WITH

—— D —— HVAC DRAIN PIPING

Ø DIA

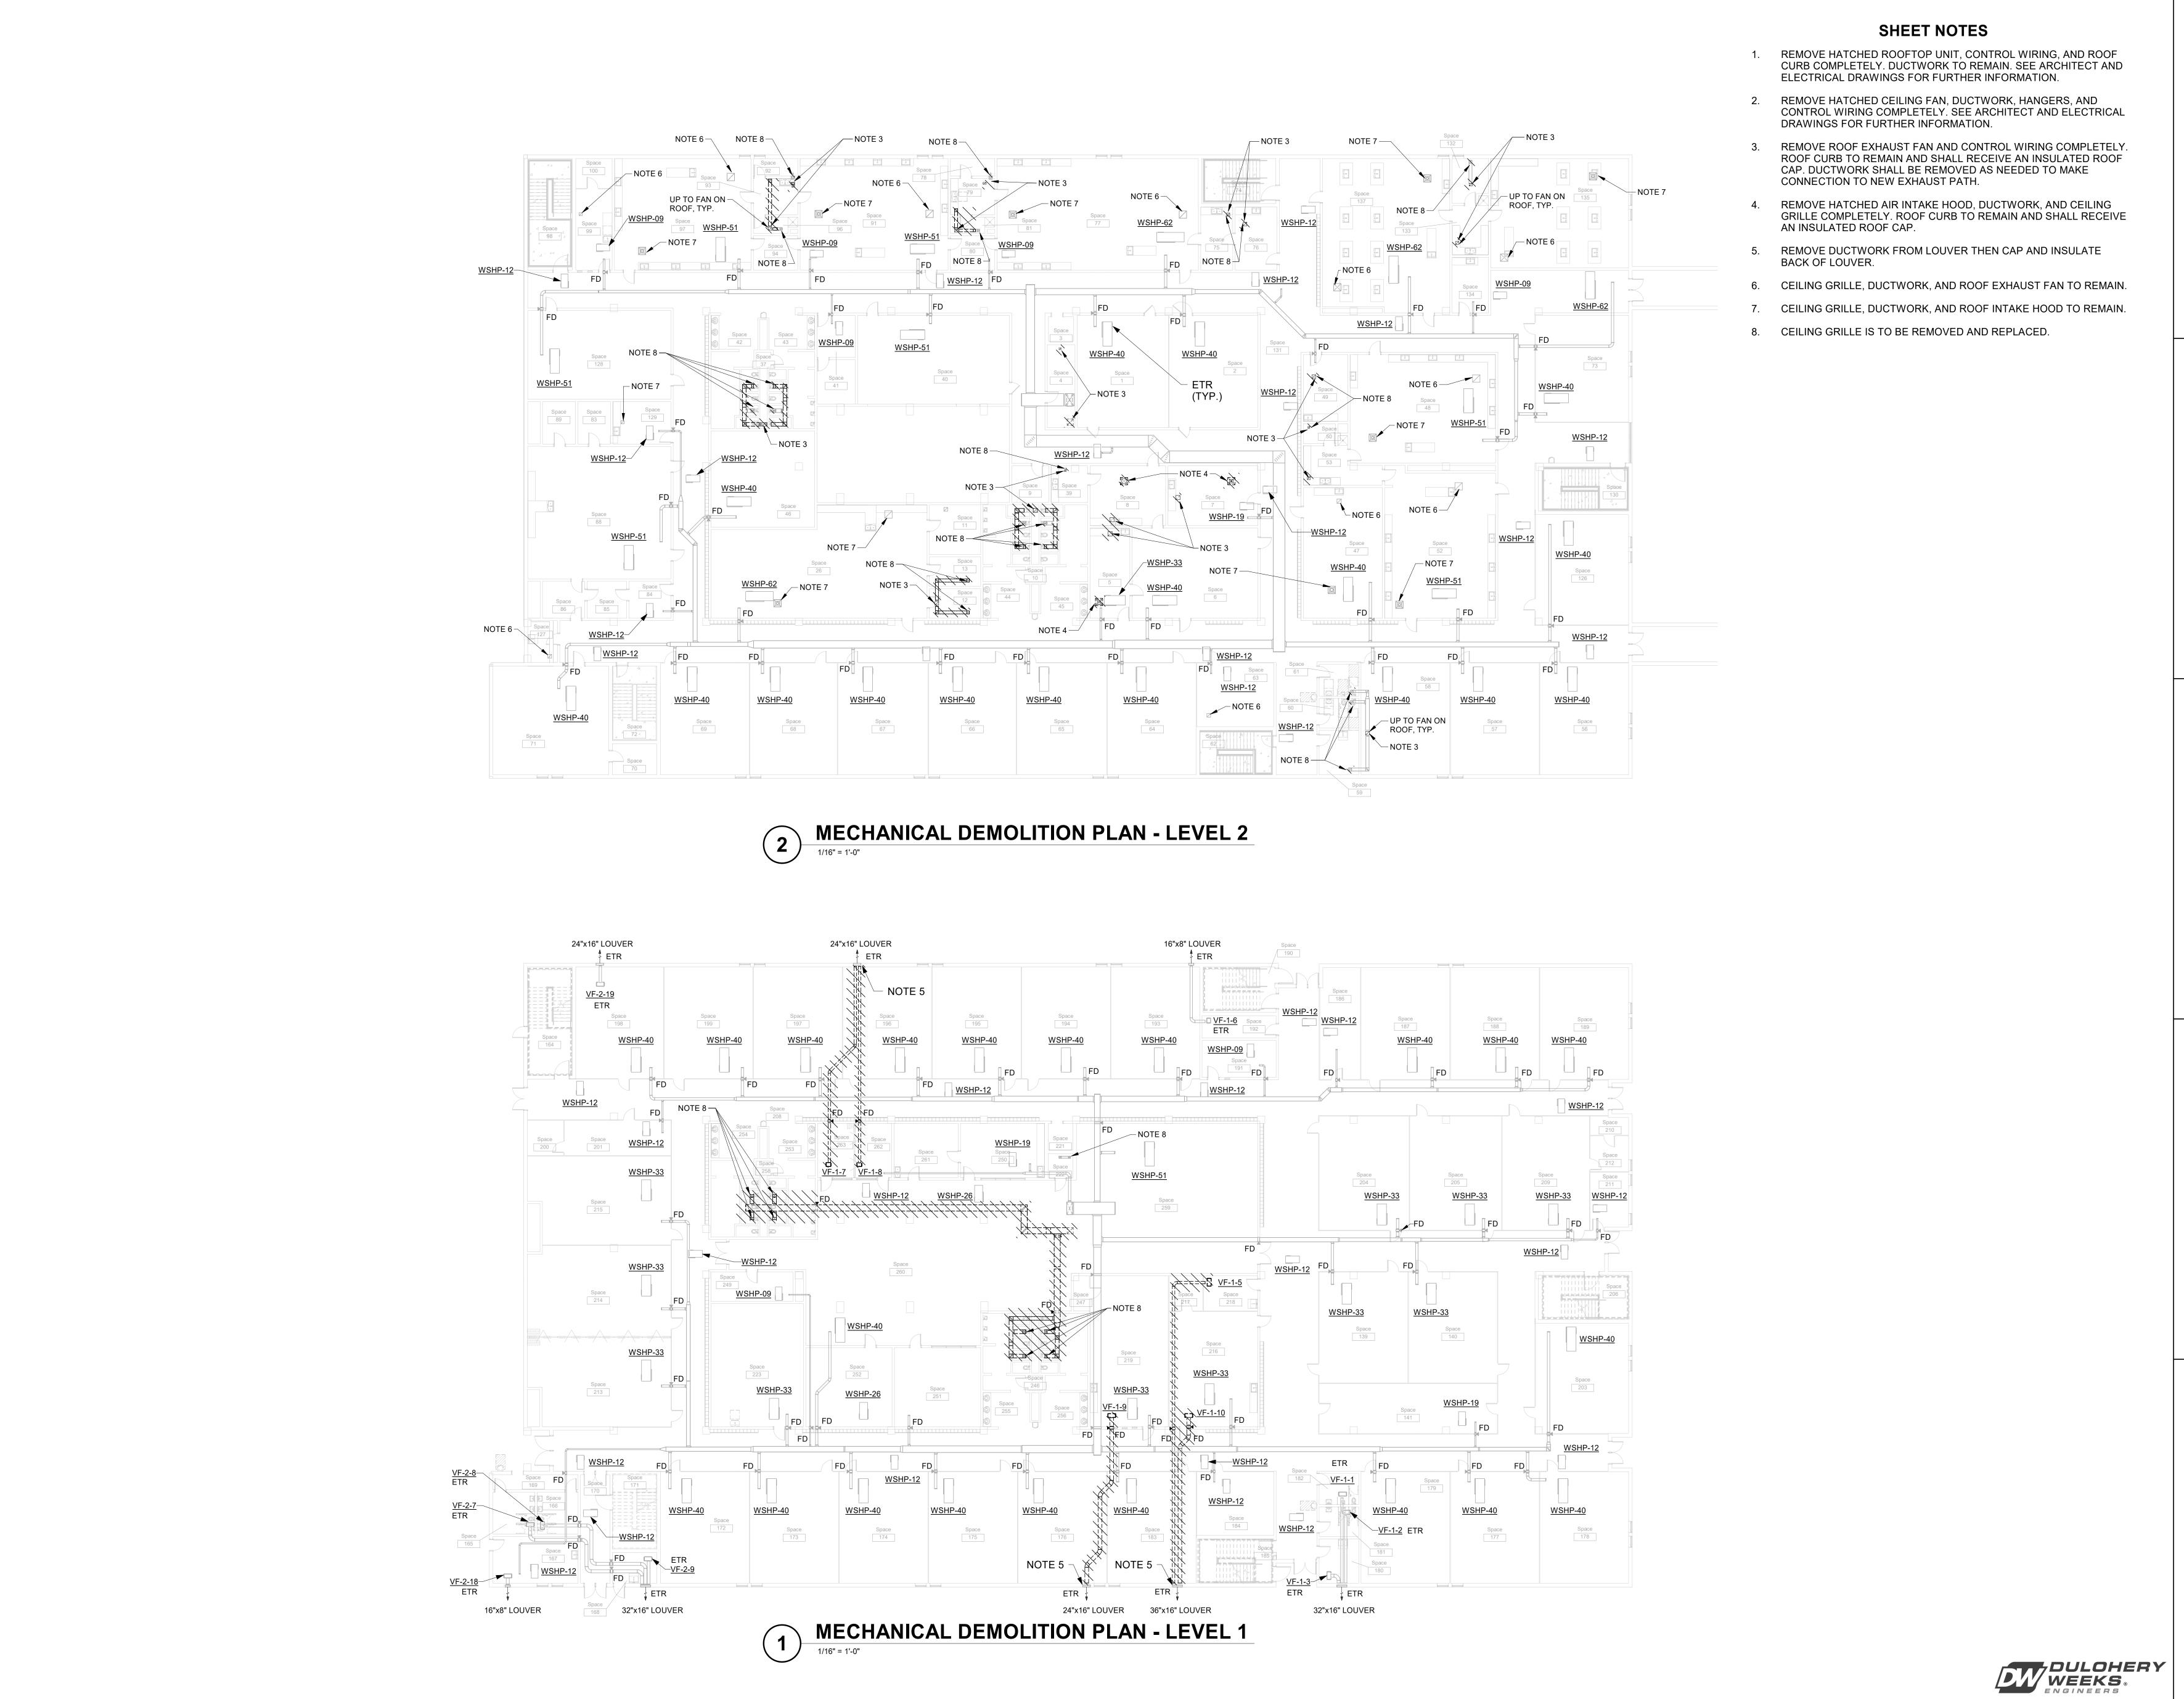






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△ DATE DESCRIPTION



MECHANICAL DEMOLITION PLAN

ORIG SUBMISSION:

MD101 CONSTRUCTION DOCUMENTS

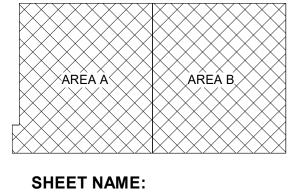

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Solleton County MS Mechanical Replacement

DATE DESCRIPTION

AREA A AREA B

SHEET NAME:

MECHANICAL

DEMOLITION PLAN
ROOF


ORIG SUBMISSION:

мD102

04/30/2024

CONSTRUCTION DOCUMENTS

CONSTRUCTION DO

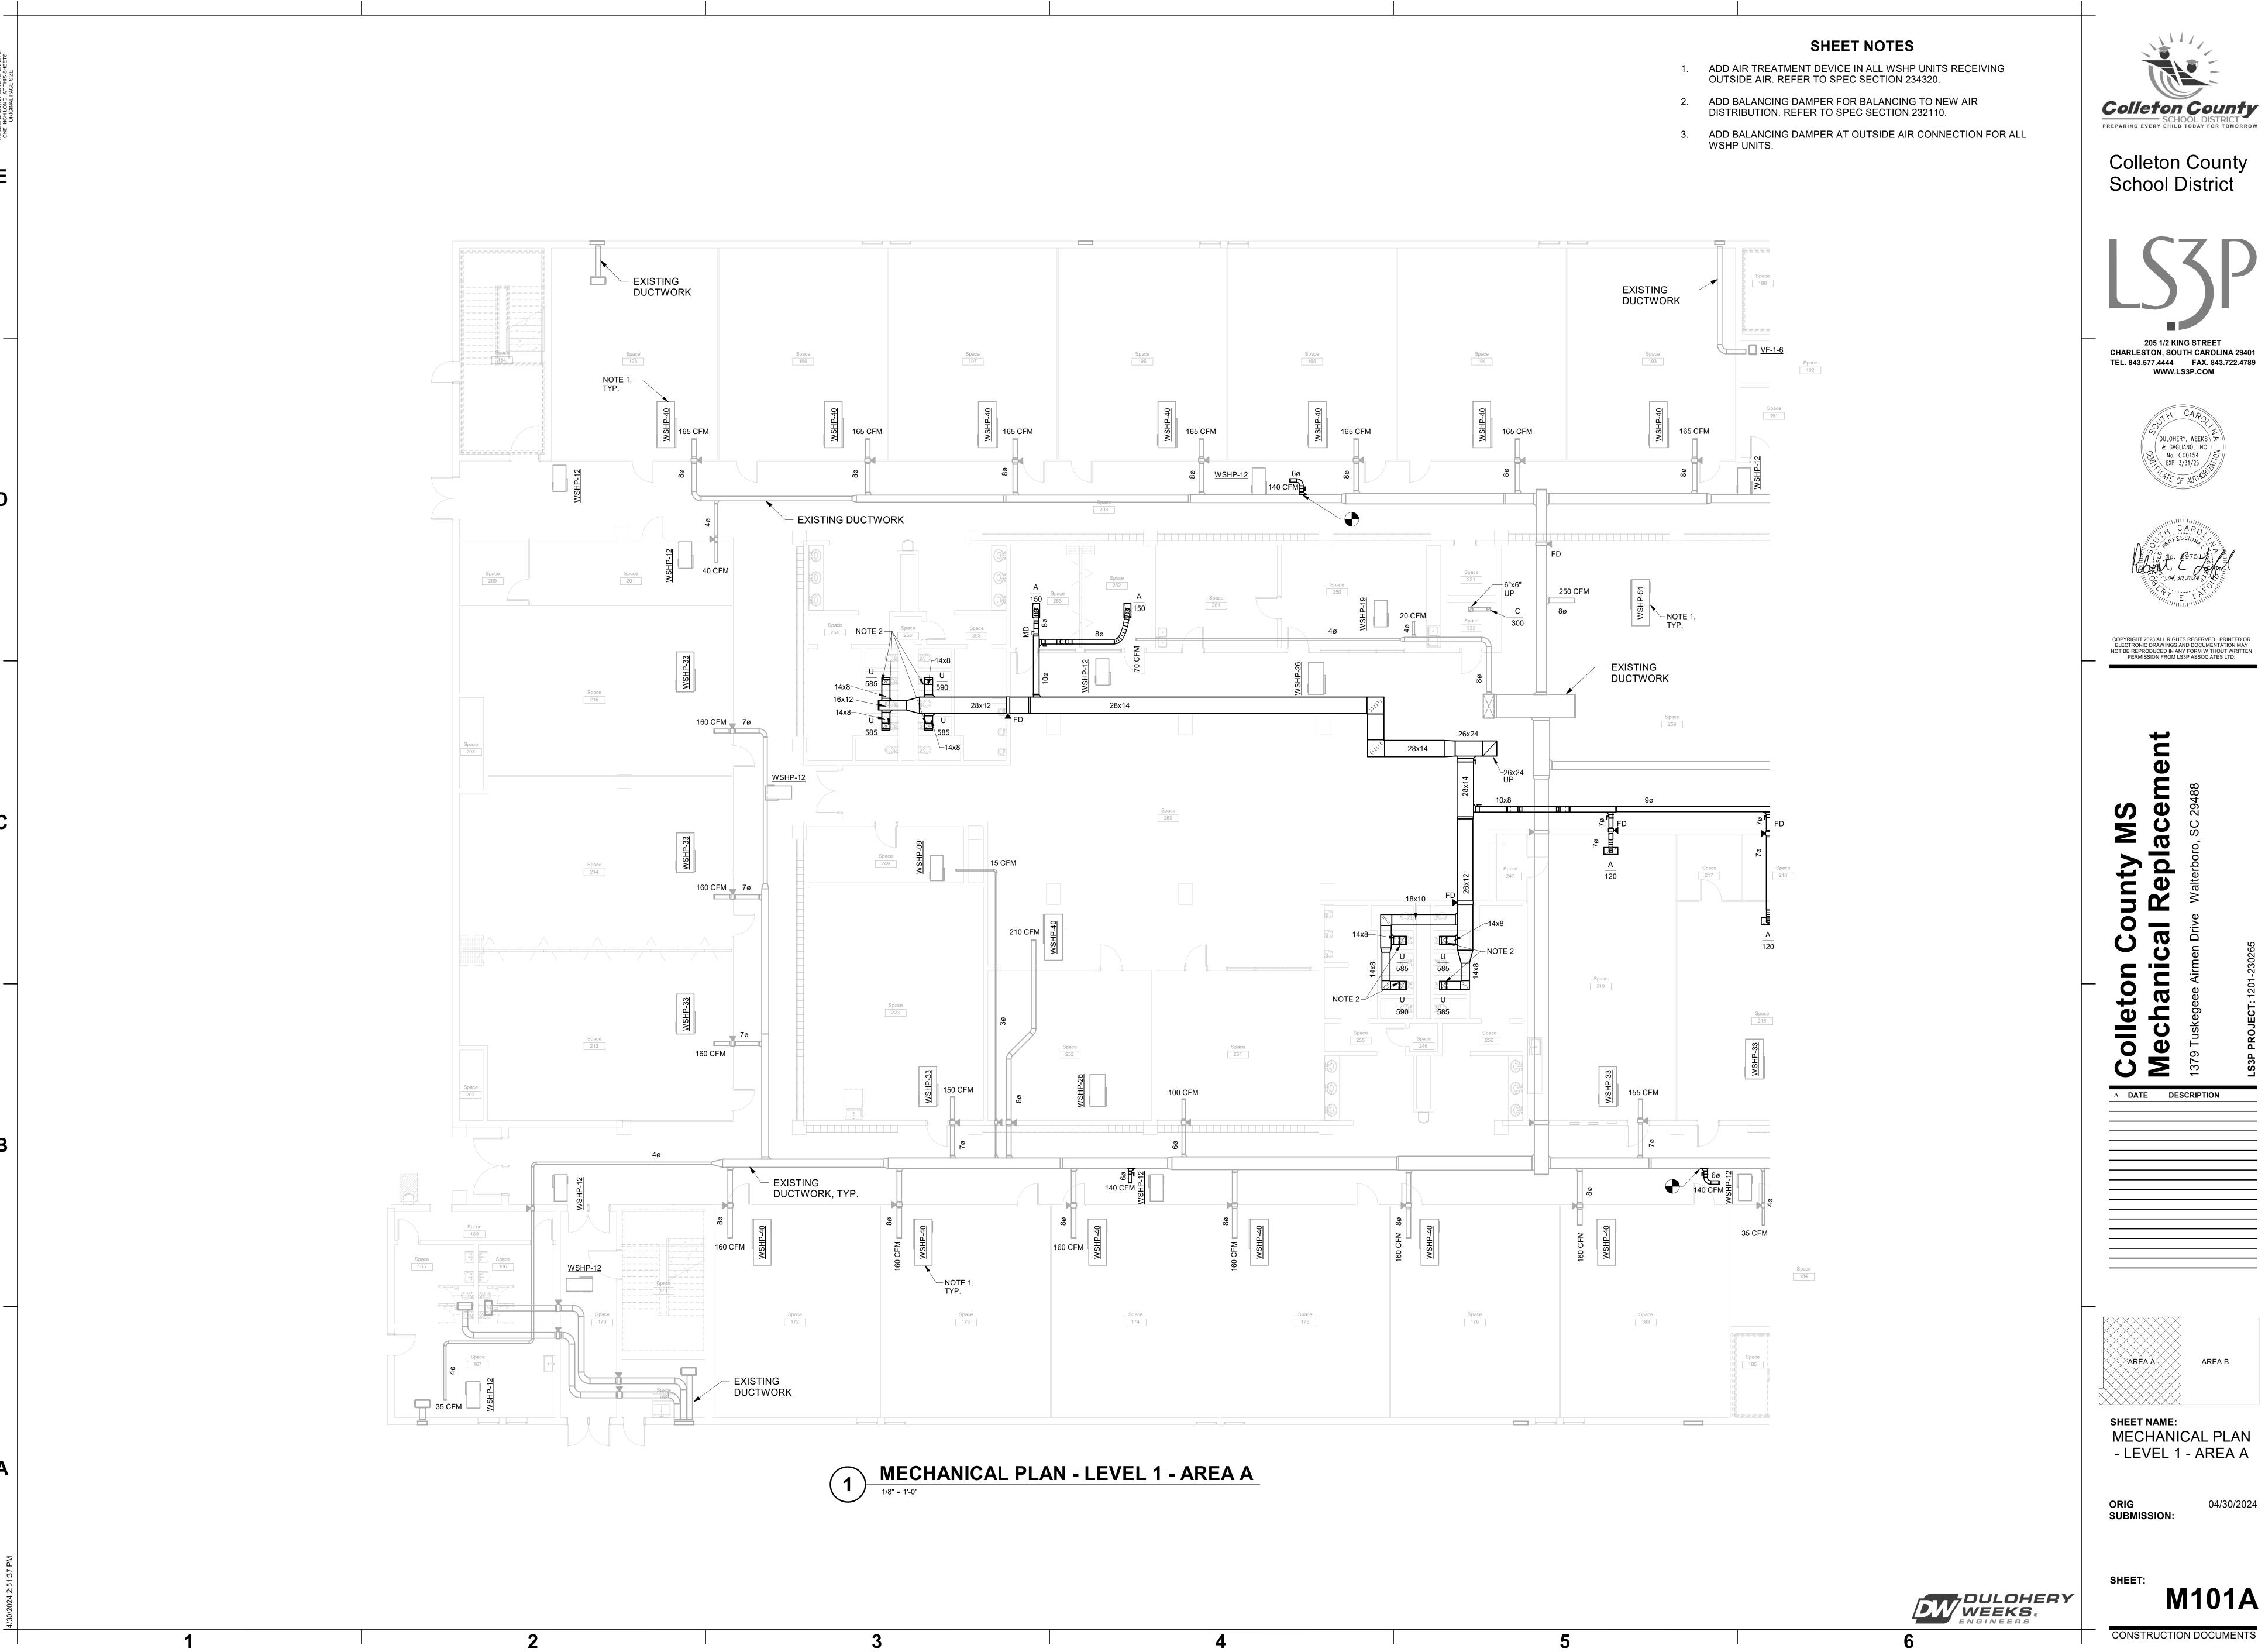










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SHEET NAME: MECHANICAL PLAN - LEVEL 1 - AREA A

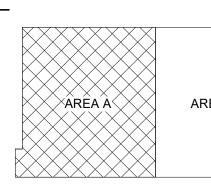ORIG SUBMISSION:

M101A











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SHEET NAME: MECHANICAL PLAN - LEVEL 1 - AREA B

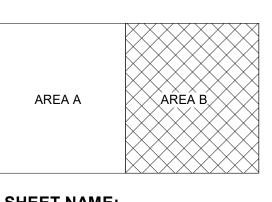ORIG SUBMISSION:

M101B



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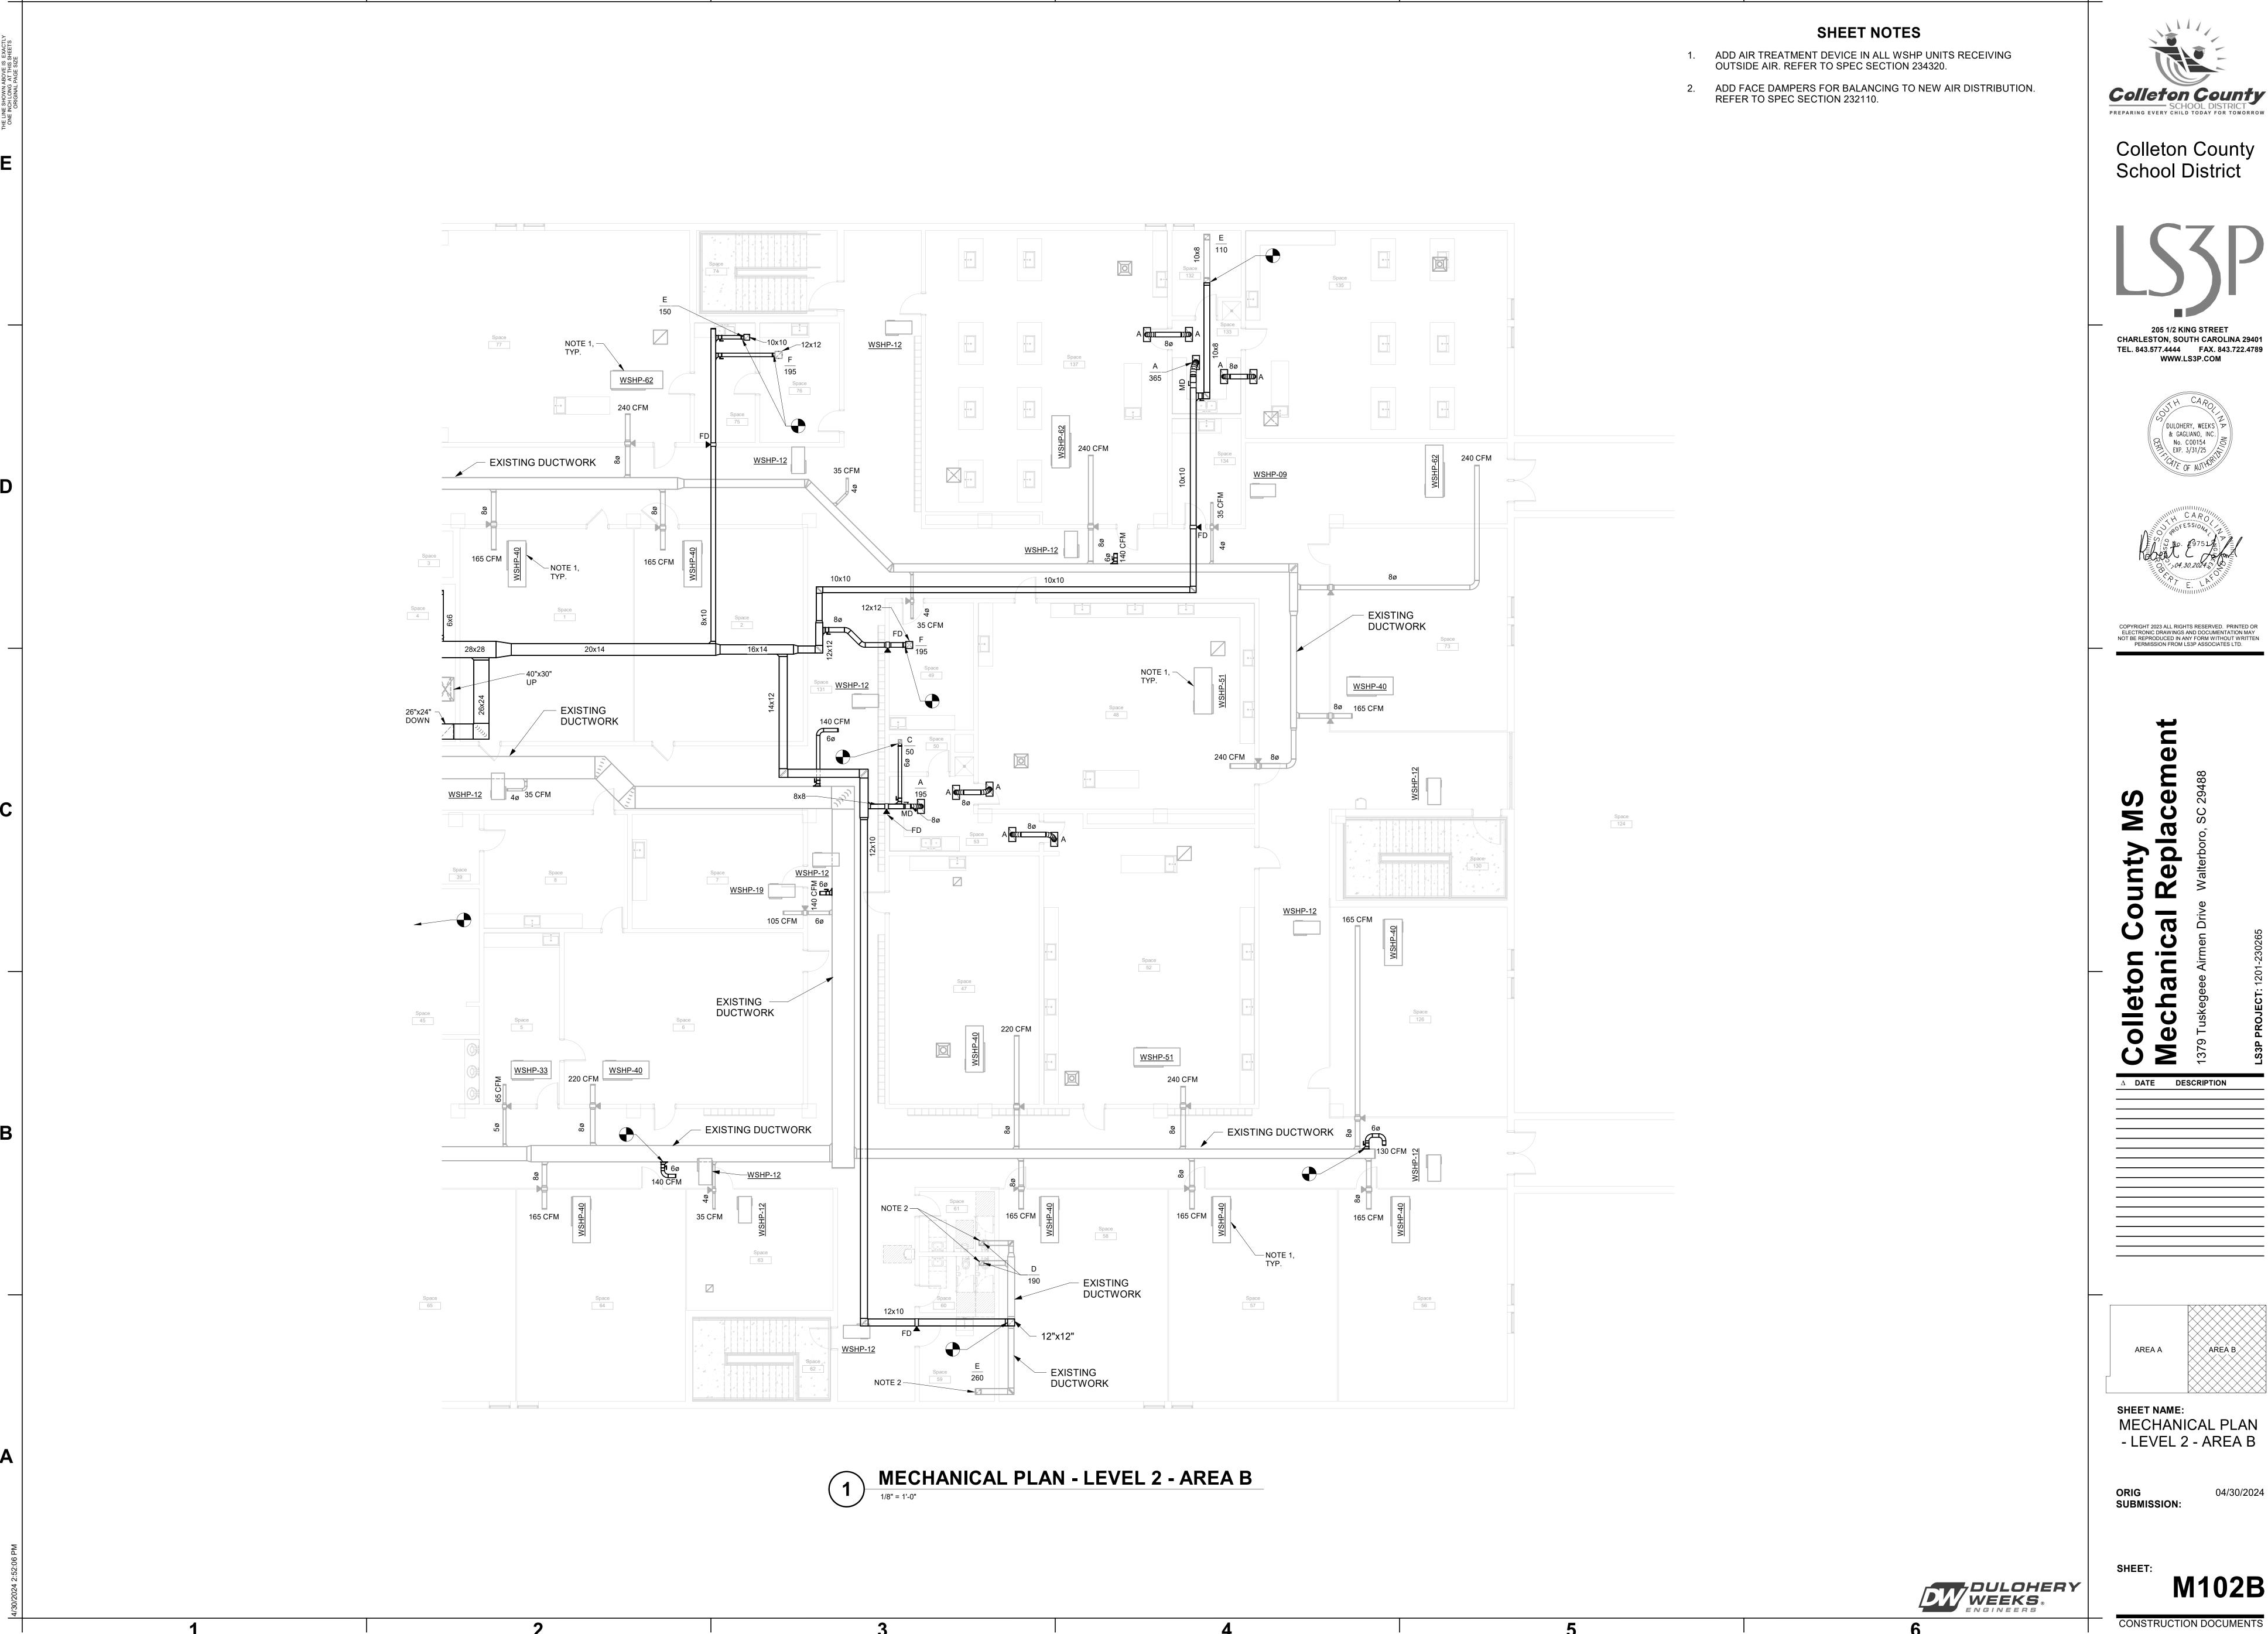
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XÂRÊA Â

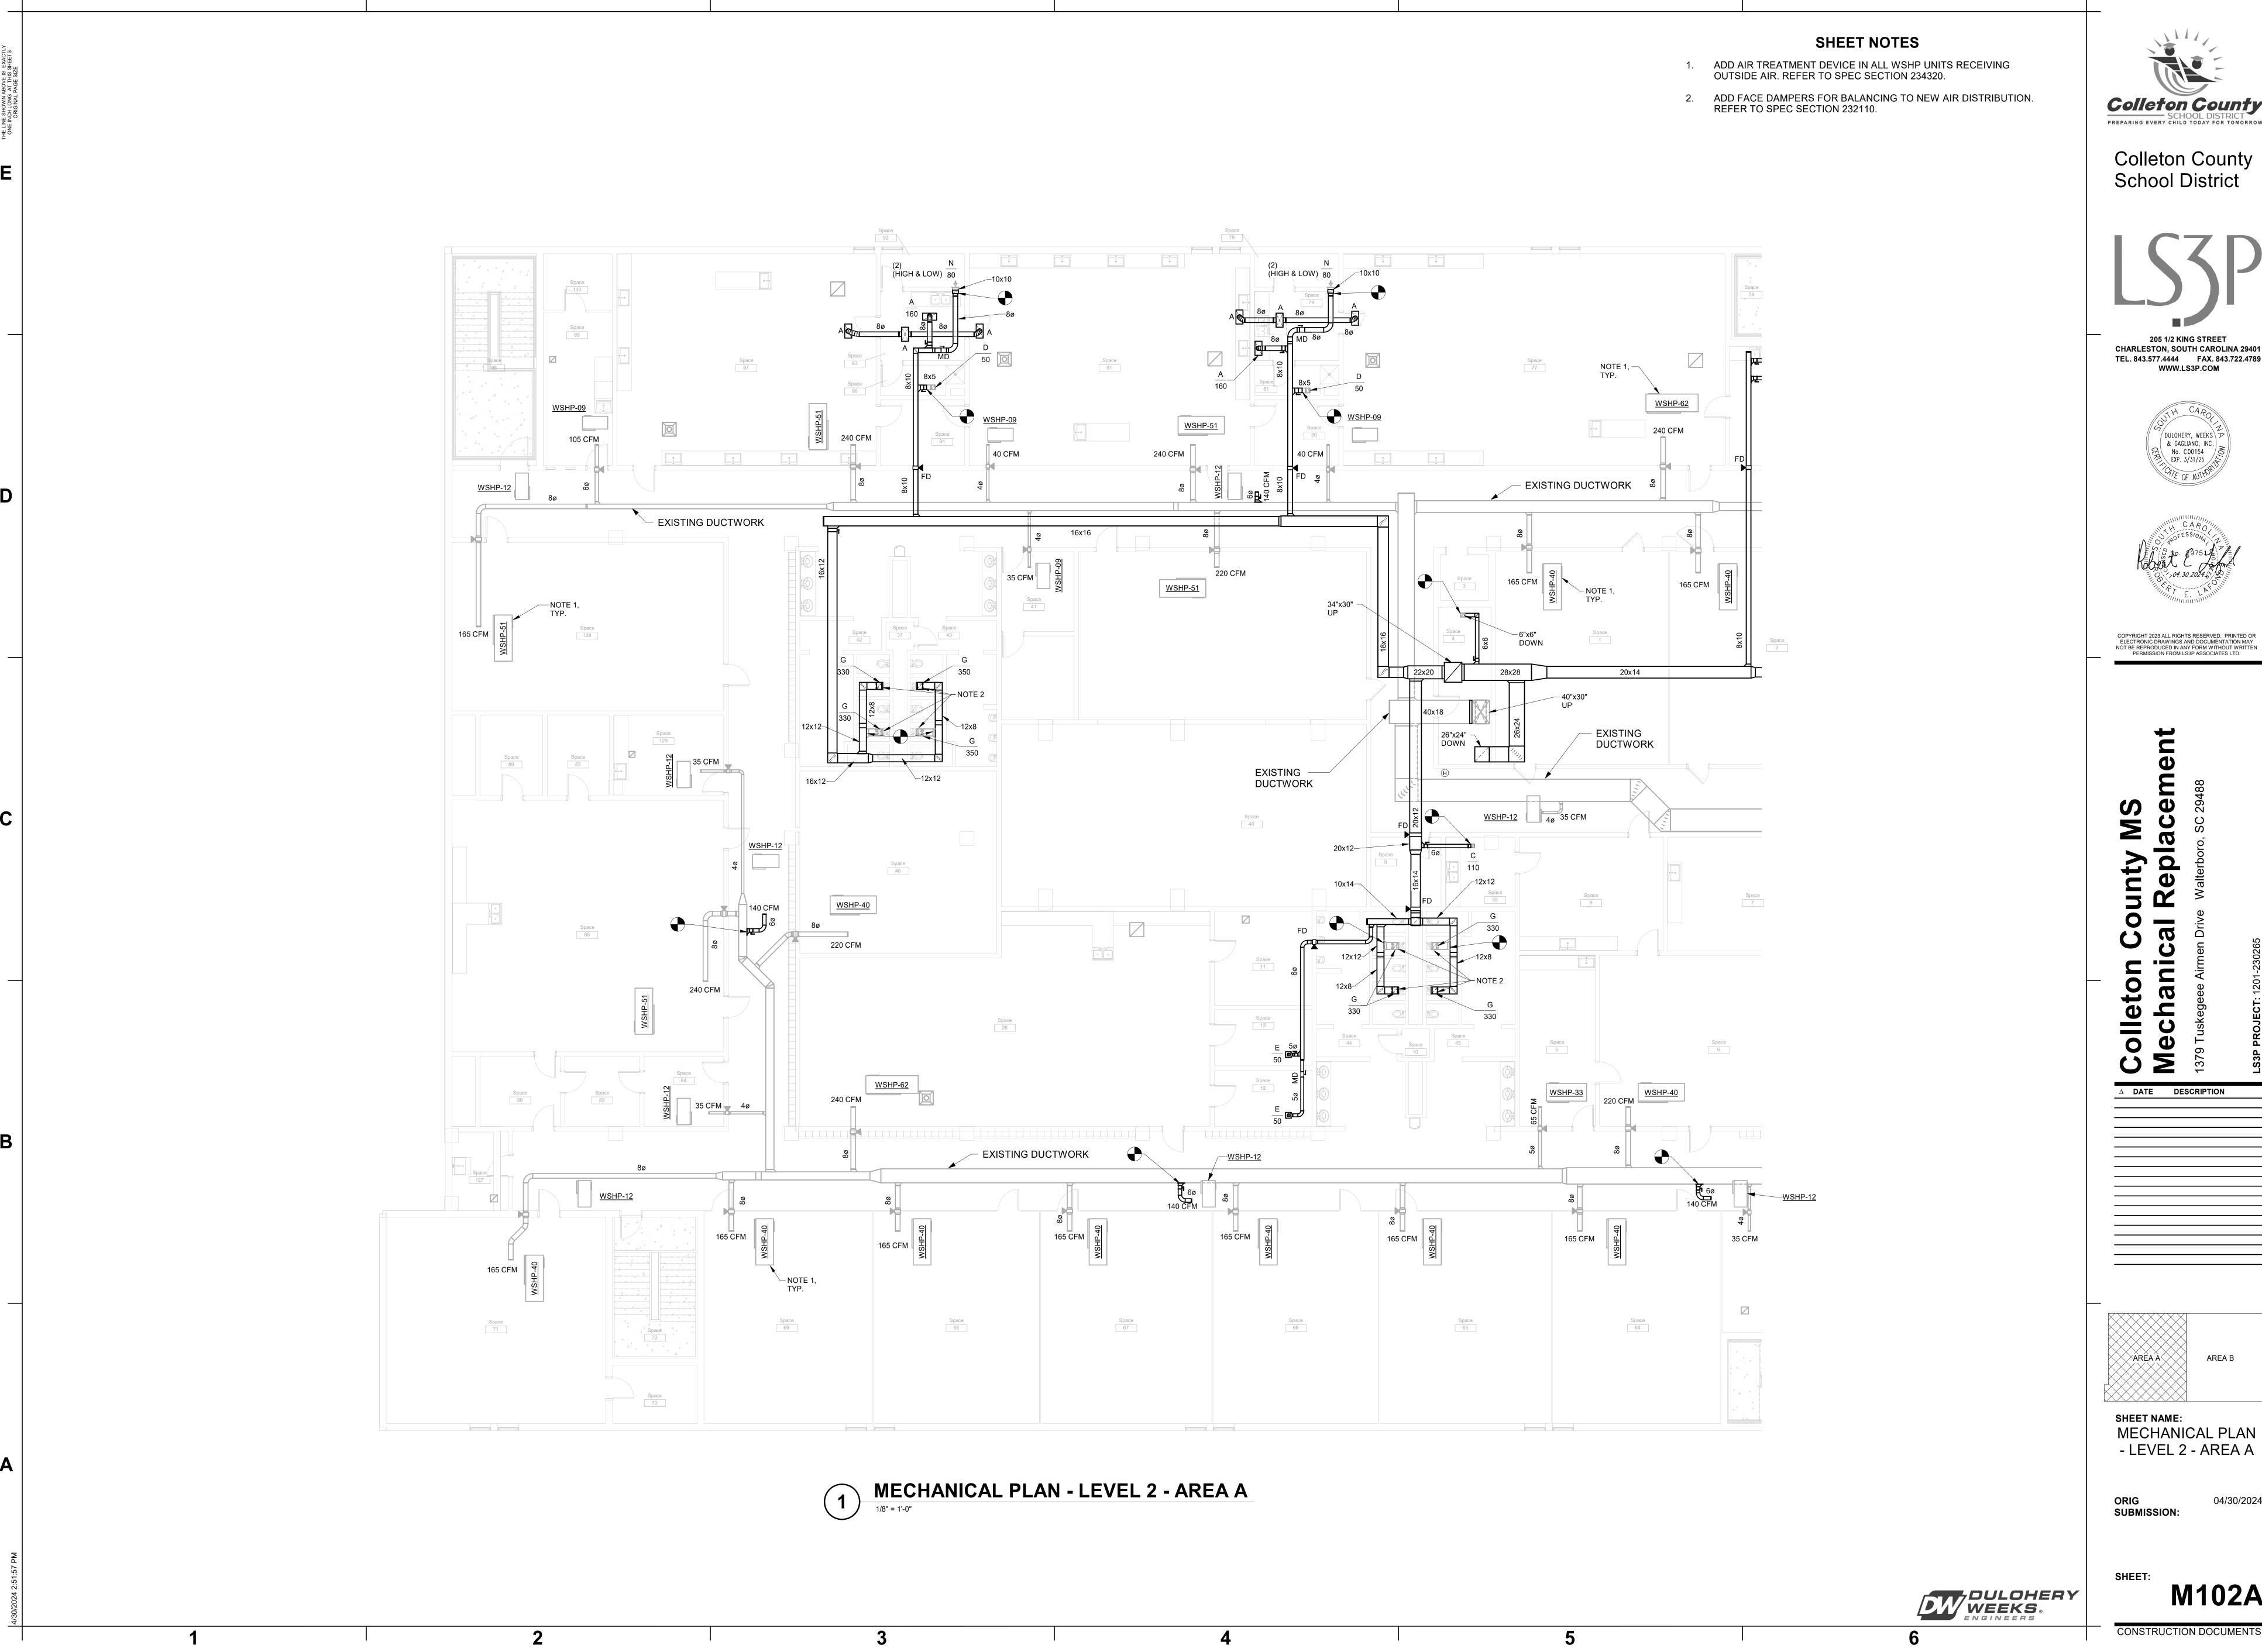SHEET NAME: MECHANICAL PLAN - LEVEL 2 - AREA A

ORIG SUBMISSION:

M102A



Colleton County

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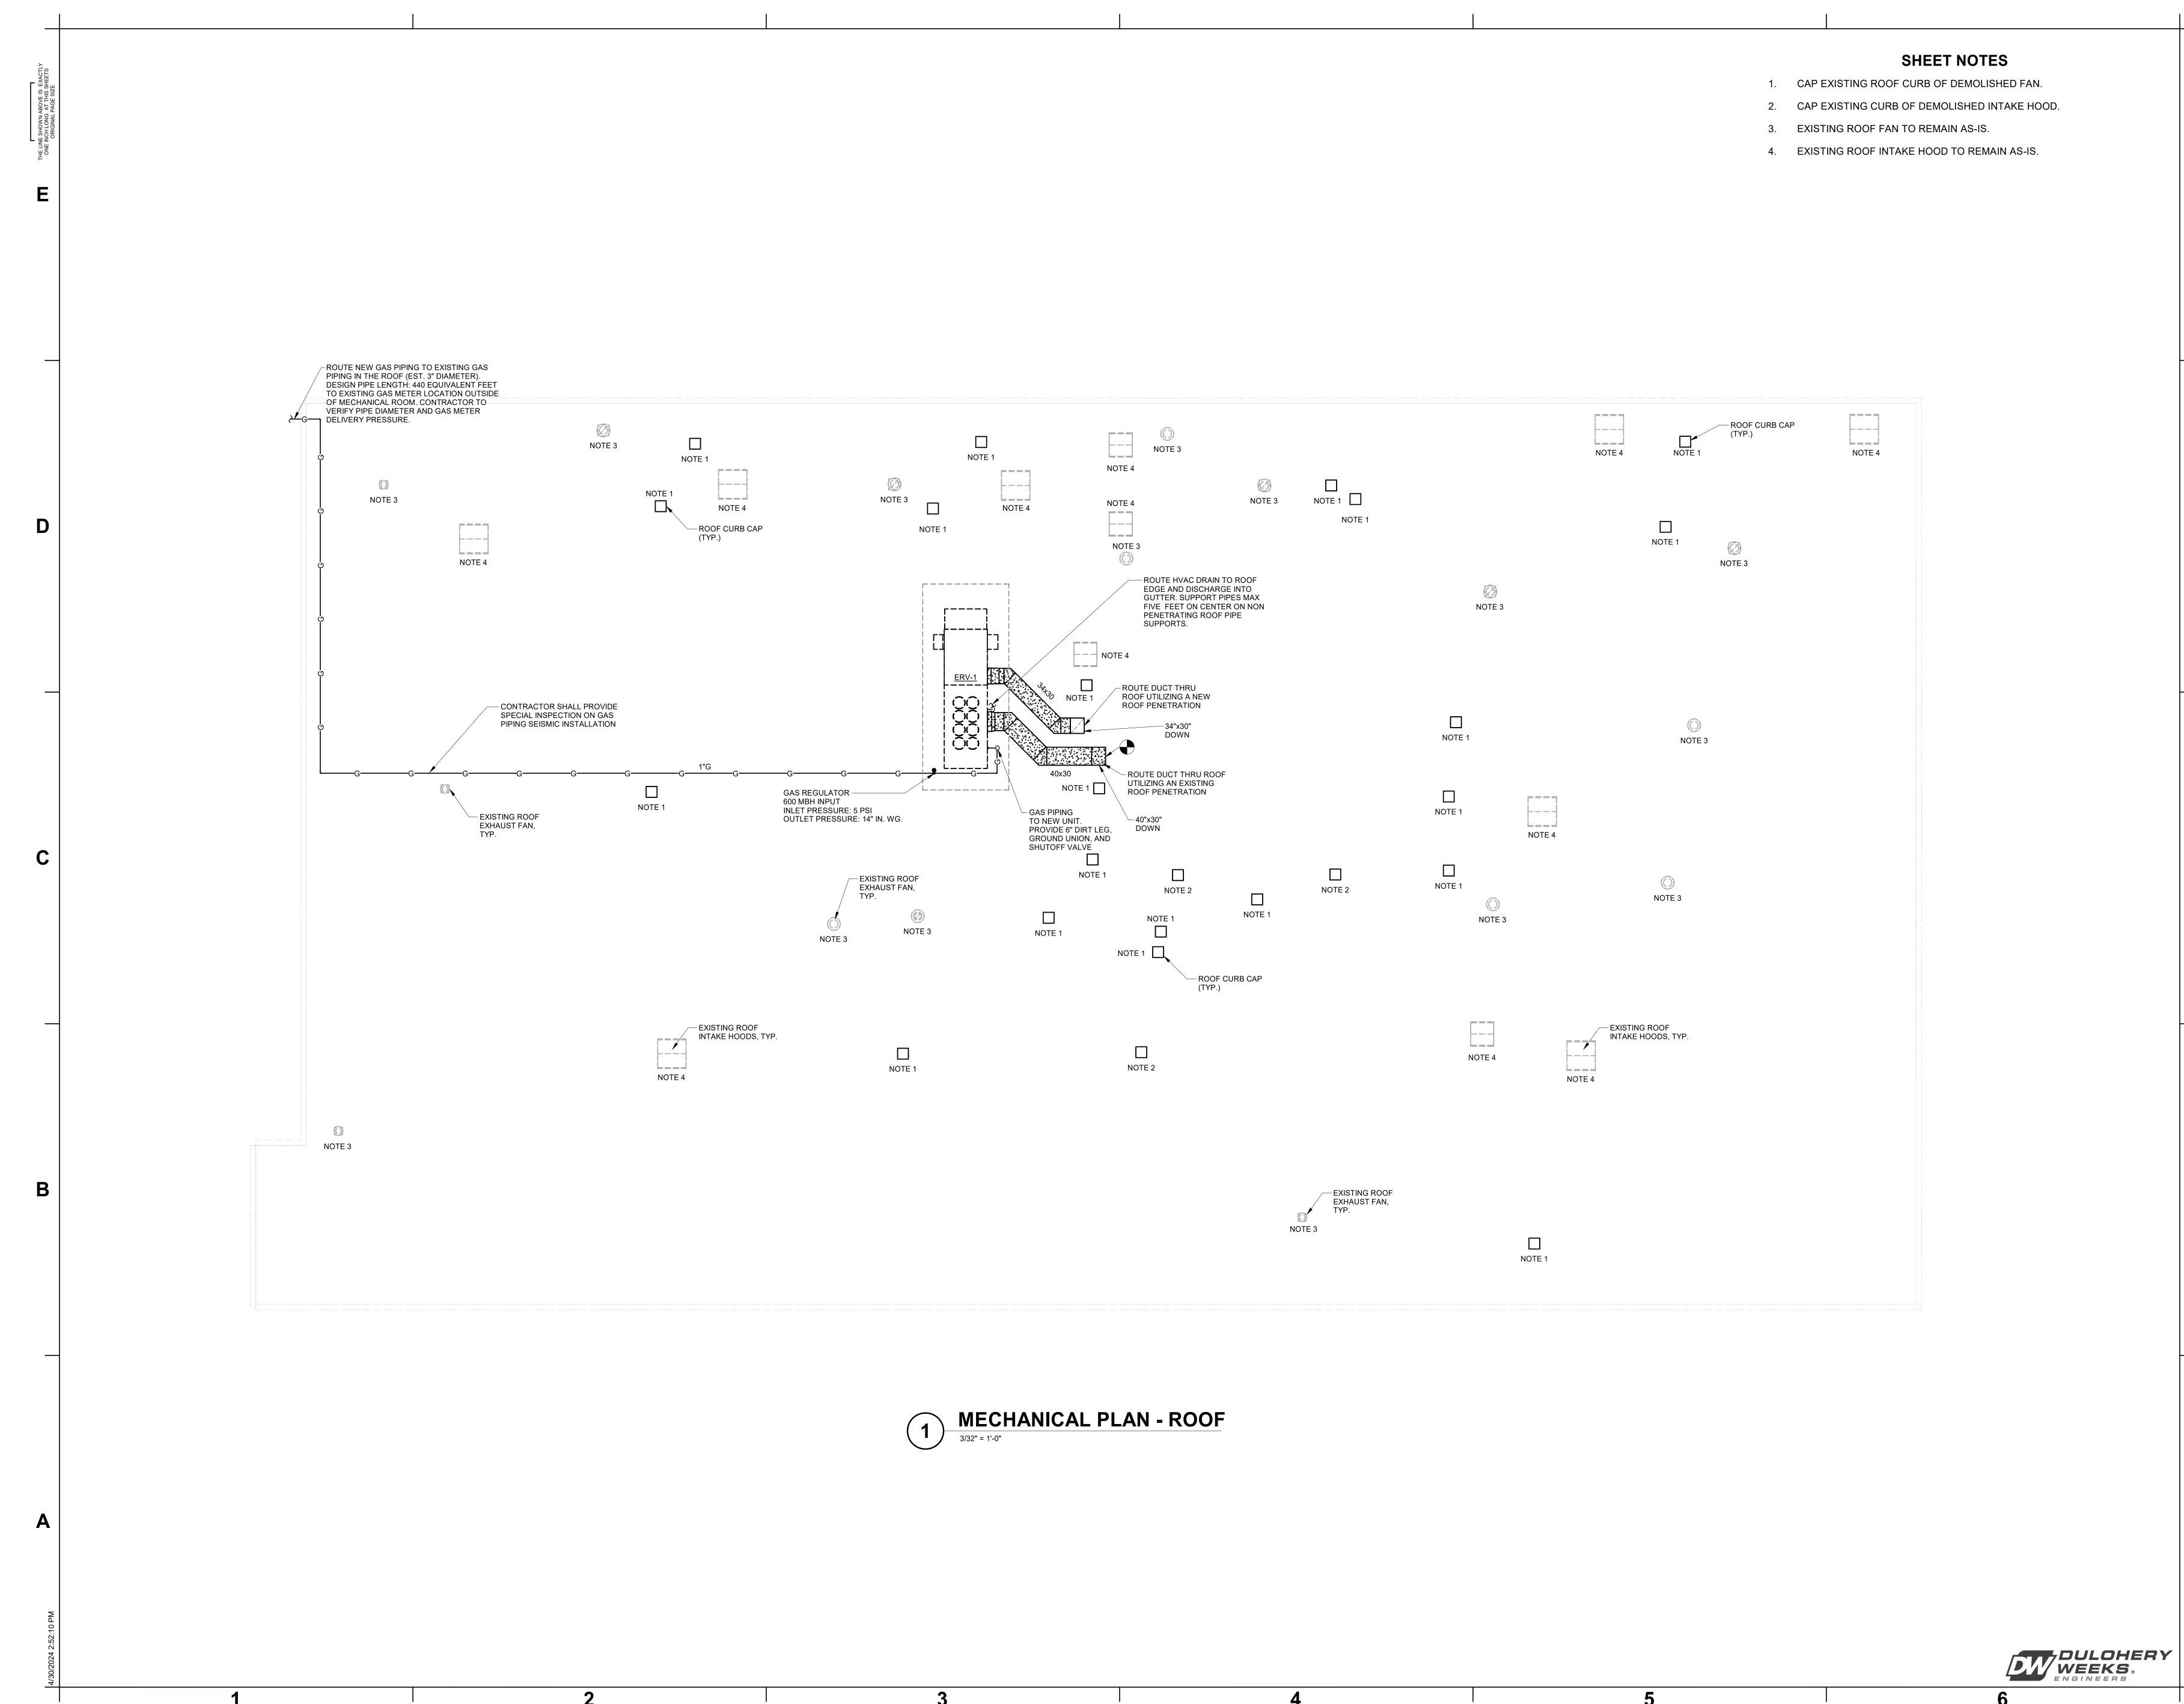
 Δ DATE DESCRIPTION

AREA A

SHEET NAME: MECHANICAL PLAN - LEVEL 2 - AREA B


ORIG SUBMISSION:

M102B



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PERMISSION FROM LS3P ASSOCIATES LTD.

Jolleton County MS

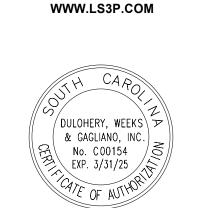Aechanical Replacement

S79 Tuskegeee Airmen Drive Walterboro, SC 29488

Δ DATE DESCRIPTION

AREA A AREA B


SHEET NAME: MECHANICAL PLAN - ROOF

ORIG SUBMISSION:

SHEET:


M103

04/30/2024

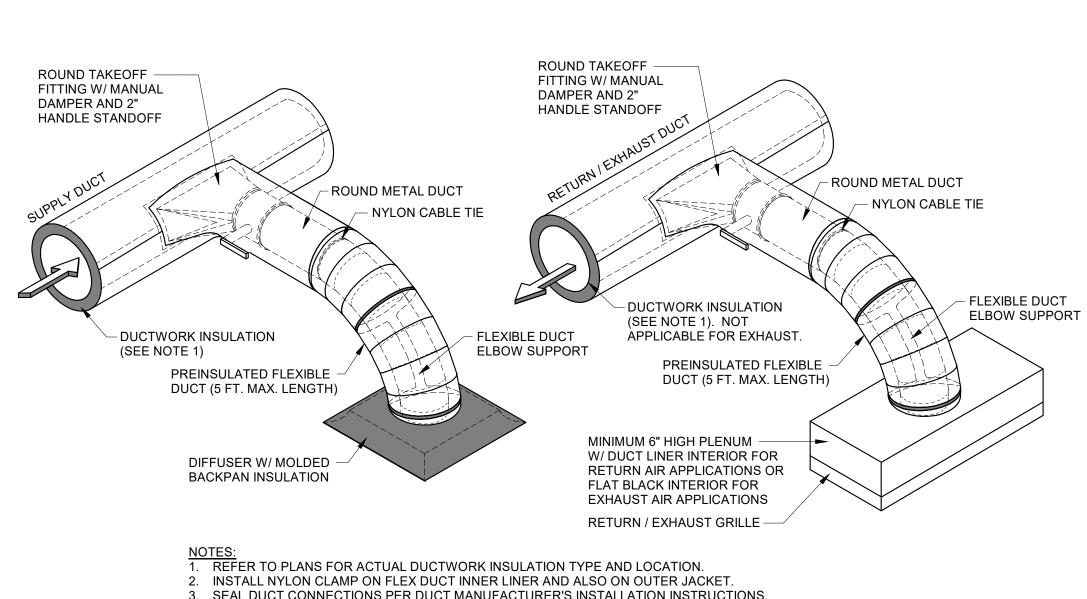


3. SEAL DUCT CONNECTIONS PER DUCT MANUFACTURER'S INSTALLATION INSTRUCTIONS. 4. DIFFUSER INSULATION SHALL BE FULL SIZE OF GRID WITH SQUARE CORNERS, DO NOT COMPRESS INSULATION OR ALLOW AIR GAPS BETWEEN INSULATION AND DIFFUSER. DO NOT TAPE INSULATION TO GRID. 5. USE FSK TAPE TO SECURE INSULATION AND BOTTOM EDGE OF DIFFUSER TO CEILING GRID. TRIM TAPE ON FACE OF DIFFUSER. TAPE SHALL NOT BE EXPOSED AT CEILING GRID. 6. PROVIDE FLEXIBLE DUCT ELBOW SUPPORT ACCESSORY FOR FLEX DUCT CONNECTION AS SPECIFIED.

DIFFUSER / GRILLE DETAIL - ROUND TRUNKS M200 NOT TO SCALE

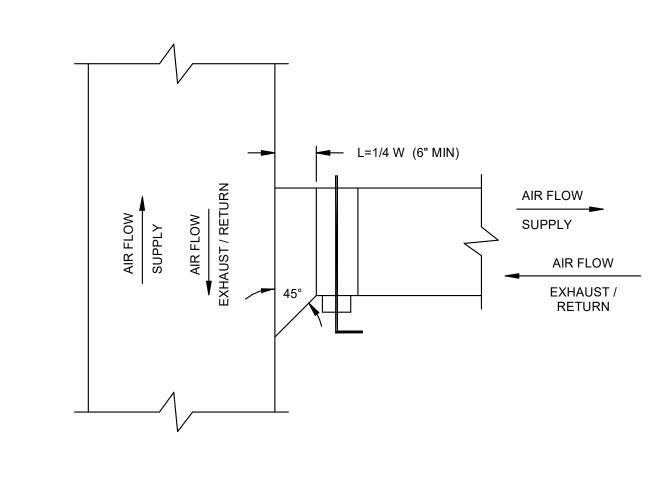

5 RECTANGULAR DUCT TAKE-OFF DETAIL

M200 NOT TO SCALE

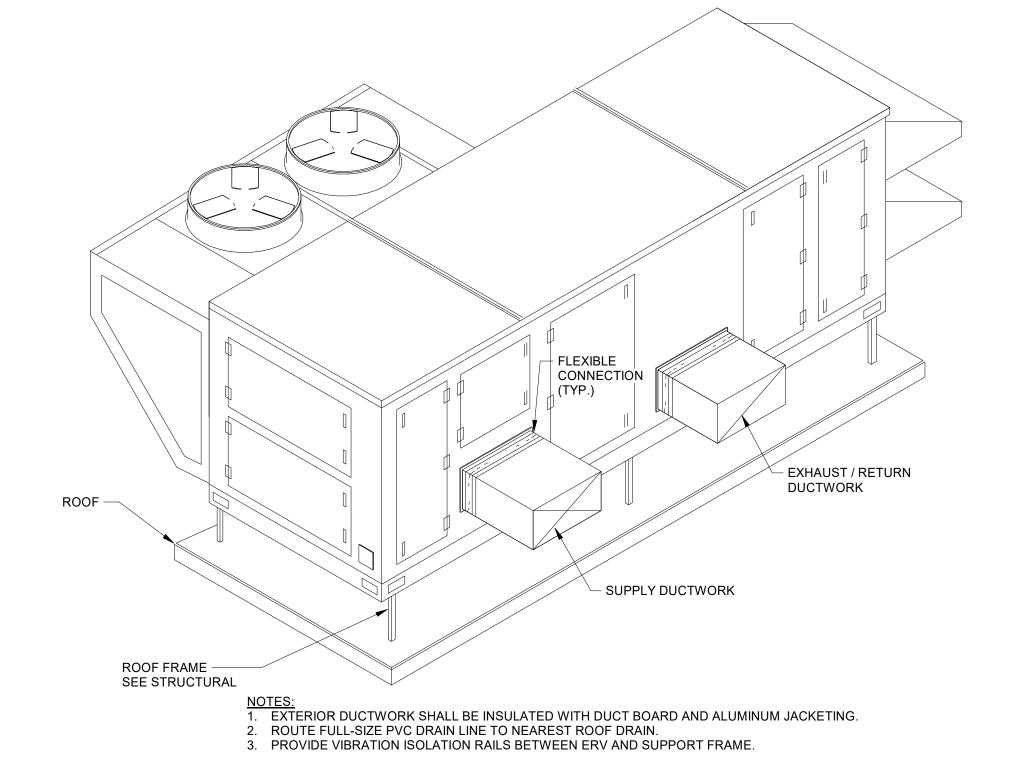

COORDINATE LOCATION -

SENSOR(S) -

4' - 0" AFF UNLESS-----INDICATED OTHERWISE. → DOORWAY ←

3 SENSOR MOUNTING DETAIL

— FLOOR

WITH LIGHT SWITCHES,

ETC. FOR SYMMETRY.

6 ENERGY RECOVERY VENTILATOR DETAIL
M200 NOT TO SCALE



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 Δ DATE DESCRIPTION

SHEET NAME: **MECHANICAL DETAILS**

SUBMISSION:

SHEET:

M200

CONSTRUCTION DOCUMENTS

DULOHERY WEEKS & ENGINEERS

ELECTRICAL SPECIFICATIONS

1. GENERAL PROVISIONS:

APPLICABLE PROVISIONS OF THE STATE AND LOCAL CODES AND OF THE NATIONAL ELECTRICAL CODE (NFPA NO. 70), CURRENTLY ADOPTED EDITION, ARE HEREBY IMPOSED ON

GENERAL BASIS FOR ELECTRICAL WORK.

PROVIDE ALL LABOR, MATERIALS, EQUIPMENT AND SUPERVISION TO CONSTRUCT A COMPLETE AND OPERABLE ELECTRICAL SYSTEM. ALL MATERIALS AND EQUIPMENT USED SHALL BE NEW, UNDAMAGED AND FREE FROM ANY DEFECTS.

WITH PERMISSION FROM THE OWNER, EXISTING ELECTRICAL EQUIPMENT MAY BE REUSED IF THE SIZE, RATING AND CAPACITY MEETS THE EXACT REQUIREMENTS AS SPECIFIED IN THESE DOCUMENTS. EQUIPMENT THAT IS REUSED SHALL BE CLEANED AND/OR REPAIRED TO ORIGINAL CONDITION BEFORE INSTALLATION. EXISTING MATERIALS MADE UNNECESSARY SHALL REMAIN THE PROPERTY OF THE OWNER.

2. DEMOLITION

REMOVE ALL POWER AND LIGHTING EQUIPMENT IN AREAS OF DEMOLITION UNLESS OTHERWISE NOTED. DEMOLITION SHALL INCLUDE THE REMOVAL OF THE ASSOCIATED OUTLET BOX, SUPPORTS, CONDUITS, FITTINGS AND CONDUCTORS. DEVICES IN AREAS OF NON-DEMOLISHED AREAS SHALL REMAIN INTACT AND OPERATIVE. RE-CIRCUIT THESE DEVICES IF CIRCUIT EXTENDS THROUGH DEMOLISHED AREA.

3. MATERIALS:

- A. ALL MATERIALS SHALL CONFORM TO U.L. & NEMA REQUIREMENTS AND SHALL BE AS SPECIFIED OR "PRIOR APPROVED EQUAL" BY THE ENGINEER.
- B. RACEWAY SYSTEM: ALL CONDUITS AND RACEWAYS SHALL BE INSTALLED CONCEALED IN FINISHED SPACES. CONCEALED CONDUITS SHALL BE EMT, IMC OR RGS. ROUTE ALL CONDUITS AND RACEWAYS PARALLEL AND PERPENDICULAR TO THE STRUCTURE AND SUPPORT AS REQUIRED BY THE NEC. ALL EXPOSED EXTERIOR OR WET LOCATED BRANCH CIRCUIT OR FEEDER RACEWAYS SHALL BE RGS OR IMC CONDUIT. ALL UNDERGROUND BRANCH CIRCUIT OR FEEDER RACEWAYS SHALL BE PVC CONDUIT. EXPOSED CONDUITS IN MECHANICAL SPACES AND CLOSETS SHALL BE RGS OR IMC. EXPOSED CONDUITS IN FINISHED SPACES SHALL BE SURFACE METAL RACEWAY (WIREMOLD). CONNECTORS/COUPLINGS FOR USE WITH EMT CONDUIT SHALL BE STEEL COMPRESSION TYPE, EXCEPT THAT STEEL, SET SCREW TYPE WILL BE ACCEPTABLE FOR EMT CONDUIT SIZES 2-1/2" AND LARGER. SUPPORT RACEWAY SYSTEM USING WOOD SCREWS TO WOOD; BY TOGGLE BOLTS ON HOLLOW MASONRY UNITS; BY CONCRETE INSERTS OR EXPANSION BOLTS ON CONCRETE OR BRICK; BY MACHINE SCREWS, WELDED THREADED STUDS, OR SPRINGTENSION CLAMPS ON STEEL WORK. CONDUIT
- TRAPEZE. THE USE OF MC CABLE IS NOT ALLOWED.
 C. BOXES: PROVIDE GALVANIZED STEEL OUTLET BOXES WITH STAMPED KNOCKOUTS FOR INTERIOR DRY LOCATIONS. PROVIDE CAST ALUMINUM BELL TYPE FOR ALL EXTERIOR WET LOCATIONS. INTERIOR FLUSH BOXES SHALL BE 4" SQUARE BY 1-1/4" DEEP. INTERIOR FLUSH BOXES FOR COMMUNICATION OUTLETS AND GFCI OUTLETS SHALL BE 4-11/16" SQUARE BY 2-1/8" DEEP. PROVIDE SINGLE GANG TILE COVERS UNLESS REQUIRED OTHERWISE.

SUPPORTS SHALL BE TWO-HOLE STRAPS, WALL BRACKETS, HANGERS OR CEILING

- D. GRADE LEVEL PULL BOXES: BOXES SHALL BE QUASITE COMPOSOLITE TYPE. PROVIDE SIZE AS INDICATED ON THE DRAWINGS. PROVIDE STACKABLE SECTIONS TO ACHIEVE BURIAL DEPTH FOR SPECIFIED FOR CONDUITS. BOXES SHALL HAVE OPEN BOTTOM AND LOCKING COVER WITH "ELECTRICAL" OR "COMMUNICATIONS" LOGO AS APPROPRIATE. PULL BOXES SHALL BE RATED FOR LIGHT VEHICULAR TRAFFIC. ENCASEMENT IS REQUIRED ONLY IF DIRECTED BY MANUFACTURER TO OBTAIN RATING.
- E. WIRE AND CABLES: CONDUCTORS SHALL BE COPPER, TYPE THHN OR THWN. CONDUCTORS SHALL BE COLOR CODED.

- I. GROUNDING: ELECTRICAL GROUNDING SHALL COMPLY WITH ARTICLE 250 OF THE NEC. PROVIDE ELECTRICAL BRAZING OR EXOTHERMIC CONNECTORS AND TERMINALS. BOLTED CLAMP WILL NOT BE ACCEPTED BETWEEN GROUNDING RODS AND GROUND CONDUCTORS. BOND EQUIPMENT GROUNDING CONDUCTORS TO ALL OUTLET BOXES WITH A SCREW USED FOR NO OTHER PURPOSE. CONNECT EQUIPMENT GROUNDING CONDUCTOR TO DEVICE GROUNDING TERMINALS. PROVIDE BARE OR GREEN INSULATED STRANDED COPPER SIZED ACCORDING TO NEC OR AS SHOWN. GROUND RODS SHALL BE 3/4" DIAMETER X 10' COPPER-CLAD STEEL, SECTIONAL TYPE.
- J. DISCONNECT SWITCHES: PROVIDE DISCONNECTS PRODUCED BY ONE OF THE FOLLOWING MANUFACTURERS: GE, SIEMENS, SQUARE D, OR CUTLER HAMMER. PROVIDE HEAVY DUTY TYPE, SHEET STEEL ENCLOSED SAFETY SWITCHES, INCORPORATING QUICK-BREAK TYPE SWITCHES. ALL SWITCHES SHALL BE UL LISTED. DISCONNECTS SHALL BE NON-FUSED TYPE. UNO.
- EQUIPMENT. SPD UNITS SHALL BE MOUNTED EXTERNAL TO POWER DISTRIBUTION EQUIPMENT. THE USE OF SPD UNITS INTEGRAL WITH POWER DISTRIBUTION EQUIPMENT IS NOT ACCEPTABLE. PROVIDE SPD UNITS BY THE FOLLOWING MANUFACTURERS/SERIES: SURGE SUPPRESSION, INC, CURRENT TECHNOLOGIES TG, AND ADVANCED PROTECTION TECHNOLOGIES. SPD FOR SERVICE EQUIPMENT SHALL BE AS FOLLOWS: SINGLE PULSE SURGE CAPACITY PER MODE: [150,000] [225,000] AMPS AND MODES: L-L, L-N, AND L-G. ALL UNITS SHALL HAVE THE FOLLOWING FEATURES: PHASE LED INDICATOR LIGHTS, DISTURBANCE COUNTER, 5-YEAR REPAIR/REPLACEMENT WARRANTY FROM MANUFACTURER IN THE NAME OF THE OWNER. INSTALL SPD UNITS ADJACENT TO ELECTRICAL EQUIPMENT, ENSURING THAT LEAD LENGTHS ARE AS SHORT AS POSSIBLE TO ACHIEVE MAXIMUM PROTECTION. CONNECT TO CIRCUIT BREAKER IN ELECTRICAL

K. SPD: PROVIDE SPD UNITS CONNECTED IN PARALLEL WITH POWER DISTRIBUTION

4. REFER TO ARCHITECTURAL SECTION FOR LOCATION OF FIRE RATED WALLS AND CEILINGS. ALL OUTLETS, FIXTURES, AND THROUGH PENETRATIONS SHALL BE MADE IN ACCORDANCE WITH THE NFPA 70 AND THE UL DESIGN No. OF THE

EQUIPMENT AS SHOWN ON THE MANUFACTURER'S WIRING DIAGRAMS.

- TYPE OF CONSTRUCTION ENCOUNTERED.

 5. SUBMITTALS: SUBMIT TO THE ARCHITECT FOR APPROVAL BEFORE BEGINNING
- A. DATA SHEETS ON ALL ITEMS LISTED ABOVE.

CONSTRUCTION THE FOLLOWING:

B. SCALED LAYOUT OF ELECTRICAL SPACES BASED ON THE ELECTRICAL EQUIPMENT BEING INSTALLED.

ITEM

LEGEND:

RECEPTACLES:

NOMINAL MOUNTING HEIGHT OF RECEPTACLES SHALL BE 18" TO CENTER, UNO. IF APPLICABLE, ADJUST SO DEVICE COVER IS IN THE CENTER OF MASONRY COURSE NEAREST THAT HEIGHT. THE HEIGHT ESTABLISHED SHALL GOVERN FOR ALL BOX INSTALLATIONS, WHERE INSTALLED IN MASONRY OR FRAMED WALLS.

ALL RECEPTACLES INSTALLED IN THE FOLLOWING LOCATIONS SHALL BE TAMPER RESISTANT TYPE:

A. DWELLING UNITS, DORM ROOMS, GUEST ROOMS AND GUEST SUITES OF HOTELS AND MOTELS.

- B. CHILD CARE FACILITIES.
 C. PRESCHOOLS AND ELEMENTARY EDUCATION FACILITIES.
 D. BUSINESS OFFICES, CORRIDORS, WAITING ROOMS AND THE LIKE IN CLINICS,
- MEDICAL AND DENTAL OFFICES AND OUTPATIENT FACILITIES.

 E. SUBSETS OF ASSEMBLY OCCUPANCIES DESCRIBED IN NEC 518.2 TO INCLUDE PLACES OF WAITING TRANSPORTATION, GYMNASIUMS, SKATING RINKS, AND AUDITORIUMS.
 - RECEPTACLE: SIMPLEX
 - RECEPTACLE: DUPLEX
 - RECEPTACLE: GROUND-FAULT-INTERRUPTING TYPE
 - RECEPTACLE: QUADRUPLEX

 IN-SLAB FLOOR BOX: SEE SPECIFICATIONS
 - → POKE-THRU DEVICE: SEE SPECIFICATIONS
 - RECEPTACLE: DRYER, 30 AMP, 120/250 VOLT

 RECEPTACLE: SPECIAL PURPOSE, COORDINATE NEMA
 - RATING WITH SPECIFIED EQUIPMENT

 ELECTRIC WATER COOLER POWER CONNECTION, GFCI
 - OUTLET

 HAND DRYER POWER CONNECTION: COORDINATE
 - MOUNTING HEIGHT W/ ARCHITECTURAL ELEVATIONS SEE HAND DRYER INSTALLATION DETAIL 1/E7.01.

 RECEPTACLE FOR CLOCK (RECESSED) AND CLOCK:

COORDINATE MOUNTING HEIGHT & LOCATION WITH

ARCHITECTURAL FLOOR PLAN AND ELEVATIONS

RECEPTACLE: CEILING MOUNTED

ELECTRICAL EQUIPMENT:

REFER TO ONE-LINE DIAGRAM AND EQUIPMENT CONNECTION SCHEDULE FOR LOAD DATA USED AS THE BASIS OF DESIGN AND REQUIRED CONNECTIONS. VERIFY LOAD AND LOCATION WITH EQUIPMENT CUT-SHEETS AND INSTALLER.

SWITCH: MOTOR RATED, WITHOUT OVERLOAD PROTECTION

DISCONNECT SWITCH

DRY-TYPE TRANSFORMER

XX-1 EQUIPMENT AS NOTED, SEE ABBREVIATIONS, THIS

PANELBOARD: SURFACE MOUNTED

GROUND CONNECTION

BRANCH CIRCUITS:

CONDUCTOR COUNTS ARE SHOWN ON THE HOMERUNS ONLY. CONTRACTOR SHALL DETERMINE COUNTS FOR INTERMEDIATE RUNS BASED ON THE MANNER IN WHICH THE CIRCUIT ELEMENTS ARE CONNECTED. REFER TO THE SPECIFICATION SECTIONS 262010, 262080, & 262030 FOR SPECIAL REQUIREMENTS.

LA-1,3,5

BRANCH CIRCUIT: CONCEALED IN FLOOR SLAB

BRANCH CIRCUIT: EXPOSED

III 'HO

'HOMERUN' TO PANEL: NUMBER OF HASH MARKS INDICATES QUANTITY OF UNGROUNDED CONDUCTORS IN MINIMUM 3/4" RACEWAY. GROUNDED CONDUCTORS (NEUTRALS) ARE NOT SHOWN. NUMBER OF ARROWHEADS DENOTES QUANTITY OF CIRCUITS INSTALLED. ONE DEDICATED NEUTRAL IS REQUIRED FOR EACH CIRCUIT INSTALLED, SEE SPECIFICATIONS. EACH CONDUCTOR SHALL BE MIN. #12 AWG UNLESS NOTED OTHERWISE. FOR MECHANICAL EQUIPMENT, SEE MECHANICAL EQUIPMENT RATINGS AND CONNECTIONS SCHEDULE FOR ELECTRICAL CHARACTERISTICS.

MISCELLANEOUS COMPONENTS:

JUNCTION BOX: MTD. ABOVE CEILING

JUNCTION BOX: WALL MTD.

COORDINATE MOUNTING HEIGHTS, DEVICE LOCATIONS & POWER/CONTROL REQUIREMENTS WITH ARCHITECTURAL DRAWINGS AND SYSTEM INSTALLER.

GENERAL NOTES:

- THE ELECTRICAL DRAWINGS ARE ONLY PART OF THE CONTRACT DOCUMENTS. THE CONTRACTOR SHALL REVIEW ALL OF THE DRAWINGS AND SPECIFICATIONS FOR THEIR INTERRELATIONSHIP AND REQUIRED COORDINATION BETWEEN DISCIPLINES.
- 2. WHERE COMPLETE BRANCH CIRCUIT WIRING IS NOT SHOWN, PROVIDE ACCORDING TO HOMERUNS SHOWN AND CORRESPONDING CIRCUIT NUMBERS ADJACENT TO THE DEVICE OR FIXTURE. REFER TO THE SPECIFICATIONS FOR THE WIRING METHODS. BRANCH CIRCUIT RATINGS SHALL BE BASED ON OVERCURRENT DEVICE RATINGS SHOWN IN THE PANEL SCHEDULES.
- REFER TO THE ELECTRICAL PANELBOARD SCHEDULES AND EQUIPMENT RATINGS &
 CONNECTIONS SCHEDULE FOR VOLTAGE, BRANCH CIRCUITS REQUIREMENTS,
 BREAKERS SIZES AND OTHER RELATED ELECTRICAL EQUIPMENT TO BE PROVIDED
 AND/OR INSTALLED BY THE ELECTRICAL CONTRACTOR.

NEW

EXTERIOR ELECTRICAL LEGEND

G	NG	GAS
sD	NSD	STORM DRAIN
ss	NSS	SANITARY SEWER
w	NW	WATER
—-OHF	——NOHF——	OVERHEAD FIBER
—ОНР	NOHP	OVERHEAD PRIMARY
——OHS———	——NOHS——	OVERHEAD SECONDARY
ОНТ	NOHT	OVERHEAD TELEPHONE
—OHTC——	——NOHTC——	OVERHEAD TELECOMMUNICATIONS
—OHTV——	NOHTV	OVERHEAD TELEVISION
——UF———	NUF	UNDERGROUND FIBER
UP	NUP	UNDERGROUND PRIMARY
US	NUS	UNDERGROUND SECONDARY
UT	NUT	UNDERGROUND TELEPHONE
——UTC——	NUTC	UNDERGROUND TELECOMMUNICATION
UTV	NUTV	UNDERGROUND TELEVISION

H HANDHOLE, FLUSH WITH FINISHED GRADE

PULL BOX, FLUSH WITH FINISHED GRADE

ELECTRICAL MANHOLE, FLUSH WITH FINISHED GRADE

TELECOMMUNICATIONS MANHOLE, FLUSH WITH FINISHED GRADE

POLE AND SIDEARM MOUNTED LIGHTING FIXTURE

PAD-MOUNTED TRANSFORMER, BY OTHERS

POLE AND TOP MOUNTED FIXTURE OR BOLLARD

LSJP

205 1/2 KING STREET
CHARLESTON, SOUTH CAROLINA 29401
TEL. 843.577.4444 FAX. 843.722.4789
WWW.LS3P.COM



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y MS placement poro, SC 29488

1anical Replace

geee Airmen Drive Walterboro, SC 29.

Me

Δ DATE DESCRIPTION

SHEET NAME:
ELECTRICAL
SCHEDULES &
LEGENDS

ORIG SUBMISSION:

SHEET:

E100

CONSTRUCTION DOCUMENTS

ERV-1 480 V 3 184.9 192.8 200 200A/3P/3R 3#4/0,#4G,2"C (300' VOLTAGE DROP)

DISCONNECT


WIRE SIZE

MECHANICAL EQUIPMENT RATINGS AND CONNECTIONS

PH FLA MCA MOCP

DULOHERY WEEKS. ENGINEERS

2 6

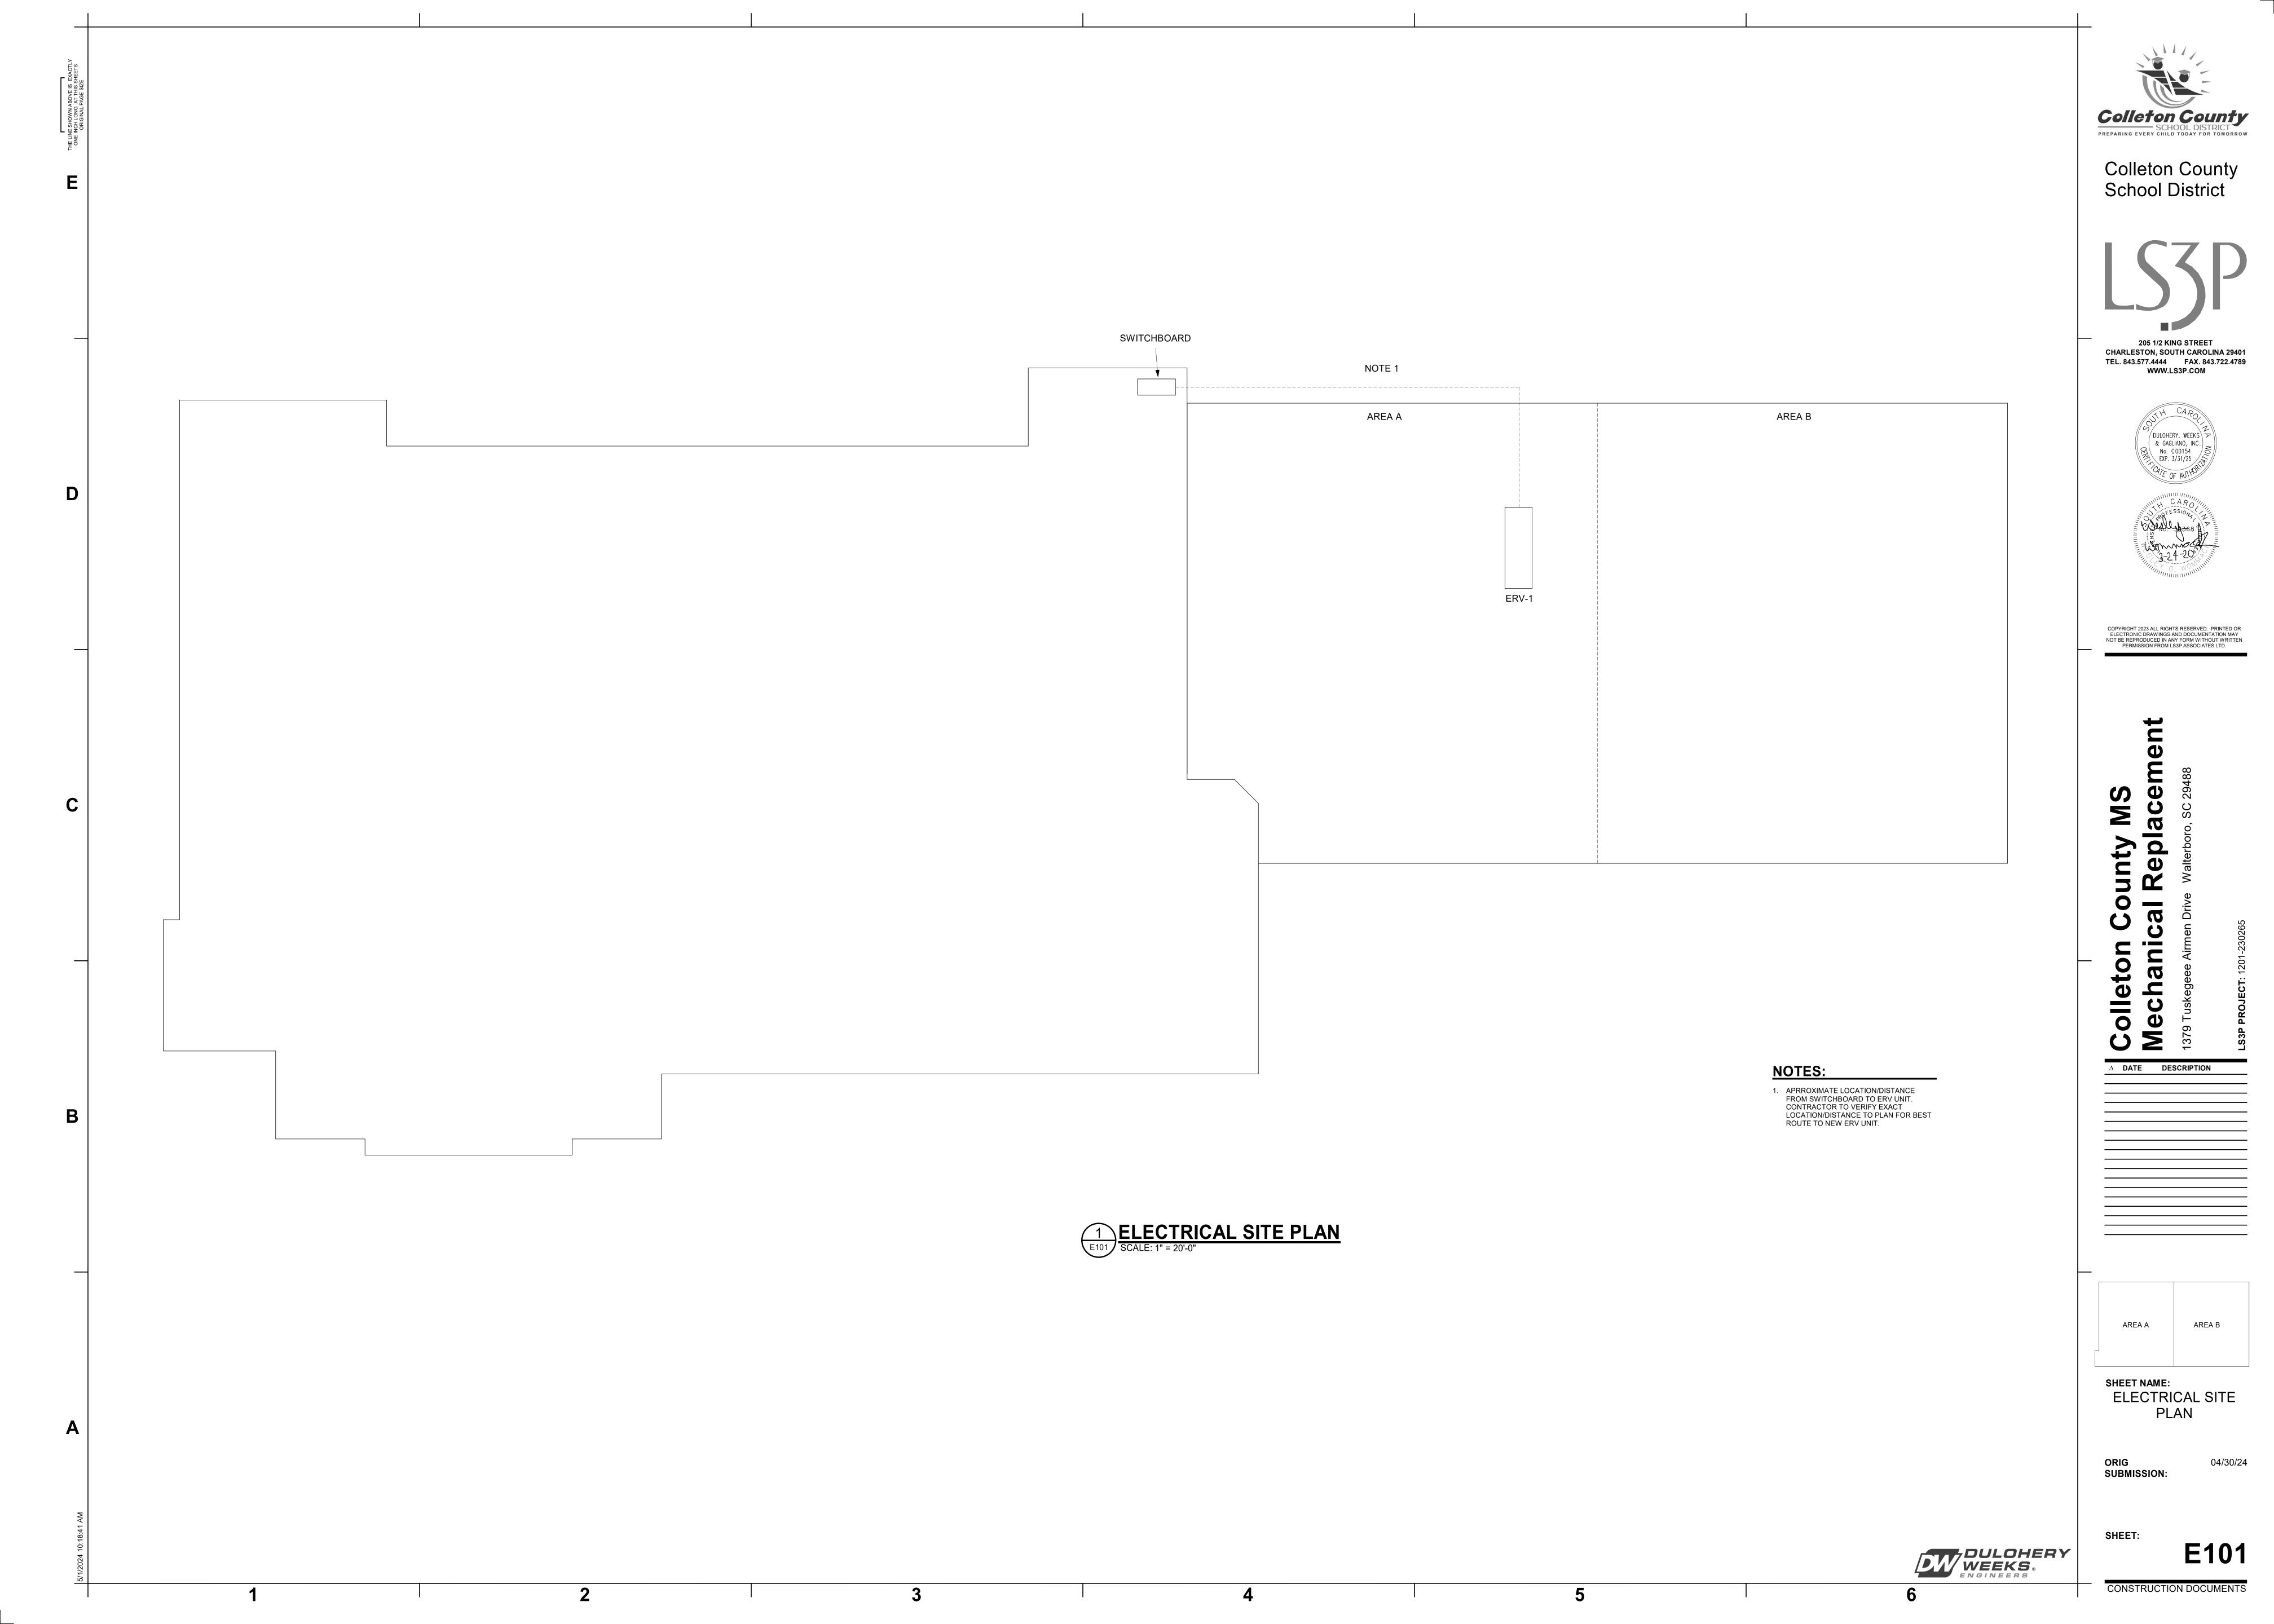



Colleton County
SCHOOL DISTRICT
PREPARING EVERY CHILD TODAY FOR TOMORROW


Colleton County School District

205 1/2 KING STREET CHARLESTON, SOUTH CAROLINA 29401 TEL. 843.577.4444 FAX. 843.722.4789





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POWER PLAN -LEVEL 2 - AREA A

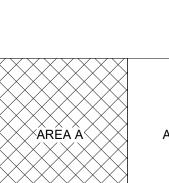E102A