PORTAGE - WEST MIDDLE SCHOOL - STORAGE BARN

PORTAGE PUBLIC SCHOOLS

Portage, Michigan CONSTRUCTION DOCUMENTS

DESIGN TEAM

ARCHITECT/ENGINEER
TowerPinkster

242 E. KALAMAZOO AVE, SUITE 100 KALAMAZOO, MICHIGAN 49007 PHONE: 269.343.6133 FAX: 269.343.6633

4 EAST FULTON STREET, SUITE 20 GRAND RAPIDS, MICHIGAN 49503 PHONE: 616.456.9944 EAX: 616.456.5936

CIVIL CONSULTANT

5725 VENTURE PARK DRIVE, SUITE A KALAMAZOO, MI 49009 PHONE: 269.250.5991 REFERENCED CODES

BUILDING: 2015 MICHIGAN BUILDING CODE AND 2012 NFPA 101 LIFE SAFETY CODE ENERGY: 2015 MICHIGAN ENERGY CODE PLUMBING: 2015 MICHIGAN PLUMBING CODE MECHANICAL: 2015 MICHIGAN MECHANICAL CODE FUEL GAS: (IFGC) 2015 INTERNATIONAL FUEL GAS CODE ELECTRICAL: 2017 NATIONAL ELECTRICAL CODE WITH MICHIGAN AMENDMENTS BARRIER-FREE: 2015 MICHIGAN BUILDING CODE AND 2009 ICC & C A117.1 USE GROUP: S-1 CONSTRUCTION TYPE: TYPE VB AUTOMATIC SPRINKLERS: NON SPRINKLED

PROJECT AREA

TOTAL FINISHED PROJECT:

2,093 SQ. FT.

DRAWING INDEX

JENEKAL 2 001 - COV

G 001 COVER SHEET

G 101 FIRST FLOOR CODE COMPLIANCE PLAN, TYPICAL SYMBOLS AND GENERAL NOTES

CIVIL

C 100 SITE PLAN

ARCHITECTURAL
A 100 FOUNDATION AND FRAMING PLAN

101 FIRST FLOOR PLAN, ROOF FRAMING PLAN AND DOOR SCHEDULE

11 EXTERIOR ELEVATIONS, BUILDING SECTIONS, 3D VIEW AND WALL SECTIONS

ELECTRICAL

E 101 FIRST FLOOR POWER PLAN

SITE ADDRESS

PORTAGE PUBLIC SCHOOLS 7145 MOORSBRIDGE RD PORTAGE, MI ZIP 49024






PROJECT TITLE
PORTAGE - WEST
MIDDLE SCHOOL STORAGE BARN

IOOLS

SCHOOLS


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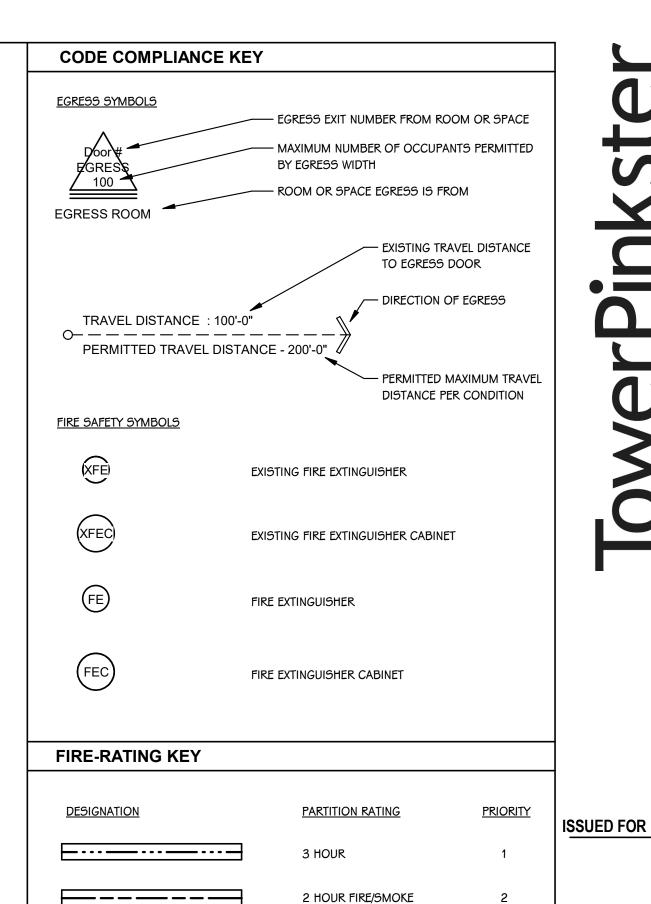



GENERAL NOTES - ARCHITECTURAL

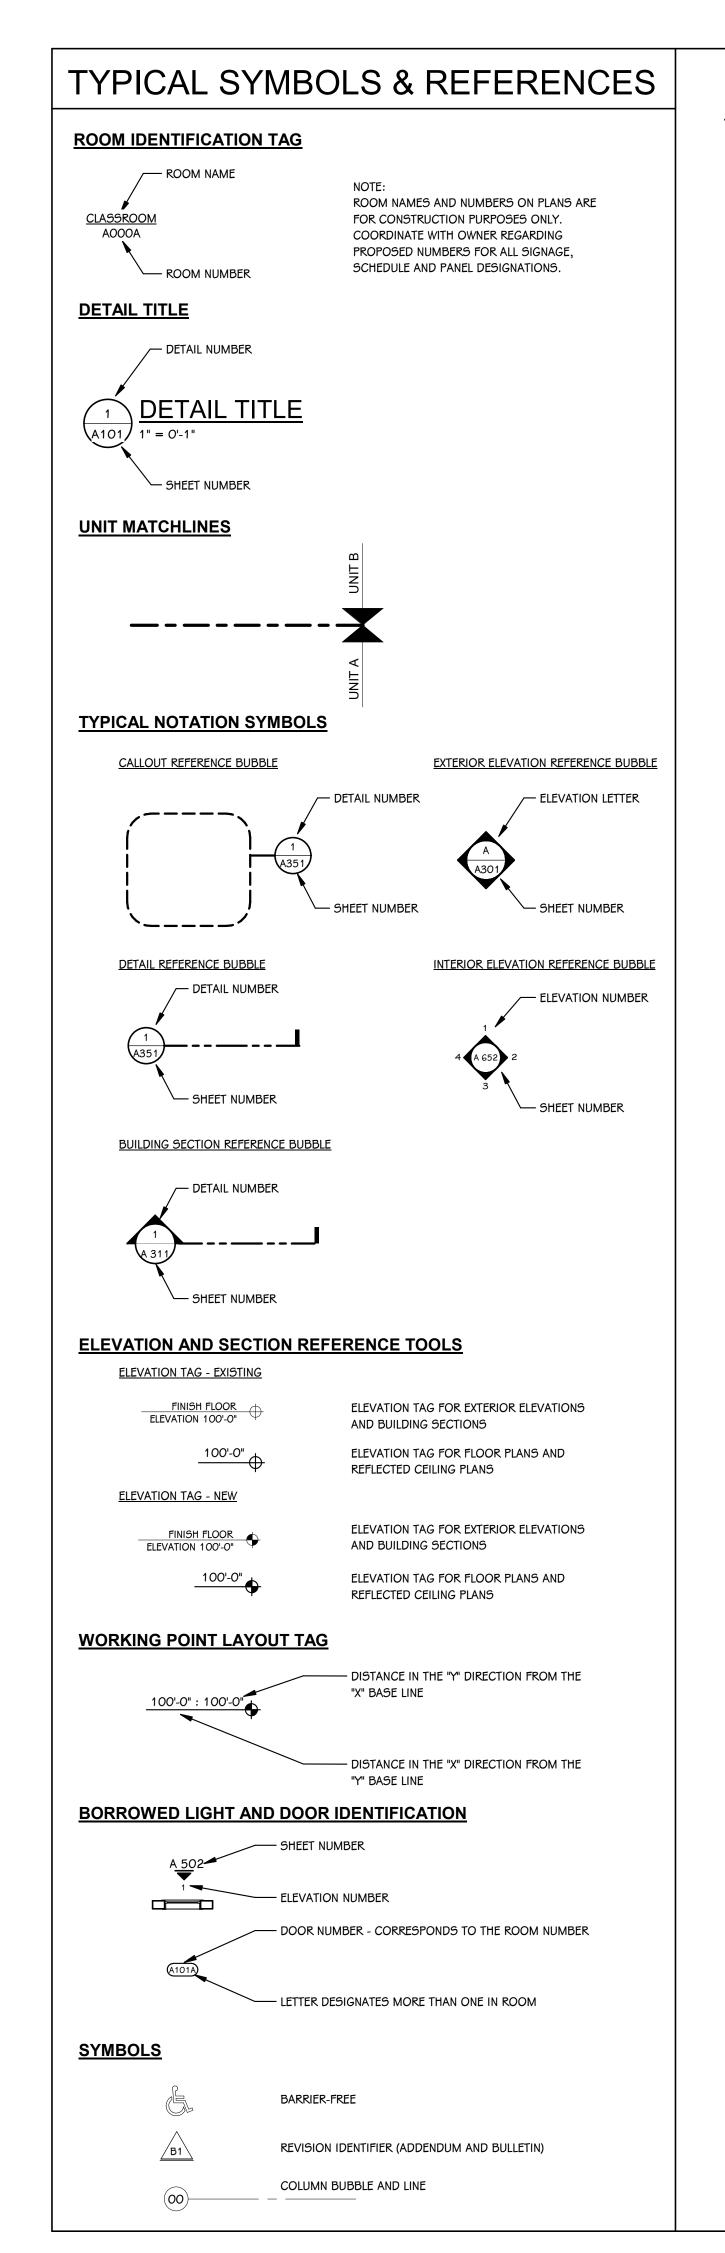- 1. THE OWNER RESERVES THE RIGHT TO REMOVE ANY ITEM FROM THE PROJECT PRIOR TO COMMENCEMENT OF CONTRACTED DEMOLITION WORK.
- 2. ALL EXISTING CONDITIONS SHOULD BE FIELD VERIFIED BEFORE WORK BEGINS.
- 3. DIMENSIONS GIVEN ARE ACTUAL AND ARE TO THE FACE OF MASONRY UNITS OR TO THE FACE OF STUD FRAMING, UNLESS NOTED OTHERWISE.
- 4. DETAILS SHOWN ILLUSTRATE DESIGN INTENT, NOT ALL POSSIBLE CONDITIONS. FOR CONDITIONS NOT SHOWN, USE DETAILS CLOSEST TO CONDITION IN QUESTION.
- 5. EXTEND ALL INTERIOR WALL PARTITIONS FROM FLOOR TO STRUCTURE/DECK ABOVE UNLESS NOTED OR DETAILED OTHERWISE.
- 6. WITHIN BUILDING INTERIOR PROVIDE BULLNOSE BLOCK IN CMU WALL ASSEMBLIES AT ALL EXPOSED OUTSIDE CORNERS, INCLUDING WINDOW AND DOOR JAMBS, UNLESS NOTED OR DETAILED OTHERWISE. PROVIDE SQUARE OUTSIDE CORNERS AT ALL LOCATIONS FINISHED WITH WALL TILE, REFER TO FINISH PLANS (AGOO SHEETS) FOR LOCATIONS.
- 7. TOOTH-IN MASONRY AT NEW OPENINGS IN EXISTING WALLS.
- 8. TOOTH-IN NEW MASONRY INFILL INTO EXISTING OPENINGS AT ALL BULLNOSE BLOCK LOCATIONS.
- 9. STUD WALLS SPANNING OVER 12'-0" IN HEIGHT SHALL BE A MINIMUM OF 20 GAGE.
- 10. STUD WALL SUPPORTING WALL CABINETS SHALL BE A MINIMUM OF 20 GAGE.
- 11. DOORS ARE TO BE 4" FROM CORNER OF ROOM, UNLESS NOTED OR DIMENSIONED
- 12. FIRESTOP ALL INTERCONNECTIONS BETWEEN VERTICAL AND HORIZONTAL SPACES AND CONCEALED WALL SPACES AT CEILING, FLOOR AND ROOF LEVELS.
- 13. FIRESEAL ALL PENETRATIONS, SUCH AS, PIPES, DUCTS, CONDUITS, ETC. THROUGH FIRE AND/OR SMOKE RATED ASSEMBLIES.
- 14. FOR CONTROL JOINT (C.J.) LOCATIONS REFER TO EXTERIOR ELEVATIONS AND/OR FLOOR PLANS.
- 15. PAINT ALL ELECTRICAL PANEL COVERS AND ACCESS PANELS TO MATCH ADJACENT FINISHES. USING OIL-BASED PAINT, NOT LATEX WALL PAINT.
- 16. PROVIDE WOOD BLOCKING IN WALLS THAT REQUIRE WALL MOUNTED EQUIPMENT OR ACCESSORIES. COORDINATE WITH EQUIPMENT OR ACCESSORY MANUFACTURER.
- 17. PROVIDE ALL ASSOCIATED CURBS FOR ROOF TOP EQUIPMENT AND MECHANICAL ROOF TOP UNITS. LARGE VOIDS BELOW THE AIR HANDLING UNITS SHALL BE FILLED WITH INSULATION AS SPECIFIED FOR NOISE CONTROL.
- 18. ALL EXISTING ROOF TOP PENETRATIONS BEING REMOVED REQUIRE ROOF PATCHING TO MATCH EXISTING ADJACENT.





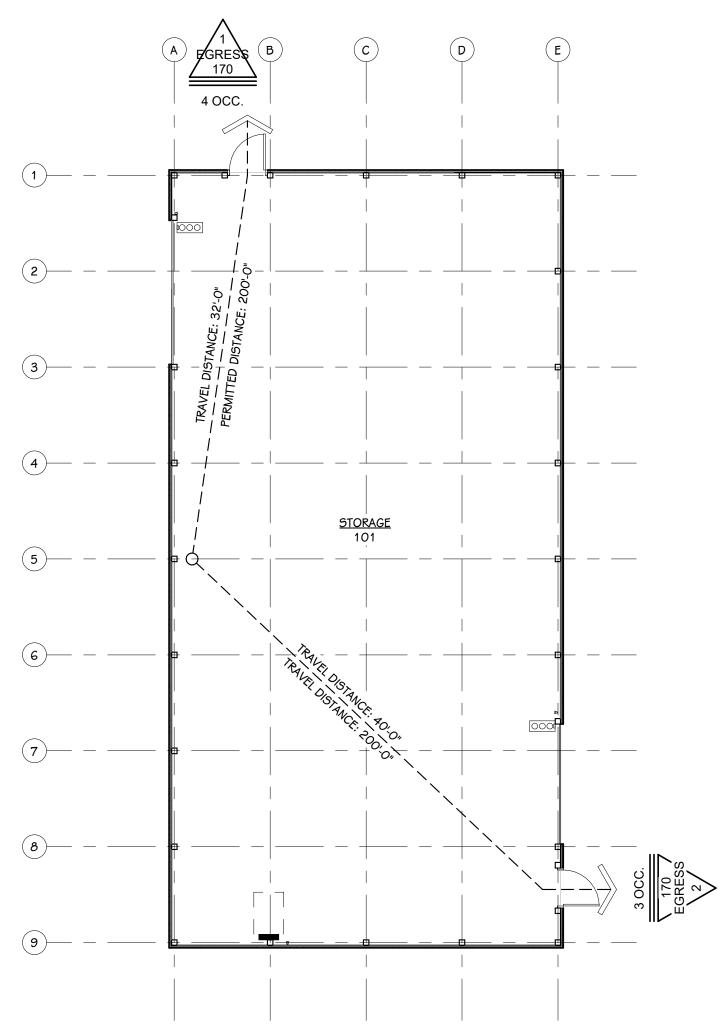

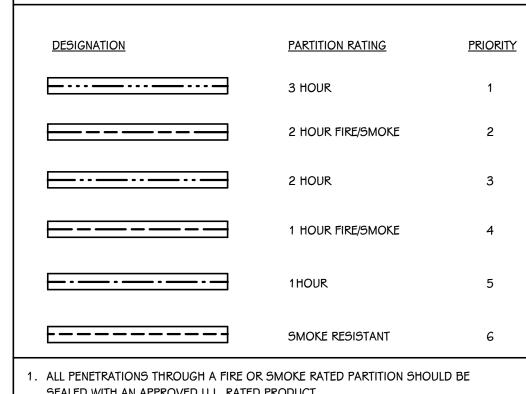

- SEALED WITH AN APPROVED U.L. RATED PRODUCT.
- 2. THE TOPS OF ALL FIRE RATED PARTITIONS SHALL BE SEALED TO THE CONTINUOUS STRUCTURE ABOVE WITH A U.L. RATED SYSTEM OR ASSEMBLY.
- 3. WOOD BLOCKING IN FIRE-RATED PARTITIONS SHALL BE NON-COMBUSTIBLE
- TREATED WOOD.
- 4. REFER TO SPECIFICATION U.L. RATING INFORMATION.
- 5. FIRE-RATED WALLS ENDING INTO AN ACOUSTICAL DECK MUST HAVE THE FLUTES FILLED, REFER TO 'TOP OF WALL DETAIL AT ACOUSTIC DECK' SHOWN ON THIS
- FOR MASONRY WALLS THE MASON SHALL FILL VOIDS AND FIRE SPRAY WITH UL LISTED
- FOR STUD WALLS USE FIRE SAFING AND FIRE CAULK.

Michigan Building Code - 2015 Edition

Section 311.2: The storage room to be classified as Moderate-hazard Storage Group S-1. (Must comply with the maximum allowable quantities of hazardous materials listed in Table 307.1 (1). Allowable Height: Occupancy 5-1, Type V-5: 40 feet Table 504.3:

Table 504.4: Allowable Stories: Occupancy 5-1, Type V-5: 1 Story

Section 506.2: Allowable Area: Occupancy 5-1, Type V-N5: 9,000 sf Section 506.3: A frontage increase is not required. The building area complies with the

allowable area in Table 506.2. Table 601 – Construction Type V-B (Non-sprinklered – Single Story) Construction in which structural elements, and exterior walls, and

interior walls are of any materials permitted by this code.

Table 1004.1.2: Occupant Load Factors

Storage Areas: 300 gross Calculated Occupancies

Storage (2,093 gross sq. ft.) - 7 Occupants

Section 1005.3: Egress Capacity Factors 1005.3.2 All others = 0.2 inches per Occupant

Table 1006.2.1: Maximum Common Path of Travel shall not exceed: Storage: 100 ft without sprinkler system and occupant load is less than 30 occupants

Section 1007.1.1 Where two exits, exit access doorways, exit access stairways or ramps, or any combination thereof, are required from any portion of the exit access, they shall be placed a distance apart equal to not less than one-half of the length of the maximum overall diagonal dimension of the building or area to be served measured in a straight line between

Exit Access Travel Distance shall not exceed:

Storage: 200 feet

Portage, Michigan E COMPLIANCE | AND GENERAL 2020 LOOR COE L SYMBOL

- FORCE AT TIME OF CONSTRUCTION.
- . THE GENERAL CONTRACTOR SHALL BE RESPONSIBLE FOR OBTAINING ALL PERMITS, PERMIT COSTS, TAP FEES, METER DEPOSITS, PERMANENT UTILITY APPLICATIONS, BONDS, AND OTHER FEES REQUIRED FOR PROPOSED WORK. THIS SHALL INCLUDE, BUT SHALL NOT BE LIMITED TO THOSE REQUIRED BY THE CITY OF PORTAGE
- CONTACT "811" AT 1-800-482-7171 FOR LOCATION OF UNDERGROUND UTILITIES A MINIMUM OF 48 HOURS BEFORE COMMENCING EXCAVATION WORK. THIS DOES NOT RELIEVE THE CONTRACTOR OF THE RESPONSIBILITY OF NOTIFYING UTILITY OWNERS WHO ARE NOT PART OF THE "811" ALERT SYSTEM. THE CONTRACTOR SHALL CONDUCT HIS OPERATIONS IN A MANNER AS TO ENSURE THAT THOSE UTILITIES NOT REQUIRING RELOCATION WILL NOT BE DISTURBED.
- DEMOLISH & REMOVE ALL EXISTING SITE FEATURES AS REQUIRED.
- . MATCH EXISTING GRADES AROUND PERIMETER WITH SLOPES AS SHOWN.
- ALL SPOT ELEVATIONS ARE TOP OF PAVEMENT GRADES AT EDGE OF METAL (EOM) UNLESS OTHERWISE NOTED.
- . ALL SOIL EROSION CONTROL MEASURES SHALL BE IN PLACE PRIOR TO MASS GRADING.
- . ALL EXCAVATION SHALL BE IN ACCORDANCE WITH THE TECHNICAL SPECIFICATIONS AND GEOTECHNICAL REPORT.
- 9. ALL EXISTING ELEVATIONS ARE TO BE VERIFIED AND ACCEPTED AS SHOWN PRIOR TO COMMENCEMENT OF WORK.
- 10. CONTRACTOR SHALL TAKE PRECAUTIONS TO AVOID TRACKING SOIL ONTO ADJACENT ROADWAYS. CONTRACTOR SHALL SWEEP IMMEDIATELY IF OCCURS.
- 1. ANY DISTURBED AREA WHICH WILL BE LEFT UNWORKED 15 DAYS OR LONGER MUST BE SEEDED TO ESTABLISH VEGETATION FOR TEMPORARY STABILIZATION. BASINS TO BE SEEDED AND MULCH BLANKETS APPLIED IMMEDIATELY TO PROVIDE A STABLE BASE AND AVOID EXCESSIVE EROSION.

GENERAL CONSTRUCTION NOTES

- ALL WORK SHALL CONFORM TO ALL LOCAL, STATE AND FEDERAL LAWS, RULES AND REGULATIONS IN FORCE AT TIME OF CONSTRUCTION.
- ALL PLUMBING WORK SHALL BE PERFORMED BY A STATE OF MICHIGAN LICENSED PLUMBER ACCORDING TO THE INTERNATIONAL PLUMBING CODE AS MODIFIED BY THE STATE OF MICHIGAN AND LOCAL HEALTH DEPARTMENT. FURNISH AND INSTALL ALL MATERIALS AND LABOR TO PROVIDE A FULL WORKING SYSTEM.
- ALL WORK SHALL CONFORM TO THE MICHIGAN HANDICAPPED ACCESSIBILITY CODE AND THE AMERICANS WITH DISABILITIES ACT.
- THE GENERAL CONTRACTOR SHALL BE RESPONSIBLE FOR OBTAINING ALL PERMITS, PERMIT COSTS, TAP FEES, METER DEPOSITS, PERMANENT UTILITY APPLICATIONS, BONDS, AND OTHER FEES REQUIRED FOR PROPOSED WORK.
- . CONTACT "MISS DIG" AT 1-800-482-7171 FOR LOCATION OF UNDERGROUND UTILITIES A MINIMUM OF 48 HOURS BEFORE COMMENCING EXCAVATION WORK, THIS DOES NOT RELIEVE THE CONTRACTOR OF THE RESPONSIBILITY OF NOTIFYING UTILITY OWNERS WHO ARE NOT PART OF THE "MISS DIG" ALERT SYSTEM. THE CONTRACTOR SHALL CONDUCT HIS OPERATIONS IN A MANNER AS TO ENSURE THAT THOSE UTILITIES NOT REQUIRING RELOCATION WILL NOT BE DISTURBED.
- MANHOLE AND CATCH BASIN STRUCTURES SHALL BE PRECAST AND HAVE A MAXIMUM OF 2 ADJUSTING RINGS FOR FINISH GRADE ADJUSTMENT.
- DEMOLISH & REMOVE ALL EXISTING SITE FEATURES AS REQUIRED.

SITE MATERIALS & CONSTRUCTION NOTES:

- SOILS EXPOSED IN THE BASE OF ALL SATISFACTORY FOUNDATION EXCAVATIONS SHOULD BE PROTECTED AGAINST ANY DETRIMENTAL CHANGES IN CONDITION SUCH AS FROM DISTURBANCE, RAIN AND FREEZING. SURFACE RUN-OFF WATER SHOULD BE DRAINED AWAY FROM THE EXCAVATION AND NOT ALLOWED TO POND. IF POSSIBLE, ALL FOOTING CONCRETE SHOULD BE POURED THE SAME DAY THE EXCAVATION IS MADE. IF THIS IS NOT PRACTICAL, THE FOOTING EXCAVATIONS SHOULD BE ADEQUATELY PROTECTED.
- REMOVE ALL SUBGRADE GRADE MATERIAL THAT MAY BE SOFTENED BY RAINS, FREEZING, OR CONSTRUCTION TRAFFIC, ETC. AND REPLACE WITH COMPACTED GRANULAR FILL.
- THE CONTRACTOR SHALL INSTALL A PEDESTRIAN FENCE AROUND ALL EXCAVATIONS TO BE LEFT OPEN OVERNIGHT AS REQUIRED.
- EXTERIOR CONCRETE SHALL HAVE A COMPRESSIVE STRENGTH OF 4000 PSI AND SHALL HAVE LIMESTONE AGGREGATE AND SHALL HAVE 4 - 6 % AIR ENTRAINMENT WITH A BROOM FINISH.
- EXPANSION JOINTS IN CONCRETE PAVEMENT AND WALLS SHALL BE 1/2" ASPHALT IMPREGNATED FULL DEPTH 40' O.C. MAXIMUM & AT SIDEWALK INTERSECTIONS. CRACK CONTROL SCORING AT SIDEWALK WIDTH DIMENSION AND @ 10'-0" O.C. IN DRIVES.

GENERAL NOTES

- DIMENSIONS TAKE PRECEDENCE OVER SCALE. CONTRACTOR TO VERIFY ALL DIMENSIONS IN FIELD.
- IF ANY ERRORS, DISCREPANCIES, OR OMISSIONS BECOME APPARENT, THESE SHALL BE BROUGHT TO THE ATTENTION OF THE ARCHITECT/ ENGINEER PRIOR TO CONSTRUCTION OF ANYTHING AFFECTED SO THAT CLARIFICATION OR REDESIGN

LEGEND

MAY OCCUR.

-///// SAWCUT

LIMITS OF CONSTRUCTION

SILT FENCE

EXISTING GRADE

SITE DATA

PROPERTY INFORMATION: PARCEL #s: 00017-095-0

SITE AREA: 2875000 SF (66 AC) OWNER: PORTAGE PUBLIC SCHOOLS 8107 MUSTANG DR

PORTAGE, MI 49002 2. ZONING:

R-1B RESIDENTIAL ABUTTING PROPERTY CURRENTLY ZONED: NORTH: R-1B RESIDENTIAL SOUTH: PD RESIDENTIAL EAST: R-1B RESIDENTIAL

STM YD

NONWOVEN GEOTEXTILE -

COARSE AGGREGATE WASHED MDOT 6A

PRECAST PERFORATED

CONCRETE STRUCTURE

NOTE:

INLET SHALL BE

CONSTRUCTED IN

PRECAST REINFORCED -

ACCORDANCE WITH ASTN

CONCRETE

BASE SECTION

COARSE AGGREGATE

WASHED MDOT 6A

SPECIFICATION C-478

FABRIC, AMOCO 4553

OR EQUAL -

E.J.I.W. #6517 (OR APPROVED EQUAL) -

RIM = 900.58

WEST: PD RESIDENTIAL/RM-1 RESIDENTIAL


PORTAGE WEST

MIDDLE SCHOOL

SETBACKS FRONT = 0' SIDES = 0' (25' IF ABUTS R DISTRICT) REAR = 0' (25' IF ABUTS R DISTRICT)

4. PARKING: NOT APPLICABLE 5. STORM WATER RETENTION REQUIRED TOTAL IMPERVIOUS AREA: 3,349 SQFT

REQUIRED STORM WATER VOLUMES BASED ON 3" OVER IMPERVIOUS AREA: REQUIRED STORAGE VOLUME: 838 CFT PROVIDED VOLUME:

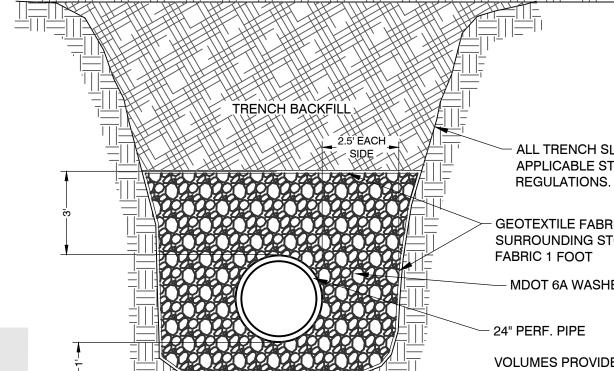

NO SCALE

4' DIA. MANHOI F -

BEEHIVE COVER

BTM: 890.20

24" HDPE E IE: 892.50

6" SDR 35 S IE: 896.23

6"x6"x6" WYE —

77LF - 6" SDR 35 @ 1.00% —

6"x6"x6" WYE -

REMOVE OLD FENCE


(SEE FENCE REMOVALS

SAWCUT CLEAN STRAIGHT EDGE FOR -

APPROXIMATE LOCATION OF

-WATER PER CITY OF PORTAGE

NEW CONCRETE CONNECTION

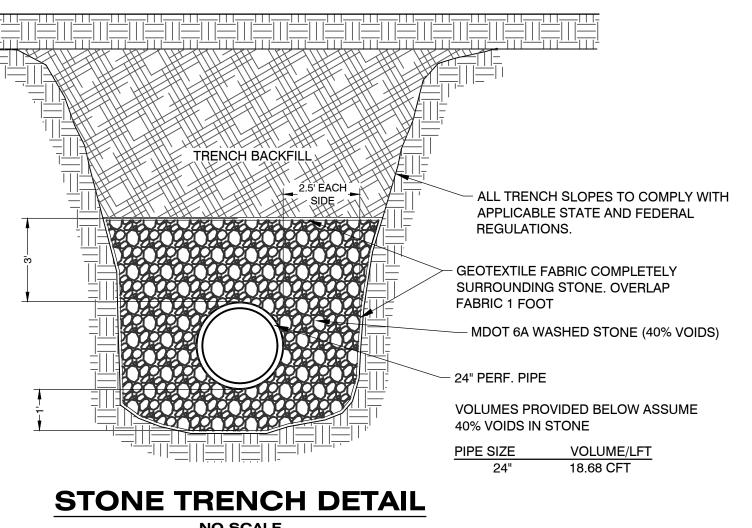

DENOTES TEMPORARY SILT FENCE. SILT FENCE SHALL BE INSTALLED AT CREEK CROSSINGS, ADJACENT TO ALL WETLANDS AND SURFACE WATERS, AND OTHER LOCATIONS AS DIRECTED BY THE ENGINEER. EACH SILT FENCE SHALL BE INSTALLED GENERALLY ALONG THE SAME CONTOUR ELEVATION.

SOIL EROSION & SEDIMENTATION CONTROL NOTES

AREAS ACT AS SEDIMENT FILTERS.

THE VARIOUS EROSION CONTROL ITEMS.

(APPLIES TO ENTIRE PROJECT)

4' DIA. LEACHING BASIN

24" HDPE W IE: 892.50

6" SDR 35 S IE: 896,23

- 6"x6"x6" WYE

BEEHIVE COVER

RIM: 899.50

SILT FENCE

- 6"x6"x6" WY

- 31 LF - CHAIN LINK FENCE CONNECTED TO BUILDING

POLE BARN

F.F. - 900.50

TOTAL SQFT: 2,048

- 40' - 24" PERFORATED HDPE PIPE

IN STONE TRENCH @ 0.00% (SEE DETAIL THIS SHEET)

UP AND APPROVAL.

RESPONSIBILITY FOR PROVIDING ALL REQUIRED EROSION CONTROL MEASURES.

ALL CONSTRUCTION METHODS SHALL BE DONE IN COMPLIANCE WITH MDOT-MDEQ. THE OWNER SHALL BE

COVERAGE" FROM MDEQ. IF APPLICABLE, PRIOR TO START OF CONSTRUCTION, THE CONTRACTOR SHALL BE

SHOWN ON THE PLANS ARE THE MINIMUM REQUIREMENTS AND SHALL NOT RELIEVE THE CONTRACTOR'S

RESPONSIBLE FOR OBTAINING A "SOIL EROSION PERMIT" FROM THE COUNTY AND A "PERMIT BY RULE/NOTICE OF

RESPONSIBLE FOR COMPLYING WITH ALL REQUIREMENTS OF THE COUNTY "SOIL EROSION PERMIT" AND FOR ALL

CERTIFIED STORM WATER INSPECTION SERVICE REQUIRED BY THE "PERMIT BY RULE." EROSION CONTROL MEASURES

AVOID UNNECESSARY DISTURBING OR REMOVING OF EXISTING VEGETATED TOPSOIL OR EARTH COVER, THESE COVER

ALL TEMPORARY SOIL EROSION PROTECTION SHALL REMAIN IN PLACE UNTIL REMOVAL IS REQUIRED FOR FINAL CLEAN

GEOTEXTILE SILT FENCE SHALL BE INSTALLED AS REQUIRED WHEN CROSSING CREEKS OR WHEN ADJACENT TO

WETLANDS OR SURFACE WATER BODIES TO PREVENT SILTATION AND ELSEWHERE AS DIRECTED BY THE ENGINEER.

MAINTENANCE, CLEANING, AND REMOVAL OF THE VARIOUS SEDIMENT CONTROL MEASURES SHALL BE INCLUDED IN

SEDIMENTATION CONTROL MEASURES. "P" DENOTES PERMANENT MEASURE AND "T" DENOTES TEMPORARY MEASURE.

FENCE REMOVALS

1:40 SCALE

GROUND SURFACE

THREADED PLUG CAP -

NUMBER IN CIRCLE REFERS TO NUMBERED DETAILS ON MDOT STANDARD PLAN R-96-D, SOIL EROSION &

SOIL EROSION CONTROL PLANS DENOTE MINIMUM EROSION MEASURES REQUIRED AS DESCRIBED BELOW.

SEEDING AND/OR SODDING SHALL BE INSTALLED ON CREEK BANKS IMMEDIATELY AFTER CONSTRUCTION TO PREVENT

DENOTES INLET PROTECTION FABRIC DROP. SHALL BE INSTALLED AT EXISTING AND PROPOSED STORM SEWER INLETS TO PROVIDE SETTLING AND FILTERING OF SILT LADEN

DENOTES PERMANENT SEEDING. ALL DISTURBED AREAS NOT PAVED OR GRAVELED SHALL

BE RESTORED. PLACE TOPSOIL SURFACE, SALV, 3 INCH, MDOT SEEDING, MIXTURE TUF APPLIED AT A RATE OF 220 LB/ACRE, FERTILIZER, CHEMICAL NUTRIENT, CL A APPLIED AT A

RATE OF 228 LB/ACRE; MULCH AT A RATE OF 2 TON/ACRE AND MULCH ANCHORING.

WATER PRIOR TO ENTRY INTO THE DRAINAGE SYSTEM.

- EJIW 1410

CONCRETE ADJUSTING

RING GRADE35S, CONC.

AND MORTAR, OR

REINF. PRECAST MANHOLE SECTION.

CONCRETE REINFORCED

GRADE 35S OR PRECAST

REINFORCED SECTION

- GRAVEL FILL (WITHIN OPENING

AROUND PIPE END SECTION)

UNLESS OTHERWISE

FOOTING

SPECIFIED

(2) 45° ($\frac{1}{8}$ BEND)


PIPE SECTION

REINF. BATTER BLOCKS

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ISSUED FOR

THIS SHEET) UNLESS OTHERWISE **SPECIFIED** STORM WATER CLEANOUT I.E. 897.00 STORM WATER CLEANOUT I.E. 897.00 SIZE OF PIPE AS SHOWN ON PLANS - 15 LF - CHAIN LINK FENCE CONNECTED TO BUILDING ELECTRICAL SERVICE FOR BUILING TO BE RUN BY OTHERS PRIOR TO PROJECT. **CLEANOUT DETAIL** 6"-4,000 P.S.I. NON-REINFORCED - CONCRETE 6" MINIMUM COMPACTED (98%) SAND SUB-BASE (MDOT CLASS II) OR AS RECOMMENDED BY GEOTECHNICAL **ENGINEER** -ALL UTILITIES AS SHOWN ARE APPROXIMATE LOCATIONS DERIVED - ACCEPTABLE COMPACTED FROM ACTUAL MEASUREMENTS AND AVAILABLE RECORDS. THEY SUB-BASE (AS RECOMMENDED SHOULD NOT BE INTERPRETED TO BE EXACT LOCATION NOR BY GEOTECHNICAL ENGINEER) SHOULD IT BE ASSUMED THAT THEY ARE THE ONLY UTILITIES IN THE AREA. FIFI D WORK PERFORMED BY: H & S ENGINEERING **LEACHING BASIN DETAIL CONC. PAVEMENT SECTION** NOT TO SCALE NOT TO SCALE

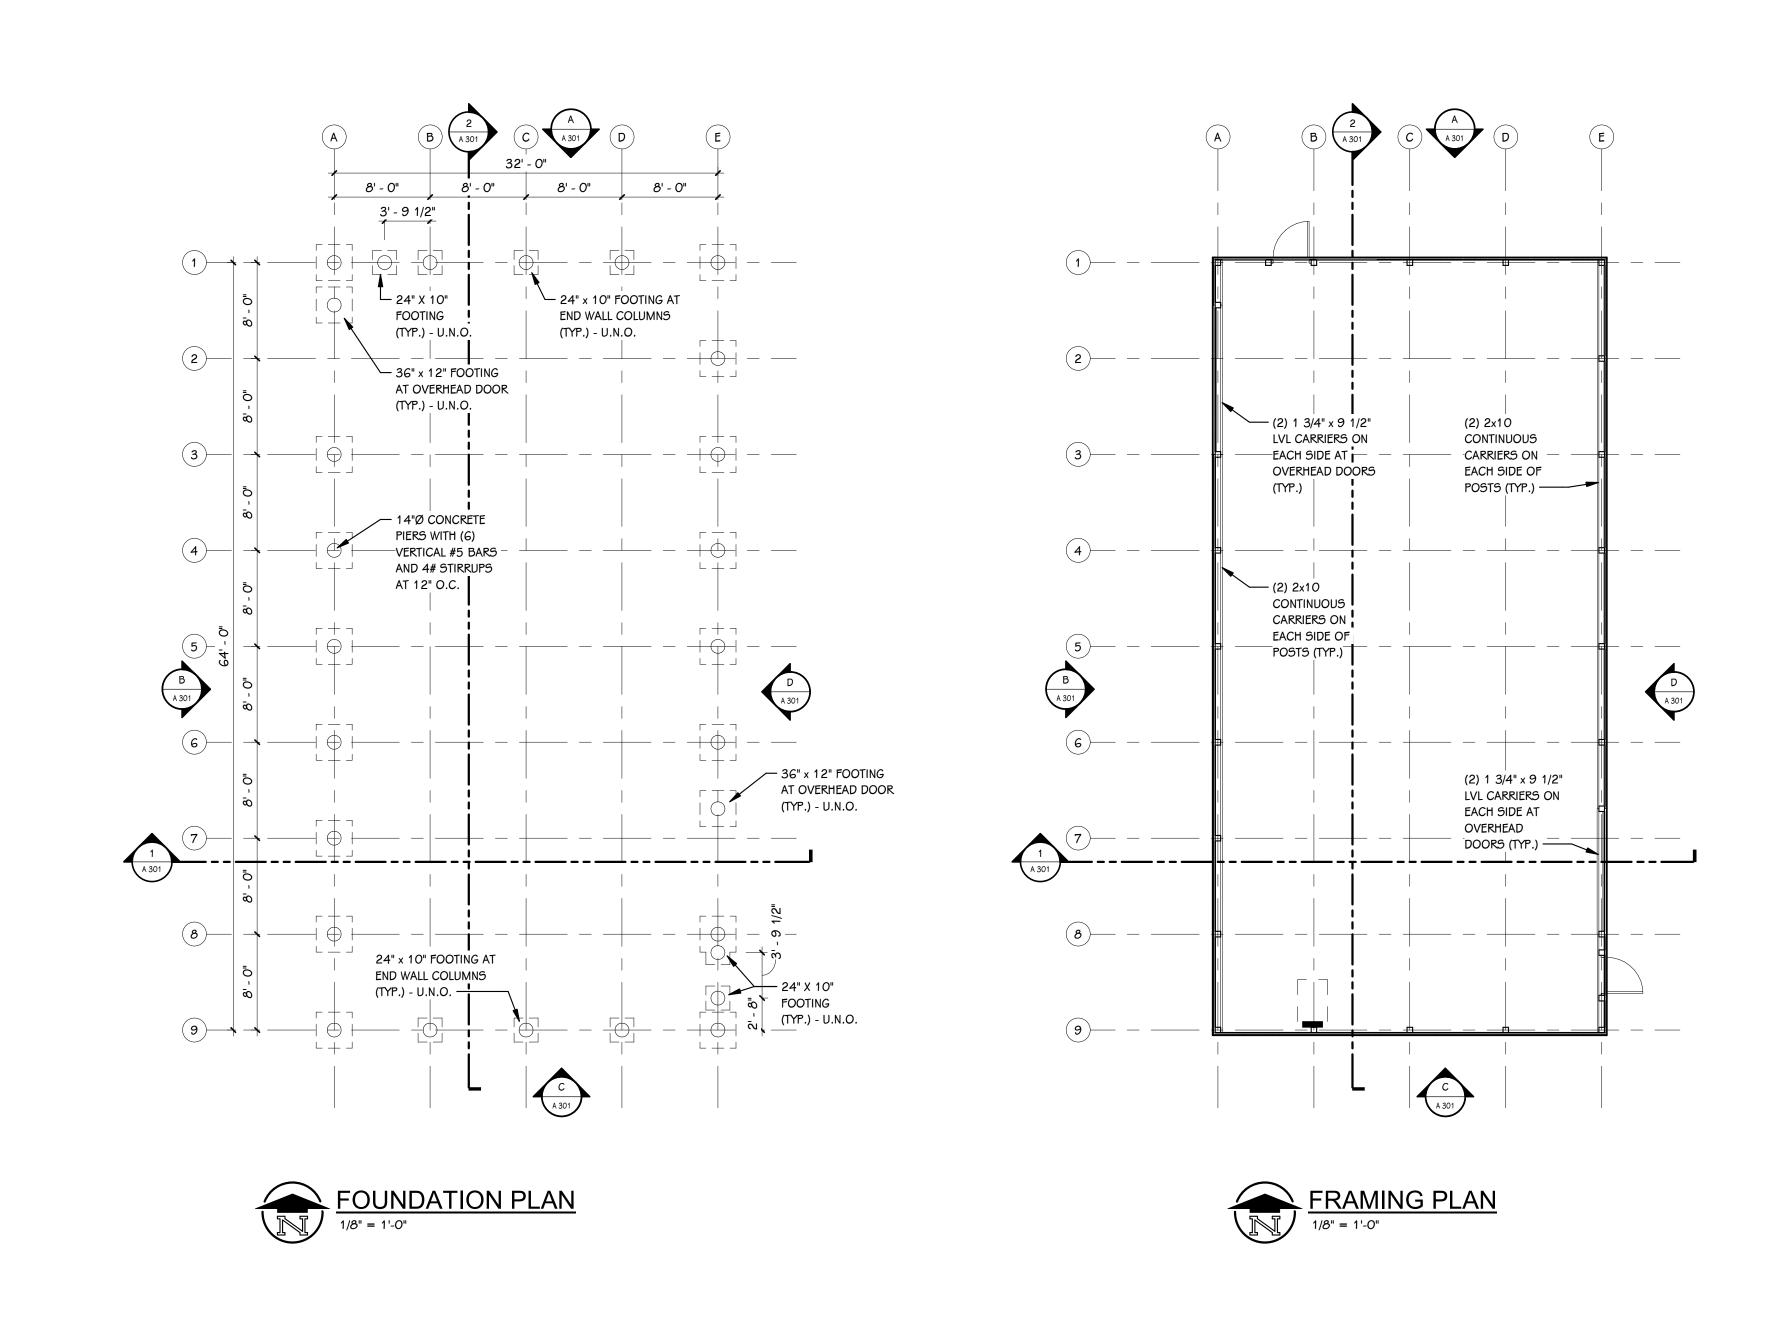


SHEET TITLE FOUNDATION AND FRAMING PLAN

OWNER PORTAGE | SCHOOLS

PROJECT TITLE PORTAGE - WEST MIDDLE SCHOOL -STORAGE BARN


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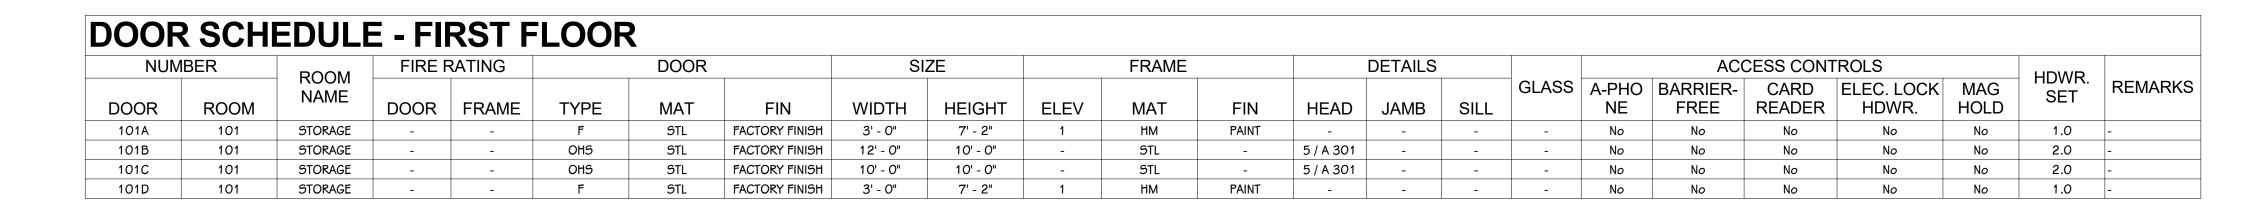



FIRST FLOOR PLAN

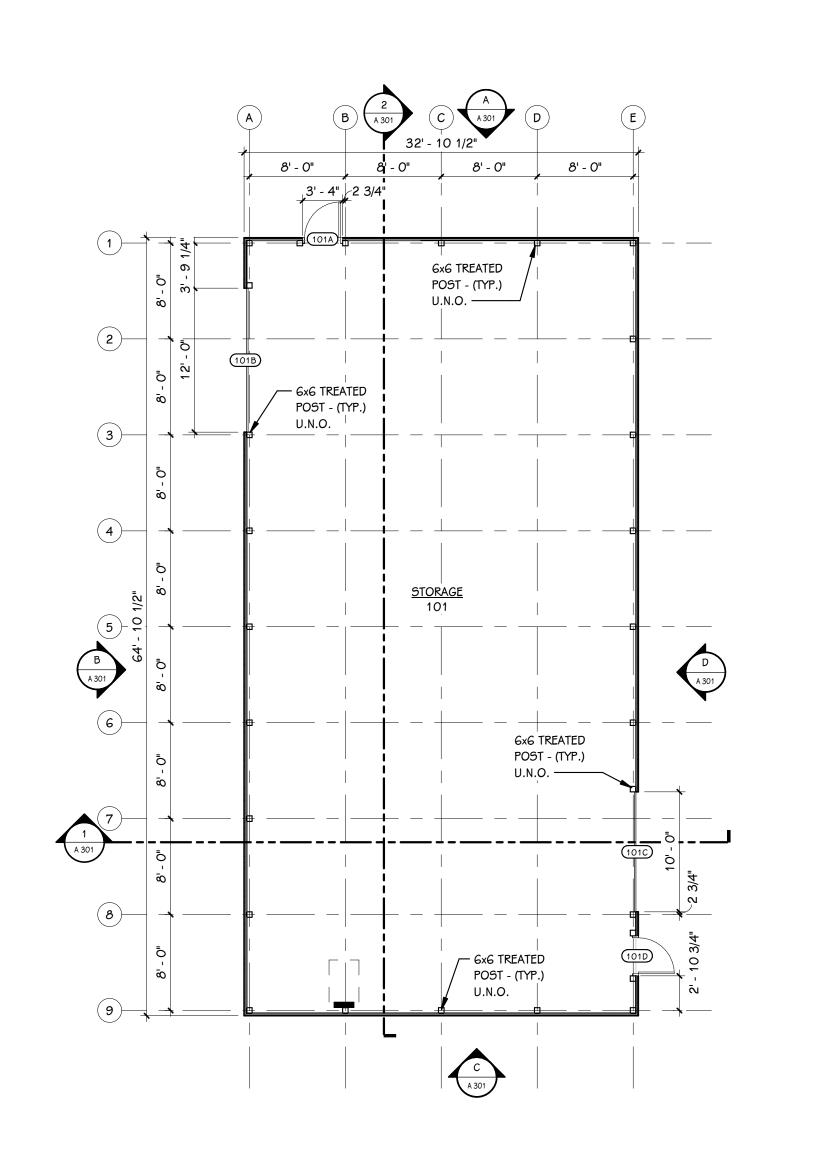1/8" = 1'-0"



 $\frac{\text{ROOF FRAMING PLAN}}{\frac{1}{8} = \frac{1}{0}}$

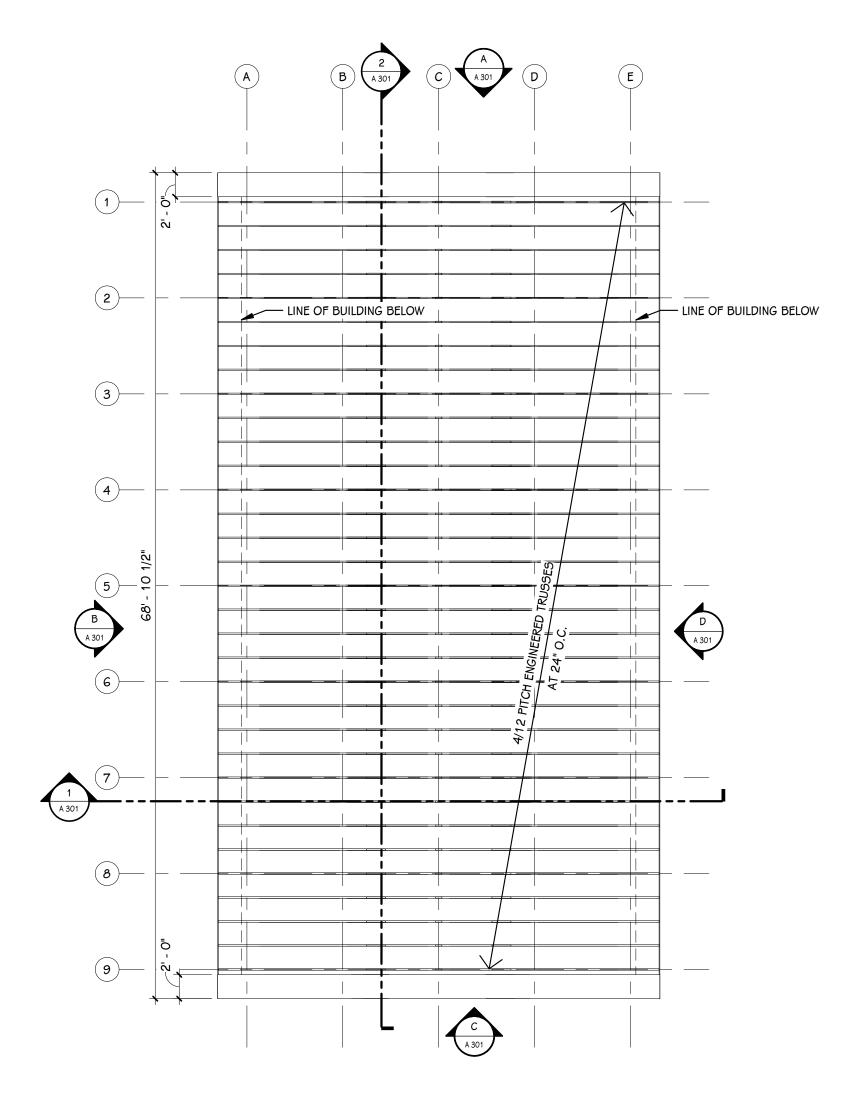

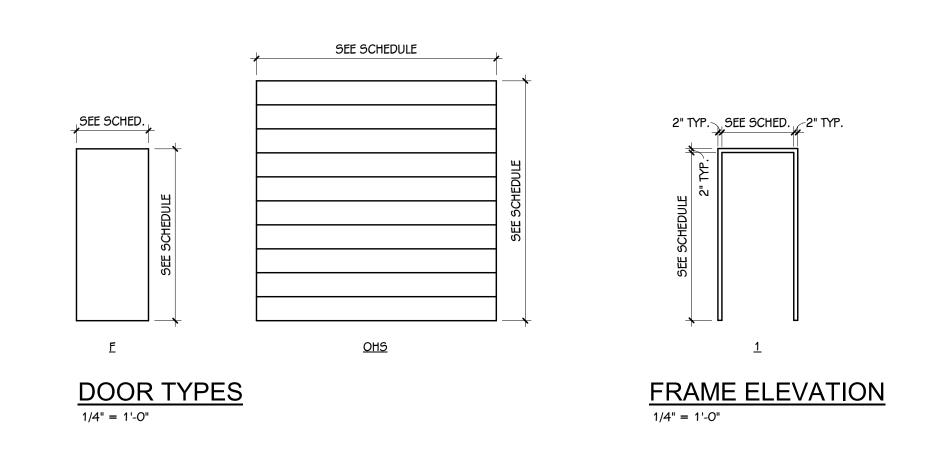

GENERAL NOTES

REFER TO CODE COMPLIANCE PLAN FOR WALL RATING LINES.

. REFER TO FLOOR FINISH PLANS FOR INTERIOR ELEVATION CALLOUTS.

. REFER TO SHEET A 501 FOR WALL AND CEILING ACCESS PANEL INFORMATION.

DATE


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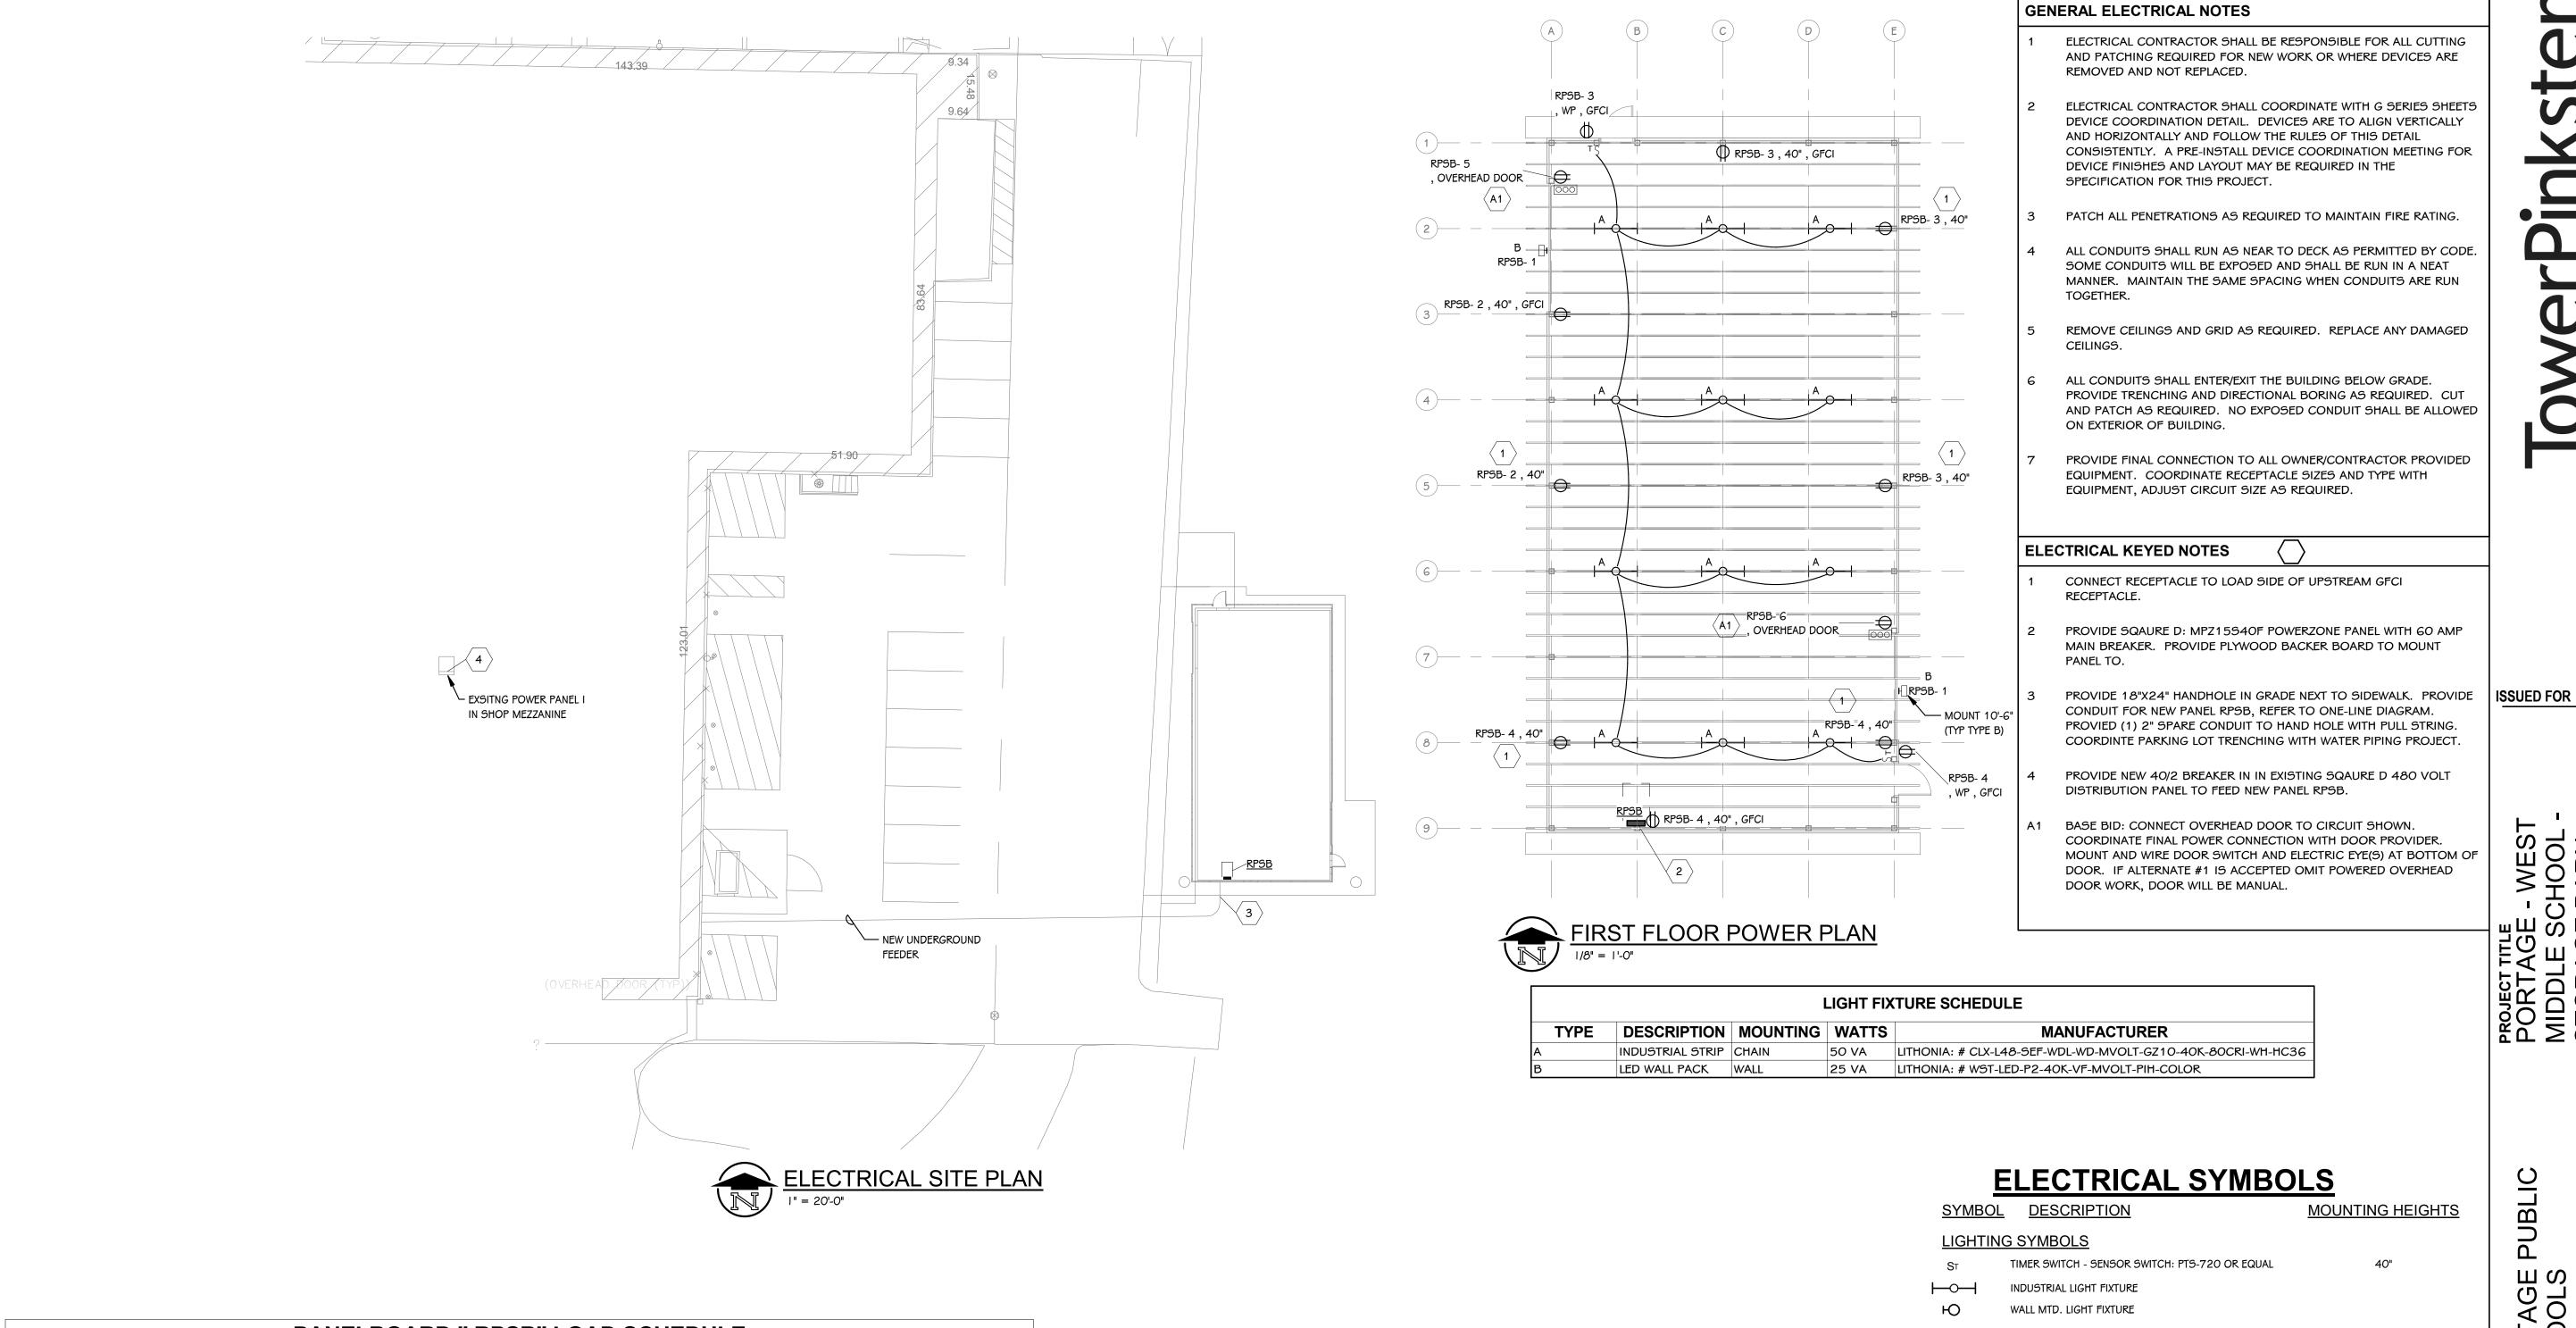
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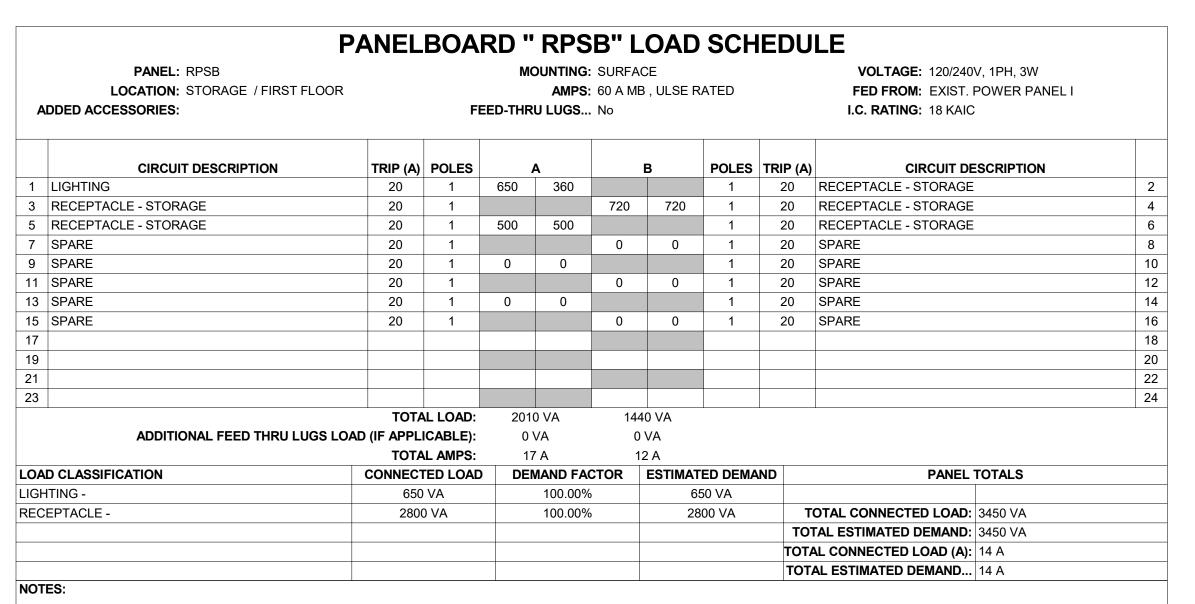
OWNER PORTAGE SCHOOLS


SHEET TITLE
FIRST FLOOR PLAN, ROOF FRAMING
PLAN AND DOOR SCHEDULE

A 101 19-220.00





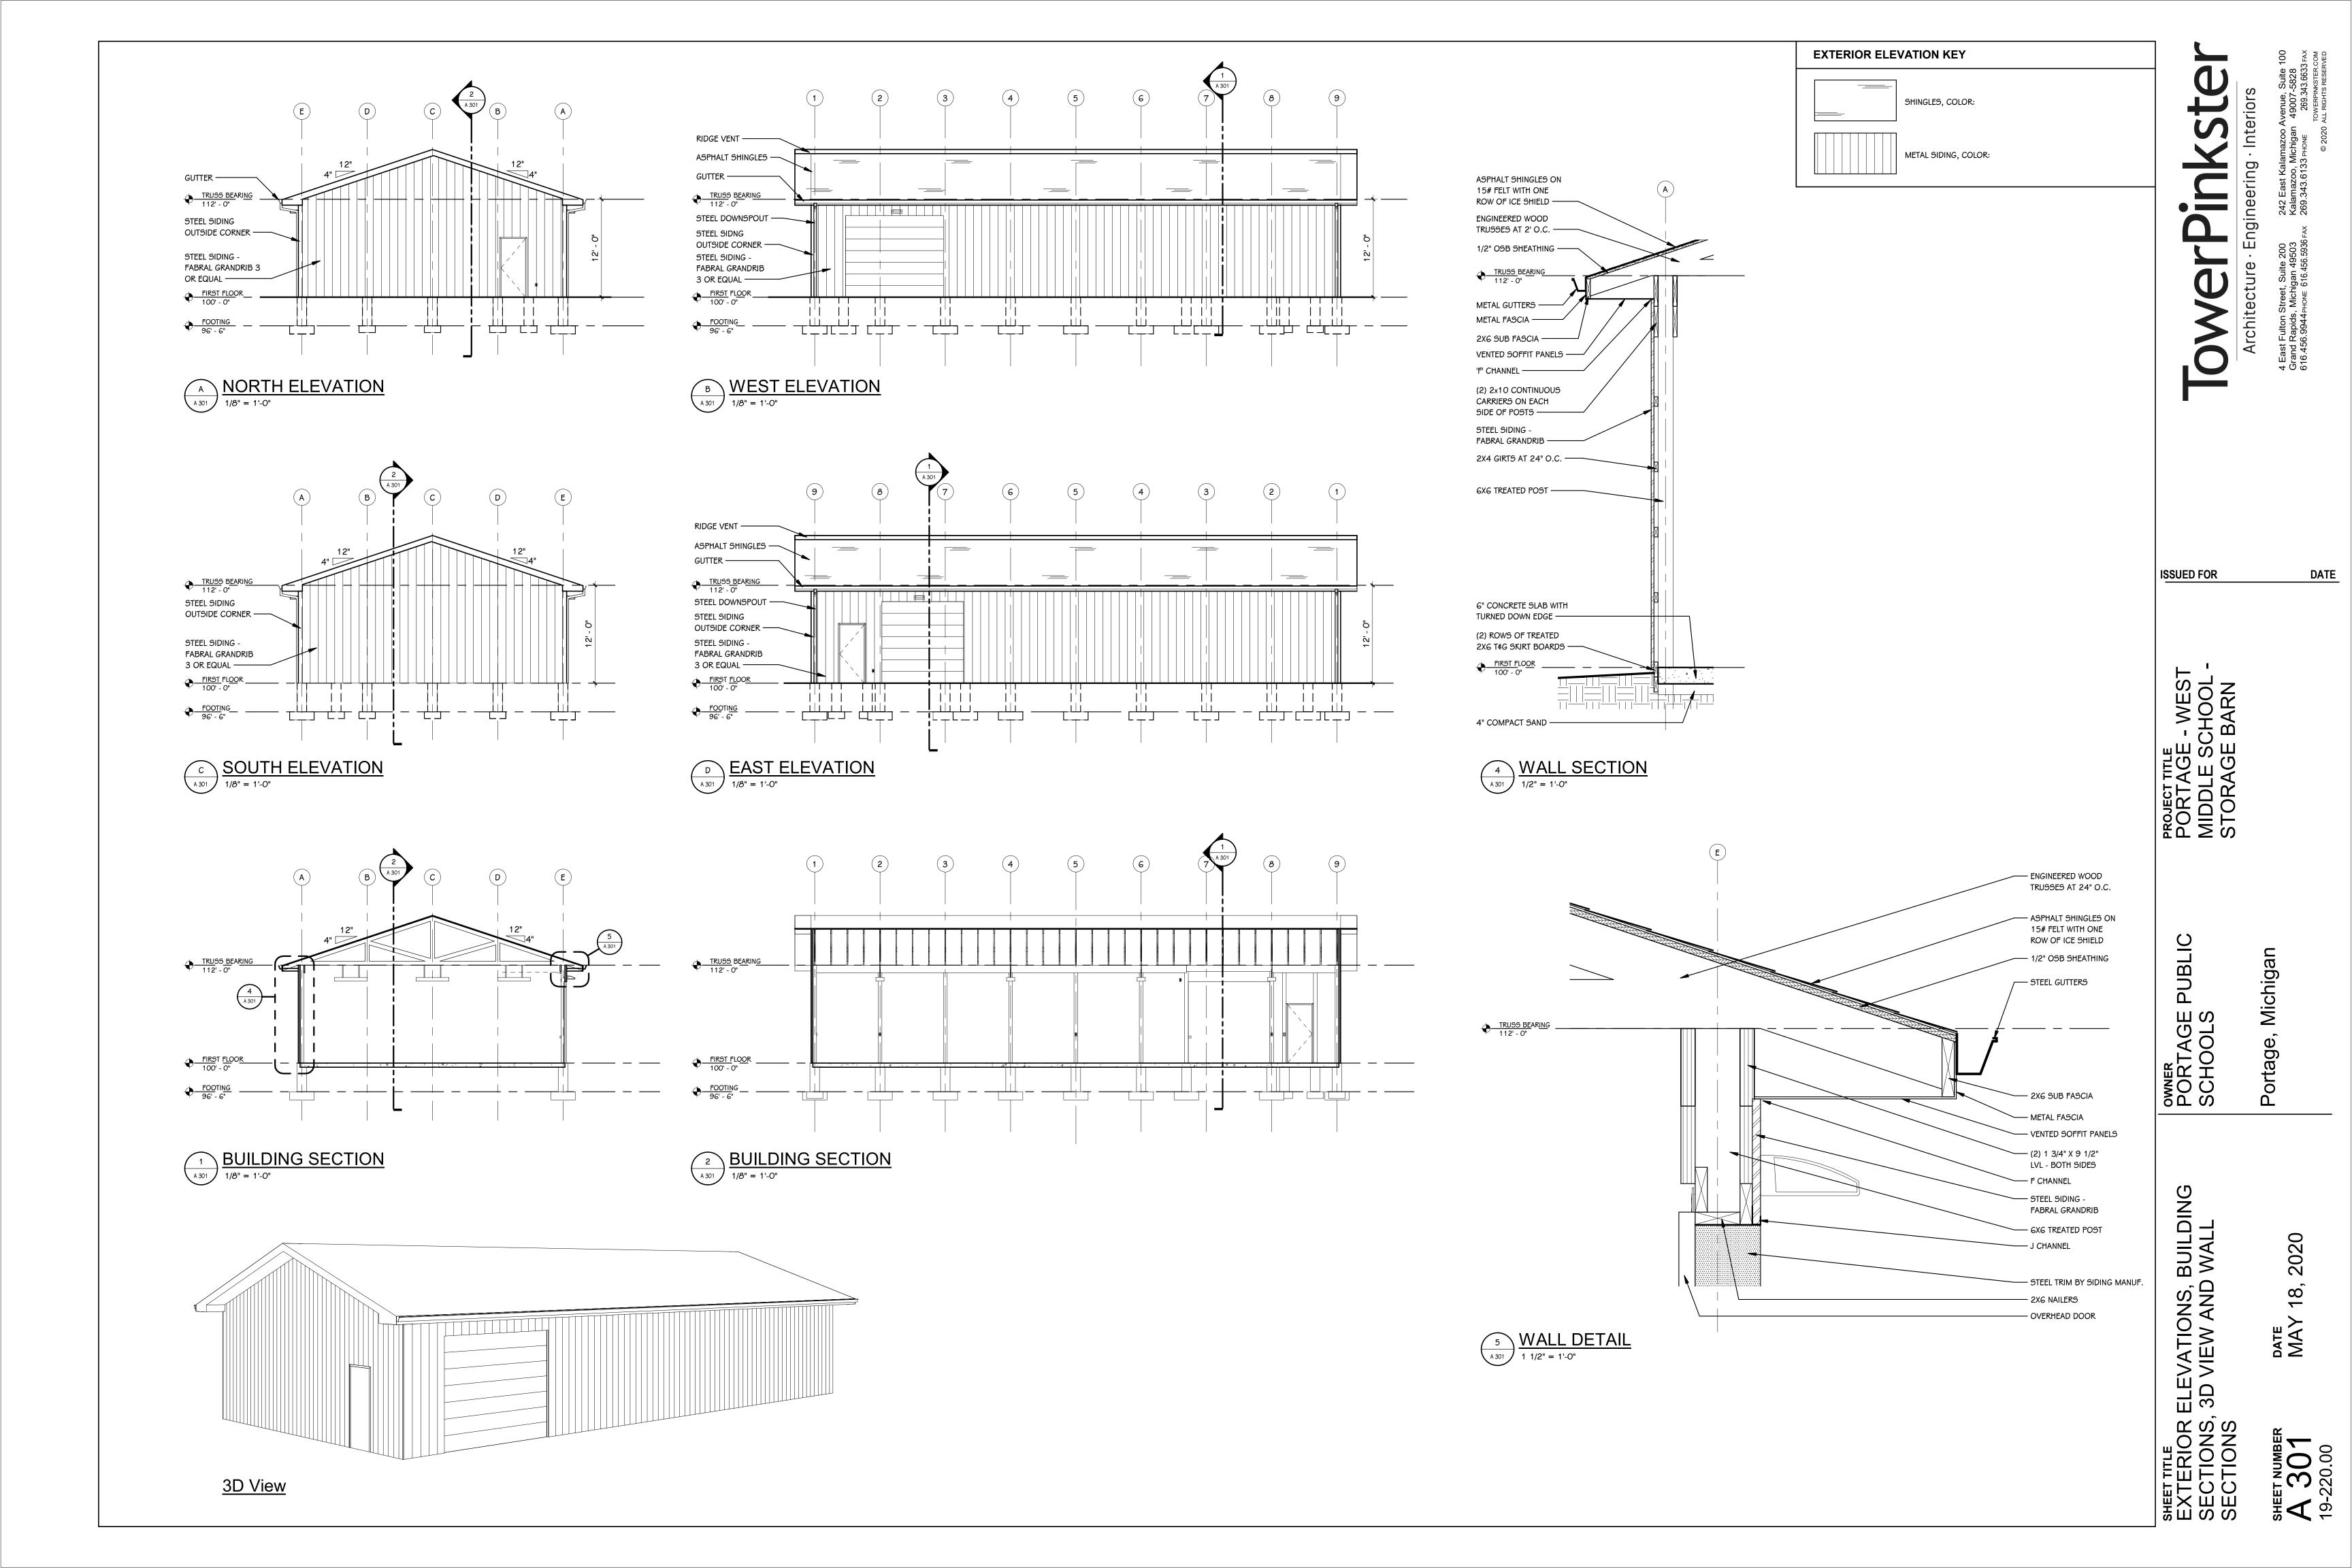

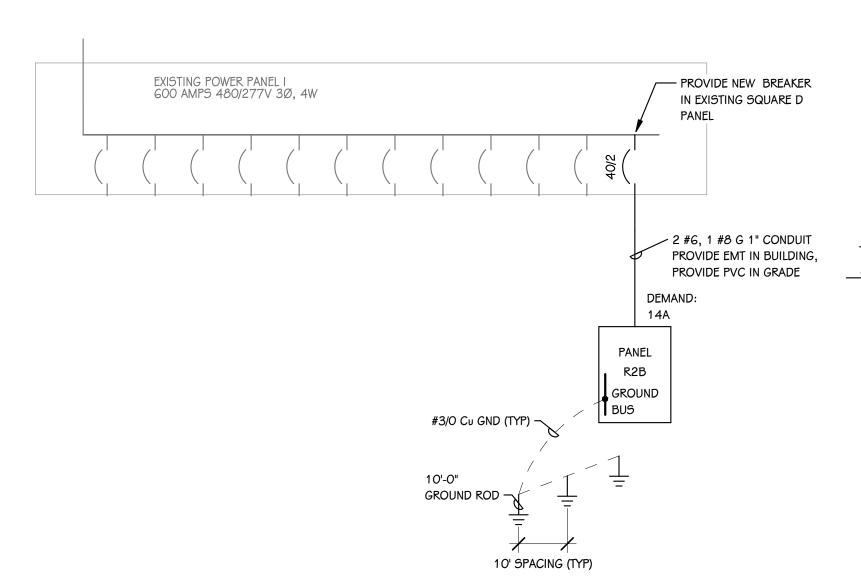

RECEPTACLE SYMBOLS DUPLEX RECEPTACLE DUPLEX RECEPTACLE - WET LOCATION ENCLOSURE WITH GFI

RECEPTACLES VARIATIONS - HEIGHT PER ABOVE UNLESS INDICATED ON DRAWINGS: DOUBLE DUPLEX RECEPTACLE GFI DUPLEX RECEPTACLE - WITH GFI

72" TO TOP

72" TO TOP

POWER SYMBOLS PANELBOARD

DISTRIBUTION PANELBOARD CIRCUIT BREAKER FLUSH IN-GRADE HAND HOLE

PUSH-BUTTON STATION - 3 HOLE

MOUNT DEVICES AT HEIGHTS INDICATED UNLESS INDICATED OTHERWISE ON PLANS. HEIGHTS ARE TO BOTTOM OF DEVICE.

PARTIAL ONE-LINE DIAGRAM

ng

DATE

PROJECT TITLE
PORTAGE - WEST
MIDDLE SCHOOL
STORAGE BARN

LOOR

2020

SHEET NUMBER 19-220.00