

INTERIOR DESIGN (ER)

YARD

. ALL WORK SHALL CONFORM TO THE 2019 EDITION TITLE 24 CALIFORNIA CODE OF REGULATIONS (C.C.R.)

THE DRAWINGS AND SPECIFICATIONS AND ALL COPIES THEREOF, ARE LEGAL INSTRUMENTS OF SERVICE FOR THE USE OF THE OWNER AND AUTHORIZED REPRESENTATIVE ON THE DESIGNATED PROPERTY ONLY. OTHER USE, WITHOUT THE EXPRESSED WRITTEN PERMISSION OF THE ARCHITECT, IS PROHIBITED

SPECIFICATIONS, DETAILS AND SCHEDULES WHICH MAY BE BOUND SEPARATELY, ARE PART OF THESE CONTRACT DOCUMENTS. DRAWINGS BY SEPARATELY CONTRACTED CONSULTING PROFESSIONALS (SUCH AS STRUCTURAL, INTERIORS OR LANDSCAPE) ARE SUPPLEMENTARY TO THE DESIGN DRAWINGS AND ARE PART OF THESE CONTRACT DOCUMENTS.

THE CONTRACTOR SHALL NOTIFY THE ARCHITECT IMMEDIATELY IF INFORMATION IS NOT SHOWN OR IS UNCLEAR. REPORT APPARENT DISCREPANCIES ON DRAWINGS AND/OR SPECIFICATIONS TO THE ARCHITECT BEFORE PROCEEDING WITH THE WORK.

THE CONTRACTOR SHALL OBTAIN ALL NECESSARY PERMITS AND APPROVAL FOR ALL WORK.

6. THE CONTRACTOR SHALL BE RESPONSIBLE FOR SCHEDULING AND

COORDINATING THE WORK FOR ALL UTILITIES AND SERVICES. ALL SYMBOLS AND ABBREVIATIONS USED ON THE DRAWINGS ARE CONSIDERED TO BE CONSTRUCTION STANDARDS. QUESTIONS REGARDING THE SAME, OR THEIR EXACT MEANING, SHALL BE DIRECTED TO THE ARCHITECT

CODE REQUIREMENTS: ALL WORK TO COMPLY WITH DIVISION OF THE STATE ARCHITECT REGULATIONS AND CURRENT EDITION OF TITLE 24 CODE OF REGULATIONS.

CONSTRUCTION IS TO COMPLY WITH ALL APPLICABLE REQUIREMENTS OF CALIFORNIA ADMINISTRATIVE CODE, TITLE 24.

10. EXISTING CONDITIONS: CONTRACTOR TO VERIFY ALL EXISTING CONDITIONS DESIGNATED AS, OR REQUIRED TO, INTERFACE WITH NEW CONSTRUCTION. REPORT ANY DISCREPANCIES, DEFICIENCIES, OR CONDITIONS INCOMPATIBLE WITH PROPOSED CONSTRUCTION PRIOR TO PROCEEDING

11. IT IS THE RESPONSIBILITY OF THE G.C. TO INSTALL ALL TEMPORARY BRACING AND SHORING TO ENSURE THE SAFETY OF THE WORK UNTIL IT IS IN ITS COMPLETED FORM. DO NOT REMOVE EXISTING STRUCTURAL SUPPORTS OR BEARING WALLS WITHOUT WRITTEN PERMISSION FROM THE ARCHITECT OR STRUCTURAL ENGINEER.

DIMENSIONS/ NOTES/ DETAILS: DO NOT SCALE DRAWINGS. VERIFY ALL DIMENSIONS AND CONDITIONS IN FIELD, AND IMMEDIATELY REPORT ANY DISCREPANCIES OR EXISTING AND PROPOSED VARIATIONS TO THE ARCHITECT THE CONTRACTOR IS RESPONSIBLE FOR CHECKING AND COORDINATING DIMENSIONS. ALL WRITTEN DIMENSIONS TO TAKE PRECEDENCE OVER SCALE SHOWN ON PLANS, SECTIONS, AND DETAILS. SPECIFIC NOTES AND DETAILS ON THE DRAWINGS SHALL TAKE PRECEDENCE OVER ANY GENERAL NOTES OR DETAILS. CONDITIONS NOT SPECIFICALLY DETAILED SHALL BE CONSTRUCTED AS SIMILAR CONDITIONS DETAILED AND/OR INDICATED ON THE DRAWINGS. ANY WORK INSTALLED IN CONFLICT WITH THE DESIGN DRAWINGS SHALL BE CORRECTED BY THE CONTRACTOR AT HIS EXPENSE

ALL EXTERIOR DIMENSIONS ARE TO ASSUMED FACE OF PLYWOOD SHEATHING OR FACE OF MASONRY UNO. INTERIOR DIMENSIONS ARE TO FACE OF GYPSUM BOARD FINISH OR CENTERLINE OF WALL UNO.

14. ONLY APPROVED WORKING DRAWINGS, WITH THE STATEMENT "APPROVED DRAWINGS", ARE TO BE USED FOR CONSTRUCTION OF THIS PROJECT. CONTRACTORS USING OTHER THAN APPROVED DRAWINGS ARE SOLELY RESPONSIBLE FOR SUCH WORK.

GEOTECHNICAL REPORTS ARE NOT INCLUDED IN THE CONTRACT DOCUMENTS BUT MAY BE MADE AVAILABLE TO THE CONTRACTOR FOR INFORMATION ONLY. THE ARCHITECT ASSUMES NO RESPONSIBILITY FOR ANY CONCLUSIONS THE CONTRACTOR MAY DRAW FROM SUCH INFORMATION. THE CONTRACTOR SHALL INVESTIGATE AND DETERMINE EXISTING SOILS AND SITE CONDITIONS UNDER WHICH CONTRACTOR WILL OPERATE IN PERFORMING THE WORK.

16. THE CONTRACTOR IS TO ASSUME SOLE AND COMPLETE RESPONSIBILITY FOR JOB SITE CONDITIONS DURING THE COURSE OF DEMOLITION AND CONSTRUCTION, INCLUDING SAFETY OF ALL PERSONS AND PROPERTY, THIS REQUIREMENT SHALL APPLY CONTINUOUSLY, AND SHALL NOT BE LIMITED TO NORMAL WORKING HOURS. CONTRACTOR SHALL RESTRICT GENERAL PUBLIC

ACCESS TO THE DEMOLITION, CONSTRUCTION, AND STORAGE AREAS. 17. HAZARDOUS MATERIALS ARE NOT TO BE STORED IN THE BUILDING, NOR USED IN CONSTRUCTION, IN QUANTITIES EXCEEDING THOSE SPECIFIED IN THE CBC.

DURING DEMOLITION AND CONSTRUCTION THE CONTRACTOR SHALL BE SOLELY RESPONSIBLE FOR DETERMINING THE EXISTENCE AND PRECISE LOCATION OF UNDERGROUND PIPING AND OTHER STRUCTURES WHICH MAY BE AFFECTED BY CONSTRUCTION. PROMPTLY NOTIFY EACH UTILITY COMPANY, MUNICIPALITY, OR OTHER AGENCY OWNING OR OPERATING ANY AFFECTED FACILITIES OR STRUCTURES, AND REQUEST ENGINEERING INFORMATION AND MARKING OF FACILITIES IN FIELD, PRIOR TO COMMENCING ANY WORK ON THE SITE. REMOVE ALL ITEMS SPECIFIED TO BE ABANDONED, AND TAKE CARE TO PREVENT ANY DAMAGE TO, OR DISRUPTION OF, ITEMS TO REMAIN.

WHERE FIRE-RATED WALL OR CEILING ASSEMBLIES ARE PENETRATED BY RECESSED FIXTURES, MECHANICAL DUCTS, OR OTHER ITEMS, THE FIXTURES, DUCTS, OR OTHER ITEMS SHALL BE FIRE-RATED TO MATCH THE WALL OR CEILING ASSEMBLY.

20. U.N.O. ALL EXTERIOR DOORS SHALL LIMIT AIR INFILTRATION WHEN IN CLOSED POSITION AS FOLLOWS: PROVIDE WEATHERSTRIPPING AT HEAD, SILL AND JAMBS. INSTALL ASTRAGAL AT MEETING PORTION OF DOUBLE DOORS. DOORS REQUIRING VERTICAL TRACKS OR GUIDES SHALL USE CONTINUOUS MOUNTING ANGLE, AND SHALL BE SEALED TO LIMIT AIR LEAKAGE.

CONTRACTOR SHALL PROVIDE AND INSTALL ALL STIFFENERS, BRACING, BLOCKING, BACKING, HANGERS, BACK-UP PLATES, AND SUPPORTING BRACKETS REQUIRED FOR THE INSTALLATION OF ALL CASEWORK, TOILET ROOM ACCESSORIES, FIXTURES, PARTITIONS, AND ALL WALL MOUNTED OR SUSPENDED MECHANICAL, KITCHEN, ELECTRICAL OR MISCELLANEOUS EQUIPMENT AND FURNISHING.

22. CONTRACTOR SHALL VERIFY EXACT SIZES AND LOCATIONS OF ALL MECHANICAL EQUIPMENT PADS, BASE STRUCTURES, ROOF OPENINGS, AS WELL AS POWER, WATER, DRAIN INSTALLATIONS AND STRUCTURAL STEEL SUPPORT LOCATIONS, WHEN APPLICABLE, WITH EQUIPMENT MANUFACTURERS BEFORE PROCEEDING WITH THE WORK. CHANGES TO ACCOMMODATE FIELD CONDITIONS OR APPROVED SUBSTITUTIONS SHALL BE MADE WITHOUT

ADDITIONAL COST TO THE OWNER. 23. ALL PIPES, CONDUIT, WIRES, AND DUCTS SHALL BE CONCEALED FROM VIEW 24. ALL GLAZING INSTALLED IN HAZARDOUS LOCATIONS, AS DEFINED BY CBC CHAPTER 24, SHALL BE TEMPERED GLASS. SKYLIGHTS ARE TO BE TEMPERED GLASS OR FIBERGLASS AS SPECIFIED

INSTALL SEALANT AT JOINTS AROUND WINDOW AND DOOR FRAMES, BETWEEN WALLS AND FOUNDATIONS, BETWEEN WALLS AND ROOF, BETWEEN WALL PANELS, AND AT PENETRATIONS OF UTILITIES THROUGH THE BUILDING ENVELOPE, TO LIMIT AIR INFILTRATION.

26. THE CONTRACTOR SHALL PROVIDE THE OWNER A LIST OF THE FEATURES. MATERIALS, COMPONENTS, AND MECHANICAL DEVICES INSTALLED IN THE BUILDING, AND INSTRUCTIONS ON HOW TO USE THEM EFFICIENTLY. THE INSTRUCTIONS SHALL BE CONSISTENT WITH SPECIFICATIONS SET FORTH BY THE EXECUTIVE DIRECTOR OF THE STATE ENERGY COMMISSION. THE ENERGY "CERTIFICATION OF COMPLIANCE" SHALL BE SUBMITTED AFTER THE INSTALLATION OF THE REQUIRED EQUIPMENT AND/OR MATERIAL, AND PRIOR TO ANY REQUEST FOR A FINAL INSPECTION.

27. ITEMS IN THESE DRAWINGS NOT SPECIFICALLY IDENTIFIED AS EXISTING ARE ASSUMED TO BE NEW

28. ALL ASTM AND/OR ANSI DESIGNATIONS REFERRED TO ON THESE DRAWINGS SHALL BE THE LATEST ADOPTED OR REVISED SPECIFICATIONS.

29. MATERIAL AND EQUIPMENT NECESSARY FOR WORK SHALL NOT BE PLACED OR STORED ON PUBLIC PROPERTY SO AS TO OBSTRUCT A FREE AND CONVENIENT APPROACH TO AND USE OF ANY FIRE HYDRANT, FIRE OR POLICE ALARM BOX UTILITY BOX, CATCH BASIN OR MANHOLE OR SO AS TO INTERFERE WITH THE FREE FLOW OF WATER IN STREET OR ALLEY GUTTER. PROTECTION AGAINST DAMAGE SHALL BE PROVIDED TO SUCH UTILITY FIXTURES DURING THE PROGRESS OF THE WORK, BUT SIGHT OF THEM SHALL NOT BE OBSTRUCTED.

30. WHERE NOT SPECIFICALLY DESCRIBED IN ANY OF THE NOTES OR SPECIFICATIONS, WORKMANSHIP SHALL CONFORM TO THE METHODS AND OPERATIONS OF BEST STANDARDS AND ACCEPTED PRACTICES OF THE RESPECTIVE TRADE.

31. CONSTRUCTION EQUIPMENT AND MATERIALS SHALL BE STORED AND PLACED SO AS NOT TO ENDANGER THE PUBLIC, THE WORKERS OR ADJOINING PROPERTY FOR THE DURATION OF THE CONSTRUCTION PROJECT

32. REQUIRED EXITS, EXISTING STRUCTURAL ELEMENTS, FIRE PROTECTION DEVICES AND SANITARY SAFEGUARDS SHALL BE MAINTAINED AT ALL TIMES DURING REMODELING, ALTERATIONS, REPAIRS OR ADDITIONS TO THE BUILDING UNLESS THE REQUIRED ELEMENTS OR DEVICES ARE BEING REMODELED ALTERED, OR REPAIRED IN WHICH CASE ADEQUATE SUBSTITUTE PROVISIONS SHALL BE MADE.

33. SERVICE UTILITY CONNECTIONS SHALL BE DISCONTINUED AND CAPPED IN ACCORDANCE WITH THE APPROVED RULES AND THE REQUIREMENTS OF THE AUTHORITY HAVING JURISDICTION.

34. SANITARY FACILITIES SHALL BE PROVIDED DURING CONSTRUCTION, REMODELING, OR DEMOLITION ACTIVITIES IN ACCORDANCE WITH 2019 CPC.

 AREAS OF CONSTRUCTION, ALTERATION OR DEMOLITION SHALL BE PROVIDED WITH NOT LESS THAN ONE APPROVED PORTABLE FIRE EXTINGUISHER PER 2019

36. REQUIRED MEANS OF EGRESS SHALL BE MAINTAINED AT ALL TIMES DURING CONSTRUCTION, DEMOLITION, REMODELING, ALTERATIONS, AND ADDITIONS TO BUILDING UNLESS APPROVED TEMPORARY MEANS OF EGRESS SYSTEMS AND FACILITIES HAVE BEEN PROVIDED.

37. PENETRATIONS OF FIRE-RESISTANCE-RATED WALLS AND HORIZONTAL ASSEMBLIES SHALL BE PROTECTED AS REQUIRED IN CBC SECTIONS 714.4 AND 714.5.

38. MANUFACTURER'S INSTALLATION INSTRUCTIONS SHALL BE AVAILABLE ON THE JOB SITE AT THE TIME OF INSPECTION.

39. IT IS THE RESPONSIBILITY OF THE GENERAL CONTRACTOR TO PROVIDE SUPERVISION OF THE CONSTRUCTION WORK TO ENSURE THAT IT IS BUILT IN CONFORMANCE WITH THE APPROVED PLANS AND SPECIFICATIONS. THE ARCHITECT WILL PROVIDE ONLY PERIODIC OBSERVATION OF THE WORK. SEE DSA INSPECTION REQUIREMENTS LISTED IN NOTE 46.

40. GRADING PLANS, DRAINAGE IMPROVEMENTS, ROAD & ACCESS REQUIREMENTS AND ENVIRONMENTAL HEALTH CONSIDERATIONS SHALL COMPLY WITH ALL LOCAL ORDINANCES.

41. CUTTING, BORING, SAWCUTTING OR DRILLING THROUGH THE NEW OR EXISTING STRUCTURAL ELEMENTS TO BE DONE ONLY WHEN SO DETAILED IN THE DRAWINGS OR ACCEPTED BY THE ARCHITECT AND THE STRUCTURAL ENGINEER WITH THE APPROVAL OF DSA REPRESENTATIVE

42. ALL WELDING SHALL BE SPECIALLY INSPECTED BY AN AWS-CWI QUALIFIED INSPECTOR APPROVED BY DSA.

43. ALL BRACING OF DUCTS AND PIPINGS SHALL BE INSTALLED IN ACCORDANCE WITH THE LATEST EDITION OF THE CALIFORNIA BUILDING CODE AND SMACNA GUIDELINES AS APPROVED BY DSA (CBC WILL GOVERN WHERE CONFLICTS OCCUR). THE FIELD INSTALLATION SHALL BE SUBJECT TO THE APPROVAL OF THE ARCHITECT. MECHANICAL ENGINEER AND FIELD ENGINEER. A COPY OF THE GUIDELINES PUBLISHED BY SMACNA AND APPROVED BY DSA SHALL BE PROVIDED BY THE CONTRACGTOR AND KEPT ON THE JOB AT ALL TIMES.

44. SHOULD ANY EXISTING CONDITIONS SUCH AS DETERIORATION OR NON COMPLYING CONSTRUCTION BE DISCOVERED WHICH IS NOT COVERED BY THE APPROVED DOCUMENTS WHEREIN THE FINISHED WORK WILL NOT COMPLY WITH TITLE 24 C.C.R., A SEPARATE SET OF PLANS AND SPECIFICATIONS, DETAILING AND SPECIFYING THE REQUIRED REPARI WORK SHALL BE SUBMITTED TO AND APPROVED BY DSA BEFORE PROCEEDING WITH THE REPAIR

45. CHANGES TO APPROVED DRAWINGS AND SPECIFICATIONS SHALL BE MADE B' AN ADDENDUM OR A CHANGE ORDER APPROVED BY THE DIVISION OF THE STATE ARCHITECT AS REQUIRED BY SECTION 4-338, PART 1, T24 C.C.R.

46. A DSA CERTIFIED INSPECTOR WITH CLASS 3 SHALL BE EMPLOYED BY THE DISTRICT AND SHALL PROVIDE CONTINUOUS INSPECTION OF THE WORK. THE DUTIES OF THE INSPECTION ARE DEFINED IN SECTION 4-342, PART 1, T24, C.C.R. THRE PROJECT INSPECTOR IS TO BE CERTIFIED BY DSA TO INSPECT

47. A DSA ACCEPTED TESTING LABORATORY DIRECTLY EMPLOYED BY THE OWNER SHALL CONDECT ALL THE REQUIRED TESTS AND INSPECTIONS FOR THE PROJECT.

48. ALL WORK (AS APPLICABLE) MUST MEET THE MANDATORY MEASURES OF THE 2019 CALIFORNIA GREEN BUILDING STANDARDS (CAL GREEN) CODE (TITLE 24,

49. THE SEISMIC ANCHORAGE OF MECHANICAL AND ELECTRICAL EQUIPMENT SHALL CONFORM TO C.C.R. TITLE 24, 2019 CBC CHAPTER 16A. ANCHORAGE DETAILS SHALL BE SHOWN ON THE PLANS.

DRAWING SHEET INDEX

G-000 TITLE SHEET

A-101

A-102 **ENLARGED SITE PLAN, ELEVATIONS & SECTIONS**

A-103 SITE DETAILS

GENERAL NOTES & DETAILS FOUNDATION PLAN & DETAILS

E100 E200 SITE ELECTRICAL PLAN

PARTIAL SITE ELECTRICAL PLAN E201 PARTIAL SITE ELECTRICAL PLAN E202

E300 SINGLE LINE DIAGRAMS EXISTING SINGLE LINE DIAGRAM PROPOSED E301


E400 MSB SHOP DRAWINGS

E500 ELECTRICAL DETAILS

TOTAL NO OF SHEETS: 14

VICINITY MAP

PROJECT LOCATION

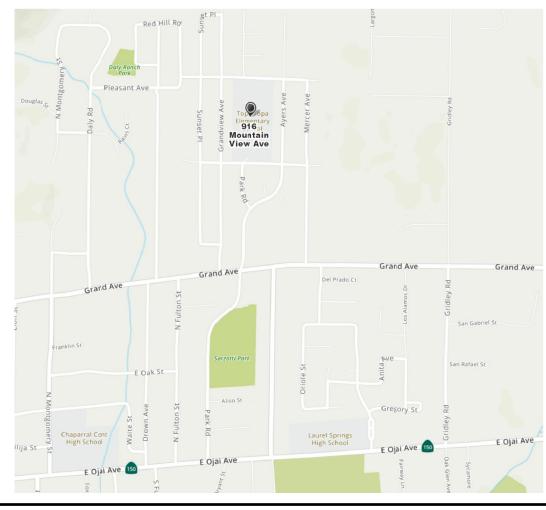

SPECIAL INSTRUCTIONS

NONE

BID ALTERNATES

NONE

DEFERED SUBMITTALS

NONE

GEOTECHNICAL REPORT

NONE

PROJECT SCOPE

THE WORK INCLUDES THE CONSTRUCTION OF A NEW ELECTRICAL EQUIPMENT ENCLOSURE IN FRONT OF THE SCHOOL AND THE INSTALLATION OF A NEW TRANSFORMER AND SWITCHBOARD TO SERVE THE SCHOOL. TWO EXISTING ELECTRICAL METERS AND SWITCHBOARDS WILL REMAIN IN PLACE AND BE ENERGIZED FROM THE NEW SERVICE. THE ENCLOSURE WILL BE CONSTRUCTED WITH CONCRETE MASONRY UNITS AND CHAIN LINK FENCING. THE PROPOSED ENCLOSURE IS ADJACENT TO AN EXISTING BUILDING, SO SLOTTED WALL CONSTRUCTION IS SPECIFIED AND DETAILED.

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NEW ELECTRICAL SERVICE & SITE IMPROVEMENTS

OJAI UNIFIED SCHOOL DISTRICT 414 EAST OJAI AVENUE OJAI, CA 93023 (805) 640-4300 **CONTACT: ADAM DUTTER** EMAIL: adutter@ojaiusd.org

PROJECT ADDRESS:

ISSUE:

TOPA TOPA ELEMENTARY SCHOOL 916 MOUNTAIN VIEW AVENUE OJAI, CA 93023

MARK	DATE	DESCRIPTION

2020.011

04CONDOC

PROJECT INFORMATION: PROJECT NUMBER:


PROJECT PHASE: DRAWN BY: **REVIEWED BY:**

TITLE SHEET

G-000

CAI	CAMPUS BUILDING CODE ANALYSIS											
BLDG. NO.	BUILDING USE	осс.	CONST. TYPE	EXIST. AFSS (Y/N)	PROP. AFSS (Y/N)	ALLOW. NO. STOR.	ALLOW. AREA (SF)	ALLOW. HT. (FT)	EXIST. NO. STOR.	EXIST. AREA (SF)	EXIST. HT. (FT)	DSA A# / APPR #
А	CLASSROOMS	E	VB	N	N	1	9,500	40	1	-	-	APPR 15970, 03-107639
В	CLASSROOMS	E	VB	N	N	1	9,500	40	1	-	-	APPR 15970, 03-107639
С	ADMIN & CLASSROOMS	E	VB	N	N	1	9,500	40	1	-	-	APPR 22796, 03-107639
D	CLASSROOMS	E	VB	N	N	1	9,500	40	1	-	-	APPR 49980
Е	CLASSROOMS	E	VB	N	N	1	9,500	40	1	-	-	APPR 52586
F	CLASSROOMS	E	VB	N	N	1	9,500	40	1	-	-	APPR 55792
G	CLASSROOMS	E	VB	N	N	1	9,500	40	1	-	-	03-103364
Н	KINDERGARTEN	E	VB	N	N	1	9,500	40	1	_	-	03-106187
	SMART START CDC	E	VB	N	N	1	9,500	40	1	-	-	03-107067
DSA CI	DSA CERTIFICATION STATUS: THERE ARE NO UNCERTIFIED PROJECTS AT THIS CAMPUS.											

PLEASANT AVE.

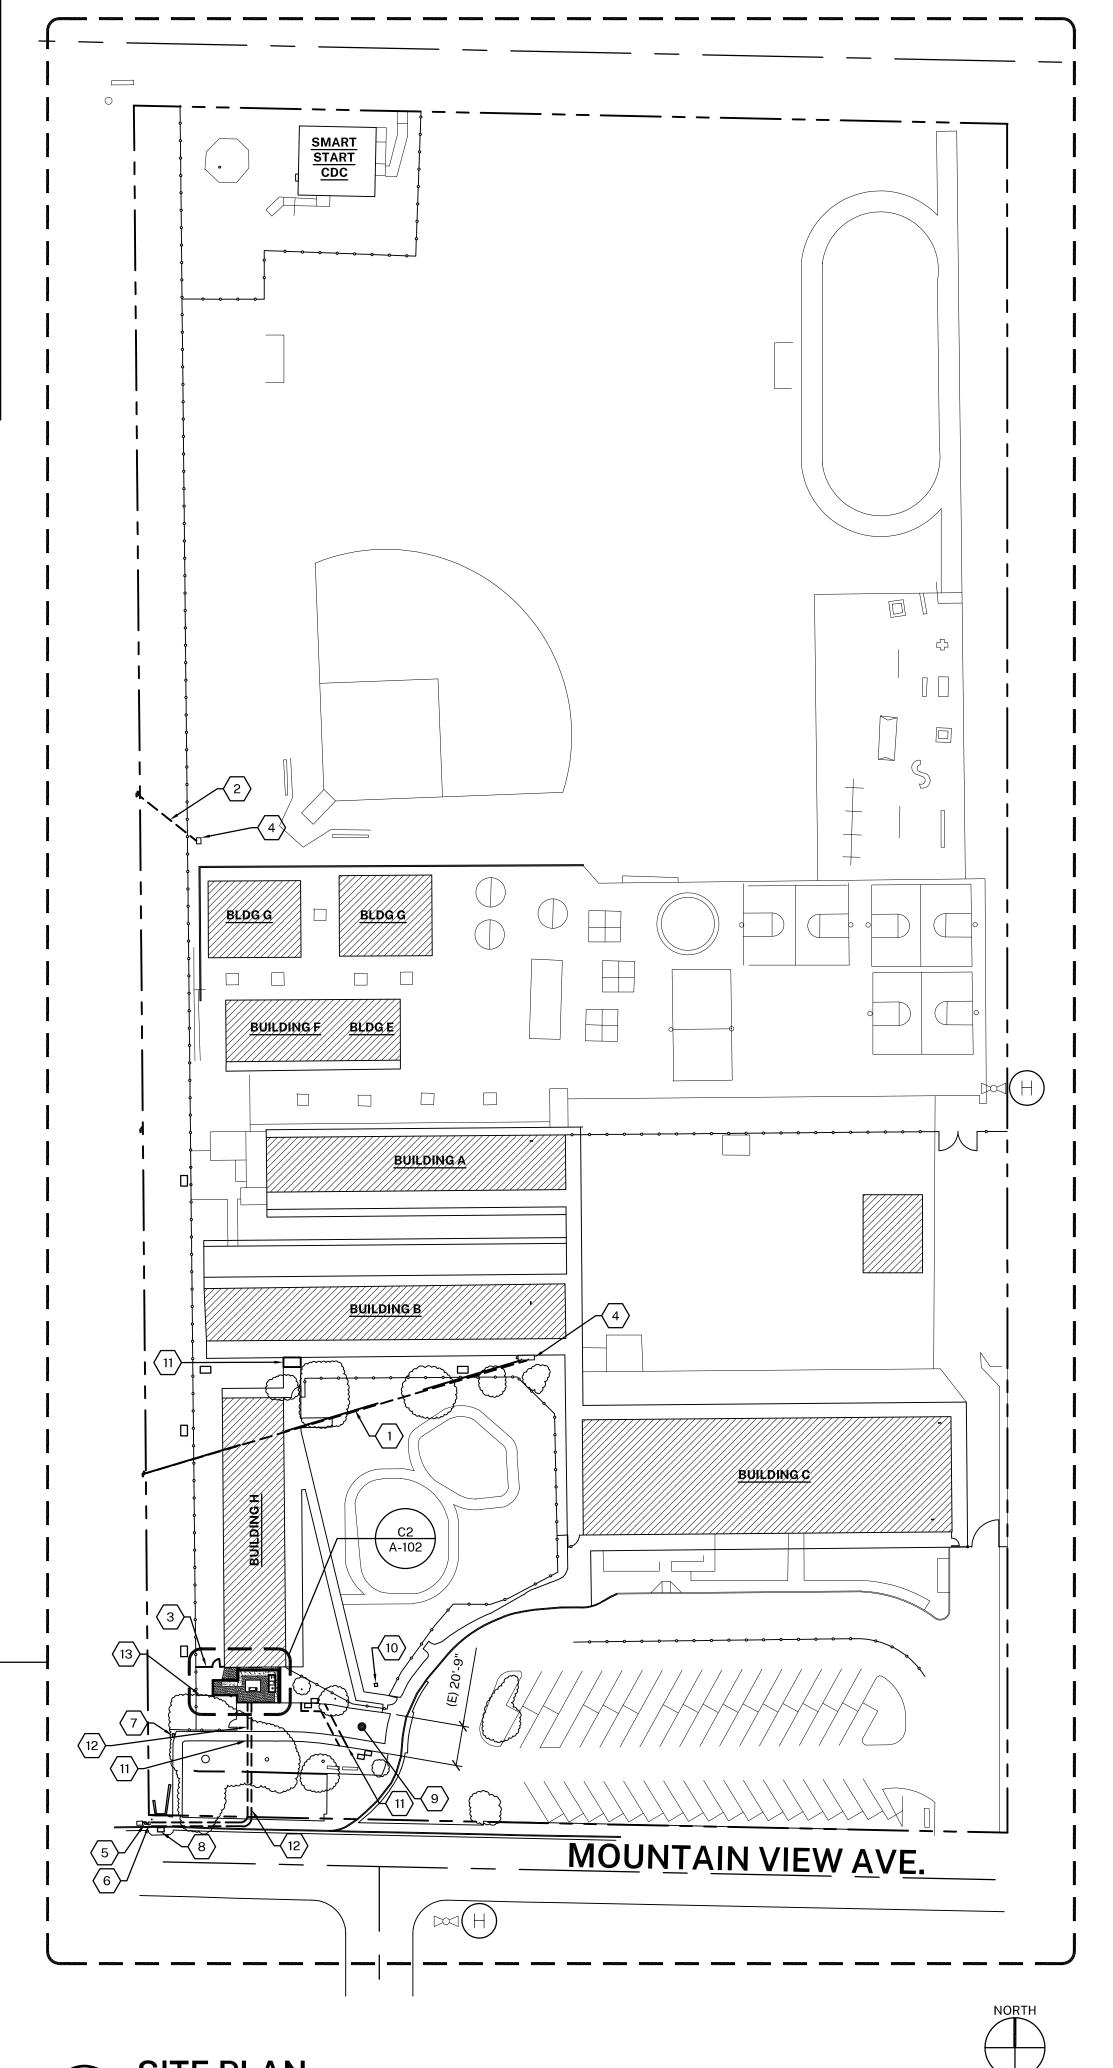

GENERAL NOTES

1. ALL TREES TO REMAIN, PROTECT IN PLACE.

SYMBOL LEGEND

— — — PROPERTY LINE

SHEET KEYNOTES

1. (E) UNDERGROUND POWER LINES, SEE ELECTRICAL DRAWINGS

4. (E) SWITCHBOARD AND DISTRIBUTION BOARD, SEE ELECTRICAL DRAWINGS

9. (E) ASPHALT CONCRETE FIRE APPARATUS ACCESS ROAD, TO REMAIN, CUT/PATCH

11. (E) CONCRETE SIDEWALK, REMOVE AS REQUIRED FOR WORK AND REPLACE, SEE

A/A-103, REMOVE AND REPLACE ENTIRE PANELS OF WALK, FINISH EDGES TO BE

12. (E) ASPHALT CONCRETE PAVING, REMOVE AS REQUIRED FOR WORK AND REPLACE,

13. (E) BIKE RACK AREA, TO REMAIN, REMOVE AND REINSTALL FENCING, RACKS, ETC.

AS REQUIRED TO CARRY OUT WORK, REFERENCE DSA A# 03-106187

2. (E) OVERHEAD POWER LINE, SEE ELECTRICAL DRAWINGS

3. (E) CHAIN LINK FENCE AND ACCESS GATE, REMOVE

6. (E) WATER METER, TO REMAIN, PROTECT IN PLACE 7. (E) GAS METER, TO REMAIN, PROTECT IN PLACE 8. (E) STORM DRAIN, TO REMAIN, PROTECT IN PLACE

10. (E) STORM DRAIN INLET, TO REMAIN, PROTECT IN PLACE

FINISH EDGES TO BE FLUSH WITH ADJACENT SURFACES

5. (E) UTILITY POLE, SEE ELECTRICAL DRAWINGS

FLUSH WITH ADJACENT SURFACES

AS NEEDED TO COMPLETE WORK

(E) FIRE HYDRANT

- 2. MAINTAIN ACCESS TO ALL EXISTING PARKING LOTS DURING CONSTRUCTION.
- 3. MAINTAIN AN ACCESSIBLE PEDESTRIAN PATH OF TRAVEL DURING CONSTRUCTION.

4. MAINTAIN ACCESS TO ALL EXISTING BUILDINGS DURING CONSTRUCTION.

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NEW ELECTRICAL SERVICE & SITE IMPROVEMENTS

OJAI UNIFIED SCHOOL DISTRICT 414 EAST OJAI AVENUE OJAI, CA 93023 (805) 640-4300 CONTACT: ADAM DUTTER EMAIL: adutter@ojaiusd.org

PROJECT ADDRESS:

TOPA TOPA ELEMENTARY SCHOOL 916 MOUNTAIN VIEW AVENUE OJAI, CA 93023

ISSUE:		
MARK	DATE	DESCRIPTION


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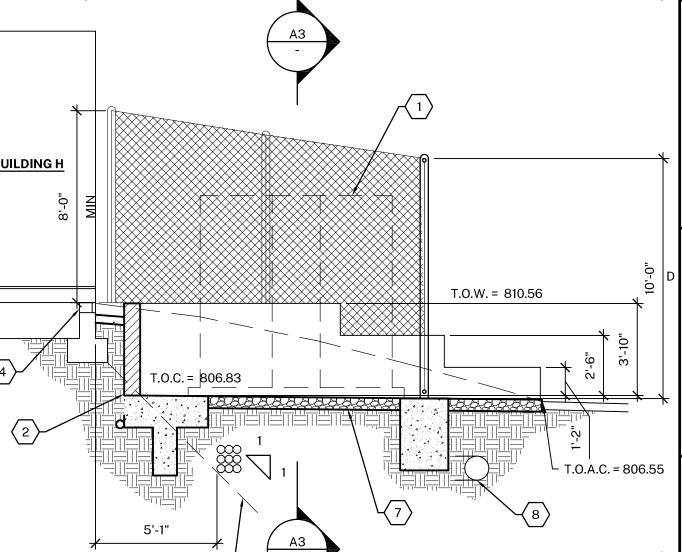
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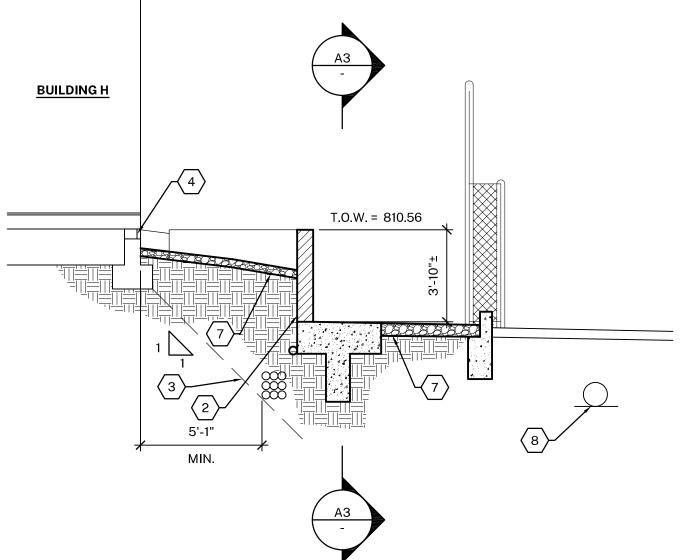
SITE PLAN

04CONDOC

A-101





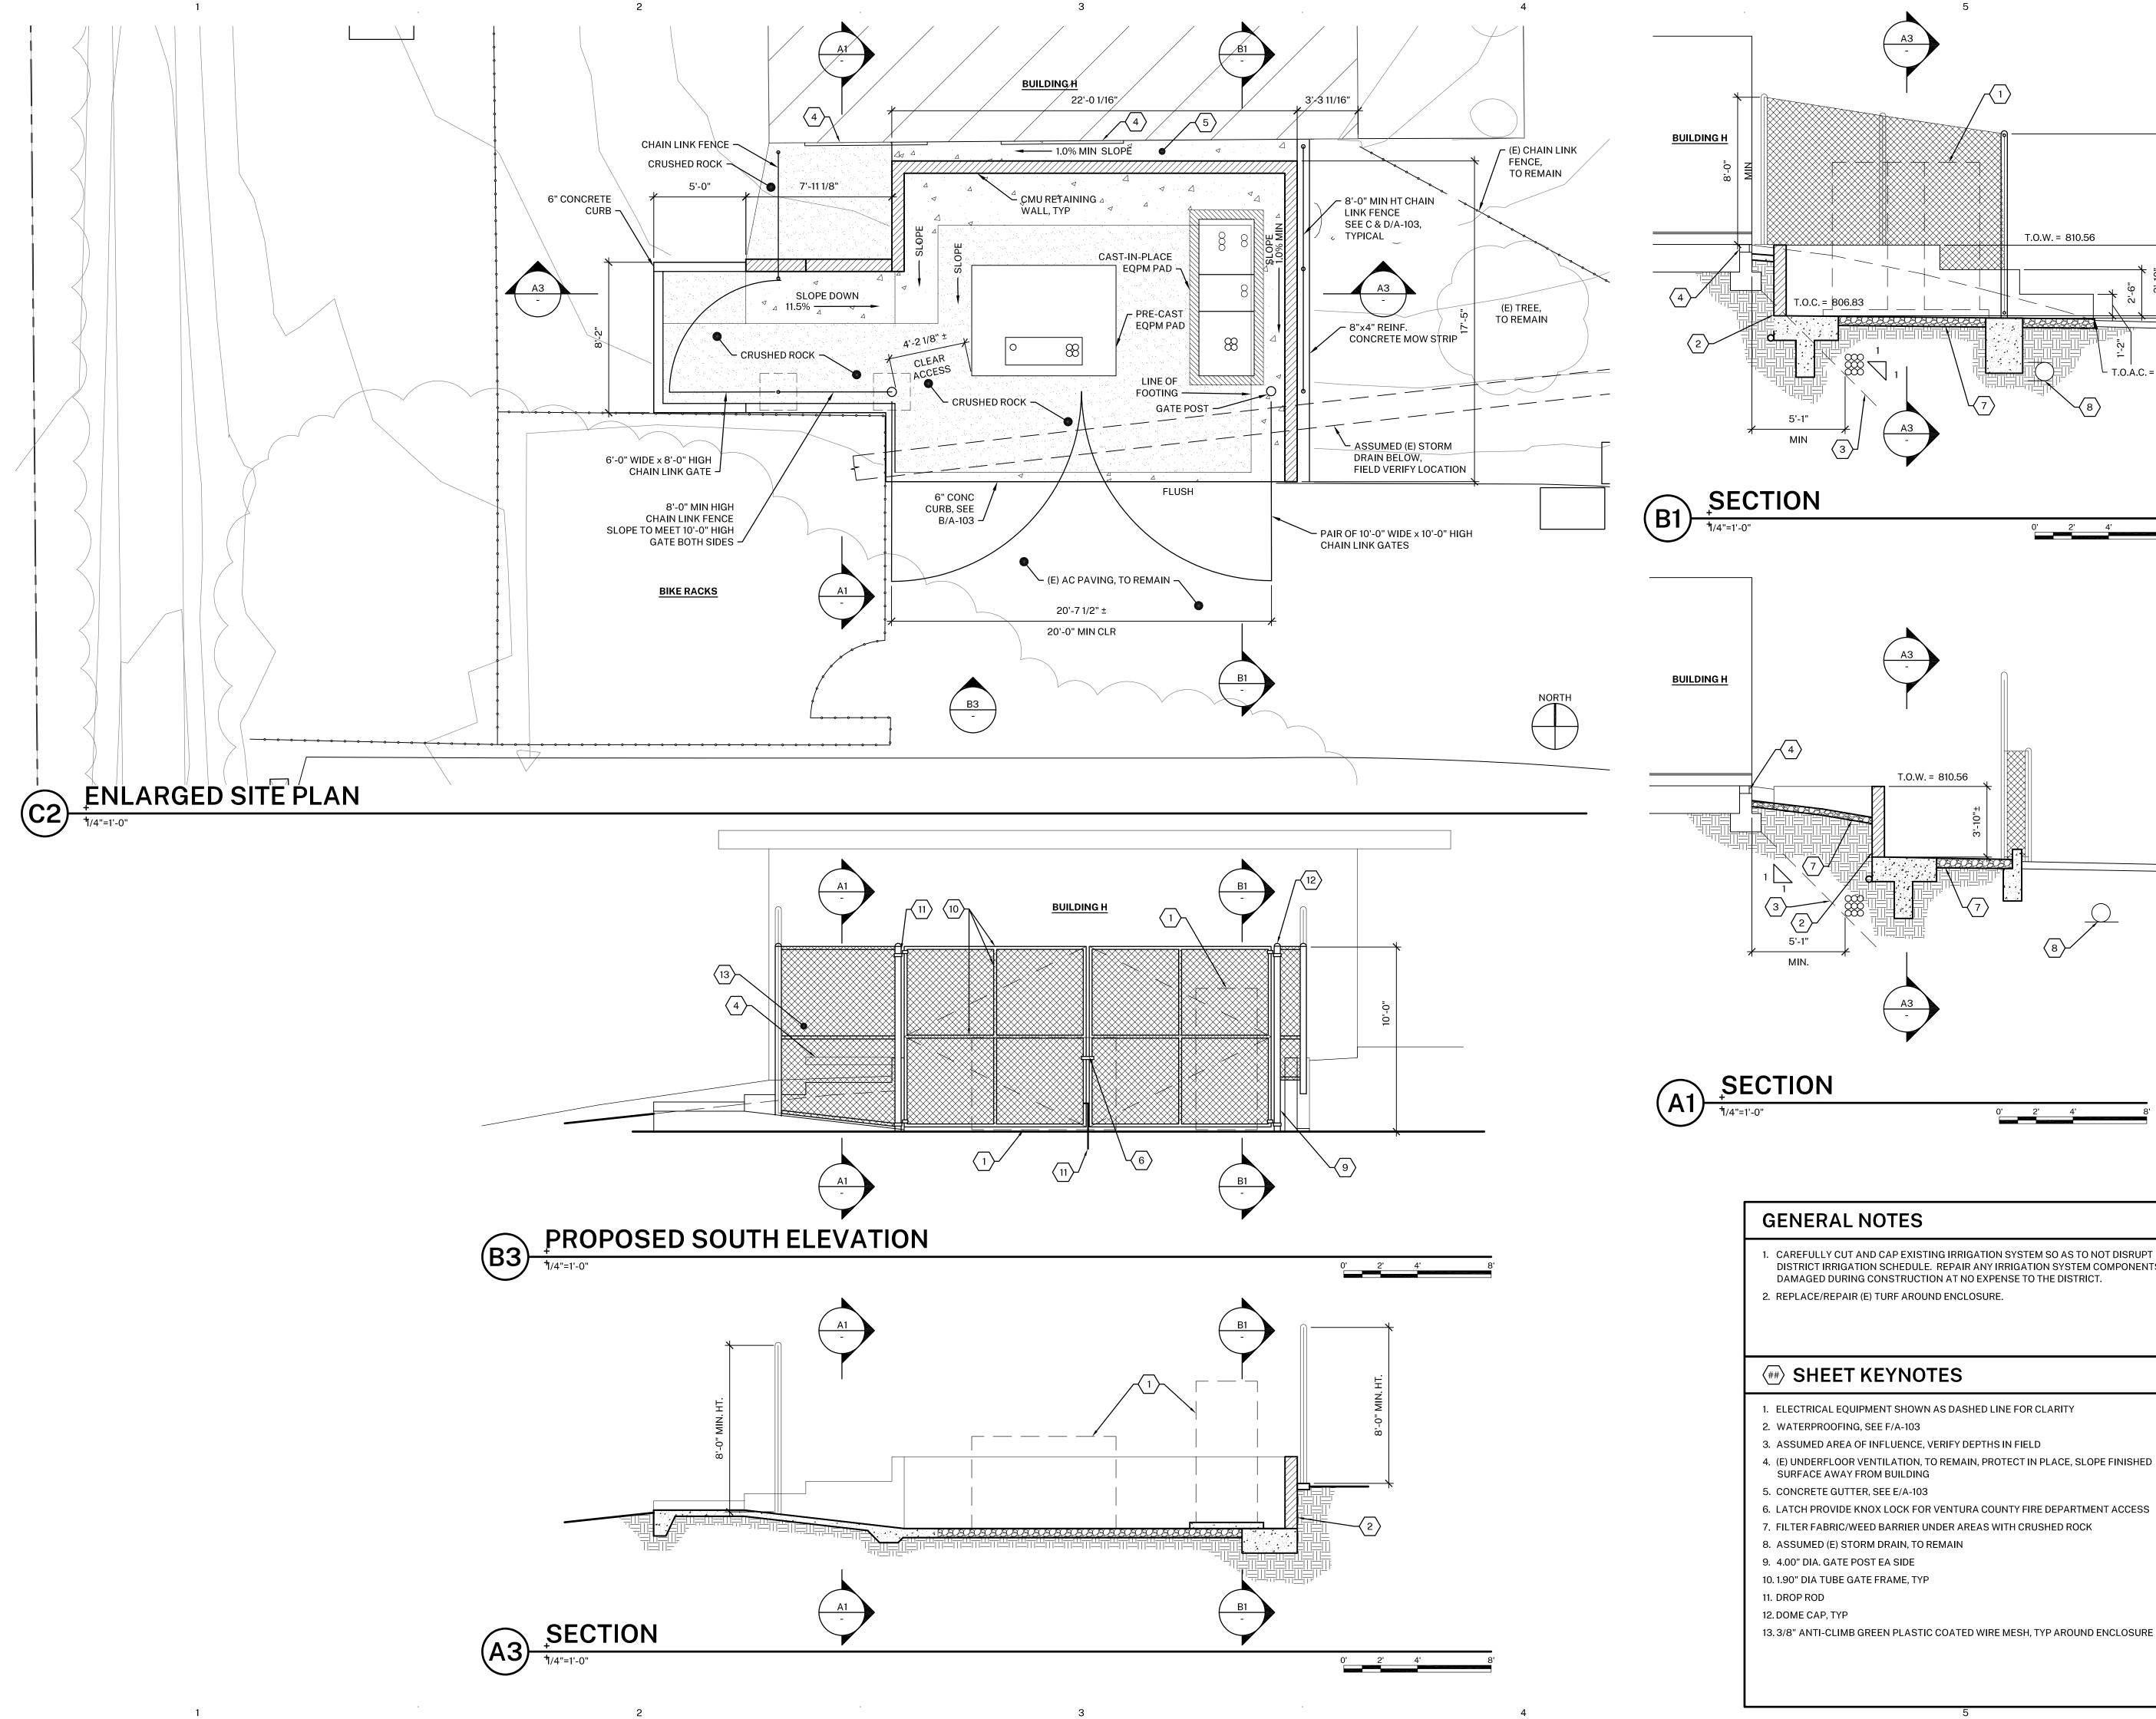

- 1. CAREFULLY CUT AND CAP EXISTING IRRIGATION SYSTEM SO AS TO NOT DISRUPT DISTRICT IRRIGATION SCHEDULE. REPAIR ANY IRRIGATION SYSTEM COMPONENTS
- 4. (E) UNDERFLOOR VENTILATION, TO REMAIN, PROTECT IN PLACE, SLOPE FINISHED

13.3/8" ANTI-CLIMB GREEN PLASTIC COATED WIRE MESH, TYP AROUND ENCLOSURE

AGENCY APPROVAL:



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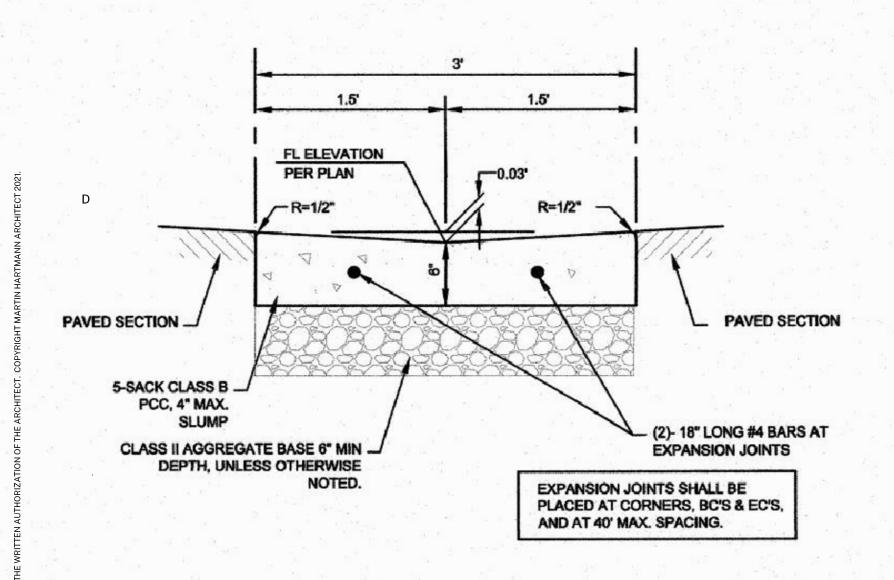
PROJECT NUMBER:

04CONDOC PROJECT PHASE:

THE ORIGINAL SIZE OF THIS SHEET IS 36"x24". IF THE CURRENT SIZE IS OTHER THAI 36"x24", THEN ADJUST THE SCALE OF THE DRAWINGS ACCORDINGLY.

ENLARGED SITE PLAN, ELEVATIONS & SECTIONS

A-102



CONCRETE GUTTER DETAIL


SCALE = NONE

PAVEMENT 1/2" X 18" SMOOTH, GREASED. DOWEL 5-SACK CLASS B SEE NOTE 13. PCC, 4" MAX. SLUMP -SEE NOTE 14. SEE NOTE 6. WEAKENED PLANE JOINT SEE NOTE 8. SEE NOTE 9.

- CONCRETE: 5 SACK P.C.C. CONCRETE, 2" MIN 4" MAX SLUMP.
- 2. FINISH: P.C.C. SHALL BE GIVEN A MEDIUM BROOM FINISH.
- SEALING & CURING: A PIGMENTED SEALING AND CURING COMPOUND SHALL BE USED IN ACCORDANCE WITH THE PROVISIONS OF THE DEPARTMENT OF TRANSPORTATION STANDARDS SPECIFICATIONS.
- 4. EXPANSION JOINTS (EJ): SHALL BE PLACED AT CURB RETURNS, DRIVEWAYS, STORM DRAIN CATCH BASINS, AROUND UTILITY POLES, AT LONGITUDINAL CURB GUTTER AND SIDEWALK INTERVALS NOT TO EXCEED 30-FEET. THE INTERVALS BETWEEN EXPANSION JOINTS SHALL VARY TO ALLOW MATCHING OF JOINTS IN ADJACENT EXISTING IMPROVEMENTS AS APPLICABLE
- 5. WEAKENED PLANE JOINTS (WPJ): SHALL BE A MINIMUM 1-INCH IN DEPTH AND PLACED AT LONGITUDINAL CURB GUTTER AND SIDEWALK INTERVALS NOT EXCEEDING 10-FEET BETWEEN EXPANSION JOINTS. THE INTERVALS BETWEEN WEAKENED PLANE JOINTS SHALL VARY TO ALLOW MATCHING OF JOINTS IN ADJACENT EXISTING IMPROVEMENTS AS APPLICABLE.
- 6. 1/2"Ø x 18" SMOOTH, GREASED DOWELS SHALL BE PLACED AT ALL EXPANSION JOINTS, TWO IN THE NEW CURB FACE, AND AT 18-INCHES ON CENTER IN NEW SIDEWALK.
- 7. WHEN PLACED IN SIDEWALKS, BOTH EXPANSION JOINTS AND WEAKENED PLANE JOINTS SHALL EXTEND THROUGH THE ADJACENT CURB.
- 8. 6" MINIMUM CLASS II AGGREGATE BASE TO 95% RELATIVE COMPACTION OR MATCH BASE THICKNESS REQUIREMENT FOR NEW OR EXISTING ROAD SECTION, WHICHEVER IS GREATEST.
- SUBGRADE TO BE SCARIFIED TO A DEPTH OF 12" MINIMUM AND RECOMPACT TO 95% RELATIVE COMPACTION.
- 10. SUBGRADE AND AGGREGATE BASE COMPACTION REQUIREMENTS SHALL EXTEND TO THE BACK OF CURB OR TO THE BACK OF ATTACHED SIDEWALK (WHICHEVER CONDITION IS APPLICABLE).
- 11. GUTTER CROSS SLOPE SHALL NOT EXCEED 5% ACROSS CURB RAMPS, 2% ACROSS ADA PATH OF TRAVEL AND ADA PARKING, OTHERWISE TYPICAL GUTTER CROSS SLOPE SHALL BE 8% UNLESS OTHERWISE NOTED.
- 12. UNDER NO CIRCUMSTANCES SHALL UTILITY LIDS AND CONCRETE COLLARS BE LOCATED WITHIN THE CURB &
- 13. WHEN CURB IS PLACED ADJACENT TO EXISTING OR FUTURE IRRIGATED LANDSCAPE AREA, PCC SHALL EXTEND DOWN AS SHOWN FOR MOISTURE BARRIER.
- 14. WHEN CURB IS NOT LOCATED AS IN NOTE 13. DEPTH MAY BE REDUCED.

CONCRETE FLUSH CURB SCALE = NONE

В

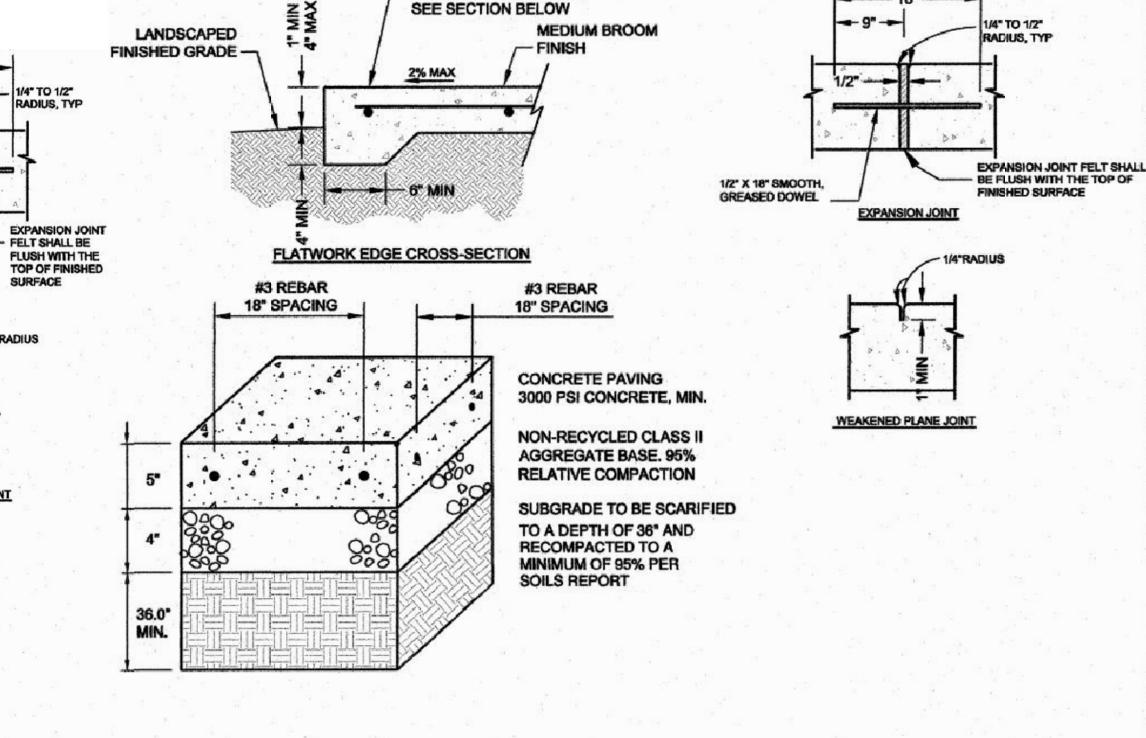

- CONCRETE FLATWORK,

- CONCRETE: 5 SACK P.C.C. CONCRETE, 2" MIN 4" MAX SLUMP.
- FINISH: P.C.C. SHALL BE GIVEN A MEDIUM BROOM FINISH.
- 3. SEALING & CURING: A PIGMENTED SEALING AND CURING COMPOUND SHALL BE USED IN ACCORDANCE WITH THE PROVISIONS OF THE DEPARTMENT OF TRANSPORTATION STANDARDS SPECIFICATIONS.
- 4. EXPANSION JOINTS (EJ): SHALL BE PLACED AT CURB RETURNS, DRIVEWAYS, STORM DRAIN CATCH BASINS, AROUND UTILITY POLES, AT LONGITUDINAL CURB GUTTER AND SIDEWALK INTERVALS NOT TO EXCEED 30-FEET. THE INTERVALS BETWEEN EXPANSION JOINTS SHALL VARY TO ALLOW MATCHING OF JOINTS IN ADJACENT EXISTING IMPROVEMENTS AS APPLICABLE
- WEAKENED PLANE JOINTS (WPJ): SHALL BE A MINIMUM 1-INCH IN DEPTH AND PLACED AT LONGITUDINAL CURB GUTTER AND SIDEWALK INTERVALS NOT EXCEEDING 10-FEET BETWEEN EXPANSION JOINTS. THE INTERVALS BETWEEN WEAKENED PLANE JOINTS SHALL VARY TO ALLOW MATCHING OF JOINTS IN ADJACENT EXISTING IMPROVEMENTS AS APPLICABLE.
- 6. 1/2"Ø x 18" SMOOTH, GREASED DOWELS SHALL BE PLACED AT ALL EXPANSION JOINTS, AND AT 18-INCHES ON CENTER IN NEW SIDEWALK.
- WHEN PLACED IN SIDEWALKS, BOTH EXPANSION JOINTS AND WEAKENED PLANE JOINTS SHALL EXTEND THROUGH THE ADJACENT CURB AND GUTTER.
- 8. 4" MINIMUM CLASS II AGGREGATE BASE TO 95% RELATIVE COMPACTION OR MATCH BASE THICKNESS REQUIREMENT FOR NEW OR EXISTING SIDEWALK, WHICHEVER IS GREATEST.
- 9. SUBGRADE TO BE SCARIFIED TO A DEPTH OF 36" MINIMUM AND RECOMPACTED TO 95% RELATIVE COMPACTION.
- 10. THE CROSS SLOPE OF THE SIDEWALK SHALL NOT EXCEED 2% (1/4-INCH PER 12-INCHES), 1.5% (3/16-INCH PER 12-INCHES) IS RECOMMENDED. LONGITUDINAL SLOPE SHALL NOT EXCEED 5%.
- 11. THE SIDEWALK SHALL BE WIDENED WHERE REQUIRED TO ALLOW FOR A MINIMUM 4-FOOT CLEAR PASSAGE AROUND ALL ABOVE GRADE OBSTACLES LOCATED WITHIN THE SIDEWALK.
- 12. TYPICAL SECTION SHALL BE:

5-INCH MIN PCC (6-INCH OR 8-INCH WHEN WITHIN A DRIVEWAY), OVER 4-INCH MIN CLASS II AGGREGATE BASE TO 95% RELATIVE COMPACTION

36" MIN SUBGRADE TO 95% RELATIVE COMPACTION IF THE R-VALUE OF THE NATIVE MATERIAL IS 55 OR GREATER THEN THE 4-INCH OF AGGREGATE BASE UNDER THE SIDEWALK ONLY MAY BE SUBSTITUTED WITH COMPACTED NATIVE MATERIAL.



AGENCY APPROVAL:

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OJAI, CA 93023 (805) 705-4772

STRUCTURAL ENGINEERING:

175 E. WILBUR RD. STE. 103

THOUSAND OAKS, CA 91360

CONTACT: JAMES VINCI SE

ELECTRICAL ENGINEERING: FERRANTI ENGINEERING 1211 MARICOPA HWY, STE. #250

EMAIL: daleferranti@live.com

CONTACT: DALE FERRANTI, EE, LEED AP ID+C

NEW ELECTRICAL SERVICE &

SITE IMPROVEMENTS

OJAI UNIFIED SCHOOL DISTRICT

TOPA TOPA ELEMENTARY SCHOOL 916 MOUNTAIN VIEW AVENUE

DATE

PROJECT INFORMATION

PROJECT NUMBER:

PROJECT PHASE:

DRAWN BY:

REVIEWED BY:

DESCRIPTION

2020.011

04CONDOC

414 EAST OJAI AVENUE

CONTACT: ADAM DUTTER EMAIL: adutter@ojaiusd.org

OJAI, CA 93023

(805) 640-4300

PROJECT ADDRESS:

OJAI, CA 93023

ISSUE:

MARK

EMAIL: jim@vincise.com

VINCI & ASSOCIATES


HARTMANN

HARTMANNARCHITECTURESTUDIO.COM

430 S. CARRILLO RD.


OJAI, CALIFORNIA 93023


(805) 798-2253

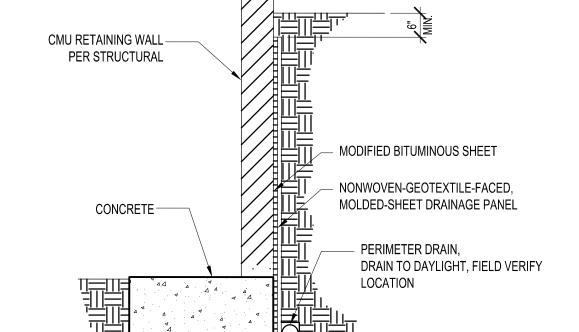

RETAINING WALL WATERPROOFING

SCALE: 1/2" = 1'-0"

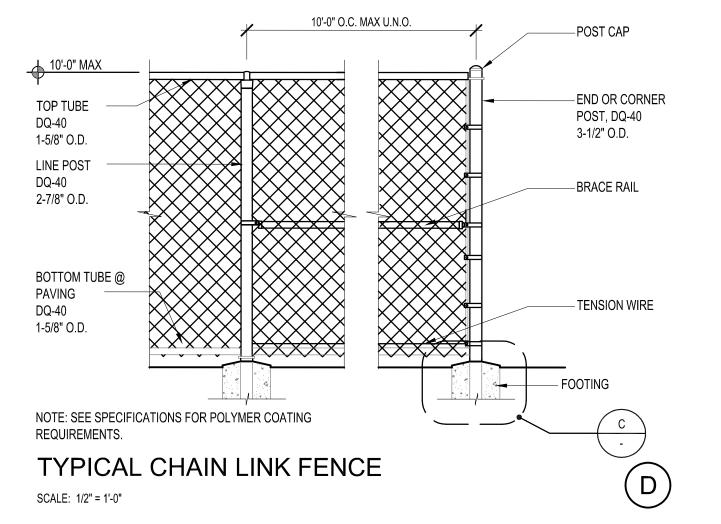

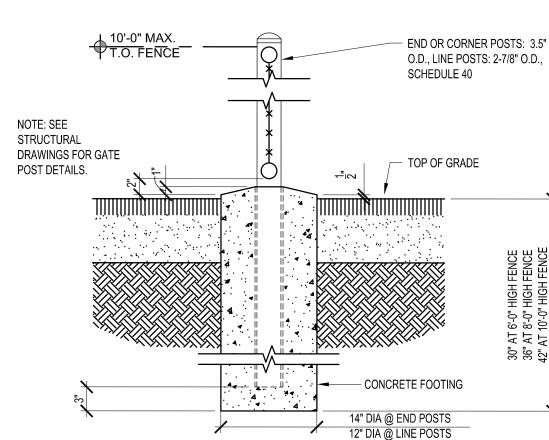


TYPICAL 10' HIGH MAX. CHAIN LINK FENCE FOOTING SCALE: 1" = 1'-0"


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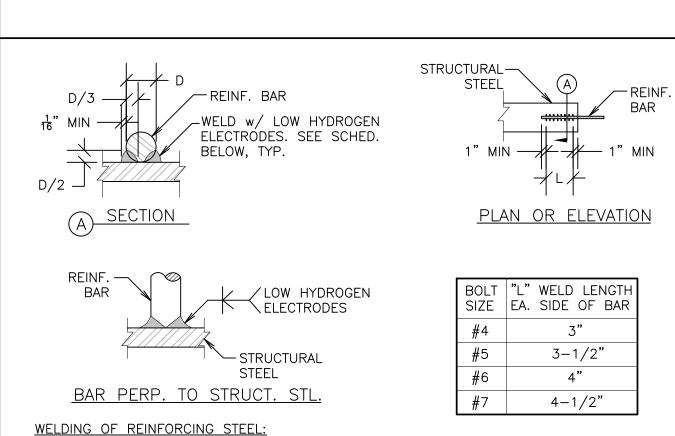
THE ORIGINAL SIZE OF THIS SHEET IS 36"x24". IF THE CURRENT SIZE 36"x24", THEN ADJUST THE SCALE OF THE DRAWINGS ACCORDINGLY.

SITE DETAILS

A-103 DATE: 03/31/2021




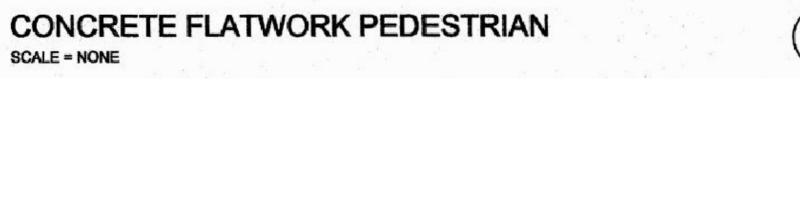


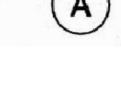

WELDING OF REINFORCING STEEL:
FIELD WELDING OF REINFORCING SHALL BE PERFORMED BY WELDERS SPECIFICALLY CERTIFIED
FOR REINFORCING STEEL. PRIOR TO WELDING, THE "CARBON EQUIVALENT" (CE) OF STEEL
SHALL BE DETERMINED. REINFORCING STEEL WHOSE "CE" CANNOT BE IDENTIFIED OR WHOSE
"CE" EXCEEDS 0.75% SHALL NOT BE WELDED. EXCEPT FOR REINFORCING STEEL CONFORMING
TO ASTM-706, REINFORCING STEEL SHALL NOT BE PRE-HEATED. IN ADDITION, STEEL WITH
"CE" BETWEEN 0.66% AND 0.75% SHALL BE WELDED ONLY WHERE PRIOR QUALIFICATION TESTS
VERIFY ACCEPTABLE WELDABILITY. (EXEMPT PER DSA 103 APPENDIX)

TYPICAL DETAIL AT WELDING OF REINFORCING STEEL 9

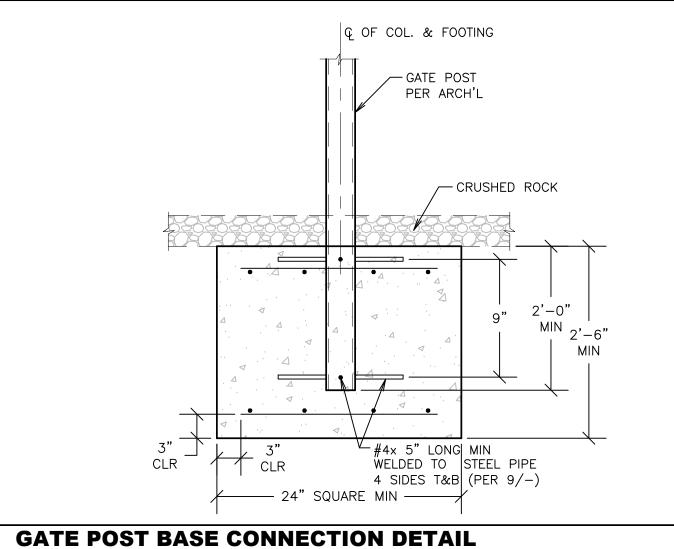

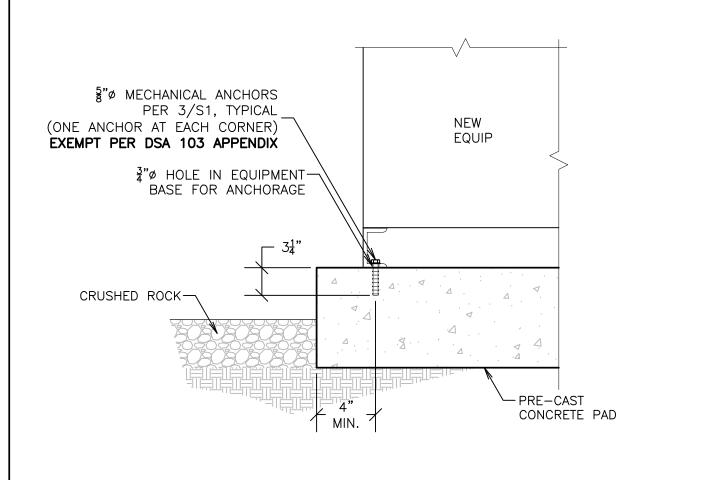

FOUNDATION NOTES:

1. ADJACENT BUILDING FOOTINGS ARE TO BE PROTECTED AGAINST MOVEMENT WHEN FOUNDATION EXCAVATION OCCURS.

2. THE PROPOSED EXCAVATIONS IMMEDIATELY ADJACENT TO THE PORTION OF THE EXISTING STRUCTURE (BUILDING H) TO REMAIN SHOULD BE SLOT CUT, UTILIZING THE A-B SLOT CUT METHOD. THE FOLLOWING SEQUENCE OF CONSTRUCTION SHOULD BE FOLLOWED DURING THE CONSTRUCTION OF THE FOOTINGS AND RETAINING WALL UTILIZING THE A-B SLOT CUT METHOD:

- A. EXCAVATE THE INITIAL A-SLOTS A MAXIMUM OF 6'-0" FEET IN WIDTH.
- B. CONSTRUCT THE FOOTING AND RETAINING WALL IN THE A—SLOTS, WATERPROOF THE WALL AND INSTALL THE SUBDRAIN SYSTEM, AND BACKFILL THE RETAINING WALL, BRACING THE RETAINING WALL AS NECESSARY PRIOR TO BACKFILLING.
- C. REPEAT THE ABOVE PROCEDURE IN THE B-SLOTS.

 DURING SLOT CUTTING OPERATIONS, ADDITIONAL LOADS SUCH AS

 VEHICLES, HEAVY EQUIPMENT, ETC., SHOULD NOT BE ALLOWED TO

 OPERATE WITHIN 5 FEET LATERALLY OF THE TOP OF THE EXCAVATION,

 OR WITHIN A LATERAL DISTANCE EQUAL TO THE EXCAVATION HEIGHT,

 WHICHEVER IS GREATER.

AGENCY APPROVAL:



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(805) 705-4772
CONTACT: DALE FERRANTI, EE, LEED AP ID+C

SEALS:



NEW ELECTRICAL SERVICE & SITE IMPROVEMENTS

OWNER:

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PROJECT ADDRESS:

MARK

TOPA TOPA ELEMENTARY SCHOOL 916 MOUNTAIN VIEW AVENUE OJAI, CA 93023

DATE

PROJECT I	NFORMATION	:
V&A PROJ	ECT NUMBER:	21-6018
PROJECT F	PHASE:	04CONDOC
5541415		n

DESCRIPTION

DRAWN BY: REVIEWED BY: THE ORIGINAL SIZE OF THIS SHEET IS 36"x24". IF THE CURRENT SIZE IS OTHER THAN 36"x24", THEN ADJUST THE SCALE OF THE DRAWINGS ACCORDINGLY.

FOUNDATION PLAN

& DETAILS

S2

DATE: 04.19.2021

SHEET NUMBER:


SHEET TITLE:

13 EQUIPMENT ANCHORAGE

14 FOUNDATION PLAN

J DI AN

SCALE: 1/4" = 1'-0"

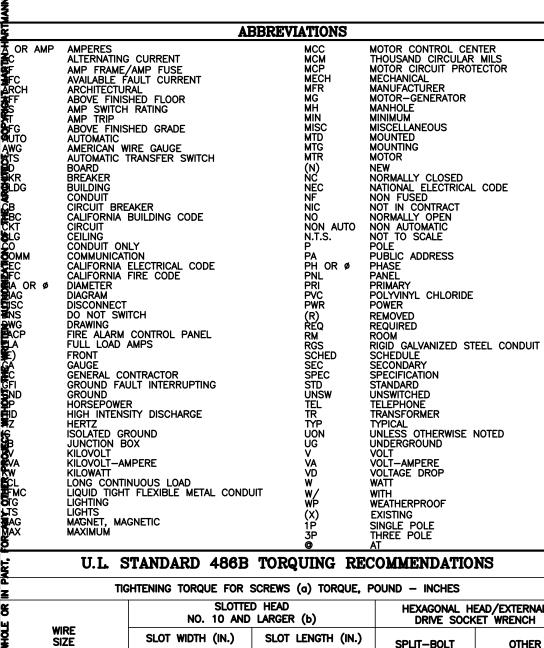

HEXAGONAL HEAD/EXTERNAL SPLIT-BOLT CONNECTORS TO 3/64 OVER 3/64 TO 1/4 OVER 1/4 20 25 110 45 165 35 45 110 150 150 50 275 50 180 385 50 50 180 250 500 50 325 325 50 50 325 375 375 375 1000 500 50 1100 500 1100 600 600 1100 1100

単THIS TABLE GIVES RECOMMENDED CONNECTOR INSTALLING TORQUES FOR COPPER AND ALUMINUM 素CONDUCTORS. THEY ARE FOR GUIDANCE ONLY WHERE NO TIGHTENING INFORMATION IS AVAILABLE AND SHOULD NOT BE USED TO REPLACE MANUFACTURER'S INSTRUCTIONS WHICH SHOULD ALWAYS BE (a) CLAMPING SCREWS WITH MULTIPLE TIGHTENING MEANS; FOR EXAMPLE FOR A SLOTTED HEXAGONA HEAD SCREW, USE THE HIGHEST TORQUE VALUE ASSOCIATED WITH THE DIFFERENT TIGHTENING

(b) FOR VALUES OF SLOT WIDTH OR LENGTH OTHER THAN THOSE SPECIFIED, SELECT THE LARGEST TORQUE VALUS ASSOCIATED WITH CONDUCTOR SIZE.

CEC ART. 310 CONDUCTOR DERATING

NEC #310.15 (B)(2)(a) ADJUSTMENT FACTORS (a) MORE THAN THREE CURRENT-CARRYING CONDUCTORS IN A RACEWAY OR CABLE. WHERE THE NUMBER OF CURRENT-CARRYING CONDUCTORS IN A RACEWAY OR CABLE EXCEEDS THREE, THE ALLOWABLE AMPACITIES SHALL BE REDUCED AS SHOWN IN THE FOLLOWING TABLE:

PERCENT OF VALUES IN TABLES AS CURRENT-CARRYING CONDUCTORS TEMPERATURE IF NECESSARY THROUGH 6 7 THROUGH 9 10 THROUGH 20 THROUGH 3 THROUGH 40

WHERE SINGLE CONDUCTORS OR MULTICONDUCTOR CABLES ARE STACKED OR BUNDLED LONGER THAN

INCHES (610 mm) WITHOUT MAINTAINING SPACING AND ARE NOT INSTALLED IN RACEWAYS, THE owable ampacity of each conductor shall be reduced as shown in the above table. EXCEPTION NO. 1: WHERE CONDUCTORS OF DIFFERENT SYSTEMS, AS PROVIDED IN SECTION 300-3, INSTALLED IN A COMMON RACEWAY OR CABLE, THE DERATING FACTORS SHOWN ABOVE SHALL APPLY THE NUMBER OF POWER AND LIGHTING (ARTICLES 210, 215, 220, AND 230) CONDUCTORS ONLY. EXCEPTION NO. 2: FOR CONDUCTORS INSTALLED IN CABLE TRAYS, THE PROVISIONS OF SECTION 392.1

41 AND ABOVE

EXCEPTION NO. 3: DERATING FACTORS SHALL NOT APPLY TO CONDUCTORS IN NIPPLES HAVING A ENGTH NOT EXCEEDING 24 INCHES (600mm).

EXCEPTION NO.4: DERATING FACTORS SHALL NOT APPLY TO UNDERGROUND CONDUCTORS ENTERING OR LEAVING AN OUTDOOR TRENCH IF THOSE CONDUCTORS HAVE PHYSICAL PROTECTION IN THE FORM OF RIGID SETAL CONDUIT, INTERMEDIATE METAL CONDUIT, OR RIGID NONMETALLIC CONDUIT HAVING A LENGTH NOT

	CEEDING 10 FEET (3.05m) ABOVE G							
INSTRU	CEC	WIRE FI	LL TABI	E 370-	16			
	JUNCTION BOX DIMENSION,	MIN.	MAXIMUM NUMBER OF CONDUCTORS					
₹	INCHES TRADE SIZE OR TYPE	CU. IN. CAP.	NO. 14	NO. 12	NO. 10	NO. 8	NO.	
₹	4 x1-1/4 ROUND OR OCTAGONAL	12.5	6	5	5	4	2	
	4 X1-1/2 ROUND OR OCTAGONAL 4 X2-1/8 ROUND OR OCTAGONAL	15.5	7	6	6	5	3	
₽	4 X2-1/8 ROUND OR OCTAGONAL	21.5	10	9	8	7	4	
	4 x1-1/4 SQUARE	18.0	9	8	7	6	3	
INCORPORATED	4 X1-1/2 SQUARE	21.0	10	9	8	7	4	
ğ	4 X2-1/8 SQUARE	30.3	15	13	12	10	6	
ğ	4-11/16 x1-1/4 SQUARE	25.5	12	11	10	8	5	
Ž	4-11/16 X1-1/2 SQUARE	29.5	14	13	11	9	5	
ž	4-11/16 X2-1/8 SQUARE	42.0	21	18	16	14	8	
DESIGNS	3 x2 x1-1/2 DEVICE	7.5	3	3	3	2	1	
	3 x2 x2 DEVICE	10.0	5	4	4	3	2	
3	3 x2 x2-1/4 DEVICE	10.5	5	4	4	3	2	
ง	3 x2 x2-1/2 DEVICE	12.5	6	5	5	4	2	
DEAS	3 x2 x2-3/4 DEVICE	14.0	7	6	5	4	2	
	3 x2 x3-1/2 DEVICE	18.0	9	8	7	6	3	
¥	4 X2-1/8 X1-1/2 DEVICE	10.3	5	4	4	3	2	
Ę	4 X2-1/8 X1-7/8 DEVICE	13.0	6	5	5	4	2	
	4 X2-1/8 X2-1/8 DEVICE	14.5	7	6	5	4	2	
DOCUMENT	3-3/4 x2 x2-1/2 MASONRY BOX / GANG	14.0	7	8	5	4	2	
	3-3/4 x2 x3-1/2 MASONRY BOX / GANG	21.0	10	9	8	7	4	
¥ E	FS - MINIMUM INTERNAL DEPTH 1-3/4 SINGLE COVER / GANG	13.5	6	6	5	4	2	
	FD - MINIMUM INTERNAL DEPTH 2-3/8 SINGLE COVER / GANG	18.0	9	8	7	6	3	
	FS - MINIMUM INTERNAL DEPTH 1-3/4 MULTIPLE COVER / GANG	18.0	9	8	7	6	3	
	FD - MINIMUM INTERNAL DEPTH 2-3/8 MULTIPLE COVER / GANG	24.0	12	10	9	8	4	

THE DRAWINGS AND THESE GENERAL NOTES DESCRIBE THE SCOPE OF WORK AND SYSTEMS. THE MATERIAL REQUIRED FOR THE WORK SHALL BE CONTRACTOR FURNISHED AND CONTRACTOR INSTALLED, UNLESS SPECIFICALLY NOTED OTHERWISE. THE WORK INCLUDES BUT IS NOT LIMITED TO THE FOLLOWING PRINCIPAL

GENERAL ELECTRICAL NOTES

PERMITS AND CHARGES:
OBTAIN AND PAY FOR ALL NECESSARY CONSTRUCTION PERMITS, INSPECTION FEES, AND OTHER CHARGES BY AGENCIES HAVING JURISDICTION.

PROVIDE AND INSTALL ALL MATERIALS IN CONFORMANCE WITH THE NATIONAL ELECTRICAL CODE, CALIFORNIA ADMINISTRATIVE CODE TITLE 8, AND OTHER CODES AND REGULATIONS HAVING JURISDICTION. INSTALL ALL EQUIPMENT IN ACCORDANCE WITH THE REQUIREMENTS OF THE INSPECTING AUTHORITY AND MANUFACTURERS

<u>VERIFYING EXISTING CONDITIONS:</u>
BEFORE SUBMITTING BID, BECOME THOROUGHLY FAMILIAR WITH ACTUAL EXISTING CONDITIONS AT THE BUILDING SITE. THE INTENT OF THE WORK IS SHOWN ON THE DRAWINGS AND DESCRIBED HEREINAFTER. BY THE ACT OF SUBMITTING A BID PROPOSAL FOR THE WORK, THE CONTRACTOR SHALL BE DEEMED TO HAVE MADE SUCH STUDY AND EXAMINATION AND TO ACCEPT ALL CONDITIONS PRESENT AT THE SITE. NO REQUEST FOR ADDITIONAL PAYMENT WILL BE CONSIDERED AS VALID, DUE TO FAILURE TO ALLOW FOR CONDITIONS

ORDINATION:
DORDINATE ALL WORK WITH OTHER TRADES. OBTAIN ALL DRAWINGS THAT WILL REQUIRE COORDINATION AND PROVIDE ALL ELECTRICAL CONNECTIONS REQUIRED WHETHER SHOWN ON ELECTRICAL DRAWINGS OR NOT. ELECTRICAL EQUIPMENT LOCATIONS INDICATED ARE SHOWN DIAGRAMMATICALLY, EXACT LOCATION SHALL BE

UNINTERRUPTED EXISTING ELECTRICAL POWER SHALL BE MAINTAINED TO OTHER TRADES FOR TEMPORARY POWER AREAS OF THE SITE DURING CONSTRUCTION. PROVIDE ANY TEMPORARY SERVICES AS MAY BE REQUIRED. IDENTIFY AT BID TIME, ALL WORK TO BE DONE ON PREMIUM TIME AND THE TOTAL OVERTIME MAN-HOURS REQUIRED FOR COMPLETION.

PROVIDE RECORD DRAWINGS TO THE OWNER WITH ALL CHANGES NOTED THEREON AT THE COMPLETION OF THE PROJECT. RECORD DRAWINGS SHALL BE SIGNED AND DATED BY CONTRACTOR PRIOR TO RELEASE OF FINAL RETENTION OF ALL MONIES.

MARK PROJECT RECORD DOCUMENTS DAILY TO INDICATE ALL CHANGES MADE IN THE FIELD. A.) IN ADDITION TO GENERAL REQUIREMENTS OF PROJECT RECORD DRAWINGS, INDICATE ON PRÁWINGS, CHANGES OF EQUIPMENT LOCATIONS AND RATINGS, TRIP SIZES, AND SETTINGS ON CIRCUIT BREAKERS, ALTERATIONS IN RACEWAY RUNS AND SIZES, CHANGES IN WIRE SIZES, CIRCUIT DESIGNATIONS, INSTALLATION DETAILS, ONE-LINE DIAGRAMS, CONTROL DIAGRAMS AND SCHEDULES.

USE GREEN TO INDICATE DELETIONS AND RED TO INDICATE ADDITIONS. A.) USE THE SAME SYMBOLS AND FOLLOW THE SAME DRAFTING PROCEDURES USED ON THE CONTRACT

LOCATE UNDERGROUND CONDUIT STUBBED-OUT FOR FUTURE USE, UNDERGROUND FEEDER CONDUITS, AND FEEDER PULL BOX LOCATIONS USING BUILDING LINES BY INDICATING ON THE PROJECT RECORD DRAWINGS. AT THE COMPLETION OF UNDERGROUND CONDUIT INSTALLATION, PROVIDE UNDERGROUND CONDUIT RECORD DOCUMENTS TO OWNER'S REPRESENTATIVE.

TWO COPIES, IN BINDER FORM, OF ALL TEST RESULTS AS REQUIRED BY THESE DOCUMENTS. TWO COPIES OF LOCAL AND/OR STATE CODE ENFORCING AUTHORITIES FINAL INSPECTION CERTIFICATES. TWO COPIES, IN BINDER FORM, OF ELECTRICAL EQUIPMENT CUT SHEETS, MANUFACTURER'S INSTALLATION INSTRUCTIONS, WARRANTY CERTIFICATES, AND PRODUCT LITERATURE FOR ALL PRODUCTS UTILIZED ON

CONTRACTOR SHALL UNCONDITIONALLY GUARANTEE ALL LABOR AND MATERIALS ON ALL WORK AGAINST DEFECTS IN WORKMANSHIP AND MATERIALS FOR A PERIOD OF ONE YEAR.

SHOP DRAWINGS AND MATERIAL LIST FOR REVIEW PRIOR TO COMMENCING ANY WORK. ALL EQUIPMENT O BEAR U.L. LABEL OR THAT OF ANOTHER ACCEPTABLE TESTING LABORATORY. SHOP DRAWINGS MUST BE STAMPED BY THE CONTRACTOR FOR CONFORMANCE PRIOR TO SUBMITTAL.
SUBMIT SIX SETS OF SHOP DRAWINGS FOR REVIEW PRIOR TO PURCHASING ALL BREAKER MOUNTING HARDWARE, DISCONNECT SWITCHES, FUSES, CONTROLLERS, LIGHTING FIXTURES, LIGHT SWITCHES,

ONTRACTOR'S BID SHALL BE BASED ON ALL WORK SHOWN ON THE PLANS AND AS SPECIFIED. I CONTRACTOR PROPOSES TO SUBSTITUTE FOR EQUIPMENT SPECIFIED, HE SHALL SUBMIT HIS REQUEST FOR CONSIDERATION OF THE OWNER AND ENGINEER PRIOR TO BID IN WRITING. ALL SUBSTITUTIONS SHALL BE REVIEWED BY THE ENGINEER IN WRITING. SUCH REVIEW SHALL NOT RELIEVE THE CONTRACTOR FROM COMPLYING WITH THE REQUIREMENTS OF THE DRAWINGS AND SPECIFICATIONS. AND THE CONTRACTOR SHALL BE RESPONSIBLE AT HIS/HER OWN EXPENSE FOR ANY CHARGES RESULTING FROM HIS PROPOSED SUBSTITUTIONS WHICH AFFECT OTHER PARTS OF HIS/HER OWN WORK, THE OWNER, ENGINEER OF RECORD OR THE WORK OF OTHER CONTRACTORS.

ALL MATERIALS SHALL BE NEW AND LISTED BY UNDERWRITERS LABORATORY (U.L.). ALL WORK AND MATERIAL SHALL CONFORM TO THE LATEST RULES OF THE GOVERNING ELECTRICAL CODE AND INSTALLATION SHALL BE OF THE LATEST INDUSTRY STANDARDS OF WORKMANSHIP.

CONDUITS:
CONDUIT SHALL BE EMT, PVC, IMC, RIGID OR FLEXIBLE STEEL TYPE, CONDUIT SHALL BE MANUFACTURED IN ACCORDANCE WITH UL-1. A GROUND WIRE IS REQUIRED IN ALL FLEXIBLE CONDUIT AND UNDERGROUND CONDUIT. BUSHINGS SHALL BE INSTALLED ON ALL COMMUNICATION, TELEPHONE & SPEAKER CONDUITS. PROVIDE 3/16" NYLON PULL STRING IN ALL EMPTY CONDUITS. NO MC, BX, OR AC90 SHALL BE PERMITTED.

SWITCHES AND RECEPTACLES: PROVIDE 20 AMP NEMA RATED SWITCHES AND RECEPTACLES OF SPECIFICATION GRADE. ALL SWITCHES SHALL BE RATED 120 AND/OR 277 VOLT AND RECEPTACLES SHALL BE NEMA 5-20R. IN ALL OFFICES AND OFFICE AREAS, DEVICES SHALL BE DECORA TYPE WITH COLOR SELECTION BY CONTRACTOR/OWNERS REPRESENTATIVE.

FEEDERS AND BRANCH CIRCUITS IDENTIFICATION:
IDENTIFY FEEDERS WITH THE CORRESPONDING CIRCUIT DESIGNATION AT THE OVER-CURRENT
DEVICE, LOAD END, AND IN PULL BOXES WITH E-Z CODE OR OTHER APPROVED WIRE MARKER. IDENTIFY BRANCH CIRCUITS WITH I.D. MARKERS, THE CORRESPONDING CIRCUIT DESIGNATION AT HE OVER-CURRENT DEVICE, AT ALL SPLICES, IN JUNCTION BOXES, AND IN OUTLETS. USE PLASTIC COATED SELF-STICKING MARKERS SUCH AS THOMAS & BETTS E-Z CODE FOR IDENTIFICATION OF CONDUCTORS. IDENTIFY SIGNAL & COMMUNICATION CABLES AT TERMINAL AND OUTLET.

CONDUCTORS:
DELIVER ALL CONDUCTORS TO THE JOB SITE IN ORIGINAL UNBROKEN CARTON OR REEL, PROPERLY TAGGED WITH U.L. LABEL, SIZE, TYPE, MANUFACTURER, TRADE NAME AND THE DATE OF MANUFACTURE. CONDUCTORS MUST BE MANUFACTURED WITHIN 6 MONTHS. PROVIDE COPPER CONDUCTORS #12 AWG MINIMUM UNLESS SPECIFICALLY NOTED OTHERWISE ON THE DRAWINGS. PROVIDE STRANDED COPPER CONDUCTORS FOR ALL WIRING. USE CONDUCTORS WITH THHN/THWN 600 VOLTS INSULATION, UNLESS OTHERWISE NOTED.

PANELBOARDS:
DISTRIBUTION AND LIGHTING PANELBOARDS WITHIN PROJECT AREA SHALL BE OF THE COPPER BUS THREE PHASE, FOUR WIRE DISTRIBUTED PHASING TYPE. CIRCUITING SHALL BE ARRANGED O PROVIDE, AS NEARLY AS POSSIBLE, AN EVENLY BALANCED LOAD ON ALL PHASES. PANELBOARDS SHALL BE BOLT-ON CIRCUIT BREAKER TYPE. AVAILABLE FAULT CURRENT IS STATED ON PANELBOARD SCHEDULE. PROVIDE PANEL IDENTIFICATION NAMEPLATE (ENGRAVED ON -ADHESIVE 1/2" MINIMUM LETTERS) AND TYPEWRITTEN LIST OF CIRCUITS IN THE DIRECTORY

STRUCTURAL SUPPORT:
EACH SECTION OF FLOOR MOUNTED SWITCHBOARD, DISTRIBUTION BOARD, MCC, ETC. SHALL BE BOLTED TO THE CONCRETE HOUSEKEEPING PAD USING (6) 3/4"-10 GRADE 2 BOLTS AND CONICAL WASHERS TORQUED TO 70LB-FT. PROVIDE MINÌMUM 4000 PSI STRENGTH CONCRETE BELOW ALL FLOOR MOUNTED ELECTRICAL EQUIPMENT. TIE THE TOP OF ALL FLOOR MOUNTED ELECTRICAL EQUIPMENT TO THE BUILDING STRUCTURE IN A SEISMICALLY APPROVED MANNER

<u>DEMOLITION:</u>
NOTIFY THE OWNER IMMEDIATELY WHEREVER EXISTING EQUIPMENT IS ENCOUNTERED WHICH MUST BE RELOCATED DUE TO THE NEW CONSTRUCTION, AND WHICH IS NOT INDICATED ON THE PLANS. ALL REMOVED MATERIALS AND EQUIPMENT WHICH ARE SALVAGEABLE SHALL REMAIN THE PROPERTY OF THE OWNER. DELIVER SUCH SALVAGED MATERIALS AND EQUIPMENT ON THE PREMISES AS DIRECTED BY THE OWNER, AND NEATLY PILE OR STORE THEM AND PROTECT FROM DAMAGE. REMOVE FROM PREMISES AND DISPOSE OF ALL MATERIALS CONSIDERED BY THE OWNER TO BE SCRAP.

2. ALL DEVICES, CIRCUIT CONDUCTORS, FEEDERS, ETC., WHEN NOTED TO BE REMOVED, SHALL BE REMOVED TO THE LAST ACTIVE DEVICE. ALL OVER-CURRENT PROTECTION AND DISCONNECT DEVICES NO LONGER UTILIZED BUT REMAINING AS LAST ACTIVE DEVICE SHALL BE LABELED AS "SPARE". COORDINATE ALL OUTAGES WITH OWNER'S REPRESENTATIVE.

EXECUTION:
CAREFULLY PROTECT ALL WALLS, TRIM, FLOORS, EQUIPMENT UTILITY LINES AND MATERIALS. WHEN WORKING ON FINISHED SURFACES, LIMIT DAMAGE TO THE CONFINES AS MUCH AS POSSIBLE AND RESTORE TO THE DRIGINAL CONDITION ALL SURFACES WHICH ARE DAMAGED BECAUSE OF THE INSTALLATION OF THE WORK UNDER THIS CONTRACT

1.) EQUIPMENT, MATERIALS AND SUPPLIES REMOVED FOR PROTECTION SHALL BE REPLACED IN ORIGINAL LOCATIONS. ANY MATERIALS DAMAGED SHALL BE REPLACED WITH NEW MATERIALS OF LIKE KIND AND QUALITY.

PER CEC 110.16, ELECTRICAL EQUIPMENT, SUCH AS SWITCHBOARDS, PANELBOARDS, INDUSTRIAL CONTROL PANELS, METER SOCKET ENCLOSURES, AND MOTOR CONTROL CENTERS SHALL BE FIELD MARKED TO WARN QUALIFIED PERSONS OF POTENTIAL ELECTRIC ARC FLASH HAZARDS. THE MARKING SHALL BE LOCATED SO AS TO BE CLEARLY VISIBLE TO QUALIFIED PERSONS BEFORE EXAMINATION, ADJUSTMENT, SERVICING, OR MAINTENANCE OF THE EQUIPMENT.

2.) DO ALL DRILLING, CUTTING, CHANNELING AND PATCHING REQUIRED TO INSTALL ELECTRICAL WORK AS INDICATED OR HEREIN SPECIFIÉD. ALL HOLES, CURBS, ETC., IN FLOORS, CEILINGS AND WALLS SHALL BE PATCHED, UNLESS INDICATED OTHERWISE. PAINT ALL NEW ELECTRICAL RACEWAYS, CABINETS, ENCLOSURES, AND FITTINGS PENETRATING INTO FIRE RATED ENVELOPES, SPACES, ETC.

3.) ALL CONDUIT RUNS SHALL BE CONCEALED, UNLESS SHOWN OTHERWISE. PROVIDE A PULL WIRE IN ALL

4.) EXISTING CONDITION SHOWN IS FROM AVAILABLE RECORD DRAWINGS AND VISUAL FIELD SURVEY AND IS SHOWN FOR REFERENCE ONLY. CONTRACTOR SHALL VERIFY ACTUAL EXISTING CONDITION AT SITE. 5.) ALL WORK SHOWN IS NEW UNLESS SPECIFICALLY INDICATED AS EXISTING (X). ALL ELECTRICAL EQUIPMENT MOUNTING AND ANCHORAGE MUST CONFORM WITH LOCAL AND STATE SEISMIC CODES.

TELEPHONE SYSTEMS:
PROVIDE RACEWAYS, AND ALL MATERIAL INCLUDING PULLING CABLE IN EACH RACEWAY AS REQUIRED FOR THE TELEPHONE SYSTEM PER THE SERVING TELEPHONE COMPANY REQUIREMENTS.

GROUNDING AND BONDING:
FURNISH AND INSTALL COMPLETE BONDING AND GROUNDING SYSTEM AS REQUIRED BY CODES. CONTINUITY
OF GROUNDING SHALL BE MAINTAINED MECHANICALLY AND ELECTRICALLY THROUGHOUT THE SYSTEM. A GREEN
GROUNDING CODE SIZED CONDUCTOR SHALL BE CARRIED THROUGH IN ALL CONDUITS.

INSTALLATION: IT IS THE INTENT OF THESE DRAWINGS AND SPECIFICATIONS THAT A COMPLETE AND WORKABLE ELECTRICAL INSTALLATION BE PROVIDED FOR ALL THE EQUIPMENT DESCRIBED OR SHOWN AS BEING IN THIS CONTRACT TOWARD THIS END FURNISH ALL LABOR AND TOOLS NECESSARY AND FURNISH AND INSTALL ALL APPARATUS, MATERIALS AND EQUIPMENT IN A FASHION COMPLYING WITH ALL APPLICABLE CODES, INCLUDING ITEMS REQUIRED BUT NOT NORMALLY SHOWN, SUCH AS LAMPS, COUPLINGS, HANGERS, BRACKETS, CLAMPS, BOXES,

1.) PROCURE ALL PERMITS FROM LEGALLY CONSTITUTED AUTHORITIES, ARRANGE FOR ALL INSPECTIONS AND PÁY ALL COSTS FOR FEES AND TESTS IN CONNECTION THEREWITH. COMPLY WITH CODES: NOTHING IN THESE DRAWINGS AUTHORIZES DEVIATION FROM APPLICABLE CODES.

2.) DETERMINE EXACT ROUTING OF CONCEALED FEEDERS AND BRANCH CIRCUIT HOMERUNS IN COOPERATION WITH OTHER TRADES TO SIMPLIFY INSTALLATION WHEREVER POSSIBLE BUT SUBJECT TO APPROVAL OF ARCHITECT FOR VISUAL AND STRUCTURAL REASONS.

3.) FOR CONNECTIONS TO EXHAUST FANS, PUMPS, COMPRESSORS, SPACE HEATERS, WATER HEATERS, AQUASTATS, SOLENOID VALVES, AND OTHER MECHANICAL EQUIPMENT AND FOR CONDUITS AND WIRE REQUIRED BUT NOT NECESSARILY SHOWN ON THESE DRAWINGS, REFER TO MECHANICAL PLANS AND DETERMINE EXACT LOCATIONS UNDER DIRECTION OF HEATING AND VENTILATING CONTRACTOR.

4.) DO NOT RUN ANY CONDUIT IN SLAB IF ITS OUTSIDE DIAMETER EXCEEDS 1/3 THE THICKNESS OF THE SLAB. LOCATE CONDUITS WITHIN THE MIDDLE OF THE SLAB. WHERE CONDUITS ARE GROUPED IN PARALLEL RUNS, SPACE THEM 3" OR MORE APART. WHERE CONDUITS CROSS EACH OTHER, THICKEN THE SLAB PROPORTIONATELY OVER A HORIZONTAL AREA EQUAL TO TEN TIMES THE DIAMETER OF THE LARGEST CONDUIT. REFER ALSO TO DETAILS SHOWN.

5.) SIZE OUTLET BOXES IN CONFORMITY WITH CODE FOR NUMBER AND GUAGE OF CONDUCTORS THEREIN,

6.) ALL ELECTRICAL WORK SHALL BE INSTALLED SO AS TO BE READILY ACCESSIBLE FOR OPERATING, SÉRVICING, MAINTAINING AND REPAIRING. ALL CONDUIT SHALL BE CONCEALED WHERE POSSIBLE. EXPÓSED CONDUIT SHALL BE IN STRAIGHT LINES PARALLEL WITH, OR AT RIGHT ANGLES TO, COLUMN LINES OR BEAMS AND SEPARATED BY AT LEAST THREE (3) INCHES FROM WATER LINES WHENEVER THEY RUN ALONG SIDE OR ACROSS SUCH LINES. CONDUIT SHALL NOT BE RUN BELOW CABLE TRAYS OR LIGHT FIXTURES WITHOUT SPECIFIC APPROVAL OF THE OWNER'S REPRESENTATIVE. HANGERS SHALL BE FASTENED TO STEEL, CONCRETE OR MASONRY, BUT NOT TO PIPING. HANGERS AND SUPPORT SYSTEMS ARE AN INTEGRAL PART OF THE VISUAL ENVIRONMENT. ALL HANGERS AND SUPPORTS EXPOSED TO PUBLIC VIEW MUST BE SHOWN IN DETAIL ON PLANS SUBMITTED TO LANDLORD FOR APPROVAL OF APPEARANCE. ALL HANGERS MUST BE UNIFORMLY SPACED AND NEATLY INSTALLED WITH NO EXCESS MATERIAL BEYOND WHAT IS REQUIRED FOR THE SUPPORT FUNCTION. CONTRACTOR SHALL SELECT ACCESSORIES AND HARDWARE WITH A SMOOTH, NEAT FINISHED APPEARANCE AND PAINT ALL EXPOSED CONDUIT HANGERS TO MATCH THE ADJACENT FINISHES.

ELECTRICAL SWITCHES: CONTROLS AND SWITCHES INTENDED TO BE USED BY THE OCCUPANT OF THE ROOM OR AREA TO CONTROL LIGHTING AND RECEPTACLE OUTLETS, APPLIANCES OR COOLING, HEATING AND VENTILATING EQUIPMENT, SHALL BE LOCATED NO MORE THAN 48" MEASURED FROM THE TOP OF OUTLET BOX NOR LESS THAN 15" MEASURED FROM THE BOTTOM OF THE OUTLET BOX TO THE LEVEL OF THE FINISHED

ELECTRICAL RECEPTACLE OUTLETS: ELECTRICAL RECEPTACLE OUTLETS ON BRANCH CIRCUITS OF 30 AMPERES OR LESS AND COMMUNICATION SYSTEM RECEPTACLES, SHALL BE LOCATED NO MORE THAN 48" MEASURED FROM THE TOP OF THE RECEPTACLE OUTLET BOX OR RECEPTACLE HOUSING NOR LESS THAN 15" MEASURED FROM THE BOTTOM OF THE RECEPTACLE OUTLET BOX OR RECEPTACLE HOUSING TO THE LEVEL OF THE FINISHED FLOOR OR WORKING PLATFORM.

9.) CONTRACTOR SHALL EXAMINE PLANS AND VERIEY IN FIFLD LOCATIONS OF ALL FIRE RATED WALLS. CÉILINGS AND FLOORS. CONTRACTOR SHALL SEAL ALL ELECTRICAL SYSTEM PENETRATIONS THROUGH FIRE RATED WALLS, CEILINGS AND FLOORS WITH U.L. LISTED MATERIAL APPROVED BY THE AUTHORITY HAVING

SURFACE MOUNTED RACEWAY COMPLETENESS: CONTRACTOR SHALL PROVIDE ALL RACEWAY, FITTINGS, SUPPORTS, BOXES, DEVICES, PLATES ETC. NECESSARY FOR A COMPLETE AND WORKABLE SURFACE MOUNTED ELECTRICAL RACEWAY SYSTEM. PRIOR TO INSTALLATION. CONTRACTOR SHALL PERFORM A PRE—INSTALLATION SURFACE MOUNTED RACEWAY JOB WALK WITH OWNER & ARCHITECT FOR CONTRACTOR TO FIELD VERIFY EXACT ROUTING OF ANY & ALL SURFACE MOUNTED RACEWAYS.

ELECTRICAL SYSTEM ANCHORAGE:
ALL ELECTRICAL EQUIPMENT SHALL BE BRACED OR SEISMICALLY ANCHORED BY THE CONTRACTOR TO RESIST SUPPORT OF ELECTRICAL RACEWAYS, CONDUITS, CABLE TRAYS, ELECTRICAL EQUIPMENT, ETC. IN ACCORDANCE WITH THE UNIFORM BUILDING CODE WITH CALIFORNIA AMENDMENTS.

THE SEISMIC BRACING AND ANCHORAGE SHALL BE PROVIDED PER THE LATEST EDITION OF THE SMACNA SEISMIC RESTRAINT GUIDELINES, OR CALIFORNIA BUILDING CODE-WHICHEVER IS MORE RESTRICTIVE. ALL ELECTRICAL SYSTEMS SHALL BE INSTALLED IN ACCORDANCE WITH THE LATEST EDITION OF SMACNA GUIDELINES. WHERE BRACING DETAILS ARE NOT SHOWN ON THE PLANS, THE FIELD INSTALLATIONS SHALL BE SUBJECT TO THE APPROVAL OF THE ENGINEERS, AND THE ARCHITECT. A COPY OF LATEST SMACNA GUIDELINES SHALL BE KEPT AT THE JOB SITE AT ALL TIMES.

APPLICABLE CODES AND REGULATIONS

PART 2-CALIFORNIA BUILDING CODE

PART 3-CALIFORNIA ELECTRICAL CODE

PART 5-CALIFORNIA PLUMBING CODE

PART 6-CALIFORNIA ENERGY CODE

PART 9-CALIFORNIA FIRE CODE

PART 4-CALIFORNIA MECHANICAL CODE

PART 10-CALIFORNIA EXISTING BUILDING CODE

PART 11-CALIFORNIA GREEN BUILDING STANDARDS CODE

PART 12-CALIFORNIA REFERENCE STANDARDS CODE

CALIFORNIA CODE OF REGULATIONS (C.C.R.), TITLE 24 (APPLIES AFTER JANUARY 1, 2020):

PART 1-CALIFORNIA BUILDINGS STANDARD ADMINISTRATIVE CODE 2019 EDITION

ELECTRICAL SYMBOL LIST

DIMENSIONS INDICATED ARE MEASURED TO CENTERLINE OF ENCLOSURE. UNLESS OTHERWISE NOTED NOTE: SOME SYMBOLS SHOWN MAY NOT APPLY TO THIS PROJECT

ANNOTATIONS & CALLOUTS (1) ELECTRICAL KEYNOTE: DENOTES KEYNOTE #1 OF NOTES ON SAME SHEET. A INDICATES LIGHTING FIXTURE TAG NUMBER 62 — INDICATES WATTAGE OF LIGHT FIXTURE (FOUND ON LIGHT FIXTURE SCHEDULE) INDICATES MECHANICAL/PLUMBING EQUIPMENT OR DEVICE (FOUND ___ ON ELECTRICAL SCHEDULE FOR MECHANICAL EQUIPMENT OR ON MECHANICAL PLANS. MECHANICAL/PLUMBING TAG NUMBER 1 INDICATES DETAIL NUMBER E3.0 INDICATES SHEET NUMBER TO FIND DETAIL BREAK LINE INDICATES WORK EXTENDED BEYOND LIMITS SHOWN ON DRAWING. CONDUIT & WIRING SYMBOLS -A5-1-3-5,7 INDICATES A HOMERUN TO PANEL A5, CKTS 1-3-5 WITH SHARED NEUTRAL & CKT 7 WITH DEDICATED NEUTRAL. CONDUIT RUN CONCEALED ABOVE CEILING OR IN WALLS CONDUIT RUN CONCEALED BELOW FLOOR OR UNDERGROUND 3/4"C - 2 #12 & 1 #12 CU GND $\frac{11}{10}$ 3/4"C - 2 #10 & 1 #10 GND #10 3/4"C - 3 #10 & 1 #10 GND $\frac{111}{10}$ 3/4"C - 4 #10 & 1 #10 GND $\frac{11111}{10}$ 3/4"C - 5 #10 & 1 #10 GND $\frac{111111}{10}$ 3/4"C - 6 #10 & 1 #10 GND CONDUIT STUB. CAP AND IDENTIFY **Q.** FLEXIBLE CONDUIT CONNECTION. SEE PLAN.

LIGHTING FIXTURE SYMBOLS

2'X4' CEILING MOUNTED FLUORESCENT LIGHT FIXTURE W/OUTLET BOX (RECESSED, SURFACE MOUNTED) a & b, ETC. INDICATES SWITCH IDENTIFICATION

2'X2' CEILING MOUNTED FLUORESCENT LIGHT FIXTURE W/OUTLET BOX (RECESSED, SURFACE MOUNTED) O CEILING MOUNTED FLUORESCENT LIGHTING FIXTURE WITH 4S OUTLET BOX

- NUMBER INDICATES LIGHT FIXTURE BRANCH CIRCUIT

(RECESSED, SURFACE MOUNTED) FLUORESCENT LIGHT FIXTURE WITH INTEGRAL 90 MINUTE EMERGENCY BATTERY PACK WITH 4S OUTLET BOX. (RECESSED, SURFACE MOUNTED) SURFACE MOUNTED FLUORESCENT STRIP LIGHTING FIXTURE WITH 4S BOX

CEILING SURFACE MOUNTED LIGHTING FIXTURE WITH OUTLET BOX

CEILING RECESSED DOWNLIGHT FIXTURE CEILING RECESSED WALL WASH DOWNLIGHT FIXTURE

TRACK LIGHTING (TRIANGLES INDICATE # OF HEADS)

EXIT SIGN WITH OUTLET BOX

-ARROW DENOTES DIRECTIONAL CHEVRON

EXIT SIGN, END MOUNT ON WALL, WITH OUTLET BOX. SHADING DENOTES FACE OF EXIT SIGN.

LIGHT FIXTURE, WALL MOUNTED WITH OUTLET BOX

EMERGENCY LIGHTING UNIT WITH OUTLET BOX.

EXIT-EMERGENCY LIGHTING UNIT COMBO WITH OUTLET BOX.

PENDANT MOUNTED LIGHT FIXTURE WITH OUTLET BOX.

NFPA 20- STANDARD FOR THE INSTALLATION OF STATIONARY PUMPS FOR FIRE PROTECTION NFPA 24- PRIVATE FIRE MAINS (CA AMENDED)

NFPA 14- STANDPIPES SYSTEMS (CA AMENDED)

NFPA 13- AUTOMATIC SPRINKLER SYSTEM (CA AMENDED)

PARTIAL LIST OF NFPA STANDARDS:

NFPA 17A- WET CHEMICAL SYSTEMS,

NFPA 72- NAT. FIRE ALARM & SIGNALING CODE 2016 EDITION (CALIFORNIA AMENDED) NFPA 80- STANDARD FOR FIRE DOORS AND OTHER 2016 EDITION OPENING PROTECTIVES 2015 EDITION

NFPA 2001 - STANDARD ON CLEAN AGENT FIRE EXTINGUISHING SYSTEMS (CA AMENDED) UL 300- STANDARD FOR FIRE TESTING OF FIRE 2005 (R2010) EXTINGUISHING SYSTEMS FOR PROTECTION OF

COMMERCIAL COOKING EQUIPMENT UL 464- AUDIBLE SIGNALING DEVICES FOR FIRE ALARM AND 2003 EDITION SIGNALING SYSTEMS, INCLUDING ACCESSORIES UL 521- STANDARD FOR HEAT DETECTORS FOR FIRE 1999 EDITION PROTECTIVE SIGNALING SYSTEMS

UL 1971 - STANDARD FOR SIGNALING DEVICES FOR THE 2002 (R2010) HEARING IMPAIRED 2019 EDITION ICC 300- STANDARD FOR BLEACHERS, FOLDING AND

TELESCOPING SEATING, AND GRANDSTANDS

FOR A COMPLETE LIST OF APPLICABLE NFPA STANDARDS REFER TO 2019 CBC (SFM) CHAPTER 35 AND CALIFORNIA FIRE CODE CHAPTER 80.

PANELBOARD PER PLANS, FLUSH MOUNTED IN WALL @ +6'-6" TO TOP OF TRIM PANELBOARD PER PLANS, SURFACE MOUNTED ON WALL @ +6'-6" TO TOP OF TRIM

SINGLE RECEPTACLE, WALL MOUNTED @ +18" AFF, NEMA 5-20R UON DUPLEX RECEPTACLE, WALL MOUNTED @ +18" AFF, NEMA 5-20R UON (GFI DENOTES GROUND FAULT INTERRUPTER RECEPTACLE)

DUPLEX RECEPTACLE, WALL MOUNTED HORIZONTALLY @ +18" AFF, NEMA 5-20R UON DUPLEX TVSS RECEPTACLE, WALL MOUNTED @ +18" AFF, NEMA 5-20R UON

DUPLEX RECEPTACLE, WALL MOUNTED @ +18" AFF, NEMA 5-20R UON TOP RECEPTACLE SWITCHED CEILING MOUNTED DUPLEX RECEPTACLE, NEMA 5-20R UON

DOUBLE DUPLEX RECEPTACLE, WALL MOUNTED @ +18" AFF, NEMA 5-20R UON SPECIAL PURPOSE ELECTRICAL OUTLET PER PLAN IN WALL @ +18", UON

JUNCTION BOX (ACCESSIBLE CEILING SPACE MTD.) SIZE PER TABLE AND NEC ARTICLE 370 JUNCTION BOX (WALL MTD.) SIZE PER TABLE AND NEC ARTICLE 370 RECESSED FLUSH FLOORBOX, FLOOR MOUNTED. SEE POWER AND SIGNAL PLANS.

VERIFY EXACT LOCATION WITH ARCHITECT PRIOR TO ROUGH-IN. COORDINATE COVER

THERMOSTAT OUTLET BOX. 4S BOX WITH SINGLE GANG RING @ +42" AFF

FINISH/COLOR WITH ARCHITECT PRIOR TO ORDERING.

VOICE/DATA SYSTEM

TELE/DATA OUTLET BOX IN WALL @ +18", STUB A 1" CO UP 12" ABOVE ACCESSIBLE CEILING WITH BUSHING, 5S BOX WITH 1-GANG P-RING, UON

TELE/DATA OUTLET BOX, MOUNTED IN WALL +6" ABOVE COUNTER OR SPLASH, STUB A 1" CO UP 12" ABOVE ACCESSIBLE CEILING WITH BUSHING, 5S BOX WITH 1-GANG P-RING, UON

FLUSH CEILING MOUNTED TELE/DATA OUTLET, 5S BOX WITH SINGLE GANG PLASTER RING, UON

TELEVISION OUTLET IN WALL @ +84", 5S BOX WITH 1-GANG RING, UON

S SINGLE-POLE SWITCH MOUNTED @ +42" AFF

SINGLE POLE SWITCH @ +42", UON a INDICATES LIGHT FIXTURE TO BE SWITCHED TWO-POLE SWITCH MOUNTED @ +42" AFF S₃ 3-WAY SWITCH MOUNTED @ +42" AFF

4-WAY SWITCH MOUNTED @ +42" AFF KEYED SWITCH MOUNTED @ +42" AFF

DIMMER SWITCH MOUNTED 9 +42" AFF, 0-10V DIMMER COMPATIBLE WITH LED LIGHT FIXTURE, UON.

HORSEPOWER RATED SWITCH MOUNTED @ +42" AFF

OCCUPANCY SENSOR WALL SWITCH PER PLANS, MOUNTED @ +42" AFF

SP SINGLE-POLE SWITCH (WITH PILOT LIGHT) @ +42" AFF TIME SWITCH, FLUSH MOUNTED @ +42" AFF. WATTSTOPPER, TS-400-W ©S CEILING MOUNTED OCCUPANCY SENSOR COMPLETE WITH OUTLET BOX, PER PLANS.

CHELSEA DIGITAL WALL SWITCH MOUNTED @ +42" AFF PUSH BUTTON WALL SWITCH MOUNTED @ +42" AFF

CIRCUIT BREAKERS AND FUSES

MOLDED CASE CIRCUIT BREAKER 225 AMP FRAME, 150 AMP TRIP RATING, 3-POLE 100AS FUSED SWITCH, 100 AMP SWITCH RATING WITH 60 AMP FUSES, 3-POLE

100A UTILITY METER (OR AS NOTED)

60AS DISCONNECT SWITCH, 60AMP SWITCH, 35 AMP FUSES, 3—POLE WITH OVERCURRENT PROTECTION UON

COMBINATION STARTER / DISCONNECT SWITCH SIZED PER PLAN

EXHAUST FAN/MOTOR, SIZE AS INDICATED ON PLANS

FIRE ALARM SYMBOLS FACP FIRE ALARM CONTROL PANEL

2016 EDITION

2016 EDITION

2017 EDITION

2016 EDITION

2016 EDITION

2017 EDITION

SMOKE DETECTOR W/ BASE

PULL STATION

WALL MOUNT STROBE

WALL MOUNT HORN/STROBE D DUCT DETECTOR

CEILING MOUNT HORN/STROBE

CEILING MOUNT STROBE

HD HEAT DETECTOR W/ BASE END-OF-LINE RESISTOR

HORN WITH WEATHERPROOF ENCLOSURE

M

MINI−HORN

HARTMANNARCHITECTURESTUDIO.COM

430 S. CARRILLO RD.

OJAI, CALIFORNIA 93023

(805) 798-2253

CONSULTANTS:

FERRANTI ENGINEERING

CONSULTING **ELECTRICAL ENGINEERS** 1211 MARICOPA HWY, SUITE 250 OJAI, CA 93023 (805) 705-4772 DALÉFERRANTI@LIVE.COM



PROJECT:

NEW ELECTRICAL SERVICE & SITE IMPROVEMENTS

OJAI UNIFIED SCHOOL DISTRICT 414 EAST OJAI AVENUE OJAI, CA 93023 (805) 640-4300 CONTACT: ADAM DUTTER EMAIL: adutter@ojaiusd.org

PROJECT ADDRESS:

TOPA TOPA ELEMENTARY SCHOOL 916 MOUNTAIN VIEW AVENUE OJAI, CA 93023

MARK	DATE	DESCRIPTION
	•	

2020.011


04CONDOC

PROJECT INFORMATION: PROJECT NUMBER: PROJECT PHASE: DRAWN BY: REVIEWED BY

THE ORIGINAL SIZE OF THIS SHEET IS 36"x24". IF THE CURRENT SIZE IS OTHER THAN 36"x24", THEN ADJUST THE SCALE OF THE DRAWINGS ACCORDINGLY. SHEET TITLE:

SHEET NUMBER:

E100

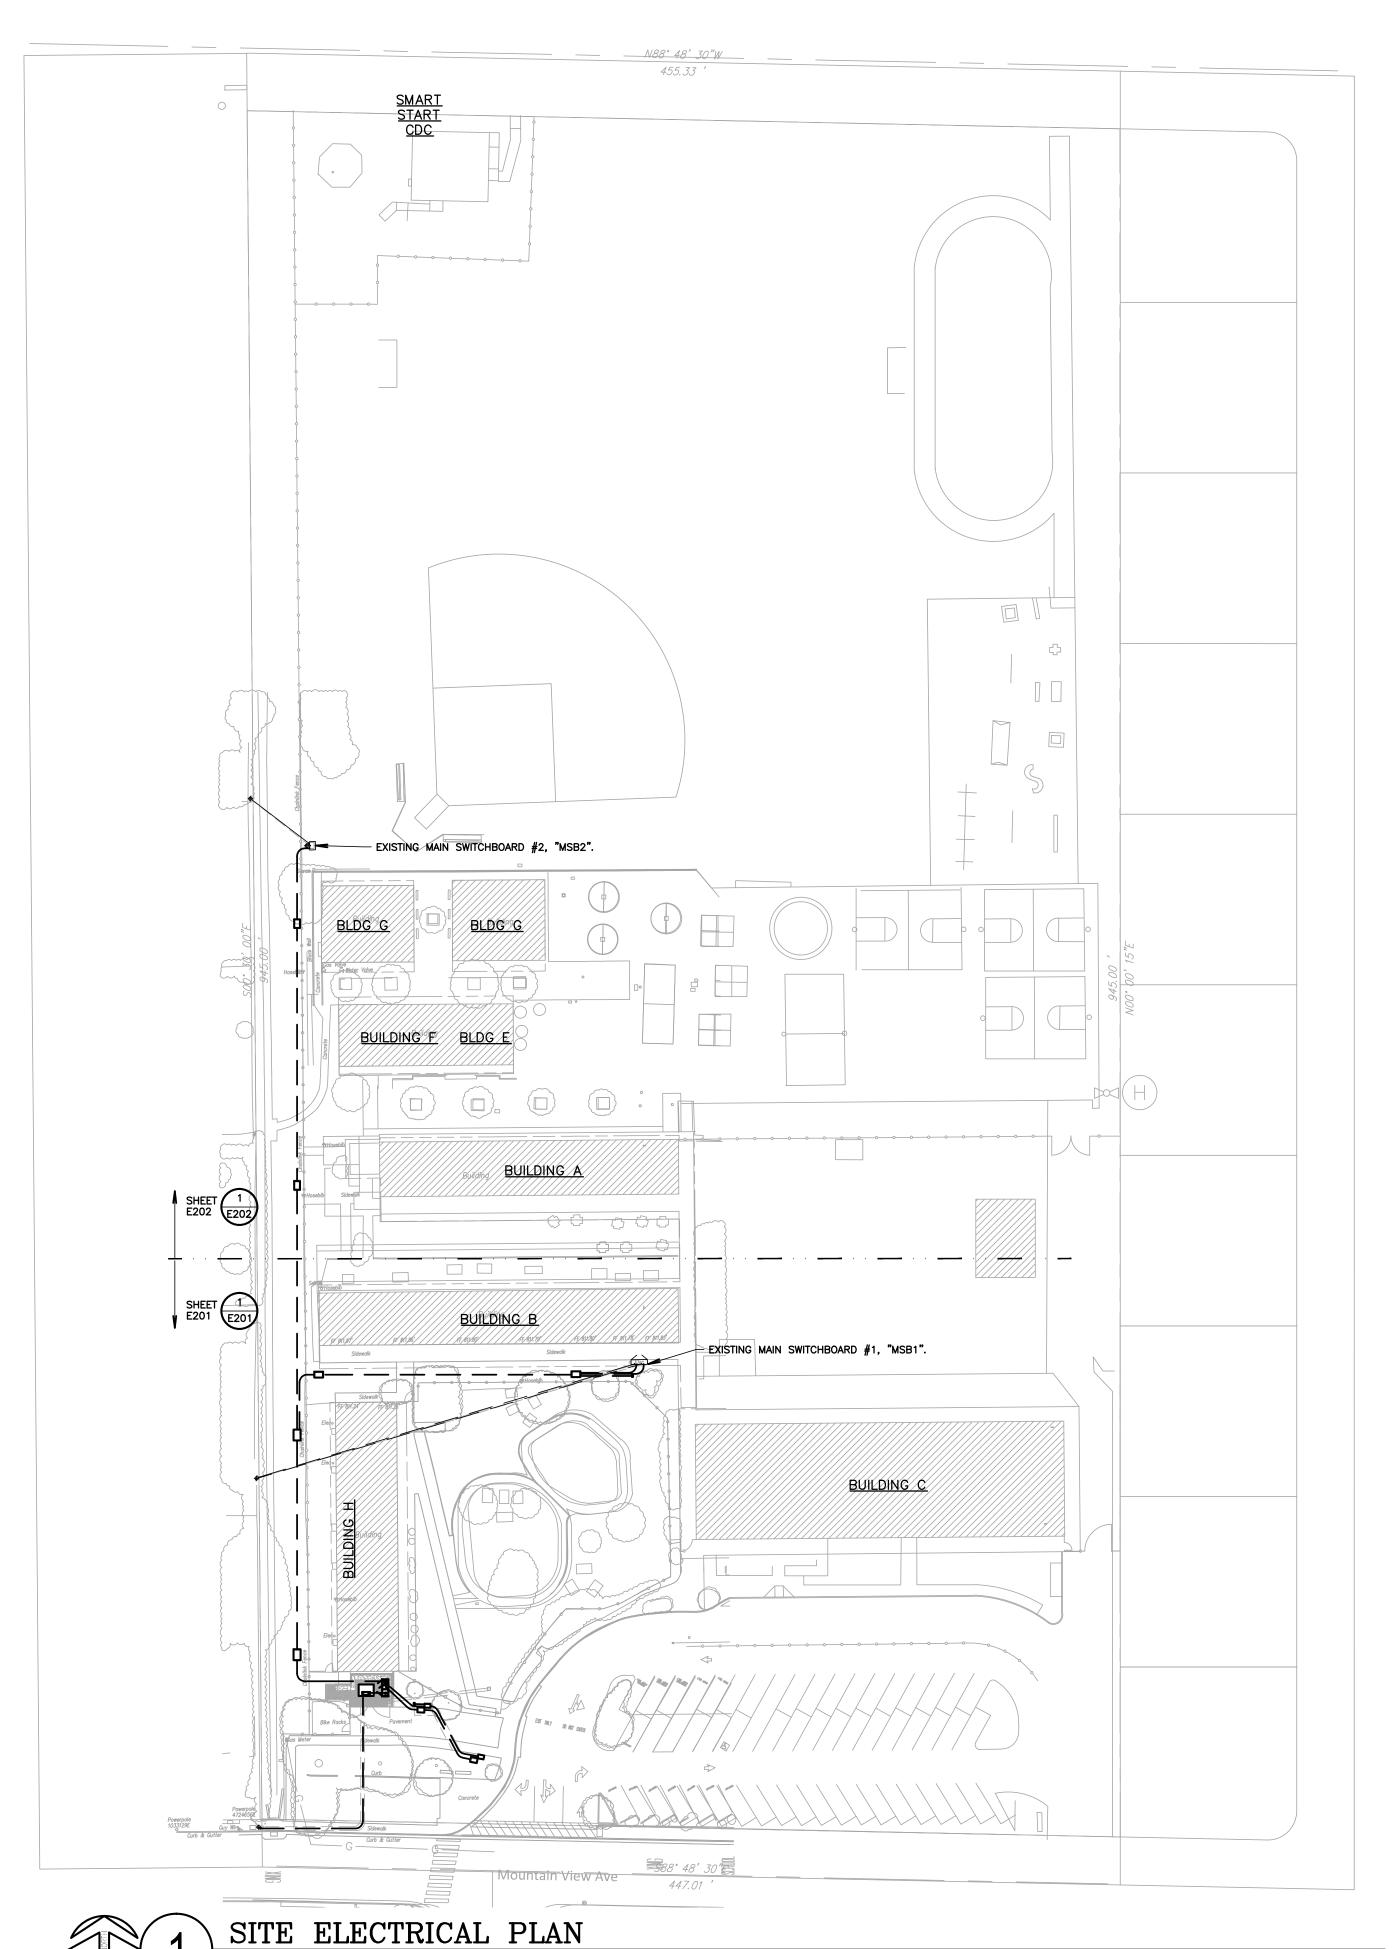

SCALE: 1"=50'-0"

1. CONTRACTOR SHALL CALL UNDERGROUND SERVICE ALERT AT 811 TO LOCATE UNDERGROUND UTILITIES AT LEAST 2 WORKING DAYS PRIOR TO DIGGING. CONTRACTOR SHALL FIELD VERIFY LOCATION AND DEPTH OF EXISTING IMPROVEMENTS PRIOR TO START

3. FIELD VERIFY LOCATION ON ALL UNDERGROUND UTILITIES PRIOR TO TRENCHING. SCHEDULE AND COORDINATE ALL SITE WORK WITH OWNER PRIOR TO

REQUIREMENTS OF ALL DEVICES/EQUIPMENT REQUIRING

SET) DRAWINGS.

7. CONTRACTOR SHALL COORDINATE AND PROVIDE ALL

DRAWINGS SHALL BE SUBMITTED TO THE LOCAL UTILITY COMPANY FOR APPROVAL, WITH WRITTEN APPROVAL RECEIVED PRIOR TO SUBMISSION TO ELECTRICAL ENGINEER FOR APPROVAL.

10. MINIMUM CONDUIT BURIAL DEPTH IS 24", 36" MINIMUM BELOW STREETS AND PARKING LOTS. FOR 0-600 VOLT SYSTEMS.

11. PROVIDE CODE SIZED EQUIPMENT GROUNDING CONDUCTORS IN ALL OCCUPIED CONDUITS.

14. CONTRACTOR SHALL FURNISH AND INSTALL PULL BOXES AS REQUIRED TO INSTALL CONDUCTORS PER CONDUCTOR MANUFACTURERS RECOMMENDATIONS, PER THE NATIONAL ELECTRICAL CODE, AND PER LOCAL

16. ALL EMPTY CONDUITS SHALL BE PROVIDED WITH DIMENSIONED NYLON PULL STRING.

17. CONTRACTOR SHALL FIELD VERIFY LOCATION OF ALL UNDERGROUND UTILITIES PRIOR TO ANY EXCAVATION OR TRENCHING. CONTRACTOR SHALL

18. VERIFY AND PROVIDE ALL UTILITY SYSTEMS PER SERVING UTILITY STANDARD REQUIREMENTS. 19. CONTRACTOR SHALL PROVIDE VOLTAGE SURGE ARRESTER PER NFPA 20, ARTICLE 10.4.1 REQUIREMENTS.

2. VERIFY LOCATION OF ALL BUILDINGS AND APPENDITURES ON ARCHITECTURAL AND CIVIL PLANS.

4. CONTRACTOR SHALL VERIFY LOCATION & ELECTRICAL CONNECTION PRIOR TO BID PROPOSAL,

ROUGH-IN, AND FINISH. 5. CONTRACTOR SHALL, IN ROUTING ALL CIRCUITS, INCREASE CONDUCTOR & CONDUIT SIZE TO ALLOW FOR VOLTAGE DROP SHOULD THE CONTRACTOR EXCEED ROUTING INDICATED ON DRAWINGS. ENGINEER OF RECORD MUST BE NOTIFIED PRIOR TO ANY DEVIATIONS FROM APPROVED PLAN CHECK (PERMIT

6. ALL 90 DEGREE CONDUIT BENDS AND RISERS SHALL BE PVC COATED RIGID STEEL.

SITE ELECTRICAL SERVICE REQUIREMENTS WITH SERVING UTILITY. 8. ALL SERVICE ENTRANCE EQUIPMENT SHOP

9. VERIFY LOCATION OF ALL EQUIPMENT ON ARCHITECTURAL AND CIVIL PLANS.

12. 1" CONDUIT MINIMUM UNDERGROUND.

13. COORDINATE WORK WITH OTHER TRADES. OBTAIN ALL DRAWINGS THAT WILL REQUIRE COORDINATION AND PROVIDE ALL ELECTRICAL CONNECTIONS, DEVICES, AND WIRING REQUIRED. WHETHER SHOWN ON THE ELECTRICAL DRAWINGS OR NOT.

AUTHORITIES HAVING JURISDICTION.

15. FIELD CONDITIONS GOVERN DEMOLITION AND NEW CONSTRUCTION. CONTRACTOR SHALL VERIFY ACTUAL CONDITIONS PRIOR TO START OF WORK. THE ARCHITECT/ENGINEER SHALL BE NOTIFIED OF POSSIBLE FIELD PROBLEMS PRIOR TO DEMOLITION. CONTRACTOR SHALL NOTIFY DISTRICT REPRESENTATIVE OF WORK BEING PERFORMED. COORDINATE WITH DISTRICT

PROTECT ALL EXISTING/REMAINING UTILITIES IN PLACE CONTRACTOR, AT HIS SÓLE EXPENSE, SHALL REPAIR ANY UTILITY SYSTEMS DAMAGED DURING CONSTRUCTION.

20. CONTRACTOR SHALL PROVIDE CONCRETE ENCASEMENT AT ALL VERIZON COMPANY CONDUIT BENDS PER VERIZON COMPANY REQUIREMENTS.



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AGENCY APPROVAL:

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SEALS:

NEW ELECTRICAL SERVICE & SITE IMPROVEMENTS

OWNER:

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04CONDOC

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DRAWN BY: REVIEWED BY:

THE ORIGINAL SIZE OF THIS SHEET IS 36"x24". IF THE CURRENT SIZE IS OTHER THAN 36"x24", THEN ADJUST THE SCALE OF THE DRAWINGS ACCORDINGLY.

SHEET TITLE:

SITE ELECTRICAL

PLAN

SHEET NUMBER:


DATE: 03/31/2021

E200

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SHEET NOTES ALERT AT 811 TO LOCATE UNDERGROUND UTILITIES AT LEAST 2 WORKING DAYS PRIOR TO DIGGING. CONTRACTOR SHALL FIELD VERIFY LOCATION AND DEPTH OF EXISTING IMPROVEMENTS PRIOR TO START

> 2. VERIFY LOCATION OF ALL BUILDINGS AND APPENDITURES ON ARCHITECTURAL AND CIVIL PLANS. 3. FIELD VERIFY LOCATION ON ALL UNDERGROUND UTILITIES PRIOR TO TRENCHING. SCHEDULE AND COORDINATE ALL SITE WORK WITH OWNER PRIOR TO ANY TRENCHING.

4. CONTRACTOR SHALL VERIFY LOCATION & REQUIREMENTS OF ALL DEVICES/EQUIPMENT REQUIRING ELECTRICAL CONNECTION PRIOR TO BID PROPOSAL,

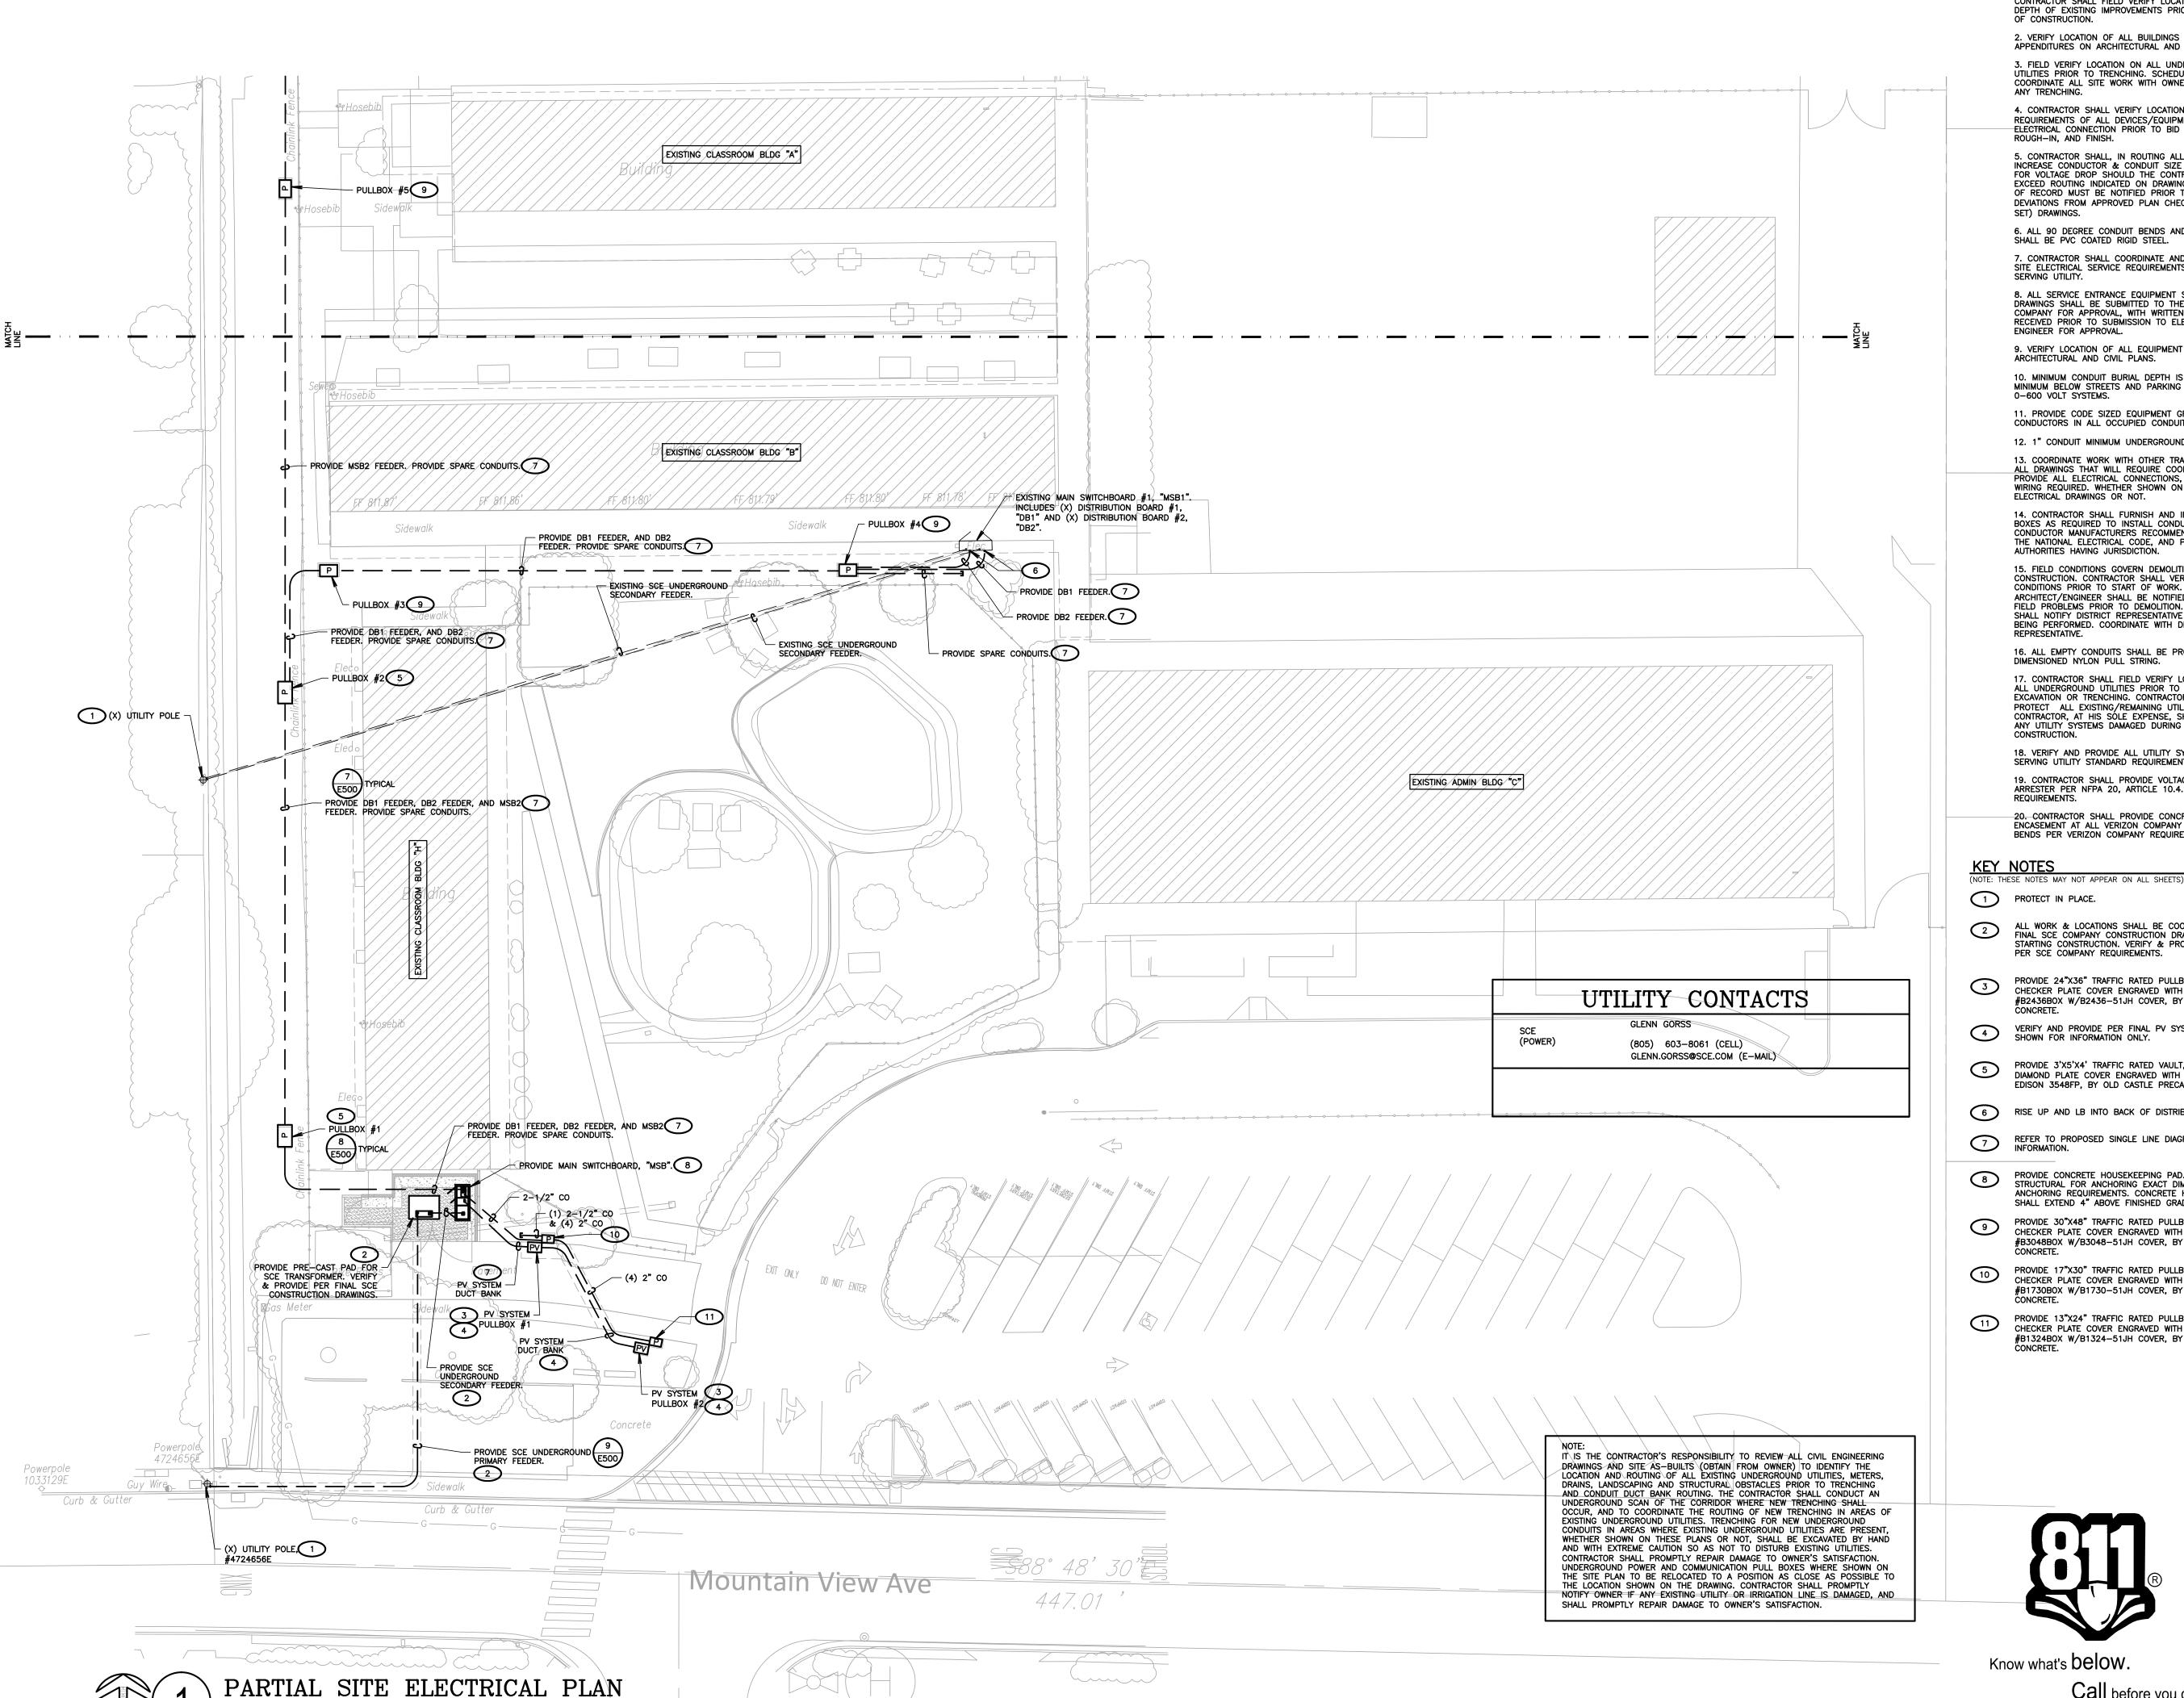5. CONTRACTOR SHALL, IN ROUTING ALL CIRCUITS, INCREASE CONDUCTOR & CONDUIT SIZE TO ALLOW FOR VOLTAGE DROP SHOULD THE CONTRACTOR EXCEED ROUTING INDICATED ON DRAWINGS. ENGINEER OF RECORD MUST BE NOTIFIED PRIOR TO ANY DEVIATIONS FROM APPROVED PLAN CHECK (PERMIT SET) DRAWINGS.

6. ALL 90 DEGREE CONDUIT BENDS AND RISERS SHALL BE PVC COATED RIGID STEEL. 7. CONTRACTOR SHALL COORDINATE AND PROVIDE ALL SITE ELECTRICAL SERVICE REQUIREMENTS WITH SERVING UTILITY.

8. ALL SERVICE ENTRANCE EQUIPMENT SHOP DRAWINGS SHALL BE SUBMITTED TO THE LOCAL UTILITY COMPANY FOR APPROVAL, WITH WRITTEN APPROVAL RECEIVED PRIOR TO SUBMISSION TO ELECTRICAL ENGINEER FOR APPROVAL.

9. VERIFY LOCATION OF ALL EQUIPMENT ON ARCHITECTURAL AND CIVIL PLANS.

10. MINIMUM CONDUIT BURIAL DEPTH IS 24", 36" MINIMUM BELOW STREETS AND PARKING LOTS. FOR 0-600 VOLT SYSTEMS.

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12. 1" CONDUIT MINIMUM UNDERGROUND.

13. COORDINATE WORK WITH OTHER TRADES. OBTAIN ALL DRAWINGS THAT WILL REQUIRE COORDINATION AND PROVIDE ALL ELECTRICAL CONNECTIONS, DEVICES, AND WIRING REQUIRED. WHETHER SHOWN ON THE ELECTRICAL DRAWINGS OR NOT.

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15. FIELD CONDITIONS GOVERN DEMOLITION AND NEW CONSTRUCTION. CONTRACTOR SHALL VERIFY ACTUAL CONDITIONS PRIOR TO START OF WORK. THE ARCHITECT/ENGINEER SHALL BE NOTIFIED OF POSSIBLE FIELD PROBLEMS PRIOR TO DEMOLITION. CONTRACTOR SHALL NOTIFY DISTRICT REPRESENTATIVE OF WORK BEING PERFORMED. COORDINATE WITH DISTRICT

16. ALL EMPTY CONDUITS SHALL BE PROVIDED WITH DIMENSIONED NYLON PULL STRING. 17. CONTRACTOR SHALL FIELD VERIFY LOCATION OF ALL UNDERGROUND UTILITIES PRIOR TO ANY EXCAVATION OR TRENCHING. CONTRACTOR SHALL PROTECT ALL EXISTING/REMAINING UTILITIES IN PLACE. CONTRACTOR, AT HIS SÓLE EXPENSE, SHALL REPAIR ANY UTILITY SYSTEMS DAMAGED DURING CONSTRUCTION.

18. VERIFY AND PROVIDE ALL UTILITY SYSTEMS PER SERVING UTILITY STANDARD REQUIREMENTS. 19. CONTRACTOR SHALL PROVIDE VOLTAGE SURGE ARRESTER PER NFPA 20, ARTICLE 10.4.1

20. CONTRACTOR SHALL PROVIDE CONCRETE ENCASEMENT AT ALL VERIZON COMPANY CONDUIT BENDS PER VERIZON COMPANY REQUIREMENTS.

1 PROTECT IN PLACE.

ALL WORK & LOCATIONS SHALL BE COORDINATED WITH FINAL SCE COMPANY CONSTRUCTION DRAWINGS PRIOR TO STARTING CONSTRUCTION. VERIFY & PROVIDE ALL WORK

PROVIDE 24"X36" TRAFFIC RATED PULLBOX WITH STEEL CHECKER PLATE COVER ENGRAVED WITH "PV SYSTEM". #B2436BOX W/B2436-51JH COVER, BY CHRISTY

VERIFY AND PROVIDE PER FINAL PV SYSTEM DRAWINGS. SHOWN FOR INFORMATION ONLY.

PROVIDE 3'X5'X4' TRAFFIC RATED VAULT, WITH STEEL DIAMOND PLATE COVER ENGRAVED WITH "ELECTRIC". EDISON 3548FP, BY OLD CASTLE PRECAST.

6 RISE UP AND LB INTO BACK OF DISTRIBUTION BOARD.

REFER TO PROPOSED SINGLE LINE DIAGRAM FOR FEEDER INFORMATION.

PROVIDE CONCRETE HOUSEKEEPING PAD. REFER TO STRUCTURAL FOR ANCHORING EXACT DIMENSIONS AND ALL ANCHORING REQUIREMENTS. CONCRETE HOUSEKEEPING PAD SHALL EXTEND 4" ABOVE FINISHED GRADE.

PROVIDE 30"X48" TRAFFIC RATED PULLBOX WITH STEEL CHECKER PLATE COVER ENGRAVED WITH "ELECTRIC". #B3048BOX W/B3048-51JH COVER, BY CHRISTY

PROVIDE 17"X30" TRAFFIC RATED PULLBOX WITH STEEL CHECKER PLATE COVER ENGRAVED WITH "ELECTRIC". #B1730BOX W/B1730-51JH COVER, BY CHRISTY CONCRETE.

PROVIDE 13"X24" TRAFFIC RATED PULLBOX WITH STEEL CHECKER PLATE COVER ENGRAVED WITH "ELECTRIC".
#B1324BOX W/B1324-51JH COVER, BY CHRISTY



Know what's below.

Call before you dig.

AGENCY APPROVAL:



HARTMANNARCHITECTURESTUDIO.COM 430 S. CARRILLO RD. OJAI, CALIFORNIA 93023 (805) 798-2253

CONSULTANTS:

FERRANTI ENGINEERING

CONSULTING **ELECTRICAL ENGINEERS** 1211 MARICOPA HWY, SUITE 250 OJAI, CA 93023 (805) 705-4772 DALÈFERRANTI@LIVE.COM

SEALS:

PROJECT:

NEW ELECTRICAL SERVICE & SITE IMPROVEMENTS

OWNER:

OJAI UNIFIED SCHOOL DISTRICT 414 EAST OJAI AVENUE OJAI, CA 93023 (805) 640-4300 CONTACT: ADAM DUTTER EMAIL: adutter@ojaiusd.org

PROJECT ADDRESS:

TOPA TOPA ELEMENTARY SCHOOL 916 MOUNTAIN VIEW AVENUE OJAI, CA 93023

SSUE:		
IARK	DATE	DESCRIPTION

2020.011

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PROJECT INFORMATION: PROJECT NUMBER: PROJECT PHASE: DRAWN BY:


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PARTIAL SITE ELECTRICAL

SHEET NUMBER:

DATE: 03/31/2021 E201



1. CONTRACTOR SHALL CALL UNDERGROUND SERVICE ALERT AT 811 TO LOCATE UNDERGROUND UTILITIES AT LEAST 2 WORKING DAYS PRIOR TO DIGGING. CONTRACTOR SHALL FIELD VERIFY LOCATION AND DEPTH OF EXISTING IMPROVEMENTS PRIOR TO START
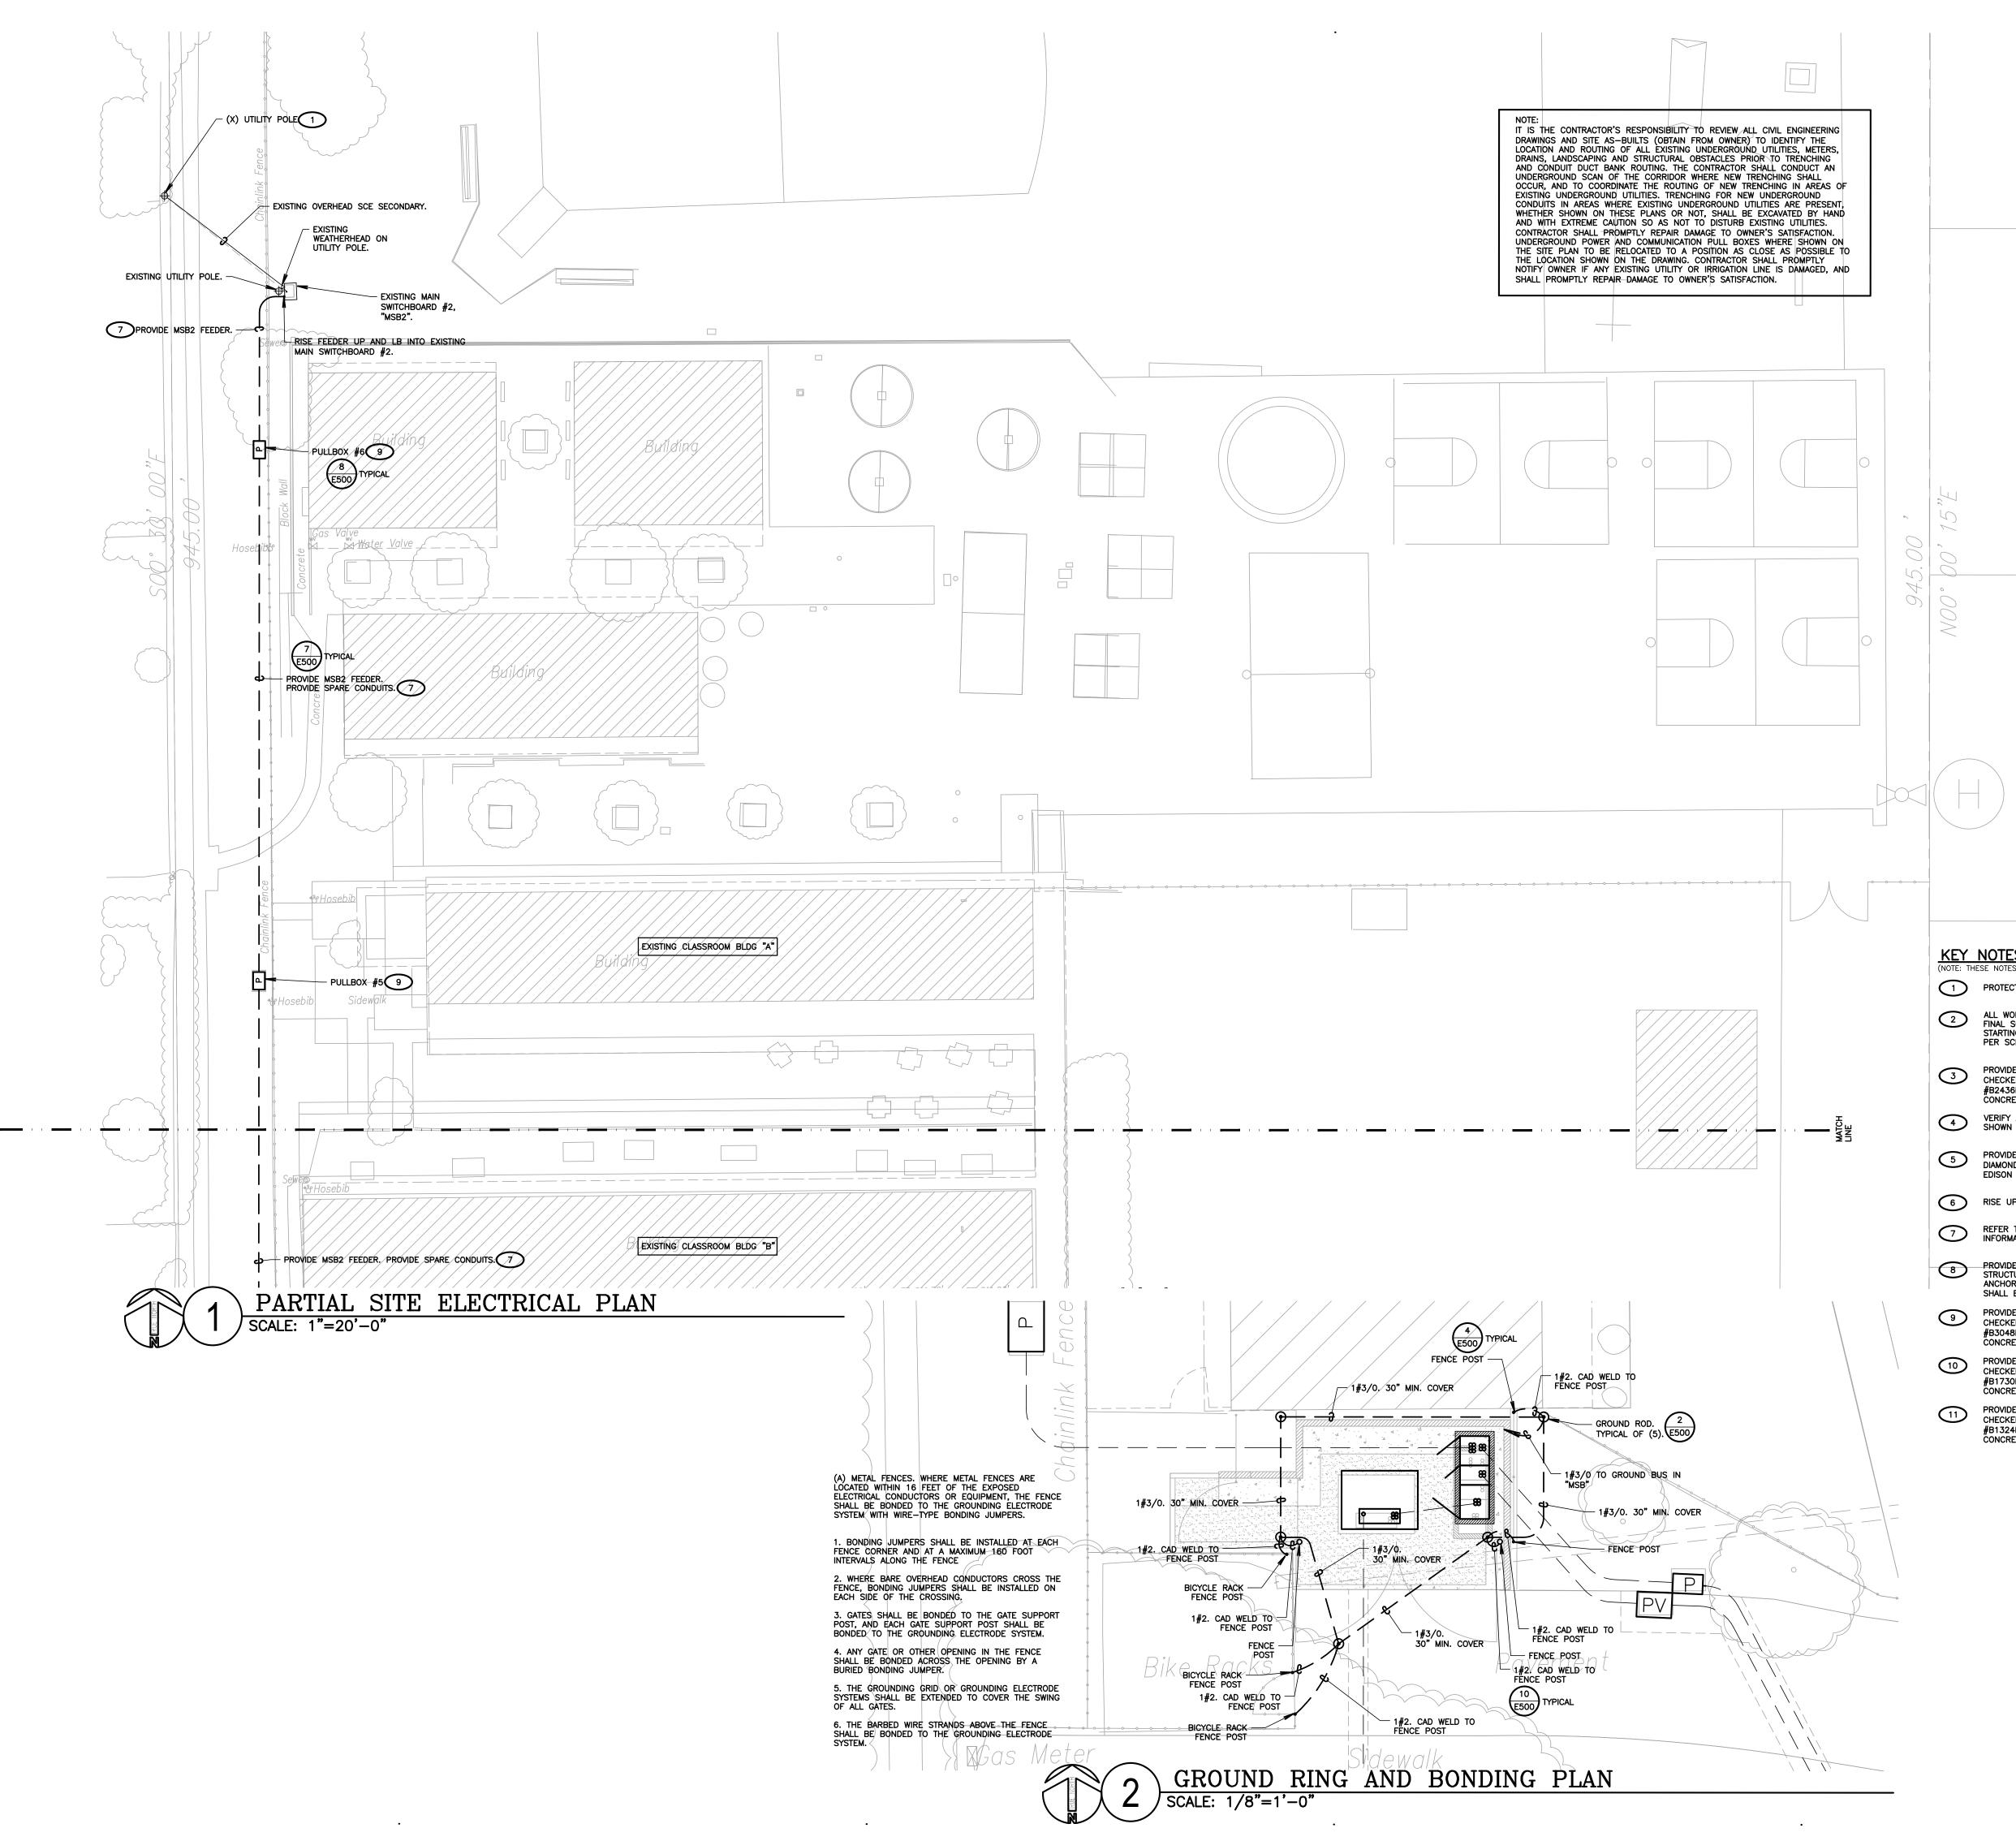
> 2. VERIFY LOCATION OF ALL BUILDINGS AND APPENDITURES ON ARCHITECTURAL AND CIVIL PLANS. 3. FIELD VERIFY LOCATION ON ALL UNDERGROUND UTILITIES PRIOR TO TRENCHING. SCHEDULE AND COORDINATE ALL SITE WORK WITH OWNER PRIOR TO ANY TRENCHING.

4. CONTRACTOR SHALL VERIFY LOCATION & REQUIREMENTS OF ALL DEVICES/EQUIPMENT REQUIRING ELECTRICAL CONNECTION PRIOR TO BID PROPOSAL, ROUGH-IN, AND FINISH.

5. CONTRACTOR SHALL, IN ROUTING ALL CIRCUITS, INCREASE CONDUCTOR & CONDUIT SIZE TO ALLOW FOR VOLTAGE DROP SHOULD THE CONTRACTOR EXCEED ROUTING INDICATED ON DRAWINGS. ENGINEER OF RECORD MUST BE NOTIFIED PRIOR TO ANY DEVIATIONS FROM APPROVED PLAN CHECK (PERMIT

6. ALL 90 DEGREE CONDUIT BENDS AND RISERS SHALL BE PVC COATED RIGID STEEL. 7. CONTRACTOR SHALL COORDINATE AND PROVIDE ALL SITE ELECTRICAL SERVICE REQUIREMENTS WITH SERVING UTILITY.

8. ALL SERVICE ENTRANCE EQUIPMENT SHOP DRAWINGS SHALL BE SUBMITTED TO THE LOCAL UTILITY COMPANY FOR APPROVAL, WITH WRITTEN APPROVAL RECEIVED PRIOR TO SUBMISSION TO ELECTRICAL ENGINEER FOR APPROVAL.

9. VERIFY LOCATION OF ALL EQUIPMENT ON ARCHITECTURAL AND CIVIL PLANS. 10. MINIMUM CONDUIT BURIAL DEPTH IS 24", 36" MINIMUM BELOW STREETS AND PARKING LOTS. FOR 0-600 VOLT SYSTEMS.

11. PROVIDE CODE SIZED EQUIPMENT GROUNDING CONDUCTORS IN ALL OCCUPIED CONDUITS. 12. 1" CONDUIT MINIMUM UNDERGROUND.

13. COORDINATE WORK WITH OTHER TRADES. OBTAIN ALL DRAWINGS THAT WILL REQUIRE COORDINATION AND PROVIDE ALL ELECTRICAL CONNECTIONS, DEVICES, AND WIRING REQUIRED. WHETHER SHOWN ON THE ELECTRICAL DRAWINGS OR NOT.

14. CONTRACTOR SHALL FURNISH AND INSTALL PULL BOXES AS REQUIRED TO INSTALL CONDUCTORS PER CONDUCTOR MANUFACTURERS RECOMMENDATIONS, PER THE NATIONAL ELECTRICAL CODE, AND PER LOCAL AUTHORITIES HAVING JURISDICTION.

15. FIELD CONDITIONS GOVERN DEMOLITION AND NEW CONSTRUCTION. CONTRACTOR SHALL VERIFY ACTUAL CONDITIONS PRIOR TO START OF WORK. THE ARCHITECT/ENGINEER SHALL BE NOTIFIED OF POSSIBLE FIELD PROBLEMS PRIOR TO DEMOLITION. CONTRACTOR SHALL NOTIFY DISTRICT REPRESENTATIVE OF WORK BEING PERFORMED. COORDINATE WITH DISTRICT REPRESENTATIVE

16. ALL EMPTY CONDUITS SHALL BE PROVIDED WITH DIMENSIONED NYLON PULL STRING. 17. CONTRACTOR SHALL FIELD VERIFY LOCATION OF ALL UNDERGROUND UTILITIES PRIOR TO ANY EXCAVATION OR TRENCHING. CONTRACTOR SHALL PROTECT ALL EXISTING/REMAINING UTILITIES IN PLACE. CONTRACTOR, AT HIS SÓLE EXPENSE, SHALL REPAIR ANY UTILITY SYSTEMS DAMAGED DURING CONSTRUCTION.

18. VERIFY AND PROVIDE ALL UTILITY SYSTEMS PER SERVING UTILITY STANDARD REQUIREMENTS. 19. CONTRACTOR SHALL PROVIDE VOLTAGE SURGE ARRESTER PER NFPA 20, ARTICLE 10.4.1 REQUIREMENTS.

20. CONTRACTOR SHALL PROVIDE CONCRETE ENCASEMENT AT ALL VERIZON COMPANY CONDUIT BENDS PER VERIZON COMPANY REQUIREMENTS.

KEY NOTES (NOTE: THESE NOTES MAY NOT APPEAR ON ALL SHEETS)

1 PROTECT IN PLACE.

ALL WORK & LOCATIONS SHALL BE COORDINATED WITH FINAL SCE COMPANY CONSTRUCTION DRAWINGS PRIOR TO STARTING CONSTRUCTION. VERIFY & PROVIDE ALL WORK PER SCE COMPANY REQUIREMENTS.

PROVIDE 24"X36" TRAFFIC RATED PULLBOX WITH STEEL CHECKER PLATE COVER ENGRAVED WITH "PV SYSTEM". #B2436BOX W/B2436-51JH COVER, BY CHRISTY

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Know what's below. Call before you dig.

AGENCY APPROVAL:



HARTMANNARCHITECTURESTUDIO.COM 430 S. CARRILLO RD. OJAI, CALIFORNIA 93023 (805) 798-2253

CONSULTANTS:

FERRANTI ENGINEERING

CONSULTING **ELECTRICAL ENGINEERS** 1211 MARICOPA HWY, SUITE 250 OJAI, CA 93023 (805) 705-4772DALEFERRANTI@LIVE.COM



PROJECT:

SEALS:

NEW ELECTRICAL SERVICE & SITE IMPROVEMENTS

OWNER:

OJAI UNIFIED SCHOOL DISTRICT 414 EAST OJAI AVENUE OJAI, CA 93023 (805) 640-4300 CONTACT: ADAM DUTTER EMAIL: adutter@ojaiusd.org

PROJECT ADDRESS:

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ISSUE:		
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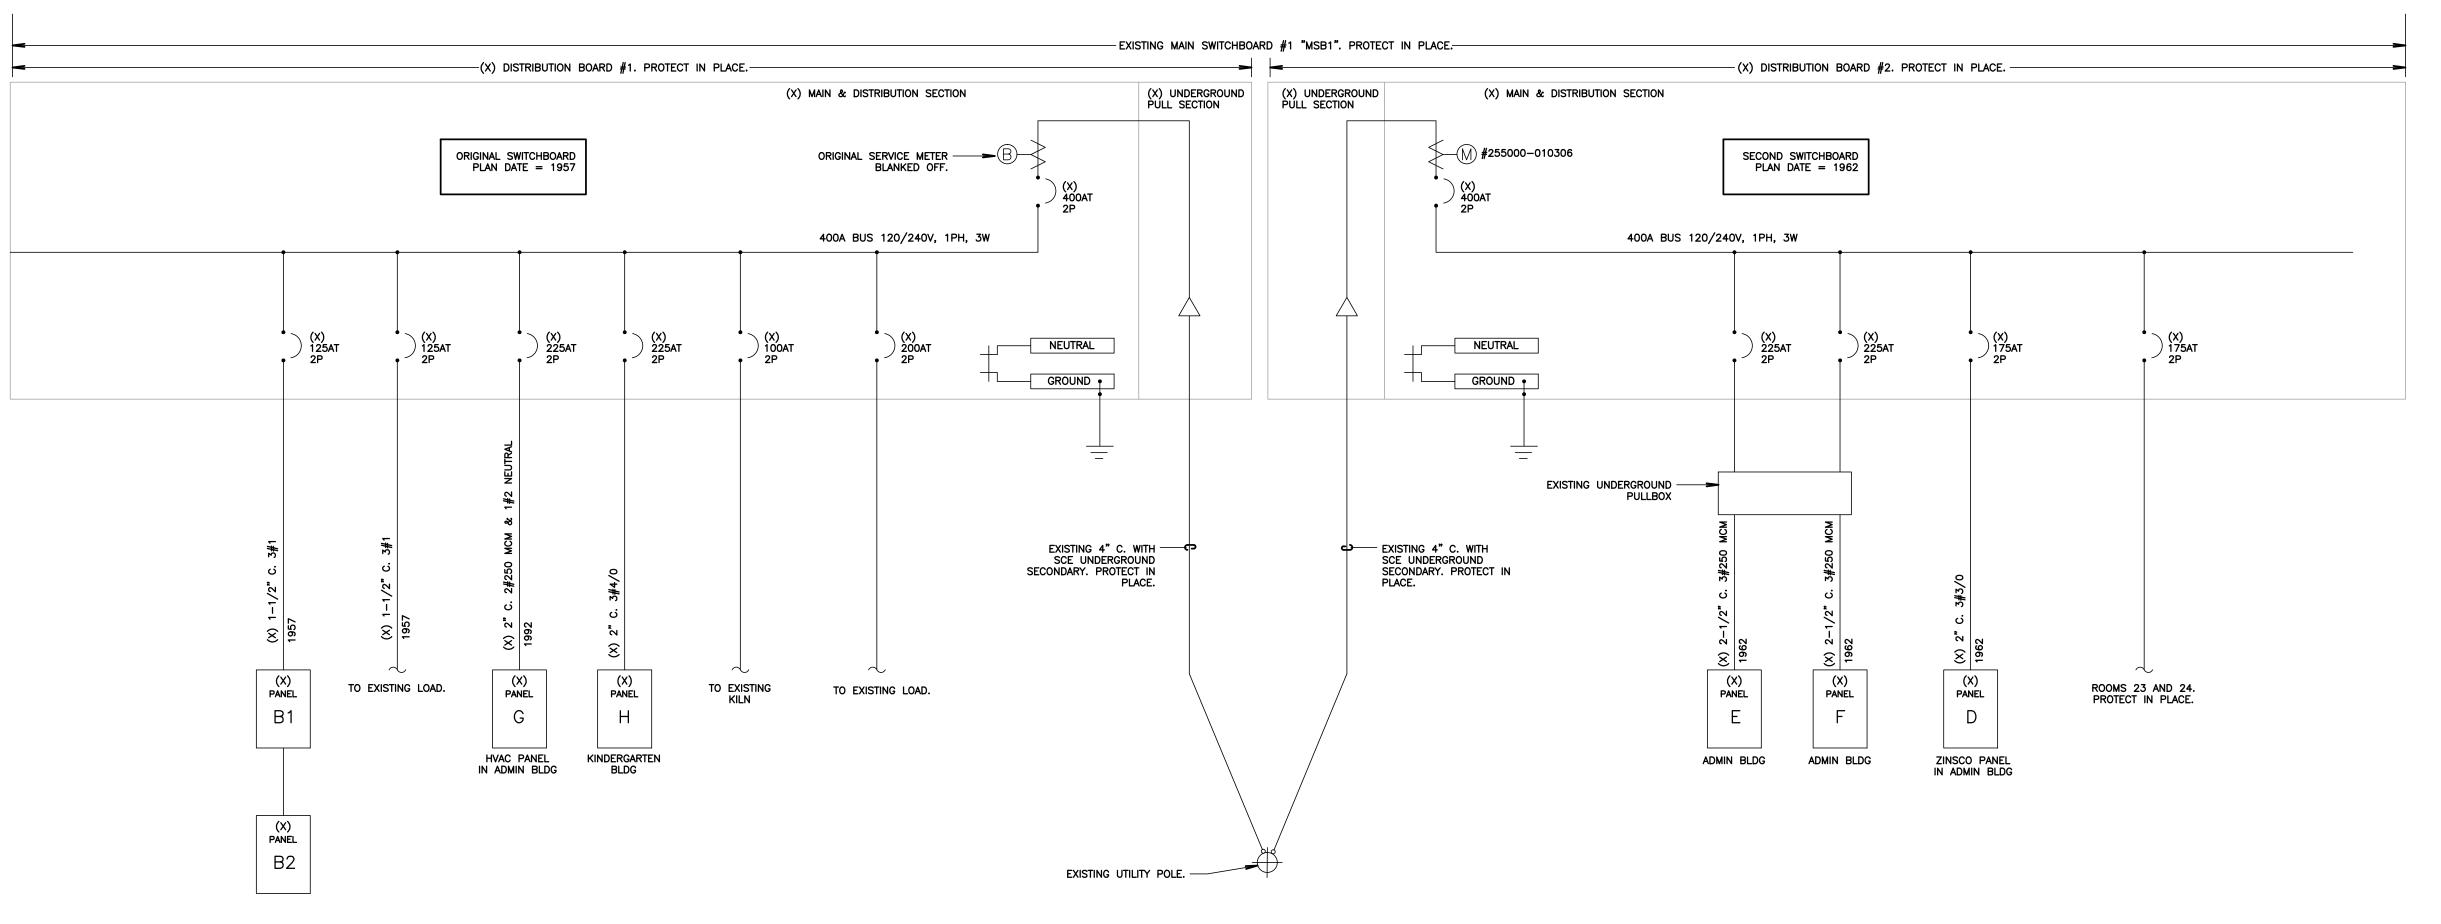
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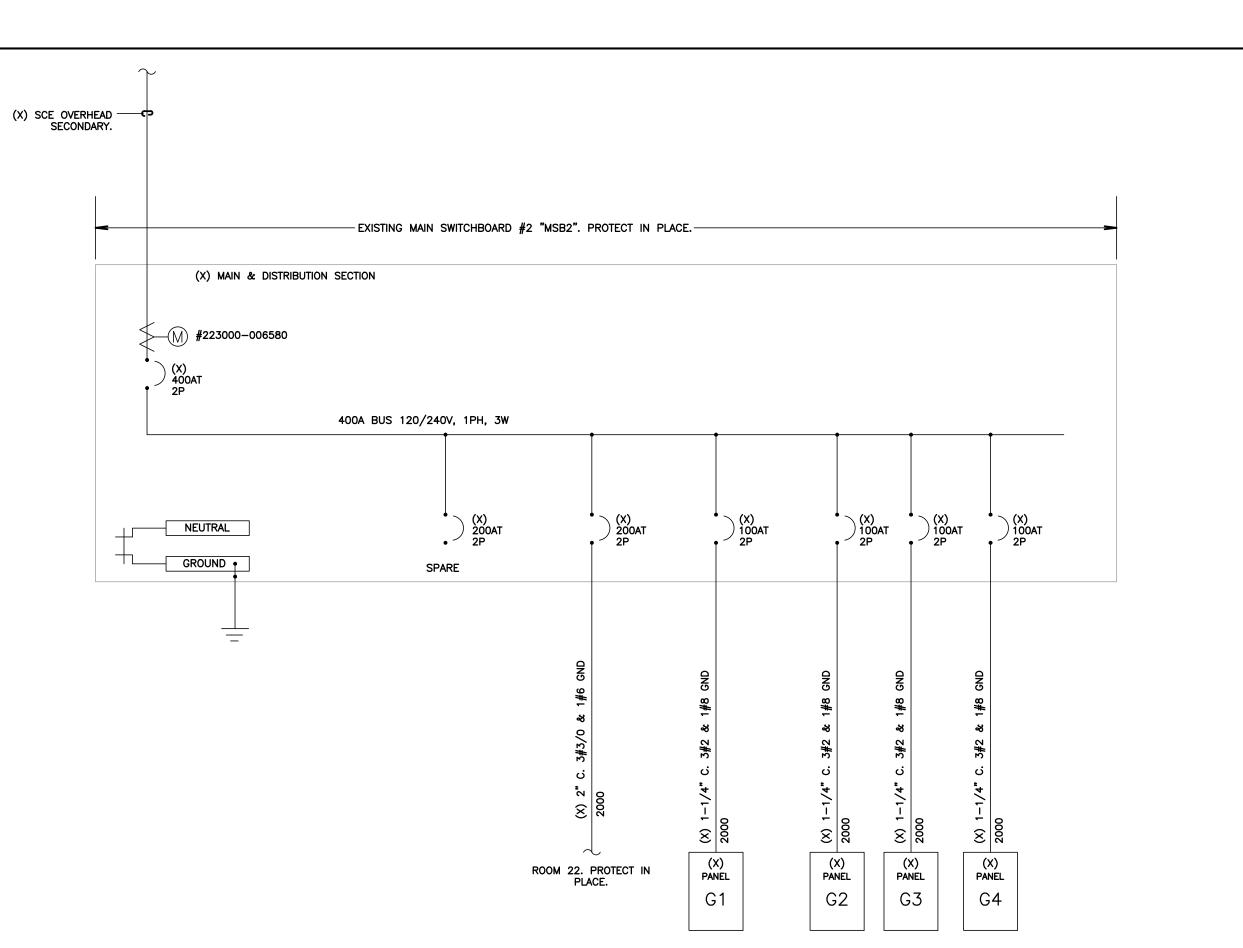
SHEET TITLE:

SHEET NUMBER:

E202



SINGLE LINE DIAGRAM (MAIN SWITCHBOARD #1, "MSB1")
SCALE: NOT TO SCALE



SINGLE LINE DIAGRAM (MAIN SWITCHBOARD #2, "MSB2")
SCALE: NOT TO SCALE


AGENCY APPROVAL:



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NEW ELECTRICAL SERVICE & SITE IMPROVEMENTS

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OJAI UNIFIED SCHOOL DISTRICT 414 EAST OJAI AVENUE OJAI, CA 93023 (805) 640-4300 CONTACT: ADAM DUTTER EMAIL: adutter©ojaiusd.org

PROJECT ADDRESS:
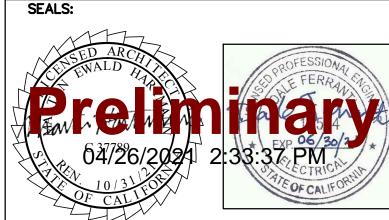
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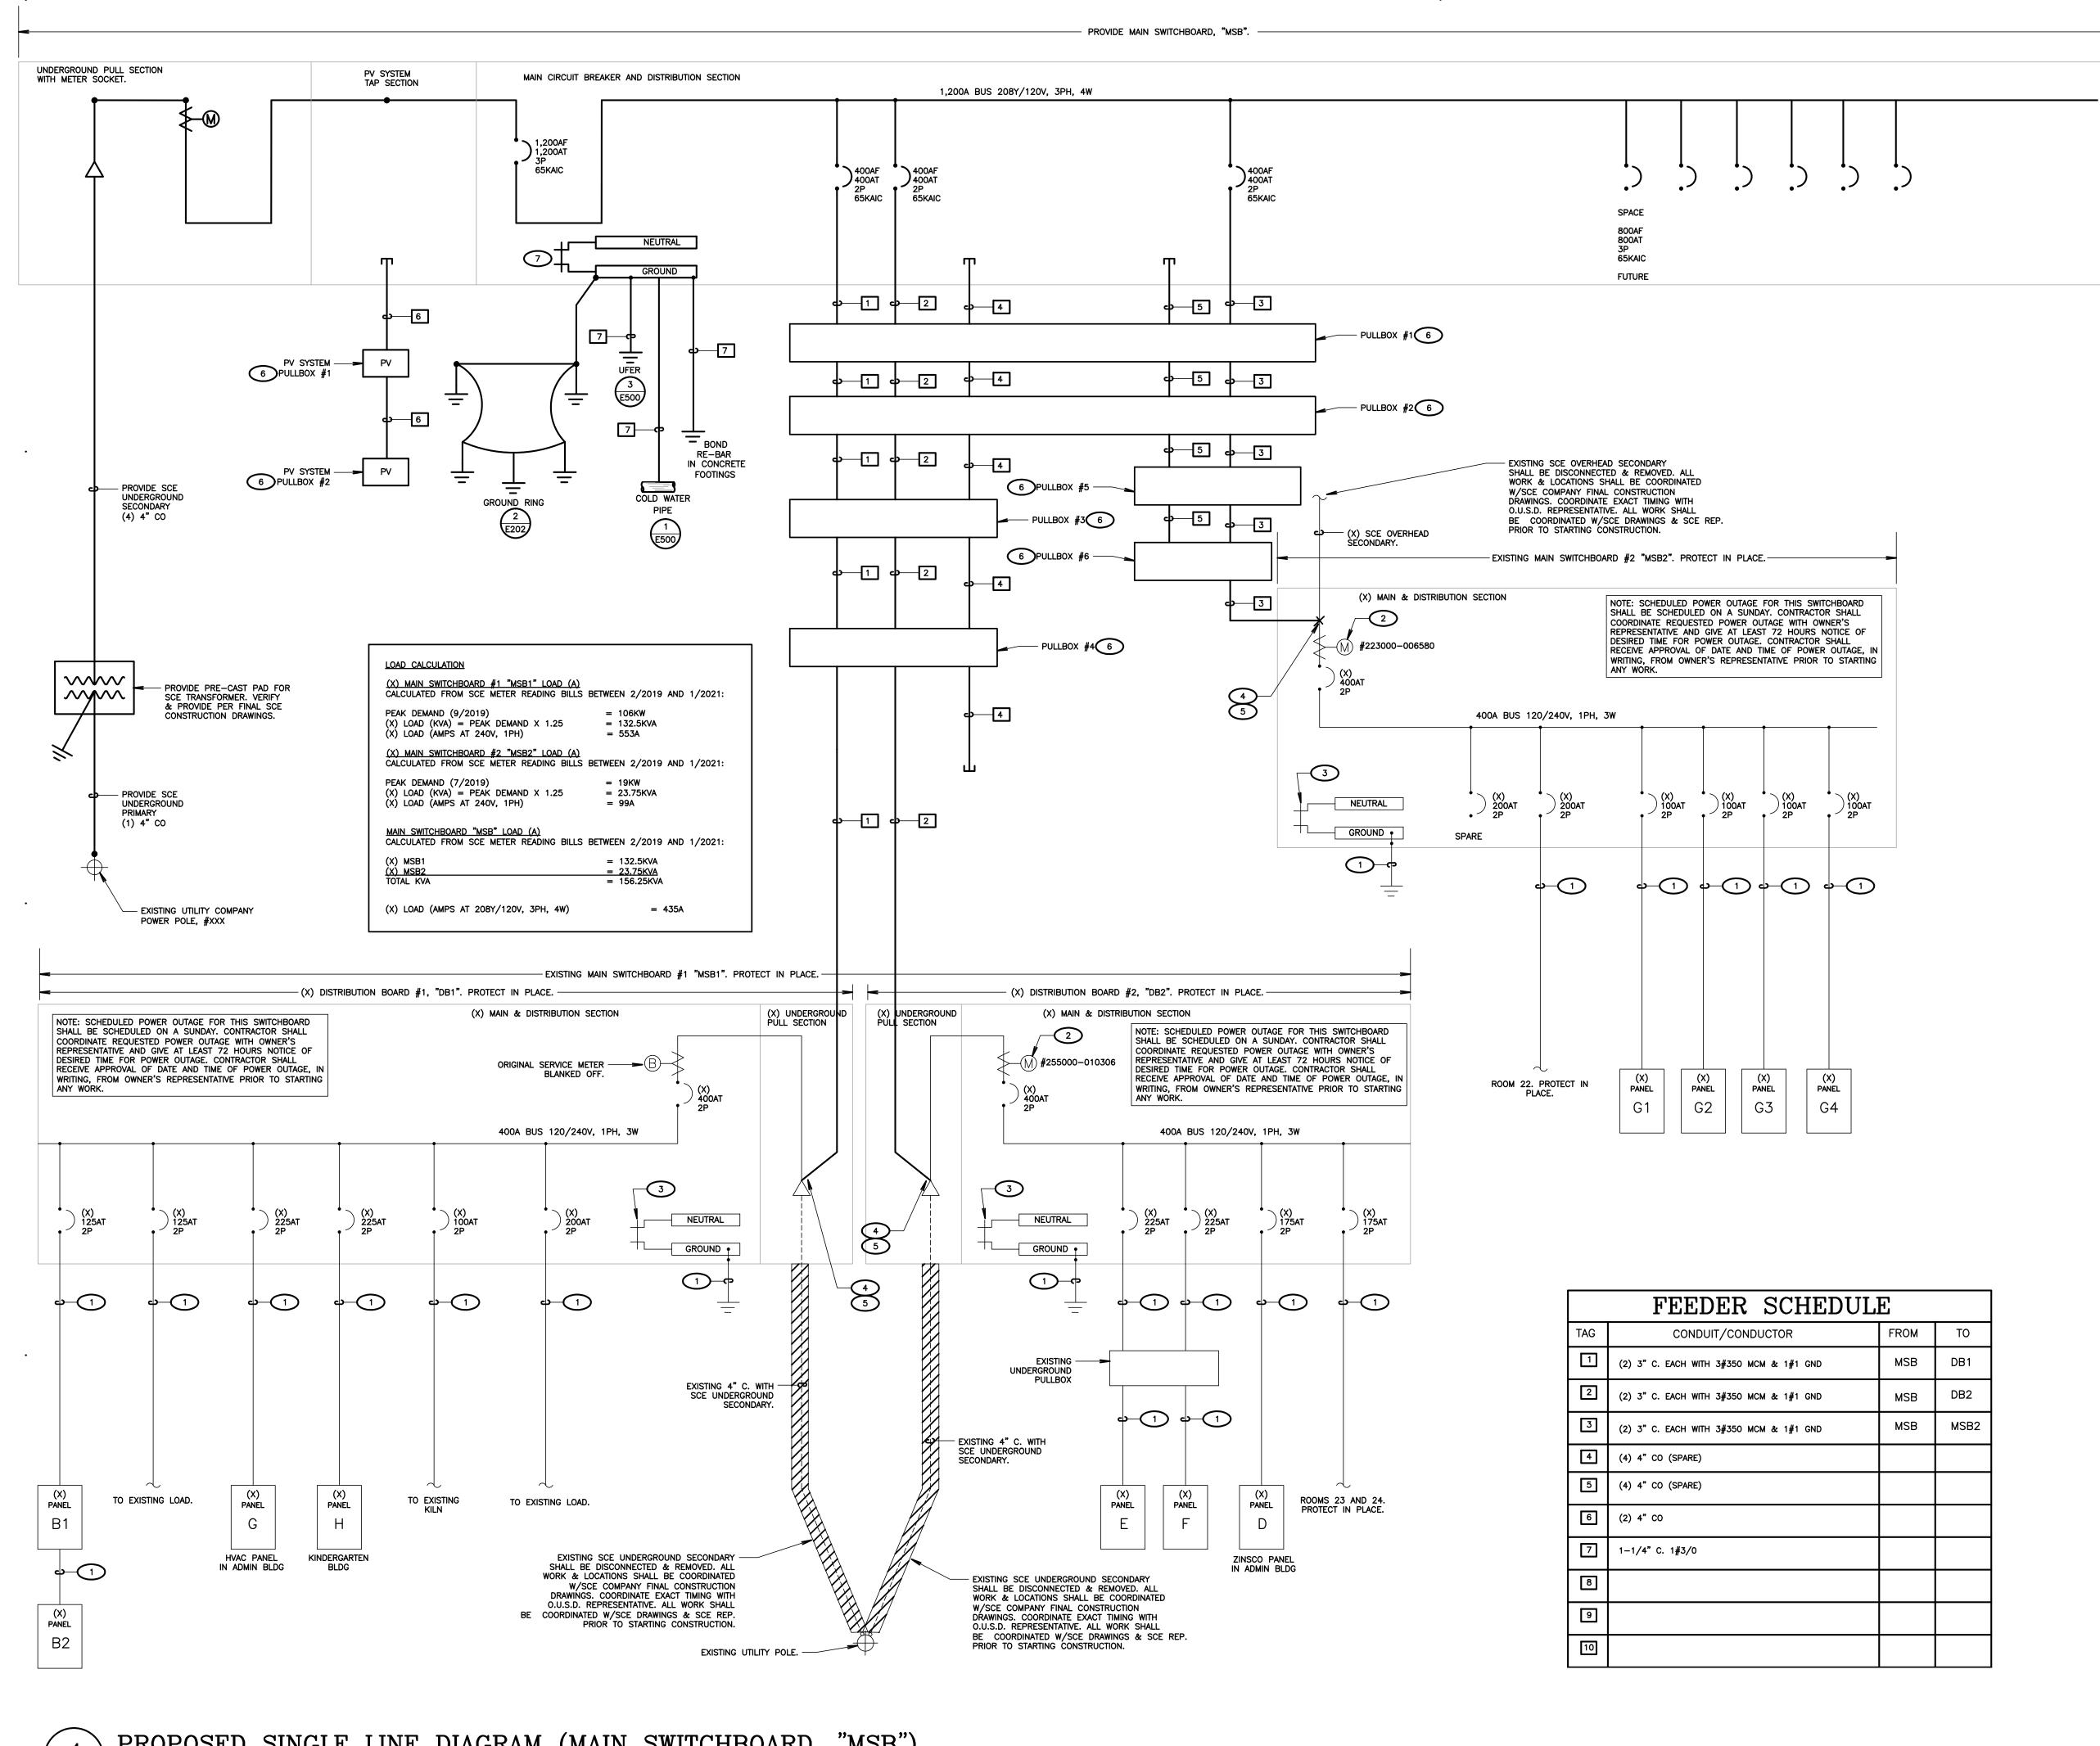
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SHEET TITLE:

SINGLE LINE DIAGRAMS EXISTING

SHEET NUMBER:

E300



- VERIFY LOCATION OF ALL BUILDINGS AND APPENDITURES ON ARCHITECTURAL AND CIVIL
- 2. CONTRACTOR SHALL VERIFY LOCATION &
- REQUIREMENTS OF ALL DEVICES/EQUIPMENT
 REQUIRING ELECTRICAL CONNECTION PRIOR TO BID PROPOSAL, ROUGH-IN, AND FINISH. 3. CONTRACTOR SHALL, IN ROUTING ALL CIRCUITS, INCREASE CONDUCTOR & CONDUIT SIZE TO ALLOW
 - EXCEED ROUTING INDICATED ON DRAWINGS. ENGINEER OF RECORD MUST BE NOTIFIED PRIOR TO ANY DEVIATIONS FROM APPROVED PLAN CHECK (PERMIT SET) DRAWINGS.

FOR VOLTAGE DROP SHOULD THE CONTRACTOR

- 4. ALL 90 DEGREE CONDUIT BENDS AND RISERS SHALL BE PVC COATED RIGID STEEL.
- 5. VERIFY LOCATION OF ALL EQUIPMENT ON ARCHITECTURAL AND CIVIL PLANS.
- 6. PROVIDE CODE SIZED EQUIPMENT GROUNDING CONDUCTORS IN ALL OCCUPIED CONDUITS.
- 7. 1" CONDUIT MINIMUM UNDERGROUND.
- 8. COORDINATE WORK WITH OTHER TRADES. OBTAIN ALL DRAWINGS THAT WILL REQUIRE COORDINATION AND PROVIDE ALL ELECTRICAL CONNECTIONS. DEVICES, AND WIRING REQUIRED. WHETHER SHOWN ON THE ELECTRICAL DRAWINGS OR NOT.
- 9. CONTRACTOR SHALL FURNISH AND INSTALL PULL BOXES AS REQUIRED TO INSTALL CONDUCTORS PER CONDUCTOR MANUFACTURERS RECOMMENDATIONS, PER THE NATIONAL ELECTRICAL CODE, AND PER LOCAL AUTHORITIES HAVING JURISDICTION.
- 10. FIELD CONDITIONS GOVERN DEMOLITION AND NEW CONSTRUCTION. CONTRACTOR SHALL VERIFY ACTUAL CONDITIONS PRIOR TO START OF WORK. THE ARCHITECT/ENGINEER SHALL BE NOTIFIED OF POSSIBLE FIELD PROBLEMS PRIOR TO DEMOLITION.
- 11. ALL EMPTY CONDUITS SHALL BE PROVIDED WITH DIMENSIONED NYLON PULL STRING.
- 12. CONTRACTOR SHALL FIELD VERIFY LOCATION OF ALL UNDERGROUND UTILITIES PRIOR TO ANY EXCAVATION OR TRENCHING. CONTRACTOR SHALL PROTECT ALL EXISTING/REMAINING UTILITIES IN PLACE. CONTRACTOR, AT HIS SOLE EXPENSE, SHALL REPAIR ANY UTILITY SYSTEMS DAMAGED DURING CONSTRUCTION.
- 13. UNLESS NOTED OTHERWISE, ALL DEVICES AND TERMINATIONS SHALL BE RATED FOR 75 DEGREES
- 14. ALL CONDUCTORS #8 AND SMALLER SHALL BE THHN/THWN CU. ALL CONDUCTORS #6 AND LARGÉR SHALL BE XHHW-2 CU.
- 15. PER CEC 110.24, SERVICE EQUIPMENT SHALL BE LEGIBLY MARKED IN THE FIELD WITH THE MAXIMUM AVAILABLE FAULT CURRENT. THE FIELD MARKING(S) SHALL INCLUDE THE DATE THE FAULT CURRENT CALCULATION WAS PERFORMED AND BE OF SUFFICIENT DURABILITY TO WITHSTAND THE ENVIRONMENT INVOLVED.
- 16. PER CEC 110.16, ELECTRICAL EQUIPMENT, SUCH AS SWITCHBOARDS, PANELBOARDS, INDUSTRIAL CONTROL PANELS, METER SOCKET ENCLOSURES, AND MOTOR CONTROL CENTERS SHALL BE FIELD MARKED TO WARN QUALIFIED PERSONS OF POTENTIAL ELECTRIC ARC FLASH HAZARDS. THE MARKING SHALL BE LOCATED SO AS TO BE CLEARLY VISIBLE TO QUALIFIED PERSONS BEFORE EXAMINATION, ADJUSTMENT, SERVICING, OR MAINTENANCE OF THE EQUIPMENT.

KEY NOTES (NOTE: THESE NOTES MAY NOT APPEAR ON ALL SHEETS)

- EXISTING FEEDER. PROTECT IN PLACE. EXISTING SCE METER SHALL BE DISCONNECTED & REMOVED. BLANK-OFF METER SOCKET IN A WAY THAT MAINTAINS U.L. LISTING OF FOUIPMENT, ALL WORK SHALL BE COORDINATED WITH SCE
- DISCONNECT & REMOVE MAIN BONDING JUMPER.
- CONTRACTOR SHALL FIELD VERIFY EXACT POINT OF CONNECTION & PROVIDE ALL NECESSARY WORK & MATERIALS IN ORDER TO RECONNECT SWITCHBOARD TO NEW

COMPANY FINAL CONSTRUCTION DRAWINGS.

- NOTE: EXACT TIMING OF CUT-OVER SHALL BE COORDINATED WITH SCE COMPANY & O.U.S.D. WORK SHALL BE PERFORMED AFTER HOURS IN ORDER TO MINIMIZE DISRUPTION TO SCHOOL SCHEDULE.
- NOTE: PULLBOXES NOT SHOWN. REFER TO SITE ELECTRICAL PLANS FOR PULLBOX LOCATIONS AND PULLBOX SPECIFICATIONS.
- REMOVABLE LINK. MAIN SWITCHBOARD SHALL BE PROVIDED WITH FACTORY INSTALLED MAIN BONDING JUMPER.

AGENCY APPROVAL:



HARTMANNARCHITECTURESTUDIO.COM 430 S. CARRILLO RD. OJAI, CALIFORNIA 93023 (805) 798-2253

CONSULTANTS:

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PROJECT:

NEW ELECTRICAL SERVICE & SITE IMPROVEMENTS

OWNER:

OJAI UNIFIED SCHOOL DISTRICT 414 EAST OJAI AVENUE OJAI, CA 93023 (805) 640-4300 CONTACT: ADAM DUTTER EMAIL: adutter@ojaiusd.org

PROJECT ADDRESS:

TOPA TOPA ELEMENTARY SCHOOL 916 MOUNTAIN VIEW AVENUE OJAI, CA 93023

ISSUE: DESCRIPTION MARK DATE

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SHEET TITLE: SINGLE


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DATE:

03/31/2021

E301

PROPOSED SINGLE LINE DIAGRAM (MAIN SWITCHBOARD, "MSB") SCALE: NOT TO SCALE

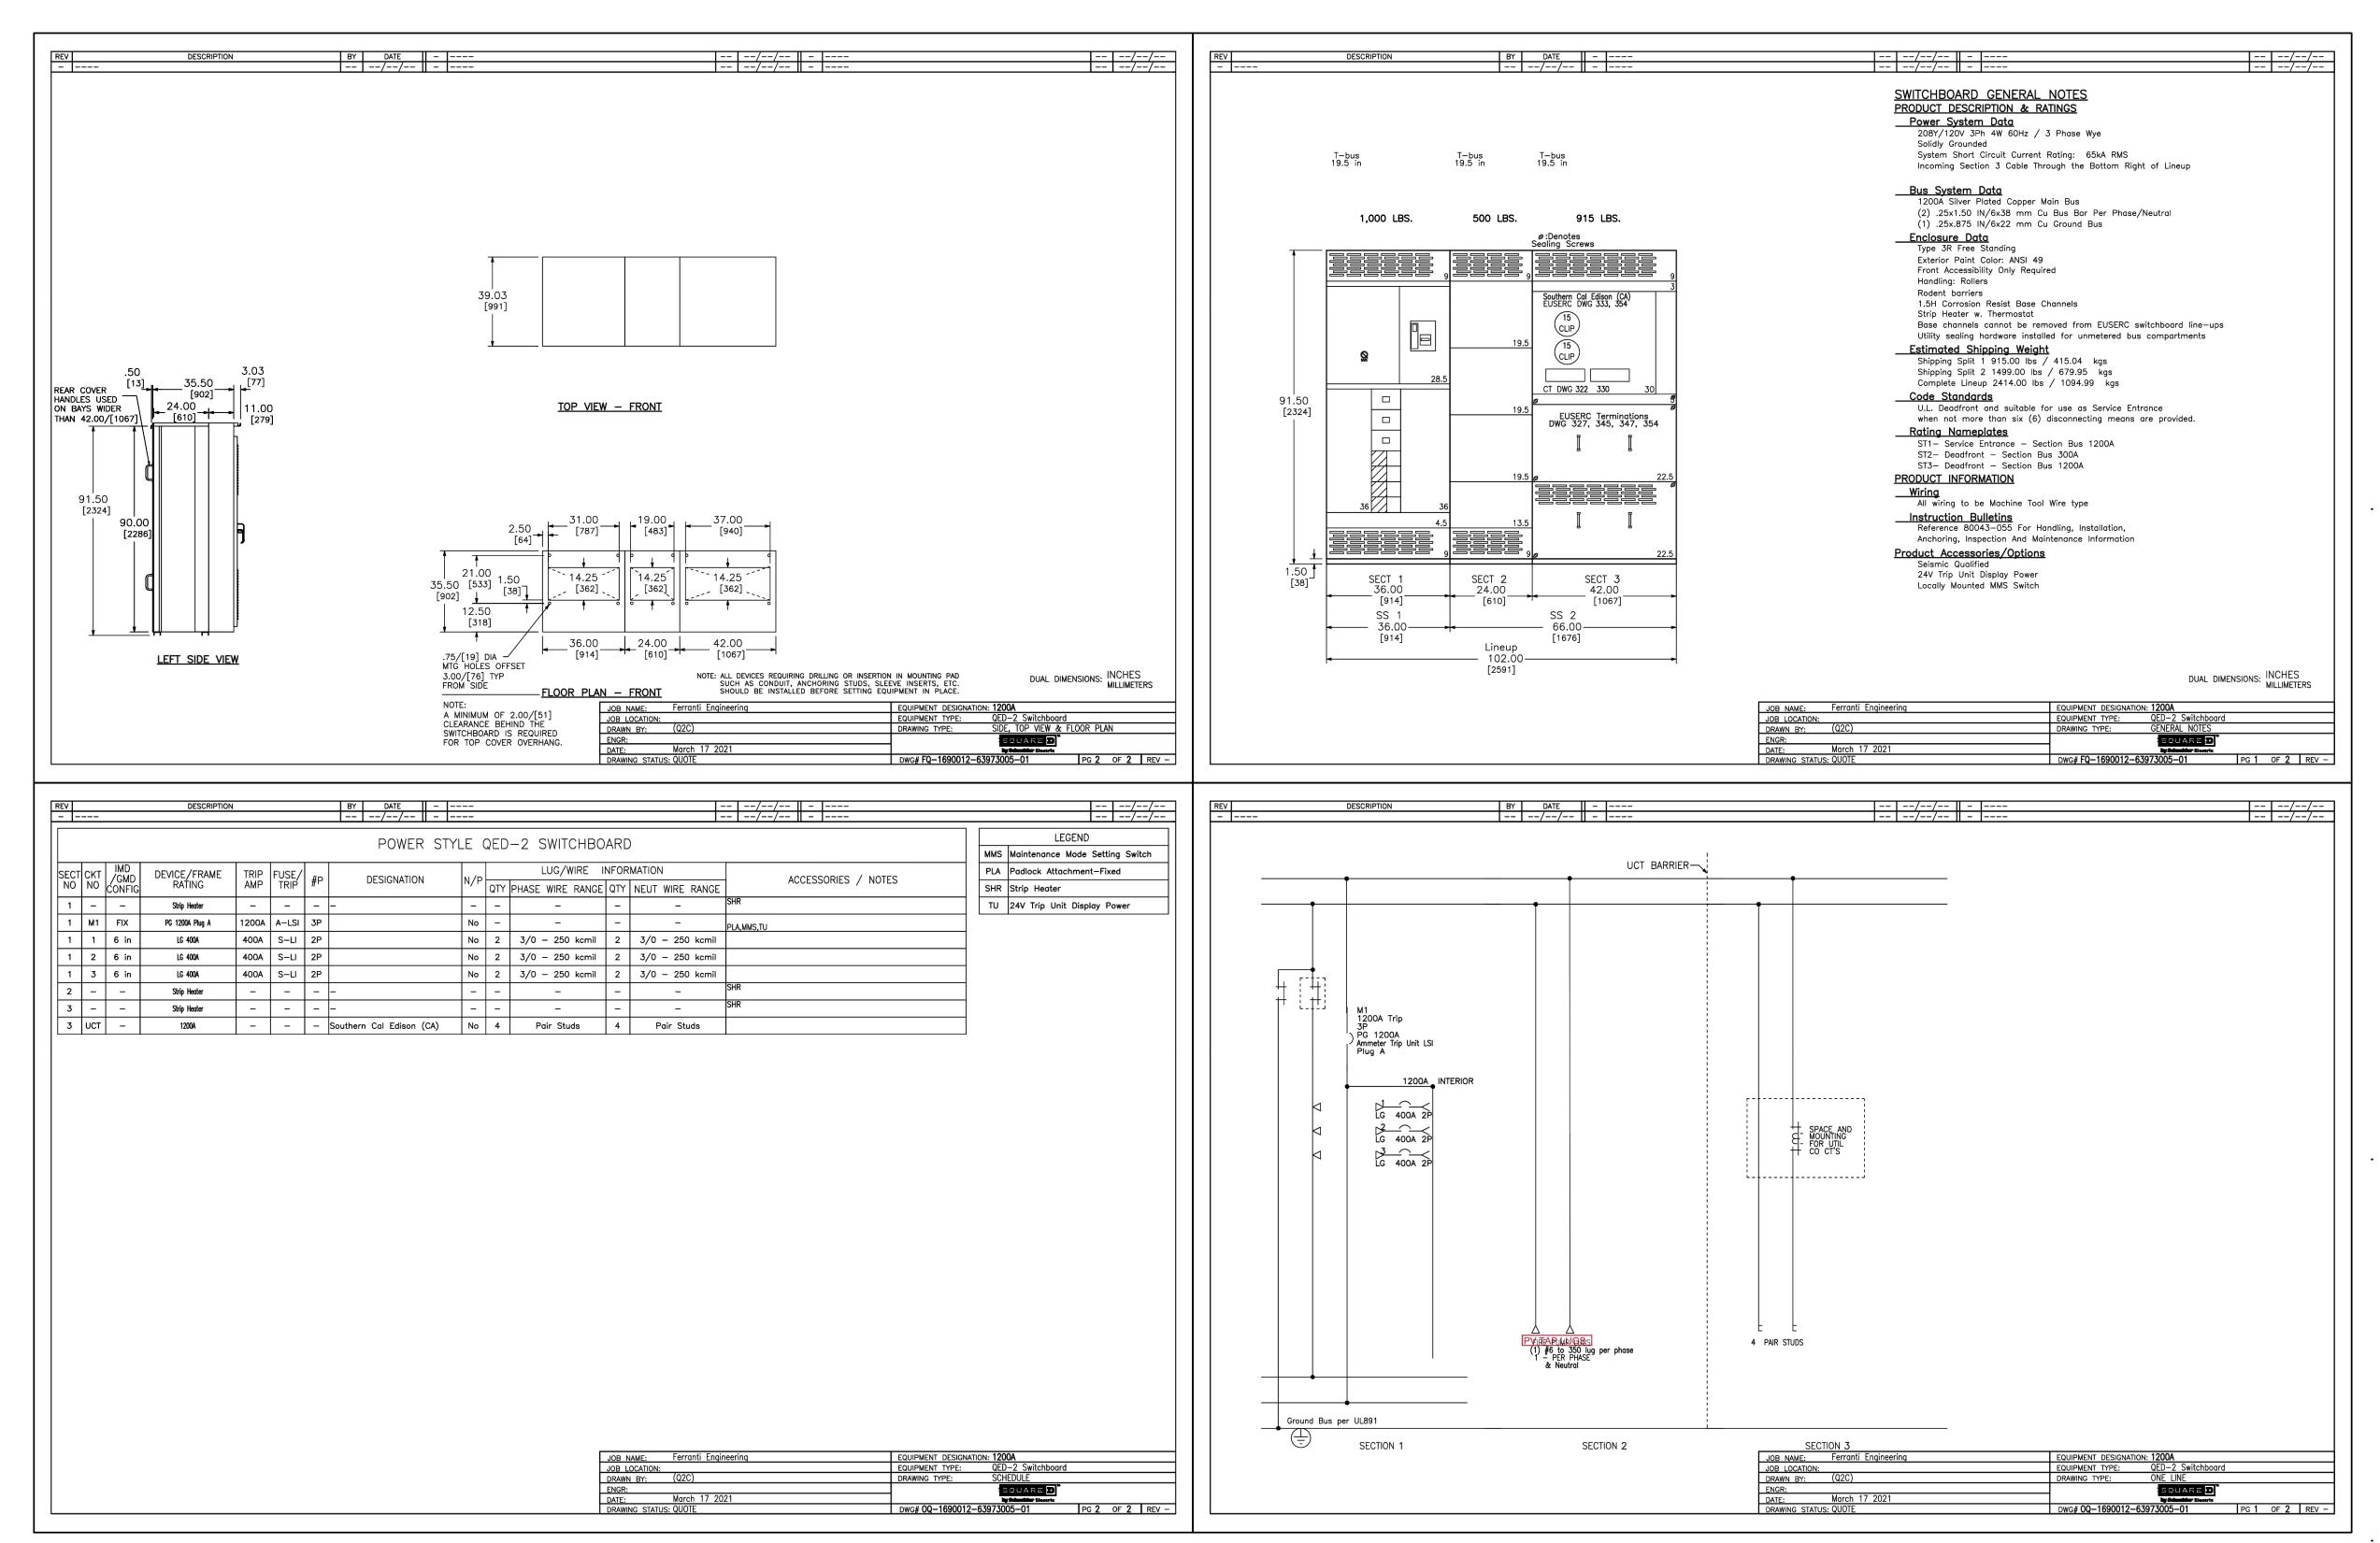

MAIN SWITCHBOARD, "MSB" SHOP DRAWINGS
SCALE: NOT TO SCALE

AGENCY APPROVAL:



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(805) 798-2253

CONSULTANTS:

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SEALS:

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DRAWINGS

SHEET NUMBER:

E400

