WEST MIDDLE SCHOOL - BID PACKAGE 2: DISTRICT WIDE ACCESS CONTROL

PORTAGE PUBLIC SCHOOLS Portage, Michigan CONSTRUCTION DOCUMENTS

DESIGN TEAM

ARCHITECT/ENGINEER

REFERENCED CODES

ENERGY: **ELECTRICAL**: BARRIER-FREE: USE GROUP:

CONSTRUCTION TYPE: AUTOMATIC SPRINKLERS: PROJECT AREA

TOTAL FINISHED PROJECT:

500 SQ. FT.

I 101C MATERIAL SELECTION SCHEDULE & FIRST FLOOR FINISH PLAN - UNIT C

EG 001 ELECTRICAL SYMBOLS AND GENERAL NOTES

E 101C FIRST FLOOR POWER PLAN - UNIT C

DRAWING INDEX

G 001 COVER SHEET

AG 001 GENERAL ARCHITECTURAL NOTES, INTERIOR PARTITION TYPES, DEVICE ALIGNMENT GUIDELINES, & ABBREVIATIONS

ARCHITECTURAL DEMOLITION

AD 101 FIRST FLOOR DEMOLITION PLAN & REFLECTED CEILING DEMOLITION PLAN

INTERIORS GENERAL

IG 001 TYPICAL SYMBOLS & GENERAL NOTES

INTERIORS

ELECTRICAL - GENERAL

ELECTRICAL


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PORTAGE WEST MIDDLE SCHOOL 7145 MOORSBRIDGE ROAD PORTAGE, MI 49024







ISSUED FOR

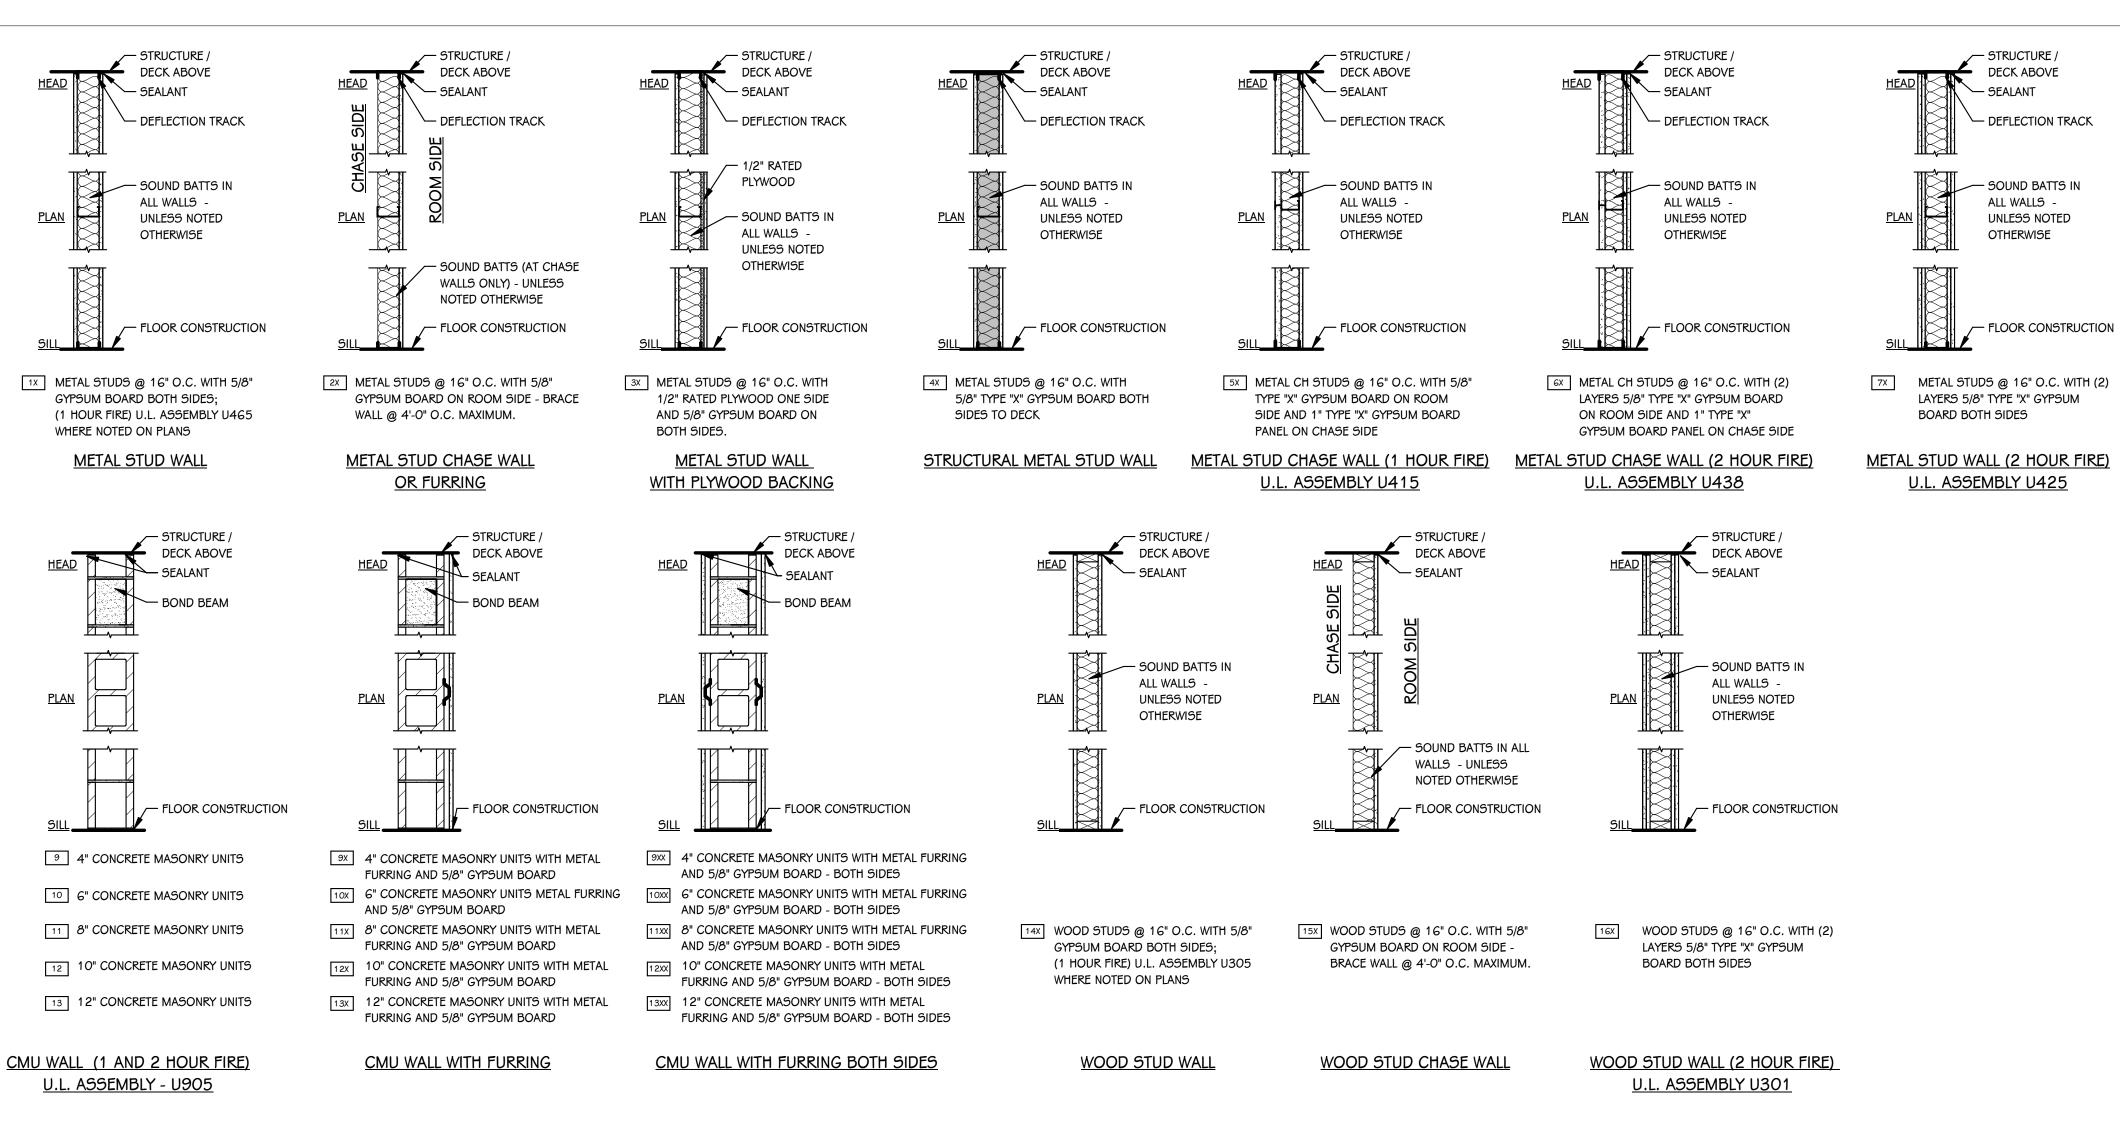

INTERIOR PARTITION TYPES

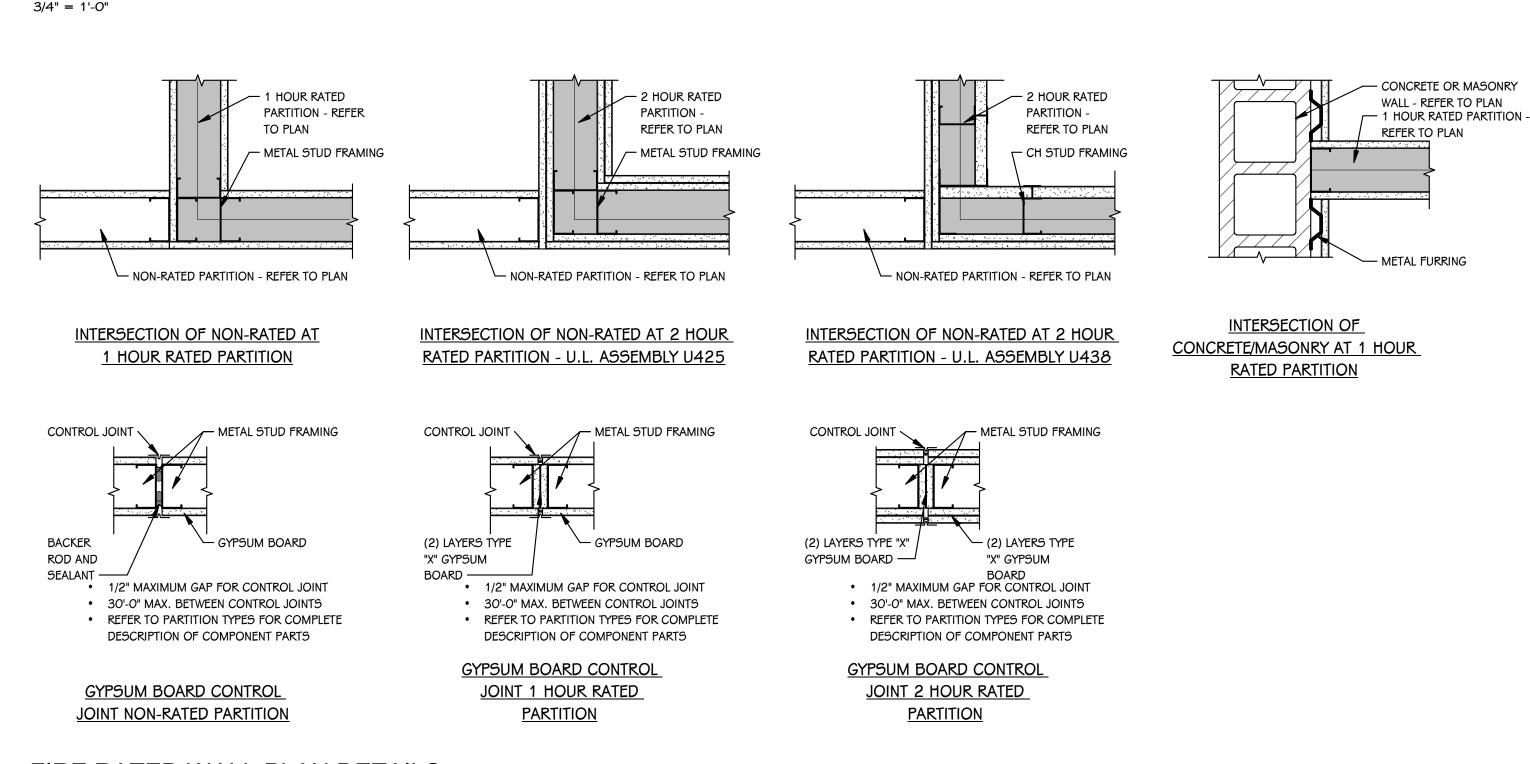

FIRE RATED WALL PLAN DETAILS

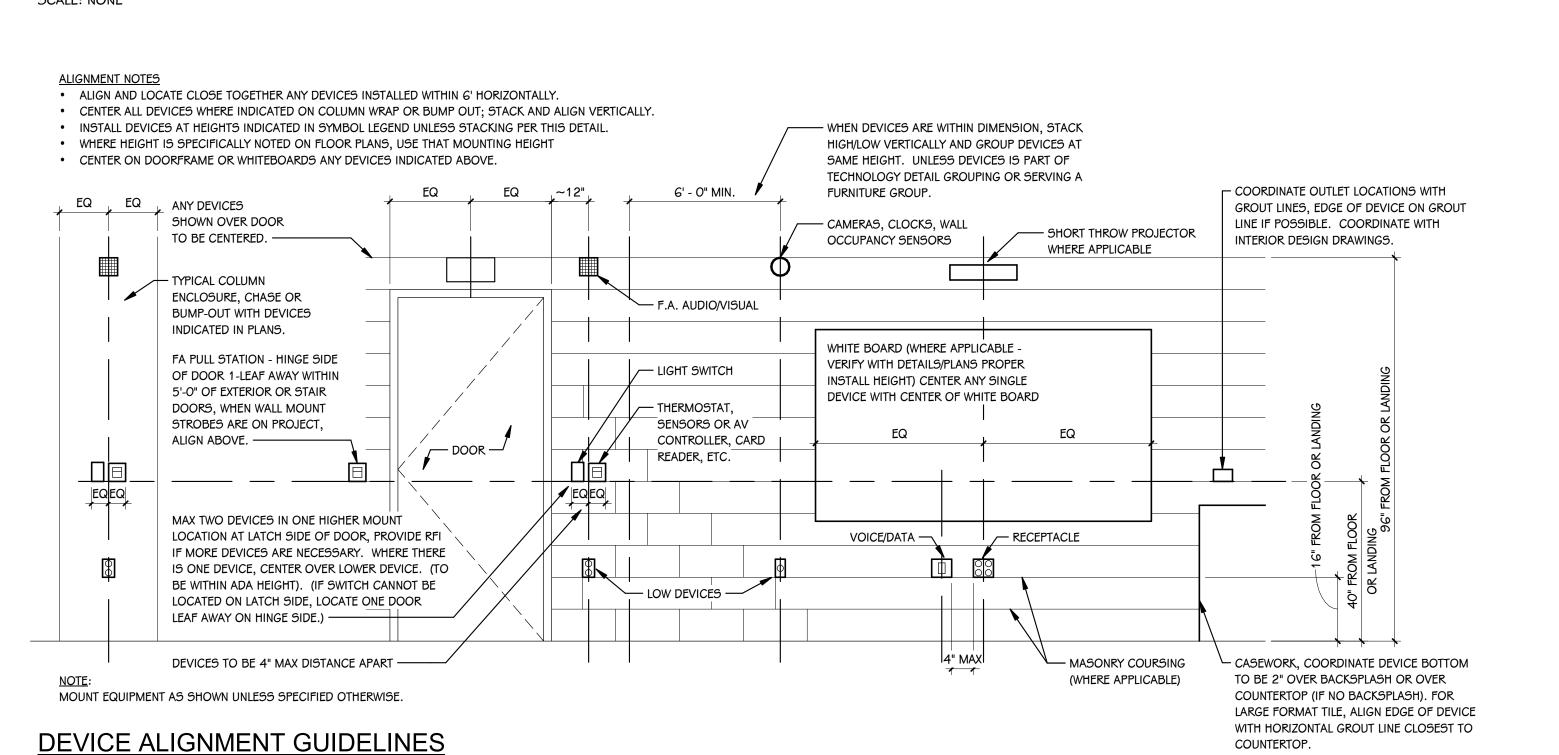

GENERAL NOTES - ARCHITECTURAL - PARTITIONS GENERAL NOTES - ARCHITECTURAL - DEMOLITION NOT ALL WALL TYPES MAY BE USED ON PROJECT. CONTRACTORS ARE REQUIRED TO INSPECT/REVIEW THE EXISTING BUILDING PRIOR TO RELATED DEMOLITION WORK. UNLESS NOTED OTHERWISE, REMOVAL OF ANY WALL, FLOOR OR CEILING INCLUDES ALL GENERAL MECHANICAL AND ELECTRICAL ITEMS WHICH REFER TO CODE COMPLIANCE PLANS FOR LOCATIONS OF SMOKE AND FIRE-RATED ARE A PART OF, OR ATTACHED TO IT. DEFLECTION TRACK PARTITIONS. CONTRACTOR SHALL VERIFY ALL EXISTING JOB SITE CONDITIONS AND DIMENSIONS AND ALL PARTITIONS EXTEND TO BOTTOM OF STRUCTURE, UNLESS NOTED OTHERWISE. BE RESPONSIBLE FOR THE SAME ADVISE CONSTRUCTION MANAGER OF ANY AND ALL SOUND BATTS IN ALL DISCREPANCIES. LINE OF STRUCTURE/DECK AS SHOWN AT THE HEAD CONDITION OF EACH PARTITION TYPE IS DIAGRAMMATIC ONLY AND DOES NOT INDICATE EXACT CONSTRUCTION PATCH FLOORS, WALLS AND CEILINGS DAMAGED DURING CONSTRUCTION AND CONDITIONS. TERMINATE RATED PARTITIONS AT UNDERSIDE OF STRUCTURAL DECK TO DEMOLITION AS REQUIRED. FINISH TO MATCH EXISTING. MAINTAIN RATING. PROVIDE APPROPRIATE FRAMING AND GYPSUM BOARD TO OFFSET AROUND STRUCTURE OR OTHER OBSTRUCTIONS, SUCH AS PIPING OR DUCTWORK. ACCOMMODATE NEW CONSTRUCTION IF NOT INDICATED. PARTITIONS MAY TERMINATE AT STRUCTURAL MEMBERS WITH A RATING GREATER THAN OR EQUAL THE PARTITION, PROVIDED THAT RATING IS CONTINUOUS TO STRUCTURAL PROTECT ALL EXISTING FINISHES THROUGHOUT PROJECT. /— FLOOR CONSTRUCTION REFER TO DEMOLITION ELEVATIONS, SECTIONS AND DETAILS FOR ADDITIONAL NON-RATED PARTITIONS THAT EXTEND TO STRUCTURE SHALL TERMINATE AT UNDERSIDE 8 6" TOP AND BOTTOM TRACK WITH 3 5/8" OF STRUCTURAL DECK TO MAINTAIN A CONTINUOUS PLANE OF GYPSUM BOARD AS A NOISE, SMOKE OR OTHER TYPE OF BARRIER. (OFFSET) WITH 5/8" GYPSUM BOARD BOTH REFER TO STRUCTURAL, MECHANICAL, PLUMBING AND ELECTRICAL PLANS FOR ADDITIONAL DEMOLITION NOTES. ALL PARTITIONS EXTENDING TO STRUCTURE ABOVE SHALL TERMINATE WITH DEFLECTION TRACK - REFER TO INTERIOR PARTITION TYPE DETAIL ON THIS SHEET. SALVAGE ALL UNISTRUT AND PROTECT FOR RE-USE IN NEW CONSTRUCTION, IF REQUIRED. ALL GYPSUM BOARD PARTITIONS NOT EXTENDING TO THE STRUCTURE MUST BE AT LOCATIONS OF REMOVED WALLS, ALL ASSOCIATED ITEMS ATTACHED TO THE WALL ARE TO BE REMOVED. SUCH AS: DOORS, WINDOWS, FRAMES, MARKERBOARDS, UL DESIGN NUMBERS REFER TO THE FIRE RESISTANCE DIRECTORY; UNDERWRITERS TACKBOARDS, TACK STRIPS, ETC. LABORATORY, LATEST EDITION. GENERAL NOTES - ARCHITECTURAL - NEW CONSTRUCTION MISCELLANEOUS NON-RATED CHASES TO BE 5/8" GYPSUM BOARD ON 3 5/8" METAL STUD FRAMING AT 16" O.C., UNLESS NOTED OTHERWISE. THE OWNER RESERVES THE RIGHT TO REMOVE ANY ITEM FROM THE PROJECT PRIOR TO COMMENCEMENT OF CONTRACTED DEMOLITION WORK. MISCELLANEOUS FURRING AROUND COLUMNS TO BE 5/8" GYPSUM BOARD ON 11/2" STUDS, UNLESS NOTED OTHERWISE. ALL EXISTING CONDITIONS SHOULD BE FIELD VERIFIED BEFORE WORK BEGINS. FIRE-RATED PARTITIONS TO HAVE FIRE-STOPPING SEALANTS AT HEAD, SILL JUNCTURE DIMENSIONS GIVEN ARE ACTUAL AND ARE TO THE FACE OF MASONRY UNITS OR TO THE WITH DISSIMILAR MATERIALS, ETC. AND AROUND ALL PENETRATIONS AND OPENINGS. FACE OF STUD FRAMING, UNLESS NOTED OTHERWISE. 3 CONSTRUCT ALL PARTITIONS WITH SOUND ATTENUATION BATTS WITH THE FOLLOWING DETAILS SHOWN ILLUSTRATE DESIGN INTENT, NOT ALL POSSIBLE CONDITIONS. FOR SOUND BATT THICKNESS: 2 1/2" OR LESS METAL STUD - 1 1/2" THICKNESS, 3 5/8" OR CONDITIONS NOT SHOWN, USE DETAILS CLOSEST TO CONDITION IN QUESTION. LARGER METAL STUD - 3" THICKNESS. UNLESS NOTED OTHERWISE. EXTEND ALL INTERIOR WALL PARTITIONS FROM FLOOR TO STRUCTURE/DECK ABOVE UNLESS NOTED OR DETAILED OTHERWISE. 1X 60 PARTITION STUD KEY - METAL, CH, AND WOOD WITHIN BUILDING INTERIOR PROVIDE BULLNOSE BLOCK IN CMU WALL ASSEMBLIES AT METAL STUD/FURRING ALL EXPOSED OUTSIDE CORNERS, INCLUDING WINDOW AND DOOR JAMBS, UNLESS DESIGNATION SIZE NOTES OR DETAILED OTHERWISE. PROVIDE SQUARE CORNERS AT ALL LOCATIONS GYPSUM BOARD DIRECT APPLIED TO CMU FINISHED WITH WALL TILE, REFER TO FINISH PLANS (1100 SHEETS) FOR LOCATIONS. 1 1/2" TOOTH-IN MASONRY AT NEW OPENINGS IN EXISTING WALLS. TOOTH-IN NEW MASONRY INFILL INTO EXISTING OPENINGS AT ALL BULLNOSE BLOCK LOCATIONS. STUD WALLS SPANNING OVER 12'-0" IN HEIGHT SHALL BE A MINIMUM OF 20 GAGE. 10 STUD WALL SUPPORTING WALL CABINETS SHALL BE A MINIMUM OF 20 GAGE. 11 DOORS ARE TO BE 4" FROM CORNER OF ROOM, UNLESS NOTED OR DIMENSIONED OTHERWISE 12" OPEN 2 FIRESTOP ALL INTERCONNECTIONS BETWEEN VERTICAL AND HORIZONTAL SPACES AND OPEN CONCEALED WALL SPACES AT CEILING, FLOOR AND ROOF LEVELS. METAL STUD/FURRING <u>DESIGNATION</u> <u>SIZE</u> 3 FIRESEAL ALL PENETRATIONS, SUCH AS, PIPES, DUCTS, CONDUITS, ETC. THROUGH FIRE AND/OR SMOKE RATED ASSEMBLIES. 14 FOR CONTROL JOINT (C.J.) LOCATIONS REFER TO EXTERIOR ELEVATIONS AND/OR FLOOR METAL STUD/FURRING <u>DESIGNATION</u> <u>SIZE</u> 15 PAINT ALL ELECTRICAL PANEL COVERS AND ACCESS PANELS TO MATCH ADJACENT 2"x4" FINISHES. USING OIL-BASED PAINT, NOT LATEX WALL PAINT. 2"x6" 2"x8" W 6 PROVIDE WOOD BLOCKING IN WALLS THAT REQUIRE WALL MOUNTED EQUIPMENT OR PARTITION TYPE TAG (REFER TO FLOOR PLANS) ACCESSORIES. COORDINATE WITH EQUIPMENT OR ACCESSORY MANUFACTURER. PARTITION TYPE NUMBER — STUD SIZE DESIGATION 7 ROVIDE ALL ASSOCIATED CURBS FOR ROOF TOP EQUIPMENT AND MECHANICAL ROOF TOP UNITS. LARGE VOIDS BELOW THE AIR HANDLING UNITS SHALL BE FILLED WITH INSULATION AS SPECIFIED FOR NOISE CONTROL. - FIRE RATING, IF REQUIRED 18 ALL EXISTING ROOF TOP PENETRATIONS BEING REMOVED REQUIRE ROOF PATCHING TO MATCH EXISTING ADJACENT. LIST OF ABBREVIATIONS ACOUSTICAL PANEL CEILING ABOVE FINISH FLOOR ALUM ALUMINUM

— STRUCTURE /

WALLS - UNLESS

NOTED OTHERWISE

WEAVE IN-BETWEEN

SEALANT

STUDS

METAL STUD FRAMING @ 16" O.C.

METAL STUD SOUND WALL

HEAD DECK ABOVE

ANOD ANODIZED COLD FORMED METAL FRAMING CFMF CMU CONCRETE MASONRY UNIT CONC CONCRETE DCMU DECOTATIVE CONCRETE MASONRY UNIT EIFS EXTERIOR INSULATION AND FINISH SYSTEM FIRE EXTINGUISHER FIRE EXTINGUISHER CABINET FIRE RESISTANT TREATED FIELD VERIFY GYP BD GYPSUM BOARD HOLLOW METAL LAMINATED VENEER LUMBER METAL COMPOSITE MATERIAL WALL PANEL ON CENTER PRESERVATIVE TREATED PNT STAINLESS STEEL SOLID SURFACE MATERIAL SSM TYPICAL

VERIFY IN FEILD

WOOD


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ISSUED FOR

CORRIDOR 300 ROOM/MEDIA STORAGE RESOURCE OFFICE **TECHNOLOGY** RESOURCE WORK ROOM RESOURCE OFFICE RESOURCE HUB IT OFFICE OFFICE F 105F <u>OFFICE</u>

FIRST FLOOR REFLECTED CEILING DEMOLITION PLAN PARTIAL UNIT C
1/8" = 1'-0"



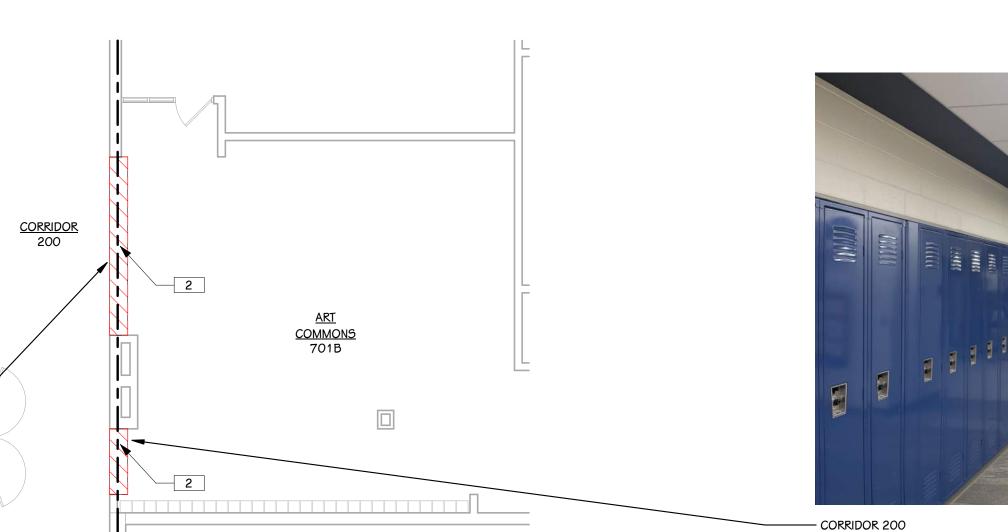

ROOM/MEDIA STORAGE 308

<u>RESOURCE</u>

OFFICE 307

MEDIA CENTER 309



CORRIDOR 300

TECHNOLOGY

RESOURCE WORK ROOM 311


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<u>OFFICE</u> 454


 $\frac{\text{FIRST FLOOR DEMOLITION PLAN - PARTIAL UNIT C}}{\frac{1}{8} = \frac{1}{-0}}$


CORRIDOR 100






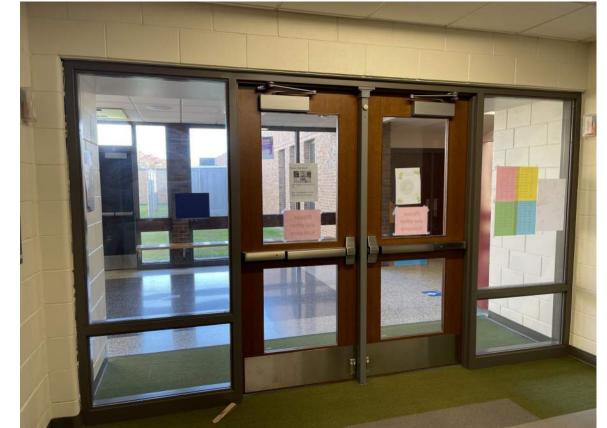

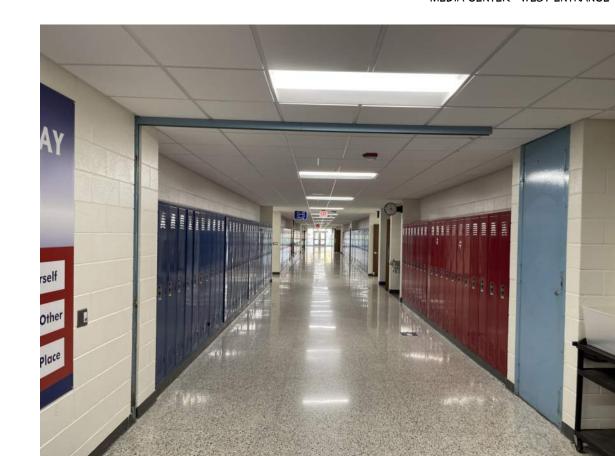

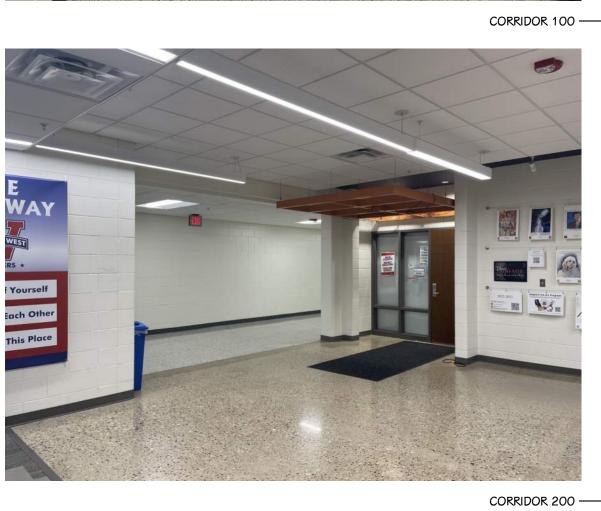

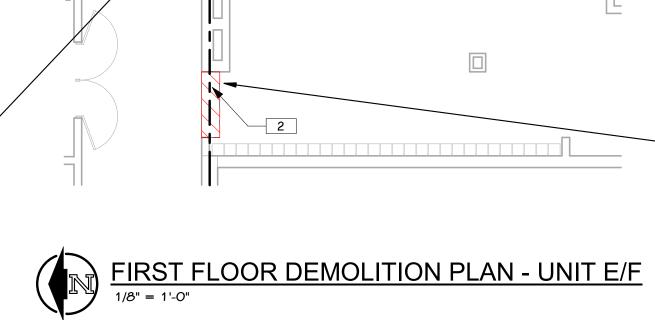


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IT IS PLOTTED INCORRECTLY. DISCARD AND OBTAIN


AN ACCURATE DRAWING



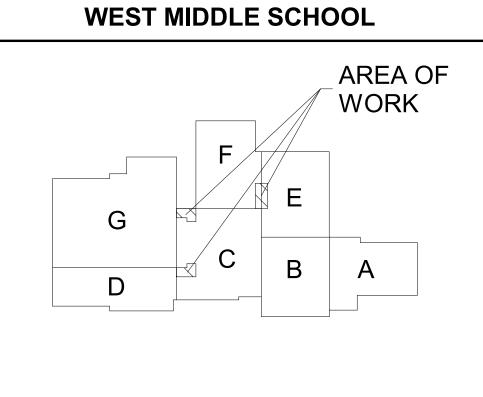

KEY PLAN SCALE: NO SCALE


SHEET TITLE
FIRST FLOOR DEMOLITION PLAN &
REFLECTED CEILING DEMOLITION F

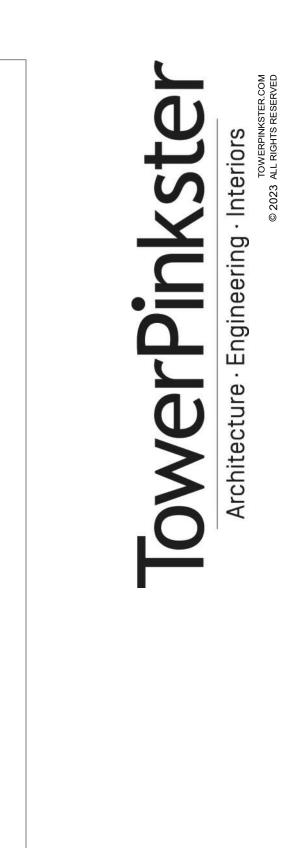





SHEET TITLE FIRST FLOOR PLAN & CEILING PLAN

AREA OF WORK

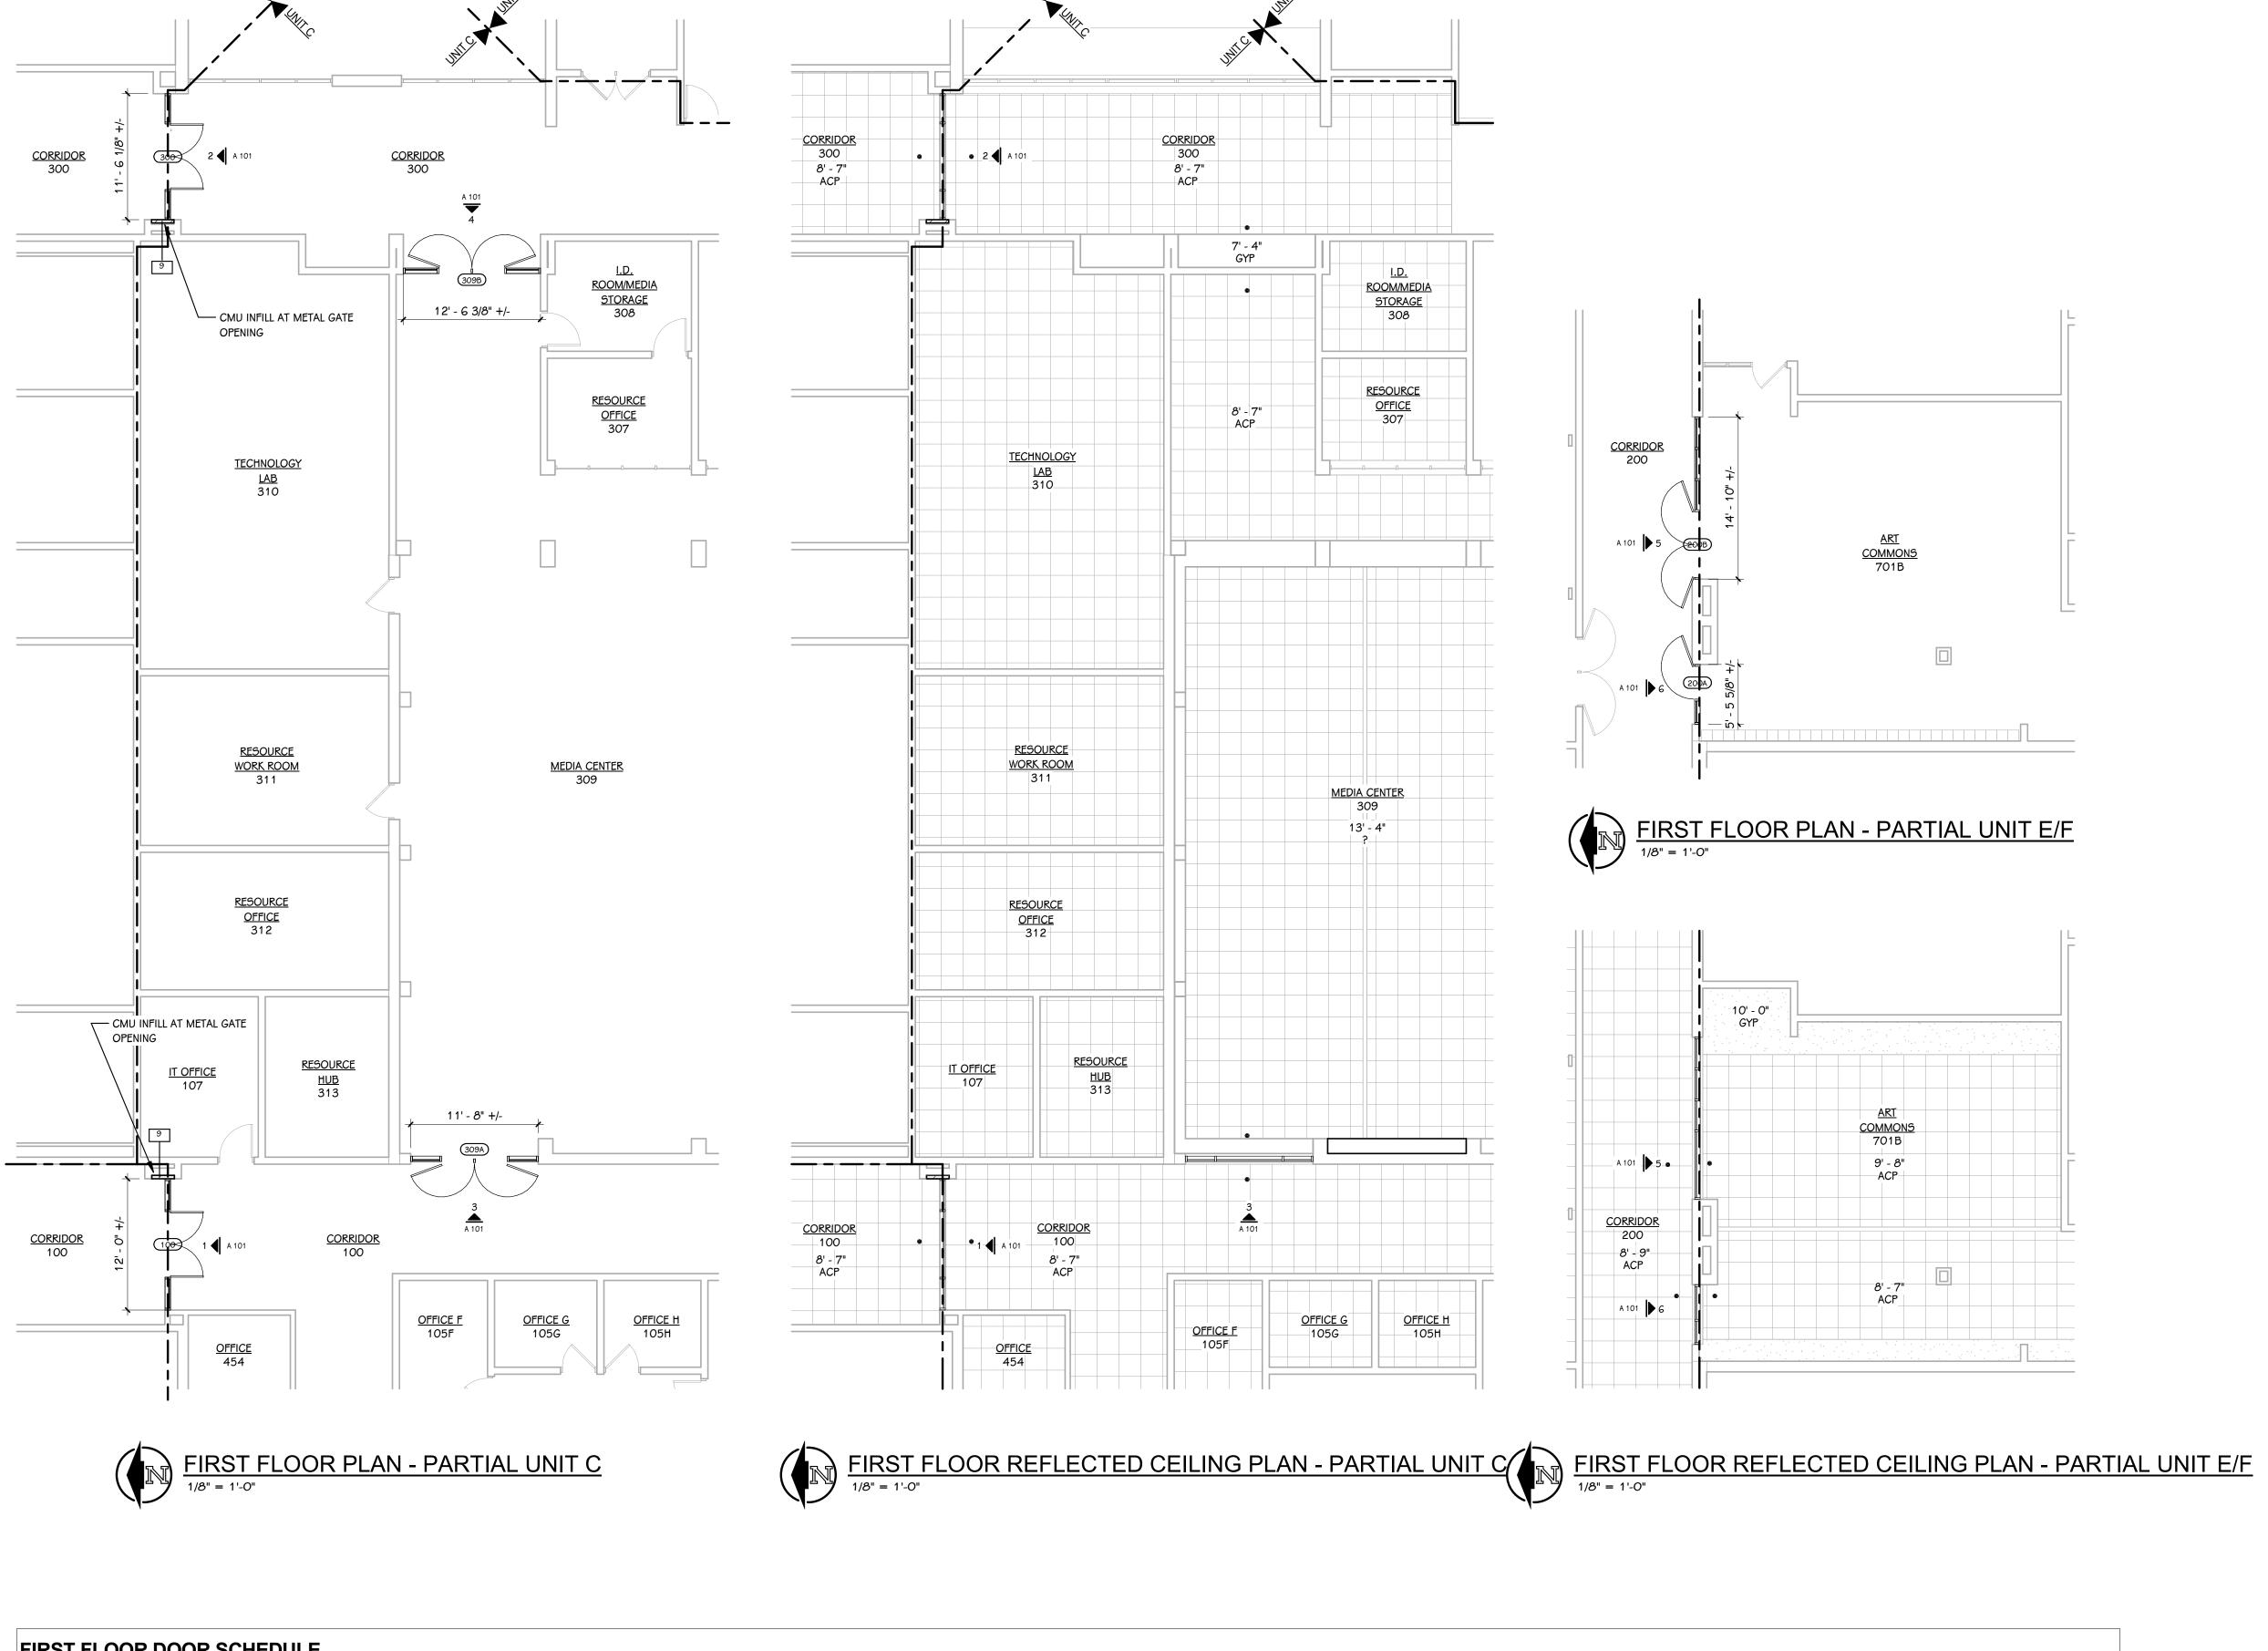

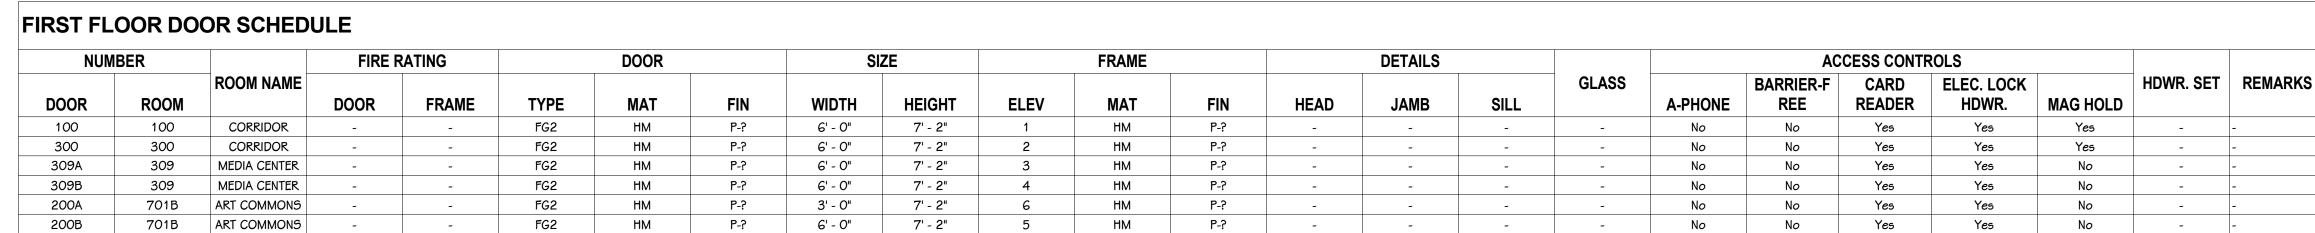

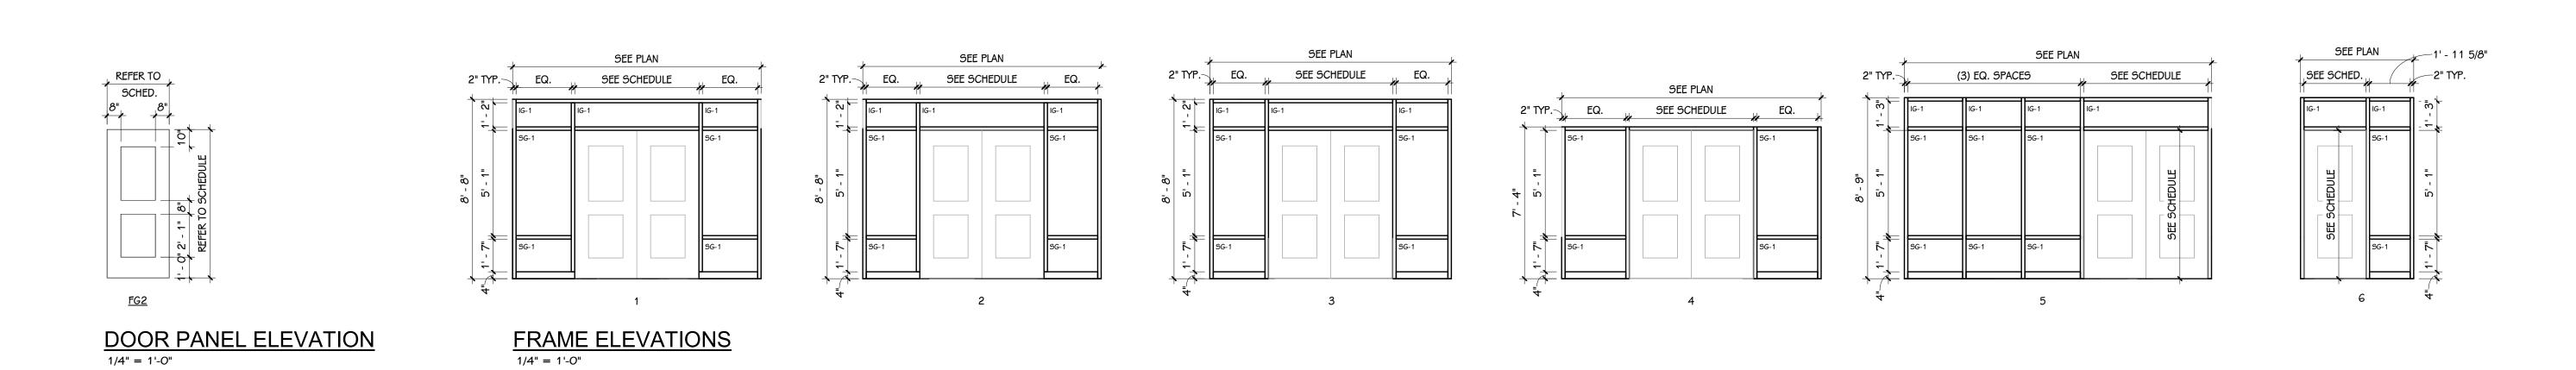

WEST MIDDLE SCHOOL

DATE

THIS DRAWING SHEET IS INTENDED TO BE PLOTTED IN COLOR. IF THIS TEXT APPEARS IN BLACK AND WHITE, IT IS PLOTTED INCORRECTLY. DISCARD AND OBTAIN AN ACCURATE DRAWING




ABBREV	ITEM	MANUFACTURER	PATTERN	COLOR	PRODUCT NO.	SIZE	SINGLE SOURCE	BASIS OF DESIGN	ADDITIONAL MANUFACTURERS	REMARKS	
ACP-1	ACOUSTIC CEILING PANEL	ARMSTRONG	ULTIMA	WHITE	1911	24" X 24"	Х			BEVELED TENGULAR	
GF-1	GLASS FILM	ЗМ	FASARA	CLOUD GRADIENT	5H2FGCL	50" W X 98.4' L ROLL	Х			INSTALL GRADIENT WITH FROST AT BOTTOM MULLION	
P-1	PAINT	SHERWIN WILLIAMS		DOVER WHITE	SW 6385		Х				
P-2	PAINT	SHERWIN WILLIAMS		GAUNTLET GREY	SW 7019		Х			DOOR FRAMES	
RB-1	RUBBER BASE	TARKETT / JOHNSONITE	TRADITIONAL DURACOVE - WITH TOE	MOON ROCK - 29	DC 29 4	4" HIGH	Х				
RB-2	RUBBER BASE	TARKETT / JOHNSONITE	TRADITIONAL DURACOVE - WITH TOE	BLACK - 40	DC 40 4	4" HIGH		Х	ROPPEE, MANNINGTON, FLEXCO		


GENERAL NOTES - MATERIAL SELECTION SCHEDULE


NO COMPARABLE PRODUCTS OR PRODUCT SUBSTITUTIONS WILL BE REVIEWED FOR PRODUCTS DESIGNATED AS SINGLE SOURCE.

2 COMPARABLE PRODUCTS WILL BE REVIEWED FOR ITEMS LISTED AS BASIS OF DESIGN. COMPARABLE PRODUCTS ARE REQUIRED TO MEET ANY MINIMUM PERFORMANCE REQUIREMENTS LISTED IN REMARKS AND APPERANCE OF SPECIFIED PRODUCT.

3 REFER TO TYPICAL DETAILS AND PRODUCT SPECIFICATION FOR TRIMS AND ACCESSORIES ASSOCIATED WITH SPECIFIED PRODUCTS ABOVE.

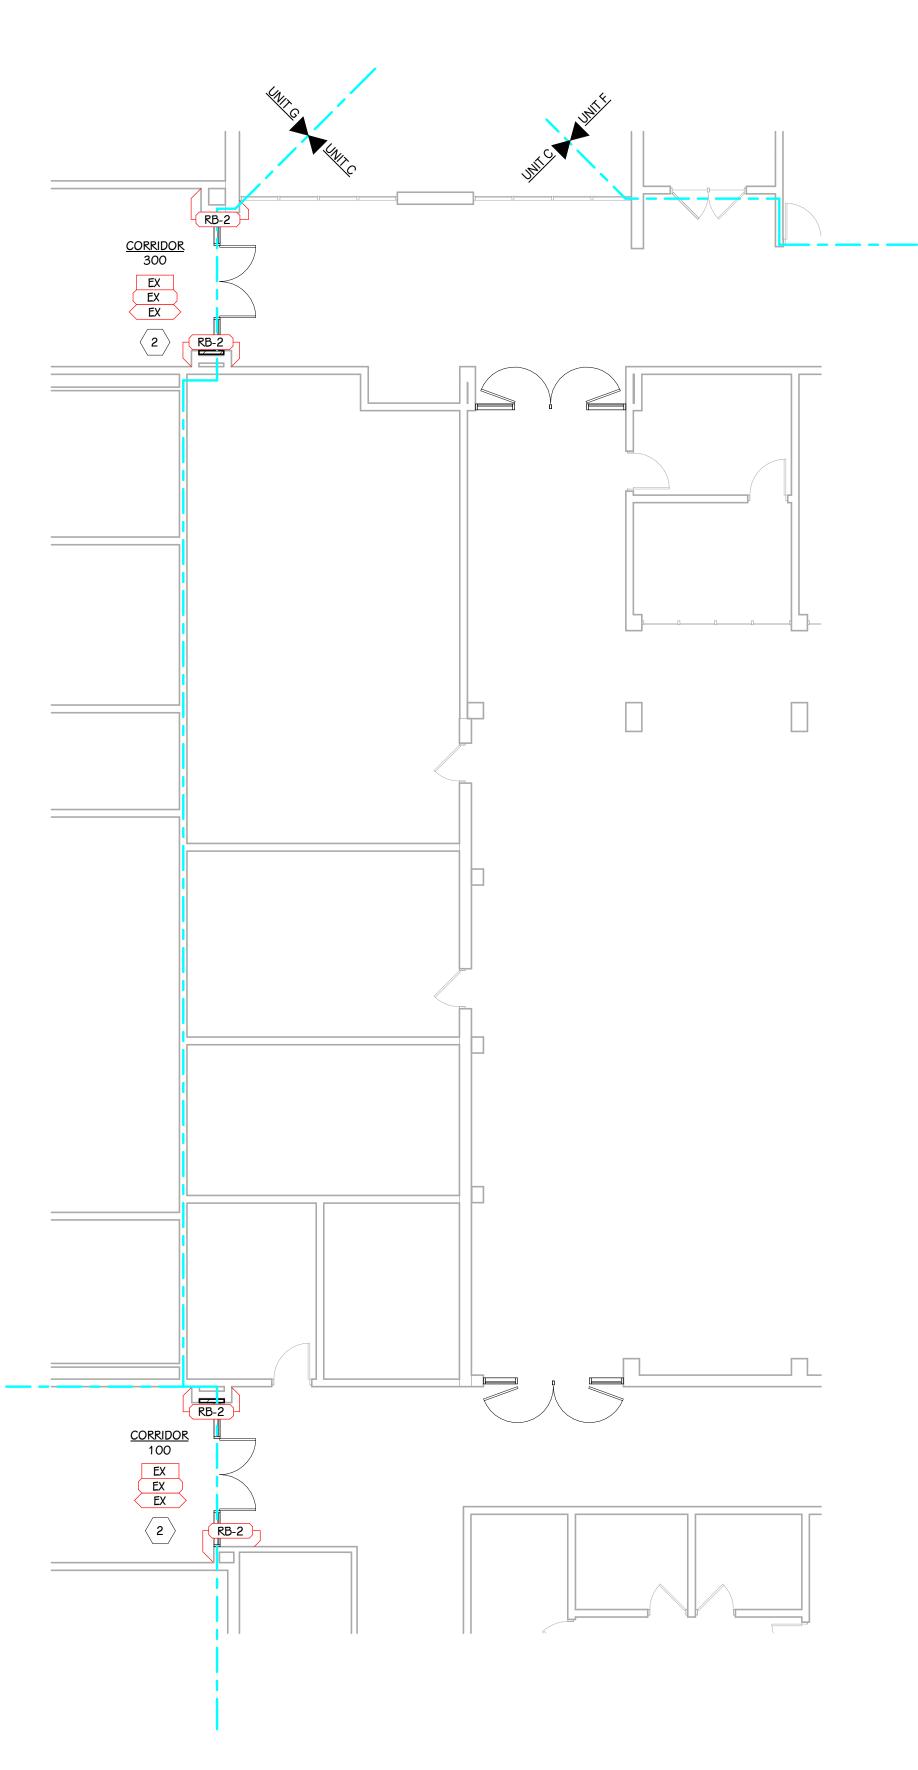

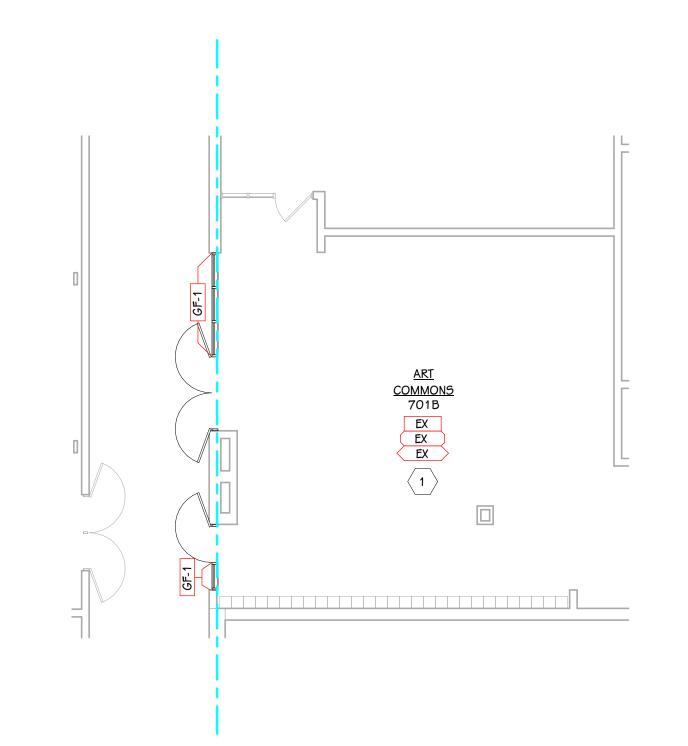

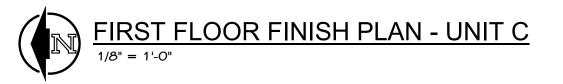



NOTES - FINISH PLANS

OTHERWISE NOTED.

- FINISH TAGS APPLY TO LIKE MATERIALS IN ENTIRE ROOM. I.E. CASEWORK TAG MAY ONLY CALLOUT ONE RUN OF CASEWORK, BUT ALL CASEWORK IN ROOM RECEIVE THE SAME FINISHES, UNLESS TAGGED DIFFERENTLY.
 - CASEWORK FINISH TAGS DO NOT APPLY TO CUSTOM MILLWORK PIECES. REFER TO ENLARGED MILLWORK DETAILS FOR FINISH MATERIALS.
 - REFER TO ENLARGED FINISH PLANS AND PATTERN PLANS FOR ADDITIONAL FINISH
 - 4 DASHED LINE INDICATES LINE OF CEILING ABOVE, REFER TO REFLECTED CEILING PLANS. WHERE NO FINISH TAG IS SHOWN ALL EXISTING FINISHES ARE TO REMAIN, UNLESS


KEYED NOTES - INTERIOR - FINISH PLAN

PATCH AND TOUCH UP WALL FINISHES WITH P-1 AND RB-1 AS NEEDED

2 PATCH AND TOUCH UP WALL PAINT AS NEEDED WITH P-1

THIS DRAWING SHEET IS INTENDED TO BE PLOTTED IN COLOR. IF THIS TEXT APPEARS IN BLACK AND WHITE, IT IS PLOTTED INCORRECTLY. DISCARD AND OBTAIN AN ACCURATE DRAWING



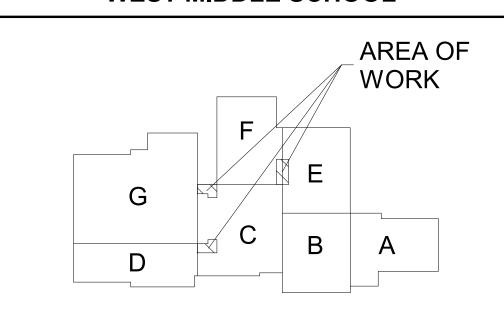



SHEET TITLE
MATERIAL SELECTION SCHEDULE
FIRST FLOOR FINISH PLAN - UNIT

SHEET NUMBER 1016 23-214.70


	STRUCTURED CABLING □ DATAWOICE OUTLET □ DATAWOICE OUTLET - SUPFACE □ SUPFACE SUPFACE SUPFACE □ CABLE TRAY □ CABLE TRAY □ CABLE TRAY □ CABLE TRAY □ PAGING SYSTEM HEAD END □ TOF INTERVENCE COMMUNICATION RACK □ 4X8X934* FIRE-RATED PLYWOOD □ CONDUIT SLEEVE AUDION/ISUAL □ TW WALL BACKBOX □ PROJECTOR (OUTLET WITHIN 16' OF PROJECTOR (OUTLET WITHIN 16' ON PROJECTOR (OUTLET WITHIN 16' ON PROJECTOR (OUTLET WITHIN 16' OUTLET WITHIN 16' ON PROJECTOR (OUTLET WITHIN 16' OUTLET WITHIN 1		GENERAL NOTES - LIGHTING 1 ALL OCCUPANCY SENSORS AND PHOTOCELLS MOUNTED IN THE SAME ROOM SHALL BE CONNECTED TOGETHER AND OPPRATE AS ONE SYSTEM. DAYLIGHT HARVESTING SHALL BE SELF CONTAINED WITHIN EACH ROOM AND SHALL BE FIELD ADJUSTED WITH ENSINEER. MANUFACTURER SHALL PROVIDE FLOOR TRANS DURING SHOT PRAWING PHASE SHOWING EVACT LOCATIONS AND QUANTITIES AS REQUIRED FOR A COMPLETE SYSTEM. 2 ALL OCCUPANCY SENSOR WIRING SHALL BE CONCEALED WITHIN CONDUIT WHERE DYCOSED. NO LOW YOLTAGE WIRING SHALL BE CONCEALED WITHIN CONDUITS WHERE DYCOSED. NO LOW YOLTAGE WIRING SHALL BE EXPOSED. 3 ALL CONDUITS SHALL RUN AS TIGHT TO DECK AS PERMITTED BY CODE. CONDUITS SHALL BE RUN IN A NEAT MANNER. MAINTAIN THE SAME SYACING WHEN CONDUITS ARE RUN TOGETHER. CONCEAL JUNCTION BOXES OVER LAY-IN CEILING AND USE ENT DROPS DOWN TO CAIDIDS. LOCATE CONDUIT RORPS TO CLOUDS AND CEILING ELEMENTS IN LEAST VISIBLE LOCATION. NO MC CABLE TO LIGHT FIXTURES SHALL BE USIBLE FROM ANY ANGLE. 4 RECESS NEW DEVICES AND ASSOCIATED CONDUIT AND BACKBOX IN EXISTING WALL. CUT AND PATCH AS REQUIRED. 5 ELECTRICAL CONTRACTOR SHALL DE RESPONSIBLE FOR ALL CUTTING AND PATCHING REQUIRED FOR NEW WORK OR WHERE DEVICES ARE PROVED AND HOT REPLACED. 2 ELECTRICAL CONTRACTOR SHALL CONSDINATE WITH G SERIES SHEETS DEVICE COORDINATION DETAIL. DEVICES ARE TO ALLON VERTICALLY AND HORIZONTALLY AND FOLLOW THE RULES OF THIS DETAIL CONSISTENTLY. A PRE-INSTALL DEVICE COORDINATION DETAIL. DEVICES ARE TO ALLON VERTICALLY AND HORIZONTALLY AND FOLLOW THE RULES OF THIS DETAIL CONSISTENTLY. A PRE-INSTALL DEVICE COORDINATION DETAIL. DEVICES ARE TO ALLON VERTICALLY AND HORIZONTALLY AND FOLLOW THE RULES OF THIS DETAIL CONSISTENTLY. A PRE-INSTALL DEVICE COORDINATION DETAIL. DEVICES ARE TO ALLON VERTICALLY AND HORIZONTALLY AND FOLLOW THE RULES OF THIS DETAIL CONSISTENTLY. A PRE-INSTALL DEVICE COORDINATE WITH SEPECIFICATION FOR THIS PROJECT. 3 PATCH ALL PENETRATIONS AS REQUIRED TO MAINTAIN FIRE RATING. 4 REFER TO INTERIOR ELEVATIONS, SECTIONS, ARCHITECTURAL ELEVATIONS AND RELATE DAY OF THE PRE	ACKAGE 2: BY
FIECTRICAL ARBREWATIONS	NOTES: MOUNT DEVICES AT HEIGHTS INDICATED UNLESS INDICATED OTHERWISE ON PLANS. HEIGHTS ARE TO BOTTOM OF DEVICE.	DUPLEX RECEPTACLE - WITH GFI DUPLEX RECEPTACLE - FOR ELECTRIC WATER COOLER, WITH GFI DUPLEX RECEPTACLE - WITH (2) U9B OUTLETS BETWEEN POWER DUPLEX RECEPTACLE - HORIZONTAL MOUNTING DUPLEX RECEPTACLE - STACK ALIGNED BELOW DEVICE ABOVE (DEVICE ALIGNMENT IS NOT LIMITED TO THOSE LABELED, REFER TO ELECTRICAL DEVICE ALIGNMENT GUIDELINES)	11 FIRE ALARM DEVICES SHOWN ARE NOT INTENDED TO REPRESENT A COMPLETE ENGINEERED FIRE ALARM DESIGN 12 THE FIRE ALARM CONTRACTOR SHALL BE RESPONSIBLE TO PROVIDE ALL NECESSARY DEVICES AND ACCESSORIES FOR A COMPLETE SYSTEM, COMPLIANT WITH APPLICABLE CODES AND JURISDICTIONAL REQUIREMENTS, EVEN IF SUCH DEVICES ARE NOT INDICATED IN THESE DOCUMENTS 13 THE FIRE ALARM CONTRACTOR SHALL BE RESPONSIBLE FOR COORINDATING WITH MECHANICAL CONTRACTOR AND ALL OTHER TRADES NECESSARY FOR DOOR HOLDS, SMOKE DAMPERS, DUCT DETECTORS, FLOW / TAMPER SWITCHES AND ANY OTHER DEVICES 14 NEW FIRE ALARM DEVICES ARE TO BE TIED INTO THE EXISTING FIRE ALARM SYSTEM DEVICES AND CONDITIONS 15 THE FIRE ALARM CONTRACTOR SHALL RESPONSIBLE FOR FIELD VERIFYING EXISTING DEVICES AND CONDITIONS 16 ALL LOW VOLTAGE CABLING SHALL BE RUN IN CONDUIT BETWEEN DEVICE AND CABLE TRAY OR TECHNOLOGY RACK. NO CABLING SHALL BE VISIBLE IN EXPOSED CEILING SPACES. EXPOSED CONDUIT SHALL BE PAINTED TO MATCH SURFACE IT IS SUPPORTED FROM. WIRING ROUTED IN ACCESSIBLE CEILING SPACES SHALL BE INDEPENDENTLY SUPPORTED WITH COMM HOOKS OR RINGS. 17 CONNECT POWER TO ALL VAV, TERMINAL UNITS AND MISCELLANEOUS MECHANICAL DAMPERS AND VALVES PROVIDED WITH LOW VOLTAGE TRANSFORMER, COORDINATE EXACT LOCATIONS AND TRANSFORMER QUANTITIES WITH BUILDING AUTOMATION SYSTEM AND MECHANICAL CONTROLS AND SEQUENCE OF OPERATIONS DETAIL. THESE ITEMS ARE NOT SHOWN ON ELECTRICAL DRAWINGS. DO NOT USE SPARE BREAKERS INDICATED IN PANEL SCHEDULES FOR THESE CIRCUITS NOTIFY PANELBOARD MANUFACTURERS OF QUANTITIES OF THESE BREAKERS REQUIRED.	PROJECT TITLE WEST MIDDLE S DISTRICT WIDE
ELECTROLA ABBRICATIONS IN 1 FROM 19 STORT 12 Lip 3 COUNTS NOW TO A 2' COUNTY 1 COU	FIRE ALARM SYMBOLS PIRE ALARM SYMBOLS PIRE ALARM SHOKE DETECTOR - CEILING TYPE MAGNETIC DOOR HOLDER, PROVIDE WITH SMOKE DETECTOR WITHIN 5 OF DOOR ON EACH SIDE, COORDINATE MOUNTING WITH DOOR HARDWARE. PIRE ALARM MANUAL PULL STATION PIRE ALARM ALDIO/VISUAL ALARM, CEILING MTD. PIRE ALARM - VISUAL ALARM, CEILING MTD.	EXISTING TO REMAIN UNDISTURBED.	 18 RECE99 NEW DEVICES AND ASSOCIATED CONDUITS AND BACKBOX IN EXISTING WALLS WHERE POSSIBLE. CUT AND PATCH AS REQUIRED. 19 PROVIDE FINAL CONNECTION TO ALL OWNER/CONTRACTOR PROVIDED EQUIPMENT. COORDINATE RECEPTACLE SIZES AND TYPE WITH EQUIPMENT, ADJUST CIRCUIT SIZE AS REQUIRED. 	

LIGHT FIXTURE SCHEDULE									
TYPE	SERIES	DESCRIPTION	MOUNTING	CEILING TYPE	DRIVER	WATTS	MANUFACTURER	NOTES	
X1	X1	EXIT SIGN - EDGE LIT	SURFACE	ACOUSTIC GRID	N/A	5 VA	LITHONIA #EDG-W-1-R-EL	1, 2	

ALL LED FIXTURES TO HAVE WARRANTY TO MEET OR EXCEED WARRANTY INCLUDED IN BASIS OF DESIGN. FIXTURES LISTED AS EQUALS SHALL MEET DELIVERED LUMENS, CRI, EFFICACY AND OPTIONS OF THAT SPECIFIED. REFER TO

SPECIFICATIONS 265100 AND 265600 FOR ADDITIONAL REQUIREMENTS.

THE MOUNTING DESCRIPTION IS GENERAL. REFER TO SHOP DRAWINGS AND MANUFACTURER'S INSTALLATION INSTRUCTIONS FOR SPECIFIC MOUNTING DETAILS.

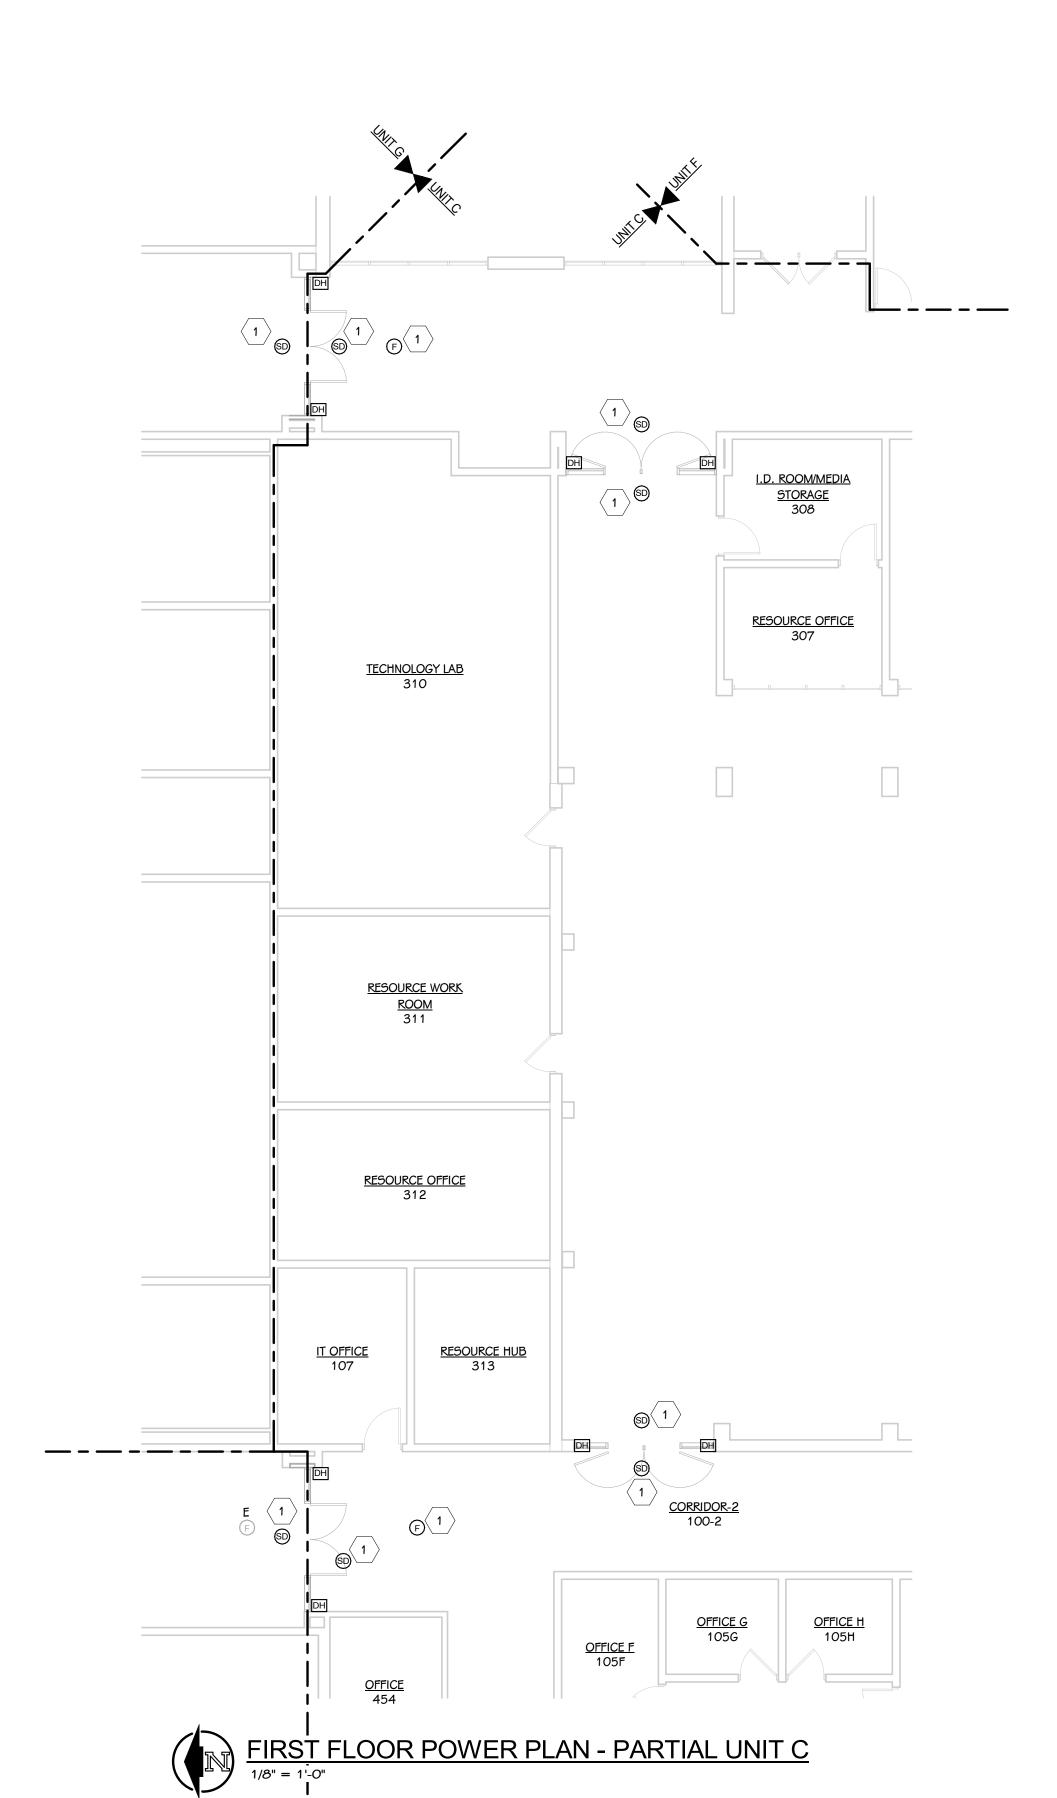

KEYED NOTES - ELECTRICAL - POWER

1 ADD NEW FIRE ALARM DEVICE TO EXISTING SYSTEM. RETAIN SERVICES OF FIRE ALARM PROVIDER FOR MODIFICATION TO EXISTING FIRE ALARM SYSTEM. PROVIDE ALL HARDWARE FOR A COMPLETE INSTALLATION.

TOWER PICTORIES DATE

OJECT TITLE
VEST MIDDLE SCHOOL - BID PACKAG
ISTRICT WIDE ACCESS CONTROL

GE PUBLIC SCHOOLS

Portage, Mi

DATE FEBRUARY 16, 2024

101C

