
CARPENTER'S PARK PH. ΙΤΥ M I L T O N С F L F Ο 0 R **100% CONSTRUCTION DOCUMENTS** PRC

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L-1.01	DEMOLITION PLAN- CROSSWALK
L-2.00	SHEET KEY
L-2.01	LAYOUT PLAN-IWF
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IWF-1.01	IWF PLUMBING PLAN

ALL EROSION AND SEDIMENTATION CONTROLS AND TREE PROTECTION MEASURES SHALL BE INSTALLED PRIOR TO GRADING.

PRIOR TO LAND-DISTURBING ACTIVITIES, THE CONTRACTOR SHALL SCHEDULE A PRE-CONSTRUCTION MEETING WITH THE AREA EROSION CONTROL INSPECTOR. CALL 704-336-4258 TO CONTACT THE INSPECTOR.

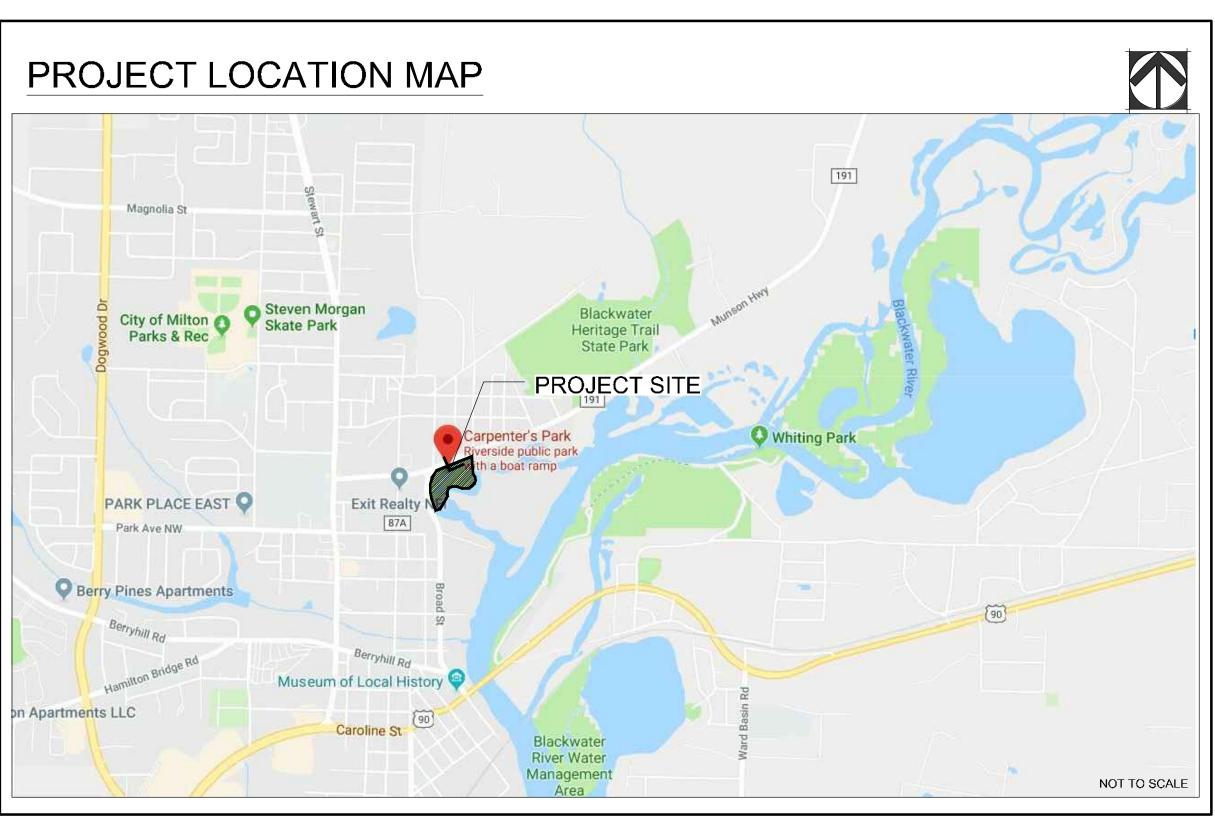



MUNSON HIGHWAY LAND LOT 0190 and 0010 MILTON, FL 32570 TAX PARCEL ID #342N28057000A000190; 342N285620006000010; 342N285620005000010

PREPARED FOR:

City of Milton 6738 Dixon Street Milton, FL 32570

PREPARED BY:



1447 PEACHTREE ST. NE, SUITE 850 ATLANTA GA 30309 404.873.6730

DATE: JANUARY 21, 2019 PROJECT No: 18157


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I D A
DJECT DIRECTORY
OWNER / DEVELOPER City of Milton 6738 Dixon Street Milton, Florida 32570 Contact: Mr. Randy Jorgenson, citymanager@mymiltonflorida.com P: 850.983.5411
LANDSCAPE ARCHITECTURE TSW 1447 Peachtree Street NE, Suite 850 Atlanta, Georgia 30309 Contact: Mr. Bryan Bays, bbays@tsw-design.com P: 404.873.6730

Volkert, Inc. 215 Fairpoint Dr, Suite B Gulf Breeze, FL 32561 Contact: Mr. Mike Warnke, mike.warnke@volkert.com P: 251.968.7551

CIVIL ENGINEER

REVISIONS

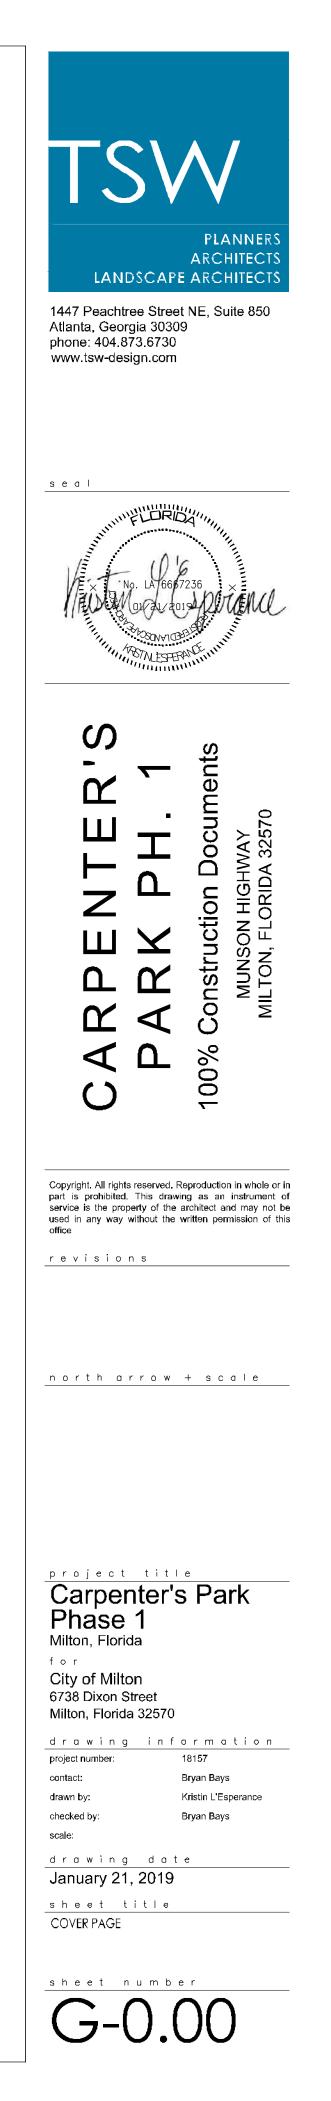

GENERAL NOTES: PROJECT NOTES

- 1. ANY DISCREPANCIES DISCOVERED WITHIN PLAN SHALL REQUIRE CONTRACTOR TO STOP WORK IMMEDIATELY AND NOTIFY LANDSCAPE ARCHITECT.
- 2. THE GENERAL CONTRACTOR SHALL CONTACT THE PROPER LOCAL AUTHORITIES OR RESPECTIVE UTILITY COMPANY TO CONFIRM THE LOCATION OF ALL EXISTING UTILITIES BEFORE COMMENCING WORK. ANY DAMAGE TO FAILURE OF THE GENERAL CONTRACTOR TO CONTACT THE PROPER AUTHORITIES SHALL BE BORNE BY THE GENERAL CONTRACTOR.
- 3. ALL REFUSE, DEBRIS AND MISCELLANEOUS ITEMS TO BE REMOVED, THAT ARE NOT BEING STOCKPILED FOR LATER USE ON THE PROJECT OR DELIVERED TO THE OWNER, SHALL BE LEGALLY DISPOSED OF OFF- SITE BY THE GENERAL CONTRACTOR.
- 4. THE GENERAL CONTRACTOR SHALL NOT ENCROACH ON PRIVATE PROPERTY. WHEN INSTALLING NEW SIDEWALKS ADJACENT TO THE EXISTING RIGHT OF WAY, CONTRACTOR SHALL USE HAND TOOLS AND/OR SAWCUT THE EXISTING SIDEWALK 6" FROM THE RIGHT OF WAY WHERE NECESSARY TO AVOID IMPACTS.
- 5. ALL POINTS OF CONSTRUCTION INGRESS AND EGRESS SHALL BE PROTECTED AS DIRECTED BY THE CITY OF MILTON TO PREVENT TRACKING OF MUD ONTO PUBLIC WAYS. ANY MUD ON PUBLIC WAYS ORIGINATION FROM THE JOB SITE SHALL BE CLEANED IMMEDIATELY BY THE CONTRACTOR.
- 6. CONTRACTOR MUST MAINTAIN OPERATION OF TRAFFIC DURING CONSTRUCTION. COORDINATE CONSTRUCTION STAGING WITH THE CITY.
- 7. THE CONTRACTOR IS RESPONSIBLE FOR VERIFYING DIMENSIONS SHOWN PRIOR TO CONSTRUCTION, AND SHALL NOTIFY LANDSCAPE ARCHITECT OF ANY DISCREPANCIES.
- 8. ALL CONSTRUCTION MUST CONFORM TO APPLICABLE LOCAL STANDARDS, SPECIFICATIONS, AND DETAILS.
- 9. CONTRACTOR IS RESPONSIBLE FOR VERIFYING ALL DIMENSIONS SHOWN ON THE PLANS FOR ALL STRUCTURES AS WELL AS ALL UTILITY LOCATIONS WITH CURRENT ARCHITECTURAL, STRUCTURAL, AND PLUMBING PLANS AND ENSURE THERE ARE NO CONFLICTS.
- 10. SIGNAGE AND STRIPING TO BE PROVIDED BY THE CONTRACTOR ACCORDING TO THE MANUAL ON UNIFORM TRAFFIC CONTROL DEVICES, CURRENT EDITION WITH ALL REVISIONS INCLUDED.
- 11. ALL CONSTRUCTION VEHICLES SHALL PARK IN AREAS DESIGNATED BY THE OWNER.
- 12.NECESSARY BARRICADES, SUFFICIENT LIGHTS, SIGNS AND OTHER TRAFFIC CONTROL DEVICES AS MAY BE NECESSARY FOR THE PROTECTION AND SAFETY OF THE PUBLIC SHALL BE PROVIDED IN ACCORDANCE WITH THE CURRENT EDITION MANUAL ON UNIFORM TRAFFIC CONTROL DEVICES, AND MAINTAINED WHEN WORKING IN CLOSE PROXIMITY TO PUBLIC ROADS.

AMERICANS WITH DISABILITIES (ADA) NOTES:

- 1. THIS PROJECT SHALL CONFORM TO 2010 ADA STANDARDS FOR ACCESSIBILITY.
- 2. ALL HANDICAP ACCESSIBLE ROUTES SHALL NOT EXCEED MAXIMUM SLOPE OF 5% AND A MAXIMUM CROSS-SLOPE OF 2%, EXCEPT RAMPS.
- 3. ALL ADA STALLS AND ACCESS AISLES ARE NOT TO EXCEED 2% IN ANY DIRECTION.
- 4. THE CONTRACTOR SHALL VERIFY ELEVATIONS SHOWN IN PLANS AND FIELD STAKE LAYOUT WITHIN ALL ADA AREAS PRIOR TO INSTALLATION OF APPLICABLE PAVING. SHOULD ANY AREAS WITHIN AN ACCESSIBLE AREA EXCEED MAXIMUM GRADE, THE CONTRACTOR SHALL CONTACT CIVIL ENGINEER FOR FURTHER DIRECTION.
- 5. RAMPS SHALL NOT EXCEED 1:12 SLOPE AND SHALL INCLUDE RAILINGS, LANDINGS, AND CLEARANCE PER ADA STANDARDS.

TREE PROTECTION NOTES:

- 1. NO CONSTRUCTION, ALTERING OF GRADE, STORAGE OF EQUIPMENT OR MATERIALS, OR DISPOSAL OF MATERIALS MAY OCCUR WITHIN A TREE PROTECTION ZONE (TPZ).
- 2. NO PERSON UNDER ANY CIRCUMSTANCE IS TO ENTER A TREE PROTECTION ZONE.
- 3. DIRECTIONAL TUNNELING AND BORING MAY BE PERMITTED WITHIN A TPZ IF APPROVED BY ARBORIST.
- 4. OPEN-FACE CUTS OUTSIDE A TPZ REQUIRED BY APPROVED PLANS THAT REQUIRE ROOT PRUNING REQUIRE THE SERVICES OF A QUALIFIED ARBORIST OR APPROVED TREE PROFESSIONAL, EXPLORATORY EXCAVATION, BY HAND OR LOW WATER PRESSURE HYDRO-VAC, MUST BE COMPLETED PRIOR TO COMMENCING OPEN FACE CUTS OUTSIDE A TPZ.
- 5. TREE PROTECTION BARRIERS MUST BE IN ACCORDANCE WITH LOCAL LAW.
- 6. WHERE FILL, OR TEMPORARY STORAGE, MUST BE ACCOMMODATED NEAR A TPZ, A PLYWOOD BARRIER MUST BE ERECTED TO ENSURE NO MATERIALS ENTER A TPZ.
- 7. ROOT PROTECTION SHALL BE INSTALLED WHERE REQUIRED IN ACCESS LOCATIONS. ROOT PROTECTION SHALL CONSIST OF A COMBINATION OF FILTER FABRIC, CLEAN CRUSHED STONE, AND STEEL PLATING OR OTHER MATERIAL AS APPROVED BY ARBORIST.

LANDSCAPE NOTES:

- 1. CONTRACTOR TO BE RESPONSIBLE FOR LOCATION OF UNDERGROUND UTILITIES PRIOR TO DIGGING OR INSTALLATION OF ANY PLANT MATERIAL. CALL LOCAL JURISDICTION UTILITY LOCATOR PRIOR TO COMMENCING WORK.
- 2. A 3" DEPTH OF PLANTING MIX MINERAL TOPSOIL, AGED FINES, AND COMPOSTED COW MANURE SHALL BE ROTO-TILLED TO A DEPTH OF 6-8" IN LANDSCAPE PLANTING BEDS. SOIL MIXES APPROVED AS EQUALS MAY BE UTILIZED AT THE DISCRETION OF LANDSCAPE ARCHITECT OR OWNER'S REPRESENTATIVE.
- 3. ALL PLANTING BEDS ARE TO BE MULCHED TO A MINIMUM DEPTH OF 3". FREE-STANDING TREES ARE TO BE MULCHED IN A MIN. 5' DIAMETER UNLESS IMPEDED BY SITE HARDSCAPES.

- 4. IF STAKING OR EARTHEN TREE RINGS ARE TO BE UTILIZED, CONTRACTOR IS RESPONSIBLE TO REMOVE WITHIN 1-YEAR OF INSTALLATION. 5. ALL PLANT MATERIALS ARE TO CONFORM TO THE LATEST EDITION OF THE AMERICAN ASSOCIATION OF NURSERYMAN STANDARDS FOR NURSERY STOCK.
- 6. SUBSTITUTIONS OF PLANT SPECIES IS PROHIBITED, UNLESS APPROVED BY LANDSCAPE ARCHITECT.
- 7. CONTRACTOR IS RESPONSIBLE FOR WATERING PLANT MATERIAL UNTIL FINAL ACCEPTANCE BY OWNER.
- 8. LANDSCAPE CONTRACTOR IS TO GUARANTEE ALL PLANT MATERIAL FOR 1-YEAR FROM FINAL ACCEPTANCE OF OWNER. DEAD PLANTS AND PLANTS NOT MEETING THE AMERICAN ASSOCIATION OF NURSERYMEN STANDARDS FOR NURSERY STOCK SHALL BE REPLACED BY CONTRACTOR AT THE EARLIEST TIME SEASONABLE AND PRACTICAL TO PLANT.
- 9. BURLAP IS TO BE PULLED BACK TO EXPOSE TOP OF ROOTBALL AND THE TOPS OF WIRE BASKETS ARE TO BE CUT OR BENT BACK INTO PLANTING HOLE.
- 10. TOPS OF ROOTBALLS FOR TREES ARE TO BE PLANTED ABOUT AN INCH ABOVE SURROUNDING GRADE.
- 11. PLANTING HOLES FOR TREES AND SHRUBS NOT IN PLANTING BEDS SHOULD BE APPROX. TWICE THE DIAMETER OF THE ROOTBALL.
- 12.BACKFILL MIX SHALL BE A 50-50 MIX OF SUITABLE EXISTING SOIL, AND PLANTING MIX. EXISTING SOIL IS TO BE FREE FROM DELETERIOUS MATERIALS AND STONES GREATER THAN ¹/₂" DIA.
- 13. IRRIGATION IS TO BE COMPLETED AT THE DIRECTION OF OWNER.

LAYOUT PLAN NOTES:

- 1. UNLESS OTHERWISE NOTED. ALL DIMENSIONS ARE AT FACE OF WALL. FACE OF BUILDING, FACE OF CURB, EDGE OF PAVEMENT, OR CENTERLINE OF PAVEMENT.
- 2. ALL EDGES OF PAVEMENT ARE TO BE STRAIGHT AND RADII CONSISTENT. 3. ALL CONSTRUCTION LAYOUT STAKING IS TO BE PERFORMED BY A LAND SURVEYOR OR APPROVED PROFESSIONAL. TO ENSURE ACCURACY, DIGITAL DRAWINGS MAY BE PROVIDED BY THE LANDSCAPE ARCHITECT OR CIVIL ENGINEER.
- 4. DO NOT SCALE FROM DRAWINGS.
- 5. IF DIMENSIONS VARY BY 1/2" OR MORE, CONTACT THE LANDSCAPE ARCHITECT OR OWNER'S REPRESENTATIVE FOR REVIEW AND CONFIRMATION PRIOR TO PROCEEDING WITH CONSTRUCTION.
- 6. ALL ANGLES ARE 90° UNLESS OTHERWISE NOTED.
- 7. ALL +/- DIMENSIONS SHOULD NOT VARY MORE THAN 1". IF VARIATIONS ARE GREATER THAN 1" CONTACT THE LANDSCAPE ARCHITECT OR OWNER'S REPRESENTATIVE PRIOR TO PROCEEDING WITH CONSTRUCTION.
- 8. THE CONTRACTOR IS RESPONSIBLE FOR ACCURATE HORIZONTAL AND VERTICAL STAKING. A REGISTERED SURVEYOR IS REQUIRED TO PERFORM ALL DEMOLITION AND CONSTRUCTION STAKING INCLUDING STREET LIGHT PLACEMENT PRIOR TO INSPECTION BY THE OWNER'S REPRESENTATIVE FOR APPROVAL.
- 9. PROVIDE EXPANSION JOINTS AT ALL VERTICAL SURFACES INCLUDING BUT NOT LIMITED TO BUILDING WALL, SITE WALL, STEPS RISERS AND CURBS
- 10.PROVIDE EXPANSION JOINTS AT THE BACK OF ALL CURBS ADJACENT TO CONCRETE SIDEWALKS.
- 11. THE CONTRACTOR SHALL HAVE ALL SUB-SURFACE UTILITY AND SLEEVING WORK INSPECTED AND APPROVED PRIOR TO BEGINNING OF HARDSCAPE STAKING AND CONSTRUCTION.
- 12.SEE SITE CONSTRUCTION DETAILS FOR DIMENSIONS OF SITE ELEMENTS. 13. ALL EXPANSION AND CONTROL JOINTS SHALL ALIGN WHEREVER PROPOSED WORK MEETS EXISTING.
- 14. THE CONTRACTOR MUST COORDINATE THE PLACEMENT OF ELECTRICAL AND DRAINAGE SLEEVING OR THE ACTUAL ROUTING OF THESE SERVICES FOR THE SITE WITH THE APPROPRIATE CONTRACTOR PRIOR TO POURING ANY PAVEMENT.
- 15. AT ALL LOCATIONS WHERE EXISTING CURB OR PAVEMENT ABUT NEW CONSTRUCTION, THE EDGE OF THE EXISTING CURB OR PAVEMENT SHALL BE SAWCUT TO A CLEAN, SMOOTH EDGE. THE COST FOR THIS WORK SHALL BE INCLUDED IN THE PRICE BID FOR GRADING COMPLETE.

GRADING PLAN NOTES:

1.	ABBF	EVIATIONS:		
	TC:	TOP OF CURB	TW:	TOP OF WALL
	BC:	BOTTOM OF CURB	BW:	BOTTOM OF V

- TR: TOP OF RAMP INV: DRAIN INVERT
- 2. SEE THE EXISTING SITE SURVEY INCLUDED IN THIS CONSTRUCTION SET FOR ALL EXISTING SITE INFORMATION.
- 3. THE CONTRACTOR SHALL ESTABLISH AND PROTECT A TEMPORARY BENCHMARK (T.B.M.) TO BE USED DURING CONSTRUCTION. THE CONTRACTOR SHALL SUBMIT THE (T.B.M) LOCATION AND ELEVATION TO THE PROJECT MANAGER PRIOR TO CONSTRUCTION.
- 4. ALL FORM WORK ELEVATIONS SHALL BE SET AND CHECKED RELATIVE TO THE (T.B.M) PRIOR TO CONSTRUCTING HARDSCAPE ELEMENTS INCLUDING BUT NOT LIMITED TO CURBS, SIDEWALKS, STEPS, AND WALLS. IT IS THE CONTRACTOR'S RESPONSIBILITY TO EMPLOY A REGISTERED SURVEYOR TO EXECUTE HORIZONTAL LAYOUT AND VERTICAL CONTROL TO ASSURE PROPER DRAINAGE AND PLACEMENT FOR THE HARDSCAPE ELEMENTS.
- 5. ALL FORM WORK SHALL BE REVIEWED BY LANDSCAPE ARCHITECT OR CLIENT'S REPRESENTATIVE PRIOR TO INSTALLING RAMPS, PLANTERS, OR PAVEMENTS.
- 6. GRADES (ELEVATIONS) SHOULD NOT VARY MORE THAN 1/2" AND MUST STILL ALLOW FOR SAME POSITIVE DRAINAGE RELATIONSHIP TOWARD THE CURB AS ORIGINALLY ESTABLISHED BY THE HARDSCAPE GRADING PLAN.

WALLS BR: BOTTOM OF RAMP

- 7. ALL PLANTERS SHALL BE EXCAVATED TO A DEPTH OF 1'-6" BELOW TOP OF SIDEWALK WALL AND THE SOIL REMOVED FROM THE PROJECT SITE. ALL FILL MATERIAL IN THE LANDSCAPE AREAS SHALL BE FREE FROM ROCKS LARGER THAN 1" AND SOLID ORGANIC MATERIAL AS NOTED ON PLANTING PLANS AND IN THE SPECIFICATIONS. ALL PLANTERS SHALL BE MOUNDED 6" TO THE CENTER.
- 8. THE CONTRACTOR SHALL CLEAN ALL CURBS, PAVEMENTS AND MASONRY SURFACES PRIOR TO THE FINAL INSPECTION.
- 9. THE CONTRACTOR SHALL COMPLETE ALL SITE CLEANUP PRIOR TO FINAL INSPECTION.
- 10. GRADES BETWEEN SPOT ELEVATIONS ARE INTENDED TO BE CONSTANT SLOPES.
- 11.NO FINISHED SLOPES SHALL BE LESS THAN 1 PERCENT AND SHALL HAVE A POSITIVE FLOW INTO THE GUTTER AS SHOWN ON THE GRADING PLAN.
- 12. THE CONTRACTOR SHALL PROVIDE POSITIVE DRAINAGE AT ALL STORM INLETS UNTIL THE FINAL ASPHALT REPAIR WORK IS INSTALLED. COORDINATE AND REVIEW PROCEDURES WITH THE CITY OF MILTON PUBLIC WORKS DEPARTMENT INSPECTOR ON THIS PROJECT
- 13. THE CONTRACTOR IS ADVISED THAT HE IS REQUIRED TO RAISE OR LOWER EXISTING ASPHALT ELEVATIONS IN SOME AREAS TO ACCOMMODATE THE NEW SURFACE DRAINAGE. AS SUCH, HIS BID WILL BE CONSIDERED AS INCLUSIVE OF THIS WORK. THE CONTRACTOR IS ADVISED TO REVIEW THE GRADING PLAN AND VISIT THE SITE TO DETERMINE THE EXTENT OF THIS WORK ELEMENT AS PART OF THE PREPARATION BID.
- 14. THE CONTRACTOR SHALL CONFIRM INVERT ELEVATIONS OF ALL INLETS PRIOR TO BEGINNING DEMOLITION WORK. ANY DISCREPANCY, BETWEEN EXISTING CONDITIONS, AND THE SURVEY, SHALL BE REPORTED TO THE OWNER AND/OR OWNER'S REPRESENTATIVE.
- 15. THE CONTRACTOR SHALL REVIEW PROPOSED DRAINAGE LINE PLACEMENT, SLOPE AND LENGTH WITH THE CITY OF MILTON ENGINEER FOR ALL SITUATIONS.
- 16. SIDEWALKS- GENERAL DESIGN CROSS SLOPE IS 2% MAXIMUM, AS MEASURED PERPENDICULAR (TRANSVERSE) TO THE PRIMARY DIRECTION OF PEDESTRIAN TRAVEL. THE DESIGN SLOPE VARIES IN THE PRIMARY (LONGITUDINAL) DIRECTION OF PEDESTRIAN TRAVEL FROM A MINIMUM OF 1% TO A MAXIMUM OF 4.9%.
- 17.RAMPS MAXIMUM SLOPE IS 8.33%.
- 18. FLOW LINE AGAINST CURB- MINIMUM SLOPE IS 0.5%
- 19. PIPES- MINIMUM SLOPE IS 0.75%
- 20.CURBS- CURB HEIGHT MAY VARY FROM 4" 6"
- 21.CONTRACTOR TO REBUILD AS NECESSARY, EXISTING DRAIN INLETS SHALL BE RECONSTRUCTED TO STANDARD GDOT NUMBER 1011-A MANHOLES.
- 22. THE GENERAL CONTRACTOR SHALL MAINTAIN OR ADJUST TO NEW FINISH GRADE AS NECESSARY ALL UTILITY AND SITE STRUCTURES SUCH AS LIGHT POLES, SIGN POLES, MANHOLES, CATCH BASINS, HAND HOLES, WATER AND GAS GATES, HYDRANTS, ETC. UNLESS OTHERWISE NOTED ON THE PLANS OR AS DIRECTED BY THE OWNER'S REPRESENTATIVE. IN THE EVENT A UTILITY OWNER IS TO RELOCATE ITS OWN FACILITIES, THE CONTRACTOR SHALL COORDINATE HIS WORK WITH THESE COMPANIES AND SHALL NOTIFY THEM OF WORK AFFECTING THEIR FACILITIES IN ADVANCE.
- 23. THE CONTRACTOR SHALL REMOVE ALL SILT AND DEBRIS FROM EXISTING DRAINAGE STRUCTURES, PIPES AND CULVERTS THAT ARE RETAINED BEFORE ANY WORK BEGINS AND AT THE COMPLETION OF THE PROJECT. THE COST OF THIS WORK SHALL BE INCLUDED IN THE PRICE FOR GRADING COMPLETE.
- 24.WHERE NEW PAVING MEETS EXISTING PAVING, MEET LINE AND GRADE OF EXISTING WITH NEW CONSTRUCTION.
- 25.FINISH GRADES: THE CONTRACTOR SHALL BE RESPONSIBLE FOR ENSURING THAT ALL NEW SIDEWALK AREAS ARE GRADED TO DRAIN, EITHER TO EXISTING OR NEW STRUCTURES. CONTRACTOR SHALL BE RESPONSIBLE FOR ENSURING COMPLIANCE WITH ALL FEDERAL, STATE AND LOCAL ACCESSIBILITY CODES.

MAINTENANCE OF TRAFFIC AS PER FDOT INDEX

1. THE CONTRACTOR SHALL TAKE STEPS NECESSARY TO PREVENT EROSION AND ANY OFF-SITE SEDIMENT TRANSPORT RESULTING FROM INCREASED RUNOFF DURING CONSTRUCTION BY PROVIDING SILT FENCE AND/OR STAKED HAY BALES AS REQUIRED BY FDOT INDEX 102, THE FLORIDA STORMWATER, EROSION, AND SEDIMENT CONTROL INSPECTOR'S MANUAL, 2000 EDITION, OR AS INDICATED ON THE PLANS. ALL EROSION CONTROL MEASURES SHALL REMAIN IN PLACE UNTIL ASSOCIATED DISTURBED AREAS ARE STABILIZED AS TO REDUCE SEDIMENT RUNOFF, UNLESS OTHERWISE DIRECTED BY THE ENGINEER OR DESIGN

BID ALTERNATES:

BID ALTERNATES

ALTERNATE	ALT.
ALT 01	CONCRETE PAVING AND STRUCTURES
ALT 02	Site Furniture Group 1
ALT 03	DRINKING FOUNTAINS
ALT 04	SITE FURNITURE Group 2
ALT 05	PARKING LOT STRIPING
ALT 06	RESTROOM UPGRADES
ALT 07	Crosswalk

DESCRIPTION

Furnish and install all proposed materials and work associated with exterior concrete paving and cast in place concrete work including base, concrete sidewalks, walls, steps, detectable warning surfaces, and reinforcing as required by the plans. Site grading shall be covered in the base bid. This work shall not include any concrete work within the area marked Interactive Water Feature, or railings associates with stairs Furnish and install all proposed materials and work associated with the site furniture near the Interactive Water Feature to

Furnish and install all proposed materials and work associated with 2 Drinking Fountains including all required utilities from the from the point of connection at the water meter. Furnish and install all proposed materials and work associated the site furniture to include: 12 Bike Racks, 6 Trash Cans, and 1

include: 5 Benches, 8 Umbrellas, and 8 Tables

Bench Furnish and install all proposed materials and work associated the new thermoplastic striping within the existing parking lot. Work shall include removal of existing striping. Furnish and install all proposed materials and work associated

with interior upgrades to the restroom building.

Furnish and install all proposed materials and work associated with the new pedestrian cross walk at Munson Highway. This work will include all signage, beacons, and pavement striping.





project title Carpenter's Park Phase 1 Milton, Florida fог

northarrow + scale

City of Milton 6738 Dixon Street Milton, Florida 32570

drawing information project number: contact: drawn by: checked by: scale:


18157 Brvan Bavs Kristin L'Esperance Bryan Bays

drawing date January 21, 2019 sheet title

General notes

sheet number

- 1. CONTRACTOR TO COORDINATE ALL SITE WALLS AND PAVING WITH IRRIGATION LAYOUT PRIOR TO COMMENCEMENT OF WORK. ALL PIPES ARE TO BE SLEEVED AND CONCEALED FROM VIEW.
- 2. CONTRACTOR TO BE FAMILIAR WITH ALL SITE PLANS PRIOR TO INSTALLATION OF ANY ELEMENT WITHIN THIS SHEET SET. ANY DISCREPANCY IS TO BE BROUGHT TO THE ATTENTION OF THE LANDSCAPE ARCHITECT/OWNER.
- 3. CONTRACTOR SHALL VERIFY QUANTITIES BASED ON THE PLANS PRIOR TO BEGINNING CONSTRUCTION.
- 4. INTERACTIVE WATER FEATURE (IWF) POOL AREA TO BE NO MORE THAN 2,499 SF, AND IS A FLOW-THROUGH / SINGLE-PASS SYSTEM THAT DOES NOT REQUIRE FHD PERMITTING.
- 5. CONTRACTOR TO COORDINATE WITH CITY ON THE TIMING OF THE ITEMS THE CITY IS RESPONSIBLE FOR AND THEIR EFFECTS ON THE PROJECT TIMELINE.

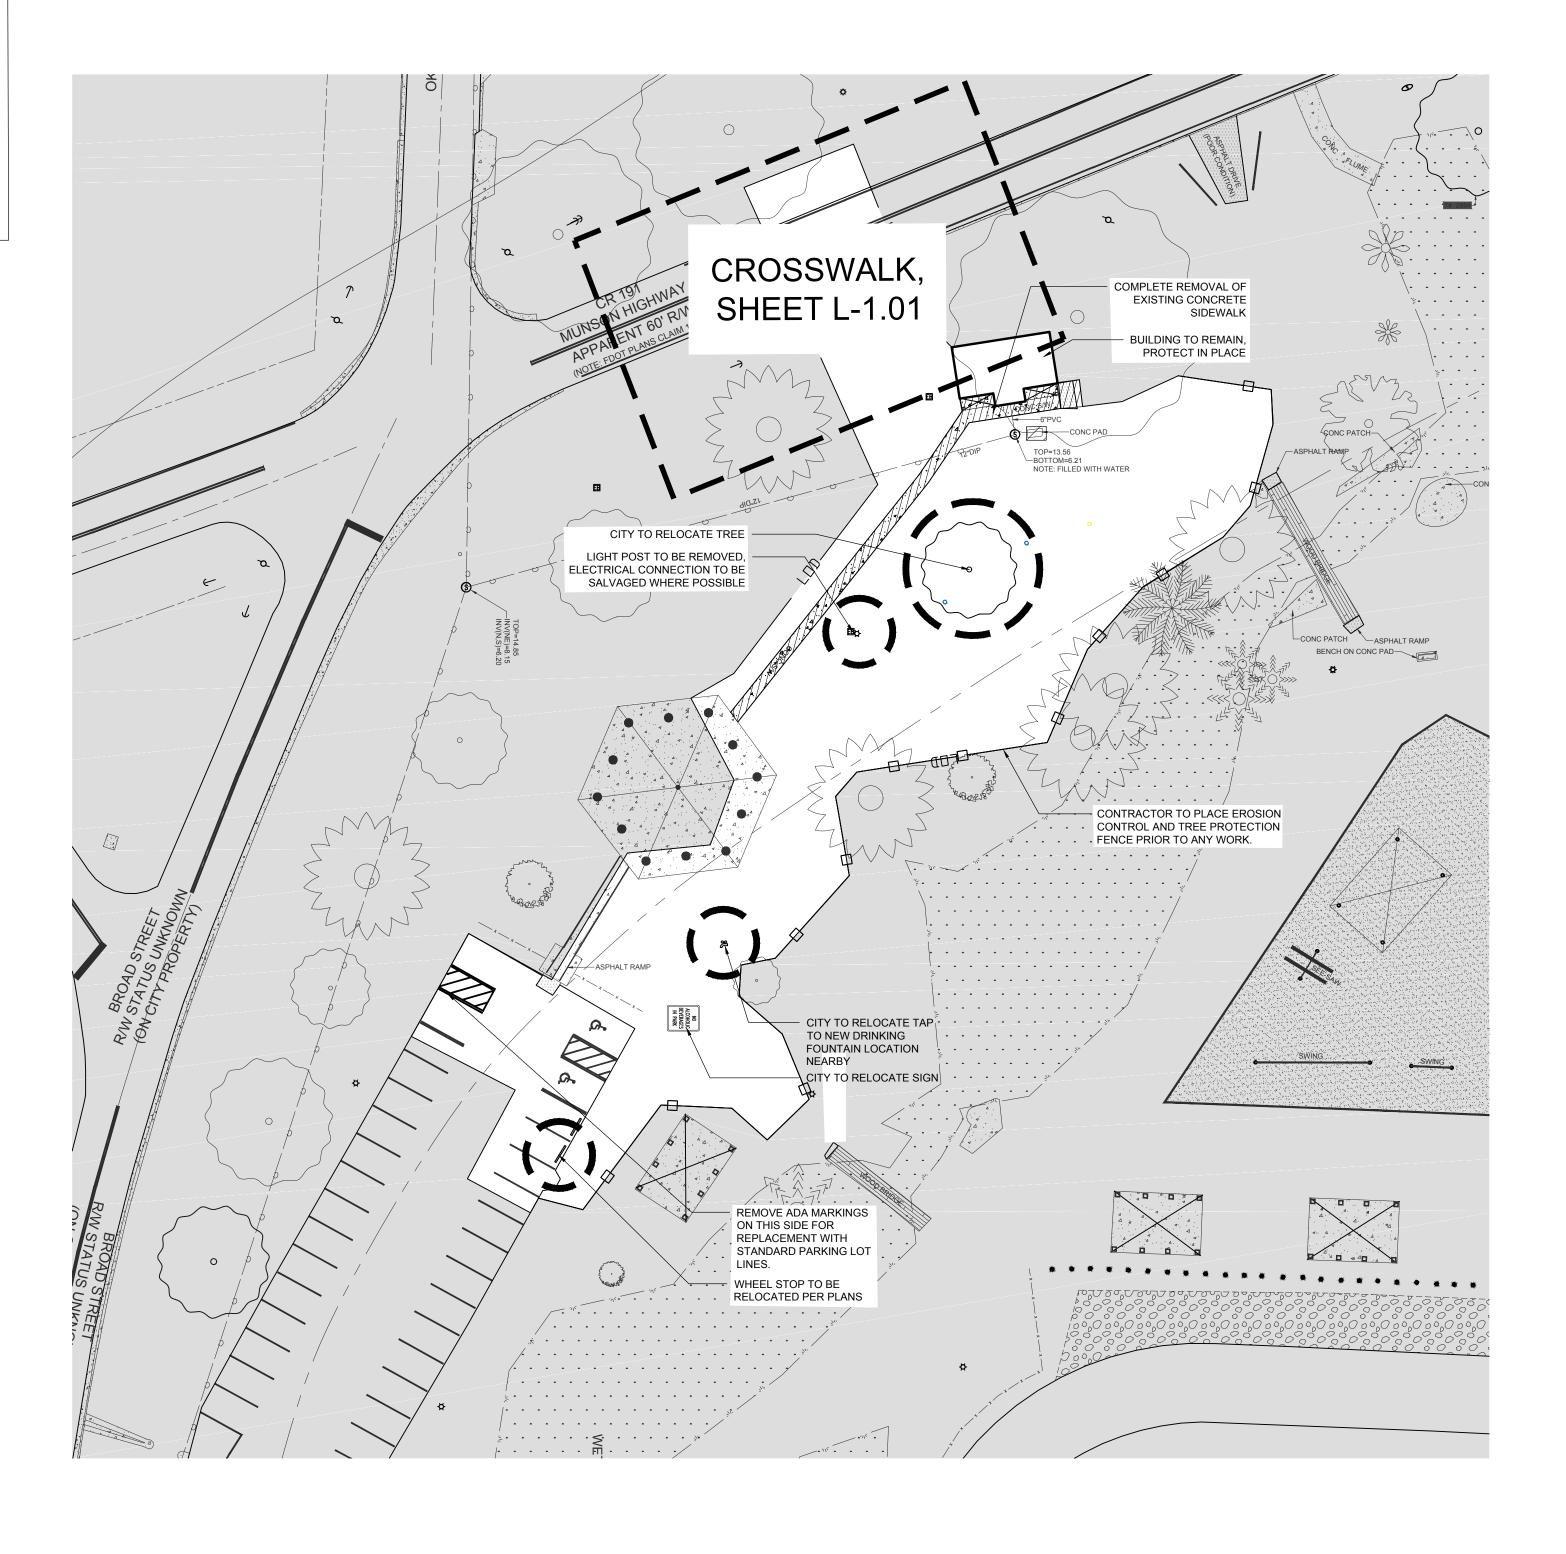





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revisions

_northarrow + scale



for City of Milton 6738 Dixon Street Milton, Florida 32570


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18157 Bryan Bays Kristin L'Esperance Bryan Bays 1'' = 30'-0''


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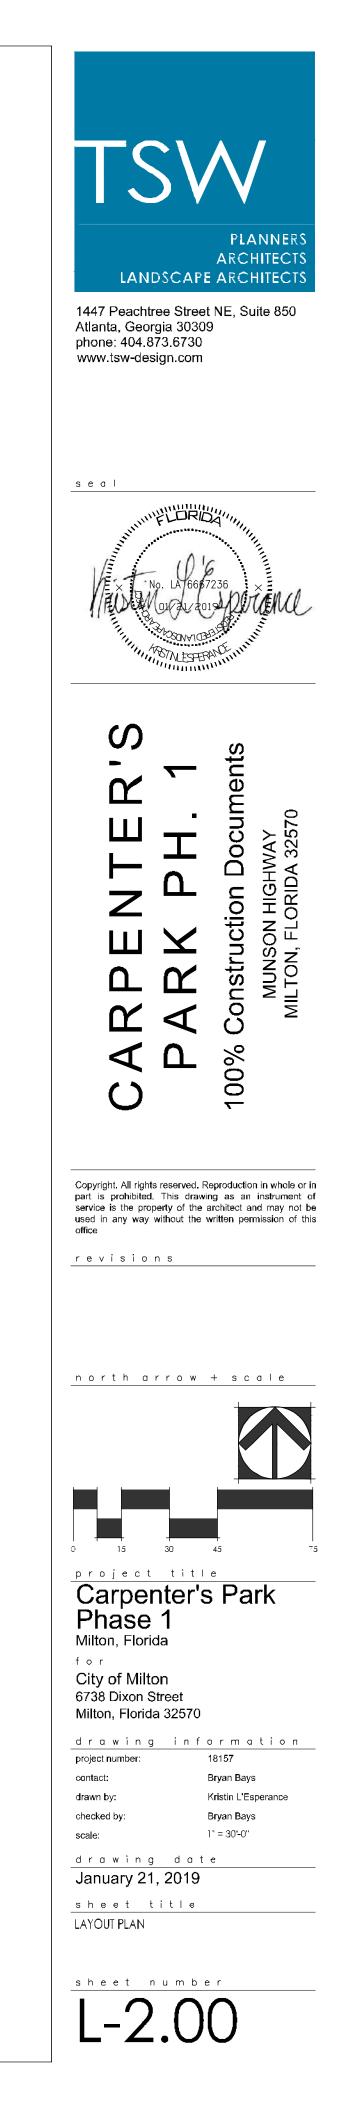
sheet title DEMOLITION PLAN

sheet number L-




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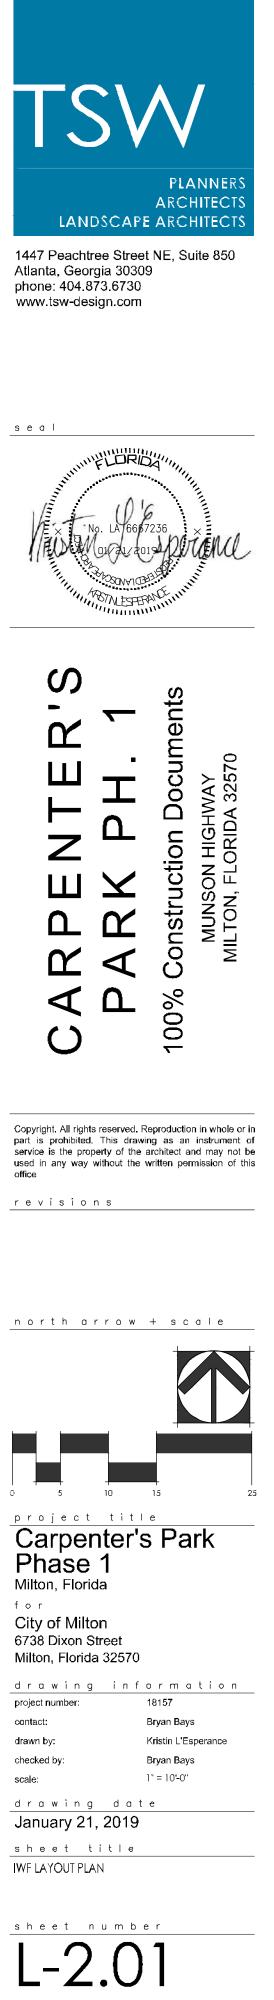


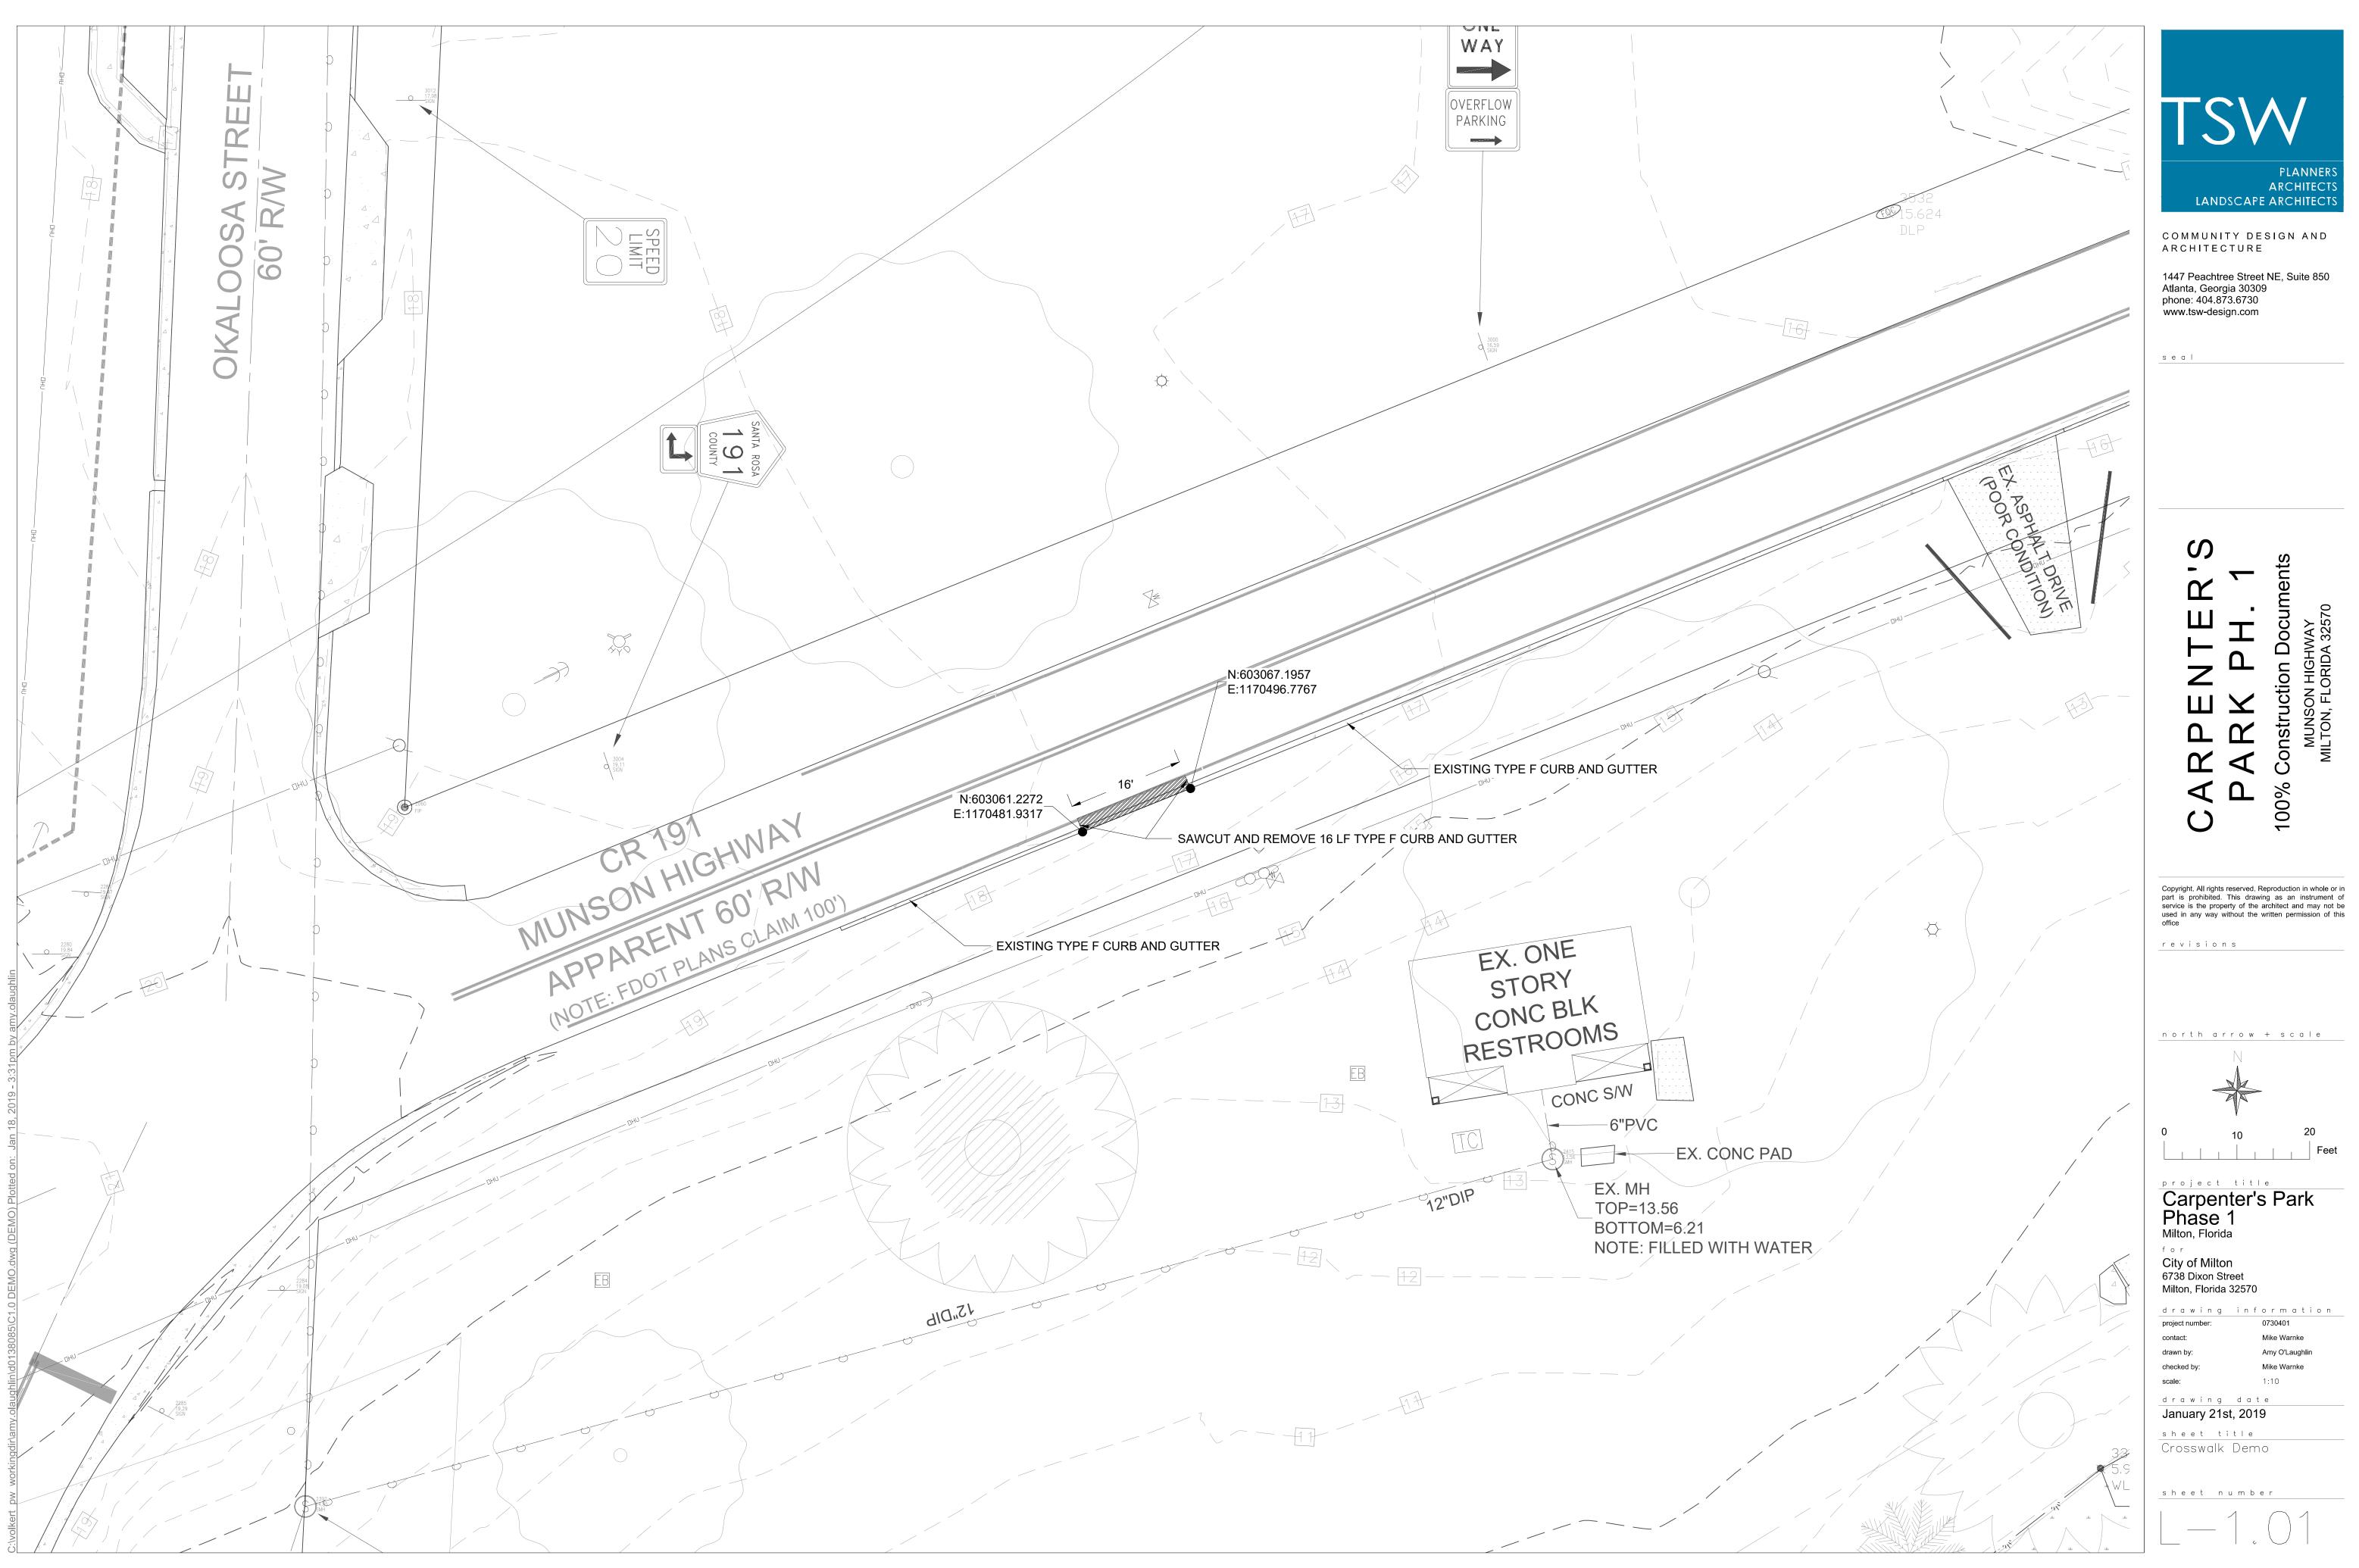


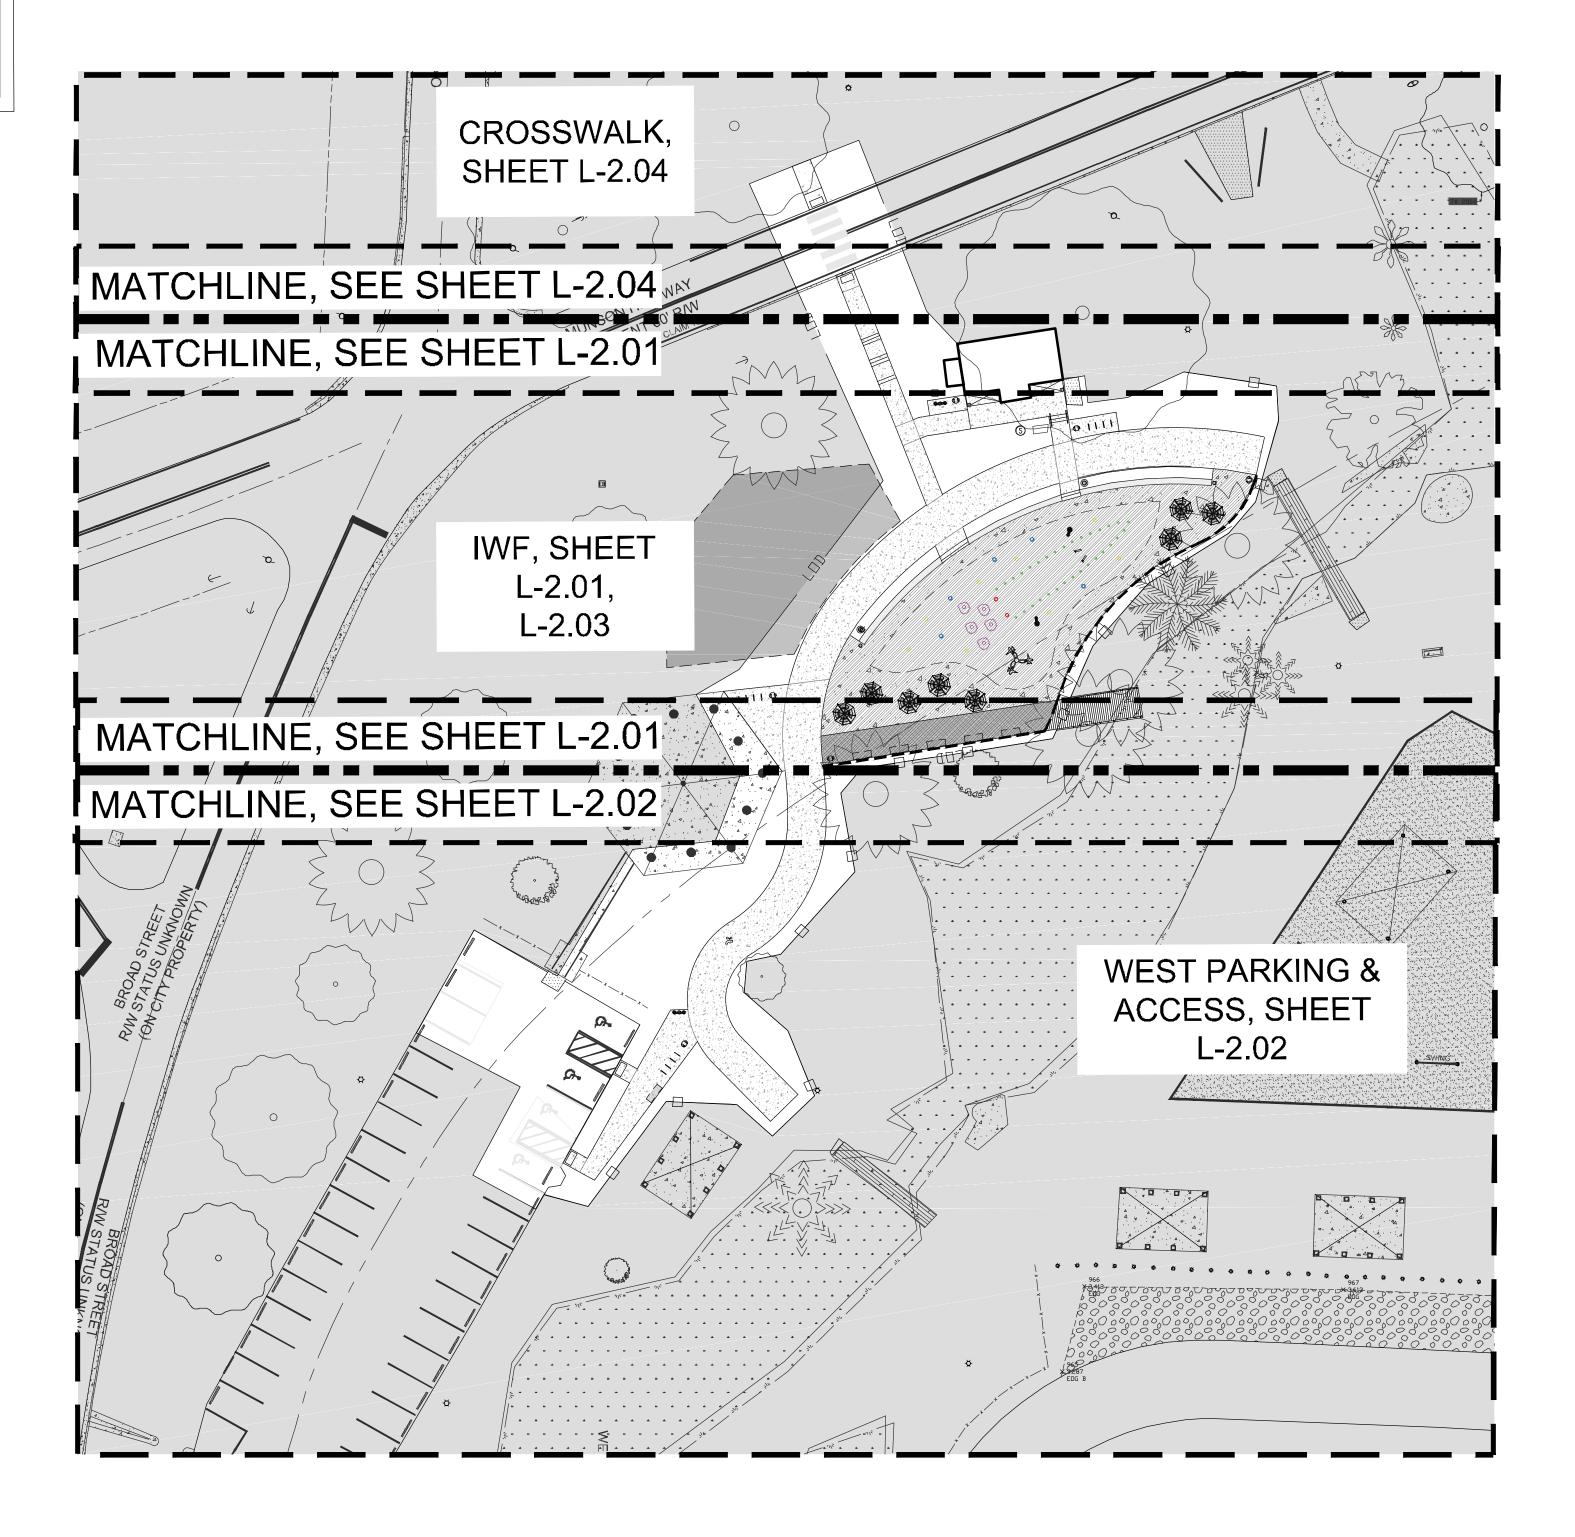
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\bigcirc	LANDSCAPE ITEMS	DET/SHT
1	CONCRETE PAVING (PLAIN)	2 / L-7.00; 1 / L-7.01
2	INTERACTIVE WATER FEATURE (IWF)	L-2.03; IWF-1.00/1.01
3	NEW POOL LIGHT	E-1.00; E-1.01
4	ADA RAMP	4 / L-7.05
5	ADA DETECTABLE WARNING	2 / L-7.00; 5 / L-7.05
6	CONCRETE STAIRS	4 / L-7.02
7	TURN DOWN SLAB	2 / L-7.01
8	CONCRETE SEAT WALL	2 / L-7.02
9	WOOD BOARDWALK	1 / L-7.03
10	WHEEL STOP	RELOCATED EXISTING
11	UMBRELLAS & TABLES	1 / L-7.00
12	STANDARD BENCH	1/L-7.00; 1 / L-7.02
13	BIKE RACKS	1 / L-7.00
14	WASTE RECEPTACLE	2 / L-7.00
15	NEW PUMP HOUSE	A-0.01
16	HANDRAIL	3, 4 / L-7.02
17	DRINKING FOUNTAIN	1 / L-7.00
18	IWF SHOWER	1 / L-7.00; 3 / L-7.01
19	CONCRETE PAVING (STAINED)- A	L-2.03; 2 / L-7.00; 1 / L-7.01
20	CONCRETE PAVING (STAINED)- B	L-2.03; 2 / L-7.00; 1 / L-7.01
21	CONCRETE PAVING (STAINED)- C	L-2.03; 2 / L-7.00; 1 / L-7.01
22	CONCRETE PAVING (STAINED)- D	L-2.03; 2 / L-7.00; 1 / L-7.01
23	CONCRETE PAVING (STAINED)- E	L-2.03; 2 / L-7.00; 1 / L-7.01
24	HANDICAP PARKING SPACE STRIPING, TYP	4/ L-7.05
25	TYPICAL PARKING SPACE STRIPING, TYP	3/ L-7.05





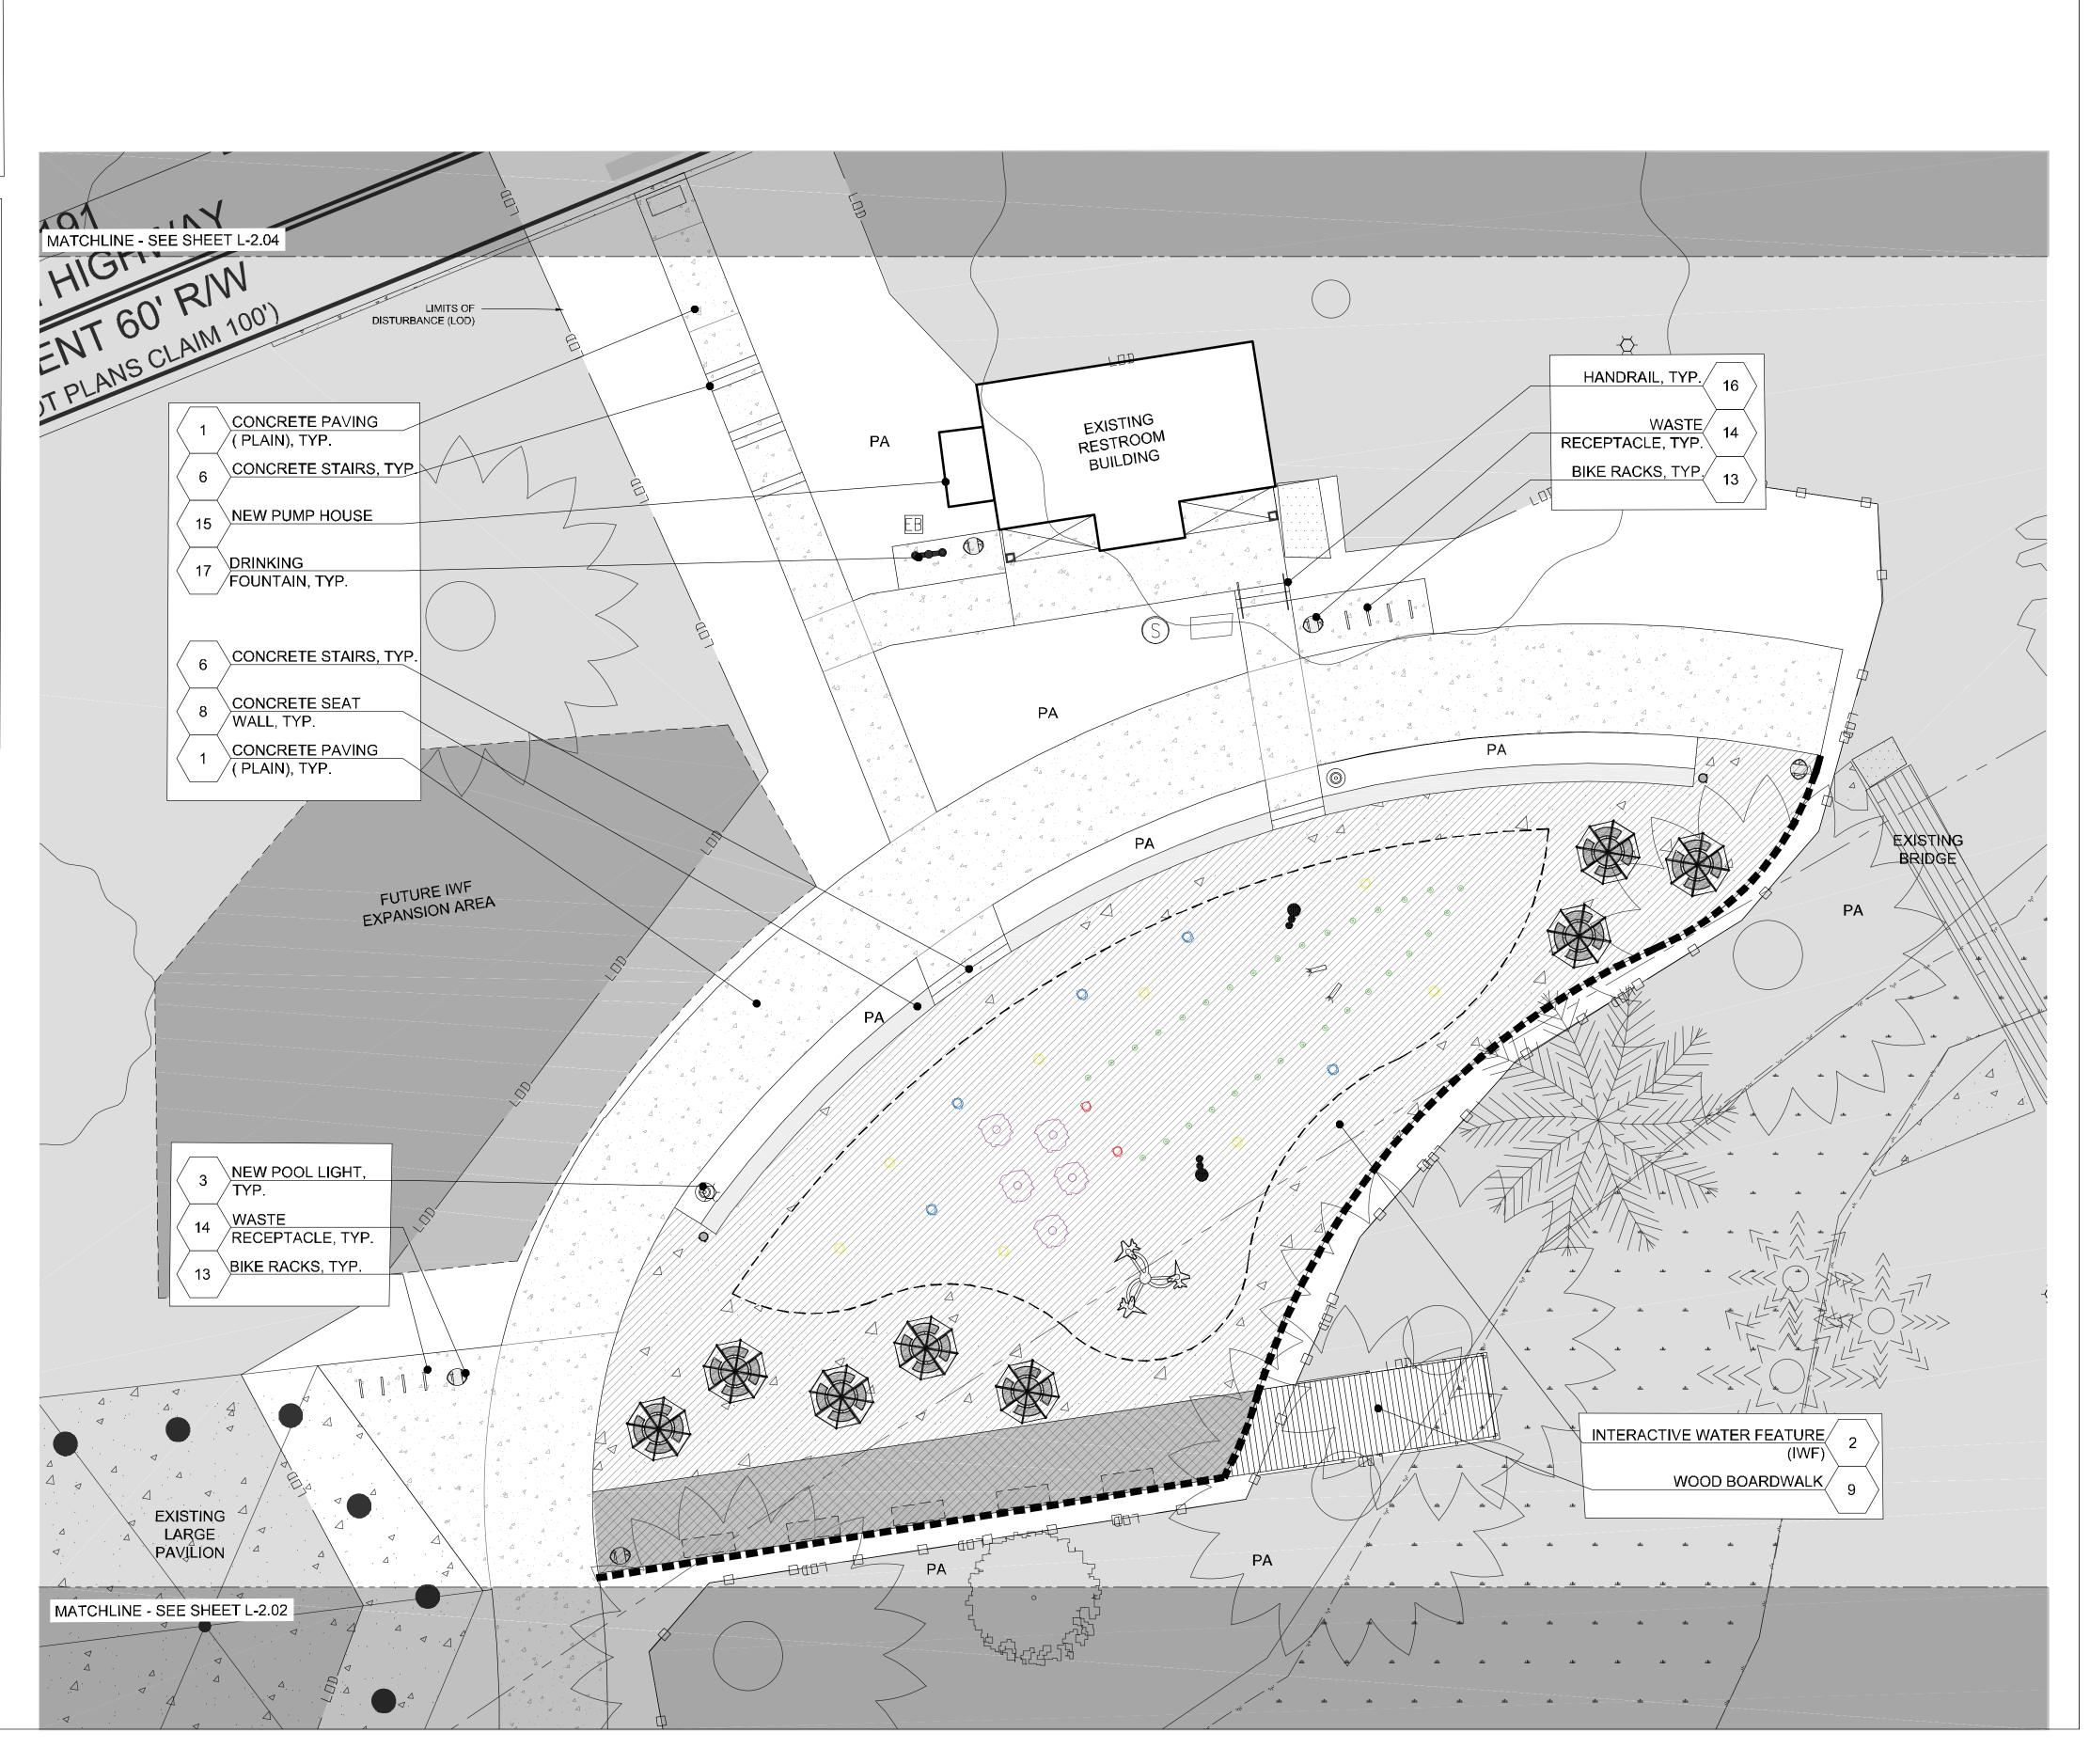


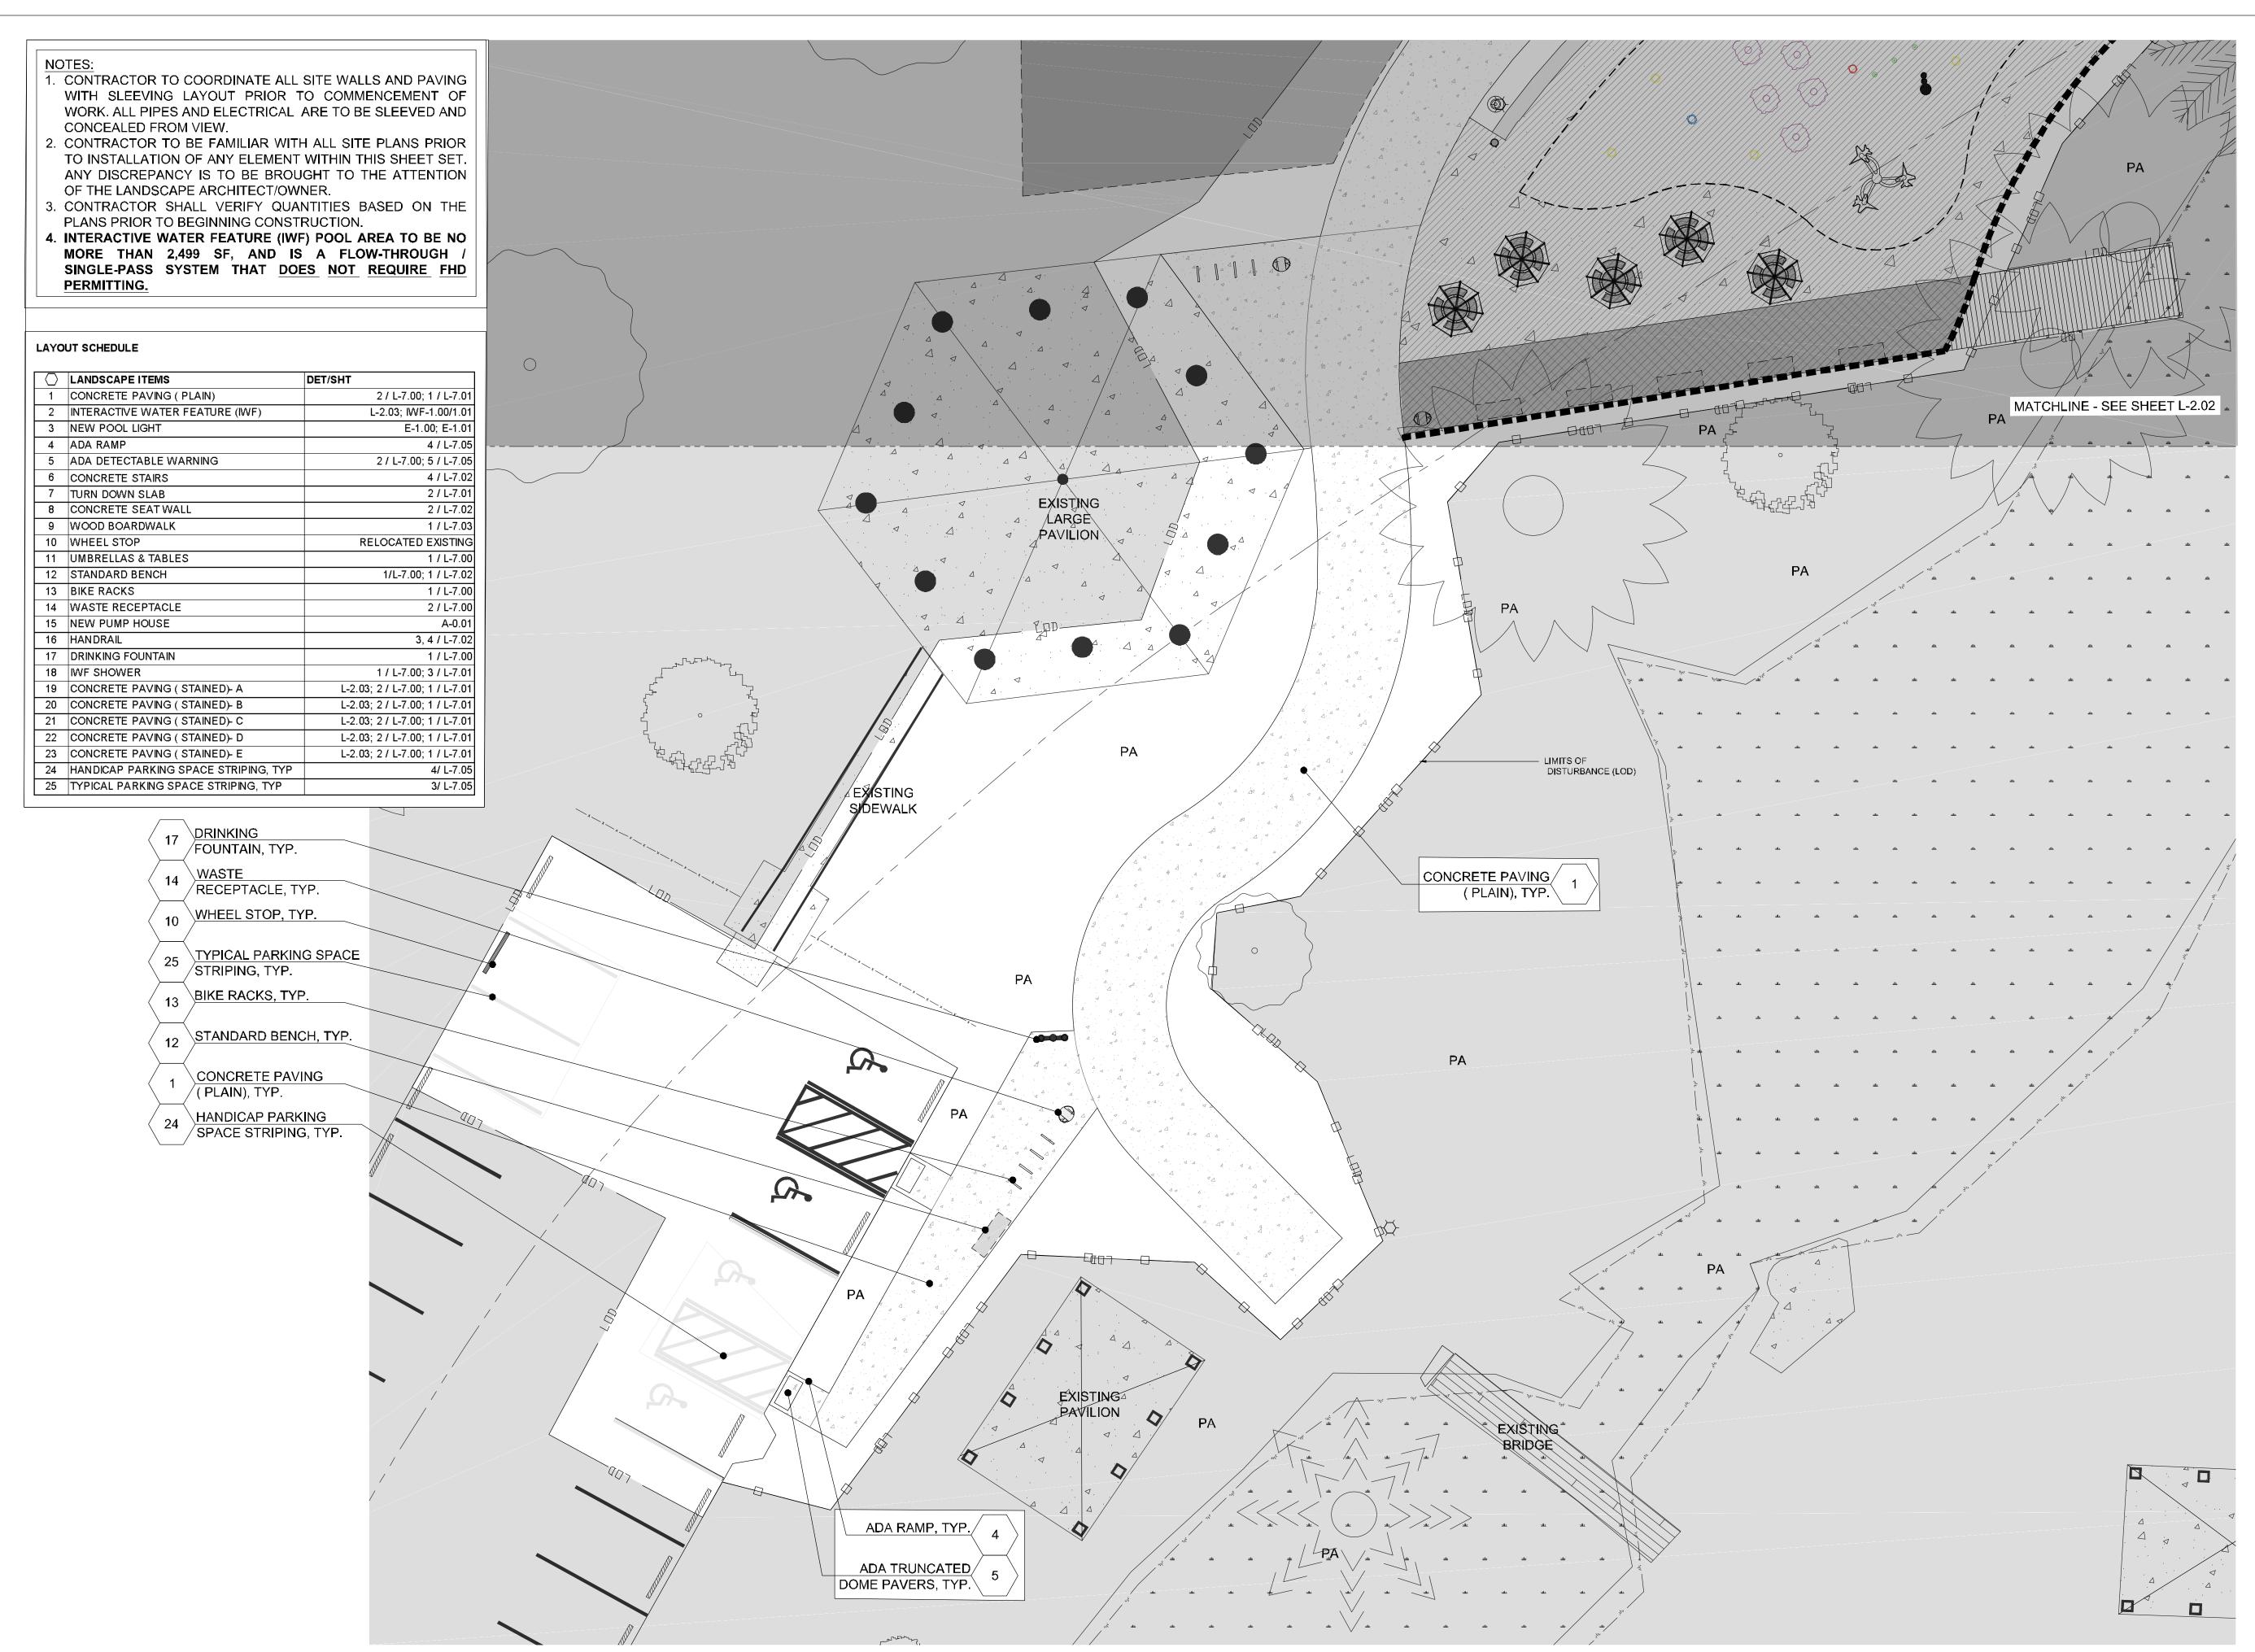

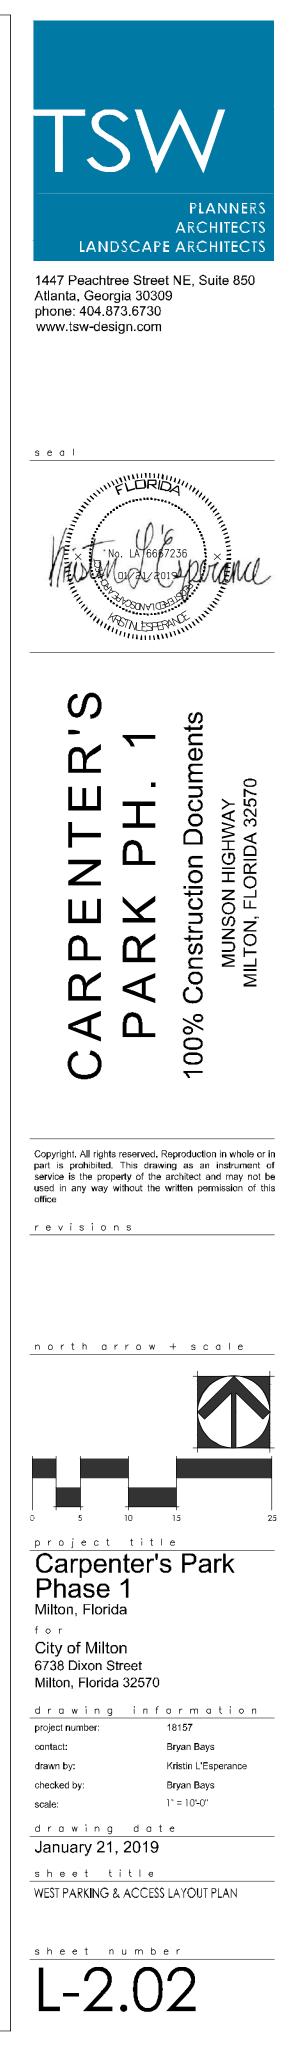



- WORK. ALL PIPES AND ELECTRICAL ARE TO BE SLEEVED AND CONCEALED FROM VIEW.
- SET. ANY DISCREPANCY IS TO BE BROUGHT TO THE ATTENTION OF THE LANDSCAPE ARCHITECT/OWNER.
- SINGLE-PASS SYSTEM THAT DOES NOT REQUIRE FHD PERMITTING.


LAYOUT SCHEDULE				
\bigcirc	LANDSCAPE ITEMS	DET/SHT		
1	CONCRETE PAVING (PLAIN)	2 / L-7.00; 1 / L-7.01		
2	INTERACTIVE WATER FEATURE (IWF)	L-2.03; IWF-1.00/1.01		
3	NEW POOL LIGHT	E-1.00; E-1.01		
4	ADA RAMP	4 / L-7.05		
5	ADA DETECTABLE WARNING	2 / L-7.00; 5 / L-7.05		
6	CONCRETE STAIRS	4 / L-7.02		
7	TURN DOWN SLAB	2 / L-7.01		
8	CONCRETE SEAT WALL	2 / L-7.02		
9	WOOD BOARDWALK	1 / L-7.03		
10	WHEEL STOP	RELOCATED EXISTING		
11	UMBRELLAS & TABLES	1 / L-7.00		
12	STANDARD BENCH	1/L-7.00; 1 / L-7.02		
13	BIKE RACKS	1 / L-7.00		
14	WASTE RECEPTACLE	2 / L-7.00		
15	NEW PUMP HOUSE	A-0.01		
16	HANDRAIL	3, 4 / L-7.02		
17	DRINKING FOUNTAIN	1 / L-7.00		
18	IWF SHOWER	1 / L-7.00; 3 / L-7.01		
19	CONCRETE PAVING (STAINED)- A	L-2.03; 2 / L-7.00; 1 / L-7.01		
20	CONCRETE PAVING (STAINED)- B	L-2.03; 2 / L-7.00; 1 / L-7.01		
21	CONCRETE PAVING (STAINED)- C	L-2.03; 2 / L-7.00; 1 / L-7.01		
22	CONCRETE PAVING (STAINED)- D	L-2.03; 2 / L-7.00; 1 / L-7.01		
23	CONCRETE PAVING (STAINED)- E	L-2.03; 2 / L-7.00; 1 / L-7.01		
24	HANDICAP PARKING SPACE STRIPING, TYP	4/ L-7.05		
25	TYPICAL PARKING SPACE STRIPING, TYP	3/ L-7.05		

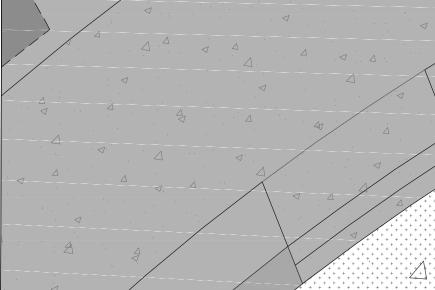





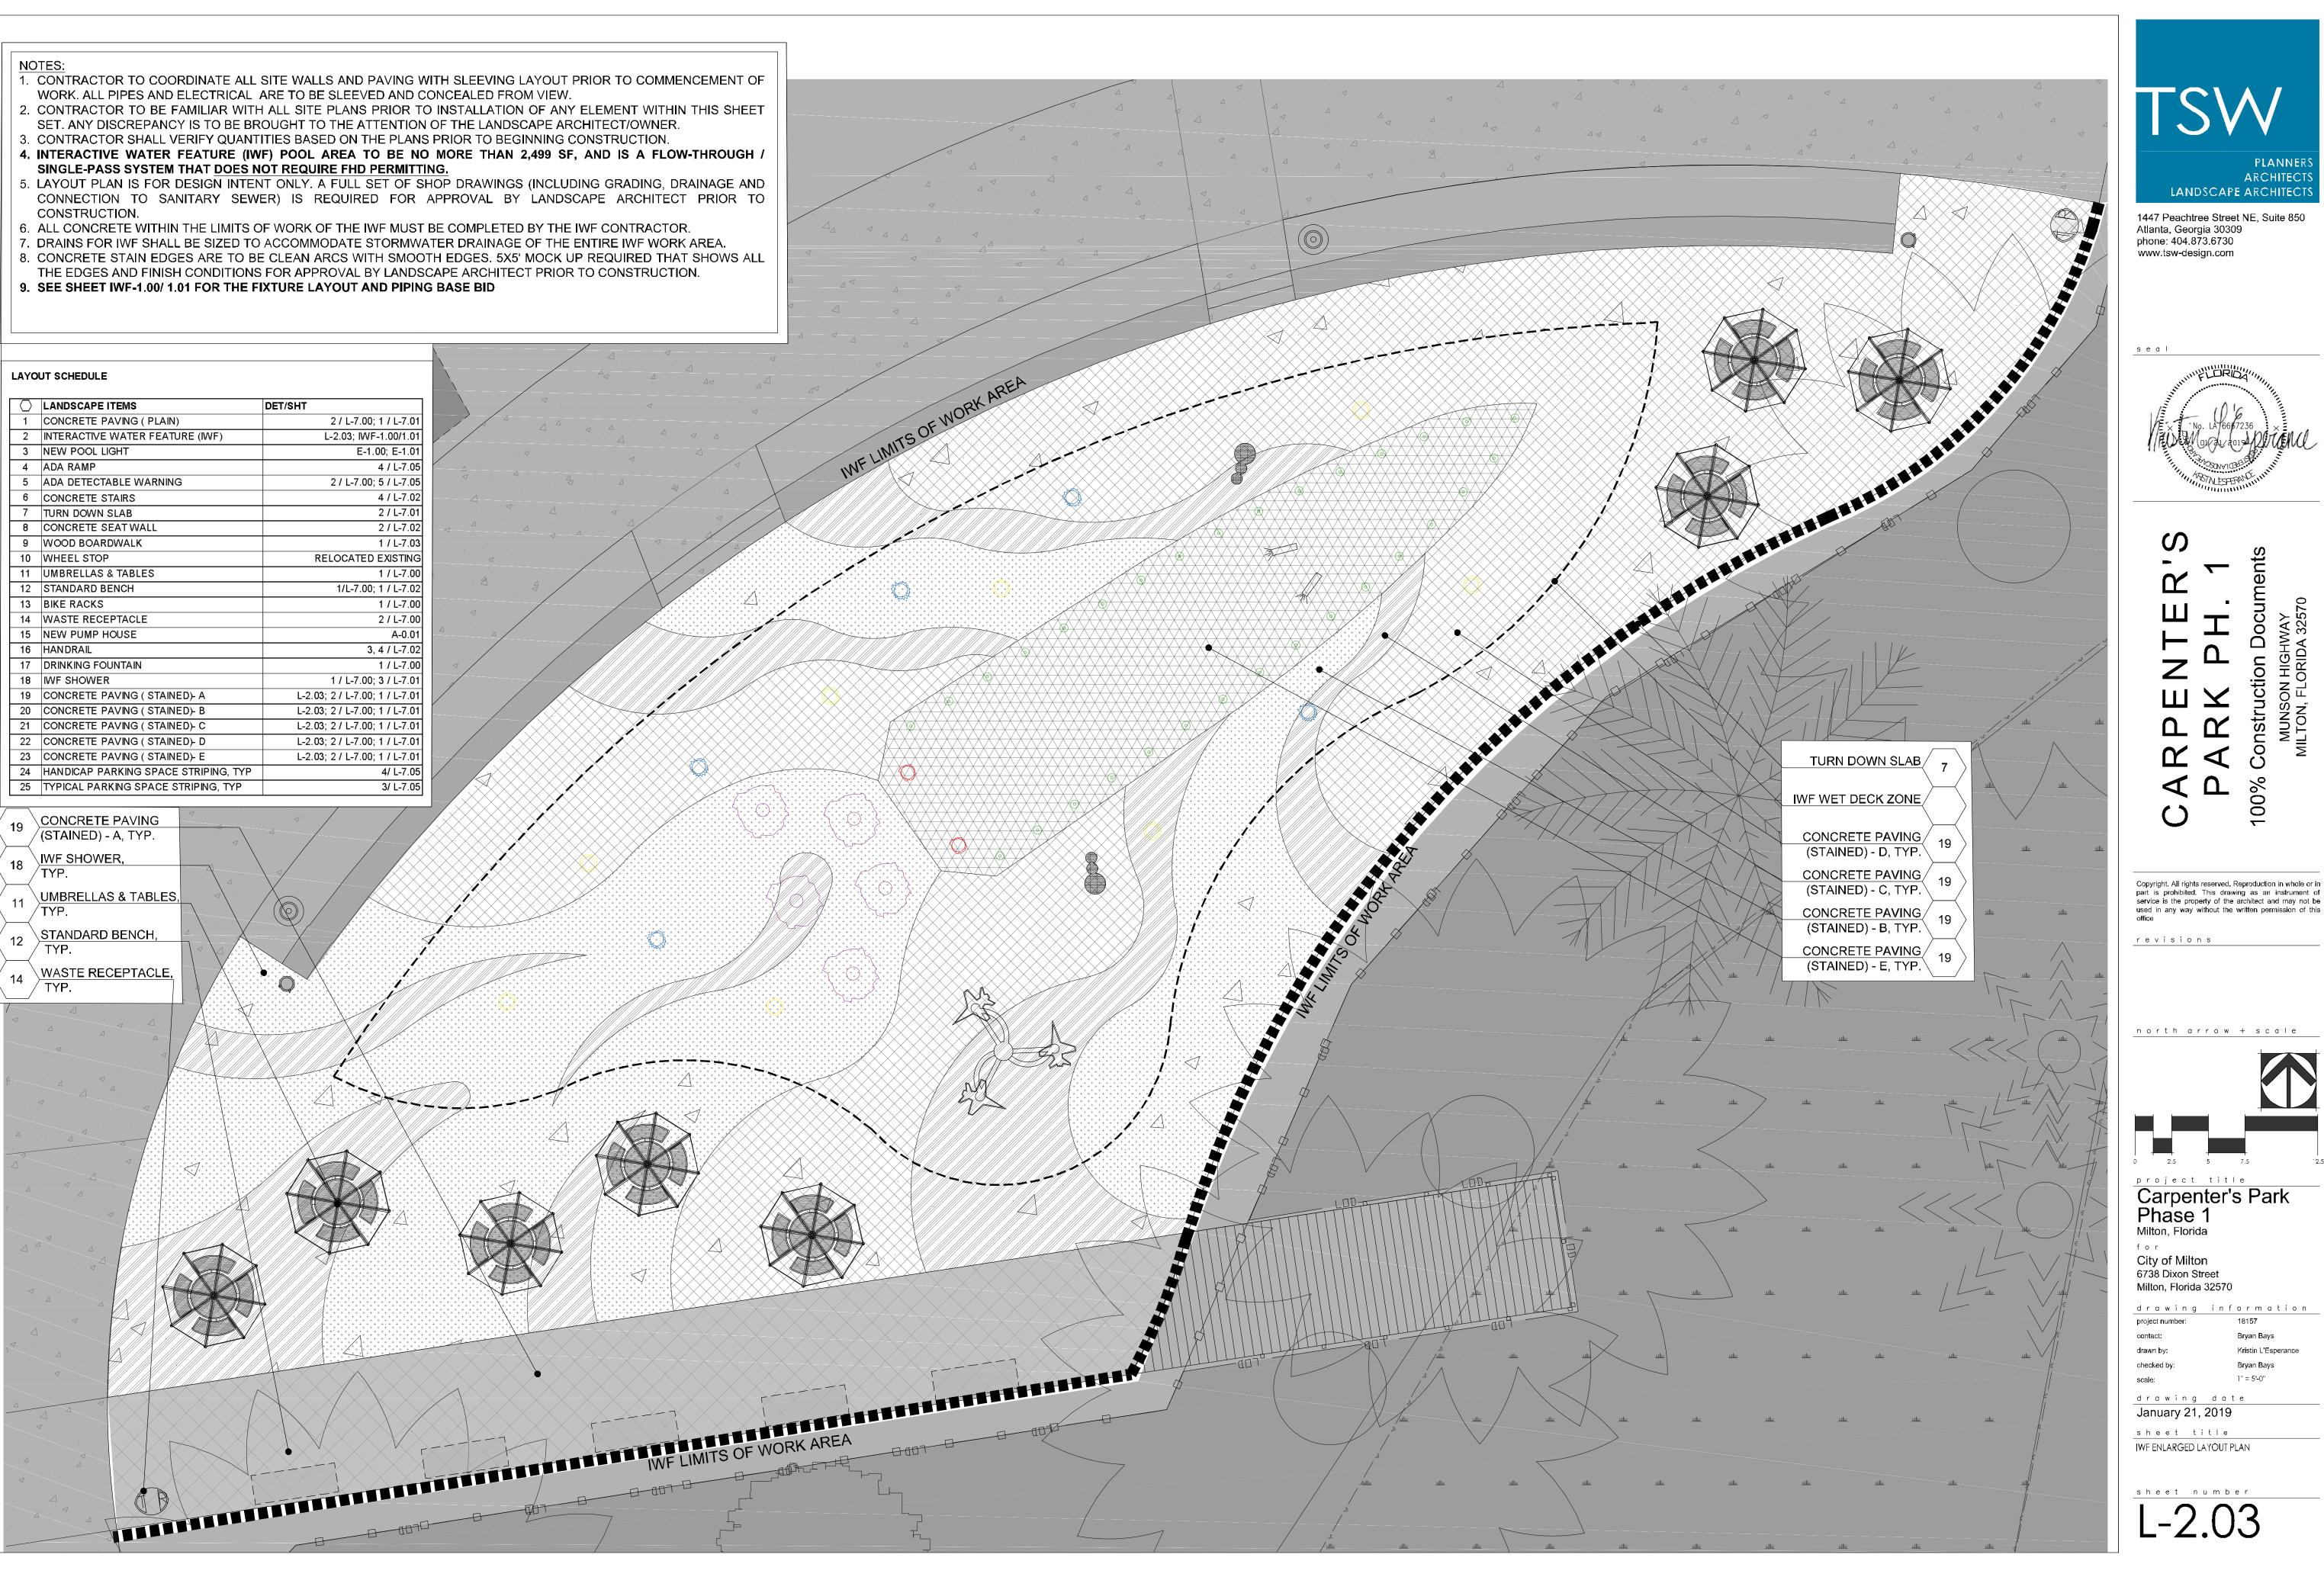


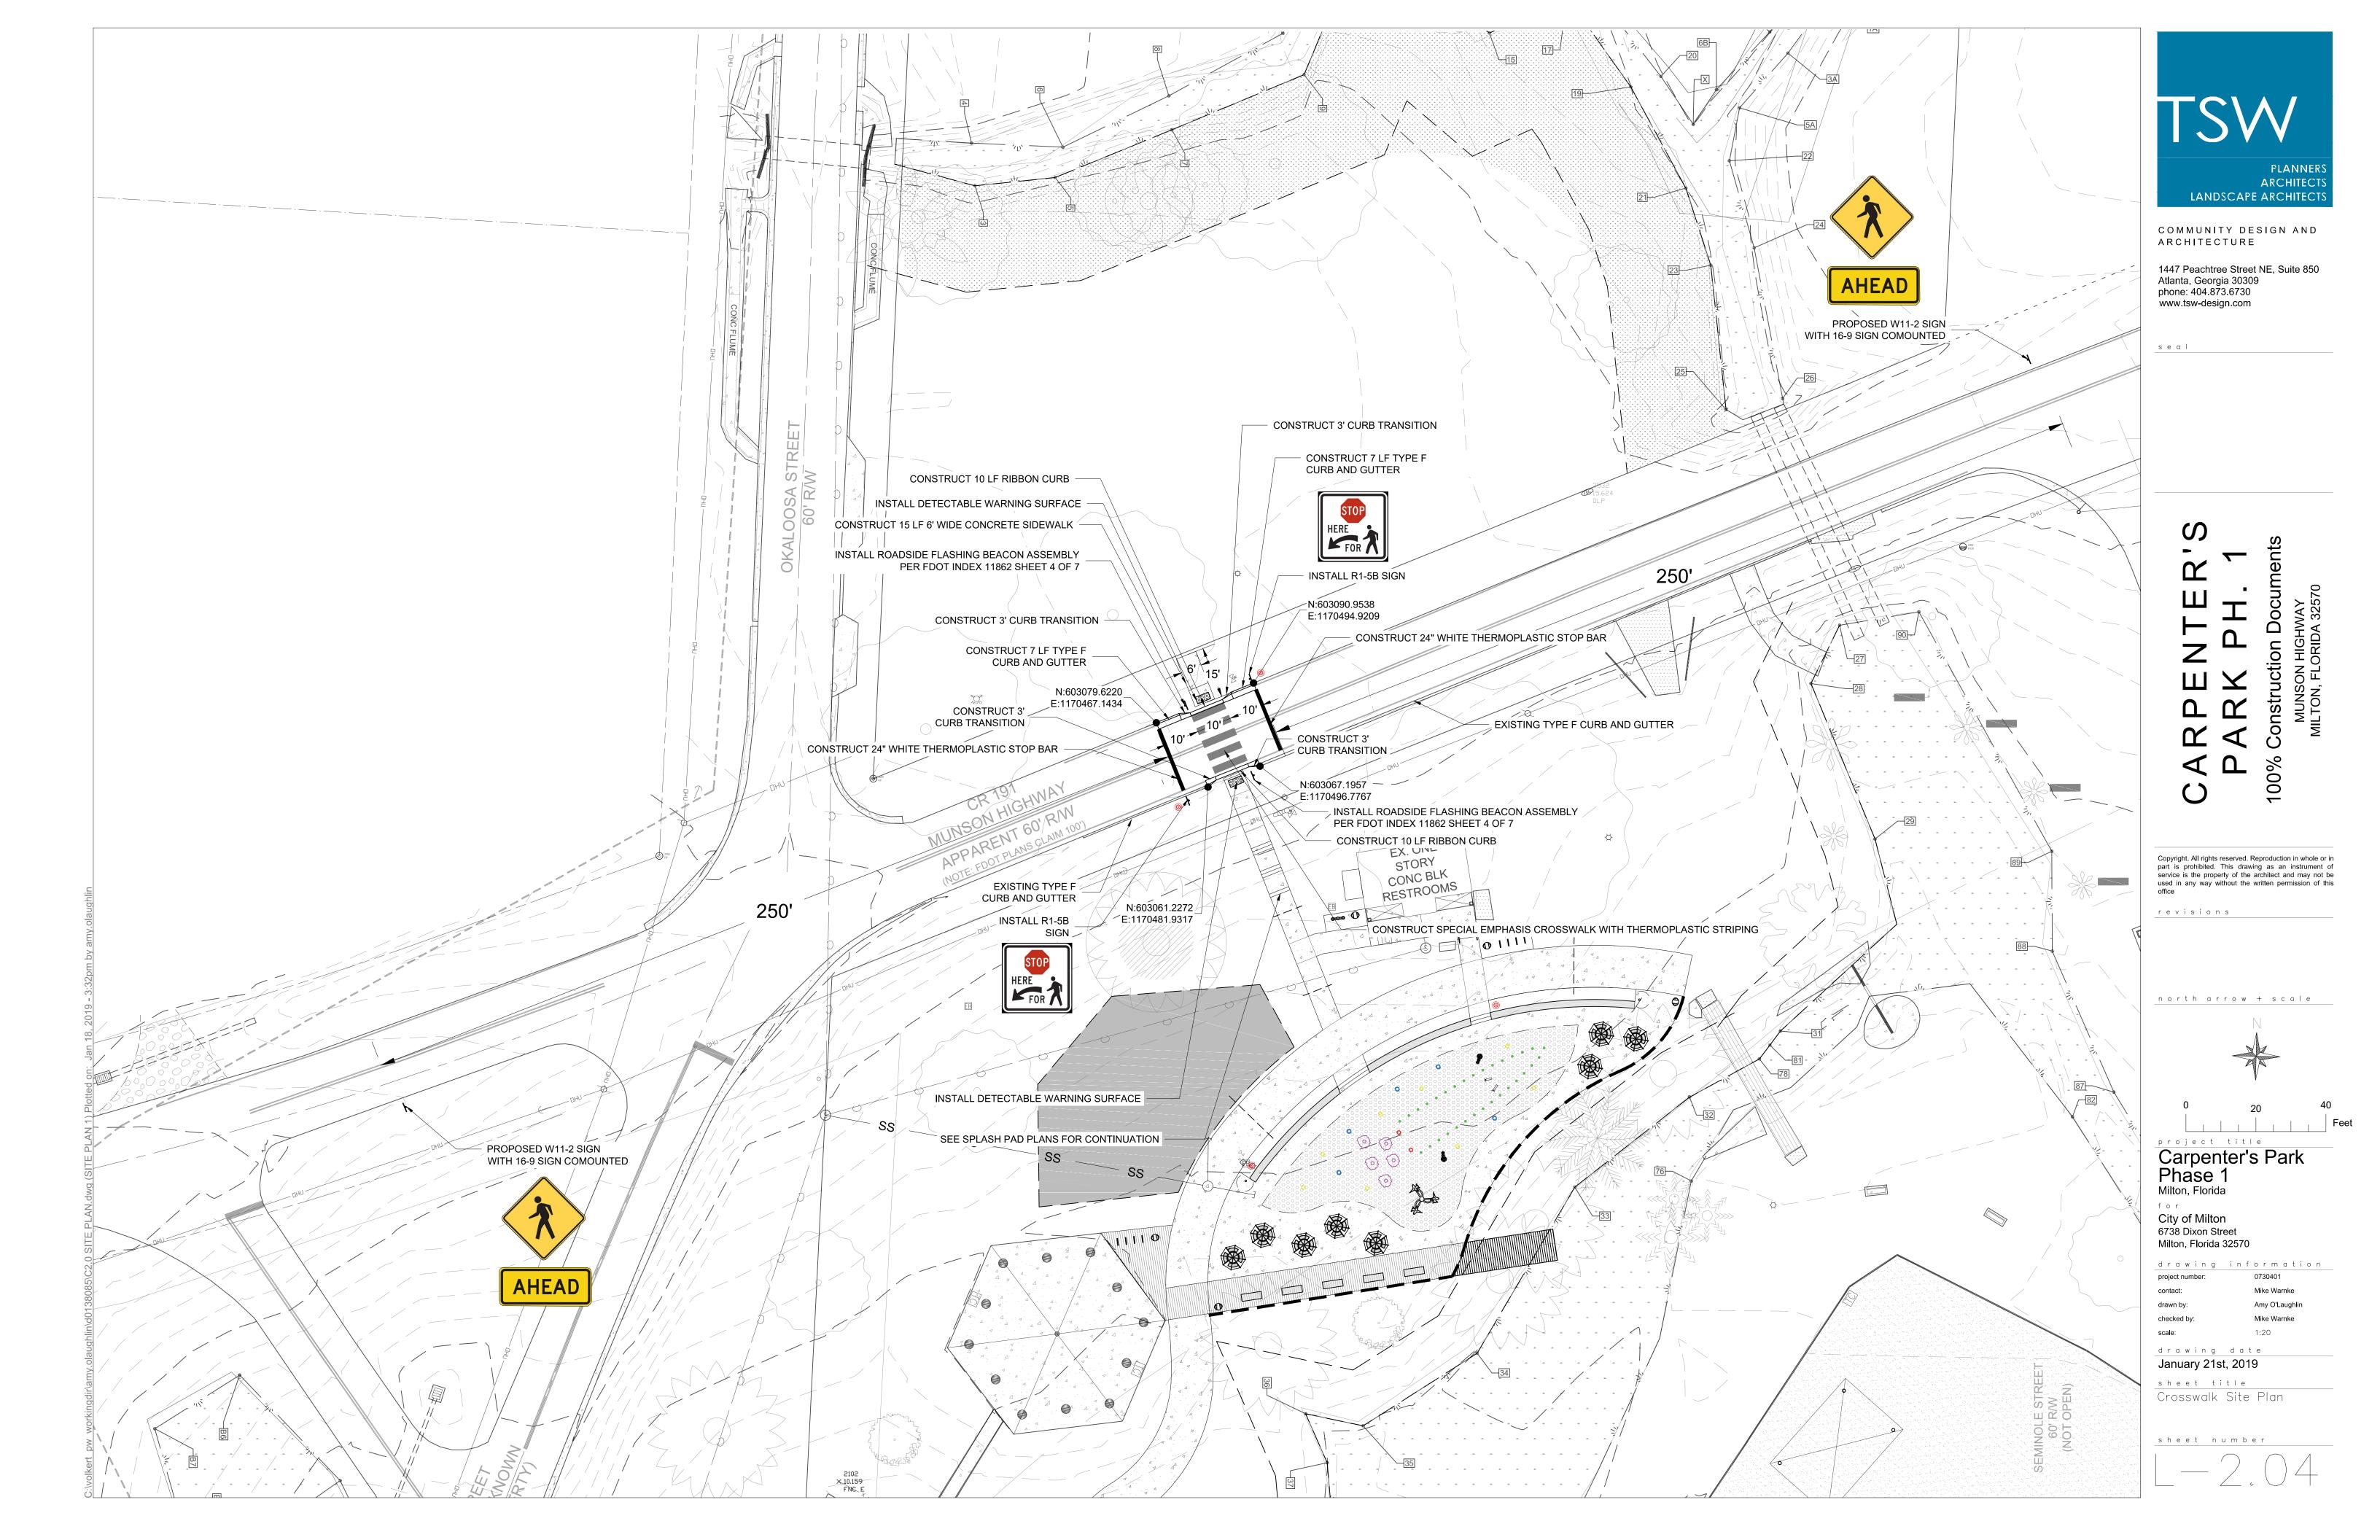

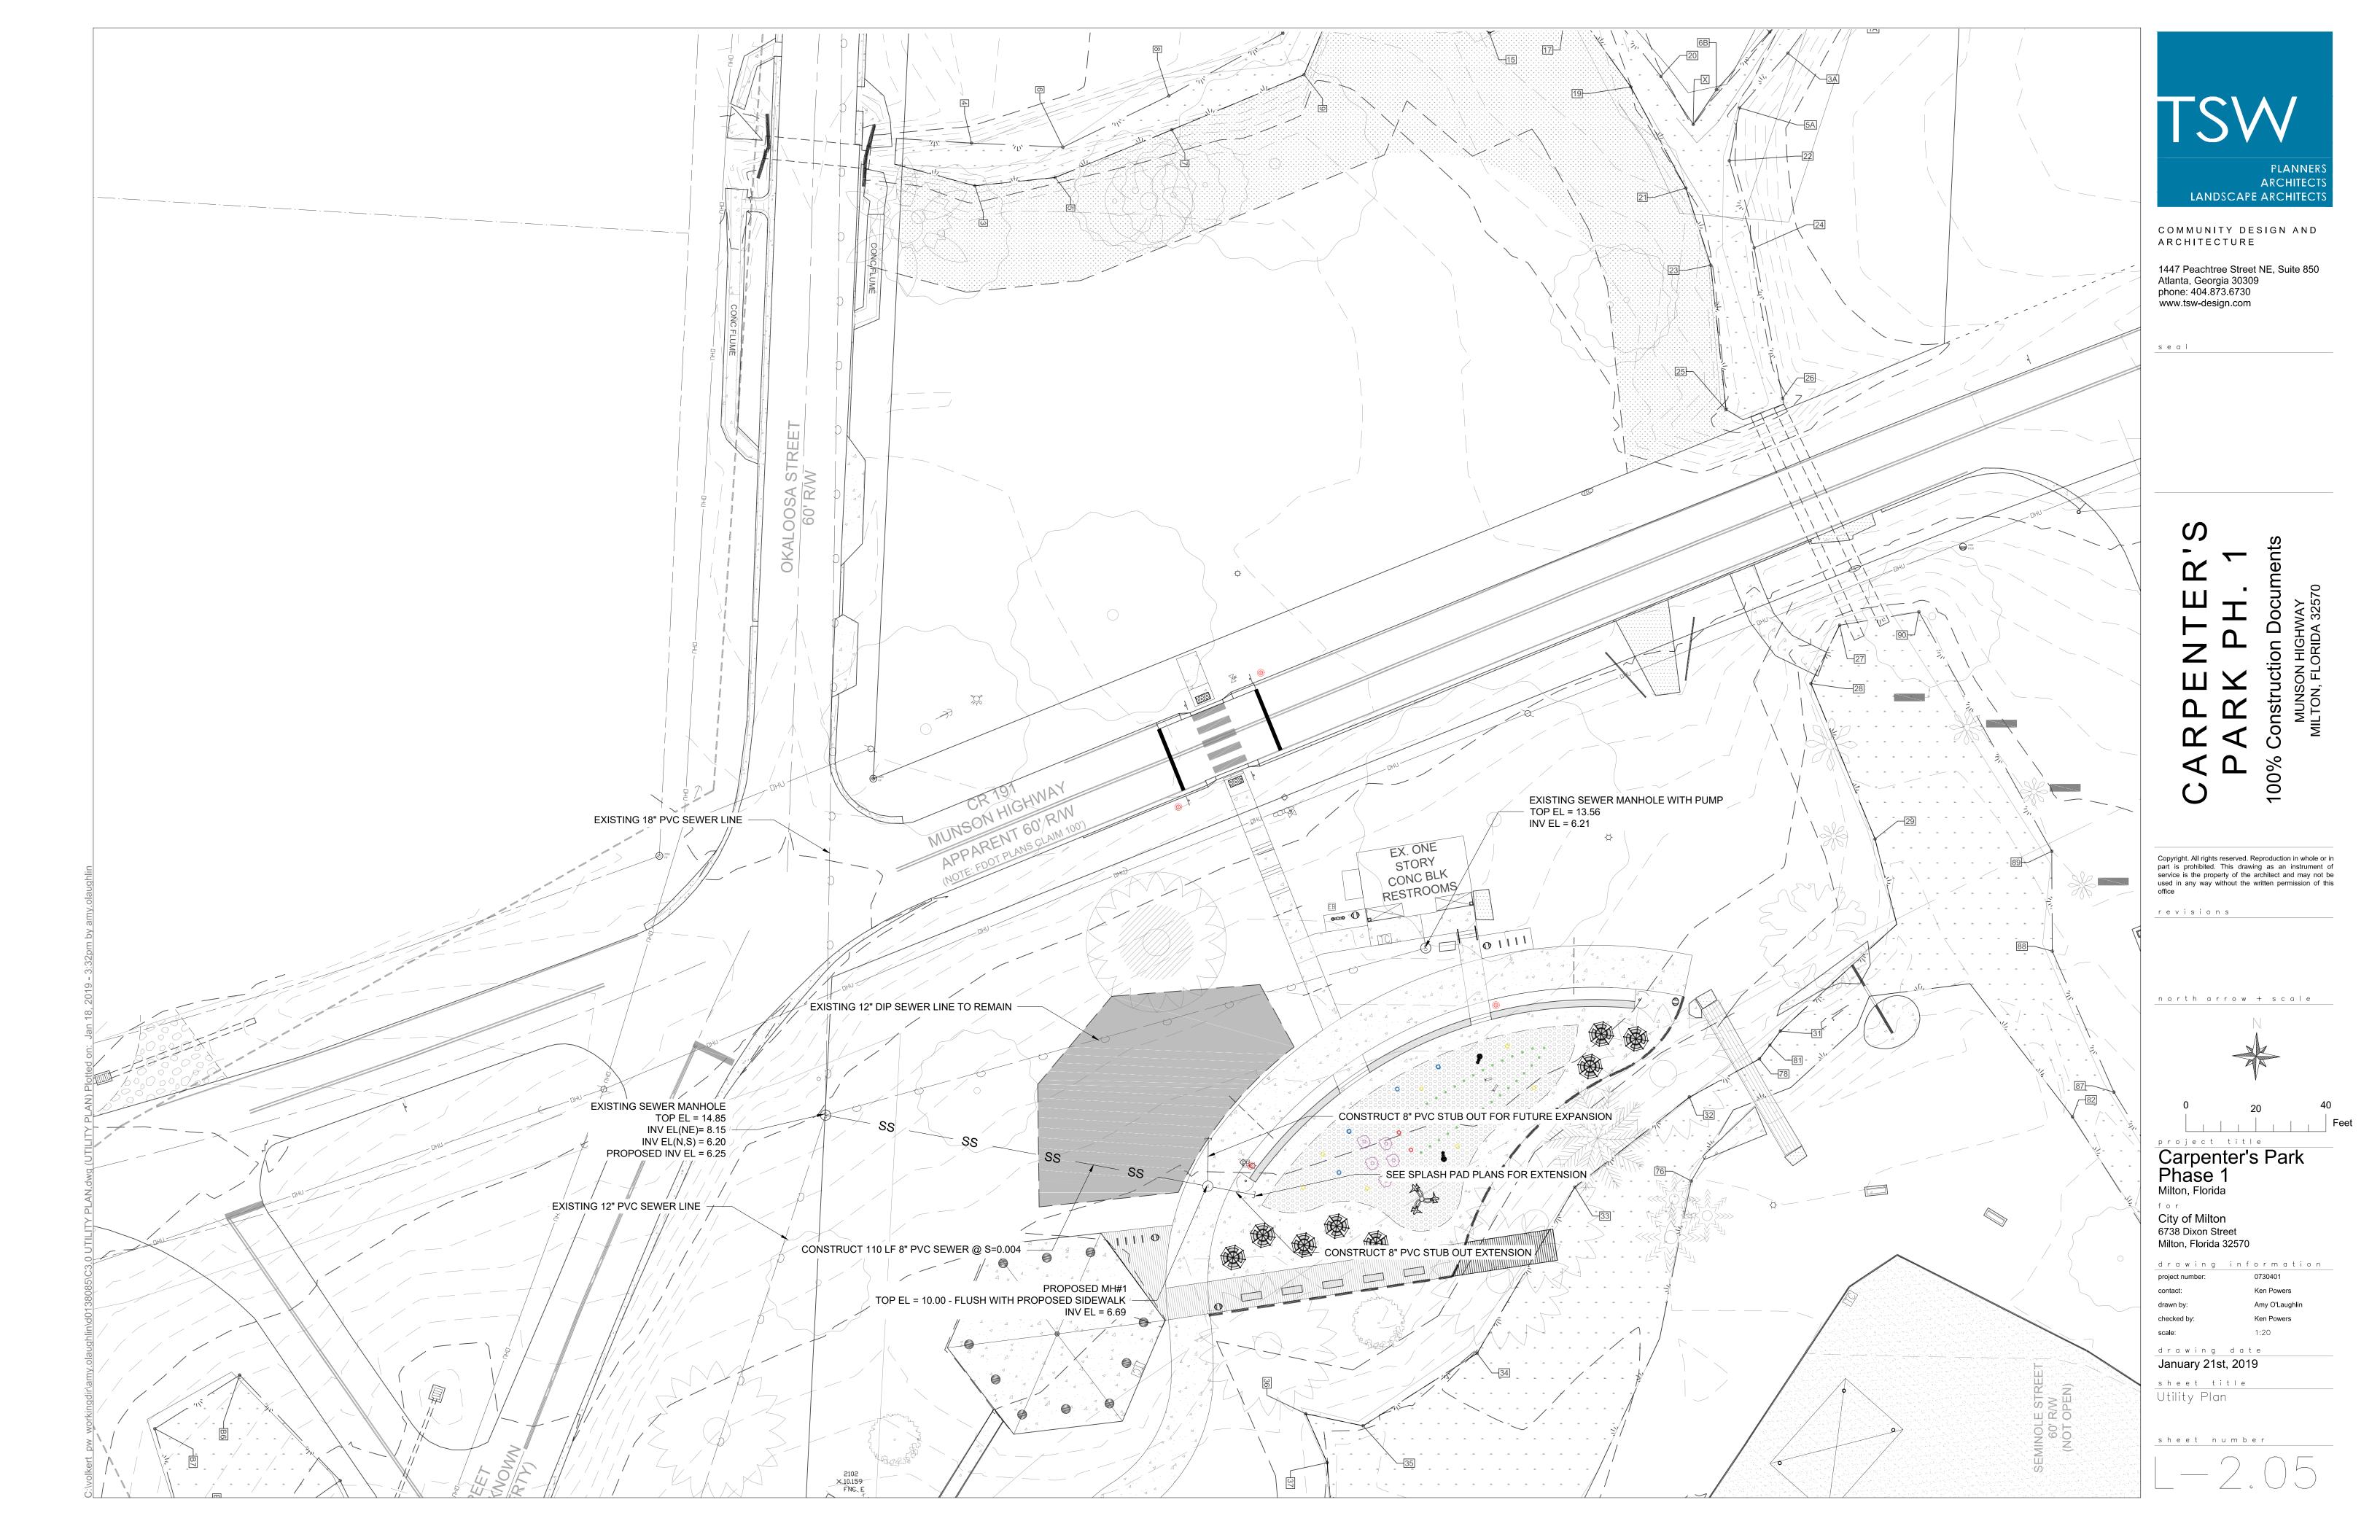


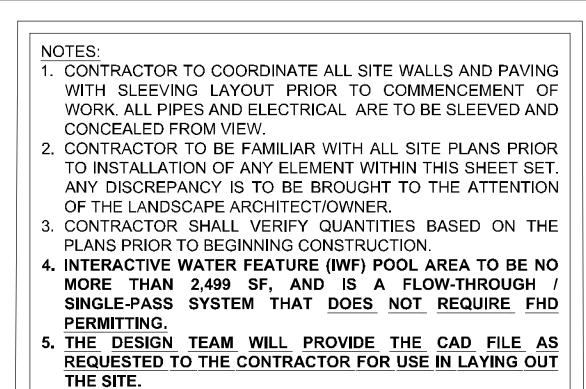


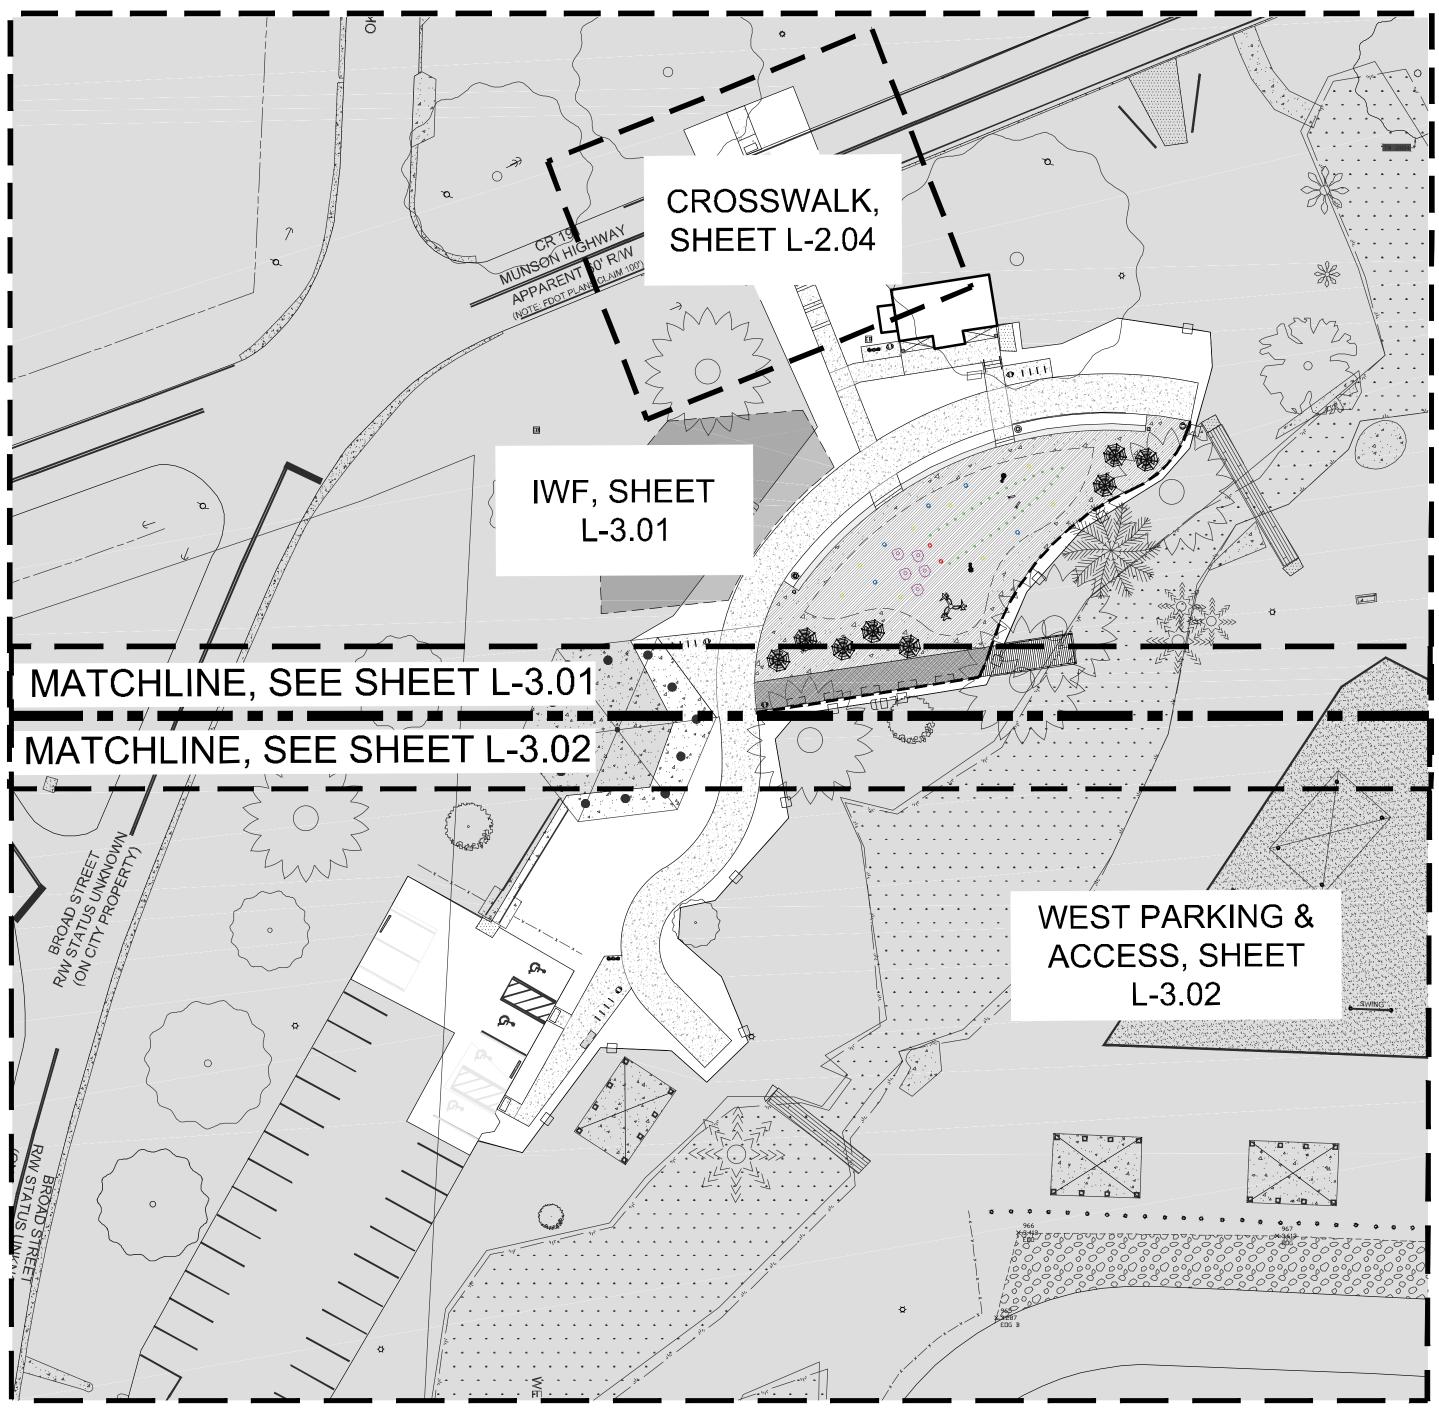


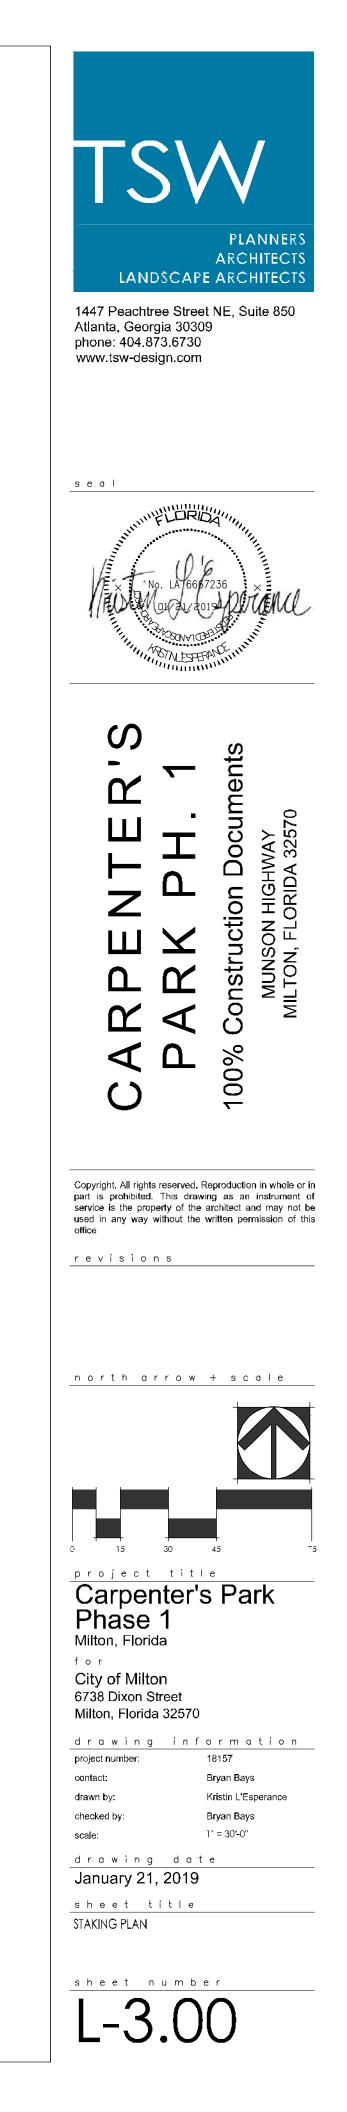


- CONTRACTOR TO COORDINATE ALL SITE WALLS AND PAVING WITH SLEEVING LAYOUT PRIOR TO COMMENCEMENT OF WORK. ALL PIPES AND ELECTRICAL ARE TO BE SLEEVED AND CONCEALED FROM VIEW.
- 2. CONTRACTOR TO BE FAMILIAR WITH ALL SITE PLANS PRIOR TO INSTALLATION OF ANY ELEMENT WITHIN THIS SHEET SET. ANY DISCREPANCY IS TO BE BROUGHT TO THE ATTENTION OF THE LANDSCAPE ARCHITECT/OWNER.
- 3. CONTRACTOR SHALL VERIFY QUANTITIES BASED ON THE PLANS PRIOR TO BEGINNING CONSTRUCTION.
- 4. INTERACTIVE WATER FEATURE (IWF) POOL AREA TO BE NO MORE THAN 2,499 SF, AND IS A FLOW-THROUGH / SINGLE-PASS SYSTEM THAT DOES NOT REQUIRE FHD PERMITTING.
- 5. THE DESIGN TEAM WILL PROVIDE THE CAD FILE AS REQUESTED TO THE CONTRACTOR FOR USE IN LAYING OUT THE SITE.

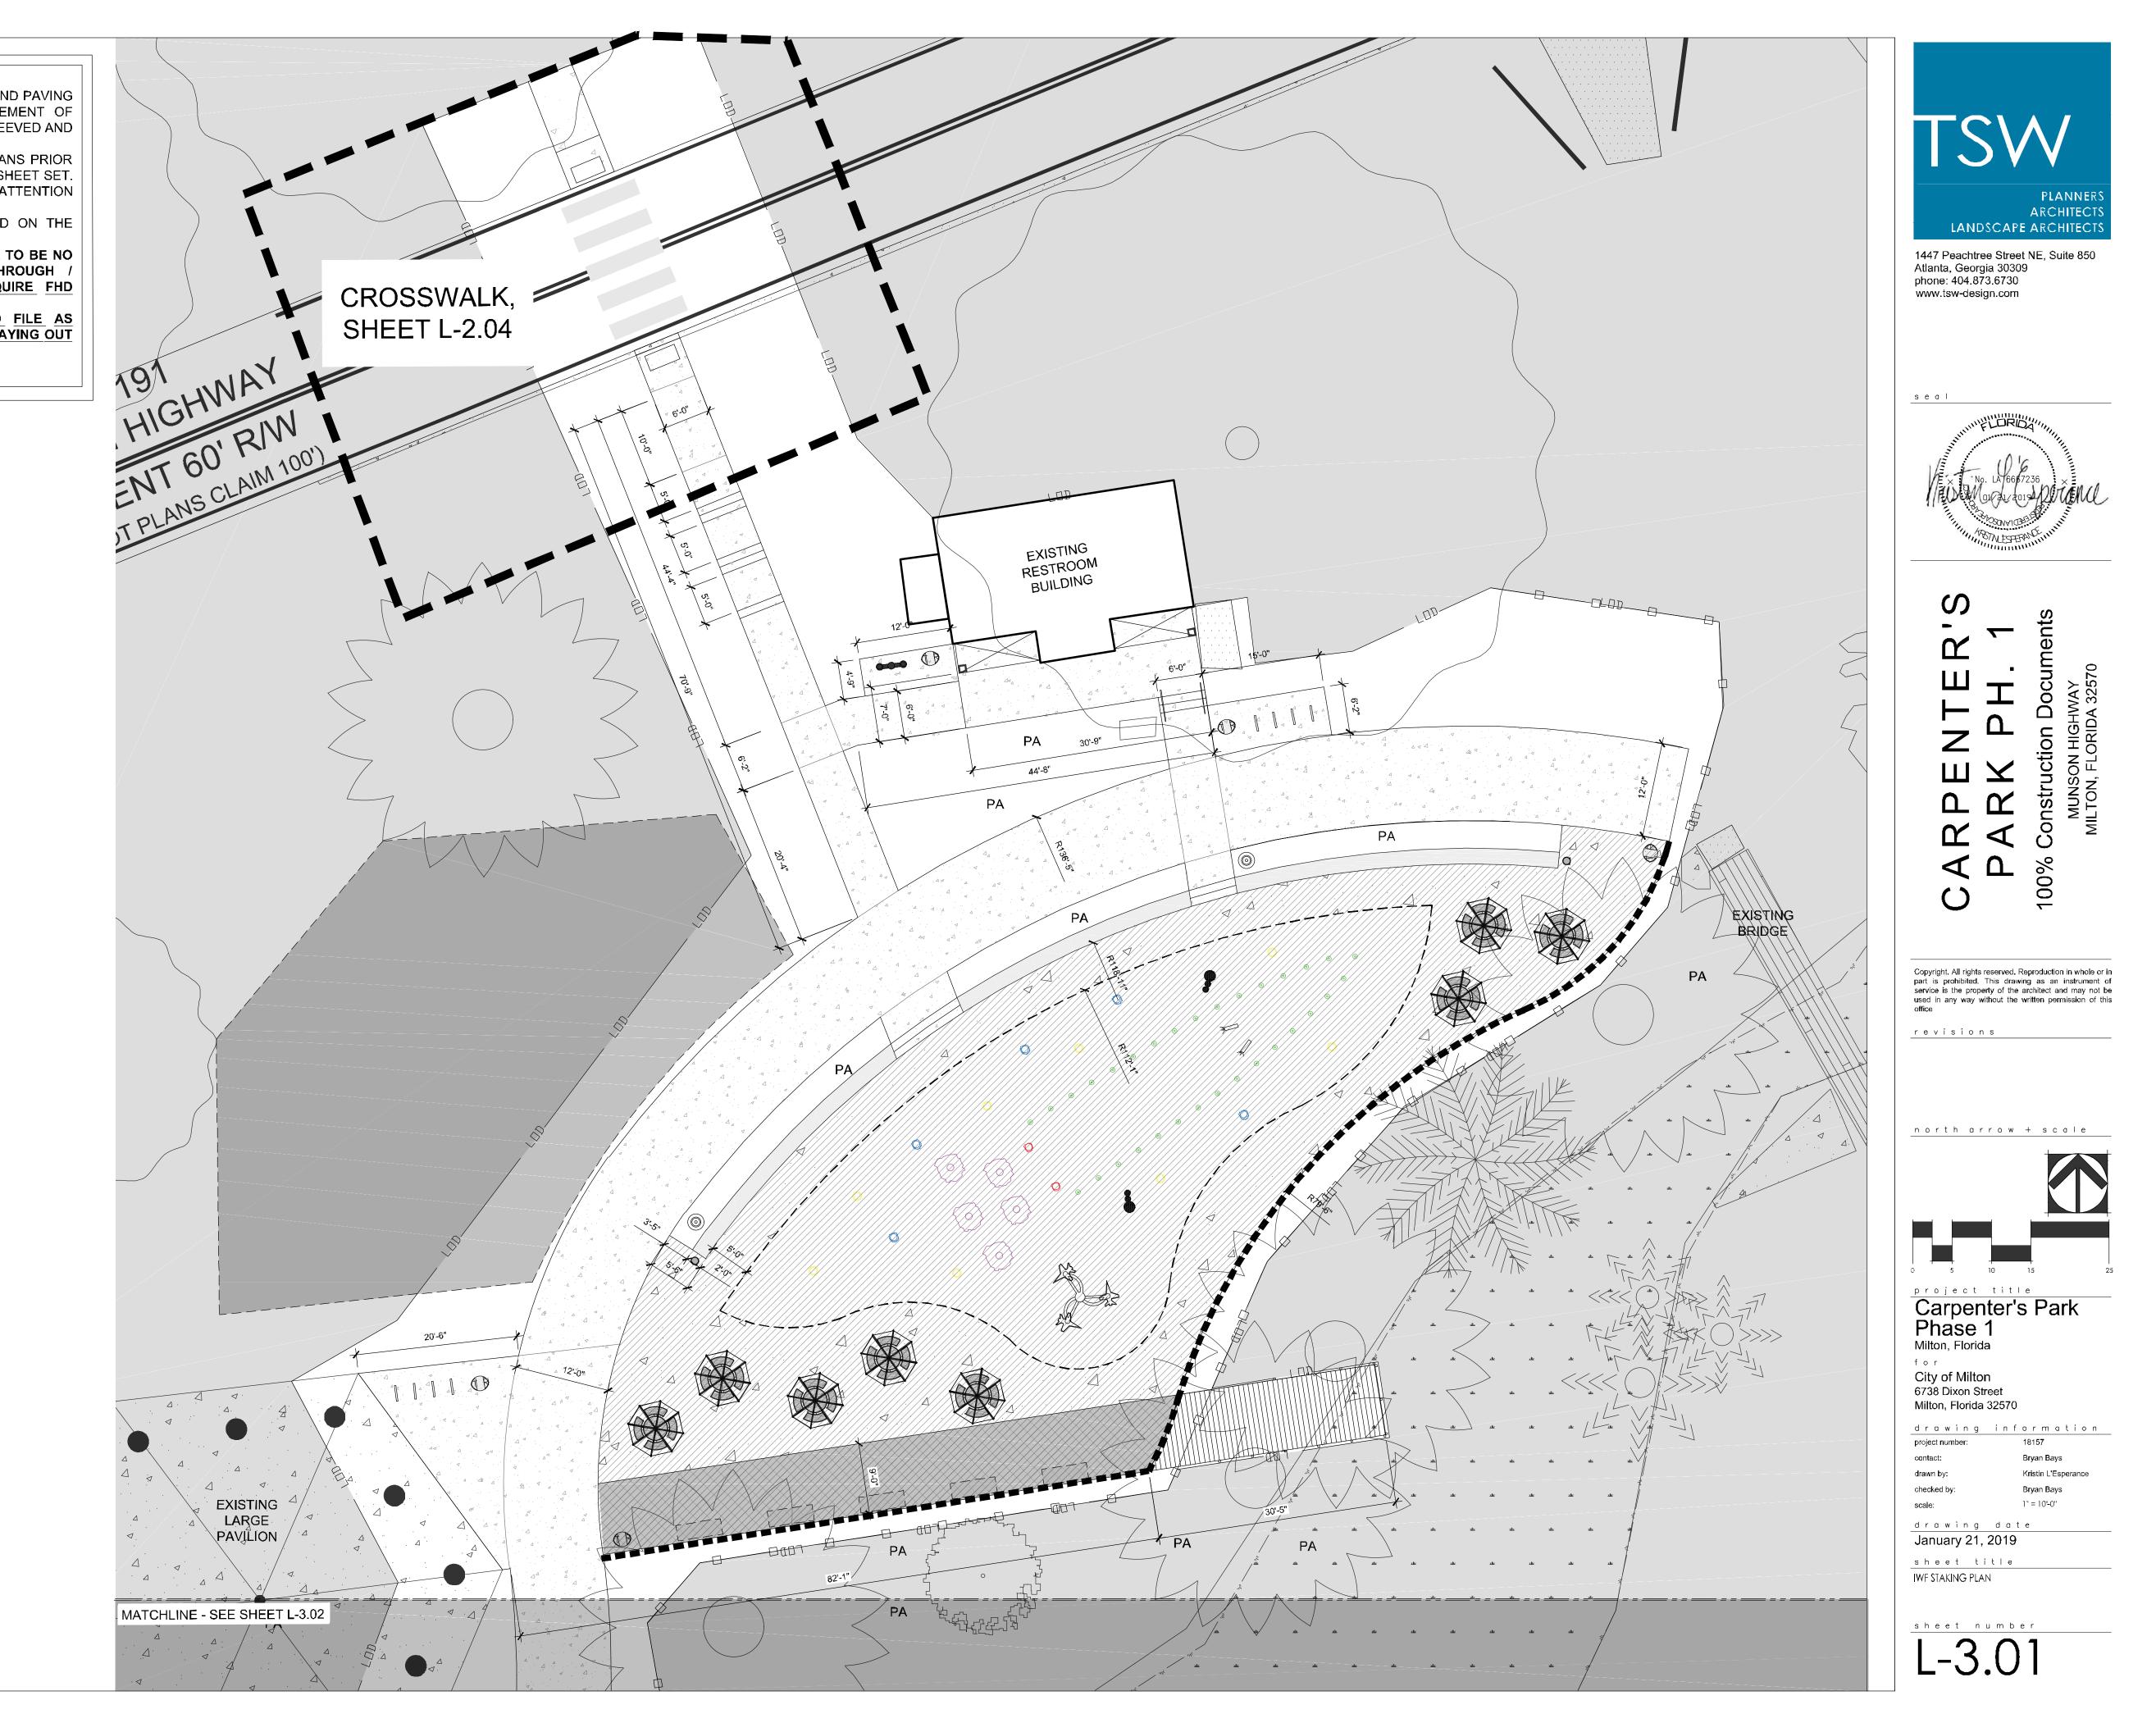

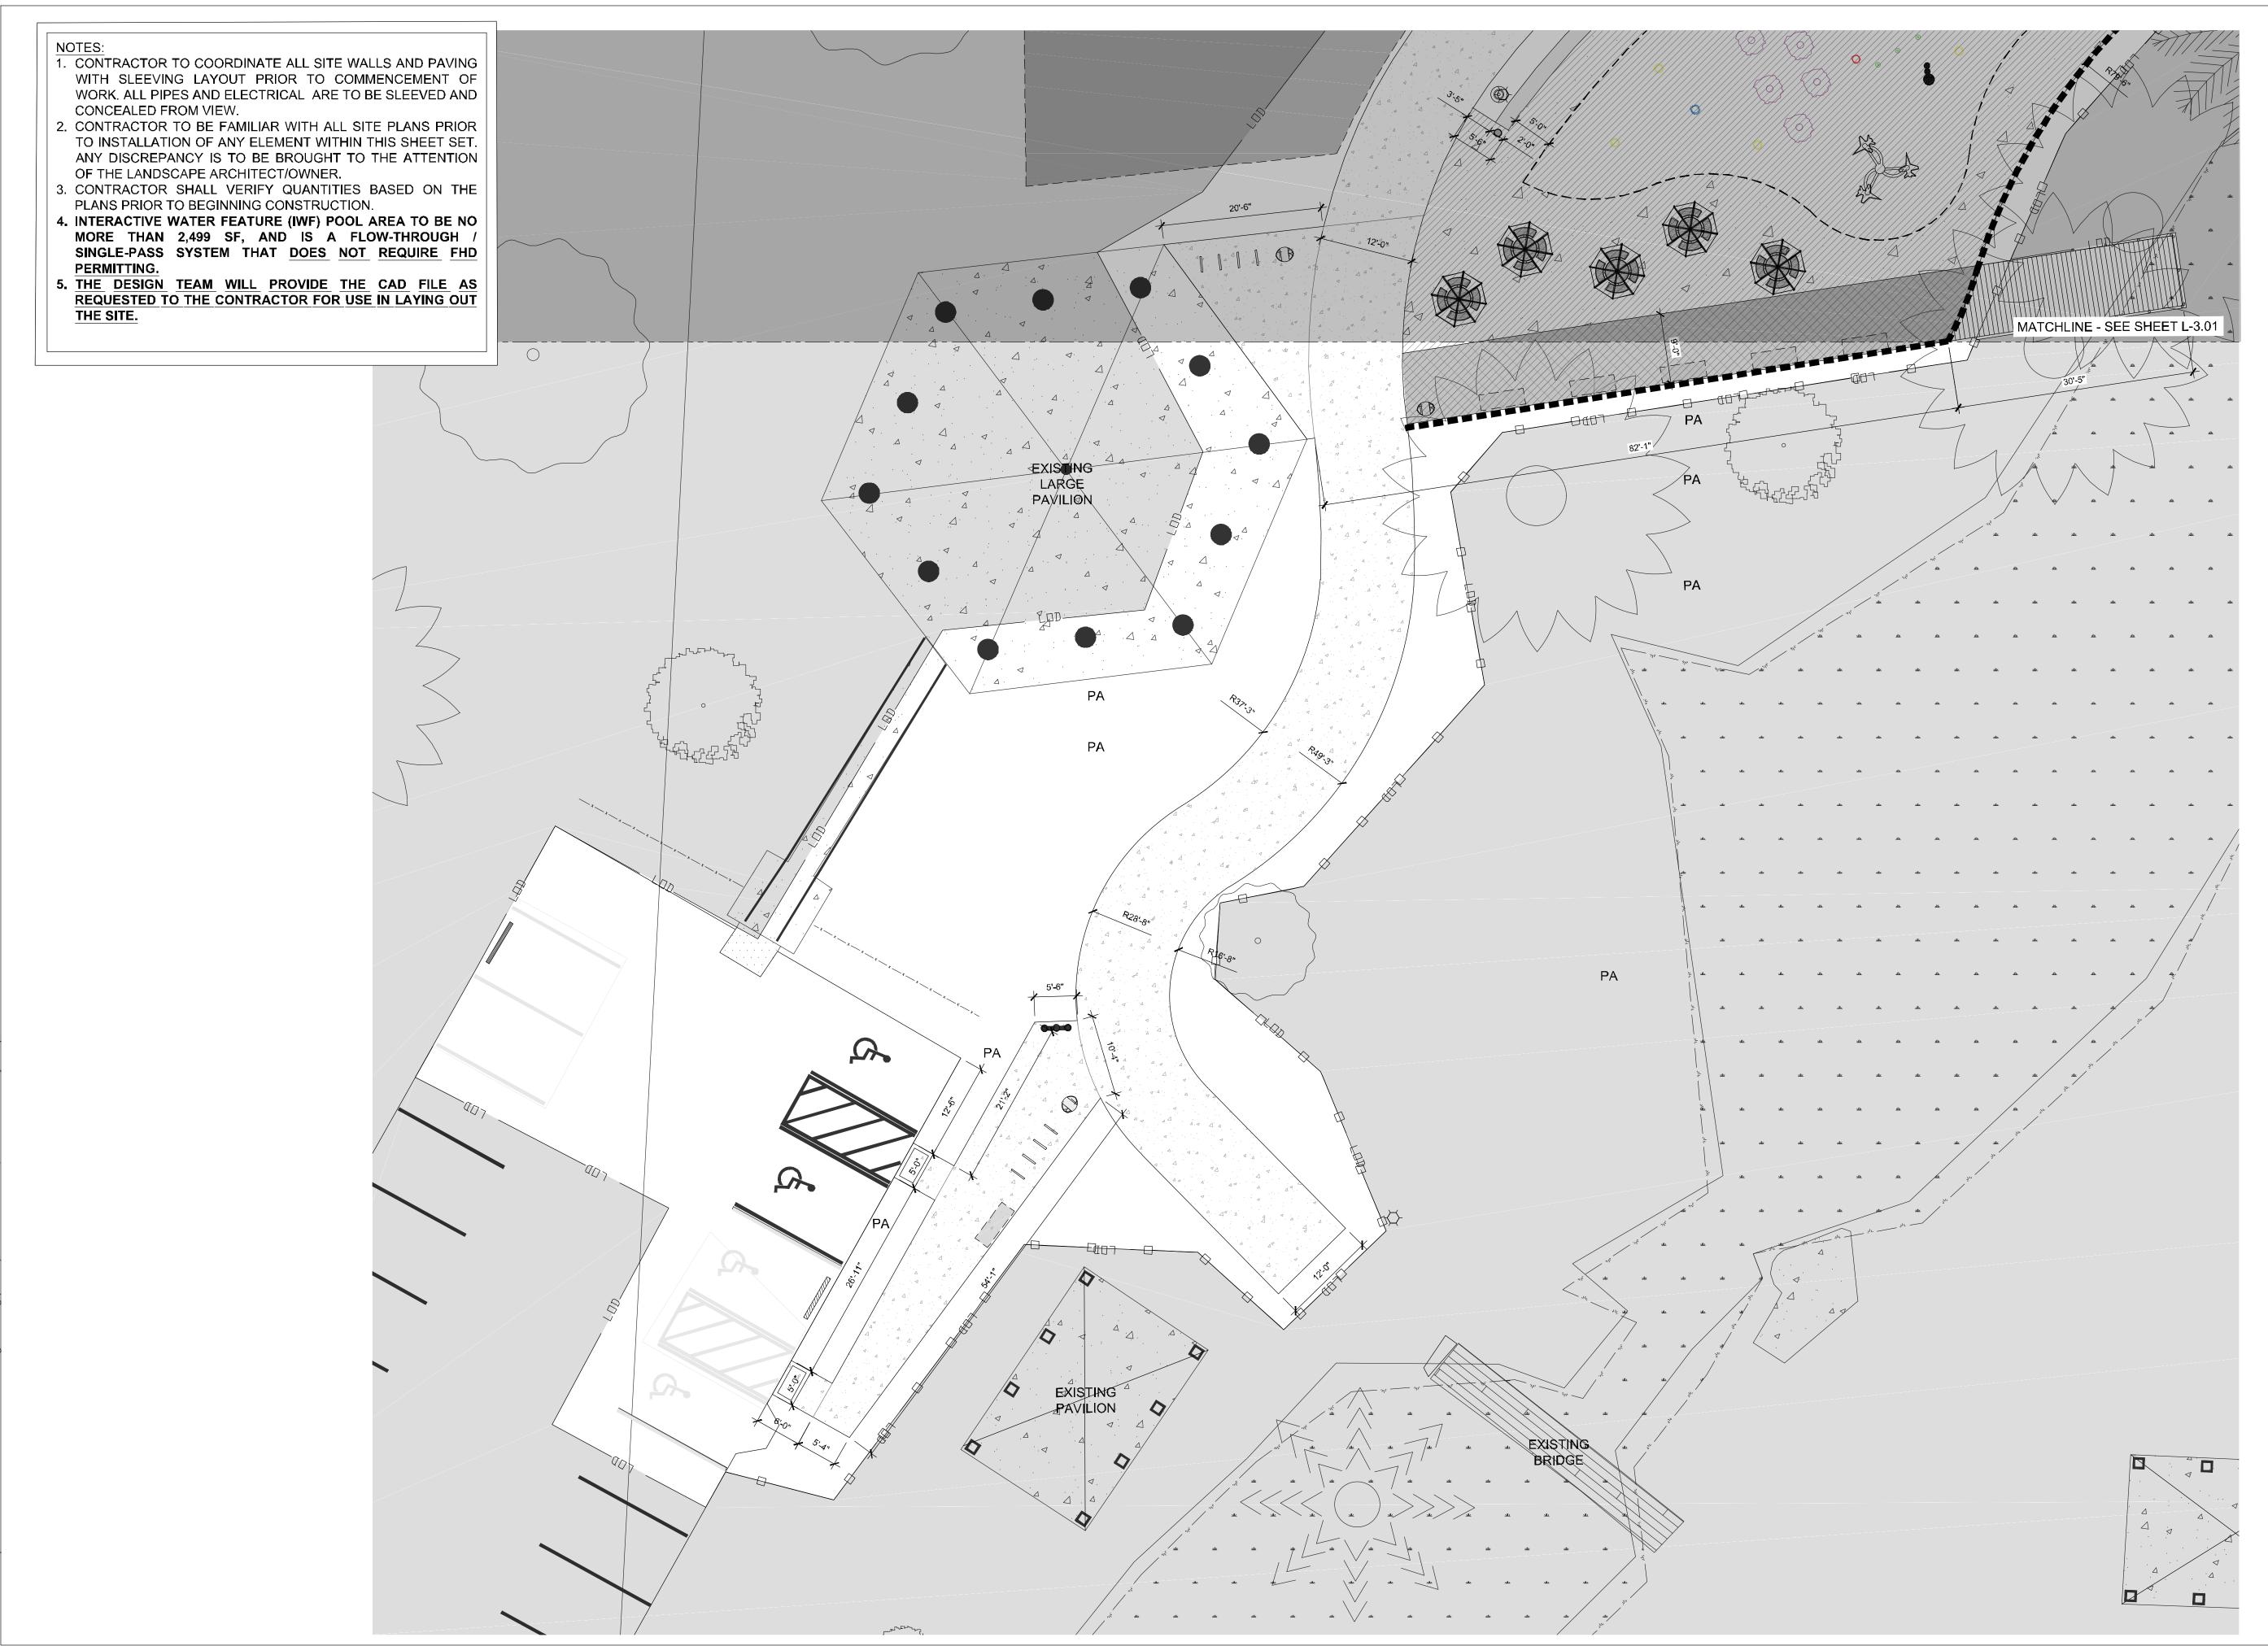

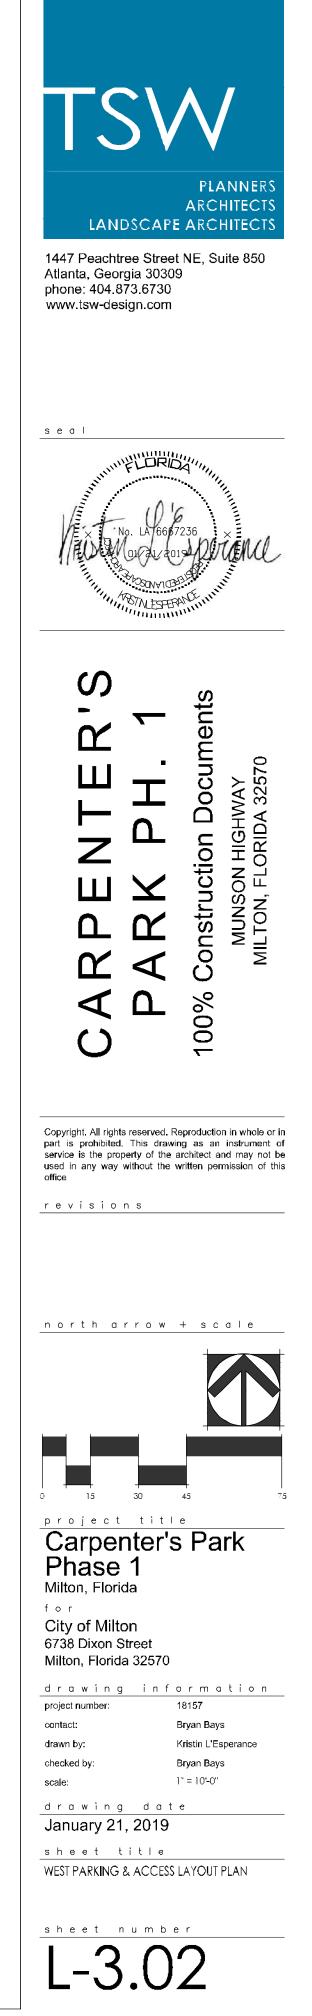

- 1. CONTRACTOR TO COORDINATE ALL SITE WALLS AND PAVING WITH SLEEVING LAYOUT PRIOR TO COMMENCEMENT OF WORK. ALL PIPES AND ELECTRICAL ARE TO BE SLEEVED AND CONCEALED FROM VIEW.
- 2. CONTRACTOR TO BE FAMILIAR WITH ALL SITE PLANS PRIOR TO INSTALLATION OF ANY ELEMENT WITHIN THIS SHEET SET. ANY DISCREPANCY IS TO BE BROUGHT TO THE ATTENTION OF THE LANDSCAPE ARCHITECT/OWNER.
- 3. CONTRACTOR SHALL VERIFY QUANTITIES BASED ON THE PLANS PRIOR TO BEGINNING CONSTRUCTION.
- 4. INTERACTIVE WATER FEATURE (IWF) POOL AREA TO BE NO MORE THAN 2,499 SF, AND IS A FLOW-THROUGH / SINGLE-PASS SYSTEM THAT DOES NOT REQUIRE FHD PERMITTING.
- 5. EROSION CONTROL FENCING TO BE A DOUBLE SILT FENCE OR A SILT FENCE WITH HAY BAILS.

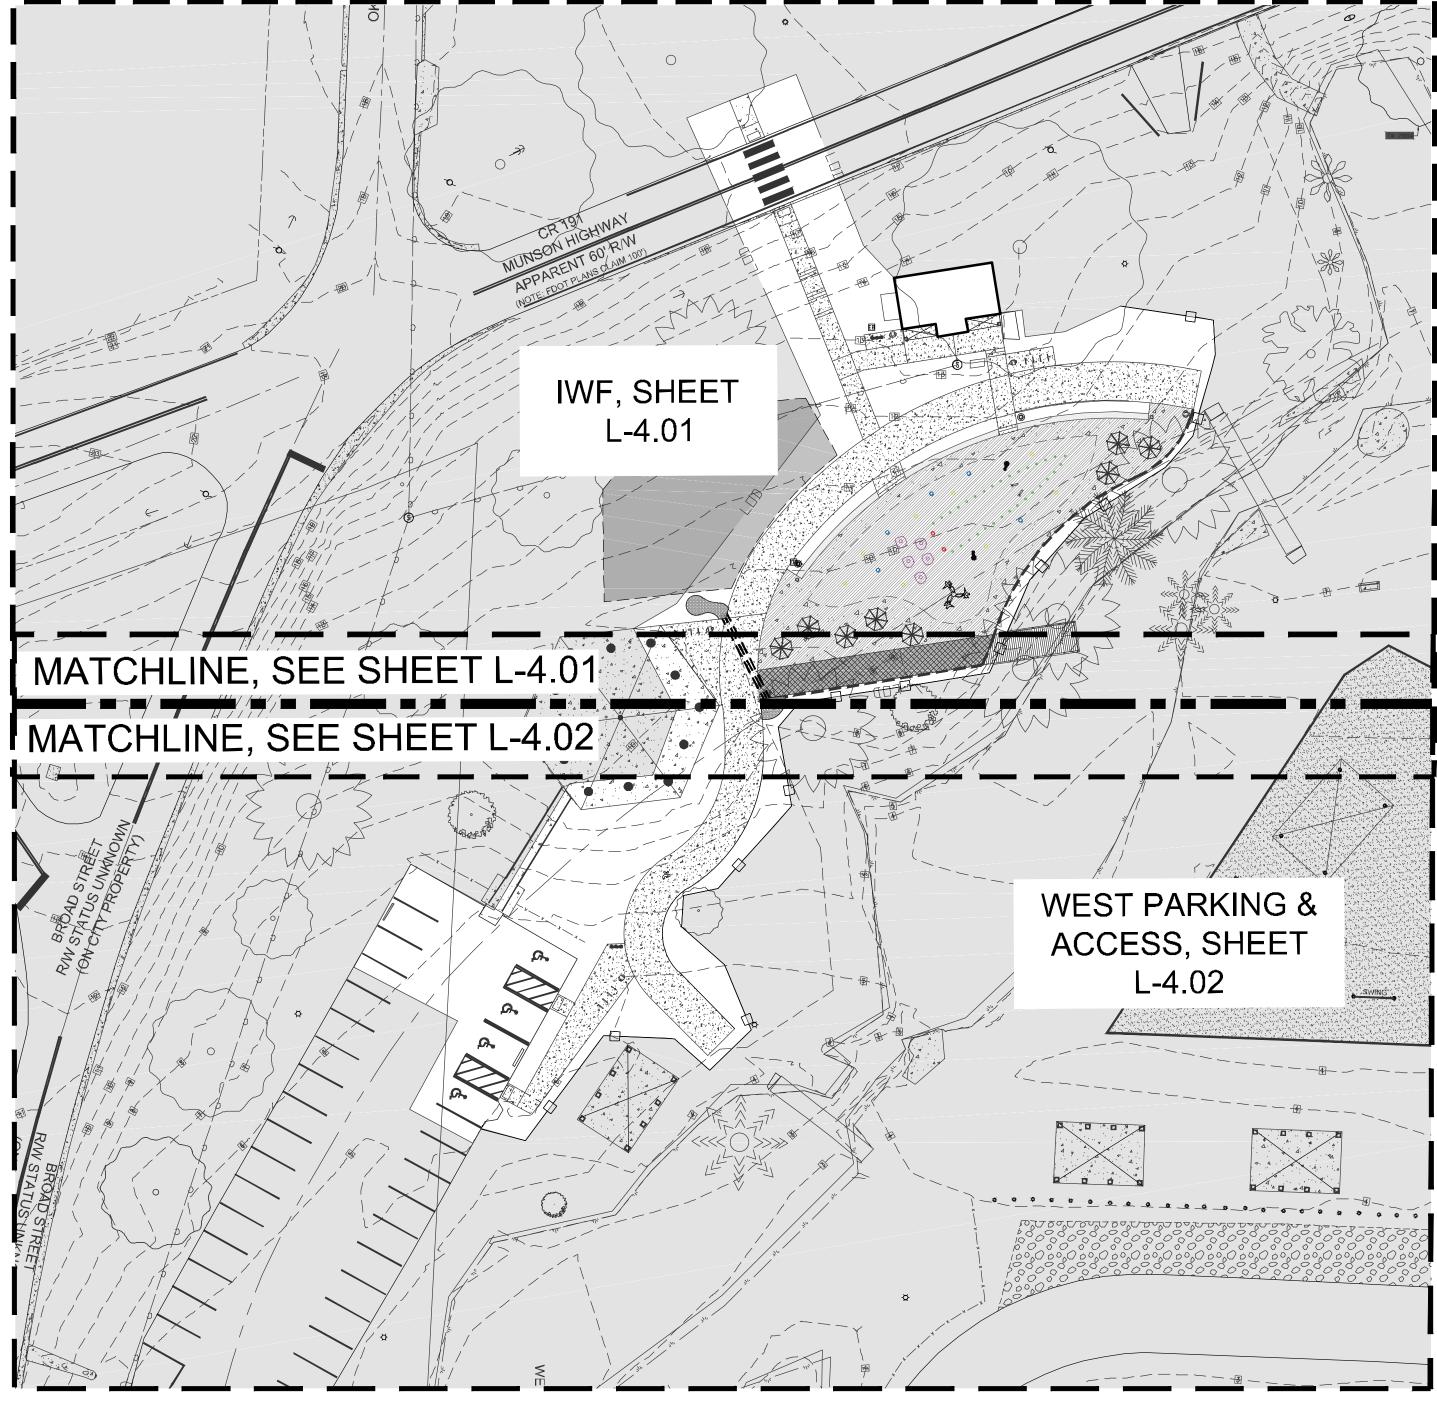



Stormwater Runoff Table				
Limits of Construction Area	0.34	0.346 acres 0.01 acres		
Existing Impervious Area	0.0			
Proposed Imervious Area	0.1	2 acres		
Proposed Splash Pad Area	0.1	0.18 acres		
Existing C Value	0.3			
Proposed C Value	0.352			
Storm Event	Intensity (in/hr)	Peak Runoff Existing	Peak Runoff Proposed	
5 Year	9.68	1.01	0.57	
10 Year	11	1.14	0.64	
25 Year	12.8	1.33	0.75	
100 Year	15.3	1.59	0.90	

rates, thus stormwater facilities will not be required.



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revisions

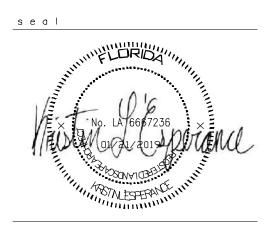

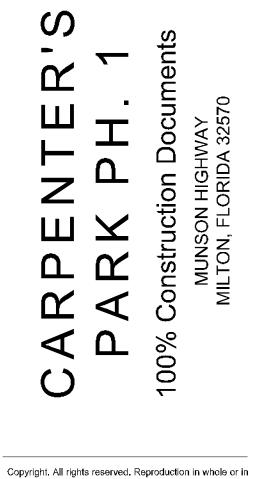

City of Milton 6738 Dixon Street Milton, Florida 32570

drawing information project number: contact: drawn by: checked by: scale:

18157 Bryan Bays Kristin L'Esperance Bryan Bays 1" = 30'-0"


drawing date January 21, 2019 sheet title


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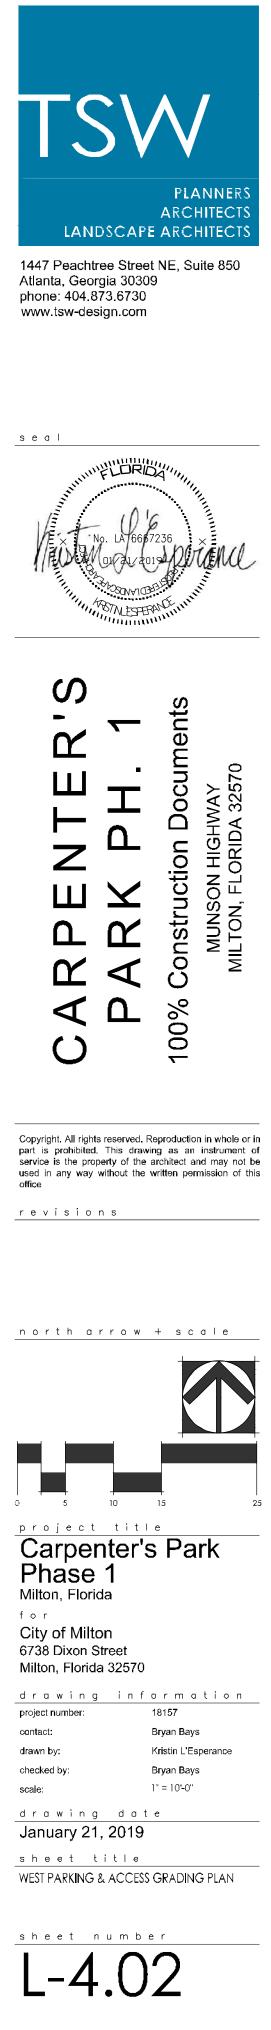
L-4.(

GRADING PLAN

- 1. CONTRACTOR TO COORDINATE ALL SITE WALLS AND PAVING WITH SLEEVING LAYOUT PRIOR TO COMMENCEMENT OF WORK. ALL PIPES AND ELECTRICAL ARE TO BE SLEEVED AND CONCEALED FROM VIEW.
- 2. CONTRACTOR TO BE FAMILIAR WITH ALL SITE PLANS PRIOR TO INSTALLATION OF ANY ELEMENT WITHIN THIS SHEET SET. ANY DISCREPANCY IS TO BE BROUGHT TO THE ATTENTION OF THE LANDSCAPE ARCHITECT/OWNER.
- 3. CONTRACTOR SHALL VERIFY QUANTITIES BASED ON THE PLANS PRIOR TO BEGINNING CONSTRUCTION.
- 4. INTERACTIVE WATER FEATURE (IWF) POOL AREA TO BE NO MORE THAN 2,499 SF, AND IS A FLOW-THROUGH / SINGLE-PASS SYSTEM THAT DOES NOT REQUIRE FHD PERMITTING.
- 5. EROSION CONTROL FENCING TO BE A DOUBLE SILT FENCE OR A SILT FENCE WITH HAY BAILS.
- 6. DRAINS IN IWF TO BE SIZED TO MEET DRAINAGE REQUIREMENTS OF THE IWF & DECK AREA.
- 7. DESIGN OF IWF FOR DESIGN INTENT ONLY, SHOP DRAWINGS, INCLUDING GRADING & DRAINAGE, ARE REQUIRED FOR APPROVAL BY LANDSCAPE ARCHITECT PRIOR TO CONSTRUCTION.



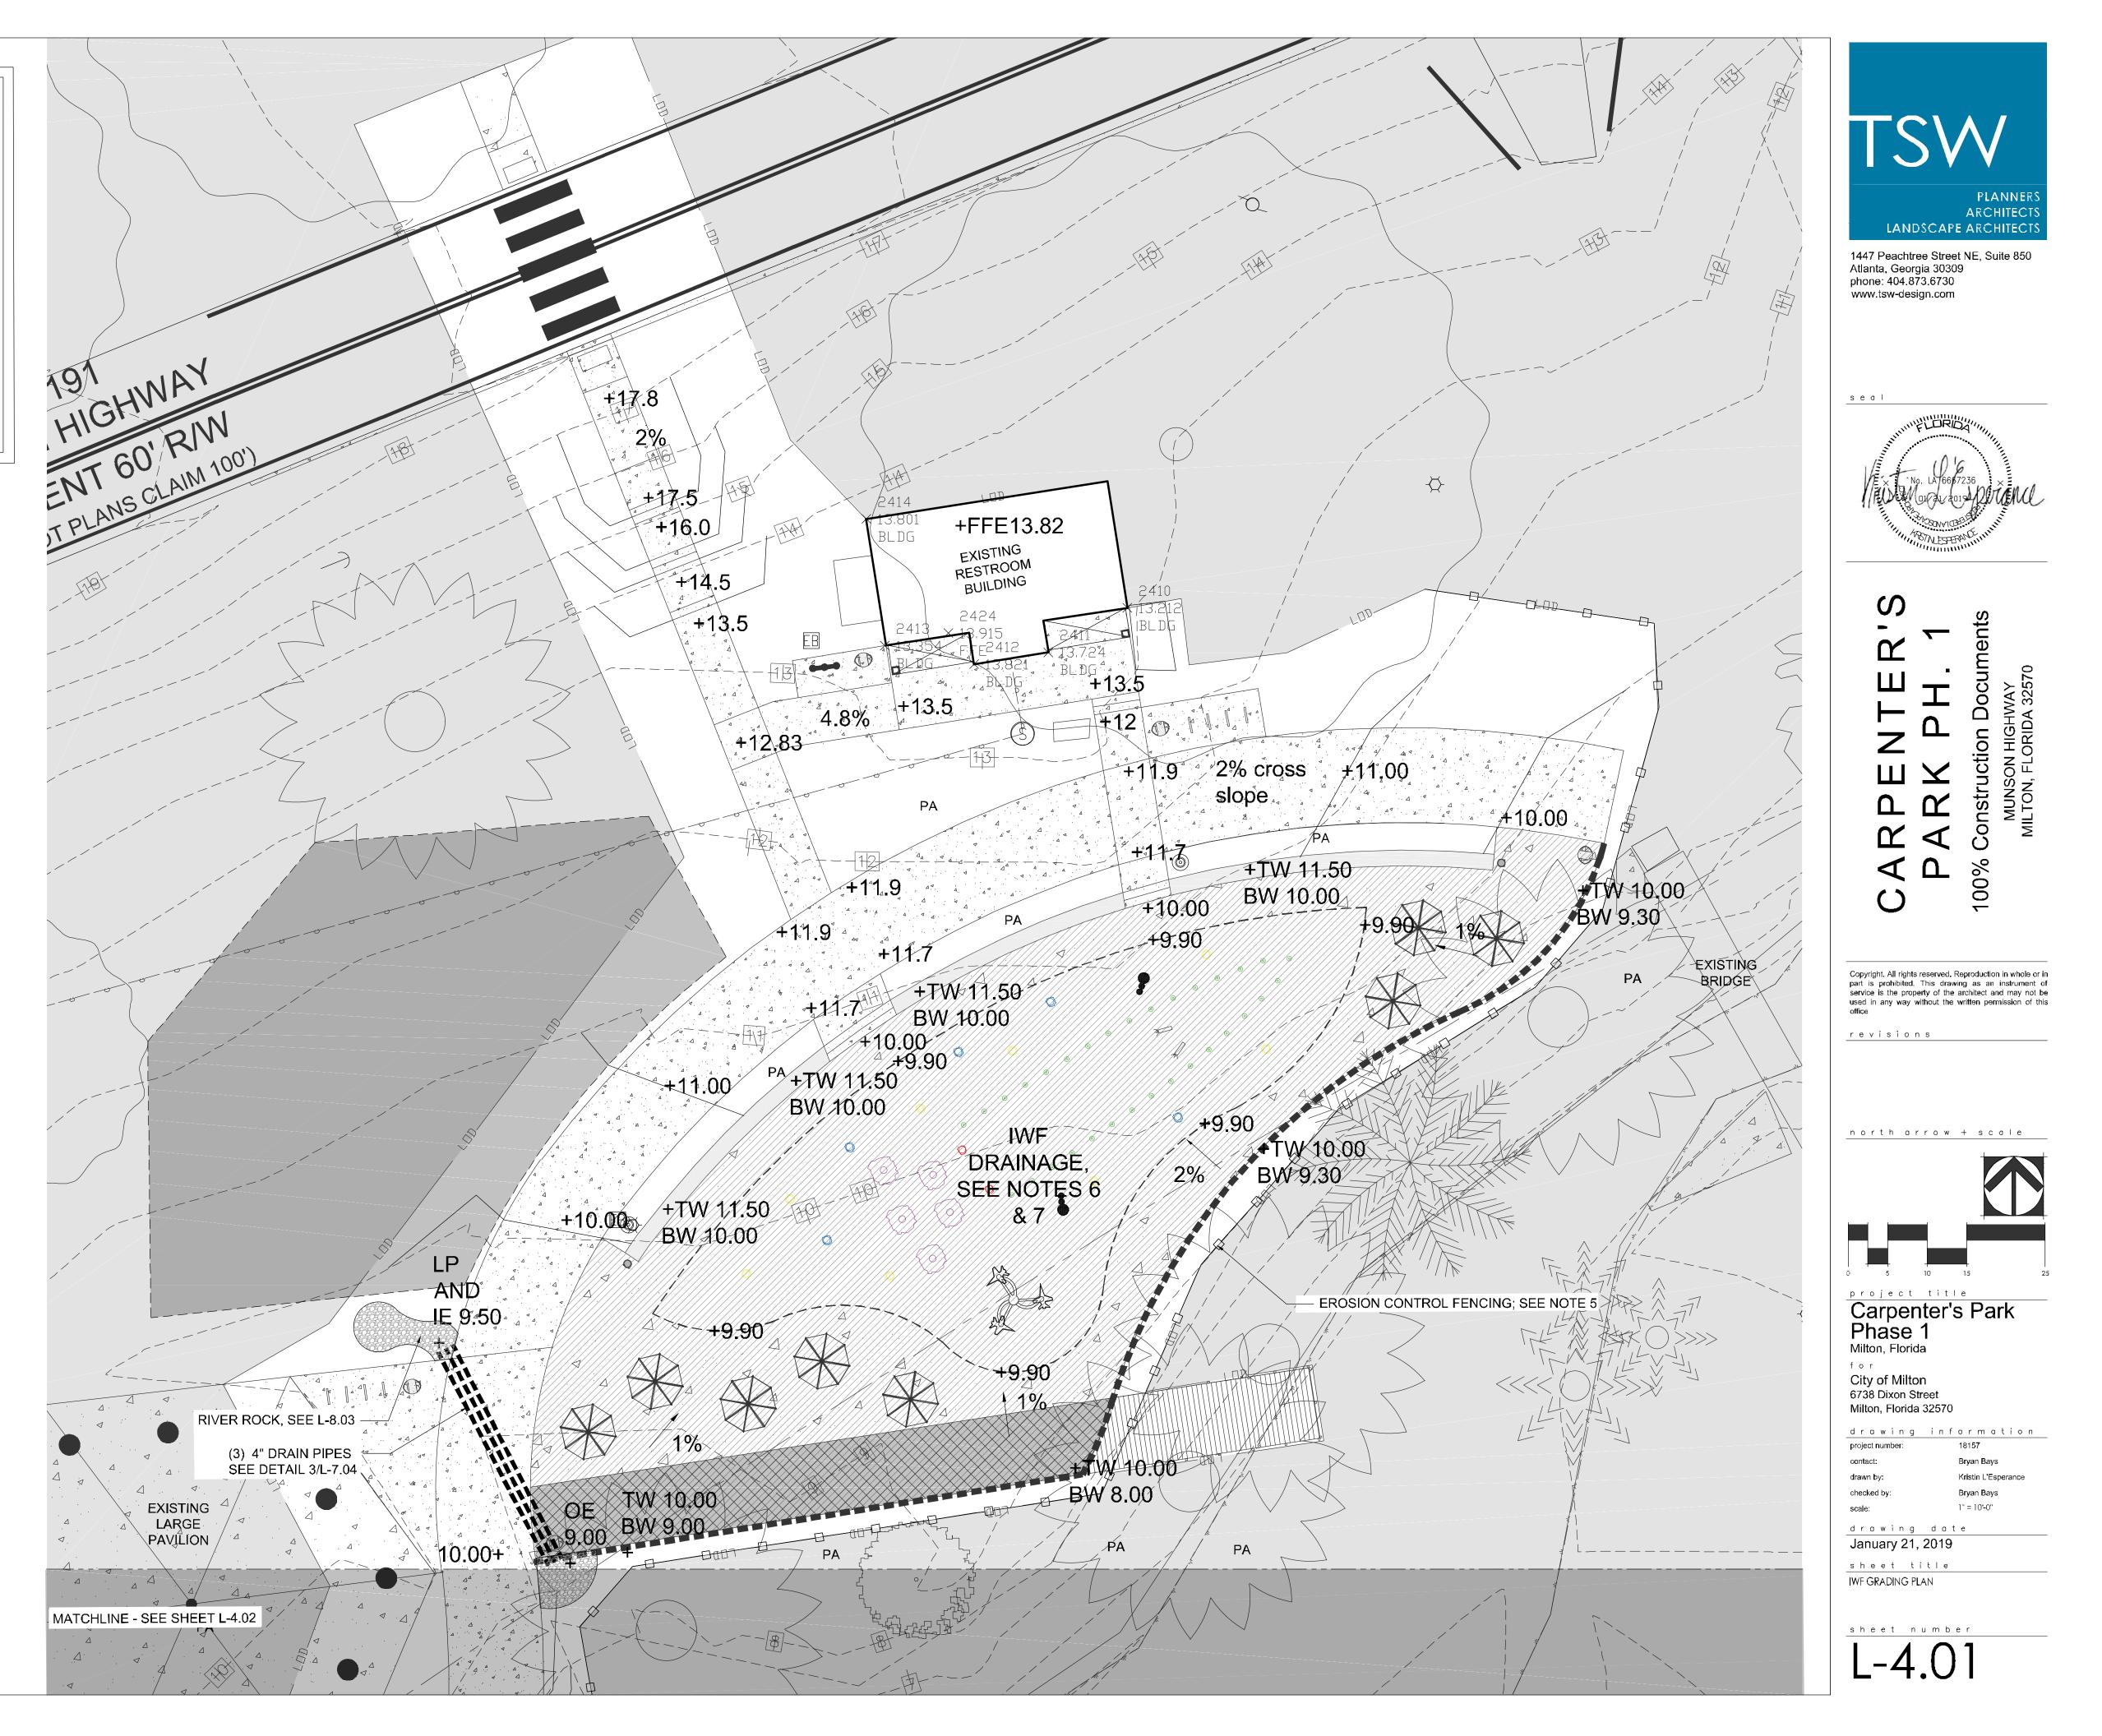

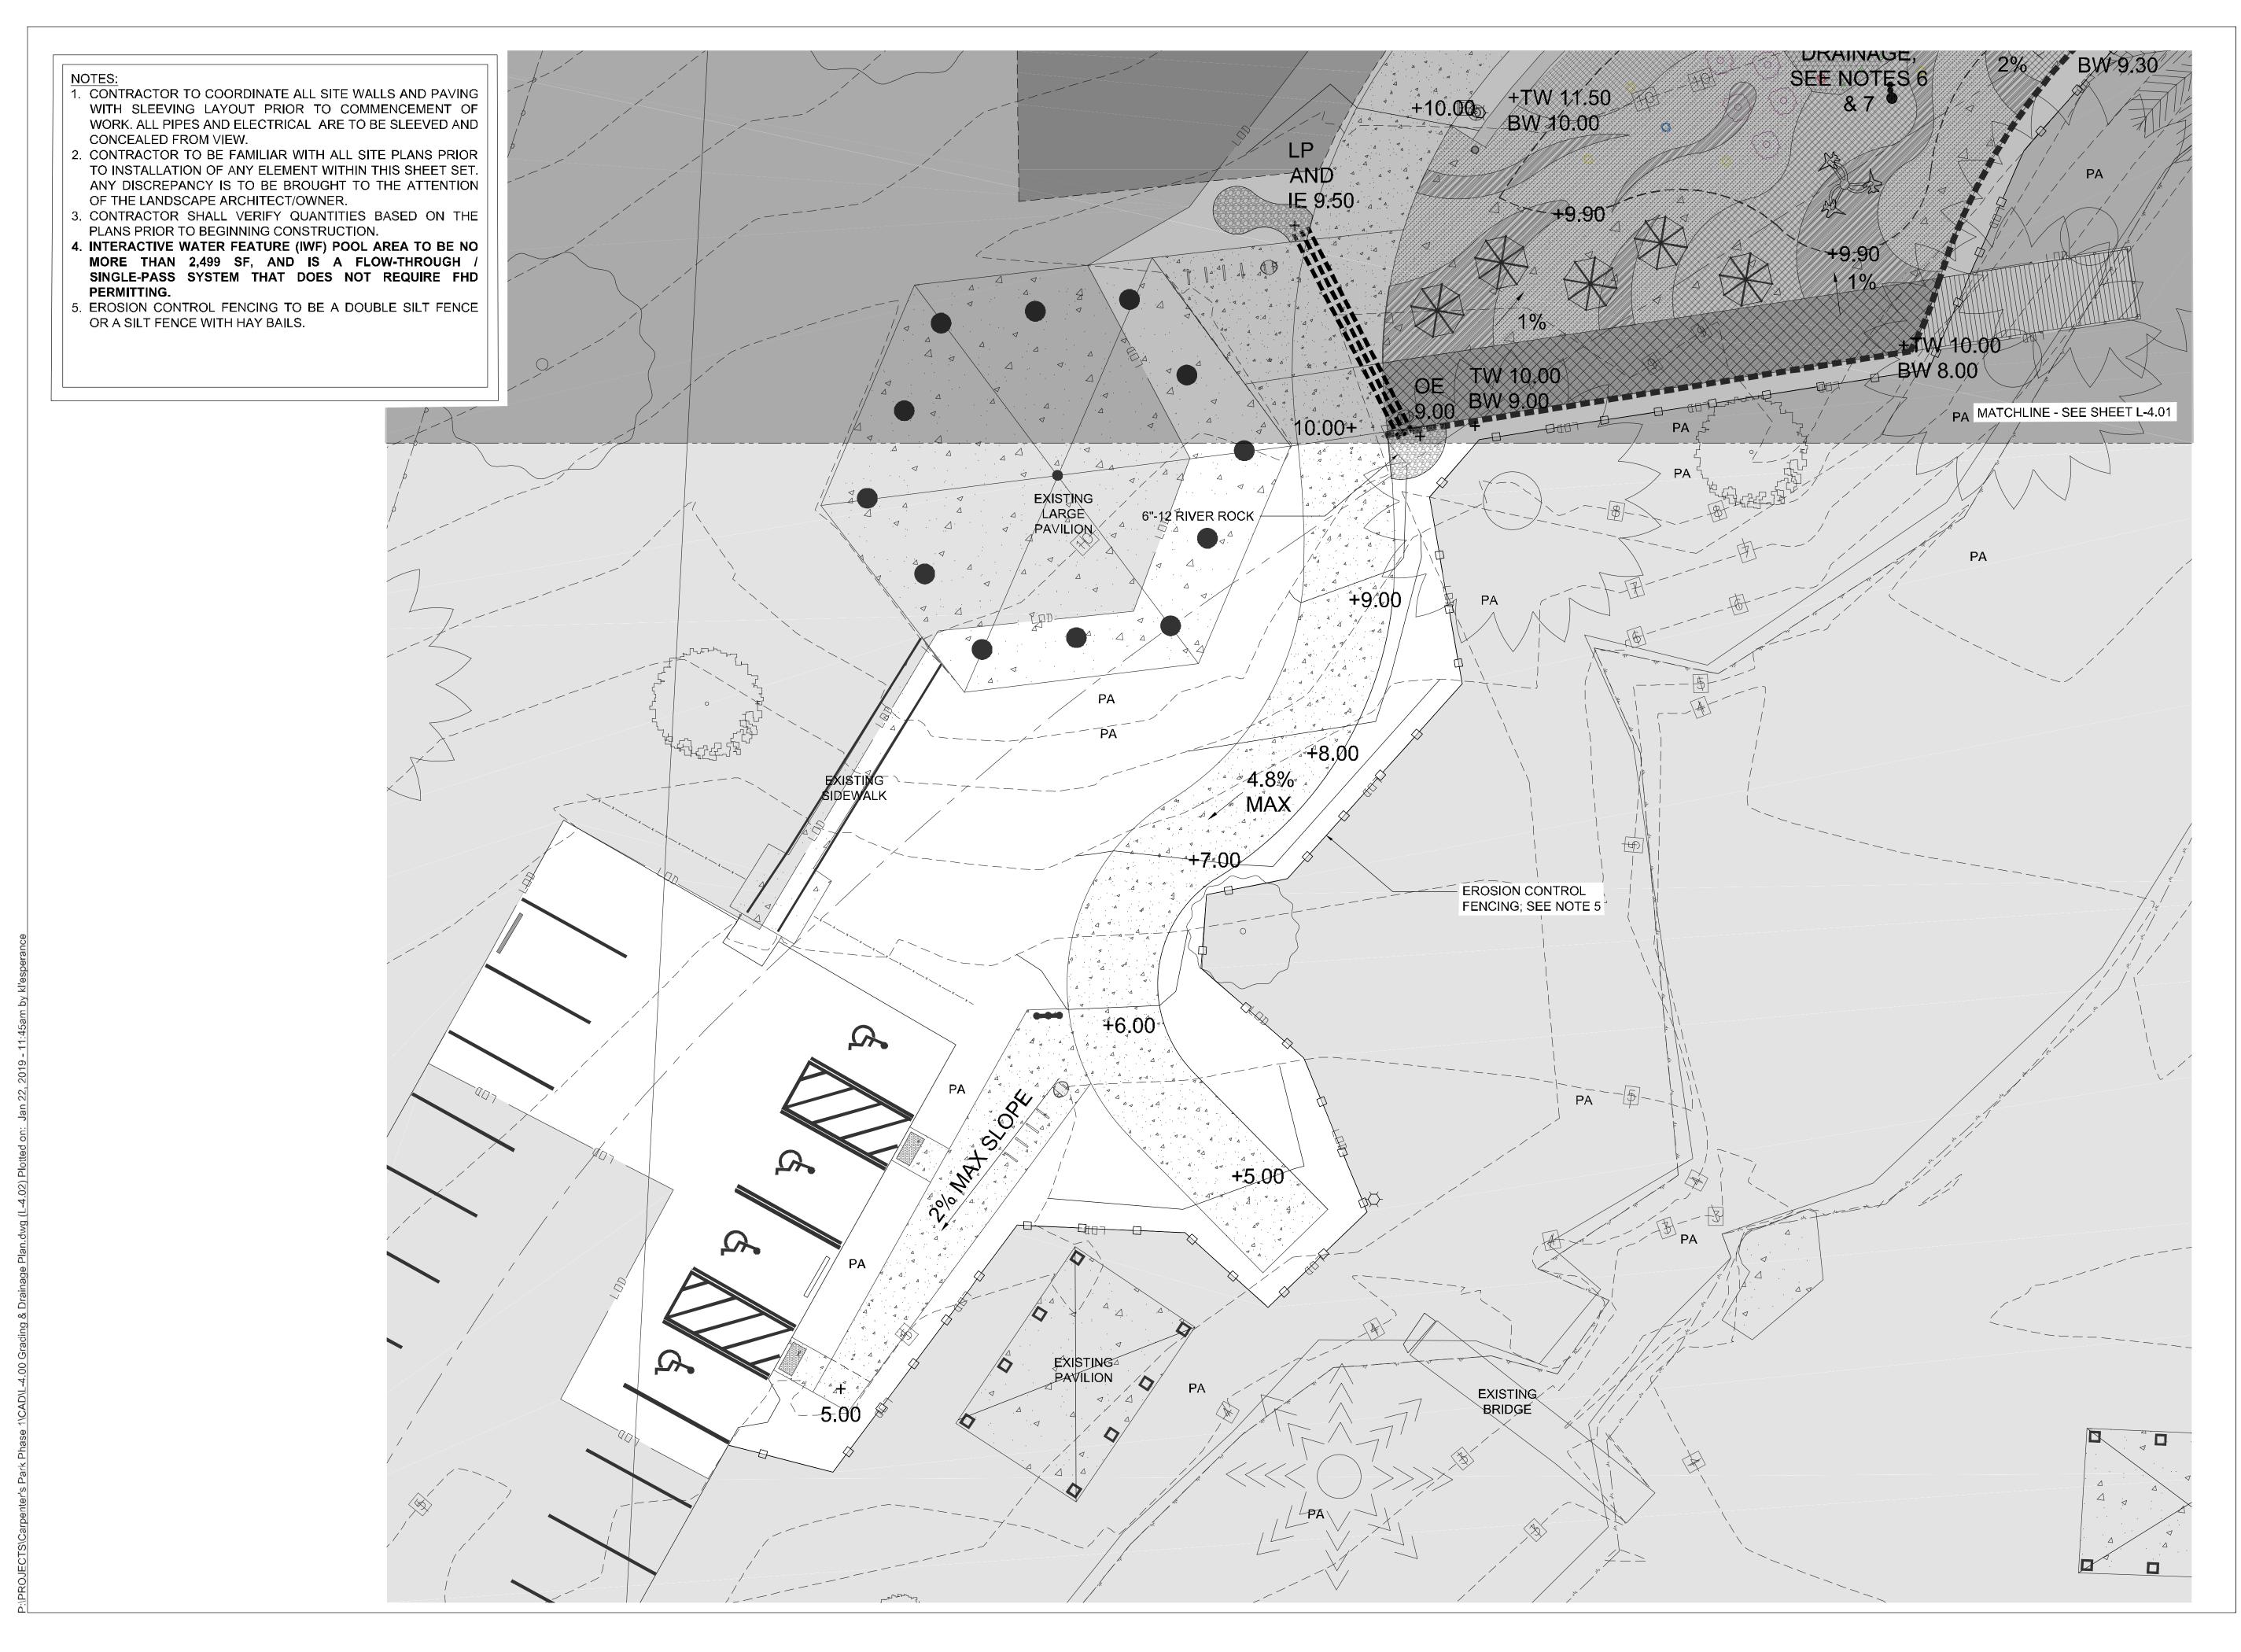

REFERENCE	# LABEL	PRODUCT DESCRIPTION	MANUFACTURER	PRODUCT/DIMENSIONS	COLOR/FINISH	MOUNTING
11	UMBRELLA	MODERN STATIONARY METAL UMBRELLA	LANDSCAPE FORMS http://www.landscapeforms. com	SOLSTICE UMBRELLA STYLE: ALTAIR	POWDERCOATED COLOR: TBD FROM FULL POSSIBLE COLOR RANGE	SURFACE MOUNTE
11	PICNIC TABLE	66" DIA x 30"; ROUND CONCRETE TABLE WITH ATTACHED BENCH SEATS AND WITH INCORPORATED HOLE FOR UMBRELLA.	WAUSAU www.wausaumade.com	REGULAR: TF3125 ROUND 4-BENCH CONCRETE TABLE and ADA: TF3110 ROUND 2-BENCH CONCRETE TABLE	WHITE: A30 LEGS AND G 30 TABLE TOP AND BENCH TOP	SURFACE MOUNTE
12	STANDARD BENCH - BACKED	EXTERIOR BACKED BENCH WITH WOODEN SLAT SEAT AND ALUMINUM STRUCTURE AND ARMS; 69" L	LANDSCAPE FORMS http://www.landscapeforms. com	NEOLIVIANO BACKED BENCH 69"	ALUMINUM STRUCTURE COLOR: TBD FFROM FULL POSSIBLE COLOR RANGE	SURFACE MOUNTE
13	BIKE RACK	INVERTED U-SHAPED BIKE RACK	BELSON OUTDOORS www.belson.com	CBBR-2UR-SS 2 BIKE 'U' BIKE RACK	STAINLESS STEEL	SURFACE MOUNTE
14	WASTE RECEPTACLE	CONTEMPORARY TRASH WITH WOOD SLATS ON SIDES	LANDSCAPE FORMS http://www.landscapeforms. com	FGP LITTER: 20" X 37"X 17 GAL	ALUMINUM STRUCTURE COLOR: TBD FFROM FULL POSSIBLE COLOR RANGE	SURFACE MOUNTE
17	DRINKING FOUNTAIN	FREESTANDING FOUNTAIN WITH TWO DRINKING SPOUTS AND BUILT-IN WATER BOTTLE FILLER	MOST DEPENDABLE FOUNTAINS www.mostdependable.com	MODEL 10145SM	STAINLESS STEEL	SURFACE MOUNTE
18	POOL SHOWER	ALL PURPOSE SHOWER/FOOT SPRAY WITH (2) GRAB BARS AND (3) SPRAY HEADS. SURFACE MOUNTED. 80" HEIGHT. STAINLESS STEEL. WHEELCHAIR ACCESSIBLE	FOUNTAINS	575 SMSS	STAINLESS STEEL OR MATCH EXISTING, RAL COLOR: SILVER 39/90000 BY TIGER DRYLAC (OR EQUAL)	SURFACE MOUNTE


18	POOL SHOWER	(2) GRAB BARS A SURFACE MOUN STAINLESS STEEL

$\left(1 \right)$	FURNITURE SCHEDULE
\bigvee	N/A

REFERENCE #	LABEL	PRODUCT DESCRIPTION	MANUFACTURER	PRODUCT/DIMENSIONS	COLOR/FINISH	MOUNTING	
1	CONCRETE PAVING (PLAIN)	PLAIN CONCRETE			MED BROOM FINISH		
		G (STAINED)- A ACRYLIC STAIN TO BE APPLIED TO PLAIN CONCRETE PAVING AS SHOWN	ACRYLIC STAIN: TUFF COAT	ACRYLIC STAIN PATTERN PAINTED ON SURFACE	BROOM FINISH		
19	CONCRETE PAVING (STAINED)- A				BROWN TO BE SELECTED FROM MANUFACTURER'S FULL AVAILABLE		
					RANGE OF COLORS		
		ACRYLIC STAIN TO BE APPLIED TO PLAIN		ACRYLIC STAIN PATTERN PAINTED	BROOM FINISH		
20	CONCRETE PAVING (STAINED)- B	CONCRETE PAVING AS SHOWN	ACRYLIC STAIN: TUFF COAT		LIGHT BLUE TO BE SELECTED FROM MANUFACTURER'S FULL		
					AVAILABLE RANGE OF COLORS		
		TE PAVING (STAINED)- C	ACRYLIC STAIN: TUFF COAT	ACRYLIC STAIN PATTERN PAINTED	BROOM FINISH		
21	CONCRETE PAVING (STAINED)- C				MEDIUM BLUE TO BE SELECTED FROM MANUFACTURER'S FULL		
					AVAILABLE RANGE OF COLORS		
22	CONCRETE PAVING (STAINED)- D	ACRYLIC STAIN TO BE APPLIED TO PLAIN CONCRETE PAVING AS SHOWN	ACRYLIC STAIN: TUFF COAT	ACRYLIC STAIN PATTERN PAINTED	BROOM FINISH		
					DARK BLUE TO BE SELECTED FROM MANUFACTURER'S FULL		
					AVAILABLE RANGE OF COLORS		
23	CONCRETE PAVING (STAINED)- E	TE PAVING (STAINED)- E ACRYLIC STAIN TO BE APPLIED TO PLAIN CONCRETE PAVING AS SHOWN	ACRYLIC STAIN: TUFF COAT	ACRYLIC STAIN PATTERN PAINTED	BROOM FINISH		
					WHITE TO BE SELECTED FROM MANUFACTURER'S FULL AVAILABLE		
					RANGE OF COLORS		
		TRUNCATED DOMES - 2' WIDE SURFACE	ARMOR-TILE				
5	ADA DETECTABLE WARNING	APPLIED TACTILE DETECTABLE WARNING		http://www.armor-tile.com/	n/ ADA-S-2460	COLOR PER CITY STANDARD	SURFACE MOUNTED
		SURFACE					
	WOOD BOARDWALK - DECKING		DASSO XTR				
9		RDWALK - DECKING EUSED BAMBOO DECKING	http://dassoxtr.com/	XTR-DK20-G2-PP DOUBLE GROOVE;	RIBBED SIDE UP	MOUNTED TO JOIST	
				20mm x 137mmx 1820 mm			

2 HARDSCAPE SCHEDULE

D	
D	
D	
D	
D	
D	
D	

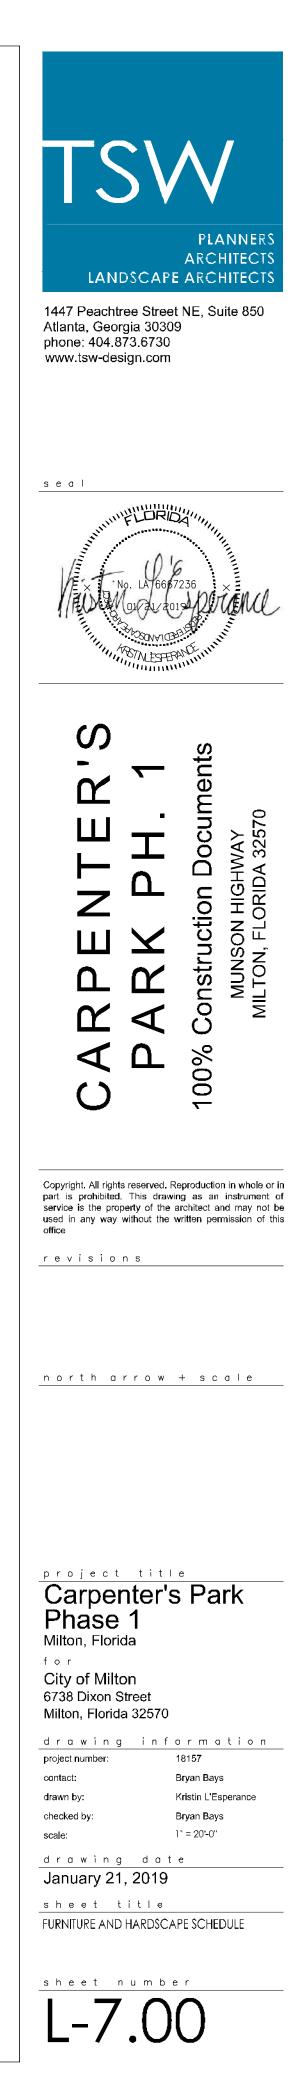





WALL BEYOND

1/4" RADIUS

SEALER

ASPHALT -IMPREGNATED FILLER

CONTROL JOINT SEE

PLANS FOR SPACING


CONSTRUCTION JOINT


DOWEL AT COLD JOINT, TYP.

MEDIUM BROOM FINISH PERPENDICULAR TO

DIRECTION OF TRAVEL; SEE CONCRETE

SCHEDULE FOR FINISH AND COLOR

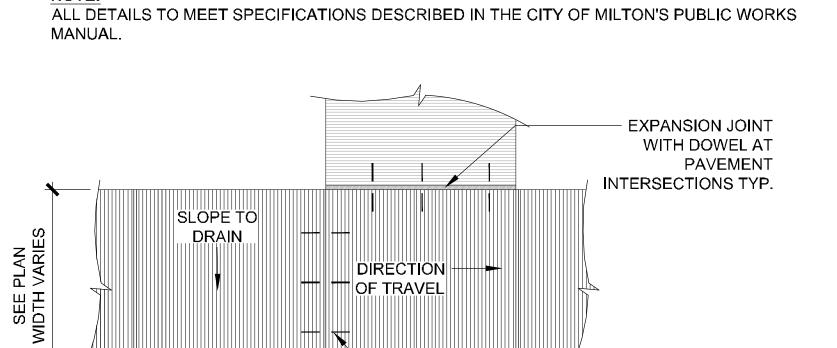

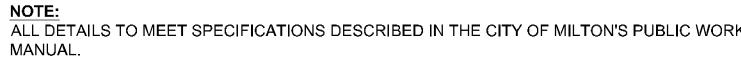





1" = 1' -0"

CONCRETE SIDEWALK


ALL DETAILS TO MEET SPECIFICATIONS DESCRIBED IN THE CITY OF MILTON'S PUBLIC WORKS MANUAL.

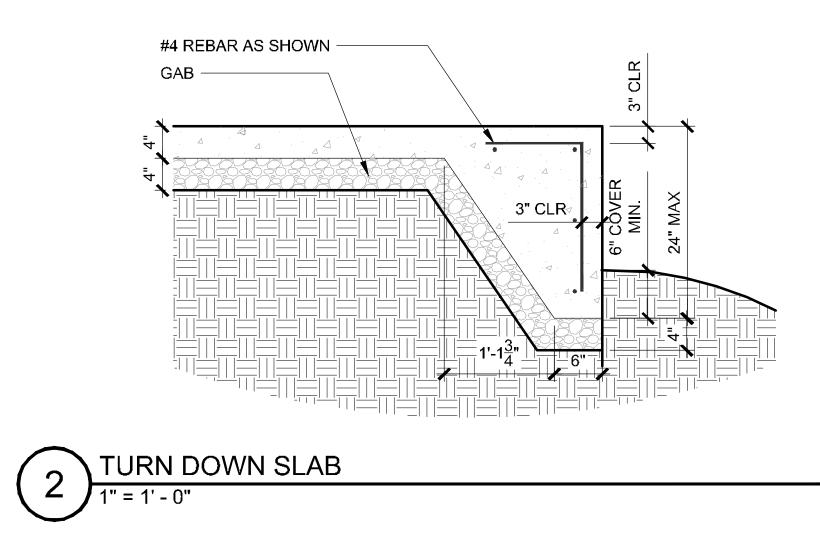





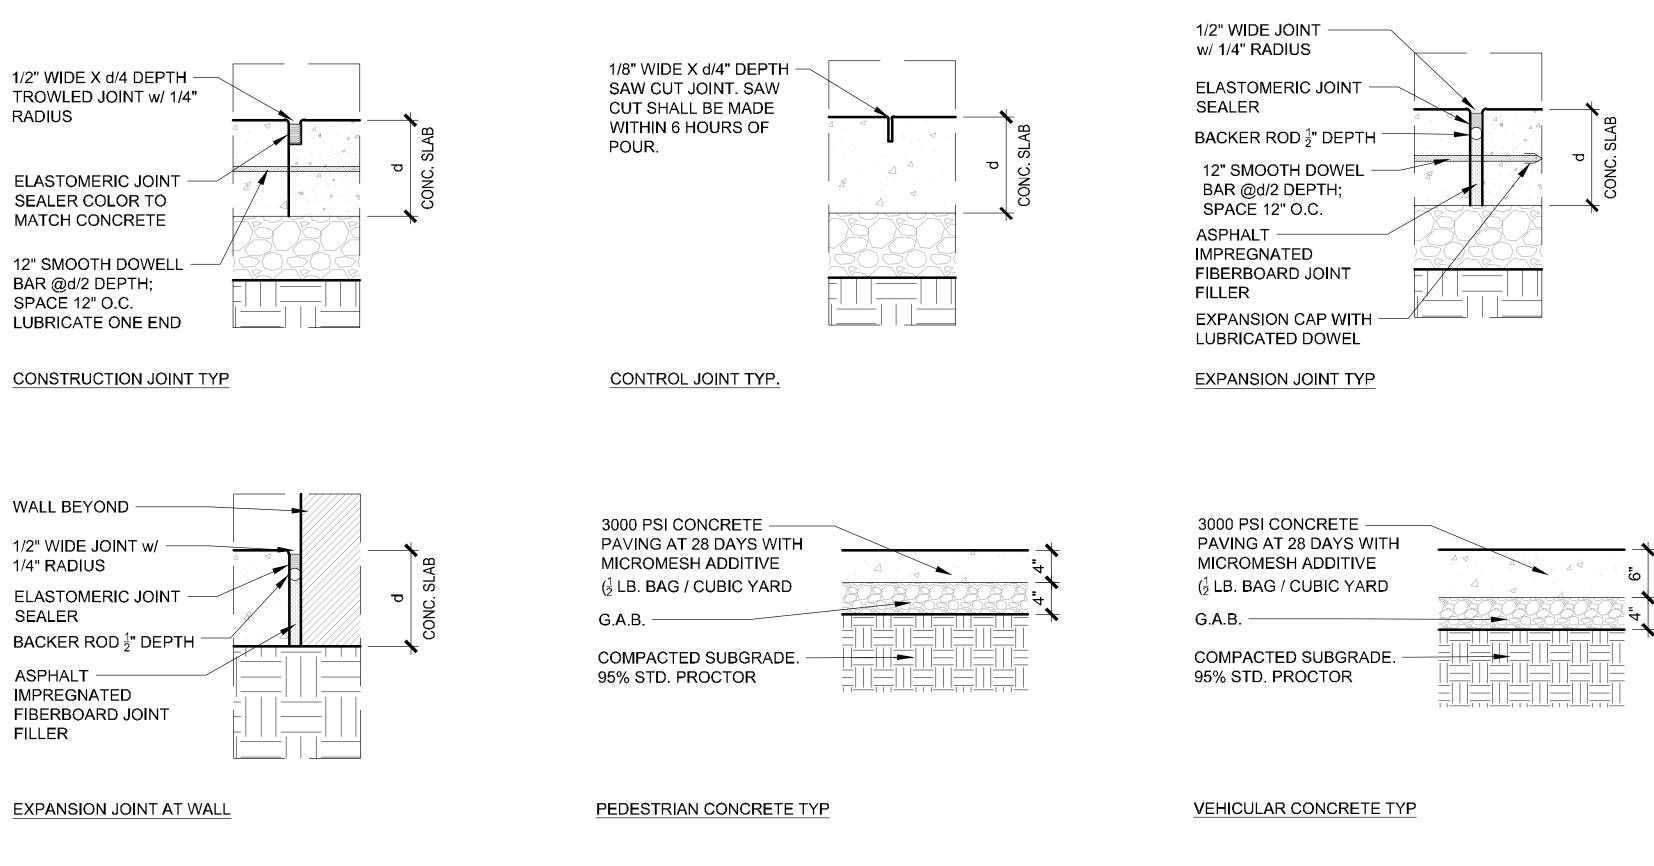


NOTE: 1. SHOWER DRAIN TO TIE INTO IWF SANITARY SEWER DRAIN SYSTEM

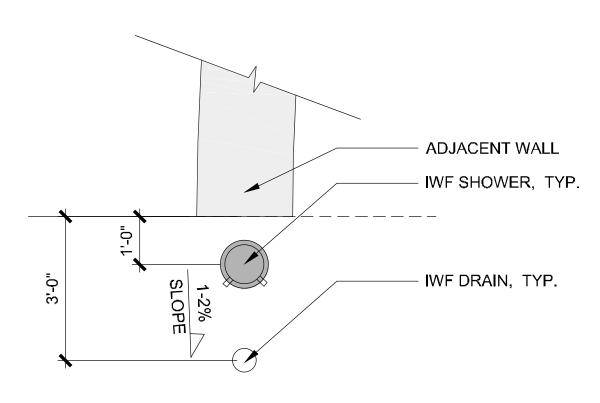


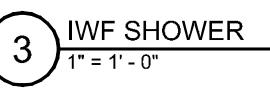

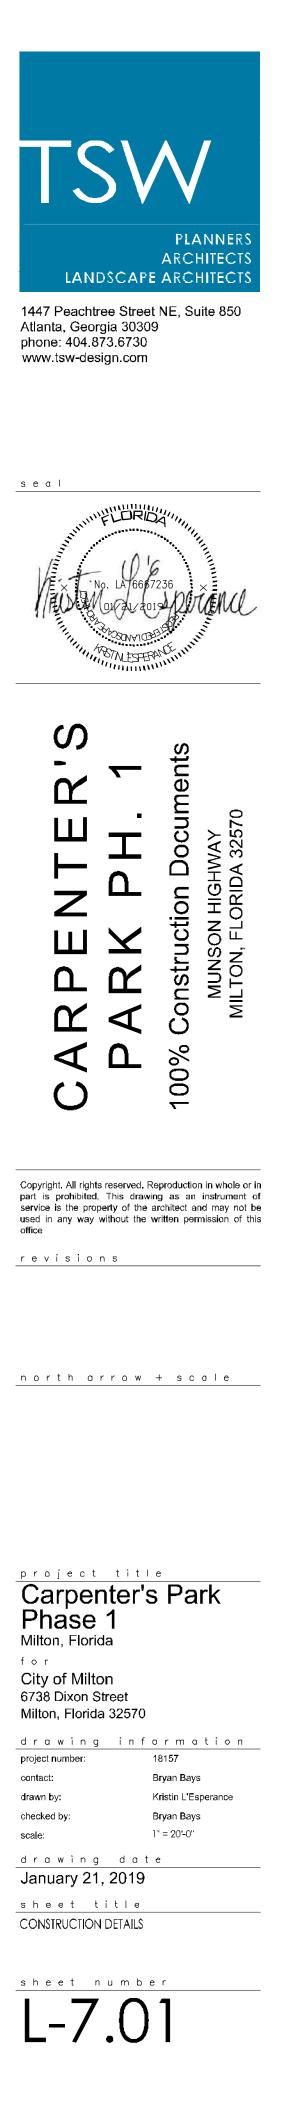

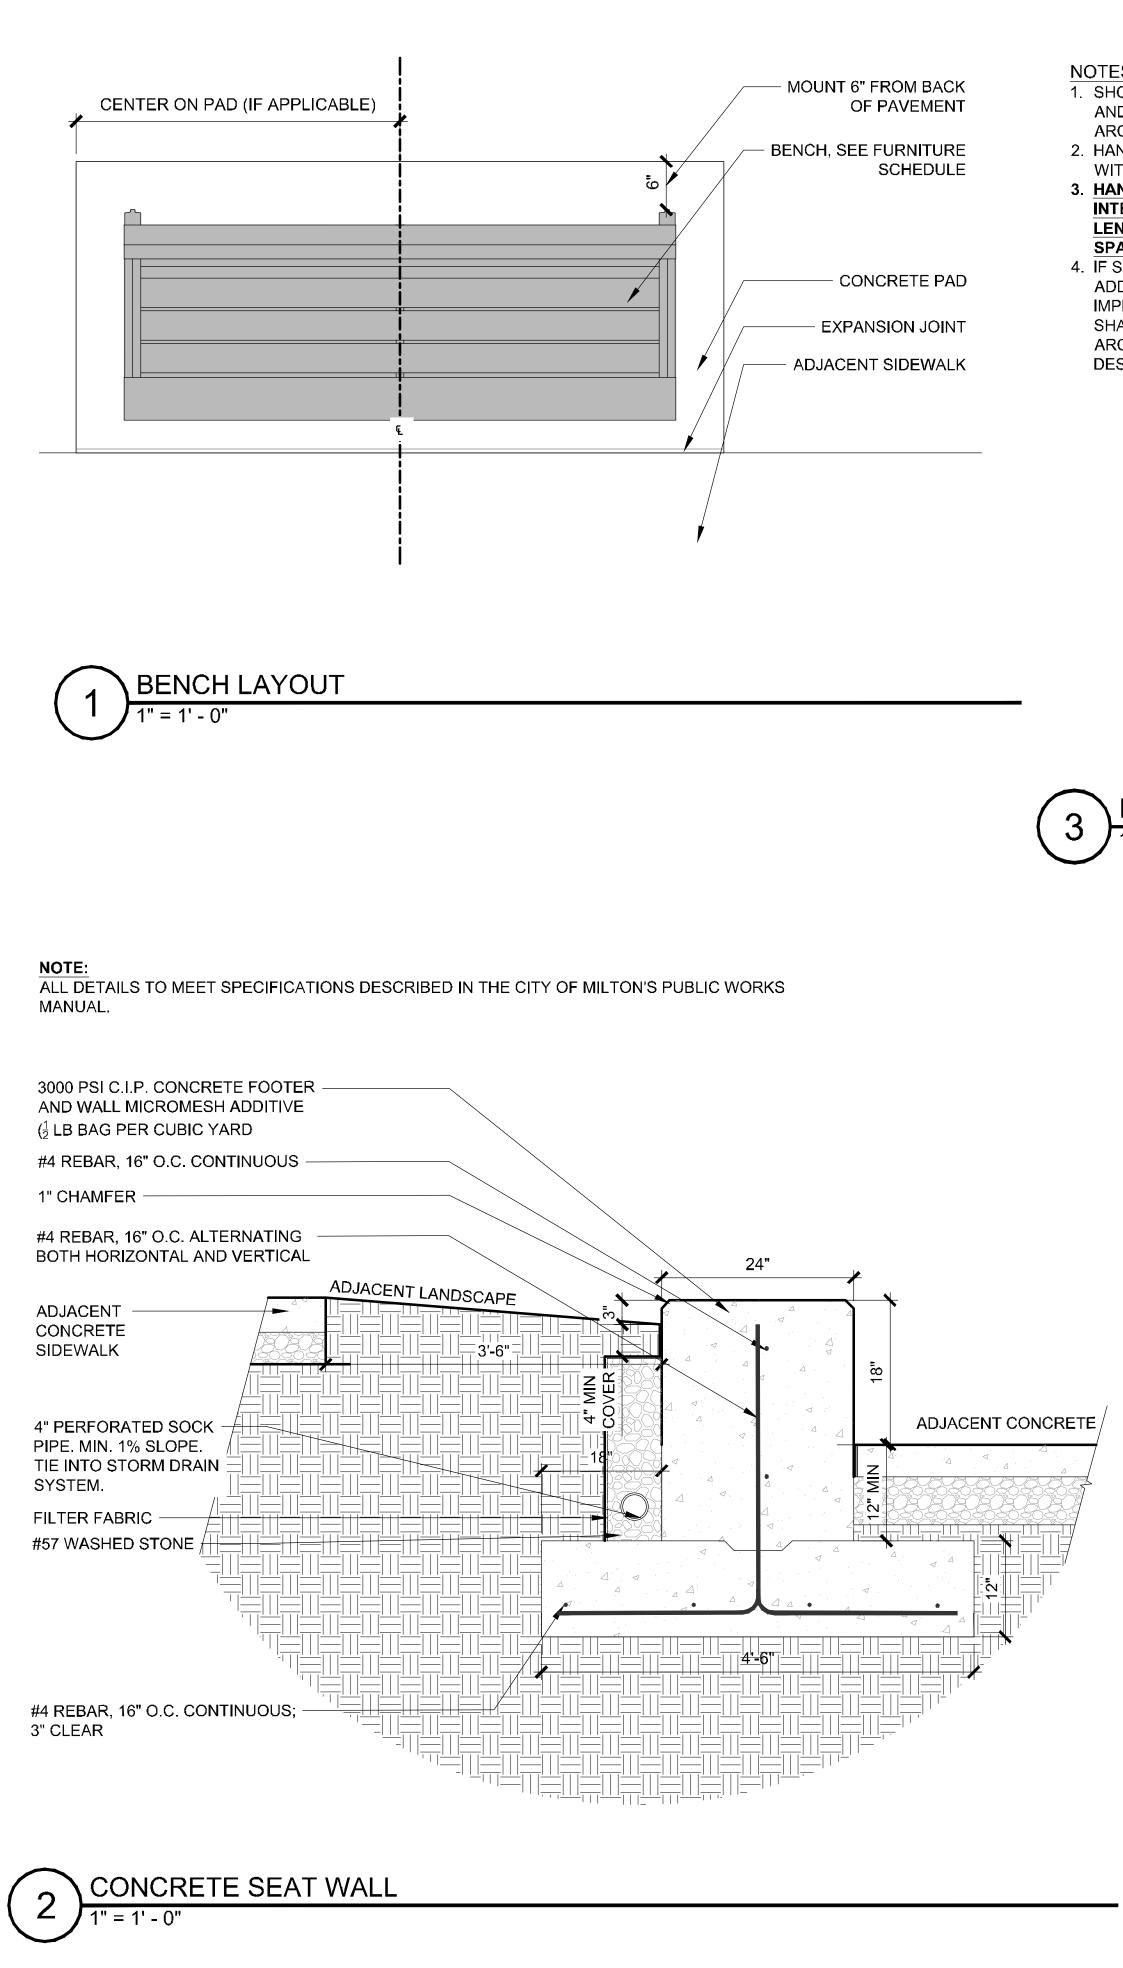


- 1. SHOP DRAWINGS ARE TO BE PROVIDED AND APPROVED BY LANDSCAPE ARCHITECT PRIOR TO CONSTRUCTION.
- 2. HANDRAILS TO BE 316 STAINLESS STEEL WITH POLISHED FINISH.
- 3. HANDRAILS THAT REQUIRE INTERMITTENT RETURNS DUE TO SPAN LENGTHS SHOULD HAVE EQUALLY SPACED POSTS.
- 4. IF SITE INSPECTOR REQUIRES ADDITIONAL HANDRAILS TO BE IMPLEMENTED THEN THE CONTRACTOR SHALL CONSULT WITH THE LANDSCAPE ARCHITECT ON THE LOCATION AND DESIGN OF SUCH HANDRAILS.

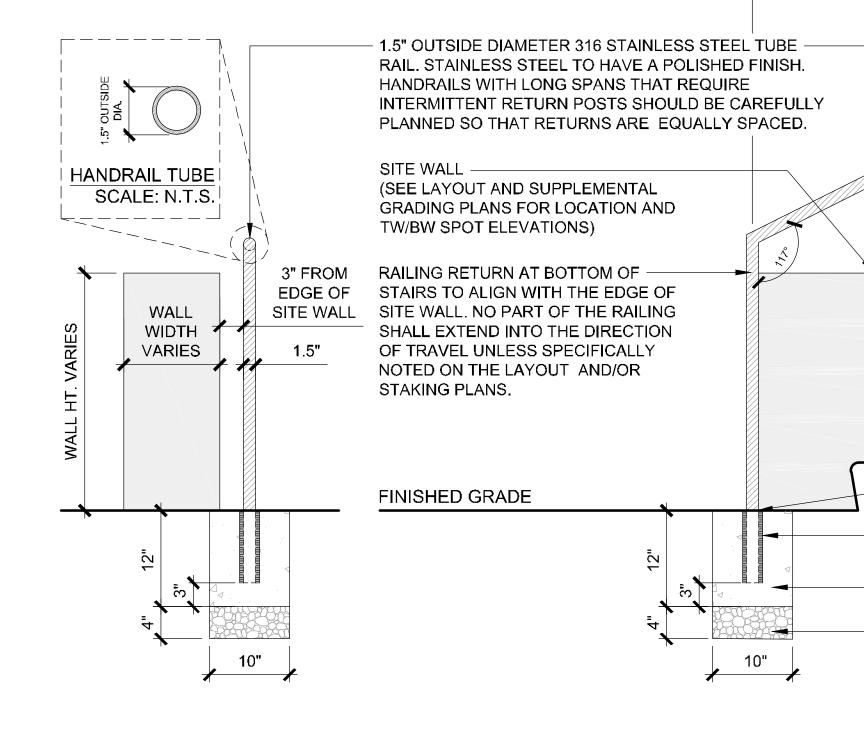


HANDRAIL = 1' - 0"

NOTES

- 1. NUMBER OF STAIRS VARIES SEE PLANS
- RISER HEIGHTS ARE EQUAL (4" MIN 7" MAX) SEE PLANS FOR RISER HEIGHT CALL OUTS. 2
- ALL CONCRETE STAIRS SHOULD HAVE A PLAIN FINISH (SEE CONCRETE & FINISHES SCHEDULE DETAIL). - 3

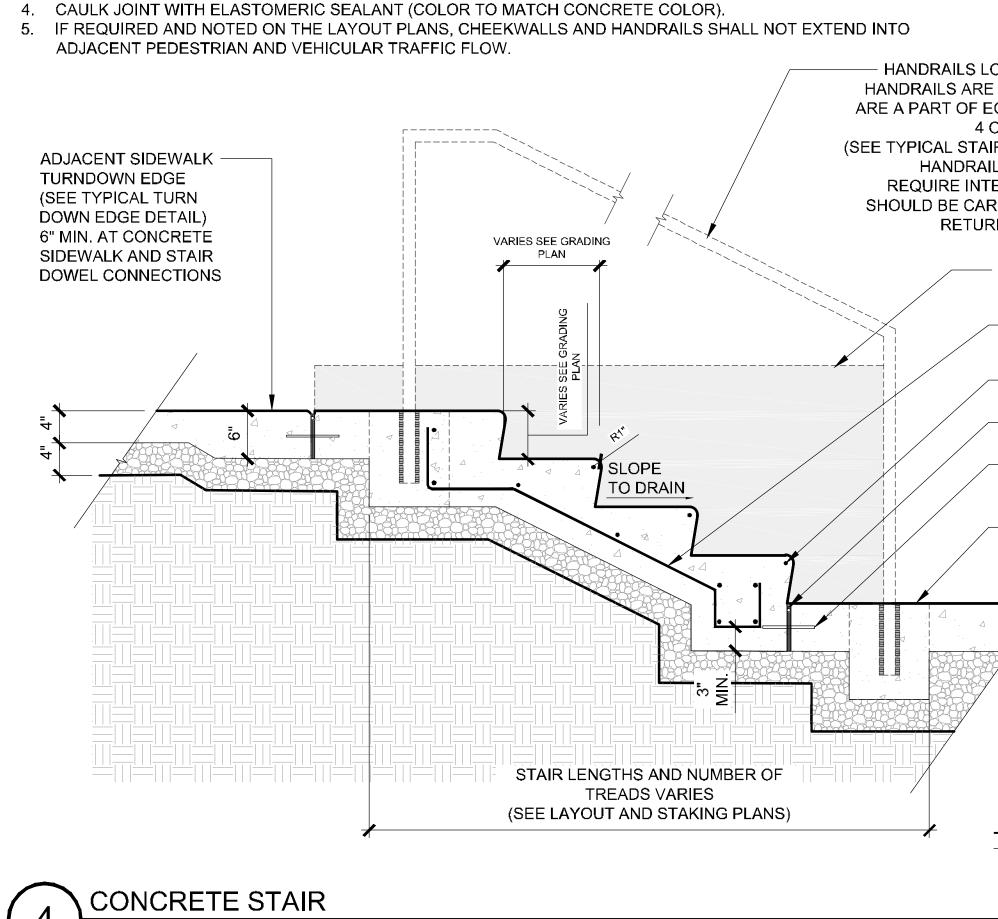

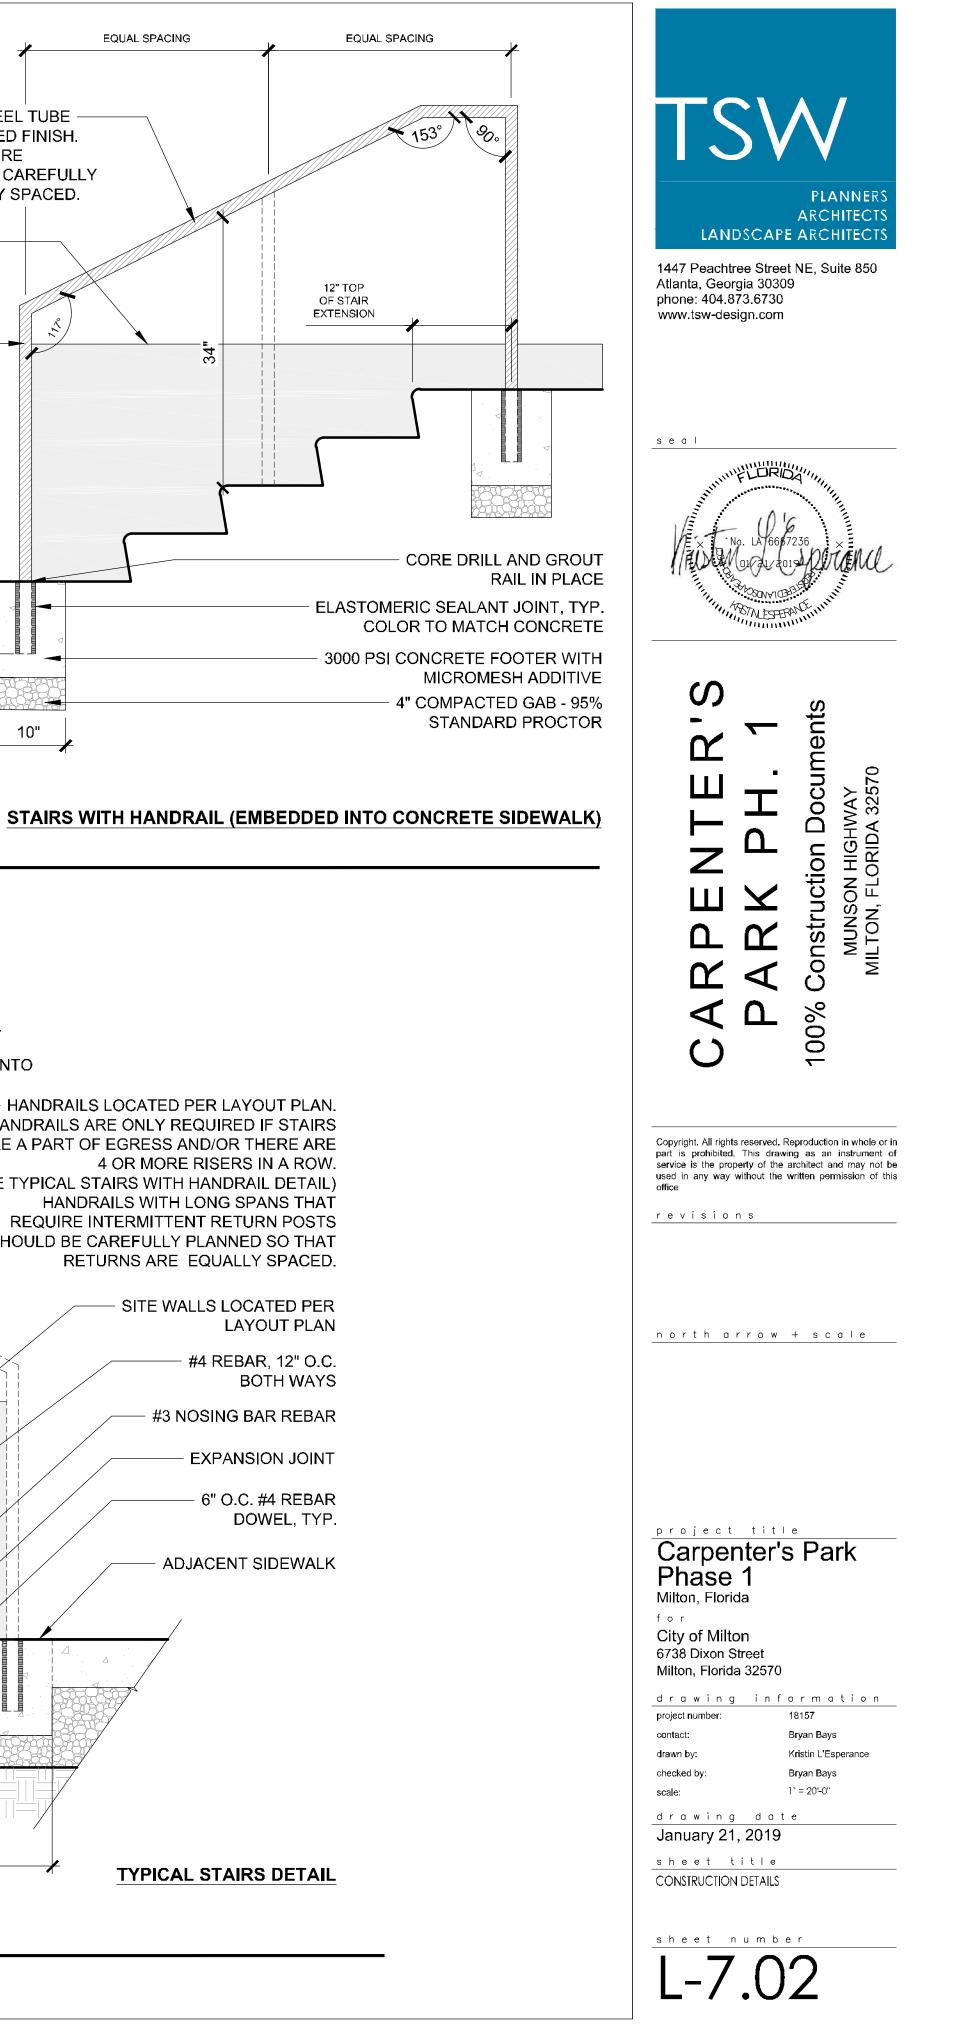

HANDRAILS LOCATED PER LAYOUT PLAN. HANDRAILS ARE ONLY REQUIRED IF STAIRS ARE A PART OF EGRESS AND/OR THERE ARE 4 OR MORE RISERS IN A ROW. (SEE TYPICAL STAIRS WITH HANDRAIL DETAIL) HANDRAILS WITH LONG SPANS THAT **REQUIRE INTERMITTENT RETURN POSTS** SHOULD BE CAREFULLY PLANNED SO THAT RETURNS ARE EQUALLY SPACED.

EQUAL SPACING

SITE WALLS LOCATED PER LAYOUT PLAN

> #4 REBAR, 12" O.C. BOTH WAYS


#3 NOSING BAR REBAR


EXPANSION JOINT


6" O.C. #4 REBAR DOWEL, TYP.


ADJACENT SIDEWALK

TYPICAL STAIRS DETAIL

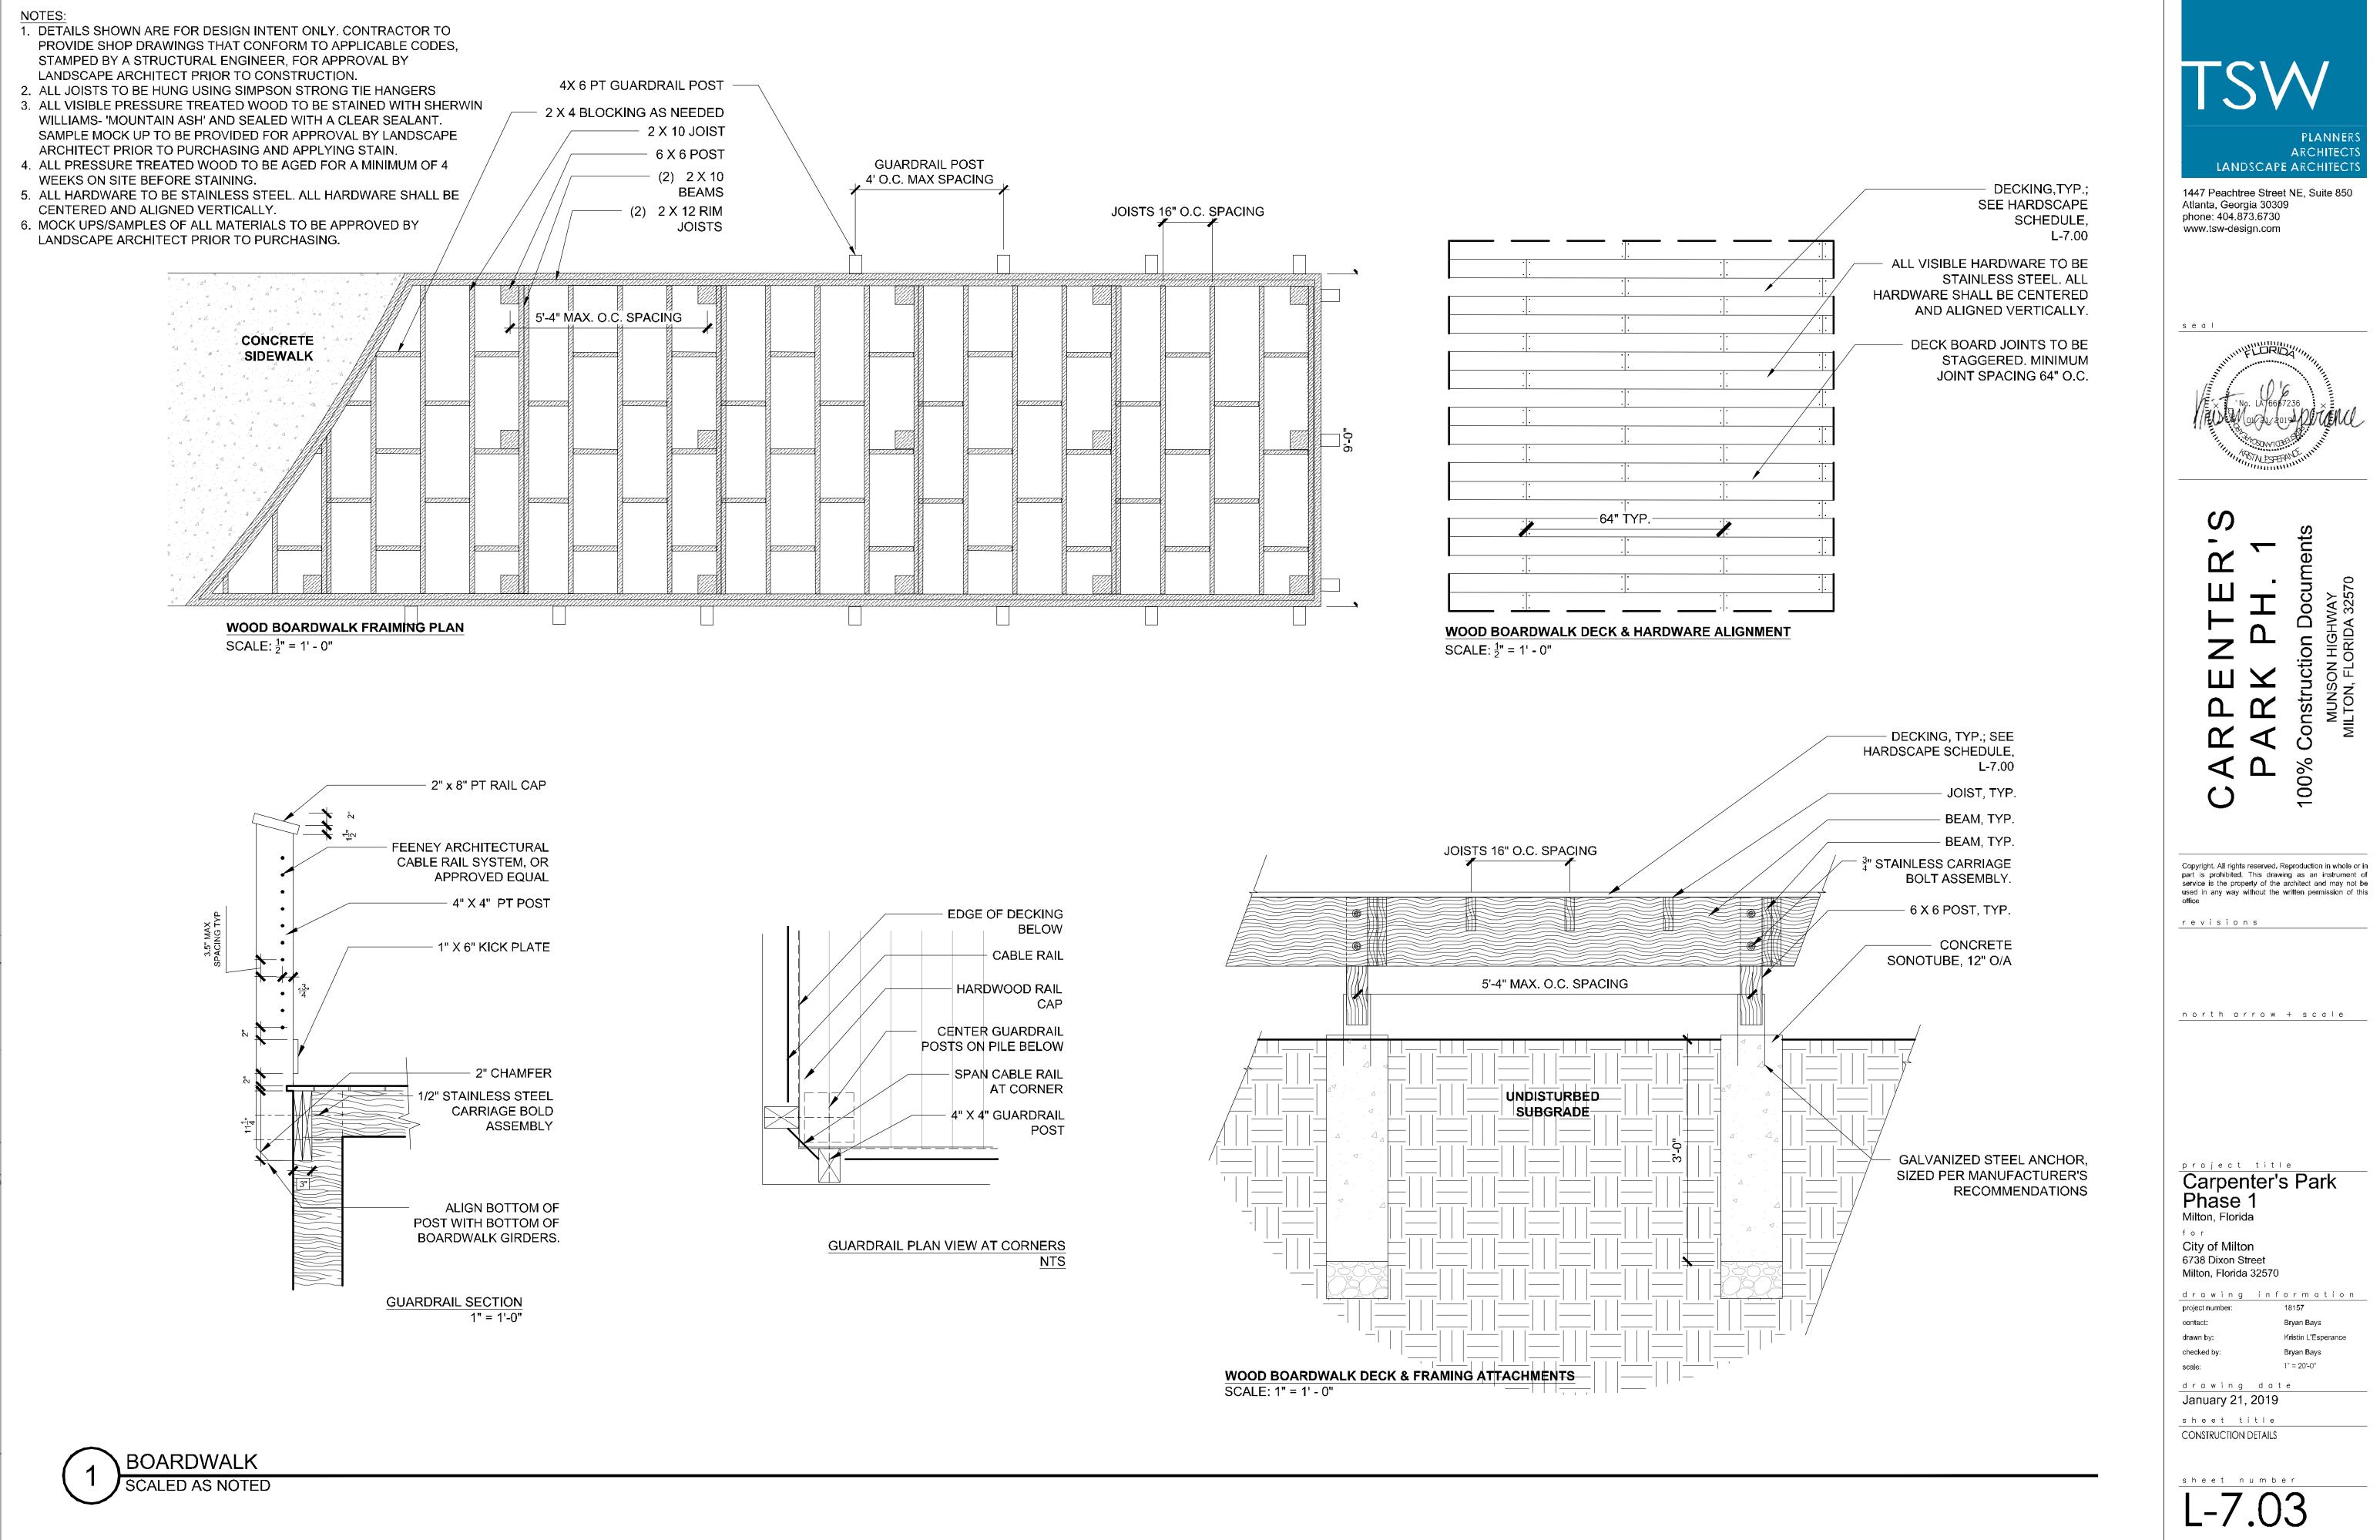

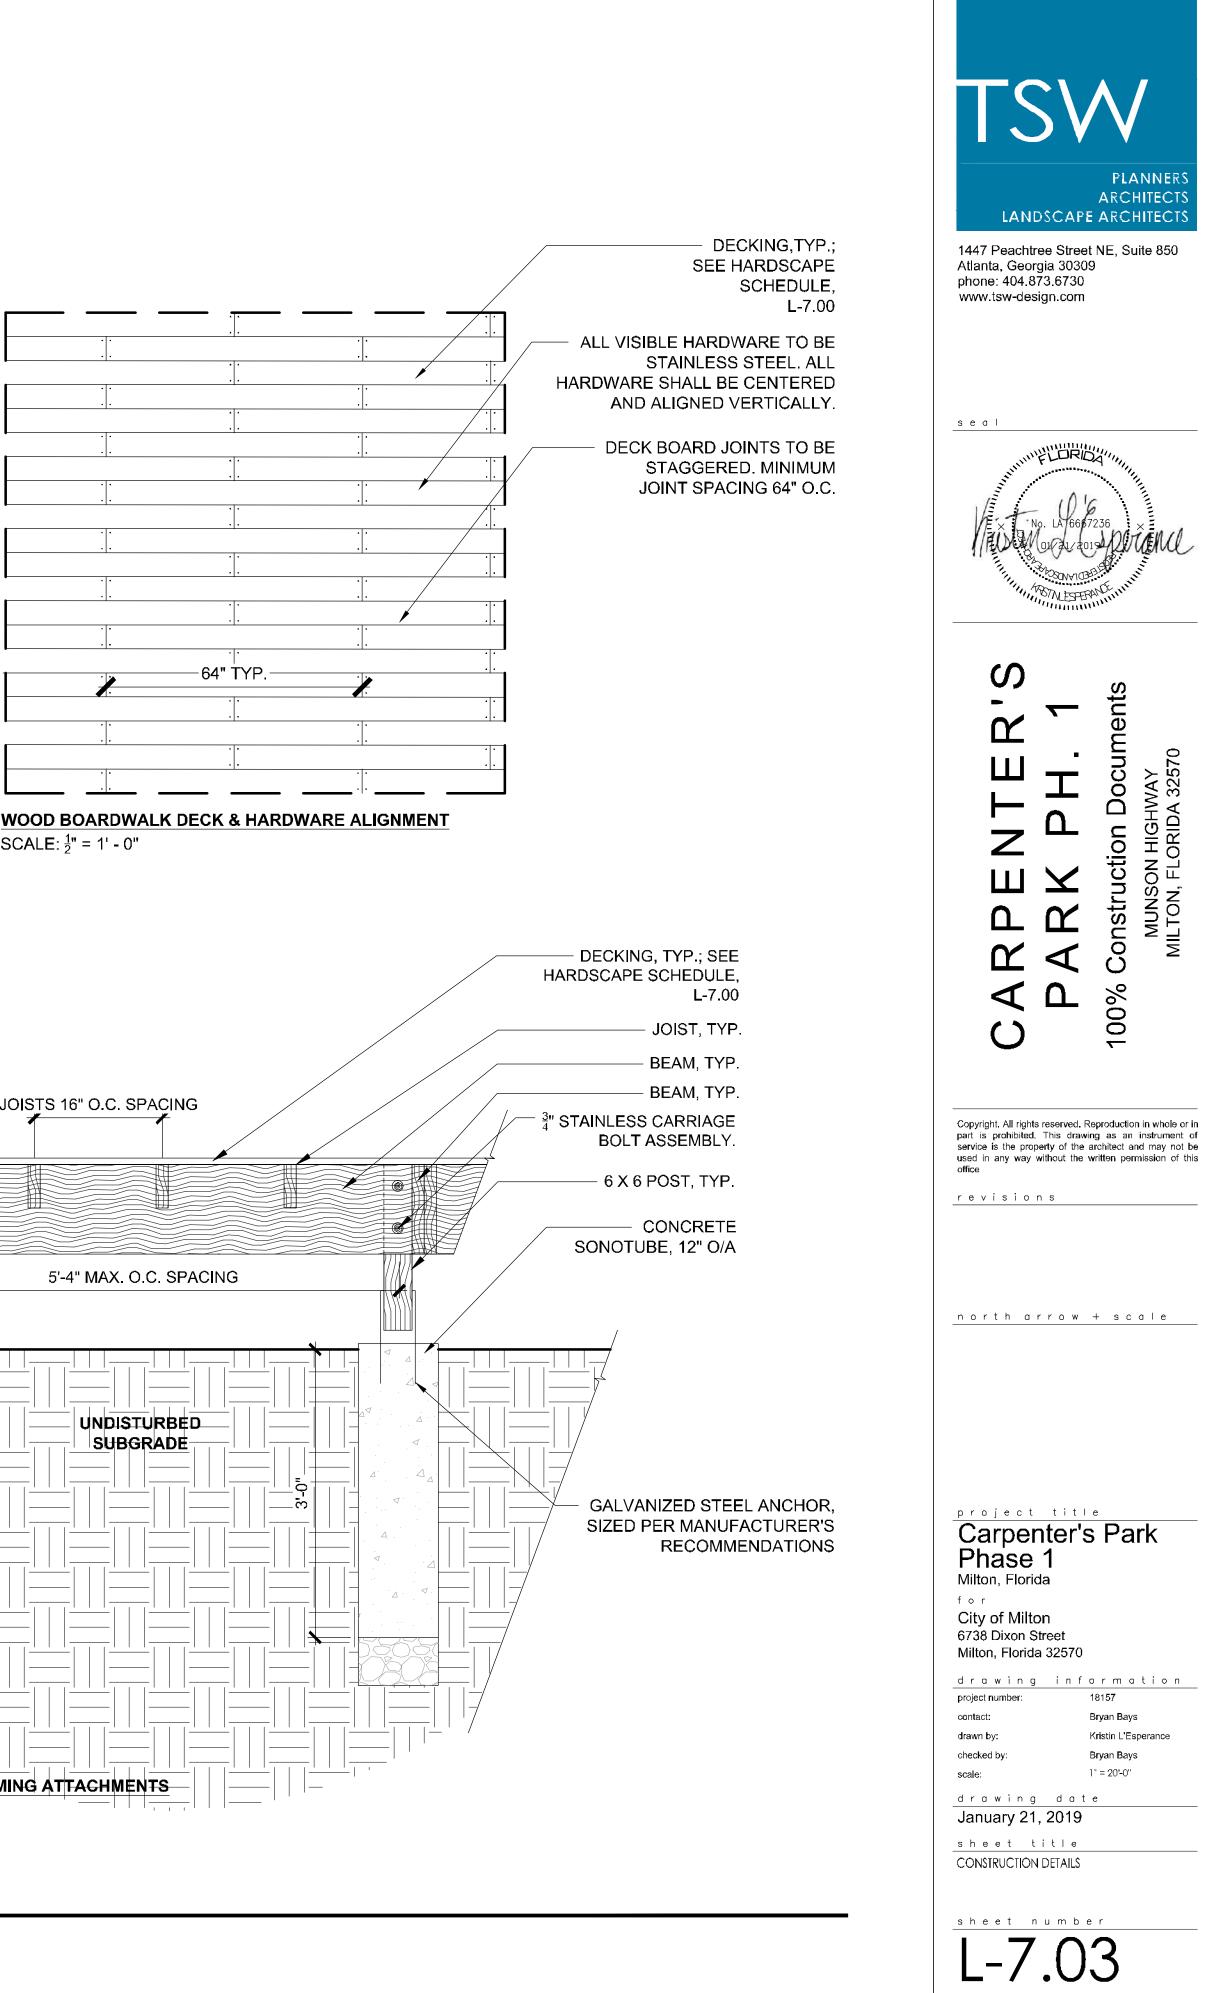

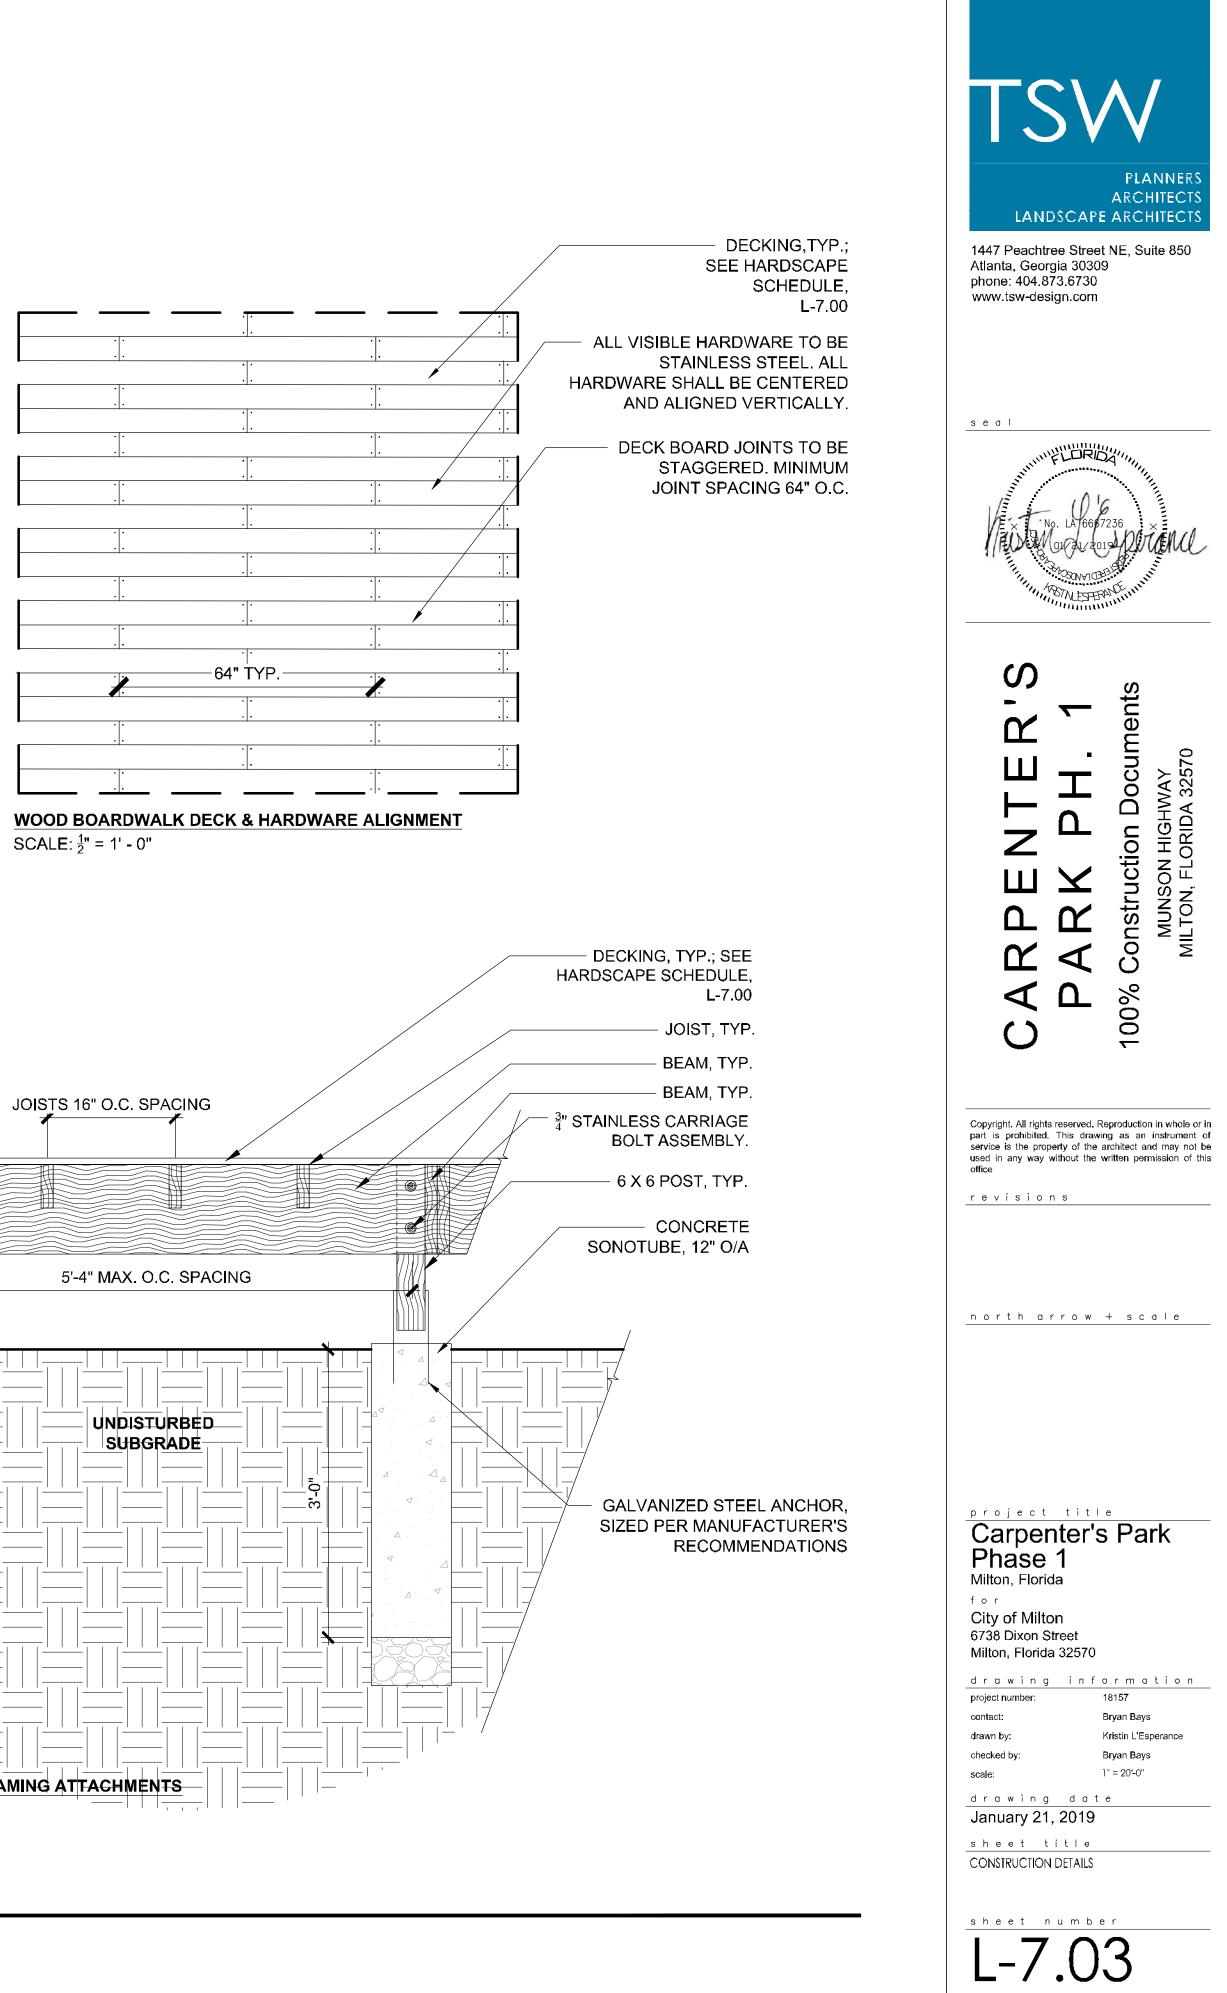

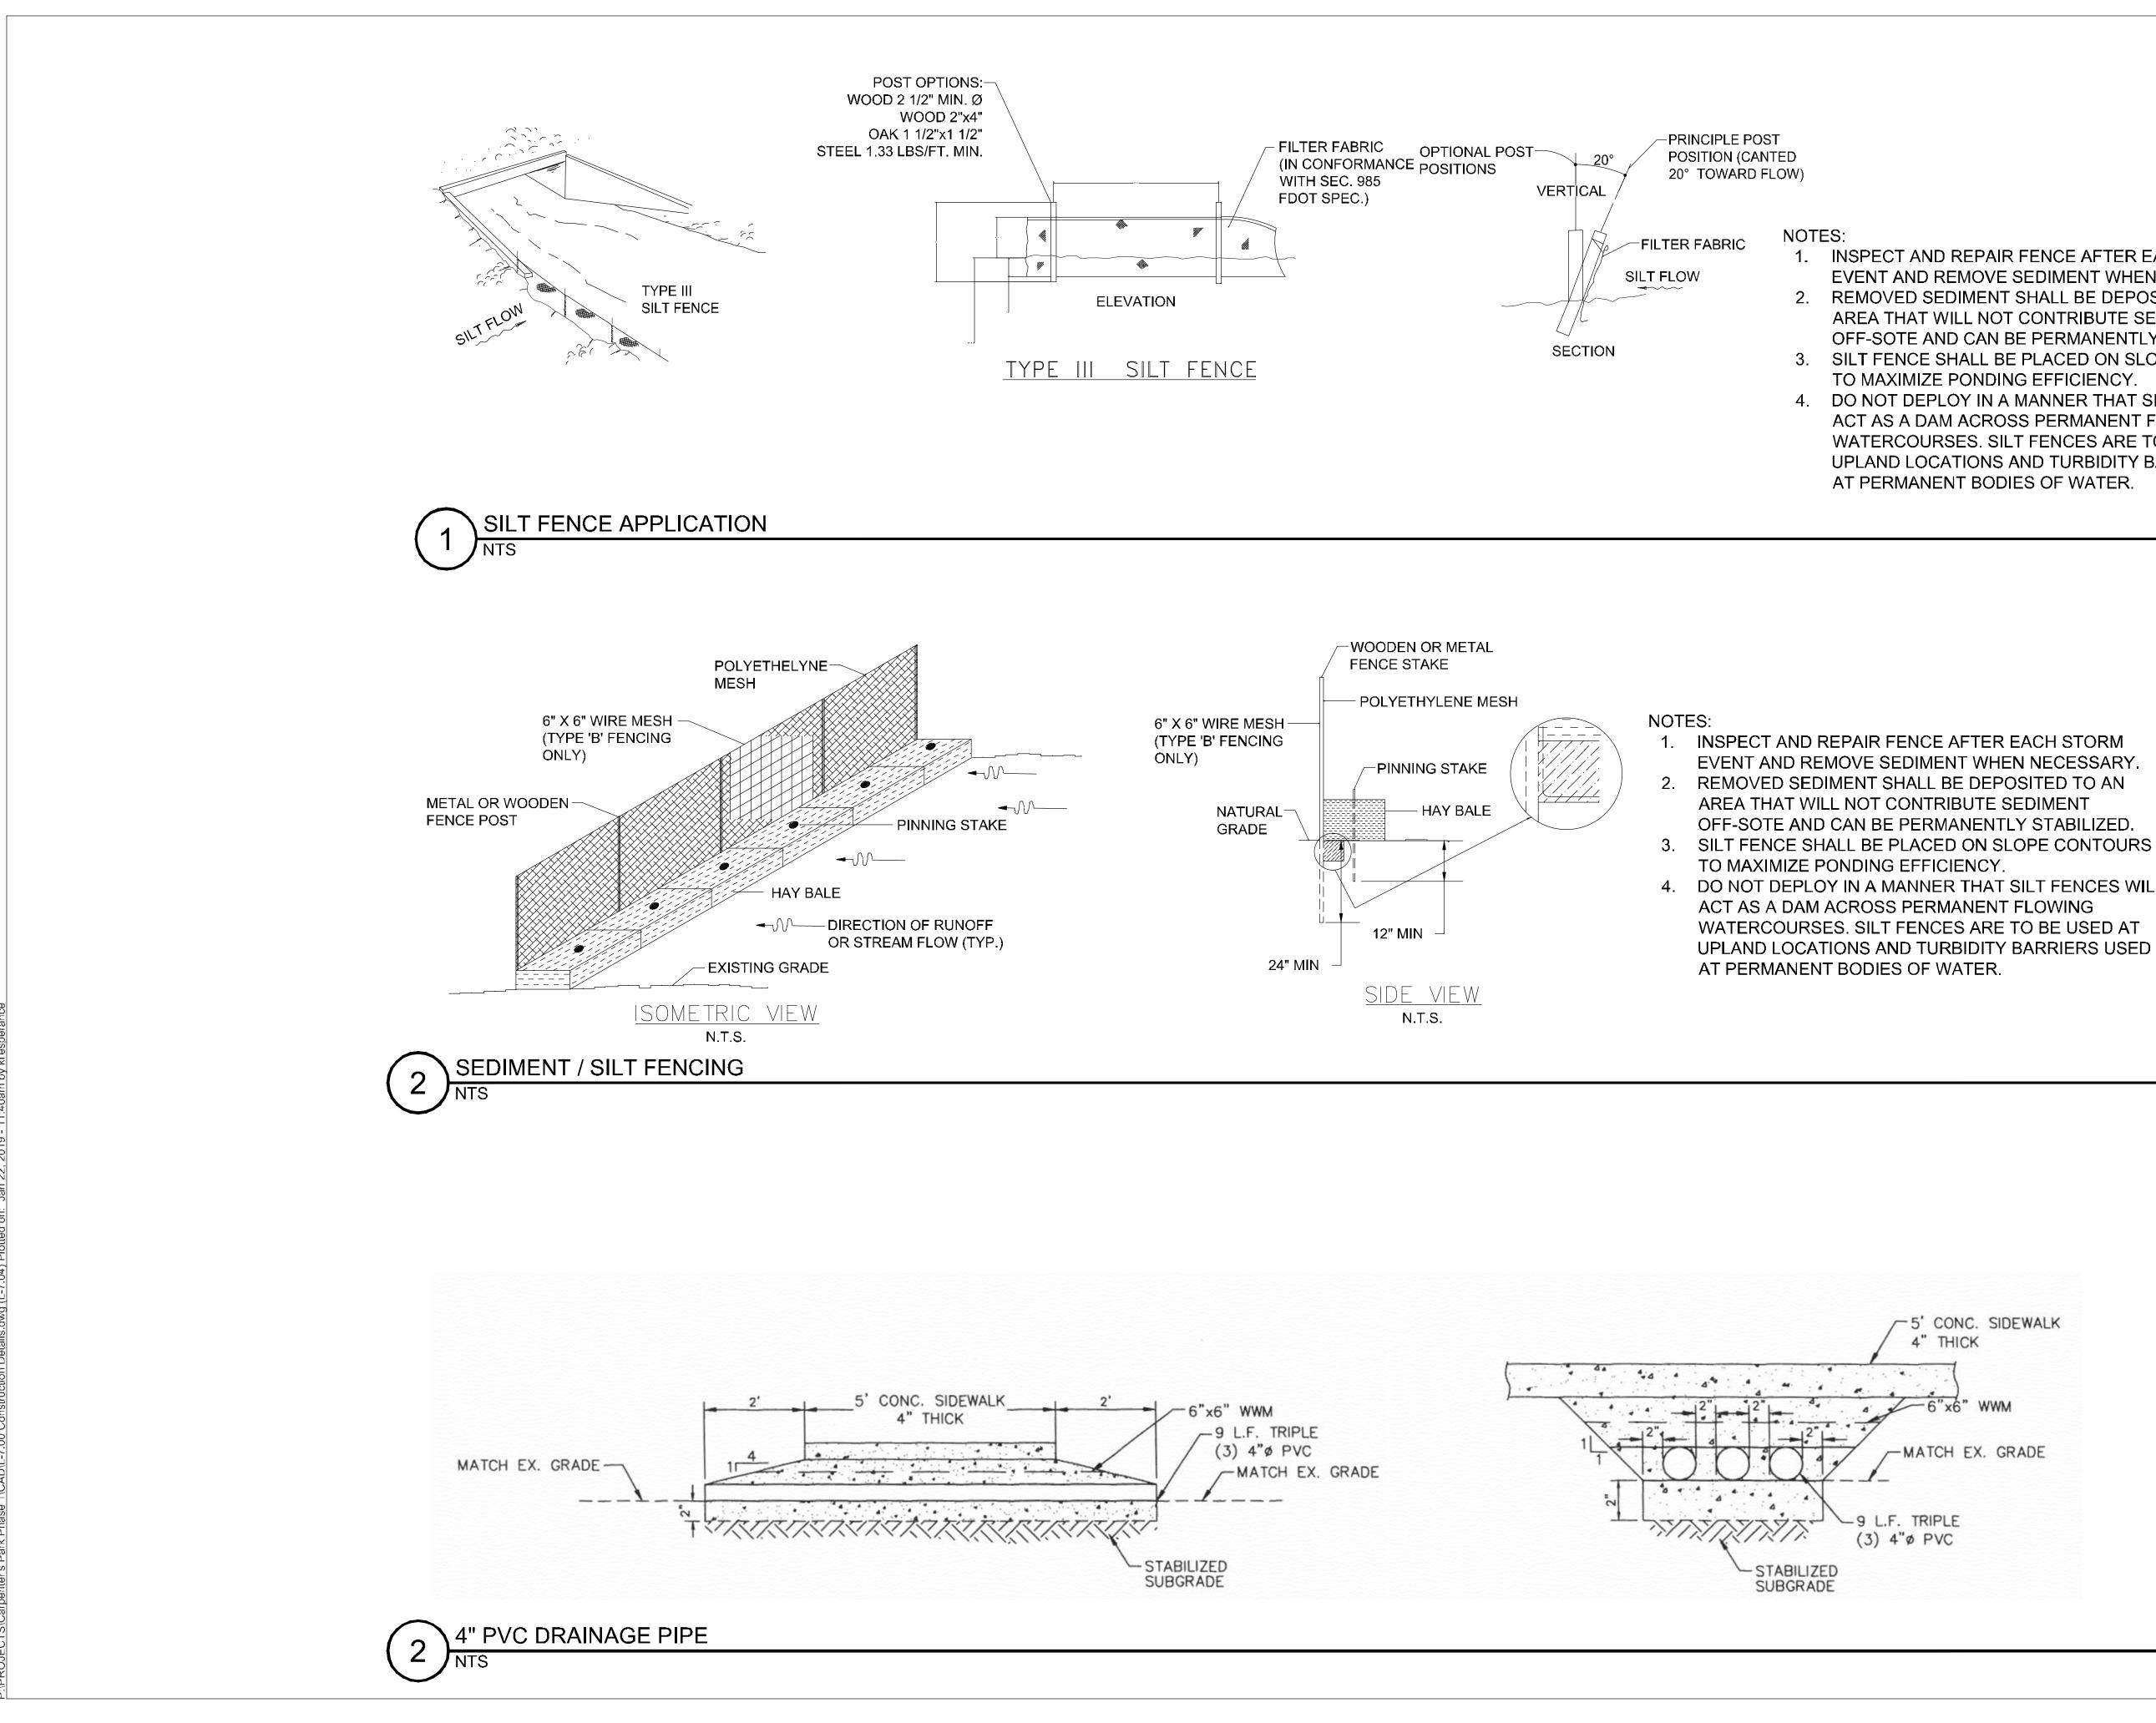


1. INSPECT AND REPAIR FENCE AFTER EACH STORM EVENT AND REMOVE SEDIMENT WHEN NECESSARY. 2. REMOVED SEDIMENT SHALL BE DEPOSITED TO AN AREA THAT WILL NOT CONTRIBUTE SEDIMENT OFF-SOTE AND CAN BE PERMANENTLY STABILIZED. 3. SILT FENCE SHALL BE PLACED ON SLOPE CONTOURS TO MAXIMIZE PONDING EFFICIENCY. 4. DO NOT DEPLOY IN A MANNER THAT SILT FENCES WILL ACT AS A DAM ACROSS PERMANENT FLOWING WATERCOURSES. SILT FENCES ARE TO BE USED AT UPLAND LOCATIONS AND TURBIDITY BARRIERS USED AT PERMANENT BODIES OF WATER.


EVENT AND REMOVE SEDIMENT WHEN NECESSARY. OFF-SOTE AND CAN BE PERMANENTLY STABILIZED. 4. DO NOT DEPLOY IN A MANNER THAT SILT FENCES WILL WATERCOURSES. SILT FENCES ARE TO BE USED AT UPLAND LOCATIONS AND TURBIDITY BARRIERS USED

> -5' CONC. SIDEWALK 4" THICK


WWM

-MATCH EX. GRADE

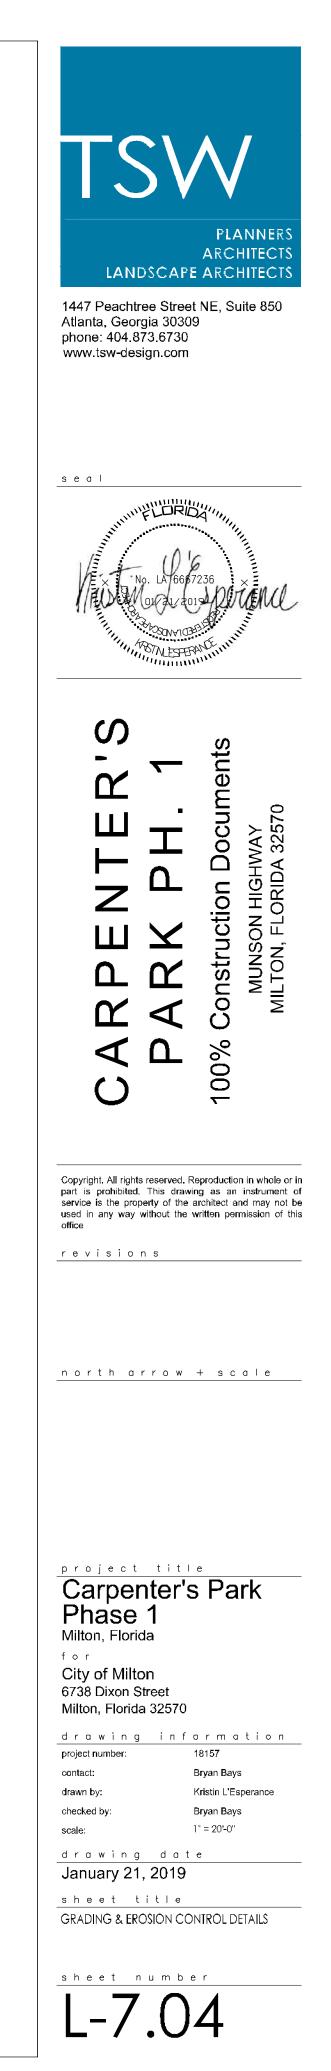

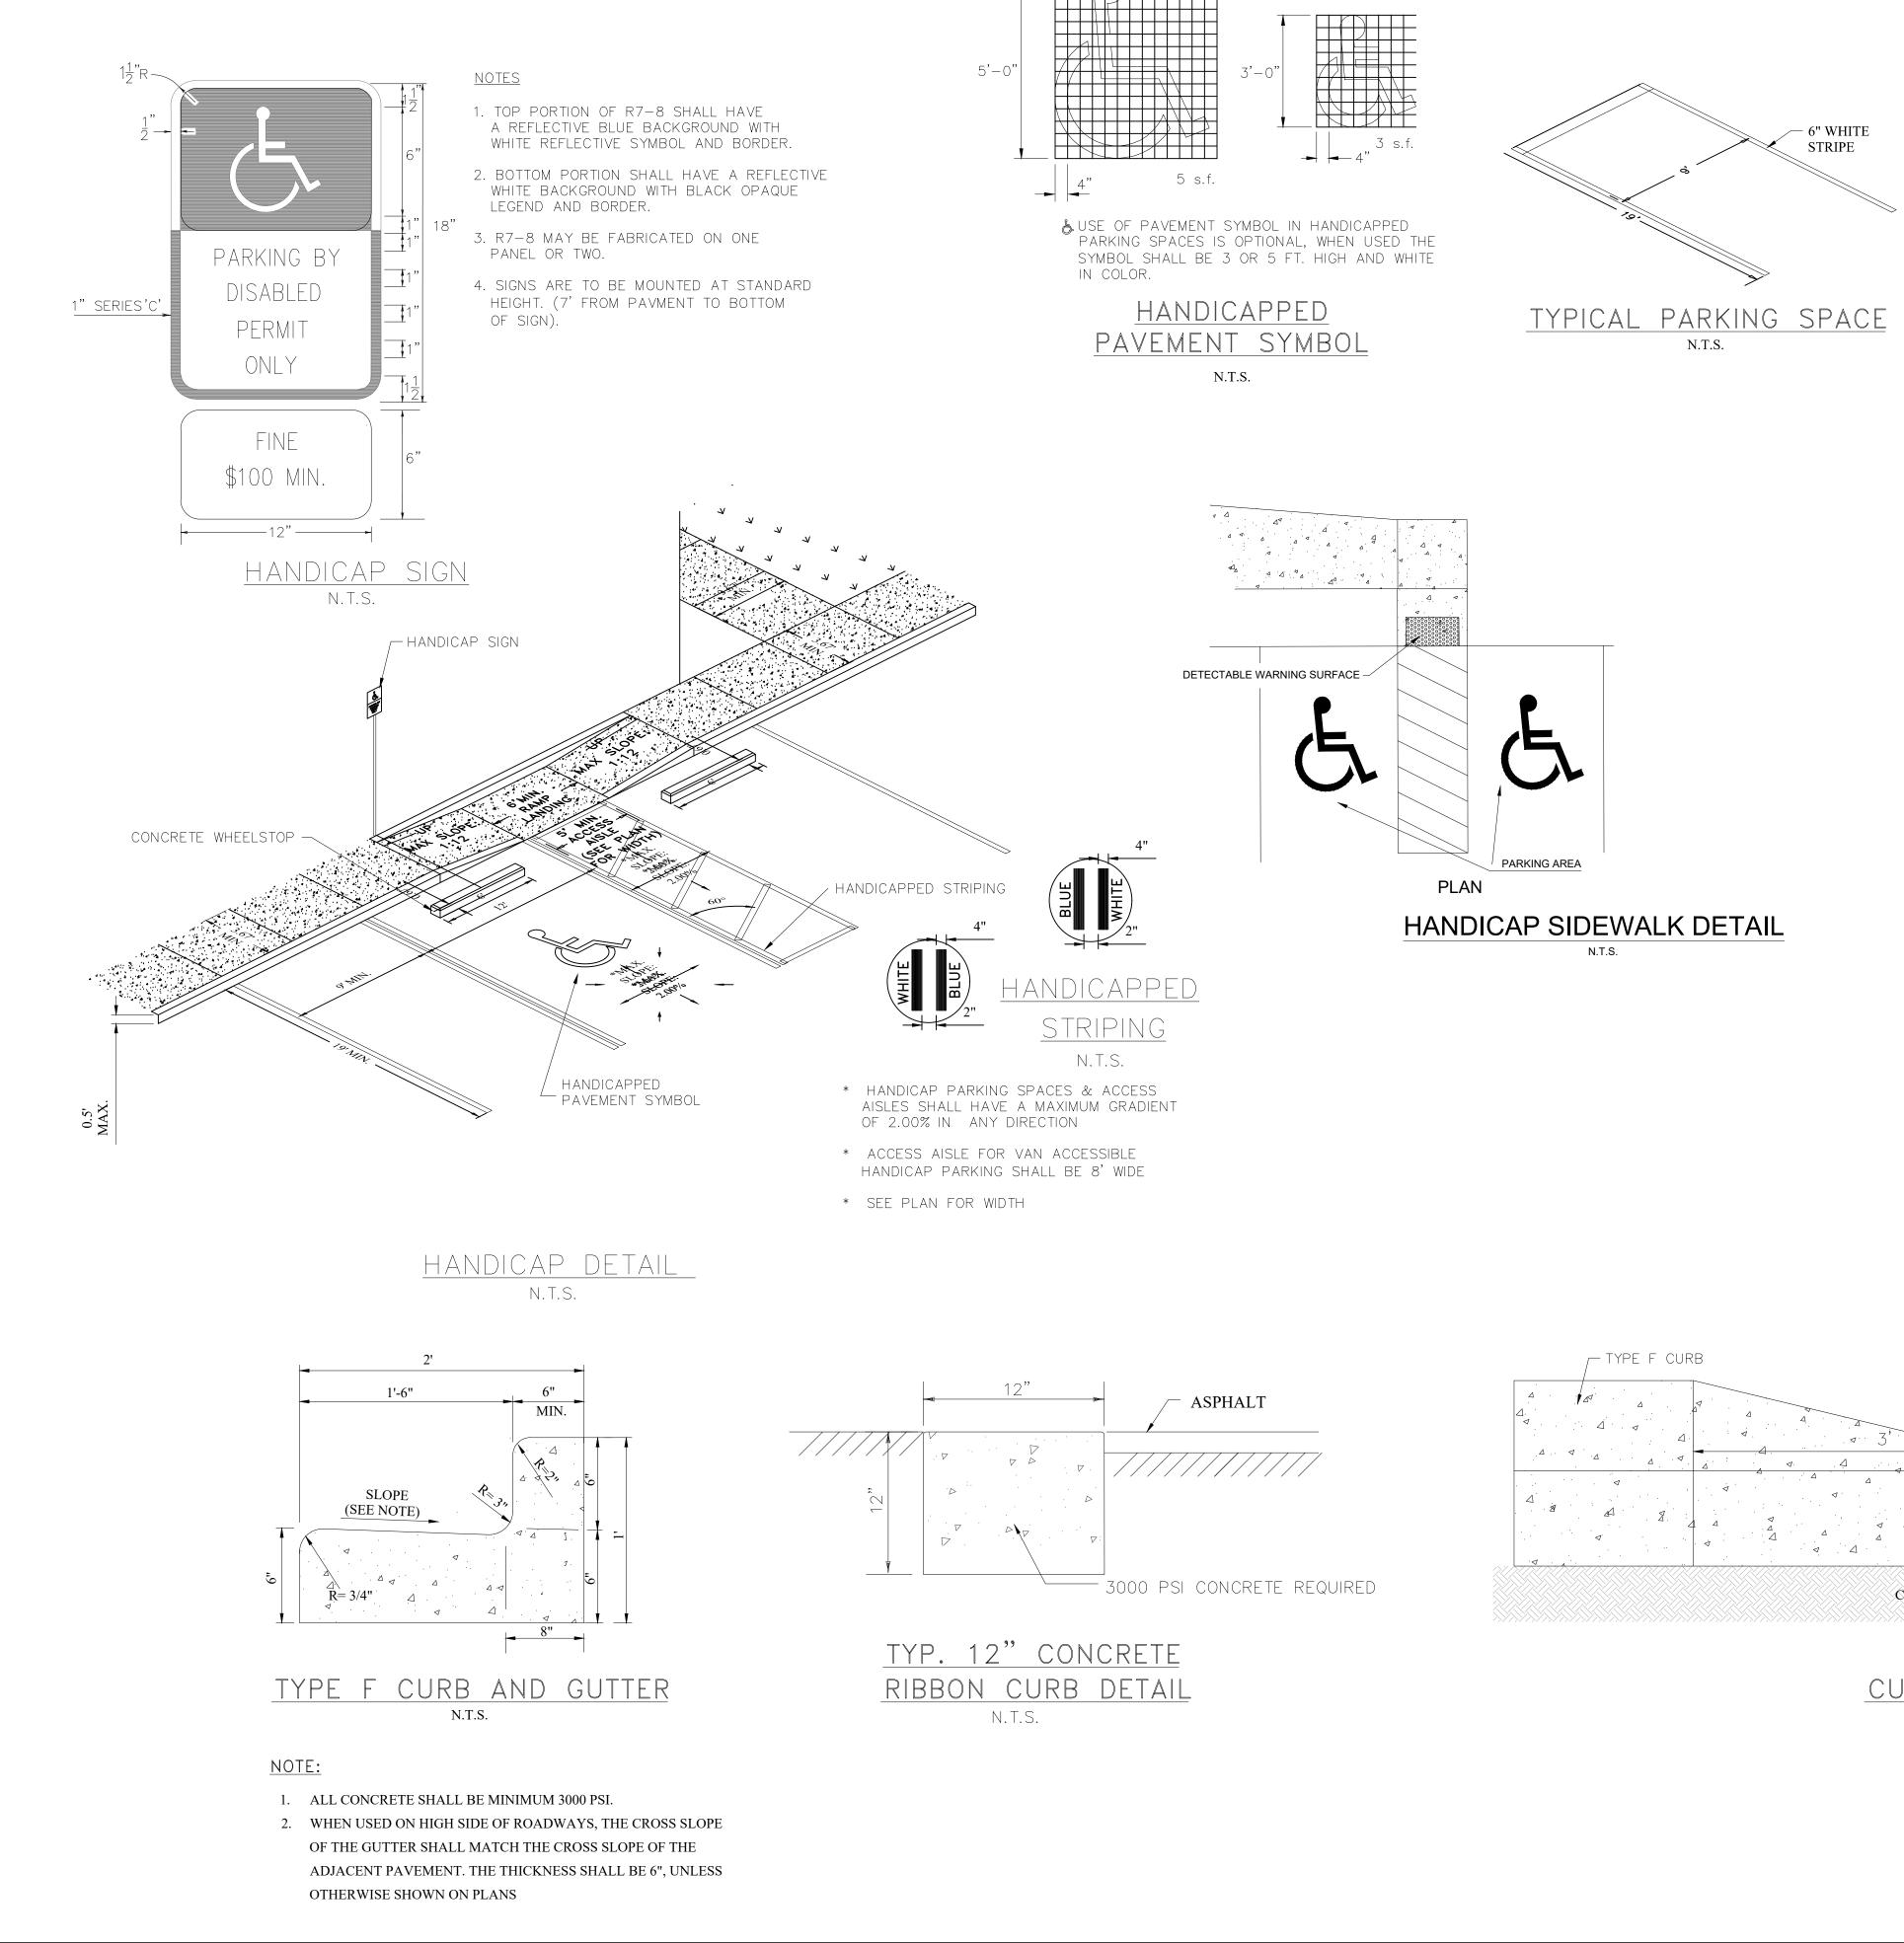

CURB TRANSITION N.T.S.

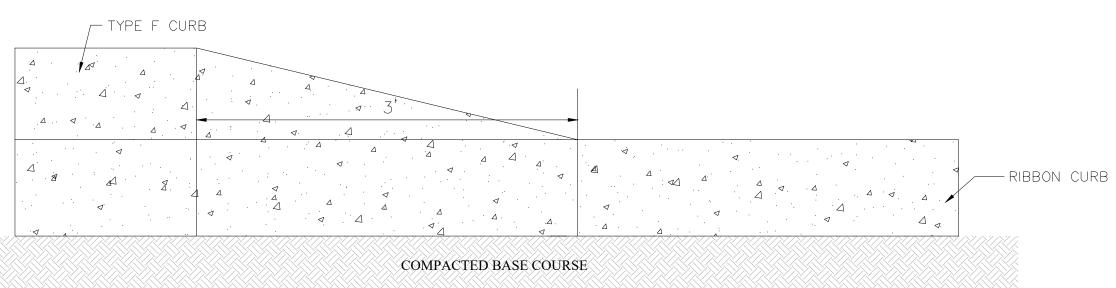



COMMUNITY DESIGN AND ARCHITECTURE

1447 Peachtree Street NE, Suite 850 Atlanta, Georgia 30309 phone: 404.873.6730 . www.tsw-design.com

s e a l



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revisions

northarrow + scale

project title Carpenter's Park Phase 1 Milton, Florida for

City of Milton 6738 Dixon Street Milton, Florida 32570


project number: contact: drawn by: checked by: scale:


drawing information 0730401 Mike Warnke Amy O'Laughlin Mike Warnke

drawing date January 21st, 2019 sheet title

Crosswalk Details

sheet number

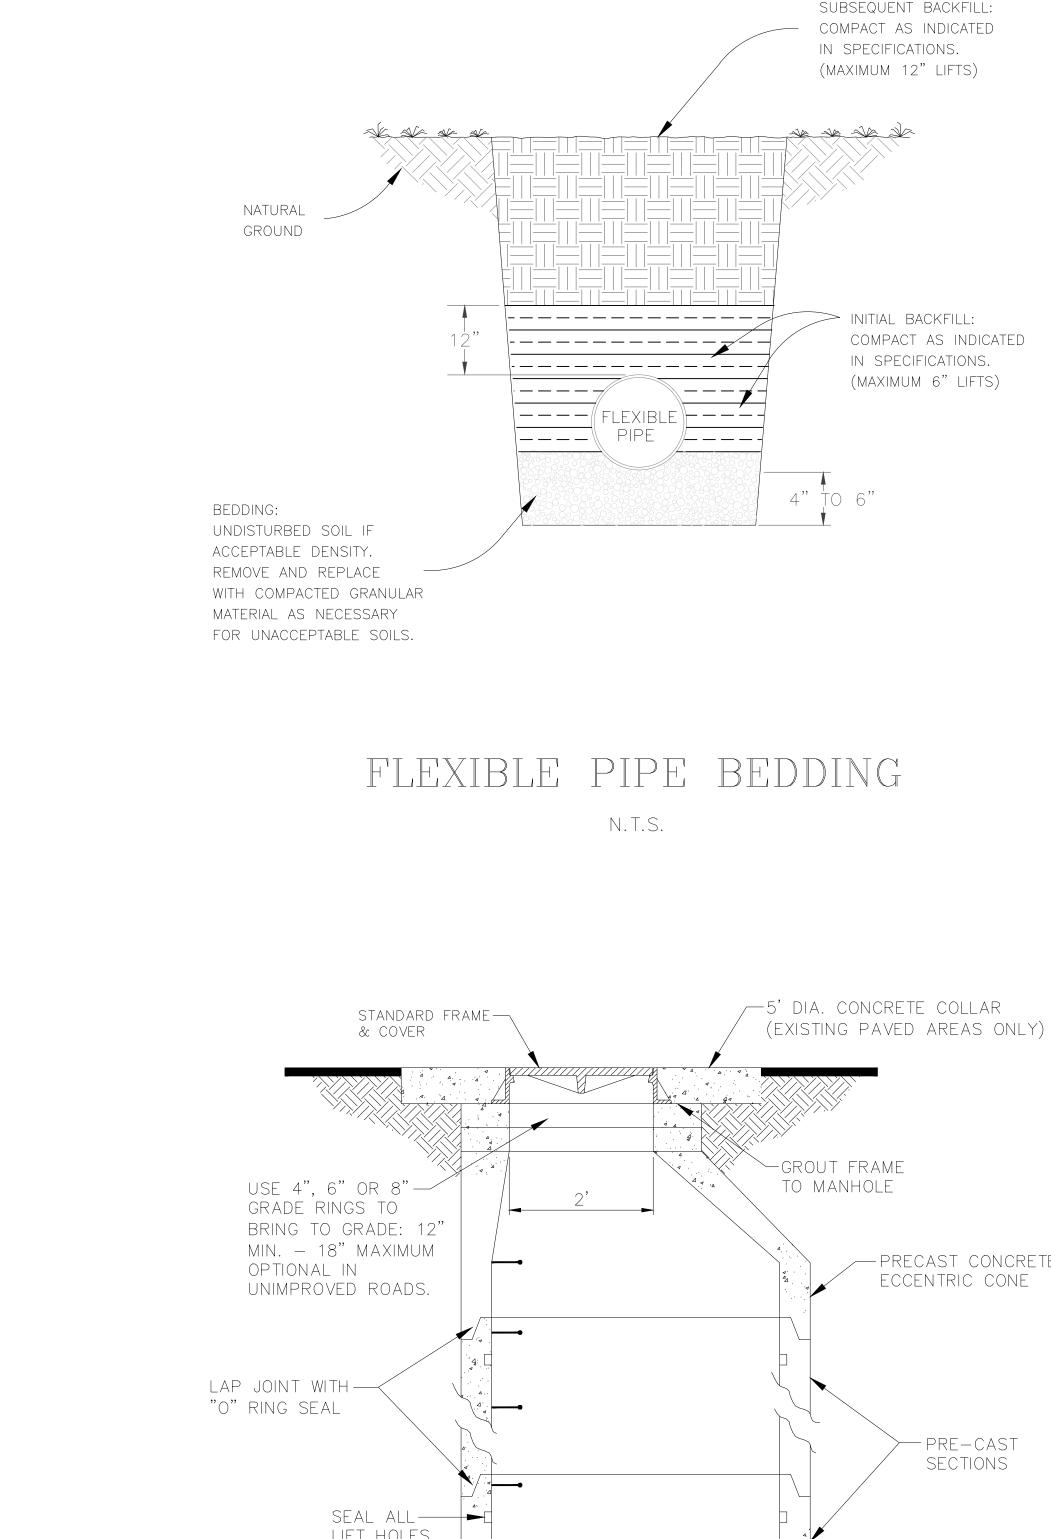

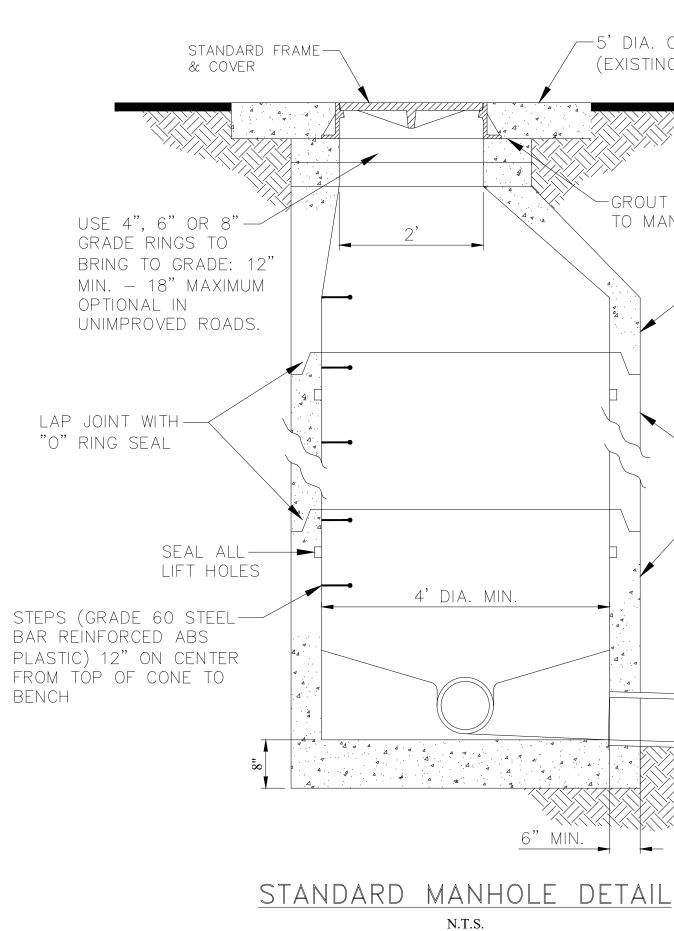


SUBSEQUENT BACKFILL:

COMPACT AS INDICATED

-PRECAST CONCRETE ECCENTRIC CONE




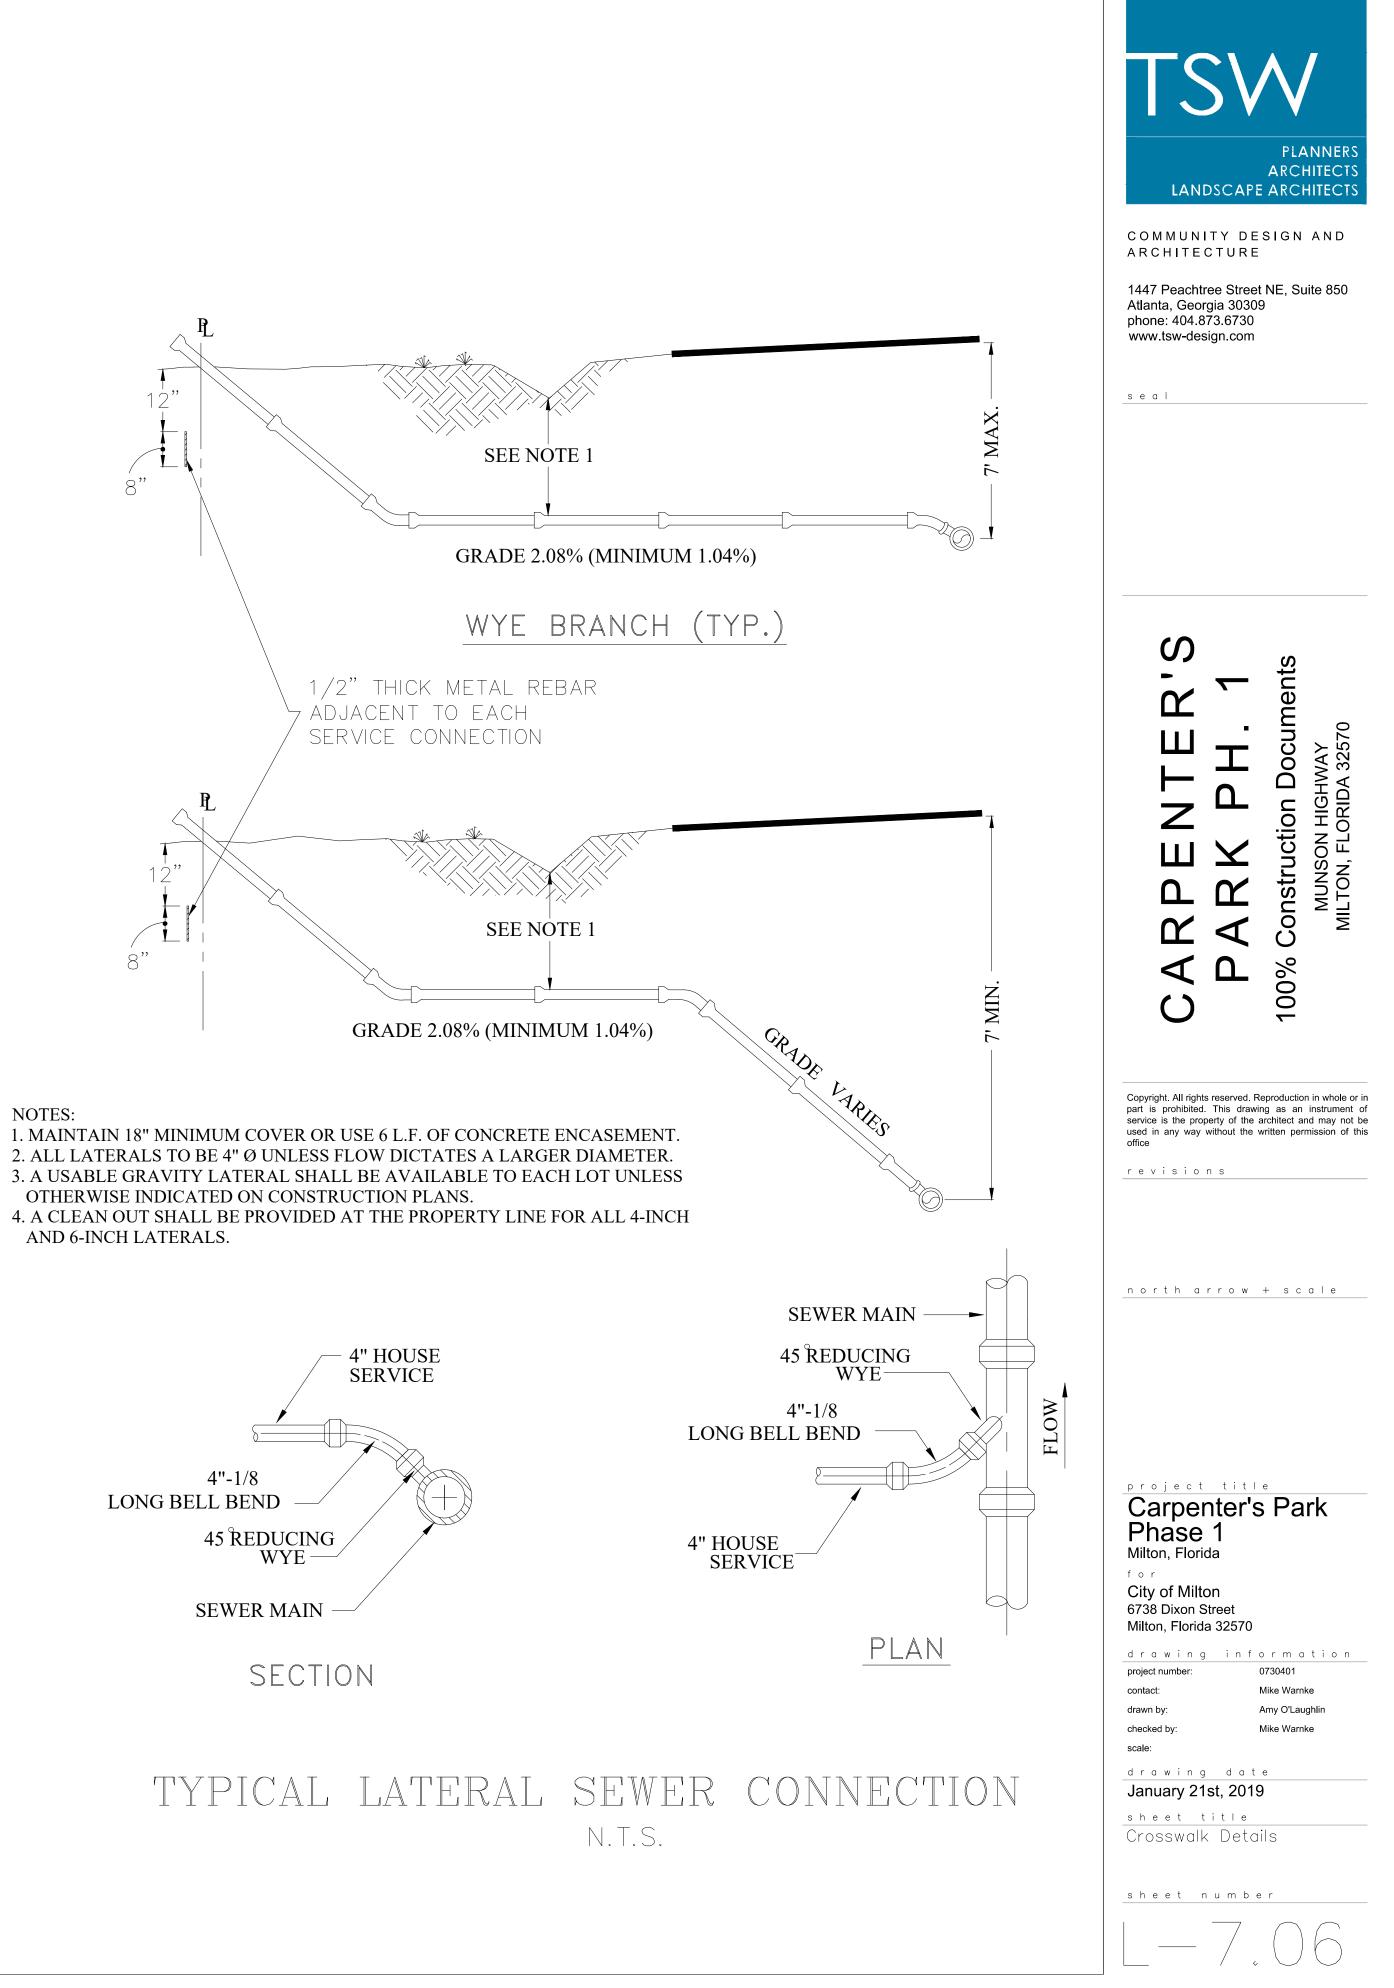


NOTES:


OTHERWISE INDICATED ON CONSTRUCTION PLANS.

AND 6-INCH LATERALS.

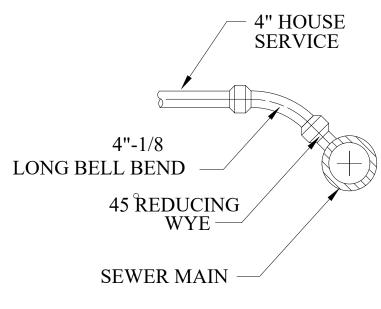


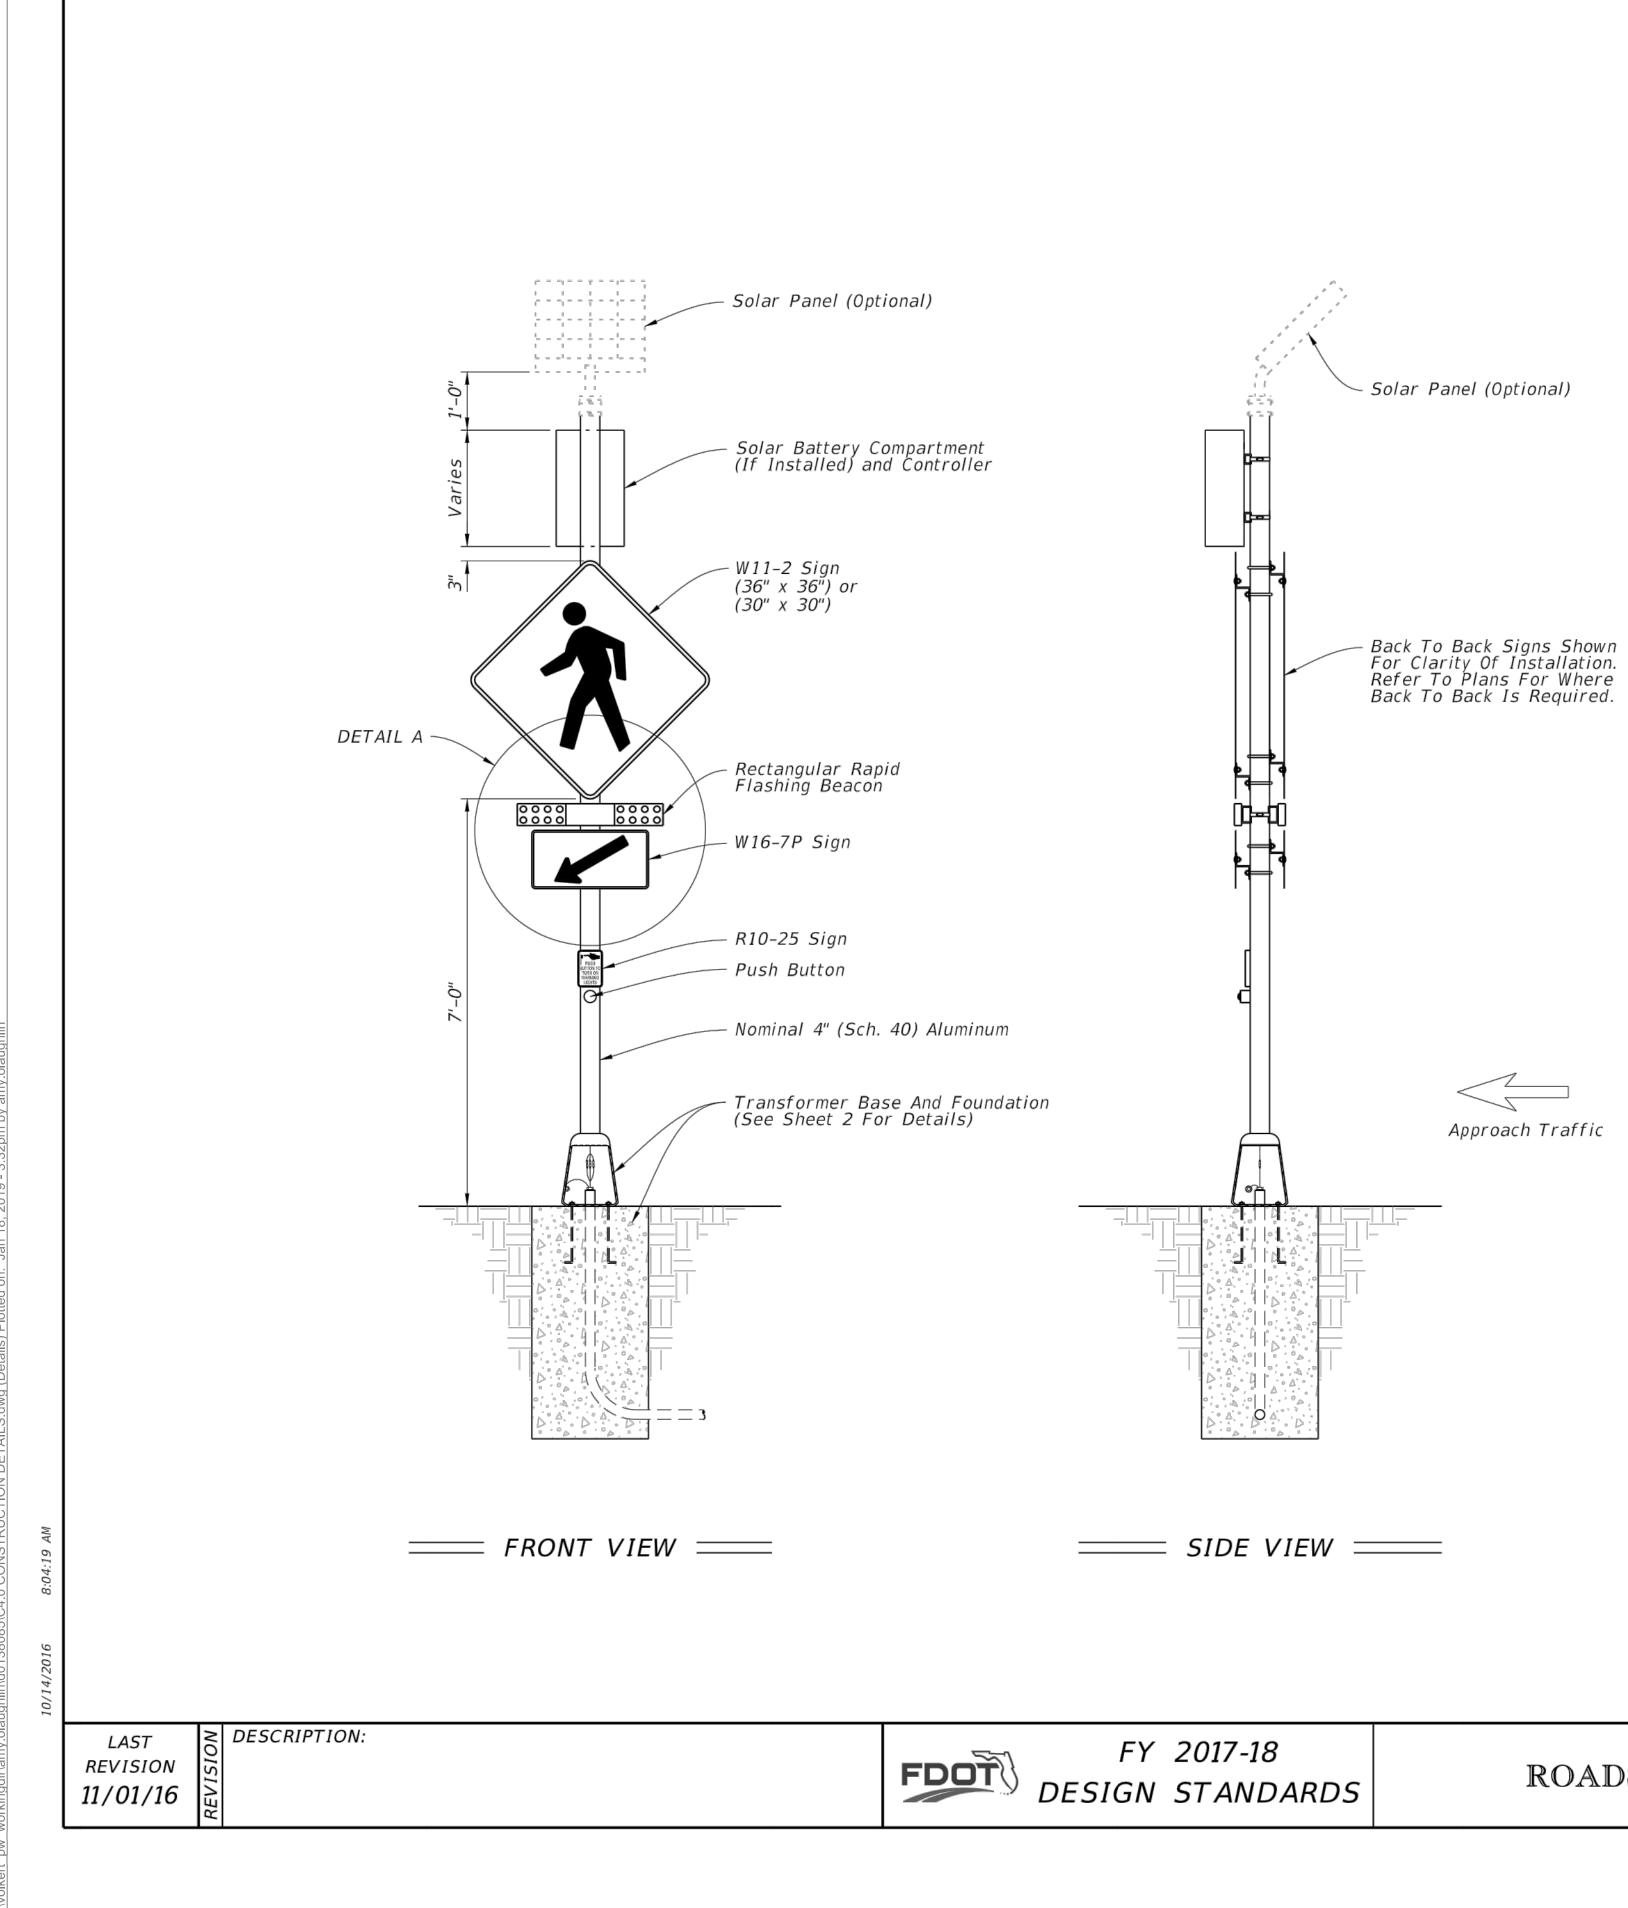

- for multi-lane facilities.

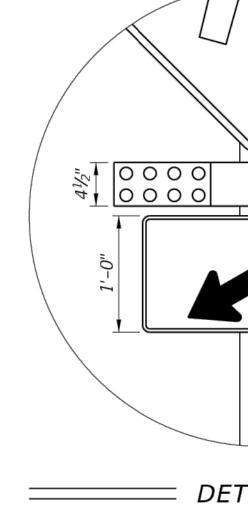

TSW PLANNERS ARCHITECT LANDSCAPE ARCHITECTS COMMUNITY DESIGN AND ARCHITECTURE 1447 Peachtree Street NE, Suite 850 Atlanta, Georgia 30309 phone: 404.873.6730 www.tsw-design.com seal NOTES: 1. A transformer base is required for both conventional powered and solar powered applications. (Conventional Power Shown) 2. Use Rectangular Rapid Flashing Beacon (RRFB) equipment and hardware that are listed on the Approved Products List (APL). 3. Install the RRFB in pairs, one on either side of approach traffic. S 4. Install controller on the backside of post from approach traffic. ent Ŷ 5. Install a 30" X 30" W11-2 sign on single lane facilities and a 36" X 36" W11-2 sign nn ON HIGHWAY FLORIDA 32570 Ш Т Doci 6. Install push button and R10-25 sign in accordance with Index 17784. Ω Construction | MUNSON HIGH MILTON, FLORID Ζ Ш \mathbf{X} $\mathbf{\mathcal{L}}$ Ω 0 C Ľ %00 \mathbf{O} $\overline{}$ Copyright. All rights reserved. Reproduction in whole or in TT Th part is prohibited. This drawing as an instrument of service is the property of the architect and may not be used in any way without the written permission of this office revisions 0000 northarrow + scale 0000 project title **Carpenter's Park** Phase 1 Milton, Florida for City of Milton 6738 Dixon Street — DETAIL A ———— Milton, Florida 32570 drawing information project number: 0730401 contact: Mike Warnke drawn by: Amy O'Laughlin checked by: Mike Warnke RECTANGULAR RAPID FLASHING BEACON (RRFB) DETAILS scale: drawing date January 21st, 2019 SHEET INDEX sheet title NO. NO. ROADSIDE FLASHING BEACON ASSEMBLY Crosswalk Details 11862 5 of 8 sheet number · _ _ 7

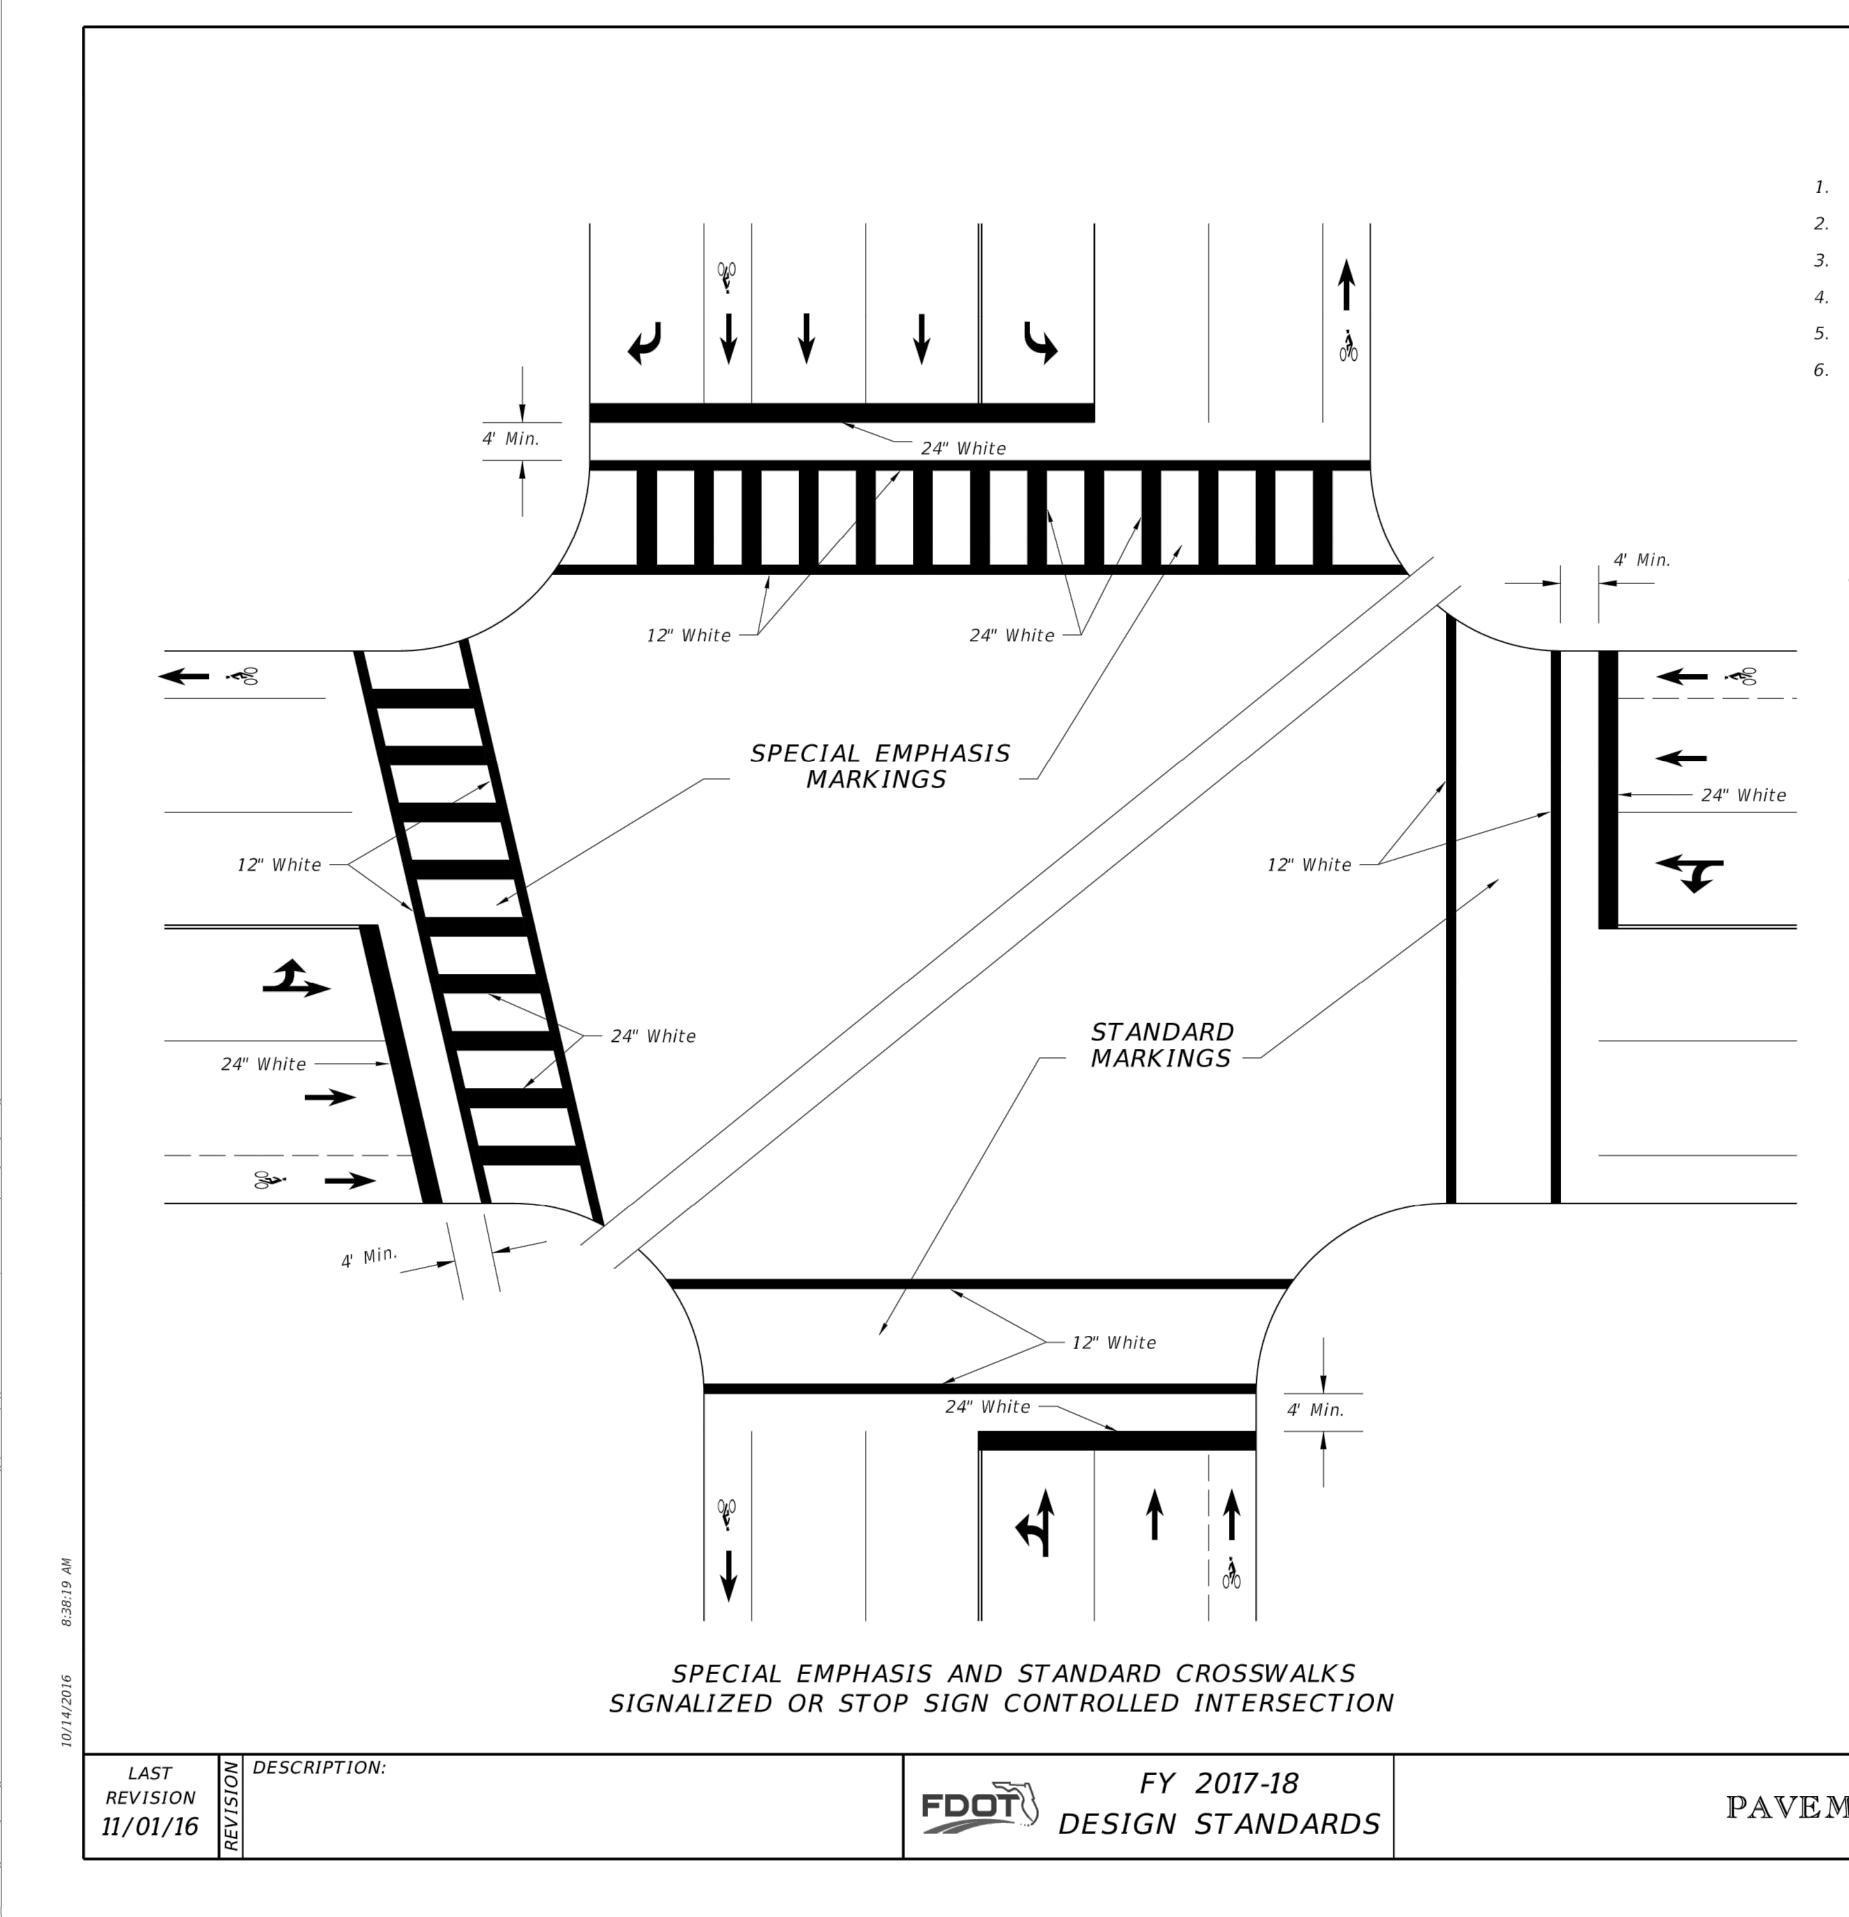

GENERAL NOTES

- 1. For traffic and pedestrian signal installation, refer to Index No. 17721 through 17890. 2. For public sidewalk curb ramps, refer to Index No. 304.
- 3. For pavement marking and sign installation, refer to Indexes 11200 through 17356.
- 4. Crosswalk minimum widths: Intersection Crosswalk 6'. Midblock Crosswalk 10'.

60" Max.

- 12"


- 5. All crosswalk marking must be white.
- 6. Longitudinal markings in Special Emphasis Crosswalk must be 24" wide and spaced to avoid the wheel path of vehicles (see detail). Center the longitudinal markings at each lane line. Place additional longitudinal markings at the center of each lane (1/2W). The maximum spacing allowed between longitudinal markings is 60".


to the lane lines.


12" Transverse lines in the Special Emphasis Crosswalk may be standard thermoplastic or preformed thermoplastic.


FY 2017-18 DESIGN STANDARDS	PAVEMENT MARKINGS
DESIGN STANDARDS	


- When the Crosswalk is skewed to the lane lines, the longitudinal markings should be parallel
- 24" Longitudinal Bars in Special Emphasis Crosswalk must be preformed thermoplastic.

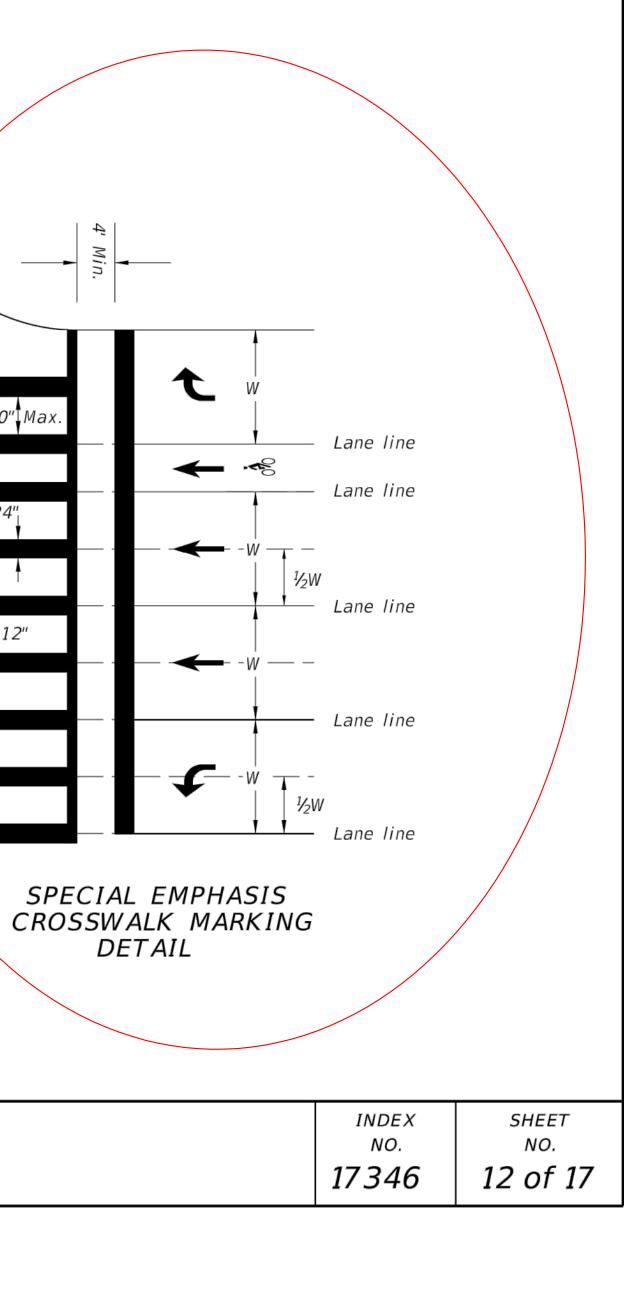

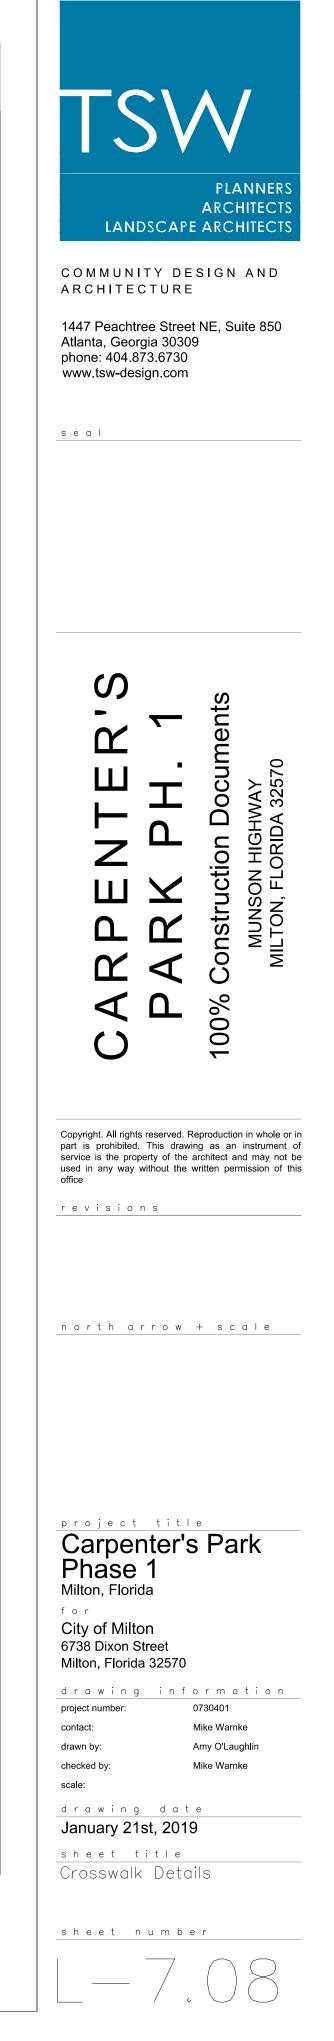

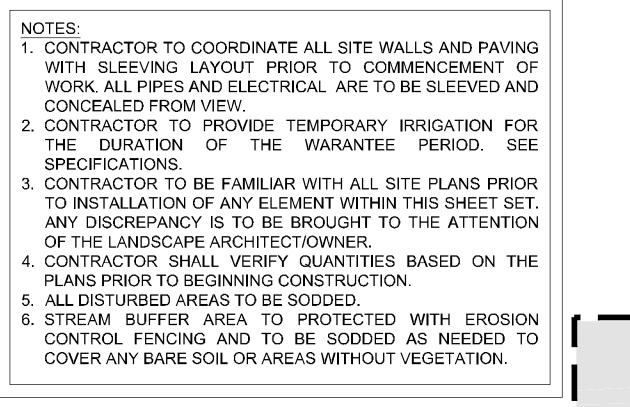

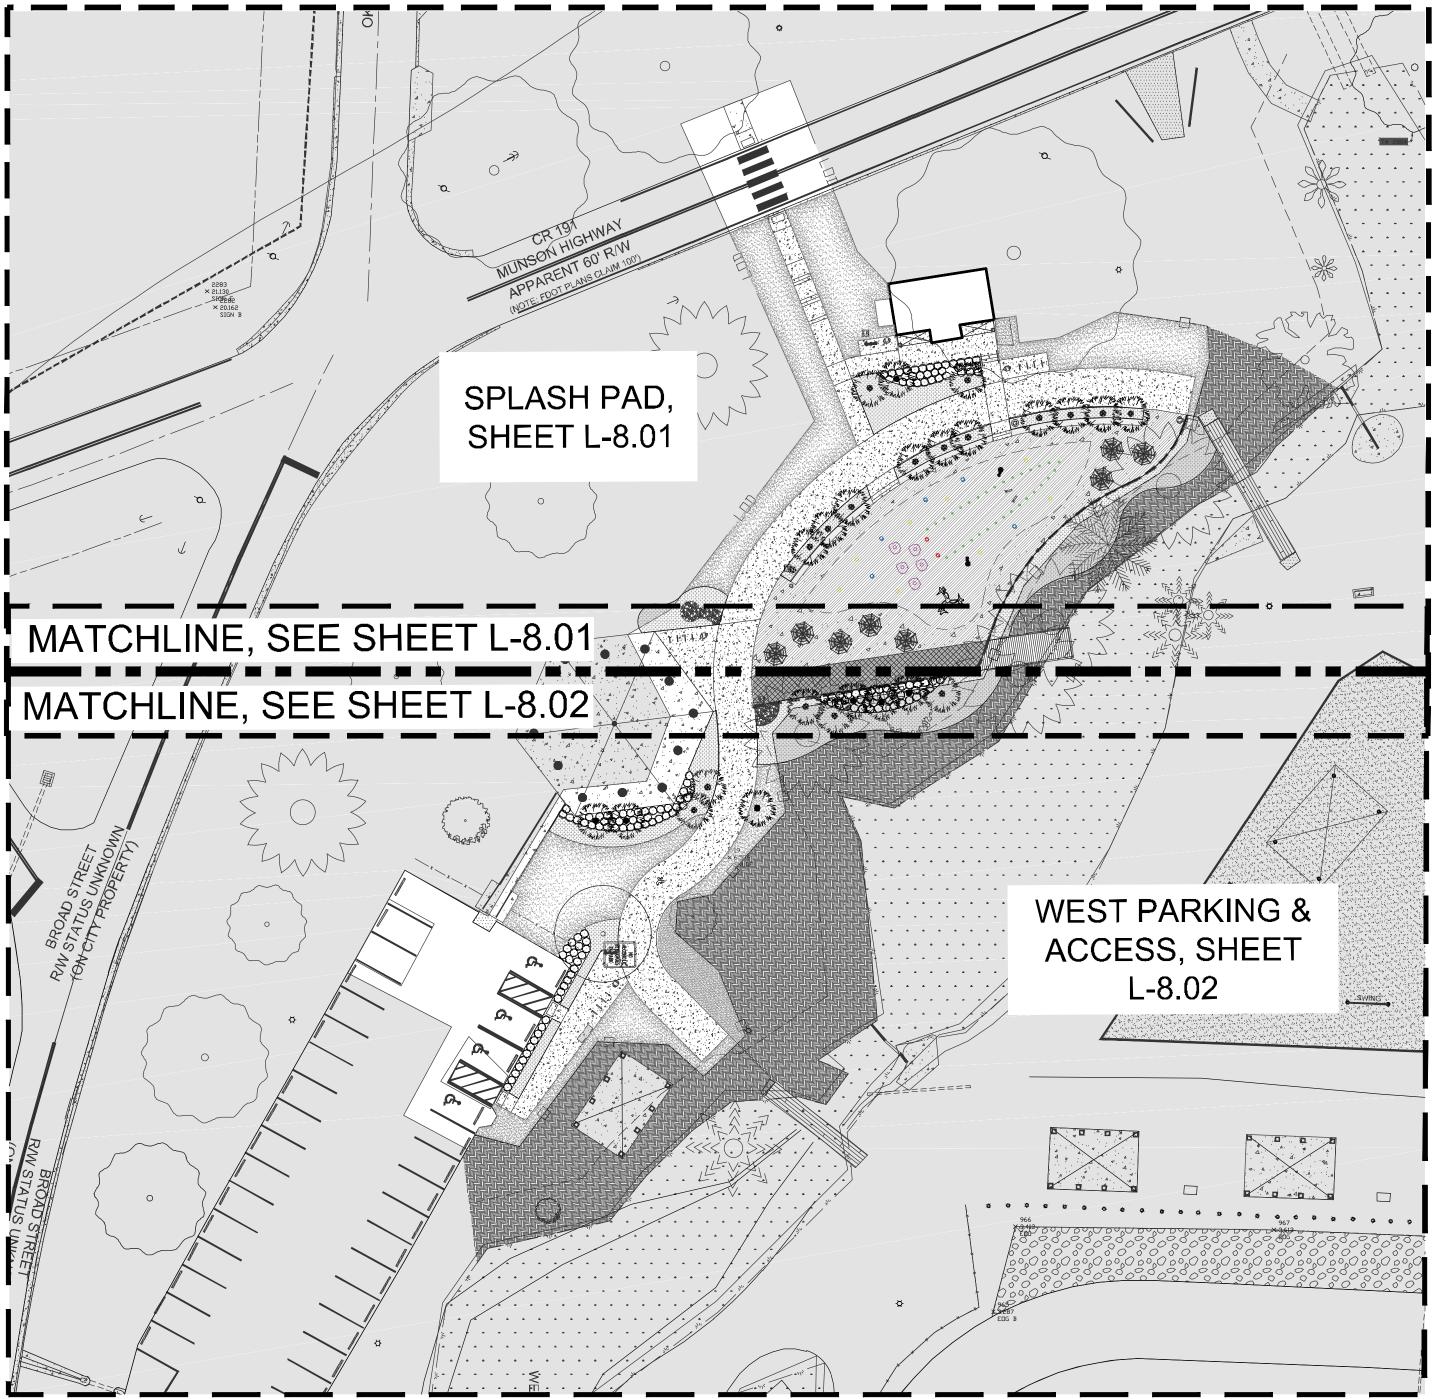

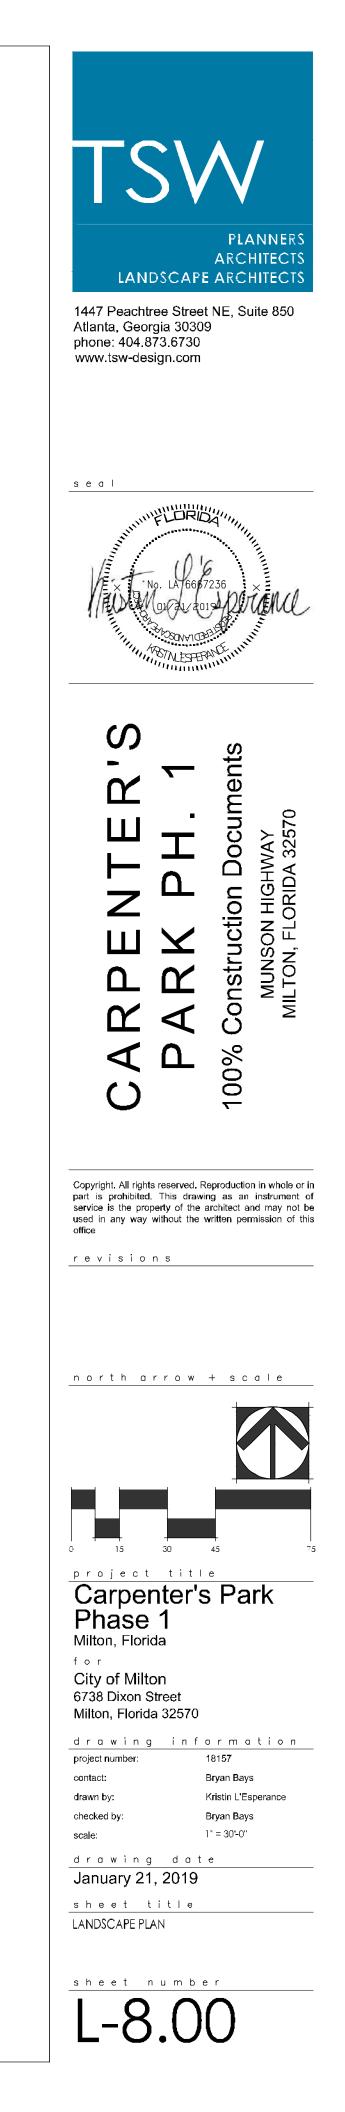

- 1. CONTRACTOR TO COORDINATE ALL SITE WALLS AND PAVING WITH SLEEVING LAYOUT PRIOR TO COMMENCEMENT OF WORK. ALL PIPES AND ELECTRICAL ARE TO BE SLEEVED AND CONCEALED FROM VIEW.
- 2. CONTRACTOR TO PROVIDE TEMPORARY IRRIGATION FOR THE DURATION OF THE WARANTEE PERIOD. SEE SPECIFICATIONS.
- 3. CONTRACTOR TO BE FAMILIAR WITH ALL SITE PLANS PRIOR TO INSTALLATION OF ANY ELEMENT WITHIN THIS SHEET SET. ANY DISCREPANCY IS TO BE BROUGHT TO THE ATTENTION OF THE LANDSCAPE ARCHITECT/OWNER.
- 4. CONTRACTOR SHALL VERIFY QUANTITIES BASED ON THE PLANS PRIOR TO BEGINNING CONSTRUCTION.
- 5. ALL DISTURBED AREAS TO BE SODDED.
- 6. STREAM BUFFER AREA TO PROTECTED WITH EROSION CONTROL FENCING AND TO BE SODDED AS NEEDED TO COVER ANY BARE SOIL OR AREAS WITHOUT VEGETATION. HIGHWA

191

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T 60' RIV.

RR 59 sf MC 68

ΓING

PAVILION


MATCHLINE - SEE SHEET L-8.02


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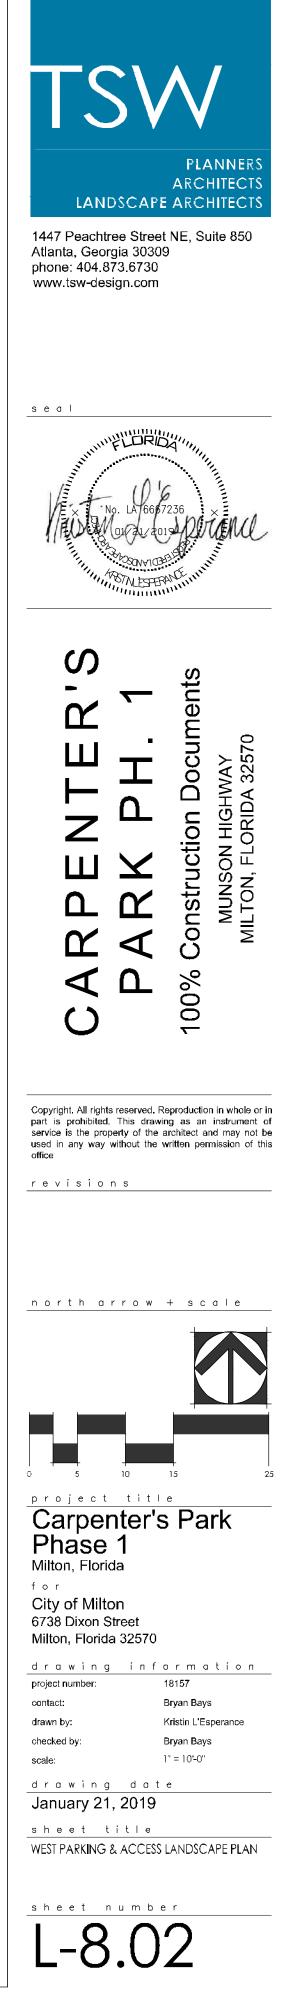
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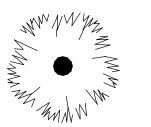






PLANT SCHEDULE WHOLE PROJECT

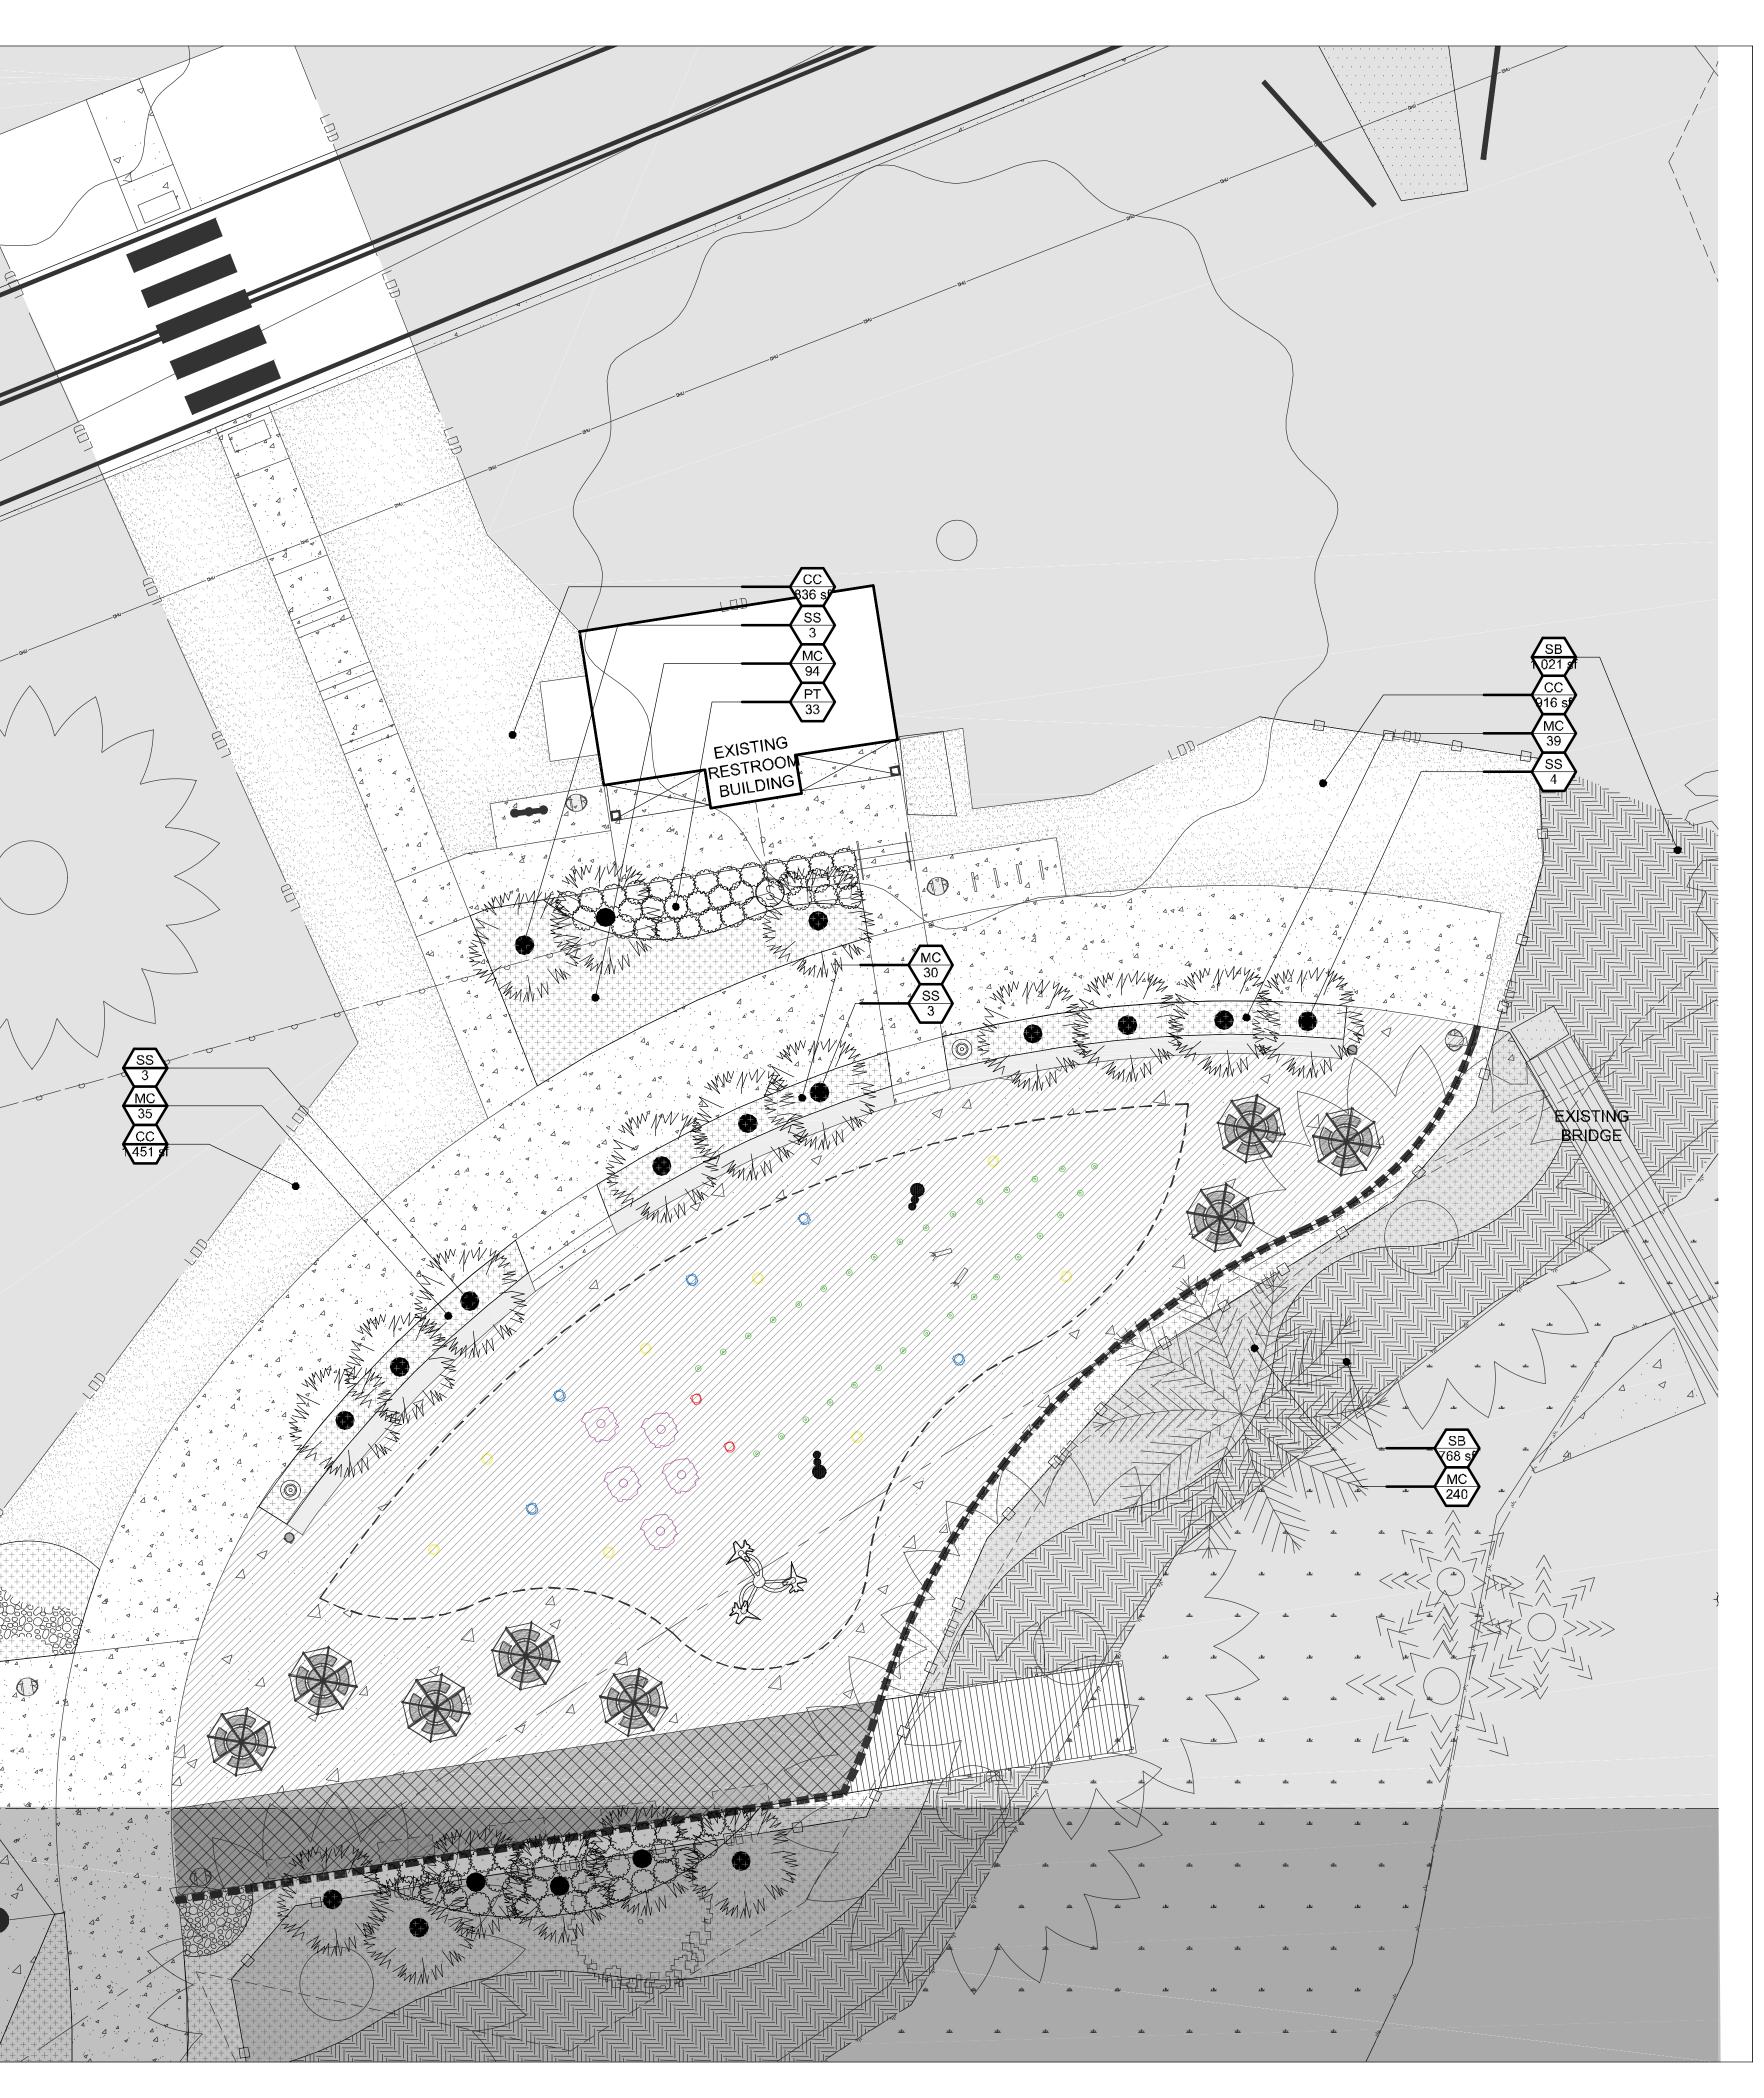
TREES

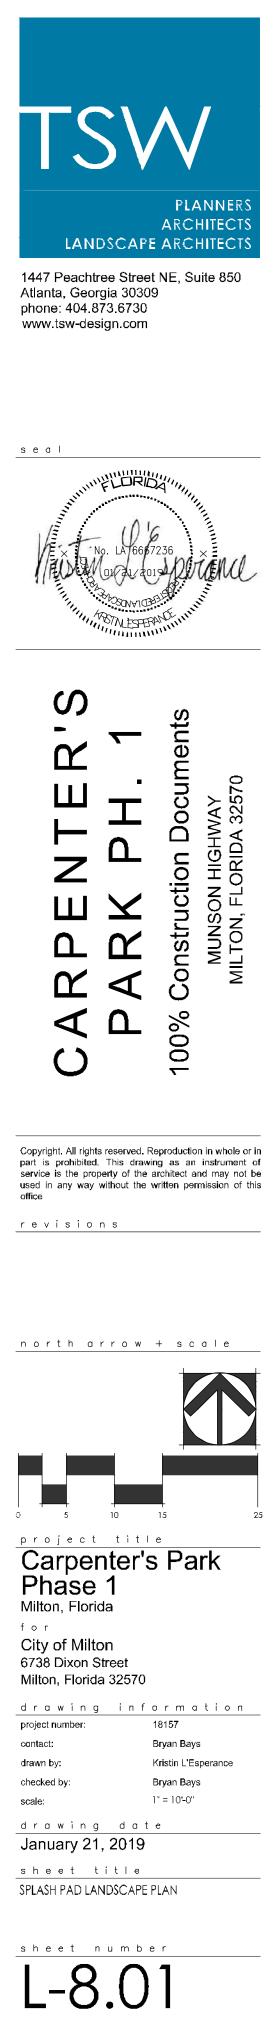

SHRUBS



SHRUB AREAS

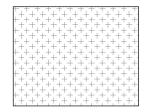

BOTANICAL NAME / COMMON NAME

Sabal palmetto / Cabbage Palmetto 6` clear trunk height;

BOTANICAL NAME / COMMON NAME


Pittosporum tobira `Turner`s Variegated Dwarf` / Variegate

BOTANICAL NAME / COMMON NAME


Muhlenbergia capillaris / Pink Muhly

GROUND COVERS


BOTANICAL NAME / COMMON NAME

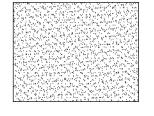

Cynodon dactylon `Celebration` / Celebration Bermuda Gr

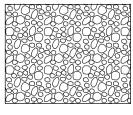



River Rock river rock river rock / river rock MIX OFf 4" TO 6" RIVER ROCK @12-18" DEPTH ON FILT

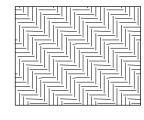



STREAM BUFFER PLANTINGS / Cynodon dactylon `Cele STREAM BUFFER AREA TO BE SODDED AS NEED TO SOIL/ NON VEGITATED AREA.

	CONT	<u>SIZE</u>		QTY
	Field Grown	8`-10` HT		24
	SIZE	-		QTY
ated Dwarf Pittosporum	3 gal			145
	CONT	FIELD3	SPACING	QTY
	1 gal		24" o.c.	907
	CONT	-	<u>SPACING</u>	<u>QTY</u>
Grass	sod			5,720 sf
ILTER FABRIC	Square Feet			104 sf
elebration` O COVER ANY BARE	sod			9,455 sf

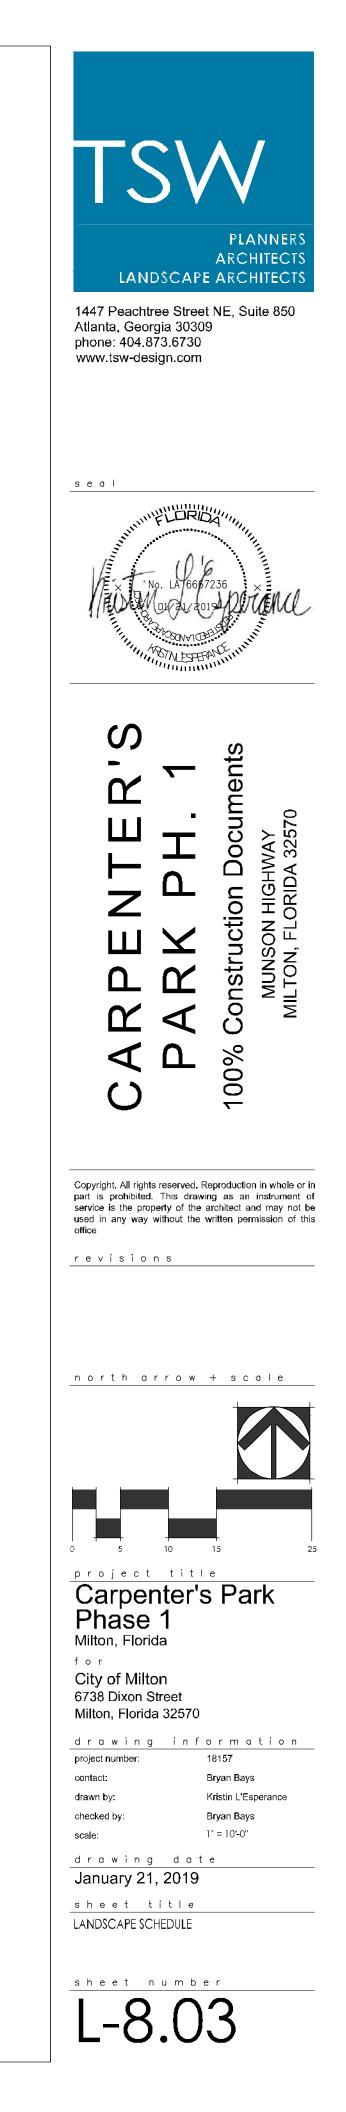


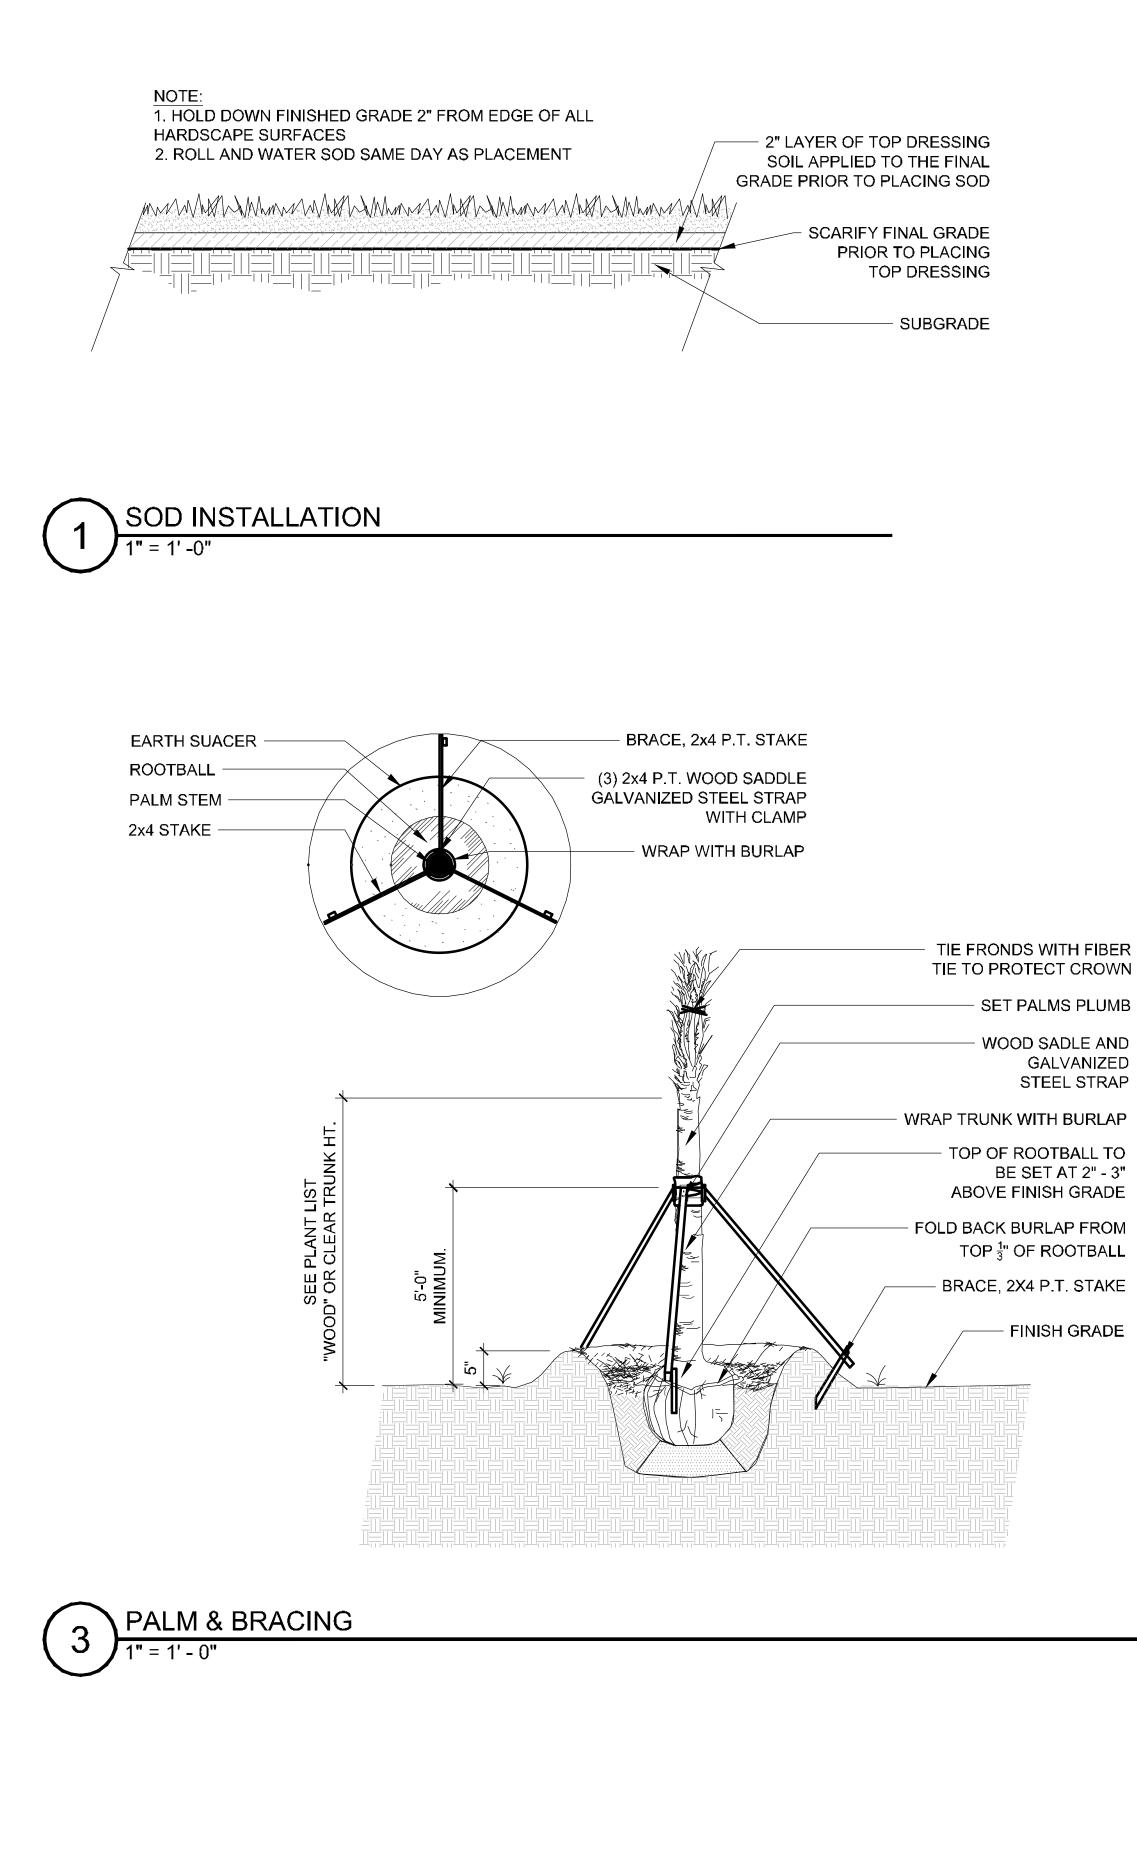


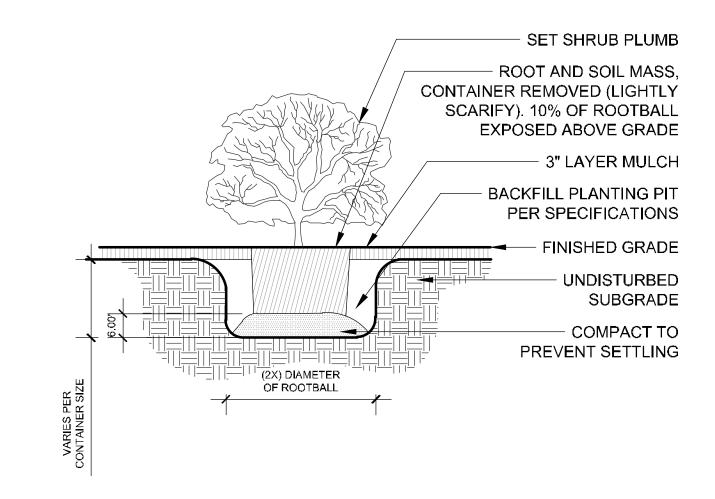


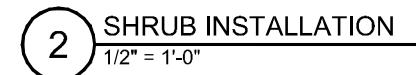


GALVANIZED STEEL STRAP

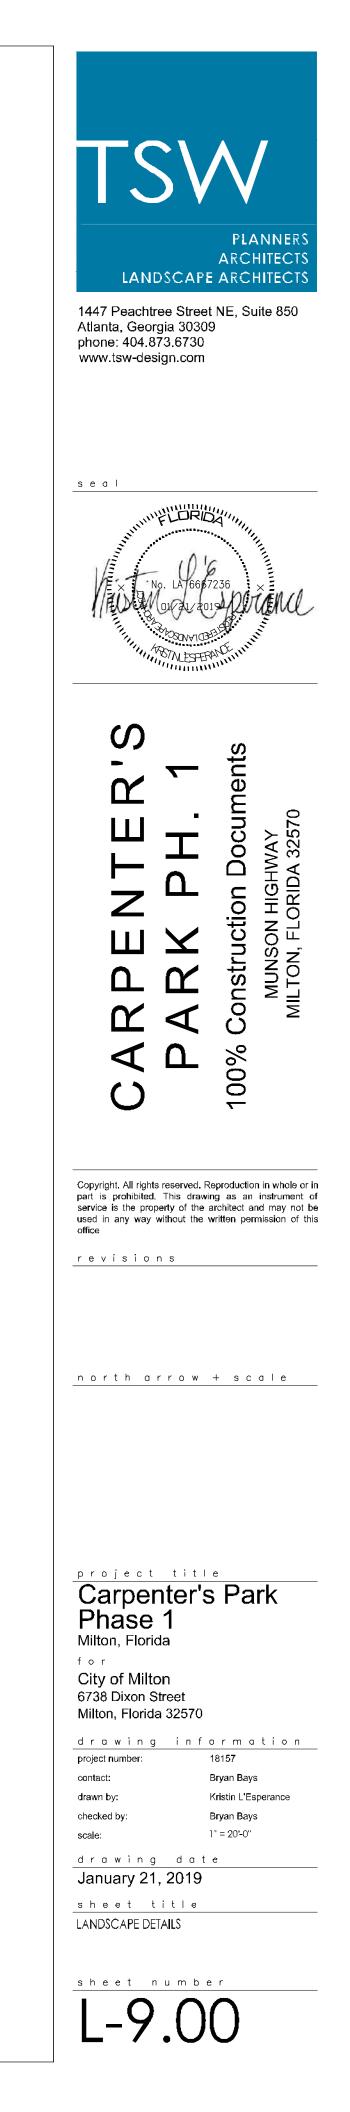

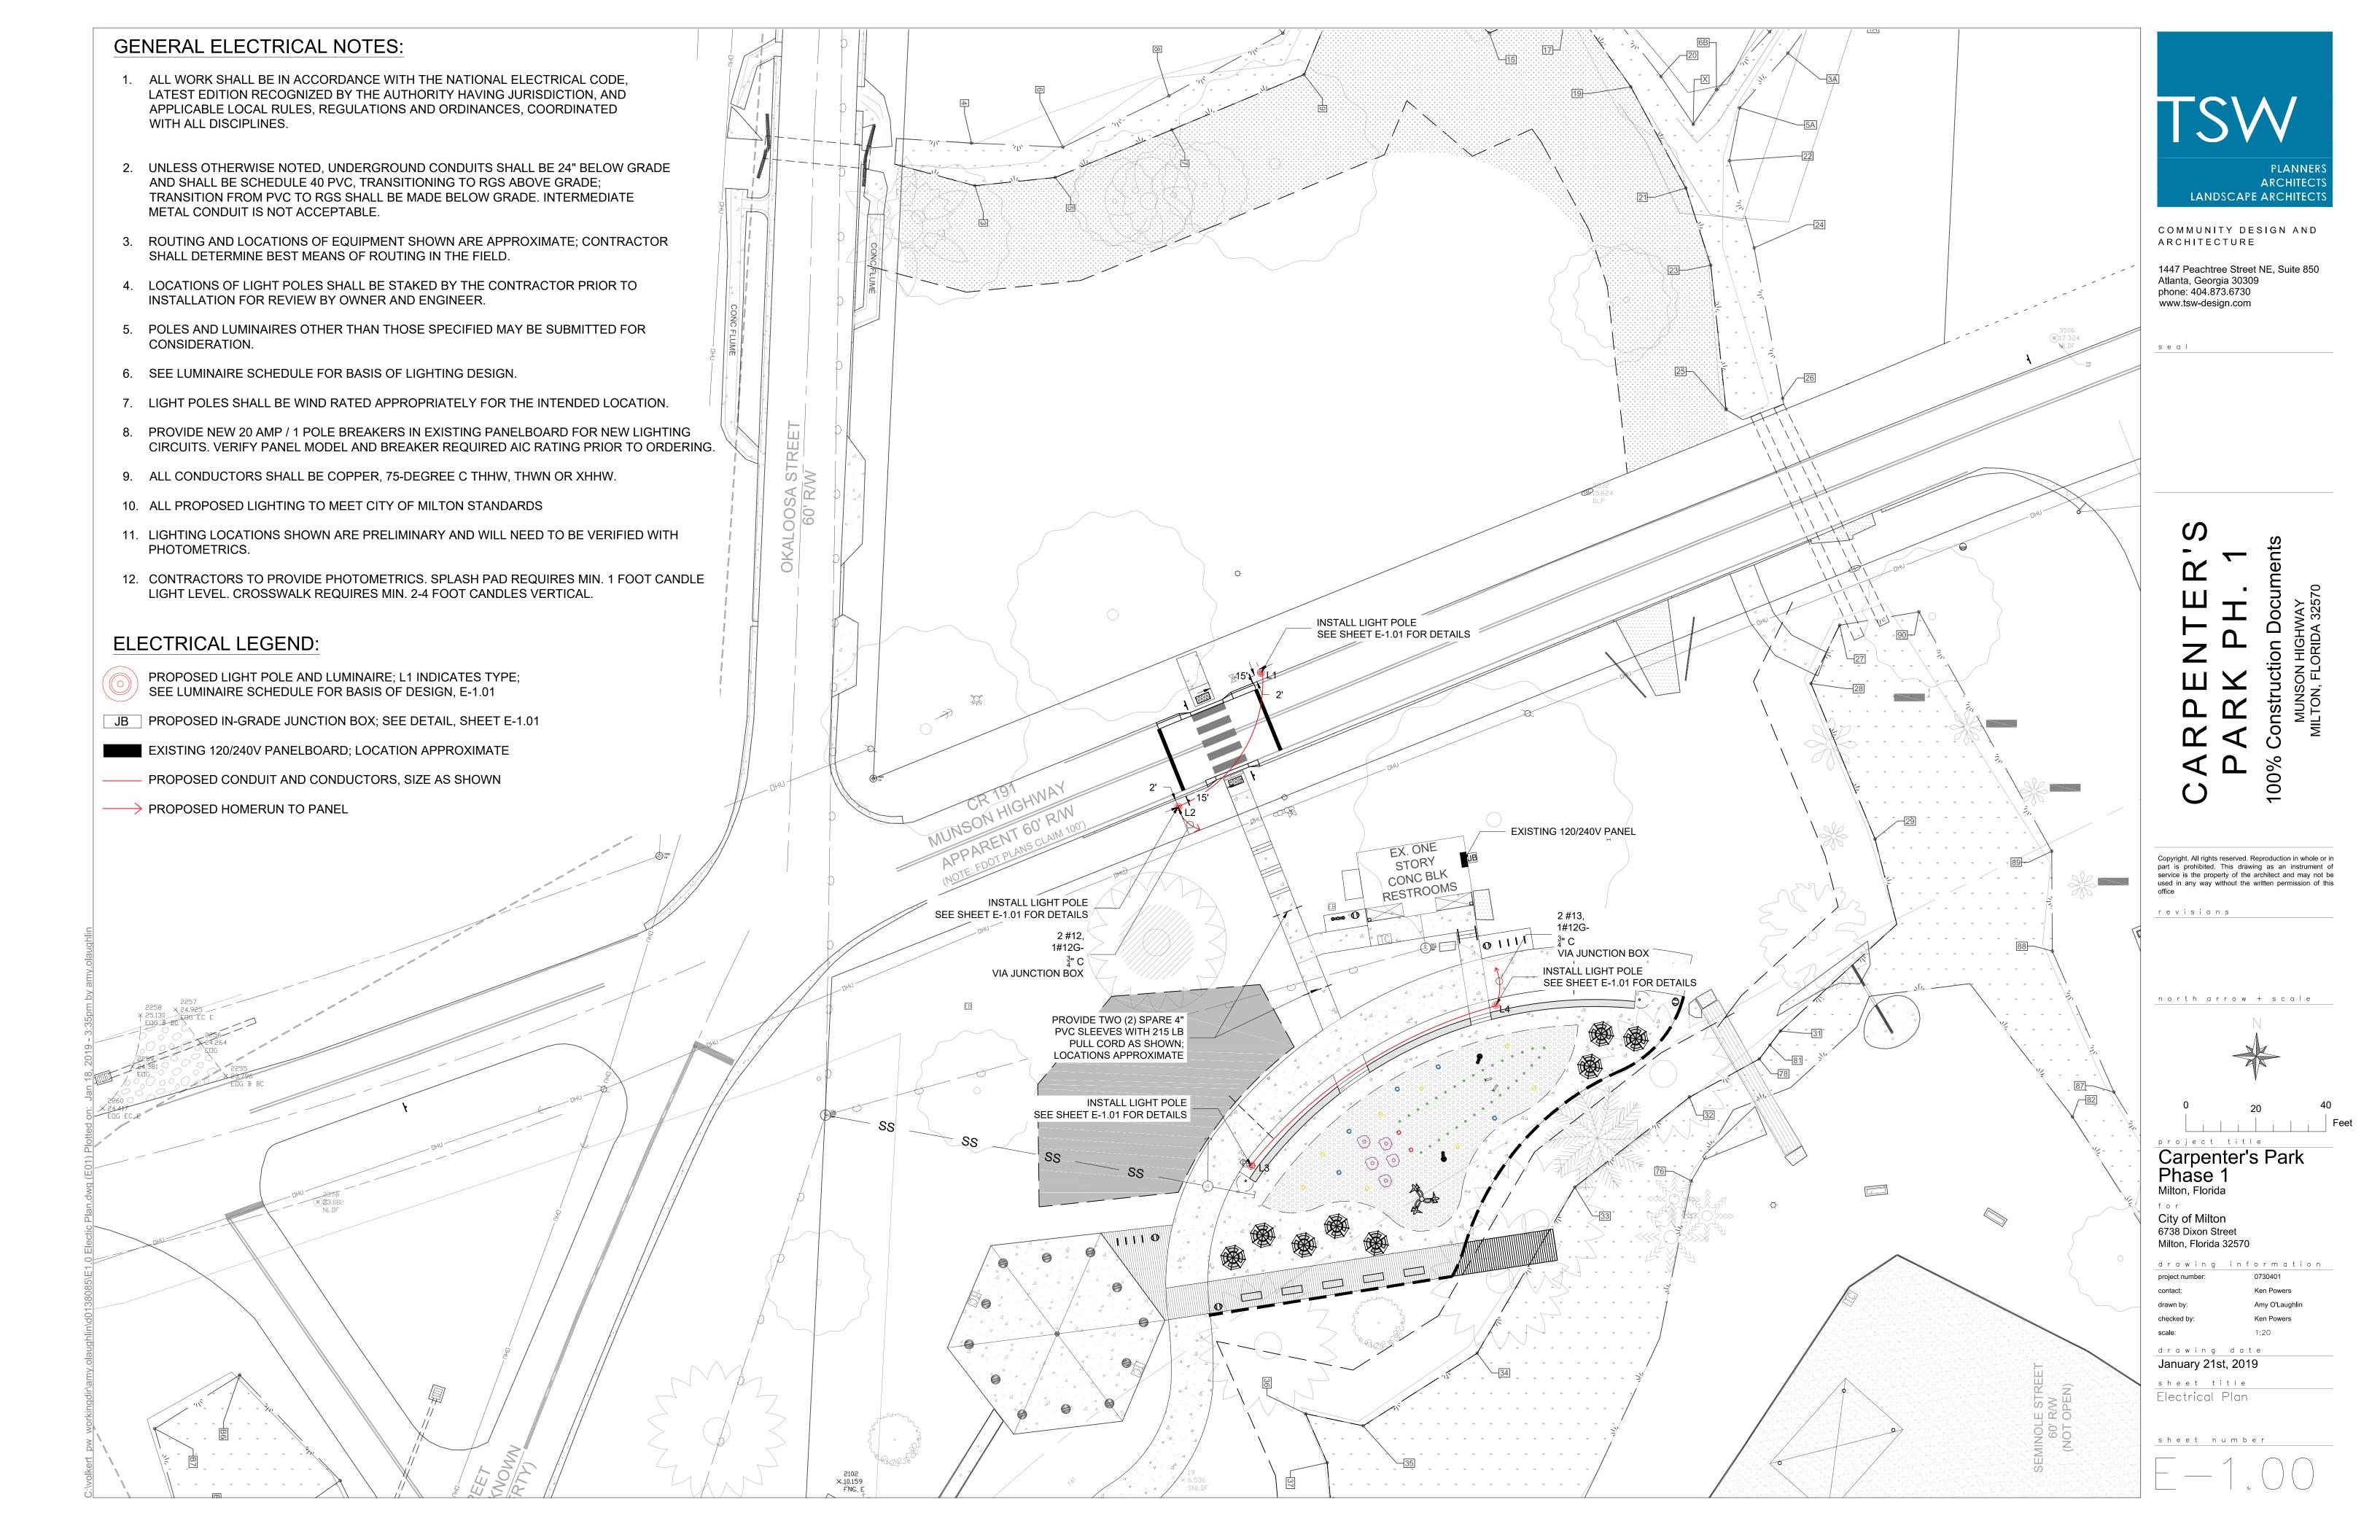

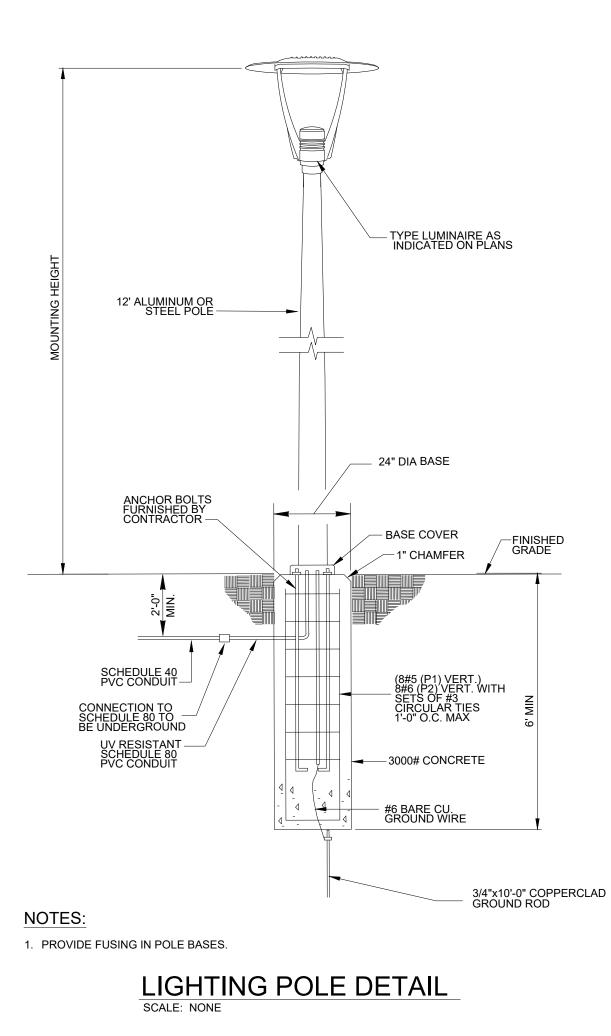


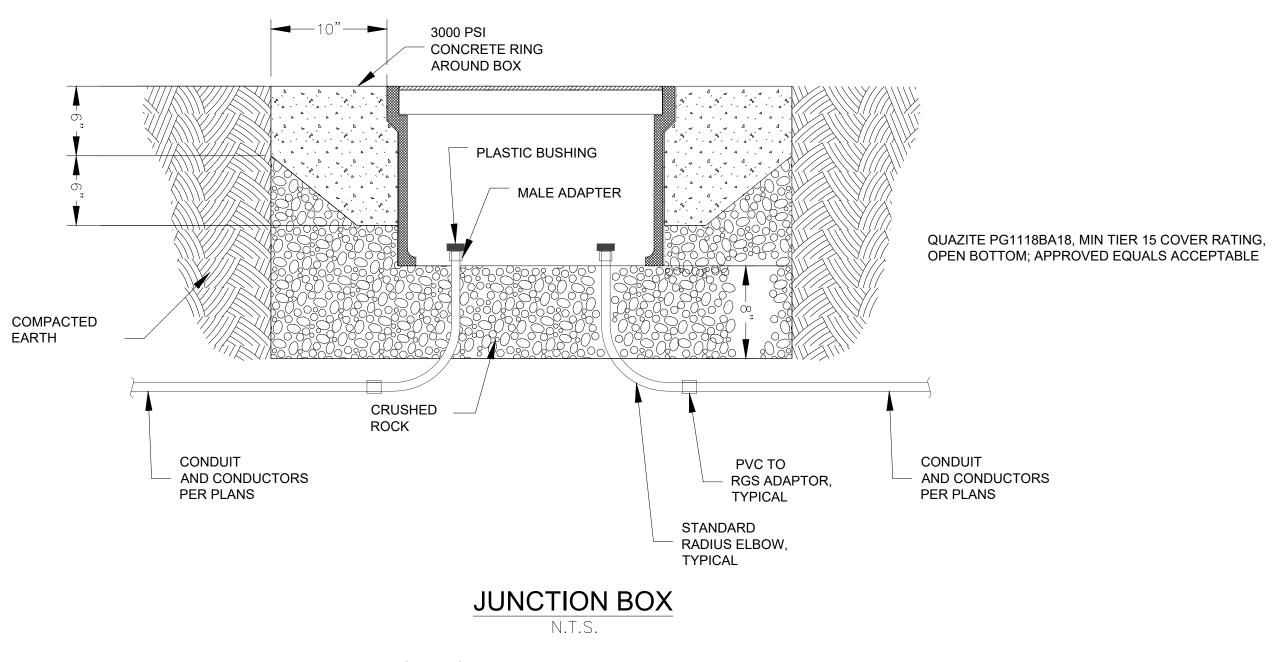

	LUMINAIRE SCHEDULE								
LIGHT POLE	Northing	Easting	Luminis Part No.	LumenPulse Part No.					
L1	603093.8598	1170496.9998	MA21-L1W30R1-R2-34W-120-BKT-SP-K35	PUR100Y-120-CSL-S40-35K-CRI 80-2-BK-SP					
L2	603055.5218	1170473.4330	MA21-L1W30R1-R2-34W-120-BKT-SP-K35	PUR100Y-120-CSL-S40-35K-CRI 80-2-BK-SP					
L3	602953.0406	1170494.2031	MA21-L3W46R0-R5-139W-120-BKT-SP-K35	PUR100Y-120-CSL-M110-35K-CRI 80-5-BK-SP					
L4	602998.9049	1170564.1564	MA21-L3W46R0-R5-139W-120-BKT-SP-K35	PUR100Y-120-CSL-M110-35K-CRI 80-5-BK-SP					

APPROVED EQUALS ARE ACCEPTABLE

POLES SHALL BE LUMINIS PAA-512, LUMENSPULSE PLS-4-AL-R-12-M-BKTX, OR EQUAL WITH BLACK FINISH

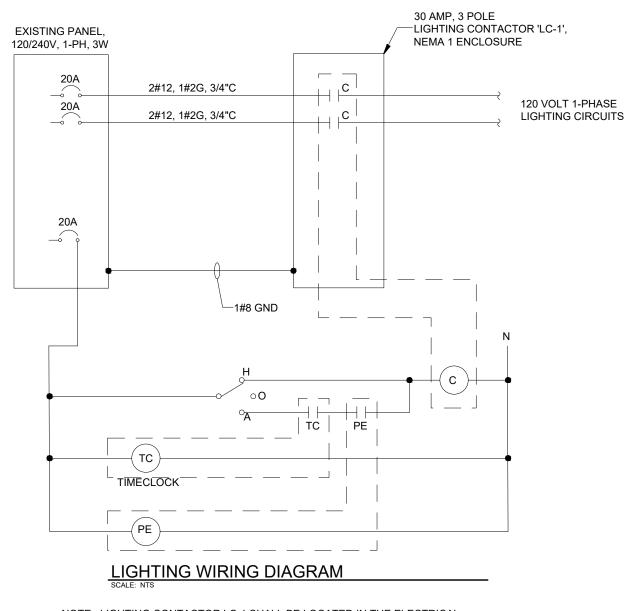

NOTE: LIGHTING CONTACTOR LC-1 SHALL BE LOCATED IN THE ELECTRICAL ROOM. PROVIDE PHOTOCELL ON EXTERIOR OF BUILDING 12" BELOW ROOFLINE. COORDINATE WITH OWNER FOR TIMECLOCK PARAMETERS.

LIGHTING CONTROL DIAGRAM

DETAIL NOTES:


1. PROVIDE CONDUITS AND CONDUCTORS AS DENOTED ON PLAN SHEETS.





COMMUNITY DESIGN AND ARCHITECTURE

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seal



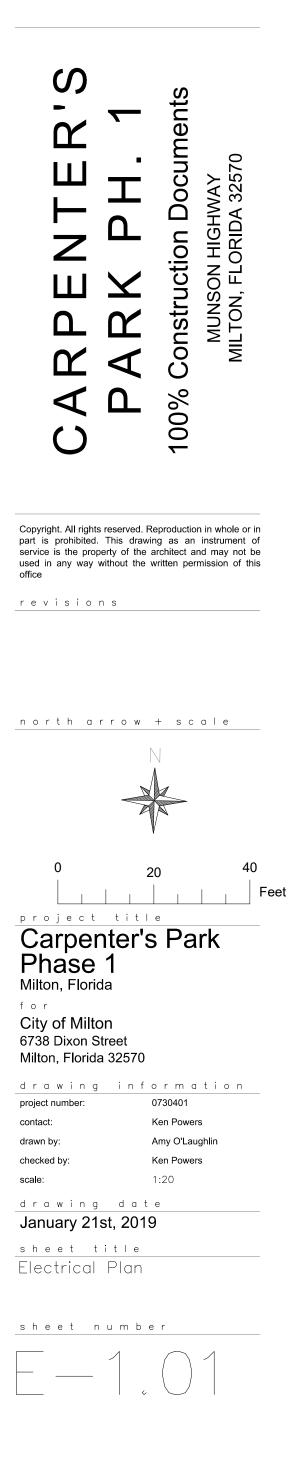

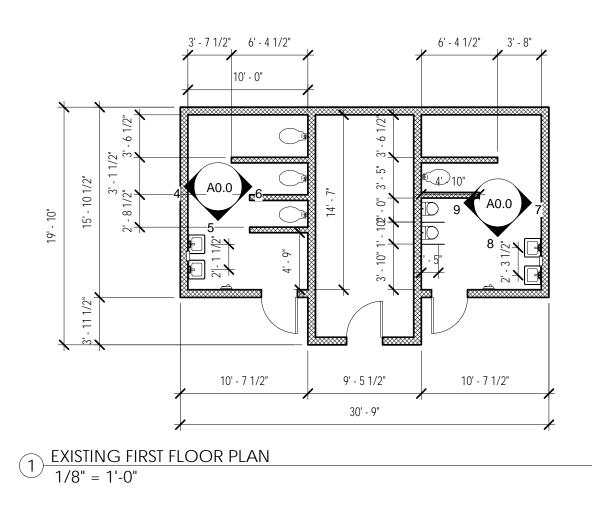


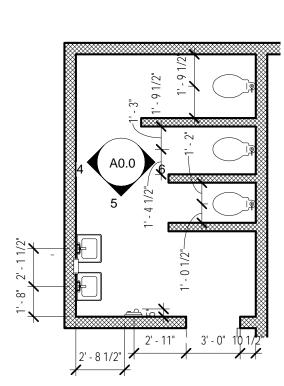(2) Existing Women Detail 3/16" = 1'-0"

3' - 8" 3' - 11" 11

3 Existing Men Detail 3/16" = 1'-0"

fixtures measured to lowest operable part - please verify all dimensions in the field

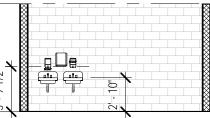





 $\underbrace{5}_{1/8"} = 1'-0"$

		_																	
--	--	---	--	--	--	--	--	--	--	--	--	--	--	--	--	--	--	--	--

 $6 \frac{\text{Existing Women's Restroom 3}}{1/8" = 1'-0"}$

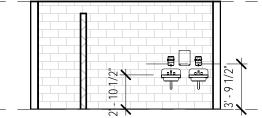

4 Existing Women's Restroom 1 1/8" = 1'-0"

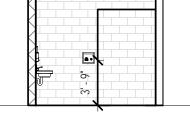

 $7 \frac{\text{Existing Men's Restroom 1}}{1/8" = 1'-0"}$ $\textcircled{8} \quad \underbrace{\text{Existing Men's Restroom 2}}_{1/8" = 1'-0"}$

9 Existing Men's Restroom 3 1/8" = 1'-0"

Potential Accessibility Issues:

1. The toilet stalls in the men's and women's restrooms as configured are not wheel-chair accessible and need to be reconfigured.

The urinals in the men's restroom do not appear to allow for wheel-chair access, and there is some question about whether they meet the 2. 15" clearance on either side to meet the plumbing code.

3. The depth of the current hand dryers exceeds the 4" depth requirement set by the ADA. This needs to be replaced with either a model that is 4" deep (as measured from the wall), or select a recessed hand dryer that would not protrude more than 4" into the room.

4. The plumbing code specifies that fixtures – including sinks and toilets- must be 30" from each other (centerline to centerline) and 15" from the centerline other obstacles such as a wall or partition. Several of the sinks appear to violate that requirement and should be verified.


5. The sink operation may be too difficult to operate without full hand function. Ensure that the current fixtures can be operated with one hand, that no pinching or pulling is needed, and that any pushing does not exceed 5 pounds of force.


6. The highest lip of the sinks must not exceed 34" in the front for ADA access – the sinks may need to be adjusted to ensure that they do not exceed that limit. Please ensure that there is a knee clearance of 27 inches high, 30 inches wide, and 11 to 25 inches deep. Insulated pipes under the sink are required.



ARCHITECTS LANDSCAPE ARCHITECTS

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northarrow + scale

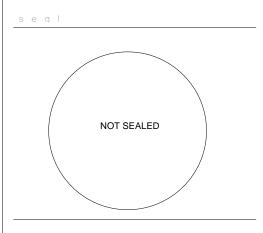revisions

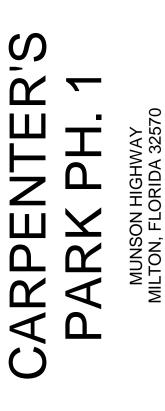project title CARPENTER'S PARK PH. 1

City of Milton

arawing in	l o r
project number:	18157
contact:	Bryan
drawn by:	Alex F
checked by:	Bryan
scale:	As ind
drawing da	t e
e e e e e e e e e e e	


ing information 18157 Bryan Bays Alex Fite-Wassilak Bryan Bays As indicated

1/21/2019 sheet title


Bathroom Existing Conditions

sheet number

A0.0

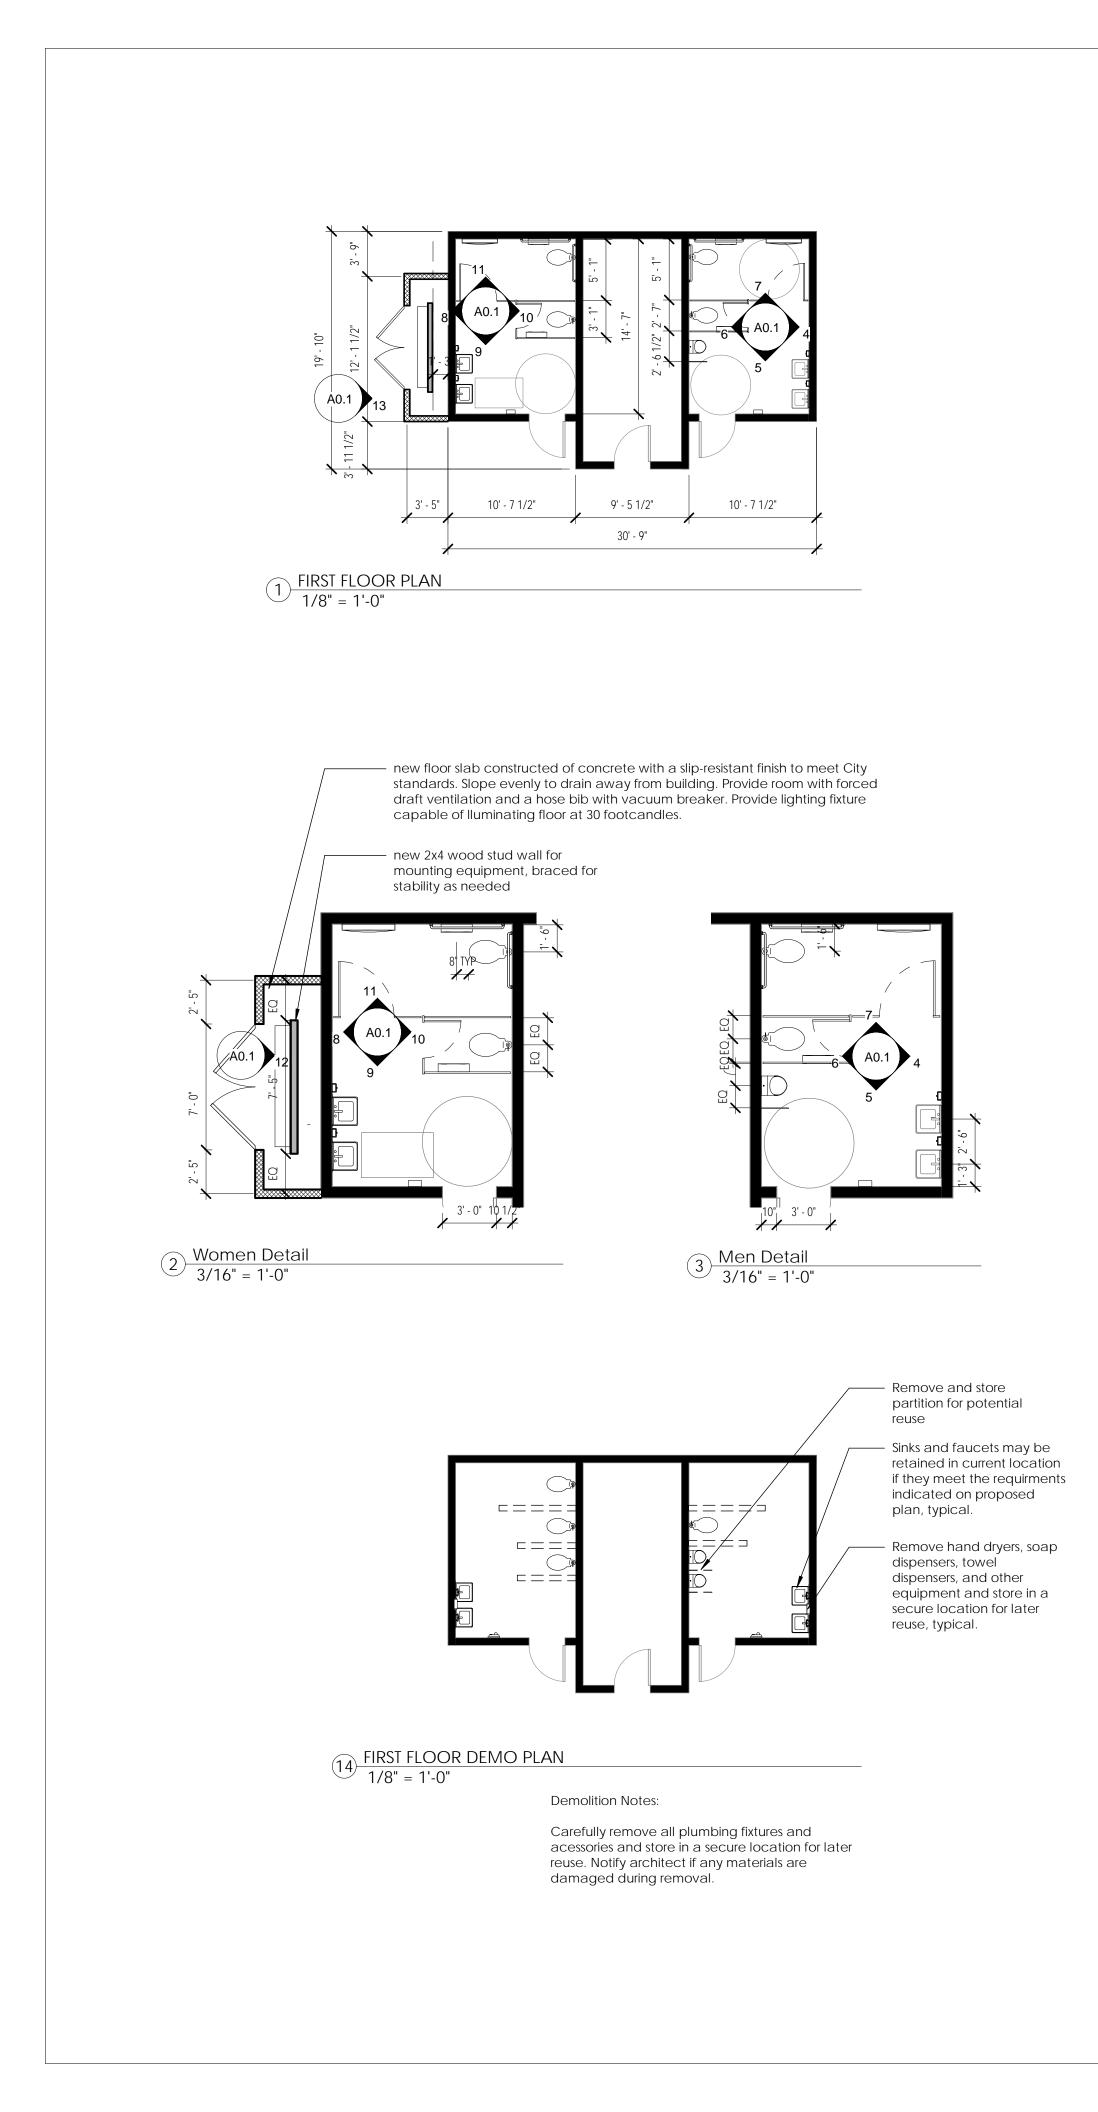

fixtures measured to lowest operable part - please verify all dimensions in the field

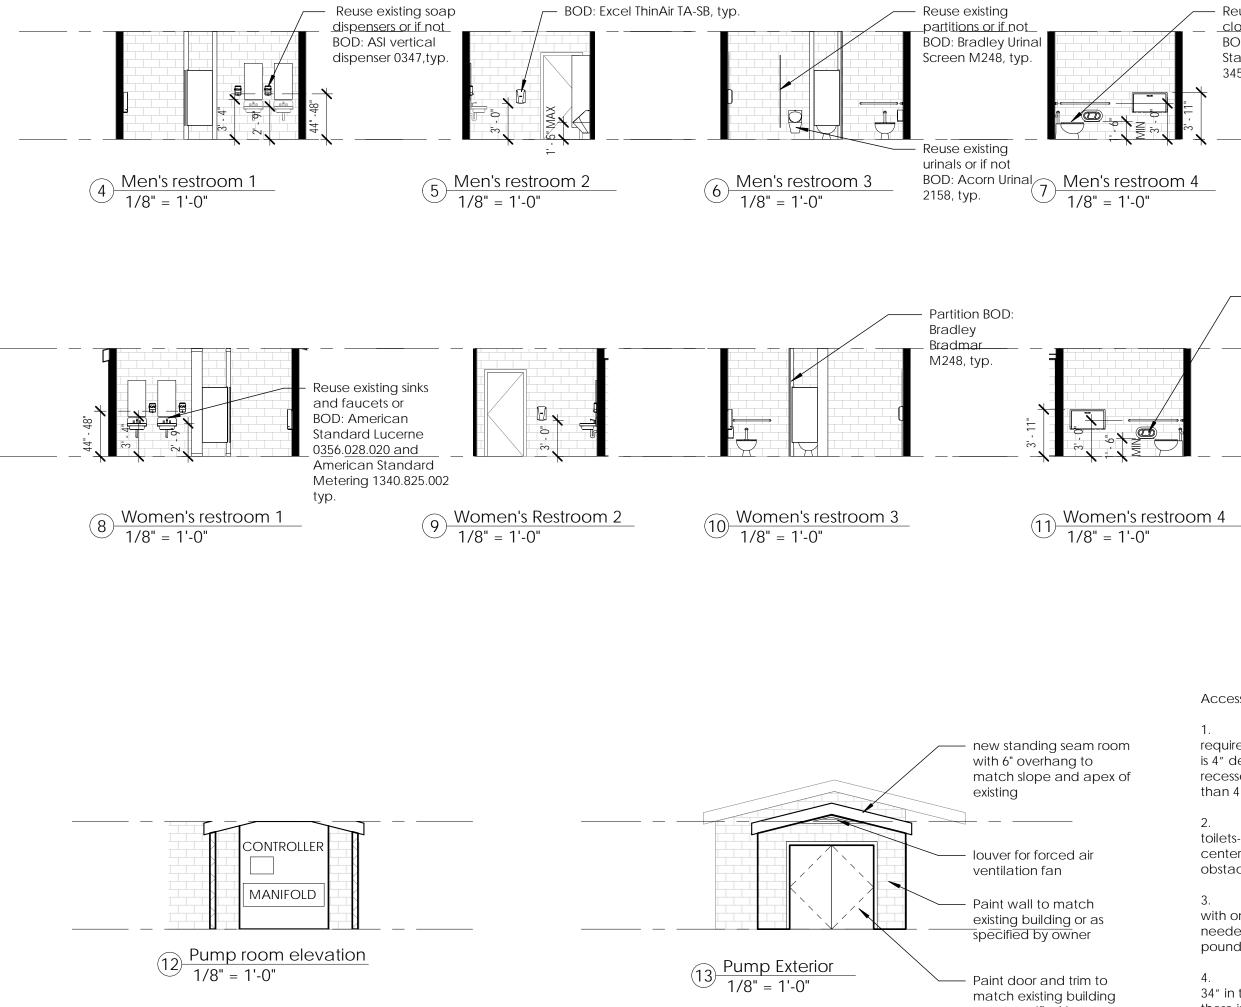

Reuse existing water <u>closets or</u> if not BOD: American Standard Madera 3451.528.020, typ.

Reuse existing toilet paper dispensers or if not BOD: ASI 0039, typ.

Accessibility Notes:

or as specified by owner

1. Hand dryers must not exceed 4" depth requirement set by the ADA. Provide a model that is 4" deep (as measured from the wall), or select a recessed hand dryer that would not protrude more than 4" into the room.


2. All plumbing fixtures- including sinks and toilets- must be 30" from each other (centerline to centerline) and 15" from the centerline other obstacles such as a wall or partition.

3. Sink fixtures must be able to be operated with one hand, that no pinching or pulling is needed, and that any pushing does not exceed 5 pounds of force.

4. The highest lip of the sinks must not exceed 34" in the front for ADA access. Please ensure that there is a knee clearance of 27 inches high, 30 inches wide, and 11 to 25 inches deep. Insulated pipes under the sink are required.

PLANNERS ARCHITECTS LANDSCAPE ARCHITECTS

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<u>northarrow + scale</u>

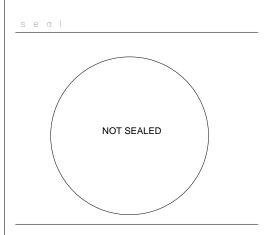revisions

project title CARPENTER'S PARK PH. 1

City of Milton

drawing	information
project number:	18157
contact:	Bryan Bays
drawn by:	Alex Fite-Wassilak
checked by:	Bryan Bays
scale:	As indicated
drawing	date

1/21/2019


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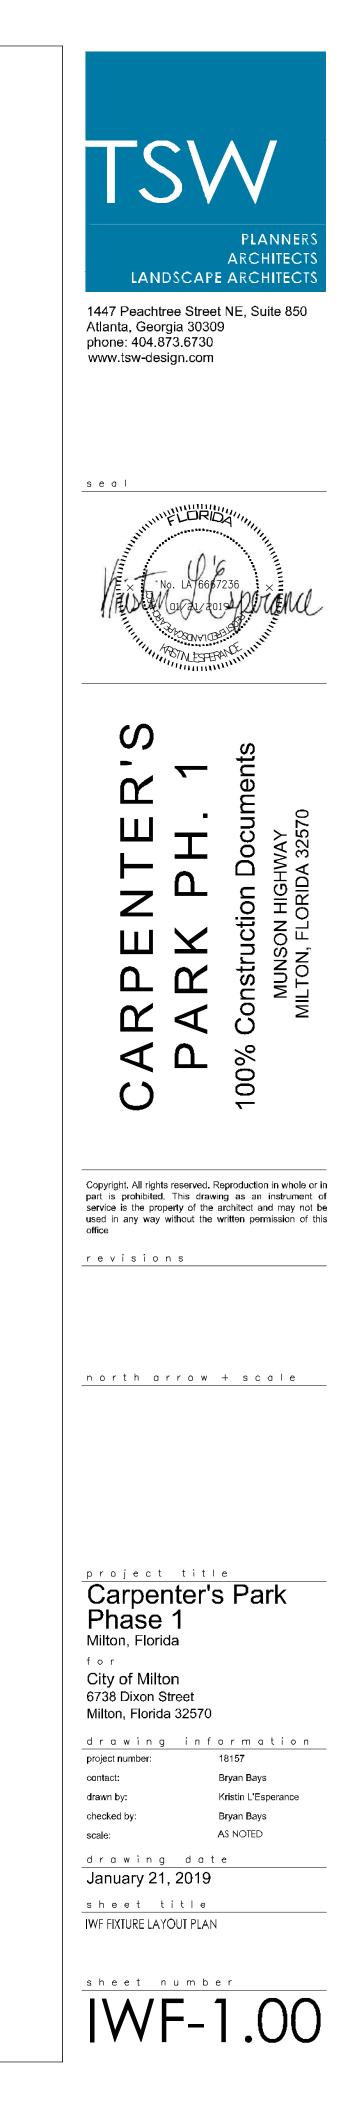
Bathroom Proposed Changes

sheet number

sheet title

- 1. CONTRACTOR TO COORDINATE ALL SITE WALLS AND PAVING WITH IRRIGATION LAYOUT PRIOR TO COMMENCEMENT OF WORK. ALL PIPES ARE TO BE SLEEVED AND CONCEALED FROM VIEW.
- 2. CONTRACTOR TO BE FAMILIAR WITH ALL SITE PLANS PRIOR TO INSTALLATION OF ANY ELEMENT WITHIN THIS SHEET SET. ANY DISCREPANCY IS TO BE BROUGHT TO THE ATTENTION OF THE LANDSCAPE ARCHITECT/OWNER.
- 3. CONTRACTOR SHALL VERIFY QUANTITIES BASED ON THE PLANS PRIOR TO BEGINNING CONSTRUCTION.
- 4. INTERACTIVE WATER FEATURE (IWF) POOL AREA TO BE NO MORE THAN 2,499 SF, AND IS A FLOW-THROUGH / SINGLE-PASS SYSTEM THAT DOES NOT REQUIRE FHD PERMITTING.
- 5. LAYOUT PLAN IS FOR DESIGN INTENT ONLY. A FULL SET OF SHOP DRAWINGS (INCLUDING GRADING, DRAINAGE AND CONNECTION TO SANITARY SEWER) IS REQUIRED FOR APPROVAL BY LANDSCAPE ARCHITECT PRIOR TO CONSTRUCTION.
- 6. ALL CONCRETE WITHIN THE LIMITS OF WORK OF THE IWF MUST BE COMPLETED BY THE IWF CONTRACTOR.
- 7. CONCRETE STAIN EDGES ARE TO BE CLEAN ARCS WITH SMOOTH EDGES. 5X5' MOCK UP REQUIRED THAT SHOWS ALL THE EDGES AND FINISH CONDITIONS FOR APPROVAL BY LANDSCAPE ARCHITECT PRIOR TO CONSTRUCTION.
- BRAINS SHALL BE SIZED TO ACCOMMODATE STORM WATER DRAINAGE OF ENTIRE IWF AREA. REFER TO SHEET L-2.03 FOR LIMITS OF DRAINAGE AREA.



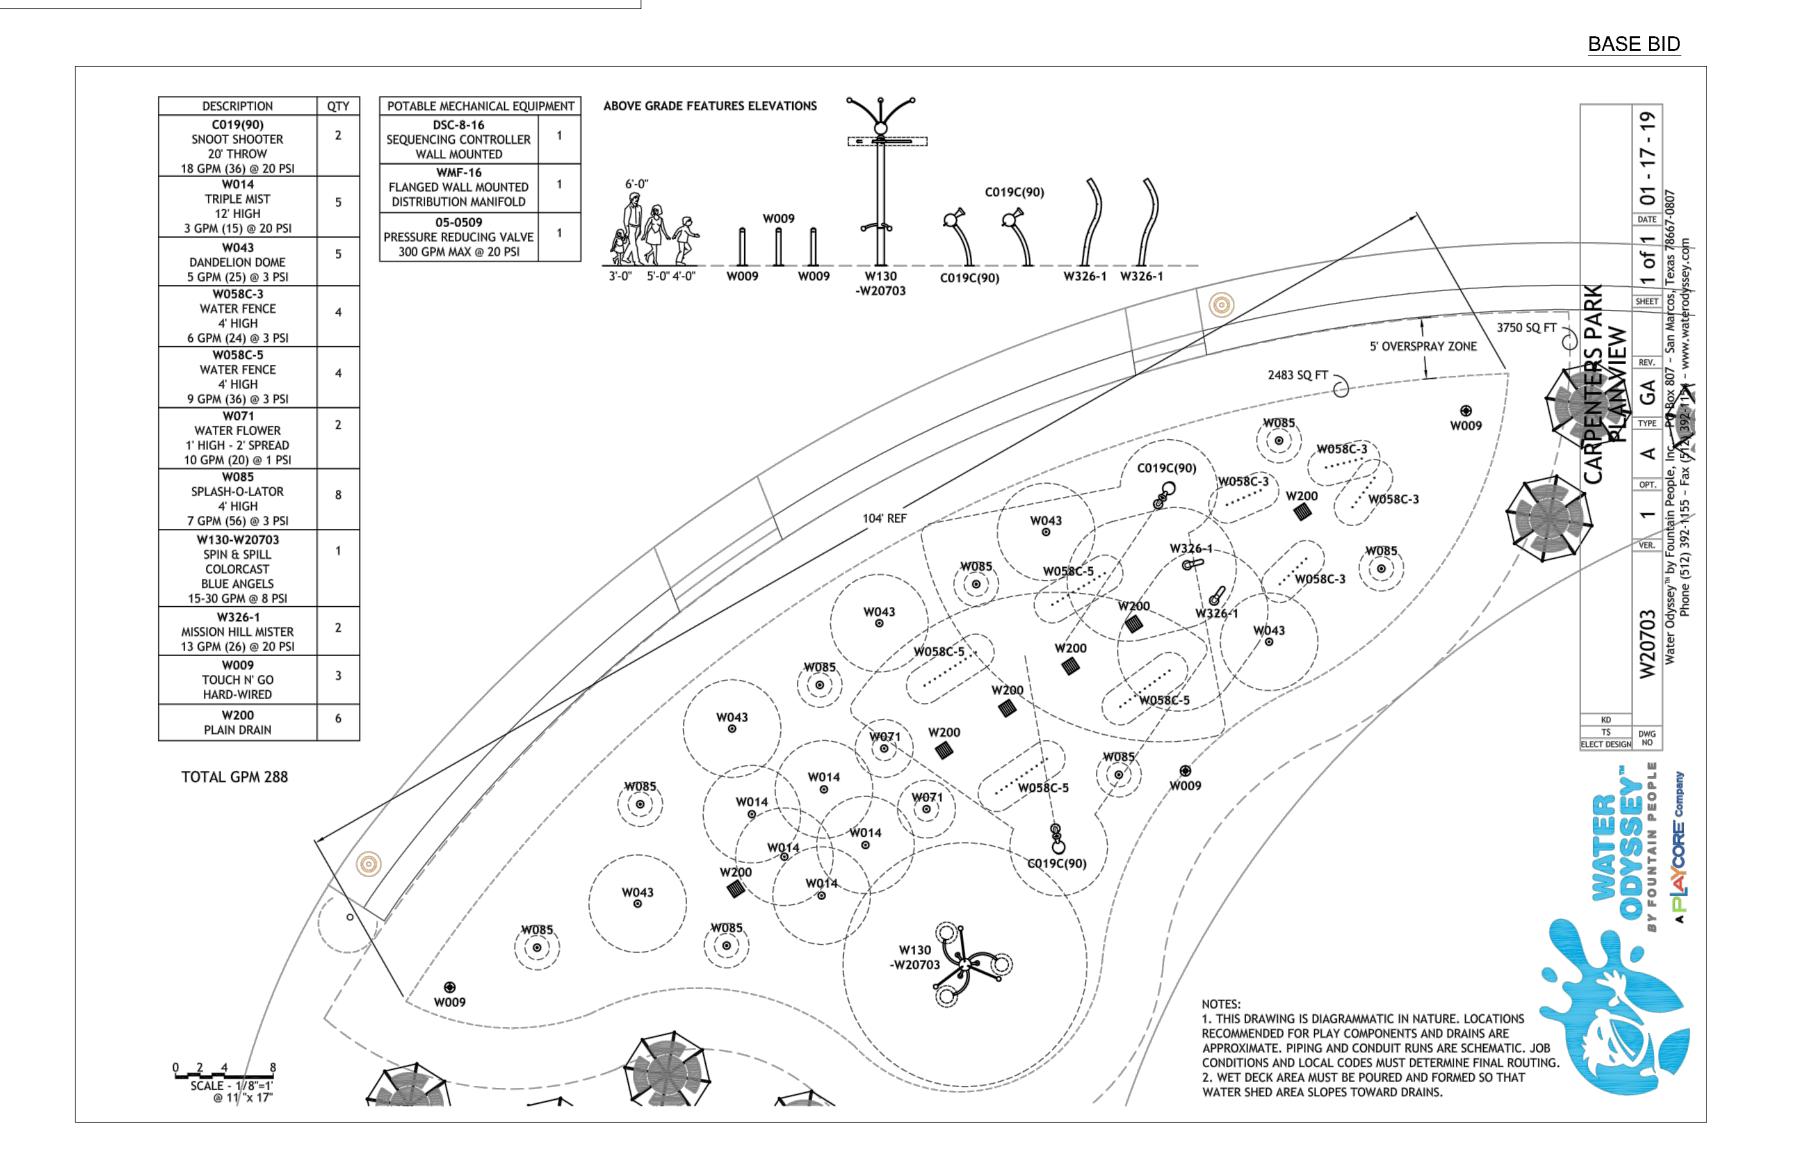

- 1. CONTRACTOR TO COORDINATE ALL SITE WALLS AND PAVING WITH IRRIGATION LAYOUT PRIOR TO COMMENCEMENT OF WORK. ALL PIPES ARE TO BE SLEEVED AND CONCEALED FROM VIEW.
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- BRAINS SHALL BE SIZED TO ACCOMMODATE STORM WATER DRAINAGE OF ENTIRE IWF AREA. REFER TO SHEET L-2.03 FOR LIMITS OF DRAINAGE AREA.

