# A RENOVATION TO:

# MONTGOMERY VILLAGE

4530 JOE LEWIS ROAD KNOXVILLE, TENNESSEE 37920

### MECHANICAL/ELECTRICAL/PLUMBING CONSULTANTS:

I.C. THOMASSON ASSOCIATES, INC.

Phone : (615) 346-3400 Fax : (615) 346-3550 2950 KRAFT DRIVE, SUITE 500 NASHVILLE, TN 37204

www.icthomasson.com



# CIVIL & ENVIRONMENTAL ENGINEERING/CONSULTANTS:

CIVIL & ENVIRONMENTAL CONSULTANTS, Inc.

Phone : (865) 977-9997 Fax : (865) 977-9919 2704 CHEROKEE FARM WAY, SUITE 101 KNOXVILLE, TN 37920

www.cecinc.com



### OWNER:


KNOXVILLE'S COMMUNITY
DEVELOPMENT CORP.
Phone: (865) 755-6007
P.O. BOX 3550
KNOXVILLE, TN 37927

Contact : JACK CANADA Phone : (865) 403-1371 302 EAST ANDERSON ST. KNOXVILLE, TN 37917

www.kcdc.org





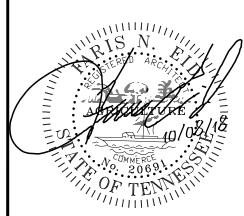

MERY VILLAGE

This drawing is the property of DESIGN INNOVATIONS ARCHITECTS, INC. and is not to be reproduced or copied in whole or in part without authorization from DESIGN INNOVATIONS ARCHITECTS, INC.. It is to be used for the project and site specifically identified herein and is not to be used on any other project. It is to be returned upon request. Do not scale drawings, written dimensions take precedence. All drawings and designs shown on these drawings are copyright © of DESIGN INNOVATIONS ARCHITECTS, INC.

Sheet Title

COVER

Project Number
18110

Date
10-08-18

Sheet Number

G-000

10-08-18				
18110		PART - MALE - MA		
		Joseph Market Ma		
PROJECT				
of DESIGN INNOVATIONS ARC				
be used for the project and site specifically did be used on any other project. It is to be return scale drawings, written dimensions take prec designs shown on these drawings.		SITE LOCATION /		
This drawing is the property of DESIGN INNO INC. and is not to be reproduced or copied authorization from INEGIGN INNOVATIONS &				
>>>		EDMGTON BY TAP VILL		
		Ep,		
> D				
>>[]		SITE REFERENCE		
>>>				
>>>			L WORK SHALL CONFORM TO ALL APPLICABLE CODES AND SHALL BE OF BEST PRACTICE OF EACH TRADE.	13.
DATE   ISSUE FOR			THE CONTRACTOR SHALL PROVIDE AND INSTALL ALL NECESSARY BLOCKING, BACKING, FRAMING, HANGERS, OR OTHER SUPPORT FOR ALL ITEMS REQUIRING THE SAME.	12.
			11. DETAILS ARE INTENDED TO SHOW DESIGN INTENT OF ACCOMPLISHING WORK. MINOR MODIFICATIONS MAY BE REQUIRED TO SUIT JOB CONDITIONS AND SHALL BE INCLUDED AS PART OF THE WORK.	11.
			PAY FOR ANY ADDITIONAL ASSOCIATED COSTS RELATED TO THE COORDINATION OR ANY REMEDIATION WORK ARISING FROM THE PARTIAL DISTRIBUTION OF THE CONTRACT DOCUMENTS. THIS PAYMENT SHALL OCCUR AT NO ADDITIONAL COSTS TO THE OWNER, ARCHITECT OR ANY OF THEIR EMPLOYEES OR CONSULTANTS.	PP ON
			T DOCUMENTS. IE BABTIAL SETS ARE DISTRIBUTED BY THE GENERAL CONTRACTOR. THEN THE GENERAL CONTRACTOR SHALL BE RESPONSIBLE FOR ALL COORDINATION.	10.
			9. FIREPROOFING & SEALANTS MAY NOT BE SHOWN ON SOME DRAWINGS FOR CLARITY. HOWEVER, ALL ASSEMBLIES MUST BE INSTALLED IN ACCORDANCE WITH THE LISTED LIFE SAFETY DESIGN. ALL ASSEMBLIES SHALL BE INSTALLED & COORDINATED WITH ALL DISCIPLINES AS OUTLINED IN THE APPLICABLE U.L. (OR EQUIVALENT) DETAIL AS CALLED OUT IN THE LIFE SAFETY DESIGN. THE CONTRACTOR SHALL BE RESPONSIBLE FOR OBTAINING CLARIFICATION FROM THE OWNER'S REPRESENTATIVE BEFORE CONTINUING CONSTRUCTION.	9.F
M			RICATION SHALL BEGIN UNTIL THE CONTRACTOR HAS RECEIVED AND THOROUGHLY REVIEWED ALL PLANS AND CONTRACT DOCUMENTS A	8.1
ON			PERSONS AND PROPERTY DURING THE PERFORMANCE OF THE WORK. THIS REQUIREMENT SHALL APPLY CONTINUOUSLY AND SHALL INCLUDE BUT NOT BE LIMITED TO MAINTAINING ALL BARRICADES, WARNING SIGNS, FLASHING LIGHTS, AND TRAFFIC CONTROL DEVICES DURING CONSTRUCTION. THE CONTRACTOR SHALL COMPLY WITH OSHA REGULATIONS AND SAFETY REQUIREMENTS.	SIG PE
T			SHALL BE PERFORMED IN STRICT COMPLIANCE WITH LOCAL, COUNTY, STATE AND FEDERAL CODES AND ORDINANCES.  ANCE WITH GENERALLY ACCEPTED CONSTRUCTION PRACTICES, THE GENERAL CONTRACTOR WILL BE SOLELY RESPONSIBLE FOR CONDITIONS AT THE JOB SITE. INCLUDING THE SAFETY	7.1
G			ISTING STRUC	
MC				CENT ASSEMBLY. ANY PENETRATIONS WILL BE PATCHED AT TREATED AS A 1 HR RATED PENETRATION.  4.
OVA I <b>EF</b>			ELD RESPONSIBLE FOR KNOWLEDGE OF THE GENERAL NOTES INCLUDED THROUGHOUT THE CONTRACT DOCUMENTS AND THE AP	DES IN EFFECT FOR KNOX COUNTY AND THE BUILDINGS WOULD HAVE BEEN CONSTRUCTED.
RY		PROPOSED PRIVATE SITE WATER AND SANITARY	1. GENERAL PROJECT NOTES APPLY TO ALL SHEETS.  2. ANY DEVIATIONS FROM THE CONTRACT DOCUMENTS WHICH ARE NECESSITATED BY FIELD CONDITIONS SHALL BE BROUGHT TO THE ATTENTION OF THE ARCHITECT.	CONSIDERED IN COMPLIANCE WITH THE PROVISIONS OF THIS CODE UNLESS THE BUILDING HAS SUSTAINED SUBSTANTIAL  DERGOING MORE THAN A LIMITED STRUCTURAL ALTERATION AS DEFINED IN ECTION 807.5.3, THE BUILDINGS AT MONTGOMERY VILLAGE  DERGOING MORE THAN A LIMITED STRUCTURAL ALTERATION. THE ORIGINAL CONSTRUCTION OF THE BUILDINGS WOULD HAVE
V		C1 PROPOSED PRIVATE SITE WATER AND SANITARY SEWER IMPROVEMENTS  C2 PROPOSED PRIVATE SITE WATER AND SANITARY SEWER IMPROVEMENTS	<del> </del>	2 ALTERATIONS. EXISTING CONSTRUCTION IS IN COMPLIANCE WITH THE LAWS IN EXISTENCE AT THE TIME. THE
IL		OWNER PROVIDED REFERENCE DRAWINGS		
LA		E-101 BUILDINGS B, C, D, E, F AND G UNIT PLANS - LIGHTING  E-102 BUILDINGS I AND J UNIT PLANS - LIGHTING	ZONING  C-3 (RESIDENTIAL PERMITTED BY EXCEPTION)	3. 2012 IEBC - 705.1 - UNDER THE IEBC, NO PORTION OF THE MEANS OF EGRESS, (OTHER THAN REPLACING LIGHT FIXTURES AT THE DWELLING UNIT STAIRS) IS INCLUDED WITHIN THE DESIGNATED WORK  AREAS, NONE OF THE DESIGNATED "WORK AREAS" INCLUDE A TOTAL WORK AREA GREATER THAN 50% OF THE FLOOR THEY ARE ON THEREFORE THE SUPPLEMENTAL REQUIREMENTS ARE NOT  TRICCEPED.
GI		P-205 BUILDINGS J UNIT PLANS - NEW & DEMO - WATER		
		P-202 BUILDINGS B, C & D UNIT PLANS - NEW & DEMO - WATER  P-203 BUILDINGS E, F & G UNIT PLANS - NEW & DEMO - WATER  P-204 BUILDINGS I UNIT PLANS - NEW & DEMO - WATER	INCIDENTAL USE SEPARATION NA NA	1. NFPA 101-24.2.2.3 - SECONDARY MEANS OF ESCAPE - REQUIRES WINDOWS USED AS SECONDARY MEANS OF ESCAPE TO HAVE A NET CLEAR OPENING OF 5.7 sqft, AN OPENING NO HIGHER THAN 44"  A.F.F., NOT LESS THAN 20" IN WIDTH, AND A HEIGHT NOT LESS THAN 24" (ALL WINDOWS ARE WITHIN 20' OF GRADE).
		BUILDING A UNIT PLANS - NEW & DEMO - WATER BUILDING A UNIT PLANS - NEW & DEMO - WATER	EILING)	I. THE SCREENS ARE OPERABLE AND SWING OUT FROM THE CONTINUOUS HINGE MOUNTED AT THE TOP OF THE BOTTOM PANEL.
		PLUMBING PLUMBING PLUMBING PLUMBING PLUMBING PLUMBING	RATION (WALLS)	2. EGRESS COMPONENTS:  A. FACH OF THE TWO-STORY APARTMENTS HAVE TWO EXISTS ON GRADE AND EACH OF THE BEDROOMS HAVE OPERABLE WINDOWS.  DIVIDION OF THE TWO-STORY APARTMENTS HAVE TWO EXISTS ON GRADE AND EACH OF THE BEDROOMS HAVE OPERABLE WINDOWS.  DIVIDION OF THE TWO-STORY APARTMENTS HAVE TWO EXISTS ON GRADE AND EACH OF THE BEDROOMS HAVE OPERABLE WINDOWS.
		COMMUNITY BUILDING PLAI MAINTENANCE GARAGE - R	CTION	IZATION EFFORT DOES NOT INVOLVE A CHANGE OF OCCUPANCY (12 IEBC CHAPTER 9)
		BUILDING J PLANS & ELEVATION BUILDING J UNIT PLANS - NEW	EXTERIOR BEARING WALLS  0-HOUR (IBC TABLE 601) - EXISTING  STRUCTURAL FRAME  0-HOUR (IBC TABLE 601) - EXISTING  FLOOR CONSTRUCTION  0-HOUR (IBC TABLE 601) - EXISTING	AS INCIDENTAL TO THE PRIMARY WORK BEING PERFORMED AND WILL NOT BE UPDATED/ CHANGED UNLESS THE ED
		BUILDINGS E, F & G ONI FLAN BUILDINGS E, F & G PLANS & E	NG WALLS	RAISEMORK INCIDENTAL TO THE INSTALLATION OF WATER RISERS ARE REMOVED AND REINSTALLED WILL BE TREATED AS A LEVEL 1 ALTERATION.
		A-103 BUILDINGS B, C & D UNIT PLANS - NEW & DEMO  A 105 RUIL DINGS E F & G LINIT PLANS - NEW & DEMO	E PROTECTION  NOTE: SEE SHEET G-003 FOR NEW & EXISTING WALL, FLOOR-CEILING AND ROOF-CEILING RATINGS INTERIOR REARING WALLS OLHOUR / IRC TARL E 601). EXISTING	DJECT IS BEING SUBMITTED UNDER THE 2012 INTERNATIONAL EXISTING BUILDING CODE.  ARFAS WHERE NEW WATER RISERS AND BATHROOM VANITIES ARE INSTALLED WILL BE TREATED AS A LEVEL 2 ALTERATION
OF TE		BUILDING A UNIT PLANS - NEV	) 	CODE RELATED ITEMS:
				REPLACEMENT OF APPLIANCES, DOOR HARDWARE AND OTHER MISCELLANEOUS ITEMS.  STI
		CIVIL/ SITE DETAILS	OCCUPANCY CLASSIFICATION EXISTING APARTMENT BUILDING (CHPT 31) - OPTION 2	REPLACEMENT OF APARTMENT WALL HUNG SINKS WITH NEW SINKS AND VANITIES WHERE FEASIBLE.
A DO A		C-500 WATER SERVICE REHABILITATION PLAN  C-501 WATER SERVICE REHABILITATION PLAN  C-502 WATER SERVICE REHABILITATION PLAN	LEVEL 2 ALIERATIONS	ni I I
		PAVEMENT RESTORATION PLAN PAVEMENT RESTORATION PLAN	WORK AREA COMPLIANCE METHOD REPAIRS (IEBC CHPT 5)  LEVEL 1 ALTERATIONS (IEBC CHPT 6)	D ADDITIONAL INSULATION TO ATTIC SPACES.
1.18 T		C-100 PAVEMENT RESTORATION PLAN	RUCTION CLASSIFICATION TYPE V, U	CONSTRUCT NEW PD. IN PLACE CONCRETE PADS FOR APARTMENT CONDENSING UNITS.
)es		G-002 LIFE SAFETY PLANS G-003 LIFE SAFETY SECTIONS	ST BUILDING CODE (IEBC)	COURTS. INT'L
sigi		G-001 PROJECT INFORMATION	BUILDING	THE PRIMARY COPE OF WORK SHALL ALSO INCLUDE REPLACING THE INTERIOR WATER SUPPLY MAINS BETWEEN THE KUB METERS AND THE APARTMENT BUILDINGS.  THE FOLLOWING ITEMS ARE ALSO INCLUDED AS PART OF THE PROJECT SCOPE.
n In	BID SE SECO	SHEE		
no	ET IND BID	T NUMB	2012 INTERNATIONAL FUEL GAS CODE (IFGC) WITH LOCAL ADOPTED ORDINANCES  2012 INTERNATIONAL MECHANICAL CODE (IMC)  2013	APARTMENTS HAVE POURED CONCRETE FLOORS AT THE SECOND FLOOR AND SOME CMU BEARING WALLS AT THE FIRST FLOOR. ALL OF THE NON-BEARING WALLS ARE OF WOOD FRAME CONSTRUCTION.
	SET	ER		CONSTRUCTION IS BRICK VENEER ON WOOD-FRAME CONSTRUCTION - R2 OCCUPANCY (2012 IBC).
			ICABLE CODES    INTERNATIONAL EXISTING BUILDING CODE (IEBC) WITH LOCAL	1. THE MODERNIZATION EFFORTS AT MONTGOMERY VILLAGE WILL INVOLVE 65 BUILDINGS HOUSING A TOTAL OF 384 APARTMENT UNITS, EACH BUILDING IS A TWO STORY BUILDING TYPICALLY FILLED WITH TWO STORY APARTMENTS THAT EXIT ON GRADE, HOWEVER, NINE OF THE EXISTING TWO STORY BUILDINGS ARE MADE UP OF STACKED SINGLE STORY, SINGLE BEDROOM UNITS WITH AN EXTERIOR CORRIDOR AND TWO EXTERIOR /  UNENCLOSED EXIT STAIRS, EACH APARTMENT UNIT IS ONE OF SIX POSSIBLE UNIT LAYOUTS RANGING FROM ONE TO 5 BEDROOMS.
	10-08-2	RE-ISSUED REVISED	REGULATORY	CONSTRUCTION / OCCUPANCY:
	—   č	<b>_</b> │█┃ <b>├</b>	Y = A TODY	
	ויססיום בטס.		LECT CODE AND ZONING INEORMATION	


4530 JOE LEWIS ROAD


KNOXVILLE, TENNESSEE 37920

G-001

402 S. Gay Street, Suite 201, Knoxville, TN 37902 ph 865.637.8540 or 865.291.2221 fx 865.544.3840 www.dia-arch.com



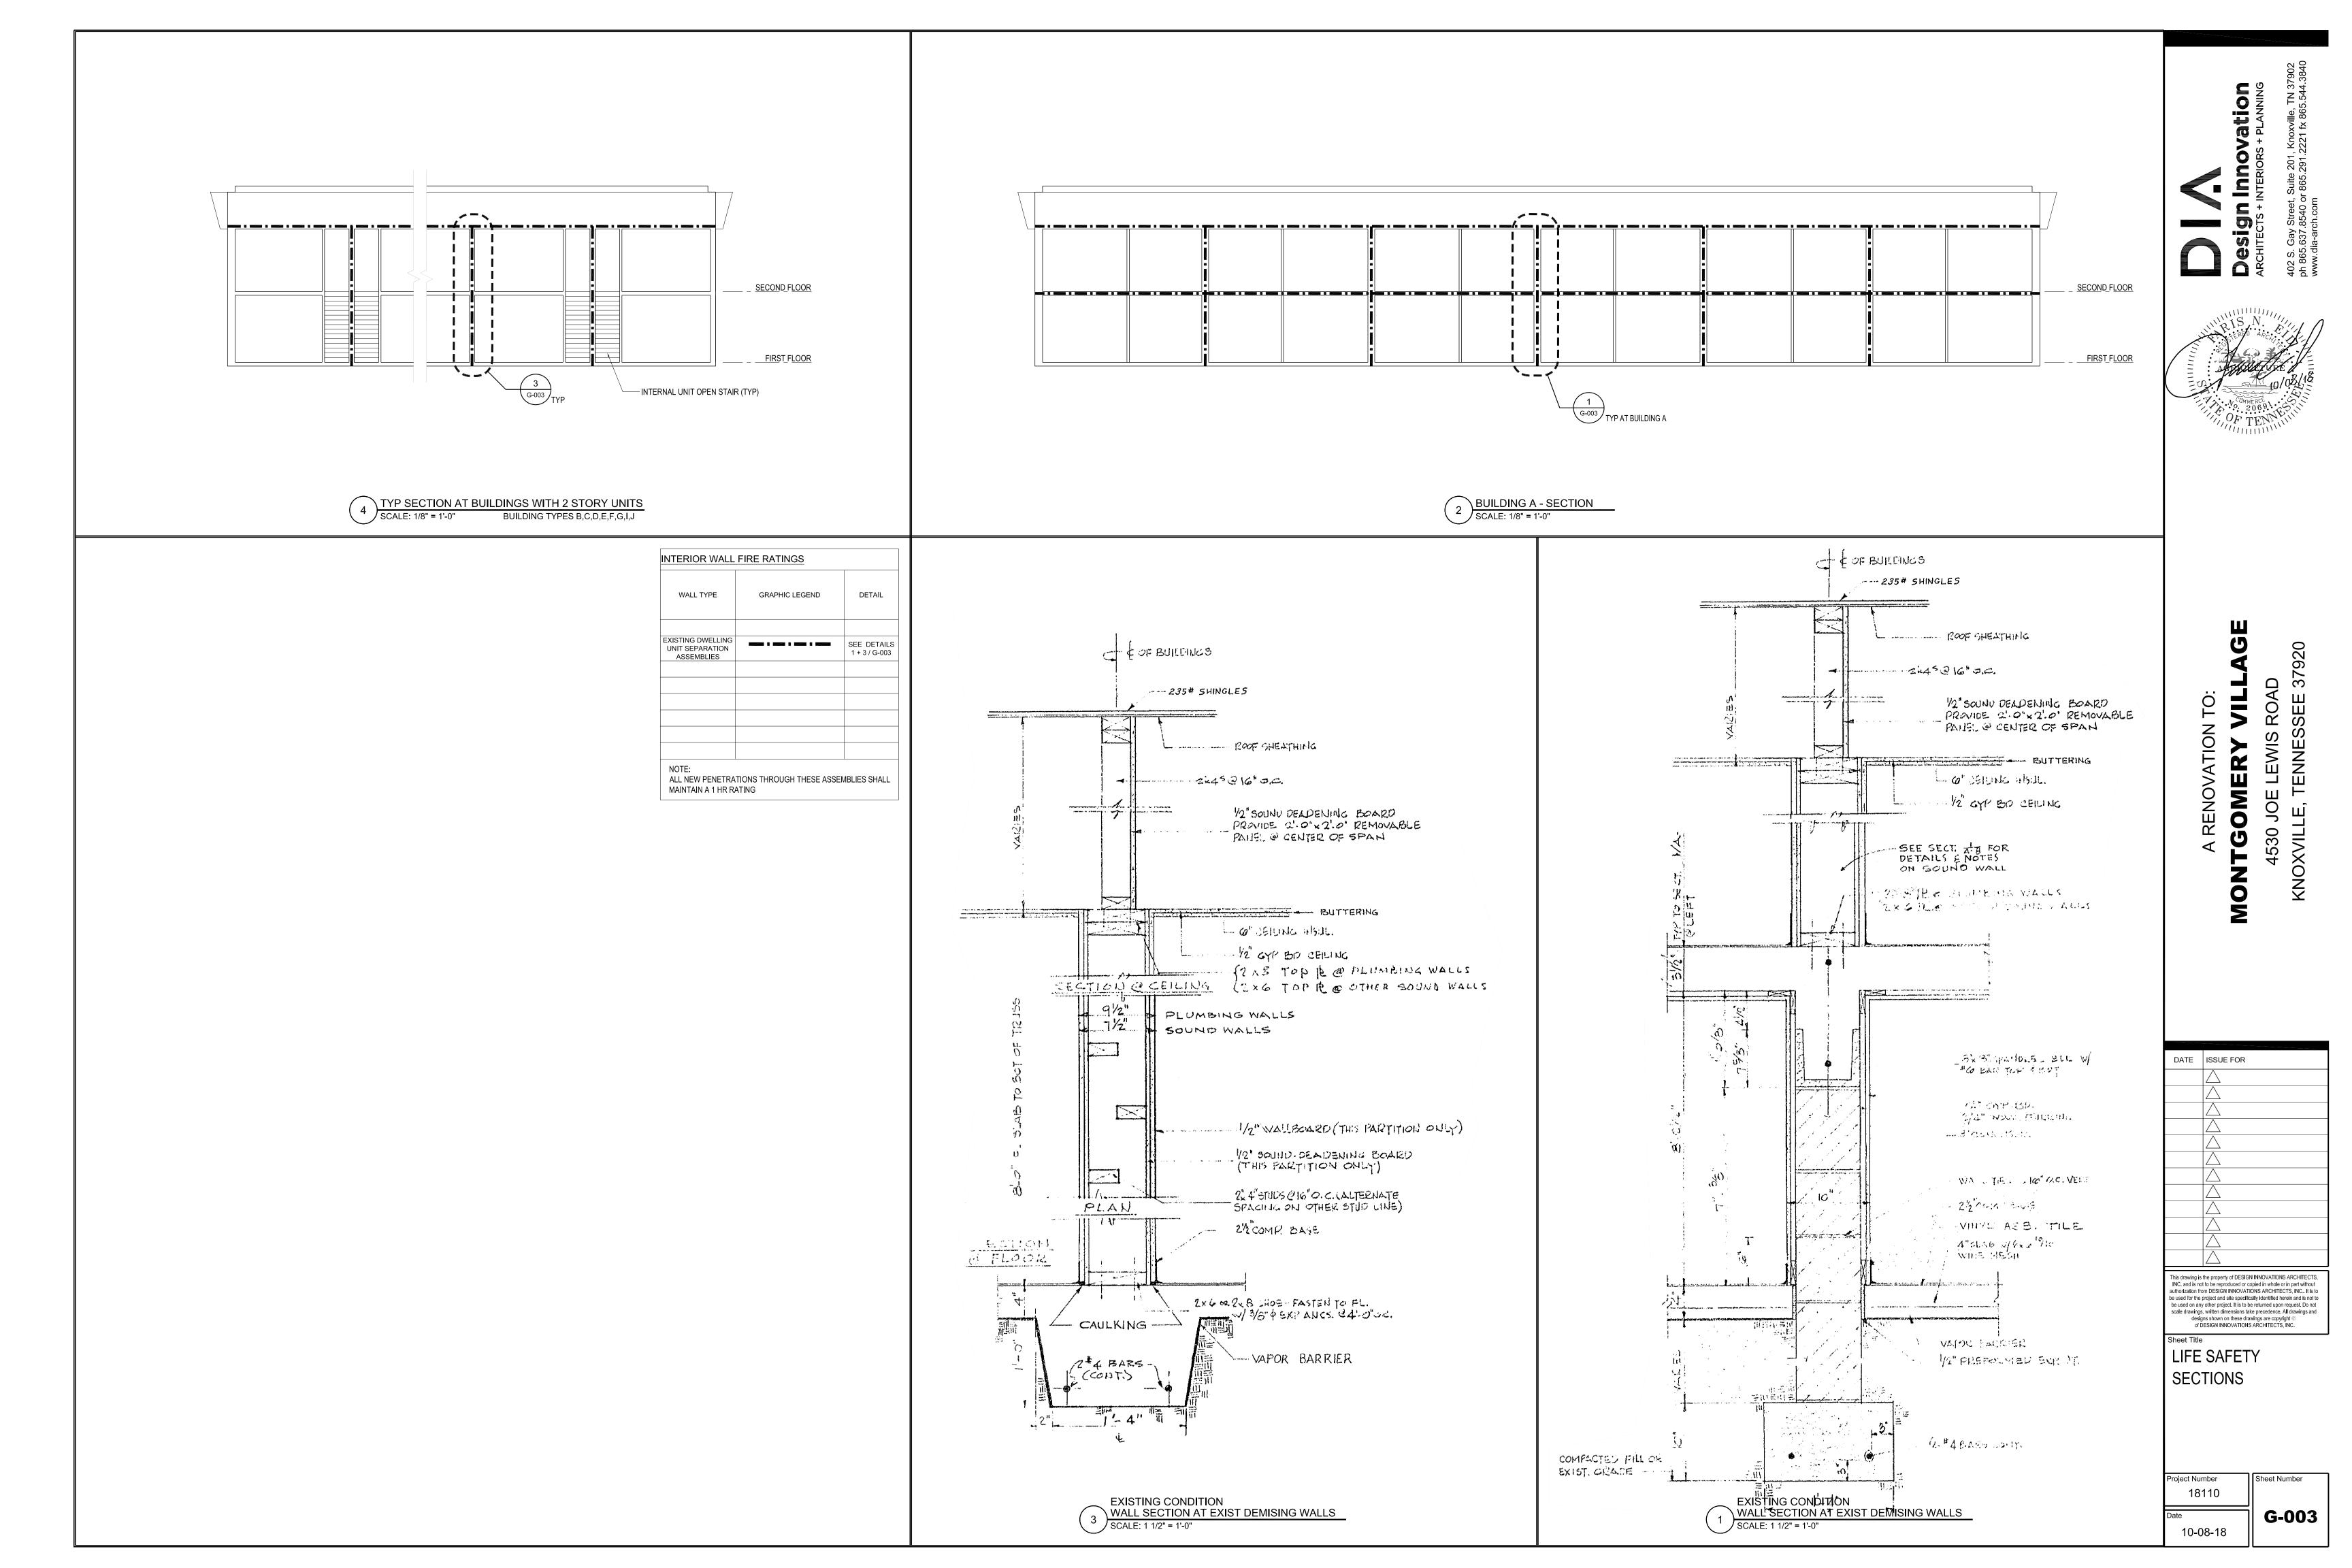

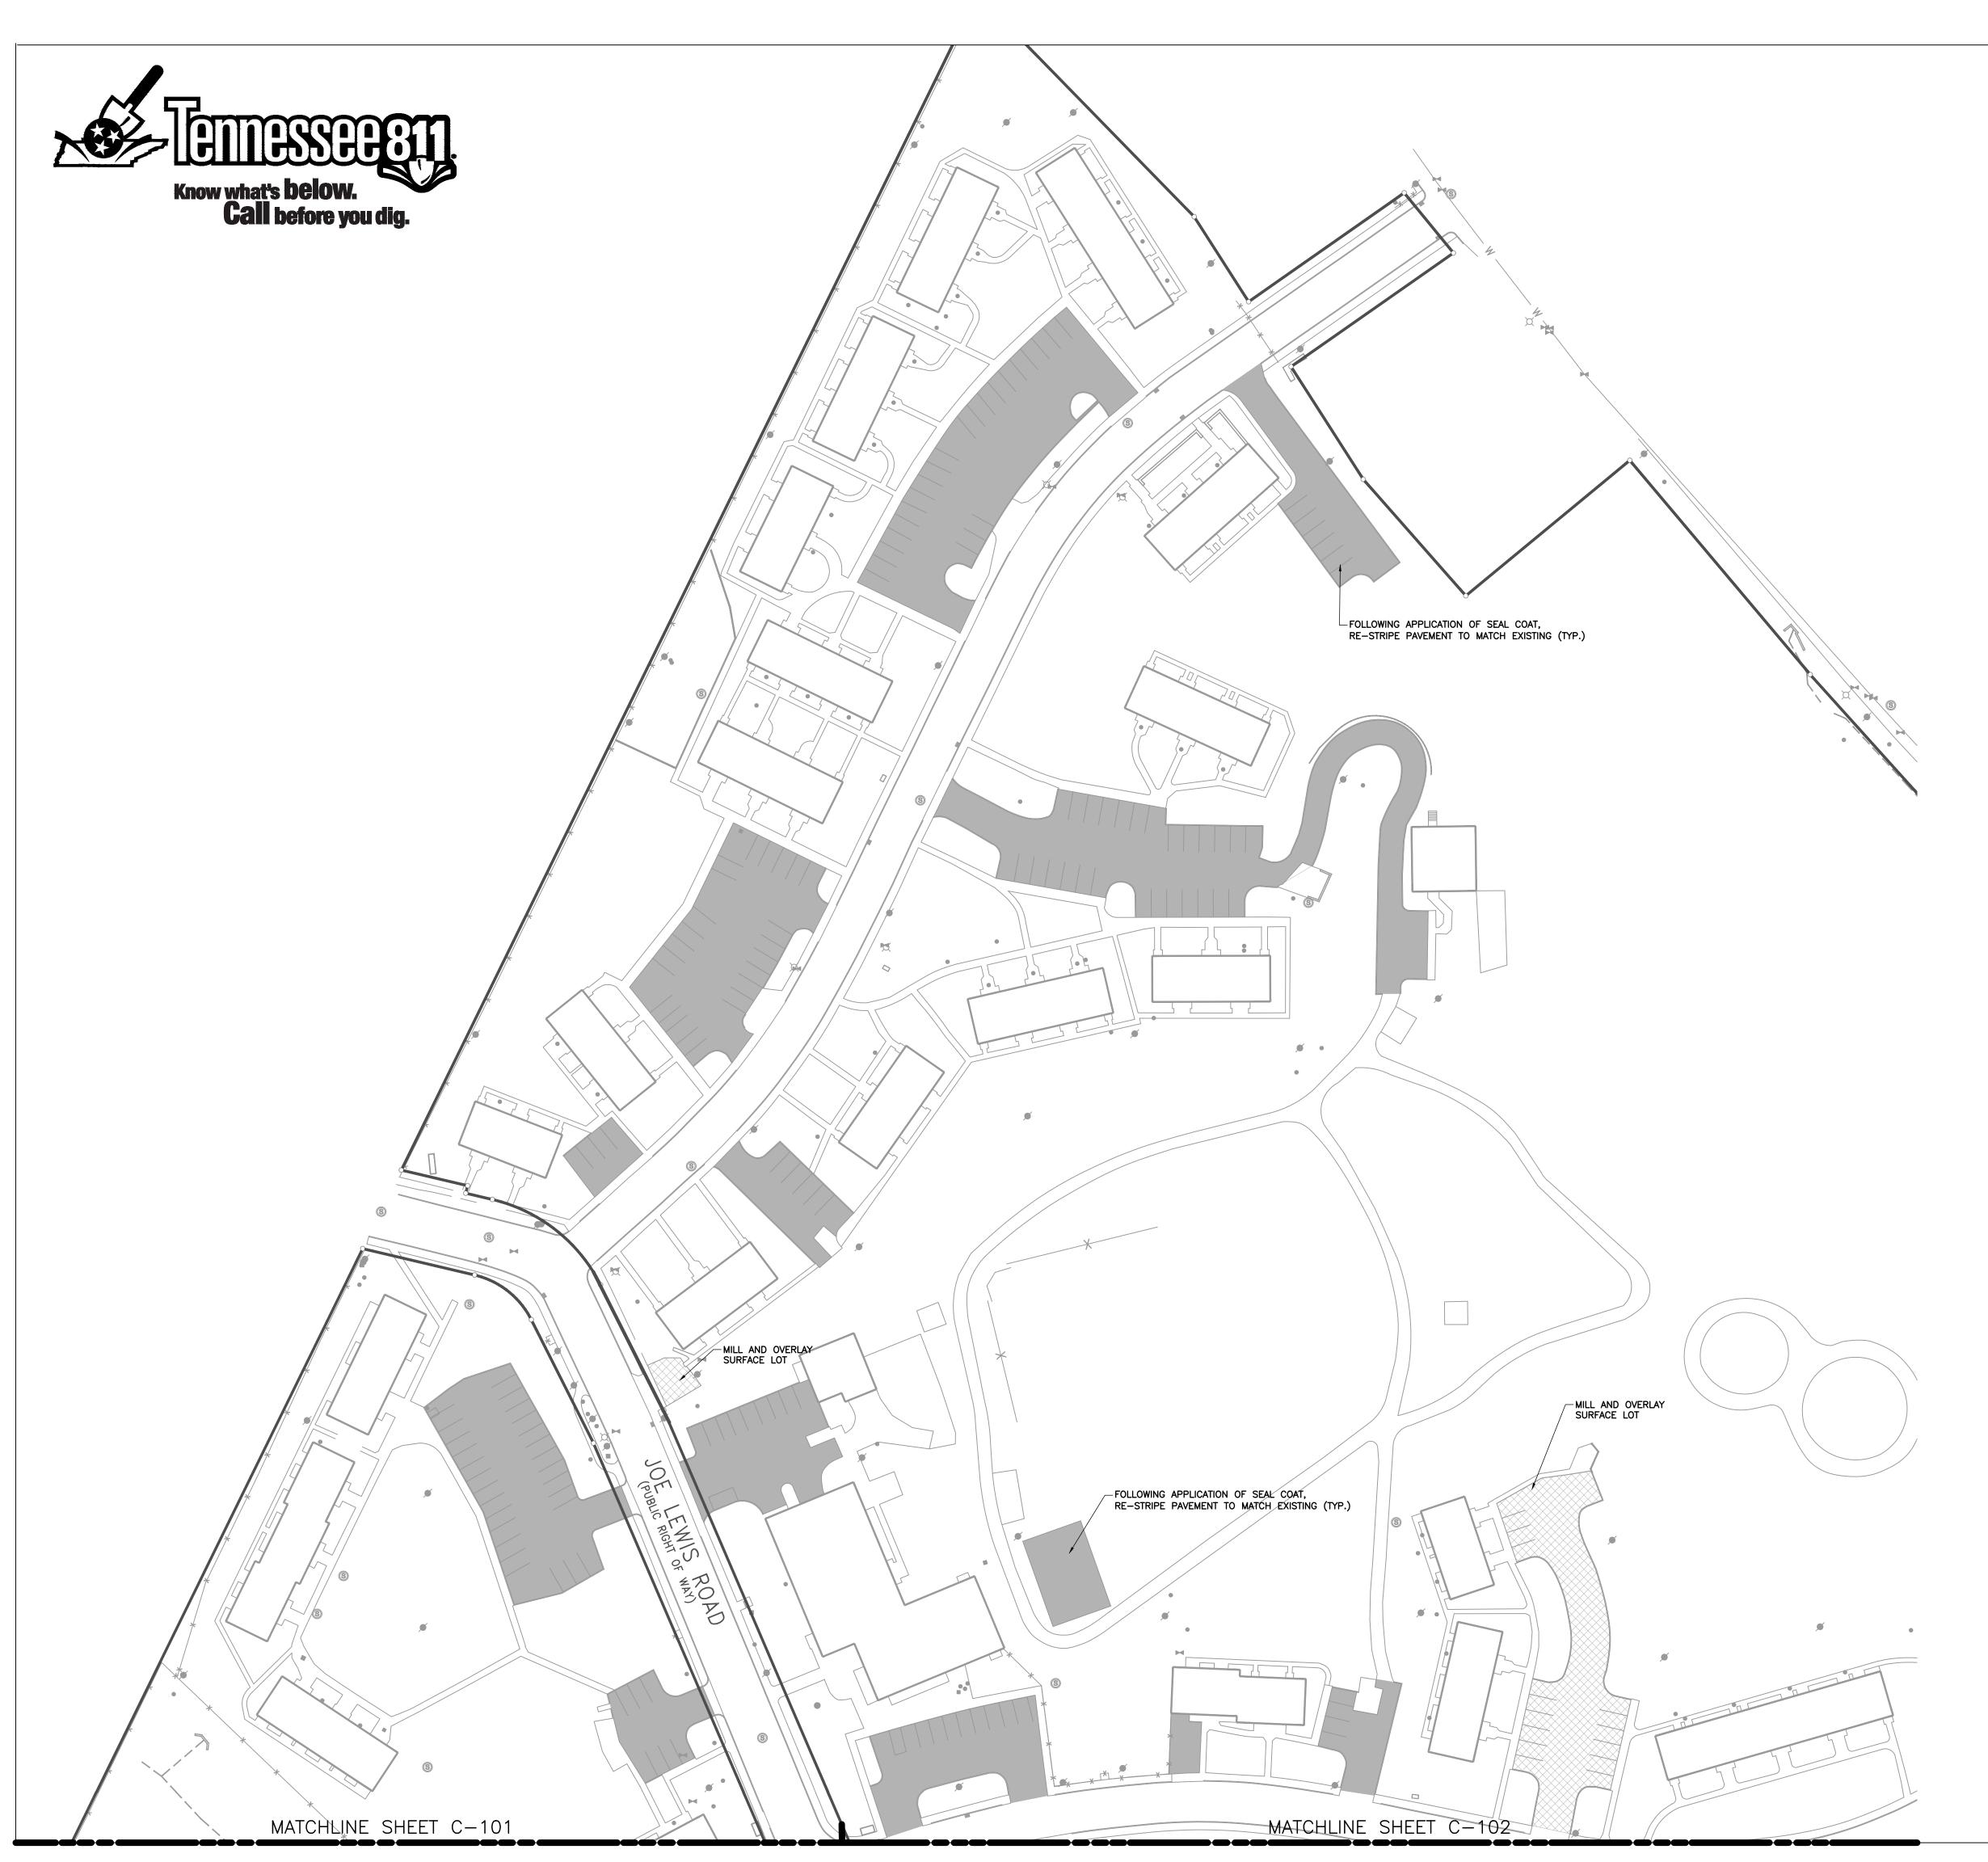



- EXISTING PROPERTY SURVEY DATA SHOWN IS FROM A SURVEY PREPARED BY ROTH LAND SURVEYING DATED JANUARY 3, 2017. ARCHITECT/ENGINEER IS NOT RESPONSIBLE FOR THE ACCURACY OR COMPLETENESS OF THE INFORMATION SHOWN.
- 2. ASPHALT BASE PAVEMENT SEALER (SEAL COAT) SHALL BE A MINERAL FILLER ASPHALT EMULSION PAVEMENT SEALER SUCH AS POLYMER-MODIFIED MASTERSEAL AS MANUFACTURED BY SEALMASTER, OR APPROVED EQUAL, MEETING THE REQUIREMENTS OF ASTM D8099/D8099M-17. SEALER/SAND MIX SHALL BE APPLIED IN ACCORDANCE WITH THE MANUFACTURER'S RECOMMENDATIONS AT A RATE OF 70 TO 80 SQUARE FEET PER GALLON. TWO COATS OF SEALER SHALL BE APPLIED WITH EACH COAT ALLOWED TO THOROUGHLY DRY BEFORE APPLYING SUCCESSIVE COATS. THE SURFACE OF THE EXISTING PAVEMENT SHALL BE CLEANED AND CRACKS IN EXCESS OF 1/8 INCH WIDE FILLED PRIOR TO APPLICATION OF THE SEALER.
- 3. PARKING STALL STRIPING SHALL BE NON-REFLECTIVE TRAFFIC PAINT. STRIPING SHALL BE, WATERBOURNE OR SOLVENT BOURNE, USING COLORS AS SPECIFIED HEREIN. WATERBOURNE PAINTS SHALL CONFORM TO FS
  TT-P-1952. SOLVENT BOURNE PAINTS SHALL CONFORM TO FS
  A-A-2886 OR AASHTO M248. PAINT SHALL BE APPLIED NO EARLIER THAN 14 DAYS PRIOR TO SUBSTANTIAL COMPLETION. PAINT COLORS SHALL FOLLOW THE FEDERAL STANDARD 595B COLOR NUMBERS AS FOLLOWS: BLUE-COLOR 15180, WHITE-COLOR 37925, AND YELLOW-COLOR 33538.
- 4. CONTRACTOR SHALL MEASURE AND RECORD PARKING DIMENSIONS BEFORE SEALING. ANY DIMENSIONS NOT MEETING CURRENT CITY OR STATE REQUIREMENTS SHALL BE RE-STRIPED TO MEET CURRENT REGULATIONS. REFER TO SHEET C-800 FOR PARKING SPACE MARKING DETAIL.
- ALL PAVING RESTORATION SHOWN HEREIN SHALL BE PERFORMED AFTER LAND DISTURBANCE IN THE IMMEDIATE VICINITY IS COMPLETE AND PERMANENT STABILIZATION HAS BEEN ACHIEVED.
- 6. COORDINATE WITH OWNER FOR CLOSURE OF PARKING AND ROAD FACILITIES. PAVING RESTORATION, SURFACING AND STRIPING MAY BE DONE IN PHASES AT OWNER'S DISCRETION IN ORDER TO MAINTAIN THE NECESSARY PARKING CAPACITY OF THE FACILITY.

### LEGEND

LLGLIND		
	EXISTING	PROPERTY LINE
×	EXISTING	FENCE
(\$)	EXISTING	SANITARY MANHOLE
ø	EXISTING	UTILITY POLE
•	EXISTING	CLEANOUT
H	EXISTING	WATER VALVE

PROPOSED PAVEMENT SEAL COAT

PROPOSED MILL AND OVERLAY

DATE	ISSUE FOR
	$\triangle$
	$\wedge$

This drawing is the property of DESIGN INNOVATIONS ARCHITECTS, INC. and is not to be reproduced or copied in whole or in part without authorization from DESIGN INNOVATIONS ARCHITECTS, INC.. It is to be used for the project and site specifically identified herein and is not to be used on any other project. It is to be returned upon request. Do not scale drawings, written dimensions take precedence. All drawings and designs shown on these drawings are copyright © of DESIGN INNOVATIONS ARCHITECTS, INC.

PAVEMENT RESTORATION PLAN

Sheet Number oject Number

C-100 10-15-2018

Civil & Environmental Consultants, Inc.

2704 CHEROKEE FARM WAY - KNOXVILLE, TN 37920 PH:865-977-9997 · FAX:865-977-9919 www.cecinc.com

### **NOTES**

- EXISTING PROPERTY SURVEY DATA SHOWN IS FROM A SURVEY PREPARED BY ROTH LAND SURVEYING DATED JANUARY 3, 2017. ARCHITECT/ENGINEER IS NOT RESPONSIBLE FOR THE ACCURACY OR COMPLETENESS OF THE INFORMATION SHOWN.
- 2. ASPHALT BASE PAVEMENT SEALER (SEAL COAT) SHALL BE A MINERAL FILLER ASPHALT EMULSION PAVEMENT SEALER SUCH AS POLYMER-MODIFIED MASTERSEAL AS MANUFACTURED BY SEALMASTER, OR APPROVED EQUAL, MEETING THE REQUIREMENTS OF ASTM D8099/D8099M-17. SEALER/SAND MIX SHALL BE APPLIED IN ACCORDANCE WITH THE MANUFACTURER'S RECOMMENDATIONS AT A RATE OF 70 TO 80 SQUARE FEET PER GALLON. TWO COATS OF SEALER SHALL BE APPLIED WITH EACH COAT ALLOWED TO THOROUGHLY DRY BEFORE
  APPLYING SUCCESSIVE COATS. THE SURFACE OF THE EXISTING PAVEMENT
  SHALL BE CLEANED AND CRACKS IN EXCESS OF 1/8 INCH WIDE FILLED PRIOR TO APPLICATION OF THE SEALER.
- 3. PARKING STALL STRIPING SHALL BE NON-REFLECTIVE TRAFFIC PAINT. STRIPING SHALL BE, WATERBOURNE OR SOLVENT BOURNE, USING COLORS AS SPECIFIED HEREIN. WATERBOURNE PAINTS SHALL CONFORM TO FS
  TT-P-1952. SOLVENT BOURNE PAINTS SHALL CONFORM TO FS
  A-A-2886 OR AASHTO M248. PAINT SHALL BE APPLIED NO EARLIER THAN 14 DAYS PRIOR TO SUBSTANTIAL COMPLETION. PAINT COLORS SHALL FOLLOW THE FEDERAL STANDARD 595B COLOR NUMBERS AS FOLLOWS: BLUE-COLOR 15180, WHITE-COLOR 37925, AND YELLOW-COLOR 33538.
- 4. CONTRACTOR SHALL MEASURE AND RECORD PARKING DIMENSIONS BEFORE SEALING. ANY DIMENSIONS NOT MEETING CURRENT CITY OR STATE REQUIREMENTS SHALL BE RE-STRIPED TO MEET CURRENT REGULATIONS. REFER TO SHEET C-800 FOR PARKING SPACE MARKING DETAIL.
- ALL PAVING RESTORATION SHOWN HEREIN SHALL BE PERFORMED AFTER LAND DISTURBANCE IN THE IMMEDIATE VICINITY IS COMPLETE AND PERMANENT STABILIZATION HAS BEEN ACHIEVED.
- 6. COORDINATE WITH OWNER FOR CLOSURE OF PARKING AND ROAD FACILITIES. PAVING RESTORATION, SURFACING AND STRIPING MAY BE DONE IN PHASES AT OWNER'S DISCRETION IN ORDER TO MAINTAIN THE NECESSARY PARKING CAPACITY OF THE FACILITY.

### LEGEND

LLGLIID		
	EXISTING	PROPERTY LINE
×	EXISTING	FENCE
(5)	EXISTING	SANITARY MANHOLE
ø	EXISTING	UTILITY POLE
•	EXISTING	CLEANOUT
H	EXISTING	WATER VALVE

PROPOSED PAVEMENT SEAL COAT

This drawing is the property of DESIGN INNOVATIONS ARCHITECTS, INC. and is not to be reproduced or copied in whole or in part without authorization from DESIGN INNOVATIONS ARCHITECTS, INC.. It is to be used for the project and site specifically identified herein and is not to be used on any other project. It is to be returned upon request. Do not scale drawings, written dimensions take precedence. All drawings and designs shown on these drawings are copyright © of DESIGN INNOVATIONS ARCHITECTS, INC.

PAVEMENT RESTORATION PLAN

Sheet Number oject Number 18110

C-101 10-15-2018

Civil & Environmental Consultants, Inc. 2704 CHEROKEE FARM WAY - KNOXVILLE, TN 37920 PH:865-977-9997 · FAX:865-977-9919 www.cecinc.com





### **NOTES**

- 1. EXISTING PROPERTY SURVEY DATA SHOWN IS FROM A SURVEY PREPARED BY ROTH LAND SURVEYING DATED JANUARY 3, 2017. ARCHITECT/ENGINEER IS NOT RESPONSIBLE FOR THE ACCURACY OR COMPLETENESS OF THE INFORMATION SHOWN.
- 2. ASPHALT BASE PAVEMENT SEALER (SEAL COAT) SHALL BE A MINERAL FILLER ASPHALT EMULSION PAVEMENT SEALER SUCH AS POLYMER-MODIFIED MASTERSEAL AS MANUFACTURED BY SEALMASTER, OR APPROVED EQUAL, MEETING THE REQUIREMENTS OF ASTM D8099/D8099M-17. SEALER/SAND MIX SHALL BE APPLIED IN ACCORDANCE WITH THE MANUFACTURER'S RECOMMENDATIONS AT A RATE OF 70 TO 80 SQUARE FEET PER GALLON. TWO COATS OF SEALER SHALL BE APPLIED WITH EACH COAT ALLOWED TO THOROUGHLY DRY BEFORE
  APPLYING SUCCESSIVE COATS. THE SURFACE OF THE EXISTING PAVEMENT
  SHALL BE CLEANED AND CRACKS IN EXCESS OF 1/8 INCH WIDE FILLED PRIOR TO APPLICATION OF THE SEALER.
- 3. PARKING STALL STRIPING SHALL BE NON-REFLECTIVE TRAFFIC PAINT.
  STRIPING SHALL BE, WATERBOURNE OR SOLVENT BOURNE, USING COLORS
  AS SPECIFIED HEREIN. WATERBOURNE PAINTS SHALL CONFORM TO FS
  TT-P-1952. SOLVENT BOURNE PAINTS SHALL CONFORM TO FS
  A-A-2886 OR ASSHTO M248. PAINT SHALL BE APPLIED NO EARLIER THAN 14 DAYS PRIOR TO SUBSTANTIAL COMPLETION. PAINT COLORS SHALL FOLLOW THE FEDERAL STANDARD 595B COLOR NUMBERS AS FOLLOWS: BLUE—COLOR 15180, WHITE—COLOR 37925, AND YELLOW—COLOR 33538.
- 4. CONTRACTOR SHALL MEASURE AND RECORD PARKING DIMENSIONS BEFORE SEALING. ANY DIMENSIONS NOT MEETING CURRENT CITY OR STATE REQUIREMENTS SHALL BE RE-STRIPED TO MEET CURRENT REGULATIONS. REFER TO SHEET C-800 FOR PARKING SPACE MARKING DETAIL.
- ALL PAVING RESTORATION SHOWN HEREIN SHALL BE PERFORMED AFTER LAND DISTURBANCE IN THE IMMEDIATE VICINITY IS COMPLETE AND PERMANENT STABILIZATION HAS BEEN ACHIEVED.
- 6. COORDINATE WITH OWNER FOR CLOSURE OF PARKING AND ROAD FACILITIES. PAVING RESTORATION, SURFACING AND STRIPING MAY BE DONE IN PHASES AT OWNER'S DISCRETION IN ORDER TO MAINTAIN THE NECESSARY PARKING CAPACITY OF THE FACILITY.

### **LEGEND**

	EXISTING	PROPERTY LINE
×	EXISTING	FENCE
(\$)	EXISTING	SANITARY MANHOL
ø	EXISTING	UTILITY POLE
•	EXISTING	CLEANOUT
H	EXISTING	WATER VALVE

PROPOSED MILL AND OVERLAY

PROPOSED PAVEMENT SEAL COAT

DATE	ISSUE FOR
	$\triangle$
	Λ

This drawing is the property of DESIGN INNOVATIONS ARCHITECTS, INC. and is not to be reproduced or copied in whole or in part without authorization from DESIGN INNOVATIONS ARCHITECTS, INC.. It is to be used for the project and site specifically identified herein and is not to be used on any other project. It is to be returned upon request. Do not scale drawings, written dimensions take precedence. All drawings and designs shown on these drawings are copyright © of DESIGN INNOVATIONS ARCHITECTS, INC.

PAVEMENT RESTORATION PLAN

Civil & Environmental Consultants, Inc.


oject Number 18110

C-102 10-15-2018

Sheet Number


2704 CHEROKEE FARM WAY - KNOXVILLE, TN 37920 PH:865-977-9997 · FAX:865-977-9919 www.cecinc.com



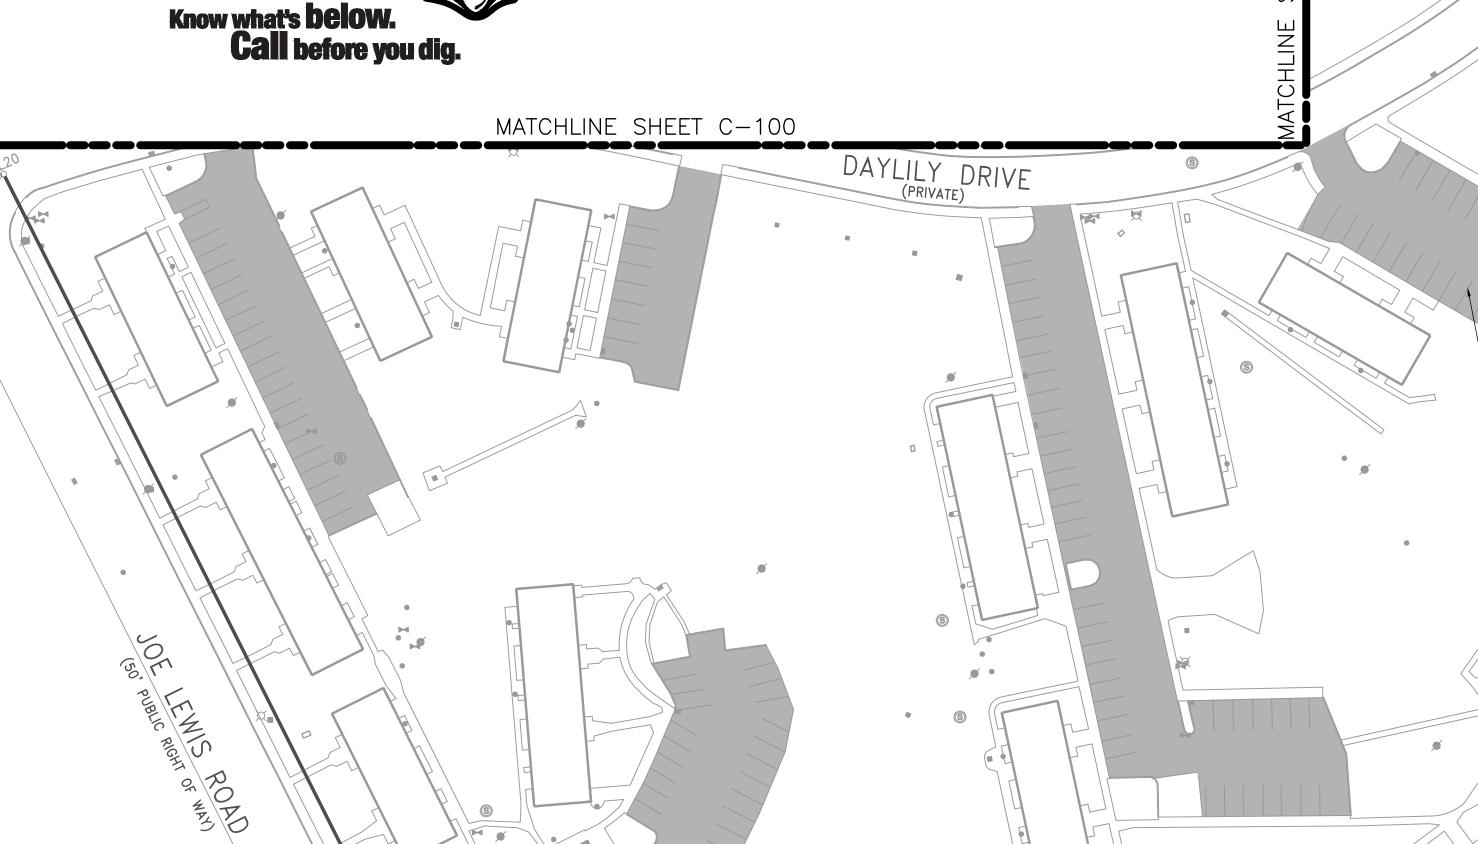

FOLLOWING APPLICATION OF SEAL COAT,

RE-STRIPE PAVEMENT TO MATCH EXISTING (TYP.)

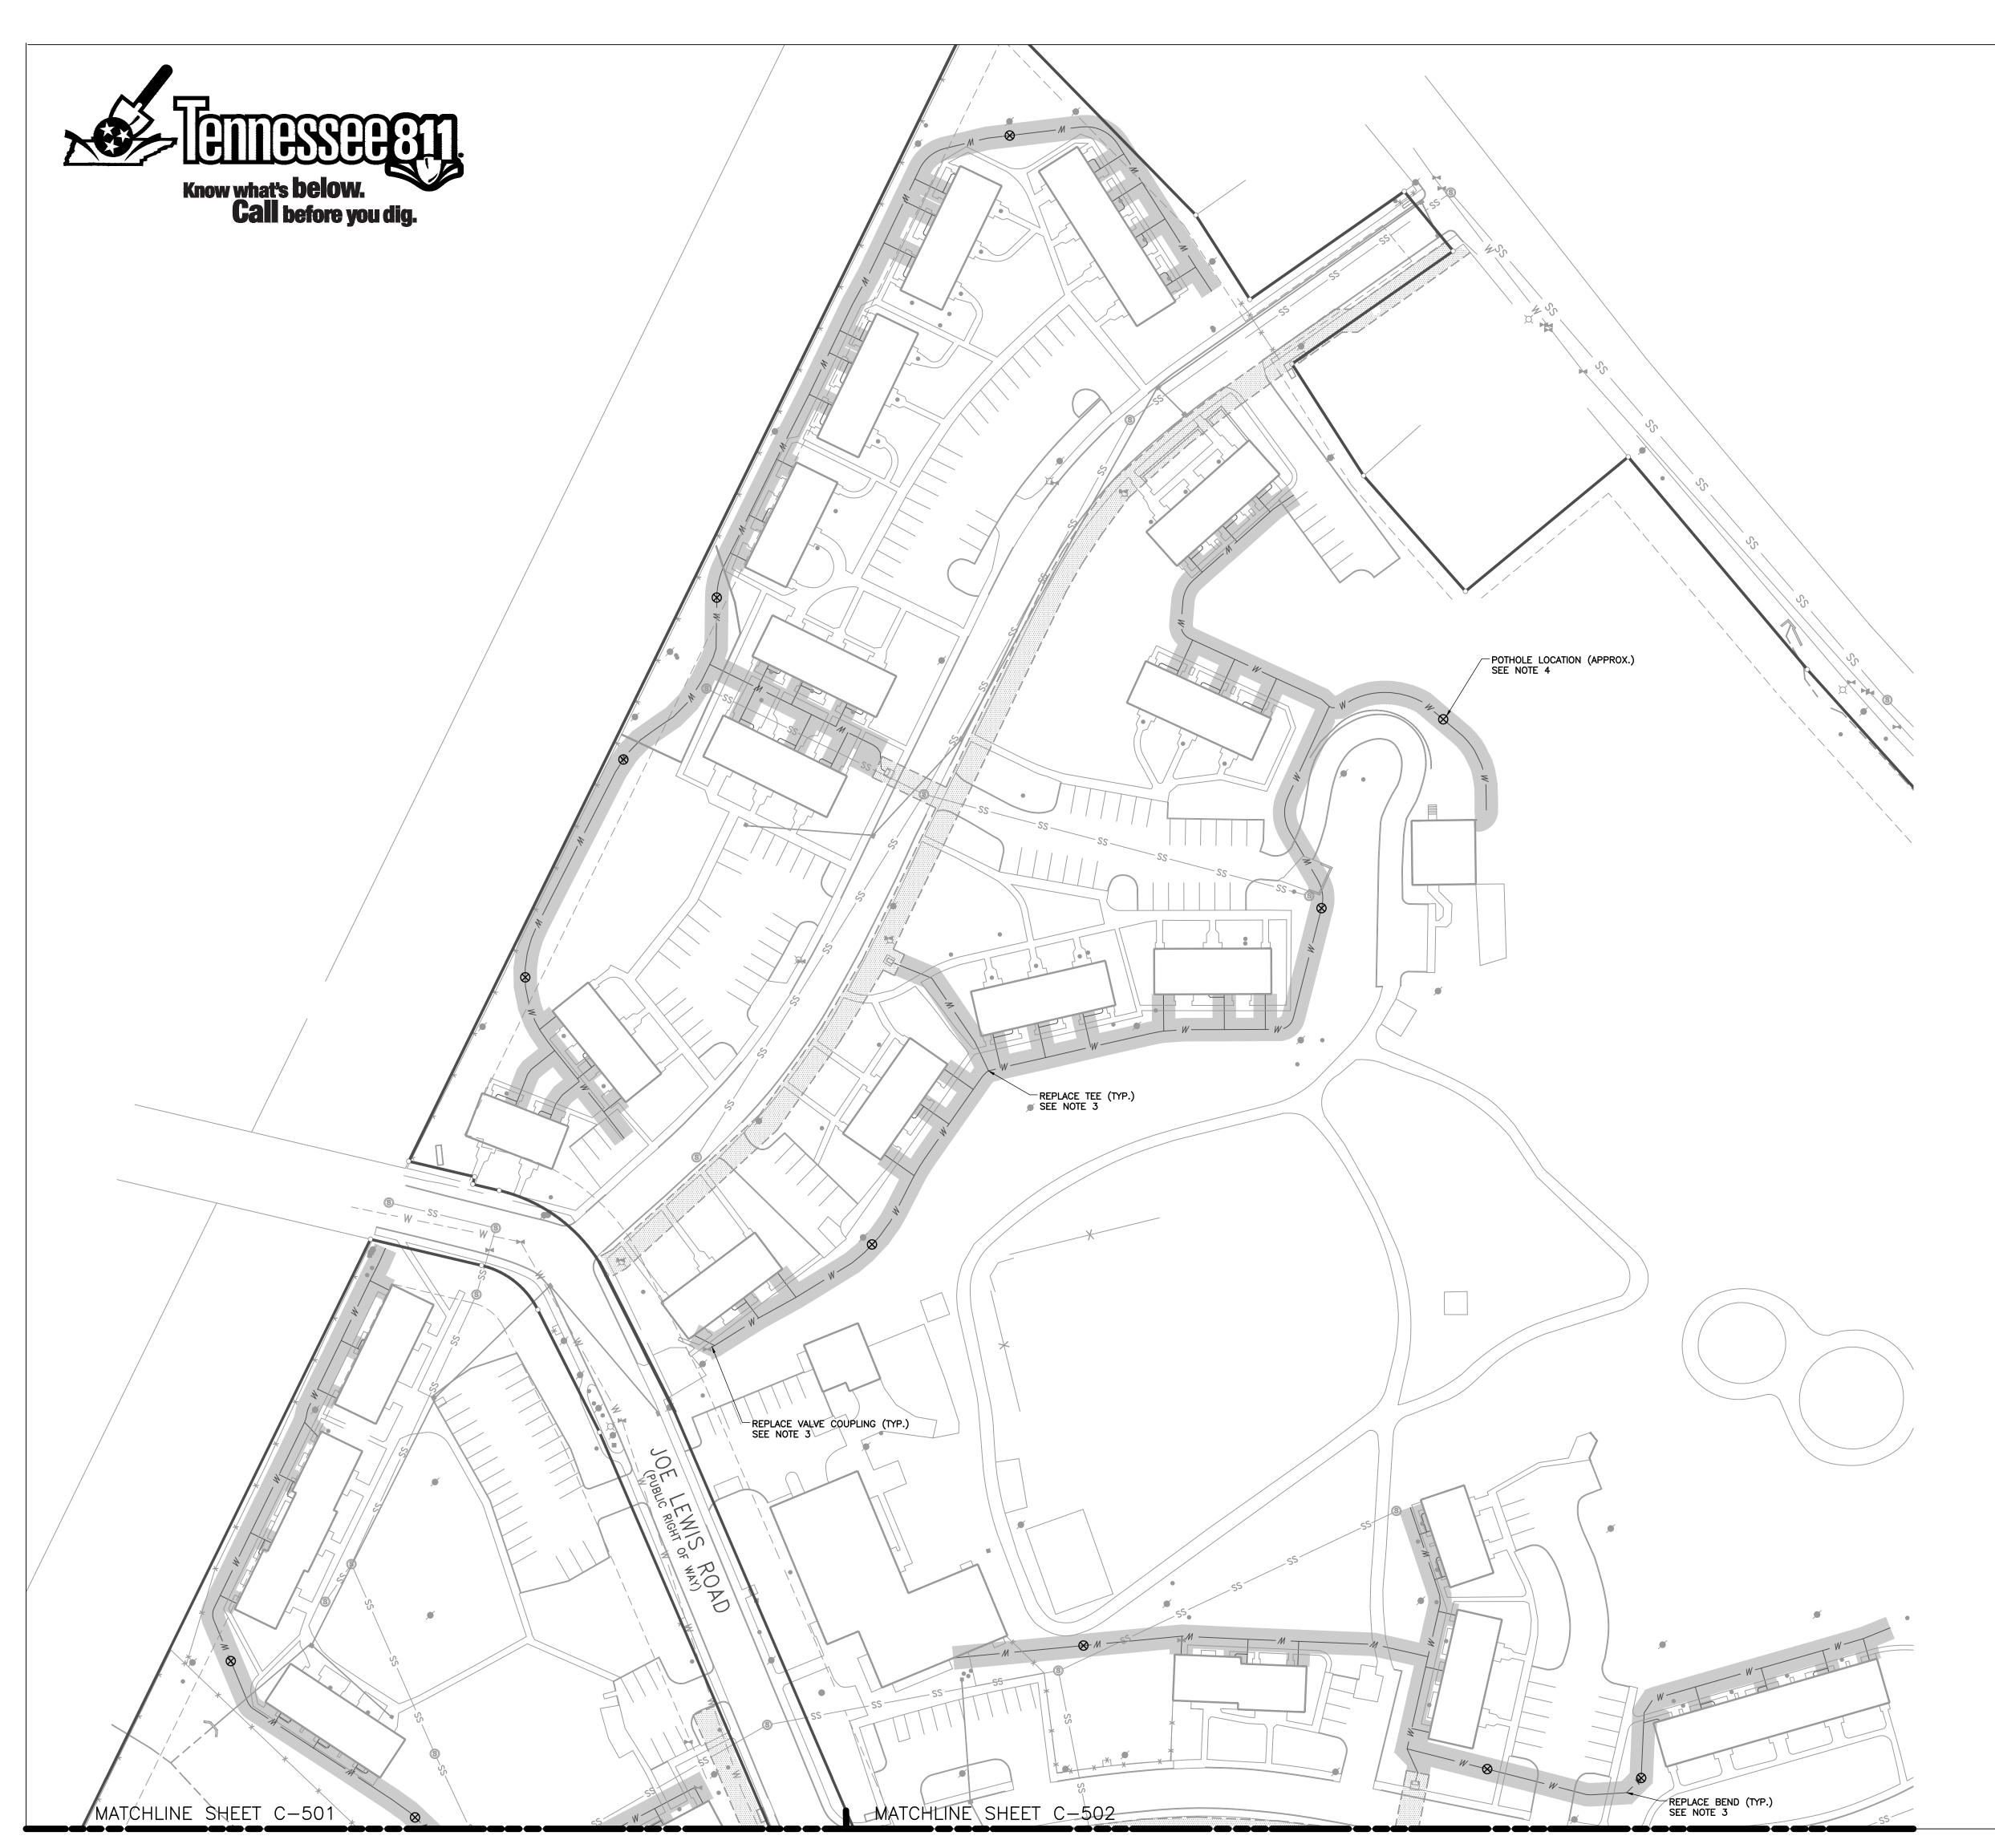



- 1. EXISTING PROPERTY SURVEY DATA SHOWN IS FROM A SURVEY PREPARED BY ROTH LAND SURVEYING DATED JANUARY 3, 2017. ARCHITECT/ENGINEER IS NOT RESPONSIBLE FOR THE ACCURACY OR COMPLETENESS OF THE INFORMATION SHOWN.
- 2. EXISTING WATER DISTRIBUTION NETWORK SHOWN IS FROM ORIGINAL DESIGN PLANS BY FULGHUM MACINDOE & ASSOCIATES DATED MARCH 27, 2010. THE LOCATIONS OF WATER AND ALL OTHER UTILITIES ARE APPROXIMATE AND SHALL BE VERIFIED BY THE CONTRACTOR. ARCHITECT/ENGINEER IS NOT RESPONSIBLE FOR THE ACCURACY OR COMPLETENESS OF THE INFORMATION SHOWN.
- 3. REFERENCE ATTACHED FULGHUM MACINDOE & ASSOCIATES DRAWINGS DATED MARCH 27, 2010 FOR ANTICIPATED WATER DISTRIBUTION NETWORK PIPE
- 4. SHADED AREA REPRESENTS EXTENT OF PRIVATE WATER SERVICE LINE TO BE REHABILITATED VIA REPLACEMENT OF FITTINGS. REFERENCE ALLOWANCE AND UNIT PRICE SECTIONS OF CONSTRUCTION MANUAL FOR SPECIFIC FITTINGS TO BE LOCATED AND REPLACED UNDER THIS CONTRACT.
- 5. POTHOLE LOCATIONS ARE APPROXIMATE AND INDICATE GENERAL LOCATION WHERE PIPE COVER DEPTH SHOULD BE DETERMINED. EXACT LOCATION SHALL BE SELECTED SUBJECT TO THE LOCATION OF WATER SERVICE LINE AND AVOIDANCE OF SURFACE AND SUB-SURFACE OBSTACLES TO THE MAXIMUM EXTENT POSSIBLE. ALL POTHOLED LOCATIONS WHERE COVER DEPTH IS LESS THAN 36 INCHES FROM THE CROWN OF PIPE SHALL BE RECORDED, MARKED AND REPORTED TO THE OWNER.
- 6. THE CONTRACTOR SHALL OBTAIN ALL REQUIRED PERMITS AND PAY ALL PERMITTING FEES PRIOR TO COMMENCEMENT OF CONSTRUCTION.
- 7. COORDINATE WORK ON PRIVATE WATER UTILITIES WITH OWNER. AT OWNER'S DISCRETION, WORK MAY BE PERFORMED IN PHASES IN ORDER TO MAINTAIN WATER SERVICE TO INHABITED FACILITIES.
- 8. NO WORK SHALL BE PERFORMED ON PUBLIC WATER DISTRIBUTION
- 9. NOTIFY OWNER IMMEDIATELY IF DEFECTIVE WATER SYSTEMS OUTSIDE OF THE SCOPE OF THIS WORK ARE UNCOVERED DURING CONSTRUCTION.
- 10. ALL TRENCH SPOILS SHALL BECOME THE PROPERTY OF THE CONTRACTOR UNLESS OTHERWISE DESIGNATED SHALL BE REMOVED BY THE CONTRACTOR AND DISPOSED OF OFFSITE AT NO ADDITIONAL COST TO THE OWNER IN ACCORDANCE WITH ALL LOCAL AND STATE CODES AND PERMIT
- 11. ALL WORK OR ALTERATIONS TO EXISTING PRIVATE WATER SERVICE LINES SHALL BE PERFORMED BY A LICENSED PLUMBER PER CITY OF KNOXVILLE
- 12. MECHANICAL FITTINGS AND COUPLINGS SHALL BE DESIGNED FOR USE AND COMPATIBLE WITH HDPE PIPE, INCLUDING INTERNAL STIFFENERS WHEN REQUIRED BY MANUFACTURER. MECHANICAL FITTINGS AND COUPLINGS SHALL HAVE A PRESSURE RATING EQUAL TO OR GREATER THAN THE HOST PIPE AND SHALL BE DESIGNED TO RESIST PULLOUT.
- 13. EMPLOY RESTRAINT DEVICES OR ANCHORAGE SYSTEMS AS RECOMMENDED BY MANUFACTURER FOR ALL MECHANICAL COUPLING APPLICATIONS TO PREVENT AXIAL MOVEMENT TO WATER SERVICE LINES.
- 14. MAINTAIN MINIMUM 10-FOOT HORIZONTAL AND 18-INCH MINIMUM VERTICAL SEPARATION BETWEEN SANITARY SEWER, STORM SEWER AND WATER SUPPLY LINE, UNLESS OTHERWISE INDICATED.
- 15. NOTIFY ARCHITECT IF CONDITIONS IN THE FIELD DEVIATE FROM THOSE SHOWN ON THE PLANS.
- 16. EROSION CONTROL 16.1. TEMPORARY SEEDING IS REQUIRED WHEN EARTHMOVING OPERATIONS ARE TEMPORARILY HALTED FOR OVER 14 DAYS AND ON SOIL STOCKPILES. 16.2. PERMANENT SEEDING IS REQUIRED WHEN EARTHMOVING OPERATIONS ARE COMPLETED AND WHEN CONSTRUCTION OPERATIONS WILL NOT IMPACT
- THE DISTURBED AREA. CONTRACTOR SHALL INSPECT THE SITE PERIODICALLY TO REPAIR AND RE-ESTABLISH VEGETATION TO DAMAGED AREAS INCLUDING SEEDED AREAS THAT SHOW SIGNS OF EXCESSIVE EROSION. EROSION CONTROL MATTING SHALL BE USED ON ALL
- DISTURBED SLOPES STEEPER THAN 3 TO 1.

  16.3. INSTALL INLET PROTECTION IN ALL STORMWATER INLET STRUCTURES RECEIVING RUNOFF FROM LAND DISTURBING ACTIVITIES ASSOCIATED WITH THIS PROJECT. ADDITIONAL EROSION PREVENTION METHODS AS SHOWN IN THE PROJECT DETAILS OR OUTLINED IN THE TIN EPSC HANDBOOK SHALL BE EMPLOYED AS—NEEDED TO STABILIZE DISTURBED AREAS AND PREVENT SEDIMENT FROM ENTERING STORM DRAINS OR ROADWAYS.

### **LEGEND**

- EXISTING PROPERTY LINE

———— SS ———— EXISTING SANITARY SEWER

- EXISTING STORM SEWER

— w — EXISTING WATER SERVICE NETWORK

EXISTING SANITARY MANHOLE

EXISTING UTILITY POLE

EXISTING CLEANOUT

EXISTING WATER VALVE

PROPOSED POTHOLE LOCATION

EXISTING UTILITY EASEMENT

PROPOSED ZONE OF WATER SERVICE REHAB

Civil & Environmental

Consultants, Inc. 2704 CHEROKEE FARM WAY - KNOXVILLE, TN 37920 PH:865-977-9997 · FAX:865-977-9919

C-500 10-15-2018


DATE ISSUE FOR

his drawing is the property of DESIGN INNOVATIONS ARCHITECTS, INC. and is not to be reproduced or copied in whole or in part without authorization from DESIGN INNOVATIONS ARCHITECTS, INC.. It is to e used for the project and site specifically identified herein and is not to be used on any other project. It is to be returned upon request. Do not scale drawings, written dimensions take precedence. All drawings and designs shown on these drawings are copyright © of DESIGN INNOVATIONS ARCHITECTS, INC.

WATER SERVICE REHABILITATION

PLAN

Sheet Number oject Number 18110

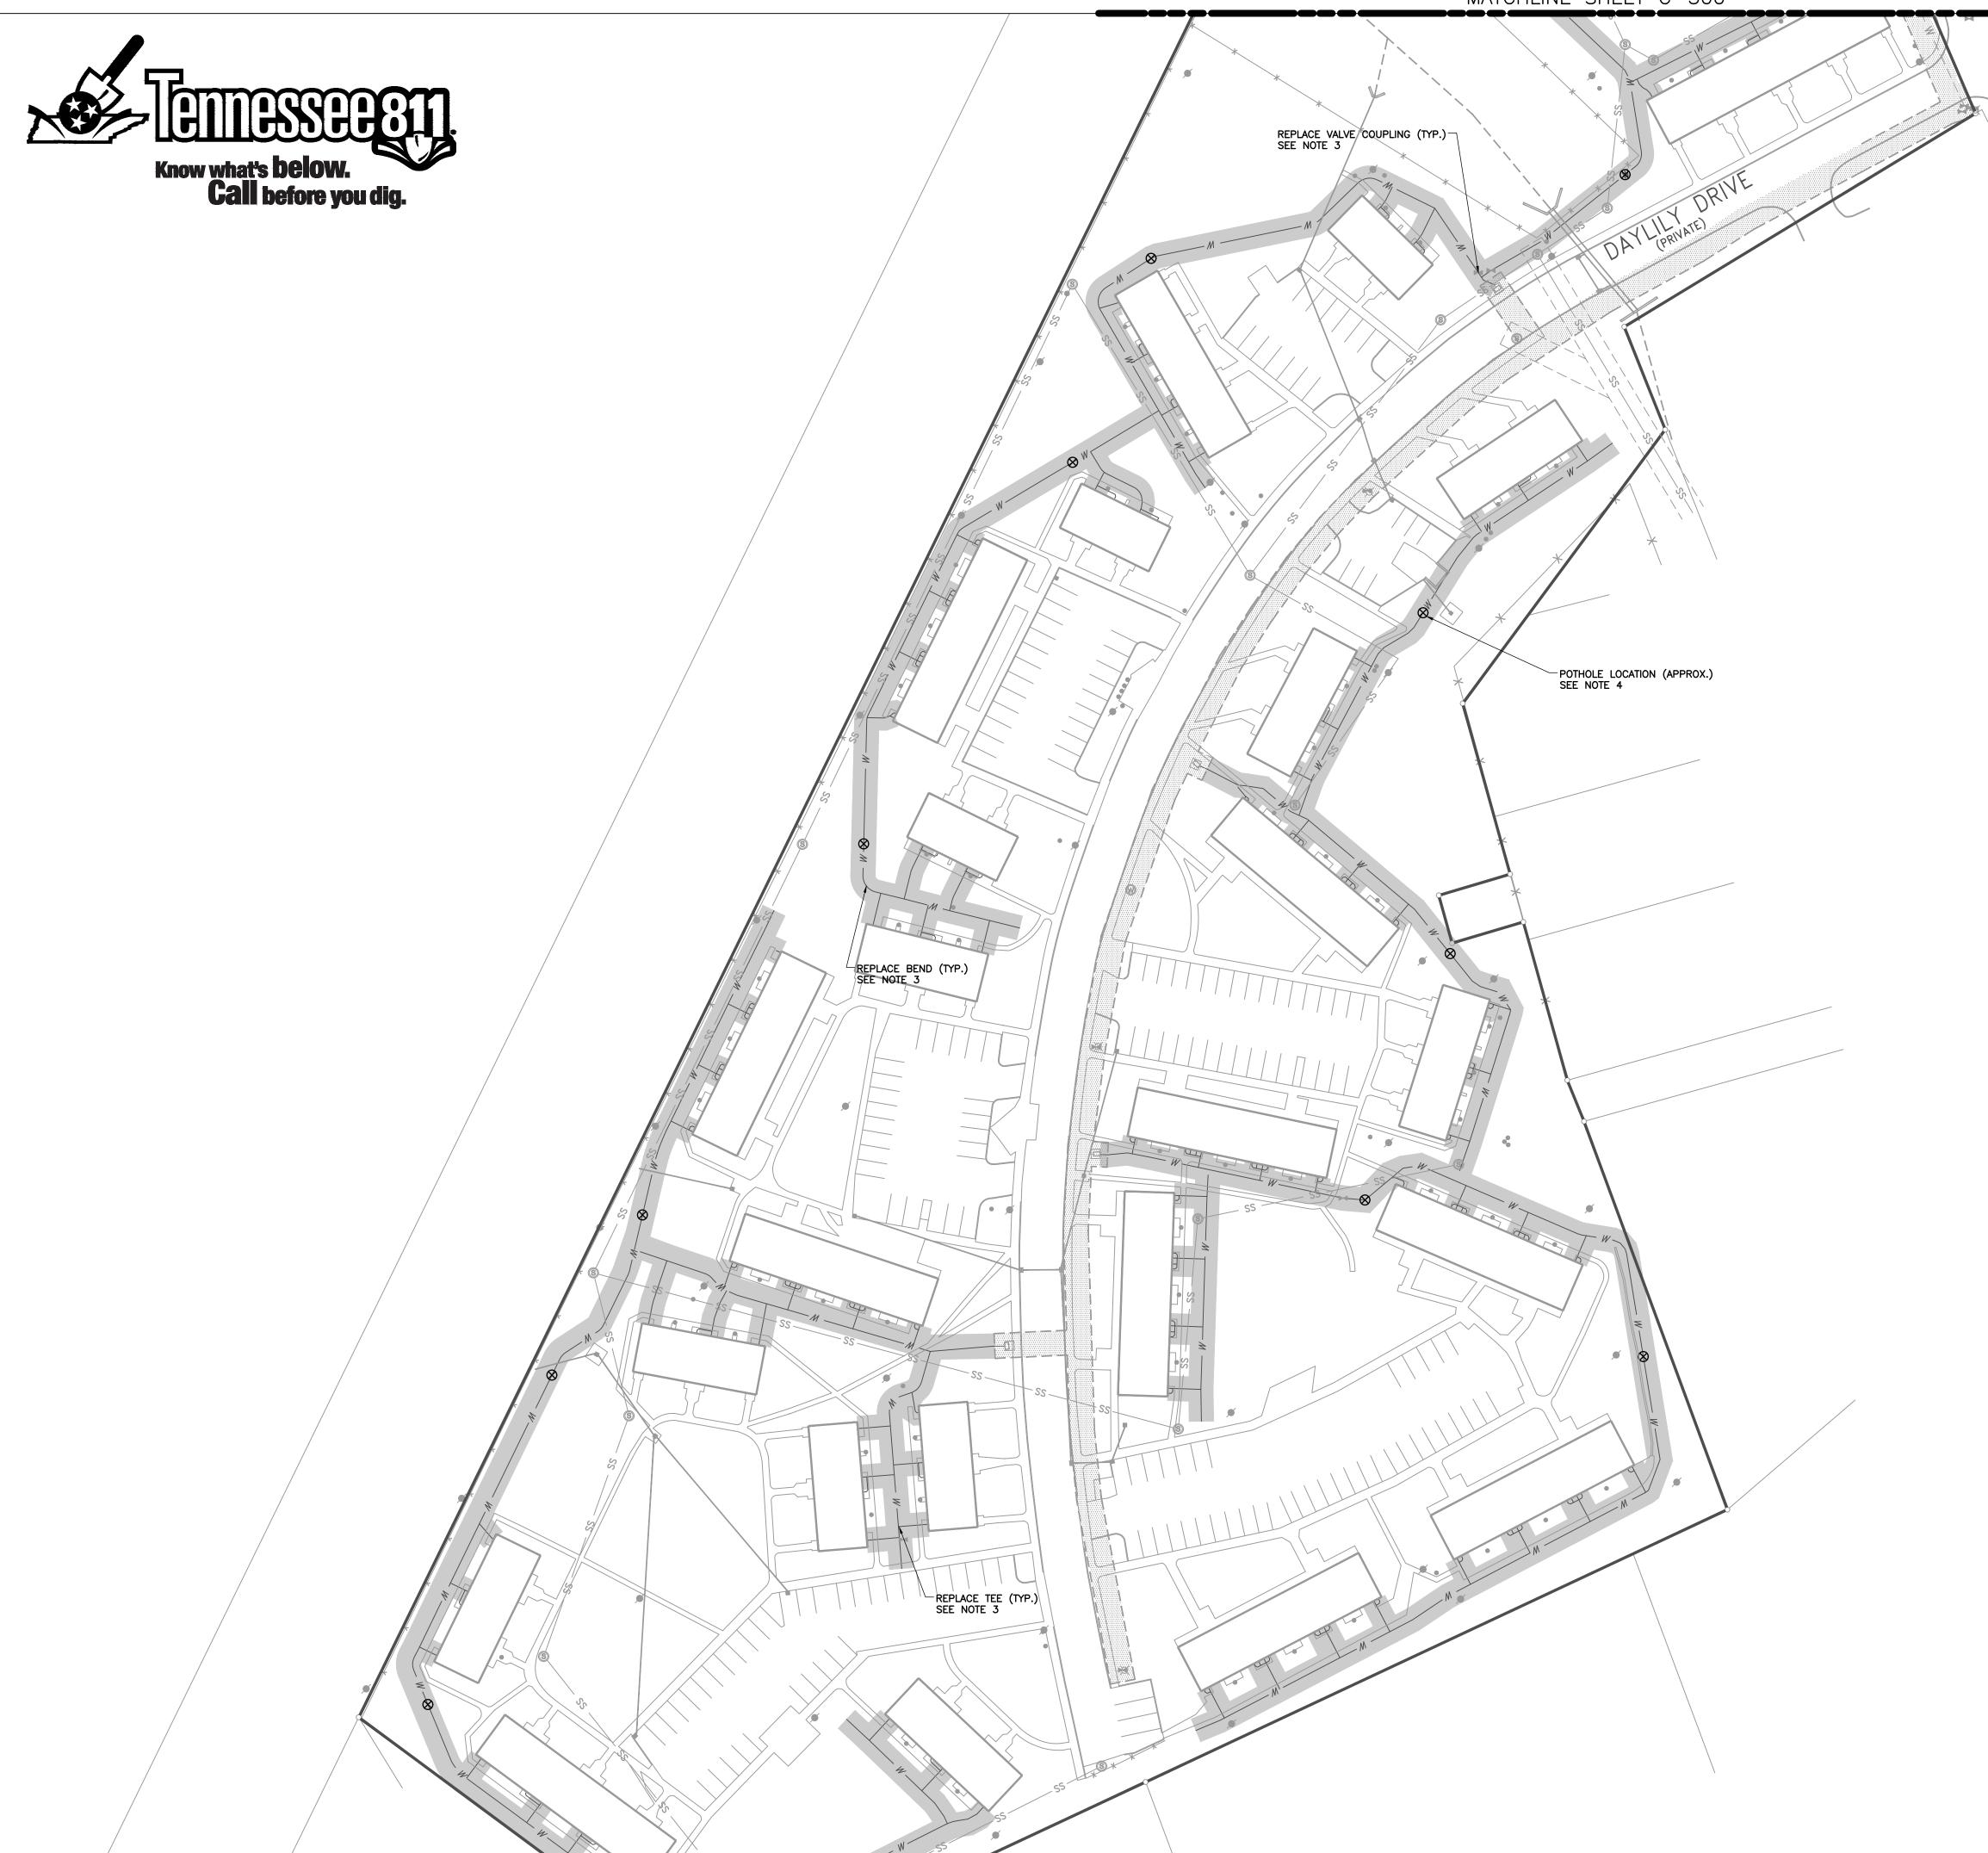



- 1. EXISTING PROPERTY SURVEY DATA SHOWN IS FROM A SURVEY PREPARED BY ROTH LAND SURVEYING DATED JANUARY 3, 2017. ARCHITECT/ENGINEER IS NOT RESPONSIBLE FOR THE ACCURACY OR COMPLETENESS OF THE INFORMATION SHOWN.
- 2. EXISTING WATER DISTRIBUTION NETWORK SHOWN IS FROM ORIGINAL DESIGN PLANS BY FULGHUM MACINDOE & ASSOCIATES DATED MARCH 27, 2010. THE LOCATIONS OF WATER AND ALL OTHER UTILITIES ARE APPROXIMATE AND SHALL BE VERIFIED BY THE CONTRACTOR. ARCHITECT/ENGINEER IS NOT RESPONSIBLE FOR THE ACCURACY OR COMPLETENESS OF THE INFORMATION SHOWN.
- 3. REFERENCE ATTACHED FULGHUM MACINDOE & ASSOCIATES DRAWINGS DATED MARCH 27, 2010 FOR ANTICIPATED WATER DISTRIBUTION NETWORK PIPE
- 4. SHADED AREA REPRESENTS EXTENT OF PRIVATE WATER SERVICE LINE TO BE REHABILITATED VIA REPLACEMENT OF FITTINGS. REFERENCE ALLOWANCE AND UNIT PRICE SECTIONS OF CONSTRUCTION MANUAL FOR SPECIFIC FITTINGS TO BE LOCATED AND REPLACED UNDER THIS CONTRACT.
- 5. POTHOLE LOCATIONS ARE APPROXIMATE AND INDICATE GENERAL LOCATION WHERE PIPE COVER DEPTH SHOULD BE DETERMINED. EXACT LOCATION SHALL BE SELECTED SUBJECT TO THE LOCATION OF WATER SERVICE LINE AND AVOIDANCE OF SURFACE AND SUB-SURFACE OBSTACLES TO THE MAXIMUM EXTENT POSSIBLE. ALL POTHOLED LOCATIONS WHERE COVER DEPTH IS LESS THAN 36 INCHES FROM THE CROWN OF PIPE SHALL BE RECORDED, MARKED AND REPORTED TO THE OWNER.
- 6. THE CONTRACTOR SHALL OBTAIN ALL REQUIRED PERMITS AND PAY ALL PERMITTING FEES PRIOR TO COMMENCEMENT OF CONSTRUCTION.
- 7. COORDINATE WORK ON PRIVATE WATER UTILITIES WITH OWNER. AT OWNER'S DISCRETION, WORK MAY BE PERFORMED IN PHASES IN ORDER TO MAINTAIN WATER SERVICE TO INHABITED FACILITIES.
- 8. NO WORK SHALL BE PERFORMED ON PUBLIC WATER DISTRIBUTION
- 9. NOTIFY OWNER IMMEDIATELY IF DEFECTIVE WATER SYSTEMS OUTSIDE OF THE SCOPE OF THIS WORK ARE UNCOVERED DURING CONSTRUCTION.
- 10. ALL TRENCH SPOILS SHALL BECOME THE PROPERTY OF THE CONTRACTOR UNLESS OTHERWISE DESIGNATED SHALL BE REMOVED BY THE CONTRACTOR AND DISPOSED OF OFFSITE AT NO ADDITIONAL COST TO THE OWNER IN ACCORDANCE WITH ALL LOCAL AND STATE CODES AND PERMIT REQUIREMENTS.
- 11. ALL WORK OR ALTERATIONS TO EXISTING PRIVATE WATER SERVICE LINES SHALL BE PERFORMED BY A LICENSED PLUMBER PER CITY OF KNOXVILLE
- 12. MECHANICAL FITTINGS AND COUPLINGS SHALL BE DESIGNED FOR USE AND COMPATIBLE WITH HDPE PIPE, INCLUDING INTERNAL STIFFENERS WHEN REQUIRED BY MANUFACTURER. MECHANICAL FITTINGS AND COUPLINGS SHALL HAVE A PRESSURE RATING EQUAL TO OR GREATER THAN THE HOST PIPE AND SHALL BE DESIGNED TO RESIST PULLOUT.
- 13. EMPLOY RESTRAINT DEVICES OR ANCHORAGE SYSTEMS AS RECOMMENDED BY MANUFACTURER FOR ALL MECHANICAL COUPLING APPLICATIONS TO PREVENT AXIAL MOVEMENT TO WATER SERVICE LINES.
- 14. MAINTAIN MINIMUM 10-FOOT HORIZONTAL AND 18-INCH MINIMUM VERTICAL SEPARATION BETWEEN SANITARY SEWER, STORM SEWER AND WATER SUPPLY LINE, UNLESS OTHERWISE INDICATED.
- 15. NOTIFY ARCHITECT IF CONDITIONS IN THE FIELD DEVIATE FROM THOSE SHOWN ON THE PLANS.
- 16. EROSION CONTROL 16.1. TEMPORARY SEEDING IS REQUIRED WHEN EARTHMOVING OPERATIONS ARE
- TEMPORARILY HALTED FOR OVER 14 DAYS AND ON SOIL STOCKPILES. 16.2. PERMANENT SEEDING IS REQUIRED WHEN EARTHMOVING OPERATIONS ARE COMPLETED AND WHEN CONSTRUCTION OPERATIONS WILL NOT IMPACT THE DISTURBED AREA. CONTRACTOR SHALL INSPECT THE SITE
- PERIODICALLY TO REPAIR AND RE-ESTABLISH VEGETATION TO DAMAGED AREAS INCLUDING SEEDED AREAS THAT SHOW SIGNS OF EXCESSIVE EROSION. EROSION CONTROL MATTING SHALL BE USED ON ALL
- DISTURBED SLOPES STEEPER THAN 3 TO 1.

  16.3. INSTALL INLET PROTECTION IN ALL STORMWATER INLET STRUCTURES RECEIVING RUNOFF FROM LAND DISTURBING ACTIVITIES ASSOCIATED WITH THIS PROJECT. ADDITIONAL EROSION PREVENTION METHODS AS SHOWN IN THE PROJECT DETAILS OR OUTLINED IN THE TIN EPSC HANDBOOK SHALL BE EMPLOYED AS—NEEDED TO STABILIZE DISTURBED AREAS AND PREVENT SEDIMENT FROM ENTERING STORM DRAINS OR ROADWAYS.

### **LEGEND**

- EXISTING PROPERTY LINE

- EXISTING STORM SEWER

DATE ISSUE FOR

his drawing is the property of DESIGN INNOVATIONS ARCHITECTS, INC. and is not to be reproduced or copied in whole or in part without authorization from DESIGN INNOVATIONS ARCHITECTS, INC.. It is to e used for the project and site specifically identified herein and is not to be used on any other project. It is to be returned upon request. Do not scale drawings, written dimensions take precedence. All drawings and designs shown on these drawings are copyright © of DESIGN INNOVATIONS ARCHITECTS, INC.

WATER SERVICE REHABILITATION

oject Number


PLAN

Sheet Number 18110

C-501 10-15-2018

Civil & Environmental Consultants, Inc. 2704 CHEROKEE FARM WAY - KNOXVILLE, TN 37920 PH:865-977-9997 · FAX:865-977-9919



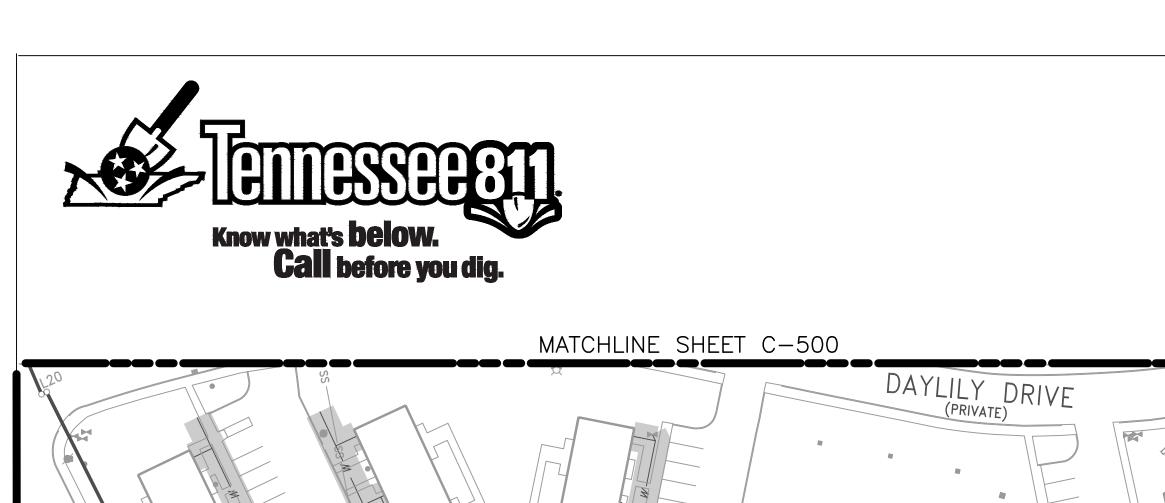

REPLACE TEE (TYP.)-

SEE NOTE 3

### **NOTES**

REPLACE BEND (TYP.)-SEE NOTE 3

REPLACE VALVE COUPLING (TYP.)
SEE NOTE 3

POTHOLE LOCATION (APPROX.)
SEE NOTE 4

- 1. EXISTING PROPERTY SURVEY DATA SHOWN IS FROM A SURVEY PREPARED BY ROTH LAND SURVEYING DATED JANUARY 3, 2017. ARCHITECT/ENGINEER IS NOT RESPONSIBLE FOR THE ACCURACY OR COMPLETENESS OF THE
- 2. EXISTING WATER DISTRIBUTION NETWORK SHOWN IS FROM ORIGINAL DESIGN PLANS BY FULGHUM MACINDOE & ASSOCIATES DATED MARCH 27, 2010. THE LOCATIONS OF WATER AND ALL OTHER UTILITIES ARE APPROXIMATE AND SHALL BE VERIFIED BY THE CONTRACTOR. ARCHITECT/ENGINEER IS NOT RESPONSIBLE FOR THE ACCURACY OR COMPLETENESS OF THE
- 3. REFERENCE ATTACHED FULGHUM MACINDOE & ASSOCIATES DRAWINGS DATED MARCH 27, 2010 FOR ANTICIPATED WATER DISTRIBUTION NETWORK PIPE
- 4. SHADED AREA REPRESENTS EXTENT OF PRIVATE WATER SERVICE LINE TO BE REHABILITATED VIA REPLACEMENT OF FITTINGS. REFERENCE ALLOWANCE AND UNIT PRICE SECTIONS OF CONSTRUCTION MANUAL FOR SPECIFIC FITTINGS TO BE LOCATED AND REPLACED UNDER THIS CONTRACT.
- 5. POTHOLE LOCATIONS ARE APPROXIMATE AND INDICATE GENERAL LOCATION WHERE PIPE COVER DEPTH SHOULD BE DETERMINED. EXACT LOCATION SHALL BE SELECTED SUBJECT TO THE LOCATION OF WATER SERVICE LINE AND AVOIDANCE OF SURFACE AND SUB-SURFACE OBSTACLES TO THE MAXIMUM EXTENT POSSIBLE. ALL POTHOLED LOCATIONS WHERE COVER DEPTH IS LESS THAN 36 INCHES FROM THE CROWN OF PIPE SHALL BE RECORDED, MARKED AND REPORTED TO THE OWNER.
- 6. THE CONTRACTOR SHALL OBTAIN ALL REQUIRED PERMITS AND PAY ALL PERMITTING FEES PRIOR TO COMMENCEMENT OF CONSTRUCTION.
- 7. COORDINATE WORK ON PRIVATE WATER UTILITIES WITH OWNER. AT OWNER'S DISCRETION, WORK MAY BE PERFORMED IN PHASES IN ORDER TO MAINTAIN WATER SERVICE TO INHABITED FACILITIES.
- 8. NO WORK SHALL BE PERFORMED ON PUBLIC WATER DISTRIBUTION
- 9. NOTIFY OWNER IMMEDIATELY IF DEFECTIVE WATER SYSTEMS OUTSIDE OF THE SCOPE OF THIS WORK ARE UNCOVERED DURING CONSTRUCTION.
- 10. ALL TRENCH SPOILS SHALL BECOME THE PROPERTY OF THE CONTRACTOR UNLESS OTHERWISE DESIGNATED SHALL BE REMOVED BY THE CONTRACTOR AND DISPOSED OF OFFSITE AT NO ADDITIONAL COST TO THE OWNER IN ACCORDANCE WITH ALL LOCAL AND STATE CODES AND PERMIT
- 11. ALL WORK OR ALTERATIONS TO EXISTING PRIVATE WATER SERVICE LINES SHALL BE PERFORMED BY A LICENSED PLUMBER PER CITY OF KNOXVILLE
- 12. MECHANICAL FITTINGS AND COUPLINGS SHALL BE DESIGNED FOR USE AND COMPATIBLE WITH HDPE PIPE, INCLUDING INTERNAL STIFFENERS WHEN REQUIRED BY MANUFACTURER. MECHANICAL FITTINGS AND COUPLINGS SHALL HAVE A PRESSURE RATING EQUAL TO OR GREATER THAN THE HOST PIPE AND SHALL BE DESIGNED TO RESIST PULLOUT.
- 13. EMPLOY RESTRAINT DEVICES OR ANCHORAGE SYSTEMS AS RECOMMENDED BY MANUFACTURER FOR ALL MECHANICAL COUPLING APPLICATIONS TO PREVENT AXIAL MOVEMENT TO WATER SERVICE LINES.
- 14. MAINTAIN MINIMUM 10-FOOT HORIZONTAL AND 18-INCH MINIMUM VERTICAL SEPARATION BETWEEN SANITARY SEWER, STORM SEWER AND WATER SUPPLY LINE, UNLESS OTHERWISE INDICATED.
- 15. NOTIFY ARCHITECT IF CONDITIONS IN THE FIELD DEVIATE FROM THOSE SHOWN ON THE PLANS.
- 16. EROSION CONTROL
  16.1. TEMPORARY SEEDING IS REQUIRED WHEN EARTHMOVING OPERATIONS ARE TEMPORARILY HALTED FOR OVER 14 DAYS AND ON SOIL STOCKPILES. 16.2. PERMANENT SEEDING IS REQUIRED WHEN EARTHMOVING OPERATIONS ARE COMPLETED AND WHEN CONSTRUCTION OPERATIONS WILL NOT IMPACT
- THE DISTURBED AREA. CONTRACTOR SHALL INSPECT THE SITE PERIODICALLY TO REPAIR AND RE-ESTABLISH VEGETATION TO DAMAGED AREAS INCLUDING SEEDED AREAS THAT SHOW SIGNS OF EXCESSIVE EROSION. EROSION CONTROL MATTING SHALL BE USED ON ALL DISTURBED SLOPES STEEPER THAN 3 TO 1.
- 16.3. INSTALL INLET PROTECTION IN ALL STORMWATER INLET STRUCTURES
  RECEIVING RUNOFF FROM LAND DISTURBING ACTIVITIES ASSOCIATED WITH
  THIS PROJECT. ADDITIONAL EROSION PREVENTION METHODS AS SHOWN IN THE PROJECT DETAILS OR OUTLINED IN THE TN EPSC HANDBOOK SHALL BE EMPLOYED AS-NEEDED TO STABILIZE DISTURBED AREAS AND PREVENT SEDIMENT FROM ENTERING STORM DRAINS OR ROADWAYS.

- EXISTING STORM SEWER

### **LEGEND**

- EXISTING PROPERTY LINE

———— SS ———— EXISTING SANITARY SEWER

DATE ISSUE FOR

This drawing is the property of DESIGN INNOVATIONS ARCHITECTS. INC. and is not to be reproduced or copied in whole or in part without authorization from DESIGN INNOVATIONS ARCHITECTS, INC.. It is to be used for the project and site specifically identified herein and is not to be used on any other project. It is to be returned upon request. Do not scale drawings, written dimensions take precedence. All drawings and designs shown on these drawings are copyright © of DESIGN INNOVATIONS ARCHITECTS, INC.


WATER SERVICE REHABILITATION PLAN


Sheet Number oject Number 18110

10-15-2018

C-502

Civil & Environmental Consultants, Inc. 2704 CHEROKEE FARM WAY - KNOXVILLE, TN 37920 PH:865-977-9997 · FAX:865-977-9919

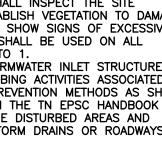

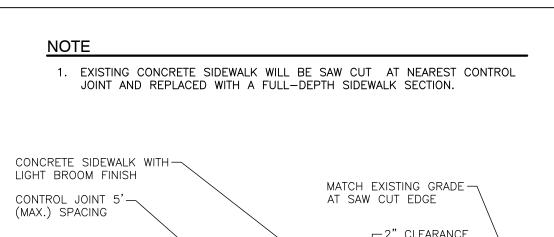


4 4 4 4 └-4" (MIN.) COMPACTED CONTINUOUS 6"x6" - W1.4xW1.4-FREÈ-DRAINING COARSE W.W.F. WITH 8" LAP AT EDGES AGGREGATE COMPACTED SUBGRADE -

TYPICAL CONCRETE SIDEWALK

NOT TO SCALE

### 1. EXISTING ASPHALT WILL BE SAW CUT AND REPLACED WITH A FULL-DEPTH ASPHALT PAVEMENT SECTION. A TWO YEAR PERFORMANCE BOND AND A THREE YEAR MAINTENANCE BOND WILL BE REQUIRED FOR ASPHALT

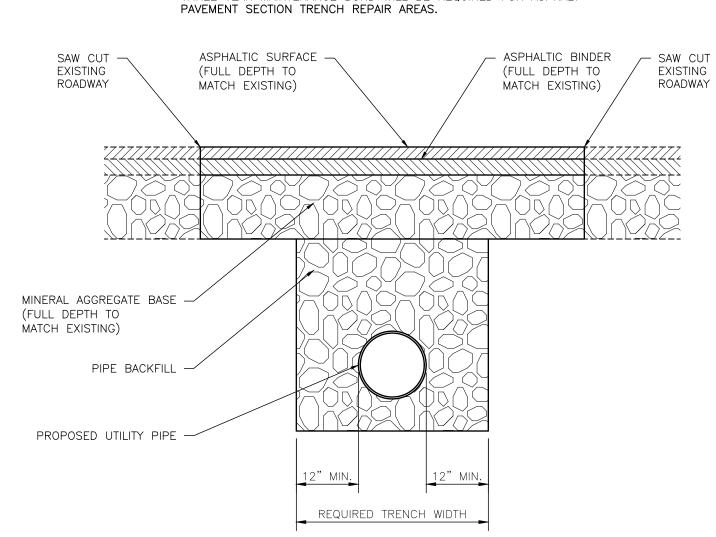

**ASPHALT PAVEMENT SECTION TRENCH REPAIR** NOT TO SCALE

### TEMPORARY SEEDING MIXTURES

GRASS SEED	PERCENTAGES
ITALIAN RYE	50%
SUMMER OATS	50%
SUDAN-SORGHURM	100%
STARR MILLET	100%
BALBOA RYE	67%
ITALIAN RYE	33%
	ITALIAN RYE  SUMMER OATS  SUDAN-SORGHURM  STARR MILLET  BALBOA RYE

### SOURCE TOOT STANDARDS SPECIFICATIONS

### PERMANENT SEEDING MIXTURES

SEEDING DATES	GRASS SEED	PERCENTAGES
FEBRUARY 1 TO JULY 1	KENTUCKY 31 FESCUE	88%
PEDRUARI I IO JULI I	ENGLISH RYE	12%
	KENTUCKY 31 FESCUE	60%
JUNE 1 TO AUGUST 15	ENGLISH RYE	25%
	GERMAN MILLET	15%
	KENTUCKY 31 FESCUE	70%
AUGUST 1 TO DECEMBER 1	ENGLISH RYE	20%
	WHITE CLOVER	10%
DECEMBER 1 TO FEBRUARY 1	KENTUCKY 31 FESCUE	83%
DECEMBER I TO FEBRUART I	ENGLISH RYE	17%

SOURCE TOOT STANDARDS SPECIFICATIONS


1" REBAR FOR BAG REMOVAL FORM INLET SEDIMENT SACK INSTALLATION DETAIL EXPANSION RESTRAINT (1/4" NYLON ROPE, 2" FLAT WASHERS) 2 EACH BAGS SHOULD BE CLEANED OUT AFTER EVERY RAIN EVENT AND/OR AS BAG DETAIL

SILT BAG INLET PROTECTION DETAIL

NOT TO SCALE

### **SEEDING SCHEDULE**

NOT TO SCALE

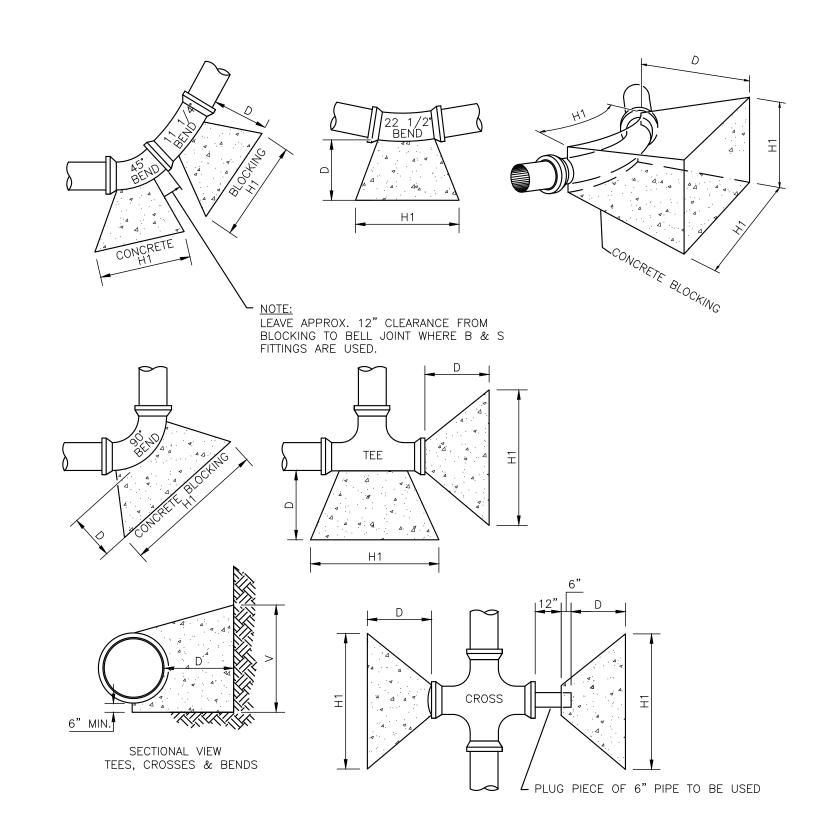



							<u> </u>				1016		<u> </u>	2.04	2116				1715						
SIZE	I		G SLE & PLU		<u> </u>	1,	90° B			IMEN	ISIC	9NS 45° B			ONC		<u>ЕВ</u> 2 1/2 °			IG	1	11 1/4	⊦° BEN	NDS	
OF PIPE	H <sub>1</sub>	Н2	٧	D	CU. FT.	H <sub>1</sub>	Н2	V	D	CU. FT.	H <sub>1</sub>	Н2	V	D	CU. FT.	H <sub>1</sub>	Н2	٧	D	CU. FT.	H <sub>1</sub>	Н2	٧	D	CU. FT.
2"& 2-1/4"	18"	10"	12"	18"	1.90	18"	10"	12"	18"	1.90	18"	6"	12"	18"	1.50	18"	6"	12"	18"	1.50	18"	6"	12"	18"	1.50
3"&4"	24"	12"	12"	18"	2.25	24"	12"	12"	18"	2.25	18"	8"	12"	18"	1.60	18"	8"	12"	18"	1.60	18"	8"	12"	18"	1.60
6"	24"	16"	18"	18"	3.50	30"	16"	18"	18"	4.05	24"	10"	16"	18"	3.20	24"	10"	16"	18"	3.20	24"	10"	16"	18"	3.20
8"	36"	18"	18"	18"	5.05	39"	18"	24"	18"	7.30	30"	11"	18"	18"	3.95	24"	11"	18"	18"	3.40	24"	11"	16"	18"	3.40
10"	48"	24"	18"	24"	7.15	54"	32"	12"	18"	10.25	24"	18"	21"	18"	4.60	24"	18'	21"	18"	4.60	24"	18"	21"	18"	4.60
12"	54"	30"	24"	24"	13.4	54"	36"	26"	24"	18.15	42"	18"	24"	24"	9.60	24"	18"	24"	24"	6.80	24"	18"	21"	24"	6.10
16"	66"	34"	36"	24"	22.5	69"	48"	48"	24"	29.0	48"	30"	36"	24"	17.0	24"	30"	27"	24"	11.8	27"	24"	27"	24"	9.10
24"	84"	48"	46"	30"	75.6	88"	68"	68"	36"	126.	B 60"	36"	42"	36"	48.0	36"	30"	42"	36"	22.7	36"	30"	42"	36"	22.7

TABLE IS BASED ON 225 P.S.I. OR 150 P.S.I. WORKING PRESSURE PLUS 50% WATER HAMMER.


1. CONCRETE USED FOR BLOCKING SHALL BE 3,500#/SQ. IN. 2. EARTH PRESSURES ARE FIGURED AT 4,000# PER SQ. FT. BEARING AREA OF KICKERS SHALL BE INCREASED WHEN POURED AGAINST SAND, LOOSE FILL, WET EARTH, CINDERS, ECT.


### **CONCRETE THRUST BLOCKING** NOT TO SCALE

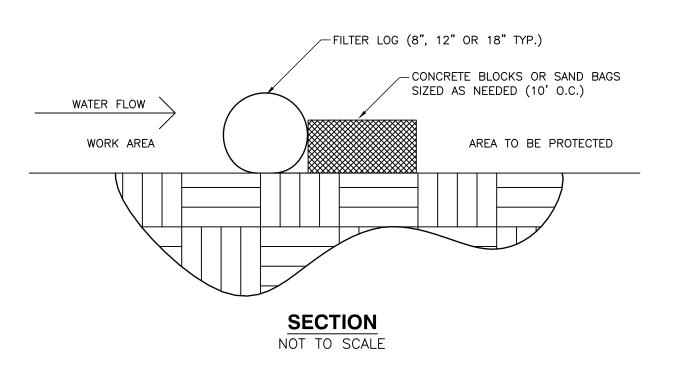

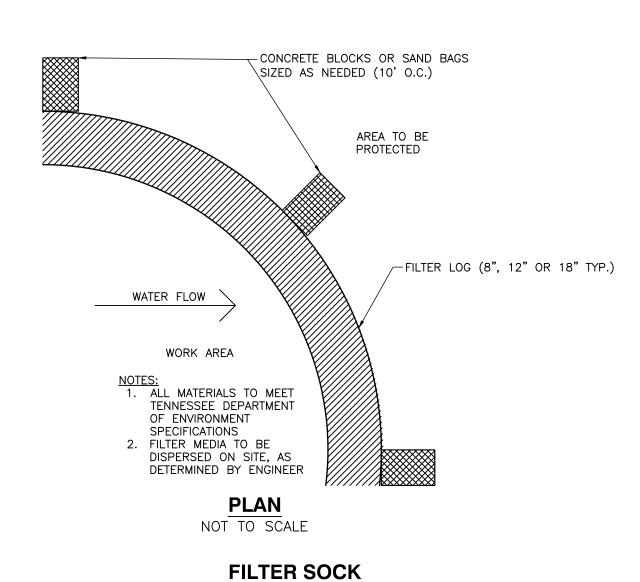

NOT TO SCALE

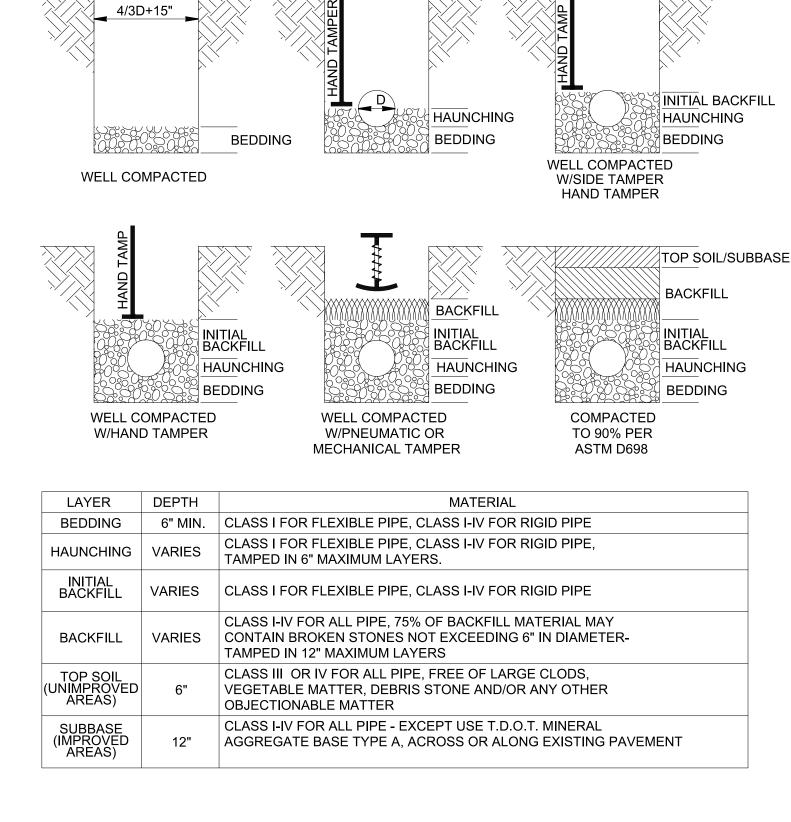

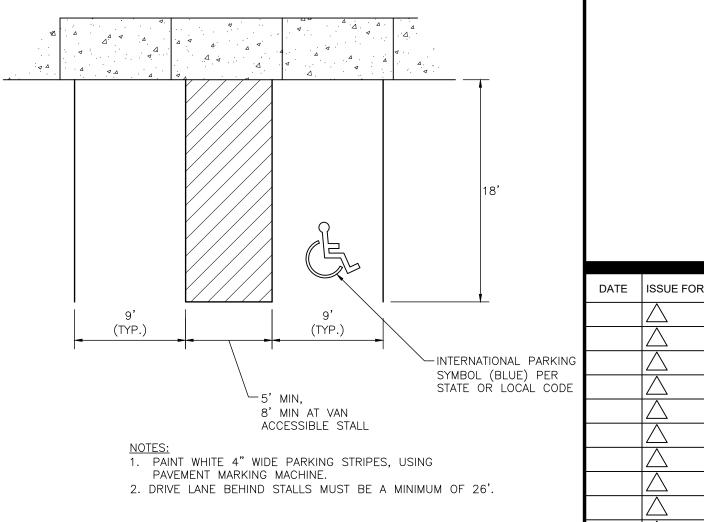



Civil & Environmental Consultants, Inc. 2704 CHEROKEE FARM WAY - KNOXVILLE, TN 37920

PH:865-977-9997 · FAX:865-977-9919

Sheet Number oject Number 18110 **C-800** 

10-15-2018

TRENCH BACKFILLING & COMPACTION IN UNIMPROVED AND IMPROVED AREAS

NOT TO SCALE

designs shown on these drawings are copyright © of DESIGN INNOVATIONS ARCHITECTS, INC. CIVIL/SITE DETAILS

This drawing is the property of DESIGN INNOVATIONS ARCHITECTS, INC. and is not to be reproduced or copied in whole or in part without

authorization from DESIGN INNOVATIONS ARCHITECTS. INC It is to e used for the project and site specifically identified herein and is not to

be used on any other project. It is to be returned upon request. Do not scale drawings, written dimensions take precedence. All drawings and

ABBRE	VATION LIST:								
A# AB	ADDENDUM ANCHOR BOLT	d D	PENNY (AS IN NAIL, Id) DRYER	G G#	GAS GENERAL INFORMATION	M M#	METER(S) MECHANICAL	R R#	REVISION, REVISED REVISION, REVISED
ABV ACC	ABOVE ACCESS	DA DB	DOUBLE ACTIVE DRY BULB	GA GAL	GAUGE OR GAGE GALLON(S)	MAC MAS	MACHINE MASONRY	RA RAD	RETURN AIR RADIUS
ACI ACT	ACCESS  AMERICAN CONCRETE INSTITUTE  ACOUSTICAL TILE	DBL DBLH	DOUBLE DOUBLE HUNG	GALV GB	GALVANÌZÉD	MATL MAX	MATERIAL(S) MAXIMUM	RB RC	RUBBER BASE REMOTE CONTROL
ACU AD	AIR CONDITIONING UNIT ACCESS DOOR	DC DCJ	DENTAL CASEWORK DOWELED CONTROL JOINT	GC GCMU	GENERAL CONTRACT(OR) GLAZED CONCRETE MASONRY UNIT	MB MBR	MACHINE BOLTS MEMBER	R/C RCP	ROOF-CEILING REFLECTED CEILING PLAN
ADD ADH	ADDENDUM ADHESIVE	DCJT DCL	DUMMY CONTROL JOINT DOOR CLOSER	GCO GEN	GROUND CLEANOUT	MCAB MCJ	MEDICAL CABINET MASONRY CONTROL JOINT	RD REC	ROOF DRAIN RECEPTACLE
ADJ	ADHESIVE ADJACENT, ADJUNCT ADJUSTABLE	DD DEG	DESIGN DEVELOPMENT DEGREE	GF GFI	GROUND FACE	MCO MECH	METAL CASED OPENING MECHANIC(AL)	REF. REG	REFRIGERATOR REGLET
ADJT ADO AFF	AUTOMATIC DOOR OPERATOR ABOVE FINISHED FLOOR	DEG DEM DEP	DEGREE DEMOLISH DEPRESSED	GFRC GFRP	GLASS FIBER REINFORCED CONCRETE	MED MEP	MEDIUM MECHANICAL, ELECTRICAL, PLUMBING	REG REF REINF	REGLET REFERENCE REINFORCED
AG#	ARCHITECTURAL GENERAL	DEP DEPR DEPT	DEPRESSION	GI	GALVANIZED IRON	MER MES	MECHANICAL EQUIPMENT ROOM	REM REQD	REMOVE(ABLE)
AGG AHU	AGGREGATE AIR HANDLING UNIT	DET	DEPARTMENT DETAIL DEVIAGO FOLINTAIN	GL GLB	GLASS BLOCK	MFD MFG	METAL EDGE STRIP METAL FLOOR DECKING MANUFACTUR(ER)	RES RET	REQUIRED RESILIENT
AISC ALT	AMERICAN INSTITUTE STEEL CONSTRUCTION ALTERNATE	DF DH	DRINKING FOUNTAIN DUCT HEATER	GLF GKT		MGT	MATTE-GLAZED TÍLE	REV	RETURN REVISION(S)
ALUM AMB	ALUMINUM AMBIENT	DIA DIAG	DIAMETER DIAGRAM	GND GOV		MH MIN	MANHOLE MINIMUM	RFG	REVISED ROOFING
ANC ANOD	ANCHOR ANODIZED	DIM DISC	DIMENSION DISCONNECT	GP GPL		MIR MISC	MIRROR MISCELLANEOUS	RFH RFL	ROOF HATCH REFLECT(ED)(IVE)(OR)
ANSI AP	AMERICAN NATIONAL STANDARDS INSTITUTE ACCESS PANEL	DISP DIST	DISPENSER DISTRIBUTION	GPM GPPL	GALLONS PER MINUTE GYSPUM PLASTER, FINISH FLOOR	ML MLDG	METAL LATH MOULDING	RGE RGH	RANGE ROUGH
APPD APPROX	APPROVED APPROXIMATE	DIV DL	DIVISION DEAD LOAD	GPT GR		MM	MILLIMETER(S)	RH RIS	RIGHT HAND RISER
ARCH AS#	ARCHITECT (URAL) ARCHITECTURAL SITE	DN DP	DOWN DAMPPROOFING	G'RAIL GRN		MMB MNIC	MEMBRANE MATERIAL NOT IN CONTRACT,	RL RM	RAIL(ING) ROOM
ASB ASC	ASBESTOS ABOVE SUSPENDED CEILING	DPR DR	DAMPER DOOR	GRTG GSS		МО	(INSTALLATION BY CONTRACTOR) MASONRY OPENING	RND RO	ROUND ROUGH OPENING
ASPH AUTO	ASPHALT AUTOMATIC	DRN DS	DRAIN DOWNSPOUT	GST GSU	GLAZED STRUCTURAL UNITS	MOD MOD.	MODULAR MODIFIED	ROW RP	RIGHT OF WAY RETRACTABLE PARTITION
AVG AWC	AVERAGE ACOUSTICAL WALL COVERING	DTA DTS	DOVETAIL ANCHOR DOVETAIL ANCHOR SLOT	GT GUT		MONO MOV	MONOLITHIC MOVABLE	RPRT RR	RAISED PATTERN RUBBER TILE RESTROOM
AWG	AMERICAN WIRE GAUGE	DW DWG	DISHWASHER DRAWING	GVL GWB	GRAVEL GYPSUM WALL BOARD	MP MR	MOVABLE PARTITION MOISTURE RESISTANT	RSR RT	RISER RUBBER TILE
BATT BBD	BATT INSULATION BULLETIN BOARD	DWLS DWR	DOWELS DRAWER	GWT GYP	GLAZED WALL TILE GYPSUM	MRB MRD	MARBLE METAL ROOF DECKING	RUB RVS	RUBBER REVERSE (SIDE)
BC BD	BOOK CASE BOARD	DWT	DUMBWAITER	GYP BD	GYPSUM BOARD	MS MSTC	MOP SINK MASTIC	RWC	RAINWATER CONDUCTOR
BDY BEJ	BOUNDARY BRICK EXPANSION JOINT	E E#	EAST ELECTRICAL	HB HBD	HOSE BIBB HARD BOARD	MTD MTFR	MOUNT(ED)(ING) METAL FURRING	S S#	SOUTH STRUCTURAL
BEL BITUM	BELOW BITUMINOUS	EA EB	EACH EXPANSION BOLT	HC HCAP	HOLLOW CORE	MTHR MTL	METAL THRESHOLD METAL	S&R SA	SHELF AND ROD SUPPLY AIR
BL BLDG	BUILDING LINE BUILDING	EF EIFS	EACH FACE EXTERIOR INSULATION FINISH	HCWD H.D.	HOLLOW CORE WOOD DOOR	MULL MWK	MULLION MILLWORK	SAB SAF	SOUND ATTENUATION BLANKET SELF ADHEARED FLASHING
BLK(G) BM	BLOCK(ING) BEAM	ELEC	SYSTEM ELECTRIC (AL)	HD HDR	HEAD HEADER	N	NORTH	SB SC	SPLASH BLOCK SOLID CORE
B.M. BMFE	BENCH MARK BRACKET-MOUNTED FIRE EXTINGUISHER	ELEV EJ	ELEVATION EXPANSION JOINT	HDW HGT	HARDWARE	NAT NIC	NATURAL NOT IN CONTRACT	S.C. SCHED	SPECIAL COATING SCHEDULE
во	BOTTOM OF	EMER	EMERGENCY	HJT	HEAD JOINT	NFPA	NATIONAL FIRE PROTECTION AGENCY	SCUT	SCUTTLE
BOC BOS	BACK OF CONCRETE BACK OF STEEL	ENCL ENTR	ENCLOSE(URE) ENTRANCE, ENTERING	HK HM		NL NMT	NAILABLE NONMETALLIC	SCWD SD	SOLID CORE WOOD DOOR SCHEMATIC DESIGN
BOT BPL	BOTTOM BEARING PLATE	EO EOC	EDGE OF CONCRETE	HORIZ HP		NO NOM	NUMBER NOMINAL	S.D. SDI	STORM DRAIN STEEL DOOR INSTITUTE
BRCG BRDG	BRACING BRIDGING	EOM EOP	EDGE OF MASONRY EDGE OF PAVEMENT	HPT HR	HOUR	NR NRC	NOISE REDUCTION NOISE REDUCTION COEFFICIENT	SEAL SFGL	SEALANT SAFETY GLASS
BRG BRK	BEARING BRICK	EOS E.P.	EDGE OF SLAB ELECTRIC PANEL	H'RAIL HS	HIGH STRENGTH	NREQD NS	NOT REQUIRED NO SCALE	SFTU SFU	STRUCTURAL FACING TILE UNIT STRUCTURAL FACING UNIT
BRKT BRZ	BRACKET BRONZE	EP EPY	EXPLOSION PROOF EPOXY COATING	HSGYP HT	HEIGHT	NTS	NOT TO SCALE	SG SGL	SHEET GLASS SINGLE
BS BSMT	BOTH SIDES BASEMENT	EQ EQUIP	EQUAL EQUIPMENT	HTG HTR	HEATER	O.A. OA	OVERALL OUTSIDE AIR	SH SHT	SHELF, SHELVING SHEET
BT BTU	BENT BRITISH THERMAL UNIT	ESC EST	ESCALATOR ESTIMATE(D)	HVAC HWD	HEATING, VENTILATING AND AIR CONDITIONING HARDWOOD	OB OBGL	OBSCURE WIRE GLASS OBSCURE GLASS	SHTG SIM	SHEATHING SIMILAR
BTUH BUR	BTU PER HOUR BUILT-UP ROOFING	EWC EX TRZ	ELECTRIC WATER COOLER EXISTING TERRAZZO	HWH HYD.	HOT WATER HEATER HYDRANT	OC OCEW	ON CENTER ON CENTER EACH WAY	SJI SKL	STEEL JOIST INSTITUTE SKYLIGHT
BVL BW	BEVELED BOTH WAYS	EXD EXH	EXIT DEVICE EXHAUST	HYD	HYDRAULIC	OD OFF	OUTSIDE DIAMETER OFFICE	SL SM	SLEEVE SHEET METAL
C#	CIVIL	EXMP EXP	EXPANDED METAL PIPE EXPOSED	IC ICF	INTERCOM INSULATED CORE FORM	OH OJ	OVERHEAD OPEN-WEB JOIST	SMFEC	SURFACE-MOUNTED FIRE EXTINGUISHER CABINET
CAB CALC	CABINET CALCULATION	EXPL EXPN	EXPLOSION EXPANSION	ID	INSULATING CONCRETE FORM INSIDE DIAMETER	OP OPH	OPAQUE OPPOSITE HAND	SOH SPD	SIMILAR, OPPOSITE HAND SOUND-PROOF DOOR
CAP CB	CAPACITY CATCH BASIN	EXT EXST	EXTERIOR EXISTING	IFC IN	ISSUE FOR CONSTRUCTION INCH	OPNG OPP	OPENING OPPOSITE	SPEC SPF	SPECIFICATION(S) SOUNDPROOF
CEM CER	CEMENT CERAMIC	E	FAHRENHEIT	INCIN INCL	INCINERATOR INCLUDE(D)(ING)	OSB OTS	ORIENTED STRAND BOARD OPEN TO STRUCTURE	SPH SPKR	SPACE HEATER SPEAKER
CF	COMPOSITE FLOORING CONDUCTIVE FLOORING	FA FAC	FIRE ALARM FIRE APPARATUS CLOSURE	INSC INSF	INCLUDE(D)(ING) INSULATING CONCRETE INSULATING FILL	P	POLE	SQ SSTL	SQUARE STAINLESS STEEL
CFI CFM	CUBIC FEET PER MINUTE	FAI FAS	FRESH AIR INTAKE	INSUL INT	INSULATE(ING)(ION)(ED) INTERIOR	P# PA	PLUMBING PUBLIC ADDRESS	SSK SSMR	SERVICE SINK STANDING SEAM METAL ROOF
CFT CG	CUBIC FOOT CORNER GUARD	FB FBD	FASTEN(ER) FACE BRICK FIBERBOARD	INTM	INTERMEDIATE	PAR	PARALLEL	ST STC	STAINDING SEAM METAL ROOF STAIN SOUND TRANSMISSION CLASS
CHAM CHBD	CHAMFER CHALKBOARD	FBO	FURNISHED BY OTHERS	INV	INVERT(ED)	PARTN PB	PARTITION(S) PLANTING BED	STD	STANDARD
CHIM CHT	CHIMNEY CEILING HEIGHT	FBRK FC	FIRE BRICK FIRE CODE	JB JC	JUNCTION BOX JANITORS CLOSET	PBD PC	PARTICAL BOARD PIECE	STGR STL	STRINGER STEEL
CI CIPC	CAST IRON CAST IN PLACE CONCRETE	F/C FCG	FLOOR-CEILING FACING	JCT JF		PCC PCF	PRECAST CONCRETE POUNDS PER CUBIC FOOT	STN STOR	STORAGE
CIR CIRC	CIRCULAR CIRCUMFERENCE	FCJ FCU	FLOOR CONSTRUCTION JOINT FLOOR COIL UNIT	JST JT	JOIST JOINT	PCPL PD	PORTLAND CEMENT PLASTER PAVEMENT DRAIN	STRUCT SUB FL	STRUCTURE(AL) SUBFLOOR
CL CL	CONTROL JOINT CENTER LINE	F.D. FD	FIRE DAMPER FLOOR DRAIN	KD		PE PED	PORCELAIN ENAMEL PEDESTAL	SUSP SV	SUSPENDED SHEET VINYL
CLG CLKG	CEILING CAULKING	FDC FDN	FIRE DEPARTMENT CONNECTION FOUNDATION	KIT KO	KITCHEN KNOCKOUT	PERF PERI	PERFORATE(D) PERIMETER	SVF SYM	SHEET VINYL FLOORING SYMMETRICAL
CLL CLO	CONTACT LIMIT LINE CLOSET	FE FEB	FIRE EXTINGUISHER FIRE EXTINGUISHER BRACKET	KPL	KICKPLATE	PF PFL	PRE-FINISHED POUNDS PER LINEAR FOOT	SYS	SYSTEM
CLOS CLR	CLOSED CLEAR(ANCE)	FEC FF	FIRE EXTINGUISHER CABINET FACTORY FINISH	LAB LAD	LABORATORY LADDER	PG PH	PLATE GLASS PHASE	T TA	TREAD TABLE
CLRGL CLRWG	CLEAR GLASS CLEAR WIRE GLASS	FFE FFL	FINISHED FLOOR ELEVATION FINISH FLOOR LINE	LAM LAU	LAMINATE(D) LAUNDRY	PI P.L.	POINT OF INTERSECTION PROPERTY LINE	TAN TB	TANGENT TOWEL BAR
CM CMP	CENTIMETER(S) CORRUGATED METAL PIPE	FG FH	FIBERGLASS FIRE HYDRANT	LAV LB	LAVATORY	PL PLAM	PLATE PLASTIC LAMINATE	TC TCC	TERRA COTTA TEXTURED CEILING COATING
CMT CMU	CERAMIC MOSAIC TILE CONCRETE MASONRY UNIT	FHC FHS	FIRE HOSE CABINET FIRE HOSE STATION	LBR LBS	LUMBER POUNDS	PLAS PLBG	PLASTER PLUMBING	TELE TEMP	TELEPHONE TEMPORARY
CND CNTR	CONDUIT (RACEWAY, ELEC, ETC) COUNTER	FI FIG	FILM ILLUMINATOR FIGURE	LG LH	LENGTH	PLG PLYWD	PILING PLYWOOD	TERM TERR	TERMINAL TERRAZZO
CO CO2	CLEAN OUT CARBON DIOXIDE	FIN FIX	FINISH(ED) FIXTURE	LIN LKR		PNL POL	PANEL POLISHED	T&G TH	TONGUE AND GROOVE THRESHOLD
COL COM	COLUMN	FJT FL	FLUSH JOINT FLOOR	LL LLD	LIVE LOAD	PORC PCT	PORCELAIN PORCELAIN TILE	THK TKBD	THICK(NESS) TACKBOARD
COMB COMP	COMBUSTION COMPRESS(ED),(ION),(IBLE)	FLASH FLCO	FLASHING FLOOR CLEANOUT	LNTL LONG	LINTEL	PORT PP	PORTABLE POWER POLE	TKS TMPT	TACKSTRIP TEMPERATURE
COMPO COMPT	COMPOSITE, COMPOSITION COMPARTMENT	FLEX FLG	FLEXIBLE FLOORING	LP LPD	LIGHTPROOF	PPG P PTD	POLISHED PLATE GLASS PRIME PAINTED	TO TOC	TOP OF TOP OF CONCRETE
CONC	CONCRETE	FLR FLUOR	FLOOR FLUORESCENT	LR LT	LIVING ROOM LIGHT	PR PREFAB	PAIR PREFABRICATE(D)	TOIL TOL	TOILET TOLERANCE
CONN	CONNECTION	FN	FENCE	LTG	LIGHTING LONG TERM THERMAL RESISTANCE	PREFIN	PREFINISHED	TOM	TOP OF MASONRY
	CONSTRUCTION CONSTRUCTION JOINT	FND FO	FOUNDATION FACE OF	LTTR LT WT	LIGHT WEIGHT	PRF PROJ	PREFORMED PROJECT	TOP TOPO	TOP OF PLATE TOPOGRAPHY
CONT CONTR	CONTINUE(OUS) CONTRACT(OR)	FOC FOF	FACE OF CONCRETE FACE OF FINISH	LVL LVR	LAMINATED VENEER LUMBER LOUVER	PS PSC	PIPE SPACE PRESTRESSED CONCRETE	TOS TOSL	TOP OF STEEL TOP OF SLAB
COR CORR	CORNER CORRIDOR	FOM FOS	FACE OF MASONRY FACE OF STUDS	LWC	LIGHT WEIGHT CONCRETE	PSF PSI	POUNDS PER SQUARE FOOT POUNDS PER SQUARE INCH	TOT TOW	TOP OF TRUSS TOP OF WALL
COV CPL	COVERED CEMENT PLASTER	FP# FP	FIRE PROTECTION FIRE PARTITION			PT. PT	POINT PAINT	T.P. TP	TRIM PROFILE TOILET PAPER
CPR CPT	COPPER CARPET	FPL FPRF	FLOOR PLATE FIRE PROOF			PT WD PTC	PRESSURE TREATED WOOD POST-TENSIONED CONCRETE	TPD TPTN	TOILET PAPER DISPENSER TOILET PARTITION
CRES CRS	CORROSIVE RESISTANT STEEL COURSE(S)	F.R. FR	FIRE RATED FRAME(D)(ING)			PA. PTR	PAPER TOWEL DISPENSER PAPER TOWEL RECEPTOR	TR TRANS	TRANSOM TRANSVERSE
CSK CSMT	COUNTERSINK, COUNTERSUNK CASEMENT	FRA FRC	FRESH AIR FIRE-RESISTANT COATING			PV PVC	PAVE(D)(ING) POLYVINYLCHLORIDE	TSTAT TV	THERMOSTAT TELEVISION
CSMU CST	CALCIUM SILICATE MASONRY UNIT CAST STONE	FRFEC	FULLY RECESSED FIRE EXTINGUISHER CABINET			PVMT	PAVEMENT	TWU TYP	THROUGH-WALL UNIT TYPICAL
CT CTC	CERAMIC TILE CENTER TO CENTER	FRP FRT	FIBER REINFORCED PLASTIC FIRE RETARDANT			QT PT.	QUARRY TILE QUART		
CTL CTP	CARPET TILE CERAMIC TILE PANEL	FS FT	FULL SIZE FEET			QTRS QTY	QUARTERS QUANTITY		
CTR CTSK	CENTER COUNTERSUNK SCREW	FTG FUR	FOOTING FURR(ED)(ING)						
CU	CONDENSING UNIT	FUT	FUTURE						

FIELD VERIFY

FABRIC WALL COVERING

FIRE WATER

FV

CEILING VENT

CUBIC YARDS CYLINDER

CUH

CV CY

CABINET UNDER HEATER

\_\_ ELEVATION HEIGHT BUILDING SECTION REFERENCE SPOT ELEVATION REFERENCE PREVIOUS REVISION # — DETAIL# CURRENT ~ REVISION CLOUD ITEMS INSIDE CLOUD ARE MODIFIED FROM PREVIOUS ISSUE MODIFICATION CLOUD REFERENCE WALL SECTION REFERENCE SYMBOL INDICATES CONTRACTOR IS TO ALIGN FINISH FACES OF TWO NOTED WALLS / CEILINGS / ETC -OFFSET FRAMING AS REQUIRED TO ACHIEVE ALIGNMENT WALL ALIGNMENT REFERENCE SECTION DETAIL REFERENCE DIM TO FACE OF STUD, CONC, OR MASONRY OR COLUMN CENTER LINE - UNO DIMENSION REFERENCE ENLARGED DETAIL REFERENCE ,— DETAIL# EXTERIOR ELEVATION REFERENCE INTERIOR ELEVATION REFERENCE \_\_\_ DOOR # # \ \ TITLE TITLE MARKER REFERENCE DOOR REFERENCE ROOMNAME ROOMNAME 000 (001) ROOM NAME REFERENCE WINDOW REFERENCE (ELEVATION) HEIGHT TYPE FINISH NOTES **CEILING REFERENCE** FLOOR WALL BASE NOTES FLOOR WALL BASE NOTES └ FINISH ROOM FINISH REFERENCE (WHERE USED) STANDARD MATERIALS LEGEND - N.T.S. ASPHALT CONC. (FOR SECTION) FILL / DISTURBED EARTH DOOR VENEER E.I.F.S., VARIOUS INTERMITTENT WOOD BLOCKING / FURRING SAND, GYP. BD., GROUT (PLAN = CONC.) SHEATHING - OSB ... ETC. CONTINUOUS WOOD BLOCKING

UNIT COOLER UNDERGROUND

UNIT HEATER

UNEXCAVATED

VAPOR BARRIER

VENTILATOR(TION)

VERTICAL GRAIN

VAPOR RETARDER

VENT THRU ROOF

VINYL WALL COVERING

WOOD-CASED OPENING

VENT STACK

VINYL TILE

WEST WITH

WITHOUT

WOOD

WOOD BASE WASTE CLOSET

WHEEL CHAIR

WASHER/DRYER

WHEEL BUMPER

WHIRLPOOL BATH

WROUGHT IRON

WOOD DOOR WIRE GLASS

WALL HUNG WATER HEATER

WHITE

WIDTH

WINDOW

WIRE MESH WEATHERPROOF

WATERPROOF

WASTE STACK

WALL-TO-WALL

TRANSFORMER

YARD DRAIN

YARD

WELDED WIRE FABRIC

WELDED WIRE MESH

WATER STOP

WAINSCOT

WEIGHT

WATERPROOFING

WEATHER RESISTIVE BARRIER

X-RAY EQUIPMENT RADIOLOGY

WORKING POINT WASTE RECEPTACLE

WOOD BLOCKING

VERIFY IN FIELD

VINYL COMPOSITION TILE

VINYL FABRIC COVERING

UNFINISHED

UTILITY

VOLT

VARNISH VINYL BASE

VERTICAL

VESTIBULE

V-JOINT(ED) VENEER

VOLUME

VINYL

UNLESS NOTED OTHERWISE UNDERWRITERS' LABORATORIES

UNINTERRUPTIBLE POWER SYSTEM

UG

UNEX

UNFIN

UPS

UTL

VAB

VAR

VCT

VENT

VERT

VEST

VFC

VIF

VIN

VOL

VTR

VWC

W/O

WB

WC W/C

WCO

WD

W/D

WD BLK

WD DR

WG

WHB

WHP

WHT

WID

WIN

WPF

WPG

WPT

WS

WT

WTW

WWF

WWM


XRAY XFMR

Y.D. YD


WSCT

WI

VΒ

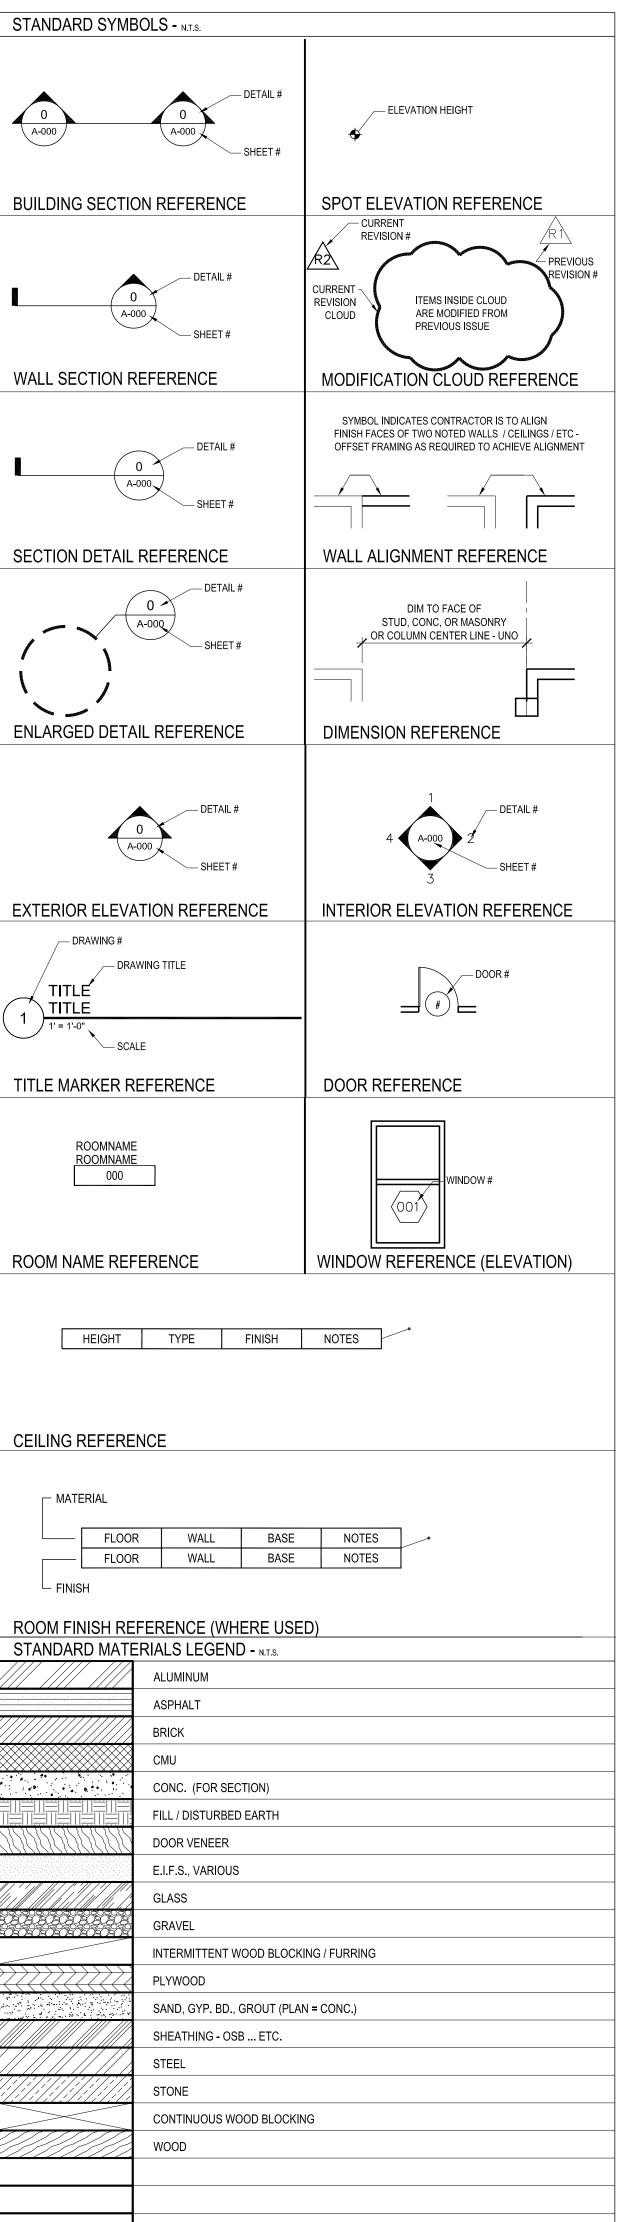



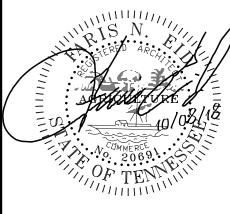



DATE ISSUE FOR This drawing is the property of DESIGN INNOVATIONS ARCHITECTS, INC. and is not to be reproduced or copied in whole or in part without authorization from DESIGN INNOVATIONS ARCHITECTS, INC.. It is to

be used for the project and site specifically identified herein and is not to be used on any other project. It is to be returned upon request. Do not scale drawings, written dimensions take precedence. All drawings and designs shown on these drawings are copyright © of DESIGN INNOVATIONS ARCHITECTS, INC. ARCHITECTURAL **GENERAL NOTES** 

AND LEGENDS INFORMATION

Project Number	Sheet Number
18110	
Date	AGO

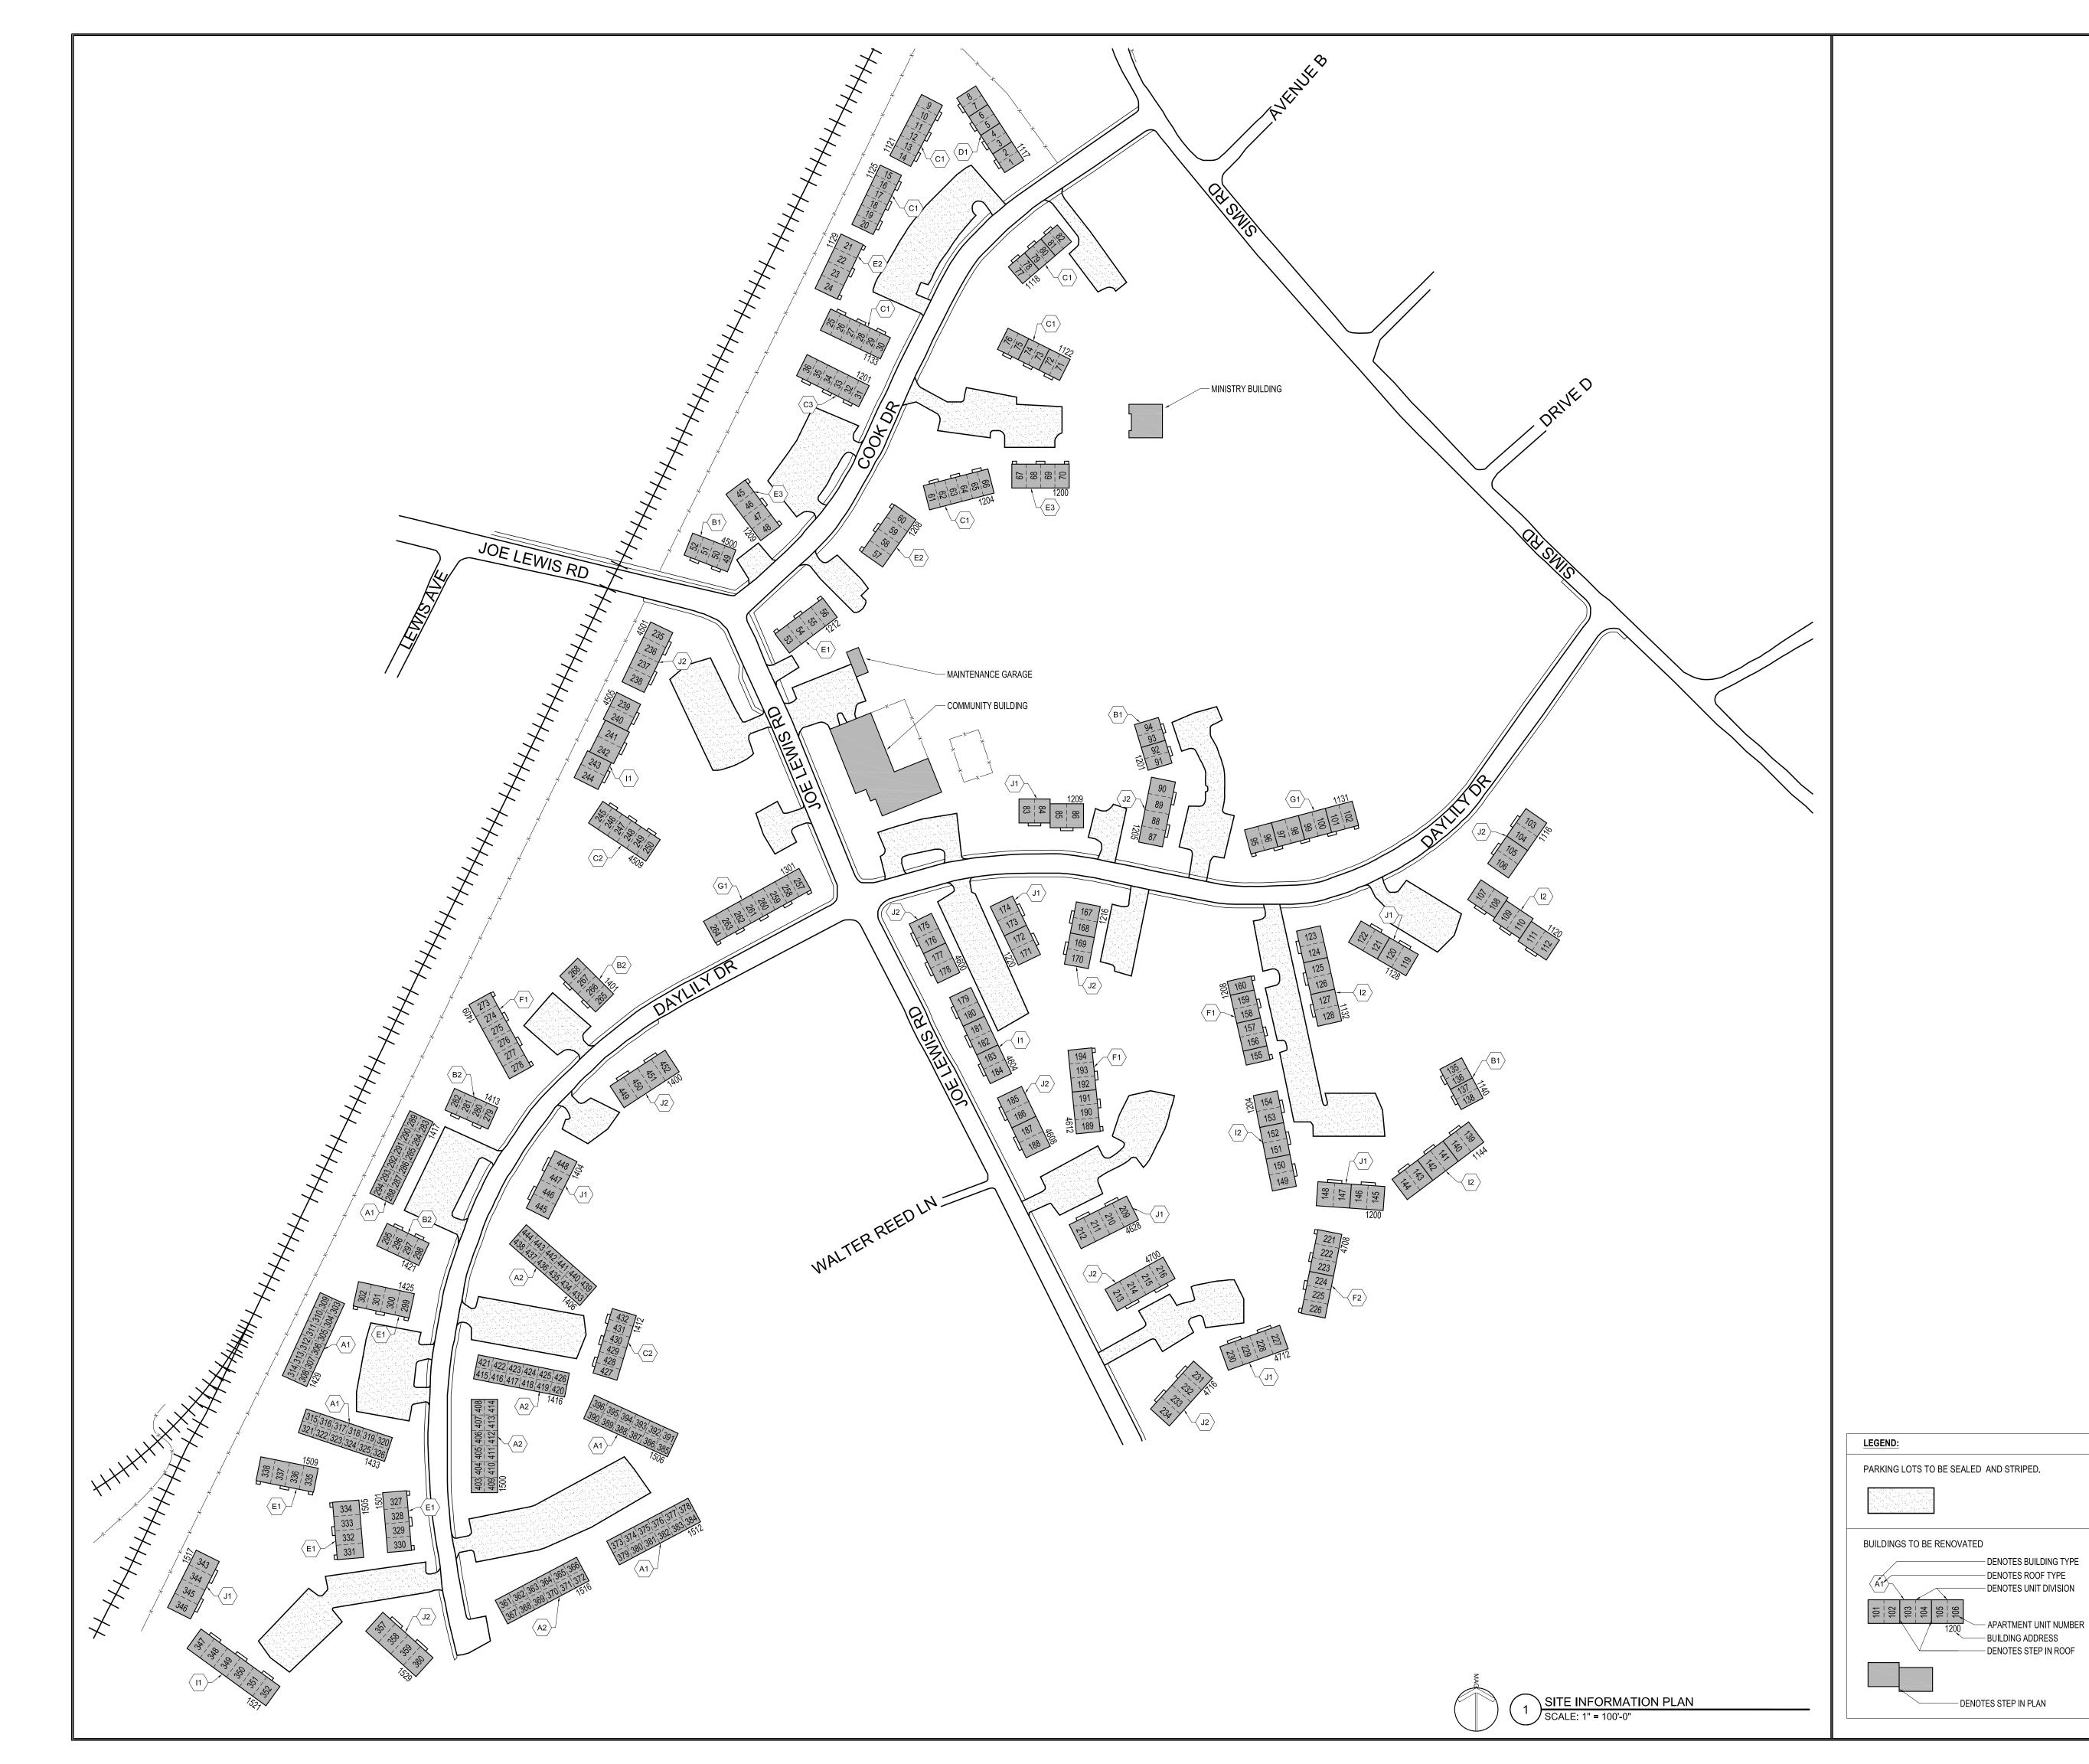

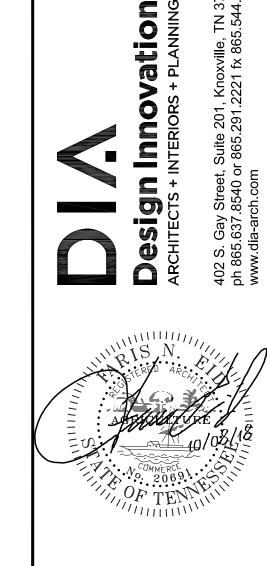

MONTGOMERY VILLAG
4530 JOE LEWIS ROAD
KNOXVILLE, TENNESSEE 37920

This drawing is the property of DESIGN INNOVATIONS ARCHITECTS, INC. and is not to be reproduced or copied in whole or in part without authorization from DESIGN INNOVATIONS ARCHITECTS, INC.. It is to be used for the project and site specifically identified herein and is not to be used on any other project. It is to be returned upon request. Do not scale drawings, written dimensions take precedence. All drawings and designs shown on these drawings are copyright © of DESIGN INNOVATIONS ARCHITECTS, INC.

BUILDING TYPE C: 9 BUILDINGS @ (6) 2 BR UNITS / BLDG = 54 UNITS

BUILDING TYPE D: 1 BUILDINGS @ (8) 2 BR UNITS / BLDG = 8 UNITS

Sheet Title

**BUILDING TYPES:** 

BUILDING TYPE H: NOT USED

TOTAL:

ROOF TYPES:

ROOF TYPE 1

ROOF TYPE 3

BUILDING TYPE A: 9 BUILDINGS @ (12) 1 BR UNITS / BLDG = 108 UNITS

| BUILDING TYPE B: | 6 BUILDINGS @ (4) 2 BR UNITS / BLDG = 24 UNITS

BUILDING TYPE E: 9 BUILDINGS @ (4) 3 BR UNITS / BLDG = 36 UNITS

BUILDING TYPE F: 4 BUILDINGS @ (6) 3 BR UNITS / BLDG = 24 UNITS

BUILDING TYPE G: 2 BUILDINGS @ (8) 3 BR UNITS / BLDG = 16 UNITS

BUILDING TYPE I: 7 BUILDINGS @ (6) 4 BR UNITS / BLDG = 42 UNITS

STRAIGHT GABLE ROOF TYPE

MULTIPLE GABLE ROOF TYPE

+ (2) 5 BR UNITS / BLDG = 72 UNITS

BUILDING TYPE J: 18 BUILDINGS @ (2) 3 BR UNITS / BLDG

65 BUILDINGS

HIP ROOF TYPE

SITE
INFORMATION
DI ANI


= 384 UNITS


Project Number


18110


Date


18110
AS101
10-08-18

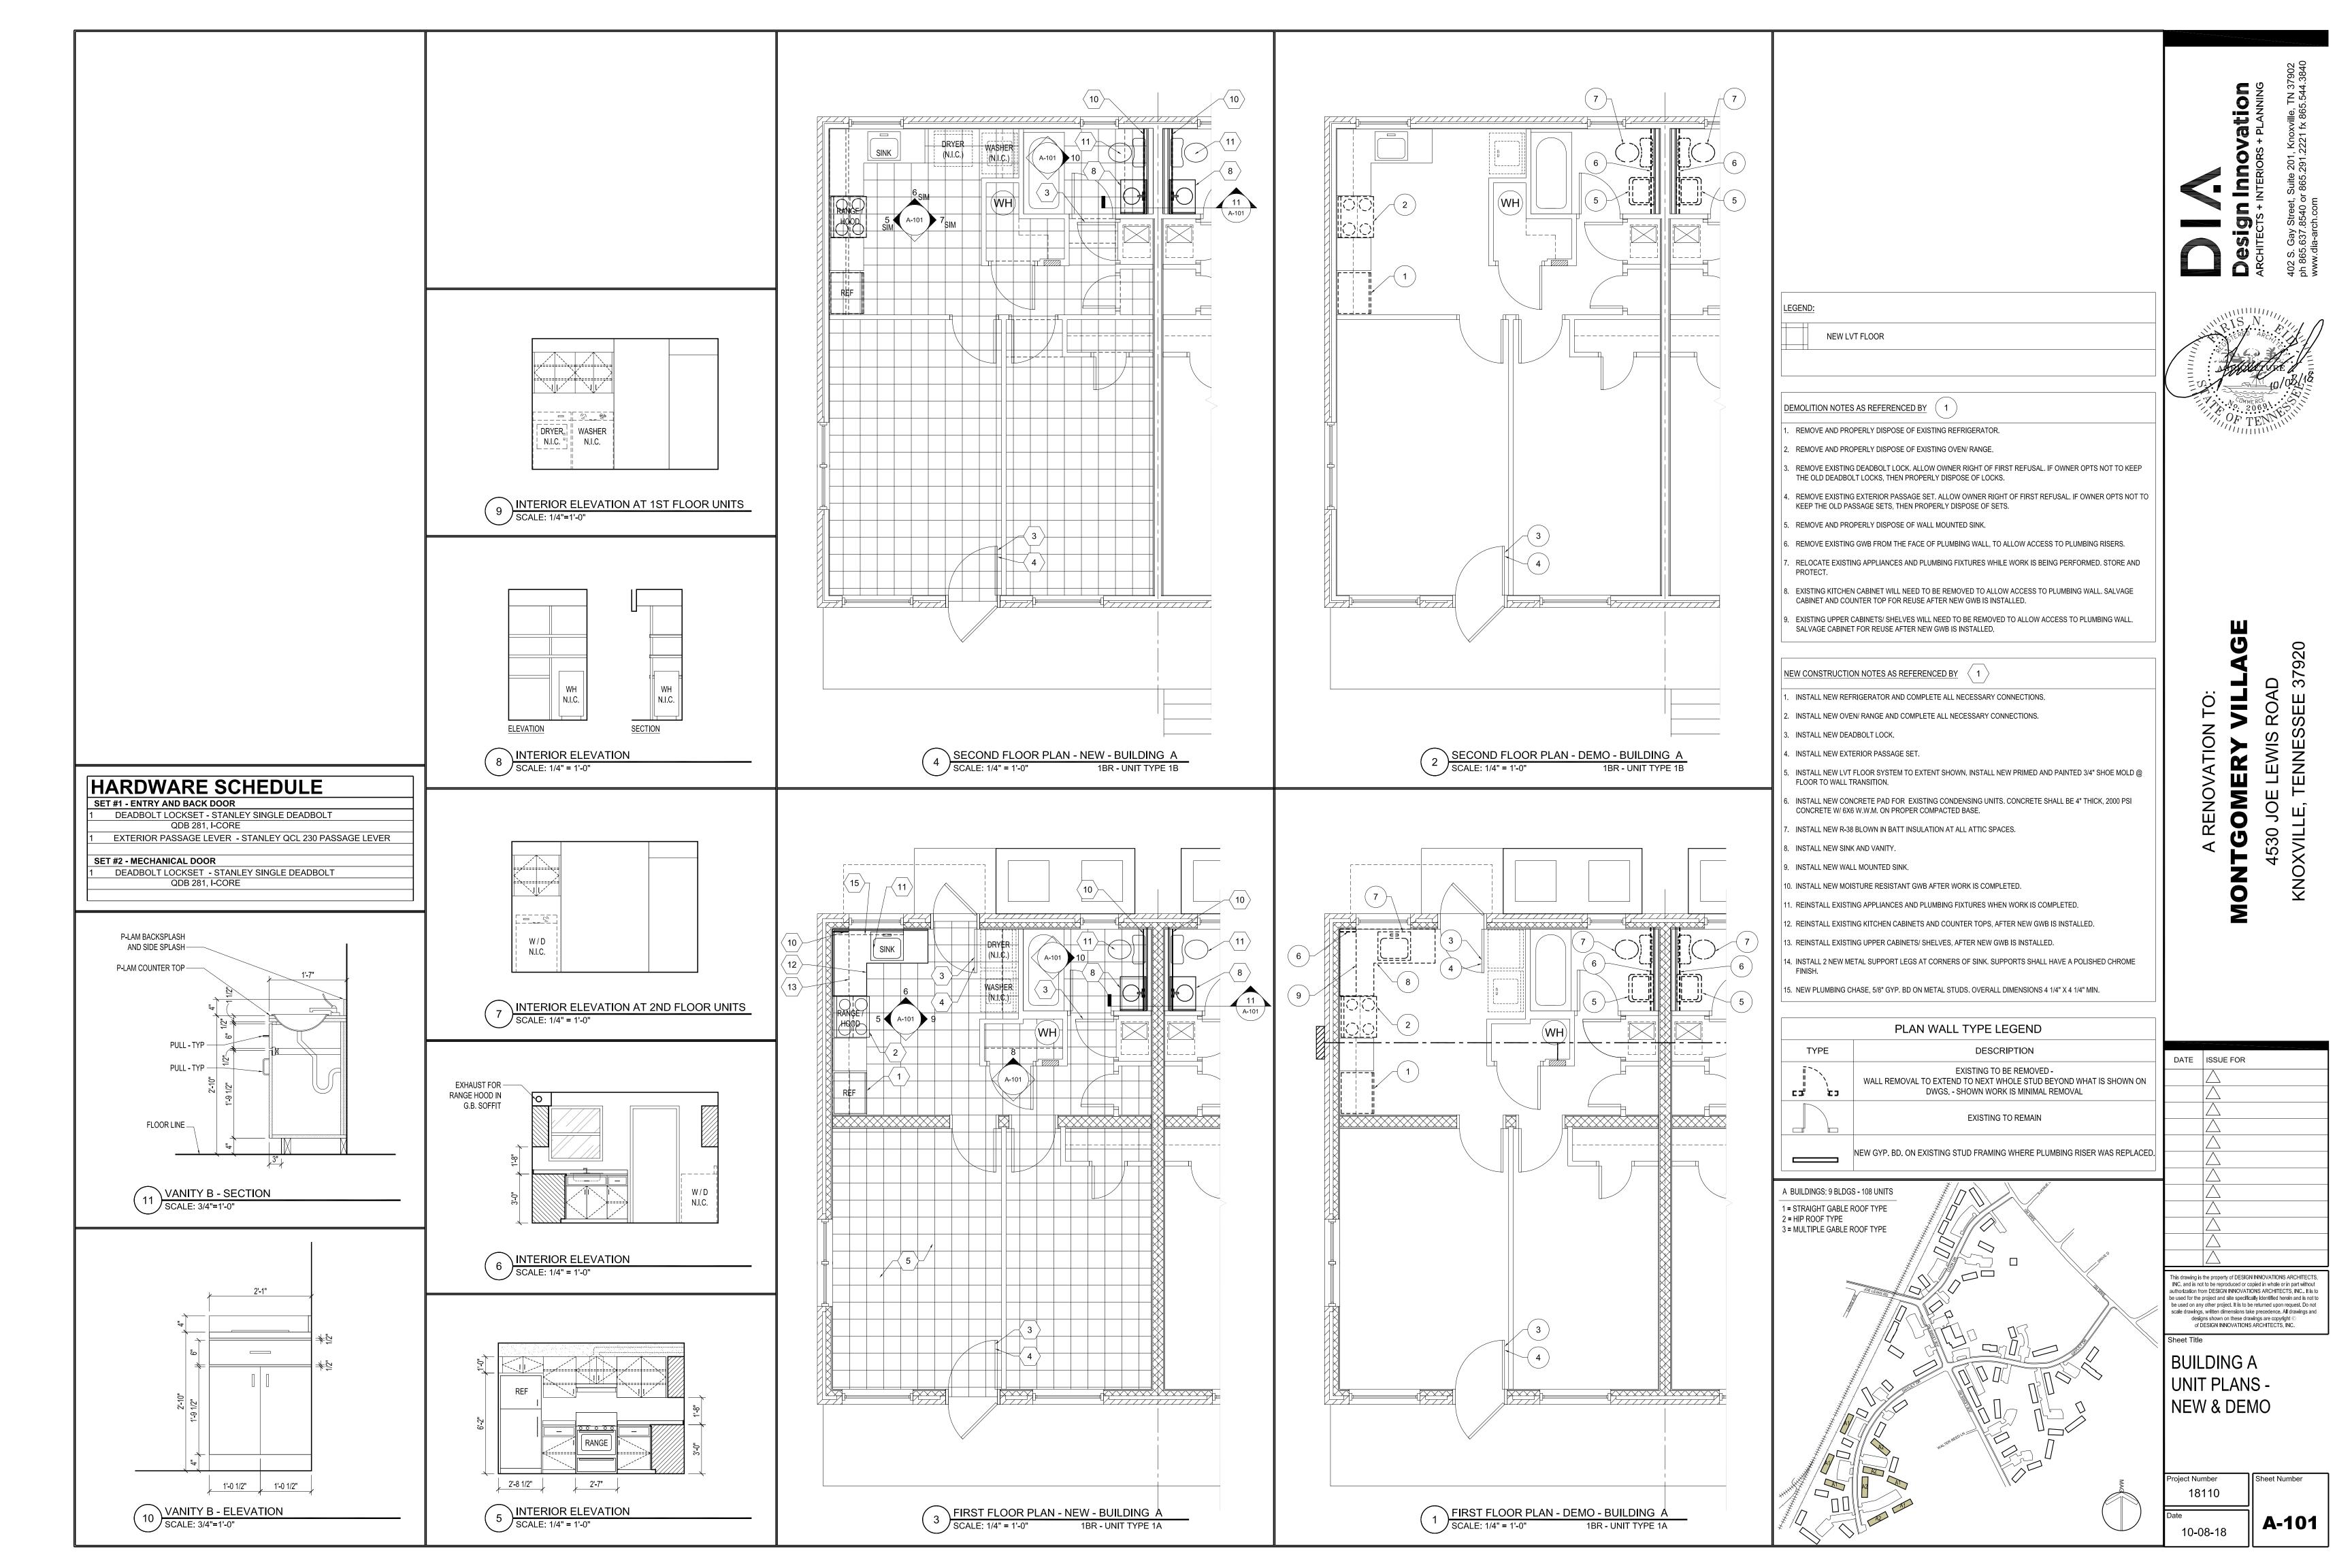

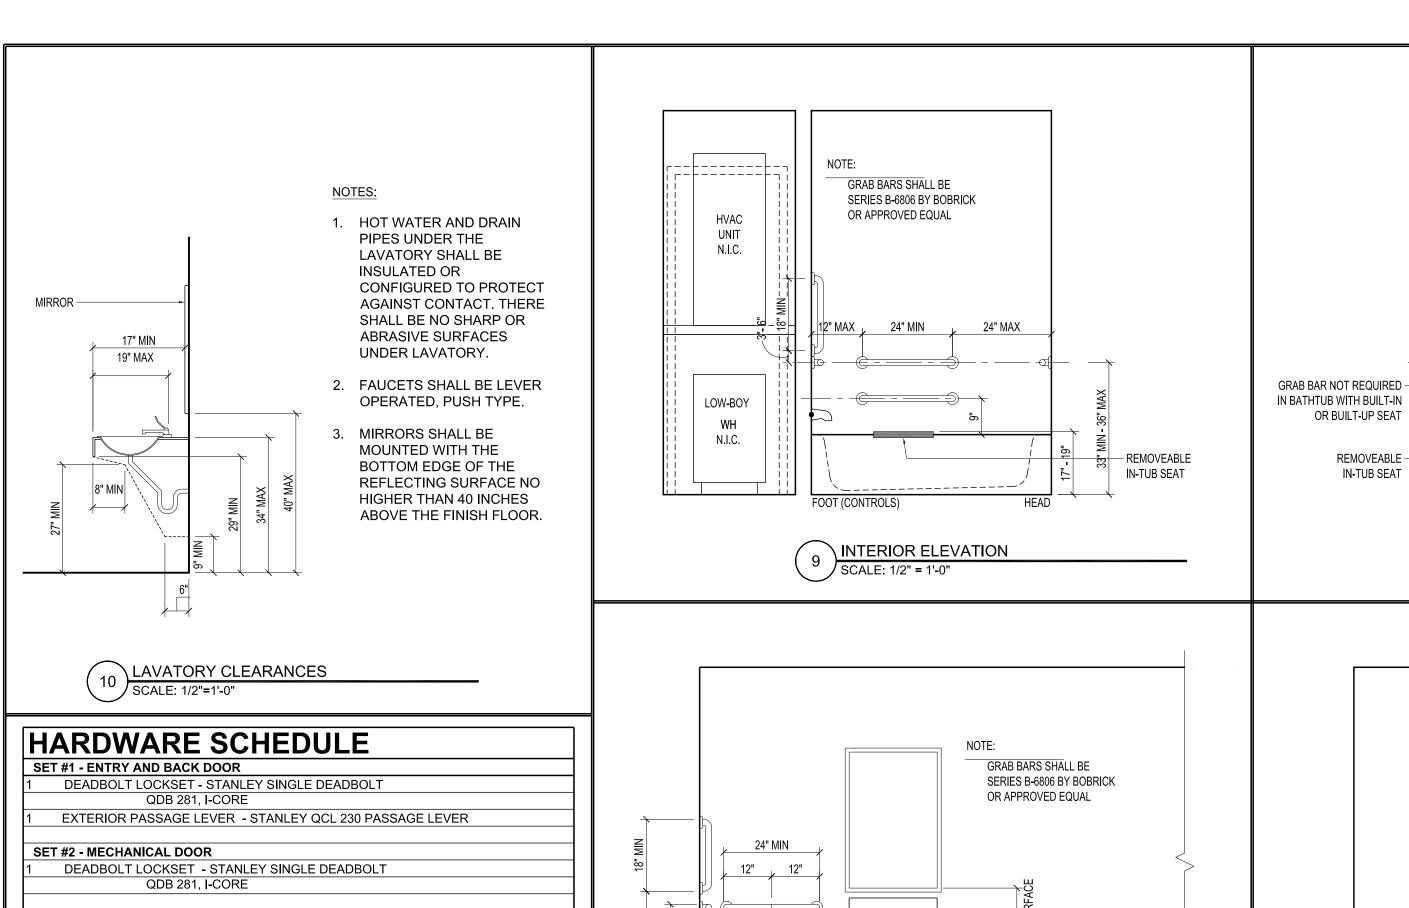

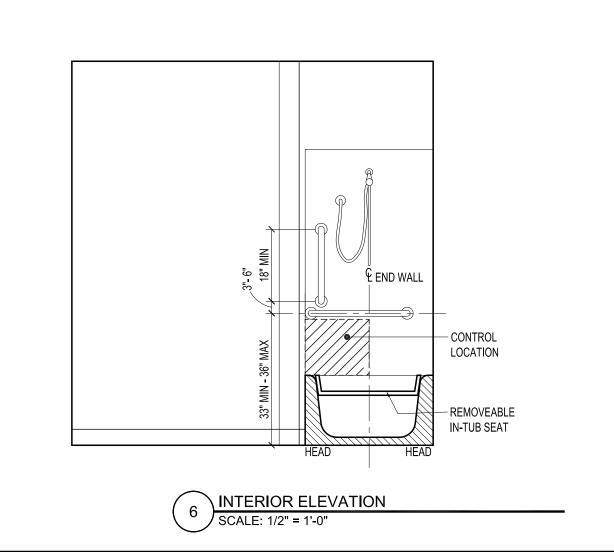

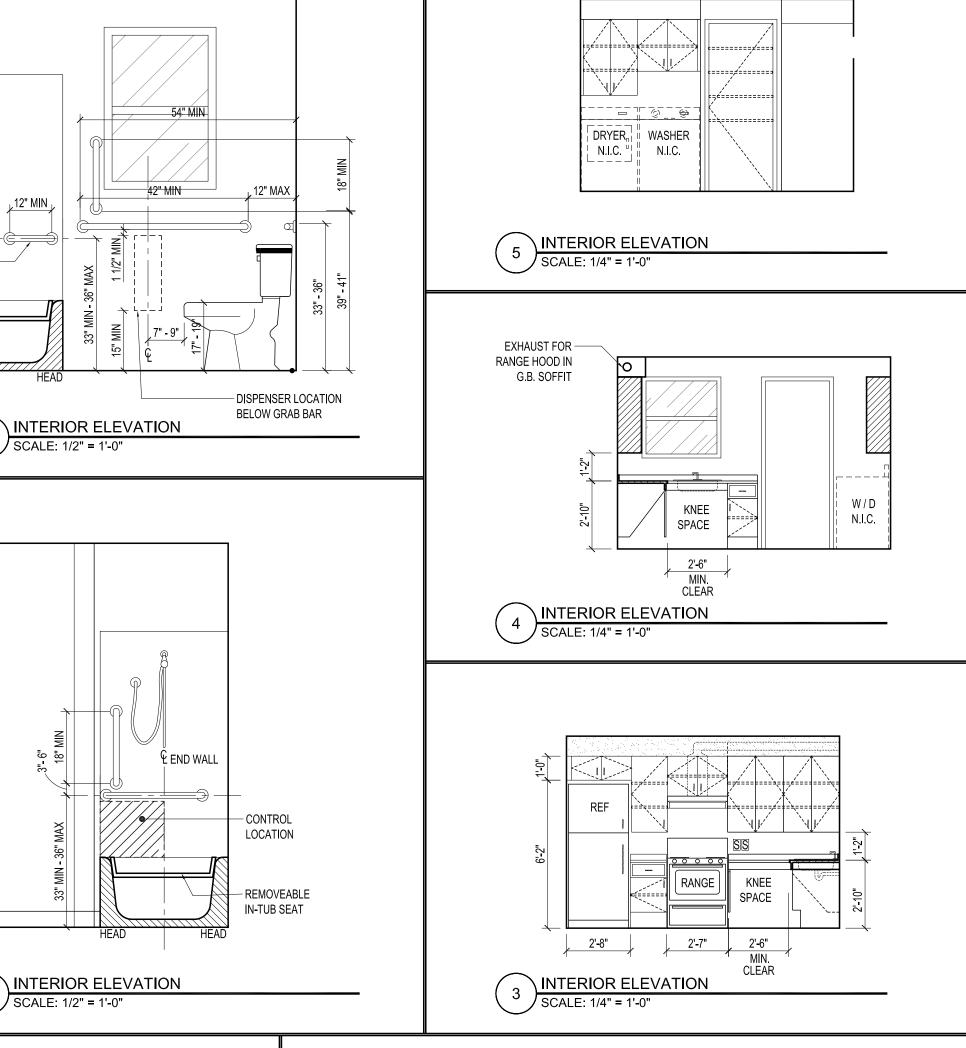

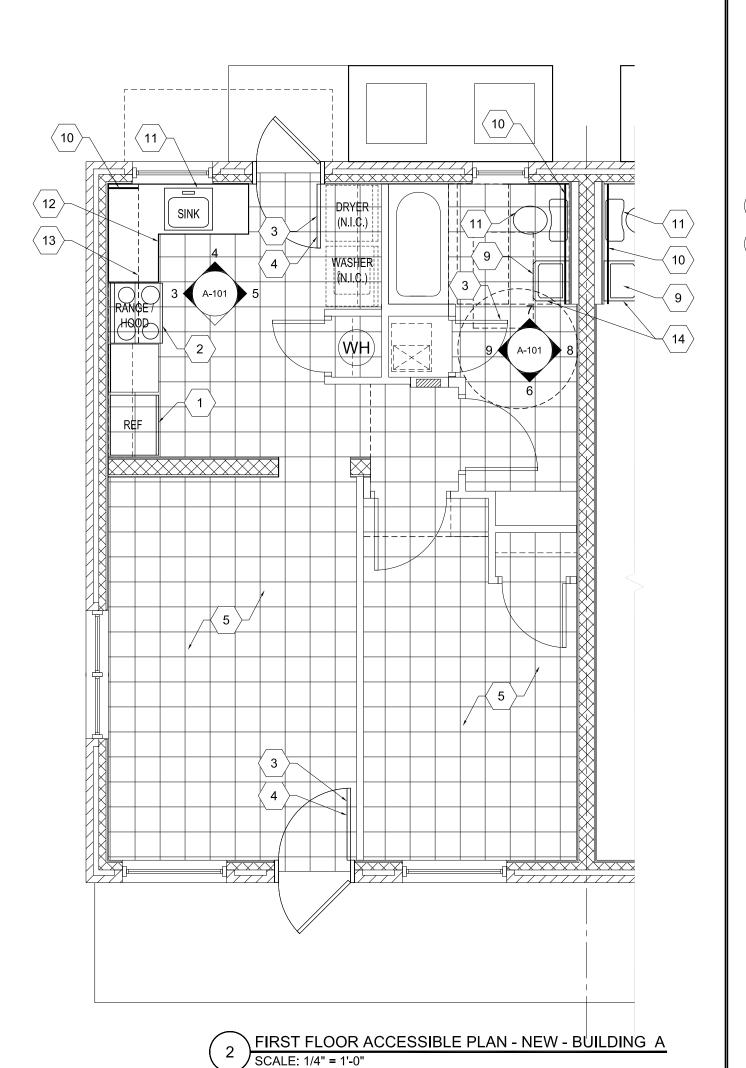



OR BUILT-UP SEAT

PIPE COVERS - SEE PLUMBING

REMOVEABLE -

IN-TUB SEAT

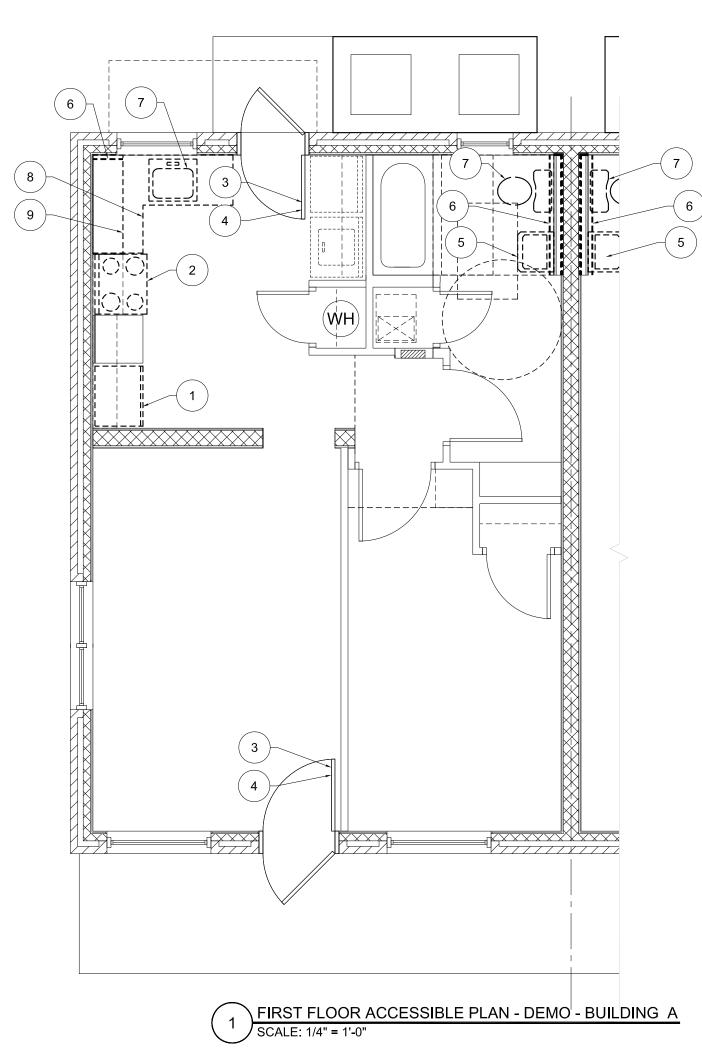

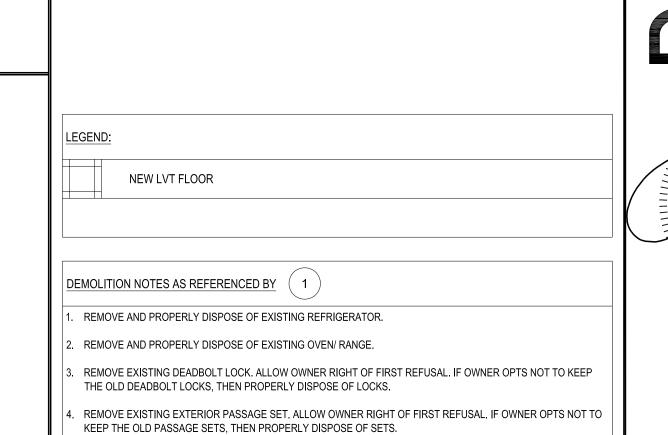

6. REMOVE EXISTING GWB FROM THE FACE OF PLUMBING WALL, TO ALLOW ACCESS TO PLUMBING RISERS. RELOCATE EXISTING APPLIANCES AND PLUMBING FIXTURES WHILE WORK IS BEING PERFORMED. STORE AND

PROTECT. 8. EXISTING KITCHEN CABINET WILL NEED TO BE REMOVED TO ALLOW ACCESS TO PLUMBING WALL. SALVAGE CABINET AND COUNTER TOP FOR REUSE AFTER NEW GWB IS INSTALLED.

9. EXISTING UPPER CABINETS/ SHELVES WILL NEED TO BE REMOVED TO ALLOW ACCESS TO PLUMBING WALL.


SALVAGE CABINET FOR REUSE AFTER NEW GWB IS INSTALLED.

## NEW CONSTRUCTION NOTES AS REFERENCED BY (1)

. REMOVE AND PROPERLY DISPOSE OF WALL MOUNTED SINK.

- . INSTALL NEW ACCESSIBLE REFRIGERATOR AND COMPLETE ALL NECESSARY CONNECTIONS.
- 2. INSTALL NEW ACCESSIBLE OVEN/ RANGE AND COMPLETE ALL NECESSARY CONNECTIONS.
- 3. INSTALL NEW DEADBOLT LOCK.
- 4. INSTALL NEW EXTERIOR PASSAGE SET.
- INSTALL NEW LVT FLOOR SYSTEM TO EXTENT SHOWN. INSTALL NEW PRIMED AND PAINTED 3/4" SHOE MOLD @ FLOOR TO WALL TRANSITION.
- INSTALL NEW CONCRETE PAD FOR EXISTING CONDENSING UNITS. CONCRETE SHALL BE 4" THICK, 2000 PSI CONCRETE W/ 6X6 W.W.M. ON PROPER COMPACTED BASE.
- 7. INSTALL NEW R-38 BLOWN IN BATT INSULATION AT EACH ATTIC SPACE.
- 8. INSTALL NEW SINK AND VANITY.
- 9. INSTALL NEW WALL MOUNTED SINK.
- 10. INSTALL NEW MOISTURE RESISTANT GWB AFTER WORK IS COMPLETED.
- 11. REINSTALL EXISTING APPLIANCES AND PLUMBING FIXTURES WHEN WORK IS COMPLETED.
- 12. REINSTALL EXISTING KITCHEN CABINETS AND COUNTER TOPS, AFTER NEW GWB IS INSTALLED.
- 13. REINSTALL EXISTING UPPER CABINETS/ SHELVES, AFTER NEW GWB IS INSTALLED.
- 14. INSTALL 2 NEW METAL SUPPORT LEGS AT CORNERS OF SINK. SUPPORTS SHALL HAVE A POLISHED CHROME

TYPE  DESCRIPTION  EXISTING TO BE REMOVED - WALL REMOVAL TO EXTEND TO NEXT WHOLE STUD BEYOND WHAT IS SHOWN ON DWGS SHOWN WORK IS MINIMAL REMOVAL  EXISTING TO REMAIN  NEW GYP. BD. ON EXISTING STUD FRAMING WHERE PLUMBING RISER WAS REPLACED.
WALL REMOVAL TO EXTEND TO NEXT WHOLE STUD BEYOND WHAT IS SHOWN ON DWGS SHOWN WORK IS MINIMAL REMOVAL  EXISTING TO REMAIN
NEW GYP. BD. ON EXISTING STUD FRAMING WHERE PLUMBING RISER WAS REPLACED.
BUILDINGS: 9 BLDGS - 108 UNITS  CCESSIBLE UNITS - BUILDING 1506    UNITS: 385, 386, 387, 388, 389, 390 BUILDING 1512    UNITS: 315, 316, 317, 318, 319, 320  UNITS: 406

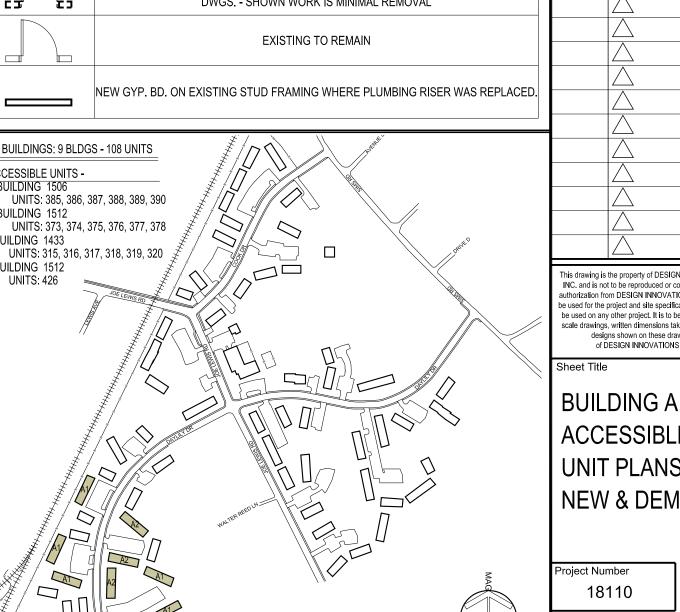



DATE ISSUE FOR This drawing is the property of DESIGN INNOVATIONS ARCHITECTS, INC. and is not to be reproduced or copied in whole or in part without authorization from DESIGN INNOVATIONS ARCHITECTS, INC.. It is to be used for the project and site specifically identified herein and is not to be used on any other project. It is to be returned upon request. Do not scale drawings, written dimensions take precedence. All drawings and designs shown on these drawings are copyright © of DESIGN INNOVATIONS ARCHITECTS, INC.

> **ACCESSIBLE UNIT PLANS NEW & DEMO**


10-08-18


Sheet Number **A-101** 

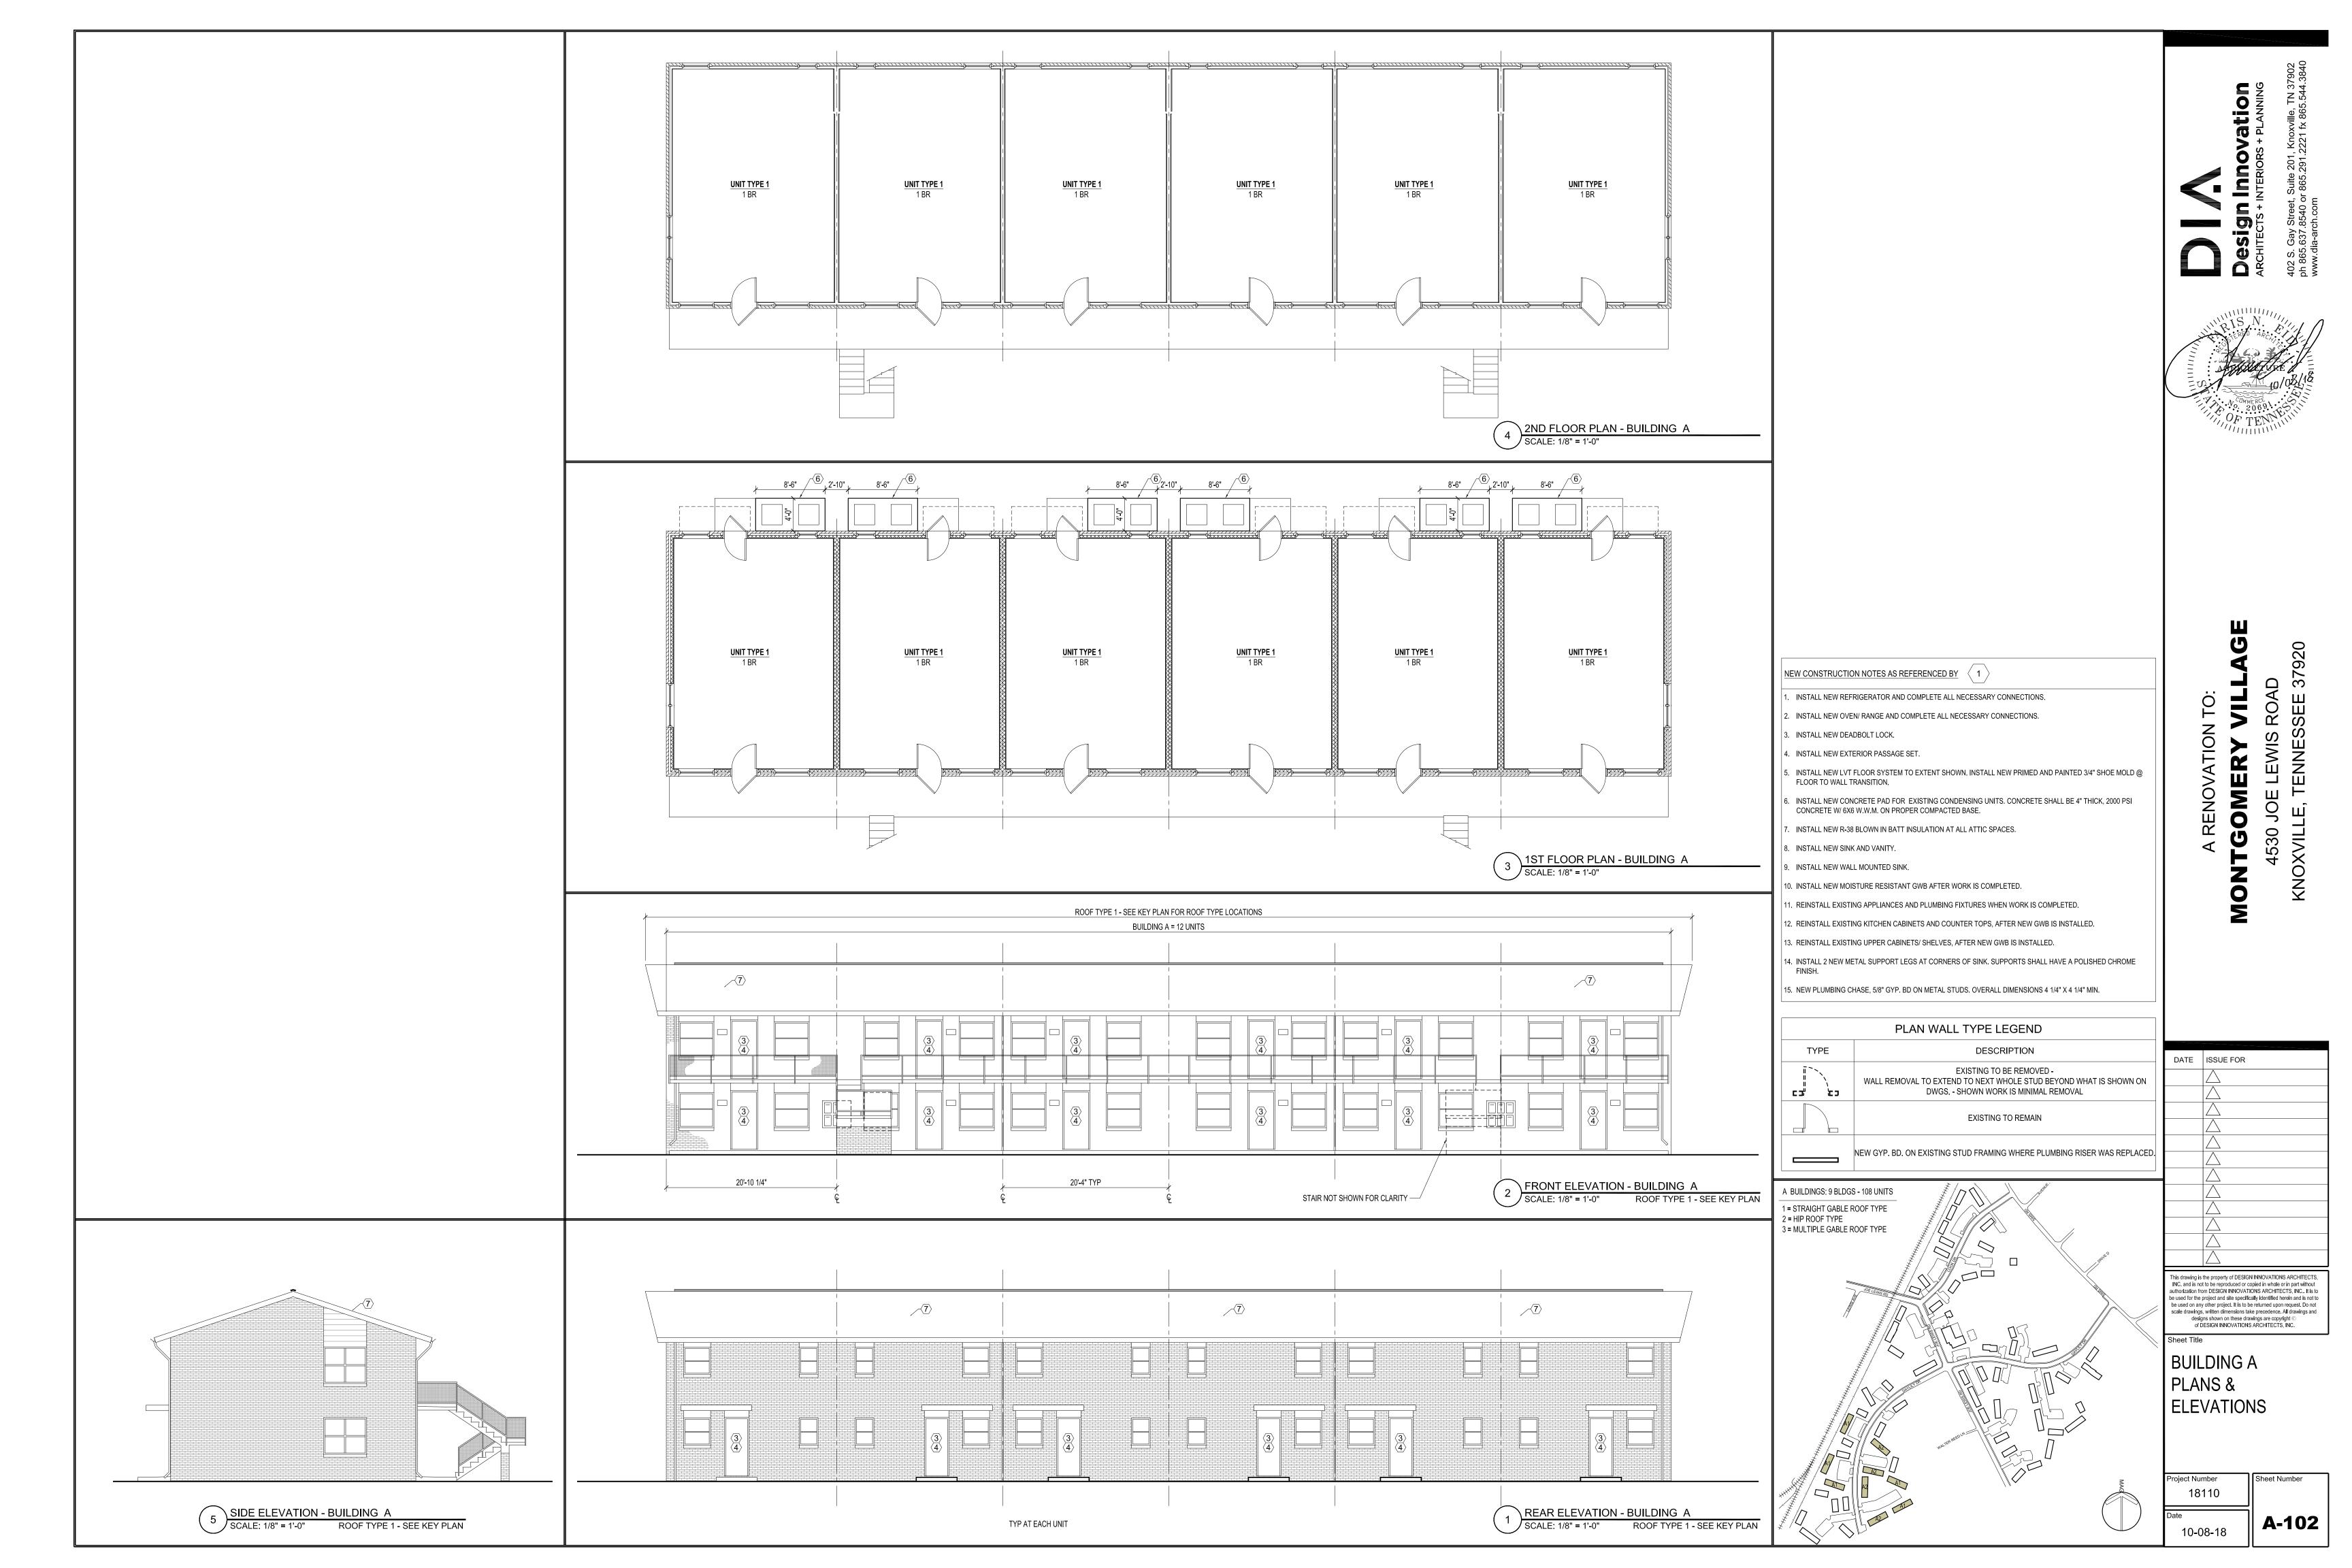

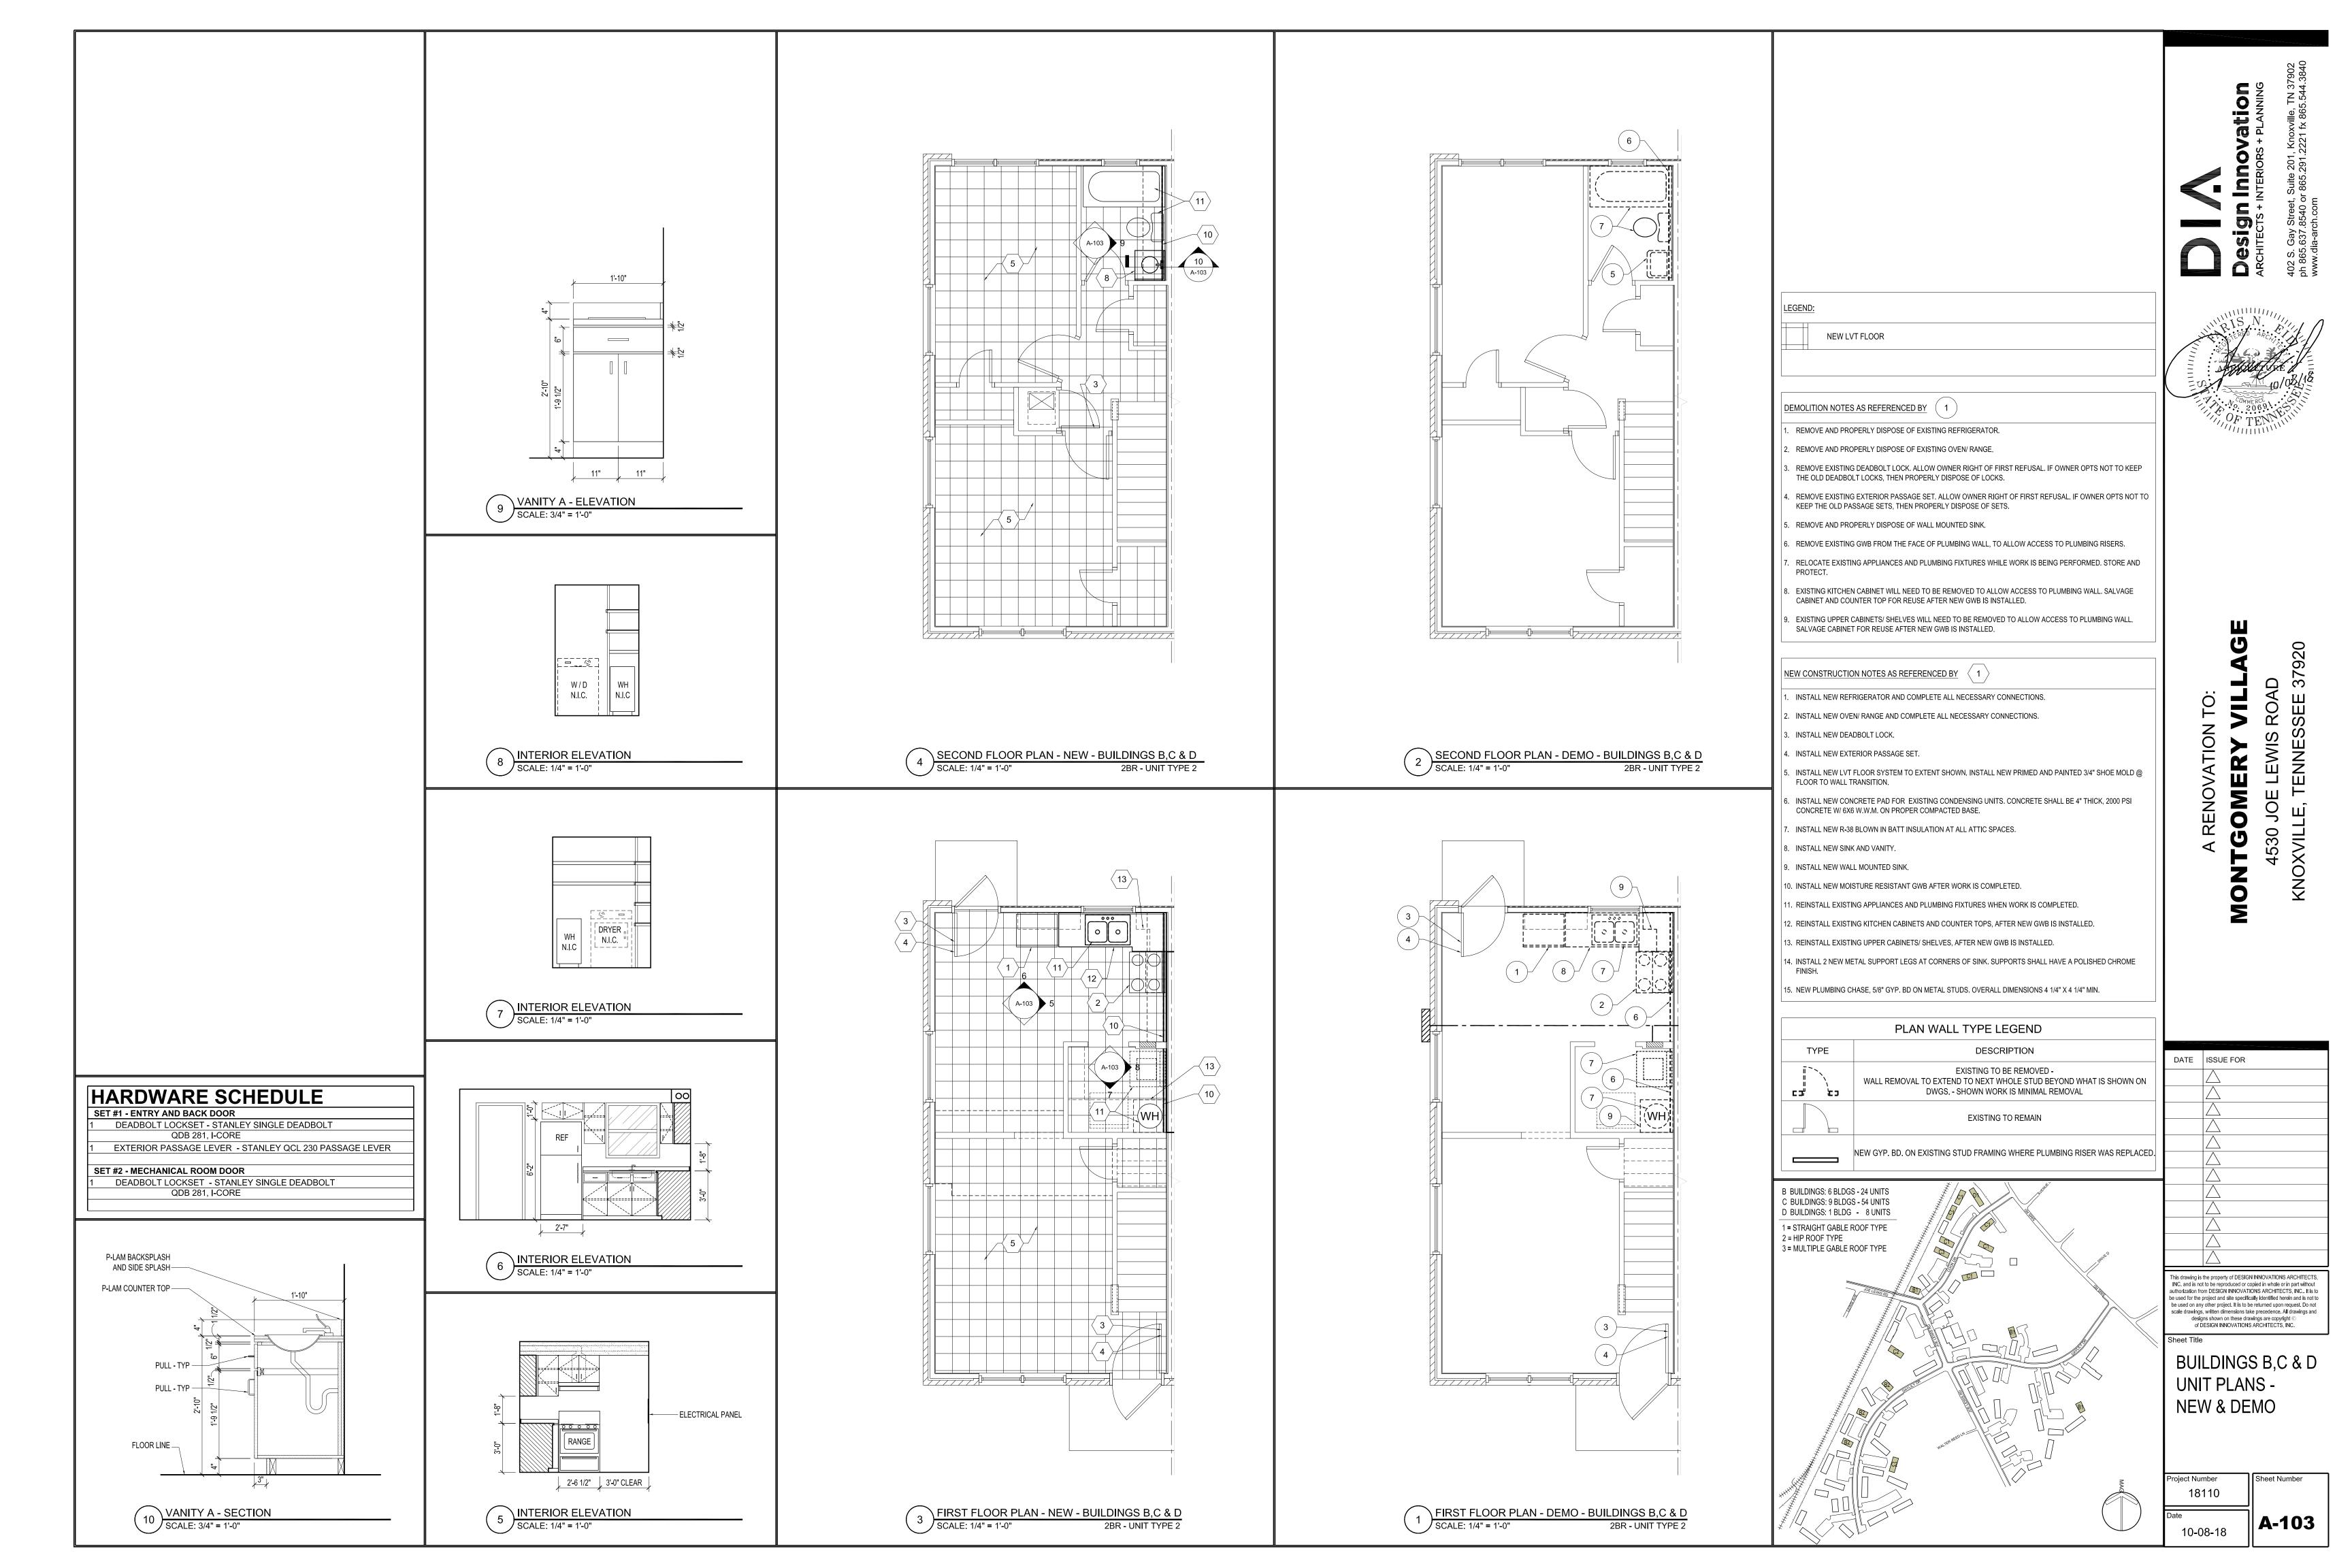





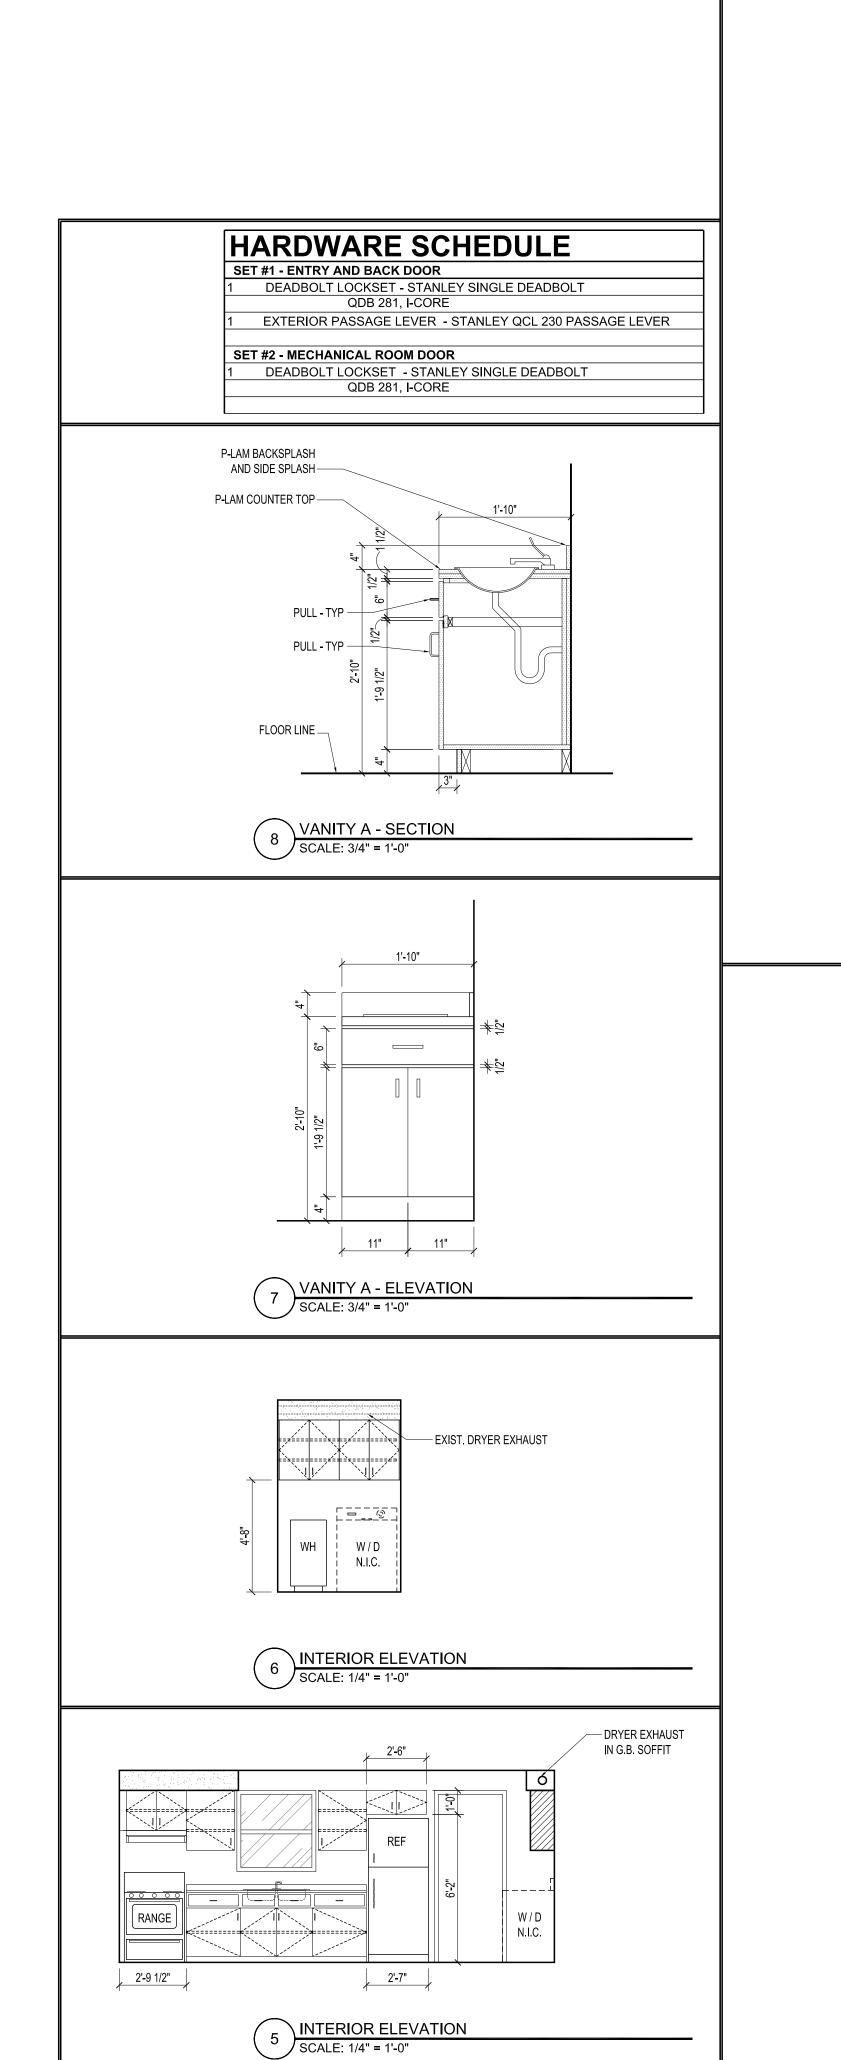

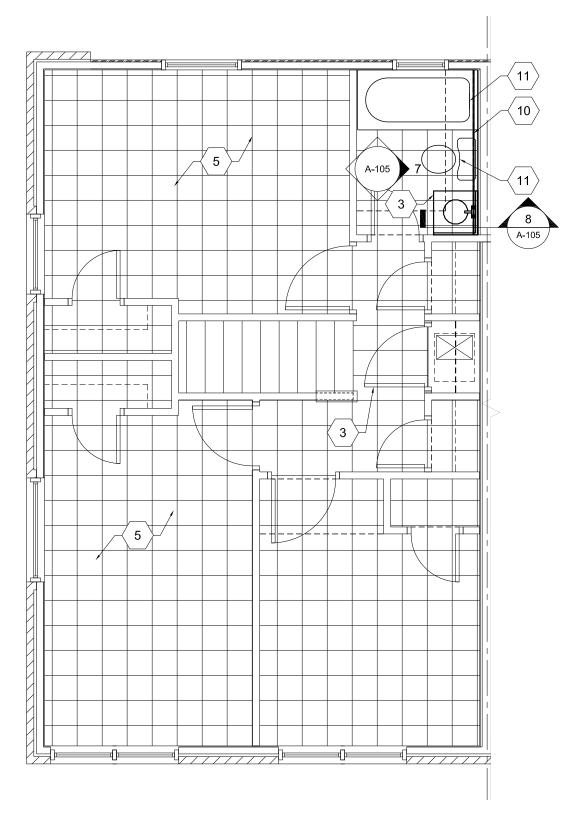





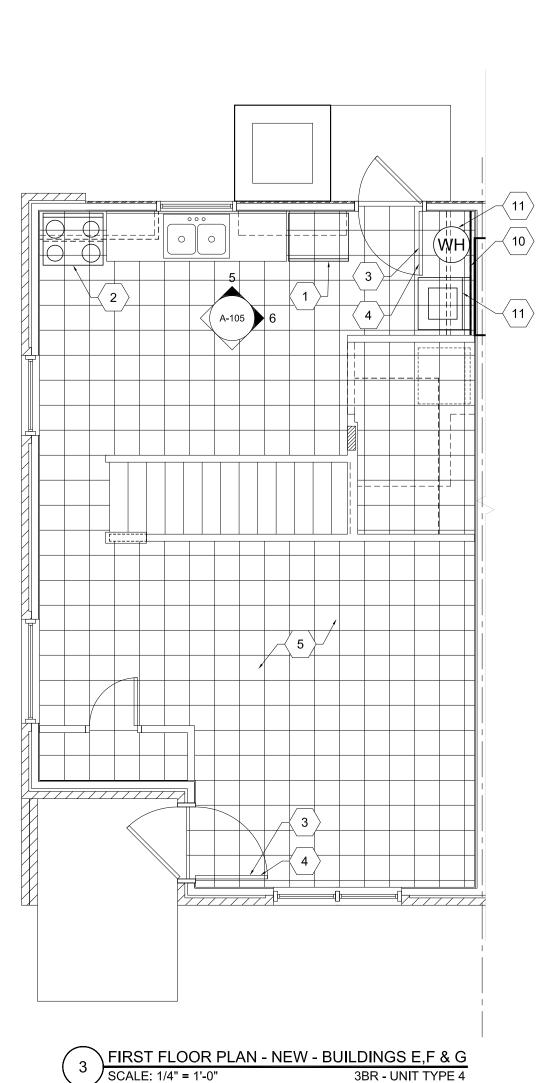

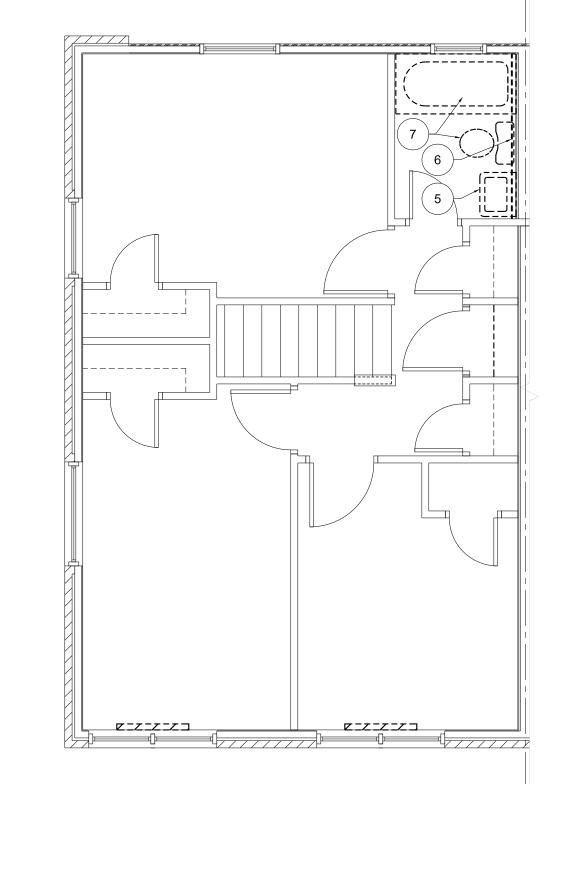

\ SECOND FLOOR PLAN - DEMO - BUILDINGS E,F & G 3BR - UNIT TYPE 4

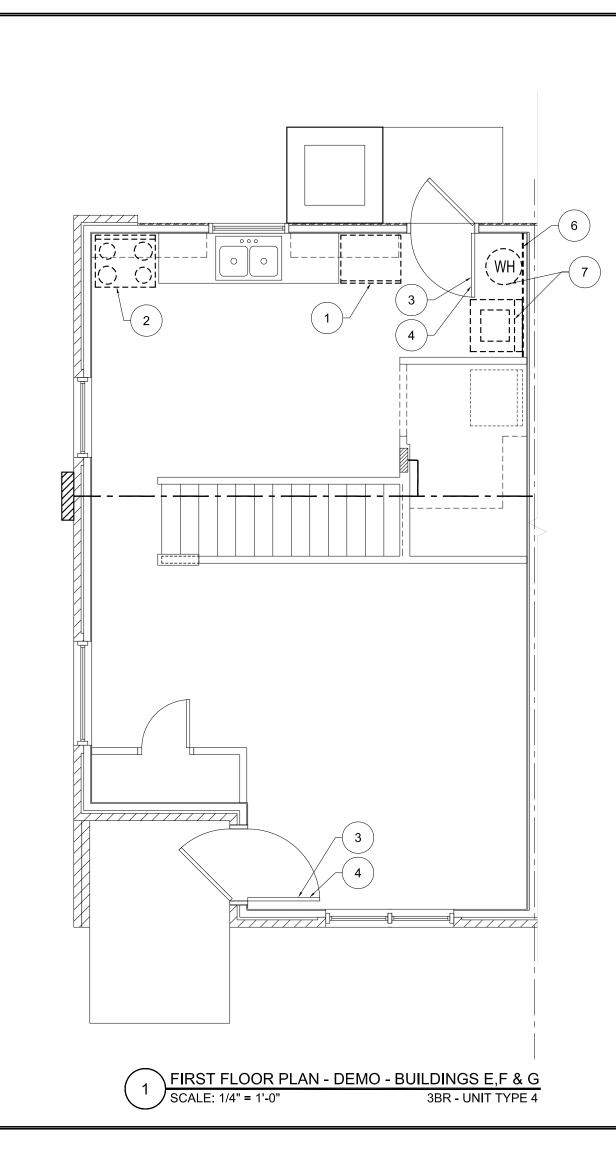

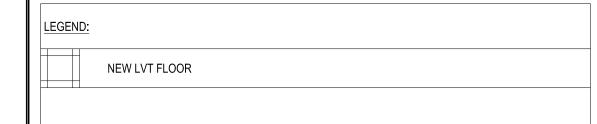

### DEMOLITION NOTES AS REFERENCED BY ( 1 )

- I. REMOVE AND PROPERLY DISPOSE OF EXISTING REFRIGERATOR.
- 2. REMOVE AND PROPERLY DISPOSE OF EXISTING OVEN/ RANGE.
- . REMOVE EXISTING DEADBOLT LOCK. ALLOW OWNER RIGHT OF FIRST REFUSAL. IF OWNER OPTS NOT TO KEEP THE OLD DEADBOLT LOCKS, THEN PROPERLY DISPOSE OF LOCKS.
- 4. REMOVE EXISTING EXTERIOR PASSAGE SET. ALLOW OWNER RIGHT OF FIRST REFUSAL. IF OWNER OPTS NOT TO
- KEEP THE OLD PASSAGE SETS, THEN PROPERLY DISPOSE OF SETS.
- 5. REMOVE AND PROPERLY DISPOSE OF WALL MOUNTED SINK. 6. REMOVE EXISTING GWB FROM THE FACE OF PLUMBING WALL, TO ALLOW ACCESS TO PLUMBING RISERS.

CABINET AND COUNTER TOP FOR REUSE AFTER NEW GWB IS INSTALLED.


- RELOCATE EXISTING APPLIANCES AND PLUMBING FIXTURES WHILE WORK IS BEING PERFORMED. STORE AND
- 8. EXISTING KITCHEN CABINET WILL NEED TO BE REMOVED TO ALLOW ACCESS TO PLUMBING WALL. SALVAGE
- 9. EXISTING UPPER CABINETS/ SHELVES WILL NEED TO BE REMOVED TO ALLOW ACCESS TO PLUMBING WALL. SALVAGE CABINET FOR REUSE AFTER NEW GWB IS INSTALLED.

### NEW CONSTRUCTION NOTES AS REFERENCED BY (1)

- . INSTALL NEW REFRIGERATOR AND COMPLETE ALL NECESSARY CONNECTIONS.
- 2. INSTALL NEW OVEN/ RANGE AND COMPLETE ALL NECESSARY CONNECTIONS.
- 3. INSTALL NEW DEADBOLT LOCK.
- 4. INSTALL NEW EXTERIOR PASSAGE SET.
- 5. INSTALL NEW LVT FLOOR SYSTEM TO EXTENT SHOWN. INSTALL NEW PRIMED AND PAINTED 3/4" SHOE MOLD @ FLOOR TO WALL TRANSITION.
- 6. INSTALL NEW CONCRETE PAD FOR EXISTING CONDENSING UNITS. CONCRETE SHALL BE 4" THICK, 2000 PSI CONCRETE W/ 6X6 W.W.M. ON PROPER COMPACTED BASE.
- INSTALL NEW R-38 BLOWN IN BATT INSULATION AT ALL ATTIC SPACES.
- 8. INSTALL NEW SINK AND VANITY.
- 9. INSTALL NEW WALL MOUNTED SINK.
- 10. INSTALL NEW MOISTURE RESISTANT GWB AFTER WORK IS COMPLETED.
- 11. REINSTALL EXISTING APPLIANCES AND PLUMBING FIXTURES WHEN WORK IS COMPLETED.
- 12. REINSTALL EXISTING KITCHEN CABINETS AND COUNTER TOPS, AFTER NEW GWB IS INSTALLED.
- 13. REINSTALL EXISTING UPPER CABINETS/ SHELVES, AFTER NEW GWB IS INSTALLED.
- 14. INSTALL 2 NEW METAL SUPPORT LEGS AT CORNERS OF SINK. SUPPORTS SHALL HAVE A POLISHED CHROME

15. NEW PLUMBING CHASE, 5/8" GYP. BD ON METAL STUDS. OVERALL DIMENSIONS 4 1/4" X 4 1/4" MIN.


	PLAN WALL TYPE LEGEND
TYPE	DESCRIPTION
[] [] [] []	EXISTING TO BE REMOVED - WALL REMOVAL TO EXTEND TO NEXT WHOLE STUD BEYOND WHAT IS SHOWN ON DWGS SHOWN WORK IS MINIMAL REMOVAL
	EXISTING TO REMAIN
	NEW GYP. BD. ON EXISTING STUD FRAMING WHERE PLUMBING RISER WAS REPLACE

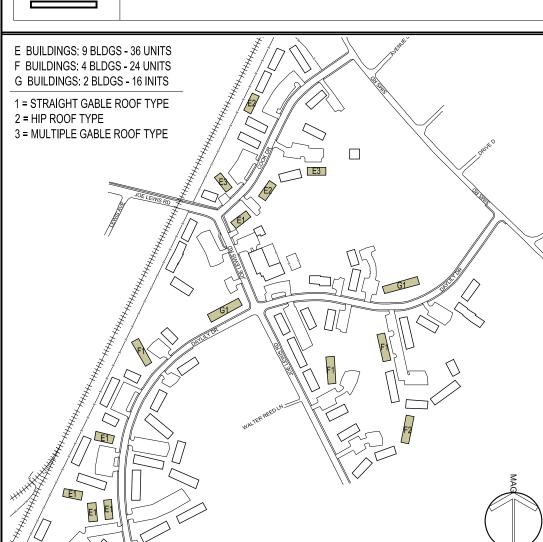


DATE ISSUE FOR


This drawing is the property of DESIGN INNOVATIONS ARCHITECTS, INC. and is not to be reproduced or copied in whole or in part without authorization from DESIGN INNOVATIONS ARCHITECTS, INC.. It is to be used for the project and site specifically identified herein and is not to be used on any other project. It is to be returned upon request. Do not scale drawings, written dimensions take precedence. All drawings and designs shown on these drawings are copyright © of DESIGN INNOVATIONS ARCHITECTS, INC.


BUILDINGS E,F & G UNIT PLANS -NEW & DEMO

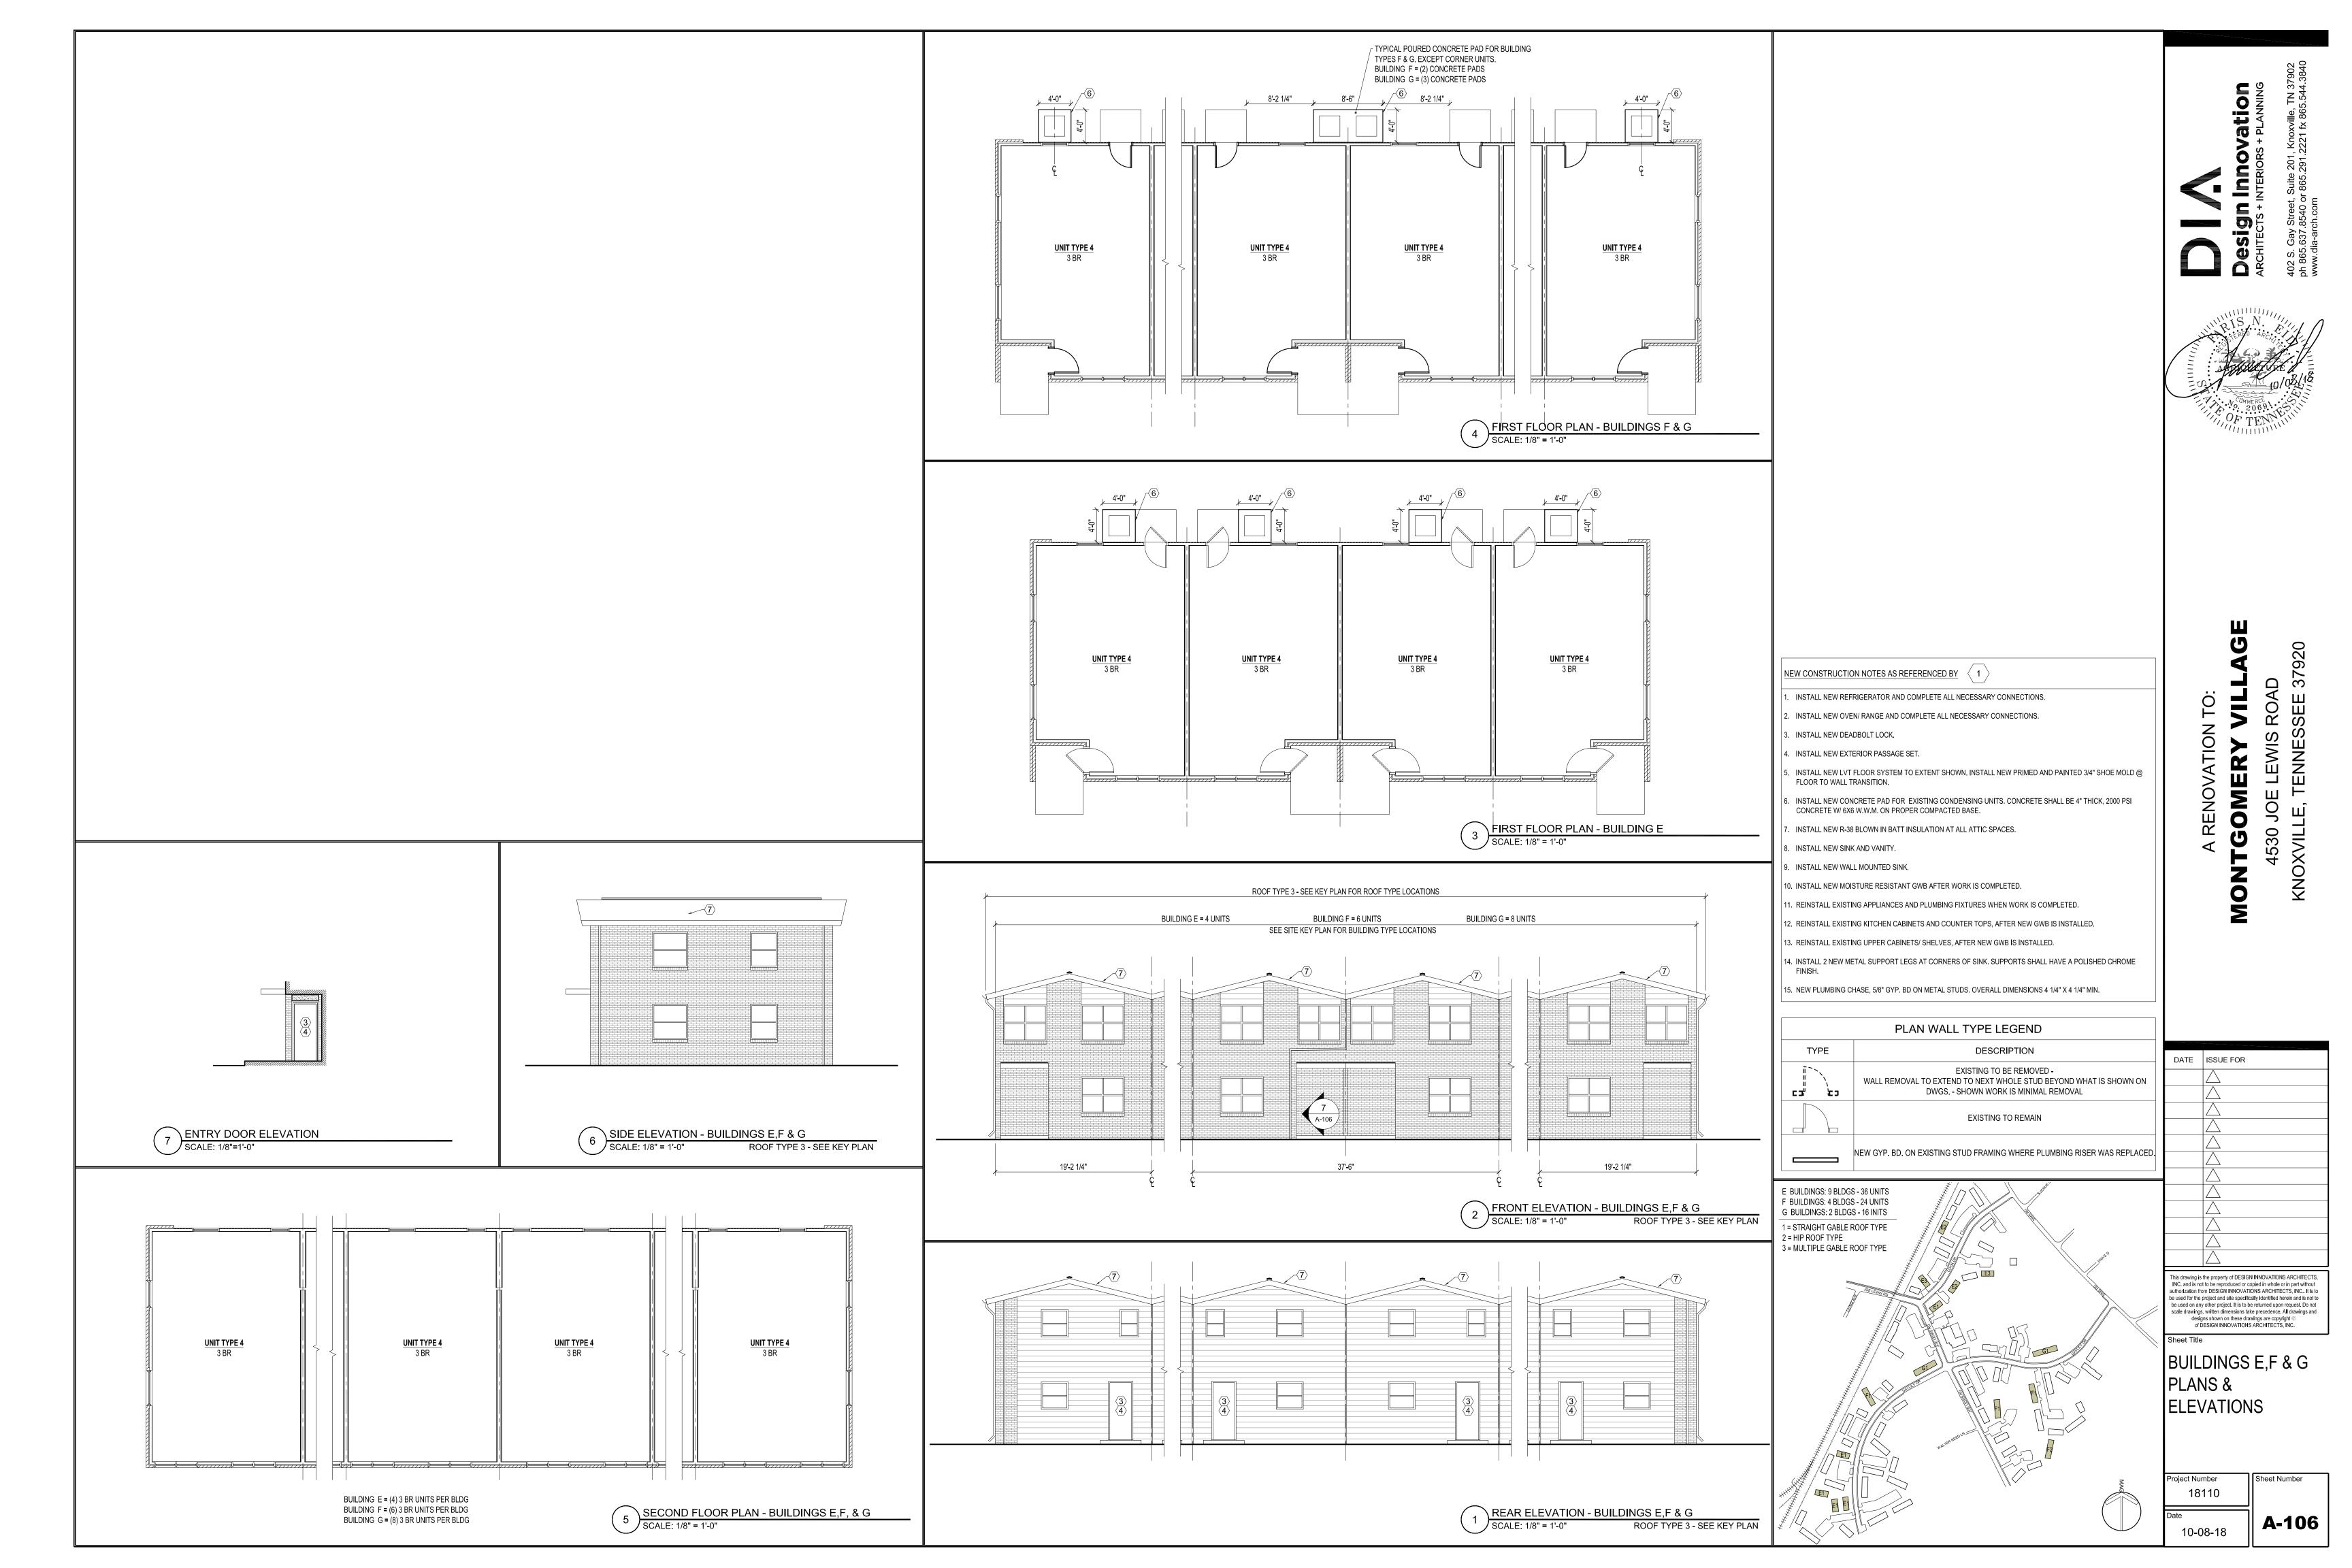

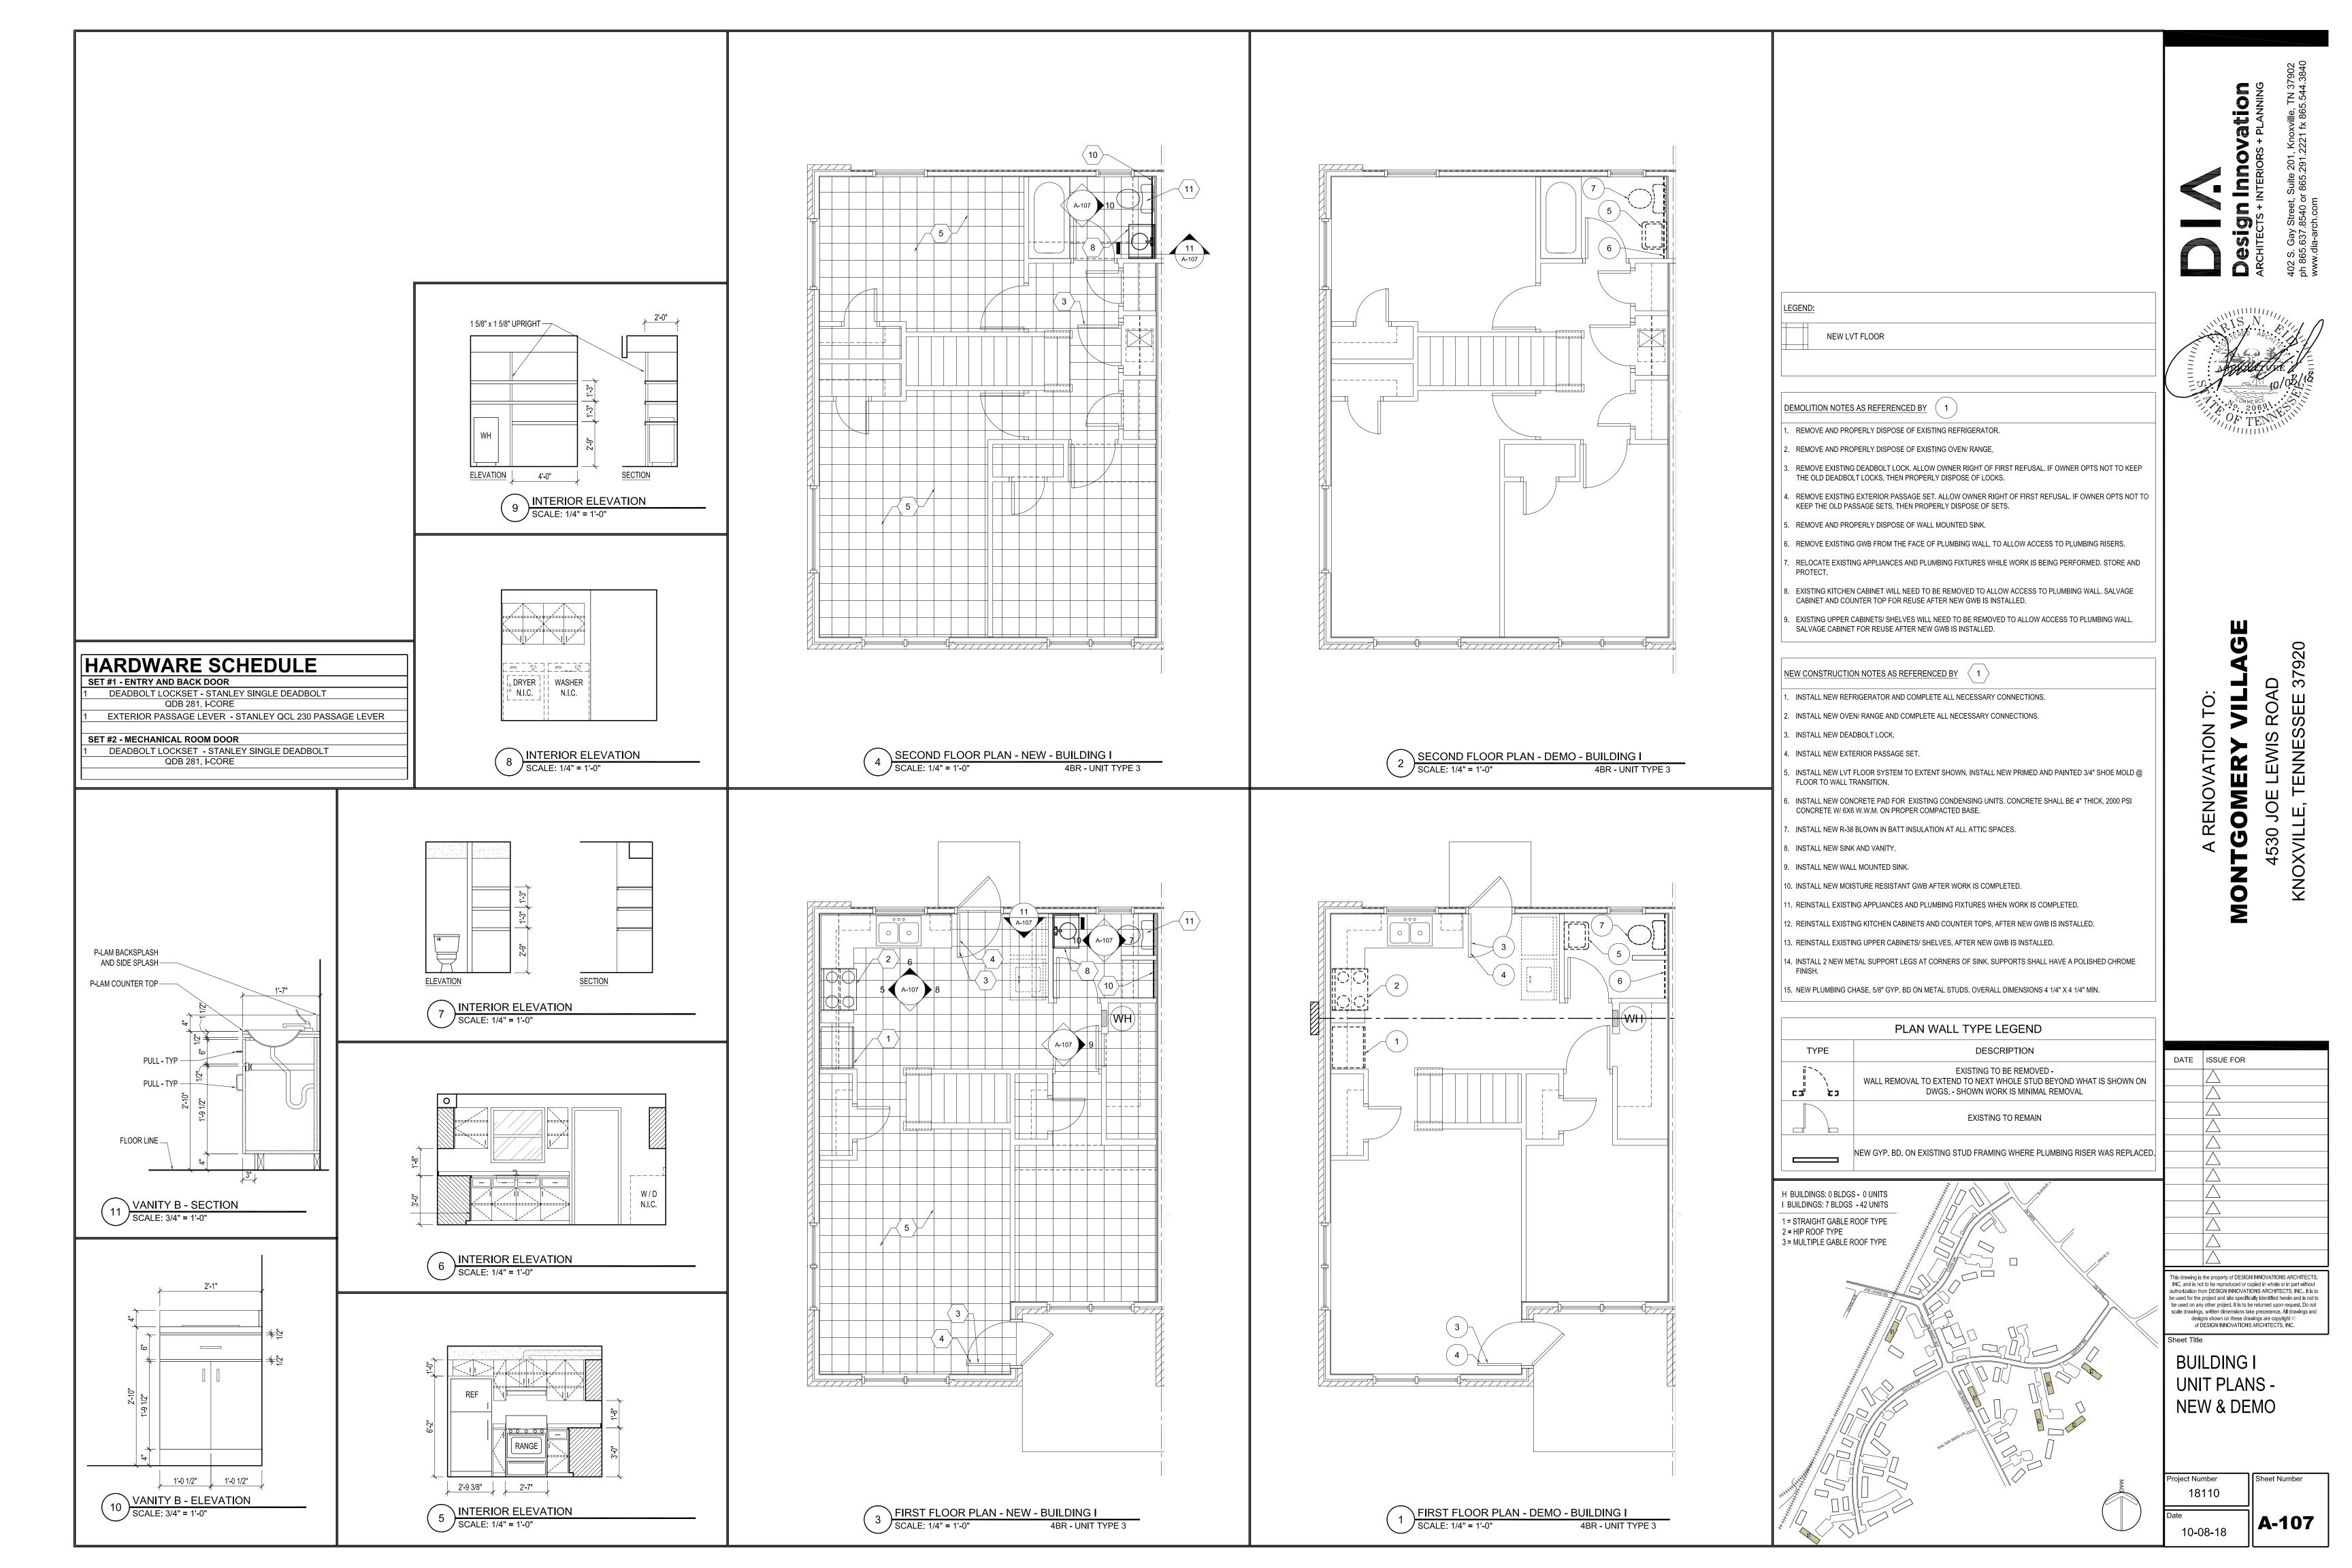




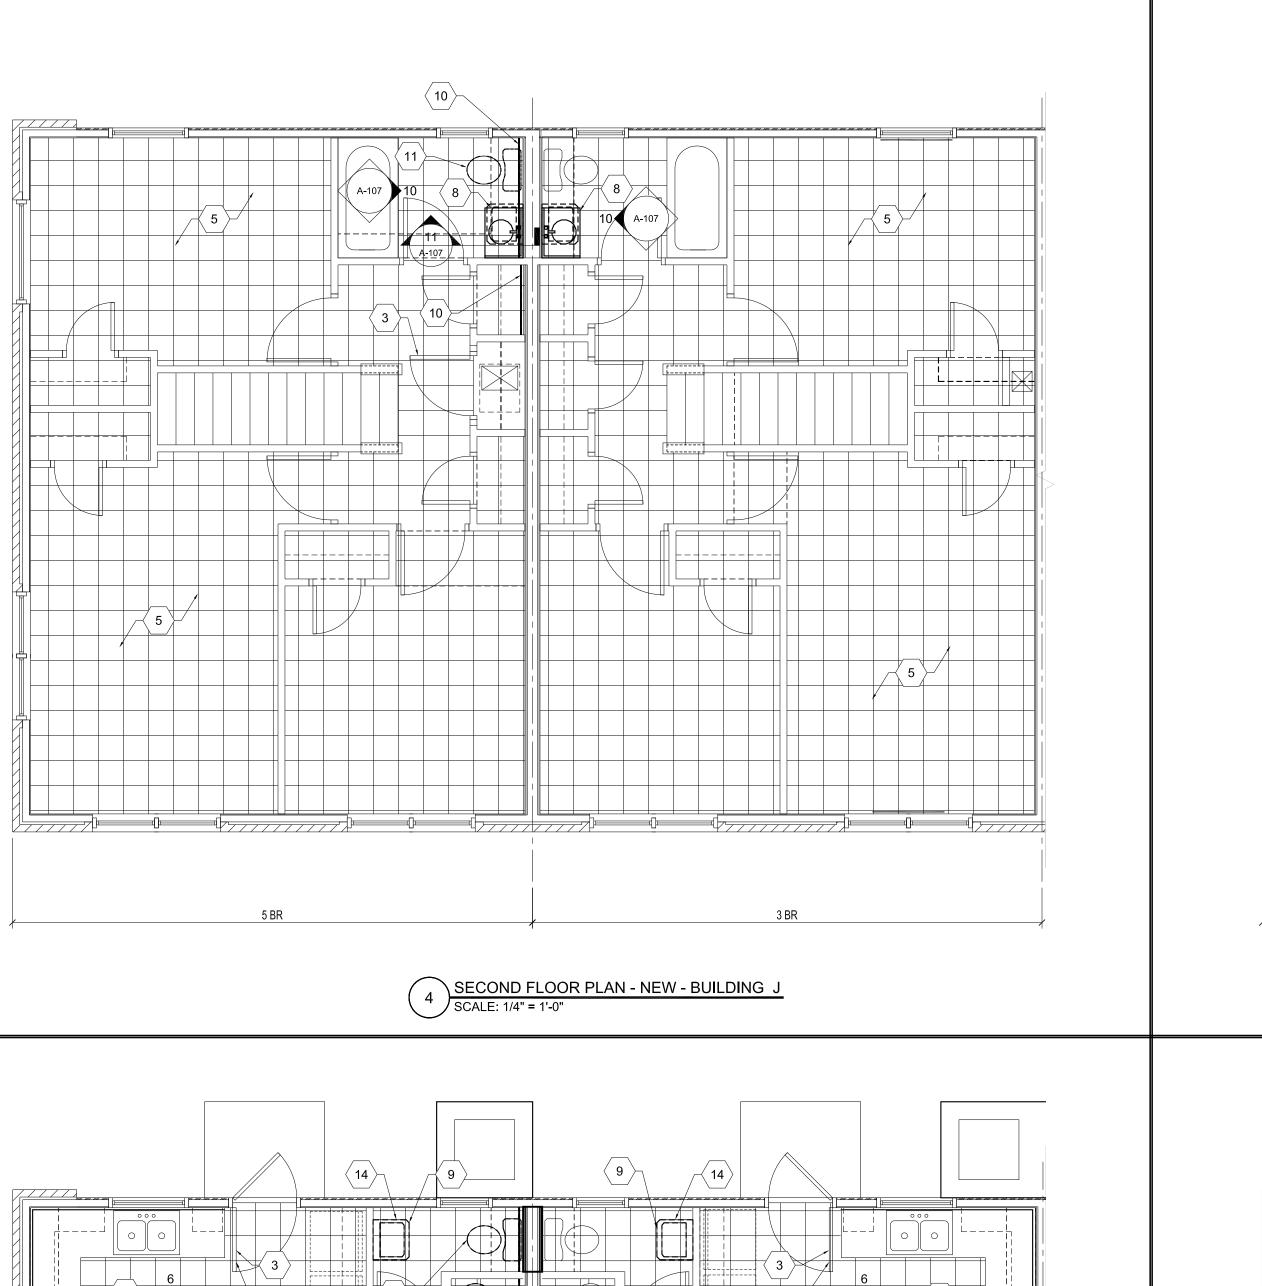


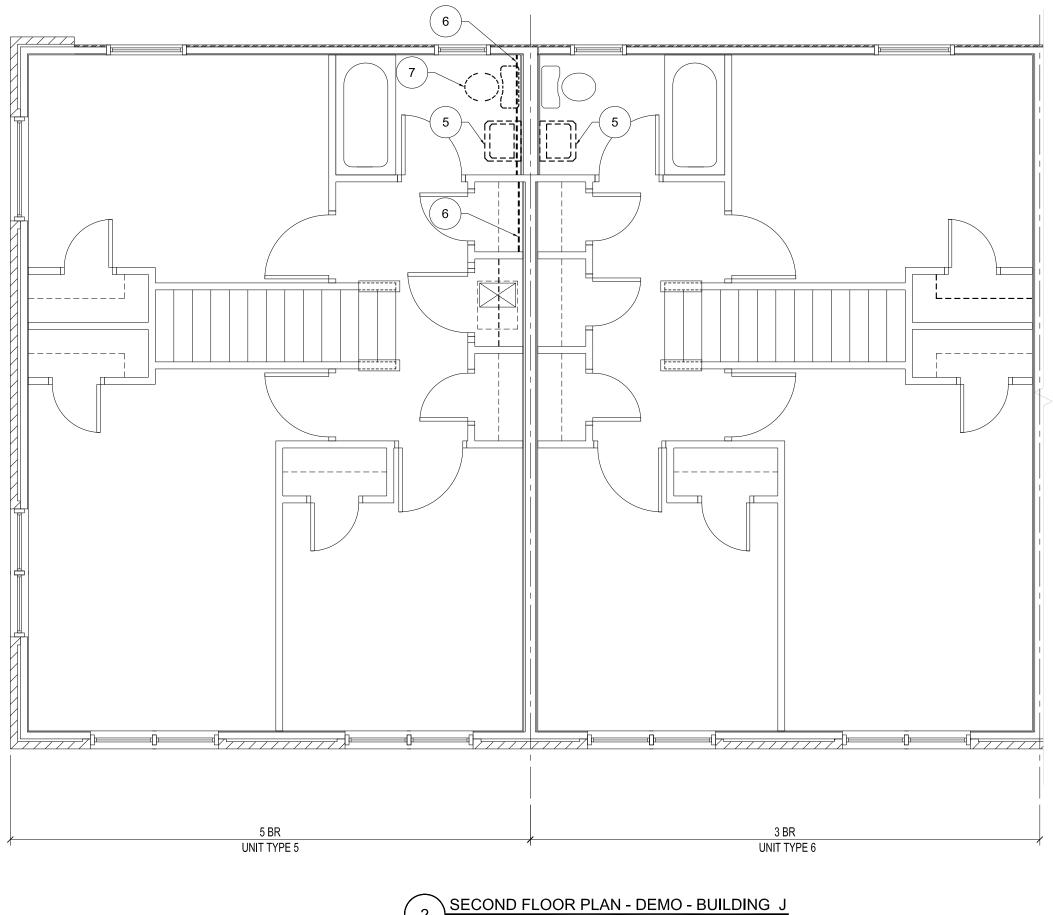


SCALE: 1/4" = 1'-0"

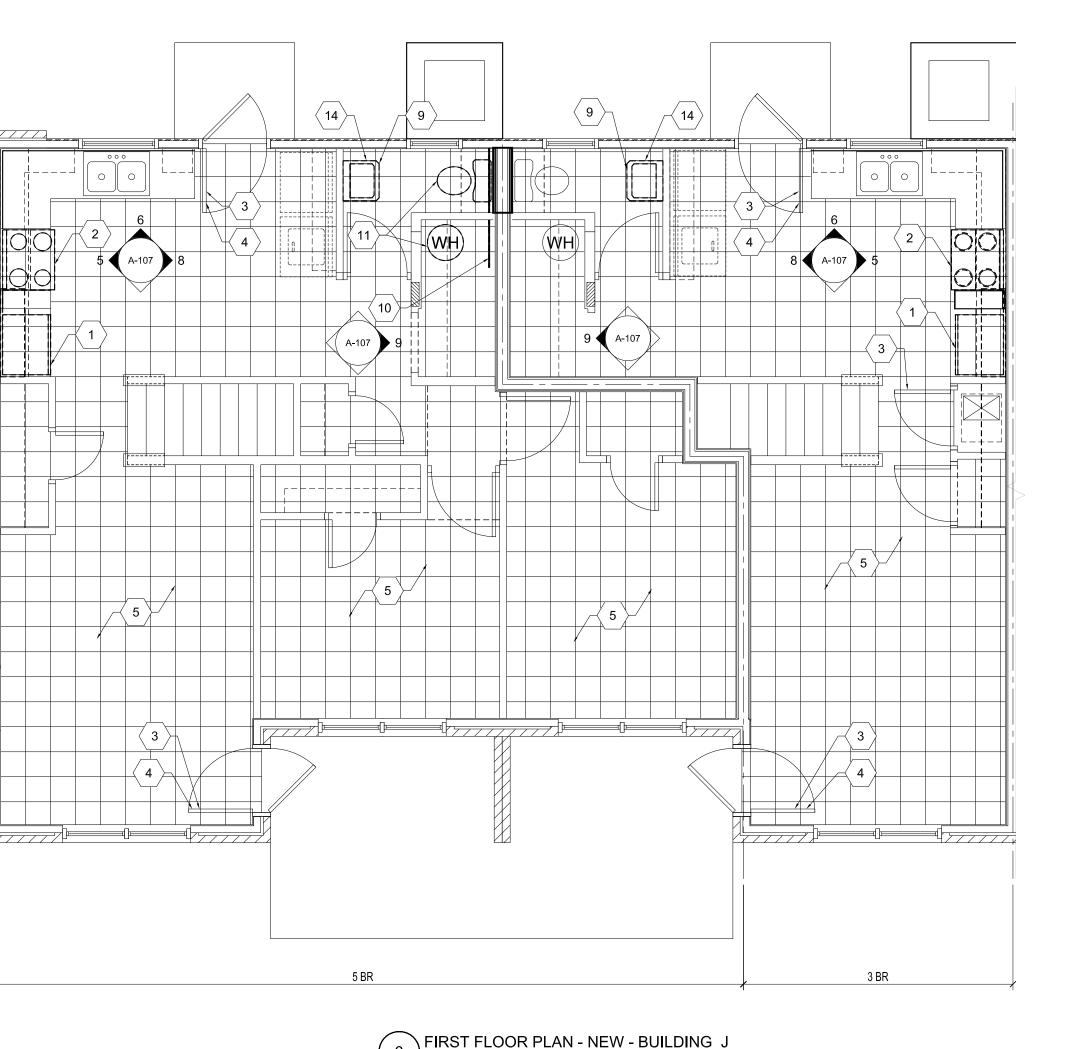

SCALE: 1/4" = 1'-0"

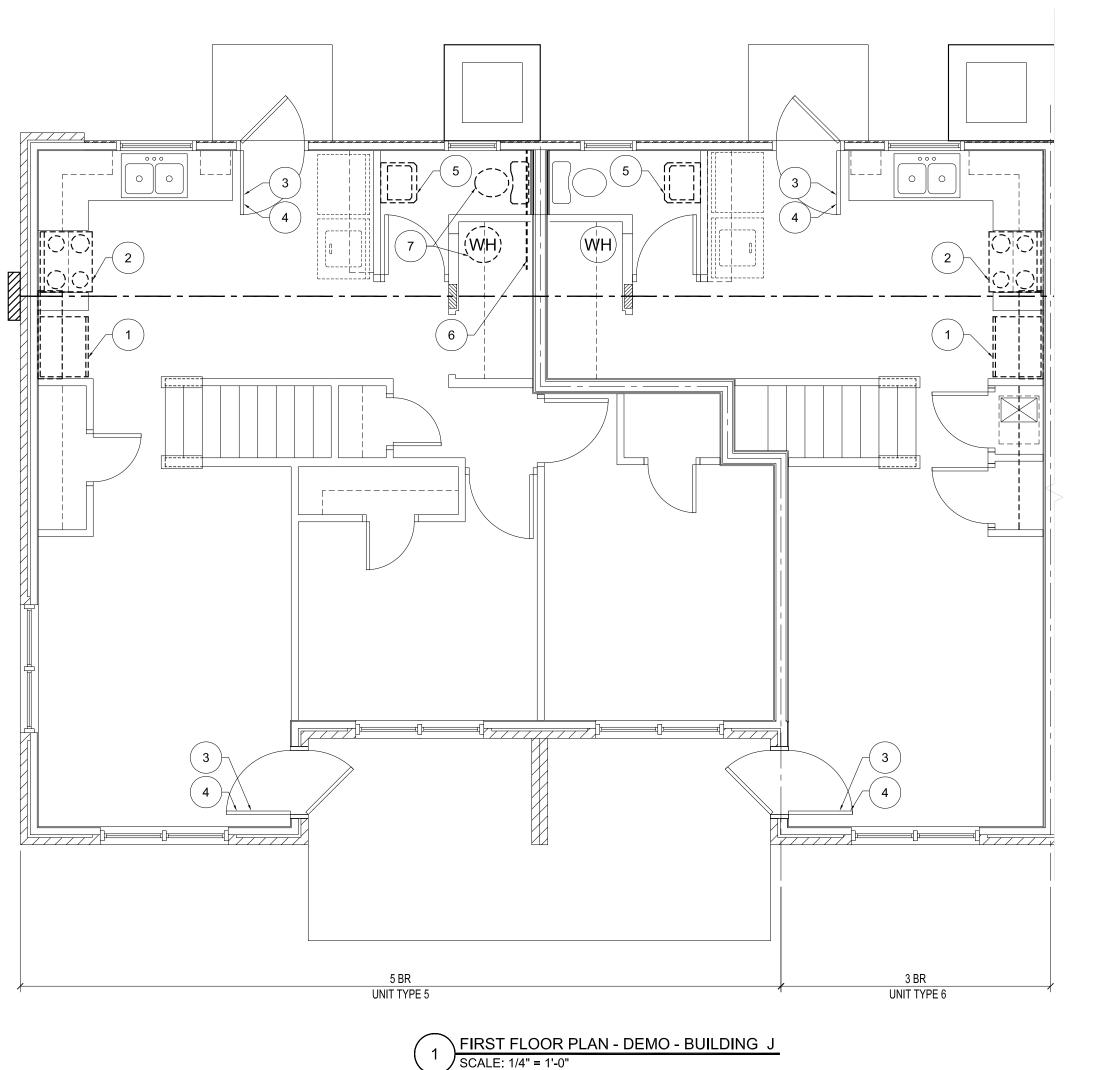

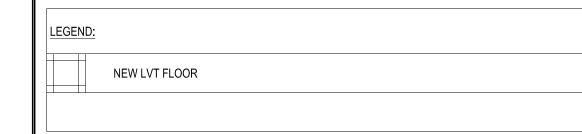


### DEMOLITION NOTES AS REFERENCED BY (1)


- 1. REMOVE AND PROPERLY DISPOSE OF EXISTING REFRIGERATOR.
- 2. REMOVE AND PROPERLY DISPOSE OF EXISTING OVEN/ RANGE.
- . REMOVE EXISTING DEADBOLT LOCK. ALLOW OWNER RIGHT OF FIRST REFUSAL. IF OWNER OPTS NOT TO KEEP THE OLD DEADBOLT LOCKS, THEN PROPERLY DISPOSE OF LOCKS.
- 4. REMOVE EXISTING EXTERIOR PASSAGE SET. ALLOW OWNER RIGHT OF FIRST REFUSAL, IF OWNER OPTS NOT TO
- KEEP THE OLD PASSAGE SETS, THEN PROPERLY DISPOSE OF SETS.
- 5. REMOVE AND PROPERLY DISPOSE OF WALL MOUNTED SINK.
- 6. REMOVE EXISTING GWB FROM THE FACE OF PLUMBING WALL, TO ALLOW ACCESS TO PLUMBING RISERS.
- RELOCATE EXISTING APPLIANCES AND PLUMBING FIXTURES WHILE WORK IS BEING PERFORMED. STORE AND
- 8. EXISTING KITCHEN CABINET WILL NEED TO BE REMOVED TO ALLOW ACCESS TO PLUMBING WALL. SALVAGE CABINET AND COUNTER TOP FOR REUSE AFTER NEW GWB IS INSTALLED.
- 9. EXISTING UPPER CABINETS/ SHELVES WILL NEED TO BE REMOVED TO ALLOW ACCESS TO PLUMBING WALL. SALVAGE CABINET FOR REUSE AFTER NEW GWB IS INSTALLED.

### NEW CONSTRUCTION NOTES AS REFERENCED BY (1)

- . INSTALL NEW REFRIGERATOR AND COMPLETE ALL NECESSARY CONNECTIONS.
- 2. INSTALL NEW OVEN/ RANGE AND COMPLETE ALL NECESSARY CONNECTIONS.
- 3. INSTALL NEW DEADBOLT LOCK.
- 4. INSTALL NEW EXTERIOR PASSAGE SET.
- 5. INSTALL NEW LVT FLOOR SYSTEM TO EXTENT SHOWN. INSTALL NEW PRIMED AND PAINTED 3/4" SHOE MOLD @ FLOOR TO WALL TRANSITION.
- 6. INSTALL NEW CONCRETE PAD FOR EXISTING CONDENSING UNITS. CONCRETE SHALL BE 4" THICK, 2000 PSI CONCRETE W/ 6X6 W.W.M. ON PROPER COMPACTED BASE.
- INSTALL NEW R-38 BLOWN IN BATT INSULATION AT ALL ATTIC SPACES.
- 8. INSTALL NEW SINK AND VANITY.
- 9. INSTALL NEW WALL MOUNTED SINK.
- 10. INSTALL NEW MOISTURE RESISTANT GWB AFTER WORK IS COMPLETED.
- 11. REINSTALL EXISTING APPLIANCES AND PLUMBING FIXTURES WHEN WORK IS COMPLETED.
- 12. REINSTALL EXISTING KITCHEN CABINETS AND COUNTER TOPS, AFTER NEW GWB IS INSTALLED.
- 13. REINSTALL EXISTING UPPER CABINETS/ SHELVES, AFTER NEW GWB IS INSTALLED.
- 14. INSTALL 2 NEW METAL SUPPORT LEGS AT CORNERS OF SINK. SUPPORTS SHALL HAVE A POLISHED CHROME
- 15. NEW PLUMBING CHASE, 5/8" GYP. BD ON METAL STUDS. OVERALL DIMENSIONS 4 1/4" X 4 1/4" MIN.

	PLAN WALL TYPE LEGEND
TYPE	DESCRIPTION
C3, F3	EXISTING TO BE REMOVED - WALL REMOVAL TO EXTEND TO NEXT WHOLE STUD BEYOND WHAT IS SHOWN ON DWGS SHOWN WORK IS MINIMAL REMOVAL
	EXISTING TO REMAIN
	NEW GYP. BD. ON EXISTING STUD FRAMING WHERE PLUMBING RISER WAS REPLACED.

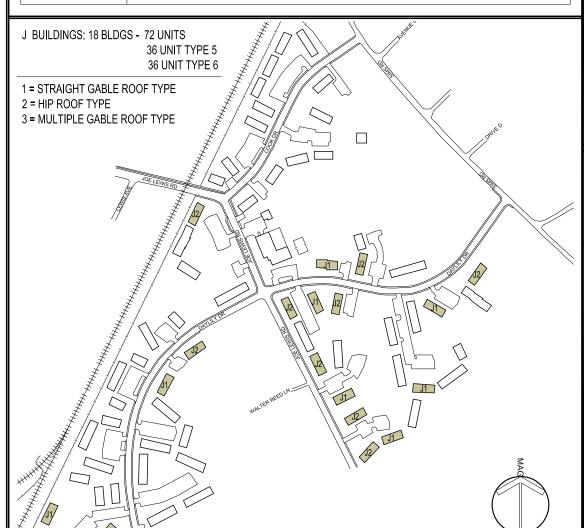


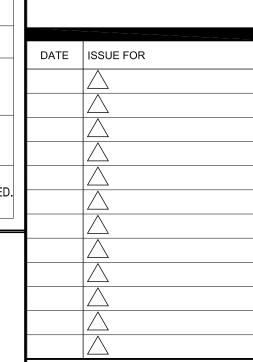



This drawing is the property of DESIGN INNOVATIONS ARCHITECTS, INC. and is not to be reproduced or copied in whole or in part without authorization from DESIGN INNOVATIONS ARCHITECTS, INC.. It is to be used for the project and site specifically identified herein and is not to be used on any other project. It is to be returned upon request. Do not scale drawings, written dimensions take precedence. All drawings and designs shown on these drawings are copyright © of DESIGN INNOVATIONS ARCHITECTS, INC.


**BUILDING J UNIT PLANS -NEW & DEMO** 




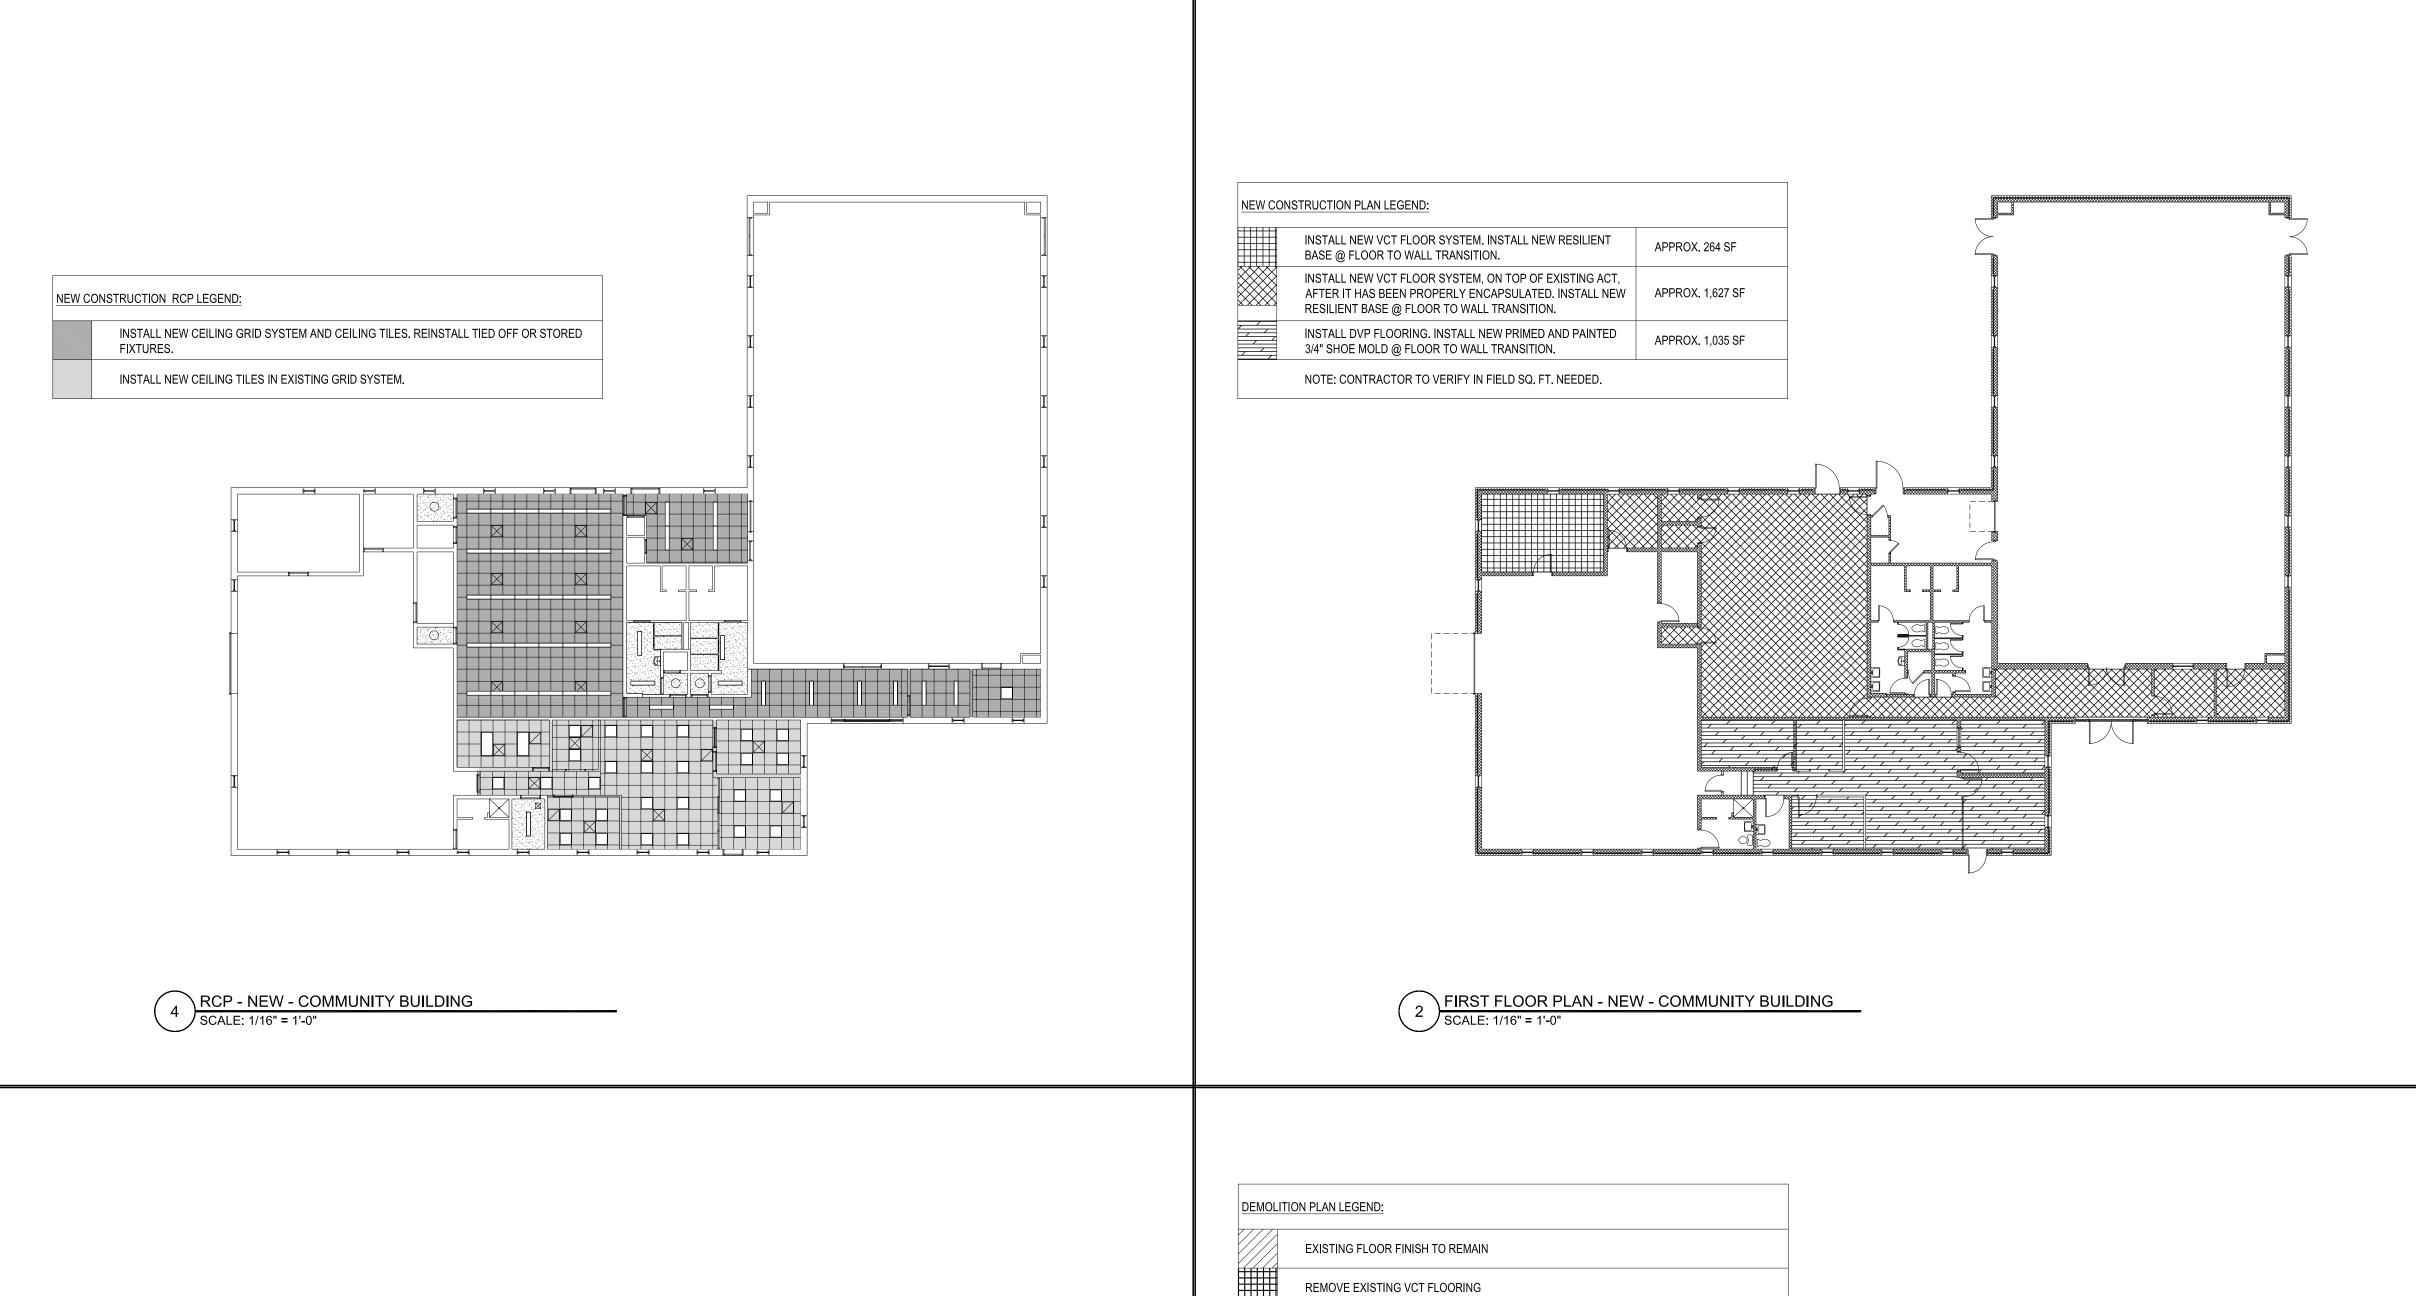

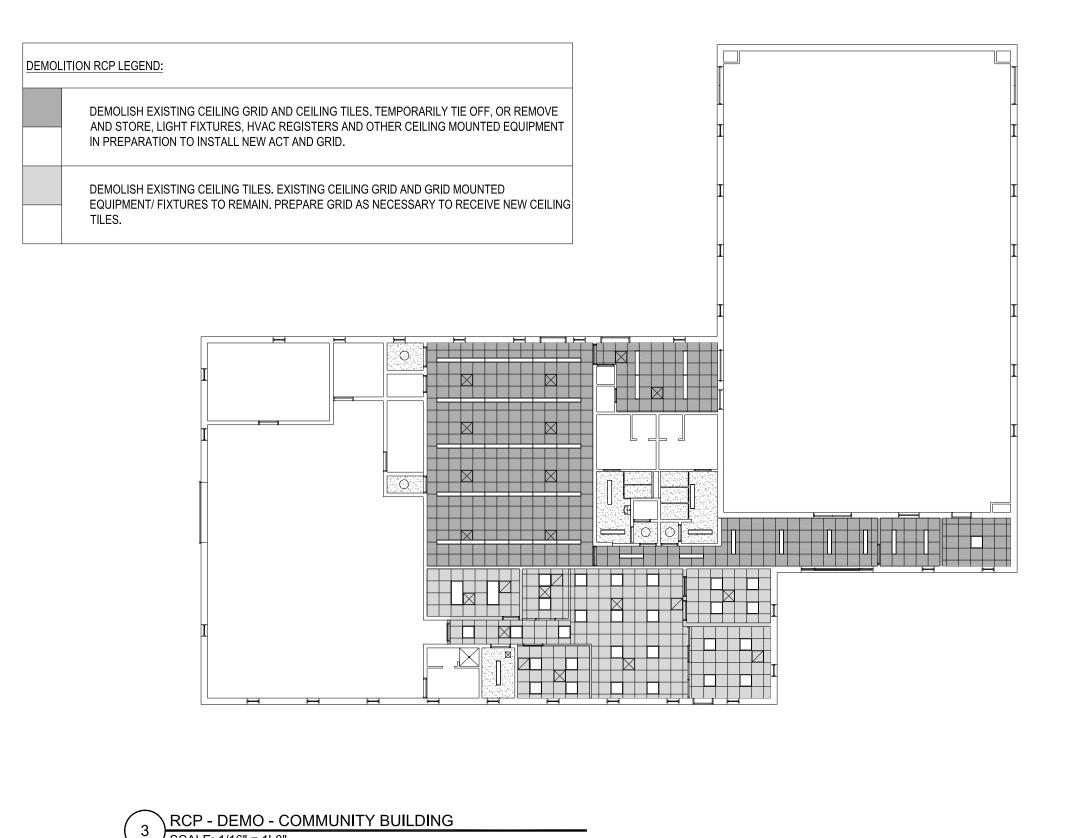

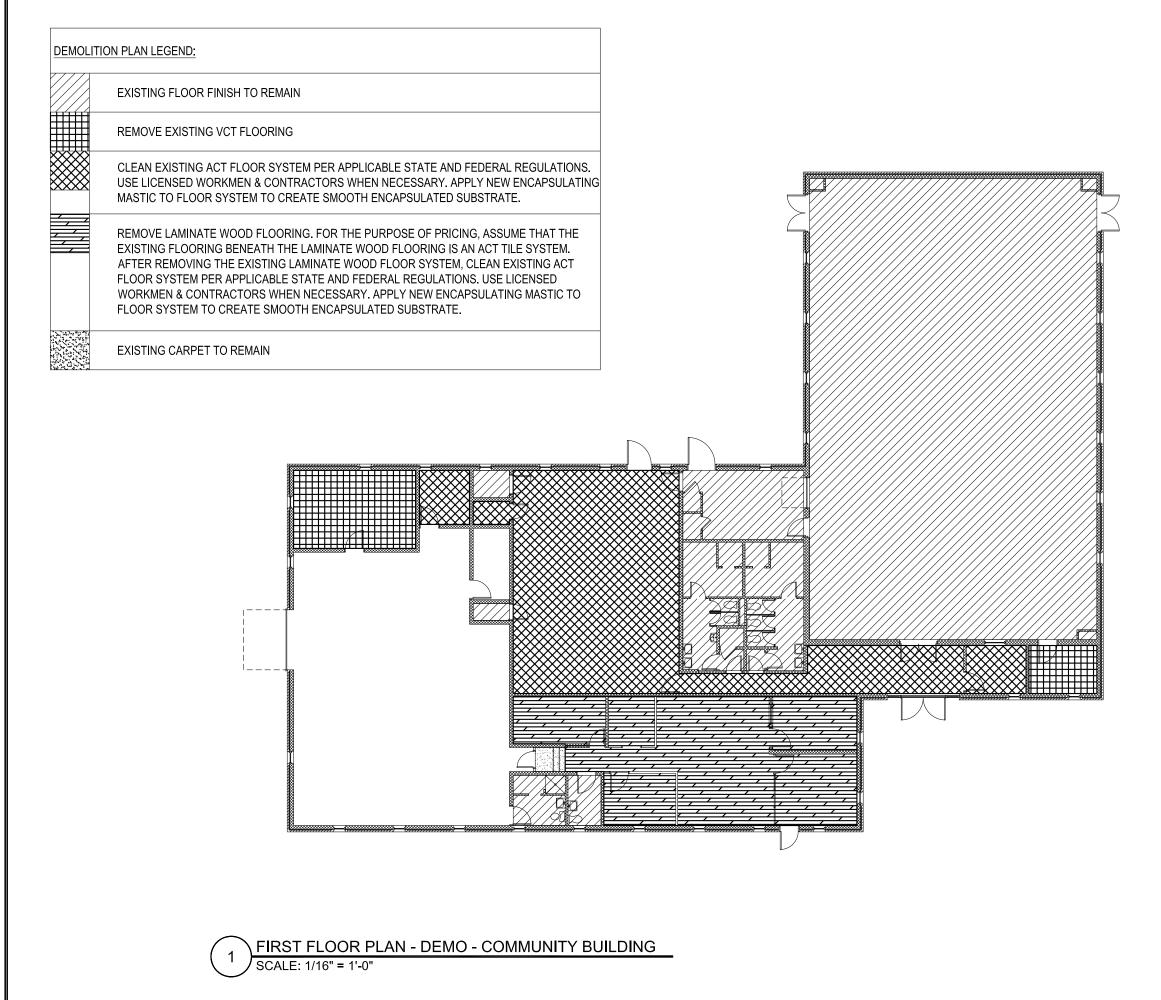

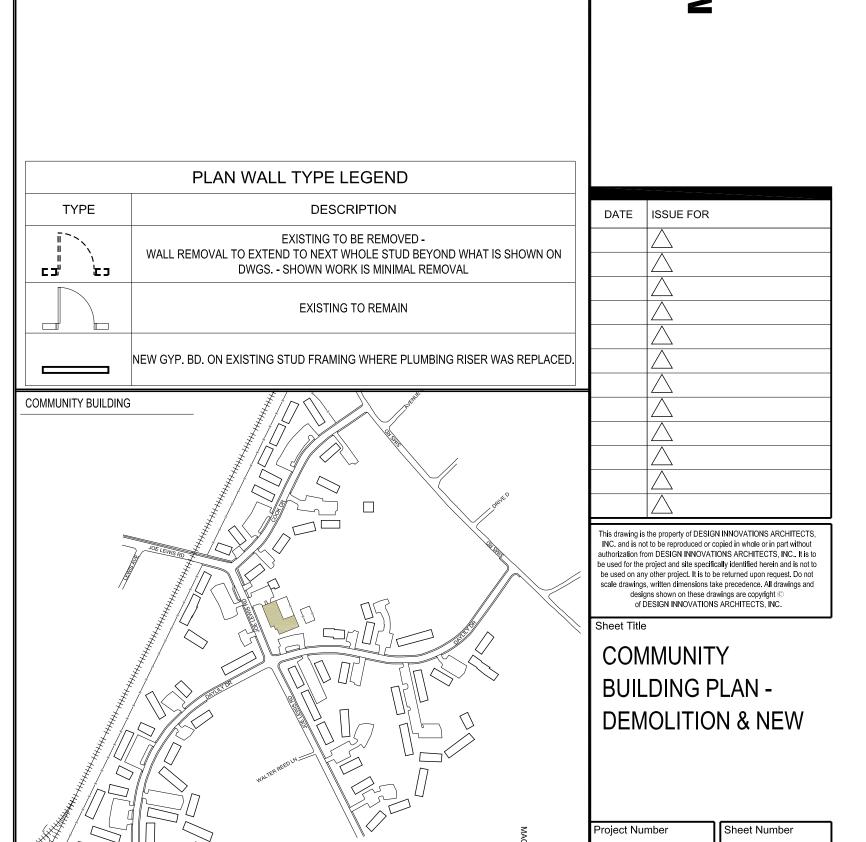


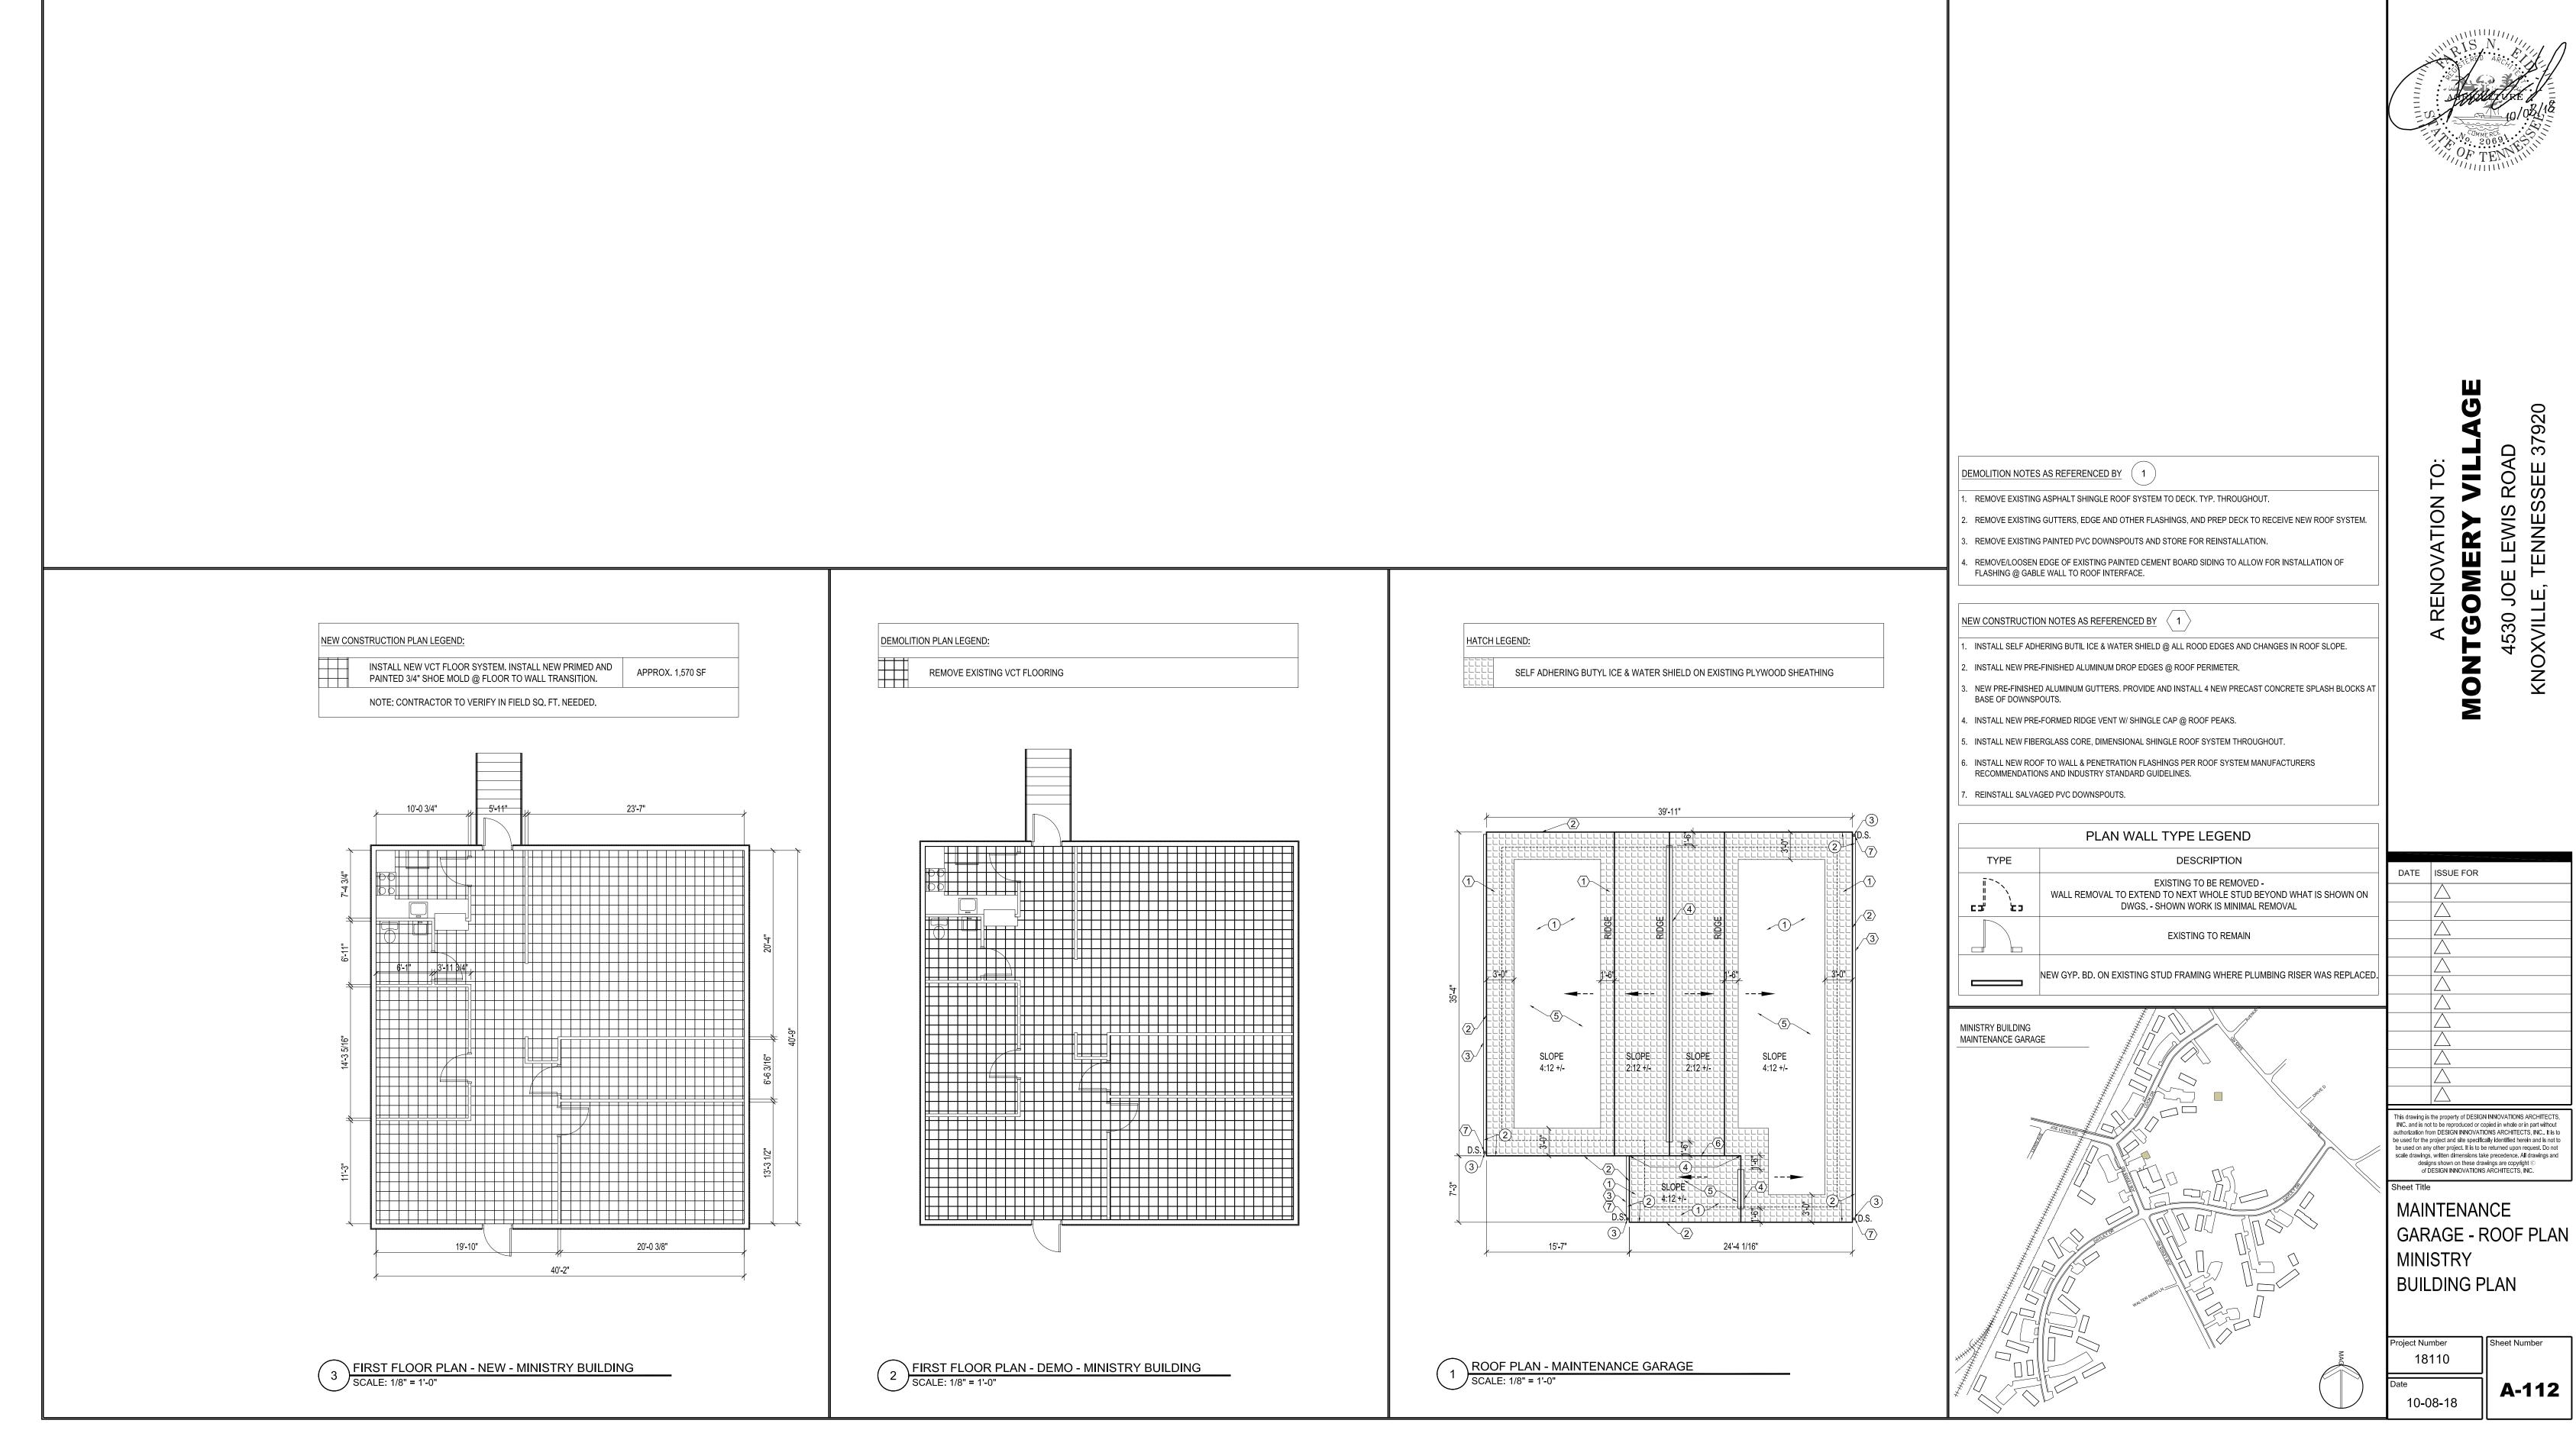

Design Innovation

ARCHITECTS + INTERIORS + PLANNING

402 S. Gay Street, Suite 201, Knoxville, TN 3790

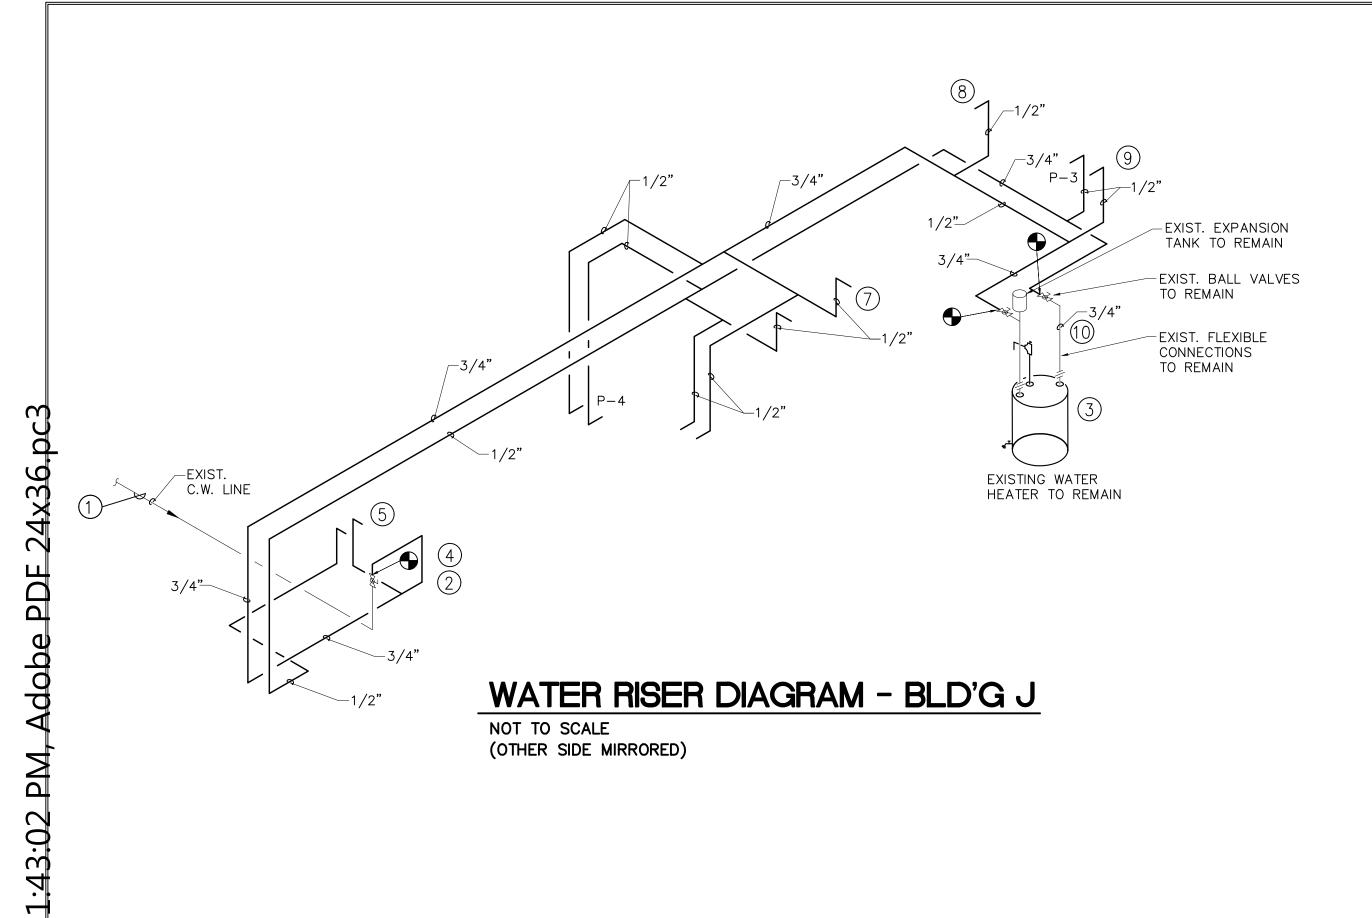

### GENERAL DEMOLITION NOTES

- 1. CONTRACTOR SHALL REMOVE EXISTING FIXTURES AS INDICATED BY DASHED LINES.
- 2. CONTRACTOR SHALL DISPOSE OF REMOVED FIXTURES AS INDICATED BY OWNER.
- 3. CONTRACTOR SHALL VERIFY ALL EXISTING CONDITIONS INCLUDING EXACT PIPE LOCATION, SIDE BEFORE STARTING CONSTRUCTION.
- 4. DEMOLITION WORK SHALL BE COORDINATED WITH ALL OTHER TRADES AND WITH THE NEW CONSTRUCTION PLANS FOR THE EXACT SCOPE OF WORK.
- 5. EXISTING ROUTING AND LOCATION OF PIPING, IS BASED ON LIMITED OBSERVATION AND LIMITED CONTRACT DOCUMENTS. CONTRACTOR SHALL ACCOUNT FOR SUCH IN BID.
- 6. ALL EXISTING WALLS, CEILING AND SLAB BEING CUT OR DAMAGED UNDER THIS CONTRACT TO BE PATCHED BACK TO MATCH EXISTING FINISH AND FIRE PROTECTION RATING. COORDINATE RE UIREMENTS WITH ARCHITECTURAL
- 7. WHETHER SHOWN OR NOT ALL EXISTING DOMESTIC WATER PIPING TO BE REMOVED OR ABANDONED.

PLUM	PLUMBING LEGEND		
SYMBOL	DESCRIPTION		
<u> </u>	COLD WATER PIPING		
— HW —	HOT WATER PIPING		
HWR	HOT WATER RICIRCULATION PIPING		
•	INDICATES NEW WORK TO CONNECT TO EXISTING WORK AT THIS POINT.		
P - 🗆	PLUMBING FIXTURE DESIGNATION		
	END CAP		

		17"			
		MIN. 8"			
LAVATORY		4"			
CARRIER		8"	12"	16"	<u> </u>
		MIN.			34" MAX.
9" MIN.	<b>-</b>	ADA (	CLEARANCES      27" 29"  MIN. MIN.		

### CONTRACTOR TO FIELD MODIFY P-TRAP AND OFFSET DRAIN TO EXACT SIZES AS SHOWN.

# ADA LAVATORY INSTALLATION DETAIL NOT TO SCALE

# FIXTURE CONNECTION SCHEDULE

	TIXTORE CONNECTION COLL			
		СО	NNECTION S	I□E
SYMBOL	DESCRIPTION	WASTE	COLD WATER	HOT WATER
P-1	LAVATORY, ADA	114"	1[2"	1 [2"
P-2	HAND HELD SHOWER			1[2"
P-3	LAVATORY	1-1 ⊈"	1[2"	1[2"
P-4	VANITY WITH LAVATORY	1-1 ⊈"	1[2"	1[2"

### NOTES:

10/5/2018

Montgomery Village\Cadd\DWG\180484-P200.c

2018\180484 KCDC

- 1. 1. ALL WALL MTD. LAVATORIES SHALL BE PROVIDED WITH FLOOR MOUNTED
- 2. ALL EXPOSED P-TRAPS SHALL BE PROVIDED WILAV SHIELDS.
- 3. PROVIDE OFFSET GRID DRAINS AT BARRIER-FREE LOCATIONS.

### NEW CONSTRUCTION KEYED NOTES

- 1. EXISTING ¾" COLD WATER ENTRANCE TO FIRST FLOOR TO REMAIN.
- 2. EXISTING BALL VALVE AND PRESSURE REDUCING VALVE TO REMAIN.
- 3. EXISTING WATER HEATER, EXPANSION TANK, BALL VALVES AND FLEXIBLE CONNECTORS TO REMAIN
- 4. PROVIDE ½" x 4" BRASS NIPPLE IPS AT BOTH ENDS FROM DISCHARGE OF PRV TO TRANSITION TO
- 5. CONNECT 1/2' HOT AND COLD WATER TO EXISTING KITCHEN SINK.
- 6. CONNECT 1/2" HOT AND COLW WATER TO EXISTING WASHING MACHINE BOX.
- 7. CONNECT ½" HOT AND COLD WATER TO SHOWER. EXISTING SHOWER VALVE TO REMAIN. CONNECT TO EXISTING PIPING ABOVE CEILING OR BELOW FLOOR TO MINIMISE DAMAGE TO SHEETROCK.
- 8. CONNECT ½" COLD WATER TO WATER CLOSET.
- 9. CONNECT ½' HOT AND COLD WATER TO NEW LAVATORY. ADJUST EXISTING WASTE ROUGH-INS AS REQUIRED TO ACCEPT NEW FIXTURE.
- 10. CONNECT NEW ½" HOT AND COLD WATER TO EXISTING LINES SERVING WATER HEATER.
- 11. EXISTING ¾" COLD WATER ENTRANCE TO SECOND FLOOR TO REMAINTO REMAIN.
- 12. EXISTING ¾" COLD WATER TO SECOND FLOOR TO REMAIN.
- 13. PROVIDE NEW HAND HELD SHOWER.
- 14. EXISTING HOT AND COLD WATER LINES TO BE ABANDONED BELOW SLAB OR REMOVED IF ABOVE SLAB.

### **GENERAL NOTES**

- 1. FOR FULL COUNT OF BUILDING TYPES AND QUANTITIES REFER TO ARCHITECTURAL.
- 2. CONTRACTOR SHALL VISIT SITE BEFORE BID AND BECOME FAMILIAR WITH EXISTING CONDITIONS WHICH MAY AFFECT WORK.
- 3. CONTRACTOR IS RESPONSIBLE FOR PROVIDING ALL REQUIRED FITTINGS TO CREATE A COMPLETE AND FUNTIONAL PLUMBING SYSTEM. CONTRACTOR SHALL DETERMINE FITTINGS REQUIRED TO CONNECTION TO FIXTURES SHOWN.
- 4. THE WATER SUPPLY SYSTEM SHALL BE PRESSURE TESTED AND PROVED TIGHT UNDER AWATER PRESSURE NOT LESS THAN 25 PSI ABOVE THE WORKING PRESSURE. THIS TEST SHALL BE PERFORMED IN THE PRESENCE OF THE OWNER. THIS TEST IS IN ADDITION TO OTHER TEST SPECIFIED AND SHALL BE THE LAST TEST PERFORMED.
- 5. COLD WATER PEX PIPING SHALL BE BLUE, NO EXCEPTIONS.
- 6. HOT WATER PEX PIPING SHALL BE RED, NO EXCEPTIONS.

18110 10-08-18

is drawing is the property of DESIGN INNOVATIONS ARCHITECT INC. and is not to be reproduced or copied in whole or in part without

be used for the project and site specifically identified herein and is not to scale drawings, written dimensions take precedence. All drawings an

BUILDINGS

WATER


MISC. DETAILS

NEW & DEMO -




4530 JC KNOXVILLE

DATE ISSUE FOR

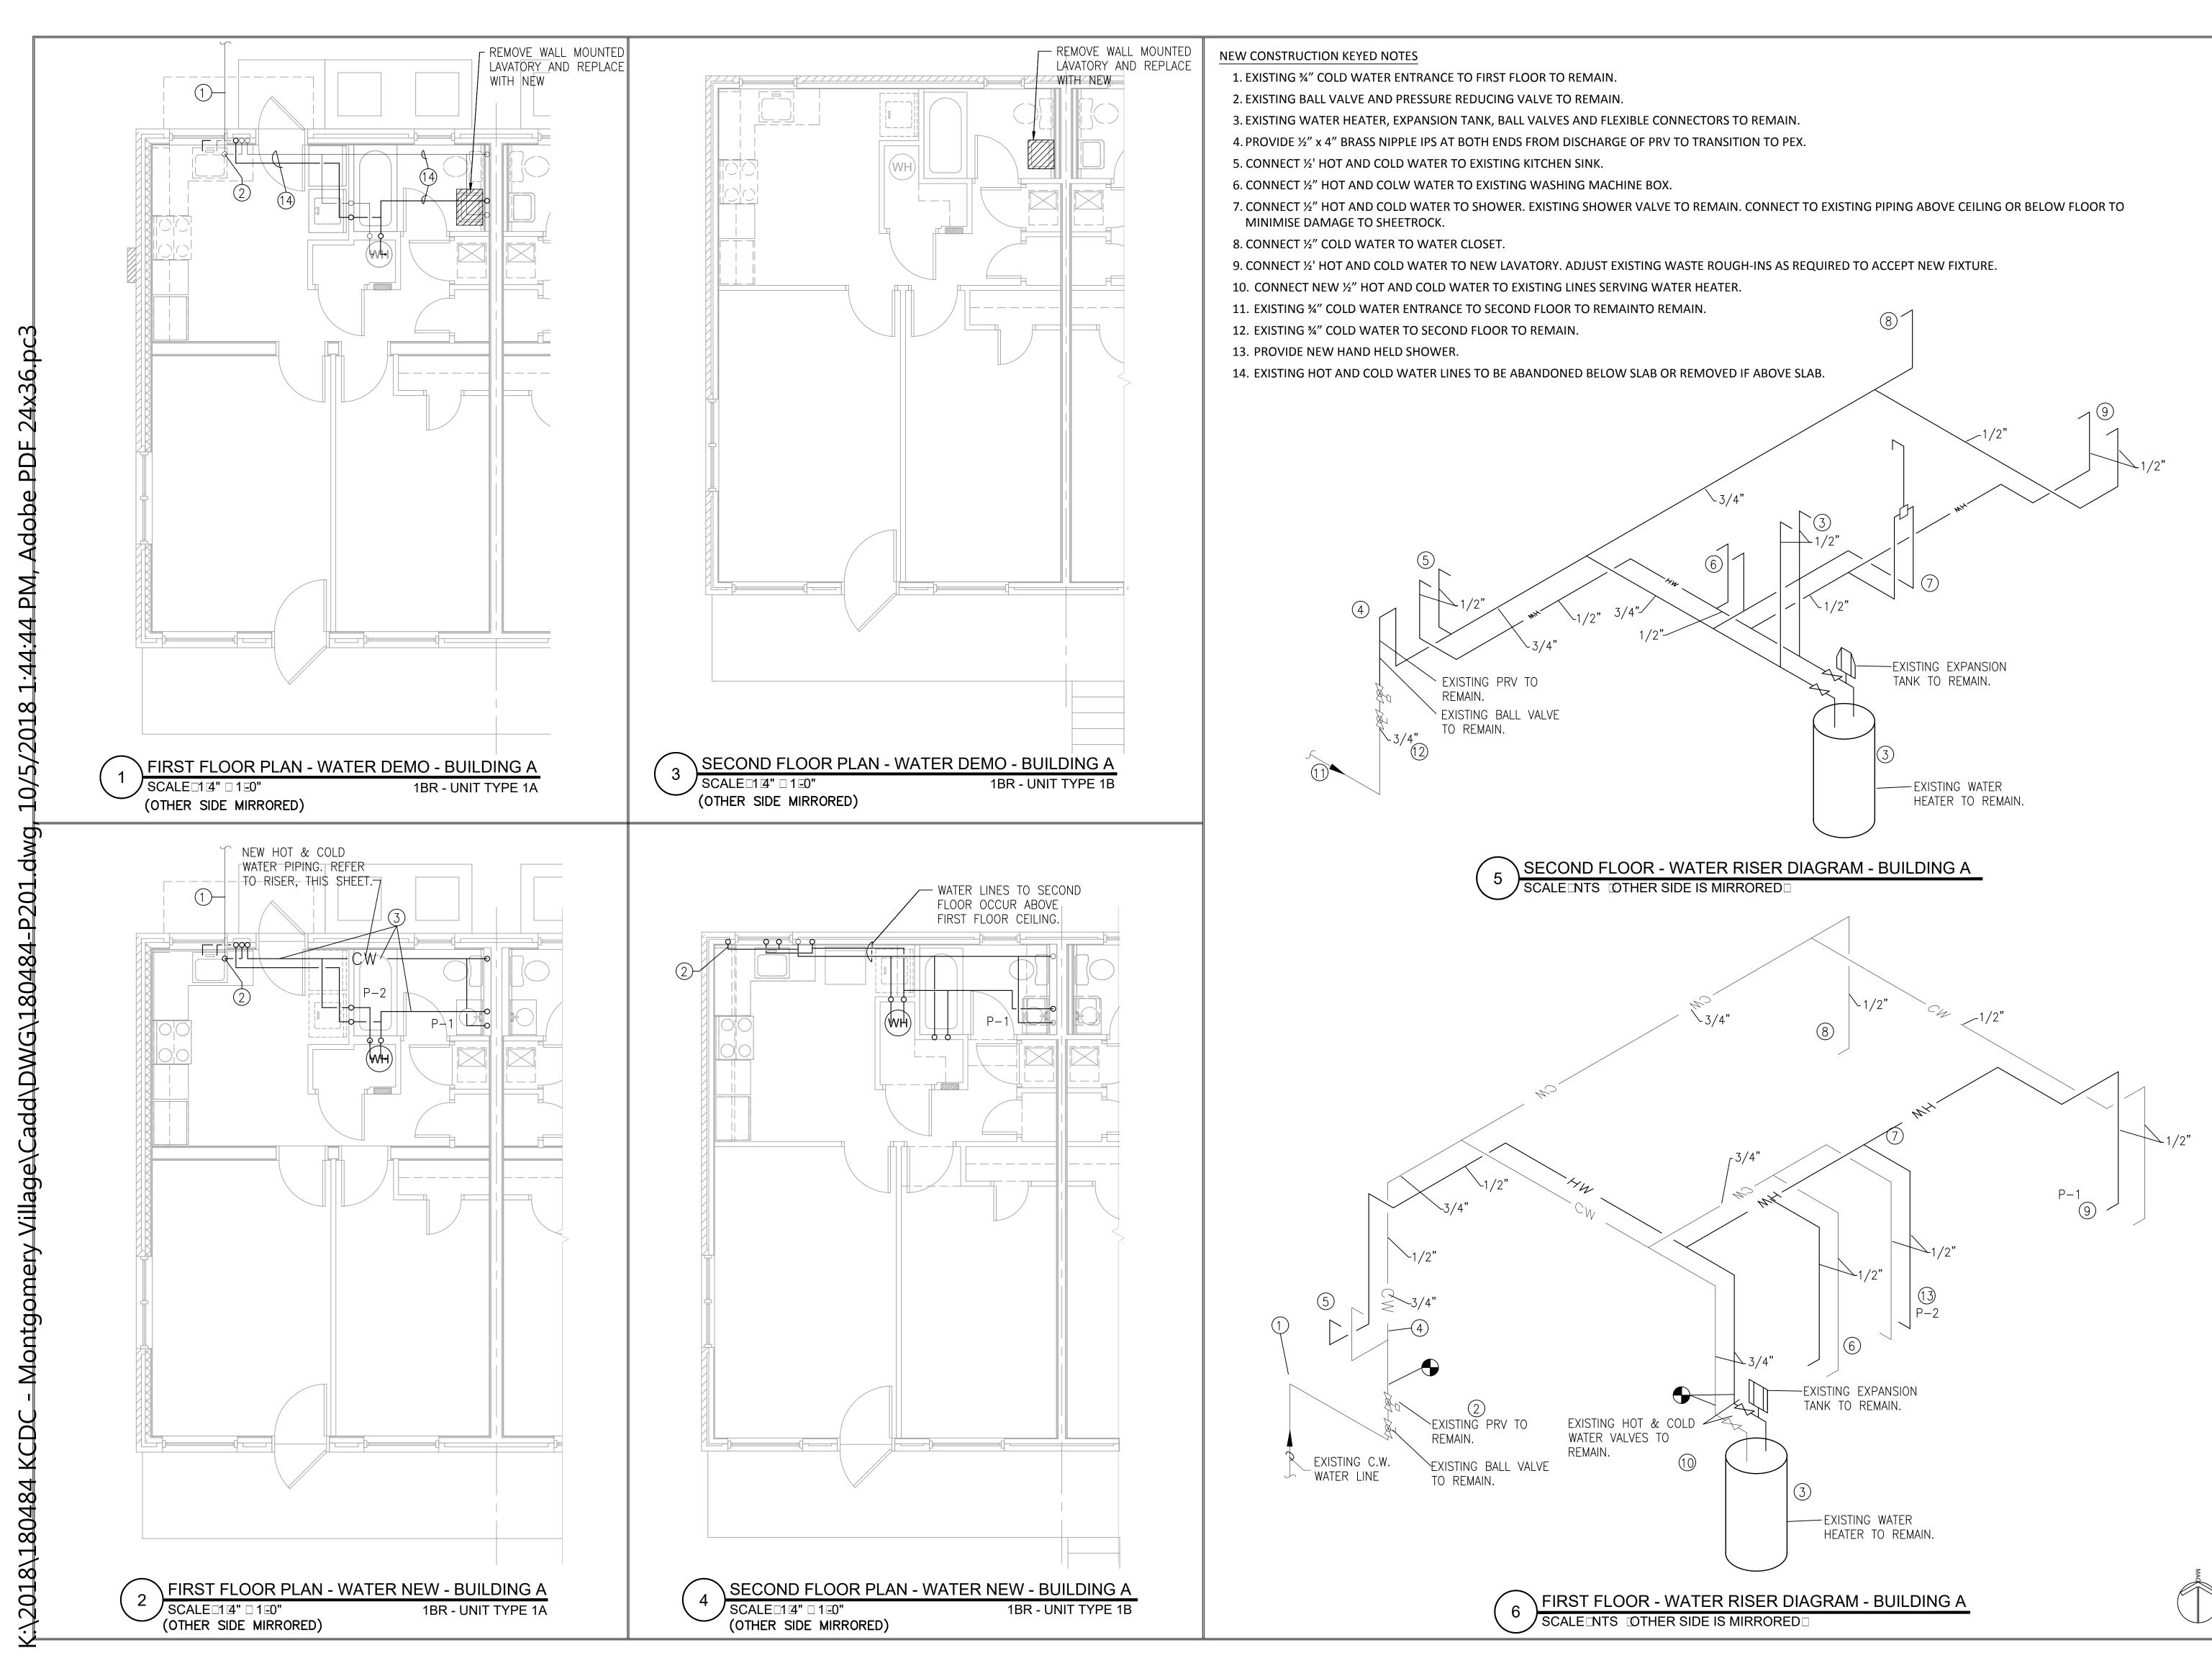

Design Innovation
ARCHITECTS + INTERIORS + PLANNING

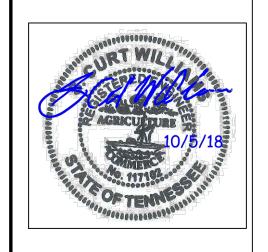



A RENOVATION TO

A RENOVATION TO

4530 JOE LEWIS ROAD

KNOXVILLE, TENNESSEE 37920

DATE ISSUE FOR

SOLUTION SARCHITECTS, INC. and is not to be used for the project and site specifically identified herein and is not to be used for the project and site specifically identified herein and is not to

This drawing is the property of DESIGN INNOVATIONS ARCHITECTS, INC. and is not to be reproduced or copied in whole or in part without authorization from DESIGN INNOVATIONS ARCHITECTS, INC.. It is to be used for the project and site specifically identified herein and is not to be used on any other project. It is to be returned upon request. Do not scale drawings, written dimensions take precedence. All drawings and designs shown on these drawings are copyright © of DESIGN INNOVATIONS ARCHITECTS, INC.

BUILDING A UNIT PLANS -NEW & DEMO -


WATER

10-08-18

Project Number
18110

Date

10.09.19

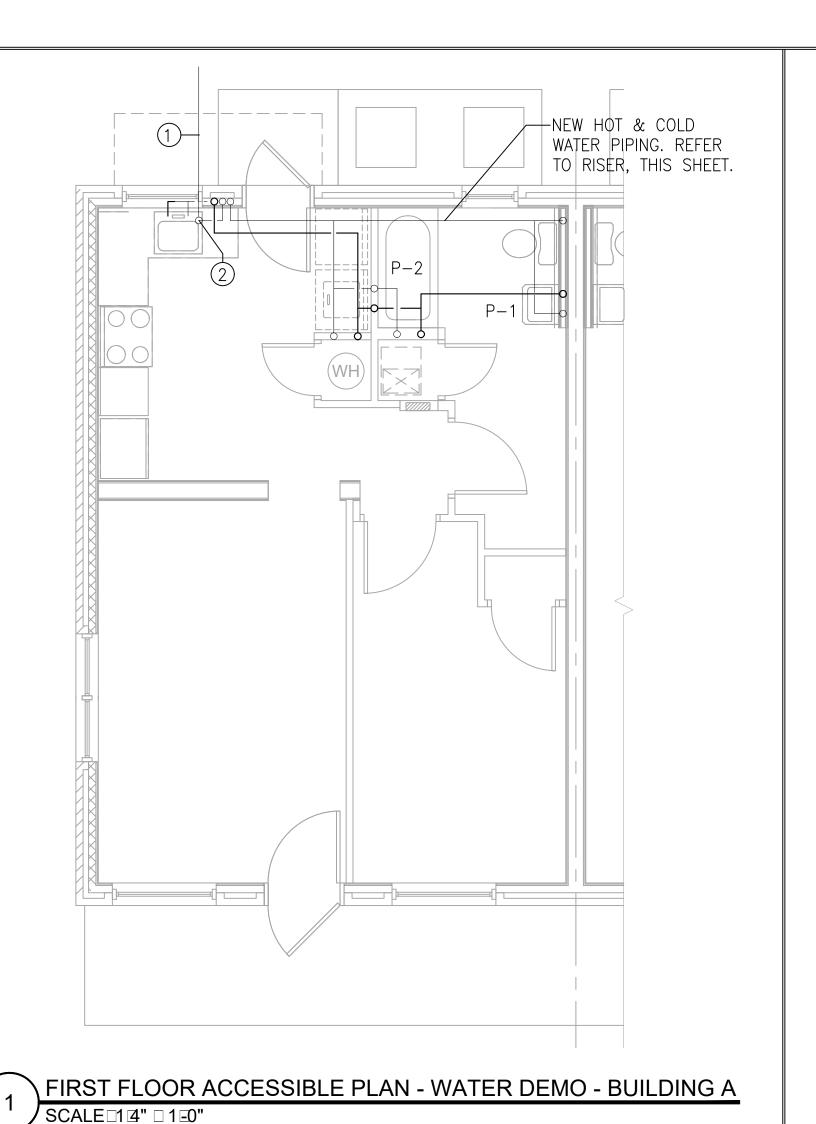

24x36.pc3

Adobe PDE


1:46:34 PM

10/5/2018


- Montgomery Village\Cadd\DWG\180484-ACC-P

2018\180484 KCDC

SCALE 14" 150"

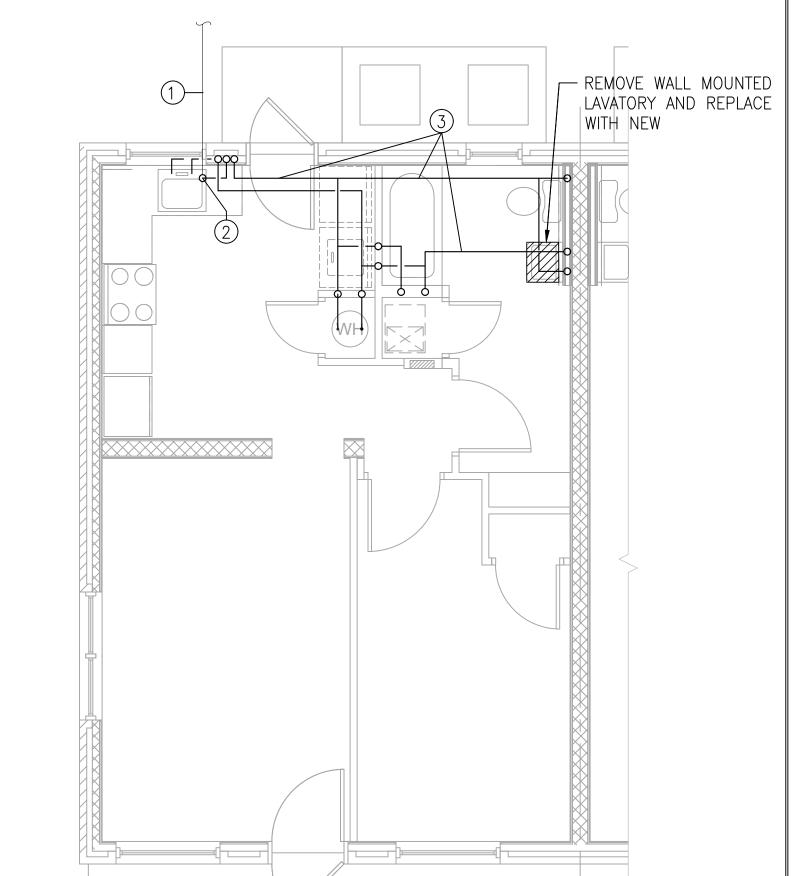

FIRST FLOOR ACCESSIBLE PLAN - WATER NEW - BUILDING A

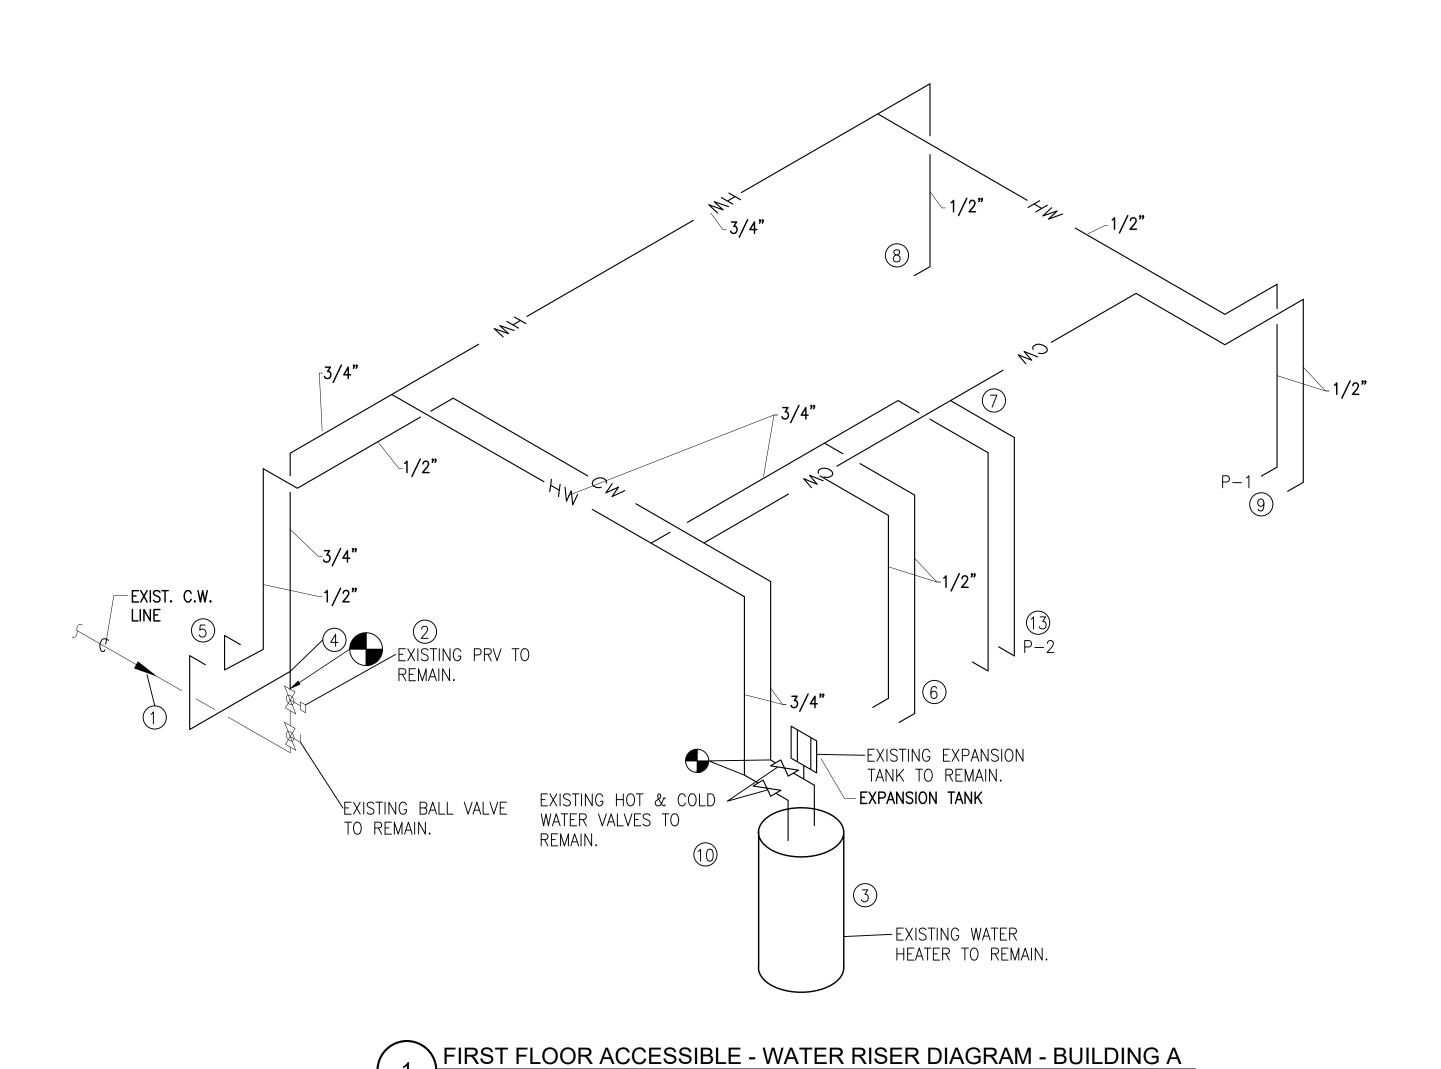

SCALE OTHER SIDE MIRRORED

### NEW CONSTRUCTION KEYED NOTES

- 1. EXISTING ¾" COLD WATER ENTRANCE TO FIRST FLOOR TO REMAIN.
- 2. EXISTING BALL VALVE AND PRESSURE REDUCING VALVE TO REMAIN.
- 3. EXISTING WATER HEATER, EXPANSION TANK, BALL VALVES AND FLEXIBLE CONNECTORS TO
- 4. PROVIDE ½" x 4" BRASS NIPPLE IPS AT BOTH ENDS FROM DISCHARGE OF PRV TO TRANSITION TO
- 5. CONNECT ½' HOT AND COLD WATER TO EXISTING KITCHEN SINK.
- 6. CONNECT 1/2" HOT AND COLW WATER TO EXISTING WASHING MACHINE BOX.
- 7. CONNECT ½" HOT AND COLD WATER TO SHOWER. EXISTING SHOWER VALVE TO REMAIN. CONNECT TO EXISTING PIPING ABOVE CEILING OR BELOW FLOOR TO MINIMISE DAMAGE TO
- 8. CONNECT ½" COLD WATER TO WATER CLOSET.
- 9. CONNECT ½' HOT AND COLD WATER TO NEW LAVATORY. ADJUST EXISTING WASTE ROUGH-INS AS REQUIRED TO ACCEPT NEW FIXTURE.
- 10. CONNECT NEW ½" HOT AND COLD WATER TO EXISTING LINES SERVING WATER HEATER.
- 11. EXISTING ¾" COLD WATER ENTRANCE TO SECOND FLOOR TO REMAINTO REMAIN.
- 12. EXISTING ¾" COLD WATER TO SECOND FLOOR TO REMAIN.
- 13. PROVIDE NEW HAND HELD SHOWER.
- 14. EXISTING HOT AND COLD WATER LINES TO BE ABANDONED BELOW SLAB OR REMOVED IF ABOVE SLAB.





Knoxville, TN 37916 **1865** □ 525 - 3488 ICT JOB No. 180484


4530 JC KNOXVILLE

DATE	ISSUE FOR
	$\triangle$
This drawing is	the property of DESIGN INNOVATIONS ARCHITECTS,

INC. and is not to be reproduced or copied in whole or in part without authorization from DESIGN INNOVATIONS ARCHITECTS, INC.. It is to be used for the project and site specifically identified herein and is not to be used on any other project. It is to be returned upon request. Do not scale drawings, written dimensions take precedence. All drawings and designs shown on these drawings are copyright © of DESIGN INNOVATIONS ARCHITECTS, INC.


BUILDING A UNIT PLANS -NEW & DEMO -WATER

Sheet Number 18110 □-□01-CC 10-08-18

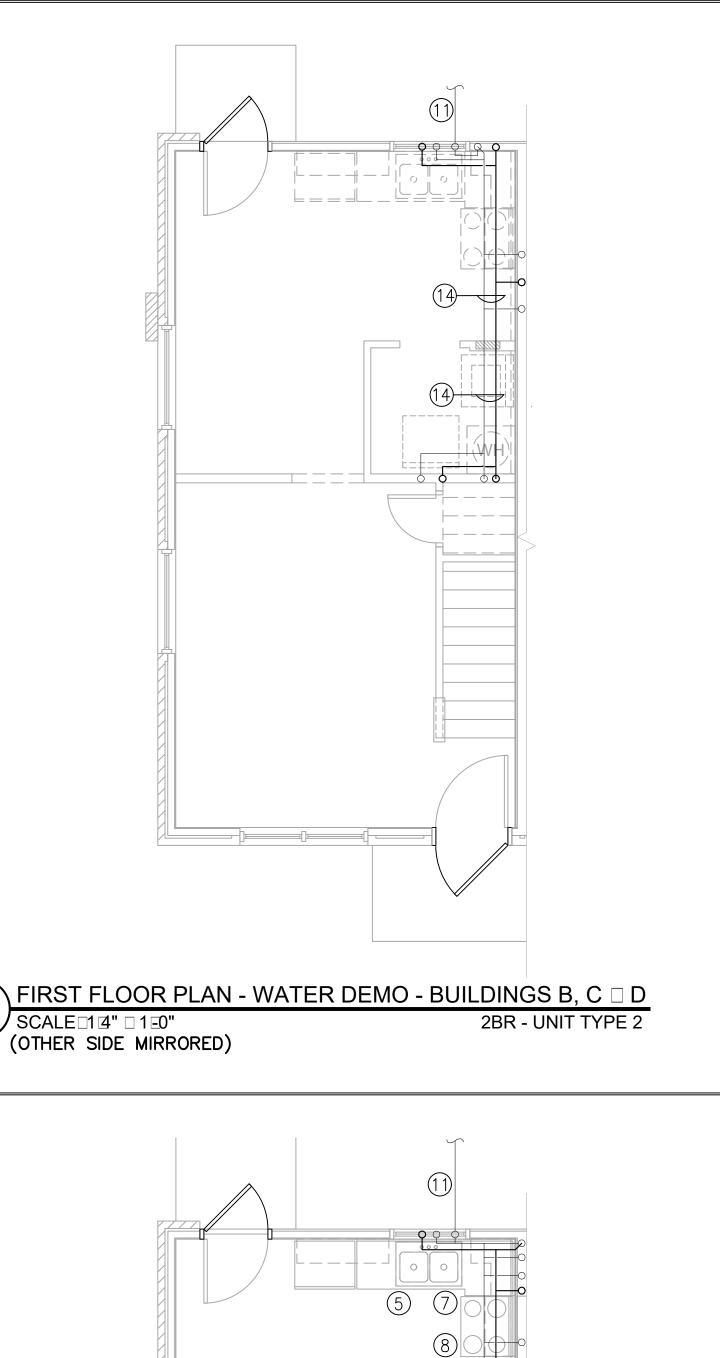


10/5/2018 1:47:56 PM,

K:\2018\180484 KCD

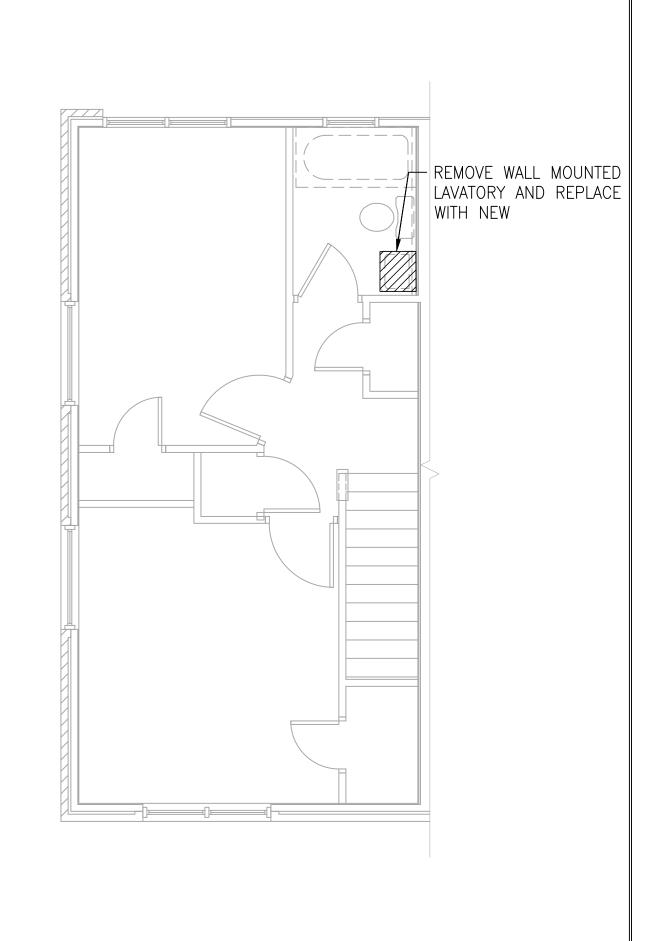


SECOND FLOOR PLAN - WATER DEMO - BUILDINGS B, C D SCALE [] [4" | 1 = 0" 2BR - UNIT TYPE 2 (OTHER SIDE MIRRORED)

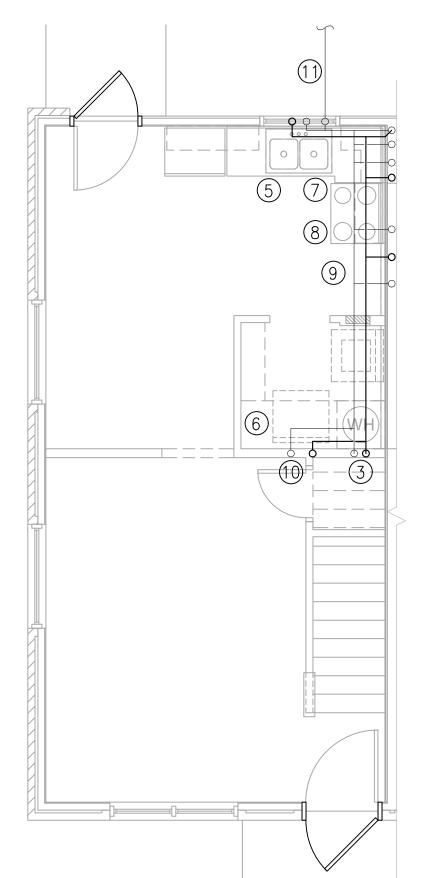

FIRST FLOOR PLAN - WATER NEW - BUILDINGS B, C D SCALE 1 4" 1 1 0"


(OTHER SIDE MIRRORED)

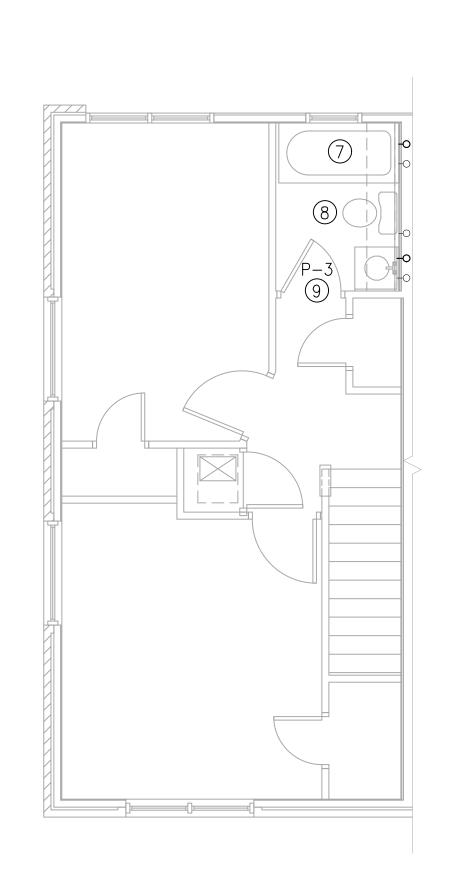

SECOND FLOOR PLAN - WATER NEW - BUILDINGS B, C D SCALE 1 4" 1 10"
(OTHER SIDE MIRRORED)

NEW CONSTRUCTION KEYED NOTES

- 1. EXISTING ¾" COLD WATER ENTRANCE TO FIRST FLOOR TO REMAIN.
- 2. EXISTING BALL VALVE AND PRESSURE REDUCING VALVE TO REMAIN.
- 3. EXISTING WATER HEATER, EXPANSION TANK, BALL VALVES AND FLEXIBLE CONNECTORS TO REMAIN.
- 4. PROVIDE ½" x 4" BRASS NIPPLE IPS AT BOTH ENDS FROM DISCHARGE OF PRV TO TRANSITION TO PEX.
- 5. CONNECT ½' HOT AND COLD WATER TO EXISTING KITCHEN SINK.
- 6. CONNECT 1/2" HOT AND COLW WATER TO EXISTING WASHING MACHINE
- 7. CONNECT ½" HOT AND COLD WATER TO SHOWER. EXISTING SHOWER VALVE TO REMAIN. CONNECT TO EXISTING PIPING ABOVE CEILING OR BELOW FLOOR TO MINIMISE DAMAGE TO SHEETROCK.
- 8. CONNECT ½" COLD WATER TO WATER CLOSET.
- 9. CONNECT ½' HOT AND COLD WATER TO NEW LAVATORY. ADJUST EXISTING WASTE ROUGH-INS AS REQUIRED TO ACCEPT NEW FIXTURE.
- 10. CONNECT NEW ½" HOT AND COLD WATER TO EXISTING LINES SERVING WATER HEATER.
- 11. EXISTING ¾" COLD WATER ENTRANCE TO SECOND FLOOR TO REMAINTO REMAIN.
- 12. EXISTING ¾" COLD WATER TO SECOND FLOOR TO REMAIN.
- 13. PROVIDE NEW HAND HELD SHOWER.
- 14. EXISTING HOT AND COLD WATER LINES TO BE ABANDONED BELOW SLAB OR REMOVED IF ABOVE SLAB.

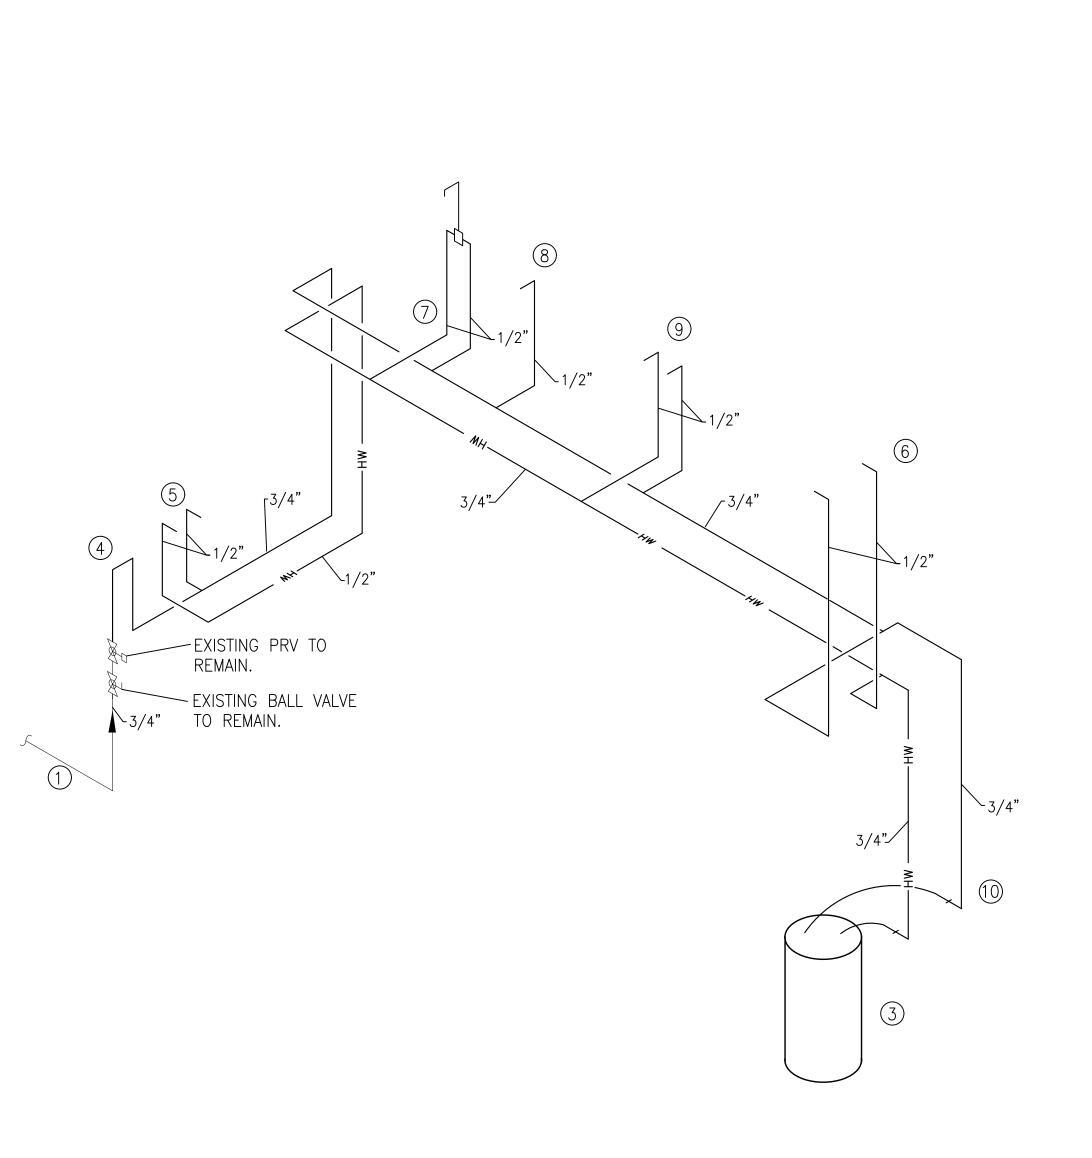

WATER RISER DIAGRAM - BUILDINGS B, C  $\square$  D SCALE INTS TOTHER SIDE MIRRORED








Knoxville, TN 37916 **2865 25-3488** ICT JOB No. 180484


DATE ISSUE FOR

This drawing is the property of DESIGN INNOVATIONS ARCHITECTS INC. and is not to be reproduced or copied in whole or in part without authorization from DESIGN INNOVATIONS ARCHITECTS, INC.. It is to be used for the project and site specifically identified herein and is not to be used on any other project. It is to be returned upon request. Do not scale drawings, written dimensions take precedence. All drawings and

BUILDINGS B, C & D UNIT PLANS -NEW & DEMO -WATER

18110

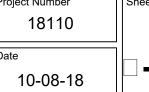

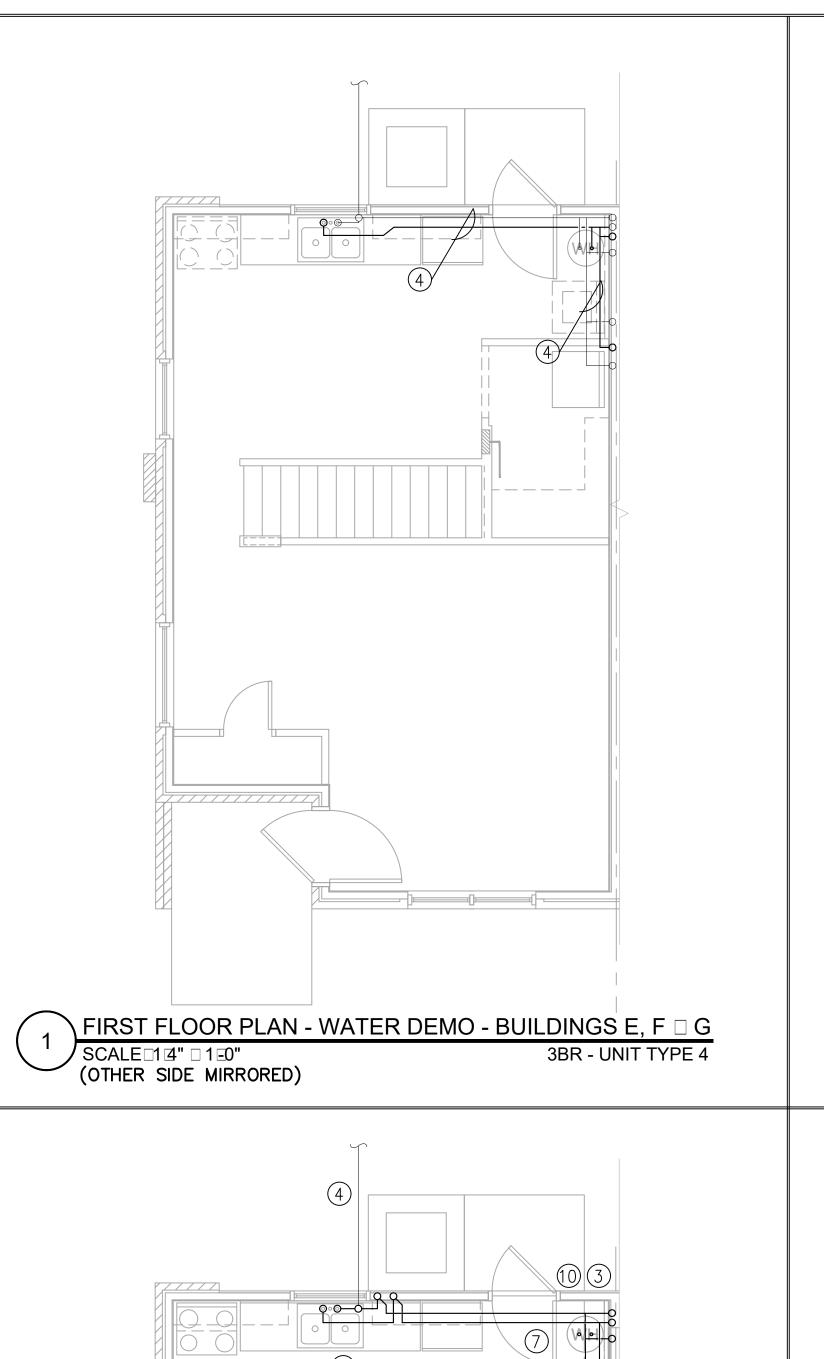



Adobe PDF


10/5/2018 1:49:41 PM,

Montgomery Village\Cadd\DWG\180484-P203

K:\2018\180484 KCDC

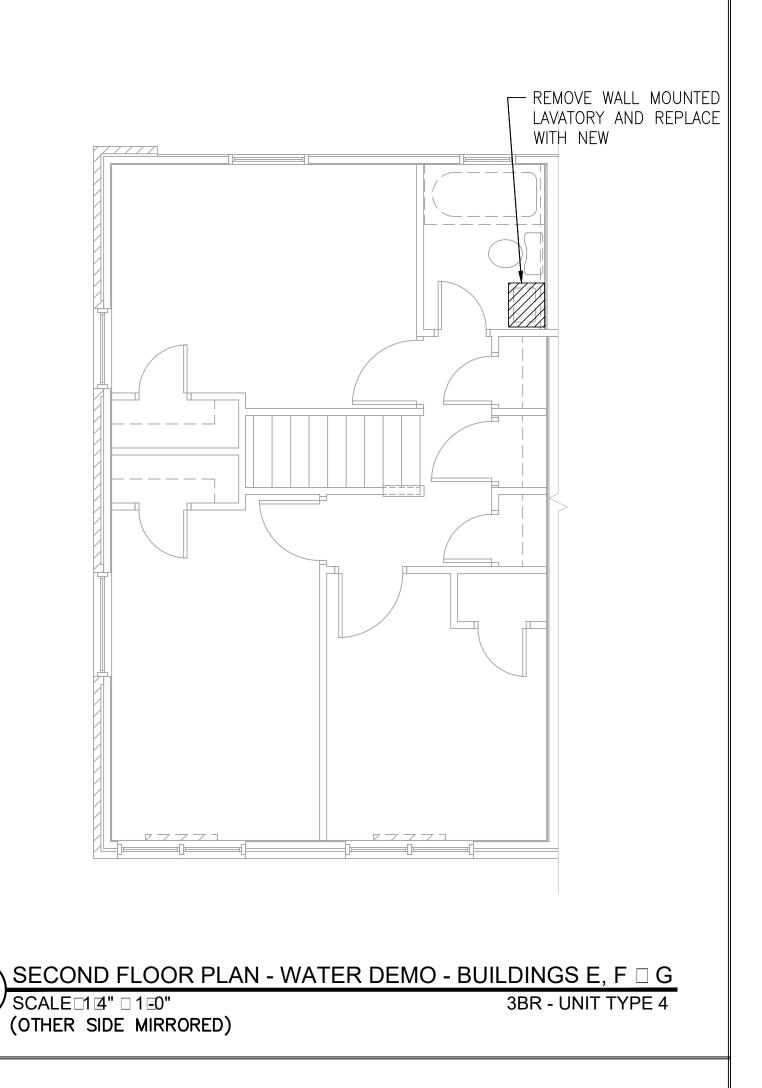


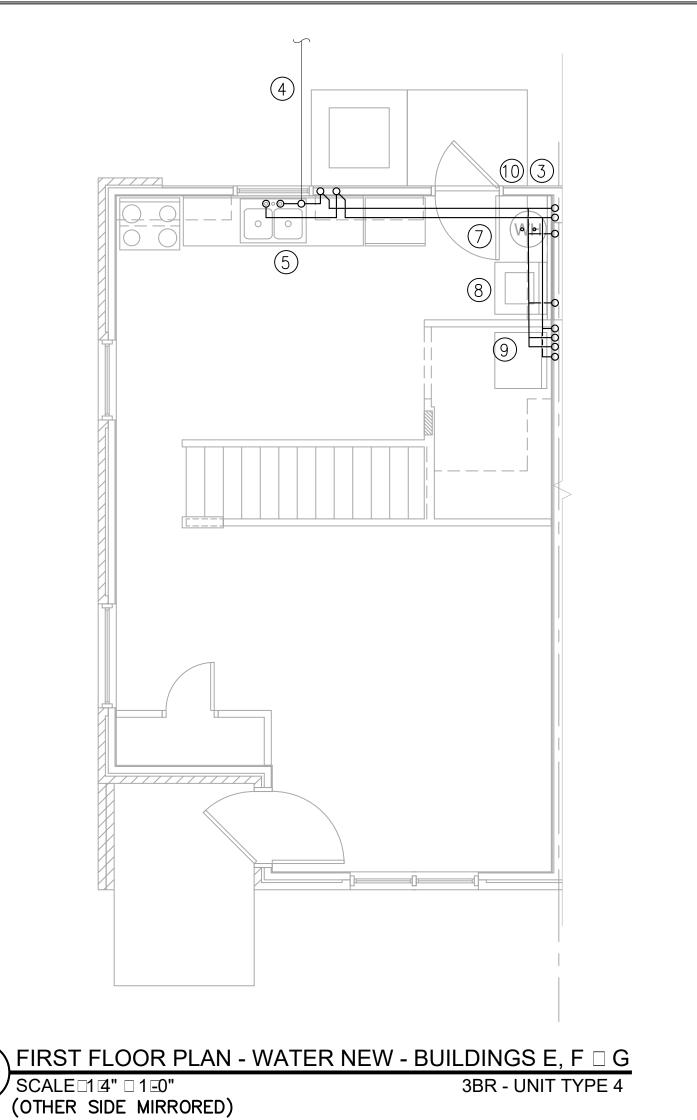


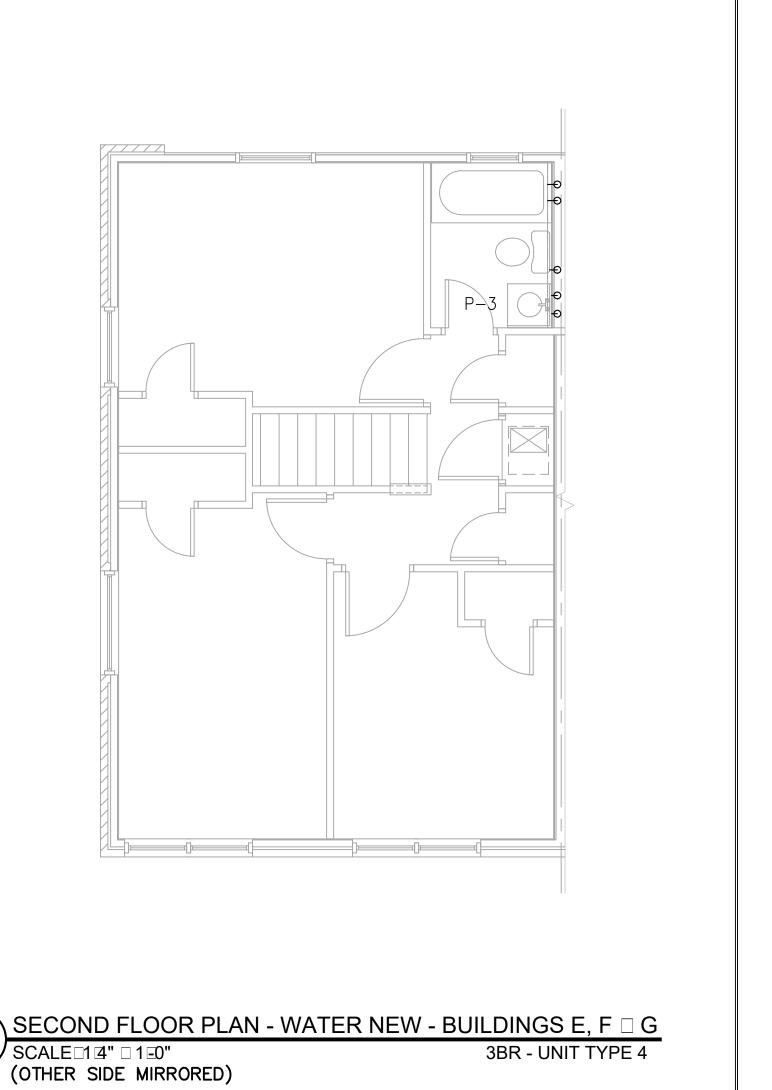

NEW CONSTRUCTION KEYED NOTES

- 1. EXISTING ¾" COLD WATER ENTRANCE TO FIRST FLOOR TO REMAIN.
- 2. EXISTING BALL VALVE AND PRESSURE REDUCING VALVE TO REMAIN.
- 3. EXISTING WATER HEATER, EXPANSION TANK, BALL VALVES AND FLEXIBLE CONNECTORS TO REMAIN.
- 4. PROVIDE ½" x 4" BRASS NIPPLE IPS AT BOTH ENDS FROM DISCHARGE OF PRV TO TRANSITION TO PEX.
- 5. CONNECT ½' HOT AND COLD WATER TO EXISTING KITCHEN SINK.
- 6. CONNECT ½" HOT AND COLW WATER TO EXISTING WASHING MACHINE
- 7. CONNECT ½" HOT AND COLD WATER TO SHOWER. EXISTING SHOWER VALVE TO REMAIN. CONNECT TO EXISTING PIPING ABOVE CEILING OR BELOW FLOOR TO MINIMISE DAMAGE TO SHEETROCK.
- 8. CONNECT ½" COLD WATER TO WATER CLOSET.
- 9. CONNECT ½' HOT AND COLD WATER TO NEW LAVATORY. ADJUST EXISTING WASTE ROUGH-INS AS REQUIRED TO ACCEPT NEW FIXTURE.
- 10. CONNECT NEW ½" HOT AND COLD WATER TO EXISTING LINES SERVING WATER HEATER.
- 11. EXISTING 3/4" COLD WATER ENTRANCE TO SECOND FLOOR TO REMAINTO REMAIN.
- 12. EXISTING 3/4" COLD WATER TO SECOND FLOOR TO REMAIN.
- 13. PROVIDE NEW HAND HELD SHOWER.
- 14. EXISTING HOT AND COLD WATER LINES TO BE ABANDONED BELOW SLAB OR REMOVED IF ABOVE SLAB.

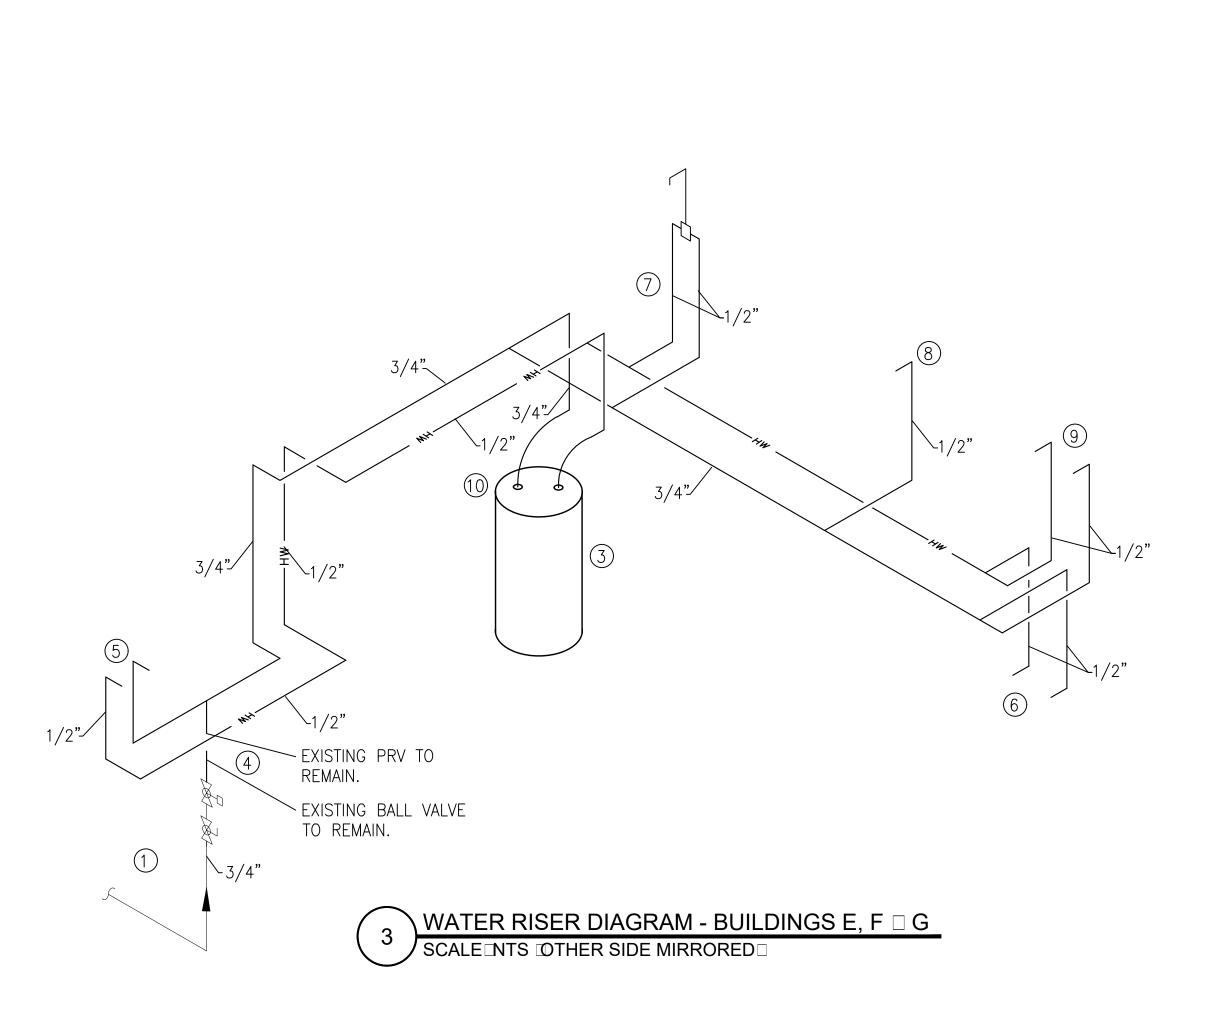

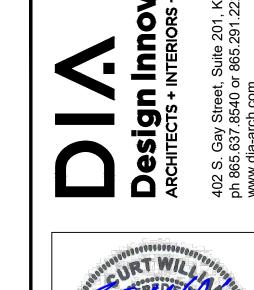






Knoxville, TN 37916 **2865 25-3488** ICT JOB No. 180484

DATE	ISSUE FOR
	$\triangle$
This describes in	the property of DECICALINING/ATIONS ADOLUTECTS

This drawing is the property of DESIGN INNOVATIONS ARCHITECTS, INC. and is not to be reproduced or copied in whole or in part without authorization from DESIGN INNOVATIONS ARCHITECTS, INC.. It is to be used for the project and site specifically identified herein and is not to be used on any other project. It is to be returned upon request. Do not scale drawings, written dimensions take precedence. All drawings and

BUILDINGS E, F & G UNIT PLANS -NEW & DEMO -WATER

18110

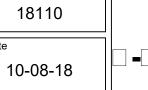




FIRST FLOOR PLAN - WATER NEW - BUILDING I


3BR - UNIT TYPE 4

10/5/2018 1.52

Montgomery Village\Cadd\DWG\180484-P204

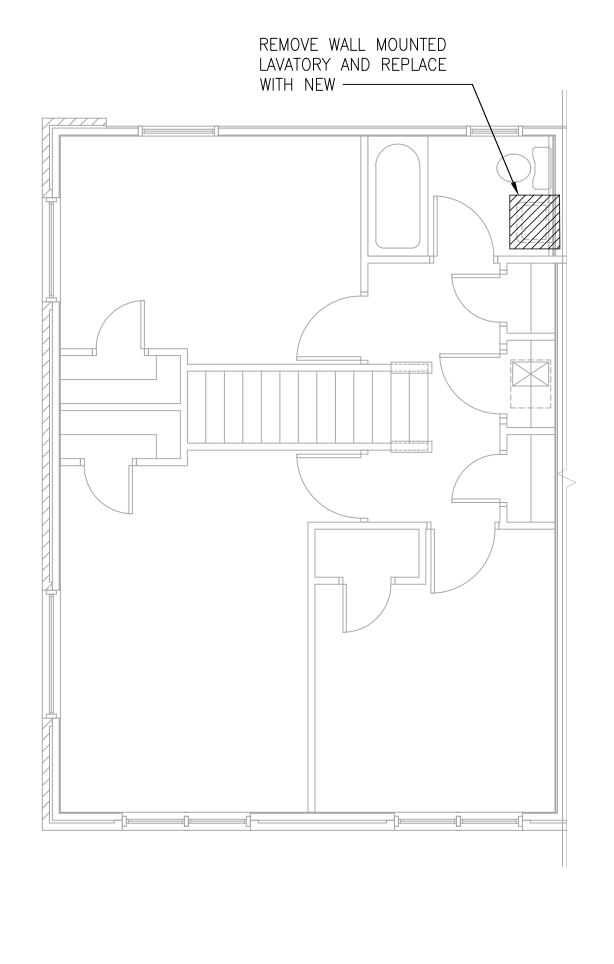


4BR - UNIT TYPE 3

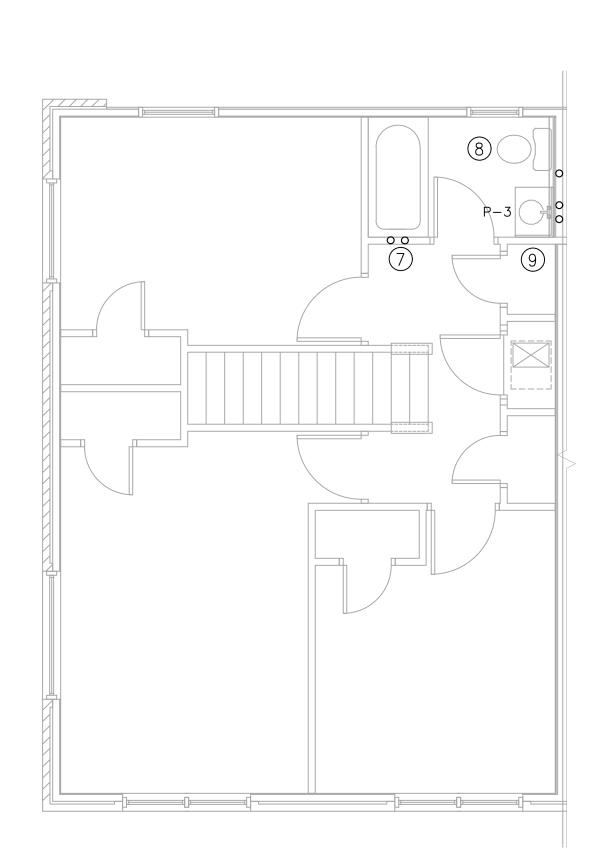



SECOND FLOOR PLAN - WATER NEW - BUILDING I 4BR - UNIT TYPE 3

### NEW CONSTRUCTION KEYED NOTES

- 1. EXISTING ¾" COLD WATER ENTRANCE TO FIRST FLOOR TO REMAIN.
- 2. EXISTING BALL VALVE AND PRESSURE REDUCING VALVE TO REMAIN.
- 3. EXISTING WATER HEATER, EXPANSION TANK, BALL VALVES AND FLEXIBLE CONNECTORS TO REMAIN.
- 4. PROVIDE ½" x 4" BRASS NIPPLE IPS AT BOTH ENDS FROM DISCHARGE OF PRV TO TRANSITION TO PEX.
- 5. CONNECT ½' HOT AND COLD WATER TO EXISTING KITCHEN SINK.
- 6. CONNECT ½" HOT AND COLW WATER TO EXISTING WASHING MACHINE BOX.
- 7. CONNECT ½" HOT AND COLD WATER TO SHOWER. EXISTING SHOWER VALVE TO REMAIN. CONNECT TO EXISTING PIPING ABOVE CEILING OR BELOW FLOOR TO MINIMISE DAMAGE TO SHEETROCK.
- 8. CONNECT ½" COLD WATER TO WATER CLOSET.
- 9. CONNECT ½' HOT AND COLD WATER TO NEW LAVATORY. ADJUST EXISTING WASTE ROUGH-INS AS REQUIRED TO ACCEPT NEW FIXTURE.
- 10. CONNECT NEW ½" HOT AND COLD WATER TO EXISTING LINES SERVING WATER HEATER.
- 11. EXISTING 3/4" COLD WATER ENTRANCE TO SECOND FLOOR TO REMAINTO REMAIN.
- 12. EXISTING ¾" COLD WATER TO SECOND FLOOR TO REMAIN.
- 13. PROVIDE NEW HAND HELD SHOWER.
- 14. EXISTING HOT AND COLD WATER LINES TO BE ABANDONED BELOW SLAB OR REMOVED IF ABOVE SLAB.

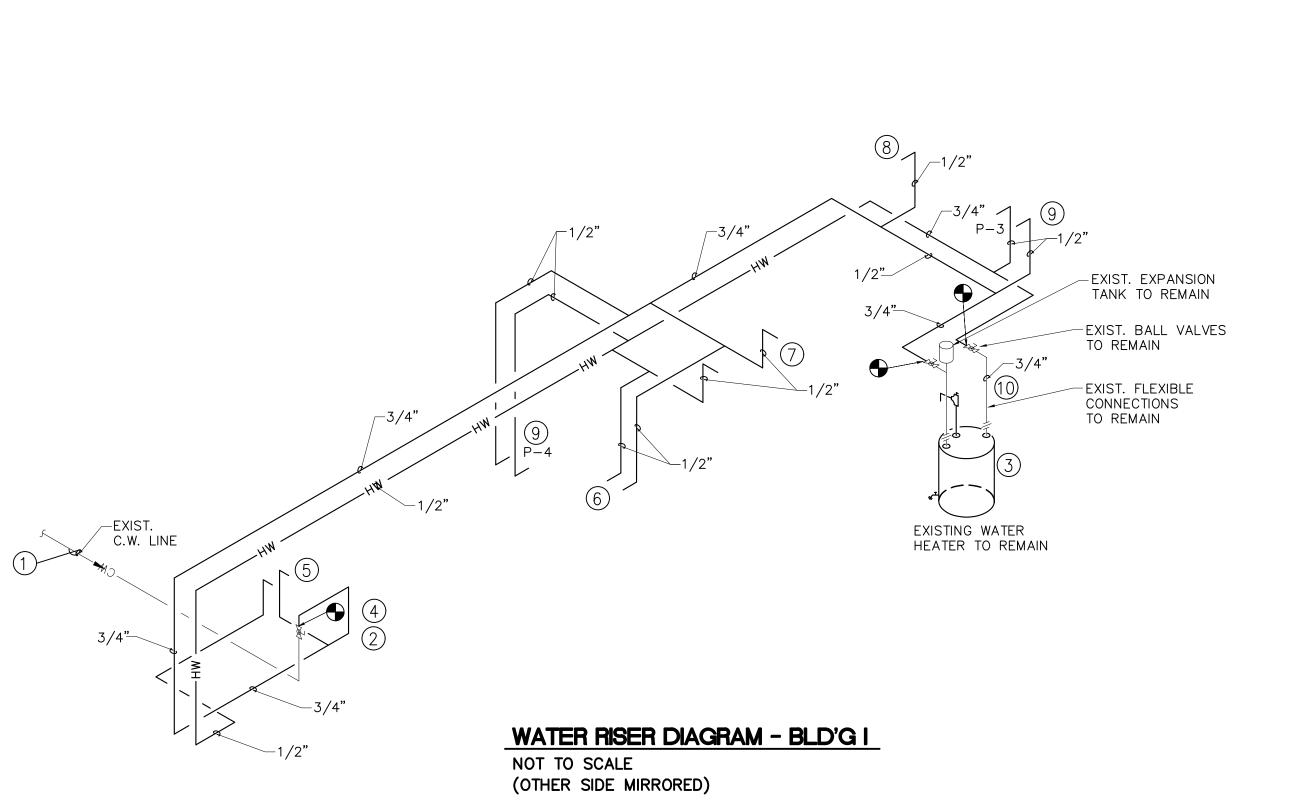

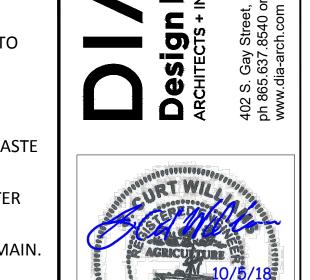

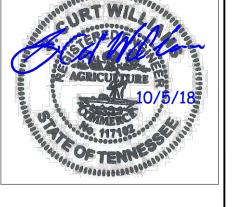




Knoxville, TN 37916 **1865** □ 525 - 3488 ICT JOB No. 180484

DATE	ISSUE FOR
	Δ
	Δ
	Δ
	$\triangle$
	Δ
	Δ
	$\triangle$
	Δ
	$\triangle$
	$\triangle$
	$\triangle$

authorization from DESIGN INNOVATIONS ARCHITECTS, INC.. It is to be used for the project and site specifically identified herein and is not to be used on any other project. It is to be returned upon request. Do not scale drawings, written dimensions take precedence. All drawings and

BUILDING I UNIT PLANS -NEW & DEMO -WATER

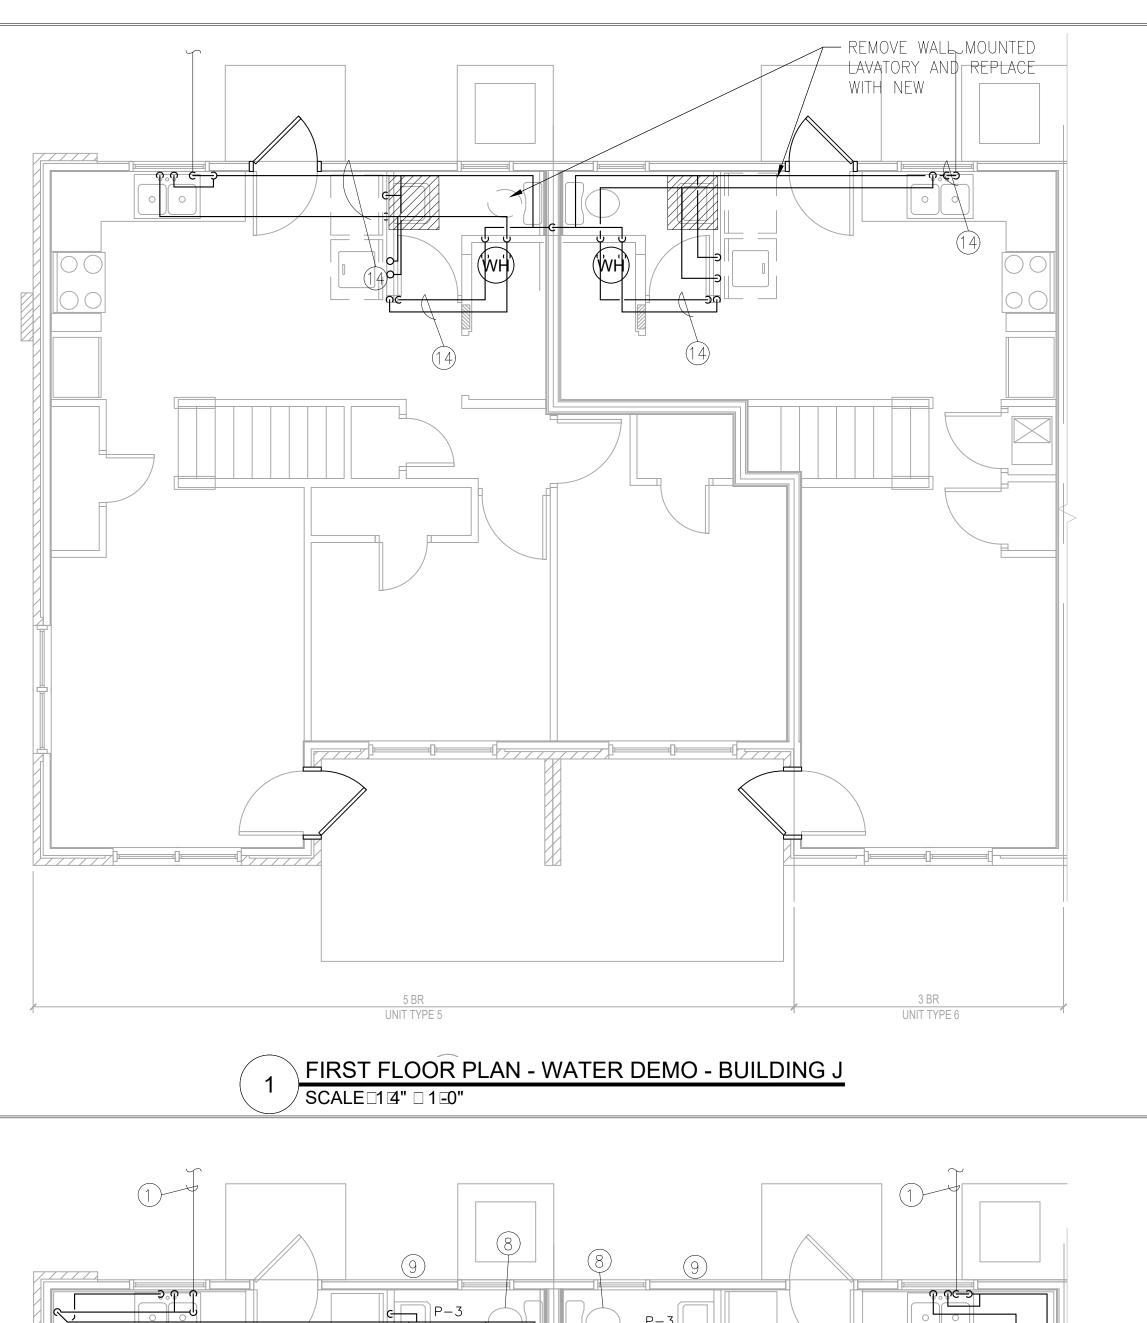

24x36.pc3

Adobe PDF

PM,

1:54:18

10/5/2018

Montgomery Village\Cadd\DWG\180484-P205

K:\2018\180484 KCDC

REMOVE WALL MOUVIED
LAWTONY AND REPLACE
OTH NEW

SER
LINIT TYPES


LINIT TYPES

LINIT TYPES

SECOND FLOOR PLAN - WATER DEMO - BUILDING J

SCALE [1 4" [ 1 E0"

FIRST FLOOR PLAN - WATER NEW - BUILDING J

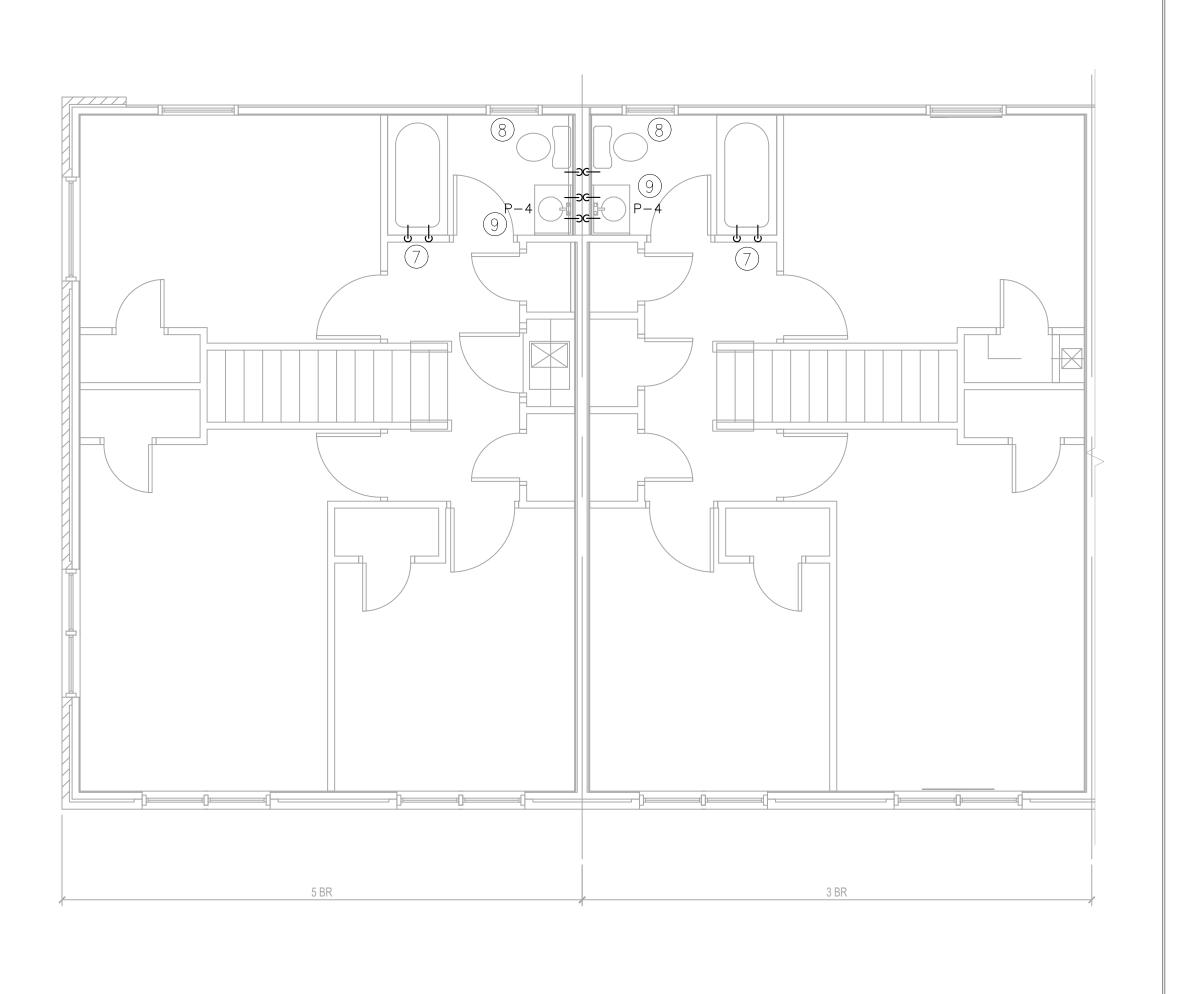

NEW CONSTRUCTION KEYED NOTES

- 1. EXISTING ¾" COLD WATER ENTRANCE TO FIRST FLOOR TO REMAIN.
- 2. EXISTING BALL VALVE AND PRESSURE REDUCING VALVE TO REMAIN.
- 3. EXISTING WATER HEATER, EXPANSION TANK, BALL VALVES AND FLEXIBLE CONNECTORS TO REMAIN.
- 4. PROVIDE ½" x 4" BRASS NIPPLE IPS AT BOTH ENDS FROM DISCHARGE OF PRV TO TRANSITION TO PEX.
- 5. CONNECT ½' HOT AND COLD WATER TO EXISTING KITCHEN SINK.
- 6. CONNECT ½" HOT AND COLW WATER TO EXISTING WASHING MACHINE
- 7. CONNECT ½" HOT AND COLD WATER TO SHOWER. EXISTING SHOWER VALVE TO REMAIN. CONNECT TO EXISTING PIPING ABOVE CEILING OR BELOW FLOOR TO MINIMISE DAMAGE TO SHEETROCK.
- 8. CONNECT ½" COLD WATER TO WATER CLOSET.
- 9. CONNECT ½' HOT AND COLD WATER TO NEW LAVATORY. ADJUST EXISTING WASTE ROUGH-INS AS REQUIRED TO ACCEPT NEW FIXTURE.
- 10. CONNECT NEW ½" HOT AND COLD WATER TO EXISTING LINES SERVING WATER HEATER.
- 11. EXISTING 3/4" COLD WATER ENTRANCE TO SECOND FLOOR TO REMAINTO REMAIN.
- 12. EXISTING ¾" COLD WATER TO SECOND FLOOR TO REMAIN.
- 13. PROVIDE NEW HAND HELD SHOWER.
- 14. EXISTING HOT AND COLD WATER LINES TO BE ABANDONED BELOW SLAB OR REMOVED IF ABOVE SLAB.

Sign Innovatio






JOE LEWIS ROAD

This drawing is the property of DESIGN INNOVATIONS ARCHITECTS, INC. and is not to be reproduced or copied in whole or in part without authorization from DESIGN INNOVATIONS ARCHITECTS, INC... It is to be used for the project and site specifically identified herein and is not to be used on any other project. It is to be returned upon request. Do not scale drawings, written dimensions take precedence. All drawings and designs shown on these drawings are copyright.


Sheet Title


BUILDING J UNIT PLANS -NEW & DEMO -WATER

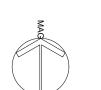


Project Number
18110

Date
10-08-18

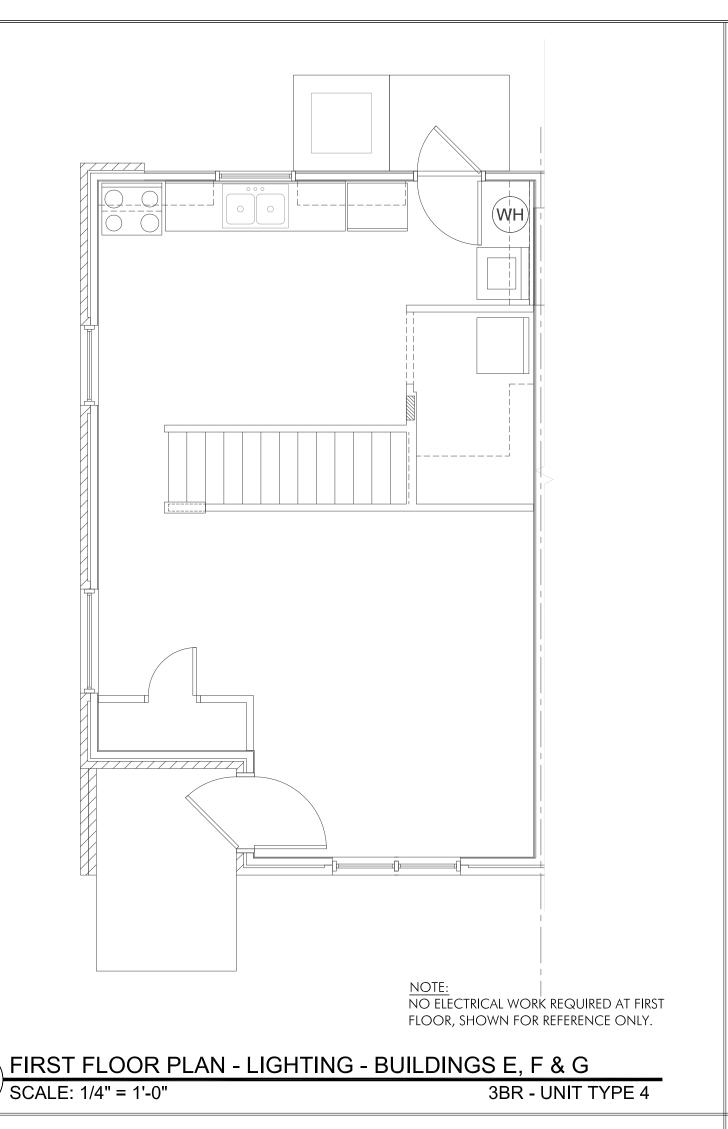

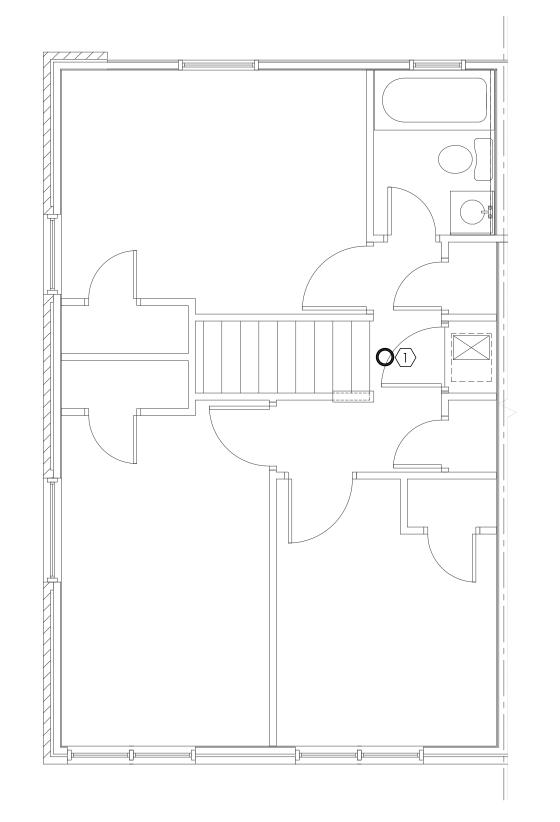


SECOND FLOOR PLAN - LIGHTING - BUILDINGS E, F & G SCALE: 1/4" = 1'-0" 3BR - UNIT TYPE 4

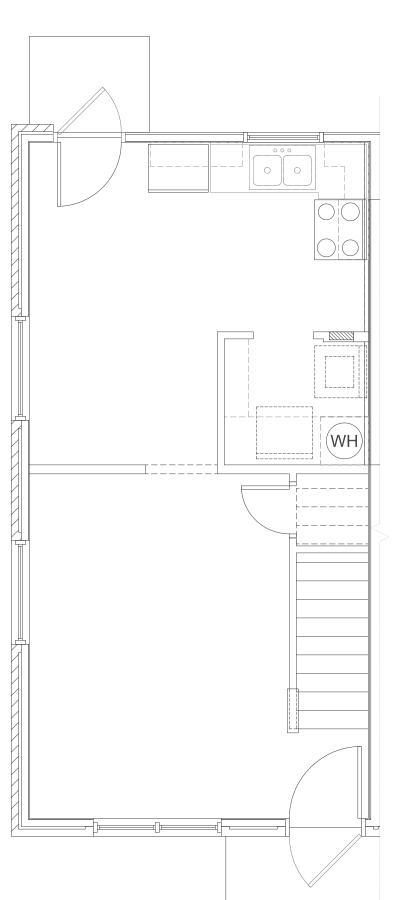

NOTE: NO ELECTRICAL WORK REQUIRED AT FIRST FLOOR, SHOWN FOR REFERENCE ONLY.

FIRST FLOOR PLAN - LIGHTING - BUILDINGS B, C & D SCALE: 1/4" = 1'-0"

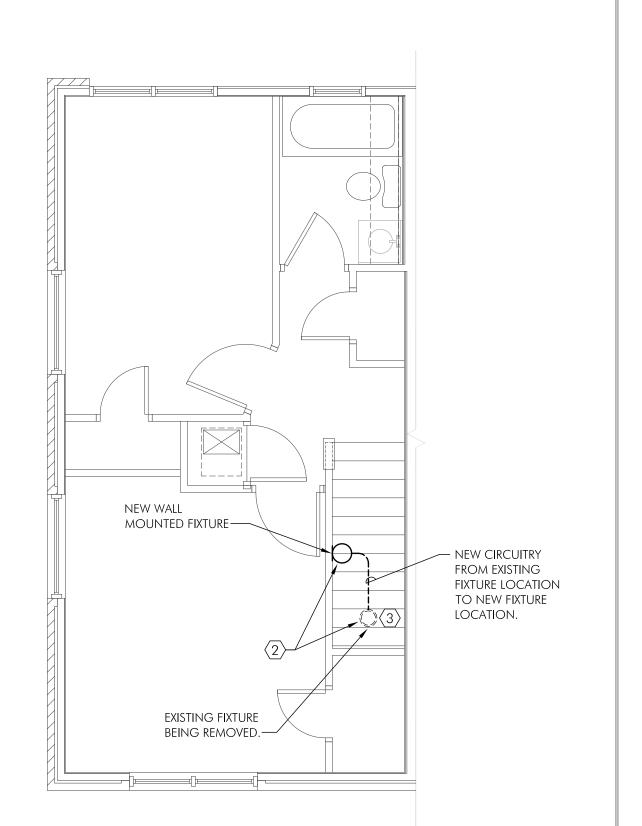

SECOND FLOOR PLAN - LIGHTING - BUILDINGS B, C & D SCALE: 1/4" = 1'-0"

### **GENERAL NOTES**

- 1. This drawing is generally diagrammatic in Nature and EXCEPT WHERE SPECIFICALLY DIMENSIONED OR DETAILED, INDICATES THE GENERAL ARRANGEMENT OF THE WORK. THE CONTRACTOR SHALL INSTALL HIS WORK TO CONFORM AS NEARLY AS POSSIBLE TO THE LOCATIONS AND ARRANGEMENTS SHOWN, WITH ONLY SUCH MINOR ADJUSTMENTS AS NECESSARY. CONTRACTOR SHALL COORDINATE THE WORK WITH ALL OTHER TRADES TO AVOID INTERFERENCES.
- 2. ALL ELECTRICAL COMPONENTS EXTENDED THROUGH A FIRE RATED STRUCTURE SHALL BE PROTECTED OR SEALED AS REQUIRED TO MAINTAIN RATING OF THE STRUCTURE.
- 3. MAINTAIN CODE REQUIRED CLEARANCES AT ALL ELECTRICAL PANELS AND DISCONNECT SWITCHES. THERE SHALL BE NO EQUIPMENT, PIPING OR DUCT WORK INSTALLED IN OR ABOVE THE WORKING CLEARANCES.

### **KEY NOTES**

- (1) EXISTING CEILING MOUNTED LIGHT FIXTURE TO BE REPLACED WITH NEW LIGHT FIXTURE IN THE SAME LOCATION. MAINTAIN EXISTING CIRCUITRY AND CONTROLS.
- $\langle 2 \rangle$  existing ceiling mounted light fixture to be removed and REPLACED WITH NEW WALL MOUNTED LIGHT FIXTURE MIDWAY BETWEEN THE FIRST AND SECOND FLOORS. CONTRACTOR SHALL EXTEND EXISTING CIRCUITRY AND SWITCH LEG TO NEW FIXTURE LOCATION AS REQUIRED USING WIREMOLD SURFACE MOUNTED NON-METALLIC RACEWAY SYSTEM. PROVIDE NEW COVER PLATE AT EXISTING FIXTURE JUNCTION BOX AND PAINT ALL SURFACE MOUNTED RACEWAY TO MATCH WALL/CEILING SURFACE. CONTRACTOR SHALL PROVIDE UNIT PRICE FOR THIS SCOPE OF WORK IN ACCORDANCE WITH SPECIFICATIONS.
- $\langle 3 \rangle$  As part of a deductive alternate, the existing fixture at this LOCATION SHALL BE SHALL BE REPLACED WITH A NEW LIGHT FIXTURE IN THE SAME LOCATION, IN LIEU OF PROVIDING A NEW WALL MOUNTED FIXTURE AS DESCRIBED IN KEY-NOTE NUMBER 2. NEW FIXTURE SHALL BE EQUAL TO SEA GULL LIGHTING MODEL NUMBER 7926EN3-15 OR EQUAL. MAINTAIN EXISTING CIRCUITRY AND CONTROLS.

### LEGEND

 $\bigcirc$ 

NEW SURFACE MOUNTED RACEWAY, SEE PLANS FOR ADDITIONAL INFORMATION.

NEW TWO LIGHT CEILING FLUSH MOUNTED LIGHTING FIXTURE WITH TWO (2) A19 LED LAMPS AND WHITE SHATTER RESISTANT ACRYLIC DIFFUSER. USE SEA GULL LIGHTING MODEL NUMBER 7926EN3-15 OR

NEW ONE LIGHT ADA COMPLIANT WALL MOUNTED LIGHTING FIXTURE WITH ONE (1) A19 LED LAMP AND WHITE ACRYLIC DIFFUSER. USE SEA GULL LIGHTING MODEL NUMBER 4938EG-15 OR EQUAL.

OVATION
OPS + PLANNING





1114 Clinch Ave., Suite 200 Knoxville, TN 37916 (865) 525-3488 ICT JOB No. 180484


37 

DATE	ISSUE FOR
	$\triangle$


authorization from DESIGN INNOVATIONS ARCHITECTS, INC., It is to be used for the project and site specifically identified herein and is not to be used on any other project. It is to be returned upon request. Do not scale drawings, written dimensions take precedence. All drawings and designs shown on these drawings are copyright © of DESIGN INNOVATIONS ARCHITECTS, INC.

BUILDINGS B, C, D, E, F, AND G UNIT PLANS -LIGHTING


E-101

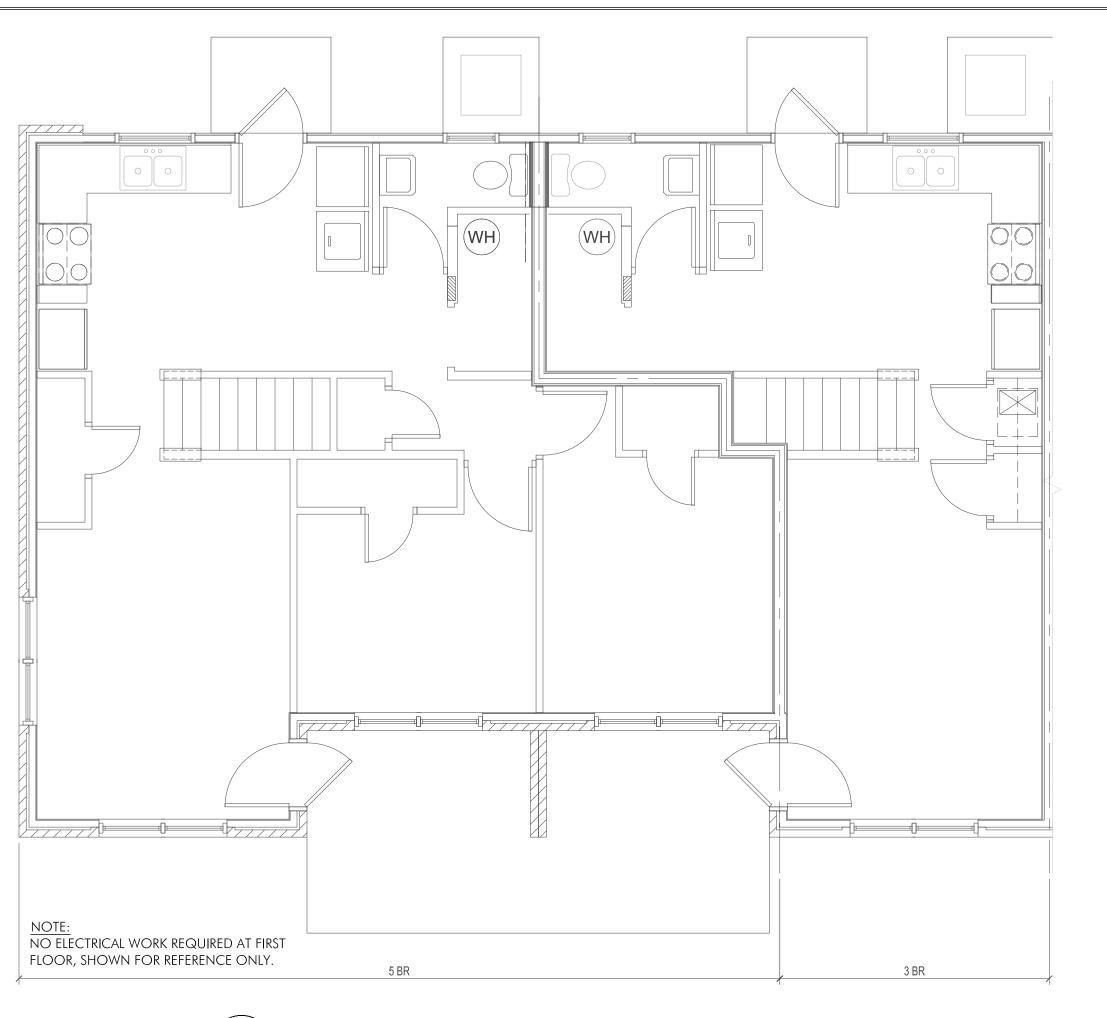

FIRST FLOOR PLAN - SANITARY NEW - BUILDING J SCALE: 1/4" = 1'-0"

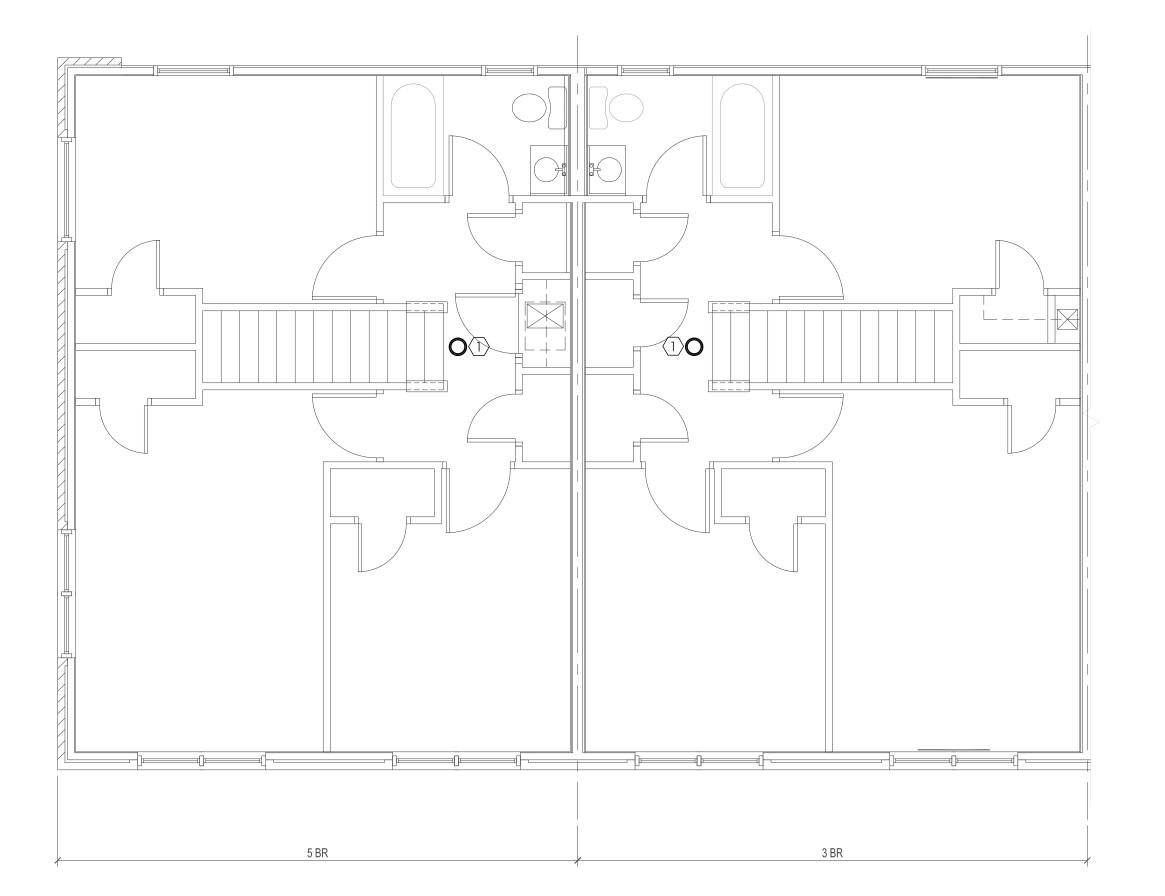


SECOND FLOOR PLAN - SANITARY NEW - BUILDING J SCALE: 1/4" = 1'-0"

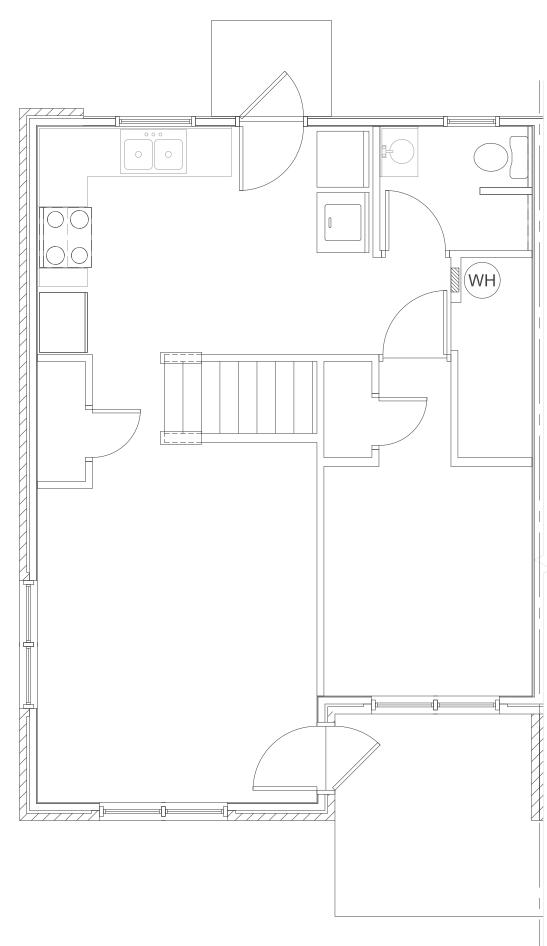

<u>NOTE:</u> NO ELECTRICAL WORK REQUIRED AT FIRST FLOOR, SHOWN FOR REFERENCE ONLY.

FIRST FLOOR PLAN - SANITARY NEW - BUILDING I SCALE: 1/4" = 1'-0"

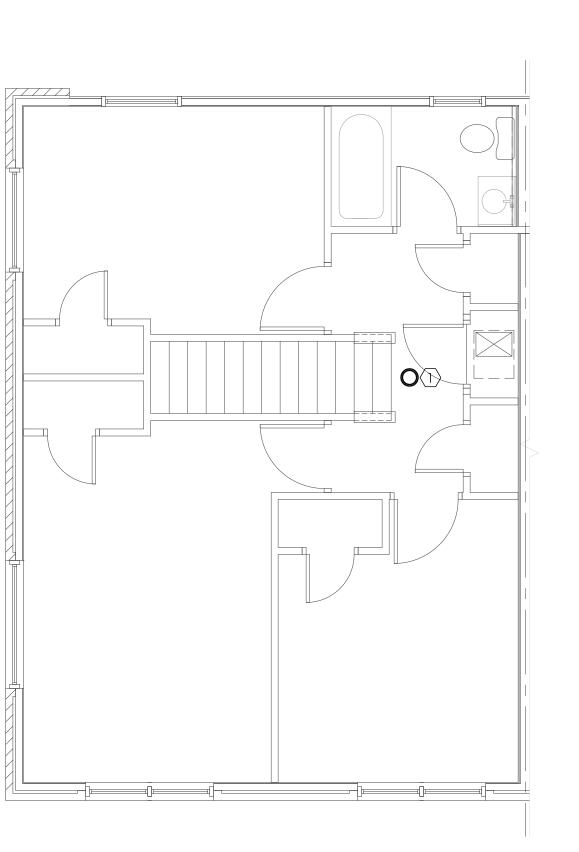

SECOND FLOOR PLAN - SANITARY NEW - BUILDING I SCALE: 1/4" = 1'-0"

### **GENERAL NOTES**

- 1. THIS DRAWING IS GENERALLY DIAGRAMMATIC IN NATURE AND EXCEPT WHERE SPECIFICALLY DIMENSIONED OR DETAILED, INDICATES THE GENERAL ARRANGEMENT OF THE WORK. THE CONTRACTOR SHALL INSTALL HIS WORK TO CONFORM AS NEARLY AS POSSIBLE TO THE LOCATIONS AND ARRANGEMENTS SHOWN, WITH ONLY SUCH MINOR ADJUSTMENTS AS NECESSARY. CONTRACTOR SHALL COORDINATE THE WORK WITH ALL OTHER TRADES TO AVOID INTERFERENCES.
- 2. ALL ELECTRICAL COMPONENTS EXTENDED THROUGH A FIRE RATED STRUCTURE SHALL BE PROTECTED OR SEALED AS REQUIRED TO MAINTAIN RATING OF THE STRUCTURE.
- 3. MAINTAIN CODE REQUIRED CLEARANCES AT ALL ELECTRICAL PANELS AND DISCONNECT SWITCHES. THERE SHALL BE NO EQUIPMENT, PIPING OR DUCT WORK INSTALLED IN OR ABOVE THE WORKING CLEARANCES.

### **KEY NOTES**

(1) EXISTING CEILING MOUNTED LIGHT FIXTURE TO BE REPLACED WITH NEW LIGHT FIXTURE IN THE SAME LOCATION. MAINTAIN EXISTING CIRCUITRY AND CONTROLS.

### LEGEND

NEW TWO LIGHT CEILING FLUSH MOUNTED LIGHTING FIXTURE WITH TWO (2) A19 LED LAMPS AND WHITE SHATTER RESISTANT ACRYLIC DIFFUSER. use sea gull lighting model number 7926EN3-15 OR EQUAL.







I.C. Thomasson Associates, Inc. 1114 Clinch Ave., Suite 200

Knoxville, TN 37916 (865) 525-3488 ICT JOB No. 180484

DATE ISSUE FOR This drawing is the property of DESIGN INNOVATIONS ARCHITECTS, INC. and is not to be reproduced or copied in whole or in part without authorization from DESIGN INNOVATIONS ARCHITECTS, INC.. It is to be used for the project and site specifically identified herein and is not to

be used on any other project. It is to be returned upon request. Do not scale drawings, written dimensions take precedence. All drawings and designs shown on these drawings are copyright ⊙ of DESIGN INNOVATIONS ARCHITECTS, INC.

BUILDING I AND J UNIT PLANS -LIGHTING

E-102 10-08-18

FOR: A RENOVATION TO:

# MONTGOMERY VILLAGE

4530 JOE LEWIS ROAD KNOXVILLE, TENNESSEE 37920

OWNER:

KNOXVILLE'S COMMUNITY DEVELOPMENT CORP. Phone: (865) 755-6007 P.O. BOX 3550 KNOXVILLE, TN 37927

Contact : JACK CANADA Phone : (865) 403-1371 302 EAST ANDERSON ST. KNOXVILLE, TN 37917



REFERENCE DWGS
COVER PAGE 10-08-18 18110 C-0

A RENOVATION TO:

**MONTGOMERY VILLAGE** 

4530 JOE LEWIS ROAD KNOXVILLE, TENNESSEE 37920

@ 4.41%

- EXISTING SANITARY SEWER LINE TO BE ABANDONED

MATCH LINE

SHEET C3

### **UTILITY NOTES:**

- 1. LOCATE EXISTING UTILITIES. CALL THE TENNESSEE ONE CALL NORTH SYSTEM, AT 1-800-351-1111.
  - 2. BLASTING WILL NOT BE ALLOWED ON THIS PROJECT WITHOUT PRIOR EXPRESS WRITTEN PERMISSION FROM THE OWNERS REPRESENTATIVE.
  - PRIOR TO COMMENCING WORK, THE CONTRACTOR SHALL CONTACT THE UTILITY OWNERS TO NOTIFY THEM OF WORK IN THE AREA AND REQUEST THEM TO PROPERLY LOCATE THEIR RESPECTIVE UTILITY. NOTIFICATION SHALL BE GIVEN AT LEAST THREE BUSINESS DAYS PRIOR TO COMMENCEMENT OF OPERATIONS AROUND THE
  - 4. CONTRACTOR MUST HAVE A VALID STATE OF TENNESSEE MUNICIPAL UTILITY LICENSE FOR CONSTRUCTION OF WATER AND SANITARY SEWER MAINS.
  - 5. THE LOCATIONS OF THE EXISTING UTILITIES SHOWN ON THESE DRAWINGS ARE APPROXIMATE. THE EXACT LOCATIONS SHALL BE DETERMINED IN THE FIELD BY POTHOLING AND BY CONTACTING THE UTILITY COMPANIES INVOLVED.
  - 6. PROVIDE ALL NECESSARY PROTECTIVE MEASURES TO SAFEGUARD THE EXISTING UTILITIES FROM DAMAGE DURING THE CONSTRUCTION OF THIS PROJECT. FURNISH ANY SPECIAL EQUIPMENT REQUIRED TO WORK OVER AND AROUND THE UTILITIES.
  - 7. TRENCH DESIGN AND SAFETY FOR PIPELINE CONSTRUCTION IS SOLELY THE RESPONSIBILITY OF THE CONTRACTOR AND SHALL CONFORM WITH ALL APPLICABLE LOCAL, STATE, AND OSHA REGULATIONS.
  - 8. INSTALL FITTINGS AS NEEDED TO AVOID CONFLICTS WITH EXISTING AND PROPOSED UNDERGROUND LINES AND OBSTRUCTIONS.
  - 9. LOCATE WATER VALVES OUTSIDE OF PAVED AREAS.
  - 10. WATER SERVICES SHOWN ON THESE DRAWINGS ARE FOR GENERAL LOCATION ONLY, PRIOR TO INSTALLATION, CONTRACTOR TO COORDINATE WITH THE UTILITY OWNER TO DETERMINE ACTUAL FIELD LOCATION OF WATER SERVICE TAPS, SERVICE LINES, VALVES, AND WATER METERS.
  - 11. UNLESS OTHERWISE NOTED, ALL SANITARY SEWER LINES SHALL BE PVC, SDR 26. ALL LATERALS TO BE 6" WITH A MINIMUM SLOPE OF
  - 12. BIDDERS SHALL FIELD VERIFY EXTENT OF CONCRETE, ASPHALT PAVEMENT, AND OTHER MATERIALS THAT WILL REQUIRE CUTTING, TRENCHING, AND RECONSTRUCTION/REPAIR DUE TO INSTALLATION OF PROPOSED WATER AND SEWER LINES AND APPURTENANCES.
  - 13. METHOD OF WATER LINE INSTALLATION IS AT THE CONTRACTOR'S OPTION. ALL METHODS SHALL BE PER SPECIFICATIONS; NO ADDITIONAL COSTS WILL BE PAID FOR ALTERNATE METHODS.
  - 14. CONTRACTOR SHALL COORDINATE WITH KUB AND OWNER TO ASSURE MINIMAL INTERRUPTION OF SERVICE. ALL INTERRUPTION OF SERVICE SHALL RECEIVE PRIOR APPROVAL AND SHALL BE SCHEDULED WITH OWNER. THE EXISTING WATER METERS AND PRIVATE WATER SYSTEM SERVING THE MONTGOMERY VILLAGE PROJECT SHALL REMAIN IN PLACE AND STAY ACTIVE UNTIL NO LONGER REQUIRED FOR WATER DELIVERY. WORK AND MATERIALS SPECIFICALLY ASSOCIATED WITH THE DISCONNECTION AND REMOVAL AND/OR ABANDONMENT OF THE EXISTING PRIVATE SYSTEM SHALL BE PROVIDED AND PERFORMED IN THIS PROJECT CONTRACT AND SHALL BE INCLUDED IN THIS BID.
  - 15. ALL TREES WITHIN 20' OF PROPOSED CONSTRUCTION SHALL BE PROPERLY PROTECTED. THE REPLACEMENT OF REMOVED TREES WILL NOT BE PERFORMED DURING THIS PHASE OF THE PROJECT. WORK AND MATERIALS SPECIFICALLY ASSOCIATED WITH THE REPLACEMENT OF TREES WILL BE PROVIDED AND PERFORMED IN A SUBSEQUENT PROJECT CONTRACT AND SHALL NOT BE INCLUDED IN THIS BID.
  - 16. THE WATER SERVICE ASSEMBLIES PER KUB FIGURE 12-02518-L WILL BE INSTALLED BY OTHERS TO A POINT AT 24" BEYOND THE METER WELLS. THE WATER METERS SHALL BE PROVIDED IN THIS CONTRACT AND THE COSTS SHALL BE INCLUDED IN THE BID. WORK AND MATERIALS SPECIFICALLY ASSOCIATED WITH THE INSTALLATION OF THE WATER METERS, DOMESTIC WATER LINES FROM A POINT 24" BEYOND THE METER WELLS, BACKFLOW PREVENTERS (SEE ALTERNATE #6), AND OTHER ASSOCIATED APPURTENANCES SHALL BE PROVIDED AND PERFORMED IN THIS CONTRACT AND SHALL BE INCLUDED IN THIS BID.

### LEGEND:

LEGEND.
SS
W
<i> DW</i>
•
——SS
<b>●</b> co
•

TYP.


(1/C2)

EXISTING WATER LINE PROPOSED WATER LINE PROPOSED WATER VALVE AND BOX PROPOSED FIRE HYDRANT ASSEMBLY PROPOSED SEWER LINE PROPOSED SEWER CLEANOUT PROPOSED SINGLE WATER METER PROPOSED BACKFLOW PREVENTER PROPOSED BLOW-OFF VALVE PROPOSED INLET SEDIMENT CONTROL

EXISTING SANITARY SEWER LINE

TYPICAL DETAIL REF. (DETAIL NO./SHT. NO.)

# **CIVIL ENGINEER:**

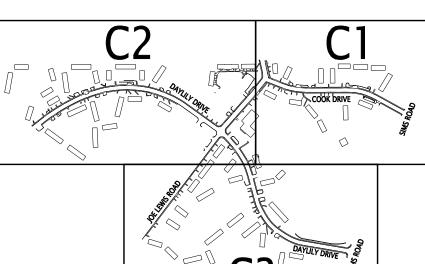



10330 HARDIN VALLEY ROAD SUITE 201 **KNOXVILLE, TN 37932** OFFICE: 865.690.6419 FAX: 865.690.6448 www.fulghummacindoe.com FMA PROJECT: 397.001


roject Number


DATE ISSUE FOR 04/27/10 / \ BID SET


4530 , KNOXVILL

is drawing is the property of DESIGN INNOVATIONS ARCHITECTS, INC. and is not to be reproduced or copied in whole or in part without authorization from DESIGN INNOVATIONS ARCHITECTS, INC.. it is to be used for the project and site specifically identified herein and is not to be used on any other project. It is to be returned upon request. Do not scale drawings, written dimensions take precedence. All drawings and designs shown on these drawings are copyright © of DESIGN INNOVATIONS ARCHITECTS, INC.

PROPOSED PRIVATE SITE WATER AND SANITARY SEWER **IMPROVEMENTS** 

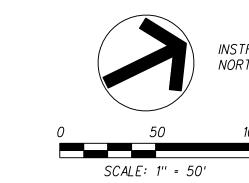


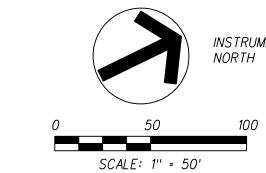

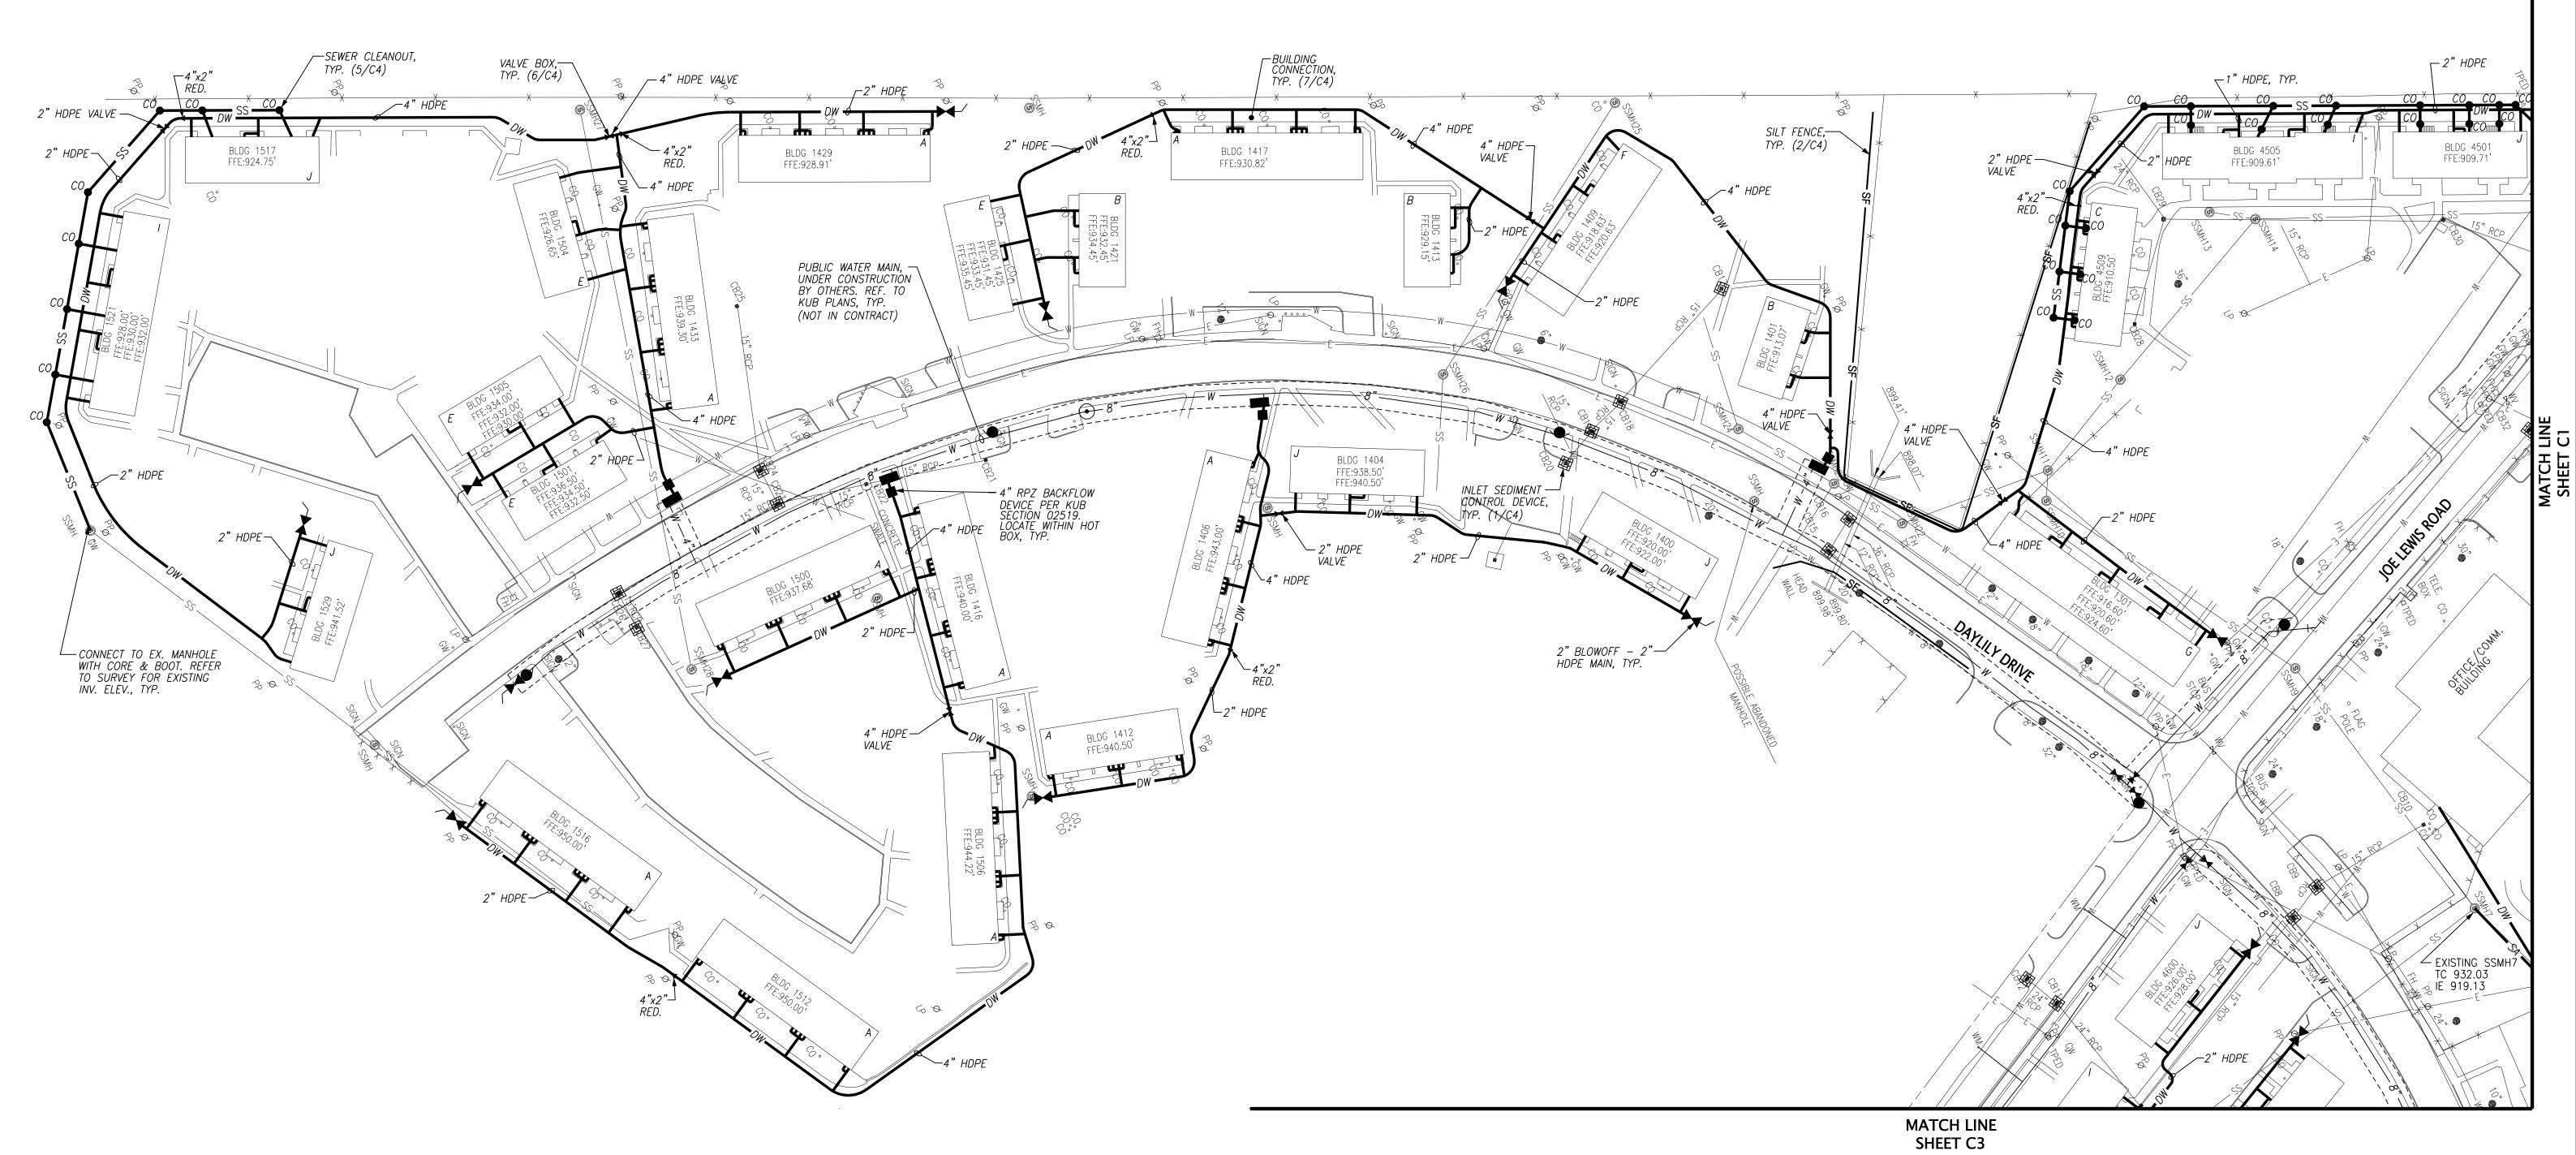

**GENERAL NOTES:** 


1. REFER TO SHEET C1 FOR NOTES AND LEGEND.

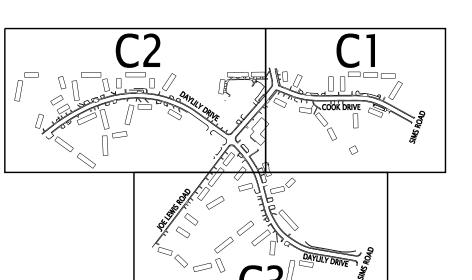



**CIVIL ENGINEER:** 

10330 HARDIN VALLEY ROAD SUITE 201 KNOXVILLE, TN 37932 OFFICE: 865.690.6419 FAX: 865.690.6448 www.fulghummacindoe.com FMA PROJECT: 397.001

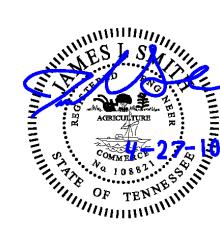



DATE ISSUE FOR 04/27/10 | A BID SET

This drawing is the property of DESIGN INNOVATIONS ARCHITECTS, INC. and is not to be reproduced or copied in whole or in part without authorization from DESIGN INNOVATIONS ARCHITECTS, INC... It is to be used for the project and site specifically identified herein and is not to be used on any other project. It is to be returned upon request. Do not scale drawings, written dimensions take precedence. All drawings and designs shown on these drawings are copyright © of DESIGN INNOVATIONS ARCHITECTS, INC.


PROPOSED PRIVATE SITE WATER AND SANITARY SEWER IMPROVEMENTS

Project Number 4/27/10

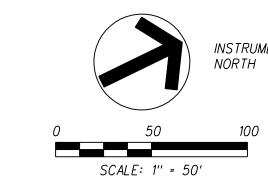

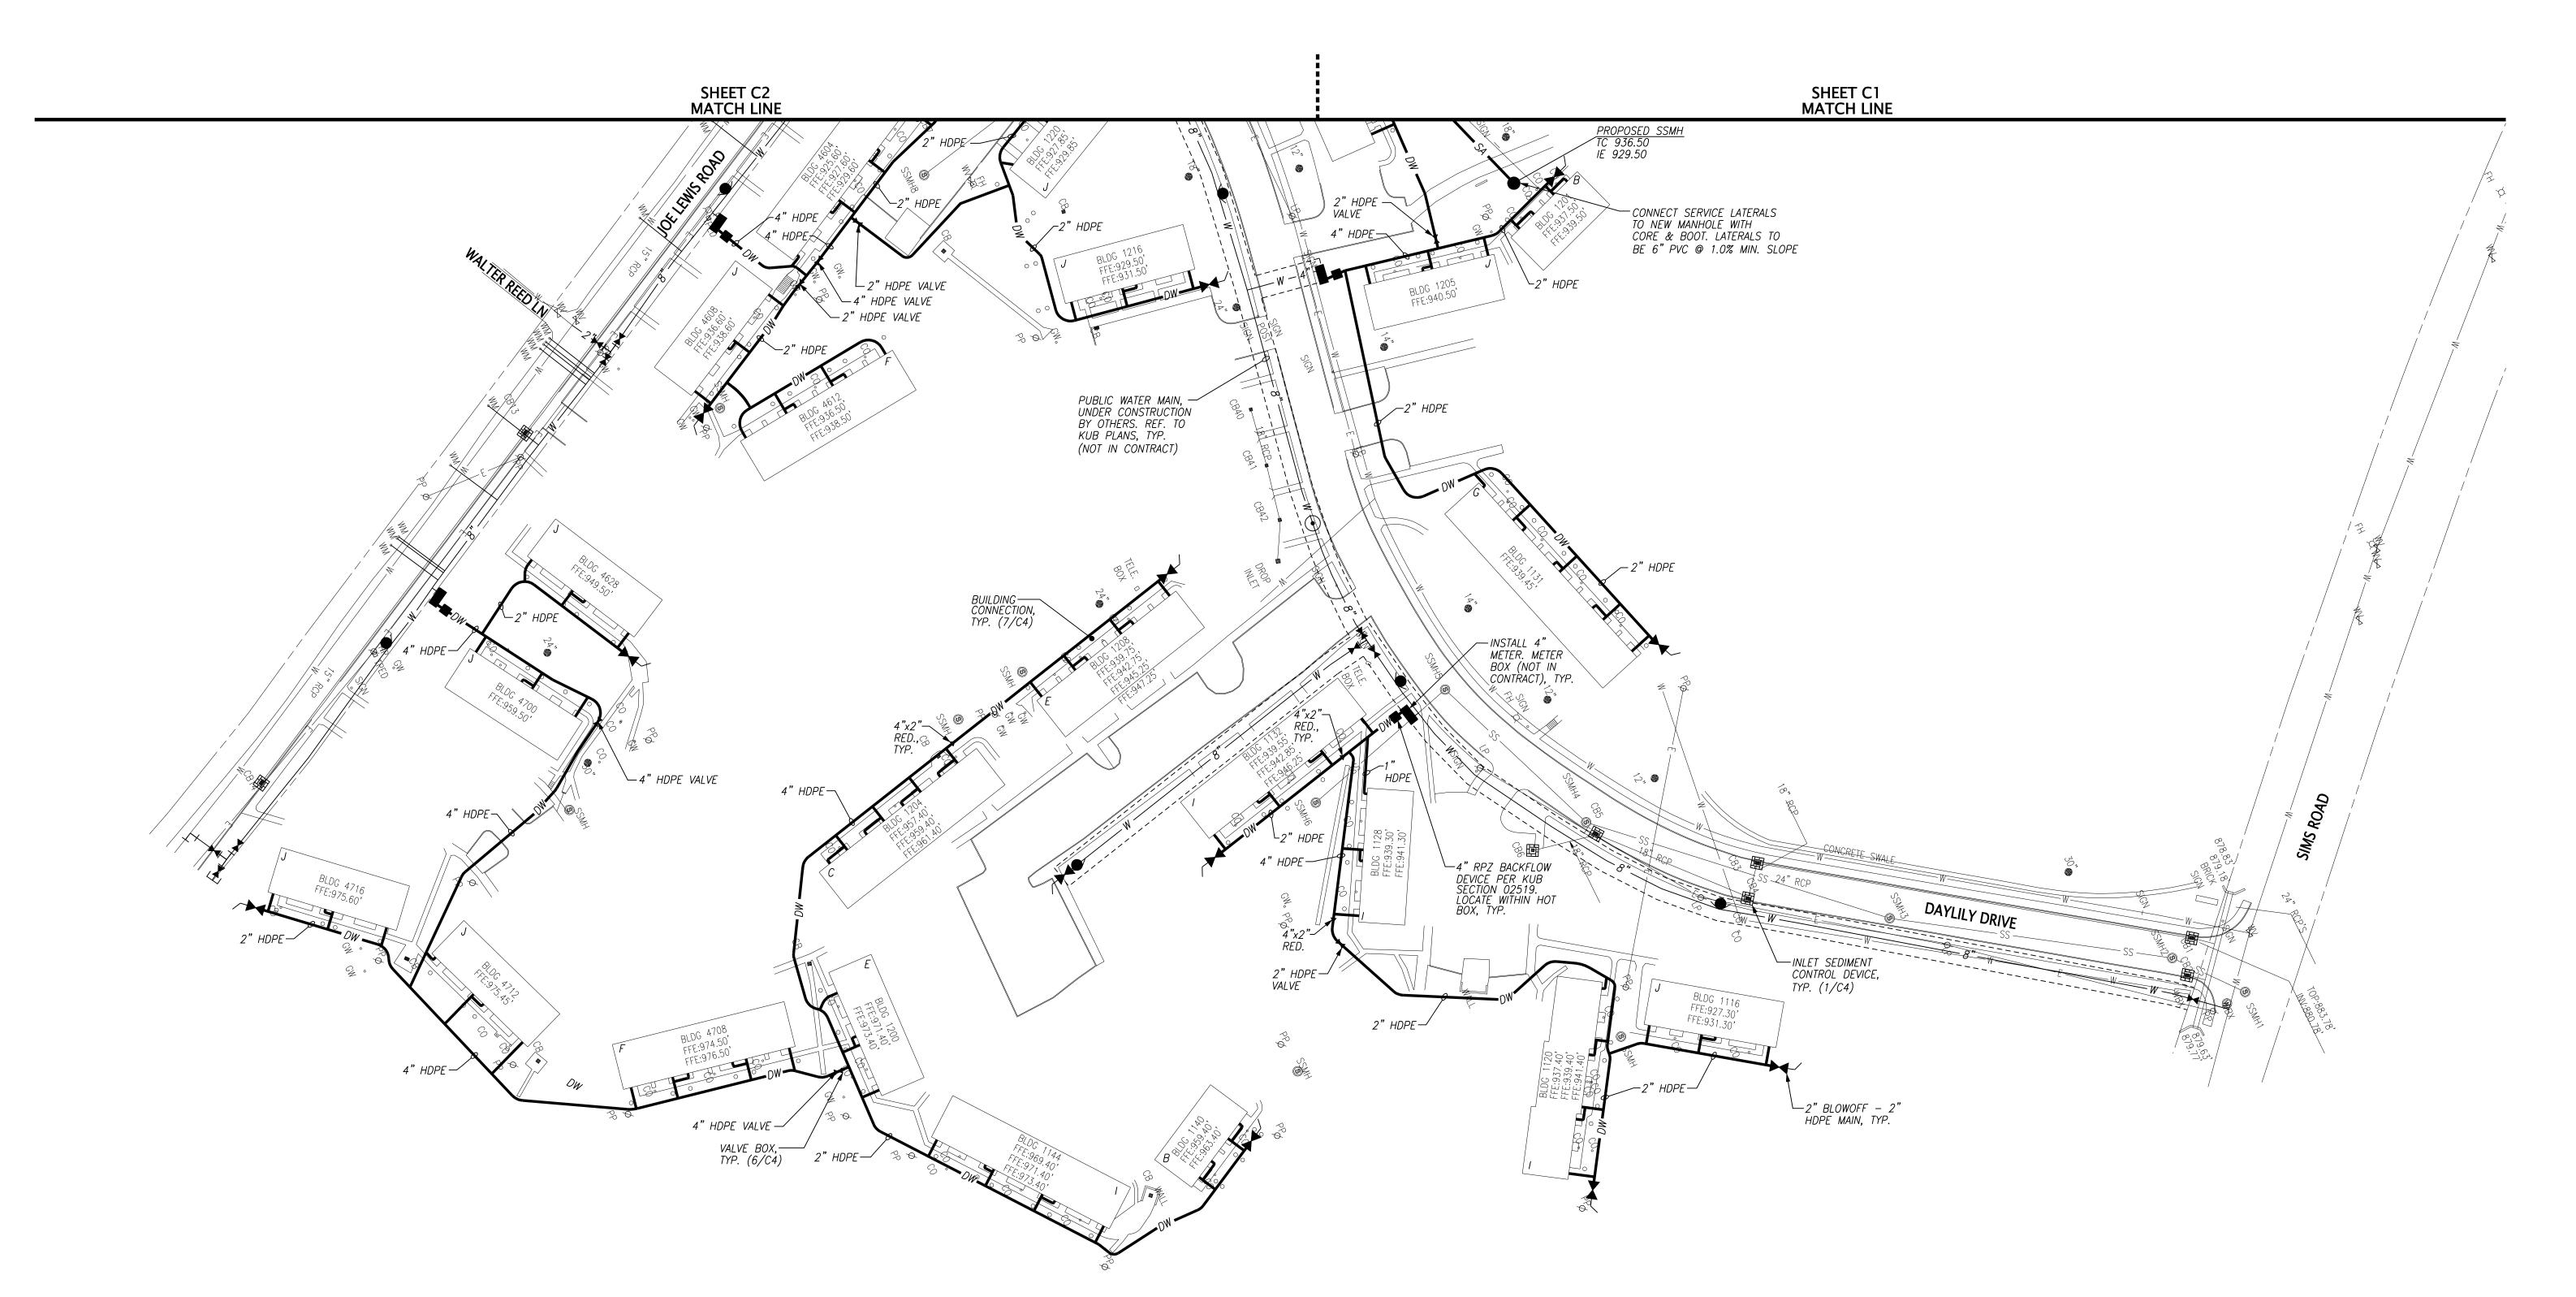

GENERAL NOTES:

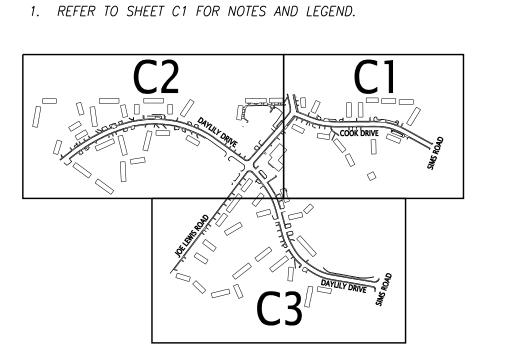

CIVIL ENGINEER:



10330 HARDIN VALLEY ROAD SUITE 201 KNOXVILLE, TN 37932 OFFICE: 865.690.6419 FAX: 865.690.6448 www.fulghummacindoe.com FMA PROJECT: 397.001 Design Innovation
RCHITECTS + INTERIORS + PLANNING



NTGOMERY VILLA 4530 JOE LEWIS ROAD

DATE	ISSUE FOR
04/27/10	A BID SET

This drawing is the property of DESIGN INNOVATIONS ARCHITECTS, INC. and is not to be reproduced or copied in whole or in part without authorization from DESIGN INNOVATIONS ARCHITECTS, INC... It is to be used for the project and site specifically identified herein and is not to be used on any other project. It is to be returned upon request. Do not scale drawings, written dimensions take precedence. All drawings and designs shown on these drawings are copyright © of DESIGN INNOVATIONS ARCHITECTS, INC.

Sheet Title
PROPOSED PRIVATE
SITE WATER AND
SANITARY SEWER
IMPROVEMENTS

Project Number 09029	Sheet Number
Date	
4/27/10	