


**CITY OF GALESBURG
PUBLIC SAFETY BUILDING
INTERIOR RENOVATIONS - PHASE IIIB
150 SOUTH BROAD STREET
GALESBURG, ILLINOIS, 61401**

**OWNER:
CITY OF GALESBURG
55 WEST TOMPKINS STREET
GALESBURG, ILLINOIS 61401**

**ARCHITECT / ENGINEER:
KLINGNER & ASSOCIATES, P.C.
49 NORTH PRAIRIE STREET
GALESBURG, ILLINOIS 61401
TEL. (309) 342-4042
FAX. (309) 341-3781**

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Area Location Plan

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Engineers • Architects • Surveyors

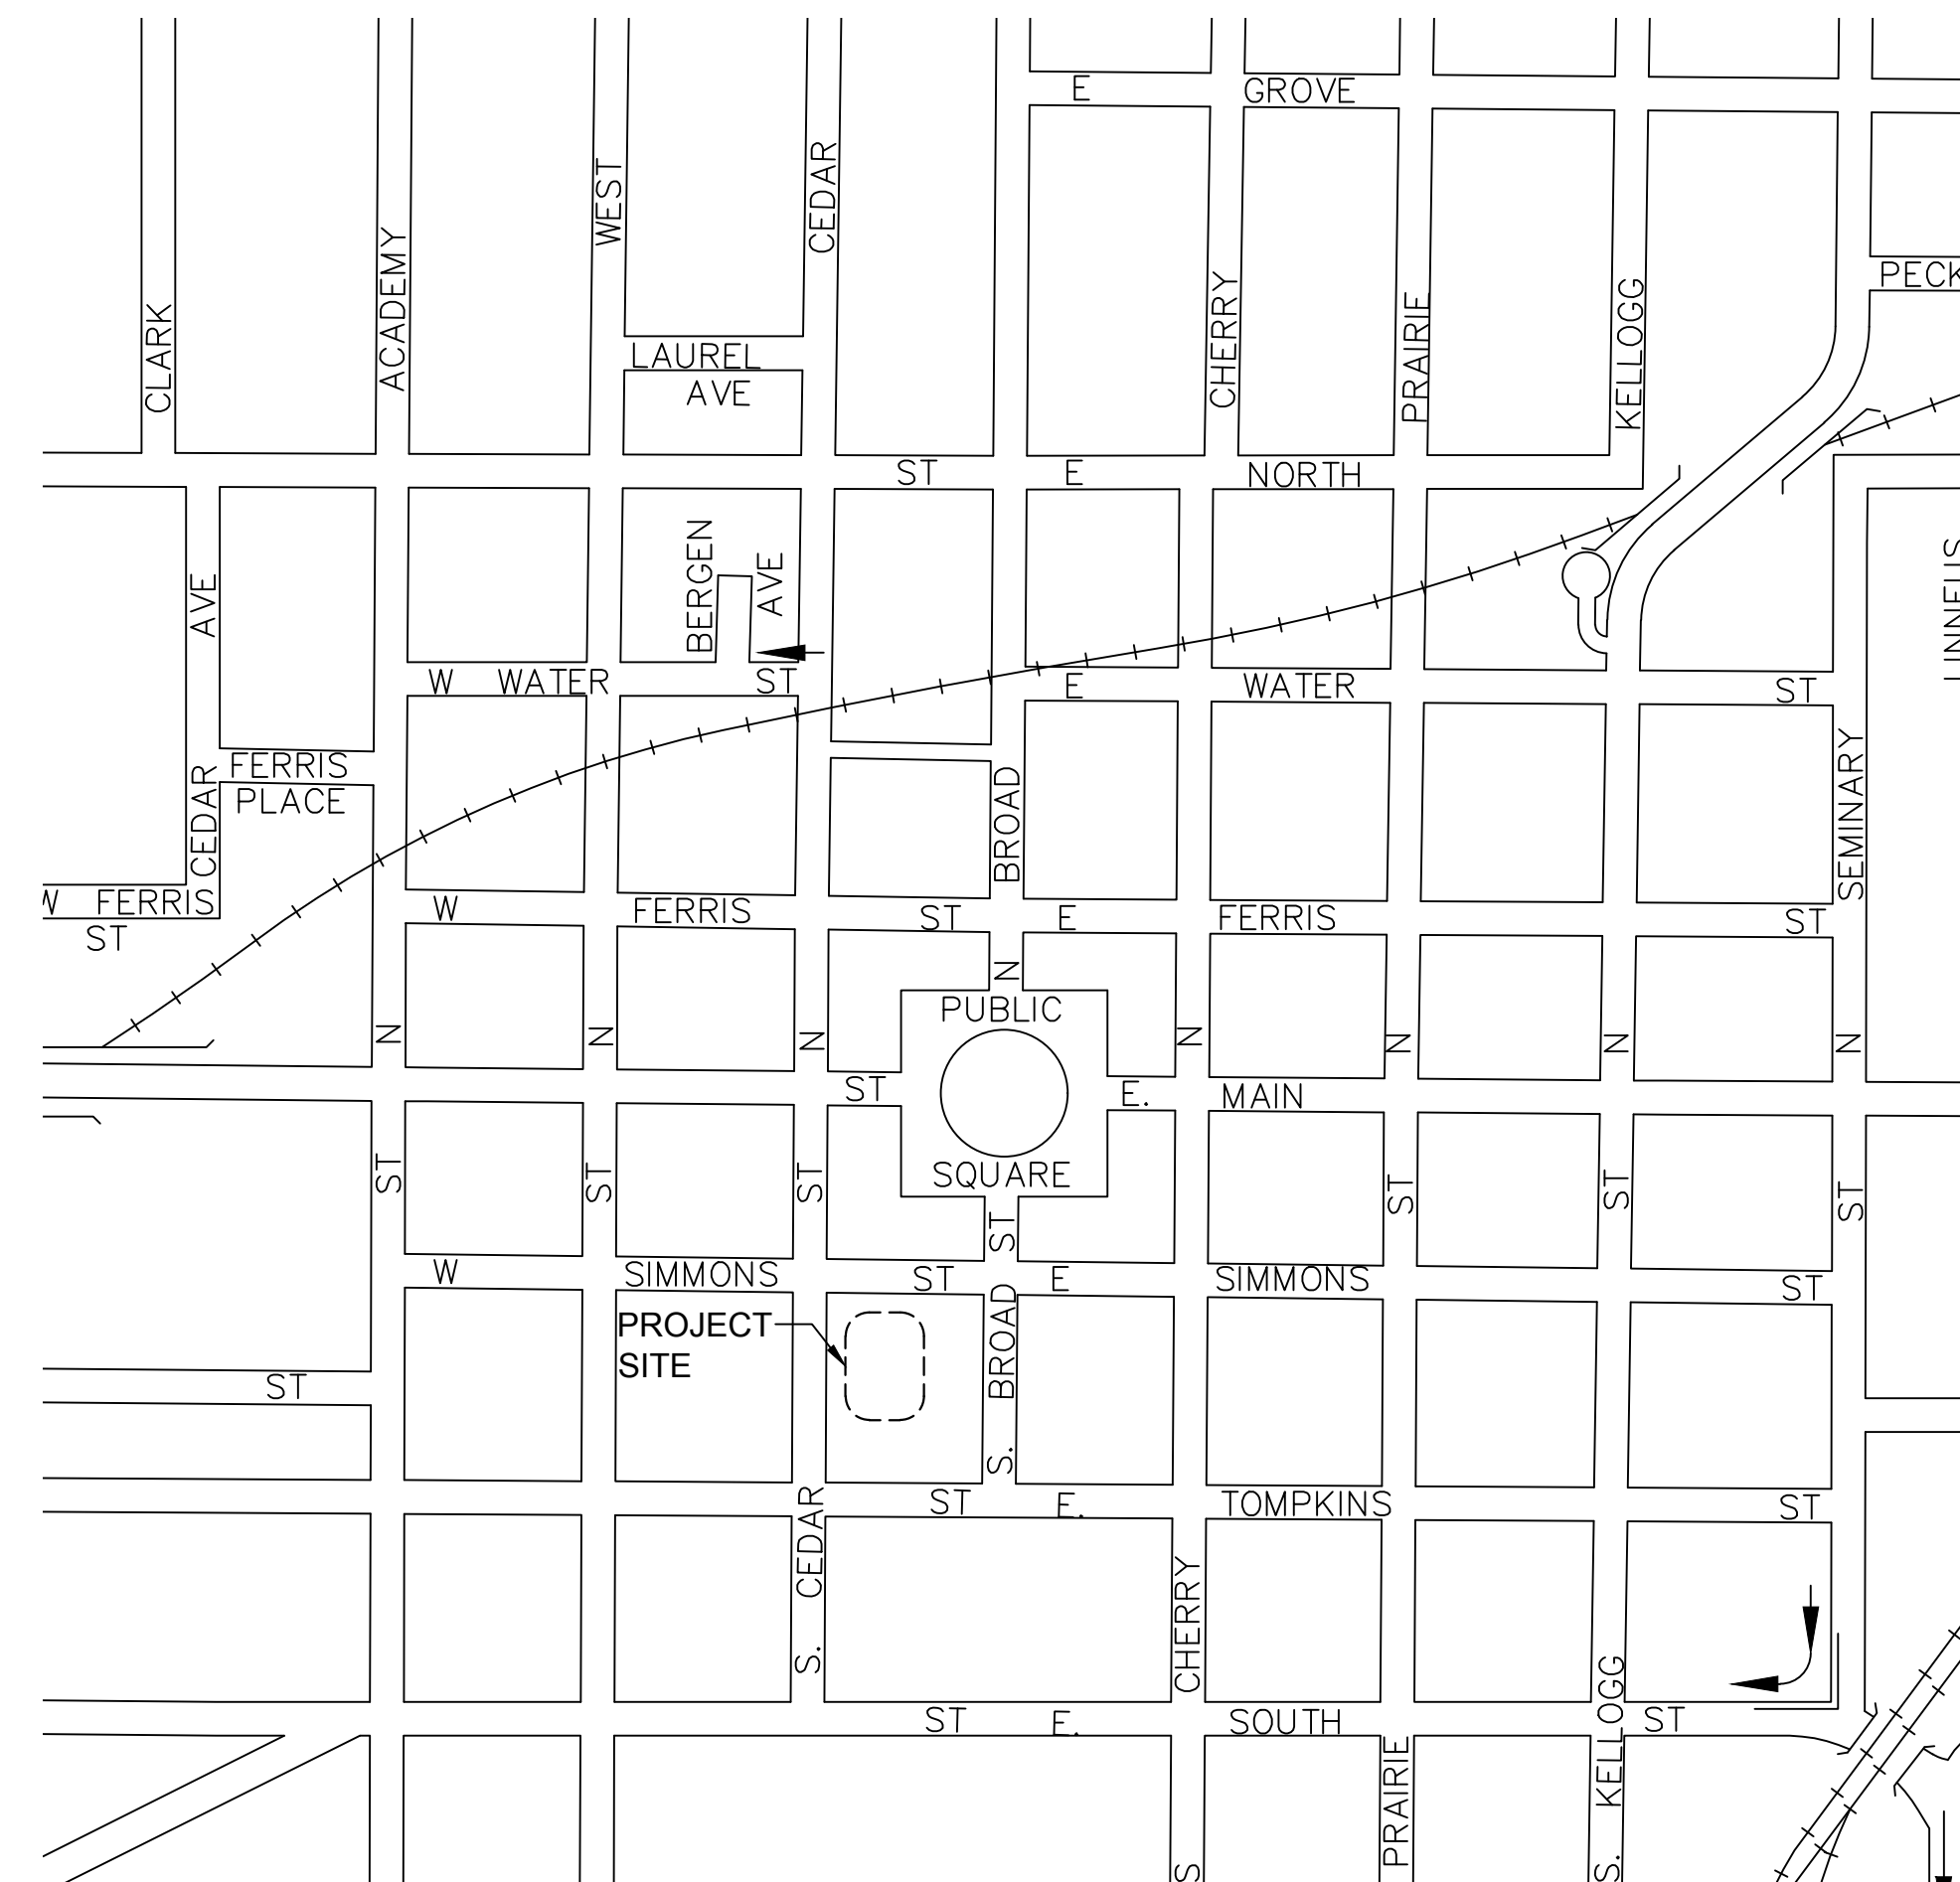616 North 24th Street, Quincy, IL Ph 217.223.3670 • Fax 217.223.3603
 4510 Paris Gravel Road, Hannibal, MO Ph 573.221.0020 • Fax 573.221.0012
 610 N. 4th Street, Suite 100, Burlington, IA Ph 319.752.3603 • Fax 319.752.3605
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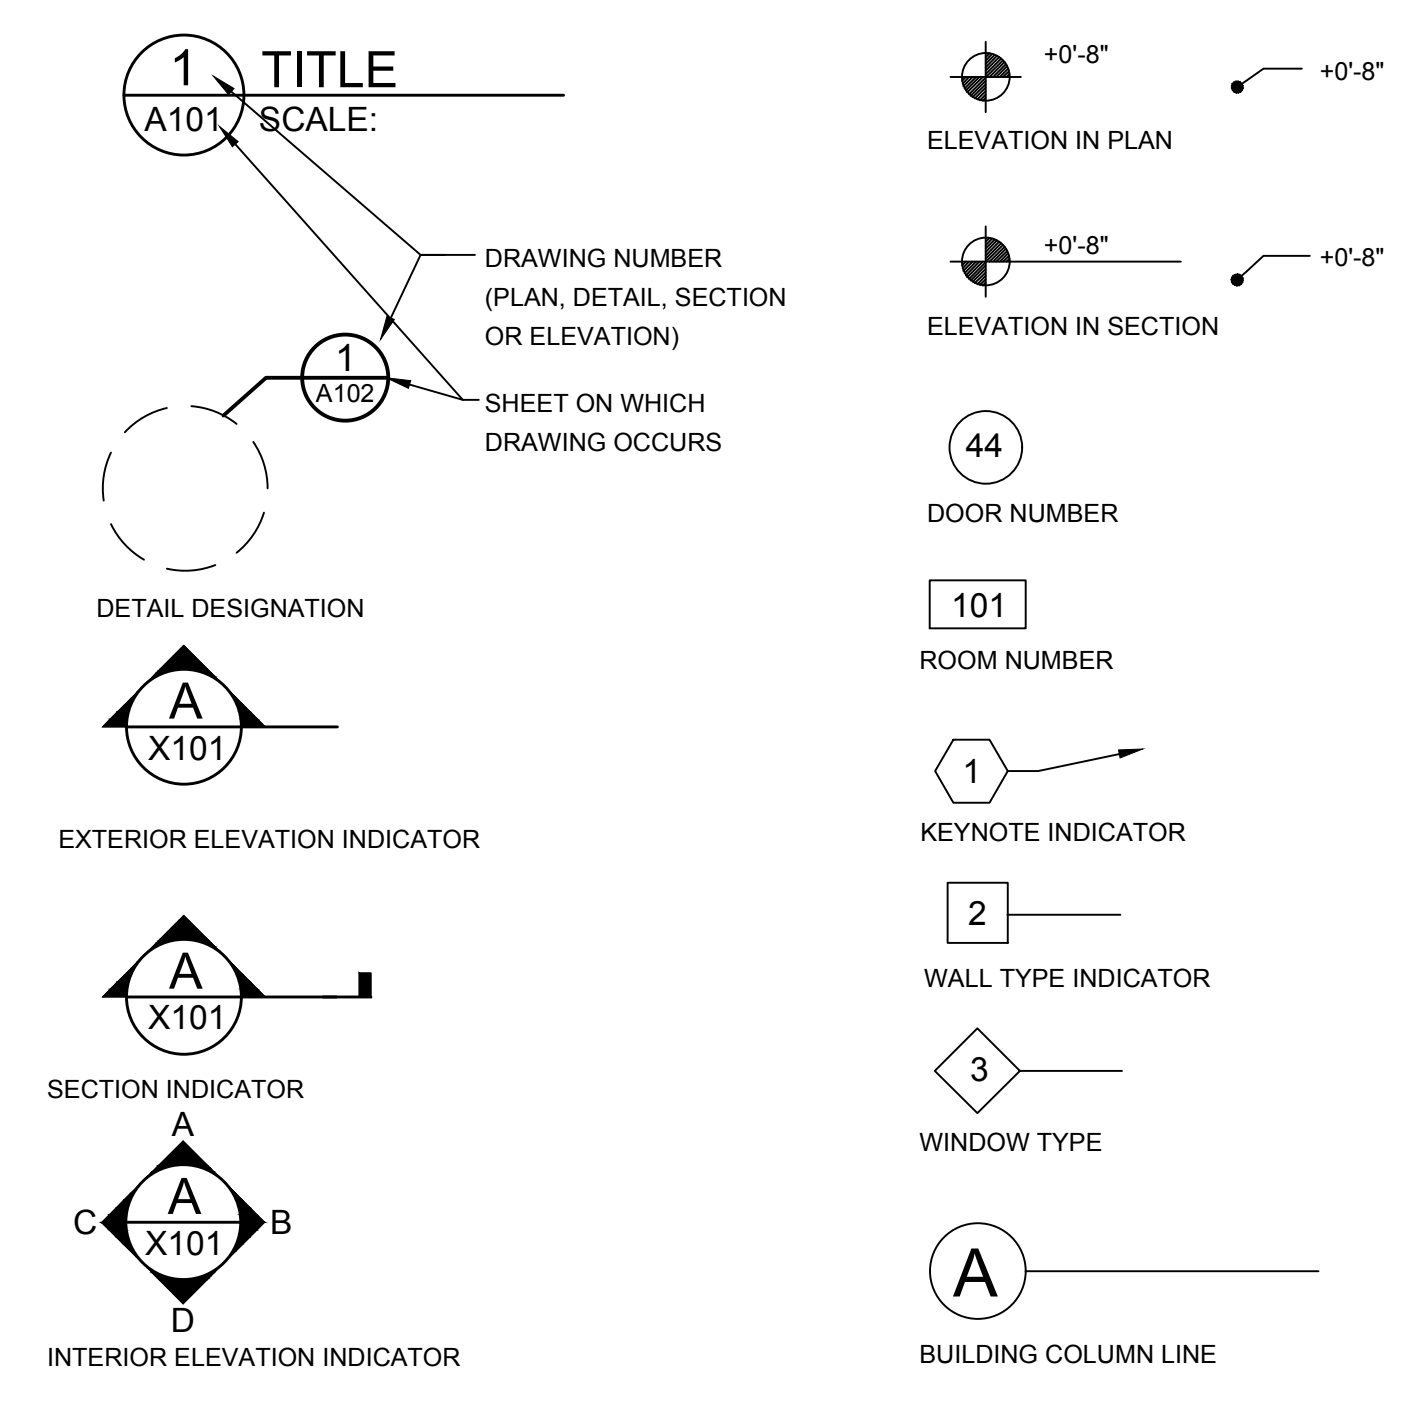
	THE PORTION OF THE TECHNICAL SUBMISSION DESCRIBED BELOW HAS BEEN PREPARED UNDER THE DIRECT SUPERVISION AND RESPONSIBLE CHARGE OF THE UNDERSIGNED.	
	CODY NICHOLAS BASHAM LICENSED ARCHITECT ILLINOIS REGISTRATION NO. 001-023641 LICENSE EXPIRATION DATE: 11/30/18 KLINGNER & ASSOCIATES P.C. DATE OF ISSUANCE: 12/19/16	
SET NO.	PROJECT NO. 3215-073 (15-3027)	SHT: G001
	DATE: DECEMBER 19, 2015	

Non-Reduced Size: 24x36

ABBREVIATIONS

@	ANCHOR BOLT	E	EAST	L	ANGLE, LONG	R	RADIUS, RANGE, RISER, THERMAL RESISTANCE
AD	AIR CONDITIONER	EA	EACH	LAM	LAMINATE(D)	RB	RUBBER BASE
A/C	ALUMINUM COMPOSITE MATERIAL	EC	ELECTRICAL (SUB)CONTRACTOR	LAM GL	LAMINATED GLASS	RCP	REFLECTED CEILING PLAN
ACM	ACOUSTICAL CEILING PANEL	EF	EXHAUST FAN	LAV	LAVATORY	RD	ROOF DRAIN, ROAD
ACP	AMERICANS WITH DISABILITIES ACT	EJ	EXPANSION JOINT	LBS	POUND	REBAR	REINFORCING STEEL BARS
ADA	ADDENDUM	EL	ELEVATION	LED	LIGHT EMITTING DIODE	REINFC	REINFORCING
ADD	ADJACENT	ELEC	ELECTRIC	LINEAR	LINEAR	REOD	REQUIRED
ADJ	ABOVE FINISHED FLOOR	EQ	EQUAL	LL	LIVE LOAD	REV	REVISION(S), REVISED
AF	AMERICAN INSTITUTE OF ARCHITECTS	ETC	ET CETERA	LLH	LONG LEG HORIZONTAL	RM	ROOM
ALT	ALTERNATE	EW	EACH WAY	LLV	LONG LEG VERTICAL	RO	ROUGH OPENING
ALUM	ALUMINUM	EWC	ELECTRIC WATER COOLER	LVR	LOUVER	ROW	RIGHT OF WAY
APPROX	APPROXIMATE	EX, EXIST	EXISTING	M	METER(S)	RST	RUBBER STAIR TREADS
ARCH	ARCHITECT (URAL)	EXP	EXPANSION	MAX	MAXIMUM	RTU	ROOF TOP UNIT
ASPH	ASPHALT	EXT	EXTERIOR	MC	MECHANICAL (SUB)CONTRACTOR	S	SOUTH
AUTO	AUTOMATIC	FA	FIRE ALARM	MECH	MECHANICAL	SAN	SANITARY
AVG	AVERAGE	FB	FACE BRICK	MEP	MECHANICAL, ELECTRICAL, & PLUMBING	SCHED	SCHEDULE
B/	BOTTOM OF	FBO	FURNISHED BY OTHERS	MEZZ	MEZZANINE	SD	SMOKE DETECTOR
BB	BASEBOARD	FCO	FLOOR CLEAN OUT	MFR	MANUFACTURER	SECT	SECTION
BD	BOARD	FD	FLOOR DRAIN	MH	MANHOLE	SF	SQUARE FEET
BIT	BITUMINOUS	FDTN	FOUNDATION	MIN	MINIMUM	SHT	SHEET
BLDG	BUILDING	FE	FIRE EXTINGUISHER	MISC	MISCELLANEOUS	SIM	SIMILAR
BLK	BLOCK	FEC	FIRE EXTINGUISHER CABINET	MM	MILLIMETER(S)	SLR	SEALER
BM	BENCHMARK	FF&E	FURNITURE, FIXTURE AND EQUIPMENT	MO	MASONRY OPENING	SNT	SEALANT
BOF	BOTTOM OF FLASHING	FF EL	FINISHED FLOOR ELEVATION	MTD	MOUNTED	SPEC	SPECIFICATION(S)
BOT	BOTTOM	FIN	FINISH(ED)	MTL	METAL	S&V	STAIN & VARNISH
BRG	BEARING	FIN GR	FINISH GRADE	N	NORTH	SS	STAINLESS STEEL
BSMT	BASEMENT	FLR	FLOOR LINE	NA	NOT APPLICABLE	ST	STREET
BTW	BETWEEN	FLL	FLOOR(ING)	NEC	NATIONAL ELECTRICAL CODE	STD	STANDARD
		FOF	FACE OF FINISH	NFPA	NATIONAL FIRE PROTECTION ASSOCIATION	STL	STEEL
CFMF	COLD-FORMED METAL FRAMING	FRP	FIBER REINFORCED PLASTIC	NIC	NOT IN CONTRACT	STOR	STORAGE
CFT	CERAMIC FLOOR TILE	FT	FEET, FIRE TREATED	NO	NO NUMBER	STRUCT	STRUCTURAL
CIR	CIRCLE	FTG	FOOTING	NOM	NOMINAL	SV	SHEET VINYL
CJ	CONTROL JOINT	FURN	FURNITURE	NRC	NOISE REDUCTION COEFFICIENT	SWI	STORM WATER INLET
CL	CENTER LINE	GA	GAGE, GAUGE	NTS	NOT TO SCALE	SYMM	SYMMETRICAL
CLG	CEILING	GALV	GALVANIZED	OC	ON CENTER(S)	T	TREAD
CLO	CLOSET	GC	GENERAL CONTRACTOR	OD	OUTSIDE DIAMETER	T/	TOP OF
CLR	CLEAR	GCMU	GLAZED CONCRETE MASONRY UNIT	OPH	OPPOSITE HAND	T&B	TOP & BOTTOM
CM	CENTIMETER(S)	GI	CERAMIC MOSAIC TILE	OPNG	OPENING	T&G	TONGUE & GROOVE
CMT	CERAMIC MOSAIC TILE	GL	GLASS	OPP	OPPOSITE	TERM	TERMINATION, TERMINAL
CMU	CONCRETE MASONRY UNIT	GPB	GYPSPUM PLASTERING BASE	PAR	PARALLEL	THK	THICK(NESS)
CO	CLEAN OUT	GR	GRADE, GRADING	PC	PIECE	THRU	THROUGH
COL	COLUMN	GWB	GYPSPUM WALLBOARD	PCF	POUNDS PER CUBIC FOOT	TMPD GL	TEMPERED GLASS
CONC	CONCRETE	GYP	GYPSPUM	PERF	PERFORATED	TS	TUBE STEEL
CONST	CONSTRUCTION	HC	HANDICAP	PL	PROPERTY LINE	TYP	TYPICAL
CONTR	CONTRACTOR	HM	HARDWOOD	PLAM	PLASTIC LAMINATE	UH	UNIT HEATER
COTG	CLEAN OUT TO GRADE	HRIZ	HORIZONTAL	PLAS	PLASTER	UL	UNDERLAYMENT
CPT	CARPET	HP	HORSE POWER	PLBG	PLUMBING	ULMT	UNDERLAYMENT UNEXCAVATED
CS	COMPOSITION STONE	HT	HEIGHT	PLF	POUNDS PER LINEAL FOOT	UNEX	UNEXCAVATED
CT	CERAMIC TILE	HTG	HEATING	PL GL	PLATE GLASS	UNO	UNLESS NOTED OTHERWISE
CU FT	CUBIC FOOT	HVAC	HEATING/VENTILATING/ AIR CONDITIONING	PLYWD	PLYWOOD	UV	ULTRAVIOLET
CU YD	CUBIC YARD			PNL	PANEL	VAV	VARIABLE AIR VOLUME
DBL	DOUBLE			POLYISO	POLYISOCYANURATE	VB	VINYL BASE
DEMO	DEMOLITION	IBC	INTERNATIONAL BUILDING CODE	PR	PAIR	VCT	VINYL COMPOSITION TILE
DF	DRINKING FOUNTAIN	ID	INSIDE DIAMETER	PREFAB	PREFABRICATE(D)	VERT	VERTICAL
DIA	DIAMETER	IGU	INSULATING GLASS UNIT	PRFIN	PREFINISH	VIF	VERIFY IN FIELD
DIAG	DIAGONAL	INSUL	INSULATION	PROJ	PROJECT	VOC	VOLATILE ORGANIC COMPOUND
DL	DEAD LOAD	INT	INTERIOR	PSF	POUNDS PER SQUARE FOOT	VT	VINYL TILE
DR	DOOR	INV	INVERT	PSI	POUNDS PER SQUARE INCH	VTR	VENT THROUGH ROOF
DS	DOWNSPOUT	J	JUNCTION BOX	PT	POINT, PRESSURE TREATED	VWC	VINYL WALL COVERING
DTL	DETAIL	JAN	JANITOR	QT	QUARRY TILE	W/	WITH
DWG	DRAWING	JC	JANITOR'S CLOSET			W	WEST, WATT, WIDE, WASTE
		JT	JOINT			WB	WOOD BASE
						WC	WATER CLOSET
						WCO	WALL CLEAN OUT
						WD	WOOD
						WG	WIRE GLASS
						WIO	WITHOUT
						WWF	WELDED WIRE FABRIC
						WIN	WINDOW


NOTATION AND SYMBOL DESIGNATIONS



GENERAL NOTES

- THE CONTRACTOR(S) SHALL CONFIRM CONDITIONS DESCRIBED HEREIN AND TELL ARCHITECT OF ANY DISCREPANCIES ENCOUNTERED PRIOR TO STARTING WORK AFFECTED THEREBY.
- THE CONTRACTOR(S) SHALL MEET ALL APPLICABLE CODES AND REGULATIONS INCLUDING BUT NOT LIMITED TO:
 - 2012 INTERNATIONAL BUILDING CODE
 - 2012 INTERNATIONAL MECHANICAL CODE
 - 2012 INTERNATIONAL FUEL GAS CODE
 - 2012 INTERNATIONAL FIRE CODE
 - 2014 NATIONAL ELECTRICAL CODE
 - 2014 ILLINOIS PLUMBING CODE
 - 2012 INTERNATIONAL ENERGY CONSERVATION CODE PER THE ILLINOIS ENERGY CONSERVATION CODE
 - EXISTING BUILDING CODE PER ILLINOIS PUBLIC ACT 096-0704: 2000 NFPA 101 LIFE SAFETY CODE (INCLUDING REQUIREMENTS FOR EXISTING BUILDINGS) PER ILLINOIS FIRE INVESTIGATION ACT 425 ILCS 25.
- THE CONTRACTOR(S) SHALL BE RESPONSIBLE FOR OSHA COMPLIANCE AND JOB SITE SAFETY.
- CONTRACTOR(S) SHALL VERIFY LOCATIONS OF ALL UTILITIES (TELEPHONE, DATA, GAS, ELECTRIC, SANITARY AND STORM SEWERS, ETC.) AT THE SITE BEFORE STARTING EXCAVATION OR CONSTRUCTION. THESE ITEMS SHALL BE MARKED AND PROTECTED.
- CONTRACTOR(S) SHALL TAKE PRECAUTIONS NECESSARY TO PROTECT ADJACENT PROPERTY FROM DAMAGE RESULTING FROM CONSTRUCTION OPERATIONS.
- THE CONTRACTOR(S) SHALL SUBMIT EVIDENCE OF INSURANCE TO OWNER AND HAVE IT APPROVED AS ACCEPTABLE TO OWNER PRIOR TO STARTING WORK.
- CONTRACTOR(S) SHALL REPORT ANY SUSPICIOUS MATERIALS (POTENTIALLY HAZARDOUS) AT THE SITE IMMEDIATELY TO THE OWNER FOR HIS/HER FURTHER ACTION. UNLESS NOTED SPECIFICALLY ON THE DRAWINGS OR PROJECT MANUAL THE ARCHITECT/ENGINEER IS NOT AWARE OF ANY HAZARDOUS MATERIALS AND HAS NOT BEEN HIRED BY THE OWNER TO DEAL WITH SUCH.

MATERIAL DESIGNATIONS

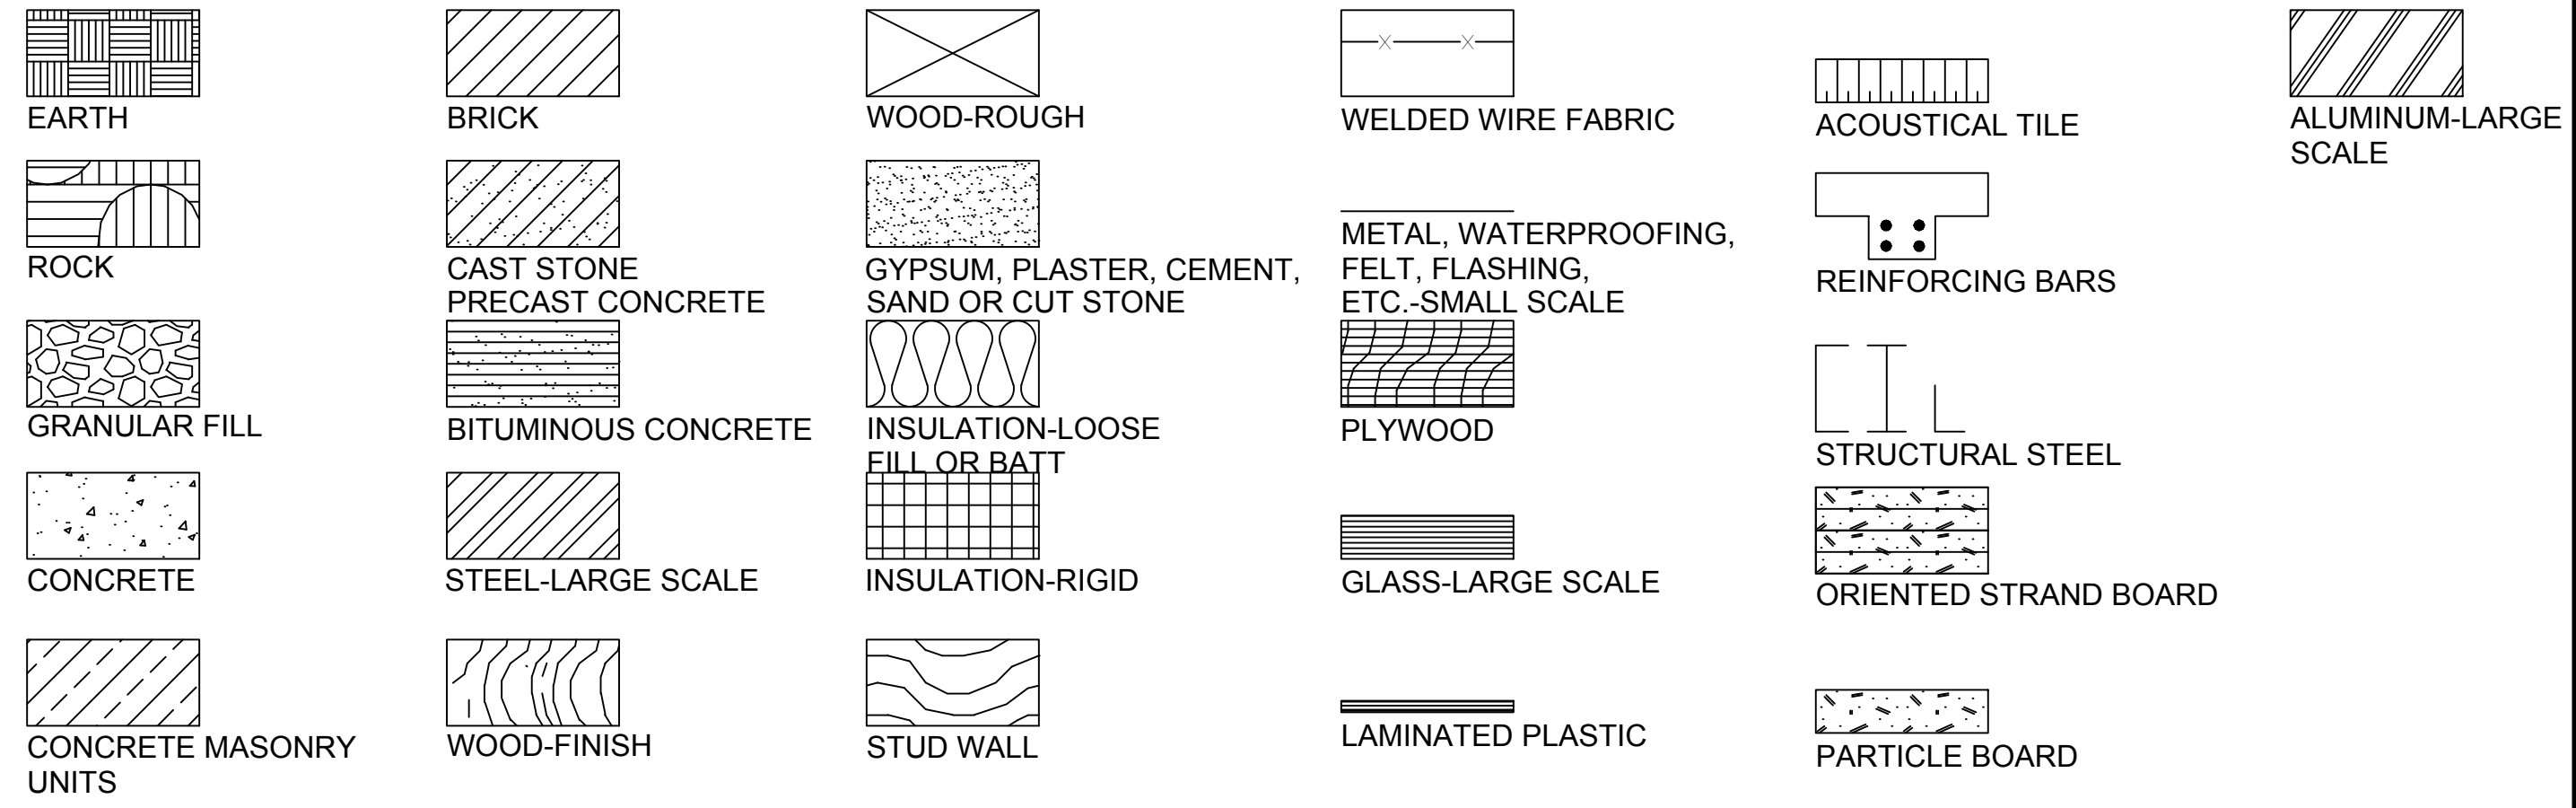

KLINGNER & ASSOCIATES, P.C.
 Engineers • Architects • Surveyors
 1018 North 24th Street, Quincy, IL 62450
 4510 Park Grove Road, Hannibal, MO 63450
 1010 N. 4th Street, Suite 100, Burlington, IA 52601
 19 North Prairie Street, Galesburg, IL 62401
 Phone: 314.221.3670 • Fax: 314.221.3683
 Phone: 572.221.0020 • Fax: 572.221.0012
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PSB INTERIOR RENOVATIONS - PHASE IIIB
 CITY OF GALESBURG
 150 SOUTH BROAD ST.
 GALESBURG, ILLINOIS 61401

Non-Reduced Sheet Size: 24" x 36"
 Full sized plans have been prepared using standard scales
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SCALE:	
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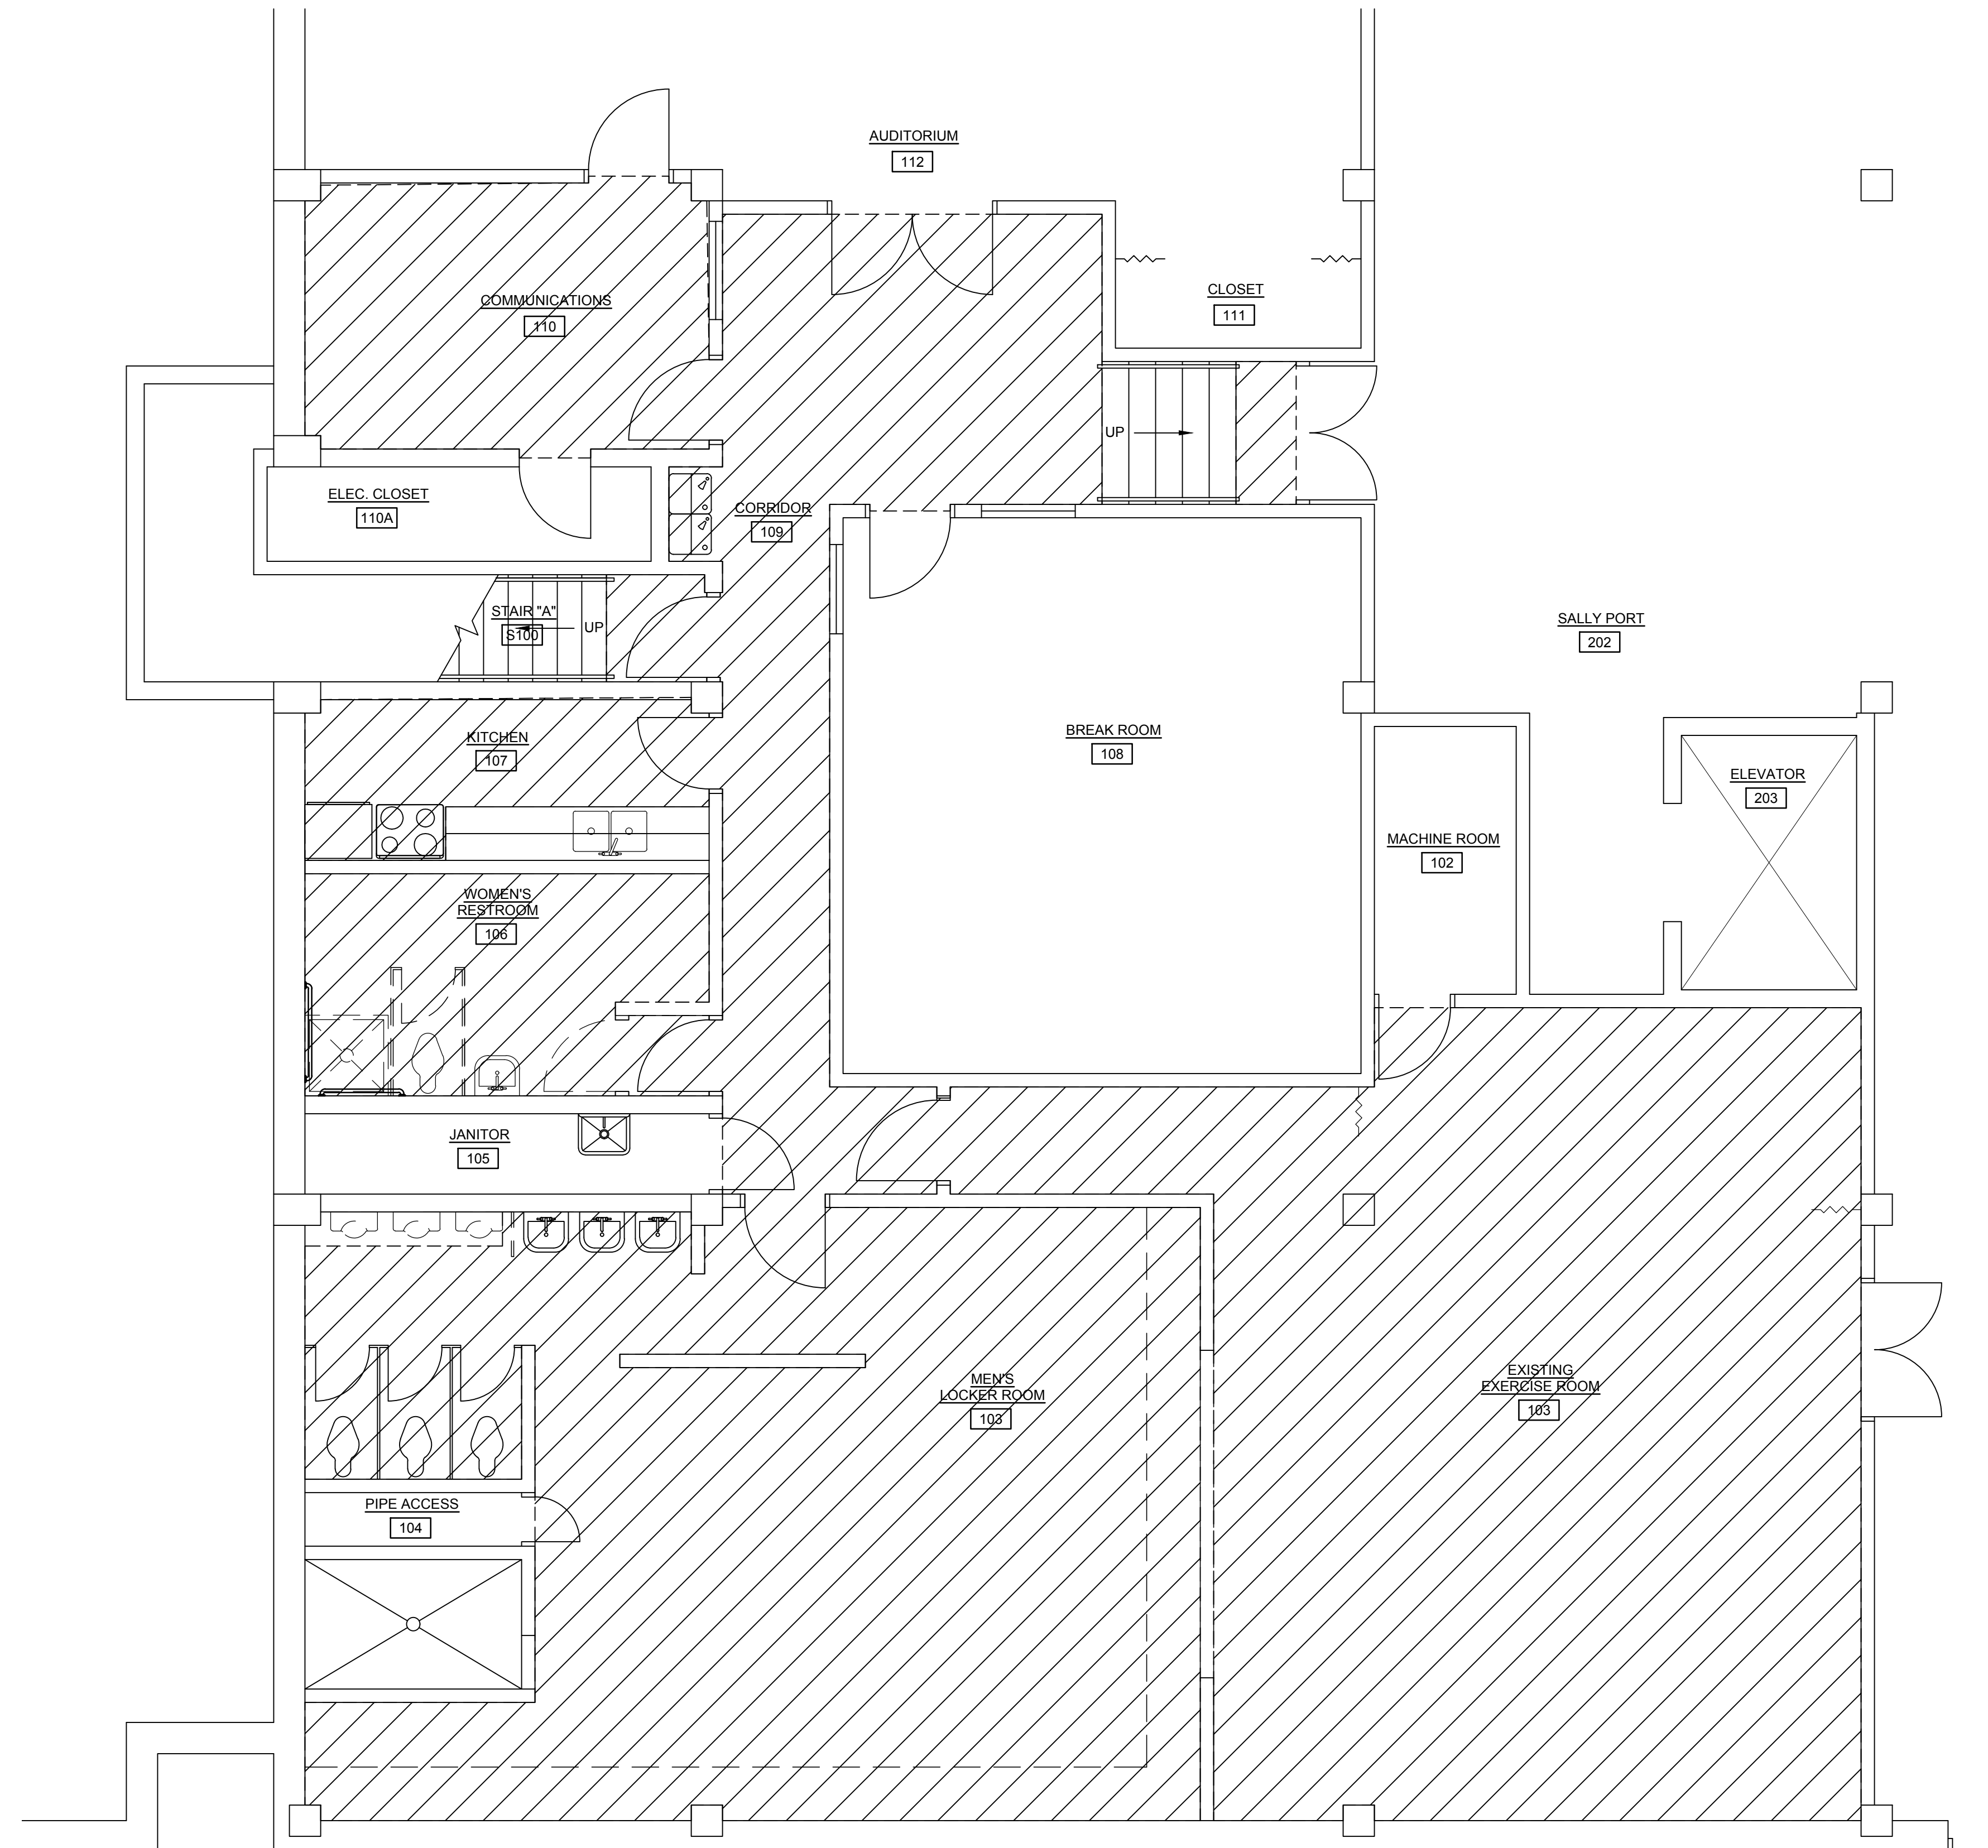
SHEET TITLE
**TITLE SHEET,
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PROJECT NO.
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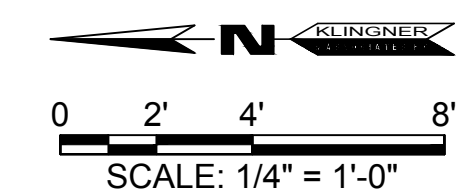
SHEET
G101

NOTES

FLOOR TILE TO BE REMOVED INDICATED ON PLAN WITH DIAGONAL HATCH PATTERN.



1 BASEMENT LEVEL - FLOOR TILE REMOVAL PLAN
AD101 SCALE: 1/4"=1'-0"



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Engineers • Architects • Surveyors
616 North 24th Street, Quincy, IL Ph: 217.223.3670 - Fax: 217.223.3603
4510 Park Grove Road, Hannibal, MO Ph: 573.221.0020 - Fax: 573.221.0012
4510 N. 4th Street, Suite 100, Burlington, IA Ph: 319.752.3603 - Fax: 319.752.3605
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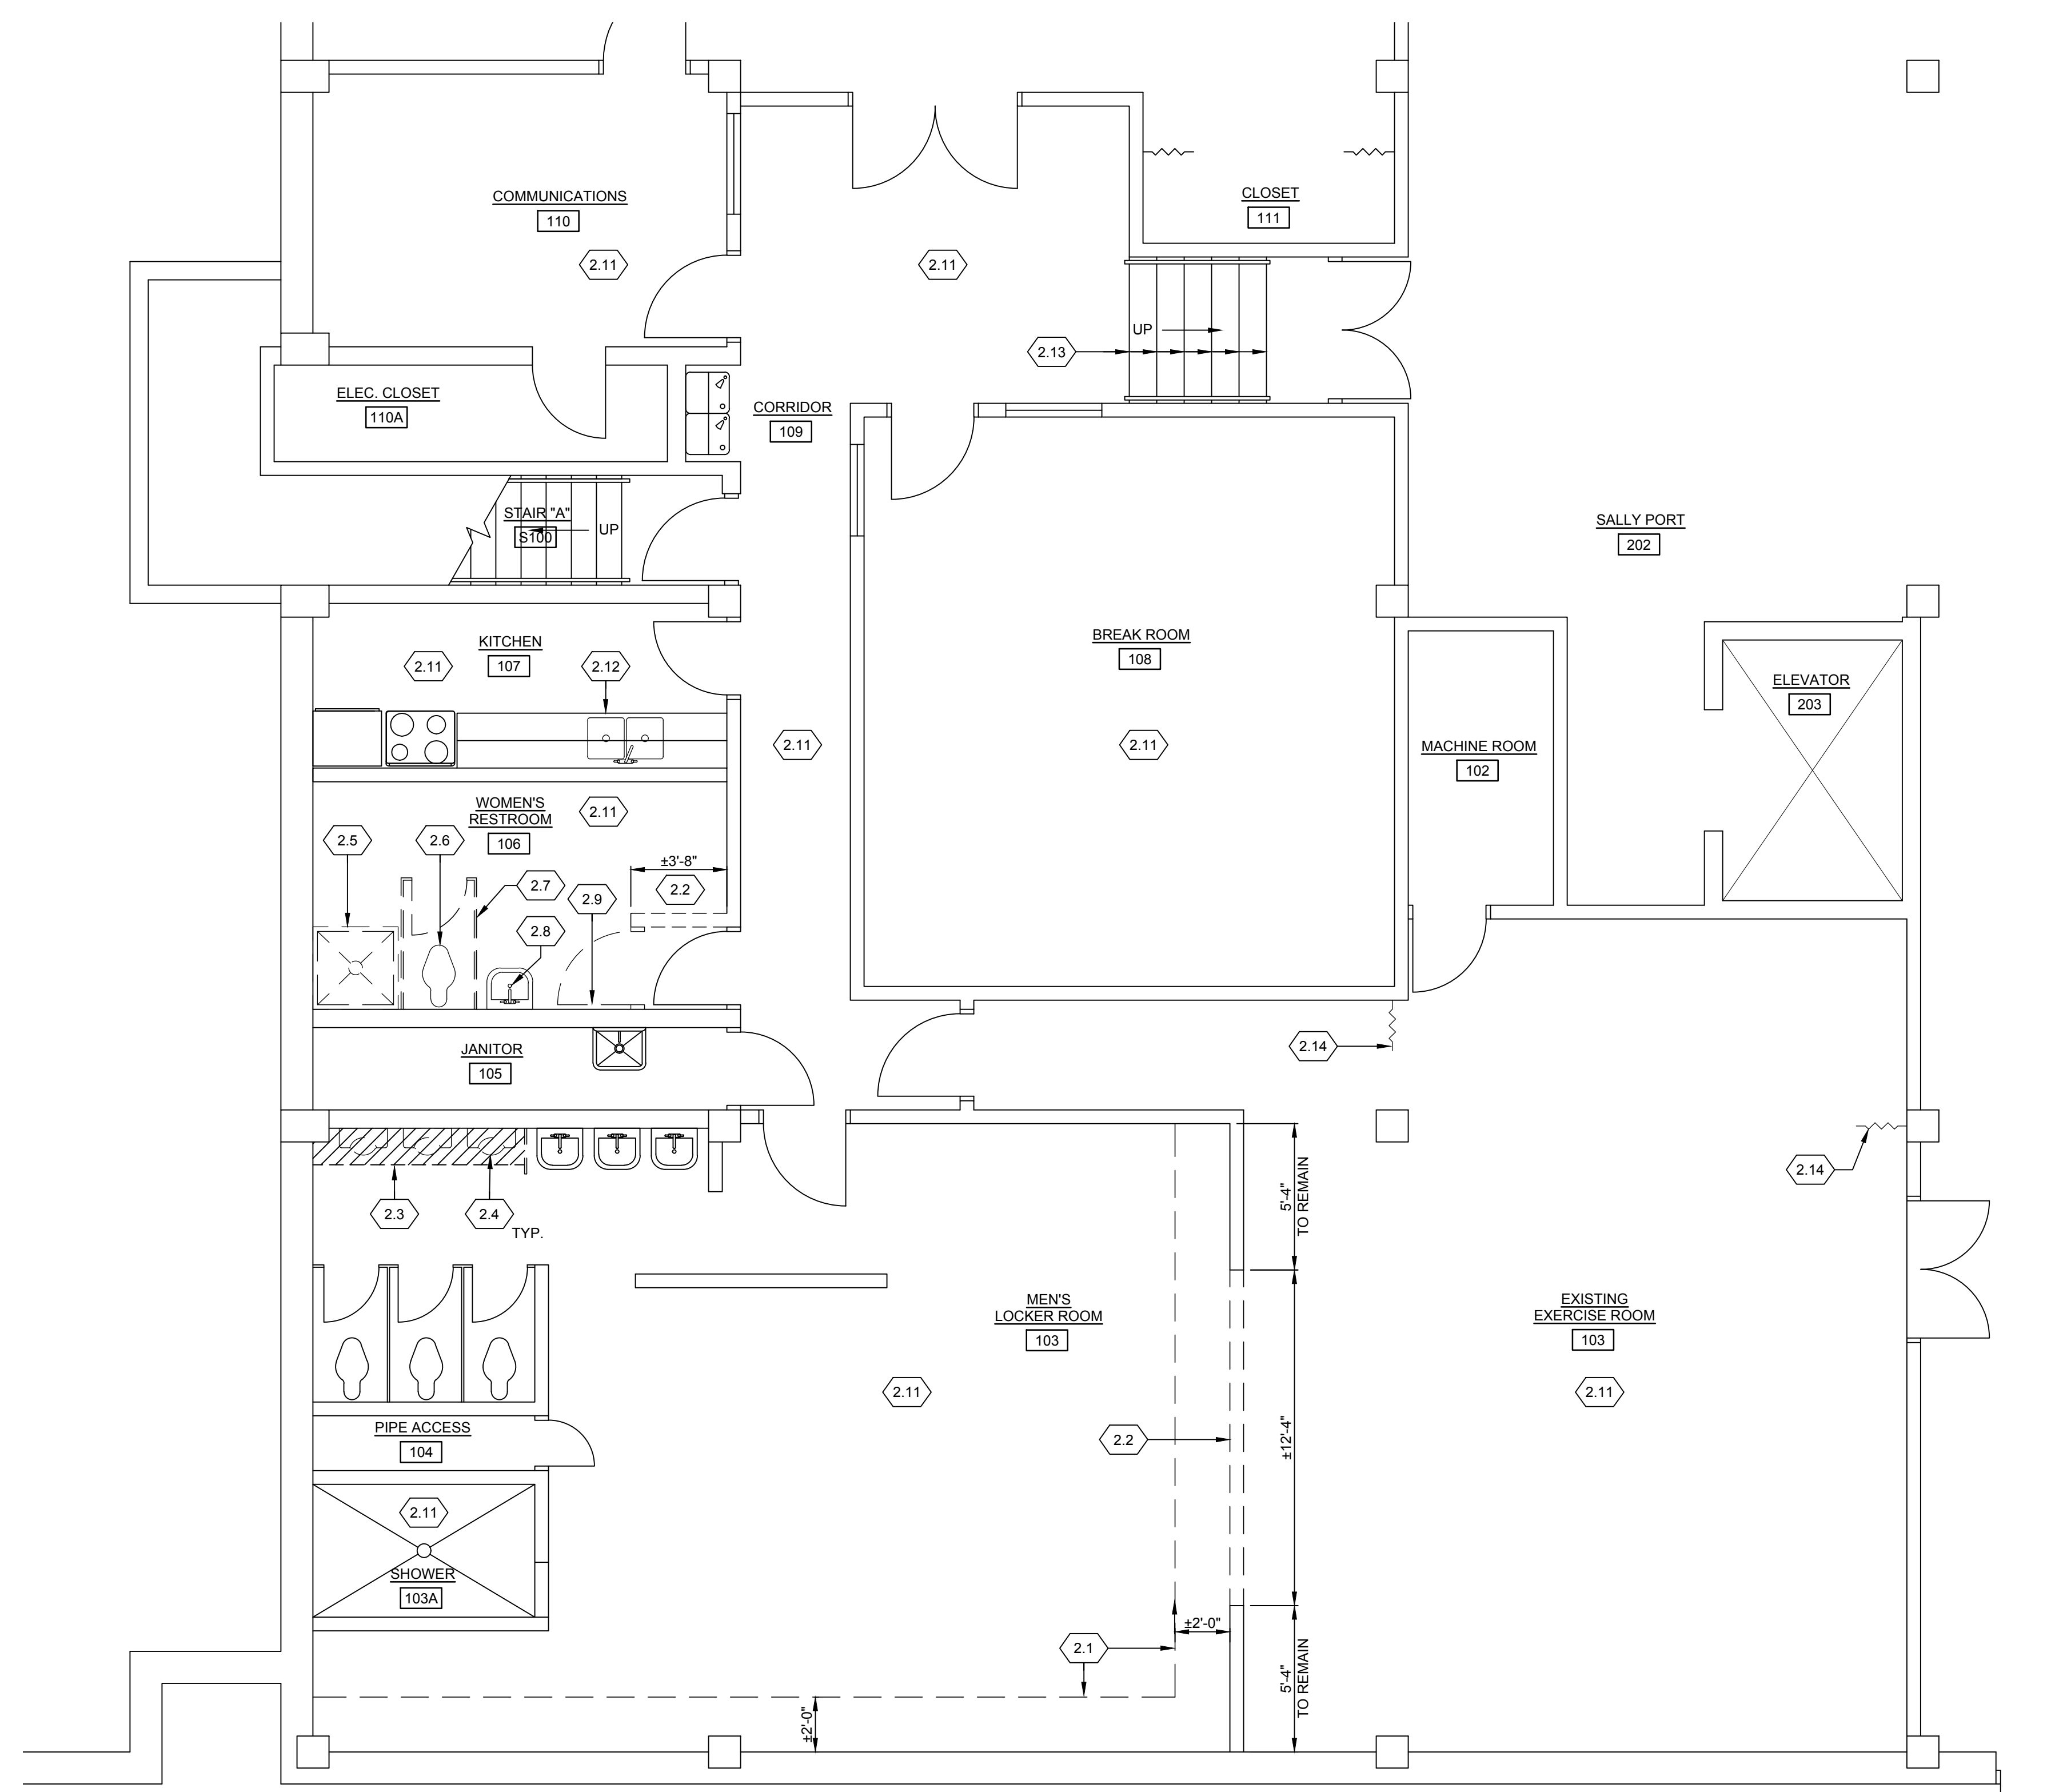
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SHEET TITLE
BASEMENT FLOOR - FLOOR TILE REMOVAL PLAN

PROJECT NO.
3215-073 (15-3027)
DRAWING ISSUED DATE:
12/14/16

SHEET
AD101



1 BASEMENT - SELECTIVE DEMOLITION
 AD102 SCALE: 1/4"=1'-0"

GENERAL NOTES

- CONTRACTOR TO REMOVE EXISTING ACOUSTICAL PANEL CEILING WHERE INDICATED ON PLAN. PROTECT AND REUSE EXISTING LIGHTING, CAMERAS, SMOKE DETECTORS, AND ANY OTHER ITEMS IN EXISTING ACOUSTICAL PANEL CEILING.
- CONTRACTOR SHALL TAKE STEPS ON A DAILY BASIS TO ASCERTAIN EFFECTIVENESS OF THE CONTROL METHOD(S) RELIED ON TO ASSURE THAT DUST FROM OPEN PLENUM CEILING DO NOT MIGRATE TO ADJACENT WORK AREAS.
- REMOVE EXISTING WALL BASE WHERE NEW FLOORING TO BE INSTALLED U.N.O.
- SEE PLUMBING DRAWINGS FOR FLOOR DEMOLITION IN NEW WOMEN'S RESTROOM. PATCH FLOOR AS NECESSARY FOR NEW FLOORING.
- CONTRACTOR SHALL REMOVE EXISTING LOCKERS IN MEN'S AND WOMEN'S LOCKER ROOMS AND PLACE IN SALLY PORT FOR OWNER TO REUSE.
- CONTRACTOR SHALL MOVE EXISTING EXERCISE EQUIPMENT CURRENTLY LOCATED IN EXERCISE ROOM TO BE RELOCATED ON 6TH LEVEL NORTH END IN NEW EXERCISE ROOM.

KEYNOTES

- 2.1 REMOVE EXISTING 4" HIGH CONCRETE LOCKER BASE. CONCRETE BASE EXPECTED TO HAVE #3 DOWELS @ 2'-0" O.C. STAGGERED INTO EXISTING CONCRETE SLAB BELOW. PATCH CONCRETE SLAB AS NECESSARY FOR NEW FLOORING.
- 2.2 SAWCUT AND REMOVE EXISTING 6" CMU WALL FROM FLOOR TO CONCRETE STRUCTURE ABOVE. BRACE AS NECESSARY DURING REMOVAL.
- 2.3 REMOVE EXISTING MOSAIC FLOOR TILE AT FLOOR MOUNTED URINALS.
- 2.4 REMOVE EXISTING FLOOR MOUNTED URINALS. PATCH FLOOR AS NECESSARY FOR NEW FLOORING.
- 2.5 REMOVE EXISTING FIBERGLASS SHOWER UNIT AND SHOWER BASE.
- 2.6 REMOVE EXISTING WALL MOUNTED TOILET.
- 2.7 REMOVE EXISTING TOILET PARTITION.
- 2.8 REMOVE EXISTING WALL MOUNTED SINK.
- 2.8 REMOVE EXISTING WALL MOUNTED SINK.
- 2.9 REMOVE EXISTING HM DOOR AND FRAME. PATCH WALL AS NECESSARY FROM FRAME ANCHORS.
- 2.10 OMIT
- 2.11 REMOVE EXISTING ACOUSTICAL PANEL CEILING SYSTEM.
- 2.12 REMOVE EXISTING LAMINATE COUNTER, BACKSPLASH, (2) BASIN SINK, AND FAUCET.
- 2.13 REMOVE EXISTING RESILIENT TREADS AND RISERS.
- 2.14 REMOVE EXISTING MOVEABLE WALL PARTITION AND CEILING MOUNTED SYSTEM.

KLINGNER & ASSOCIATES, P.C.
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 816 North 24th Street, Quincy, IL Ph: 217.223.3670 Fax: 217.223.3603
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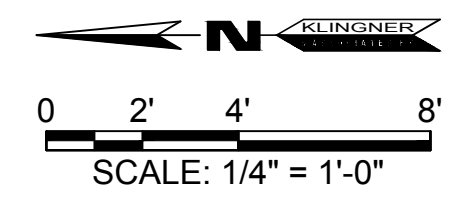
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SHEET TITLE
**BASEMENT FLOOR -
 SELECTIVE
 DEMOLITION**

PROJECT NO.
3215-073 (15-3027)
 DRAWING ISSUED DATE:
12/14/16
 SHEET

AD102



GENERAL NOTES

- CONTRACTOR TO REMOVE EXISTING ACOUSTICAL PANEL CEILING WHERE INDICATED ON PLAN. PROTECT AND REUSE EXISTING LIGHTING, CAMERAS, SMOKE DETECTORS, AND ANY OTHER ITEMS IN EXISTING ACOUSTICAL PANEL CEILING.
- CONTRACTOR SHALL TAKE STEPS ON A DAILY BASIS TO ASCERTAIN EFFECTIVENESS OF THE CONTROL METHOD(S) RELIED ON TO ASSURE THAT DUST FROM OPEN PLENUM CEILING DO NOT MIGRATE TO ADJACENT WORK AREAS.


KEYNOTES

- REMOVE EXISTING ACOUSTICAL PANEL CEILING.
- REMOVE EXISTING MASONRY FOR NEW WINDOW. SHORE MASONRY AS NECESSARY TO COMPLETE WORK.
- REMOVE EXISTING OVERHEAD COILING COUNTER DOOR AND TRACK.
- REMOVE EXISTING POLYCARBONATE SHEET AND FRAMING.
- REMOVE EXISTING LAMINATE COUNTER, LAMINATE PANEL BELOW COUNTER, AND ASSOCIATED FRAMING.
- REMOVE EXISTING HM DOOR FOR REUSE IN NEW OPENING. RELOCATE EXISTING ACCESS CONTROL HARDWARE TO NEW OPENING. SEE A102 FOR NEW DOOR LOCATION.


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1 MAIN LEVEL - SELECTIVE DEMOLITION
 AD103 SCALE: 1/8"=1'-0"




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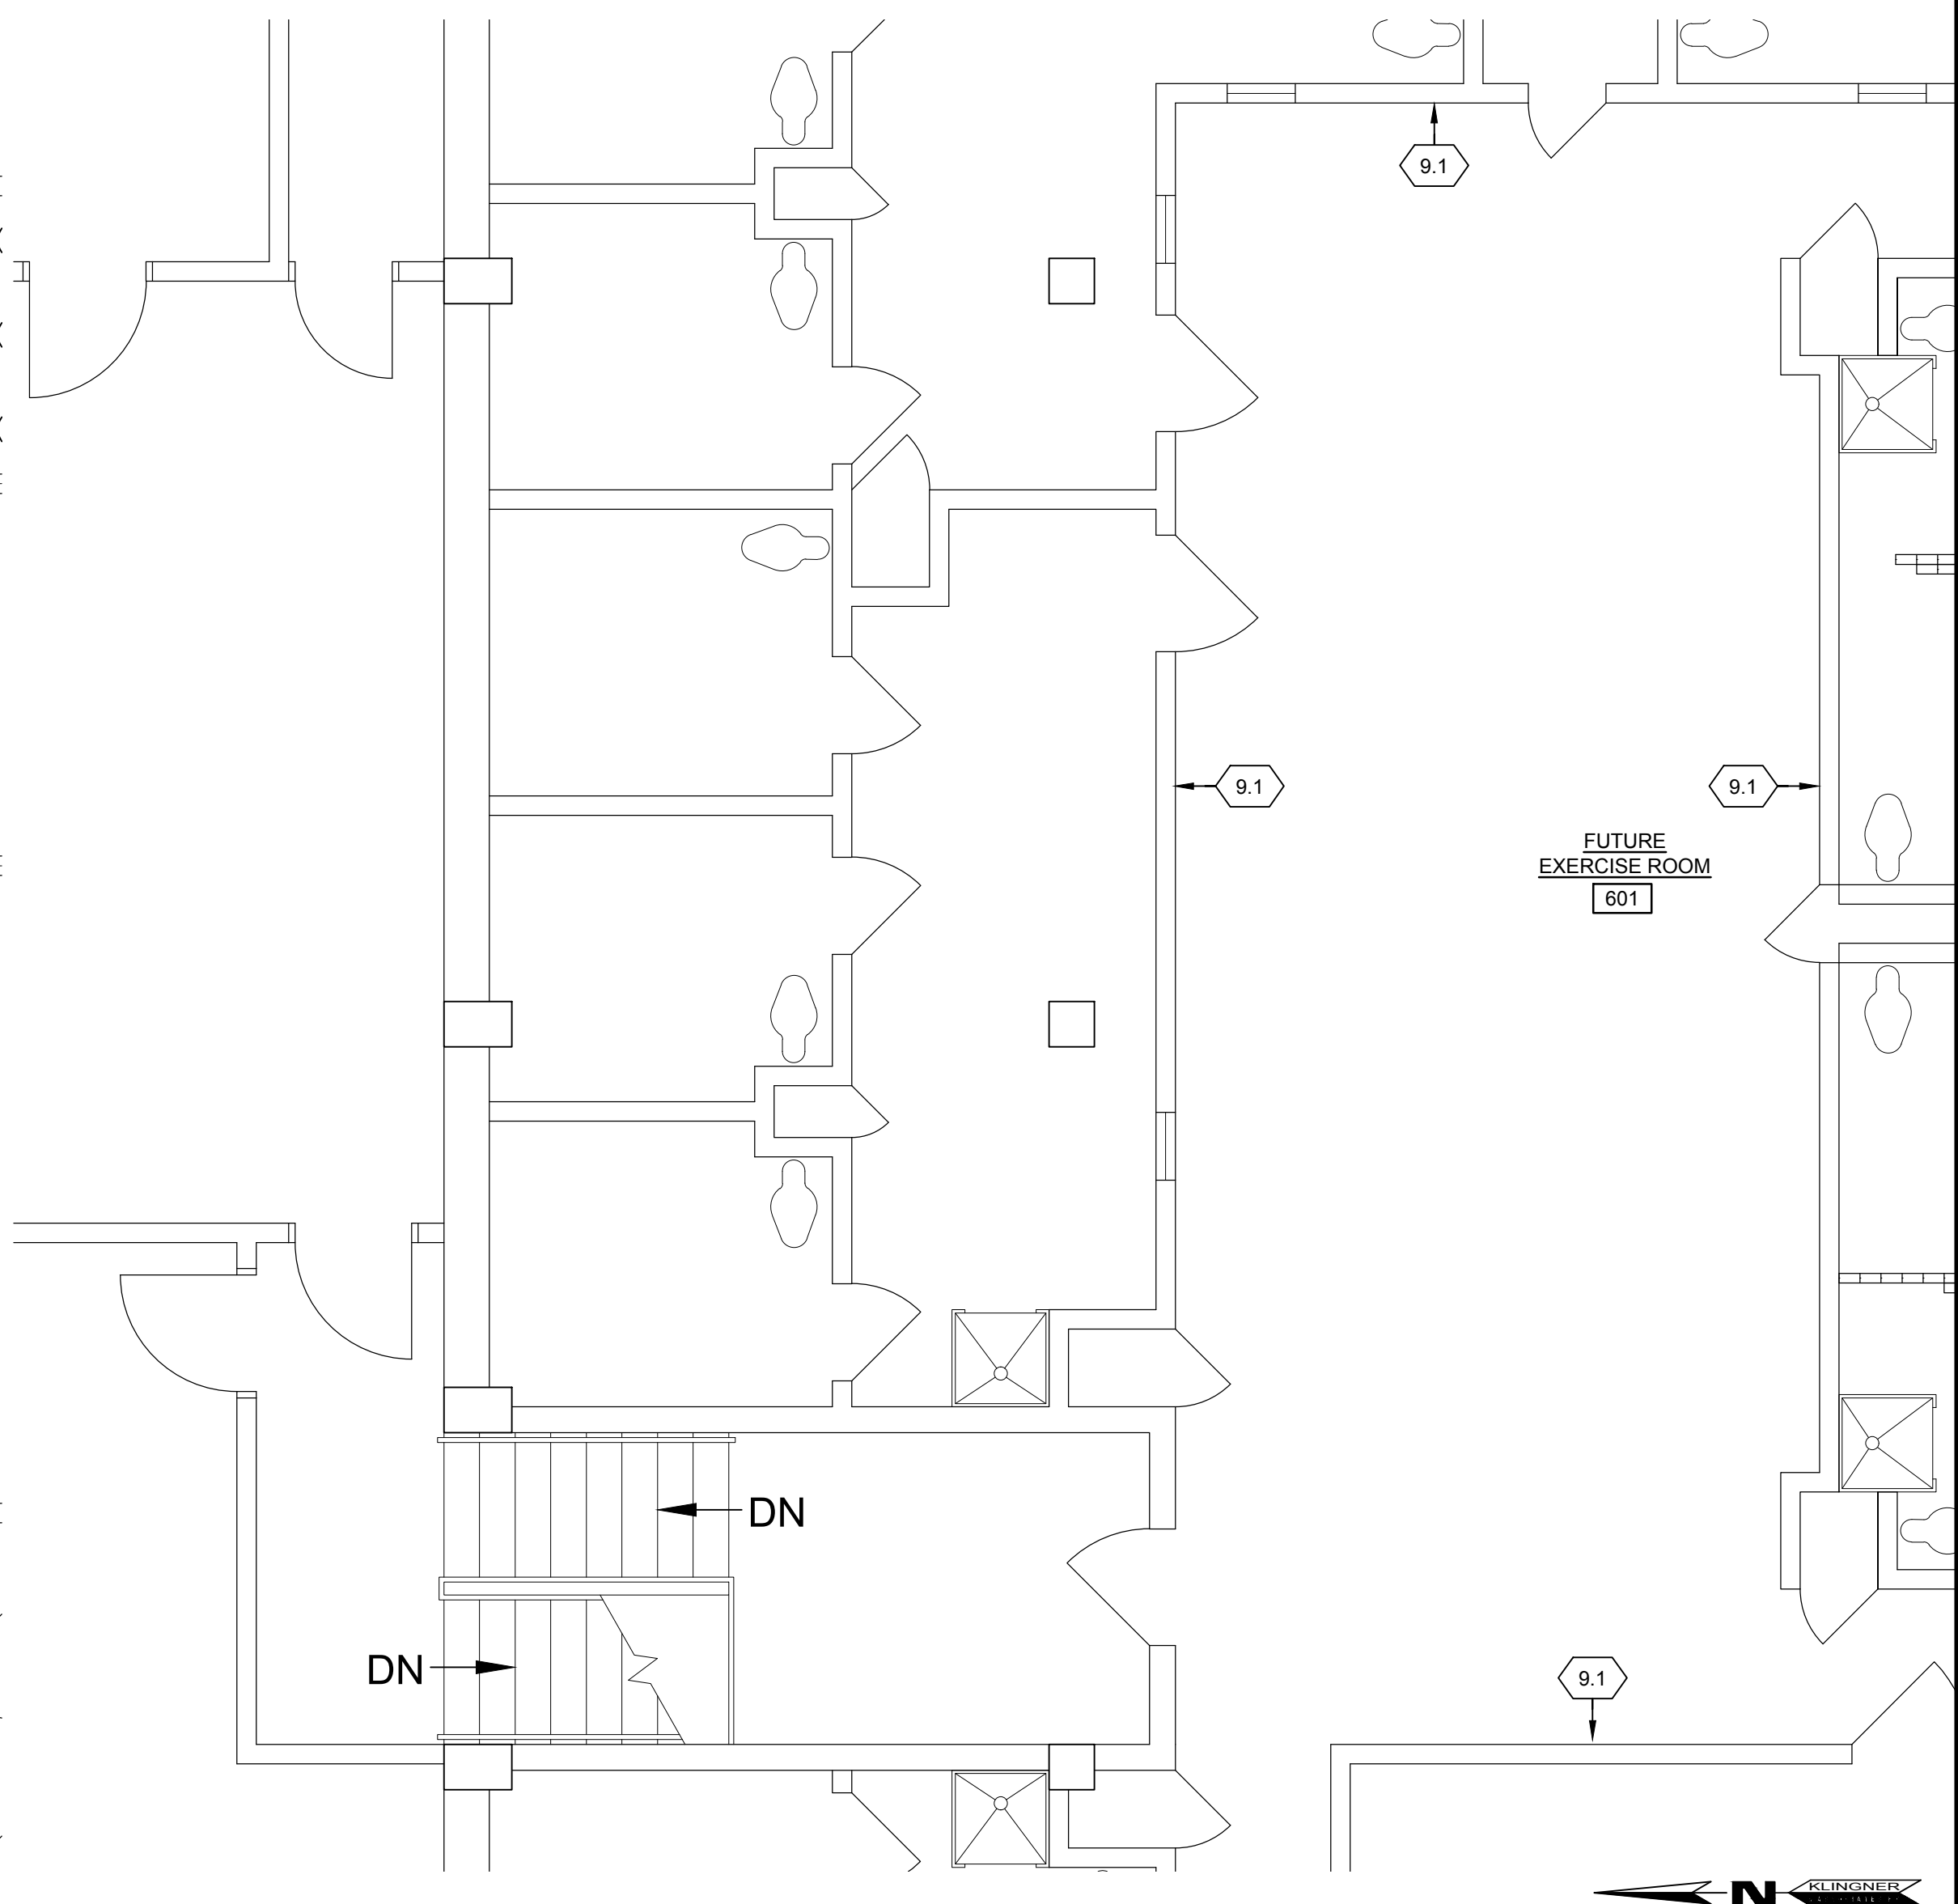
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SHEET TITLE
MAIN FLOOR - SELECTIVE DEMOLITION

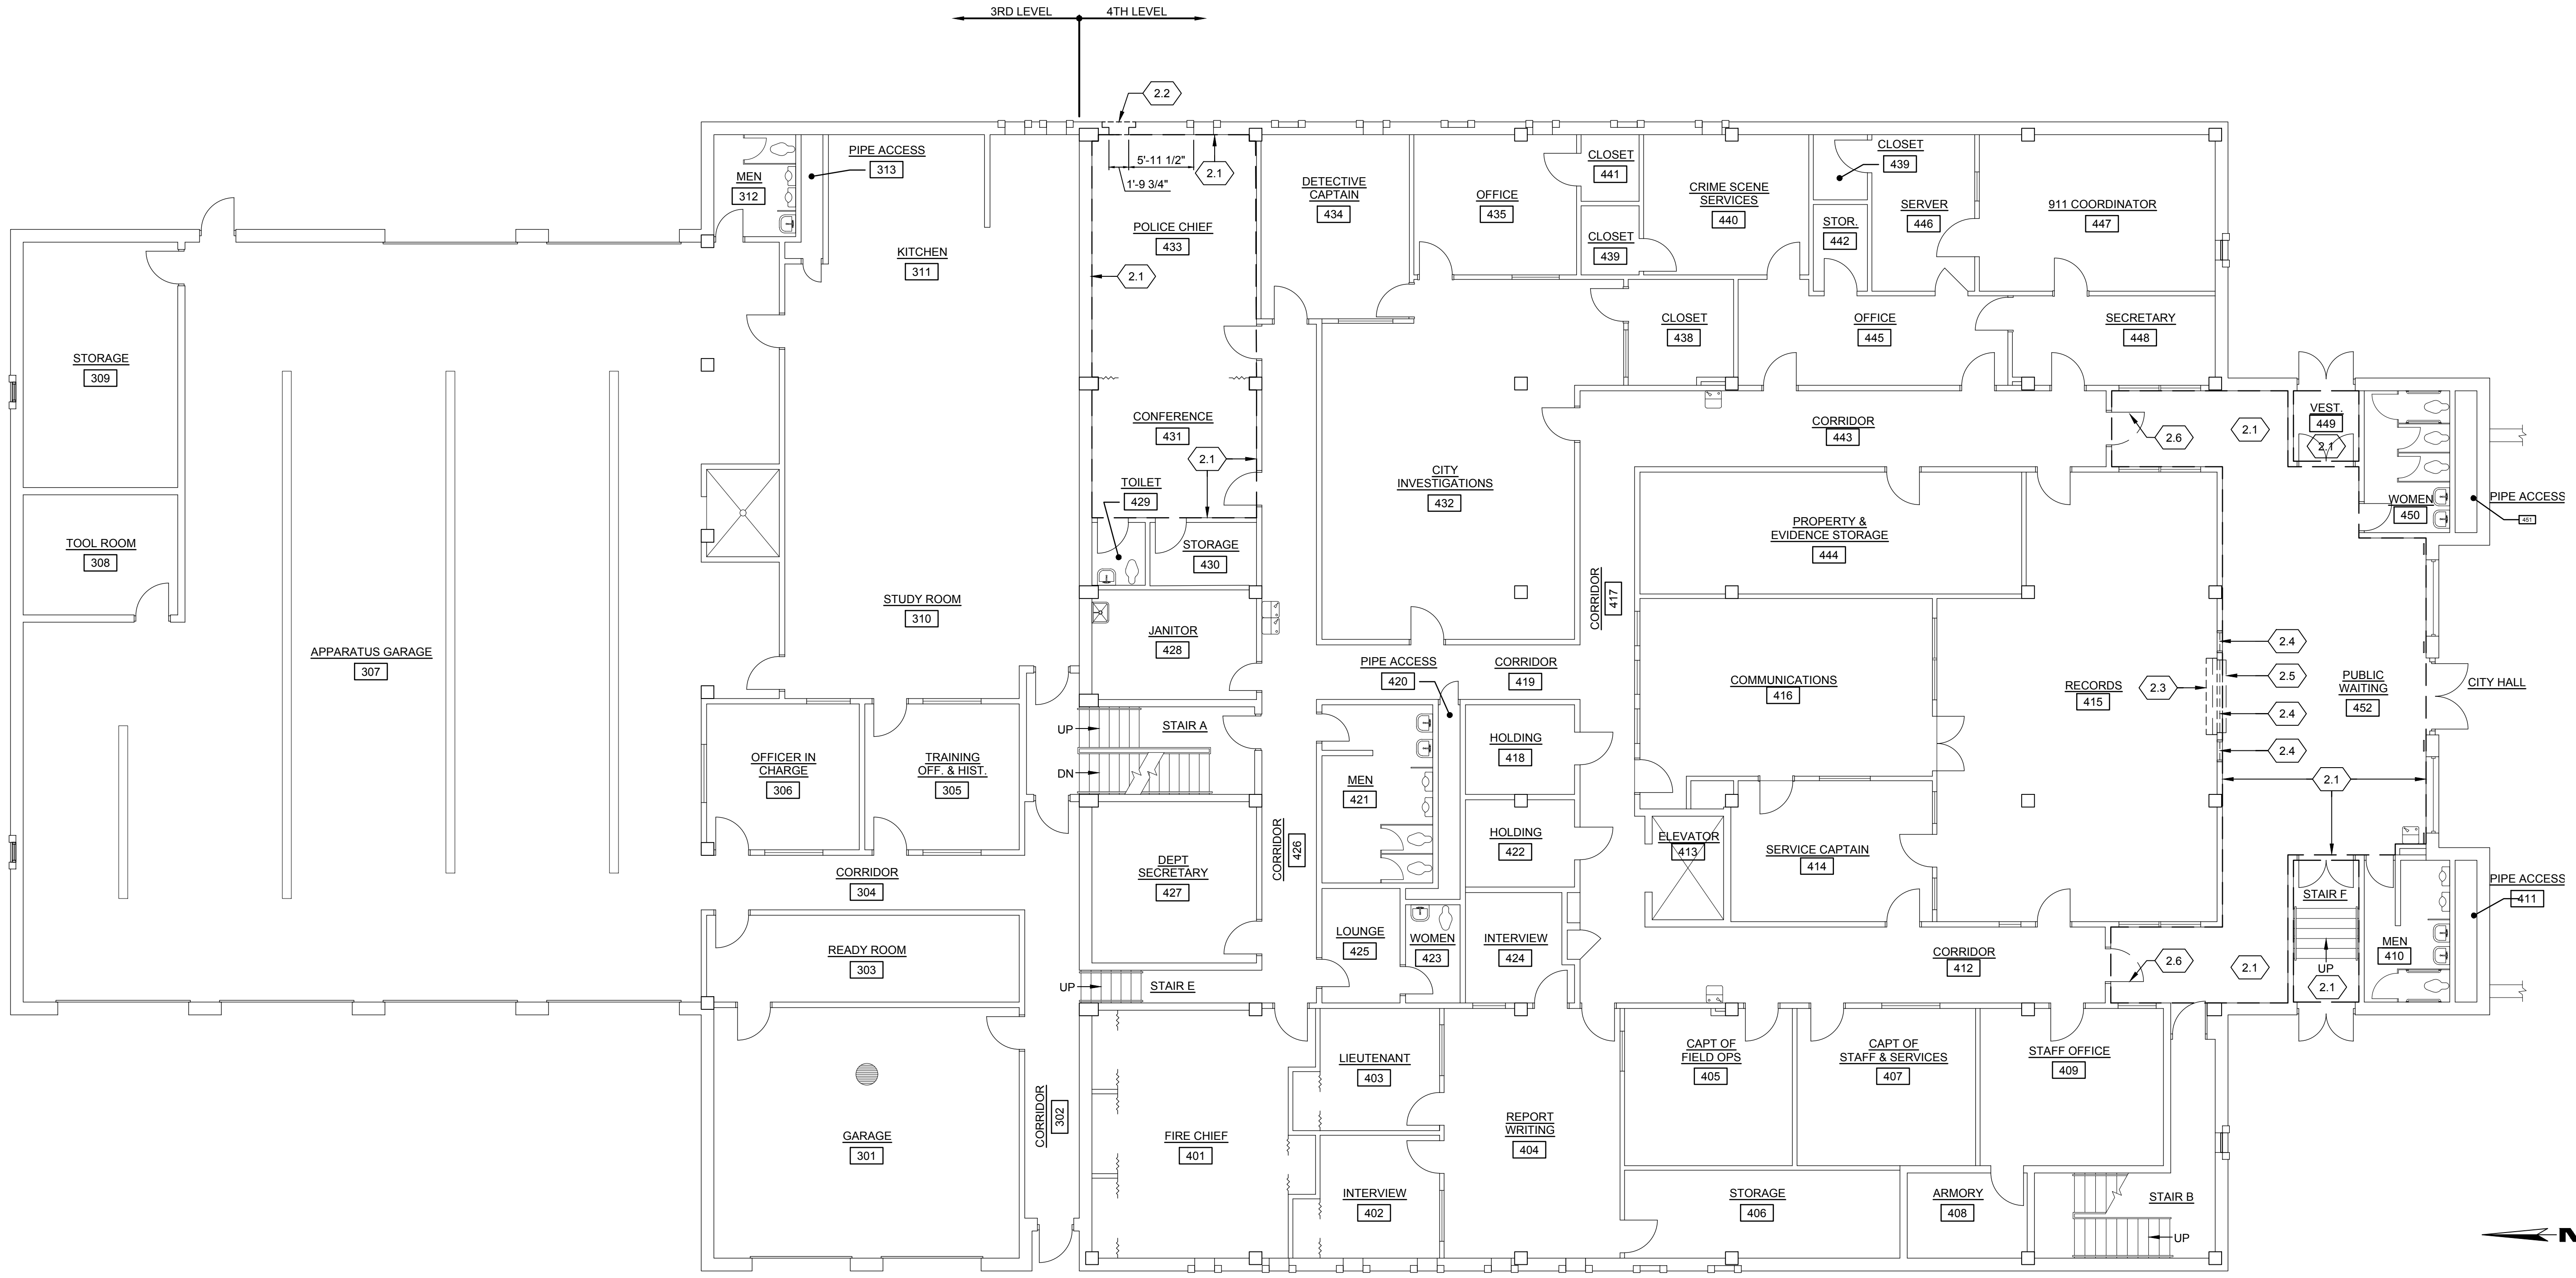
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AD103

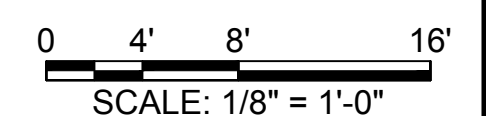

1 6TH LEVEL FLOOR PLAN DEMOLITION
 AD104 SCALE: 1/4"=1'-0"

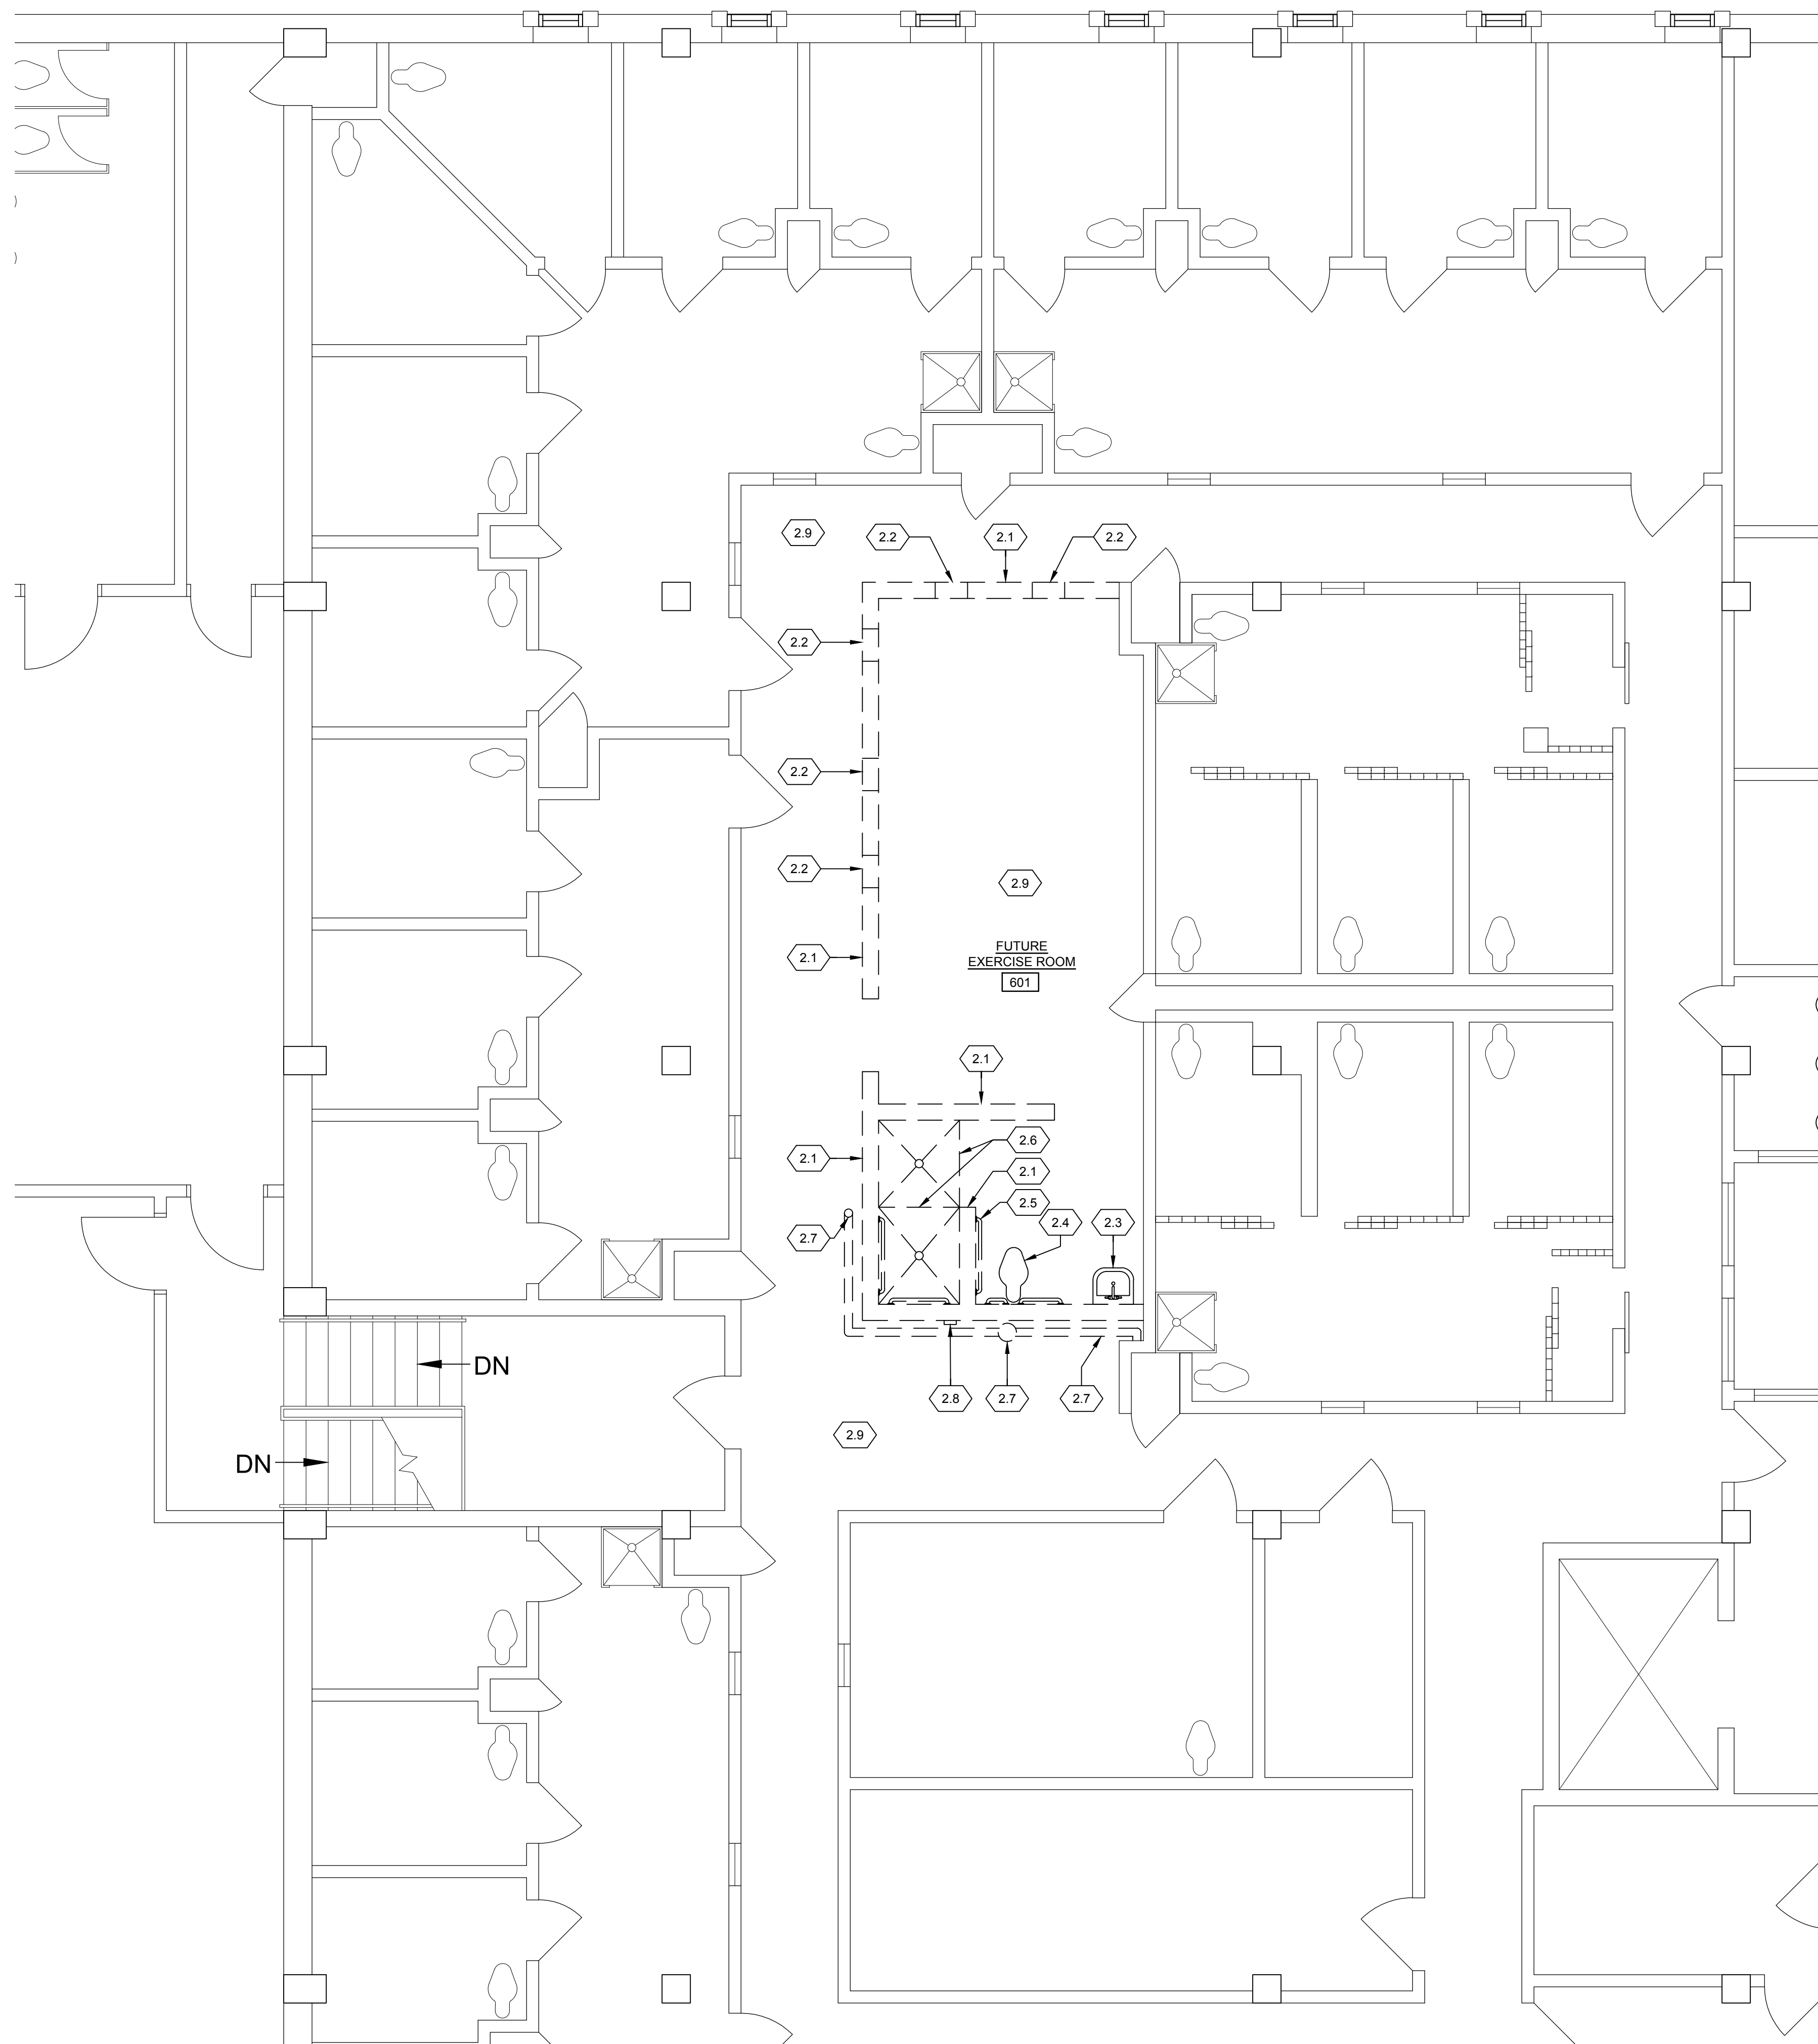

2 6TH LEVEL FLOOR PLAN - NEW WORK
 AD104 SCALE: 1/4"=1'-0"

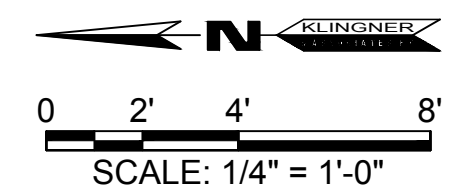

GENERAL NOTES

1. CONTRACTOR TO REMOVE EXISTING CMU WALLS AS NOTED. DO NOT DISTURB EXISTING VCT FLOORING BENEATH WALLS. FLOOR TILE IS NOT ASBESTOS CONTAINING, HOWEVER, ASBESTOS CONTAINING MASTIC IS LOCATED BENEATH THE FLOOR TILE.
2. CONTRACTOR SHALL TAKE STEPS ON A DAILY BASIS TO ASCERTAIN EFFECTIVENESS OF THE CONTROL METHOD(S) RELIED ON TO ASSURE THAT DUST DO NOT MIGRATE TO ADJACENT WORK AREAS.
3. CONTRACTOR TO REMOVE MOSAIC TILE FLOORING AS NOTED. PATCH FLOOR AS NECESSARY FOR NEW FLOORING. OWNER TO INSTALL NEW RUBBER FLOOR TILES. CONTRACTOR TO NOTIFY OWNER WHEN FLOOR IS READY FOR NEW RUBBER FLOOR TILES.
4. CONTRACTOR SHALL MOVE EXISTING EXERCISE EQUIPMENT CURRENTLY LOCATED IN EXERCISE ROOM IN THE BASEMENT TO BE RELOCATED IN FUTURE EXERCISE ROOM. EXERCISE EQUIPMENT SHALL BE MOVED TO 6TH FLOOR TO BE PLACED IN FUTURE EXERCISE ROOM WITHIN (2) BUSINESS DAYS AFTER FUTURE EXERCISE ROOM FLOOR IS SUBSTANTIALLY COMPLETE.
5. EXISTING UTILITIES NOTED TO BE REMOVED SHALL BE CAPPED AND REMOVED U.N.O.
6. EXISTING ELECTRICAL SWITCHES AND OUTLETS SHALL BE REMOVED IN 8" CMU WALL NOTED TO BE REMOVED.
7. CONTRACTOR SHALL NOT USE ELEVATOR TO TRANSPORT DEMOLITION MATERIALS.

KEYNOTES

- 2.1 REMOVE EXISTING 8" CMU FROM VCT FLOORING TO CONC CEILING STRUCTURE.
- 2.2 REMOVE EXISTING STEEL BAR OPENINGS IN EXISTING 8" CMU WALL, TYPICAL.
- 2.3 REMOVE EXISTING WALL MOUNTED SINK AND MIRROR. CAP EXISTING PLUMBING LINES.
- 2.4 REMOVE EXISTING TOILET AND ADJACENT PLUMBING LINES. CAP EXISTING PLUMBING LINES.
- 2.5 REMOVE EXISTING GRAB BARS.
- 2.6 REMOVE EXISTING MOSAIC FLOOR TILE IN SHOWER AREA. PATCH AND LEVEL FLOOR AS NECESSARY FOR NEW RUBBER TILE FLOORING TO BE INSTALLED BY OWNER.
- 2.7 REMOVE EXISTING PLUMBING LINES AND CAP.
- 2.8 REMOVE EXISTING THERMOSTAT AND RELOCATE TO ADJACENT WEST WALL.
- 2.9 REMOVE EXISTING ACOUSTICAL CEILING PANELS AND GRID. ASSOCIATED FIXTURES TO BE REMOVED. SMOKE/HEAT DETECTORS SHALL BE MOUNTED TO EXISTING CONCRETE CEILING STRUCTURE. FUTURE EXERCISE ROOM TO BE EXPOSED CEILING.
- 9.1 PAINT WALLS.

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REVISION HISTORY		
NO.	DESCRIPTION	DATE
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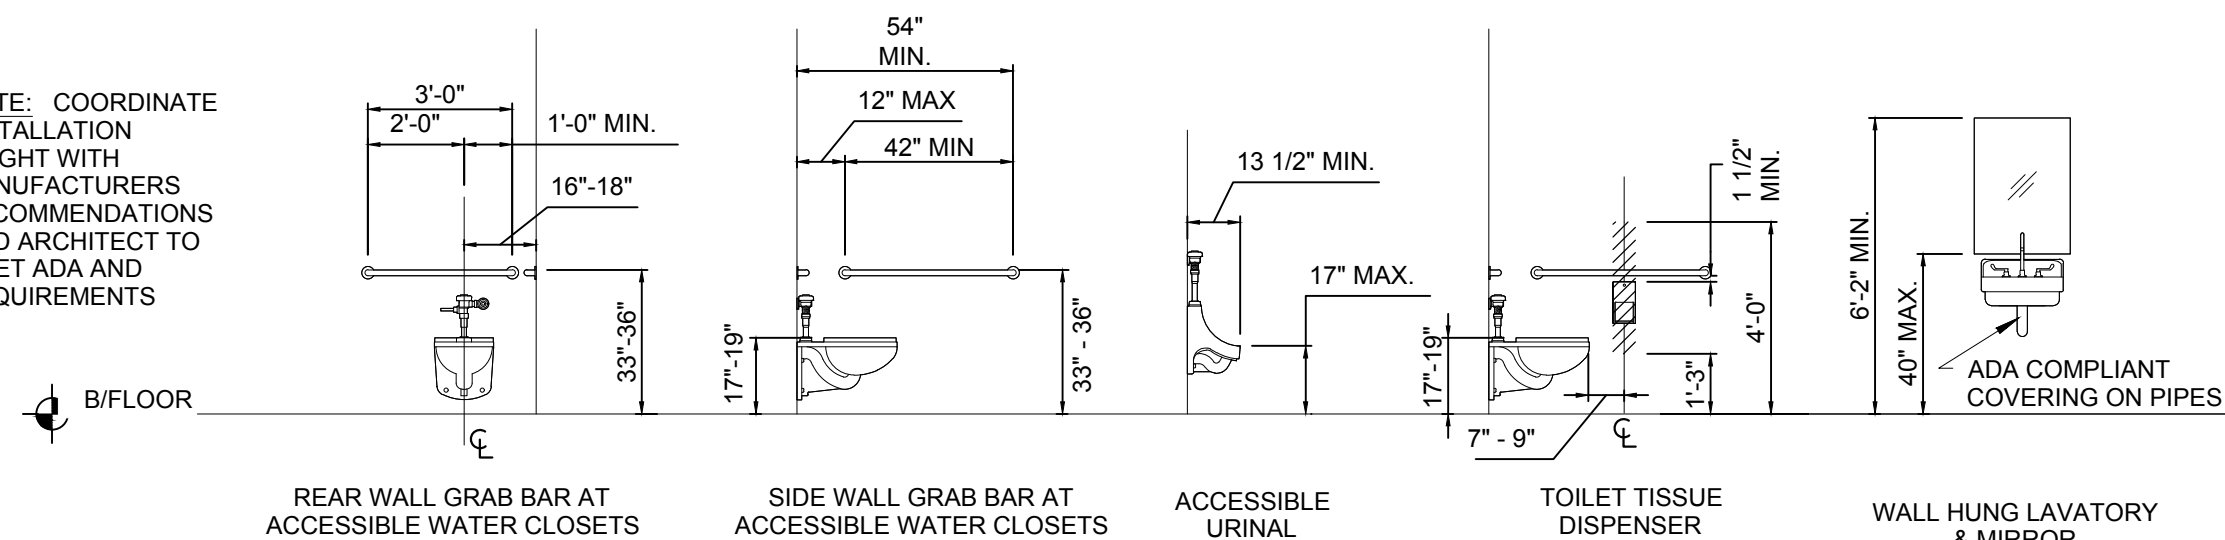
PSB INTERIOR RENOVATIONS - PHASE IIIB
 CITY OF GALESBURG
 150 SOUTH BROAD ST.
 GALESBURG, ILLINOIS 61401

Non-Reduced Sheet Size: 24" x 36"
 Full size plans have been prepared using standard scales
 Reduced size plans may not conform to standard scales.

SCALE:	
DESIGNED CNB	DRAWN CNB
FIELD	FIELD BOOK
CHECKED CNB	CHECK DATE 12/15/15
SHEET TITLE 6TH LEVEL FLOOR PLAN - SELECTIVE DEMOLITION & NEW WORK	
PROJECT NO. 3215-073 (15-3027)	
DRAWING ISSUED DATE: 12/14/16	
SHEET	

AD104

NOTE: COORDINATE INSTALLATION HEIGHT WITH MANUFACTURERS RECOMMENDATIONS AND ARCHITECT TO MEET ADA AND REQUIREMENTS



NOTE: WATER CLOSETS SHOWN ARE WALL-MOUNTED. ACTUAL TOILETS FOR PROJECT MAY VARY. USE FOR MOUNTING HEIGHTS ONLY.

GENERAL TOILET ACCESSORY NOTES:

- THE CONTRACTOR SHALL PROVIDE IN WALL BLOCKING FOR ALL WALL MOUNTED TOILET ACCESSORIES, COUNTER TOPS, ETC.

ADA MOUNTING HEIGHTS

DOOR FINISH SCHEDULE


DOOR NUMBER	FRAME		FINISH		NOTES
	MATERIAL	FINISH	MATERIAL	FINISH	
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101	EXIST	PAINT	EXIST	PAINT	REPLACE EXIST PUSH PLATE AND PULL PLATE WITH BRUSHED ALUM PUSH PLATE AND PULL PLATE. ADD NEW BRUSHED ALUM KICKPLATE
102	EXIST	PAINT	EXIST	PAINT	REPLACE EXIST PUSH PLATE AND PULL PLATE WITH BRUSHED ALUM PUSH PLATE AND PULL PLATE. ADD NEW BRUSHED ALUM KICKPLATE
103	EXIST	PAINT	EXIST	PAINT	REPLACE EXIST PUSH PLATE AND PULL PLATE WITH BRUSHED ALUM PUSH PLATE AND PULL PLATE. ADD NEW BRUSHED ALUM KICKPLATE
104	EXIST	PAINT	EXIST	PAINT	REPLACE EXIST PUSH PLATE AND PULL PLATE WITH BRUSHED ALUM PUSH PLATE AND PULL PLATE. ADD NEW BRUSHED ALUM KICKPLATE
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108	EXIST	PAINT	EXIST	PAINT	REPLACE EXIST PUSH PLATE AND PULL PLATE WITH BRUSHED ALUM PUSH PLATE AND PULL PLATE. ADD NEW BRUSHED ALUM KICKPLATE
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110	EXIST	PAINT	EXIST	PAINT	REPLACE EXIST PUSH PLATE AND PULL PLATE WITH BRUSHED ALUM PUSH PLATE AND PULL PLATE. ADD NEW BRUSHED ALUM KICKPLATE
110A	EXIST	PAINT	EXIST	PAINT	REPLACE EXIST PUSH PLATE AND PULL PLATE WITH BRUSHED ALUM PUSH PLATE AND PULL PLATE. ADD NEW BRUSHED ALUM KICKPLATE
110B	EXIST	PAINT	EXIST	PAINT	REPLACE EXIST PUSH PLATE AND PULL PLATE WITH BRUSHED ALUM PUSH PLATE AND PULL PLATE. ADD NEW BRUSHED ALUM KICKPLATE
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LEGEND




100 DOOR NUMBER

KEYNOTES


- 9.1 PAINT WINDOW FRAME
- 9.2 PAINT BASE AND WALL MOUNTED CASEWORK & PROVIDE NEW CASEWORK (7) PULLS AND (14) KNOBS. CONTRACTOR TO FIELD VERIFY COUNT OF PULLS AND KNOBS.
- 9.3 PAINT TOILET PARTITIONS
- 9.4 QUARTZ COUNTER (QTZ-1) WITH STAINLESS STEEL UNDERMOUNT SINK. PROVIDE PLUMBING HOLES.
- 9.5 PROVIDE OPAQUE SCREENING ON GLAZING. BASIS OF DESIGN PRODUCT: 3M FASARA GLASS FINISHES- SAGANO. SUBSTITUTIONS PER SECTION 016600.
- 9.6 REMOVE EXISTING GROUT AND RE-GROUT ALL SURFACES. WALL GROUT TO BE MAPEI 38 AVALANCHE. FLOOR GROUT TO BE MAPEI 27 SILVER.
- 9.7 PROVIDE NEW RUBBER STAIR TREAD WITH INTEGRATED RISER.
- 10.1 NEW LOCKER WITH BUILT-IN BENCH. TYPICAL.
- 10.2 NEW URINAL SCREEN.
- 10.3 NEW TOILET PARTITIONS.
- 10.4 NEW ADA GRAB BARS.
- 10.5 NEW 18" TOWEL BAR, MOUNTED AT 48" AFF.
- 10.6 NEW LOCKER FILLER PANEL WITH WOOD BENCH PANEL.

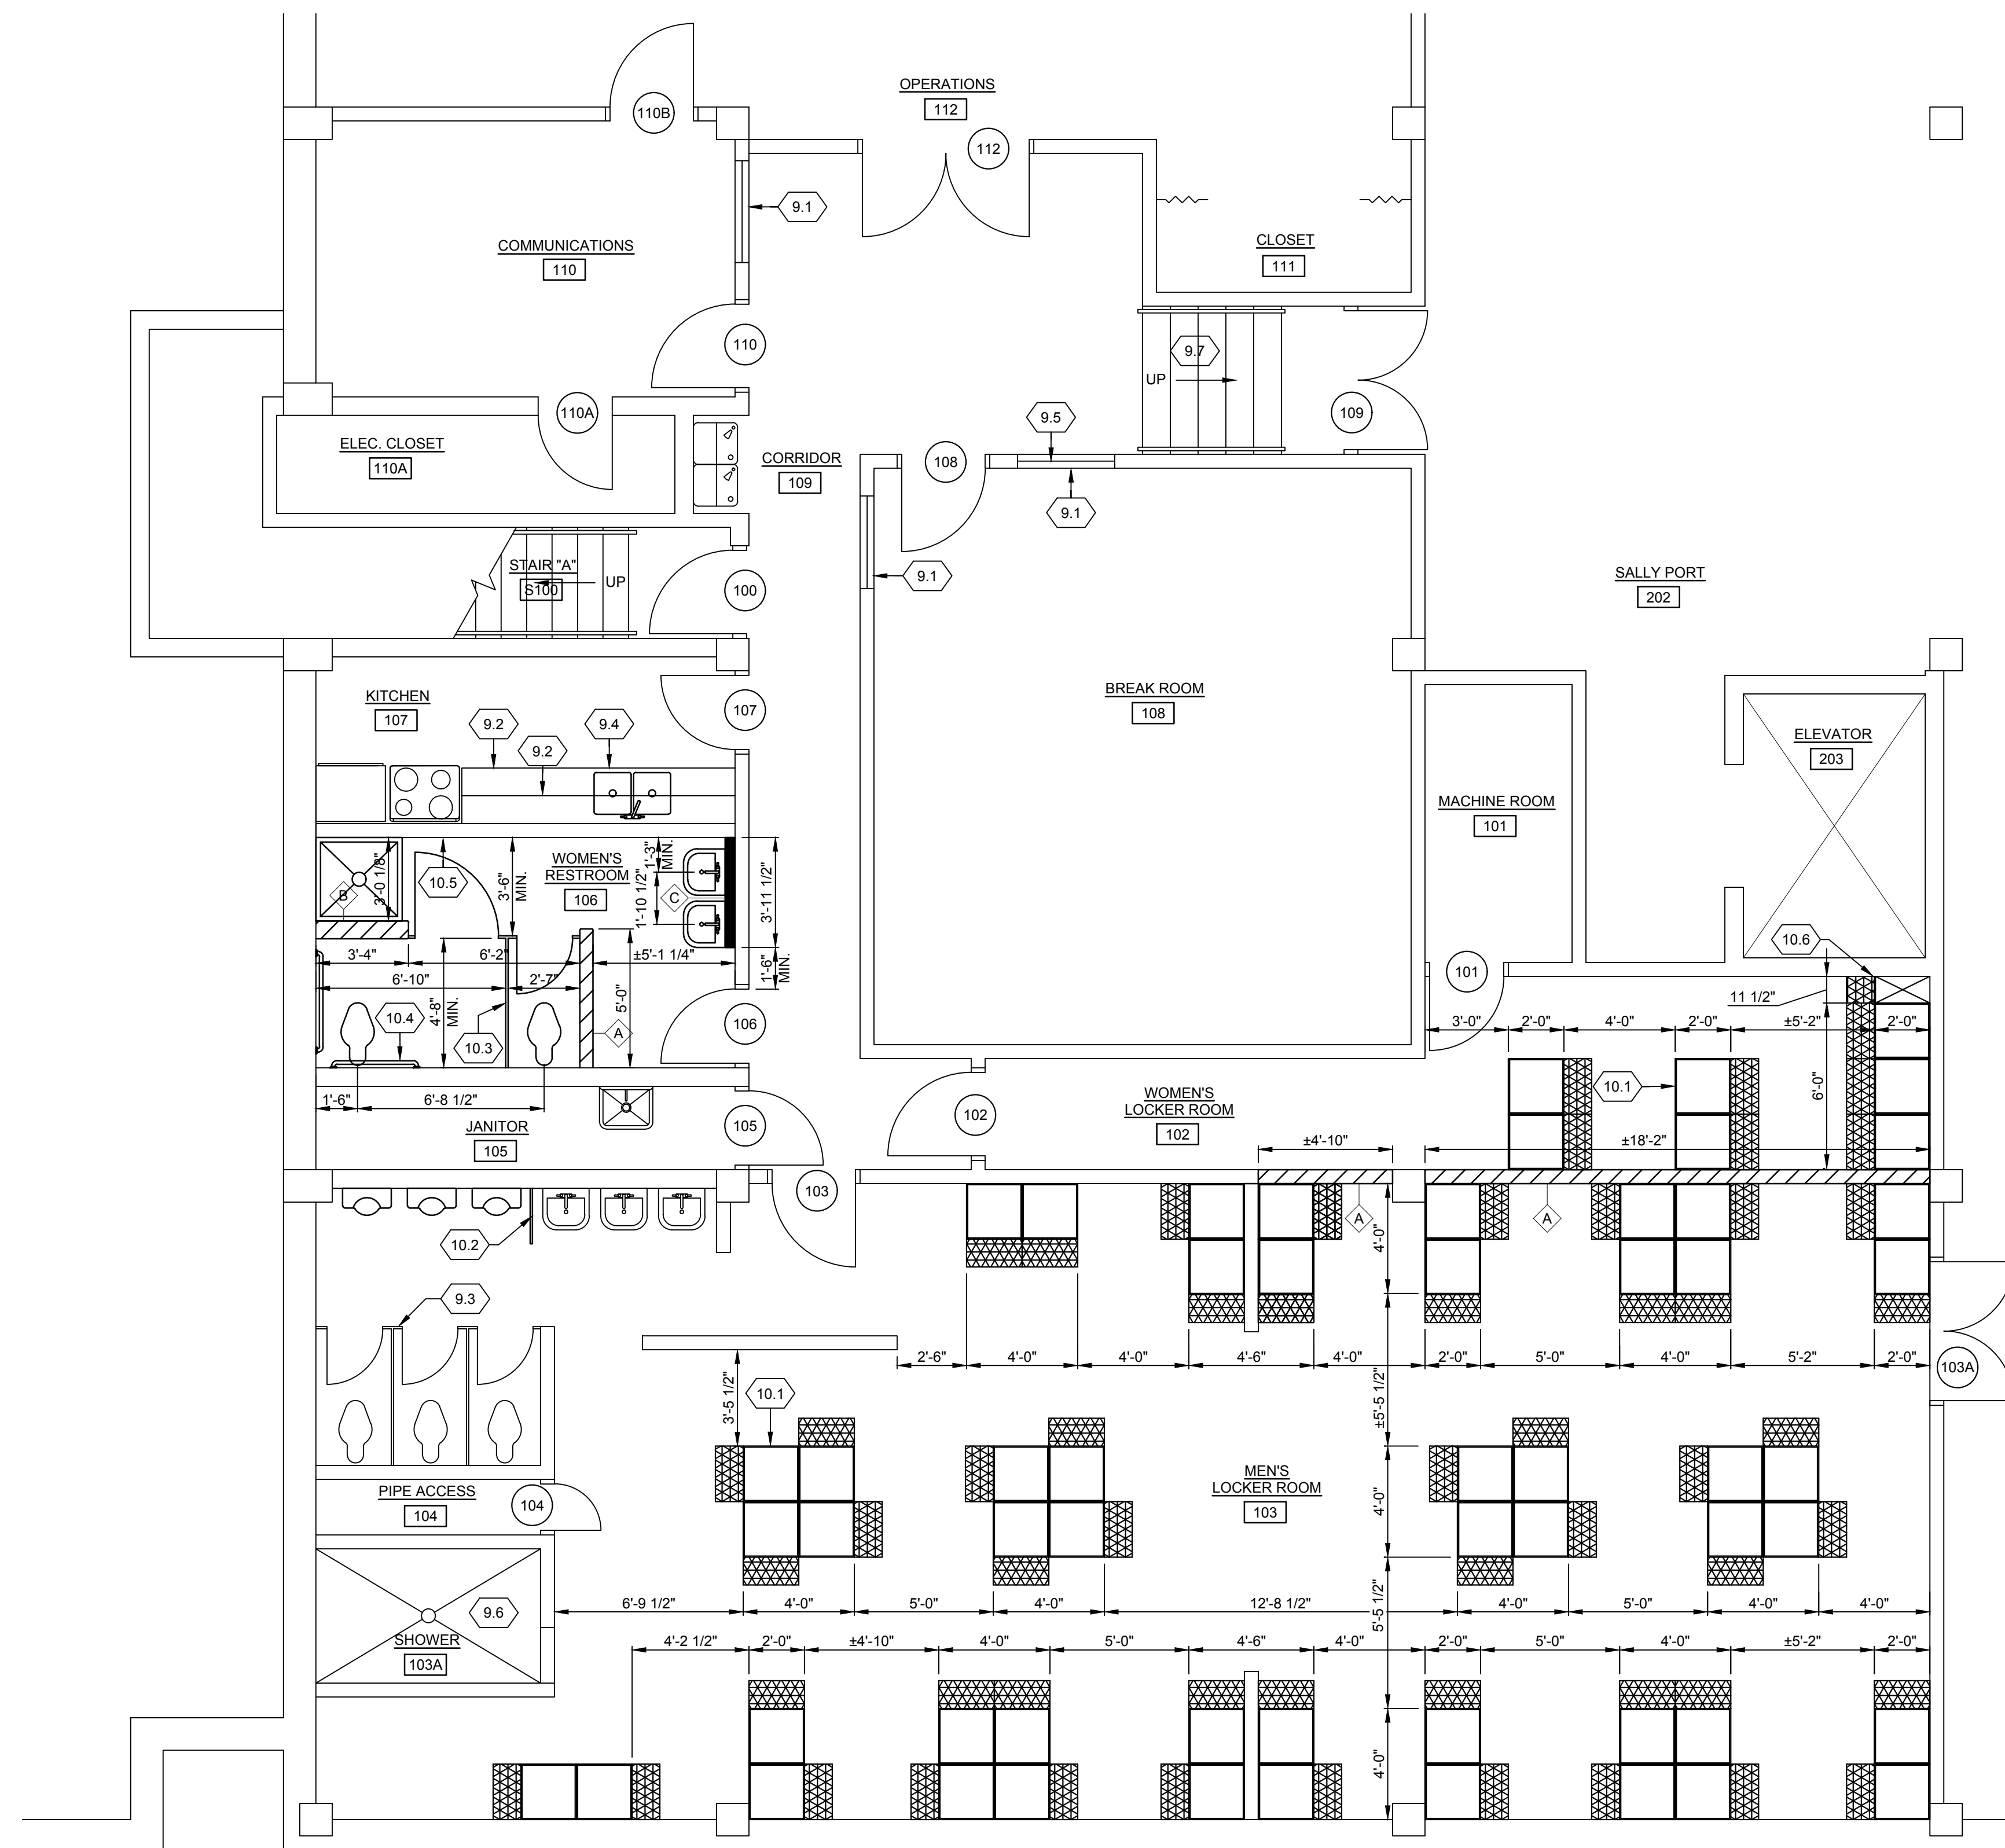

1 BASEMENT LEVEL FLOOR PLAN
A101 SCALE: 1/4"=1'-0"

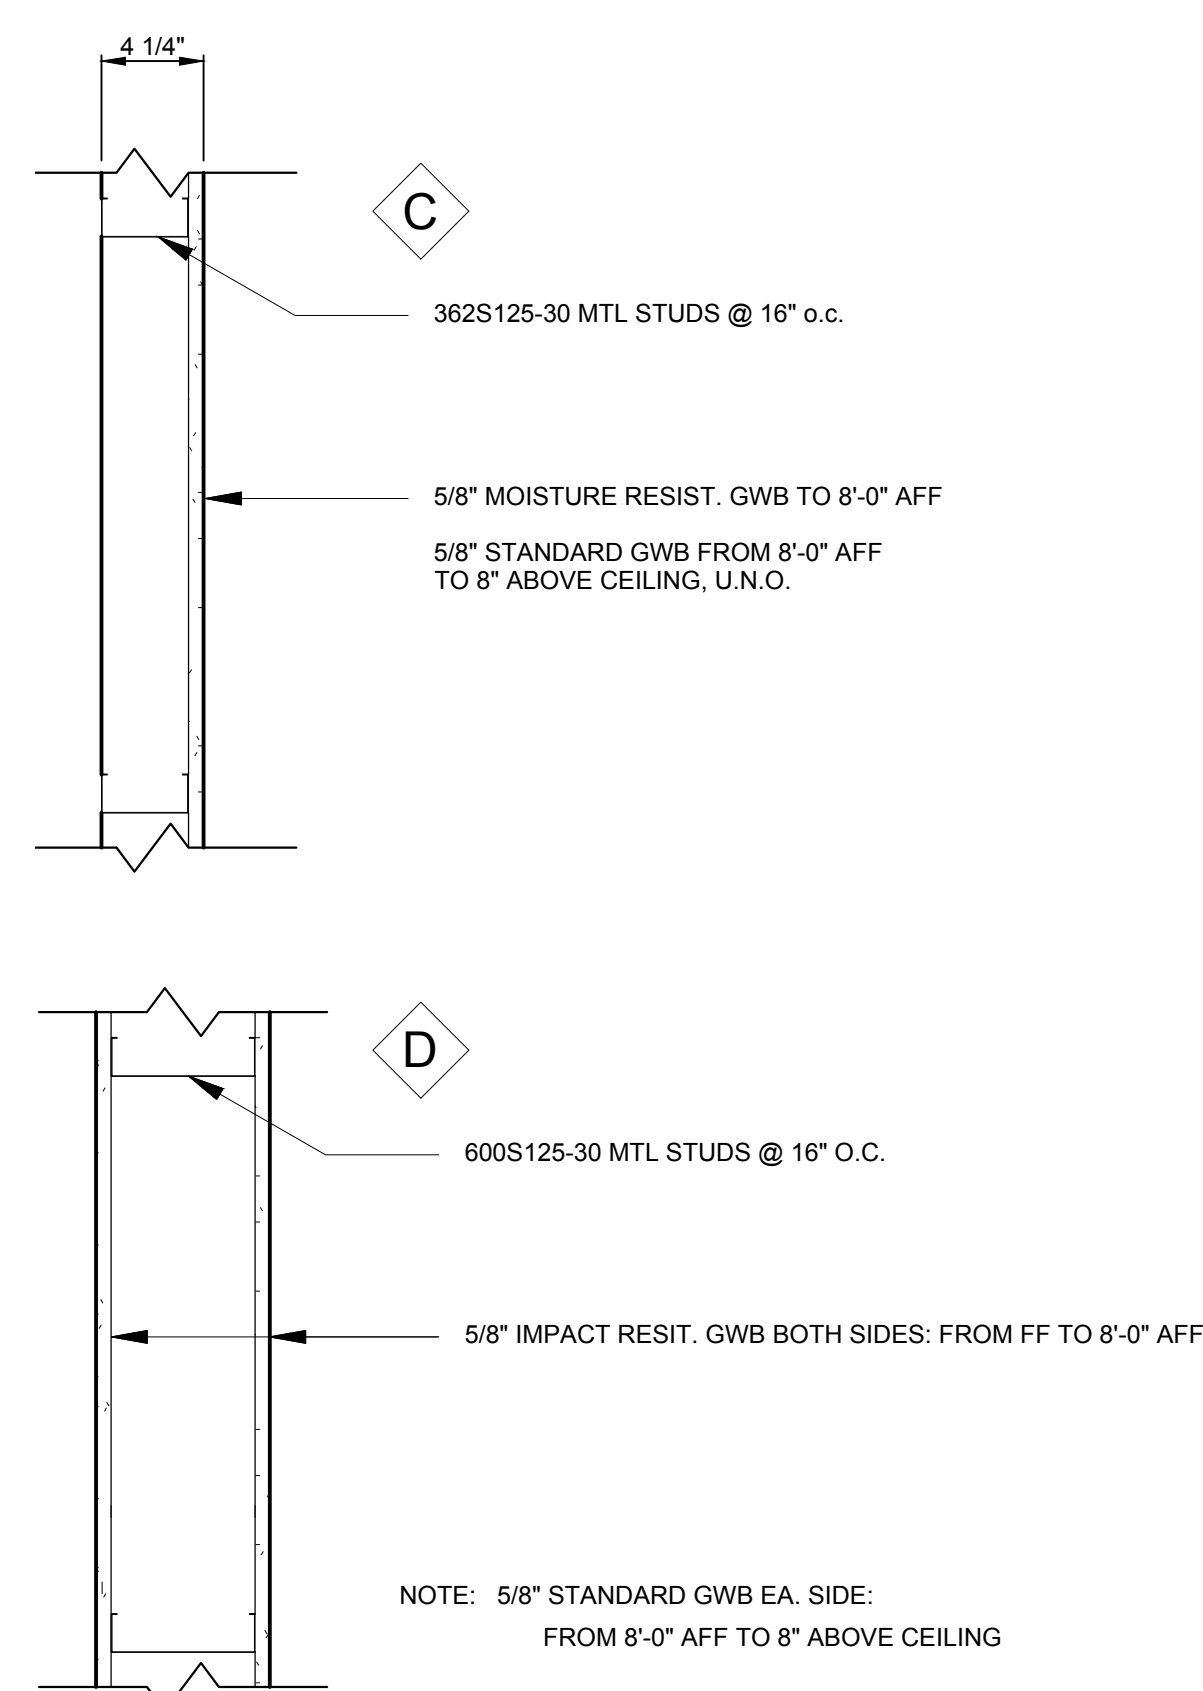
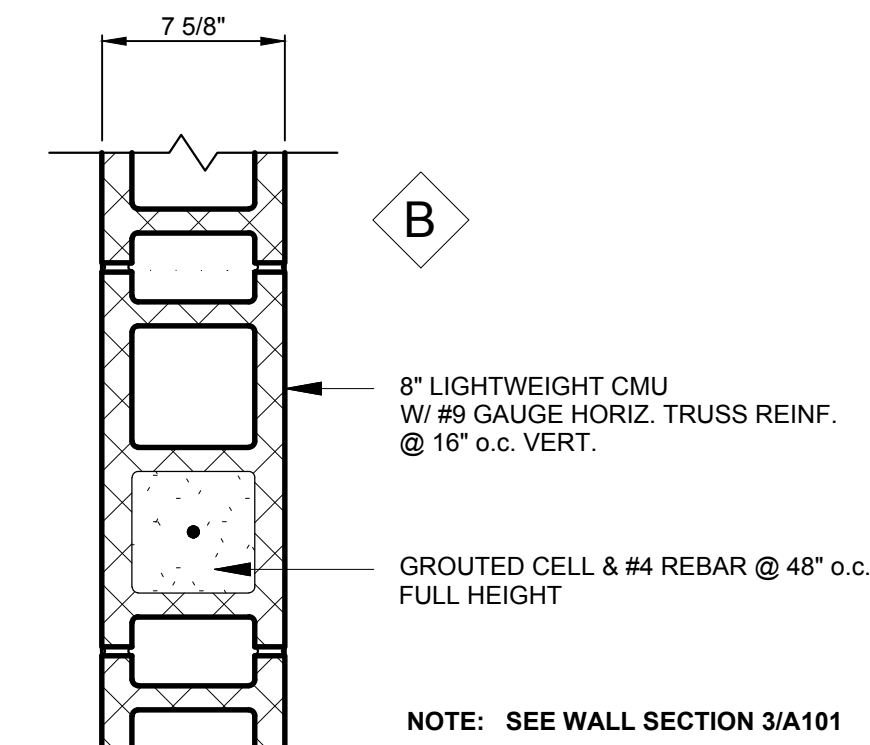
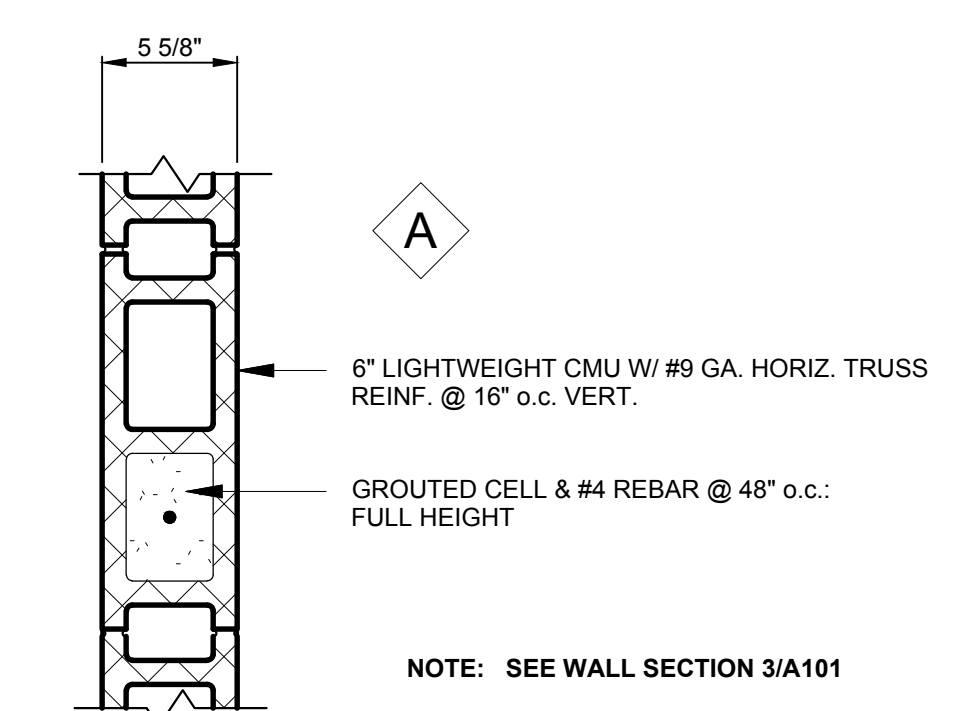


2 PARTITION TYPES
A101 SCALE: 1 1/2"=1'-0"

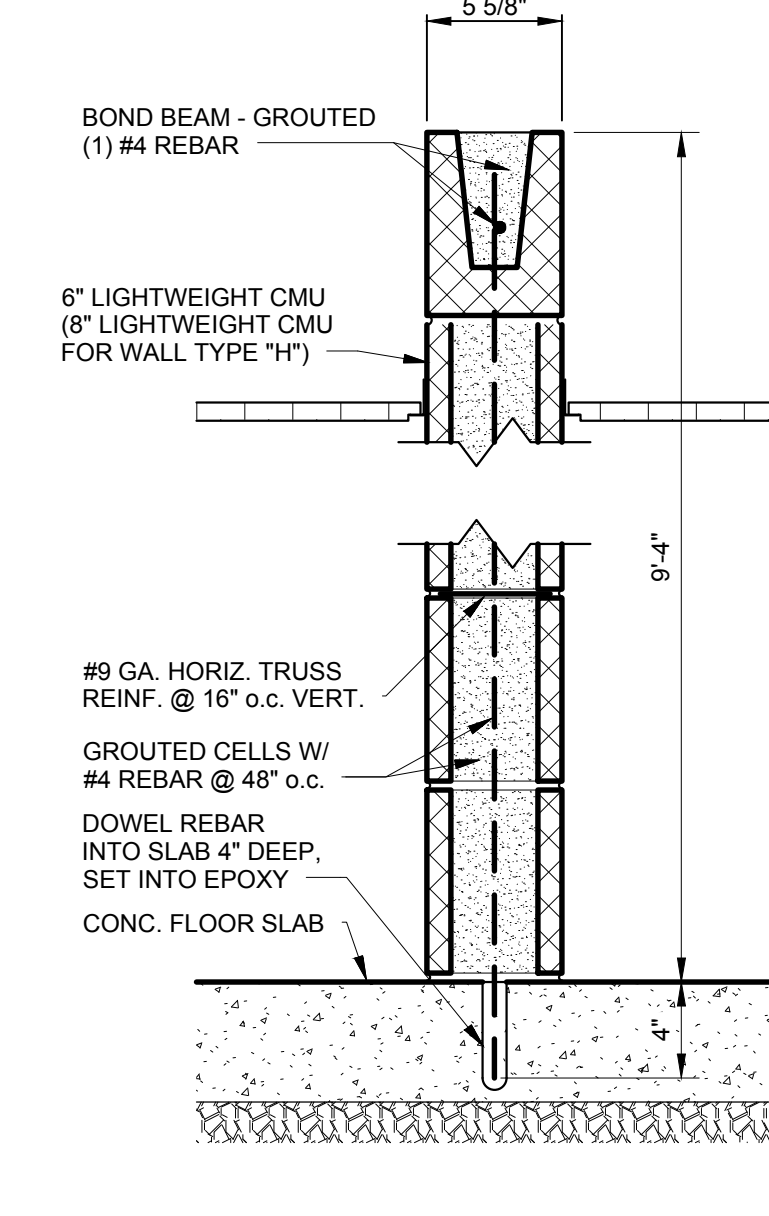

4 METAL STUD TOP OF WALL DETAIL, TYP.
A101 SCALE: 1 1/2"=1'-0"

5 BULKHEAD DETAIL, TYP.
A101 SCALE: 1 1/2"=1'-0"

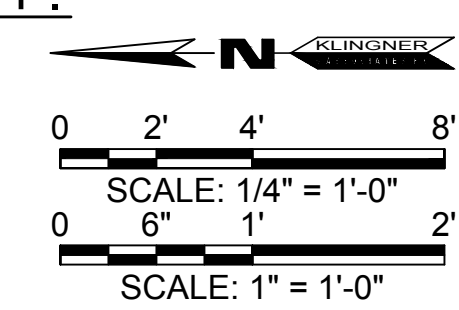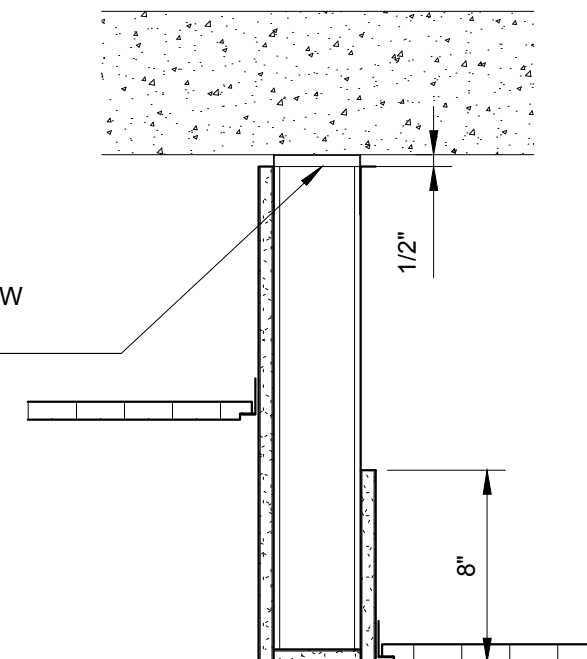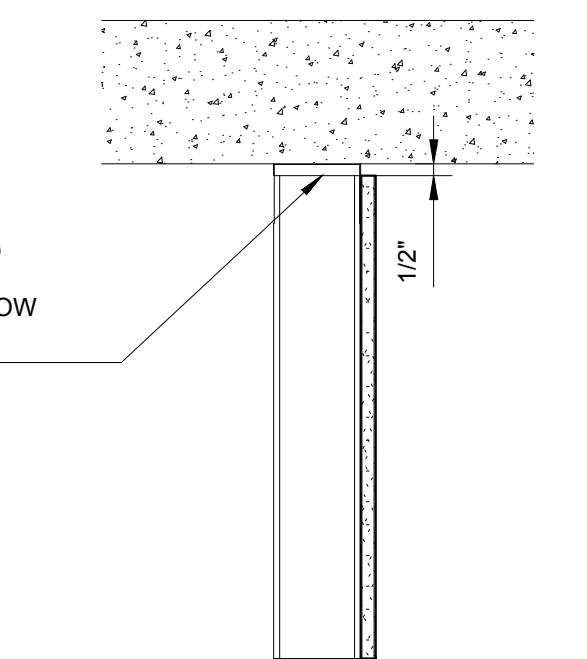

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Engineers • Architects • Surveyors • Planners
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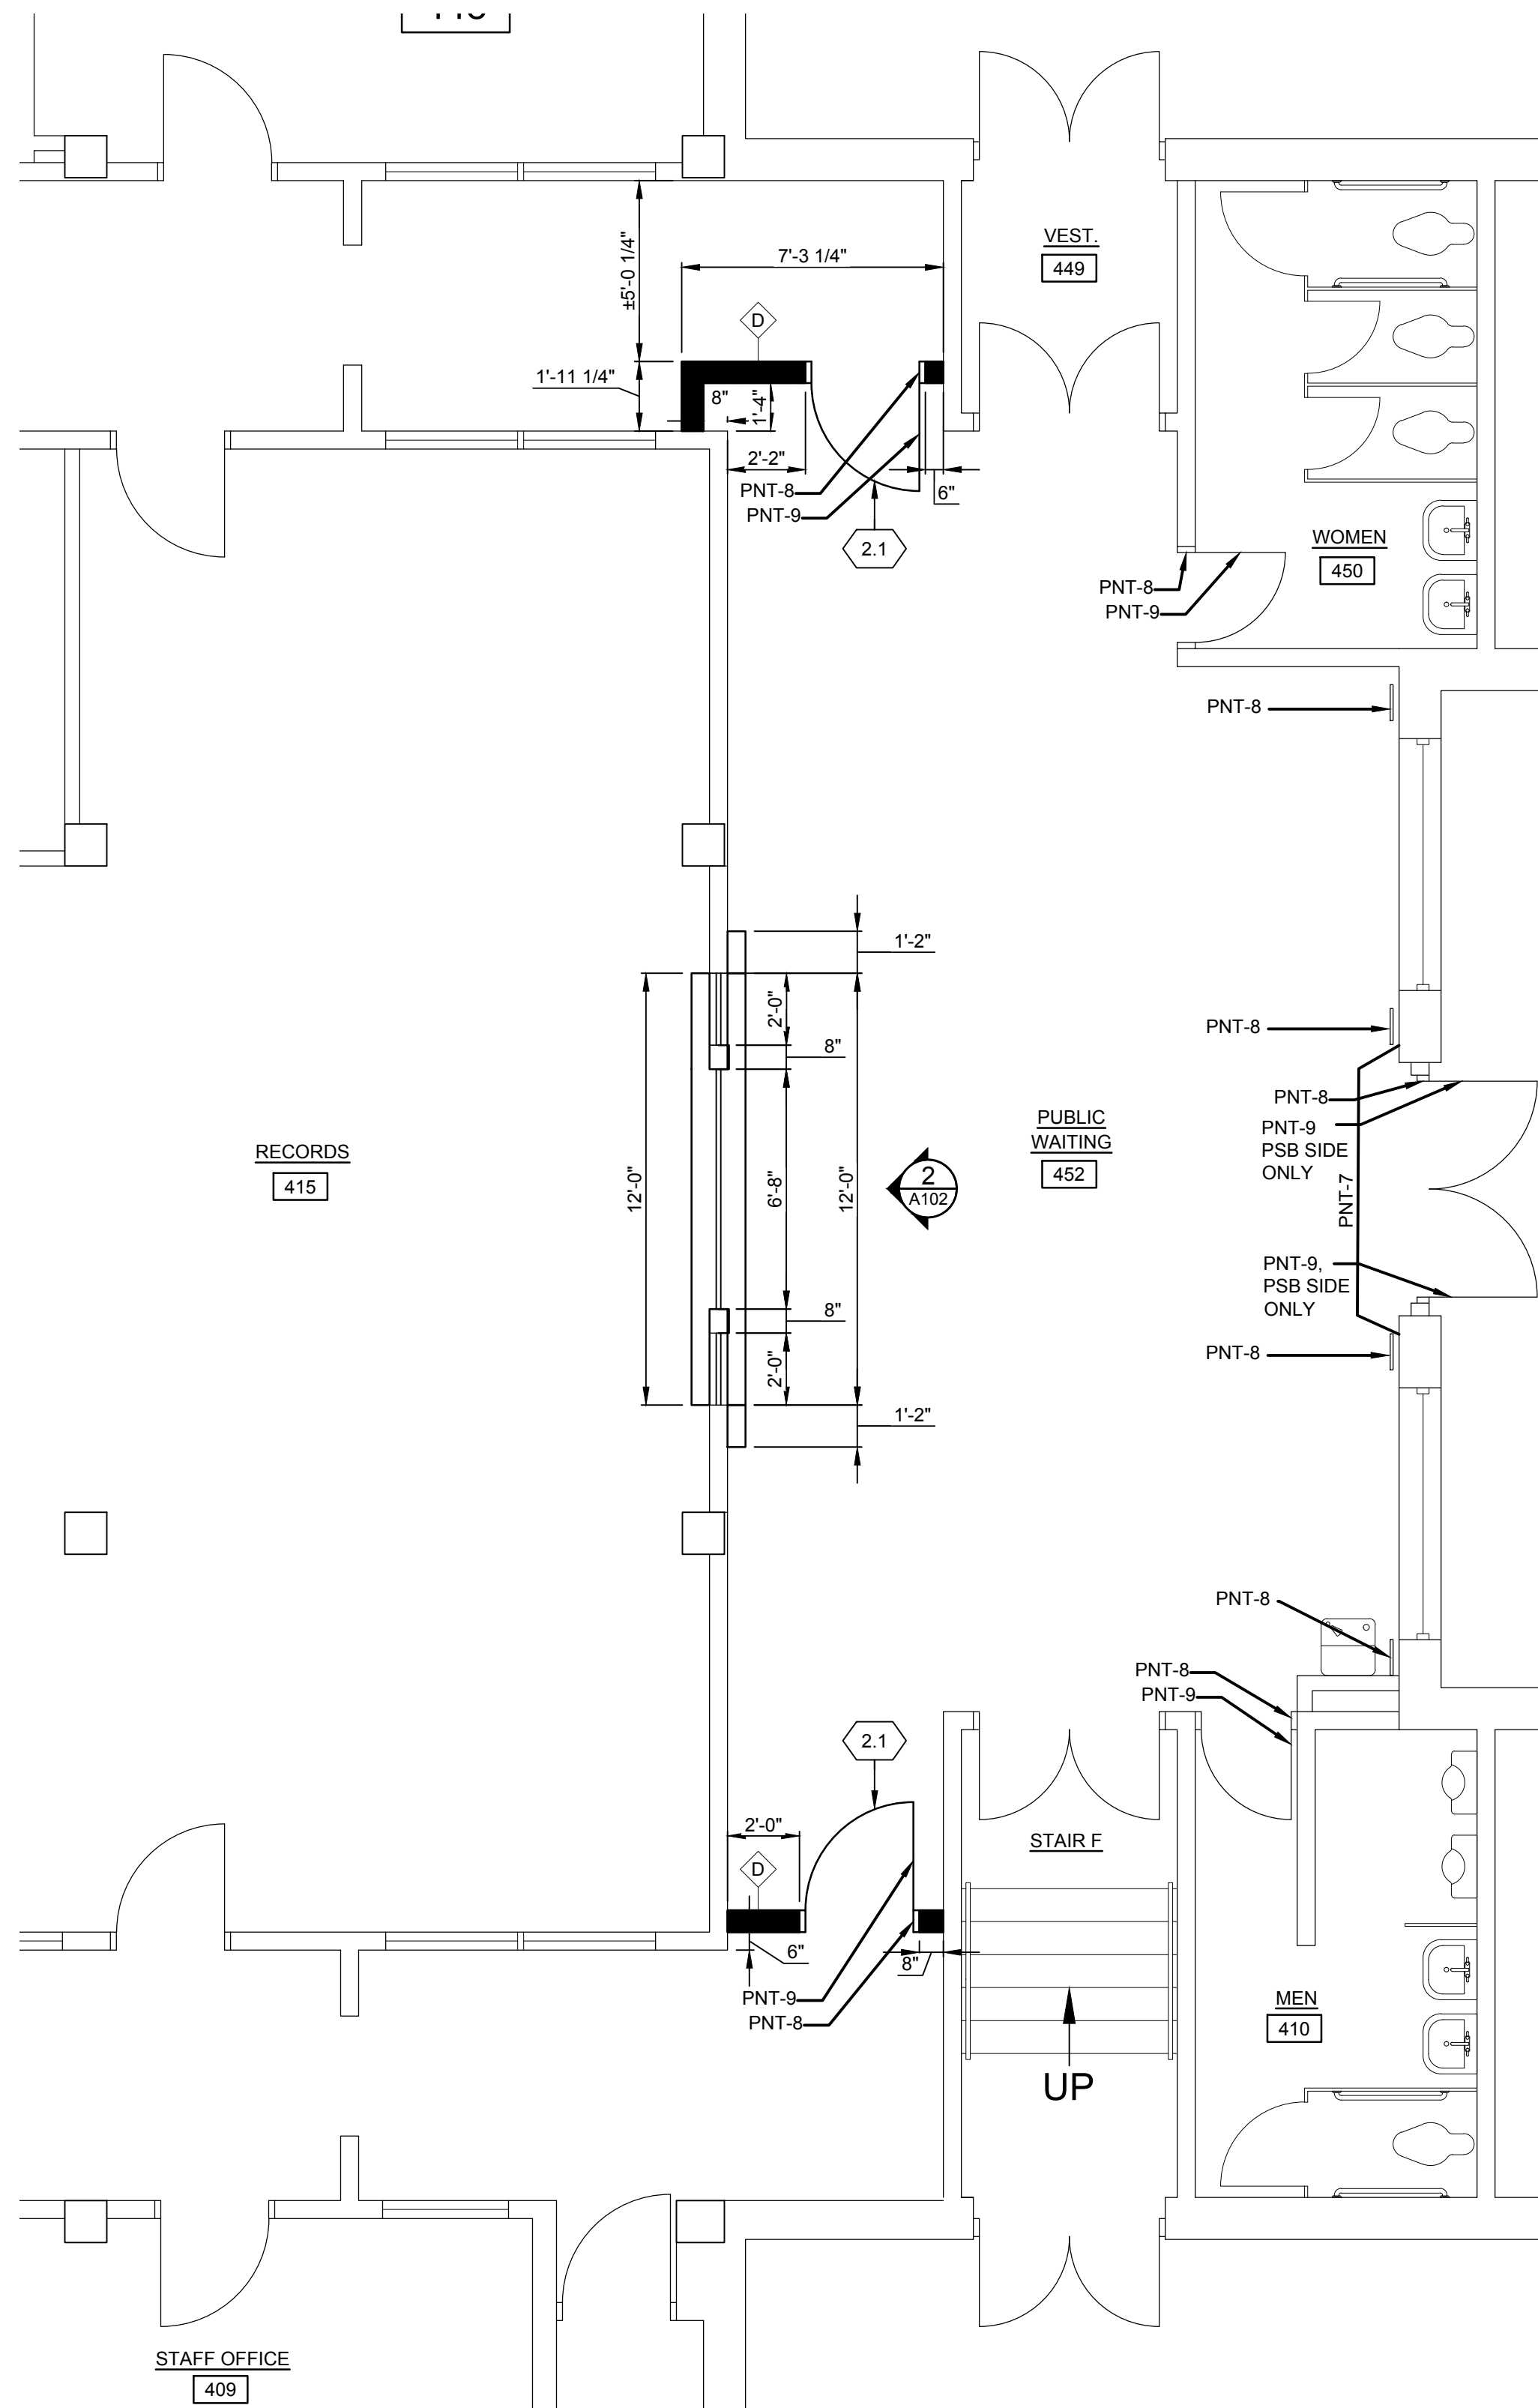
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PSB INTERIOR RENOVATIONS - PHASE IIIB
CITY OF GALESBURG
150 SOUTH BROAD ST.
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Non-Reduced Sheet Size: 24" x 36"
Full size plans have been prepared using standard scales. Reduced size plans may not conform to standard scales.


DESIGNED CNB	DRAWN CNB
FIELD CNB	FIELD BOOK
CHECKED CNB	CHECK DATE 12/15/15
SHEET TITLE BASEMENT FLOOR - FLOOR PLAN, PARTITION TYPES & DETAILS	
PROJECT NO. 3215-073 (15-3027)	
DRAWING ISSUED DATE: 12/14/16	
SHEET A101	




1 MAIN LEVEL FLOOR PLAN - NEW WORK
SCALE: 1/4"=1'-0"

KEYNOTES


2.1 INSTALL EXISTING HM DOOR IN NEW HM FRAME. INSTALL RELOCATED ACCESS CONTROL HARDWARE TO NEW OPENING.

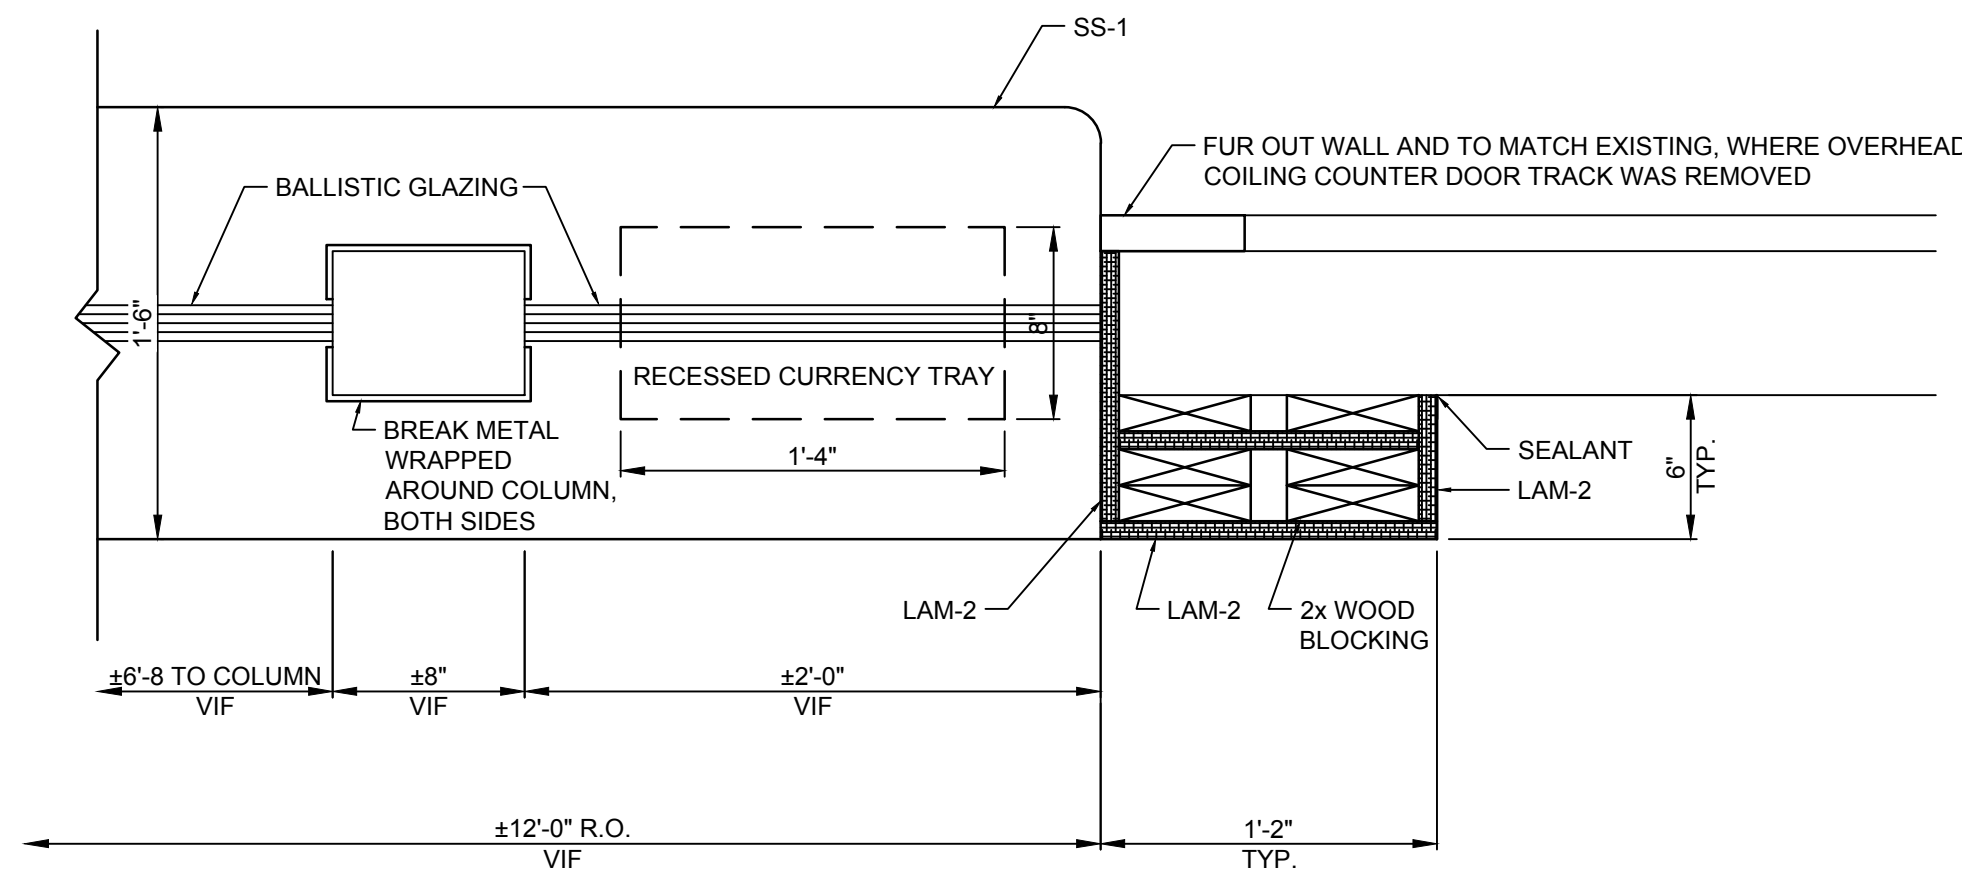


3 ENLARGED PLAN VIEW
SCALE: 1 1/2"=1'-0"

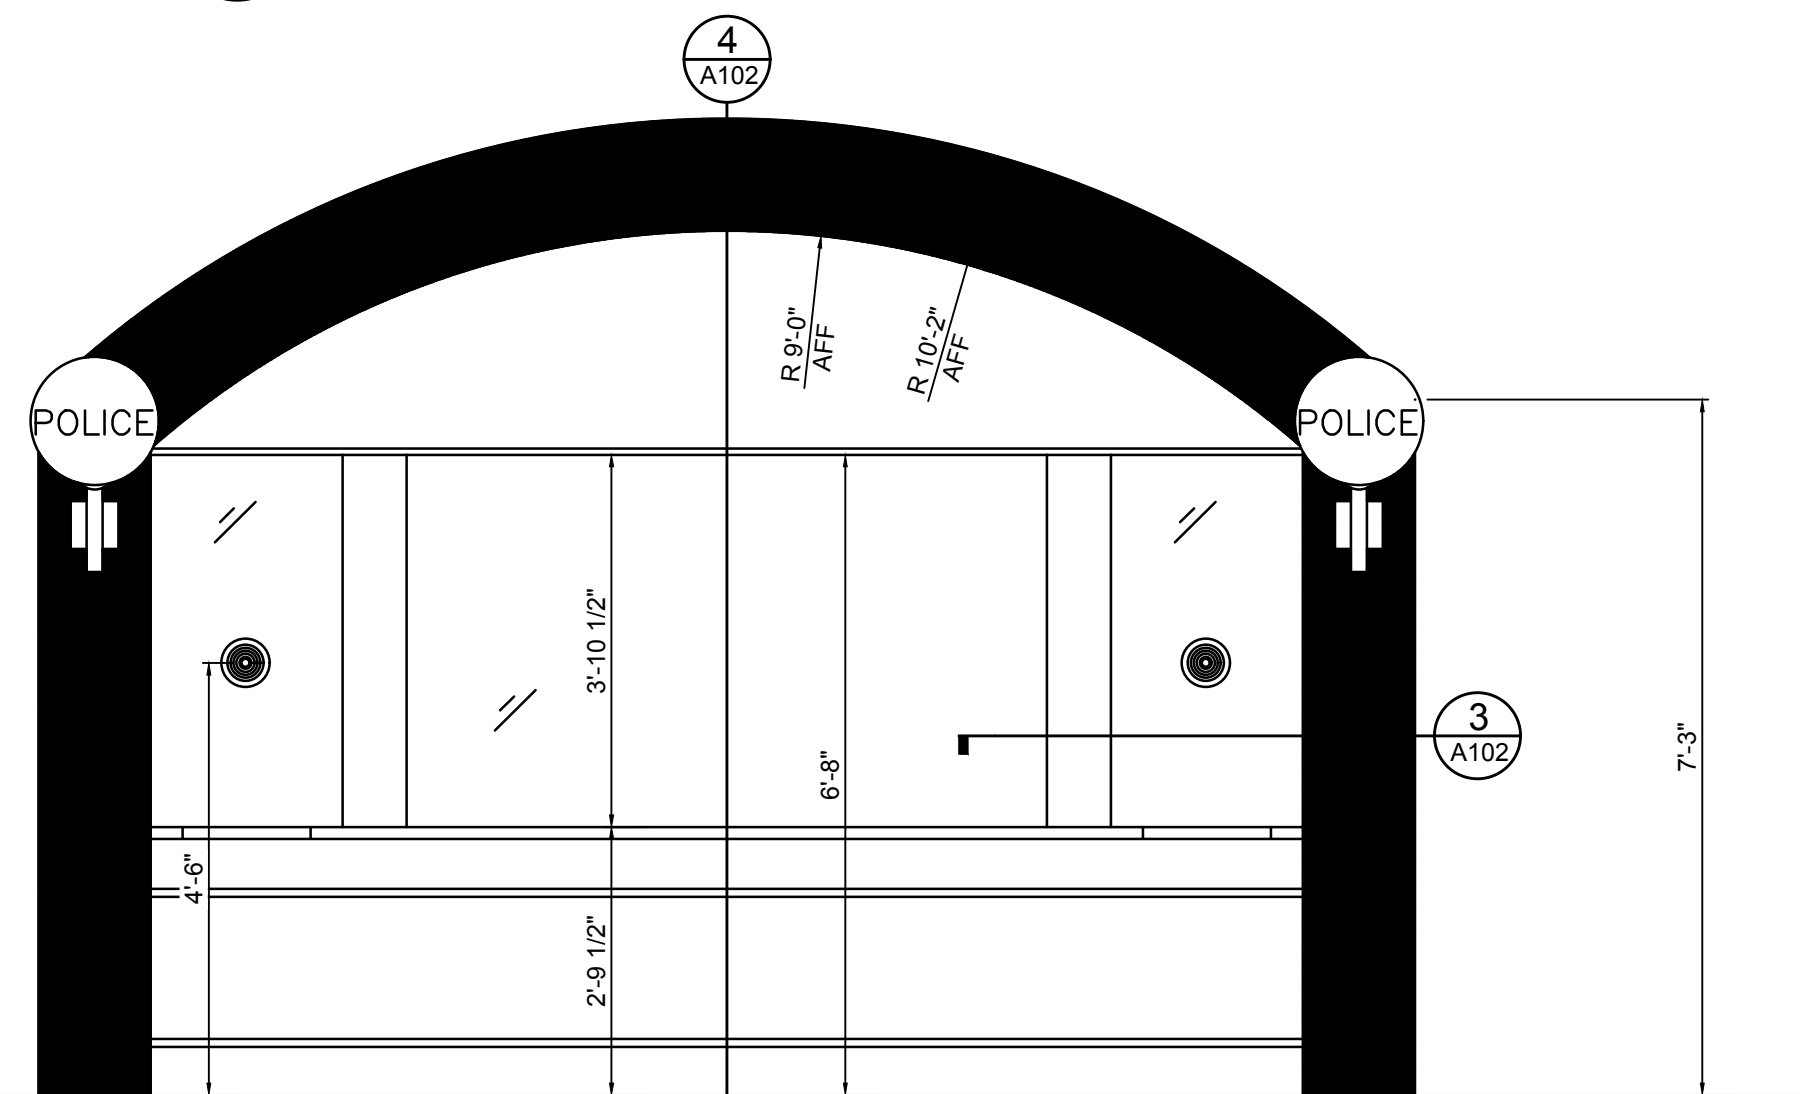

2 ELEVATION FROM LOBBY
SCALE: 1/2"=1'-0"

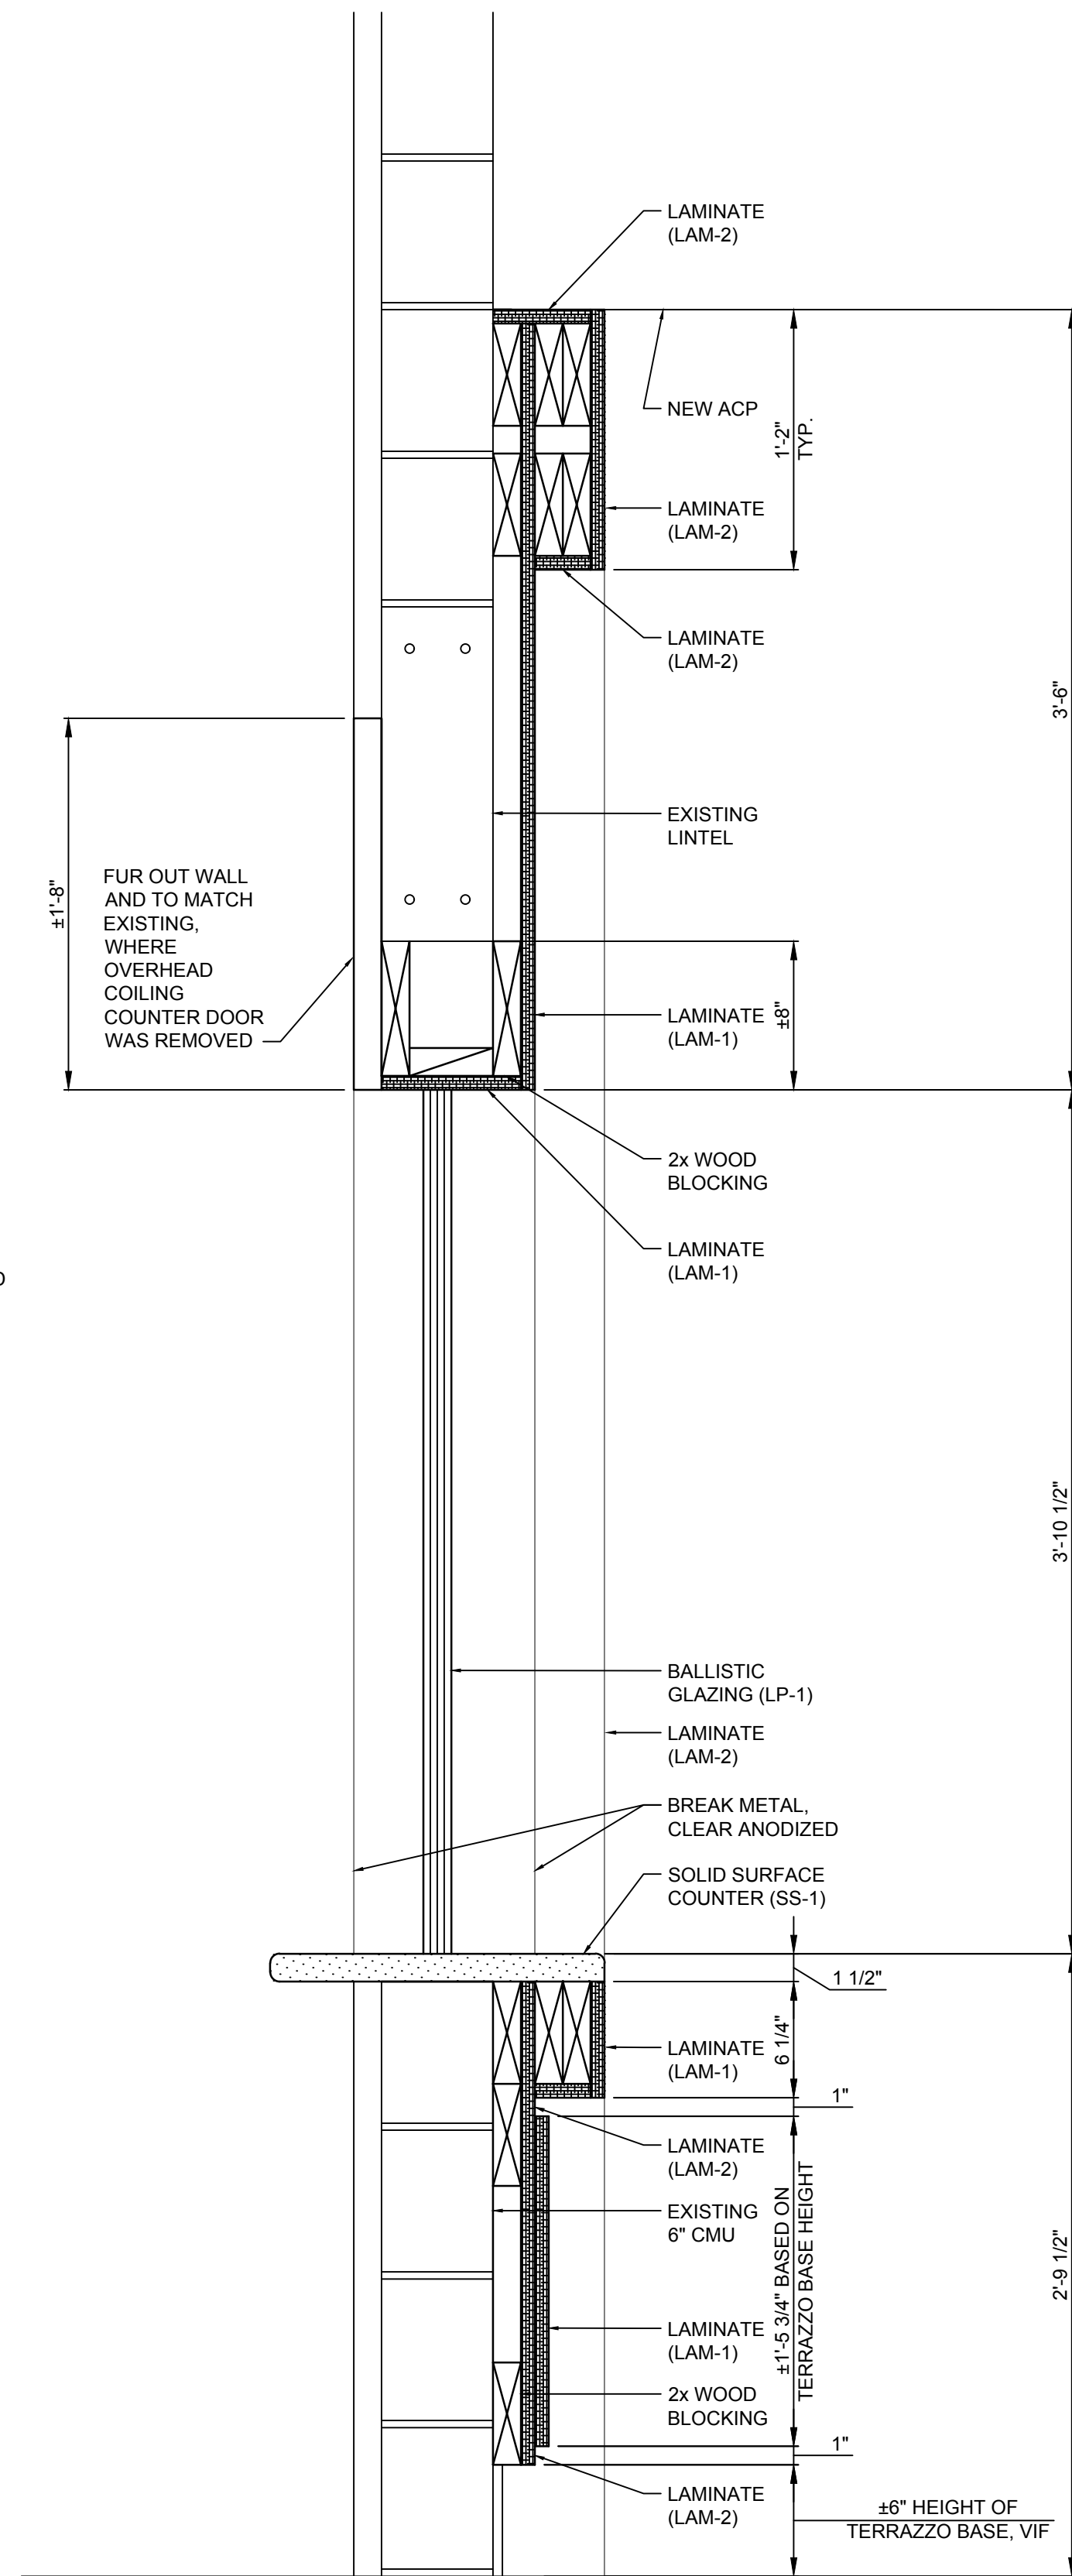

3 SECTION
SCALE: 1 1/2"=1'-0"

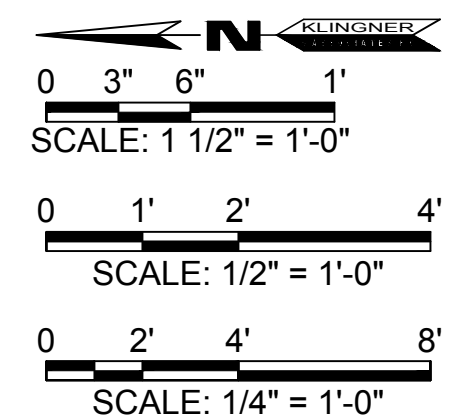

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PSB INTERIOR RENOVATIONS - PHASE IIIB
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GALESBURG, ILLINOIS 61401



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FIELD		FIELD BOOK	
CHECKED	CNB	CHECK DATE	12/15/16

SHEET TITLE
MAIN LEVEL - FLOOR PLAN, INTERIOR ELEVATION, & DETAILS

PROJECT NO.
3215-073 (15-3027)
DRAWING ISSUED DATE:
12/14/16

SHEET
A102

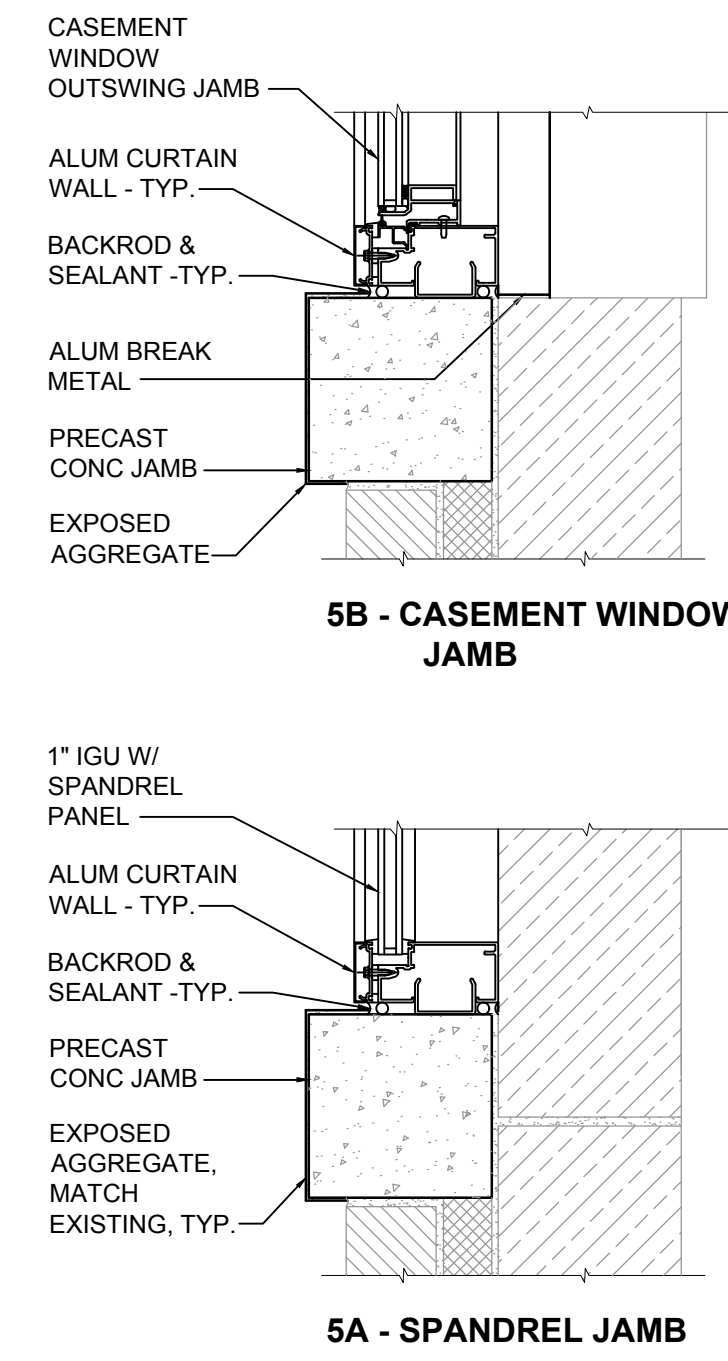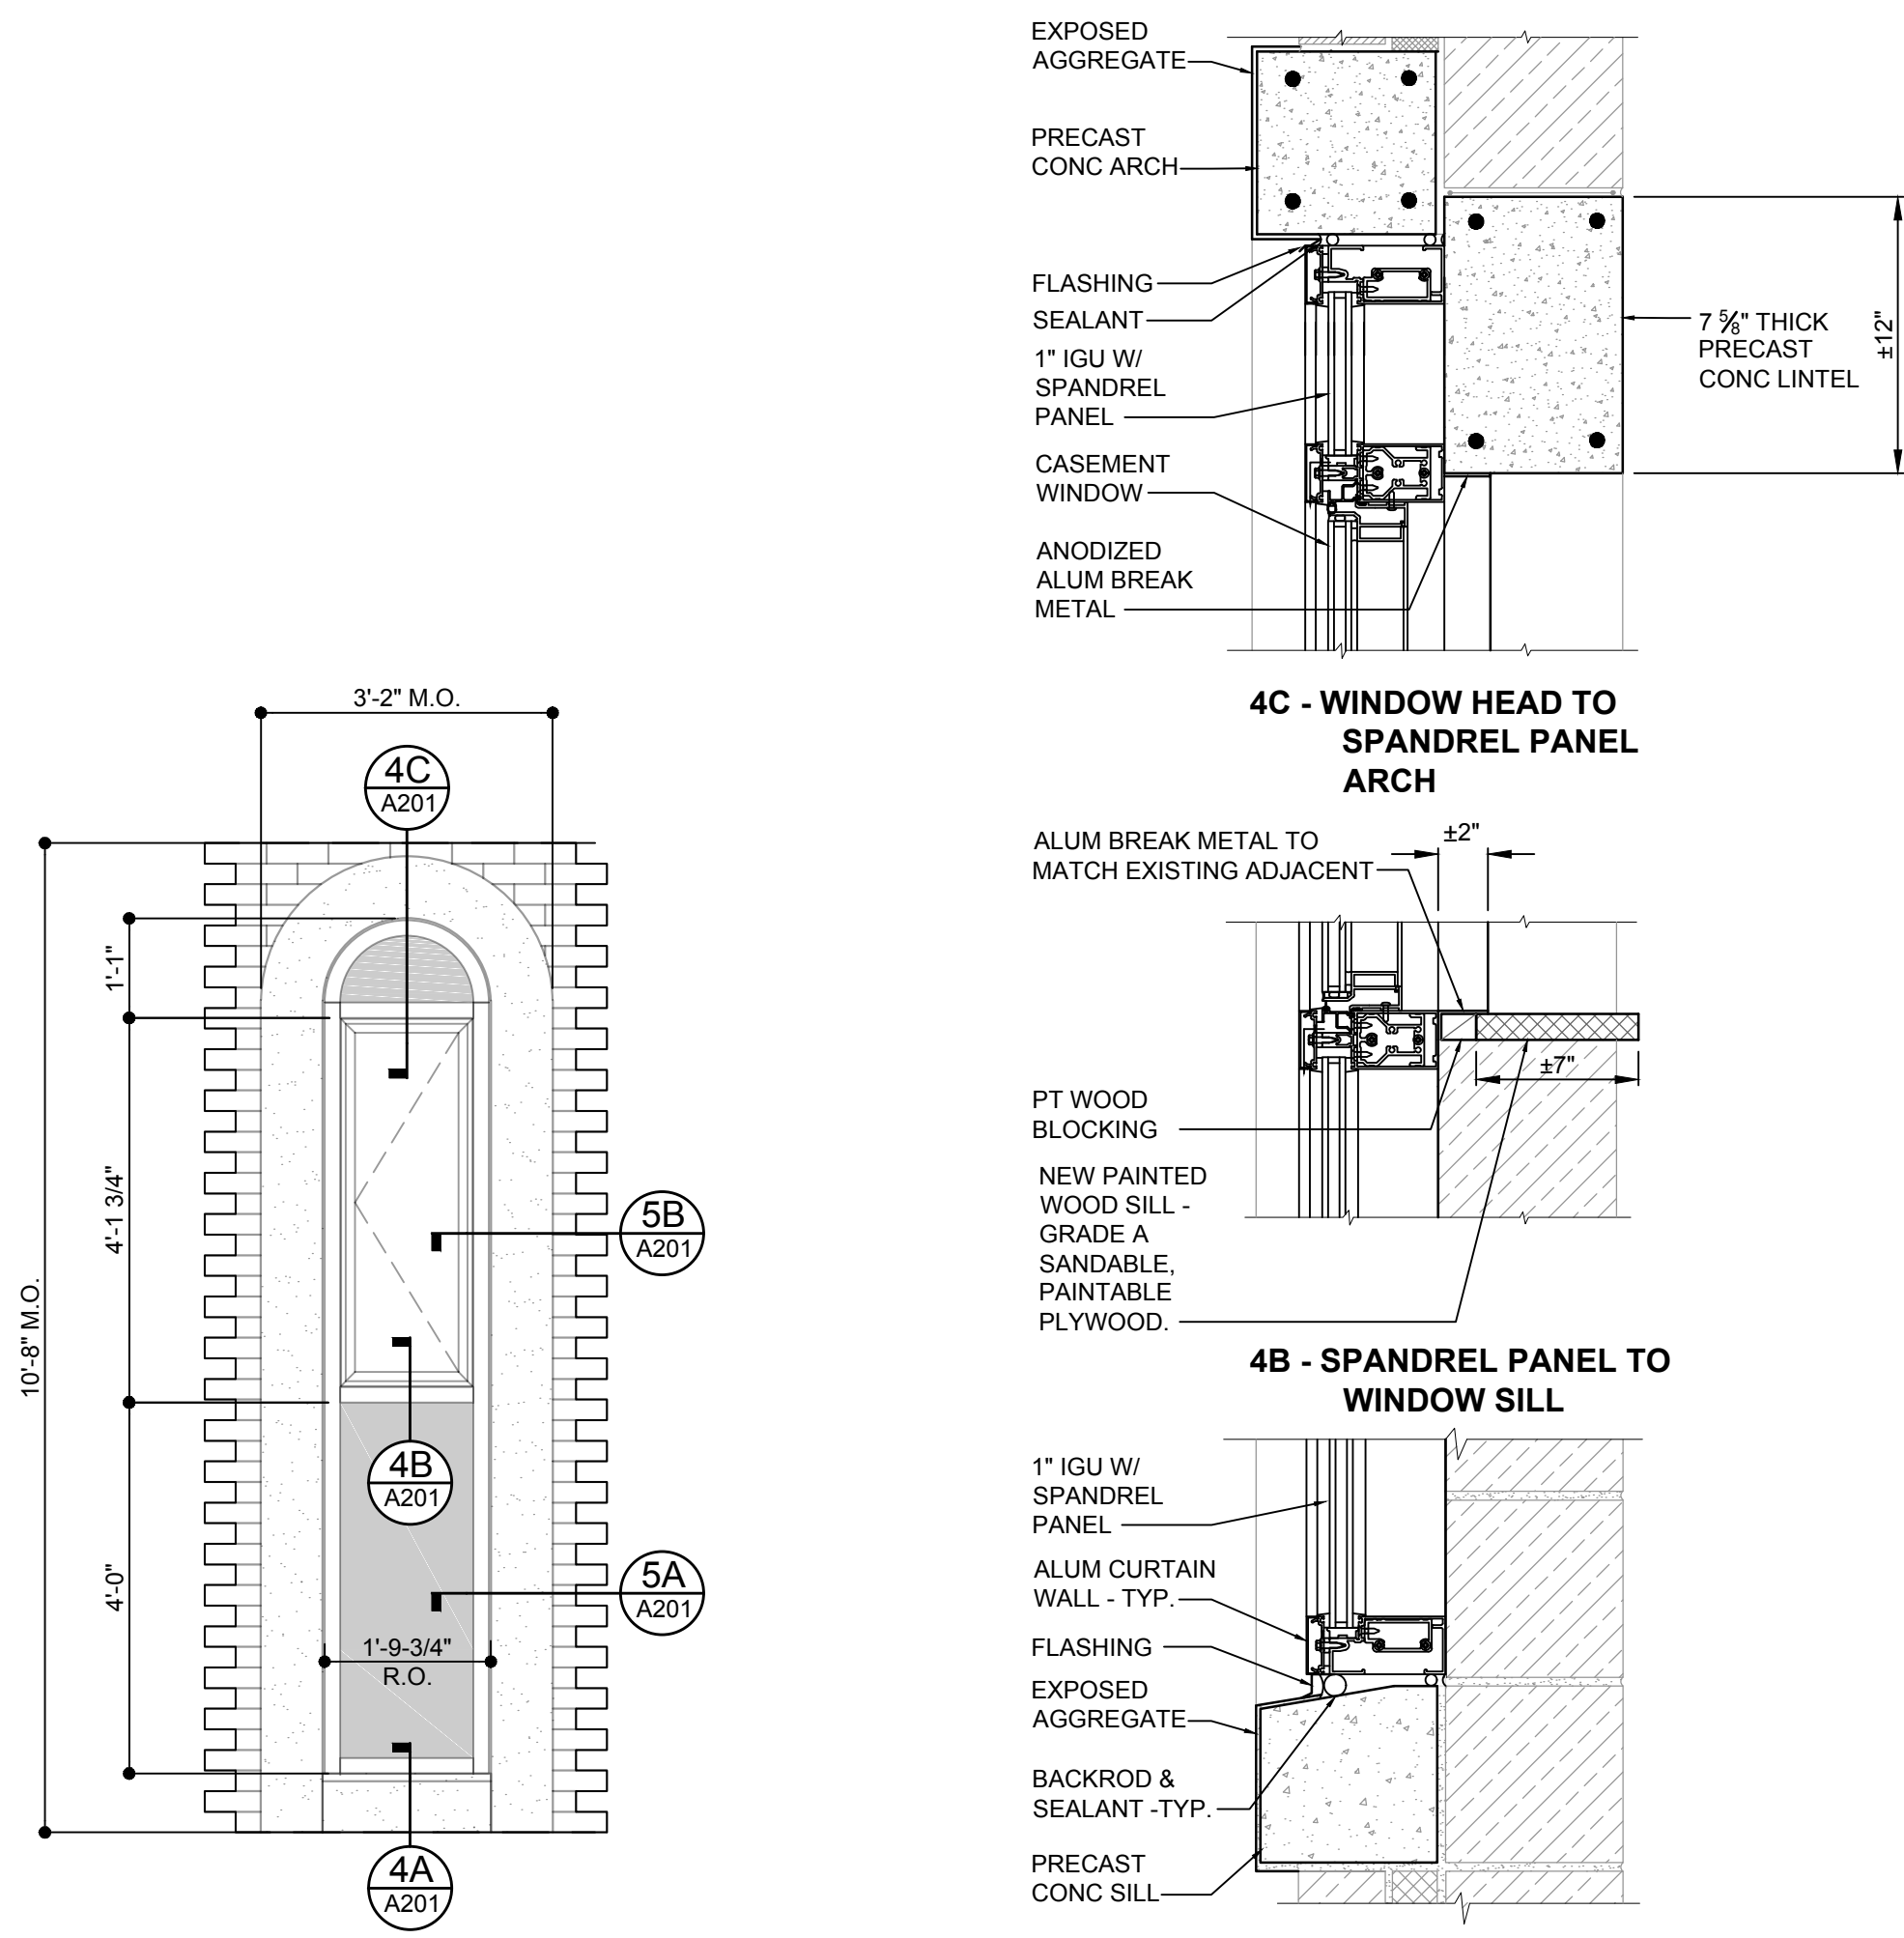

3 ELEVATION OF NEW OPENING
A201 SCALE: 1/2" = 1'-0"

4 WINDOW DETAILS TYPICAL
A201 SCALE: 1 1/2" = 1'-0"

6 WINDOW JAMB DETAILS
A201 SCALE: 1 1/2" = 1'-0"

GENERAL NOTES

- SEE A202 FOR GLAZING TYPES.
- CONTRACTOR TO VERIFY EXIST WINDOW DIMENSIONS AND MATCH EXISTING WINDOW, EXPOSED AGGREGATE SURROUND.

DEMOLITION KEYNOTES




- 2.1** CUT NEW OPENING THROUGH THE OUTER WYTHE OF BRICK AND INNER WYTHE OF CMU TO CREATE NEW WINDOW OPENING.

KEYNOTES

- 7.1** REMOVE SEALANT IF IT EXISTS, CLEAN, ADD NEW (8"X8") ALUMINUM HIGH TEMPERATURE VENT HOOD AND INSTALL NEW SEALANT SYSTEM. CONTRACTOR TO FIELD VERIFY SIZE OF OPENING FOR PROPER SIZING OF VENT HOOD.

LEGEND

- GL-1 THERMALLY BROKEN ALUMINUM FRAMING W/ 1" FIXED IGU
- GL-1 OPERABLE CASEMENT UNIT W/ 1" IGU INSERTED INTO NEW THERMALLY BROKEN ALUMINUM FRAMING
- GL-2 1" IGU W/ SPANDREL GLASS
- NEW CONC WINDOW TRIM W/ STONE FINISH TO MATCH EXISTING IN PROFILE SHAPE, AND TEXTURE

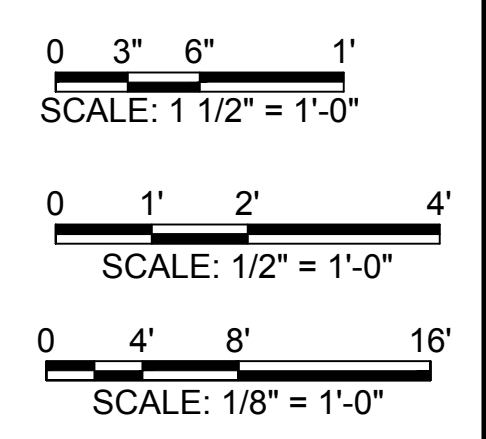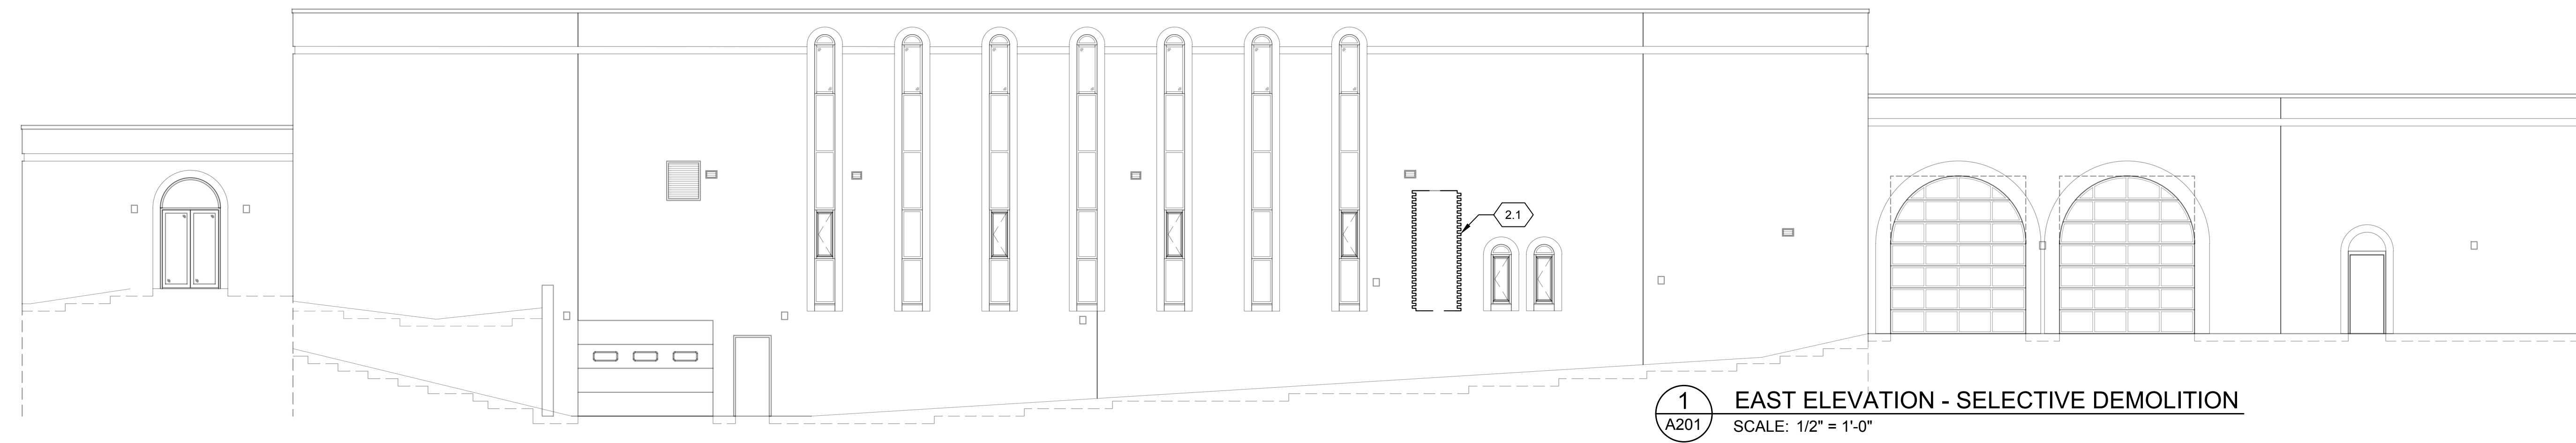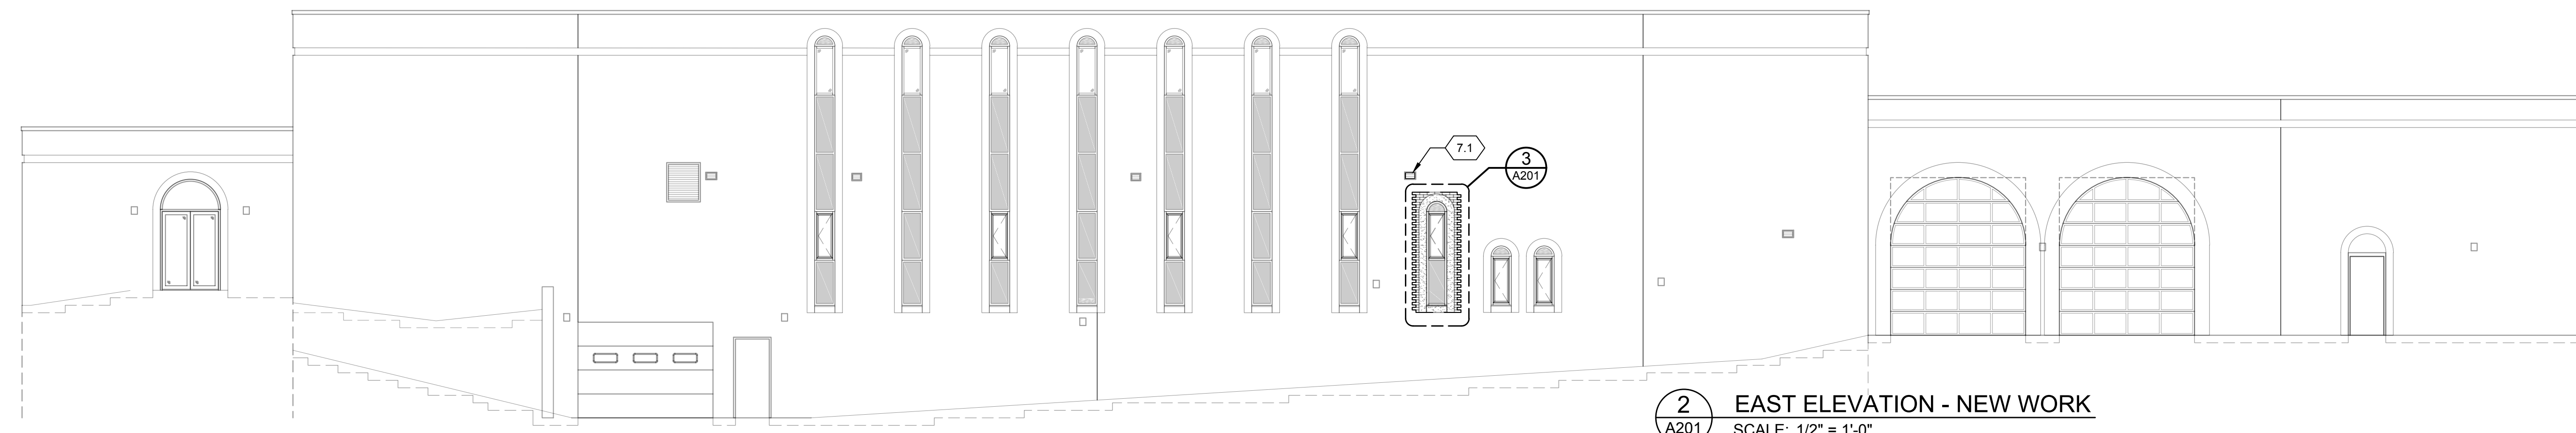

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Ph: 217.223.3670 Fax: 217.223.3603
Ph: 573.221.0020 Fax: 573.221.0012
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SHEET TITLE
EXTERIOR ELEVATIONS AND WINDOW DETAILS
PROJECT NO.
3215-073 (15-3027)
DRAWING ISSUED DATE:
12/14/16
SHEET
A201

GENERAL NOTES


- CONTRACTOR TO PROTECT AND REUSE EXISTING LIGHTING, CAMERAS, HEAT DETECTORS, AND ANY OTHER ITEMS IN EXISTING ACOUSTICAL PANEL CEILING.

LEGEND

- ACP = 24x24 ACOUSTICAL CEILING PANEL IN SUSPENDED MTL GRID
- ACP-1 TYPICAL ACP CEILING
- ACP-2 24x48 ACP CEILING SUSPENDED MTL GRID
- ACP-3 MOISTURE-RESISTANT 24x48 ACP CEILING SUSPENDED MTL GRID
- EXISTING CEILING EXIT LIGHT
- EXISTING EXHAUST VENT
- EXISTING SUPPLY DIFFUSER
- EXISTING 2x4 LIGHT FIXTURE
- EXISTING 2x4 LIGHT FIXTURE - EGGRATE
- EXISTING FIRE ALARM CEILING HEAT DETECTOR
- EXISTING CAMERA
- EXISTING SPEAKER
- EXISTING OCCUPANCY SENSOR
- EXISTING OUTLET COVER
- EXISTING SPRINKLER HEAD

KEYNOTES

- 23.1 PROVIDE NEW ALUMINUM FRAME BAR GRILL, MATCH EXISTING SIZE. FINISH SATIN.
- 23.2 RELOCATE EXISTING EXHAUST APPROXIMATELY 4'-6" DUE EAST TO BE LOCATED OVER NEW SHOWER UNIT. PROVIDE NEW ALUMINUM FRAME BAR GRILL, MATCH EXISTING SIZE. FINISH SATIN.
- 26.1 RELOCATE EXISTING SENSOR FROM EXISTING EXERCISE ROOM TO NEW WOMEN'S LOCKER ROOM.
- 26.2 REPLACE EXISTING CEILING LIGHT WITH NEW RECESSED LIGHT. SEE E101 MORE INFORMATION.
- 26.3 RELOCATE EXISTING FIRE ANNUNCIATOR AT WALL TO BE REMOVED DUE EAST AND MOUNT AT SAME ELEVATION.

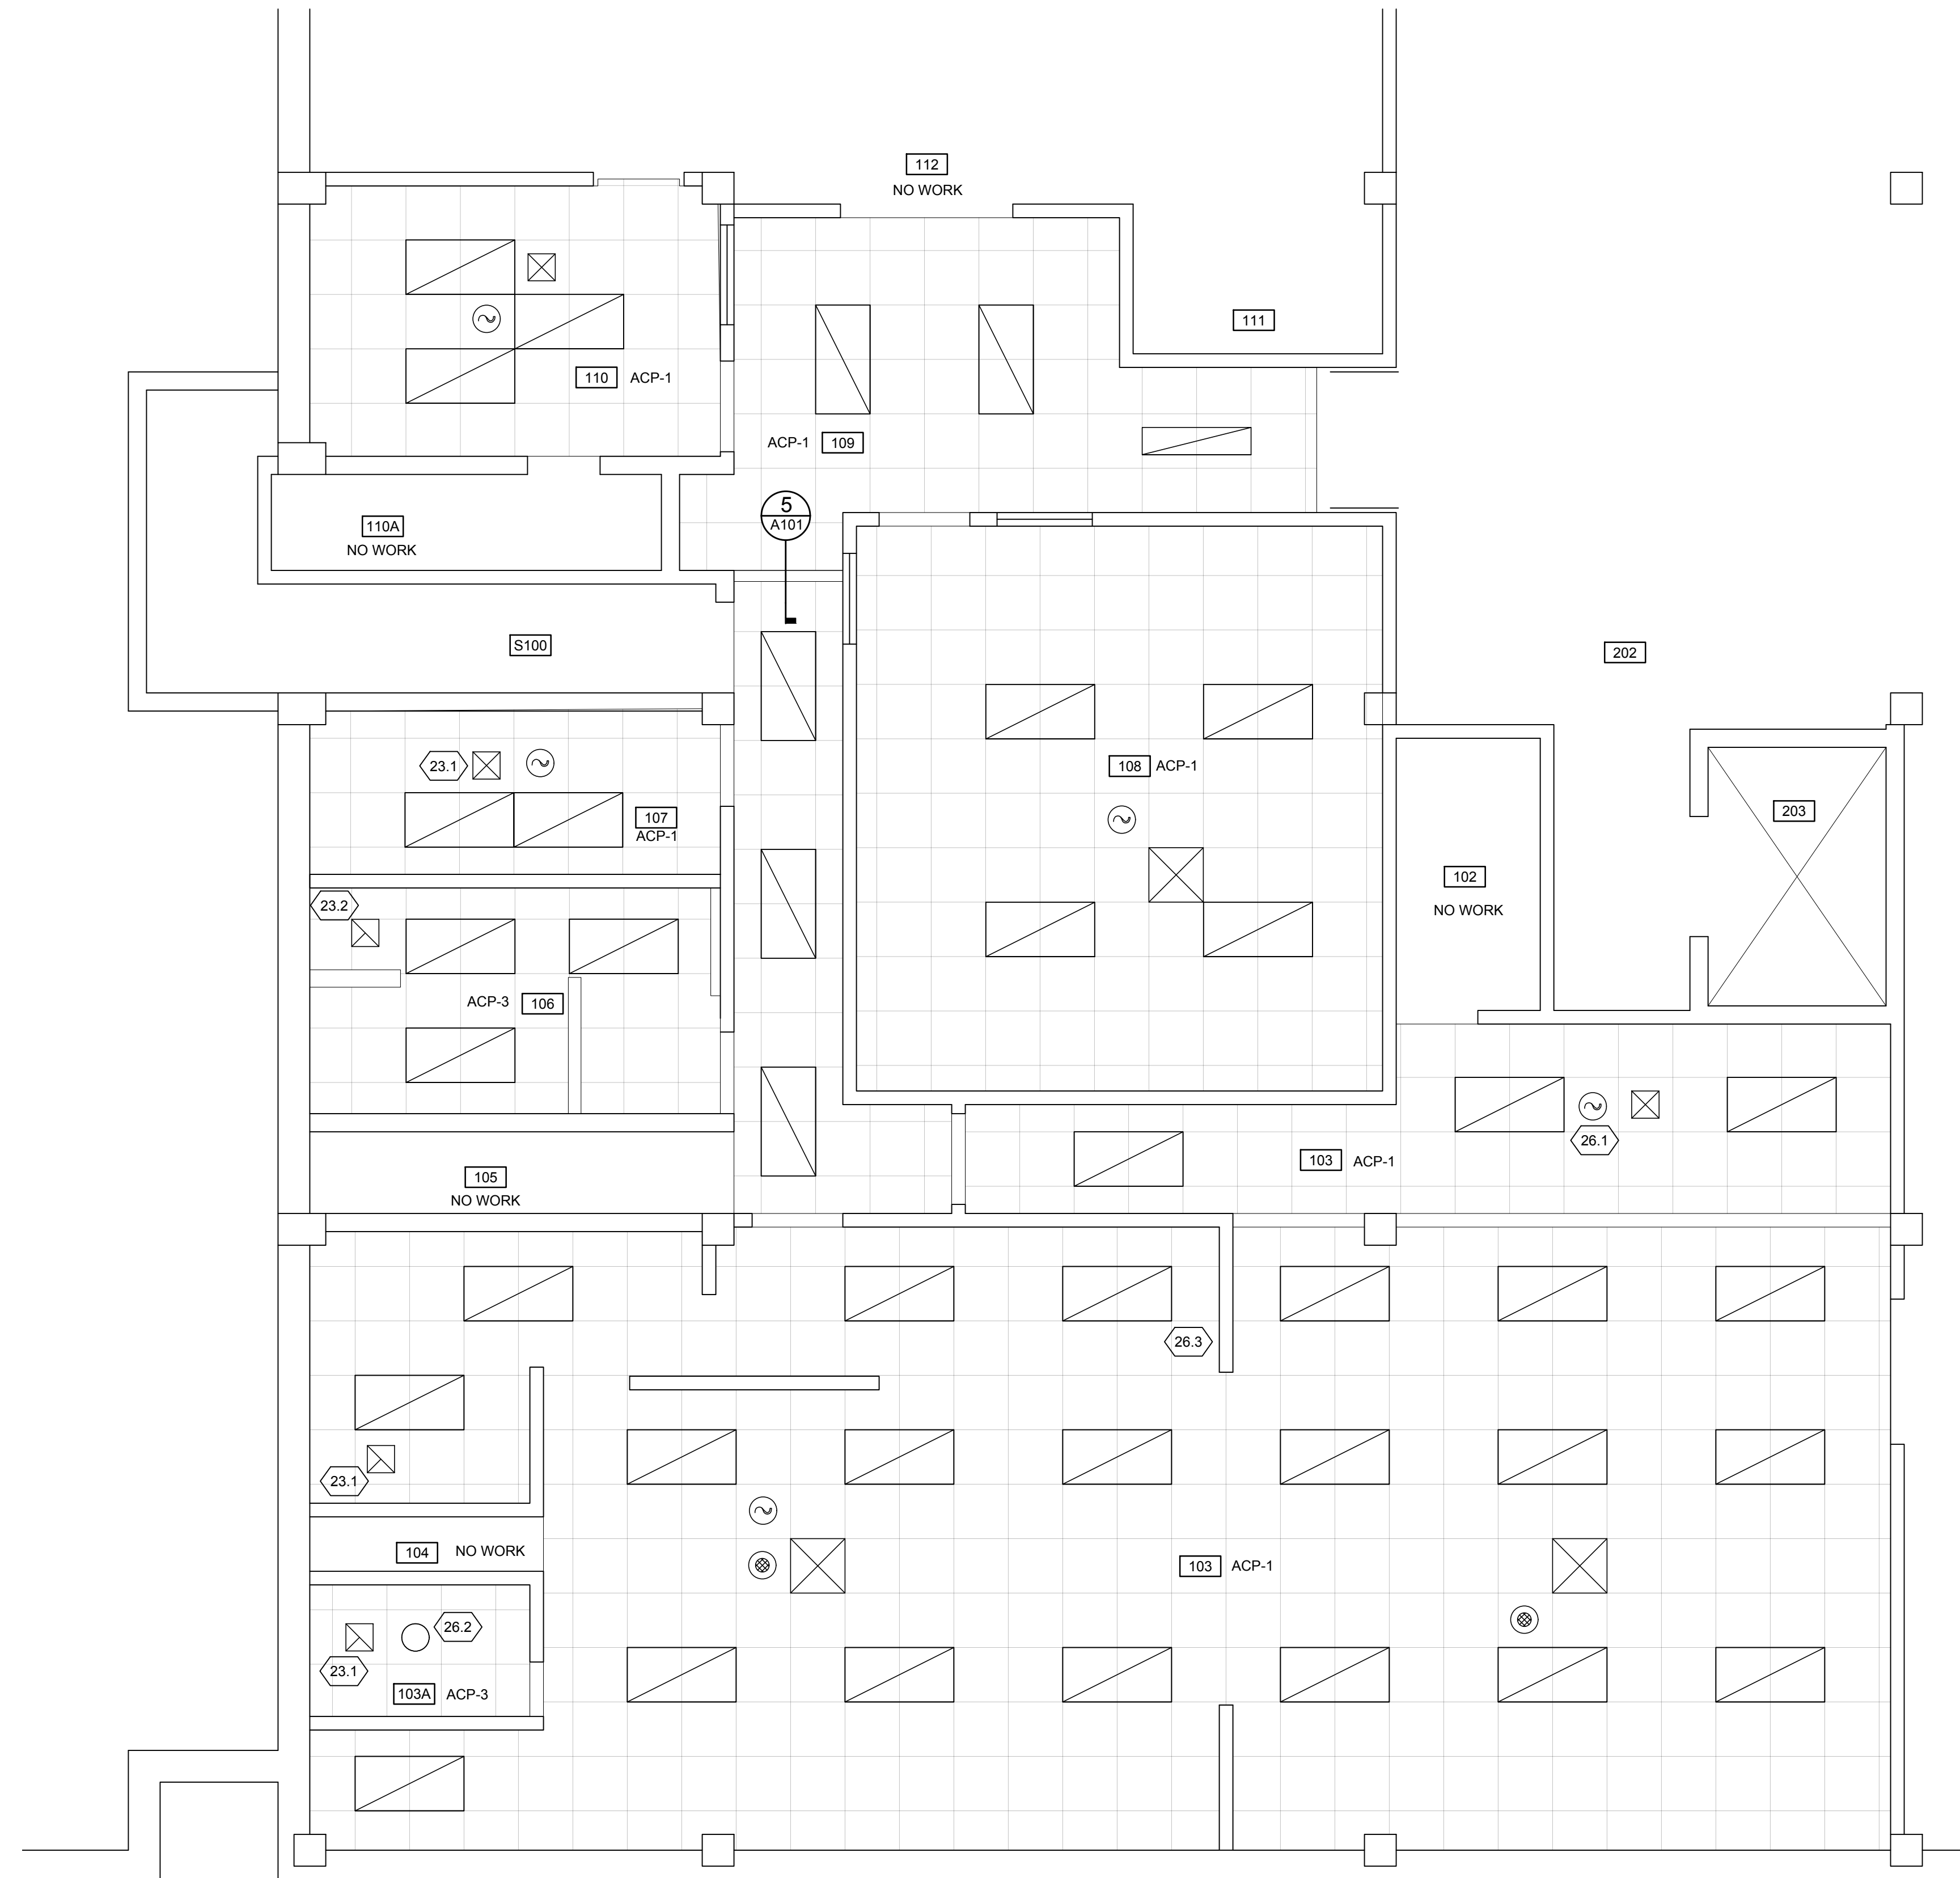

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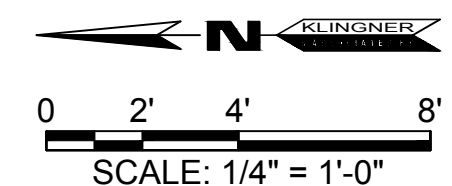
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NO.	REVISION DESCRIPTION	DATE
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SCALE:	
DESIGNED CNB	DRAWN CNB
FIELD	FIELD BOOK
CHECKED CNB	CHECK DATE 12/15/16
SHEET TITLE	
BASEMENT FLOOR - REFLECTED CEILING PLAN	
PROJECT NO. 3215-073 (15-3027)	
DRAWING ISSUED DATE: 12/14/16	
SHEET	
A301	











1 BASEMENT LEVEL - REFLECTED CEILING PLAN
 A301 SCALE: 1/4"=1'-0"

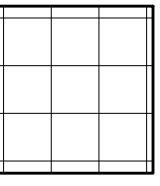


GENERAL NOTES



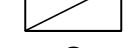
- CONTRACTOR TO PROTECT AND REUSE EXISTING LIGHTING, CAMERAS, HEAT DETECTORS, AND ANY OTHER ITEMS IN EXISTING ACOUSTICAL PANEL CEILING.

LEGEND

-  ACP = 24x24 ACOUSTICAL CEILING PANEL IN SUSPENDED MTL GRID
- ACP-1 TYPICAL ACP CEILING
- ACP-2 24x48 ACP CEILING SUSPENDED MTL GRID
- ACP-3 MOISTURE-RESISTANT 24x48 ACP CEILING SUSPENDED MTL GRID
-  EXISTING EXHAUST VENT
-  EXISTING SUPPLY DIFFUSER
-  EXISTING SUPPLY DIFFUSER
-  EXISTING EGGRATE VENT
-  EXISTING 2x4 LIGHT FIXTURE
-  EXISTING FIRE ALARM CEILING HEAT DETECTOR
-  EXISTING CAMERA
-  EXISTING SPEAKER
-  EXISTING OCCUPANCY SENSOR

KEYNOTES

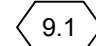
-  9.1 CLEAN EXISTING TERRAZZO FLOORING AND APPLY SLIP RESISTANT SEALER.

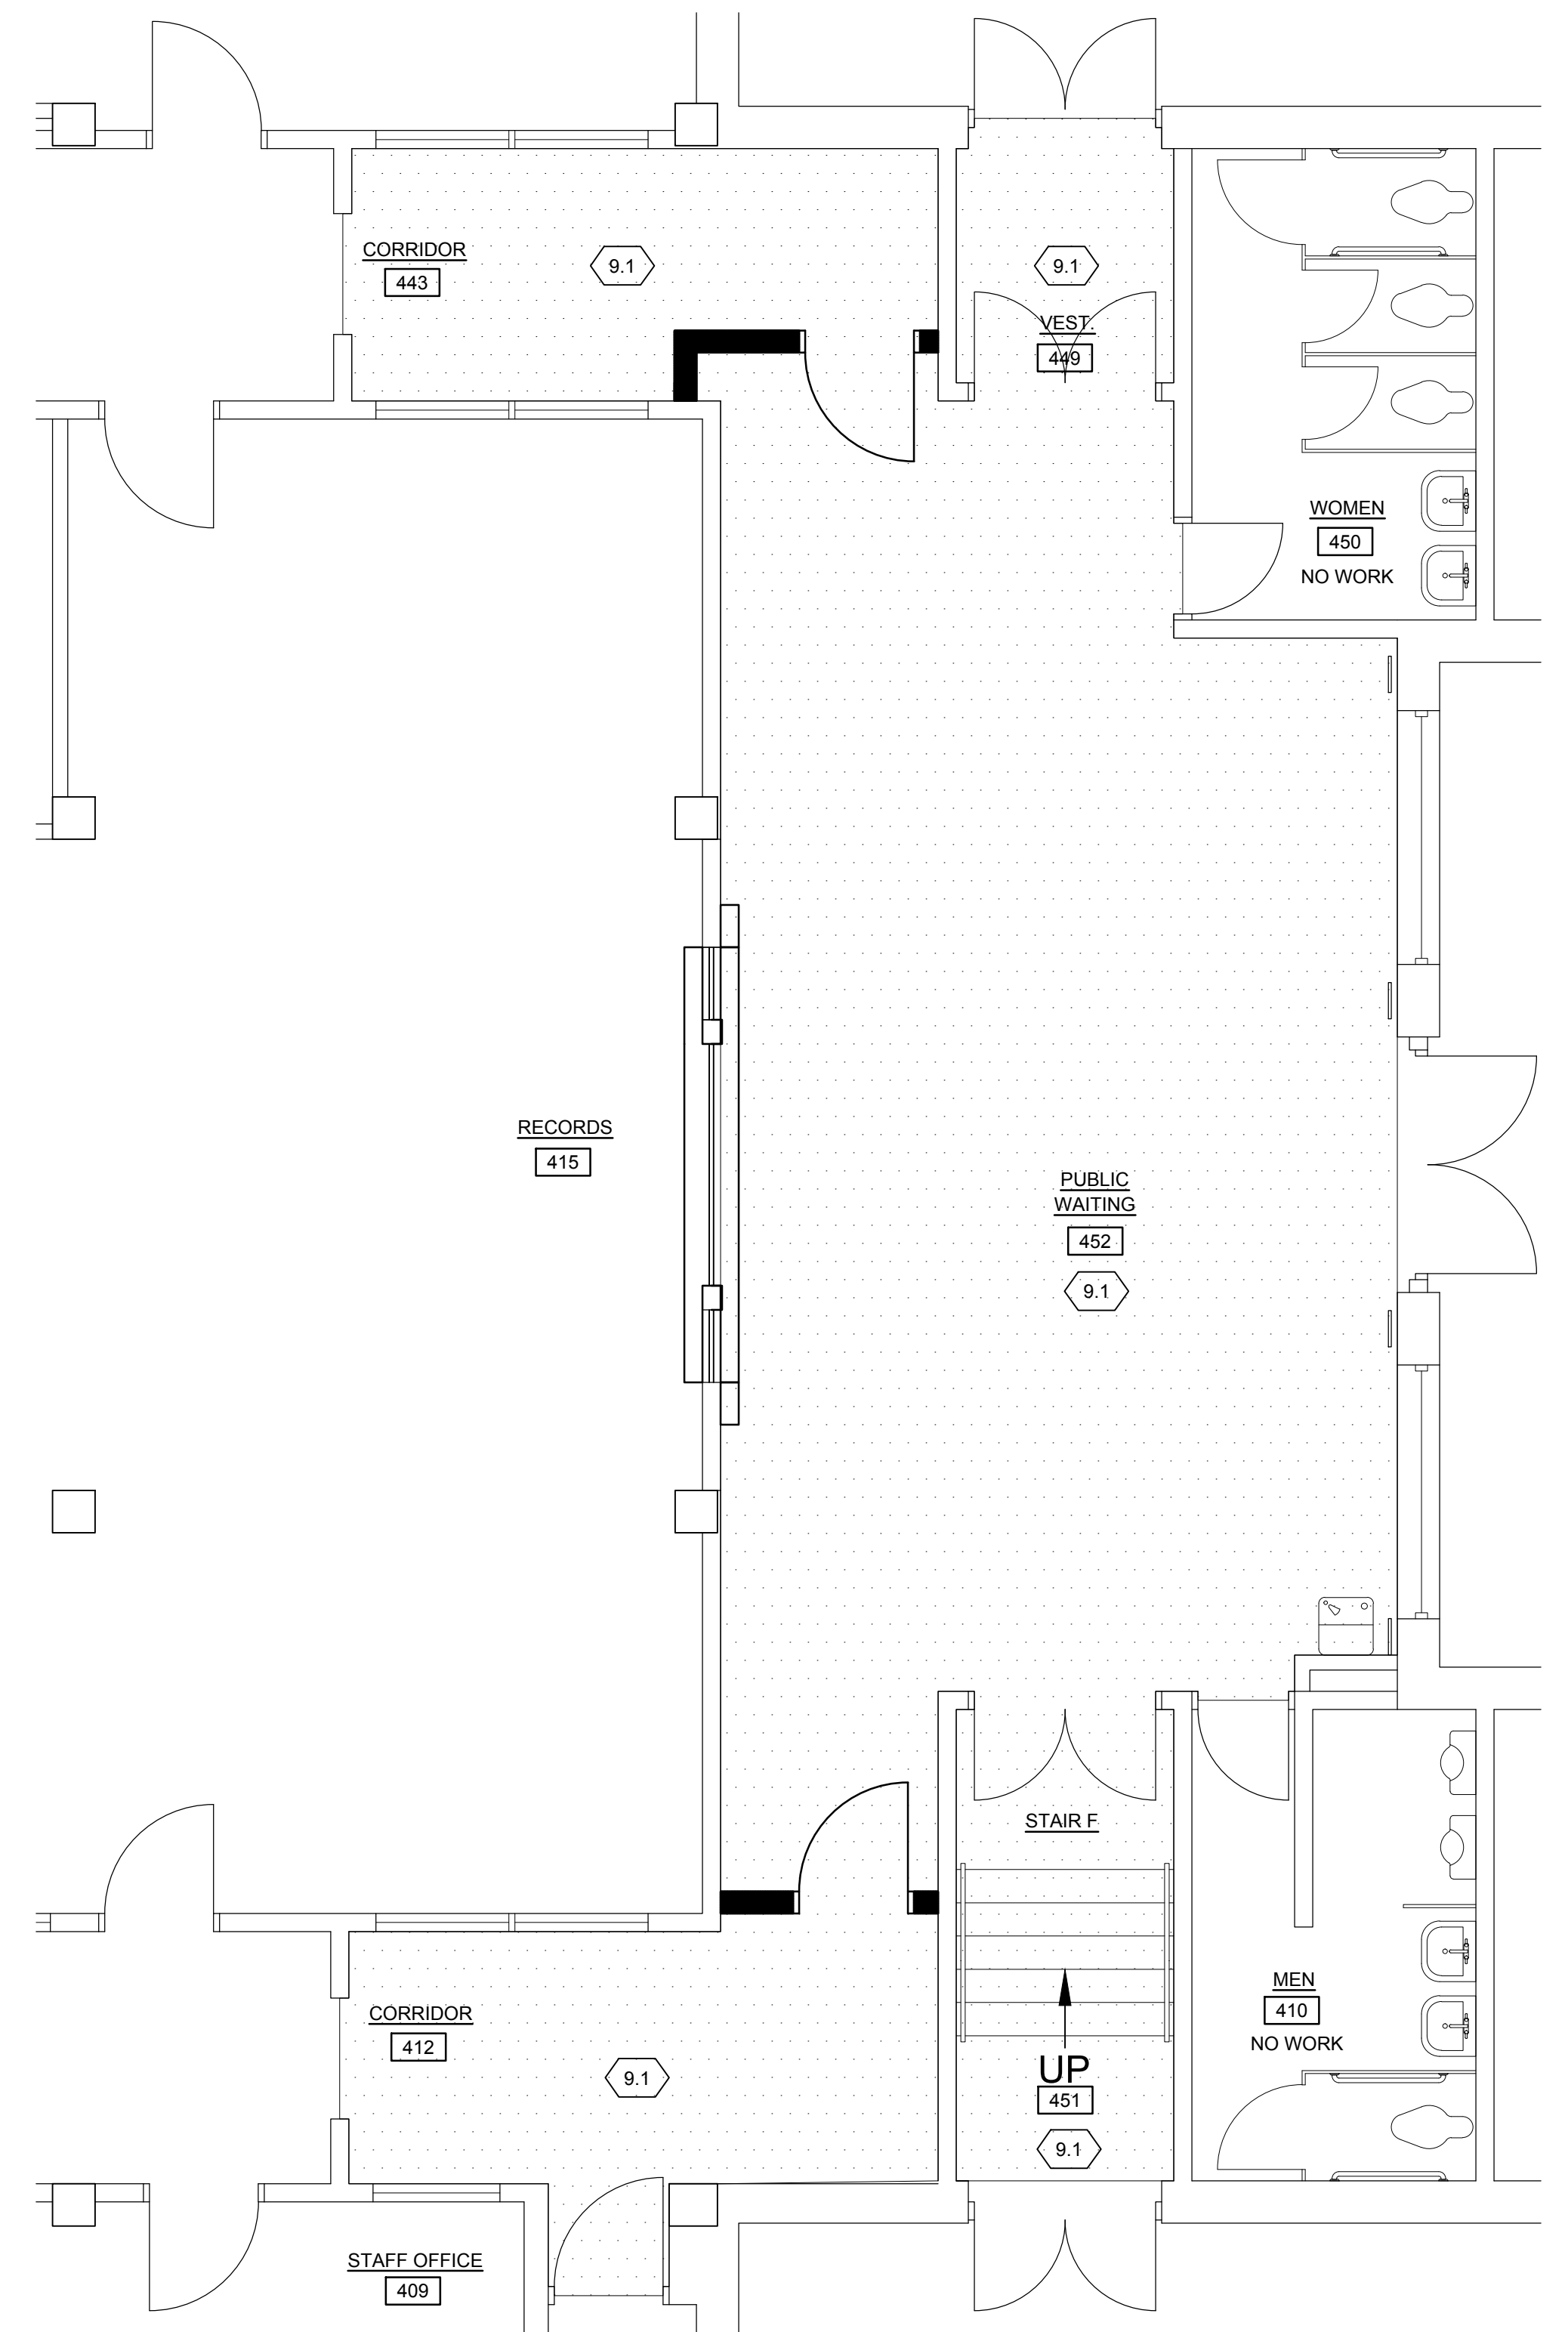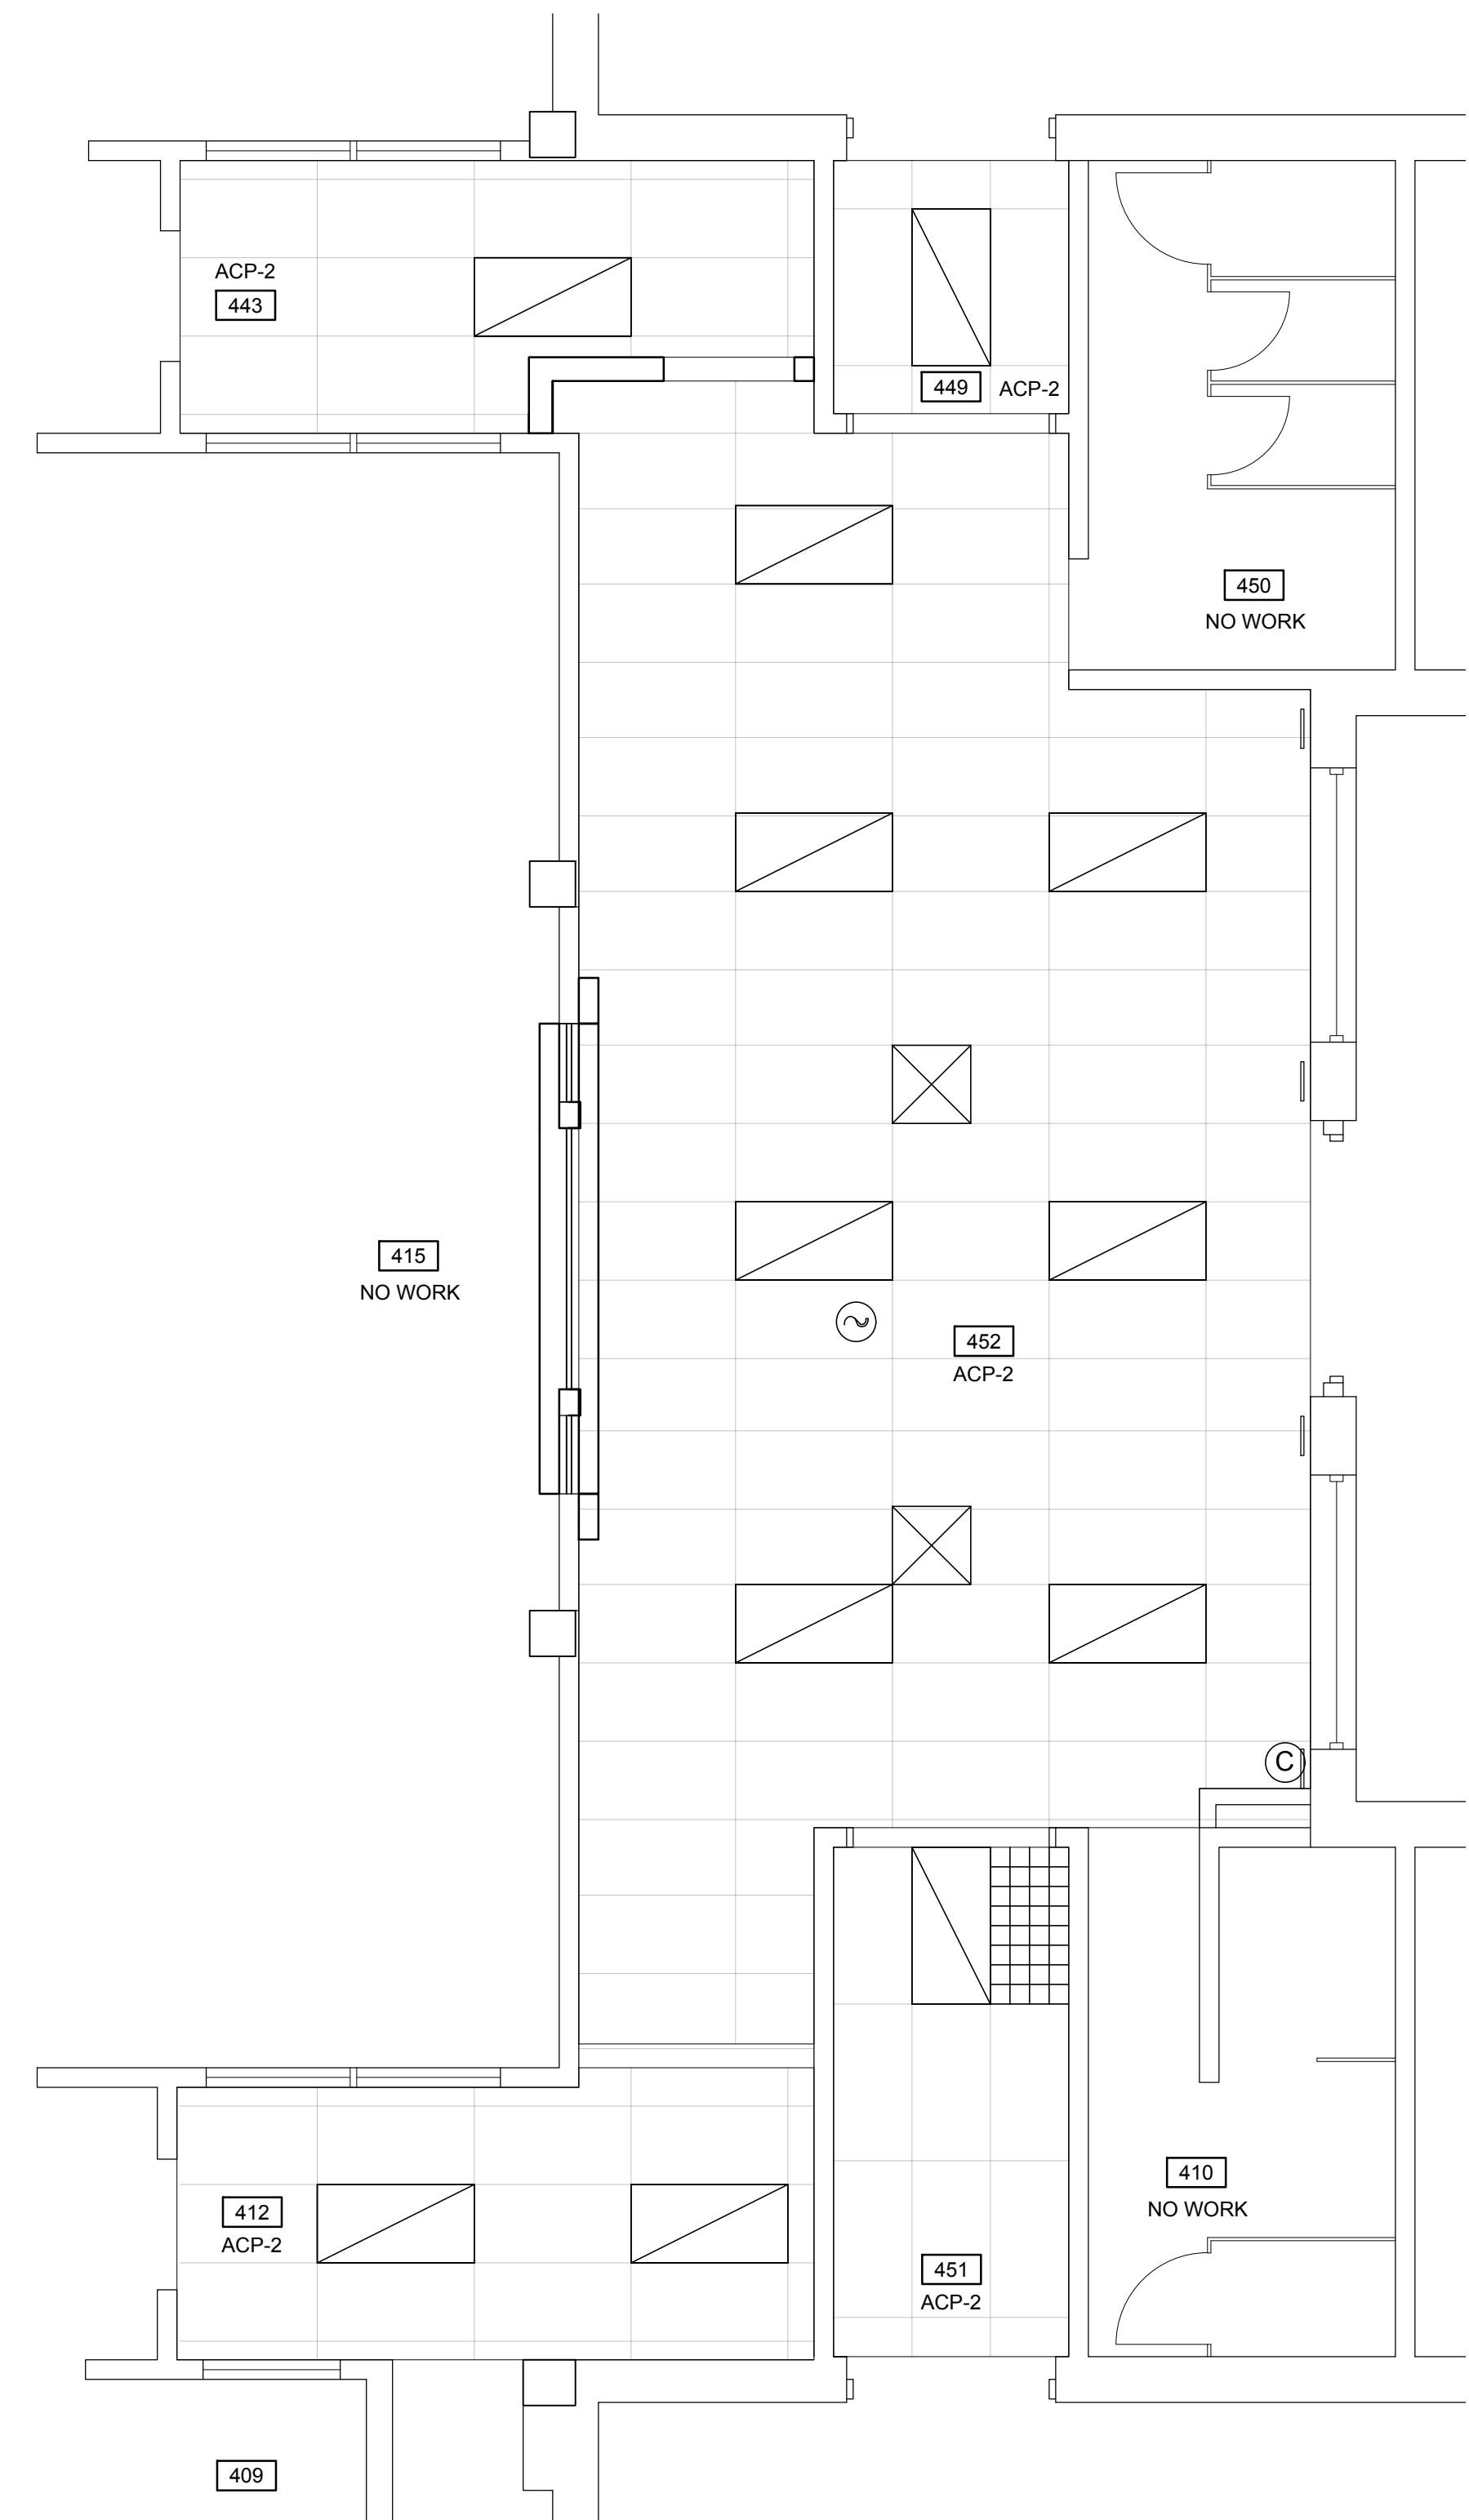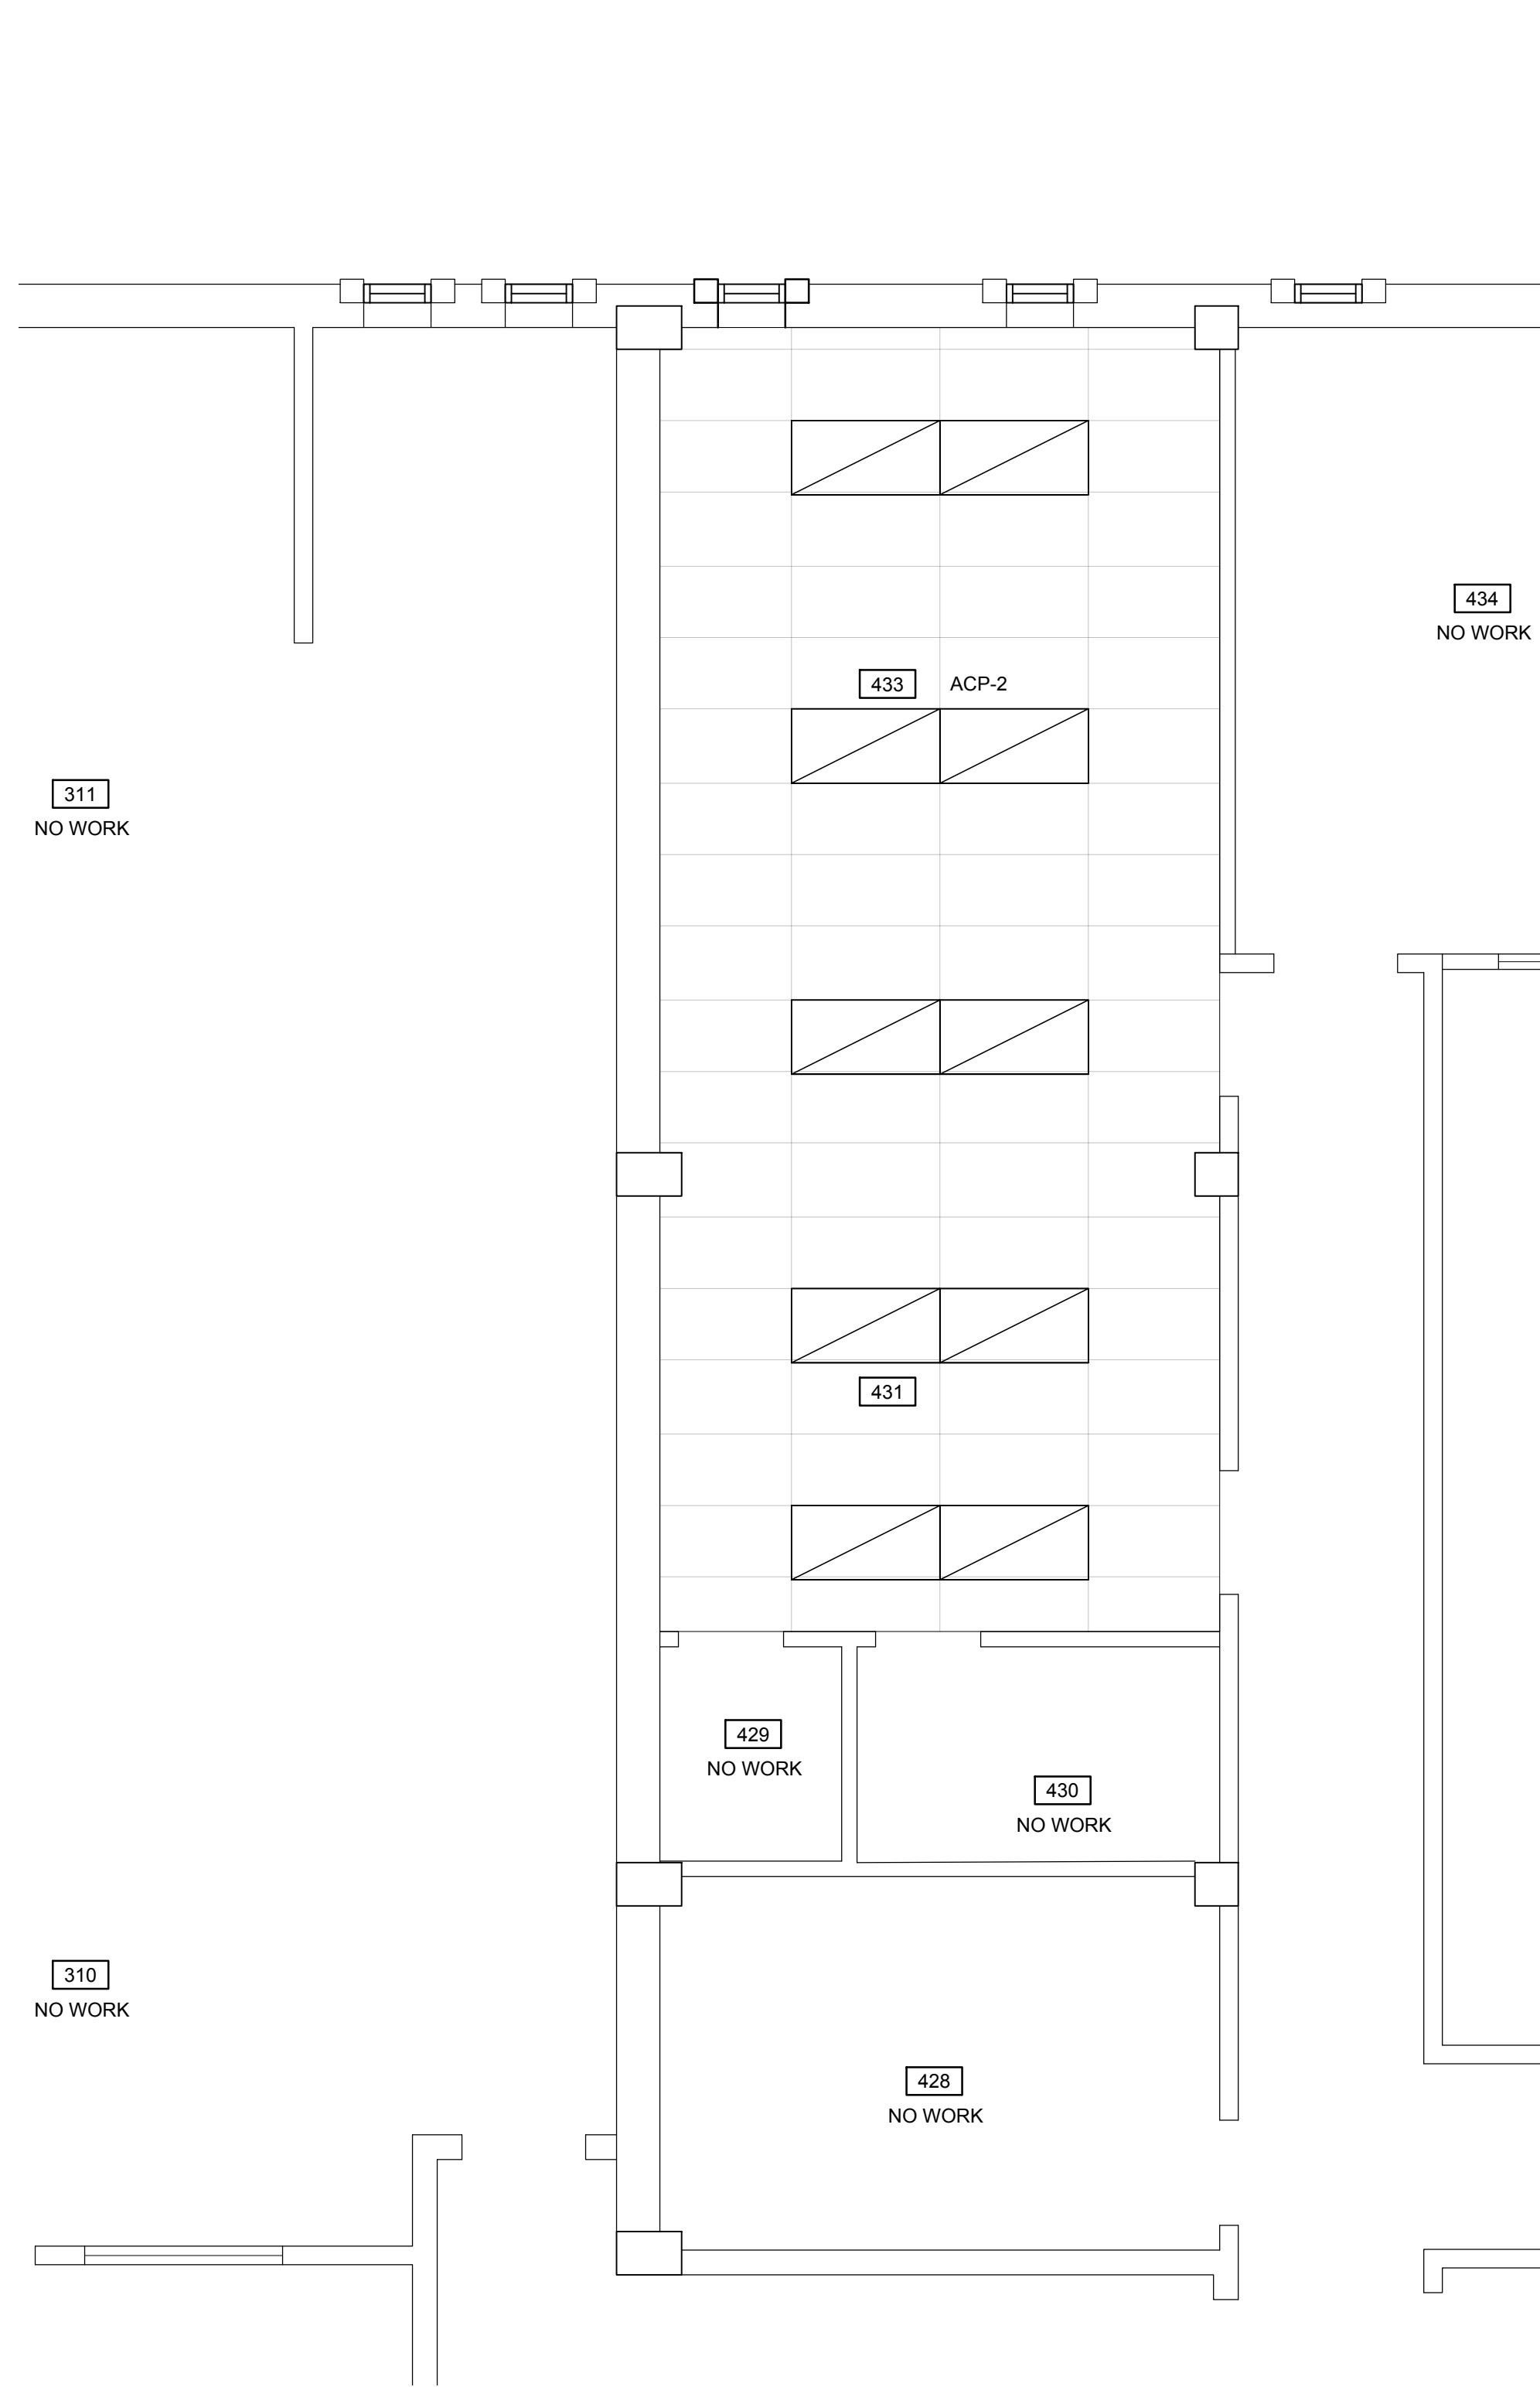

1 MAIN LEVEL - PARTIAL REFLECTED CEILING PLAN - CHIEF'S OFFICE
A302 SCALE: 1/4"=1'-0"

2 MAIN LEVEL - PARTIAL REFLECTED CEILING PLAN - LOBBY
A302 SCALE: 1/4"=1'-0"

3 MAIN LEVEL - FLOOR FINISH PLAN
A302 SCALE: 1/4"=1'-0"

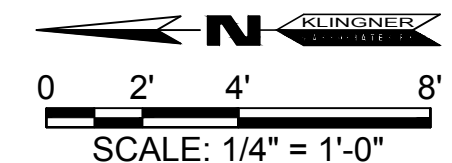

KLINGNER & ASSOCIATES, P.C.
 Engineers • Architects • Surveyors
 Ph: 217.223.3670 • Fax: 217.223.3603
 Ph: 571.221.0020 • Fax: 571.221.0012
 Ph: 319.752.3693 • Fax: 319.752.3695
 Ph: 309.342.4442 • Fax: 309.341.3781
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NO.	REVISION DESCRIPTION	DATE	BY
1	XXXX	XXXXXX	XXX

PSB INTERIOR RENOVATIONS - PHASE IIIB
 CITY OF GALESBURG
 150 SOUTH BROAD ST.
 GALESBURG, ILLINOIS 61401

Non-Reduced Sheet Size: 24" x 36"
 Full sized plans have been prepared using standard scales.
 Reduced size plans may not conform to standard scales.

DESIGNED	CNB	DRAWN	CNB
FIELD		FIELD BOOK	
CHECKED	CNB	CHECK DATE	12/15/16

SHEET TITLE
 MAIN FLOOR -
 REFLECTED
 CEILING AND
 FLOOR FINISH PLAN

PROJECT NO.
 3215-073 (15-3027)
 DRAWING ISSUED DATE:
 12/14/16

SHEET
A302

ROOM FINISH SCHEDULE

ROOM NUMBER	NAME	FLOOR MATERIAL	FINISH	BASE MATERIAL	WALL MATERIAL	FINISH	ACCENT	CEILING		NOTES
								MATERIAL	HEIGHT	
102	MACHINE ROOM	EXIST	EXIST	EXIST	EXIST	EXIST	----	EXIST	MATCH EXIST	
103A	WOMEN'S LOCKER RM	EXIST	RSN-1	RES-1	EXIST	PNT-5	----	ACP	MATCH EXIST	
103	MEN'S LOCKER RM	EXIST	RSN-1	RES-1	EXIST	PNT-5	EAST PNT-4	ACP	MATCH EXIST	
104	SHOWER	EXIST	EXIST	EXIST	EXIST	EXIST	----	EXIST	MATCH EXIST	RE-GROUT WALL AND FLOOR TILE.
105	JANITOR	EXIST	EXIST	EXIST	EXIST	EXIST	----	EXIST	MATCH EXIST	
106	WOMEN'S RESTROOM	EXIST	CT-1& 2	CB-1	EXIST	PNT-1	WEST PNT-5	ACP	MATCH EXIST	
107	KITCHEN	EXIST	CT-1& 2	CB-1	EXIST	PNT-1	WEST PNT-5	ACP	MATCH EXIST	
108	BREAK ROOM	EXIST	EXIST	EXIST	EXIST	EXIST	----	EXIST	MATCH EXIST	
109A	LOBBY	EXIST	WLK-1,2,3	CB-1	EXIST	PNT-1	EAST PNT-2	ACP	MATCH EXIST	SEE 1/A701 FOR PATTERN
109	CORRIDOR	EXIST	CT-1& 2	CB-1	EXIST	PNT-1	----	ACP	MATCH EXIST	
110	COMMUNICATIONS	EXIST	CT-1& 2	CB-1	EXIST	PNT-1	NORTH PNT-2	ACP	MATCH EXIST	
111	CLOSET	EXIST	EXIST	EXIST	EXIST	EXIST	----	EXIST	MATCH EXIST	
112	AUDITORIUM	EXIST	EXIST	EXIST	EXIST	EXIST	----	EXIST	---	

MATERIAL LEGEND

ACP = ACOUSTICAL CEILING PANEL
IN SUSPENDED MTL GRD
EXIST = EXISTING MATERIAL

NOTES



- 9.1 OMIT
- 9.2 SAND AND PAINT EXISTING CASEWORK
PNT-3.
- 9.3 PROVIDE NEW COUNTERTOP (QTZ-1)
WITH STAINLESS STEEL UNDERMOUNT
SINK.

FINISH LEGEND

- PNT-1 BASIS OF DESIGN PRODUCT: SHERWIN WILLIAMS PROMAR 200 ZERO VOC, SHEEN: SEMI-GLOSS; COLOR: SW7015 REPOSE GRAY (FIELD COLOR)
- PNT-2 BASIS OF DESIGN PRODUCT: SHERWIN WILLIAMS PROMAR 200 ZERO VOC, SHEEN: SEMI-GLOSS; COLOR SW7017 DORIAN GRAY (KITCHEN CABINET COLOR, BASEMENT LOBBY ACCENT)
- PNT-3 BASIS OF DESIGN PRODUCT: SHERWIN WILLIAMS PROMAR 200 INTERIOR ALKYD, SHEEN: SEMI-GLOSS; COLOR SW6242 BRACING BLUE (TYPICAL METAL DOOR COLOR)
- PNT-4 BASIS OF DESIGN PRODUCT: SHERWIN WILLIAMS PROMAR 200 INTERIOR ALKYD, SHEEN: SEMI-GLOSS; COLOR SW7602 INDIGO BATIK (TYPICAL DOOR & WINDOW FRAMES)
- PNT-5 BASIS OF DESIGN PRODUCT: SHERWIN WILLIAMS PROMAR 200 ZERO VOC, SHEEN: EG-SHEL; COLOR SW6243 DISTANCE (ACCENT WALL KITCHEN, WOMEN'S RESTROOM, LOCKER ROOMS)
- PNT-6 BASIS OF DESIGN PRODUCT: SHERWIN WILLIAMS PROMAR 200 ZERO VOC, SHEEN: EG-SHEL; COLOR: SW 6080 UTTERLY BEIGE (4TH FLOOR LOBBY, FIELD)
- PNT-7 BASIS OF DESIGN PRODUCT: SHERWIN WILLIAMS PROMAR 200 ZERO VOC, SHEEN: EG-SHEL; COLOR: SW6081 DOWN HOME (4TH FLOOR LOBBY, ACCENT)
- PNT-8 BASIS OF DESIGN PRODUCT: SHERWIN WILLIAMS PROMAR 200 INTERIOR ALKYD, SHEEN SEMI-GLOSS; COLOR: SW7020 BLACK FOX (4TH FLOOR LOBBY DOOR FRAMES AS INDICATED)
- PNT-9 BASIS OF DESIGN PRODUCT: SHERWIN WILLIAMS PROMAR 200 INTERIOR ALKYD, SHEEN: SEMI-GLOSS; COLOR: SW7039 VIRTUAL TAUPe (4TH FLOOR DOOR)
- WLK-1 BASIS OF DESIGN PRODUCT: VAN GELDER INC.: CHAMPION SUPER NOP TILE; COLOR: MIDNIGHT BLUE; SIZE: 19.69" X 19.69"
- WLK-2 BASIS OF DESIGN PRODUCT: VAN GELDER INC.: CHAMPION SUPER NOP TILE; COLOR: STEEL BLUE; SIZE: 19.69" X 19.69"
- WLK-3 BASIS OF DESIGN PRODUCT: VAN GELDER INC.: CHAMPION SUPER NOP TILE; COLOR: NATURAL BEIGE; SIZE: 19.69" X 19.69"
- CT-1 BASIS OF DESIGN PRODUCT: TRENDS IN CERAMIC: RIVERGRASS PORCELAIN; COLOR: CANADIAN RYE TICRGR1224; SIZE: 12"X12"; GROUT WIDTH: MINIMUM ALLOWED BY MANUFACTURER; GROUT COLOR: MAPEI PEARL GRAY 19
- CT-2 BASIS OF DESIGN PRODUCT: TRENDS IN CERAMIC: RIVERGRASS PORCELAIN; COLOR: CANADIAN RYE TICRGR1212; SIZE: 12"X12"; GROUT WIDTH: MINIMUM ALLOWED BY MANUFACTURER; GROUT COLOR: MAPEI PEARL GRAY 19
- CB-1 BASIS OF DESIGN PRODUCT: TRENDS IN CERAMIC: RIVERGRASS PORCELAIN; COLOR: CANADIAN RYE TICRGR1224; SIZE: 12"X24"; GROUT WIDTH: MINIMUM ALLOWED BY MANUFACTURER; GROUT COLOR: MAPEI PEARL GRAY 19; CUT TILE TO 6" X 24" AND TOP WITH METAL TOP CAP.
- RES-1 BASIS OF DESIGN PRODUCT: JOHNSONITE: 6" RUBBER COVE BASE; COLOR: TO BE SELECTED BY ARCHITECT
- RES-2 BASIS OF DESIGN PRODUCT: JOHNSONITE: RUBBER STAIR TREAD WITH INTEGRATED RISER RTR-XXX-SQ; COLOR: 30 INK.
- RSN-1 BASIS OF DESIGN PRODUCT: DUR-A-FLEX: HYBRI-FLEX EQ; COLOR: TO BE SELECTED BY ARCHITECT.
- LAM-1 BASIS OF DESIGN PRODUCT: WILSONART; 4842-60 CANYON ZEPHYR; MATTE FINISH
- LAM-2 BASIS OF DESIGN PRODUCT: FORMICA; 3450-58 MINERAL JET; MATTE FINISH
- QTZ-1 BASIS OF DESIGN PRODUCT: SAMSUNG RADIANT; COLOR: ADIRONDACK BIRCH AB144. (KITCHEN COUNTERTOP)
- SS-1 BASIS OF DESIGN PRODUCT: DUPONT CORIAN; COLOR: DEEP TERRAIN

FLOOR PATTERN LEGEND

- WLK-1 WALK-OFF TILE
- WLK-2 WALK-OFF TILE
- WLK-3 WALK-OFF TILE
- CT-1 CERAMIC TILE
- RSN-1 EPOXY COATING

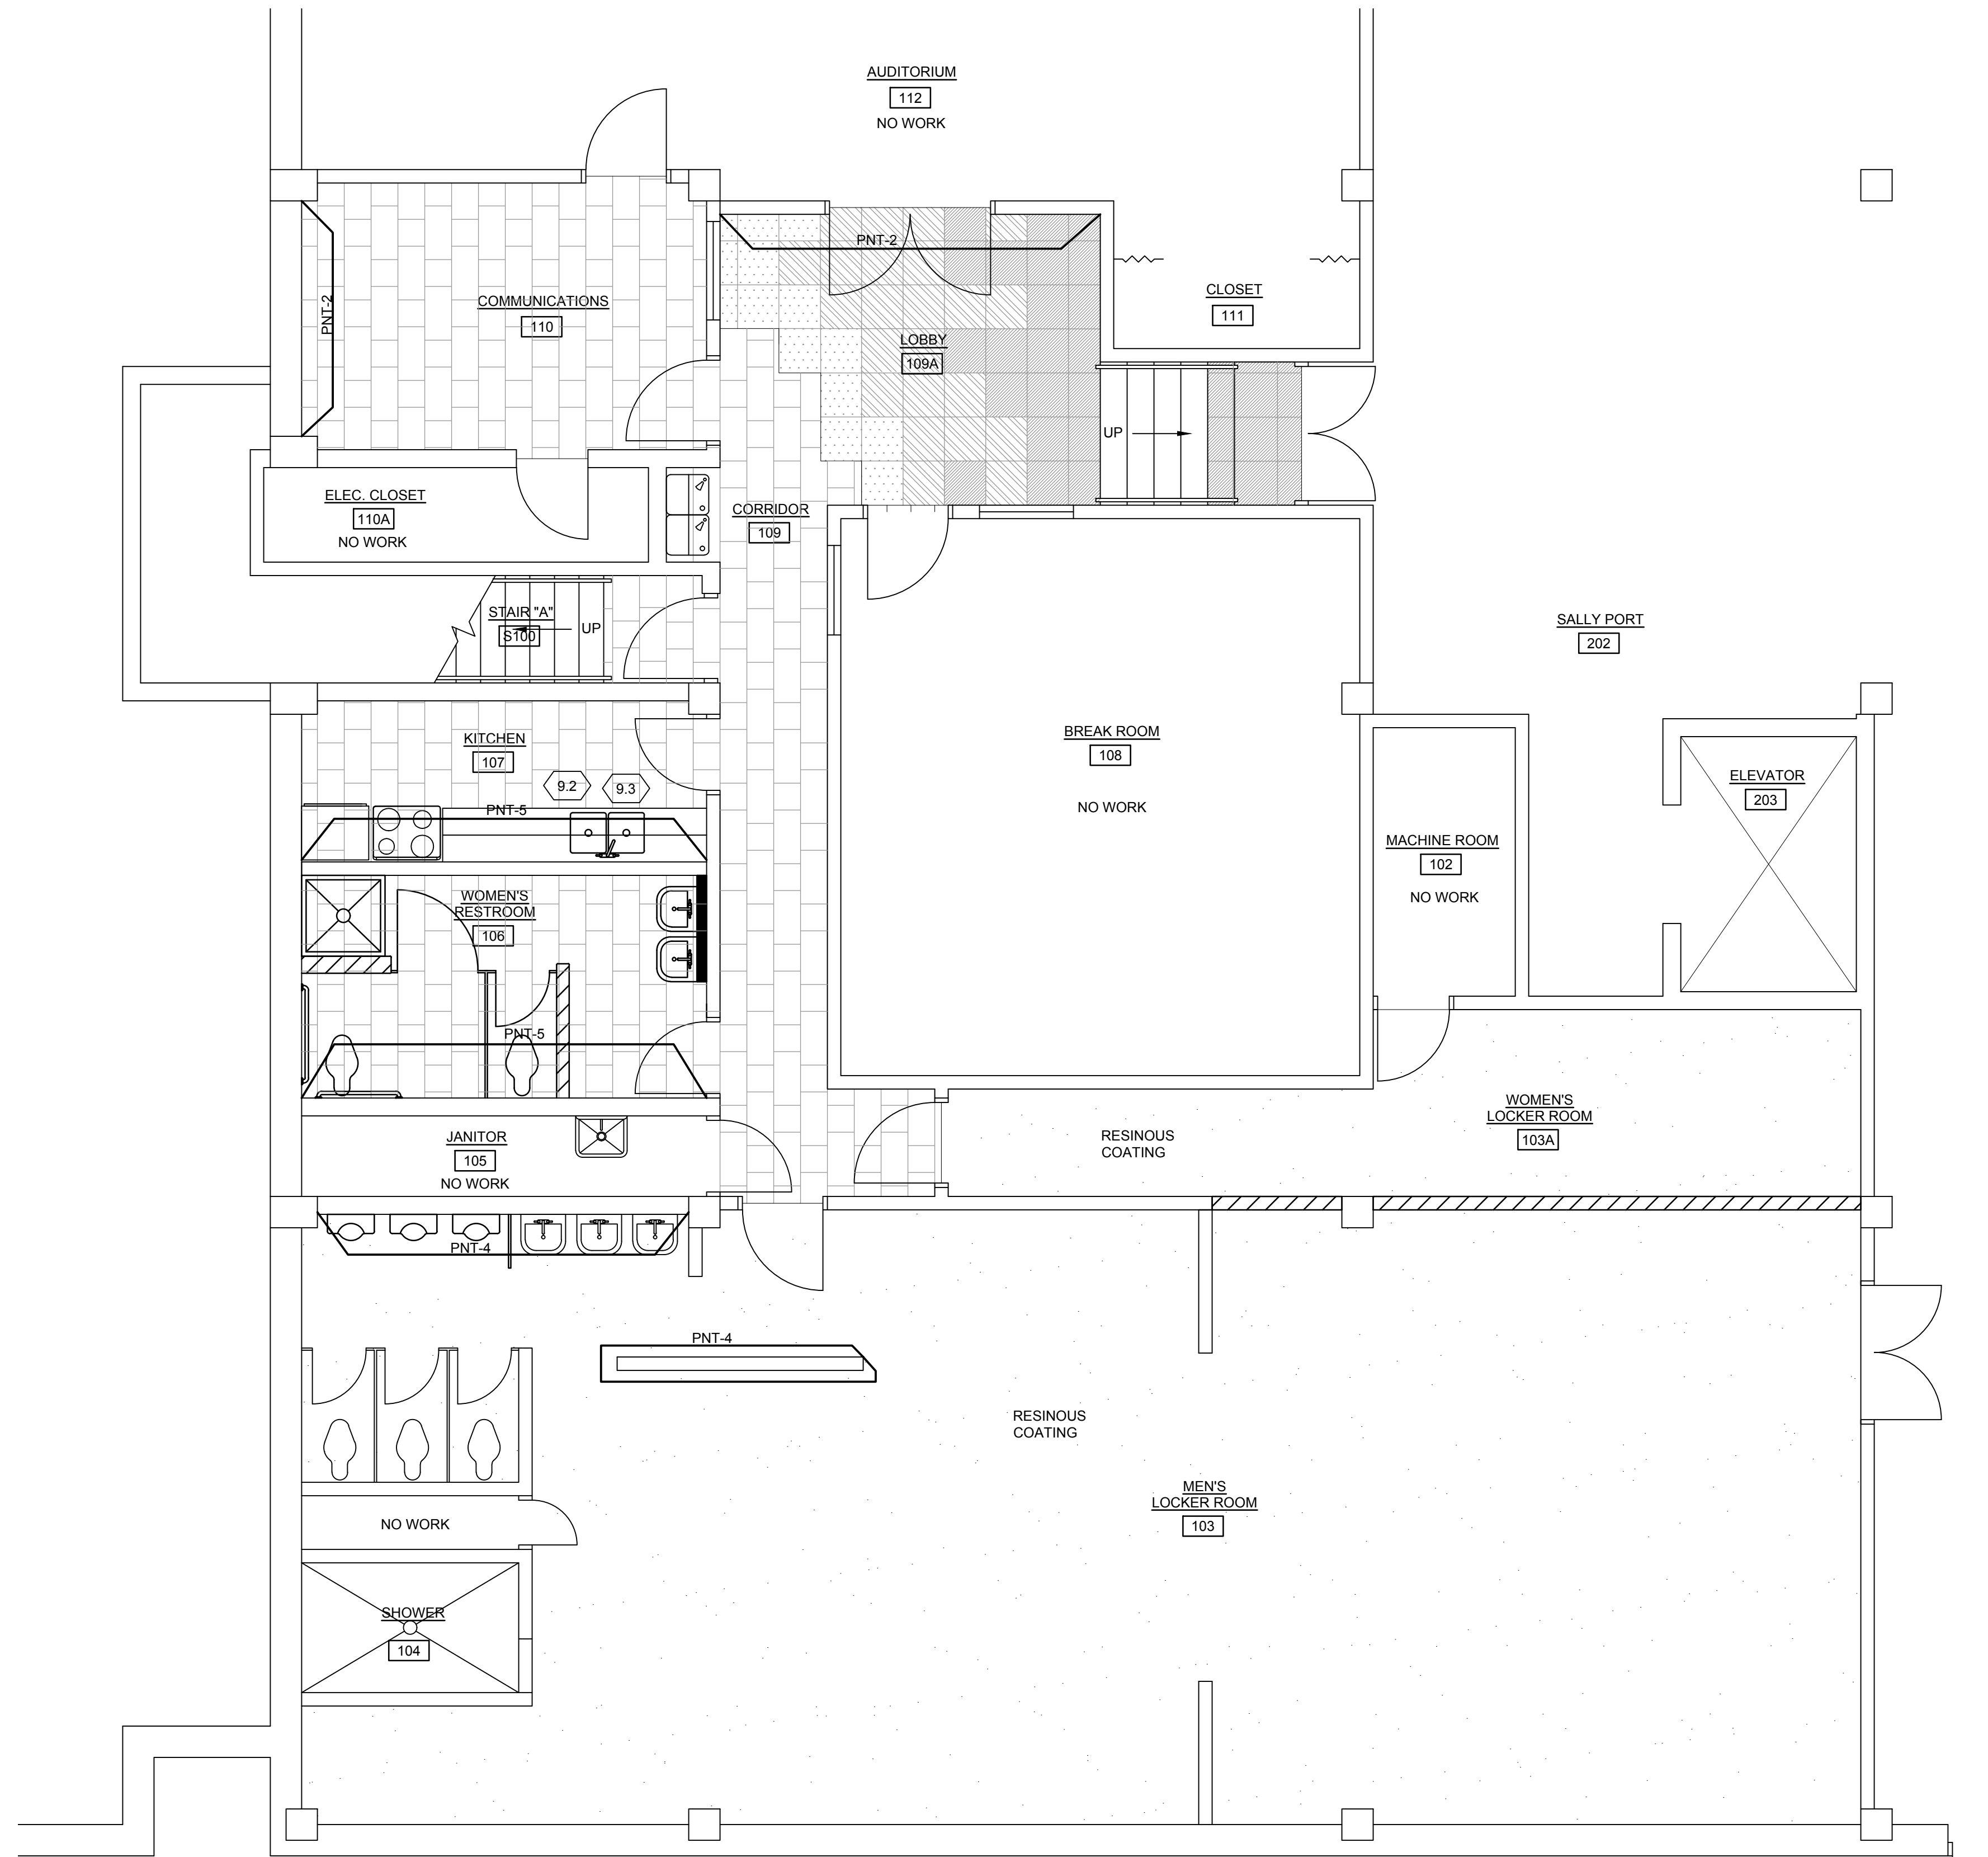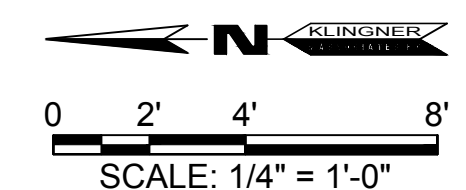

1 BASEMENT LEVEL - FLOOR FINISHES PLAN
A701 SCALE: 1/4" = 1'-0"

KLINGNER & ASSOCIATES, P.C.
Engineers • Architects • Surveyors
1616 North 24th Street, Quincy, IL
Ph: 217.223.3670 Fax: 217.223.3603
4510 Park Grove Road, Hannibal, MO
Ph: 573.221.0020 Fax: 573.221.0012
1010 N. 4th Street, Suite 100, Burlington, IA
Ph: 319.752.3603 Fax: 319.752.3605
19 North Prairie Street, Galesburg, IL
Ph: 309.342.4242 Fax: 309.341.3781
www.klingner.com

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PSB INTERIOR RENOVATIONS - PHASE IIIB
CITY OF GALESBURG
150 SOUTH BROAD ST.
GALESBURG, ILLINOIS 61401

Non-Reduced Sheet Size: 24" x 36"
Full sized plans have been prepared using standard scales
Reduced size plans may not conform to standard scales.

SCALE:	
DESIGNED CNB/HAO	DRAWN CNB
FIELD	FIELD BOOK
CHECKED CNB	CHECK DATE 12/15/16

SHEET TITLE
**BASEMENT FLOOR -
FLOOR FINISHES
PLAN**

PROJECT NO.
3215-073 (15-3027)
DRAWING ISSUED DATE:
12/14/16
SHEET

A701

MARK	DESCRIPTION	BASIS OF DESIGN			BRANCH PIPE SIZE (IN)			
		MANUFACTURER	MODEL	COMMENTS	CW	HW	W	V
WC-1	TOILET - FLOOR MOUNTED, VITREOUS CHINA, ELONGATED BOWL, SIPHON JET SEAT - ELONGATED, HEAVY DUTY, SOLID PLASTIC, OPEN FRONT, WITH LIFT OFF HINGE FLUSH VALVE - SENSOR ACTIVATED WITH BUMPER ON ANGLE STOP	AMERICAN STANDARD TOTO	3451.001 C1705EN	MOUNT 15" FLOOR TO RIM				4
WC-2	TOILET - FLOOR MOUNTED, VITREOUS CHINA, ELONGATED BOWL, SIPHON JET, ADA HEIGHT SEAT - ELONGATED, HEAVY DUTY, SOLID PLASTIC, OPEN FRONT, WITH LIFT OFF HINGE FLUSH VALVE - SENSOR ACTIVATED WITH BUMPER ON ANGLE STOP	AMERICAN STANDARD TOTO	3461.001 C1705ELN	MOUNT 17" FLOOR TO RIM				4
UR-1	URINAL - WALL MOUNTED VITREOUS CHINA, WASHOUT FLUSHING ACTION, TOP SPUD FLUSH VALVE - SENSOR ACTIVATED HIGH EFFICIENCY	GERBER TOTO	HE-27-720 UT104E	MOUNT 17" FLOOR TO RIM				
LAV-1	LAVATORY - WALL MOUNTED, VITREOUS CHINA, 4" ON CENTERS STRAINER - 1-1/4" CAST BRASS GRID STRAINER FAUCET - 4" CENTERS, LEVER ACTUATION, SEPARATE HOT/COLD THERMOSTATIC MIXING VALVE	BEMIS OLSONITE	2155C 8C					
ELAV-1	LAVATORY - EXISTING FAUCET - 4" CENTERS, LEVER ACTUATION, SEPARATE HOT/COLD THERMOSTATIC MIXING VALVE	SLOAN	ROYAL 111-1.6-ES-S-YO	1.6 GPF	1			
SH-1	SHOWER - TWO PIECE, GELCOAT, SECTIONAL MODULE FAUCET - THERMOSTATIC MIXING, BRONZE BODY SHOWER HEAD - WALL MOUNT	ZURN WADE JAY R. SMITH	Z1222 2-400-AMI-AMI 0617					2
SH-2	EXISTING SHOWER - BUILT-IN FAUCET - THERMOSTATIC MIXING, BRONZE BODY SHOWER HEAD - WALL MOUNT	SLOAN	ROYAL 186-0.5-ES-S-HEU	0.5 GPF	3/4			
S-1	SINK - UNDERMOUNT TO SOLID SURFACE COUNTER TOP STRAINER - 1-1/4" CAST BRASS GRID STRAINER FAUCET - 8" CENTERS, SINGLE LEVER ACTUATION	TOTO	LT307.4				1-1/4	1-1/4
EMS-1	MOP SINK - EXISTING FAUCET - WALL MOUNT, WITH REINFORCING BAR	CHICAGO	897MPCRF		3/4	3/4	3	2
		CHICAGO	327-XCP	0.5 GPM	1/2	1/2		
		CHICAGO	802-XKCP-E2805	SET TO 110°F	1/2	1/2		
		DELTA	R2910-MIXLF	SET TO 110°F	1/2	1/2	1-1/4	1-1/4
		DELTA	R2910-MIXLF	SET TO 110°F	1/2	1/2		
		BRADLEY	S59-2005	1.5 GPM	1/2	1/2	2	1-1/2
		BRADLEY	1C-SF	1.5 GPM	1/2	1/2	2	1-1/2
		BRADLEY	S59-2005	1.5 GPM	1/2	1/2		
		KOHLER	K-3350				1-1/4	1-1/4
		ELKAY	LK18					
		CHICAGO	1888-369CP		1/2	1/2		

GENERAL PLUMBING NOTES:

- ALL WORK SHALL COMPLY WITH APPLICABLE LOCAL, STATE, AND NATIONAL CODES AND REGULATIONS.
- PLUMBING CONTRACTOR SHALL FURNISH AND INSTALL ALL MATERIALS, ACCESSORIES, TOOLS, EQUIPMENT, TRANSPORTATION, LABOR, SERVICES AND OPERATIONS NECESSARY FOR A COMPLETE PLUMBING SYSTEM INCLUDING FIXTURES, SANITARY SEWERS, CLEANOUTS, WATER SUPPLY PIPING, AND NATURAL GAS PIPING.
- PLUMBING CONTRACTOR SHALL OBTAIN ALL NECESSARY PERMITS AND ARRANGE FOR ALL INSPECTIONS REQUIRED BY STATE OR LOCAL AUTHORITIES.
- MATERIALS MUST BE NEW, IN FIRST CLASS CONDITION.
- WORK SHALL BE DONE BY TRAINED, EXPERIENCED, SKILLED, JOURNEYMAN UNDER AN APPROVED FULL TIME SUPERVISOR. WORK SHALL BE PERFORMED IN A NEAT WORKLIKE MANNER.
- PIPE INSTALLATION SHALL BE COORDINATED WITH OTHER TRADES.
- PIPING SHALL BE SEPARATELY HUNG AND ANCHORED, FREE TO EXPAND AND CONTRACT QUIETLY, WITHOUT IMPOSING STRAINS ON STRUCTURE, PIPING, VALVES, DEVICES, AND EQUIPMENT. PIPING SHALL BE RUN PARALLEL OR PERPENDICULAR TO BUILDING LINES.
- CONNECTIONS BETWEEN DISSIMILAR METALS SHALL BE SEPARATED BY DIELECTRIC COUPLINGS.
- CONTRACTOR SHALL PERFORM EXCAVATION REQUIRED TO INSTALL HIS WORK.
- PIPING, ETC., SHALL BE TESTED TO AT LEAST 125 PSI.
- PIPE HANGERS AND SUPPORTS SHALL MEET THE LOCAL SEISMIC REQUIREMENTS.
- PROVIDE BALL VALVE ON PIPES TO EACH GROUP OF FIXTURES OR TO EACH PIECE OF EQUIPMENT.
- PLUMBING CONTRACTOR SHALL INSTALL GAS PIPING TO WITHIN 2' OF EACH APPLIANCE AND TERMINATE WITH A GAS COCK. HVAC CONTRACTOR TO MAKE FINAL CONNECTION.
- LOCATE ALL SHUT-OFFS, CLEANOUTS, AND OTHER DEVICES REQUIRING ACCESS IN AN EASILY ACCESSIBLE AREA.
- DRAWINGS ARE SCHEMATIC AND SHOW APPROXIMATE LOCATIONS OF PIPING. EXACT LOCATIONS SHALL BE COORDINATED BY THE CONTRACTOR AND VERIFIED IN THE FIELD PRIOR TO ROUGH-IN.
- SEE ARCHITECTURAL SHEET FOR FIRE RATED CONSTRUCTION LOCATIONS. ALL PLUMBING PENETRATIONS IN FIRE RATED CONSTRUCTION SHALL BE UL LISTED OF EQUAL OR GREATER HOUR RATING.


NOTES

- REMOVE ALL EXISTING DOMESTIC WATER PIPING SERVING THE BASEMENT AS INDICATED.
- PROVIDE ALL NEW WATER PIPING TO BASEMENT PLUMBING FIXTURES.
- EXISTING LAVATORIES TO REMAIN. PROVIDE NEW FAUCETS AND INSTALL ON EXISTING FIXTURES, TYPICAL OF 3.
- 2" CW, 1" HW, AND 3/4" HWC UP.
- EXISTING MOP SINK TO REMAIN. PROVIDE NEW, WALL MOUNTED FAUCET.
- COORDINATE FLOOR REMOVAL AND REPLACEMENT FOR INSTALLATION OF NEW UNDERFLOOR PLUMBING. EXCAVATE AND BACKFILL AS NECESSARY AND MAKE CONNECTION TO EXISTING BELOW FLOOR PIPE.
- CONNECT NEW PLUMBING VENT PIPING TO EXISTING WITHIN THE EXISTING PLUMBING CHASE.
- RECONNECT TO EXISTING WATER CLOSET FLUSH VALVE (TYPICAL OF 3).


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 Engineers • Architects • Surveyors
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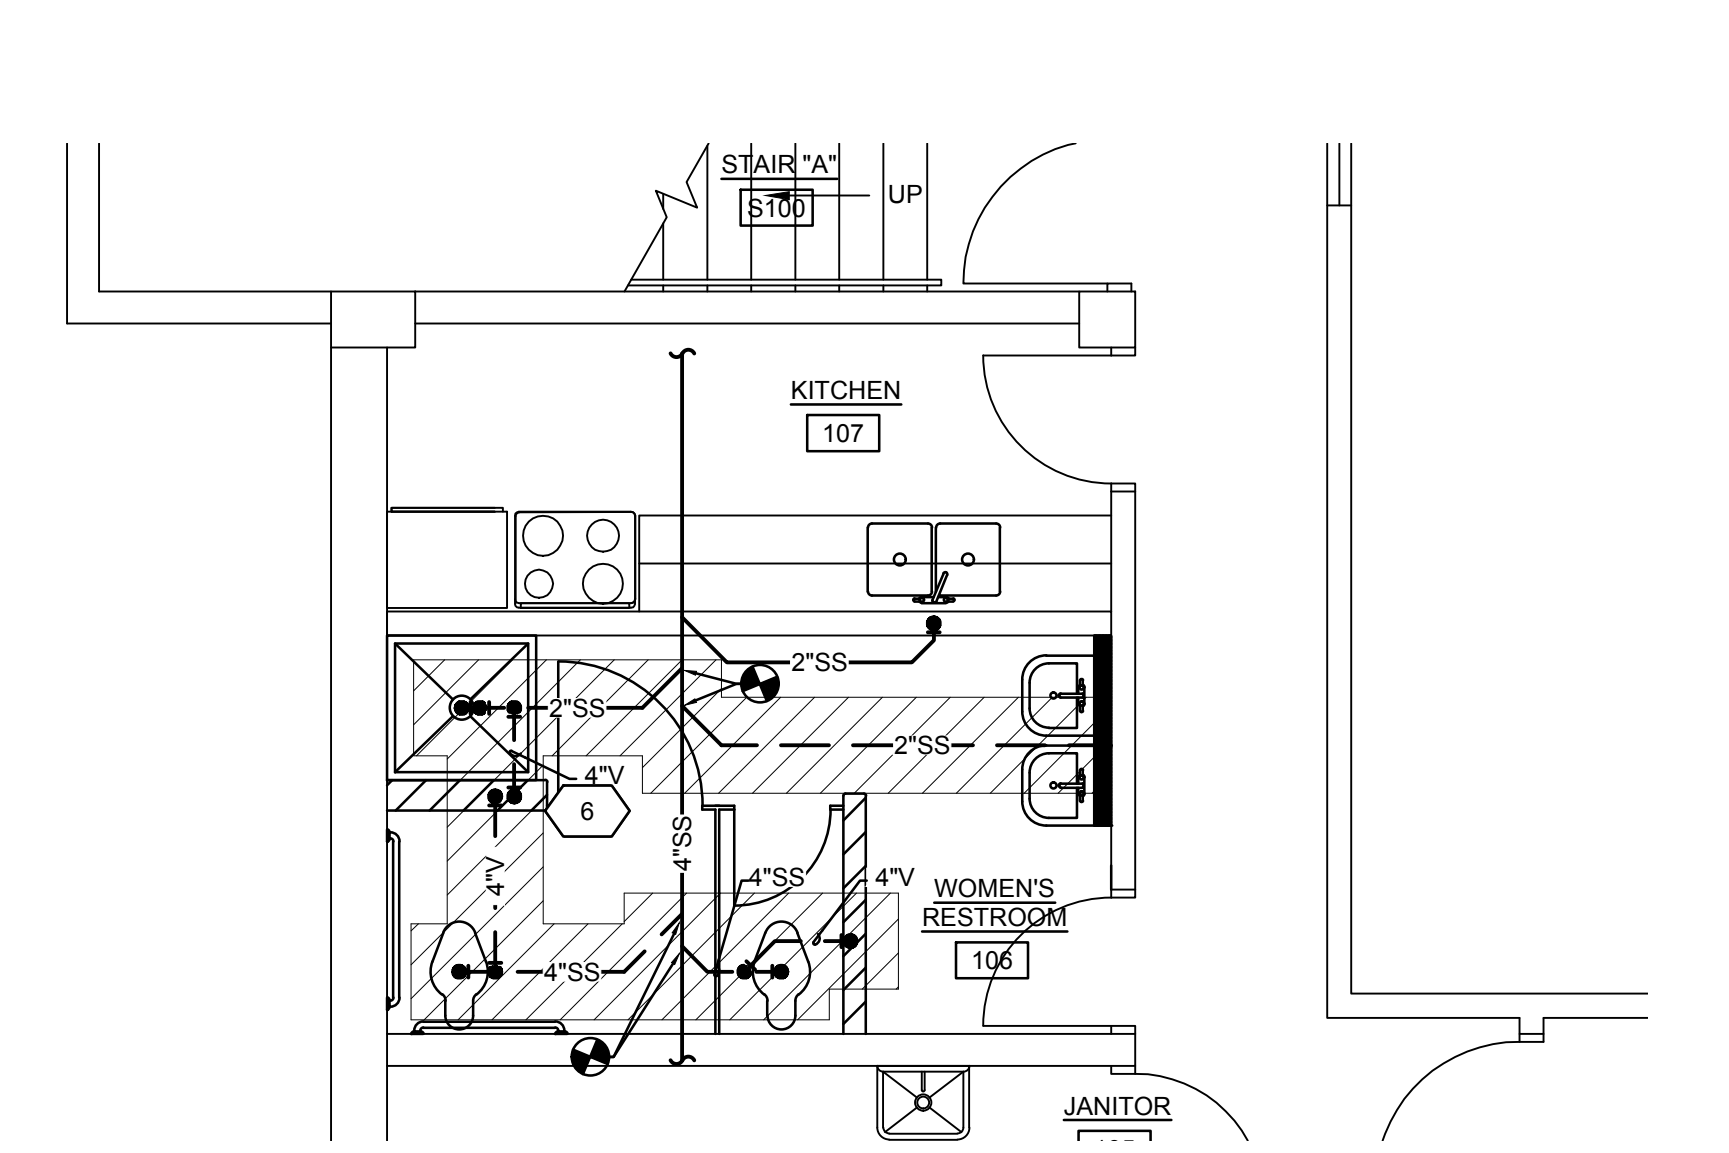
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NO.	REVISION DESCRIPTION	DATE	BY/PP
1	XXXX	XXXXXX	XXXX




1 BASEMENT PLUMBING PLAN - DEMOLITION
 P101
 0 2' 4' 8'
 SCALE: 1/4" = 1'-0"

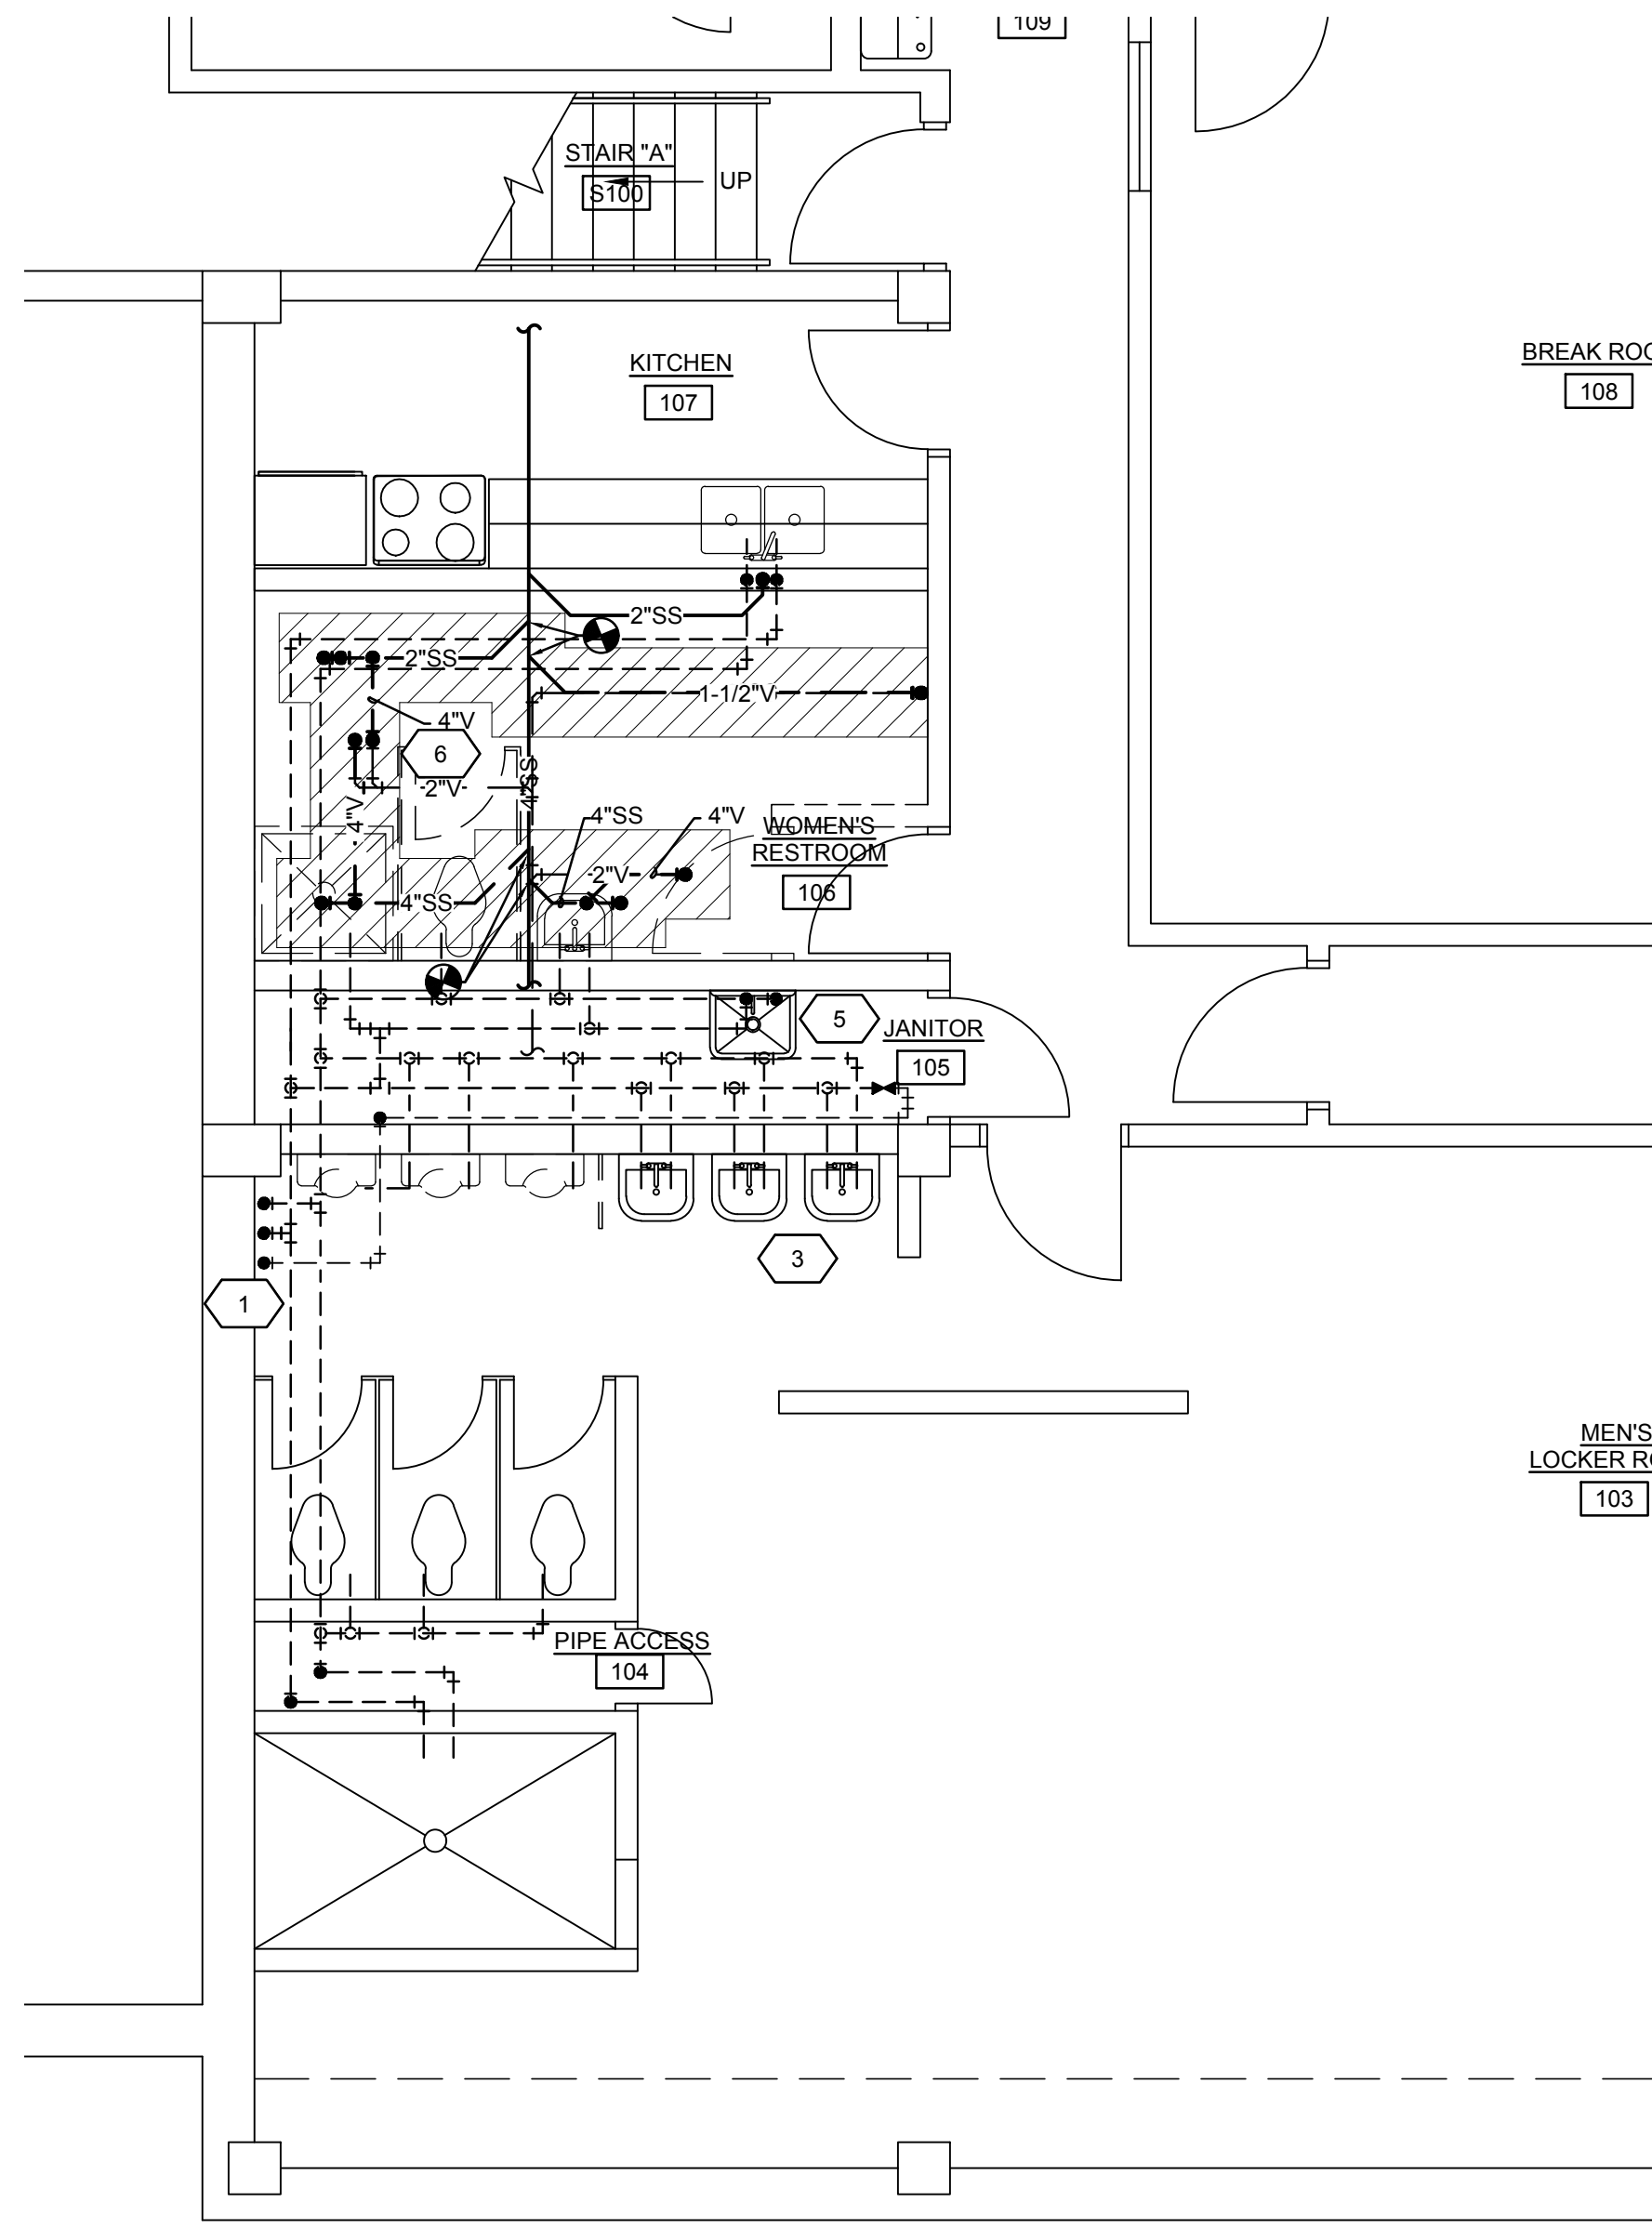

2 BASEMENT PLUMBING PLAN - NEW WORK
 P101
 0 2' 4' 8'
 SCALE: 1/4" = 1'-0"

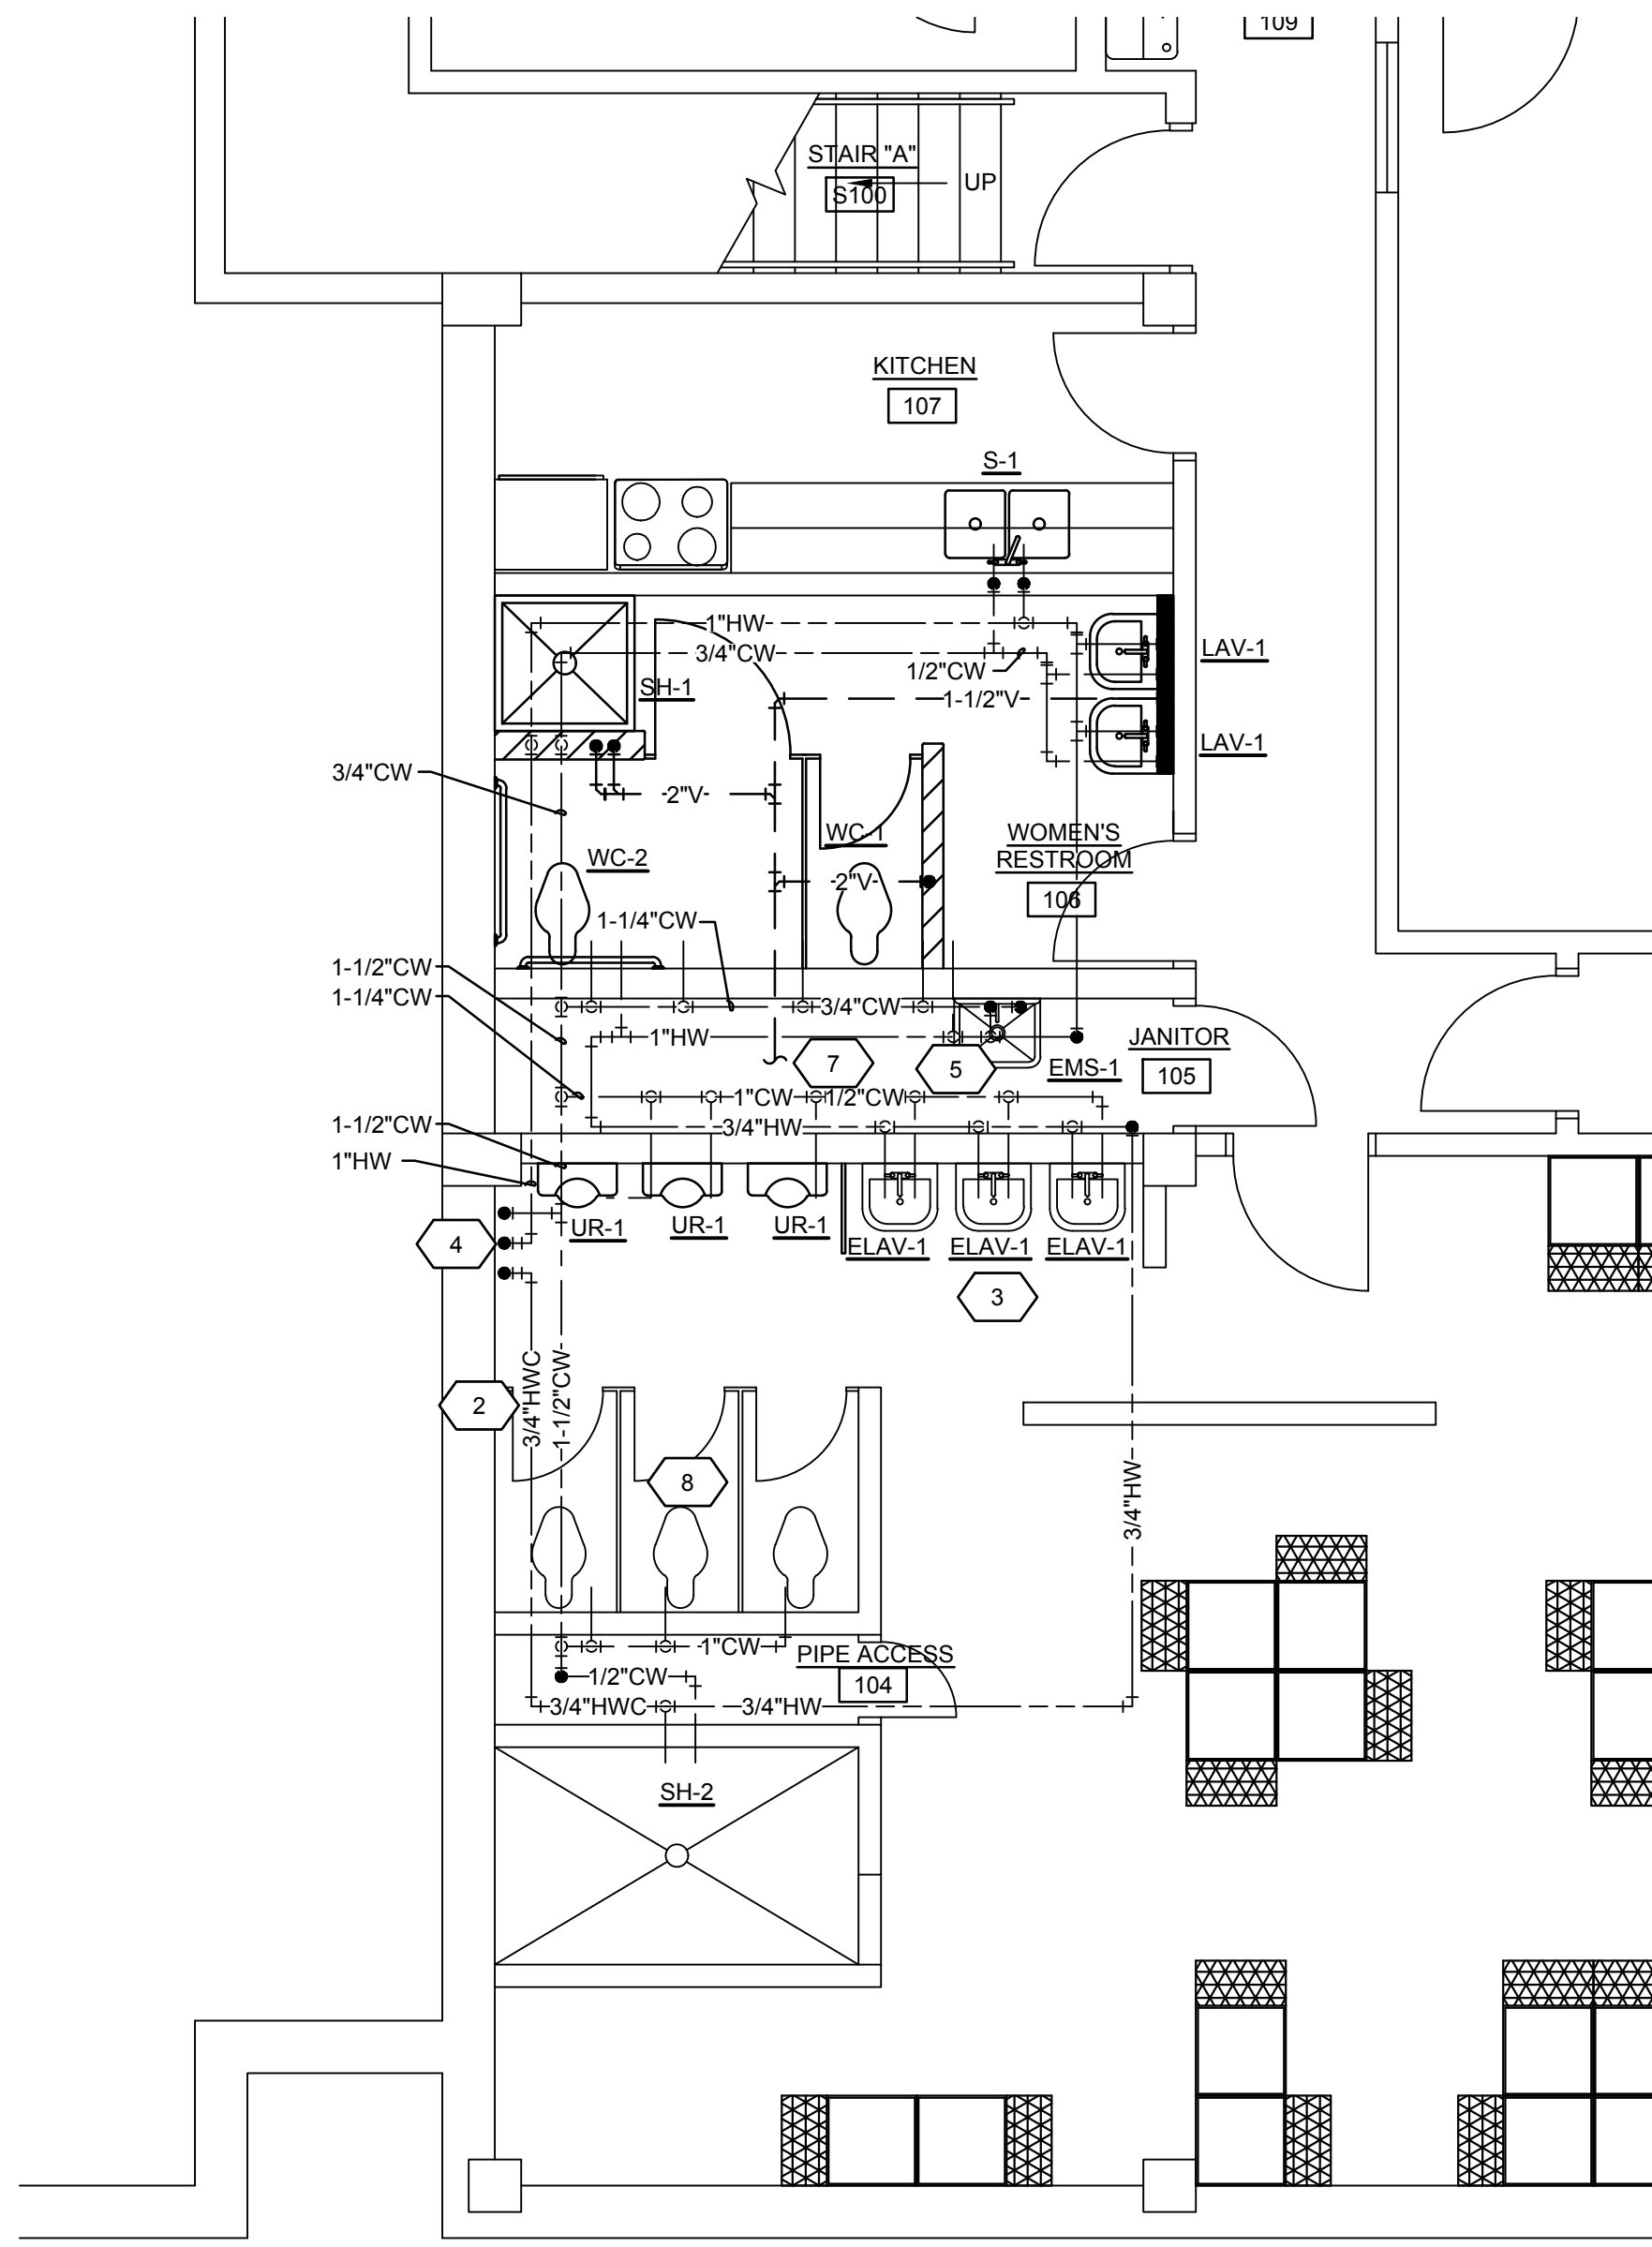

3 BASEMENT BELOW FLOOR PLUMBING PLAN - NEW WORK
 P101
 0 2' 4' 8'
 SCALE: 1/4" = 1'-0"

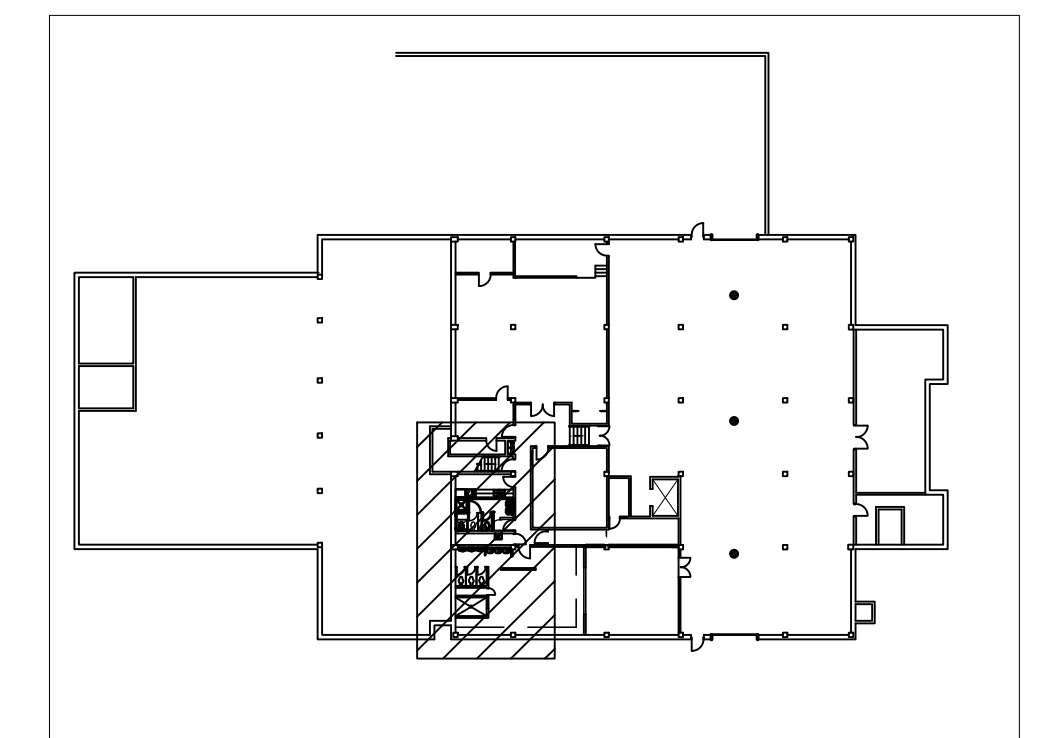

KEY PLAN
 NO SCALE
 0 2' 4' 8'
 SCALE: 1/4" = 1'-0"

PSB INTERIOR RENOVATIONS - PHASE IIIB
 CITY OF GALESBURG
 150 SOUTH BROAD ST.
 GALESBURG, ILLINOIS 61401

Non-Reduced Sheet Size: 24" x 36"
 Full sized plans have been prepared using standard scales. Reduced size plans may not conform to standard scales.

SCALE:	DESIGNED	DRAWN
	ALD	ALD
	FIELD	FIELD BOOK
	CHECKED	CHECK DATE
	SHEET TITLE	

PROJECT NO. 3215-073 (15-3027)
 DRAWING ISSUED DATE: 12/14/16
 SHEET
P101


NOTES

- 1 REMOVE ALL EXISTING DOMESTIC WATER PIPING SERVING THE BASEMENT AS INDICATED.
- 2 PROVIDE ALL NEW WATER PIPING TO BASEMENT PLUMBING FIXTURES.
- 3 EXISTING LAVATORIES TO REMAIN. FURNISH NEW FAUCETS AND INSTALL ON EXISTING FIXTURES, TYPICAL OF 3.
- 4 2" CW, 1" HW, AND 3/4" HWC DOWN.
- 5 CONNECT TO EXISTING DOMESTIC WATER PIPING ABOVE CEILING IN THIS LOCATION.
- 6 REPLACE ALL COLD WATER PIPING BACK TO WATER METER.


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 Engineers • Architects • Surveyors
 616 North 24th Street, Quincy, IL
 4510 Park Crest Road, Hannibal, MO
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 Internet Address: www.klingner.com
 Ph: 217.223.3670 - Fax: 217.223.3603
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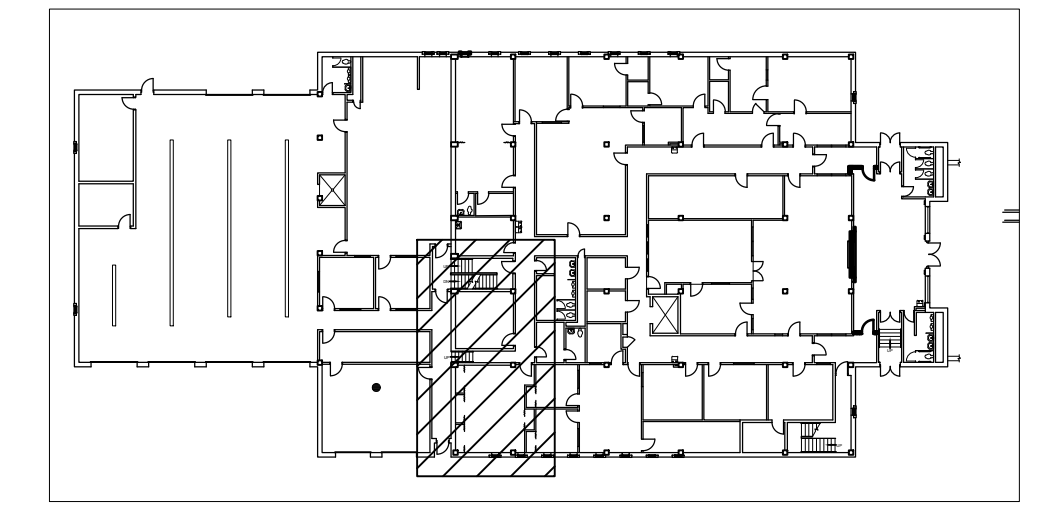
REVISION HISTORY			
NO.	REVISION DESCRIPTION	DATE	APPN.
1	XXXX	XXXXXX	XXX




1 LEVEL 2 PLUMBING PLAN - DEMOLITION
 P102
 0 2' 4' 8'
 SCALE: 1/4" = 1'-0"

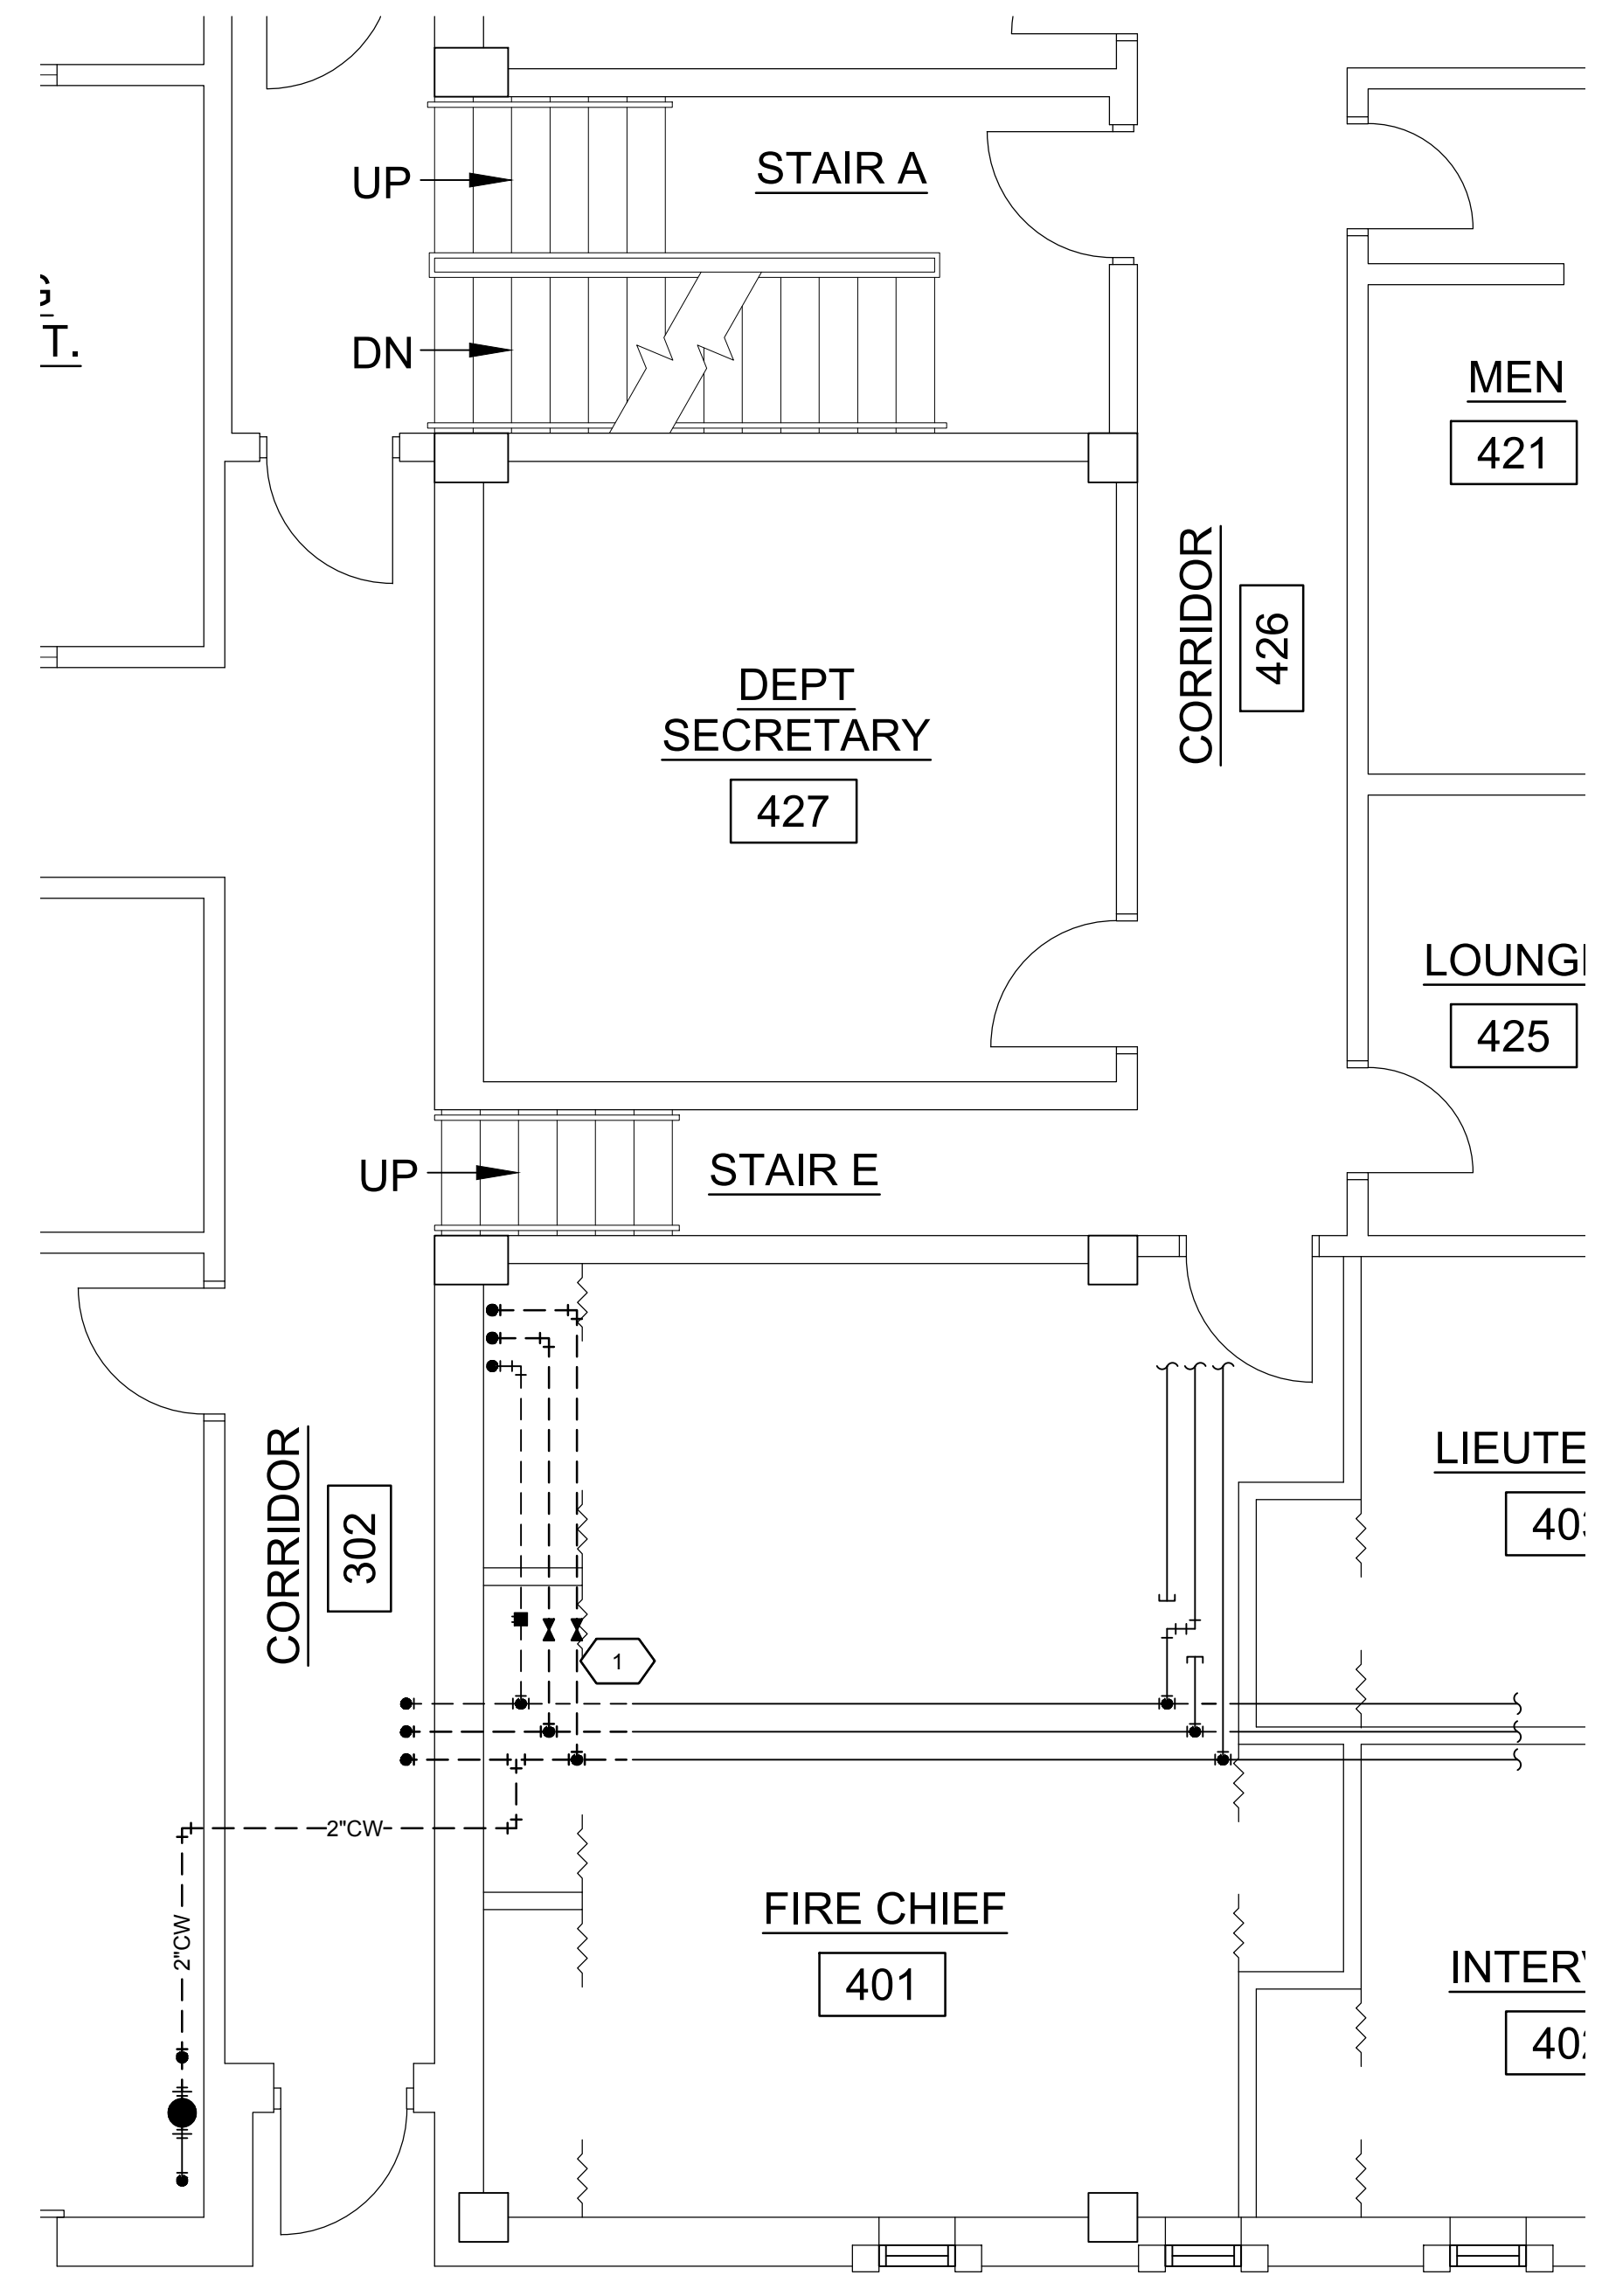

2 LEVEL 2 PLUMBING PLAN - NEW WORK
 P102
 0 2' 4' 8'
 SCALE: 1/4" = 1'-0"

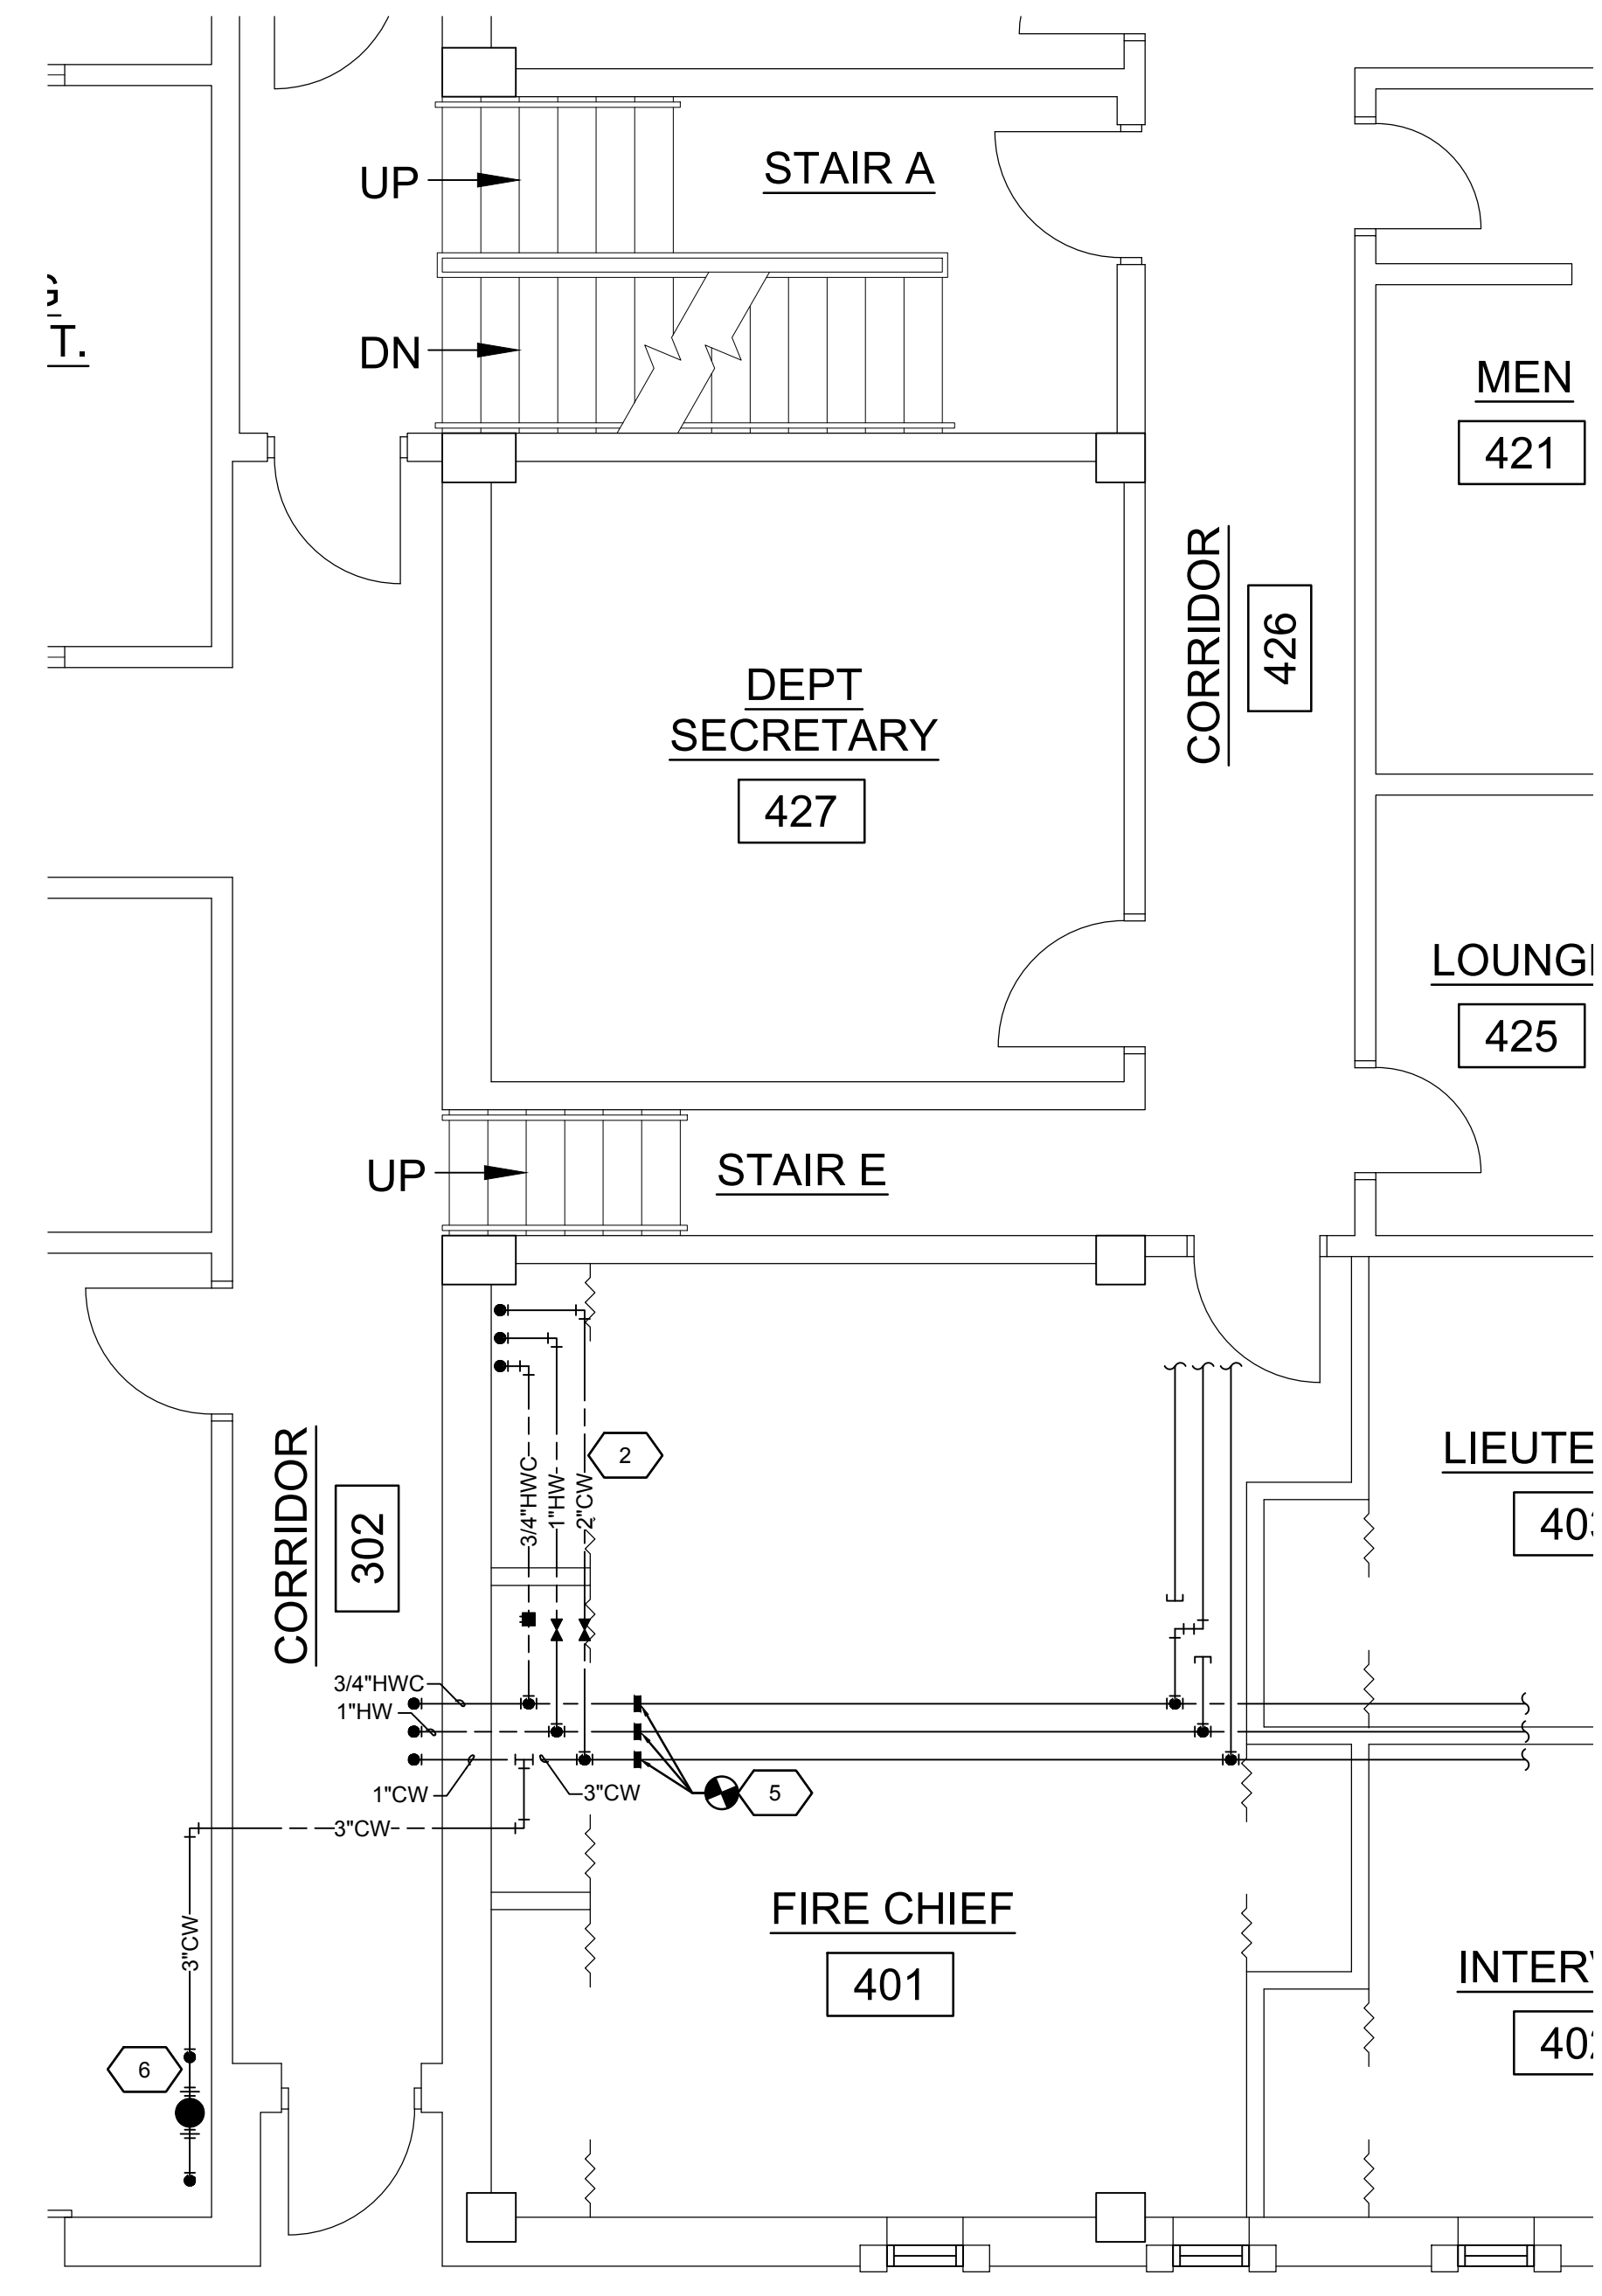

KEY PLAN
 NO SCALE

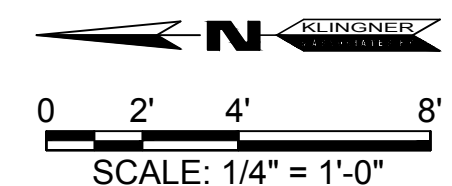

PSB INTERIOR RENOVATIONS - PHASE IIIB
 CITY OF GALESBURG
 150 SOUTH BROAD ST.
 GALESBURG, ILLINOIS 61401

Non-Reduced Sheet Size: 24" x 36"
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DESIGNED ALD	DRAWN ALD
FIELD	FIELD BOOK
CHECKED	CHECK DATE

SHEET TITLE
 LEVEL 2 - PLUMBING PLANS

PROJECT NO.
 3215-073 (15-3027)
 DRAWING ISSUED DATE:
 12/14/16
 SHEET
P102


NOTES

- 1 REUSE EXISTING WATER. PROVIDE NEW 20 GALLON POTABLE WATER EXPANSION TANK WITH MINIMUM 12 GALLON ACCEPTANCE VOLUME.


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 Ph 217.223.3670 • Fax 217.223.3693
 Ph 573.221.0020 • Fax 573.221.0012
 Ph 319.752.3693 • Fax 319.752.3695
 Ph 309.342.4442 • Fax 309.341.3781
 Internet Address: www.klingner.com

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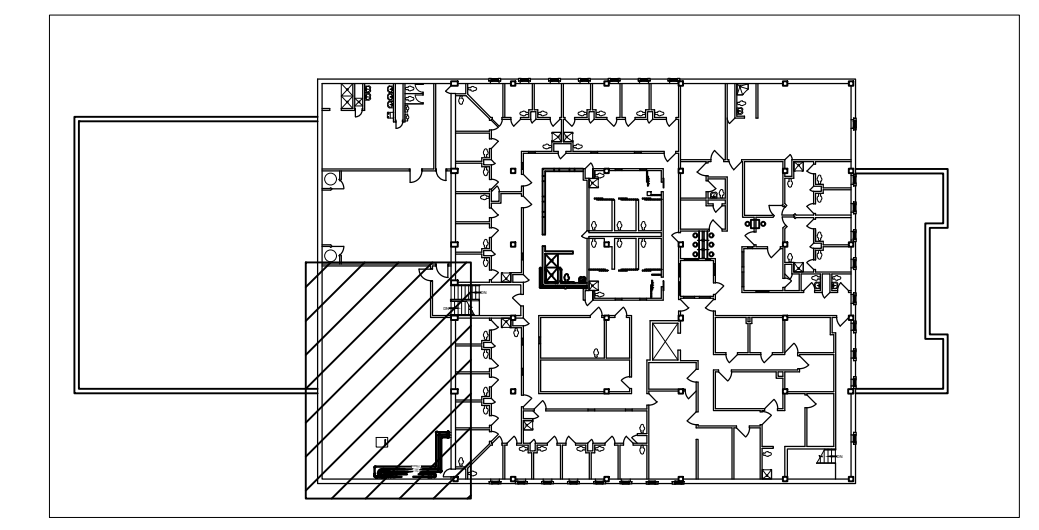
REVISION HISTORY		
NO.	REVISION DESCRIPTION	DATE
1	XXXX	XXXXXX XXX

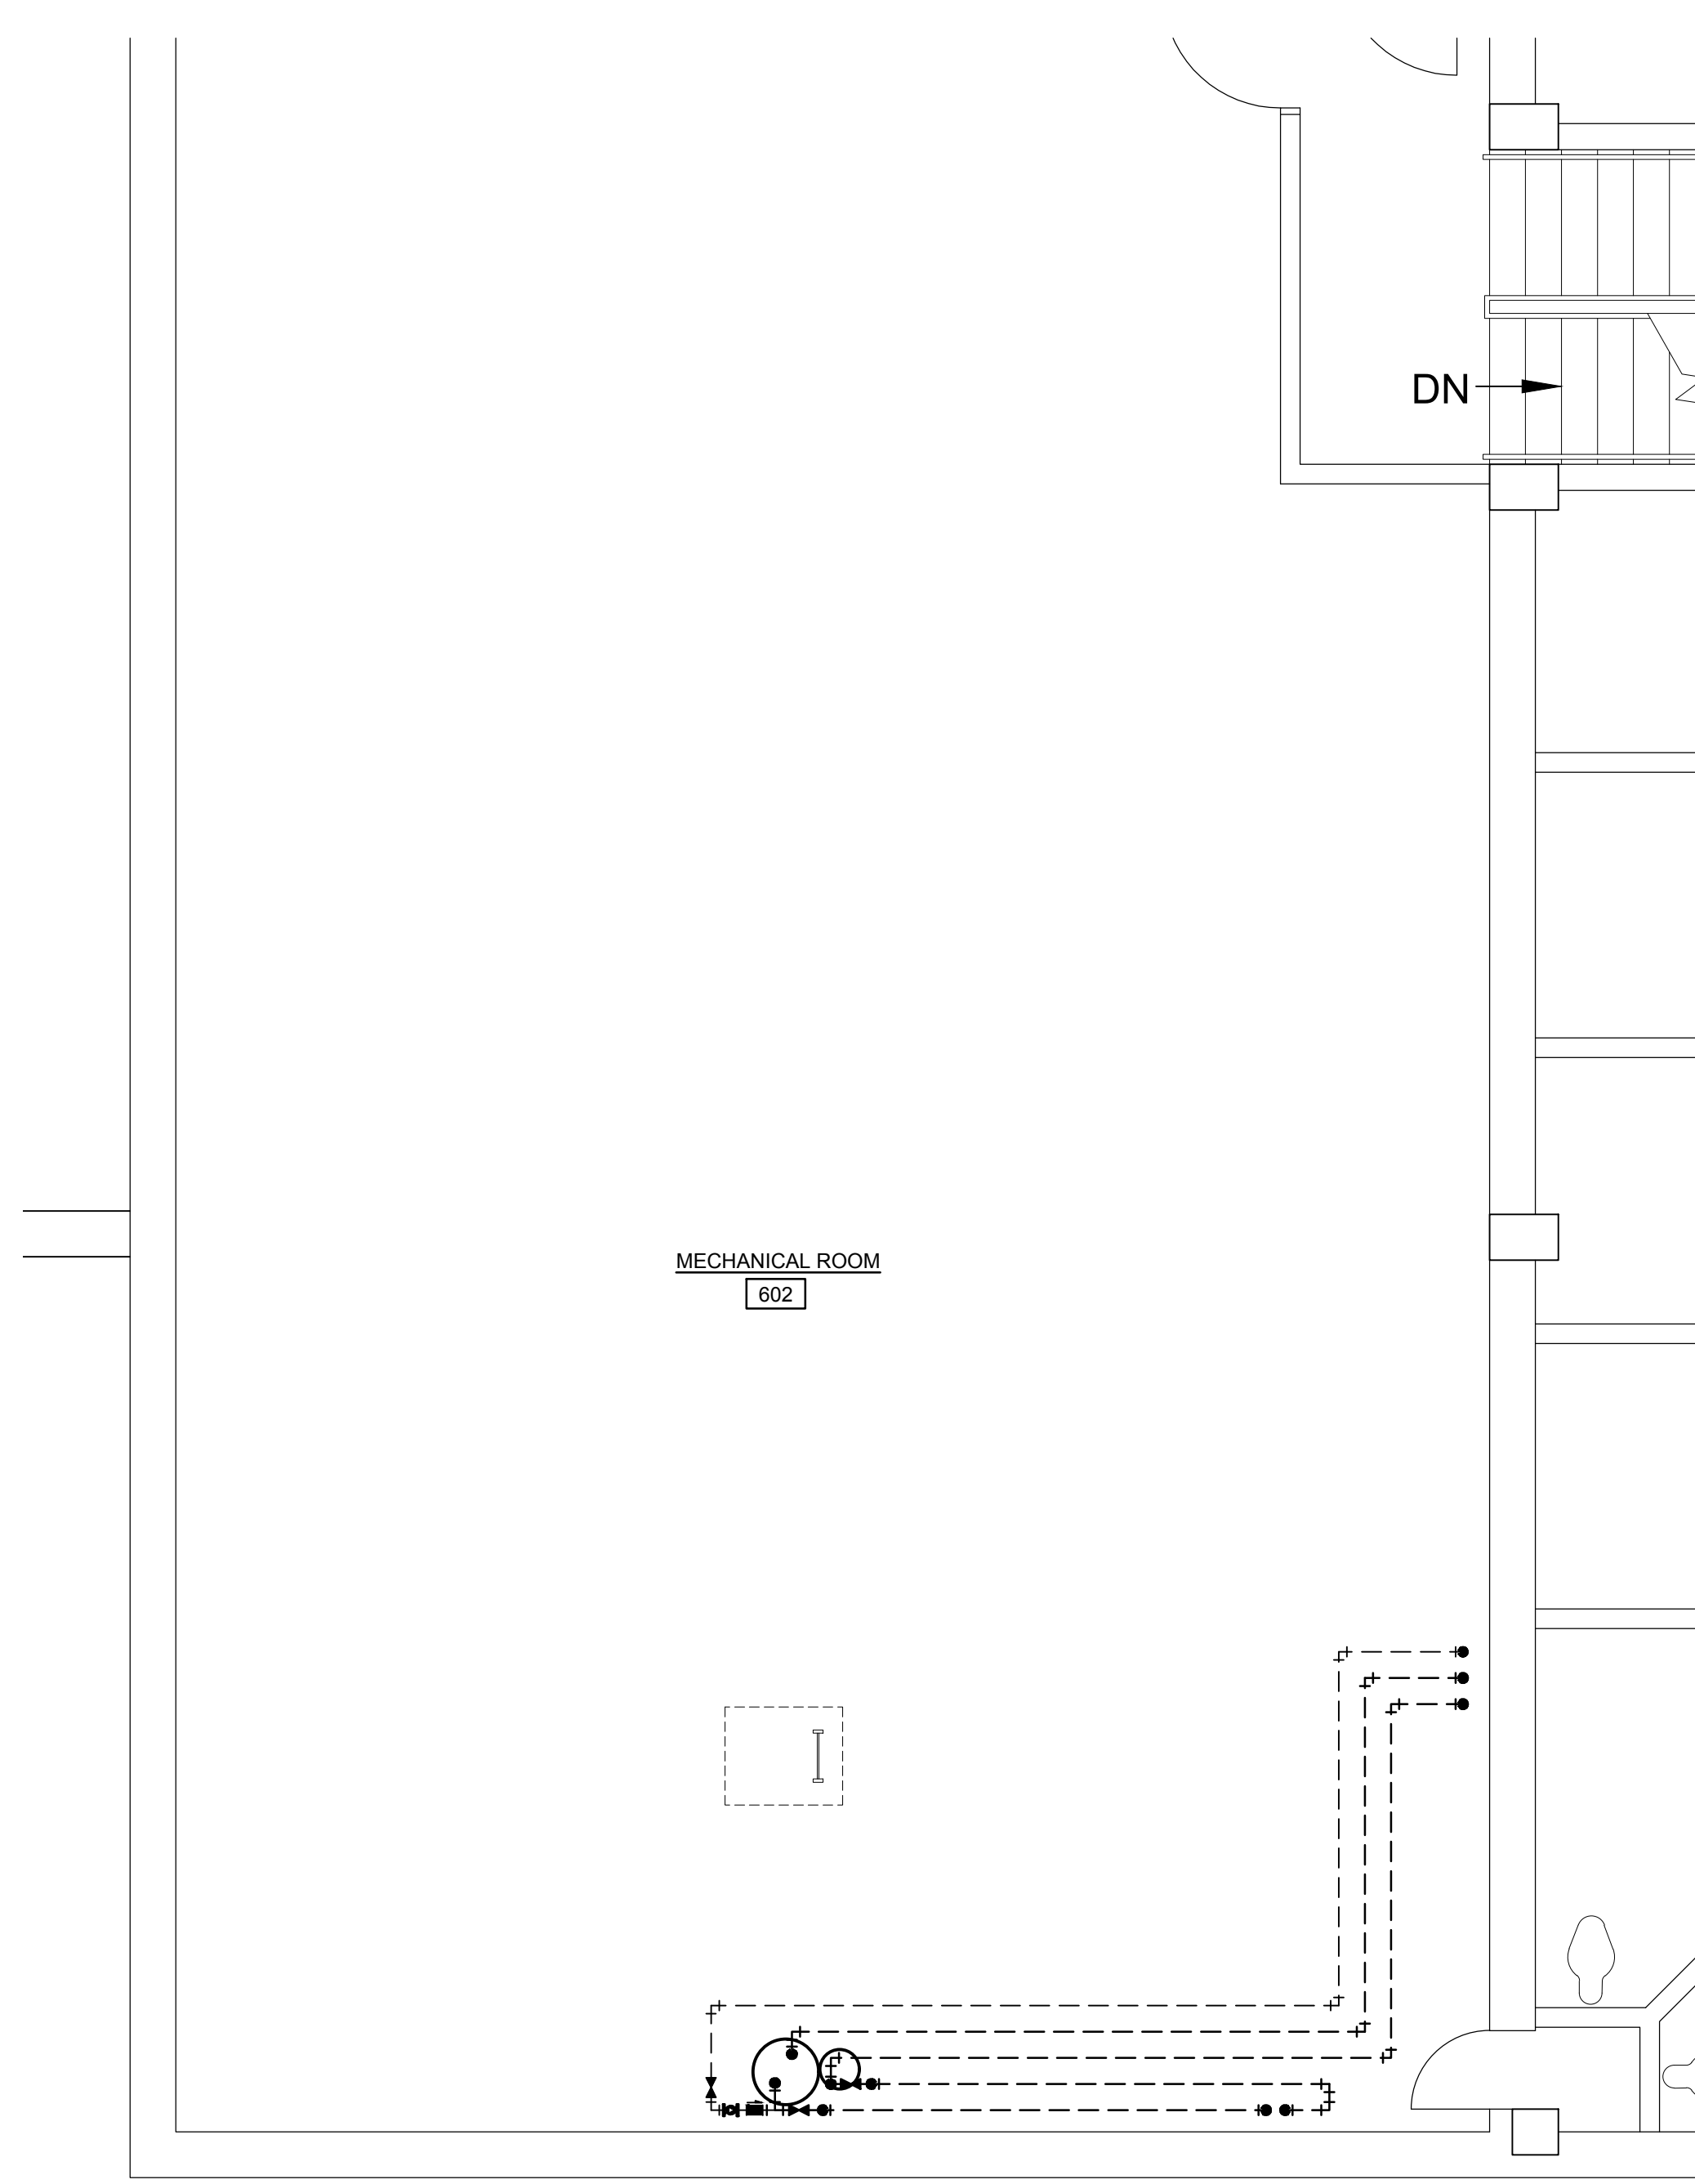


1 LEVEL 3 PLUMBING PLAN - DEMOLITION
 P103
 SCALE: 1/4" = 1'-0"

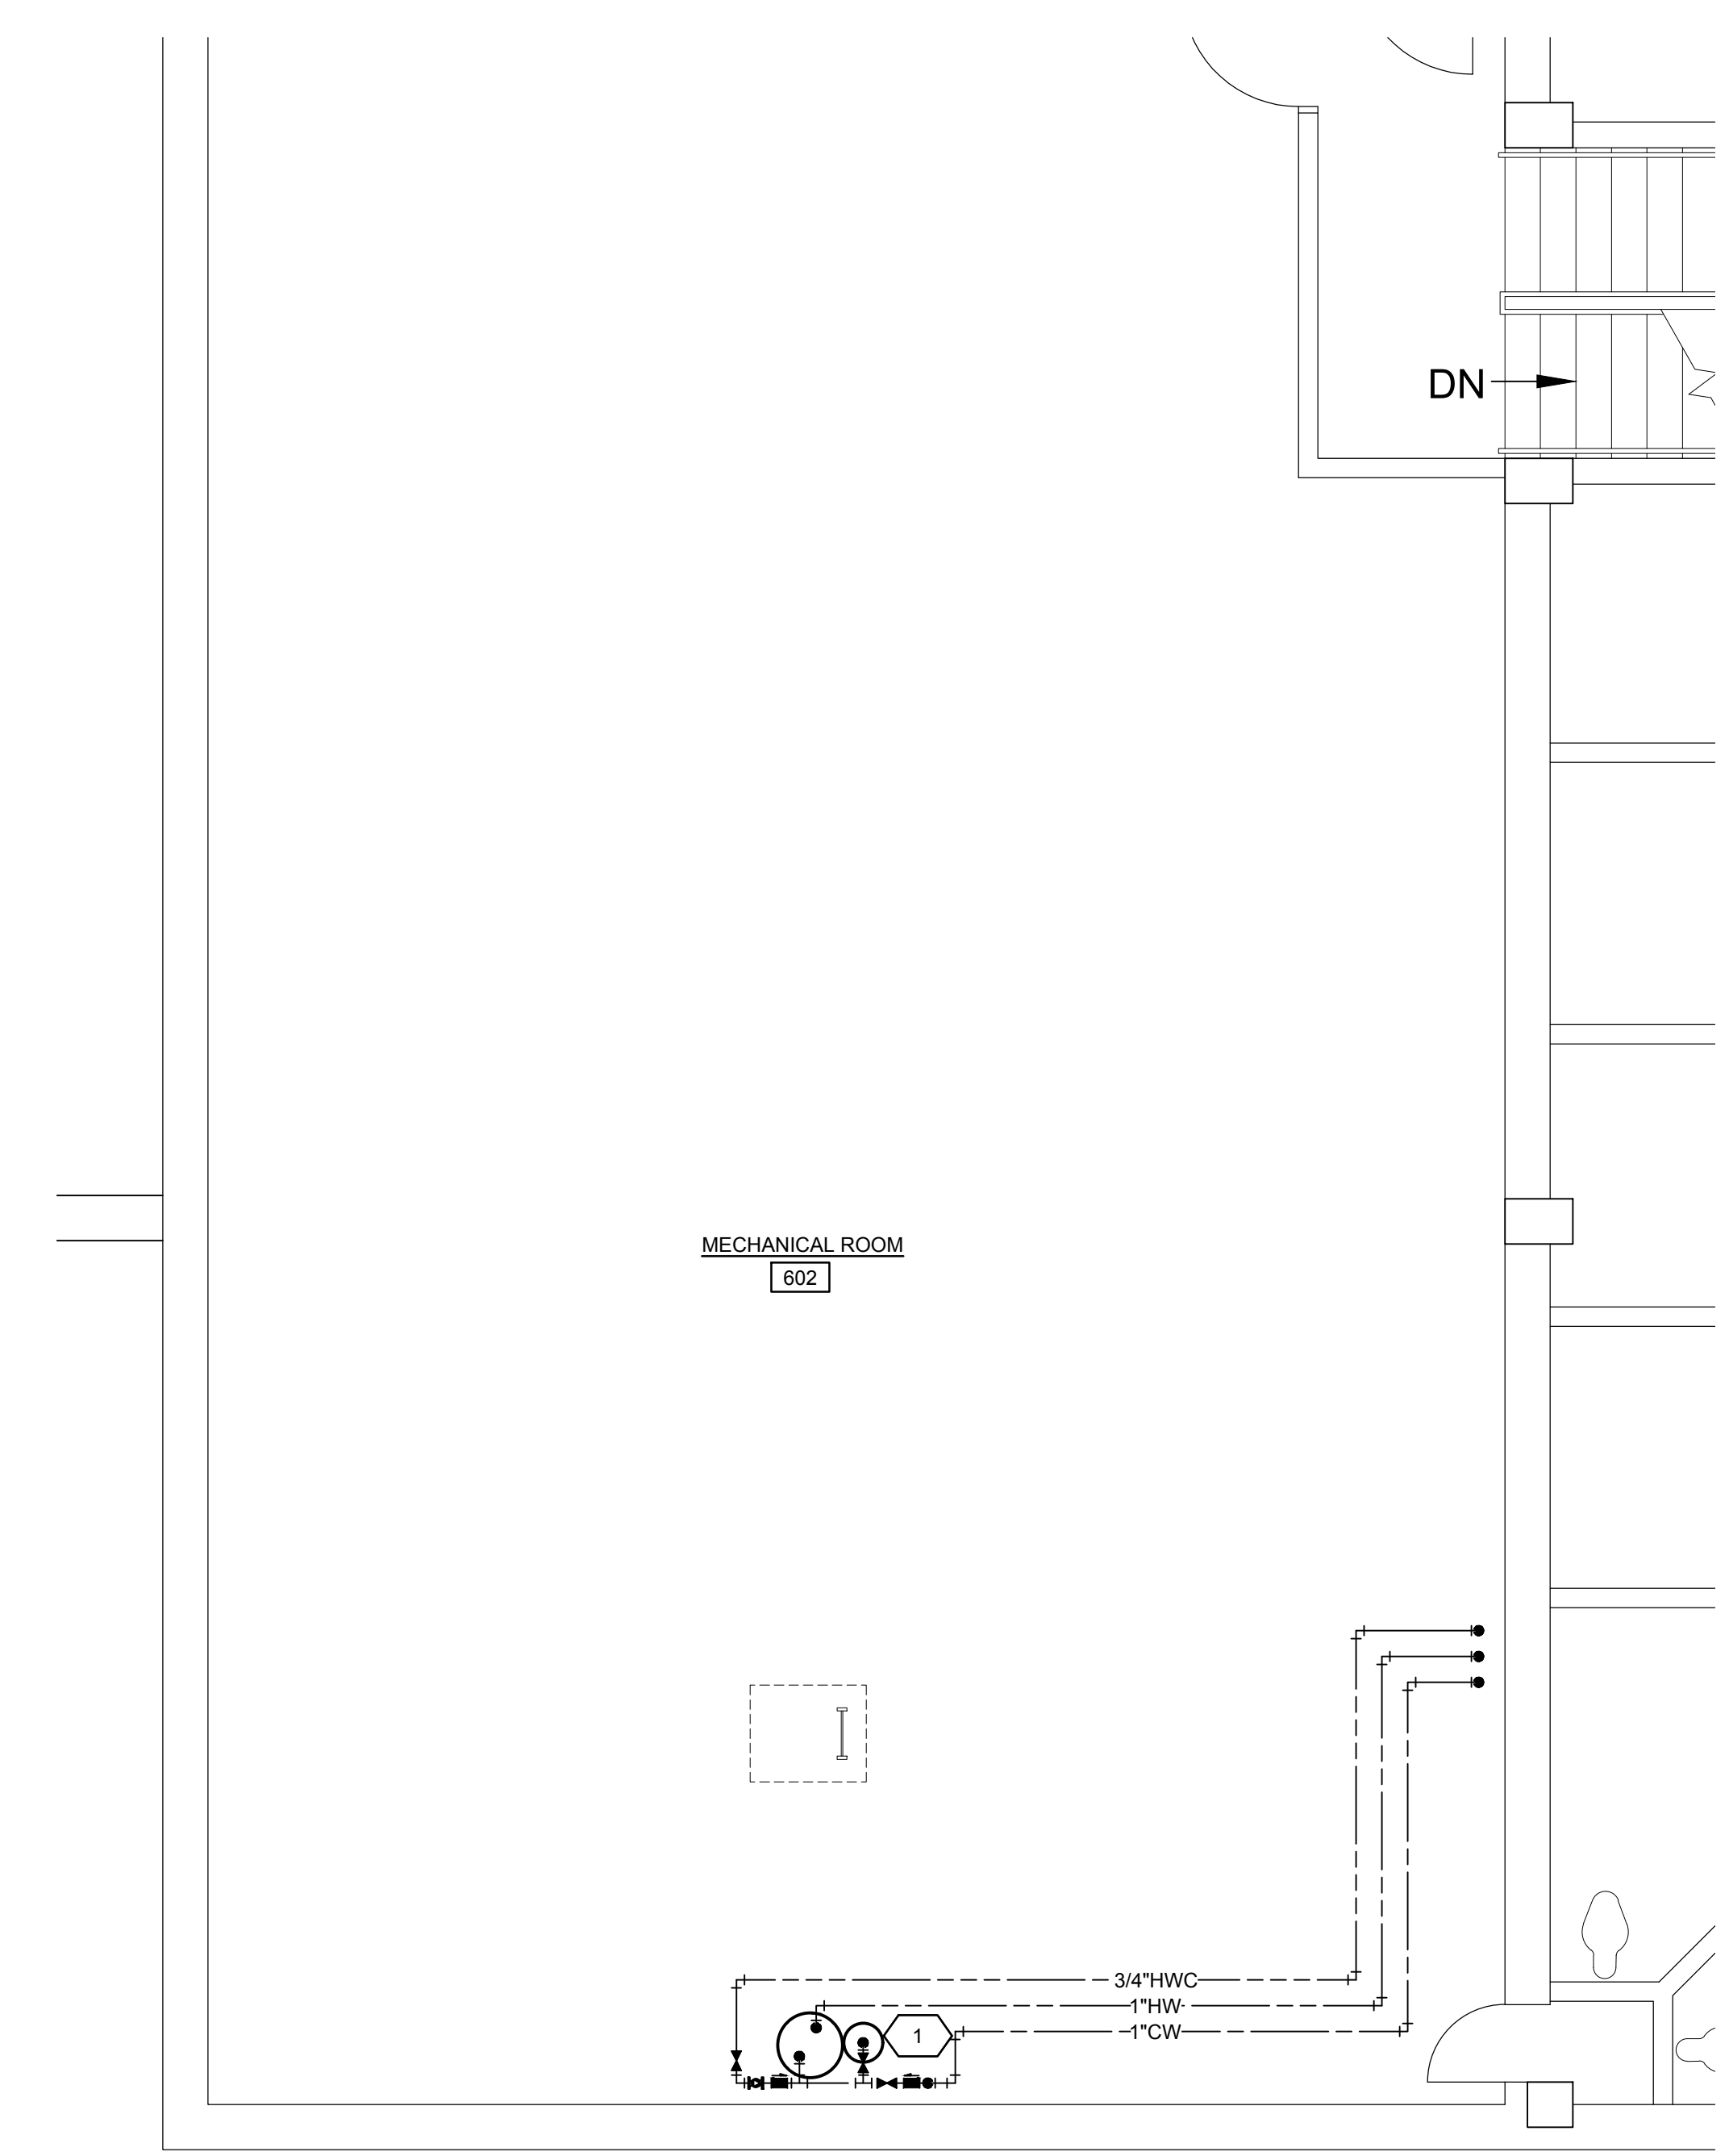

2 LEVEL 3 PLUMBING PLAN - NEW WORK
 P101
 SCALE: 1/4" = 1'-0"



KEY PLAN
 NO SCALE

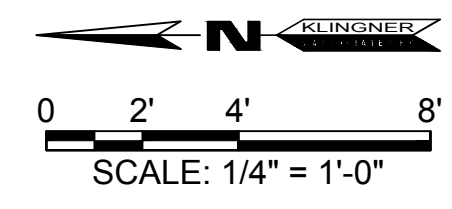

PSB INTERIOR RENOVATIONS - PHASE IIIB
 CITY OF GALESBURG
 150 SOUTH BROAD ST.
 GALESBURG, ILLINOIS 61401


Non-Reduced Sheet Size: 24" x 36"
 Full sized plans have been prepared using standard scales.
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ALD	ALD
FIELD	FIELD BOOK
CHECKED	CHECK DATE

SHEET TITLE
LEVEL 3 - PLUMBING PLANS

PROJECT NO.
 3215-073 (15-3027)
 DRAWING ISSUED DATE:
 12/14/16

SHEET
P103

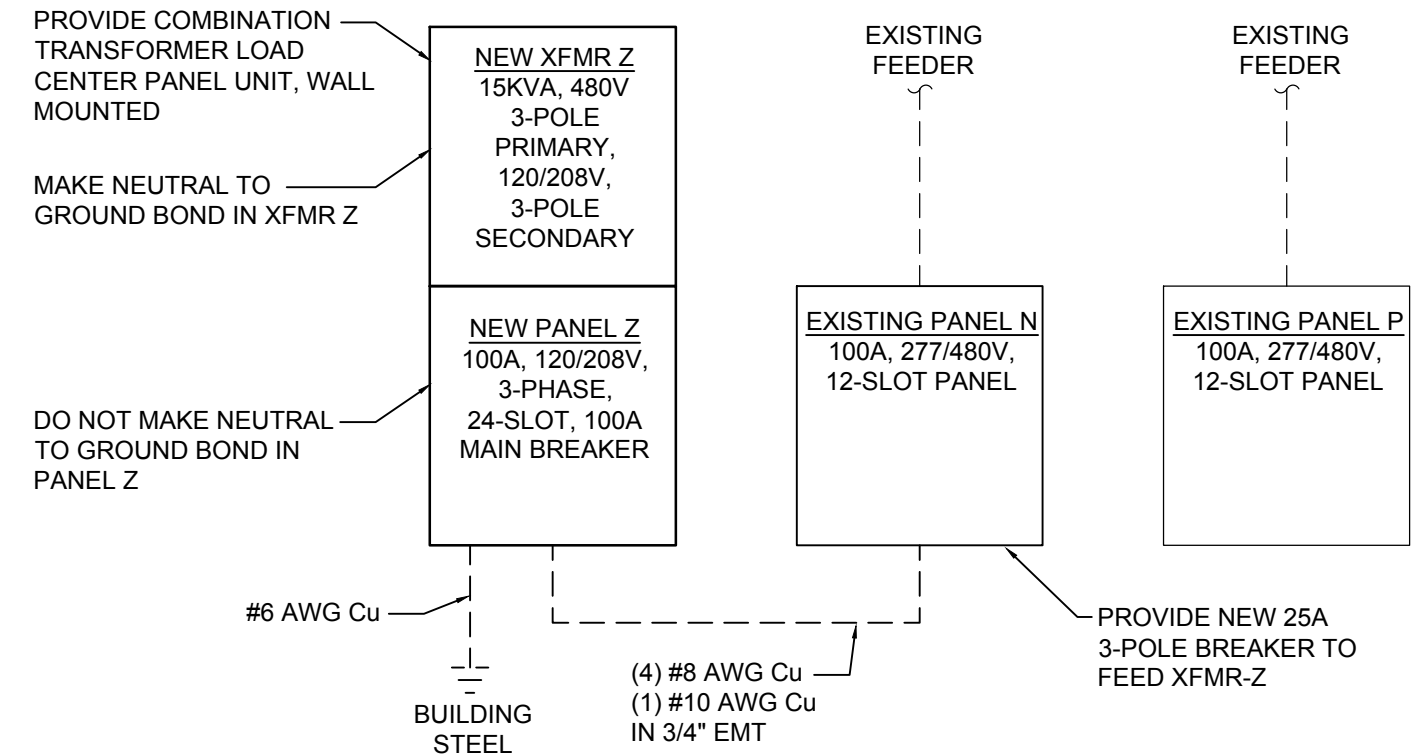


2 BASEMENT ELECTRICAL PLAN
NO SCALE

NOTES


- 1 PROVIDE SURFACE MOUNTED JUNCTION BOX AND CONDUIT AND MAKE FINAL CONNECTION TO LOCKERS. PAINT BOX AND CONDUIT TO MATCH WALL FINISH.
- 2 PROVIDE RECESSED JUNCTION BOX AND MAKE FINAL CONNECTION TO LOCKERS. PAINT BOX COVER PLATE TO MATCH WALL FINISH.
- 3 PROVIDE CEILING MOUNTED POWER POLE FROM CEILING TO TOP OF LOCKERS AND MAKE FINAL CONNECTION TO LOCKERS. PAINT POLE TO MATCH WALL FINISH.
- 4 REPLACE EXISTING RECEPTACLE WITH SURFACE MOUNTED BOX AND GFCI PROTECTED DUPLEX RECEPTACLE. PROVIDE SURFACE MOUNTED WIREMOLD TO ADDITIONAL BREAKROOM RECEPTACLES.
- 5 PROVIDE 15KVA TRANSFORMER AND 100A, 120/208V, 24-SLOT, LOAD CENTER COMBINATION UNIT REFER TO ONE-LINE DIAGRAM FOR DETAILS.
- 6 REPLACE EXISTING CEILING LIGHT WITH RECESSED, WET LOCATION LISTED, 2'x2' LAY-IN TROFFER (EATON MODEL GR2242FALD44340 OR APPROVED EQUAL).

ELECTRICAL NOTES:

1. APPLICABLE STANDARDS: NFPA-70, NFPA-101, STATE BUILDING CODES, AND THE OCCUPATIONAL SAFETY AND HEALTH ACT (OSHA) OF 1971 AND ALL AMENDMENTS THERETO; EQUIPMENT, DEVICES, APPARATUS, SYSTEMS, AND INSTALLATIONS SHALL BE ENTIRELY SUITABLE AND SAFE FOR EACH INTENDED APPLICATION AND BE IN FULL COMPLIANCE WITH APPLICABLE STANDARDS, REQUIREMENTS, RULES, REGULATIONS, CODES, STATUTES, ORDINANCES, ETC., OF MUNICIPAL, COUNTY, AND STATE GOVERNMENTS, OWNERS' INSURANCE COMPANY, LOCAL UTILITIES, AND LABOR REGULATIONS. NOTHING CONTAINED IN THESE PLANS AND SPECIFICATIONS SHALL BE CONSTRUED TO CONFLICT WITH THESE LAWS, CODES, AND ORDINANCES.
2. DRAWINGS ARE SCHEMATIC AND SHOW APPROXIMATE LOCATIONS OF ELECTRICAL EQUIPMENT. EXACT LOCATIONS SHALL BE COORDINATED BY THE CONTRACTOR AND VERIFIED IN THE FIELD PRIOR TO ROUGH-IN.
3. INSTALLATIONS WHICH INCLUDE ELECTRICAL FIXTURES, DEVICES, CONDUIT, SWITCHES, PANELS, HANGERS, WIRE, CABLE, STANDARDS, ETC., MUST BE ENTIRELY SUITABLE FOR TEMPERATURES, HUMIDITY, DAMP AREAS, VOLTAGE, FREQUENCY, AND ALL INSTALLATION CONDITIONS ENCOUNTERED.
4. INSTALLATION MUST BE ENTIRELY SAFE IN EVERY RESPECT, AND MUST NOT CREATE ANY CONDITIONS OF ANY KIND WHICH WILL BE HARMFUL TO ANY OCCUPANT OF THE BUILDING. IF CONTRACTOR BELIEVES THAT INSTALLATION WILL NOT BE SAFE FOR ALL PEOPLE, HE/SHE SHALL SO REPORT IN WRITING TO ENGINEER BEFORE ANY EQUIPMENT IS PURCHASED OR WORK IS INSTALLED, GIVING EXACT RECOMMENDATIONS, AND REASONS FOR THEM.
5. GROUNDING: ALL GROUNDING SHALL BE IN STRICT ACCORDANCE WITH THE LATEST EDITION OF THE NATIONAL ELECTRICAL CODE (NEC).
6. INSTALLATION OF ELECTRICAL DEVICES SHALL BE COORDINATED WITH OTHER TRADES AS NECESSARY TO PREVENT ANY CONFLICTS DURING CONSTRUCTION.
7. WHERE PHONE/DATA OUTLET LOCATIONS ARE INDICATED INSTALL 1" EMT FROM OUTLET BOX (4"x4"x1/2" MIN.) TO TOP OF FINISHED WALL (ABOVE S.A.T. CEILING) OR TO THE PHONE/DATA EQUIPMENT LOCATION, UNLESS LOCATED IN WIREMOLD.
8. LIGHTING: FURNISH AND INSTALL ALL LIGHTING FIXTURES COMPLETE WITH LAMPS IN ACCORDANCE WITH THE LIGHTING FIXTURE SCHEDULE SHOWN ON THE DRAWINGS. ALL UNITS SHALL BE COMPLETE WITH SUSPENSION ACCESSORIES, CANOPIES, SOCKETS, LOUVERS, FRAMES, AND ROUGH-IN BOXES, WIRED AND ASSEMBLES TO FURNISH A COMPLETE WORKABLE SYSTEM.
9. LOW VOLTAGE CONDUIT AND JUNCTION BOXES SHALL BE INSTALLED BY THE ELECTRICAL CONTRACTOR.
10. EQUIPMENT GROUNDING CONDUCTORS SHALL BE PULLED WITH ALL BRANCH CIRCUITS. CONDUIT SHALL NOT BE USED AS A GROUND U.N.O.
11. ELECTRICAL CONTRACTOR SHALL FURNISH AND INSTALL ALL MATERIALS, ACCESSORIES, TOOLS, EQUIPMENT, TRANSPORTATION, LABOR, SERVICES AND OPERATIONS NECESSARY FOR A COMPLETE ELECTRICAL SYSTEM.
12. ELECTRICAL CONTRACTOR SHALL OBTAIN ALL NECESSARY PERMITS AND ARRANGE FOR ALL INSPECTIONS REQUIRED BY STATE OR LOCAL AUTHORITIES.
13. MATERIALS MUST BE NEW, IN FIRST CLASS CONDITION.
14. CONDUIT SHALL BE SEPARATELY HUNG AND ANCHORED, FREE TO EXPAND AND CONTRACT QUIETLY, WITHOUT IMPOSING STRAINS ON STRUCTURE, DEVICES, AND EQUIPMENT. CONDUIT SHALL BE RUN PARALLEL OR PERPENDICULAR TO BUILDING LINES.
15. CONTRACTOR SHALL PERFORM EXCAVATION REQUIRED TO INSTALL HIS WORK.
16. SEE ARCHITECTURAL SHEET FOR FIRE RATED CONSTRUCTION LOCATIONS. ALL ELECTRICAL PENETRATIONS IN FIRE RATED CONSTRUCTION SHALL BE UL LISTED OF EQUAL OR GREATER HOUR RATING.
17. XXXXXX CLEARANCE REQUIREMENTS ???

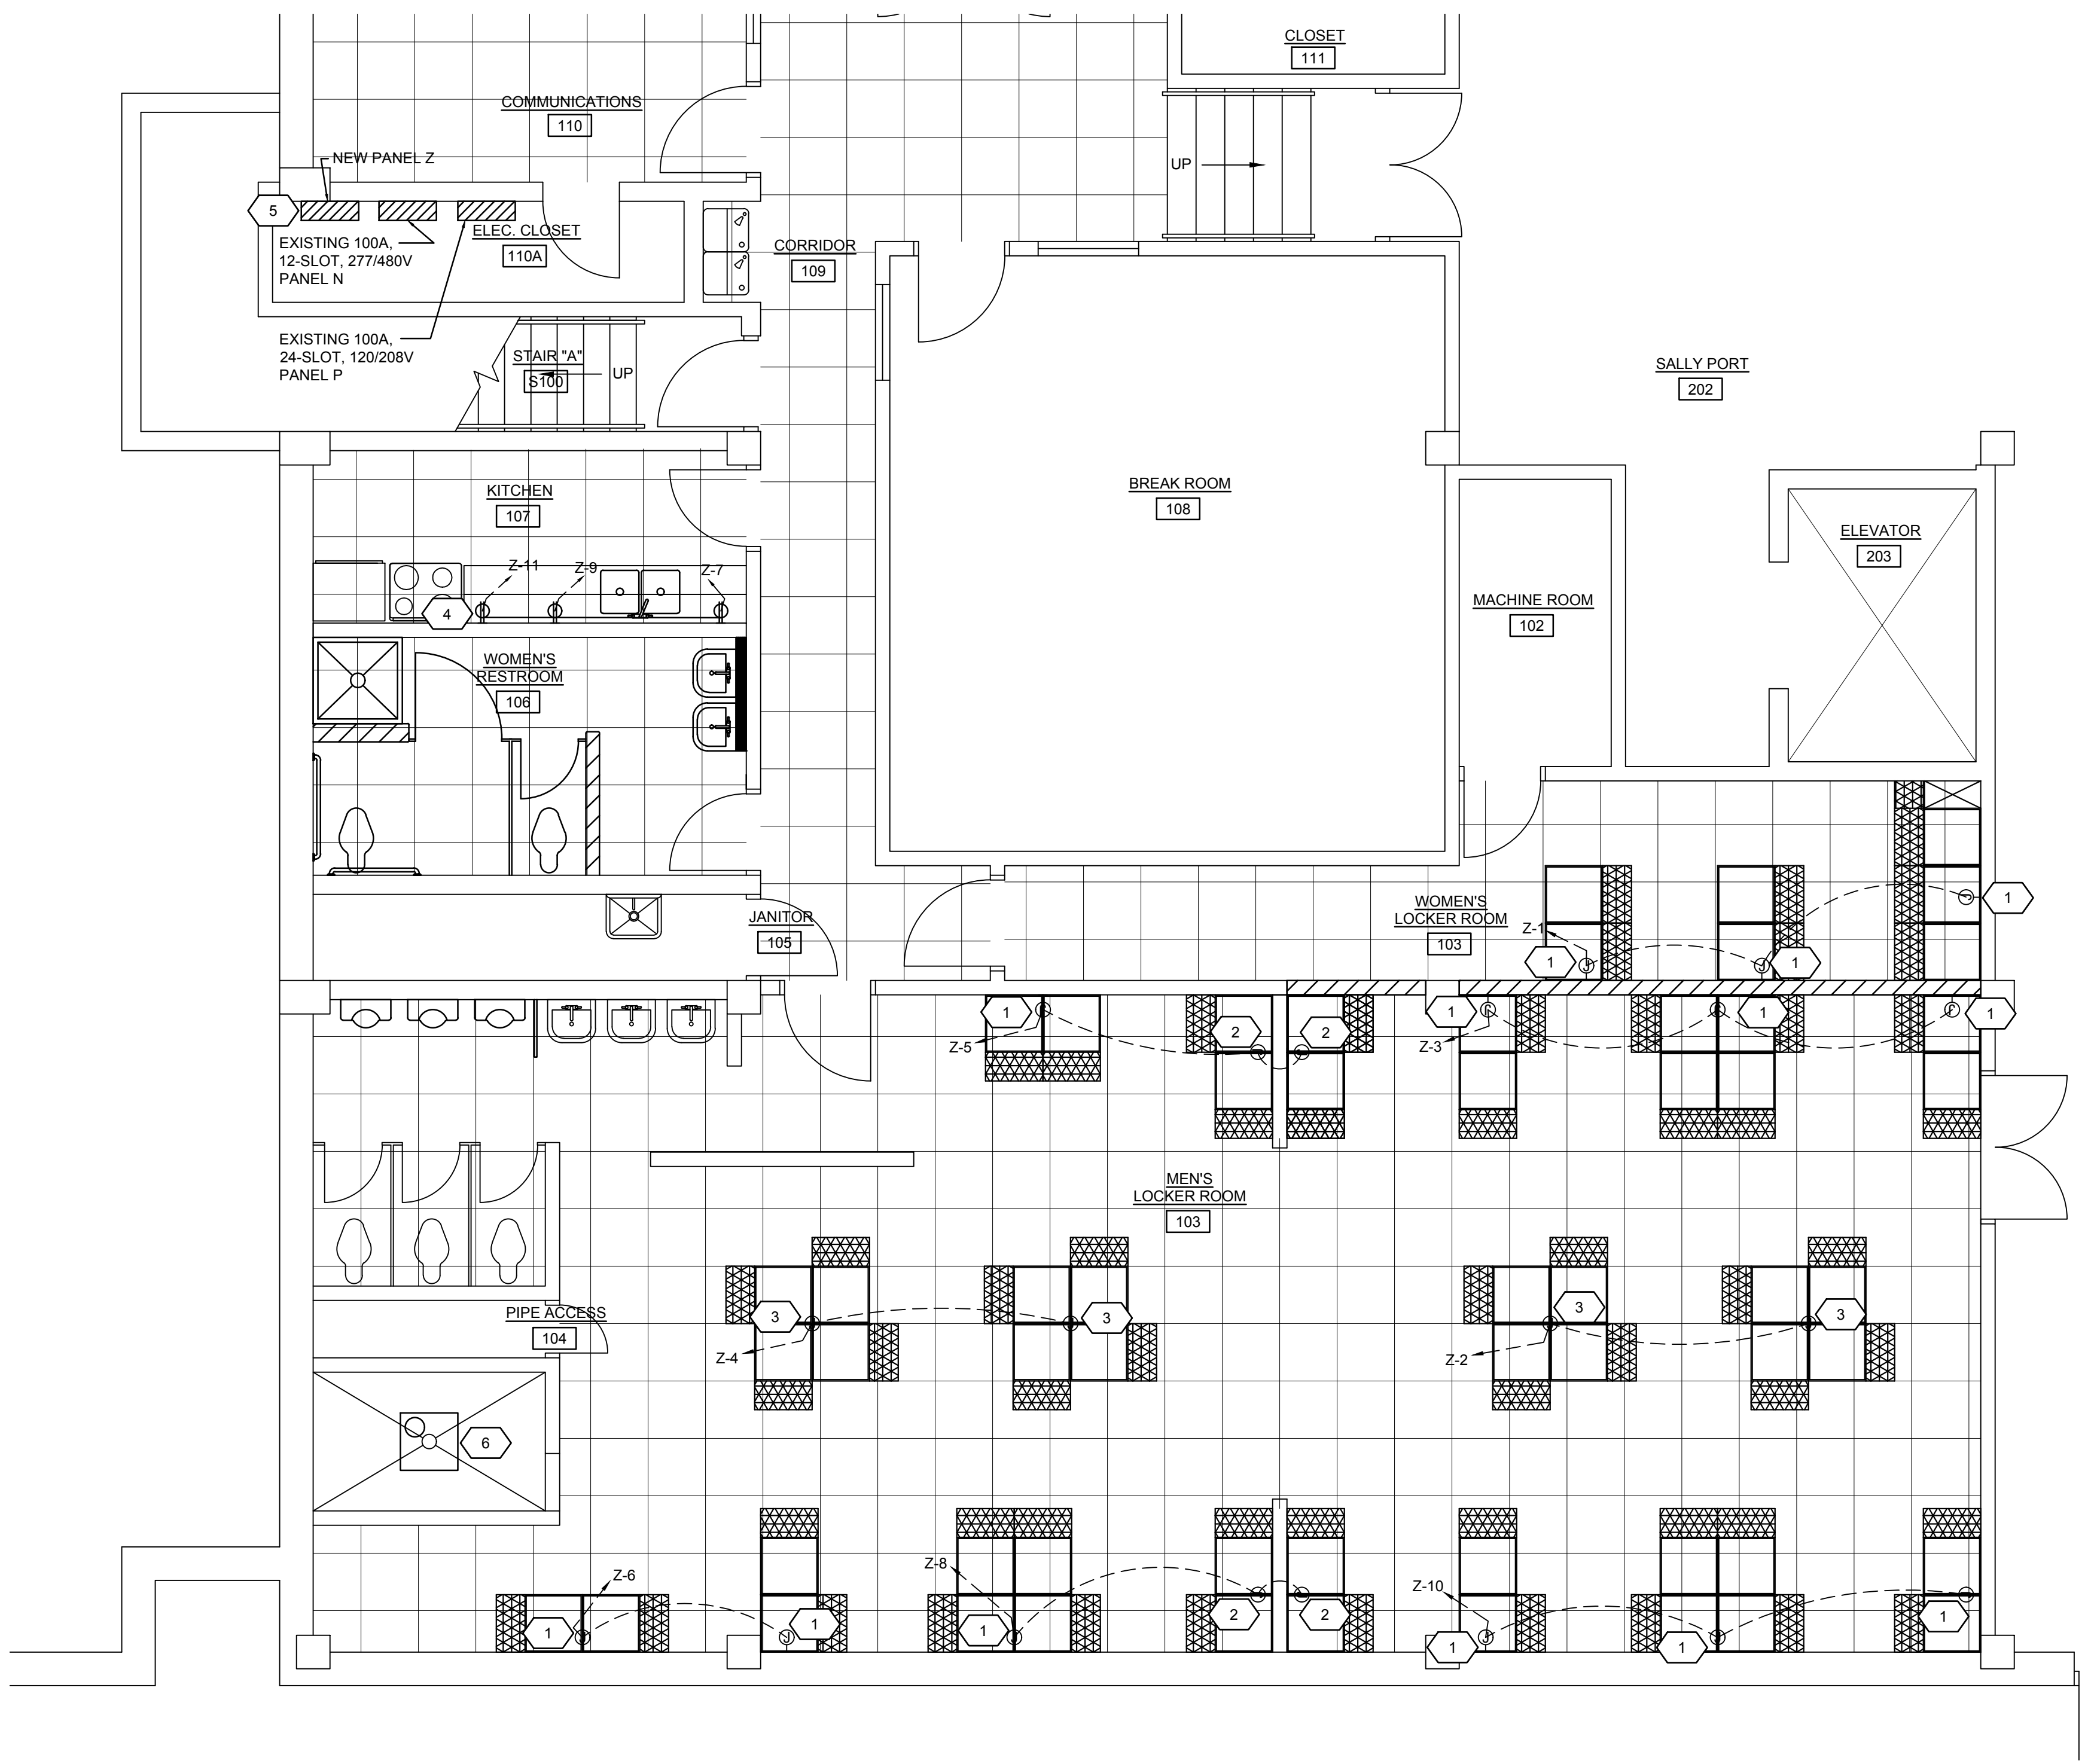

1 BASEMENT ELECTRICAL PLAN
NO SCALE
SCALE: 1/4" = 1'-0"

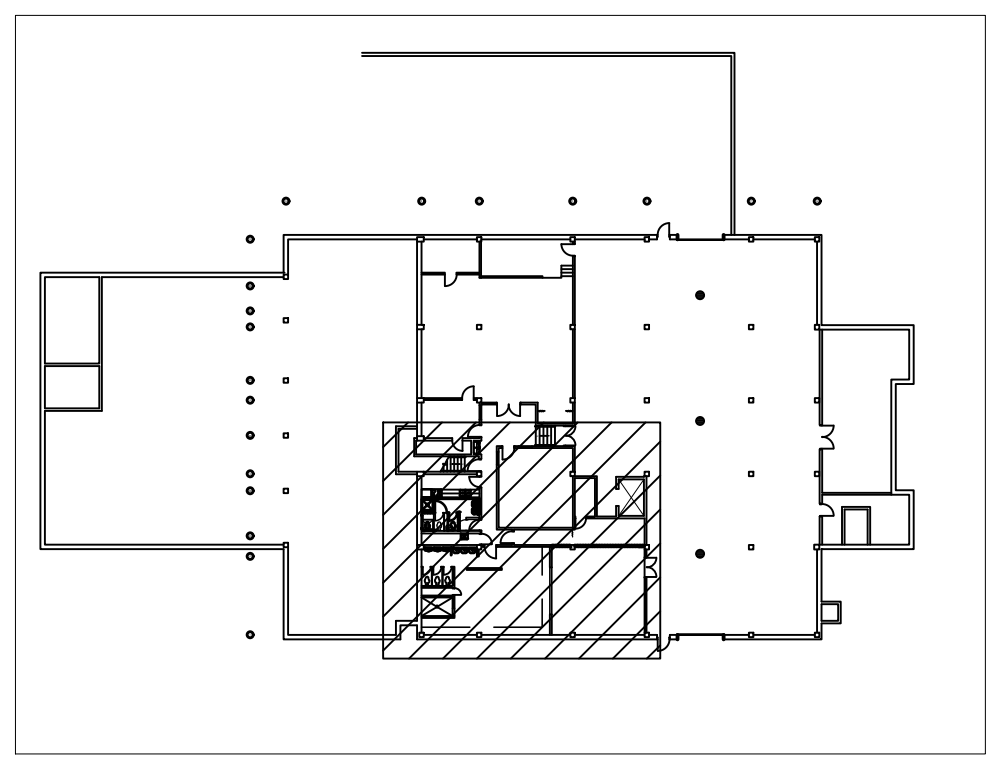

KEY PLAN
NO SCALE
SCALE: 1/4" = 1'-0"

KLINGNER & ASSOCIATES, P.C.
Engineers • Architects • Surveyors
PH 217.223.3670 • Fax 217.223.3603
PH 571.221.0020 • Fax 571.221.0012
PH 319.752.3603 • Fax 319.752.3605
PH 309.542.4642 • Fax 309.541.3761
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REVISION HISTORY		
NO.	REVISION DESCRIPTION	DATE
XXXX		XXXXXX

PSB INTERIOR RENOVATIONS - PHASE IIIB
CITY OF GALESBURG
150 SOUTH BROAD ST.
GALESBURG, ILLINOIS 61401



Non-Reduced Sheet Size: 24" x 36"
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FIELD		FIELD BOOK	
CHECKED		CHECK DATE	


SHEET TITLE
BASEMENT - ELECTRICAL PLANS
PROJECT NO.
3215-073 (15-3027)
DRAWING ISSUED DATE:
12/14/16
SHEET
E101

NOTES

- 1 PROVIDE CRENSHAW MODEL 4857-WBC POLICE WALL SCONCE AND POWER FROM EXISTING RECEPTION LIGHT CIRCUIT.

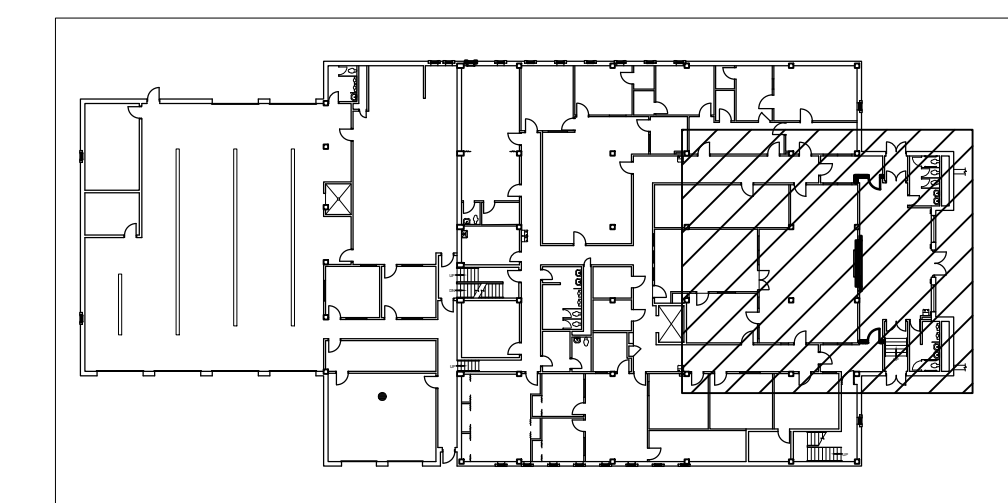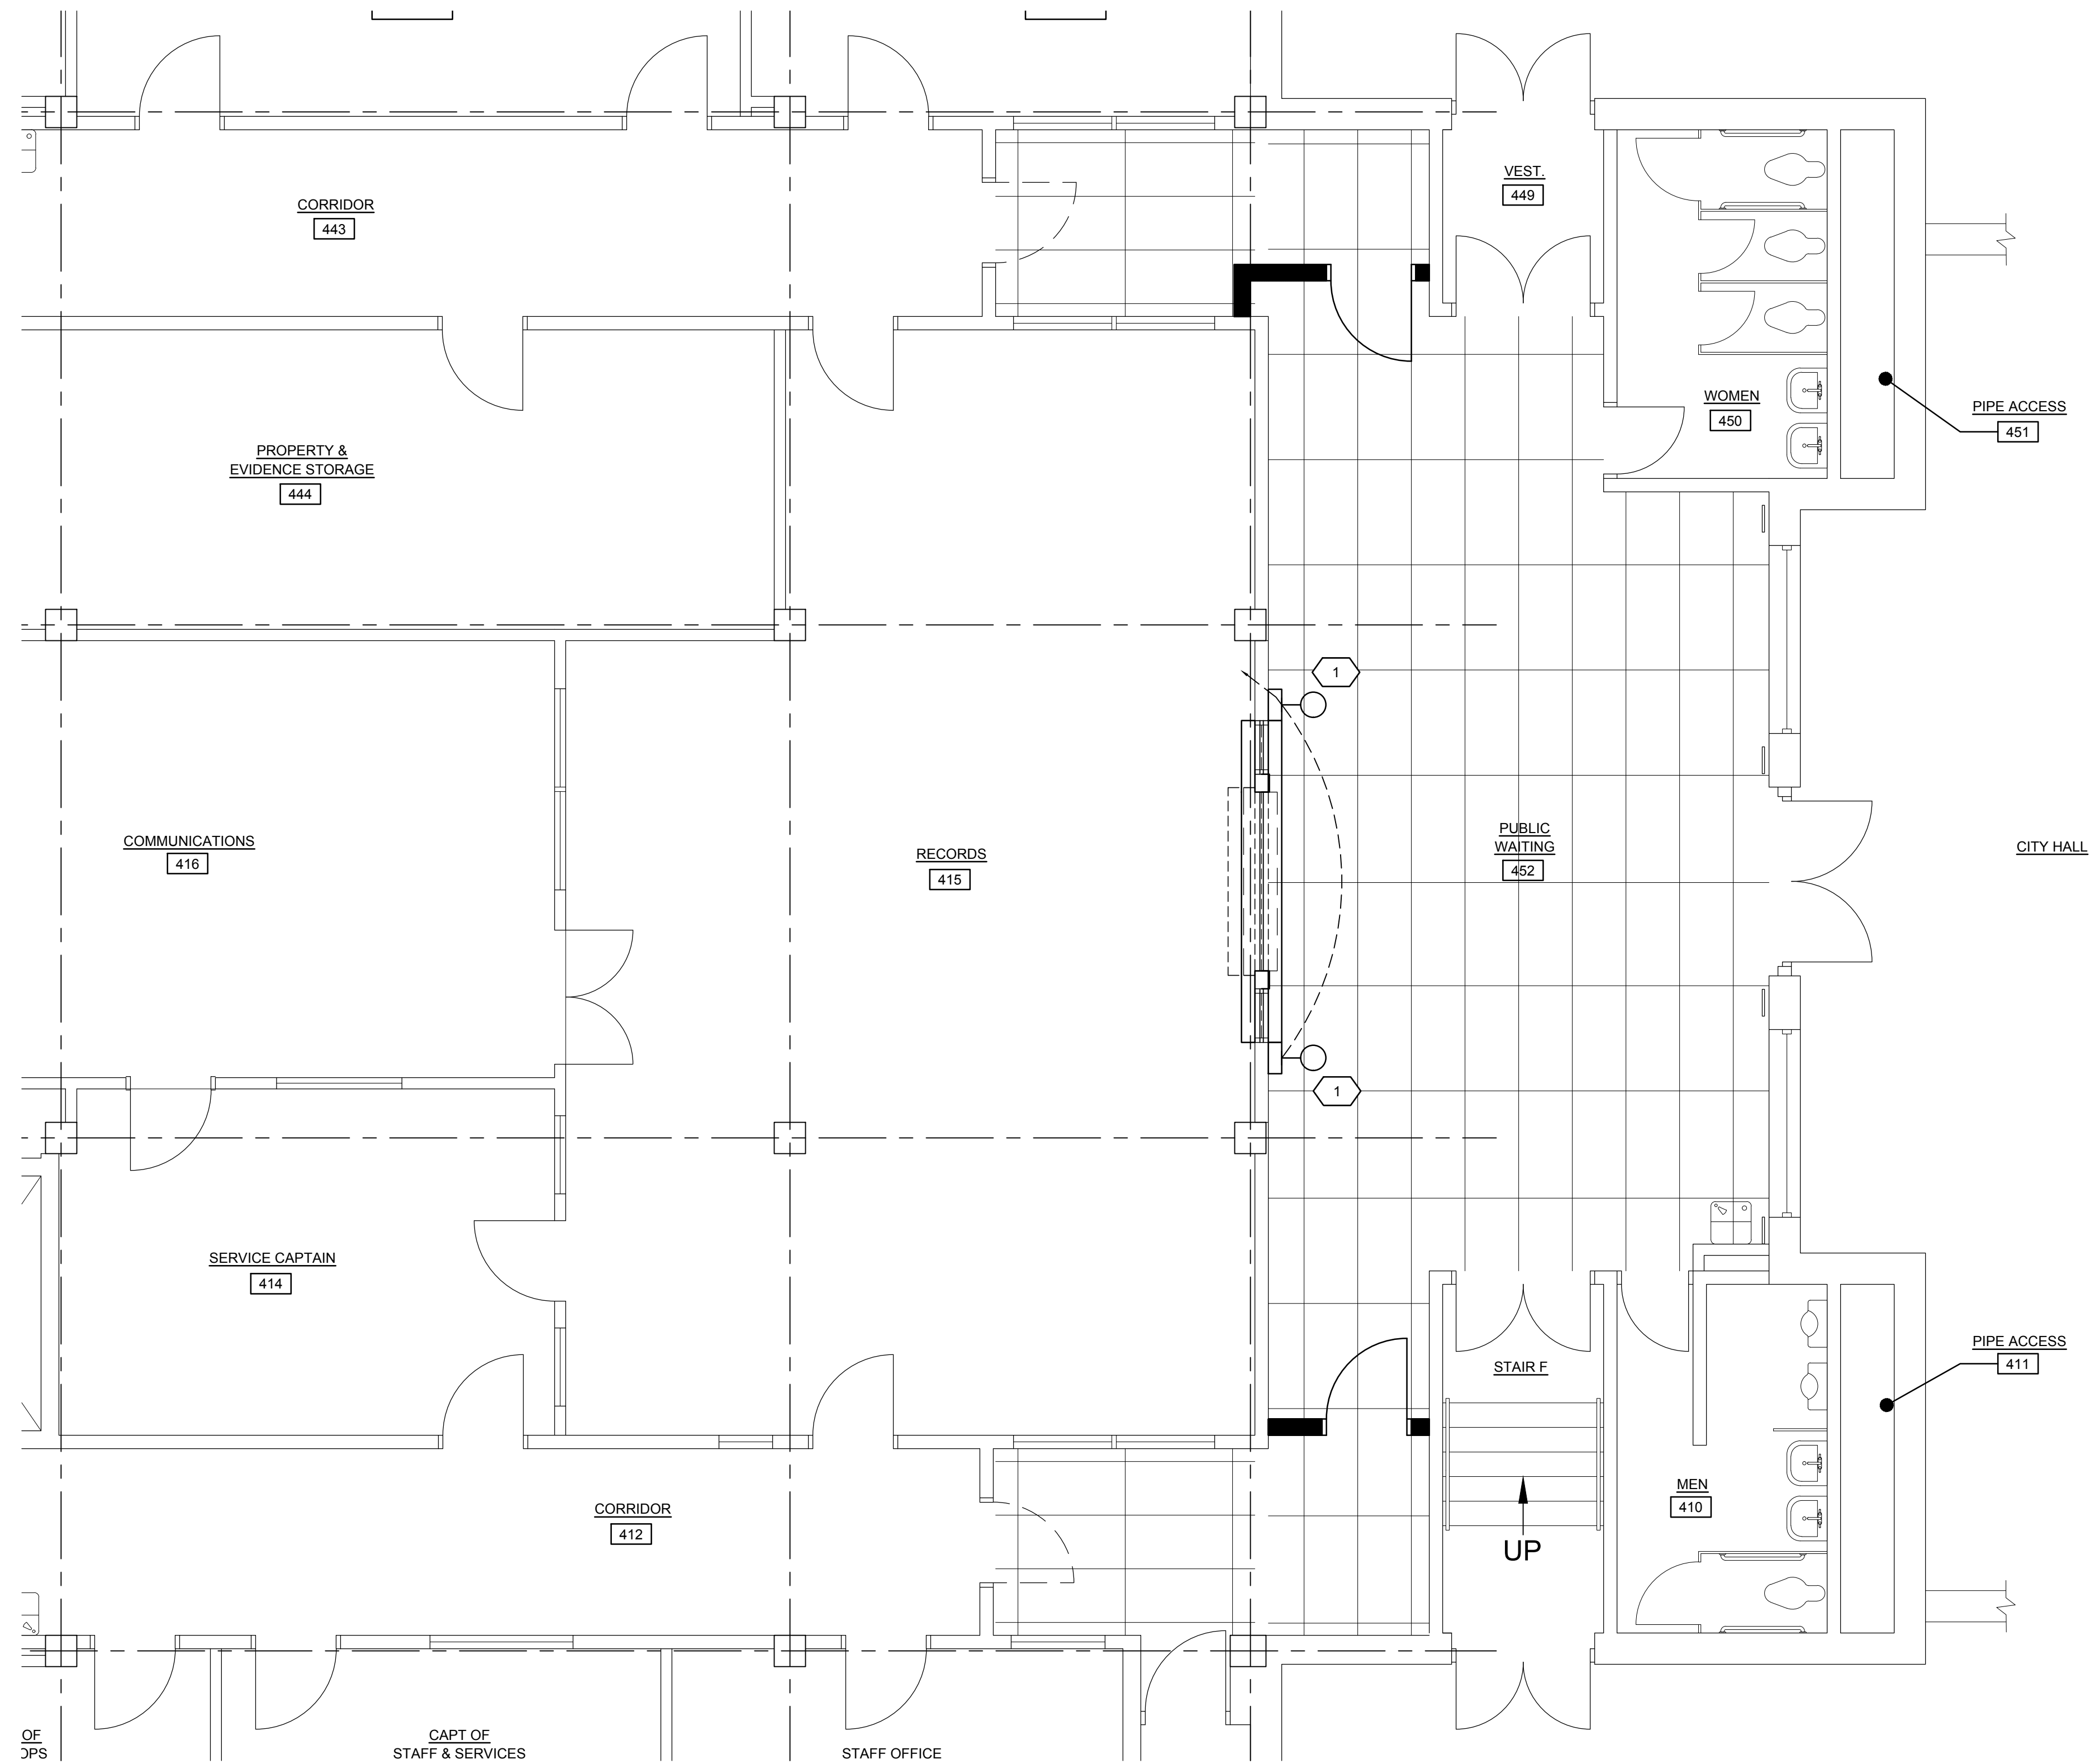

KEY PLAN
NO SCALE

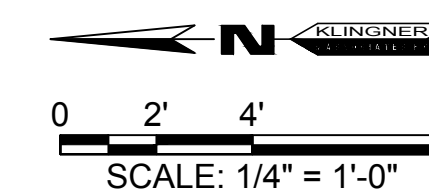

2 LEVEL 4 ELECTRICAL PLAN
E102
0 2' 4' 8'
SCALE: 1/4" = 1'-0"

KLINGNER & ASSOCIATES, P.C.
Engineers • Architects • Surveyors
 616 North 24th Street, Quincy, IL
 Ph: 217.221.3670 - Fax: 217.221.3603
 4510 Park Grove Road, Hannibal, MO
 Ph: 573.221.0020 - Fax: 573.221.0012
 610 N. 4th Street, Suite 100, Burlington, IA
 Ph: 319.752.3603 - Fax: 319.752.3605
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1	XXXX	XXXXXX	XXX

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CITY OF GALESBURG
150 SOUTH BROAD ST.
GALESBURG, ILLINOIS 61401


Non-Reduced Sheet Size: 24" x 36"
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SCALE:	
DESIGNED ALD	DRAWN ALD
FIELD	FIELD BOOK
CHECKED	CHECK DATE

SHEET TITLE
LEVEL 4 - ELECTRICAL PLAN

PROJECT NO.
3215-073 (15-3027)
 DRAWING ISSUED DATE:
12/14/16
 SHEET

E102

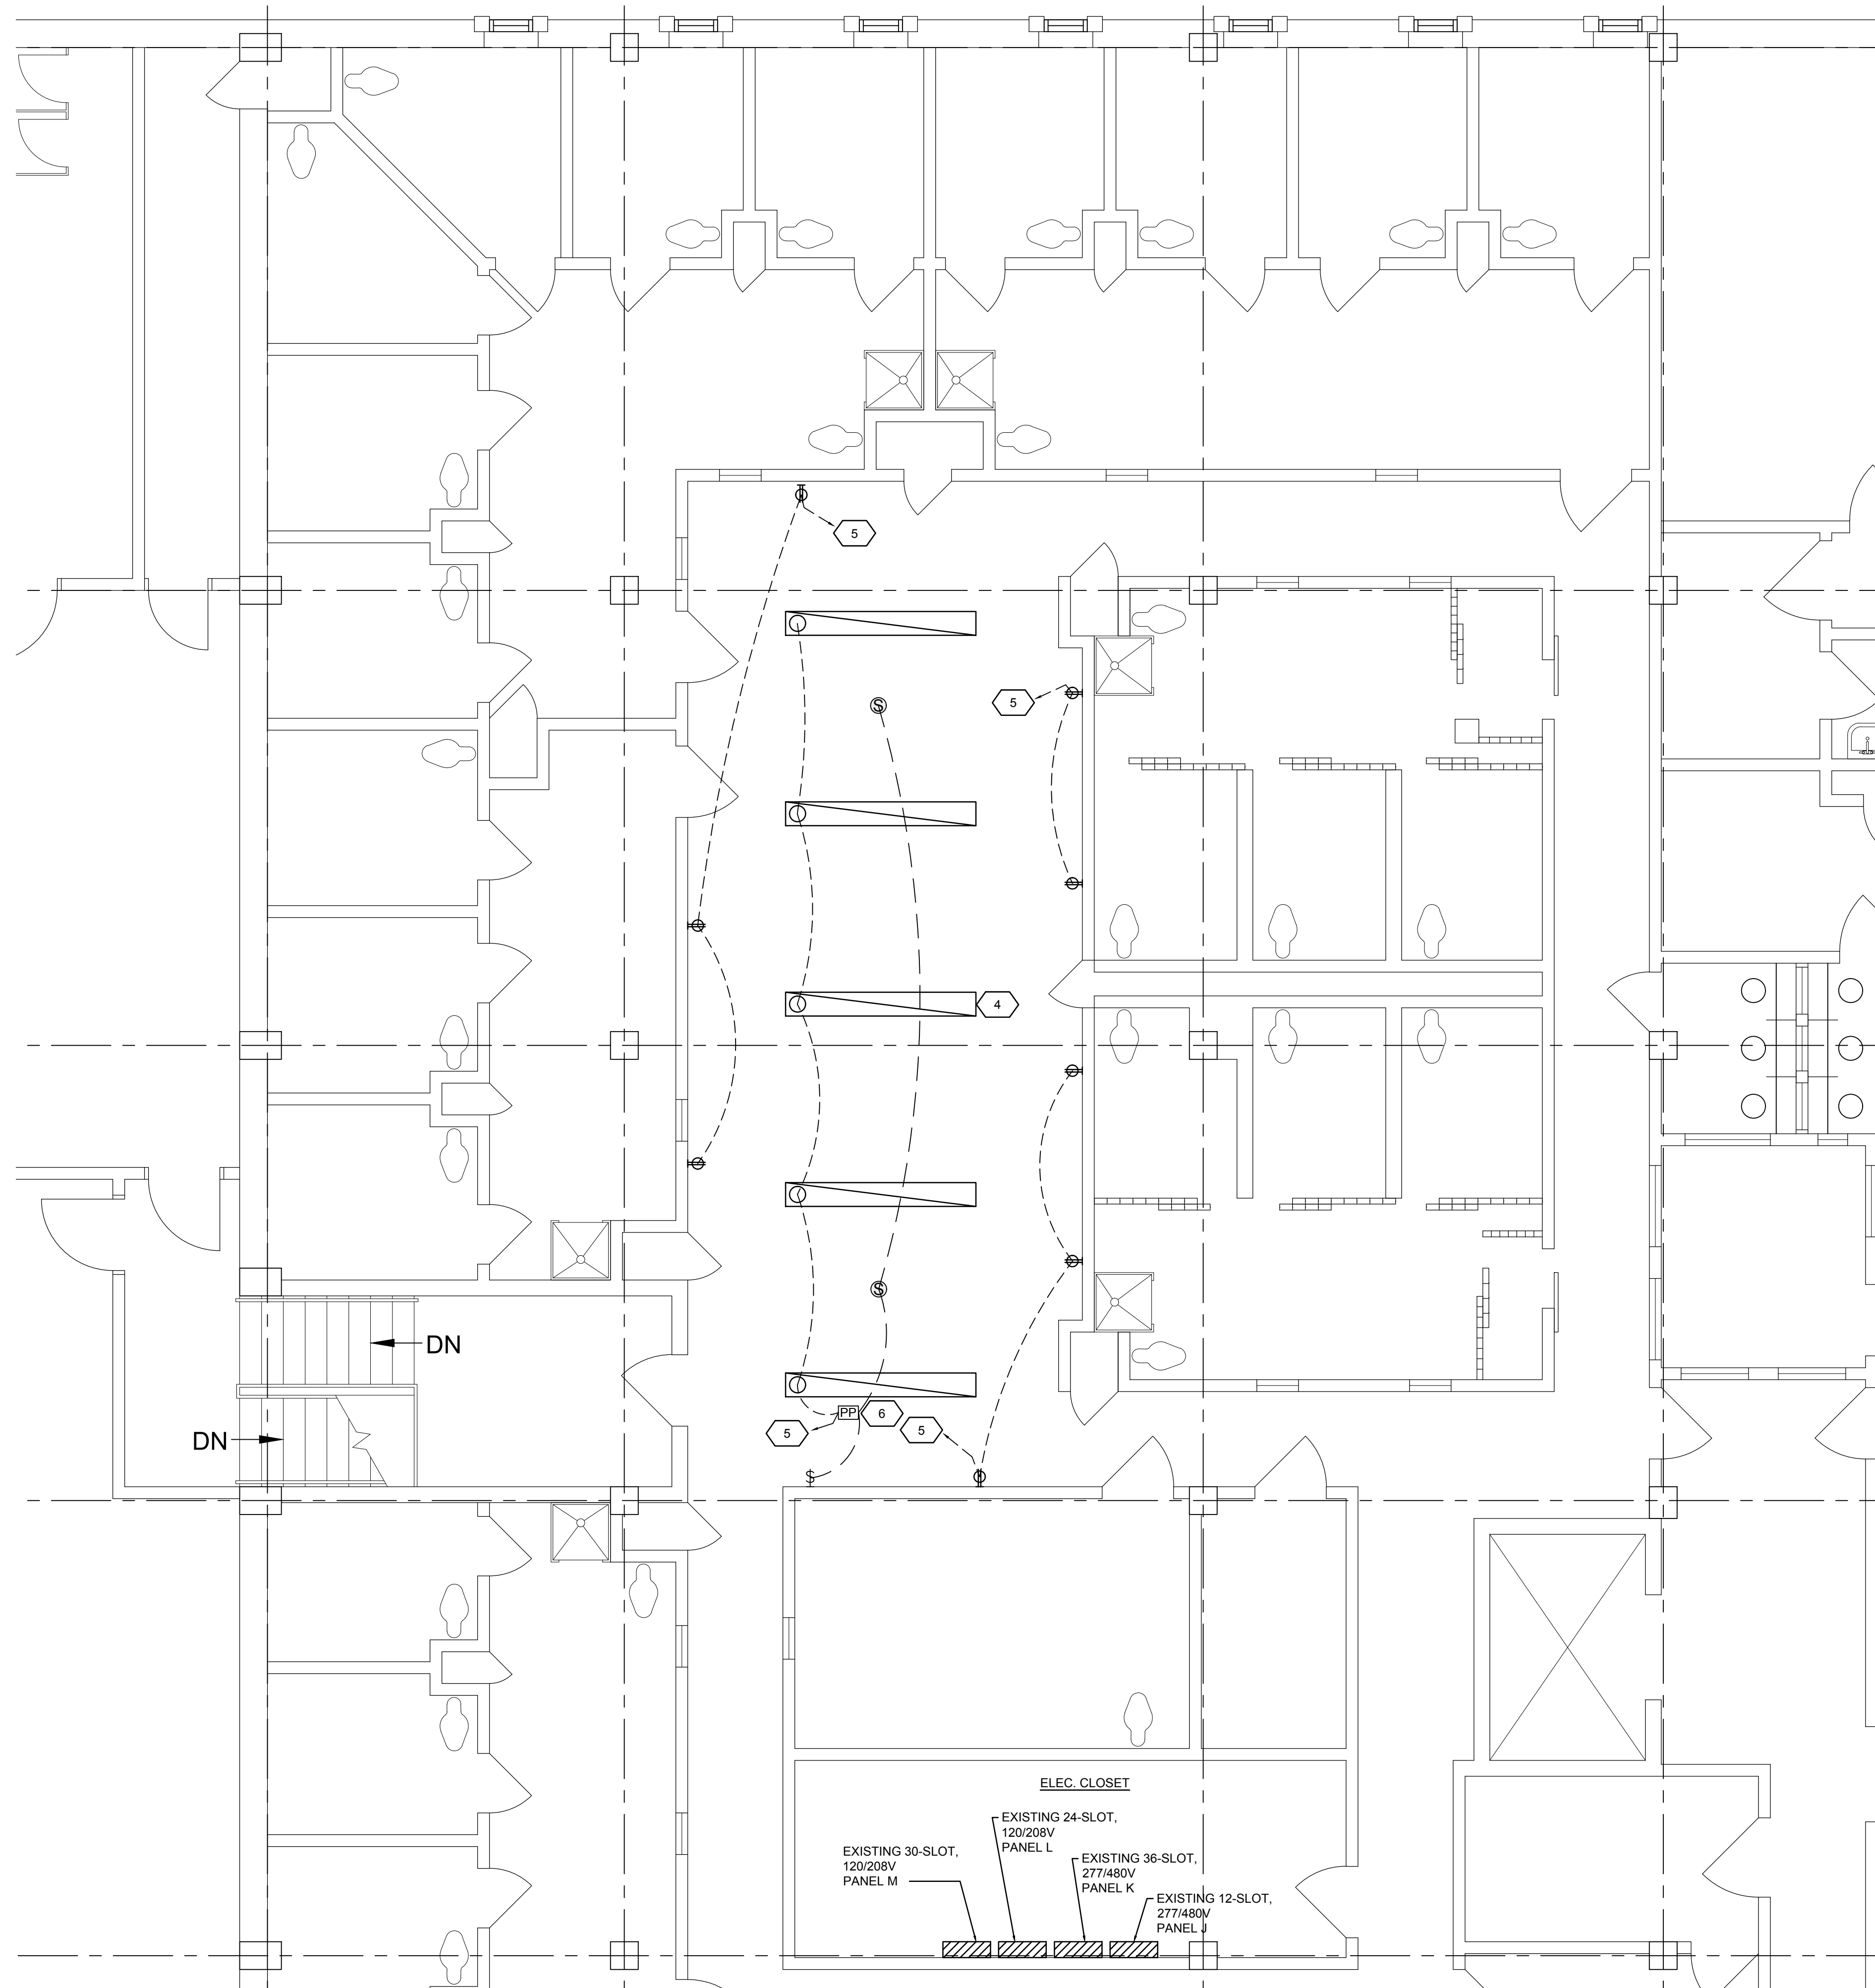


1 BASEMENT ELECTRICAL PLAN
 E101
 0 2' 4' 8'
 SCALE: 1/4" = 1'-0"

NOTES


- 1 PROVIDE SURFACE MOUNTED JUNCTION BOX AND CONDUIT AND MAKE FINAL CONNECTION TO LOCKERS. PAINT BOX AND CONDUIT TO MATCH WALL FINISH.
- 2 PROVIDE RECESSED JUNCTION BOX AND MAKE FINAL CONNECTION TO LOCKERS. PAINT BOX COVER PLATE TO MATCH WALL FINISH.
- 3 PROVIDE CEILING MOUNTED POWER POLE FROM CEILING TO TOP OF LOCKERS AND MAKE FINAL CONNECTION TO LOCKERS. PAINT POLE TO MATCH WALL FINISH.
- 4 PROVIDE LITHONIA SUSPENDED LINEAR LIGHT FIXTURE MODEL GRD-8FT-MSL8-80CRI-40K-ID1000-20/80SCT-24A-C210 OR ENGINEER APPROVED EQUAL (TYPICAL).
- 5 REUSE EXISTING CIRCUIT IN THIS AREA FED FROM PANEL ON THIS FLOOR.
- 6 PROVIDE POWER PACK AND COMPATIBLE OCCUPANCY SENSORS AND LOW VOLTAGE WALL SWITCH.

ELECTRICAL NOTES:

1. APPLICABLE STANDARDS: NFPA-70, NFPA-101, STATE BUILDING CODES, AND THE OCCUPATIONAL SAFETY AND HEALTH ACT (OSHA) OF 1971 AND ALL AMENDMENTS THERETO; EQUIPMENT, DEVICES, APPARATUS, SYSTEMS, AND INSTALLATIONS SHALL BE ENTIRELY SUITABLE AND SAFE FOR EACH INTENDED APPLICATION AND BE IN FULL COMPLIANCE WITH APPLICABLE STANDARDS, REQUIREMENTS, RULES, REGULATIONS, CODES, STATUTES, ORDINANCES, ETC., OF MUNICIPAL, COUNTY, AND STATE GOVERNMENTS, OWNER'S INSURANCE COMPANY, LOCAL UTILITIES, AND LABOR REGULATIONS. NOTHING CONTAINED IN THESE PLANS AND SPECIFICATIONS SHALL BE CONSTRUED TO CONFLICT WITH THESE LAWS, CODES, AND ORDINANCES.
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8. LIGHTING: FURNISH AND INSTALL ALL LIGHTING FIXTURES COMPLETE WITH LAMPS IN ACCORDANCE WITH THE LIGHTING FIXTURE SCHEDULE SHOWN ON THE DRAWINGS. ALL UNITS SHALL BE COMPLETE WITH SUSPENSION ACCESSORIES, CANOPIES, SOCKETS, LOUVERS, FRAMES, AND ROUGH-IN BOXES, WIRED AND ASSEMBLES TO FURNISH A COMPLETE WORKABLE SYSTEM.
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KEY PLAN
 NO SCALE

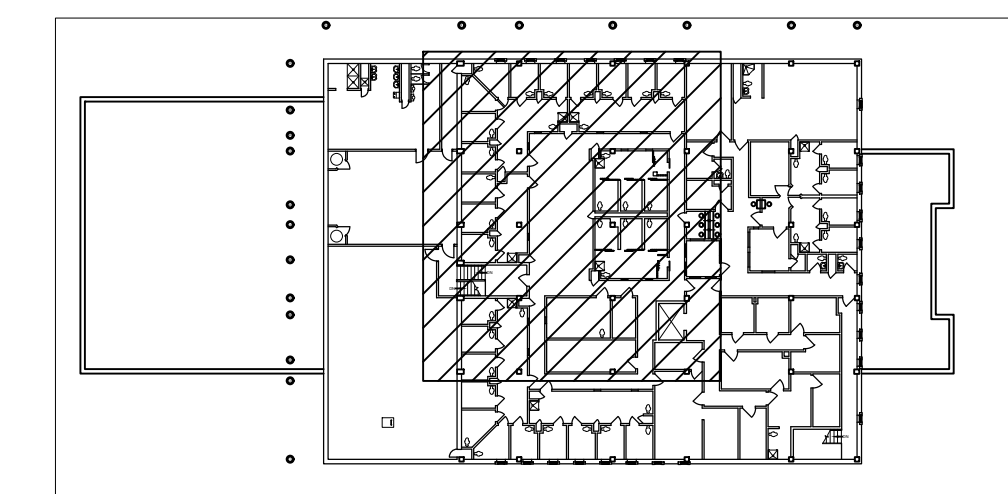

KLINGNER & ASSOCIATES, P.C.
 Engineers • Architects • Surveyors
 1616 North 24th Street, Quincy, IL Ph: 217.221.3670 Fax: 217.221.3613
 4510 Park Grove Road, Hannibal, MO Ph: 573.221.0020 Fax: 573.221.0012
 1010 N. 4th Street, Suite 100, Burlington, IA Ph: 319.752.3693 Fax: 319.752.3685
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PSB INTERIOR RENOVATIONS - PHASE IIIB
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CHECKED		CHECK DATE	

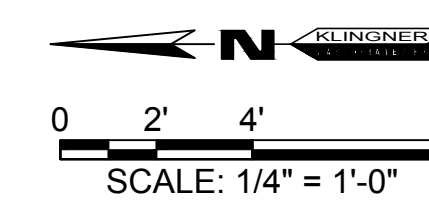SHEET TITLE
LEVEL 6 - ELECTRICAL PLAN

PROJECT NO.
 3215-073 (15-3027)
 DRAWING ISSUED DATE:
 12/14/16
 SHEET
E103