## AREA MAP STATESBORO, GA.

# PROJECT TYPE FOR

# BULLOCH COUNTY EMS

W GRADEY STREET, STATESBORO, GA

#### - PROJECT SITE



PARTIAL MAP STATESBORO, GA

#### INDEX OF DRAWINGS

CIVIL

ACI.O EXISTING & PROPOSED SITE PLAN

STRUCTURAL

SI.O FOUNDATION PLAN

ARCHITECTURAL

DI.O EXISTING FLOOR PLAN A I .O NEW TOTAL FLOOR PLAN

A2.0 ADDITION DIMENSIONED A3.0 REFLECTEDCEILING PLAN

UI.O UTILITIES & ELEVATION

## GENERAL NOTES

THE FOLLOWING NOTES SUPPLEMENT AND ADD TO THE DRAWINGS AND SPECIFICATION. IF THERE IS ANY CONFLICT, AMBIGUITY, ETC., CREATED BY ANY NOTE, THE CONTRACTOR SHALL COMPLY WITH THE MORE STRINGENT REQUIREMENT.

- I. TIE ALL NEW CONTOURS AND GRADES INTO EXISTING WITH SMOOTH, UNIFORM AND EVEN SLOPES TO ENSURE THAT WATER DRAINS AWAY FROM AND AROUND BUILDINGS.
- 2. CONTRACTOR SHALL PREPARE MASONRY WALLS TO MEET ALL REQUIREMENTS OF IBC/IRC.
- 3. JOINT REINFORCING MAY BE OMITTED IN DETAILING FOR CLARITY 3.1. INSTALL MASONRY JOINTS AT DESIGNATED INTERVALS WHETHER SHOWN OR NOT 4. OVERLAP ALL FLASHING JOINTS 4" MINIMUM AND SEAL WATERTIGHT
- 5. THE GENERAL CONTRACTOR, SUB-CONTRACTORS AND ALL EMPLOYEES ON THIS PROJECT ARE NOT ALLOWED TO SCALE DRAWINGS TO DETERMINE DISTANCES IF NOT DIMENSIONED. 5.1. IF CLARIFICATION IS REQUIRED CONTACT ARCHITECT FOR WRITTEN CONFIRMATION OF
- DIMENSIONS. 5.2. ALL DIMENSIONS ARE GIVEN TO FACE OF CMU, BRICK OR STUD UNLESS NOTED
- OTHERWISE. 6. CONTRACTOR SHALL VERIFY ALL DIMENSION, GRADE PITCHES AND OTHER CONDITIONS BY TAKING MEASUREMENTS PRIOR TO ORDERING MATERIALS OR DOING WORK.
- 6.1. REFER DISCREPANCIES TO ARCHITECT FOR ADDITIONAL INSTRUCTIONS. CONTRACTOR IS RESPONSIBLE FOR MEASUREMENTS
- 6.3. NO CONSIDERATION WILL BE GIVEN TO ANY CLAIM BASED ON DIFFERENCES BETWEEN DRAWINGS OR SPECIFICATIONS AND ACTUAL MEASUREMENTS.
- 7. COORDINATING ROUTING OF CONTRACTORS WORK WITH OTHER TRADES IS ESSENTIAL AND ANY EXPENSE REQUIRED FOR REMOVAL AND RELOCATION SHALL BE BORNE BY CONTRACTOR 8. WHERE A DETAIL OR SECTION IS SHOWN FOR ONE CONDITION IT APPLIES TO ALL LIKE OR
- SIMILAR CONDITIONS. 9. ALL WORK SHALL BE INSTALLED TRUE, PLUMB ,SQUARE, SMOOTH AND IN A QUALITY WORKMANSHIP LIKE MANNER

### OVERALL DESIGN INFORMATION

FLOOR LIVE LOAD

WIND PRESSURE VELOCITY - I I OMPH

IMPORTANCE FACTOR - 1.0 INTERNAL PRESSURE COEFICIENT +/- 0.18

#### COMPONENT AND CLADDING PRESSURE

3.1. ROOF - +20/-50 PSF 3.2. ROOF W/N 8' EDGE/RIDGE - +20/-85PSF

3.3. ROOF W/N 8' CORNERS - +20/-125PSF 3.4. WALLS - +45/-48PSF 3.5. WALLS W/N 8' CORNERS - +45/-60PSF

4. STRUCTURAL COMPONENTS AND SYSTEMS SHALL BE DESIGNED FOR THE FOLLOWING DEFLECTIONS

4.1. WINDOWS AND WINDOW SUPPORTS L/360 4.2. WALLS L/480 4.3. FLOORS L/360L/240

#### SEISMIC LOADING INFORMATION

4.4. ROOFS

5.1. SITE CLASS - D 5.2. DESIGN SPECTRAL RESPONSE ACCELERATION 5.2.1. SDS (0.2 SEC) 0.236

5.2.2. SDI (O. I SEC) 0.154 5.3. SEISMIC DESIGN CATEGORY C

IMPORTANCE FACTOR (I) 1.25 RESPONSE MODIFICATION FACTOR (R) 5.3.3. DEFLECTION AMPLIFICATION FACTOR (CD)

L/240L/180

5.3.4. SEISMIC BASE SHEAR 0.091\*W

#### PROJECT SCOPE:

NEW ADDITION CONSTRUCTION COMMERCIAL

APPLICABLE CODES

IBC/IRC 2018 EDITION (INCLUDING GA AMENDMENTS)

PLUMBING CODE IPC 2018

IMC 2018 MECHANICAL NEC 2018 ELECTRICAL

IFC 2018 (INCLUDING GA AMENDMENTS) NFPA 101 2018(INCLUDING GA AMENDMENTS)

ADA 2010 EDITION (ANSI-117.1)

TYPES OF CONSTRUCTION - (TABLE 601)

NON-COMBUSTIBLE PRE-ENGINEERED METAL BUILDING. INTERIOR NON-LOAD BEARING WOOD PARTITIONS.

EMS STATION TRANSIENT OCCUPANCY

## TYPICAL ABBREVIATIONS

\_\_\_ ANGLE \_\_\_ ANCHOR BOLT

A.F.F. ABOVE FINISH FLOOR ALT. ALTERNATE ALUM. ALUMINUM

\_ ANODIZED ACOUSTICAL TILE **ASH URN** 

BABY CHANGING STATION **BOARD** 

BLOCK **BULL NOSE** 

BM. \_\_\_\_ BEAM \_\_\_ CHANNEL \_ CENTERLINE

CAB. \_\_\_ CABINET \_\_\_ CHALKBOARD

CLG. \_\_\_ CEILING \_\_\_\_ CONCRETE MASONRY UNIT \_\_\_ COLUMN

CONC. CONCRETE CONT. CONTINUOUS C.R. \_\_\_ CLASSROOM

C.T. \_\_\_ CERAMIC TILE CTR. \_\_\_\_ CENTER \_\_\_ DIAMETER D.B.N.\_\_ DOUBLE BULL NOSE

DET. \_\_\_\_ DETAIL D.F. \_\_\_\_ DRINKING FOUNTAIN DIM. \_\_\_ DIMENSION

MANUE. MANUFACTURER MAX.\_\_\_ MAXIMUM MBH\_\_\_\_ MOP AND BROOM HOLDER

\_\_\_\_ MEDICINE CABINET MET\_\_\_\_ METAL \_\_ MINIMUM MIRROR

MISC.\_\_\_ MISCELLANEOUS M.O. \_\_\_ MASONRY OPENING N.I.C.\_\_\_ NOT IN CONTRACT NOM.\_\_\_ NOMINAL

\_\_\_\_ON CENTER

N.T.S.\_\_\_ NOT TO SCALE \_\_\_ OVERHEAD OPP. \_\_\_\_ OPPOSITE

O.D. \_\_\_\_ OUTSIDE DIAMETER P.C.B. PAINTED CONCRETE BLOCK

P.E.J.\_\_\_ PREFORMED EXPANSION JOINT P.L. \_\_\_\_ PROPERTY LINE PLYWD. PLYWOOD

PROJ.\_\_\_ PROJECTION PS \_\_\_\_ PURSE SHELF

P.T. \_\_\_\_ PRESSURE TREATED PTD \_\_\_\_ PAPER TOWEL DISPENSER PTDR\_\_\_ PAPER TOWEL DISPENSER

PTR \_\_\_\_ PAPER TOWEL RECEPTACLE Q.T. \_\_\_\_ QUARRY TILE

RAD\_\_\_\_RADIUS R.D. \_\_\_\_ ROOF DRAIN REINE. REINFORCED REQ'D. REQUIRED

DISP.\_\_\_ DISPENSER ELECTRIC HAND DRYER

EXPANSION JOINT EQUAL EXPANSION

FINISH FLOOR **FINISH** 

\_\_\_\_ FLOOR F.R. \_\_\_\_ FIRE RATED FSS \_\_\_\_ FOLDING SHOWER SEAT

\_ FOOT FTD \_\_\_\_ FACIAL TISSUE DISPENSER

GA. \_\_\_ GAUGE GALV.\_\_ GALVANIZED GB \_\_\_\_ GRAB BAR G.C.C.B. GLAZE COATED CONCRETE BLOCK

GYP.\_\_\_ GYPSUM H.C. \_\_\_\_ HANDICAPPED ACCESSIBLE H.M. \_\_\_\_ HOLLOW METAL

HT. \_\_\_ HEIGHT INSUL\_ INSULATION JOINT

LAM.\_\_\_ LAMINATED L.F. \_\_\_\_ LINEAL FOOT ROBE HOOK ROOM RIGHT OF WAY

\_\_\_\_ STORAGE CABINET SCD \_\_\_\_ SEAT COVER DISPENSER \_ SHOWER CURTAIN AND HOOKS SHOWER CURTAIN ROD

\_\_\_\_ SOAP DISPENSER SDSOUARE FOOT SIMILAR

SANITARY NAPKIN DISPENSER SNR \_\_\_\_ SANITARY NAPKIN RECEPTACLE SQ. FT. SQUARE FOOT

\_\_\_\_ ŠŤĂINLĖSS STEEL SOAP TRAY STL. \_\_\_\_ STEEL

STOR. STORAGE SUSP.\_\_\_ SUSPENDED T.B. \_\_\_\_ TACK BOARD TBH \_\_\_\_ TUMBLER/TOOTHBRUSH HOLDER

T.C. \_\_\_\_ TEACHER'S CABINET TEMP.\_\_\_ TEMPERED TH \_\_\_\_ TOWEL HOLDER

TK. \_\_\_\_ THICK \_\_\_ TOWEL PIN TOWEL ROD

TTD \_\_\_\_ TOILET TISSUE DISPENSER TYP.\_\_\_ TYPICAL

U.N. \_\_\_\_ UNLESS NOTED USU \_\_\_\_ UTILITY SHELF UNIT

\_ WITH WIND. WINDOW



COVER

 $\Box$  $\Box$ 



ARC 08/08/2023


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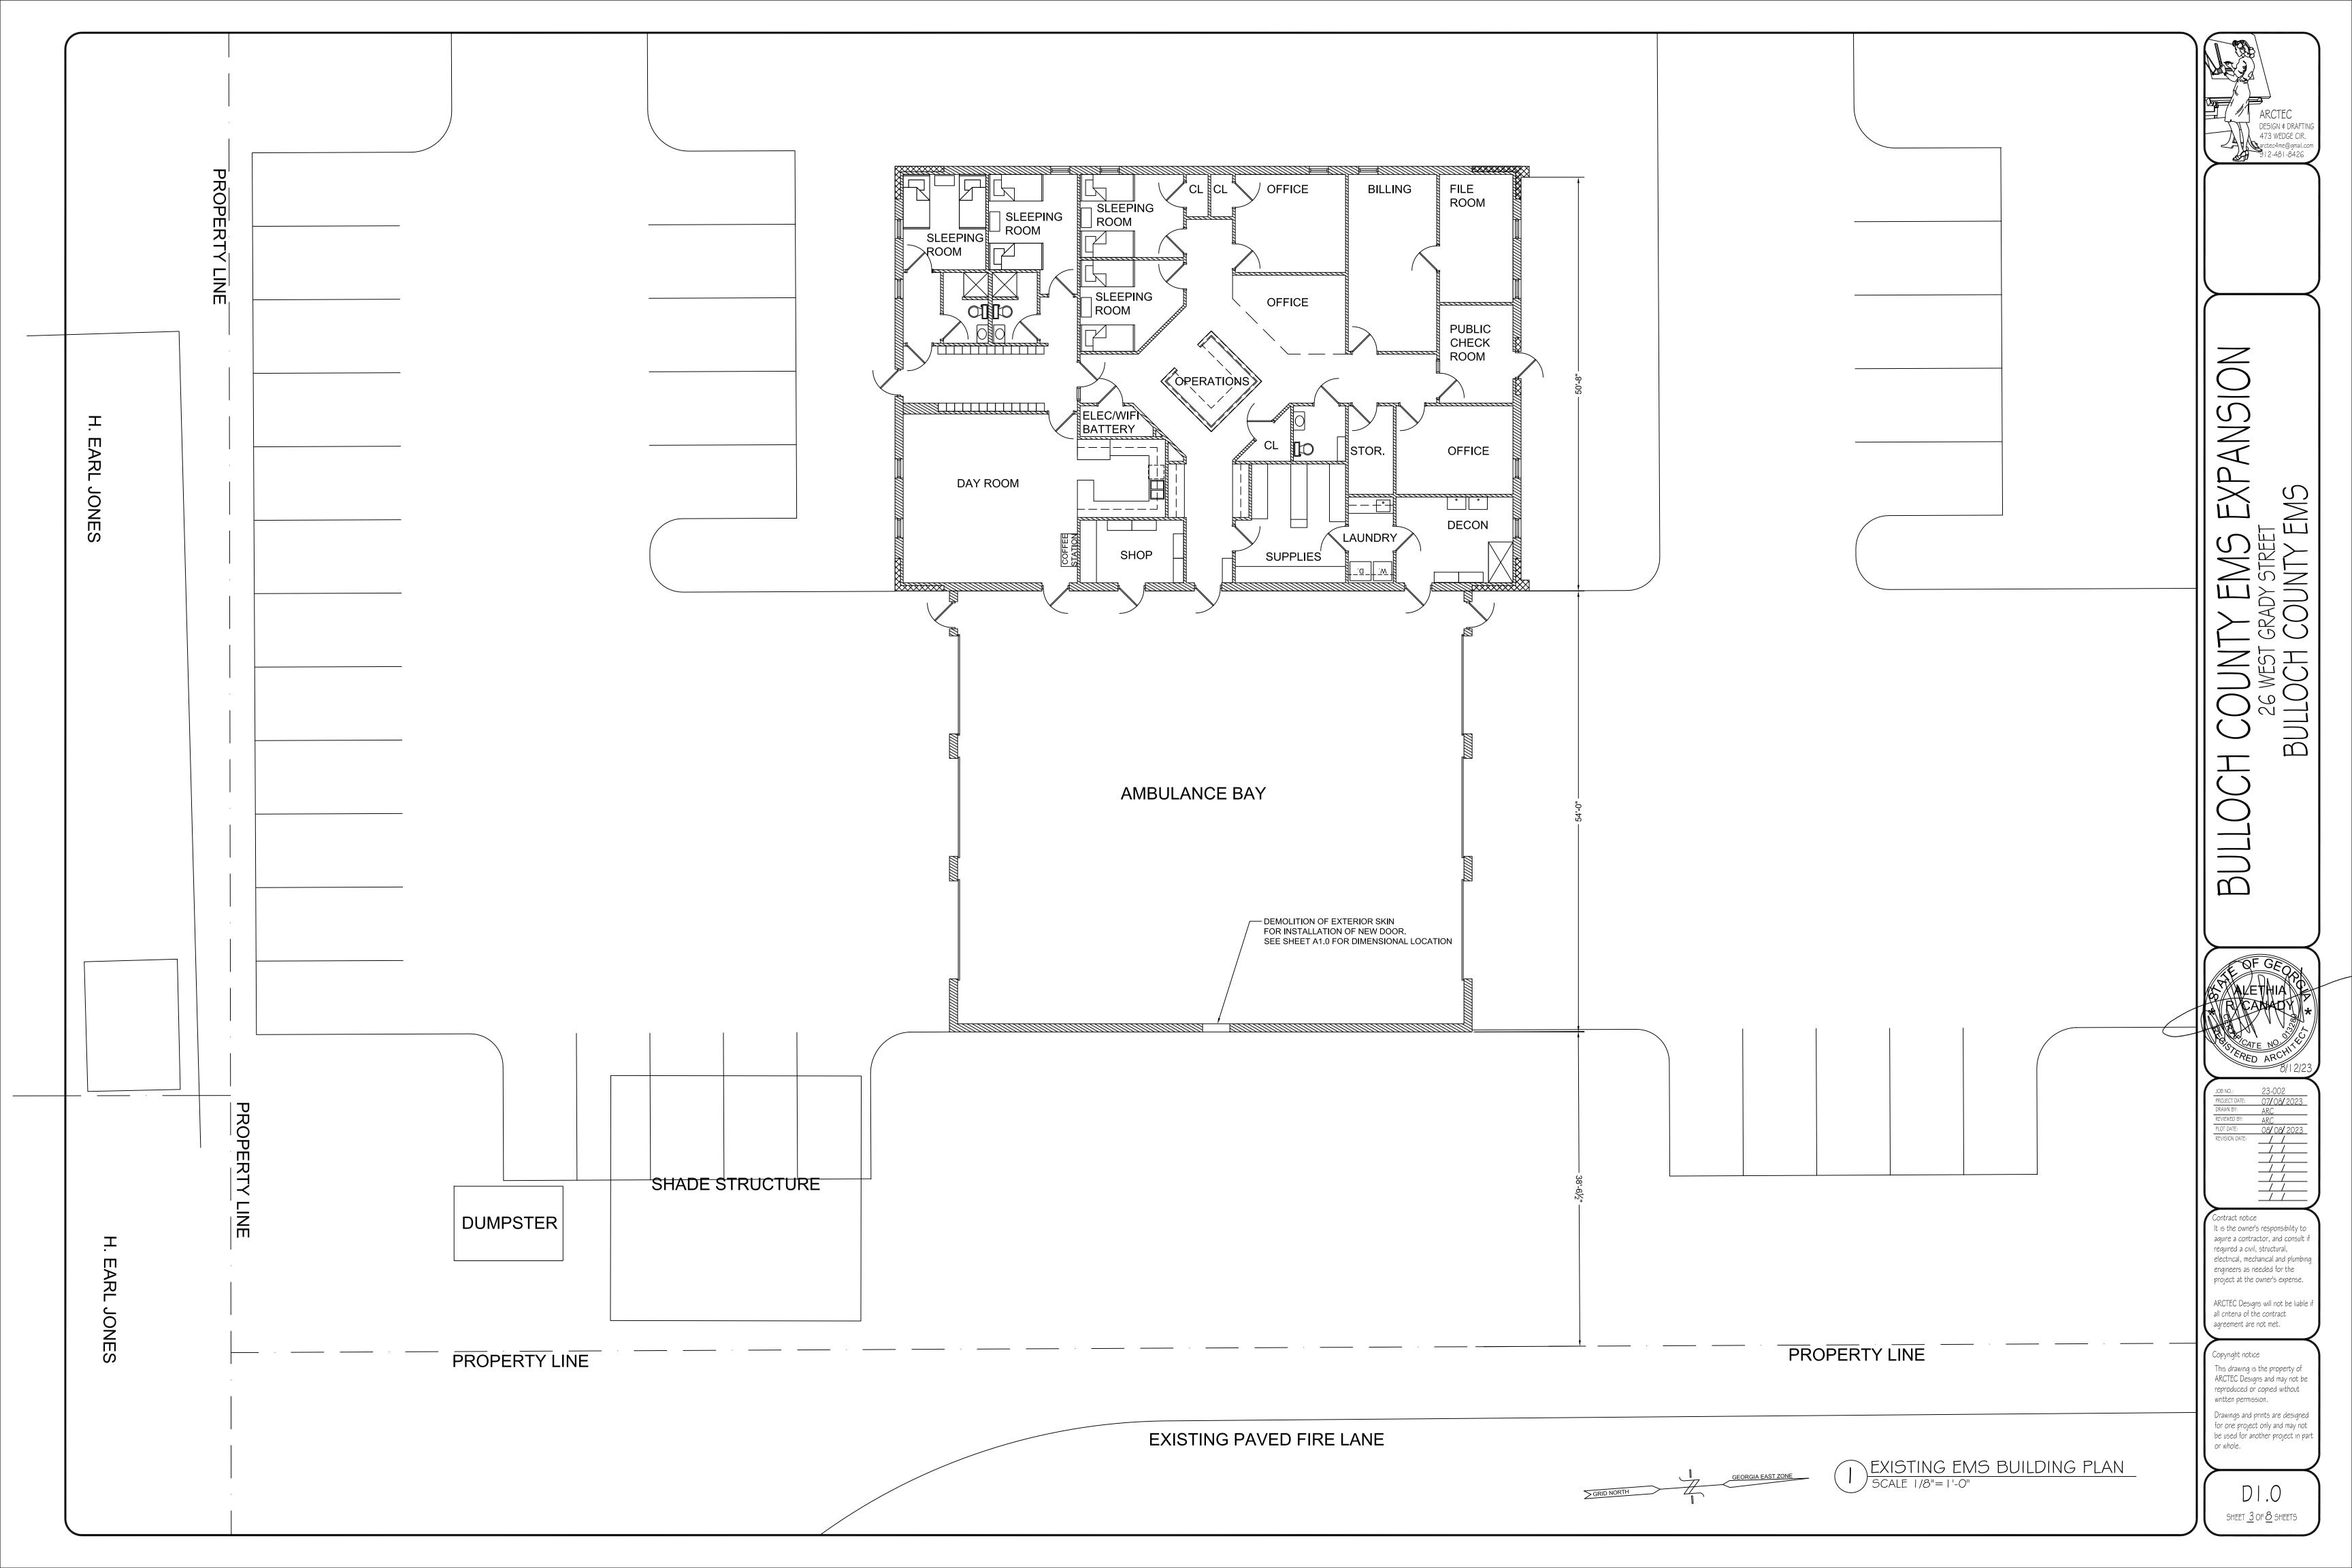
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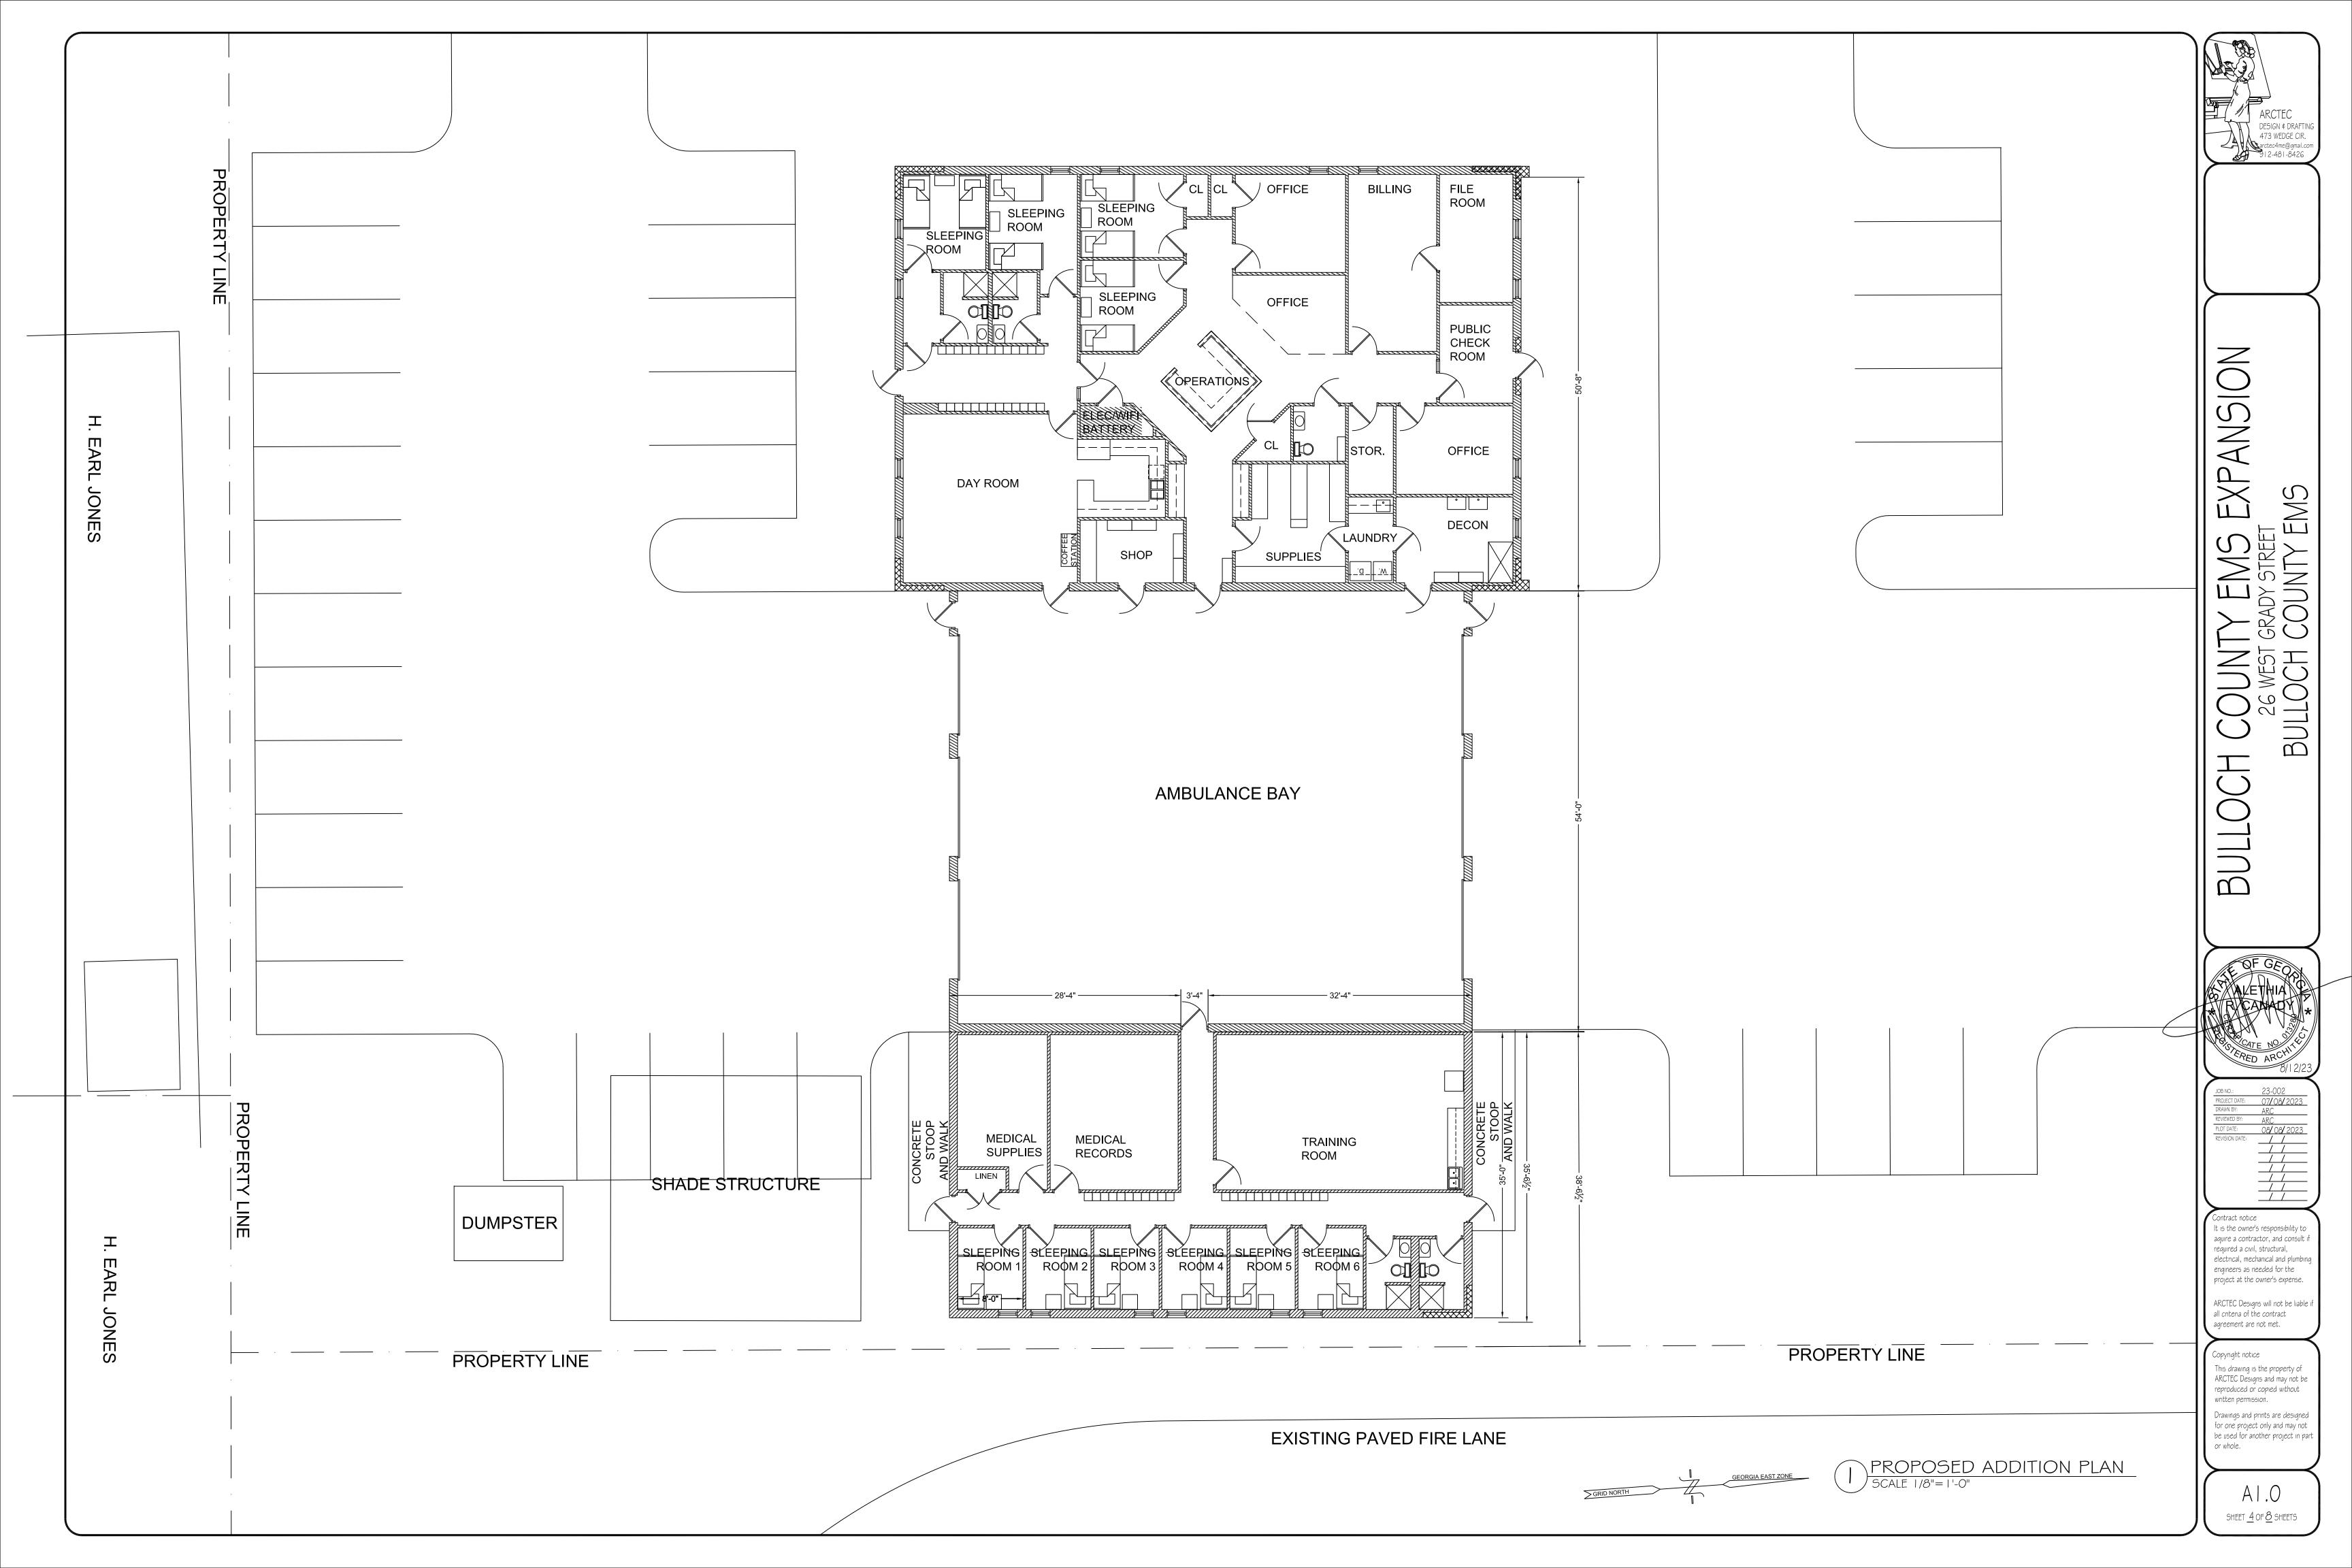
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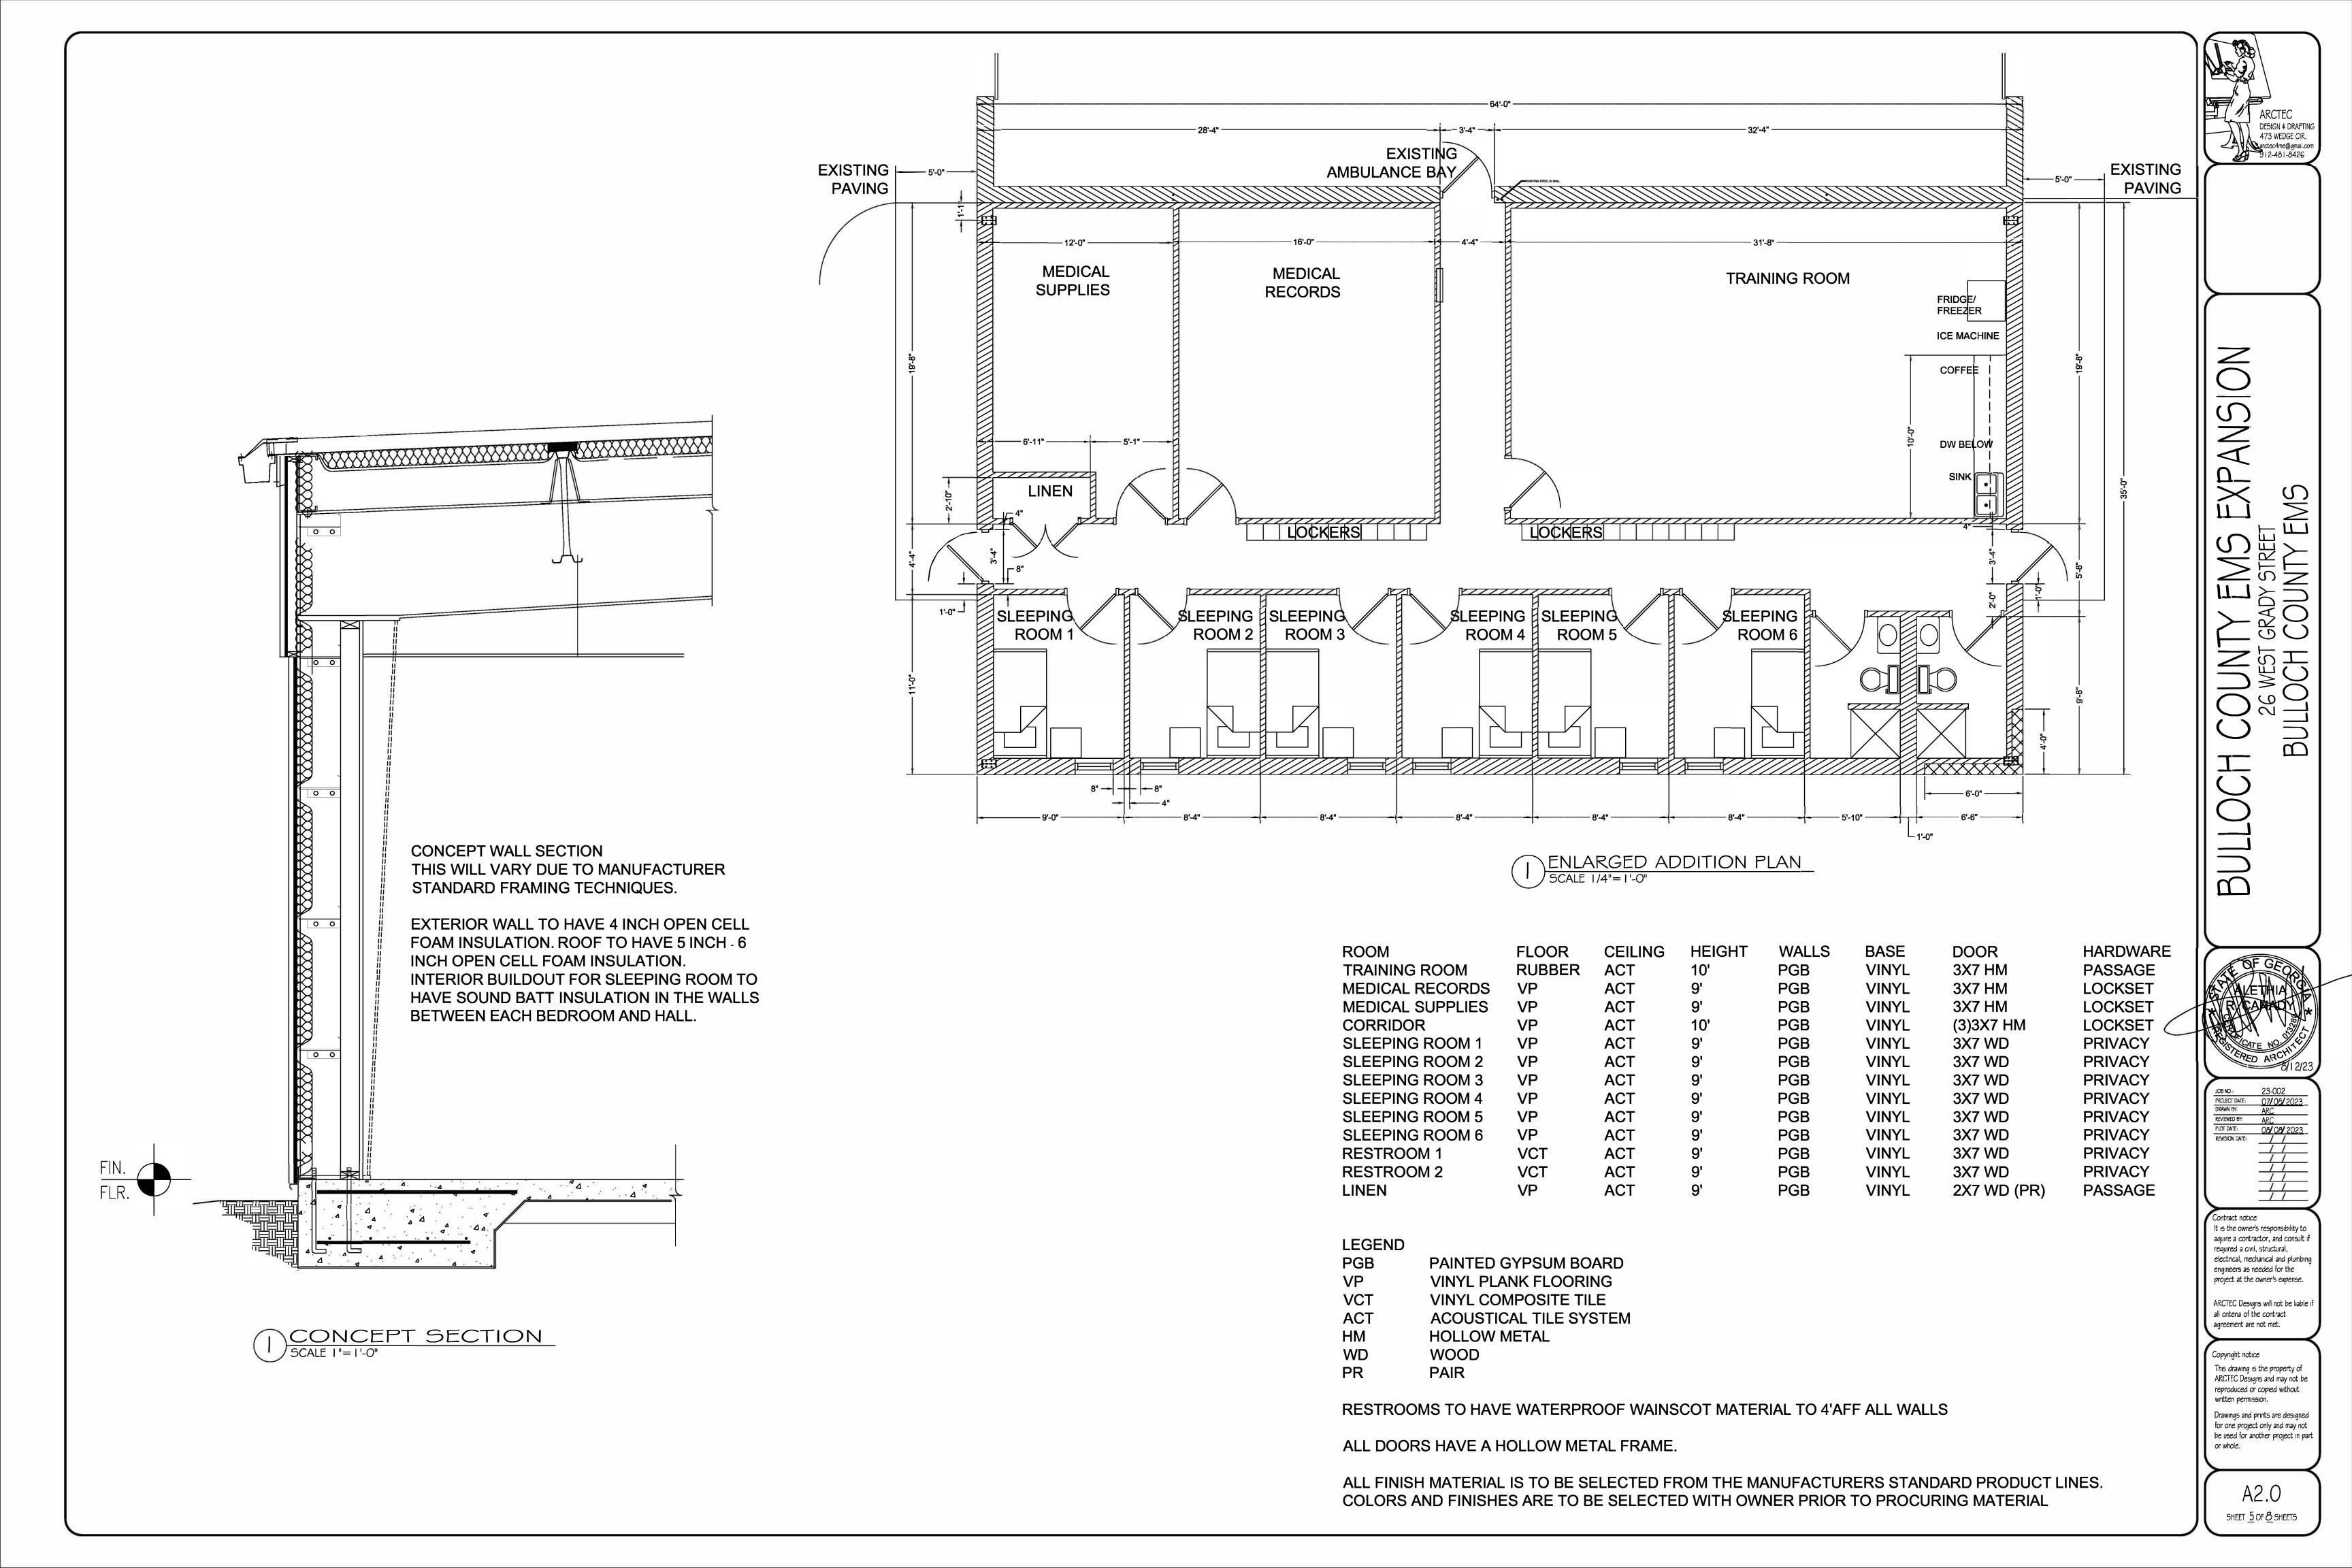
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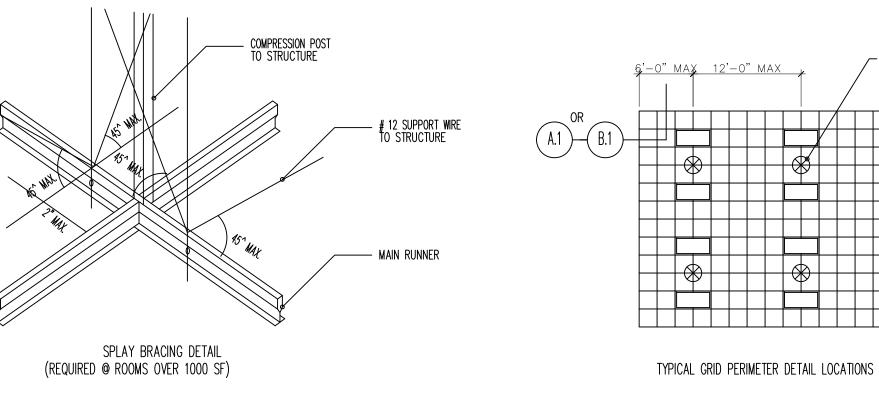
SHEET O OF \_ SHEETS










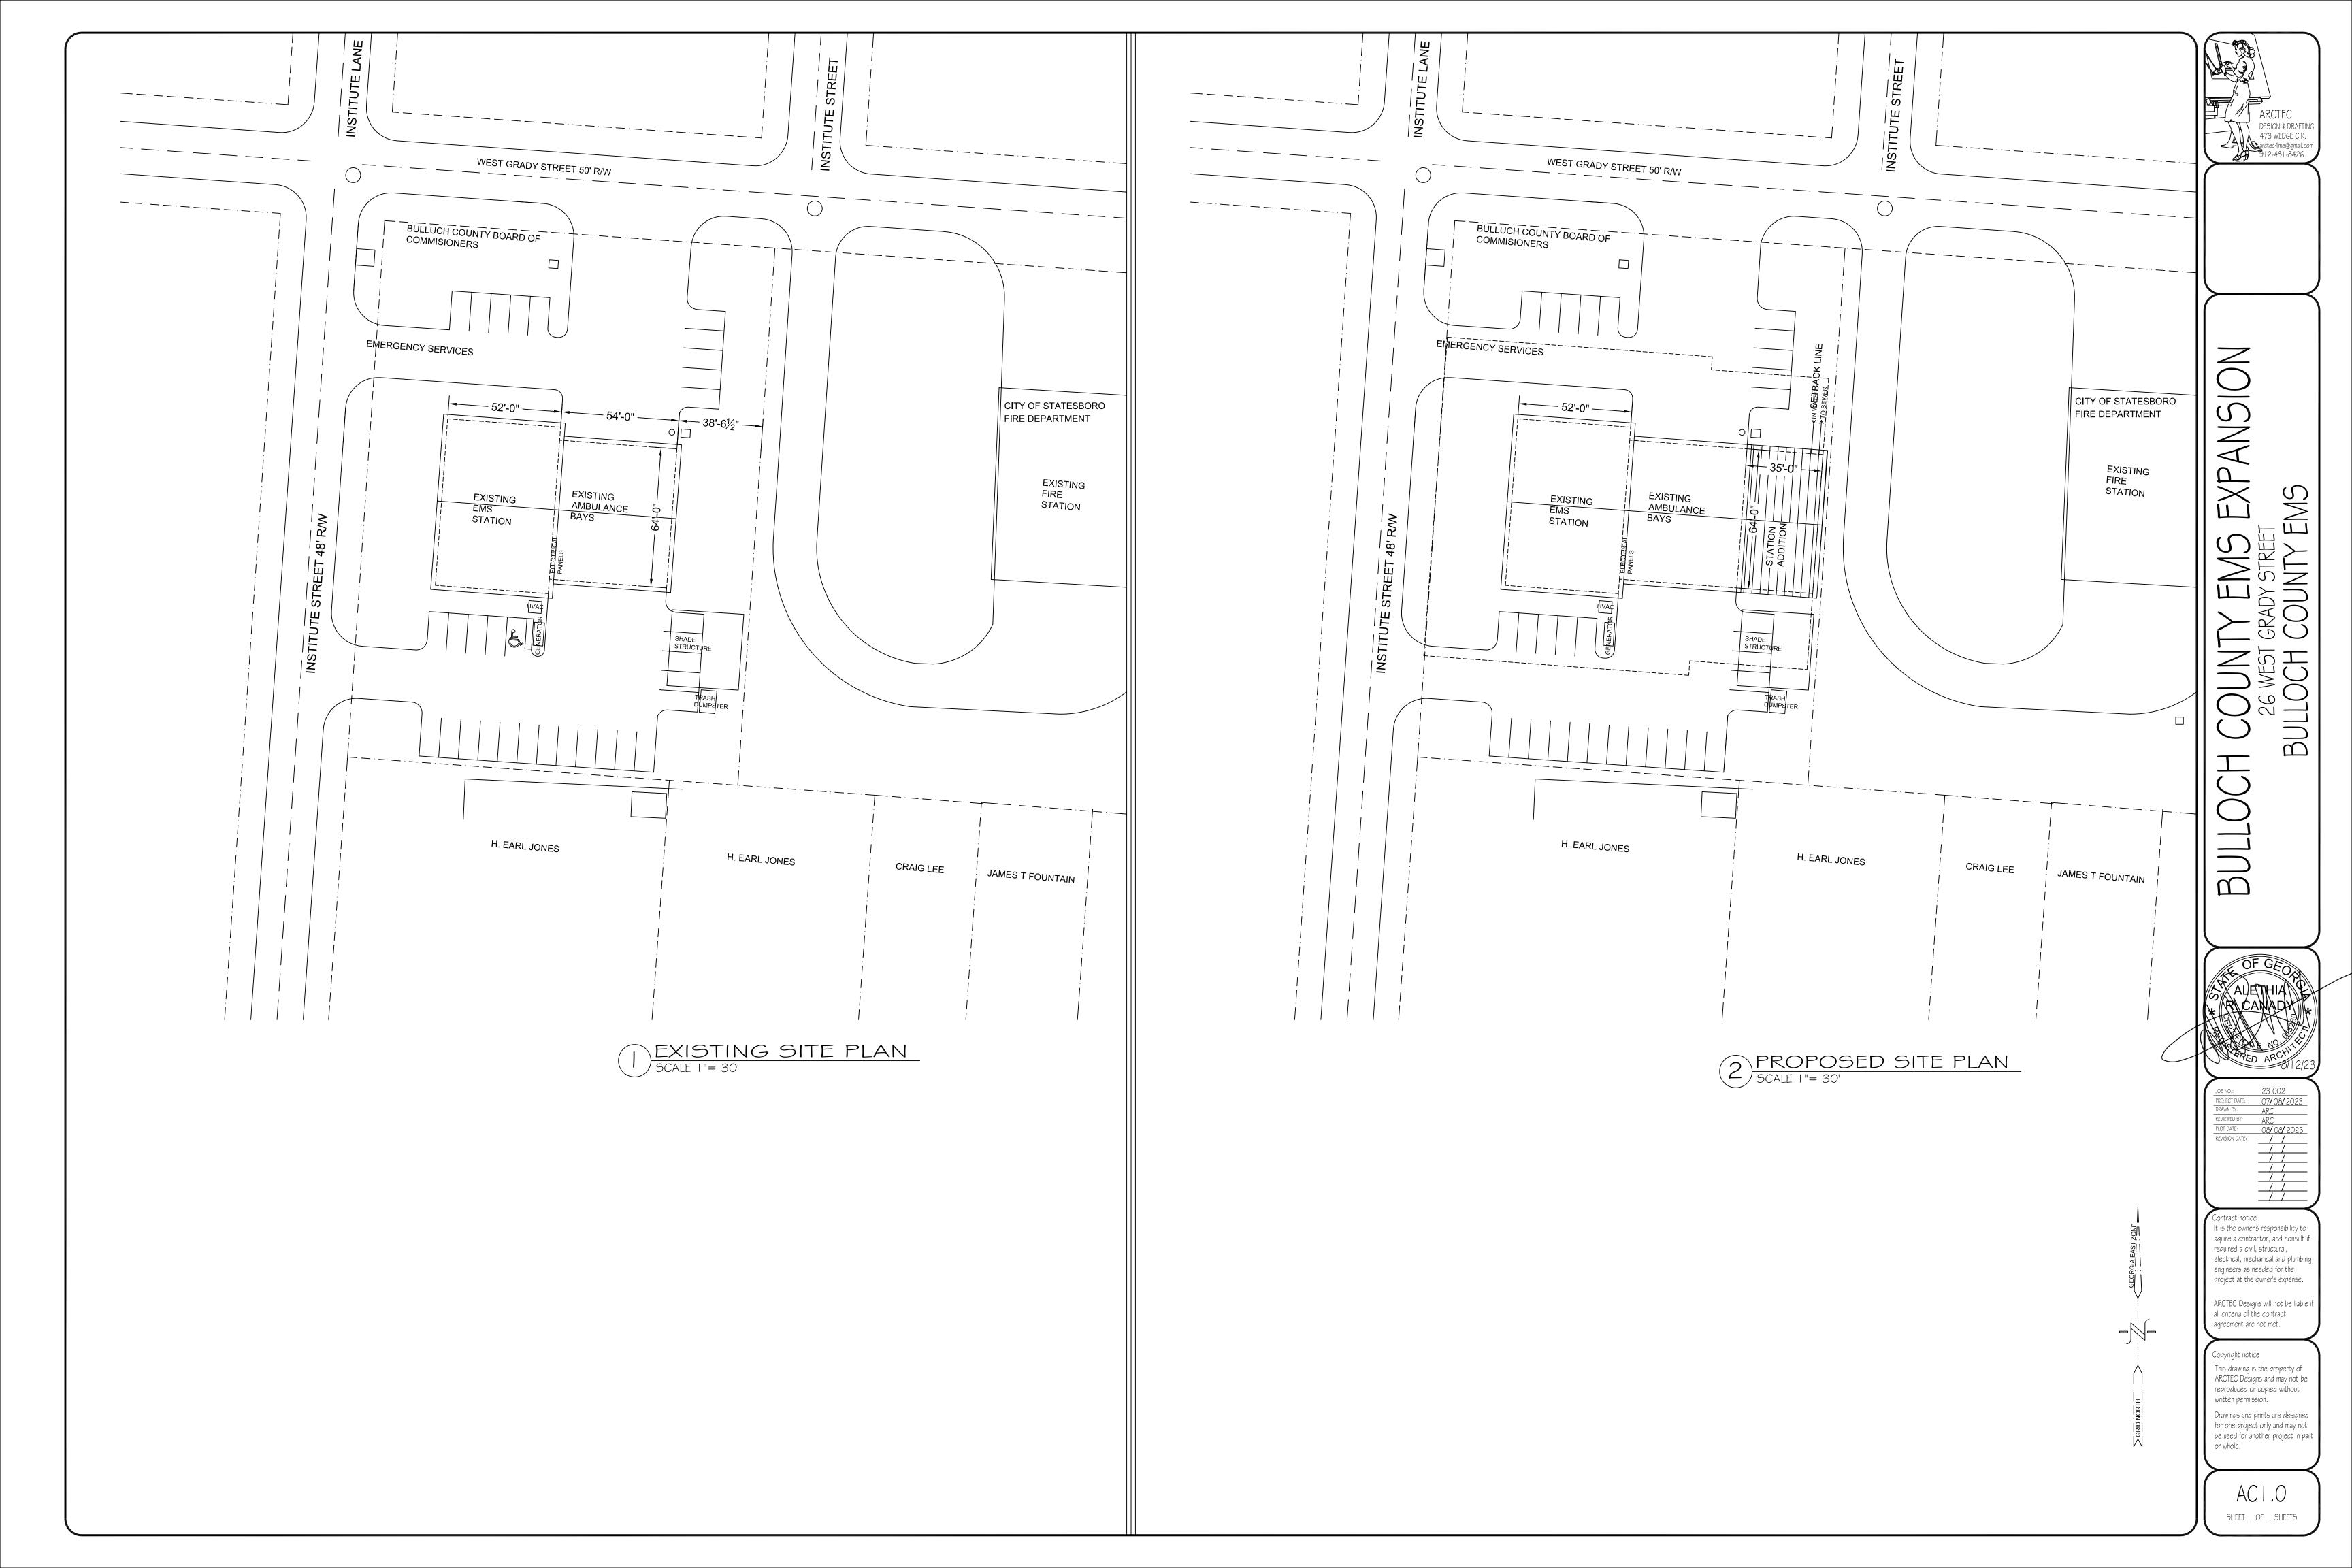

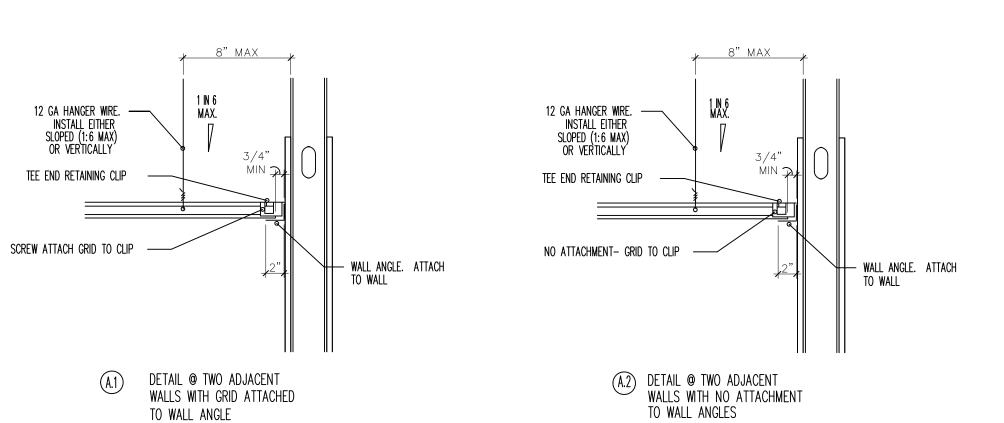

2 TYPICAL ACT DETAILS
SCALE - N.T.S.

#### REFLECTED CEILING PLAN LEGEND

Wall mounted light fixture on photo sensors switches

Exit light fixture with battery back-up - test button included

Recessed ceiling mounted exhaust fan

2x4 florescent light fixture

Suspended ceiling mounted florescent light fixture

Ceiling mounted exit light fixture with battery back-up

SD Smoke detector

Occupancy sensor

Emergency lighting wall mounted with battery back-up

Fire extinguisher and cabinet

Supply diffuser

Return diffuser





BULL

JOB NO.:	23-002
PROJECT DATE:	07/08/2023
DRAWN BY:	ARC
REVIEWED BY:	ARC
PLOT DATE:	08/08/2023
REVISION DATE:	
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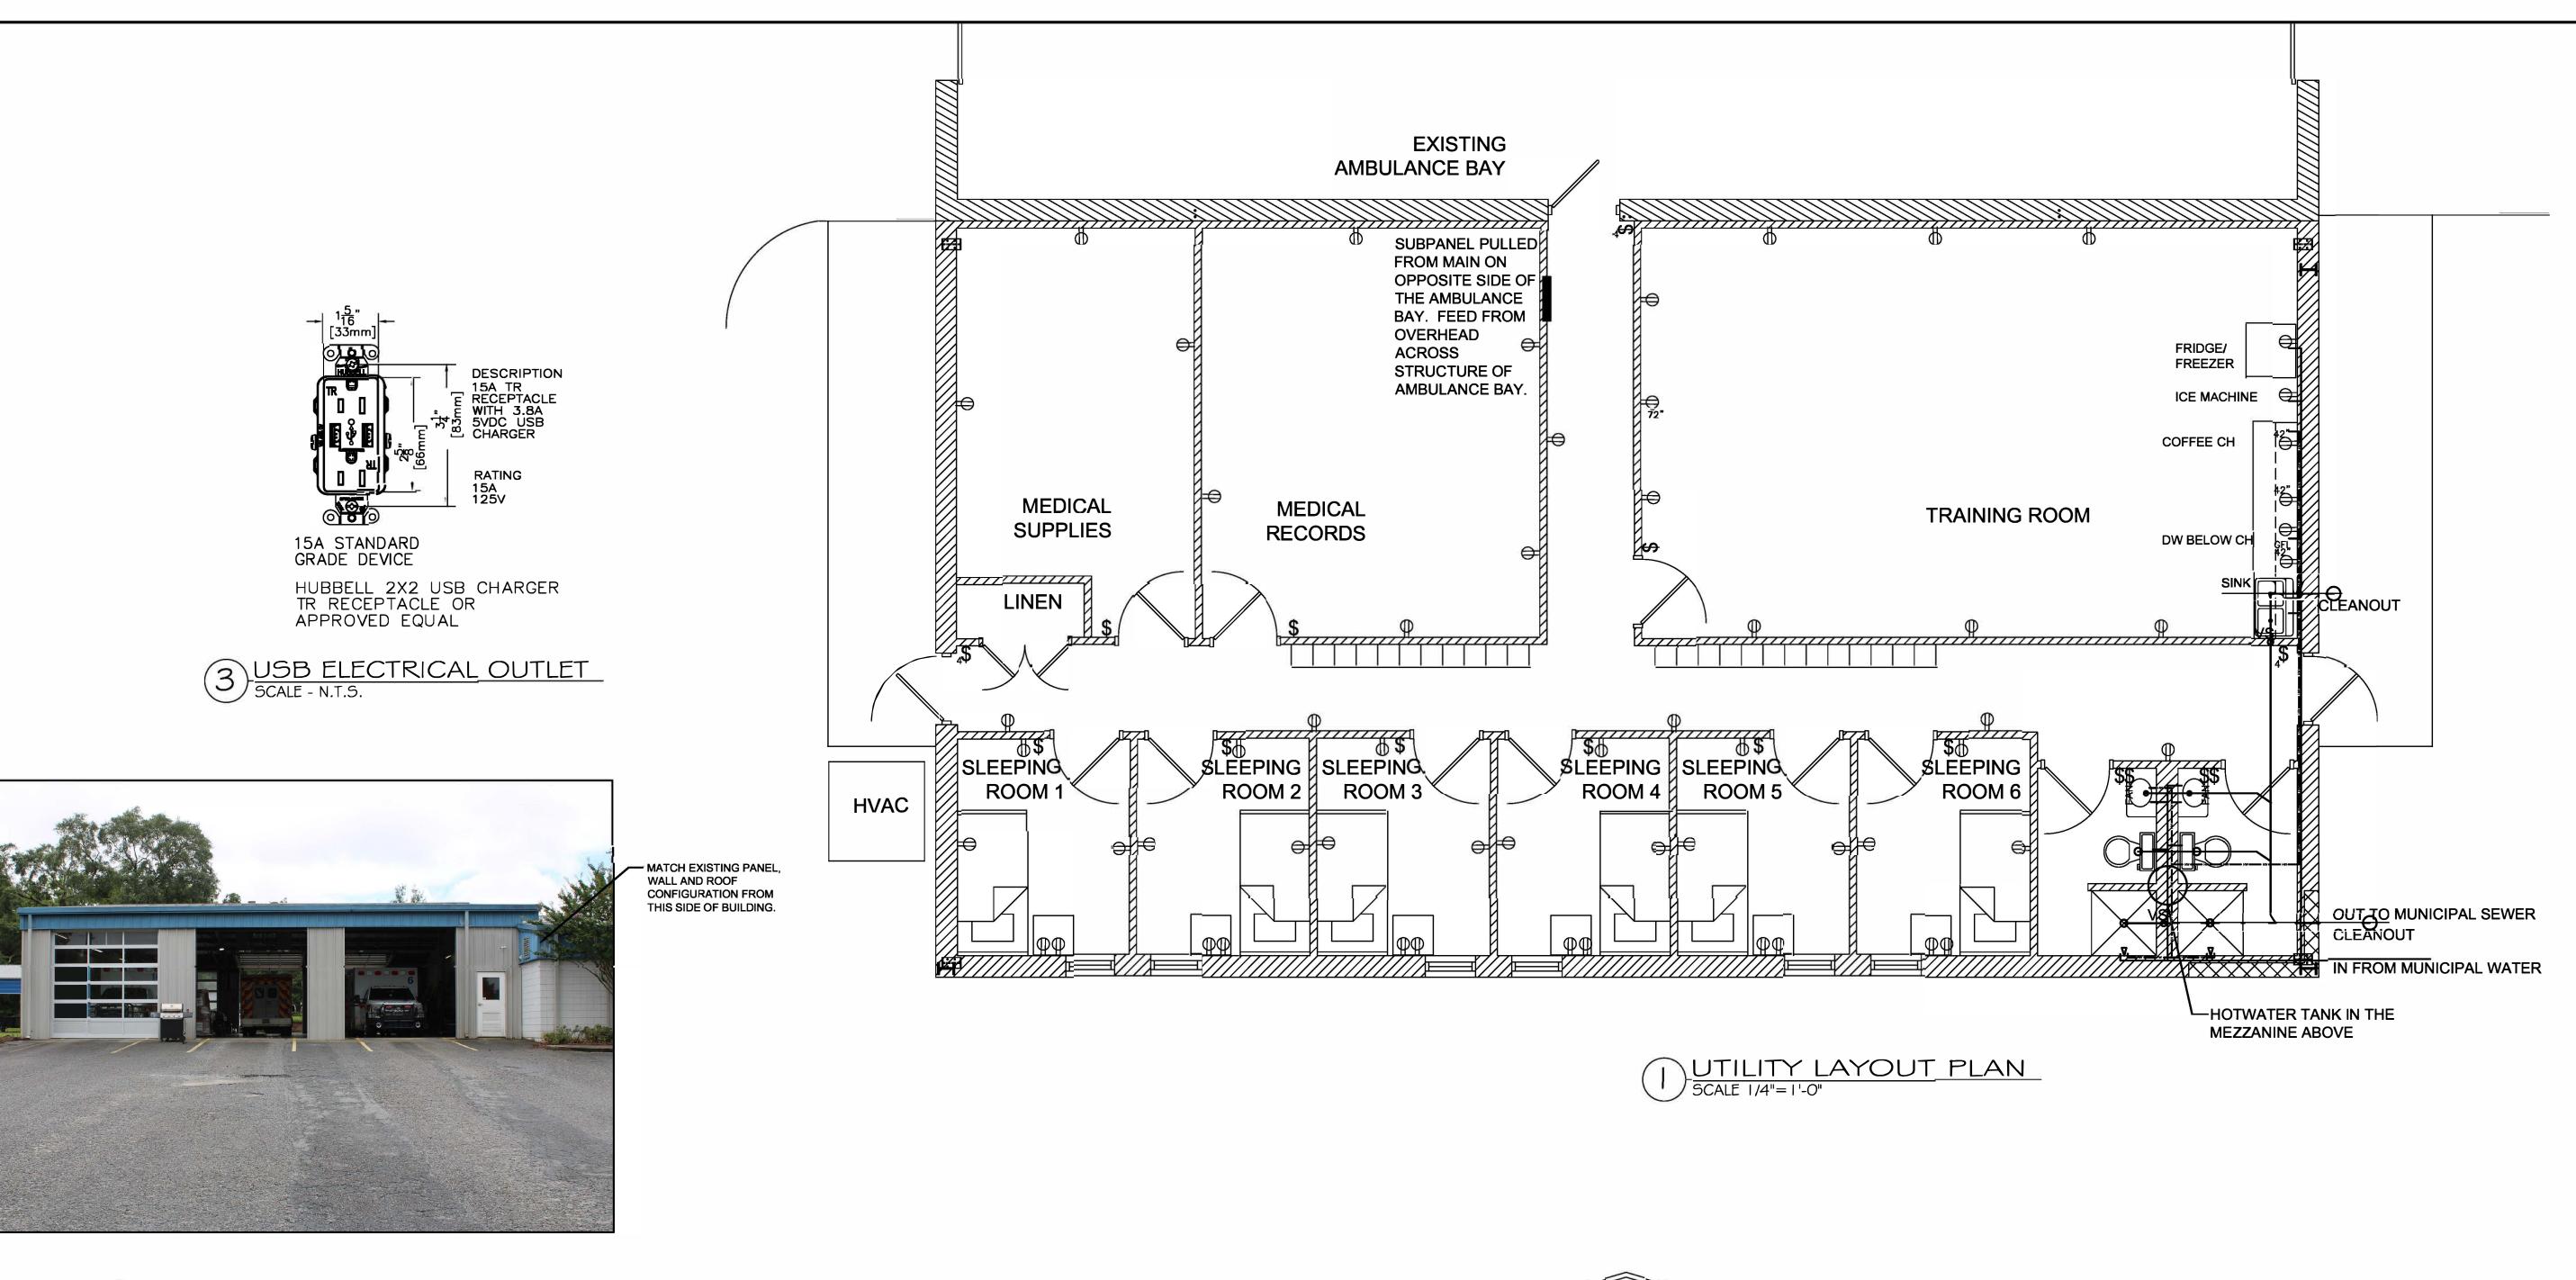
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A3.0



4 EXISTING FRONT ELEVATION SCALE - N.T.S.

EXISTING LOUVERS TO REAMIN IN PLACE

NEW ROOF PEAK IS TO


AND CLEAR.

LOUVERS.

BE BELOW THE



5 EXISTING FRONT/END ELEVATION SCALE - N.T.S.

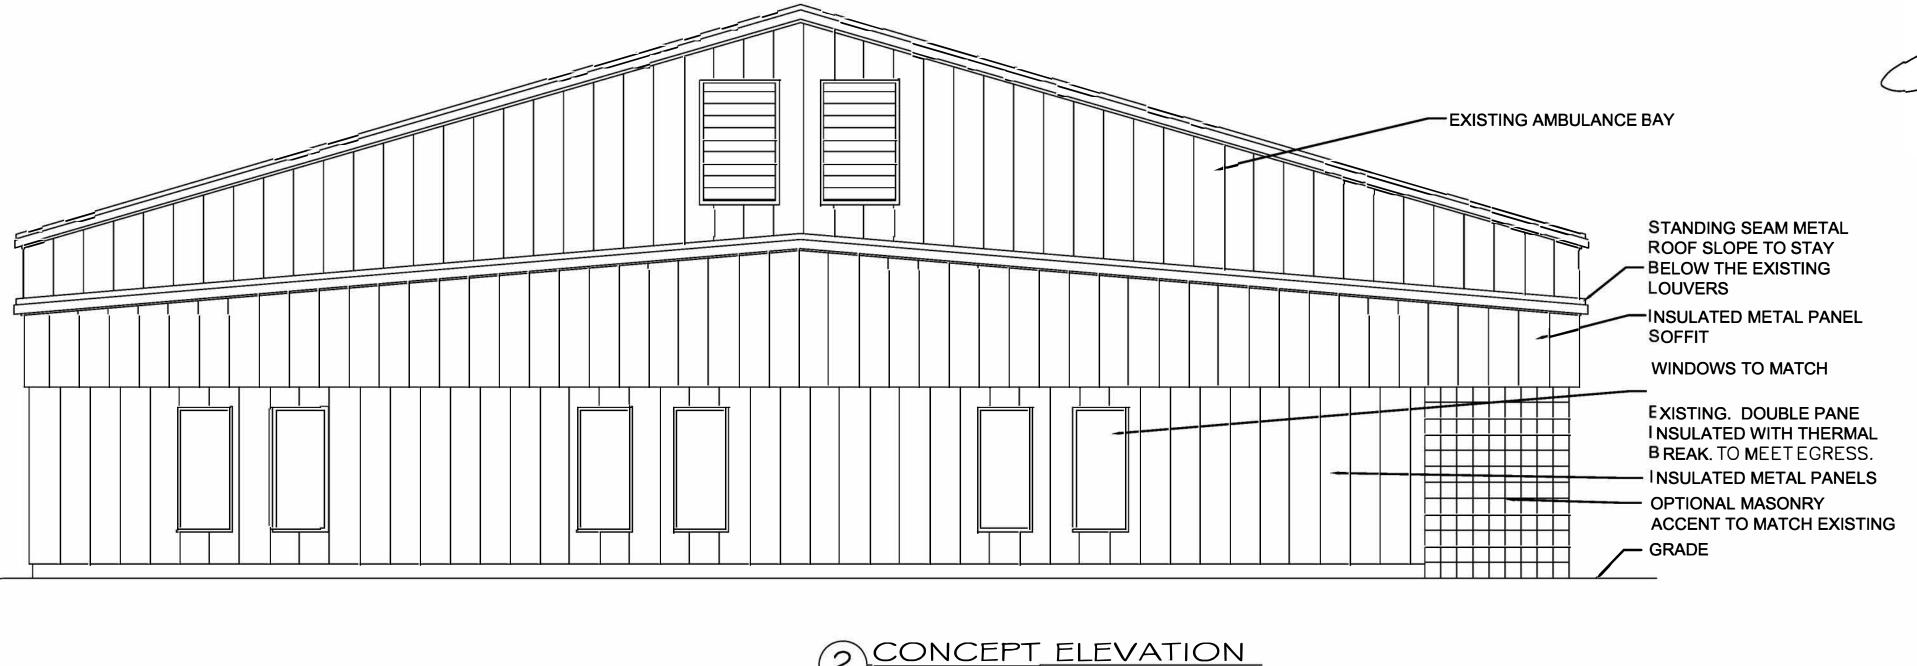

2 CONCEPT ELEVATION
SCALE 1/4"=1'-0"

BU

BOL

DESIGN & DRAFTING 473 WEDGE CIR. arctec4me@gmail.com 912-481-8426

ANSI

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