ADDENDUM

Addendum No: 004

Date 03/05/2021

Project: Brown Early Childhood Center

520 W 5th St, Portales, NM 88130

Project No: 18-0032

PSFA Project No: K-18-011 & S-20-008

RFP No: 20-21-0001

From: Formative Architecture

209 Gold Ave SW Albuquerque, NM 87102

To: All Prospective Bidders and Plan Holders



This Addendum forms a part of the Procurement Documents and modifies the Procurement Documents issued by Formative Architecture and dated 12/10/2019. Acknowledge receipt of this Addendum on the Price Proposal Form. Failure to do so may subject the offeror to disqualification. All other provisions of the Procurement Documents shall remain unchanged. This Addendum contains a total of three (3) 8 ½"x11" pages, twenty-four (24) 24" x 36" pages.

1. RFP REQUIREMENTS:

1.1. RFP DEADLINE AND LOCATION REMAIN UNCHANGED. FINAL ADDENDUM DATE CHANGED

2. SPECIFICATIONS:

NO CHANGES TO THE SPECIFICATIONS AT THIS TIME

3. DRAWINGS:

- 3.1. <u>AD102 EXISTING SLAB DEMOLITION PLAN AND NEW SLAB PLAN</u> Revised Sheet AD102 is attached and made part of this Addendum.
 - 3.1.1. **RENAME** sheet to read "SLAB AND UTILITY TRENCHING DEMOLITION PLAN AND NEW PLAN"
 - 3.1.2. **REVISE** Legend in its entirety
 - 3.1.3. **REVISE** Reference Keynotes in it entirety
 - 3.1.4. **REPLACE** drawing 'A5' and 'D5' in their entirety
 - 3.1.5. **RENAME** drawing 'A5' and 'D5'
- 3.2. AS101 SITE PLAN Revised Sheet AS101 is attached and made part of this Addendum.
 - 3.2.1. **ADD** general note "J. ITEMS OUTSIDE PROPERTY LINE ARE CONSIDERED ABOVE ADEQUACY AND WILL BE PAID FOR BY DISTRICT AS PART OF BID LOT #4"
 - 3.2.2. ADD property line to drawing A5
 - 3.2.3. **REVISE** keynotes to include Bid Lot designations
 - 3.2.4. **ADD** note to read "REFER TO <u>AD102</u> FOR FULL EXTENTS OF NEW CONCRETE AND LANDSCAPING WORK"
- 3.3. FX101A FIRE PROTECTION FLOOR PLAN AREA A BID LOT #1
 - 3.3.1.Revised location of Fire protection BFP, FDC. See plan.
 - 3.3.2.Revised Keynote 4, to include coordination of routing to avoid existing trees and existing tree root system.

ADDENDUM

- 3.3.3.Added Keynote 9. For reference to Water Entry detail. See plan.
- 3.3.4.Added Keynote 10 for noting ordinary hazard group 1 coverage at Electrical and IT rooms. See plan.
- 3.3.5.Added Keynote 11 for noting that Electrical and IT spaces be provided with dedicated branch lines. See plan.
- 3.3.6.Added General note N. to General Sheet Notes for upright fire protection where combustible materials are found in the ceiling plenum. See plan.
- 3.4. FX101B FIRE PROTECTION FLOOR PLAN AREA- B BID LOT #1
 - 3.4.1.Revised General note, see plan.
 - 3.4.2. Revised notes 4, 5 and 6. See plan.
 - 3.4.3. Added notes to Jan 121, Elec 122 and Jan., See plan
- 3.5. FX501 FIRE PROTECTION DETAILS
 - 3.5.1. Revised Fire riser diagram A3, see sheet.
 - 3.5.2.General notation change, see plan.
- 3.6. PD100A PLUMBING DEMOLITION FLOOR PLAN AREA A
 - 3.6.1.Added General note K and L, see plan.
 - 3.6.2. Modified keynote 5 to read Not Used.
 - 3.6.3. Added keynote 6. See plan.
 - 3.6.4. Miscellaneous phasing changes to plan, see plan.
 - 3.6.5. Added keynote 6 to plan. See plan.
- 3.7. PD100B PLUMBING DEMOLITION FLOOR PLAN AREA B
 - 3.7.1.Added General note K, see plan.
 - 3.7.2. Revised keynotes 3,4 and 5. See plan.
 - 3.7.3. Miscellaneous phasing changes to plan, see plan.
- 3.8. PD101A PLUMBING DEMOLITION FLOOR PLAN AREA A -BID LOT #1
 - 3.8.1.Added General note K and L, see plan.
 - 3.8.2. Added Keynotes 8 and 9, see plan.
 - 3.8.3. Miscellaneous phasing changes to plan, see plan.
- 3.9. PD101B PLUMBING DEMOLITION FLOOR PLAN AREA B-BID LOT #1
 - 3.9.1. Revised Keynotes 4, 6, 7, 8, 9, and 10. See plan.
 - 3.9.2.Added General note K and L, see plan.
 - 3.9.3. Miscellaneous phasing changes to plan, see plan.
- 3.10. PG101A PIPED GASES FLOOR PLAN AREA A BID LOT #1
 - 3.10.1. Keynotes 1 and 2 changed to not used, see plan.
 - 3.10.2. Added Keynote 3 for phasing requirements, see plan.
- PL100A WASTE AND VENT FLOOR PLAN AREA A
 - 3.11.1. Revised keynote 5, see plan.
 - 3.11.2. Added keynotes 10, 11, 12, 13, and 14. See plan.
 - 3.11.3. Miscellaneous waste and vent routing changes, see plan.
- 3.12. PL100B WASTE AND VENT FLOOR PLAN AREA B
 - 3.12.1. Revised keynote 10, see plan.
 - 3.12.2. Added keynotes 14, 15, 16 and 17. See plan.
 - 3.12.3. Miscellaneous waste and vent routing changes, see plan.
- 3.13. PL101A WASTE AND VENT FLOOR PLAN AREA A BID LOT #1
 - 3.13.1. Revised keynote 3 to not used, see plan.
 - 3.13.2. Revised keynotes 8, 9 and 10. See plan.
 - 3.13.3. Miscellaneous waste and vent routing changes, see plan.
- 3.14. PL101B WASTE AND VENT FLOOR PLAN AREA B BID LOT #1
 - 3.14.1. Revised Keynote 9, see plan.
 - 3.14.2. Added keynotes 11. 12. 13 and 14. See plan.
 - 3.14.3. Miscellaneous waste and vent routing changes, see plan.
- 3.15. PL140A PLUMBING ROOF PLAN AREA A
 - 3.15.1. Revised keynotes 1, 2, 3, 6 and 7.
 - 3.15.2. Pipe sizing, pressure and routing revisions, See plan.
- 3.16. PL140B PLUMBING ROOF PLAN AREA B
 - 3.16.1. Revised keynotes 1 and 2. See plan.

ADDENDUM

	3.16.2. Added keynotes 8 and 9, see plan.	
	3.16.3. Pipe sizing, pressure and routing revisions, See plan.	
3.17.	PL141A PLUMBING ROOF PLAN AREA A – Bid Lot #1	
	3.17.1. Revised keynotes 1 and 2, see plan.	
	3.17.2. Pipe sizing, pressure and routing revisions, See plan.	
3.18.	PL141B PLUMBING ROOF PLAN AREA B – Bid Lot #1	
	3.18.1. Revised keynotes 1 and 2, see plan.	
	3.18.2. Pipe sizing, pressure and routing revisions, See plan.	
3.19.	PP100A PRESSURE PIPING FLOOR PLAN AREA A	
	3.19.1. Revised plan to show additional sizing requirements and fixture call outs,	See
	plan.	
3.20.	PP100B PRESSURE PIPING FLOOR PLAN AREA B	
	3.20.1. Revised plan to show additional sizing requirements and fixture call outs,	See
	plan.	
3.21.	PP101A PRESSURE PIPING FLOOR PLAN AREA A BID LOT #1	
	3.21.1. Revised plan to show additional sizing requirements and fixture call outs,	See
	plan.	
3.22.	PP101B PRESSURE PIPING FLOOR PLAN AREA B BID LOT #1	
	3.22.1. Revised plan to show additional sizing requirements and fixture call outs,	See
	plan.	
	3.22.2. Added Keynote 2, see plan.	
3.23.	P-501 PLUMBING DETAILS	
	3.23.1. Revised details A3, C3, C5 and added D1, and added NATURAL GAS	
	METER/REGULATOR DEATAIL.	
3.24.	P-701 PLUMBING SPECIFICATIONS	
	3.24.1. Revised Plumbing Fixture Schedule, see sheet.	

4. PRIOR APPROVALS

NO PRIOR APPROVALS AT THIS TIME

5. **RESPONSES TO QUESTIONS**

NO RESPONSES TO QUESTIONS AT THIS TIME

All other provisions of the Contract Documents shall remain unchanged. This addendum is hereby made a part of the Contract Documents to the same extent as those provisions contained in the original documents and all itemized listings thereof.

End of Addendum

NOTE: EXACT LOCATION OF SEWER LINE IS UNKNOWN. THERE IS A POSSIBILITY SLAB AND UTILITY TRENCHING DEMOLITION PLAN

COMPUTER LAB

CLASSROOM

TEACHER LOUNGE

03 3000.03-

03 3000.03—

03 3000.03----

(A5) NEW SLAB AND UTILITY TRENCHING PLAN

1/16" = 1'-0"

*—*03 3000.02

,03 3000.03

02 4100.48—

02 4100.49

02 4100.48---

02 4100.48

CLASSROOM

.03 3000.01—

// 03 3000.02—

03 3000.01-

03 3000.02

03 3000.03-

32 9200.01

03 3000.18-

32 9200.01

03 3000.03-

32 9200.01

PHASE 1 PHASE 2

02 4100.46—

02 4100.50

GIRLS

BOYS

02 4100.50-

PHASE 2 —

CLASSROOM

02 4100.46

→ PHASE 1

CLASSROOM

─02 4100.49

CLASSROOM

02 4100.46---

ANTICIPATED BELOW GRADE.

NOTE: TO THE GREATEST EXTENT POSSIBLE, RE-USE

DURING SITE DEMOLITION

03 3000.03—

TRENCHES CREATED

03 3000.18 | 03 3000.18 |

−03 3000.03

32 9200.01-

NEW SIDEWALK, STAIRS, RAMP AND RAILING. REFER TO A4/AS501

NOTE: EXACT LOCATION OF SEWER LINE IS UNKNOWN. ALL UTILITY

TRENCHING SOUTH OF THE BUILDING TO BE HAND EXCAVATED.

ADDITIONAL EXISTING WATER/GAS/ELECTRICAL SERVICES ARE

02 4100.46—

02 4100.49

CLASSROOM

02 4100.47

CLASSROOM

CLASSROOM

CLASSROOM

02 4100.45

NOTE: FIELD VERIFY AND COORDINATE ALL TRENCHING WITH OTHER

EXISTING ADJACENT LANDSCAPED AREA.

__03 3000.03

__03 3000.03

---03 3000.03

03 3000.02----

TRADES. CONTRACTOR TO COORDINATE ALL UTILITY TRENCHING TO OCCUR WITHIN LANDSCAPED AREA AS MUCH AS POSSIBLE TO AVOID DEMOLITION

OF EXISTING CONCRETE SITE WORK. UTILITY TRENCHING THAT OCCURS WITHIN LANDSCAPED AREA TO BE INFILLED AND LANDSCAPED TO MATCH

VESTIBULE

02 4100.46

02 4100.50

REFER TO AS101 FOR

CONTINUATION OF SITE -

THIS SHEET IS FOR REFERENCE ONLY. BASE BID AND ALL BID LOTS ARE SHOWN TOGETHER FOR CLARITY WORK

02 4100.46-

02 4100.46---

02 4100.50 =

32 9200.01

REFER TO AS101

FOR CONTINUATION -

OF SITE WORK

---02 4100.48

02 4100.46

IEP CONFERENCE ROOM

STOR./

COPIER

___03 3000.03 03 3000.03—

03 3000.18

ROOM

ROOM

WORK ROOM

RECEPTION

02 4100.50—

02 4100.46-

02 4100.50

02 4100.48

-02 4100.47

GIRLS

EXISTING RAMP

THAT TRENCHING COULD OCCUR


THROUGH EXISTING RAMP

PORTION OF EXISTING CONCRETE SLAB TO BE SAWCUT

PORTION OF EXISTING CONCRETE TO BE REMOVED AS NECESSARY FOR UTILITY TRENCHING

NEW CONCRETE SLAB. FINISH HEIGHT TO MATCH EXISTING SLAB

PATCH AND REPAIR LANDSCAPE AS NECESSARY AT

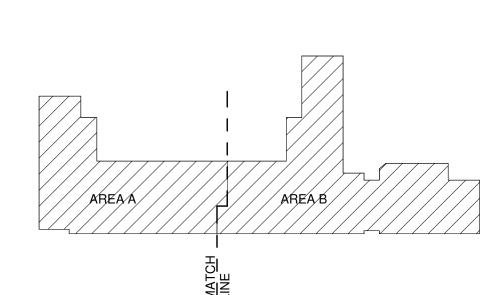

architecture A. IT SHALL BE ASSUMED THAT THE CONTRACTOR HAS PHYSICALLY SURVEYED THE SITE TO OBTAIN A SOLID UNDERSTANDING OF EXISTING CONDITIONS, BOTH ONSITE AND ADJACENT TO THE SITE, THAT WILL AFFECT SCHEDULING OF WORK INCLUDING: DEMOLITION AND REMOVAL OF DEBRIS. ANY

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NO.005432

PROJECT

DURING DEMOLITION, ALL STRUCTURES, FINISHES, ETC. WHICH ARE NOT TO BE REMOVED ARE TO BE Q. EXISTING FLOORING AND WALL BASE TO REMAIN UNLESS OTHERWISE NOTED. PROTECT FROM

COORDINATE REMOVAL OF ALL EXISTING FLOOR FINISHES WITH NEW SCHEDULED FLOOR FINISHES. REPAIR CONCRETE AS REQUIRED RELATED TO ALL UTILITY IMPROVEMENTS. REFER TO PLUMBING DEMO SHEETS FOR SLAB SAWCUT LOCATIONS. FOR PATCHING DETAIL AT SLAB SAWCUT LOCATIONS REFER TO STRUCTURAL ALL EXISTING WALL & CEILING DEVICES IN CLASSROOMS TO BE REMOVED. ITEMS INCLUDED BUT NOT LIMITED TO EXISTING CHALKBOARDS, CUBBIES, CASEWORK, WALL CLOCKS, SPEAKERS, DISPENSERS,

W. ASBESTOS ABATEMENT TO BE PROVIDED BY OWNER. CONTRACTOR TO COORDINATE SCHEDULING WITH OWNER PRIOR TO COMMENCEMENT OF WORK. ABATEMENT TO OCCUR IN TWO PHASES TO ALLOW SCHOOL TO REMAIN OPERATIONAL, COORDINATE WITH CONSTRUCTION PHASING. ABATEMENT FOR EACH PHASE MUST BE COMPLETED IN THE AREA PRIOR TO CONSTRUCTION. ALL LOCKSETS FROM EXISTING DOORS TO BE CAREFULLY REMOVED AND SALVAGED TO BE REUSED ON NEW DOORS; REFER TO DOOR SCHEDULE AE621

ALL EXTERIOR PLASTER WALLS AND SOFFITS TO BE CLEANED AND PREPPED TO RECEIVE NEW PLASTER FINISH AS SPECIFIED. ALL EXISTING WALL & CEILING DEVICES ON EXTERIOR TO BE PROTECTED. REFERENCE SECTION 09 0170 FOR ADDITIONAL INFORMATION NOT ALL ITEMS OF DEMOLITION ARE SHOWN ON THIS DEMOLITION PLAN. THERE ARE MANY SPECIFIC AND SMALL ITEMS OF DEMOLITION THAT WILL BE NECESSARY THROUGHOUT THE COURSE OF THE WORK WHICH IS APPARENT BY A COMPLETE AND THOROUGH REVIEW OF EXISTING CONDITIONS AND ALL OF THE CONSTRUCTION DOCUMENTS. IT IS THE CONTRACTORS RESPONSIBILITY TO PERFORM ALL DEMOLITION OPERATIONS REQUIRED FOR THIS PROJECT.

REFERENCE KEYNOTES

GENERAL SHEET NOTES

	NEFERE	INCE RETINOTES
Ī	02 4100.45	EXISTING RAMP AND RAILING TO BE REMOVED, SALVAGE RAILING TO OWNER
	02 4100.46	HATCHED AREA DENOTES PLUMBING SAWCUT LOCATIONS. EXTENTS TO BE ADEQUATE FOR NEW TOILET AND FLOOR DRAIN INSTALLATION. UTILIZE EXISTING FLOOR VAULT IF AVAILABLE TO AVOID ADDITIONAL SAW CUTTING. CORE DRILL SLABS AT THESE LOCATIONS. PROTECT, PATCH AND REPAIR ADJACENT FLOORIN AS NECESSARY.
	02 4100.47	HATCHED AREA DENOTES PORTION OF EXISTING SLAB TO BE SAWCUT AND REMOVED, EXACT LOCATION UNKNOWN. COORDINATE LOCATION WITH PLUMBIN LINE TO BE REMOVED
	02 4100.48	HATCHED AREA DENOTES PORTION OF EXISTING SLAB TO BE REMOVED IN ITS ENTIRETY
	02 4100.49	HATCHED AREA DENOTES PORTION OF EXISTING CONCRETE TO BE REMOVED AS NECCESARY FOR NEW UTILITY TRENCHING
	02 4100.50	HATCHED AREA DENOTES PORTION OF EXISTING LANDSCAPE TO BE REMOVED FOR UTILITY TRENCHING. UTILITY TRENCHING TO BE HAND EXCAVATED.
	03 3000.01	HATCHED AREA DENOTES 2" RECESSED SLAB TO ACCEPT FLOOR TILE SYSTEM. COORDINATE EXACT EXTENTS OF RECESS WITH ARCHITECTURAL REQUIREMENTS. REFER TO STRUCTURAL FOR SLAB DETAIL.
	03 3000.02	HATCHED AREA DENOTES NEW SLAB ON GRADE. FINISH LEVEL AND DEPTH TO MATCH EXISTING SLABS; REFER TO STRUCTURAL.
	03 3000.03	HATCHED AREA DENOTES NEW CONCRETE SLAB INFILL TO MATCH ADJACENT SLAB
	03 3000.18	PATCH AND REPAIR CONCRETE AS NECESSARY AT UTILITY TRENCHING LOCATIONS
	32 9200.01	PATCH AND REPAIR LANDSCAPE AS NECESSARY AT UTILITY TRENCHING

LEGEND


PORTION OF EXISTING CONCRETE SLAB TO BE REMOVED

PORTION OF EXISTING LANDSCAPE TO BE REMOVED AS NECESSARY FOR UTILITY TRENCHING

NEW CONCRETE SLAB. RECESSED 2" TO ACCEPT FLOOR TILE SYSTEM

PATCH AND REPAIR CONCRETE AS NECESSARY AT UTILITY TRENCHING LOCATIONS

UTILITY TRENCHING LOCATIONS

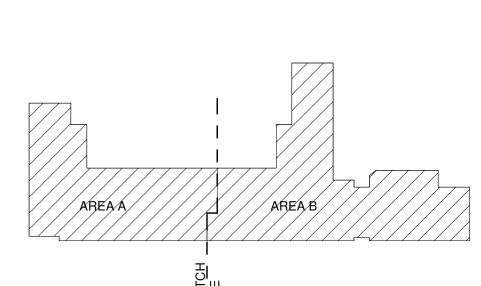

DRAWING NAME SLAB AND UTILITY **TRENCHING** DEMOLITION PLAN AND NEW PLAN

CONSTRUCTION

DOCUMENTS

1 02/17/2021 ADDENDUM 001

03/05/2021 ADDENDUM 004

REVISIONS

DRAWN BY

DATE

REVIEWED BY

PROJECT NO


PSFA PRE-K PROJECT NO:

PSFA SYSTEMS

PROJECT NO:

SHEET NO

AD102

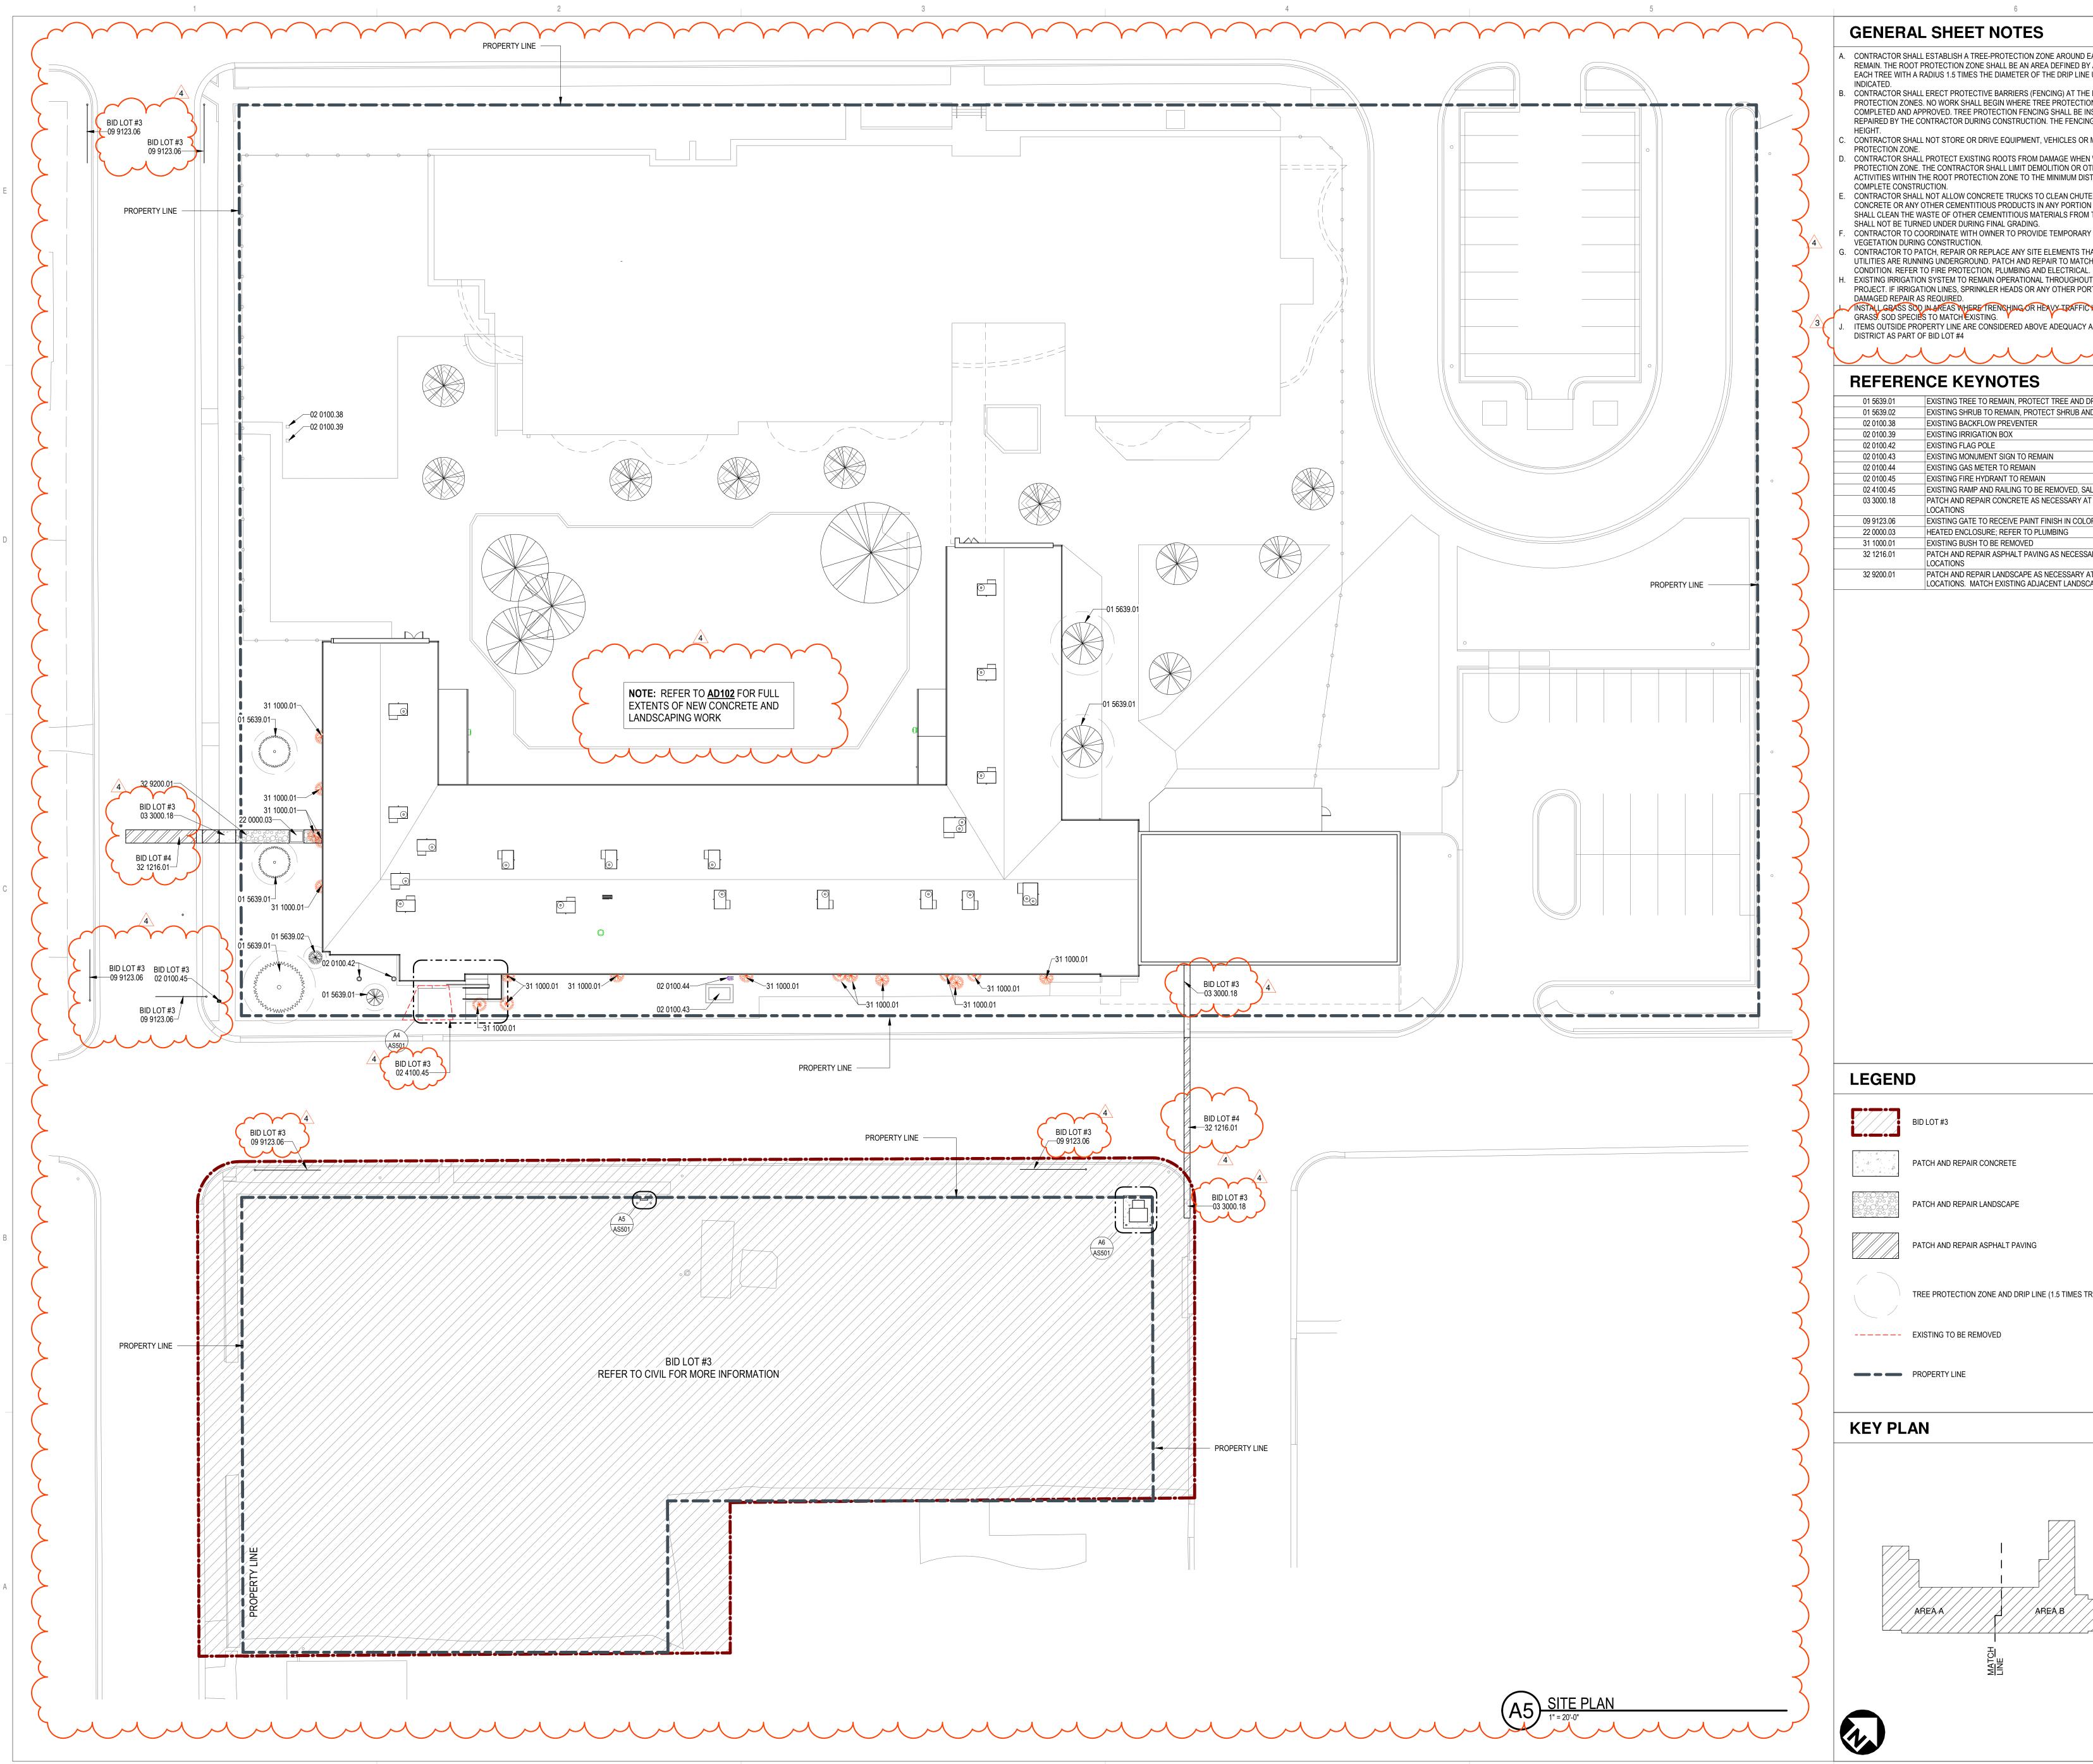

. CONTRACTOR SHALL ESTABLISH A TREE-PROTECTION ZONE AROUND EACH EXISTING TREE TO REMAIN. THE ROOT PROTECTION ZONE SHALL BE AN AREA DEFINED BY A CIRCLE CONCENTRIC WITH EACH TREE WITH A RADIUS 1.5 TIMES THE DIAMETER OF THE DRIP LINE UNLESS OTHERWISE

CONTRACTOR SHALL ERECT PROTECTIVE BARRIERS (FENCING) AT THE PERIMETER OF TREE-PROTECTION ZONES. NO WORK SHALL BEGIN WHERE TREE PROTECTION FENCING HAS NOT BEEN COMPLETED AND APPROVED. TREE PROTECTION FENCING SHALL BE INSTALLED, MAINTAINED AND

REPAIRED BY THE CONTRACTOR DURING CONSTRUCTION. THE FENCING WILL BE A MINIMUM OF 4'

CONTRACTOR SHALL NOT STORE OR DRIVE EQUIPMENT, VEHICLES OR MATERIALS WITHIN THE TREE-PROTECTION ZONE. CONTRACTOR SHALL PROTECT EXISTING ROOTS FROM DAMAGE WHEN WORKING WITHIN THE TREE-

PROTECTION ZONE. THE CONTRACTOR SHALL LIMIT DEMOLITION OR OTHER CONSTRUCTION ACTIVITIES WITHIN THE ROOT PROTECTION ZONE TO THE MINIMUM DISTURBANCE REQUIRED TO COMPLETE CONSTRUCTION. CONTRACTOR SHALL NOT ALLOW CONCRETE TRUCKS TO CLEAN CHUTES OR DUMP EXCESS

CONCRETE OR ANY OTHER CEMENTITIOUS PRODUCTS IN ANY PORTION OF THE SITE. CONTRACTOR SHALL CLEAN THE WASTE OF OTHER CEMENTITIOUS MATERIALS FROM THE SURFACE AND THEY SHALL NOT BE TURNED UNDER DURING FINAL GRADING. CONTRACTOR TO COORDINATE WITH OWNER TO PROVIDE TEMPORARY IRRIGATION TO EXISTING VEGETATION DURING CONSTRUCTION. CONTRACTOR TO PATCH, REPAIR OR REPLACE ANY SITE ELEMENTS THAT ARE REMOVED WHERE UTILITIES ARE RUNNING UNDERGROUND. PATCH AND REPAIR TO MATCH PREVIOUSLY EXISTING SITE

EXISTING IRRIGATION SYSTEM TO REMAIN OPERATIONAL THROUGHOUT THE DURATION OF THE PROJECT. IF IRRIGATION LINES, SPRINKLER HEADS OR ANY OTHER PORTIONS OF THE SYSTEM ARE DAMAGED REPAIR AS REQUIRED. INSTALL GRASS SOD IN AREAS WHERE TRENSHING OR HEAVY TRAFFIC HAS DAMAGED EXISTING GRASS. SOD SPECIES TO MATCH EXISTING. ITEMS OUTSIDE PROPERTY LINE ARE CONSIDERED ABOVE ADEQUACY AND WILL BE PAID FOR BY

REFERENCE KEYNOTES

01 5639.01	EXISTING TREE TO REMAIN, PROTECT TREE AND DRIP LINE AREA AS INDICATED
01 5639.02	EXISTING SHRUB TO REMAIN, PROTECT SHRUB AND DRIP LINE AREA AS INDICATE
02 0100.38	EXISTING BACKFLOW PREVENTER
02 0100.39	EXISTING IRRIGATION BOX
02 0100.42	EXISTING FLAG POLE
02 0100.43	EXISTING MONUMENT SIGN TO REMAIN
02 0100.44	EXISTING GAS METER TO REMAIN
02 0100.45	EXISTING FIRE HYDRANT TO REMAIN
02 4100.45	EXISTING RAMP AND RAILING TO BE REMOVED, SALVAGE RAILING TO OWNER
03 3000.18	PATCH AND REPAIR CONCRETE AS NECESSARY AT UTILITY TRENCHING LOCATIONS
09 9123.06	EXISTING GATE TO RECEIVE PAINT FINISH IN COLOR TBD
22 0000.03	HEATED ENCLOSURE; REFER TO PLUMBING
31 1000.01	EXISTING BUSH TO BE REMOVED
32 1216.01	PATCH AND REPAIR ASPHALT PAVING AS NECESSARY AT UTILITY TRENCHING LOCATIONS
32 9200.01	PATCH AND REPAIR LANDSCAPE AS NECESSARY AT UTILITY TRENCHING LOCATIONS. MATCH EXISTING ADJACENT LANDSCAPE

PATCH AND REPAIR CONCRETE

PATCH AND REPAIR LANDSCAPE

PATCH AND REPAIR ASPHALT PAVING

TREE PROTECTION ZONE AND DRIP LINE (1.5 TIMES TREE CANOPY)

PROJECT

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CONSTRUCTION DOCUMENTS

REVISIONS 3 03/03/2021 ADDENDUM 003 03/05/2021 ADDENDUM 004

NW
OK
12/10/2019
18-0032
K-18-011

AS101

- A. THE CONTRACTOR SHALL COMPLY WITH NFPA-13 AND REQUIREMENTS OF THE AHJ.
- B. THE CONTRACTOR SHALL SUBMIT SHOP DRAWINGS TO THE ARCHITECT/ENGINEER FOR APPROVAL PRIOR TO COMMENCING WORK.
- C. ALL EQUIPMENT AND MATERIALS SHALL CONFORM TO NFPA STANDARDS AND BE UL LISTED. D. SPRINKLER SYSTEMS SHALL BE DESIGNED FOR LIGHT HAZARD WITH DESIGN DENSITY OF 0.10 GPM / 1500 SQ.FT. THROUGHOUT ENTIRE BUILDING UNLESS NOTED
- OTHERWISE. MAXIMUM SPRINKLER HEAD COVERAGE SHALL BE 225
- SQ.FT. PER HEAD IN LIGHT HAZARD AREAS. F. THE CONTRACTOR SHALL COORDINATE THEIR WORK WITH THE MECHANICAL, PLUMBING, AND ELECTRICAL PRIOR TO FABRICATION AND DURING INSTALLATION.

G. THE CONTRACTOR SHALL SUPPLY AND INSTALL AN

- INSPECTORS TEST CONNECTION (ITC) FOR EACH SPRINKLER SYSTEM. RUN THROUGH EXTERIOR WALLS WHERE APPROVED BY ARCHITECT / ENGINEER.
- H. THE ARCHITECT SHALL APPROVE THE AESTHETICS OF THE SPRINKLER HEADS AND EXPOSED PIPING LAYOUT.
- PROVIDE PENDANT AND UPRIGHT SPRINKLERS IN ALL CONCEALED COMBUSTIBLE SPACES. USE FLUSH CONCEALED HEADS IN ALL TOILET ROOMS.
- PROVIDE SPRINKLERS UNDER EXPOSED DUCT OR **OBSTRUCTIONS 48" WIDE AND LARGER.** K. REFER TO CEILING TILE DETAIL C1/FX-501 FOR SPRINKLER HEAD LOCATIONS IN CEILING TILES.
- PROVIDE SIDEWALL SPRINKLER HEADS AT TOP OF SKYLIGHTS.
- M. REFER TO FIRE RISER DIAGRAM A3/FX501 FOR MORE N. PROVIDE UPRIGHT SPRINKLER PROTECTION WHERE CUMBUSTABLE MATERIALS ARE FOUND IN CEILING

○KEYNOTES

. CONNECT NEW 6" BRANCH LINE TO PUBLIC WATER UTILITY MAIN. PUBLIC UTILITY MAIN SHUTOFF VALVE & VALVE BOX.

3 POST INDICATOR VALVE, REFER TO DETAIL DE/EX501 FOR ADDITIONAL INFORMATION.

4. HEATED ENCLOSURE, REFER TO DETAIL A1/FX501 FOR ADDITIONAL INFORMATION. COORDINATE LOCATION AND FIRE LINE ROUTING WITH SITE LANDSCAPING AND CIVIL PLANS. EXISTING TREE IN THIS AREA ARE TO REMAIN. COORDINATE ROUTING TO AVOID EXISTING TREES AND TREE ROOT SYSTEM.

5. FIRE RISER ASSEMBLY, REFER TO DETAIL D3/FX501 FOR ADDITIONAL INFORMATION. 6. FIRE SPRINKLER SUPPLY MAIN. PHASE 1 INTERIM INSPECTOR TEST VALVE LOCATION.

8 TERMINATE IN ACCORDANCE WITH NERA-13
9. WATER ENTRY, SEE DETAIL B3/FX501. 10. PROVIDE ORDINARY HAZARD GROUP 1 COVERAGE AT DESIGN DENSITY OF 0.15 GPM/1,500 SQ.FT. SUPPLY THIS SPACE WITH A DEDICATED BRANCH LINE. NO OTHER PIPING SHALL RUN THROUGH

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architecture

SEAL

PROJECT

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CONSTRUCTION DOCUMENTS

REVISIONS

DRAWN BY REVIEWED BY DATE PROJECT NO

PSFA PRE-K PROJECT NO: K-18-011 PSFA SYSTEMS S-20-008 PROJECT NO: DRAWING NAME

FIRE PROTECTION FLOOR PLAN -AREA A - BID LOT

SHEET NO

FX101A

KEYPLAN

FIRE PROTECTION FIRST FLOOR PLAN - AREA A - BID LOT #1 SCALE: 1/8" = 1'-0"

- A. THE CONTRACTOR SHALL COMPLY WITH NFPA-13 AND
- REQUIREMENTS OF THE AHJ. B. THE CONTRACTOR SHALL SUBMIT SHOP DRAWINGS TO THE ARCHITECT/ENGINEER FOR APPROVAL PRIOR TO
- COMMENCING WORK.
- C. ALL EQUIPMENT AND MATERIALS SHALL CONFORM TO NFPA STANDARDS AND BE UL LISTED. D. SPRINKLER SYSTEMS SHALL BE DESIGNED FOR LIGHT HAZARD WITH DESIGN DENSITY OF 0.10 GPM / 1500 SQ.FT.
- OTHERWISE. MAXIMUM SPRINKLER HEAD COVERAGE SHALL BE 225

THROUGHOUT ENTIRE BUILDING UNLESS NOTED

- SQ.FT. PER HEAD IN LIGHT HAZARD AREAS. F. THE CONTRACTOR SHALL COORDINATE THEIR WORK WITH THE MECHANICAL, PLUMBING, AND ELECTRICAL PRIOR TO FABRICATION AND DURING INSTALLATION. G. THE CONTRACTOR SHALL SUPPLY AND INSTALL AN
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- SPRINKLER HEADS AND EXPOSED PIPING LAYOUT. PROVIDE PENDANT AND UPRIGHT SPRINKLERS IN ALL CONCEALED COMBUSTIBLE SPACES.
- USE FLUSH CONCEALED HEADS IN ALL TOILET ROOMS. PROVIDE SPRINKLERS UNDER EXPOSED DUCT OR **OBSTRUCTIONS 48" WIDE AND LARGER.**
- K. REFER TO CEILING TILE DETAIL C1/FX-501 FOR SPRINKLER HEAD LOCATIONS IN CEILING TILES. PROVIDE SIDEWALL SPRINKLER HEADS AT TOP OF
- SKYLIGHTS. M. REFER TO FIRE RISER DIAGRAM A3/FX501 FOR MORE
- CUMBUSTABLE MATERIALS ARE FOUND IN CEILING

○KEYNOTES

INSPECTOR'S TEST VALVE, REFER TO DETAIL B5/FX501 FOR ADDITIONAL INFORMATION. 3 MOST REMOTE HEAD. 4. NO WORK IN THIS AREA. PROVIDE ORDINARY HAZARD GROUP 1 COVERAGE AT DESIGN DENSITY OF 0.15 GPM/1,500 SQ. SUPPLY THIS SPACE WITH A DEDICATED BRANCH LINE. NO OTHER PIPING SHALL RUN THROUGH

architecture

209 GOLD AVENUE SW ALBUQUERQUE, NM 87102 505.510.4600 4600 C Montgomery Blvd. NE Albuquerque, NM 87109 505.883.4111 www.bpce.com

SEAL

PROJECT

TERMINATE IN ACCORDANCE WITH NFPA-13. THIS ROOM.

Childhoo

CONSTRUCTION DOCUMENTS

REVISIONS 2 3/5/2021 ADDENDUM 4

DRAWN BY REVIEWED BY DATE PROJECT NO PSFA PRE-K PROJECT NO: K-18-011

PSFA SYSTEMS S-20-008 PROJECT NO: DRAWING NAME


FIRE PROTECTION FLOOR PLAN -AREA B - BID LOT

SHEET NO

FX101B

AREA A

FIRE PROTECTION FIRST FLOOR PLAN - AREA B - BID LOT #1

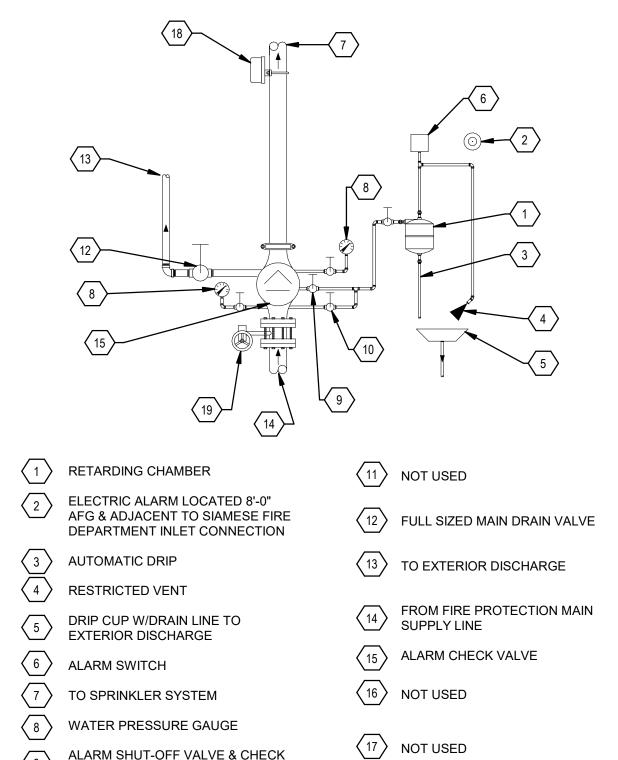


(18) FLOW SWITCH

SPRINKLER ALARM VALVE SCALE: NOT TO SCALE

9 ALARM SHUT-OFF VALVE & CHECK VALVE (NORMALLY OPEN)

ALARM TEST VALVE (NORMALLY CLOSED)

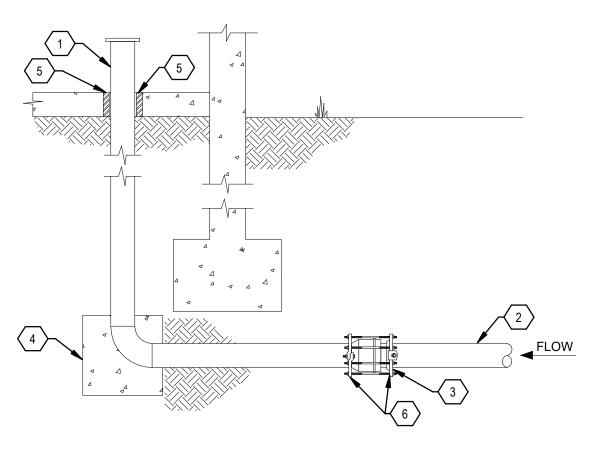

4 CONCRETE THRUST BLOCK SIZED IN ACCORDANCE WITH UBC IF REQUIRED BY 1 AMES IN-BUILDING RISER. STAINLESS STEEL TYPE 304. SEE PLANS FOR SIZE AND SERVICE

2 DUCTILE, CAST-IRON, OR PVC WATER SERVICE. 5 PIPE SLEEVE, SEE SPECIFICATIONS 6 MEGALUG PIPE RESTRAINT HARNESS MECHANICAL JOINT FROM SUPPLY PIPE TO STAINLESS STEEL, CONTINUE INTO BUILDING WITH STAINLESS STEEL


POST INDICATOR -

SCALE: NOT TO SCALE



HEATED ENCLOSURE

(HE-1)

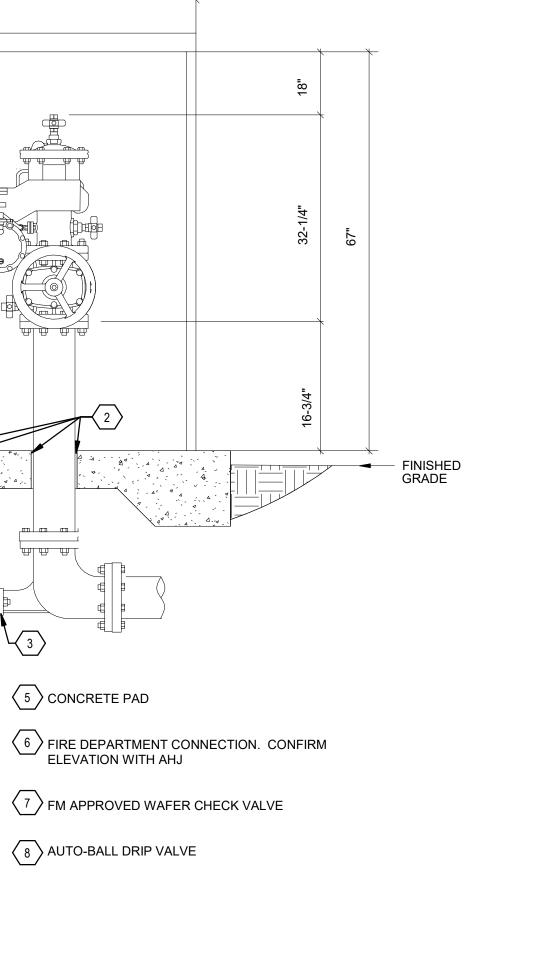

REDUCED PRESSURE BACK FLOW PREVENTER WITH FDC SCALE: NOT TO SCALE

NOTE:
ON CEILING TILES THAT ARE LESS THAN FULL
HEAD SHALL BE CENTERED IN ALL DIRECTIONS

HEAD PERMITTED ON HALF TILE ONLY WHERE 2 x 2 LIGHT OR DIFFUSER SHARES

CEILING TILE

TYPICAL CENTER

TYPICAL FIRE SPRINKLER CEILING TILE DETAIL

60" X 99"

2" X 2" TILE

2'-0"

N-PATTERN FIRE REDUCED PRESSURE

2 SLEEVE AND CAULK SLAB PENETRATION

4 HEATED ENCLOSURE CUSTOM MODEL

3 VALVE SETTER

BACKFLOW PREVENTER ASSEMBLY.
DOMESTIC BACKFLOW PREVENTER NOT
SHOWN FOR CLARITY

architecture 209 GOLD AVENUE SW ALBUQUERQUE, NM 87102 505.510.4600



PROJECT

Center O hildhoo

CONSTRUCTION **DOCUMENTS**

REVISIONS 2 3/5/2021 ADDENDUM 4

DRAWN BY	PCN
REVIEWED BY	SDS
DATE	12/10/2019
PROJECT NO	18-0032
PSFA PRE-K PROJECT NO:	K-18-011
PSFA SYSTEMS PROJECT NO:	S-20-008
DRAWING NAME	

FIRE PROTECTION **DETAILS**

SHEET NO

FX501

A. INFORMATION REGARDING THE EXISTING CONDITIONS WAS GATHERED FROM THE AVAILABLE EXISTING DRAWINGS, SURVEY AND CORRESPONDENCE WITH UTILITY, STAFF AND MUNICIPAL PERSONAL. THERE ARE NO GUARANTEE AS TO THE ACCURACY OF THIS INFORMATION AND IS OFFERED FOR INFORMATION ONLY. THE CONTRACTOR SHOULD VISIT THE SITE PRIOR TO

SUBMITTAL OF BID. . VERIFY EXISTING LOCATIONS OF EQUIPMENT, PIPING AND SYSTEM COMPONENTS PRIOR TO DEMOLITION. IF EXISTING CONDITIONS ARE DIFFERENT THAN WHAT IS INDICATED ON THE CONTRACT DOCUMENTS, THE CONTRACTOR SHALL NOTIFY THE ARCHITECT PRIOR TO PROCEEDING WITH WORK.

MINIMIZE DISTURBANCE AND /OR DAMAGE TO EXISTING FINISHED SURFACES AND FINISHES. WHERE DEMOLITION OF EXISTING PLUMBING SYSTEM COMPONENTS DAMAGES EXISTING SURFACES THAT ARE TO REMAIN, RESTORE THOSE SURFACES TO THE SAME CONDITION AS THE ADJACENT SURFACES. RESTORATION MUST BE PERFORMED BY WORKMAN SKILLED IN PERFORMING SUCH WORK. ALL FIRE AND SMOKE RATINGS SHALL BE RETAINED AS PART OF THE REPAIRS AND PATCH/SEAL HOLES WEATHERTIGHT WHERE REQUIRED. ALL PATCHES AND REPAIRS SHALL BE SUBJECT TO REVIEW AND APPROVAL BY THE ARCHITECT.

ALL AREAS OF EGRESS SHALL BE KEPT OPEN AND FREE FROM DEBRIS AT ALL TIMES. E. DO NOT REMOVE ITEMS SUPPORTING OTHER ITEMS WITHOUT PROVIDING OTHER TEMPORARY OR PERMANENT SUPPORT AS REQUIRED. SEE DRAWINGS FOR AREAS AND EXTENT OF DEMOLITION. PROPERLY SUPPORT ALL EXISTING ITEMS TO REMAIN. CONTRACTOR SHALL BE RESPONSIBLE FOR PROVIDING REQUIRED SUPPORTS FOR AFFECTED ITEMS. VERIFY EXTENT OF PIPING, EQUIPMENT, COMPONENTS AND CONTROLS TO BE RETAINED OR REUSED PRIOR TO THE DEMOLITION OF SPECIFIC SYSTEM. PROTECT ITEMS WHICH ARE TO BE REUSED ON SITE TO MINIMIZE POST CONSTRUCTION REPAIRS. ANY ITEMS THAT ARE DAMAGED SHALL BE THE RESPONSIBILITY OF THE CONTRACTOR AND SHALL BE REPAIRED OR REPLACED AT

NO ADDITIONAL COST TO THE CONTRACT. VERIFY ALL EXISTING STRUCTURAL CONDITIONS AND NOTIFY STRUCTURAL ENGINEER FOR APPROVAL PRIOR TO PENETRATING EXISTING BUILDING STRUCTURAL SYSTEMS. NO DEMOLITION SHALL OCCUR WHICH LEAVES THE BUILDING INTERIOR WITHOUT WEATHER PROTECTION. ALL DEMOLITION OF EXTERIOR SURFACES OR EQUIPMENT SHALL BE FOLLOWED IMMEDIATELY BY PROTECTIVE CONSTRUCTION. CONTRACTOR SHALL PROVIDE AND INSTALL TEMPORARY PROTECTION IN ALL OPENINGS WHERE EQUIPMENT HAS BEEN REMOVED TO BUILDING EXTERIOR. THE CONTRACTOR SHALL REFER TO ALL SECTIONS AND DRAWINGS OF THE CONTRACT DOCUMENTS FOR DEMOLITION OF PLUMBING SYSTEM COMPONENTS INCLUDED IN THE

PLUMBING CONTRACT. NOTIFY THE ARCHITECT OF ALL DISCREPANCIES OR QUESTIONS PERTAINING TO EXTENT OF WORK PRIOR TO BIDDING AMONG CONTRACTORS, FOR SPECIFIC PORTIONS OF CUTTING AND PATCHING WORK.

CONTRACTOR SHALL REFER TO THE SPECIFICATIONS FOR DISTRIBUTION OF RESPONSIBILITY CONTRACTOR SHALL COORDINATE ALL CUTTING AND PATCHING WORK WITH ALL OTHER CONTRACTORS INVOLVED AS DEFINED IN THE SPECIFICATIONS

K. REMOVE AND CAP ALL EXISTING PIPING IN VAULTS. THERE MAY BE ACTIVE LINES THAT WILL

NEED TO REMAIN FOR PHASE 2, TO REMAIN OPERATIONAL. DEMOLITION OF PIPE AT PLAYGROUND SIDE SHOULD STOP AT THE CORNER OF EXISTING/NEW

○KEYNOTES

KEYPLAN

REMOVE PIPING UP TO THIS POINT. REMOVE ALL PIPING DOWNSTREAM OF THIS POINT.

NOT USED. 4. REMOVE GAS PIPING DOWN STREAM OF METER/REGULATOR ASSEMBLY IN A PHASED MANNER THAT MAINTAINS FUNCTIONALITY OF ALL DOWN STREAM EQUIPMENT AS REQUIRED TO KEEP SERVICE TO GAS SYSTEM THAT IS TO BE DOMOLISHED AS PART OF PHASE 2. . REFER TO DETAIL 6. COORDINATE SAWCUTING, PATCHING AND REPAIR REQUIREMENTS WITH ARCHITECTURAL.

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SEAL

PROJECT

209 GOLD AVENUE SW ALBUQUERQUE, NM 87102

CONSTRUCTION DOCUMENTS

REVISIONS

DRAWN BY REVIEWED BY

DATE PROJECT NO PSFA PRE-K PROJECT NO: K-18-011 PSFA SYSTEMS S-20-008 PROJECT NO: DRAWING NAME

PLUMBING DEMOLITION FLOOR PLAN -AREA A

SHEET NO

PD100A

- A. INFORMATION REGARDING THE EXISTING CONDITIONS WAS GATHERED FROM THE AVAILABLE EXISTING DRAWINGS, SURVEY AND CORRESPONDENCE WITH UTILITY, STAFF AND MUNICIPAL PERSONAL. THERE ARE NO GUARANTEE AS TO THE ACCURACY OF THIS INFORMATION AND IS OFFERED FOR INFORMATION ONLY. THE CONTRACTOR SHOULD VISIT THE SITE PRIOR TO SUBMITTAL OF BID.
- . VERIFY EXISTING LOCATIONS OF EQUIPMENT, PIPING AND SYSTEM COMPONENTS PRIOR TO DEMOLITION. IF EXISTING CONDITIONS ARE DIFFERENT THAN WHAT IS INDICATED ON THE CONTRACT DOCUMENTS, THE CONTRACTOR SHALL NOTIFY THE ARCHITECT PRIOR TO PROCEEDING WITH WORK.
- MINIMIZE DISTURBANCE AND /OR DAMAGE TO EXISTING FINISHED SURFACES AND FINISHES. WHERE DEMOLITION OF EXISTING PLUMBING SYSTEM COMPONENTS DAMAGES EXISTING SURFACES THAT ARE TO REMAIN, RESTORE THOSE SURFACES TO THE SAME CONDITION AS THE ADJACENT SURFACES. RESTORATION MUST BE PERFORMED BY WORKMAN SKILLED IN PERFORMING SUCH WORK. ALL FIRE AND SMOKE RATINGS SHALL BE RETAINED AS PART OF THE REPAIRS AND PATCH/SEAL HOLES WEATHERTIGHT WHERE REQUIRED. ALL PATCHES AND REPAIRS SHALL BE SUBJECT TO REVIEW AND APPROVAL BY THE ARCHITECT.
- ALL AREAS OF EGRESS SHALL BE KEPT OPEN AND FREE FROM DEBRIS AT ALL TIMES. E. DO NOT REMOVE ITEMS SUPPORTING OTHER ITEMS WITHOUT PROVIDING OTHER TEMPORARY OR PERMANENT SUPPORT AS REQUIRED. SEE DRAWINGS FOR AREAS AND EXTENT OF DEMOLITION. PROPERLY SUPPORT ALL EXISTING ITEMS TO REMAIN. CONTRACTOR SHALL BE RESPONSIBLE FOR PROVIDING REQUIRED SUPPORTS FOR AFFECTED ITEMS. VERIFY EXTENT OF PIPING, EQUIPMENT, COMPONENTS AND CONTROLS TO BE RETAINED OR REUSED PRIOR TO THE DEMOLITION OF SPECIFIC SYSTEM. PROTECT ITEMS WHICH ARE TO BE REUSED ON SITE TO MINIMIZE POST CONSTRUCTION REPAIRS. ANY ITEMS THAT ARE DAMAGED SHALL BE THE RESPONSIBILITY OF THE CONTRACTOR AND SHALL BE REPAIRED OR REPLACED AT NO ADDITIONAL COST TO THE CONTRACT.
- VERIFY ALL EXISTING STRUCTURAL CONDITIONS AND NOTIFY STRUCTURAL ENGINEER FOR APPROVAL PRIOR TO PENETRATING EXISTING BUILDING STRUCTURAL SYSTEMS. NO DEMOLITION SHALL OCCUR WHICH LEAVES THE BUILDING INTERIOR WITHOUT WEATHER PROTECTION. ALL DEMOLITION OF EXTERIOR SURFACES OR EQUIPMENT SHALL BE FOLLOWED IMMEDIATELY BY PROTECTIVE CONSTRUCTION. CONTRACTOR SHALL PROVIDE AND INSTALL TEMPORARY PROTECTION IN ALL OPENINGS WHERE EQUIPMENT HAS BEEN REMOVED TO BUILDING EXTERIOR. THE CONTRACTOR SHALL REFER TO ALL SECTIONS AND DRAWINGS OF THE CONTRACT DOCUMENTS FOR DEMOLITION OF PLUMBING SYSTEM COMPONENTS INCLUDED IN THE PLUMBING CONTRACT. NOTIFY THE ARCHITECT OF ALL DISCREPANCIES OR QUESTIONS PERTAINING TO EXTENT OF WORK PRIOR TO BIDDING
- CONTRACTOR SHALL REFER TO THE SPECIFICATIONS FOR DISTRIBUTION OF RESPONSIBILITY AMONG CONTRACTORS, FOR SPECIFIC PORTIONS OF CUTTING AND PATCHING WORK. CONTRACTOR SHALL COORDINATE ALL CUTTING AND PATCHING WORK WITH ALL OTHER NEED TO REMAIN FOR PHASE 2, TO REMAIN OPERATIONAL.

○KEYNOTES

REMOVE PIPING UP TO THIS POINT.

AREA A

2 PEMOVE PIPING BETWEEN THESE APPROXIMATE POINTS

3. EXISTING PLUMBING FIXTURE TO REMAIN. EXISTING SANITARY PIPING IN THIS AREA SHALL BE HAND EXCAVATED. ADDITIONAL EXISTING \$ WATER/GAS/ELECTRICAL SERVICES MAY EXIST BELOW GRADE. FIELD COORDINATE ALL TRENCHING IN THIS AREA WITH ALL TRADES. COORDINATE SAWCUTING, PATCHING AND REPAIR REQUIREMENTS WITH ARCHITECTURAL. munimum minument

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SEAL

PROJECT

209 GOLD AVENUE SW ALBUQUERQUE, NM 87102 505.510.4600

CONSTRUCTION DOCUMENTS

REVISIONS

DRAWN BY REVIEWED BY DATE

PROJECT NO 18-0032 PSFA PRE-K PROJECT NO: K-18-011 PSFA SYSTEMS S-20-008 PROJECT NO: DRAWING NAME

PLUMBING DEMOLITION FLOOR PLAN -AREA B

SHEET NO

PD100B

PLUMBING FLOOR DEMOLITION PLAN

- A. INFORMATION REGARDING THE EXISTING CONDITIONS WAS GATHERED FROM THE AVAILABLE EXISTING DRAWINGS, SURVEY AND CORRESPONDENCE WITH UTILITY, STAFF AND MUNICIPAL PERSONAL. THERE ARE NO GUARANTEE AS TO THE ACCURACY OF THIS INFORMATION AND IS OFFERED FOR INFORMATION ONLY. THE CONTRACTOR SHOULD VISIT THE SITE PRIOR TO
- SUBMITTAL OF BID. . VERIFY EXISTING LOCATIONS OF EQUIPMENT, PIPING AND SYSTEM COMPONENTS PRIOR TO DEMOLITION. IF EXISTING CONDITIONS ARE DIFFERENT THAN WHAT IS INDICATED ON THE CONTRACT DOCUMENTS, THE CONTRACTOR SHALL NOTIFY THE ARCHITECT PRIOR TO PROCEEDING WITH WORK.
- MINIMIZE DISTURBANCE AND /OR DAMAGE TO EXISTING FINISHED SURFACES AND FINISHES. WHERE DEMOLITION OF EXISTING PLUMBING SYSTEM COMPONENTS DAMAGES EXISTING SURFACES THAT ARE TO REMAIN, RESTORE THOSE SURFACES TO THE SAME CONDITION AS THE ADJACENT SURFACES. RESTORATION MUST BE PERFORMED BY WORKMAN SKILLED IN PERFORMING SUCH WORK. ALL FIRE AND SMOKE RATINGS SHALL BE RETAINED AS PART OF THE REPAIRS AND PATCH/SEAL HOLES WEATHERTIGHT WHERE REQUIRED. ALL PATCHES AND REPAIRS SHALL BE SUBJECT TO REVIEW AND APPROVAL BY THE ARCHITECT.
- ALL AREAS OF EGRESS SHALL BE KEPT OPEN AND FREE FROM DEBRIS AT ALL TIMES. E. DO NOT REMOVE ITEMS SUPPORTING OTHER ITEMS WITHOUT PROVIDING OTHER TEMPORARY OR PERMANENT SUPPORT AS REQUIRED. SEE DRAWINGS FOR AREAS AND EXTENT OF DEMOLITION. PROPERLY SUPPORT ALL EXISTING ITEMS TO REMAIN. CONTRACTOR SHALL BE RESPONSIBLE FOR PROVIDING REQUIRED SUPPORTS FOR AFFECTED ITEMS. VERIFY EXTENT OF PIPING, EQUIPMENT, COMPONENTS AND CONTROLS TO BE RETAINED OR REUSED PRIOR TO THE DEMOLITION OF SPECIFIC SYSTEM. PROTECT ITEMS WHICH ARE TO BE REUSED ON SITE TO MINIMIZE POST CONSTRUCTION REPAIRS. ANY ITEMS THAT ARE DAMAGED SHALL BE THE RESPONSIBILITY OF THE CONTRACTOR AND SHALL BE REPAIRED OR REPLACED AT NO ADDITIONAL COST TO THE CONTRACT.
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- CONTRACTOR SHALL REFER TO THE SPECIFICATIONS FOR DISTRIBUTION OF RESPONSIBILITY AMONG CONTRACTORS, FOR SPECIFIC PORTIONS OF CUTTING AND PATCHING WORK. CONTRACTOR SHALL COORDINATE ALL CUTTING AND PATCHING WORK WITH ALL OTHER CONTRACTORS INVOLVED AS DEFINED IN THE SPECIFICATIONS

 K. REMOVE AND CAP ALL EXISTING PIPING IN VAULTS. THERE MAY BE ACTIVE LINES THAT WILL NEED TO REMAIN FOR PHASE 2, TO REMAIN OPERATIONAL. DEMOLITION OF PIPE AT PLAYGROUND SIDE SHOULD STOP AT THE CORNER OF EXISTING/NEW

PERTAINING TO EXTENT OF WORK PRIOR TO BIDDING

○KEYNOTES

- REMOVE EXISTING PLUMBING FIXTURE & TRIM COMPLETE. REMOVE ALL SUSPENDED & BURIED WATER, WASTE, AND VENT PIPING ASSOCIATED WITH FIXTURES. REMOVE EXISTING FLOOR DRAIN & ASSOCIATED DWV PIPING COMPLETE.
- ABANDON IN PLACE. DO NOT SAW CUT SLAB. 4. CAP BELOW SLAB AND ABANDON IN PLACE. PATCH FLOOR AS REQUIRED.
- 5. PRESSURE WASH AND ABANDON IN PLACE SANITARY SEWER PIPING AND CAP WITH GAS TIGHT CONNECTIONS, (TYPICAL THROUGH OUT).
- REMOVE ALL PIPING DOWNSTREAM OF THIS POINT. Z REMOVE CLEANOUT TO GRADE 8. EXISTING SANITARY PIPING IN THIS AREA SHALL BE HAND EXCAVATED. ADDITIONAL EXISTING

WATER/GAS/ELECTRICAL SERVICES MAY EXIST BELOW GRADE. FIELD COORDINATE ALL TRENCHING IN THIS AREA WITH ALL TRADES. COORDINATE SAWCUTING, PATCHING AND REPAIR REQUIREMENTS WITH ARCHITECTURAL.

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SEAL

PROJECT

209 GOLD AVENUE SW ALBUQUERQUE, NM 87102

CONSTRUCTION DOCUMENTS

REVISIONS

DRAWN BY	Author
REVIEWED BY	Checker
DATE	12/10/2019
PROJECT NO	18-0032
PSFA PRE-K PROJECT NO:	K-18-011
PSFA SYSTEMS PROJECT NO:	S-20-008

DRAWING NAME **PLUMBING** DEMOLITION FLOOR PLAN -AREA A - BID LOT

SHEET NO

PD101A

KEYPLAN

- A. INFORMATION REGARDING THE EXISTING CONDITIONS WAS GATHERED FROM THE AVAILABLE EXISTING DRAWINGS, SURVEY AND CORRESPONDANCE WITH UTILITY, STAFF AND MUNICIPAL PERSONAL. THERE ARE NO GUARANTEE AS TO THE ACCURACY OF THIS INFORMATION AND IS OFFERED FOR INFORMATION ONLY. THE CONTRACTOR SHOULD VISIT THE SITE PRIOR TO
- SUBMITTAL OF BID. VERIFY EXISTING LOCATIONS OF EQUIPMENT, PIPING AND SYSTEM COMPONENTS PRIOR TO DEMOLITION. IF EXISTING CONDITIONS ARE DIFFERENT THAN WHAT IS INDICATED ON THE CONTRACT DOCUMENTS, THE CONTRACTOR SHALL NOTIFY THE ARCHITECT PRIOR TO PROCEEDING WITH WORK.
- MINIMIZE DISTURBANCE AND /OR DAMAGE TO EXISTING FINISHED SURFACES AND FINISHES. WHERE DEMOLITION OF EXISTING PLUMBING SYSTEM COMPONENTS DAMAGES EXISTING SURFACES THAT ARE TO REMAIN, RESTORE THOSE SURFACES TO THE SAME CONDITION AS THE ADJACENT SURFACES. RESTORATION MUST BE PERFORMED BY WORKMAN SKILLED IN PERFORMING SUCH WORK. ALL FIRE AND SMOKE RATINGS SHALL BE RETAINED AS PART OF THE REPIAIRS AND PATCH/SEAL HOLES WEATHERTIGHT WHERE REQUIRED. ALL PATCHES AND REPAIRS SHALL BE SUBJECT TO REVIEW AND APPROVAL BY THE ARCHITECT.
- ALL AREAS OF EGRESS SHALL BE KEPT OPEN AND FREE FROM DEBRIS AT ALL TIMES. E. DO NOT REMOVE ITEMS SUPPORTING OTHER ITEMS WITHOUT PROVIDING OTHER TEMPORARY OR PERMANENT SUPPORT AS REQUIRED. SEE DRAWINGS FOR AREAS AND EXTENT OF DEMOLITION. PROPERLY SUPPORT ALL EXISTING ITEMS TO REMAIN. CONTRACTOR SHALL BE RESPONSIBLE FOR PROVIDING REQUIRED SUPPORTS FOR AFFECTED ITEMS. VERIFY EXTENT OF PIPING, EQUIPMENT, COMPONENTS AND CONTROLS TO BE RETAINED OR REUSED PRIOR TO THE DEMOLITION OF SPECIFIC SYSTEM. PROTECT ITEMS WHICH ARE TO BE REUSED ON SITE TO MINIMIZE POST CONSTRUCTION REPAIRS. ANY ITEMS THAT ARE DAMAGED SHALL BE THE RESPONSIBILITY OF THE CONTRACTOR AND SHALL BE REPAIRED OR REPLACED AT NO ADDITIONAL COST TO THE CONTRACT.
- VERIFY ALL EXISTING STRUCTURAL CONDITIONS AND NOTIFY STRUCTURAL ENGINEER FOR APPROVAL PRIOR TO PENETRATING EXISTING BUILDING STRUCTURAL SYSTEMS. NO DEMOLITION SHALL OCCUR WHICH LEAVES THE BUILDING INTERIOR WITHOUT WEATHER PROTECTION. ALL DEMOLITION OF EXTERIOR SURFACES OR EQUIPMENT SHALL BE FOLLOWED IMMEDIATELY BY PROTECTIVE CONSTRUCTION. CONTRACTOR SHALL PROVIDE AND INSTALL TEMPORARY PROTECTION IN ALL OPENINGS WHERE EQUIPMENT HAS BEEN REMOVED TO BUILDING EXTERIOR. THE CONTRACTOR SHALL REFER TO ALL SECTIONS AND DRAWINGS OF THE CONTRACT DOCUMENTS FOR DEMOLITION OF PLUMBING SYSTEM COMPONENTS INCLUDED IN THE PLUMBING CONTRACT. NOTIFY THE ARCHITECT OF ALL DISCREPANCIES OR QUESTIONS PERTAINING TO EXTENT OF WORK PRIOR TO BIDDING
- CONTRACTOR SHALL REFER TO THE SPECIFICATIONS FOR DISTRIBUTION OF RESPONSIBILITY AMONG CONTRACTORS, FOR SPECIFIC PORTIONS OF CUTTING AND PATCHING WORK. CONTRACTOR SHALL COORDINATE ALL CUTTING AND PATCHING WORK WITH ALL OTHER CONTRACTORS INVOLVED AS DEFINED IN THE SPECIFICATIONS (2)
- NEED TO REMAIN FOR PHASE 2, TO REMAIN OPERATIONAL. DEMOLITION OF PIPE AT PLAYGROUND SIDE SHOULD STOP AT THE CORNER OF EXISTING/NEW CONTRUCTION.


○KEYNOTES

- REMOVE EXISTING PLUMBING FIXTURE & TRIM COMPLETE. REMOVE ALL SUSPENDED & BURIED WATER, WASTE, AND VENT PIPING ASSOCIATED WITH FIXTURES. REMOVE EXISTING FLOOR DRAIN & ASSOCIATED DWV PIPING COMPLETE..
 - CONNECTIONS, (TYPICAL THROUGH OUT). EXISTING PLUMBING FIXTURE TO REMAIN.
- REMOVE EXISTING SANITARY PIPING UP THIS POINT. EXISTING SANITARY PIPING IN THIS AREA SHALL BE HAND EXCAVATED. ADDITIONAL EXISTING WATER/GAS/ELECTRICAL SERVICES MAY EXIST BELOW GRADE. FIELD COORDINATE ALL TRENCHING IN THIS AREA WITH ALL TRADES. 10. REMOVE PIPING BETWEEN THESE APPROXIMATE POINTS.

architecture 209 GOLD AVENUE SW ALBUQUERQUE, NM 87102



SEAL

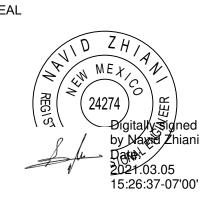

PROJECT

CONSTRUCTION DOCUMENTS

REVISIONS

DRAWN BY **REVIEWED BY** DATE PROJECT NO PSFA PRE-K K-18-011 PROJECT NO: PSFA SYSTEMS S-20-008

DRAWING NAME **PLUMBING** DEMOLITION FLOOR PLAN -AREA B - BID LOT

PROJECT NO:

SHEET NO

PD101B

KEYPLAN

PLUMBING FIRST FLOOR DEMOLITION PLAN - AREA B - BID LOT #1

PIPED GASES FIRST FLOOR PLAN - AREA A - BID LOT #1 SCALE: 1/8" = 1'-0"

GENERAL SHEET NOTES

A. FINISHED FLOOR ELEVATION = 100'-0" UNLESS OTHERWISE INDICATED. B. THE CONTRACTOR SHALL VISIT THE SITE PRIOR TO BIDDING AND PERFORM A FIELD SURVEY TO CONFIRM LOCATION AND SIZES OF EXISTING PLUMBING SERVICES. THE CONTRACTOR MAY SUBMIT HIS BID BASED ON AN ALTERNATE PIPING LAYOUT, PROVIDING IT

COMPLIES WITH FOLLOWING: 1. FIELD SURVEY HAS BEEN COMPLETED AND PROPOSED PLUMBING LAYOUT WON'T CONFLICT WITH EXISTING EQUIPMENTOR WILL NOT DISRUPT PRESENTLY OCCUPIED AREAS. 2. CONTRACTOR HAS REVIEWED ALL PLANS FOR COORDINATING WITH HVAC, FIRE

PROTECTION, ARCHITECTURAL, AND ELECTRICAL TRADES TO AVOID CONFLICTS. 3. NEW PIPING SHALL NOT CONNECT TO EXISTING SERVICES OF LESSER SIZE. 4. INSTALLATION COMPLIES WITH STATE AND LOCAL CODES. PIPING LOCATIONS HAVE BEEN SHOWN FOR CLARITY AND DO NOT NECESSARILY REFLECT THE

EXACT LOCATION OF PIPE. COORDINATE ROUTING WITH ALL OTHER TRADES BEFORE INSTALLATION OR MAKEUP OF PIPE. PROVIDE COORDINATION DRAWINGS PER SPECIFICATIONS. COORDINATE ALL PLUMBING PIPING WITH ALL OTHER TRADES AND PROVIDE NECESSARY OFFSETS TO AVOID CONFLICTS AND TO MAINTAIN REQUIRED EQUIPMENT ACCESS AND

SERVICEABILITY. REFER TO ARCHITECTURAL DRAWINGS FOR EXACT LOCATION OF ALL FIRE RATED AND OR SMOKE RATED WALLS AND ASSEMBLIES. PIPING PENETRATIONS OF FIRE AND SMOKE RATED WALLS AND LISTED ASSEMBLIES SHALL BE CAULKED AIRTIGHT TO THE ADJACENT STRUCTURE BY MEANS OF U.L. LISTED FIRE PROOF CAULKING MATERIAL.

UNDERGROUND STORM AND SANITARY PIPING SHOWN ON DRAWINGS RUNNING IN THE CORRIDORS SHALL BE INSTALLED IN THE MIDDLE OF THE CORRIDOR WHERE POSSIBLE.

CONTRACTOR SHALL NOT UNDERMINE FOOTINGS. I. ALL MATERIALS SHALL BE DISPOSED OF IN A PROPER MANNER. THE CONTRACTOR SHALL BE RESPONSIBLE FOR CLEANUP OF WORKSITE OF ANY MATERIAL THAT IS OF THEIR TRADE. ALL PENETRATIONS THROUGH EXISTING DRYWALL OR SOLID SURFACES SHALL BE PROVIDED WITH ESCUTCHEONS IF EXPOSED. PENETRATIONS SHALL BE PATCHED TO MATCH SURROUNDING SURFACES.

REFER TO ARCHITECTURAL FLOOR PLANS FOR EXACT LOCATION AND HEIGHTS OF ALL PLUMBING FIXTURES BEFORE ROUGH-IN OR INSTALLATION OF PIPE. PLUMBING FIXTURES SHALL BE MOUNTED AT HEIGHTS SHOWN ON ARCHITECTURAL ELEVATION DRAWINGS. K. ALL PIPING IN FINISHED ROOMS SHALL BE CONCEALED IN FURRED CHASES UNLESS OTHERWISE NOTED ON THIS DRAWING. PROVIDE HINGED ACCESS DOORS FOR VALVES, WATER HAMMER ARRESTERS, ISOLATION BALL VALVES LOCATED IN NONACCESSIBLE CEILINGS AND CHASES. DOORS FURNISHED PER

ARCHITECTURAL SPECIFICATIONS AND PURCHASED AND INSTALLED PER DIVISION 22. ACCESS DOOR RATING SHALL MATCH THE CLASSIFICATION OF WALLS AND CEILING FIRE RATING. COORDINATE COLOR AND TYPE OF ACCESS DOOR WITH ARCHITECTURAL PRIOR TO PERFORMING WORK.

M. SANITARY SEWER PIPING SHALL BE C.I NO-HUB UNLESS NOTED OTHERWISE. INSTALL PER UPC

N. DOMESTIC HOT AND COLD WATER PIPIING SHALL BE TYPE K OR L COPPER WITH 95-5 SOLDER JOINTS. ALL WATER PIPING SHALL BE INSULATED PER SPECIFICATIONS. O. ALL PIPING SHALL BE TESTED PER 2015 UPC AND PER SPECIFICATIONS.

P. REFER TO DRAWING P-701 FOR PLUMBING ROUGH IN REQUIREMENTS.

○KEYNOTES

KEYPLAN

NOT USED.

THE NATURAL GAS AND WATER HEATER INSTALLATION SHALL BE PART OF BASE BID. SHOWN HERE FOR CLARITY. 1/2" NGM GAS LINE DOWN FROM ROOF TO FIRE RISER 108. ROUTE 1/2" NGM PIPING TO VENTLESS REGULATOR. REGULATOR SHALL REDUCE PRESSURE DOWN TO 7" TO 14" W.C. EXTEND 3/4" GAS PIPING TO WATER HEATER AND CONNECT PER MANUFACTURERS REQUIREMENTS. PROVIDE CONNECTION TO WATER HEATER WITH UNION, PETE'S PLUGS, DIRT-LEG, GAS COCK AND FLEXIBLE CONNECTION, REFER TO A3/P501 FOR ADDITIONAL INFORMATION.

architecture

209 GOLD AVENUE SW ALBUQUERQUE, NM 87102

SEAL

PROJECT

 \sim NOT USED.

Childhoo

CONSTRUCTION DOCUMENTS

REVISIONS

DRAWN BY	Author
REVIEWED BY	Checker
DATE	12/10/2019
PROJECT NO	18-0032
PSFA PRE-K PROJECT NO:	K-18-011
PSFA SYSTEMS PROJECT NO:	S-20-008

DRAWING NAME PIPED GASES

FLOOR PLAN -AREA A - BID LOT

SHEET NO

PG101A

- A. FINISHED FLOOR ELEVATION = 100'-0" UNLESS OTHERWISE INDICATED. B. THE CONTRACTOR SHALL VISIT THE SITE PRIOR TO BIDDING AND PERFORM A FIELD SURVEY TO CONFIRM LOCATION AND SIZES OF EXISTING PLUMBING SERVICES. THE CONTRACTOR MAY SUBMIT HIS BID BASED ON AN ALTERNATE PIPING LAYOUT, PROVIDING IT
- COMPLIES WITH FOLLOWING: 1. FIELD SURVEY HAS BEEN COMPLETED AND PROPOSED PLUMBING LAYOUT WON'T CONFLICT WITH EXISTING EQUIPMENT WILL NOT DISRUPT PRESENTLY OCCUPIED AREAS.
- 2. CONTRACTOR HAS REVIEWED ALL PLANS FOR COORDINATING WITH HVAC, FIRE PROTECTION, ARCHITECTURAL, AND ELECTRICAL TRADES TO AVOID CONFLICTS. 3. NEW PIPING SHALL NOT CONNECT TO EXISTING SERVICES OF LESSER SIZE.
- PIPING LOCATIONS HAVE BEEN SHOWN FOR CLARITY AND DO NOT NECESSARILY REFLECT THE EXACT LOCATION OF PIPE. COORDINATE ROUTING WITH ALL OTHER TRADES BEFORE INSTALLATION OR MAKEUP OF PIPE. PROVIDE COORDINATION DRAWINGS PER SPECIFICATIONS. COORDINATE ALL PLUMBING PIPING WITH ALL OTHER TRADES AND PROVIDE NECESSARY
- OFFSETS TO AVOID CONFLICTS AND TO MAINTAIN REQUIRED EQUIPMENT ACCESS AND SERVICEABILITY. REFER TO ARCHITECTURAL DRAWINGS FOR EXACT LOCATION OF ALL FIRE RATED AND OR SMOKE RATED WALLS AND ASSEMBLIES. PIPING PENETRATIONS OF FIRE AND SMOKE RATED WALLS AND LISTED ASSEMBLIES SHALL BE CAULKED AIRTIGHT TO THE ADJACENT STRUCTURE BY
- CORRIDORS SHALL BE INSTALLED IN THE MIDDLE OF THE CORRIDOR WHERE POSSIBLE.
- RESPONSIBLE FOR CLEANUP OF WORKSITE OF ANY MATERIAL THAT IS OF THEIR TRADE. WITH ESCUTCHEONS IF EXPOSED. PENETRATIONS SHALL BE PATCHED TO MATCH SURROUNDING SURFACES.
- PROVIDE HINGED ACCESS DOORS FOR VALVES, WATER HAMMER ARRESTERS, ISOLATION BALL VALVES LOCATED IN NONACCESSIBLE CEILINGS AND CHASES. DOORS FURNISHED PER ARCHITECTURAL SPECIFICATIONS AND PURCHASED AND INSTALLED PER DIVISION 22. ACCESS DOOR RATING SHALL MATCH THE CLASSIFICATION OF WALLS AND CEILING FIRE RATING. COORDINATE COLOR AND TYPE OF ACCESS DOOR WITH ARCHITECTURAL PRIOR TO PERFORMING WORK.
- JOINTS, ALL WATER PIPING SHALL BE INSULATED PER SPECIFICATIONS. O. ALL PIPING SHALL BE TESTED PER 2015 UPC AND PER SPECIFICATIONS.
- Q. AT CONTRACTORS OPTION THEY CAN REUSE EXISTING VTR LOCATION. VENT PIPING SHALL BE APPROPRIATELY SIZE PER CODE.

○KEYNOTES

KEYPLAN

WASTE & VENT FLOOR PLAN - AREA A

SCALE: 1/8" = 1'-0"

- INSTALL DOUBLE CLEANOUT TO GRADE IN ACCORDANCE WITH DETAIL
- INSTALL FLOOR DRAIN IN ACCORDANCE WITH DETAIL C1/P-501. INSTALL WALL CLEANOUT IN ACCORDANCE WITH DETAIL C5/P-501.
- . TREE PROTECTION ZONE. REFER TO ARCHITECT AND COORDINATE SANITARY PIPE ROUTING. SEE PL101A FOR EXTENSION TO BID LOT.
- 10. COORDINATE EXACT ROUTING WITH ARCHITECT.
- . ENCASE SANITARY PIPING IN CONCRETE IN PROXIMITY OF WATER LINE. 12. EXISTING SANITARY PIPING IN THIS AREA SHALL BE HAND EXCAVATED TO AVOID EXISTING TREES

- 4. INSTALLATION COMPLIES WITH STATE AND LOCAL CODES.
- MEANS OF U.L. LISTED FIRE PROOF CAULKING MATERIAL. UNDERGROUND STORM AND SANITARY PIPING SHOWN ON DRAWINGS RUNNING IN THE
- CONTRACTOR SHALL NOT UNDERMINE FOOTINGS. ALL MATERIALS SHALL BE DISPOSED OF IN A PROPER MANNER. THE CONTRACTOR SHALL BE ALL PENETRATIONS THROUGH EXISTING DRYWALL OR SOLID SURFACES SHALL BE PROVIDED
- REFER TO ARCHITECTURAL FLOOR PLANS FOR EXACT LOCATION AND HEIGHTS OF ALL PLUMBING FIXTURES BEFORE ROUGH-IN OR INSTALLATION OF PIPE. PLUMBING FIXTURES SHALL BE MOUNTED AT HEIGHTS SHOWN ON ARCHITECTURAL ELEVATION DRAWINGS. . ALL PIPING IN FINISHED ROOMS SHALL BE CONCEALED IN FURRED CHASES UNLESS OTHERWISE NOTED ON THIS DRAWING.
- M. SANITARY SEWER PIPING SHALL BE C.I NO-HUB UNLESS NOTED OTHERWISE. INSTALL PER UPC
- N. DOMESTIC HOT AND COLD WATER PIPING SHALL BE TYPE K OR L COPPER WITH 95-5 SOLDER
- P. REFER TO DRAWING P-701 FOR PLUMBING ROUGH IN REQUIREMENTS.

- AND EXISTING TREE ROOT SYSTEM. ADDITIONAL EXISTING WATER/GAS/ELECTRICAL SERVICES MAY EXIST BELOW GRADE. FIELD COORDINATE ALL TRENCHING IN THIS AREA WITH ALL TRADES OFFSET AND ROUTE VENT PIPING BELOW CHANGING STATION.

 14. ROUTE 2" SANITARY PIPING AT 1/4" PER FOOT IN WALL. DROP TO BELOW GRADE AS SHOWN AND PROVIDE WITH A WALL CLEAN OUT (WCO).

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/___ architecture

SEAL

PROJECT

hildhoo

CONSTRUCTION **DOCUMENTS**

REVISIONS

2 3/5/2021 ADDENDUM 4

DRAWN BY	MAD
REVIEWED BY	SDS
DATE	12/10/2019
PROJECT NO	18-0032
PSFA PRE-K PROJECT NO:	K-18-011
PSFA SYSTEMS PROJECT NO:	S-20-008

DRAWING NAME WASTE & VENT FLOOR PLAN -AREA A

SHEET NO PL100A

- A. FINISHED FLOOR ELEVATION = 100'-0" UNLESS OTHERWISE INDICATED. B. THE CONTRACTOR SHALL VISIT THE SITE PRIOR TO BIDDING AND PERFORM A FIELD SURVEY TO CONFIRM LOCATION AND SIZES OF EXISTING PLUMBING SERVICES. THE CONTRACTOR MAY SUBMIT HIS BID BASED ON AN ALTERNATE PIPING LAYOUT, PROVIDING IT
- COMPLIES WITH FOLLOWING: 1. FIELD SURVEY HAS BEEN COMPLETED AND PROPOSED PLUMBING LAYOUT WON'T CONFLICT WITH EXISTING EQUIPMENT WILL NOT DISRUPT PRESENTLY OCCUPIED AREAS.
- 2. CONTRACTOR HAS REVIEWED ALL PLANS FOR COORDINATING WITH HVAC, FIRE PROTECTION, ARCHITECTURAL, AND ELECTRICAL TRADES TO AVOID CONFLICTS. 3. NEW PIPING SHALL NOT CONNECT TO EXISTING SERVICES OF LESSER SIZE.
- PIPING LOCATIONS HAVE BEEN SHOWN FOR CLARITY AND DO NOT NECESSARILY REFLECT THE EXACT LOCATION OF PIPE. COORDINATE ROUTING WITH ALL OTHER TRADES BEFORE INSTALLATION OR MAKEUP OF PIPE. PROVIDE COORDINATION DRAWINGS PER SPECIFICATIONS. COORDINATE ALL PLUMBING PIPING WITH ALL OTHER TRADES AND PROVIDE NECESSARY
 - OFFSETS TO AVOID CONFLICTS AND TO MAINTAIN REQUIRED EQUIPMENT ACCESS AND SERVICEABILITY. REFER TO ARCHITECTURAL DRAWINGS FOR EXACT LOCATION OF ALL FIRE RATED AND OR SMOKE RATED WALLS AND ASSEMBLIES. PIPING PENETRATIONS OF FIRE AND SMOKE RATED WALLS AND LISTED ASSEMBLIES SHALL BE CAULKED AIRTIGHT TO THE ADJACENT STRUCTURE BY
 - MEANS OF U.L. LISTED FIRE PROOF CAULKING MATERIAL. UNDERGROUND STORM AND SANITARY PIPING SHOWN ON DRAWINGS RUNNING IN THE CORRIDORS SHALL BE INSTALLED IN THE MIDDLE OF THE CORRIDOR WHERE POSSIBLE.
 - CONTRACTOR SHALL NOT UNDERMINE FOOTINGS. ALL MATERIALS SHALL BE DISPOSED OF IN A PROPER MANNER. THE CONTRACTOR SHALL BE RESPONSIBLE FOR CLEANUP OF WORKSITE OF ANY MATERIAL THAT IS OF THEIR TRADE. ALL PENETRATIONS THROUGH EXISTING DRYWALL OR SOLID SURFACES SHALL BE PROVIDED WITH ESCUTCHEONS IF EXPOSED. PENETRATIONS SHALL BE PATCHED TO MATCH SURROUNDING
 - REFER TO ARCHITECTURAL FLOOR PLANS FOR EXACT LOCATION AND HEIGHTS OF ALL PLUMBING FIXTURES BEFORE ROUGH-IN OR INSTALLATION OF PIPE. PLUMBING FIXTURES SHALL BE MOUNTED AT HEIGHTS SHOWN ON ARCHITECTURAL ELEVATION DRAWINGS. ALL PIPING IN FINISHED ROOMS SHALL BE CONCEALED IN FURRED CHASES UNLESS OTHERWISE NOTED ON THIS DRAWING.
 - PROVIDE HINGED ACCESS DOORS FOR VALVES, WATER HAMMER ARRESTERS, ISOLATION BALL VALVES LOCATED IN NONACCESSIBLE CEILINGS AND CHASES. DOORS FURNISHED PER ARCHITECTURAL SPECIFICATIONS AND PURCHASED AND INSTALLED PER DIVISION 22. ACCESS DOOR RATING SHALL MATCH THE CLASSIFICATION OF WALLS AND CEILING FIRE RATING. COORDINATE COLOR AND TYPE OF ACCESS DOOR WITH ARCHITECTURAL PRIOR TO
 - M. SANITARY SEWER PIPING SHALL BE C.I NO-HUB UNLESS NOTED OTHERWISE. INSTALL PER UPC
 - N. DOMESTIC HOT AND COLD WATER PIPING SHALL BE TYPE K OR L COPPER WITH 95-5 SOLDER JOINTS. ALL WATER PIPING SHALL BE INSULATED PER SPECIFICATIONS. . ALL PIPING SHALL BE TESTED PER 2015 UPC AND PER SPECIFICATIONS.
 - REFER TO DRAWING P-701 FOR PLUMBING ROUGH IN REQUIREMENTS. Q. AT CONTRACTORS OPTION THEY CAN REUSE EXISTING VTR LOCATION. VENT PIPING SHALL BE APPROPRIATELY SIZE PER CODE.

KEYNOTES

- EXISTING TO REMAIN, NO PLUMBING SCOPE OF WORK IN THIS AREA. INSTALL DOUBLE CLEANOUT TO GRADE IN ACCORDANCE WITH DETAIL
- INSTALL FLOOR DRAIN IN ACCORDANCE WITH DETAIL C1/P-501.
- 4. INSTALL WALL CLEANOUT IN ACCORDANCE WITH DETAIL C5/P-501. 5. TERMINATE CONDENSATE DRAIN LINE INDIRECTLY INTO SERVICE SINK 2X PIPE DIA. ABOVE SINK
- 6. EXTEND NEW SANITARY SEWER PIPING FROM EXISTING POINT AS INDICATED.
- INSTALL NEW PIPING IN EXISTING TRENCH. 8. ROUTE PIPING TO AVOID TREE PROTECTION ZONE AREA.

AREA A

- 12. TERMINATE CONDENSATE DRAIN LINE DIRECTLY INTO SINK TAIL PIECE, REFER TO A1/ P-501. 13. REFER TO GENERAL NOTE Q. FOR VENT. FIELD VERIFY EXISTING VENT PIPE LINE AND VTR.
- 6. ROUTE 2" SANITARY PIPING AT 1/4" PER FOOT IN WALL. DROP TO BELOW GRADE AS SHOWN AND PROVIDE WITH A WALL CLEAN OUT (WCO).
- AVOID EXISTING TREES AND TREE ROOT SYSTEM. FIELD COORDINATE ALL TRENCHING IN THIS

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SEAL

PROJECT

209 GOLD AVENUE SW ALBUQUERQUE, NM 87102 505.510.4600

CONSTRUCTION DOCUMENTS

REVISIONS

2 3/5/2021 ADDENDUM 4

DRAWN BY **REVIEWED BY** DATE PROJECT NO 18-0032

PSFA PRE-K PROJECT NO: K-18-011 PSFA SYSTEMS S-20-008 PROJECT NO: DRAWING NAME

WASTE & VENT FLOOR PLAN -AREA B

SHEET NO

PL100B



- A. FINISHED FLOOR ELEVATION = 100'-0" UNLESS OTHERWISE INDICATED. B. THE CONTRACTOR SHALL VISIT THE SITE PRIOR TO BIDDING AND PERFORM A FIELD SURVEY TO CONFIRM LOCATION AND SIZES OF EXISTING PLUMBING SERVICES. THE CONTRACTOR MAY SUBMIT HIS BID BASED ON AN ALTERNATE PIPING LAYOUT, PROVIDING IT
- COMPLIES WITH FOLLOWING: 1. FIELD SURVEY HAS BEEN COMPLETED AND PROPOSED PLUMBING LAYOUT WON'T CONFLICT WITH EXISTING EQUIPMENTOR WILL NOT DISRUPT PRESENTLY OCCUPIED AREAS. 2. CONTRACTOR HAS REVIEWED ALL PLANS FOR COORDINATING WITH HVAC, FIRE PROTECTION, ARCHITECTURAL, AND ELECTRICAL TRADES TO AVOID CONFLICTS.
- 3. NEW PIPING SHALL NOT CONNECT TO EXISTING SERVICES OF LESSER SIZE. 4. INSTALLATION COMPLIES WITH STATE AND LOCAL CODES. PIPING LOCATIONS HAVE BEEN SHOWN FOR CLARITY AND DO NOT NECESSARILY REFLECT THE EXACT LOCATION OF PIPE. COORDINATE ROUTING WITH ALL OTHER TRADES BEFORE INSTALLATION OR MAKEUP OF PIPE. PROVIDE COORDINATION DRAWINGS PER SPECIFICATIONS.
- COORDINATE ALL PLUMBING PIPING WITH ALL OTHER TRADES AND PROVIDE NECESSARY OFFSETS TO AVOID CONFLICTS AND TO MAINTAIN REQUIRED EQUIPMENT ACCESS AND SERVICEABILITY. REFER TO ARCHITECTURAL DRAWINGS FOR EXACT LOCATION OF ALL FIRE RATED AND OR
- SMOKE RATED WALLS AND ASSEMBLIES. PIPING PENETRATIONS OF FIRE AND SMOKE RATED WALLS AND LISTED ASSEMBLIES SHALL BE CAULKED AIRTIGHT TO THE ADJACENT STRUCTURE BY MEANS OF U.L. LISTED FIRE PROOF CAULKING MATERIAL.
- UNDERGROUND STORM AND SANITARY PIPING SHOWN ON DRAWINGS RUNNING IN THE CORRIDORS SHALL BE INSTALLED IN THE MIDDLE OF THE CORRIDOR WHERE POSSIBLE. CONTRACTOR SHALL NOT UNDERMINE FOOTINGS.
- ALL MATERIALS SHALL BE DISPOSED OF IN A PROPER MANNER. THE CONTRACTOR SHALL BE RESPONSIBLE FOR CLEANUP OF WORKSITE OF ANY MATERIAL THAT IS OF THEIR TRADE. ALL PENETRATIONS THROUGH EXISTING DRYWALL OR SOLID SURFACES SHALL BE PROVIDED WITH ESCUTCHEONS IF EXPOSED. PENETRATIONS SHALL BE PATCHED TO MATCH SURROUNDING
- REFER TO ARCHITECTURAL FLOOR PLANS FOR EXACT LOCATION AND HEIGHTS OF ALL PLUMBING FIXTURES BEFORE ROUGH-IN OR INSTALLATION OF PIPE. PLUMBING FIXTURES SHALL BE MOUNTED AT HEIGHTS SHOWN ON ARCHITECTURAL ELEVATION DRAWINGS. . ALL PIPING IN FINISHED ROOMS SHALL BE CONCEALED IN FURRED CHASES UNLESS OTHERWISE NOTED ON THIS DRAWING.
- PROVIDE HINGED ACCESS DOORS FOR VALVES, WATER HAMMER ARRESTERS, ISOLATION BALL VALVES LOCATED IN NONACCESSIBLE CEILINGS AND CHASES. DOORS FURNISHED PER ARCHITECTURAL SPECIFICATIONS AND PURCHASED AND INSTALLED PER DIVISION 22. ACCESS DOOR RATING SHALL MATCH THE CLASSIFICATION OF WALLS AND CEILING FIRE RATING. COORDINATE COLOR AND TYPE OF ACCESS DOOR WITH ARCHITECTURAL PRIOR TO PERFORMING WORK.
- M. SANITARY SEWER PIPING SHALL BE C.I NO-HUB UNLESS NOTED OTHERWISE. INSTALL PER UPC
- N. DOMESTIC HOT AND COLD WATER PIPIING SHALL BE TYPE K OR L COPPER WITH 95-5 SOLDER JOINTS. ALL WATER PIPING SHALL BE INSULATED PER SPECIFICATIONS. O. ALL PIPING SHALL BE TESTED PER 2015 UPC AND PER SPECIFICATIONS.
- P. REFER TO DRAWING P-701 FOR PLUMBING ROUGH IN REQUIREMENTS. Q. AT CONTRACTORS OPTION THEY CAN REUSE EXISTING VTR LOCATION. VENT PIPING SHALL BE APPROPRIATELY SIZE PER CODE.

○KEYNOTES

KEYPLAN

I. SEE PL100A FOR EXTENSION FROM BASE BID. INSTALL DOUBLE CLEANOUT TO GRADE IN ACCORDANCE WITH DETAIL

D2/P-501 3. NOT USED. 4. INSTALL FLOOR SINK IN ACCORDANCE WITH DETAIL C2/P-501.

- 6. INSTALL NEW PIPING IN EXISTING TRENCH.
- REFER TO GENERAL NOTE Q. FOR VENT. FIELD VERIFY EXISTING VENT PIPE LINE AND VTR. 8. INSTALL FLOOR DRAIN IN ACCORDANCE WITH DETAIL C1/P-501. 9. OFFSET AND ROUTE VENT PIPING BELOW CHANGING STATION.

10. ROUTE 2" SANITARY PIPING AT 1/4" PER FOOT IN WALL. DROP TO BELOW GRADE AS SHOWN AND PROVIDE WITH A WALL CLEAN OUT (WCO).



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SEAL

PROJECT

5. INSTALL WALL CLEANOUT IN ACCORDANCE WITH DETAIL C5/P-501.

CONSTRUCTION DOCUMENTS

REVISIONS

	DRAWN BY	MAD
	REVIEWED BY	SDS
	DATE	12/10/2019
	PROJECT NO	18-0032
	PSFA PRE-K PROJECT NO:	K-18-011
	PSFA SYSTEMS PROJECT NO:	S-20-008
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DRAWING NAME WASTE & VENT FLOOR PLAN -AREA A - BID LOT

SHEET NO PL101A

- A. FINISHED FLOOR ELEVATION = 100'-0" UNLESS OTHERWISE INDICATED. B. THE CONTRACTOR SHALL VISIT THE SITE PRIOR TO BIDDING AND PERFORM A FIELD SURVEY TO CONFIRM LOCATION AND SIZES OF EXISTING PLUMBING SERVICES. THE CONTRACTOR MAY SUBMIT HIS BID BASED ON AN ALTERNATE PIPING LAYOUT, PROVIDING IT
- COMPLIES WITH FOLLOWING: 1. FIELD SURVEY HAS BEEN COMPLETED AND PROPOSED PLUMBING LAYOUT WON'T CONFLICT WITH EXISTING EQUIPMENTOR WILL NOT DISRUPT PRESENTLY OCCUPIED AREAS.
- 2. CONTRACTOR HAS REVIEWED ALL PLANS FOR COORDINATING WITH HVAC, FIRE PROTECTION, ARCHITECTURAL, AND ELECTRICAL TRADES TO AVOID CONFLICTS. 3. NEW PIPING SHALL NOT CONNECT TO EXISTING SERVICES OF LESSER SIZE. 4. INSTALLATION COMPLIES WITH STATE AND LOCAL CODES.
- PIPING LOCATIONS HAVE BEEN SHOWN FOR CLARITY AND DO NOT NECESSARILY REFLECT THE EXACT LOCATION OF PIPE. COORDINATE ROUTING WITH ALL OTHER TRADES BEFORE INSTALLATION OR MAKEUP OF PIPE. PROVIDE COORDINATION DRAWINGS PER SPECIFICATIONS. COORDINATE ALL PLUMBING PIPING WITH ALL OTHER TRADES AND PROVIDE NECESSARY OFFSETS TO AVOID CONFLICTS AND TO MAINTAIN REQUIRED EQUIPMENT ACCESS AND
 - SERVICEABILITY. REFER TO ARCHITECTURAL DRAWINGS FOR EXACT LOCATION OF ALL FIRE RATED AND OR SMOKE RATED WALLS AND ASSEMBLIES. PIPING PENETRATIONS OF FIRE AND SMOKE RATED WALLS AND LISTED ASSEMBLIES SHALL BE CAULKED AIRTIGHT TO THE ADJACENT STRUCTURE BY MEANS OF U.L. LISTED FIRE PROOF CAULKING MATERIAL.
 - UNDERGROUND STORM AND SANITARY PIPING SHOWN ON DRAWINGS RUNNING IN THE CORRIDORS SHALL BE INSTALLED IN THE MIDDLE OF THE CORRIDOR WHERE POSSIBLE.
 - CONTRACTOR SHALL NOT UNDERMINE FOOTINGS. ALL MATERIALS SHALL BE DISPOSED OF IN A PROPER MANNER. THE CONTRACTOR SHALL BE RESPONSIBLE FOR CLEANUP OF WORKSITE OF ANY MATERIAL THAT IS OF THEIR TRADE. ALL PENETRATIONS THROUGH EXISTING DRYWALL OR SOLID SURFACES SHALL BE PROVIDED WITH ESCUTCHEONS IF EXPOSED. PENETRATIONS SHALL BE PATCHED TO MATCH SURROUNDING
 - REFER TO ARCHITECTURAL FLOOR PLANS FOR EXACT LOCATION AND HEIGHTS OF ALL PLUMBING FIXTURES BEFORE ROUGH-IN OR INSTALLATION OF PIPE. PLUMBING FIXTURES SHALL BE MOUNTED AT HEIGHTS SHOWN ON ARCHITECTURAL ELEVATION DRAWINGS. . ALL PIPING IN FINISHED ROOMS SHALL BE CONCEALED IN FURRED CHASES UNLESS OTHERWISE NOTED ON THIS DRAWING.
- PROVIDE HINGED ACCESS DOORS FOR VALVES, WATER HAMMER ARRESTERS, ISOLATION BALL VALVES LOCATED IN NONACCESSIBLE CEILINGS AND CHASES. DOORS FURNISHED PER ARCHITECTURAL SPECIFICATIONS AND PURCHASED AND INSTALLED PER DIVISION 22. ACCESS DOOR RATING SHALL MATCH THE CLASSIFICATION OF WALLS AND CEILING FIRE RATING. COORDINATE COLOR AND TYPE OF ACCESS DOOR WITH ARCHITECTURAL PRIOR TO
- M. SANITARY SEWER PIPING SHALL BE C.I NO-HUB UNLESS NOTED OTHERWISE. INSTALL PER UPC
- N. DOMESTIC HOT AND COLD WATER PIPIING SHALL BE TYPE K OR L COPPER WITH 95-5 SOLDER JOINTS. ALL WATER PIPING SHALL BE INSULATED PER SPECIFICATIONS. . ALL PIPING SHALL BE TESTED PER 2015 UPC AND PER SPECIFICATIONS.
- P. REFER TO DRAWING P-701 FOR PLUMBING ROUGH IN REQUIREMENTS. Q. AT CONTRACTORS OPTION THEY CAN REUSE EXISTING VTR LOCATION. VENT PIPING SHALL BE APPROPRIATELY SIZE PER CODE.

○KEYNOTES

- SEE PL100A FOR EXTENSION FROM BASE BID. REUSE EXISTING PIPING WITHIN WALL, ROUTE NEW PIPING THROUGH WALL FURRING TO MAKE CONNECTION AT NEW SINK LOCATION. CONNECT NEW VENT PIPING TO EXISTING VENT PIPING WITH
- 3. CONNECT EXISTING PIPING FROM EXISTING TEACHERS LOUNGE TO NEW SANITARY PIPING. 4. INSTALL CLEANOUT TO GRADE IN ACCORDANCE WITH DETAIL
- INSTALL DOUBLE CLEANOUT TO GRADE IN ACCORDANCE WITH DETAIL D3/P-501.
- INSTALL FLOOR DRAIN IN ACCORDANCE WITH DETAIL C1/P-501. INSTALL WALL CLEANOUT IN ACCORDANCE WITH DETAIL C5/P-501.
- 8. TERMINATE CONDENSATE DRAIN LINE INDIRECTLY INTO SERVICE

9. CONDENSATE DRAIN DOWN FROM ROOF. ROUTE AND DROP DOWN IN WALL AND TERMINATE CONDENSATE DRAIN LINE DIRECTLY INTO SINK TAIL PIECE, REFER TO A1/ P-501. TO: REFER TO GENERAL NOTE Q. FOR VENT. FIELD VERIFY EXISTING VENT PIPE LINE AND VTR. MATCH

PIRE LINE SIZE

11. OFFSET AND ROUTE VENT PIPING BELOW CHANGING STATION.

ROUTE 2" SANITARY PIPING AT 1/4" PER FOOT IN WALL. DROP TO BELOW GRADE AS SHOWN AN PROVIDE WITH A WALL CLEAN OUT (WCO). 14. EXISTING SANITARY PIPING BELOW GRADE TO REMAIN.

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209 GOLD AVENUE SW ALBUQUERQUE, NM 87102 505.510.4600

CONSTRUCTION DOCUMENTS

REVISIONS

2 3/5/2021 ADDENDUM 4

DRAWN BY REVIEWED BY DATE PROJECT NO PSFA PRE-K PROJECT NO: PSFA SYSTEMS

S-20-008 PROJECT NO: DRAWING NAME WASTE & VENT

FLOOR PLAN -AREA B - BID LOT

SHEET NO

PL101B

PLUMBING ROOF PLAN - AREA A SCALE: 1/8" = 1'-0"



A. FINISHED FLOOR ELEVATION = 100'-0" UNLESS OTHERWISE INDICATED. CONFIRM LOCATION AND SIZES OF EXISTING PLUMBING SERVICES.

COMPLIES WITH FOLLOWING: 1. FIELD SURVEY HAS BEEN COMPLETED AND PROPOSED PLUMBING LAYOUT WON'T CONFLICT WITH EXISTING EQUIPMENTOR WILL NOT DISRUPT PRESENTLY OCCUPIED AREAS. 2. CONTRACTOR HAS REVIEWED ALL PLANS FOR COORDINATING WITH HVAC, FIRE

PROTECTION, ARCHITECTURAL, AND ELECTRICAL TRADES TO AVOID CONFLICTS. 3. NEW PIPING SHALL NOT CONNECT TO EXISTING SERVICES OF LESSER SIZE. 4. INSTALLATION COMPLIES WITH STATE AND LOCAL CODES.

PIPING LOCATIONS HAVE BEEN SHOWN FOR CLARITY AND DO NOT NECESSARILY REFLECT THE EXACT LOCATION OF PIPE. COORDINATE ROUTING WITH ALL OTHER TRADES BEFORE INSTALLATION OR MAKEUP OF PIPE. PROVIDE COORDINATION DRAWINGS PER SPECIFICATIONS. COORDINATE ALL PLUMBING PIPING WITH ALL OTHER TRADES AND PROVIDE NECESSARY

SERVICEABILITY. REFER TO ARCHITECTURAL DRAWINGS FOR EXACT LOCATION OF ALL FIRE RATED AND OR SMOKE RATED WALLS AND ASSEMBLIES. PIPING PENETRATIONS OF FIRE AND SMOKE RATED WALLS AND LISTED ASSEMBLIES SHALL BE CAULKED AIRTIGHT TO THE ADJACENT STRUCTURE BY MEANS OF U.L. LISTED FIRE PROOF CAULKING MATERIAL.

UNDERGROUND STORM AND SANITARY PIPING SHOWN ON DRAWINGS RUNNING IN THE CORRIDORS SHALL BE INSTALLED IN THE MIDDLE OF THE CORRIDOR WHERE POSSIBLE.

CONTRACTOR SHALL NOT UNDERMINE FOOTINGS. ALL MATERIALS SHALL BE DISPOSED OF IN A PROPER MANNER. THE CONTRACTOR SHALL BE RESPONSIBLE FOR CLEANUP OF WORKSITE OF ANY MATERIAL THAT IS OF THEIR TRADE. ALL PENETRATIONS THROUGH EXISTING DRYWALL OR SOLID SURFACES SHALL BE PROVIDED WITH ESCUTCHEONS IF EXPOSED. PENETRATIONS SHALL BE PATCHED TO MATCH SURROUNDING SURFACES.

REFER TO ARCHITECTURAL FLOOR PLANS FOR EXACT LOCATION AND HEIGHTS OF ALL PLUMBING FIXTURES BEFORE ROUGH-IN OR INSTALLATION OF PIPE. PLUMBING FIXTURES SHALL BE MOUNTED AT HEIGHTS SHOWN ON ARCHITECTURAL ELEVATION DRAWINGS. . ALL PIPING IN FINISHED ROOMS SHALL BE CONCEALED IN FURRED CHASES UNLESS OTHERWISE NOTED ON THIS DRAWING. PROVIDE HINGED ACCESS DOORS FOR VALVES, WATER HAMMER ARRESTERS, ISOLATION BALL

JOINTS. ALL WATER PIPING SHALL BE INSULATED PER SPECIFICATIONS.

P. REFER TO DRAWING P-701 FOR PLUMBING ROUGH IN REQUIREMENTS.

1. PROVIDE PLUG VALVE, PETE'S PLUG (BEFORE AND AFTER REGULAOR), UNION, VENTLESS REGULATOR, DIRTLEG AND FLEX CONNECTION TO MECHANICAL EQUIPMENT. REFER TO MECHANICAL DRAWINGS AND DETAIL C3/P-501. REGULATOR SHALL REDUCE PRESSURE DOWN TO

REFER TO SHEET PL141A FOR EXTENSION AND CONTINUATION TO BID LOT #1. ROUTE CONDENSATE PIPE DOWN INTO CEILING SPACE, TIGHT TO

STRUCTURE. SLOPE TO DRAIN AND ROUTE TO NEAREST FLOOR SINK/MOP SINK AND TERMINATE INDIRECTLY AT FIXTURE. FIELD COORDINATE ROUTING.
4. CONNECT CONDENSATE DRAIN TO UNIT WITH UNION AND FLEXIBLE

5. CONDENSATE PIPING ROUTED EXPOSED ON ROOF. PROVIDE

CONNECT NGM GAS TO EXISTING MAIN AS REQUIRED TO KEEP SERVICE RUNING TO EXISTING RTU'S NOT BEING REPLACED UNTIL PHASE 2. THIS INCLUDES A TEMPORARY LINE TO ALSO SERVE THE EXISTING ORWHASHING AS LOND. RIGHD OF OPPINATE EXACT ROTH TO A CONVERTION

B. THE CONTRACTOR SHALL VISIT THE SITE PRIOR TO BIDDING AND PERFORM A FIELD SURVEY TO THE CONTRACTOR MAY SUBMIT HIS BID BASED ON AN ALTERNATE PIPING LAYOUT, PROVIDING IT

OFFSETS TO AVOID CONFLICTS AND TO MAINTAIN REQUIRED EQUIPMENT ACCESS AND

VALVES LOCATED IN NONACCESSIBLE CEILINGS AND CHASES. DOORS FURNISHED PER ARCHITECTURAL SPECIFICATIONS AND PURCHASED AND INSTALLED PER DIVISION 22. ACCESS DOOR RATING SHALL MATCH THE CLASSIFICATION OF WALLS AND CEILING FIRE RATING. COORDINATE COLOR AND TYPE OF ACCESS DOOR WITH ARCHITECTURAL PRIOR TO PERFORMING WORK.

M. SANITARY SEWER PIPING SHALL BE C.I NO-HUB UNLESS NOTED OTHERWISE. INSTALL PER UPC

N. DOMESTIC HOT AND COLD WATER PIPIING SHALL BE TYPE K OR L COPPER WITH 95-5 SOLDER

O. ALL PIPING SHALL BE TESTED PER 2015 UPC AND PER SPECIFICATIONS.

○KEYNOTES

POOFTOP RIPING SUPPORTS(EQUAL TO DURA BLOK).

6. GAS PIPING ROUTED ON ROOF. PROVIDE ROOF TOP SUPPORTS(EQUAL TO DURA-BLOK).

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PROJECT

209 GOLD AVENUE SW ALBUQUERQUE, NM 87102

CONSTRUCTION DOCUMENTS

REVISIONS

2 3/5/2021 ADDENDUM 4

DRAWN BY	MAD
REVIEWED BY	SDS
DATE	12/10/2019
PROJECT NO	18-0032
PSFA PRE-K PROJECT NO:	K-18-011
PSFA SYSTEMS PROJECT NO:	S-20-008

DRAWING NAME PLUMBING ROOF PLAN - AREA A

SHEET NO

PL140A

KEYPLAN

PHASE 1 — PHASE 2

PLUMBING ROOF PLAN - AREA B

GENERAL SHEET NOTES

A. FINISHED FLOOR ELEVATION = 100'-0" UNLESS OTHERWISE INDICATED. CONFIRM LOCATION AND SIZES OF EXISTING PLUMBING SERVICES.

COMPLIES WITH FOLLOWING: 1. FIELD SURVEY HAS BEEN COMPLETED AND PROPOSED PLUMBING LAYOUT WON'T CONFLICT WITH EXISTING EQUIPMENTOR WILL NOT DISRUPT PRESENTLY OCCUPIED AREAS.

2. CONTRACTOR HAS REVIEWED ALL PLANS FOR COORDINATING WITH HVAC, FIRE PROTECTION, ARCHITECTURAL, AND ELECTRICAL TRADES TO AVOID CONFLICTS. 3. NEW PIPING SHALL NOT CONNECT TO EXISTING SERVICES OF LESSER SIZE.

PIPING LOCATIONS HAVE BEEN SHOWN FOR CLARITY AND DO NOT NECESSARILY REFLECT THE EXACT LOCATION OF PIPE. COORDINATE ROUTING WITH ALL OTHER TRADES BEFORE INSTALLATION OR MAKEUP OF PIPE. PROVIDE COORDINATION DRAWINGS PER SPECIFICATIONS. COORDINATE ALL PLUMBING PIPING WITH ALL OTHER TRADES AND PROVIDE NECESSARY

OFFSETS TO AVOID CONFLICTS AND TO MAINTAIN REQUIRED EQUIPMENT ACCESS AND SERVICEABILITY. REFER TO ARCHITECTURAL DRAWINGS FOR EXACT LOCATION OF ALL FIRE RATED AND OR SMOKE RATED WALLS AND ASSEMBLIES. PIPING PENETRATIONS OF FIRE AND SMOKE RATED

FIXTURES BEFORE ROUGH-IN OR INSTALLATION OF PIPE. PLUMBING FIXTURES SHALL BE MOUNTED AT HEIGHTS SHOWN ON ARCHITECTURAL ELEVATION DRAWINGS. . ALL PIPING IN FINISHED ROOMS SHALL BE CONCEALED IN FURRED CHASES UNLESS OTHERWISE NOTED ON THIS DRAWING. PROVIDE HINGED ACCESS DOORS FOR VALVES, WATER HAMMER ARRESTERS, ISOLATION BALL VALVES LOCATED IN NONACCESSIBLE CEILINGS AND CHASES. DOORS FURNISHED PER

PERFORMING WORK.

N. DOMESTIC HOT AND COLD WATER PIPIING SHALL BE TYPE K OR L COPPER WITH 95-5 SOLDER JOINTS, ALL WATER PIPING SHALL BE INSULATED PER SPECIFICATIONS.

P. REFER TO DRAWING P-701 FOR PLUMBING ROUGH IN REQUIREMENTS.

4. CONNECT CONDENSATE DRAIN TO UNIT WITH UNION AND FLEXIBLE CONNECTOR.

CONDENSATE PIPING ROUTED EXPOSED ON ROOF. PROVIDE

ROOFTOP PIPING SUPPORTS(EQUAL TO DURA-BLOK). GAS PIPING ROUTED ON ROOF. PROVIDE ROOF TOP SUPPORTS(EQUAL TO DURA-BLOK).

FLEX FOR CONNECTION TO EXISTING LINE SERVING EXISTING GYMNASIUM. EXISTING REGULATOR SERVING GYMASIUM SHALL BE REMOVED AND REPLACED. CONNECT PIPING TO 3/4" NGM (2 PSI) PIPING TO EXISTING REGULATOR SERVING EXISTING GYMNASIUM. The string of th

B. THE CONTRACTOR SHALL VISIT THE SITE PRIOR TO BIDDING AND PERFORM A FIELD SURVEY TO THE CONTRACTOR MAY SUBMIT HIS BID BASED ON AN ALTERNATE PIPING LAYOUT, PROVIDING IT

4. INSTALLATION COMPLIES WITH STATE AND LOCAL CODES.

WALLS AND LISTED ASSEMBLIES SHALL BE CAULKED AIRTIGHT TO THE ADJACENT STRUCTURE BY

MEANS OF U.L. LISTED FIRE PROOF CAULKING MATERIAL. UNDERGROUND STORM AND SANITARY PIPING SHOWN ON DRAWINGS RUNNING IN THE CORRIDORS SHALL BE INSTALLED IN THE MIDDLE OF THE CORRIDOR WHERE POSSIBLE.

CONTRACTOR SHALL NOT UNDERMINE FOOTINGS. ALL MATERIALS SHALL BE DISPOSED OF IN A PROPER MANNER. THE CONTRACTOR SHALL BE RESPONSIBLE FOR CLEANUP OF WORKSITE OF ANY MATERIAL THAT IS OF THEIR TRADE. ALL PENETRATIONS THROUGH EXISTING DRYWALL OR SOLID SURFACES SHALL BE PROVIDED WITH ESCUTCHEONS IF EXPOSED. PENETRATIONS SHALL BE PATCHED TO MATCH SURROUNDING SURFACES.

REFER TO ARCHITECTURAL FLOOR PLANS FOR EXACT LOCATION AND HEIGHTS OF ALL PLUMBING ARCHITECTURAL SPECIFICATIONS AND PURCHASED AND INSTALLED PER DIVISION 22. ACCESS

DOOR RATING SHALL MATCH THE CLASSIFICATION OF WALLS AND CEILING FIRE RATING. COORDINATE COLOR AND TYPE OF ACCESS DOOR WITH ARCHITECTURAL PRIOR TO

M. SANITARY SEWER PIPING SHALL BE C.I NO-HUB UNLESS NOTED OTHERWISE. INSTALL PER UPC

O. ALL PIPING SHALL BE TESTED PER 2015 UPC AND PER SPECIFICATIONS.

○KEYNOTES

KEYPLAN

AREA A

1. PROVIDE PLUG VALVE, PETE'S PLUG (BEOFRE AND AFTER REGULATOR), UNION, DIRTLEG AND FLEX CONNECTION TO MECHANICAL EQUIPMENT. REFER TO MECHANICAL DRAWINGS AND DETAIL

STRUCTURE.

0 hildhoo

architecture

SEAL

PROJECT

209 GOLD AVENUE SW ALBUQUERQUE, NM 87102

CONSTRUCTION DOCUMENTS

REVISIONS

2 3/5/2021 ADDENDUM 4

DRAWN BY	MAD
REVIEWED BY	SDS
DATE	12/10/2019
PROJECT NO	18-0032
PSFA PRE-K PROJECT NO:	K-18-011
PSFA SYSTEMS PROJECT NO:	S-20-008

DRAWING NAME

PLUMBING ROOF PLAN - AREA B

SHEET NO

PL140B



PLUMBING ROOF PLAN - AREA A - BID LOT #1 SCALE: 1/8" = 1'-0"

GENERAL SHEET NOTES

- A. FINISHED FLOOR ELEVATION = 100'-0" UNLESS OTHERWISE INDICATED. B. THE CONTRACTOR SHALL VISIT THE SITE PRIOR TO BIDDING AND PERFORM A FIELD SURVEY TO CONFIRM LOCATION AND SIZES OF EXISTING PLUMBING SERVICES. THE CONTRACTOR MAY SUBMIT HIS BID BASED ON AN ALTERNATE PIPING LAYOUT, PROVIDING IT
- COMPLIES WITH FOLLOWING: 1. FIELD SURVEY HAS BEEN COMPLETED AND PROPOSED PLUMBING LAYOUT WON'T CONFLICT WITH EXISTING EQUIPMENTOR WILL NOT DISRUPT PRESENTLY OCCUPIED AREAS. 2. CONTRACTOR HAS REVIEWED ALL PLANS FOR COORDINATING WITH HVAC, FIRE
- PROTECTION, ARCHITECTURAL, AND ELECTRICAL TRADES TO AVOID CONFLICTS. 3. NEW PIPING SHALL NOT CONNECT TO EXISTING SERVICES OF LESSER SIZE. 4. INSTALLATION COMPLIES WITH STATE AND LOCAL CODES. PIPING LOCATIONS HAVE BEEN SHOWN FOR CLARITY AND DO NOT NECESSARILY REFLECT THE EXACT LOCATION OF PIPE. COORDINATE ROUTING WITH ALL OTHER TRADES BEFORE
- INSTALLATION OR MAKEUP OF PIPE. PROVIDE COORDINATION DRAWINGS PER SPECIFICATIONS. COORDINATE ALL PLUMBING PIPING WITH ALL OTHER TRADES AND PROVIDE NECESSARY OFFSETS TO AVOID CONFLICTS AND TO MAINTAIN REQUIRED EQUIPMENT ACCESS AND SERVICEABILITY. REFER TO ARCHITECTURAL DRAWINGS FOR EXACT LOCATION OF ALL FIRE RATED AND OR
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- UNDERGROUND STORM AND SANITARY PIPING SHOWN ON DRAWINGS RUNNING IN THE CORRIDORS SHALL BE INSTALLED IN THE MIDDLE OF THE CORRIDOR WHERE POSSIBLE.
- CONTRACTOR SHALL NOT UNDERMINE FOOTINGS. I. ALL MATERIALS SHALL BE DISPOSED OF IN A PROPER MANNER. THE CONTRACTOR SHALL BE RESPONSIBLE FOR CLEANUP OF WORKSITE OF ANY MATERIAL THAT IS OF THEIR TRADE. ALL PENETRATIONS THROUGH EXISTING DRYWALL OR SOLID SURFACES SHALL BE PROVIDED WITH ESCUTCHEONS IF EXPOSED. PENETRATIONS SHALL BE PATCHED TO MATCH SURROUNDING SURFACES.
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- M. SANITARY SEWER PIPING SHALL BE C.I NO-HUB UNLESS NOTED OTHERWISE. INSTALL PER UPC
- N. DOMESTIC HOT AND COLD WATER PIPIING SHALL BE TYPE K OR L COPPER WITH 95-5 SOLDER JOINTS. ALL WATER PIPING SHALL BE INSULATED PER SPECIFICATIONS.
- O. ALL PIPING SHALL BE TESTED PER 2015 UPC AND PER SPECIFICATIONS. P. REFER TO DRAWING P-701 FOR PLUMBING ROUGH IN REQUIREMENTS.

○KEYNOTES

KEYPLAN

PROVIDE PLUG VALVE, PETE'S PLUG (BEFORE AND AFTER REGULATOR), UNION, VENTLESS REGULATOR, DIRTLEG AND FLEX CONNECTION TO MECHANICAL EQUIPMENT. REFER TO MECHANICAL DRAWINGS AND DETAIL C3/P-501. REGULATOR SHALL REDUCE PRESSURE DOWN TO

CONNECTOR.

- 4. CONDENSATE PIPING ROUTED EXPOSED ON ROOF. PROVIDE ROOFTOP PIPING SUPPORTS(EQUAL TO DURA-BLOK).
- GAS PIPING ROUTED ON ROOF. PROVIDE ROOF TOP SUPPORTS(EQUAL TO DURA-BLOK). 6. ROUTE GAS LINE DOWN TO FIRE RISER 108.

architecture

SEAL

PROJECT

209 GOLD AVENUE SW ALBUQUERQUE, NM 87102 505.510.4600

CONSTRUCTION DOCUMENTS

REVISIONS

DRAWN BY REVIEWED BY DATE 18-0032 PROJECT NO PSFA PRE-K

K-18-011 PROJECT NO: PSFA SYSTEMS S-20-008

PROJECT NO: DRAWING NAME

PLUMBING ROOF PLAN - AREA A -BID LOT #1

SHEET NO

PL141A

- A. FINISHED FLOOR ELEVATION = 100'-0" UNLESS OTHERWISE INDICATED. B. THE CONTRACTOR SHALL VISIT THE SITE PRIOR TO BIDDING AND PERFORM A FIELD SURVEY TO CONFIRM LOCATION AND SIZES OF EXISTING PLUMBING SERVICES. THE CONTRACTOR MAY SUBMIT HIS BID BASED ON AN ALTERNATE PIPING LAYOUT, PROVIDING IT
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○KEYNOTES

 $\overline{}$ PROVIDE PLUG VALVE, PETE'S PLUG (BEOFRE AND AFTER REGULATOR) UNION, DIRTLEG AND FLEX CONNECTION TO MECHANICAL EQUIPMENT. REFER TO MECHANICAL DRAWINGS AND DETAIL


- CONDENSATE PIPING ROUTED EXPOSED ON ROOF. PROVIDE ROOFTOP PIPING SUPPORTS(EQUAL TO DURA-BLOK).
- 6. GAS PIPING ROUTED ON ROOF. PROVIDE ROOF TOP SUPPORTS(EQUAL TO DURA-BLOK).

/_/ architecture

209 GOLD AVENUE SW ALBUQUERQUE, NM 87102 505.510.4600



SEAL

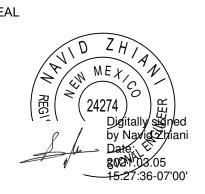

PROJECT

STRUCTURE. 4. CONNECT CONDENSATE DRAIN TO UNIT WITH UNION AND FLEXIBLE CONNECTOR.

hildhoo

CONSTRUCTION DOCUMENTS

REVISIONS

DRAWN BY	MAD
REVIEWED BY	SDS
DATE	12/10/2019
PROJECT NO	18-0032
PSFA PRE-K PROJECT NO:	K-18-011
PSFA SYSTEMS PROJECT NO:	S-20-008

DRAWING NAME PLUMBING ROOF

PLAN - AREA B -BID LOT #1

SHEET NO

PL141B

KEYPLAN

PLUMBING ROOF PLAN - AREA B - BID LOT #1 SCALE: 1/8" = 1'-0"

PRESSURE PIPING FLOOR PLAN - AREA A SCALE: 1/8" = 1'-0"

GENERAL SHEET NOTES

- A. FINISHED FLOOR ELEVATION = 100'-0" UNLESS OTHERWISE INDICATED. B. THE CONTRACTOR SHALL VISIT THE SITE PRIOR TO BIDDING AND PERFORM A FIELD SURVEY TO CONFIRM LOCATION AND SIZES OF EXISTING PLUMBING SERVICES. THE CONTRACTOR MAY SUBMIT HIS BID BASED ON AN ALTERNATE PIPING LAYOUT, PROVIDING IT
- COMPLIES WITH FOLLOWING: 1. FIELD SURVEY HAS BEEN COMPLETED AND PROPOSED PLUMBING LAYOUT WON'T CONFLICT WITH EXISTING EQUIPMENTOR WILL NOT DISRUPT PRESENTLY OCCUPIED AREAS. 2. CONTRACTOR HAS REVIEWED ALL PLANS FOR COORDINATING WITH HVAC, FIRE PROTECTION, ARCHITECTURAL, AND ELECTRICAL TRADES TO AVOID CONFLICTS.
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WALLS AND LISTED ASSEMBLIES SHALL BE CAULKED AIRTIGHT TO THE ADJACENT STRUCTURE BY

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- M. SANITARY SEWER PIPING SHALL BE C.I NO-HUB UNLESS NOTED OTHERWISE. INSTALL PER UPC
- N. DOMESTIC HOT AND COLD WATER PIPIING SHALL BE TYPE K OR L COPPER WITH 95-5 SOLDER JOINTS. ALL WATER PIPING SHALL BE INSULATED PER SPECIFICATIONS.
- O. ALL PIPING SHALL BE TESTED PER 2015 UPC AND PER SPECIFICATIONS. P. REFER TO DRAWING P-701 FOR PLUMBING ROUGH IN REQUIREMENTS.

○KEYNOTES

- WATER ENTRY. REFER TO DETAIL D2/P-501. SEE PP101A FOR EXTENSION TO BID LOT. BYPASS NORMALLY OPEN UNDER BASE BID.
- 4. CAPPED FOR FOR EXTENSION TO PHASE 2. 5. DOMESTIC WATER HEATER, REFER TO DETAIL A3/P-501 FOR MORE INFORMATION.
- 6. REMOVE PIPING, CLOSE VALVE, AND CAP PIPE DOWNSTREAM OF ISOLATION VALVES UPON COMPLETION OF PHASE 2.

architecture

SEAL

PROJECT

209 GOLD AVENUE SW ALBUQUERQUE, NM 87102 505.510.4600

CONSTRUCTION DOCUMENTS

REVISIONS

DRAWN BY	MAD
REVIEWED BY	SDS
DATE	12/10/2019
PROJECT NO	18-0032
PSFA PRE-K PROJECT NO:	K-18-011
PSFA SYSTEMS PROJECT NO:	S-20-008
DRAWING NAME	

PRESSURE PIPING FLOOR PLAN - AREA A

SHEET NO

PP100A

KEYPLAN

PHASE 1 → PHASE 2

GENERAL SHEET NOTES

- A. FINISHED FLOOR ELEVATION = 100'-0" UNLESS OTHERWISE INDICATED. B. THE CONTRACTOR SHALL VISIT THE SITE PRIOR TO BIDDING AND PERFORM A FIELD SURVEY TO CONFIRM LOCATION AND SIZES OF EXISTING PLUMBING SERVICES. THE CONTRACTOR MAY SUBMIT HIS BID BASED ON AN ALTERNATE PIPING LAYOUT, PROVIDING IT
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- UNDERGROUND STORM AND SANITARY PIPING SHOWN ON DRAWINGS RUNNING IN THE CORRIDORS SHALL BE INSTALLED IN THE MIDDLE OF THE CORRIDOR WHERE POSSIBLE.
- CONTRACTOR SHALL NOT UNDERMINE FOOTINGS. ALL MATERIALS SHALL BE DISPOSED OF IN A PROPER MANNER. THE CONTRACTOR SHALL BE RESPONSIBLE FOR CLEANUP OF WORKSITE OF ANY MATERIAL THAT IS OF THEIR TRADE. ALL PENETRATIONS THROUGH EXISTING DRYWALL OR SOLID SURFACES SHALL BE PROVIDED WITH ESCUTCHEONS IF EXPOSED. PENETRATIONS SHALL BE PATCHED TO MATCH SURROUNDING SURFACES. REFER TO ARCHITECTURAL FLOOR PLANS FOR EXACT LOCATION AND HEIGHTS OF ALL PLUMBING
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- N. DOMESTIC HOT AND COLD WATER PIPIING SHALL BE TYPE K OR L COPPER WITH 95-5 SOLDER JOINTS. ALL WATER PIPING SHALL BE INSULATED PER SPECIFICATIONS.
- O. ALL PIPING SHALL BE TESTED PER 2015 UPC AND PER SPECIFICATIONS. P. REFER TO DRAWING P-701 FOR PLUMBING ROUGH IN REQUIREMENTS.

I. EXISTING TO REMAIN, NO PLUMBING SCOPE OF WORK IN THIS AREA. SEE PP101B FOR EXTENSION TO BID LOT.



/_/ architecture

SEAL

PROJECT

○KEYNOTES

. BYPASS NORMALLY OPEN UNDER BASE BID.

hildhoo

CONSTRUCTION DOCUMENTS


REVISIONS

DRAWN BY	MAD
REVIEWED BY	SDS
DATE	12/10/2019
PROJECT NO	18-0032
PSFA PRE-K PROJECT NO:	K-18-011
PSFA SYSTEMS PROJECT NO:	S-20-008
DRAWING NAME	

PRESSURE PIPING FLOOR PLAN - AREA B

SHEET NO PP100B

PRESSURE PIPING FLOOR PLAN - AREA B SCALE: 1/8" = 1'-0"

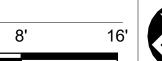



KEYPLAN

AREA A

- A. FINISHED FLOOR ELEVATION = 100'-0" UNLESS OTHERWISE INDICATED. B. THE CONTRACTOR SHALL VISIT THE SITE PRIOR TO BIDDING AND PERFORM A FIELD SURVEY TO CONFIRM LOCATION AND SIZES OF EXISTING PLUMBING SERVICES. THE CONTRACTOR MAY SUBMIT HIS BID BASED ON AN ALTERNATE PIPING LAYOUT, PROVIDING IT
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○KEYNOTES

1. SEE PP100A FOR EXTENSION FROM BASE BID.

CONSTRUCTION DOCUMENTS

architecture

SEAL

PROJECT

209 GOLD AVENUE SW ALBUQUERQUE, NM 87102 505.510.4600

REVISIONS

DRAWN BY

REVIEWED BY DATE PROJECT NO PSFA PRE-K PROJECT NO: K-18-011 PSFA SYSTEMS S-20-008 PROJECT NO: DRAWING NAME

PRESSURE PIPING FLOOR PLAN - AREA A -BID LOT #1

SHEET NO

PRESSURE PIPING FIRST FLOOR PLAN - AREA A - BID LOT #1

SCALE: 1/8" = 1'-0"

16'

16'

KEYPLAN

PP101A

PRESSURE PIPING FIRST FLOOR PLAN - AREA A - BID LOT #1

GENERAL SHEET NOTES

- A. FINISHED FLOOR ELEVATION = 100'-0" UNLESS OTHERWISE INDICATED. B. THE CONTRACTOR SHALL VISIT THE SITE PRIOR TO BIDDING AND PERFORM A FIELD SURVEY TO CONFIRM LOCATION AND SIZES OF EXISTING PLUMBING SERVICES. THE CONTRACTOR MAY SUBMIT HIS BID BASED ON AN ALTERNATE PIPING LAYOUT, PROVIDING IT
- COMPLIES WITH FOLLOWING: 1. FIELD SURVEY HAS BEEN COMPLETED AND PROPOSED PLUMBING LAYOUT WON'T CONFLICT WITH EXISTING EQUIPMENTOR WILL NOT DISRUPT PRESENTLY OCCUPIED AREAS. 2. CONTRACTOR HAS REVIEWED ALL PLANS FOR COORDINATING WITH HVAC, FIRE PROTECTION, ARCHITECTURAL, AND ELECTRICAL TRADES TO AVOID CONFLICTS.
- 3. NEW PIPING SHALL NOT CONNECT TO EXISTING SERVICES OF LESSER SIZE. 4. INSTALLATION COMPLIES WITH STATE AND LOCAL CODES. PIPING LOCATIONS HAVE BEEN SHOWN FOR CLARITY AND DO NOT NECESSARILY REFLECT THE EXACT LOCATION OF PIPE. COORDINATE ROUTING WITH ALL OTHER TRADES BEFORE INSTALLATION OR MAKEUP OF PIPE. PROVIDE COORDINATION DRAWINGS PER SPECIFICATIONS.
- COORDINATE ALL PLUMBING PIPING WITH ALL OTHER TRADES AND PROVIDE NECESSARY OFFSETS TO AVOID CONFLICTS AND TO MAINTAIN REQUIRED EQUIPMENT ACCESS AND SERVICEABILITY.
- REFER TO ARCHITECTURAL DRAWINGS FOR EXACT LOCATION OF ALL FIRE RATED AND OR SMOKE RATED WALLS AND ASSEMBLIES. PIPING PENETRATIONS OF FIRE AND SMOKE RATED WALLS AND LISTED ASSEMBLIES SHALL BE CAULKED AIRTIGHT TO THE ADJACENT STRUCTURE BY MEANS OF U.L. LISTED FIRE PROOF CAULKING MATERIAL.
- UNDERGROUND STORM AND SANITARY PIPING SHOWN ON DRAWINGS RUNNING IN THE CORRIDORS SHALL BE INSTALLED IN THE MIDDLE OF THE CORRIDOR WHERE POSSIBLE.
- CONTRACTOR SHALL NOT UNDERMINE FOOTINGS. ALL MATERIALS SHALL BE DISPOSED OF IN A PROPER MANNER. THE CONTRACTOR SHALL BE RESPONSIBLE FOR CLEANUP OF WORKSITE OF ANY MATERIAL THAT IS OF THEIR TRADE. ALL PENETRATIONS THROUGH EXISTING DRYWALL OR SOLID SURFACES SHALL BE PROVIDED WITH ESCUTCHEONS IF EXPOSED. PENETRATIONS SHALL BE PATCHED TO MATCH SURROUNDING SURFACES. REFER TO ARCHITECTURAL FLOOR PLANS FOR EXACT LOCATION AND HEIGHTS OF ALL PLUMBING
- FIXTURES BEFORE ROUGH-IN OR INSTALLATION OF PIPE. PLUMBING FIXTURES SHALL BE MOUNTED AT HEIGHTS SHOWN ON ARCHITECTURAL ELEVATION DRAWINGS. K. ALL PIPING IN FINISHED ROOMS SHALL BE CONCEALED IN FURRED CHASES UNLESS OTHERWISE NOTED ON THIS DRAWING. PROVIDE HINGED ACCESS DOORS FOR VALVES, WATER HAMMER ARRESTERS, ISOLATION BALL VALVES LOCATED IN NONACCESSIBLE CEILINGS AND CHASES. DOORS FURNISHED PER ARCHITECTURAL SPECIFICATIONS AND PURCHASED AND INSTALLED PER DIVISION 22. ACCESS
- DOOR RATING SHALL MATCH THE CLASSIFICATION OF WALLS AND CEILING FIRE RATING. COORDINATE COLOR AND TYPE OF ACCESS DOOR WITH ARCHITECTURAL PRIOR TO PERFORMING WORK. M. SANITARY SEWER PIPING SHALL BE C.I NO-HUB UNLESS NOTED OTHERWISE. INSTALL PER UPC
- N. DOMESTIC HOT AND COLD WATER PIPIING SHALL BE TYPE K OR L COPPER WITH 95-5 SOLDER JOINTS. ALL WATER PIPING SHALL BE INSULATED PER SPECIFICATIONS.
- O. ALL PIPING SHALL BE TESTED PER 2015 UPC AND PER SPECIFICATIONS. P. REFER TO DRAWING P-701 FOR PLUMBING ROUGH IN REQUIREMENTS.

○KEYNOTES

1 SEE PP100B FOR EXTENSION FROM BASE BID.
2 FXISTING JANITORS SINK IS TO REMAIN, CONNECT NEW 3/4" DHWIDOW TO EXISTING PIPING SERVING EXISTING JANITOR SINK. FIELD VERIFY EXACT POINT OF CONNECTION.

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/_/\ architecture

4600 C Montgomery Blvd. NE Albuquerque, NM 87109 505.883.4111 www.bpce.com

SEAL

PROJECT

209 GOLD AVENUE SW ALBUQUERQUE, NM 87102

CONSTRUCTION DOCUMENTS

REVISIONS

DRAWN BY	MAD
REVIEWED BY	SDS
DATE	12/10/2019
PROJECT NO	18-0032
PSFA PRE-K PROJECT NO:	K-18-011
PSFA SYSTEMS PROJECT NO:	S-20-008


DRAWING NAME PRESSURE

PIPING FLOOR PLAN - AREA B -BID LOT #1

SHEET NO

PP101B

KEYPLAN

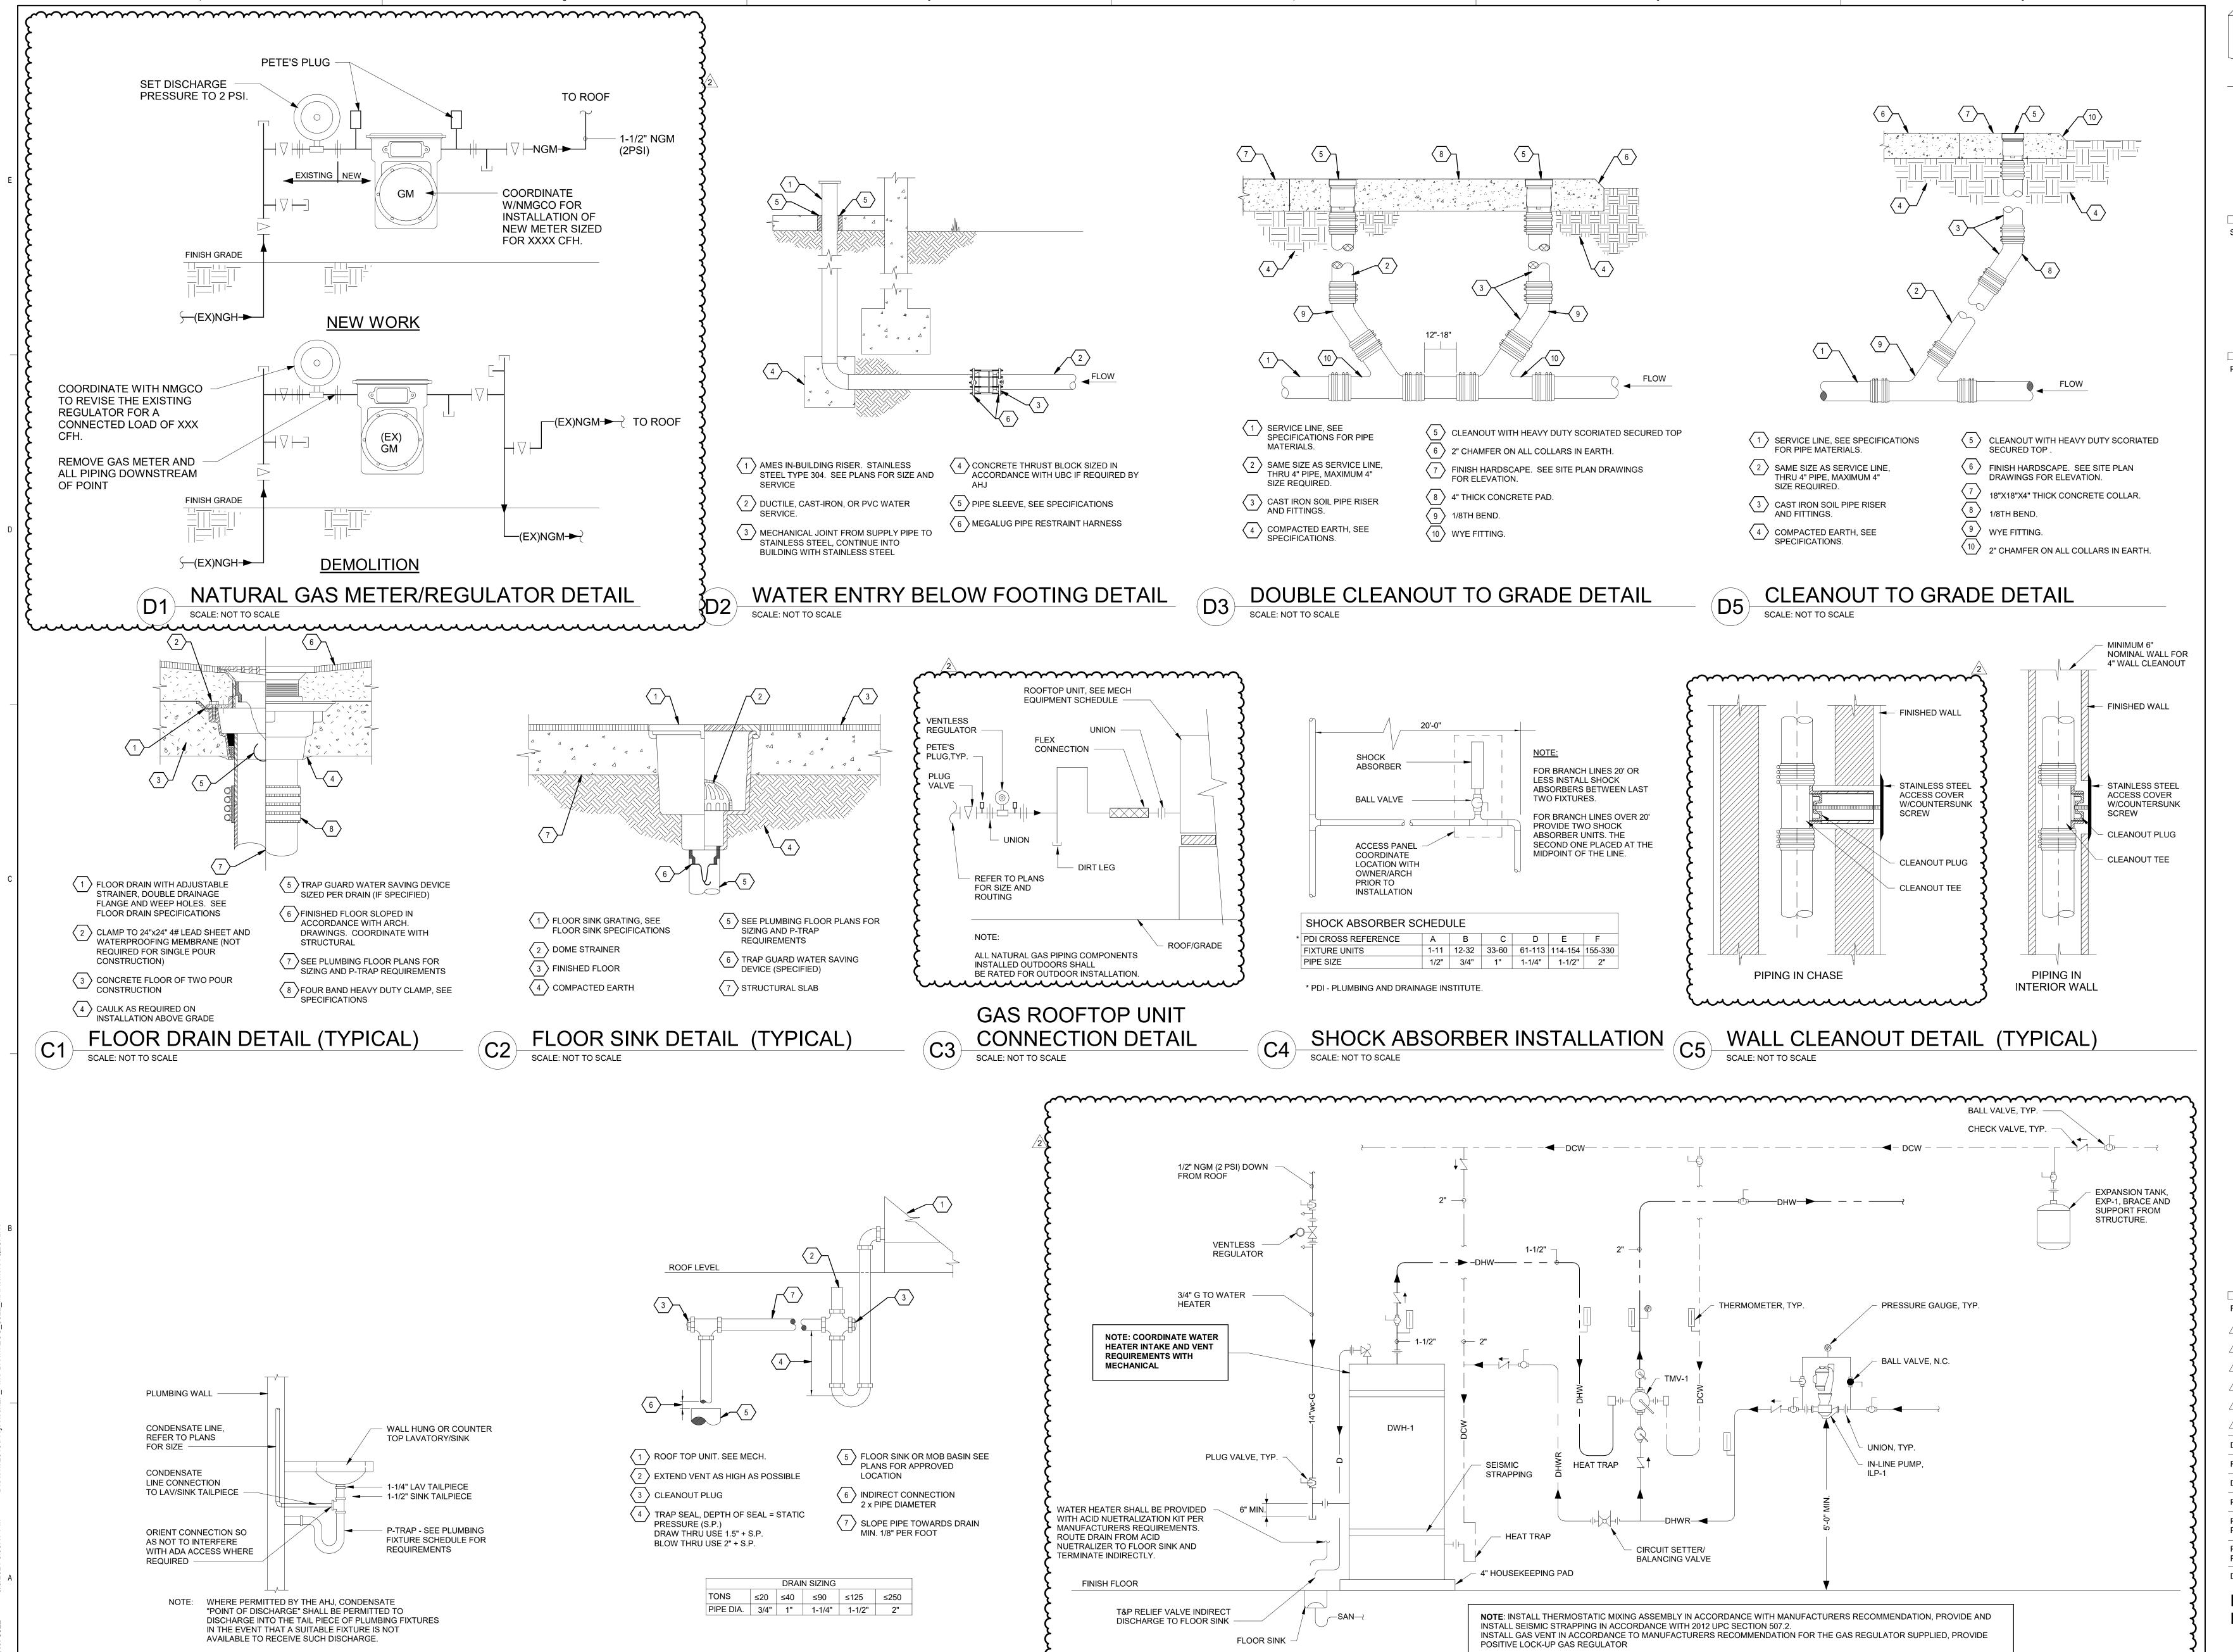

(A3)

SCALE: NOT TO SCALE

DOMESTIC WATER HEATER WITH MIXING VALVE DIAGRAM

ROOF TOP UNIT DRAIN DETAIL (TYP.)

SCALE: NOT TO SCALE

LAV-SINK CONDENSATE

SCALE: NOT TO SCALE

DRAIN CONNECTION (TYPICAL)

architecture 209 GOLD AVENUE SW ALBUQUERQUE, NM 87102

4600 C Montgomery Blvd. NE Albuquerque, NM 87109 505.883.4111 www.bpce.com SEAL

PROJECT

hild

CONSTRUCTION DOCUMENTS

REVISIONS 2\ 3/5/2021 ADDENDUM 4

DRAWN BY **REVIEWED BY** SDS DATE

PROJECT NO 18-0032 PSFA PRE-K K-18-011 PROJECT NO: **PSFA SYSTEMS** S-20-008 PROJECT NO: DRAWING NAME

PLUMBING DETAILS

SHEET NO

P-501

	N	ATURAL GA	AS SIZING (PITE								
		ATOTAL OF			-1/1/							
	FOTAL LENGTH = 235 FEET X 1.3 (FOR MISC. FITTINGS) = "TDL" FOTAL DEVELOPED LENGTH (TDL) = 350 FEET PIPING SIZED PER CHAPTER 4 OF THE 2015 INTERNATIONAL FUEL GAS CODE											
GAS PRESSU	JRE LEAVING	REGULATOR = 14	"W.C. (2 PSI EN	TERING	MAIN REGULATO	PR)						
TOTAL DESIG	GN LOAD = 205	56 CFH										
	ŀ	NATURAL G	AS DEMAN	ID LC	AD							
SYMBOL	QUANTITY	INPUT BTU/H	ELEVATION	MB	MBH PER H CFH	CFH						
DWH-1	1	120000.0	4200	120	0.832	144						
RTU-1	1	72000.0	4200	72	0.832	87						
RTU-2	1	72000.0	4200	72	0.832	87						
RTU-3	1	72000.0	4200	72	0.832	87						
RTU-4	1	72000.0	4200	72	0.832	87						
RTU-5	1	72000.0	4200	72	0.832	87						
RTU-6	1	72000.0	4200	72	0.832	87						
RTU-7	1	72000.0	4200	72	0.832	87						
RTU-8	1	72000.0	4200	72	0.832	87						
RTU-9	1	72000.0	4200	72	0.832	87						
RTU-10	1	72000.0	4200	72	0.832	87						
RTU-11	1	125000.0	4200	125	0.832	150						
RTU-12	1	72000.0	4200	72	0.832	87						
RTU-13	1	72000.0	4200	72	0.832	87						
RTU-14	1	150000.0	4200	150	0.832	180						
RTU-15	1	150000.0	4200	150	0.832	180						
RTU-16	1	115000.0	4200	115	0.832	138						
RTU-17	1	72000.0	4200	72	0.832	87						
RTU-18	1	115000.0	4200	115	0.832	138						
TOTAL:	TOTAL: 1711000.0 1711 2056											

					Pl	LUMBING	ROUGH-IN SCHEDULE
			UGH-IN		VENT		
SYMBOL	FIXTURE	CW	HW	WASTE		TRAP	REMARKS
P1	WATER CLOSET - FLOOR MTD FLUSH VALVE MANUAL	1"	-	4"	2"	INTEGRAL	ELONGATED BOWL, VITREOUS CHINA, 1-1/2" TOP SPUD. NOTE: REFER TO ARCHITECTURAL FOR MOUNTING HEIGHTS.
P1a	WATER CLOSET (BARRIER FREE) - FLOOR MTD FLUSH VALVE MANUAL	1"	-	4"	2"	INTEGRAL	ELONGATED BOWL, VITREOUS CHINA, 1-1/2" TOP SPUD. NOTE: REFER TO ARCHITECTURAL FOR MOUNTING HEIGHTS.
P1b	WATER CLOSET - WALL MTD FLUSH VALVE MANUAL	1"	-	4"	2"	INTEGRAL	ELONGATED BOWL, VITREOUS CHINA, 1-1/2" TOP SPUD. NOTE: REFER TO ARCHITECTURAL FOR MOUNTING HEIGHTS.
P2	URINAL - WALL MTD FLUSH VALVE	3/4"	-	2"	2"	INTEGRAL	WHITE VITREOUS CHINA, 3/4" TOP SPUD. NOTE: REFER TO ARCHITECTURAL FOR MOUNTING HEIGHTS.
P3	LAVATORY (BARRIER FREE) - WALL MTD.	1/2"	1/2"	1-1/2"	1-1/2"	1-1/4" X 1-1/2"	THREE HOLE, WHITE VITREOUS CHINA, 21-1/4" X 18-1/8". REFER TO ARCHITECTURAL DRAWINGS FOR MOUNTING HEIGHT.
P3a	LAVATORY (BARRIER FREE) -WALL MTD.	1/2"	1/2"	1-1/2"	1-1/2"	1-1/4" X 1-1/2"	THREE HOLE, WHITE VITREOUS CHINA, 21-1/4" X 18-1/8". REFER TO ARCHITECTURAL DRAWINGS FOR MOUNTING HEIGHT.
P4	SINK - SINGLE COMPARTMENT WITH BUBBLER	1/2"	1/2"	1-1/2"	1-1/2"	1-1/4" X 1-1/2"	xxx
P4a	SINK - DOUBLE COMPARTMENT	1/2"	1/2"	1-1/2"	1-1/2"	1-1/4" X 1-1/2"	XXX
P4b	SINK - NURSE - DOUBLE COMPARTMENT	1/2"	1/2"	1-1/2"	1-1/2"	1-1/4" X 1-1/2"	XXX
P5	SERVICE SINK	1/2"	1/2"	3"	1-1/2"	3"	FLOOR MOUNTED, TERRAZZO, 36"x36"x12" DEEP, 3" DRAIN. PROVIDE: 3" CAST IRON P-TRAP.
P6a	DRINKING FOUNTAIN (BARRIER FREE)	1/2"	-	2"	1-1/2"	1-1/4" X 1-1/2"	BI-LEVEL, WALL MOUNTED, BARRIER FREE COOLER, SENSOR OPERATED BOTTLE FILLER, VANDAL RESISTANT, HEAVY-DUTY, GALVANIZED FRAME SHALL SUPPORT 14 GAUGE STAINLESS STEEL EXTERIOR PANELS. 8 GPH CAPACITY AT 90 DEGREE AMBIENT AND 50 DEGREE WATER OUTLET, FLEXI-GUARD STREAM SAVER. NOTE: PROVIDE WITH 3 WIRE GROUNDING TYPE CORD AND PLUG, UL LISTED, 115V/1PH/60HZ.
P8	SHOWER	1/2"	1/2"	2"	1-1/2"	2"	PROVIDE: PAN LINER SHALL BE FURNISHED BY PLUMBING CONTRACTOR. 2" SHOWER DRAIN (SEE DRAIN SCHEDULE), 2" CAST IRON P-TRAP.
P9	SUPPLY BOX - REFRIGERATOR	1/2"	-	-	-	-	SPACE SAVER DESIGNED FOR ICEMAKER HOOK-UP. ROUGH OPENING: 10"Wx8-3/4"Hx3-1/2"D. VALVE: COMPRESSION ANGLE VALVE 1/2" FIP INLETx1/4" OUTLET
P10	WATER HAMMER ARRESTOR	1/2"	-	-	-	-	IN-LINE, PISTON TYPE, TYPE "L" COPPER BARREL WITH CAP ATTACHED WITH 95-5 SOLDER, LOW LEAD BRASS, EPDM "O" RINGS, 0 TO 200 PSIG MAX. OPERATING PRESSURE, 1" LINE SIZE, 1-11 FIXTURE UNITS

	FLOOR DRAIN SPECIFICATIONS											
SYMBOL	MANUFACTURER	MODEL	VENT	REMARKS:								
FD1	JAY R. SMITH	2005	2"	SQUARE TOP, CAST IRON BODY, CLAMPING DEVICE, 6" DIAMETER NICKEL BRONZE STRAINER, DEEP SEAL P-TRAP. SERVICE:GENERAL PURPOSE RESTROOMS, LOCKER ROOMS, ETC, SIZE AS INDICATED ON DRAWINGS. PROVIDE SURE SEAL IN-LINE TRAP SEAL, SIZE AND TYPE TO FIT DRAIN.								
FS1	ZURN	Z-1900	2"	CAST IRON BODY WITH WHITE ACID RESISTING ENAMEL BODY INTERIOR, SLOTTED 3/4 LOOSE SET GRATE ALUMINUM ANTI-SPASH DOME STRAINER, (DEEP SEAL P-TRAP MFG: ZURN Z1000). DIAMETER OF OUTLET AS SHOWN ON DRAWINGS. PROVIDE WITH SURE SEAL IN-LINE TRAP SEAL. SIZE AND TYPE TO FIT DRAIN.								

	WATER HEATER SCHEDULE															
	STORAGE											VATER OVERY				
SYMBOL	MANUFACTURER	MODEL NO.	LOCATION	SERVICE	SET POINT (DEGREES)	FUEL	EFFICIENCY	VOLUME (GAL.)		ELEVATION	OPERATION WEIGHT	RATE (GPH)	ΔT°F	MIXING VALVE	EXPANSION TANK	N REMARKS
DHW-1	A.O. SMITH	BTH-120	MECH	DOMESTIC HW	140	NATURAL GAS	97%	60	120,000	4,200	1385	138	100	SEE TMV-1	SEE EXP-1	

	THERMOSTATIC MIXING VALVE SCHEDULE												
					OUTLET	PIPE	PIPE	PIPE	SYSTEM FLOW &				
SYMBOL	MANUFACTURER	MODEL NO.	LOCATION	SERVICE	TEMPERATURE	SIZE	SIZE	SIZE	PRESSURE DROP	REMARKS			
TMV-1	LEONARD	TM-420B-LF-DT-IT-TC	MECH	DOMESTIC HW	120°	2"	2"	3/4"	18 GPM @ 10 PSI				

	EXPANSION TANK SCHEDULE												
					TANK	TANK							
SYMBOI	. MANUFACTURER	MODEL NO.	SERVICE	DESIGN DEG °F	VOLUME (GAL.)	ACCEPTANCE (GAL.)	PSIG	WEIGHT (LBS.)	REMARKS				
EXP-1	AMTROL	ST-12C	DOMESTIC HW	140	6.4	1.5	150	17					

						PLUMI	BING PU	MP SCH	IEDULE					
		CAPACITY									ELECT	RICAL		
SYMBOL	MANUFACTURER	MODEL NO.	LOCATION	SERVICE	TYPE	GPM	TOTAL FT. HD.	PUMP (RPM)	MOTOR (HP)	V	PH	HZ	FLA	REMARKS
ILP-1	BELL & GOSSETT	PL130B	MECH	BROWN ECC	IN-LINE	5	15	2650	1/12	115	1	60	1.4	3/4" NPT CONNECTION, LEAD FREE

							HE	ATED EN	ICLOSU	RE SCHE	EDULE		
		MODEL			NUMBER OF	ELECTRICAL					INTERIOR		
SYMBOL	MANUFACTURER	NO.	LOCATION	SERVICE	HEATERS	V	PH	HZ	WATTS	PAD SIZE	DIMENSION	PAD SIZE	REMARKS
HE-1	SAFE-T-COVER	600TLU880-AL	ON-SITE	FIRE PROTECTION	1	120	1	60	2000		44x38x48	58x52x6	

	BACKFLOW PREVENTER SCHEDULE												
/MBOL	MANUFACTURER	MODEL	LOCATION	SERVICE	TYPE	PIPE SIZE	REMARKS						
BFP-1	FEDCO	LF870V	HE-1	FIRE PROTECTION	N PATTERN	6							

PROJECT

7

CONSTRUCTION **DOCUMENTS**

REVISIONS

PROJECT NO

PSFA PRE-K PROJECT NO:

DRAWN BY REVIEWED BY

PSFA SYSTEMS PROJECT NO: S-20-008 DRAWING NAME PLUMBING

SPECIFICATIONS

SHEET NO

K-18-011

P-701