CONSTRUCTION PLANS FOR REPLACEMENT PREPARED FOR **OCTOBER 2021**

SWWTF REUSE CONTROL PANEL INDIAN RIVER COUNTY UTILITIES DEPARTMENT



BOARD of COUNTY COMMISSIONERS

DISTRICT 2 DISTRICT 2 DISTRICT 3 DISTRICT 4 DISTRICT 5

SUSAN ADAMS JOSEPH FLESCHER TIM ZORC PETER O'BRYAN BOB SOLARI

CHAIRMAN VICE-CHAIRMAN COMMISSIONER COMMISSIONER COMMISSIONER


DATE BY

VINCENT BURKE, P.E. – DIRECTOR OF UTILITIES

REVISIONS

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1920 WEKIVA WAY SUITE 200, WEST PALM BEACH, FL 33411 PHONE: 561-845-0665 FAX: 561-863-8175 WWW.KIMLEY-HORN.COM CA 00000696

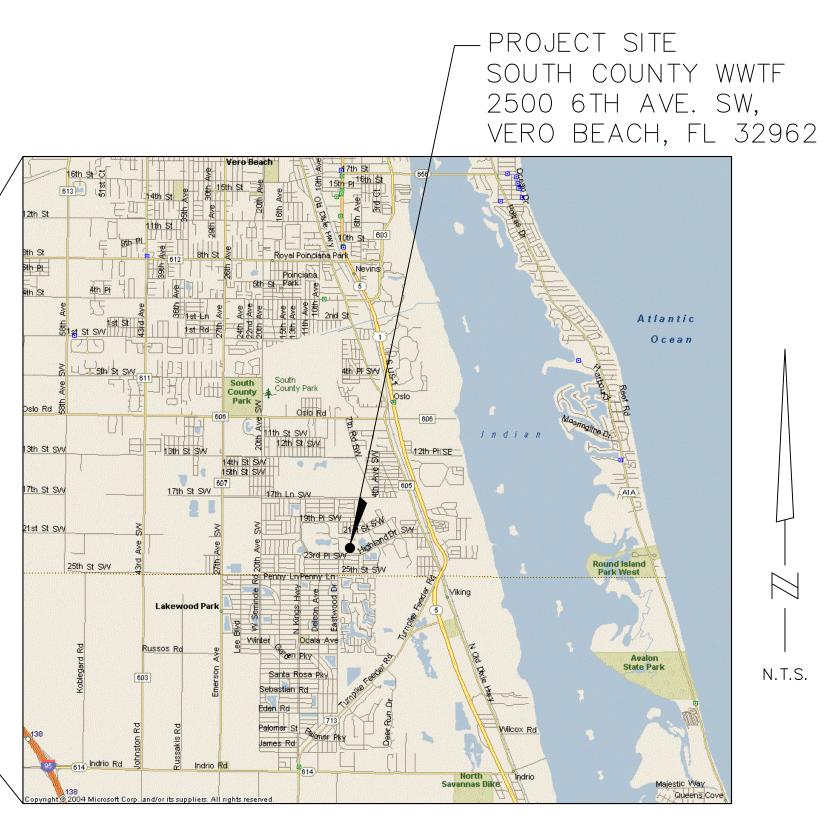

LOCATION MAP

N.T.S.




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SHEET NUMBER

COVER SHEET

G-1

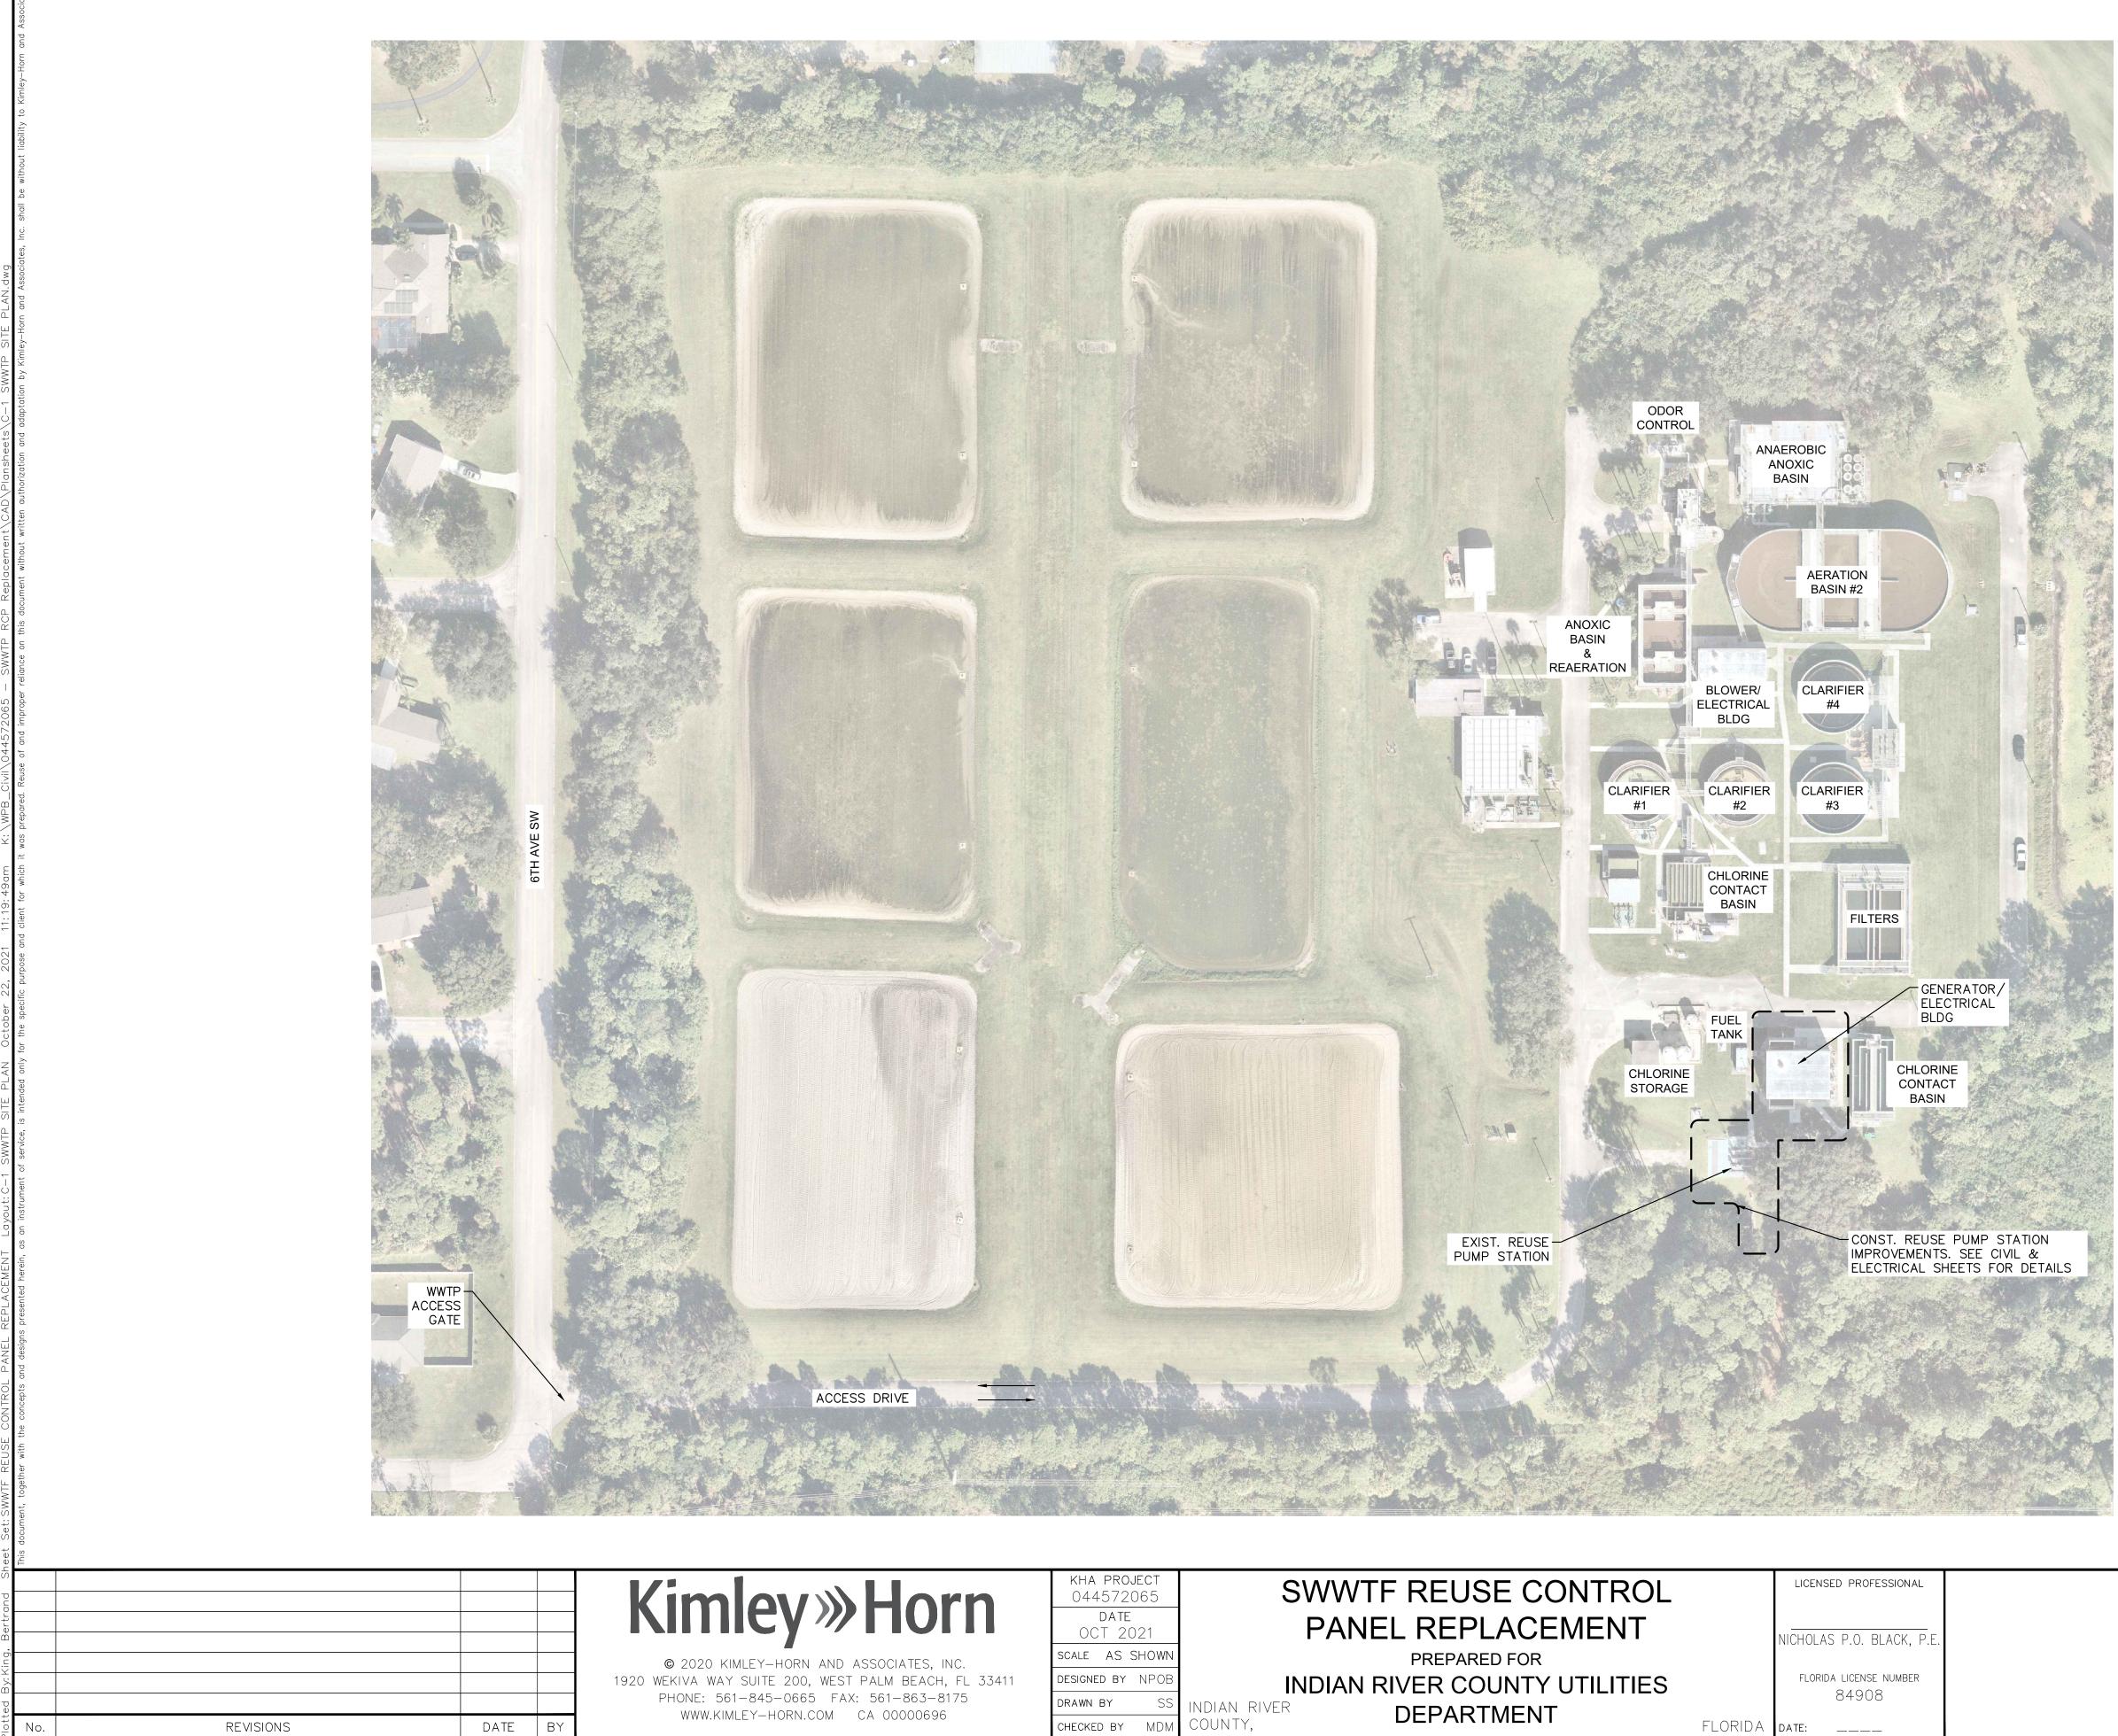


orn	KHA PROJECT 044572065	SWWTF REUSE CONTROL		LICENSED PROFESSIONAL	
orn	DATE OCT 2021	PANEL REPLACEMENT		NICHOLAS P.O. BLACK, P.E.	
TES, INC.	SCALE AS SHOWN	PREPARED FOR		,	
BEACH, FL 33411	DESIGNED BY NPOB	INDIAN RIVER COUNTY UTILITIES		FLORIDA LICENSE NUMBER	
363–8175 00696	DRAWN BY SS	INDIAN RIVER DEPARTMENT		84908	
	CHECKED BY MDM	COUNTY, DEPARTMENT	FLORIDA	DATE:	

SITE PLAN

SHEET NUMBER

C-1


GRAPHIC SCALE IN FEET 0 30 60 120

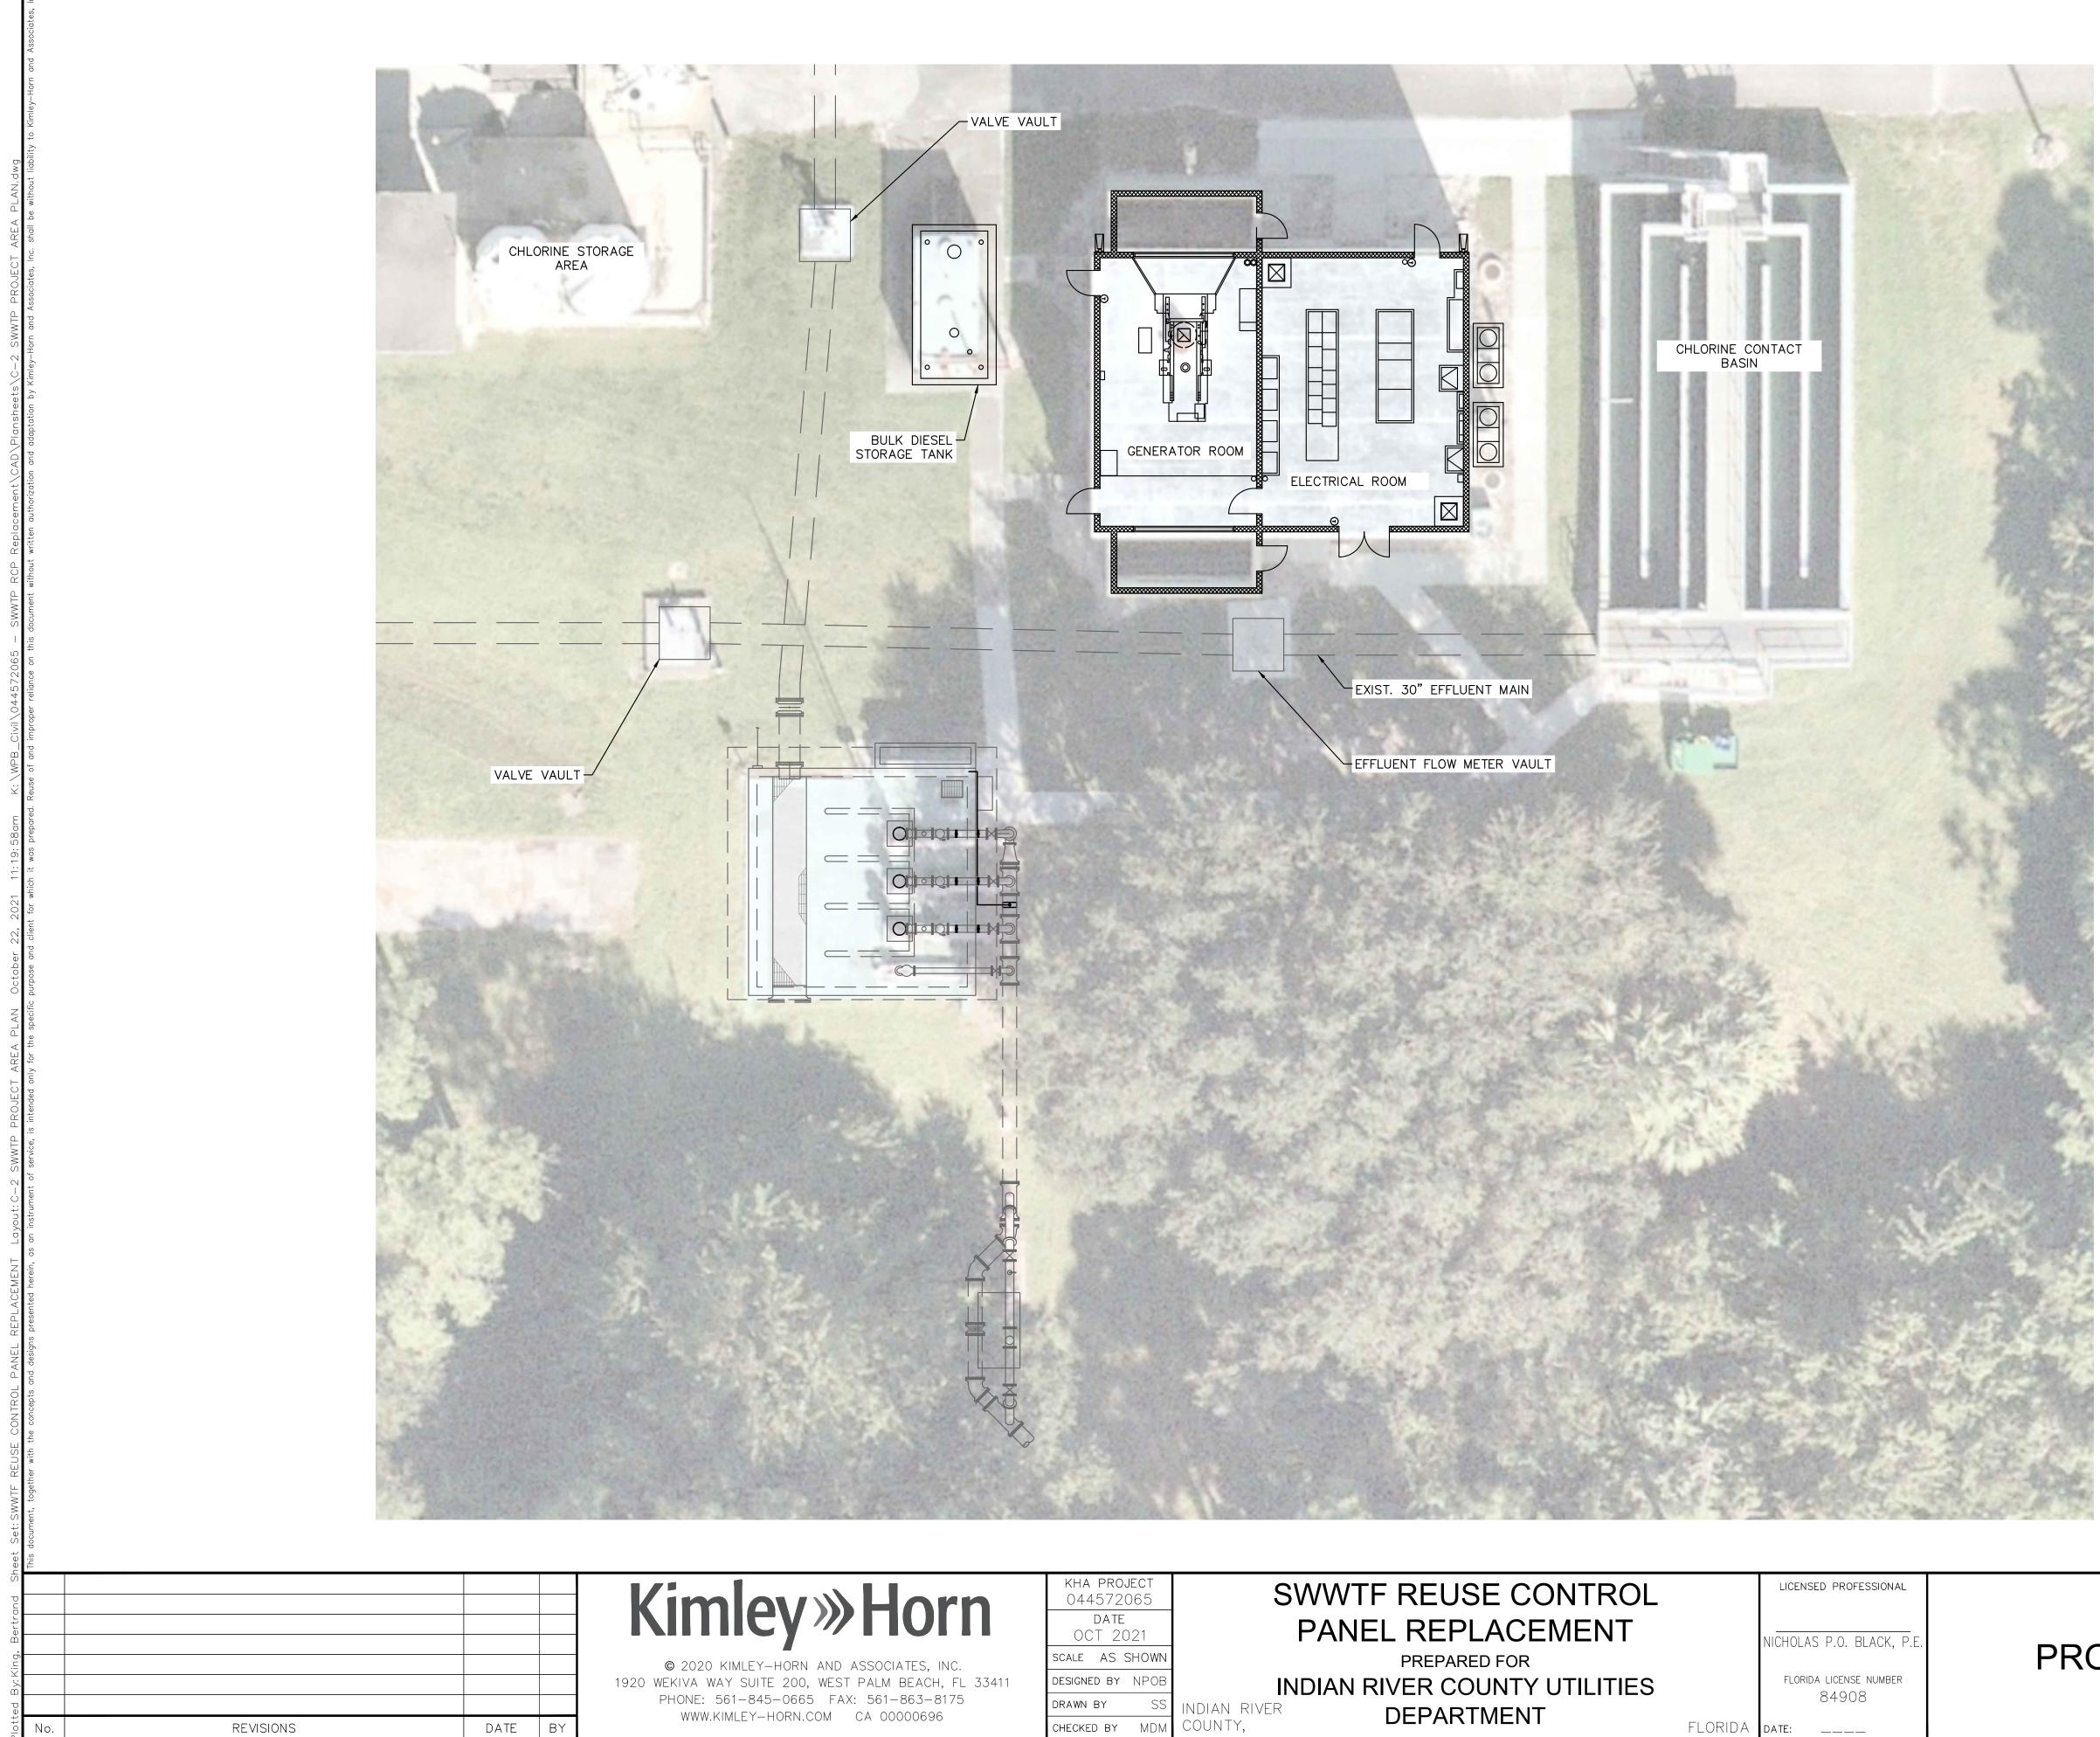

orn	kha project 044572065	SWWTF REUSE CONTROL		LICENSED PROFESSIONAL	
orn	DATE OCT 2021	PANEL REPLACEMENT		NICHOLAS P.O. BLACK, P.E.	
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00030	CHECKED BY MDM	COUNTY, DEFAILTMENT	FLORIDA	DATE:	


PROJECT AREA PLAN

SHEET NUMBER

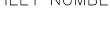



C-2

GRAPHIC SCALE IN FEET 0 5 10 20 20

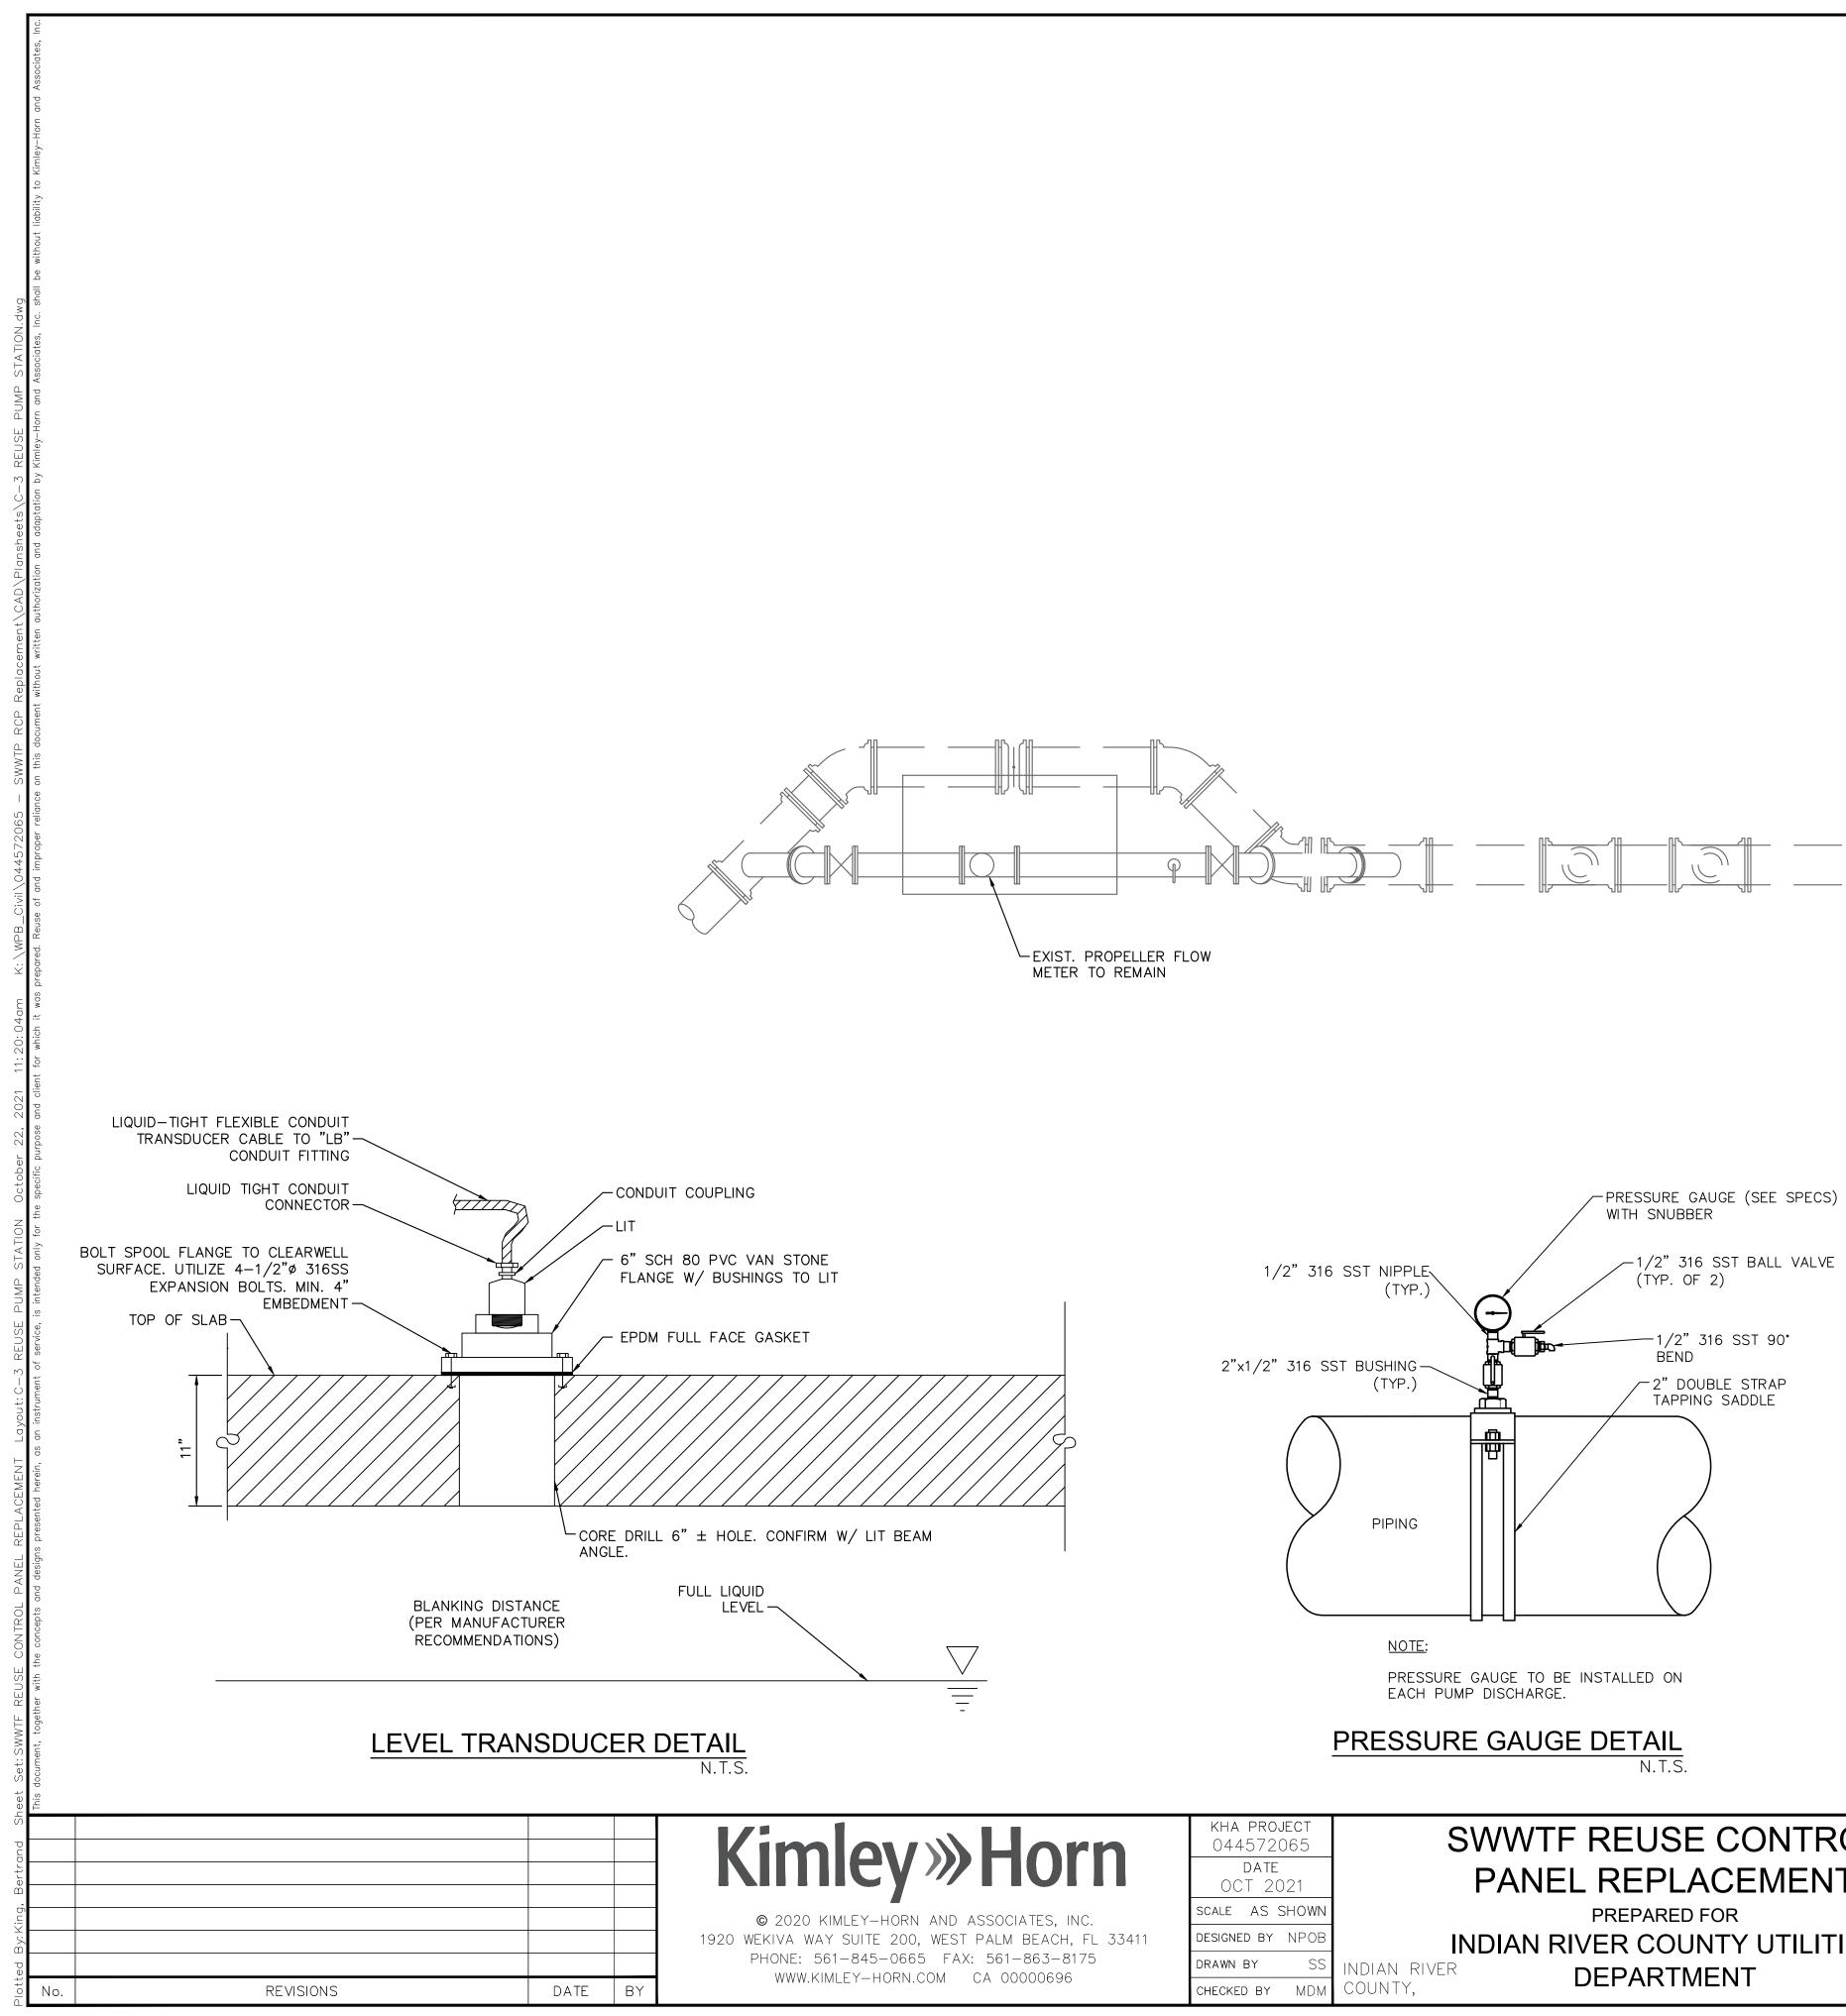

	2"x1/2" 316 SS	I PIPING PIPING NOTE: PRESSURE GAUGE TO BE INSTALLED ON EACH PUMP DISCHARGE. PRESSURE GAUGE DETAIL N.T.S.			1,
OTA TES, INC. BEACH, FL 33411 863–8175 000696	KHA PROJECT 044572065DATE OCT 2021SCALEAS SHOWNDESIGNED BYNPOBDRAWN BYSSCHECKED BYMDM	SWWTF REUSE CONTROL PANEL REPLACEMENT PREPARED FOR INDIAN RIVER COUNTY UTILITIES DEPARTMENT	FLORIDA	LICENSED PROFESSIONAL NICHOLAS P.O. BLACK, P.E. FLORIDA LICENSE NUMBER 84908 DATE:	

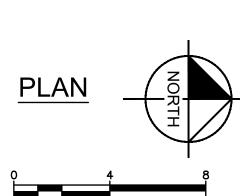

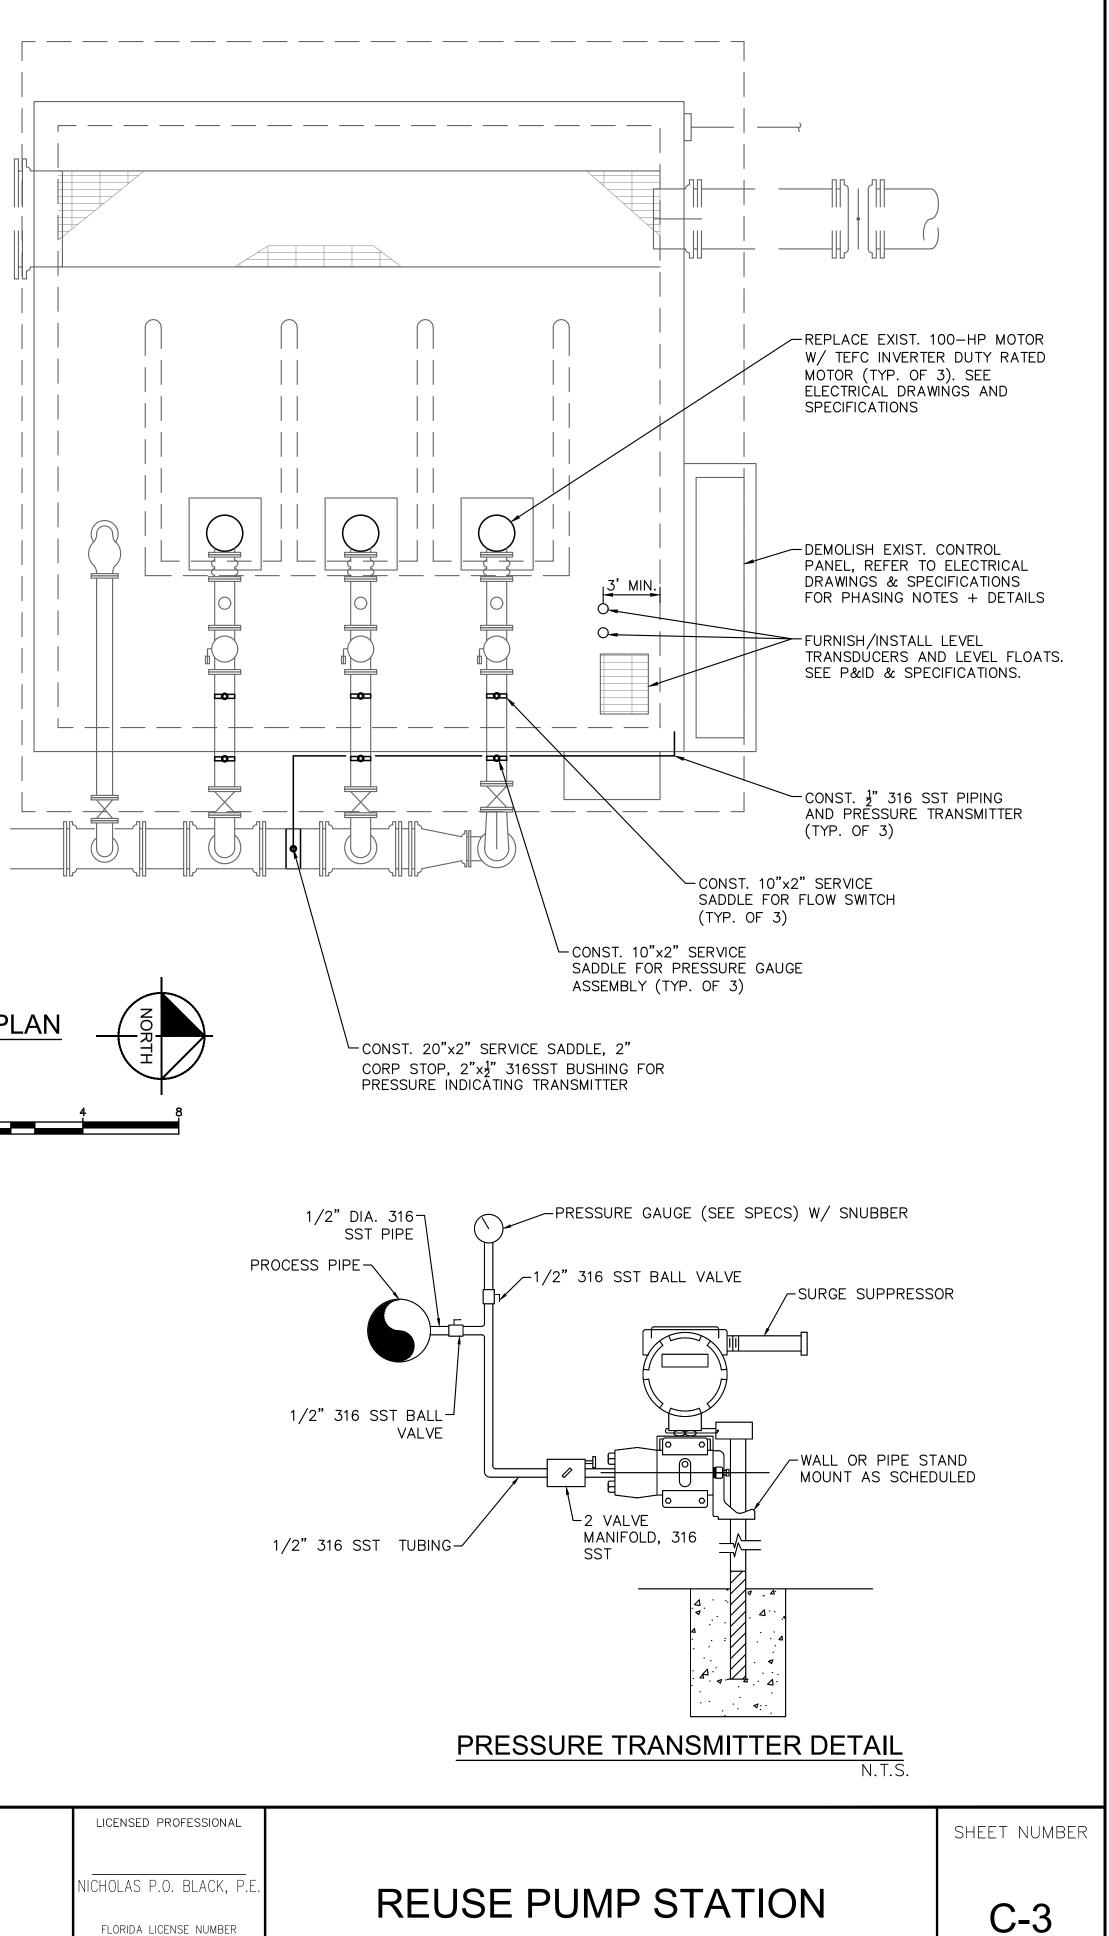

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PIPING AND EQUIPMENT SYMBOLS	VALVE SYMBOLS	INSTRUMENT SYMBOLS	
CENTRIFUGAL PUMP	*	PRIMARY CHOICE ALTERNATE CHOICE COMPUTER SYSTEMS OR OR SYSTEMS BASIC SAFETY AND PROCESS INISTRUMENTED SOFTWARE	ME
BLOWER FILTER VESSEL	VACUUM RELIEF VALVE	CONTROL SYSTEM SYSTEM SOFTWARE	
PARISTALTIC PUMP BAG FILTER	DAMPER	- LOCATED IN THE FIELD - NOT PANEL, CABINET, OR CONSOLE MOUNTED - VISIBLE AT FIELD LOCATION - NORMALLY OPERATOR ACCESSIBLE	B
POSITIVE DISPLACEMENT PUMP (W/MANUAL STROKE ADJUSTMENT)	LINE SYMBOLS	- LOCATED IN OR ON FRONT OF CENTRAL OR MAIN PANEL OR CONSOLE - VISIBLE ON FRONT OF PANEL OR ON VIDEO DISPLAY	
ROTARY COMPRESSOR ROTARY COMPRESSOR DEGASIFIER	PROCESS PIPING	- NORMALLY OPERATOR ACCESSIBLE AT PANEL FRONT OF CONSOLE - LOCATED IN REAR OF CENTRAL OR MAIN PANEL - LOCATED IN CABINET BEHIND PANEL	F
VERTICAL TURBINE PUMP	PNEUMATIC SIGNAL PNEUMATIC SIGNAL ELECTRICAL SIGNAL (OR FUTURE)	- NOT VISIBLE ON FRONT OF PANEL OR ON VIDEO DISPLAY - NOT NORMALLY OPERATOR ACCESSIBLE AT PANEL OR CONSOLE	G H
MIXING TEE SCRUBBER	FIBER OPTIC	- LOCATED IN OR ON FRONT OF SECONDARY OR LOCAL PANEL OR CONSOLE - VISIBLE ON FRONT OF PANEL OR ON VIDEO DISPLAY - NORMALLY OPERATOR ACCESSIBLE AT PANEL FRONT OR CONSOLE	J
HEATER	PORT N.C. (OPEN WHEN ENERGIZED)	- LOCATED IN REAR OF SECONDARY OR LOCAL PANEL - LOCATED IN FIELD CABINET - NOT VISIBLE ON FRONT OF PANEL OR ON VIDEO	L
MIXER OR AGITATOR VALVE SYMBOLS	PORT N.O. (CLOSE WHEN ENERGIZED) <u>DETAIL "A"</u>	- NOT VISIBLE ON FRONT OF PANEL OR ON VIDEO DISPLAY - NOT NORMALLY OPERATOR ACCESSIBLE AT PANEL OR CONSOLE	N 0
GATE STATIC MIXER GLOBE	(SOLENOID VALVE OPERATION)	INSTRUMENT DEVICE OR FUNCTION SYMBOLS, MISC.	P
SG SIGHT GLASS BALL ≤ 2"	<u>Control valves/</u> Actuators	- SIGNAL PROCESSING FUNCTION - LOCATE IN UPPER RIGHT OR LEFT QUADRANT OF SYMBOLS ABOVE - ATTACH TO SYMBOLS ABOVE WHERE AFFECTED SIGNALS ARE CONNECTD	R
LEVEL GAUGE BALL > 2"	PRESSURE REDUCING	- INSERT SIGNAL PROCESSING SYMBOLS FROM TABLE 5.6 - EXPAND SYMBOL BY 50% INCREMENTS FOR LARGER FUNCTION SYMBOLS - INSTRUMENTS OR FUNCTIONS SHARING A COMMON HOUSING	S
FG FLOW SIGHT GLASS	REGULATOR, SELF	 INSTRUMENTS OR FONCTIONS SHARING A COMMON HOUSING IT IS NOT MANDATORY TO SHOW A COMMON HOUSING NOTES SHALL BE USED TO IDENTIFY INSTRUMENTS IN COMMON HOUSINGS NOT USING THIS SYMBOL 	U
MOTOR CHECK	BACK PRESSURE REGULATOR, SELF CONTAINED	- PILOT LIGHT - CIRCLE SHALL BE REPLACED WITH ANY SYMBOL FROM COLUMN D	V
G GENERATOR DIAPHRAGM	$ \begin{array}{cccc} & \text{MOTOR OPERATED BALL} \\ & \text{VALVE} \leq 2" \end{array} $	- PILOT LIGHT - CIRCLE SHALL BE REPLACED WITH ANY SYMBOL FROM COLUMN D	w χι
WEARDARE MARKEDA MARKEDA AND A	MOTOR OPERATED BALL	FLOW MEASUREMENT SYMBOLS	Y
QUICK DISCONNECT NEEDLE	MOTOR OPERATED BUTTERFLY VALVE		
FLOOR DRAIN	MOTOR OPERATED GLOBE VALVE		ANY FIRS PD=DIFFE SCANNING DESCRIPT
RUPTURE DISC		LOJ (TURBINE METER) 2.	DENOTING
CHEMICAL SEAL SHEET)	MOTOR OPERATED DAMPER		IN THE D
	MODULATING CONTROL VALVE	STANDARD PITOT TUBE	NEAR EA
Y-STRAINER HUNDER PULSATION DAMPENER	<u>SPECIAL IDENTIFICATION</u>		<u>on tf</u>
dus beseuted	SDI – SILT DENSITY INDEX TEST FILTER HOLDER W/0.45 MICRON FILTER HOLDER		DI
CALIBRATION COLUMN 4-WAY	N.C. – NORMALLY CLOSED	FI INLINE FLOW INDICATOR	
ATM. VENT TO ATMOSPHERE 5-WAY	N.O. – NORMALLY OPEN F.C. – FAIL CLOSED	FI INLINE FLOW INDICATOR (ROTOMETER)	AI
MEMBRANE TREATMENT	F.O. – FAIL OPEN	FLOW/PRESSURE SWITCH	(AO)
EXPANSION JOINT		VENTURI METER	
Kim	HA PROLOCIALS	SWWIF REUSE CONTROL	۹L
	KIMLEY-HORN AND ASSOCIATES, INC.	PANEL REPLACEMENT NICHOLAS P.O. BLACK, SHOWN PREPARED FOR	
Y 1920 WEKIVA WA M PHONE: 5	Y SUITE 200, WEST PALM BEACH, FL 33411 61-845-0665 FAX: 561-863-8175 MLEY-HORN.COM CA 00000696 CHECKED BY	NPOB INDIAN RIVER COUNTY UTILITIES FLORIDA LICENSE NUMBER SS INDIAN RIVER DEPARTMENT 84908 MDM COUNTY, FLORIDA DATE:	२

INSTRUMENT IDENTIFICATION LETTERS					
FIRST LET	TER (OR PAIR)		SUCCEEDING LETTER	?S	
MEASURED/ INITIATING VARIABLE	G VARIABLE MODIFIER	READOUT/PASSIVE FUNCTION	OUTPUT/ACTIVE FUNCTION	FUNCTION MODIFIER	
ANALYSIS(2)		ALARM			
		USERS CHOICE(3)	USERS CHOICE(3)	USERS CHOICE(3)	
CONDUCTIVITY (ELECTRIC)			CONTROL	CLOSE	
	DIFFERENTIAL				
VOLTAGE (E.M.F.)		PRIMARY ELEMENT			
FLOW RATE	RATIO (FUNCTION)				
GAGING (DIMENSION)		GLASS (DIRECT VIEW)	GATE		
HAND (MANUAL)				HIGH	
CURRENT (ELECTRIC)		INDICATE			
POWER	SCAN				
TIME OR TIME SCHEDULE			CONTROL STATION		
LEVEL		LIGHT(PILOT)		LOW	
MOISTURE OR HUMIDITY				MIDDLE	
USER'S CHOICE(3)		USERS CHOICE(3)	USERS CHOICE(3)	NORMAL	
OXIDE REDUCT. POTENTIAL		ORFICE (RESTRICTION)		OPEN	
PRESSURE OR VACUUM		TEST OR SAMPLE POINT			
QUANTITY OR EVENT	INTERGRATE/ TOTALIZER				
RATIO		RECORD OR PRINT			
SPEED OR FREQUENCY	SAFETY		SWITCH		
TEMPERATURE			TRANSMIT		
MULTIVARIABLE		MULTIFUNCTION	MULTIFUNCTION	MULTIFUNCTION	
VISCOSITY			VALVE,DAMPER, OR LOUVER		
WEIGHT OR FORCE		WELL			
UNCLASSIFIED(4)	UNCLASSIFIED(4)	UNCLASSIFIED(4)	UNCLASSIFIED(4)	UNCLASSIFIED(4)	
USERS CHOICE(3)		LIGHT SOURCE	RELAY OR COMPUTE		
POSITION			DRIVE, ACTUATE, ETC		
			•		

FIRST LETTER COMBINED W/ MODIFIER REPRESENTS A NEW AND SEPARATE MEASURED VARIABLE. EXAMPLES: DIFFERENTIAL PRESSURE,FQ=TOTALIZED OR INTERGRATED FLOW. EXCEPTION IS MODIFIER "J" FOR MULTIPOINT NNING. "A" IS USED FOR ANALYTICAL VARIABLES. EXAMPLES: pH,Na,SiO~s2~S,O~s2~S,ETC. A SYMBOL OR CRIPTION

DTING THE FUNCTION IS SHOWN OUTSIDE THE INSTRUMENT SYMBOL. EXAMPLE: $\left(\begin{array}{c} A \mid T \end{array} \right)_{DH}$

NING OF A "USER CHOICE" LETTER SHALL BE CONSISTENT THROUGHOUT A PROJECT AND SHALL BE SPECIFIED HE DRAWING LEGEND.

ASSIFIED LETTER MAY HAVE A FEW DIFFERENT MEANINGS ON A PROJECT. THE MEANING SHALL BE SPECIFIED REACH INSTRUMENT SYMBOL USING THE UNCLASSIFIED LETTER.

TROL SYMBOLS

DISCRETE INPUT

DISCRETE OUTPUT


ANALOG INPUT

ANALOG OUTPUT

SHEET NUMBER

PROCESS AND INSTRUMENTATION DIAGRAM

1-1

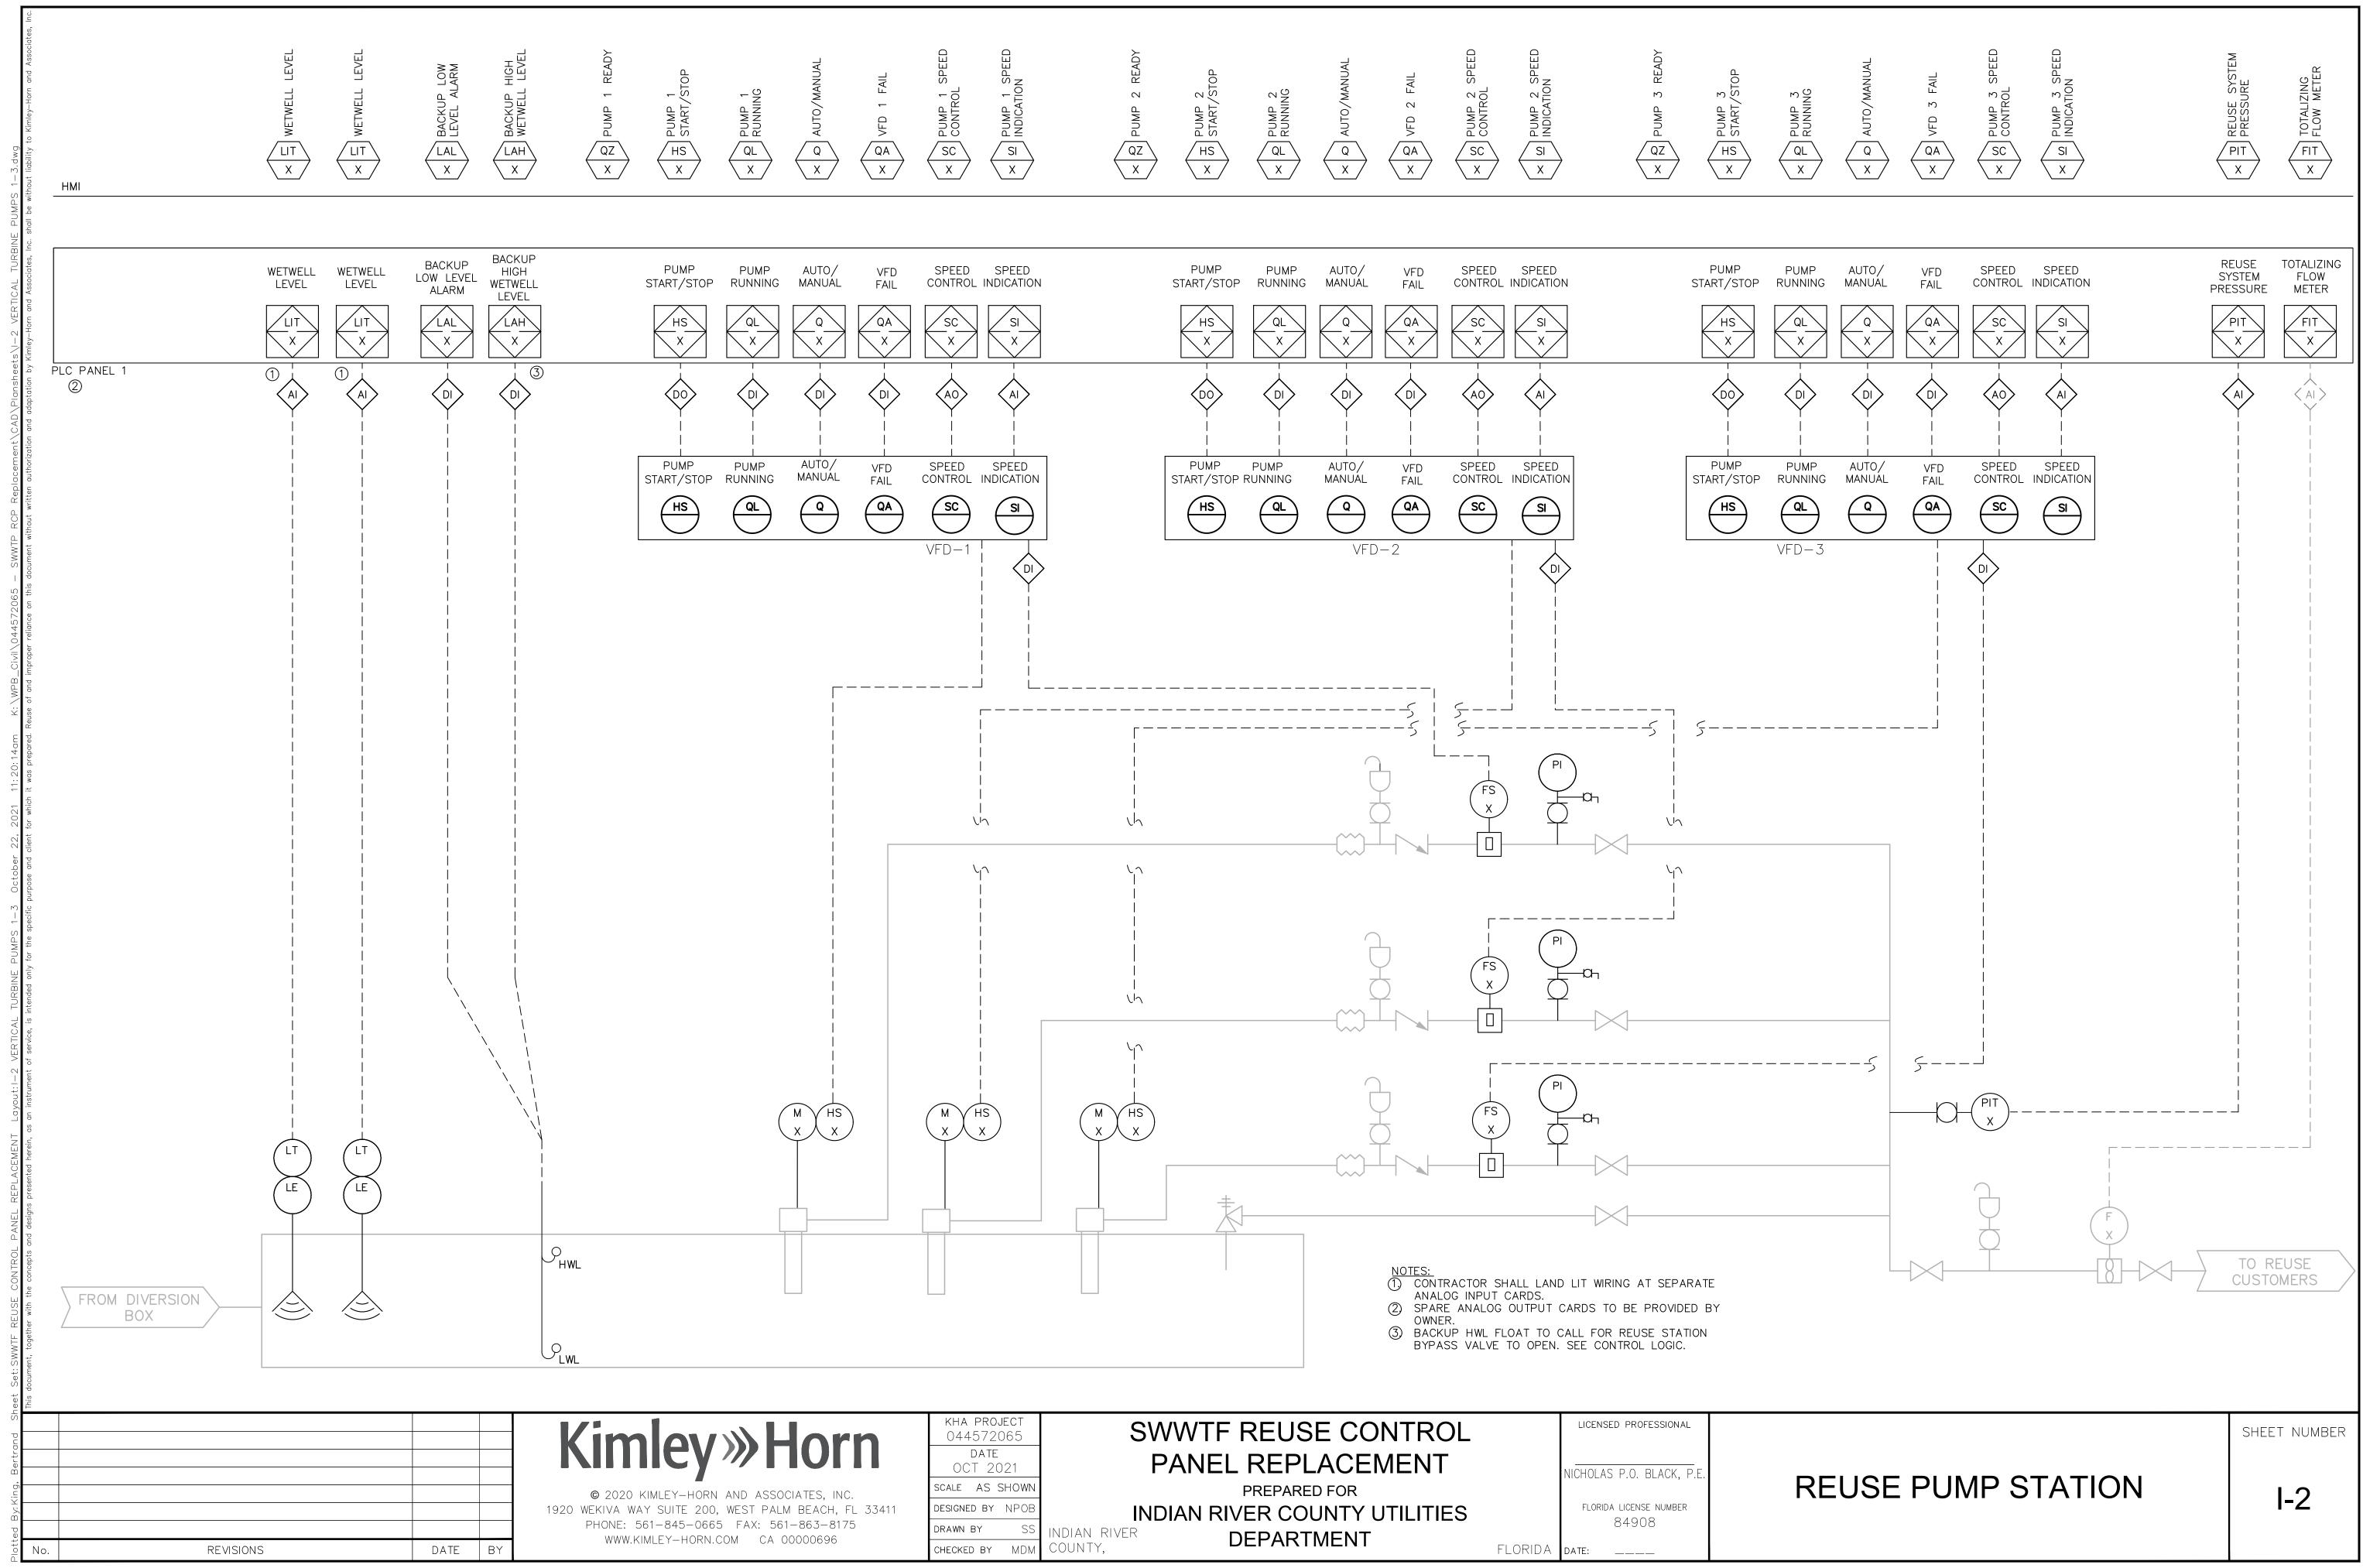

SS	INDIAN RIVER
MDM	COUNTY.

GENERAL ELECTRICAL NOTES

- 1. <u>READ THE SPECIFICATIONS</u> REFER TO THE SPECIFICATIONS FOR ADDITIONAL REQUIREMENTS. THERE ARE REQUIREMENTS NOTED IN THE SPECIFICATIONS WHICH ARE NOT INDICATED ON THE DRAWINGS.
- 2. <u>SCHEMATIC NATURE</u> PLAN VIEWS ARE SCHEMATIC IN NATURE AND MEANT TO SHOW THE SCHEMATIC ARRANGEMENT OF EQUIPMENT AND CONDUIT.

3. <u>APPROVED SHOP DRAWINGS</u>

USE APPROVED SHOP DRAWINGS FOR LAY OUT OF EQUIPMENT. THE CONTRACT DOCUMENTS WILL VARY FROM THE SHOP DRAWINGS. INFORM THE ENGINEER IMMEDIATELY IF THERE ARE LAY OUT ISSUES OR INADEQUATE SPACE FOR EQUIPMENT OR CLEARANCES. LAND CONDUITS IN OPENINGS OF ENCLOSURES PER THE APPROVED SHOP DRAWINGS, DO NOT USE THE CONTRACT DRAWINGS.

4. <u>CLEARANCES</u> IT SHALL BE THE CONTRACTOR'S RESPONSIBILITY TO MEET N.E.C. CLEARANCES ABOUT EQUIPMENT.

- 5. <u>ROUTING</u> CONDUIT ROUTING IS SCHEMATIC IN NATURE. CONDUIT ROUTING IS SHOWN FOR CLARITY ON THE CONTRACT DRAWINGS. ROUTE CONDUITS AS MAY BE REQUIRED.
- 6. <u>FUTURES FACILITIES</u> WHERE FUTURE FACILITIES ARE INDICATED. CONDUIT ROUTING SHALL ACCOUNT FOR SUCH FACILITIES.

7. <u>RESPONSIBILITIES</u>

BIDDERS, SUPPLIERS, EQUIPMENT VENDORS, GENERAL CONTRACTOR, SUB CONTRACTORS AND OTHER SIMILAR ENTITIES ARE REQUIRED TO READ ALL THE CONTRACT DOCUMENTS INCLUDING DRAWINGS AND SPECIFICATIONS.

<u>HOMERUNS</u>

CONTRACTOR SHALL COORDINATE HOME RUNS BETWEEN PLAN VIEWS. WHERE ANY CONDUIT IS SHOWN IN ANY PLAN VIEW IT SHALL BE INSTALLED THE ENTIRE LENGTH AS MAY BE REQUIRED.

ELECTRICAL LEGEND

	RACEWAY EXPOSED LIGHTING RACEWAY CONCEALED RACEWAY CONCEALED	070 0 010	LEVEL SWITCH, FLOAT SWITCH	\$ \$3
•	RACEWAY TURNED UP/DOWN		PRESSURE SWITCH	
5	MOTOR	2 2 2 2 2 2 2 2 2 2 2 2 2 2 2 2 2 2 2	LIMIT SWITCH THERMAL SWITCH	\boxtimes
μμ	TRANSFORMER	——————————————————————————————————————	HEATER	J
	FUSE	(G)	PILOT LIGHT	
 (←	CIRCUIT BREAKER CAPACITOR	C01 C02	DENOTES SEPARATE CONDUITS WITH SEPARATE WIRE	////
	LIGHTNING ARRESTER SAFETY DISCONNECT	(A-3)	DENOTES PANELBOARD A, CIRCUIT 3	MS G
ı	SWITCH, HP RATED GROUND	ETM	ELAPSED TIME METER	مله مح
	DUPLEX, 14" AFF		SELECTOR SWITCH	olo
\ominus	SIMPLEX, 14" AFF	~ ~	PUSH BUTTON	
— —-	NORMALLY OPEN CONTACT	0 ⁻ 0	ON-OFF SWITCH	\bigcirc
\	NORMALLY CLOSED CONTACT			(<u>C01</u>)

MATERIAL SCHEDULE

LOCATION	CONDUIT	ENCLOSURE MATERIALS	ENCLOSURE NEMA RATING	FASTENERS, STRUT, THREADED ROD, ETC.	REMARKS
EXTERIOR					
BELOW GRADE	PVC SCHED. 40	CONCRETE BOXES	N/A	316 SS	
ABOVE GRADE	PVC SCHED. 80	316 SS	4X	316 SS	

GENERAL NOTES

- 1. THE FOLLOWING SHALL ESTABLISH THE MINIMUM LEVEL OF QUALITY FOR MATERIALS.
- 2. THE FOLLOWING SHALL APPLY UNLESS OTHERWISE INDICATED BY DRAWINGS
- 3. THE FOLLOWING SHALL NOT APPLY TO POWER TRANSFORMERS, LIGHT FIXTURES AND LIGHT POLES, THOSE ELEMENTS ARE NOTED OR INDICATED ELSEWHERE

ELECTRICAL ABBREVIATIONS

37 CONDUCTOR CABLE

37C

070	
ATB	ANALOG TERMINAL BOX
AXS	AUTO TRANSFORMER STARTER
CR	CONTROL RELAY
СР	CONTROL PANEL
CPB	CONTROL PULL BOX
CS	CONTROL STATION
CSD	CONTROL SYSTEM DESIGN INC.
CTB	CONTROL TERM. BOX
DISC	DISCONNECT SWITCH
DMM	DIGITAL MULTIMETER
	DOOR SWITCH
	DISCRETE TERMINAL BOX
	ETHERNET
	ELAPSED TIME METER
F	FUSE
	FLYGT CONTROL PANEL
	FIBER OPTIC
	FIBER OPTIC ETHERNET CABLE
	F/O WELL 6 TO PMB
FSA	FIELD SURGE ARRESTOR
GFI	GROUND FAULT INTERRUPTER
HOA	HAND-OFF-AUTO
HOR	HAND-OFF-REMOTE
	INST. PULL BOX
IPB ITB	INST. FULL BOX INST. TERMINAL BOX
LA	LIGHTNING ARRESTER
LIT	LEVEL INDICATING TRANSMITTER
LOR	LOCAL-OFF-REMOTE
М	MOTOR STARTER
M MB+	MOTOR STARTER MODBUS PLUS
M MB+ MCC	MOTOR STARTER MODBUS PLUS MOTOR CONTROL CENTER
M MB+	MOTOR STARTER MODBUS PLUS

LEGEND

N/A	NOT APPLICABLE
316 SS	316 STAINLESS STEEL
EMT	ELECTRICAL METALLIC T
ALUMINUM	ALUMINUM RIGID COND

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REVISIONS	DATE	

SWITCH 48"AFF,

SWITCH 48"AFF, 3-WAY

ENCLOSED COMBINATION STARTER

JUNCTION BOX PANELBOARD, ELECTRICAL EQUIP. ENCL

CROSS HATCH DENOTES DELETION

MANUAL MOTOR STARTER


RED, MAINTAINED PUSH BUTTON

TIMING CONTACT

FLOW SWITCH

CONTROL RELAY, MOTOR STARTER, ETC.

DENOTES CONDUIT TAG 01

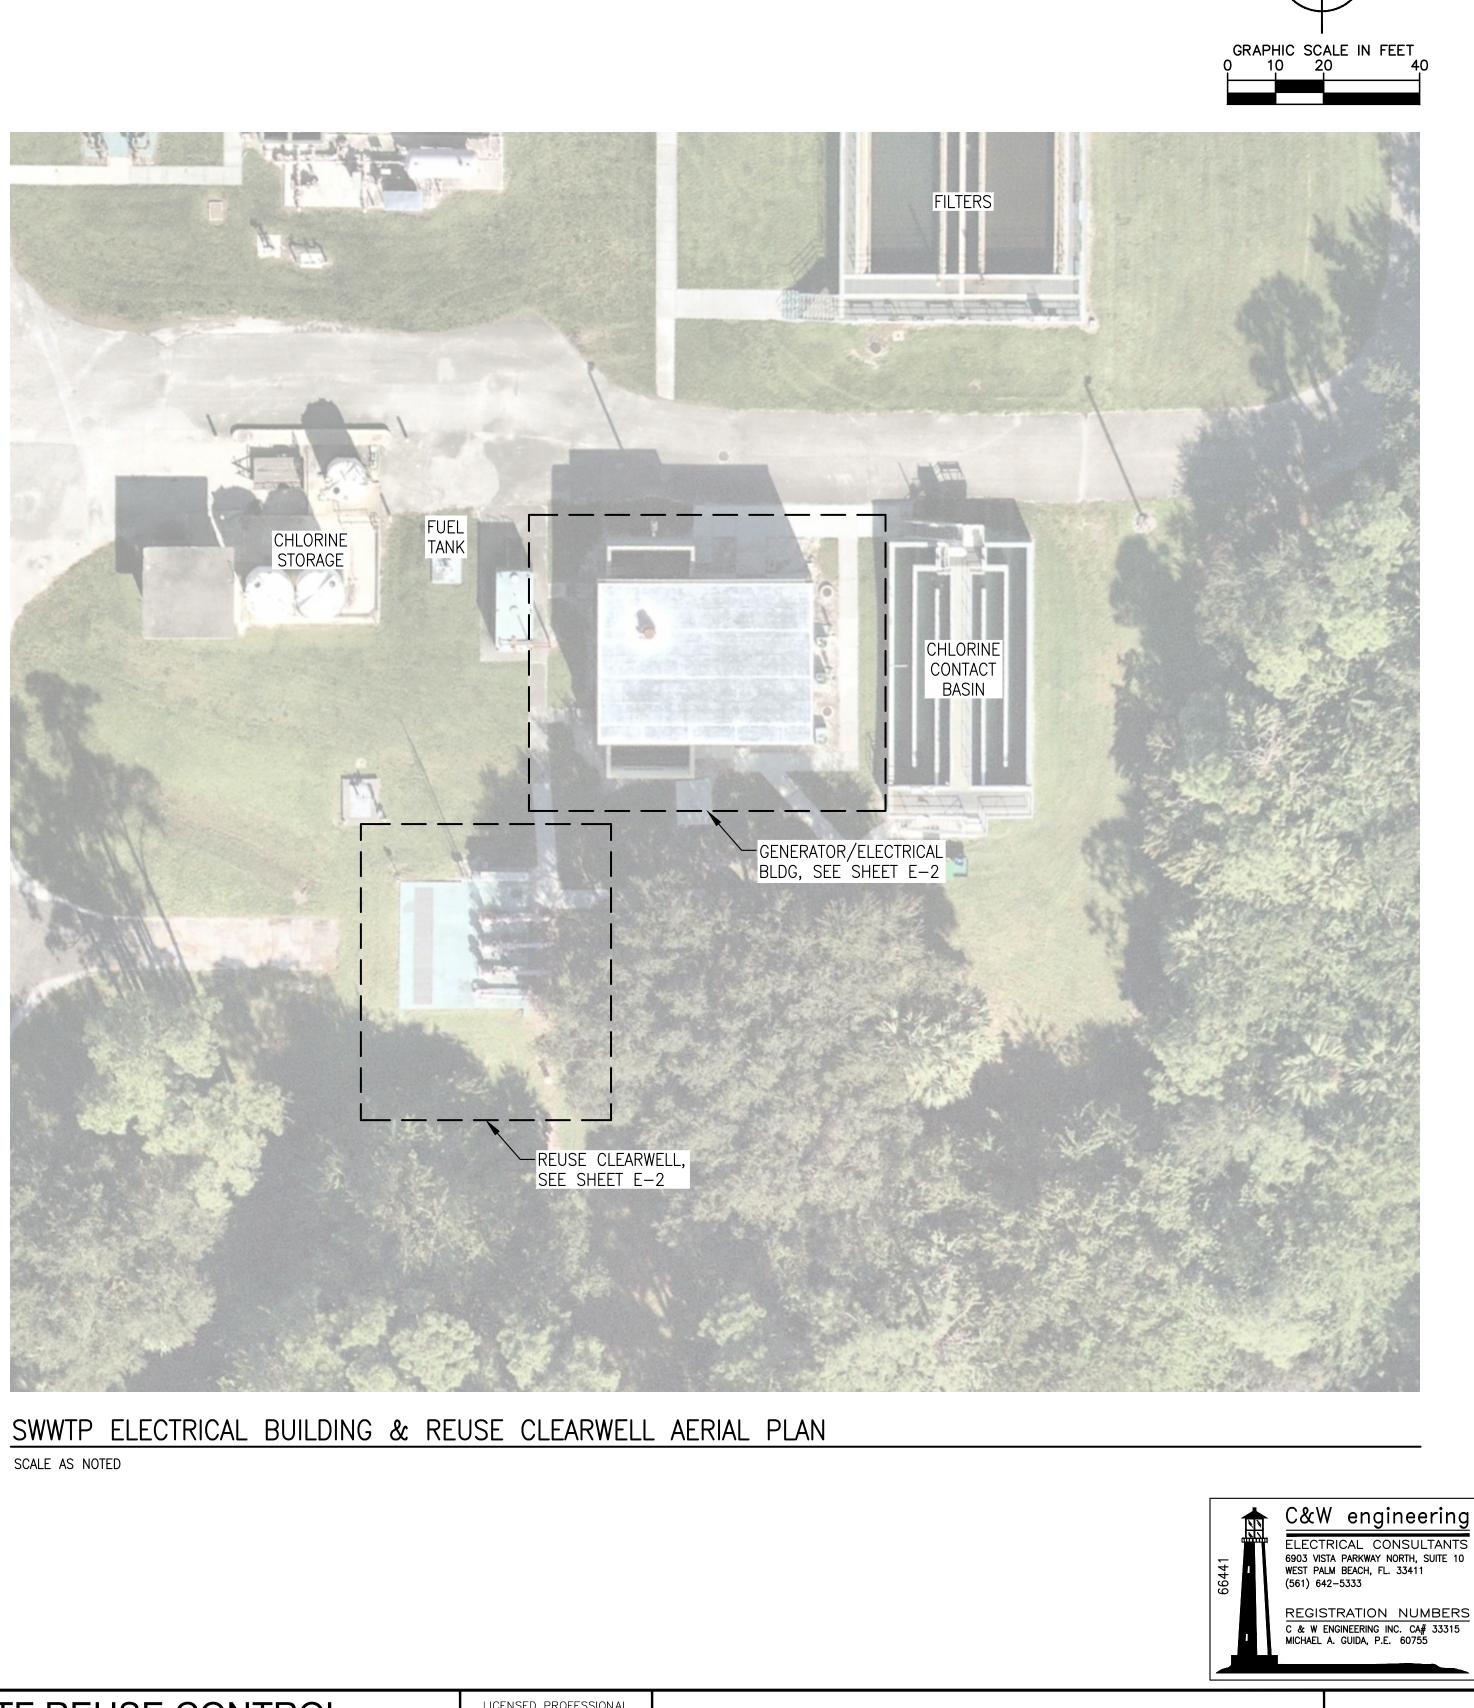


IC TUBING, GALV. STEEL ONDUIT 6063 ALLOY, NOT ALUMINUM EMT

044572065 DATE DATE OCT. 2021 SCALE AS SHOWN DESIGNED BY JLR NTES, 175 DESIGNED BY	KHA PROJECT 044572065	orn	SWWTF REUSE CONTROL		LICENSED PROFESSIONAL	
SCALE AS SHOWN PREPARED FOR BEACH, FL 33411 DESIGNED BY JLR B63=8175 INDIAN RIVER COUNTY UTILITIES			PANEL REPLACEMENT		MICHAEL A. GUIDA	
BEACH, FL 33411 DESIGNED BY JLR INDIAN RIVER COUNTY UTILITIES 60755	SCALE AS SHOWN	ES. INC.	PREPARED FOR			E
863-8175 00/00	11 DESIGNED BY JLR	EACH, FL 33411	INDIAN RIVER COUNTY UTILITIES			
DO0696 DEPARTMENT DEPARTMENT	DRAWN BY AOD				60755	
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ELECTRICAL NOTES & LEGENDS

SHEET NUMBER


E-1

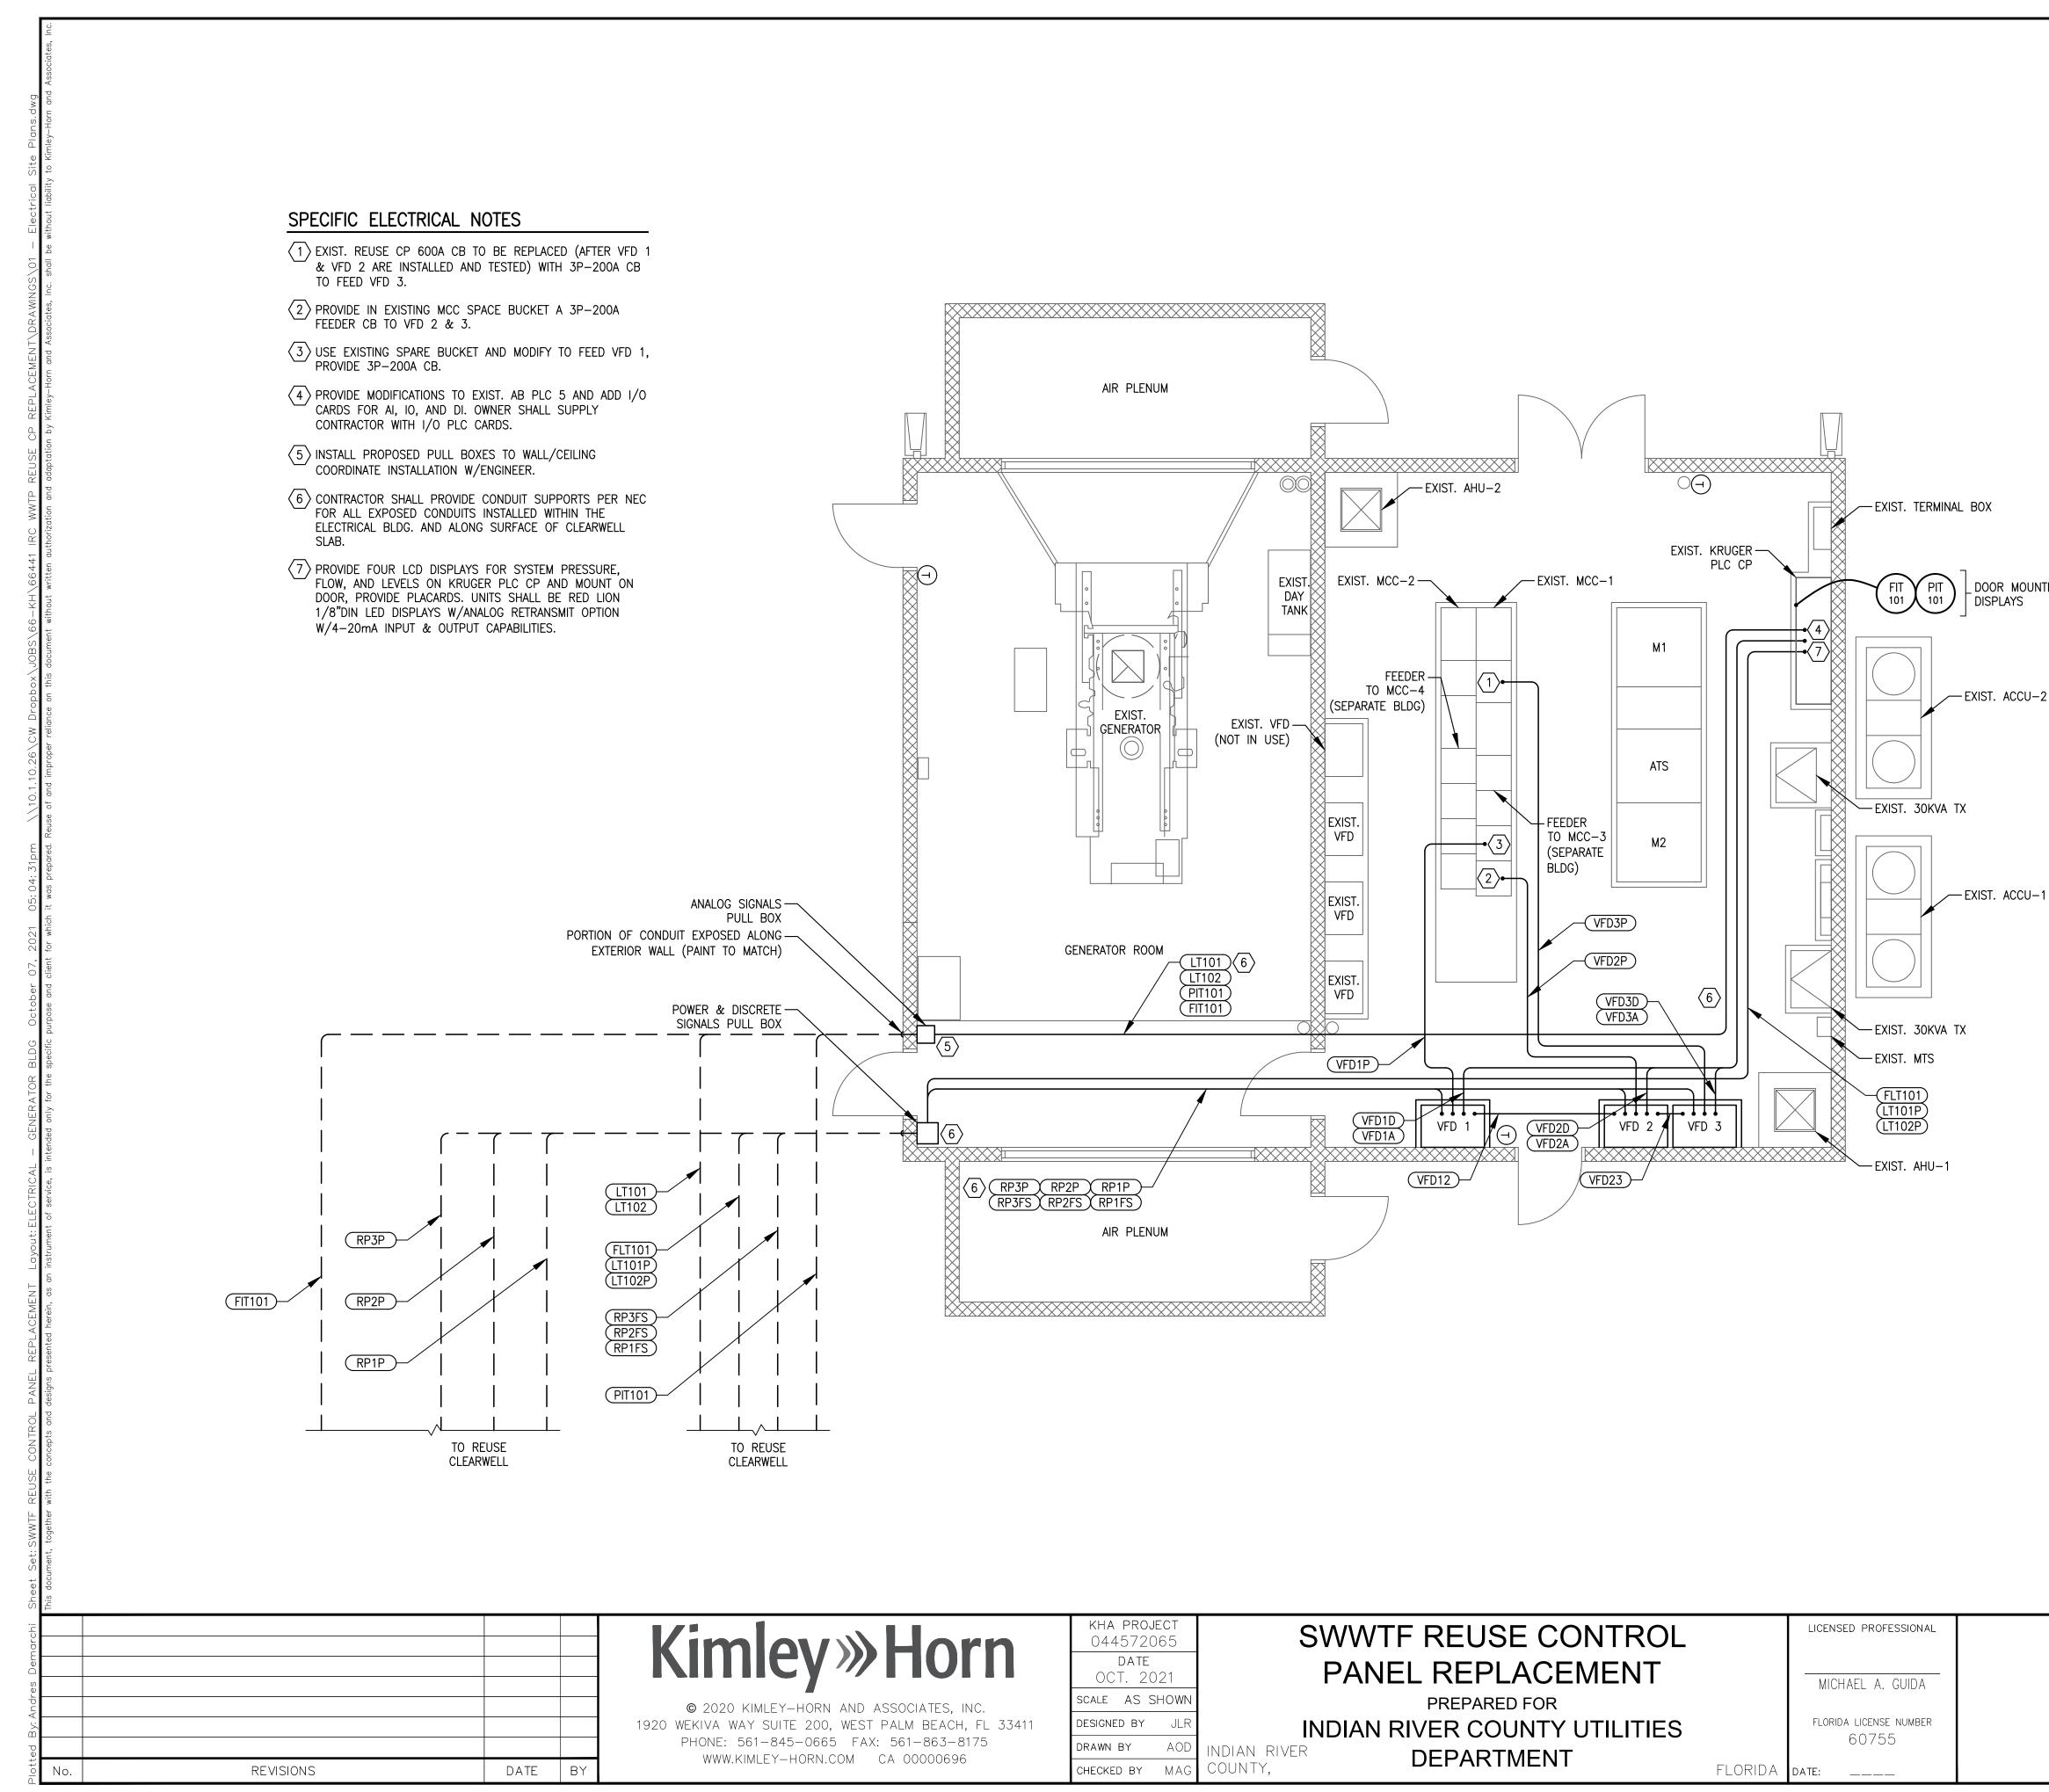

GENERATOR BUILDING ELECTRICAL PLAN

SHEET NUMBER

E-2

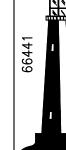

C&W engineering

ELECTRICAL CONSULTANT 6903 VISTA PARKWAY NORTH, SUITE 1 WEST PALM BEACH, FL. 33411 (561) 642-5333

REGISTRATION NUMBERS C & W ENGINEERING INC. CA# 33315 MICHAEL A. GUIDA, P.E. 60755

GRAPHIC SCALE IN FEET 0 1 2 3 4

PIT 101 DOOR MOUNTED DISPLAYS DISPLAYS

← EXIST. ACCU-2

DEMO EXISTING CP, COORDINATE NEW INSTALLATION -OF VFDS, POWER & CONTROL CONDUITS, MOTORS WITH DEMO. SEE OTHER DRAWINGS AND SPECS

E-8

SPECIFIC ELECTRICAL NOTES


- (1) CONTRACTOR SHALL HAVE INSTALLED ALL VFD EQUIPMENT, AND RUN MOST POWER AND CONTROL CONDUITS AND WIRES BEFORE ANY DEMO WORK BEGINS. SEE E-2.
- 2 This includes having VFD 1 and 2 energized from NeW Feeder breakers inside existing MCC buckets. See Hex NOTES 2 AND 3 ON SHEET E-2.
- $\langle 3 \rangle$ at clearwell contractor shall have installed most of the PROPOSED EQUIPMENT, INCLUDING THE RACEWAY AND WIRES FOR REMOTE ON/OFF, FLOW SWITCHES AND THEIR RELATED RACEWAYS AND WIRES, AND THE PRESSURE AND LEVEL INSTRUMENTS.
- $\langle 4 \rangle$ PREPARE AND COORDINATE WITH PLANT PERSONNEL THE SHUT DOWN OF ALL THREE PUMPS WHILE THE EXISTING CONTROL PANEL WIRING IS TEMPORARILY DISCONNECTED SO THIS ENTIRE PANEL MAY BE ROTATED 90 DEGREES COUNTER-CLOCKWISE FROM ITS LEFT SIDE AS THE AXIS, SEE PLAN ON THIS SHEET.
- $\langle 5 \rangle$ AFTER ROTATING THIS CONTROL PANEL, PROVIDE 4X4 WOOD BLOCKS AND OR CONCRETE BLOCKS AS SUPPORTS TO TEMPORARILY LAY PANEL ON UNEVEN GRASSY AREA NORTH OF EXISTING CLEARWELL PAD. AT THIS TIME PROVIDE TEMPORARY SPLICES AND RECONNECT ALL POWER AND CONTROL WIRING, ORIGINAL PARALLEL 800 AMPS FEEDERS WIRES AND PORTION OF CONDUITS OUTSIDE.
- $\langle 6 \rangle$ RECONNECT ALL POWER AND CONTROL WIRING USING WATERPROOF SPLICE KITS. AFTER PLACING ALL PUMPS BACK ON AND CONFIRMING ALL IS WORKING OKAY, DEMO MAY BEGIN. REMOVE THE 1st STARTER SECTION AND SWITCH IT OVER TO VFD.
- $\langle 7 \rangle$ REPEAT THE PROCESS FOR THE 2nd STARTER TO BE DEMO AND BE REPLACED WITH VFD.
- 8 DEMO 3rd STARTER SECTION AND REMAINDER OF THE CONTROL PANEL.
- $\langle 9 \rangle$ REPLACE AT THE EXISTING MCC 1 THE 600A BREAKER WITH VFD 3 200A BREAKER AND CONNECT TO VFD3. SEE E-2.
- $\langle 10 \rangle$ complete all necessary connections to control/status AND FIELD INSTRUMENTS AND DEMO PORTION OF SLAB WHERE CONTROL PANEL WAS SITTING, LEAVING IN CONCRETE THE NEW PENETRATIONS FROM THE VFD FEEDER CONDUITS AND PLC SIGNALS.
- (11) COORDINATE W/PLANT PERSONNEL AND REMOVE 120V POWER AND PROCEED TO DEMO ALL DFS EQUIPMENT. PROVIDE AN ANALOG TERMINAL 4X JBOX TO EXTEND EXISTING 4-20mA SIGNAL.
- $\langle 12 \rangle$ provide a quazite 15–1/2"x25"x12" min pullbox, PG1324Z80112 SERIES OR EQUAL AND PROVIDE WEATHERPROOF POLARIS TAPS FOR FLOAT SIGNALS.
- NOTE: THE HEX NOTES DESCRIBE A SUGGESTED ORDER OF NEW EQUIPMENT INSTALLATION AND EXISTING EQUIPMENT BEING DEMO. THE CONTRACTOR MAY PROVIDE ALTERNATIVE TO BE SUBMITTED FOR REVIEW AND APPROVAL.

DATE BY

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REVISIONS	




ES, INC.	SCALE AS	SHOWN
,	DESIGNED BY	JLR
53-8175 0696	DRAWN BY	AOD
0690	CHECKED BY	MAG

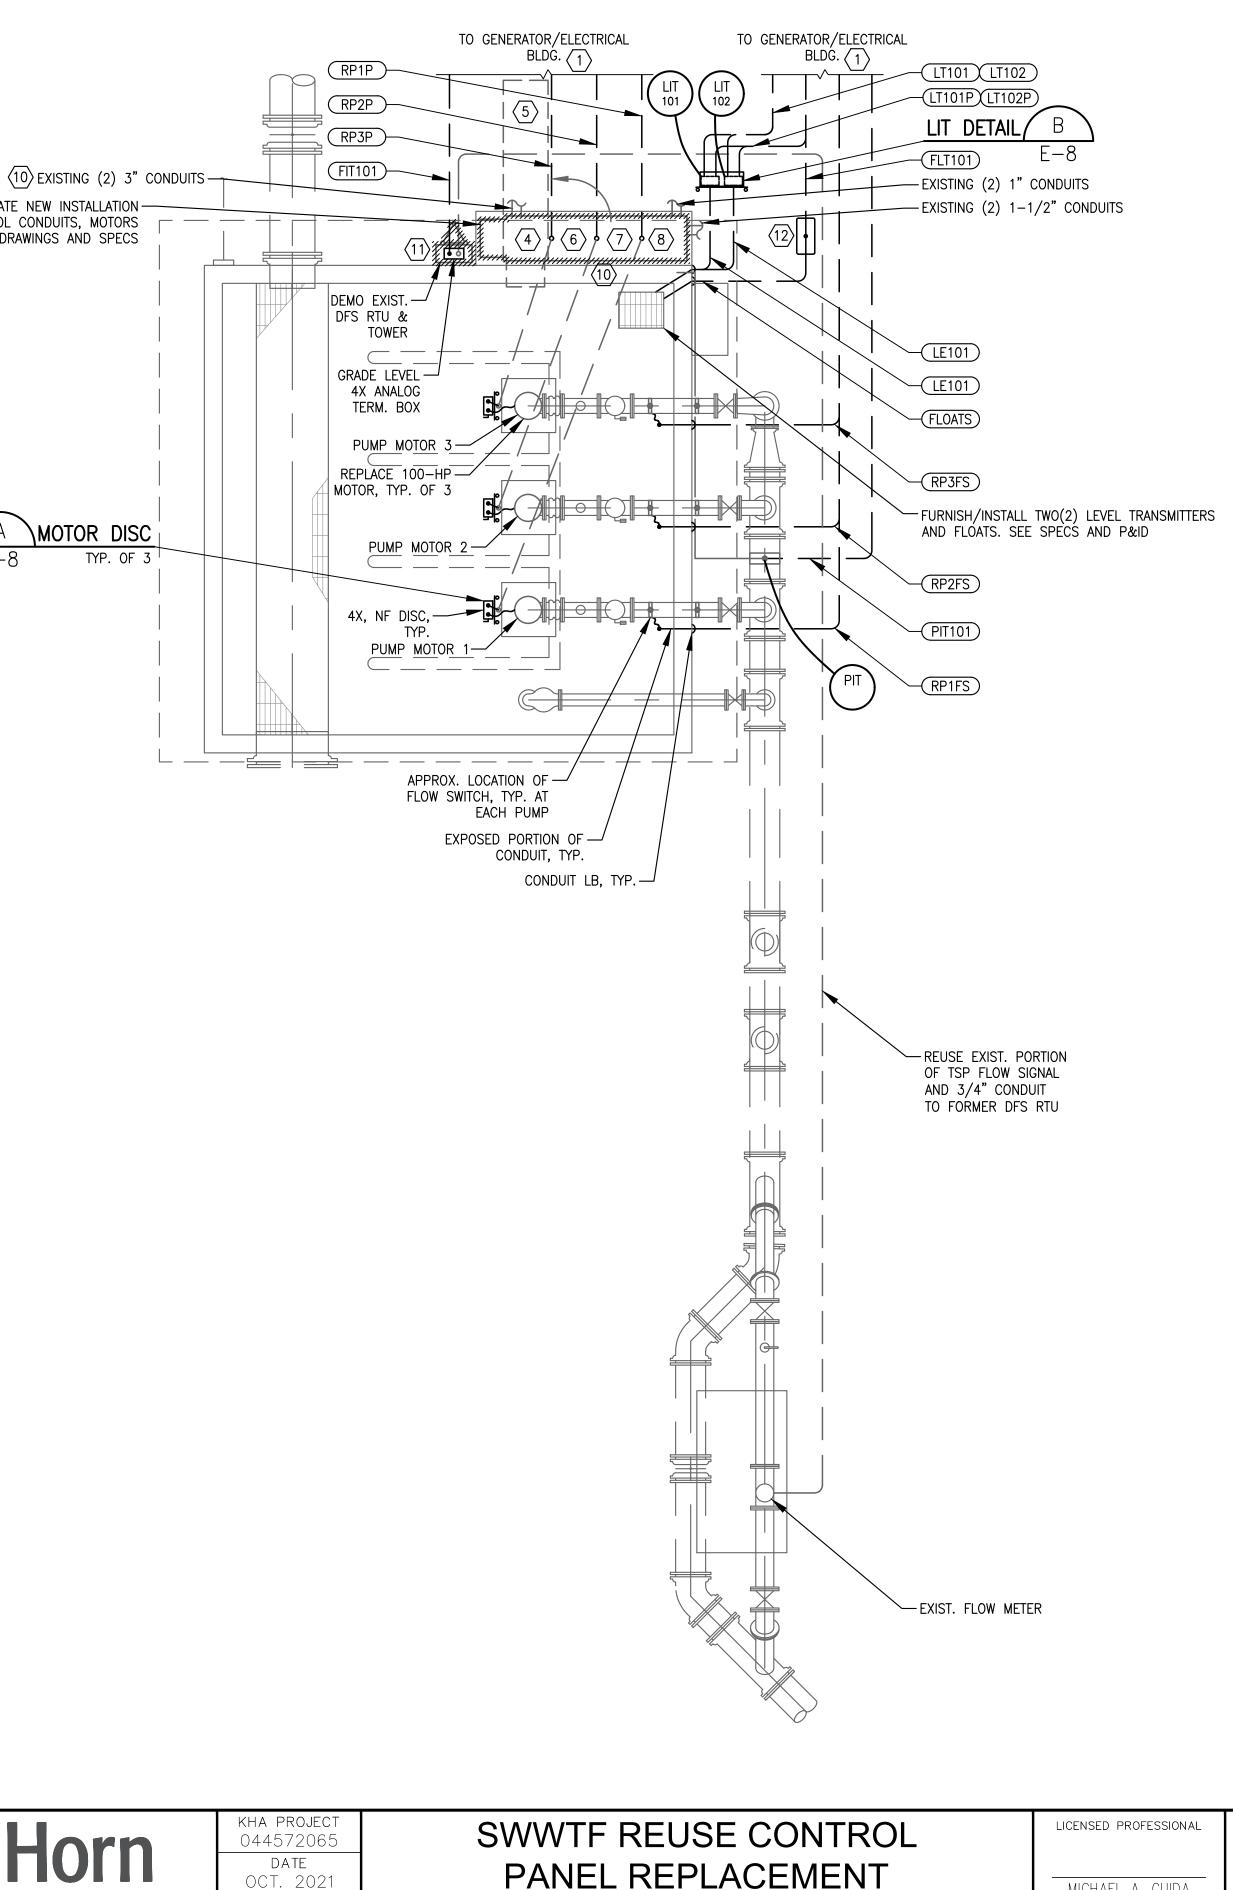PANEL REPLACEMENT PREPARED FOR INDIAN RIVER COUNTY UTILITIES INDIAN RIVER DEPARTMENT COUNTY,

	MICHAEL A. GUIDA
	FLORIDA LICENSE NUMBER
	60755
FLORIDA	
ILUNIDA	DATE:

REUSE CLEARWELL ELECTRICAL PLAN

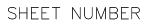



ELECTRICAL CONSULTANTS 6903 VISTA PARKWAY NORTH, SUITE 10 WEST PALM BEACH, FL. 33411 (561) 642-5333

REGISTRATION NUMBERS C & W ENGINEERING INC. CA# 33315 MICHAEL A. GUIDA, P.E. 60755


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GRAPHIC SCALE IN FEET

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		IS	DATE	BY	1920 WEKIVA WAY SUITE 200, WEST PALM E Phone: 561-845-0665 FAX: 561-8 WWW.KIMLEY-HORN.COM CA 000
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This document, together with the concepts and designs presented herein, as an instrument of service, is intended only for the specific purpose and client for which it was prepared. Reuse of and improper reliance on this document without written authorization and adaptation by Kimley-Horn and Association association and Associated associated associated asso					
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ONELINE

3 REUSE PUMPS, WHERE X=1,2,3



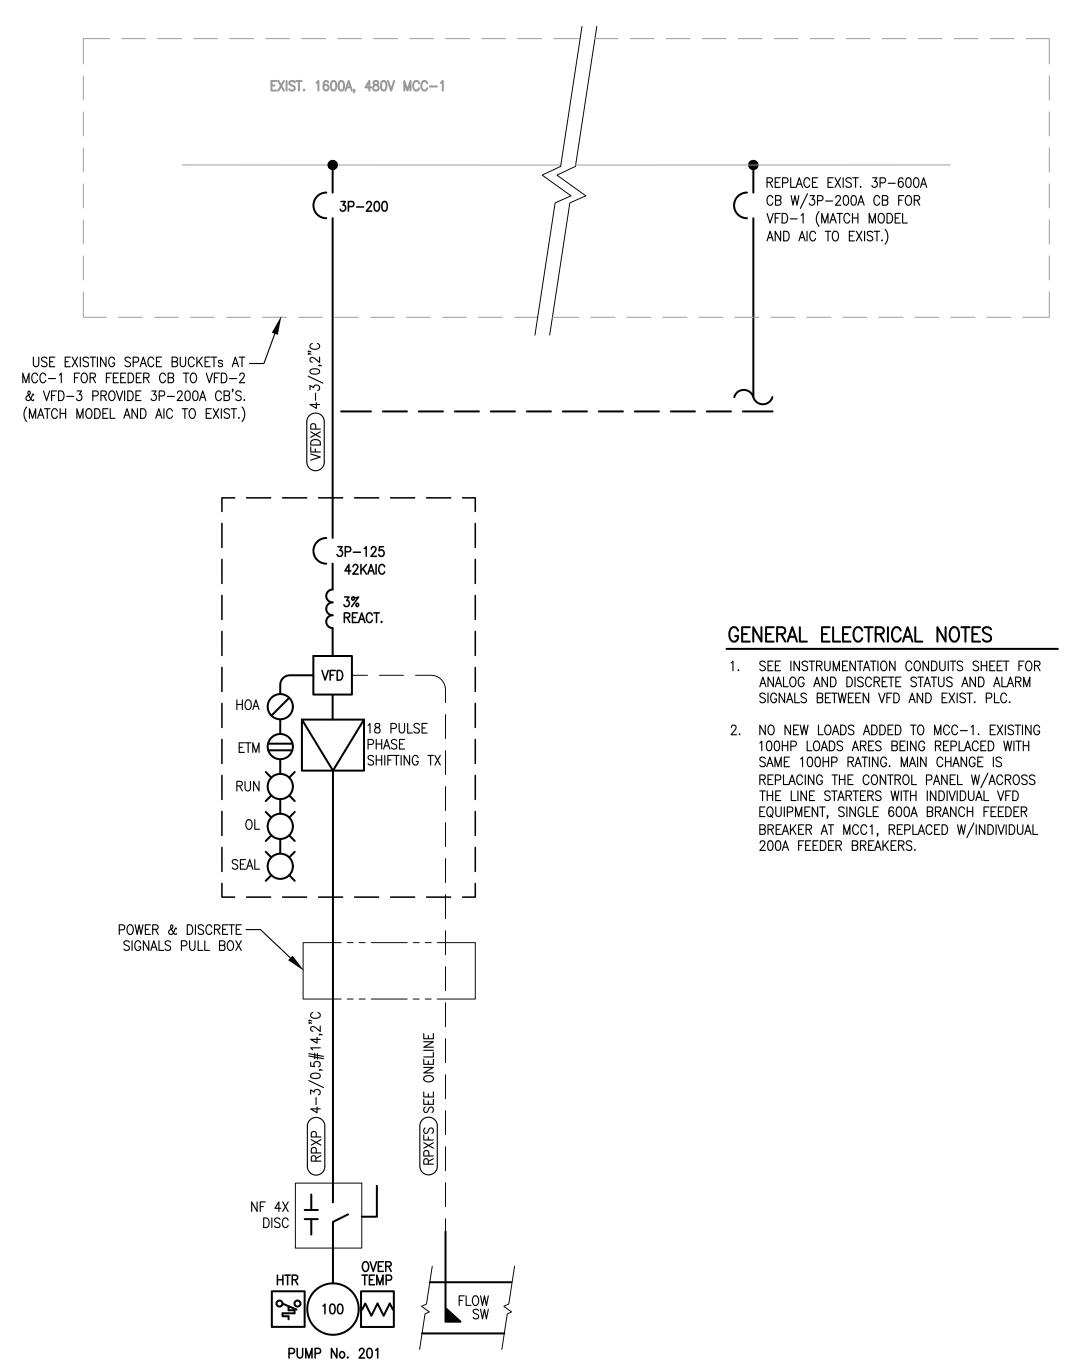


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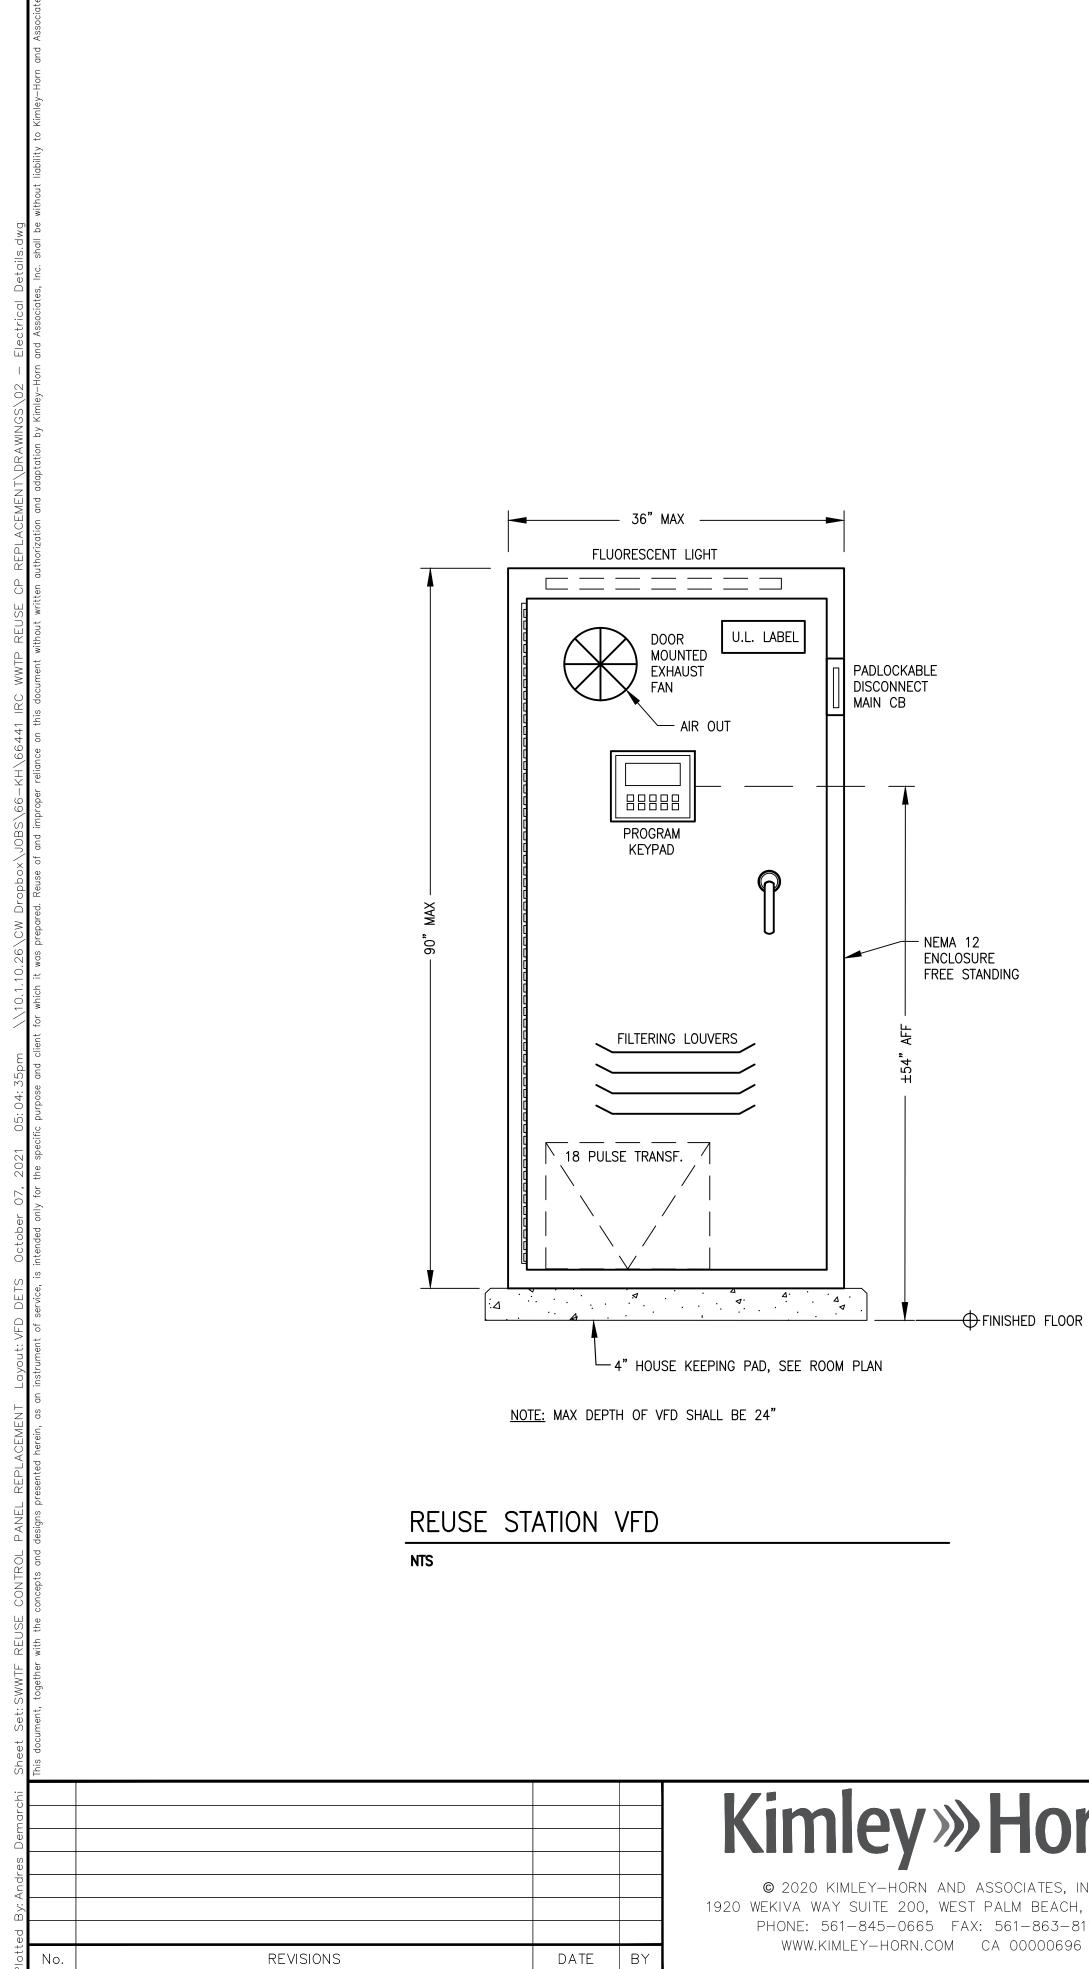
C&W engineering


ELECTRICAL CONSULTANTS 6903 VISTA PARKWAY NORTH, SUITE 10 WEST PALM BEACH, FL. 33411 (561) 642–5333

REGISTRATION NUMBERS C & W ENGINEERING INC. CA# 33315 MICHAEL A. GUIDA, P.E. 60755



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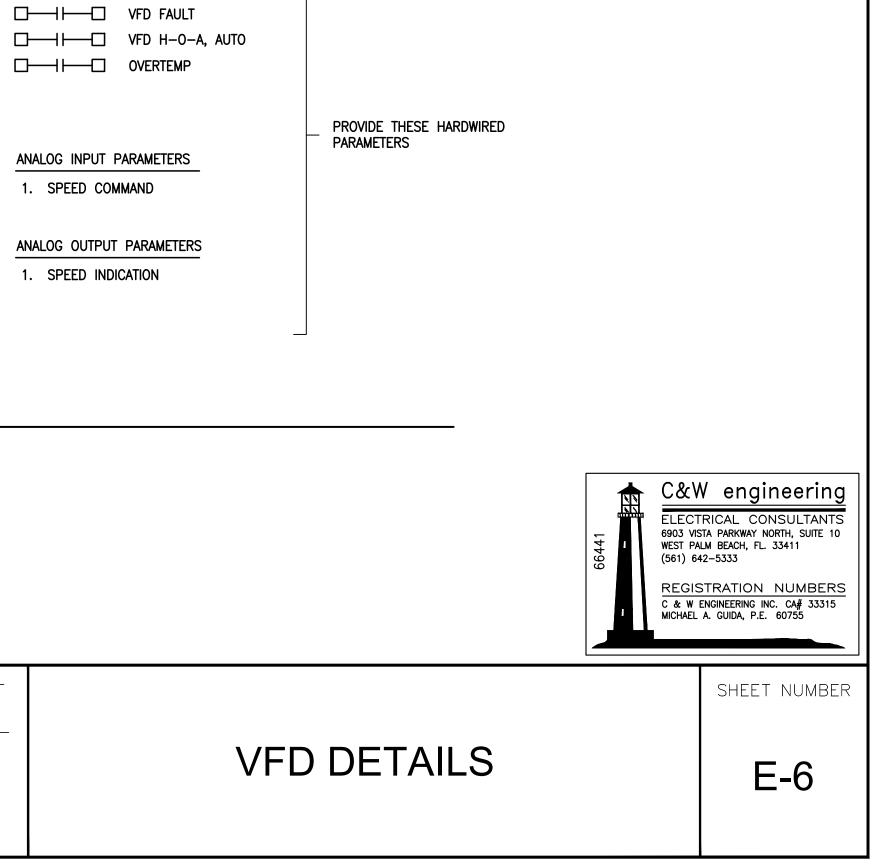


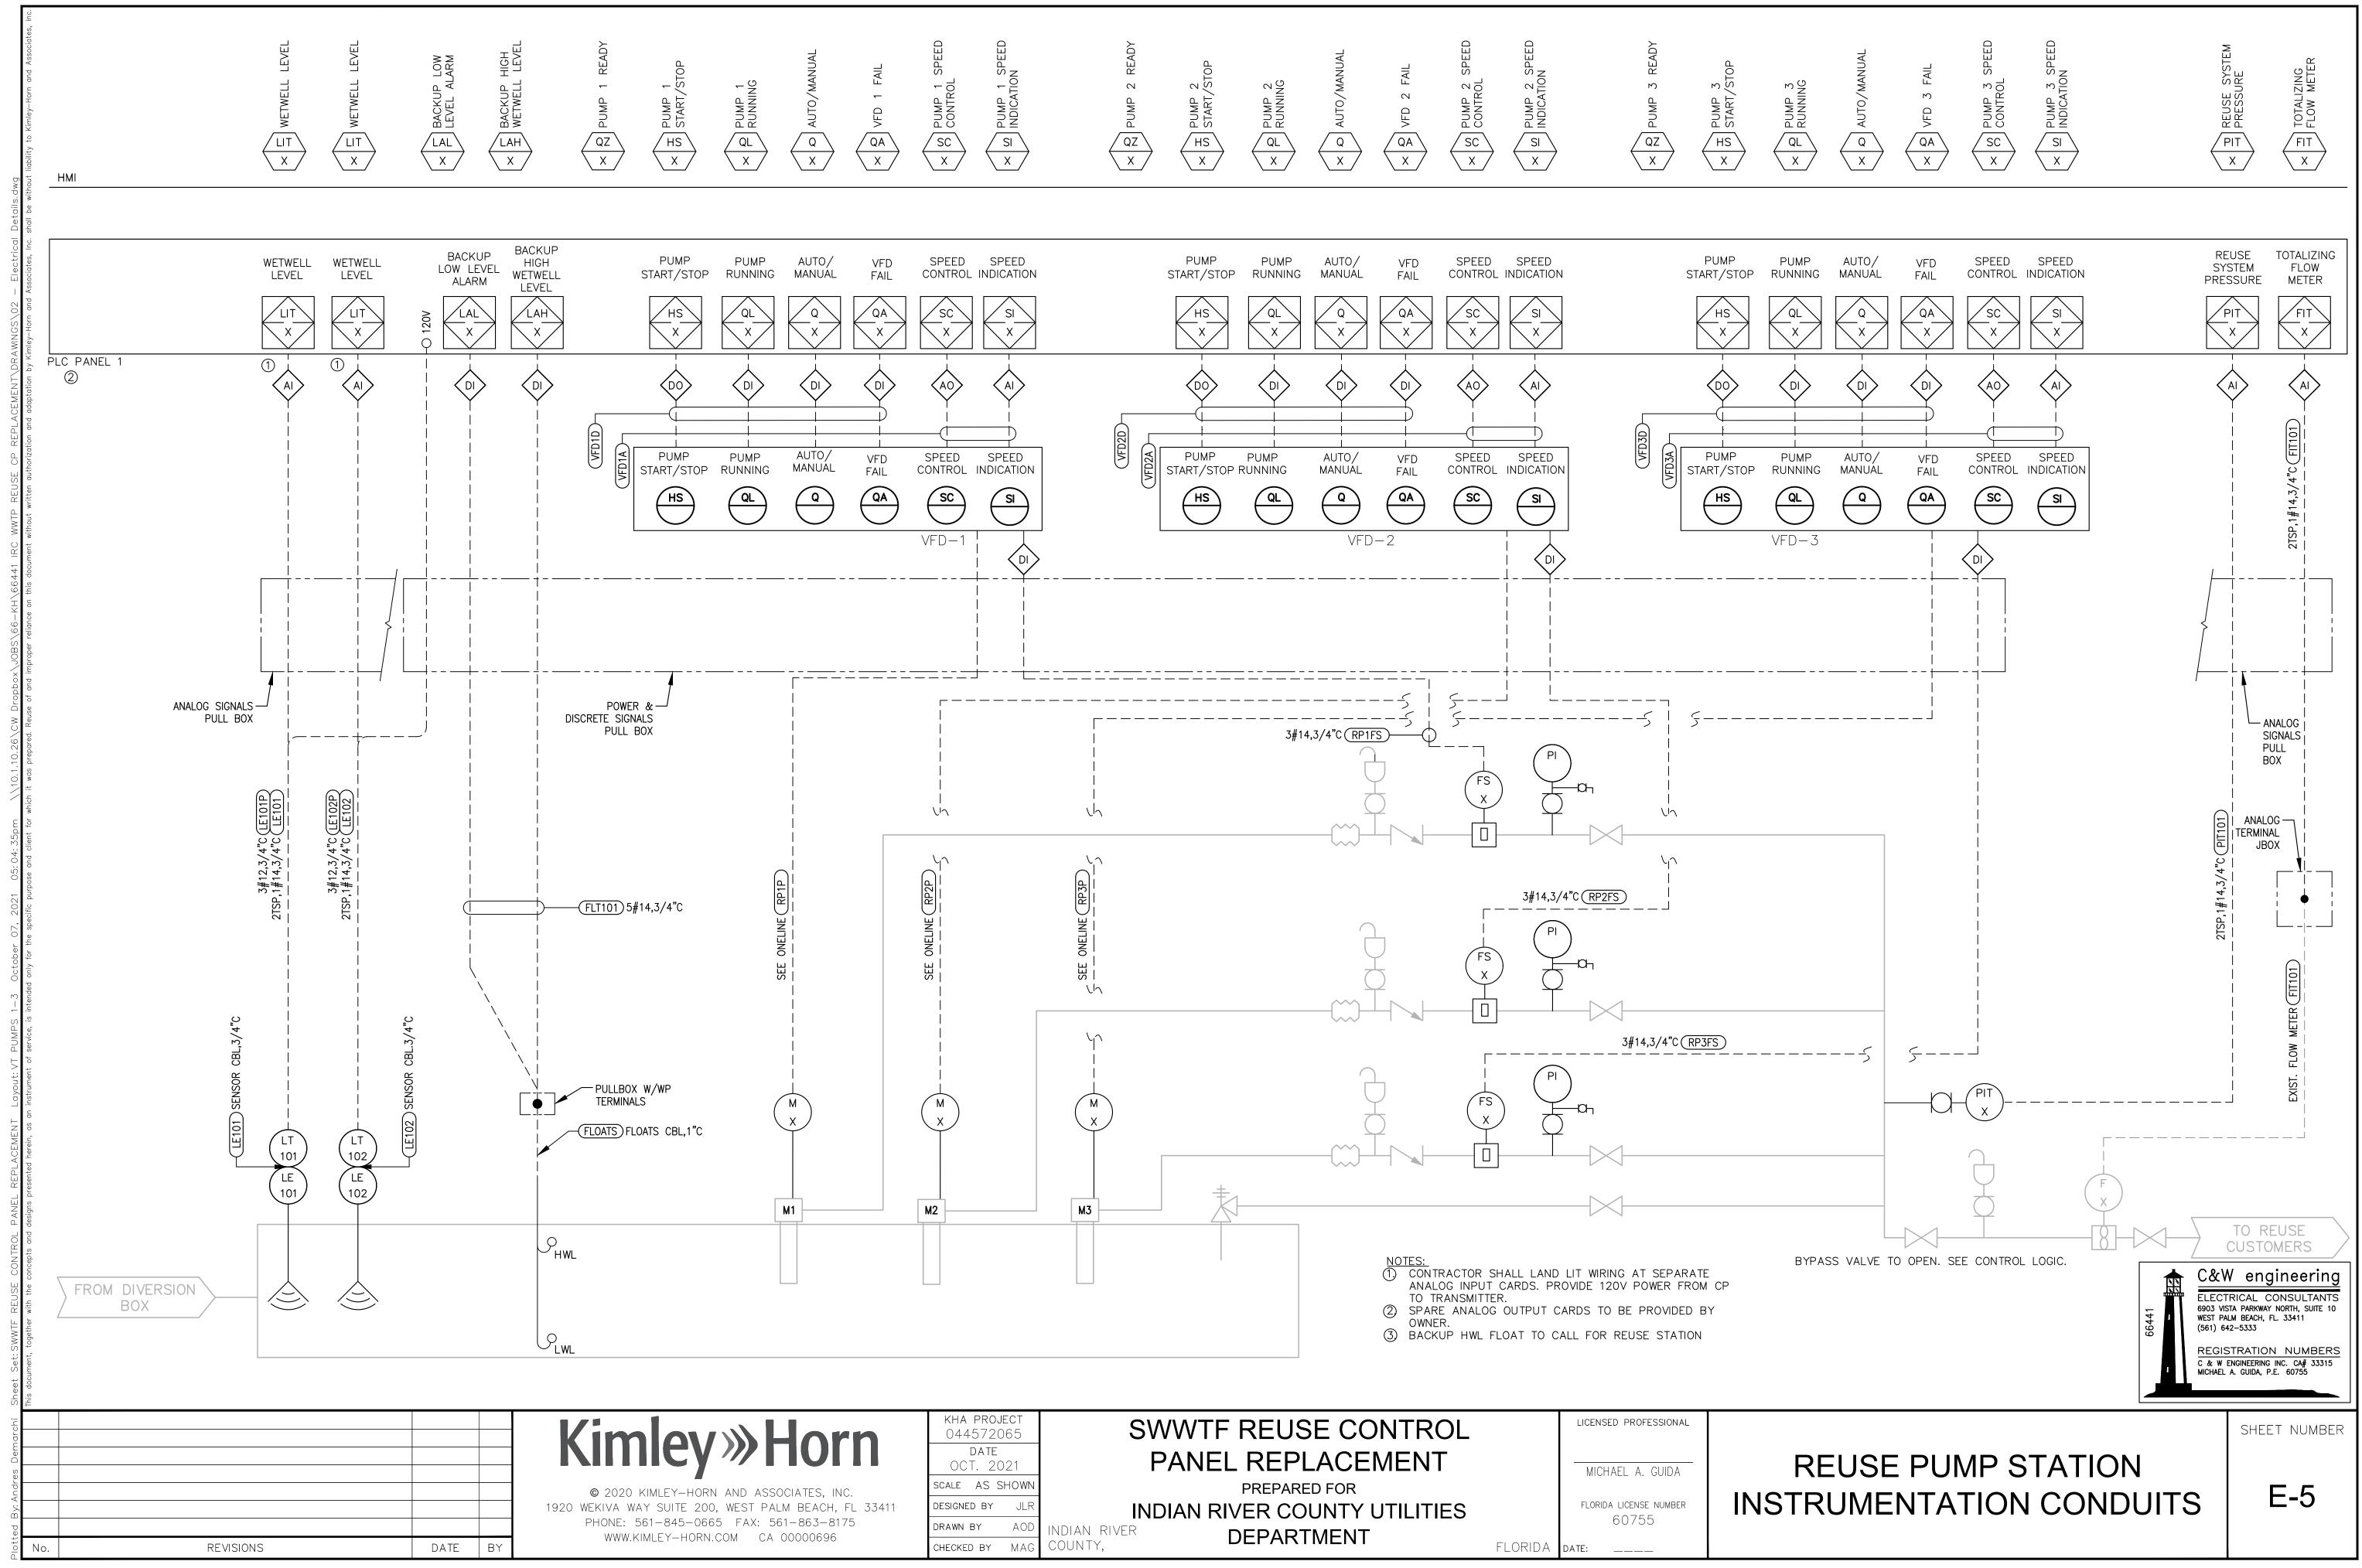

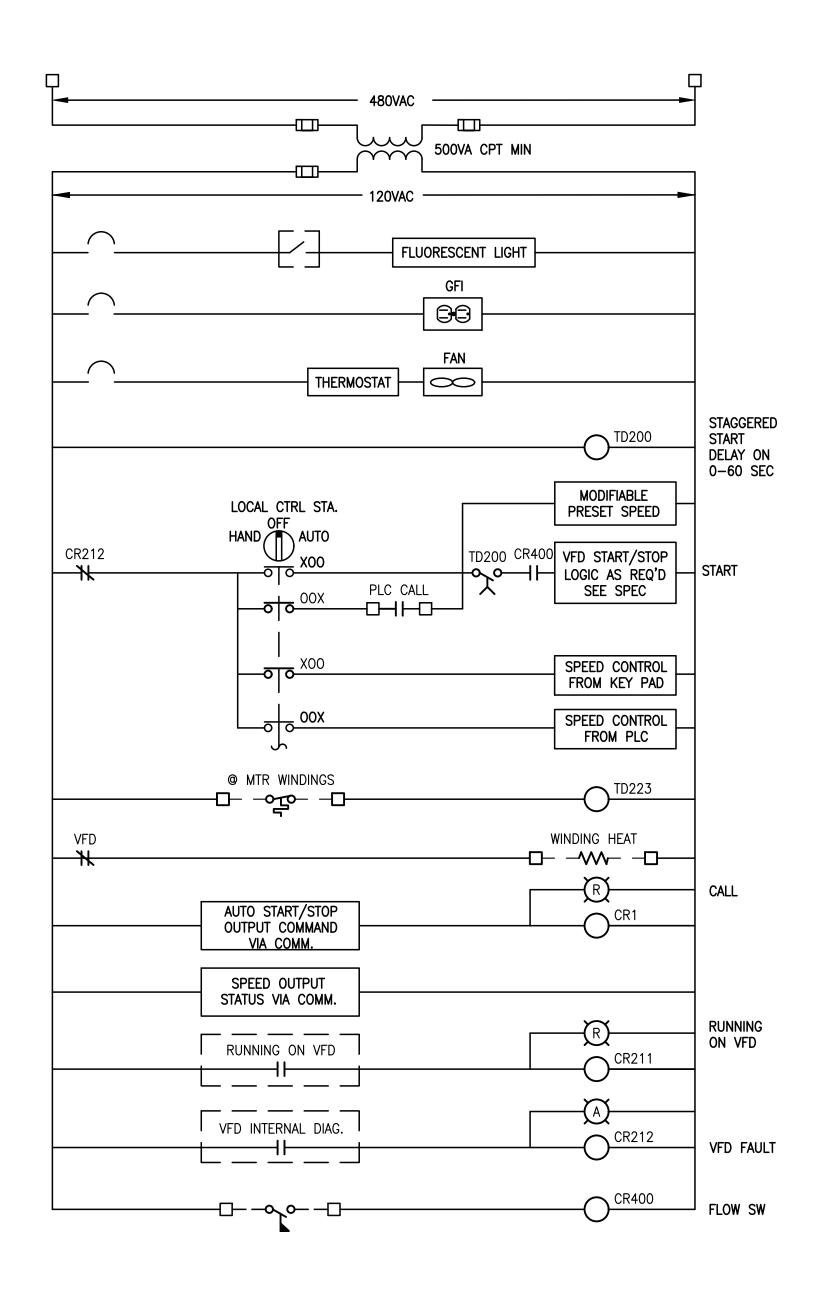VFD SCHEMATIC

TYP. FOR REUSE VFD EQUIPMENT


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orn	DATE OCT. 2021	PANEL REPLACEMENT		MICHAEL A. GUIDA	
TES, INC.	SCALE AS SHOWN	SHOWN PREPARED FOR			
BEACH, FL 33411	DESIGNED BY JLR	INDIAN RIVER COUNTY UTILITIES		FLORIDA LICENSE NUMBER	
863-8175 000696	DRAWN BY AOD	INDIAN RIVER DEPARTMENT		60755	
00030		COUNTY, DEFAILTNENT	FLORIDA	DATE:	





SEE PID DIAGRAM AND NETWORK DIAGRAM


PARAMETERS TO PLC


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Sheet Set:SWWTF REUSE CONTROL PANEL REPLACEMENT Layout:LO		TYPICAL AI LOOP DIAGRA		TYPICAL AO LOOP I	DIAGRAM
Plotted By: Andres Demarchi	Image: Second	© 2020 KIMLEY-HORN AND ASSOCIATES, INC. 1920 WEKIVA WAY SUITE 200, WEST PALM BEACH, FL 33411 PHONE: 561-845-0665 FAX: 561-863-8175 WWW.KIMLEY-HORN.COM CA 00000696	DATE OCT. 2021 SCALE AS SHOWN DESIGNED BY JLR INDIAN RIVE	EUSE CONTROL REPLACEMENT REPARED FOR R COUNTY UTILITIES PARTMENT	LICENSED PROFESSIONAL MICHAEL A. GUIDA FLORIDA LICENSE NUMBER 60755 A DATE:

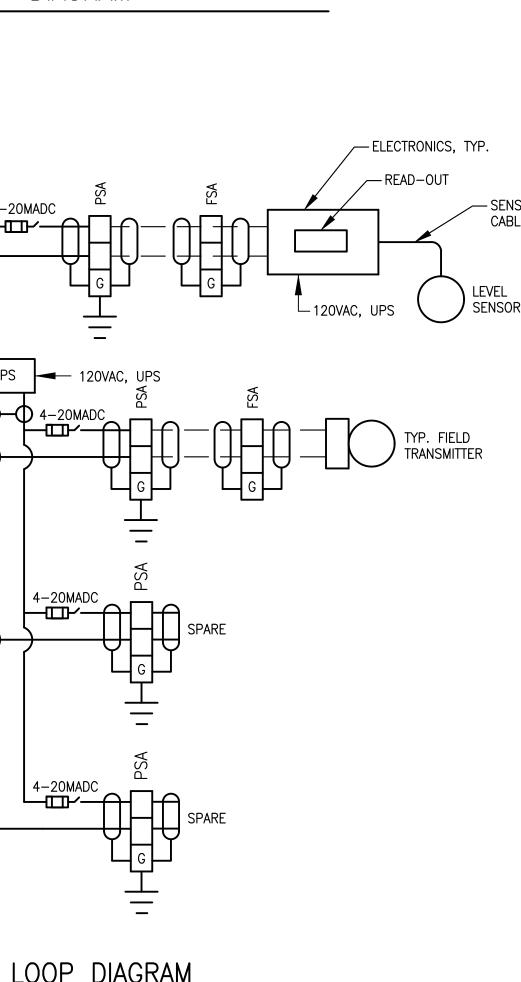


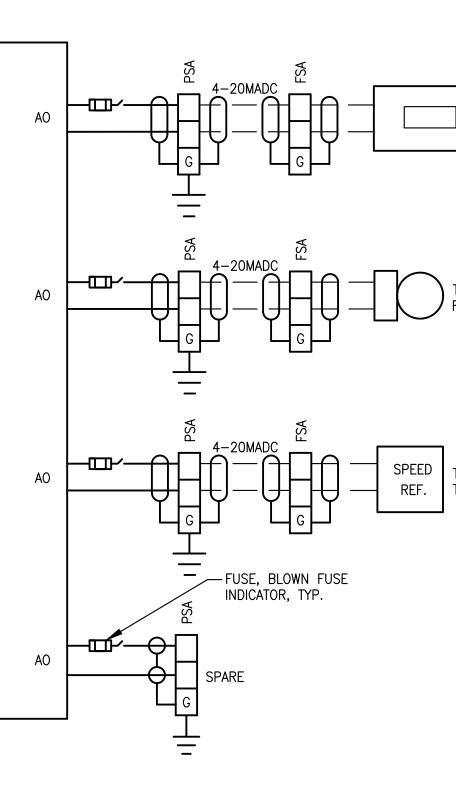


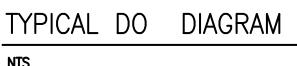

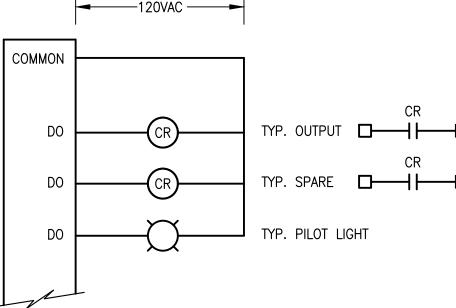

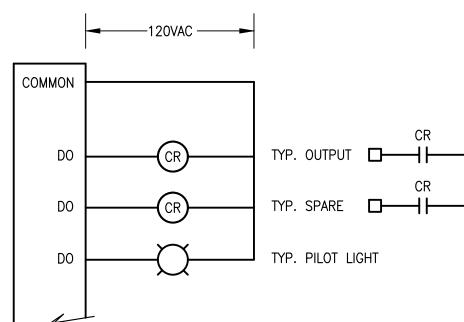

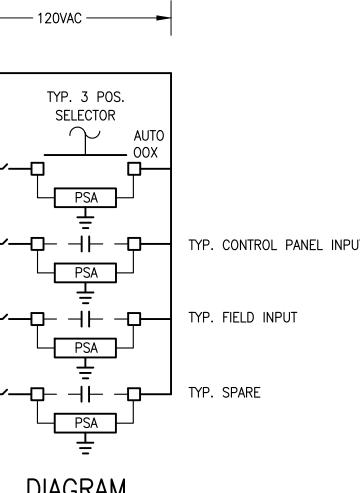

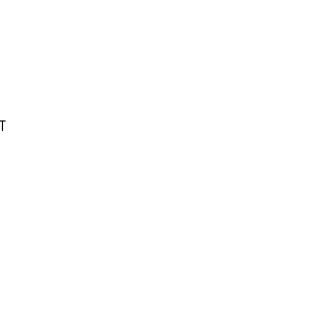

STANDARD LOOP DIAGRAMS

E-7

SHEET NUMBER

REGISTRATION NUMBERS C & W ENGINEERING INC. CA# 33315 MICHAEL A. GUIDA, P.E. 60755

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C&W engineering

TYP. OUTPUT TO DRIVE

TYP. FIELD RECEIVER

