
# INTERIOR UPFIT FOR: (ALTERATION LEVEL 2) HANAHAN CITY HALL

1255 YEAMANS HALL ROAD HANAHAN, SC 29410



## DRAWING INDEX

DRAWING NO.	DRAWING NAME	ISSUE DAT
GENERAL		
G001	COVER SHEET	06.23.202
G101	CEILING SEISMIC REQUIREMENTS AND DETAILS	06.23.202
DEMOLITION		
DEMOLITION	EVICTING DI ANG	06.00.000
D101	EXISTING PHOTOGRAPHS	06.23.202
	EXISTING PLANS EXISTING PHOTOGRAPHS	06.23.202 06.23.202
D101 D102	EXISTING PHOTOGRAPHS	
D101	EXISTING PHOTOGRAPHS	
D101 D102 ARCHITECTURA	EXISTING PHOTOGRAPHS	06.23.202

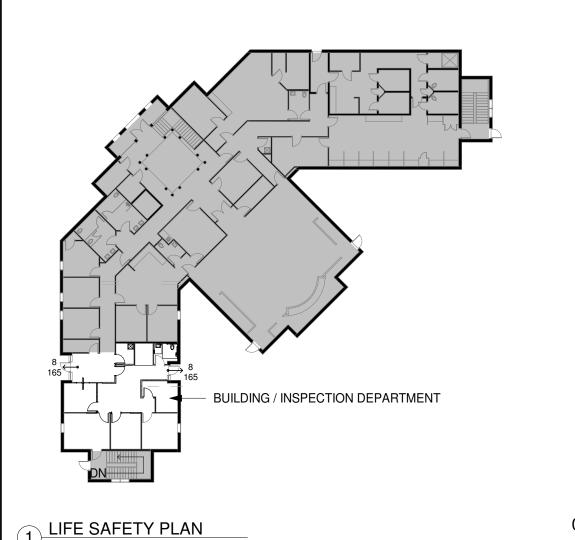

INTERIOR FINISH NOTES (SUB NOTES TO TABLE 803.13)

SMOKE DEVELOPED 0-450

SMOKE DEVELOPED 0-450 FLAME SPREAD 76-200 SMOKE DEVELOPED 0-450

FLAME SPREAD 26-75

**GENERAL PROVISIONS** 

MEANS OF EGRESS SIZING

EXIT ACCESS TRAVEL DISTANCE

EXIT ACCESS TRAVEL DISTANCE

EXITS, NUMBER OF EXITS AND CONTINUITY

DAYCARE

INTERIOR EXIT STAIRWAYS AND RAMPS

EXTERIOR EXIT RAMPS AND STAIRS

ORDINARY HAZARD (1) 2A-10B-C EXTINGUISHER / 3,000 SF.

75' MAX. TRAVEL DISTANCE TO EXTINGUISHER

**ELEVATOR** 

STAIRWAYS

**EXIT SIGNS** 

HANDRAILS

**EXIT ACCESS** 

CORRIDOR WIDTH

DEAD END CORRIDORS

HORIZONTAL EXITS

**ASSEMBLY AISLES** 

AISLE ACCESSORIES

GUARDS

DOORS

SUB-TOTAL OF

OCCUPANT LOAD


(SEE LIFE SAFETY


PLAN FOR ROOM-BY-

ROOM OCCUPANCY)

10

INTERNATIONAL EXISTING BUILDING CODI 2021 EDITION INTERNATIONAL BUILDING CODE MANUAL FIRE ALARM SYSTEM INTERNATIONAL PLUMBING CODE 2021 EDITION N Y/N (718.3) DRAFTSTOPPING N Y/N (709) SMOKE BARRIERS FIRE EXTINQUISHERS Y/N (906) 2017 EDITION NATIONAL ELECTRIC CODE - NFPA 70 2017 EDITION HANDICAP ACCESSIBILITY ICC/ANSI A117.1

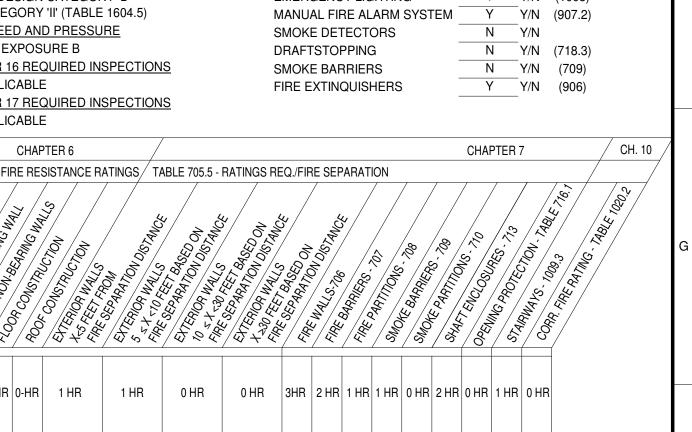

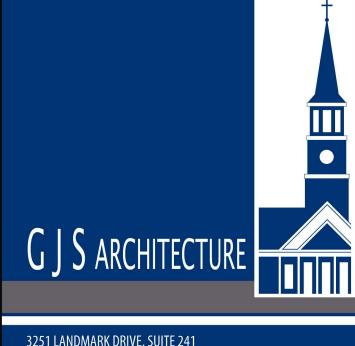

3251 LANDMARK DRIVE, SUITE 241 NORTH CHARLESTON, SC 29418 843-722-4334 (T) 843-722-4135 (F)

**INTERIOR UPFIT FOR:** HANAHAN CITY HALL

1255 YEAMANS HALL RD HANAHAN, SC 29410





VISI	SNC	
RK	DATE	DESCRIPTION

DATE: 06.23.2023 DRAWN BY: CA CHECKED BY: RVG

DRAWING TITLE

DRAWING NUMBER

VICINITY MAP

GENERAL CONTRACTOR

CITY OF HANAHAN 1255 YEAMANS HALL ROAD HANAHAN, SC 29410 TEL: 843.576.5260

LIFE SAFETY LEGEND \*

1 HOUR FIRE-RATED WALL

2 HOUR FIRE-RATED WALL

3 HOUR FIRE-RATED WALL

NON-RATED PARTITION

1 HOUR FIRE-RATED

ACTUAL EGRESS EGRESS CAPACITY

FIRE EXTINGUISHER

FIRE EXTINGUISHER

**EMERGENCY LIGHT** 

FIRE ALARM VISUAL

MANUAL PULL STATION

STROBE / HORN 80" TO TOP

STROBE ONLY 80" TO TOP

AND CABINET

EXIT SIGN

FLOOR/CEILING ASSEMBLY

**DESIGN TEAM** 

CONTACT: LARRY STURDIVANT

1/32" = 1'-0"

OWNER

CITY OF HANAHAN

HANAHAN, SC 29410

TEL: 843.576.5260

TENANT

TABLE 1005.1

ST

1255 YEAMANS HALL ROAD

CONTACT: LARRY STURDIVANT

ARCHITECT GJS ARCHITECTURE, LLC 3251 LANDMARK DRIVE, SUITE 241 NORTH CHARLESTON, SC 29418 TEL: 843.722.4334 CONTACT: ROBERT V. GERBER, AIA NCARB CSI CDT

1/32" = 1'-0"

OTHER EGRESS

W/ SPRINKLER 8

COMMUNICATIO

-<sub>220</sub> - >

3'-0" DOOR

 $-\frac{7}{445} \leftarrow \rightarrow$ 

PAIR 3'-0" DOORS

N SYSTEM

0.15" PER OCC.

**CONTACT:** 

MINIMUM REQ'D EGRESS WIDTH

**STAIRS** 

0.3" PER OCC.

3'-0" DOOR

**~**224 ← **>** 

FS TS

PAIR 3'-0" DOORS

OTHER

**EGRESS** 

3'-0" DOOR

**~**334 ← →

PAIR 3'-0" DOORS

\* <u>NOTE:</u> SEE ALSO MECHANICAL & ELECTRICAL ENGINEERING DRAWINGS FOR ADDITIONAL LIFE SAFETY COMPONENTS

SMOKE DETECTOR

FLOW SWITCH

TAMPER SWITCH

0.2" PER OCC. | VOICE ALARM

**PROJECT** SITE

PAQUE THERMAL ENVELOPE REQUIREMENTS

IECC 2009 - TABLE C302.2(1)				(EXIS
CLIMATE ZONE	3			
		REQUIREMENT	APPLICABLE	
ROOF				
INSULATION ENTIRELY ABOVE DECK		R-20ci		
METAL BUILDINGS (WITH R-5 THERMAL BLOCKS)		R-13 + R-13		
ATTIC AND OTHER		R-38		
WALLS, ABOVE GRADE				
MASS		R-7.6ci		
METAL BUILDING		R-19		
METAL FRAMED		R-13 + R-3.8ci		
WOOD FRAMED AND OTHER		R-13		
WALLS, BELOW GRADE				
BELOW-GRADE WALL		NO REQUIREMENT		
FLOORS				
MASS		R-6.3 ci		
JOIST/FRAMING		R-19		
SLAB-ON GRADE FLOORS				
UNHEATED SLABS		NO REQUIREMENT		
HEATED SLABS		R-10 FOR 24" BELOW		

R-10 FOR 24" BELOW **OPAQUE DOORS** U-0.70 R-1.45 101.5.2 LOW ENERGY BUILDINGS. THE FOLLOWING BUILDINGS, OR PORTIONS THEREOF, SEPARATED FROM THE REMAINDER OF THE BUILDING BY BUILDING THERMAL ENVELOPE ASSEMBLIES COMPLYING WITH THIS CODE SHALL BE EXEMPT FROM THE THOSE WITH A PEAK DESIGN RATE OF ENERGY USAGE LESS THAN 3.4 BTU/H.FT2 (10.7 W/M2) OR 1.0 WATT/FT2 (10.7 W/M2) C

FCC 2009 - TABLE C502 2(1) DESIGNED

SPECIAL OCCUPANCIES ASSEMBLY (1109) SIGNAGE (1112) MOUNTING HEIGHTS (ANSI A117.1, ADA) | SEE SHEET A401

**EDUCATION-CLASSROOM AREA** KITCHENS STAGES AND PLATFORMS SUPPORT AREA STORAGE (WAREHOUSE) TOTAL OCCUPANCY LOAD **CHAPTER 11** ACCESSIBILITY (ABBREVIATED) ACCESSIBLE ROUTE (1104) ACCESSIBLE ENTRANCES (1105) PARKING/PASSENGER LOADING (1106) | SITE

TABLE 2902.1 (ABBREVIATED) REQUIRED PLUMBING FIXTURES FIXTURE TYPE BUILDING, SITE -SEE CIVIL YES YES BUILDING -SEE CIVIL YES YES -SEE CIVIL YES YES NO N/A FIXED SEATING WHEEL CHAIR SPACES N/A ASSISTIVE LISTENING SYSTEM N/A

1,444

YES YES YES YES

**EXCEEDING 50 DRINKING FOUNTAIN** SERVICE SINKS ASSISTED USE TOILET

1 PER 40 FOR THE FIRST 80 AND MALE 1 PER 80 FOR THE REMAINDER FEMALE AGGREGATE 6 TOILETS OR MORE AMBULATORY ACCESSIBLE IF 6 OR MORE WC ARE PROVIDED MALE

(ANSI A117.1, ADA)

**ROLL-UP OR SLIDING** BUILDING THERMAL ENVELOPE PROVISIONS OF THIS CODE LOOR AREA FOR SPACE CONDITIONING PURPOSES.

THOSE THAT DO NOT CONTAIN CONDITIONED SPACE

CHAPTER 3 / CH. 4 /

EXISTING BUILDING

(2.) UNLESS REQUIRED TO BE 2 HOUR BY SECTION 704.10

INTERIOR WALL AND CEILING FINISH REQUIREMENTS

SPRINKLERED

REQ'D ACTUAL COMMENT

OK | CLASS II | CLASS II

TABLE 1004.5 (ABBREVIATED) MAXIMUM FLOOR AREA ALLOWANCES

OR N/A

REQ'D ACTUAL COMMENT

PER 903.2.1.3

PER 907.2.1

SEE CIVIL

HOODS PER 904.2.2

STAGES PER 905.3.4

CLASS A, 1,500 SF/A

FLOOR AREA IN SQ.

FT. PER OCCUPANT

RATIO

300 GROSS

PER SECTION 1004.6

5 NET

15 NET

150 GROSS

35 NET

20 NET

200 GROSS

15 NET

200 GROSS

500 GROSS

TABLE 803.13 (ABBREVIATED)

**MATRIX NOTES** 

EXIT ENCLOSURES AND

**ENCLOSED SPACES** 

CORRIDORS & EXITS

SECTION 804.4.2

CHAPTER 9

905 STANDPIPES

FUNCTION OF SPACE

DAYCARE

SSEMBLY WITH FIXED SEATS

SSEMBLY WITHOUT FIXED SEATS

CONCENTRATED (CHAIRS ONLY-NOT FIXED)

STANDING SPACE UNCONCENTRATED (TABLES AND CHAIRS)

BUSINESS -BUILDING DEPARTMENT ONLY

906 FIRE EXTINGUISHERS

903 AUTOMATIC SPRINKLER SYSTEM

907 FIRE ALARMS AND DETECTION SYSTEMS

912 FIRE DEPARTMENT CONNECTIONS

904 ALTERNATE AUTOMATIC FIRE EXTINQUISHING SYSTEM

PER OCCUPANT FOR FUNCTIONS IN THIS FACILITY

ACCESSORY STORAGE AREAS, MECHANICAL EQUIPMENT ROOM

SEE SHEET A001

RATIOS: MALE = 5, FEMALE = 5

1 PER 50 FOR THE REMAINDER

1 PER 25 FOR THE FIRST 50 AND MALE

PER SECTION 1005 - .3 STAIRS/.2 OTHER

PER SECTION 1009.4

PER SECTION 1010

PER SECTION 1011

PER SECTION 1012

PER SECTION 1013

PER SECTION 1014

PER SECTION 1015

PER SECTION 1016

PER SECTION 1017

PER TABLE 1017.2

PER SECTION 1020

PER TABLE 1020.3

PER SECTION 1023

PER SECTION 1024

PER SECTION 1026

PER SECTION 1027

PER SECTION 1030.9

PER SECTION 1030.13

PER SECTION 1020.5 - 20'-0", EXCEPTIONS NOT USED

PER SECTION 1030, NOT SMOKE PROTECTED SEATING

MINIMUM NUMBER OF EXITS (1006.3.3)

MORE THAN 1000 4 REQUIRED

2 REQUIRED

3 REQUIRED

PER SECTIONS 1022, 1007 - 2 MINIMUM

2,654 SF /3,000 SF= 1 EXISTING


REMARKS


PROJECT NO: 2022.04.11

PHASE: CONSTRUCTION DOCUMENTS

**COVER SHEET** 

PERMITTING & CONSTRUCTION

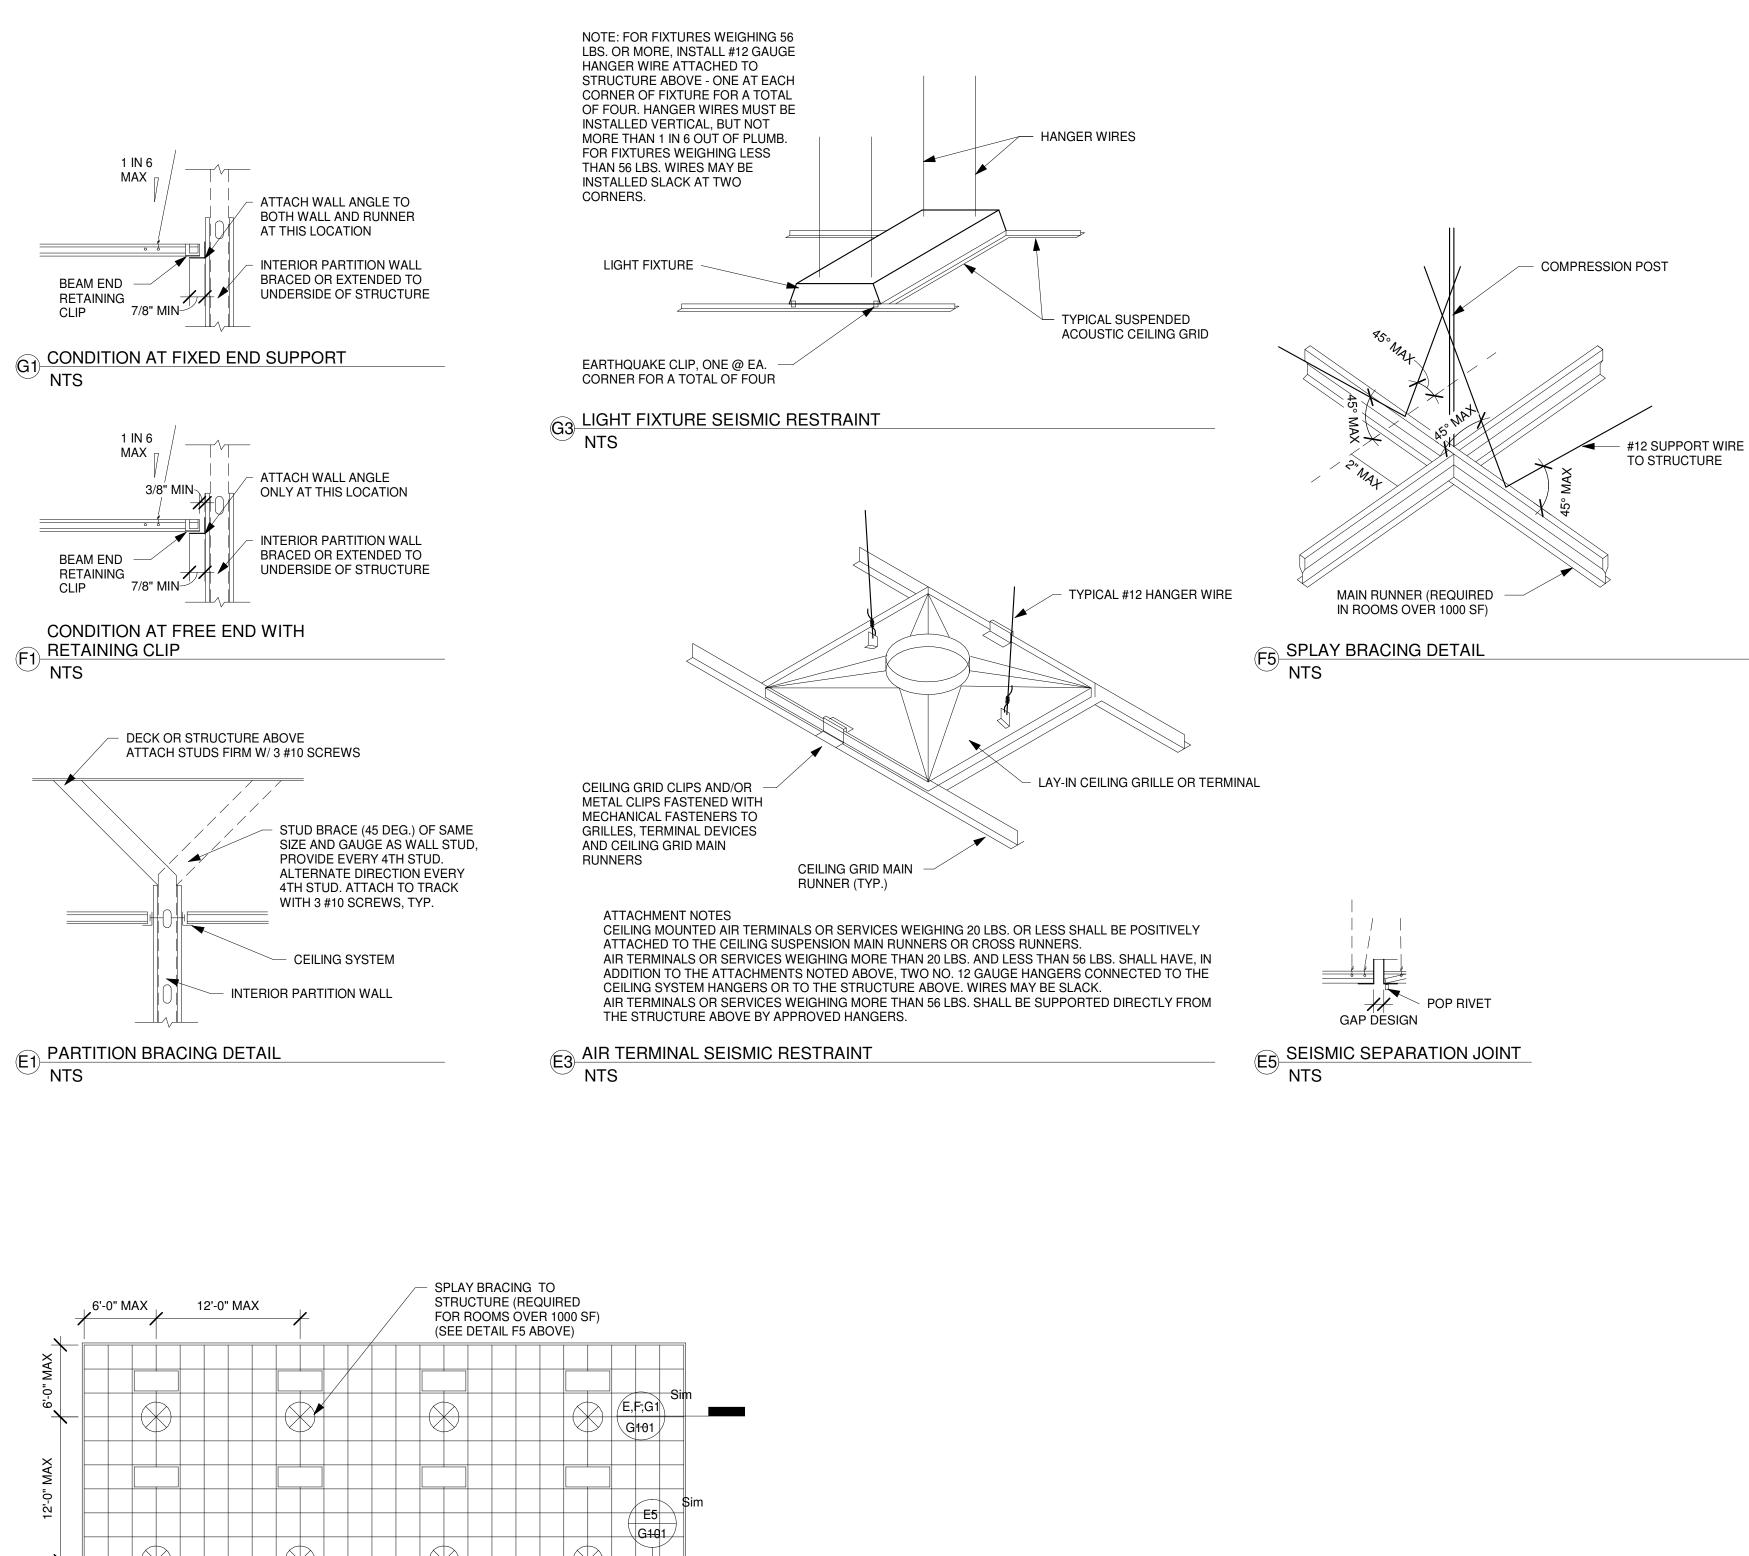

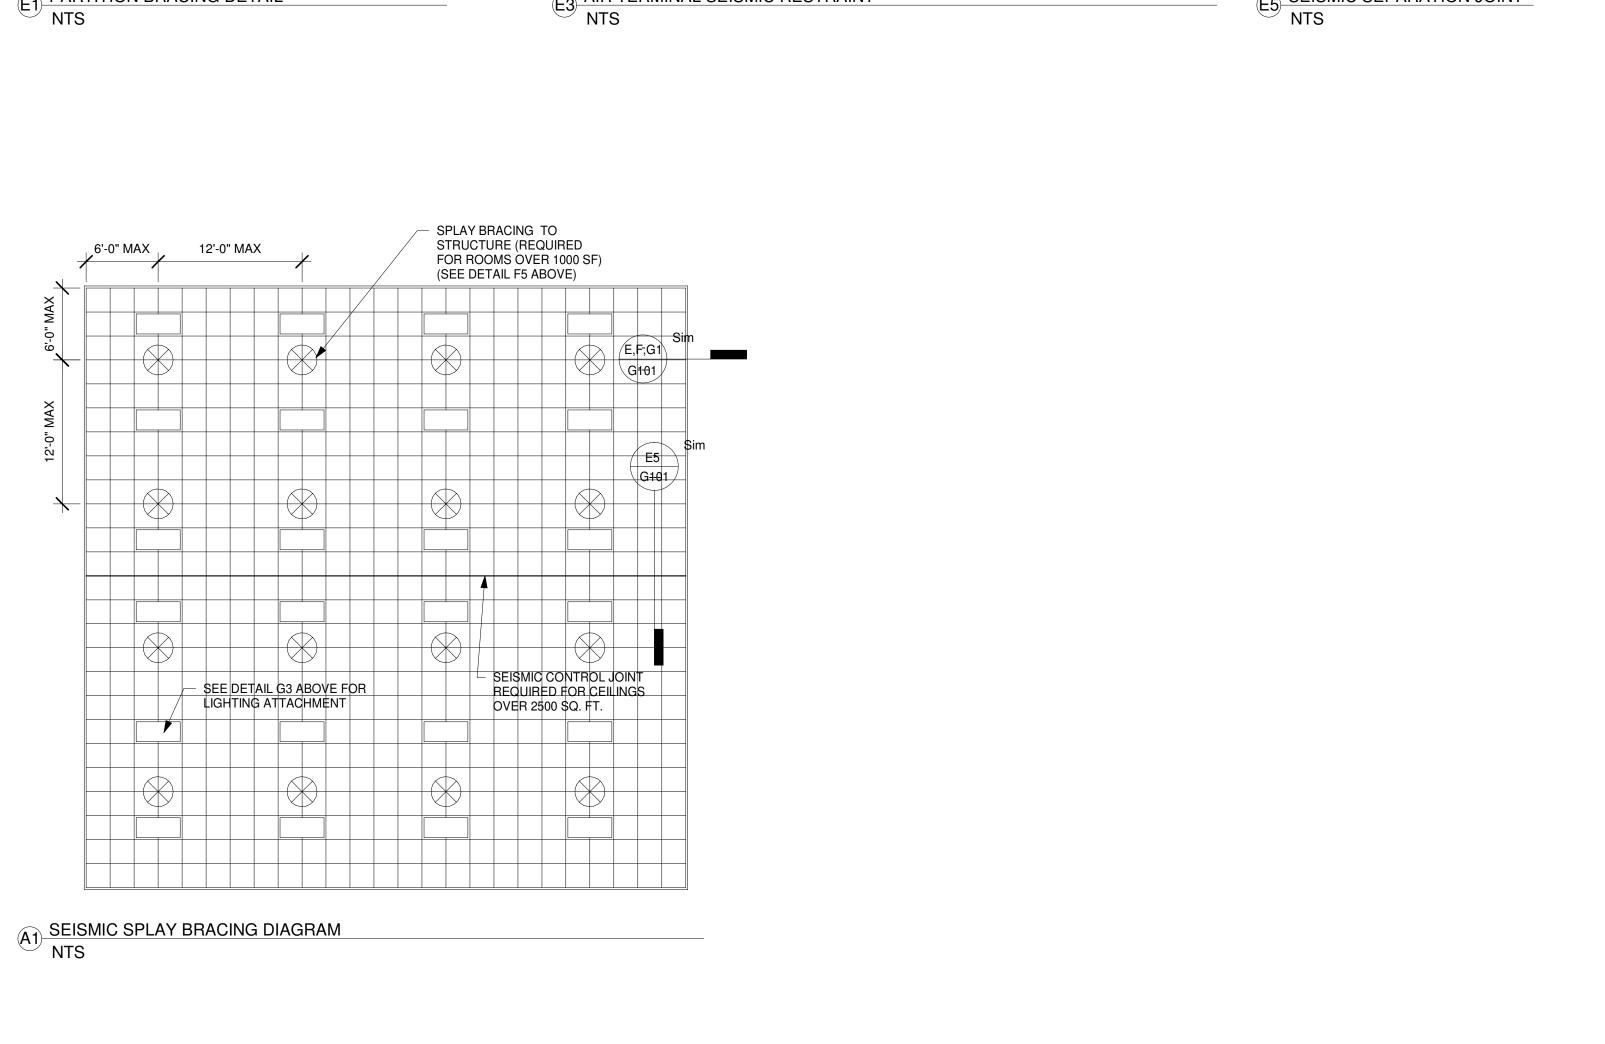

NOTE: SIMILAR CONDITIONS FOR MASONRY AND WOOD FRAME CONSTRUCTION

	IBC SEISMIC		SEISMIC ZONES A & B HAVE NO ALTERNATE METHOD (9)	UBC 25-2 REQUIREMENT
ASIC CONNECTIONS, PERIMETER	R, AND LATE	RAL SPLAY BRACING	, ,	
IINIMUM INTERSECTION	С	60 LBS.	60 LBS.	180 LBS.
TRENGTH LIMITS @ MT/CT (3)	D, E, F	180 LBS.	180 LBS.	
ERTICAL HANGER WIRES 12- iauge @ 4' O.C.	D, E, F	REQUIRED REQUIRED	REQUIRED REQUIRED	REQUIRED
ONNECTION DEVICE FROM	C	NOT REQUIRED	NOT REQUIRED	
ERTICAL WIRE TO THE TRUCTURE ABOVE MUST	D, E, F	REQUIRED	REQUIRED	REQUIRED
USTAIN MIN. 100 LBS.	C	INTERMEDIATE OR HEAVY DUTY	INTERMEDIATE OR HEAVY DUTY	
IAIN-TEE LASSIFICATIONS (4)	D, E, F	HEAVY DUTY	INTERMEDIATE OR HEAVY DUTY	INTERMEDIATE OR HEAVY DUTY (4)
IN 6 MAX PLUMB OF	С	REQUIRED	REQUIRED	REQUIRED
ERTICAL HANGER WIRES ERIMETER VERTICAL	D, E, F	REQUIRED	REQUIRED	TL GOTTLES
ANGER WIRES NOT MORE HAN 8" FROM WALL	D, E, F	NOT REQUIRED UNLESS MOLDING < 7/8"  REQUIRED	NOT REQUIRED  NOT REQUIRED	REQUIRED
RID END / WALL	C	MIN. 3/8"	MIN. 3/8"	SOME CLEARANCE ON TWO NON-
LEARANCE	D, E, F	MIN. 3/4"	MIN. 3/8" - MAX. 3/4"	ATTACHED WALLS, IF APPLICABLE
ERIMETER CLOSURE MOLDING) WIDTH	С	MIN. 7/8" (OR USE PERIMETER WIRES)  MIN. 2"	MIN. 7/8" MIN. 7/8"	MIN. 7/8"
RID CONNECTION TO	D, E, F	NOT PERMITTED	PERMITTED	
ERIMETER ATTACHED ON WO ADJACENT WALLS	D, E, F	REQUIRED	REQUIRED	OPTIONAL
ERIMETER TEE ENDS IED TOGETHER AT	С	REQUIRED	REQUIRED (ACM7 CLIP)	REQUIRED
ERIMETERS ORIZONTAL RESTRAINT	D, E, F	REQUIRED	REQUIRED (ACM7 CLIP)	
SPLAY WIRES OR RIGID RACING) WITHIN 2" OF	C	NOT REQUIRED	NOT REQUIRED	REQUIRED (6,7)
ITERSEĆTION AND SPLAYED O APART AT 45 ANGLES	D, E, F	REQUIRED (5,6)	REQUIRED (5,6)	,
OMPRESSION POSTS (STRUTS) 2' O.C. IN BOTH DIRECTIONS,	С	NOT REQUIRED	NOT REQUIRED	
TARTING 6' FROM WALLS	D, E, F	REQUIRED (5,6)	REQUIRED (5,6)	REQUIRED (6,7)
PLAY BRACING CONNECTION				
TRENGTH 200 LBS. OR THE ESIGN LOAD, WHICHEVER IS	C	NOT REQUIRED	NOT REQUIRED	REQUIRED
REATER	D, E, F	REQUIRED  ALLOWED ONLY IF CEILING IS	REQUIRED  ALLOWED ONLY IF CEILING IS	
ARTITION	С	ABLE TO MOVE LATERALLY	ABLE TO MOVE LATERALLY	ALLOWED WITH BRACING
TTACHMENT	D, E, F	BRACING INDEPENDENT OF CEILING SPLAY BRACING	BRACING INDEPENDENT OF CEILING SPLAY BRACING	
EISMIC EPARATION	С	NOT REQUIRED (OR FULL HEIGHT PARTITION) (8)	NOT REQUIRED	NOT REQUIRED
TNIC	D, E, F	REQUIRED FOR AREAS > 2,500 SQ. FT.	REQUIRED FOR AREAS > 2,500 SQ. FT. (OR FULL HEIGHT PARTITION) (6)	NOT HEQUINED
IGID BRACING FOR CEILING LANE ELEVATION CHANGES	С	NOT REQUIRED	NOT REQUIRED	NOT REQUIRED
   IGHT FIXTURE ATTACHMENT	D, E, F	REQUIRED	REQUIRED	
IGHT FIXTURE (ALL TYPES)				
IECHANICALLY ATTACHED TO RID PER NEC 410-16 (TWO PER IXTURE UNLESS	C	REQUIRED (2)	REQUIRED	
NDEPENDENTLY SUPPORTED) URFACE MOUNTED	D, E, F	REQUIRED (8)	REQUIRED	DECLUDED (INCLUDING CAFETY
IXTURES ATTACHED TO GRID	D, E, F	NOT REQUIRED  NOT REQUIRED	NOT REQUIRED  NOT REQUIRED	REQUIRED (INCLUDING SAFETY WIRES TO VERTICAL WIRE OR STRUCTURE) (8)
ENDANT-HUNG FIXTURES IRECTLY SUPPORTED FROM				STRUCTURE) (0)
TRUCTURE WITH 9-GAUGE //IRE (OR APPROVED	C D, E, F	REQUIRED REQUIRED	REQUIRED REQUIRED	REQUIRED
LTERNATIVE)		TIEQUITED	TIEGOTTED	
IGID LAY-IN OR CAN LIGHT FIXTU 10 LBS ONE WIRE TO	IRES C	REQUIRED	REQUIRED	
TRUCTURE (MAY BE LACK)	D, E, F	REQUIRED	REQUIRED	LOWER LIMIT IS 20 LBS.
0 TO 56 LBS TWO WIRES			750,075	
ROM HOUSING TO TRUCTURE (MAY BE SLACK)	C D, E, F	REQUIRED REQUIRED	REQUIRED REQUIRED	REQUIRED - LOWER LIMIT IS 20 LBS.
	, -, •			
56 LBS SUPPORTED IRECTLY TO STRUCTURE	С	REQUIRED	REQUIRED	REQUIRED
Y APPROVED HANGERS	D, E, F	REQUIRED	REQUIRED	· · · · · · · · · · · · · · · · · · ·
ERVICE APPLICATIONS				
IR TERMINALS < 20 LBS OSITIVELY ATTACHED TO RID	D, E, F	REQUIRED REQUIRED	REQUIRED REQUIRED	REQUIRED
RID IR TERMINAL 20 - 56 LBS OSITIVELY ATTACHED TO				
OSITIVELY ATTACHED TO RID AND TWO 12-GAUGE /IRES TO STRUCTURE (MAY	D, E, F	REQUIRED REQUIRED	REQUIRED REQUIRED	REQUIRED
E SLACK)  IR TERMINAL > 56 LBS				
IR TERMINAL > 56 LBS IRECTLY SUPPORTED TO TRUCTURE	D, E, F	REQUIRED REQUIRED	REQUIRED REQUIRED	REQUIRED
PRINKLER HEADS AND	о, <u>е</u> , г	MIN. 3/8" ON ALL SIDES	MIN. 3/8" ON ALL SIDES	
THER PENETRATION LEARANCE	D, E, F	MIN. 2" DIAMETER OPENING OR A SWING JOINT	MIN. 2" DIAMETER OPENING OR A SWING JOINT	NOT REQUIRED
ABLE TRAYS AND				
LECTRICAL CONDUIT IDEPENDENTLY	D, E, F	NOT REQUIRED  REQUIRED	NOT REQUIRED REQUIRED	NOT REQUIRED
UPPORTED AND BRACED				
	ON RECOMM	MENDATIONS FOR ZONES 0-2 VIA ASCE 7-02. MENDATIONS FOR ZONES 3-4 VIA ASCE 7-02.		
Ú ALL 1100 DOMEST - **		ON SYSTEMS MEET THESE REQUIREMENTS.		
Ý) PER ASTM C635.	∃ER [HAN 1			
I) PER ASTM C635. 5) REQUIRED FOR CEILINGS LARG 8) WHERE SUBSTANTIATING DES	IGN CALCUL			
4) PER ASTM C635. 5) REQUIRED FOR CEILINGS LARG 5) WHERE SUBSTANTIATING DES 7) SEISMIC STANDARDS GENERA 8) WHEN INTERMEDIATE-DUTY SY	IGN CALCUL LLY APPLY 1 YSTEMS ARE	TO CEILINGS LARGER THAN 144 S.F. E USED, NO. 12-GAUGE HANGER WIRES SHAI	LL BE ATTACHED TO THE	
I) PER ASTM C635.  S) REQUIRED FOR CEILINGS LARG  S) WHERE SUBSTANTIATING DES  Y) SEISMIC STANDARDS GENERA  S) WHEN INTERMEDIATE-DUTY SY  USPENSION MEMBERS WITHIN T  B) REFER TO AC3235 FOR MORE	IGN CALCUL LLY APPLY T YSTEMS ARE THREE INCHI INFORMATIC	TO CEILINGS LARGER THAN 144 S.F. E USED, NO. 12-GAUGE HANGER WIRES SHAI ES OF EACH CORNER OF EACH FIXTURE. DN.	LL BE ATTACHED TO THE	
É) PER ASTM C635.  E) REQUIRED FOR CEILINGS LARG  E) WHERE SUBSTANTIATING DES  E) SEISMIC STANDARDS GENERA  E) WHEN INTERMEDIATE-DUTY SY  USPENSION MEMBERS WITHIN T	IGN CALCUL LLY APPLY T YSTEMS ARE THREE INCHI INFORMATIC	TO CEILINGS LARGER THAN 144 S.F. E USED, NO. 12-GAUGE HANGER WIRES SHAI ES OF EACH CORNER OF EACH FIXTURE. DN.	LL BE ATTACHED TO THE	
<ul> <li>PER ASTM C635.</li> <li>REQUIRED FOR CEILINGS LARGED WHERE SUBSTANTIATING DESTONION</li> <li>SEISMIC STANDARDS GENERAD WHEN INTERMEDIATE-DUTY SYUSPENSION MEMBERS WITHIN TO REFER TO AC3235 FOR MORE</li> </ul>	IGN CALCUL LLY APPLY T YSTEMS ARE THREE INCHI INFORMATIC TH ASTM C6:	TO CEILINGS LARGER THAN 144 S.F. E USED, NO. 12-GAUGE HANGER WIRES SHAI ES OF EACH CORNER OF EACH FIXTURE. DN. 36.	LL BE ATTACHED TO THE	

-PER TABLE 1604.5

>-AS BASED UPON USGS DESIGN MAPS SUMMARY REPORT

RISK CATEGORY

-S DS -S D1

1 LANDMARK DRIVE, SUITE 241 RTH CHARLESTON, SC 29418 -722-4334 (T) 3-722-4135 (F)

NTERIOR UPFIT FOR: HANAHAN CITY HALL

1255 YEAMANS HALL RD HANAHAN, SC 29410



DATE DESCRIPTION

ECT NO: 2022.04.11 DATE: 06.23.2023 AWN BY: CA


KED BY: RVG PHASE: CONSTRUCTION DOCUMENTS

WING TITLE

CEILING SEISMIC REQUIREMENTS AND DETAILS


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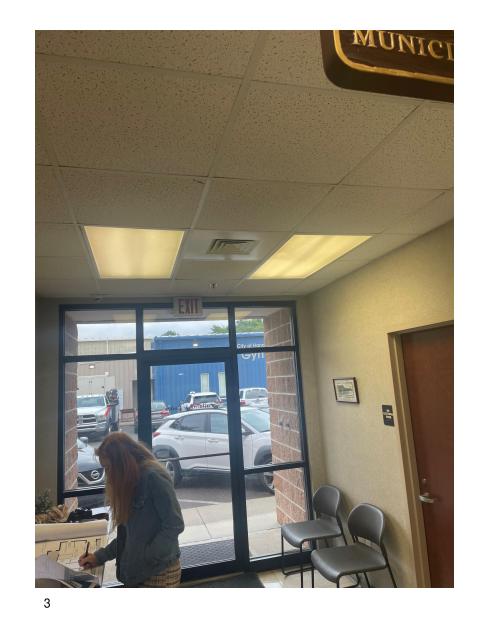
G101 **PERMITTING & CONSTRUCTION** 

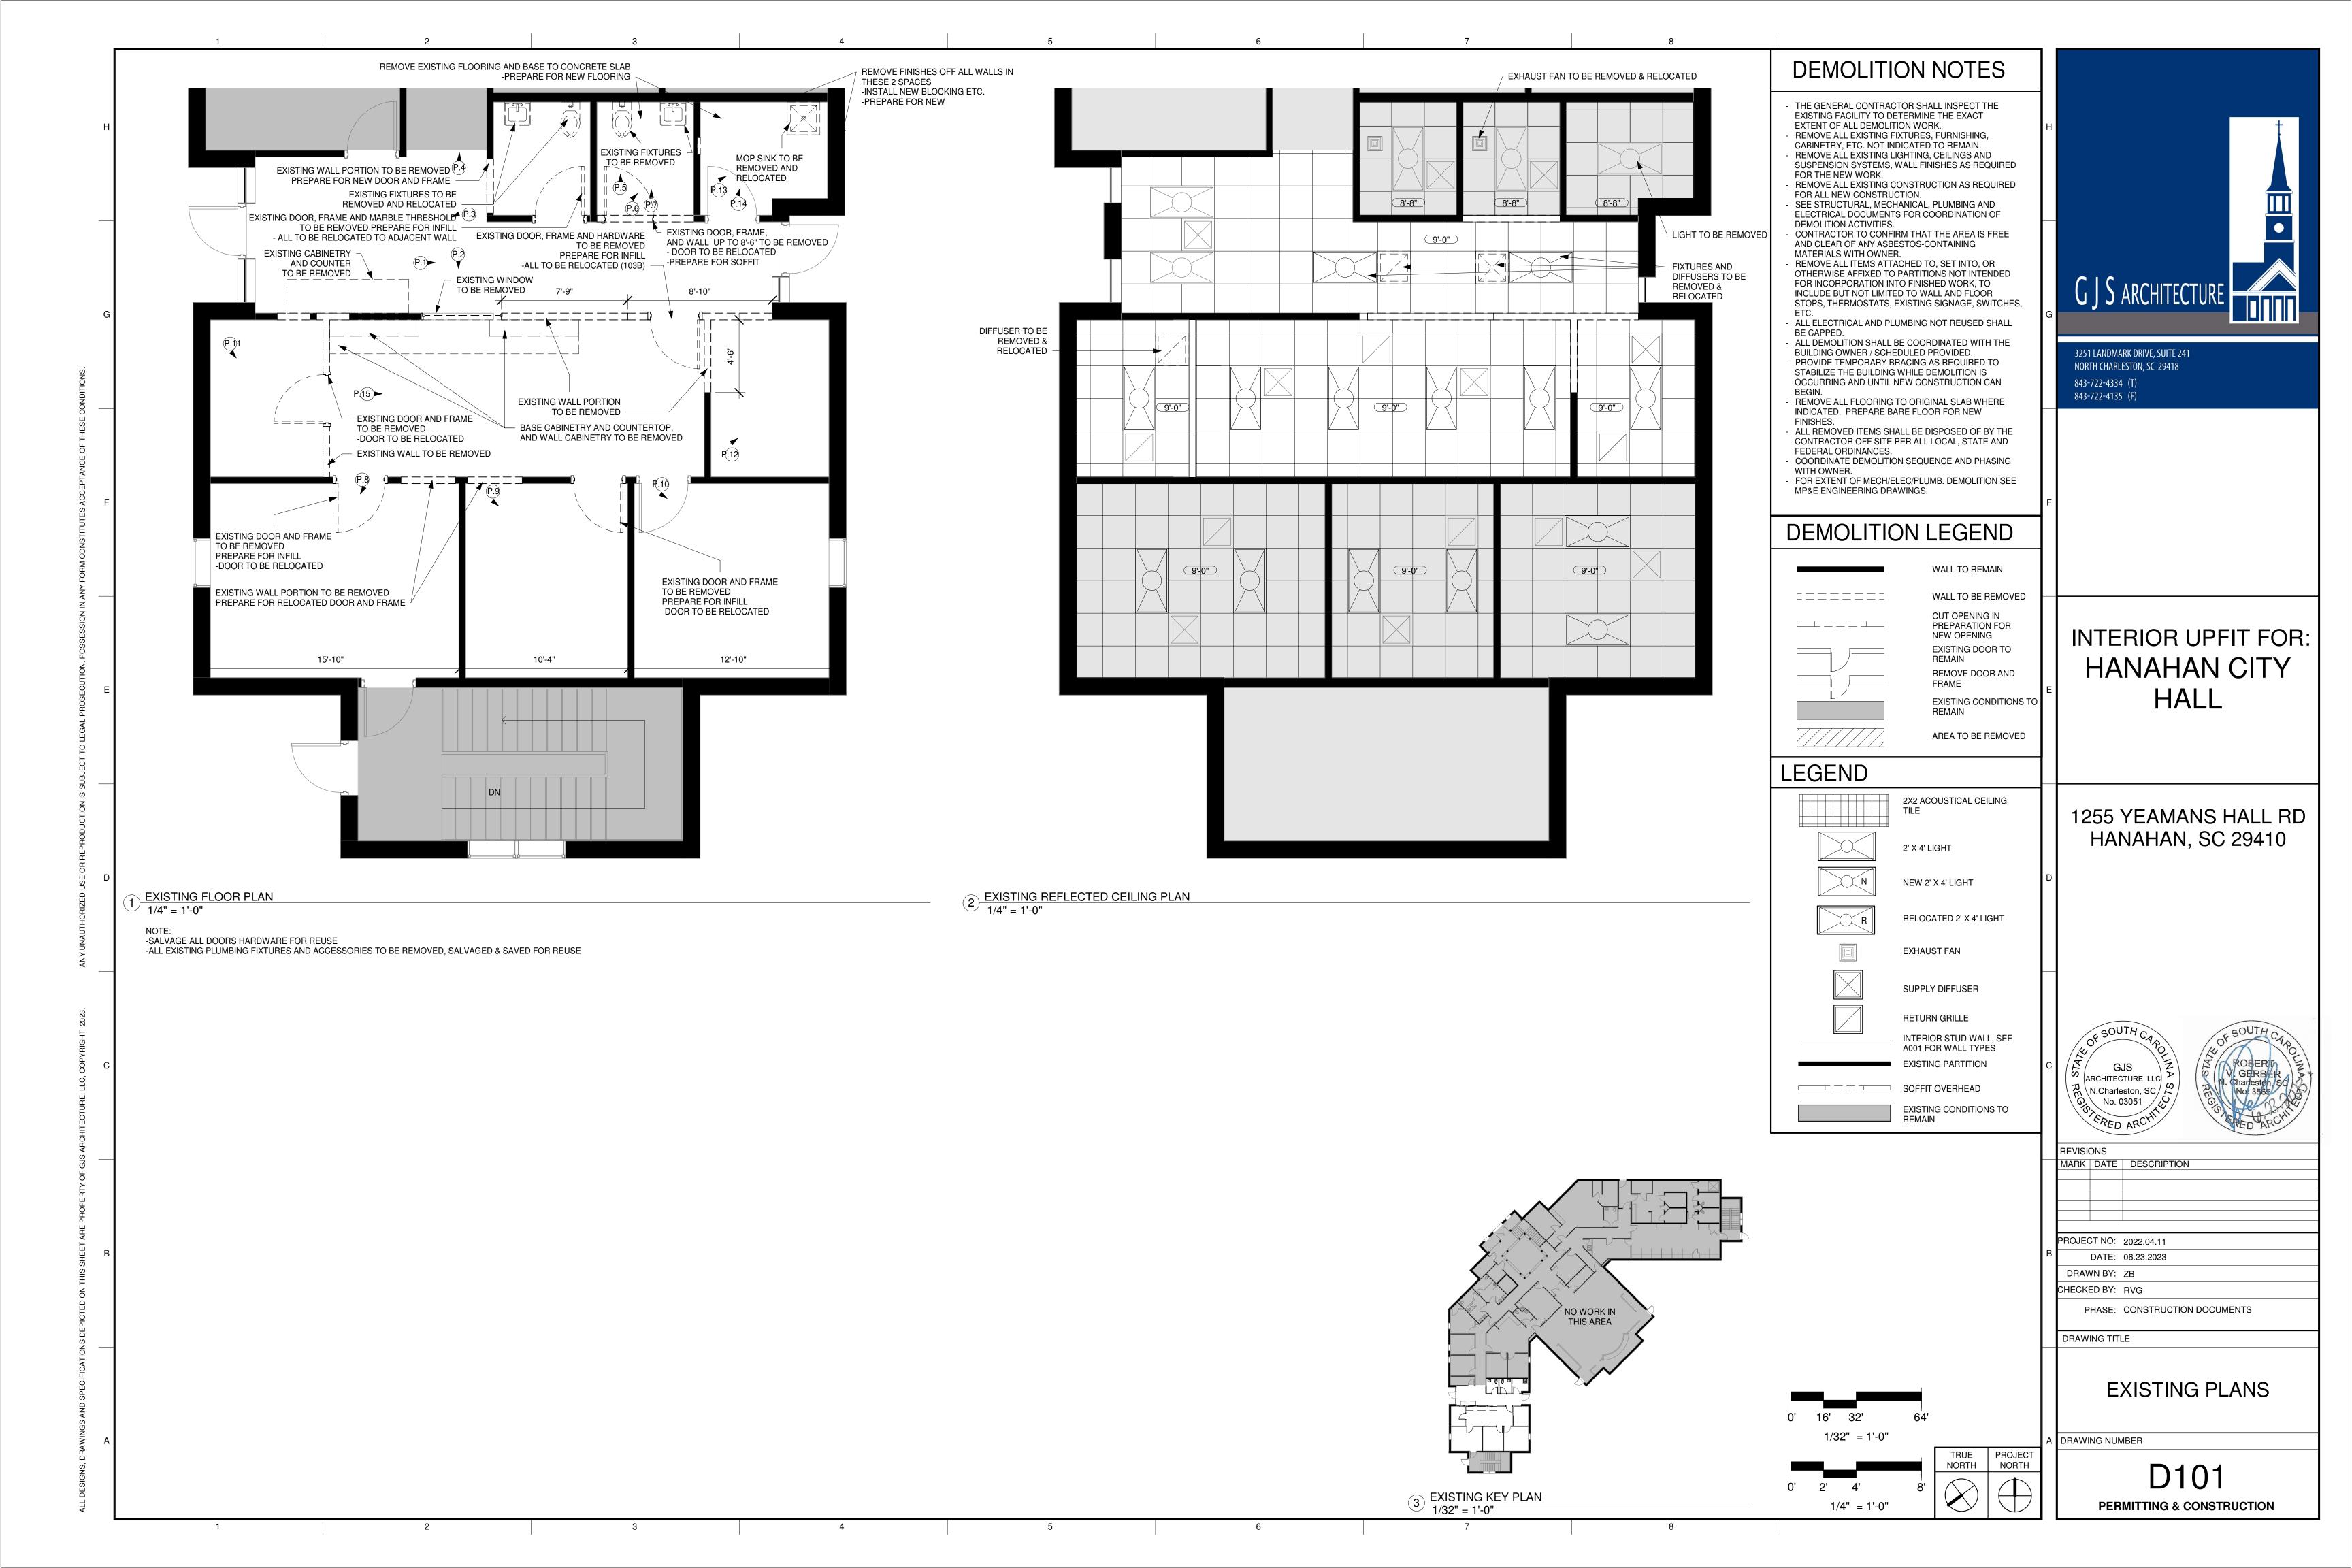


# **EXISTING PHOTOGRAPHS**





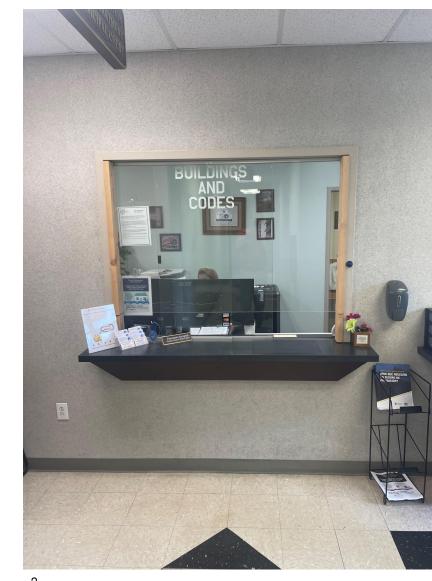


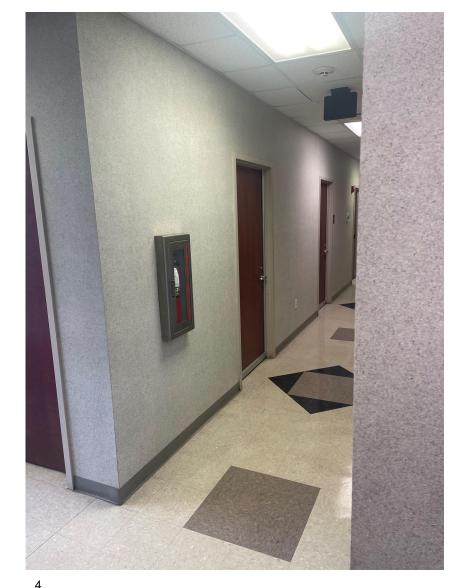









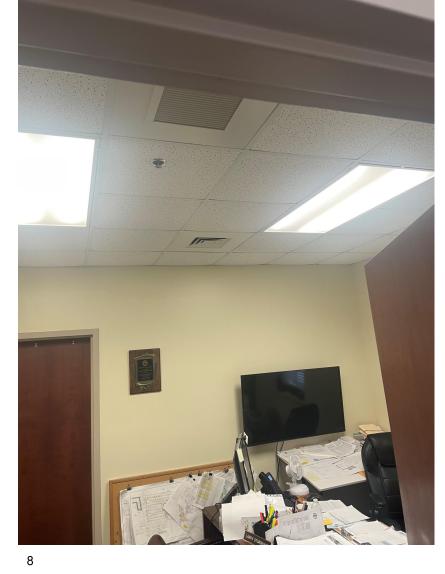

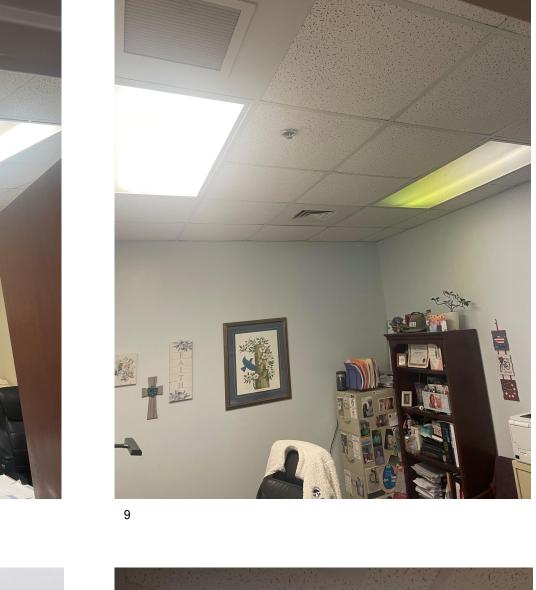








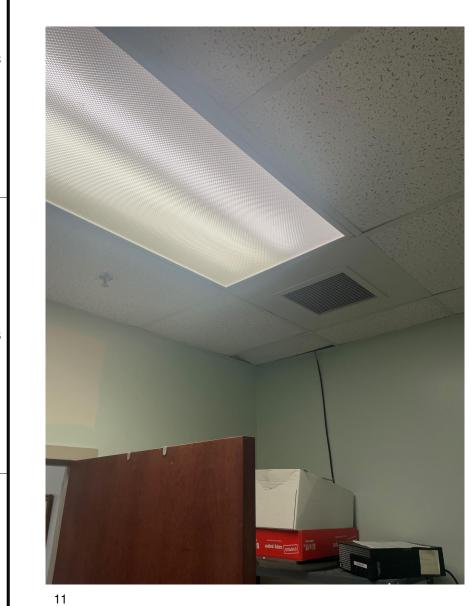



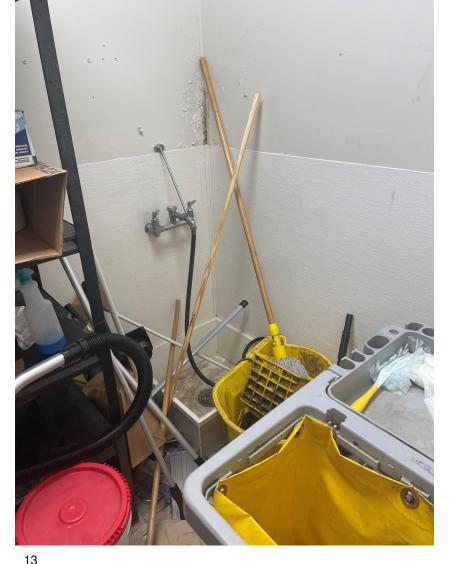

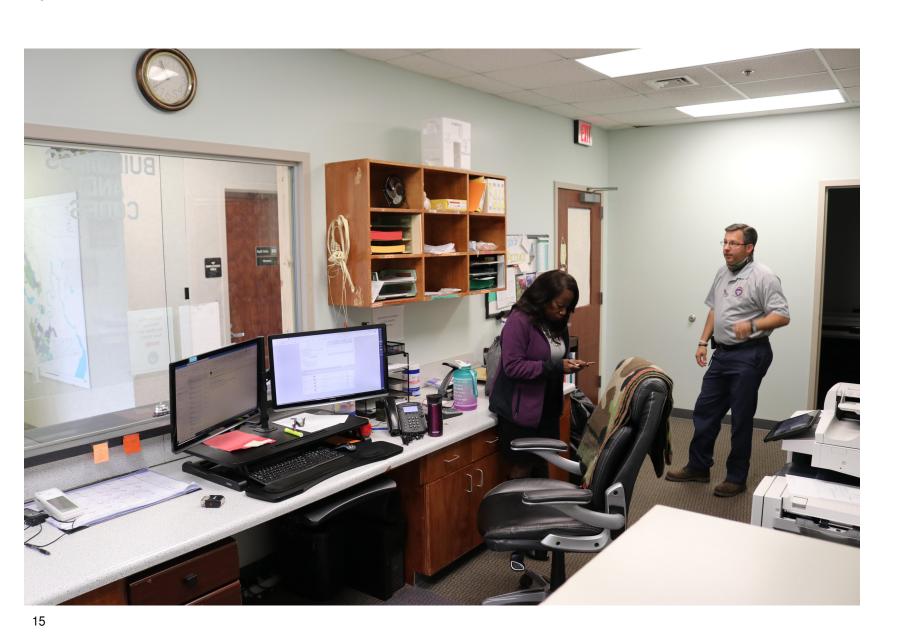


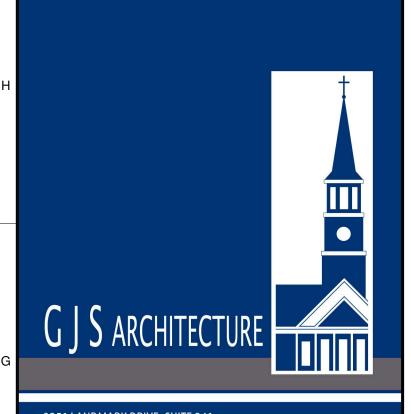

843-722-4334 (T) 843-722-4135 (F)

INTERIOR UPFIT FOR: HANAHAN CITY HALL

1255 YEAMANS HALL RD HANAHAN, SC 29410

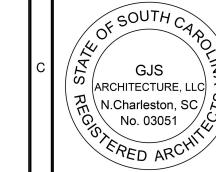


REVISIONS
MARK DATE DESCRIPTION


PROJECT NO: 2022.04.11 DATE: 06.23.2023 DRAWN BY: ZB


CHECKED BY: RVG

EXISTING PHOTOGRAPHS

D102 PERMITTING & CONSTRUCTION

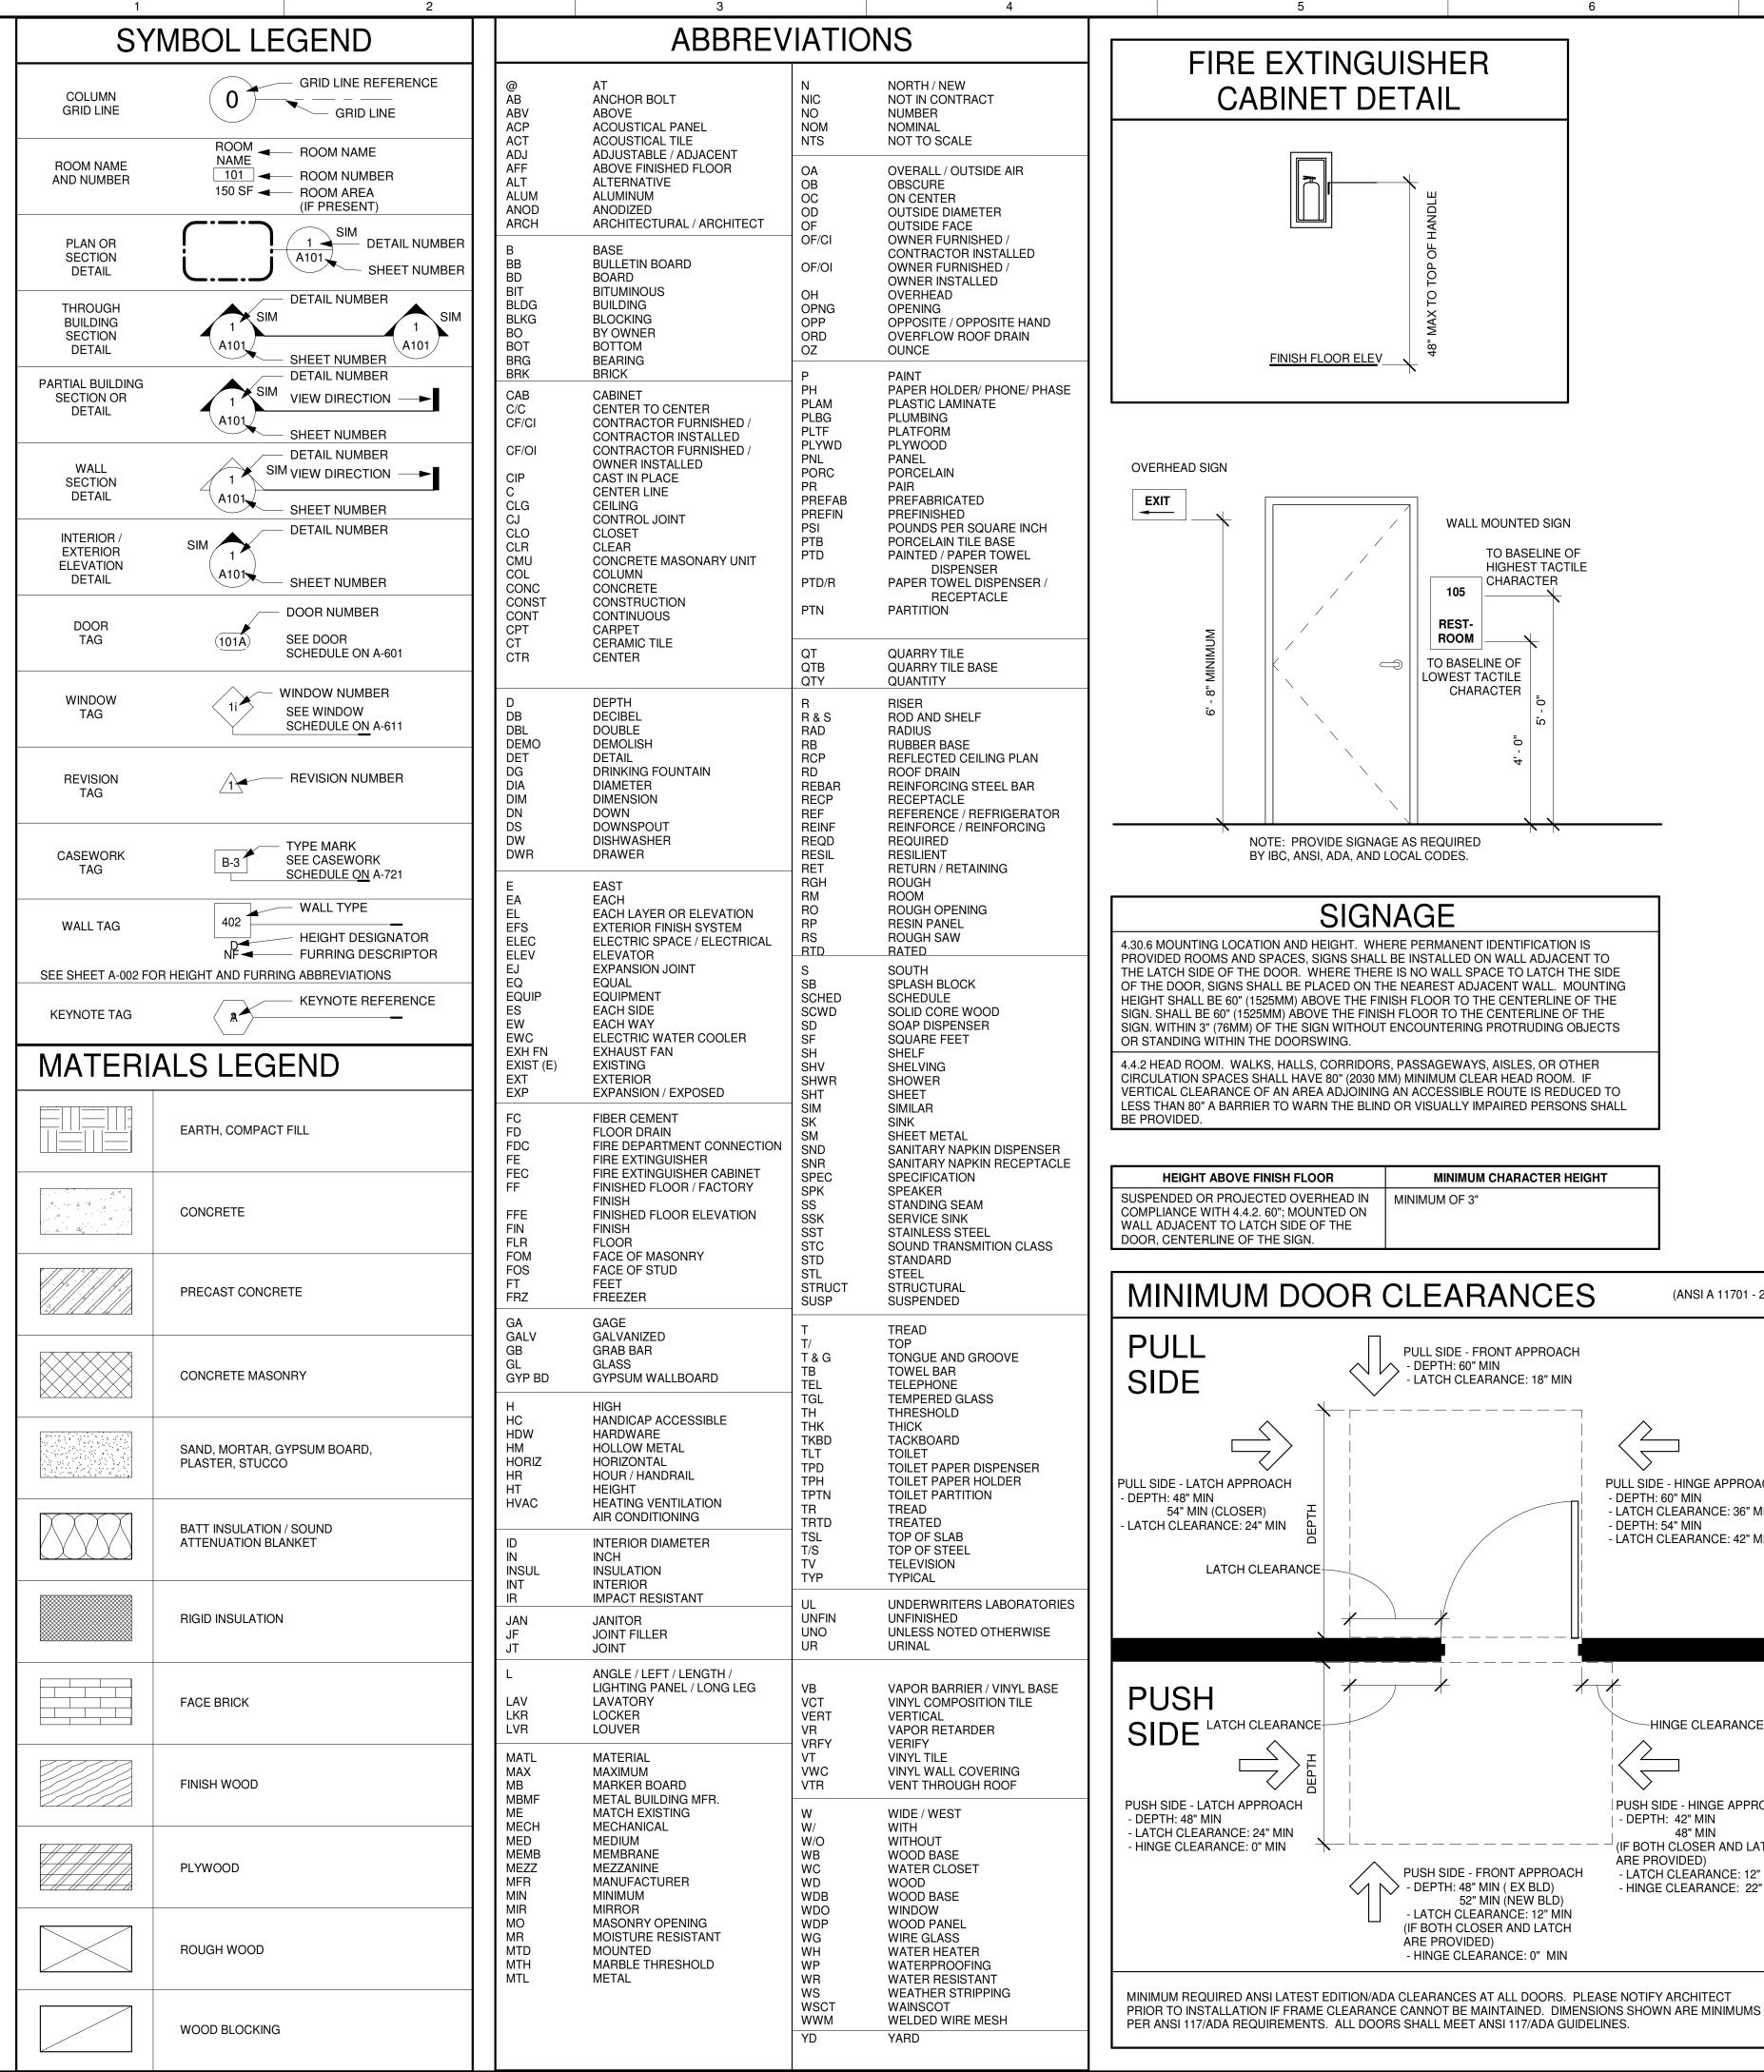


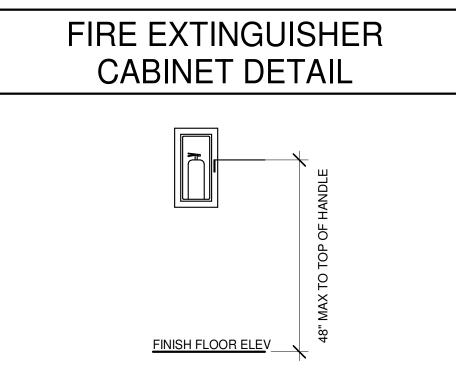

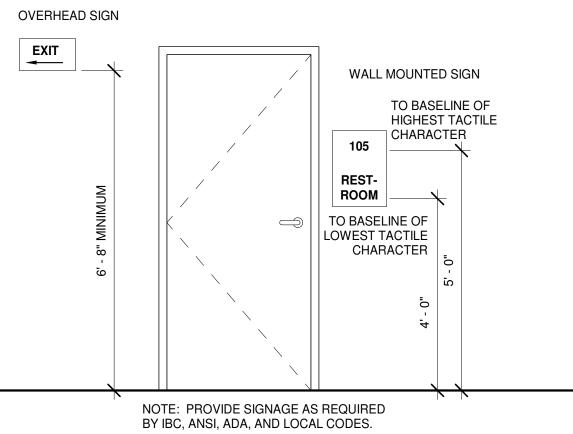


SIGNAGE
4.30.6 MOUNTING LOCATION AND HEIGHT. WHERE PERMANENT IDENTIFICATION IS PROVIDED ROOMS AND SPACES, SIGNS SHALL BE INSTALLED ON WALL ADJACENT TO THE LATCH SIDE OF THE DOOR. WHERE THERE IS NO WALL SPACE TO LATCH THE SIDE OF THE DOOR, SIGNS SHALL BE PLACED ON THE NEAREST ADJACENT WALL. MOUNTING HEIGHT SHALL BE 60" (1525MM) ABOVE THE FINISH FLOOR TO THE CENTERLINE OF THE SIGN. SHALL BE 60" (1525MM) ABOVE THE FINISH FLOOR TO THE CENTERLINE OF THE SIGN. WITHIN 3" (76MM) OF THE SIGN WITHOUT ENCOUNTERING PROTRUDING OBJECTS OR STANDING WITHIN THE DOORSWING.
4.4.2 HEAD ROOM. WALKS, HALLS, CORRIDORS, PASSAGEWAYS, AISLES, OR OTHER CIRCULATION SPACES SHALL HAVE 80" (2030 MM) MINIMUM CLEAR HEAD ROOM. IF VERTICAL CLEARANCE OF AN AREA ADJOINING AN ACCESSIBLE ROUTE IS REDUCED TO LESS THAN 80" A BARRIER TO WARN THE BLIND OR VISUALLY IMPAIRED PERSONS SHALL

HEIGHT ABOVE FINISH FLOOR	MINIMUM CHARACTER HEIGHT
SUSPENDED OR PROJECTED OVERHEAD IN COMPLIANCE WITH 4.4.2. 60"; MOUNTED ON WALL ADJACENT TO LATCH SIDE OF THE DOOR, CENTERLINE OF THE SIGN	MINIMUM OF 3"

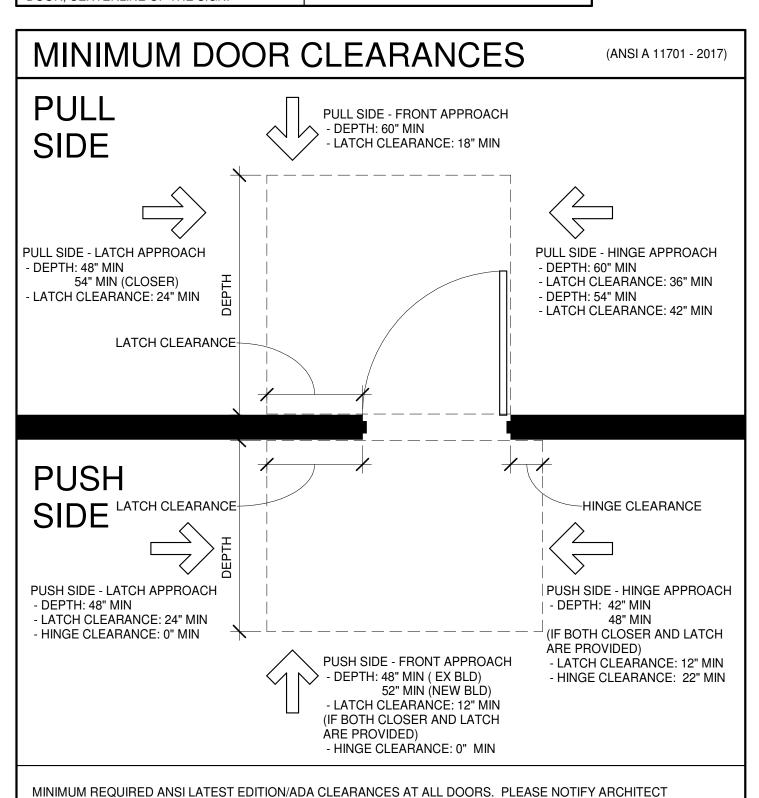


WALL TYPE LEGEND - STEEL STUDS											
TAG	WALL TYPE	FIRE RATING	UL#	STC RATING	DESCRIPTION						
501	18/1			43	3-5/8" METAL STUDS @ 16" OC 1 LAYER OF 5/8" GYP BD EACH SIDE 3-1/2" SOUND ATTENUATION BATT						

HEADER AND JAMB STUDS											
LEVEL	WIDTH	HEADER / SILL	JAMB STUD								
FINISHED FLOOR TO ROOF	3'-0"	800JS250-33 (50 KSI)	800JS250-33 (50 KSI)								
FINISHED FLOOR TO ROOF	6'-0"	800JS250-33 (50 KSI)	800JS250-43 (50 KSI)								

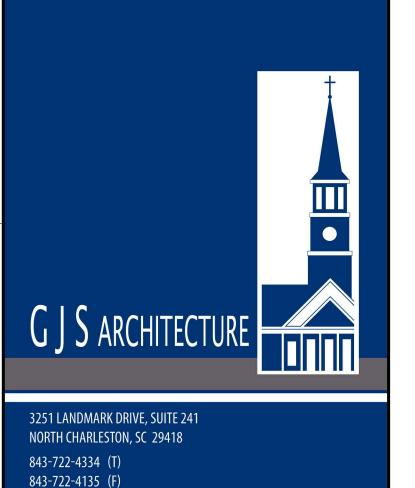

INTERIOR UPFIT FOR: HANAHAN CITY HALL

1255 YEAMANS HALL RD HANAHAN, SC 29410

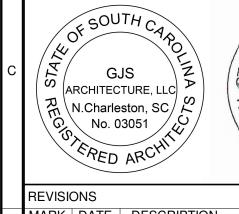


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REVISIONS	
MARK DATE	DESCRIPTION
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DATE:	06.23.2023
DRAWN BY:	CA
CHECKED BY:	RVG
PHASE:	CONSTRUCTION DOCUMENTS


DRAWING TITLE ABBREVIATIONS, SYMBOLS, & STANDARD

**DETAILS** A DRAWING NUMBER

> A001 **PERMITTING & CONSTRUCTION**

WALL TYPE TAG LEGEND EXAMPLE: STEEL STUD WALL, NOT RATED, WALL GOES UP TO DECK ABOVE 4 = CMU5 = STEEL STUD 6 = WOOD STUD FIRE RATING 0 = NON-RATED 2 = 2 HR3 = 3 HRWALL TYPE DESIGNATOR WALL HAS: FURRING (BLANK) NO FURRING ('NF') / FURRING ONE SIDE ('F1S') (400-SERIES WALLS ONLY) HEIGHT DESIGNATION:
L LOW WALL (SEE SECTION) CEILING HEIGHT (4" ABOVE HIGHEST ADJACENT CEILING) TO UNDERSIDE OF DECK ABOVE

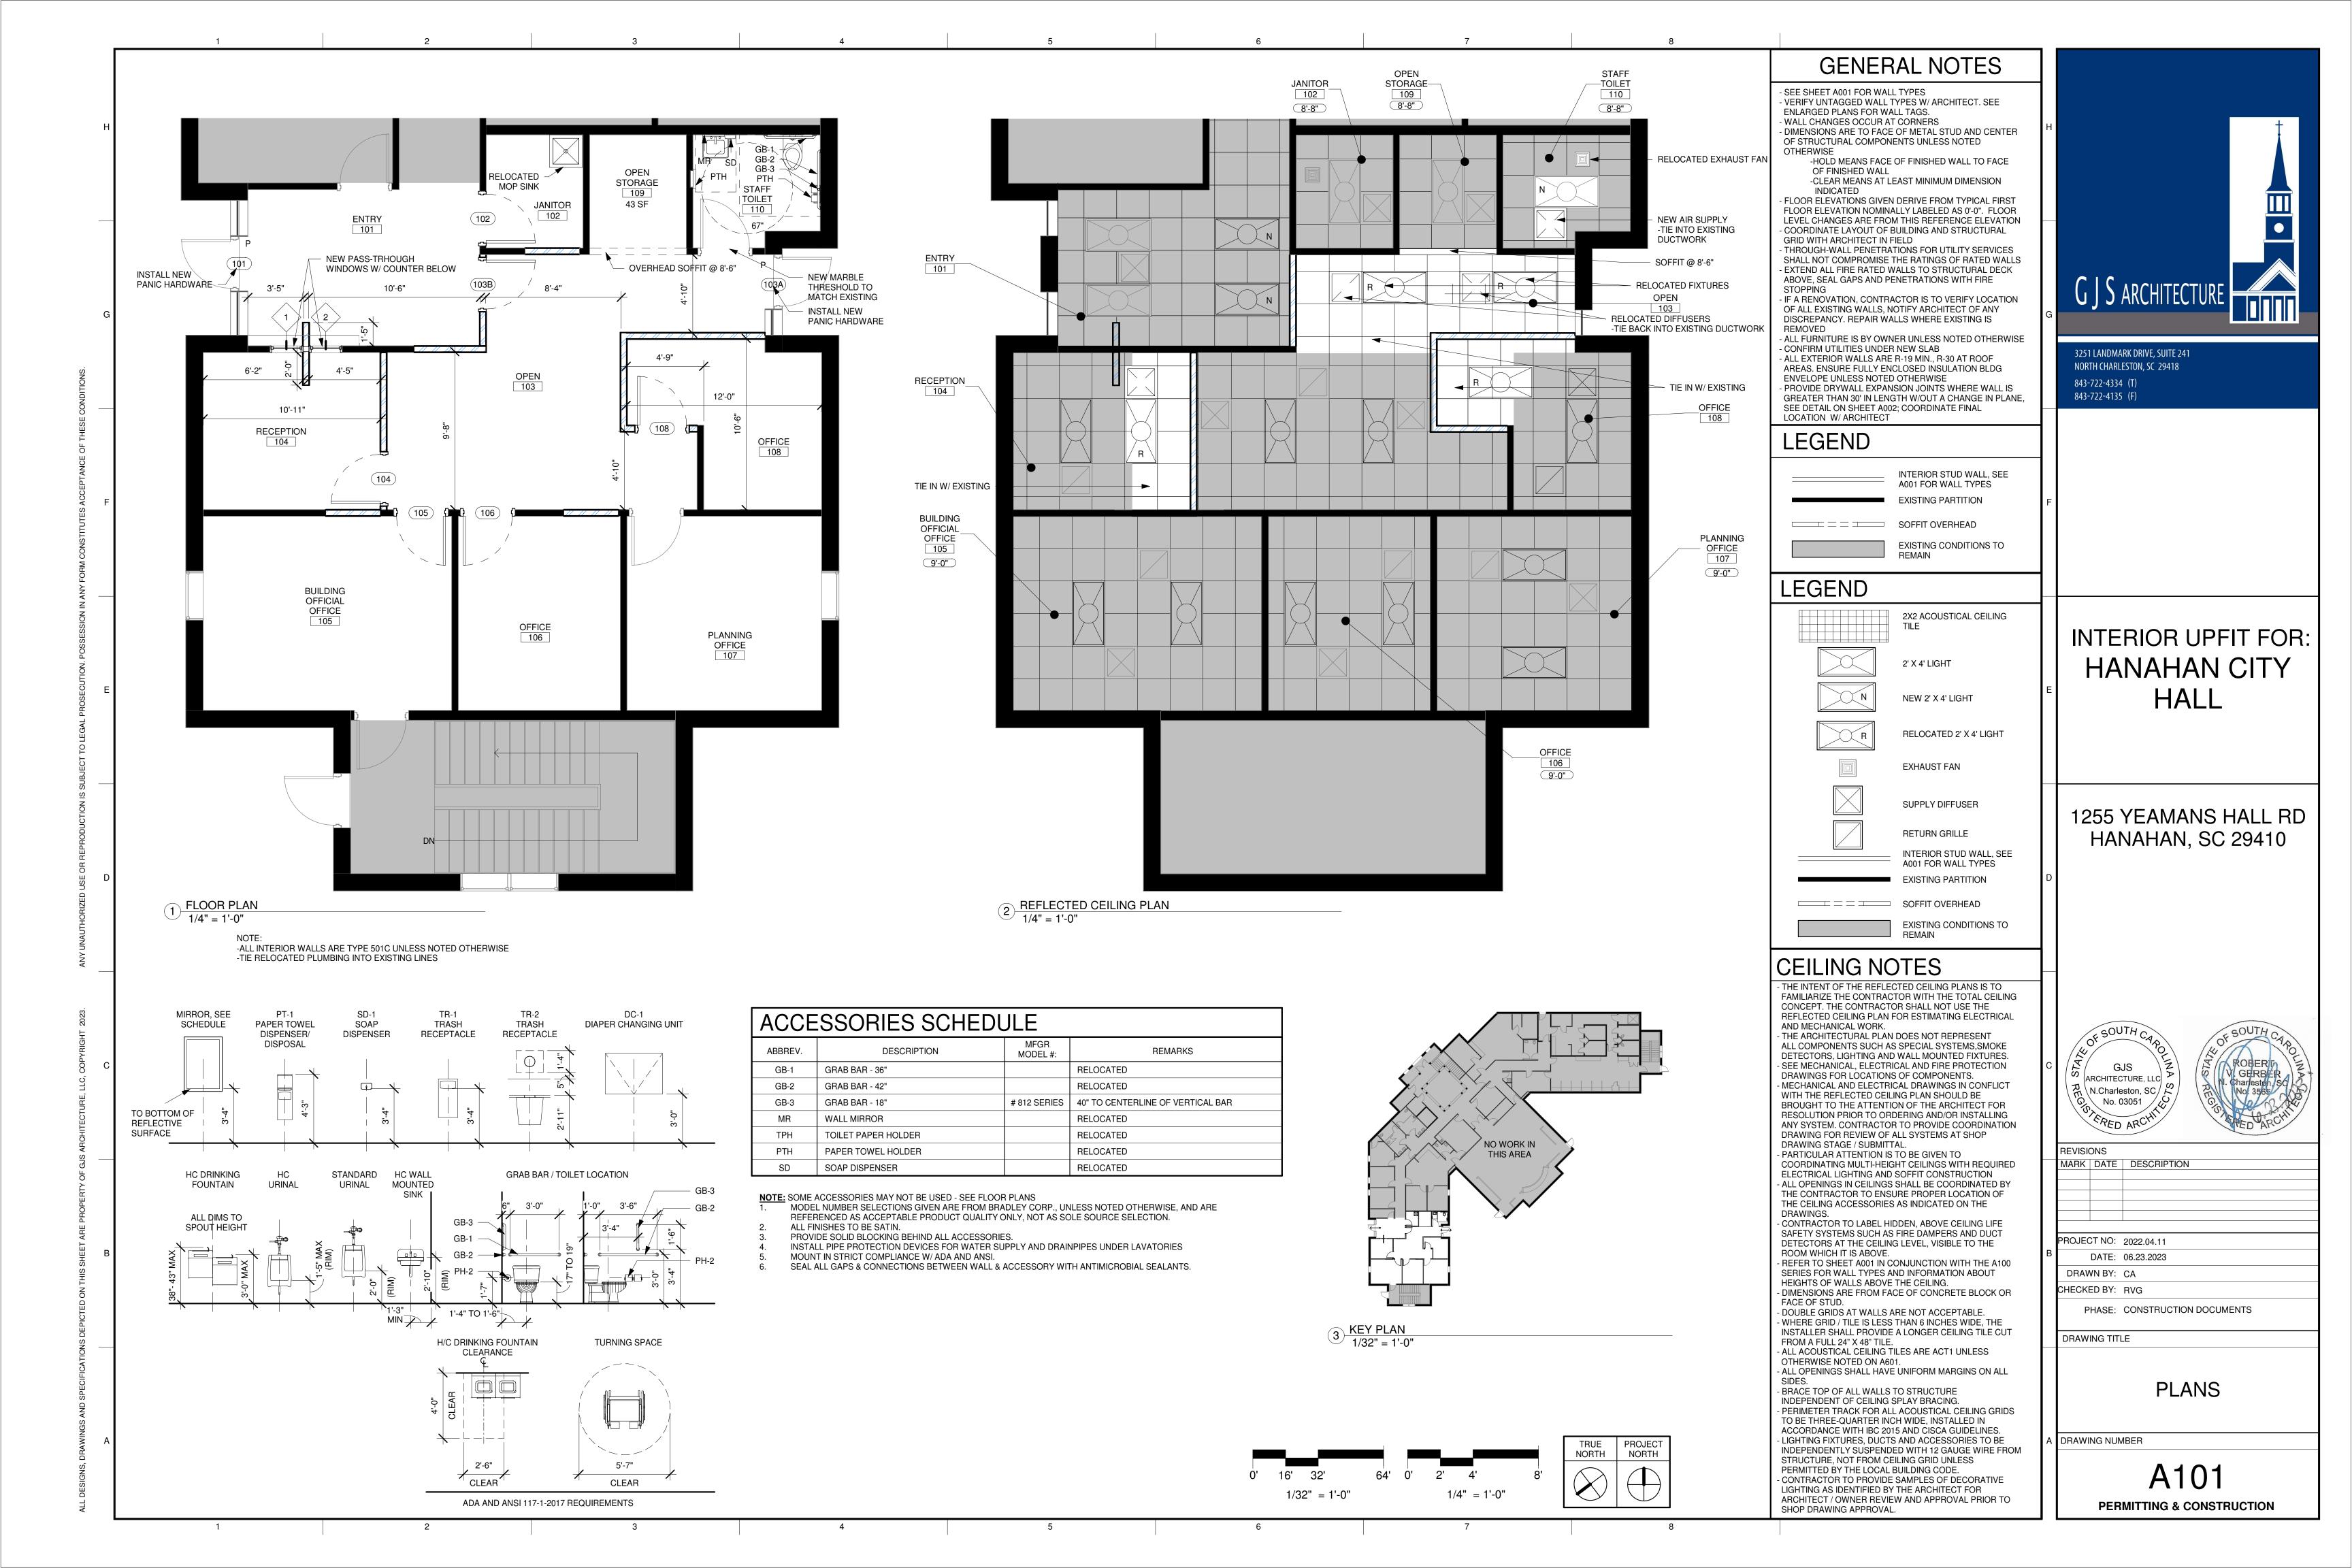

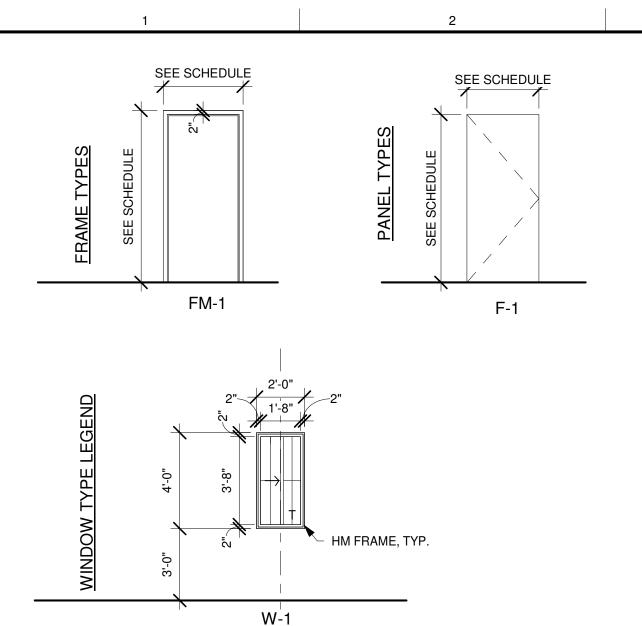

ABBREVIATIONS

ACRYLIC

BASE

ACOUSTICAL TILE

BASE-INTEGRAL

**CULTURED MARBLE** 

CARPET TILE/SQUARE

CONCRETE

CARPET

**EXPOSED** 

**EXISTING** 

**FINISH** GRANITE

FACTORY FINISH

GYPSUM BOARD

HORIZONTAL

LINER PANEL

MATERIAL

PLASTER

PAINT

LUXURY VINYL TILE

MANUFACTURER

PLASTIC LAMINATE

PORCELAIN TILE

QUARRY TILE

RUBBER BASE

PORCELAIN TILE BASE

QUARRY TILE BASE

RUBBER FLOORING

REINFORCED PANELS

STAINED CONCRETE

VINYL COMPOSITION TILE

VINYL WALL COVERING

SOLID SURFACE

STAIN

VINYL

VINYL BASE

VERTICAL

WOOD

WOOD BASE

WOOD PANELING

INTERIOR LINOLEUM

IMPACT RESISTANT GYPSUM BOARD

MOISTURE RESISTANT GYPSUM BOARD

MATERIAL

ABBREVIATION

ACR

CONC

CPTS

EXP

GRAN

GYP BD

GYP BD IR

HORZ

MFR

MATL

PLAM

PORC

PTB

QTB

QT

SS

VCT

VERT

VWC

WD

WDB

WDP

GYP BD MR

EXIST (EX)

### DOOR SCHEDULE NOTES

- PANIC HARDWARE: A DOOR LATCHING ASSEMBLY INCORPORATING A DEVICE WHICH RELEASES THE LATCH UPON THE APPLICATION OF A FORCE IN THE DIRECTION OF EXIT TRAVEL.
- ALL DOORS WITH PANIC HARDWARE SHALL BE SELF-CLOSING (CLOSERS).
- ALL EXTERIOR HM FRAMES AND HM DOORS TO BE GALVANIZED.

THROAT DIMENSION VARIES BY WALL CONSTRUCTION

- SEE FINISH SCHEDULE FOR DOOR AND FRAME FINISHES.
- HARDWARE BY ALLOWANCE. NOT ALL DOOR TYPES OR FRAME TYPES WILL OCCUR IN EACH PROJECT. SEE SCHEDULE AND
- FLOOR PLANS FOR LOCATION AND TYPES OF DOORS. PROVIDE FRAMING ANCHORS AS REQUIRED BY WALL CONSTRUCTION

#### WINDOW SCHEDULE NOTES

- PROVIDE TEMPERED GLASS AT ALL LOCATIONS REQUIRED BY CODE
- -WITHIN 24" OF A DOOR AND WITHIN 60" OF WALKING SURFACE
- -GREATER THAN 9 SF WITH BOTTOM LESS THAN 18" ABOVE THE FLOOR SEE PLAN A101 FOR LOCATION & QUANTITY OF TYPES
- FIELD VERIFY ROUGH OPENING DIMENSIONS, DIMENSIONS SHOWN ARE NOMINAL

	GL	AZING SCHEDULE NOTES
MARK	THICKNESS	DESCRIPTION
CG-T	1/4"	CLEAR GLASS - TEMPERED
FL	1/4"	FIRELITE GLASS
MG	1/4"	ONE WAY MIRROR GLASS
LEC	1-5/16"	LOW-E CLEAR INSULATED GLASS
LEC-T	1-5/16"	LOW-E CLEAR INSULATED GLASS - TEMPERED
LEC-IM	1-5/16"	LOW-E CLEAR INSULATED GLASS - IMPACT RESISTANT GLAZING AND TEMPERED GLASS SACRIFICIAL EXTERIOR GLASS
LET	1-5/16"	LOW-E TINTED INSULATED GLASS
LET-T	1-5/16"	LOW-E TINTED INSULATED GLASS - TEMPERED
LET-IM	1-5/16"	LOW-E TINTED INSULATED GLASS - IMPACT RESISTANT GLAZING AND TEMPERED GLASS SACRIFICIAL EXTERIOR GLASS
SP-IM	1-5/16"	SPANDREL GLASS - IMPACT RESISTANT GLAZING
Т	1/4"	TEMPERED GLASS
TG	1/4"	TINTED GLASS
TG-T	1/4"	TINTED GLASS - TEMPERED
WG	1/4"	WIRED GLASS - ORTHOGONAL ORIENTATION

- DOORS TO BE FACTORY FINISHED WITH PAINTED FRAME, UNLESS NOTED OTHERWISE UNDER FINISH NOTES
- FOR CLARIFICATION OF FINISHES WHERE CASEWORK, BUILT-INS OR SPECIAL TREATMENTS OCCUR, REFER
- ALL MISCELLANEOUS GRILLES, DIFFUSER, PLATES, ETC. OCCURRING ON WALLS AND / OR CEILINGS ARE TO BE FINISHED TO MATCH THE WALL OR CEILING ON WHICH THEY OCCUR.
- OF UNIFORM FINISH, COLOR, AND APPEARANCE. UNLESS OTHERWISE INDICATED ON THE DRAWINGS OR IN THE SPECIFICATIONS, EGGSHELL FINISH/LATEX AT TYPICAL WALLS/OR FLAT FINISH/LATEX AT TYPICAL CEILINGS. SEMI-GLOSS FINISH/ALKYD AT TRIM AT ALL
- PAINTED/STAINED SAME AS FACE IN WHICH DOOR OPENS. ALL MATERIALS AND SURFACES WHICH ARE TO RECEIVE A STAINED FINISH SHALL BE STAINED TO MATCH
- PROCEEDING WITH THE STAINING AND FINISHING OF ANY ITEM. COLOR FINISH AND MATERIAL FOR COMPLETED WORK SHALL MATCH THAT OF THE APPROVED SAMPLE.
- PROTECTION AS SET FORTH BY IBC 2018. D. CLASSIFICATION OF INTERIOR WALL AND CEILING FINISH SHALL BE CLASS B MATERIAL OR BETTER WITH AN APPROVED FLAME SPREAD INDEX NOT TO EXCEED 75 AND SMOKE DENSITY SHALL NOT BE GREATER THAN
- 450 WHEN TESTED IN ACCORDANCE WITH ASTM E84 IN THE WAY INTENDED FOR USE. 1. PAINT INTERIOR SURFACES OF DUCTWORK WHICH IS EXPOSED TO VIEW 'FLAT BLACK'. 2. NO INTERIOR FINAL PAINTING IS TO COMMENCE UNTIL THE FACILITY IS WEATHER-TIGHT AND ENVIRONMENTALLY CONDITIONED. THIS SUPERSEDES THE PAINTING MANUFACTURER'S

											DOC	RS SC	HEDU	ILE							
			DOC	R PANE	L					F	RAME						HARD	WARE			П
		SIZE	•						SIZ	ZE			DI	ETAI	L	BEL		_			
MARK PANEL TYPE	WIDTH	НЕІСНТ	THICKNESS	MATL	FIN	GLAZING	DP RATING	FRAME TYPE	FRAME WIDTH	FRAME HEIGHT	MATL	N	HEAD	JAMB	SILL	FIRE RATING LA	SET NO	KEYSIDE RM NO	COMMENTS	MARK	Н
101 F-1	3'-0"	7'-0"	1 3/4"	EX WD	EX ST			FM-1	3'-4"	7'-2"	EX HM	PT							EXISTING DOOR WITH NEW PANIC HARDWARE	101	
102 F-1	3'-0"	7'-0"	1 3/4"	EX WD	EX ST			FM-1	3'-4"	7'-2"	EX HM	PT							RELOCATED DOOR, DOOR FRAME, MARBLE THRESHOLD AND HARDWARE	102	H
103A F-1	3'-0"	7'-0"	1 3/4"	EX WD	EX ST			FM-1	3'-4"	7'-2"	EX HM	PT							EXISTING DOOR WITH NEW PANIC HARDWARE	103A	П
103B F-1	3'-0"	7'-0"	1 3/4"	EX WD	EX ST			FM-1	3'-4"	7'-2"	EX HM	PT							RELOCATED DOOR, DOOR FRAME AND HARDWARE	103B	
104 F-1	3'-0"	7'-0"	1 3/4"	EX WD	EX ST			FM-1	3'-4"	7'-2"	EX HM	PT							RELOCATED DOOR, DOOR FRAME AND HARDWARE	104	
105 F-1	3'-0"	7'-0"	1 3/4"	EX WD	EX ST			FM-1	3'-4"	7'-2"	EX HM	PT							RELOCATED DOOR, DOOR FRAME AND HARDWARE	105	
	3'-0"			EX WD	EX ST			FM-1	3'-4"	7'-2"	EX HM	PT							RELOCATED DOOR, DOOR FRAME AND HARDWARE	106	Ш
	3'-0"			EX WD	EXST	T DOOR E	PAMES	FM-1	3'-4"	7'-2"	EX HM	PT							RELOCATED DOOR, DOOR FRAME AND HARDWARE	108	Ш
NOTE. CLE	MIN EVI	STING	STAINE	D DOORS AI	ND NEFAIN	I DOON FI	IMIVIES													I	

		WINDOW SCHEDULE													
울 SIZE							AME			DETAIL					
	\RK	PE MAI	HTO	IGHT	보	\TL	7	AZ	AD	MB	7	OTES	ARK		
	Ž	₽	⋝	里	■S	Ž		ฮ	뽀	₹	SIIS	N S	<b>\S</b>		
ı	1	W-1	2'-0"	4'-0"	3'-0"	НМ	PT	Т				SLIDING WINDOW	1		
1	2	\\/ 1	2'-0"	4'-O"	3'_0"	ни	DT	Т				SLIDING WINDOW	2		

						FINIS	SH SCHEDULE							
	ROOM NAME	FLOOR		WALLS					CEILING		CASEWORK			
<u>Ö</u>		FLOOR	BASE	N	E	S	W							S.
ROOM				MATL	MATL	FIN	FIN	N.	MATL	Z	HORZ	VERT	NOTES	ROOM
101	ENTRY	EX	EX VB	EX	GYP BD	GYP BD	EX		EX					101
102	JANITOR	EX	EX VB	EX	EX	GYP BD MR	CT/PT EX		EX			CT TO N	MATCH EXISTING	102
103	OPEN	CPTS	VB	GYP BD	GYP BD	GYP BD	GYP BD		ACT	FF				103
104	RECEPTION	CPTS	VB	GYP BD	GYP BD	GYP BD	EX		ACT	FF				104
105	BUILDING OFFICIAL OFFICE	EX CPT	EX VB	GYP BD	EX	EX	EX		EX					105
106	OFFICE	EX CPT	EX VB	GYP BD	EX	EX	EX		EX					106
107	PLANNING OFFICE	EX CPT	EX VB	EX	EX	EX	EX		EX					107
108	OFFICE	CPTS	VB	GYP BD	EX	GYP BD	GYP BD		ACT	FF				108
109	OPEN STORAGE	CPTS	VB	EX	EX		EX		ACT	FF				109
110	STAFF TOILET	CT	СТВ	GYP BD MR CT/F	T GYP BD MR	CT/PT GYP BD MR	CT/PT GYP BD M	R CT/PT	EX			NEW MA	ARBLE THRESHOLD MATCH EXISTING	110

FINISH DESCRIPTIONS

MANUFACTURER

--

MATERIAL

CARPET SQUARES

CERAMIC TILE BASE

ACOUSTICAL CEILING TILE

VINYL BASE

CERAMIC TILE

ITEM NO.

FLOOR

CPTS


CTB

BASE

WALL

CEILING

NOTE: ALL INTERIOR PAINTING TO BE UNDER SEPARATE AGREEMENT

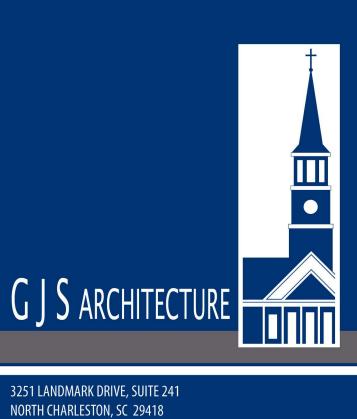

NORTH CHARLESTON, SC 29418 843-722-4334 (T) 843-722-4135 (F)

INTERIOR UPFIT FOR: HANAHAN CITY HALL

1255 YEAMANS HALL RD HANAHAN, SC 29410



ROOM ORIENTATION LEGEND

NORTH

ROOM

SOUTH

DESCRIPTION

TO BE SELECTED

MATCH EXISTING


MATCH EXISTING

MATCH EXISTING

MATCH EXISTING

PRODUCT

| --

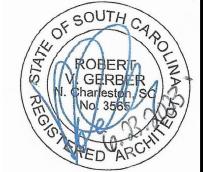

REVISIONS MARK DATE DESCRIPTION PROJECT NO: 2022.04.11 DATE: 06.23.2023 DRAWN BY: CA

PHASE: CONSTRUCTION DOCUMENTS DRAWING TITLE

CHECKED BY: RVG

DRAWING NUMBER

SCHEDULES AND TYPES

PERMITTING & CONSTRUCTION

TG	1/4"	TINTED GLASS						
TG-T	1/4"	TINTED GLASS - TEMPERED						
WG	1/4"	WIRED GLASS - ORTHOGONAL ORIENTATION						
FINISH NOTES								
1. INTERIOR FINISH SPECIFICATIONS ARE INCLUDED. ANY QUESTIONS REGARDING THE SPECIFICATIO								

WHICH REQUIRE CLARIFICATION, CONSULT THE ARCHITECT BEFORE PROCEEDING. AN OWNER/ARCHITECT/CONTRACTOR PRE-FINISH MEETING SHALL BE HELD PRIOR TO ORDERING OR

COLUMN ON FINISH SCHEDULE. IN SITUATIONS WHERE FRAMES ARE DIFFERENT COLORS AT A DOORWAY,

DOORS ARE TO BE PAINTED/STAINED TO MATCH COORDINATING FRAME. TO THE ELEVATIONS AND DETAILS.

ALL PAINTED SURFACES ARE TO RECEIVE ONE PRIME AND A MINIMUM OF TWO FINISH COATS. PRIME ALL SURFACES ACCORDING TO MANUFACTURER'S SPECIFICATIONS PRIOR TO APPLICATION OF PAINT. THE NUMBER OF COATS SPECIFIED IS THE MINIMUM NUMBER REQUIRED; APPLY ADDITIONAL WHEN UNDERCOATS, STAINS OR OTHER CONDITIONS SHOW THROUGH FINAL COAT OF PAINT UNTIL PAINT FILM IS

AREAS THROUGHOUT. SEMI-GLOSS FINISH/ALKYD BASE AT MILLWORK, WOOD AND METAL TRIM.

SAMPLES PROVIDED BY THE DESIGNER. CONTRACTOR SHALL PREPARE A SAMPLE OF EACH STAINED FINISH ON THE APPROPRIATE MATERIAL AND SUBMIT THAT SAMPLE TO THE DESIGNER FOR APPROVAL PRIOR TO

WHERE SOFFIT OCCURS, PAINT THE UNDERSIDE SAME COLOR AS CEILING, UNLESS OTHERWISE NOTED. INTERIOR WALL AND CEILING FINISH SHALL CONFORM TO THE FIRE RESISTANT STANDARDS FOR FIRE

3. PROVIDE SMOOTH, NON-ABSORBENT WALL FINISH AT WET WALLS PER IBC 1210.2