



**ENGINEER**  
DEPARTMENT OF  
ENVIRONMENTAL SERVICES


FACILITIES & ENGINEERING DIVISION  
ENGINEERING BUREAU  
2100 CLARENDON BOULEVARD, SUITE 813  
ARLINGTON, VA 22201  
PHONE: 703.228.3629 FAX: 703.228.3606  
WWW.ARLINGTONVA.US

**OWNER**  
DEPARTMENT OF  
ENVIRONMENTAL SERVICES

DIVISION OF TRANSPORTATION & DEVELOPMENT  
TRANSPORTATION PLANNING  
2100 CLARENDON BOULEVARD, SUITE 900,  
ARLINGTON, VA 22201  
PHONE: 703.228.3681 FAX: 703.228.7584  
WWW.ARLINGTONVA.US

**CONTRACTOR**  
TO BE DETERMINED

## LOCATION MAP

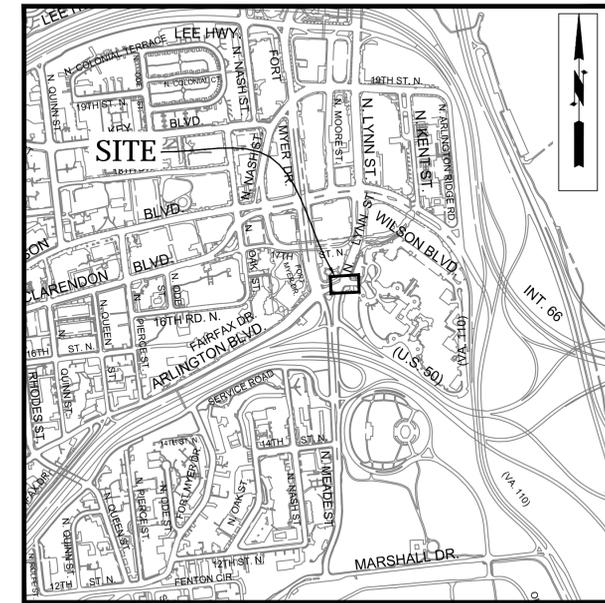


0 600' 1200'  
GRAPHIC SCALE



DEPARTMENT OF  
ENVIRONMENTAL SERVICES  
FACILITIES & ENGINEERING DIVISION  
ENGINEERING BUREAU  
2100 CLARENDON BOULEVARD, SUITE 813  
ARLINGTON, VA 22201  
PHONE: 703.228.3629  
FAX: 703.228.3606

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SEAL

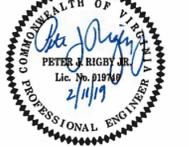

APPROVALS DATE

*[Signature]* 2/19/19  
QUALITY CONTROL ENGINEER  
*[Signature]* 2/15/19  
CONSTRUCTION MANAGEMENT SUPERVISOR  
*[Signature]* 2/19/19  
WATER, SEWER, STREETS BUREAU CHIEF  
*[Signature]* 2/12/19  
TRANSPORTATION DIRECTOR  
*[Signature]* 2/12/19  
PROJECT MANAGER

REVISIONS DATE

# CONSTRUCTION DRAWINGS FOR: FAIRFAX DR. & N. LYNN ST. SE CORNER AT INTERSECTION

PROJECT CODE: P14D

## GENERAL NOTES:

### GENERAL CONSTRUCTION NOTES

- ALL CONSTRUCTION WORK FOR THIS PROJECT SHALL CONFORM TO THE ARLINGTON COUNTY DEPARTMENT OF ENVIRONMENTAL SERVICES, CONSTRUCTION STANDARDS AND SPECIFICATIONS, AND WHERE APPLICABLE THE VIRGINIA DEPARTMENT OF TRANSPORTATION (VDOT) ROAD AND BRIDGE SPECIFICATIONS, AND ROAD AND BRIDGE STANDARDS. THE LATEST EDITIONS OF EACH RELEVANT MANUAL SHALL BE USED.
- ALL CONSTRUCTION AND WORK ACTIVITIES SHALL COMPLY WITH THE VIRGINIA WORK AREA PROTECTION MANUAL AND ALL OTHER RELEVANT WORK SAFETY REQUIREMENTS, LATEST EDITIONS.
- THE CONTRACTOR SHALL IMMEDIATELY NOTIFY THE PROJECT OFFICER OF ANY DISCREPANCIES BETWEEN ACTUAL FIELD CONDITIONS AND THE APPROVED PLANS.
- THE CONTRACTOR SHALL CONTACT "MISS UTILITY" AT 811 FOR MARKING THE LOCATIONS OF EXISTING UNDERGROUND UTILITIES (i.e. WATER, SEWER, GAS, TELEPHONE, ELECTRIC, AND CABLE TV) AT LEAST 72 HOURS PRIOR TO ANY EXCAVATION OR CONSTRUCTION. THE CONTRACTOR IS REQUIRED TO IDENTIFY AND PROTECT ALL OTHER UTILITY LINES FOUND IN THE WORK SITE AREA BELONGING TO OTHER OWNERS THAT ARE NOT MEMBERS OF "MISS UTILITY". PRIVATE WATER, SEWER AND GAS LATERALS WILL NOT BE MARKED BY MISS UTILITY OR THE COUNTY. THE CONTRACTOR SHALL LOCATE AND PROTECT THESE SERVICES DURING CONSTRUCTION.
- THE CONTRACTOR SHALL BE RESPONSIBLE FOR LAYING OUT THE WORK AND SHALL RETAIN A PROFESSIONAL LAND SURVEYOR LICENSED IN THE COMMONWEALTH OF VIRGINIA TO PROVIDE ALL NECESSARY CONSTRUCTION LAYOUTS AND ESTABLISH ALL CONTROL LINES, GRADES, AND ELEVATION DURING CONSTRUCTION. THE CONTRACTOR SHALL SUBMIT A COPY OF ALL CUT SHEETS FOR REVIEW, PER THE SPECIFICATIONS. THE COST OF ALL NECESSARY SURVEYING SERVICES SHALL BE CONSIDERED INCIDENTAL TO THE WORK AND, UNLESS OTHERWISE SPECIFIED, THE COST SHALL BE INCORPORATED INTO THE COSTS FOR RELEVANT ITEMS.
- THE LOCATION OF ALL EXISTING UTILITIES SHOWN ON THESE PLANS ARE FROM BEST AVAILABLE RECORDS AND SHALL BE CONSIDERED TO BE APPROXIMATE. WHEN CONSTRUCTION ACTIVITY REACHES IN PROXIMITY TO EXISTING UTILITIES, THE TRENCHES SHALL BE OPENED A SUFFICIENT DISTANCE AHEAD OF THE WORK OR TEST PITS SHALL BE MADE TO VERIFY THE EXACT LOCATION AND INVERTS OF THE UTILITY TO ALLOW FOR POSSIBLE CHANGES IN THE LINE OR GRADE AS DIRECTED BY OFFICER. THE CONTRACTOR SHALL BE RESPONSIBLE FOR ANY DAMAGE TO THE EXISTING UTILITIES AND THE RELATED STRUCTURES. ALL EXISTING UTILITY SYSTEMS SHALL BE PROTECTED TO PREVENT DAMAGE DURING THE CONTRACTOR'S OPERATIONS. ANY SYSTEM DAMAGED SHALL BE PROMPTLY REPAIRED AT NO COST TO THE OWNER.
- EXISTING MANHOLE FRAMES, COVERS, VALVE BOXES, AND OTHER APPURTENANCES SHALL BE ADJUSTED TO THE FINAL GRADE OR REPLACED, AS NECESSARY. UNLESS OTHERWISE SPECIFIED, THE COST FOR THIS SHALL BE CONSIDERED INCIDENTAL TO THE WORK, AND SHALL BE INCORPORATED INTO THE COSTS FOR RELEVANT ITEMS.
- THE CONTRACTOR SHALL PROVIDE ADA COMPLIANT ACCESS THROUGH OR AROUND THE SITE AT ALL TIMES AND SHALL ENSURE THE SAFETY OF ALL THOSE PASSING THROUGH OR ADJACENT TO THE SITE.

### STORMWATER AND ENVIRONMENTAL PROTECTION

- THE CONTRACTOR SHALL CONFINE ALL ACTIVITIES AT THE SITE ASSOCIATED WITH CONSTRUCTION ACTIVITIES, TO INCLUDE STORAGE OF EQUIPMENT AND OR MATERIALS, ACCESS TO THE WORK, FORMWORK, ETC. TO WITHIN THE DESIGNATED LIMITS OF DISTURBANCE (LOD).

### TREE PROTECTION

- TREES SHALL BE PROTECTED PER THE REQUIREMENTS OF ARLINGTON PARKS & RECREATION STANDARD.

### TRAFFIC CONTROL

- CONTRACTOR SHALL NOTIFY THE PROJECT OFFICER AT LEAST 3 WORKING DAYS PRIOR TO DISTURBING ANY EXISTING, OR INSTALLING ANY NEW, TRAFFIC SIGNS, SIGNALS, OR OTHER TRAFFIC CONTROL DEVICES.
- THE CONTRACTOR SHALL PREMARK THE LAYOUT OF ANY PERMANENT TRAFFIC CONTROL STRIPING, INDICATING THE PROPOSED LOCATION AND TYPE OF MARKING TO BE INSTALLED. THE PREMARKING MAY CONSIST OF TYPE D TAPE, CHALK, OR LUMBER CRAYONS. THE CONTRACTOR SHALL ALLOW 3 WORKING DAYS FOR THE INSPECTION AND APPROVAL OF THE PREMARKINGS PRIOR TO PLACING THE PERMANENT MARKINGS.
- THE CONTRACTOR SHALL SUBMIT ANY REQUESTS FOR TEMPORARY "NO PARKING" RESTRICTIONS TO THE PROJECT OFFICER AT LEAST 3 WORKING DAYS PRIOR TO THE DESIRED ONSET OF RESTRICTIONS.
- THE CONTRACTOR SHALL PRESERVE ALL BUS STOPS, INCLUDING MAINTAINING ADEQUATE ACCESSIBILITY THROUGH AND ADJACENT TO THE CONSTRUCTION FOR BUSES AND THEIR PASSENGERS. THE CONTRACTOR SHALL NOT CLOSE, RELOCATE, OR OTHERWISE MODIFY A BUS STOP WITHOUT PRIOR REQUEST OF THE PROJECT OFFICER. TYPICALLY ANY RELOCATION OR CLOSURE OF A BUS STOP WILL REQUIRE AT LEAST FOUR WEEKS ADVANCE NOTICE FOR COORDINATION WITH THE COUNTY'S BUS STOP COORDINATOR. ALL TEMPORARY AND FINAL BUS TRAVEL LANES MUST BE MINIMUM 11' WIDE
- WHEN CONDITIONS WARRANT DUE TO TRAFFIC VOLUMES, PATTERNS, OR SPECIAL EVENTS, THE COUNTY MAY SUSPEND OR OTHERWISE DIRECT THE CONTRACTOR'S ACTIVITIES TO PROTECT THE PUBLIC AND OR THE COUNTY'S TRANSPORTATION NETWORK.

### WATER DISTRIBUTION, STORM, AND SANITARY SEWER SYSTEMS

- UNLESS OTHERWISE DIRECTED, CONTRACTORS ARE EXPRESSLY PROHIBITED FROM OPERATING ANY WATER VALVES OR APPURTENANCES. CONTRACTORS SHALL SUBMIT ALL REQUESTS FOR VALVE OPERATIONS TO THE PROJECT OFFICER AT LEAST 3 WORKING DAYS IN ADVANCE OF THE REQUIRED OPERATION.
- IN THE EVENT OF A WATER OR SEWER EMERGENCY, THE CONTRACTOR SHALL IMMEDIATELY NOTIFY THE COUNTY'S WATER CONTROL CENTER AT 703-228-5555 AND THE PROJECT OFFICER.

## TABLE OF CONTENTS

| SHEET NUMBER | SHEET TITLE                       |
|--------------|-----------------------------------|
| 1            | COVER SHEET                       |
| 2            | LEGEND                            |
| 3            | DETAILS SHEET                     |
| 4            | EXISTING CONDITION                |
| 5            | DEMOLITION PLAN                   |
| 6            | EROSION AND SEDIMENT CONTROL PLAN |
| 7            | GEOMETRIC CONTROL                 |
| 8            | PLAN AND PROFILE                  |
| 9            | RAMP DETAIL                       |
| 10           | CROSS SECTIONS                    |
| 11           | SIGNAGE AND STRIPING              |
| 12           | MOT_PLAN I                        |
| 13           | MOT_PLAN II                       |

## ADT

3,900 - VPD FAIRFAX DRIVE - 2017 - TE & O  
21,000 - VPD N. LYNN ST. 2017 - TE & O

## STREET CLASSIFICATION

PRINCIPAL ARTERIAL N. LYNN ST. 25 MPH  
NEIGHBORHOOD PRINCIPAL FAIRFAX DRIVE 25 MPH

MAINTAINING AGENCY : ARLINGTON COUNTY

## POSTED/ DESIGN SPEED

25 MPH - FAIRFAX DRIVE  
25 MPH - N. LYNN ST.

## DESIGN VEHICLE

2011 AASHTO CITY BUS

AUTOTURN (TURNING MOVEMENT) USED SPEED: 10MPH

FAIRFAX DR. & N. LYNN ST.

COVER SHEET

FAIRFAX DR. & N. LYNN ST.  
SE CORNER AT INTERSECTION

DESIGNED: K. PATEL  
DRAWN : K. PATEL  
CHECKED : P. RIGBY  
MISS UTILITY TRANSMITTAL #: N/A

FILENAME: P14D\_B-4-200 COVER.DWG  
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PATH: FAIRFAX DR & N LYNN STREET\CAD FILES\ACTIVE


PLOTTED: JANUARY 30 2019

PLOTTED BY: RPATEL

SCALE: AS NOTED

SHEET 1 OF 13

**SEAL**

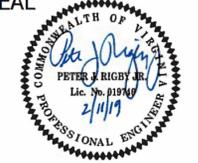

| APPROVALS                          | DATE    |
|------------------------------------|---------|
| <i>[Signature]</i>                 | 2/14/19 |
| QUALITY CONTROL ENGINEER           |         |
| <i>[Signature]</i>                 | 2/15/19 |
| CONSTRUCTION MANAGEMENT SUPERVISOR |         |
| <i>[Signature]</i>                 | 2/19/19 |
| WATER, SEWER, STREETS BUREAU CHIEF |         |
| <i>[Signature]</i>                 | 2/19/19 |
| TRANSPORTATION DIRECTOR            |         |
| <i>[Signature]</i>                 | 2/19/19 |
| PROJECT MANAGER                    |         |

| REVISIONS | DATE |
|-----------|------|
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**FAIRFAX DR. & N. LYNN ST.**  
**LEGEND**  
**FAIRFAX DR. & N. LYNN ST.**  
**SE CORNER AT INTERSECTION**  
P14D

DESIGNED: K. PATEL  
 DRAWN : K. PATEL  
 CHECKED : P. RIGBY  
 MISS UTILITY TRANSMITTAL #: N/A  
 FILENAME: P14D-B-4-202-LEGEND.DWG  
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 PATH: FAIRFAX DR & N LYNN STREET CAD FILES\ACTIVE  
 PLOTTED: JANUARY 30 2019  
 PLOTTED BY: KPATEL

**SCALE: AS NOTED**

**LINETYPE LEGEND**

| FEATURE  | EXISTING                    | PROPOSED                    |
|--|-----------------------------|-----------------------------|
| BACK OF CURB                                   | ---                         | ---                         |
| BUILDING                                       | ---                         | ---                         |
| CENTERLINE / BASELINE                          | ---                         | ---                         |
| COMMUNICATIONS CABLE                           | --- COM ---                 | --- COM ---                 |
| CONTOURS                                       | --- 250 --- 250 --- 250 --- | --- 250 --- 250 --- 250 --- |
| CRITICAL ROOT ZONE                             | --- CRZ --- CRZ ---         | --- CRZ --- CRZ ---         |
| EASEMENT                                       | ---                         | ---                         |
| ELECTRIC (UNDERGROUND)                         | --- UGE --- UGE ---         | ---                         |
| FACE OF CURB                                   | ---                         | ---                         |
| FENCE (MATERIAL NOTED)                         | -X-X-X-X-X-                 | -X-X-X-X-X-                 |
| FIBER OPTIC                                    | ---                         | ---                         |
| GAS LINE                                       | --- GAS --- GAS ---         | --- GAS --- GAS ---         |
| X" GAS LINE (SIZE INCLUDED IF AVAILABLE)       | --- X" G --- X" G ---       | --- X" G --- X" G ---       |
| GUARDRAIL                                      | o-o-o-o-o-o                 | o-o-o-o-o-o                 |
| HARDSCAPE FEATURE (MATERIAL NOTED)             | ---                         | ---                         |
| LIMITS OF DISTURBANCE                          | --- LOD ---                 | --- LOD ---                 |
| LIMITS OF WORK                                 | --- LOW --- LOW ---         | --- LOW --- LOW ---         |
| OVERHEAD WIRES                                 |                             |                             |
| PAVEMENT MINI SKIP LINE                        | ---                         | ---                         |
| PAVEMENT SKIP LINE                             | ---                         | ---                         |
| PROPERTY LINE                                  | ---                         | ---                         |
| RIGHT-OF-WAY LINE                              | ---                         | ---                         |
| ROOT PRUNING                                   | --- RP --- RP ---           | --- RP --- RP ---           |
| SANITARY SEWER                                 | ---                         | --- SAN --- SAN ---         |
| X" SANITARY SEWER (SIZE INCLUDED IF AVAILABLE) | --- X" S --- X" S ---       | ---                         |
| SILT FENCE                                     | --- SF --- SF ---           | --- SF --- SF ---           |
| STORM (SIZE NOTED)                             | ---                         | ---                         |
| STREAM   | ---                         | ---                         |
| STREET LIGHT CONDUIT                           | --- SL --- SL ---           | --- SL --- SL ---           |
| TELEPHONE (UNDERGROUND)                        | --- UGT ---                 | --- UGT ---                 |
| TREE LINE                                      | ---                         | ---                         |
| TREE PROTECTION FENCE                          | --- TPF --- TPF ---         | --- TPF --- TPF ---         |
| WALL   | ---                         | ---                         |
| WATER  | ---                         | ---                         |
| X" WATER (SIZE INCLUDED IF AVAILABLE)          | --- X" W --- X" W ---       | --- X" W --- X" W ---       |

**SYMBOL LEGEND**


| EXISTING  | PROPOSED                                     |
|---|--|
| EX BENCHMARK  | PROP FIRE HYDRANT                            |
| EX CABLE PEDESTAL                                       | PROP GAS VALVE                               |
| EX ELECTRIC BOX   | PROP LIGHT POLE                              |
| EX FIRE HYDRANT   | PROP PAY STATION                             |
| EX GAS VALVE  | PROP SANITARY MANHOLE                        |
| EX GROUND LIGHT   | PROP STORM CATCH BASIN (TO SCALE)            |
| EX GUY WIRES  | PROP STORM MANHOLE                           |
| EX IRON PIPE OR PIN                                     | PROP TRAFFIC SIGN                            |
| EX LIGHT POLE   | PROP TRASH CAN                               |
| EX MAILBOX  | PROPOSED TREE REMOVAL                        |
| EX MONUMENT   | PROP UTILITY POLE                            |
| EX PARKING METER  | PROP WATER MANHOLE                           |
| EX PAY STATION  | PROP WATER METER                             |
| EX SANITARY MANHOLE                                     | PROP WATER VALVE                             |
| EX STORM BASIN  | PROP YARD INLET (TO SCALE)                   |
| EX STORM MANHOLE  | CONSTRUCTION NOTES (LEADER TO AREA AFFECTED) |
| EX TELEPHONE PEDESTAL                                   | CURVE NUMBER (SEE CURVE TABLE)               |
| EX TRAFFIC CONTROL BOX                                  | LINE NUMBER (SEE LINE TABLE)                 |
| EX TRAFFIC SIGN   | NORTH ARROW                                  |
| EX TRASH CAN  | TEST HOLE                                    |
| EX TRAVERSE   |  |
| EX TREES, WOODED AREA                                   |  |
| EX UTILITY MANHOLE (TYPE INDICATED ELECTRIC, TELE, ETC) |  |
| EX UTILITY POLE   |  |
| EX WATER MANHOLE  |  |
| EX WATER METER  |  |
| EX WATER VALVE  |  |
| EX YARD INLET   |  |

**HATCH LEGEND**

|  |  |
|--|--|
| PROP MILL & OVERLAY (SEE TYPICAL SECTION FOR DETAILS)                  |  |
| PROP FULL DEPTH ASPHALT (SEE TYPICAL SECTION FOR DETAILS)              |  |
| PROP CONCRETE  |  |
| REPLACE & MATCH EXISTING DRIVEWAY OR LEADWALK (SEE CONSTRUCTION NOTES) |  |
| DEMOLITION AREA  |  |

**LABEL LEGEND**

| EXISTING  | PROPOSED  |
|---|---|
| EX SAN STRUC NO. (EXISTING SANITARY STRUCTURE NUMBER)         | PROP SAN SEW STRUC NO. (PROPOSED SANITARY SEWER STRUCTURE NUMBER) |
| EX STRM SEW STRUC NO. (EXISTING STORM SEWER STRUCTURE NUMBER) | PROP STRM SEW STRUC NO. (PROPOSED STORM SEWER STRUCTURE NUMBER)   |

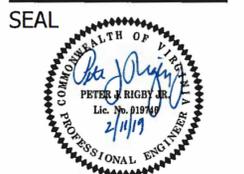


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|------------------------------------|---------|
| <i>[Signature]</i>                 | 2/14/19 |
| QUALITY CONTROL ENGINEER           |         |
| <i>[Signature]</i>                 | 2/15/19 |
| CONSTRUCTION MANAGEMENT SUPERVISOR |         |
| <i>[Signature]</i>                 | 2/19/19 |
| WATER, SEWER, STREETS BUREAU CHIEF |         |
| <i>[Signature]</i>                 | 2/19/19 |
| TRANSPORTATION DIRECTOR            |         |
| <i>[Signature]</i>                 | 2/19/19 |
| PROJECT MANAGER                    |         |

| REVISIONS | DATE |
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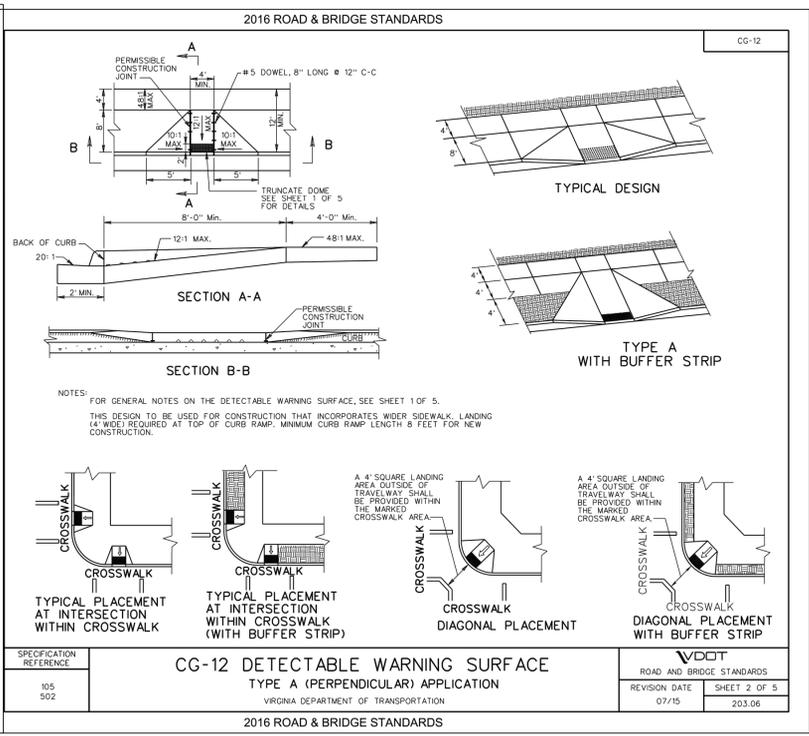
**FAIRFAX DR. & N. LYNN ST.**  
**DETAILS SHEET**  
**FAIRFAX DR. & N. LYNN ST.**  
**SE CORNER AT INTERSECTION**

DESIGNED: K. PATEL  
 DRAWN : K. PATEL  
 CHECKED : P. RIGBY  
 MISS UTILITY TRANSMITTAL #: N/A  
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 PLOTTED: FEBRUARY 4 2019  
 PLOTTED BY: KPATEL


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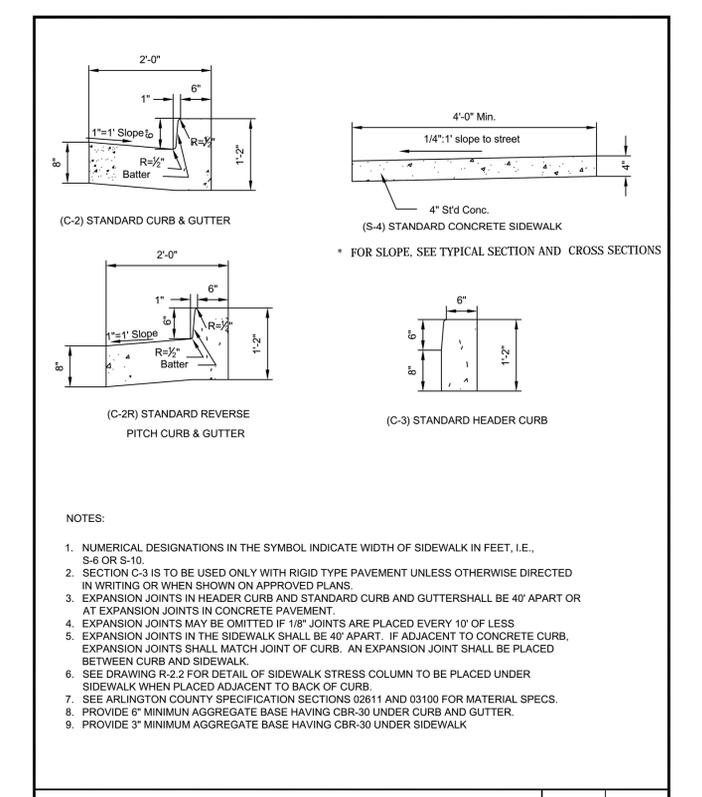
- NOTES:
- ALL PAVEMENTS SHALL BE WIDENED IN ACCORDANCE WITH VDOT STANDARD WP-2. PROPOSED FULL DEPTH PAVEMENT REPLACEMENT SHALL MATCH EXISTING PAVEMENT IN ACCORDANCE WITH VDOT STANDARD WP-2.
  - AGGREGATE SUBBASE THICKNESS BENEATH THE WIDENED PAVEMENT SHALL BE AS INDICATED (6 INCHES) ON THIS SHEET OR MATCH THE EXISTING AGGREGATE BASE MATERIAL, WHICHEVER IS GREATER.
  - PROVIDE 1' WIDE GRADING BENCH BEHIND PROPOSED SIDEWALKS WHEN SPACE ALLOWS.
  - AS INDICATED IN TYPICAL SECTIONS, THE SUBBASE 21-B SHALL BE CONNECTED TO A VDOT STANDARDS UD-4 EDGE DRAIN LOCATED BENEATH THE PROPOSED CURB AND GUTTER, TO BE SECURELY CONNECTED TO OUTFALL AT AN ADJACENT DRAINAGE STRUCTURE.
  - THE ADJACENT TRAVEL LANE SHALL BE MILLED TO A DEPTH OF 2" AND REPLACED WITH 2" ASPHALT CONCRETE TYPE SM-9.5D.
  - 4" MINIMUM, PROVIDED ATTAINING MINIMUM 4" OF AGGREGATE ON TOP OF THE EDGEDRAIN.

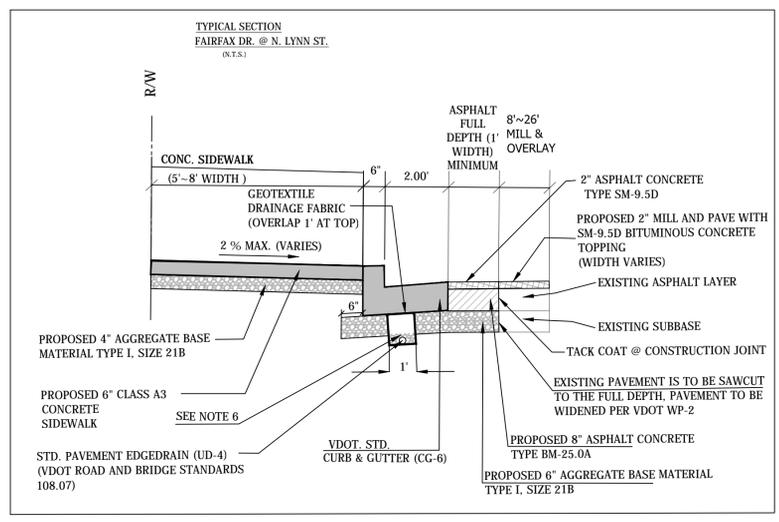


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| ROAD AND BRIDGE STANDARDS | 203.06     |




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| ROAD AND BRIDGE STANDARDS | 203.02 |

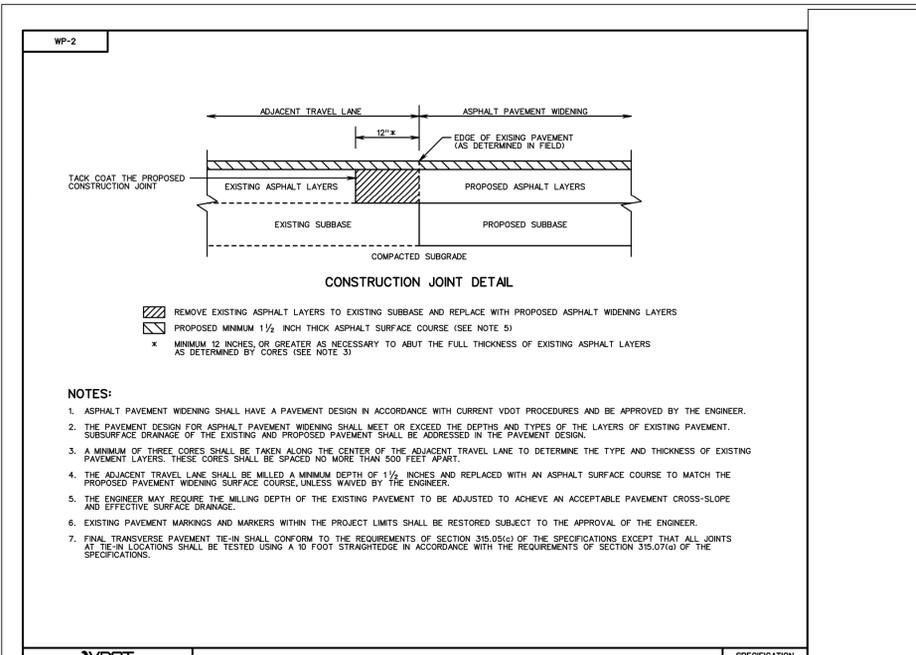


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| ROAD AND BRIDGE STANDARDS | 203.01     |

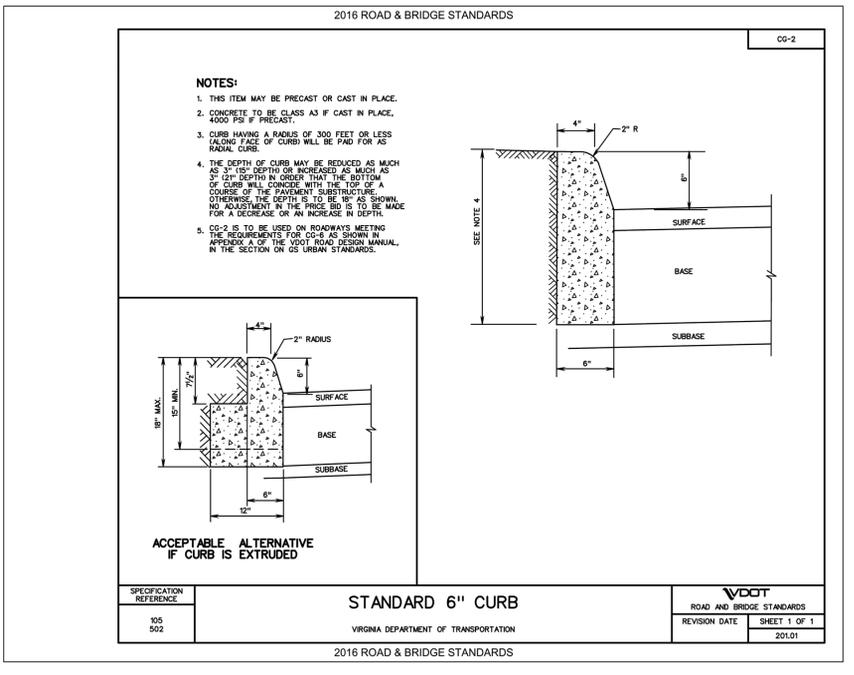

| SPECIFICATION REFERENCE   | 105<br>502 |
|---------------------------|------------|
| ROAD AND BRIDGE STANDARDS | 203.01     |

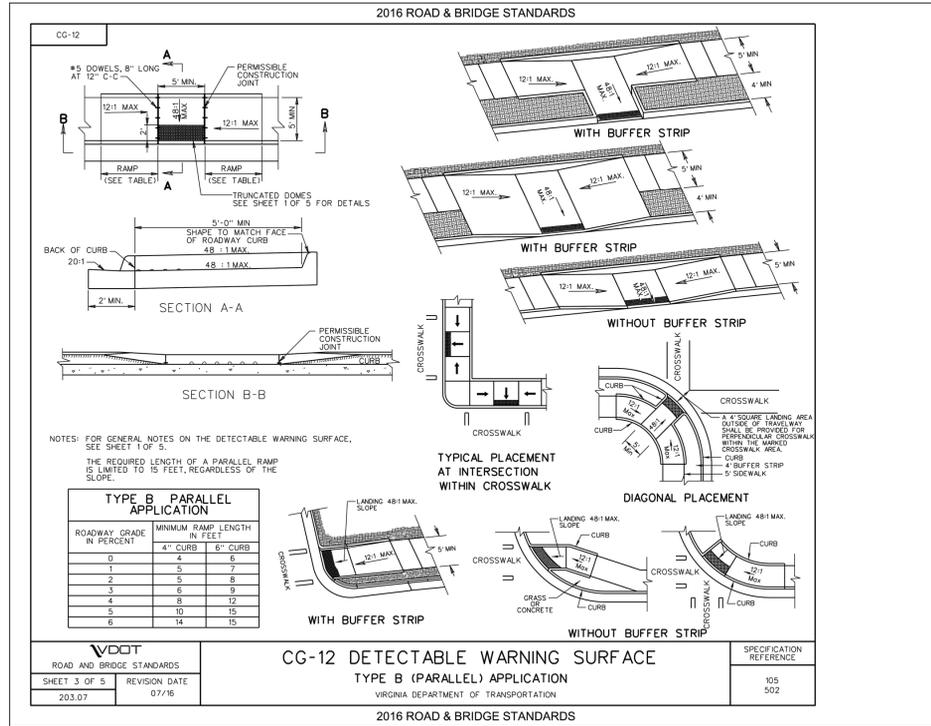

| SPECIFICATION REFERENCE   | 105<br>502 |
|---------------------------|------------|
| ROAD AND BRIDGE STANDARDS | 203.07     |

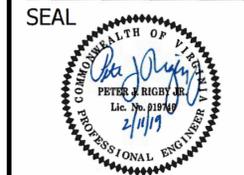

| APPROVALS                          | DATE    |
|------------------------------------|---------|
| QUALITY CONTROL ENGINEER           | 2/14/19 |
| CONSTRUCTION MANAGEMENT SUPERVISOR | 2/15/19 |
| WATER, SEWER, STREETS BUREAU CHIEF | 2/19/19 |
| TRANSPORTATION DIRECTOR            | 2/19/19 |
| PROJECT MANAGER                    | 2/14/19 |


REVISIONS DATE

| REVISIONS | DATE |
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**FAIRFAX DR. & N. LYNN ST.**  
**EXISTING CONDITION**  
**FAIRFAX DR. & N. LYNN ST.**  
**SE CORNER AT INTERSECTION**

DESIGNED: K. PATEL  
DRAWN: K. PATEL  
CHECKED: P. RIGBY  
MISS UTILITY TRANSMITTAL #: N/A  
FILENAME: P14D\_B-4-214-EXISTING-CONDITIONS.DWG  
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PLOTTED: JANUARY 31 2019  
PLOTTED BY: MPATEL

SCALE:

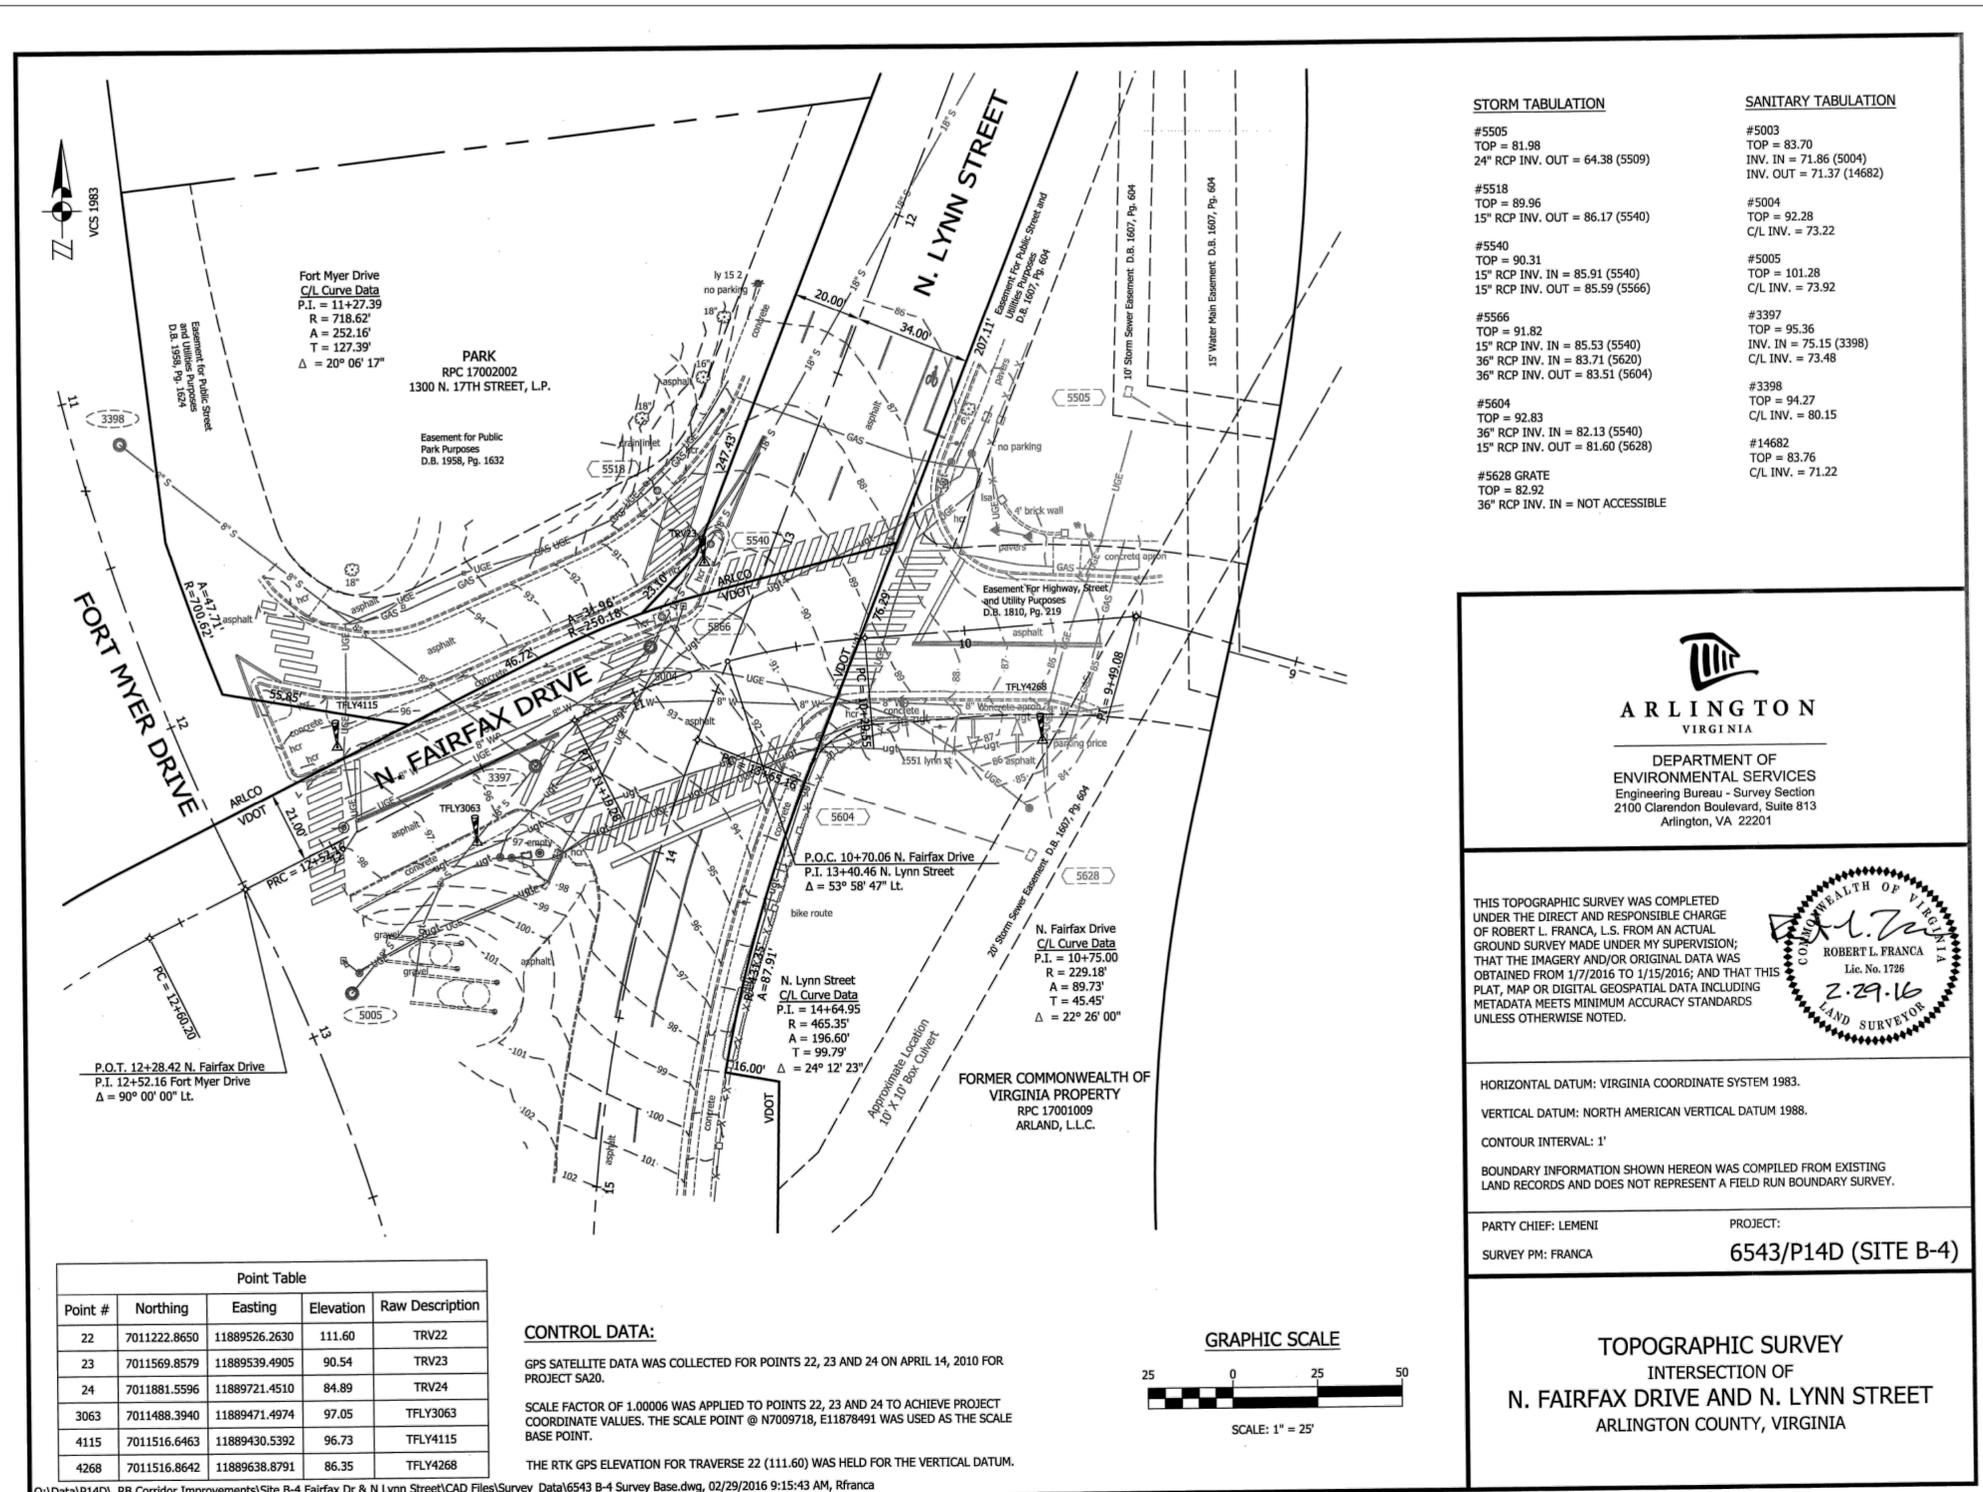


| STORM TABULATION  | SANITARY TABULATION  |
|---|--|
| #5505<br>TOP = 81.98<br>24" RCP INV. OUT = 64.38 (5509)   | #5003<br>TOP = 83.70<br>INV. IN = 71.86 (5004)<br>INV. OUT = 71.37 (14682) |
| #5518<br>TOP = 89.96<br>15" RCP INV. OUT = 86.17 (5540)   | #5004<br>TOP = 92.28<br>C/L INV. = 73.22                                   |
| #5540<br>TOP = 90.31<br>15" RCP INV. IN = 85.91 (5540)<br>15" RCP INV. OUT = 85.59 (5566)                                   | #5005<br>TOP = 101.28<br>C/L INV. = 73.92                                  |
| #5566<br>TOP = 91.82<br>15" RCP INV. IN = 85.53 (5540)<br>36" RCP INV. IN = 83.71 (5620)<br>36" RCP INV. OUT = 83.51 (5604) | #3397<br>TOP = 95.36<br>INV. IN = 75.15 (3398)<br>C/L INV. = 73.48         |
| #5604<br>TOP = 92.83<br>36" RCP INV. IN = 82.13 (5540)<br>15" RCP INV. OUT = 81.60 (5628)                                   | #3398<br>TOP = 94.27<br>C/L INV. = 80.15                                   |
| #5628 GRATE<br>TOP = 82.92<br>36" RCP INV. IN = NOT ACCESSIBLE  | #14682<br>TOP = 83.76<br>C/L INV. = 71.22                                  |

**ARLINGTON**  
VIRGINIA

DEPARTMENT OF ENVIRONMENTAL SERVICES  
Engineering Bureau - Survey Section  
2100 Clarendon Boulevard, Suite 813  
Arlington, VA 22201

THIS TOPOGRAPHIC SURVEY WAS COMPLETED UNDER THE DIRECT AND RESPONSIBLE CHARGE OF ROBERT L. FRANCA, L.S. FROM AN ACTUAL GROUND SURVEY MADE UNDER MY SUPERVISION; THAT THE IMAGERY AND/OR ORIGINAL DATA WAS OBTAINED FROM 1/17/2016 TO 1/15/2016; AND THAT THIS PLAN, MAP OR DIGITAL GEOSPATIAL DATA INCLUDING METADATA MEETS MINIMUM ACCURACY STANDARDS UNLESS OTHERWISE NOTED.

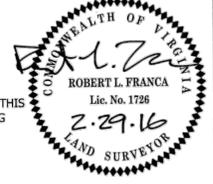


HORIZONTAL DATUM: VIRGINIA COORDINATE SYSTEM 1983.  
VERTICAL DATUM: NORTH AMERICAN VERTICAL DATUM 1988.  
CONTOUR INTERVAL: 1'  
BOUNDARY INFORMATION SHOWN HEREON WAS COMPILED FROM EXISTING LAND RECORDS AND DOES NOT REPRESENT A FIELD RUN BOUNDARY SURVEY.



PARTY CHIEF: LEMENI PROJECT: 6543/P14D (SITE B-4)  
SURVEY PM: FRANCA

**TOPOGRAPHIC SURVEY**  
INTERSECTION OF  
**N. FAIRFAX DRIVE AND N. LYNN STREET**  
ARLINGTON COUNTY, VIRGINIA


| Point # | Northing     | Easting       | Elevation | Raw Description |
|---------|--------------|---------------|-----------|-----------------|
| 22      | 7011222.8650 | 11889526.2630 | 111.60    | TRV22           |
| 23      | 7011569.8579 | 11889539.4905 | 90.54     | TRV23           |
| 24      | 7011881.5596 | 11889721.4510 | 84.89     | TRV24           |
| 3063    | 7011488.3940 | 11889471.4974 | 97.05     | TFLY3063        |
| 4115    | 7011516.6463 | 11889430.5392 | 96.73     | TFLY4115        |
| 4268    | 7011516.8642 | 11889638.8791 | 86.35     | TFLY4268        |

**CONTROL DATA:**  
GPS SATELLITE DATA WAS COLLECTED FOR POINTS 22, 23 AND 24 ON APRIL 14, 2010 FOR PROJECT SA20.  
SCALE FACTOR OF 1.00006 WAS APPLIED TO POINTS 22, 23 AND 24 TO ACHIEVE PROJECT COORDINATE VALUES. THE SCALE POINT @ N7009718, E11878491 WAS USED AS THE SCALE BASE POINT.  
THE RTK GPS ELEVATION FOR TRAVERSE 22 (111.60) WAS HELD FOR THE VERTICAL DATUM.

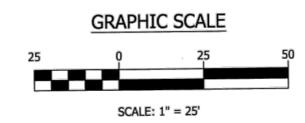

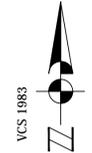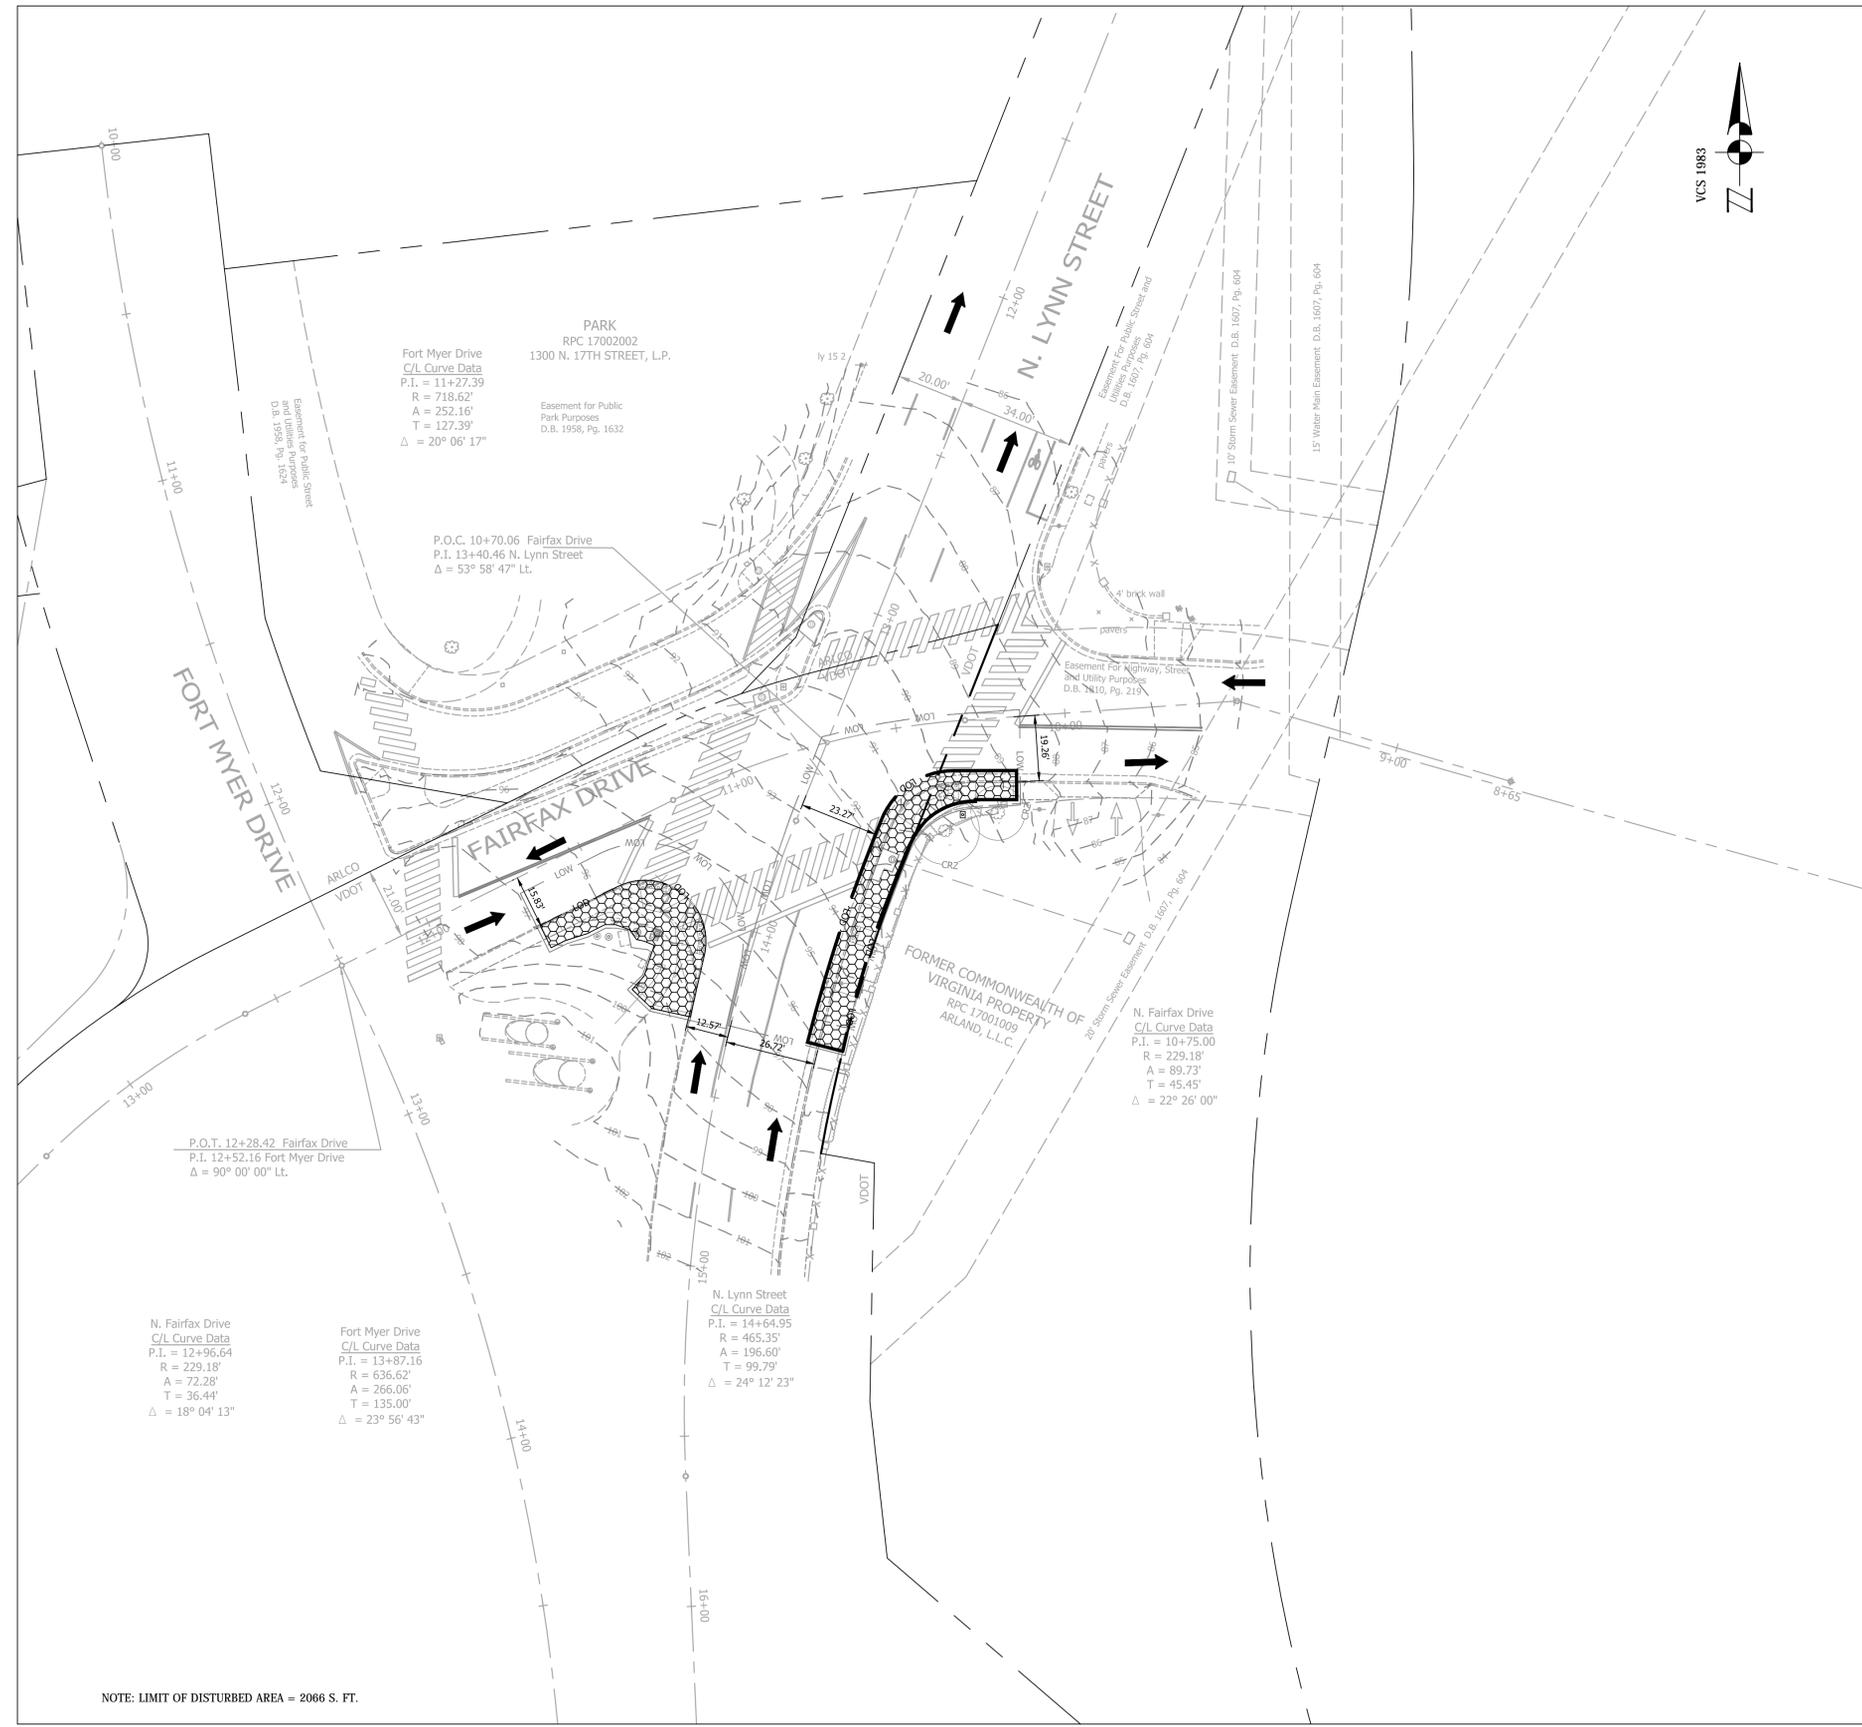

NOTE: LIMIT OF DISTURBED AREA = 2066 S. FT.

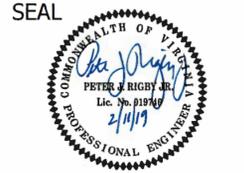


| APPROVALS                          | DATE    |
|------------------------------------|---------|
| <i>[Signature]</i>                 | 2/14/18 |
| QUALITY CONTROL ENGINEER           |         |
| <i>[Signature]</i>                 | 2/15/18 |
| CONSTRUCTION MANAGEMENT SUPERVISOR |         |
| <i>[Signature]</i>                 | 2/17/19 |
| WATER, SEWER, STREETS BUREAU CHIEF |         |
| <i>[Signature]</i>                 | 2/12/19 |
| TRANSPORTATION DIRECTOR            |         |
| <i>[Signature]</i>                 | 2/14/18 |
| PROJECT MANAGER                    |         |

| REVISIONS | DATE |
|-----------|------|
|           |      |
|           |      |
|           |      |
|           |      |
|           |      |

**FAIRFAX DR. & N. LYNN ST.**  
**DEMOLITION PLAN**  
**FAIRFAX DR. & N. LYNN ST.**  
**SE CORNER AT INTERSECTION**  
P.14D

DESIGNED: K. PATEL  
DRAWN : K. PATEL  
CHECKED : P. RIGBY  
MISS UTILITY TRANSMITTAL #: N/A  
FILENAME: P14D-B-4 228- DEMOLITION\_PLAN.DWG  
PATH: Q:\DATA\P14D\_BB CORRIDOR IMPROVEMENTS\SITE B-4 FAIRFAX DR & N LYNN STREET\CAD FILES\ACTIVE  
PLOTTED: FEBRUARY 5 2019  
PLOTTED BY: KPATEL

SCALE: AS NOTED

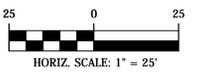



P.O.C. 10+70.06 Fairfax Drive  
 P.I. 13+40.46 N. Lynn Street  
 $\Delta = 53^\circ 58' 47''$  Lt.



| FFX-CONN-VDOT |        |        |                      |                 |               |                           |                         |
|---------------|--------|--------|----------------------|-----------------|---------------|---------------------------|-------------------------|
|               | Length | Radius | Line/Chord Direction | Station (Start) | Station (End) | Northing, Easting (Start) | Northing, Easting (End) |
| C16           | 89.73  | 229.18 | S74° 46' 15.54"W     | 10+29.55        | 11+19.28      | 7011547.25, 11889586.70   | 7011523.83, 11889500.67 |
| C17           | 72.28  | 229.18 | S54° 31' 09.04"W     | 12+60.20        | 13+32.48      | 7011461.07, 11889374.50   | 7011419.29, 11889315.88 |
| C18           | 89.73  | 229.18 | S74° 46' 15.54"W     | 10+29.55        | 11+19.28      | 7011547.25, 11889586.70   | 7011523.83, 11889500.67 |
| L26           | 84.08  |        | N73° 41' 44.46"W     | 8+65.00         | 9+49.08       | 7011529.27, 11889747.67   | 7011552.88, 11889666.97 |
| L27           | 80.47  |        | S85° 59' 15.54"W     | 9+49.08         | 10+29.55      | 7011552.88, 11889666.97   | 7011547.25, 11889586.70 |
| L28           | 140.92 |        | S63° 33' 15.54"W     | 11+19.28        | 12+60.20      | 7011523.83, 11889500.67   | 7011461.07, 11889374.50 |
| L29           | 127.52 |        | S45° 29' 02.54"W     | 13+32.48        | 14+60.00      | 7011419.29, 11889315.88   | 7011329.88, 11889224.95 |

END CONSTRUCTION BL-2  
 MEDIAN EOP STA = 0+86.79 =  
 STA 11+70.60, O/S 15.48' LT.  
 C.L. FFX-CONN-VDOT

END CONSTRUCTION BL- EOP  
 STA = 1+12.51 = STA:  
 10+16.41, O/S 16.73' LT.  
 FAIRFAX DR.

FAIRFAX DR.

FAIRFAX DR.

N. LYNN ST.

BEGIN CONSTRUCTION  
 BL-2 EOP MEDIAN STA:  
 0+03.16 = STA:  
 14+27.77 O/S 12.17' RT.  
 C.L. LYNN-CONN-VDOT

BEGIN CONSTRUCTION BL- EOP STA: 0+0 = STA:  
 14+27.68 O/S 24.27' LT. C.L. LYNN-CONN-VDOT

| Point Table |              |               |           |                 |
|-------------|--------------|---------------|-----------|-----------------|
| Point #     | Northing     | Easting       | Elevation | Raw Description |
| 22          | 7011222.8650 | 11889526.2630 | 111.60    | TRV22           |
| 23          | 7011569.8579 | 11889539.4905 | 90.54     | TRV23           |
| 24          | 7011881.5596 | 11889721.4510 | 84.89     | TRV24           |
| 3063        | 7011488.3940 | 11889471.4974 | 97.05     | TFLY3063        |
| 4115        | 7011516.6463 | 11889430.5392 | 96.73     | TFLY4115        |
| 4268        | 7011516.8642 | 11889638.8791 | 86.35     | TFLY4268        |

| BL LOD LT |        |        |                      |                 |               |                           |                         |
|-----------|--------|--------|----------------------|-----------------|---------------|---------------------------|-------------------------|
|           | Length | Radius | Line/Chord Direction | Station (Start) | Station (End) | Northing, Easting (Start) | Northing, Easting (End) |
| L37       | 3.00   |        | N42° 04' 34.64"E     | 0+00.00         | 0+03.00       | 7011466.75, 11889487.26   | 7011468.98, 11889489.27 |
| L38       | 4.15   |        | N42° 04' 34.64"E     | 0+03.00         | 0+07.15       | 7011468.98, 11889489.27   | 7011472.06, 11889492.05 |
| L39       | 9.59   |        | N18° 29' 38.40"E     | 0+07.15         | 0+16.74       | 7011472.06, 11889492.05   | 7011481.16, 11889495.09 |
| L40       | 3.55   |        | N36° 00' 27.70"W     | 0+22.30         | 0+25.85       | 7011482.91, 11889489.85   | 7011485.78, 11889487.76 |
| L41       | 4.27   |        | N70° 13' 34.98"W     | 0+25.85         | 0+30.12       | 7011485.78, 11889487.76   | 7011487.22, 11889483.74 |
| L42       | 3.10   |        | N89° 25' 38.39"W     | 0+30.12         | 0+33.22       | 7011487.22, 11889483.74   | 7011487.25, 11889480.64 |
| L43       | 6.16   |        | S63° 33' 24.97"W     | 0+33.22         | 0+39.38       | 7011487.25, 11889480.64   | 7011484.51, 11889475.13 |
| L44       | 6.24   |        | S72° 43' 26.81"W     | 0+39.38         | 0+45.62       | 7011484.51, 11889475.13   | 7011482.66, 11889469.17 |
| L45       | 4.75   |        | S63° 57' 13.10"W     | 0+45.62         | 0+50.36       | 7011482.66, 11889469.17   | 7011480.57, 11889464.91 |
| L46       | 2.98   |        | S63° 04' 12.21"W     | 0+50.36         | 0+53.34       | 7011480.57, 11889464.91   | 7011479.23, 11889462.25 |

| LYNN-CONN-VDOT |        |        |                      |                 |               |                           |                         |
|----------------|--------|--------|----------------------|-----------------|---------------|---------------------------|-------------------------|
|                | Length | Radius | Line/Chord Direction | Station (Start) | Station (End) | Northing, Easting (Start) | Northing, Easting (End) |
| C14            | 229.14 | 572.96 | S10° 14' 57.04"W     | 8+38.60         | 10+67.74      | 7012018.06, 11889687.44   | 7011794.07, 11889646.94 |
| C15            | 196.60 | 465.35 | S9° 36' 10.04"W      | 13+65.16        | 15+61.76      | 7011517.74, 11889536.94   | 7011325.34, 11889504.39 |
| C19            | 196.60 | 465.35 | S9° 36' 10.04"W      | 13+65.16        | 15+61.76      | 7011517.74, 11889536.94   | 7011325.34, 11889504.39 |
| L24            | 297.42 |        | S21° 42' 21.54"W     | 10+67.74        | 13+65.16      | 7011794.07, 11889646.94   | 7011517.74, 11889536.94 |
| L25            | 104.21 |        | S2° 30' 01.46"E      | 15+61.76        | 16+65.97      | 7011325.34, 11889504.39   | 7011221.22, 11889508.93 |

| BL- EOP |        |        |                      |                 |               |                           |                         |
|---------|--------|--------|----------------------|-----------------|---------------|---------------------------|-------------------------|
|         | Length | Radius | Line/Chord Direction | Station (Start) | Station (End) | Northing, Easting (Start) | Northing, Easting (End) |
| C1      | 18.75  | 593.23 | N15° 23' 02.23"E     | 0+00.00         | 0+18.75       | 7011452.43, 11889541.28   | 7011470.51, 11889546.26 |
| C2      | 40.49  | 441.08 | N19° 04' 33.35"E     | 0+18.75         | 0+59.25       | 7011470.51, 11889546.26   | 7011508.77, 11889559.49 |
| C3      | 26.17  | 22.00  | N55° 46' 42.22"E     | 0+68.72         | 0+94.88       | 7011517.57, 11889562.99   | 7011531.43, 11889583.37 |
| L1      | 9.47   |        | N21° 42' 21.54"E     | 0+59.25         | 0+68.72       | 7011508.77, 11889559.49   | 7011517.57, 11889562.99 |
| L2      | 5.93   |        | N89° 51' 02.90"E     | 0+94.88         | 1+00.81       | 7011531.43, 11889583.37   | 7011531.45, 11889589.30 |
| L3      | 11.68  |        | N89° 51' 02.90"E     | 1+00.81         | 1+12.49       | 7011531.45, 11889589.30   | 7011531.48, 11889600.98 |
| L4      | 9.30   |        | N89° 51' 02.90"E     | 1+12.49         | 1+21.80       | 7011531.48, 11889600.98   | 7011531.50, 11889610.29 |

| BL- BOSW |        |        |                      |                 |               |                           |                         |
|----------|--------|--------|----------------------|-----------------|---------------|---------------------------|-------------------------|
|          | Length | Radius | Line/Chord Direction | Station (Start) | Station (End) | Northing, Easting (Start) | Northing, Easting (End) |
| C4       | 59.93  | 311.98 | N17° 42' 14.58"E     | 0+00.00         | 0+59.93       | 7011450.06, 11889550.69   | 7011507.07, 11889568.89 |
| C5       | 23.49  | 20.10  | N56° 39' 02.23"E     | 0+65.03         | 0+88.52       | 7011511.75, 11889570.90   | 7011523.95, 11889589.42 |
| L5       | 5.09   |        | N23° 10' 33.10"E     | 0+59.93         | 0+65.03       | 7011507.07, 11889568.89   | 7011511.75, 11889570.90 |
| L6       | 11.56  |        | S89° 52' 28.64"E     | 0+88.52         | 1+00.08       | 7011523.95, 11889589.42   | 7011523.92, 11889600.98 |
| L7       | 9.23   |        | S89° 52' 28.64"E     | 1+00.08         | 1+09.32       | 7011523.92, 11889600.98   | 7011523.90, 11889610.22 |
| L16      | 5.09   |        | N23° 10' 33.10"E     | 0+59.93         | 0+65.03       | 7011507.07, 11889568.89   | 7011511.75, 11889570.90 |

| BL- LOD |        |        |                      |                 |               |                           |                         |
|---------|--------|--------|----------------------|-----------------|---------------|---------------------------|-------------------------|
|         | Length | Radius | Line/Chord Direction | Station (Start) | Station (End) | Northing, Easting (Start) | Northing, Easting (End) |
| C6      | 90.59  | 432.08 | N16° 02' 23.78"E     | 0+00.00         | 0+90.59       | 7011420.06, 11889544.26   | 7011506.97, 11889569.24 |
| C7      | 25.82  | 22.14  | N52° 28' 01.23"E     | 0+90.59         | 1+16.41       | 7011506.97, 11889569.24   | 7011521.82, 11889588.58 |
| L8      | 12.44  |        | N85° 59' 15.54"E     | 1+16.41         | 1+28.85       | 7011521.82, 11889588.58   | 7011522.69, 11889600.98 |
| L9      | 16.90  |        | N85° 59' 15.54"E     | 1+28.85         | 1+45.75       | 7011522.69, 11889600.98   | 7011523.87, 11889617.85 |

| BL- 2 MEDIAN |        |        |                      |                 |               |                           |                         |
|--------------|--------|--------|----------------------|-----------------|---------------|---------------------------|-------------------------|
|              | Length | Radius | Line/Chord Direction | Station (Start) | Station (End) | Northing, Easting (Start) | Northing, Easting (End) |
| C8           | 40.67  | 18.00  | N51° 42' 54.60"W     | 0+20.73         | 0+61.40       | 7011478.25, 11889509.91   | 7011498.42, 11889484.35 |
| L10          | 3.16   |        | N13° 00' 45.83"E     | 0+00.00         | 0+03.16       | 7011458.06, 11889505.24   | 7011461.13, 11889505.95 |
| L11          | 17.57  |        | N13° 00' 45.83"E     | 0+03.16         | 0+20.73       | 7011461.13, 11889505.95   | 7011478.25, 11889509.91 |
| L12          | 25.40  |        | S63° 33' 24.97"W     | 0+61.40         | 0+86.79       | 7011498.42, 11889484.35   | 7011487.11, 11889461.61 |
| L13          | 6.93   |        | S63° 33' 24.97"W     | 0+86.79         | 0+93.73       | 7011487.11, 11889461.61   | 7011484.03, 11889455.41 |


| BL 4 SW OUT |        |        |                      |                 |               |                           |                         |
|-------------|--------|--------|----------------------|-----------------|---------------|---------------------------|-------------------------|
|             | Length | Radius | Line/Chord Direction | Station (Start) | Station (End) | Northing, Easting (Start) | Northing, Easting (End) |
| C20         | 10.07  | 12.28  | N18° 35' 39.11"E     | 0+16.66         | 0+26.72       | 7011470.51, 11889494.69   | 7011479.79, 11889497.81 |
| C21         | 2.54   | 2.00   | N41° 17' 20.54"W     | 0+31.17         | 0+33.71       | 7011484.21, 11889497.81   | 7011486.00, 11889495.87 |
| C22         | 1.33   | 5.00   | N70° 03' 03.20"W     | 0+38.84         | 0+40.18       | 7011487.09, 11889490.85   | 7011487.54, 11889489.60 |
| C23         | 4.72   | 5.00   | N89° 25' 38.39"W     | 0+45.94         | 0+50.66       | 7011490.21, 11889484.49   | 7011490.26, 11889479.95 |
| C24         | 3.16   | 10.00  | S72° 37' 08.26"W     | 0+57.29         | 0+60.45       | 7011487.30, 11889474.01   | 7011486.36, 11889471.01 |
| C25         | 3.09   | 10.00  | S72° 49' 53.88"W     | 0+60.45         | 0+63.55       | 7011486.36, 11889471.01   | 7011485.45, 11889468.06 |
| L30         | 11.88  |        | N42° 04' 34.64"E     | 0+00.00         | 0+11.88       | 7011458.15, 11889483.53   | 7011466.97, 11889491.50 |
| L31         | 4.77   |        | N42° 04' 34.64"E     | 0+11.88         | 0+16.66       | 7011466.97, 11889491.50   | 7011470.51, 11889494.69 |
| L32         | 4.44   |        | N4° 53' 16.42"W      | 0+26.72         | 0+31.17       | 7011479.79, 11889497.81   | 7011484.21, 11889497.44 |
| L33         | 5.13   |        | N77° 41' 24.66"W     | 0+33.71         | 0+38.84       | 7011486.00, 11889495.87   | 7011487.09, 11889490.85 |
| L34         | 5.76   |        | N62° 24' 41.74"W     | 0+40.18         | 0+45.94       | 7011487.54, 11889489.60   | 7011490.21, 11889484.49 |
| L35         | 6.64   |        | S63° 33' 24.97"W     | 0+50.66         | 0+57.29       | 7011490.26, 11889479.95   | 7011487.30, 11889474.01 |
| L36         | 5.00   |        | S63° 57' 13.10"W     | 0+63.55         | 0+68.55       | 7011485.45, 11889468.06   | 7011483.26, 11889463.57 |

| BL- 2 EOP MEDIAN LOD RIGHT |        |        |                      |                 |               |                           |                         |
|----------------------------|--------|--------|----------------------|-----------------|---------------|---------------------------|-------------------------|
|                            | Length | Radius | Line/Chord Direction | Station (Start) | Station (End) | Northing, Easting (Start) | Northing, Easting (End) |
| C13                        | 63.26  | 28.00  | N51° 42' 54.60"W     | 0+20.73         | 0+83.99       | 7011476.00, 11889519.65   | 7011507.38, 11889479.90 |
| L20                        | 3.16   |        | N13° 00' 45.83"E     | 0+00.00         | 0+03.16       | 7011455.81, 11889514.98   | 7011458.88, 11889515.69 |
| L21                        | 17.57  |        | N13° 00' 45.83"E     | 0+03.16         | 0+20.73       | 7011458.88, 11889515.69   | 7011476.00, 11889519.65 |
| L22                        | 25.40  |        | S63° 33' 24.97"W     | 0+83.99         | 1+09.39       | 7011507.38, 11889479.90   | 7011496.07, 11889457.16 |
| L23                        | 6.93   |        | S63° 33' 24.97"W     | 1+09.39         | 1+16.32       | 7011496.07, 11889457.16   | 7011492.98, 11889450.95 |



DEPARTMENT OF ENVIRONMENTAL SERVICES  
 FACILITIES & ENGINEERING DIVISION  
 ENGINEERING BUREAU  
 2100 CLARENDON BOULEVARD, SUITE 813  
 ARLINGTON, VA 22201  
 PHONE: 703.228.3629  
 FAX: 703.228.3606

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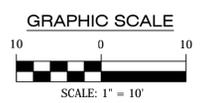
APPROVALS DATE  
 QUALITY CONTROL ENGINEER 2/14/19  
 CONSTRUCTION MANAGEMENT SUPERVISOR 2/15/19  
 WATER, SEWER, STREETS BUREAU CHIEF 2/19/19  
 TRANSPORTATION DIRECTOR 2/19/19  
 PROJECT MANAGER 2/19/19

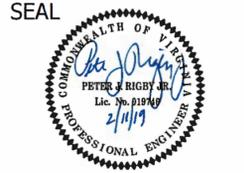REVISIONS DATE

FAIRFAX DR. & N. LYNN ST.  
 GEOMETRIC CONTROL  
 FAIRFAX DR. & N. LYNN ST.  
 SE CORNER AT INTERSECTION


DESIGNED: K. PATEL  
 DRAWN: K. PATEL  
 CHECKED: P. RICBY  
 MISS UTILITY TRANSMITTAL #: N/A  
 FILENAME: P14D-B-4-122-CORRIDOR.DWG  
 PATH: Q:\DATA\PI4D\_B-4 CORRIDOR IMPROVEMENTS\SITE B-4 FAIRFAX DR & N LYNN STREET-CAD FILES\ACTIVE  
 PLOTTED: FEBRUARY 5 2019  
 PLOTTED BY: KPATEL

SCALE: AS NOTED




SHEET 7 OF 13

C. 10+70.06 N. Fairfax Drive  
 13+40.46 N. Lynn Street  
 53° 58' 47" Lt.

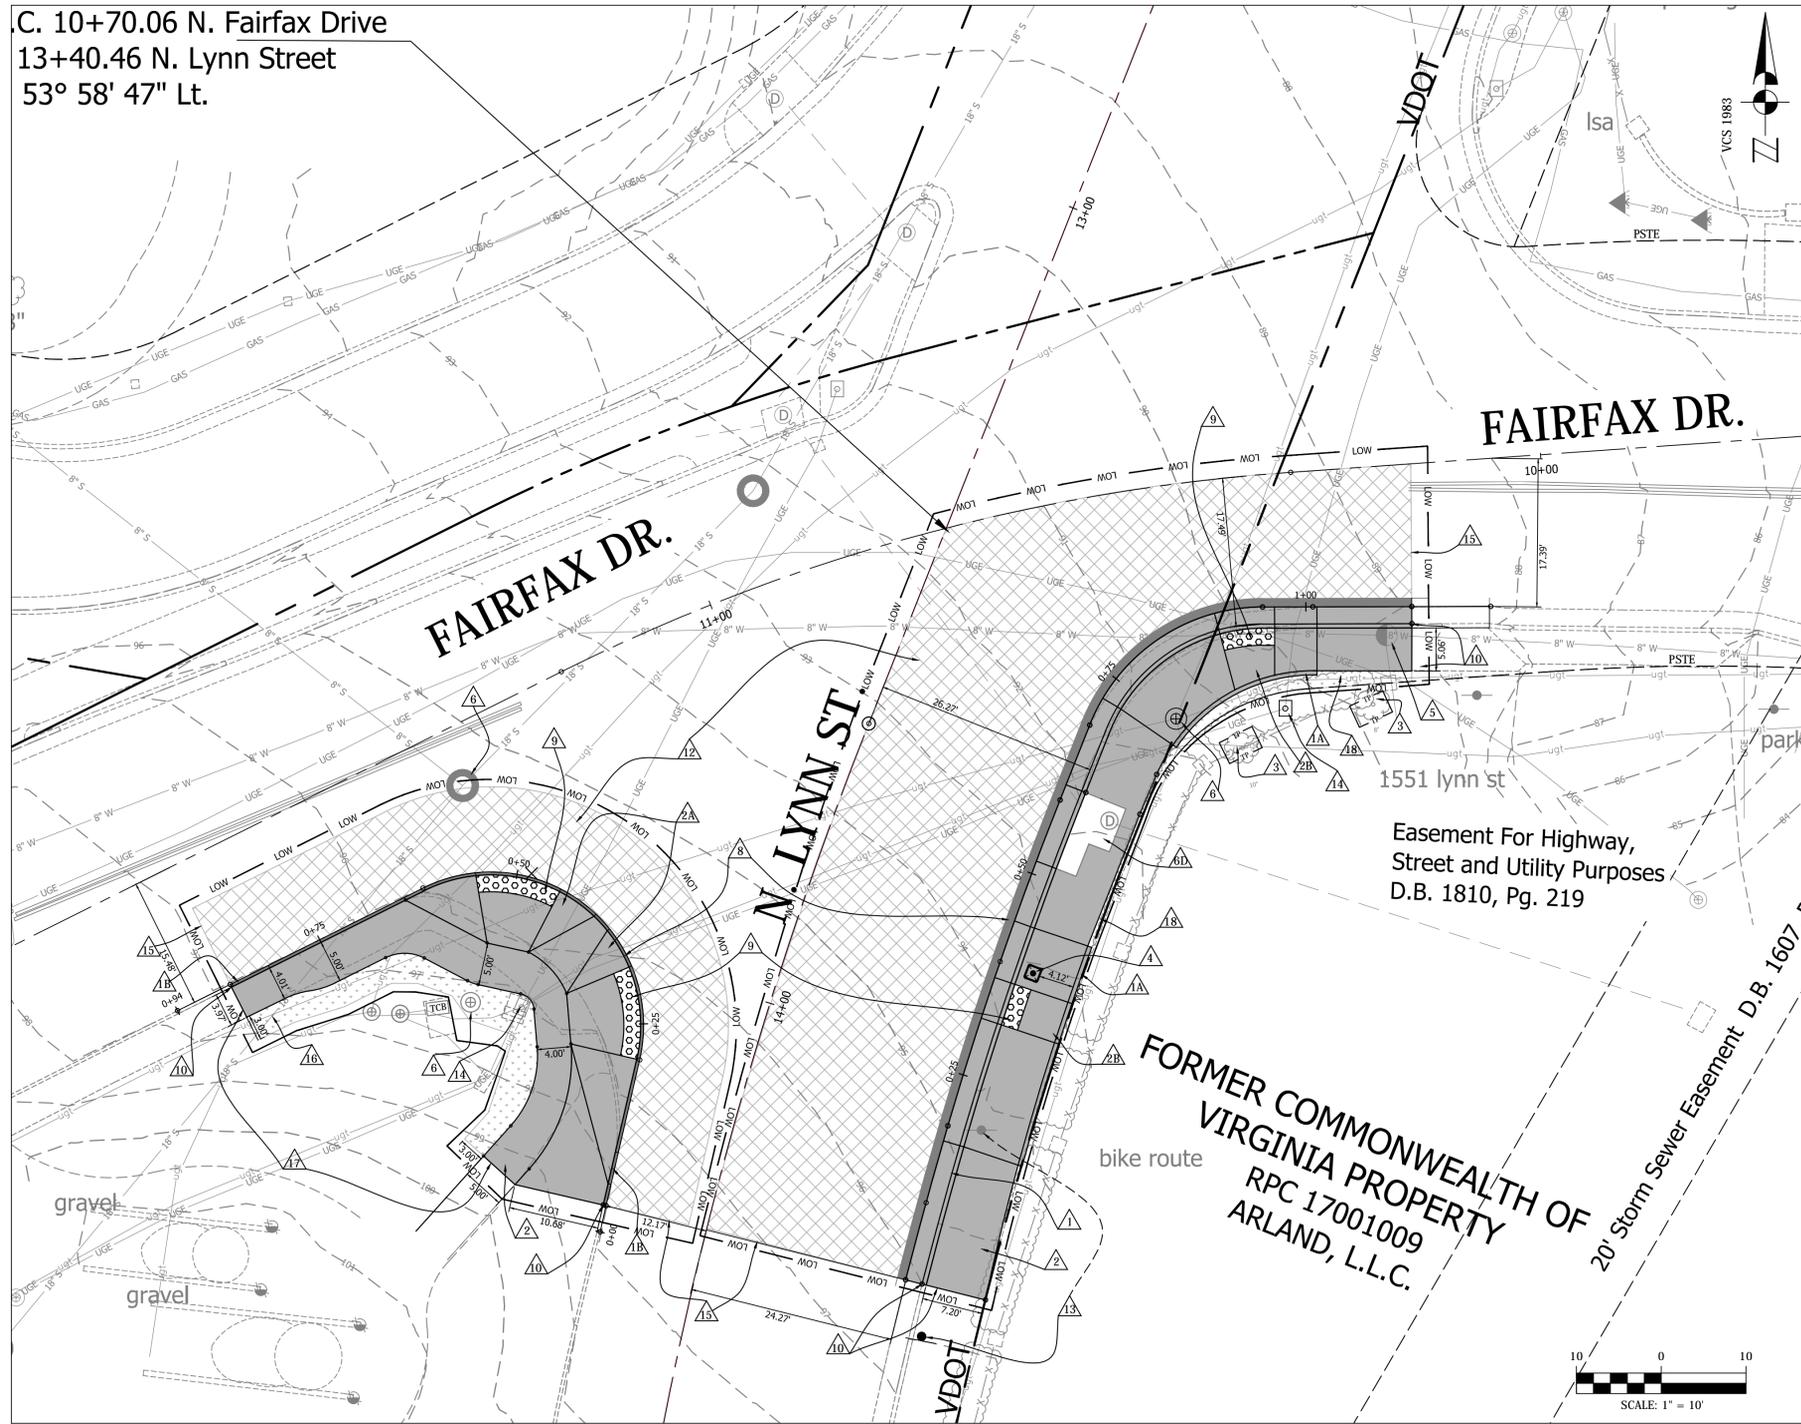

**NOTE:**  
 PROJECT MANAGER: RICHARD VIOLA, ARLINGTON COUNTY, 703-228-3699  
 SURVEYED BY: COUNTY SURVEYOR, ARLINGTON COUNTY, 703-228-7496  
 DESIGNED BY: K. PATEL, ARLINGTON COUNTY, 703-228-3503  
 SUBSURFACE UTILITY DATA PROVIDED BY : ARLINGTON COUNTY, ARLINGTON COUNTY, 703-228-7496


**ARLINGTON VIRGINIA**  
 DEPARTMENT OF ENVIRONMENTAL SERVICES  
 FACILITIES & ENGINEERING DIVISION  
 ENGINEERING BUREAU  
 2100 CLARENDON BOULEVARD, SUITE 813  
 ARLINGTON, VA 22201  
 PHONE: 703.228.3629  
 FAX: 703.228.3606  
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**SEAL**  
 COMMONWEALTH OF VIRGINIA  
 PETER J. RIGBY  
 Lic. No. 11149  
 PROFESSIONAL ENGINEER

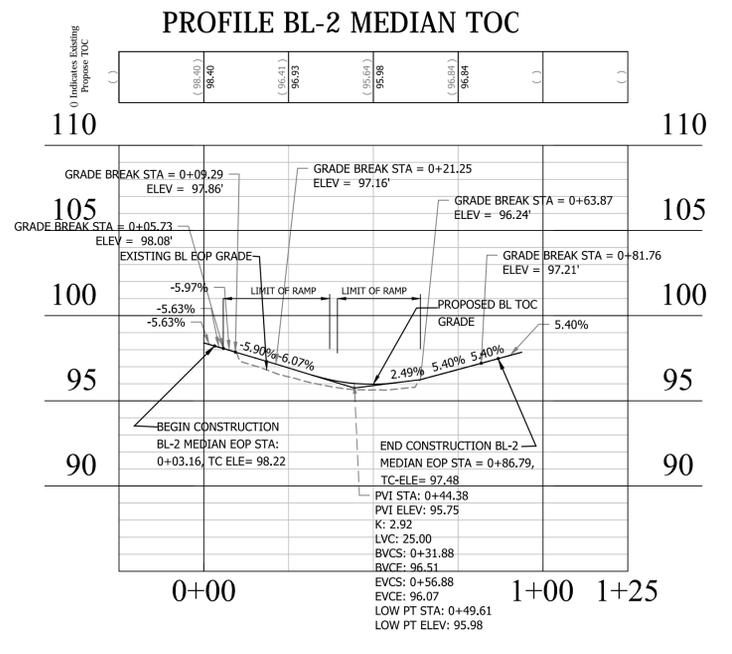**APPROVALS** DATE  
 QUALITY CONTROL ENGINEER 2/14/19  
 CONSTRUCTION MANAGEMENT SUPERVISOR 2/15/19  
 WATER, SEWER, STREETS BUREAU CHIEF 2/17/19  
 TRANSPORTATION DIRECTOR 2/19/19  
 PROJECT MANAGER 2/14/19

**REVISIONS** DATE



**FAIRFAX DR. & N. LYNN ST.**  
**PLAN AND PROFILE**  
**FAIRFAX DR. & N. LYNN ST.**  
**SE CORNER AT INTERSECTION**  
 P14D

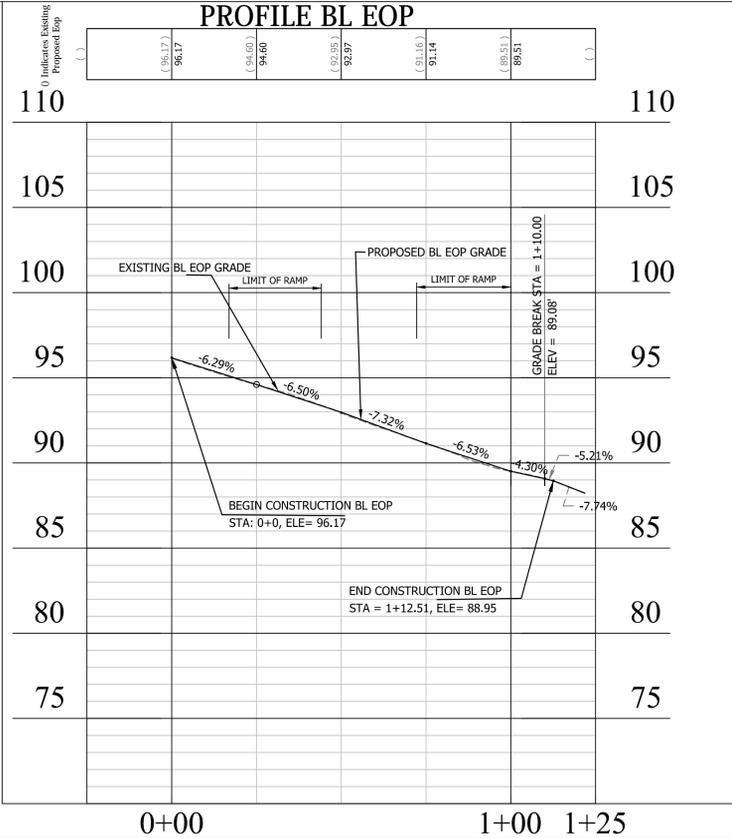DESIGNED: K. PATEL  
 DRAWN : K. PATEL  
 CHECKED : P. RIGBY  
 MISS UTILITY TRANSMITTAL #: N/A  
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PLOTTED: FEBRUARY 1 2019  
 PLOTTED BY: KPATEL  
**SCALE: AS NOTED**  
 SCALE: 1" = 25'  
 VERT. SCALE: 1" = 5'


**CONSTRUCTION NOTES:**

- 1 NEW CURB AND GUTTER (CG-6) VDOT STANDARD (201.03)
- 1A NEW HEADER CURB (C-3) ARLINGTON COUNTY STANDARD (R-2.0)
- 1B PROPOSED 4" HIGH MEDIAN CURB (VDOT CG-2) VDOT STANDARD (201.01). INCLUDES CURB FOR APRONS, RAMPS, ETC.
- 2 NEW SIDEWALK (S-4) ARLINGTON COUNTY STANDARD (R-2.0)
- 2A NEW CURB RAMP (CG-12A). VDOT ROAD & BRIDGE STANDARDS (203.06)
- 2B NEW CURB RAMP (CG-12 B MOD.) VDOT ROAD & BRIDGE STANDARDS (203.07).
- 3 MULCH IMPACTED TREE PITS AREA .(TREE PITS ARE EXCLUDED FROM L.D.A.)
- 4 INSTALL PEDESTRIAN SIGNAL HEAD WITH POLE AND FOUNDATION AS PER ARLINGTON COUNTY TRAFFIC SIGNAL & STREET LIGHT SPECIFICATION 2018. SHALL COORDINATE WITH DES-TE. & O. (703-228-3864) PRIOR TO BEGIN WORK.
- 5 WATER METER BOX. VERTICAL ADJUSTMENT TO NEW GRADE
- 6 UTILITY MANHOLE OR TRAFFIC BOX . VERTICAL ADJUSTMENT TO NEW GRADE (ARLINGTON COUNTY DETAIL S-2.5 TYPE A)
- 6A ADJUST EXISTING CATCH BASIN TOP TO PROPOSED GRADE
- 8 PROPOSED ASPHALT - FULL DEPTH REPLACEMENT ARLINGTON COUNTY STANDARD (R-1.3)
- 9 PROPOSED DETECTABLE WARNING SURFACE DARK GRAY COLOR PER ARLINGTON COUNTY STANDARD H-3.2. CURB RAMPS
- 10 MATCH EXISTING T.O.C. OR SIDEWALK GRADE. (CLEAN LINE SAW CUT BE NEEDED.)
- 12 ASPHALT - MILL AND OVERLAY (1/2" TO 3" ) PER ARLINGTON COUNTY STANDARD (R-1.4)
- 13 TRAFFIC CONTROL SIGNS, RELOCATE WITH NEW POST D1-3B. (INSTALL PER DETAIL SG-1.0) SEE SHEET # 11 FOR DETAILS. SHALL COORDINATE WITH DES-TE. & O. (703-228-3864) PRIOR TO BEGIN WORK.
- 14 EXISTING TRAFFIC PED POLE TO BE REMAIN.
- 15 PROVIDE CONSTRUCTION JOINT AS PER VDOT R&B. STD. 303.02, WP-2 (SEE DETAILS ON SHEET 3 OF 13)
- 16 SOD,TALL FESCUE/ BLUEGRASS MIXTURE
- 17 TRANSITION LEAD WALK TO MEET PROPOSED SIDEWALK
- 18 HEDGE ROW REMOVE, RESET, AND MULCH (INCLUDE ALL LABOR AND MATERIALS)
- TP PROTECT TREE DURING CONSTRUCTION OF PROPOSED WORK AS SHOWN. CALL URBAN FORESTER (702-228-6557) PRIOR TO BEGINNING WORK ADJACENT TO TREE.

**NOTE:**  
 THE CONTRACTOR IS RESPONSIBLE FOR ALL COSTS INVOLVED WITH REPLACING ANY TRAFFIC DETECTION LOOPS THAT ARE DAMAGED DURING CONSTRUCTION. THE CONTRACTOR SHALL INSTALL REPLACEMENT CONDUIT STUB OUTS. THE CONTRACTOR SHALL COORDINATE WITH DES- TRAFFIC ENGINEERING AND OPERATIONS (703-228-3864) FOR SPLICING OF LOOPS AND INSPECTIONS FOLLOWING INSTALLATION.






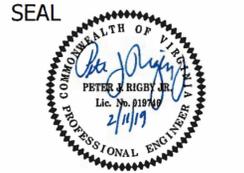

| APPROVALS  | DATE    |
|--|---------|
| <i>[Signature]</i><br>QUALITY CONTROL ENGINEER           | 2/14/19 |
| <i>[Signature]</i><br>CONSTRUCTION MANAGEMENT SUPERVISOR | 2/15/19 |
| <i>[Signature]</i><br>WATER, SEWER, STREETS BUREAU CHIEF | 2/19/19 |
| <i>[Signature]</i><br>TRANSPORTATION DIRECTOR            | 2/19/19 |
| <i>[Signature]</i><br>PROJECT MANAGER                    | 2/19/19 |

| REVISIONS | DATE |
|-----------|------|
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CONSTRUCTION SIGNAGE NOTES

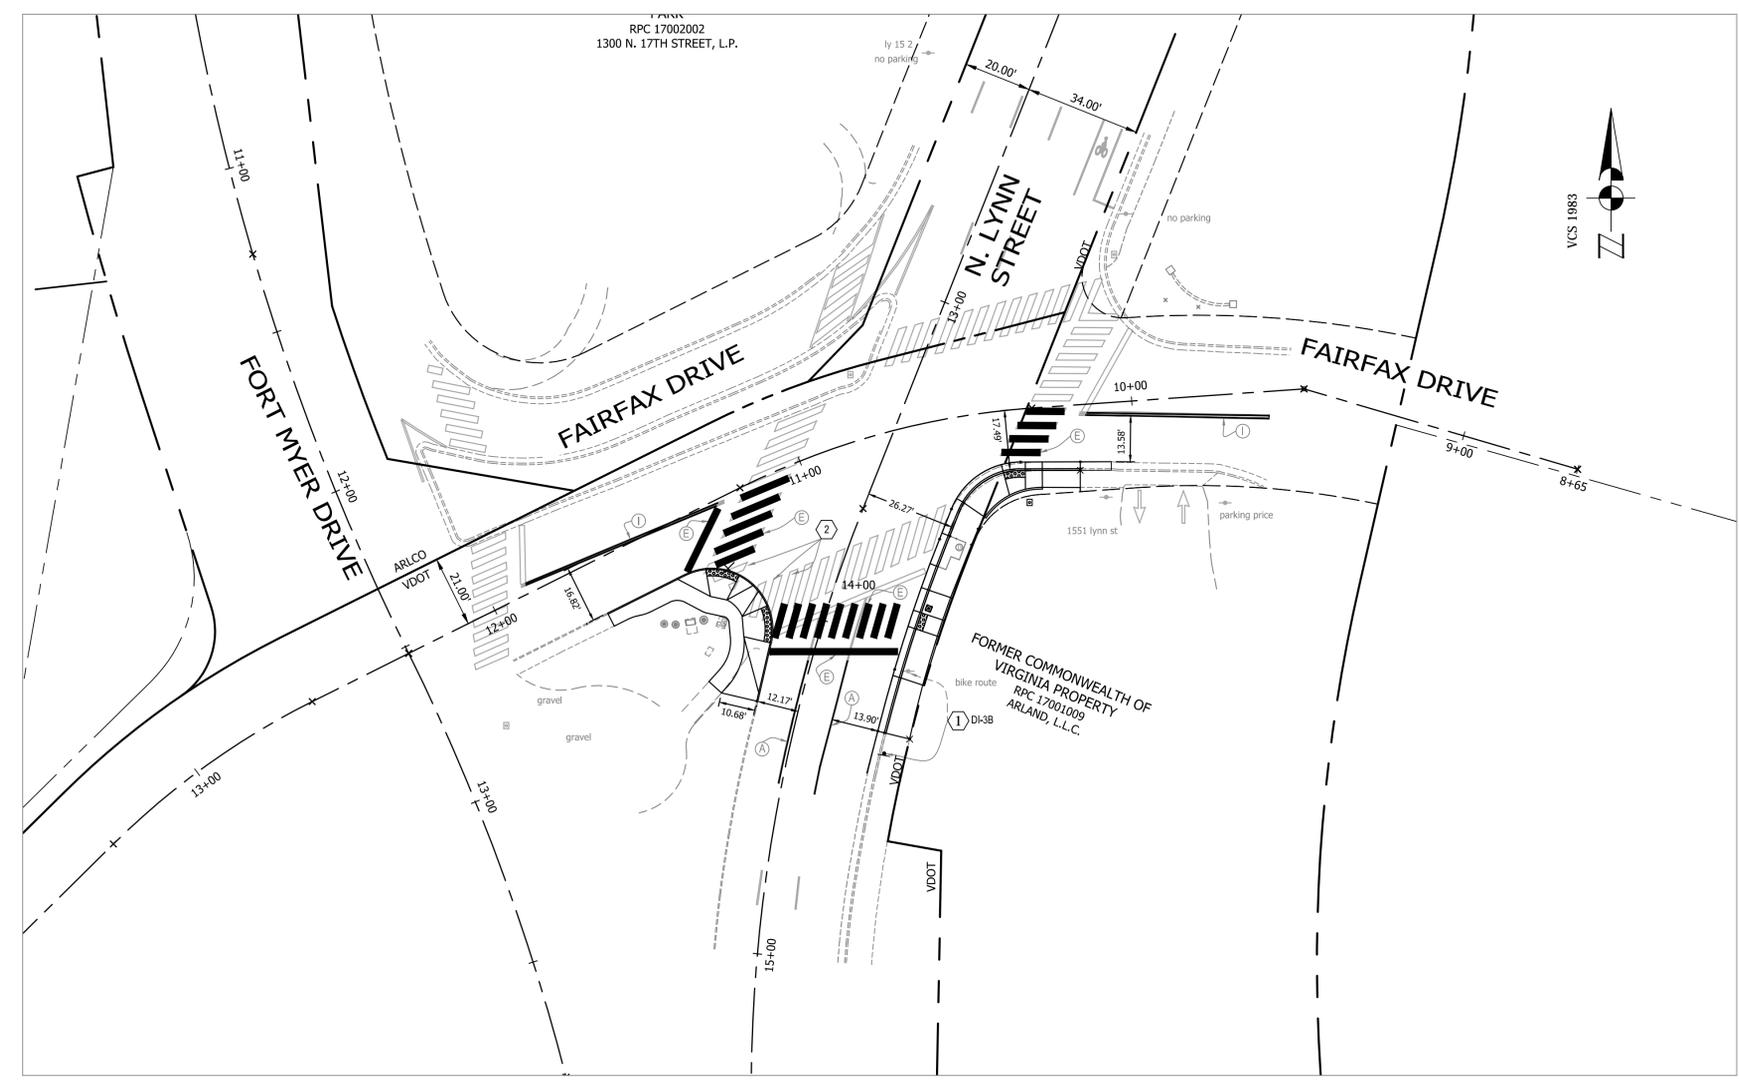- ① RELOCATE EXISTING SIGN TO NEW POLE
- ② ERADICATE AND RE-STRIP AS NECESSARY ANY EXISTING PAVEMENT MARKING THAT ARE IN CONFLICT WITH NEW TRAFFIC PATTERNS.

All existing signage to remain.  
Unless otherwise noted.

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SIGNAGE AND STRIPING  
FAIRFAX DR. & N. LYNN ST.  
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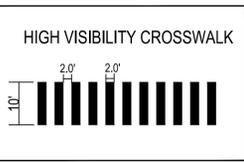
STANDARD PAVEMENT MARKING LEGEND:

|   |  |
|---|--|
| Ⓐ TYPE B CLASS 1.....WHITE 4" WIDTH                           | PARKING LINES, EDGE LINES, LANE LINES          |
| Ⓑ TYPE B CLASS 1.....WHITE 4" WIDTH, 10' LONG, 30' SPACING    | DASHED LANE LINES                              |
| Ⓒ TYPE B CLASS 1.....WHITE 4" WIDTH, 2' LONG, 10' SPACING     | LANE TRANSITIONS, TURN LANE SKIPS              |
| Ⓓ TYPE B CLASS 1.....WHITE 18" WIDTH                          | STOP BARS                                      |
| Ⓔ TYPE B CLASS 1.....WHITE 24" WIDTH                          | CONTINENTAL CROSS WALKS                        |
| Ⓕ TYPE B CLASS 1.....WHITE 6" WIDTH                           | TURN LANES, TRANSVERSE CROSSWALKS, BIKE LANES  |
| Ⓖ TYPE B CLASS 1.....YELLOW 4" WIDTH, 10' LONG, 30' SPACING   | DIVIDED TRAFFIC, TWO WAY TURN LANES            |
| Ⓗ TYPE B CLASS 1.....YELLOW 4" WIDTH                          | EDGE LINES                                     |
| Ⓛ TYPE B CLASS 1.....YELLOW 4" WIDTH, DOUBLE LINE, 4" SPACING | CENTERLINES                                    |
| Ⓚ TYPE B CLASS 1.....WHITE 6" WIDTH, 10' SPACING @45 DEGREE   | HATCH LINES, SAFETY ZONES                      |
| Ⓛ TYPE B CLASS 1.....WHITE SINGLE ARROW                       | TURN LANES                                     |
| Ⓛ TYPE B CLASS 1.....WHITE COMBINATION ARROW                  | TURN LANES                                     |
| Ⓜ TYPE B CLASS 1.....WHITE 6" LETTERS                         | PAVEMENT LETTERS (STOP, YIELD, BUS, ONLY etc.) |
| Ⓝ TYPE B CLASS 1.....WHITE 6" WIDTH, 2' LONG, 10' SPACING     | LANE TRANSITIONS, TURN LANE SKIPS              |
| Ⓞ TYPE B CLASS 1.....WHITE 12" WIDTH, 20' SPACING @45 DEGREE  | GORE MARKINGS                                  |
| Ⓟ TYPE B CLASS 1.....YELLOW 12" WIDTH, 20' SPACING @45 DEGREE | GORE MARKINGS                                  |
| Ⓠ TYPE B CLASS 1.....WHITE 6" WIDTH, 2' LONG, 4" SPACING      | LANE TRANSITIONS                               |


- SIGN AND PAVEMENT MARKING NOTES:
- STREET WIDTH MEASUREMENTS ARE FROM FACE OF CURB TO FACE OF CURB. LANES ARE MEASURED FROM CENTER OF MARKING TO CENTER OF MARKING.
  - CONTACT DENNIS HOWELL OR HIS DESIGNEE AT 703-228-6598 OR (571) 437-1077 TO APPROVE MARKING LAYOUT 48 HRS. PRIOR TO INSTALLATION OF MARKINGS.
  - PAVEMENT MARKINGS TO BE IN ACCORDANCE WITH THE FOLLOWING AND ANY REVISIONS HERE TO:
    - A) THE MANUAL ON UNIFORM TRAFFIC CONTROL DEVICES.
    - B) ARLINGTON COUNTY MARKING STANDARDS.
  - ALL MARKINGS SHALL BE THERMOPLASTIC PER ARLINGTON COUNTY MARKING STANDARDS.
  - STOP BARS SHALL BE A MINIMUM OF 4' IN ADVANCE OF A MARKED CROSSWALK. IF THERE IS NO MARKED CROSSWALK, STOP BAR SHALL BE NO MORE THAN 30' FROM THE NEAREST EDGE OF THE INTERSECTED TRAVELED WAY.
  - CROSSWALKS SHALL BE 10' WIDE UNLESS OTHERWISE NOTED.
  - LEFT TURN ARROWS SHALL BE LOCATED 25' BACK FROM STOP BAR. FOR ADDITIONAL ARROWS FOLLOW DES MARKING STANDARDS.
  - ON-STREET PARKING LANE IS 7' WIDE (UNLESS OTHERWISE NOTED) AND MARKED WITH 4" WIDE WHITE LINES. BEGINNING AND END OF PARKING SHALL BE MARKED WITH AN END LINE PERPENDICULAR TO CURB EXCEPT AT NUBS.
  - SHARROWS SHALL BE PLACED IN CENTER OF LANE, 250' APART UNLESS OTHERWISE SPECIFIED.
  - BIKE LANE SYMBOLS TO BE PLACED 330' APART UNLESS OTHERWISE SPECIFIED.




STRIPING LEGEND

| EXISTING |               | PROPOSED |
|----------|---------------|----------|
|          | BUS STOP      |          |
|          | FIRE HYDRANT  |          |
|          | PARKING METER |          |
|          | SIGN          |          |
|          | STRIPING      |          |



DESIGNED: K. PATEL  
DRAWN : K. PATEL  
CHECKED : P. RICBY  
MISS UTILITY TRANSMITTAL #: N/A  
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PLOTTED: FEBRUARY 4 2019  
PLOTTED BY: KPATEL

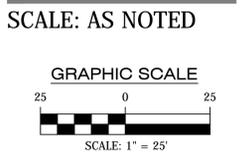

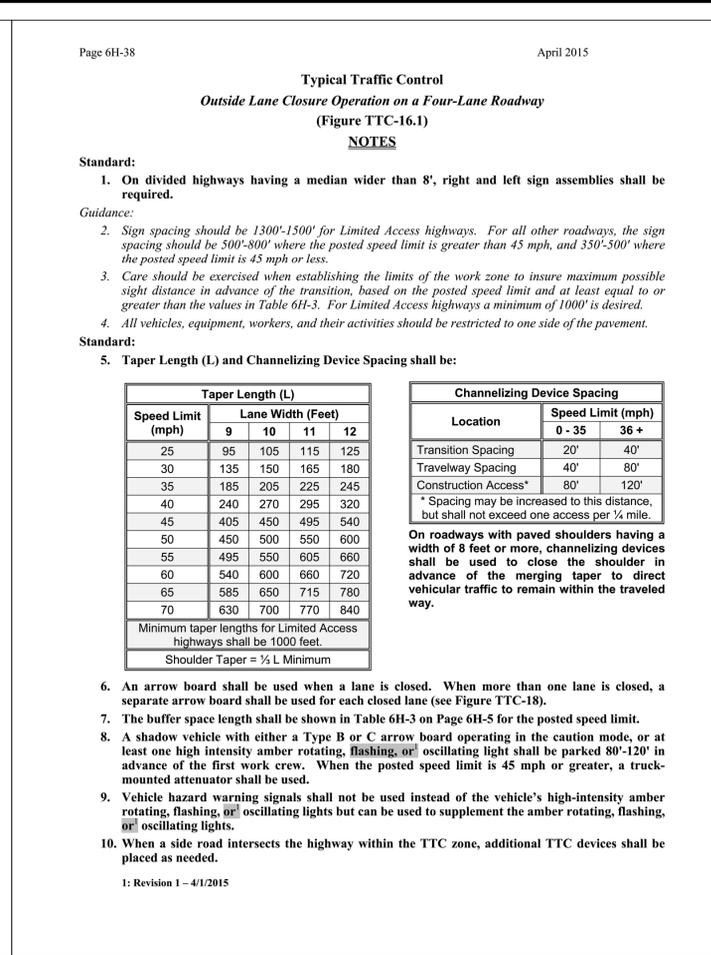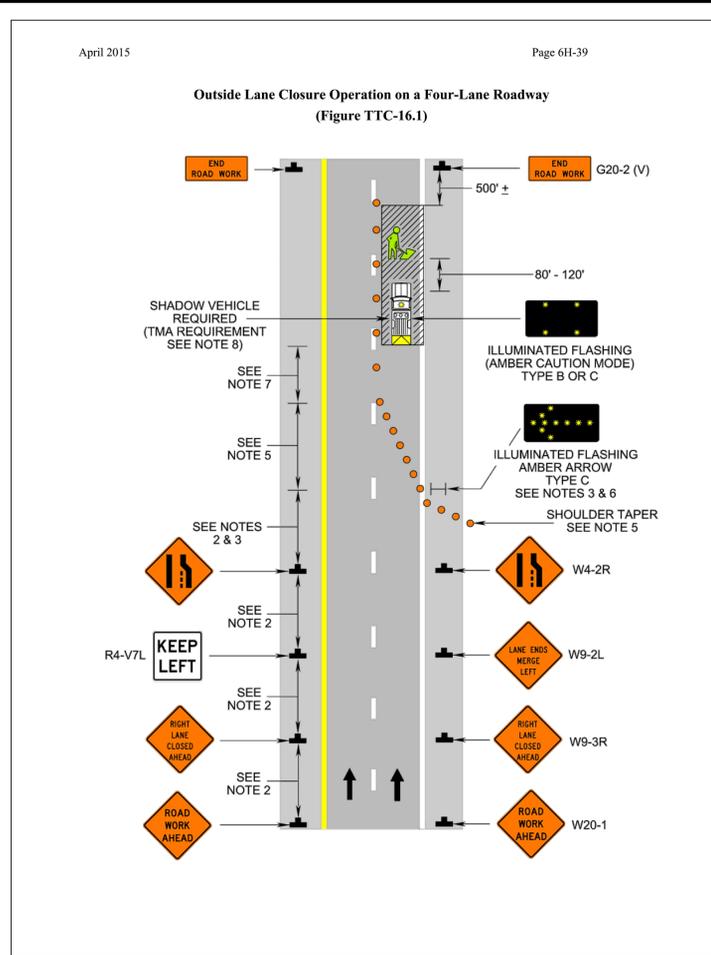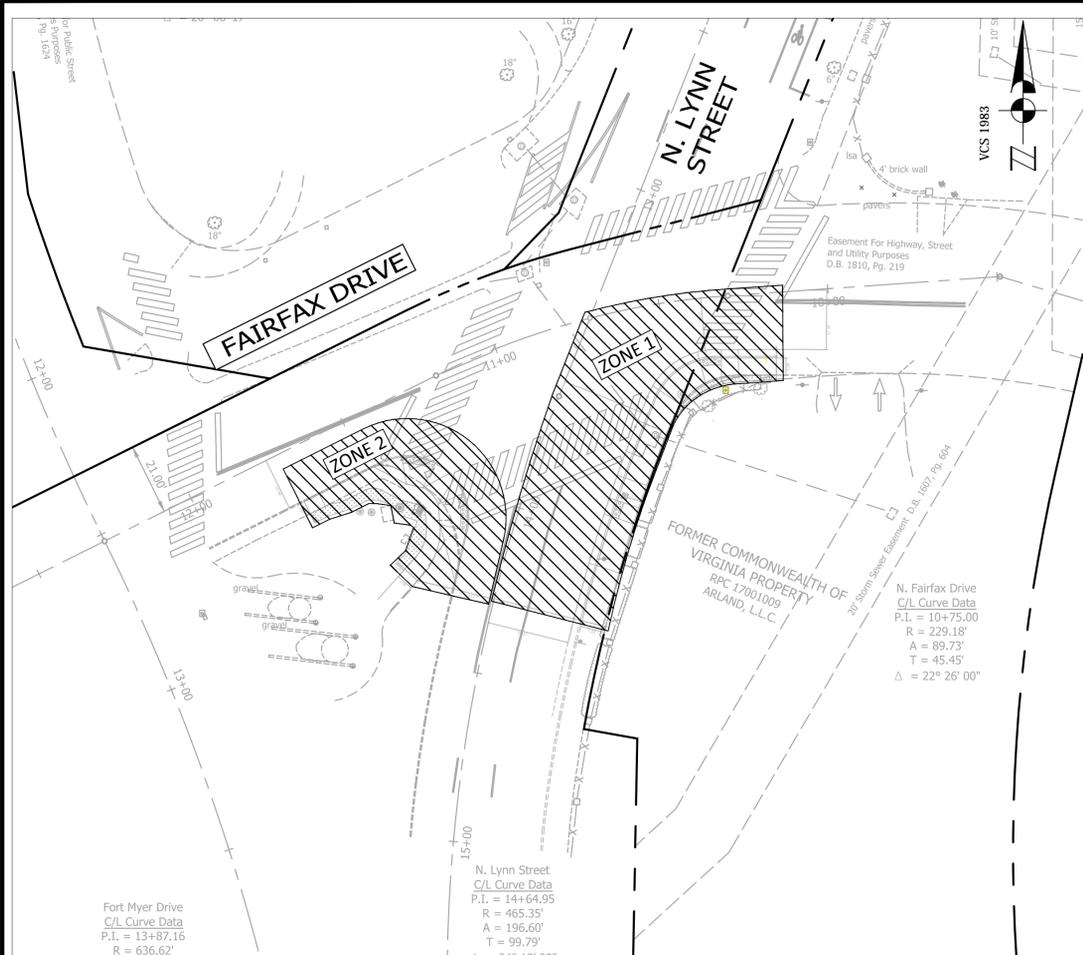

**ARLINGTON VIRGINIA**

DEPARTMENT OF ENVIRONMENTAL SERVICES  
 FACILITIES & ENGINEERING DIVISION  
 ENGINEERING BUREAU  
 2100 CLARENDON BOULEVARD, SUITE 813  
 ARLINGTON, VA 22201  
 PHONE: 703.228.3629  
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**SEAL**

APPROVALS DATE

QUALITY CONTROL ENGINEER: 2/19/19  
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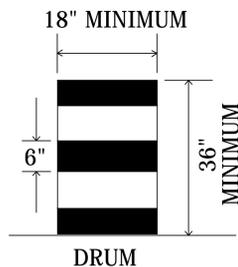
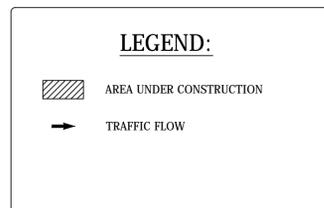
REVISIONS DATE

| ZONE#  | TTC#     | COMMENTS  | DURATION |
|--------|----------|---|----------|
| ZONE 1 | TTC-16.1 | OUTSIDE LANE CLOSURE OPERATION ON A FOUR LANE ROADWAY | MONTH    |
|        | TTC-28.1 | LANE CLOSURE OPERATION- IN AN INTERSECTION            |          |
|        | TTC-36.1 | CROSSWALK CLOSURE AND PEDESTRIAN DETOUR OPERATION     |          |
| ZONE 2 | TTC-28.1 | LANE CLOSURE OPERATION- IN AN INTERSECTION            | TWO WEEK |
|        | TTC-36.1 | CROSSWALK CLOSURE AND PEDESTRIAN DETOUR OPERATION     |          |
|        | TTC-17.1 | INSIDE LANE CLOSURE OPERATION ON A FOUR-LANE ROADWAY  |          |
|        |          |   |          |

**NOTE:**  
 THE DURATIONS SHOWN WERE DEVELOPED FOR PLANNING AND ESTIMATION PURPOSES ONLY. THE DURATIONS IN NO WAY ALTER THE CONTRACT TIME FOR COMPLETION, OR INFRINGES ON THE CONTRACTORS MEANS AND METHODS. THE CONTRACTOR'S SUBMITTED SCHEDULE SUPERSEDES THE ESTIMATED DURATIONS SHOWN.

**RESTRICTIONS ON CONCURRENT WORK AREAS:**  
 THE CONTRACTOR MAY CHOOSE THE OPTIMAL SEQUENCE FOR THEM, BUT THE DESIGNER WILL DICTATE WHICH WORK AREA CAN AND CANNOT BE CLOSED SIMULTANEOUSLY.

- NOTES:**
- WARNING SIGN SPACING : 100'
  - CHANNELIZATION DEVICES SPACING FOR TRANSITION AREAS = 20'



**NOTES:**  
 DRUM SPACING IS 20 FEET ON TRANSITIONS AND CURVES.  
 DRUM SPACING PARALLEL TO THE TRAVEL WAY IS 40 FEET.

**WORKING HOURS:**

- IN ARLINGTON RIGHT-OF-WAY: 9:30 AM TO 3:00 PM (MON.-THUR.) AND 9:30 AM TO 2:00PM (FRIDAY)
- ALL LANES SHALL BE FULLY OPEN TO TRAFFIC OUTSIDE THE ABOVE HOURS UNLESS SPECIFIED OTHERWISE IN THE MAINTENANCE OF TRAFFIC PLANS.

**MOT NOTES:**


- TRAFFIC CONTROL DEVICES AND SAFETY MEASURES SHALL COMPLY WITH THE VIRGINIA WORK AREA PROTECTION MANUAL, VDOT'S GUIDELINES FOR TEMPORARY TRAFFIC CONTROL, FEDERAL HIGHWAY ADMINISTRATION MANUAL ON UNIFORM TRAFFIC CONTROL DEVICES, ARLINGTON COUNTY STANDARDS, THE TRAFFIC CONTROL PLANS INCLUDED IN THE CONSTRUCTION DRAWINGS, AND/OR AS DIRECTED BY THE PROJECT OFFICER.
- THE CONTRACTOR SHALL SUBMIT A DETAILED SCHEDULE WHICH INDICATES START AND FINISH DATES FOR EACH SEGMENT OF THE WORK. THE SCHEDULE SHALL INDICATE THE DURATION OF ALL LANE OR SHOULDER CLOSURES. THE CONTRACTOR SHALL NOTIFY THE PROJECT OFFICER A MINIMUM OF 3 BUSINESS DAYS IN ADVANCE OF PROCEEDING TO THE NEXT WORK SEGMENT.
- THE CONTRACTOR SHALL NOTIFY THE PROJECT OFFICER OF PARKING RESTRICTION NEEDS A MINIMUM OF 3 BUSINESS DAYS PRIOR TO COMMENCEMENT OF WORK FOR EACH SEGMENT. COUNTY PROJECT OFFICER SHALL RESTRICT PARKING BY CONTACTING DES - PERMITTING SECTION, 703-228-4798.
- DURING CONSTRUCTION, THE CONTRACTOR SHALL EITHER MAINTAIN APPROPRIATE SIGHT DISTANCE TO ALL TRAFFIC SIGNS OR PROVIDE FOR TEMPORARY SIGNAGE OR FLAGGERS TO GUIDE TRAFFIC THROUGH WORK ZONES.
- THE CONTRACTOR SHALL MINIMIZE THE DURATION OF ANY BLOCKAGE TO PRIVATE ENTRANCES AND DRIVEWAYS. THE CONTRACTOR SHALL SUBMIT A SCHEDULE OF DRIVEWAY CLOSURE FOR APPROVAL BY THE PROJECT OFFICER. THE PROJECT OFFICER SHALL BE NOTIFIED A MINIMUM OF 3 BUSINESS DAYS IN ADVANCE OF SUCH ACTIVITIES. THE CONTRACTOR SHALL NOTIFY THE PROPERTY OWNER AT LEAST 24 HOURS IN ADVANCE OF THE START OF ANY WORK THAT WILL REQUIRE TEMPORARY CLOSURE OF ACCESS TO THE PROPERTY. THE CONTRACTOR SHALL MAKE ALL PRIVATE ENTRANCES AND DRIVEWAYS ACCESSIBLE AT THE CONCLUSION OF EACH WORKDAY.
- ANY EXCAVATIONS WHICH ARE SPECIFICALLY APPROVED BY THE PROJECT OFFICER TO REMAIN OPEN PAST NORMAL WORKING HOURS SHALL BE THE RESPONSIBILITY OF THE CONTRACTOR AND SHALL BE PROTECTED IN ACCORDANCE WITH THE VIRGINIA WORK AREA PROTECTION MANUAL AND AS APPROVED BY THE PROJECT OFFICER.
- PEDESTRIAN TRAFFIC SHALL BE MAINTAINED AT ALL TIMES, INCLUDING ACCESS TO BUS STOP SHELTERS, UNLESS OTHERWISE APPROVED IN THE PLANS.
- PEDESTRIAN TRAFFIC SHALL BE SEPARATED FROM WORK ZONES WITH APPROPRIATE MEASURES IN ACCORDANCE WITH MUTCD.
- ADEQUATE PROVISIONS FOR PERSONS WITH DISABILITIES SHALL BE PROVIDED AT ALL TIMES PER ADA REQUIREMENTS.
- WHEN NECESSARY, PEDESTRIANS SHALL BE APPROPRIATELY DIRECTED WITH ADVANCED WARNING SIGNS PLACED AT INTERSECTIONS, TO CROSS TO THE OPPOSITE SIDE OF THE ROADWAY IN ORDER TO PREVENT CONFLICT WITH MIDDLEBLOCK WORK SITES.
- PEDESTRIANS SHALL NOT BE LED INTO CONFLICT WITH WORK SITE EQUIPMENT, OPERATIONS, AND/OR VEHICLES MOVING THROUGH OR AROUND THE WORK SITE.
- ALL EXISTING FIRE HYDRANTS AND FIRE DEPARTMENT CONNECTIONS SHALL BE MAINTAINED UNOBSTRUCTED AND ACCESSIBLE AT ALL TIMES IN ACCORDANCE WITH SECTIONS 508.5.4 AND 508.5.5 OF THE ARLINGTON COUNTY FIRE PREVENTION CODE.
- ACCESS TO BUILDINGS FOR FIREFIGHTING SHALL BE MAINTAINED AT ALL TIMES. EXISTING FIRE APPARATUS ACCESS ROADS (FIRE LANES) SHALL BE KEPT CLEAR OF OBSTRUCTIONS IN ACCORDANCE WITH SECTION 503.4 OF THE ARLINGTON COUNTY FIRE PREVENTION CODE. ACCESS TO CONSTRUCTION SITES SHALL BE PROVIDED AND MAINTAINED IN ACCORDANCE WITH SECTION 1410 OF THE ARLINGTON COUNTY FIRE PREVENTION CODE.
- IN THE EVENT THAT EXISTING FIRE DEPARTMENT CONNECTIONS OR FIRE APPARATUS ACCESS ROADS (FIRE LANES) MUST BE OBSTRUCTED TO FACILITATE CONSTRUCTION ACTIVITIES, CONTACT THE ARLINGTON COUNTY FIRE DEPARTMENT OFFICE AT 703-228-4644 TO COORDINATE REVIEW AND APPROVAL OF TEMPORARY FIRE DEPARTMENT CONNECTIONS AND/OR FIRE APPARATUS ACCESS ROADS PRIOR TO CREATING THE OBSTRUCTION.
- VEHICLE DETECTION AT ALL TIMES DURING THE PROJECT. TRAFFIC SENSORS SHALL BE RESTORED TO THEIR PRE-CONSTRUCTION STATE PRIOR TO THE COMPLETION OF THIS PROJECT.
- WORK HOURS ARE RESTRICTED TO 9:30 AM TO 3:00 PM (MON.- THUR.) & 9:30AM TO 2:00 PM (FRIDAY)
- CONTRACTOR SHALL COVER ANY EXISTING SIGNS WHICH ARE NOT APPLICABLE OR ARE IN CONFLICT WITH THIS MOT PLAN.
- CONTRACTOR SHALL ERADICATE AND RE-STRIPE AS NECESSARY ANY EXISTING PAVEMENT MARKINGS THAT ARE IN CONFLICT OR DO NOT ALIGN WITH THE TEMPORARY PAVEMENT MARKINGS OR NEW TRAFFIC PATTERNS.
- CONTRACTOR SHALL ERADICATE ALL TEMPORARY PAVEMENT MARKING, INCLUDING TEMPORARY MARKED CROSSWALKS ONCE THE WORK AREA(S) ASSOCIATED WITH THE MARKINGS HAS BEEN COMPLETED.
- CONTRACTOR SHALL COORDINATE WITH ARLINGTON COUNTY TRANSIT AT 703-228-3049, AT LEAST FOUR (4) WEEKS PRIOR TO COMMENCEMENT OF ALL WORK AFFECTING TRANSIT STOP OR ROUTES. ALL TEMPORARY AND FINAL BUS TRAVEL LANES MUST BE MINIMUM 11' WIDE.




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Inside Lane Closure Operation on a Four-Lane Roadway (Figure TTC-17.1)



Lane Closure Operation in an Intersection (Figure TTC-28.1)

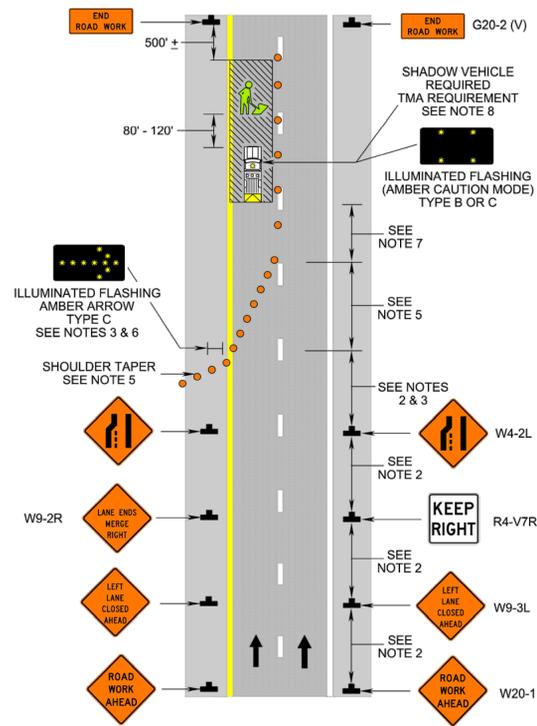

Typical Traffic Control Lane Closure Operation in an Intersection (Figure TTC-28.1)

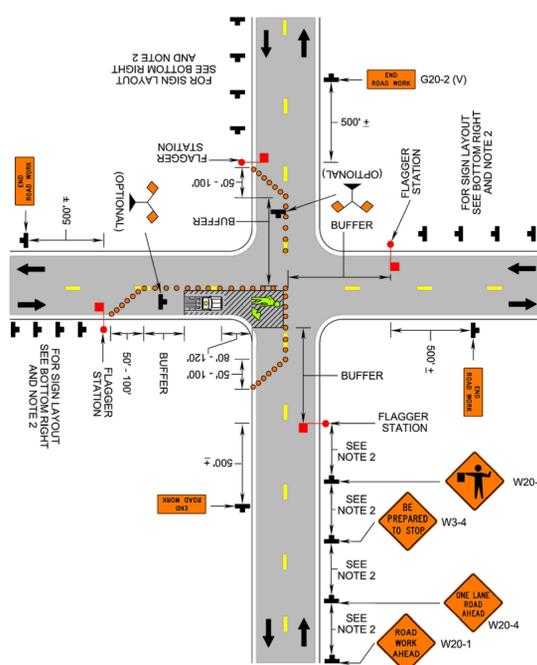- NOTES
1. The control of traffic through the intersection in order of preference should be:
a. Obtain the services of law enforcement personnel.
b. Detour the effective routes to other roads and streets as approved and directed by the Regional Traffic Engineer.
c. Place a state certified flagger on each leg of the intersection controlling a single lane of traffic.
2. Sign spacing distance should be 350'-500' where the posted speed limit is 45 mph or less, 500'-800' where the posted speed limit is greater than 45 mph.
Standard:
3. Channelizing device spacing shall be on 20' centers or less.
Guidance:
4. If room permits, a shadow vehicle with at least one rotating amber light or high intensity amber flashing or oscillating light should be parked 80'-120' in advance of the first work crew.
Standard:
5. For emergency situations (any non-planned operation) of 30 minutes or less duration, two rotating amber lights or high intensity amber flashing or oscillating lights mounted on the vehicle and visible for 360° shall be required in addition to the channelizing devices shown around the vehicle. Also, vehicle hazard warning signals shall be used.
Guidance:
6. If the work space extends across a crosswalk, the crosswalk should be closed using the information and devices shown in Figure TTC-36.
Support:
7. Turns can be prohibited as required by vehicular traffic conditions. Unless the streets are wide, it might be physically impossible to make certain turns, especially for large vehicles.

1: Revision 1 - 4/1/2015

Typical Traffic Control Inside Lane Closure Operation on a Four-Lane Roadway (Figure TTC-17.1)

- Standard:
1. On divided highways having a median wider than 8', right and left sign assemblies shall be required.
Guidance:
2. Sign spacing should be 1300'-1500' for Limited Access highways. For all other roadways, the sign spacing should be 500'-800' where the posted speed limit is greater than 45 mph, and 350'-500' where the posted speed limit is 45 mph or less.
3. Care should be exercised when establishing the limits of the work zone to insure maximum possible sight distance in advance of the transition, based on the posted speed limit and at least equal to or greater than the values in Table 6H-3. For Limited Access highways a minimum of 1000' is desired.
4. All vehicles, equipment, workers, and their activities should be restricted to one side of the pavement.
Standard:
5. Taper length (L) and channelizing device spacing shall be:


Table with 2 columns: Speed Limit (mph) and Lane Width (Feet). Rows show taper lengths for various speed limits and lane widths.

Table with 2 columns: Location and Speed Limit (mph). Rows show channelizing device spacing for different locations and speed limits.

- On roadways with paved shoulders having a width of 8 feet or more, channelizing devices shall be used to close the shoulder in advance of the merging taper to direct vehicular traffic to remain within the traveled way.
6. An arrow board shall be used when a lane is closed. When more than one lane is closed, a separate arrow board shall be used for each closed lane (see Figure TTC-18).
7. The buffer space length shall be shown in Table 6H-3 on Page 6H-5 for the posted speed limit.
8. A shadow vehicle with either a Type B or C arrow board operating in the caution mode, or at least one high intensity amber rotating, flashing, or oscillating light shall be parked 80'-120' in advance of the first work crew. When the posted speed limit is 45 mph or greater, a truck-mounted attenuator shall be used.
9. Vehicle hazard warning signals shall not be used instead of the vehicle's high-intensity amber rotating, flashing, or oscillating lights but can be used to supplement the amber rotating, flashing, or oscillating lights.
10. When a side road intersects the highway within the TTC zone, additional TTC devices shall be placed as needed.

1: Revision 1 - 4/1/2015

Crosswalk Closure and Pedestrian Detour Operation (Figure TTC-36.1)

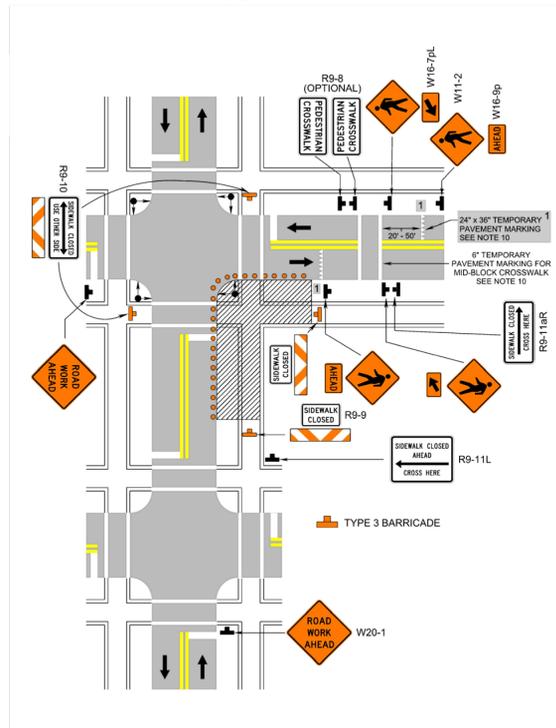

1: Revision 1 - 4/1/2015

Typical Traffic Control Crosswalk Closure and Pedestrian Detour Operation (Figure TTC-36.1)

- Standard:
1. When crosswalks or other pedestrian facilities are closed or relocated, temporary facilities shall be detectable and shall include accessibility features consistent with the features present in the existing pedestrian facility.
2. Curb parking shall be prohibited for at least 50 feet in advance of the midblock crosswalk.
Guidance:
3. Audible information devices should be considered where midblock closings and changed crosswalk areas cause inadequate communication to be provided to pedestrians who have visual disabilities.
4. Pedestrian traffic signal displays controlling closed crosswalks should be covered or deactivated.
5. Temporary markings should be considered for operations exceeding three days in duration.
Option:
6. Only the TTC devices related to pedestrians are shown. Other devices, such as lane closure signing or ROAD NARROWS (W5-1) signs, may be used to control vehicular traffic.
7. For nighttime closures, Type A Flashing warning lights may be used on barricades supporting signs and closing sidewalks.
8. In order to maintain the systematic use of the fluorescent yellow-green background for pedestrian, bicycle, and school warning signs in a jurisdiction, the fluorescent yellow-green background for pedestrian, bicycle, and school warning signs may be used in TTC zones.
Standard:
9. All sidewalk closures shall be closed with Type 3 Barricades.
Support:
10. Refer to Sections 3B-16 through 3B-18 of the 2009 MUTCD and the Virginia Supplement to the MUTCD for crosswalk lines, yield lines and other related TTC devices that may be used to control vehicular traffic at midblock crosswalks.


1: Revision 1 - 4/1/2015



DEPARTMENT OF ENVIRONMENTAL SERVICES FACILITIES & ENGINEERING DIVISION ENGINEERING BUREAU 2100 CLARENDON BOULEVARD, SUITE 813 ARLINGTON, VA 22201 PHONE: 703.228.3629 FAX: 703.228.3606

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SEAL

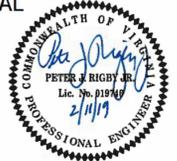

APPROVALS DATE

Quality control and approval signatures with dates: 2/14/19, 2/15/19, 2/19/19, 2/12/19, 2/14/19.

REVISIONS DATE

FAIRFAX DR. & N. LYNN ST.

MOT\_PLAN II

FAIRFAX DR. & N. LYNN ST. SE CORNER AT INTERSECTION

P14D

DESIGNED: K. PATEL DRAWN: K. PATEL CHECKED: P. RIGBY MISS UTILITY TRANSMITTAL #: N/A

FILENAME: P14D-B-4-286-MOT.DWG

PATH: Q:\DATA\P14D\_B-4 CORRIDOR IMPROVEMENTS\SITE B-4 FAIRFAX DR & N LYNN STREET\CAD FILES\ACTIVE

PLOTTED: FEBRUARY 4 2019 PLOTTED BY: KPATEL

SCALE: AS NOTED

SHEET 13 OF 13