

**ENGINEER** DEPARTMENT OF **ENVIRONMENTAL SERVICES** 

WWW.ARLINGTONVA.US

CONSTRUCTION DRAWINGS FOR:


FACILITIES & ENGINEERING DIVISION ENGINEERING BUREAU 2100 CLARENDON BOULEVARD, SUITE 813 ARLINGTON, VA 22201 PHONE: 703.228.3629 FAX: 703.228.3606

**OWNER** DEPARTMENT OF **ENVIRONMENTAL SERVICES** 

DIVISION OF TRANSPORTATION & DEVELOPMENT TRANSPORTATION PLANNING 2100 CLARENDON BOULEVARD, SUITE 900, ARLINGTON, VA 22201 PHONE: 703.228.3681 FAX: 703.228.7584 WWW.ARLINGTONVA.US


CONTRACTOR TO BE DETERMINED

# LOCATION MAP

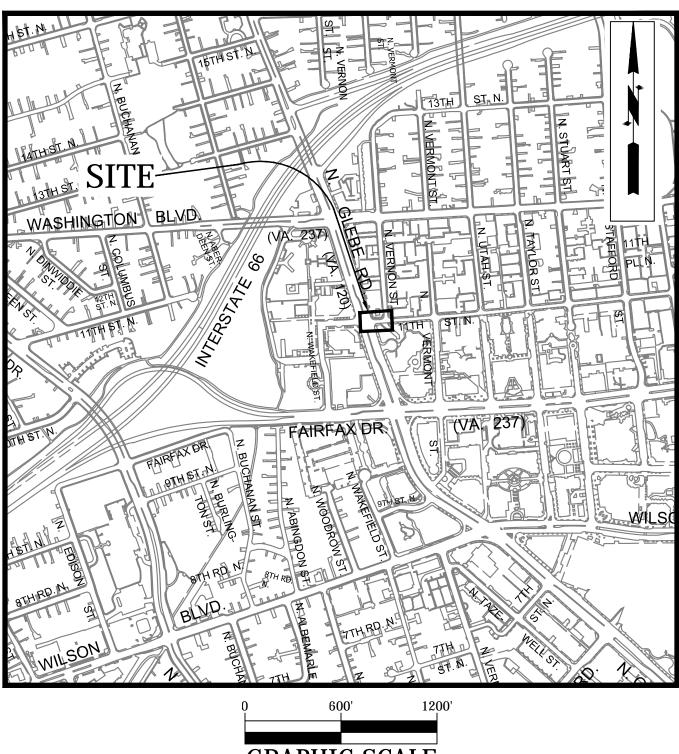

ARLINGTON

DEPARTMENT OF ENVIRONMENTAL SERVICE

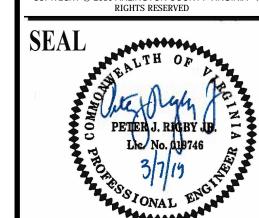

DATE

**REVISIONS** 

# GENERAL NOTES:

NE & SE CORNER AT INTERSECTION

N. GLEBE RD. @ 11TH ST. N.

PROJECT CODE: P14D

- ALL CONSTRUCTION WORK FOR THIS PROJECT SHALL CONFORM TO THE ARLINGTON COUNTY DEPARTMENT OF ENVIRONMENTAL SERVICES, CONSTRUCTION STANDARDS AND SPECIFICATIONS, AND WHERE APPLICABLE THE VIRGINIA DEPARTMENT OF TRANSPORTATION (VDOT) ROAD AND BRIDGE SPECIFICATIONS, AND ROAD AND BRIDGE STANDARDS. THE LATEST EDITIONS OF EACH RELEVANT MANUAL SHALL BE USED.
- 2. ALL CONSTRUCTION AND WORK ACTIVITIES SHALL COMPLY WITH THE VIRGINIA WORK AREA PROTECTION MANUAL AND ALL OTHER RELEVANT WORK SAFETY REQUIREMENTS, LATEST
- 3. THE CONTRACTOR SHALL IMMEDIATELY NOTIFY THE PROJECT OFFICER OF ANY DISCREPANCIES BETWEEN ACTUAL FIELD CONDITIONS AND THE APPROVED PLANS.
- 4. THE CONTRACTOR SHALL CONTACT "MISS UTILITY" AT 811 FOR MARKING THE LOCATIONS OF EXISTING UNDERGROUND UTILITIES (i.e. WATER, SEWER, GAS, TELEPHONE, ELECTRIC, AND CABLE TV) AT LEAST 72 HOURS PRIOR TO ANY EXCAVATION OR CONSTRUCTION. THE CONTRACTOR IS REQUIRED TO IDENTIFY AND PROTECT ALL OTHER UTILITY LINES FOUND IN THE WORK SITE AREA BELONGING TO OTHER OWNERS THAT ARE NOT MEMBERS OF "MISS UTILITY". PRIVATE WATER, SEWER AND GAS LATERALS WILL NOT BE MARKED BY MISS UTILITY OR THE COUNTY. THE CONTRACTOR SHALL LOCATE AND PROTECT THESE SERVICES DURING
- 5. THE CONTRACTOR SHALL BE RESPONSIBLE FOR LAYING OUT THE WORK AND SHALL RETAIN A PROFESSIONAL LAND SURVEYOR LICENSED IN THE COMMONWEALTH OF VIRGINIA TO PROVIDE ALL NECESSARY CONSTRUCTION LAYOUTS AND ESTABLISH ALL CONTROL LINES, GRADES, AND ELEVATION DURING CONSTRUCTION. THE CONTRACTOR SHALL SUBMIT A COPY OF ALL CUT SHEETS FOR REVIEW, PER THE SPECIFICATIONS. THE COST OF ALL NECESSARY SURVEYING SERVICES SHALL BE CONSIDERED INCIDENTAL TO THE WORK AND, UNLESS OTHERWISE SPECIFIED, THE COST SHALL BE INCORPORATED INTO THE COSTS FOR RELEVANT ITEMS.
- 6. THE LOCATION OF ALL EXISTING UTILITIES SHOWN ON THESE PLANS ARE FROM BEST AVAILABLE RECORDS AND SHALL BE CONSIDERED TO BE APPROXIMATE. WHEN CONSTRUCTION ACTIVITY REACHES IN PROXIMITY TO EXISTING UTILITIES, THE TRENCH(ES) SHALL BE OPENED A SUFFICIENT DISTANCE AHEAD OF THE WORK OR TEST PITS SHALL BE MADE TO VERIFY THE EXACT LOCATION AND INVERTS OF THE UTILITY TO ALLOW FOR POSSIBLE CHANGES IN THE LINE OR GRADE AS DIRECTED BY OFFICER. THE CONTRACTOR SHALL BE RESPONSIBLE FOR ANY DAMAGE TO THE EXISTING UTILITIES AND THE RELATED STRUCTURES. ALL EXISTING UTILITY SYSTEMS SHALL BE PROTECTED TO PREVENT DAMAGE DURING THE CONTRACTOR'S OPERATIONS. ANY SYSTEM DAMAGED SHALL BE PROMPTLY REPAIRED AT NO COST TO THE
- 7. EXISTING MANHOLE FRAMES, COVERS, VALVE BOXES, AND OTHER APPURTENANCES SHALL BE ADJUSTED TO THE FINAL GRADE OR REPLACED, AS NECESSARY. UNLESS OTHERWISE SPECIFIED, THE COST FOR THIS SHALL BE CONSIDERED INCIDENTAL TO THE WORK, AND SHALL BE INCORPORATED INTO THE COSTS FOR RELEVANT ITEMS.
- 8. THE CONTRACTOR SHALL PROVIDE ADA COMPLIANT ACCESS THROUGH OR AROUND THE SITE AT ALL TIMES AND SHALL ENSURE THE SAFETY OF ALL THOSE PASSING THROUGH OR ADJACENT TO THE SITE.

9. THE CONTRACTOR SHALL CONFINE ALL ACTIVITIES AT THE SITE ASSOCIATED WITH CONSTRUCTION ACTIVITIES, TO INCLUDE STORAGE OF EQUIPMENT AND OR MATERIALS, ACCESS TO THE WORK, FORMWORK, ETC. TO WITHIN THE DESIGNATED LIMITS OF DISTURBANCE

#### TREE PROTECTION

10. TREES SHALL BE PROTECTED PER THE REQUIREMENTS OF ARLINGTON PARK & RECREATION STANDARDS.

### TRAFFIC CONTROL

- 11. CONTRACTOR SHALL NOTIFY THE PROJECT OFFICER AT LEAST 3 WORKING DAYS PRIOR TO DISTURBING ANY EXISTING, OR INSTALLING ANY NEW, TRAFFIC SIGNS, SIGNALS, OR OTHER TRAFFIC CONTROL DEVICES.
- 12. THE CONTRACTOR SHALL PREMARK THE LAYOUT OF ANY PERMANENT TRAFFIC CONTROL STRIPING, INDICATING THE PROPOSED LOCATION AND TYPE OF MARKING TO BE INSTALLED. THE PREMARKING MAY CONSIST OF TYPE D TAPE, CHALK, OR LUMBER CRAYONS. THE CONTRACTOR SHALL ALLOW 3 WORKING DAYS FOR THE INSPECTION AND APPROVAL OF THE PREMARKINGS PRIOR TO PLACING THE PERMANENT MARKINGS.
- 13. THE CONTRACTOR SHALL SUBMIT ANY REQUESTS FOR TEMPORARY "NO PARKING" RESTRICTIONS TO THE PROJECT OFFICER AT LEAST 3 WORKING DAYS PRIOR TO THE DESIRED ONSET OF RESTRICTIONS.
- 14. THE CONTRACTOR SHALL PRESERVE ALL BUS STOPS, INCLUDING MAINTAINING ADEQUATE ACCESSIBILITY THROUGH AND ADJACENT TO THE CONSTRUCTION FOR BUSES AND THEIR PASSENGERS. THE CONTRACTOR SHALL NOT CLOSE, RELOCATE, OR OTHERWISE MODIFY A BUS STOP WITHOUT PRIOR REQUEST OF THE PROJECT OFFICER. TYPICALLY ANY RELOCATION OR CLOSURE OF A BUS STOP WILL REQUIRE AT LEAST FOUR (4) WEEKS ADVANCE NOTICE FOR COORDINATION WITH THE COUNTY'S BUS STOP COORDINATOR AT 703-228-3049. ALL TEMPORARY AND FINAL BUS TRAVEL LANES MUST BE MINIMUM 11' WIDE.
- 15. WHEN CONDITIONS WARRANT DUE TO TRAFFIC VOLUMES, PATTERNS, OR SPECIAL EVENTS, THE COUNTY MAY SUSPEND OR OTHERWISE DIRECT THE CONTRACTOR'S ACTIVITIES TO PROTECT THE PUBLIC AND OR THE COUNTY'S TRANSPORTATION NETWORK.

#### WATER DISTRIBUTION, STORM, AND SANITARY SEWER SYSTEMS

- 16. UNLESS OTHERWISE DIRECTED, CONTRACTORS ARE EXPRESSLY PROHIBITED FROM OPERATING ANY WATER VALVES OR APPURTENANCES. CONTRACTORS SHALL SUBMIT ALL REQUESTS FOR VALVE OPERATIONS TO THE PROJECT OFFICER AT LEAST 3 WORKING DAYS IN ADVANCE OF THE REQUIRED OPERATION.
- 17. IN THE EVENT OF A WATER OR SEWER EMERGENCY, THE CONTRACTOR SHALL IMMEDIATELY NOTIFY THE COUNTY'S WATER CONTROL CENTER AT 703-228-5555 AND THE PROJECT OFFICER.

# TABLE OF CONTENTS

SHEET NUMBER SHEET TITLE **COVER SHEET** LEGEND **DETAILS SHEET EXISTING CONDITIONS** DEMOLITION PLAN EROSION AND SEDIMNT CONTROL PLAN GEOMETRIC CONTROL PLAN AND PROFILE RAMP DETAILS **CROSS SECTIONS** SIGNAGE AND STRIPING MOT PLAN I MOT\_PLAN II

S RD Z 17,000 -VPD N. GLEBE RD. - 2017 - TE & O 9,300 - VPD 11TH ST. N. 2017 - TE & O DESIGNED: K.PATEL DRAWN : K.PATEL CHECKED : P.RIGBY

STREET CLASSIFICATION NEIGHBOURHOOD PRINCIPAL - 11TH ST. N.

PRINCIPAL ARTERIAL - N. GLEBE RD.

MAINTAINING AGENCY: ARLINGTON COUNTY

2011 AASHTO CITY BUS

POSTED/ DESIGN SPEED 30 MPH - N. GLEBE RD.

DESIGN VEHICLE

**SHEET** 

1 OF 13

MISS UTILITY TRANSMITTAL #: N/A

 $PATH: {\tiny Q:\ DATA:P14D\subseteq RS\ CORRIDOR\ IMPROVEMENTS:SITE\ B-5\ N\ GLEBE\ ROAD\ IIITH\ STREET\ N:\ CAD\ FILES:ACTIVE$ 

FILENAME: P14D\_B-5-200-COVER.DWG

SCALE: AS NOTED

PLOTTED: MARCH 4 2019

PLOTTED BY: KPATEL

evised: 01/21/2016

AUTOTURN (TURNING MOVEMENT) USED SPEED: 10MPH


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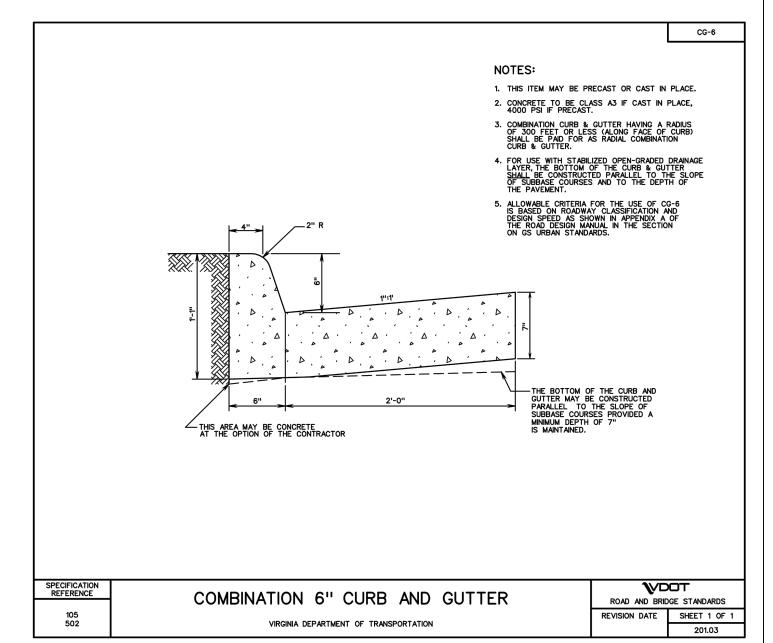
	LINETY	PE LEGEND	<u>SY</u>	MBOL LEGE	END .	
<u>FEATURE</u>	EXISTING	PROPOSED	EXIST	TING	PROPOSED	
BACK OF CURB			EX BENCHMARK		PROP FIRE HYDRANT	
BUILDING			EX CABLE PEDESTAL	С	PROP GAS VALVE	
CENTERLINE / BASELINE			EX ELECTRIC BOX	E	PROP LIGHT POLE	
COMMUNICATIONS CABLE	COM	сом	EX FIRE HYDRANT -	<del>-</del>	PROP PAY STATION	
CONTOURS		<del></del>	EX GAS VALVE	•	PROP SANITARY MANHOLE	
			EX GROUND LIGHT	€	THOI SANTAKI FIAMIOLE	
CRITICAL ROOT ZONE		——————————————————————————————————————	EX GUY WIRES	<b>&gt;</b>	PROP STORM CATCH BASIN (TO SCALE)	0
EASEMENT				•	PROP STORM MANHOLE	0
ELECTRIC (UNDERGROUND)	UGE			<b>9</b>	PROP TRAFFIC SIGN	
FACE OF CURB					PROP TRASH CAN	<b>⊛</b>
FENCE (MATERIAL NOTED)	xxxxx	xxxxx		lacktriangle	PROPOSED TREE REMOVAL	X
,				PS		
FIBER OPTIC		fo		0	PROP UTILITY POLE	
GAS LINE	——— GAS————	——— GAS————			PROP WATER MANHOLE	
X" GAS LINE (SIZE INCLUDED IF AVAILABLE)	X" G X" G	——————————————————————————————————————		0	PROP WATER METER	$lackbox{}$
GUARDRAIL			EX TELEPHONE PEDESTAL	T	PROP WATER VALVE	•
HARDSCAPE FEATURE			EX TRAFFIC CONTROL BOX		PROP YARD INLET (TO SCALE)	
(MATERIAL NOTED)	LOD	LOD	EX TRAFFIC SIGN –	•	CONSTRUCTION NOTES	
LIMITS OF DISTURBANCE	LOD —	LOD	EX TRASH CAN	₩	(LEADER TO AREA AFFECTED)	
LIMITS OF WORK	LOW	LOW	EX TRAVERSE	$\triangle$	CURVE NUMBER (SEE CURVE TABLE)	(C1)
OVERHEAD WIRES			EX TREES, WOODED AREA	(   1	LINE NUMBER (SEE LINE TABLE)	
PAVEMENT MINI SKIP LINE			EX UTILITY MANHOLE TYPE INDICATED ELECTRIC, TELE, ETC	<b>(</b>		
PAVEMENT SKIP LINE			EX UTILITY POLE		NORTH ARROW	
PROPERTY LINE			EX WATER MANHOLE	θ		
PROPERTY LINE			EX WATER METER		TEST HOLE	
RIGHT-OF-WAY LINE			EX WATER VALVE			
ROOT PRUNING	——————————————————————————————————————	———— RP ————	EX YARD INLET			
SANITARY SEWER		SAN SAN			HATCH LEGE	<u>ND</u>
X" SANITARY SEWER (SIZE INCLUDED IF AVAILABLE)	X" S X" S				PROP MILL & OVERLAY SEE TYPICAL SECTION FOR DETAILS	
SILT FENCE	SF SF	SF SF			PROP FULL DEPTH ASPHALT	******
					SEE TYPICAL SECTION FOR DETAILS	
STORM (SIZE NOTED)					PROP CONCRETE	
STREAM					REPLACE & MATCH EXISTING DRIVEWAY OR LEADWALK SEE CONSTRUCTION NOTES	
STREET LIGHT CONDUIT	—— SL ——— SL ———	SL			DEMOLITION AREA	
TELEPHONE (UNDERGROUND)		UGT		LABEL LEG		
TREE LINE			EVICTING	rader re(		
TDEE DO OFFICE OF THE STATE OF			EXISTING  EX SAN STRUC NO. EXISTING SANITARY STRUCTURE NUMBER	(XXXX)	PROPOSED  PROP SAN SEW STRUC NO. PROPOSED SANITARY SEWER STRUCTURE NUMBER	XXXX
TREE PROTECTION FENCE	——— TPF ———— TPF ———	——————————————————————————————————————	EX STRM SEW STRUC NO. EXISTING STORM SEWER STRUCTUE NUMBE		PROP STRM SEW STRUC NO. PROPOSED STORM SEWER STRUCTURE NUMBER	XXXXX
WALL						
WATER						
X" WATER	X" W X" W	X" W X" W				


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DEPAR ENVIRONM FACILITIES & EN ENGINE 2100 CLARENDON ARLINGT	RTMENT OF ENTAL SERVICES NGINEERING DIVISION ERING BUREAU BOULEVARD, SUITE 813 TON, VA 22201
FAX: 7 COPYRIGHT © 2016 ARL	703.228.3629 703.228.3606 INGTON COUNTY VIRGINIA - ALL HTS RESERVED
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APPROVALS	
QUALITY CONTRO	DI ENCHIEER U3/12/19
CONSTRUCTION N	MAR 1 1 2019 MANAGEMENT SUPERVISOR  LH- 110
WATER SEWER, S	STREETS BUREAU CHIEF
TRANSPORTATION	N DIRECTOR 3/12/19
PROJECT MANAGE	- 101 - 12 19 ER
REVISION	NS DATE
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JECT NAME AND LOCATION  N. GLEBE RD. @ 11TH ST. N	LEGEND N. GLEBE RD. @ 11TH ST. N NE & SE CORNER AT INTERSEC
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PROJECT NAME AND LOCATION N. GLEBE RD. @ 11TH	F RI
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	' '
DESIGNED: K.PATE DRAWN : K.PATE CHECKED : P.RIGB	EL.
DESIGNED: K.PATE DRAWN: K.PATE	EL EL BY
DESIGNED: K. PATE DRAWN : K. PATE CHECKED : P. RIGB MISS UTILITY TRA FILENAME: P14D-B-5	EL EL BY NSMITTAL #: N/A
DESIGNED: K. PATE DRAWN : K. PATE CHECKED : P. RIGB MISS UTILITY TRA FILENAME: P14D-B-5	CL CL SY ANSMITTAL #: N/A 5-202-LEGEND.DWG RRIDOR IMPROVEMENTS\SITE B-5 N GLEBE ROAD & LESVACTIVE 2019
DESIGNED: K.PATE DRAWN: K.PATE CHECKED: P.RIGB MISS UTILITY TRA FILENAME: P14D-B-5 PATH: Q:\DATA\P14D\RB COI 11TH STREET N\CAD FI PLOTTED: MARCH 4	CL CL BY ANSMITTAL #: N/A 5-202-LEGEND.DWG RRIDOR IMPROVEMENTS/SITE B-5 N GLEBE ROAD & LESVACTIVE 2019 EL
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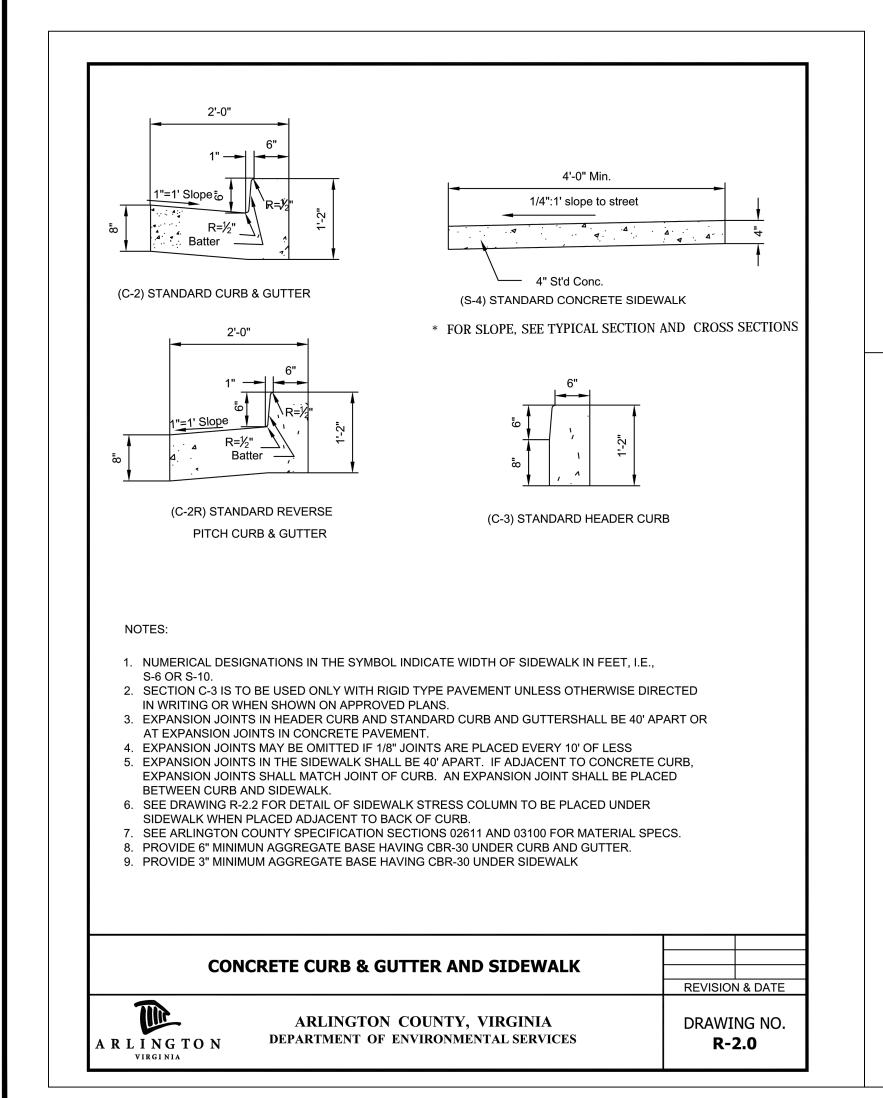
SHEET 2 OF 13






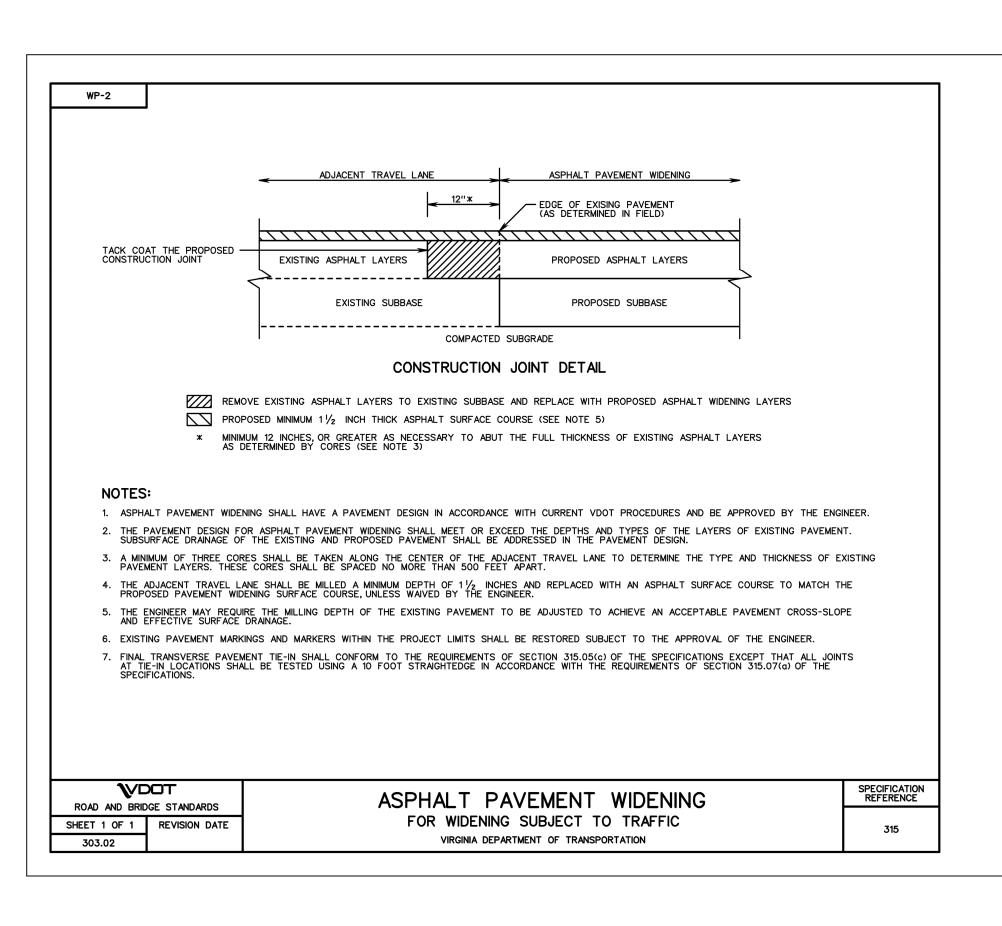

- 1. ALL PAVEMENTS SHALL BE WIDENED IN ACCORDANCE WITH VDOT STANDARD WP-2. PROPOSED FULL DEPTH PAVEMENT REPLACEMENT SHALL MATCH EXISTING PAVEMENT IN ACCORDANCE WITH VDOT STANDARD WP-2.
- 2. AGGREGATE SUBBASE THICKNESS BENEATH THE WIDENED PAVEMENT SHALL BE AS INDICATED (6 INCHES) ON THIS SHEET OR MATCH THE EXISTING AGGREGATE BASE MATERIAL, WHICHEVER IS GREATER.
- 3. PROVIDE 1' WIDE GRADING BENCH BEHIND PROPOSED SIDEWALKS WHEN SPACE ALLOWS.
- 4. AS INDICATED IN TYPICAL SECTIONS, THE SUBBASE 21-B SHALL BE CONNECTED TO A VDOT STANDARD UD-4 EDGE DRAIN LOCATED BENEATH THE PROPOSED CURB AND GUTTER, TO BE SECURELY CONNECTED TO OUTFALL AT AN ADJACENT DRAINAGE STRUCTURE.
- 5. THE ADJACENT TRAVEL LANE SHALL BE MILLED TO A DEPTH OF 2" AND REPLACED WITH 2" ASPHALT CONCRETE TYPE SM-9.5D.
- 6. 4" MINIMUM, PROVIDED ATTAINING MINIMUM 4" OF AGGREGATE ON TOP OF THE EDGEDRAIN.

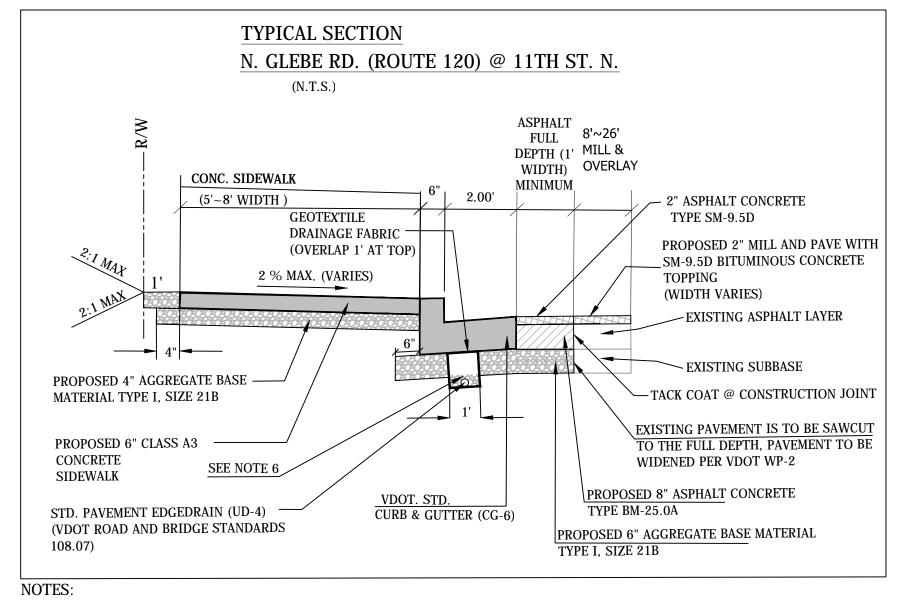

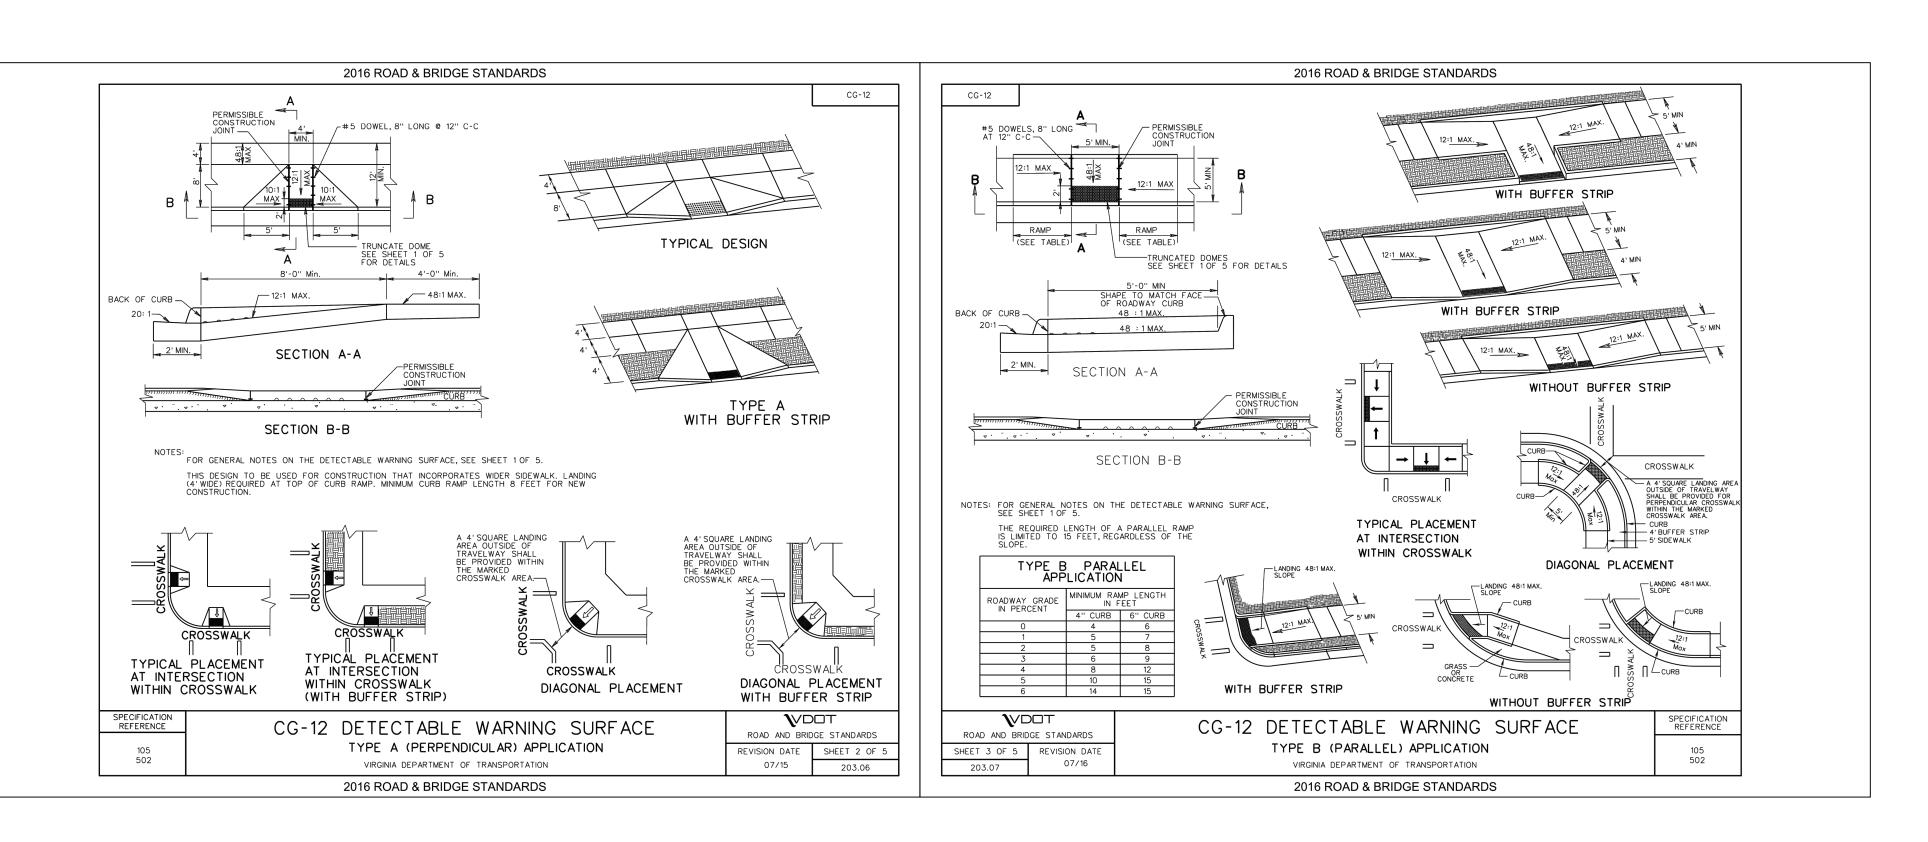


DEPARTMENT OF ENVIRONMENTAL SERVICES FACILITIES & ENGINEERING DIVISION ENGINEERING BUREAU 100 CLARENDON BOULEVARD, SUITE 813 ARLINGTON, VA 22201 PHONE: 703.228.3629 FAX: 703.228.3606 COPYRIGHT © 2016 ARLINGTON COUNTY VIRGINIA - ALL RIGHTS RESERVED APPROVALS WATER, SEWER, STREETS BUREAU CHIEF RANSPORTATION DIRECTOR PROJECT MANAGER DATE **REVISIONS** GLEBE Z DESIGNED: K.PATEL DRAWN : K.PATEL CHECKED : P.RIGBY MISS UTILITY TRANSMITTAL #: N/A FILENAME: P14D-B-5-202-LEGEND.DWG PLOTTED: MARCH 4 2019 PLOTTED BY: KPATEL SCALE: AS NOTED SHEET 3 OF 13


ARLINGTON

VIRGINIA

evised: 01/21/2016

N.GLEBE RD. @ 11TH ST. N.

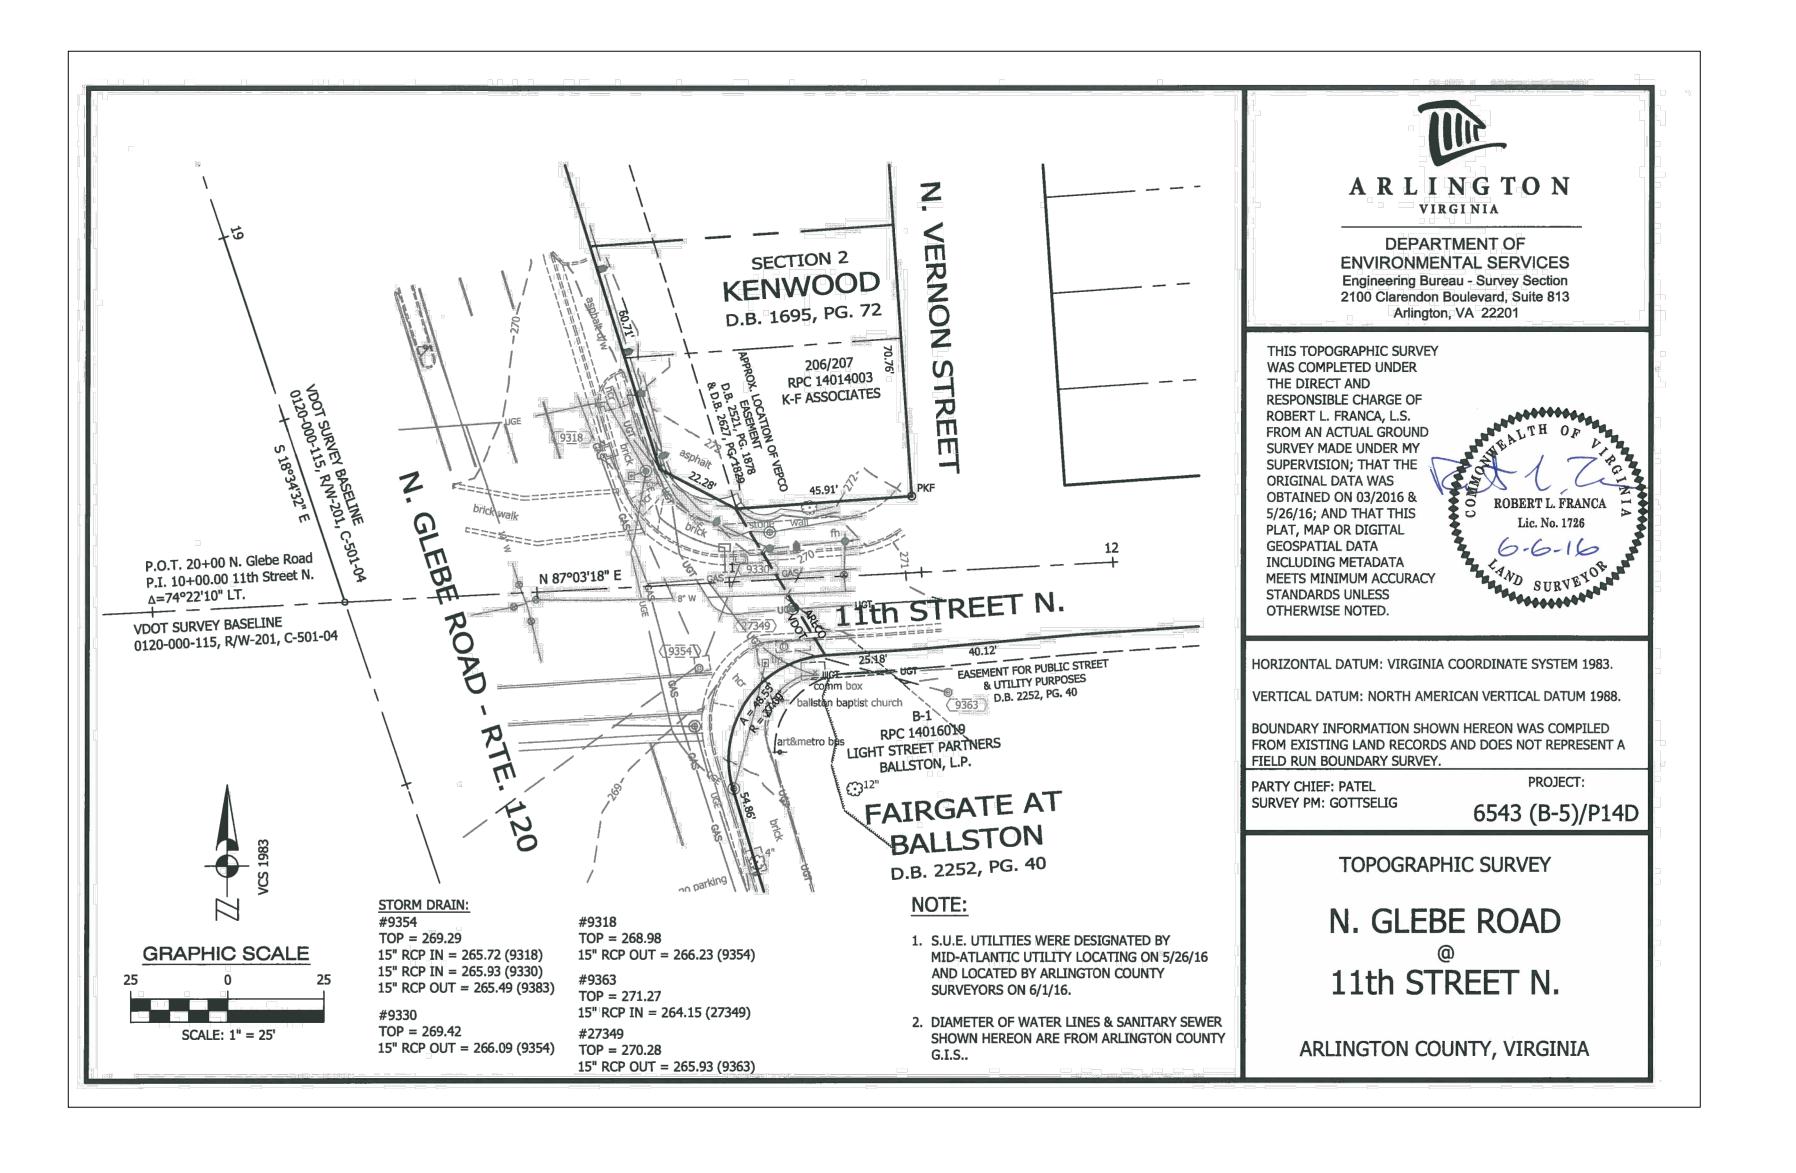

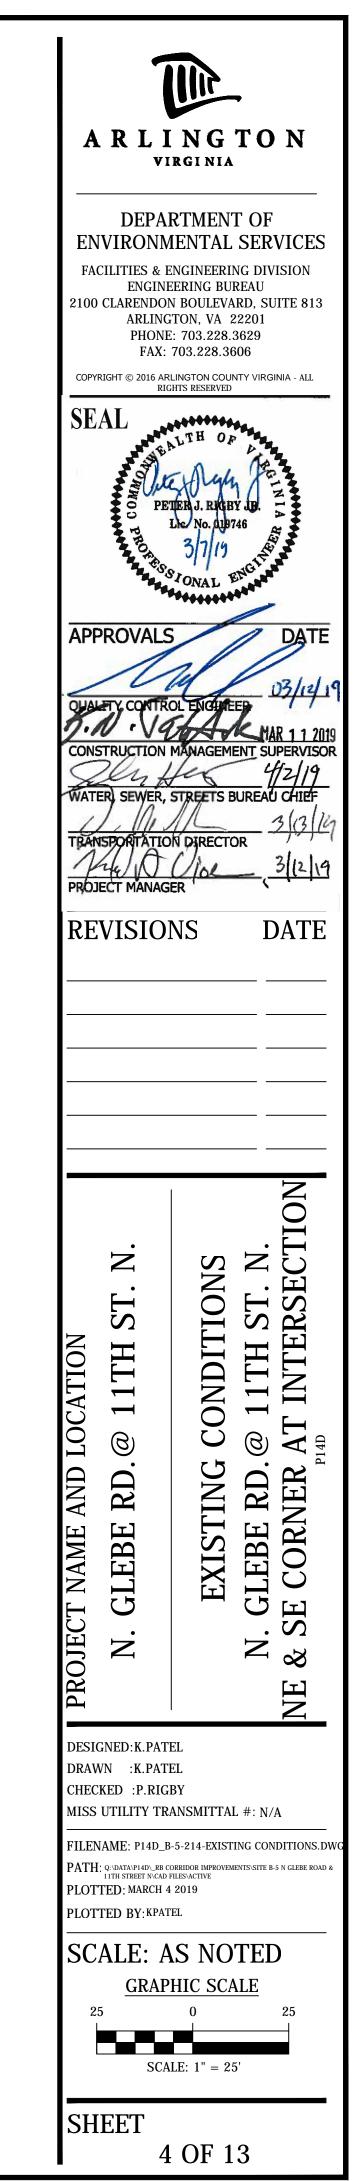





DEPARTMENT OF

ENVIRONMENTAL SERVICES FACILITIES & ENGINEERING DIVISION

2100 CLARENDON BOULEVARD, SUITE 813 ARLINGTON, VA 22201 PHONE: 703.228.3629 FAX: 703.228.3606

ENGINEERING BUREAU

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APPROVALS

TRANSPORTATION DIRECTOR

DATE

WATER SEWER, STREETS BUREAU CHIE

REVISIONS

Z 11TH ST.

DEMOLITION PLAN

N. GLEBE RD. @ 11TH ST. I

E. SE CORNER AT INTERSEC

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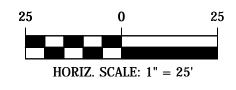
DESIGNED:K.PATEL DRAWN :K.PATEL CHECKED : P.RIGBY MISS UTILITY TRANSMITTAL #: N/A

N. GLEBE RD. @

FILENAME: P14D-B-5 228- DEMOLITION\_PLAN.DWG


PATH; Q:\Data\p14D\\_rb corridor improvements\site b-5 n glebe road & 11TH STREET N\CAD FILES\aCTIVE
PLOTTED: MARCH 4 2019 PLOTTED BY: KPATEL


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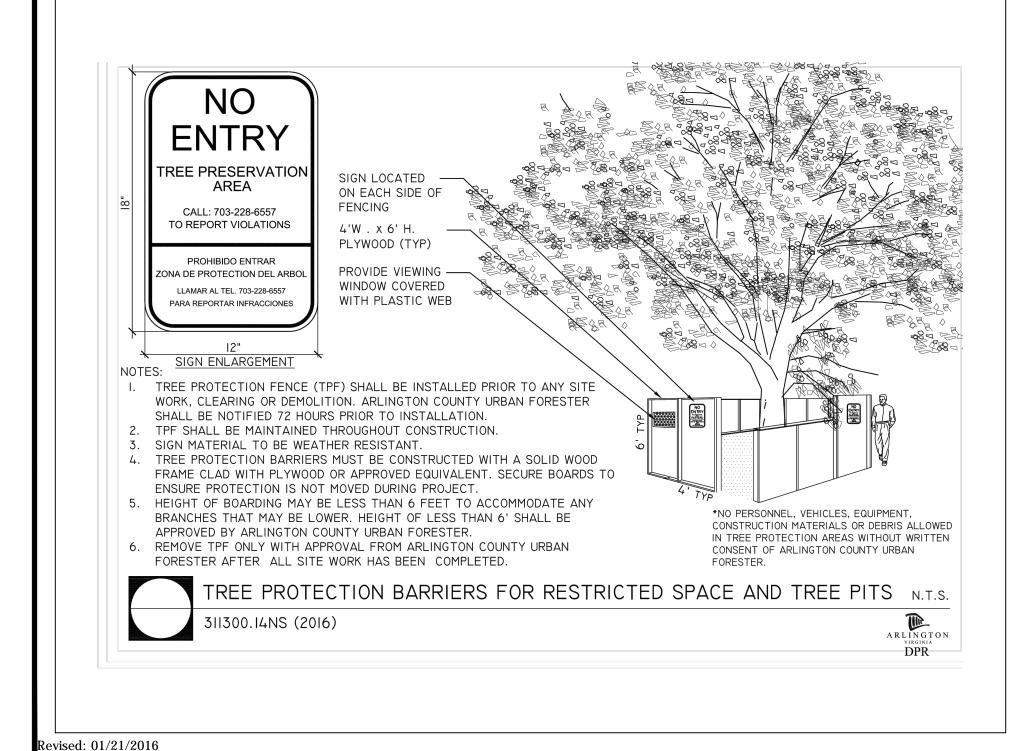


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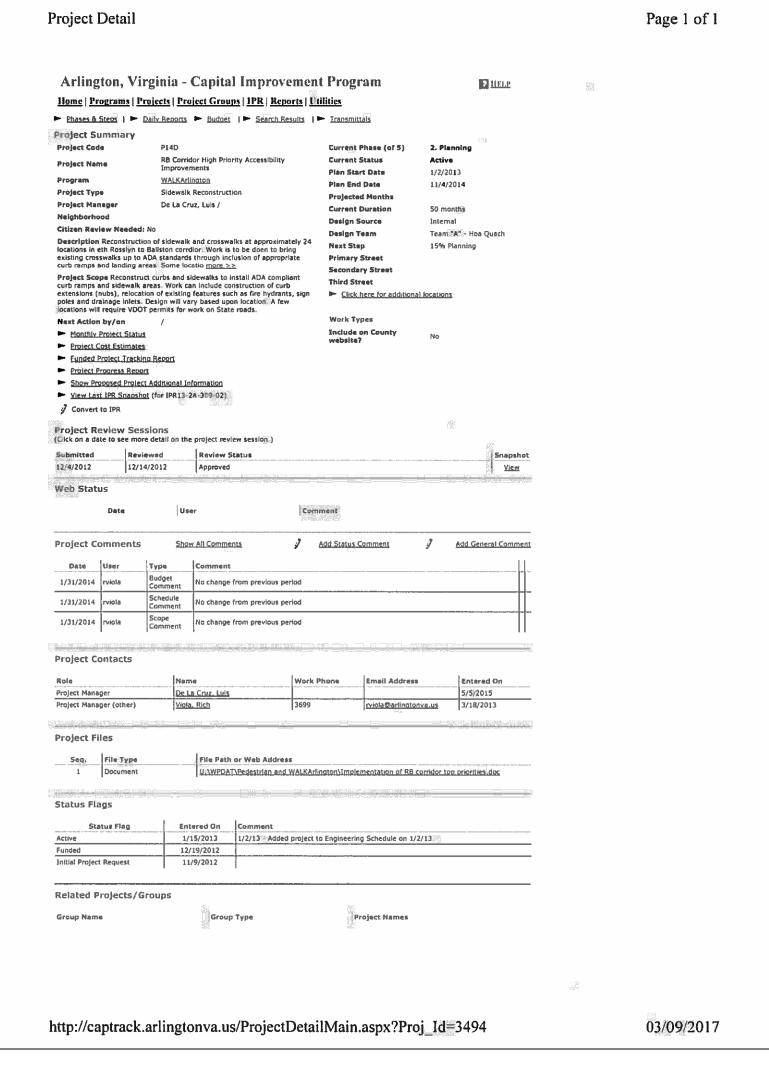





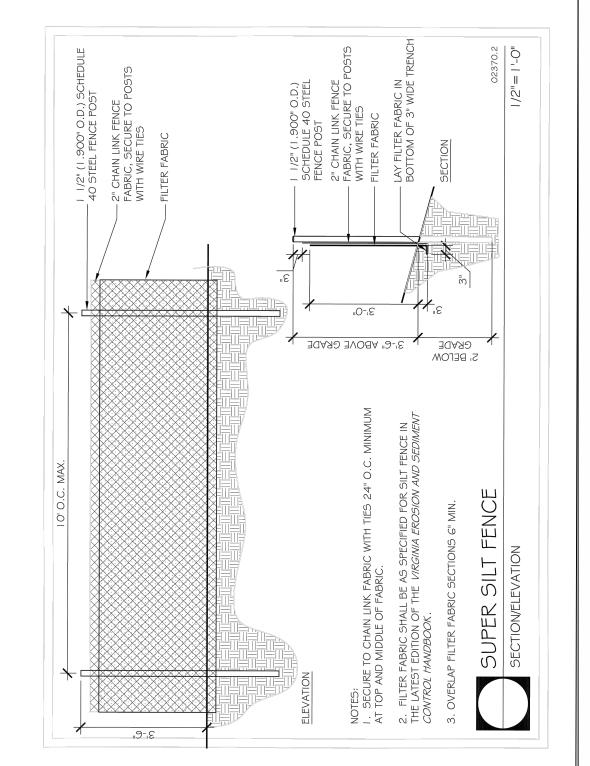

## NOTES:

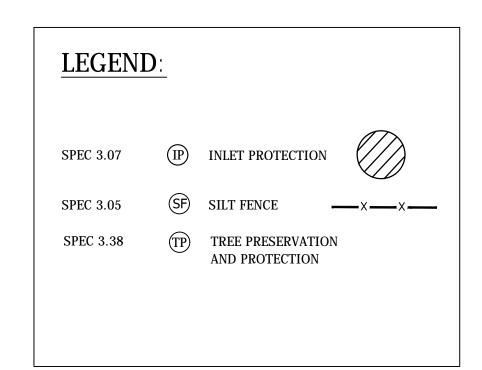- CONTRACTOR TO CONTACT THE ARLINGTON URBAN FORESTER TO SCHEDULE A PRE-CONSTRUCTION INSPECTION OF THE TREE PROTECTION MEASURES BEFORE ANY WORK NEAR THE CRITICAL ROOT ZONES OF THE TREE. TO SCHEDULE THE PRE-CONSTRUCTION MEETING CALL 703-228-1863
- CONTRACTOR TO PROTECT TREES PER THE PLAN ACCORDING TO THE ARLINGTON COUNTY DPR DESIGN STANDARD DETAIL 02231.1
- CONTRACTOR TO ROOT PRUNE TREE PER THE PLAN ACCORDING TO THE ARLINGTON COUNTY DPR DESIGN STANDARD DETAIL 02231.5, WHERE CALLED OUT ON THE PLAN
- CONTRACTOR TO CALL THE URBAN FORESTER AT 703-228-1863, 72 HOURS BEFORE PLANTING, TO SCHEDULE INSPECTION OF THE TREES TO BE PLANTED.WARRANTY FOR 1 YEAR AFTER PLANTING SHALL BE THE CONTRACTOR'S RESPONSIBILITY. THE URBAN FORESTER AND DPR IS RESPONSIBLE FOR INSPECTION.
- CONTRACTOR TO CONTACT THE ASSIGNED CONSTRUCTION MANAGEMENT SPECIALIST ON THE LDA PERMITS FROM THE DEVELOPMENT SERVICE BUREAU BEFORE START OF CONSTRUCTION



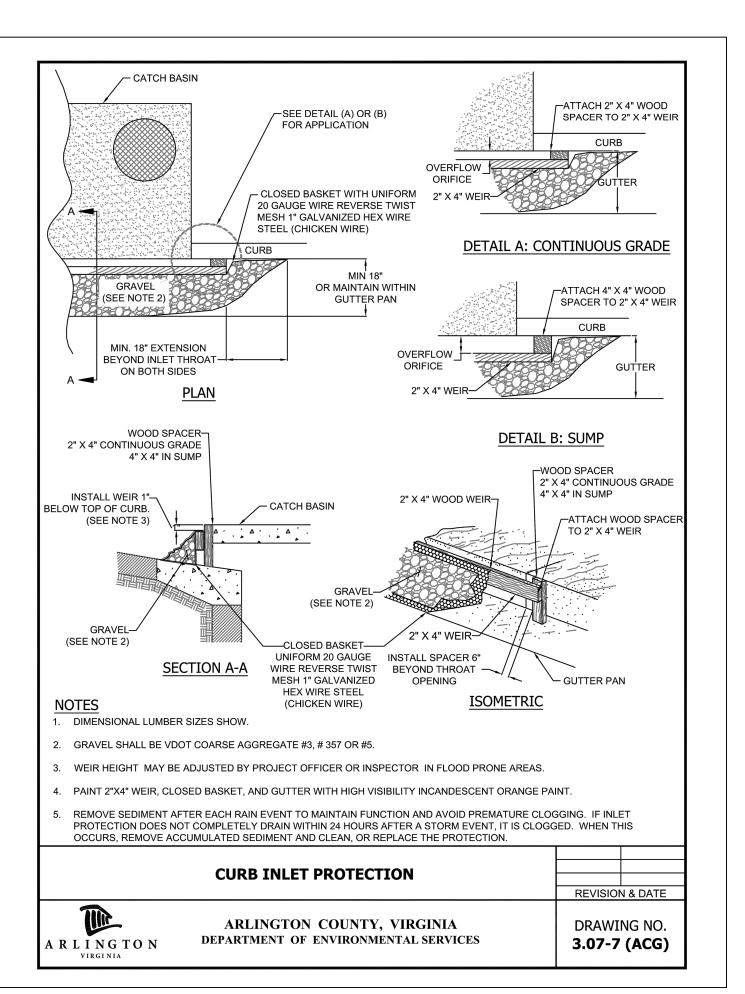



DEPARTMENT OF ENVIRONMENTAL SERVICES

FACILITIES & ENGINEERING DIVISION ENGINEERING BUREAU 2100 CLARENDON BOULEVARD, SUITE 813 ARLINGTON, VA 22201 PHONE: 703.228.3629

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FAX: 703.228.3606

CONSTRUCTION MANAGEMENT SUPERVISOR WATER, SEWER, STREETS BUREAU CHIEF

DATE

**REVISIONS** 

1TH ST. N. INTERSECTION RD NE

DESIGNED: K.PATEL DRAWN :K.PATEL CHECKED : P.RIGBY MISS UTILITY TRANSMITTAL #: N/A


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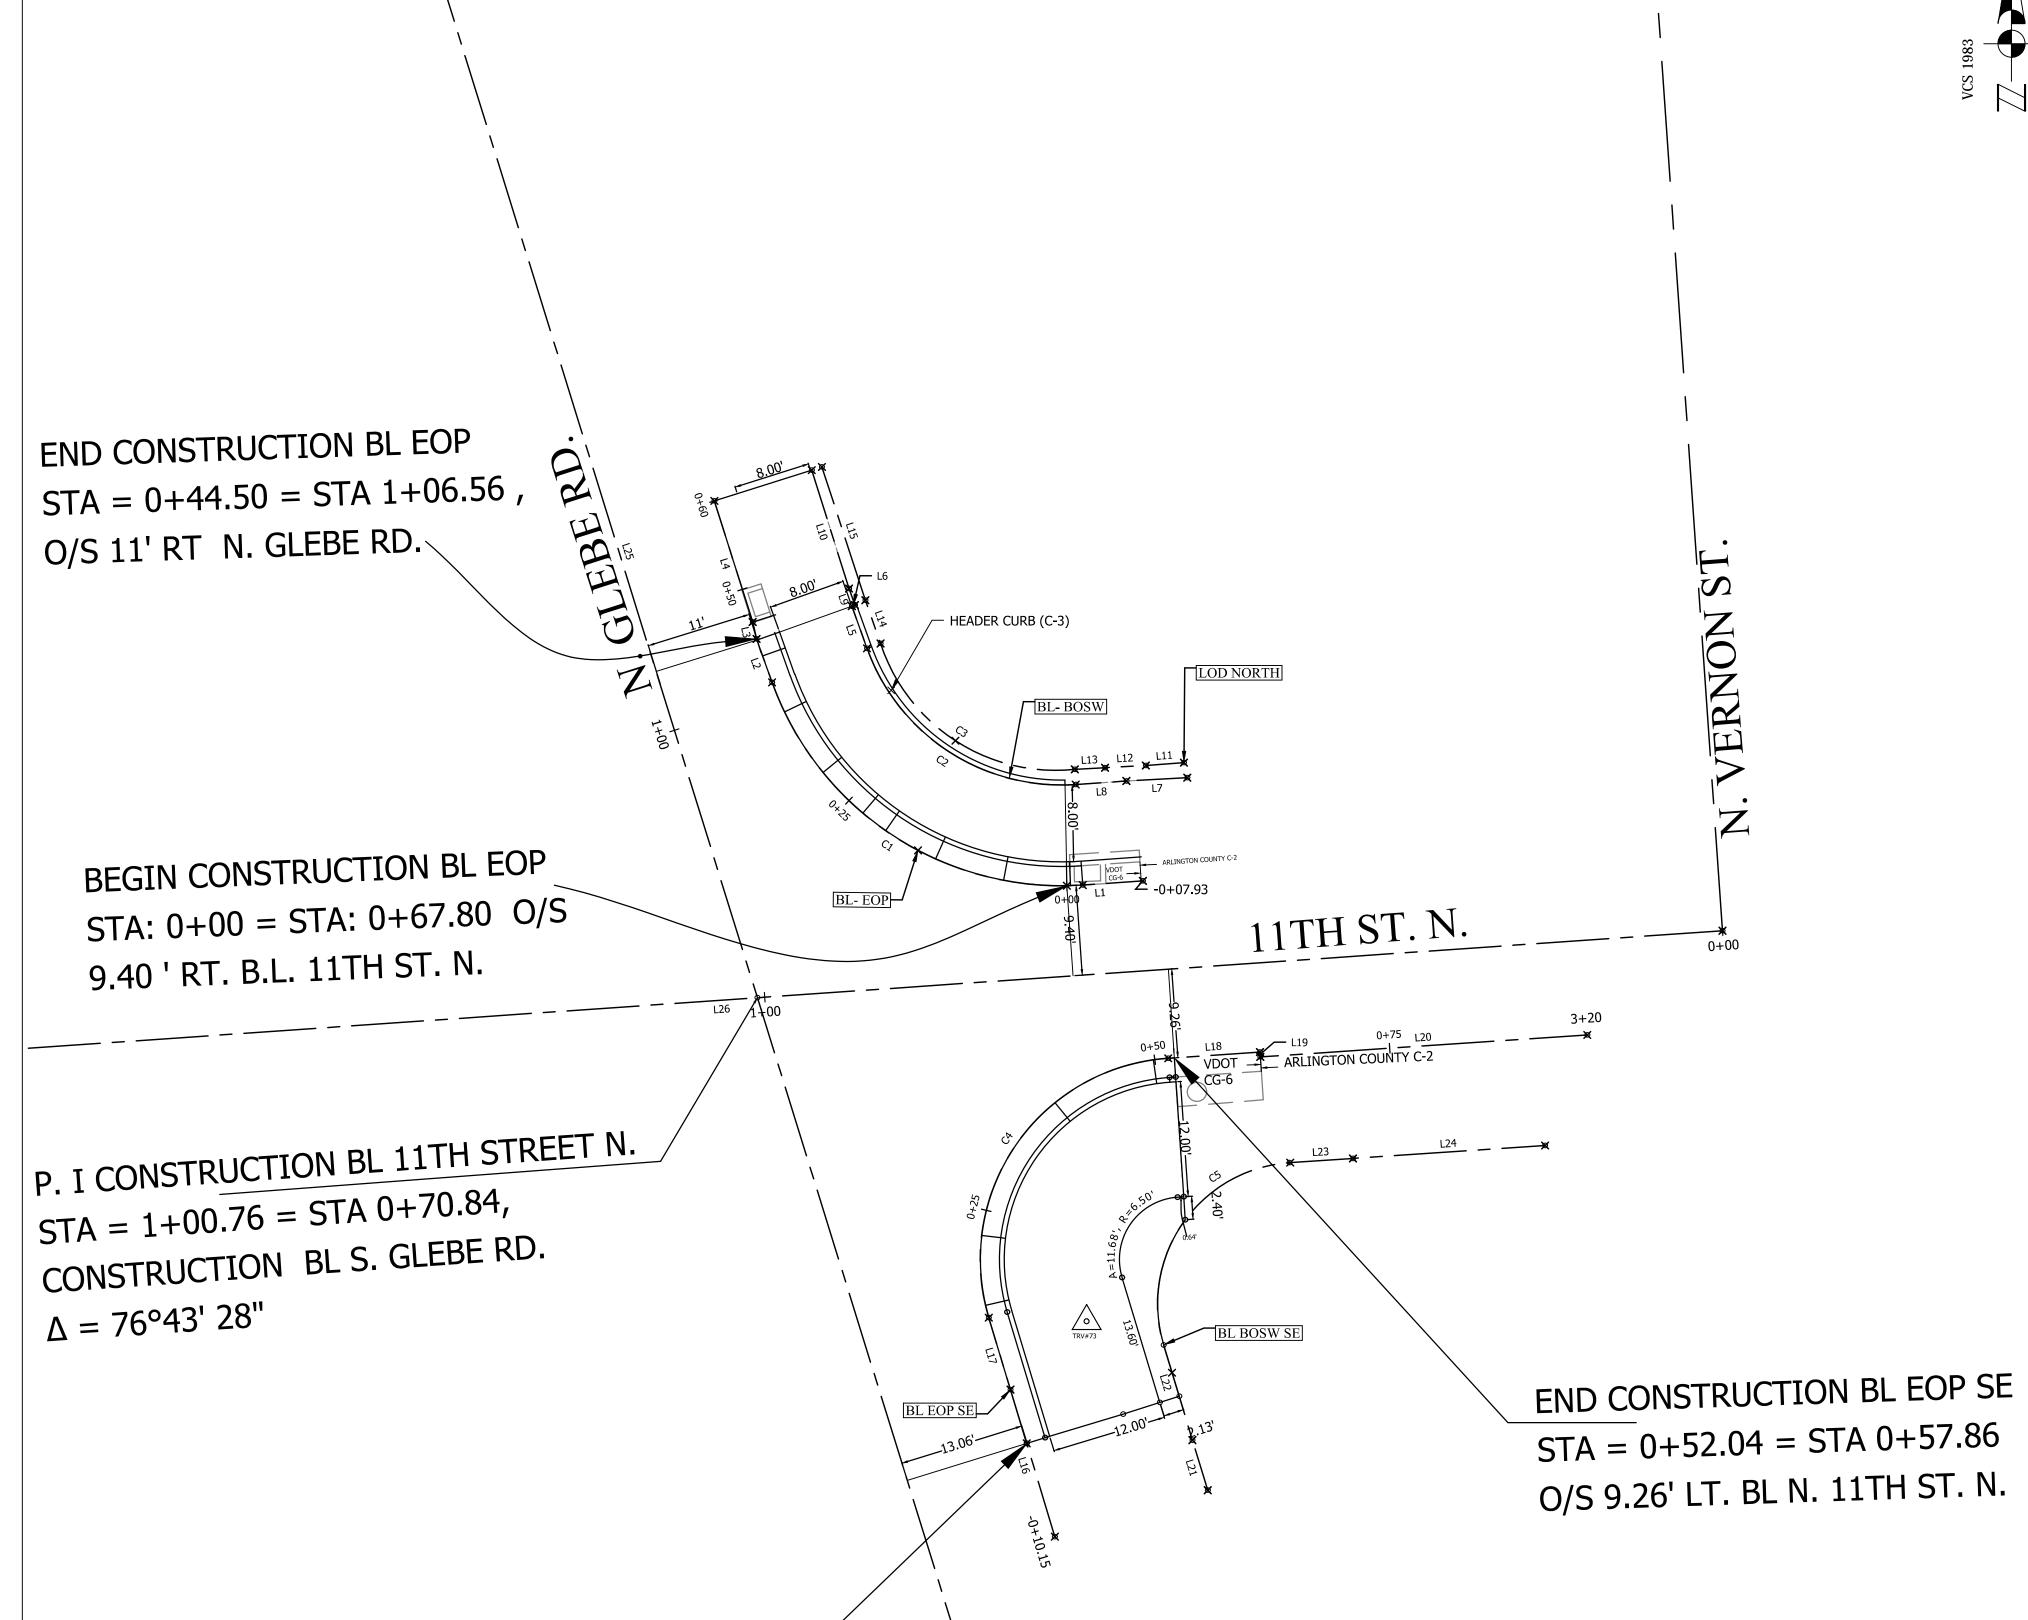
SCALE: AS NOTED GRAPHIC SCALE SCALE: 1'' = 25'

**SHEET** 

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					BL- EOP		
	Length	Radius	Line/Chord Direction	Station (Start)	Station (End)	Northing, Easting (Start)	Northing, Easting (End)
C1	41.47	32.00	N56° 52' 17.30"W	-0+01.66	0+39.82	7007827.93, 11876798.46	7007849.04 , 11876766.11
L1	6.28		S85° 59' 56.00"W	-0+07.93	-0+01.66	7007828.37, 11876804.72	7007827.93, 11876798.46
L2	4.81		N19° 44' 30.59"W	0+39.82	0+44.63	7007849.04, 11876766.11	7007853.57, 11876764.48
L3	1.81		N12° 52' 37.76"W	0+44.63	0+46.44	7007853.57, 11876764.48	7007855.34, 11876764.08
L4	13.23		N17° 31' 57.23"W	0+46.44	0+59.67	7007855.34, 11876764.08	7007867.95, 11876760.10

	BL- BOSW							
	Length	Radius	Line/Chord Direction	Station (Start)	Station (End)	Northing, Easting (Start)	Northing, Easting (End)	
C2	27.87	21.50	N56° 52' 17.30"W	0+11.64	0+39.51	7007838.40, 11876797.73	7007852.59 , 11876775.99	
L5	4.68		N19° 44' 30.59"W	0+39.51	0+44.18	7007852.59, 11876775.99	7007856.99, 11876774.41	
L6	0.34		N70° 15' 29.41"E	0+44.18	0+44.53	7007856.99, 11876774.41	7007857.11, 11876774.73	
L7	6.35		S86° 51' 35.21"W	0+00.00	0+06.35	7007839.12, 11876809.35	7007838.77, 11876803.01	
L8	5.30		S85° 59' 56.00"W	0+06.35	0+11.64	7007838.77, 11876803.01	7007838.40, 11876797.73	
L9	1.82		N19° 44' 30.59"W	0+44.53	0+46.35	7007857.11, 11876774.73	7007858.82, 11876774.12	
L10	12.93		N17° 26' 54.13"W	0+46.35	0+59.27	7007858.82, 11876774.12	7007871.15, 11876770.24	

	LOD NORTH							
	Length	Radius	Line/Chord Direction	Station (Start)	Station (End)	Northing, Easting (Start)	Northing, Easting (End)	
C3	26.07	19.19	N57° 03' 23.10"W	0+11.39	0+37.46	7007839.99, 11876797.63	7007853.10 , 11876777.40	
L11	3.98		S85° 36' 30.58"W	0+00.00	0+03.98	7007840.69, 11876809.00	7007840.39, 11876805.04	
L12	4.26		S86° 54' 49.53"W	0+03.98	0+08.24	7007840.39, 11876805.04	7007840.16, 11876800.79	
L13	3.16		S86° 54' 49.53"W	0+08.24	0+11.39	7007840.16, 11876800.79	7007839.99, 11876797.63	
L14	4.77		N19° 19' 37.00"W	0+37.46	0+42.23	7007853.10, 11876777.40	7007857.60, 11876775.82	
L15	14.60		N18° 03' 51.49"W	0+42.23	0+56.84	7007857.60, 11876775.82	7007871.49, 11876771.29	

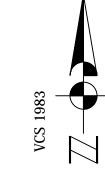BL EOP SE							
	Length	Radius	Line/Chord Direction	Station (Start)	Station (End)	Northing, Easting (Start)	Northing, Easting (End)
C4	37.74	21.00	N34° 40' 40.95"E	0+13.68	0+51.41	7007782.87, 11876788.67	7007809.89 , 11876807.37
L16	16.00		N16° 48' 01.28"W	-0+10.15	0+05.85	7007760.06, 11876795.56	7007775.38, 11876790.94
L17	7.82		N16° 48' 01.28"W	0+05.85	0+13.68	7007775.38, 11876790.94	7007782.87, 11876788.67
L18	9.58		N86° 09' 23.17"E	0+51.41	0+60.99	7007809.89, 11876807.37	7007810.53, 11876816.93
L19	0.50		S3° 52' 40.85"E	0+60.99	0+61.49	7007810.53, 11876816.93	7007810.03, 11876816.96
L20	34.13		N86° 09' 23.17"E	0+61.49	0+95.62	7007810.03, 11876816.96	7007812.32, 11876851.02

	BL BOSW SE						
	Length	Radius	Line/Chord Direction	Station (Start)	Station (End)	Northing, Easting (Start)	Northing, Easting (End)
C5	26.52	14.75	N34° 38' 19.98"E	0+05.65	0+32.18	7007780.01, 11876806.88	7007799.01 , 11876820.01
L21	5.45		N17° 00' 48.52"W	-0+10.15	-0+04.70	7007764.89, 11876811.48	7007770.11, 11876809.89
L22	10.35		N16° 52' 27.02"W	-0+04.70	0+05.65	7007770.11, 11876809.89	7007780.01, 11876806.88
L23	6.62		N86° 09' 06.98"E	0+32.18	0+38.79	7007799.01, 11876820.01	7007799.46, 11876826.61
L24	20.06		N86° 09' 06.98"E	0+38.79	0+58.85	7007799.46, 11876826.61	7007800.80, 11876846.62

	BL_ N GLEBE RD						
	Length	Radius	Line/Chord Direction	Station (Start)	Station (End)	Northing, Easting (Start)	Northing, Easting (End)
L25	238.44		N17° 14' 47.16"W	0+00.00	2+38.44	7007748.55, 11876785.58	7007976.26, 11876714.8


Length         Radius         Line/Chord Direction         Station (Start)         Station (End)         Northing, Easting (Start)         Northing, Easting (End)           L26         200.00         S86° 01' 45.06"W         0+00.00         2+00.00         7007823.18, 11876865.10         7007809.33, 11876665.58								
L26         200.00         S86° 01' 45.06"W         0+00.00         2+00.00         7007823.18, 11876865.10         7007809.33, 11876665.58		Length	Radius	•			J. J	J. J.
	L26	200.00		S86° 01' 45.06"W	0+00.00	2+00.00	7007823.18, 11876865.10	7007809.33, 11876665.58

SURVEY CONTROL DATA						
Point #	Northing	Easting	Elevation	Raw Description		
72	7008184.9115	11876667.0166	278.40	TR 72		
73	7007782.4825	11876798.8515	269.31	TR 73		
74	7008093.6104	11876596.8896	276.10	TRV74		



DEPARTMENT OF ENVIRONMENTAL SERVICES

PHONE: 703.228.3629

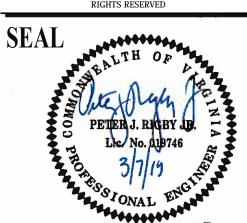


DATE

**REVISIONS** 

DESIGNED: K.PATEL DRAWN :K.PATEL

MISS UTILITY TRANSMITTAL #: N/A

SCALE: AS NOTED

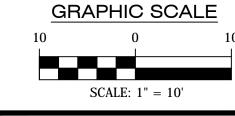


SHEET


7 OF 13


BEGIN CONSTRUCTION BL EOP SE

STA: 0+00 = STA: 0+18.18 O/S


13.06 ' RT. B.L. N. GLEBE RD.

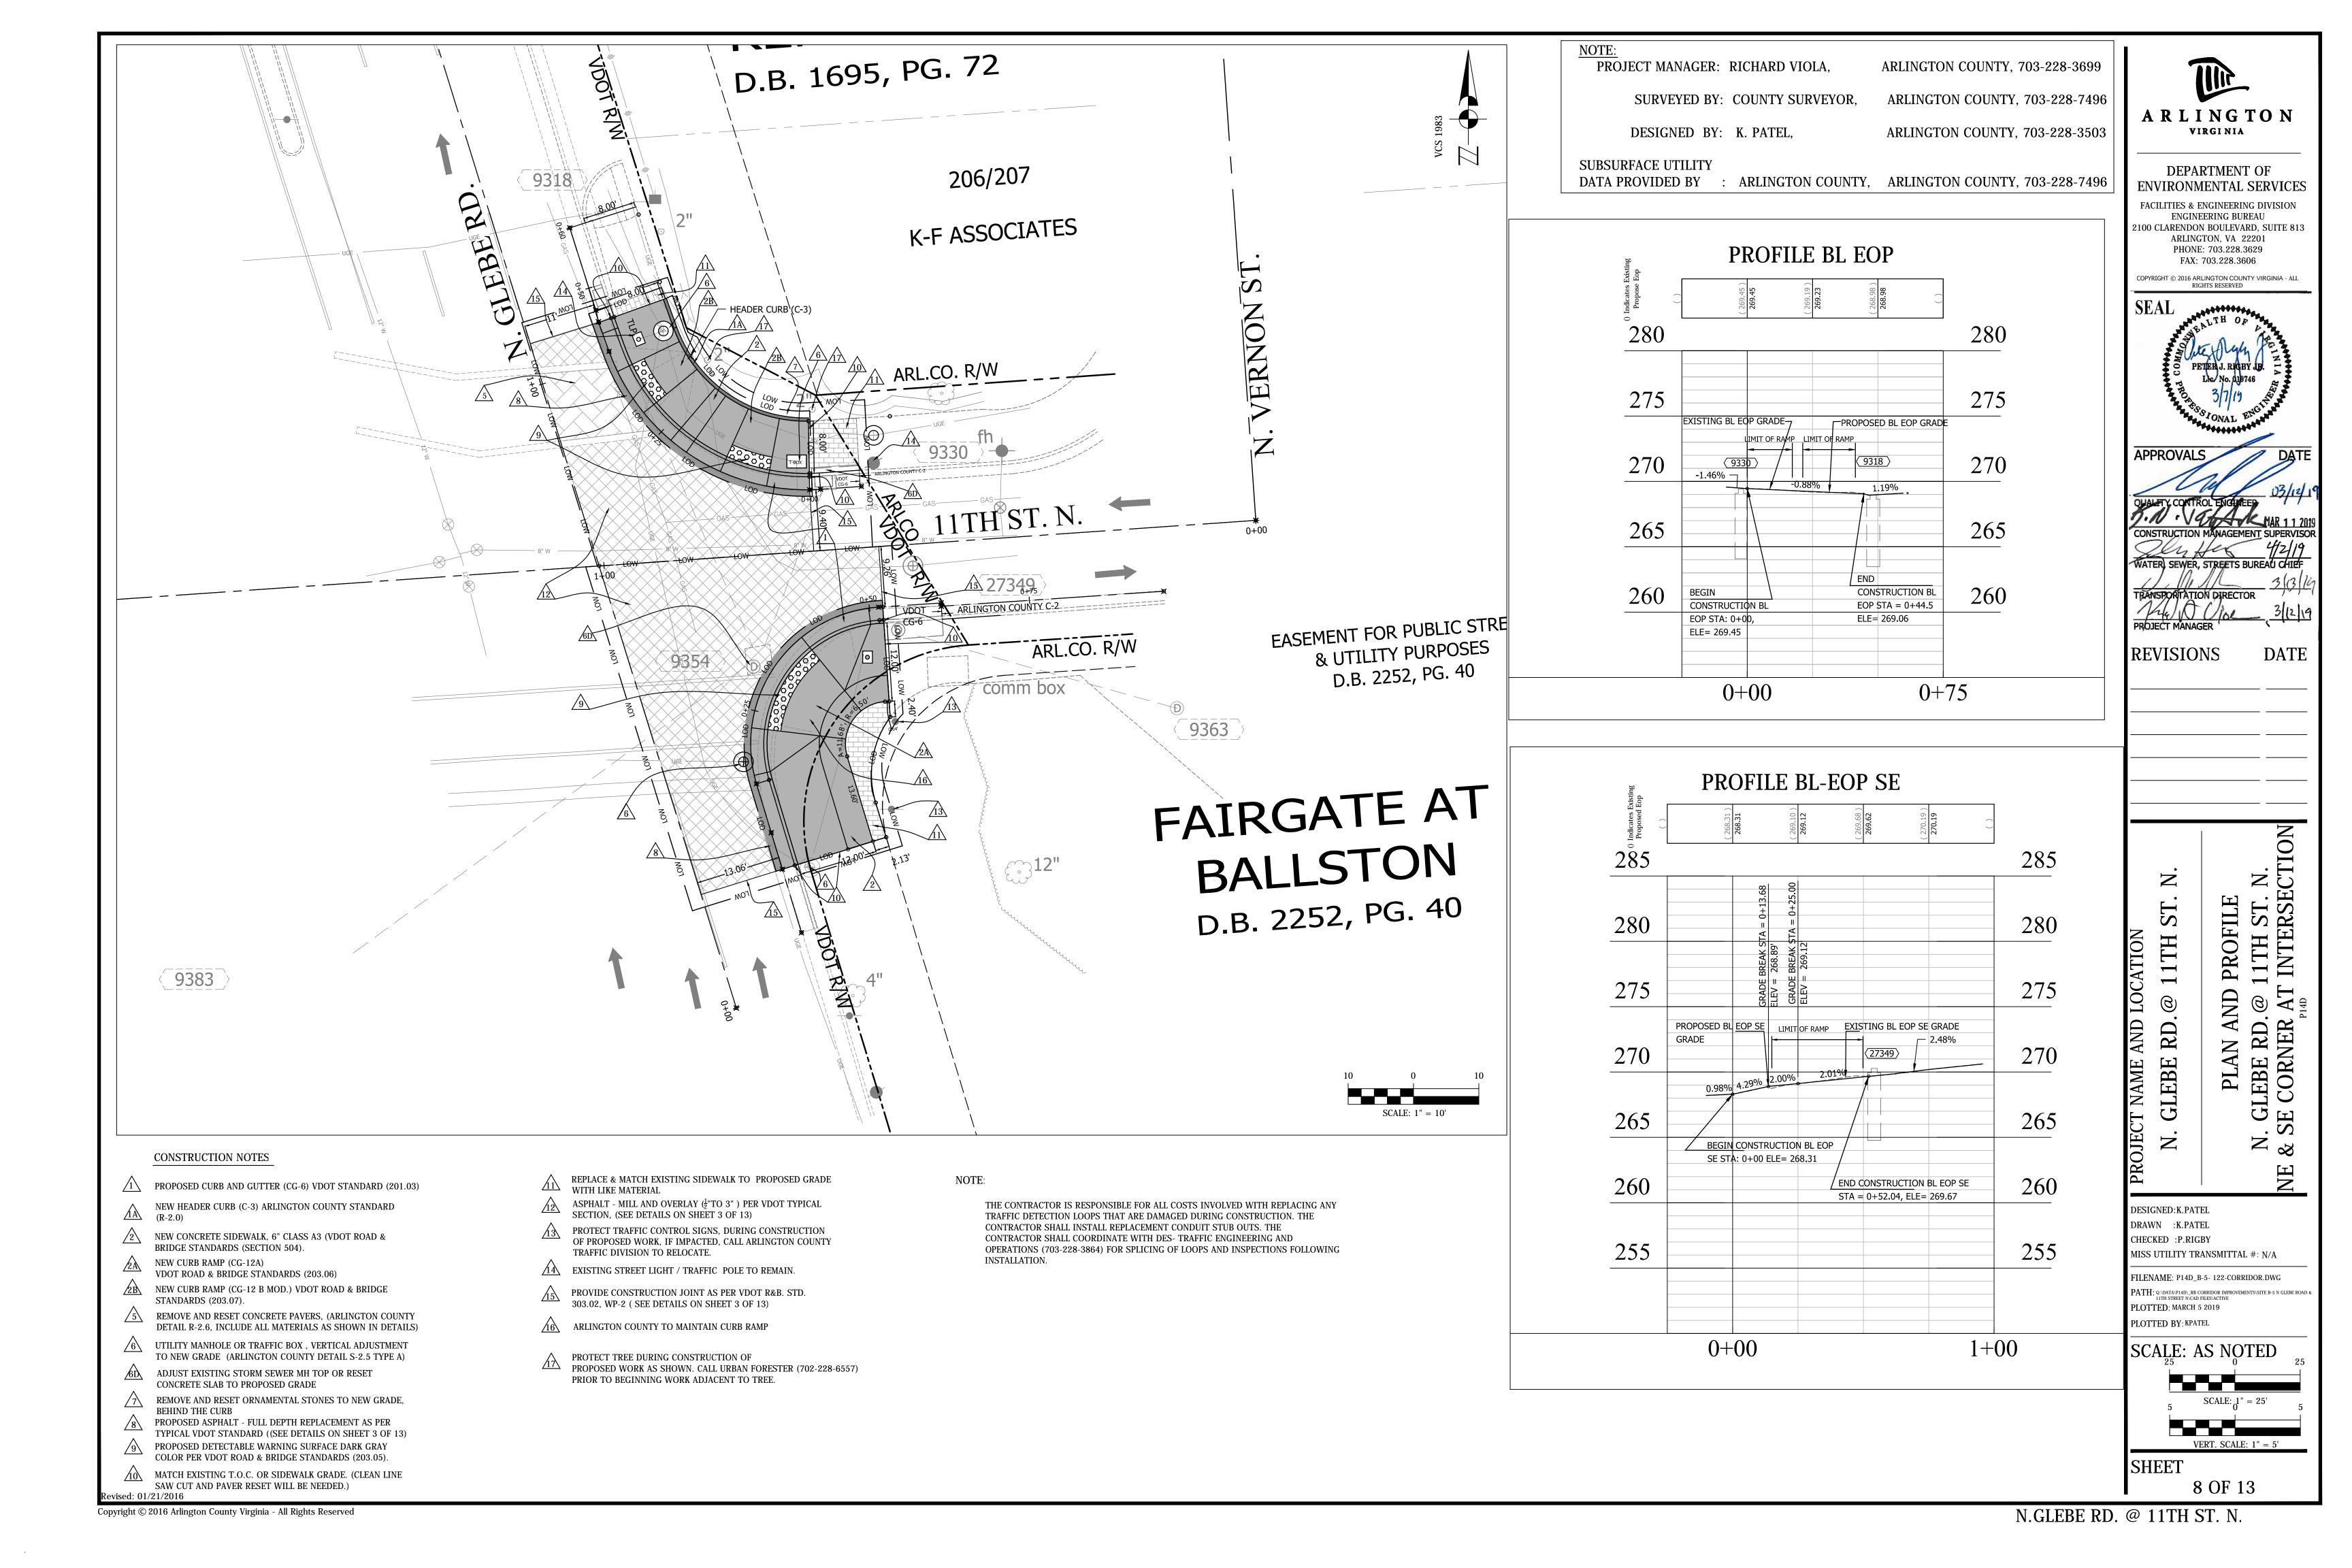

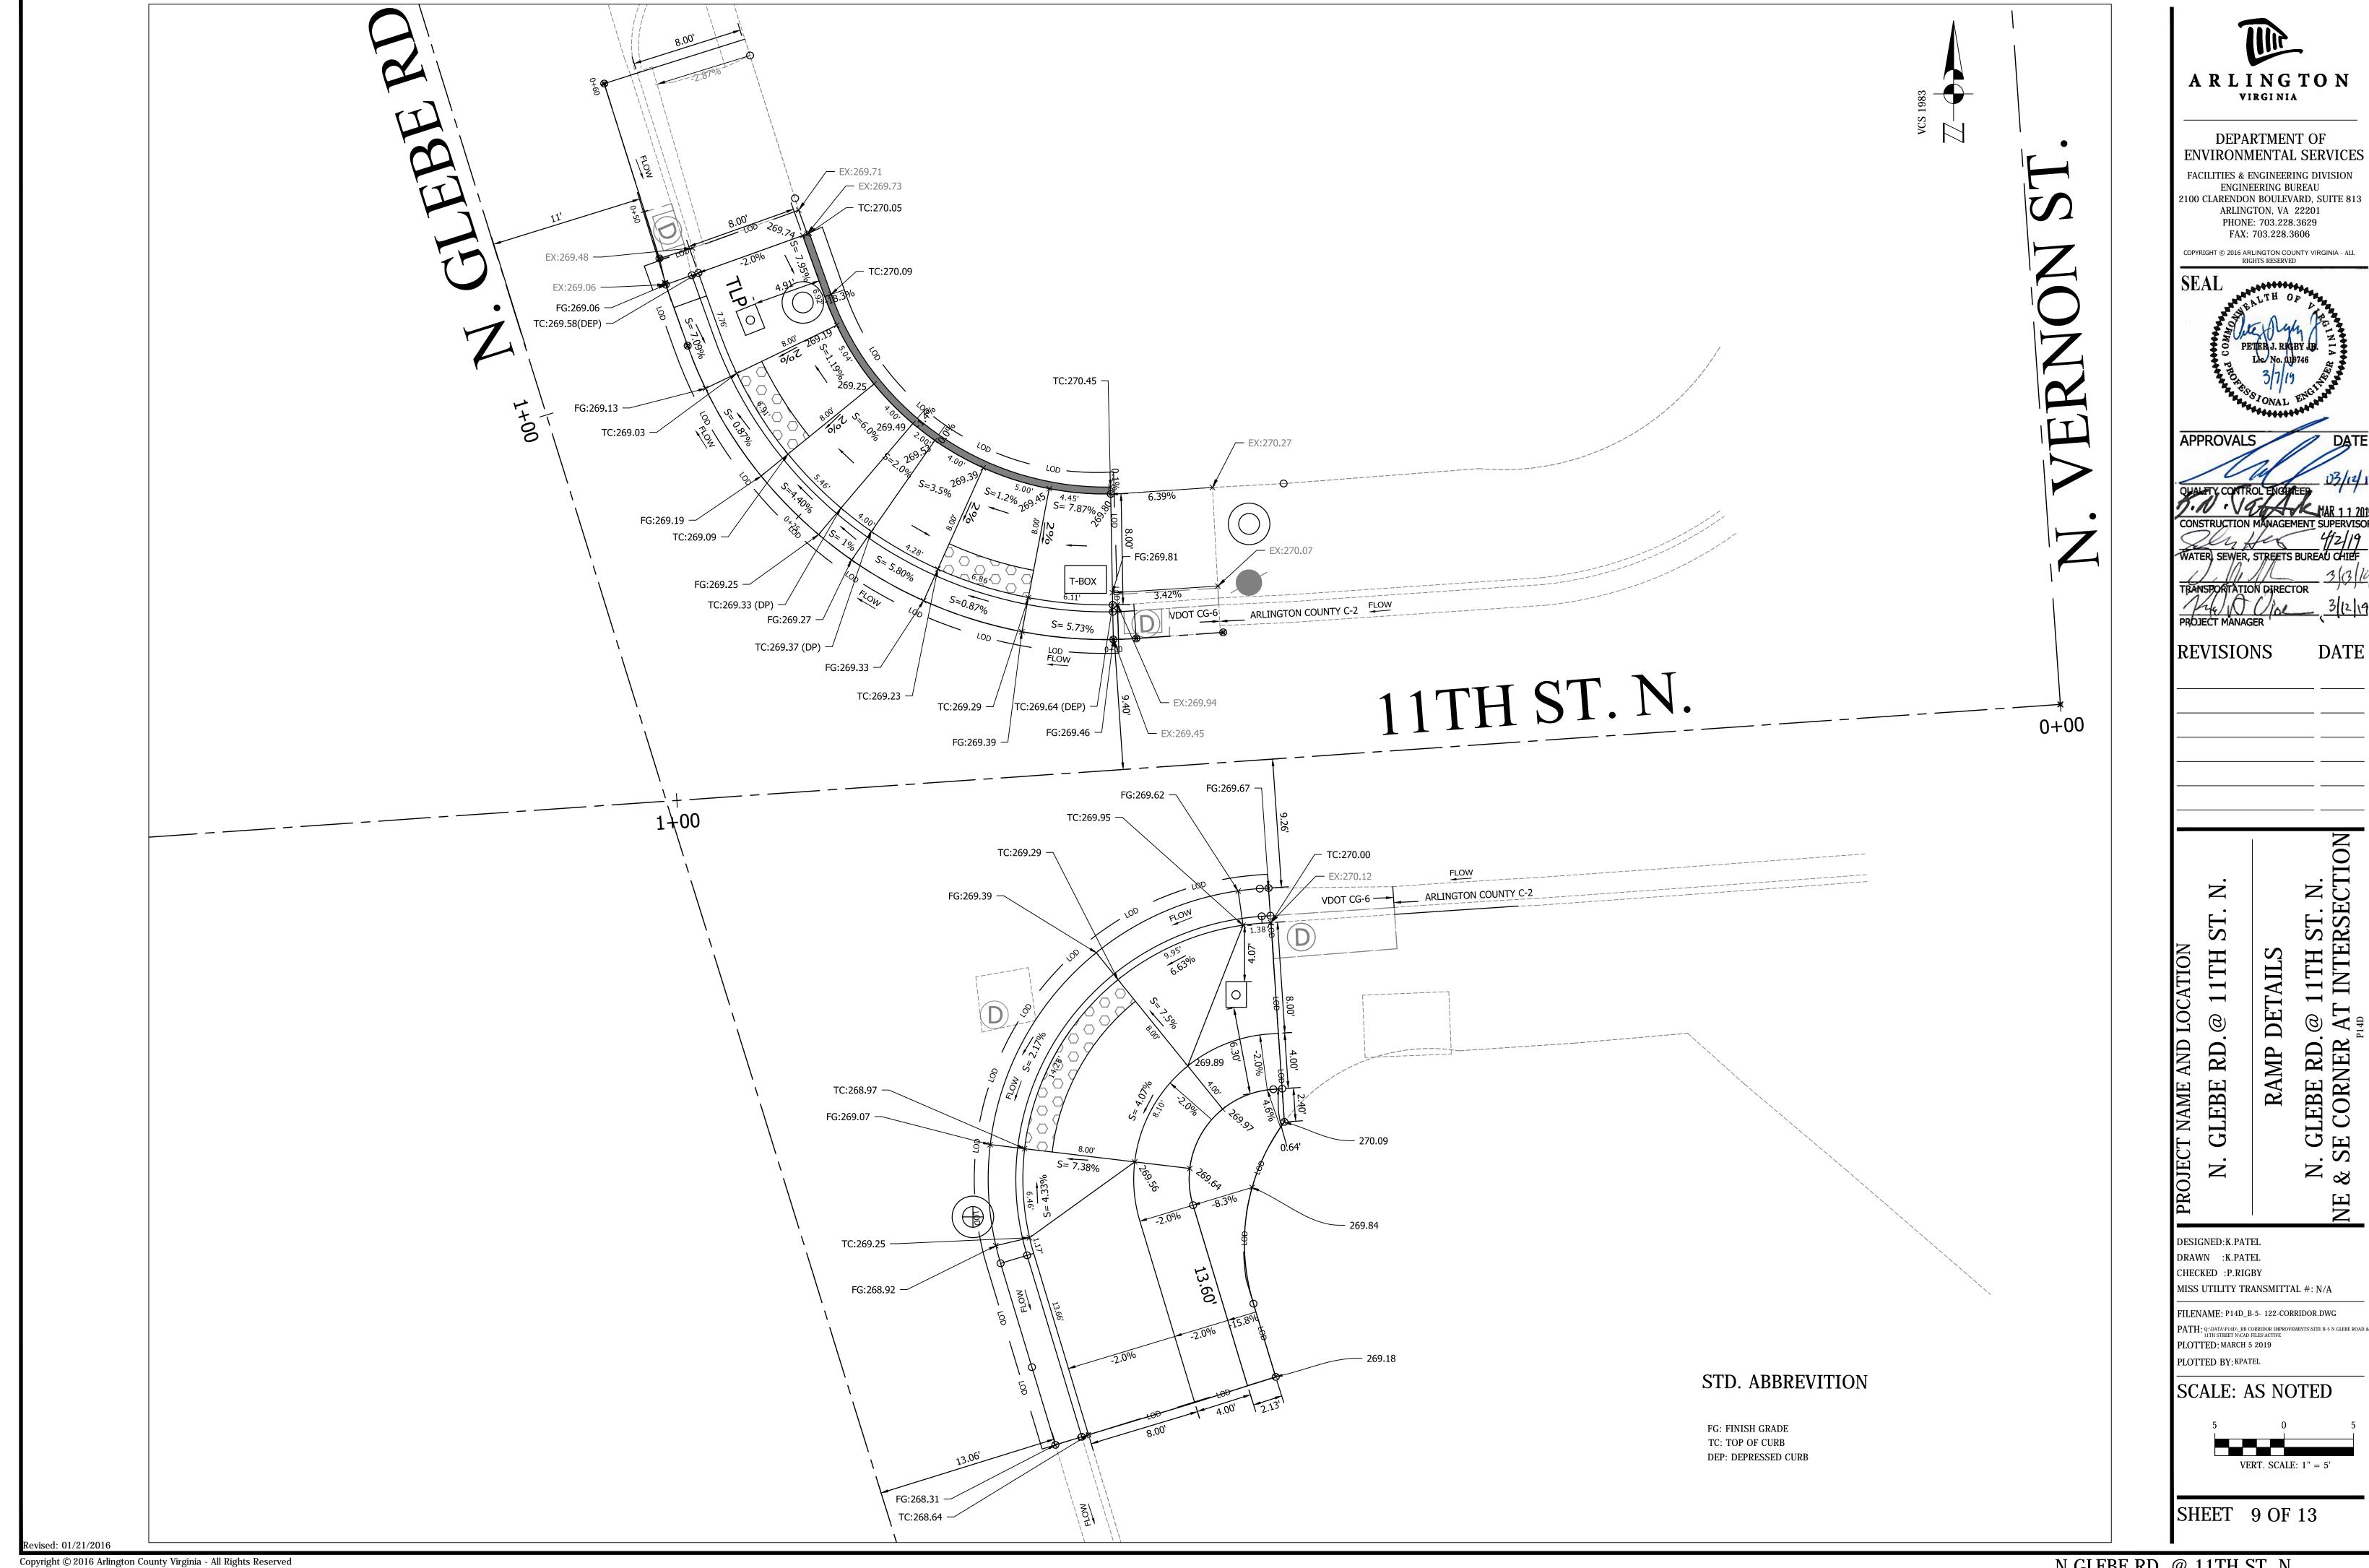

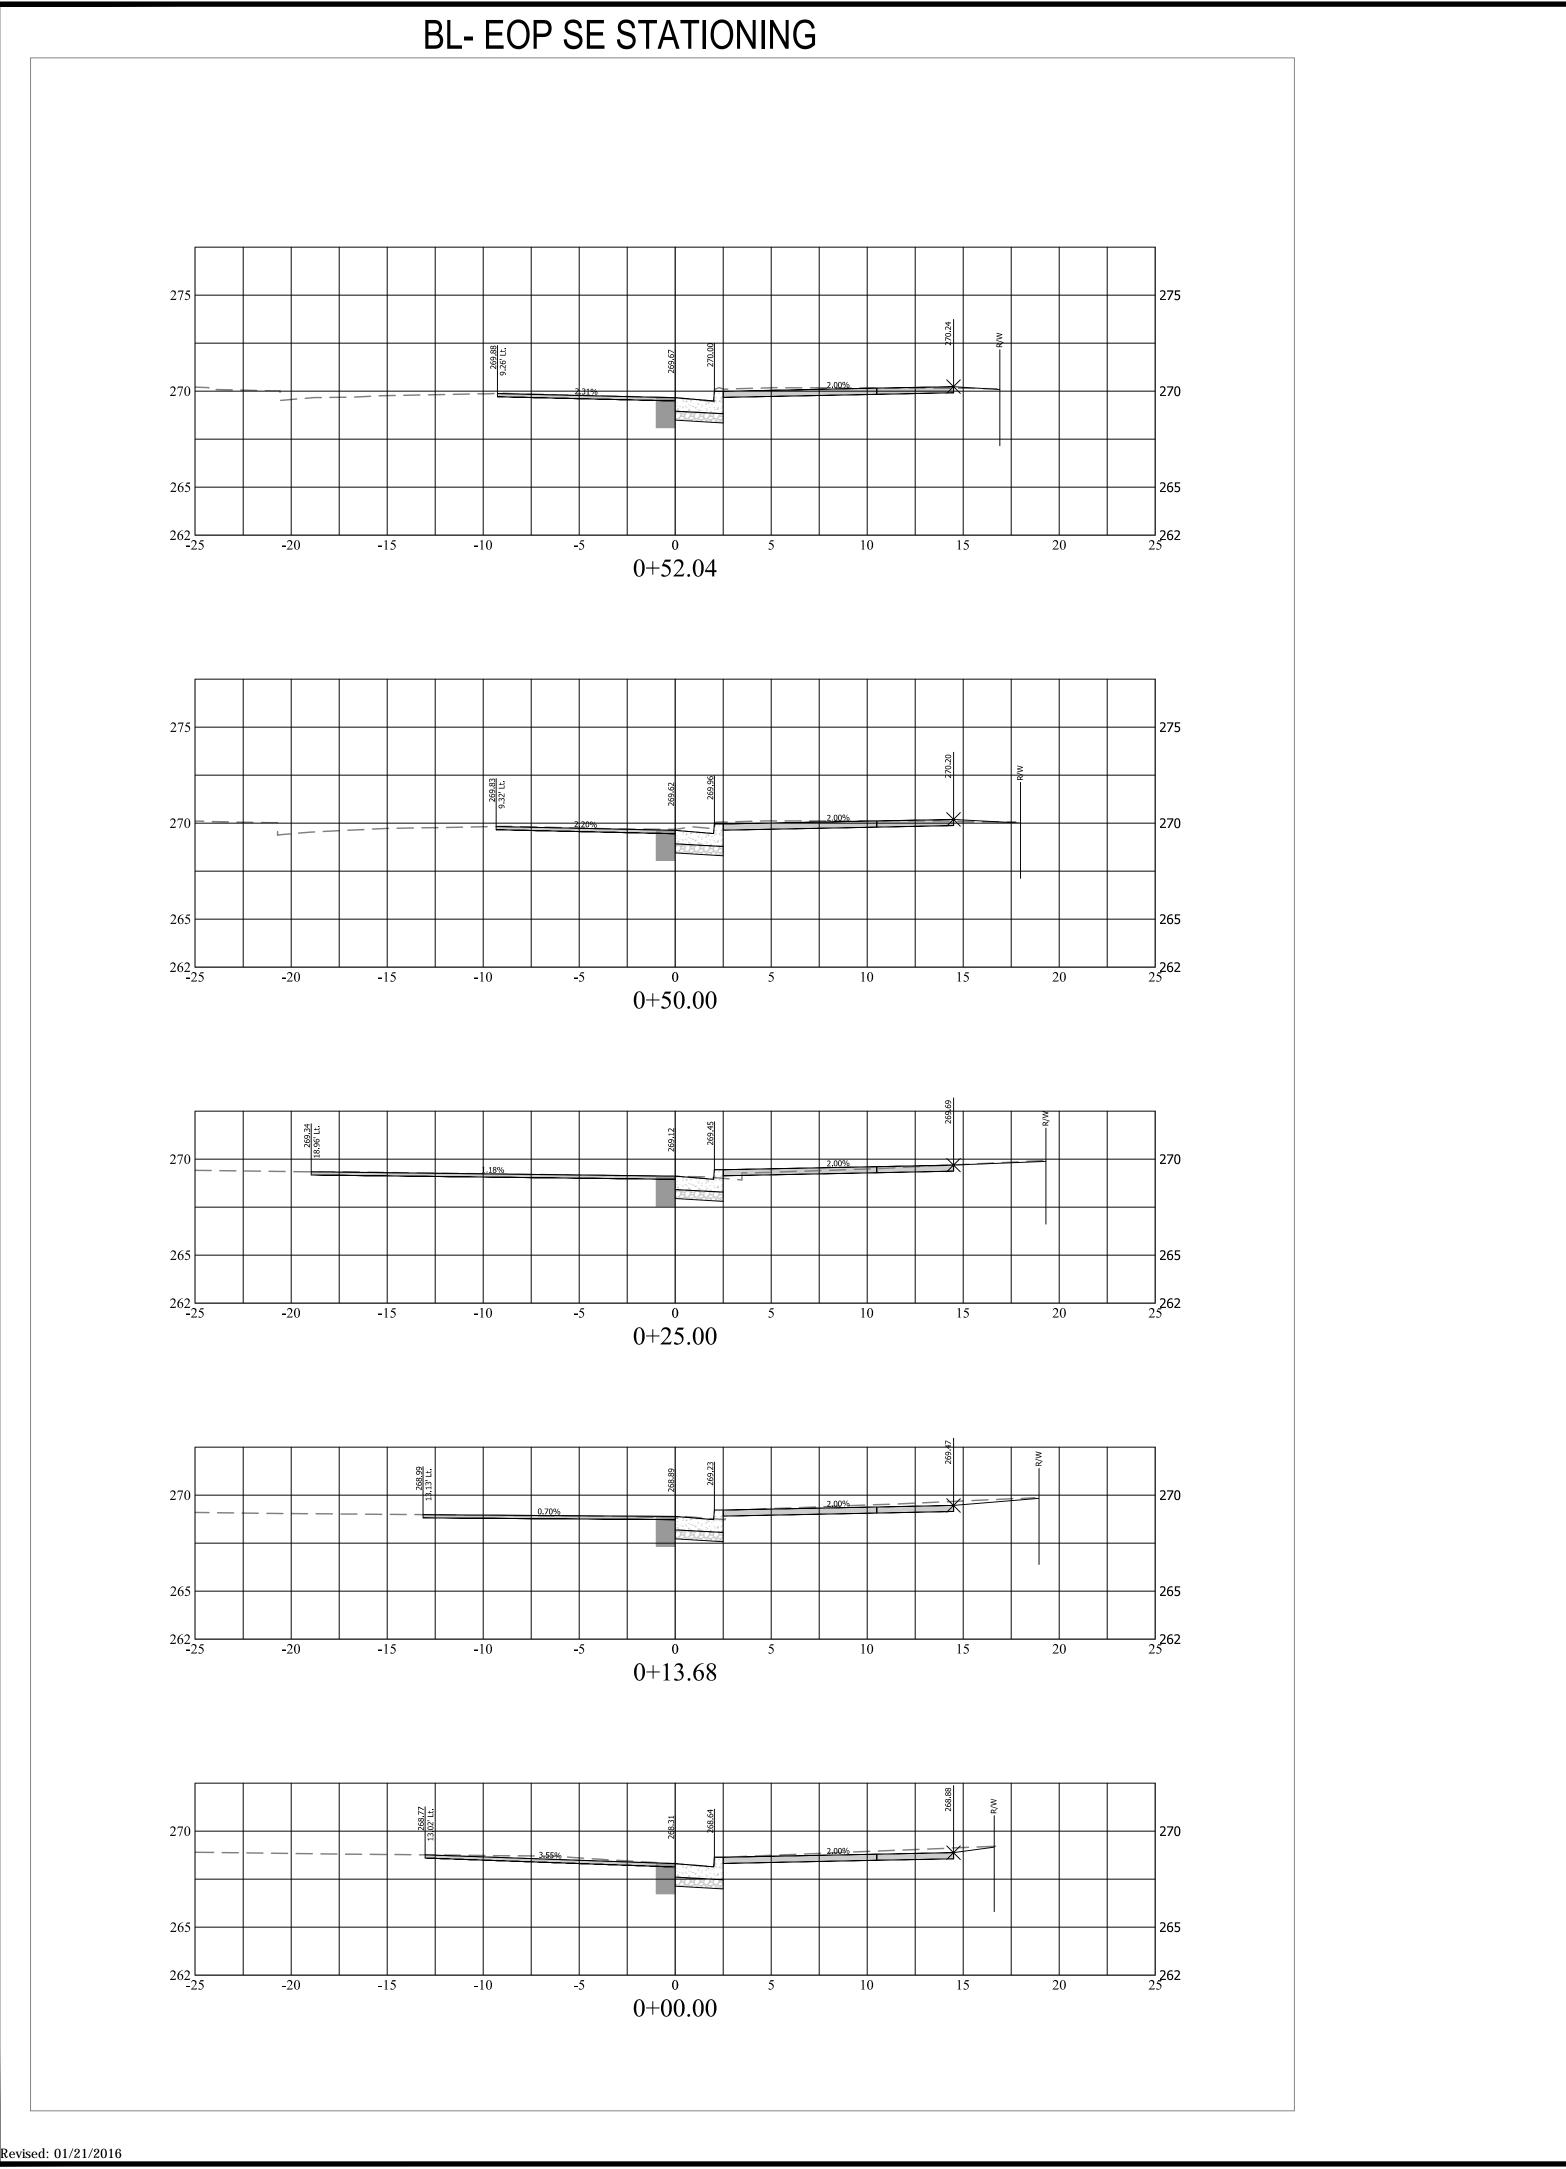

# **BL- EOP STATIONING**

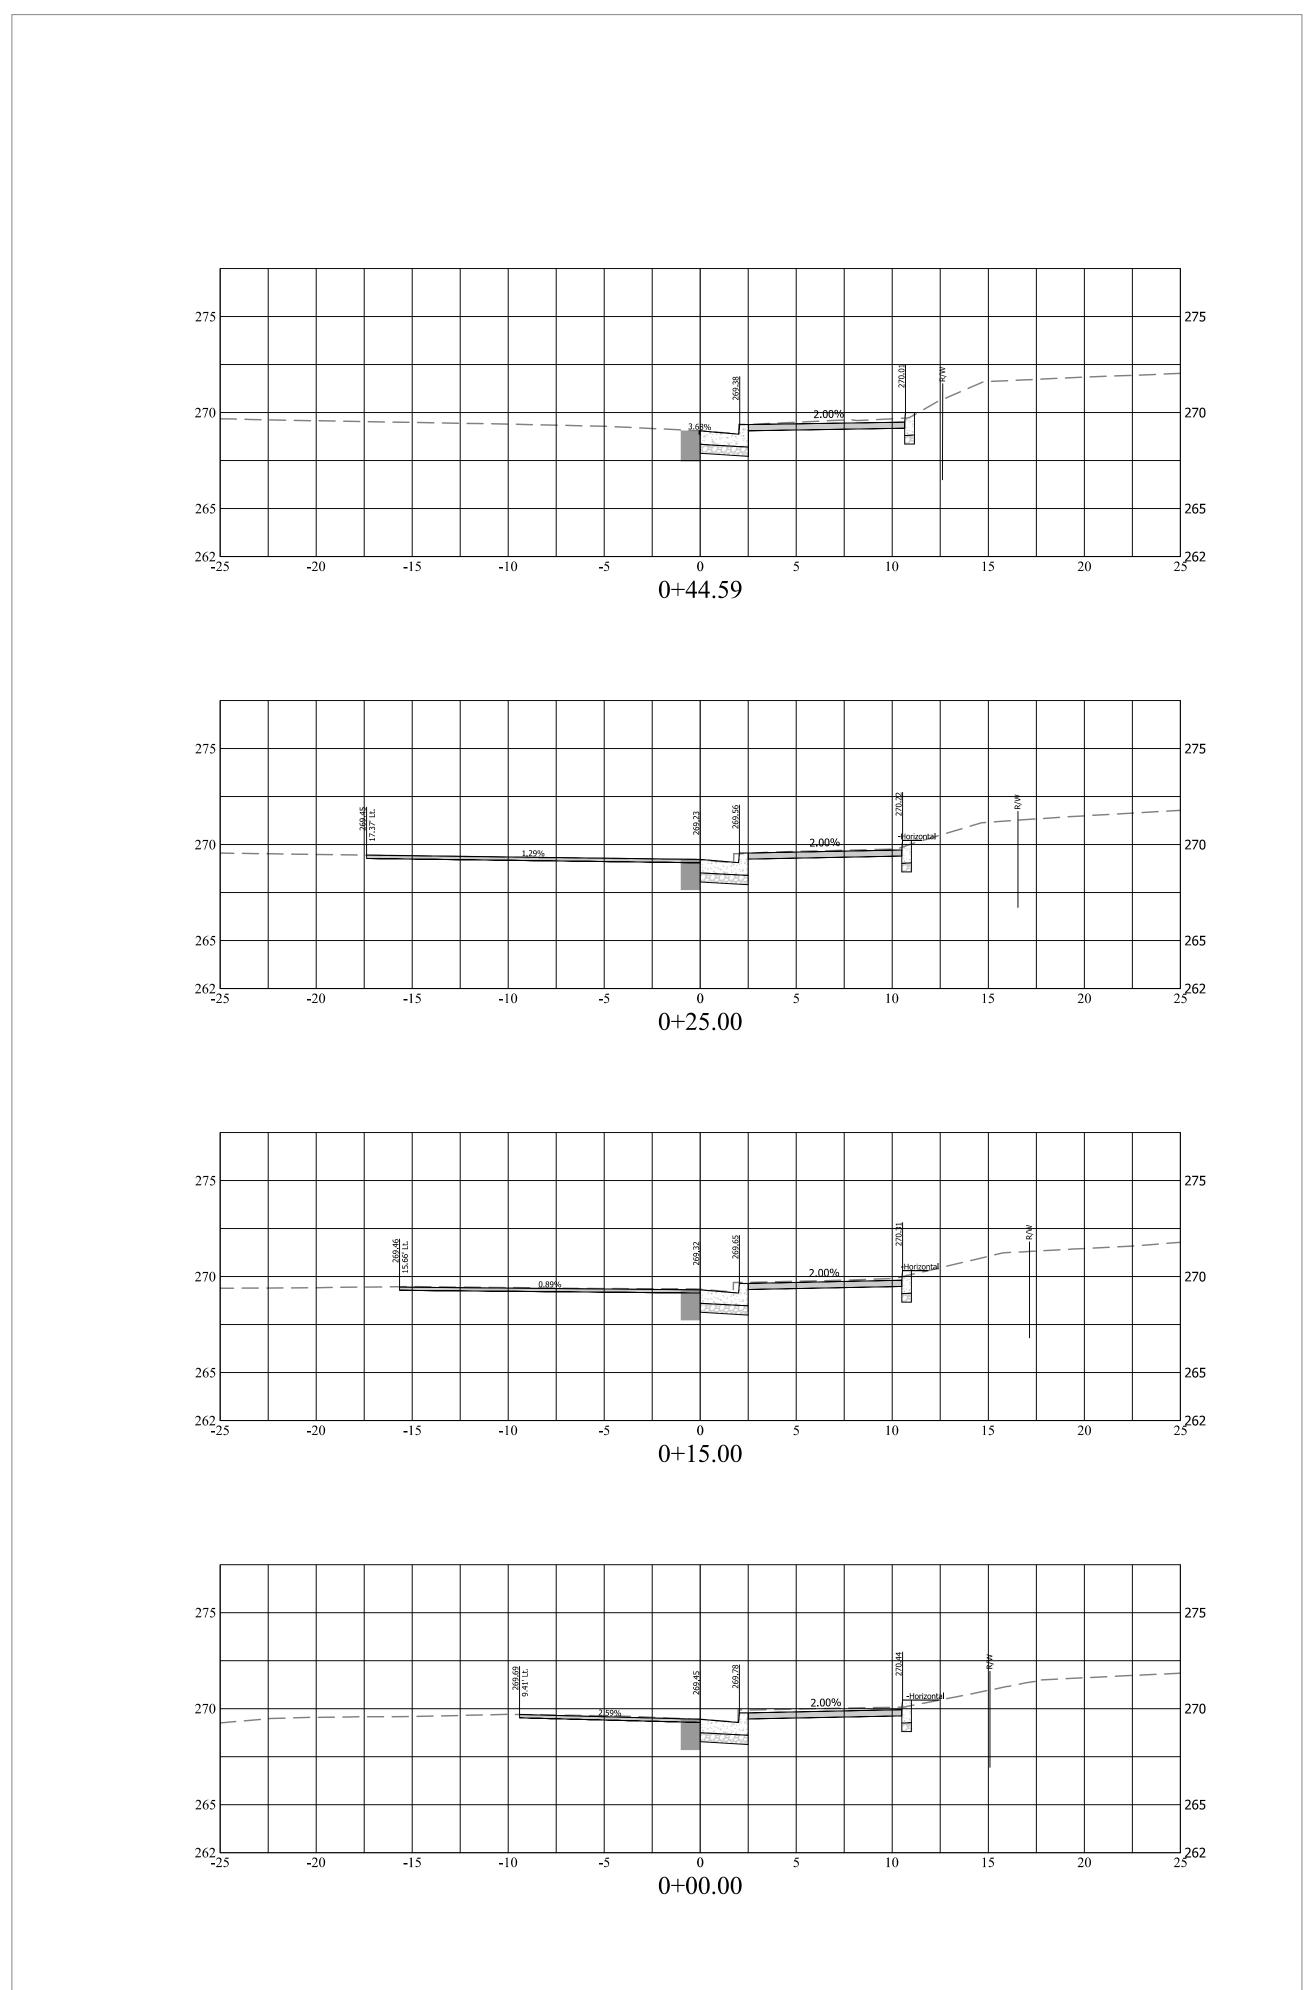



DEPARTMENT OF ENVIRONMENTAL SERVICES

FACILITIES & ENGINEERING DIVISION ENGINEERING BUREAU 2100 CLARENDON BOULEVARD, SUITE 813

PHONE: 703.228.3629 FAX: 703.228.3606

ARLINGTON, VA 22201

TRANSPORTATION DIRECTOR
PROJECT MANAGER

REVISIONS DATE

GLEBE RD.@

N. GLEBE RD. @ 11TH ST. N. & SE CORNER AT INTERSECTION

DESIGNED:K.PATEL DRAWN :K.PATEL


CHECKED :P.RIGBY MISS UTILITY TRANSMITTAL #: N/A

FILENAME: P14D\_B-5- 122-CORRIDOR.DWG  $PATH: \ \tiny{Q:DATA|P14D\ RB \ CORRIDOR \ IMPROVEMENTS\ SITE B-5 \ N \ GLEBE\ ROAD\ 8} \\ PLOTTED: \ MARCH\ 5\ 2019$ 

PLOTTED BY: KPATEL SCALE: AS NOTED

HOR. & VERT. SCALE: 1'' = 5'


**SHEET** 

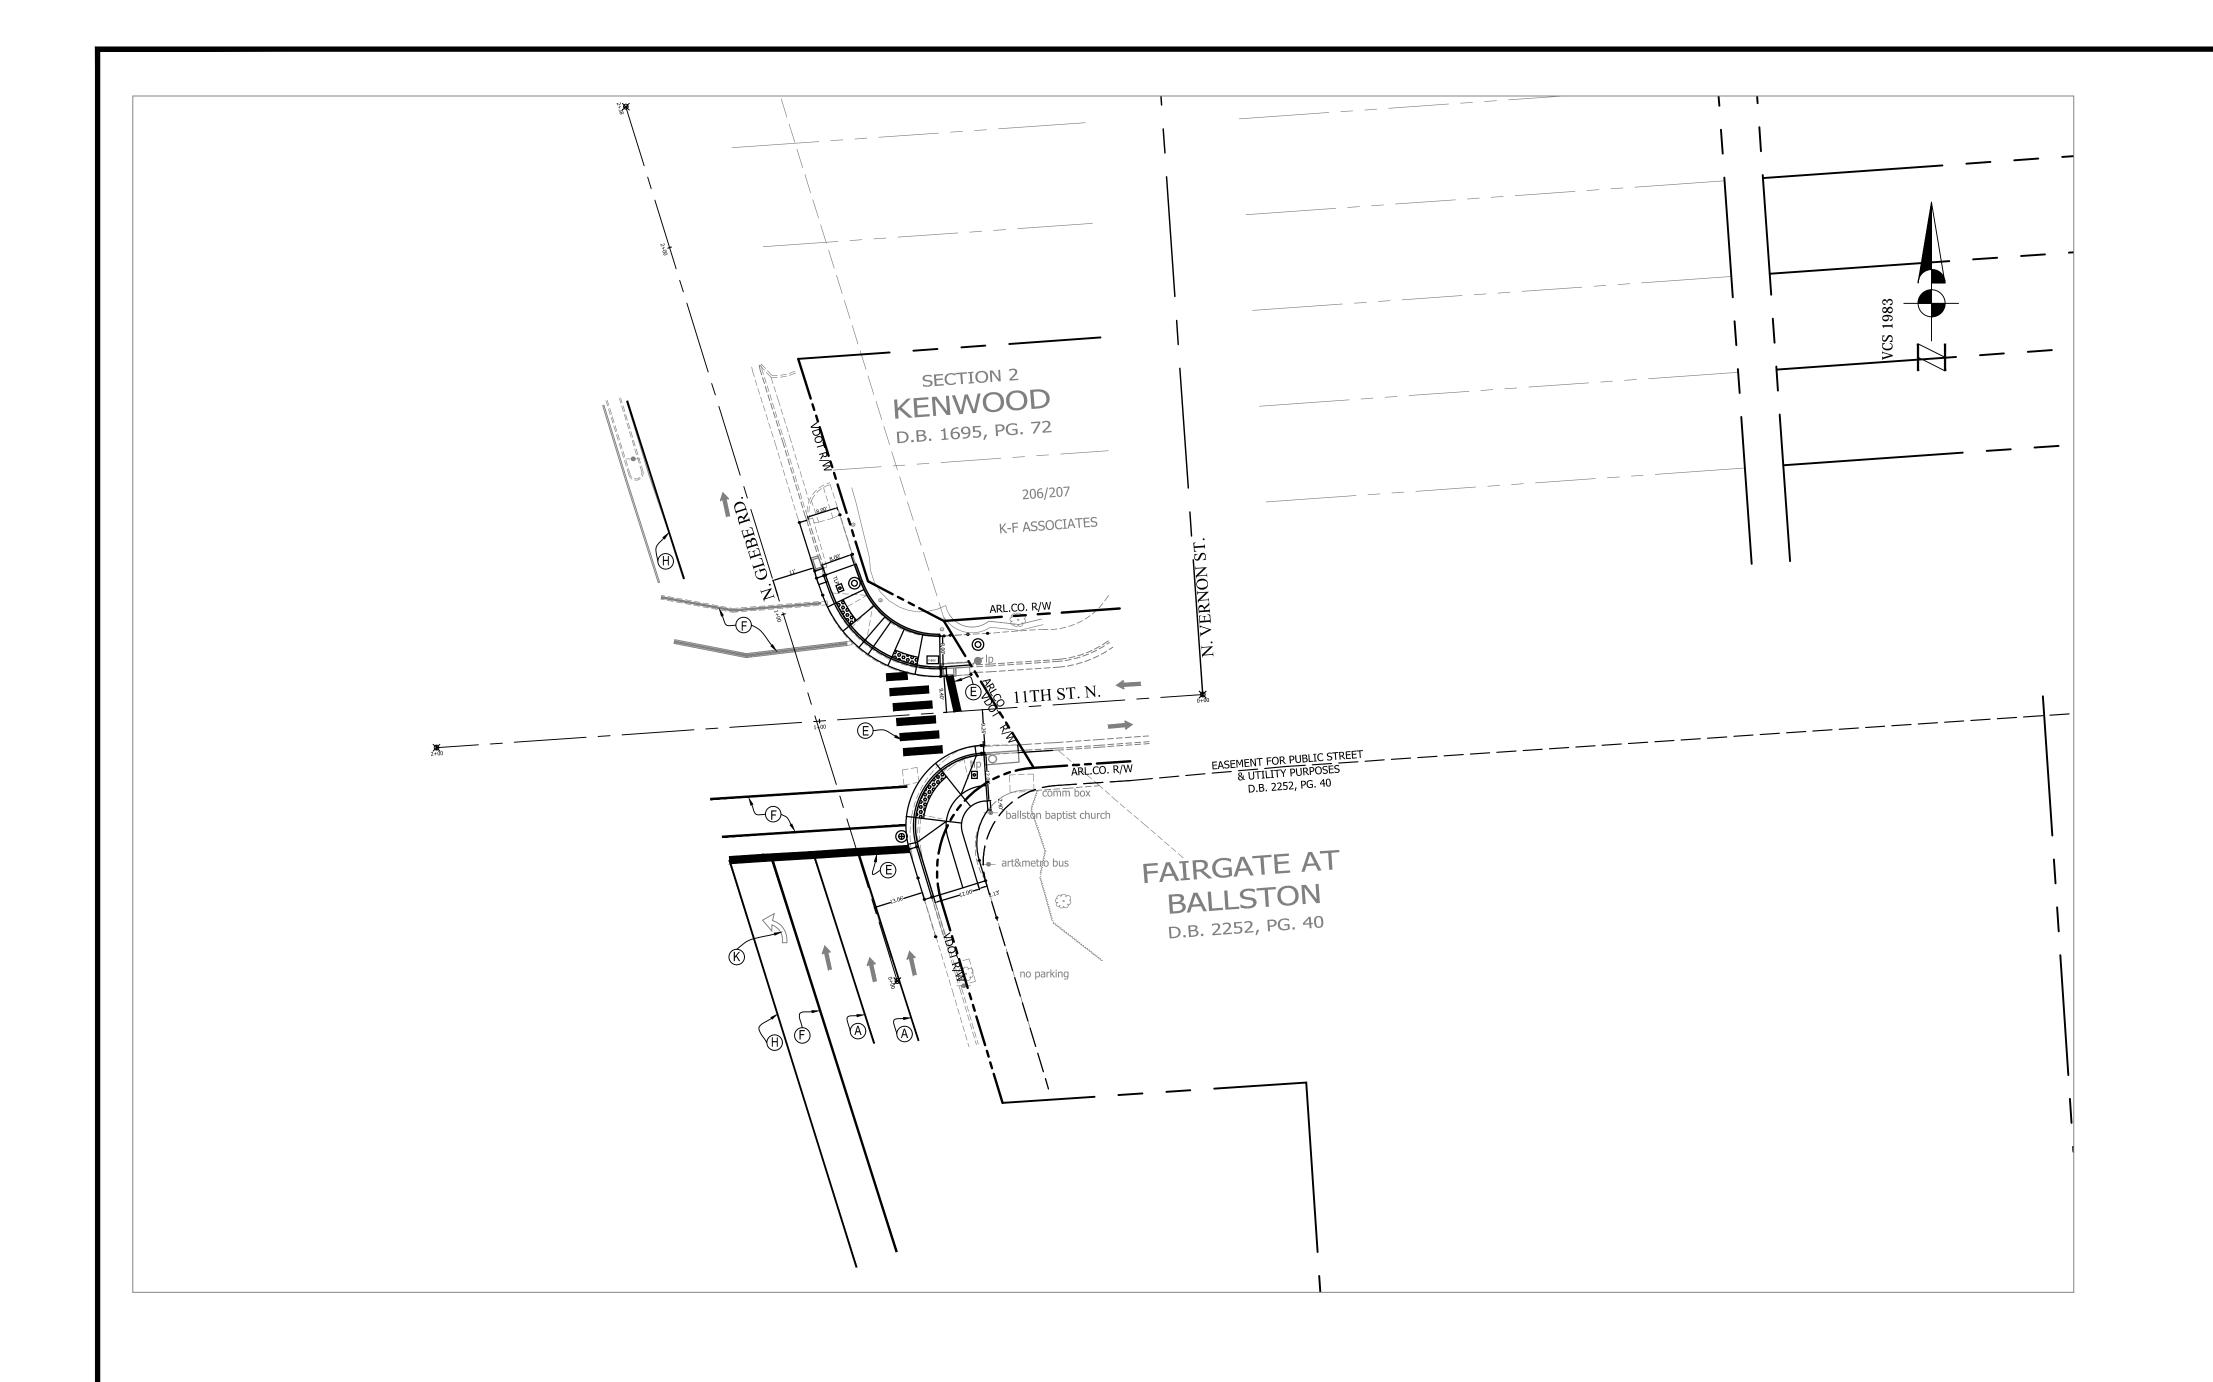


All existing signage to remain unless otherwise noted.

(A) TYPE B CLASS 1WHITE 4" WIDTH PARKING LANES. EDGE LINES. LANE LINES 1. ST	GN AND PAVEMENT MARKING NOTES:  STREET WIDTH MEASUREMENTS ARE FROM FACE OF CURB TO FACE OF CURB. LANES ARE MEASURED FROM CENTER OF MARKING TO CENTER OF MARKING.  CONTACT DENNIS HOWELL OR HIS DESIGNEE AT 703-228-6598 OR (571) 437-1077 TO APPROVE MARKING LAYOUT 48 HRS. PRIOR TO INSTALLATION OF MARKINGS.
TIPE B CLASS I, WHITE 4 WIDTH PARKING LAINES, EDGE LINES, LAINE LINES	MARKING TO CENTER OF MARKING.  CONTACT DENNIS HOWELL OR HIS DESIGNEE AT 703-228-6598 OR (571) 437-1077 TO APPROVE MARKING LAYOUT 48 HRS.
TYPE B CLASS 1,WHITE 18" WIDTH  ETYPE B CLASS 1,WHITE 24" WIDTH  ETYPE B CLASS 1,WHITE 6" WIDTH  ETYPE B CLASS 1,WHITE 6" WIDTH  ETYPE B CLASS 1,WHITE 6" WIDTH  ETYPE B CLASS 1,YELLOW 4" WIDTH, 10' LONG, 30' SPACING  ETYPE B CLASS 1,YELLOW 4" WIDTH, 10' LONG, 30' SPACING  ETYPE B CLASS 1,YELLOW 4" WIDTH, 10' LONG, 30' SPACING  ETYPE B CLASS 1,WHITE 6" WIDTH, 10' SPACING @45 DEGREE  ETYPE B CLASS 1,WHITE 6" WIDTH, 10' SPACING @45 DEGREE  ETYPE B CLASS 1,WHITE SINGLE ARROW  ETYPE B CLASS 1,WHITE SINGLE ARROW  ETYPE B CLASS 1,WHITE 8' LETTERS  ETYPE B CLASS 1,WHITE 8' LETTERS  ETYPE B CLASS 1,WHITE 6" WIDTH, 2' LONG, 10' SPACING  ETYPE B CLASS 1,WHITE 12" WIDTH, 20' SPACING @45 DEGREE  ETYPE B CLASS 1,WHITE 12" WIDTH, 20' SPACING @45 DEGREE  ETYPE B CLASS 1,WHITE 12" WIDTH, 20' SPACING @45 DEGREE  ETYPE B CLASS 1,WHITE 12" WIDTH, 20' SPACING @45 DEGREE  ETYPE B CLASS 1,WHITE 12" WIDTH, 20' SPACING @45 DEGREE  ETYPE B CLASS 1,WHITE 12" WIDTH, 20' SPACING @45 DEGREE  ETYPE B CLASS 1,WHITE 12" WIDTH, 20' SPACING @45 DEGREE  ETYPE B CLASS 1,WHITE 12" WIDTH, 20' SPACING @45 DEGREE  ETYPE B CLASS 1,YELLOW 12" WIDTH, 20' SPACING @45 DEGREE  ETYPE B CLASS 1,YELLOW 12" WIDTH, 20' SPACING @45 DEGREE  ETYPE B CLASS 1,YELLOW 12" WIDTH, 20' SPACING @45 DEGREE  ETYPE B CLASS 1,YELLOW 12" WIDTH, 20' SPACING @45 DEGREE  ETYPE B CLASS 1,YELLOW 12" WIDTH, 20' SPACING @45 DEGREE  ETYPE B CLASS 1,YELLOW 12" WIDTH, 20' SPACING @45 DEGREE  ETYPE B CLASS 1,YELLOW 12" WIDTH, 20' SPACING @45 DEGREE  ETYPE B CLASS 1,YELLOW 12" WIDTH, 20' SPACING @45 DEGREE  ETYPE B CLASS 1,YELLOW 12" WIDTH, 20' SPACING @45 DEGREE  ETYPE B CLASS 1,YELLOW 12" WIDTH, 20' SPACING @45 DEGREE  ETYPE B CLASS 1,YELLOW 12" WIDTH, 20' SPACING @45 DEGREE  ETYPE B CLASS 1,YELLOW 12" WIDTH, 20' SPACING @45 DEGREE	PAVEMENT MARKINGS TO BE IN ACCORDANCE WITH THE FOLLOWING AND ANY REVISIONS HERE TO: A.) THE MANUAL ON UNIFORM TRAFFIC CONTROL DEVICES. B) ARLINGTON COUNTY MARKING STANDARDS.  ALL MARKINGS SHALL BE THERMOPLASTIC PER ARLINGTON COUNTY MARKING STANDARDS.  STOP BARS SHALL BE A MINIMUM OF 4' IN ADVANCE OF A MARKED CROSSWALK, IF THERE IS NO MARKED CROSSWALK, STOP BAR SHALL BE NO MORE THAN 30' FROM THE NEAREST EDGE OF THE INTERSECTED TRAVELED WAY.  CROSSWALKS SHALL BE 10' WIDE UNLESS OTHERWISE NOTED.  LEFT TURN ARROWS SHALL BE LOCATED 25' BACK FROM STOP BAR. FOR ADDITIONAL ARROWS FOLLOW DES MARKING STANDARDS.  ON-STREET PARKING LANE IS 7' WIDE (UNLESS OTHERWISE NOTED) AND MARKED WITH 4" WIDE WHITE LINES. BEGINING AND END OF PARKING SHALL BE MARKED WITH AN END LINE PERPENDICULAR TO CURB EXCEPT AT NUBS.  SHARROWS SHALL BE PLACED IN CENTER OF LANE, 250' APART UNLESS OTHERWISE SPECIFIED.

	STRIPING LEGEND		
<u>EXISTING</u>		PROPOSED	
	BUS STOP	F	
-\$-	FIRE HYDRANT	<b>+</b>	
<del>\\ \\ \\ \\ \\ \\ \\ \\ \\ \\ \\ \\ \\ </del>	PARKING METER	$\triangleright$	
0	SIGN	•	
( <u>A</u> )	STRIPING	A	

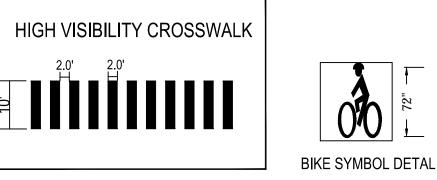


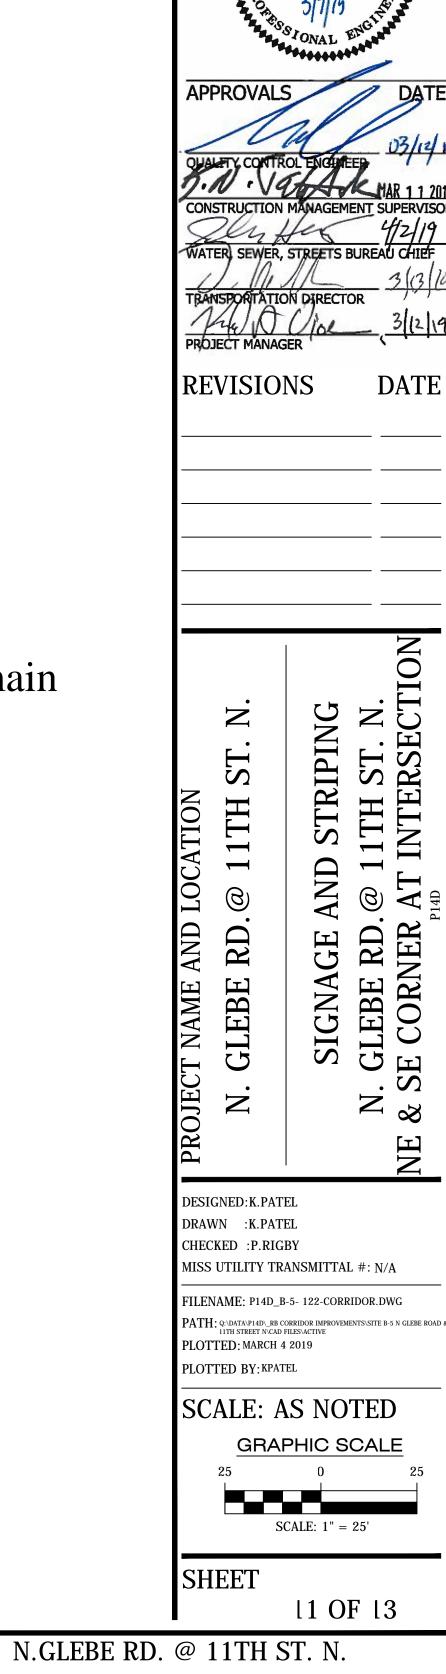


ARLINGTON VIRGINIA

DEPARTMENT OF ENVIRONMENTAL SERVICES

FACILITIES & ENGINEERING DIVISION ENGINEERING BUREAU 2100 CLARENDON BOULEVARD, SUITE 813 ARLINGTON, VA 22201 PHONE: 703.228.3629 FAX: 703.228.3606

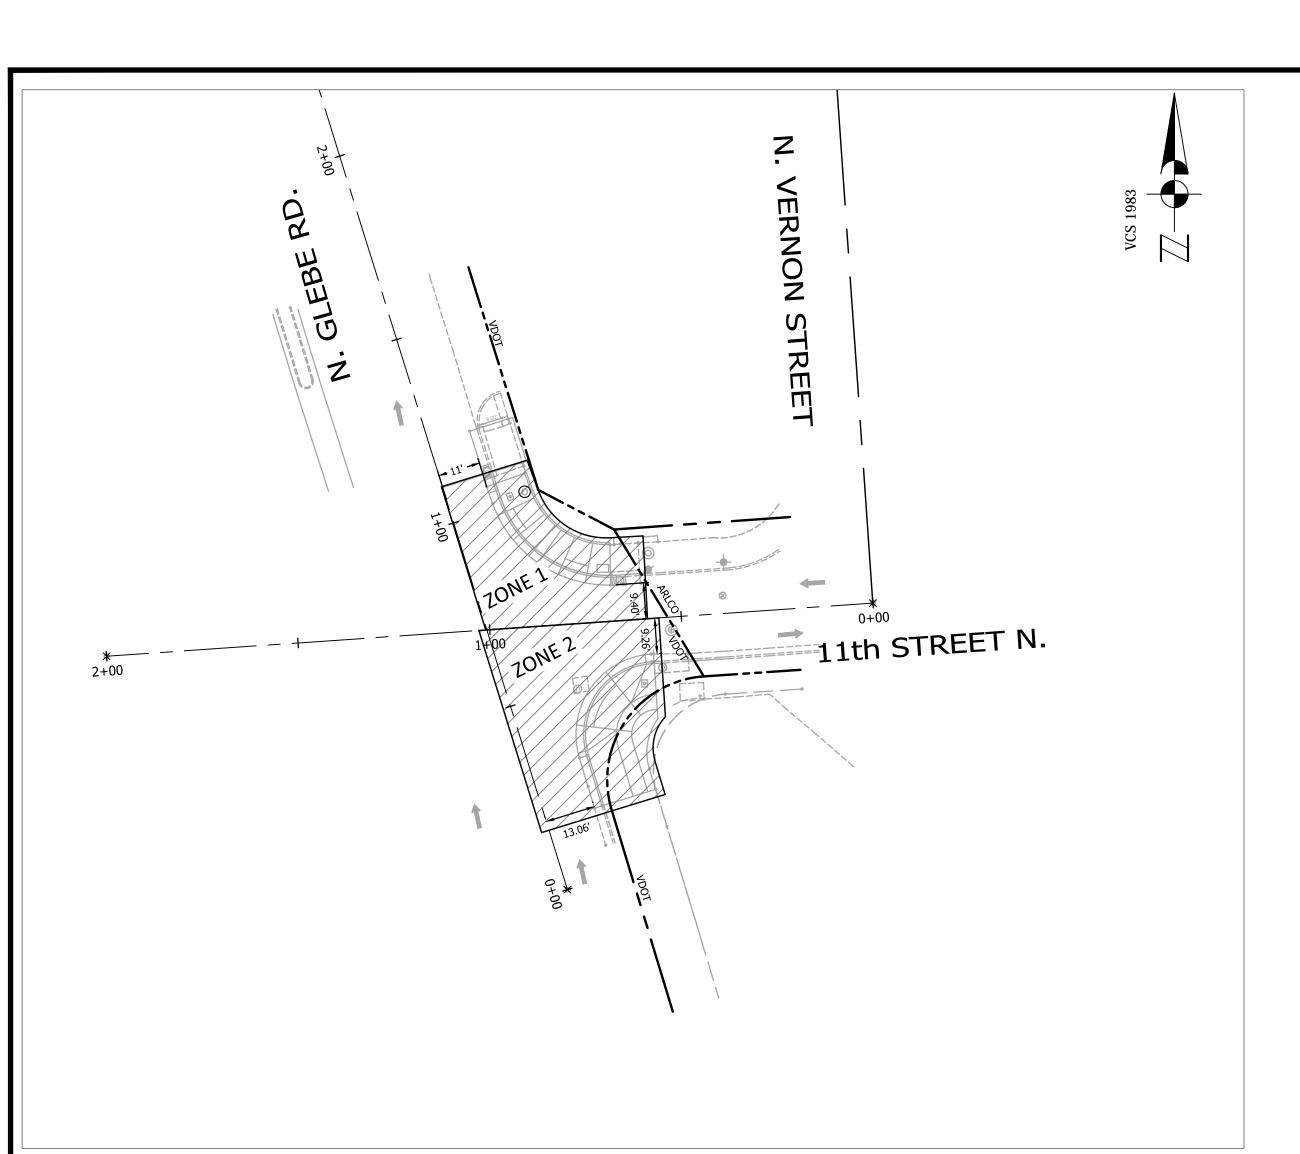

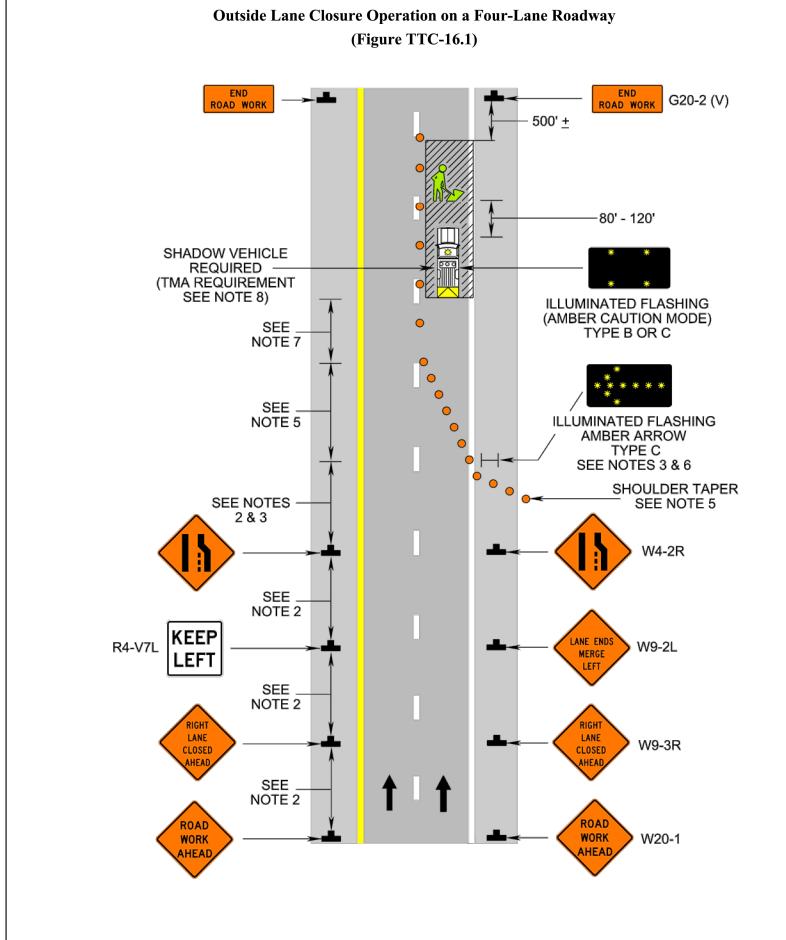

April 2015

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Page 6H-39

April 2015

#### Typical Traffic Control Outside Lane Closure Operation on a Four-Lane Roadway (Figure TTC-16.1)

**NOTES** 

1. On divided highways having a median wider than 8', right and left sign assemblies shall be required.

Guidance: 2. Sign spacing should be 1300'-1500' for Limited Access highways. For all other roadways, the sign spacing should be 500'-800' where the posted speed limit is greater than 45 mph, and 350'-500' where

- the posted speed limit is 45 mph or less. 3. Care should be exercised when establishing the limits of the work zone to insure maximum possible sight distance in advance of the transition, based on the posted speed limit and at least equal to or
- greater than the values in Table 6H-3. For Limited Access highways a minimum of 1000' is desired. 4. All vehicles, equipment, workers, and their activities should be restricted to one side of the pavement.
- 5. Taper Length (L) and Channelizing Device Spacing shall be:

Taper Length (L)						
Speed Limit	Lane Width (Feet)					
(mph)	9	10	11	12		
25	95	105	115	125		
30	135	150	165	180		
35	185	205	225	245		
40	240	270	295	320		
45	405	450	495	540		
50	450	500	550	600		
55	495	550	605	660		
60	540	600	660	720		
65	585	650	715	780		
70	630	700	770	840		
Minimum taper lengths for Limited Access highways shall be 1000 feet.						
Shoulder Taper = 1⁄₃ L Minimum						

Channelizing Device Spacing					
Laastian	Speed Limit (mph)				
Location	0 - 35	36 +			
Transition Spacing	20'	40'			
Travelway Spacing	40'	80'			
Construction Access*	80'	120'			
* Spacing may be increased to this distance, but shall not exceed one access per 1/4 mile.					

On roadways with paved shoulders having a width of 8 feet or more, channelizing devices shall be used to close the shoulder in advance of the merging taper to direct vehicular traffic to remain within the traveled

6. An arrow board shall be used when a lane is closed. When more than one lane is closed, a separate arrow board shall be used for each closed lane (see Figure TTC-18).

7. The buffer space length shall be shown in Table 6H-3 on Page 6H-5 for the posted speed limit.

- 8. A shadow vehicle with either a Type B or C arrow board operating in the caution mode, or at least one high intensity amber rotating, flashing, or oscillating light shall be parked 80'-120' in advance of the first work crew. When the posted speed limit is 45 mph or greater, a truckmounted attenuator shall be used.
- 9. Vehicle hazard warning signals shall not be used instead of the vehicle's high-intensity amber rotating, flashing, or oscillating lights but can be used to supplement the amber rotating, flashing, or oscillating lights.
- 10. When a side road intersects the highway within the TTC zone, additional TTC devices shall be placed as needed.

1: Revision 1 – 4/1/2015

		ZONE TABLE		
ZONE#	TTC#	COMMENTS	DURATION	
ZONE 1		OUTSIDE LANE CLOSURE OPERATION ON A FOUR LANE ROADWAY		
		LANE CLOSURE OPERATION- IN AN INTERSECTION	MONTH	
	TTC-36.1	CROSSWALK CLOSURE AND PEDESTRIAN DETOUR OPERATION		
ZONE 2	TTC-16.1	OUTSIDE LANE CLOSURE OPERATION ON A FOUR LANE ROADWAY		
	TTC-28.1	LANE CLOSURE OPERATION- IN AN INTERSECTION	TWO WEEK	
	TTC-36.1	CROSSWALK CLOSER AND PEDESTRIAN DETOUR OPERATION		


THE DURATIONS SHOWN WERE DEVELOPED FOR PLANNING AND ESTIMATION PURPOSES ONLY. THE DURATIONS IN NO WAY ALTER THE CONTRACT TIME FOR COMPLETION, OR INFRINGES ON THE CONTRACTORS MEANS AND METHODS. THE CONTRACTOR'S SUBMITTED SCHEDULE SUPERSEDES THE ESTIMATED DURATIONS SHOWN.

RESTRICTIONS ON CONCURRENT WORK AREAS:

THE CONTRACTOR MAY CHOOSE THE OPTIMAL SEQUENCE FOR THEM, BUT THE DESIGNER WILL DICTATE WHICH WORK AREA CAN AND CANNOT BE CLOSED SIMULTANEOUSLY.

NOTES: 1. WARNING SIGN SPACING: 100'

2. CHANNELIZATION DEVICES SPACING FOR TRANSITION AREAS = 20'

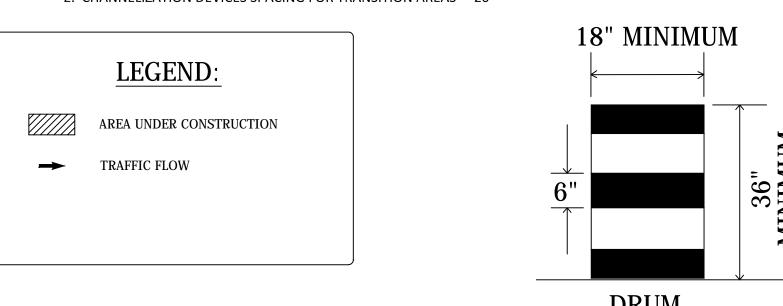

### **WORKING HOURS:**

1. IN VDOT RIGHT-OF-WAY: 9:30 AM TO 3:00 PM (MON.-FRI.) AND 9:30 AM TO 2:00 PM (FRIDAY). 2. ALL LANES SHALL BE FULLY OPEN TO TRAFFIC OUTSIDE THE ABOVE HOURS UNLESS SPECIFIED OTHERWISE IN THE MAINTENANCE OF TRAFFIC PLANS.

### MOT NOTES:

- 1. TRAFFIC CONTROL DEVICES AND SAFETY MEASURES SHALL COMPLY WITH THE VIRGINIA WORK AREA PROTECTION MANUAL, VDOT'S GUIDELINES FOR TEMPORARY TRAFFIC CONTROL, FEDERAL HIGHWAY ADMINISTRATION MANUAL ON UNIFORM TRAFFIC CONTROL DEVICES, ARLINGTON COUNTY STANDARDS, THE TRAFFIC CONTROL PLANS INCLUDED IN THE CONSTRUCTION DRAWINGS. AND/OR AS DIRECTED
- THE CONTRACTOR SHALL SUBMIT A DETAILED SCHEDULE WHICH INDICATES START AND FINISH DATES FOR EACH SEGMENT OF THE WORK. THE SCHEDULE SHALL INDICATE THE DURATION OF ALL LANE OR
- SHOULDER CLOSURES. THE CONTRACTOR SHALL NOTIFY THE PROJECT OFFICER A MINIMUM OF 3 BUSINESS DAYS IN ADVANCE OF PROCEEDING TO THE NEXT WORK SEGMENT. THE CONTRACTOR SHALL NOTIFY THE PROJECT OFFICER OF PARKING RESTRICTION NEEDS A MINIMUM OF 3 BUSINESS DAYS PRIOR TO COMMENCEMENT OF WORK FOR EACH SEGEMENT. COUNTY PROJECT
- OFFICER SHALL RESTRICT PARKING BY CONTACTING DES PERMITTING SECTION, 703-228-4798. 4. DURING CONSTRUCTION, THE CONTRACTOR SHALL EITHER MAINTAIN APPROPRIATE SIGHT DISTANCE TO ALL TRAFFIC SIGNS OR PROVIDE FOR TEMPORARY SIGNAGE OR FLAGGERS TO GUIDE TRAFFIC
- THE CONTRACTOR SHALL MINIMIZE THE DURATION OF ANY BLOCKAGE TO PRIVATE ENTRANCES AND DRIVEWAYS. THE CONTRACTOR SHALL SUBMIT A SCHEDULE OF DRIVEWAY CLOSURE FOR APPROVAL BY THE PROJECT OFFICER. THE PROJECT OFFICER SHALL BE NOTIFIED A MINIMUM OF 3 BUSINESS DAYS IN ADVANCE OF SUCH ACTIVITIES. THE CONTRACTOR SHALL NOTIFY THE PROPERTY OWNER AT LEAST 24 HOURS IN ADVANCE OF THE START OF ANY WORK THAT WILL REQUIRE TEMPORARY CLOSURE OF ACCESS TO THE PROPERTY. THE CONTRACTOR SHALL MAKE ALL PRIVATE ENTRANCES AND DRIVEWAYS
- ACCESSIBLE AT THE CONCLUSION OF EACH WORKDAY. 6. ANY EXCAVATIONS WHICH ARE SPECIFICALLY APPROVED BY THE PROJECT OFFICER TO REMAIN OPEN PAST NORMAL WORKING HOURS SHALL BE THE RESPONSIBILITY OF THE CONTRACTOR AND SHALL BE
- PROTECTED IN ACCORDANCE WITH THE VIRGINIA WORK AREA PROTECTION MANUAL AND AS APPROVED BY THE PROJECT OFFICER. PEDESTRIAN TRAFFIC SHALL BE MAINTAINED AT ALL TIMES, INCLUDING ACCESS TO BUS STOP SHELTERS, UNLESS OTHERWISE APPROVED IN THE PLANS.
- PEDESTRIAN TRAFFIC SHALL BE SEPARATED FROM WORK ZONES WITH APPROPRIATE MEASURES IN ACCORDANCE WITH MUTCD.
- 9. ADEQUATE PROVISIONS FOR PERSONS WITH DISABILITIES SHALL BE PROVIDED AT ALL TIMES PER ADA REQUIREMENTS.
- 10. WHEN NECESSARY, PEDESTRIANS SHALL BE APPROPRIATELY DIRECTED WITH ADVANCED WARNING SIGNS PLACED AT INTERSECTIONS, TO CROSS TO THE OPPOSITE SIDE OF THE ROADWAY IN ORDER TO PREVENT CONFLICT WITH MIDBLOCK WORK SITES.
- 11. PEDESTRIANS SHALL NOT BE LED INTO CONFLICT WITH WORK SITE EQUIPMENT, OPERATIONS, AND/OR VEHICLES MOVING THROUGH OR AROUND THE WORK SITE. 12. ALL EXISTING FIRE HYDRANTS AND FIRE DEPARTMENT CONNECTIONS SHALL BE MAINTAINED UNOBSTRUCTED AND ACCESSIBLE AT ALL TIMES IN ACCORDANCE WITH SECTIONS 508.5.4 AND 508.5.5 OF THE
- 13. ACCESS TO BUILDINGS FOR FIREFIGHTING SHALL BE MAINTAINED AT ALL TIMES. EXISTING FIRE APPARATUS ACCESS ROADS (FIRE LANES) SHALL BE KEPT CLEAR OF OBSTRUCTIONS IN ACCORDANCE WITH SECTION 503.4 OF THE ARLINGTON COUNTY FIRE PREVENTION CODE. ACCESS TO CONSTRUCTION SITES SHALL BE PROVIDED AND MAINTAINED IN ACCORDANCE WITH SECTION 1410 OF THE ARLINGTON
- 14. IN THE EVENT THAT EXISTING FIRE DEPARTMENT CONNECTIONS OR FIRE APPARATUS ACCESS ROADS (FIRE LANES) MUST BE OBSTRUCTED TO FACILITATE CONSTRUCTION ACTIVITIES, CONTACT THE ARLINGTON COUNTY FIRED DEPARTMENT FIRE PREVENTION OFFICE AT 703-228-4644 TO COORDINATE REVIEW AND APPROVAL OF TEMPORARY FIRE DEPARTMENT CONNECTIONS AND/OR FIRE APPARATUS
- ACCESS ROADS PRIOR TO CREATING THE OBSTRUCTION.
- 15. VEHICLE DETECTION AT ALL TIMES DURING THE PROJECT. TRAFFIC SENSORS SHALL BE RESTORED TO THEIR PRE-CONSTRUCTION STATE PRIOR TO THE COMPLETION OF THIS PROJECT. 16. WORK HOURS ARE RESTRICTED IN V.D.O.T- R.O.W. " 9:30 AM TO 3:00 PM (MON.-THUR.) AND 9:30AM TO 2PM (FRI)" SINCE GLEBE RD. IS A STATE ROAD.
- 17. CONTRACTOR SHALL COVER ANY EXISTING SIGNS WHICH ARE NOT APPLICABLE OR ARE IN CONFLICT WITH THIS MOT PLAN.
- 18. CONTRACTOR SHALL ERADICATE AND RE-STRIPE AS NECESSARY ANY EXISTING PAVEMENT MARKINGS THAT ARE AM CONFLICT OR DO NOT ALIGN WITH THE TEMPORARY PAVEMENT
- 19. CONTRACTOR SHALL ERADICATE ALL TEMPORARY PAVEMENT MARKING, INCLUDING TEMPORARY MARKED CROSSWALKS ONCE THE WORK AREA(S) ASSOCIATED WITH THE MARKINGS
- 20. CONTRACTOR SHALL COORDINATE WITH ARLINGTON COUNTY TRANSIT AT 703-228-3049, AT LEAST FOUR (4) WEEKS PRIOR TO COMMENCEMENT OF ALL WORK AFFECTING TRANSIT STOPS. COORDINATE TAPER WITH BUS STOP MANAGER.

ARLINGTON VIRGINIA

DEPARTMENT OF **ENVIRONMENTAL SERVICES** 


FACILITIES & ENGINEERING DIVISION ENGINEERING BUREAU 100 CLARENDON BOULEVARD, SUITE 813

ARLINGTON, VA 22201

PHONE: 703.228.3629

FAX: 703.228.3606

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CONSTRUCTION MANAGEMENT SUPERVISOR WATER, SEWER, STREETS BUREAU CHIEF TRANSPORTATION DIRECTOR

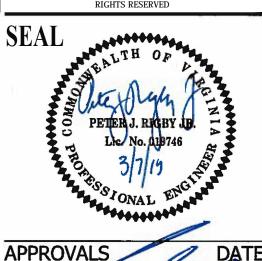DATE REVISIONS

PROJECT MANAGER


GLEBE Z

DESIGNED:K.PATEL DRAWN : K.PATEL CHECKED : P.RIGBY

MISS UTILITY TRANSMITTAL #: N/A FILENAME: P14D-B-5-286-MOT.DWG PATH: Q:\data\p14d\\_rb corridor improvements\site b-5 n glebe road a 11th street n\cad files\active

PLOTTED: MARCH 4 2019 PLOTTED BY: KPATEL

SCALE: AS NOTED

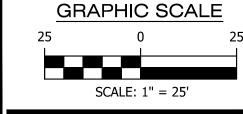

SHEET

April 2015 Page 6H-63 **Lane Closure Operation in an Intersection** (Figure TTC-28.1) S aton ana FOR SIGN LAYOUT SEE BOTTOM RIGHT NOITATS -FLAGGER **FLAGGER** STATION

Page 6H-62

### April 2015

#### Lane Closure Operation in an Intersection (Figure TTC-28.1)

**Typical Traffic Control** 

#### **NOTES**

#### 1. The control of traffic through the intersection in order of preference should be:

- a. Obtain the services of law enforcement personnel.
- b. Detour the effective routes to other roads and streets as approved and directed by the Regional Traffic Engineer.
- c. Place a state certified flagger on each leg of the intersection controlling a single lane of traffic. Appropriate signing as shown should be used for law enforcement and flagging operations. For detour
- 2. Sign spacing distance should be 350'-500' where the posted speed limit is 45 mph or less, 500'-800' where the posted speed limit is greater than 45 mph.

#### 3. Channelizing device spacing shall be on 20' centers or less.

4. If room permits, a shadow vehicle with at least one rotating amber light or high intensity amber flashing or oscilllating light should be parked 80'-120' in advance of the first work crew.

#### Standard:

5. For emergency situations (any non-planned operation) of 30 minutes or less duration, two rotating amber lights or high intensity amber flashing or oscillating lights mounted on the vehicle and visible for 360° shall be required in addition to the channelizing devices shown around the vehicle. Also, vehicle hazard warning signals shall be used.

6. If the work space extends across a crosswalk, the crosswalk should be closed using the information and


### devices shown in Figure TTC-36.

7. Turns can be prohibited as required by vehicular traffic conditions. Unless the streets are wide, it might be physically impossible to make certain turns, especially for large vehicles.

1: Revision 1 – 4/1/2015

April 2015

**Crosswalk Closure and Pedestrian Detour Operation** (Figure TTC-36.1)

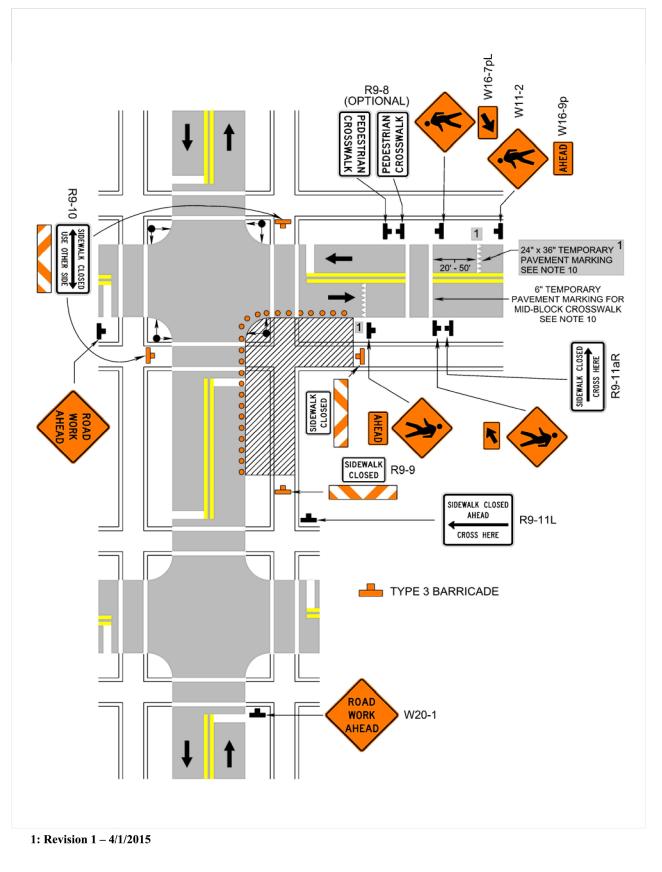

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**Typical Traffic Control** 

April 2015

#### Crosswalk Closure and Pedestrian Detour Operation (Figure TTC-36.1)

### **NOTES**

## 1. When crosswalks or other pedestrian facilities are closed or relocated, temporary facilities shall

be detectable and shall include accessibility features consistent with the features present in the 2. Curb parking shall be prohibited for at least 50 feet in advance of the midblock crosswalk.

#### Guidance:

- 3. Audible information devices should be considered where midblock closings and changed crosswalk areas cause inadequate communication to be provided to pedestrians who have visual disabilities.
- 4. Pedestrian traffic signal displays controlling closed crosswalks should be covered or deactivated.
- 5. Temporary markings should be considered for operations exceeding three days in duration.

#### 6. Only the TTC devices related to pedestrians are shown. Other devices, such as lane closure signing or

- ROAD NARROWS (W5-1) signs, may be used to control vehicular traffic. 7. For nighttime closures, Type A Flashing warning lights may be used on barricades supporting signs and
- closing sidewalks. 8. In order to maintain the systematic use of the fluorescent yellow-green background for pedestrian,
- bicycle, and school warning signs in a jurisdiction, the fluorescent yellow-green background for pedestrian, bicycle, and school warning signs may be used in TTC zones.

## Standard:

9. All sidewalk closures shall be closed with Type 3 Barricades.

10. Refer to Sections 3B-16 through 3B-18 of the 2009 MUTCD and the Virginia Supplement to the MUTCD<sup>1</sup> for crosswalk<sup>1</sup> lines, yield lines and other related TTC devices that may be used to control vehicular traffic at midblock crosswalks.

1: Revision 1 - 4/1/2015




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APPROVALS

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REVISIONS

1TH ST. N. INTERSECTION Z ST. 11TH GLEBE RD.@

V. GLEBE RD. (SE CORNER) Ż Z %

DESIGNED: K.PATEL DRAWN :K.PATEL CHECKED :P.RIGBY MISS UTILITY TRANSMITTAL #: N/A

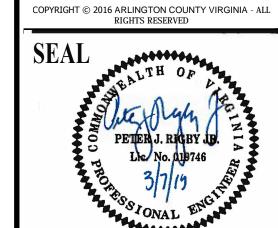FILENAME: P14D-B-5-286-MOT.DWG  $PATH;_{1:1TH\ STREET\ N:CAD\ FILES\ACTIVE} (2): NGLEBE\ ROAD\ \&$ PLOTTED: MARCH 4 2019

PLOTTED BY: KPATEL

SCALE: AS NOTED

SHEET

PROJECT NAME AND LOCATION