

ENGINEER DEPARTMENT OF ENVIRONMENTAL SERVICES

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CONSTRUCTION DRAWINGS FOR:

FACILITIES & ENGINEERING DIVISION ENGINEERING BUREAU 2100 CLARENDON BOULEVARD, SUITE 813 ARLINGTON, VA 22201 PHONE: 703.228.3629 FAX: 703.228.3606

OWNER DEPARTMENT OF **ENVIRONMENTAL SERVICES**

DIVISION OF TRANSPORTATION & DEVELOPMENT TRANSPORTATION PLANNING 2100 CLARENDON BOULEVARD, SUITE 900, ARLINGTON, VA 22201 PHONE: 703.228.3681 FAX: 703.228.7584 WWW.ARLINGTONVA.US


CONTRACTOR TO BE DETERMINED

LOCATION MAP





DEPARTMENT OF ENVIRONMENTAL SERVICI

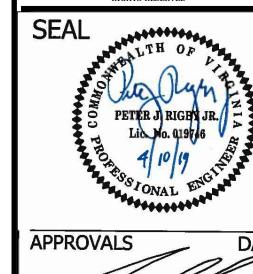

REVISIONS

GENERAL NOTES:

N. GLEBE RD. & WASHINGTON BLVD.

NE CORNER AT INTERSECTION

PROJECT CODE: P14D

- ALL CONSTRUCTION WORK FOR THIS PROJECT SHALL CONFORM TO THE ARLINGTON COUNTY DEPARTMENT OF ENVIRONMENTAL SERVICES, CONSTRUCTION STANDARDS AND SPECIFICATIONS, AND WHERE APPLICABLE THE VIRGINIA DEPARTMENT OF TRANSPORTATION (VDOT) ROAD AND BRIDGE SPECIFICATIONS, AND ROAD AND BRIDGE STANDARDS. THE LATEST EDITIONS OF EACH RELEVANT MANUAL SHALL BE USED.
- 2. ALL CONSTRUCTION AND WORK ACTIVITIES SHALL COMPLY WITH THE VIRGINIA WORK AREA PROTECTION MANUAL AND ALL OTHER RELEVANT WORK SAFETY REQUIREMENTS, LATEST EDITIONS.
- 3. THE CONTRACTOR SHALL IMMEDIATELY NOTIFY THE PROJECT OFFICER OF ANY DISCREPANCIES BETWEEN ACTUAL FIELD CONDITIONS AND THE APPROVED PLANS.
- 4. THE CONTRACTOR SHALL CONTACT "MISS UTILITY" AT 811 FOR MARKING THE LOCATIONS OF EXISTING UNDERGROUND UTILITIES (i.e. WATER, SEWER, GAS, TELEPHONE, ELECTRIC, AND CABLE TV) AT LEAST 72 HOURS PRIOR TO ANY EXCAVATION OR CONSTRUCTION. THE CONTRACTOR IS REQUIRED TO IDENTIFY AND PROTECT ALL OTHER UTILITY LINES FOUND IN THE WORK SITE AREA BELONGING TO OTHER OWNERS THAT ARE NOT MEMBERS OF "MISS UTILITY". PRIVATE WATER, SEWER AND GAS LATERALS WILL NOT BE MARKED BY MISS UTILITY OR THE COUNTY. THE CONTRACTOR SHALL LOCATE AND PROTECT THESE SERVICES DURING
- 5. THE CONTRACTOR SHALL BE RESPONSIBLE FOR LAYING OUT THE WORK AND SHALL RETAIN A PROFESSIONAL LAND SURVEYOR LICENSED IN THE COMMONWEALTH OF VIRGINIA TO PROVIDE ALL NECESSARY CONSTRUCTION LAYOUTS AND ESTABLISH ALL CONTROL LINES, GRADES, AND ELEVATION DURING CONSTRUCTION. THE CONTRACTOR SHALL SUBMIT A COPY OF ALL CUT SHEETS FOR REVIEW, PER THE SPECIFICATIONS. THE COST OF ALL NECESSARY SURVEYING SERVICES SHALL BE CONSIDERED INCIDENTAL TO THE WORK AND, UNLESS OTHERWISE SPECIFIED, THE COST SHALL BE INCORPORATED INTO THE COSTS FOR RELEVANT ITEMS.
- 6. THE LOCATION OF ALL EXISTING UTILITIES SHOWN ON THESE PLANS ARE FROM BEST AVAILABLE RECORDS AND SHALL BE CONSIDERED TO BE APPROXIMATE. WHEN CONSTRUCTION ACTIVITY REACHES IN PROXIMITY TO EXISTING UTILITIES, THE TRENCH(ES) SHALL BE OPENED A SUFFICIENT DISTANCE AHEAD OF THE WORK OR TEST PITS SHALL BE MADE TO VERIFY THE EXACT LOCATION AND INVERTS OF THE UTILITY TO ALLOW FOR POSSIBLE CHANGES IN THE LINE OR GRADE AS DIRECTED BY OFFICER. THE CONTRACTOR SHALL BE RESPONSIBLE FOR ANY DAMAGE TO THE EXISTING UTILITIES AND THE RELATED STRUCTURES. ALL EXISTING UTILITY SYSTEMS SHALL BE PROTECTED TO PREVENT DAMAGE DURING THE CONTRACTOR'S OPERATIONS. ANY SYSTEM DAMAGED SHALL BE PROMPTLY REPAIRED AT NO COST TO THE
- 7. EXISTING MANHOLE FRAMES, COVERS, VALVE BOXES, AND OTHER APPURTENANCES SHALL BE ADJUSTED TO THE FINAL GRADE OR REPLACED, AS NECESSARY. UNLESS OTHERWISE SPECIFIED, THE COST FOR THIS SHALL BE CONSIDERED INCIDENTAL TO THE WORK, AND SHALL BE INCORPORATED INTO THE COSTS FOR RELEVANT ITEMS.
- 8. THE CONTRACTOR SHALL PROVIDE ADA COMPLIANT ACCESS THROUGH OR AROUND THE SITE AT ALL TIMES AND SHALL ENSURE THE SAFETY OF ALL THOSE PASSING THROUGH OR ADJACENT TO THE SITE.

9. THE CONTRACTOR SHALL CONFINE ALL ACTIVITIES AT THE SITE ASSOCIATED WITH CONSTRUCTION ACTIVITIES, TO INCLUDE STORAGE OF EQUIPMENT AND OR MATERIALS, ACCESS TO THE WORK, FORMWORK, ETC. TO WITHIN THE DESIGNATED LIMITS OF DISTURBANCE

TREE PROTECTION

10. TREES SHALL BE PROTECTED PER THE REQUIREMENTS OF ARLINGTON PARKS & RECREATION STANDARD.

TRAFFIC CONTROL

- 11. CONTRACTOR SHALL NOTIFY THE PROJECT OFFICER AT LEAST 3 WORKING DAYS PRIOR TO DISTURBING ANY EXISTING, OR INSTALLING ANY NEW, TRAFFIC SIGNS, SIGNALS, OR OTHER TRAFFIC CONTROL DEVICES.
- 12. THE CONTRACTOR SHALL PREMARK THE LAYOUT OF ANY PERMANENT TRAFFIC CONTROL STRIPING, INDICATING THE PROPOSED LOCATION AND TYPE OF MARKING TO BE INSTALLED. THE PREMARKING MAY CONSIST OF TYPE D TAPE, CHALK, OR LUMBER CRAYONS. THE CONTRACTOR SHALL ALLOW 3 WORKING DAYS FOR THE INSPECTION AND APPROVAL OF THE PREMARKINGS PRIOR TO PLACING THE PERMANENT MARKINGS.
- 13. THE CONTRACTOR SHALL SUBMIT ANY REQUESTS FOR TEMPORARY "NO PARKING" RESTRICTIONS TO THE PROJECT OFFICER AT LEAST 3 WORKING DAYS PRIOR TO THE DESIRED ONSET OF RESTRICTIONS.
- 14. THE CONTRACTOR SHALL PRESERVE ALL BUS STOPS, INCLUDING MAINTAINING ADEQUATE ACCESSIBILITY THROUGH AND ADJACENT TO THE CONSTRUCTION FOR BUSES AND THEIR PASSENGERS. THE CONTRACTOR SHALL NOT CLOSE, RELOCATE, OR OTHERWISE MODIFY A BUS STOP WITHOUT PRIOR REQUEST OF THE PROJECT OFFICER. TYPICALLY ANY RELOCATION OR CLOSURE OF A BUS STOP WILL REQUIRE AT LEAST FOUR WEEKS ADVANCE NOTICE FOR COORDINATION WITH THE COUNTY'S BUS STOP COORDINATOR @ (DES-TRANSIT 703-228-3049) ALL TEMPORARY AND FINAL BUS TRAVEL LANES MUST BE MINIMUM 11' WIDE.
- 15. WHEN CONDITIONS WARRANT DUE TO TRAFFIC VOLUMES, PATTERNS, OR SPECIAL EVENTS, THE COUNTY MAY SUSPEND OR OTHERWISE DIRECT THE CONTRACTOR'S ACTIVITIES TO PROTECT THE PUBLIC AND OR THE COUNTY'S TRANSPORTATION NETWORK.

WATER DISTRIBUTION, STORM, AND SANITARY SEWER SYSTEMS

- 16. UNLESS OTHERWISE DIRECTED, CONTRACTORS ARE EXPRESSLY PROHIBITED FROM OPERATING ANY WATER VALVES OR APPURTENANCES. CONTRACTORS SHALL SUBMIT ALL REQUESTS FOR VALVE OPERATIONS TO THE PROJECT OFFICER AT LEAST 3 WORKING DAYS IN ADVANCE OF THE REQUIRED OPERATION.
- 17. IN THE EVENT OF A WATER OR SEWER EMERGENCY, THE CONTRACTOR SHALL IMMEDIATELY NOTIFY THE COUNTY'S WATER CONTROL CENTER AT 703-228-5555 AND THE PROJECT OFFICER.

TABLE OF CONTENTS

SHEET NUMBER	SHEET TITLE
1	COVER SHEET
2	LEGEND
3	DETAILS SHEET
4	EXISTING CONDITIONS
5	DEMOLITION PLAN
6	EROSION AND SEDIMENT CONTROL PL
7	GEOMETRIC CONTROL
8	PLAN AND PROFILE
9	RAMP DETAIL
10	CROSS SECTIONS
11	SIGNAGE AND STRIPING
12	MOT_PLAN I
13	MOT_PLAN II

BLV 19,000 - VPD WASHINGTON BLVD (KIRKWOOD RD. TO N. GLEBE RD.) 2017 - TE & O 2017- TE & O 2017 - TE & O 2017 - TE & O DESIGNED: K. PATEL DRAWN :K.PATEL

15,000 -VPD WASHINGTON BLVD (ROUTE 237 TO N. GLEBE RD.) 28,000 - VPD N. GLEBE RD. (I-66 TO WASHINGTON BLVD.) 25,000 - VPD N. GLEBE RD. (WASHINGTON BLVD. TO FAIRFAX DR.) STREET CLASSIFICATION PRINCIPAL ARTERAL WASHINGTON BLVD PRINCIPAL ARTERAL N. GLEBE RD. MAINTAINING AGENCY: ARLINGTON COUNTY POSTED/ DESIGN SPEED 30 MPH - WASHINGTON BLVD.

DESIGN VEHICLE

2011 AASHTO CITY BUS

SHEET AUTO TURN (TURNING MOVEMENT) USED SPEED: 10MPH

1 OF 13

CHECKED :P. RIGBY

PLOTTED: MAY 28 2019

PLOTTED BY: KPATEL

MISS UTILITY TRANSMITTAL #: N/A

SCALE: AS NOTED

FILENAME: P14D_C-3-200-COVER.DWG


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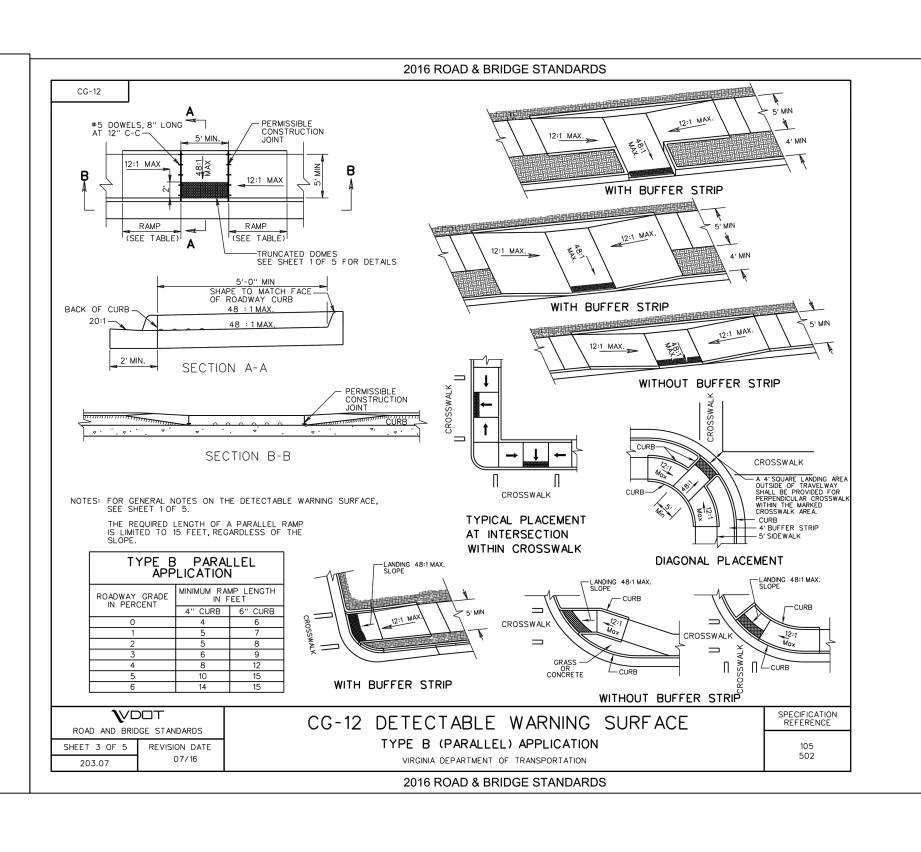
		<u>PE LEGEND</u>	_	SYMBOL LEGE		
FEATURE BACK OF CURB	EXISTING	PROPOSED	<u>EX</u>	<u>(ISTING</u>	PROPOSED PROP FIRE HYDRANT	
BACK OF CORD			EX BENCHMARK		PROP FIRE HIDRAIN	
BUILDING			EX CABLE PEDESTAL	С	PROP GAS VALVE	
CENTERLINE / BASELINE			EX ELECTRIC BOX	E	PROP LIGHT POLE	
COMMUNICATIONS CABLE	сом	сом	EX FIRE HYDRANT		PROP PAY STATION	
			EX GAS VALVE	•		
CONTOURS	—— 250 —— 250 ——	—— 250 —— 250 ——	EX GROUND LIGHT	•	PROP SANITARY MANHOLE	
CRITICAL ROOT ZONE	——————————————————————————————————————	——————————————————————————————————————	EX GUY WIRES	>-	PROP STORM CATCH BASIN (TO SCALE)	0
EASEMENT			EX IRON PIPE OR PIN	•	PROP STORM MANHOLE	0
ELECTRIC (UNDERGROUND)	——————————————————————————————————————		EX LIGHT POLE		PROP TRAFFIC SIGN	<u> </u>
			EX MAILBOX			_
FACE OF CURB			EX MONUMENT		PROP TRASH CAN	❸
ENCE (MATERIAL NOTED)	_xxxx	_xxxxx	EX PARKING METER	Θ	PROPOSED TREE REMOVAL	X
FIBER OPTIC		fo	EX PAY STATION	PS	PROP UTILITY POLE	
GAS LINE	——— GAS————	GAS	EX SANITARY MANHOLE	0	PROP WATER MANHOLE	
X" GAS LINE			EX STORM BASIN	0		
(SIZE INCLUDED IF AVAILABLE)	——————————————————————————————————————	——————————————————————————————————————	EX STORM MANHOLE	0	PROP WATER METER	
GUARDRAIL	. 0 0 0 0 0 0.		EX TELEPHONE PEDESTAL	T	PROP WATER VALVE	$oldsymbol{\Theta}$
HARDSCAPE FEATURE (MATERIAL NOTED)			EX TRAFFIC CONTROL BOX		PROP YARD INLET (TO SCALE)	
IMITS OF DISTURBANCE	LOD	LOD	EX TRAFFIC SIGN	-	CONSTRUCTION NOTES (LEADER TO AREA AFFECTED)	
			EX TRASH CAN	₩	CLIDVE NUMBER (CEE CLIDVE TARLE)	
IMITS OF WORK	—— LOW ———	—— LOW ———	EX TRAVERSE		CURVE NUMBER (SEE CURVE TABLE)	(C1)
OVERHEAD WIRES			EX TREES, WOODED AREA		LINE NUMBER (SEE LINE TABLE)	
PAVEMENT MINI SKIP LINE			EX UTILITY MANHOLE TYPE INDICATED ELECTRIC, TELE, ETC	(4)		
PAVEMENT SKIP LINE			EX UTILITY POLE		NORTH ARROW	
PROPERTY LINE			EX WATER MANHOLE	Θ		
ROPERTT LINE			EX WATER METER		TEST HOLE	
right-of-way line			EX WATER VALVE			
ROOT PRUNING	——————————————————————————————————————		EX YARD INLET			
SANITARY SEWER		SAN			HATCH LEGE	<u>END</u>
(" SANITARY SEWER SIZE INCLUDED IF AVAILABLE)	X" S X" S				PROP MILL & OVERLAY SEE TYPICAL SECTION FOR DETAILS	
SILT FENCE	——————————————————————————————————————	——————————————————————————————————————			PROP FULL DEPTH ASPHALT SEE TYPICAL SECTION FOR DETAILS	
STORM (SIZE NOTED)					PROP CONCRETE	
STREAM					REPLACE & MATCH EXISTING DRIVEWAY OR LEADWALK SEE CONSTRUCTION NOTES	
STREET LIGHT CONDUIT	SL	SL			OV PROPANATU SEE CONSTRUCTION NOTES	
relephone (underground)	UGT				DEMOLITION AREA	
				LABEL LE	<u>GEND</u>	
TREE LINE		$\bigcirc \bigcirc $	EXISTING EX SAN STRUC NO.		PROPOSED PROP SAN SEW STRUC NO.	
TREE PROTECTION FENCE	TPF TPF	TPF TPF	EXISTING SANITARY STRUCTURE NUMBER EX STRM SEW STRUC NO.		PROPOSED SANITARY SEWER STRUCTURE NUMBER PROP STRM SEW STRUC NO.	
WALL		•	EXISTING STORM SEWER STRUCTUE NU	MBER (_XXXX_)	PROPOSED STORM SEWER STRUCTURE NUMBER	< xxxx
VATER						


ARLINGTON, VA 22201 PHONE: 703.228.3629 FAX: 703.228.3606 COPYRIGHT © 2016 ARLINGTON COUNTY VIRGINIA - ALL RIGHTS RESERVED SEAL APPROVALS ONAL OUALITY CONTROL ENGINEER OUALITY CONTROL ENGINEER WATER, SEWER, STREETS BUREAU CHIEF TRANSPORTATION DIRECTOR PROJECT MANAGER	APPROVALS	ENV	VIR DEPAR' /IRONME	NGTON GINIA TMENT OF ENTAL SERVICE GINEERING DIVISION RING BUREAU
APPROVALS DATE QUALITY CONTROL ENGINEER CONSTRUCTION MANAGEMENT SUPERVISOR WATER, SEWER, STREETS BUREAU CHIEF	APPROVALS DATE QUALITY CONTROL ENGINEER CONSTRUCTION MANAGEMENT SUPERVISO WATER, SEWER, STREETS BUREAU CHIEF TRANSPORTATION DIRECTOR PROJECT MANAGER REVISIONS DATE ON THE CONTROL ENGINEER ON THE CONTROL ENGINEER	COPYRIO	CLARENDON ARLINGTO PHONE: FAX: 70 GHT © 2016 ARLIN RIGHT	BOULEVARD, SUITE 81 ON, VA 22201 703.228.3629 03.228.3606 AGTON COUNTY VIRGINIA - ALL TH OF ER J RIGHY JR.
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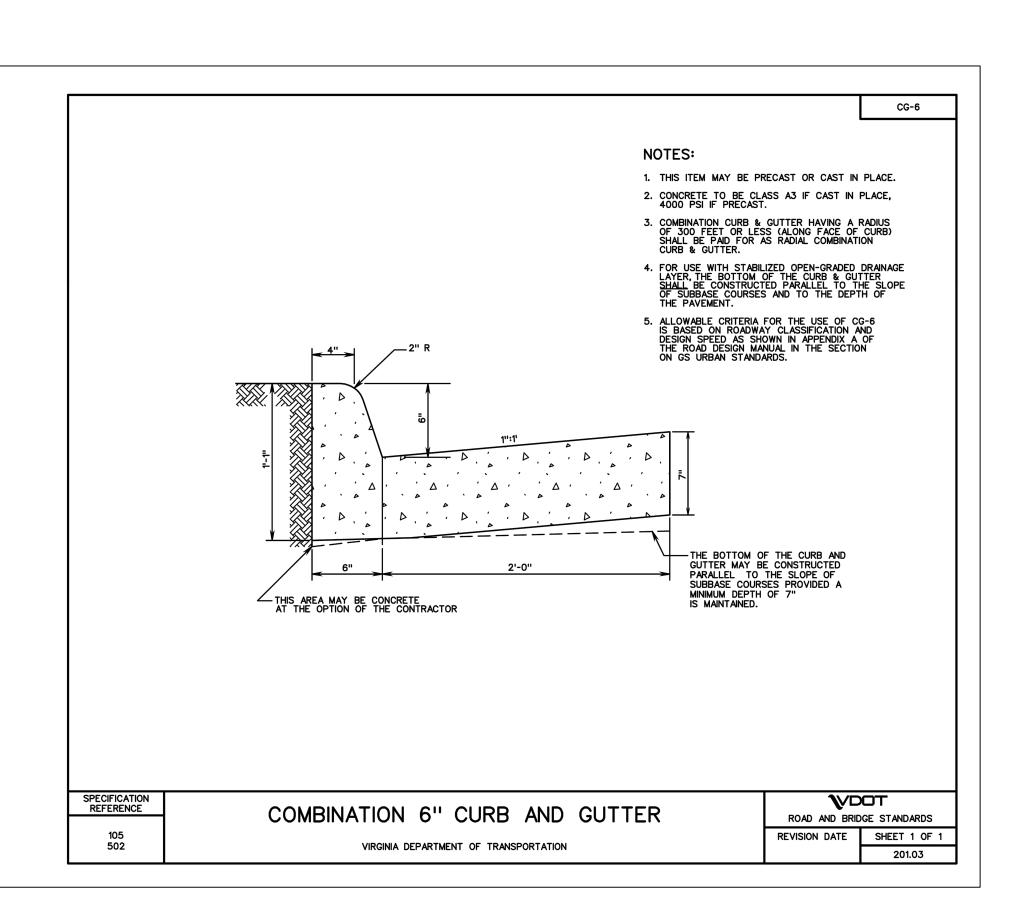
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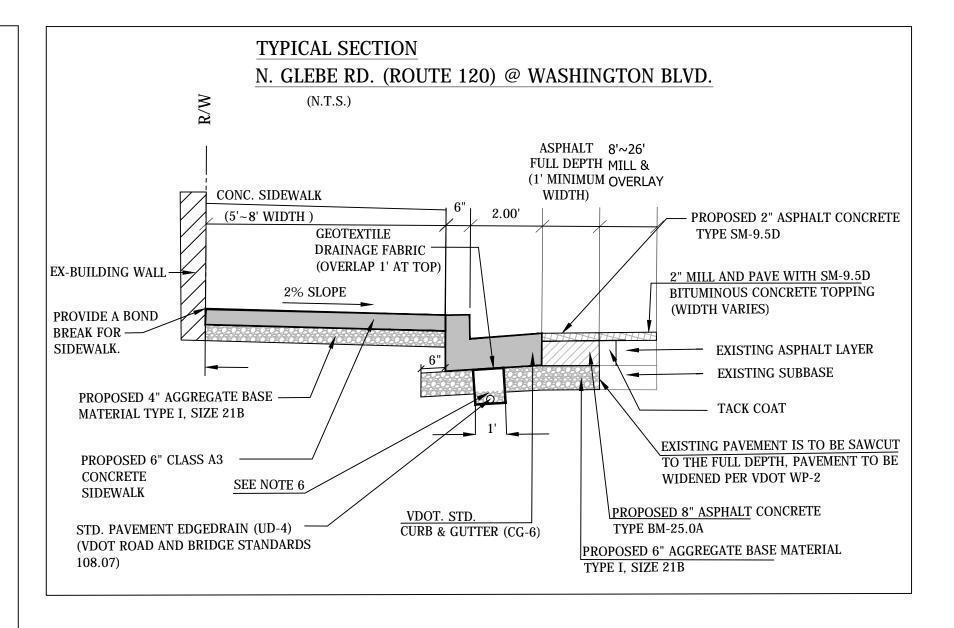
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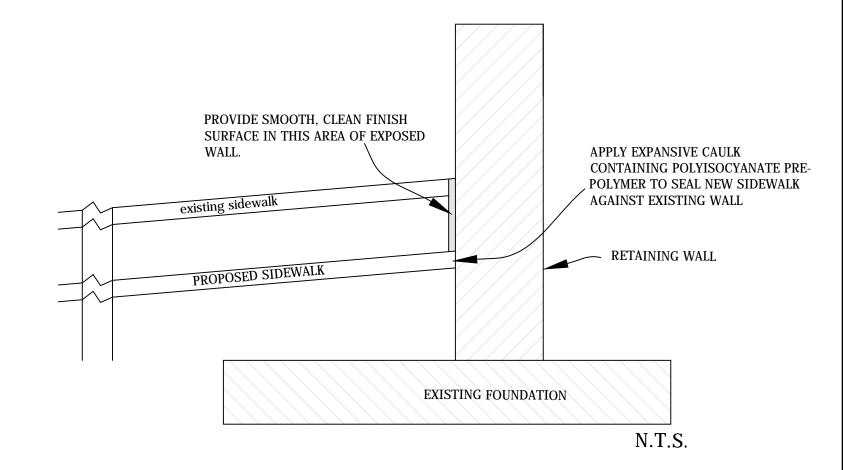






NOTES:

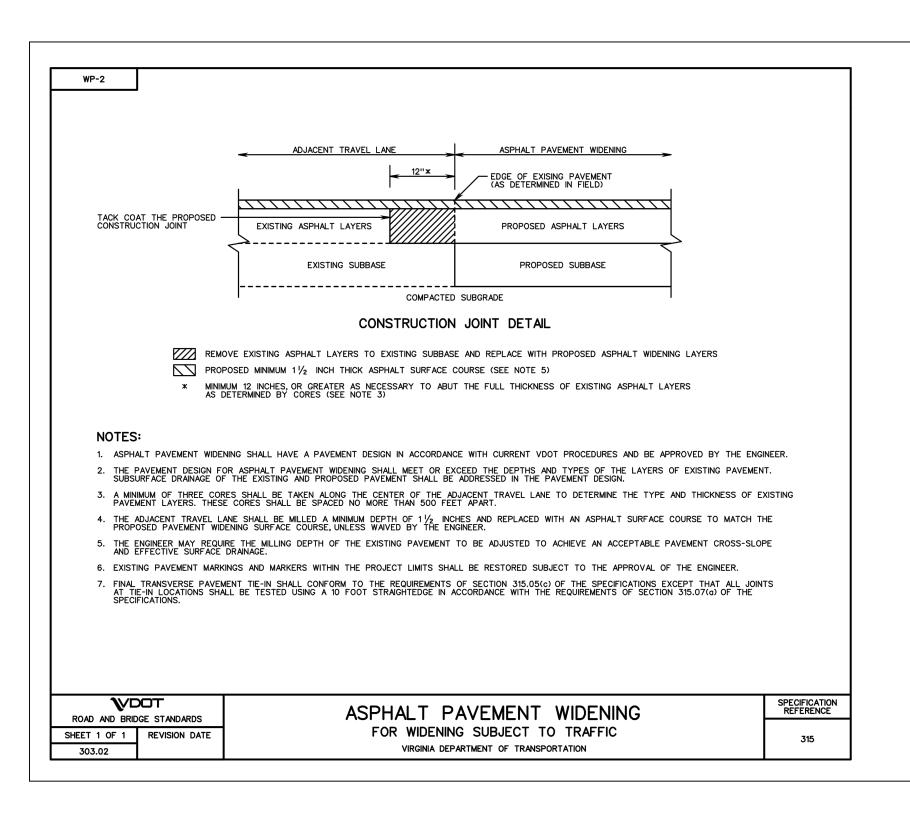- 1. ALL PAVEMENTS SHALL BE WIDENED IN ACCORDANCE WITH VDOT STANDARD WP-2. PROPOSED FULL DEPTH PAVEMENT REPLACEMENT SHALL MATCH EXISTING PAVEMENT IN ACCORDANCE WITH VDOT STANDARD WP-2.
- 2. AGGREGATE SUBBASE THICKNESS BENEATH THE WIDENED PAVEMENT
 SHALL BE AS INDICATED (6 INCHES) ON THIS SHEET OR MATCH THE EXISTING AGGREGATE BASE MATERIAL,
 WHICHEVER IS GREATER.
- PROVIDE 1' WIDE GRADING BENCH BEHIND PROPOSED SIDEWALKS WHEN SPACE ALLOWS.
- 4. AS INDICATED IN TYPICAL SECTIONS, THE SUBBASE 21-B SHALL BE CONNECTED TO A VDOT STANDARDS UD-4 EDGE DRAIN LOCATED BENEATH THE PROPOSED CURB AND GUTTER, TO BE SECURELY CONNECTED TO OUTFALL AT AN ADJACENT DRAINAGE STRUCTURE.
- 5. THE ADJACENT TRAVEL LANE SHALL BE MILLED TO A DEPTH OF 2" AND REPLACED WITH 2" ASPHALT CONCRETE TYPE SM-9.5D.
- 6. 4" MINIMUM, PROVIDED ATTAINING MINIMUM 4" OF AGGREGATE ON TOP OF THE EDGEDRAIN.

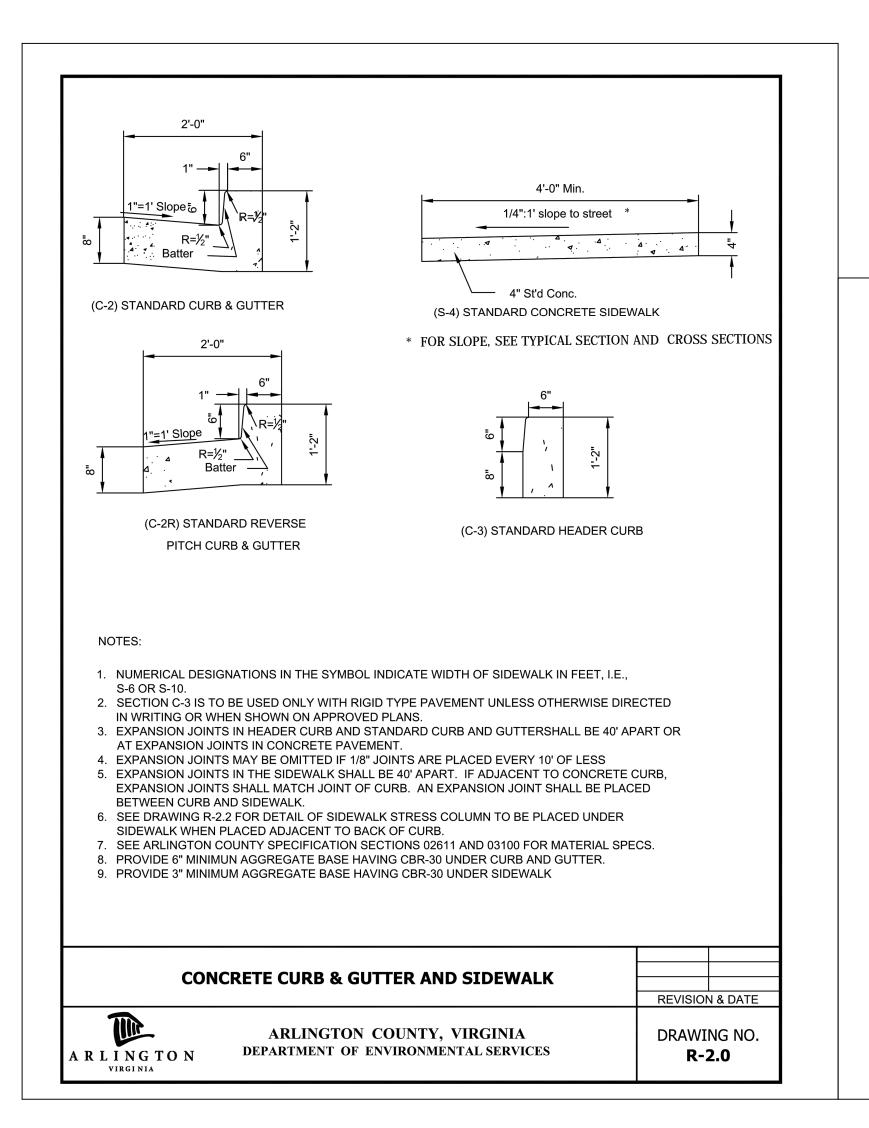

TYPICAL DETAILS @ WALL

<u>UTILITIES</u>

- 1. THE UTILITY INFORMATION SHOWN ON THESE PLANS IS TAKEN FROM INFORMATION RECEIVED FROM DEPARTMENT OF ENVIRONMENTAL SERVICES WHICH DOES NOT GUARANTEE THAT THE UTILITY INFORMATION SHOWN ON THE PLANS IS COMPLETE OR ACCURATE. THE CONTRACTOR MUST VERIFY THE UTILITY LOCATIONS PRIOR TO CONSTRUCTION.
- 2. ALL EXISTING UNDERGROUND UTILITIES SHALL BE MARKED IN THE FIELD BY MISS UTILITY PRIOR TO CONSTRUCTION. THE CONTRACTOR SHALL BE RESPONSIBLE FOR SCHEDULING THE FIELD MARKING OF UTILITIES WITH MISS UTILITY.
- 3. ALL EXISTING UNDERGROUND UTILITIES SHALL BE PHYSICALLY LOCATED BY THE CONTRACTOR PRIOR TO THE
- BEGINNING OF ANY CONSTRUCTION IN THE VICINITY OF THESE UTILITIES.
- 4. THE CONTRACTOR SHALL BE RESPONSIBLE FOR ENSURING THAT EXISTING UTILITIES ARE DISCONNECTED, PRIOR TO CLEARING THE SITE OF TREES, BUILDINGS, FOUNDATIONS, ETC. WITHIN THE LIMITS OF CONSTRUCTION IN ACCORDANCE WITH THE REQUIREMENTS INDICATED ON THE CONSTRUCTION PLANS.
- 5. FOR MARKING LOCATIONS OF EXISTING UNDERGROUND UTILITY FACILITIES (GAS, TELEPHONE, ELECTRIC AND CABLE TV), CONTRACTOR SHALL CONTACT "MISS UTILITY" AT 811 OR 1-800-257-7777 48 HOURS PRIOR TO ANY EXCAVATION OR CONSTRUCTION.


 UTILITY COMPANIES
 OFFICE NUMBER
 EMERGENCY NUMBER

 COMCAST CABLE COMMUNICATIONS DOMINION VIRGINIA POWER PEPCO
 (703) 567-4191 (703) 838-2210 (202) 872-2845 (202) 872-2845 (202) 833-7500 WASHINGTON GAS
 (703) 750-1000 (703) 750-4831 (703) 954-6611 MISS UTILITY
 (703) 954-6611 (703) 954-6611 1-800-257-7777
 A R L I N G T O N VIRGINIA

DEPARTMENT OF ENVIRONMENTAL SERVICES

FACILITIES & ENGINEERING DIVISION ENGINEERING BUREAU 2100 CLARENDON BOULEVARD, SUITE 813 ARLINGTON, VA 22201 PHONE: 703.228.3629

FAX: 703.228.3606

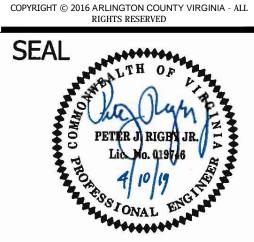

QUALITY CONTROL ENGINEER

QUALITY CONTROL ENGINEER

FIGURE

CONSTRUCTION MANAGEMENT SUPERVISOR

WATER, SEWER, STREETS BUREAU CHIEF

TRANSPORTATION DIRECTOR

PROJECT MANAGER

REVISIONS DATE

GLEBE RD. & WASHINGTON BLVD.

DETAILS SHEET
GLEBE RD. & WASHINGTON BLVD.

NE CORNER AT INTERSECTION

DESIGNED:K.PATEL

DRAWN :K.PATEL

CHECKED :P. RIGBY

MISS UTILITY TRANSMITTAL #: N/A

FILENAME: P14D_C-3-202-LEGEND.DWG


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PLOTTED: MAY 28 2019

PLOTTED BY: KPATEL

SCALE: AS NOTED

SHEET



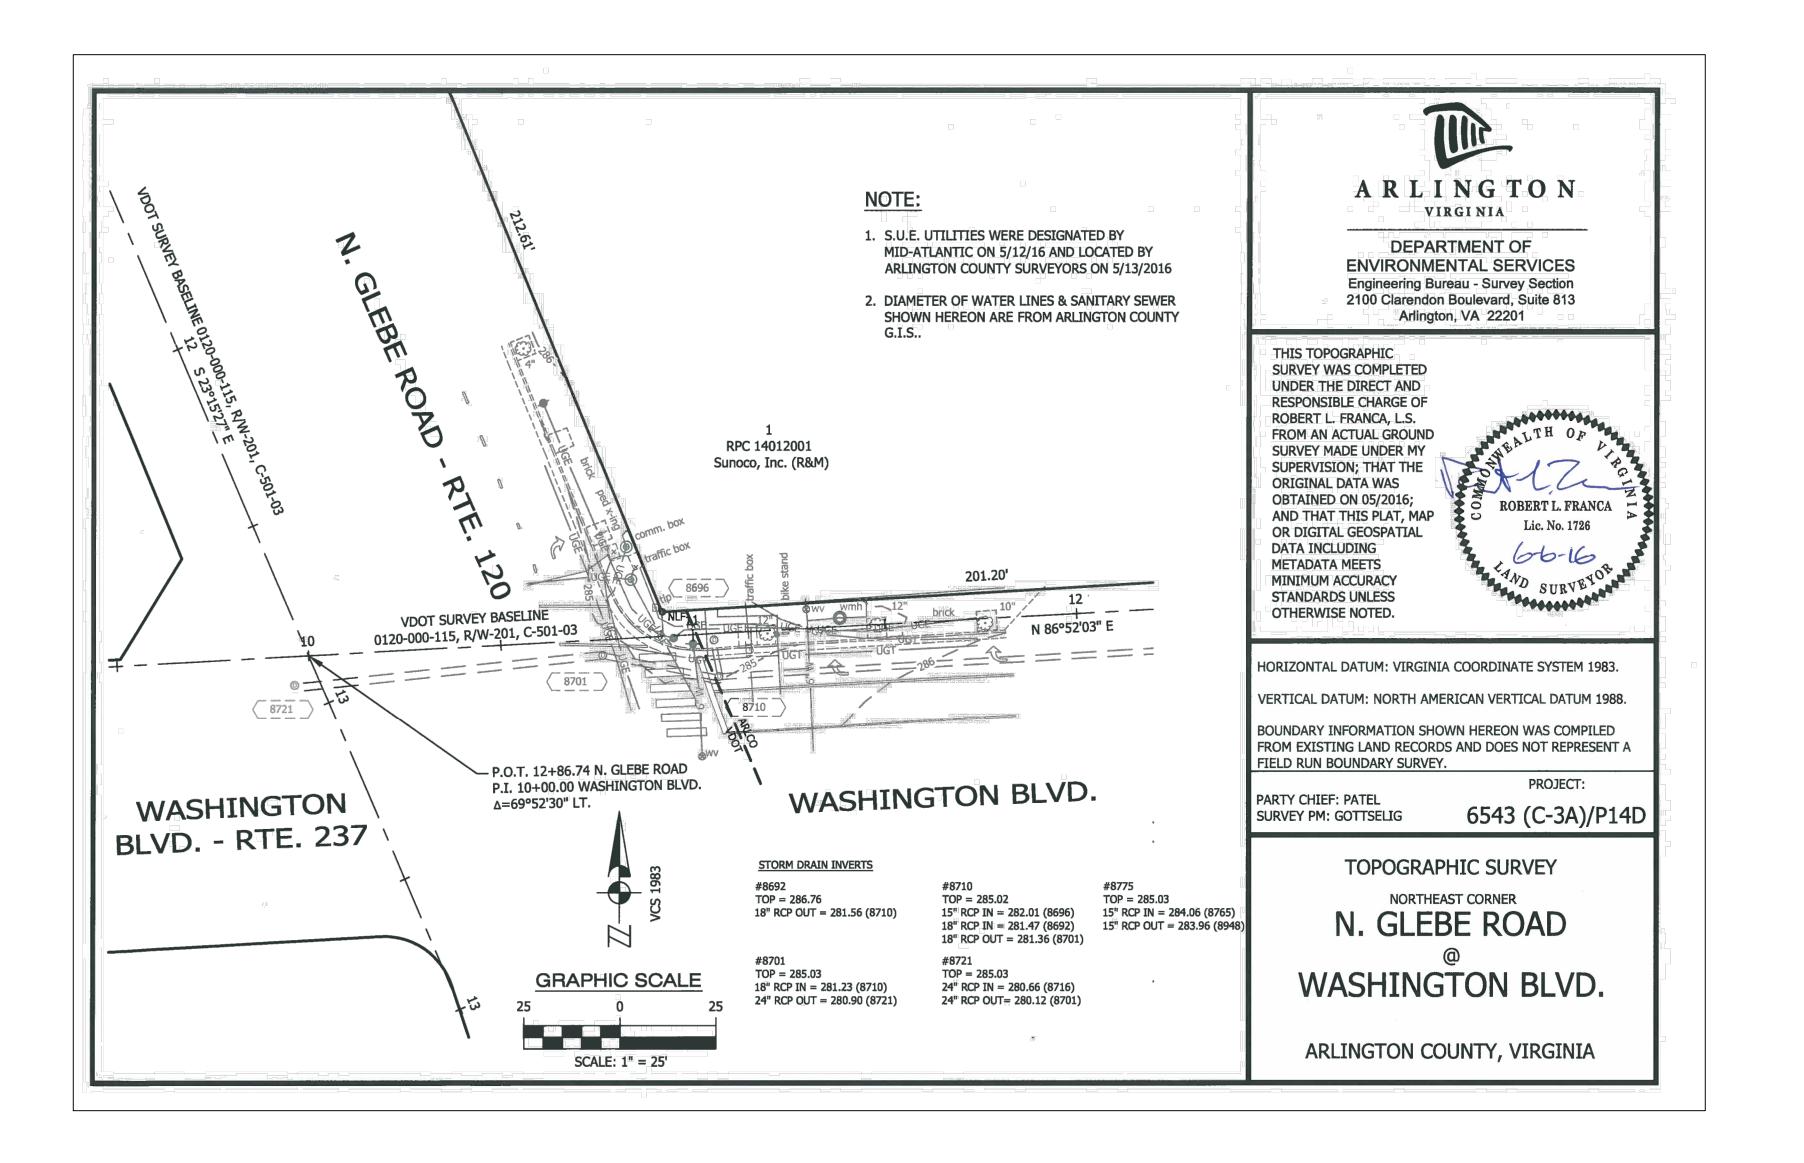

DEPARTMENT OF ENVIRONMENTAL SERVICES

FACILITIES & ENGINEERING DIVISION
ENGINEERING BUREAU
2100 CLARENDON BOULEVARD, SUITE 813
ARLINGTON, VA 22201
PHONE: 703.228.3629

FAX: 703.228.3606

SEAL

PETER J RIGHT JR.

Lio 10. 01976

QUALITY CONTROL ENGINEER

QUALITY CONTROL ENGINEER

CONSTRUCTION MANAGEMENT SUPERVISOR

WATER, SEWER, STREETS BUREAU CHIEF

TRANSPORTATION DIRECTOR

PROJECT MANAGEMENT

PROJECT MANAGEMEN

REVISIONS

DATE

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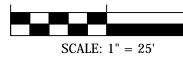
DESIGNED: K.PATEL
DRAWN : K.PATEL
CHECKED : P. RIGBY
MISS UTILITY TRANSMITTAL #: N/A

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PLOTTED BY: KPATEL

SCALE: AS NOTED


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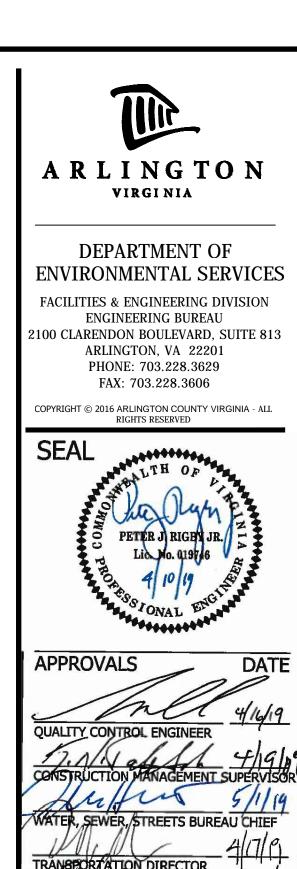
SHEET

4 OF 13

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NOTE: PLEASE SEE SHEET # 2 , FOR HATCH LEGEND, OTHER DETAILS.



REVISIONS

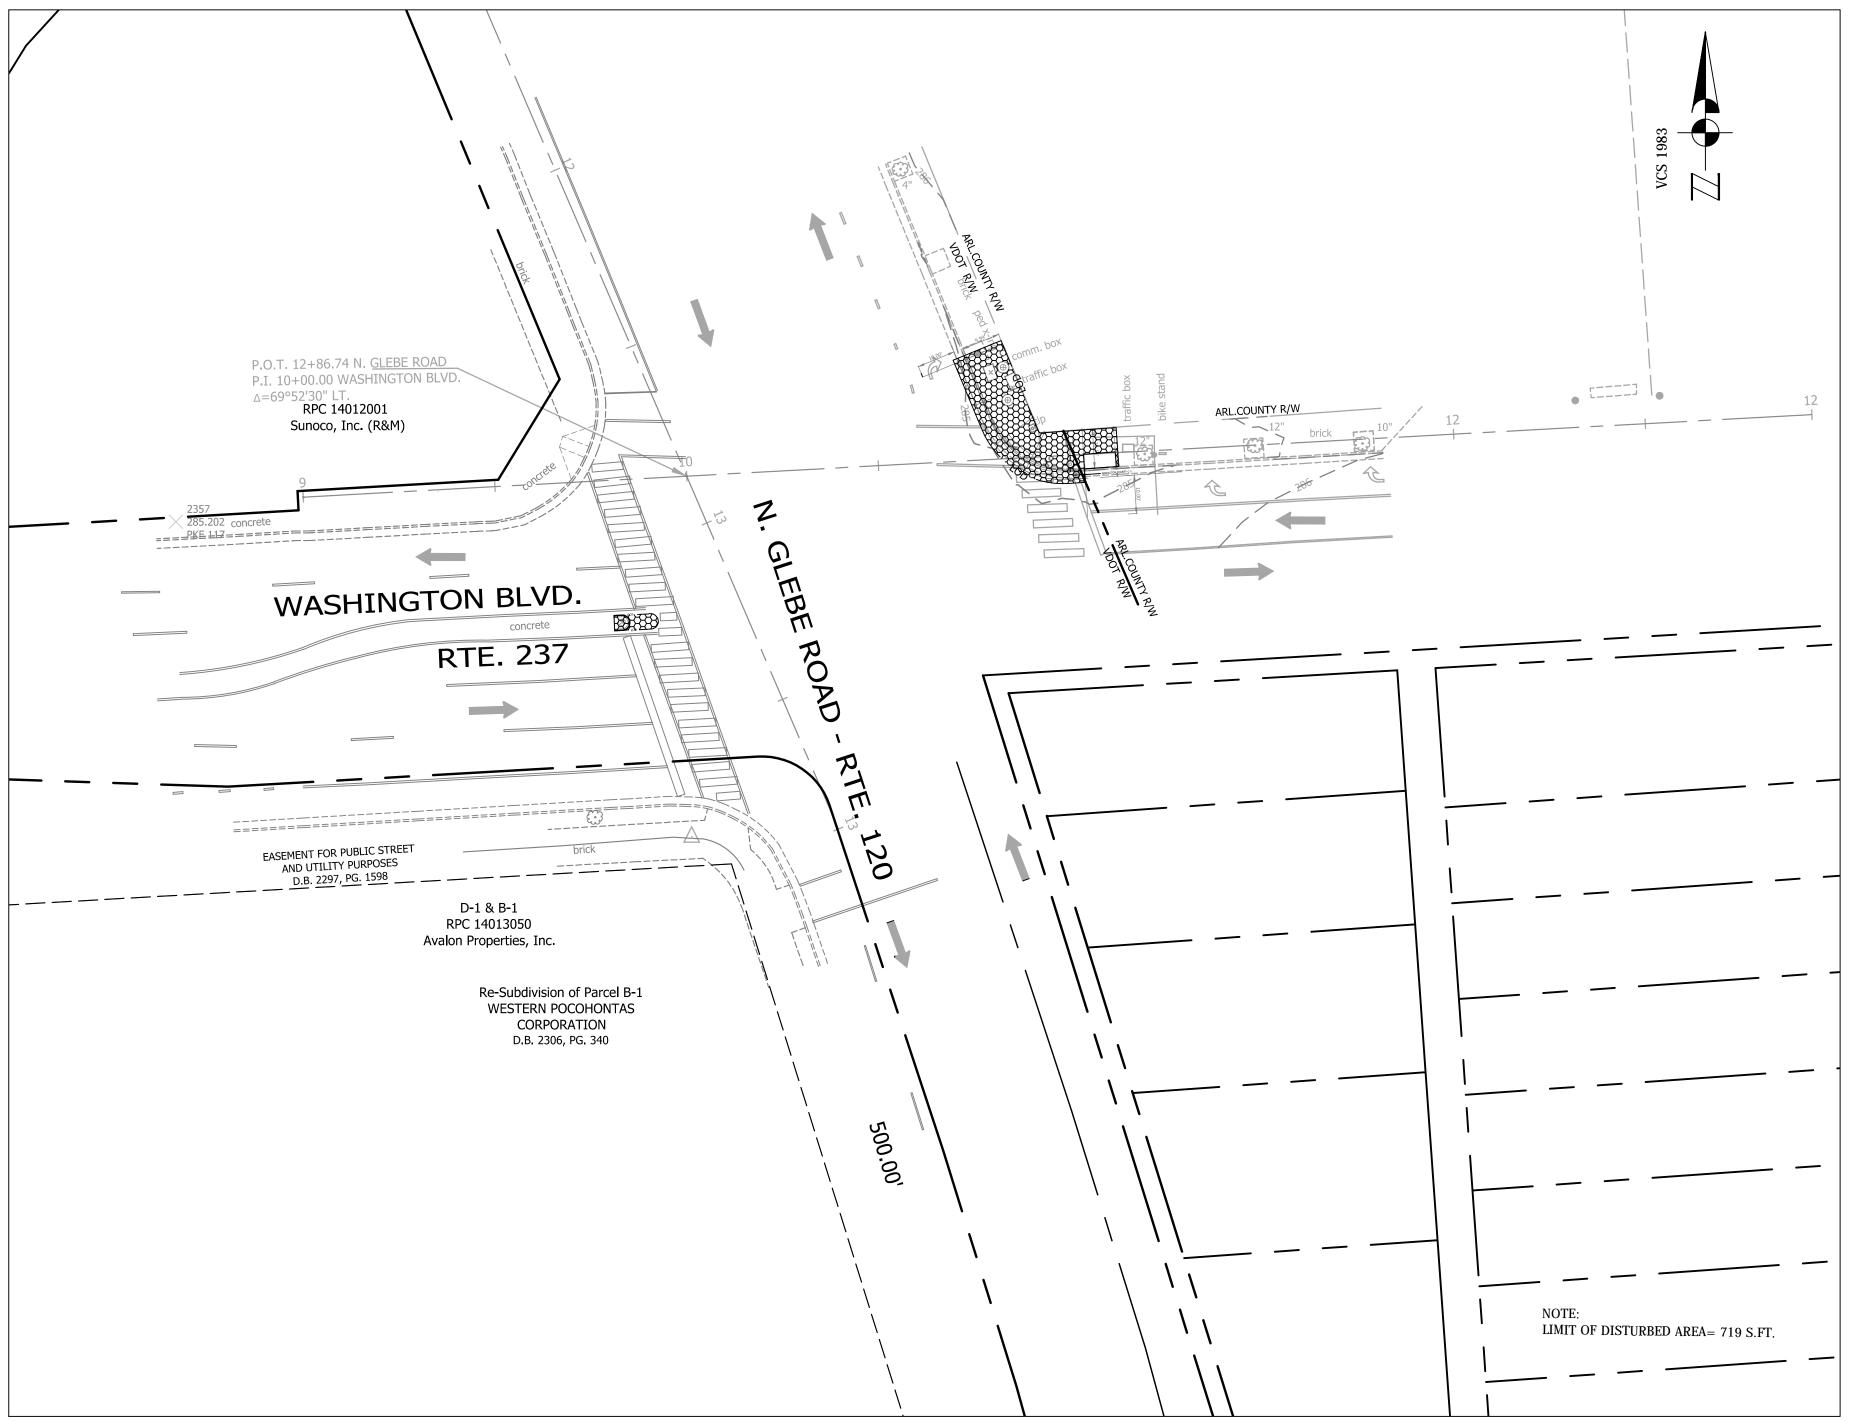DATE


DESIGNED:K.PATEL DRAWN :K.PATEL

CHECKED :P. RIGBY MISS UTILITY TRANSMITTAL #: N/A


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PLOTTED:MAY 28 2019


PLOTTED BY: KPATEL


SCALE: AS NOTED

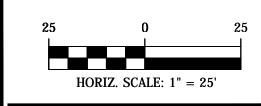

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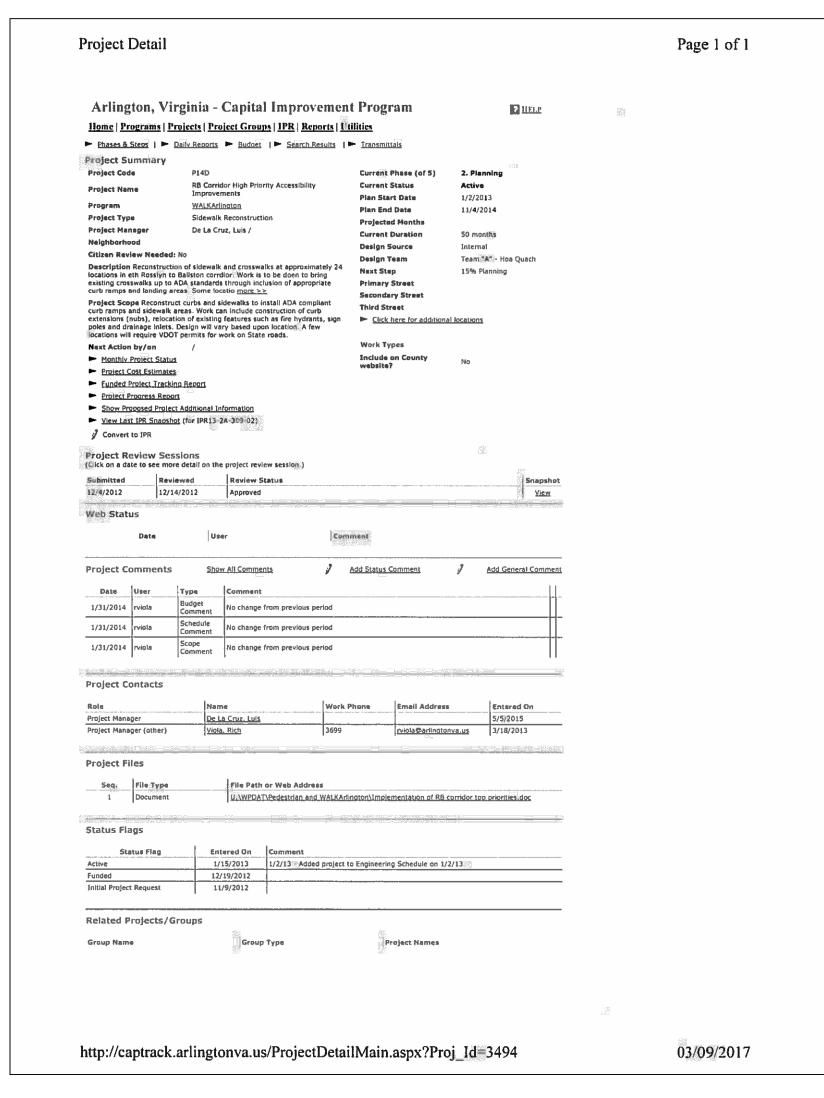


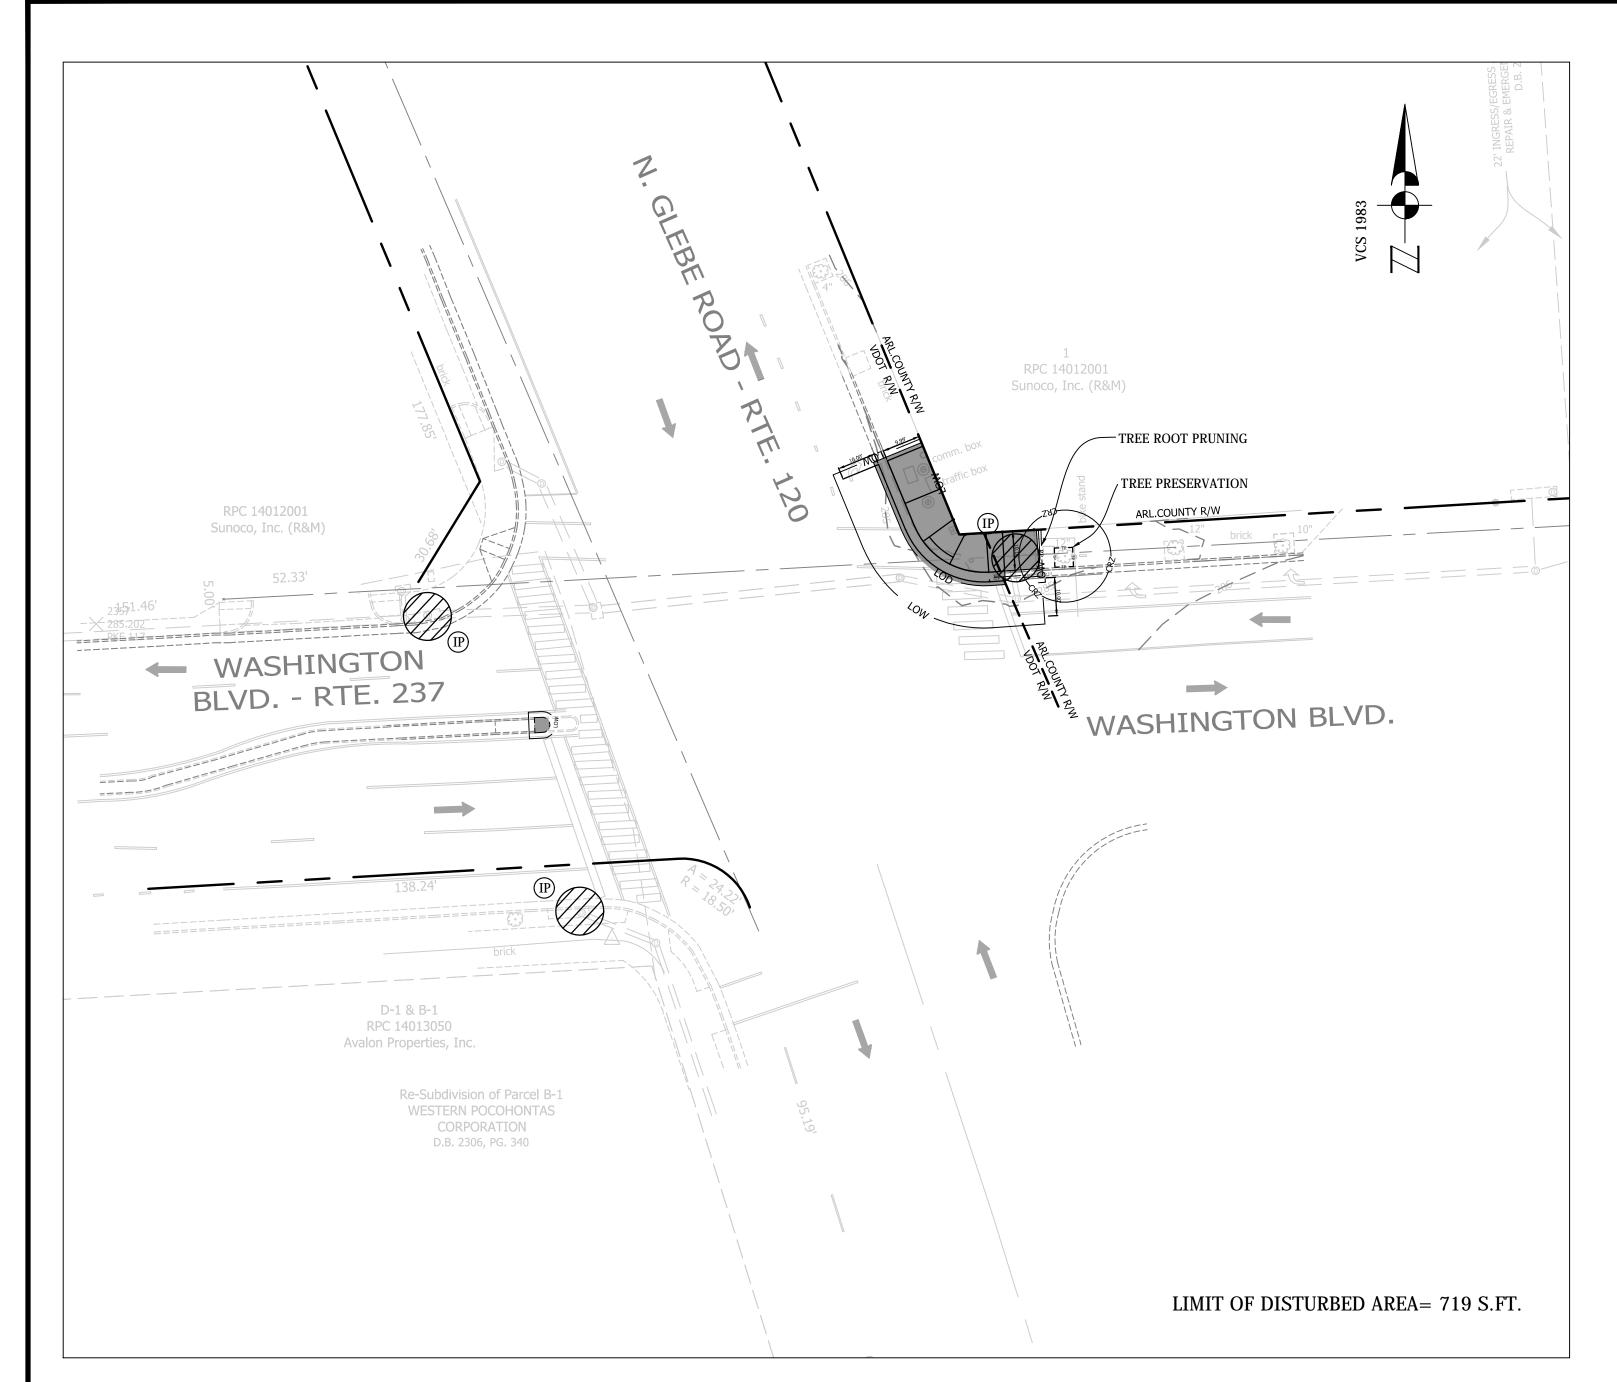


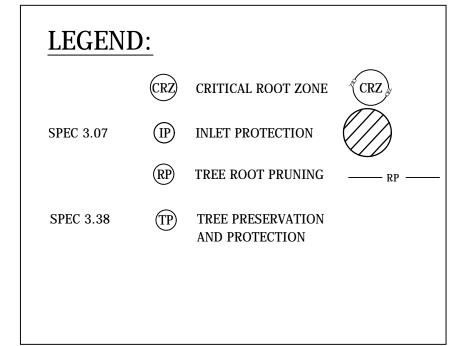


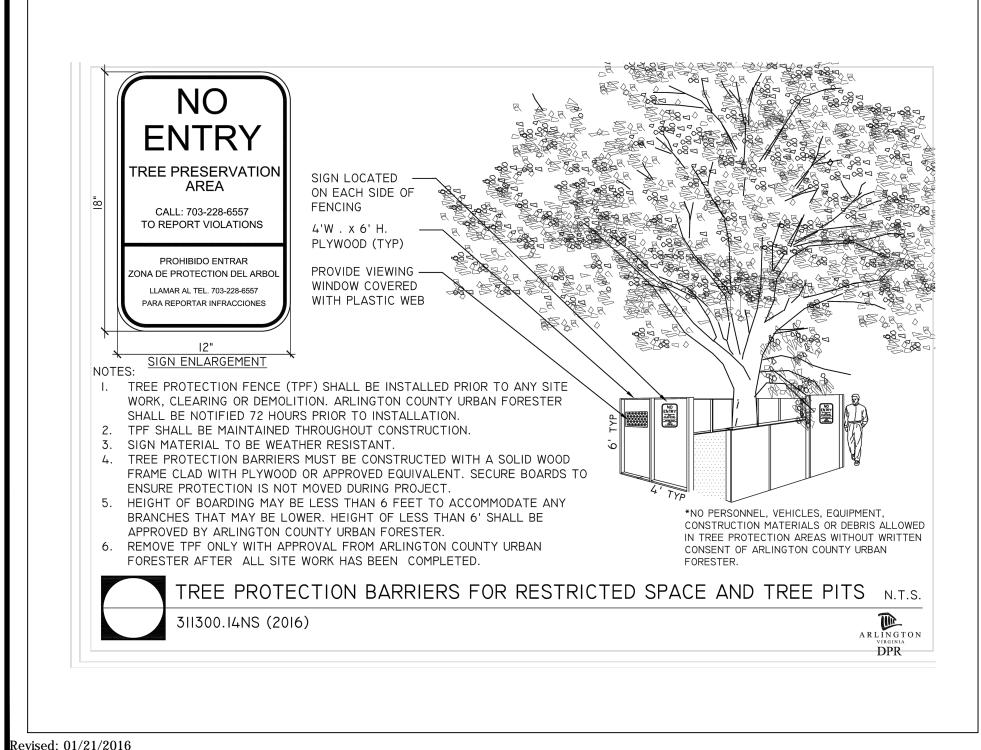NOTES:

- CONTRACTOR TO CONTACT THE ARLINGTON URBAN FORESTER TO SCHEDULE A PRE-CONSTRUCTION INSPECTION OF THE TREE PROTECTION MEASURES BEFORE ANY WORK NEAR THE CRITICAL ROOT ZONES OF THE TREE. TO SCHEDULE THE PRE-CONSTRUCTION MEETING CALL 703-228-1863
- 2 CONTRACTOR TO PROTECT TREES PER THE PLAN ACCORDING TO THE ARLINGTON COUNTY DPR DESIGN STANDARD DETAIL 311300.14NS
- CONTRACTOR TO ROOT PRUNE TREE PER THE PLAN ACCORDING TO THE ARLINGTON COUNTY DPR DESIGN STANDARD DETAIL 311100.5, WHERE CALLED OUT ON THE PLAN
- CONTRACTOR TO CALL THE URBAN FORESTER AT 703-228-1863, 72 HOURS BEFORE PLANTING, TO SCHEDULE INSPECTION OF THE TREES TO BE PLANTED. WARRANTY FOR 1 YEAR AFTER PLANTING SHALL BE THE CONTRACTOR'S RESPONSIBILITY. THE URBAN FORESTER AND DPR IS RESPONSIBLE FOR INSPECTION.
- CONTRACTOR TO CONTACT THE ASSIGNED CONSTRUCTION MANAGEMENT SPECIALIST ON THE LDA PERMITS FROM THE DEVELOPMENT SERVICE BUREAU BEFORE START OF CONSTRUCTION




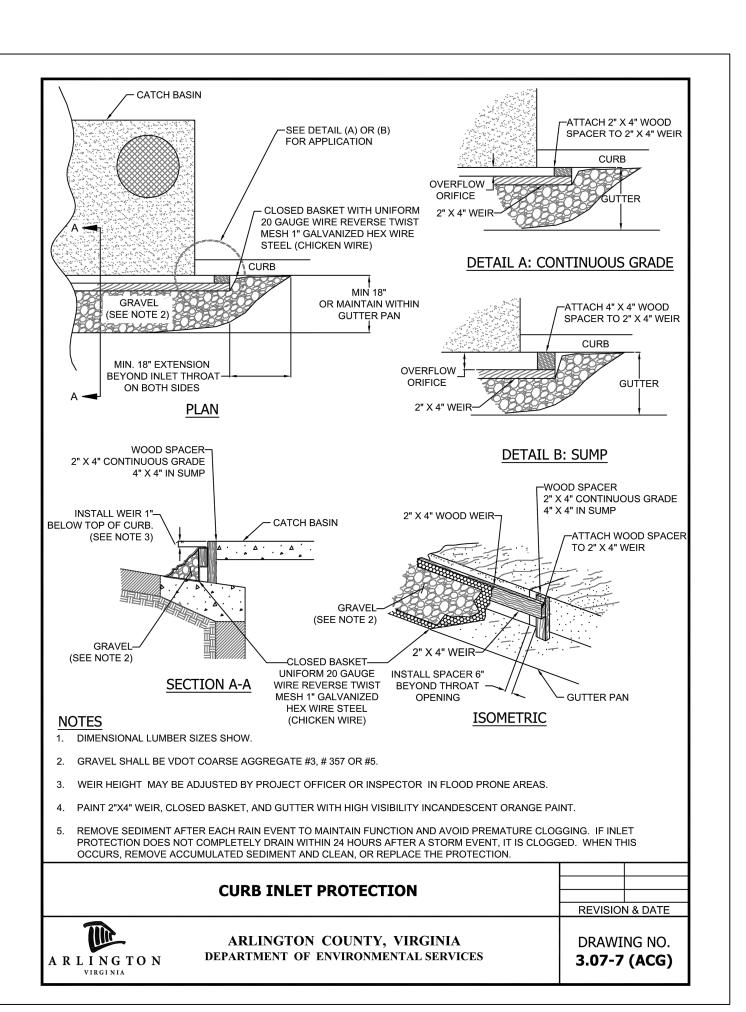

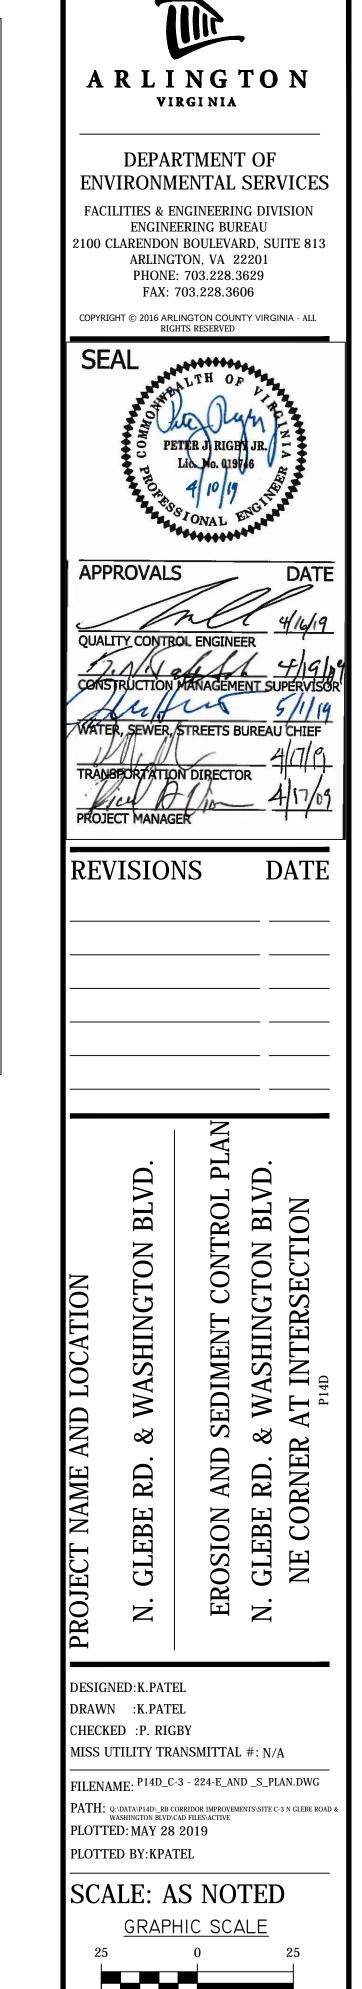

SHEET

SCALE: 1'' = 25'

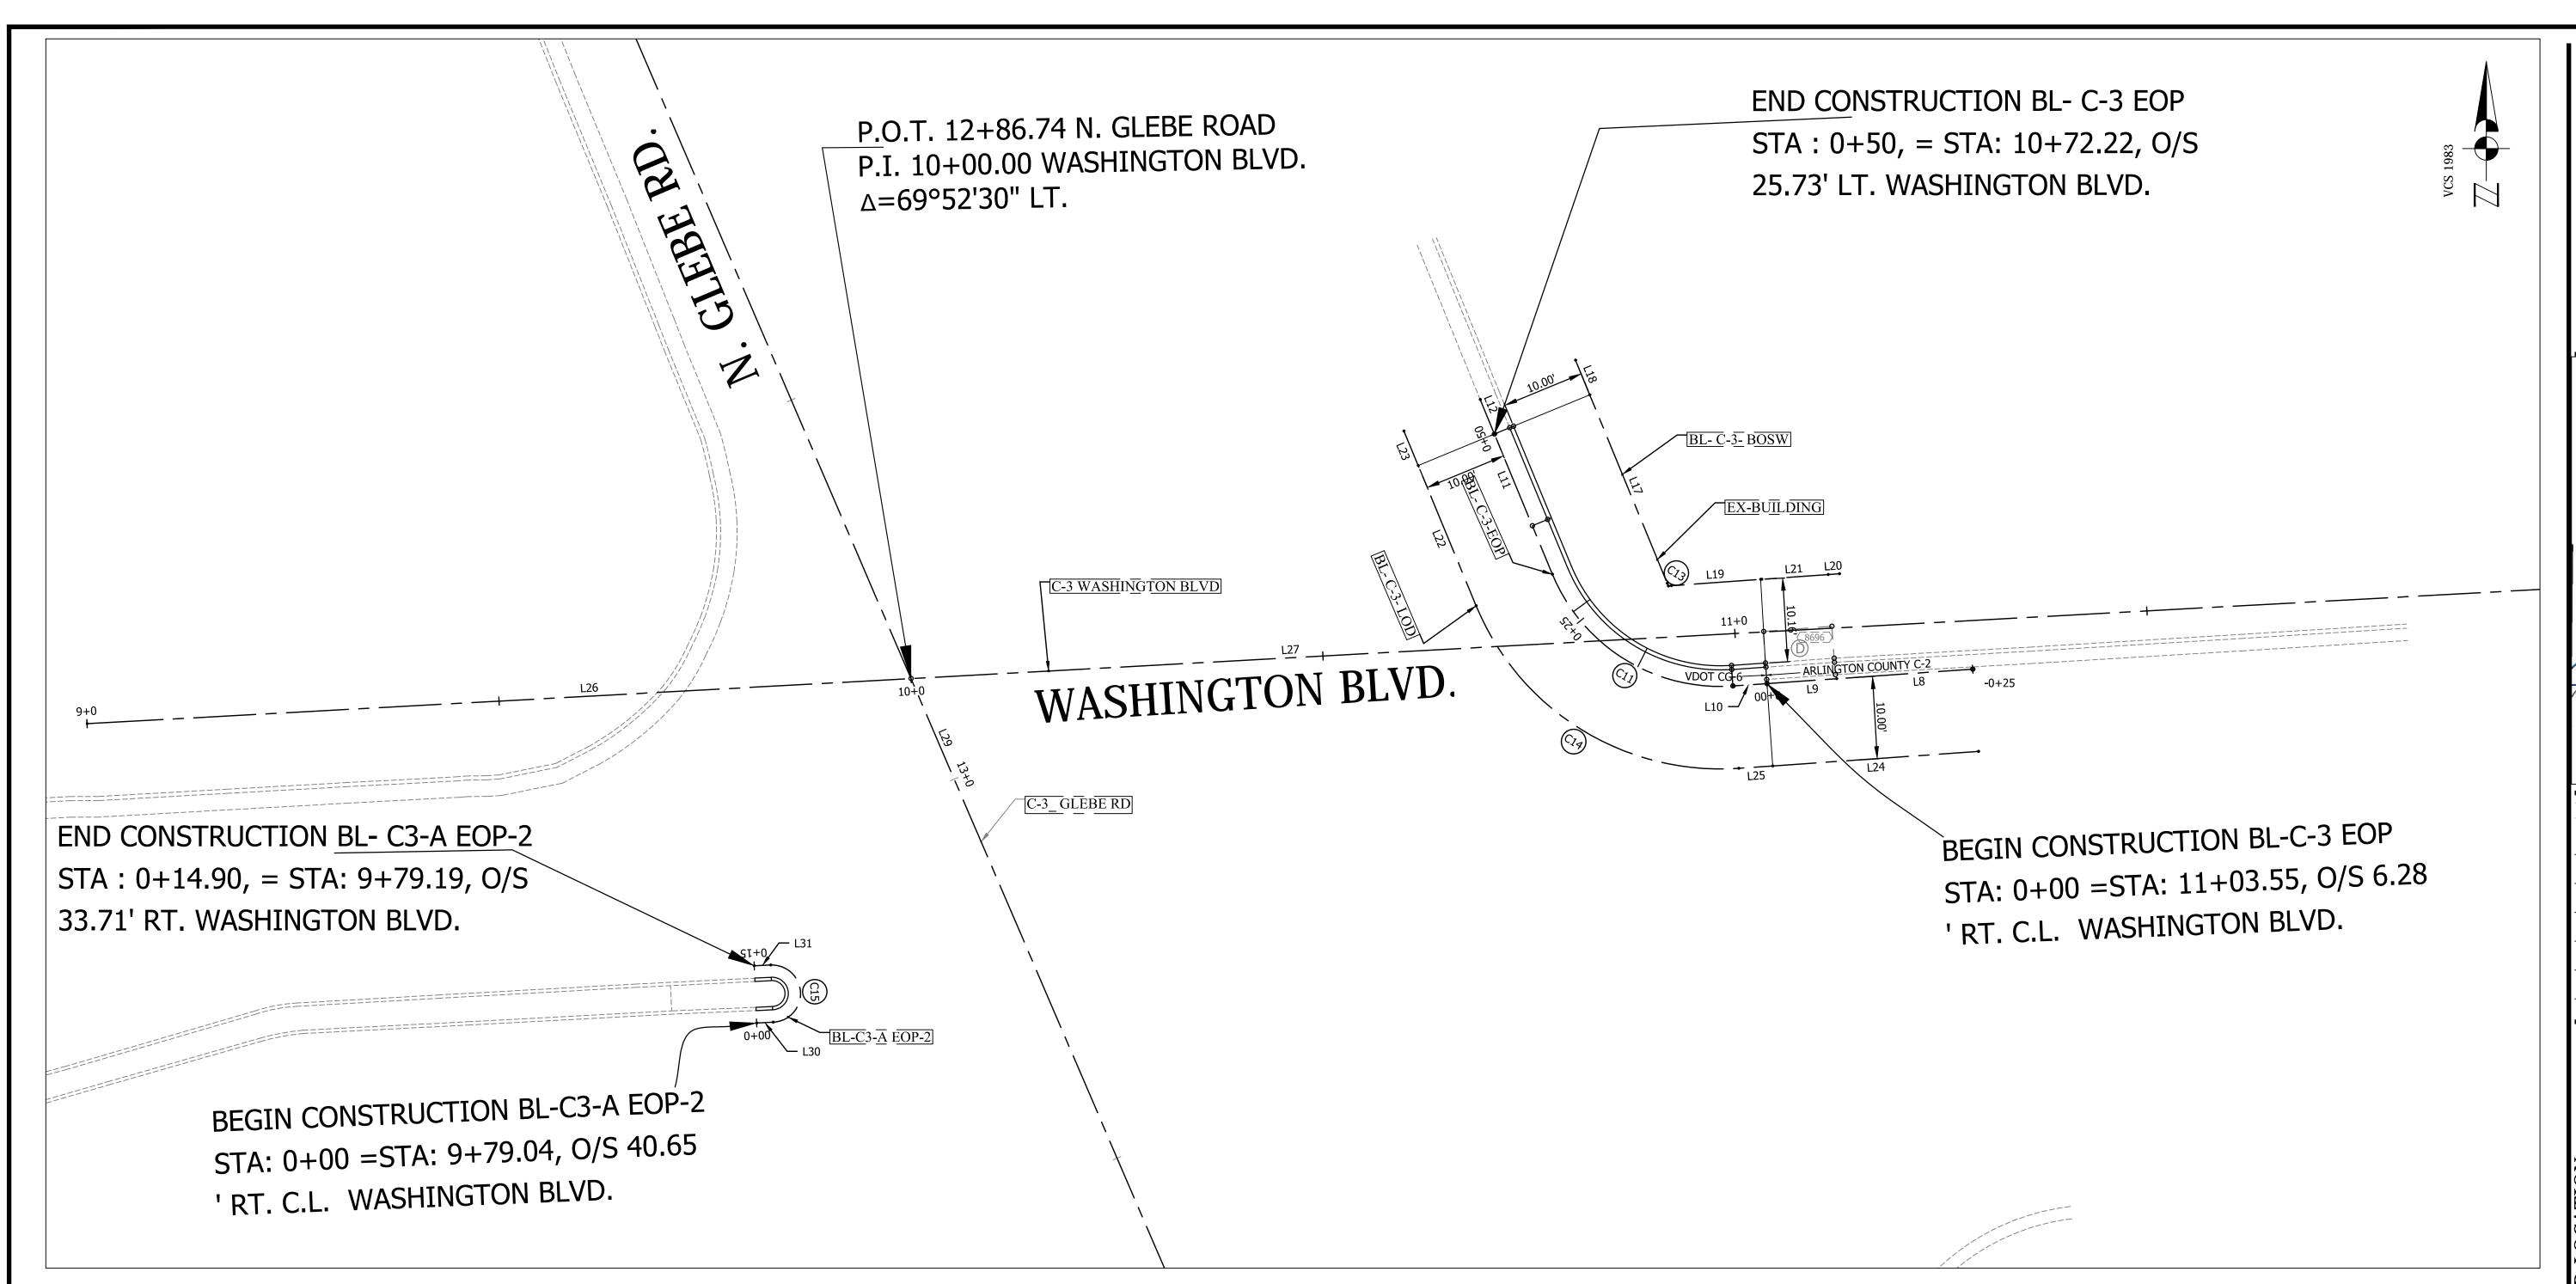

				В	L- C-3-EOF		
	Length	Radius	Line/Chord Direction	Station (Start)	Station (End)	Northing, Easting (Start)	Northing, Easting (End)
C11	27.48	22.00	N58° 14' 28.13"W	0+04.13	0+31.61	7008495.67, 11876580.10	7008509.21 , 11876558.23
L8	16.53		S85° 58' 50.18"W	-0+25.00	-0+08.47	7008497.71, 11876609.16	7008496.55, 11876592.67
L9	8.47		S85° 58' 50.18"W	-0+08.47	0+00.00	7008496.55, 11876592.67	7008495.96, 11876584.23
L10	4.13		S85° 58' 50.18"W	0+00.00	0+04.13	7008495.96, 11876584.23	7008495.67, 11876580.10
L11	18.39		N22° 27' 46.44"W	0+31.61	0+50.00	7008509.21, 11876558.23	7008526.20, 11876551.20
L12	4.53		N22° 27' 46.44"W	0+50.00	0+54.53	7008526.20, 11876551.20	7008530.39, 11876549.47

				BL-	- C-3- BOS	W	
	Length	Radius	Line/Chord Direction	Station (Start)	Station (End)	Northing, Easting (Start)	Northing, Easting (End)
C13	0.63	0.50	N58° 13' 34.13"W	0+10.98	0+11.60	7008507.82, 11876572.64	7008508.13 , 11876572.14
L17	24.69		N22° 21' 49.35"W	0+11.60	0+36.29	7008508.13, 11876572.14	7008530.96, 11876562.75
L18	4.53		N22° 21' 49.35"W	0+36.29	0+40.82	7008530.96, 11876562.75	7008535.15, 11876561.02
L19	10.84		S85° 54' 41.08"W	0+00.13	0+10.98	7008508.59, 11876583.46	7008507.82, 11876572.64
L20	1.38		S85° 54' 41.08"W	-0+09.45	-0+08.07	7008509.27, 11876593.01	7008509.17, 11876591.64

				BL	C-3- LO	D	
	Length	Radius	Line/Chord Direction	Station (Start)	Station (End)	Northing, Easting (Start)	Northing, Easting (End)
C14	39.97	32.00	N58° 14' 08.36"W	0+29.13	0+69.11	7008485.69, 11876580.80	7008505.39 , 11876548.98
L22	18.39		N22° 27' 06.90"W	0+69.11	0+87.49	7008505.39, 11876548.98	7008522.38, 11876541.96
L23	4.53		N22° 27' 06.90"W	0+87.49	0+92.02	7008522.38, 11876541.96	7008526.57, 11876540.23
L24	25.00		S85° 58' 50.18"W	0+00.00	0+25.00	7008487.73, 11876609.86	7008485.98, 11876584.93
L25	4.13		S85° 58' 50.18"W	0+25.00	0+29.13	7008485.98, 11876584.93	7008485.69, 11876580.80

				BL-	-C3-A EOP	P-2	
	Length	Radius	Line/Chord Direction	Station (Start)	Station (End)	Northing, Easting (Start)	Northing, Easting (End)
C15	10.90	3.47	N2° 26' 20.28"W	0+02.00	0+12.90	7008454.92, 11876463.79	7008461.85 , 11876463.50
L30	2.00		N87° 33' 39.72"E	0+00.00	0+02.00	7008454.84, 11876461.79	7008454.92, 11876463.79
L31	2.00		S87° 33' 39.72"W	0+12.90	0+14.90	7008461.85, 11876463.50	7008461.77, 11876461.50

				C-3 WA	SHINGTON	I BLVD	
	Length	Radius	Line/Chord Direction	Station (Start)	Station (End)	Northing, Easting (Start)	Northing, Easting (End)
L26	100.00		N86° 52' 02.52"E	9+00.00	10+00.00	7008491.10, 11876380.65	7008496.57, 11876480.50
L27	293.42		N86° 52' 02.52"E	10+00.00	12+93.42	7008496.57, 11876480.50	7008512.60, 11876773.48

				C-3	B_ GLEBE R	RD	
	Length	Radius	Line/Chord Direction	Station (Start)	Station (End)	Northing, Easting (Start)	Northing, Easting (End)
L28	251.74		S23° 15' 27.48"E	10+35.00	12+86.74	7008727.85, 11876381.10	7008496.57, 11876480.50
L29	100.00		S23° 15' 27.48"E	12+86.74	13+86.74	7008496.57, 11876480.50	7008404.69, 11876519.99


		CONTROL		
POINT #	NORTHING	EASTING	ELEV.	DESC.
71	7008402.6700	11876481.7800	284.15	PK NAIL
72	7008184.9200	11876667.0200	278.40	PK NAIL
74	7008093.6100	11876596.8900	276.10	PK NAIL



DEPARTMENT OF ENVIRONMENTAL SERVICES

FACILITIES & ENGINEERING DIVISIO ENGINEERING BUREAU 100 CLARENDON BOULEVARD, SUITE ARLINGTON, VA 22201 PHONE: 703.228.3629

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APPROVALS

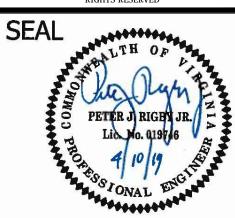DATE

QUALITY CONTROL ENGINEER

FIG.

CONSTRUCTION MANAGEMENT SUPERVISOR

WATER, SEWER, STREETS BUREAU CHIEF

TRANSPORTATION DIRECTOR

4170

DATE

REVISIONS

LEBE RD. & WASHINGTON BLVD.
GEOMETRIC CONTROL
LEBE RD. & WASHINGTON BLVD.

DESIGNED:K.PATEL
DRAWN :K.PATEL
CHECKED :P. RIGBY
MISS UTILITY TRANSMITTAL #: N/A

FILENAME: P14D_C3-122-CORRIDOR.DWG

PATH: Q:\Data\p14D_RB CORRIDOR IMPROVEMENT: WASHINGTON BLVD\CAD FILES\ACTIVE
PLOTTED: MAY 28 2019
PLOTTED BY: KPATEL

SCALE: AS NOTED

GRAPHIC SCALE


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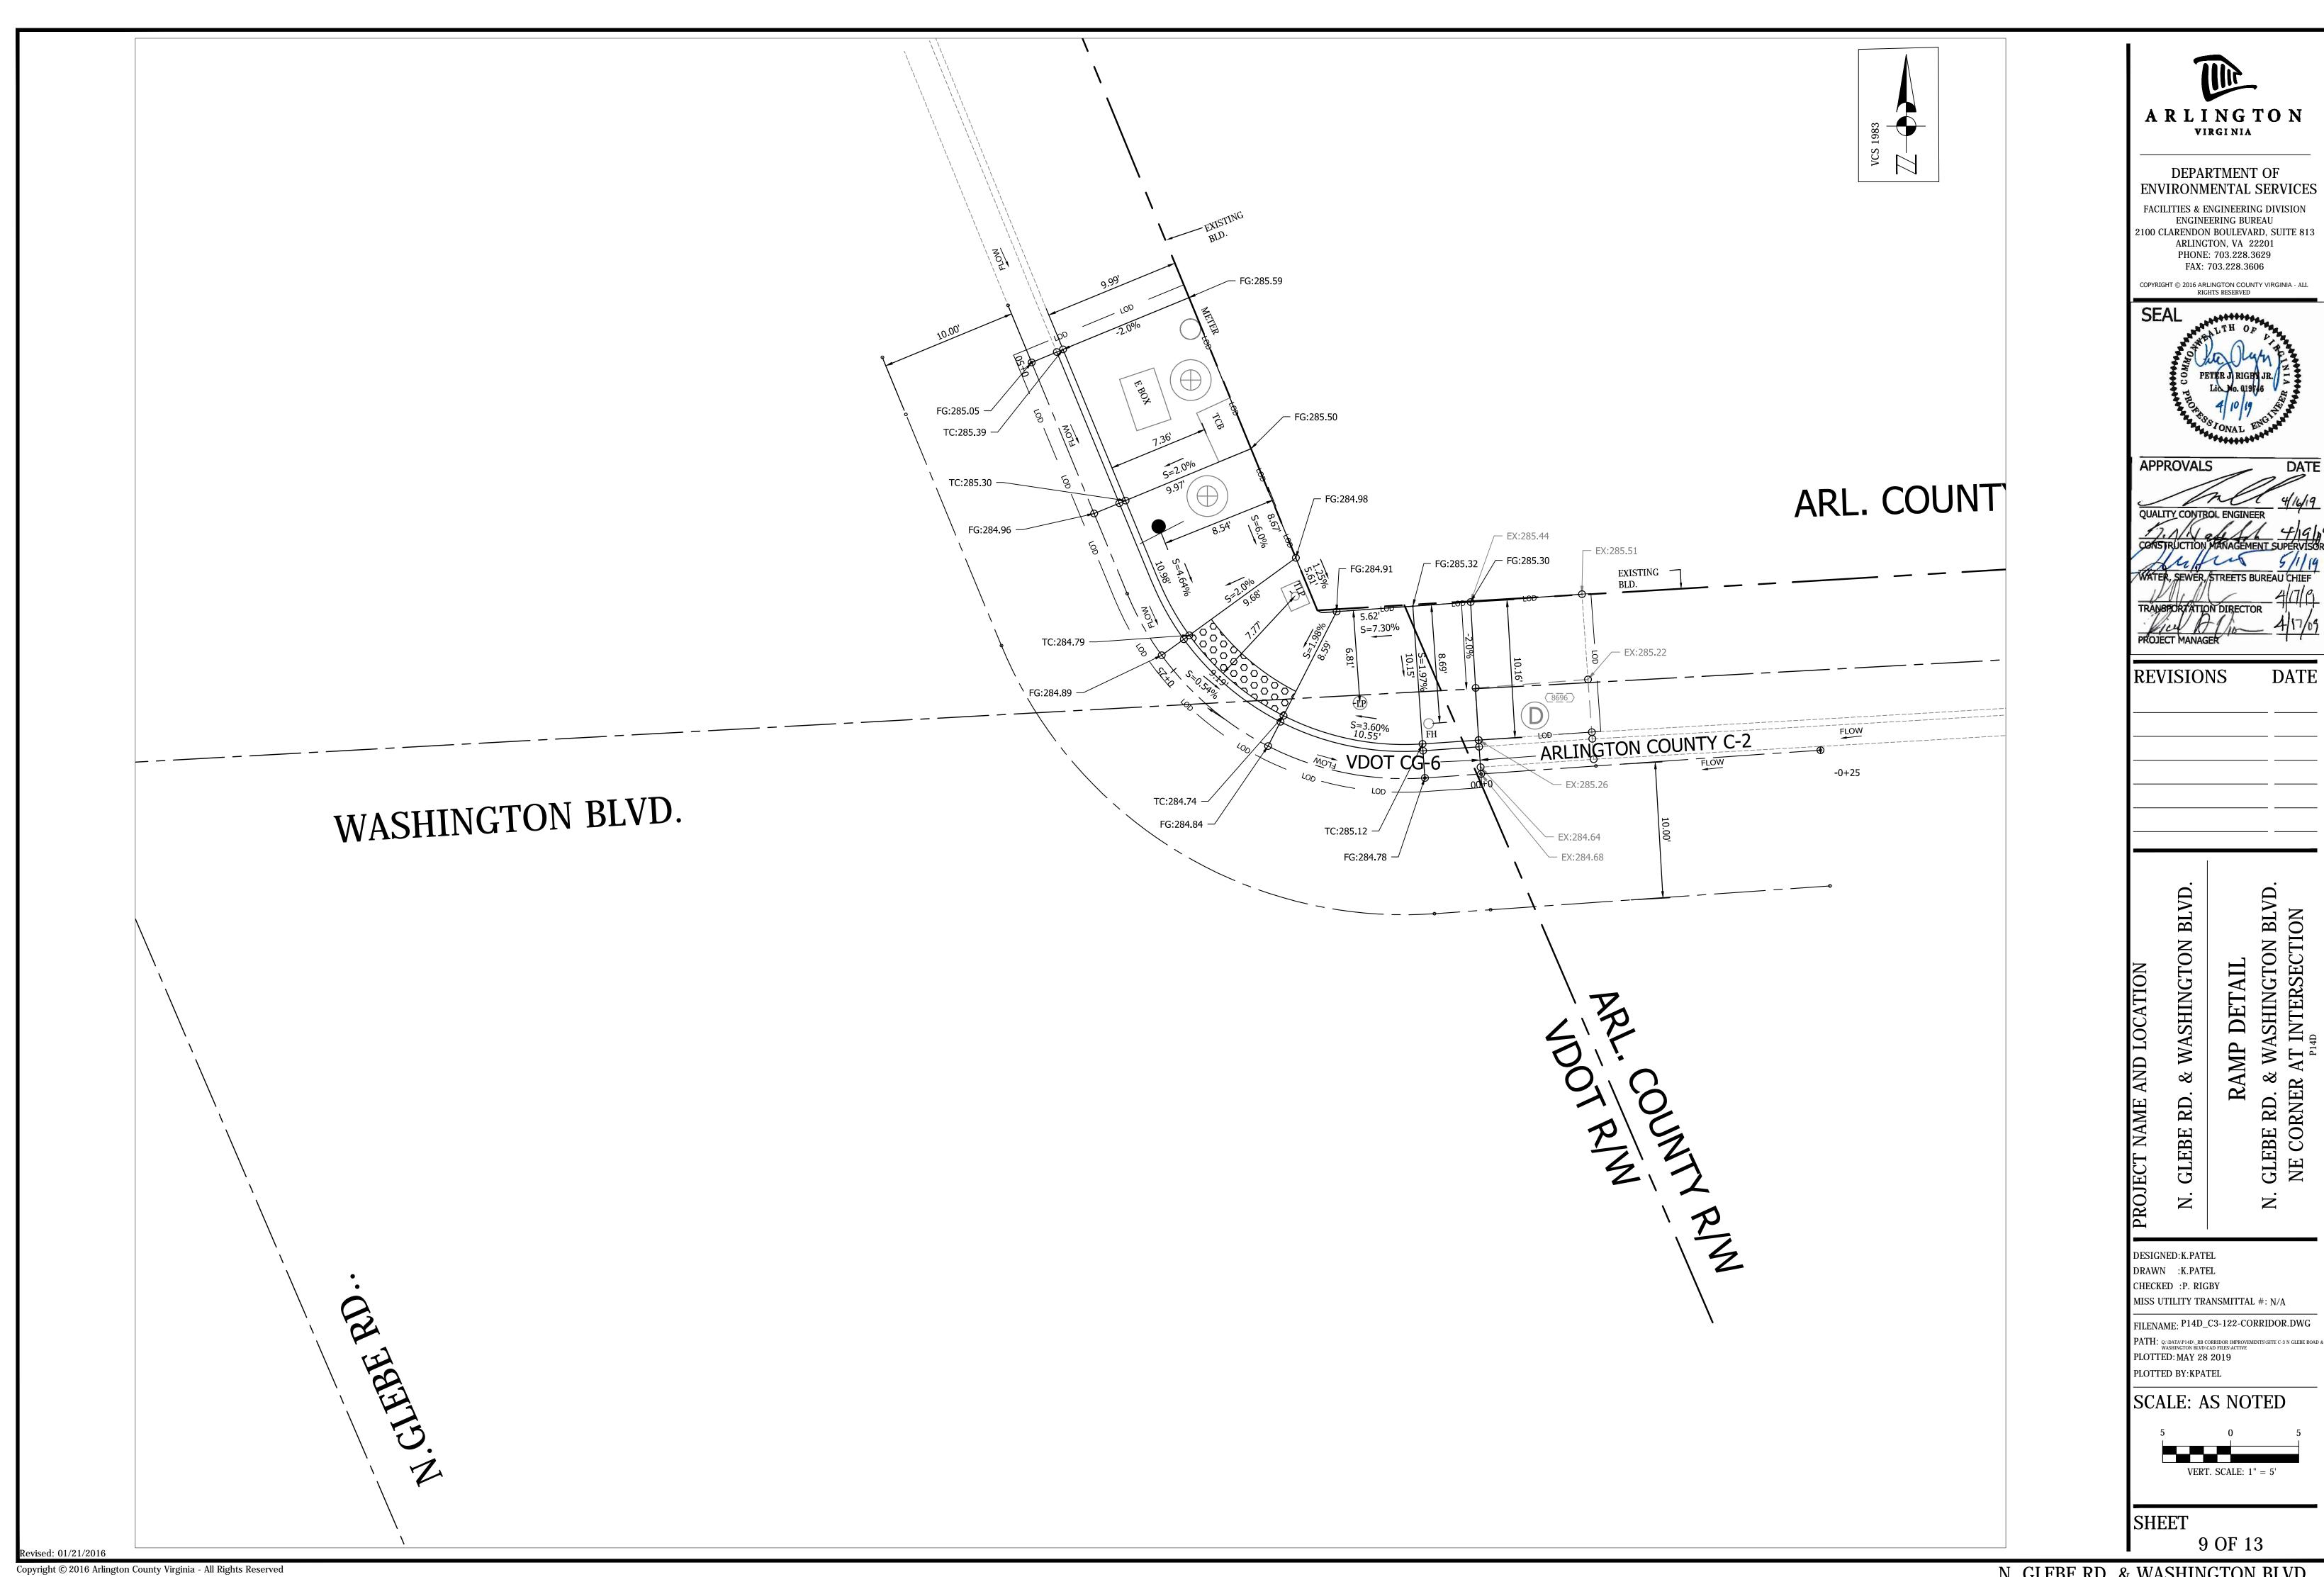
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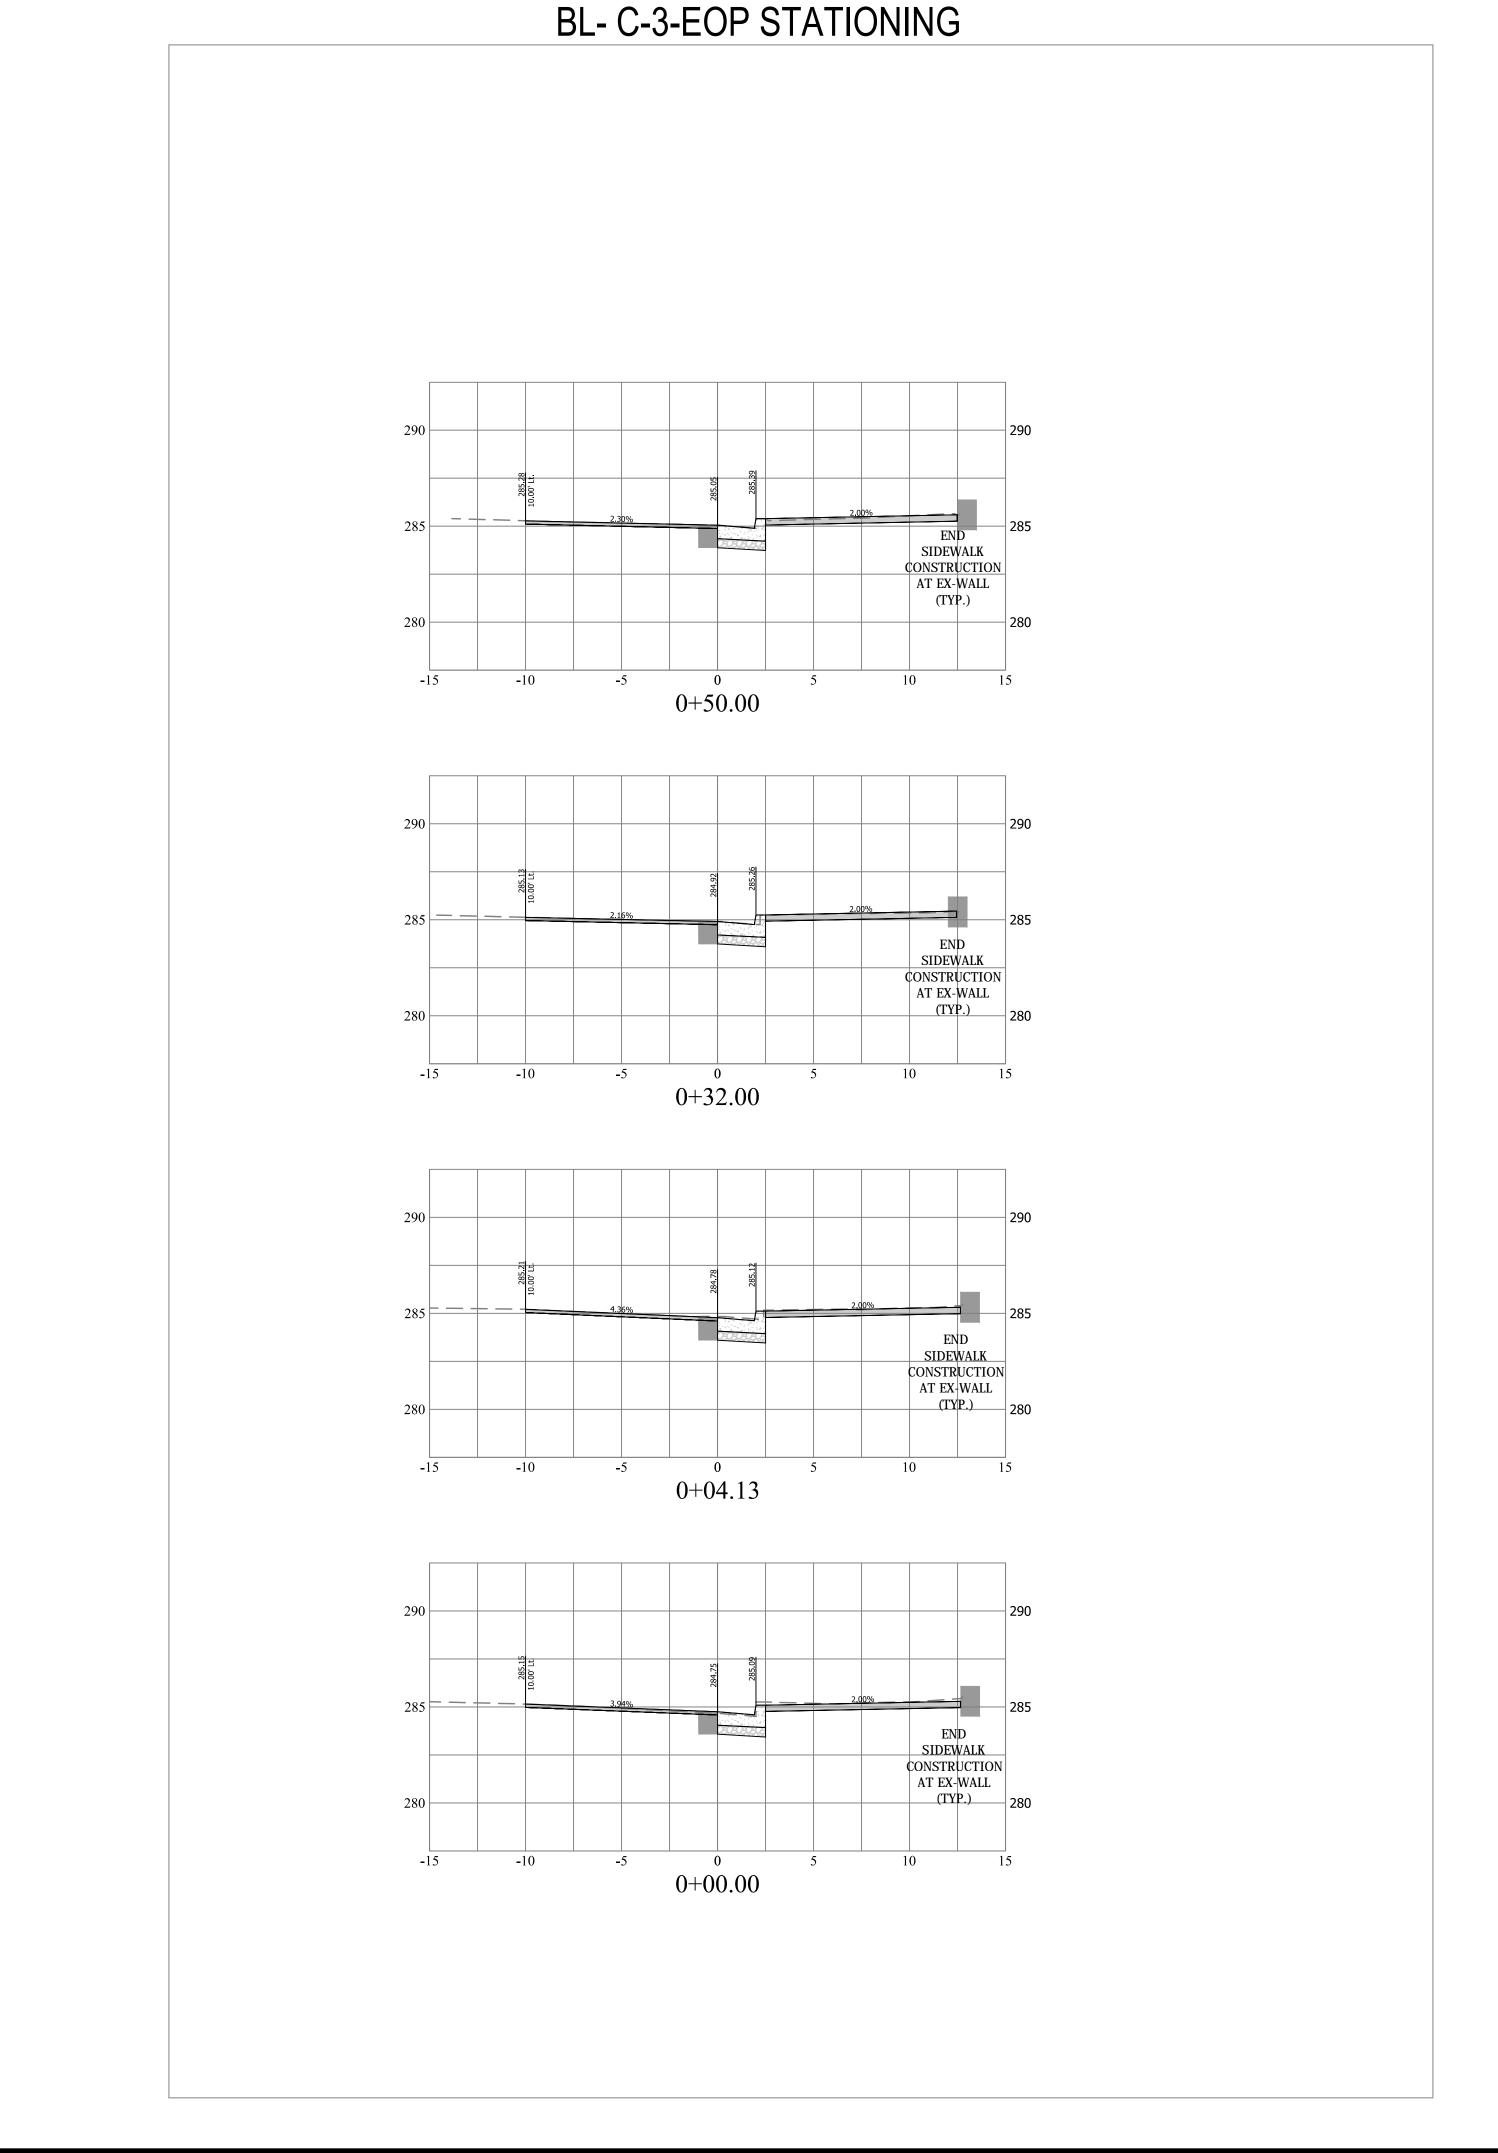
SCALE: 1" = 10'

SHEET

SHEET 7 OF 13






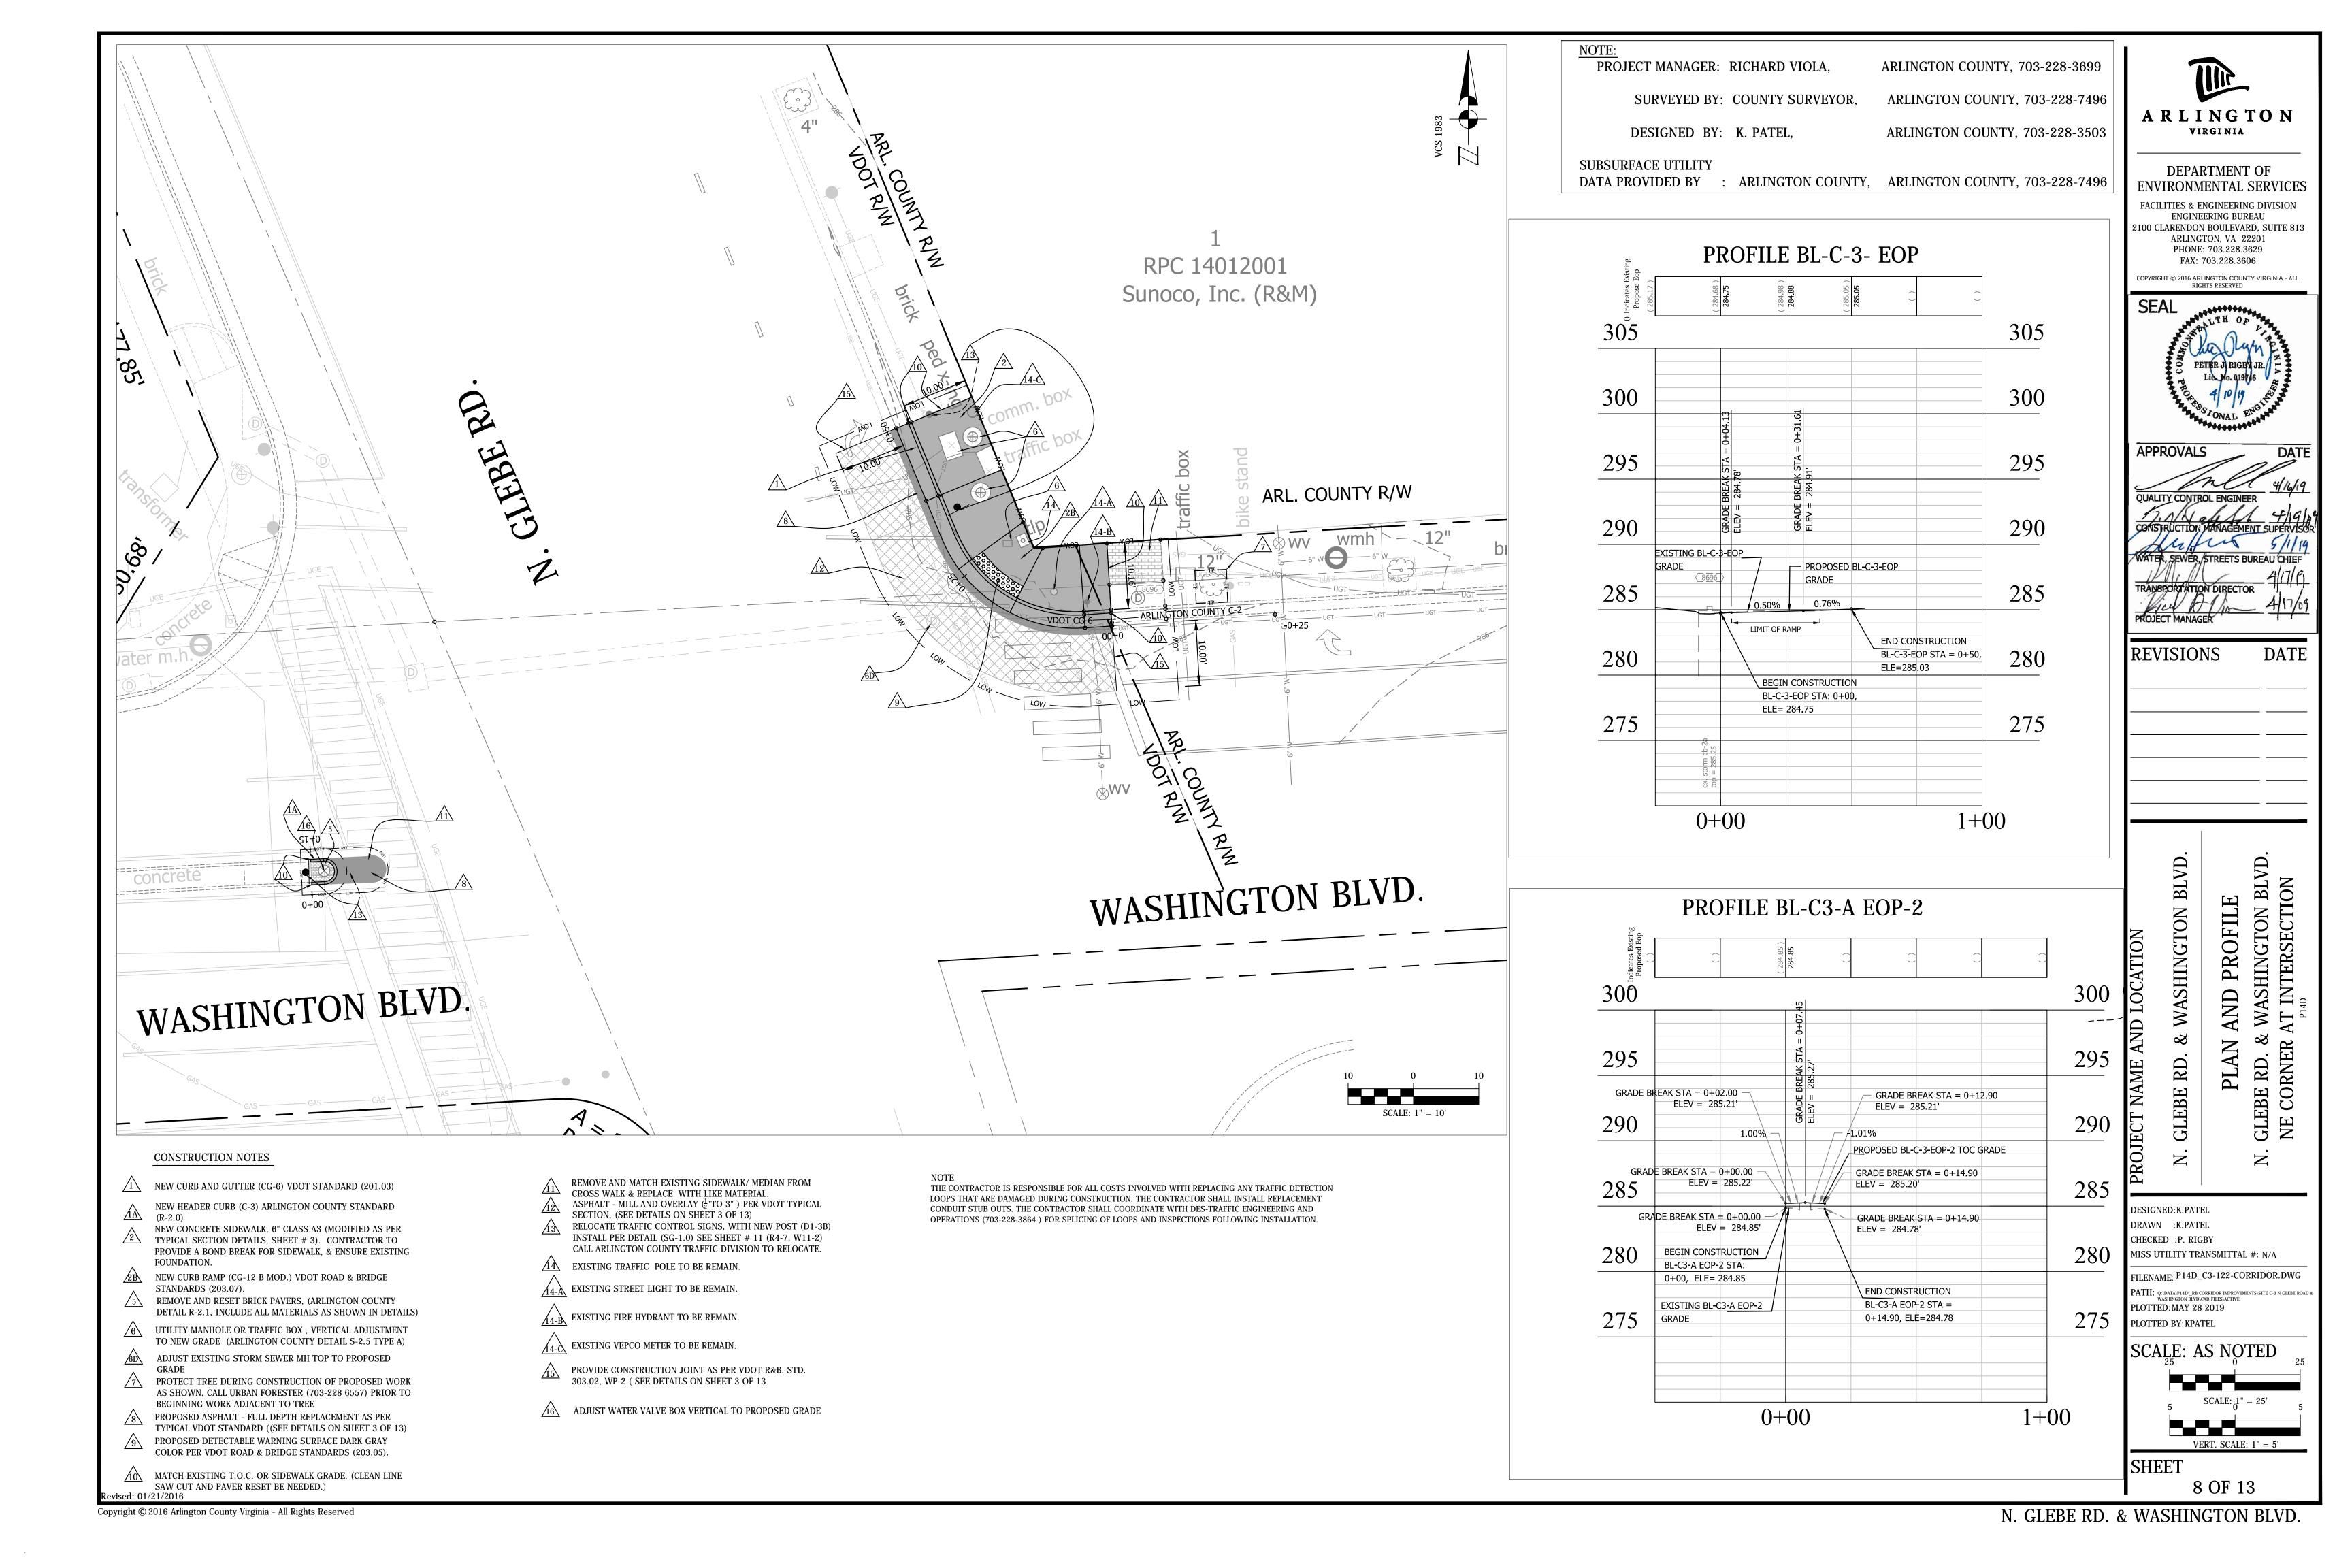



DEPARTMENT OF ENVIRONMENTAL SERVICES

FACILITIES & ENGINEERING DIVISION ENGINEERING BUREAU 2100 CLARENDON BOULEVARD, SUITE 813 ARLINGTON, VA 22201 PHONE: 703.228.3629 FAX: 703.228.3606

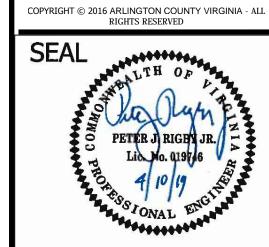

REVISIONS DATE

DESIGNED:K.PATEL DRAWN :K.PATEL CHECKED :P. RIGBY MISS UTILITY TRANSMITTAL #: N/A

FILENAME: P14D_C3-122-CORRIDOR.DWG


PATH: Q:\Data\pi4d_rb corridor improvements\site c-3 n glebe road a washington blvd\cad files\active PLOTTED: MAY 28 2019

PLOTTED BY: KPATEL

SCALE: AS NOTED

HOR. & VERT. SCALE: 1'' = 5'

SHEET

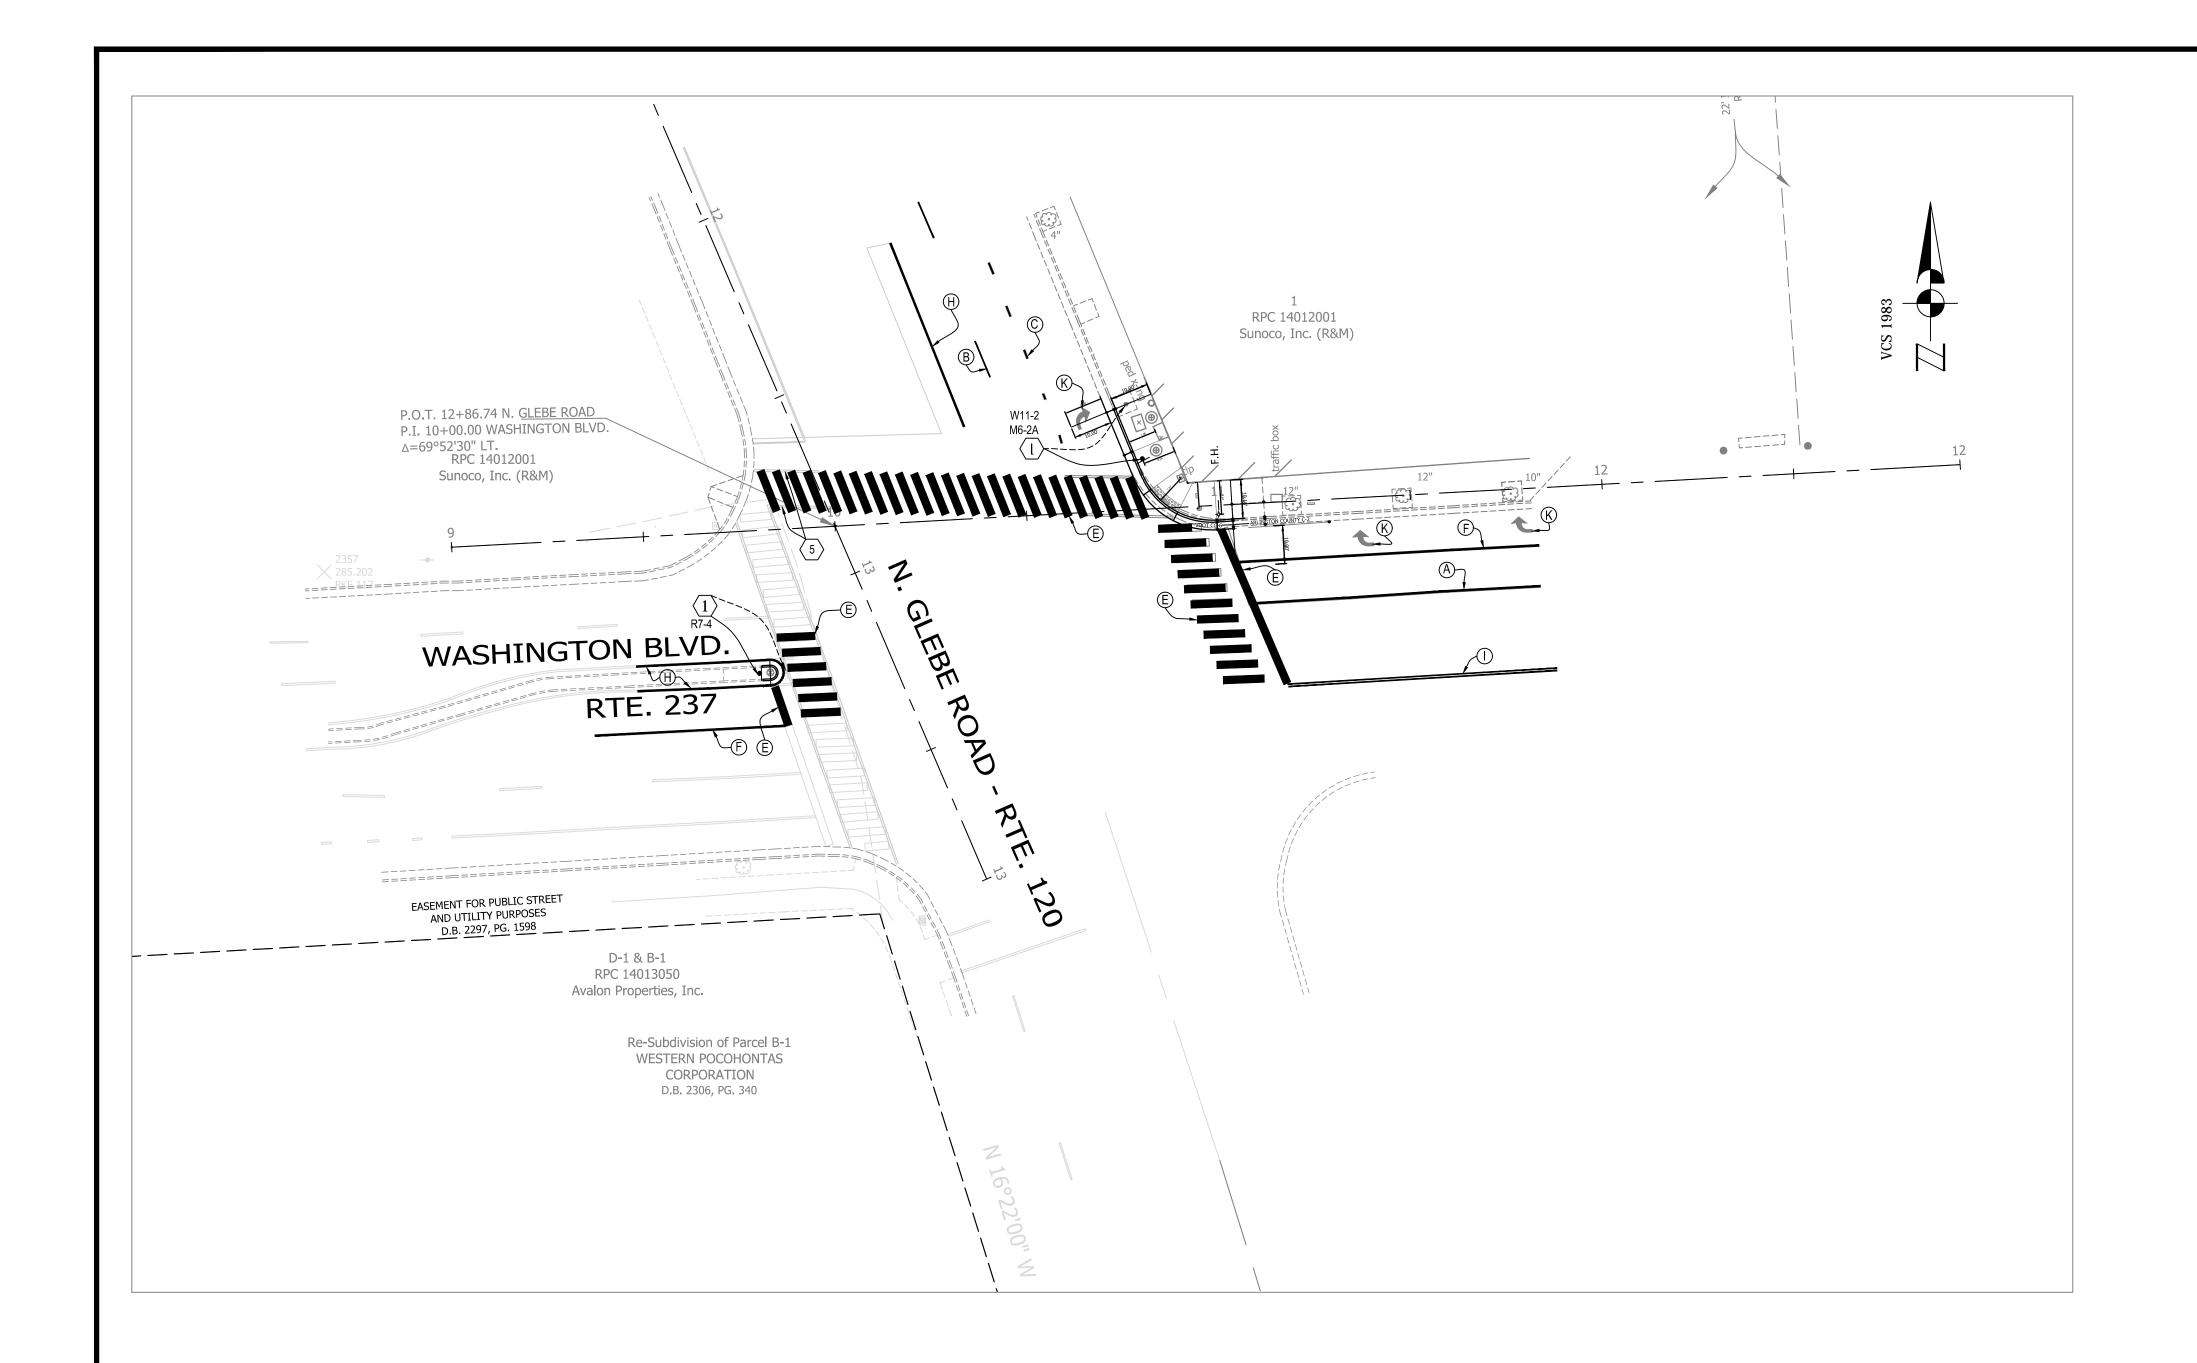

CONSTRUCTION SIGNAGE NOTES

ERADICATE AS NACESSARY ANY EXISTING PAVEMENT

EXISTING SIGN TO BE REMOVED AND REPLACED WITH NEW POLE

All existing signage to remain unless otherwise noted.

2. CONTACT DENNIS HOWELL OR HIS DESIGNEE AT 703-228-6598 OR (571) 437-1077 TO APPROVE MARKING LAYOUT 48 HRS. © TYPE B CLASS 1.....,WHITE 4" WIDTH, 2' LONG, 10' SPACING STRIPING LEGEND LANE TRANSITIONS, TURN LANE SKIPS PRIOR TO INSTALLATION OF MARKINGS. ① TYPE B CLASS 1.....,WHITE 18" WIDTH STOP BARS 3. PAVEMENT MARKINGS TO BE IN ACCORDANCE WITH THE FOLLOWING AND ANY REVISIONS HERE TO: E TYPE B CLASS 1.....,WHITE 24" WIDTH CONTINENTAL CROSS WALKS A.) THE MANUAL ON UNIFORM TRAFFIC CONTROL DEVICES. TYPE B CLASS 1.....,WHITE 6" WIDTH B) ARLINGTON COUNTY MARKING STANDARDS. TURN LANES, TRANSVERSE CROSSWALKS, BIKE LANES © TYPE B CLASS 1.....,YELLOW 4" WIDTH, 10' LONG, 30' SPACING DIVIDED TRAFFIC, TWO WAY TURN LANES 4. ALL MARKINGS SHALL BE THERMOPLASTIC PER ARLINGTON COUNTY MARKING STANDARDS. (H) TYPE B CLASS 1.....,YELLOW 4" WIDTH EDGE LINES 5. STOP BARS SHALL BE A MINIMUM OF 4' IN ADVANCE OF A MARKED CROSSWALK, IF THERE IS NO MARKED CROSSWALK, TYPE B CLASS 1....., YELLOW 4" WIDTH, DOUBLE LINE, 4" SPACING CENTERLINES STOP BAR SHALL BE NO MORE THAN 30' FROM THE NEAREST EDGE OF THE INTERSECTED TRAVELED WAY. TYPE B CLASS 1.....,WHITE 6" WIDTH, 10' SPACING @45 DEGREE HATCH LINES, SAFETY ZONES 6. CROSSWALKS SHALL BE 10' WIDE UNLESS OTHERWISE NOTED. K TYPE B CLASS 1.....,WHITE SINGLE ARROW TURN LANES 7. LEFT TURN ARROWS SHALL BE LOCATED 25' BACK FROM STOP BAR. FOR ADDITIONAL ARROWS FOLLOW DES MARKING TYPE B CLASS 1....., WHITE COMBINATION ARROW TURN LANES STANDARDS. M TYPE B CLASS 1.....,WHITE 8' LETTERS PAVEMENT LETTERS (STOP, YIELD, BUS, ONLY etc.) B. ON-STREET PARKING LANE IS 7' WIDE (UNLESS OTHERWISE NOTED) AND MARKED WITH 4" WIDE WHITE LINES. BEGINING N TYPE B CLASS 1.....,WHITE 6" WIDTH, 2' LONG, 10' SPACING LANE TRANSITIONS, TURN LANE SKIPS AND END OF PARKING SHALL BE MARKED WITH AN END LINE PERPENDICULAR TO CURB EXCEPT AT NUBS. ① TYPE B CLASS 1.....,WHITE 12" WIDTH, 20' SPACING @45 DEGREE GORE MARKINGS 9. SHARROWS SHALL BE PLACED IN CENTER OF LANE, 250' APART UNLESS OTHERWISE SPECIFIED. P TYPE B CLASS 1....., YELLOW 12" WIDTH, 20' SPACING @45 DEGREE GORE MARKINGS

10. BIKE LANE SYMBOLS TO BE PLACED 330' APART UNLESS OTHERWISE SPECIFIED.

SIGN AND PAVEMENT MARKING NOTES:


PARKING LANES, EDGE LINES, LANE LINES

DASHED LANE LINES

LANE TRANSITIONS

1. STREET WIDTH MEASUREMENTS ARE FROM FACE OF CURB TO FACE OF CURB. LANES ARE MEASURED FROM CENTER OF

<u>EXISTING</u>		PROPOSED	
	BUS STOP	F	
	FIRE HYDRANT	+	
()	PARKING METER	$\stackrel{\triangleright}{\Box}$	
0	SIGN	•	
(<u>A</u>)	STRIPING	A	

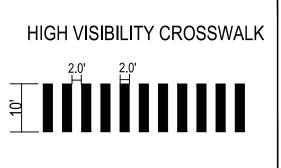




ARLINGTON VIRGINIA DEPARTMENT OF **ENVIRONMENTAL SERVICES** FACILITIES & ENGINEERING DIVISION ENGINEERING BUREAU 2100 CLARENDON BOULEVARD, SUITE 813 ARLINGTON, VA 22201 PHONE: 703.228.3629 FAX: 703.228.3606 COPYRIGHT © 2016 ARLINGTON COUNTY VIRGINIA - ALL RIGHTS RESERVED **APPROVALS REVISIONS** DATE WASHINGTON GLEBE RD. & NE CORNER DESIGNED: K.PATEL DRAWN :K.PATEL CHECKED :P. RIGBY MISS UTILITY TRANSMITTAL #: N/A FILENAME: P14D_C3-122-CORRIDOR.DWG $PATH: \underbrace{\text{Q:NDATA:P14D_RB CORRIDOR IMPROVEMENTS:SITE C-3 N GLEBE ROAD WASHINGTON BLVD\CAD FILES\ACTIVE}$ PLOTTED: MAY 28 2019 PLOTTED BY: KPATEL SCALE: AS NOTED GRAPHIC SCALE SCALE: 1'' = 25'


STANDARD PAVEMENT MARKING LEGEND:

B TYPE B CLASS 1.....,WHITE 4" WIDTH, 10' LONG, 30' SPACING

A TYPE B CLASS 1.....,WHITE 4" WIDTH

SHEET

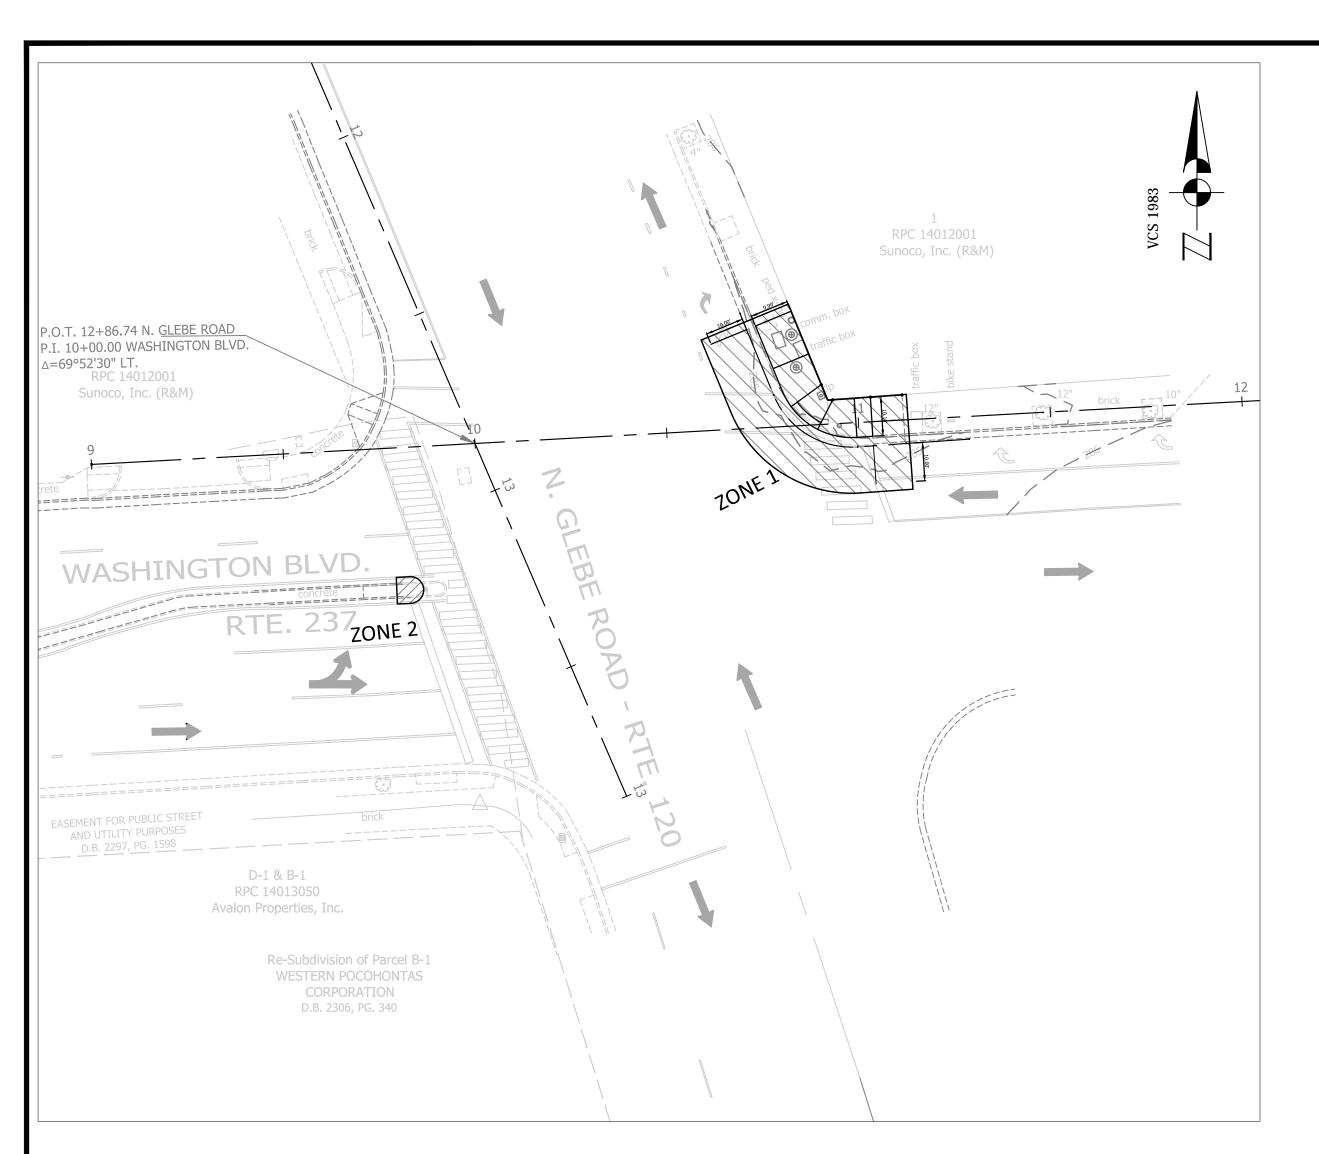

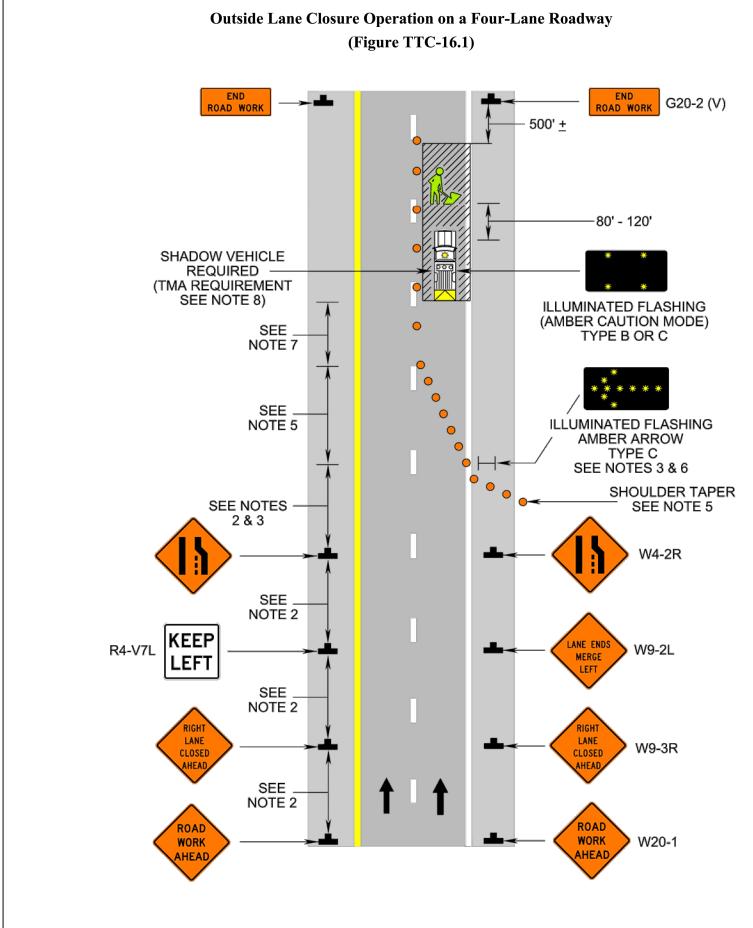

April 2015

Page 6H-38

Typical Traffic Control Outside Lane Closure Operation on a Four-Lane Roadway (Figure TTC-16.1)

NOTES

1. On divided highways having a median wider than 8', right and left sign assemblies shall be required.

Guidance:

Page 6H-39

- 2. Sign spacing should be 1300'-1500' for Limited Access highways. For all other roadways, the sign spacing should be 500'-800' where the posted speed limit is greater than 45 mph, and 350'-500' where the posted speed limit is 45 mph or less.
- 3. Care should be exercised when establishing the limits of the work zone to insure maximum possible sight distance in advance of the transition, based on the posted speed limit and at least equal to or greater than the values in Table 6H-3. For Limited Access highways a minimum of 1000' is desired.
- 4. All vehicles, equipment, workers, and their activities should be restricted to one side of the pavement.

5. Taper Length (L) and Channelizing Device Spacing shall be:

Т	aper Le	ength (L	.)					
Speed Limit	L	Lane Width (Feet)						
(mph)	9	10	11	12				
25	95	105	115	125				
30	135	150	165	180				
35	185	205	225	245				
40	240	270	295	320				
45	405	450	495	540				
50	450	500	550	600				
55	495	550	605	660				
60	540	600	660	720				
65	585	650	715	780				
70	630	700	770	840				
Minimum tape	er length	ns for Li	mited A	ccess				

highways shall be 1000 feet. Shoulder Taper = 1/3 L Minimum

Channelizing Device Spacing			
Location	Speed Limit (mph)		
Location	0 - 35	36 +	
Transition Spacing	20'	40'	
Travelway Spacing	40'	80'	
Construction Access*	80'	120'	
* Spacing may be increased to this distance, but shall not exceed one access per ¼ mile.			

April 2015

On roadways with paved shoulders having a width of 8 feet or more, channelizing devices shall be used to close the shoulder in advance of the merging taper to direct vehicular traffic to remain within the traveled

- 6. An arrow board shall be used when a lane is closed. When more than one lane is closed, a separate arrow board shall be used for each closed lane (see Figure TTC-18).
- 7. The buffer space length shall be shown in Table 6H-3 on Page 6H-5 for the posted speed limit.
- 8. A shadow vehicle with either a Type B or C arrow board operating in the caution mode, or at least one high intensity amber rotating, flashing, or oscillating light shall be parked 80'-120' in advance of the first work crew. When the posted speed limit is 45 mph or greater, a truckmounted attenuator shall be used.
- 9. Vehicle hazard warning signals shall not be used instead of the vehicle's high-intensity amber rotating, flashing, or oscillating lights but can be used to supplement the amber rotating, flashing, or oscillating lights.
- 10. When a side road intersects the highway within the TTC zone, additional TTC devices shall be placed as needed.

1: Revision 1 – 4/1/2015

WORKING HOURS:

1. IN ARLINGTON RIGHT-OF-WAY: 9:30 AM TO 3:00 PM (MON.-FRI.) AND 9:30AM TO 2:00PM (FRIDAY) SINCE GLEBE RD. IS STATE ROAD.

- 1. TRAFFIC CONTROL DEVICES AND SAFETY MEASURES SHALL COMPLY WITH THE VIRGINIA WORK AREA PROTECTION MANUAL, VDOT'S GUIDELINES FOR TEMPORARY TRAFFIC CONTROL, FEDERAL HIGHWAY
- SHOULDER CLOSURES. THE CONTRACTOR SHALL NOTIFY THE PROJECT OFFICER A MINIMUM OF 3 BUSINESS DAYS IN ADVANCE OF PROCEEDING TO THE NEXT WORK SEGMENT.
- OFFICER SHALL RESTRICT PARKING BY CONTACTING DES PERMITTING SECTION, 703-228-4798.
- THE CONTRACTOR SHALL MINIMIZE THE DURATION OF ANY BLOCKAGE TO PRIVATE ENTRANCES AND DRIVEWAYS. THE CONTRACTOR SHALL SUBMIT A SCHEDULE OF DRIVEWAY CLOSURE FOR APPROVAL BY THE PROJECT OFFICER. THE PROJECT OFFICER SHALL BE NOTIFIED A MINIMUM OF 3 BUSINESS DAYS IN ADVANCE OF SUCH ACTIVITIES. THE CONTRACTOR SHALL NOTIFY THE PROPERTY OWNER AT LEAST
- 6. ANY EXCAVATIONS WHICH ARE SPECIFICALLY APPROVED BY THE PROJECT OFFICER TO REMAIN OPEN PAST NORMAL WORKING HOURS SHALL BE THE RESPONSIBILITY OF THE CONTRACTOR AND SHALL BE
- PEDESTRIAN TRAFFIC SHALL BE MAINTAINED AT ALL TIMES, INCLUDING ACCESS TO BUS STOP SHELTERS, UNLESS OTHERWISE APPROVED IN THE PLANS.
- PEDESTRIAN TRAFFIC SHALL BE SEPARATED FROM WORK ZONES WITH APPROPRIATE MEASURES IN ACCORDANCE WITH MUTCD.
- 10. WHEN NECESSARY, PEDESTRIANS SHALL BE APPROPRIATELY DIRECTED WITH ADVANCED WARNING SIGNS PLACED AT INTERSECTIONS, TO CROSS TO THE OPPOSITE SIDE OF THE ROADWAY IN ORDER TO
- SECTION 503.4 OF THE ARLINGTON COUNTY FIRE PREVENTION CODE. ACCESS TO CONSTRUCTION SITES SHALL BE PROVIDED AND MAINTAINED IN ACCORDANCE WITH SECTION 1410 OF THE ARLINGTON
- ARLINGTON COUNTY FIRED DEPARTMENT FIRE PREVENTION OFFICE AT 703-228-4644 TO COORDINATE REVIEW AND APPROVAL OF TEMPORARY FIRE DEPARTMENT CONNECTIONS AND/OR FIRE APPARATUS
- 15. VEHICLE DETECTION AT ALL TIMES DURING THE PROJECT. TRAFFIC SENSORS SHALL BE RESTORED TO THEIR PRE-CONSTRUCTION STATE PRIOR TO THE COMPLETION OF THIS PROJECT.
- 16. WORK HOURS ARE RESTRICTED TO 9:30 AM TO 3:00 PM (MON.- THUR.) AND 9:30 AM. TO 2:00 PM. (FRI.) SINCE GLEBE RD. IS STATE RD.

2. ALL LANES SHALL BE FULLY OPEN TO TRAFFIC OUTSIDE THE ABOVE HOURS UNLESS SPECIFIED OTHERWISE IN THE MAINTENANCE OF TRAFFIC PLANS.

MOT NOTES:

- ADMINISTRATION MANUAL ON UNIFORM TRAFFIC CONTROL DEVICES, ARLINGTON COUNTY STANDARDS, THE TRAFFIC CONTROL PLANS INCLUDED IN THE CONSTRUCTION DRAWINGS, AND/OR AS DIRECTED
- THE CONTRACTOR SHALL SUBMIT A DETAILED SCHEDULE WHICH INDICATES START AND FINISH DATES FOR EACH SEGMENT OF THE WORK. THE SCHEDULE SHALL INDICATE THE DURATION OF ALL LANE OR THE CONTRACTOR SHALL NOTIFY THE PROJECT OFFICER OF PARKING RESTRICTION NEEDS A MINIMUM OF 3 BUSINESS DAYS PRIOR TO COMMENCEMENT OF WORK FOR EACH SEGEMENT. COUNTY PROJECT
- 4. DURING CONSTRUCTION, THE CONTRACTOR SHALL EITHER MAINTAIN APPROPRIATE SIGHT DISTANCE TO ALL TRAFFIC SIGNS OR PROVIDE FOR TEMPORARY SIGNAGE OR FLAGGERS TO GUIDE TRAFFIC
- 24 HOURS IN ADVANCE OF THE START OF ANY WORK THAT WILL REQUIRE TEMPORARY CLOSURE OF ACCESS TO THE PROPERTY. THE CONTRACTOR SHALL MAKE ALL PRIVATE ENTRANCES AND DRIVEWAYS
- PROTECTED IN ACCORDANCE WITH THE VIRGINIA WORK AREA PROTECTION MANUAL AND AS APPROVED BY THE PROJECT OFFICER.
- 9. ADEQUATE PROVISIONS FOR PERSONS WITH DISABILITIES SHALL BE PROVIDED AT ALL TIMES PER ADA REQUIREMENTS.
- PREVENT CONFLICT WITH MIDBLOCK WORK SITES. 11. PEDESTRIANS SHALL NOT BE LED INTO CONFLICT WITH WORK SITE EQUIPMENT, OPERATIONS, AND/OR VEHICLES MOVING THROUGH OR AROUND THE WORK SITE
- 12. ALL EXISTING FIRE HYDRANTS AND FIRE DEPARTMENT CONNECTIONS SHALL BE MAINTAINED UNOBSTRUCTED AND ACCESSIBLE AT ALL TIMES IN ACCORDANCE WITH SECTIONS 508.5.4 AND 508.5.5 OF THE 13. ACCESS TO BUILDINGS FOR FIREFIGHTING SHALL BE MAINTAINED AT ALL TIMES. EXISTING FIRE APPARATUS ACCESS ROADS (FIRE LANES) SHALL BE KEPT CLEAR OF OBSTRUCTIONS IN ACCORDANCE WITH
- 14. IN THE EVENT THAT EXISTING FIRE DEPARTMENT CONNECTIONS OR FIRE APPARATUS ACCESS ROADS (FIRE LANES) MUST BE OBSTRUCTED TO FACILITATE CONSTRUCTION ACTIVITIES, CONTACT THE ACCESS ROADS PRIOR TO CREATING THE OBSTRUCTION.
- 17. AND CONTRACTOR SHALL COVER ANY EXISTING SIGNS WHICH ARE NOT APPLICABLE OR ARE IN CONFLICT WITH THIS MOT PLAN.
- 18. CONTRACTOR SHALL ERADICATE AND RE-STRIPE AS NECESSARY ANY EXISTING PAVEMENT MARKINGS THAT ARE AM CONFLICT OR DO NOT ALIGN WITH THE TEMPORARY PAVEMENT
- 19. CONTRACTOR SHALL ERADICATE ALL TEMPORARY PAVEMENT MARKING, INCLUDING TEMPORARY MARKED CROSSWALKS ONCE THE WORK AREA(S) ASSOCIATED WITH THE MARKINGS
- 20. CONTRACTOR SHALL COORDINATE WITH ARLINGTON COUNTY TRANSIT AT 703-228-3049, AT LEAST FOUR (4) WEEKS PRIOR TO COMMENCEMENT OF ALL WORK AFFECTING TRANSIT STOP OR ROUTES. ALL TEMPORARY AND FINAL BUS TRAVEL LANES MUST BE MINIMUM 11' WIDE.

ZONE#	TTC#	COMMENTS		
ZONE 1	TTC-16.1	OUTSIDE LANE CLOSURE OPERATION ON A FOUR LANE ROADWAY	TWO WEEKS TO	
20112	TTC-28.1	LANE CLOSURE OPERATION- IN AN INTERSECTION	MONTH	
	TTC-36.1	CROSSWALK CLOSURE AND PEDESTRIAN DETOUR OPERATION		
70NF 2	TTC-16.1	OUTSIDE LANE CLOSURE OPERATION ON A FOUR LANE ROADWAY		
ZONE Z	TTC-26.1	LANE CLOSER OPERATION- NEAR SIDE OF AN INTERSECTION	ONE WEEK	
	TTC-36.1	CROSSWALK CLOSURE AND PEDESTRIAN DETOUR OPERATION		
	TTC-29.1	TURN LANE CLOSURE OPERATION		

ZONE TABLE


THE DURATIONS SHOWN WERE DEVELOPED FOR PLANNING AND ESTIMATION PURPOSES ONLY. THE DURATIONS IN NO WAY ALTER THE CONTRACT TIME FOR COMPLETION, OR INFRINGES ON THE CONTRACTORS MEANS AND METHODS. THE CONTRACTOR'S SUBMITTED SCHEDULE SUPERSEDES THE ESTIMATED DURATIONS SHOWN.


RESTRICTIONS ON CONCURRENT WORK AREAS:

THE CONTRACTOR MAY CHOOSE THE OPTIMAL SEQUENCE FOR THEM, BUT THE DESIGNER WILL DICTATE WHICH WORK AREA CAN AND CANNOT BE CLOSED SIMULTANEOUSLY.

NOTES: 1. WARNING SIGN SPACING: 100'

2. CHANNELIZATION DEVICES SPACING FOR TRANSITION AREAS = 20'

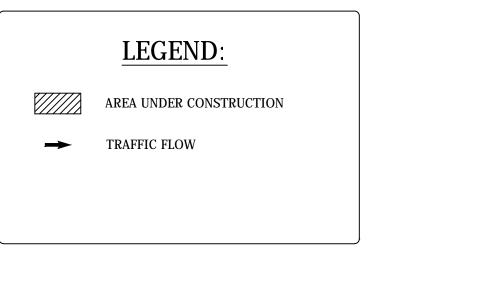

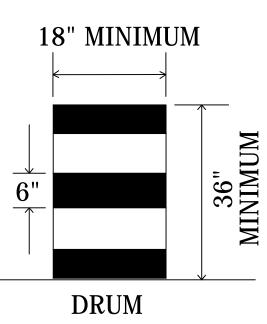

DURATION

NOTES:

DRUM SPACING IS 20 FEET ON TRANSITIONS AND CURVES. DRUM SPACING PARALLEL TO THE TRAVEL WAY IS 40 FEET.

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ARLINGTON VIRGINIA


DEPARTMENT OF **ENVIRONMENTAL SERVICES**

FACILITIES & ENGINEERING DIVISION ENGINEERING BUREAU 100 CLARENDON BOULEVARD, SUITE 813

FAX: 703.228.3606

ARLINGTON, VA 22201

PHONE: 703.228.3629

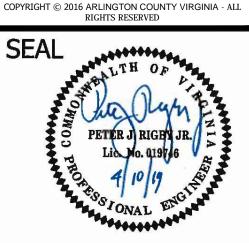

APPROVALS QUALITY CONTROL ENGINEER WATER, SEWER, STREETS BUREAU CHIEF

REVISIONS

DESIGNED: K. PATEL DRAWN : K.PATEL

CHECKED :P. RIGBY

MISS UTILITY TRANSMITTAL #: N/A FILENAME: P14D_C-3-286-MOT.DWG


LOTTED: MAY 28 2019 PLOTTED BY: KPATEL

SCALE: AS NOTED GRAPHIC SCAL SCALE: 1" = 25'

12 OF 13

SHEET

N. GLEBE RD. & WASHINGTON BLVD.

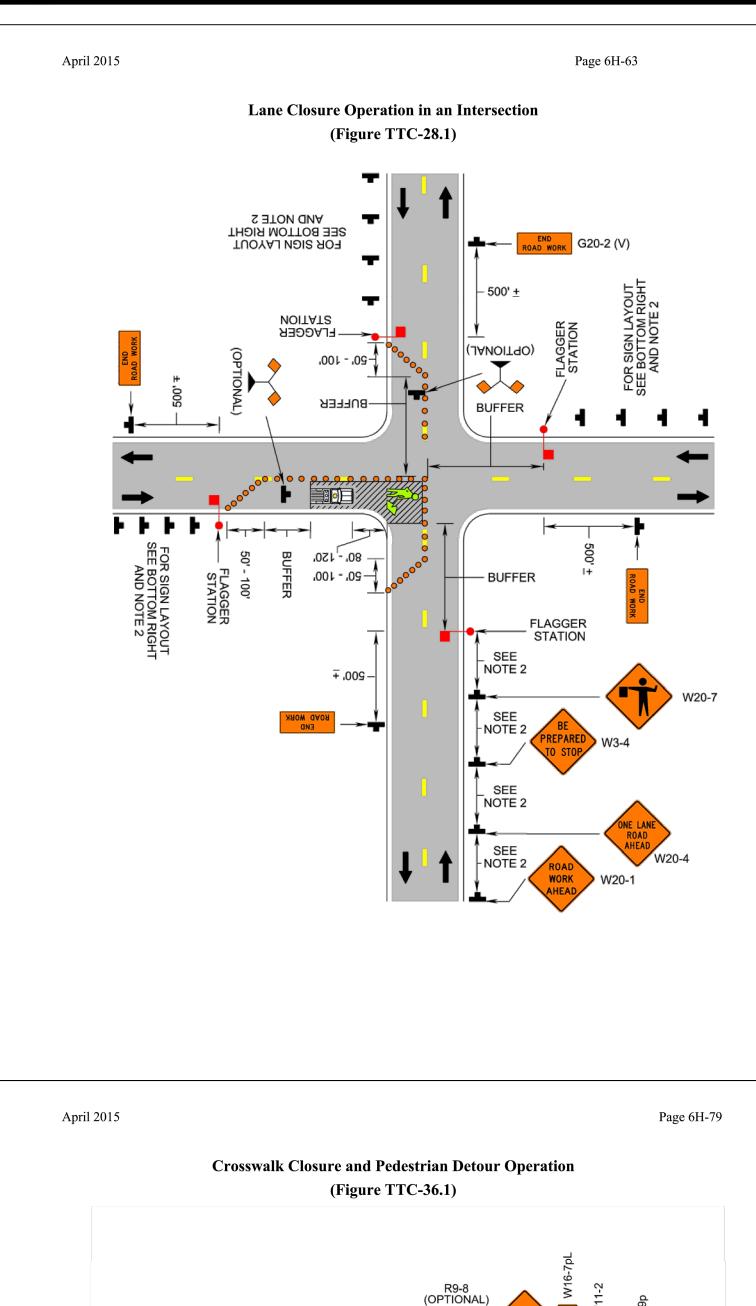

Page 6H-62

Typical Traffic Control Lane Closure Operation in an Intersection (Figure TTC-28.1)

April 2015

NOTES

1. The control of traffic through the intersection in order of preference should be:

- a. Obtain the services of law enforcement personnel.
- b. Detour the effective routes to other roads and streets as approved and directed by the Regional Traffic Engineer.
- c. Place a state certified flagger on each leg of the intersection controlling a single lane of traffic. Appropriate signing as shown should be used for law enforcement and flagging operations. For detour
- 2. Sign spacing distance should be 350'-500' where the posted speed limit is 45 mph or less, 500'-800' where the posted speed limit is greater than 45 mph.

Standard: 3. Channelizing device spacing shall be on 20' centers or less.

Guidance:

4. If room permits, a shadow vehicle with at least one rotating amber light or high intensity amber flashing or oscilllating¹ light should be parked 80'-120' in advance of the first work crew.

Standard:

Guidance:

Guidance:


5. For emergency situations (any non-planned operation) of 30 minutes or less duration, two rotating amber lights or high intensity amber flashing or oscillating lights mounted on the vehicle and visible for 360° shall be required in addition to the channelizing devices shown around the vehicle. Also, vehicle hazard warning signals shall be used.

- 6. If the work space extends across a crosswalk, the crosswalk should be closed using the information and devices shown in Figure TTC-36.
- 7. Turns can be prohibited as required by vehicular traffic conditions. Unless the streets are wide, it might be physically impossible to make certain turns, especially for large vehicles.


1: Revision 1 – 4/1/2015

April 2015 Page 6H-59

Lane Closure Operation - Near Side of an Intersection (Figure TTC-26.1)

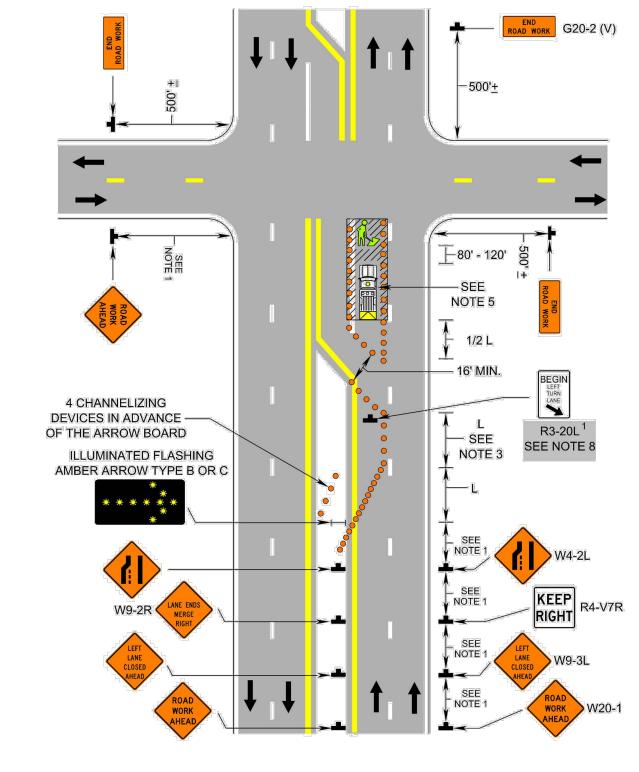

1: Revision 1 – 4/1/2015

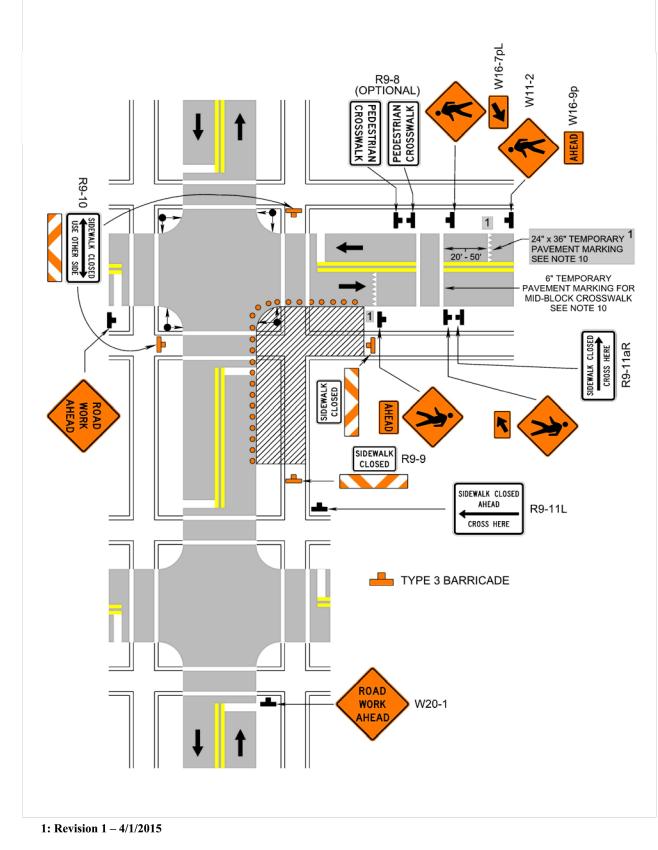

Page 6H-78

Typical Traffic Control Crosswalk Closure and Pedestrian Detour Operation (Figure TTC-36.1)

Standard:

1. When crosswalks or other pedestrian facilities are closed or relocated, temporary facilities shall be detectable and shall include accessibility features consistent with the features present in the

NOTES

- 2. Curb parking shall be prohibited for at least 50 feet in advance of the midblock crosswalk. Guidance:
- 3. Audible information devices should be considered where midblock closings and changed crosswalk
- areas cause inadequate communication to be provided to pedestrians who have visual disabilities. 4. Pedestrian traffic signal displays controlling closed crosswalks should be covered or deactivated.
- 5. Temporary markings should be considered for operations exceeding three days in duration.

Option: 6. Only the TTC devices related to pedestrians are shown. Other devices, such as lane closure signing or

- ROAD NARROWS (W5-1) signs, may be used to control vehicular traffic.
- 7. For nighttime closures, Type A Flashing warning lights may be used on barricades supporting signs and closing sidewalks.
- 8. In order to maintain the systematic use of the fluorescent yellow-green background for pedestrian, bicycle, and school warning signs in a jurisdiction, the fluorescent yellow-green background for pedestrian, bicycle, and school warning signs may be used in TTC zones.

Standard:

9. All sidewalk closures shall be closed with Type 3 Barricades.

10. Refer to Sections 3B-16 through 3B-18 of the 2009 MUTCD and the Virginia Supplement to the MUTCD¹ for crosswalk¹ lines, yield lines and other related TTC devices that may be used to control vehicular traffic at midblock crosswalks.

1: Revision 1 - 4/1/2015

Page 6H-58

April 2015

Typical Traffic Control Lane Closure Operation - Near Side of an Intersection (Figure TTC-26.1)

Guidance:

1. Sign spacing distance should be 350'-500' where the posted speed limit is 45 mph or less, 500'-800' where the posted speed limit is greater than 45 mph.

NOTES

- Standard: 2. On divided highways having a median wider than 8', right and left sign assemblies shall be
- 3. Taper length (L) and channelizing device spacing shall be:

Taper Length (L)				
Speed Limit	Limit Lane Width (Feet)			
(mph)	9	10	11	12
25	95	105	115	125
30	135	150	165	180
35	185	205	225	245
40	240	270	295	320
45	405	450	495	540
50	450	500	550	600
55	495	550	605	660
60	540	600	660	720
65	585	650	715	780
70	630	700	770	840
Minimum tar highw		hs for Li II be 100		ccess
Should	er Tape	r = ½ L N	/linimum	

Channelizing Device Spacing			
Location	Speed Limit (mph)		
	0 - 35	36 +	
Transition Spacing	20'	40'	
Travelway Spacing	40'	80'	
Construction Access*	80'	120'	
* Spacing may be increased to this distance, but shall not exceed one access per ¼ mile.			

April 2015

On roadways with paved shoulders having a width of 8 feet or more, channelizing devices shall be used to close the shoulder in advance of the merging taper to direct vehicular traffic to remain within the traveled

On three or more lane roadways, the merging tapers shall be installed as shown in TTC-18.

4. If room permits, a shadow vehicle with at least one rotating, oscillating, or amber strobe light should be

parked 80'-120' in advance of the first work crew.

5. If the posted speed limit is 45 mph or greater, the shadow vehicle shall have a truck-mounted

- 6. For emergency situations (any non-planned operation) of 30 minutes or less duration, two rotating amber lights or two high intensity amber flashing or oscillating lights mounted on the vehicle and visible for 360° shall be required in addition to the channelizing devices shown around the vehicle. Also, vehicle hazard warning signals shall be used.

Guidance:

7. If the work space extends across a crosswalk, the crosswalk should be closed using the information and devices shown in Figure TTC-36.

8. If the left turn lane is closed a NO LEFT TURN (Symbol) (R3-2) shall be used.¹

1: Revision 1 – 4/1/2015

ARLINGTON VIRGINIA


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APPROVALS QUALITY CONTROL ENGINEER WATER, SEWER, STREETS BUREAU CHIEF

REVISIONS **DATE**

E WASHINGTON BLVD.
AT INTERSECTION BLVD. WASHINGTON

PROJECT NAME AND LOCATION GLEBE RD. & NE CORNER RD. GLEBE ż

DESIGNED: K. PATEL DRAWN : K.PATEL CHECKED :P. RIGBY MISS UTILITY TRANSMITTAL #: N/A

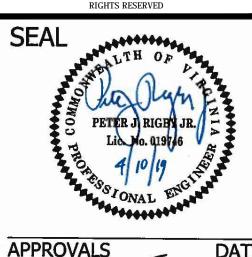TILENAME: P14D_C-3-286-MOT.DWG PLOTTED: MAY 28 2019

PLOTTED BY: KPATEL SCALE: AS NOTED

SHEET