



HARDWARE SCHEDULE


SET #1 - ENTRY AND BACK DOOR	
1	DEADBOLT LOCKSET - STANLEY SINGLE DEADBOLT QDB 281, I-CORE
1	EXTERIOR PASSAGE LEVER - STANLEY QCL 230 PASSAGE LEVER
SET #2 - MECHANICAL ROOM DOOR	
1	DEADBOLT LOCKSET - STANLEY SINGLE DEADBOLT QDB 281, I-CORE

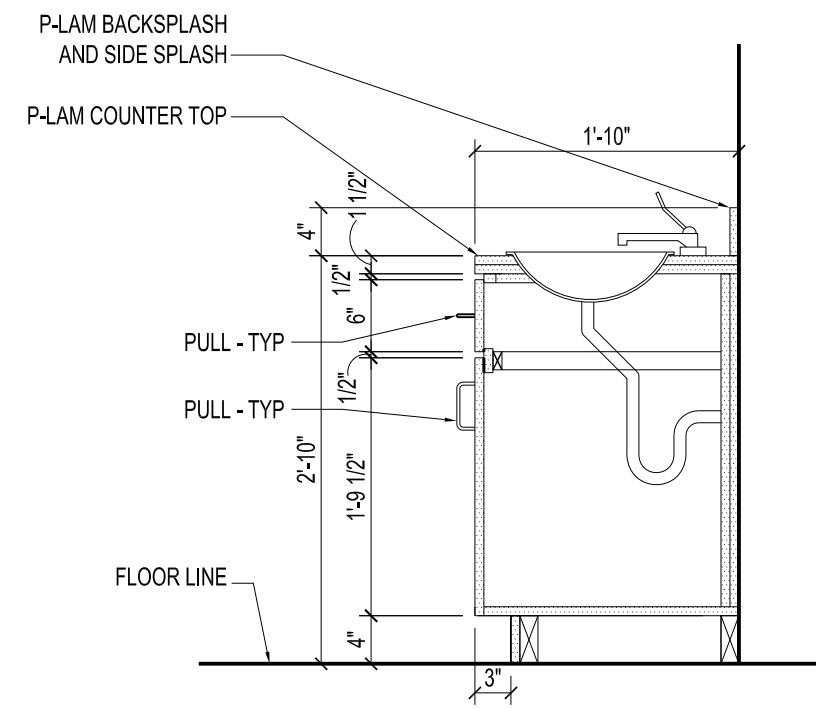


8 VANITY A - SECTION
SCALE: 3/4" = 1'-0"

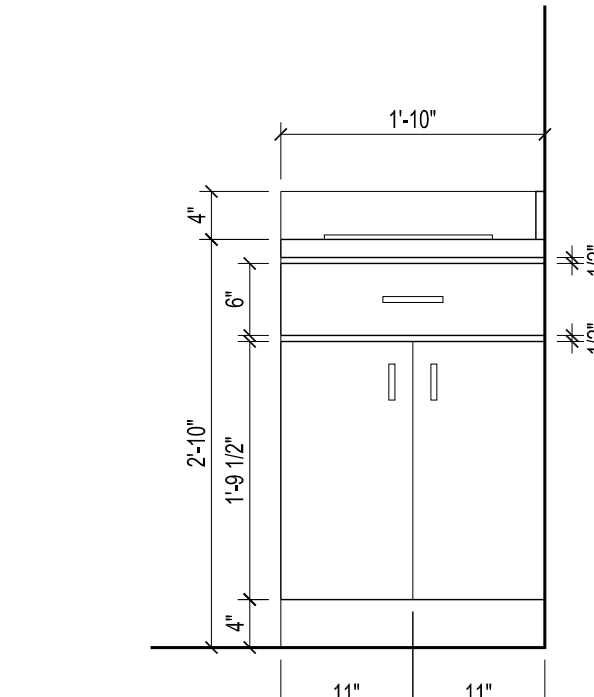


7 VANITY A - ELEVATION
SCALE: 3/4" = 1'-0"

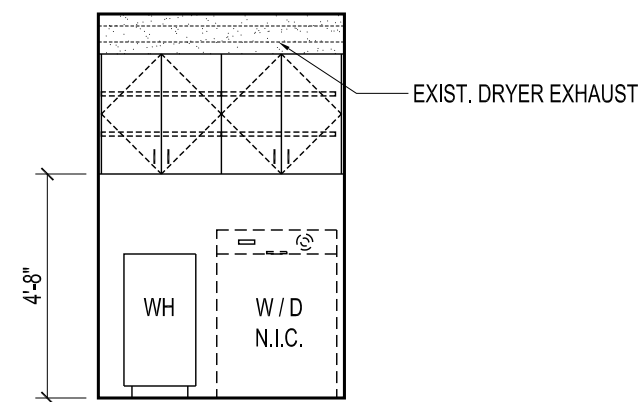


6 INTERIOR ELEVATION
SCALE: 1/4" = 1'-0"

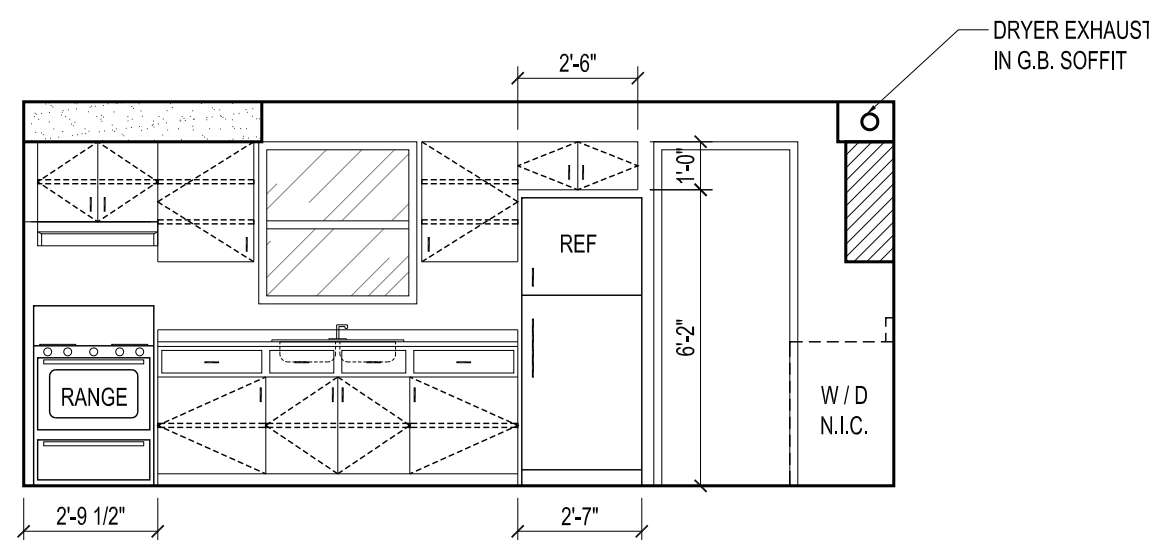


5 INTERIOR ELEVATION
SCALE: 1/4" = 1'-0"

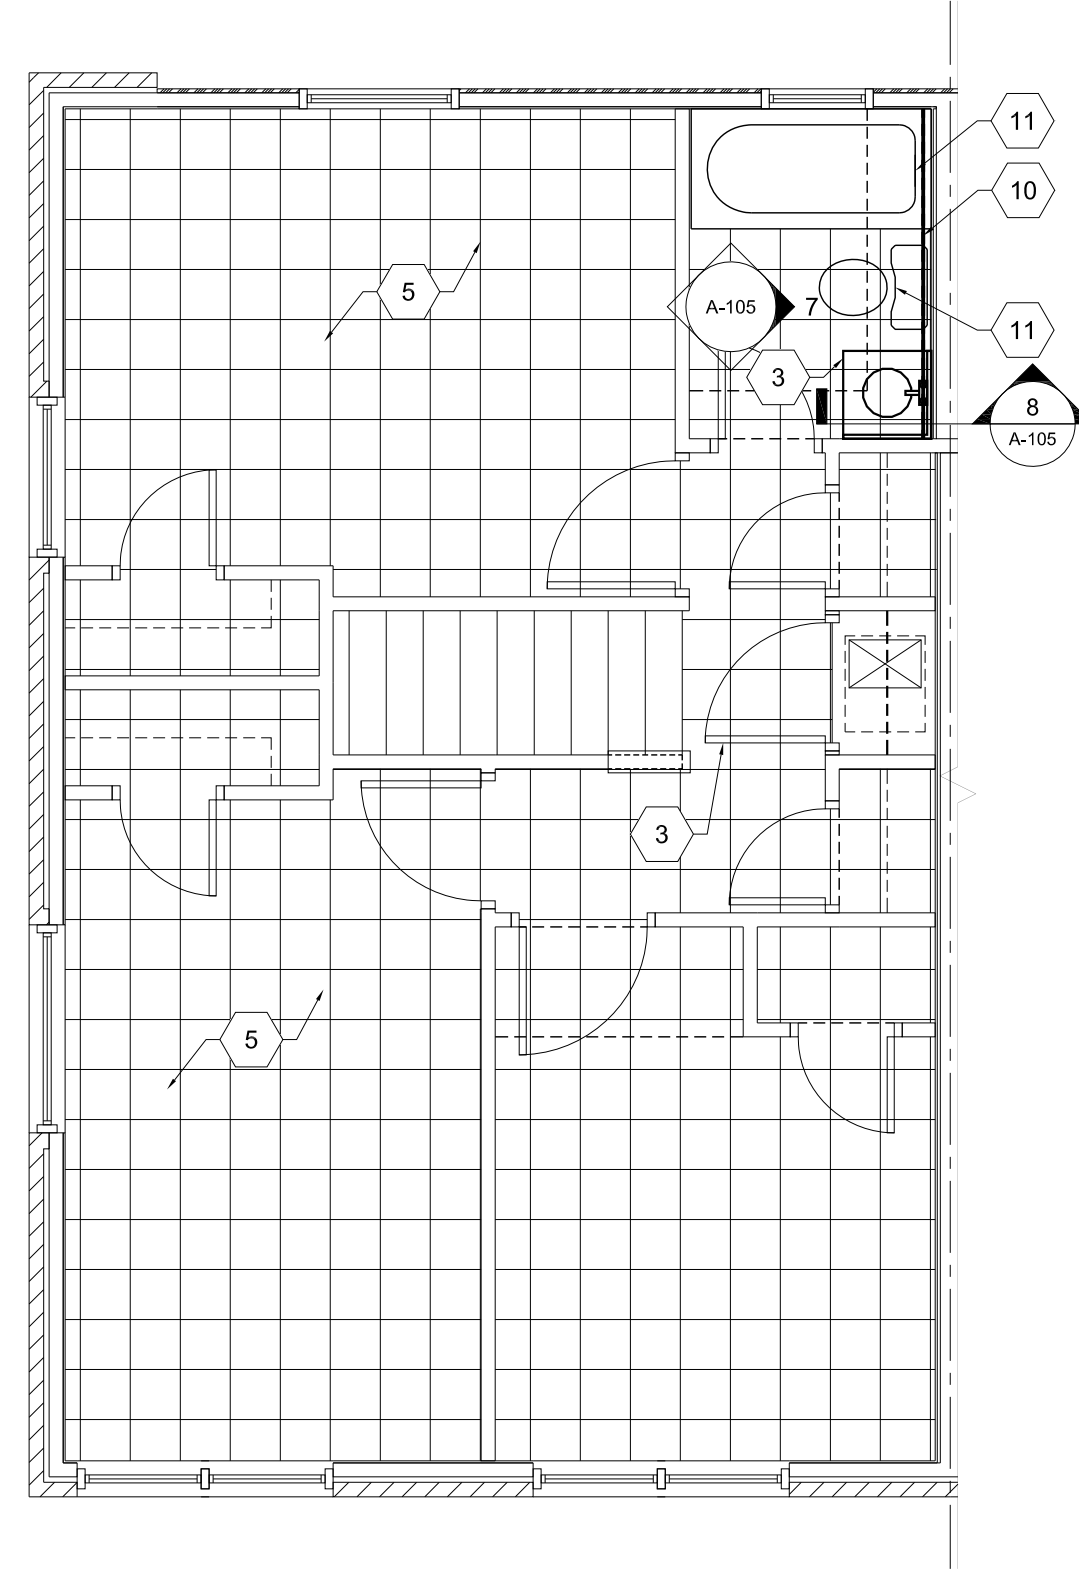


4 SECOND FLOOR PLAN - NEW - BUILDINGS E, F & G
SCALE: 1/4" = 1'-0" 3BR - UNIT TYPE 4

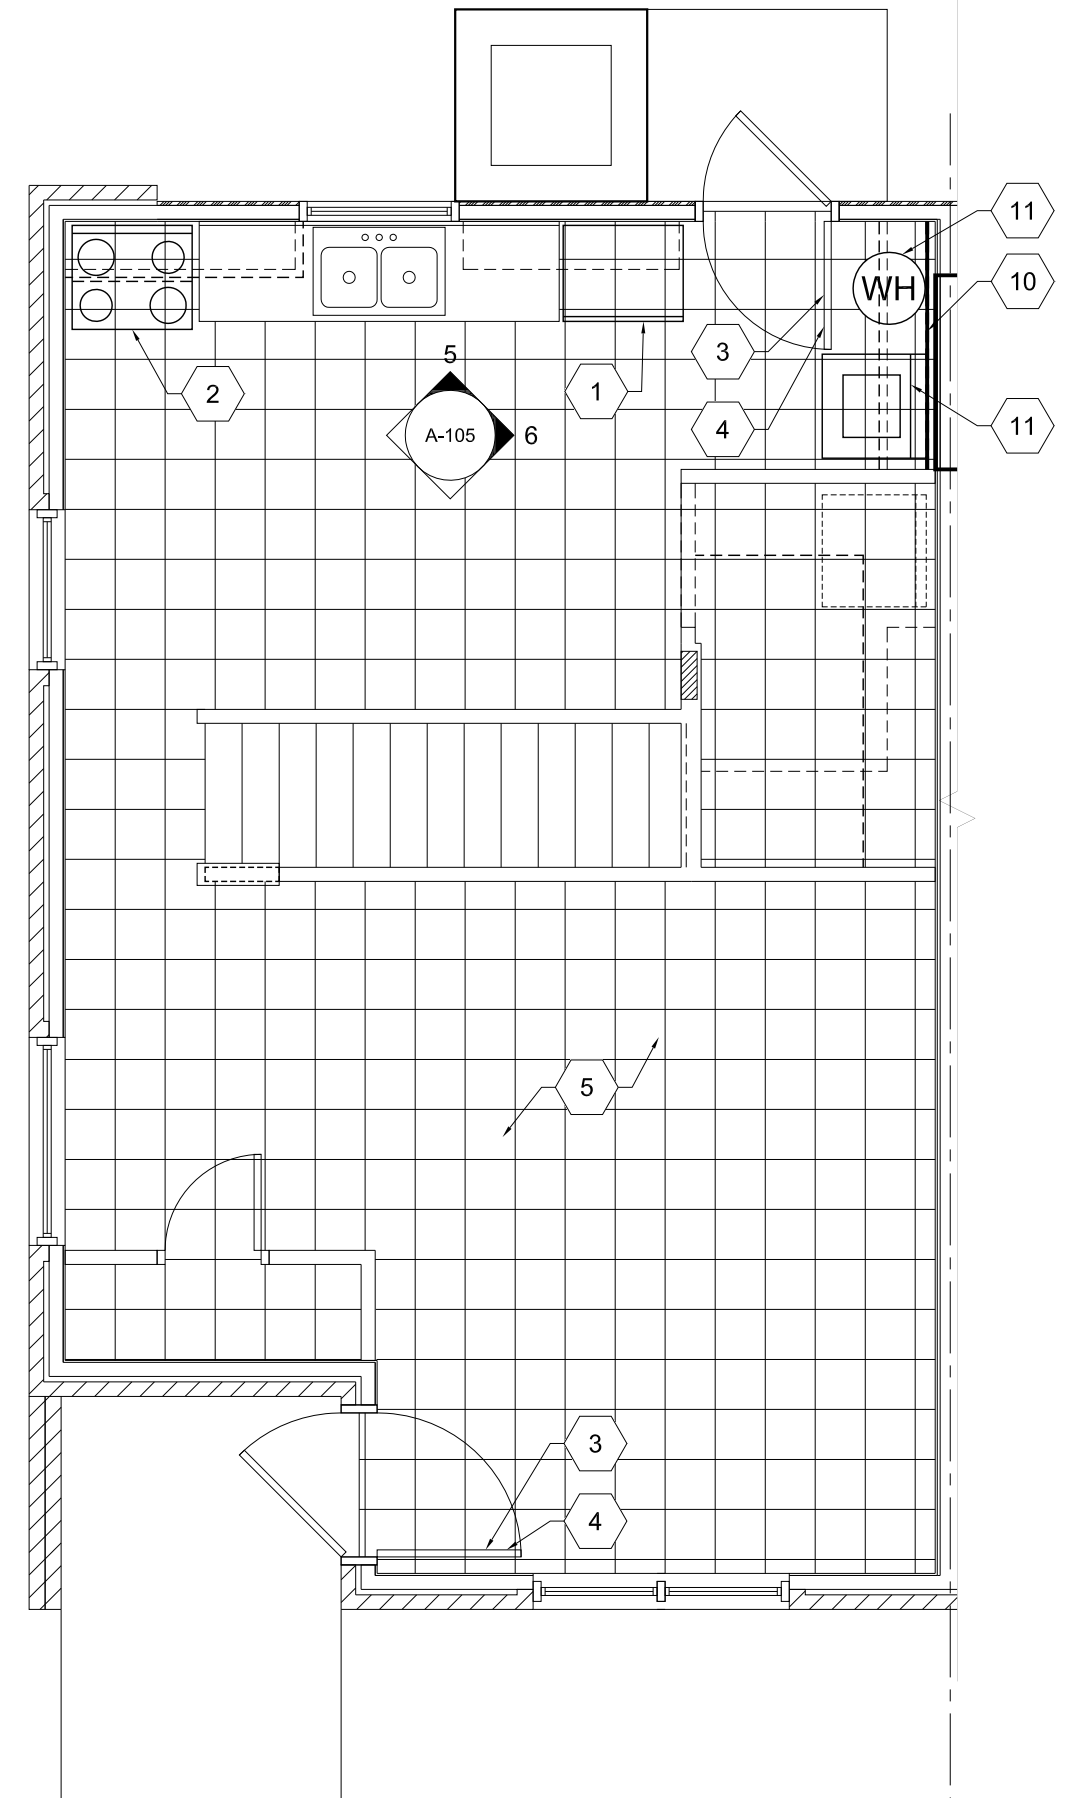

3 FIRST FLOOR PLAN - NEW - BUILDINGS E, F & G
SCALE: 1/4" = 1'-0" 3BR - UNIT TYPE 4

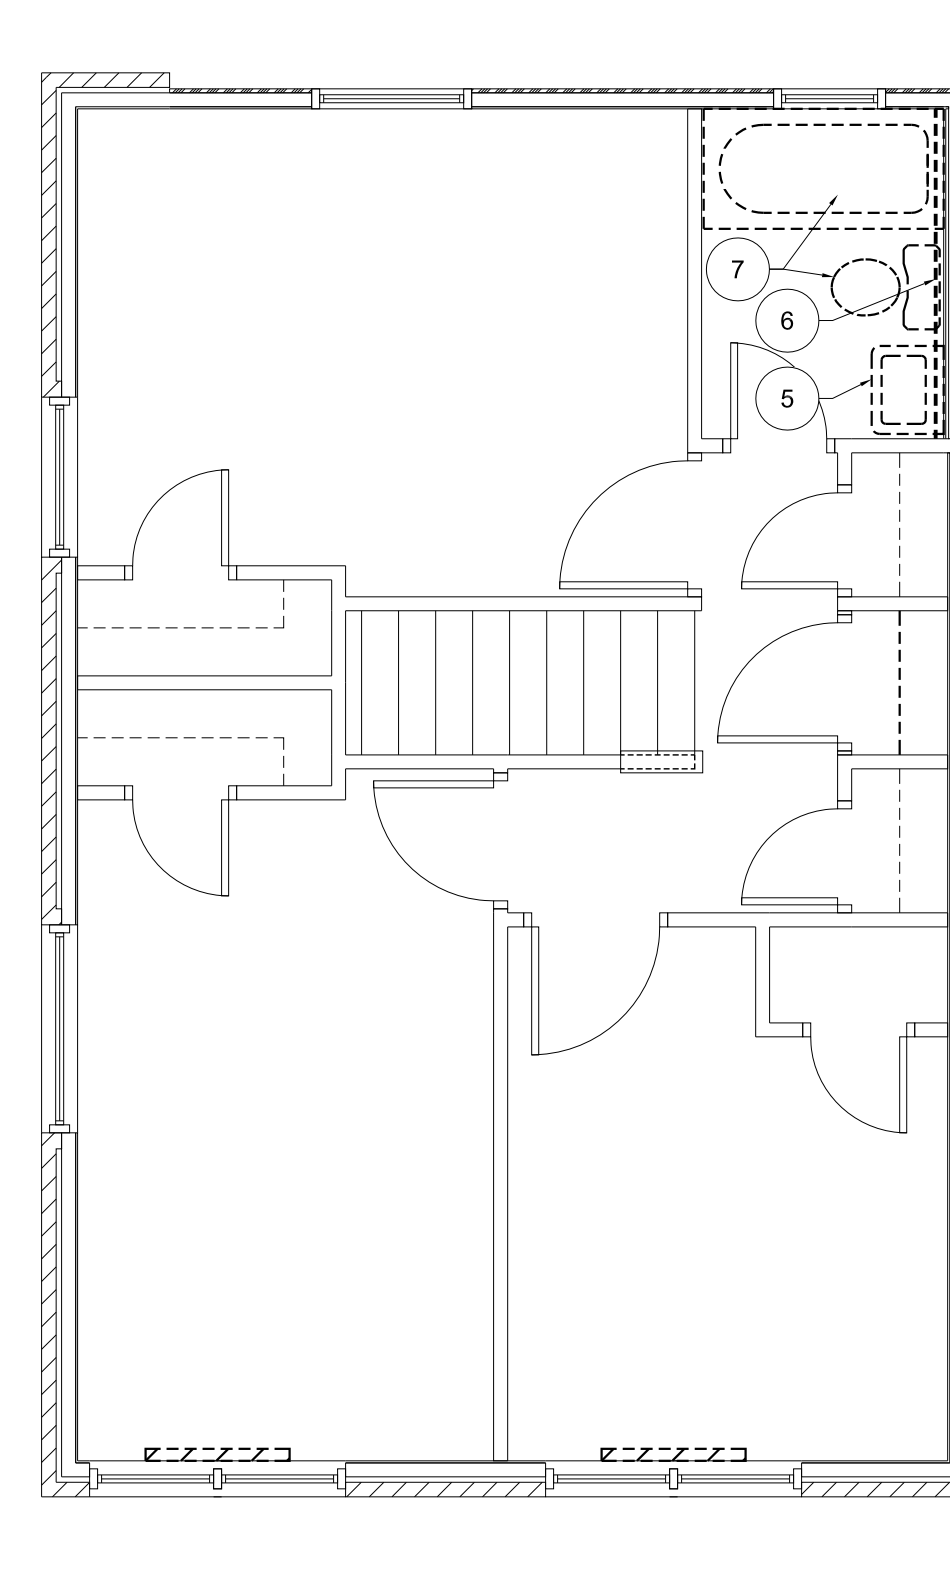

2 SECOND FLOOR PLAN - DEMO - BUILDINGS E, F & G
SCALE: 1/4" = 1'-0" 3BR - UNIT TYPE 4

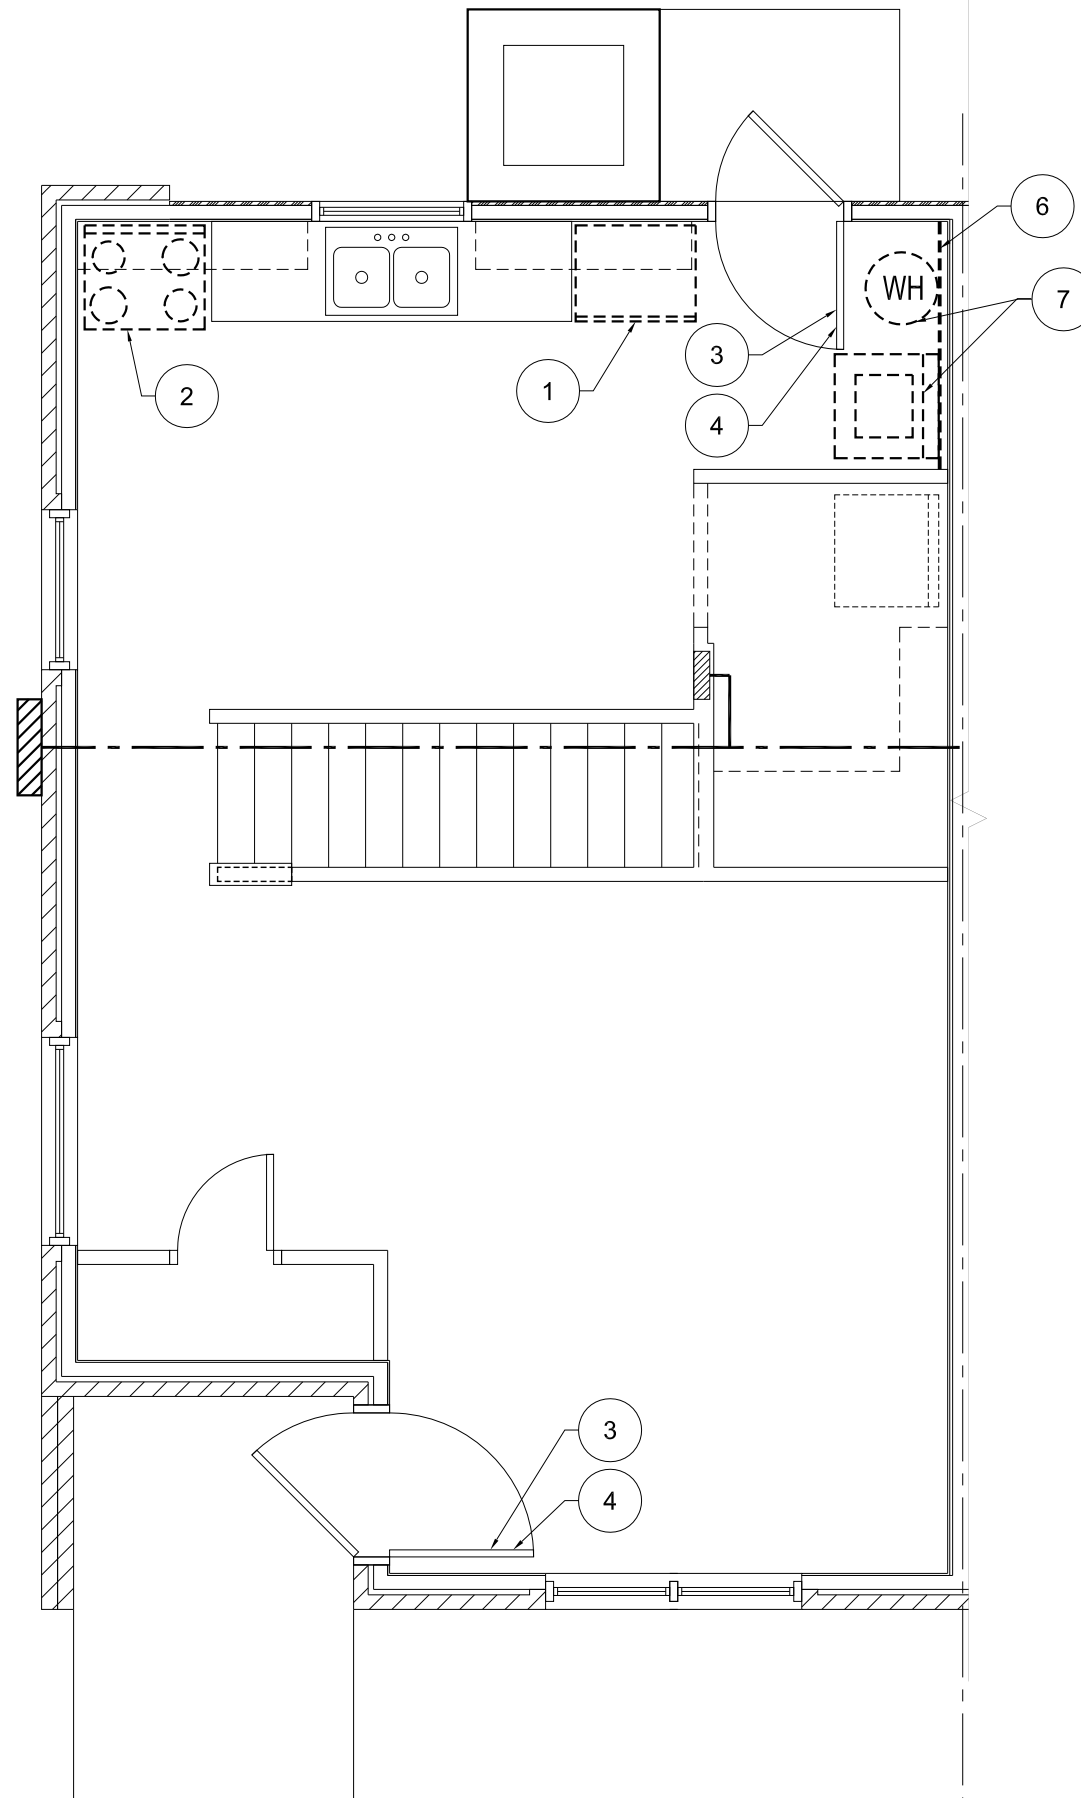

1 FIRST FLOOR PLAN - DEMO - BUILDINGS E, F & G
SCALE: 1/4" = 1'-0" 3BR - UNIT TYPE 4

LEGEND:

NEW LVT FLOOR

DEMOLITION NOTES AS REFERENCED BY 1

- REMOVE AND PROPERLY DISPOSE OF EXISTING REFRIGERATOR.
- REMOVE AND PROPERLY DISPOSE OF EXISTING OVEN/RANGE.
- REMOVE EXISTING DEADBOLT LOCK. ALLOW OWNER RIGHT OF FIRST REFUSAL. IF OWNER OPTS NOT TO KEEP THE OLD DEADBOLT LOCKS, THEN PROPERLY DISPOSE OF LOCKS.
- REMOVE EXISTING EXTERIOR PASSAGE SET. ALLOW OWNER RIGHT OF FIRST REFUSAL. IF OWNER OPTS NOT TO KEEP THE OLD PASSAGE SETS, THEN PROPERLY DISPOSE OF SETS.
- REMOVE AND PROPERLY DISPOSE OF WALL MOUNTED SINK.
- REMOVE EXISTING GWB FROM THE FACE OF PLUMBING WALL. TO ALLOW ACCESS TO PLUMBING RISERS.
- RELOCATE EXISTING APPLIANCES AND PLUMBING FIXTURES WHILE WORK IS BEING PERFORMED. STORE AND PROTECT.
- EXISTING KITCHEN CABINET WILL NEED TO BE REMOVED TO ALLOW ACCESS TO PLUMBING WALL. SALVAGE CABINET AND COUNTER TOP FOR REUSE AFTER NEW GWB IS INSTALLED.
- EXISTING UPPER CABINETS/ SHELVES WILL NEED TO BE REMOVED TO ALLOW ACCESS TO PLUMBING WALL. SALVAGE CABINET FOR REUSE AFTER NEW GWB IS INSTALLED.

NEW CONSTRUCTION NOTES AS REFERENCED BY 1

- INSTALL NEW REFRIGERATOR AND COMPLETE ALL NECESSARY CONNECTIONS.
- INSTALL NEW OVEN/RANGE AND COMPLETE ALL NECESSARY CONNECTIONS.
- INSTALL NEW DEADBOLT LOCK.
- INSTALL NEW EXTERIOR PASSAGE SET.
- INSTALL NEW LVT FLOOR SYSTEM TO EXTENT SHOWN. INSTALL NEW PRIMED AND PAINTED 3/4" SHOE MOLD @ FLOOR TO WALL TRANSITION.
- INSTALL NEW CONCRETE PAD FOR EXISTING CONDENSING UNITS. CONCRETE SHALL BE 4" THICK, 2000 PSI CONCRETE W/ 6X6 W.W.M. ON PROPER COMPACTED BASE.
- INSTALL NEW R-38 BLOWN IN BATT INSULATION AT ALL ATTIC SPACES.
- INSTALL NEW SINK AND VANITY.
- INSTALL NEW WALL MOUNTED SINK.
- INSTALL NEW MOISTURE RESISTANT GWB AFTER WORK IS COMPLETED.
- REINSTALL EXISTING APPLIANCES AND PLUMBING FIXTURES WHEN WORK IS COMPLETED.
- REINSTALL EXISTING KITCHEN CABINETS AND COUNTER TOPS. AFTER NEW GWB IS INSTALLED.
- REINSTALL EXISTING UPPER CABINETS/ SHELVES. AFTER NEW GWB IS INSTALLED.
- INSTALL 2 NEW METAL SUPPORT LEGS AT CORNERS OF SINK. SUPPORTS SHALL HAVE A POLISHED CHROME FINISH.
- NEW PLUMBING CHASE, 5/8" GYP. BD ON METAL STUDS. OVERALL DIMENSIONS 4 1/4" X 4 1/4" MIN.

TYPE	DESCRIPTION
	EXISTING TO BE REMOVED - WALL REMOVAL TO EXTEND TO NEXT WHOLE STUD BEYOND WHAT IS SHOWN ON DWGS. - SHOWN WORK IS MINIMAL REMOVAL
	EXISTING TO REMAIN
	NEW GYP. BD. ON EXISTING STUD FRAMING WHERE PLUMBING RISER WAS REPLACED.

E BUILDINGS: 9 BLDGS - 36 UNITS
F BUILDINGS: 4 BLDGS - 24 UNITS
G BUILDINGS: 2 BLDGS - 16 UNITS
1 = STRAIGHT GABLE ROOF TYPE
2 = HIP ROOF TYPE
3 = MULTIPLE GABLE ROOF TYPE



DATE	ISSUE FOR

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Sheet Title
**BUILDINGS E, F & G
UNIT PLANS -
NEW & DEMO**

Project Number 18110	Sheet Number A-105
Date 10-08-18	