




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STA. 72+14.07 to STA. 72+52.92

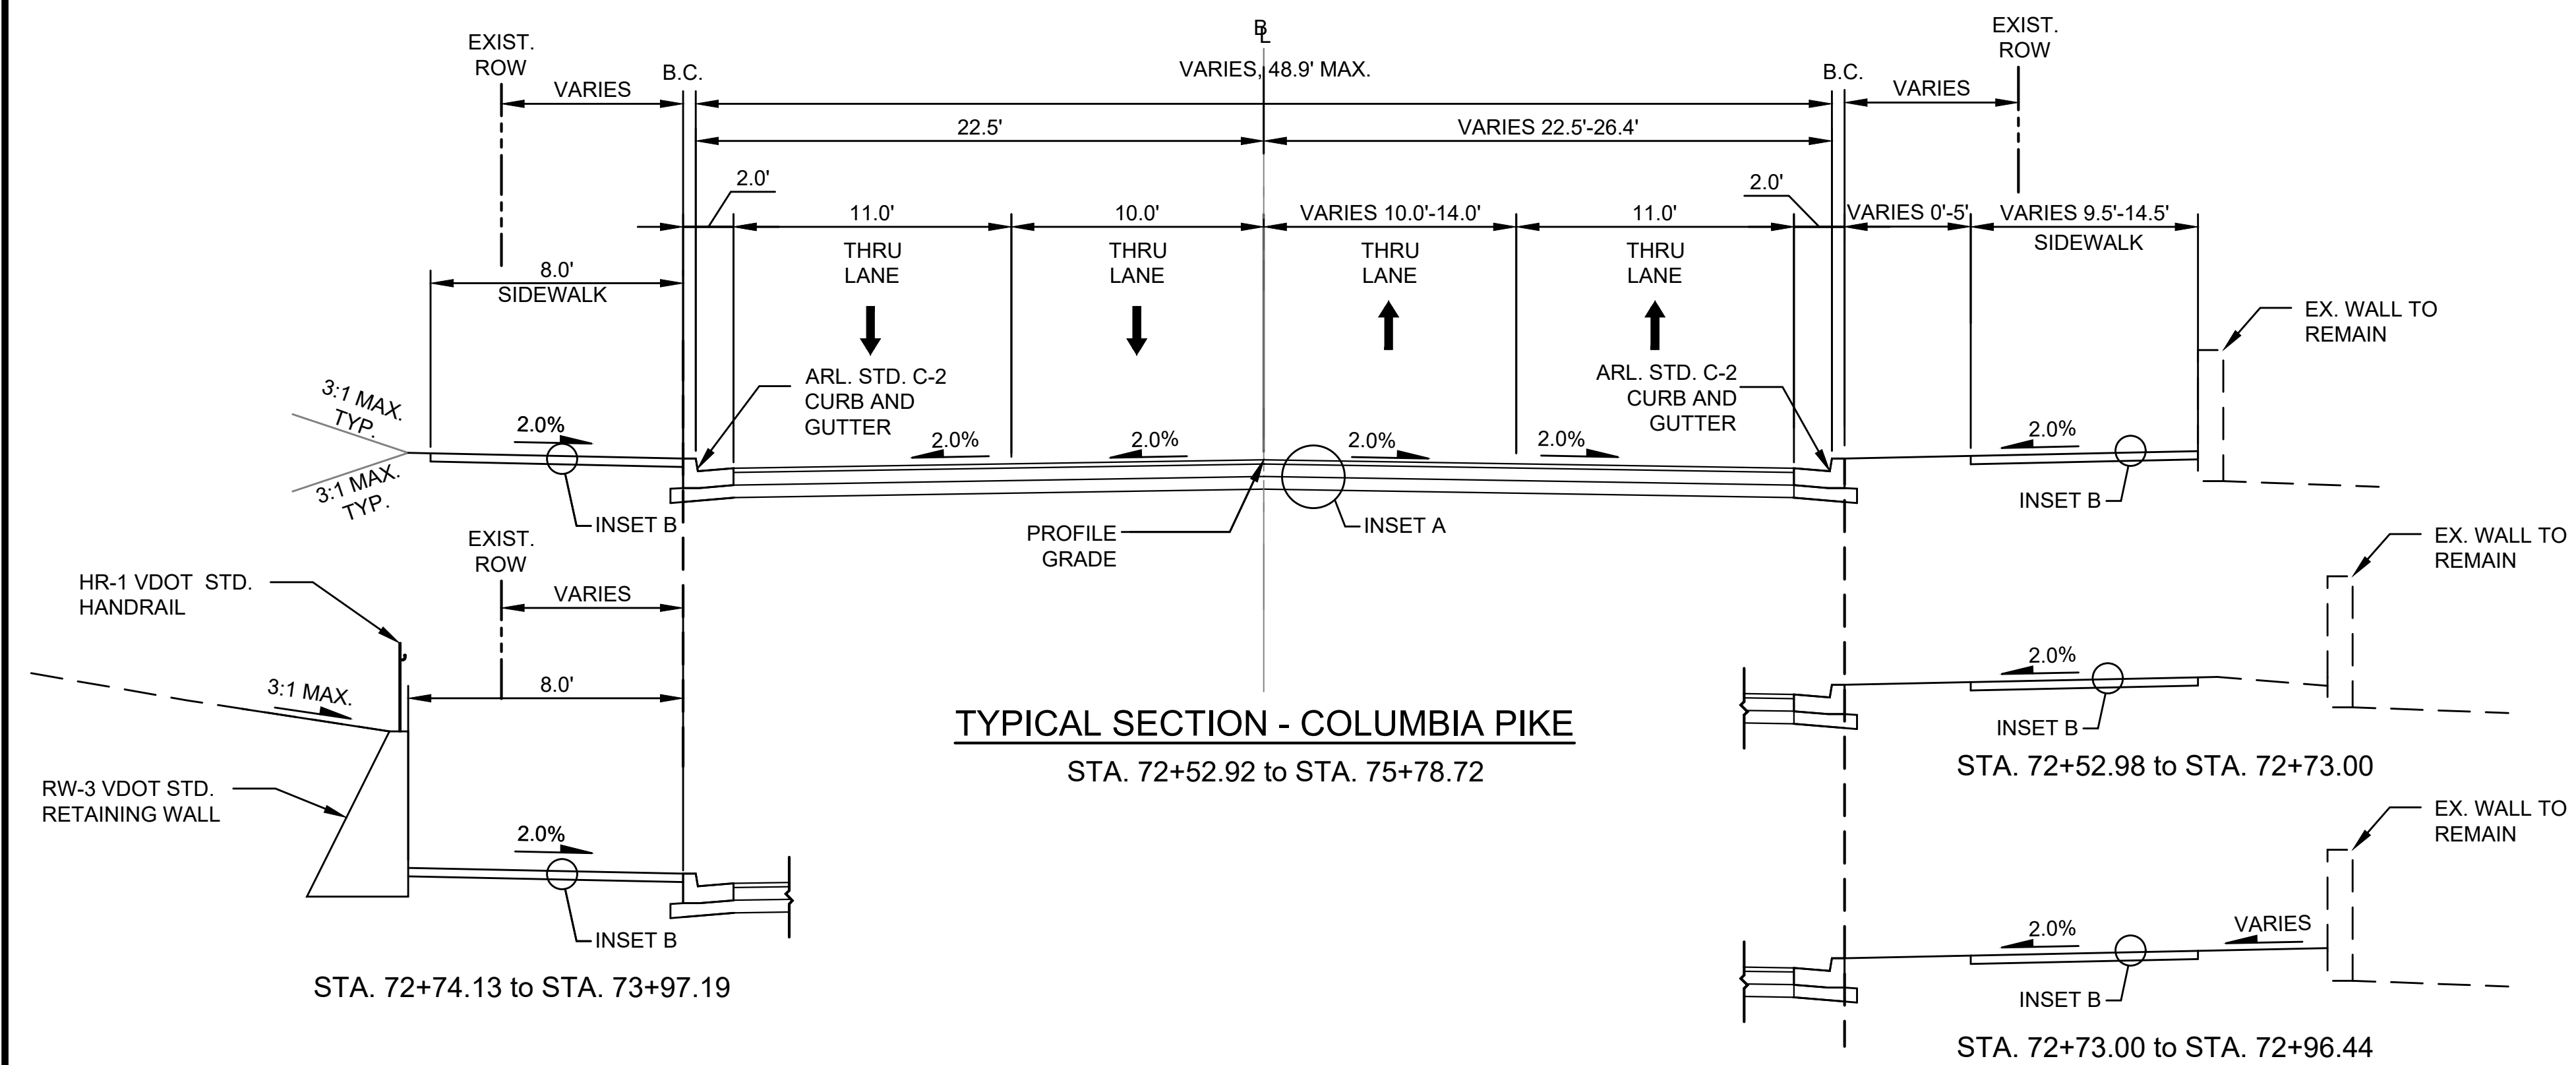


TYPICAL SECTION - COLUMBIA PIKE
STA. 72+52.92 to STA. 75+78.72

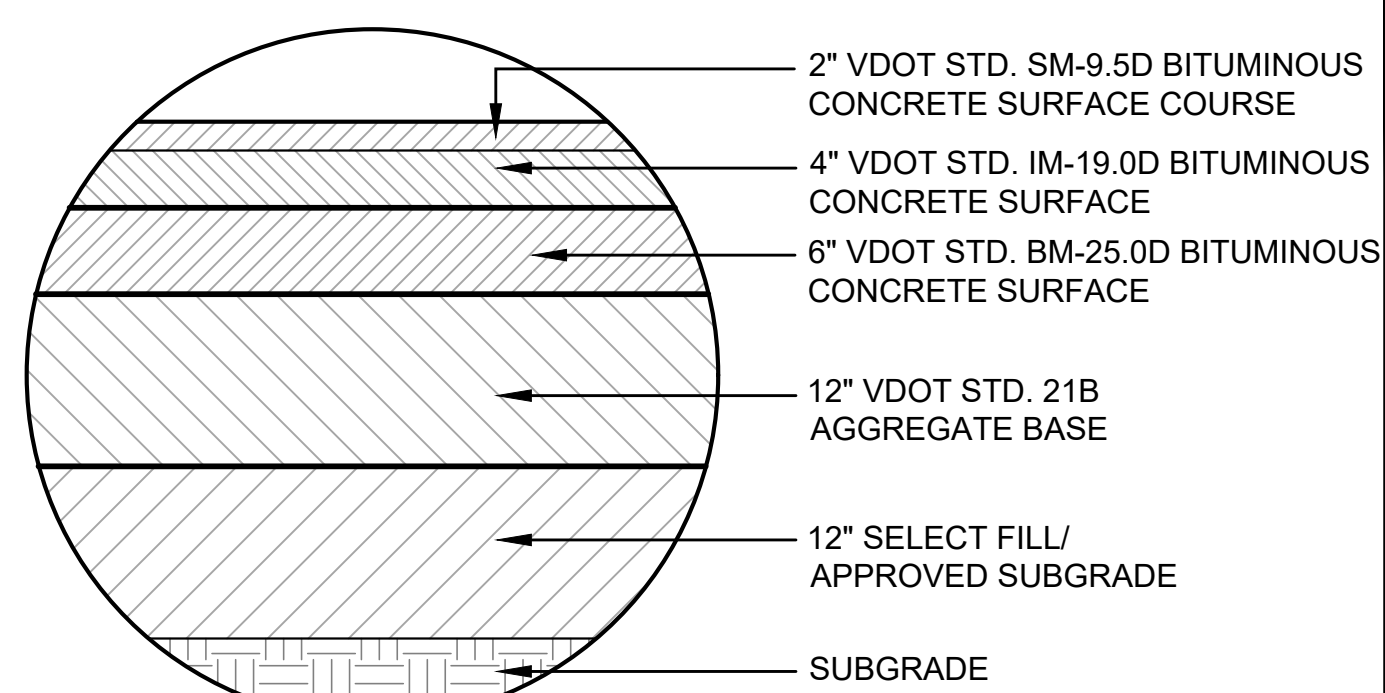


INSET A
FULL DEPTH PAVEMENT

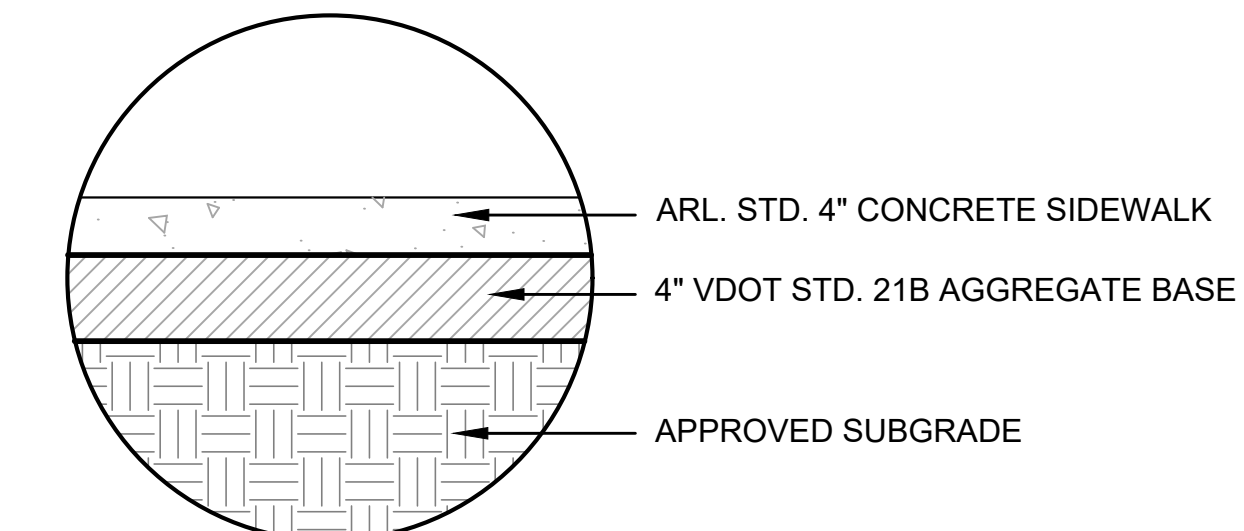


INSET B
SIDEWALK

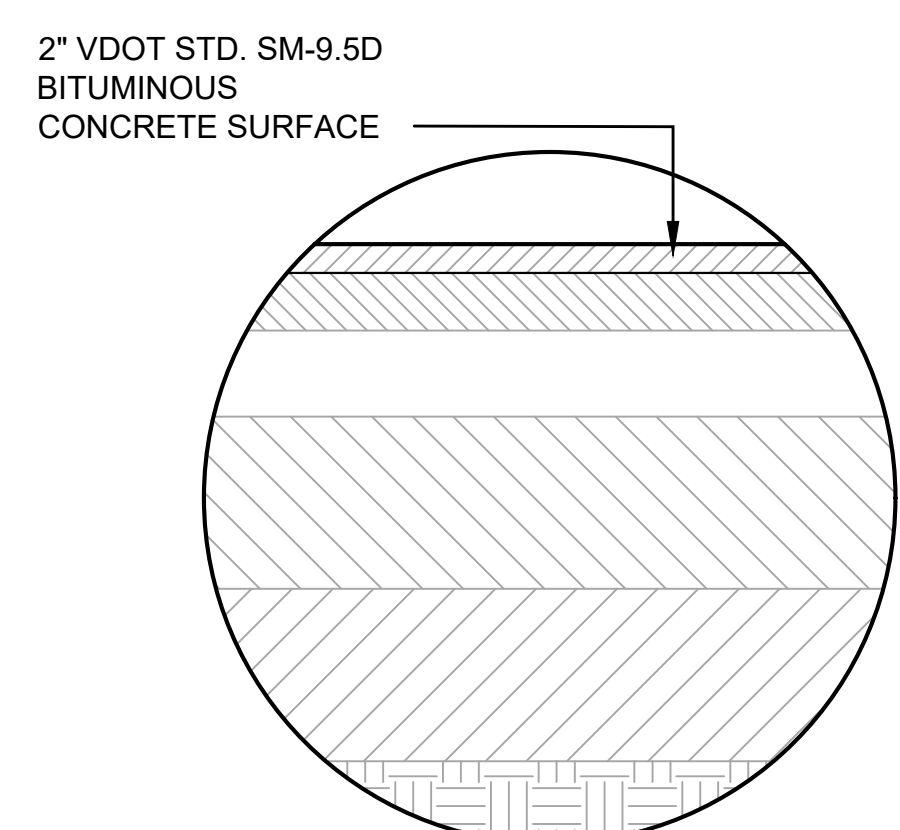

INSET D
MILL & OVERLAY PAVEMENT

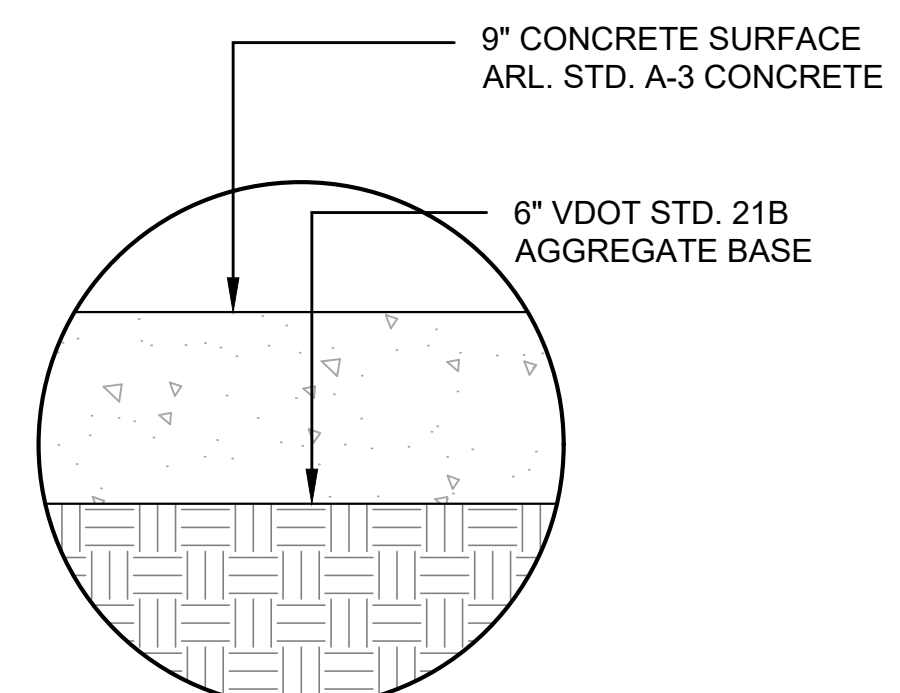


CONCRETE PAVEMENT SECTION:
COMMERCIAL DRIVEWAY

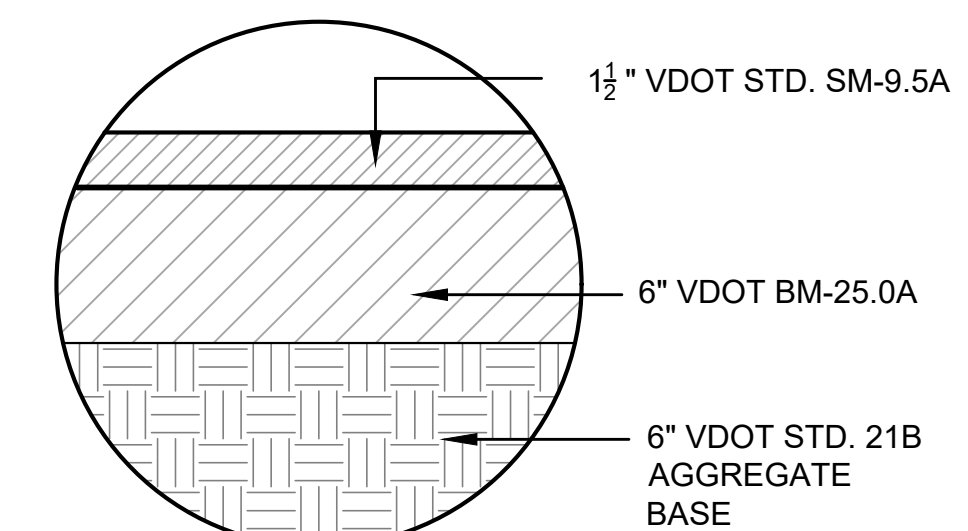

PAVEMENT SECTION:
PRIVATE DRIVEWAY

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Reston, Virginia 20191
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Fax: 703-674-1300

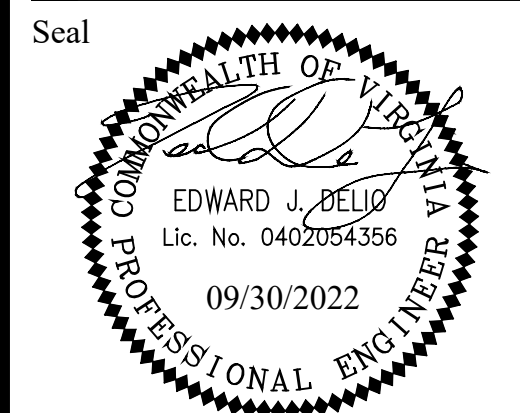

Approvals _____ Date _____

Design Team Engineer Supervisor _____

Construction Management Supervisor _____

Water, Sewer, Streets Bureau Chief _____

Transportation Director _____

Project Manager _____

Revisions _____ Date _____

Designed: MAT
Drawn: MAT
Checked: EJD
Miss Utility Transmittal #: _____



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Plotted: September 30, 2022
Plotted by: Thomas.Super

ARLINGTON COUNTY, VIRGINIA
DEPARTMENT OF ENVIRONMENTAL SERVICES

TYPICAL SECTIONS
COLUMBIA PIKE - ROUTE 244
COLUMBIA PIKE - MULTIMODAL STREET IMPROVEMENTS
SEGMENT C

SCALE: HOR. N/A VERT. N/A SHEET: C3.1 of C3.5

ARLINGTON VIRGINIA
DEPARTMENT OF ENVIRONMENTAL SERVICES
Luis Araya
BUREAU CHIEF, DES - DEVELOPMENT SERVICES
11/15/2022
APPROVAL DATE

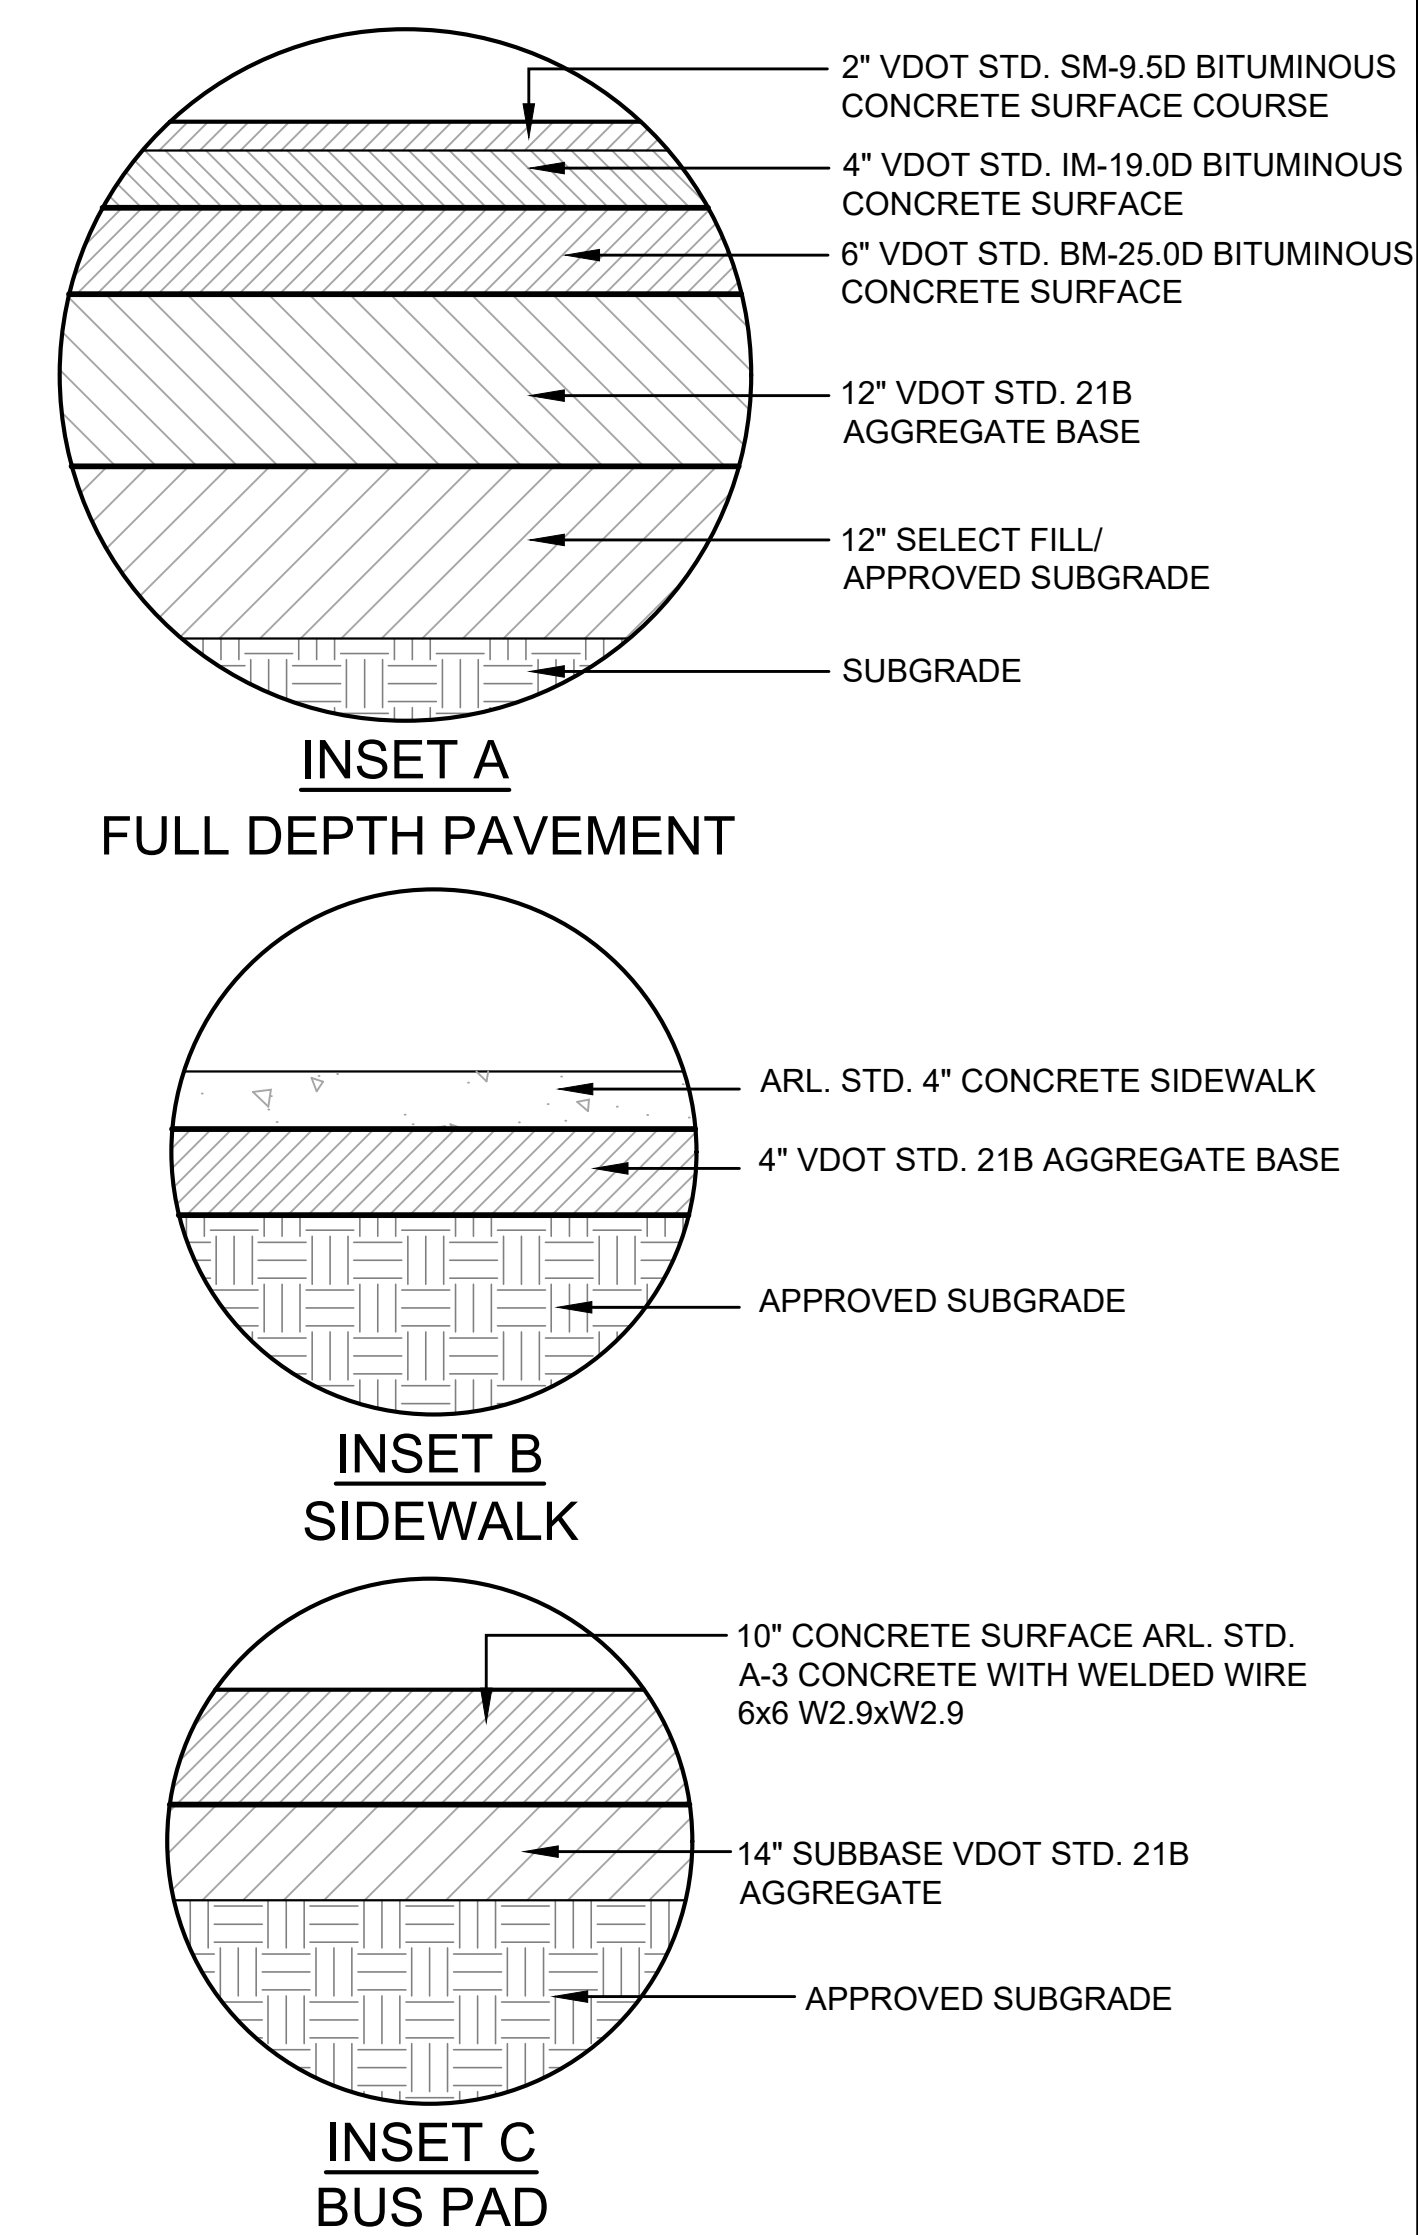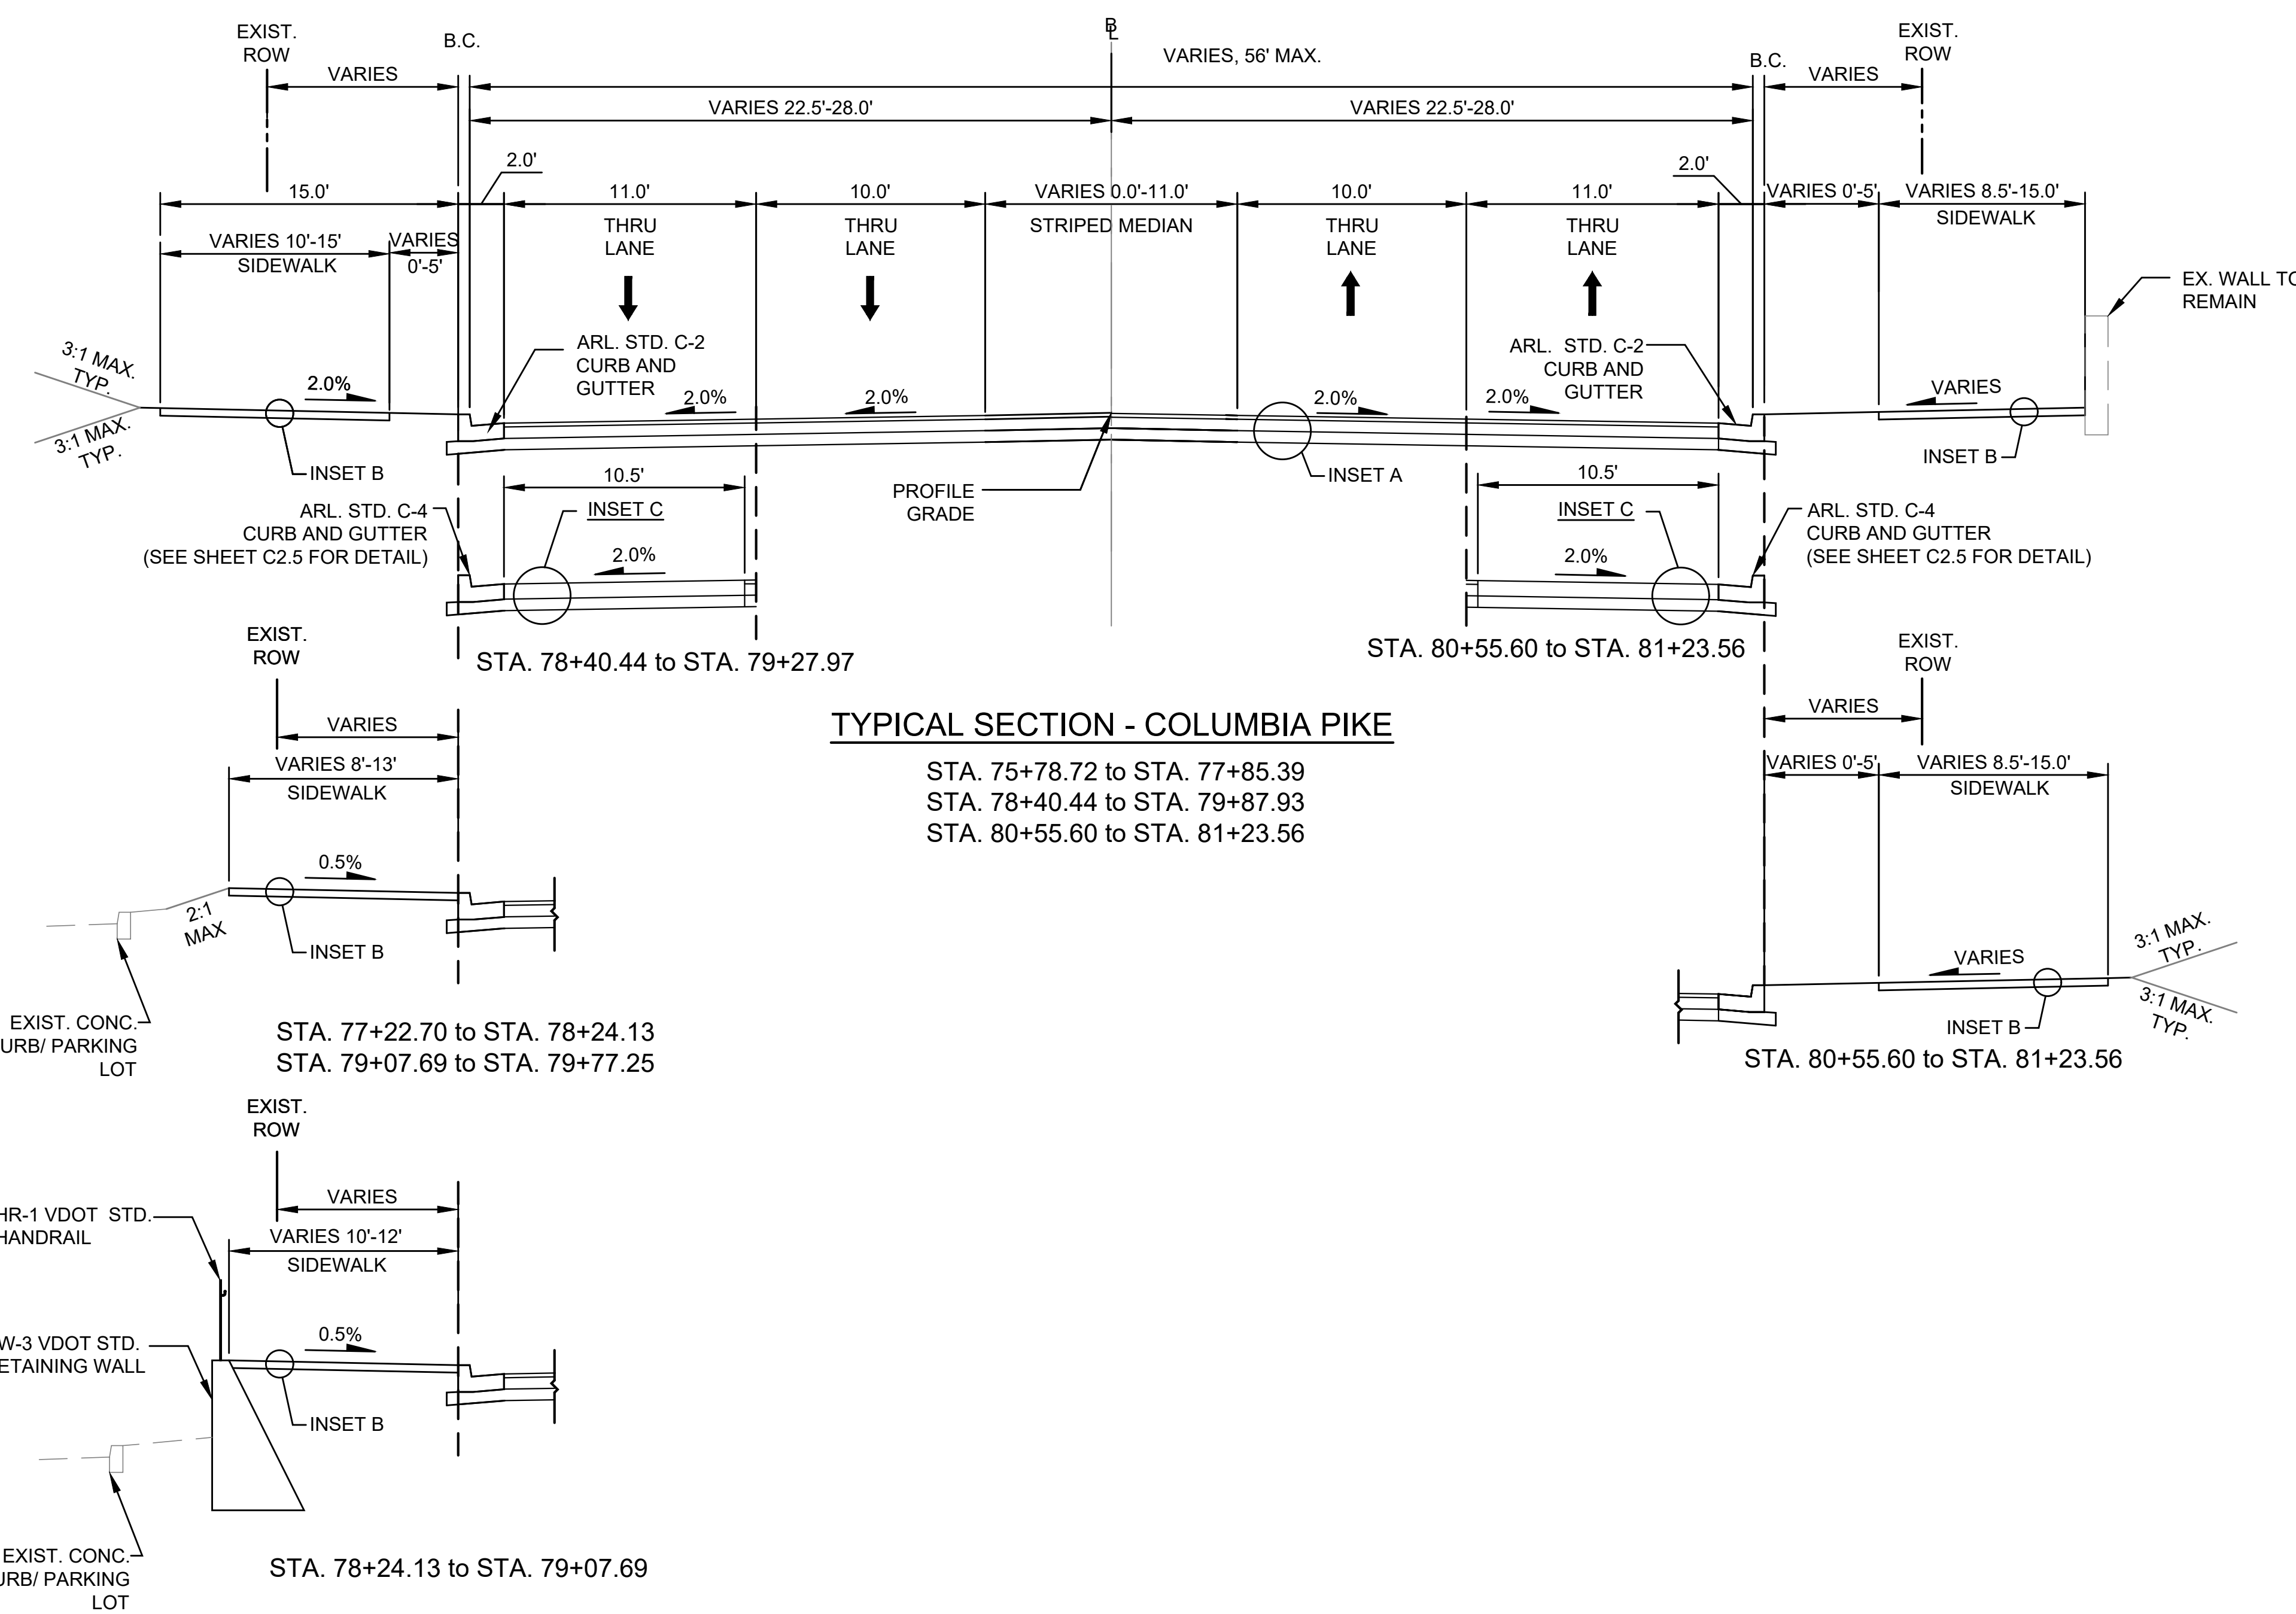

ARLINGTON VIRGINIA

DEPARTMENT OF ENVIRONMENTAL SERVICES

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Seal

EDWARD J. DELIO
 Lic. No. 0402054356
 09/30/2022
 PROFESSIONAL ENGINEER

Approvals	Date
Design Team Engineer Supervisor	
Construction Management Supervisor	
Water, Sewer, Streets Bureau Chief	
Transportation Director	
Project Manager	

Revisions	Date

Designed: MAT
 Drawn: MAT
 Checked: EJD
 Miss Utility Transmittal #:

Filename: 010073-C-TYP-SEC.dwg
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 Plotted: September 30, 2022
 Plotted by: Thomas.Super

ARLINGTON COUNTY, VIRGINIA
 DEPARTMENT OF ENVIRONMENTAL SERVICES

TYPICAL SECTIONS
 COLUMBIA PIKE - ROUTE 244
 COLUMBIA PIKE - MULTIMODAL STREET IMPROVEMENTS
 SEGMENT C


SCALE: HOR. 1" = 10' VERT. 1" = 10' SHEET: C3.1.1 of C3.5

ARLINGTON VIRGINIA

DEPARTMENT OF ENVIRONMENTAL SERVICES

Luiz Araya
 BUREAU CHIEF, DES - DEVELOPMENT SERVICES



11/15/2022
 APPROVAL DATE

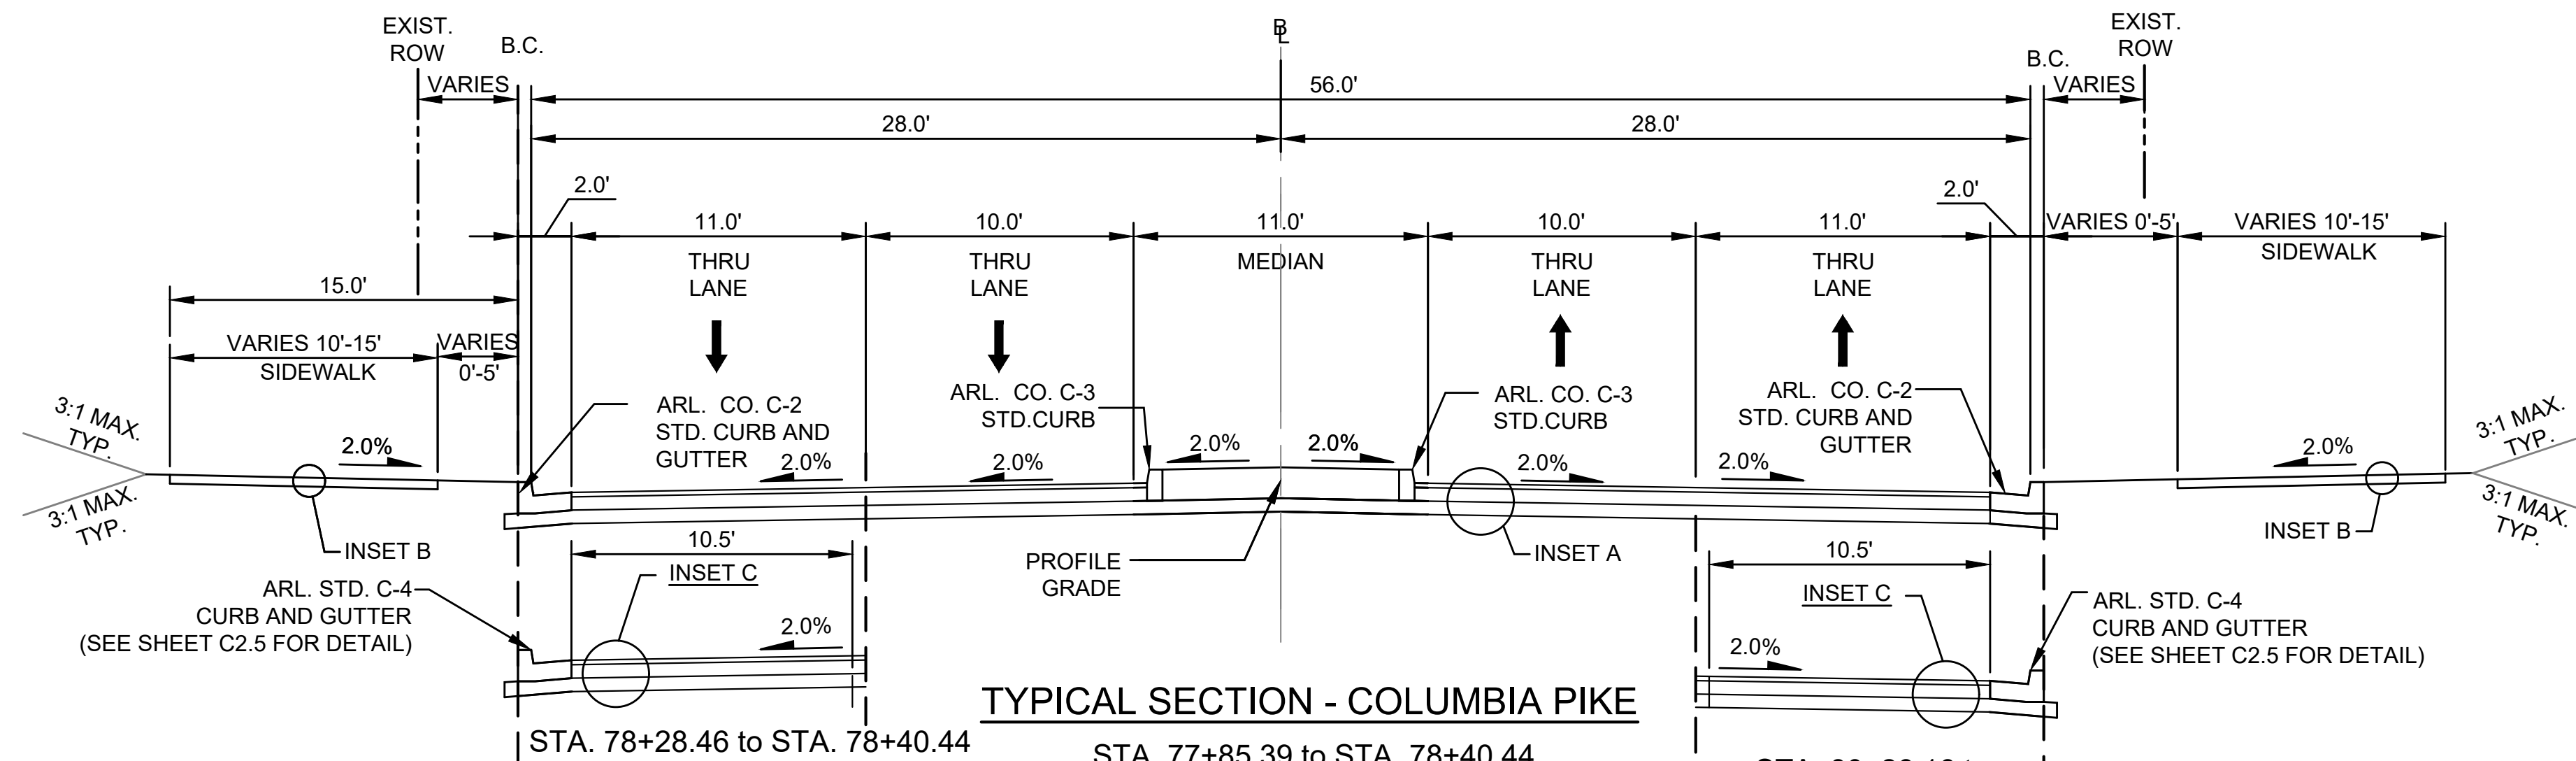


*FOR ALTERNATE BACK-OF-CURB TREATMENTS, SEE THIS SHEET

TYPICAL SECTION - COLUMBIA PIKE


STA. 77+85.39 to STA. 78+40.44
 STA. 79+87.93 to STA. 80+55.60
 STA. 81+23.56 to STA. 81+74.64
 STA. 84+80.34 to STA. 85+99.34

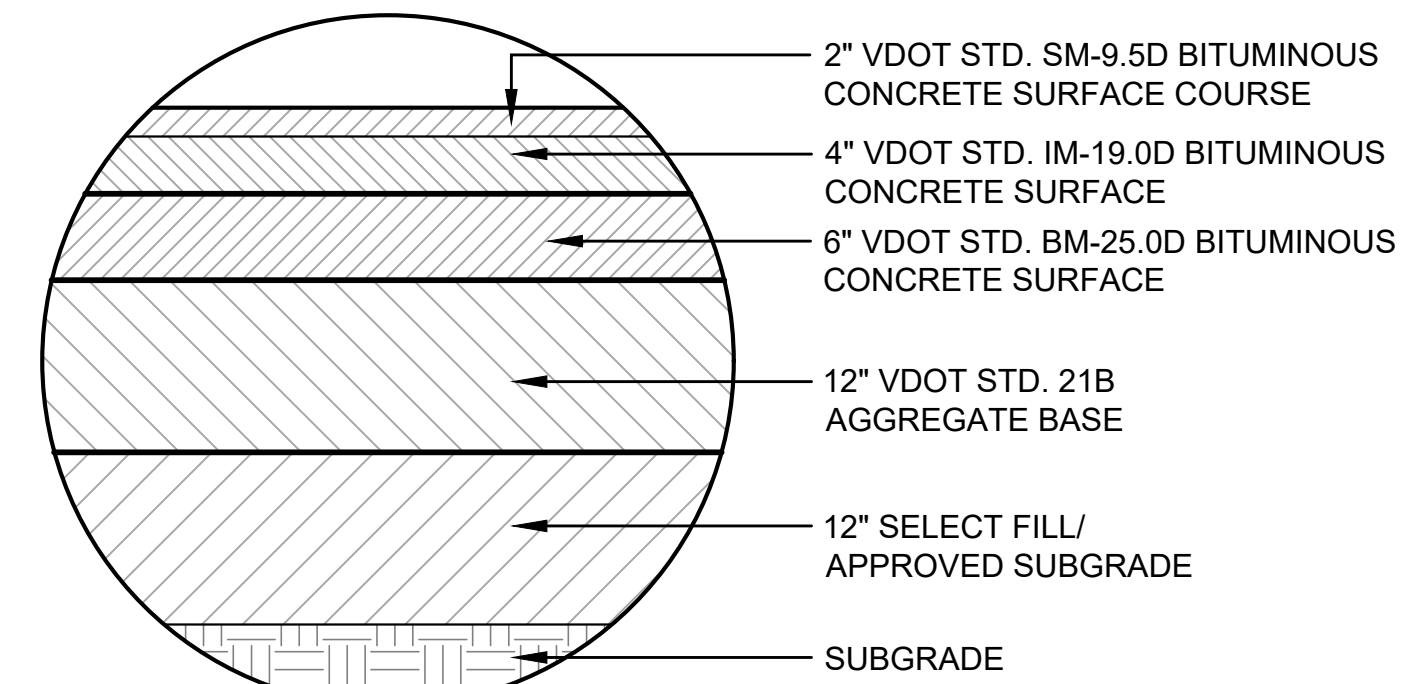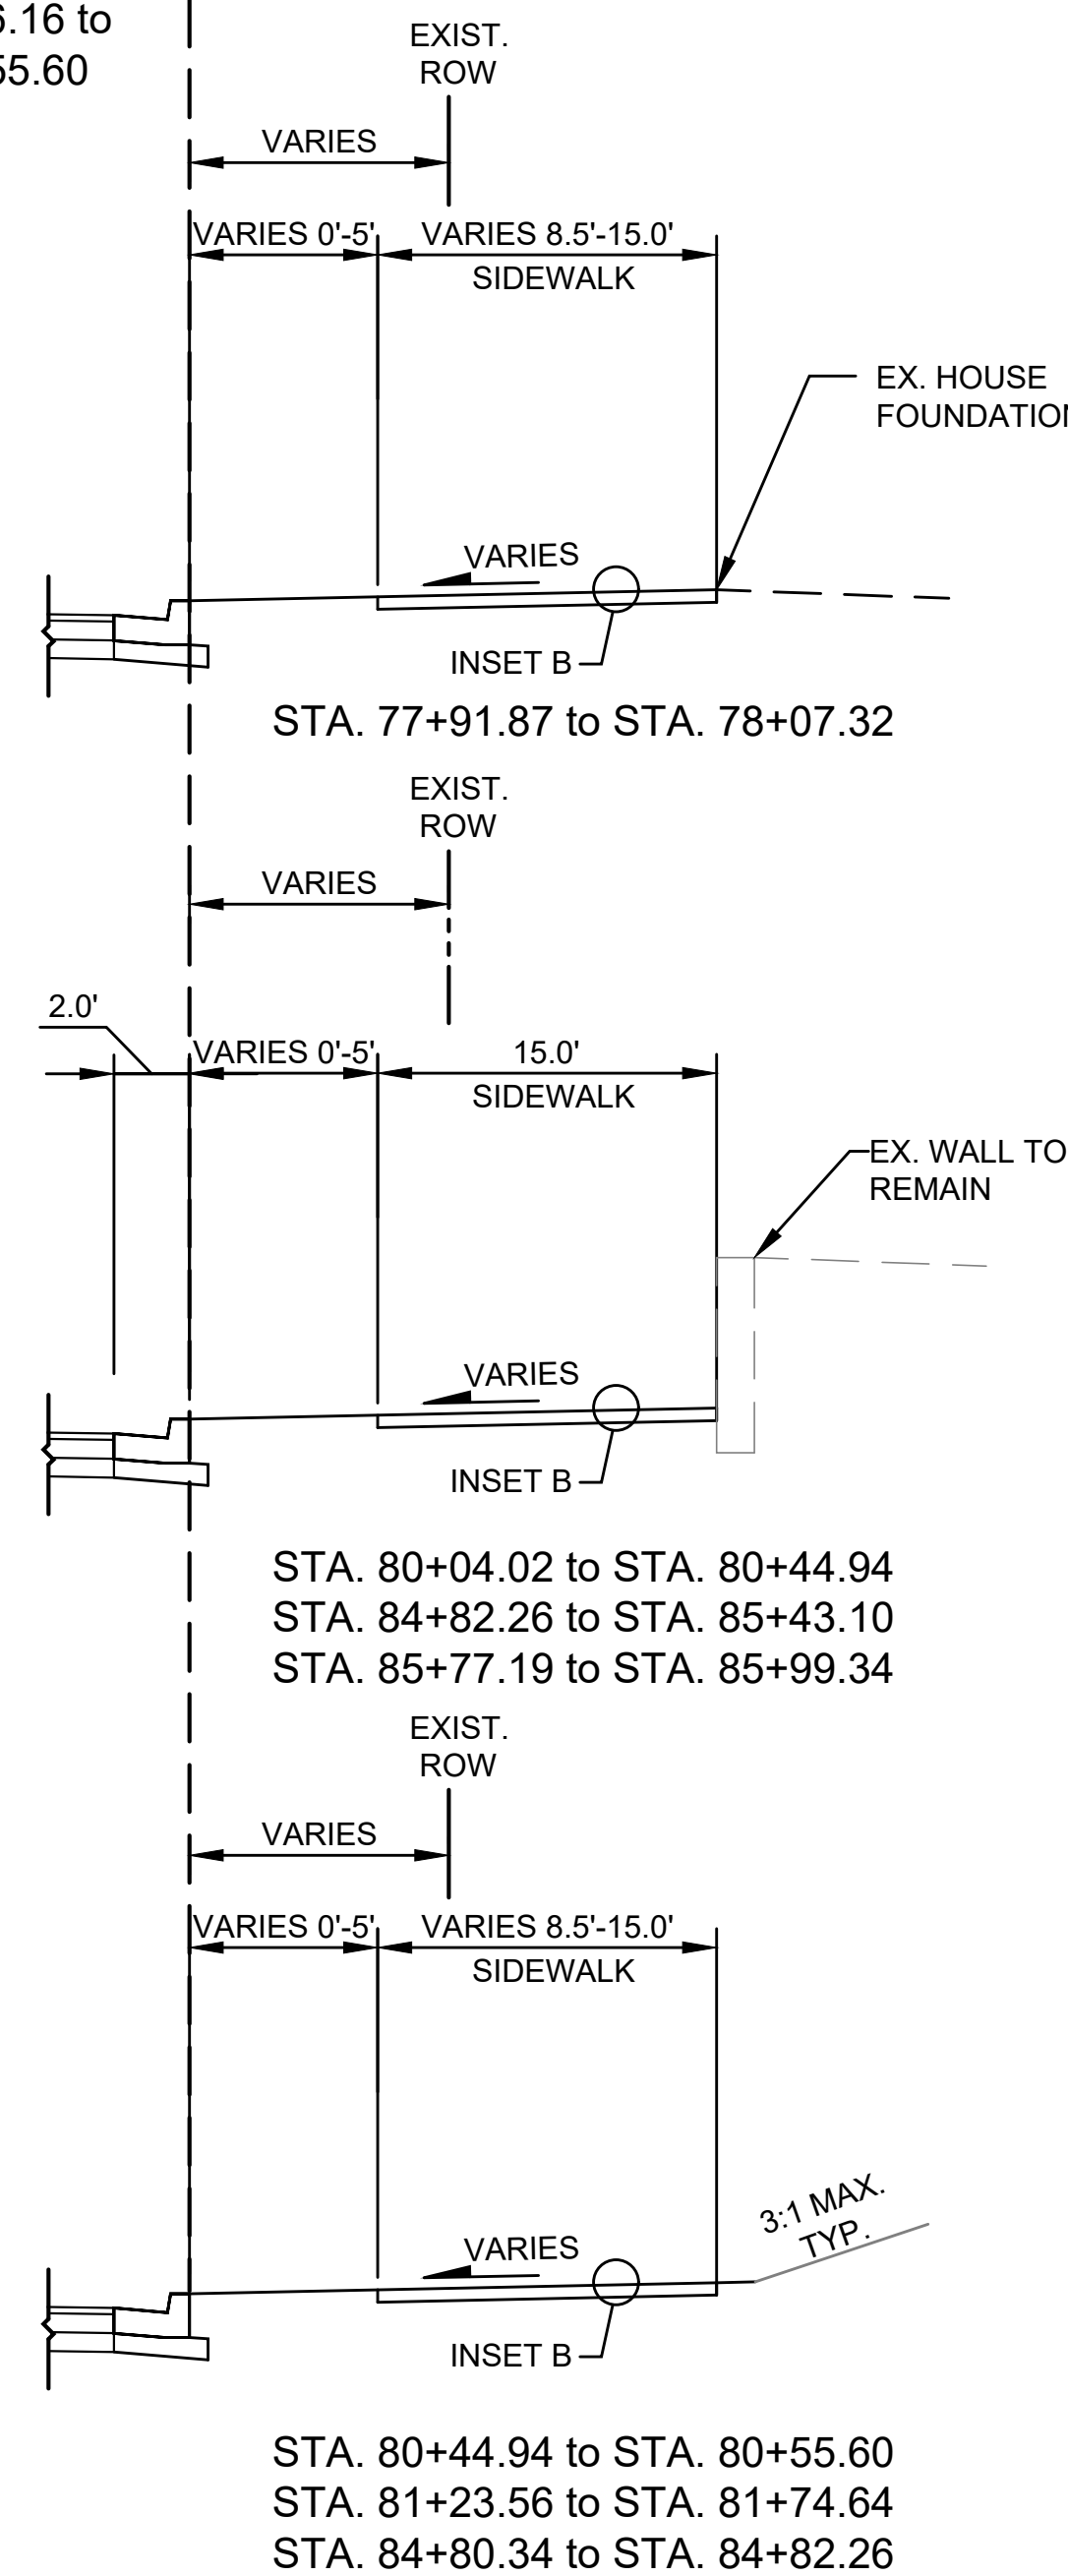

**INSET A
FULL DEPTH PAVEMENT**

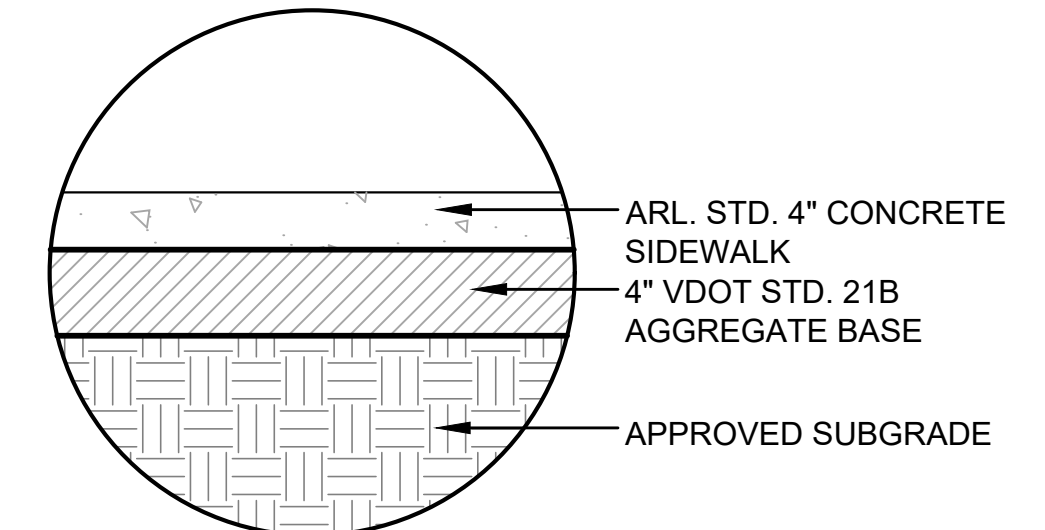

**INSET B
SIDEWALK**

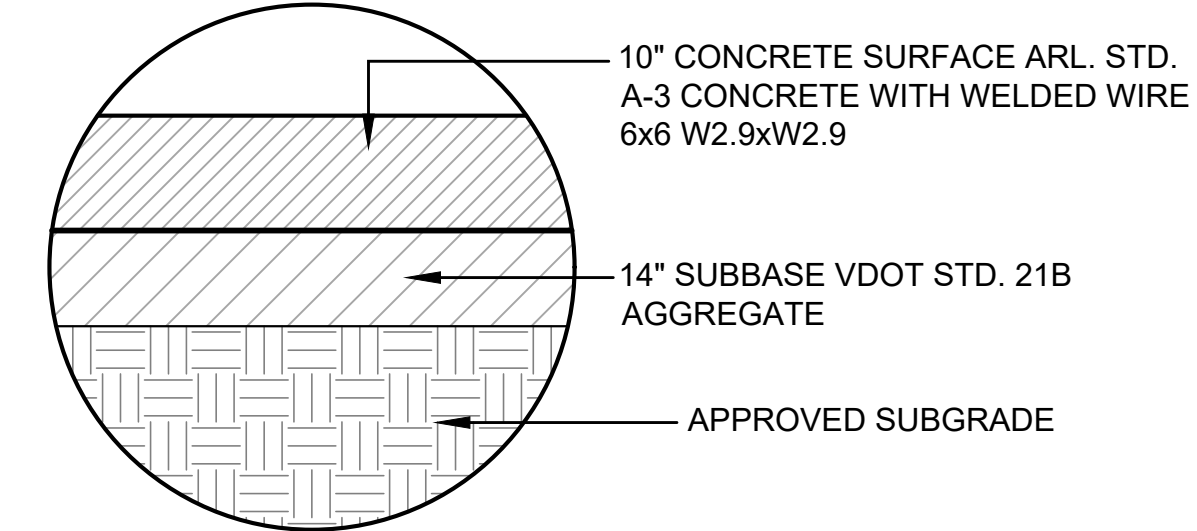


**INSET C
BUS PAD**



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Approvals _____ Date _____

Design Team Engineer Supervisor _____

Construction Management Supervisor _____

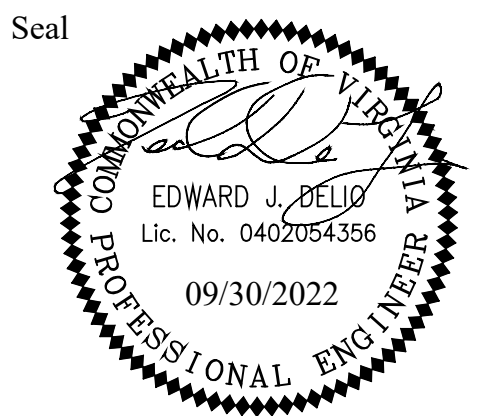Water, Sewer, Streets Bureau Chief _____

Transportation Director _____


Project Manager _____

Revisions _____ Date _____

Designed: MAT
 Drawn: MAT
 Checked: EJD
 Miss Utility Transmittal #: _____


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 Plotted: September 30, 2022
 Plotted by: Thomas.Super

ARLINGTON COUNTY, VIRGINIA DEPARTMENT OF ENVIRONMENTAL SERVICES	
TYPICAL SECTIONS COLUMBIA PIKE - ROUTE 244 COLUMBIA PIKE - MULTIMODAL STREET IMPROVEMENTS SEGMENT C	
SCALE: HOR. N/A VERT. N/A	SHEET: C3.2 of C3.5

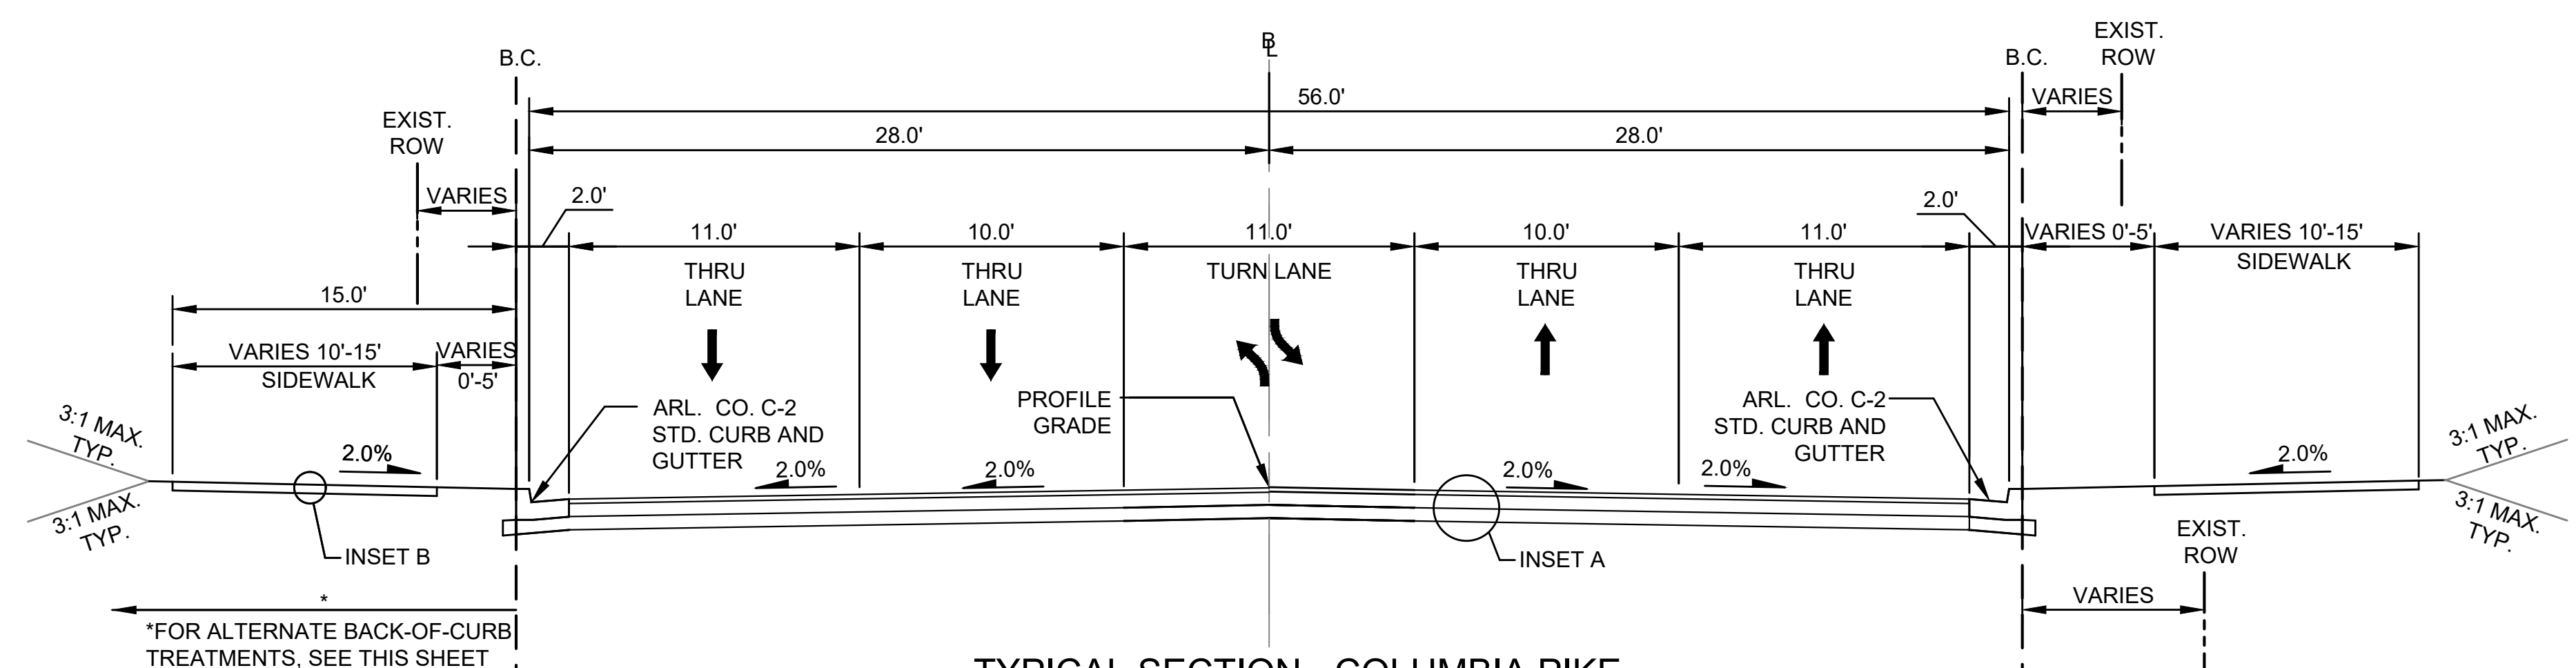


TYPICAL SECTION - COLUMBIA PIKE


STA. 81+74.64 to STA. 84+80.34
 STA. 85+99.34 to STA. 88+50.00

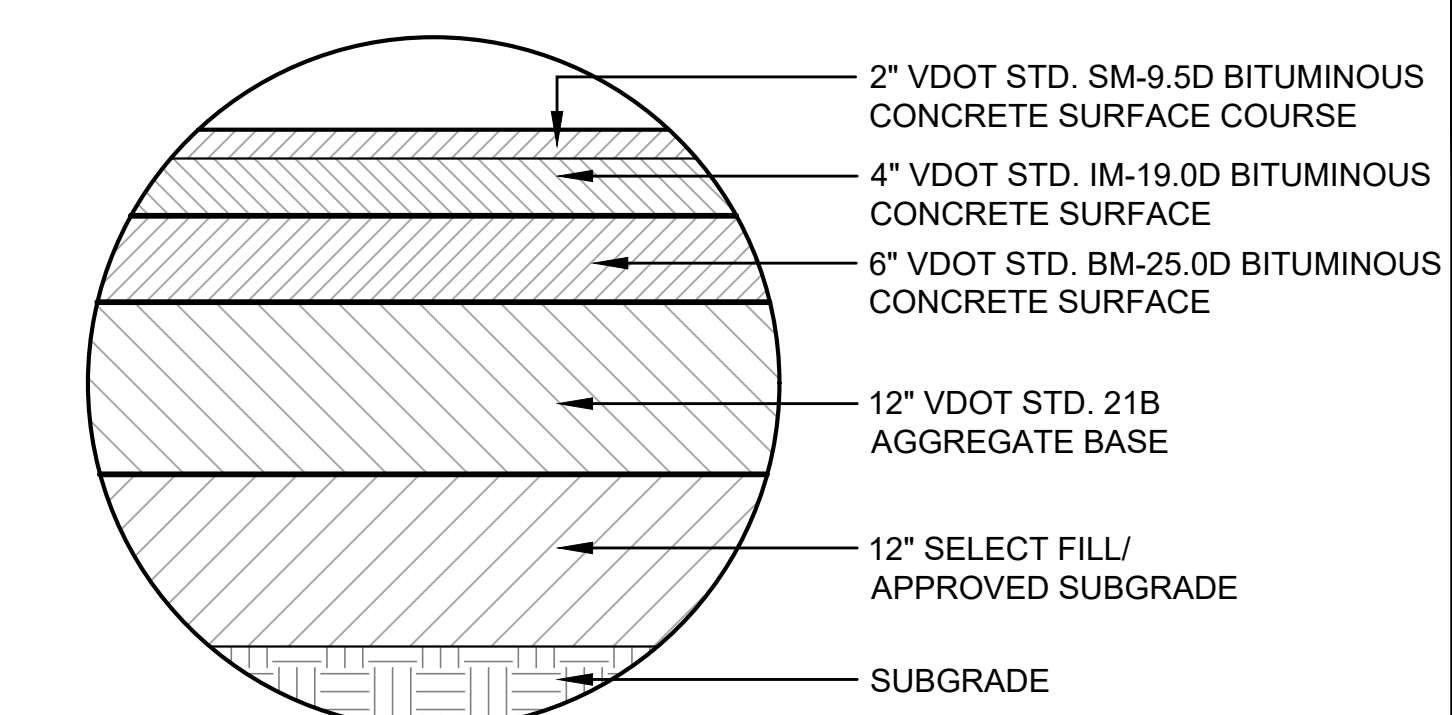

INSET A
 FULL DEPTH PAVEMENT

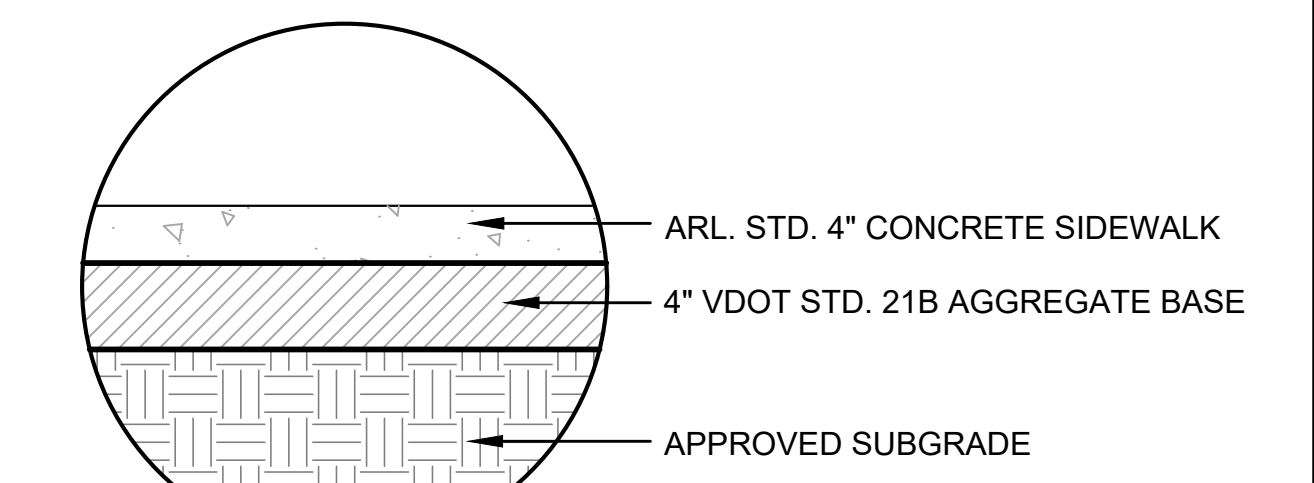


INSET B
 SIDEWALK

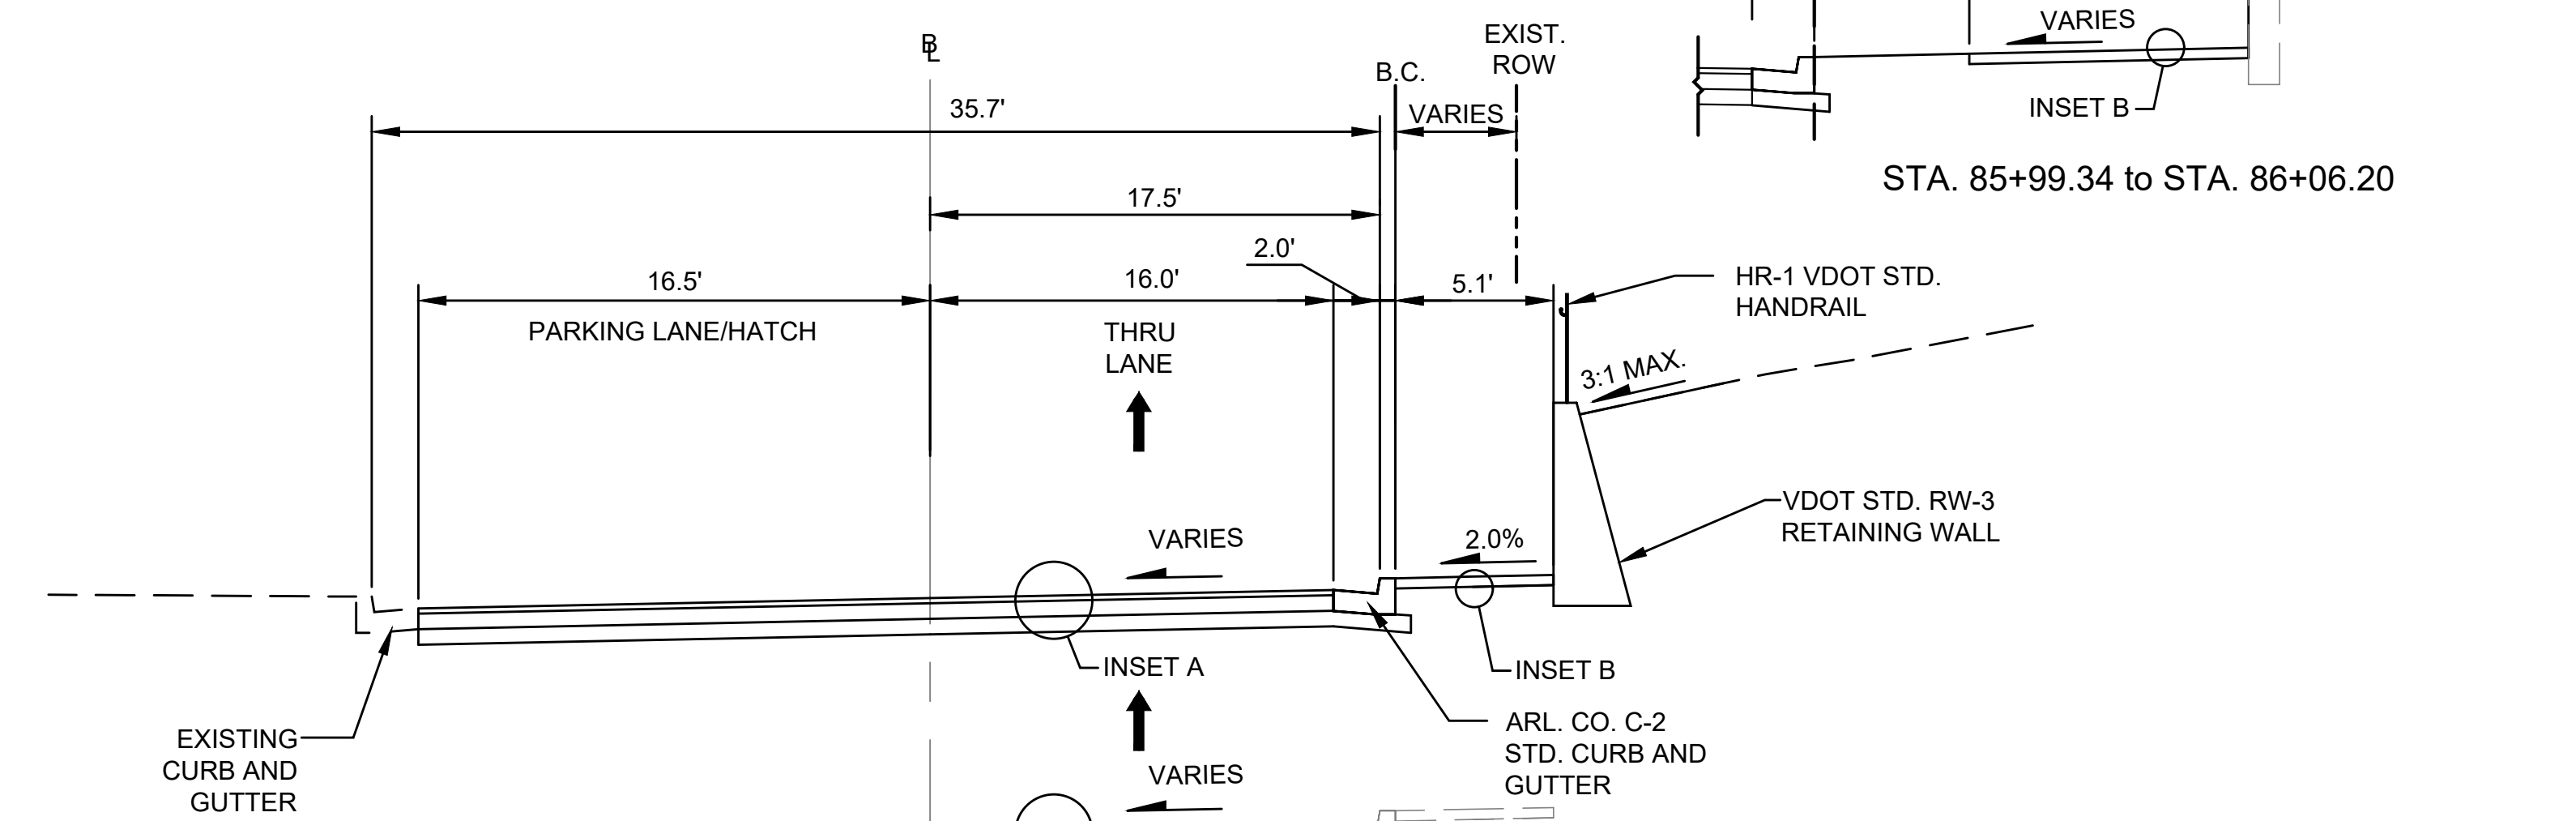


TYPICAL SECTION - S. QUINN STREET

STA. 40+51.77 to STA. 40+71.52
 STA. 40+00.00 to STA. 40+71.52

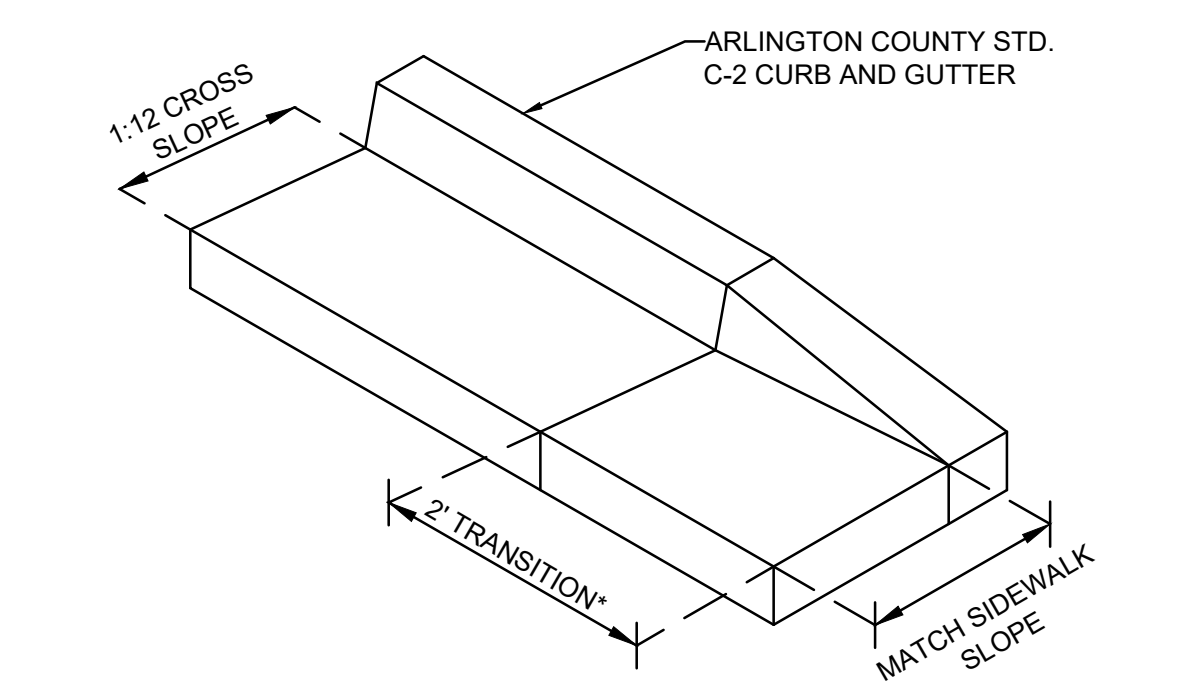


ENTRANCE CURB & GUTTER TRANSITION DETAIL

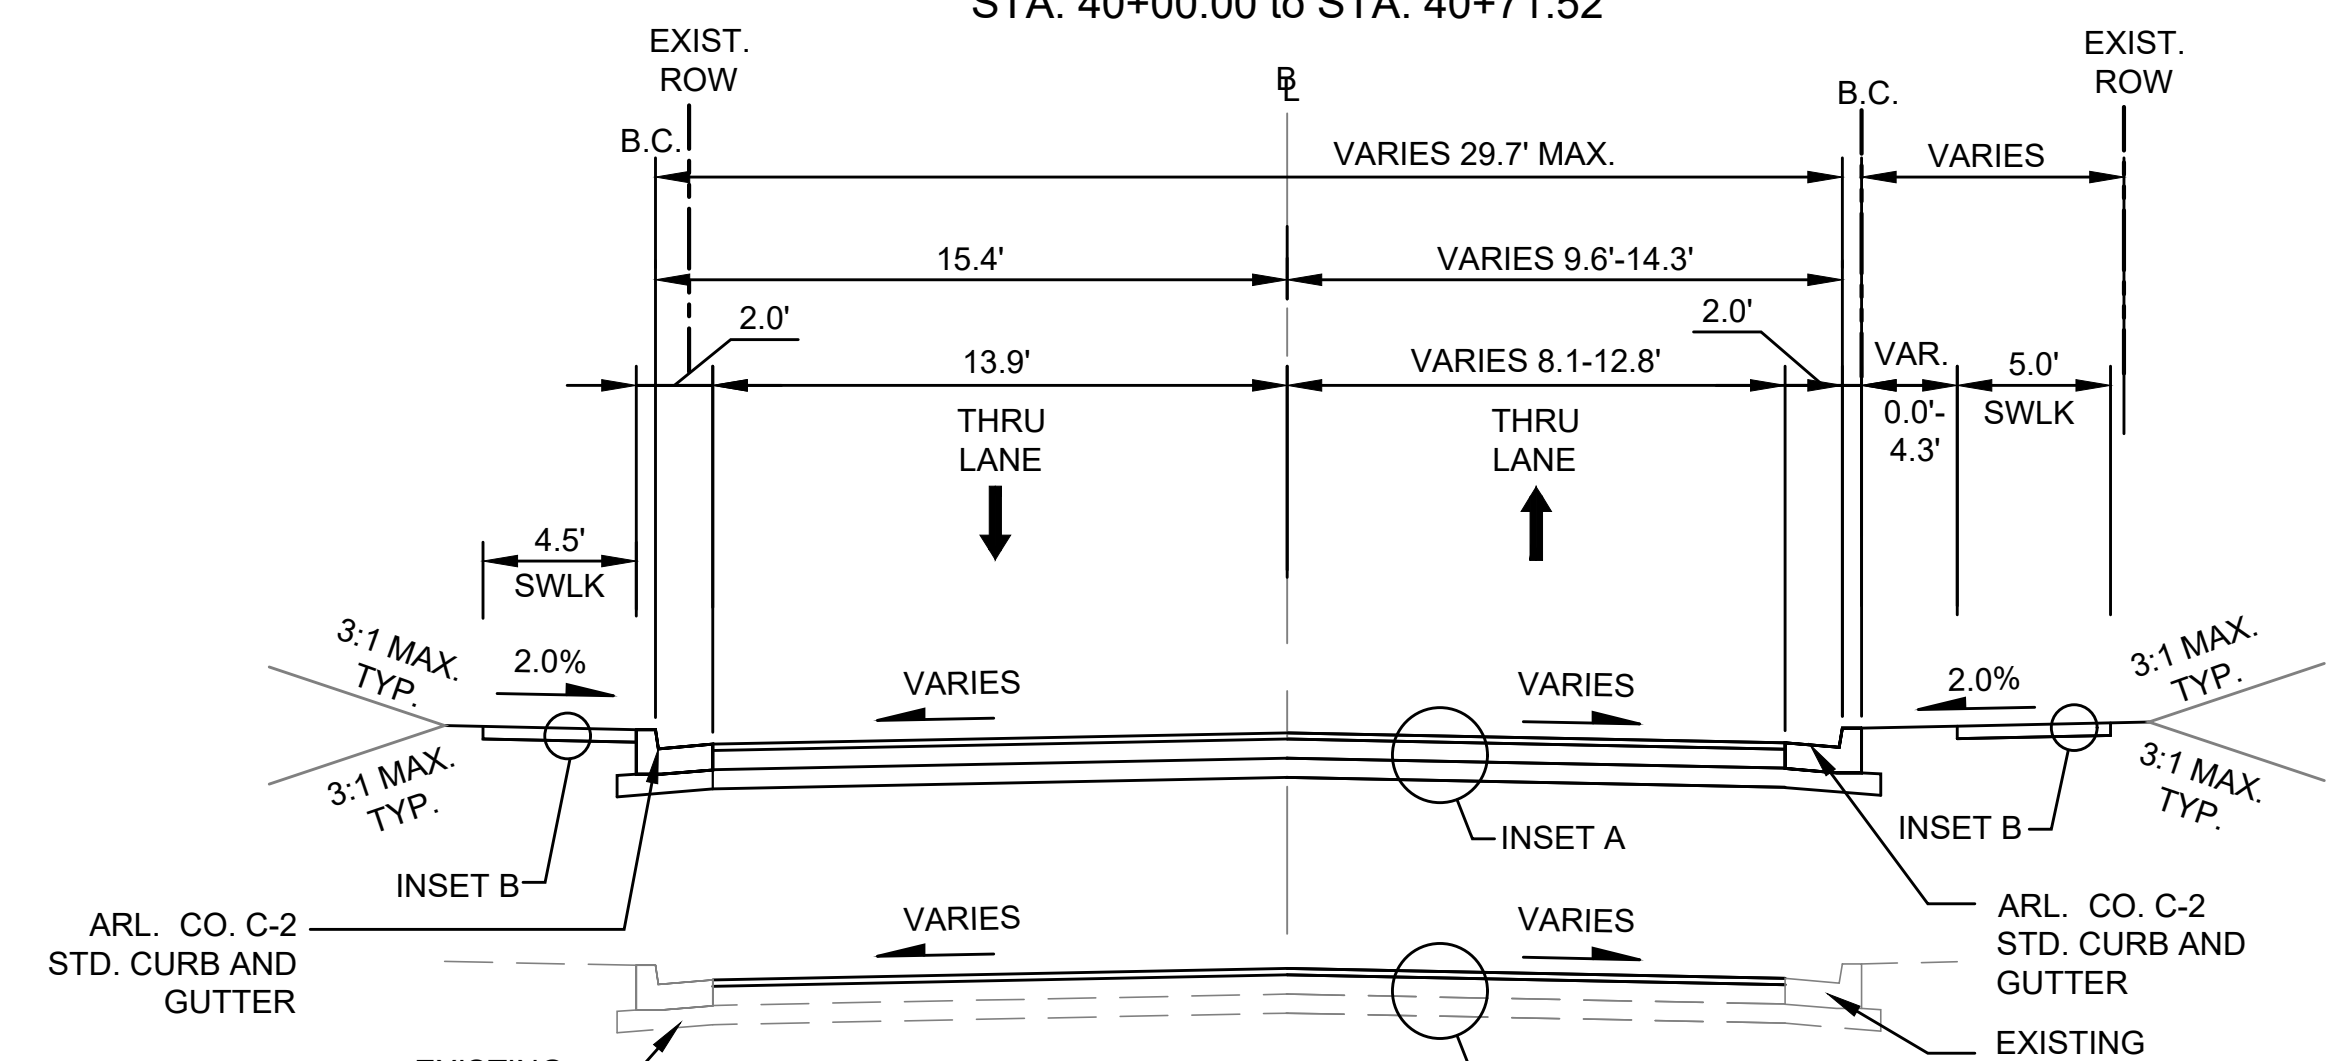

TYPICAL SECTION - S. ROLFE ST. SOUTH OF COLUMBIA PIKE

STA. 45+98.89 to STA. 46+15.75
 STA. 45+52.29 to STA. 46+15.75

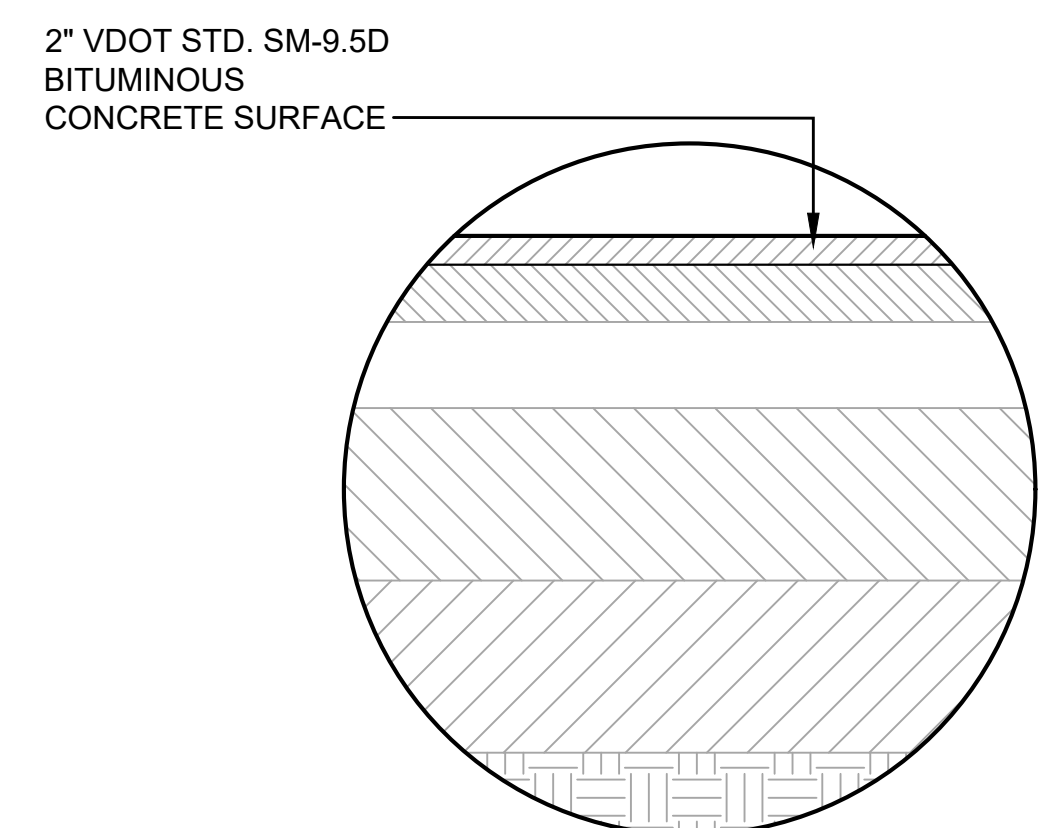

INSET D
 MILL & OVERLAY PAVEMENT

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Seal
 COMMONWEALTH OF VIRGINIA
 EDWARD J. DEJONG
 Lic. No. 0402054356
 09/30/2022
 PROFESSIONAL ENGINEER

Approvals	Date
Design Team Engineer Supervisor	
Construction Management Supervisor	
Water, Sewer, Streets Bureau Chief	
Transportation Director	
Project Manager	
Revisions	Date


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 Checked: EJD
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 Plotted: September 30, 2022
 Plotted by: Thomas.Super

ARLINGTON COUNTY, VIRGINIA
 DEPARTMENT OF ENVIRONMENTAL SERVICES


TYPICAL SECTIONS
 COLUMBIA PIKE - ROUTE 244
 COLUMBIA PIKE - MULTIMODAL STREET IMPROVEMENTS
 SEGMENT C

SCALE:	HOR. N/A VERT. N/A	SHEET:	C3.3 of C3.5
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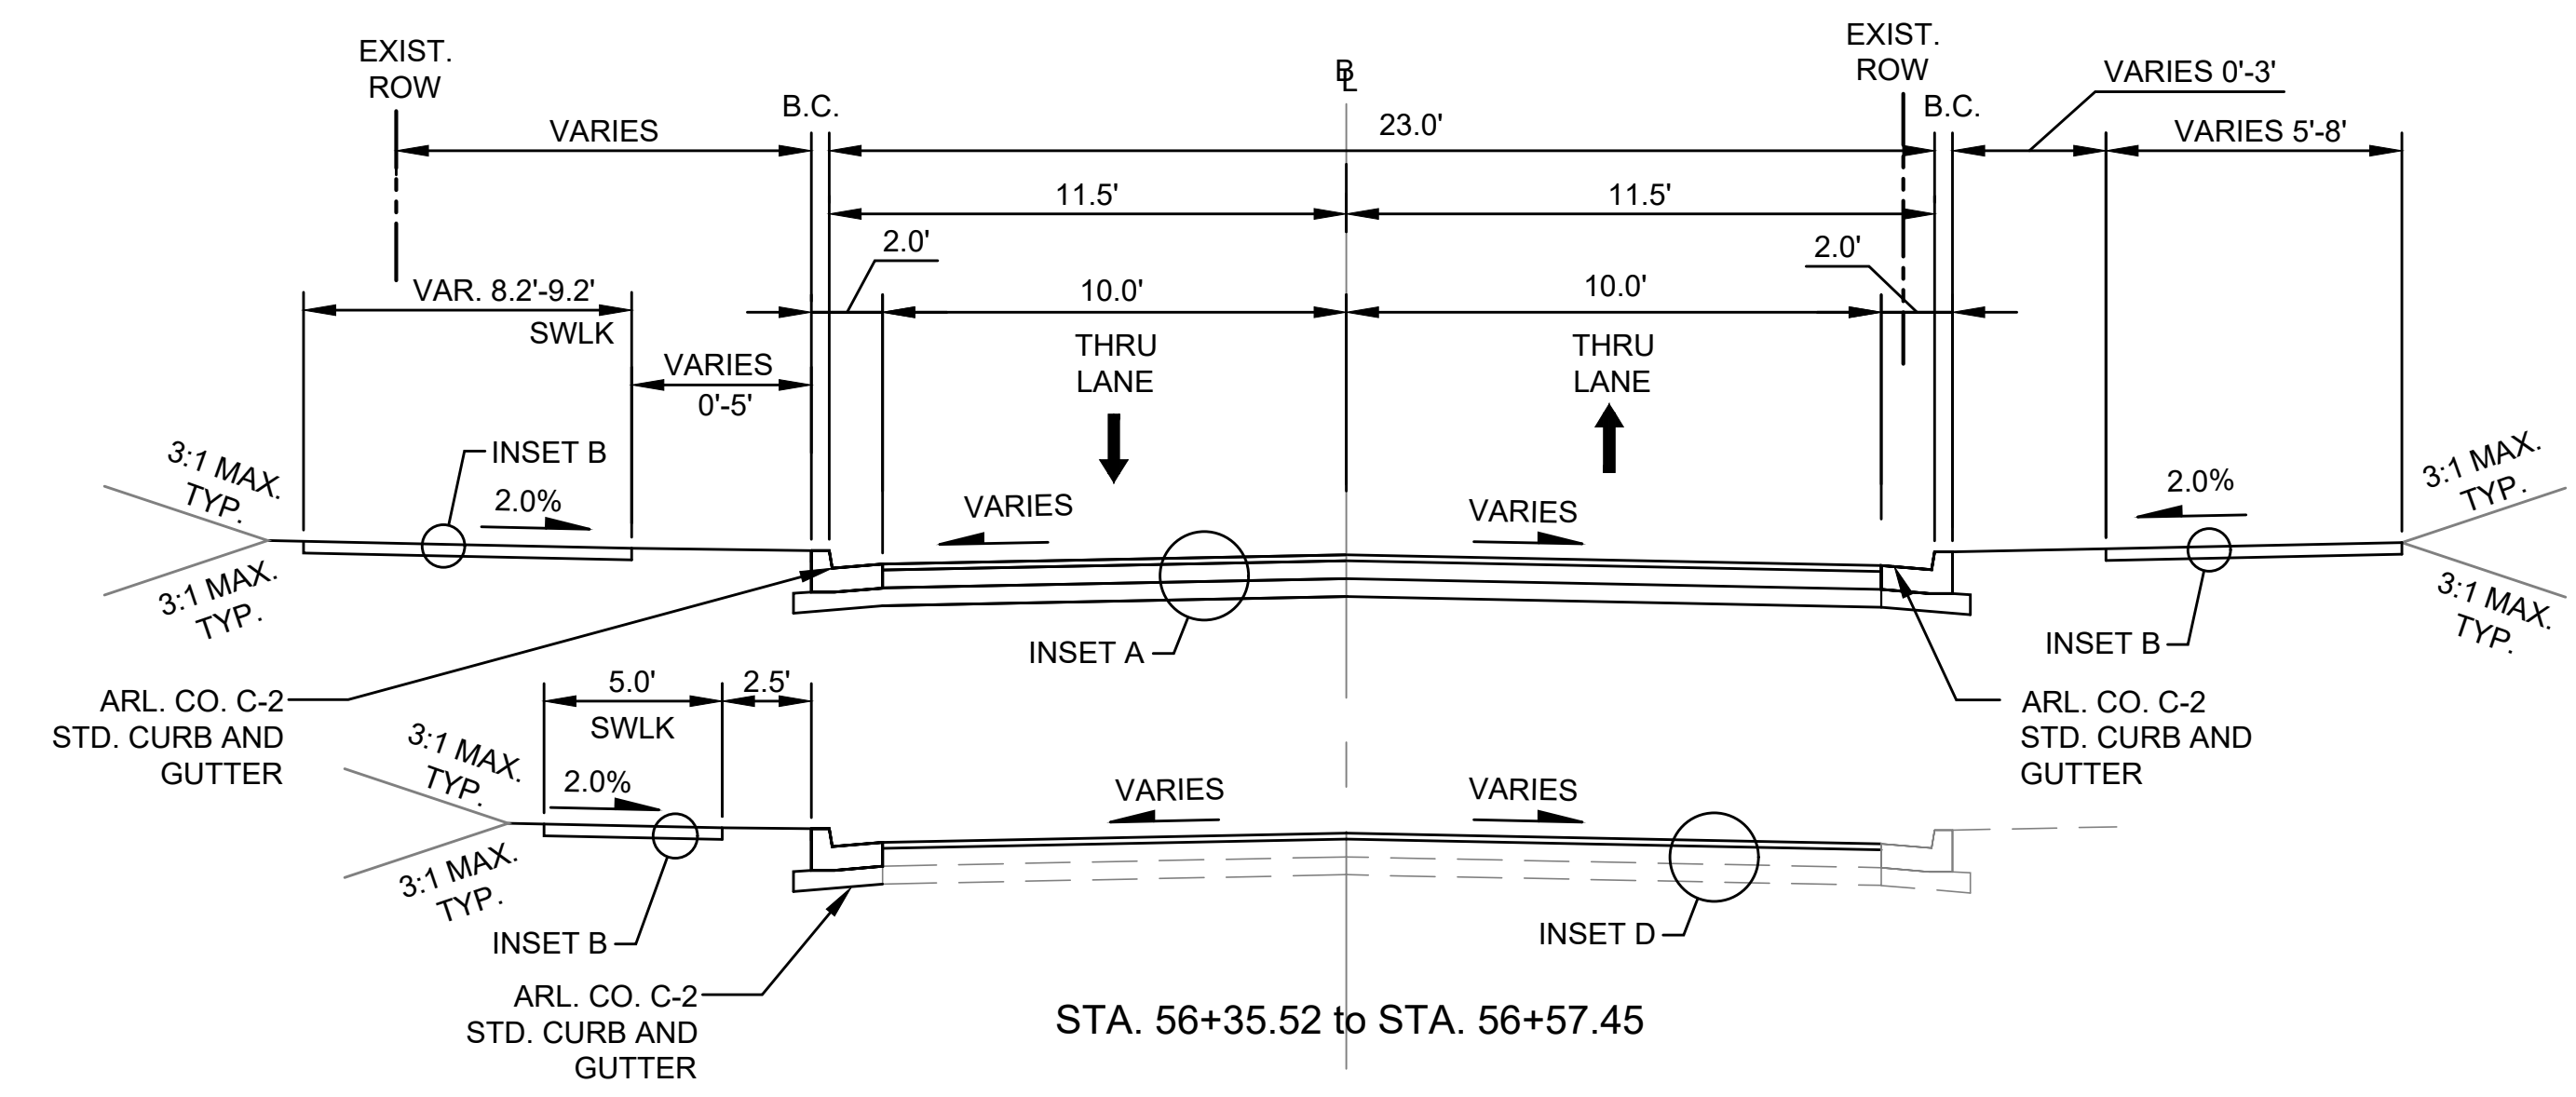
ARLINGTON VIRGINIA
 DEPARTMENT OF ENVIRONMENTAL SERVICES
 LUIS ARAYA
 BUREAU CHIEF, DES - DEVELOPMENT SERVICES
 11/15/2022
 APPROVAL DATE

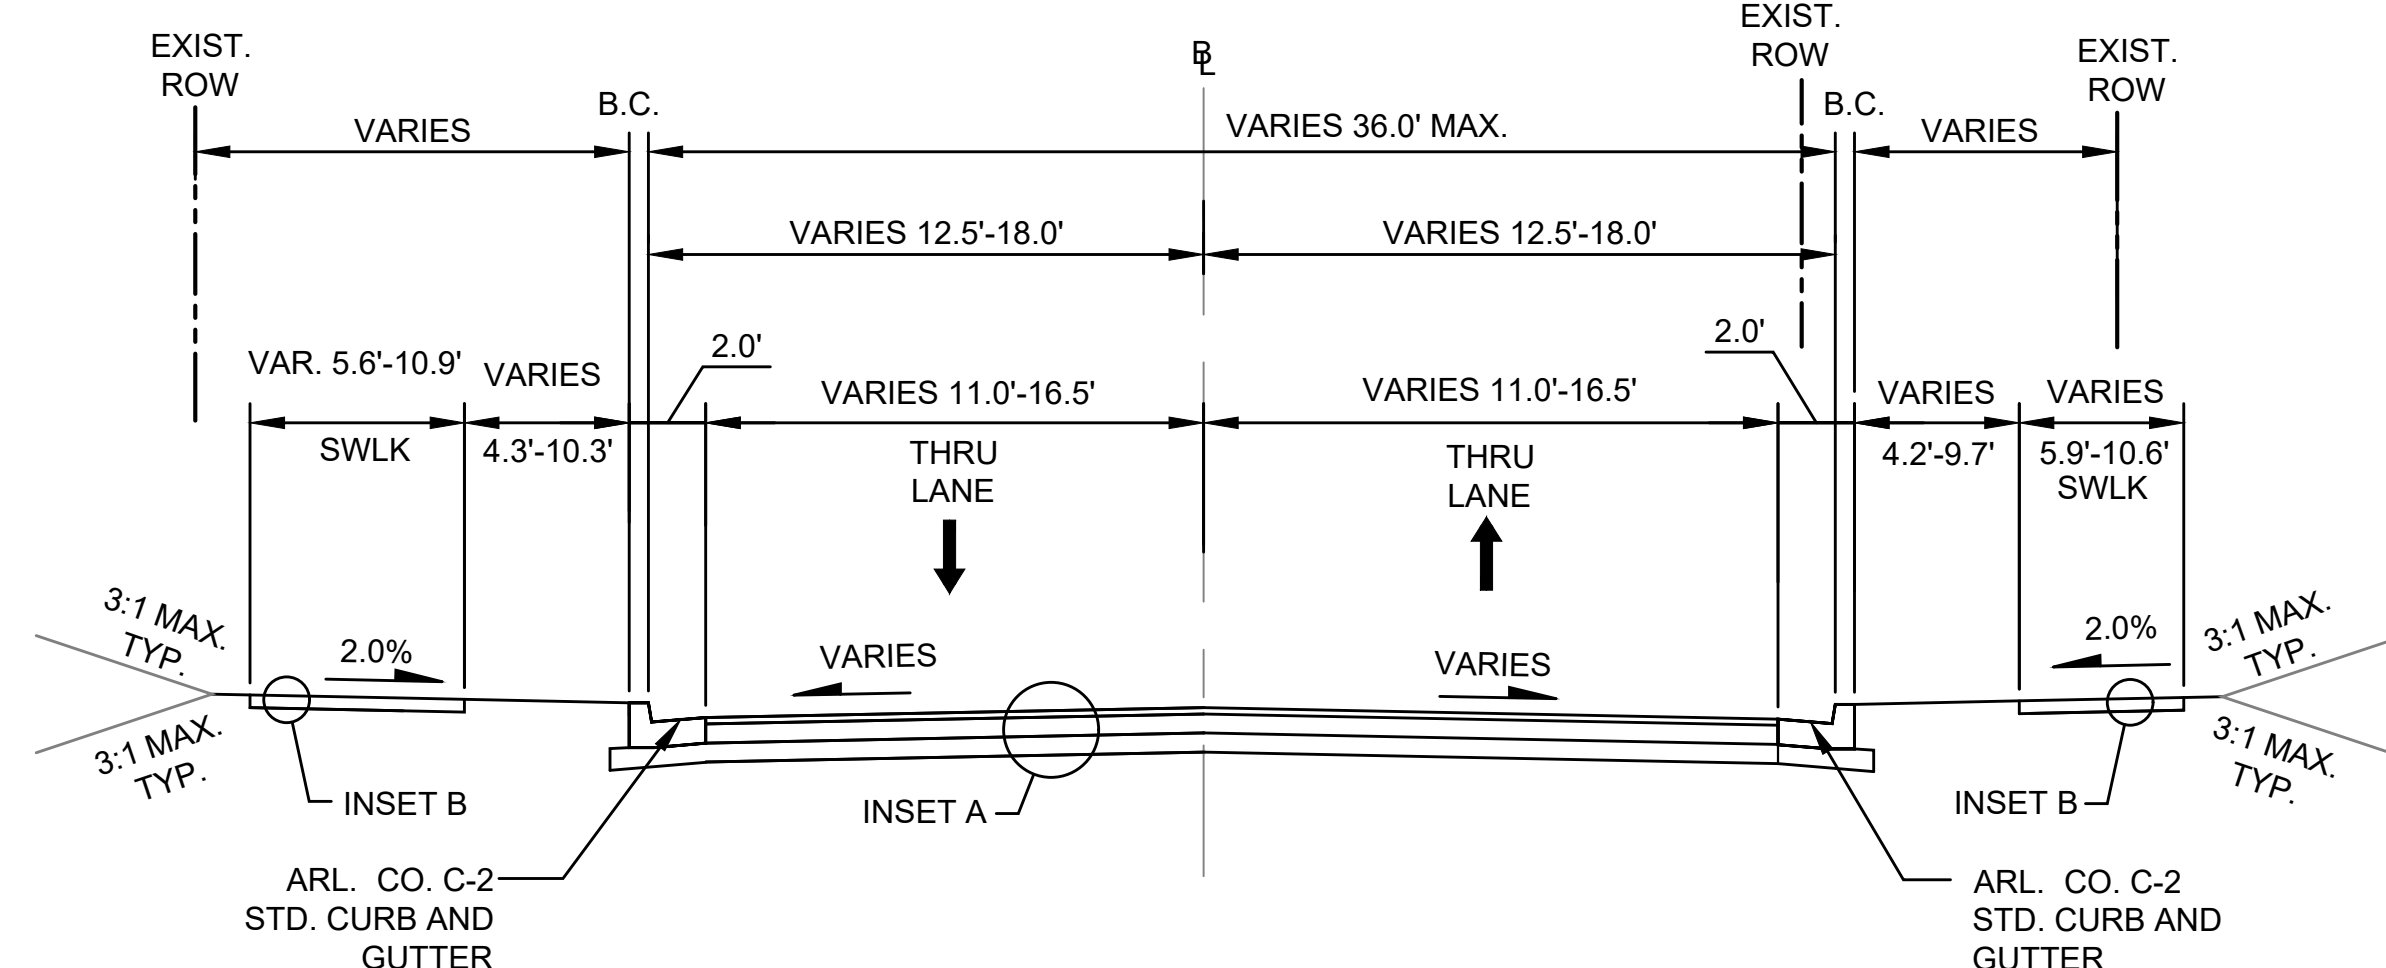


TYPICAL SECTION - S. ROLFE ST. NORTH OF COLUMBIA PIKE
STA. 50+00 to STA. 50+65.34

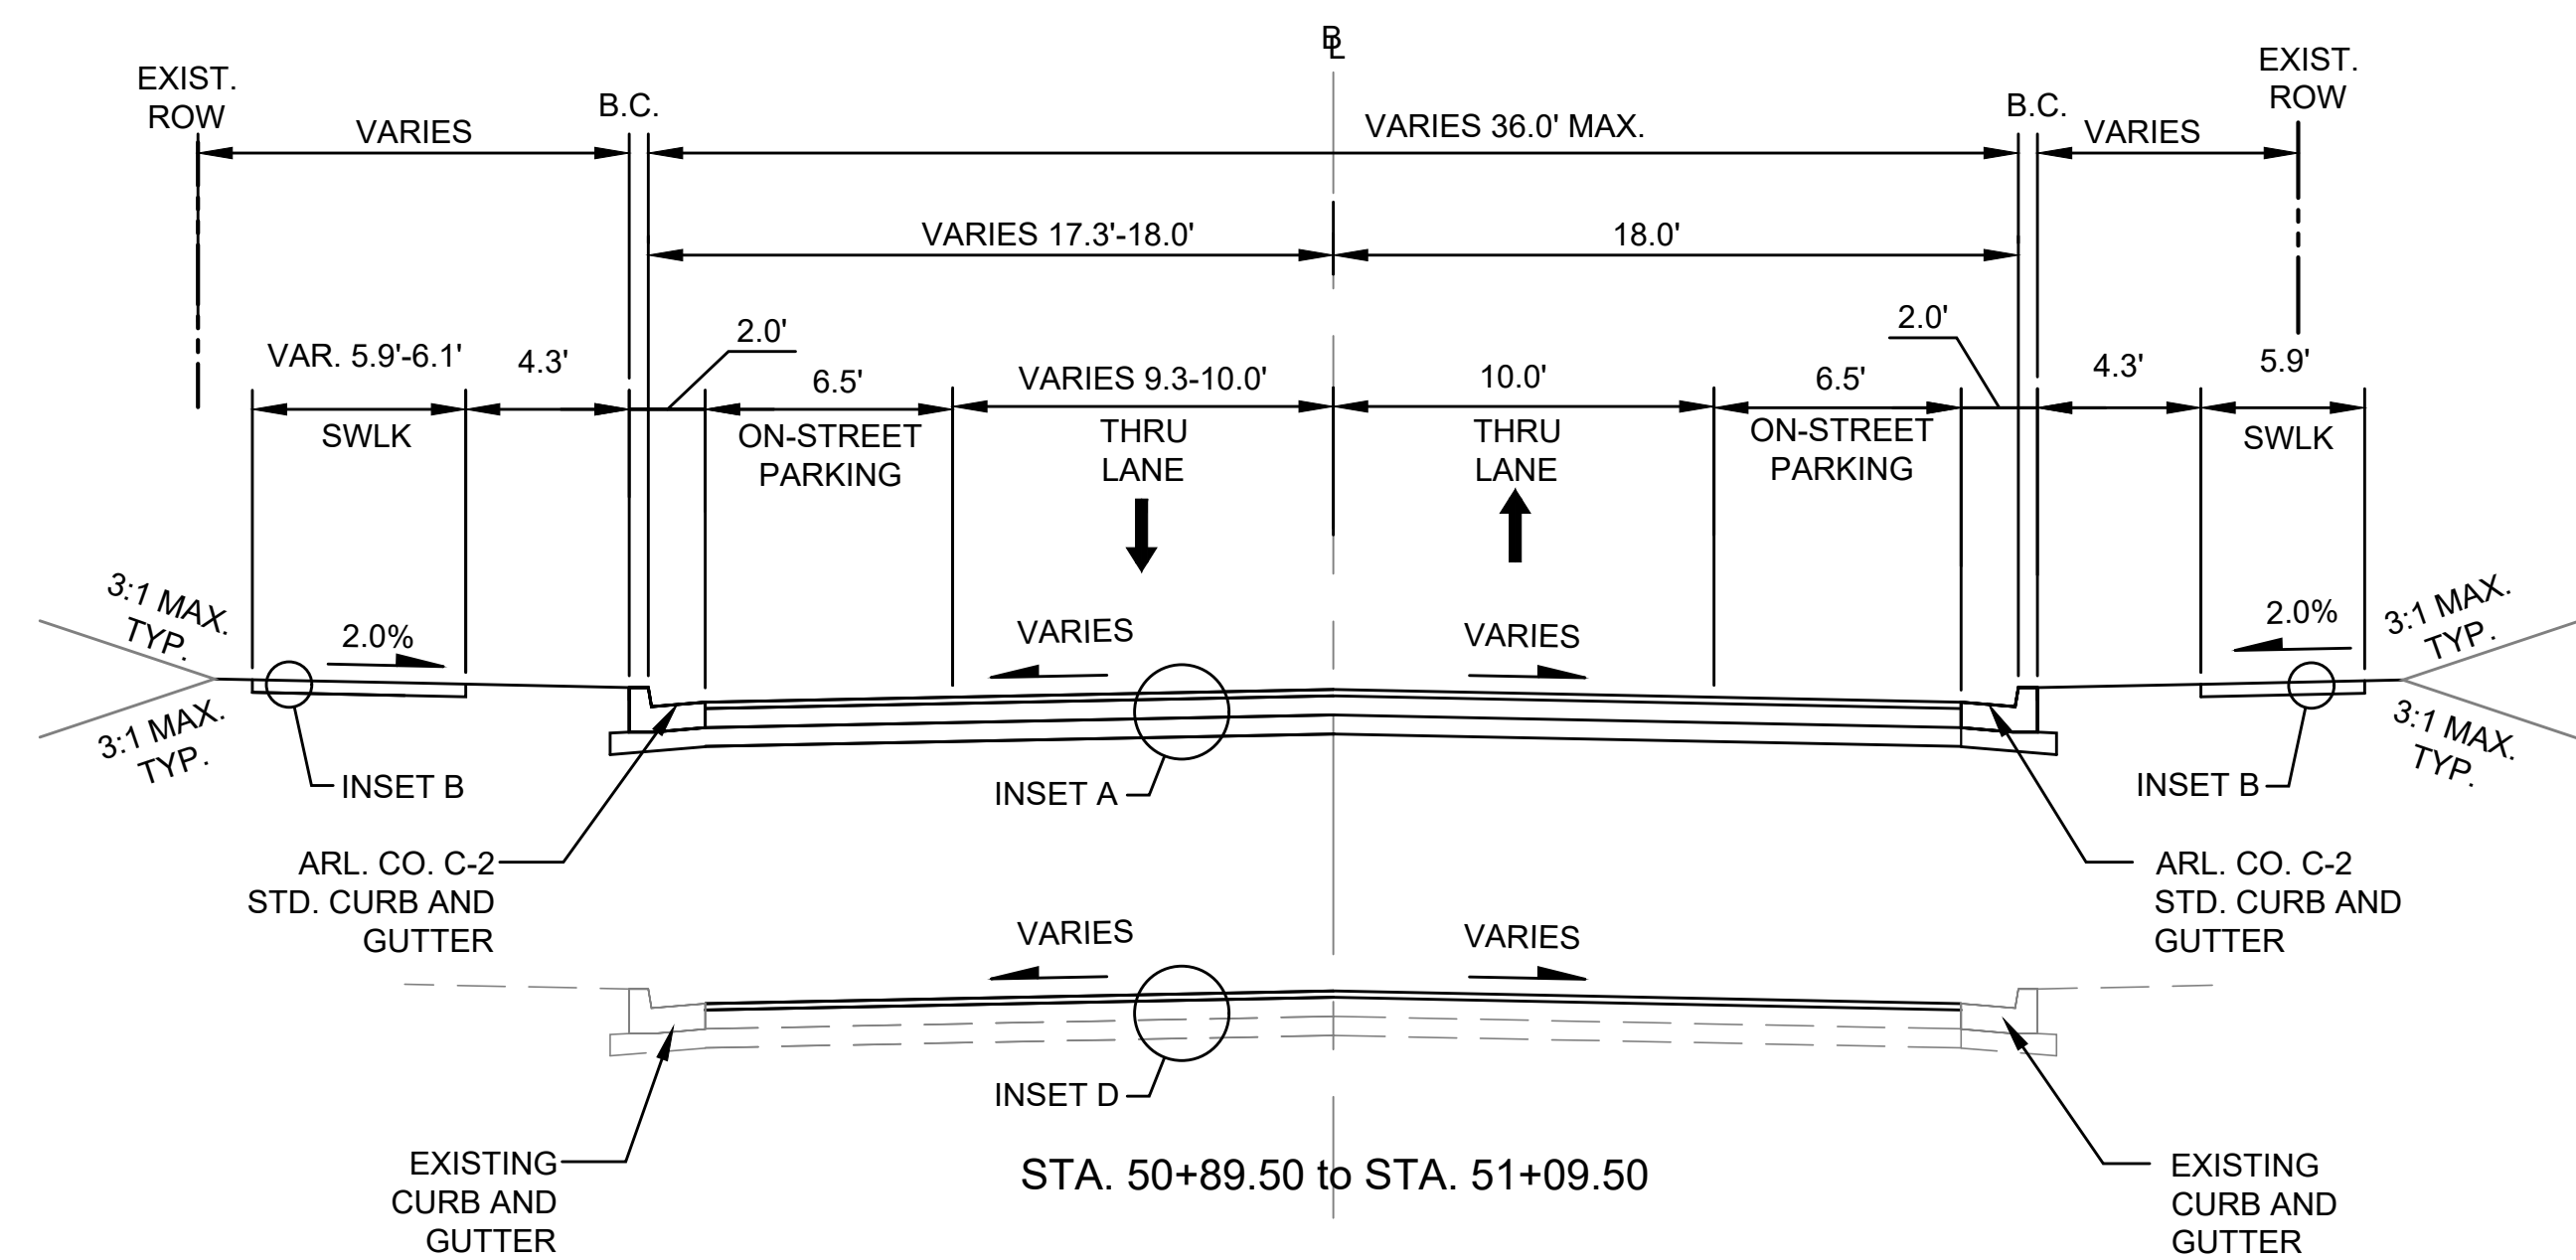


TYPICAL SECTION - S. ROLFE ST. NORTH OF COLUMBIA PIKE
STA. 50+65.34 to STA. 51+09.50




TYPICAL SECTION - S. SCOTT ST. NORTH OF COLUMBIA PIKE
STA. 55+57.74 to STA. 56+57.45

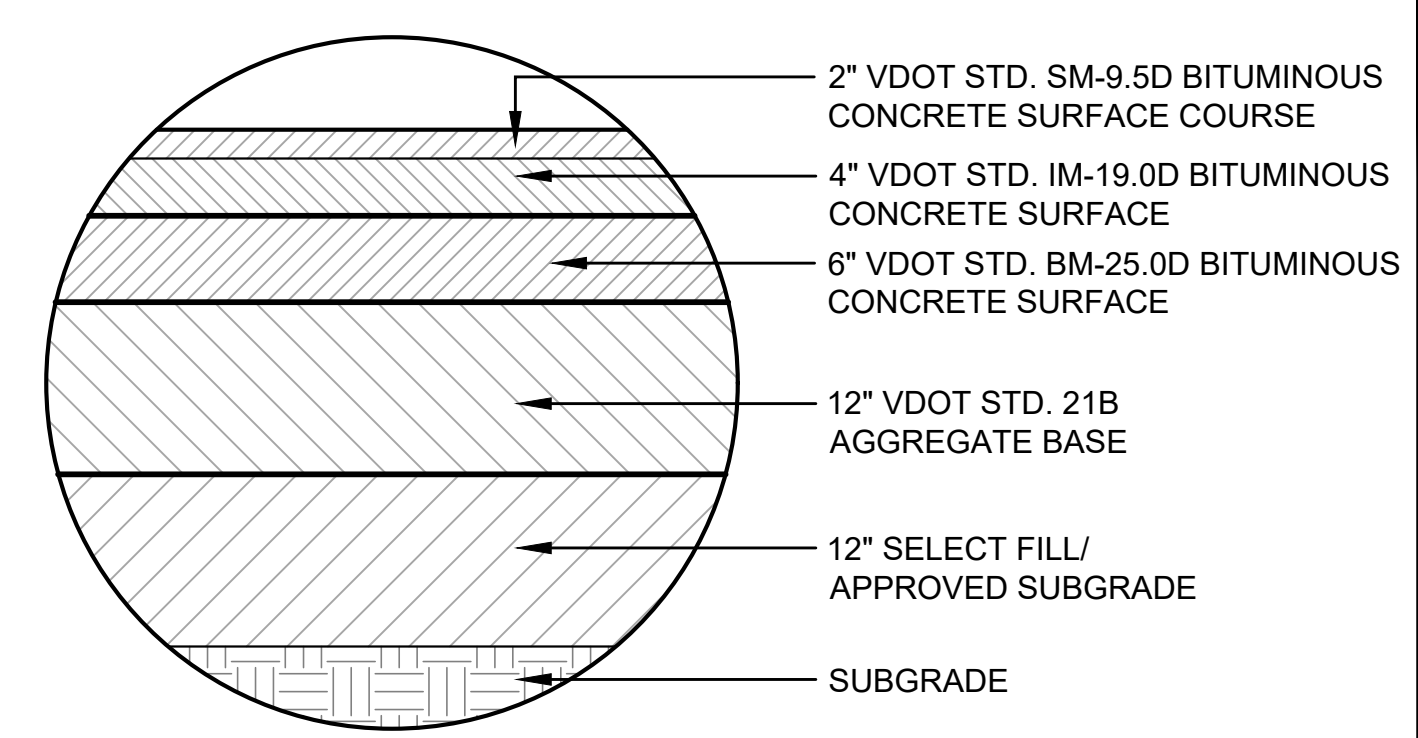

INSET A
FULL DEPTH PAVEMENT

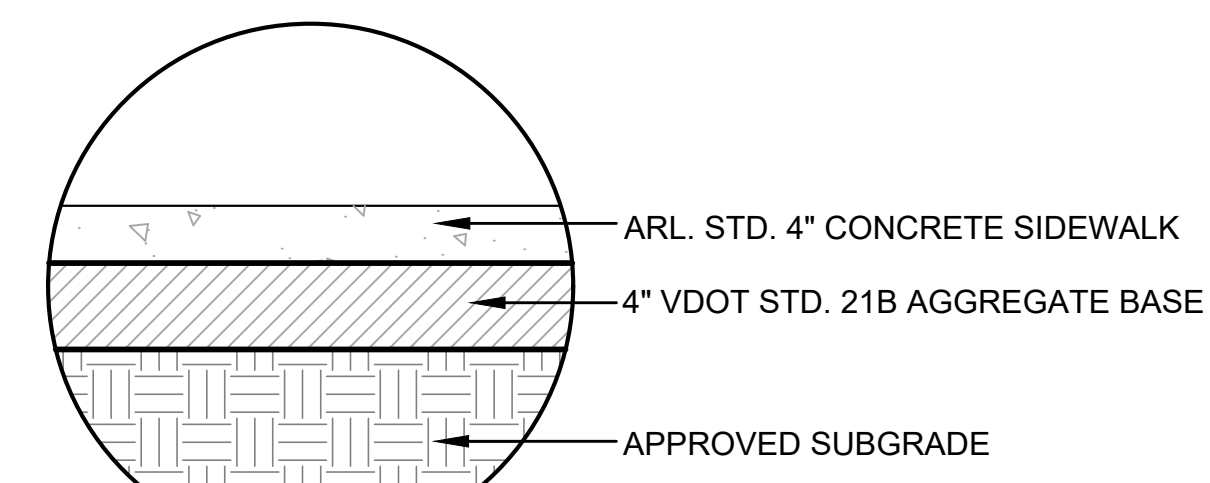


INSET B

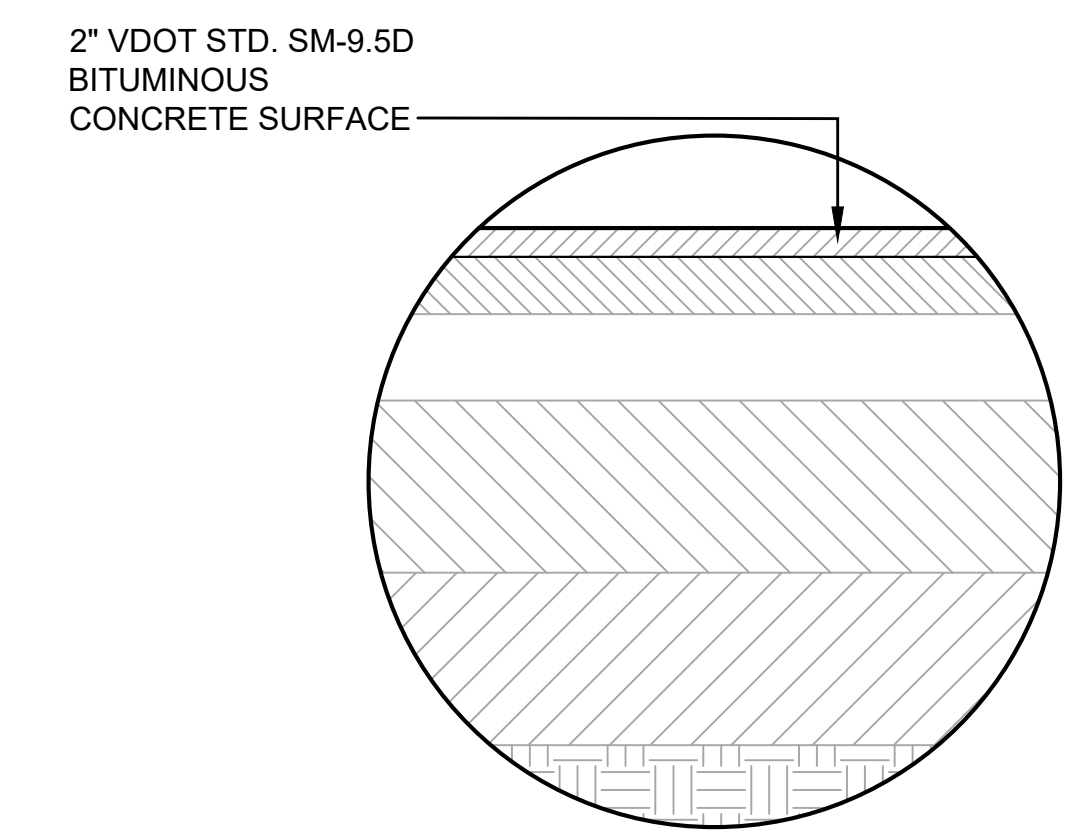

INSET D
MILL & OVERLAY PAVEMENT

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Approvals _____ Date _____

Design Team Engineer Supervisor _____

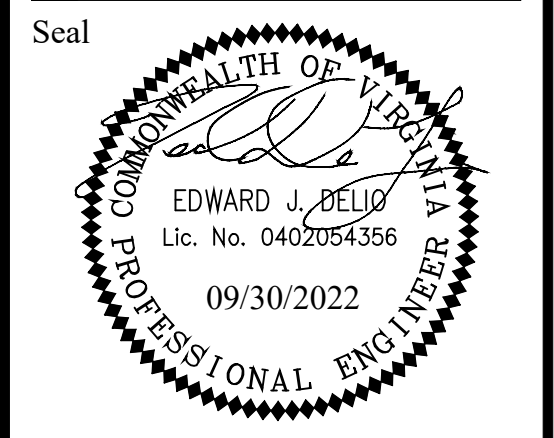Construction Management Supervisor _____

Water, Sewer, Streets Bureau Chief _____

Transportation Director _____

Project Manager _____

Revisions _____ Date _____


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Checked: EJD
Miss Utility Transmittal #: _____

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Plotted: September 30, 2022
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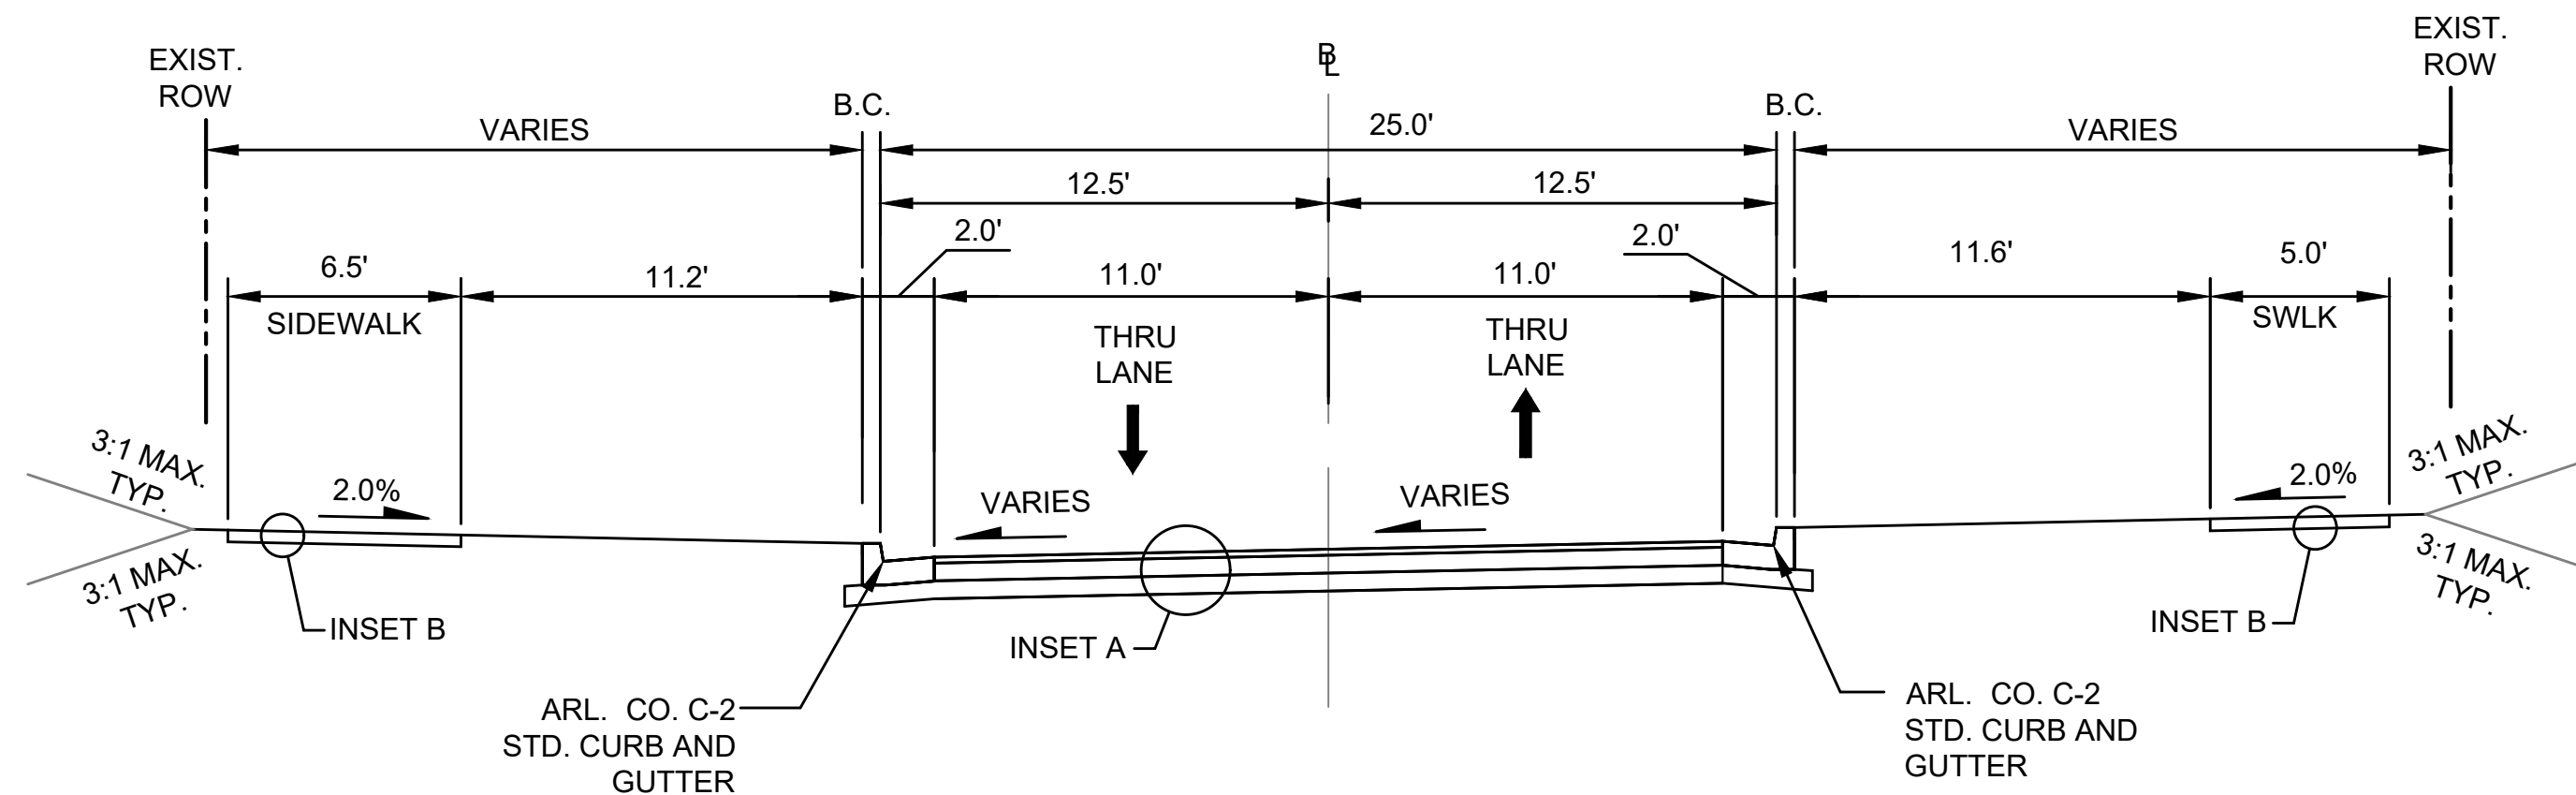
ARLINGTON COUNTY, VIRGINIA
DEPARTMENT OF ENVIRONMENTAL SERVICES

TYPICAL SECTIONS
COLUMBIA PIKE - ROUTE 244
COLUMBIA PIKE - MULTIMODAL STREET IMPROVEMENTS
SEGMENT C


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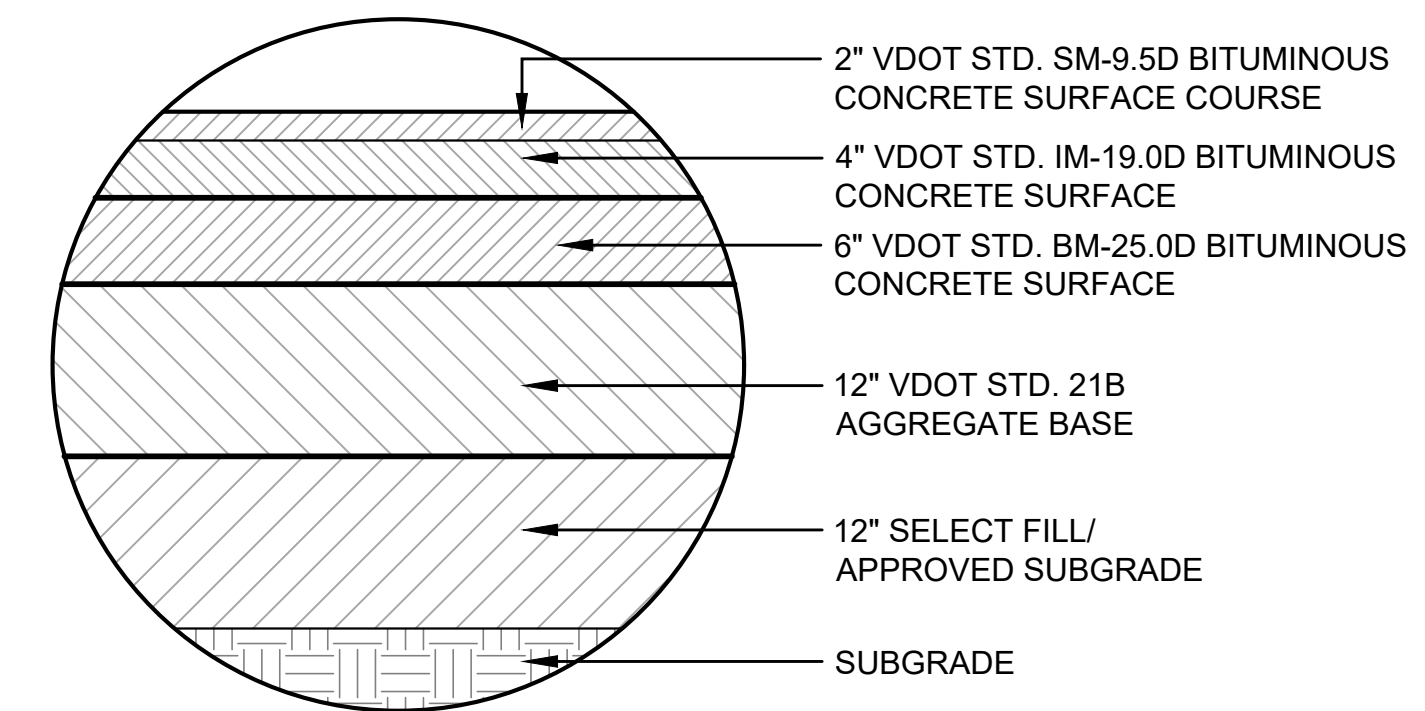
TYPICAL SECTION - S. SCOTT ST. NORTH OF COLUMBIA PIKE
 STA. 56+57.45 to STA. 56+86.91

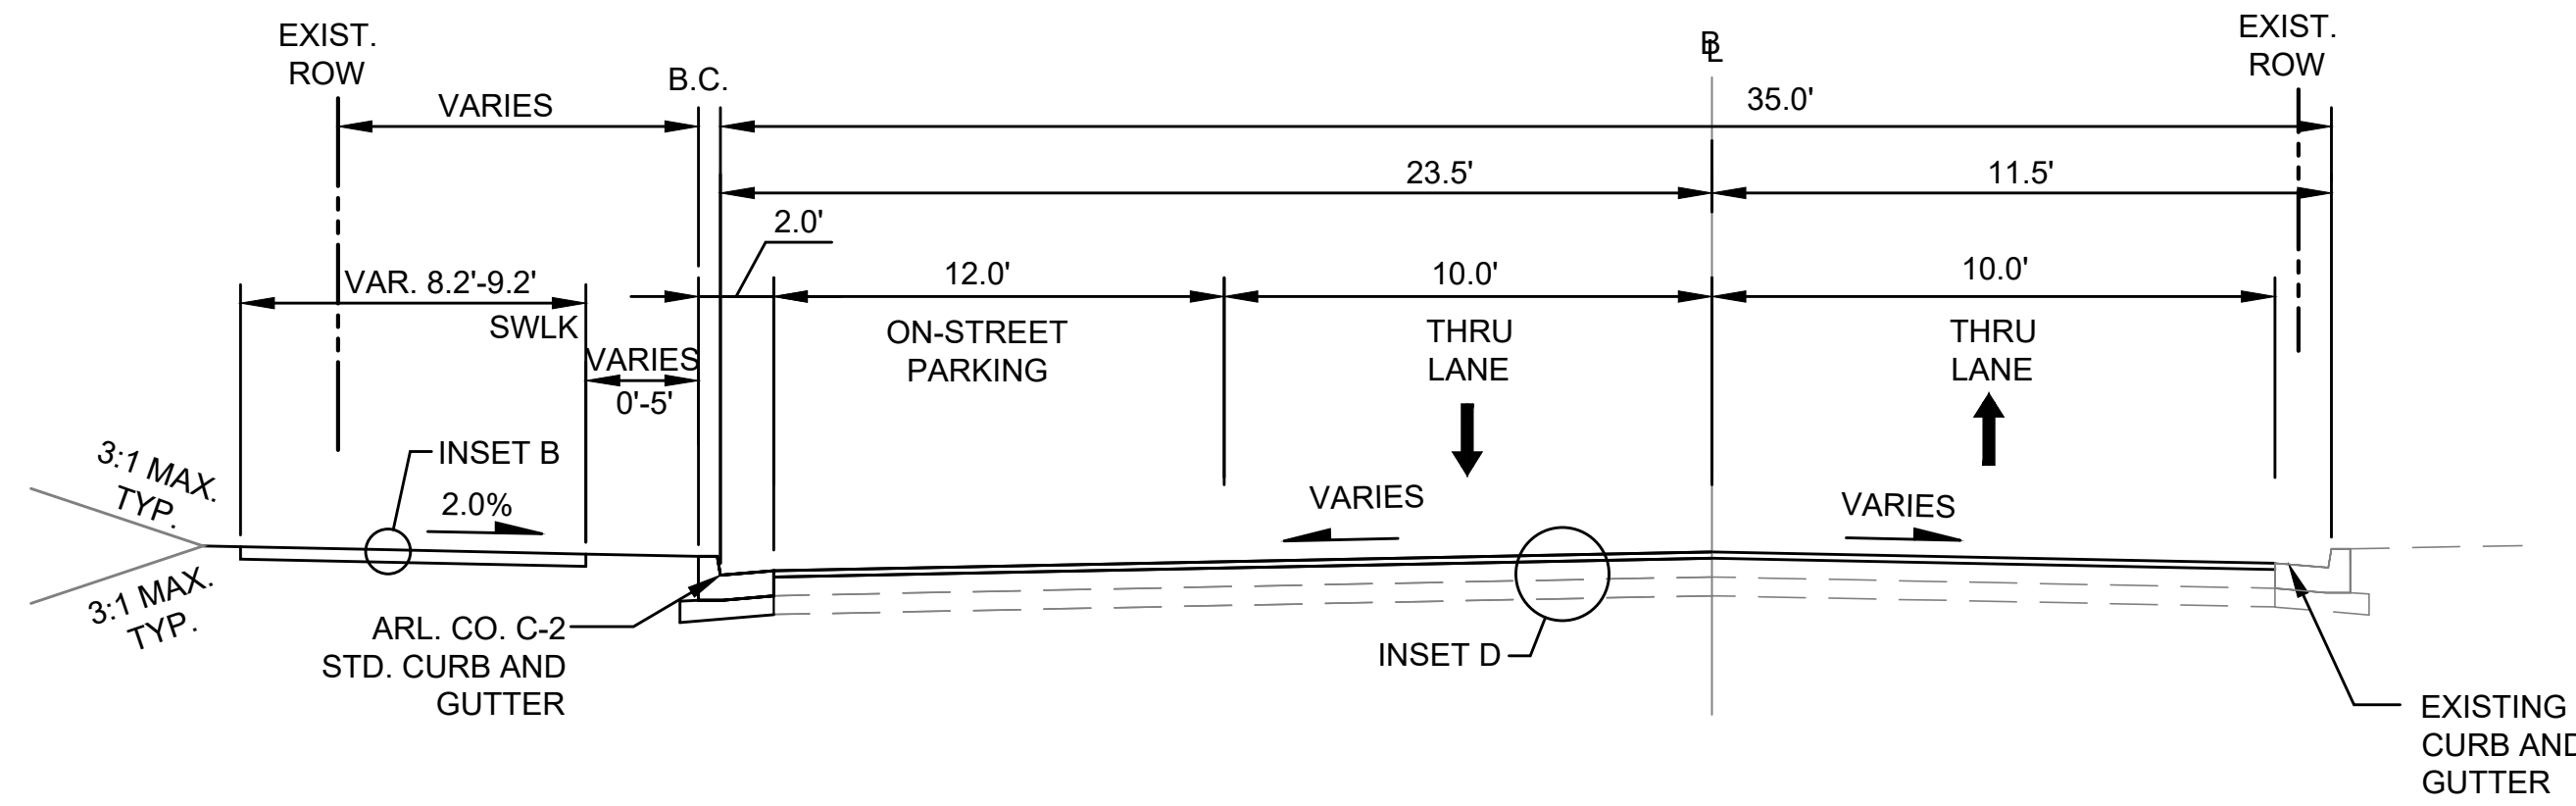


TYPICAL SECTION - S. SCOTT ST. SOUTH OF COLUMBIA PIKE
 STA. 60+00 to STA. 60+58.88



TYPICAL SECTION - S. SCOTT ST. SOUTH OF COLUMBIA PIKE
 STA. 60+58.88 to STA. 61+15.33

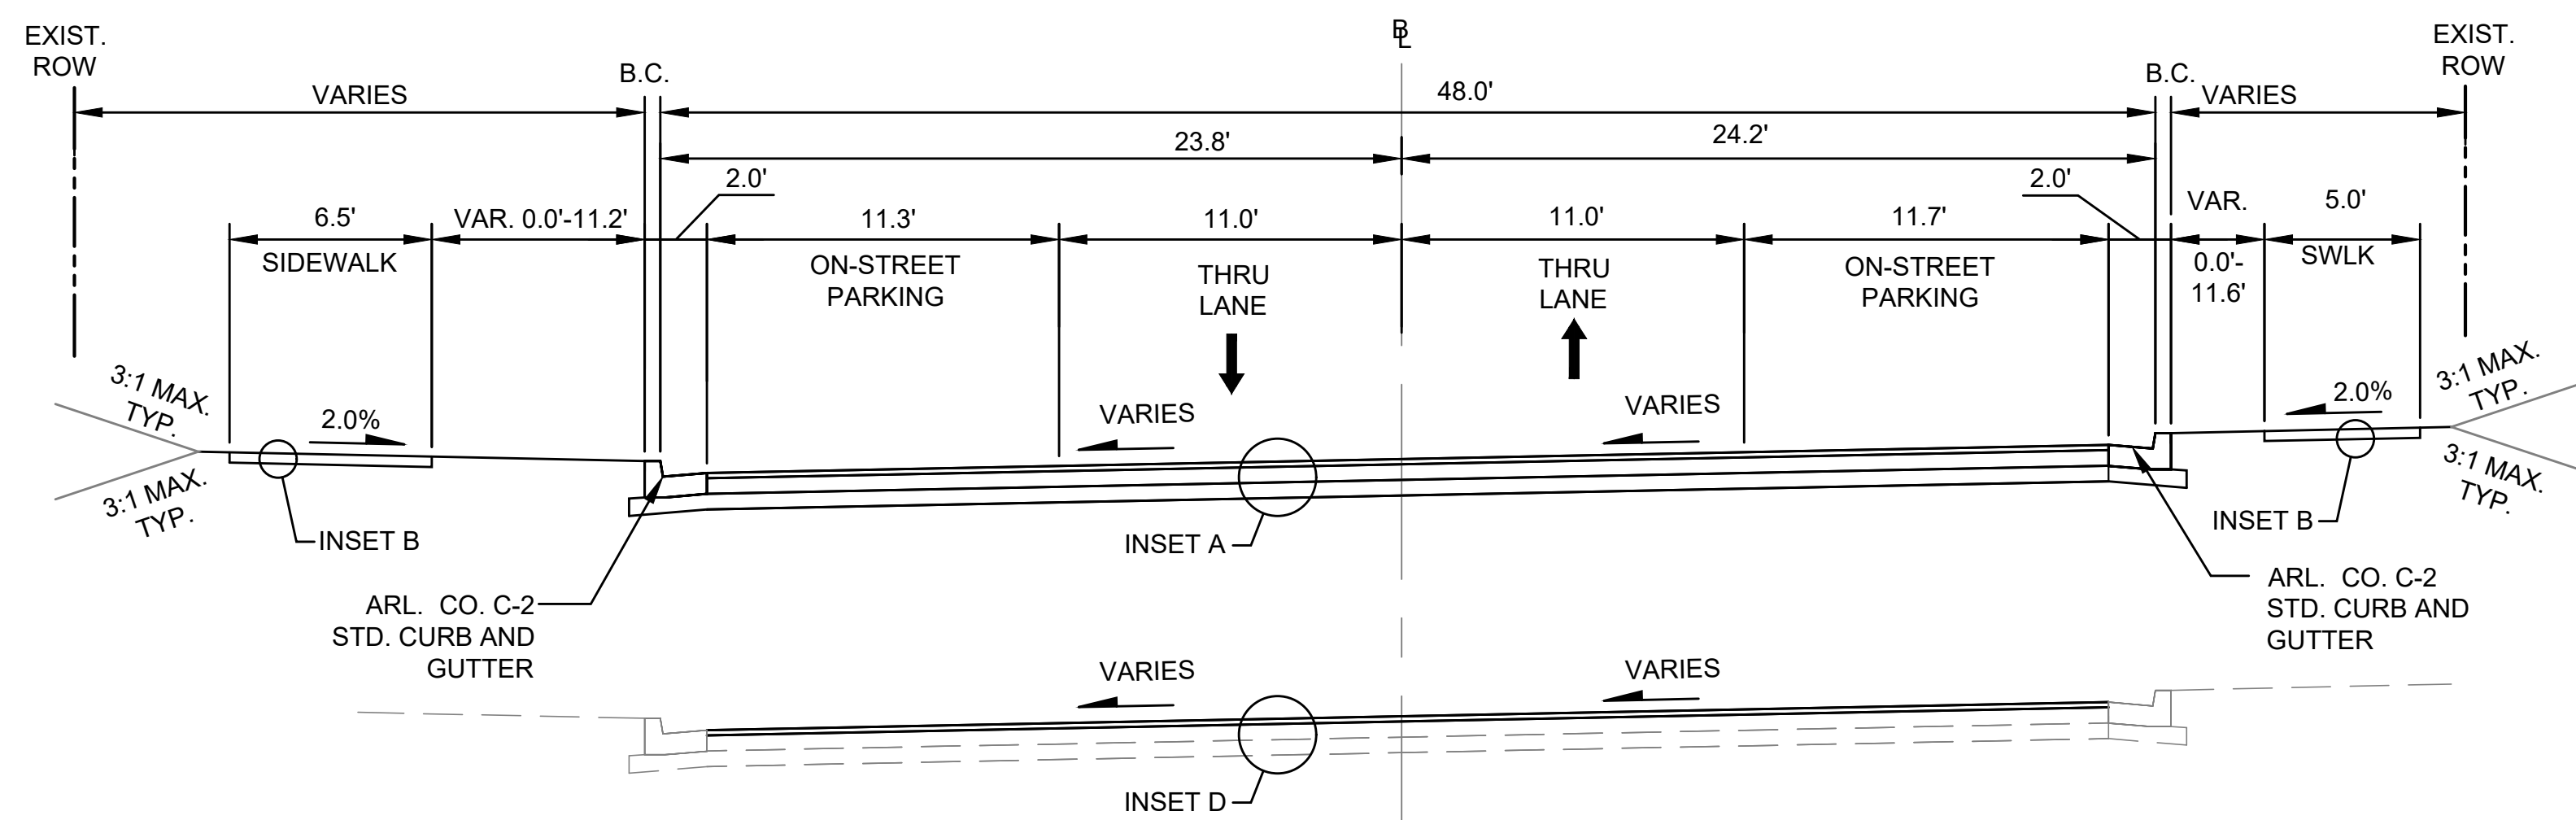


INSET A
 FULL DEPTH PAVEMENT

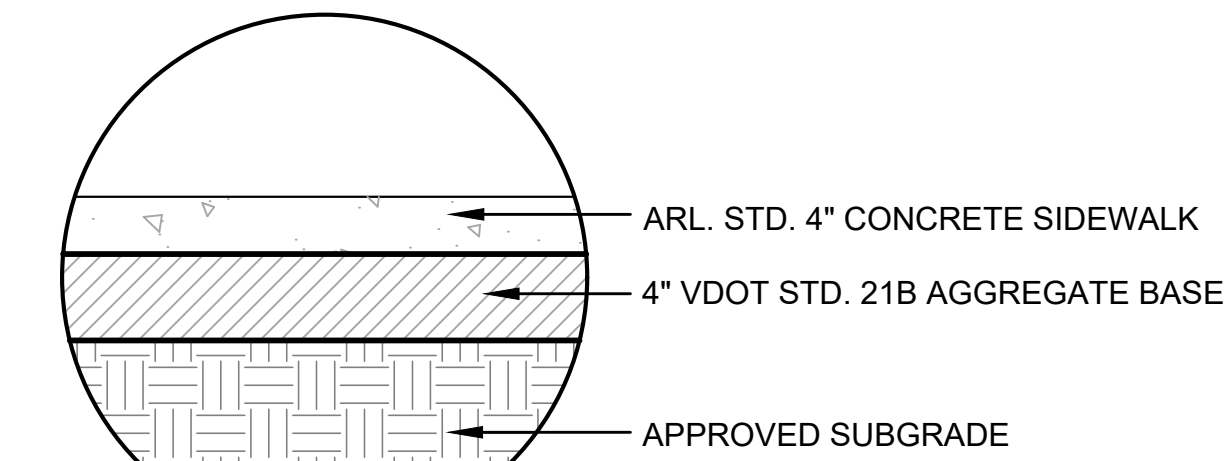

INSET B

2" VDOT STD. SM-9.5D BITUMINOUS CONCRETE SURFACE

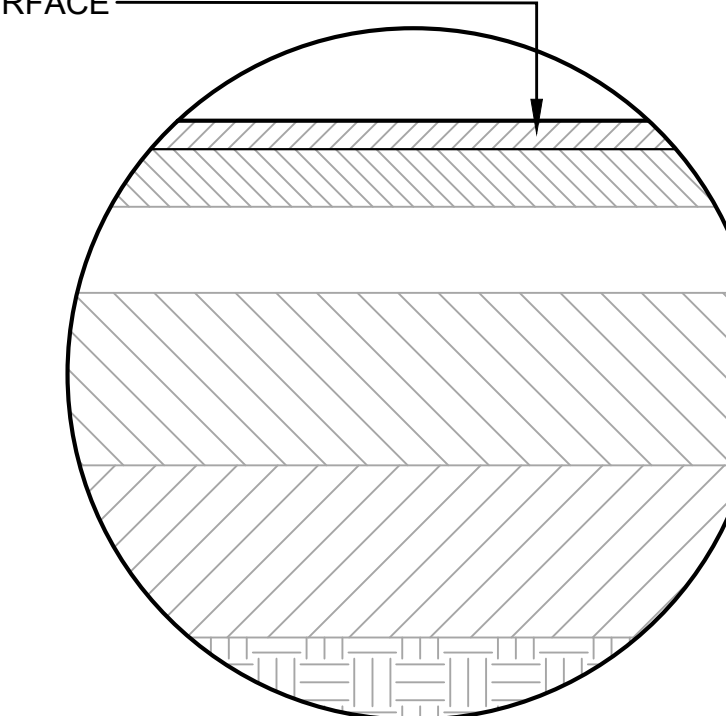


INSET D
 MILL & OVERLAY PAVEMENT



DEPARTMENT OF ENVIRONMENTAL SERVICES

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Approvals _____ Date _____

Design Team Engineer Supervisor _____

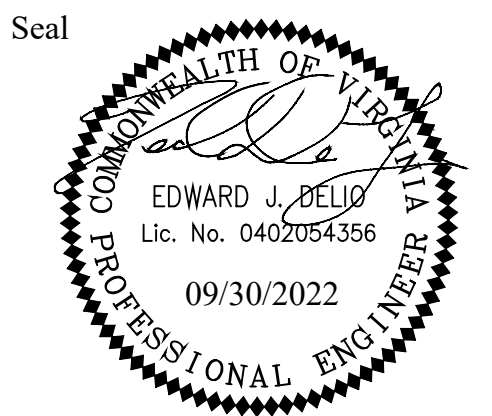Construction Management Supervisor _____

Water, Sewer, Streets Bureau Chief _____

Transportation Director _____

Project Manager _____

Revisions _____ Date _____


Designed: MAT
 Drawn: MAT
 Checked: EJD
 Miss Utility Transmittal #: _____

Filename: 010073-C-TYP-SEC.dwg
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 Plotted: September 30, 2022
 Plotted by: Thomas.Super

ARLINGTON COUNTY, VIRGINIA
 DEPARTMENT OF ENVIRONMENTAL SERVICES

TYPICAL SECTIONS
 COLUMBIA PIKE - ROUTE 244
 COLUMBIA PIKE - MULTIMODAL STREET IMPROVEMENTS
 SEGMENT C

SCALE: HOR. N/A VERT. N/A SHEET: C3.5 of C3.5

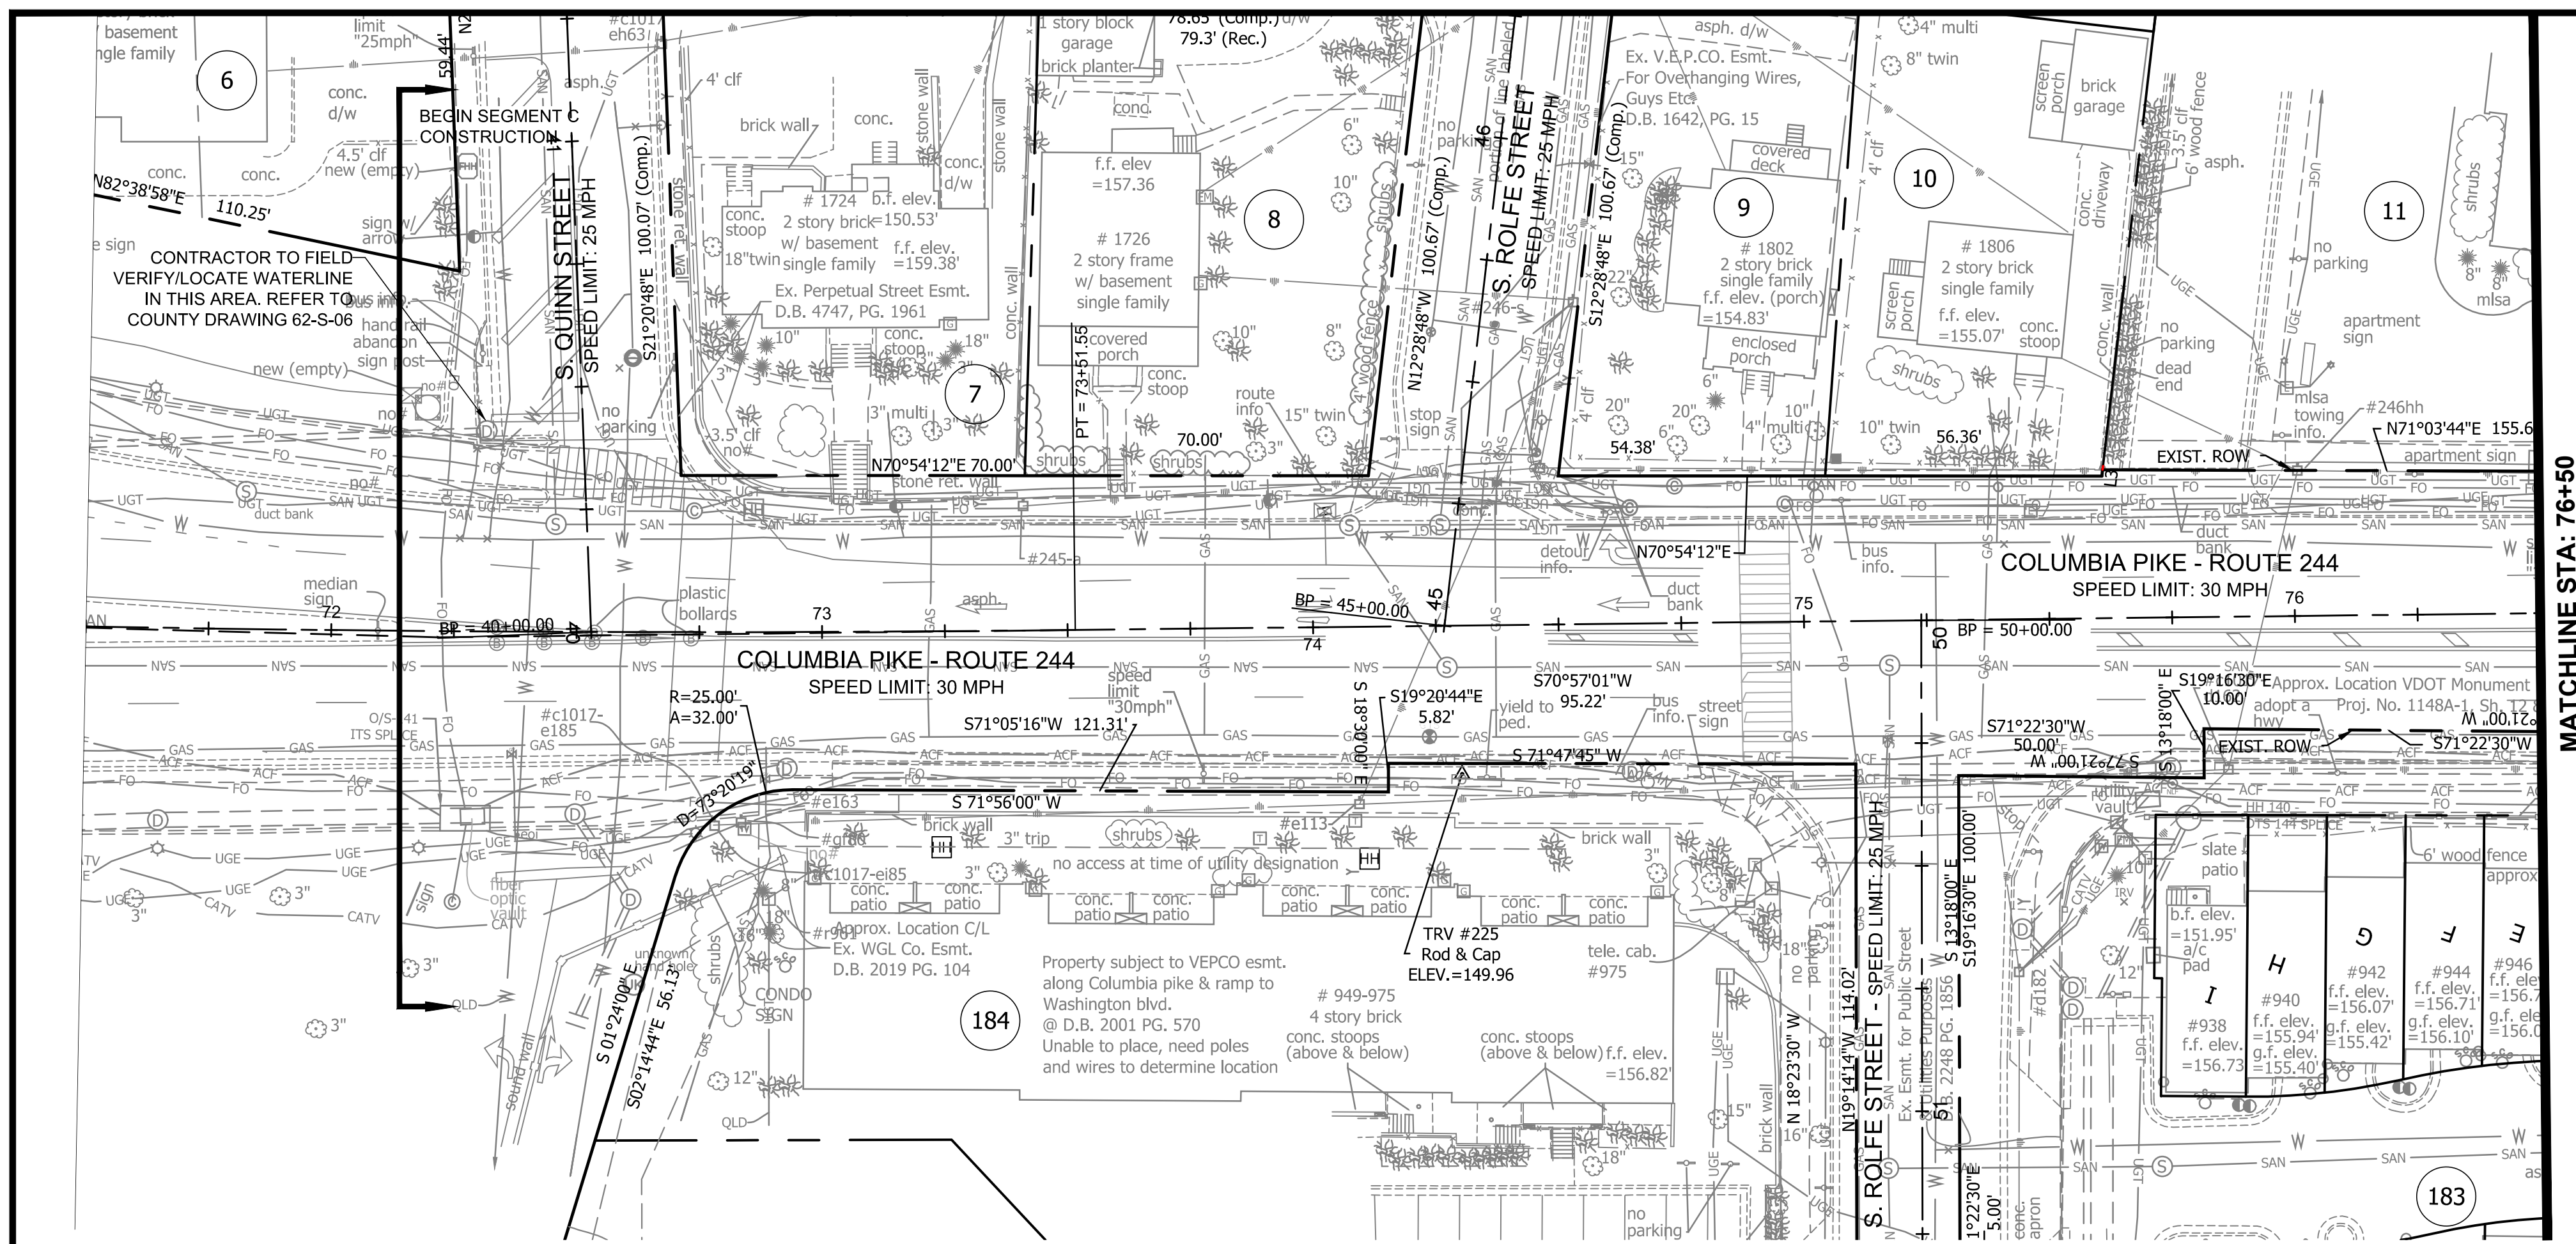

MATCHLINE STA: 76+50



MATCHLINE STA: 81+50 - SEE SHEET C4.2

NOTE:
1. SURVEY CONTROL DATA SHOWN ON SHEET C4.2.

NOTE:
* NOTE: ARLINGTON COUNTY FIBER LOCATED IN THE ORIGINAL SURVEY IS SHOWN AS "ACF" IN THE PLANS. ARLINGTON COUNTY FIBER LOCATED BY MAUL IN A SURVEY DATED SEPTEMBER 2020 IS SHOWN AS "AF" IN THE PLANS. CONTRACTOR TO FIELD VERIFY LOCATION OF COUNTY FIBER PRIOR TO CONSTRUCTION.
** NOTE: UNKNOWN UTILITY LINE MARKED BY "UNK" IN THE PLANS WAS FOUND BY MAUL DURING ADDITIONAL SURVEY EFFORT REQUESTED BY THE COUNTY AND DATED APRIL 3-6, 2020. CONTRACTOR TO FIELD VERIFY LOCATION AND TYPE OF UTILITY AND DETERMINE THE STATUS OF THE UTILITY (ACTIVE OR ABANDONED) PRIOR TO CONSTRUCTION.


CONTRACTOR TO FIELD VERIFY/LOCATE WATERLINE IN THIS AREA. REFER TO COUNTY DRAWING 62-S-06
CONTRACTOR TO FIELD VERIFY/LOCATE WATERLINE IN THIS AREA. REFER TO COUNTY DRAWING 62-N-3
CONTRACTOR TO FIELD VERIFY/LOCATE SANITARY LATERALS FROM PARCEL 179

Exist.		Prop.	
[Symbol]	Storm Str. # [Symbol]	[Symbol]	Coniferous Tree [Symbol]
[Symbol]	Catch Basin [Symbol]	[Symbol]	Deciduous Tree [Symbol]
[Symbol]	Sanitary Manhole [Symbol]	[Symbol]	Bush/Hedge/Shrub [Symbol]
[Symbol]	Sanitary Str. # [Symbol]	[Symbol]	Traffic Mast Arm Pole [Symbol]
[Symbol]	Fire Hydrant [Symbol]	[Symbol]	Traffic Pedestrian Pole [Symbol]
[Symbol]	Watermain Reducer [Symbol]	[Symbol]	Traffic Control Box [Symbol]
[Symbol]	Water - Valve [Symbol]	[Symbol]	Traffic Electrical Box [Symbol]
[Symbol]	Blowoff Valve [Symbol]	[Symbol]	Traffic Junction Box [Symbol]
[Symbol]	Water - Cross [Symbol]	[Symbol]	Traffic Service Meter [Symbol]
[Symbol]	Water - Tee [Symbol]	[Symbol]	Construction Notes [Symbol]
[Symbol]	Water - Typical Bend [Symbol]	[Symbol]	Benchmark [Symbol]
[Symbol]	Water Meter [Symbol]	[Symbol]	Monument (GPS) [Symbol]
[Symbol]	Water Cap [Symbol]	[Symbol]	Monument [Symbol]
[Symbol]	Water - Manhole Cover [Symbol]	[Symbol]	Iron Rod Found [Symbol]
[Symbol]	Slamase Connection [Symbol]	[Symbol]	Iron Pipe Found [Symbol]
[Symbol]	CableTV Pedestal [Symbol]	[Symbol]	Rebar Rod Found [Symbol]
[Symbol]	Electrical Box [Symbol]	[Symbol]	P.K. Nail Found [Symbol]
[Symbol]	Telephone Pedestal [Symbol]	[Symbol]	Traverse [Symbol]
[Symbol]	Cobrahead Light [Symbol]	[Symbol]	North Arrow [Symbol]
[Symbol]	Carlyle Light [Symbol]	[Symbol]	North Arrow [Symbol]
[Symbol]	Ground Light [Symbol]	[Symbol]	North Arrow [Symbol]
[Symbol]	Light Pole [Symbol]	[Symbol]	North Arrow [Symbol]
[Symbol]	Utility Pole [Symbol]	[Symbol]	North Arrow [Symbol]
[Symbol]	Guy Wire [Symbol]	[Symbol]	North Arrow [Symbol]
[Symbol]	Utility Cover [Symbol]	[Symbol]	North Arrow [Symbol]
[Symbol]	Gas Valve [Symbol]	[Symbol]	North Arrow [Symbol]
[Symbol]	Gas Line Marker [Symbol]	[Symbol]	North Arrow [Symbol]
[Symbol]	Test Hole [Symbol]	[Symbol]	North Arrow [Symbol]
[Symbol]	Bollard [Symbol]	[Symbol]	North Arrow [Symbol]
[Symbol]	Mailbox [Symbol]	[Symbol]	North Arrow [Symbol]
[Symbol]	Parking Meter [Symbol]	[Symbol]	North Arrow [Symbol]
[Symbol]	Sign [Symbol]	[Symbol]	North Arrow [Symbol]
[Symbol]	Dry Utility Vault [Symbol]	[Symbol]	North Arrow [Symbol]
[Symbol]	Telephone Box [Symbol]	[Symbol]	North Arrow [Symbol]

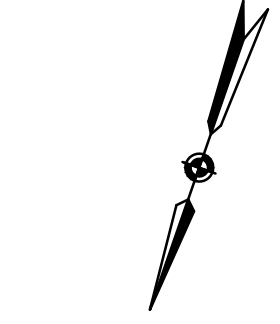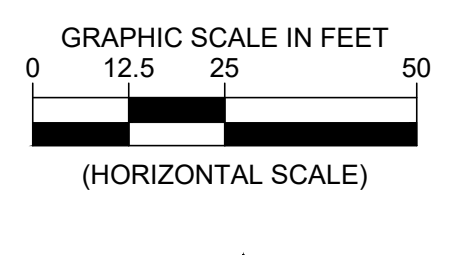

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© 2022 KIMLEY-HORN AND ASSOCIATES, INC.
11400 Commerce Park Drive, Suite 400
Reston, Virginia 20191
Phone: 703-674-1300
Fax: 703-674-1300

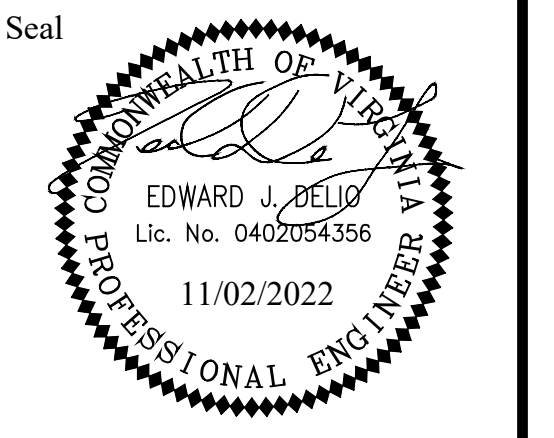

Approvals	Date
Design Team Engineer Supervisor	
Construction Management Supervisor	
Water, Sewer, Streets Bureau Chief	
Transportation Director	
Project Manager	
Revisions	Date

Designed: MAT
Drawn: MAT
Checked: EJD
Miss Utility Transmittal #:

Filename: 010073-C-EX701.dwg
Path: S:\2022\ARLINGTON\110000001 Columbia Pike Multimodal\Production\Drawings\2022\02\11\02\110000001.dwg
Plotted: November 02, 2022
Plotted by: Ted.DeLio

ARLINGTON COUNTY, VIRGINIA
DEPARTMENT OF ENVIRONMENTAL SERVICES

EXISTING CONDITIONS
COLUMBIA PIKE - ROUTE 244
COLUMBIA PIKE - MULTIMODAL STREET IMPROVEMENTS
SEGMENT C
STA. 72+15 TO STA. 81+50


SCALE: HOR. 1" = 25' VERT. N/A SHEET: C4.1 of C4.2

ARLINGTON VIRGINIA
DEPARTMENT OF ENVIRONMENTAL SERVICES



Ted DeLio
BUREAU CHIEF, DES - DEVELOPMENT SERVICES

11/15/2022
APPROVAL DATE

MATCHLINE STA: 81+50 - SEE SHEET C4.1

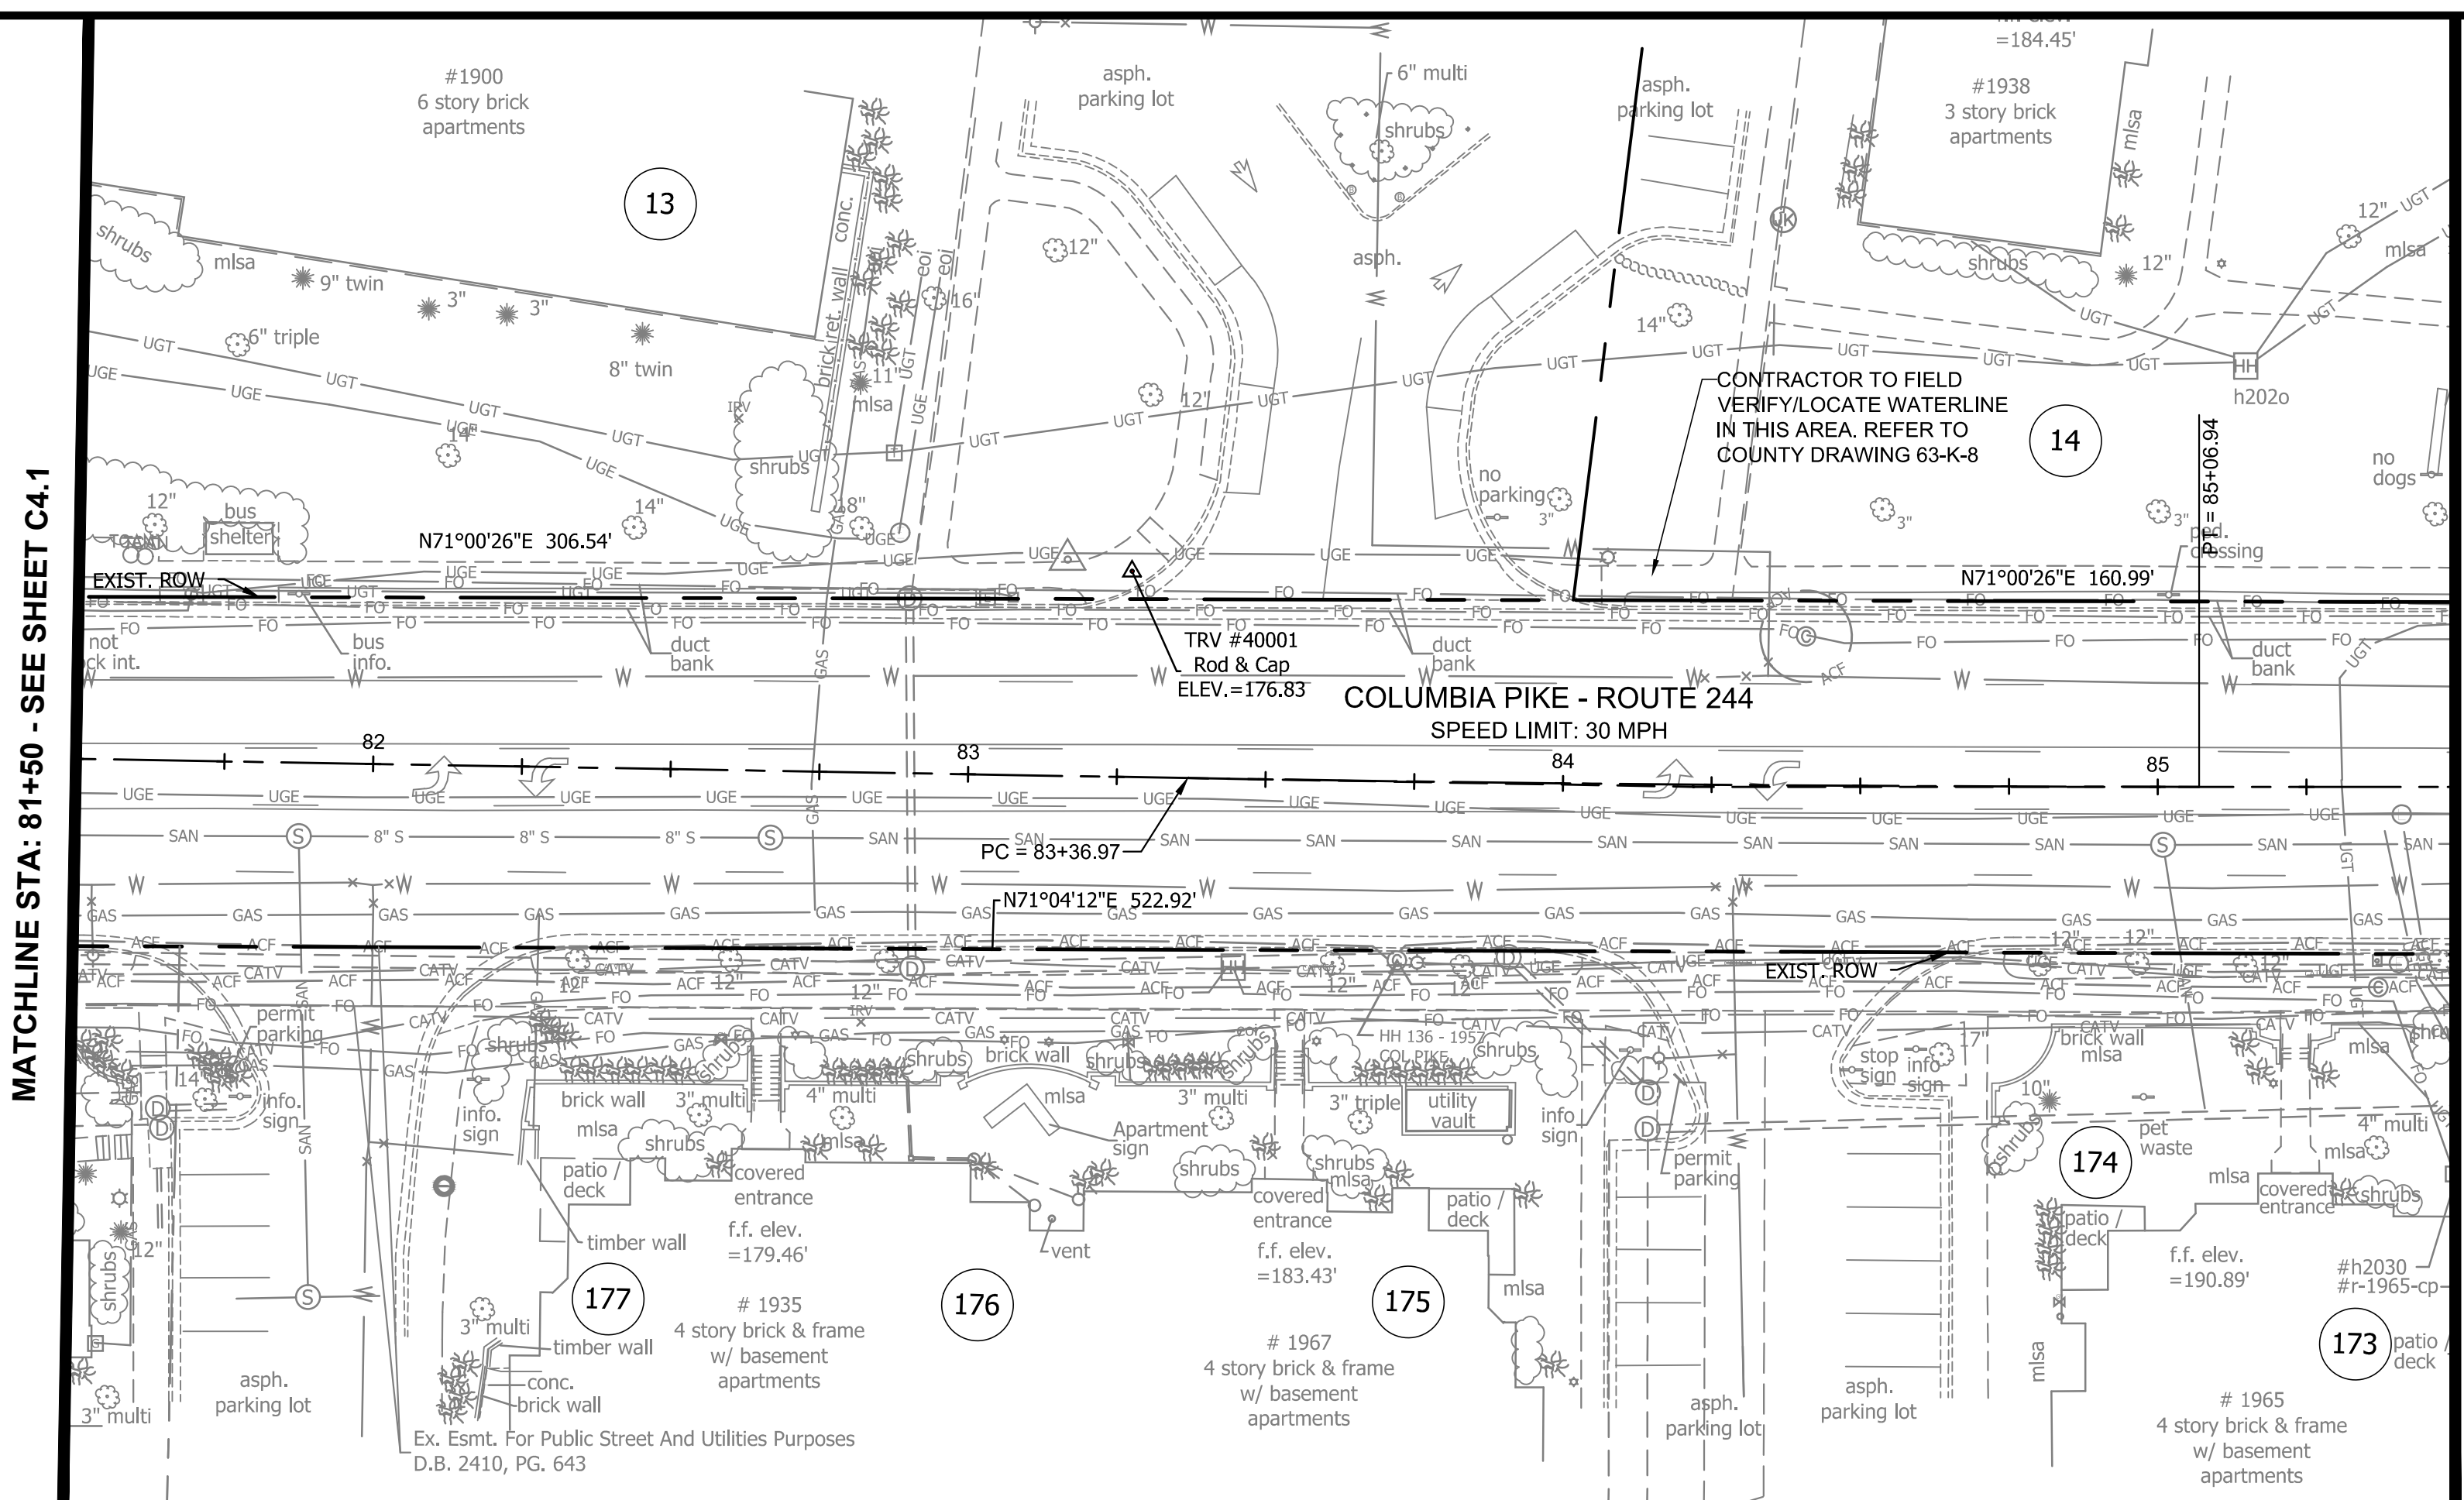

MATCHLINE STA: 85+50

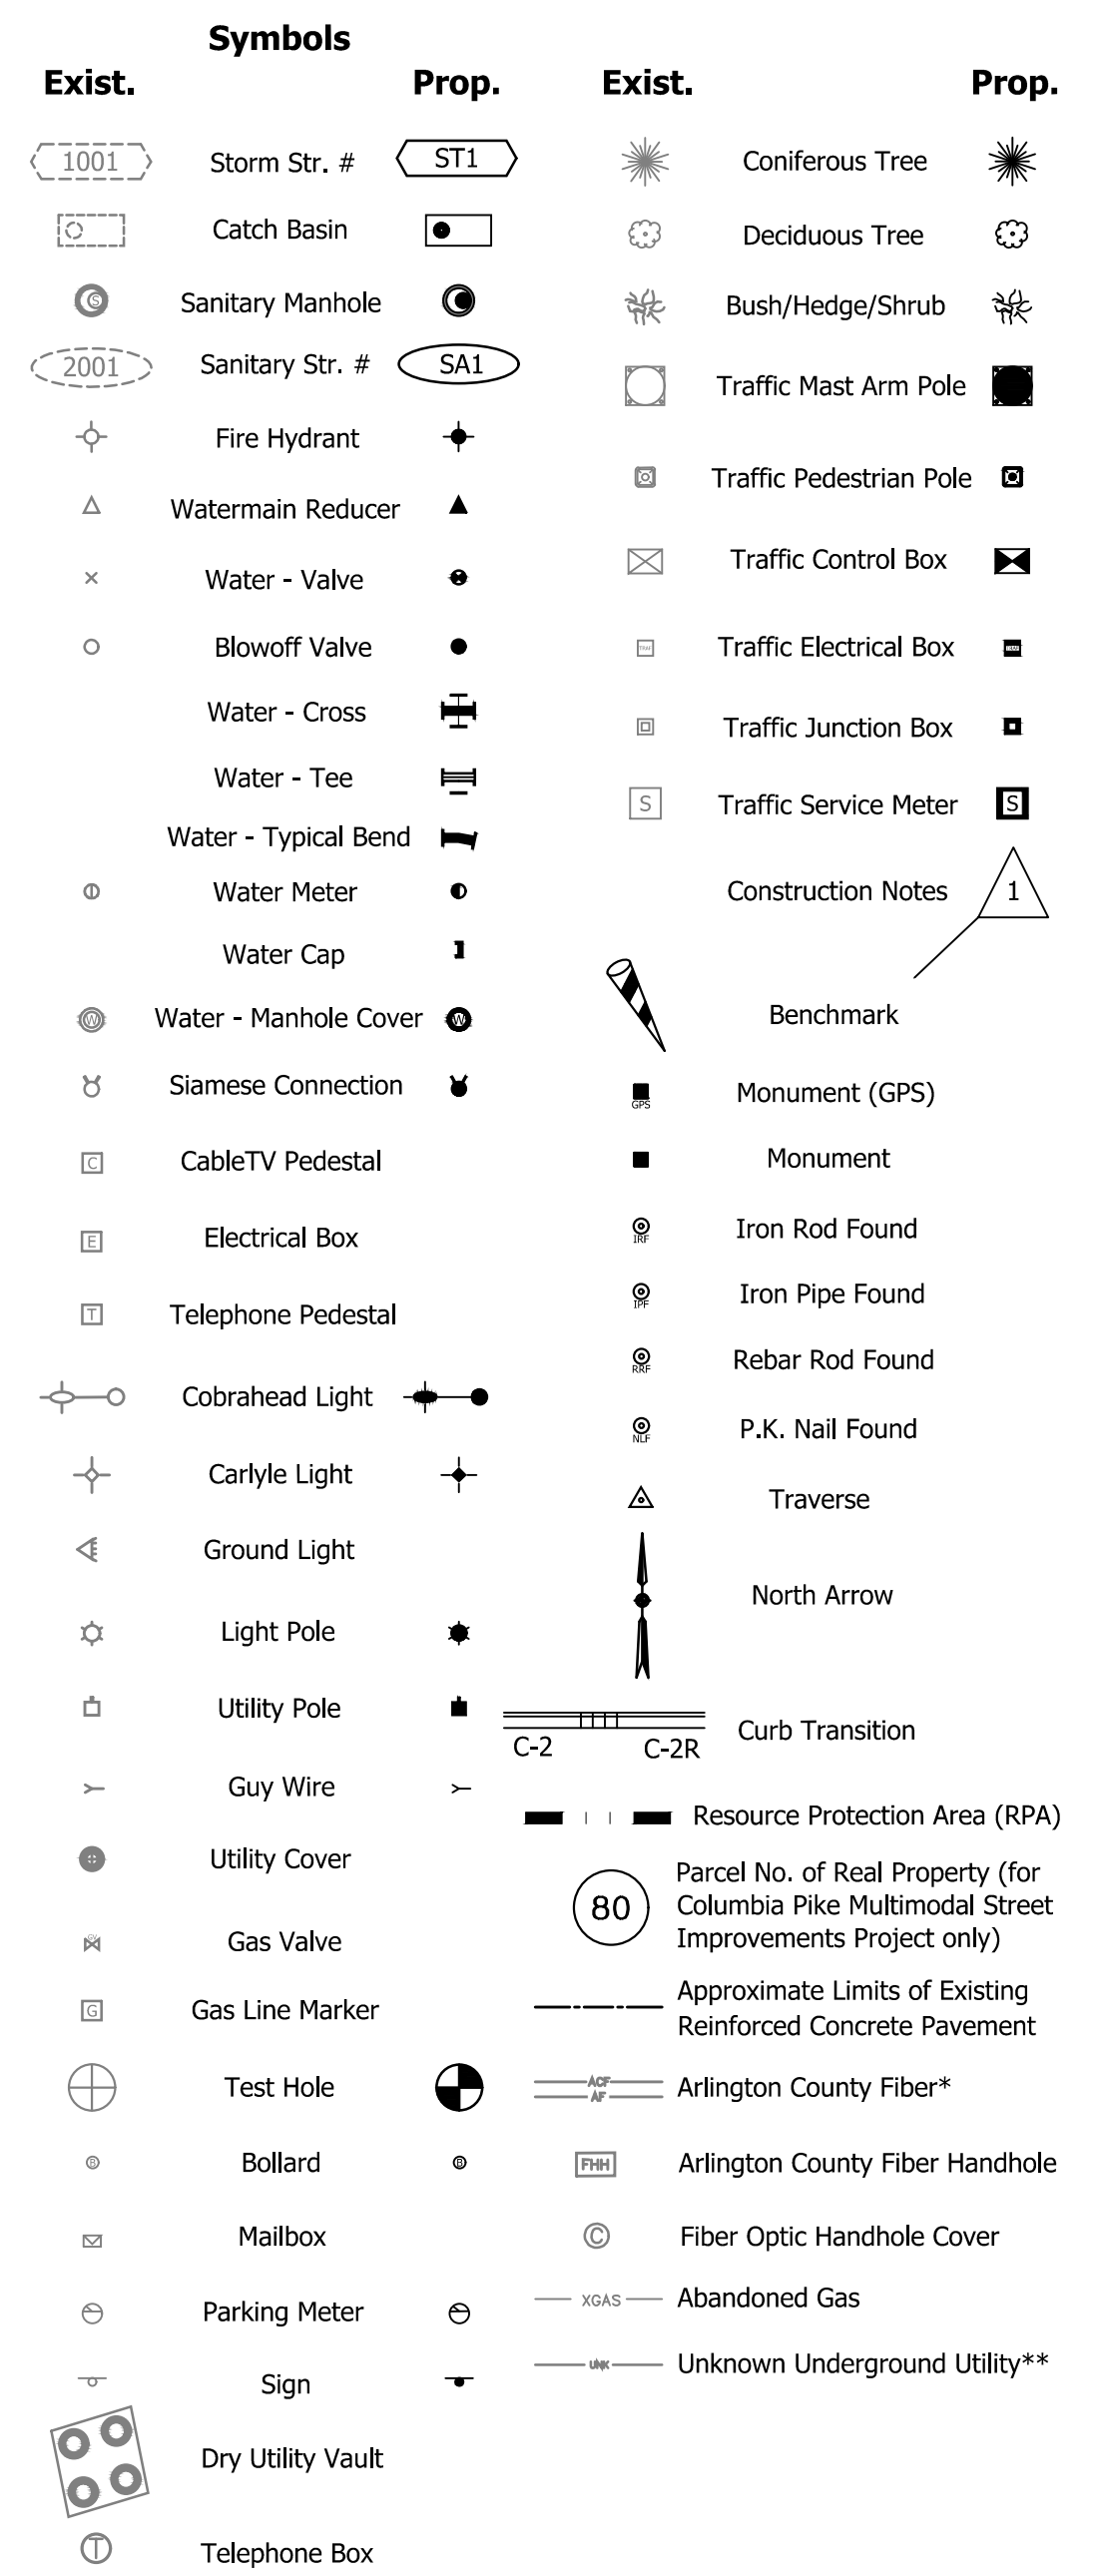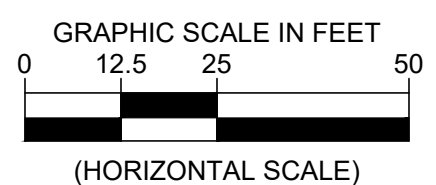

* NOTE: ARLINGTON COUNTY FIBER LOCATED IN THE ORIGINAL SURVEY IS SHOWN AS "ACF" IN THE PLANS. ARLINGTON COUNTY FIBER LOCATED BY MAUL IN A SURVEY DATED SEPTEMBER 2020 IS SHOWN AS "AF" IN THE PLANS. CONTRACTOR TO FIELD VERIFY LOCATION OF COUNTY FIBER PRIOR TO CONSTRUCTION.

** NOTE: UNKNOWN UTILITY LINE MARKED BY "UNK" IN THE PLANS WAS FOUND BY MAUL DURING ADDITIONAL SURVEY EFFORT REQUESTED BY THE COUNTY AND DATED APRIL 3-6, 2020. CONTRACTOR TO FIELD VERIFY LOCATION AND TYPE OF UTILITY AND DETERMINE THE STATUS OF THE UTILITY (ACTIVE OR ABANDONED) PRIOR TO CONSTRUCTION.

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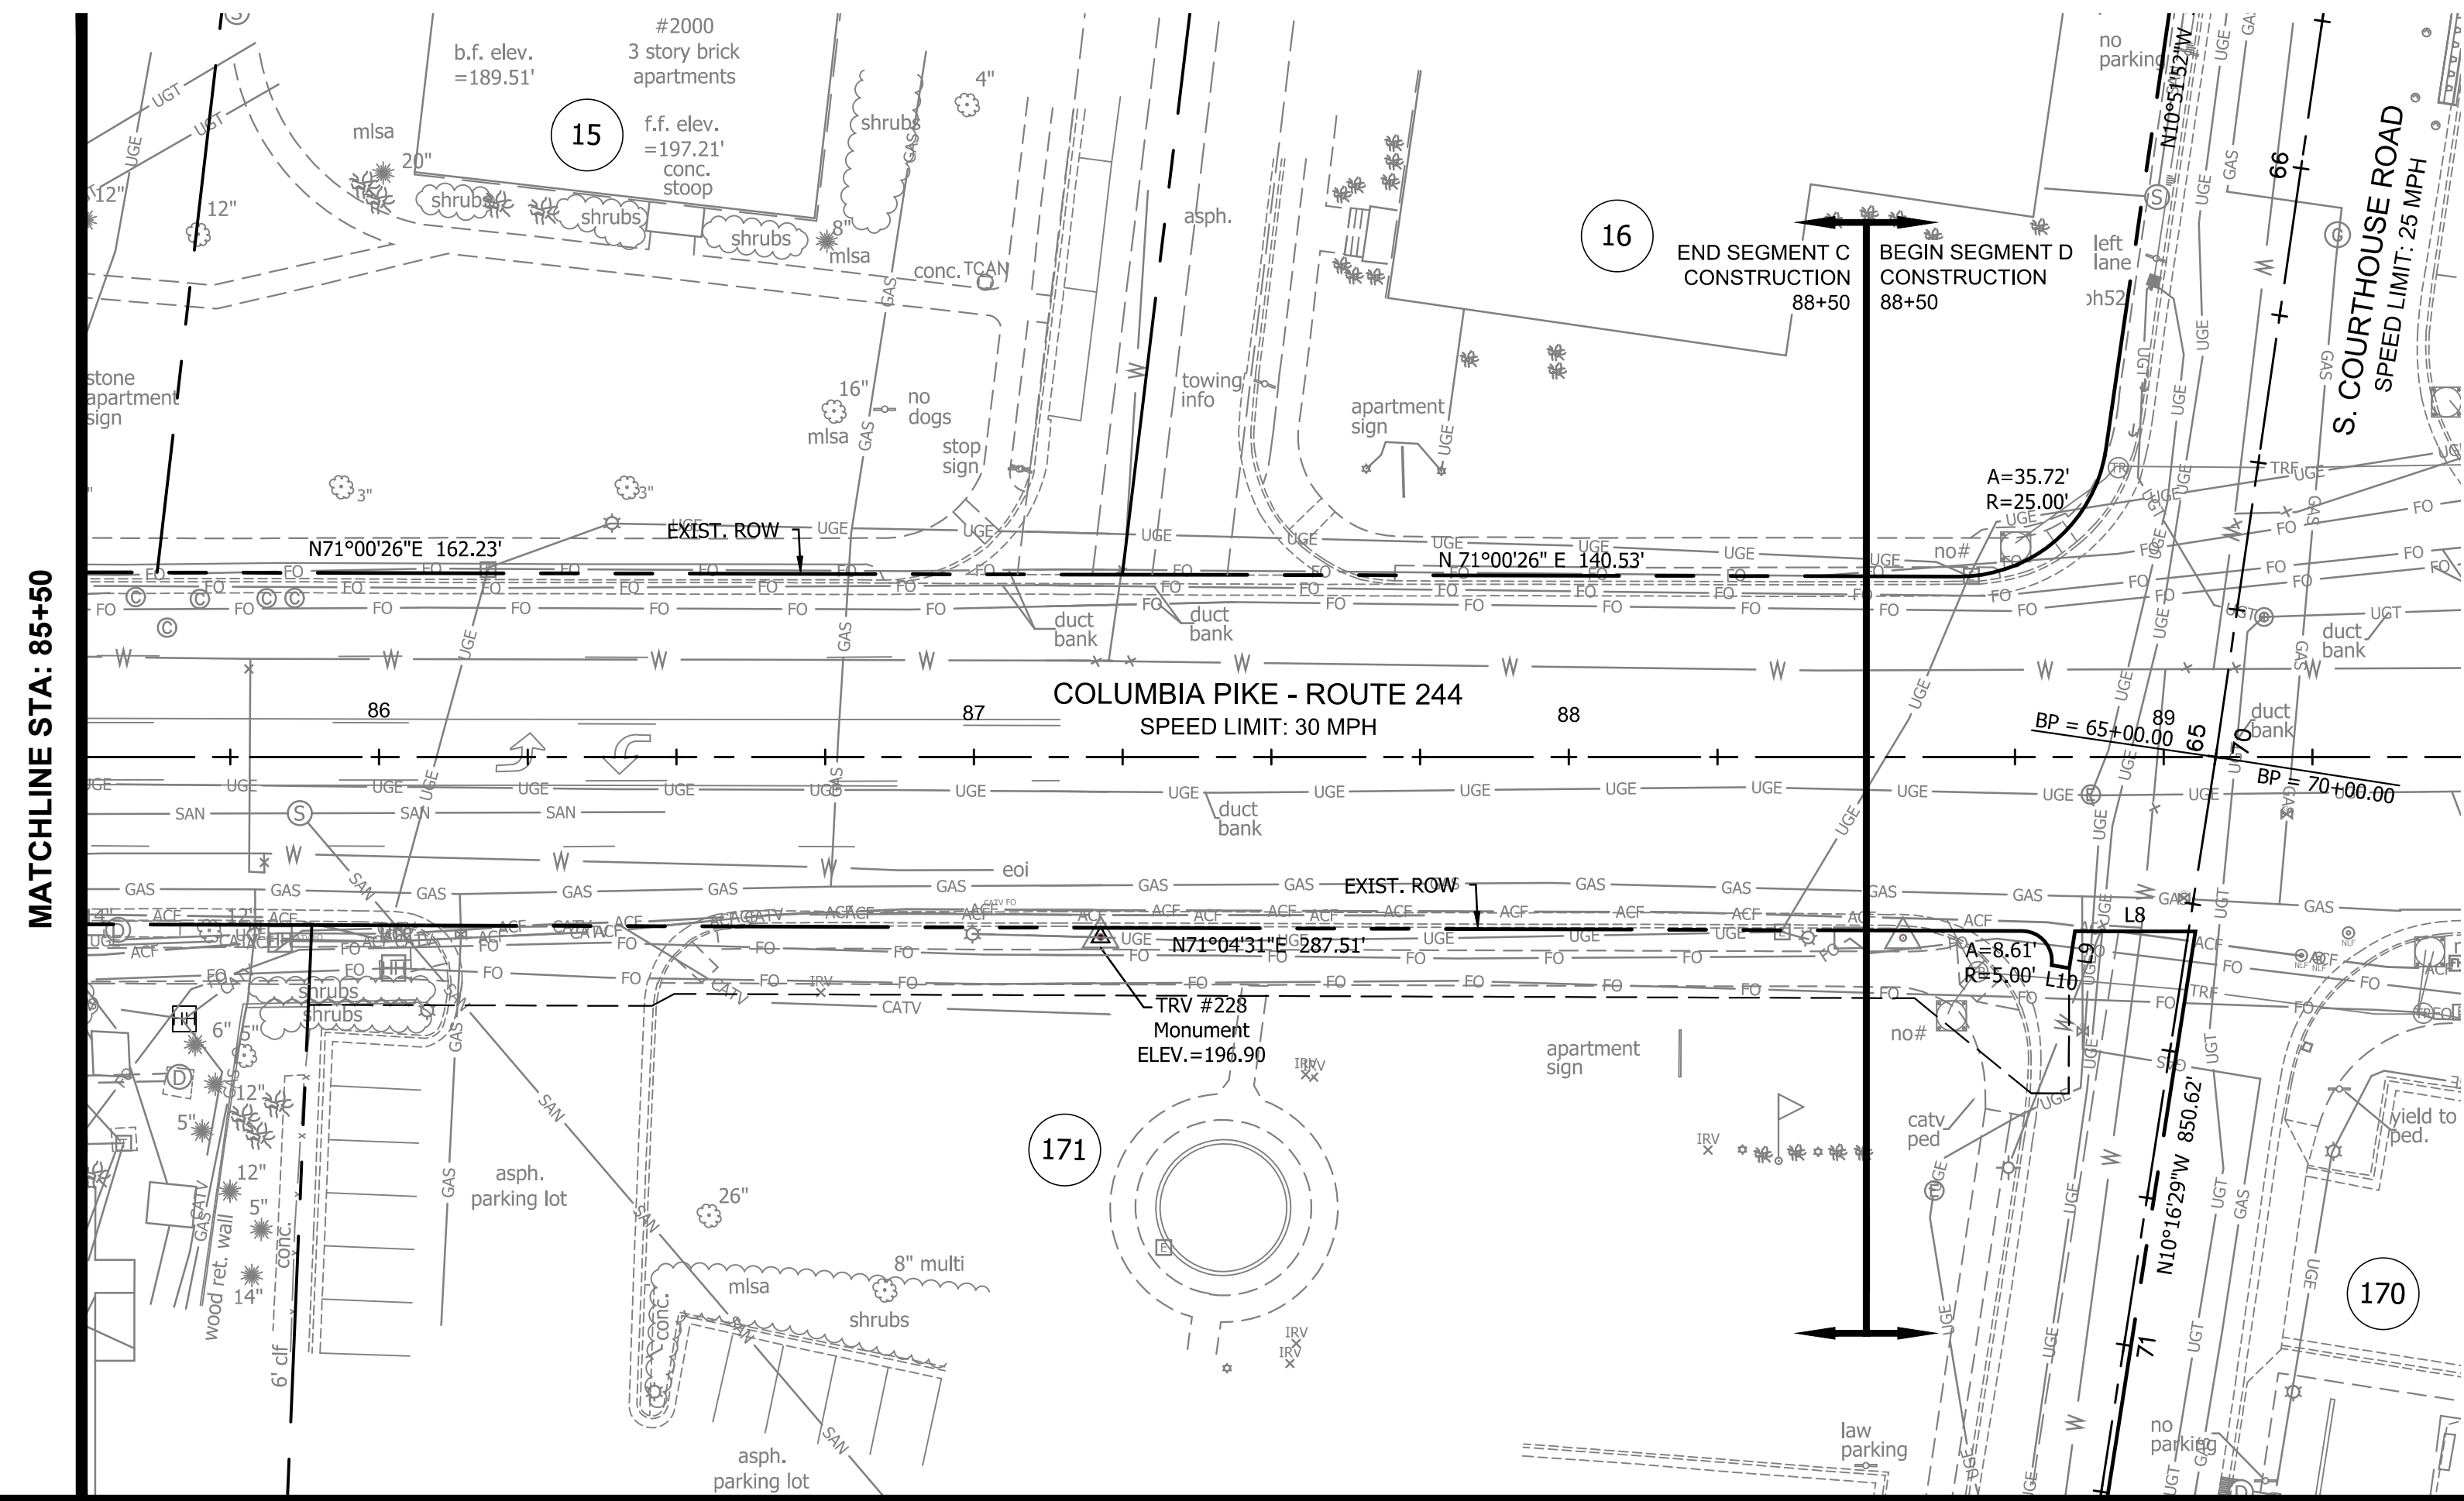
Seal
EDWARD J. BELLO
Lic. No. 0402054356
11/02/2022
PROFESSIONAL ENGINEER

Approvals	Date
Design Team Engineer Supervisor	
Construction Management Supervisor	
Water, Sewer, Streets Bureau Chief	
Transportation Director	
Project Manager	
Revisions	Date

Designed: MAT
Drawn: MAT
Checked: EJD
Miss Utility Transmittal #:

Filename: 010073-C-EX701.dwg
Path: S:\DATA\2020\11\18\00971 Columbia Pike Multimodal\Production\Task Design\Plotters
Plotted: November 02, 2022
Plotted by: Ted.DeLio

MATCHLINE STA: 85+50



Control Table (Ground Values)


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224	7001457.314	11888926.157	128.54	Rod & Cap
225	7001437.684	11888516.032	149.96	Rod & Cap
226	7001240.376	11888134.299	158.91	Rod & Cap
40001	7001082.801	11887689.562	176.83	Rod & Cap
228	7001016.665	11887295.791	196.90	Monument

NOTE:
A SCALE FACTOR OF 1.00006 WAS APPLIED TO THIS FILE TO ACHIEVE GROUND COORDINATE VALUES. THE SCALE POINT AT (NORTH) 7009718.00, (EAST) 11878491.00 WAS USED AS THE SCALE POINT.

ARLINGTON COUNTY, VIRGINIA
DEPARTMENT OF ENVIRONMENTAL SERVICES



EXISTING CONDITIONS
COLUMBIA PIKE - ROUTE 244
COLUMBIA PIKE - MULTIMODAL STREET IMPROVEMENTS
SEGMENT C
STA. 81+50 TO STA. 89+50

SCALE: HOR. 1" = 25' VERT. N/A SHEET: C4.2 of C4.2

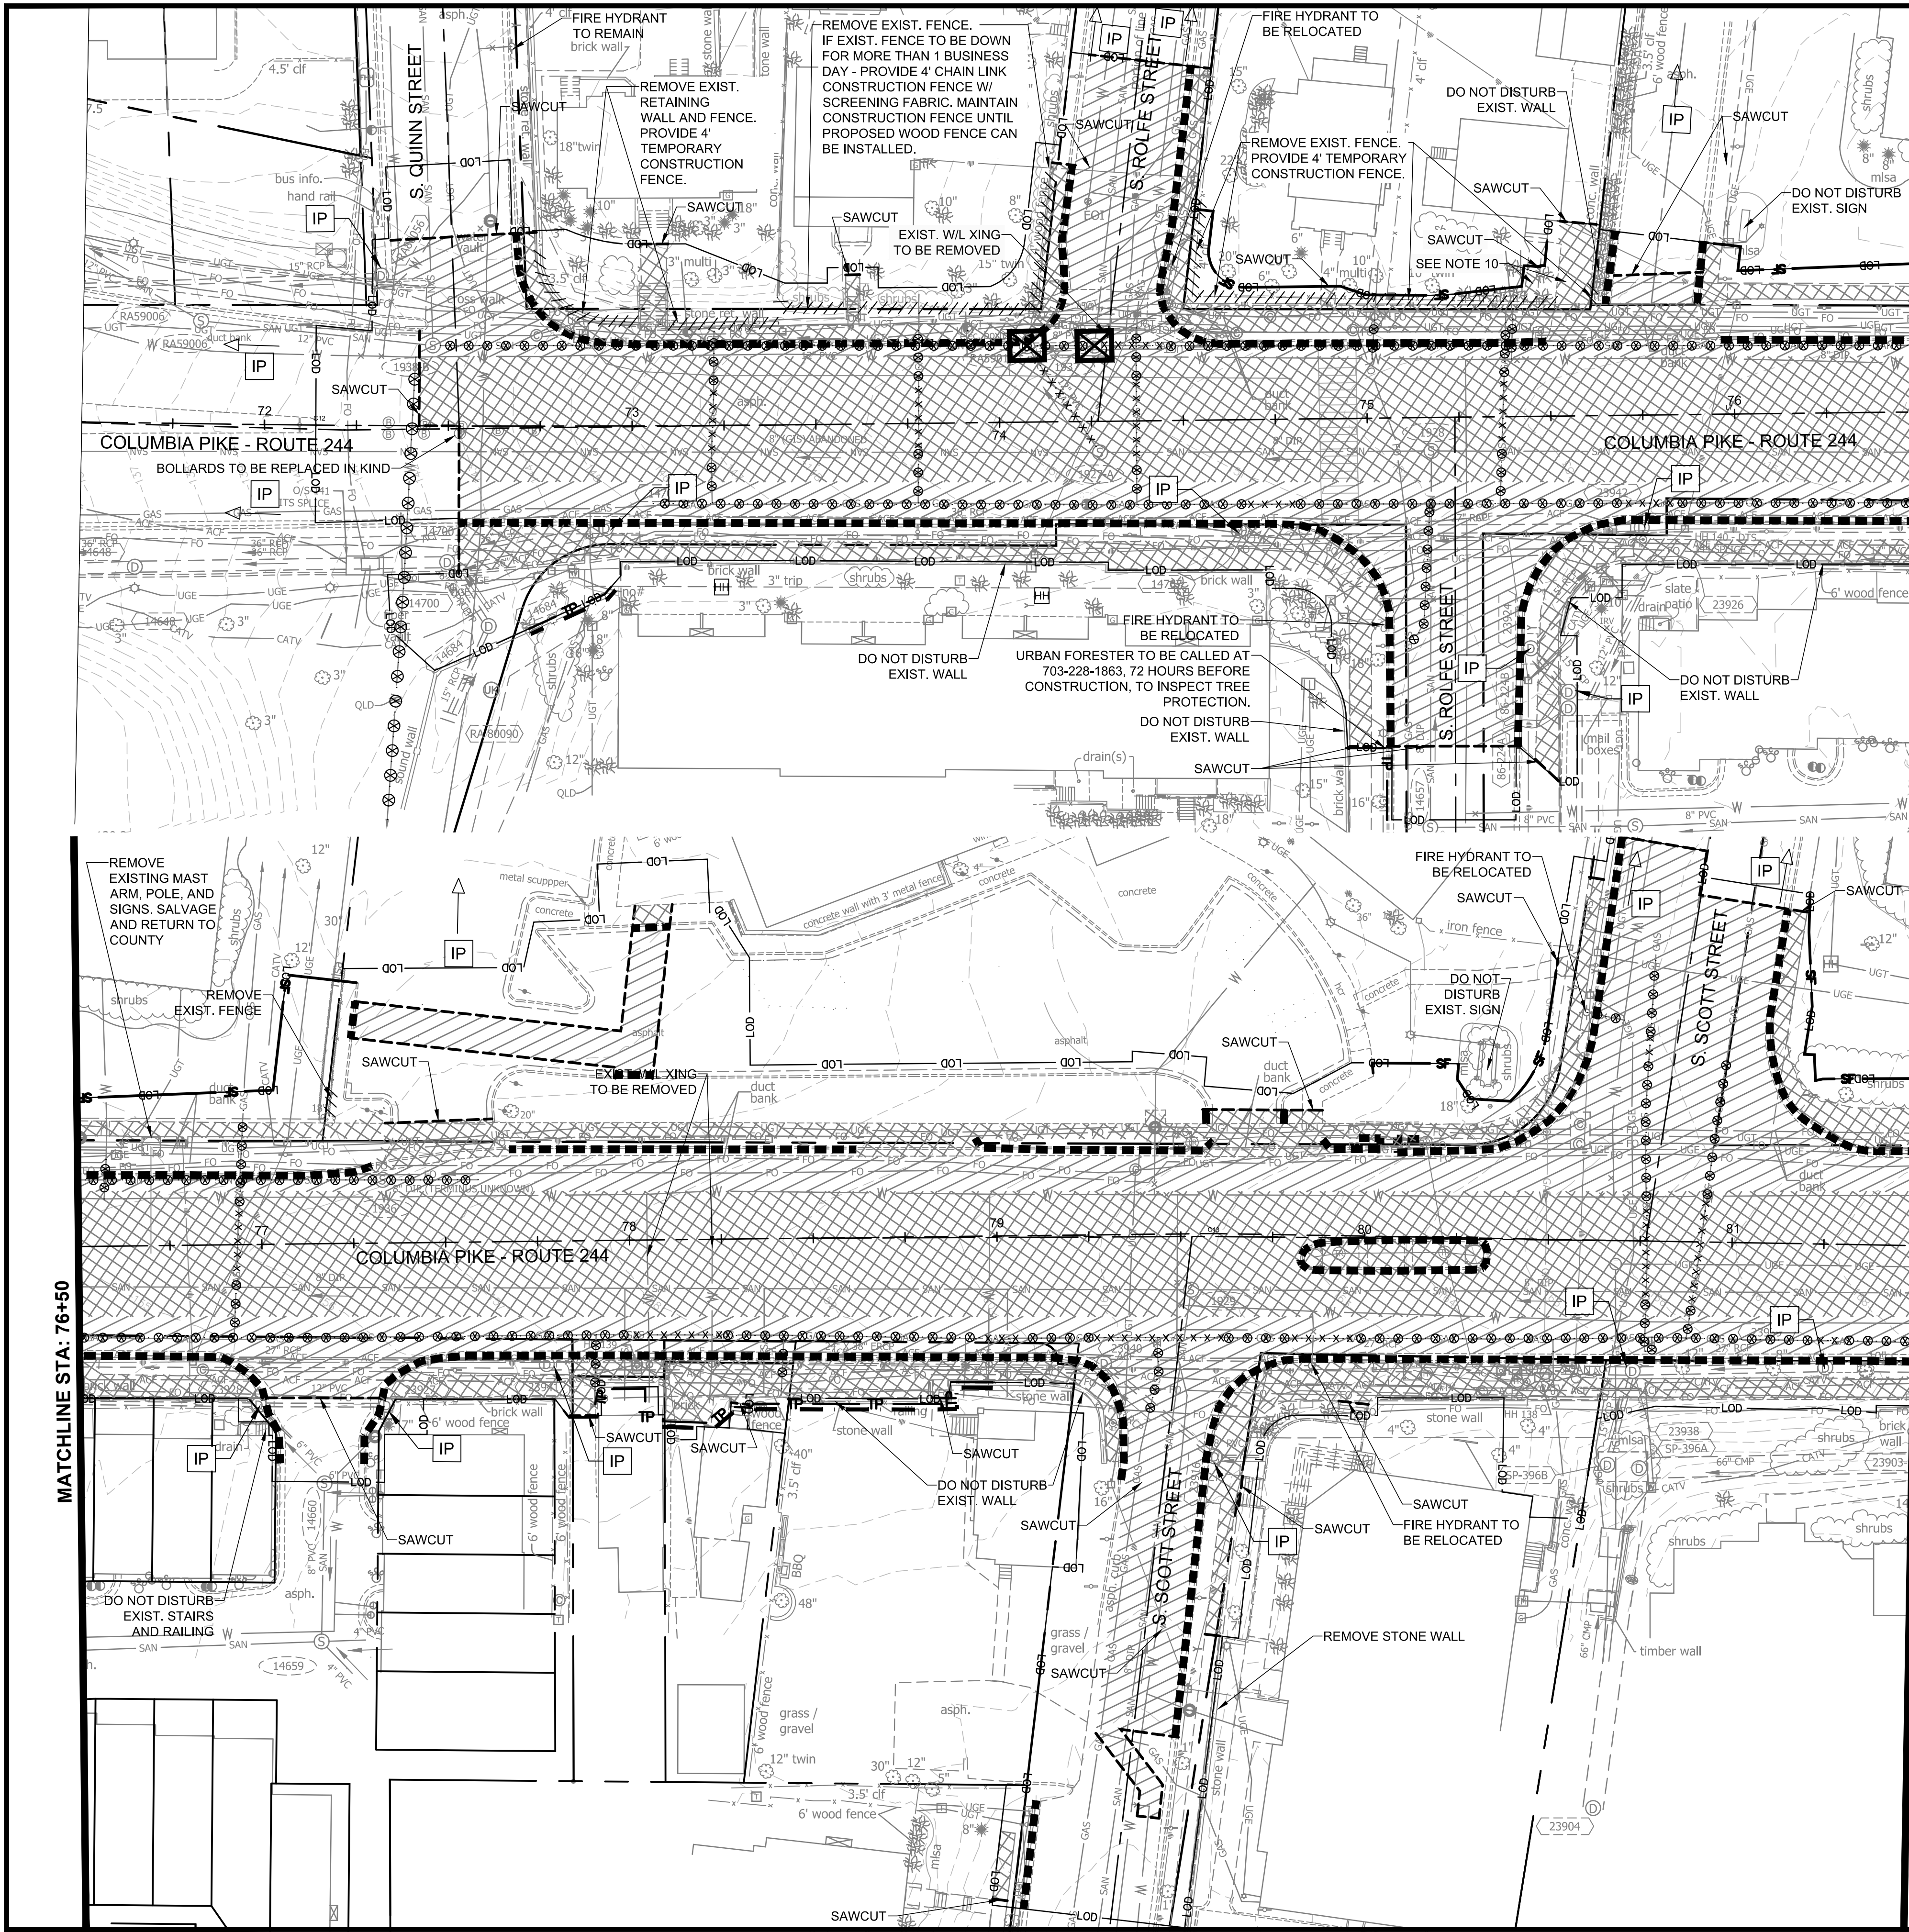

MATCHLINE STA: 76+50

MATCHLINE STA: 81+50 - SEE SHEET C6.2

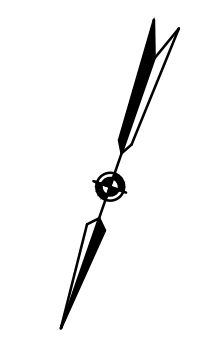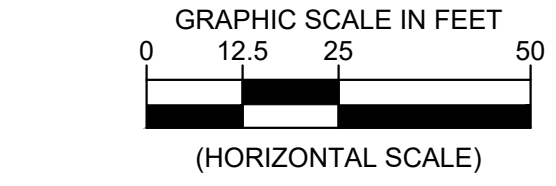

LEGEND

- REMOVE FULL DEPTH PAVEMENT TO SUBGRADE
- REMOVE FULL DEPTH PAVEMENT AND CONCRETE BASE TO SUBGRADE
- FULL DEPTH SAWCUT
- REMOVE CONCRETE CURB AND GUTTER
- REMOVE UTILITY LINE
- FILL & ABANDON UTILITY LINE
- REMOVE FENCE OR WALL
- STORM SEWER STRUCTURE INLET PROTECTION TYPE A OR B
- INLET PROTECTION LOCATED OFF OF THE SHEET
- REMOVE STRUCTURE
- EROSION CONTROL FENCE (SILT FENCE)
- TREE PROTECTION
- LIMITS OF DISTURBANCE

NOTES:

1. BUS SHELTER TO BE RELOCATED DURING CONSTRUCTION. SEE MOT PLAN FOR RELOCATION AND TEMPORARY LOCATIONS.
2. SEE TREE PROTECTION PLAN FOR TREE REMOVAL, TREE PROTECTION AND ROOT PRUNING DETAILS.
3. EROSION AND SEDIMENT PROTECTION MEASURES SHALL BE INSTALLED ONLY WHEN NEEDED FOR CONSTRUCTION. IF A PROTECTION MEASURE IS NO LONGER NEEDED IT SHALL BE REMOVED IMMEDIATELY.
4. SEE LIGHTING PLAN FOR DEMOLITION OF STREET LIGHTS.
5. SEE TRAFFIC SIGNALS PLAN FOR DEMOLITION OF TRAFFIC SIGNALS.
6. SEE SIGNING AND MARKING PLAN FOR LOCATIONS OF SIGNS TO BE REMOVED OR RELOCATED. COORDINATE RELOCATIONS WITH ARLINGTON COUNTY.
7. EXISTING TRASH CANS AND BIKE RACKS TO BE RETURNED TO ARLINGTON COUNTY OR RELOCATED AS DIRECTED BY THE COUNTY.
8. GAS LINE TO BE DEMOLISHED OR FILLED/ABANDONED BY WASHINGTON GAS.
9. CONCRETE SLAB OF THE DRIVEWAY, WALKWAY, AND SIDEWALK MUST BE SAW CUT AND FULLY ISOLATED PRIOR TO ANY JACK HAMMERING WORK.
10. WHERE EXISTING PAVEMENT IS TO BE REMOVED WITHIN THE CRITICAL ROOT ZONE OF A TREE, LEAVE PAVEMENT IN PLACE AS LONG AS POSSIBLE DURING CONSTRUCTION (REFER TO SHEETS C14.9 AND C14.10 FOR CRITICAL ROOT ZONES). REMOVE PAVEMENT WITH THE ROLLBACK TECHNIQUE, KEEP EQUIPMENT ON PAVING, AND LIMIT OVERDIG. ONCE PAVEMENT HAS BEEN REMOVED, VEHICULAR TRAFFIC IS STRICTLY PROHIBITED UNTIL PAVING IS REPLACED. REPLACED PAVING SHOULD BE A BRIDGED, TREE-FRIENDLY DETAIL WITH NO COMPACTION BEYOND 85%. COORDINATE WITH THE URBAN FORESTER WHEN PROCESS OR CONSTRUCTION DETAILS CAN'T FOLLOW THIS SPECIFICATION.

ARLINGTON VIRGINIA
DEPARTMENT OF ENVIRONMENTAL SERVICES

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Seal

Approvals	Date
Design Team Engineer Supervisor	
Construction Management Supervisor	
Water, Sewer, Streets Bureau Chief	
Transportation Director	
Project Manager	
Revisions	Date

Designed: MAT
Drawn: MAT
Checked: EJD
Miss Utility Transmittal #:

Filename: 010073-C-DEMO.dwg
Path: \\...
Plotted: September 29, 2022
Plotted by: Ted.DeLio

ARLINGTON COUNTY, VIRGINIA
DEPARTMENT OF ENVIRONMENTAL SERVICES

PHASE 1 EROSION CONTROLS & DEMOLITION PLAN
COLUMBIA PIKE - ROUTE 244
COLUMBIA PIKE - MULTIMODAL STREET IMPROVEMENTS
SEGMENT C
STA. 72+15 TO STA. 81+50


SCALE: HOR. 1" = 25' VERT. N/A SHEET: C6.1 of C6.2

ARLINGTON VIRGINIA
DEPARTMENT OF ENVIRONMENTAL SERVICES

LURE ARAYA
BUREAU CHIEF, DES - DEVELOPMENT SERVICES




11/15/2022
APPROVAL DATE

MATCHLINE STA: 81+50 - SEE SHEET C6.1

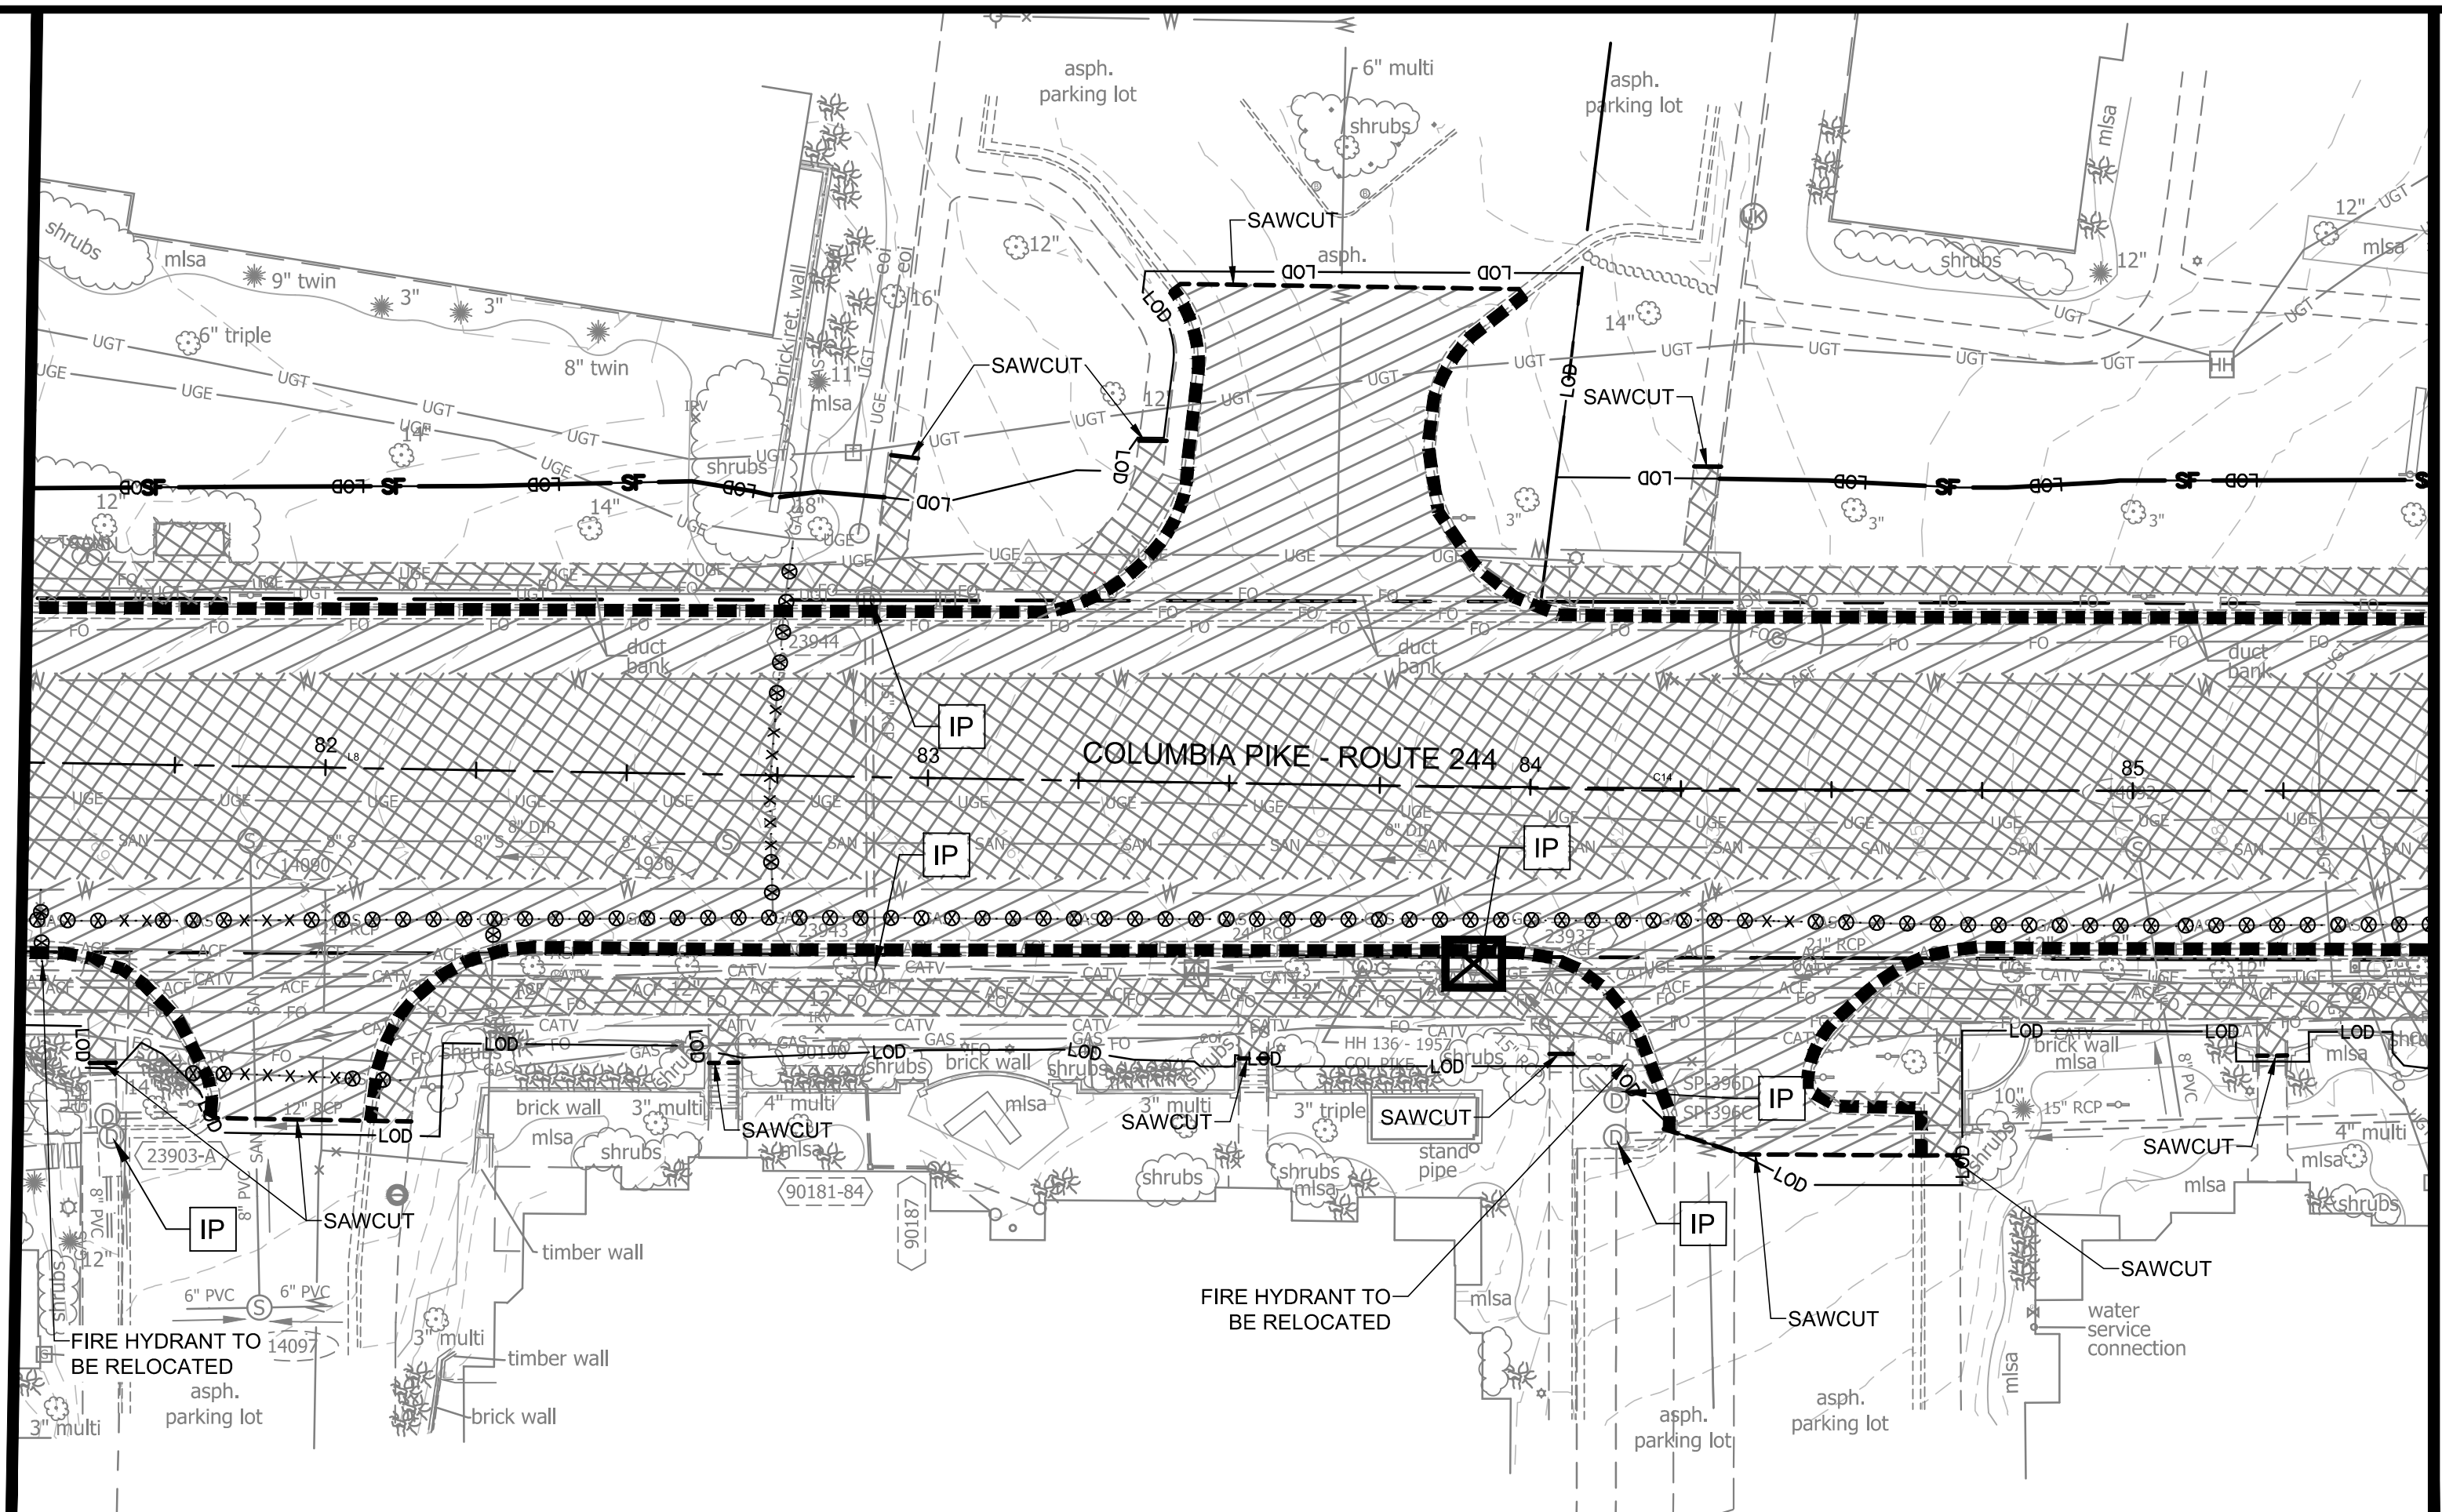

MATCHLINE STA: 85+50

MATCHLINE STA: 85+50

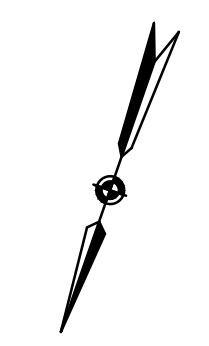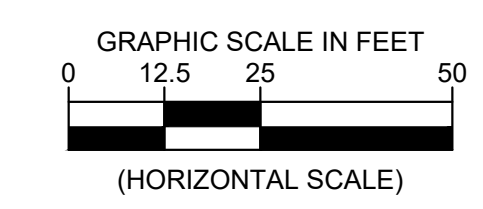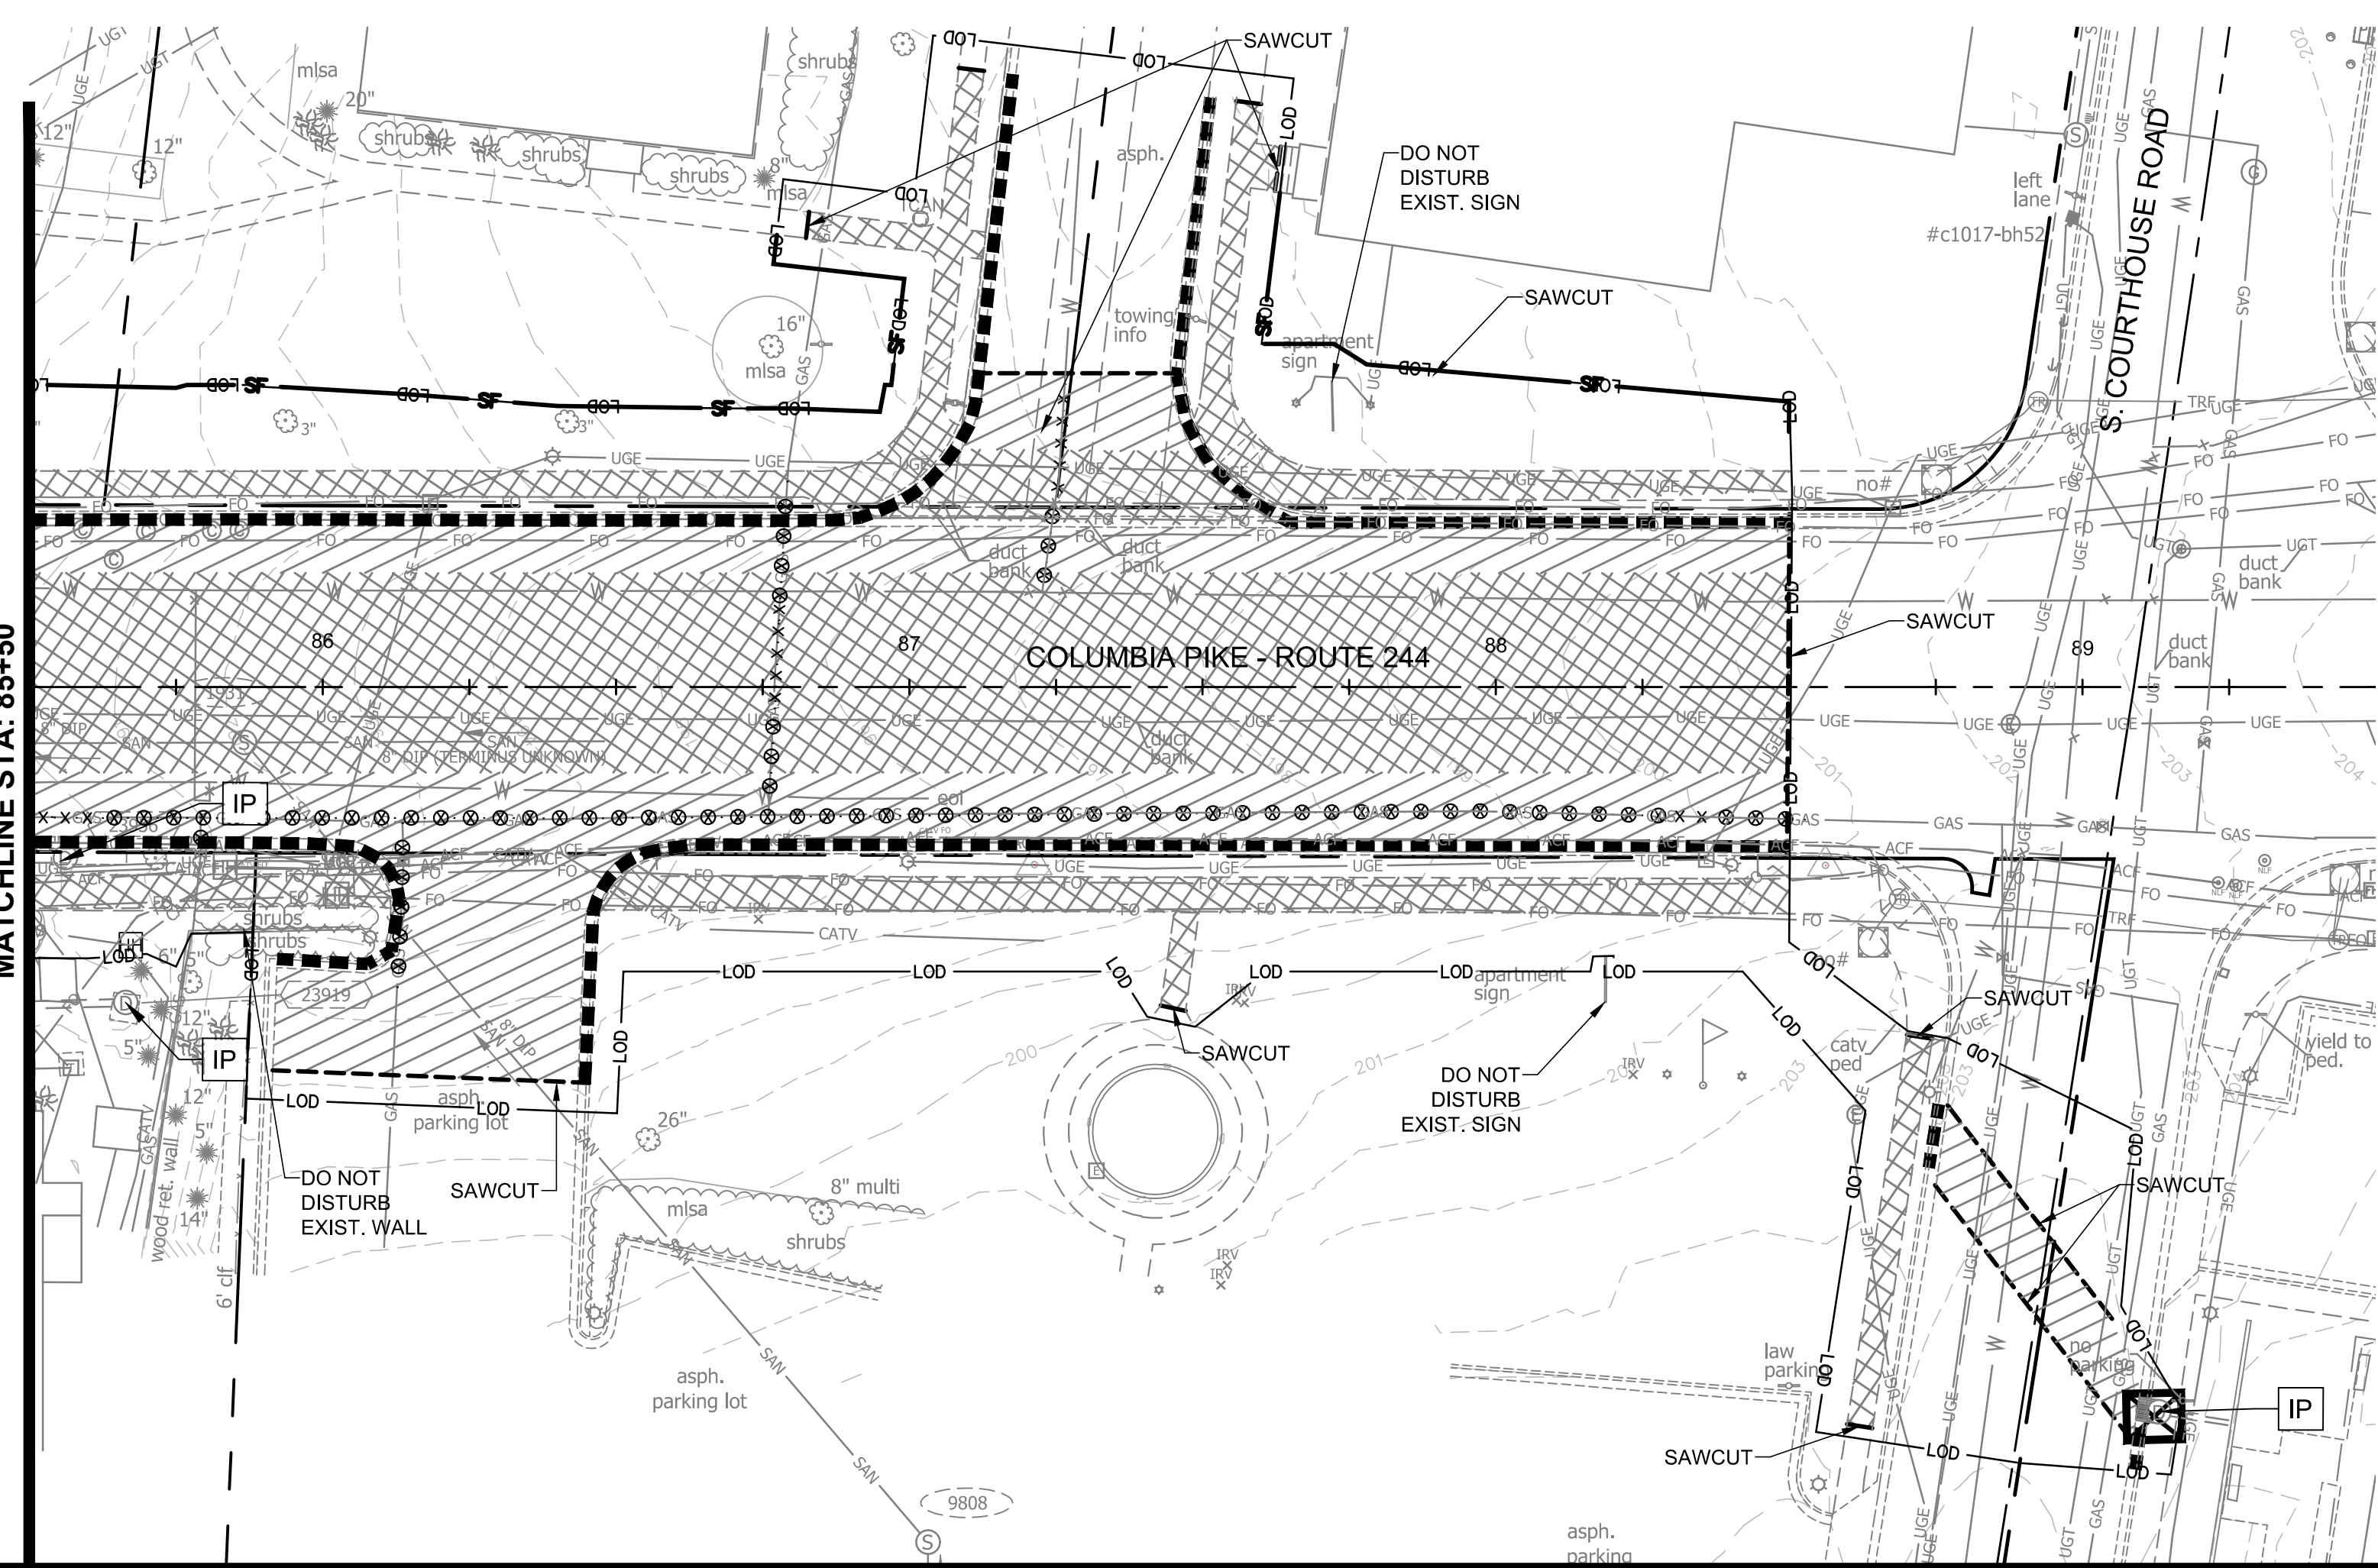

LEGEND


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Construction Management Supervisor	
Water, Sewer, Streets Bureau Chief	
Transportation Director	
Project Manager	
Revisions	Date

Designed: MAT
 Drawn: MAT
 Checked: EJD
 Miss Utility Transmittal #:

Filename: 010073-C-DEMO.dwg
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 Plotted: September 29, 2022
 Plotted by: Thomas.Super

ARLINGTON COUNTY, VIRGINIA
 DEPARTMENT OF ENVIRONMENTAL SERVICES

PHASE I EROSION CONTROLS & DEMOLITION PLAN
 COLUMBIA PIKE - ROUTE 244
 COLUMBIA PIKE - MULTIMODAL STREET IMPROVEMENTS
 SEGMENT C
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SCALE: HOR. 1" = 25' VERT. N/A SHEET: C6.2 of C6.2

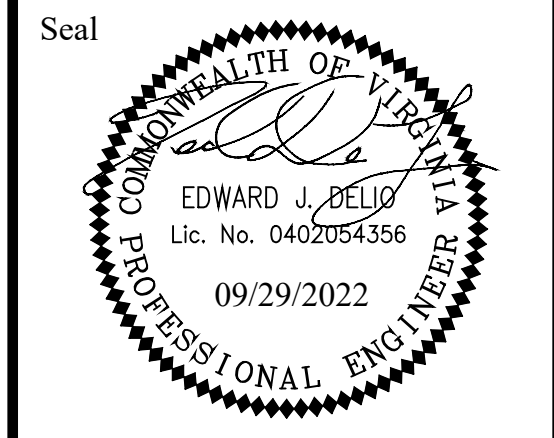ARLINGTON VIRGINIA
 DEPARTMENT OF ENVIRONMENTAL SERVICES

David D. Araya
 BUREAU CHIEF, DES - DEVELOPMENT SERVICES

11/15/2022
 APPROVAL DATE