

SITE PLAN CERTIFICATIONS
ENGINEER'S CERTIFICATION
IT IS HEREBY CERTIFIED THAT THIS SITE PLAN WAS PREPARED USING A SURVEY OF THE PROPERTY PREPARED BY SCOTT WOOD, RLS, AND DATED AUGUST 30, 2011; AND FURTHER THAT THE PROPOSED DEVELOPMENT MEETS ALL REQUIREMENTS OF THE JACKSON COUNTY UNIFIED DEVELOPMENT CODE, AS APPLICABLE TO THE PROPERTY.

BY (NAME): KENNETH L. PETERS
SIGNED:
REGISTERED PROFESSIONAL ENGINEER NO. 26331
ADDRESS: 303 SWANSON DRIVE, LAWRENCEVILLE, GA 30043
TELEPHONE NUMBER: (770) 962-1387
DATE:

OWNER'S CERTIFICATION
AS THE OWNER OF THIS LAND, AS SHOWN ON THIS SITE PLAN, OR HIS AGENT, I CERTIFY THAT THIS DRAWING WAS MADE FROM AN ACTUAL SURVEY, AND ACCURATELY PORTRAYS THE EXISTING LAND AND ITS FEATURES AND THE PROPOSED DEVELOPMENT AND IMPROVEMENTS THERETO.

DATE:
OWNER/AGENT (NAME): KEVIN POE
SIGNED:

SITE DEVELOPMENT PLANS

FOR

JACKSON COUNTY GOVERNMENT

PROPOSED EMS FACILITY

G.M.D. : 455

SITE ADDRESS: 4285 PLAINVIEW ROAD

MAYSVILLE, GA 30558

NOVEMBER 2015

ENVIRONMENTAL HEALTH DEPARTMENT CERTIFICATION
THE LOTS SHOWN HAVE BEEN REVIEWED BY THE JACKSON COUNTY ENVIRONMENTAL HEALTH DEPARTMENT AND ARE APPROVED FOR PRELIMINARY SUBDIVISION SITE WORK ONLY.
DATED THIS ____ DAY OF _____, 20____.

BY: _____
TITLE: _____

JACKSON COUNTY ROADS DEPARTMENT CERTIFICATION
THE LOTS SHOWN HAVE BEEN REVIEWED BY THE JACKSON COUNTY ROADS DEPARTMENT AND ARE APPROVED FOR PRELIMINARY SUBDIVISION SITE WORK ONLY.
DATED THIS ____ DAY OF _____, 20____.

BY: _____
ROADS SUPERINTENDENT

WATER AND SEWER PROVIDER CERTIFICATION
THIS DEVELOPMENT, AS SHOWN, HAS BEEN REVIEWED AND IS APPROVED FOR CONSTRUCTION ACTIVITY ONLY IN THAT IT HAS BEEN DESIGNED TO MEET THE REQUIREMENTS OF THE JACKSON COUNTY WATER & SEWERAGE AUTHORITY STANDARD SPECIFICATIONS WITH REGARD TO:

WATER SUPPLY (STRIKE THROUGH IF NOT APPLICABLE)
SEWAGE DISPOSAL (STRIKE THROUGH IF NOT APPLICABLE)

AND THAT ALL OF THE PROPOSED UTILITY EASEMENTS TO BE DEDICATED TO JCWSA ARE SHOWN ON THE PRELIMINARY PLAT AND CONSTRUCTION DRAWINGS.

THE JCWSA IS NOT RESPONSIBLE FOR THE ADEQUACY OF THE DESIGN, WHICH IS THE SOLE RESPONSIBILITY OF THE ENGINEER OF RECORD, WHOM STAMPED AND SEALED THE PLANS.
DATED THIS ____ DAY OF _____, 20____.

BY: _____
TITLE: _____
ORGANIZATION: _____


COMMISSIONERS _____

- TOM CROW, CHAIRMAN
- JIM HIX, COMMISSIONER DISTRICT 1
- CHAS HARDY, COMMISSIONER DISTRICT 2
- RALPH RICHARDSON, JR., COMMISSIONER DISTRICT 3
- DWAIN SMITH, COMMISSIONER DISTRICT 4


- KEVIN POE, COUNTY MANAGER
- STEVE NICHOLS, EMERGENCY SERVICES DIRECTOR
- JASON BAKER, EMS DIRECTOR

INDEX _____

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LOCATION MAP
N.T.S.

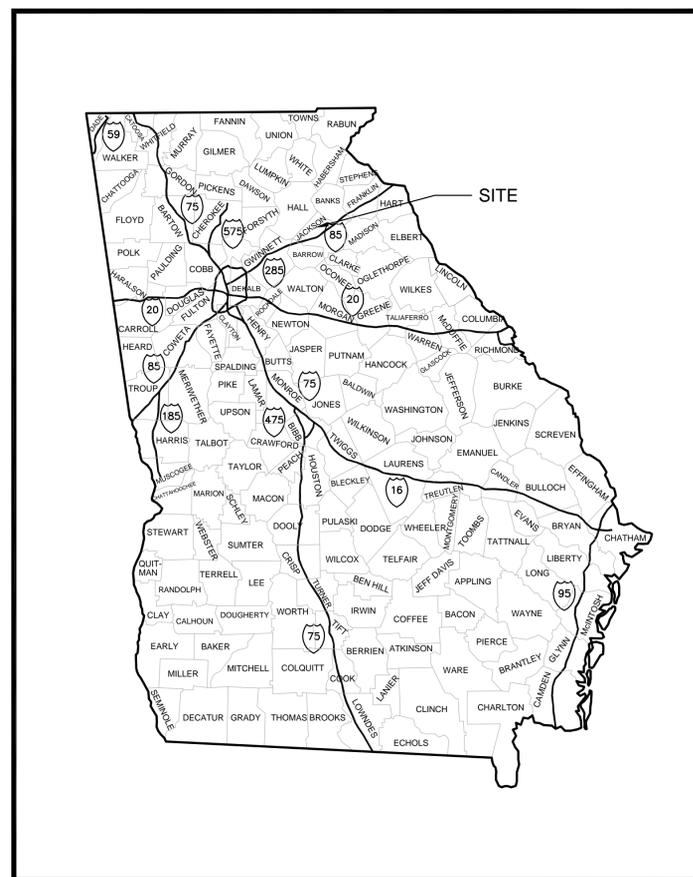

PROJECT MAP
N.T.S.
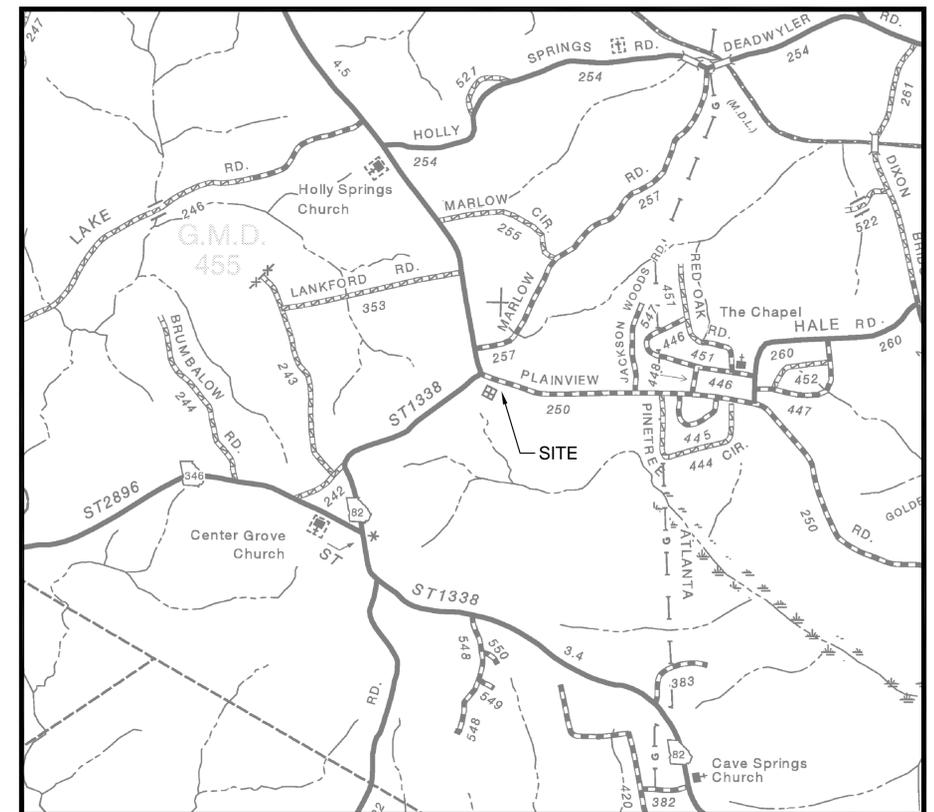
| DATE | NO. | DESCRIPTION |
|----------|-----|---|
| 12/14/15 | 1 | SUBMIT FOR INITIAL REVIEW |
| 01/06/16 | 2 | ADDRESS GASWCC COMMENTS |
| 01/26/16 | 3 | REVISE PLAN TO RELOCATE STORMWATER POND |
| | | |
| | | |
| | | |
| | | |
| | | |
| | | |
| | | |

G1

STAMP

SHEET NO.

OWNER:
JACKSON COUNTY GOVERNMENT
 67 ATHENS STREET
 JEFFERSON, GA 30549
CONTACT: KEVIN POE, COUNTY MANAGER
 (706) 367-6314
 (706) 367-9083 (FAX)



303 Swanson Drive, Lawrenceville, GA 30043
 phone 770-962-1387 fax # 770-962-8010
 www.eminc.biz


PROJECT CONTACTS: KEN PETERS

GENERAL NOTES:

- TOTAL ACREAGE = 9.21 ACRES (DISTURBED AREA = 1.50 ACRES).
- ZONING IS A-2 WITH PUBLIC INSTITUTIONAL LAND USE.
- PROPOSED DEVELOPMENT = A NEW 3,500 S.F. EMS FACILITY WITH ASSOCIATED SITE IMPROVEMENTS (I.E. PARKING, STORM DRAINAGE, UTILITIES, ETC.).
- LOCATION OF PROPERTY LINES WERE OBTAINED FROM BOUNDARY SURVEY FOR JACKSON COUNTY GOVERNMENT BY WOOD BROTHERS & SCOTT, INC., DATED FEBRUARY 13, 2009.
- TOPOGRAPHIC INFORMATION BASED ON FIELD-RUN TOPOGRAPHY BY LAND DEVELOPMENT SURVEYORS, INC. DATED OCTOBER 29, 2015.
- LOT TO BE SERVED BY ONSITE SEPTIC SYSTEM.
- WATER PROVIDED BY JACKSON COUNTY WATER AND SEWERAGE AUTHORITY.
- NATURAL VEGETATION TO REMAIN ON THE PROPERTY UNTIL THE ISSUANCE OF A LAND DISTURBANCE PERMIT.
- NO PORTION OF THE SUBJECT PROPERTY LIES WITHIN A DESIGNATED FLOOD HAZARD AREA, PER FEMA FIRM PANEL NUMBER 13157C0107C, DATED DECEMBER 17, 2010 AND FIRM PANEL NUMBER 13157C0110C, DATED DECEMBER 17, 2010.
- LAND DISTURBANCE LIMITED TO AREAS NEEDED FOR GRADING AND CONSTRUCTION TO BUILD A 3,500 S.F. BUILDING, PARKING LOT, DRIVEWAYS, SIDEWALKS AROUND BUILDING, UTILITIES TO SUPPLY BUILDING, AND A STORMWATER MANAGEMENT POND.
- THE CONTRACTOR SHALL NOTIFY EACH INDIVIDUAL UTILITY OWNER OF HIS PLAN OF OPERATION IN THE AREA OF WORK. PRIOR TO COMMENCING WORK, THE CONTRACTOR SHALL CONTACT THE UTILITY LOCATION SERVICE AND REQUEST THEM TO PROPERLY LOCATE THEIR RESPECTIVE UTILITY ON THE GROUND. THIS NOTIFICATION SHALL BE GIVEN AT LEAST THREE BUSINESS DAYS PRIOR TO COMMENCEMENT OF WORK.
- CONTRACTOR TO NOTIFY THE UTILITY PROTECTION AGENCY 72 HOURS PRIOR TO START OF WORK. PHONE 1-800-282-7411.
- THE CONTRACTOR SHALL BE RESPONSIBLE FOR MAINTAINING EROSION CONTROL MEASURES AT ALL TIMES.
- CONTRACTOR SHALL VERIFY LOCATION AND ELEVATION OF ALL UTILITIES PRIOR TO EXCAVATION OR DEMOLITION. ADDITIONAL UTILITIES MAY NOT BE SHOWN ON THESE PLANS. CONTRACTOR SHALL IMMEDIATELY NOTIFY OWNER AND ENGINEER IF UNKNOWN UTILITIES ARE DISCOVERED.
- IF THE CONTRACTOR DAMAGES ANY EXISTING UTILITIES DURING CONSTRUCTION, HE SHALL, AT HIS OWN EXPENSE, HAVE REPLACED OR REPAIRED THE UTILITIES TO THEIR ORIGINAL OR BETTER CONDITION AND QUALITY, AS APPROVED BY THE OWNER AND REPRESENTATIVE OF THE APPROPRIATE UTILITY COMPANY. THE CONTRACTOR SHALL BE SOLELY RESPONSIBLE FOR CONTACTING ALL AFFECTED UTILITIES PRIOR TO SUBMITTING HIS BID.
- A MINIMUM HORIZONTAL SEPARATION OF 10' SHALL BE MAINTAINED BETWEEN WATER LINES AND SANITARY SEWER LINES WHERE POSSIBLE. AN 18" MINIMUM VERTICAL SEPARATION SHALL BE MAINTAINED AT CROSSINGS OF WATER AND SEWER LINES. WHEN CROSSING A WATER LINE OR SEWER LINE, PIPE JOINTS SHALL BE PLACED AS FAR AWAY AS POSSIBLE FROM THE OTHER PIPE.
- ALL CONSTRUCTION STAKING SHALL BE BY THE CONTRACTOR AT HIS EXPENSE. THE OWNER SHALL PROVIDE ADEQUATE CONTROL AND BENCHMARKS.
- WHEN CONSTRUCTION INVOLVES THE REMOVAL OF FENCE, POLES, SIDEWALKS, DRIVES, TEMPORARY OR FIXED STRUCTURES; THE CONTRACTOR AT HIS EXPENSE SHALL PROVIDE FOR TEMPORARY SERVICE OR CONTAINMENT TO THE AFFECTED PROPERTY, AND SHALL REPLACE SUCH ITEMS WITH SIMILAR OR BETTER MATERIALS AS SOON AS PRACTICAL OR AS DIRECTED BY THE OWNER FOLLOWING CONSTRUCTION.
- THE CONTRACTOR SHALL RESTORE OR HAVE RESTORED, AT HIS EXPENSE, ALL EXISTING FACILITIES WHICH HAVE BEEN DAMAGED DUE TO HIS CONSTRUCTION ACTIVITIES, TO THE ORIGINAL OR BETTER CONDITION. THE CONTRACTOR SHALL UTILIZE THE SAME MATERIAL COMPOSITION AS EXISTING TO REPLACE THE EXISTING FACILITIES UNLESS APPROVED OTHERWISE BY THE OWNER.
- SEE SHEET EC-A FOR SOIL EROSION AND SEDIMENT CONTROL NOTES AND LEGEND.
- PEDESTRIAN AND LOCAL VEHICULAR TRAFFIC SHALL BE MAINTAINED AT ALL TIMES DURING CONSTRUCTION. SAFETY DEVICES AND FLAGMEN SHALL BE PROVIDED BY THE CONTRACTOR AT HIS EXPENSE. WRITTEN PERMISSION TO CLOSE THE CONSTRUCTION AREA TO TRAFFIC MUST BE OBTAINED FROM THE APPROPRIATE GOVERNMENT AGENCY PRIOR TO THE CLOSING. ALL LOCAL EMERGENCY SERVICES SHALL BE NOTIFIED IN WRITING A MINIMUM 72 HOURS PRIOR TO ROAD CLOSINGS.
- DURING CONSTRUCTION, THE CONTRACTOR IS RESPONSIBLE FOR PROVIDING TEMPORARY TRAFFIC CONTROL MEASURES TO ENSURE SAFETY AT ALL TIMES FOR EMPLOYEES, RESIDENTS, AND MOTORISTS, IN ACCORDANCE WITH THE "MANUAL OF UNIFORM TRAFFIC CONTROL DEVICES", LATEST REVISION.
- ALL EARTHWORK OPERATIONS SHALL COMPLY WITH THE REQUIREMENTS OF OSHA.
- CONTRACTOR IS RESPONSIBLE FOR REPLACING ALL PROPERTY PINS THAT ARE DISTURBED DURING CONSTRUCTION ACTIVITY.
- OWNER'S INSPECTOR SHALL CONFIRM COMPACTION OF DRIVEWAYS PRIOR TO INSTALLATION OF THE BASE COURSE.
- OWNER'S INSPECTOR SHALL CONFIRM THICKNESS OF BASE AND ASPHALT/CONCRETE DURING CONSTRUCTION.

UTILITY OWNERS:

LOCAL POWER: JACKSON EMC PHONE: (706) 367-5281
 WATER SYSTEMS: JACKSON COUNTY WATER & SEWER AUTHORITY PHONE: (706) 367-1741
 SEWER SYSTEMS: N/A PHONE: N/A

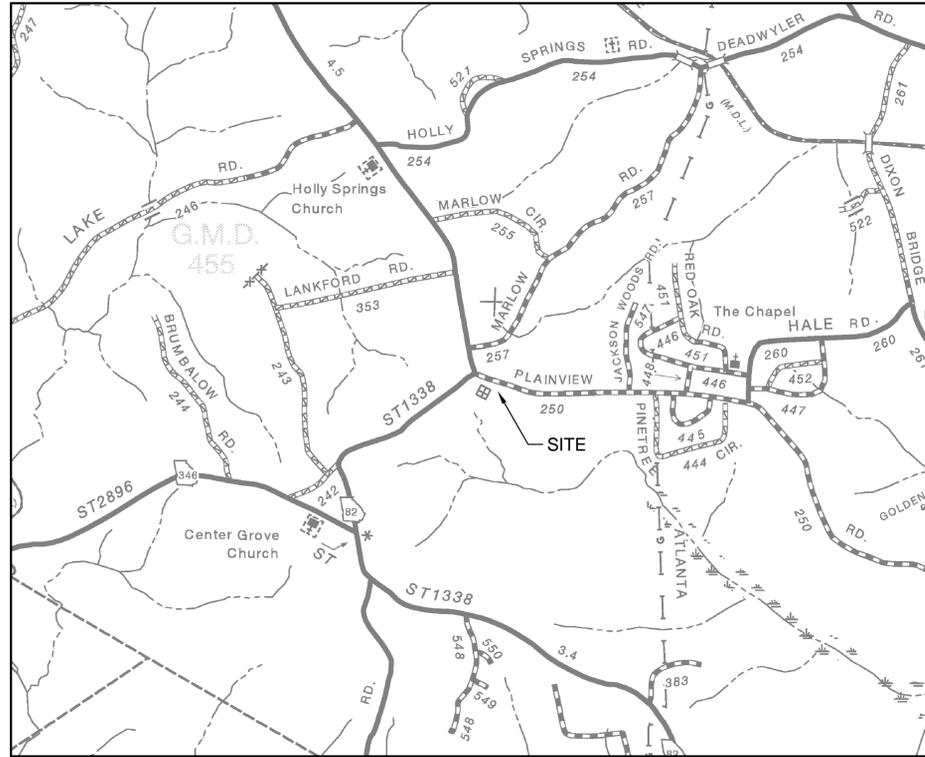

SITE LOCATION MAP
 JACKSON COUNTY, GEORGIA
 NTS

ABBREVIATIONS:

| | | |
|----------|---|--------------------------------------|
| A.R.V. | = | AIR RELEASE VALVE |
| B.M. | = | BENCHMARK |
| C.B. | = | CATCH BASIN |
| C.F. | = | CUBIC FEET |
| C | = | CENTER LINE |
| C.M.P. | = | CORRUGATED METAL PIPE |
| C.O. | = | CLEANOUT |
| C.T.F. | = | CRIMP TOP FOUND |
| C.Y. | = | CUBIC YARD |
| D.E. | = | DRAINAGE EASEMENT |
| D.I. | = | DROP INLET |
| D.I.P. | = | DUCTILE IRON PIPE |
| D/W | = | DRIVEWAY |
| ELEV. | = | ELEVATION |
| E.O.P. | = | EDGE OF PAVEMENT |
| E.R. | = | EDGE OF ROAD |
| F.E.S. | = | FLARED END SECTION |
| F.F.E. | = | FINISHED FLOOR ELEVATION |
| F.H. | = | FIRE HYDRANT |
| G.D.O.T. | = | GEORGIA DEPARTMENT OF TRANSPORTATION |
| G.M.D. | = | GEORGIA MILITIA DISTRICT |
| G.V. | = | GAS VALVE |
| G.W. | = | GUY WIRE |
| HDWL. | = | HEADWALL |
| I.E. | = | INVERT ELEVATION |
| I.P.F. | = | IRON PIN FOUND |
| J.B. | = | JUNCTION BOX |
| L.F. | = | LINEAR FOOT |
| M.H. | = | MANHOLE |
| N.A. | = | NOT APPLICABLE |
| N/F | = | NOW OR FORMERLY |
| O.T.F. | = | OPEN TOP FOUND |
| R | = | PROPERTY LINE |
| P.P. | = | POWER POLE |
| P.V.C. | = | POLYVINYLCHLORIDE PIPE |
| R.C.P. | = | REINFORCED CONCRETE PIPE |
| R/W | = | RIGHT OF WAY |
| S.S.E. | = | SANITARY SEWER EASEMENT |
| STA. | = | STATION |
| T.B.M. | = | TEMPORARY BENCHMARK |
| T.C.E. | = | TEMPORARY CONSTRUCTION EASEMENT |
| UP | = | UTILITY POLE |
| V.C.P. | = | VITRIFIED CLAY PIPE |
| W.L. | = | WATER LINE |
| W.M. | = | WATER METER |
| W.V. | = | WATER VALVE |

EXISTING

| | |
|-----|---------------------------------|
| --- | WATER |
| --- | SANITARY SEWER |
| --- | PROCESS SEWER |
| --- | GAS LINE |
| --- | OVERHEAD POWER LINE |
| --- | UNDERGROUND POWER LINE |
| --- | OVERHEAD TELEPHONE LINE |
| --- | UNDERGROUND TELEPHONE LINE |
| --- | FIBER OPTIC LINE |
| --- | STORM DRAIN |
| --- | TOP OF BANK |
| --- | RIGHT-OF-WAY |
| --- | EDGE OF PAVEMENT |
| --- | PERMANENT EASEMENT |
| --- | TEMPORARY CONSTRUCTION EASEMENT |
| --- | PROPERTY LINE |
| --- | CREEK/DITCH CENTERLINE |
| --- | ROAD CENTERLINE |
| --- | POWER POLE |
| --- | GUY WIRE |
| --- | MANHOLE |
| --- | WATER VALVE |
| --- | FIRE HYDRANT |
| --- | GUARDRAIL |
| --- | WATER METER |
| --- | TELEPHONE PEDESTAL |
| --- | AIR RELEASE VALVE |
| --- | AIR RELEASE/VACUUM VALVE |
| --- | SIGN |
| --- | BUILDING |
| --- | FENCE |
| --- | TREE LINE |
| --- | TREE |
| --- | BENCHMARK |
| --- | CONTROL POINT |
| --- | SOIL BORING W/BORING NO. |
| --- | ASPHALTIC CONCRETE PAVING |
| --- | CONCRETE PAVING |
| --- | GRAVEL ROAD |
| --- | GUARD POST |
| --- | RAILROAD |
| --- | CATCH BASIN |
| --- | CLEANOUT |
| --- | POST INDICATOR VALVE |
| --- | POLE |
| --- | LIGHT POLE |
| --- | MONITORING WELL |
| --- | SURFACE FLOW |
| --- | UNDERGROUND TELEPHONE PEDESTAL |
| --- | CONTOUR |
| --- | SPOT ELEVATION |
| --- | RIP RAP |
| --- | JUNCTION BOX |
| --- | FIBER OPTIC POST/SIGN |
| --- | UNDERGROUND TELEPHONE POST/SIGN |
| --- | CHECK DAM |

LEGEND

PROPOSED

| | | |
|-----|---------------------------------|------|
| --- | WATER | N.A. |
| --- | SANITARY SEWER | N.A. |
| --- | PROCESS SEWER | N.A. |
| --- | GAS LINE | N.A. |
| --- | OVERHEAD POWER LINE | N.A. |
| --- | UNDERGROUND POWER LINE | N.A. |
| --- | OVERHEAD TELEPHONE LINE | N.A. |
| --- | UNDERGROUND TELEPHONE LINE | N.A. |
| --- | FIBER OPTIC LINE | N.A. |
| --- | STORM DRAIN | N.A. |
| --- | TOP OF BANK | N.A. |
| --- | RIGHT-OF-WAY | N.A. |
| --- | EDGE OF PAVEMENT | N.A. |
| --- | PERMANENT EASEMENT | N.A. |
| --- | TEMPORARY CONSTRUCTION EASEMENT | N.A. |
| --- | PROPERTY LINE | N.A. |
| --- | CREEK/DITCH CENTERLINE | N.A. |
| --- | ROAD CENTERLINE | N.A. |
| --- | POWER POLE | N.A. |
| --- | GUY WIRE | N.A. |
| --- | MANHOLE | N.A. |
| --- | WATER VALVE | N.A. |
| --- | FIRE HYDRANT | N.A. |
| --- | GUARDRAIL | N.A. |
| --- | WATER METER | N.A. |
| --- | TELEPHONE PEDESTAL | N.A. |
| --- | AIR RELEASE VALVE | N.A. |
| --- | AIR RELEASE/VACUUM VALVE | N.A. |
| --- | SIGN | N.A. |
| --- | BUILDING | N.A. |
| --- | FENCE | N.A. |
| --- | TREE LINE | N.A. |
| --- | TREE | N.A. |
| --- | BENCHMARK | N.A. |
| --- | CONTROL POINT | N.A. |
| --- | SOIL BORING W/BORING NO. | N.A. |
| --- | ASPHALTIC CONCRETE PAVING | N.A. |
| --- | CONCRETE PAVING | N.A. |
| --- | GRAVEL ROAD | N.A. |
| --- | GUARD POST | N.A. |
| --- | RAILROAD | N.A. |
| --- | CATCH BASIN | N.A. |
| --- | CLEANOUT | N.A. |
| --- | POST INDICATOR VALVE | N.A. |
| --- | POLE | N.A. |
| --- | LIGHT POLE | N.A. |
| --- | MONITORING WELL | N.A. |
| --- | SURFACE FLOW | N.A. |
| --- | UNDERGROUND TELEPHONE PEDESTAL | N.A. |
| --- | CONTOUR | N.A. |
| --- | SPOT ELEVATION | N.A. |
| --- | RIP RAP | N.A. |
| --- | JUNCTION BOX | N.A. |
| --- | FIBER OPTIC POST/SIGN | N.A. |
| --- | UNDERGROUND TELEPHONE POST/SIGN | N.A. |
| --- | CHECK DAM | N.A. |



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| DATE | NO. | DESCRIPTION |
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| 12/14/15 | 1 | SUBMIT FOR INITIAL REVIEW |
| 01/06/16 | 2 | ADDRESS GAS/VCC COMMENTS |
| 01/28/16 | 3 | REVISE PLAN TO RELOCATE STORMWATER POND |

EMI ENGINEERING MANAGEMENT
 Experience • Trust • Solutions
 303 Swanson Drive, Lawrenceville, GA 30043
 phone 770-962-1387 fax # 770-962-8010
 www.emiinc.biz

**JACKSON COUNTY GOVERNMENT
 NEW EMS STATION
 LOCATED IN G.M.D. 455
 JACKSON COUNTY, GEORGIA**

| | | |
|--------------------|------------|-----|
| GENERAL NOTES | CHECKED BY | DWB |
| SHEET TITLE | DRAWN BY | KLP |
| DESIGN BY | KLP | |

GEORGIA REGISTERED PROFESSIONAL ENGINEER
 NO. 28331
 KENNETH LEE PETERS

STAMP



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| 12/01/15 | DATE |
| 15037 | JOB NUMBER |
| z:\projects | FILE LOCATION |

G2

REVISION

PROJECT

SHEET

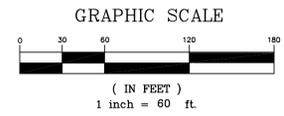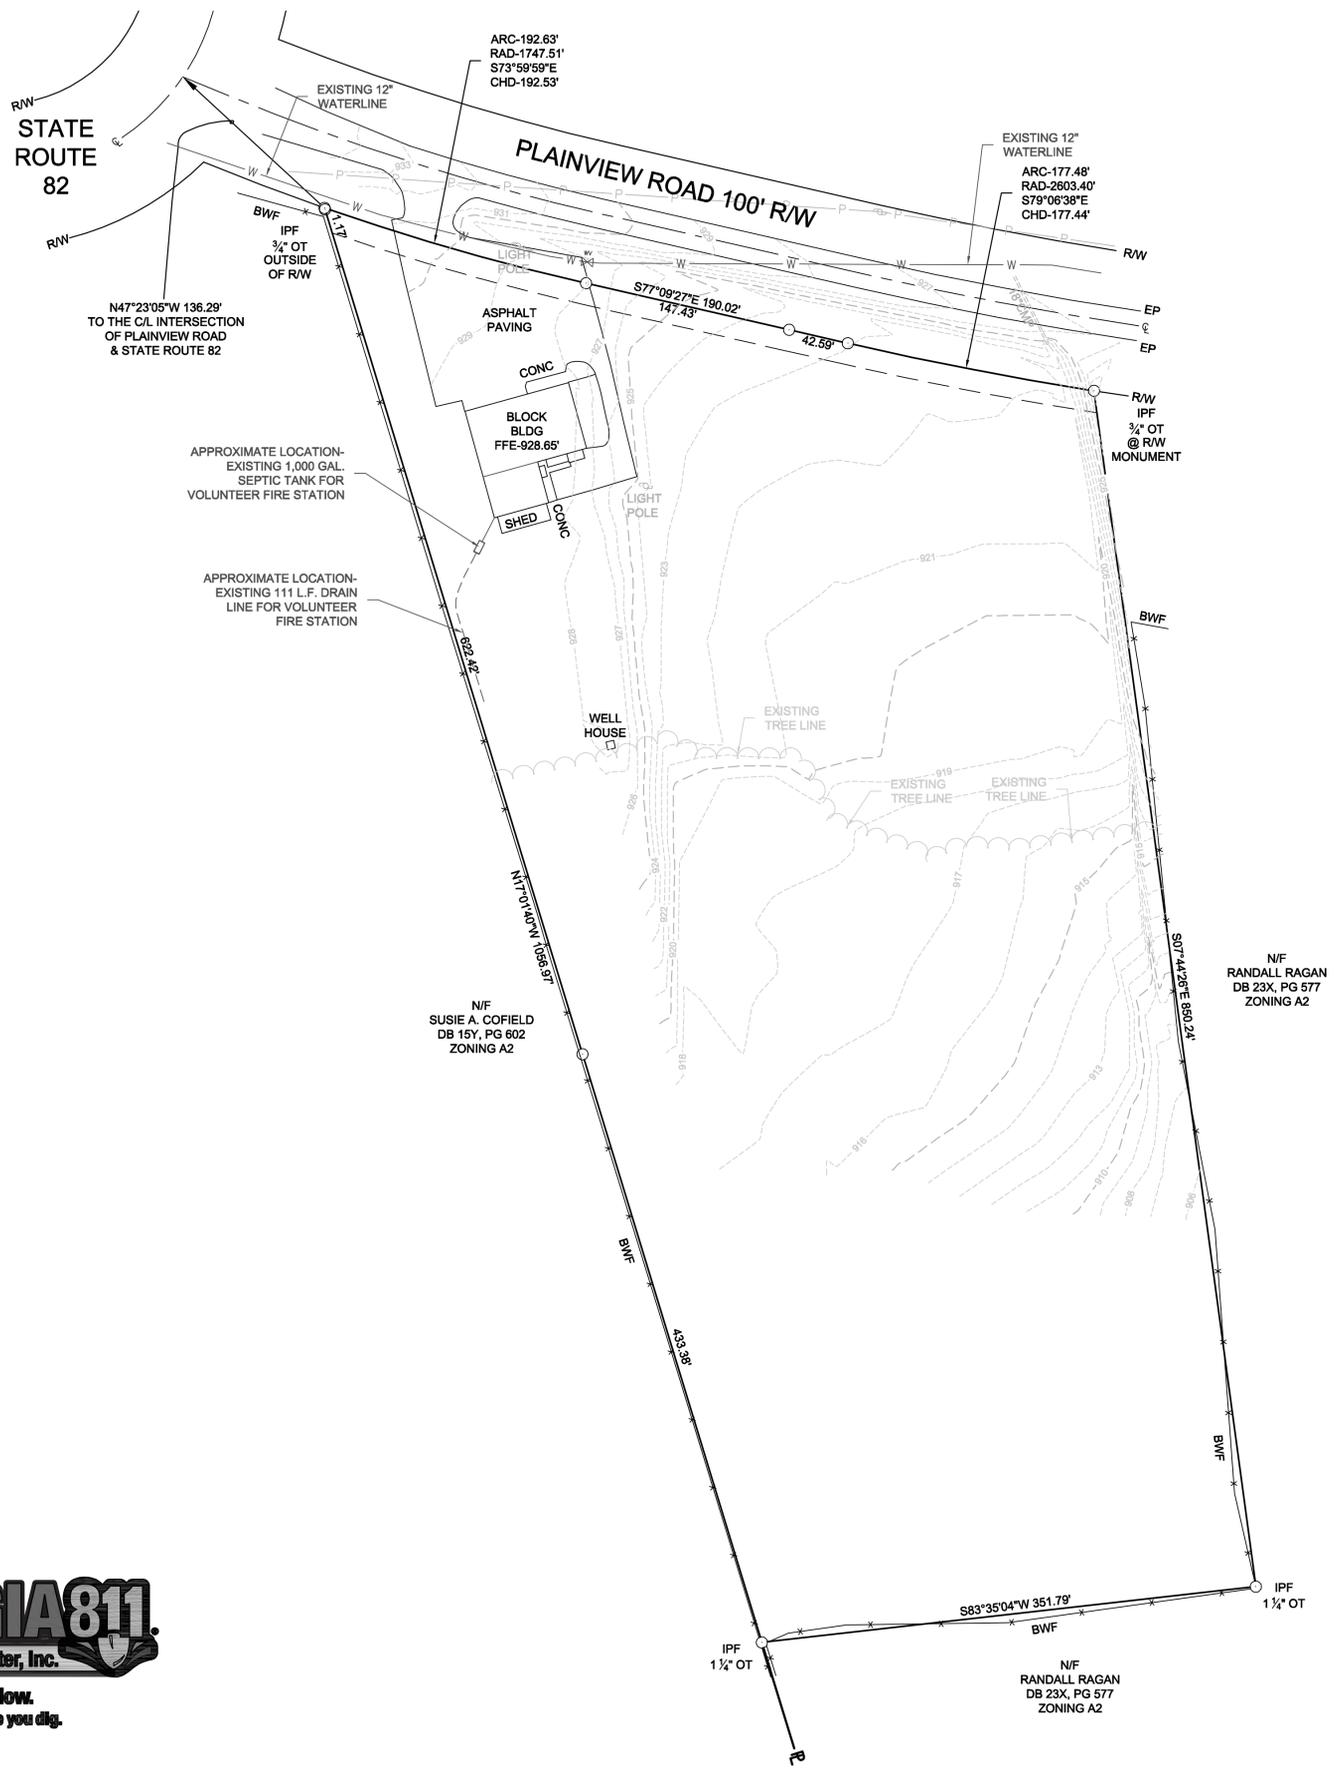

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**JACKSON COUNTY GOVERNMENT
 NEW EMS STATION**
 LOCATED IN G.M.D. 455
 JACKSON COUNTY, GEORGIA

| | | |
|---------------------|-----------|------------|
| EXISTING CONDITIONS | DESIGN BY | CHECKED BY |
| | KLP | DWB |
| SHEET TITLE | DRAWN BY | DWB |
| | KLP | DWB |





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C1

REVISION

PROJECT

SHEET

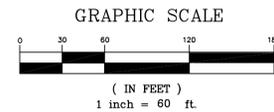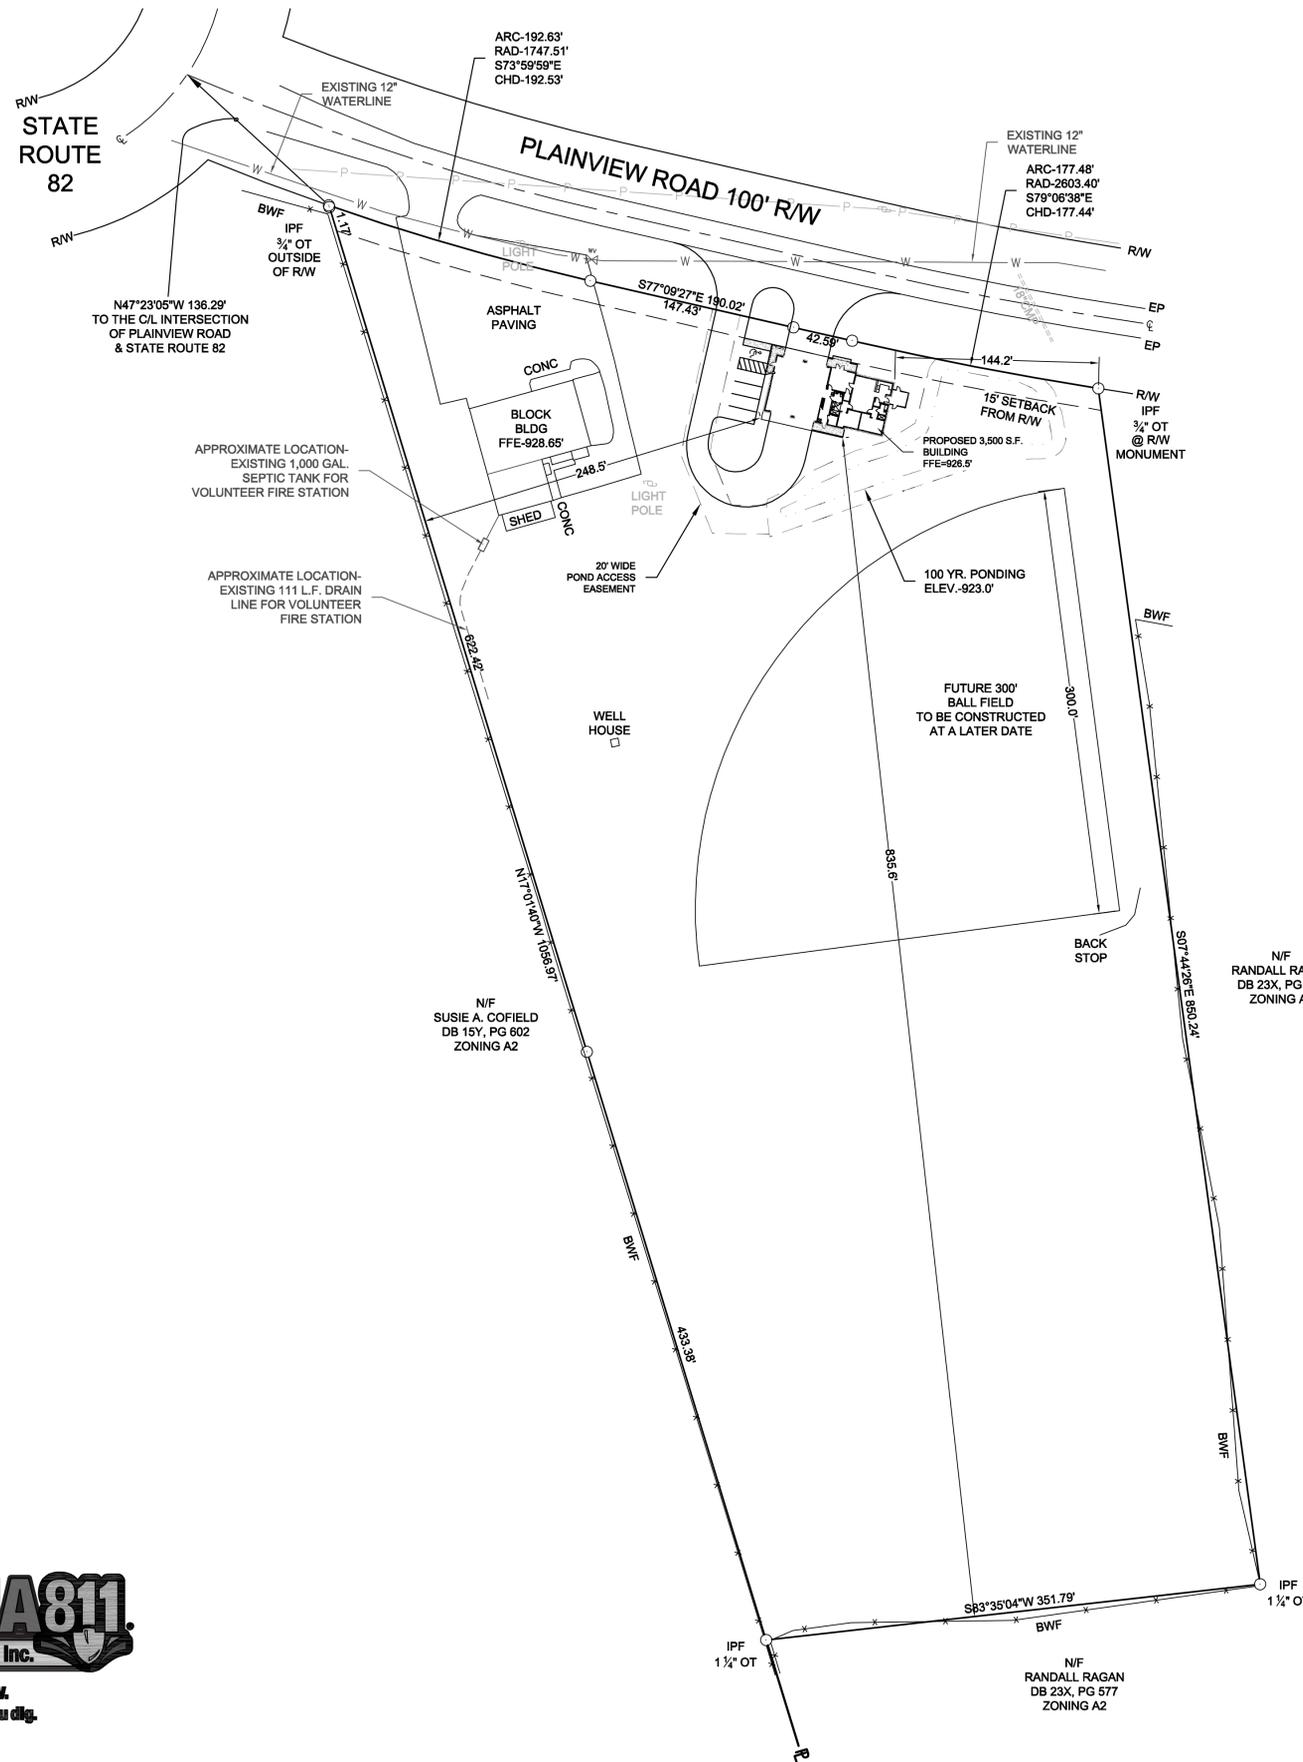

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**JACKSON COUNTY GOVERNMENT
 NEW EMS STATION
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 JACKSON COUNTY, GEORGIA**

| | | |
|--------------------|------------|-----|
| OVERALL PLAN | CHECKED BY | DWB |
| SHEET TITLE | DRAWN BY | KLP |
| DESIGN BY | KLP | DWB |



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|-------------|---------------|
| 12/01/15 | DATE |
| 15037 | JOB NUMBER |
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C2

REVISION

PROJECT

SHEET

WETLANDS NOTE
 APPROVAL OF THESE PLANS DOES NOT CONSTITUTE APPROVAL BY JACKSON COUNTY OF ANY LAND DISTURBING ACTIVITIES WITHIN WETLAND AREAS. IT IS THE RESPONSIBILITY OF THE PROPERTY OWNER TO CONTACT THE APPROPRIATE REGULATORY AGENCY FOR APPROVAL OF ANY WETLAND DISTURBANCE.

UTILITY DISCLAIMER
 EXISTING UTILITY LINES SHOWN ARE APPROXIMATE LOCATIONS ONLY. CONTRACTOR SHALL FIELD VERIFY ALL EXISTING UTILITY LINE LOCATIONS PRIOR TO ANY CONSTRUCTION. ANY DEVIATIONS FROM THE DESIGN LOCATIONS SHALL BE REPORTED TO THE PROJECT ENGINEER PRIOR TO CONSTRUCTION. DAMAGE TO EXISTING UTILITY LINES RESULTING FROM CONTRACTOR NEGLIGENCE SHALL BE REPAIRED AT CONTRACTOR EXPENSE.

CONSTRUCTION NOTES

1. MAXIMUM CUT AND FILL SLOPES IS 2H:1V, EXCEPT EARTHEN DAM EMBANKMENTS, ROCK CUTS, WHERE CERTIFIED BY A PROFESSIONAL GEOTECHNICAL ENGINEER.
2. FILL MATERIALS SHALL CONSIST OF CLEAN SOIL, FREE OF ORGANIC OR DELETERIOUS MATERIALS, ROCKS, OR BROKEN PIECES OF CONCRETE LARGER THAN THREE INCHES IN SIZE.
3. FILL MATERIALS SHALL BE SPREAD EVENLY IN HORIZONTAL LAYERS OF NOT MORE THAN 8 INCHES IN LOOSE LIFTS OVER THE FULL WIDTH AND COMPACTED TO 95% MAXIMUM DENSITY BY STANDARD PROCTOR COMPACTION TEST ASTM D 698.
4. ALL CONSTRUCTION MATERIALS AND PROCEDURES SHALL CONFORM TO THE APPLICABLE JACKSON COUNTY AND GEORGIA D.O.T. STANDARDS.
5. ANY EXISTING SITE IMPROVEMENTS DAMAGED DURING CONSTRUCTION SHALL BE REPLACED BY THE CONTRACTOR.

NOTES:
 PARKING LOTS SHALL BE MAINTAINED IN GOOD CONDITION, FREE OF POTHoles, WEEDS, DUST, TRASH, AND DEBRIS.

NO CERTIFICATE OF OCCUPANCY WILL BE ISSUED UNTIL ALL SITE IMPROVEMENTS HAVE BEEN COMPLETED.

ALL CONSTRUCTION TO COMPLY WITH JACKSON COUNTY STANDARDS.

HIGH INTENSITY LIGHTING FACILITIES SHALL BE SO ARRANGED THAT THE SOURCE OF ANY LIGHT IS CONCEALED FROM PUBLIC VIEW AND FROM ADJACENT RESIDENTIAL PROPERTY AND DOES NOT INTERFERE WITH TRAFFIC.

NO DUMPSTERS ARE PROPOSED UNDER THIS PERMIT.


ALL SIGNS AND STRIPING TO BE PROVIDED AND INSTALLED BY THE OWNER. NOT IN CONTRACT.

SIDEWALK NOTES:


1. SIDEWALKS SHALL BE CONSTRUCTED OF CONCRETE A MINIMUM 4" IN WIDTH AND 4" THICK. SIDEWALKS SHALL BE CONSTRUCTED WITH A CROSS SLOPE OF 0.25 IN./FT. CONCRETE SHALL BE CLASS "B" AND HAVE A STRENGTH OF 2200 PSI AT 28 DAYS.
2. INTERSECTION RADIUS CURB RAMPS SHALL BE PROVIDED AT STREET INTERSECTIONS. STRAIGHT RAMPS MAY BE PROVIDED AT INTERSECTIONS OF CURBED DRIVEWAYS AND AT STREETS WITHOUT SIDEWALKS.

BUILDING PLAN REVIEW NOTES:

EACH BUILDING AND ITS RELATIVE LOCATION TO PROPERTY LINES AND OTHER STRUCTURES SHALL COMPLY WITH THE 2006 INTERNATIONAL BUILDING CODE WITH GEORGIA STATE AMENDMENTS (IBC) WITH REGARDS TO THE HEIGHT AND AREA REQUIREMENTS OF IBC TABLE 503 AND THE FIRE RESISTANCE AND HORIZONTAL SEPARATION REQUIREMENTS OF IBC TABLES 601 AND 602 BASED ON OCCUPANCY GROUP CLASSIFICATION AND TYPE OF CONSTRUCTION.

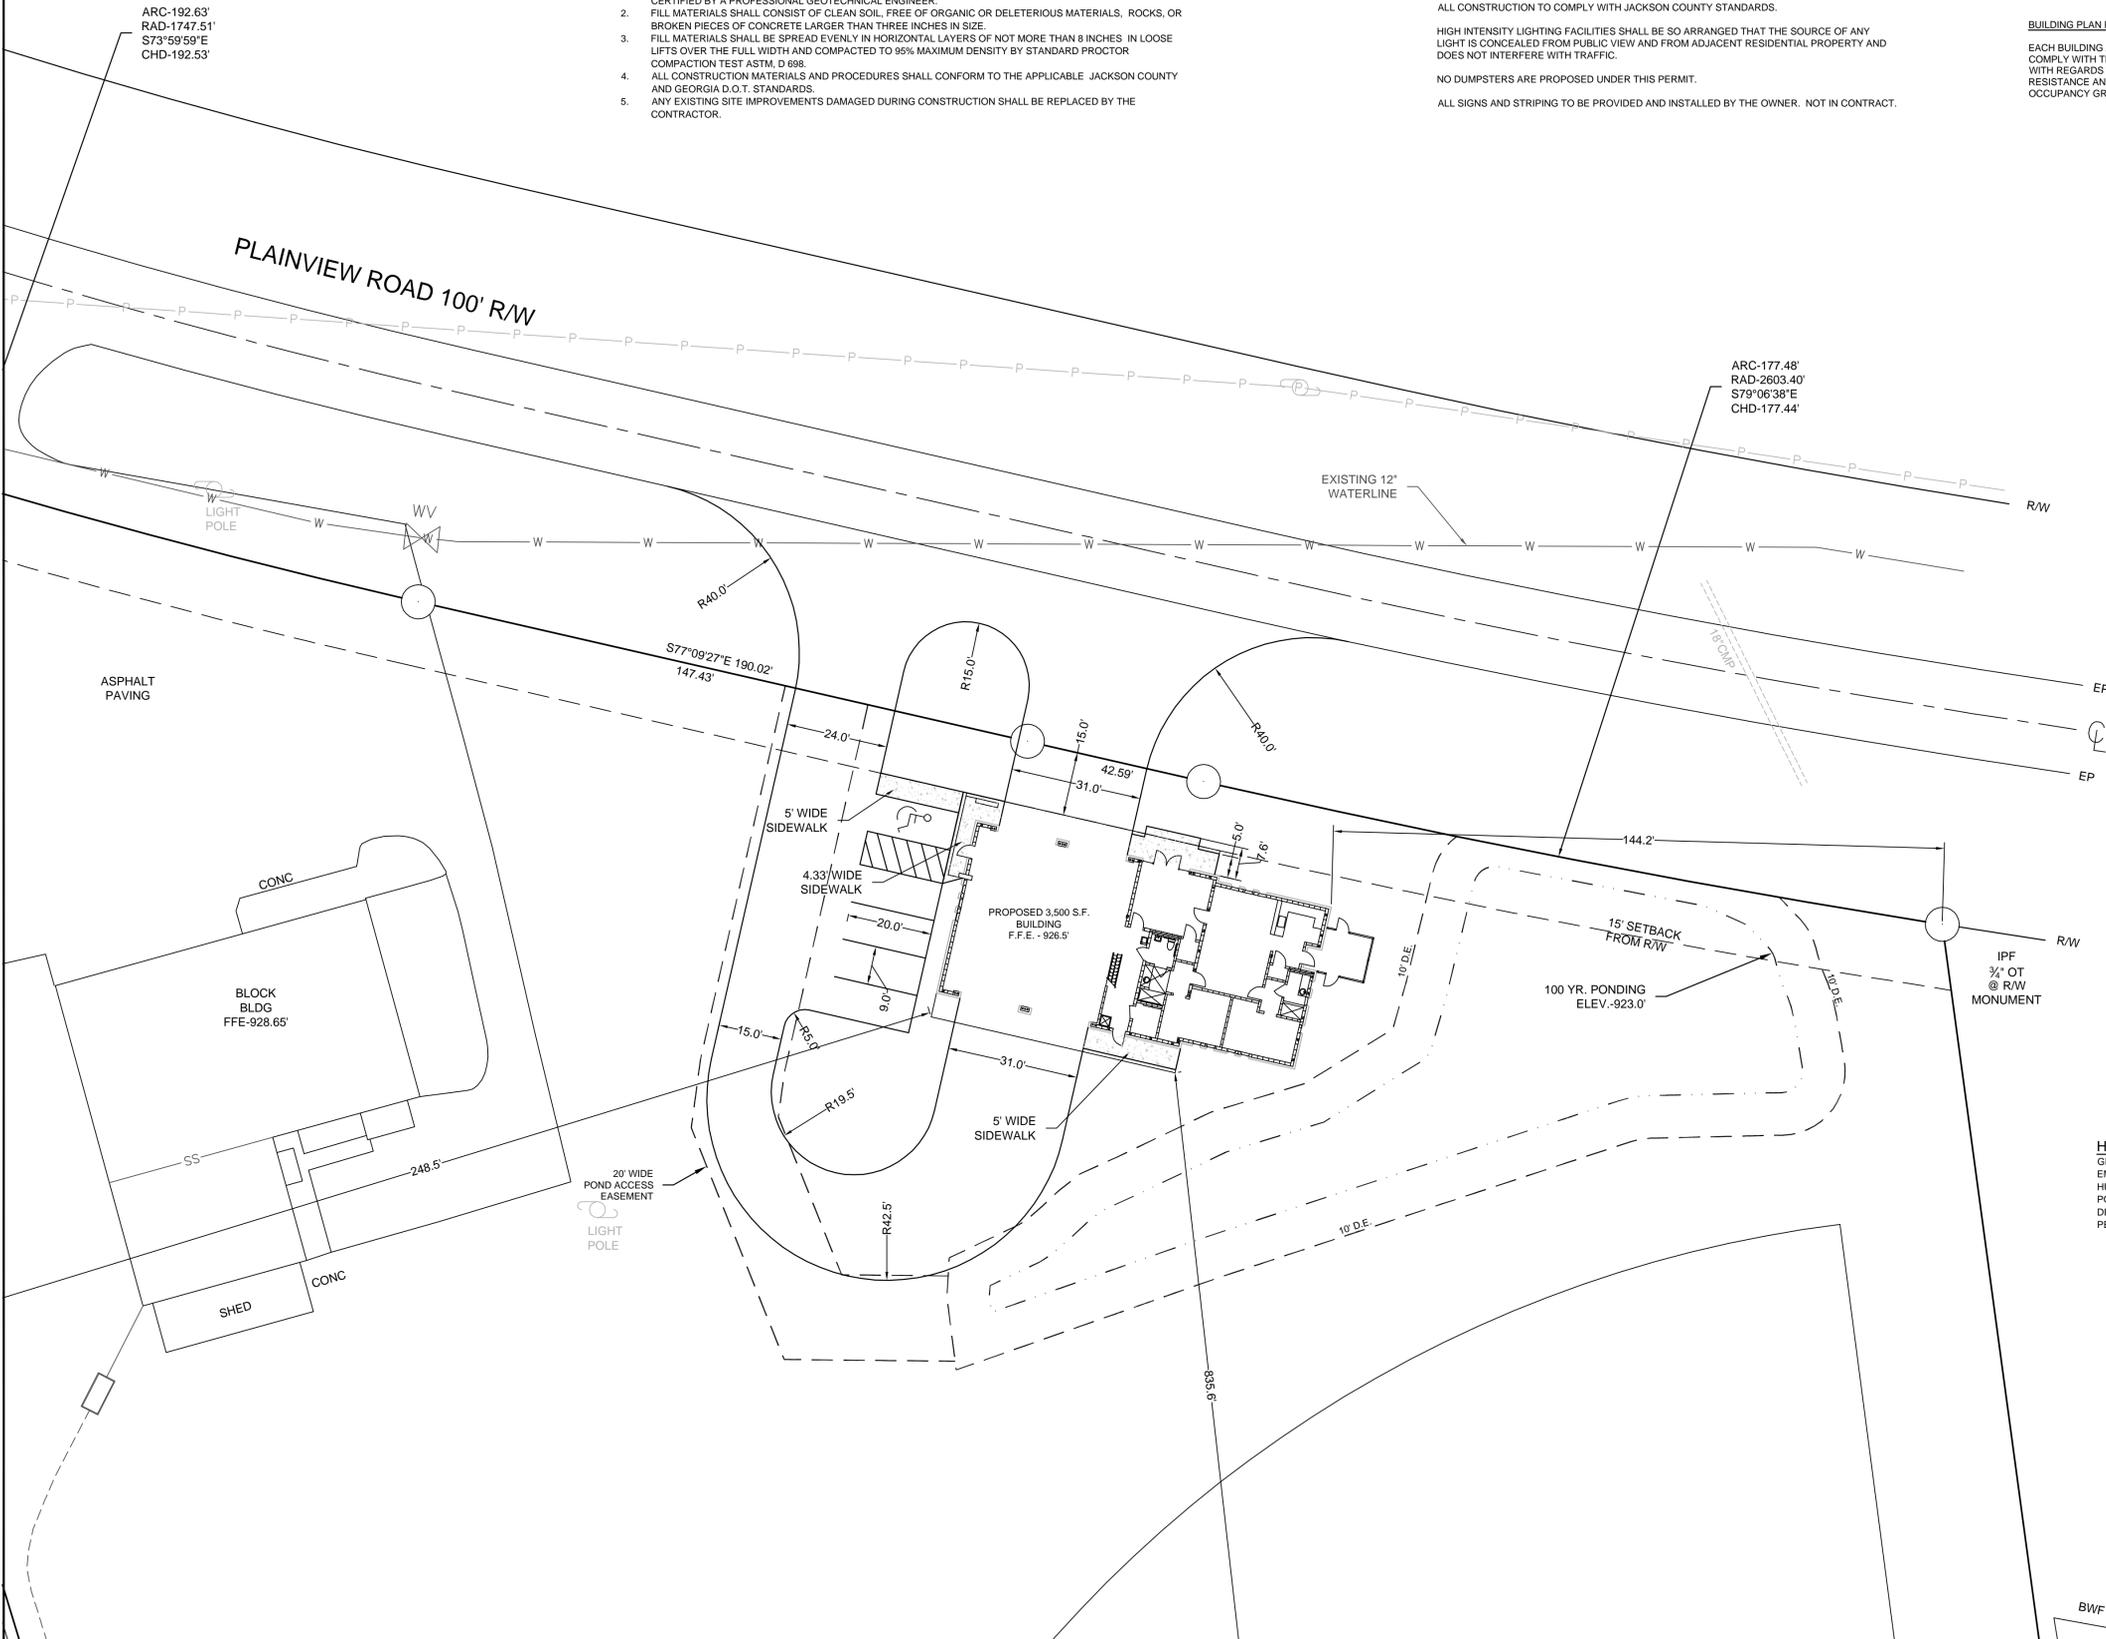

HEALTH DEPARTMENT NOTE
 GEORGIA CODE 290-5-25-.03 (1) REQUIRES THE PROVISION OF SEWAGE DISPOSAL FOR EVERY WORK SITE WHERE EMPLOYEES REMAIN FOR TWO HOURS OR MORE. FURTHERMORE, TOILET FACILITIES MUST BE AVAILABLE WITHIN TWO HUNDRED (200) FEET OF A WORK SITE. YOU SHOULD ASSESS YOUR PROJECT FOR COMPLIANCE WITH THIS HEALTH CODE. PORTABLE TOILETS ARE AN ACCEPTABLE MEANS OF SEWAGE DISPOSAL AT WORK SITES WHERE PERMANENT SEWAGE DISPOSAL CAPABILITY IS NOT YET IN PLACE. FAILURE TO COMPLY WITH THIS CODE COULD RESULT IN CIVIL AND/OR CRIMINAL PENALTIES AGAINST YOU.

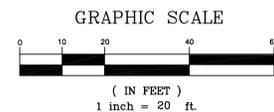

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| 01/26/16 | 3 | REVISE PLAN TO RELOCATE STORMWATER POND |

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JACKSON COUNTY GOVERNMENT
 NEW EMS STATION
 LOCATED IN G.M.D. 455
 JACKSON COUNTY, GEORGIA

| | |
|-------------|------------|
| SITE PLAN | CHECKED BY |
| SHEET TITLE | DWB |
| DRAWN BY | KLP |
| DESIGN BY | KLP |

REGISTERED PROFESSIONAL ENGINEER
 NO. 28331
 KENNETH LEE PETERS

STAMP

12/01/15
 DATE

15037
 JOB NUMBER

z:\projects
 FILE LOCATION

PATH & FILE: z:\PROJECTS\1515037-Jackson Co-Plainview EMS\Design Stage\15037-C-Base-01-12-16



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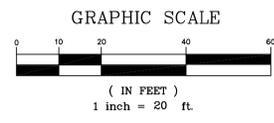
REVISION

PROJECT

SHEET



- NOTES:**
1. CONTOUR INTERVALS ARE 1 FEET.
 2. ALL EARTHWORK OPERATIONS SHALL COMPLY WITH REQUIREMENTS OF OSHA CONSTRUCTION STANDARDS, PART 1926, SUBPART P EXCAVATIONS, TRENCHING, AND SHORING, AND SUBPART O, MOTOR VEHICLES, MECHANIZED EQUIPMENT, AND MARINE OPERATIONS, AND SHALL BE CONDUCTED IN A MANNER ACCEPTABLE TO ENGINEER.
 3. FILL MATERIALS SHALL CONSIST OF CLEAN SOIL, FREE OF ORGANIC OR DELETERIOUS MATERIALS, ROCKS, OR BROKEN PIECES OF CONCRETE LARGER THAN THREE INCHES IN SIZE, OR OF ANY OTHER FOREIGN OBJECTS THAT COULD IMPEDE COMPACTION RESULTS.
 4. FILL MATERIALS SHALL BE SPREAD EVENLY IN HORIZONTAL LAYERS OF NOT MORE THAN 8 INCHES IN LOOSE LIFTS OVER THE FULL WIDTH OF FILL AND COMPACTED TO AT LEAST 95% MAXIMUM DRY DENSITY BY STANDARD PROCTOR COMPACTION TEST ASTM D698 UNLESS OTHERWISE NOTED.
 5. MAXIMUM CUT OR FILL SLOPES ARE 2H:1V.
 6. GRADE TO PROVIDE POSITIVE DRAINAGE AWAY FROM BUILDINGS INTO STORM CHANNELS. JACKSON COUNTY ASSUMES NO RESPONSIBILITY FOR OVERFLOW OR EROSION OF NATURAL OR ARTIFICIAL DRAINS BEYOND THE EXTENT OF THE STREET RIGHT-OF-WAY, OR FOR THE EXTENSION OF CULVERTS BEYOND THE POINT SHOWN ON THE APPROVED AND RECORDED PLAN. JACKSON COUNTY DOES NOT ASSUME THE RESPONSIBILITY FOR THE MAINTENANCE OF PIPES IN DRAINAGE EASEMENTS BEYOND THE COUNTY RIGHT-OF-WAY.
 7. THERE ARE NO PROPOSED DISTURBANCE TO WETLANDS ON SITE.
 8. AS-BUILT WATER PLANS REQUIRED PRIOR TO ISSUANCE OF CERTIFICATE(S) OF OCCUPANCY, OR RECORDING OF FINAL SUBDIVISION PLAT. SUBMIT TO WATER AND/OR SEWER PROVIDER.
 9. EARTHWORK NUMBERS:
 CUT - 133 YDS
 FILL - 4,044 YDS
 NET - 3,911 YDS (FILL)
 THE FILL NUMBERS INCLUDE 15% SHRINKAGE AND ARE TO FINAL GRADE (NOT SUB-GRADE).

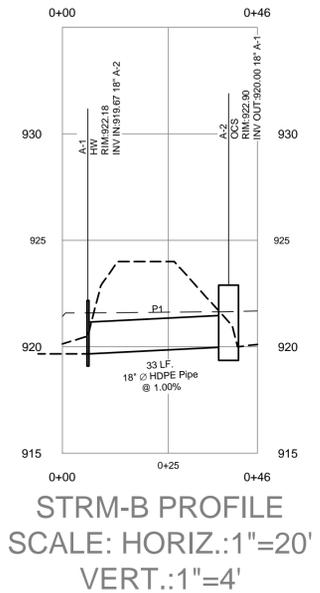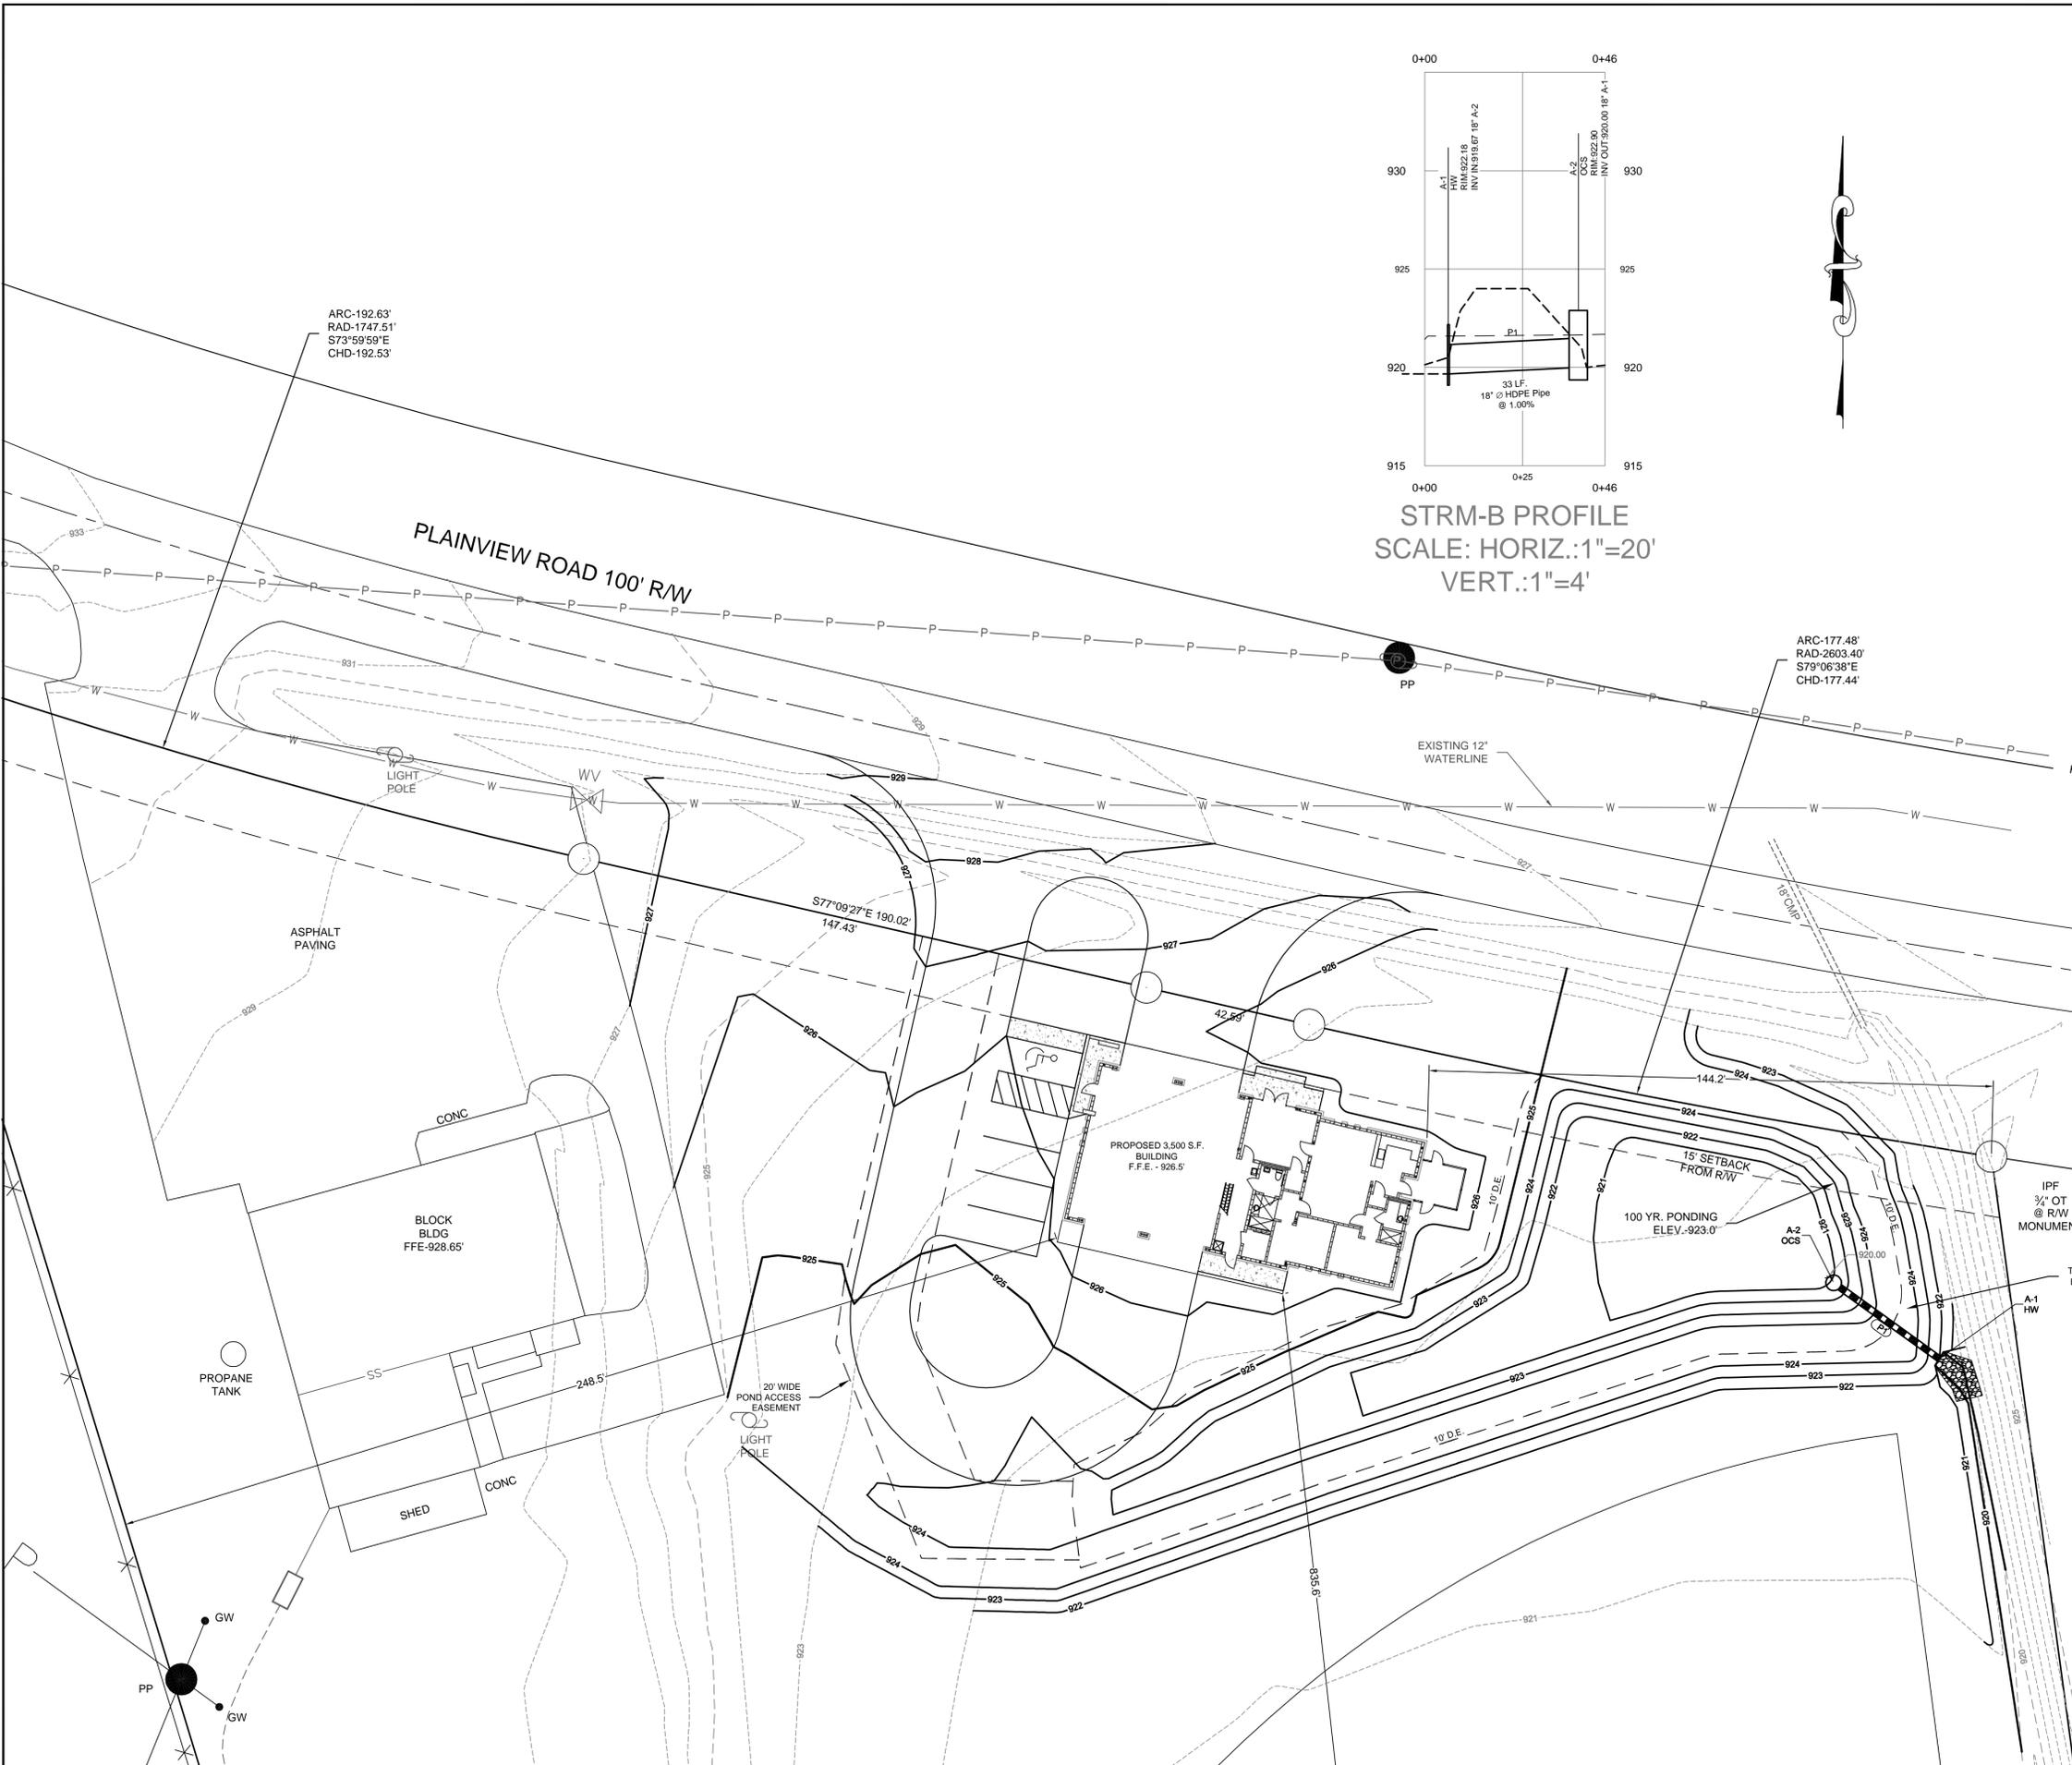

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| GRADING PLAN | CHECKED BY |
| SHEET TITLE | DWB |
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REGISTERED PROFESSIONAL ENGINEER
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 KENNETH LEE PETERS

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PATH & FILE: z:\PROJECTS\1515037-Jackson Co-Plainview EMS\Design Stage\15037-C-Base-01-12-16

REVISION

PROJECT

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SEPTIC SYSTEM CALCULATIONS - NEW EMS FACILITY

DESIGN FLOW = 400 GPD (BASED ON 2 FULL TIME EMPLOYEES @ 150 GPD AND 4 VISITORS @ 25 GPD)

SEPTIC TANK = 1,000 GALLONS (ALLOWS FOR 24 HOUR RETENTION)

FOR PRIMARY DRAIN FIELD USING MADISON SOILS

WITH PERC RATE = 50 MIN/IN

LF CONVENTIONAL DRAIN LINE = (400/5) = 1.414 SF/GAL

1.414 SF/GAL X 400 GPD = 189 LF

3 FT WIDE TRENCH

USE 190 LF OF CONVENTIONAL DRAIN LINE IN DRAIN FIELD.

TRENCH DEPTH OF 34" TO 38"

SEPTIC SYSTEM CALCULATIONS - EXISTING FIRE STATION

DESIGN CALCULATIONS

DESIGN FLOW = 100 GPD (BASED ON ORIGINAL SEPTIC PERMIT)

SEPTIC TANK = 1,000 GALLONS (ALLOWS FOR 24 HOUR RETENTION)

FOR PRIMARY DRAIN FIELD USING FILL OVER MADISON 1 SOILS

WITH PERC RATE = 65 MIN/IN

LF CONVENTIONAL DRAIN LINE = (100/5) = 1.612 SF/GAL

1.612 SF/GAL X 100 GPD = 54 LF

3 FT WIDE TRENCH

USE 111 LF OF CONVENTIONAL DRAIN LINE IN DRAIN FIELD.

TRENCH DEPTH OF 40" TO 45"

GENERAL PIPE INSTALLATION:

1. WATER/SEWER PIPE AND APPURTENANCES SHALL BE INSTALLED ONLY WHEN TRENCH CONDITIONS ARE SUITABLE.
2. TRENCHES MUST BE DRY.
3. PROPER IMPLEMENTS, TOOLS, AND FACILITIES SHALL BE PROVIDED BY CONTRACTOR FOR SAFE AND CONVENIENT PERFORMANCE OF THE WORK.
4. PREVENT DAMAGE TO PIPE MATERIALS AND PROTECTIVE COATINGS AND LININGS.
5. DO NOT DROP OR DUMP PIPELINE INTO TRENCH.
6. CAREFULLY EXAMINE PIPE AND FITTINGS FOR CRACKS AND OTHER DEFECTS WHILE SUSPENDED ABOVE TRENCH IMMEDIATELY BEFORE INSTALLATION IN FINAL POSITION. DEFECTIVE PIPE OR FITTINGS SHALL BE CLEARLY MARKED AND SHALL BE REMOVED FROM SITE.
7. CLEAN BELL AND SPIGOT ENDS OF EACH PIPE THOROUGHLY BEFORE PIPE IS LAID.
8. PREVENT FOREIGN MATERIAL FROM ENTERING PIPE WHILE IT IS BEING PLACED IN LINE.
 - A. PROVIDE PROTECTIVE COVERING FOR ENDS OF PIPE UNTIL CONNECTION IS MADE TO ADJACENT PIPE, IF NECESSARY.
 - B. NO DEBRIS, TOOLS, CLOTHING, OR OTHER MATERIALS SHALL BE PLACED IN PIPE DURING LAYING OPERATIONS.
9. AS EACH LENGTH OF PIPE IS PLACED IN TRENCH, SPIGOT END SHALL BE CENTERED IN BELL AND PIPE FORCED HOME AND BROUGHT TO CORRECT LINE AND GRADE.
 - A. PIPE SHALL BE SECURED IN PLACE WITH APPROVED BACK FILL MATERIAL TAMPED AROUND IT.
 - B. PRECAUTIONS SHALL BE TAKEN TO PREVENT DIRT FROM ENTERING JOINT SPACE.
10. OPEN ENDS OF PIPE SHALL BE CLOSED BY WATERTIGHT PLUG, OR OTHER MEANS APPROVED BY OWNER. AT TIMES WHEN PIPE LAYING IS NOT IN PROGRESS, IF WATER IS IN TRENCH, PLUG SHALL REMAIN IN PLACE UNTIL TRENCH IS PUMPED COMPLETELY DRY. WATER SHALL NOT BE ALLOWED TO RUN INTO PIPE AT ANY TIME DURING CONSTRUCTION.
11. LAY PIPE WITH BELL ENDS FACING IN DIRECTION OF LAYING, UNLESS DIRECTED OTHERWISE BY OWNER.

PRE CONSTRUCTION MEETING REQUIRED BETWEEN SEPTIC CONTRACTOR AND HEALTH DEPARTMENT.

| | |
|--|----------------|
| County: Jackson | Date: 11/28/15 |
| Client: EMI (Contact: Ken Peters) | |
| Site Location Address: Portion of property on Plainview Road | |
| Phone Number: 678/990-6067 | Lot Number(s): |
| Subdivision: NA | |
| Scale: 1" = 60' | |
| Intensity Level of Investigation: Level III | |

| Soil Series <i>See Suitability Codes</i> | Slope % <i>Ranges Of the Soil Type</i> | Depth To Bedrock (inches) | Depth to Seasonal High H ₂ O Table (inches) | Expected Perc Rate At Recommended Trench Depth (min/in) | Recommended Trench Depth (inches) | Suitability Code (listed below) |
|---|---|------------------------------|---|--|--------------------------------------|------------------------------------|
| Pacolet Series | 0 - 2 | 63 - >72 | >72 | 50 | 36/34-38 | A |
| Madison Series | 0 - 2 | >72 | >72 | 50 | 36/36-44 | A |
| Fill Over Madison I | 0 - 2 | >74 | >74 | 65 | 42/40-45 | A |
| Fill Over Madison II | 0 - 2 | >86 | >86 | See Codes | See Codes | NR |

SUITABILITY CODE DESCRIPTIONS


A - Soil should be suitable for installation of an on site system with proper design, installation & maintenance. Soil classified as Fill Over Madison I had < 24" of surficial fill. However, soil characteristics at recommended trench depth were such that soil should be suitable.

NR - This soil had > 24" fill at the surface. Use of this soil is not recommended without additional study. There appears to be plenty of usable soil at the site without utilizing this soil.

FIELD NOTES

Property covers many acres, but client indicated Jackson County is planning a small EMS station at the site. The client indicated a desired installation in the area presently occupied by a baseball field. Borings were installed in this area, but a portion of the area was found to have relatively thick fill at the surface. Two borings were placed in a second study area (to locate additional suitable soil) south of the preferred location. Elevations shown are relative and contour lines are approximate. Seven borings were installed in the study areas covering approximately 1.1 acres. Seven borings in an area this size meets Level III boring density requirements.

The recommended depths and perc rates are based on current surface elevations. If surface elevation is significantly altered, the depths and/or rates would have to be adjusted and/or the recommendations herein may not be valid.

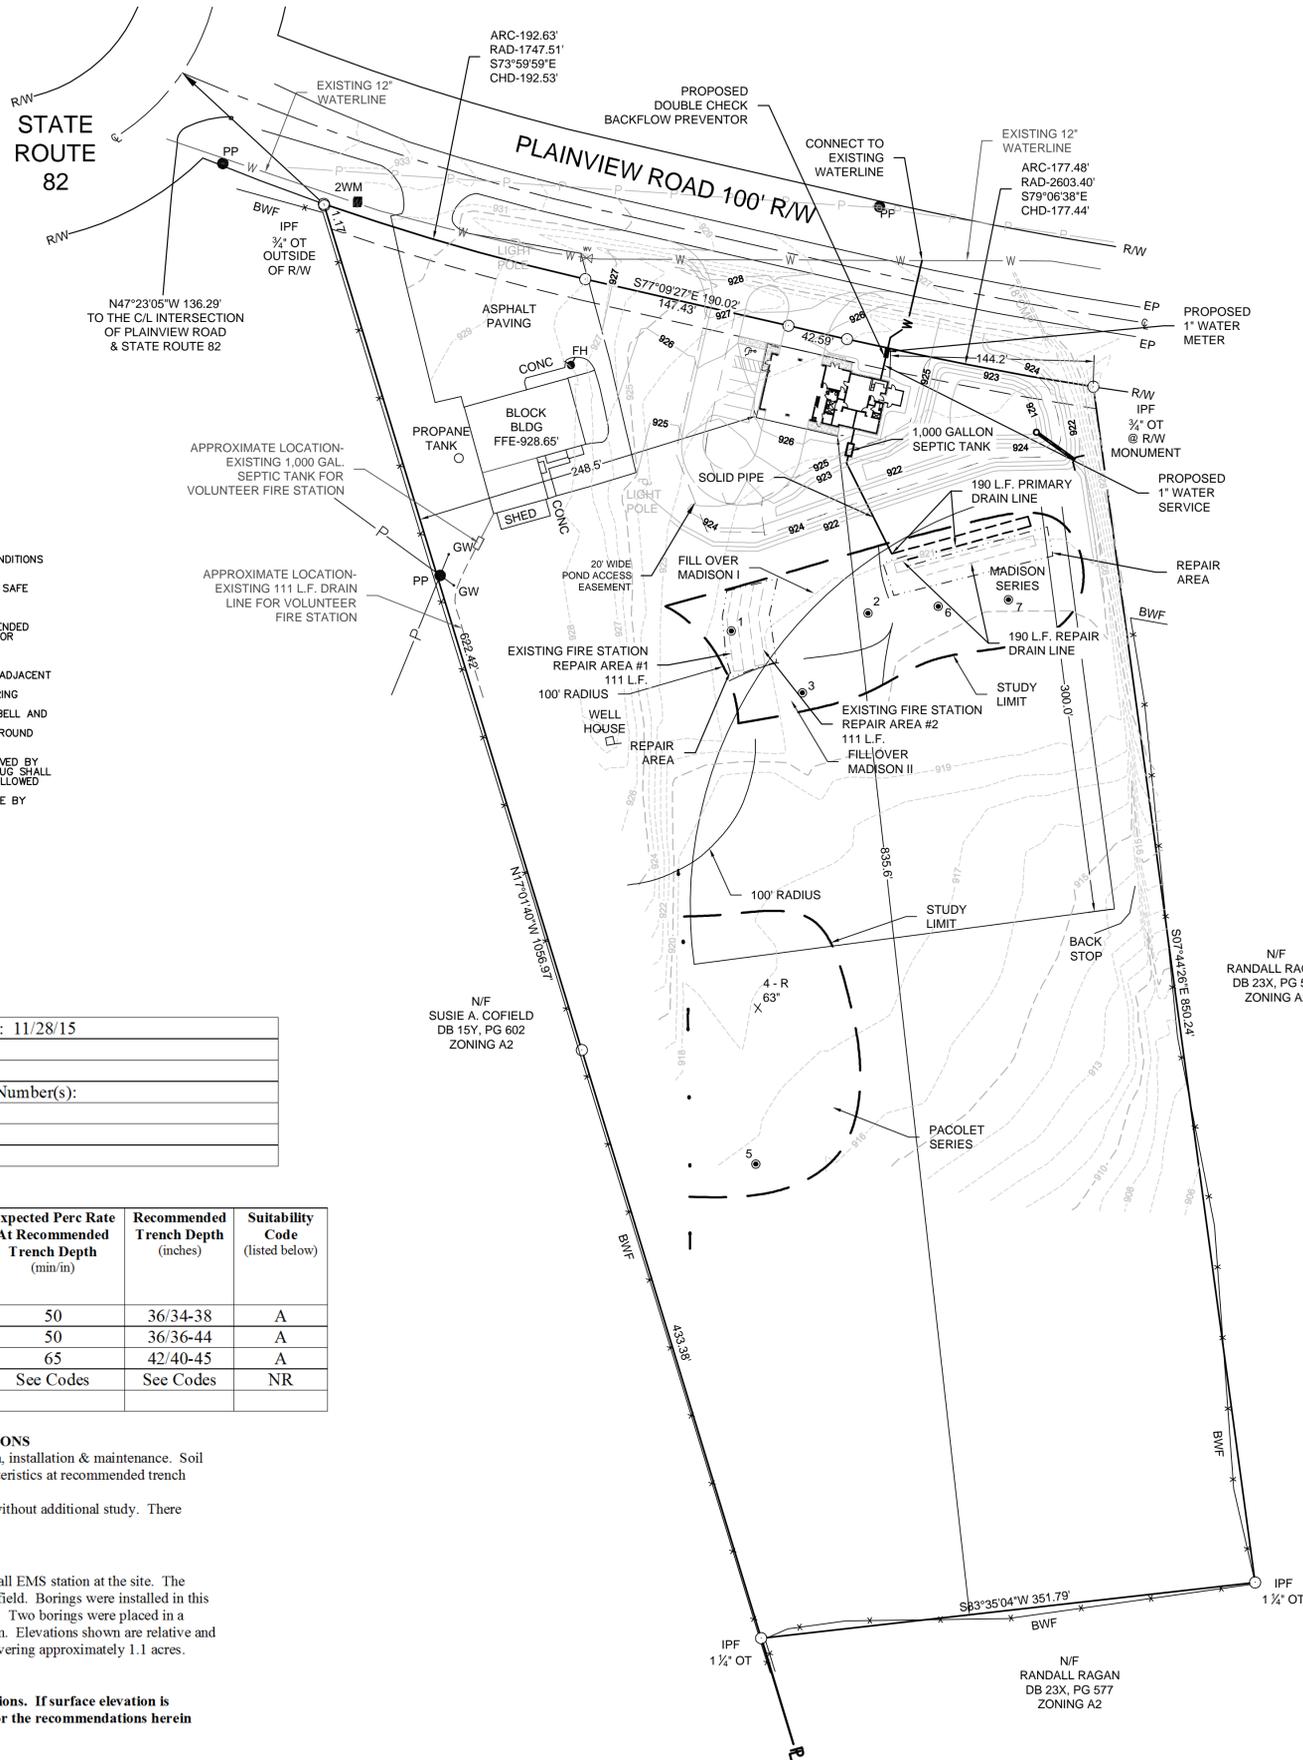


UTILITY INSTALLATION NOTES:

1. CONTRACTOR IS RESPONSIBLE FOR ASSURING HIS WORK AREA IS ALWAYS MAINTAINED IN A SAFE CONDITION AND CAUSES NO SOURCE OF POTENTIAL DAMAGE TO ANY NEARBY PROPERTY. THIS INCLUDES BUT IS NOT LIMITED TO HIS PLACING BARRIERS THAT BOTH PROTECT THE WORK AREA FROM UNAUTHORIZED ACCESS AND PROTECT ADJACENT PROPERTY FROM DAMAGE. PLACE ANY REQUIRED EROSION CONTROL SHEETING, SHORING, BRACING AND/OR SIMILAR APPURTENANCES - AS MAY BE NEEDED. PROTECT, SUPPORT AND/OR UNDERPIN ANY ADJACENT UTILITIES DISCOVERED. ASSURE THAT TESTED TRENCH RE-COMPACTION OCCURS IN MAXIMUM 8' LIFTS AS ANY PROTECTION APPURTENANCE IS RAISED OUT OF TRENCHING IN SIMILAR INCREMENTS.
2. WHERE SEWER PIPELINES ARE LOCATED IN OR ACROSS STREAM BEDS OR DRAINAGE DITCHES, CONTRACTOR SHALL DIVERT STREAM FLOW AND DEWATER EACH SECTION AS WORK PROGRESSES. DO NOT ALLOW WATER TO RUN OR STAND IN TRENCH WHILE PIPE LAYING IS IN PROGRESS. BEFORE THE JOINTS ARE COMPLETELY SET, OR BEFORE TRENCH HAS BEEN BACKFILLED, CONTRACTOR AT NO TIME SHALL OPEN UP MORE TRENCH THAN HIS AVAILABLE PUMP FACILITIES ARE ABLE TO DEWATER.
3. ADJACENT TO OPEN TRENCHES, ASSURE THAT NO MATERIALS ARE DEPOSITED THAT MAY POSE A RISK TO THE WORK AND/OR ADJACENT PROPERTY - ESPECIALLY DURING HIGH RISK RAIN AND/OR SURFACE WASH.
4. START BACKFILLING AND COMPACTION OF TRENCH(ES) IMMEDIATELY AFTER THE SECURE BEDDING OF PROPERLY SLOPED PIPING.
5. EXCAVATE NO MORE TRENCH THAN CAN BE STABILIZED DURING ANY POTENTIAL PRECIPITATION EVENT.
6. PERFORM ALL WORK TO CAUSE THE LEAST POSSIBLE INCONVENIENCE TO THE PUBLIC.
7. AT NO COST TO OWNER, REPAIR ANY PIPING NOT PROPERLY BEDDED & SLOPED UNIFORMLY AND/OR DAMAGES CAUSED BY UTILITY TRENCHING AND/OR INSTALLATION.

* EACH BUILDING AND ITS LOCATION RELATIVE TO PROPERTY LINES AND OTHER STRUCTURES SHALL COMPLY WITH THE 2006 INTERNATIONAL BUILDING CODE WITH GA STATE AMENDMENTS (IBC) WITH REGARDS TO THE HEIGHT AND AREA REQUIREMENTS OF IBC TABLE 503 AND THE FIRE RESISTANCE AND HORIZONTAL SEPARATION REQUIREMENTS OF IBC TABLES 601 AND 602 BASED ON OCCUPANCY GROUP CLASSIFICATION AND TYPE OF CONSTRUCTION.

* THIS SITE PLAN INDICATES POTABLE WATER SERVICE LINES AND SANITARY SEWER LATERALS. GEORGIA STATE LAW REQUIRES THIS WORK TO BE INSTALLED BY A GEORGIA LICENSED MASTER PLUMBER. THIS WORK REQUIRES A SEPARATE SITE PLUMBING PERMIT WHICH SHALL BE OBTAINED FROM JACKSON COUNTY BUILDING PERMITS.


ALL WORK TO BE PERFORMED ACCORDING TO THE JACKSON COUNTY CODE OF ORDINANCES, CURRENT EDITION. ACTUAL FIELD CONDITIONS COULD DICTATE MORE STRINGENT REQUIREMENTS, IF DEEMED NECESSARY BY INSPECTOR.

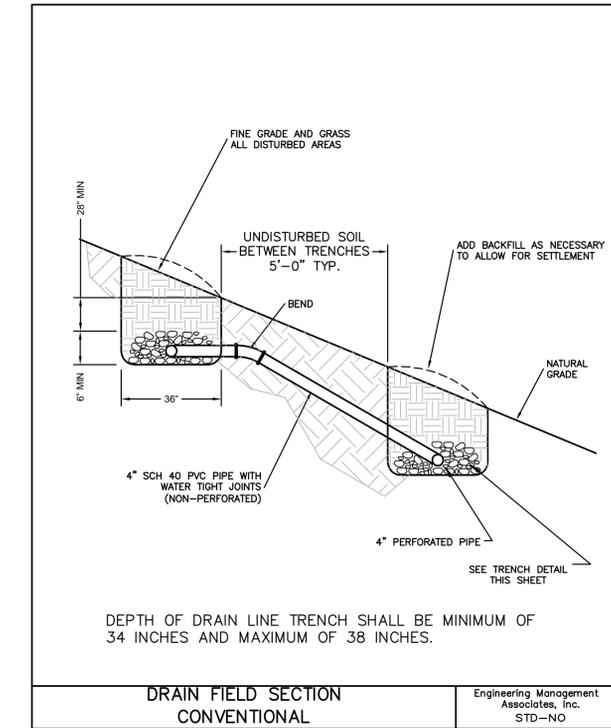

DEPTH OF DRAIN LINE TRENCH SHALL BE MINIMUM OF 34 INCHES AND MAXIMUM OF 38 INCHES.

DRAIN FIELD SECTION CONVENTIONAL

Engineering Management Associates, Inc. STD-NO

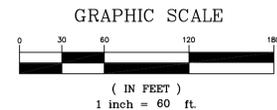

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JACKSON COUNTY GOVERNMENT
NEW EMS STATION
LOCATED IN G.M.D. 455
JACKSON COUNTY, GEORGIA

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| UTILITY PLAN | CHECKED BY | DWB |
| SHEET TITLE | DRAWN BY | KLP |
| DESIGN BY | KLP | |



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| DATE | 12/01/15 |
| JOB NUMBER | 15037 |
| FILE LOCATION | z:\projects |

C5

REVISION

PROJECT

SHEET

PROJECT DESCRIPTION

THIS PROJECT CONSISTS OF THE CONSTRUCTION OF A 3,500 S.F. EMS STATION ALONG WITH ASSOCIATED DRIVEWAYS, PARKING, SIDEWALKS, STORM DRAINAGE STRUCTURES, AND UTILITIES. THE PROPERTY IS LOCATED ON THE SOUTH SIDE OF PLAINVIEW ROAD AT THE INTERSECTION OF PLAINVIEW ROAD AND S.R. 82 WITHIN THE LIMITS OF UNINCORPORATED JACKSON COUNTY. THE TOTAL SITE AREA IS 9.21 ACRES. THE TOTAL AREA TO BE DISTURBED IS 1.50 ACRES.

DESCRIPTION OF NATURE OF CONSTRUCTION ACTIVITY

- INSTALLATION AND MAINTENANCE OF EROSION AND SEDIMENTATION CONTROL MEASURES
ROUGH GRADING OF THE SITE WHERE THE PROPOSED IMPROVEMENTS ARE LOCATED
INSTALLATION OF STORM DRAINAGE STRUCTURES, WATER, SANITARY SEWER, ELECTRIC, AND GAS UTILITIES
GRADING AND STABILIZATION OF THE BUILDING PAD
CONSTRUCTION AND STABILIZATION OF THE ACCESS DRIVEWAY AND PARKING LOT
FINAL GRADING OF THE YARD AREAS
ESTABLISHING TEMPORARY AND PERMANENT VEGETATION

AREAS WHERE DISTURBANCE OCCURS WILL INCLUDE THE PROPOSED BUILDING AND PARKING LOT AND ALL AREAS OUTSIDE OF THE PERMANENT STRUCTURES TO BE RESTORED WITH PERMANENT GRASS VEGETATION. A PROPOSED DETENTION POND WILL BE USED TO HANDLE THE INCREASE IN STORMWATER RUNOFF DUE TO THE PROJECT SO THAT DOWNSTREAM PROPERTIES ARE NOT ADVERSELY AFFECTED.

SEE SHEET EC-C FOR PROJECT LOCATION, IDENTIFICATION OF STATE WATERS AND RECEIVING WATERS, IDENTIFICATION AND ACREAGE OF ONSITE AND OFF SITE DRAINAGE BASINS, AND STORM WATER SAMPLING LOCATIONS.

STORM-DRAIN PIPE AND WEIR VELOCITIES:

APPROPRIATELY SIZED RIPRAP APRONS WILL BE PLACED AT THE DISCHARGE END OF ALL PROPOSED STORM-DRAIN PIPES.

SEDIMENT STORAGE:

CONSTRUCTION ACTIVITY INCLUDES GRADING, INSTALLATION OF A DETENTION POND AND ASSOCIATED DRAINAGE STRUCTURES, CONSTRUCTION OF ASPHALT PARKING, CONSTRUCTION OF A PROPOSED BUILDING, AND MAINTAINING EROSION CONTROL MEASURES AND GRASSING OF ALL DISTURBED AREAS. GIVEN THE NATURE OF THE PROJECT, THE PROPOSED DETENTION POND WILL BE USED AS A TEMPORARY SEDIMENT BASIN DURING THE CONSTRUCTION ACTIVITIES. WHEN ALL CONSTRUCTION ACTIVITIES ARE COMPLETE AND PRIOR TO FINAL STABILIZATION OF THE SITE, THE ACCUMULATED SILT WILL BE REMOVED FROM THE TEMPORARY SEDIMENT POND AND SPREAD EVENLY IN THE DISTURBED AREAS ADJACENT TO THE POND. ONCE THE ACCUMULATED SILT IS REMOVED FROM THE POND, THE TEMPORARY SEDIMENT POND WILL BE CONVERTED TO A PERMANENT STORMWATER MANAGEMENT POND. SILT FENCE AND TEMPORARY & PERMANENT GRASSING WILL ALSO BE USED FOR SEDIMENT CONTROL FOR THE PROJECT.

DISTURBED AREA TOTAL = 1.50 ACRES

REQUIRED VOLUME OF SEDIMENT STORAGE: (1.50 ACRES)(67 CUBIC YARDS/ACRE)=100.5 C.Y.

STORAGE PROVIDED: TEMPORARY SEDIMENT POND: MINIMUM OF 100.5 C.Y. (SEE RI CALCULATIONS THIS PAGE)

TOTAL AMOUNT OF ON SITE STORAGE: 100.5 C.Y.

POLLUTION PREVENTION PRACTICES & REMEDIATION OF PETROLEUM SPILLS AND LEAKS:

THE CONTRACTOR IS PROHIBITED FROM STORING OIL OR ANY HAZARDOUS WASTE MATERIAL AT THE CONSTRUCTION SITE. CONSTRUCTION EQUIPMENT AND VEHICLES ARE THE ONLY ANTICIPATED SOURCE OF POTENTIAL POLLUTION EXPECTED WITHIN THE CONSTRUCTION AREA FOR THIS PROJECT.

PREVENTION OF SPILLS AND LEAKS:

THE CONTRACTOR IS RESPONSIBLE FOR MINIMIZING THE POTENTIAL OF POLLUTION FROM EQUIPMENT AND VEHICLE LEAKS OR SPILLS REACHING ANY RECEIVING WATERS. AT A MINIMUM, THE FOLLOWING PRACTICES SHALL BE IMPLEMENTED:

REGULARLY INSPECT ONSITE VEHICLES AND EQUIPMENT FOR LEAKS AND REPAIR IMMEDIATELY.

CHECK INCOMING VEHICLES AND EQUIPMENT FOR LEAKING OIL AND FLUIDS. DO NOT ALLOW LEAKING VEHICLES OR EQUIPMENT ONSITE.

IF FUELING MUST OCCUR ONSITE, USE LOCATIONS AWAY FROM DRAINAGE COURSES TO PREVENT THE RUNON OF STORMWATER AND THE RUNOFF OF SPILLS. ALWAYS USE SECONDARY CONTAINMENT, SUCH AS A DRAIN PAN, WHEN FUELING TO CATCH SPILLS/LEAKS.

IF MAINTENANCE MUST OCCUR ONSITE, USE A DESIGNATED AREA AND SECONDARY CONTAINMENT, LOCATED AWAY FROM DRAINAGE COURSES, TO PREVENT THE RUNON OF STORMWATER AND THE RUNOFF OF SPILLS.

ALWAYS USE SECONDARY CONTAINMENT, SUCH AS DRAIN PAN OR DROP CLOTH, TO CATCH SPILLS OR LEAKS WHEN REMOVING OR CHANGING FLUIDS. PROMPTLY TRANSFER USED FLUIDS TO PROPER WASTE OR RECYCLING CONTAINERS. IMMEDIATELY REMOVE FROM SITE AND DISPOSE OF IN ACCORDANCE WITH LOCAL, STATE AND FEDERAL REGULATIONS.

TO THE EXTENT THAT THE WORK CAN BE ACCOMPLISHED SAFELY, SPILLS OF OIL OR PETROLEUM PRODUCTS SHOULD BE CONTAINED AND CLEANED UP IMMEDIATELY. SPILLS SHOULD BE COVERED AND PROTECTED FROM STORMWATER RUNON DURING RAINFALL TO THE EXTENT THAT IT DOESN'T COMPROMISE CLEAN UP ACTIVITIES.

CLEANUP OF PETROLEUM LEAKS OR SPILLS:

CLEAN UP LEAKS AND SPILLS IMMEDIATELY. NEVER HOSE DOWN OR BURY SPILLS. REMOVE CONTAMINATED SOILS AND DISPOSE OF IN ACCORDANCE WITH LOCAL, STATE AND FEDERAL REGULATIONS.

MINOR SPILLS

CONTAIN THE SPREAD OF THE SPILL, REMOVE CONTAMINATED SOILS, AND DISPOSE OF IN ACCORDANCE WITH LOCAL, STATE AND FEDERAL REGULATIONS.

SEMI-SIGNIFICANT SPILLS

SPILLS SHOULD BE CLEANED UP IMMEDIATELY WITH THE AID OF AS MANY ONSITE PERSONNEL AS NECESSARY. IMMEDIATELY CONTAIN THE SPILL BY CONSTRUCTING AN EARTHEN DIKE. DIG UP AND PROPERLY DISPOSE OF CONTAMINATED SOIL IN ACCORDANCE WITH LOCAL, STATE AND FEDERAL REGULATIONS.

SIGNIFICANT SPILLS

FOR SIGNIFICANT SPILLS THAT CANNOT BE CONTROLLED BY PERSONNEL IN THE IMMEDIATE VICINITY, THE FOLLOWING STEPS SHOULD BE TAKEN:

NOTIFY THE LOCAL EMERGENCY RESPONSE BY CONTACTING 911. IN ADDITION TO 911, THE CONTRACTOR WILL NOTIFY THE PROPER 24 HOUR EMERGENCY CONTACT. THE SERVICES OF A SPILLS CONTRACTOR OR A HAZ-MAT TEAM SHOULD BE OBTAINED IMMEDIATELY. CONSTRUCTION PERSONNEL SHOULD NOT ATTEMPT TO CLEAN UP UNTIL THE APPROPRIATE AND QUALIFIED STAFFS HAVE ARRIVED AT THE JOB SITE.

THE CONTRACTOR IS REQUIRED TO ADHERE TO ALL REPORTING REQUIREMENTS OF GEORGIA'S OIL OR HAZARDOUS MATERIAL SPILLS OR RELEASES ACT (O.C.G.A. §§12-14-2, ET SEQ.), 40 CFR PART 117 AND 40 CFR PART 302, WHERE A RELEASE CONTAINING A HAZARDOUS SUBSTANCE IN AN AMOUNT EQUAL TO OR IN EXCESS OF A REPORTING QUANTITY ESTABLISHED UNDER EITHER GEORGIA'S OIL OR HAZARDOUS MATERIAL SPILLS OR RELEASES ACT (O.C.G.A. §§12-14-2, ET SEQ.), 40 CFR 117 OR 40 CFR 302 OCCURS DURING A 24 HOUR PERIOD, THE CONTRACTOR IS REQUIRED TO NOTIFY EPA AT (404) 656-4863 OR (800) 241-4113 AND THE NATIONAL RESPONSE CENTER (NRC) AT (800) 424-9802 IN ACCORDANCE WITH THE REQUIREMENTS OF GEORGIA'S OIL OR HAZARDOUS MATERIAL SPILLS OR RELEASES ACT (O.C.G.A. §§12-14-2, ET SEQ.), 40 CFR 117 AND 40 CFR 302 AS SOON AS HE/SHE HAS KNOWLEDGE OF THE DISCHARGE.

POST CONSTRUCTION POLLUTION CONTROL MEASURES:

THIS PROJECT CONSISTS OF THE CONSTRUCTION OF A 3,500 S.F. EMS FACILITY ALONG WITH ASSOCIATED DRIVEWAYS, PARKING, SIDEWALKS, STORM DRAINAGE STRUCTURES, AND UTILITIES. THE AREAS OUTSIDE OF PERMANENT STRUCTURES WILL BE RE-ESTABLISHED WITH PERMANENT VEGETATION AS SOON AS POSSIBLE. A PROPOSED DETENTION POND WILL BE USED TO CONTROL INCREASES IN THE POST DEVELOPED RUNOFF. THEREFORE, THE PROPOSED DETENTION POND ALONG WITH PERMANENT GRASS VEGETATION ON DISTURBED AREAS WILL HELP CONTROL POST CONSTRUCTION RUNOFF AND POLLUTION.

THE CONTRACTOR SHALL ENSURE SATISFACTORY GROWTH AND COVERAGE OF PERMANENT GRASS VEGETATION ON DISTURBED AREAS. GRASSSED AREAS WILL BE CONSIDERED ACCEPTABLE WHEN PERMANENT GRASS VEGETATION HAS REACHED A POINT OF MATURITY, COVERAGE IS AT LEAST 95% OF THE TOTAL AREA WITH NO BARE SPOTS EXCEEDING ONE SQUARE FOOT, AND GROUND SURFACE IS FULLY STABILIZED AGAINST EROSION. SILT FENCE AND CHECKS DAMS INSTALLED DURING THE CLEARING PHASE WILL BE KEPT IN PLACE AND MAINTAINED UNTIL PERMANENT VEGETATION HAS BEEN EFFECTIVELY ESTABLISHED AND THE CONTRACTOR HAS RECEIVED FINAL ACCEPTANCE BY THE OWNER.

WASTE MATERIALS:

WASTE MATERIALS SHALL NOT BE DISCHARGED TO WATERS OF THE STATE, EXCEPT BY A SECTION 404 PERMIT. ANY WASTE MATERIAL FROM CONSTRUCTION ACTIVITIES SHALL BE COLLECTED AND STORED IN A SECURE, LIDDED CONTAINER. AT THE END OF EACH WORK DAY WASTE MATERIAL SHALL BE REMOVED FROM THE CONSTRUCTION SITE AND DISPOSED OF PROPERLY.

IF EXISTING SANITARY FACILITIES ARE UNAVAILABLE, PORTABLE SANITARY FACILITIES SHALL BE PROVIDED. CONTRACTOR SHALL PAY THE COST FOR INSTALLATION, MAINTENANCE, AND REMOVAL OF TEMPORARY SANITARY FACILITIES. UNITS SHALL BE CLEANED AND SANITARY WASTE SHALL BE COLLECTED A MINIMUM OF ONE TIME PER WEEK BY A LICENSED PORTABLE FACILITY PROVIDER AND IN COMPLIANCE WITH LOCAL AND STATE REGULATIONS.

UNITS SHALL BE LOCATED AT SUCH PLACES AS APPROVED BY THE OWNER AND WHERE THE LIKELIHOOD OF THE UNIT CONTRIBUTING TO STORM WATER DISCHARGE IS NEGLIGIBLE.

INSPECTION OF BMP'S:

CONTRACTOR SHALL NOTIFY THE ES&PC DESIGN PROFESSIONAL WHEN INITIAL CONSTRUCTION ACTIVITY IS TO BEGIN. THE ES&PC DESIGN PROFESSIONAL WILL INSPECT THE INSTALLATION OF BMP'S WITHIN 7 DAYS AFTER INITIAL CONSTRUCTION ACTIVITY BEGINS.

ES&PC PLAN AMENDMENTS/REVISIONS:

ANY AMENDMENT TO THE EROSION CONTROL PLANS WHICH HAS A SIGNIFICANT EFFECT ON BMP'S WITH A HYDRAULIC COMPONENT MUST BE CERTIFIED BY THE ES&PC PLAN DESIGN PROFESSIONAL.

CONCRETE WASHDOWN:

CONCRETE WASHDOWN OF TOOLS, CONCRETE MIXER CHUTES, HOPPERS, DRUMS, THE REAR OF VEHICLES, AND/OR ANY OTHER EQUIPMENT IS PROHIBITED ON THE PROJECT SITE.

STATE WATERS:

THE PROJECT IMPROVEMENTS ARE NOT LOCATED WITHIN 200 FT OF THE UNNAMED TRIBUTARY TO STOCKTON CREEK.

STREAM BUFFER INFORMATION:

THE PROJECT IMPROVEMENTS ARE NOT LOCATED WITHIN 200 FT OF THE UNNAMED TRIBUTARY TO STOCKTON CREEK. THERE ARE NO STATE WATERS BUFFERS ONSITE.

NO OTHER ACTIVITIES WILL BE PERMITTED IN THE 25 FT STREAM BUFFER ALONG THE BANKS OF ANY STATE WATERS WITHOUT FIRST REQUIRING THE NECESSARY VARIANCES AND PERMITS.

EXISTING LAND USE:

THE EXISTING LANDS AT THE PROJECT SITE CONSIST OF AN EXISTING FIRE STATION AND ASPHALT PARKING AND LAND PREVIOUSLY GRADED TO CREATE A LEVEL PAD FOR A BALL FIELD. THE AREA HAS EXISTING GRASS ESTABLISHED.

GPS COORDINATES & DISTRICT & ADJACENT SITES & CRITICAL AREAS INFORMATION:

PROJECT GPS COORDINATES (CONSTRUCTION EXIT) LATITUDE - 34.22°N LONGITUDE - 83.63°W THIS PROJECT IS LOCATED IN G.M.D. 455, JACKSON COUNTY, GEORGIA. THE SITE IS SURROUNDED BY LARGE AGRICULTURAL TRACTS. THE PROPERTY TO THE EAST IS A LARGE TRACT WITH OPEN FIELDS. THE PROPERTY TO THE WEST IS A LARGE TRACT WITH OPEN FIELDS. THE PROPERTY TO THE SOUTH IS PART OF THE LARGE TRACT TO THE EAST AND IT IS WOODED. THE PROPERTY TO THE NORTH AND ACROSS PLAINVIEW ROAD IS A LARGE TRACT WITH OPEN FIELDS.

PRIMARY PERMITTEE:

THIS PROJECT IS A MUNICIPAL PROJECT FOR THE JACKSON COUNTY GOVERNMENT, IN JACKSON COUNTY, GEORGIA. THE COUNTY ASSUMES ALL RESPONSIBILITIES OF THE PRIMARY PERMITTEE.

EROSION, SEDIMENTATION AND POLLUTION CONTROL INSPECTIONS AND REPORTING:

SEE SHEET EC-B OF THE EROSION, SEDIMENTATION, & POLLUTION CONTROL PLAN FOR INSPECTION AND REPORTING REQUIREMENTS.

LEGEND: VEGETATIVE EROSION CONTROL MEASURES

MULCHING [Ds1]

MULCH OR TEMPORARY GRASSING SHALL BE APPLIED TO ALL EXPOSED AREAS WITHIN 14 DAYS OF DISTURBANCE. MULCH CAN BE USED AS A SINGULAR EROSION CONTROL DEVICE FOR UP TO SIX MONTHS, BUT IT SHALL BE APPLIED AT THE APPROPRIATE DEPTH, DEPENDING ON THE MATERIAL USED, ANCHORED AND HAVE A CONTINUOUS 90% COVER OR GREATER OF THE SOIL SURFACE.

MAINTENANCE SHALL BE REQUIRED TO MAINTAIN APPROPRIATE DEPTH AND 90% COVER. TEMPORARY VEGETATION MAY BE EMPLOYED INSTEAD OF MULCH IF THE AREA WILL REMAIN UNDISTURBED FOR LESS THAN SIX MONTHS.

MATERIALS AND APPLICATION RATES

- DRY STRAW OR HAY SHALL BE APPLIED AT A DEPTH OF 2 TO 4 INCHES PROVIDING COMPLETE SOIL COVERAGE.
WOOD WASTE (CHIPS, SAWDUST OR BARK) SHALL BE APPLIED AT A DEPTH OF 2 TO 3 INCHES. ORGANIC MATERIAL FROM THE CLEARING STAGE OF DEVELOPMENT SHOULD REMAIN ON SITE, BE CHIPPED, AND APPLIED AS MULCH.

TEMPORARY GRASSING [Ds2]

TEMPORARY GRASSING SHALL CONSIST OF SOWING A QUICK GRASS SUCH AS RYE GRASS, BROWN TOP MILLET, OR A GRASS SUITABLE TO THE AREA AND SEASON. LIME AND FERTILIZER WILL BE OMITTED. MULCH IS NOT REQUIRED BUT SHOULD BE USED AS DICTATED BY EXISTING SITE CONDITIONS.

Table with 3 columns: SPECIES, RATE, PLANTING DATE. Rows include RYE, BROWNTOP MILLET, and WHEAT.

PERMANENT GRASSING: [Ds3]

PERMANENT GRASSING SHALL CONSIST OF GROUND PREPARATION, LIMING AND FERTILIZATION, SEEDING, AND MULCHING.

THE GROUND SHALL BE PREPARED BY PLOWING AND DISKING NOT LESS THAN 4". FERTILIZER AND LIME SHALL BE UNIFORMLY MIXED INTO THE GROUND - LIME AT A RATE OF 2000#/AC AND FERTILIZER AT THE RATES LISTED BELOW PER SPECIES PLANTED.

FERTILIZER REQUIREMENTS

Table with 5 columns: SPECIES, YEAR, ANALYSIS OR EQUIVALENT N-P-K, RATE, N TOP DRESSING RATE. Rows include COOL SEASON GRASSES, TALL FESCUE, and WARM SEASON GRASSES.

THE GROUND SHALL BE FINISHED OFF SMOOTH AND UNIFORM BEING FREE OF ROCKS, CLODS, ROOTS, ETC. SEEDING SHALL BE DONE WITHIN 24 HOURS OF THE FERTILIZER APPLICATION, WEATHER PERMITTING. SEED SHALL BE UNIFORMLY SPREAD AT THE RATE SHOWN BELOW.

SEEDING REQUIREMENTS

Table with 3 columns: SPECIES, RATE, PLANTING DATE. Rows include TALL FESCUE, COMMON BERMUDA (HULLED), COMMON BERMUDA (UNHULLED), and WEEPING LOVEGRASS.

MULCHING IS REQUIRED AND SHALL BE DONE IMMEDIATELY AFTER SEEDING. MULCH SHALL BE UNIFORMLY APPLIED OVER THE AREA AND ACHIEVE 75% TO 100% SOIL COVER.

MULCH MATERIALS AND APPLICATION RATES

- DRY STRAW OR HAY OF GOOD QUALITY AND FREE OF WEED SEEDS CAN BE USED. DRY STRAW SHALL BE APPLIED AT THE RATE OF 2 TONS PER ACRE. DRY HAY SHALL BE APPLIED AT A RATE OF 2 1/2 TONS PER ACRE.
WOOD CELLULOSE MULCH OR WOOD PULP FIBER SHALL BE USED WITH HYDRAULIC SEEDING. IT SHALL BE APPLIED AT THE RATE OF 500 POUNDS PER ACRE. DRY STRAW OR DRY HAY SHALL BE APPLIED (AT THE RATE INDICATED ABOVE) AFTER HYDRAULIC SEEDING.

PRODUCT SPECIFIC PRACTICES:

PETROLEUM BASED PRODUCTS - CONTAINERS FOR PRODUCTS SUCH AS FUELS, LUBRICANTS, AND TARS WILL BE INSPECTED DAILY FOR LEAKS AND SPILLS. THIS INCLUDES ONSITE VEHICLES AND MACHINERY DAILY INSPECTIONS AND REGULAR PREVENTATIVE MAINTENANCE OF SUCH EQUIPMENT. EQUIPMENT MAINTENANCE AREAS WILL BE LOCATED AWAY FROM STATE WATERS, NATURAL DRAINS, AND STORM WATER DRAINAGE INLETS. IN ADDITION, TEMPORARY FUELING TANKS SHALL HAVE A SECONDARY CONTAINMENT LINER TO PREVENT/MINIMIZE SITE CONTAMINATION. DISCHARGE OF OILS, FUELS, AND LUBRICANTS IS PROHIBITED. PROPER DISPOSAL METHODS WILL INCLUDE COLLECTION IN A SUITABLE CONTAINER AND DISPOSAL AS REQUIRED BY LOCAL AND STATE REGULATIONS.

PAINTS/FINISHES/SOLVENTS - ALL PRODUCTS WILL BE STORED IN TIGHTLY SEALED ORIGINAL CONTAINERS WHEN NOT IN USE. EXCESS PRODUCT WILL NOT BE DISCHARGED TO THE STORM WATER COLLECTION SYSTEM. EXCESS PRODUCT, MATERIALS USED WITH THESE PRODUCTS, AND PRODUCT CONTAINERS WILL BE DISPOSED OF ACCORDING TO MANUFACTURERS' SPECIFICATIONS AND RECOMMENDATIONS.

CONCRETE TRUCK WASHING - NO CONCRETE TRUCKS WILL BE ALLOWED TO WASH OUT OR DISCHARGE SURPLUS CONCRETE OR DRUM WASH WATER ONSITE.

FERTILIZER/HERBICIDES - THESE PRODUCTS WILL BE APPLIED AT RATES THAT DO NOT EXCEED THE MANUFACTURER'S SPECIFICATIONS OR ABOVE THE GUIDELINES SET FORTH IN THE CROP ESTABLISHMENT OR IN THE GSWCC MANUAL FOR EROSION AND SEDIMENT CONTROL IN GEORGIA. ANY STORAGE OF THESE MATERIALS WILL BE UNDER ROOF IN SEALED CONTAINERS.

BUILDING MATERIALS - NO BUILDING OR CONSTRUCTION MATERIALS WILL BE BURIED OR DISPOSED OF ONSITE. ALL SUCH MATERIAL WILL BE DISPOSED OF IN PROPER WASTE DISPOSAL PROCEDURES.

OWNER:

JACKSON COUNTY GOVERNMENT
67 ATHENS STREET
JEFFERSON, GA 30549

24 HOUR CONTACT:

MR. KEVIN POE, COUNTY MANAGER
JACKSON COUNTY GOVERNMENT
67 ATHENS STREET
JEFFERSON, GA 30549
PHONE: (706) 367-6314
FAX: (706) 367-9083

EROSION CONTROL NOTES:

THE DESIGN PROFESSIONAL WHO PREPARED THE ES&PC PLAN IS TO INSPECT THE INSTALLATION OF THE INITIAL SEDIMENT STORAGE REQUIREMENTS AND PERIMETER CONTROL BMPS WITHIN 7 DAYS AFTER INSTALLATION.

NON-EXEMPT ACTIVITIES SHALL NOT BE CONDUCTED WITHIN THE 25 OR 50-FOOT UNDISTURBED STREAM BUFFERS AS MEASURED FROM THE POINT OF WRESTED VEGETATION WITHOUT FIRST ACQUIRING THE NECESSARY VARIANCES AND PERMITS.

AMENDMENTS/REVISIONS TO THE ES&PC PLAN WHICH HAVE A SIGNIFICANT EFFECT ON BMPS WITH A HYDRAULIC COMPONENT MUST BE CERTIFIED BY THE DESIGN PROFESSIONAL.

WASTE MATERIALS SHALL NOT BE DISCHARGED TO WATERS OF THE STATE, EXCEPT AS AUTHORIZED BY A SECTION 404 PERMIT.

THE ESCAPE OF SEDIMENT FROM THE SITE SHALL BE PREVENTED BY THE INSTALLATION OF EROSION AND SEDIMENT CONTROL MEASURES AND PRACTICES PRIOR TO LAND DISTURBING ACTIVITIES.

EROSION CONTROL MEASURES WILL BE MAINTAINED AT ALL TIMES. IF FULL IMPLEMENTATION OF THE APPROVED PLAN DOES NOT PROVIDE FOR EFFECTIVE EROSION CONTROL, ADDITIONAL EROSION AND SEDIMENT CONTROL MEASURES SHALL BE IMPLEMENTED TO CONTROL OR TREAT THE SEDIMENT SOURCE.

ANY DISTURBED AREA LEFT EXPOSED FOR A PERIOD GREATER THAN 14 DAYS SHALL BE STABILIZED WITH MULCH OR TEMPORARY SEEDING.

THE EXTENT AND LOCATION OF EROSION CONTROL MEASURES SHOWN (SHEET EC1-EC3) ARE THE ESTIMATED REQUIRED. ADDITIONAL EROSION CONTROL MEASURES MAY BE REQUIRED DUE TO THE ACTUAL FIELD CONDITIONS, AND WILL BE INSTALLED AT THE OWNER/DEVELOPERS EXPENSE WHEN DIRECTED BY THE PROPER GOVERNING AUTHORITY.

ANTICIPATED ACTIVITY SCHEDULE:

START DATE: FEBRUARY 1, 2016
END DATE: JUNE 1, 2016

Activity schedule table with columns for ACTIVITY, MONTH 1, MONTH 2, MONTH 3, MONTH 4. Includes activities like EROSION CONTROL INSTALLATION, ROUGH GRADING, and GRASSING.

CERTIFICATION - ES&PC DESIGN PROFESSIONAL

I CERTIFY THAT THE PERMITTEE'S EROSION, SEDIMENTATION AND POLLUTION CONTROL PLAN PROVIDES FOR AN APPROPRIATE AND COMPREHENSIVE SYSTEM OF BEST MANAGEMENT PRACTICES REQUIRED BY THE GEORGIA WATER QUALITY CONTROL ACT AND THE DOCUMENT "MANUAL FOR EROSION AND SEDIMENT CONTROL IN GEORGIA" (MANUAL) PUBLISHED BY THE STATE SOIL AND WATER CONSERVATION COMMISSION AS OF JANUARY 1 OF THE YEAR IN WHICH THE LAND-DISTURBING ACTIVITY WAS PERMITTED, PROVIDES FOR THE SAMPLING OF THE RECEIVING WATER(S) OR THE SAMPLING OF THE STORM WATER OUTFALLS AND THAT THE DESIGNED SYSTEM OF BEST MANAGEMENT PRACTICES AND SAMPLING METHODS IS EXPECTED TO MEET THE REQUIREMENTS CONTAINED IN THE GENERAL NPDES PERMIT NO. GAR100001."

I CERTIFY UNDER PENALTY OF LAW THAT THIS PLAN WAS PREPARED AFTER A SITE VISIT TO THE LOCATIONS DESCRIBED HEREIN BY MYSELF OR MY AUTHORIZED AGENT, UNDER MY SUPERVISION."

KENNETH PETERS DATE
P.E. - LICENSE NO. 26331
GSWCC LEVEL II CERTIFICATION NO. 919

I certify under penalty of law that this report and all attachments were prepared under my direction or supervision in accordance with a system designed to assure that certified personnel properly gather and evaluate the information submitted. Based on my inquiry of the person or persons who manage the system, or those persons directly responsible for gathering the information, the information submitted is, to the best of my knowledge and belief, true, accurate, and complete. I am aware that there are significant penalties for submitting false information, including the possibility of fine and imprisonment for knowing violations."

OWNER/AGENT DATE

IMPAIRED STREAM REQUIREMENTS, TMDL PLANS, AND ALTERNATIVE BMP NOTES:

- THIS PROJECT IS LOCATED WITHIN ONE LINEAR MILE AND WITHIN THE SAME WATERSHED AS STOCKTON CREEK. STOCKTON CREEK IS NOT LISTED ON GEORGIA'S 2012 "305(b)(303(d)) LIST DOCUMENTS".
ALTERNATIVE BMPS WILL NOT BE INSTALLED DURING THIS PROJECT.

SOIL TABLE

Soil table with columns: SYMBOL, NAME, SLOPE, PERMEABILITY (IN/HR), DEPTH (IN), SOIL STRUCTURE, TEXTURE, ERODIBILITY, DRAINAGE, K FACTOR, T FACTOR. Rows include CeB, PuD2, and Cfc2.

RIPRAP APRON SUMMARY

Riprap apron summary table with columns: UPSTREAM PIPE ID, PIPE DIAMETER (d), FLOW RATE (cfs), VELOCITY (fps), TAILWATER CONDITION, APRON LENGTH (La), WIDTH UPSTREAM (W1), WIDTH DOWNSTREAM (W=Do+0.4La), RIP RAP SIZE (d50), RIP RAP DEPTH (in), RIP RAP TYPE. Row includes P1 with 18" diameter and NSA R-3 type.

RT

STORAGE CALCULATIONS

- REQUIRED STORMWATER STORAGE = 253 C.Y. (AS DETERMINED BY LOCAL ORDINANCE)
REQUIRED SEDIMENT STORAGE = 100.5 C.Y. (67 CY/AC * 1.50 AC, DISTURBED AREA - TOTAL AREA DRAINING TO POND)
TOTAL REQUIRED STORAGE = 253 + 100.5 = 353.5 C.Y.
AVAILABLE STORAGE = 596 C.Y.
IS THE AVAILABLE STORAGE (4) GREATER THAN THE TOTAL REQUIRED STORAGE (3)? X YES NO
IF "NO", THE SEDIMENT STORAGE CAPACITY OF THE POND MUST BE INCREASED. CHOOSE THE METHOD TO BE USED:
RAISE THE INVERT OF THE OUTLET STRUCTURE _____ INCHES
UNDERCUT THE POND _____ FEET
OTHER _____
CLEAN OUT ELEVATION = 920.90 FT (ELEVATION CORRESPONDING TO 22 CY/AC * 1.50 AC DISTURBED AREA)
IS THE LENGTH - WIDTH RATIO 2:1 OR GREATER? X YES NO
IF "NO", THE LENGTH OF FLOW MUST BE INCREASED. CHOOSE THE METHOD TO BE USED:
BAFFLES (TYPE OF BAFFLE: _____)
OTHER _____
NOTE THE CMP DIAMETER AND HEIGHT IF A HALF - ROUND CMP RETROFIT IS TO BE USED.
DIAMETER = 30 INCHES HEIGHT = 1.6 FEET

1996 ASCE INC. ALL RIGHTS RESERVED. THESE CONSTRUCTION DOCUMENTS AND ANY PARTS HEREOF ARE THE PROPERTY OF EMI ENGINEERING MANAGEMENT, INC. ANY REUSE OR REPRODUCTION OF THESE DOCUMENTS WITHOUT THE WRITTEN PERMISSION OF EMI ENGINEERING MANAGEMENT, INC. IS PROHIBITED.

Revision table with columns: DATE, NO., DESCRIPTION. Includes entries for SUBMIT FOR INITIAL REVIEW and REVISE PLAN TO RELOCATE STORMWATER POND.

EMI ENGINEERING MANAGEMENT logo and contact information for Kenneth Lee Peters, P.E., License No. 26331, GSWCC Level II Certification No. 919.

JACKSON COUNTY GOVERNMENT NEW EMS STATION logo and location information: LOCATED IN G.M.D. 455 JACKSON COUNTY, GEORGIA.

EROSION CONTROL NOTES & LEGEND SHEET TITLE. Includes checkboxes for DESIGN BY, DRAWN BY, CHECKED BY, and KLP.

Professional Engineer Stamp for Kenneth Lee Peters, No. 26331, State of Georgia.

DATE 12/01/15, JOB NUMBER 15037, FILE LOCATION z:\projects.

EC-A SHEET label.

REVISION

PROJECT

SHEET

PATH & FILE: z:\PROJECTS\1515037-Jackson Co-Plainview EMS\Design_Sheet\15037-C-Base-01-12-16

INSPECTION REQUIREMENTS

- 1) Each day when any type of construction activity has taken place at a primary permittee's site, certified personnel provided by the primary permittee shall inspect...
2) Measure rainfall once every 24 hours except any non-working Saturday, non-working Sunday and non-working Federal holiday...
3) Certified personnel (provided by the primary permittee) shall inspect the following at least once every seven (7) calendar days...

- e) The sampling container should be held so that the opening faces upstream.
f) The samples should be kept free from floating debris.
g) Permittees do not have to sample sheetflow that flows onto undisturbed natural areas or areas stabilized by the project...

SAMPLING FREQUENCY

- 1) The primary permittee must sample in accordance with the Plan at least once for each rainfall event described below. For a qualifying event, the permittee shall sample at the beginning of any storm water discharge...
2) However, where manual and automatic sampling are impossible (as defined in this permit), or are beyond the permittee's control, the permittee shall take samples as soon as possible...
3) Sampling by the permittee shall occur for the following qualifying events:

SAMPLING REQUIREMENTS

- 1) Sampling shall be performed at the locations indicated on the USGS topographic map, see Sheet EC-C of the construction plans.
2) Analytical methods used to collect and analyze the samples and quality control/quality assurance procedures shall be in accordance with methodology and test procedures established by 40 CFR Part 136...
3) Unnamed Tributary to Stockton Creek is the only state and receiving water located down stream of this project...

NON-STORM WATER DISCHARGES

Except for flows from firefighting activities, sources of non-storm water listed in Part III.A.2 of this permit that are combined with storm water discharges associated with construction activity must be identified in the Plan. The Plan shall identify and ensure the implementation of appropriate pollution prevention measures for the non-storm water component(s) of the discharge.

REPORTING

- 1) The applicable permittees are required to submit the sampling results to the EPD at the address shown in Part II.C. by the fifteenth day of the month following the reporting period. Reporting periods are months during which samples are taken in accordance with this permit.
2) All sampling reports shall include the following information:
a. The rainfall amount, date, exact place and time of sampling or measurements;
b. The name(s) of the certified personnel who performed the sampling and measurements;
c. The date(s) analyses were performed;
d. The time(s) analyses were initiated;
e. The name(s) of the certified personnel who performed the analyses;
f. References and written procedures, when available, for the analytical techniques or methods used;
g. The results of such analyses, including the bench sheets, instrument readouts, computer disks or tapes, etc., used to determine these results;
h. Results which exceed 1000 NTU shall be reported as "exceeds 1000 NTU;" and
i. Certification statement that sampling was conducted as per the Plan.
3) All written correspondence required by this permit shall be submitted by return receipt certified mail (or similar service) to the appropriate District Office of the EPD according to the schedule in Appendix A of this permit.

RETENTION OF RECORDS

- 1) The primary permittee shall retain the following records at the construction site or the records shall be readily available at a designated alternate location from commencement of construction until such time as a NOT is submitted in accordance with Part VI.
a. A copy of all Notices of Intent submitted to EPD;
b. A copy of the Erosion, Sedimentation and Pollution Control Plan required by this permit;
c. The design professional's report of the results of the inspection conducted in accordance with Part IV.A.5 of this permit;
d. A copy of all sampling information, results, and reports required by this permit;
e. A copy of all inspection reports generated in accordance with Part IV.D.4.a of this permit;
f. A copy of all violation summaries and violation summary reports generated in accordance with Part III.D.2 of this permit; and
g. Daily rainfall information collected in accordance with Part IV.D.4.a(2) of this permit.
2) Copies of all Notices of Intent, Notices of Termination, inspection reports, sampling reports (including all calibration and maintenance records and all original strip chart recordings for continuous monitoring instrumentation) or other reports requested by the EPD, Erosion, Sedimentation and Pollution Control Plans, records of all data used to complete the Notice of Intent to be covered by this permit and all other records required

EROSION, SEDIMENTATION & POLLUTION CONTROL PLAN CHECKLIST STAND ALONE CONSTRUCTION PROJECTS

Project Name: NEW EMS STATION Address: PLAINVIEW ROAD
City/County: JACKSON COUNTY Date on Plans: 12/01/15

Plan Included

Page # Y/N

EC-B

ECA-EC3

N/A

EC-A

EC-A

EC-A

ECA-EC1

ECA-EC3

EC-A

EC-C

ECA-EC3

EC-A

N/A

EC-A

EC-B

EC-B

EC-B

EC-B

ECA-EC3

EC1-EC3

EC1-EC3

EC1-EC3

N/A

N/A

N/A

N/A

EC-C

EC-C

EC-A

EC1-EC3

EC1-EC3

ECA-EC1

EC1-EC3

D1

ECA-EC1-EC3

29 Provide complete requirements of inspections and record keeping by the primary permittee.*

30 Provide complete requirements of sampling frequency and reporting of sampling results.*

31 Provide complete details for retention of records as per Part IV.F. of the permit.*

32 Description of analytical methods to be used to collect and analyze the samples from each location.*

33 Appendix B rationale for NTU values at all outfall sampling points where applicable.*

34 Delineate all sampling locations, perennial and intermittent streams and other water bodies into which storm water is discharged.*

35 A description of appropriate controls and measures that will be implemented at the construction site including:

(1) initial sediment storage requirements and perimeter control BMPs, (2) intermediate grading and drainage BMPs, and (3) final BMPs. For construction sites where there will be no mass grading and the initial perimeter control BMPs, intermediate grading and drainage BMPs, and final BMPs are the same, the plan may combine all of the BMPs into a single phase.*

36 Graphic scale and North arrow.

37 Existing and proposed contour lines with contour lines drawn at an interval in accordance with the following:

Table with 3 columns: Map Scale, Ground Slope, Contour Intervals, ft.
1 inch = 100ft or larger scale, Flat 0 - 2%, Rolling 2 - 8%, Steep 8% +

38 Use of alternative BMPs whose performance has been documented to be equivalent to or superior to conventional BMPs as certified by a Design Professional (unless disapproved by EPD or the Georgia Soil and Water Conservation Commission). Please refer to the Alternative BMP Guidance Document found at www.gaswcc.org.

39 Use of alternative BMP for application to the Equivalent BMP List. Please refer to Appendix A-2 of the Manual for Erosion & Sediment Control in Georgia 2016 Edition.*

40 Delineation of the applicable 25-foot or 50-foot undisturbed buffers adjacent to state waters and any additional buffers required by the Local Issuing Authority. Clearly note and delineate all areas of impact

41 Delineation of on-site wetlands and all state waters located on and within 200 feet of the project site.

42 Delineation and acreage of contributing drainage basins on the project site.

43 Provide hydrology study and maps of drainage basins for both the pre- and post-developed conditions.*

44 An estimate of the runoff coefficient or peak discharge flow of the site prior to and after construction activities are completed.

45 Storm-drain pipe and weir velocities with appropriate outlet protection to accommodate discharges without erosion. Identify/Delineate all storm water discharge points.

46 Soil series for the project site and their delineation.

47 The limits of disturbance for each phase of construction.

48 Provide a minimum of 67 cubic yards of sediment storage per acre drained using a temporary sediment basin, retrofitted detention pond, and/or excavated inlet sediment traps for each common drainage location. Sediment storage volume must be in place prior to and during all land disturbance activities until final stabilization of the site has been achieved. A written justification explaining the decision to use equivalent controls when a sediment basin is not attainable must be included in the plan for each common drainage location in which a sediment basin is not provided. A written justification as to why 67 cubic yards of storage is not attainable must also be given. Worksheets from the Manual included for structural BMPs and all calculations used by the storage design professional to obtain the required sediment when using equivalent controls. When discharging from sediment basins and impoundments, permittees are required to utilize outlet structures that withdraw water from the surface, unless infeasible. If outlet structures that withdraw water from the surface are not feasible, a written justification explaining this decision must be included in the plan.

49 Location of Best Management Practices that are consistent with and no less stringent than the Manual for Erosion and Sediment Control in Georgia. Use uniform coding symbols from the Manual, Chapter 6, with legend.

50 Provide detailed drawings for all structural practices. Specifications must, at a minimum, meet the guidelines set forth in the Manual for Erosion and Sediment Control in Georgia.

51 Provide vegetative plan, noting all temporary and permanent vegetative practices. Include species, planting dates and seeding, fertilizer, lime and mulching rates. Vegetative plan shall be site specific for appropriate time of the year that seeding will take place and for the appropriate geographic region of Georgia.

*If using this checklist for a project that is less than 1 acre and not part of a common development but within 200 ft of a perennial stream the * checklist items would be f

Effective January 1, 2016

IMPAIRED STREAM REQUIREMENTS, TMDL PLANS, AND ALTERNATIVE BMP NOTES:

- 1. STORM WATER FROM THIS PROJECT SITE WILL NOT DISCHARGE WITHIN ONE LINEAR MILE OF AN IMPAIRED STREAM ACCORDING TO THE 2012 3058/3030 LIST OF IMPAIRED STREAMS. A TMDL IMPLEMENTATION PLAN HAS THEREFORE NOT BEEN WRITTEN, AND APPENDIX I DOES NOT APPLY TO THIS PROJECT.
2. ALTERNATIVE BMPs WILL NOT BE INSTALLED DURING THIS PROJECT.

CERTIFICATION - ES&PC DESIGN PROFESSIONAL

KENNETH PETERS DATE
P.E. - LICENSE NO. 26331
GSWCC LEVEL II CERTIFICATION NO. 919

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JACKSON COUNTY GOVERNMENT
NEW EMS STATION
LOCATED IN G.M.D. 455
JACKSON COUNTY, GEORGIA

EROSION CONTROL NOTES & CHECKLIST
SHEET TITLE
DESIGN BY: KLP
DRAWN BY: KLP
CHECKED BY: KLP
DATE: 12/01/15
JOB NUMBER: 15037
FILE LOCATION: z:\projects

GEORGIA REGISTERED PROFESSIONAL ENGINEER
NO. 26331
KENNETH LEE PETERS

STAMP
12/01/15
15037
z:\projects

EC-B

REVISION

PROJECT


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Table with 3 columns: DATE, NO., DESCRIPTION
12/14/15 1 SUBMIT FOR INITIAL REVIEW
01/06/16 2 ADDRESS GASWCC COMMENTS
01/28/16 3 REVISE PLAN TO RELOCATE STORMWATER POND

PATH & FILE: z:\PROJECTS\1515037-Jackson Co-Plainview EMS\Design_Sheet15037-C-Base-01-12-16

**USGS TOPOGRAPHIC
MAP**



- SHEET NOTES:**
1. AN UN-NAMED TRIBUTARY TO STOCKTON CREEK IS THE PROJECT RECEIVING WATER.
 2. SEE THE EROSION CONTROL NOTES AND CHECKLIST (SHEET EC-A) FOR ADDITIONAL INFORMATION REGARDING RECEIVING WATERS. SEE SHEET EC1-EC3 FOR DETAILED LOCATION OF EROSION CONTROL BMPs.
 3. A SITE VISIT DETERMINED THAT THERE IS NO VISIBLE SIGN OF WETLANDS IN THE VICINITY OF THIS PROJECT.
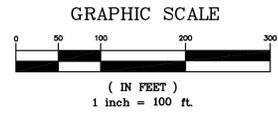
| WATERSHED INFORMATION | | | | |
|---|---------------|---|---|--|
| WATERSHED | TOTAL ACREAGE | DESCRIPTION OF AREAS WITHIN THE WATERSHED | RUNOFF CURVE NUMBER (CN) PRE-CONSTRUCTION | RUNOFF CURVE NUMBER (CN) POST-CONSTRUCTION |
| WATERSHED A STATE & RECEIVING WATER #1 - UNNAMED TRIBUTARY TO STOCKTON CREEK | 12.03 | WOODED, AGRICULTURAL, MUNICIPAL | 62 | 63 |

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DATE

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| DESIGN BY | DRAWN BY | CHECKED BY |
| KLP | KLP | DWB |



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| 12/01/15 | 15037 | z:\projects |

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REVISION

PROJECT

EROSION, SEDIMENTATION AND POLLUTION CONTROL NARRATIVE

PROJECT DESCRIPTION

THIS PROJECT CONSISTS OF THE CONSTRUCTION OF A 3,500 S.F. EMS STATION ALONG WITH ASSOCIATED DRIVEWAYS, PARKING, SIDEWALKS, STORM DRAINAGE STRUCTURES, AND UTILITIES. THE PROPERTY IS LOCATED ON THE SOUTH SIDE OF PLAINVIEW ROAD AT THE INTERSECTION OF PLAINVIEW ROAD AND S.R. 82 WITHIN THE LIMITS OF UNINCORPORATED JACKSON COUNTY. THE TOTAL SITE AREA IS 9.21 ACRES. THE TOTAL AREA TO BE DISTURBED IS 1.50 ACRES.

ADJACENT PROPERTY

THE SITE IS SURROUNDED BY LARGE AGRICULTURAL TRACTS. THE PROPERTY TO THE EAST IS A LARGE TRACT WITH OPEN FIELDS. THE PROPERTY TO THE WEST IS A LARGE TRACT WITH OPEN FIELDS. THE PROPERTY TO THE SOUTH IS PART OF THE LARGE TRACT TO THE EAST AND IT IS WOODED. THE PROPERTY TO THE NORTH AND ACROSS PLAINVIEW ROAD IS A LARGE TRACT WITH OPEN FIELDS.

CRITICAL AREAS

CRITICAL AREAS ON THIS SITE ARE THE EXISTING CHANNEL LOCATED ALONG THE EASTERN SIDE OF THE SITE AND THE EXISTING BALL FIELD. THE CHANNEL CONVEYS WATER TO THE REAR OF THE PROPERTY.

EROSION CONTROL MEASURES

EROSION CONTROL MEASURES TO BE USED ON THIS SITE INCLUDE SILT FENCING, CONSTRUCTION EXIT, TEMPORARY GRASSING, AND PERMANENT GRASSING, STONE CHECK DAMS, RETROFIT, AND A RIP RAP APRON.

SEDIMENT STORAGE CALCULATIONS:

DISTURBED AREA TOTAL = 1.50 ACRES

REQUIRED VOLUME OF SEDIMENT STORAGE: (1.50 ACRES)(67 CUBIC YARDS/ACRES) = 100.5 C.Y.

STORAGE PROVIDED:

TEMPORARY SEDIMENT POND: MINIMUM OF 100.5 C.Y. (SEE RI CALCULATIONS PAGE EC-A)

TOTAL AMOUNT OF ON SITE STORAGE: 100.5 C.Y.

CONTROLS

a) EROSION AND SEDIMENT CONTROLS.

- (1) STABILIZATION MEASURES - SEE ACTIVITY SCHEDULE.
- (2) STRUCTURAL PRACTICES - SEE SEDIMENT AND EROSION CONTROL PLAN NOTES.
- (3) SEDIMENT STORAGE.

b) STORM WATER MANAGEMENT

- (1) VELOCITY DISSIPATION DEVICES SHALL BE PLACED AT DISCHARGE. LOCATIONS OF ALL STORM DRAIN PIPES. (2) THE PROPOSED DETENTION POND WILL BE USED TO CONTROL THE QUANTITY OF THE POST CONSTRUCTION STORMWATER RUNOFF. THE MEASURES SHOULD PROTECT THE DOWNSTREAM WATER COURSE SO THAT THE NATURAL PHYSICAL AND BIOLOGICAL CHARACTERISTICS AND FUNCTIONS ARE MAINTAINED AND PROTECTED [e.g. NO SIGNIFICANT CHANGES IN THE HYDROLOGICAL REGIME OF THE RECEIVING WATER(S)].

c) OTHER CONTROLS.

- (1) WASTE DISPOSAL. SOLID MATERIALS, INCLUDING BUILDING MATERIALS, SHALL NOT BE DISCHARGED TO WATERS OF THE STATE, EXCEPT AS AUTHORIZED BY A SECTION 404 PERMIT.
- (2) OFF-SITE VEHICLE TRACKING OF DIRT, SOILS, AND SEDIMENTS AND THE GENERATION OF DUST SHALL BE MINIMIZED OR ELIMINATED TO THE MAXIMUM EXTENT PRACTICAL. THE PLAN SHALL INCLUDE THE BEST MANAGEMENT PRACTICE TO BE IMPLEMENTED AT THE SITE OF CONSTRUCTION ACTIVITY.
- (3) ALL PERMITTEES SHALL ENSURE AND DEMONSTRATE THAT THEIR PLAN IS IN COMPLIANCE WITH APPLICABLE STATE AND LOCAL WASTE DISPOSAL, SANITARY SEWER OR SEPTIC SYSTEM REGULATIONS.
- (4) THE PLAN SHALL INCLUDE BEST MANAGEMENT PRACTICES FOR THE REMEDIATION OF ALL PETROLEUM SPILLS AND LEAKS AS APPROPRIATE.

| | |
|--|-------|
| PRE-DEVELOPED RUN OFF COEFFICIENT MIX OF GRASSED AND WOODED AREAS W/ EXISTING FIRE STATION | CN=62 |
| POST-DEVELOPMENT RUN OFF COEFFICIENT MIX OF GRASSED AND WOODED AREAS W/ EXISTING & PROPOSED IMPROVEMENTS | CN=63 |

| EROSION CONTROL LEGEND | |
|------------------------|---|
| Sd1-NS | SILT FENCE TYPE 'S' |
| C0 | CONSTRUCTION EXIT/ENTRANCE |
| RI | RETROFIT |
| Ss | SLOPE STABILIZATION |
| St | STORM DRAIN OUTLET PROTECTION |
| Ds1 | DISTURBED AREA STABILIZATION (WITH MULCHING ONLY) |
| Ds2 | DISTURBED AREA STABILIZATION (WITH TEMPORARY SEEDING) |
| DISTURBED LIMITS | |

UTILITY DISCLAIMER



IN ADDITION TO SHOWING THE STRUCTURES TO BE BUILT UNDER THIS CONTRACT, THE DRAWINGS SHOW CERTAIN INFORMATION OBTAINED BY THE ENGINEER REGARDING THE PIPES, POLE LINES, CONDUITS, AND OTHER STRUCTURES WHICH EXIST ALONG THE LINE OF THE WORK, BOTH AT AND BELOW THE SURFACE OF THE GROUND. THE ENGINEER AND THE OWNER EXPRESSLY DISCLAIM ANY RESPONSIBILITY FOR THE ACCURACY OR COMPLETENESS OF THE INFORMATION GIVEN ON THE DRAWINGS WITH REGARD TO EXISTING STRUCTURES, AND THE CONTRACTOR WILL NOT BE ENTITLED TO ANY EXTRA COMPENSATION ON ACCOUNT OF ANY INACCURACY OR INCOMPLETENESS OF SUCH INFORMATION. SAID STRUCTURES BEING INDICATED ONLY FOR THE CONVENIENCE OF THE CONTRACTOR, WHO MUST VERIFY THE INFORMATION TO HIS OWN SATISFACTION. THE GIVING OF THIS INFORMATION UPON THE CONTRACT DRAWINGS WILL NOT RELIEVE THE CONTRACTOR OF HIS OBLIGATION TO SUPPORT AND PROTECT ALL PIPES, CONDUITS, AND OTHER STRUCTURES. THE CONTRACTOR SHALL LOCATE ALL UNDERGROUND OBSTRUCTIONS PRIOR TO EXCAVATION SO AS TO PREVENT ANY DAMAGE TO THOSE SERVICES OR OTHER UTILITIES. ANY SUCH DAMAGES MUST BE REPAIRED WITHOUT DELAY AND THE COST OF SUCH REPAIRS MUST BE BORNE BY THE CONTRACTOR.

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KENNETH PETERS DATE
P.E. - LICENSE NO. 26331
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EROSION CONTROL SHEET NOTES:

1. MULCH OR TEMPORARY GRASSING SHALL BE APPLIED TO ALL EXPOSED AREAS WITHIN 7 DAYS OF LAND DISTURBANCE. ALL DISTURBED AREAS LEFT MULCHED AFTER 30 DAYS SHALL BE STABILIZED WITH TEMPORARY GRASSING. PERMANENT VEGETATION MEASURES SHALL BE USED WHEN GRADING AND DRAINAGE INSTALLATION ARE COMPLETE AND SURROUNDING CONSTRUCTION AREA HAS BEEN CLEANED UP, AND PREPARATION OF THE SUBSOIL IS COMPLETE.
2. ALL CONSTRUCTION VEHICLES LEAVING THE CONSTRUCTION AREA SHALL HAVE MUD CLEANED FROM THEIR TIRES BEFORE LEAVING THE AREA TO PROTECT PUBLIC STREETS FROM THE TRANSPORTATION OF SEDIMENT FROM THE SITE.
3. THE CONTRACTOR SHALL USE ALL MEANS NECESSARY TO CONTROL DUST ON AND NEAR THE WORK WHEN DUST IS CAUSED BY THE OPERATIONS DURING PERFORMANCE OF THE WORK OR IF RESULTING FROM THE CONDITION IN WHICH THE CONTRACTOR LEAVES THE SITE. THE CONTRACTOR SHALL THOROUGHLY MOISTEN ALL SURFACES AS REQUIRED TO PREVENT DUST BEING A NUISANCE TO THE PUBLIC, NEIGHBORS AND CONCURRENT PERFORMANCE OF WORK ON THE SITE.
4. TOTAL PROJECT AREA = 9.21 ACRES. TOTAL DISTURBED AREA = 1.50 ACRES.
5. HEIGHT (") PER DETAIL Sd1-NS, SHEET D1 IS 28". THEREFORE, THE TOTAL FABRIC LENGTH IS 36".



RETROFIT JUSTIFICATION:
THE JACKSON COUNTY LAND DEVELOPMENT ORDINANCE ONLY REQUIRES STORMWATER DETENTION IN AREAS THAT ARE NOT URBANIZED PER THE JACKSON COUNTY MS4 PERMIT. THEREFORE, THE ONSITE STORMWATER MANAGEMENT POND DOES NOT HAVE PROVISIONS FOR WATER QUALITY AND CHANNEL PROTECTION. THE LOW FLOW ORIFICE DESIGNED PER THE OUTLET CONTROL STRUCTURE (SHOWN SHEET D2) IS AN 8" ORIFICE. THE 8" ORIFICE DOES NOT ALLOW FOR THE CONNECTION OF THE FLOATING SURFACE SKIMMER TO THE PERMANENT OUTLET CONTROL STRUCTURE. THEREFORE, A RETROFIT IS PROPOSED TO PROVIDE TEMPORARY SEDIMENT STORAGE WITHIN THE PERMANENT STORMWATER MANAGEMENT POND.

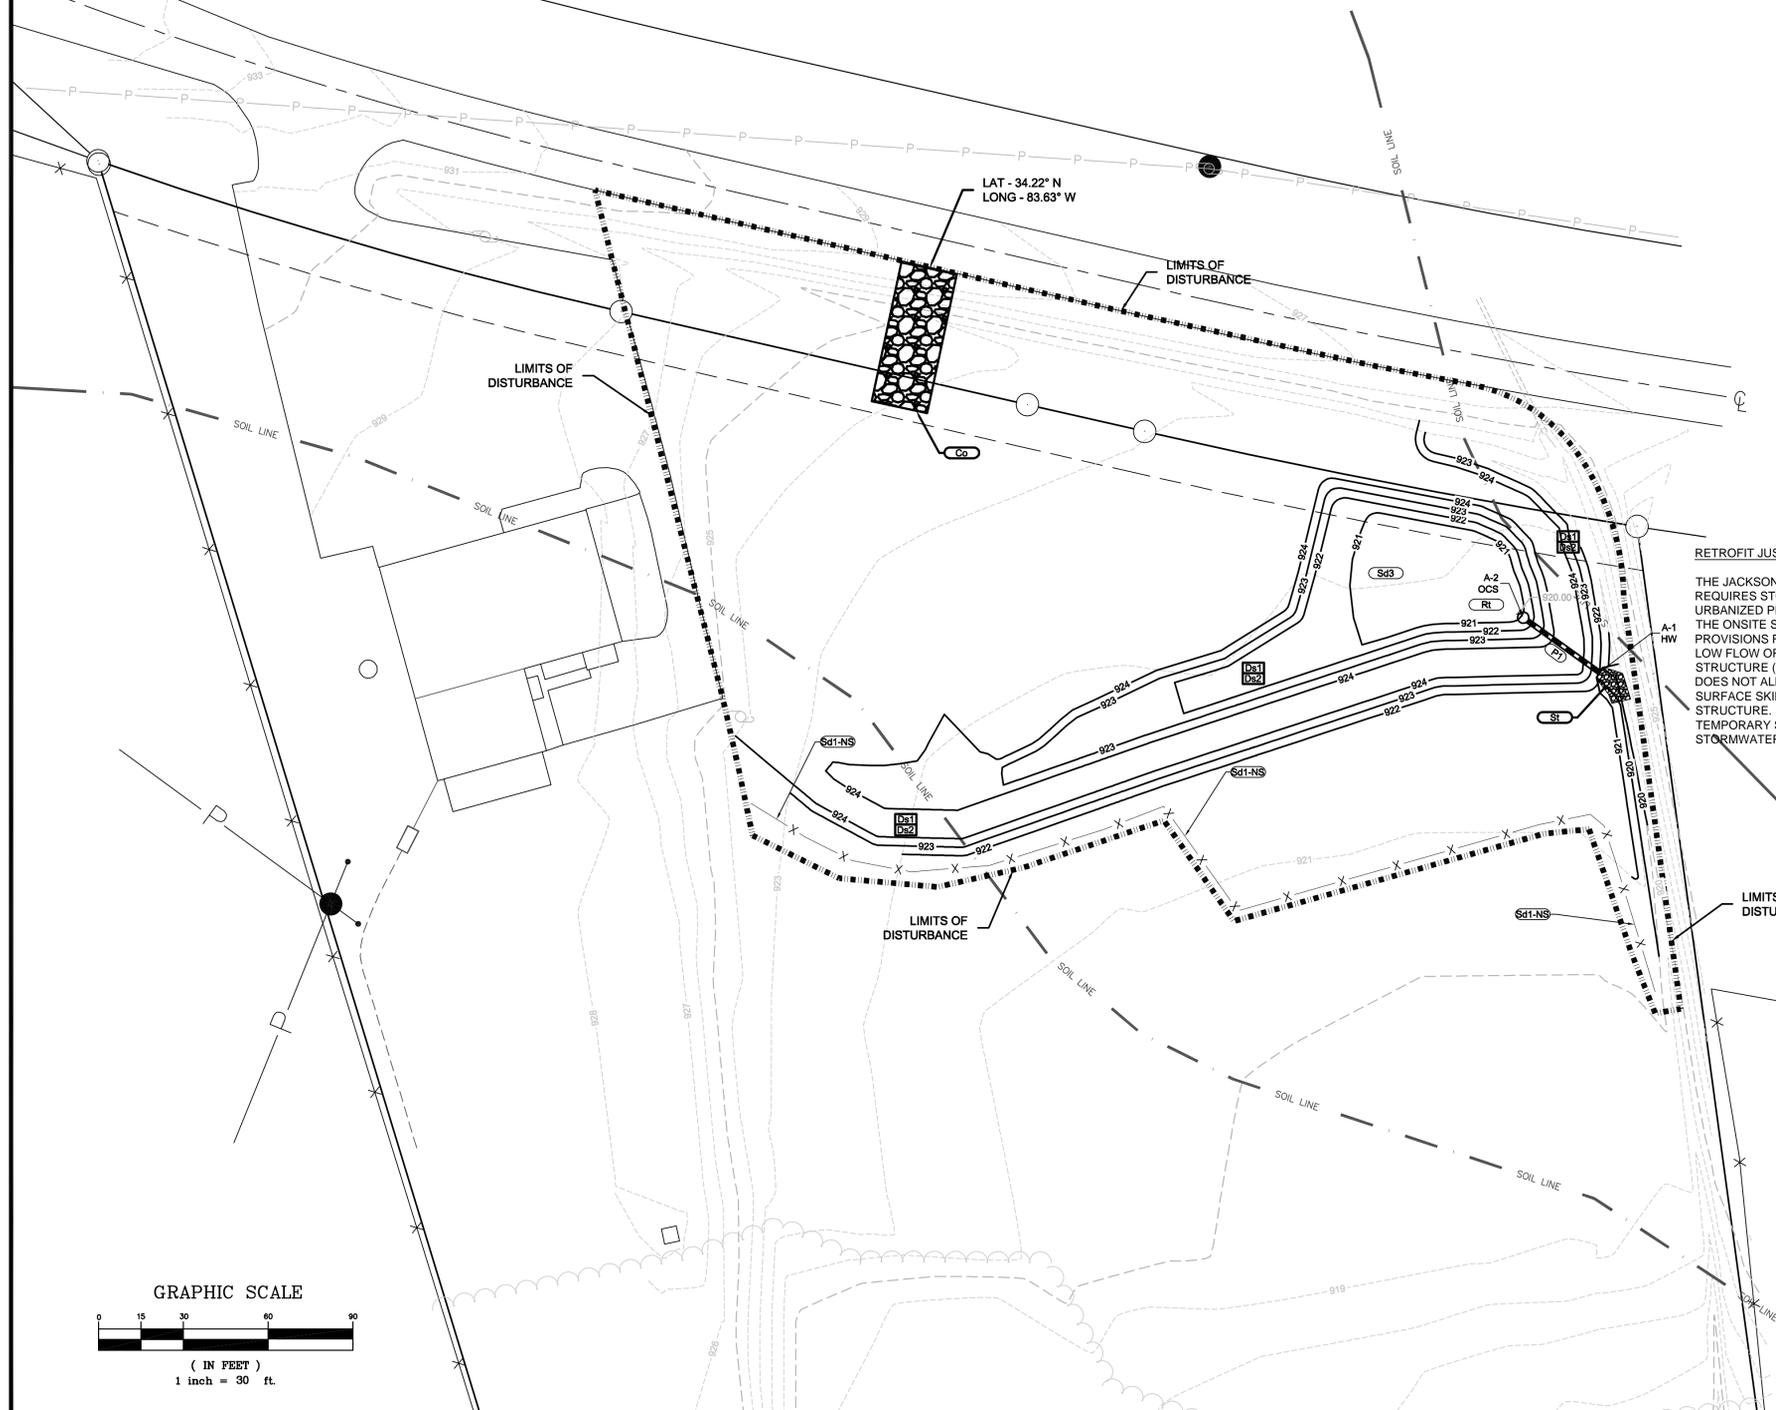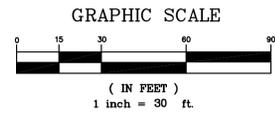

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JACKSON COUNTY GOVERNMENT
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LOCATED IN G.M.D. 455
JACKSON COUNTY, GEORGIA

| | | | |
|----------------------|---------------|---------------|-----|
| EROSION CONTROL PLAN | INITIAL PHASE | CHECKED BY | DWB |
| SHEET TITLE | KL | DRAWN BY | KLP |
| DESIGN BY | KLP | FILE LOCATION | |

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KENNETH LEE PETERS

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- EROSION CONTROL SHEET NOTES:**
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EROSION CONTROL LEGEND

| | | |
|--------|---|---|
| Sd1-NS | SILT FENCE TYPE 'S' | X |
| Co | CONSTRUCTION EXIT/ENTRANCE | |
| Rt | RETROFIT | |
| Ss | SLOPE STABILIZATION | |
| St | STORM DRAIN OUTLET PROTECTION | |
| Ds1 | DISTURBED AREA STABILIZATION (WITH MULCHING ONLY) | |
| Ds2 | DISTURBED AREA STABILIZATION (WITH TEMPORARY SEEDING) | |
| | DISTURBED LIMITS | |


CERTIFICATION - ES&PC DESIGN PROFESSIONAL

KENNETH PETERS
P.E. - LICENSE NO. 28331
GSWCC LEVEL II CERTIFICATION NO. 919

DATE _____

ANTICIPATED ACTIVITY SCHEDULE:
START DATE: FEBRUARY 1, 2016
END DATE: JUNE 1, 2016

| ACTIVITY | 2016 | | | | | | | | | | | | | | | |
|---|---------|---|---|---|---------|---|---|---|---------|---|---|---|---------|---|---|---|
| | MONTH 1 | | | | MONTH 2 | | | | MONTH 3 | | | | MONTH 4 | | | |
| | 1 | 2 | 3 | 4 | 1 | 2 | 3 | 4 | 1 | 2 | 3 | 4 | 1 | 2 | 3 | 4 |
| EROSION CONTROL INSTALLATION OF SILT FENCE, CONSTRUCTION EXIT, TEMPORARY SEDIMENT POND, AND TEMPORARY MULCHING Co Sd1-NS Ds1 Rt | | | | | | | | | | | | | | | | |
| ROUGH GRADING OF THE SITE, INSTALLATION OF STORM DRAIN STRUCTURES AND ASSOCIATED PIPING AND UTILITIES | | | | | | | | | | | | | | | | |
| FINAL GRADING OF THE SITE AND BUILDING PAD AREA, CONSTRUCTION OF THE PARKING AREA AND DRIVEWAYS. | | | | | | | | | | | | | | | | |
| INSTALLATION OF TEMPORARY AND PERMANENT GRASSING IN AREAS WHERE SITE IMPROVEMENTS ARE COMPLETE AND IN DISTURBED AREAS LEFT EXPOSED FOR GREATER THAN 14 DAYS Ds2 Ds3 St | | | | | | | | | | | | | | | | |
| MAINTAIN INSTALLED EROSION CONTROL BMPs UNTIL PERMANENT VEGETATION IS ESTABLISHED AND EFFECTIVE CONTROL OF EROSION HAS BEEN ACHIEVED IN DISTURBED AREAS Co Sd1-NS Ds2 Ds3 | | | | | | | | | | | | | | | | |

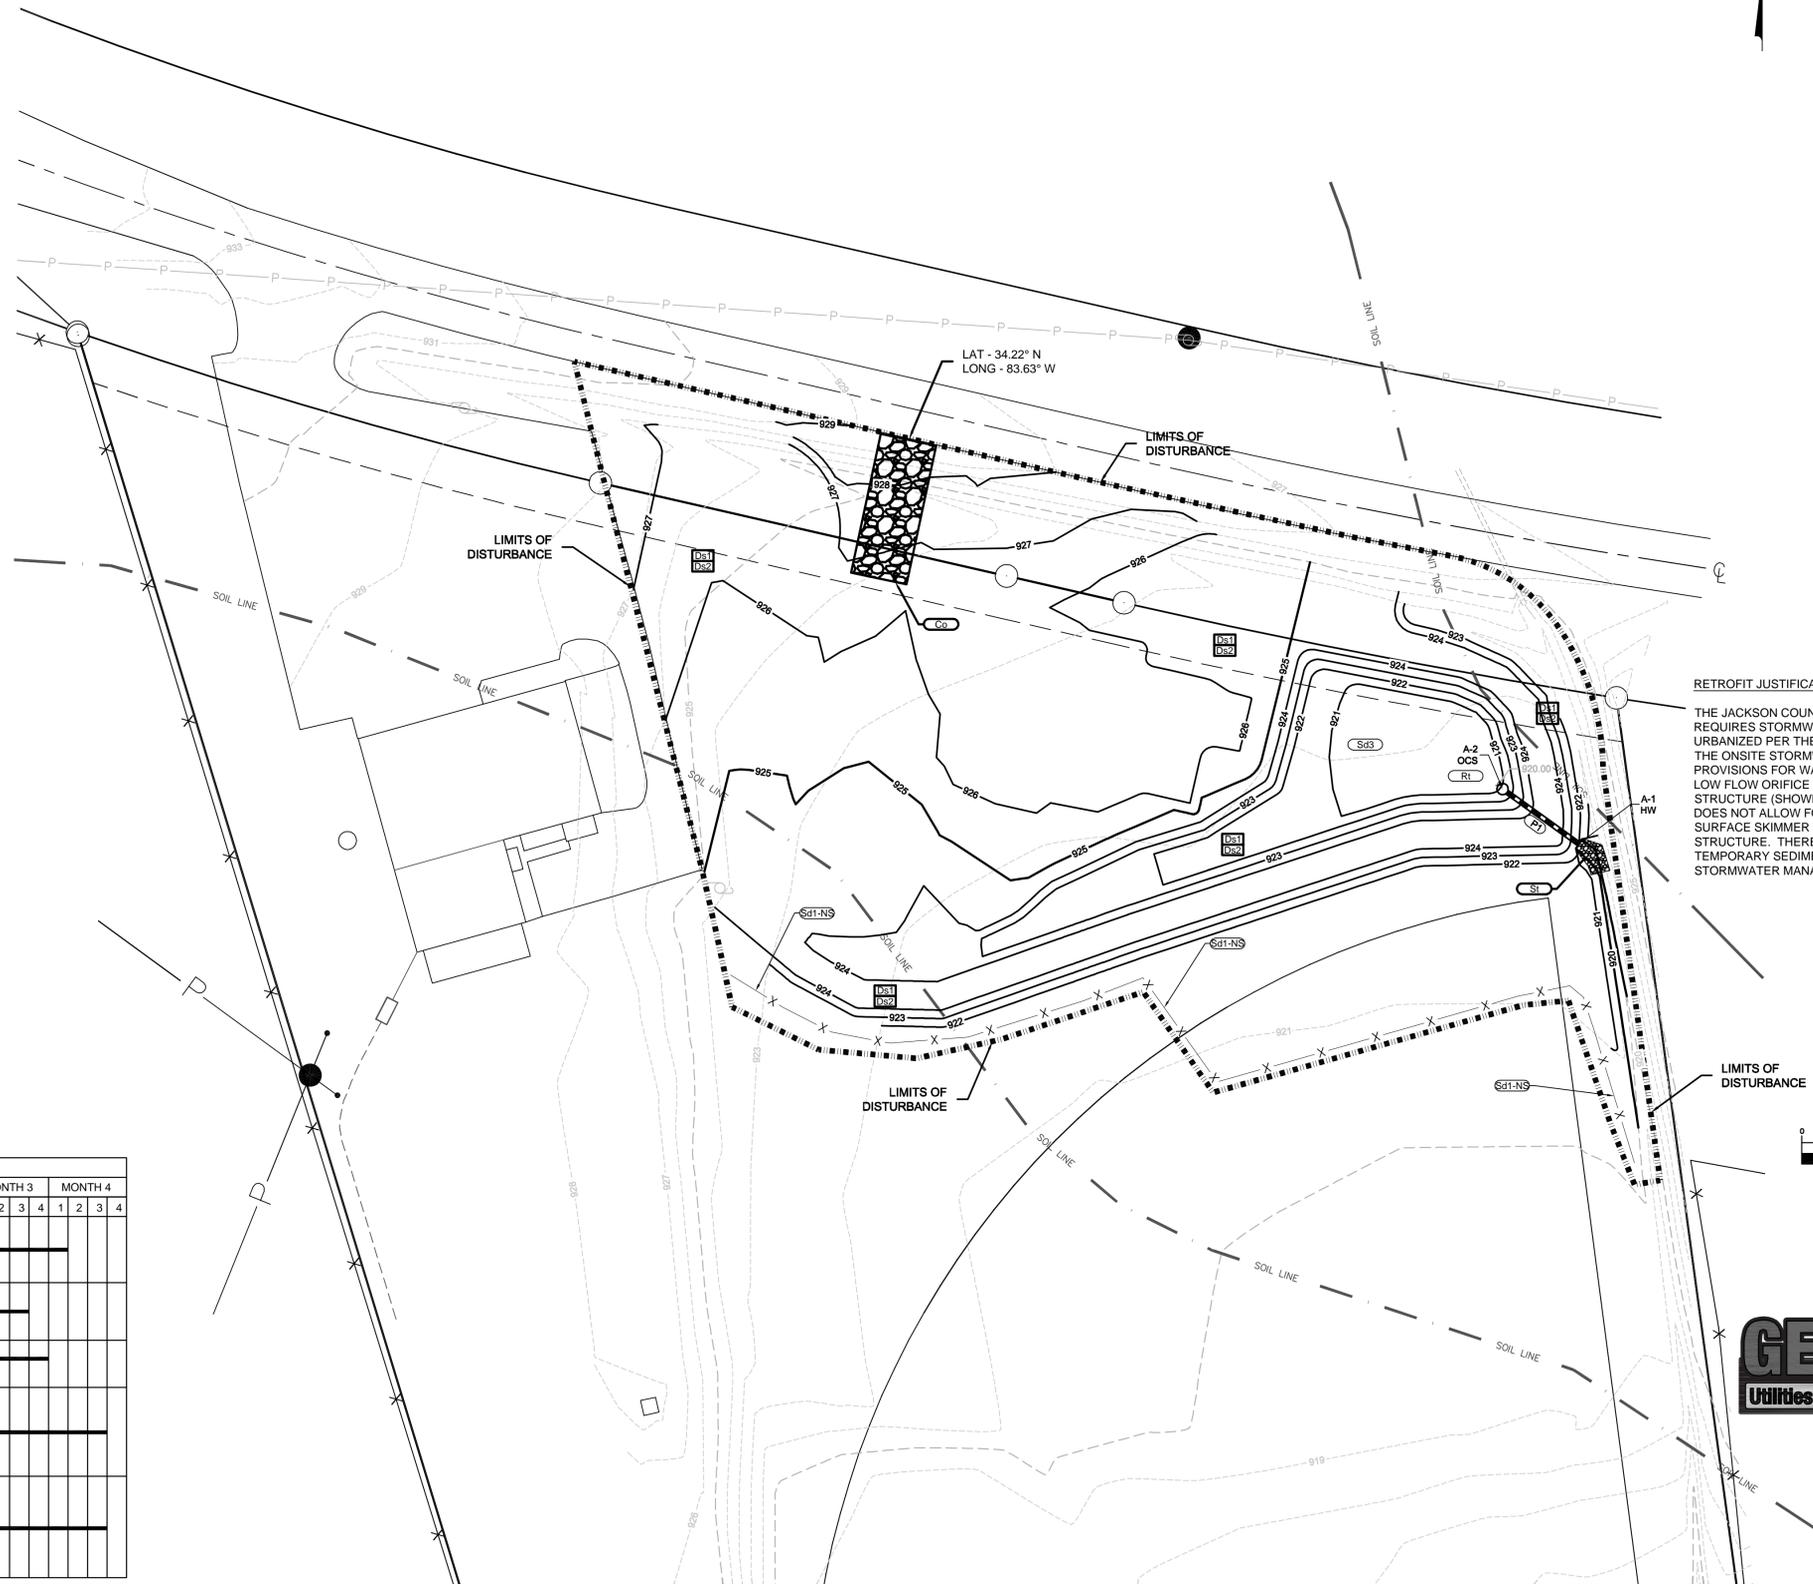

RETROFIT JUSTIFICATION:

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**JACKSON COUNTY GOVERNMENT
NEW EMS STATION**

LOCATED IN G.M.D. 455
JACKSON COUNTY, GEORGIA

EROSION CONTROL INTERMEDIATE PHASE SHEET TITLE

DESIGN BY: KLP
DRAWN BY: KLP
CHECKED BY: KLP
DWB

GEORGIA REGISTERED PROFESSIONAL ENGINEER
NO. 28331
KENNETH LEE PETERS

STAMP

12/01/15 DATE
15037 JOB NUMBER
z:\projects FILE LOCATION

EC2


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PROJECT

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- EROSION CONTROL SHEET NOTES:**
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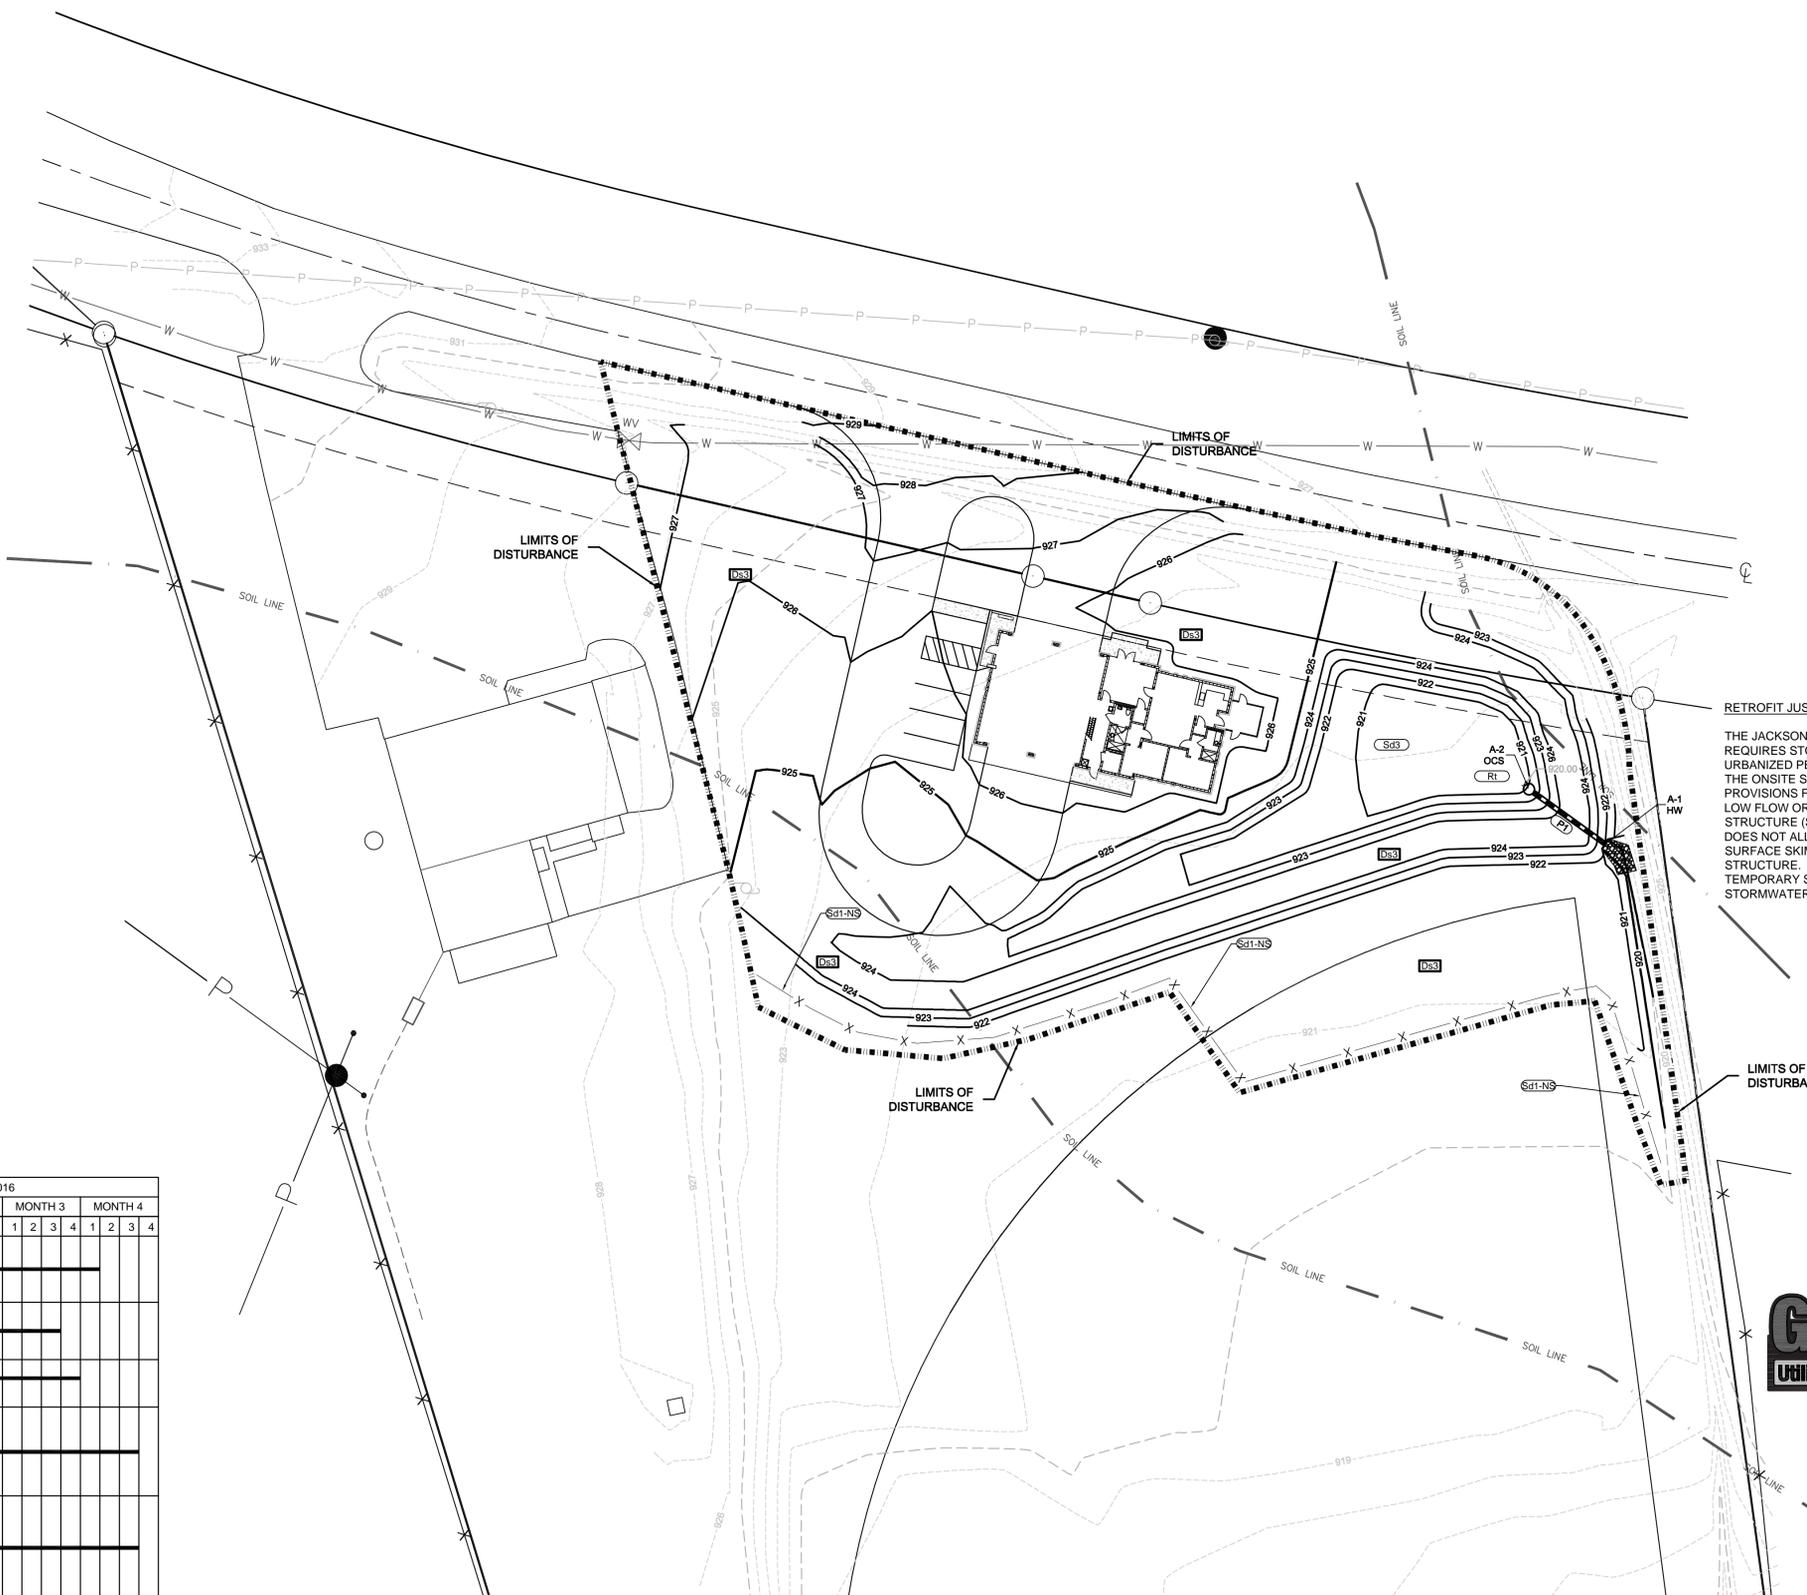


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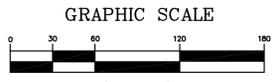
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GSWCC LEVEL II CERTIFICATION NO. 919

ANTICIPATED ACTIVITY SCHEDULE:
START DATE: FEBRUARY 1, 2016
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| ACTIVITY | 2016 | | | | | | | | | | | | | | | |
|--|---------|---|---|---|---------|---|---|---|---------|---|---|---|---------|---|---|---|
| | MONTH 1 | | | | MONTH 2 | | | | MONTH 3 | | | | MONTH 4 | | | |
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| MAINTAIN INSTALLED EROSION CONTROL BMPs UNTIL PERMANENT VEGETATION IS ESTABLISHED AND EFFECTIVE CONTROL OF EROSION HAS BEEN ACHIEVED IN DISTURBED AREAS (Co Sd1-NS Ds2 Ds3) | | | | | | | | | | | | | | | | |

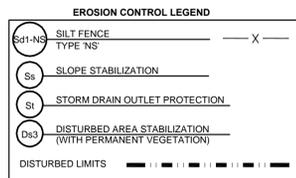

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| 01/06/16 | 2 | ADDRESS GAS/WCC COMMENTS |
| 01/28/16 | 3 | REVISE PLAN TO RELOCATE STORMWATER POND |

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JACKSON COUNTY GOVERNMENT
NEW EMS STATION
LOCATED IN G.M.D. 455
JACKSON COUNTY, GEORGIA

EROSION CONTROL FINAL PHASE
SHEET TITLE
DESIGN BY: KLP
DRAWN BY: KLP
CHECKED BY: DWB
DWB



STAMP
12/01/15 DATE
15037 JOB NUMBER
z:\projects FILE LOCATION

EC3

REVISION

PROJECT

SHEET

PATH & FILE: z:\PROJECTS\1515037-Jackson Co\Planview EMS\Design_Sheet\15037-C-Base-01-12-16

LANDSCAPING CALCULATIONS

1. TREE DENSITY REQUIREMENTS

| | | |
|------------------------|------|----------------|
| Total Project Limits = | 4.29 | Acres |
| Total Buffer Area = | 0 | Acres |
| Net Area = | 4.29 | Acres |
| Tree Density Units = | 17 | Units per Acre |
| Tree Density = | 72.9 | Units Required |
| Tree Density = | 8.0 | Units Provided |

2. EXISTING DECIDUOUS TREES TO REMAIN

| DIAMETER BREST HEIGHT (DBH) | UNITS | NUMBER OF TREES TO REMAIN | TOTAL UNITS |
|--------------------------------|-------|------------------------------|-------------|
| 0 | 0.0 | 0 | 0.0 |
| - | - | - | - |
| TOTAL UNITS TO REMAIN | | | 0.0 |

TREES - REQUIRED PLANTING

| Symbol | Botanical Name | Common Name | Height at time of planting (ft) | Quantity | Diameter(inch) | Units | Total Units |
|-----------------|-------------------|-------------------|---------------------------------|-----------|----------------|-------|-------------|
| Cf | Cornus Florida | Flowering Dogwood | 6 | 2 | 2 | 0.5 | 1.0 |
| Ap | Acer Palmatum | Japanese Maple | 6 | 5 | 2 | 0.5 | 2.5 |
| Cc | Cercis Canadensis | Eastern Redbud | 6 | 5 | 2 | 0.5 | 2.5 |
| Ab | Acer Buergeranum | Trident Maple | 6 | 4 | 2 | 0.5 | 2.0 |
| Subtotal | | | | 16 | | | 8.0 |

3. 10' FRONTAGE LANDSCAPE STRIP

| | |
|--|------------|
| Total Frontage for Proposed Site = | 367.5 L.F. |
| Total Frontage = | 367.5 L.F. |
| Proposed Driveway Width = | 55 L.F. |
| Total Frontage Required to be Landscaped = | 312.5 L.F. |
| Jackson County UDO requires 1 Tree Unit/60 L.F. of Frontage = | 5.2 Units |
| Total number - Frontage Trees Required (planting 2" Caliper trees) = | 10 Trees |
| Jackson County UDO requires 10 shrubs/60 L.F. of Frontage = | 52 Shrubs |

4. 5' SIDE YARD LANDSCAPE STRIP Side yard length adjacent to Fire Station is 148 L.F.

| | |
|--|---------------|
| Jackson County UDO requires 1 Tree Unit/60 L.F. of Side yard = | 2.5 Units |
| Total number -Side Yard Trees Required (planting 2" Caliper trees) = | 4.9 Trees |
| | Plant 5 Trees |

ONE JAPANESE MAPLE, ONE TRIDENT MAPLE, FOUR DWARF BURFORD HOLLIES, AND FOUR KAEMPFERI AZALEAS ARE PLANTED IN THE YARD AREA ADJACENT TO THE BUILDING AND PARKING LOT DUE TO THE LOCATION OF THE STORMWATER MANAGEMENT POND.


GENERAL PLANTING NOTES

- ALL PLANTS MUST BE HEALTHY, VIGOROUS MATERIAL, FREE OF PESTS AND DISEASE.
- ALL PLANTS MUST BE CONTAINER-GROWN OR BALLED AND BURLAPPED AS SPECIFIED.
- ALL TREES MUST BE STRAIGHT TRUNKED AND FULL HEADED.
- ALL PLANTS ARE SUBJECT TO APPROVAL OF THE OWNER BEFORE, DURING, AND AFTER INSTALLATION.
- ALL TREES MUST BE GUYED OR STAKED AS SHOWN.
- ALL PLANTS AND PLANTING AREAS MUST BE COMPLETELY MULCHED.
- PRIOR TO CONSTRUCTION, THE OWNER SHALL BE RESPONSIBLE FOR LOCATING ALL UNDERGROUND UTILITIES AND SHALL AVOID DAMAGE TO ALL UTILITIES DURING THE COURSE OF THE WORK. THE OWNER IS RESPONSIBLE FOR REPAIRING ALL UTILITIES, STRUCTURES, SITE APPURTENANCES, ETC. WHICH OCCURS AS A RESULT OF THE LANDSCAPE CONSTRUCTION.
- THE OWNER IS RESPONSIBLE FOR VERIFYING ALL QUANTITIES SHOWN ON THESE PLANS PRIOR TO PRICING THE WORK.
- THE OWNER IS RESPONSIBLE FOR FULLY MAINTAINING ALL PLANTING, INCLUDING, BUT NOT LIMITED TO: WATERING, SPRAYING, MULCHING, FERTILIZATION ETC., OF PLANTING AREAS AND LAWNS UNTIL WORK IS ACCEPTED IN TOTAL BY THE OWNER.
- THE OWNER SHALL COMPLETELY GUARANTEE ALL PLANT MATERIAL FOR A PERIOD OF ONE YEAR BEGINNING AT THE DATE OF TOTAL ACCEPTANCE. THE OWNER SHALL PROMPTLY MAKE ALL REPLACEMENTS BEFORE OR AT THE END OF THE GUARANTEE PERIOD.
- THE OWNER AGREES TO PERFORM ALL LANDSCAPE MAINTENANCE, INCLUDING WATERING, THROUGHOUT THE ONE YEAR GUARANTEE PERIOD UNLESS OTHERWISE DETERMINED.
- AFTER BEING DUG AT THE NURSERY SOURCE, ALL TREES IN LEAF SHALL BE ACCLIMATED FOR TWO WEEKS UNDER A MIST SYSTEM PRIOR TO INSTALLATION.
- ANY PLANT MATERIAL THAT DIES, TURNS BROWN, OR DEFOLIATES, PRIOR TO ACCEPTANCE OF THE WORK, SHALL BE PROMPTLY REMOVED FROM THE SITE AND REPLACED WITH MATERIAL OF THE SAME SPECIES, QUANTITY, SIZE AND MEETING ALL SPECIFICATIONS.
- STANDARDS SET FORTH IN "AMERICAN STANDARD FOR NURSERY STOCK" REPRESENT GUIDELINE SPECIFICATIONS ONLY AND SHALL CONSTITUTE MINIMUM QUALITY REQUIREMENTS FOR PLANT MATERIAL.


PLANT LIST

| QTY | SYM | BOTANICAL NAME | COMMON NAME | SIZE | UNIT | REMARKS |
|------------------|-----|------------------------|---------------------|----------|---------|----------------------------|
| TREES | | | | | | |
| 2 | Cf | CORNUS FLORIDA | FLOWERING DOGWOOD | 2" CAL. | 0.5 | 1 FULL, NOT ROOTBOUND |
| 5 | Ap | ACER PALMATUM | JAPANESE MAPLE | 2" CAL. | 0.5 | 2.5 FULL, NOT ROOTBOUND |
| 5 | Cc | CERCIS CANADENSIS | EASTERN REDBUD | 2" CAL. | 0.5 | 2.5 FULL, NOT ROOTBOUND |
| 4 | Ab | ACER BUERGERANUM | TRIDENT MAPLE | 2" CAL. | 0.5 | 2 FULL, NOT ROOTBOUND |
| SHRUBS | | | | | | |
| 19 | Ak | AZALEA KAEMPFERI | KAEMPFERI AZALEA | 3 GAL. | | |
| 25 | Gj | GARDENIA JASMINOIDES | CAPE-JASMINE | 3 GAL. | | |
| 8 | Ibn | ILEX CORNUTA BURFORDII | DWARF BURFORD HOLLY | 3 GAL. | | |
| TURFGRASS | | | | | | |
| | | SEED FESTUCA SPP. | 'REBEL II' FESCUE | SEED/SOD | N/A | N/A SEE EROSION CONT. PLAN |
| | | | | | TOTAL = | 8 UNITS |

NOTE: ALL TREES SHALL BE A MIN. OF 6' HT. AT TIME OF PLANTING

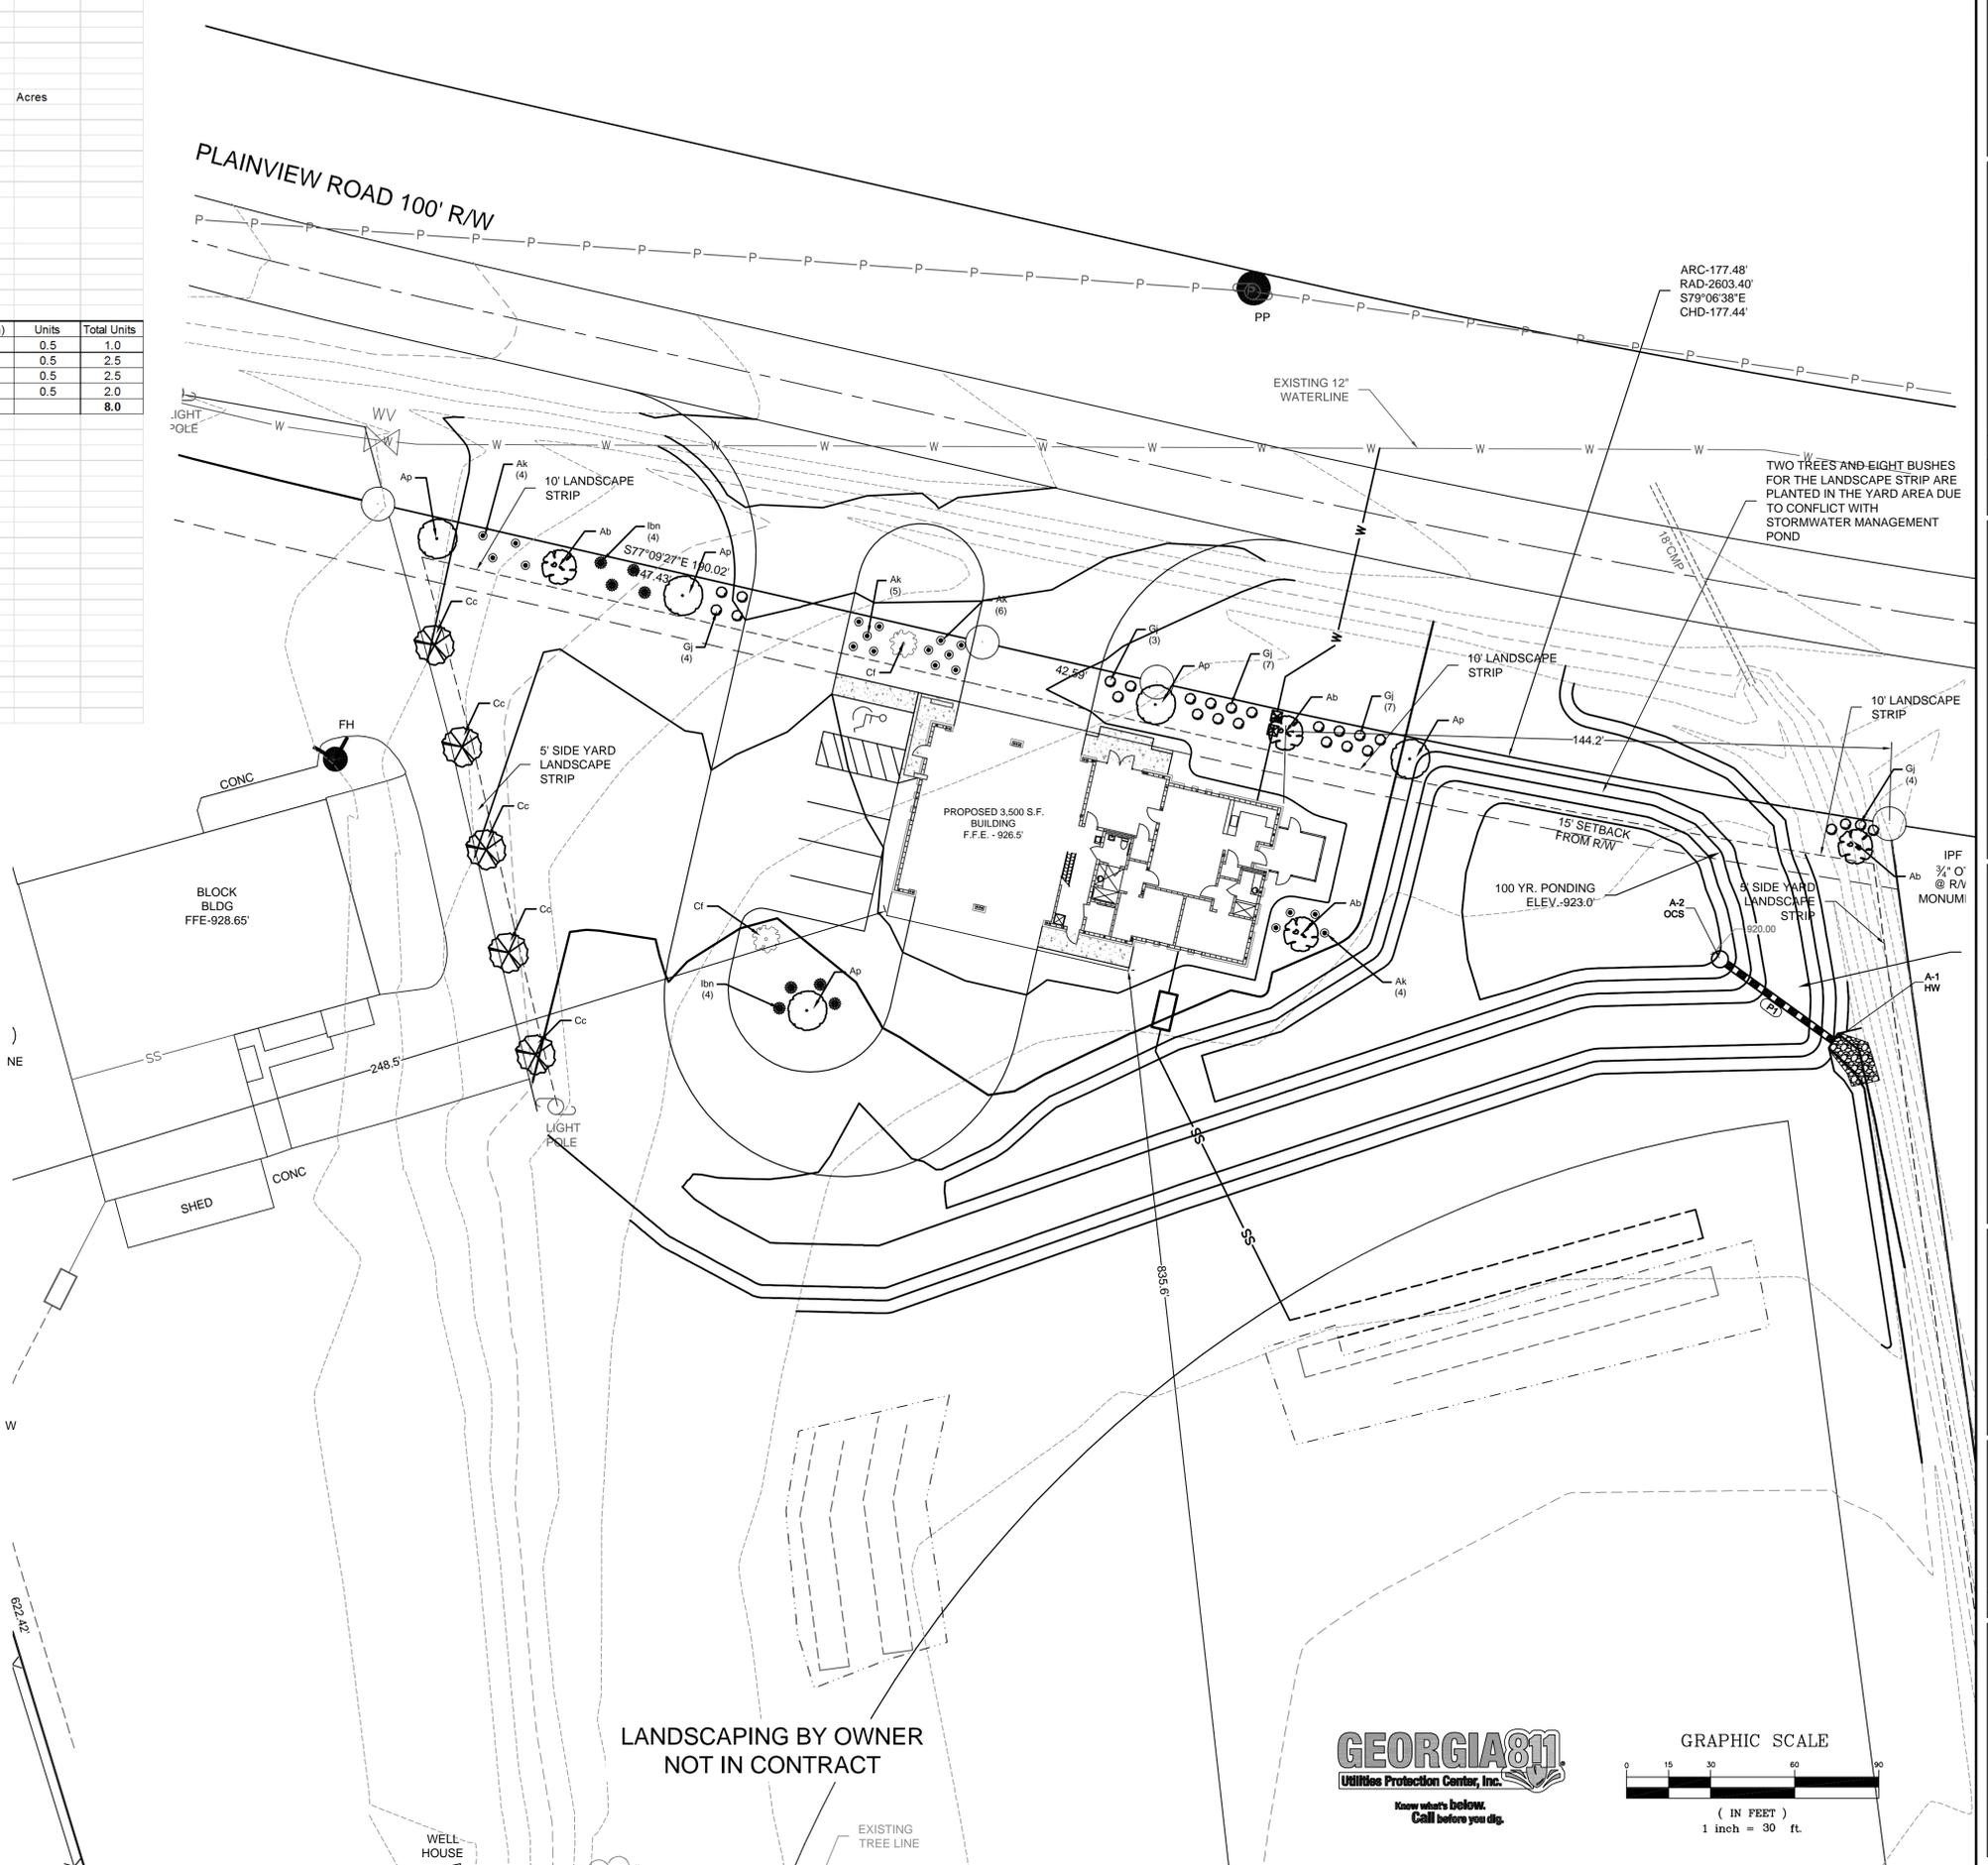

LANDSCAPING BY OWNER
NOT IN CONTRACT

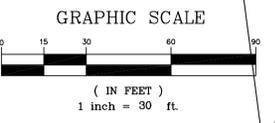

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**JACKSON COUNTY GOVERNMENT
NEW EMS STATION**

LOCATED IN G.M.D. 455
JACKSON COUNTY, GEORGIA

LANDSCAPE PLAN
SHEET TITLE
DESIGN BY: KLP
DRAWN BY: KLP
CHECKED BY: DWB
DATE: 12/01/15
JOB NUMBER: 15037
FILE LOCATION: z:\projects

STAMP

NO. 28331
KENNETH LEE PETERS
REGISTERED PROFESSIONAL ENGINEER

DATE: 12/01/15
JOB NUMBER: 15037
FILE LOCATION: z:\projects

L1

PATH & FILE: z:\PROJECTS\1515037-Jackson Co-Plainview EMS\Design_Sheet\15037-C-Base-01-12-16


REVISION

PROJECT

SHEET

CRUSHED STONE CONSTRUCTION EXIT

EXIT DIAGRAM

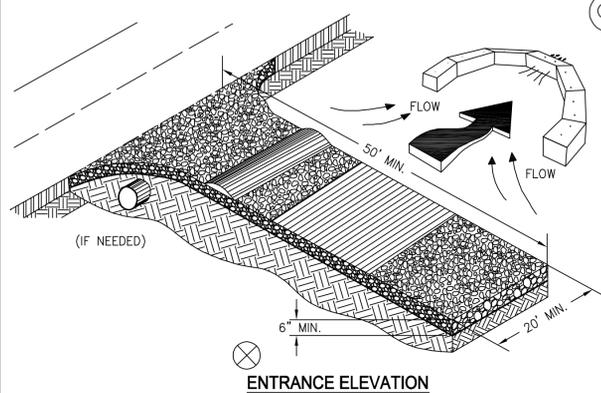


ENTRANCE ELEVATION

- NOTES:**
1. AVOID LOCATING ON STEEP SLOPES OR AT CURVES ON PUBLIC ROADS.
 2. REMOVE ALL VEGETATION AND OTHER UNSUITABLE MATERIAL FROM THE FOUNDATION AREA, GRADE, AND CROWN FOR POSITIVE DRAINAGE.
 3. AGGREGATE SIZE SHALL BE IN ACCORDANCE WITH NATIONAL STONE ASSOCIATION R-2 (1.5"-3.5" STONE).
 4. GRAVEL PAD SHALL HAVE A MINIMUM THICKNESS OF 6".
 5. PAD WIDTH SHALL BE EQUAL FULL WIDTH AT ALL POINTS OF VEHICULAR EGRESS, BUT NO LESS THAN 20'.
 6. A DIVERSION RIDGE SHOULD BE CONSTRUCTED WHEN GRADE TOWARD PAVED AREA IS GREATER THAN 2%.
 7. INSTALL PIPE UNDER THE ENTRANCE IF NEEDED TO MAINTAIN DRAINAGE DITCHES.
 8. WHEN WASHING IS REQUIRED, IT SHOULD BE DONE ON AN AREA STABILIZED WITH CRUSHED STONE THAT DRAINS INTO AN APPROVED SEDIMENT TRAP OR SEDIMENT BASIN (DIVERT ALL SURFACE RUNOFF AND DRAINAGE FROM THE ENTRANCE TO A SEDIMENT CONTROL DEVICE).
 9. WASHRACKS AND/OR TIRE WASHERS MAY BE REQUIRED DEPENDING ON SCALE AND CIRCUMSTANCE. IF NECESSARY, WASHRACK DESIGN MAY CONSIST OF ANY MATERIAL SUITABLE FOR TRUCK TRAFFIC THAT REMOVE MUD AND DIRT.
 10. MAINTAIN AREA IN A WAY THAT PREVENTS TRACKING AND/OR FLOW OF MUD ONTO PUBLIC RIGHTS-OF-WAYS. THIS MAY REQUIRE TOP DRESSING, REPAIR AND/OR CLEANOUT OF ANY MEASURES USED TO TRAP SEDIMENT.


Co

SILT FENCE - TYPE NON-SENSITIVE

SIDE VIEW

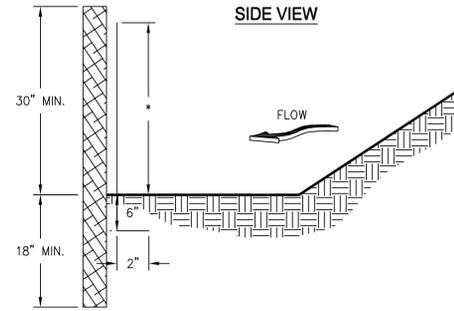

FRONT VIEW

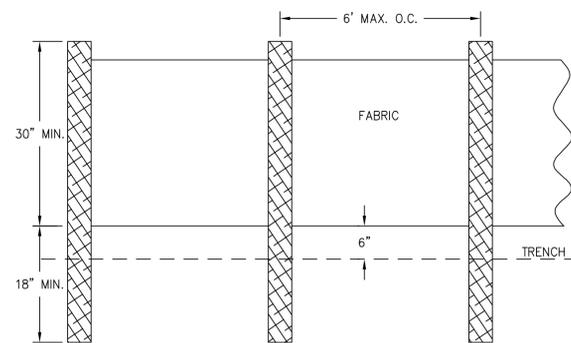


- NOTES:**
1. USE STEEL OR WOOD POSTS OR AS SPECIFIED BY THE EROSION, SEDIMENTATION, AND POLLUTION CONTROL PLAN.
 2. HEIGHT (H) IS TO BE SHOWN ON THE EROSION, SEDIMENTATION, AND POLLUTION CONTROL PLAN.


Sd1-NS

PERFORATED HALF-ROUND PIPE WITH STONE FILTER

ISOMETRICS

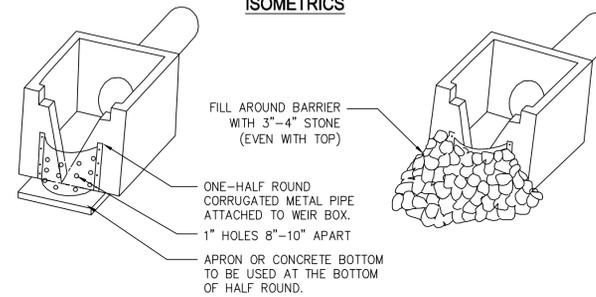


PLAN

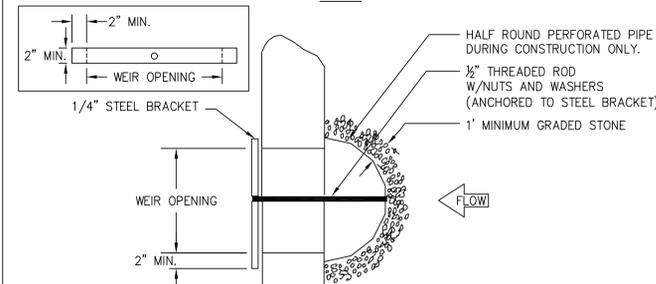


Rt-P

RIPRAP OUTLET PROTECTION



PIPE OUTLET TO FLAT AREA - NO WELL DEFINED CHANNEL

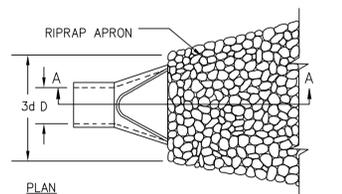

- NOTES:**
1. L_a IS THE LENGTH OF THE RIPRAP APRON.
 2. $D = 1.5$ TIMES THE MAXIMUM STONE DIAMETER BUT NOT LESS THAN 6".
 3. IN A WELL-DEFINED CHANNEL, EXTEND THE APRON UP THE CHANNEL BANKS TO AN ELEVATION OF 6" ABOVE THE MAXIMUM TAILWATER DEPTH OR TO THE TOP OF THE BANK (WHICHEVER IS LESS).
 4. A FILTER BLANKET OR FILTER FABRIC SHOULD BE INSTALLED BETWEEN THE RIPRAP AND THE SOIL FOUNDATION.

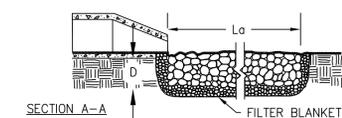



PIPE OUTLET TO WELL DEFINED CHANNEL

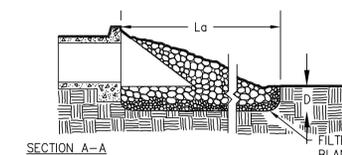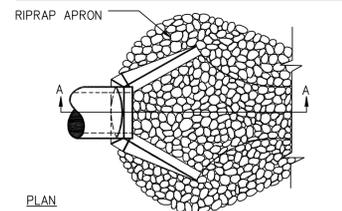

St

TYPICAL INSTALLATION GUIDELINES FOR ROLLED EROSION CONTROL PRODUCTS (RECP)


BLANKET AND MATTING CROSS-SECTIONS

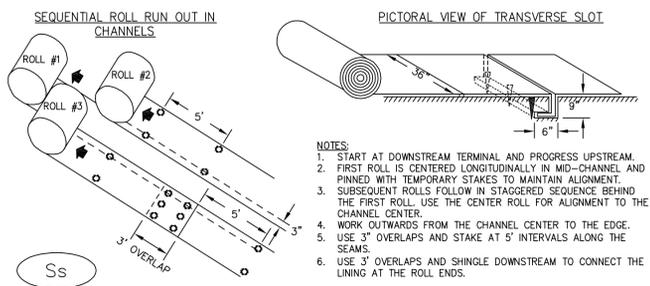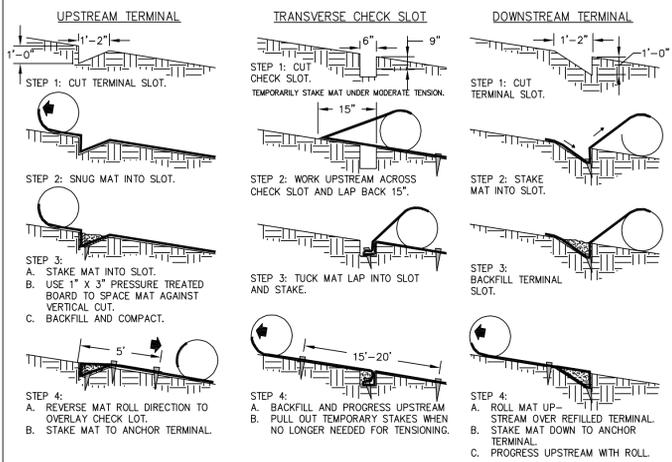

Ss

STONE CHECK DAM

CROSS SECTION

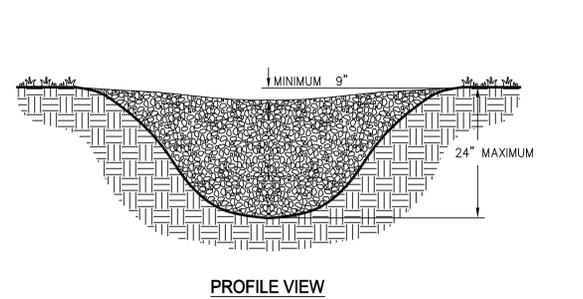

- NOTES:**
1. CHECK DAMS ARE TO BE USED ONLY IN SMALL OPEN CHANNELS (THEY ARE NOT TO BE USED IN LIVE STREAMS).
 2. THE DRAINAGE AREA FOR STONE CHECK DAMS SHALL NOT EXCEED TWO ACRES.
 3. THE CENTER OF THE CHECK DAM MUST BE AT LEAST 9 INCHES LOWER THAN THE OUTER EDGES.
 4. THE DAM HEIGHT SHOULD BE A MAXIMUM OF 2 FEET FROM CENTER TO RIM EDGE.
 5. THE SIDE SLOPES OF THE CHECK DAM SHALL NOT EXCEED A 2:1 SLOPE.
 6. GEOTEXTILE SHALL BE USED TO PREVENT THE MITIGATION OF SUBGRADE SOIL PARTICLES INTO THE STONES (REFER TO AASHTO M288-96, SECTION 7.3, TABLE 3).

Ss

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JACKSON COUNTY GOVERNMENT
 NEW EMS STATION
 LOCATED IN G.M.D. 455
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EROSION CONTROL DETAILS
 SHEET TITLE
 DESIGN BY: KLP
 DRAWN BY: KLP
 CHECKED BY: DWB
 DATE: 12/01/15

GEORGIA REGISTERED PROFESSIONAL ENGINEER
 NO. 26331
 KENNETH LEE PETERS

12/01/15 DATE
 15037 JOB NUMBER
 z:Projects z:Projects
 FILE LOCATION



D1

CERTIFICATION - ES&PC DESIGN PROFESSIONAL
 KENNETH PETERS
 P.E. - LICENSE NO. 26331
 GSWCC LEVEL II CERTIFICATION NO. 919

REVISION

PROJECT


SHEET

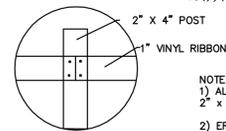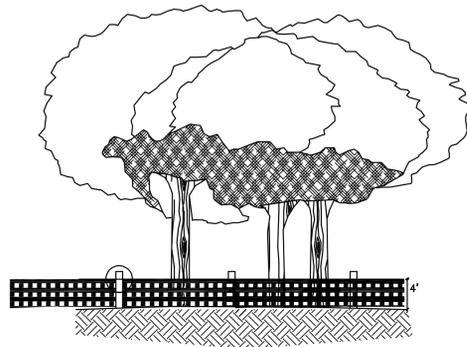

NOTE:
 1) ALTERNATIVE TREE FENCING IS 12 GAUGE 2" X 4" MESH
 2) EROSION CONTROL FENCING LOCATED ALONG TREE SAVE-LAND DISTURBANCE INTERFACE BACKED BY WIRE MESH IN CRITICAL EROSION AREAS.

PROTECTIVE TREE FENCING


Engineering Management Associates, Inc. LS05

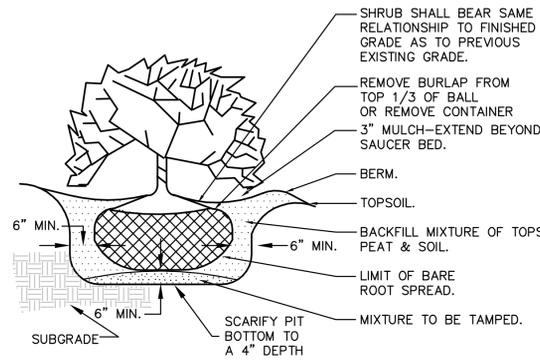

(B & B OR CONT.)


TYPICAL SHRUB PLANTING

Engineering Management Associates, Inc. LS01

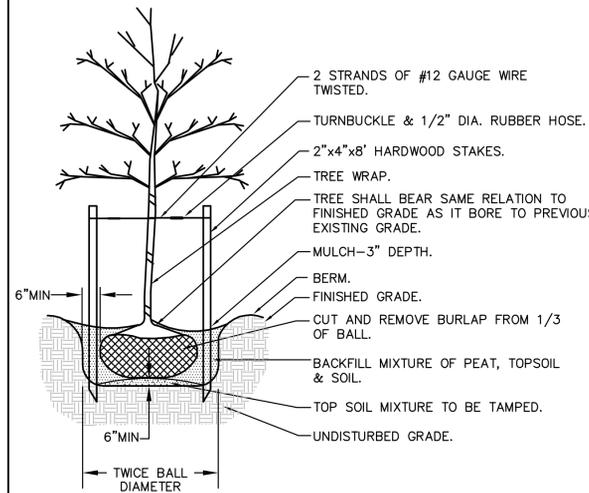


TYPICAL TREE PLANTING

Engineering Management Associates, Inc. LS03

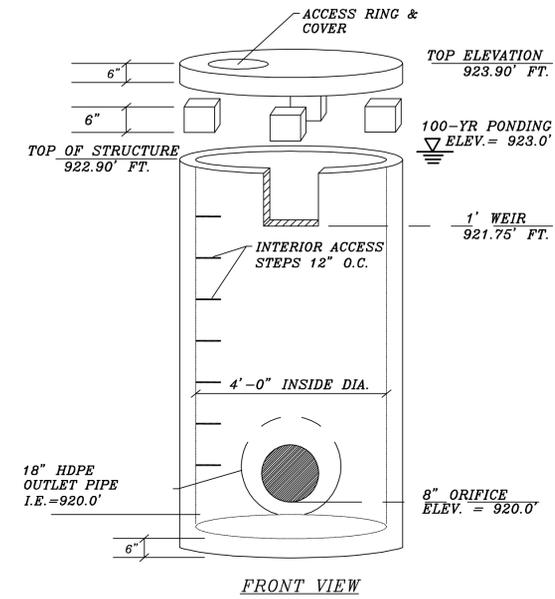


STORMWATER POND OCS


Engineering Management Associates, Inc.

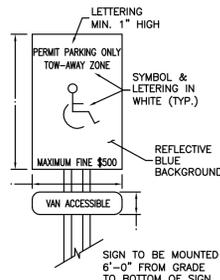

HANDICAP SIGN
SCALE: NTS

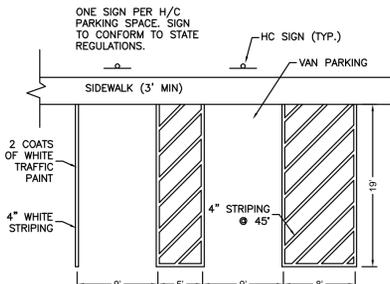

HANDICAP STRIPING
SCALE: NTS

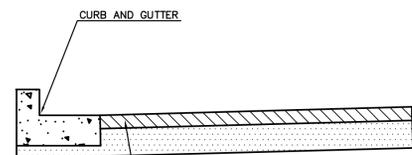


3" ASPHALT TOPPING
12.5 mm SUPERPAVE (HMA)
 8" GRADED AGGREGATE BASE - MAX. 1" COMPACTED TO 100% STD. PROCTOR.
 SUBGRADE PREPARED IN ACCORDANCE WITH GA. DOT SPECIFICATIONS.

NOTE:
 OWNER'S INSPECTOR SHALL CONFIRM THICKNESS OF BASE AND ASPHALT DURING CONSTRUCTION.


HEAVY DUTY PAVEMENT

Engineering Management Associates, Inc. PP01

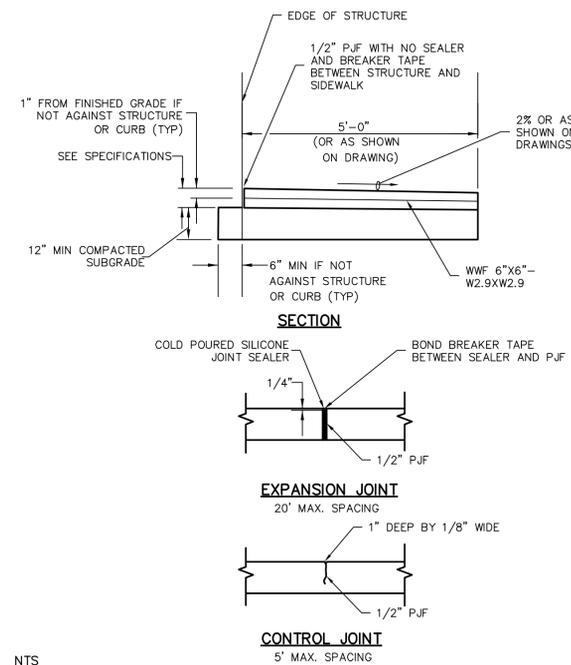

NTS

CONCRETE SIDEWALK DETAIL

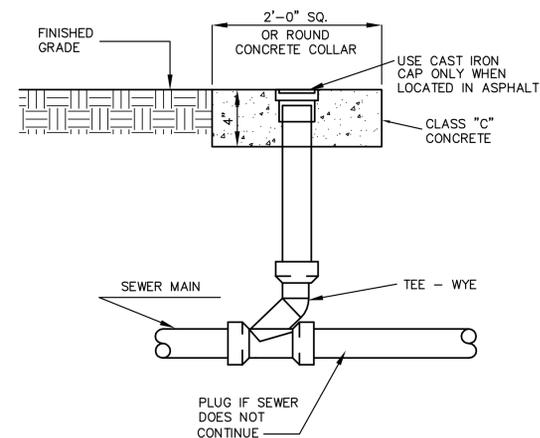

CLEAN OUT DETAIL

Engineering Management Associates, Inc. S10

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 LOCATED IN G.M.D. 455
 JACKSON COUNTY, GEORGIA

| | | |
|----------------------|------------|-----|
| CONSTRUCTION DETAILS | CHECKED BY | DWB |
| SHEET TITLE | DRAWN BY | KLP |
| DESIGN BY | KLP | |

REGISTERED PROFESSIONAL ENGINEER
 NO. 28331
 KENNETH LEE PETERS

| | | |
|----------|------------|---------------|
| 12/01/15 | 15037 | z:\projects |
| DATE | JOB NUMBER | FILE LOCATION |


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REVISION


PROJECT

SHEET

DOUBLE CHECK ASSEMBLY INSTALLATION

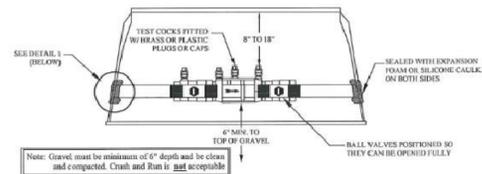


DOUBLE CHECK ASSEMBLY DETAIL

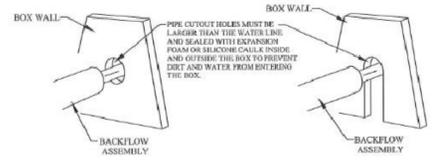

DETAIL 1 INSIDE VIEW

JCWSA Standard Double Check Assembly
Page 1 of 3


FOUNDATION VARIATIONS

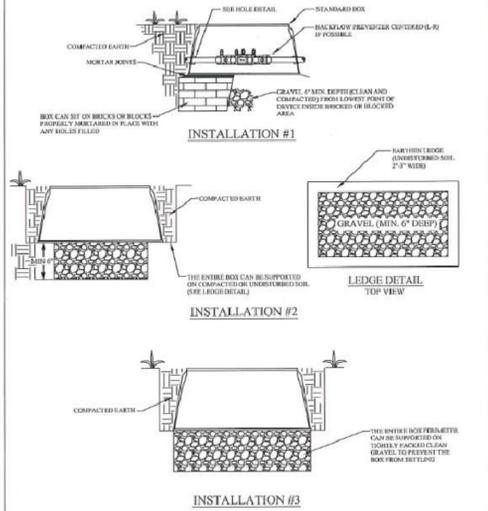

JCWSA Standard Double Check Assembly


Page 2 of 3

ASSEMBLY VARIATIONS

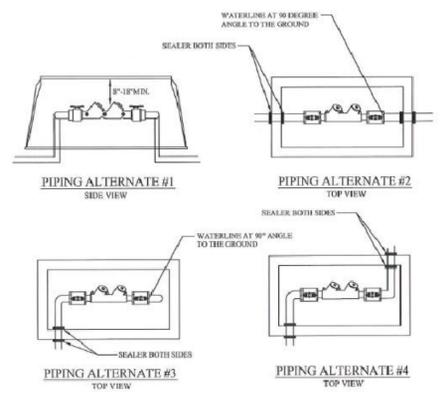

- NOTES:**
- ASSEMBLIES SHOULD BE CENTERED IN THE BOX TO ALLOW ACCESS FOR TESTING AND REPAIR.
 - BOX MUST NOT REST ON THE WATERLINE.
 - ENTRY AND EXIT POINTS OF THE WATER LINE MUST BE SEALED ON BOTH SIDES TO PREVENT ENTRY OF WATER AND DIRT.
 - MINIMUM CLEARANCES TO BE MAINTAINED - 6" FROM TOP OF ASSEMBLY TO TOP OF BOX, 6" FROM BOTTOM OF DEVICE TO TOP OF GRAVEL.
 - A SMALLER BOX MAY BE USED, WITH PRIOR APPROVAL OF THE INSPECTOR, IF SPACE RESTRICTIONS WILL NOT ALLOW INSTALLATION OF THE BOX OR ITS EQUIVALENT.

JCWSA Standard Double Check Assembly
Page 3 of 3

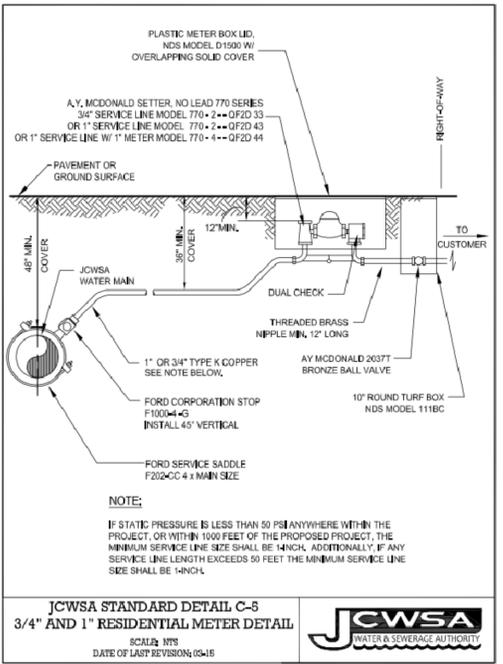

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| | | |
|-----------|----------|------------|
| DESIGN BY | DRAWN BY | CHECKED BY |
| KLP | KLP | DWB |

WATER SYSTEM DETAILS
SHEET TITLE

REGISTERED PROFESSIONAL ENGINEER
KENNETH LEE PETERS
NO. 28331
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