#### SPECIFICATIONS FOR

### **TOM GREEN COUNTY**

## Public Defenders Office at Edd. B. Keyes Building

**SAN ANGELO, TEXAS** 



ARCHITECT OF RECORD 37B WEST CONCHO SAN ANGELO, TX 76903 (325) 653-2900

POWER SYSTEMS INC. MEP CONSULTANT (325) 659-2235

Project Manual 100% Design Development Review Set December 07, 2021

Owner's Project No. 21-07

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#### 100% DESIGN DEVELOPMENT REVIEW SET

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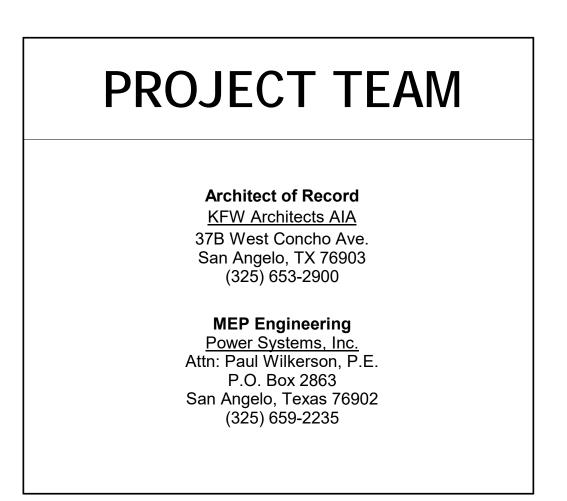
12 2413 ROLLER SHADES

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# TOM GREEN COUNTY PUBLIC DEFENDERS OFFICE

RENOVATION AT EDD B. KEYES BUILDING 113 W. BEAUREGARD AVE SAN ANGELO, TEXAS 76903





CODE REVIEW

SHEET NO. SHEET NAME

A0.00 COVER
A1.01 DEMO & ACOUSTIC PART. PLANS
A2.01 PLANS & SCHEDULES
A3.01 ELEVATIONS & SECTIONS
A4.01 ENLARGED PLANS, ELEVATIONS, DETAILS

TRUCTURAL E

CIVIL ENGI

STRU

CONCHO AVE

VGELO, TX 76903
3.2900
Chitects.com

37B W. CONC SAN ANGELO, 325.653.2900 kfwarchitects

OCCUPANT LOAD

OFFICE SPACE - APPROX. 4,865 SQUARE FEET

TO STATE OF THE PARTY OF THE PA

1 LIFE SAFETY PLAN

1/8" = 1'-0"


Date DECEMBER 07, 202

Sheet Number

AO.OO

100%

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DEMOLITION PLAN

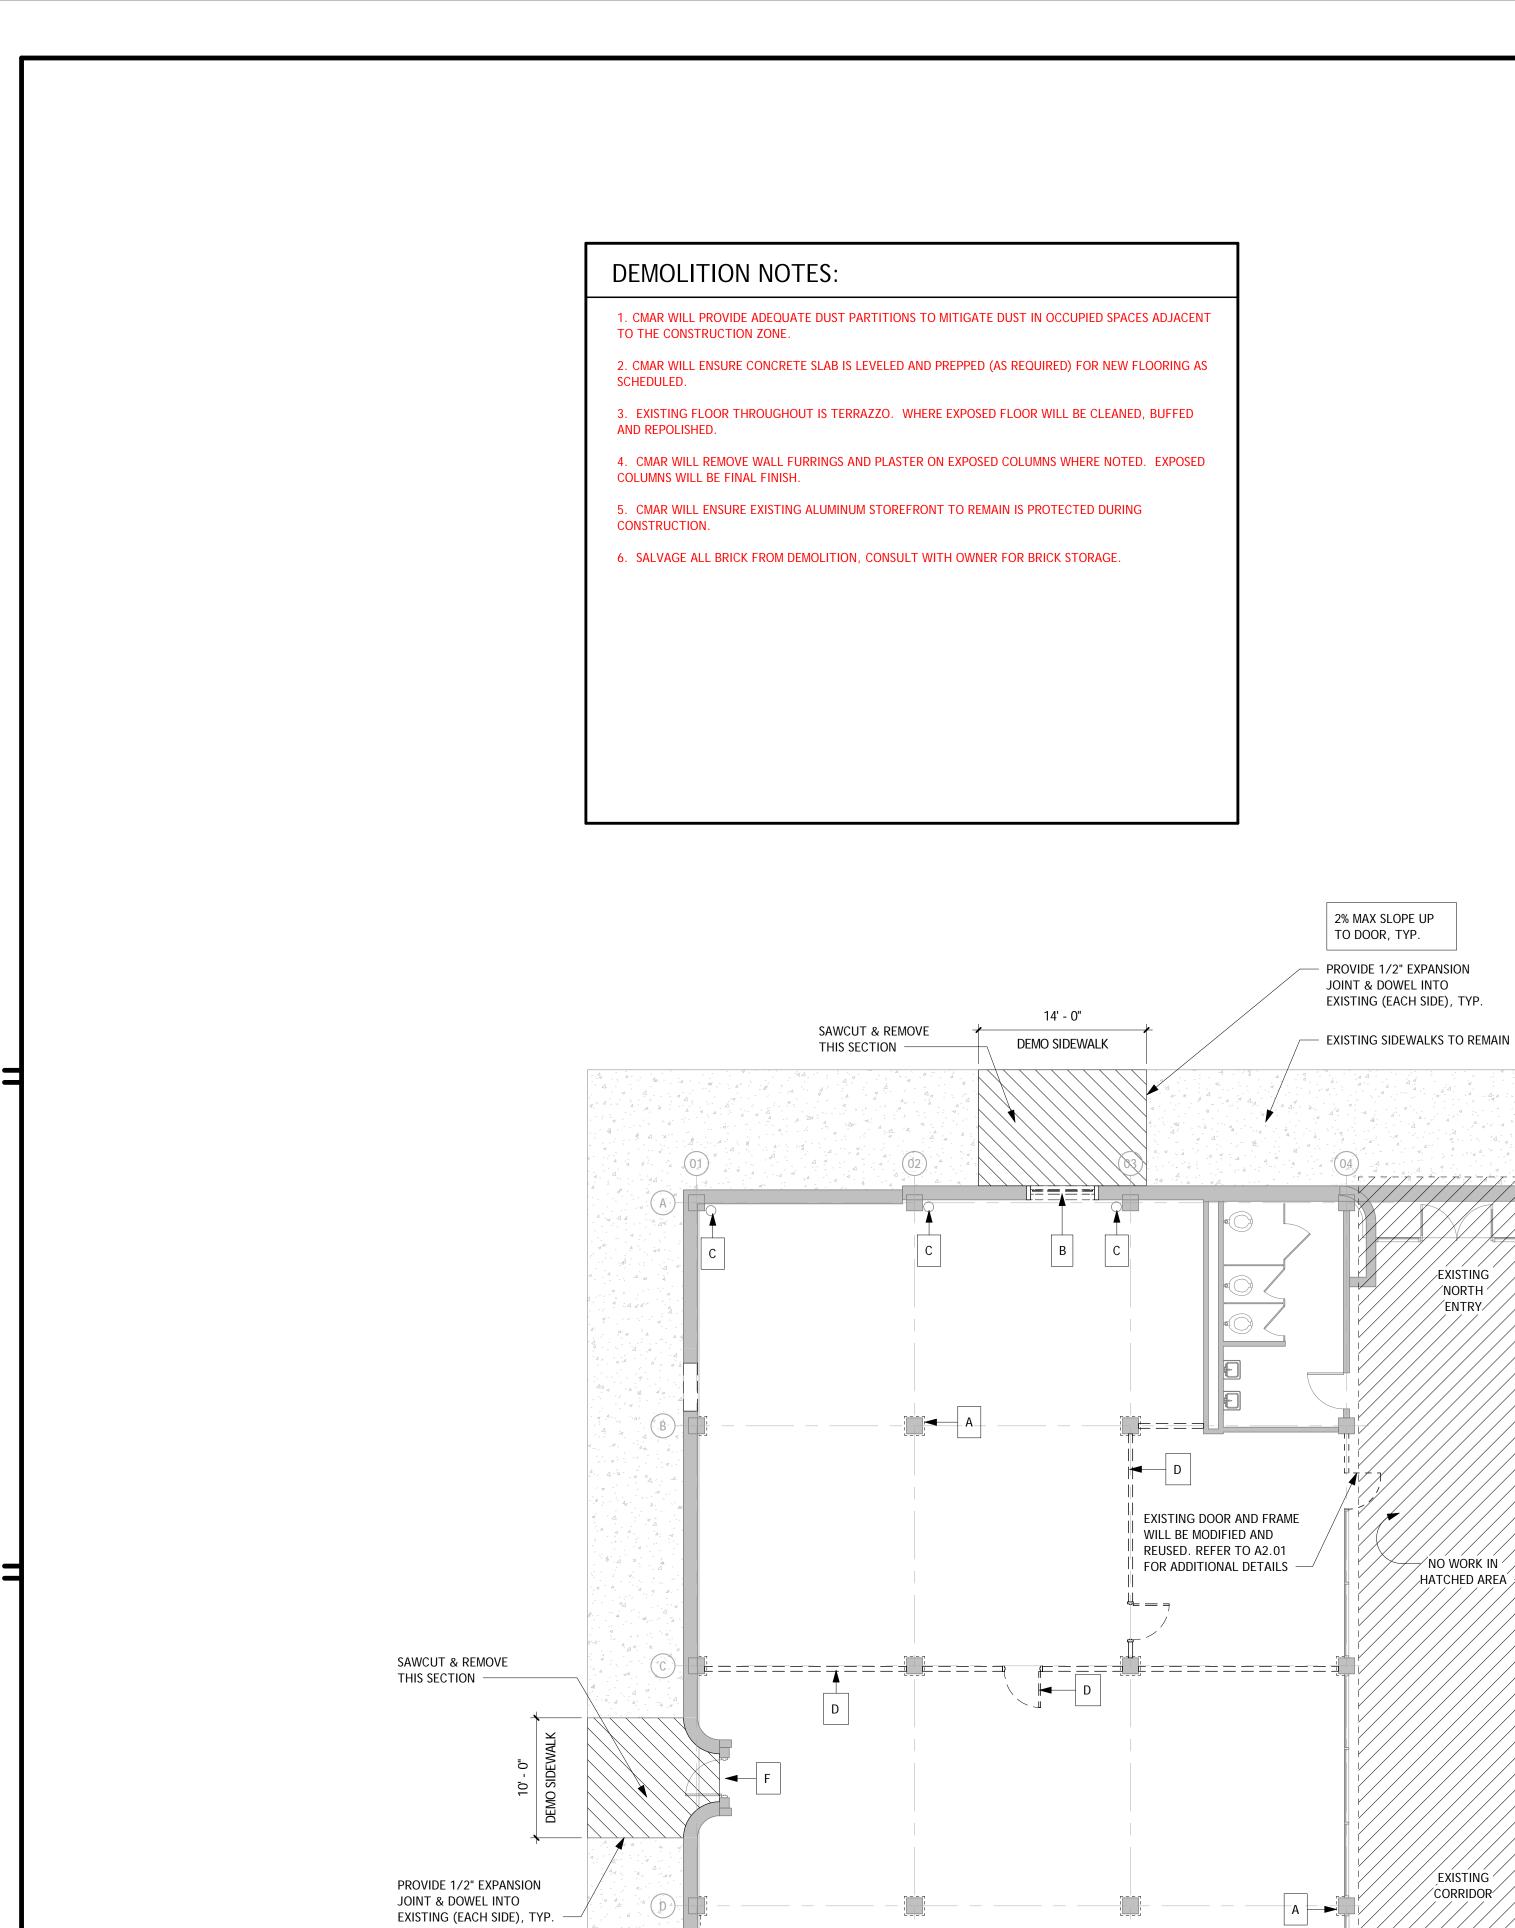1/8" = 1'-0"

2% MAX SLOPE UP TO DOOR, TYP.

NO WORK IN

HATCHED AREA

EXISTING /

/CORRIDOR/

NO WORK IN HATCHED AREA

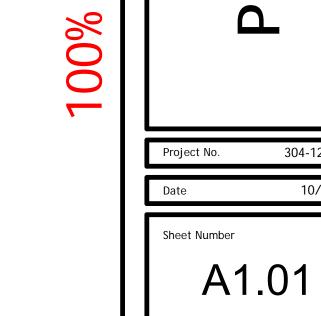
EXISTING SOUTH VESTIBULE

ACOUSTIC PARTITION NOTES: ACOUSTIC WALL: • INTERIOR WALLS SHOWN WITH INSULATION ARE ACOUSTIC WALLS AND WILL BE CONSTRUCTED AS SPECIFIED BELOW. • MTL STUDS @ 16" O.C WITH 5/8" ACOUSTIC GYP BD ON ONE SIDE AND 5/8" GYP BD ON THE OTHER SIDE. • INSTALL ACOUSTIC BATT INSULATION IN WALL CAVITY BETWEEN STUDS. • INSTALL BEAD OF ACOUSTIC SILICONE CAULK BETWEEN GYP BOARD AND EACH STUD FACE. • INSTALL CONTINUOUS BEAD OF ACOUSTIC CAULK AT TOP AND BOTTOM OF GYP. BD. • STAGGER ALL ELECTRICAL BOXES SO THAT NONE ARE BACK-TO-BACK. • SEAL ALL PENETRATIONS WITH ACOUSTIC CAULK.



2 ACOUSTIC PARTITION & FLOORING PLAN

1/8" = 1'-0"



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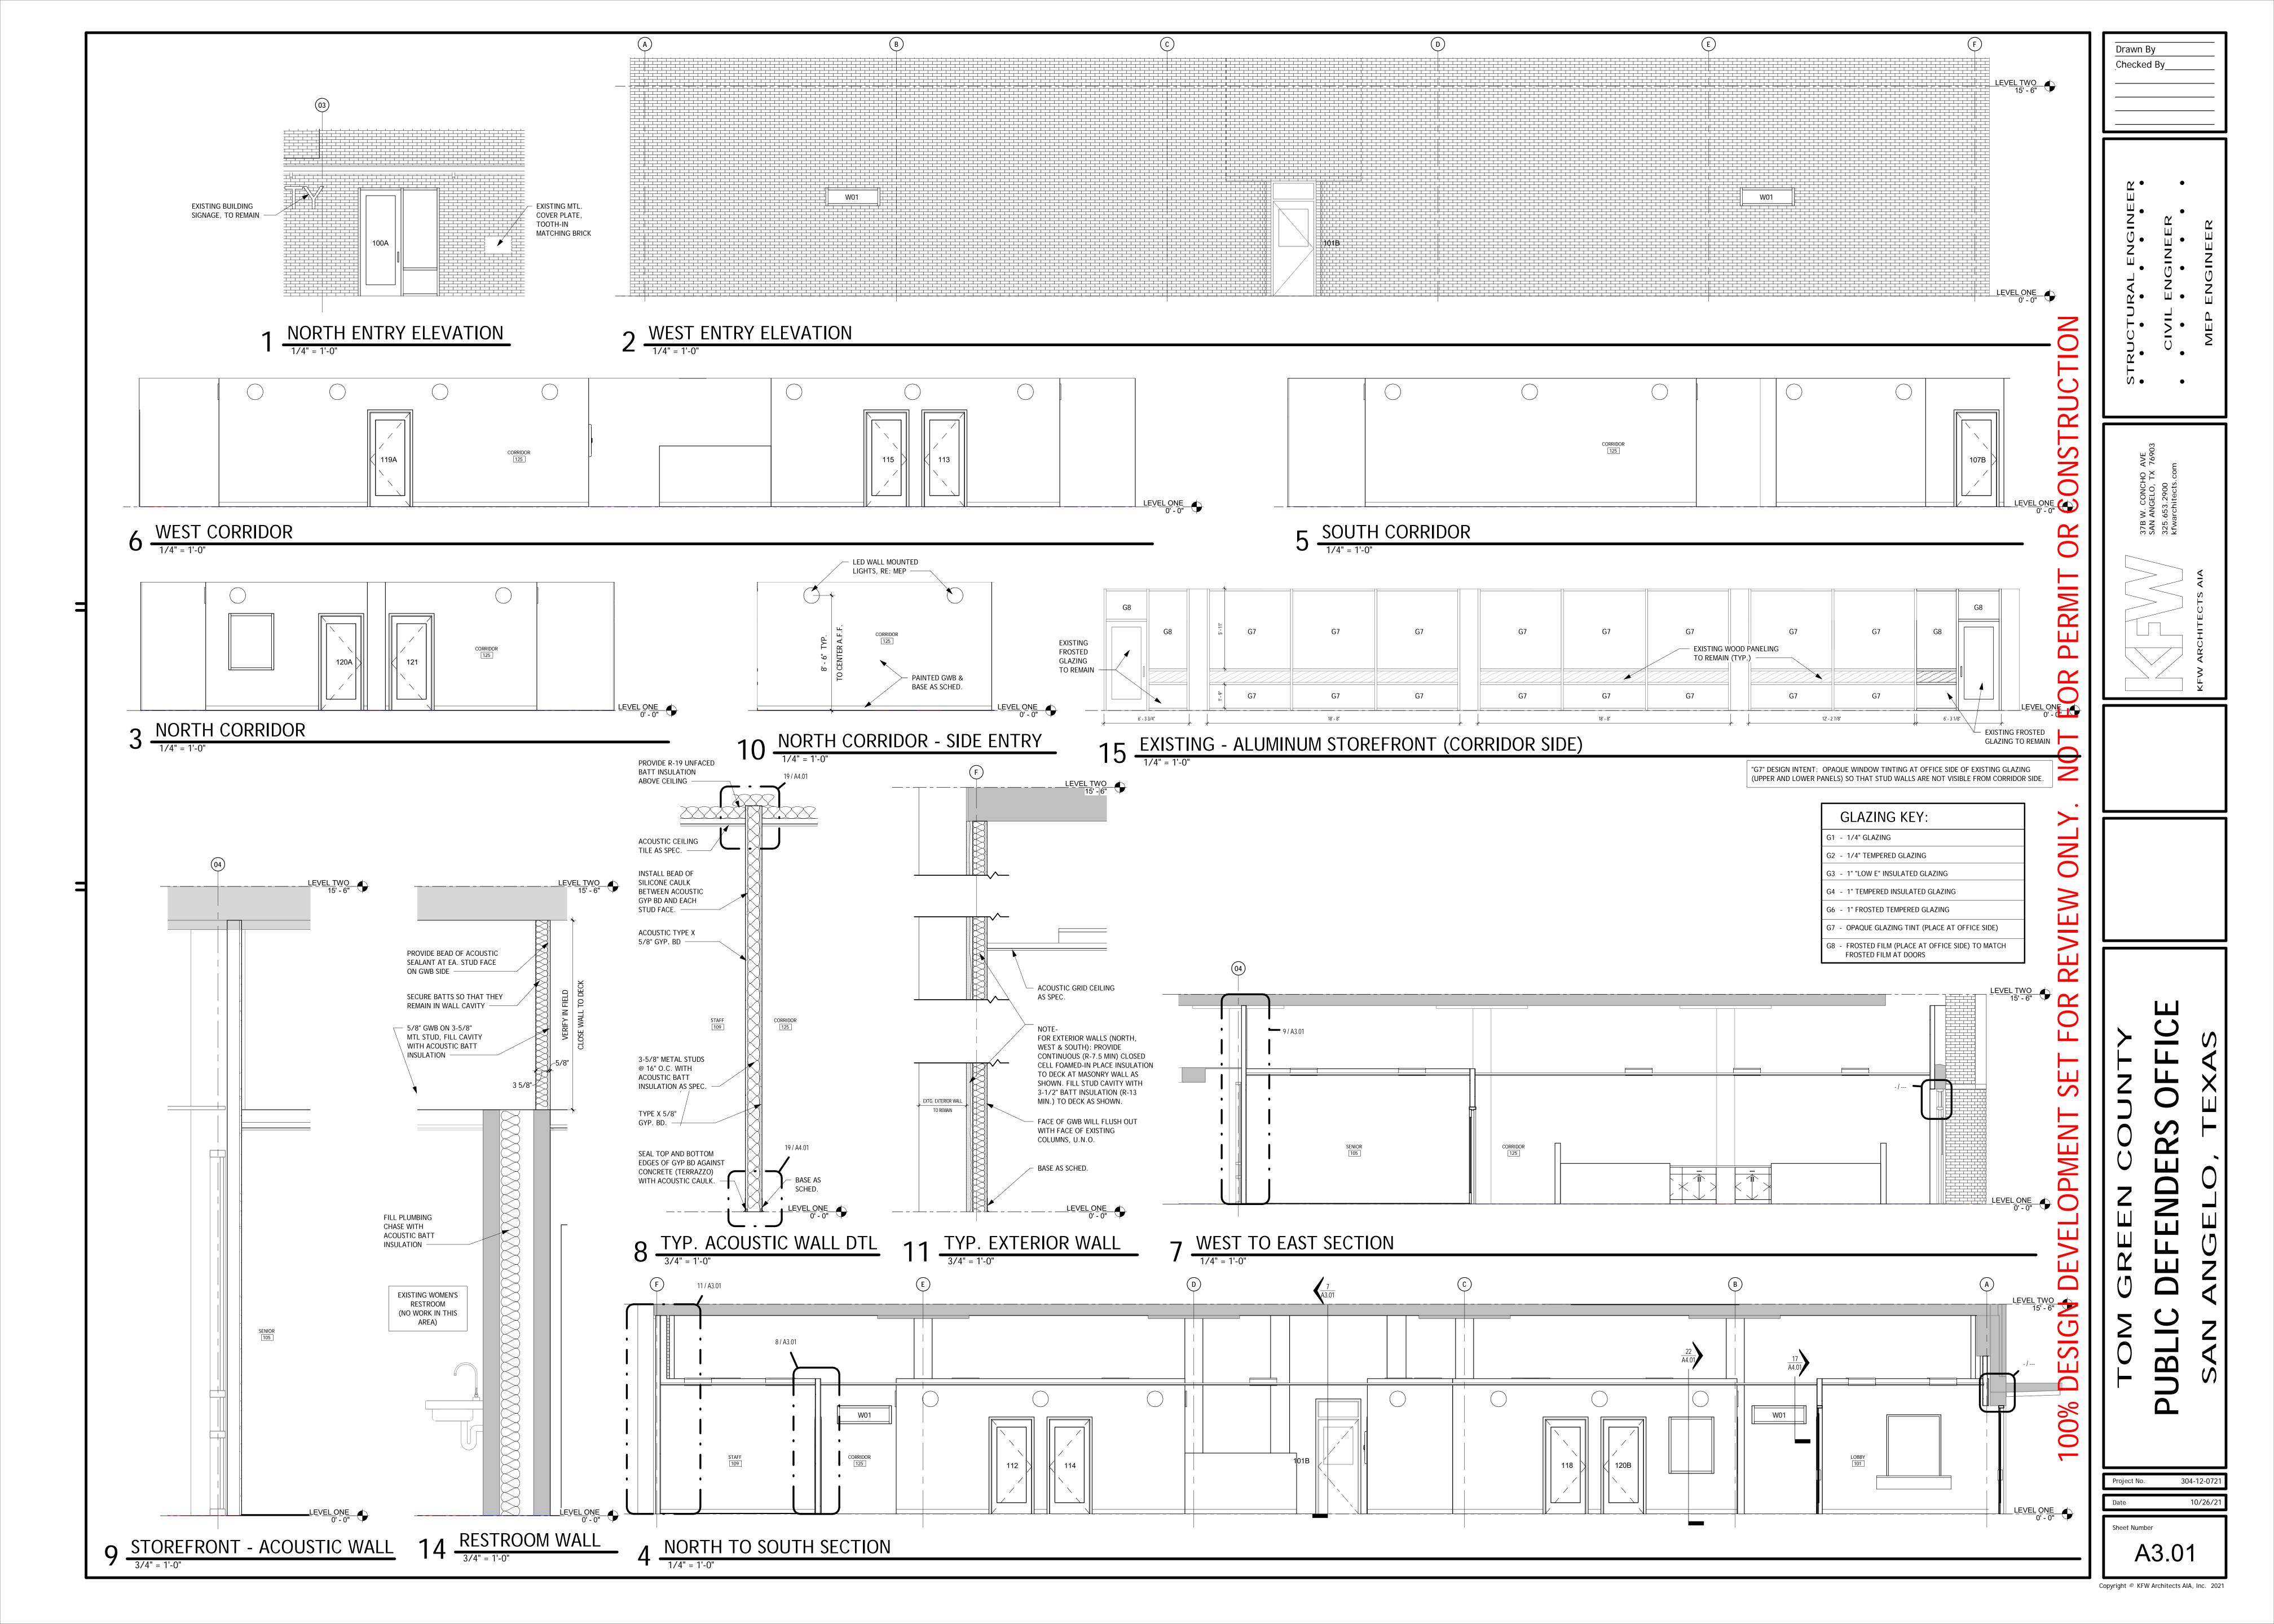
DOOR SCHEDULE FINISH SCHEDULE PLAN NOTES WALL PARTITION SCHEDULE OVERALL SIDE 1 SIDE 1 HEIGHT WALL STRUCTURE SIDE 2 SIDE 2 HEIGHT RATING WALL INSULATION NO. ROOM NAME | FLOOR FINISH | FINISH | WALL FINISH | CEILING FINISH | COMMENTS FRAME ACOUSTIC FIRE 1. COORDINATE SECURITY MEASURES WITH OWNER BEFORE CONSTRUCTION S NO. | WIDTH | HEIGHT | THICK | MATERIAL MATERIAL FINISH DEPTH TREATMENT RATING ELEVATION COMMENTS FINISH 5/8" GYP. BOARD 6" ABOVE ADJ. CEILING 3-5/8" METAL STUD 5/8" GYP. BOARD 6" ABOVE ADJ. CEILING . THE CONTRACTOR SHALL VERIFY ALL EXISTING SITE AND JOB CONDITIONS RUBBER PAINTED GYP BD ACOUSTIC TILE CLG INCLUDING UTILITIES, AND REPORT ANY DISCREPANCIES TO THE ARCHITECT B RUBBER PAINTED GYP BD NO CEILING 100A | 3' - 0" | 7' - 10" | 0' - 1 3/4" | ALUMINUM DK BRONZE | ALUMINUM | DK BRONZE | 0' - 4 1/2" SUBMITTING BID. DK BRONZE | ALUMINUM | DK BRONZE | 0' - 4 1/2" SENIOR RUBBER PAINTED GYP BD ACOUSTIC TILE CLG 101B 3' - 0" 7' - 0" 0' - 1 3/4" HOLLOW METAL PAINTED HOLLOW METAL PAINTED 0' - 5 3/4" REUSE EXISTING HM FRAME SENIOR RUBBER PAINTED GYP BD ACOUSTIC TILE CLG 3. CONTRACTOR SHALL HAVE LIMITED USE OF BUILDING - CONSULT WITH OW 102 3' - 0" 7' - 0" 0' - 1 3/4" WOOD STAINED HOLLOW METAL PAINTED 0' - 5 3/4" RUBBER PAINTED GYP BD ACOUSTIC TILE CLG SENIOR FOR STAGING AREAS. 103 3' - 0" 7' - 0" 0' - 1 3/4" WOOD STAINED HOLLOW METAL PAINTED 0' - 5 3/4" TYPE B SENIOR RUBBER PAINTED GYP BD ACOUSTIC TILE CLG 104 3' - 0" 7' - 0" 0' - 1 3/4" WOOD STAINED HOLLOW METAL PAINTED 0' - 5 3/4" TYPE B 4. DIMENSIONS ARE TO STUD FACE UNLESS NOTED OTHERWISE. (VERIFY ALL CHIEF RUBBER PAINTED GYP BD ACOUSTIC TILE CLG 105 3' - 0" 7' - 0" 0' - 1 3/4" WOOD TYPE B STAINED HOLLOW METAL PAINTED 0' - 5 3/4" DIMENSIONS IN FIELD, CONSULT ARCHITECT WITH ANY DISCREPANCIES.) EXIST. TO REMAIN E.T.R. E.T.R. E.T.R. ELECTRICAL 106 3' - 0" 7' - 0" 0' - 1 3/4" WOOD TYPE B HOLLOW METAL PAINTED 0' - 5 3/4" STAFF RUBBER PAINTED GYP BD ACOUSTIC TILE CLG 5. CONTRACTOR RESPONSIBLE FOR INSTALLING WOOD BLOCKING WHERE 107A 3' - 0" 7' - 0" 0' - 1 3/4" WOOD STAINED HOLLOW METAL PAINTED 0' - 5 3/4" TYPE B RESOURCE LIBRARY RUBBER PAINTED GYP BD ACOUSTIC TILE CLG 107B 3' - 0" 7' - 0" 0' - 1 3/4" WOOD TYPE B REF. ALTERNATES ACCESSORIES OR EQUIPMENT ATTACH TO WALLS - THIS IS TYPICAL IN ALL ARE STAINED HOLLOW METAL PAINTED 0' - 5 3/4" RUBBER PAINTED GYP BD ACOUSTIC TILE CLG BREAKROOM 108 3' - 0" 7' - 0" 0' - 1 3/4" HOLLOW METAL PAINTED THIS BUILDING. HOLLOW METAL PAINTED 0' - 5 3/4" STAFF RUBBER PAINTED GYP BD ACOUSTIC TILE CLG 109 3' - 0" 7' - 0" 0' - 1 3/4" WOOD HOLLOW METAL PAINTED 0' - 5 3/4" TYPE B STAFF 6. AREAS SHOWN IN GRAY ARE EXISTING TO REMAIN, TYPICAL. RUBBER PAINTED GYP BD ACOUSTIC TILE CLG 110 3' - 0" 7' - 0" 0' - 1 3/4" WOOD TYPE B STAINED HOLLOW METAL PAINTED 0' - 5 3/4" STAFF RUBBER PAINTED GYP BD ACOUSTIC TILE CLG 111 6' - 0" 7' - 0" 0' - 1 3/4" WOOD TYPE D STAINED HOLLOW METAL PAINTED 0' - 5 3/4" 7. REFER TO DETAILS FOR ADDITIONAL MISC. STEEL THAT MAY NOT BE SHOW STAFF RUBBER PAINTED GYP BD ACOUSTIC TILE CLG 112 3' - 0" 7' - 0" 0' - 1 3/4" WOOD STAINED HOLLOW METAL PAINTED 0' - 5 3/4" TYPE B STRUCTURAL DRAWINGS. TYPICAL. SUPPORT RUBBER PAINTED GYP BD ACOUSTIC TILE CLG 113 3' - 0" 7' - 0" 0' - 1 3/4" WOOD TYPE B STAINED HOLLOW METAL PAINTED 0' - 5 3/4" 114 3' - 0" 7' - 0" 0' - 1 3/4" WOOD COPY RUBBER PAINTED GYP BD ACOUSTIC TILE CLG STAINED HOLLOW METAL PAINTED 0' - 5 3/4" TYPE B 8. ANY ASBESTOS REMEDIATION WILL BE BY OWNER PRIOR TO WORK BEGINNI 115 3' - 0" 7' - 0" 0' - 1 3/4" WOOD TYPE B HOLLOW METAL PAINTED 0' - 5 3/4" OFFICE MANAGER RUBBER PAINTED GYP BD ACOUSTIC TILE CLG CONSULT WITH OWNER. 118 3' - 0" 7' - 0" 0' - 1 3/4" WOOD 119A 3' - 0" 7' - 0" 0' - 1 3/4" WOOD STAINED HOLLOW METAL PAINTED 0' - 5 3/4" TYPE B CONFERENCE RUBBER PAINTED GYP BD ACOUSTIC TILE CLG TYPE B STAINED HOLLOW METAL PAINTED 0' - 5 3/4" RUBBER PAINTED GYP BD ACOUSTIC TILE CLG INVESTIGATOR 119B 3' - 0" 7' - 0" 0' - 1 3/4" WOOD STAINED HOLLOW METAL PAINTED 0' - 5 3/4" TYPE B RUBBER PAINTED GYP BD ACOUSTIC TILE CLG INVESTIGATOR 120A 3' - 0" 7' - 0" 0' - 1 3/4" WOOD STAINED HOLLOW METAL PAINTED 0' - 5 3/4" TYPE B RUBBER PAINTED GYP BD ACOUSTIC TILE CLG MENTAL HEALTH TYPE B 120B 3' - 0" 7' - 0" 0' - 1 3/4" WOOD STAINED HOLLOW METAL PAINTED 0' - 5 3/4" RUBBER PAINTED GYP BD ACOUSTIC TILE CLG CASE MANAGER 121 3' - 0" 7' - 0" 0' - 1 3/4" WOOD HOLLOW METAL PAINTED 0' - 5 3/4" TYPE B RUBBER PAINTED GYP BD ACOUSTIC TILE CLG RECEPTION 122 3' - 0" 7' - 0" 0' - 1 3/4" WOOD STAINED HOLLOW METAL PAINTED 0' - 5 3/4" TYPE B RUBBER PAINTED GYP BD ACOUSTIC TILE CLG 125 CORRIDOR 123 3' - 0" 7' - 0" 0' - 1 3/4" WOOD STAINED HOLLOW METAL PAINTED 0' - 5 3/4" TYPE B 124 3' - 0" 7' - 0" 0' - 1 3/4" WOOD TYPE B STAINED HOLLOW METAL PAINTED 0' - 5 3/4" 125A | 3' - 0" | 6' - 7" | 0' - 1 3/4" | WOOD STAINED ALUMINUM DK BRONZE 0' - 4 1/2" REUSE EXISTING WD DOOR 3' - 4" 3' - 0" 2" 2' - 11 1/8" 2" 3' - 0" 3' - 4" 6' - 4" 3' - 0" 6' - 0" **GLAZING KEY:** REUSE EXISTING DOOR, G1 - 1/4" GLAZING HARDWARE & RELOCATE EXISTING CARDSWIPE. G2 - 1/4" TEMPERED GLAZING G3 - 1" "LOW E" INSULATED GLAZING G4 - 1" TEMPERED INSULATED GLAZING 2' - 2" - EXISTING STOREFRONT G6 - 1" FROSTED TEMPERED GLAZING TO REMAIN. FOR ADDITIONAL NOTES G7 - OPAQUE GLAZING TINT (PLACE AT OFFICE SIDE) REFER TO DETAIL — VERIFY ALL G8 - FROSTED FILM (PLACE AT OFFICE SIDE) TO MATCH 15 / A3.01 MEASUREMENTS ( FROSTED FILM AT DOORS IN FIELD! ∤ ′ 2' - 2" \_\_\_\_\_ DOOR TYPE A DOOR TYPE B DOOR TYPE C DOOR TYPE D EXISTING HOLLOW METAL FRAME TO REMAIN (PAINT). NEW HOLLOW METAL DOOR AND GLAZING FOR TRANSOM ABOVE. +/- 6' - 5 1/8" — 5/8" GWB ON 3-5/8" MTL STUD ON TOP OF EXISTING PARTITIONS, MODIFY THIS SECTION OF STOREFRONT SYSTEM COLUMN (A)— 3' - 0" /NORTH / B — √no work in ′ HATCHED AREA √NO WORK IN ′ HATCHED AREA HOLLOW METAL (HM-04) C — A3.01 2 5**√**A3.01 EXISTING / D-16 / A4.01 (REFER TO PROJECT ALTERNATES) WINDOW - W01 E-/NO WORK IN ( ∕HATCHED AREA LIST OF PROJECT ALTERNATES: NO WORK IN \_HATCHED AREA\_ (REFER TO SPECIFICATIONS FOR ADDITIONAL INFORMATION) ADD: TWO (2) ALUMINUM FRAMED CLERESTORY WINDOWS (W01) AT WEST ADD: REPLACE EXISTING DOOR (101B) WITH PAINTED HOLLOW METAL FRAME SOUTH AND DOOR WITH HALF LITE & COORDINATING HARDWARE /VESTIBULE REFLECTED CEILING PLAN FLOOR PLAN


BD ON OTHER SIDE


SIDE

SIATION IN WALL CAVITY
BATT INSULATION IN WALL CAVITY
FION

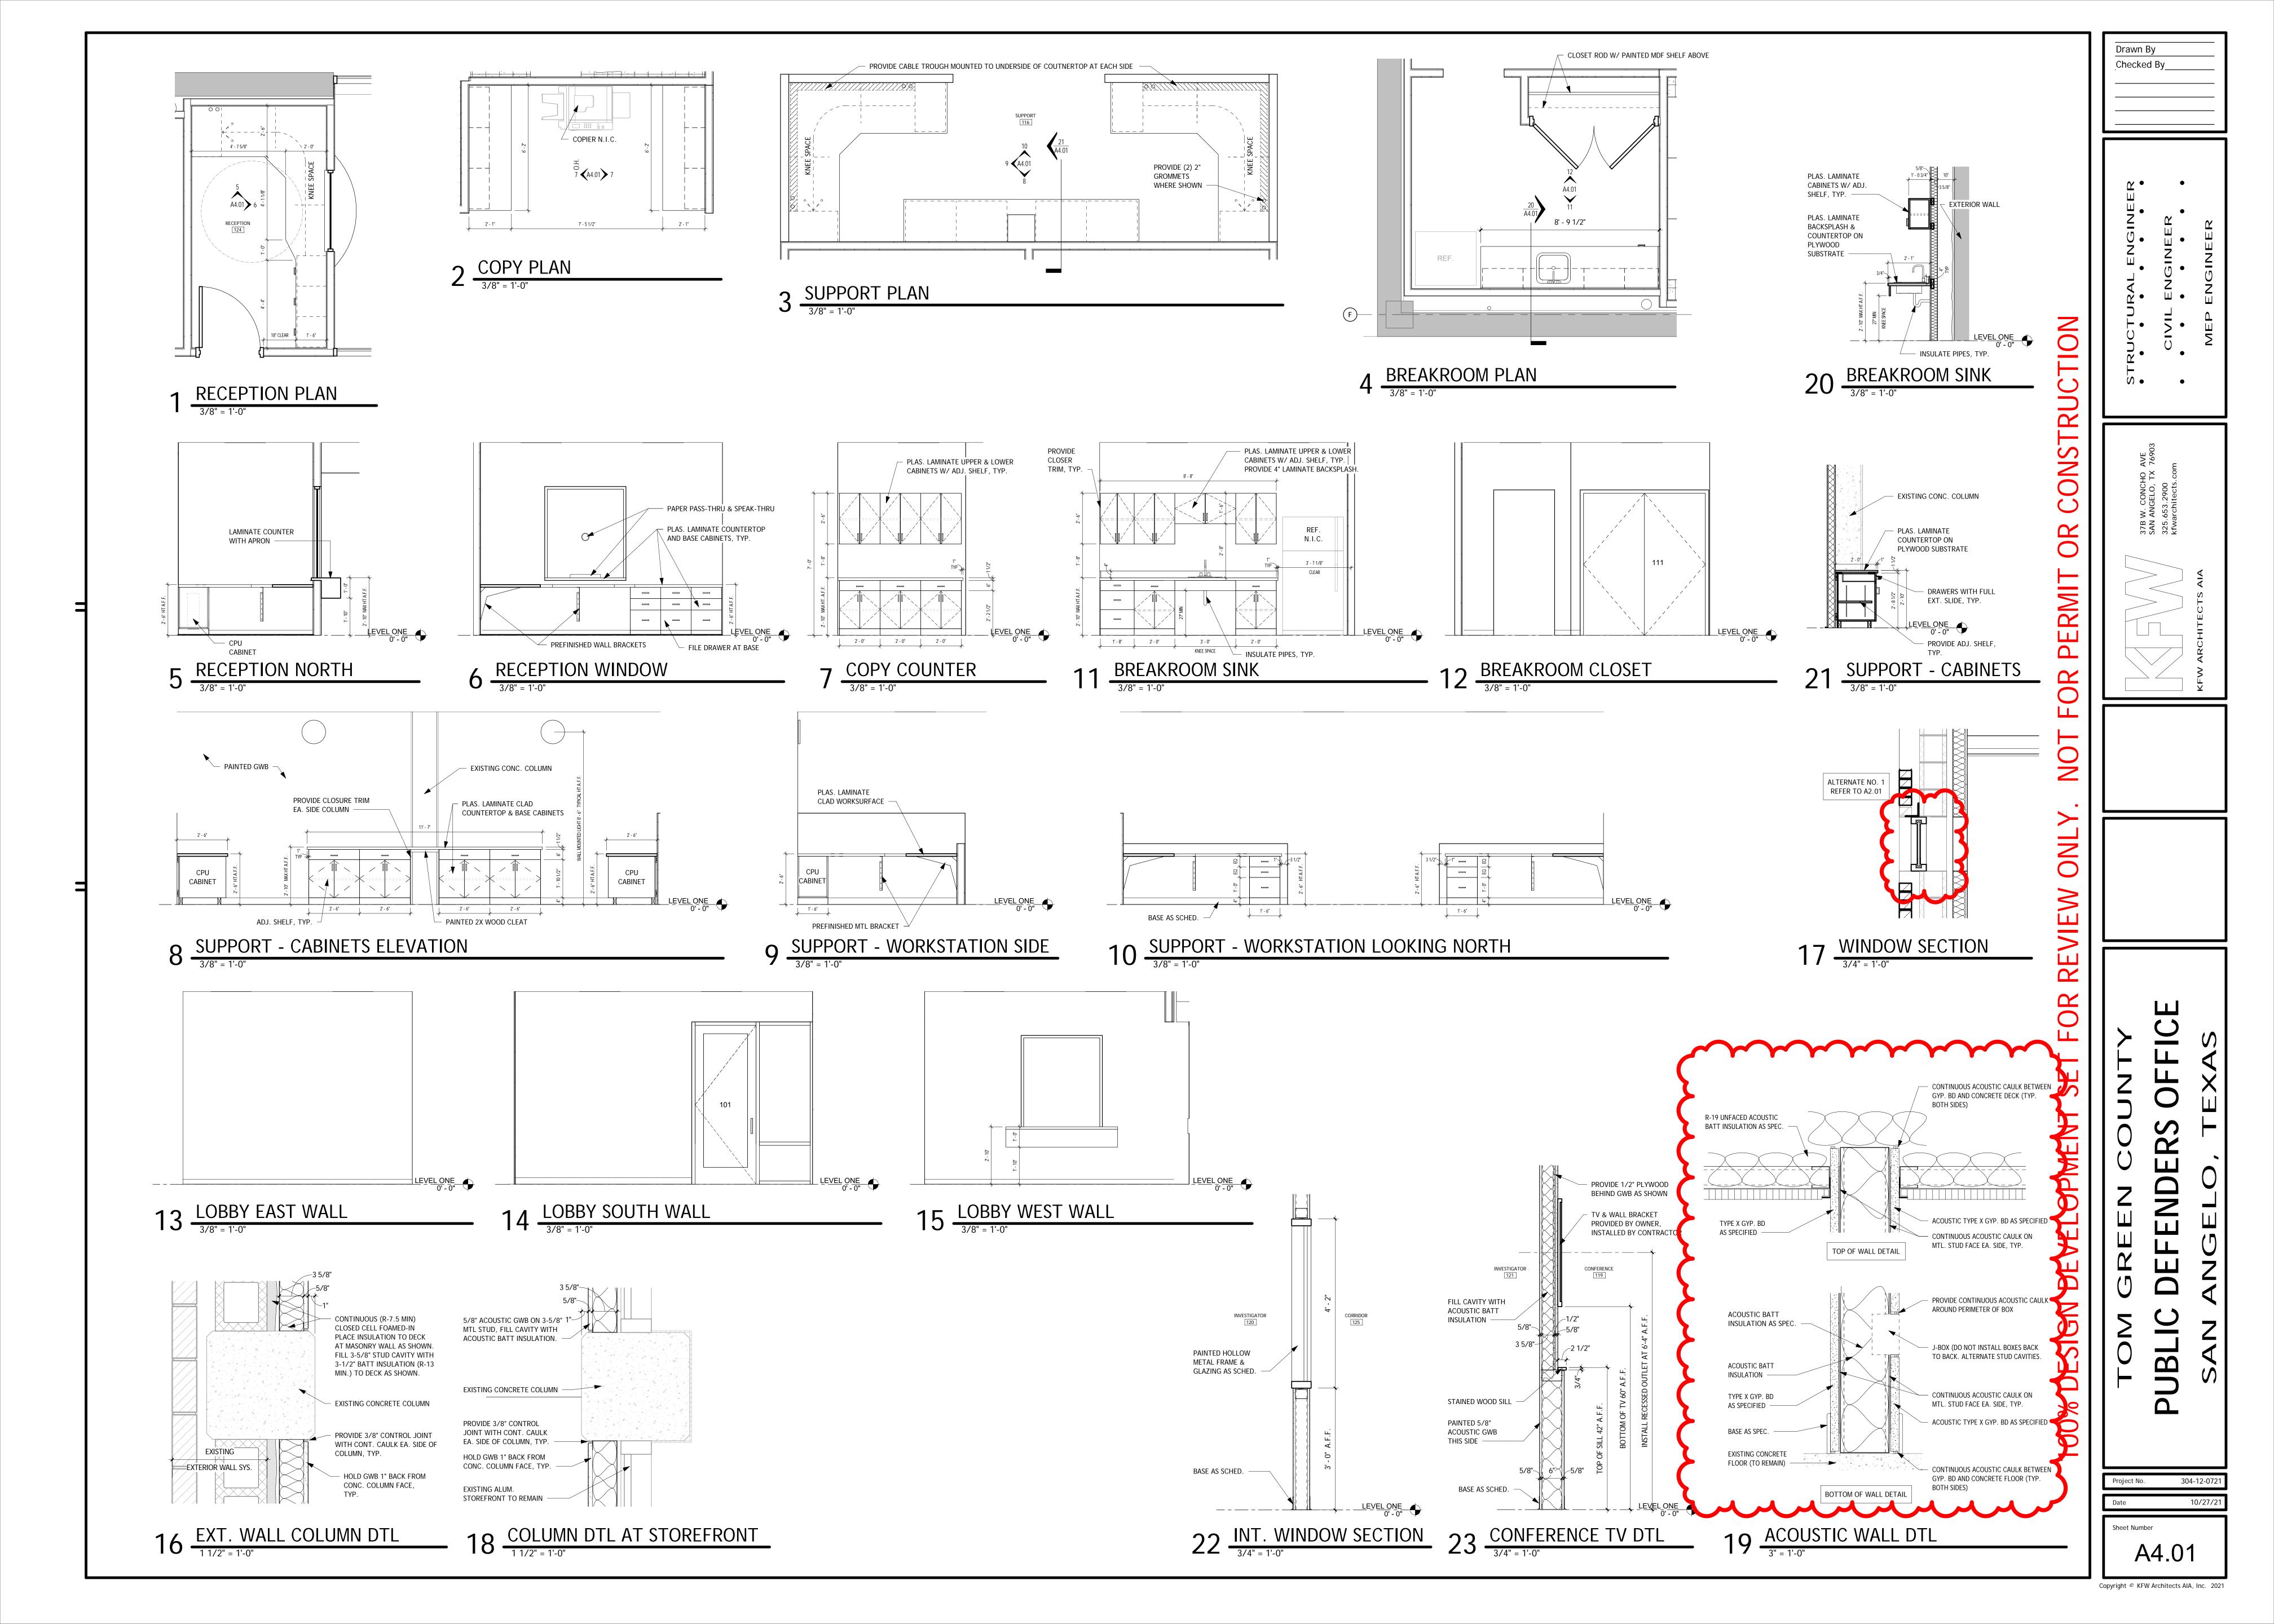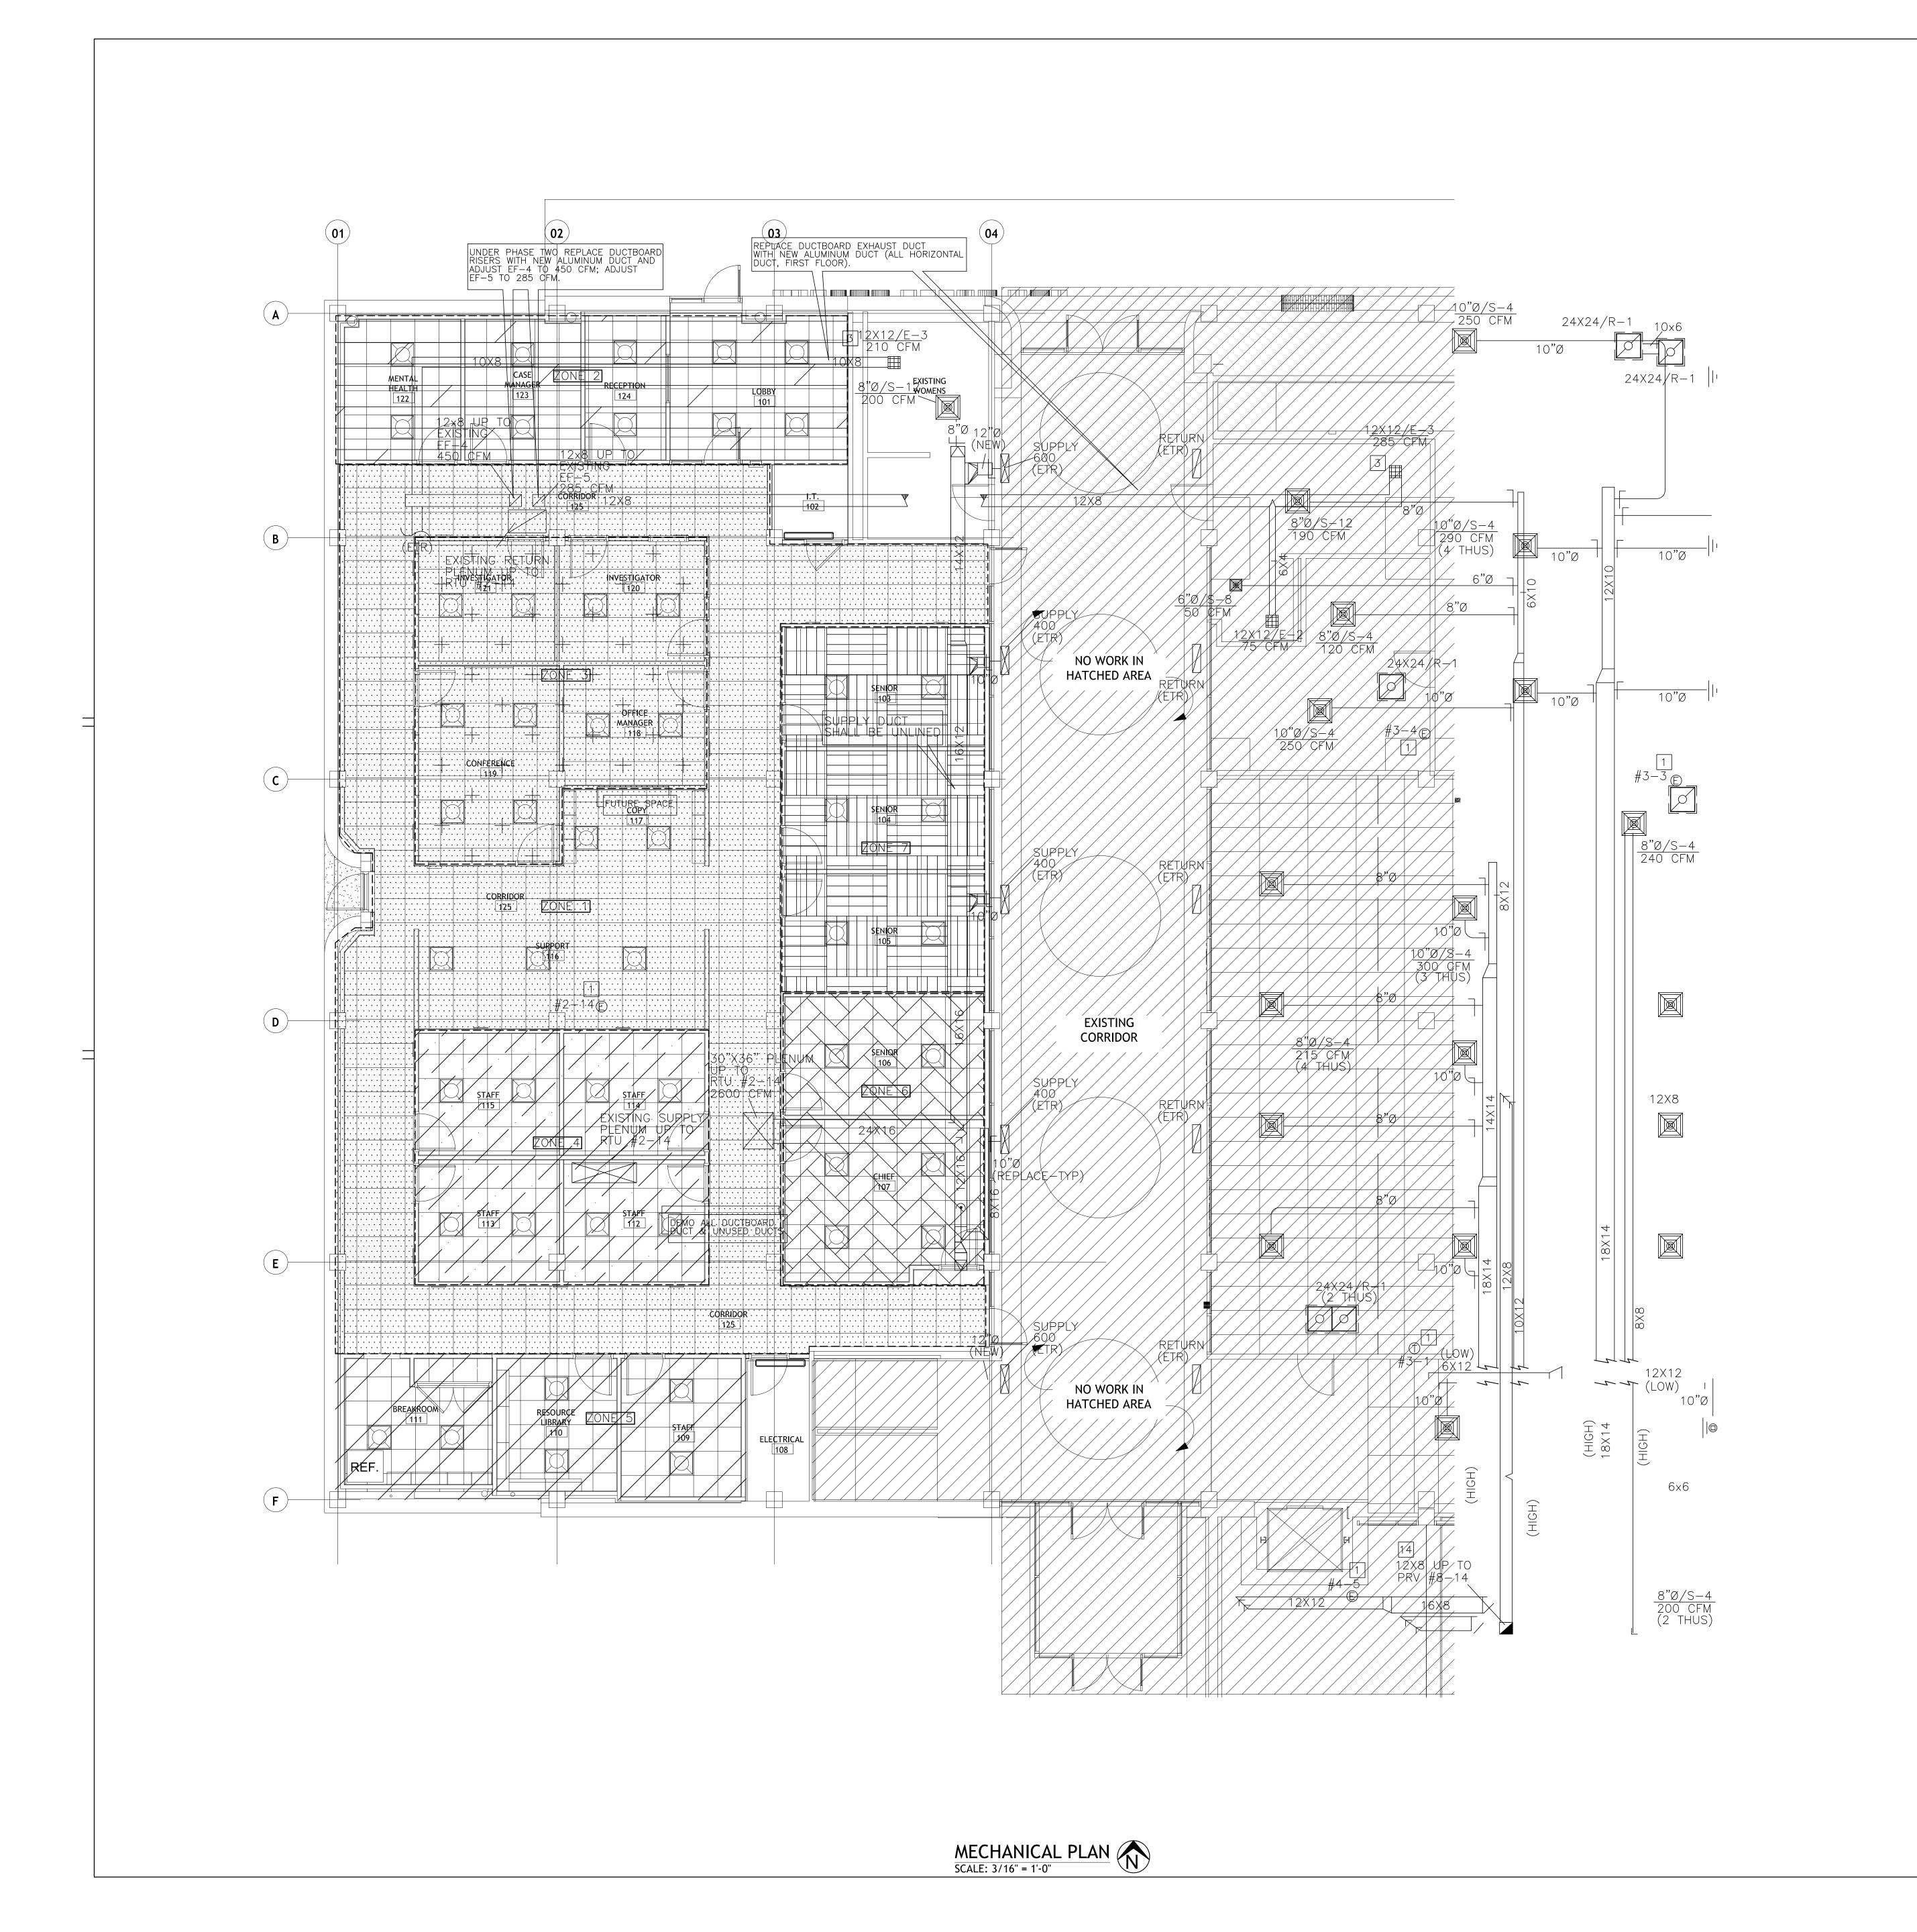N IN WALL CAVITY







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2" CW UP FROM BELOW (ETR) CASE
MANAGER
123 CONNECT TO EXISTING SEWER,
VENT STACKS, CW LOBBW IN
CHASE FOR THESE NOW FIXTURES COMNECT TO EXENTINEY CW
CONNECT TO
EXISTING VENT

P-6A 1 1/2" NO WORK IN HATCHED AREA SENIOR 103 CONTRACTOR TO PERFORM

ALL DOMESTIC WATER LINE

REPLACEMENT UNDER

PHASE I SENIOR 104 EXISTING 2 1/2" CW UP FROM BELOW CORRIDOR 3/4" W UP
FROM BELOW \_\_\_\_\_2" \_\_\_SS—\_(ETR) \_\_\_\_(ABOVE\_CEILING) 1 1/4" 4" UP NO WÓRK IN HATCHED AREA CONTRACTOR TO
PERFORM THIS WORK
UNDER PHASE I EXISTING SOUTH VESTIBULE

PLUMBING PLAN

SCALE: 3/16" = 1'-0"

**PERMI** 

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⟨A⟩(2−T) **A**— ÉXIŚTIŃG NORTH ENTRY **B** A−37 ← A−37 NO WORK IN HATCHED AREA SENIOR 103 EXISTING CORRIDOR **D** NO WORK IN HATCHED AREA SOUTH VESTIBULE

ELECTRICAL PLAN

SCALE: 3/16" = 1'-0"

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San Angelo, Texas 76902
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TOM GREEN COUR

Project No. 304-12-0721

Date 12/07/21

Sheet Number

E-2

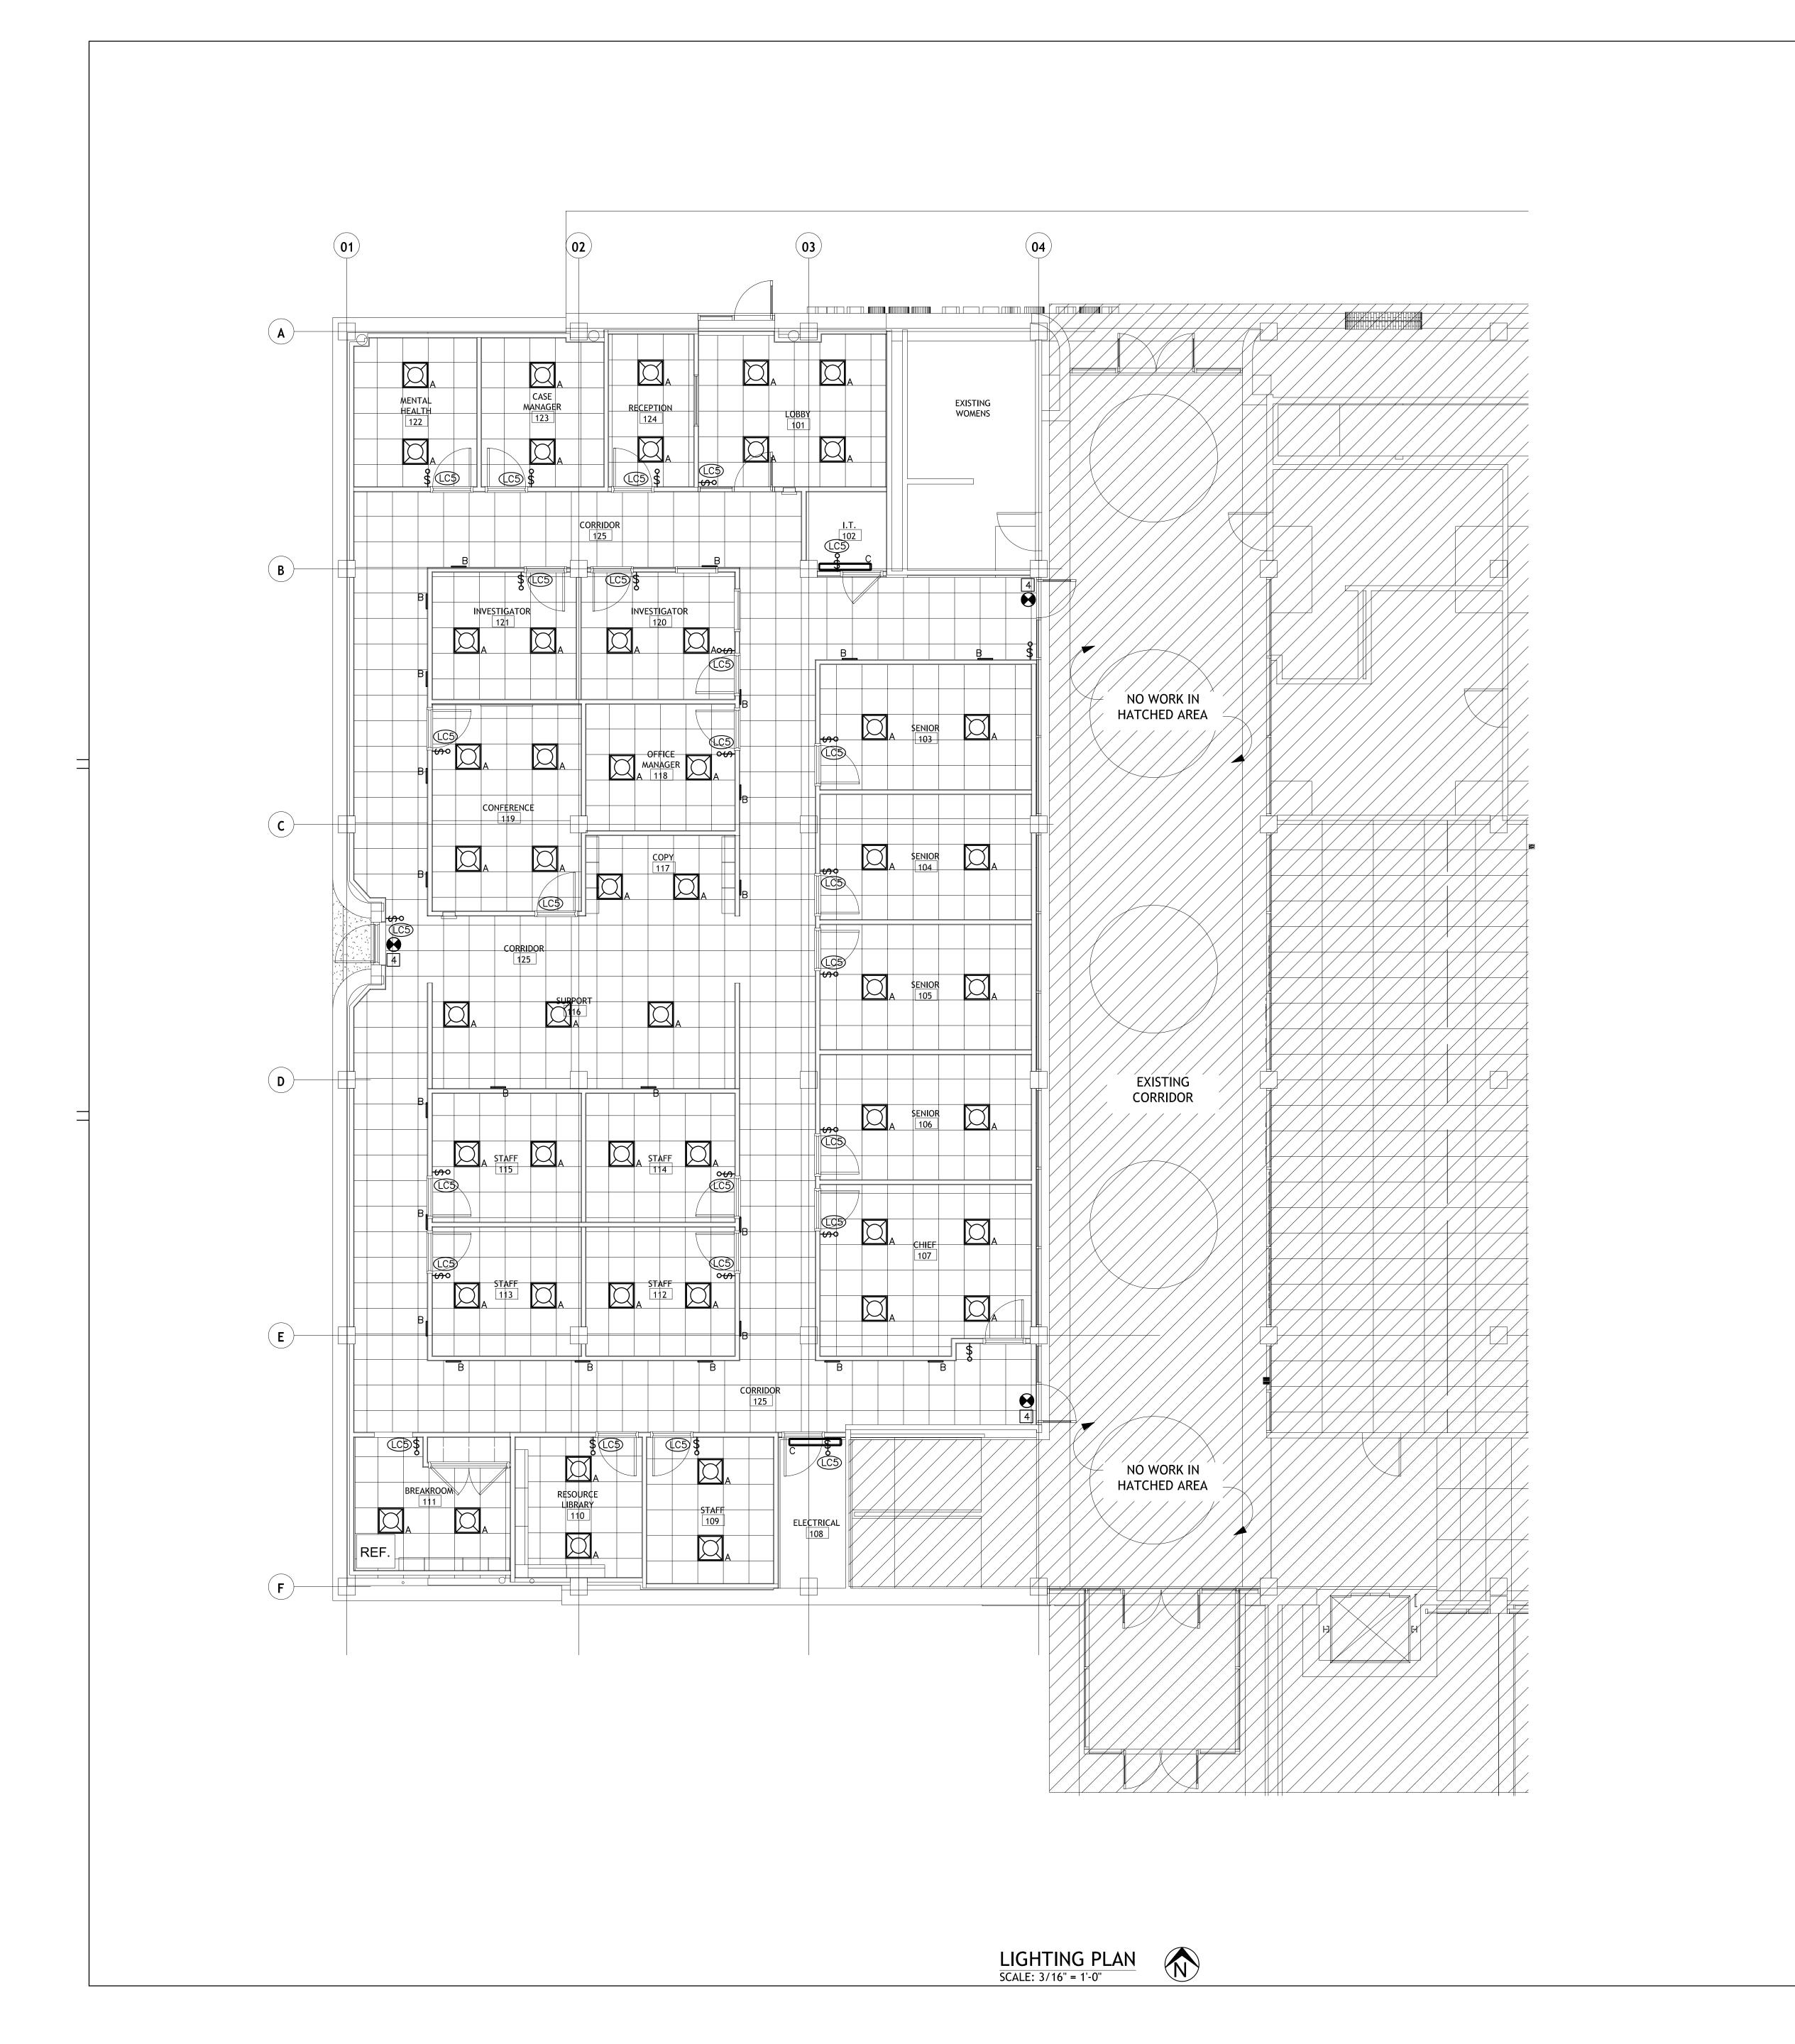
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