COMMUNITY DEVELOPMENT RENOVATION FOR ORANGE BEACH BID DOCUMENTS - JUNE 21, 2022

GENERAL NOTES:

- I. ALL PRODUCTS, MATERIALS, AND CONSTRUCTION SHALL BE PROVIDED AND/OR INSTALLED IN STRICT ACCORDANCE WITH THE MANUFACTURERS SPECIFICATIONS, GUIDELINES, AND/OR INDUSTRY STANDARDS.
- 2. THE INTENT OF THESE DRAWINGS IS TO PROVIDE THE BUILDER WITH GENERAL GUIDELINES FOR THE SOUND CONSTRUCTION OF THE STRUCTURE INDICATED WITHIN. DEVIATIONS FROM THESE DRAWINGS ARE THE BUILDERS RISK UNLESS APPROVED IN WRITING OR WITH SUPPLEMENTAL DRAWINGS FROM THE ARCHITECT.
- 3. IT IS RECOMMENDED THAT THE SERVICES OF A REGISTERED LAND SURVEYOR BE EMPLOYED FOR THE PROPER PLACEMENT OF THE STRUCTURE IN RELATION TO PROPERTY LINES, SETBACK LINES, EASEMENTS, ETC.
- 4. CONTRACTOR TO SECURE AND PAY FOR ALL NECESSARY FEES AND PERMITS FOR CONSTRUCTION, ELECTRICAL, AND PLUMBING INSPECTORS, ETC.
- 5. DO NOT SCALE DRAWINGS!!! DIMENSIONS OR LINEAR MEASUREMENTS TAKE PRECEDENCE OVER NOTED DIMENSIONS.
- 6. THE CONTRACTOR SHALL FIELD VERIFY ALL DIMENSIONS INDICATED WITHIN THESE DOCUMENTS AND SHALL NOTIFY THE ARCHITECT OF ANY VARIATION PRIOR TO THE PURCHASING OF ANY MATERIALS, STARTING FABRICATION, OR BEGINNING CONSTRUCTION
- 7. PROVIDE TEMPORARY SETTLING BASINS, HAY BALES, AND OTHER METHODS AS APPROPRIATE TO FILTER WATER AT ALL AREAS WHERE STORM WATER LEAVES THE PROJECT. CLEAN UP ALL SOIL WHICH FLOWS OFF SITE AT THE END OF THE DAY.
- 8. ALL EXISTING SITE CONDITIONS ARE TO BE VERIFIED BY CONTRACTOR BEFORE START OF CONSTRUCTION.
- 9. PROVIDE CHEMICAL BARRIER TO BUILDING FROM SUBTERRANEAN TERMITE ATTACK.
- IO. NO QUALIFYING STATEMENTS OR EXCEPTIONS TO PLANS OR NOTES TO BE ALLOWED.
- I I. ALL WORK RELATED DEBRIS SHALL BE REMOVED FROM THE SITE REGULARLY AND PROPERLY.
- I 2. THE CONTRACTOR SHALL LEAVE ALL AREAS AND FINISHED SPACES IN A CLEAN AND ACCEPTABLE CONDITION AT THE PROJECT COMPLETION.
- 13. ALL CONTRACTORS AND SUBCONTRACTORS SHALL COMPLY W/ OSHA REQUIREMENTS.
- 14. ALL NEW CONSTRUCTION SHALL COMPLY WITH ALL APPLICABLE BUILDING CODES AND RESTRICTIVE ORDINANCES FOR CONSTRUCTION, ELECTRICAL, PLUMBING, AND MECHANICAL.
- 15. ALL PRODUCTS, MATERIALS AND CONSTRUCTION SHALL BE PROVIDED AND/OR INSTALLED IN STRICT ACCORDANCE WITH THE MANUFACTURER'S SPECIFICATIONS, GUIDELINES, AND/OR INDUSTRY STANDARDS.

SHEET NO.	SHEET TITLE			
T1.0	TITLE SHEET & GENERAL NOTES			
	ARCHITECTURAL			
A1.1 A3.1	RENOVATION ROOF PLAN RENOVATION EXTERIOR ELEVATIONS			
	ROOF DETAIL DRAWINGS			
AD101 A100 A101 A101 A500 A500.2 A500.1 A500.2	DEMOLITION ROOF PLAN OVERVIEW ROOF PLAN RE-ROOF PLAN ALTERNATE 1 RE-ROOF PLAN ROOF DETAILS ROOF DETAILS ALTERNATE 1 ROOF DETAILS ALTERNATE 1 ROOF DETAILS			
	STRUCTURAL			
S1	FOUNDATION/ FRAMING			

APPLICABLE BUILDING CODES

	LOCAL OFFICIAL HAVING JURISDICTION IS ORANGE BEACH, ALABAMA
2018	INTERNATIONAL RESIDENTIAL CODE
2018	INTERNATIONAL FUEL GAS CODE
2018	INTERNATIONAL MECHANICAL CODE
2018	INTERNATIONAL PLUMBING CODE
2018	INTERNATIONAL BUILDING CODE
2017	NATIONAL ELECTRICAL CODE


DESIGN TEAM

MCCOLLOUGH ARCHITECTURE, INC 4790 Main Street, Suite F-209 Orange Beach, Alabama ARCHITECT: Sted McCollough, AIA (251)968-7222 stedm@mcarcht.com WATERMARK DESIGN GROUP, LLC 2970 Cottage Hill Road, Suite 200 Mobile, Alabama ARCHITECT: John A. McArthur, III, "Sandy", AIA (251) 378-6175


smcarthur@watermarkarch.com THOMPSON ENGINEERING, INC. 2970 Cottage Hill Road, Suite 190 Mobile, Alabama 36606 BUILDING ENVELOPE: Bryce Moore (251) 665-5425 bmoore@thompsonengineering.com Connor Harkey, RRO


(251) 285-8252 charkey@thompsonengineering.com

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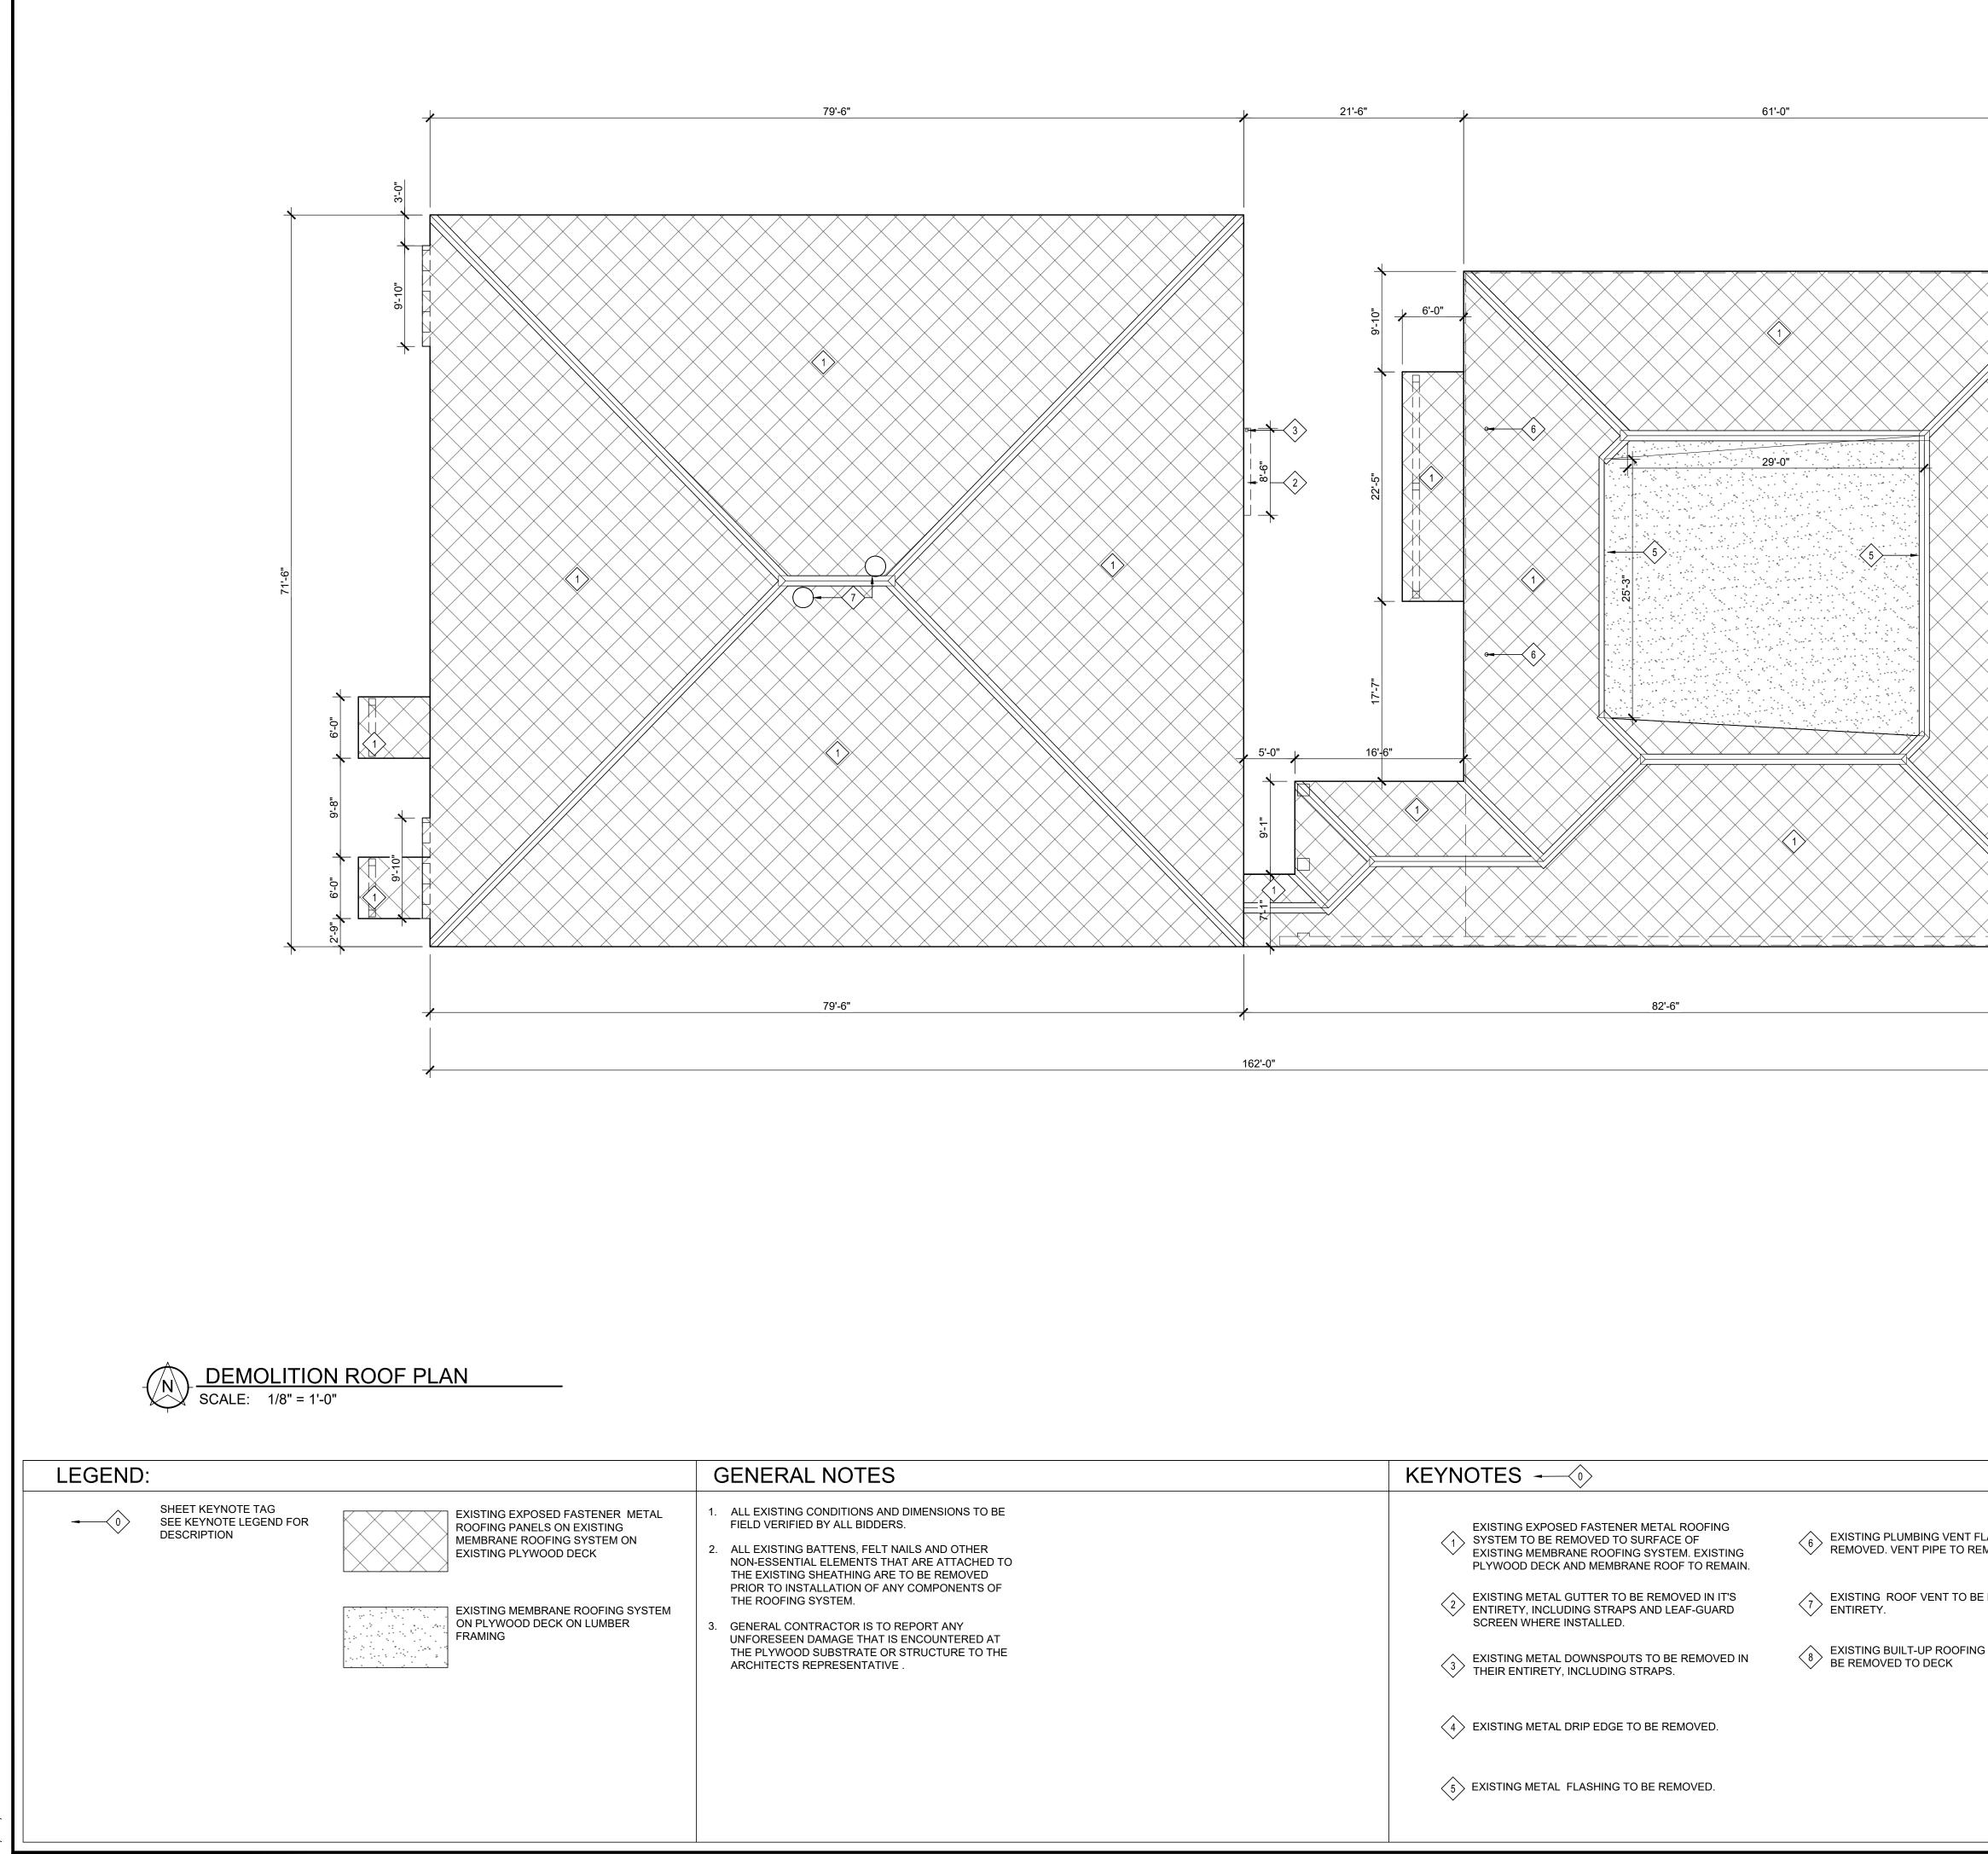

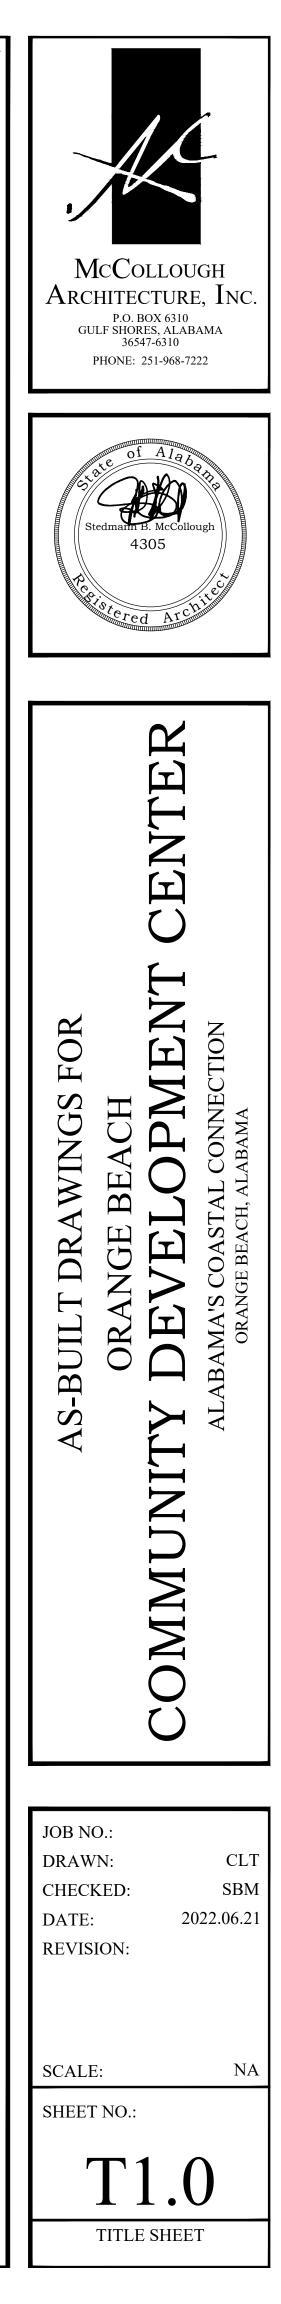
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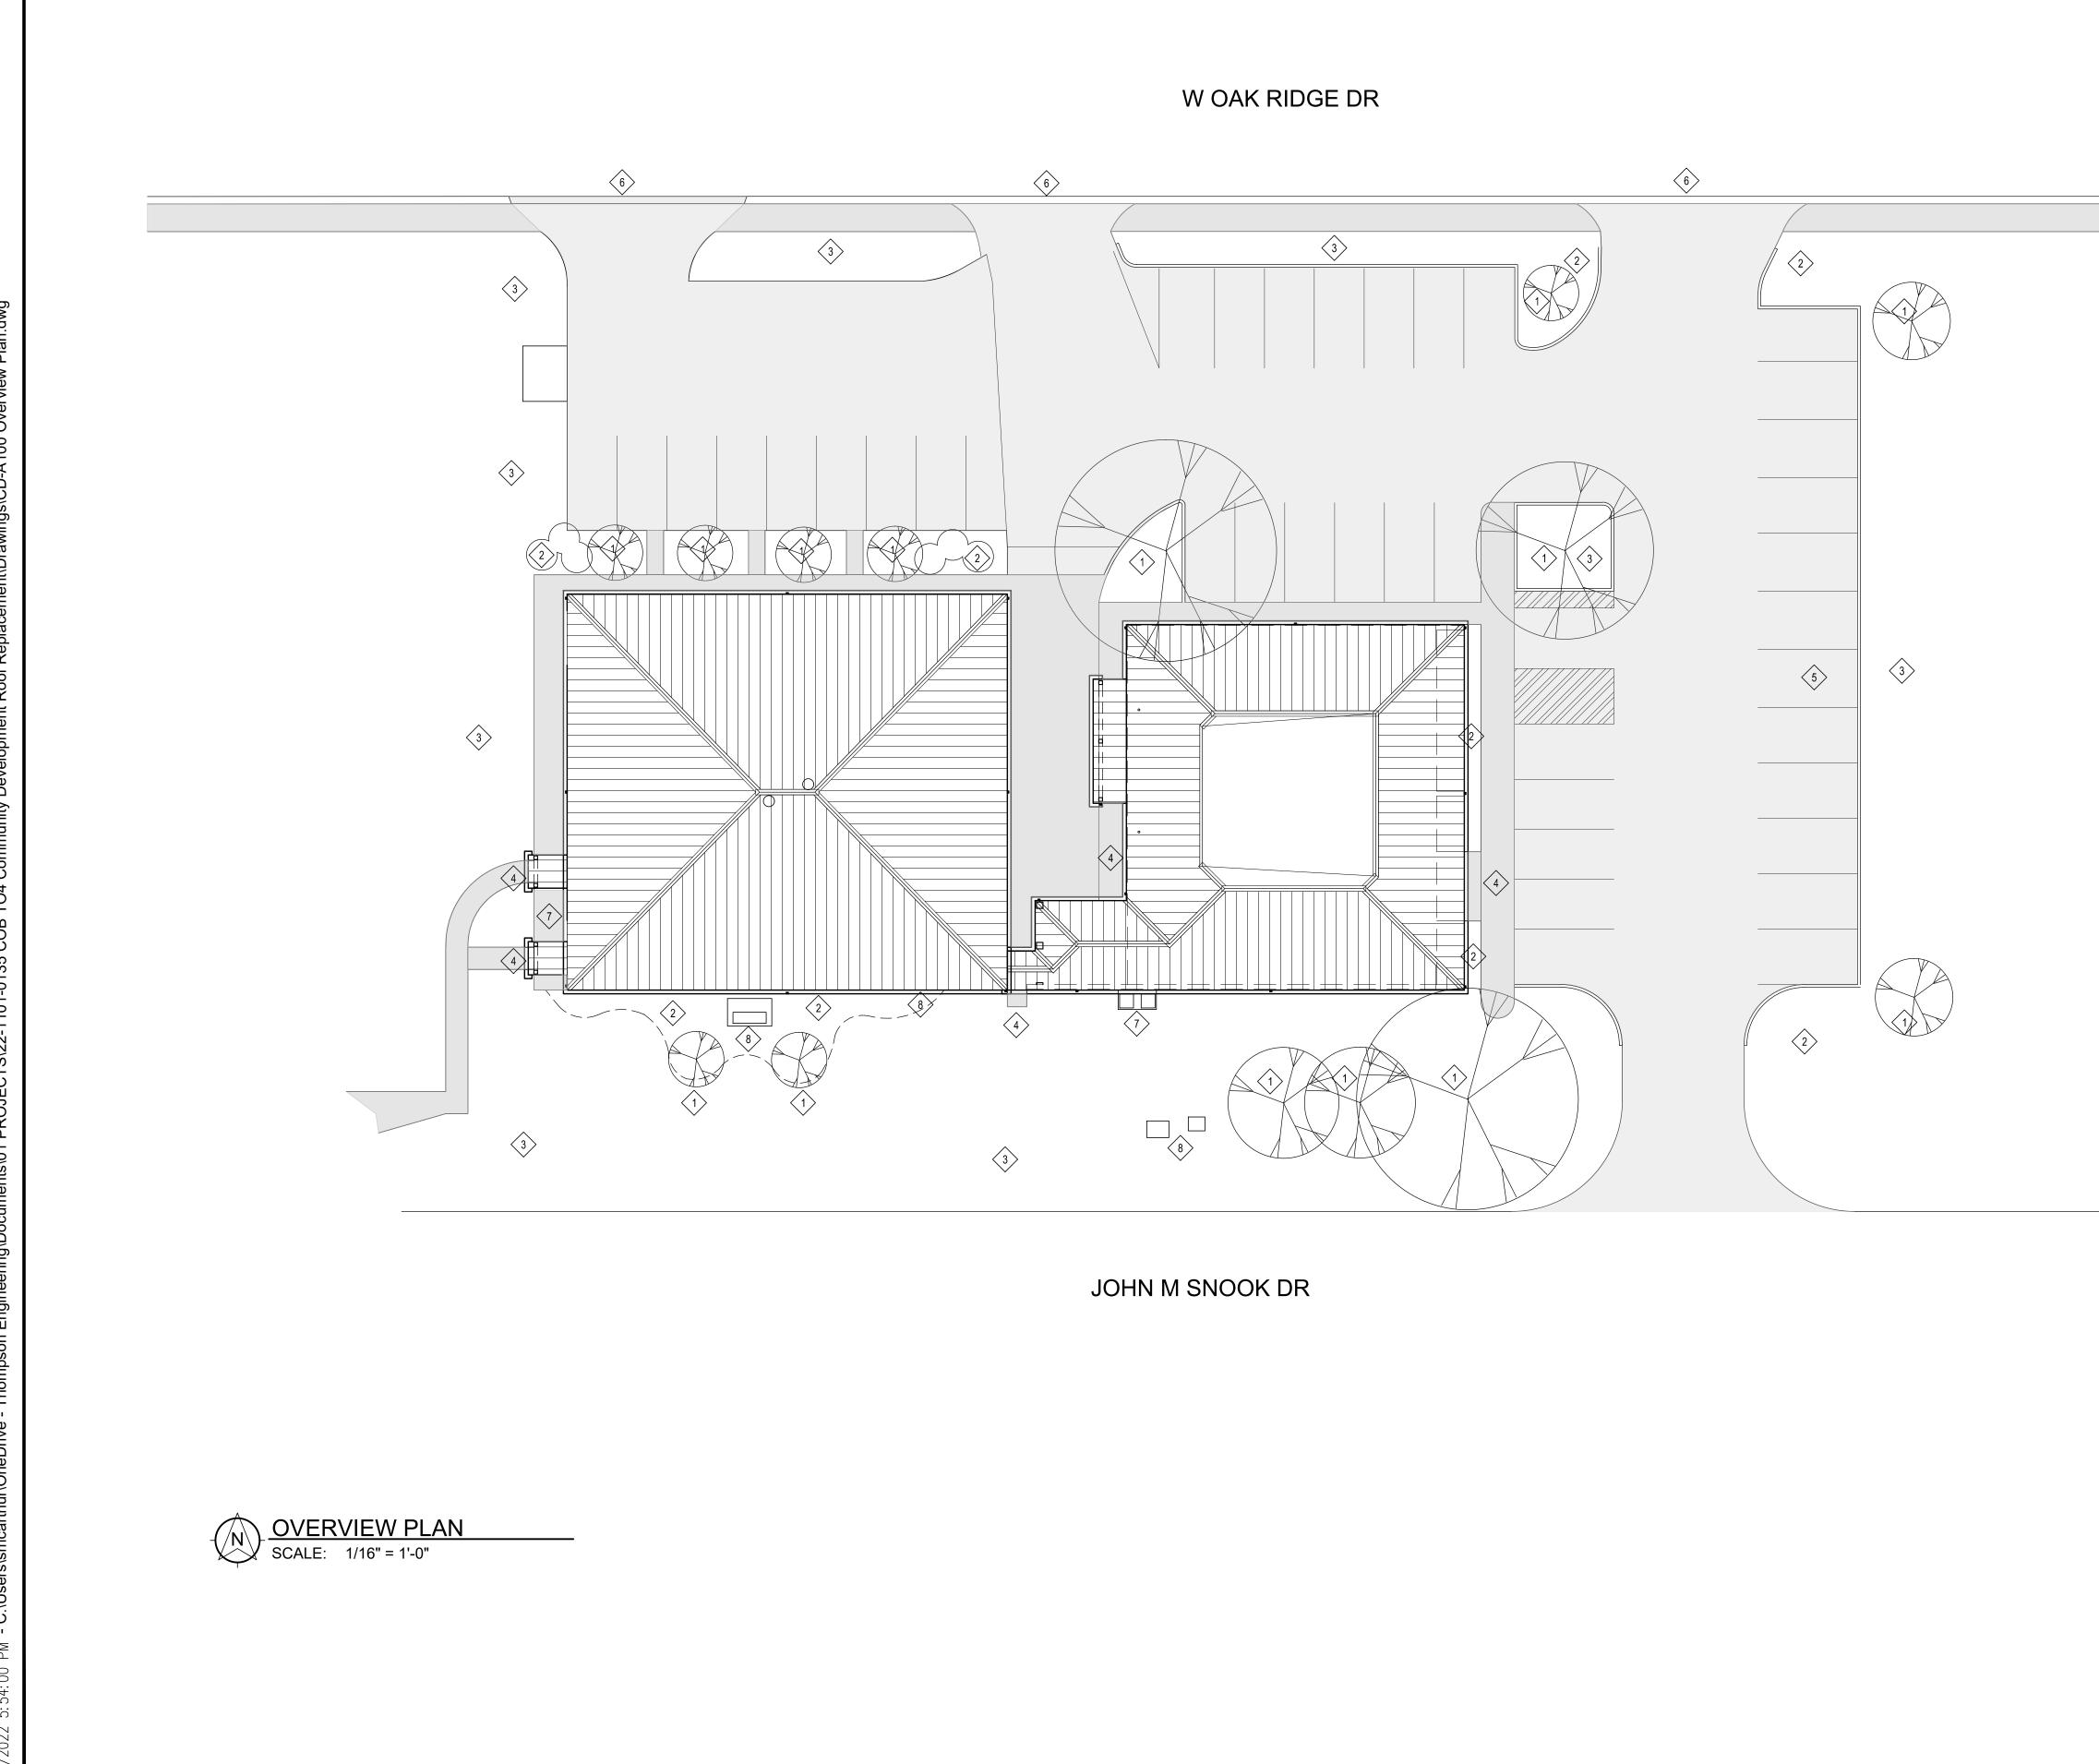





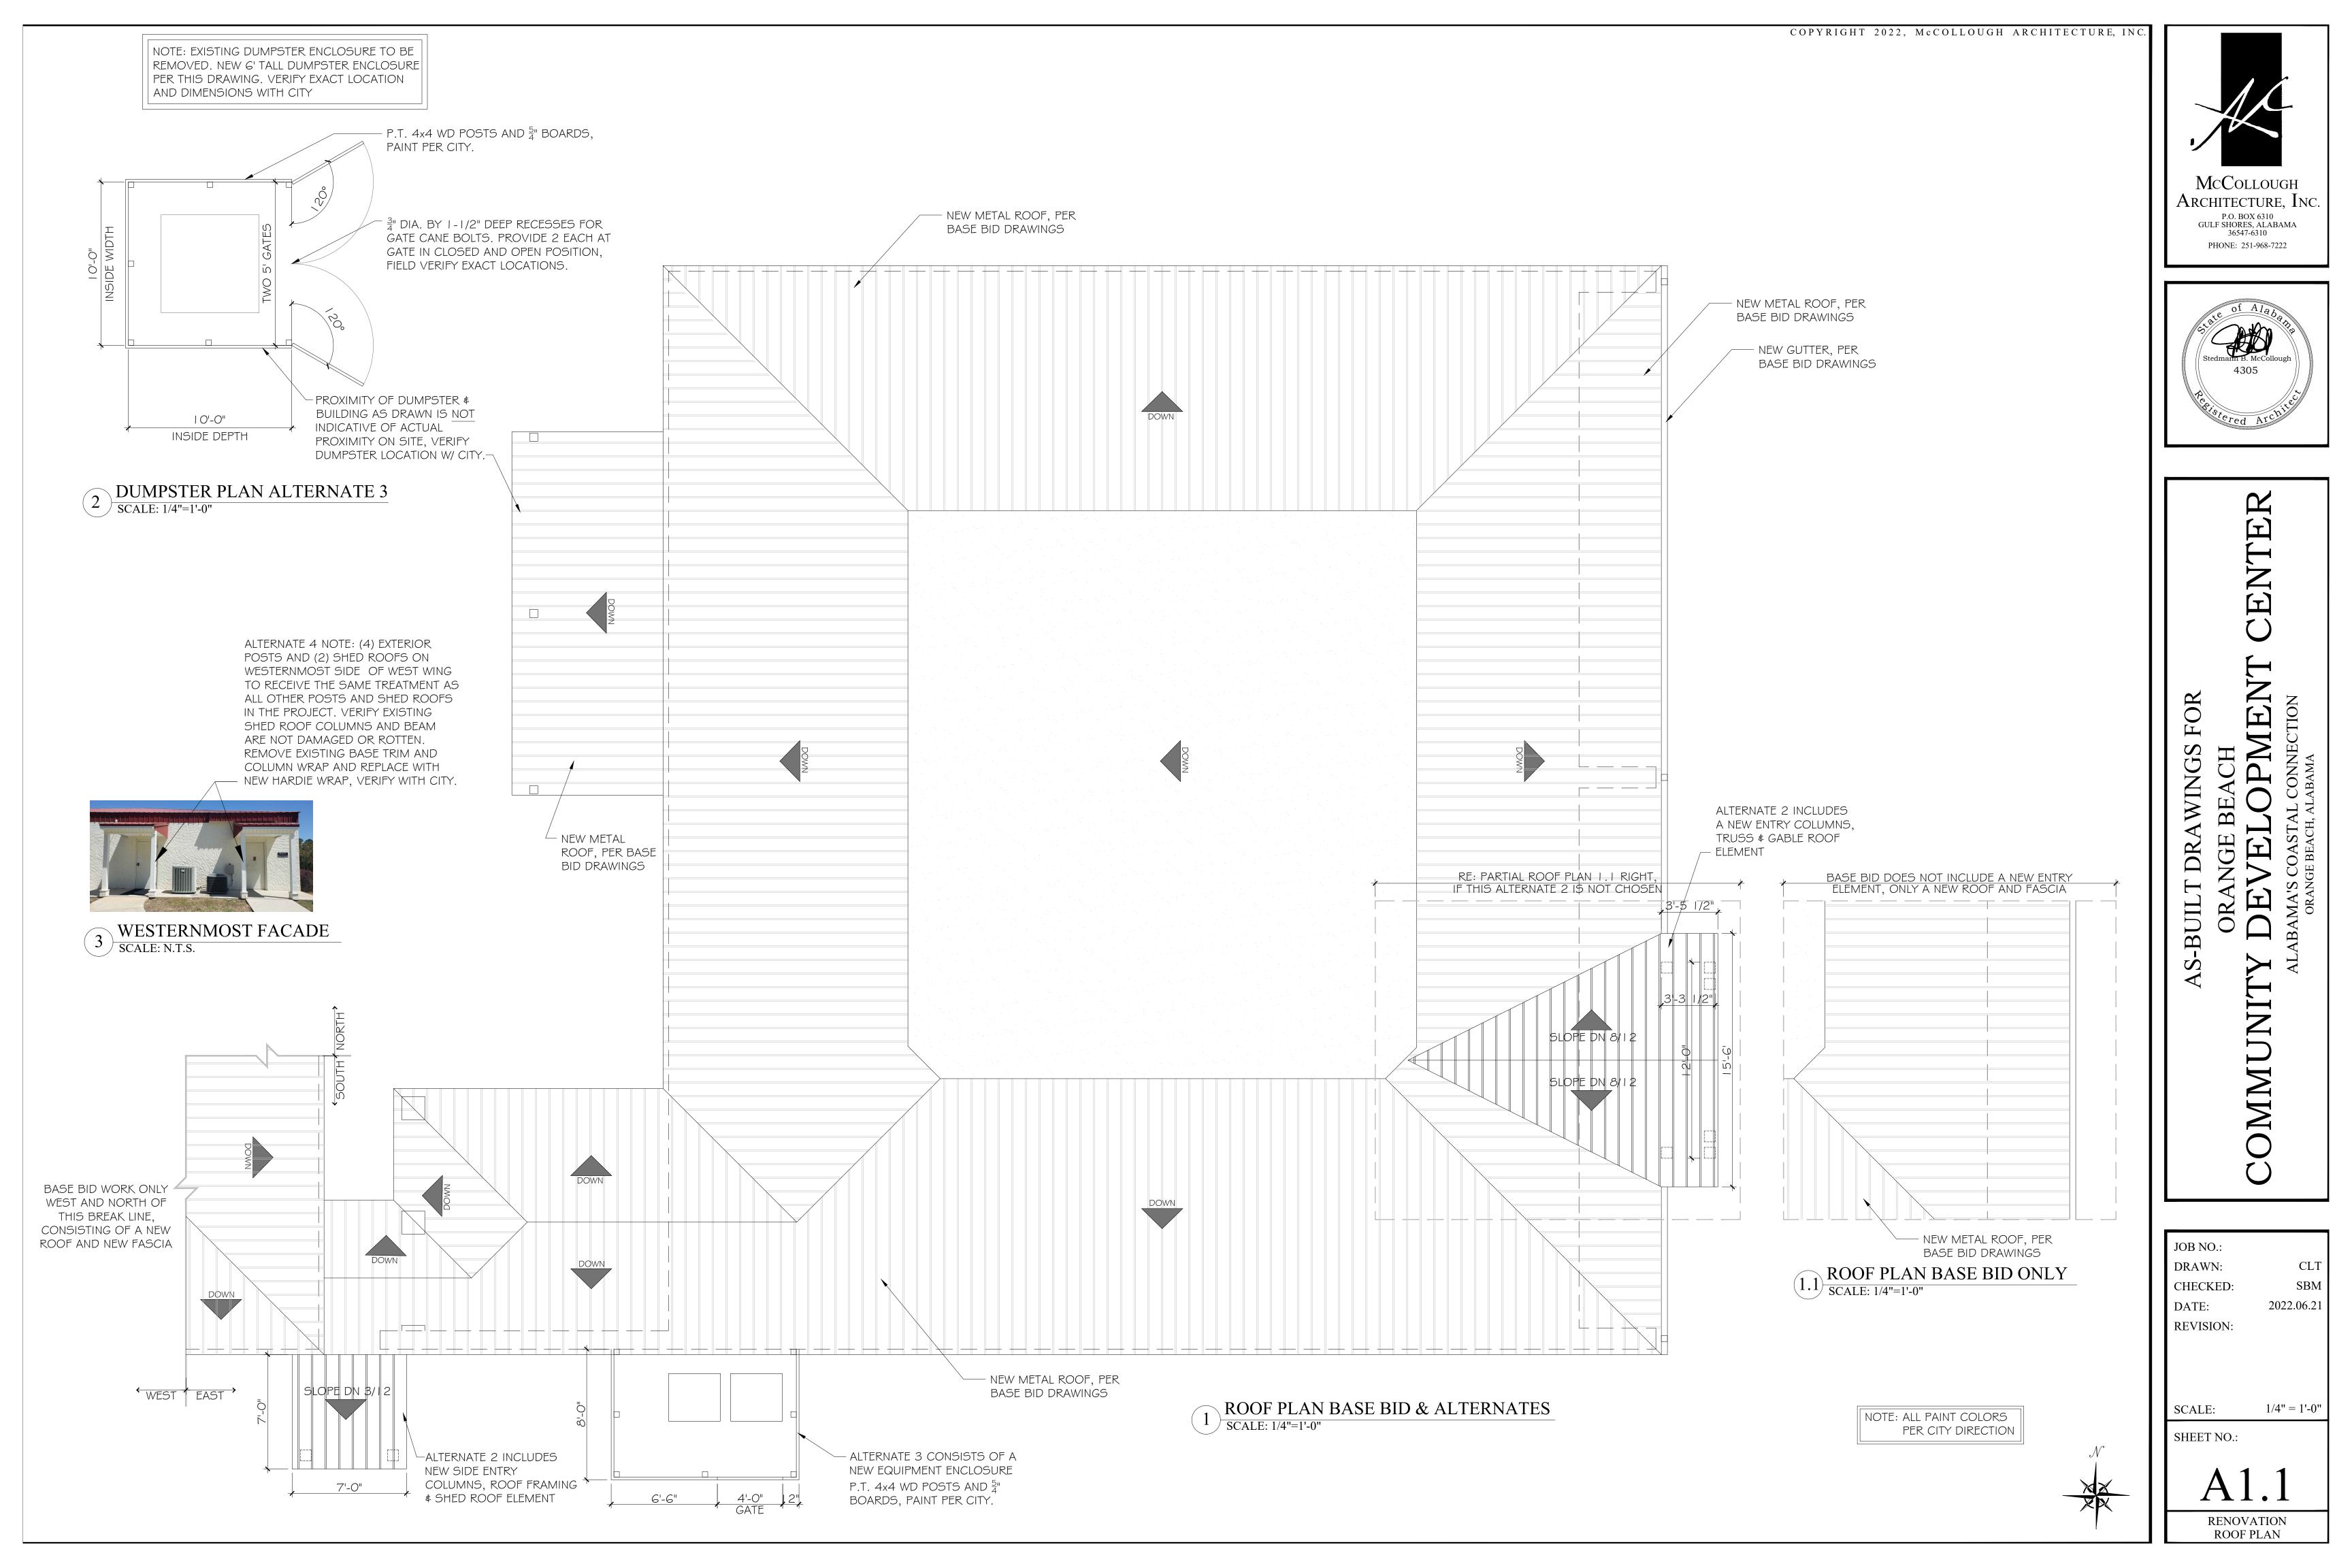


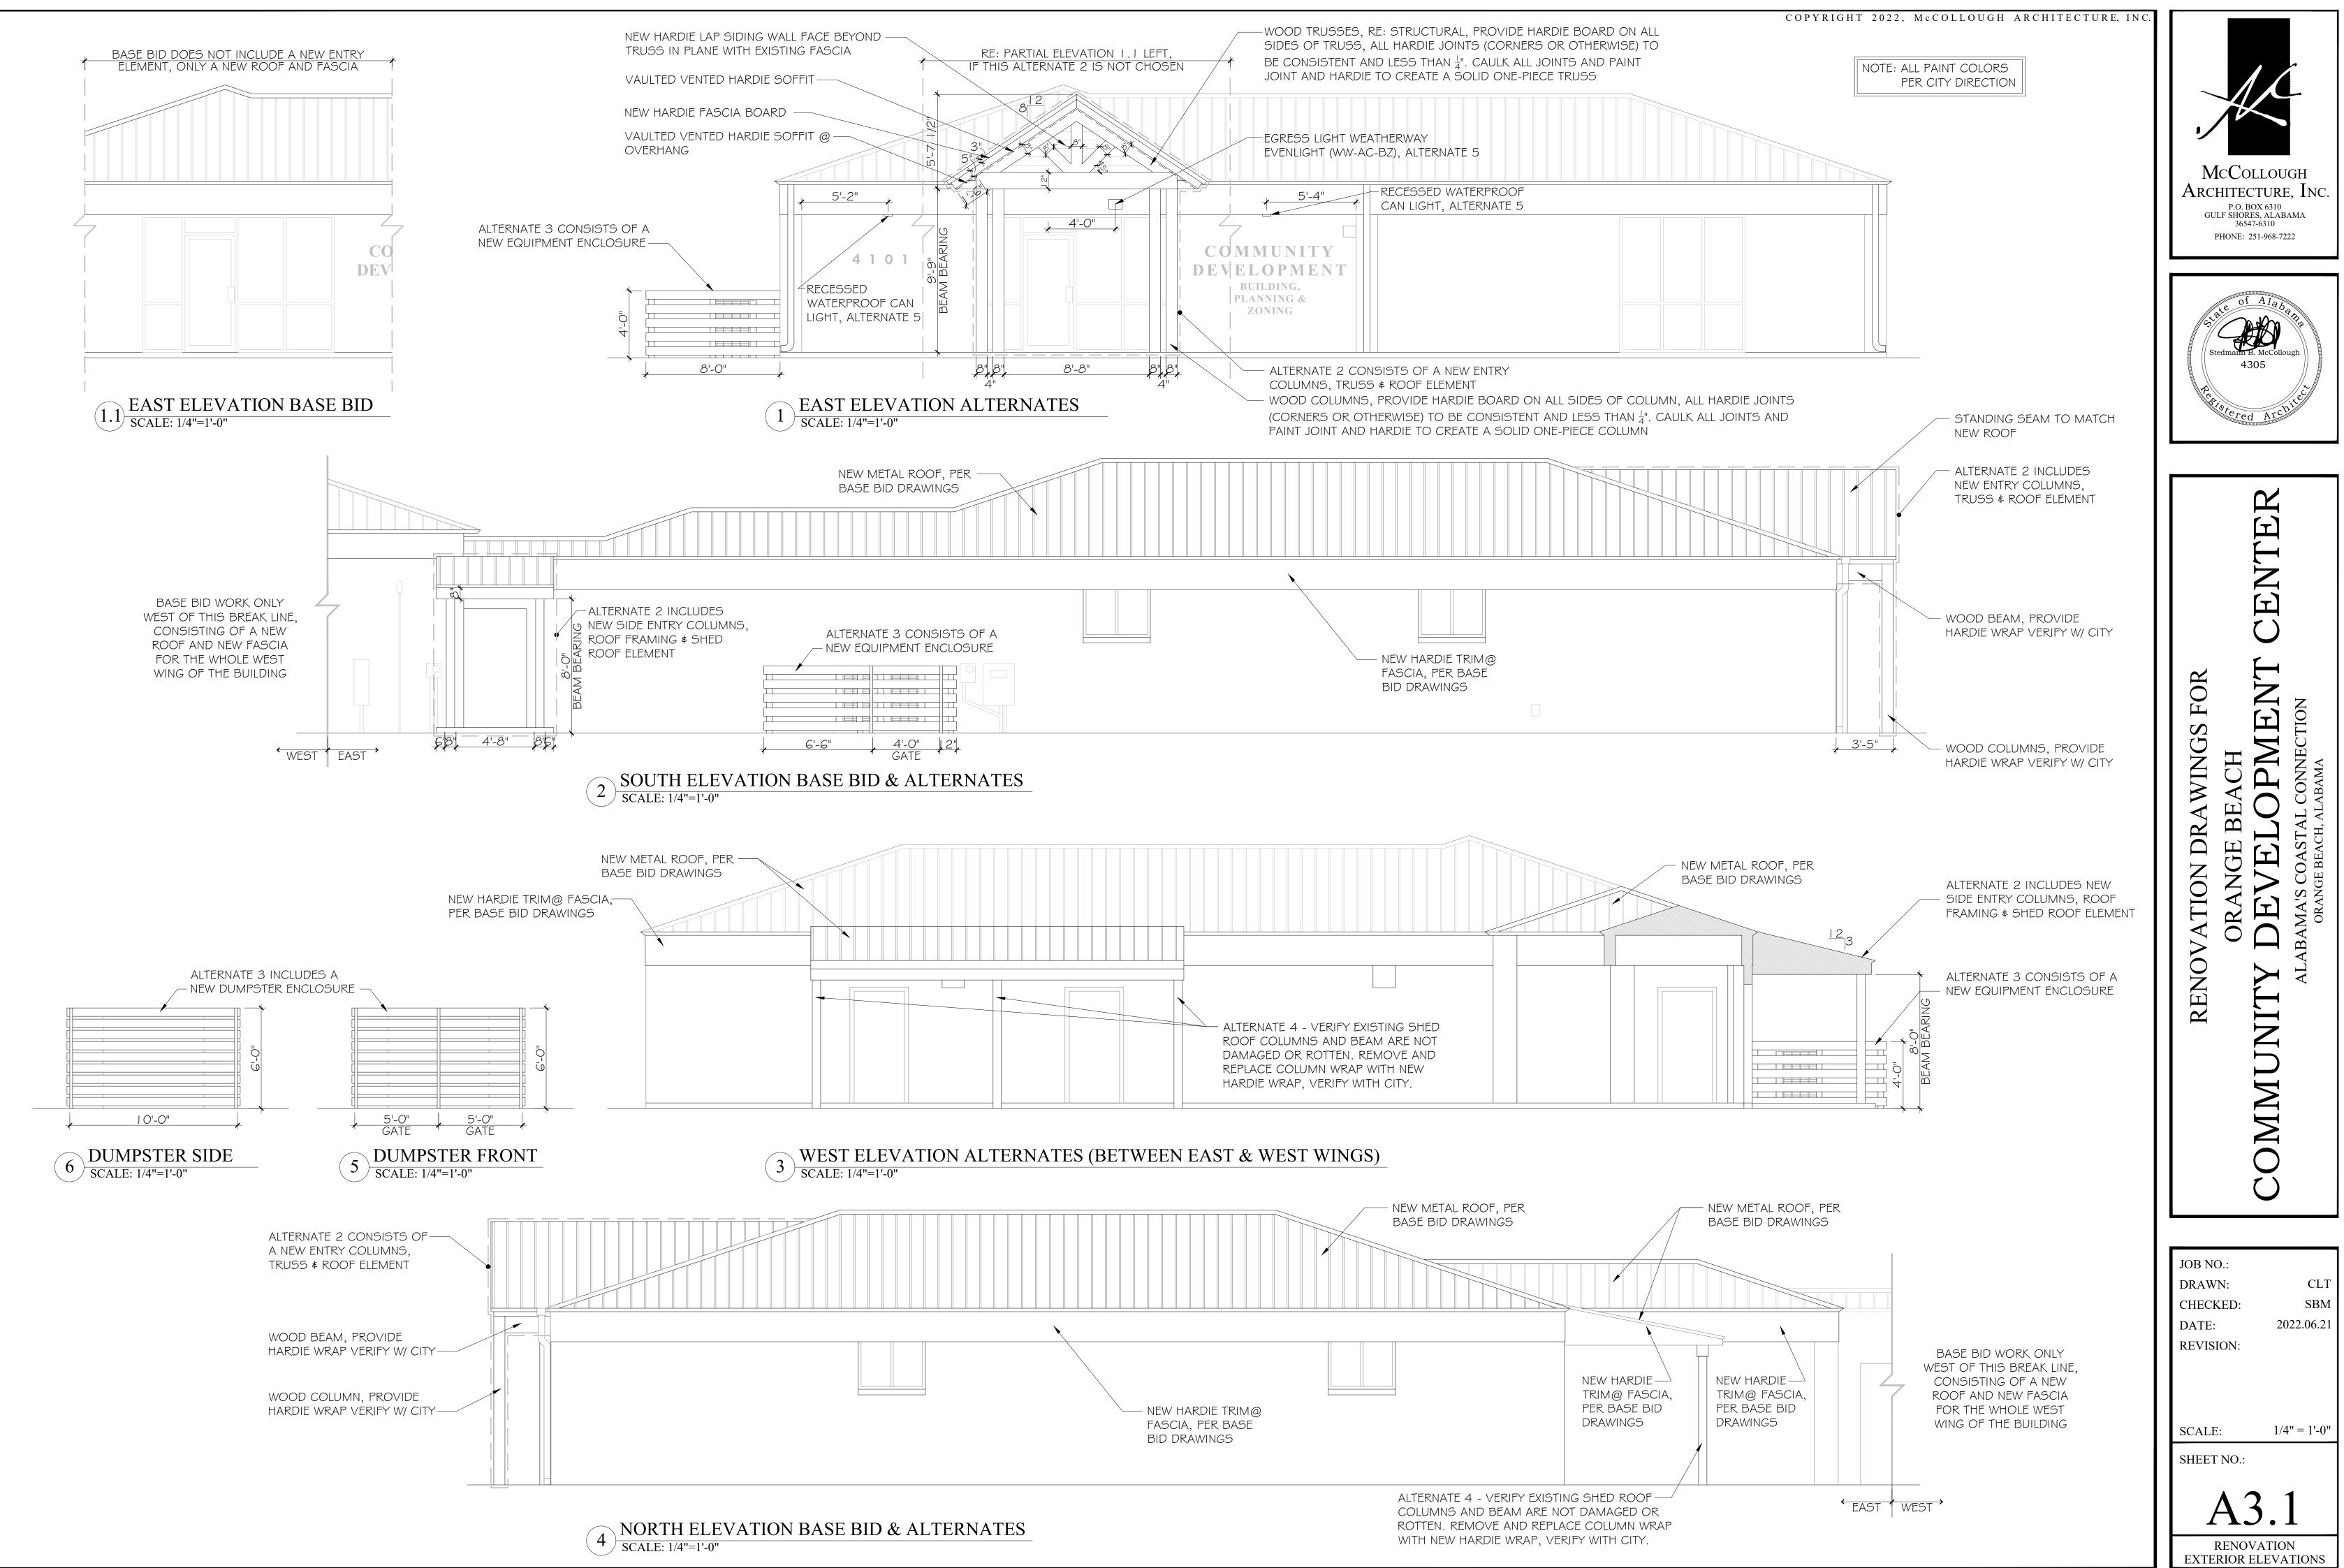

	DESIGN.GROUP, LLC DESIGN.GROUP, LLC architecture • interior design planning • landscape architecture 2970.cottage Hil Road • Suite 200 • Mobile, Alabama 36606 251.344.5515 voice • www.watermarkarchitects.com
	CITY OF ORANGE BEACH CITY-WIDE ROOF REPAIRS COMMUNITY DEVELOPMENT BUILDING ROOF REPLACEMENTS 4101 ORANGE BEACH AL 36561 AL01 ORANGE BEACH BLD, ORANGE BEACH, AL 36561 AL01 ORANGE BEACH BLD, ORANGE BEACH AL 36561 AL01 ORANGE AL 36561 AL01 ORANGE BEACH AL 36561 AL01 ORANGE BEACH AL 36561 AL01 ORANGE BEACH AL 36561 AL01 ORANGE AL 36561 AL01 ORANGE BEACH AL 36561 AL01 ORANGE AL 3
FLASHING TO BE REMAIN.	ISSUE DATE: 09-22-22 OF ALAS NCARTS 06-23-22 OF ALAS 06-23-22 THIS DRAWING REPRESENTS DESIGNS PREPARED BY WATERMARK DESIGNS PREPARED BY WATERMARK DESIGNS PREPARED BY WATERMARK DESIGN GROUP LLC FOR SPECIFIC USE ON THIS PROJECT AND IS NOT TO BE COPIED, REPRODUCED, OR ALTERED WITHOUT THE EXPRESS WRITTEN CONSENT OF THE WATERMARK DESIGN GROUP REPRESENTATIVE AUTHORIZED TO APPROVE THIS USE.
	UNAUTHORIZED USE IS SUBJECT TO LEGAL ACTION UNDER STATE AND FEDERAL LAW. SHEET TITLE: DEMOLITION ROOF PLAN SHEET NUMBER: AD101




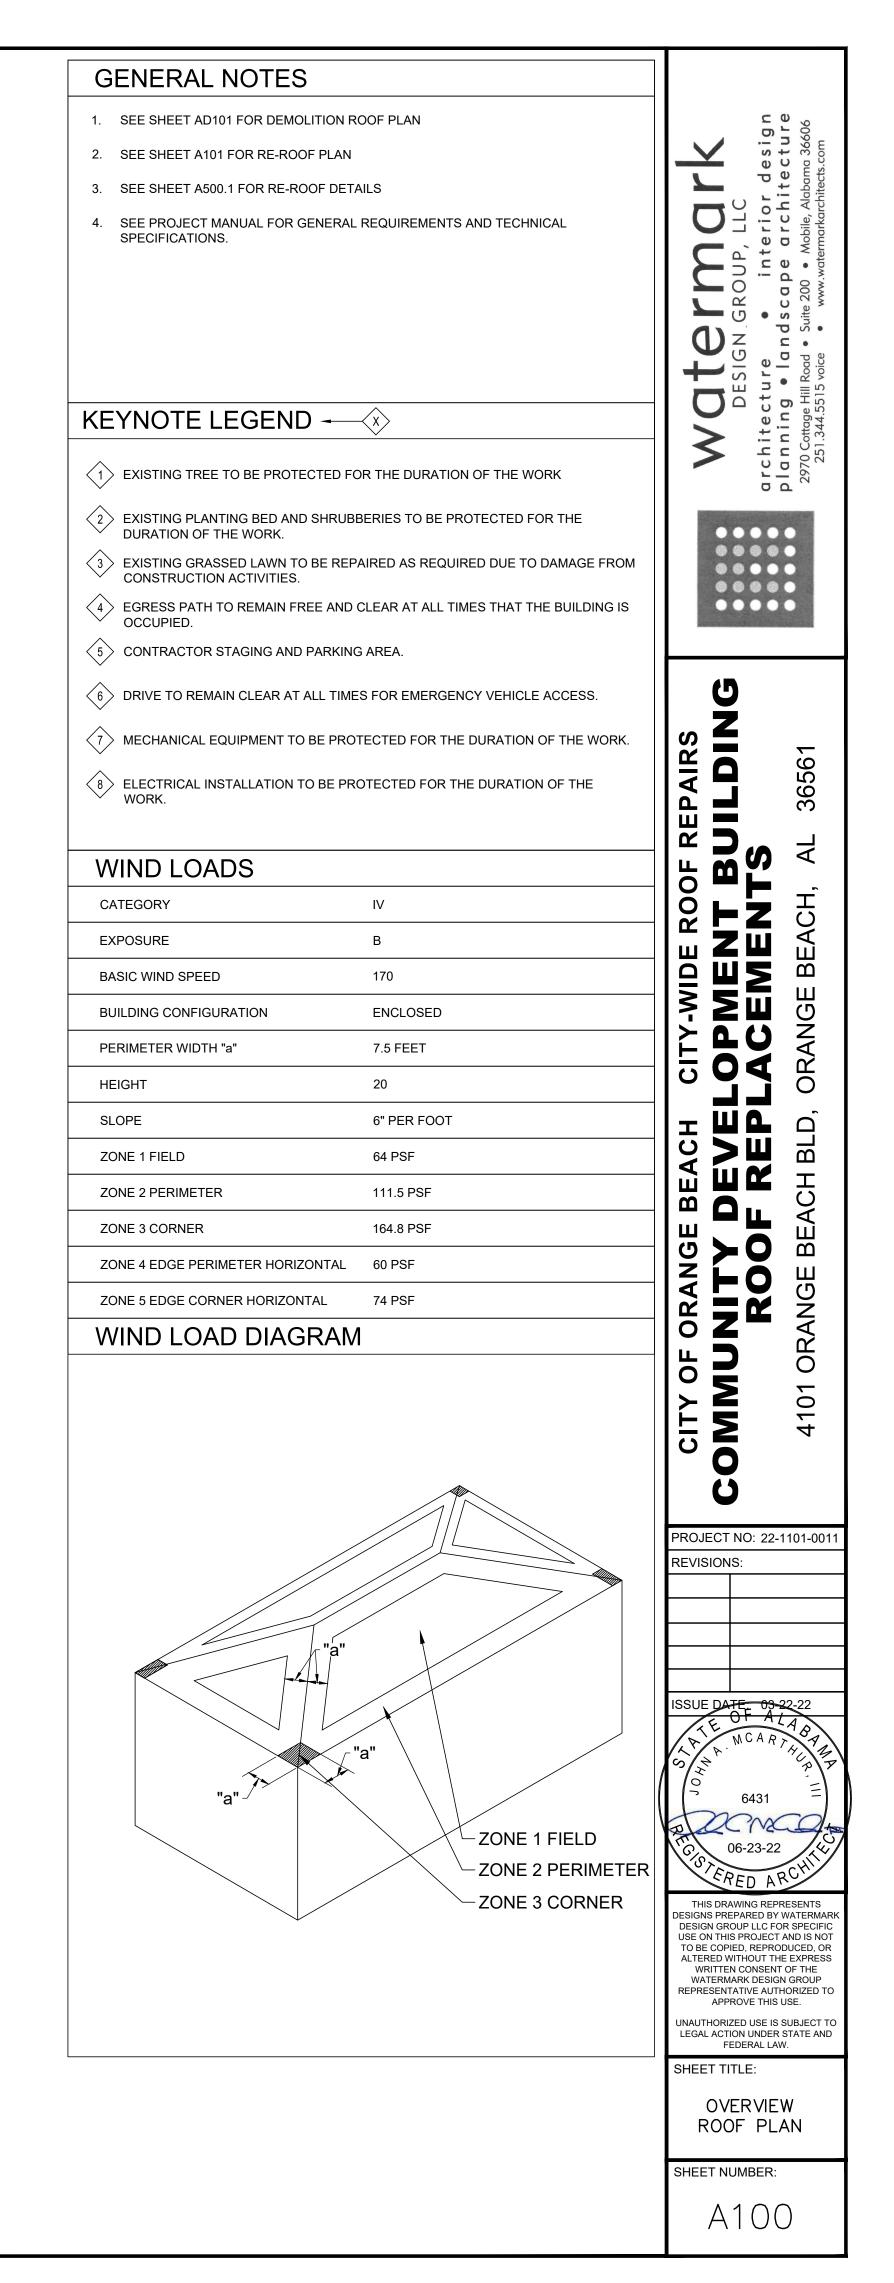

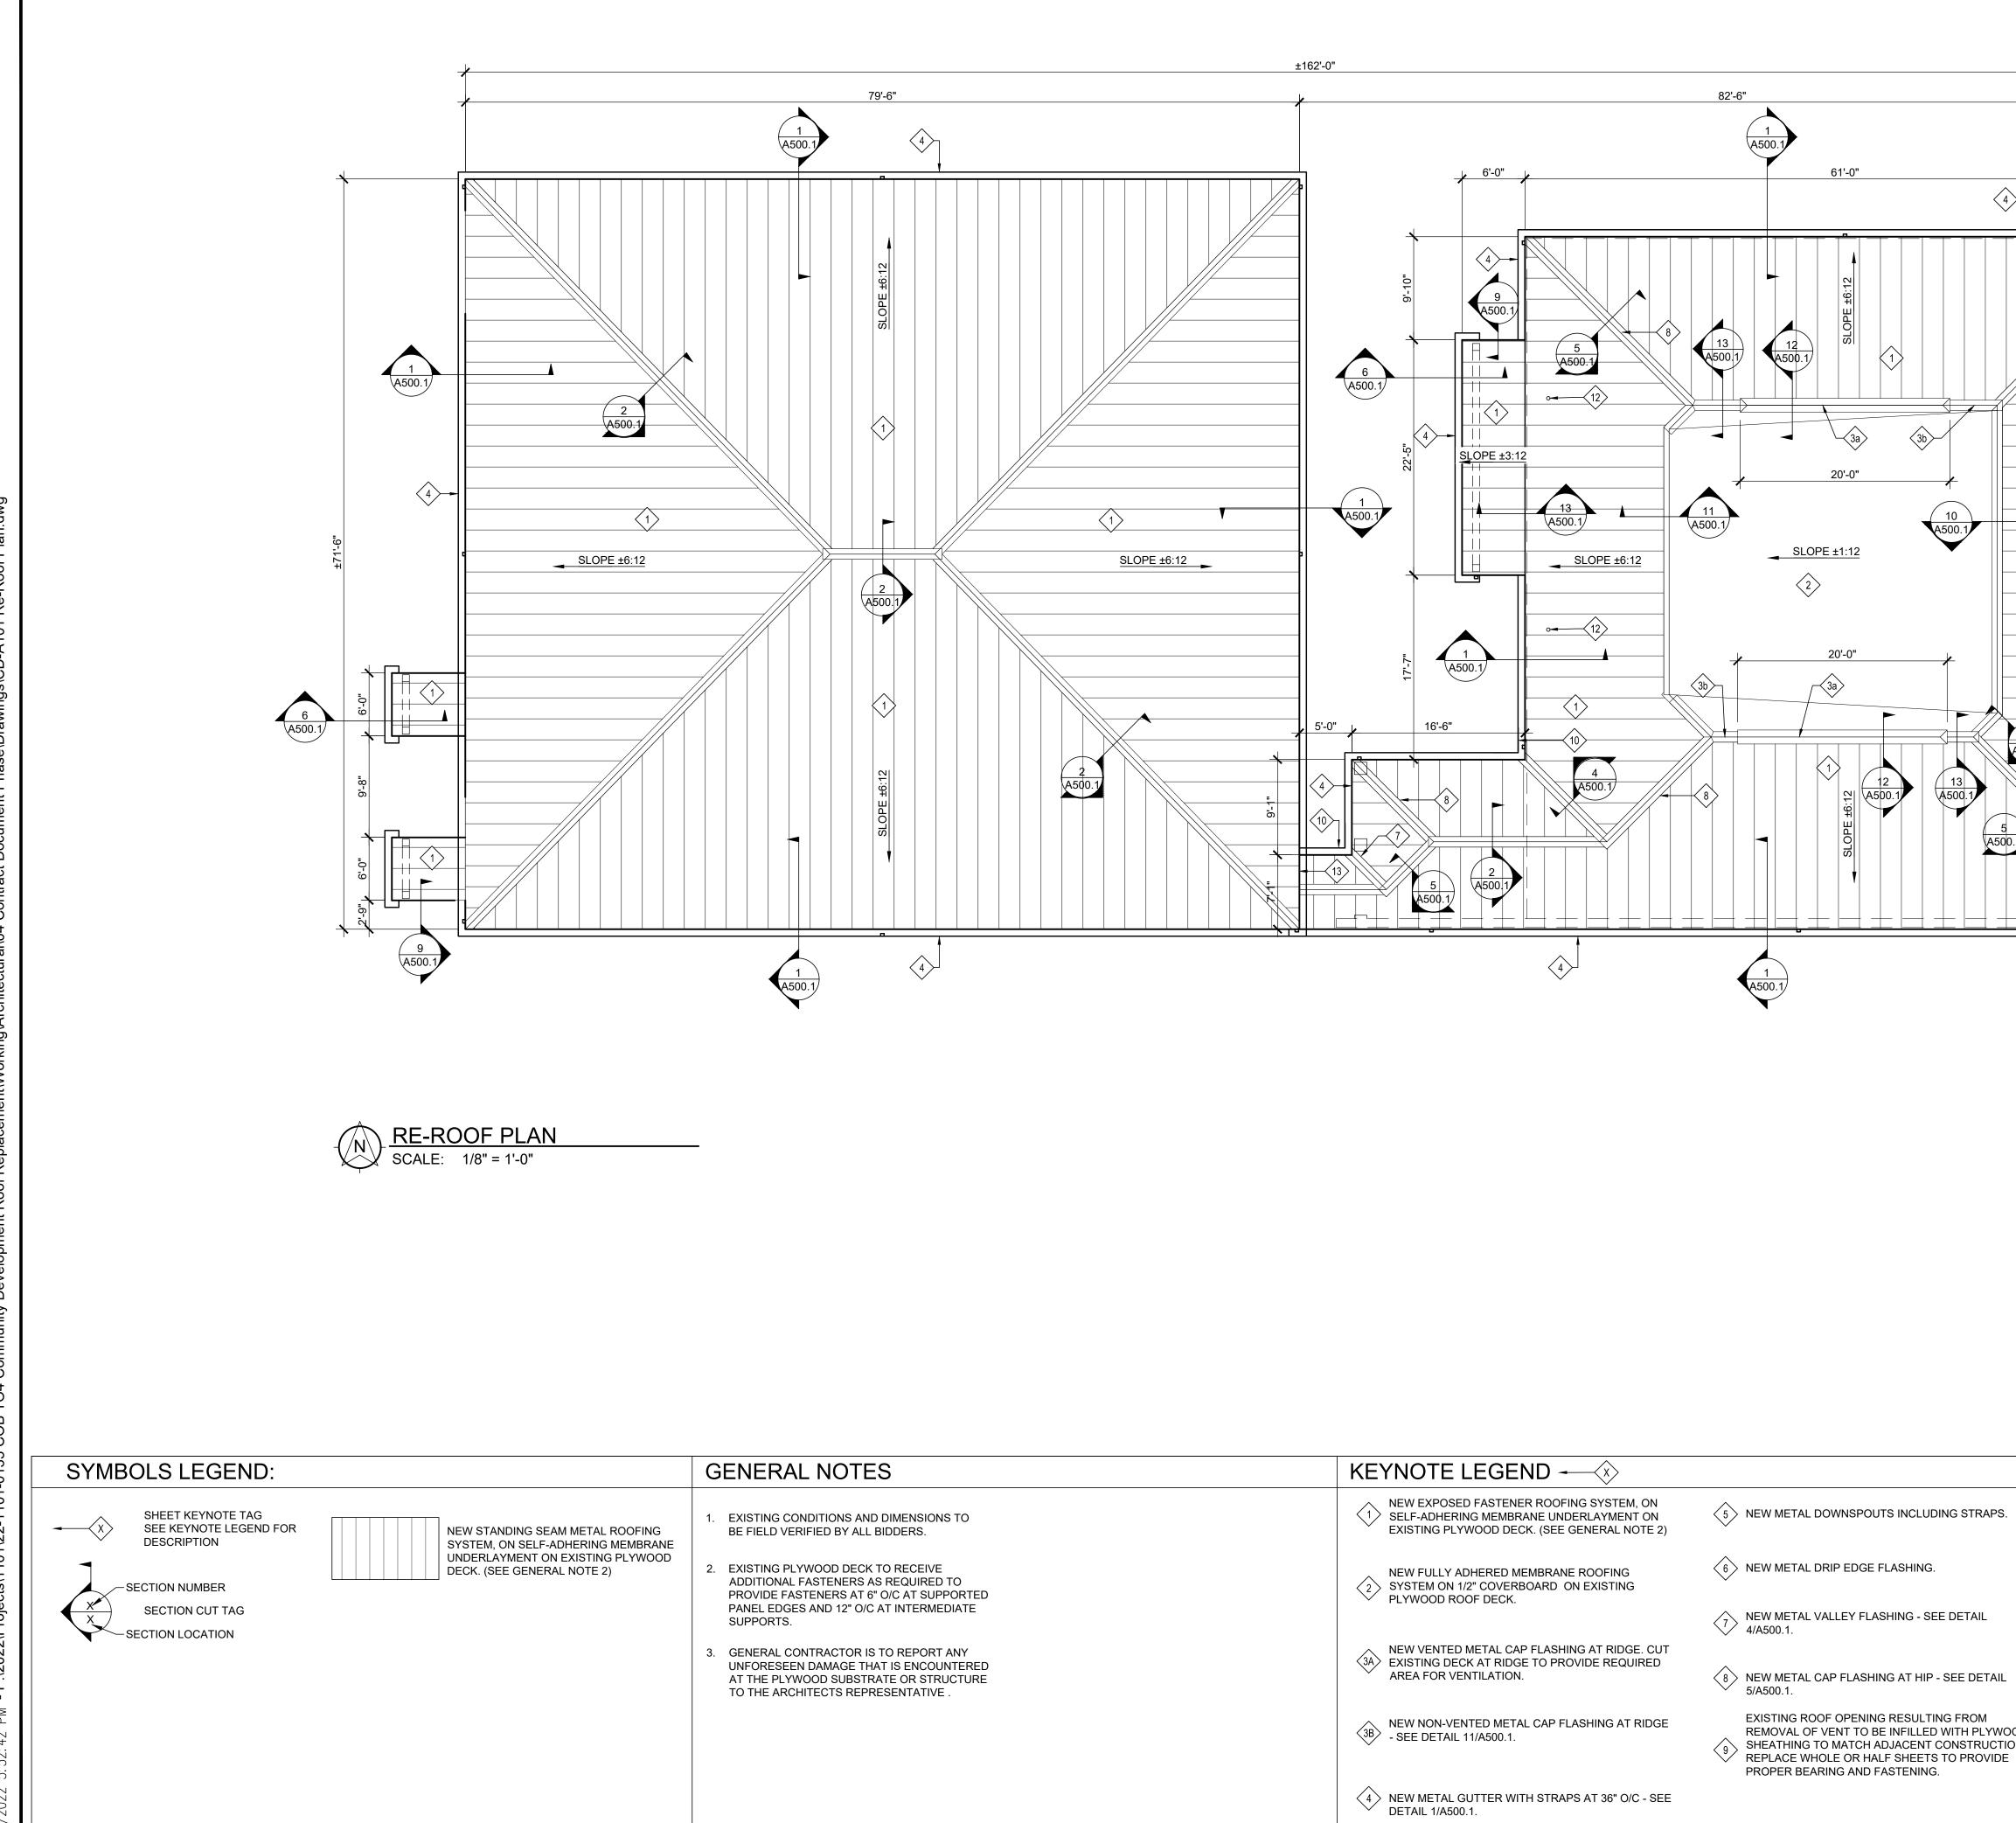



- EXISTING ROOF OPENING RESULTING FROM REMOVAL OF VENT TO BE INFILLED WITH PLYWOO


	Provident and
	CITY OF ORANGE BEACH CITY-WIDE ROOF REPAIRS COMMUNITY DEVELOPMENT BUILDING ROOF REPLACEMENTS 4101 ORANGE BEACH BLD, ORANGE BEACH, AL 36561
S. PROVIDE SPLASH GUARD/DIVERTER AT OUTSIDE EDGE OF NEW GUTTER WHERE VALLEY TERMINATES AT INSIDE CORNER CONNITION. 12 NEW PLUMBING VENT FLASHING AT EXISTING 3" AND 4" PVC VENT STACK THROUGH ROOF. (1) NEW SIDE-WALL FLASHING. SEE 7/A500.1. (1) NEW SIDE-WALL FLASHING. SEE 7/A500.1. (1) NEW VENTED HIP FLASHING. SEE 2/A500.1. VOOD TION. JE	PROJECT NO: 22-1101-0011 REVISIONS: ISSUE DATE 09-22-22 ISSUE 09-22-22 ISSUE DATE 09-22-22 ISSUE 09-20 ISSUE 09-20 I

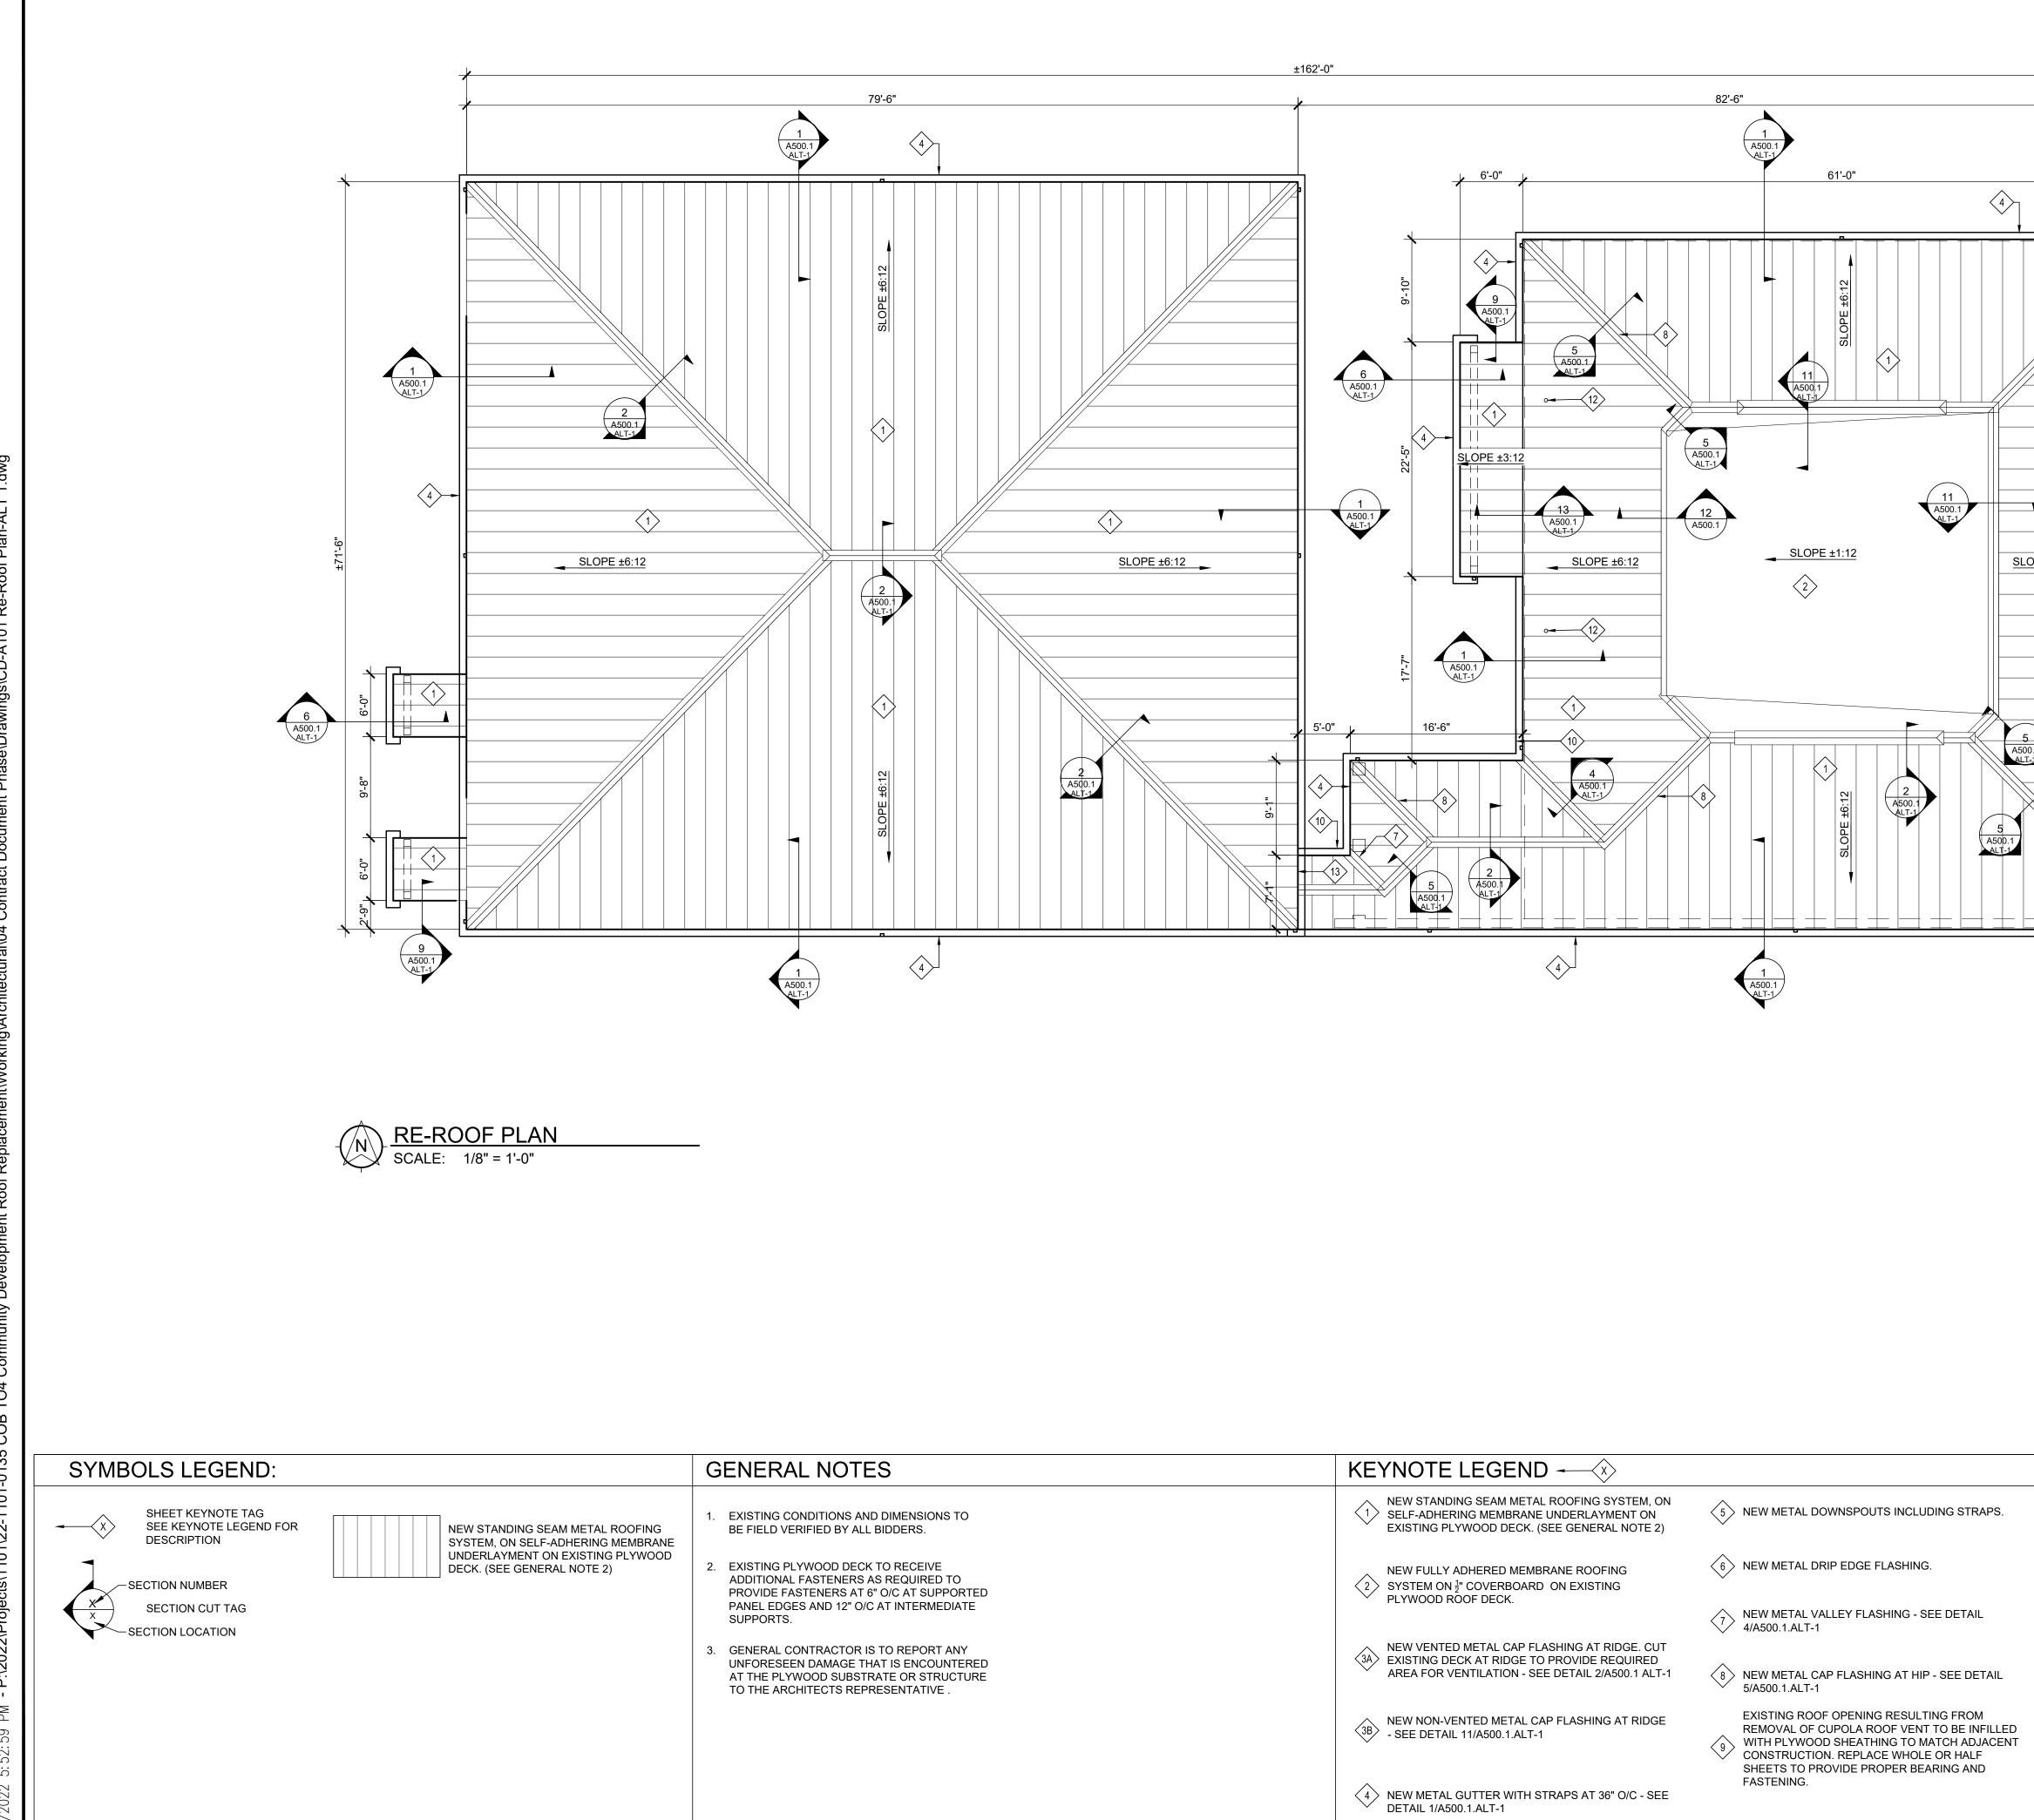



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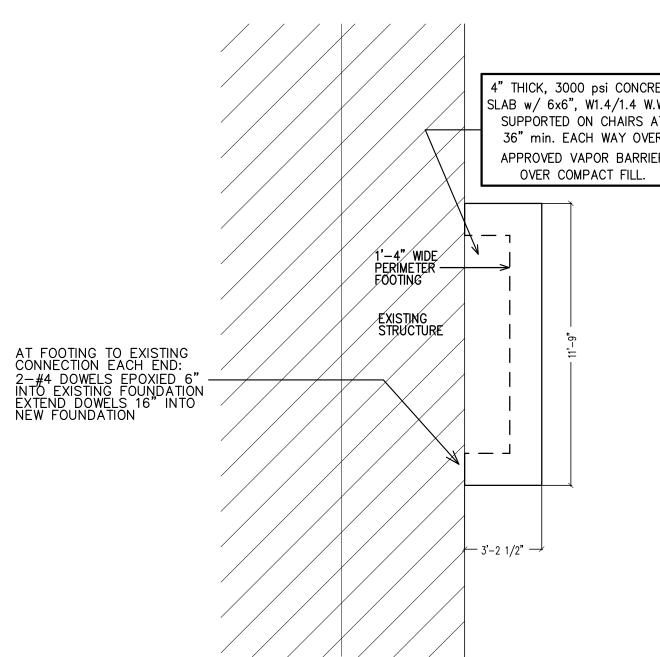


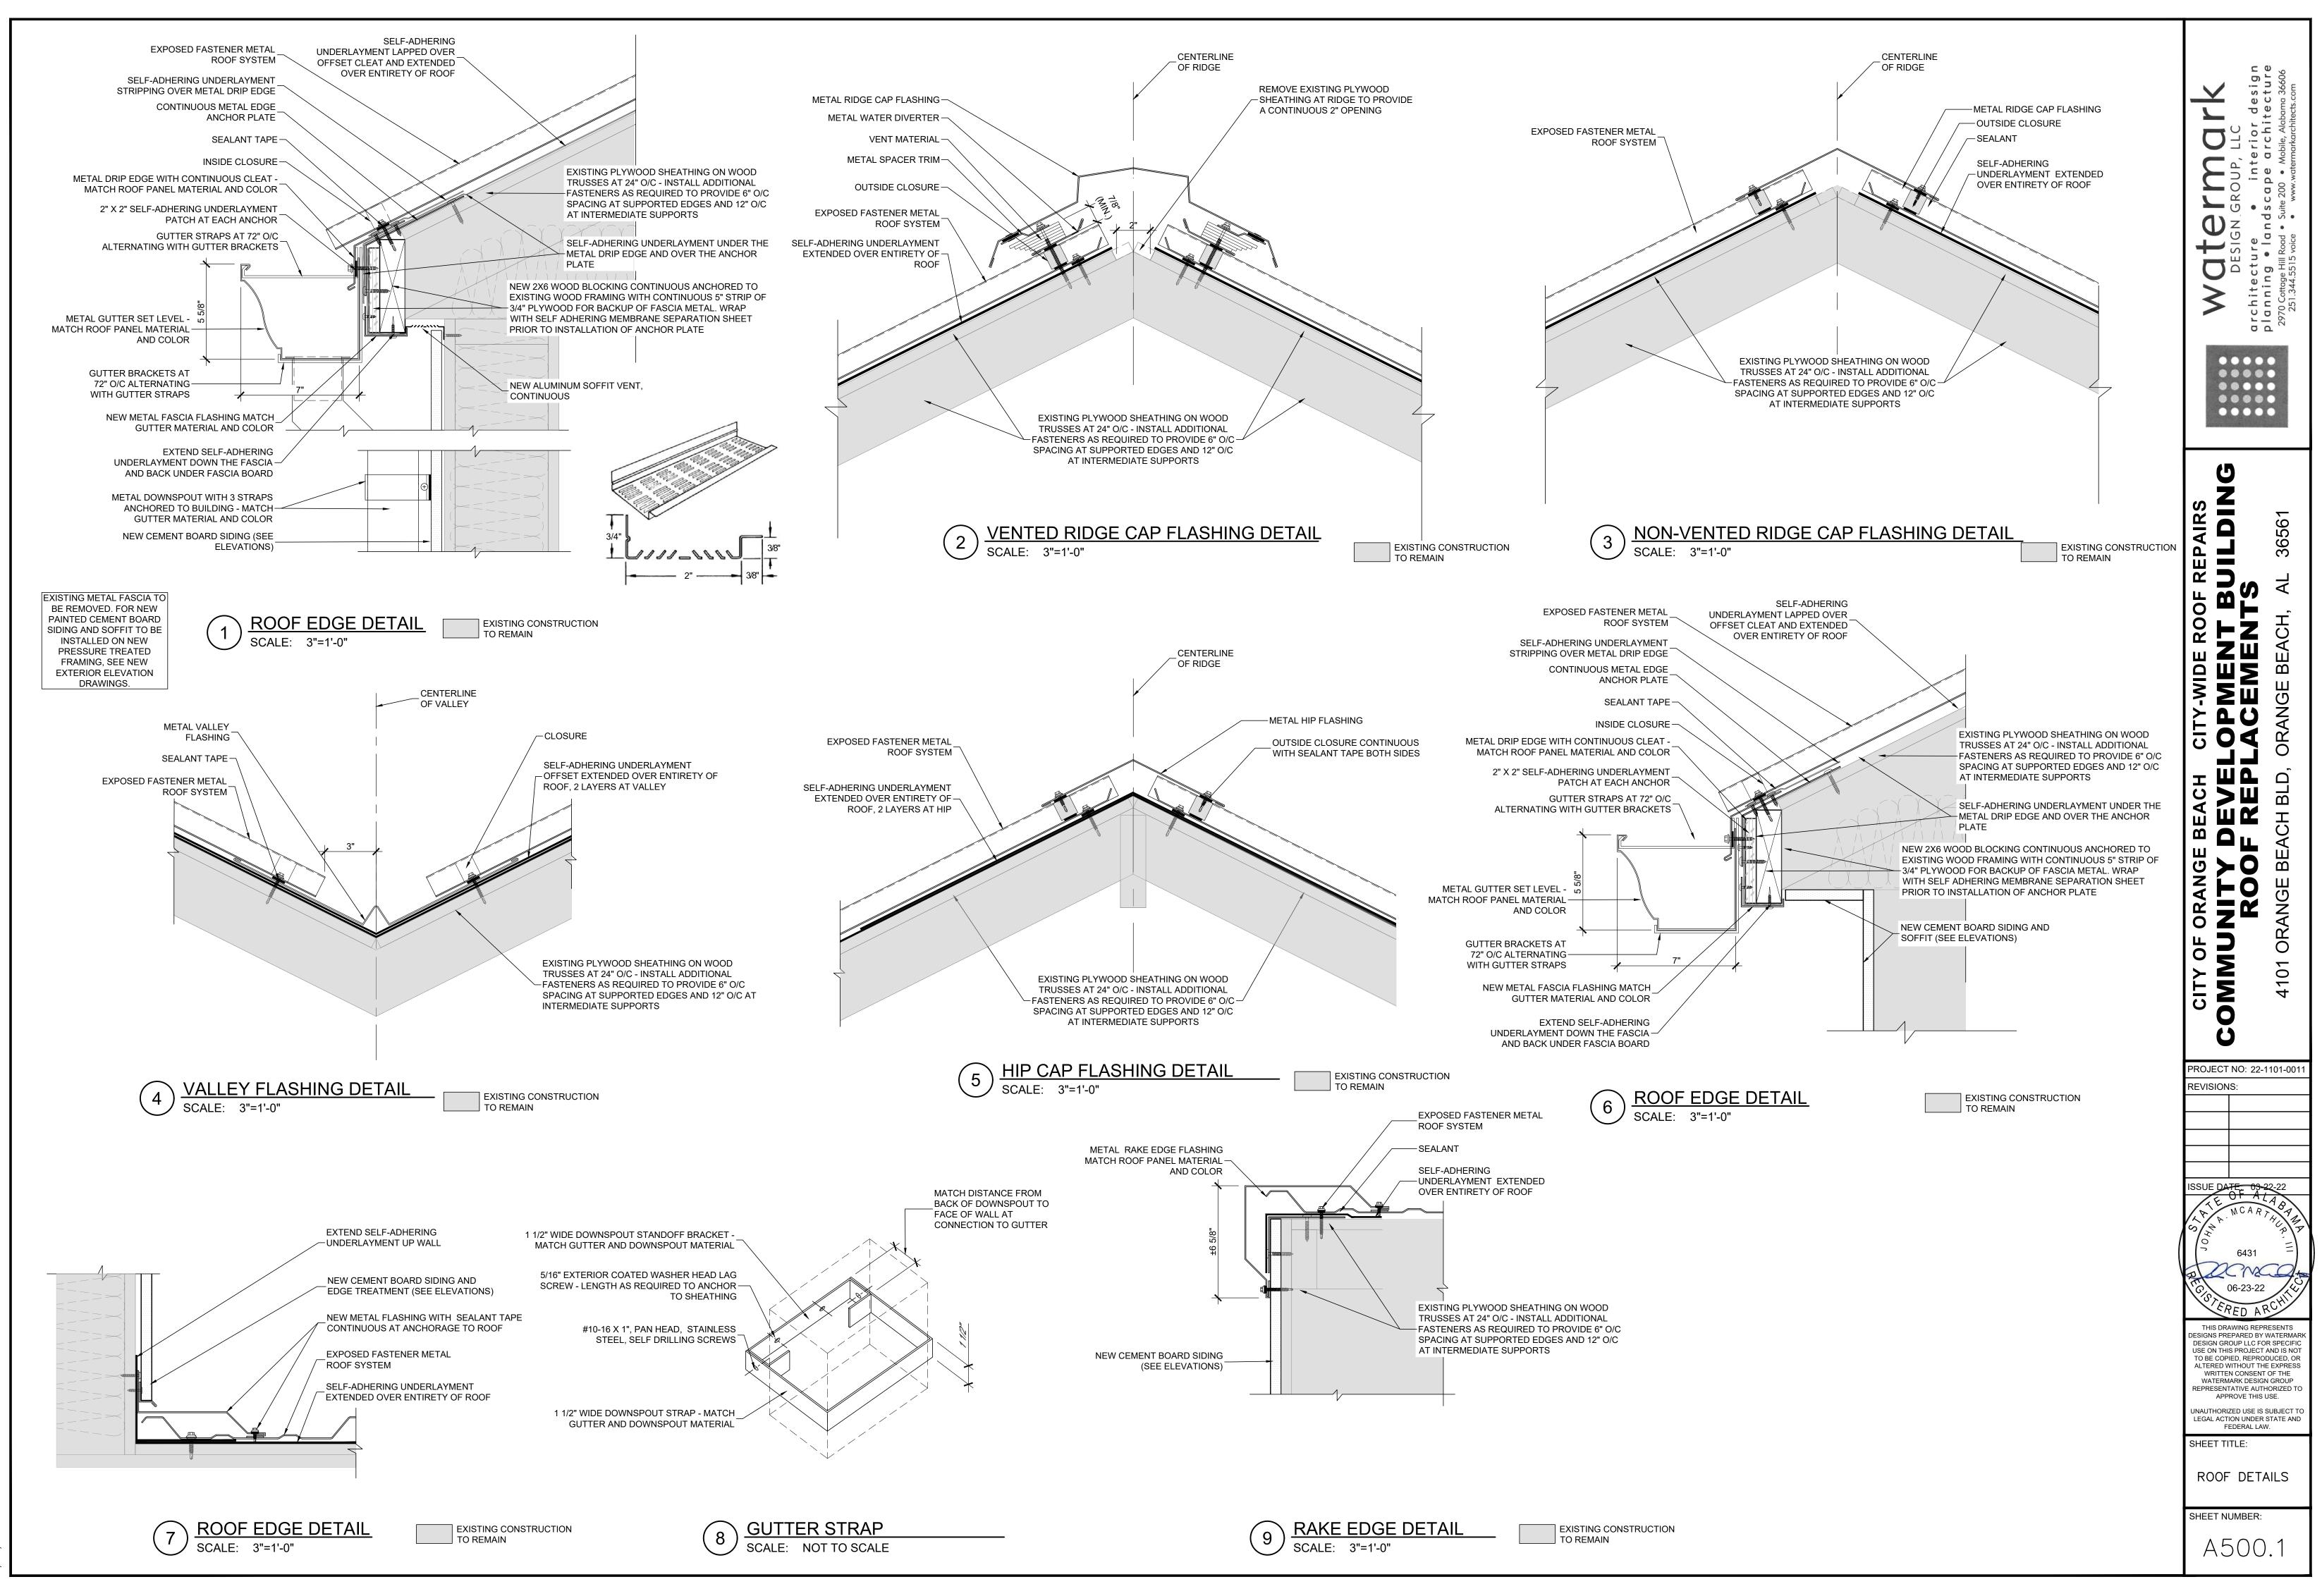

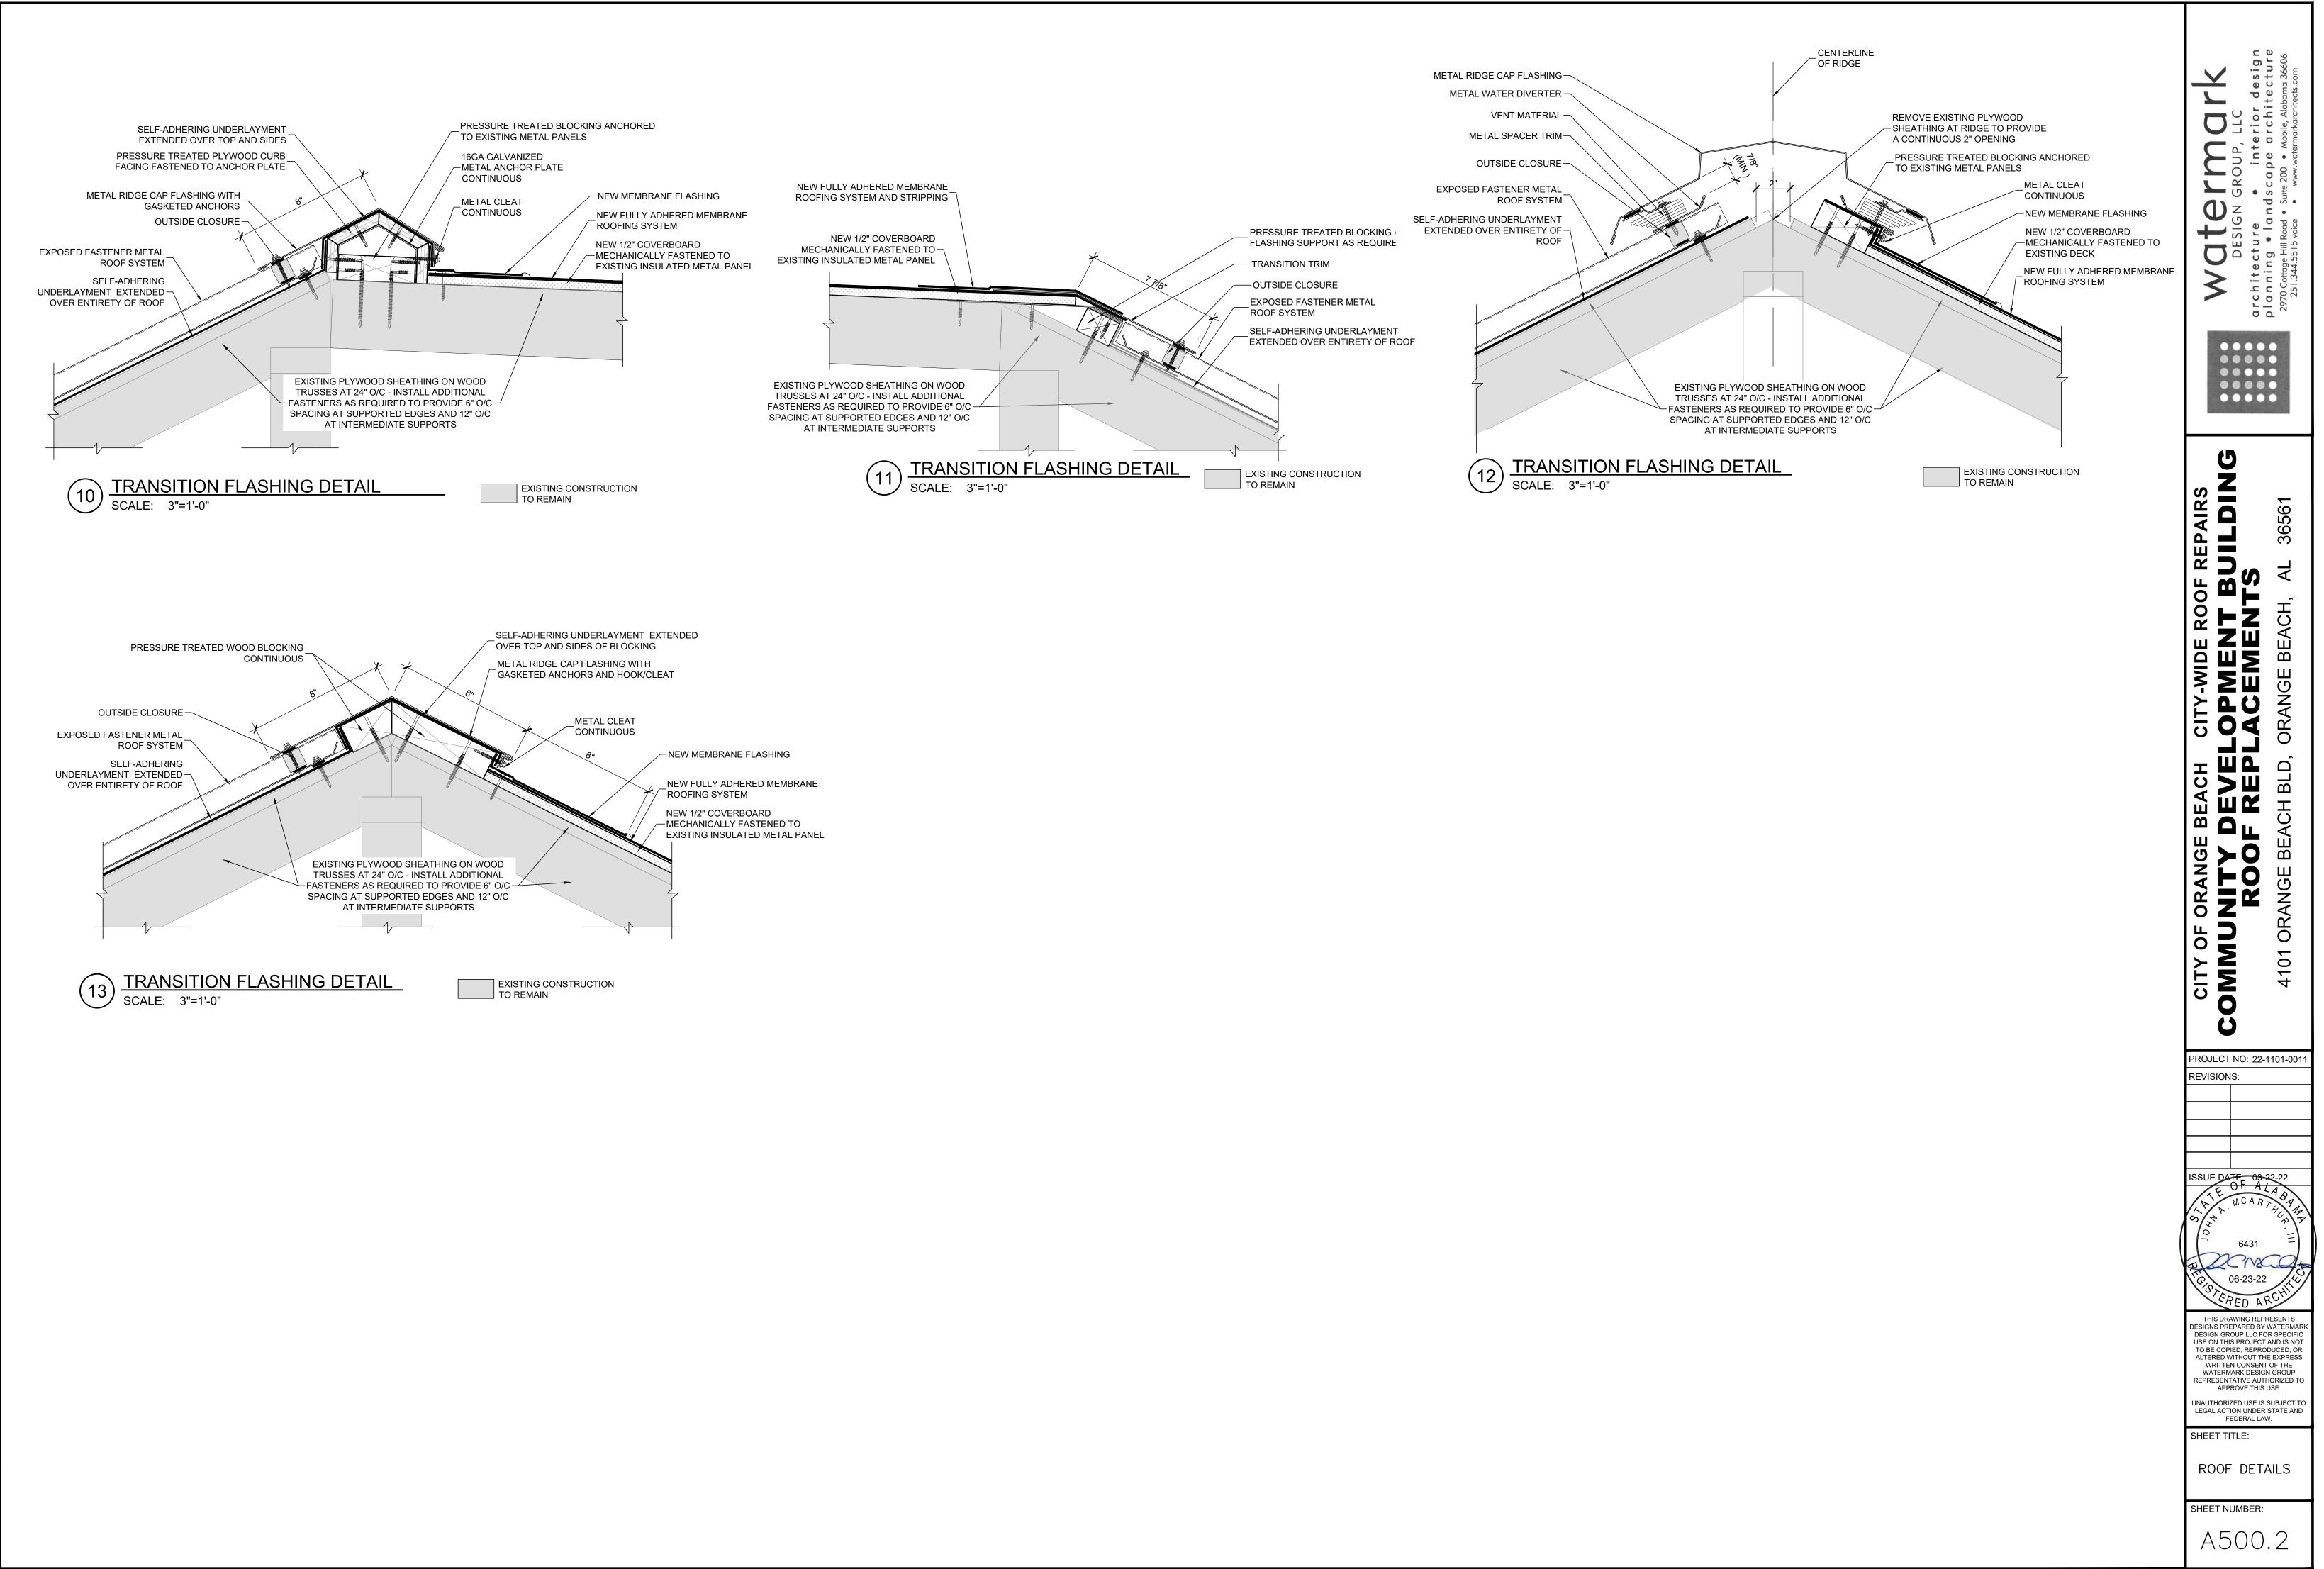

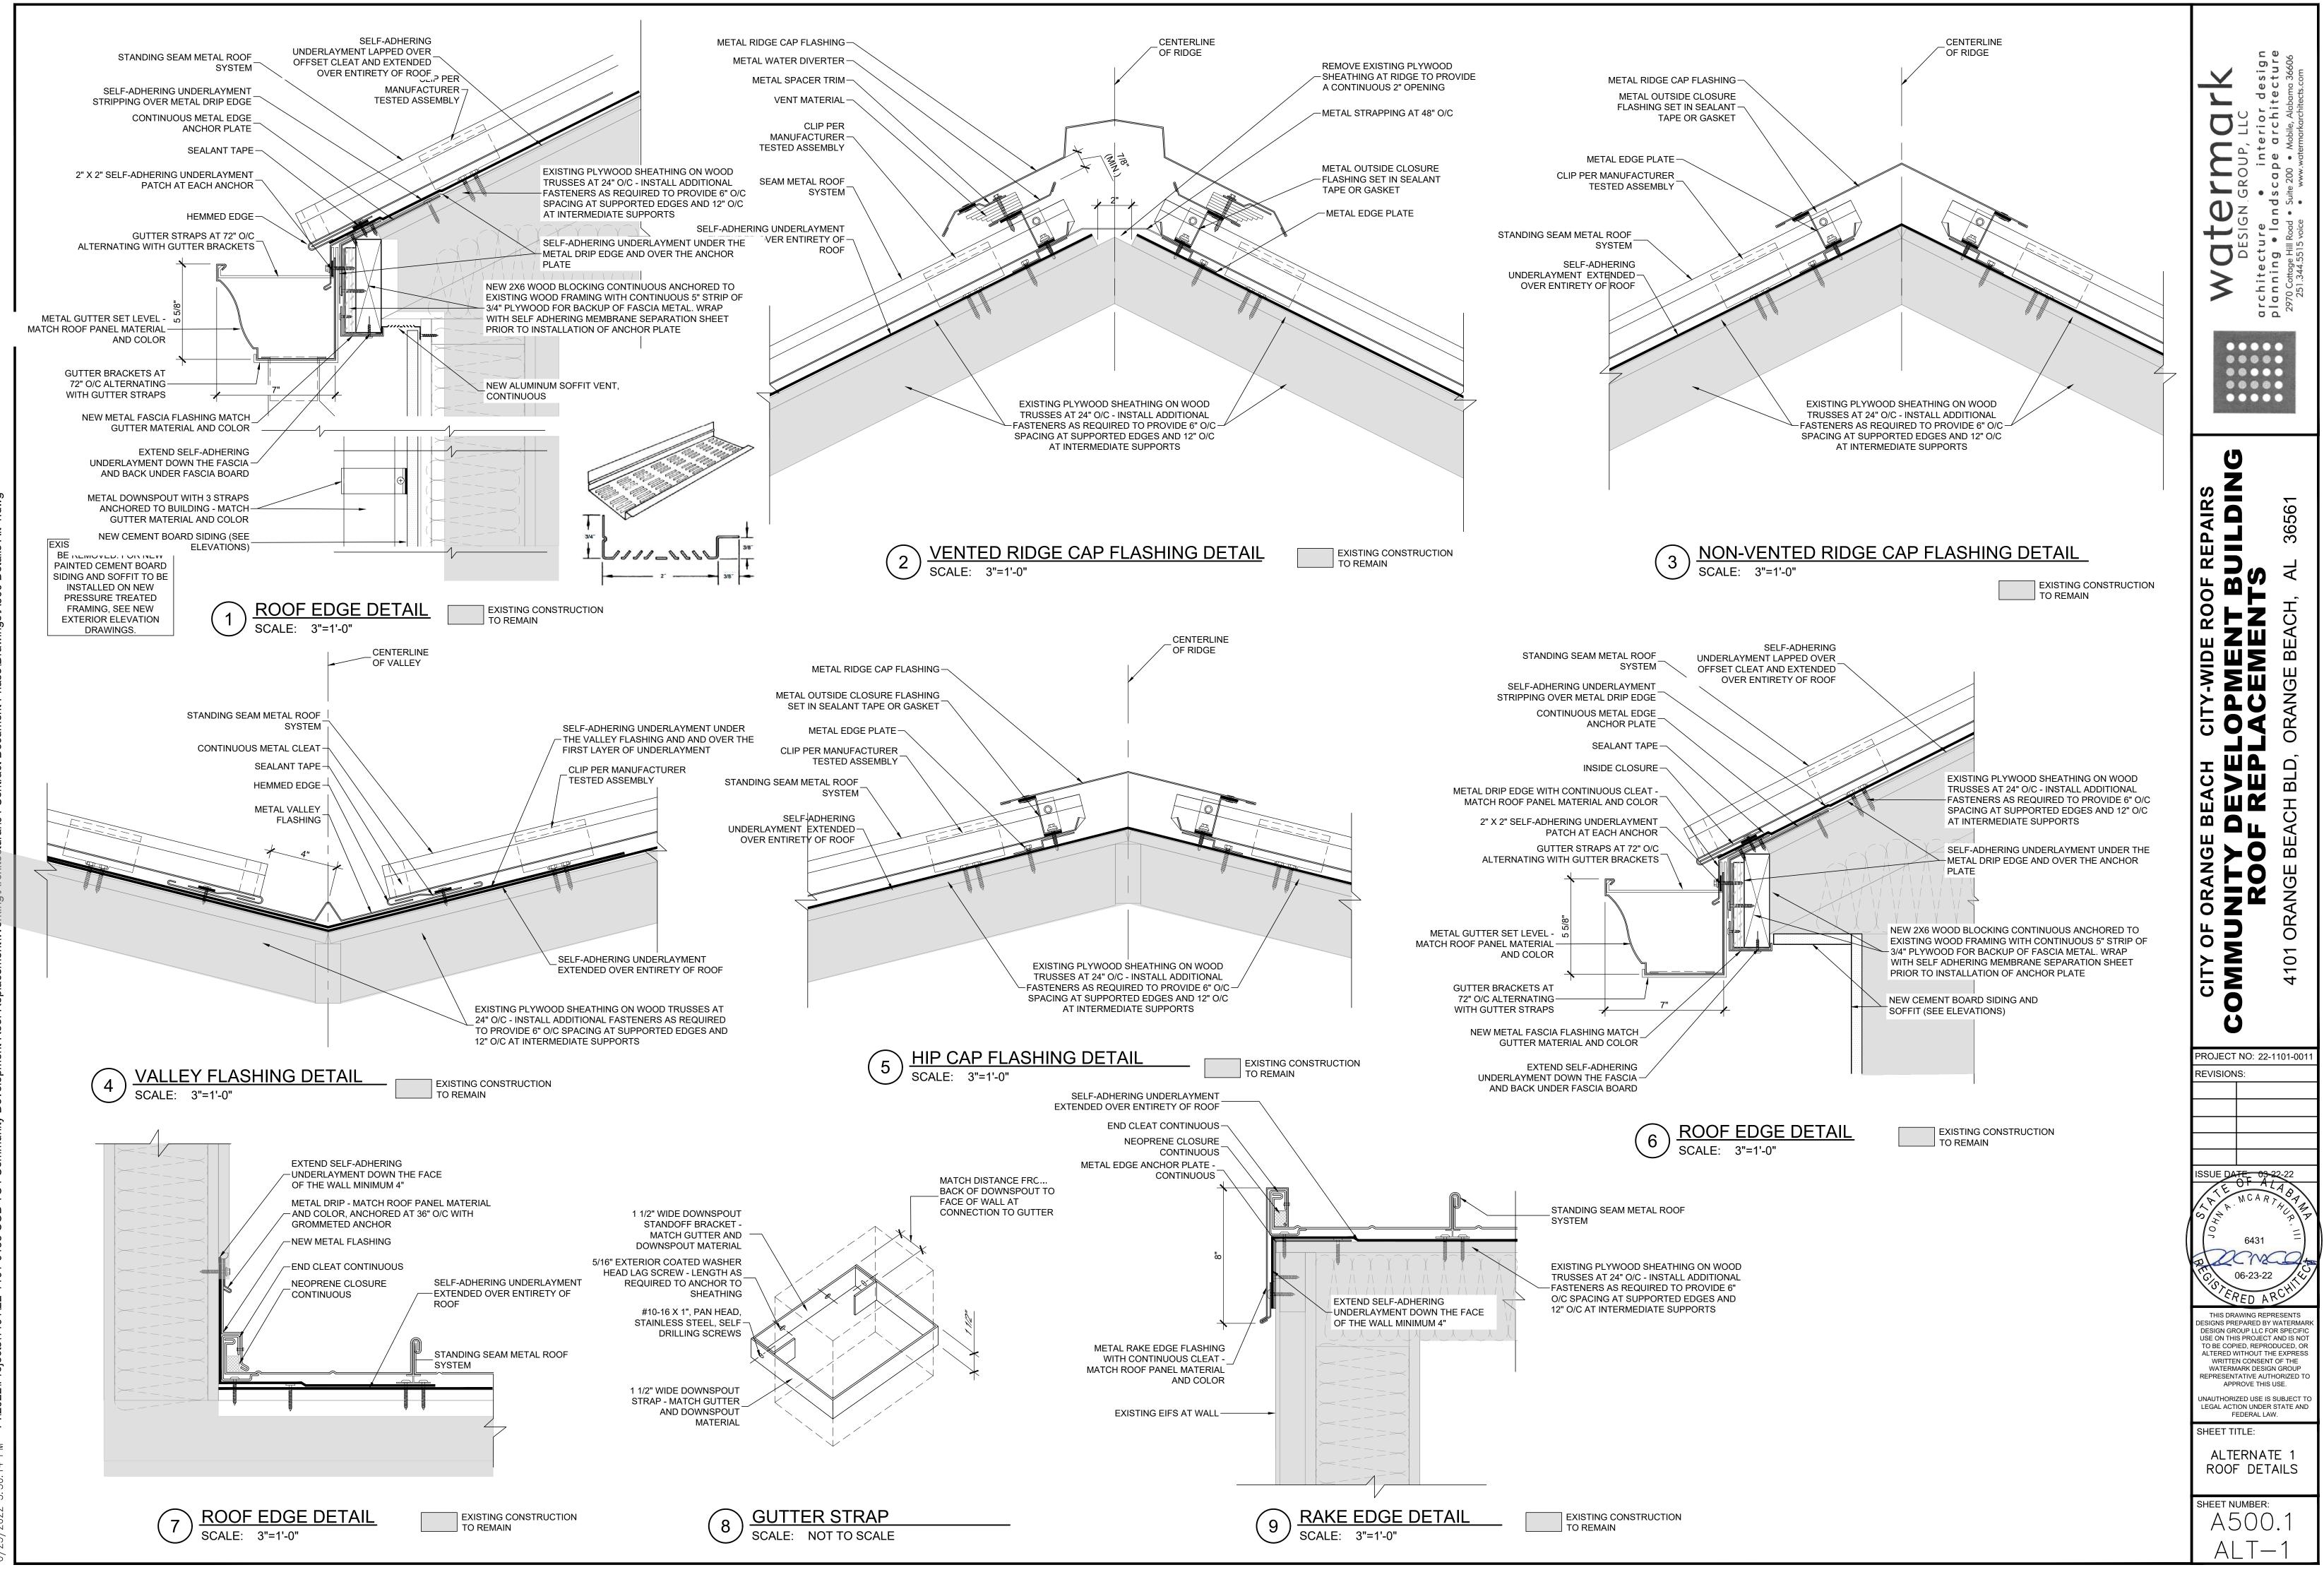

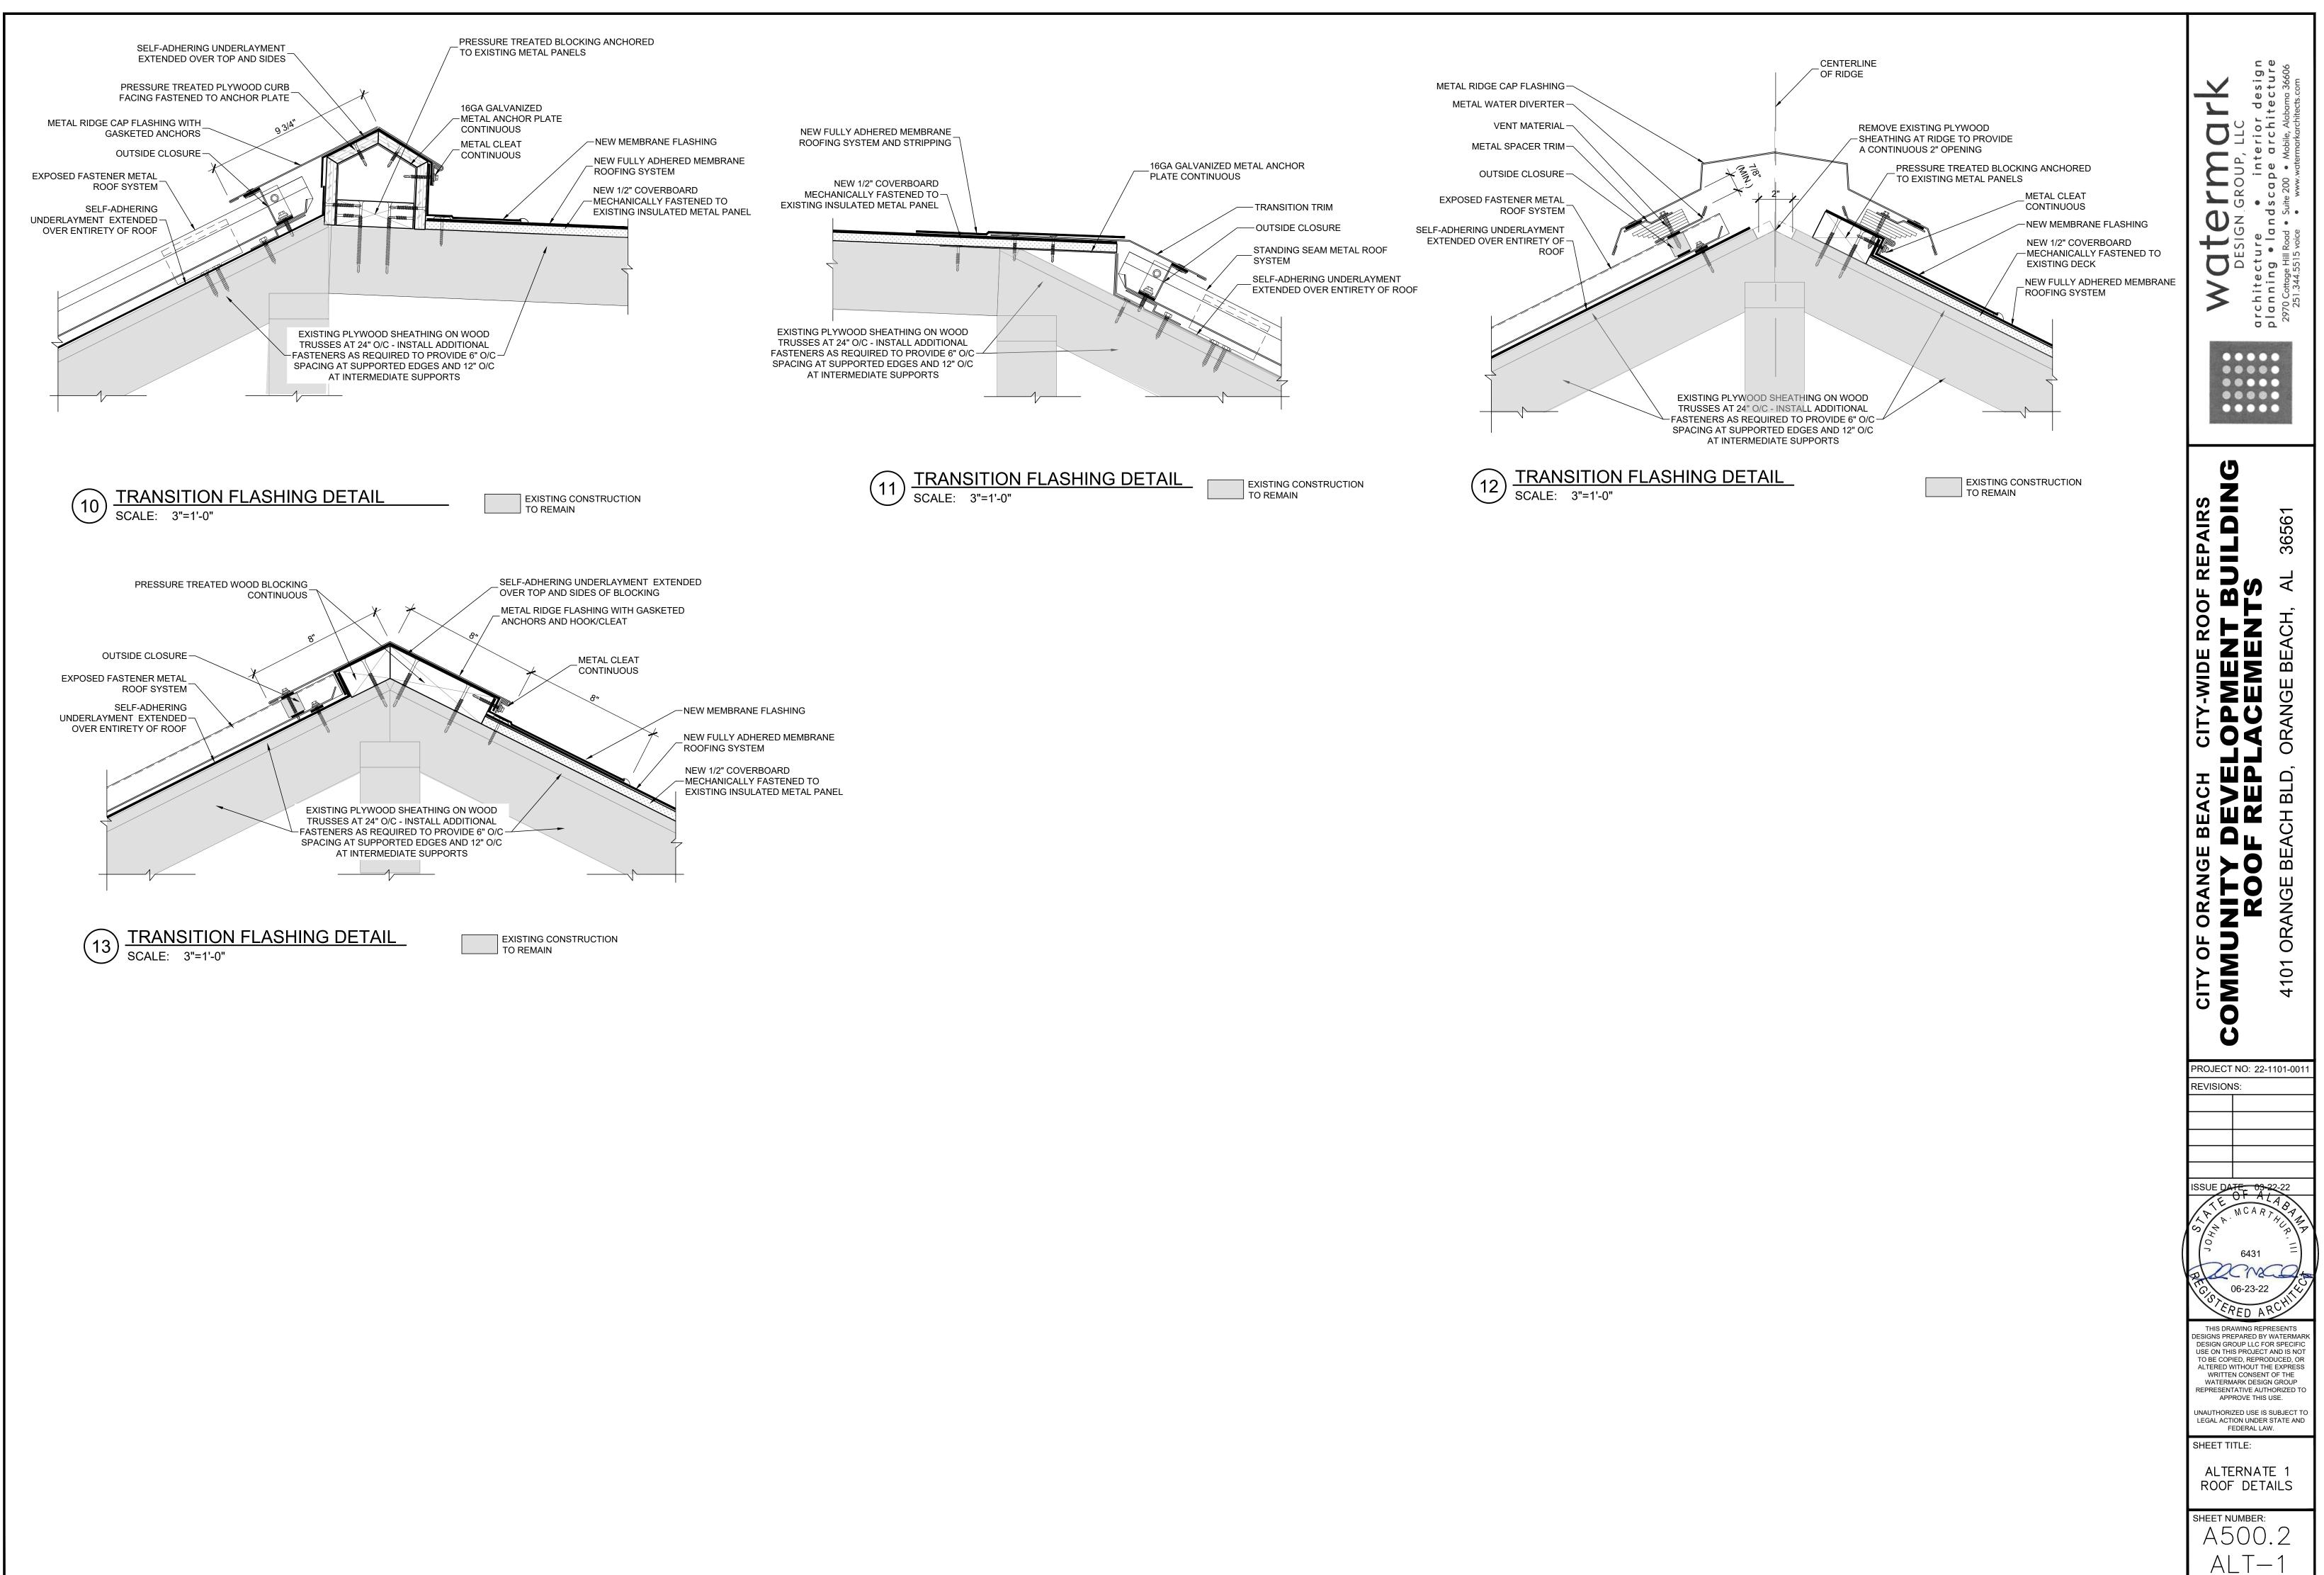

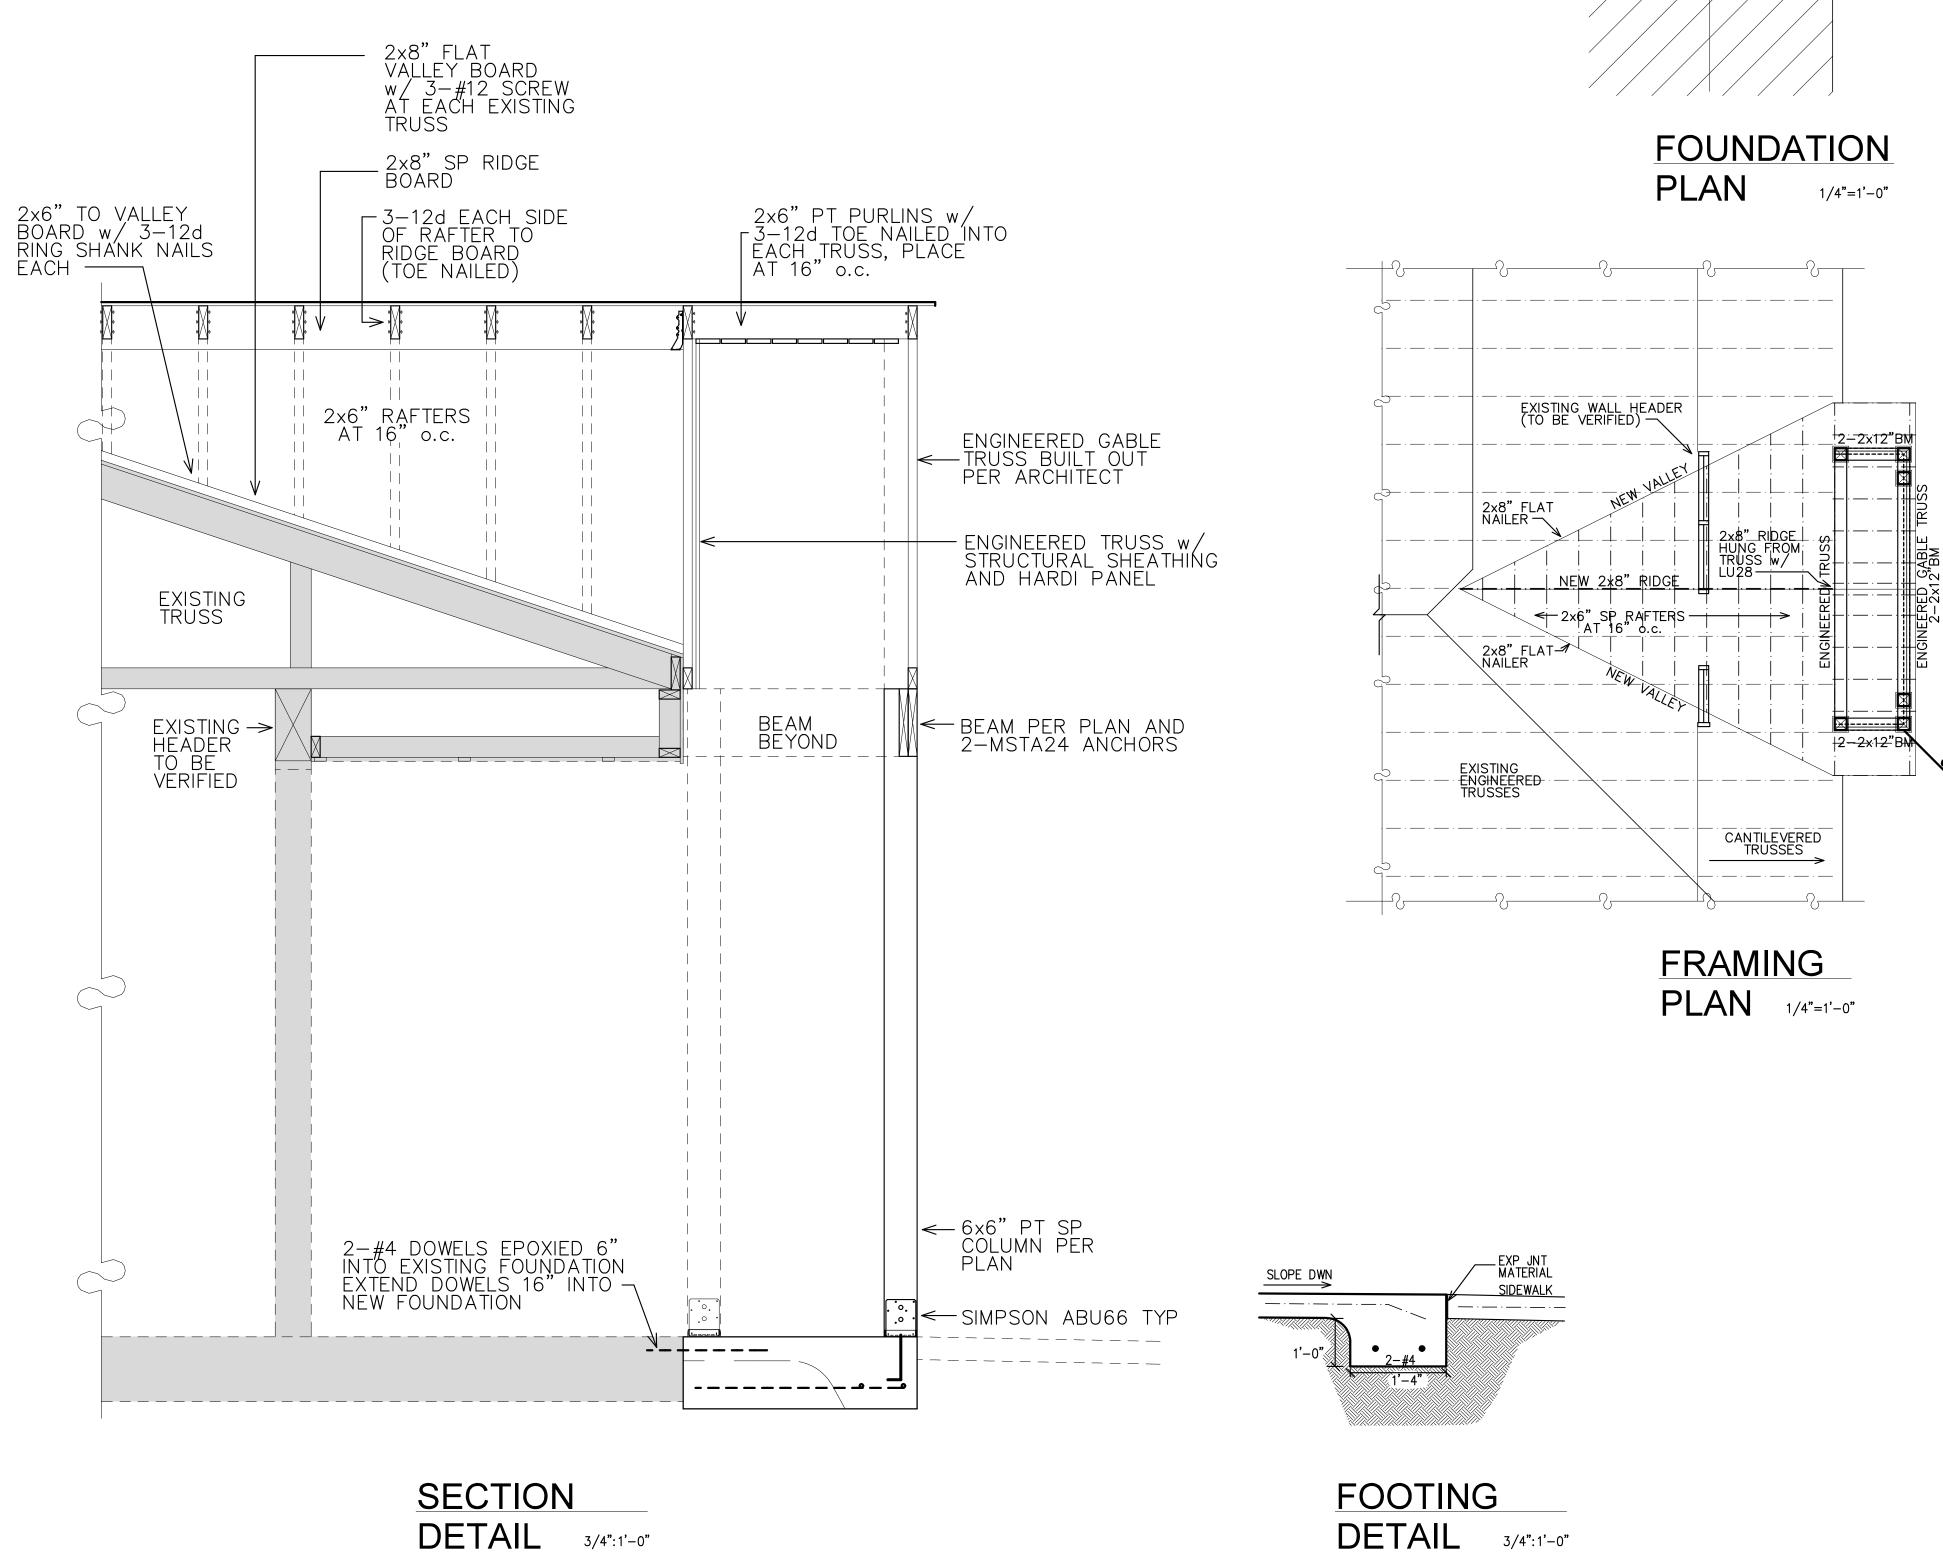

	1. Design Criteria: A. CODES: IRC 2018 AMERICAN CONCRETE INSTITUTE (ACI 318)	
RETE V.W.F. AT	 B. DESIGN LOADS: DEAD AND LIVE LOADS PER ASCE 7–16 WIND LOAD PER ASCE 7–16 SLAB ON-GRADE FOUNDATION DESIGN BASED ON SANDY SOILS w/ 2000 PSF ALLOWABLE BEARING (VERIFY WITH GEOTECHNICAL ENGINEER 	
ER IER	PRIOR TO INITIATION OF WORK) 2. SITE PREPARATION A. ALL CUT AND FILL OPERATIONS SPECIFICATIONS ARE BY OTHERS B. ALL FILL MATERIAL SHALL BE COMPACTED IN 12" LIFTS MAX AND. TO DET MODIFIED DEOCTOR DENSITY	McCollough
	TO 95% MODIFIED PROCTOR DENSITY 3. FOUNDATION: A. ALL CONCRETE SHALL BE BATCH PROPORTIONED, MIXED AND PLACED PER ACI 318 B. ALL CONCRETE SHALL OBTAIN AN ULTIMATE COMPRESSIVE STRENGTH	A RCHITECTURE, INC. P.O. BOX 6310 GULF SHORES, ALABAMA 36547-6310 PHONE: 251-968-7222
	OF 3000 PSI min. C. REFER TO ARCHITECTURAL DRAWINGS FOR ALL PLUMBING, MECHANICAL, ELECTRICAL COMPONENTS CAST INTO CONCRETE D. SLUMP FOR SLAB CONSTRUCTION SHALL NOT EXCEED 4 INCHES	A B A A
	 F. ALL REINFORCING STEEL SHALL BE GRADE 40 min CONFORMING TO ASTM A-615 G. MAINTAIN 3 INCHES CLEAR CONCRETE COVER AT REINFORCEMENT IN FOOTINGS 	No. 25893 * PROFESSIONAL *
	 General Notes: A. CONTRACTOR SHALL VERIFY ALL DIMENSIONS AND SITE CONDITIONS BEFORE INITIATION OF WORK. THE PLANS DESIGNER OR ENGINEER SHALL BE NOTIFIED IN WRITING OF ANY DISCREPANCY. B. THE ENGINEER PREPARING THESE PLANS WILL NOT BE RESPONSIBLE 	C. HAT 06-17-2022 Lane and Hatcher
	FOR, OR LIABLE FOR, UNAUTHORIZED CHANGES TO OR USES OF THESE PLANS. ALL CHANGES TO THE PLANS MUST BE IN WRITING AND MUST BE APPROVED BY THE PREPARER OF THESE PLANS. IF CONTRACTOR DEVIATES FROM THIS PLAN PRIOR TO CONTACTING AND RECEIVING APPROVAL IN WRITING FROM THE DESIGN ENGINEER THE CONTRACTOR SHALL BE LIABLE AND RESPONSIBLE FOR ALL DAMAGES AND CORRECTIONAL COSTS.	Engineers, llc 5125 OAK GLEN DR PACE, FL 850-393-0937 AL. Cert. of Auth: 2453
	C. APPROVAL BY THE INSPECTOR DOES NOT MEAN APPROVAL OR FAILURE TO COMPLY WITH THE PLANS AND SPECIFICATIONS. ANY DESIGN WHICH FAILS TO BE CLEAR OR IS AMBIGUOUS MUST BE REFERRED TO THE ENGINEER OR PLAN DESIGNER FOR INTERPRETATION OR CLARIFICATION.	K
	 D. ENGINEER OF RECORD SHALL NOT BE RESPONSIBLE FOR DAMAGE TO ADJACENT STRUCTURES AS A RESULT OF THIS CONSTRUCTION E. ALL WORKERS SHALL BE COVERED BY WORKERS COMPENSATION INSURANCE CONTRACTOR RESPONSIBLE FOR ALL JOB SITE SAFETY F. ALL EXTERIOR DOORS AND WINDOWS AND ROOF TRUSSES SHALL BE DESIGNED AND INSTALLED TO WITHSTAND DESIGN WIND LOADS BASED ON 	NTE
	ASCE 7-16 G. THE STRUCTURE IS DESIGNED TO BE SELF SUPPORTING AND STABLE AFTER THE BUILDING IS COMPLETE. IT IS THE CONTRACTORS SOLE RESPONSIBILITY TO DETERMINE ERECTION PROCEDURES AND SEQUENCE TO ENSURE SAFETY OF THE BUILDING AND ITS COMPONENTS DURING ERECTION. THIS INCLUDES THE ADDITION OF NECESSARY SHORING, SHEETING, OR TIE DOWNS.	CE
	 5. TIMBER: A. STRUCTURAL TIMBER <u>EXCEPT STUDS</u> SHALL BE #2 SOUTHERN PINE (19% max. MOISTURE CONTENT) B. PLYWOOD/OSB SHEATHING SHALL BE APA RATED (PRP-108) C. EXTERIOR STUD AND SHEAR WALL TO HAVE SOLID BLOCKING AT SHEATHING JOINTS 	IENT
	D.ENGINEERED WOOD MATERIAL SUPPLIERS MUST FURNISH ENGINEERING CALCULATIONS SEALED BY A REGISTERED ALABAMA PROFESSIONAL ENGINEER ON ALL SUPPLIED COMPONENTS. INSTALLATION INSTRUCTIONS MUST BE PROVIDED AT TIME OF DELIVERY FOR ANY FIELD BRACING AND/OR REINFORCEMENT REQUIRED TO SATISFY THE STRUCTURAL PERFORMANCE OF EACH COMPONENT.	EACH DPM CH, AL
	 E. IT IS THE ENGINEERS RECOMMENDATION THAT ALL STEEL FASTENERS EXPOSED TO OCEAN SALT AIR BE CORROSION RESISTANT STAINLESS STEEL. STAINLESS NAILS ARE REQUIRED FOR ALL STAINLESS STEEL FASTENERS. STAINLESS STEEL CONNECTOR <u>REQUIRED</u> WHERE SPECIFICALLY SPECIFIED. ** WHERE STAINLESS STEEL CONNECTORS ARE NOT USED, ALL 	E B B BEAC
	STRONG-TIE PRODUCTS SHALL BE 'ZMAX' (G185) COATED. F. ALL ROOF AND FLOOR FRAMING MEMBERS SHALL BE ENGINEERED AND CERTIFIED BY TRUSS MANUFACTURER. ALL DESIGN DRAWINGS AND LOADS PER TRUSS MANUFACTURER SHALL BE REVIEWED PRIOR TO FABRICATION BY WIND LOAD ENGINEER FOR COMPLIANCE FLOOR FRAMING AND PILE DESIGN LAYOUT. FINAL LAYOUT OF PILES AND SILL BEAMS MAY REQUIRE GEOMETRIC ALTERATION OR STRUCTURAL MEMBER ADDITIONS UPON REVIEW	ORANGI DEVE Alabama's coa
	OF ROOF AND FLOOR FRAMING DESIGNS.	ΓΥ Ι
	DIRECTIONAL PROCEDURE FOR ASCE 7–16 DESIGNED FOR: 160 MPH (ULT.), 120 MPH ALLOWABLE STRESS DESIGN TERRAIN EXPOSURE CATEGORY: D <u>DEAD AND LIVE LOAD:</u> GUST EFFECT FACTOR: 0.85 ROOF LIVE LOAD: 20 PSF INTERNAL PRESSURE: +/- 0.18 ROOF LIVE LOAD: 15 PSF RISK (OCCUPANCY) CATEGORY: II <u>C</u> EILING DEAD LOAD: 5 PSF MINIMUM UNIFORM WIND PRESSURE FOR <u>ROOF CLADDING:</u>	MMUNI
	COMPONENT AREA (s.f.) PRESSURE REQUIREMENT (psf)	MM
	ROOF SYSTEM SHALL MEET ZONE 3 REQUIREMENT HROUGHOUT ROOF AREA N HU IO (-) 125.4 PSF	
	USE COMPONENT AREA OF IO SQ FT FOR ROOFING SYSTEM USE WIND SPEED REQUIRED BY DESIGN CRITERIA LISTED ABOVE	
	FOR EXPOSURE D END ZONE= WITHIN 5FT OF MAIN BUILDING CORNERS FOLLOW FBC FOR ROOF COMPONENT AND CLADDING PRESSURE REQUIREMENTS	JOB NO.:
	NOTE TO TRUSS MANUFACTURER: ABOVE 'BOXED' SECTION IS THE WRITTEN SPECIFICATIONS FOR THE TRUSS DESIGN OF THIS PROJECT. TRUSS MANUFACTURE SHALL MEET OR EXCEED THE REQUIREMENTS FOR WIND/GRAVITY DESIGN AS LISTED INCLUDING REQUIRED WIND SPEED, TERRAIN EXPOSURE CATEGORY, INTERNAL PRESSURE, BUILDING CATEGORY AND IMPORTANCE FACTOR.	DRAWN:ACHCHECKED:ACHDATE:06-17-2022REVISION:
		SCALE: AS NOTED
		SHEET NO.:

S 1
FOUNDATION/FRAMING