NORDHOFF HIGH SCHOOL ROOFING PROJECT NO. 2018-1712

OJAI UNIFIED SCHOOL DISTRICT

ABBREVIATIONS

ADD	REVIATIONS		
Ø	DIAMETER	HR.	HOUR
&	AND	HT.	HEIGHT
CL OR C		INSUL.	INSULATION
#		INT.	INTERIOR
A.B.	ANCHOR BOLT	JT.	JOINT
ABV.	ABOVE		LAMINATE
ACP	ACOUSTICAL CEILING PANEL		LAVATORY
	AREA DRAIN	LT.	LIGHT
	ADJUSTABLE ABOVE FINISH FLOOR	MFR. MATR'L	MANUFACTURER MATERIAL
		MAX.	MAXIMUM
A.I .G. ALUM.	ALUMINUM	M.B.	MACHINE BOLT
BLDG.		MECH.	
BLKG.		MIN.	MINIMUM
BM.	BEAM	MISC.	
B.O.B.	BOTTOM OF BEAM	M.R.	MOISTURE RESISTANT
BOT.		MTL.	METAL
BTWN.		(N)	
CAB.			NOT IN CONTRACT
CALIF. C.F.O.I	CALIFORNIA CONTRACTOR FURNISHED	NO. OR # N.T.S.	NOT TO SCALE
G.F.O.I	OWNER INSTALLED	N.1.3. O/	OVER
C.I.P.	CAST IN PLACE	O.C.	ON CENTER
CJ	CONSTRUCTION JOINT	0.F.C.I.	OWNER FURNISHED
C.J.	CONTROL JOINT		CONTACTOR INSTALLED
C.L.	CHAIN LINK	O.F.O.I.	OWNER FURNISHED
CLG.	CEILING		OWNER INSTALLED
CLR.	CLEAR	OPP.	OPPOSITE
CMU	CONCRETE MASONRY UNIT	PB	PULL BOX
C.O.	CLEAN OUT	PERF.	PERFORATED
C.O.C. COL.		PL. PLAST.	PLATE OR PLASTIC
COL.	COLUMN COMPOSITION	PLAST.	PLYWOOD
CONC	CONCRETE	PR.	
CONSTR.			PROJECTION
CONT.	CONTINUOUS		PRESSURE TREATED
C.T.	CERAMIC TILE		DOUGLAS FIR
DBL.	DOUBLE DOUGLAS FIR DRINKING FOUNTAIN	R OR RAD	RADIUS
DF	DOUGLAS FIR	REFL.	
D.F. DFCI	DIMININO I CONTINUI	REFRIG. REINF.	REFRIGERATOR REINFORCED OR
DECI	CONTRACTOR INSTALL	KEINF.	REINFORCEMENT
DIA.	DIAMETER	REQ.	
DIM	DIMENSION	RM	ROOM
DN	DOWN DOOR DRAWING EXISTING EACH	S.C.	SOLID CORE
DR.	DOOR	SCHED.	SCHEDULE
DWG	DRAWING	SHT'G	SHEATHING
(E)	EXISTING	SHT.	SHEET
EA	EACH	SIM.	SIMILAR
EI ECT	EXPANSION JOINT ELECTRICAL	S M S	SAWCUT JUINT
FLEUT.	ELEVATION	SQ.	SQUARE
EQ	EQUAL		STAINLESS STEEL
EQUIP.	EQUAL EQUIPMENT	ST.	STANDARD
EXIST.	EXISTING EXTERIOR FLOOR DRAIN	STL.	STEEL
EXT.	EXTERIOR	STOR.	STORAGE
FDN	FLOOR DRAIN	STRUCT.	STRUCTURAL
FUN.	FUUNDATION	3U3P.	TOP & BOTTOM
F.E.	FIRE EXTINGUISHER FIRE EXTINGUISHER CABINET		
F.F.	FINISH FLOOR	T.O.	
FIN.	FINISH		TOP OF BEAM
FLR.	FLOOR	TS	TUBE STEEL
F.O.C.	FACE OF CONCRETE	T.W.	TOP OF WALL
F.O.F.	FACE OF FINISH	TYP.	TYPICAL
F.O.S.	FACE OF STRUCTURE	U.N.O.	UNLESS NOTED OTHERWISE
FRAM'G	FRAMING		UNLESS OTHERWISE NOTED
FRP	FIBERGLASS REINFORCED PANEL	V.C.T. VERT.	VINYL COMPOSITION TILE VERTICAL
FT.	FOOT OR FEET	VERT. V.G.D.F.	VERTICAL GRAIN
FTG.	FOOTING	v.U.D.I .	DOUGLAS FIR
F.V.	FIELD VERIFY	V.I.F.	VERIFY IN FIELD
GA.	GAUGE	W/	WITH
GALV.	GALVANIZED	WD.	WOOD
GWB	GYPSUM WALL BOARD	W.O.	WHERE OCCURS
GYP. BD	GYPSUM BOARD	W.P.	WATERPROOF

HORIZ.

HEADER

HOT DIP GALV

HORIZONTAL

HOLLOW METAL

WEIGHT

WATER RESISTANT

DEMOLITION NOTES

- 1. IDENTIFY ALL DAMAGED ELEMENTS DESIGNATED TO REMAIN OR BE RELOCATED. REQUEST CLARIFICATION FROM THE ARCHITECT BEFORE PROCEEDING WITH DEMOLITION WORK.
- 2. GENERAL CONTRACTOR IS RESPONSIBLE FOR REVIEWING AND VERIFYING DEMOLITION PLANS IN RELATION TO STRUCTURAL AND CONSTRUCTION DRAWINGS. CONTRACTOR SHALL VERIFY AND COORDINATE THE EXTENT OF DEMOLITION WORK WITH NEW WORK. THE ARCHITECT SHALL BE NOTIFIED OF ANY AND ALL CONFLICTS, DISCREPANCIES OR PROBLEMS.
- 3. THE CONTRACTOR SHALL VERIFY LOCATION OF ALL UTILITIES PRIOR TO DEMOLITION. THE CONTRACTOR SHALL BEWARE OF POTENTIAL HAZARDS FROM DEMOLITION WORK NEAR UTILITIES. PIPES AND CONDUIT ENCOUNTERED IN DEMOLISHED PARTITIONS AND AREAS WHICH ARE TO REMAIN IN USE SHALL BE RE-ROUTED AND CONCEALED. THOSE WHICH ARE TO BE ABANDONED SHALL BE CAPPED AND CONCEALED IN FLOOR, WALL OR CEILING.
- 4. THE GENERAL CONTRACTOR SHALL ERECT ALL NECESSARY TEMPORARY SOLID AND/OR PLASTIC DROP CLOTH PARTITIONS TO PROTECT AREAS TO REMAIN WHILE DEMOLITION AND CONSTRUCTION ARE IN PROGRESS.
- 5. BRACE AND SUPPORT EXISTING WORK PRIOR TO AND DURING DEMOLITION AND NEW WORK, AND UNTIL SAFE TO REMOVE SUCH BRACING AND SUPPORTS. THE CONTRACTOR IS RESPONSIBLE FOR ALL STRUCTURAL SHORING DESIGN AND CALCULATIONS.
- 6. THE CONTRACTOR SHALL PERFORM ALL DEMOLITION WORK REQUIRED INCLUDING THE REMOVAL AND PROPER DISPOSAL OF ALL DEBRIS, BROKEN CONCRETE, ETC., FROM THE SITE. PROPER SHORING SHALL BE EXECUTED FOR THE SAFETY OF THE STRUCTURE AND WORKMEN.
- 7. THE OWNER SHALL HAVE FIRST RIGHTS OF REFUSAL FOR ALL DEMOLISHED MATERIALS.
- 8. THE CONTRACTOR SHALL BE RESPONSIBLE FOR ALL DAMAGE RESULTING FROM DEMOLITION AT NO ADDITIONAL COST TO THE OWNER. THE GENERAL CONTRACTOR SHALL BE EXTREMELY CAREFUL TO PROTECT AND NOT TO DAMAGE ANY PORTION OF EXISTING INSTALLATION NOT BEING REMOVED. ANY EXISTING FACILITIES INDICATED TO REMAIN WHICH ARE SO DAMAGED SHALL BE REPLACED EQUAL TO ORIGINAL CONDITION AND TO THE SATISFACTION OF THE OWNER.
- 9. CUT EXISTING PORTIONS OF WALLS, FLOORS, CEILINGS, ETC., WHERE INDICATED AND AS NECESSARY FOR NEW WORK. UNLESS SPECIFICALLY SHOWN ON THESE PLANS. NO STRUCTURAL MEMBER SHALL BE CUT. NEITHER DRILLED NOR NOTCHED, WITHOUT PRIOR WRITTEN AUTHORIZATION FROM THE STRUCTURAL ENGINEER. THE ARCHITECT AND THE AUTHORITY HAVING JURISDICTION.
- 10. ALL TRADES CONCERNED SHALL COORDINATE EACH OTHER'S WORKS PRIOR TO AND DURING DEMOLITION.
- 11. ANY PROJECTING OR SURFACE-MOUNTED ITEMS BEING ABANDONED SHALL BE REMOVED, CAPPED AND CONCEALED BEHIND FINISHED SURFACES, UNLESS OTHERWISE NOTED. PATCH AND FINISH TO MATCH EXISTING ADJACENT SURFACE.
- 12. SURFACES WHERE MATERIAL IS REMOVED TO INSTALL NEW WORK OR TO RECEIVE NEW FINISH SHALL BE REPAIRED AND PATCHED TO MATCH ORIGINAL CONDITIONS. RETEXTURE AND REPAINT WALL OR CEILING WHERE PATCHED TO MATCH EXISTING, WITH NO EVIDENCE THAT PATCH HAS OCCURRED.
- ALL EXISTING AREAS TO REMAIN OR NEW CONSTRUCTION WORK THAT ARE DAMAGED SHALL BE PATCHED AS REQUIRED TO MATCH EXISTING ADJACENT AREA IN MATERIAL, FINISH AND COLOR, UNLESS OTHERWISE
- 14. ALL EQUIPMENT AND MATERIAL WHICH ARE IN OPERATING CONDITION WHEN REMOVED SHALL BE MAINTAINED AS SUCH AND RETURNED TO THE OWNER OR TO BE REINSTALLED WHERE INDICATED. PROPERLY RECONNECT EQUIPMENT TO RESUME OPERATION.

GENERAL NOTES

- 1. THE PROJECT MANUAL ISSUED AS PART OF THESE CONSTRUCTION DOCUMENTS IS AN INTEGRAL PART OF THE CONTRACT DOCUMENTS.
- 2. THE CONTRACTOR SHALL BE RESPONSIBLE FOR MAINTAINING THAT ALL WORKMANSHIP, MATERIALS AND CONSTRUCTION SHALL BE IN COMPLIANCE WITH THE APPLICABLE CODES AND FEDERAL REQUIREMENTS AND REGULATIONS.
- 3. THE CONTRACTOR SHALL VISIT THE SITE AND VERIFY ALL DIMENSIONS PRIOR TO SUBMITTING A BID. THE CONTRACTOR IS ALSO RESPONSIBLE FOR OBTAINING ALL REQUIRED PERMITS.
- 4. THE CONTRACTOR SHALL VERIFY ALL EXISTING CONDITIONS, GRADES, ELEVATIONS AND DIMENSIONS BEFORE STARTING WORK. THE ARCHITECT SHALL BE NOTIFIED IMMEDIATELY OF ANY DISCREPANCY OR INCONSISTENCY
- 5. THE CONTRACTOR SHALL DETERMINE THE LOCATION OF ALL EXISTING UTILITY SERVICES IN THE AREA TO BE EXCAVATED PRIOR TO THE BEGINNING OF EXCAVATION. THE CONTRACTOR SHALL PROTECT ALL UTILITY LINES AND SERVICE LINES TO REMAIN WHICH ARE ENCOUNTERED DURING
- 6. THE CONTRACTOR SHALL BE RESPONSIBLE FOR THE ENFORCEMENT OF FEDERAL AND STATE OF CALIFORNIA OCCUPATIONAL SAFETY AND HEALTH ADMINISTRATION REQUIREMENTS AND REGULATIONS.
- 7. DO NOT SCALE ANY DRAWINGS IN THIS SET.
- 8. ALL DIMENSIONS SHALL TAKE PRECEDENCE OVER SCALE SHOWN ON PLANS. SECTIONS AND DETAILS. SPECIFIC NOTES AND DETAILS SHALL TAKE PRECEDENCE OVER GENERAL NOTES AND TYPICAL DETAILS.
- 9. ALL OMISSIONS AND CONFLICTS BETWEEN THE VARIOUS ELEMENTS OF THE WORKING DRAWINGS AND/OR SPECIFICATIONS SHALL BE BROUGHT TO THE ATTENTION OF THE ARCHITECT IMMEDIATELY BEFORE PROCEEDING WITH ANY WORK SO INVOLVED. NO CHANGES ARE TO BE MADE UNLESS THE ARCHITECT AND THE OWNER ARE NOTIFIED IN WRITING AND APPROVE SUCH A CHANGE ACCORDING TO THE CONTRACT.
- 10. THE ARCHITECT IS NOT RESPONSIBLE FOR ASBESTOS ABATEMENT.
- 11. TRADE NAMES AND MANUFACTURERS REFERRED TO ARE FOR QUALITY STANDARDS ONLY. SUBSTITUTIONS WILL BE PERMITTED AS APPROVED BY THE OWNER AND THE ARCHITECT ONLY UPON SUBMITTAL, AND FOR A LIMITED PERIOD.
- 12. ITEMS SHOWN AS N.I.C. ON PLANS MAY REQUIRE SEPARATE SUBMITTALS. APPROVALS AND PERMITS. INSTALLING CONTRACTOR IS RESPONSIBLE FOR **OBTAINING PERMITS FOR SUCH ITEMS.**
- 13. CONTRACTOR SHALL ENSURE ALL FINISH MATERIALS WILL BE FLUSH WHERE NEW FINISH SURFACE MATERIALS JOIN EXISTING TO PROVIDE SMOOTH TRANSITION.
- 14. CONTRACTOR ACKNOWLEDGES THAT DRAWINGS ARE DIAGRAMMATIC IN NATURE AND ARE TO REPRESENT THE INTENT OF THE WORK TO BE ACCOMPLISHED. CONTRACTOR IS TO INSTALL MATERIALS AND SYSTEMS WITH EXPERIENCED SKILLED CRAFTSMEN WHO WILL BE RESPONSIBLE FOR
- THE INTEGRITY OF THEIR RESPECTIVE WORK. NOT EVERY DETAIL OF EACH CONDITION IS DRAWN. CONTRACTOR AND SUB-CONTRACTOR ARE RESPONSIBLE FOR COMPLETE WORKMANLIKE INSTALLATION OF ALL MATERIALS AND SYSTEMS AND WILL NEED TO PROVIDE ADDITIONAL DETAILS FOR INSTALLATION BASED ON GENERAL INFORMATION SHOWN. FOR INSTANCE, NOT EVERY WATERPROOFING OR FLASHING DETAIL FOR EVERY CONDITION IS SHOWN. CONTRACTOR IS TO PROVIDE DETAILS AND INSTALLATION FOR A COMPLETE WATERTIGHT INSTALLATION.
- 15. THE INTENT OF THESE DRAWINGS AND SPECIFICATIONS IS THAT THE WORK OF THE ALTERATION, REHABILITATION OR RECONSTRUCTION IS TO BE IN ACCORDANCE WITH TITLE 24, CALIFORNIA CODE OF REGULATIONS. SHOULD ANY EXISTING CONDITION NOT COVERED BY THE CONTRACT DOCUMENTS SUCH AS DETERIORATION OR NON-COMPLYING CONSTRUCTION BE DISCOVERED, DETAILS AND SPECIFICATIONS FOR THE REQUIRED WORK SHALL BE SUBMITTED TO AND APPROVED BY THE AUTHORITY HAVING JURISDICTION BEFORE PROCEEDING WITH THE WORK.
- DURING CONSTRUCTION PERIOD, CONSTRUCTION MATERIALS SHALL BE SPREAD OUT IF PLACED ON FRAMED FLOORS OR ROOF. THE LOAD SHALL NOT EXCEED THE DESIGN LIVE LOADS FOR EACH PARTICULAR LEVEL.

APPLICABLE CODES

CONSTRUCTION SHALL COMPLY WITH THE FOLLOWING PARTS OF THE TITLE 24 OF THE CALIFORNIA CODE OF REGULATIONS (CCR):

2016 CALIFORNIA BUILDING STANDARDS ADMINISTRATIVE CODE, C.C.R. TITLE 24 PART 1 AND 2

2016 CALIFORNIA BUILDING CODE (CBC), PART 2, TITLE 24 C.C.R. 2016 CALIFORNIA ELECTRICAL CODE (CEC), C.C.R. TITLE 24 PART 3 2016 CALIFORNIA MECHANICAL CODE (CMC), C.C.R. TITLE 24 PART 4 2016 CALIFORNIA PLUMBING CODE (CPC), C.C.R. TITLE 24 PART 5 2016 CALIFORNIA ENERGY CODE, C.C.R. TITLE 24 PART 6 2016 CALIFORNIA HISTORICAL CODE, C.C.R. TITLE 24 PART 8 2016 CALIFORNIA FIRE CODE, C.C.R. TITLE 24 PART 9 2016 CALIFORNIA EXISTING BUILDING CODE, C.C.R. TITLE 24 PART 10 2016 CALIFORNIA GREEN BUILDING STANDARDS CODE, C.C.R. TITLE 24 PART 11 2016 CALIFORNIA REFERENCED STANDARDS CODE, C.C.R. TITLE 24 PART 12

APPLICABLE STANDARDS

2016 CBC (FOR SFM) REFERENCED STANDARDS CHAPTER 35

AUTOMATIC SPRINKLER SYSTEMS (CALIF. AMENDED), 2016 EDITION

TITLE 19 C.C.R., PUBLIC SAFETY, STATE FIRE MARSHAL REGULATIONS

DRY CHEMICAL EXTINGUISHING SYSTEMS, 2017 EDITION WET CHEMICAL EXTINGUISHING SYSTEMS, 2017 EDITION PRIVATE FIRE SERVICE MAINS (CALIF. AMENDED), 2016 EDITION NATIONAL FIRE ALARM CODE (CALIF. AMENDED), 2016 EDITION CRITICAL RADIANT FLUX OF FLOOR COVERINGS, 2015 EDITION CLEAN AGENT FIRE EXTINGUISHING SYSTEMS (CALIF. AMENDED), NFPA 2001

LEGEND — – PROPERTY LINE

2015 EDITION

1:12 ► SLOPING SURFACE

→ DETAIL NUMBER A4 - SHEET DETAIL APPEARS ON 2 SECTION NUMBER


SHEET SECTION APPEARS ON

CONCRETE

SOIL

PLYWOOD

WOOD BLOCKING

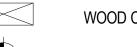

WOOD CONTINUOUS MEMBER



KEYNOTE

CONTROL POINT



1222A

DOOR NUMBER REFERENCE, REFER TO DOOR SCHEDULE WINDOW NUMBER REFERENCE, REFER TO WINDOW TYPES

WORK POINT, CONNECTION POINT, DATUM POINT OR

WALL TYPE REFERENCE, REFER TO AD101-AD106

SIGN TYPE REFERENCE, REFER TO AD701 TICK INDICATES DIMENSIONS TO FACE OF STUD. GRIDLINES

DOT INDICATES DIMENSION TO CENTERLINE

OR FACE OF STRUCTURE

ARROW INDICATES DIMENSION TO F.O. FINISH OR CLEAR DIMENSION

SPOT ELEVATION

SHEET INDEX

G-000 TITLE SHEET SITE PLAN

BLDG H - ROOF DEMOLITION PLAN BLDG I & J - ROOF DEMOLITION PLANS

BLDG F - ROOF DEMOLITION PLAN BLDG G - ROOF DEMOLITION PLANS

BLDG H - ROOF PLAN BLDG I & J - ROOF PLANS

BLDG F - ROOF PLAN BLDG G - ROOF PLANS

ROOF DETAILS - TYPICAL ROOF DETAILS - TYPICAL

PROJECT DIRECTORY

CLIENT OJAI UNIFIED SCHOOL DISTRICT 414 E. OJAI AVE

OJAI, CA 93023 CONTACT: ADAM DUTTER P: (805) 640-4300

ARCHITECT

ROESLING NAKAMURA TERADA ARCHITECTS, INC. 285 N VENTURA AVE, SUITE 102 VENTURA. CA 93001 CONTACT: CATHERINE YOUNG P: (805) 626-5330

PROJECT DESCRIPTION


REMOVE AND REPLACE ROOF OF:

BUILDING F BUILDING G BUILDING H BUILDING I BUILDING J

ROOF RESTORATION OF:

BUILDING Q (BUILT-UP ROOFING)

VICINITY MAP

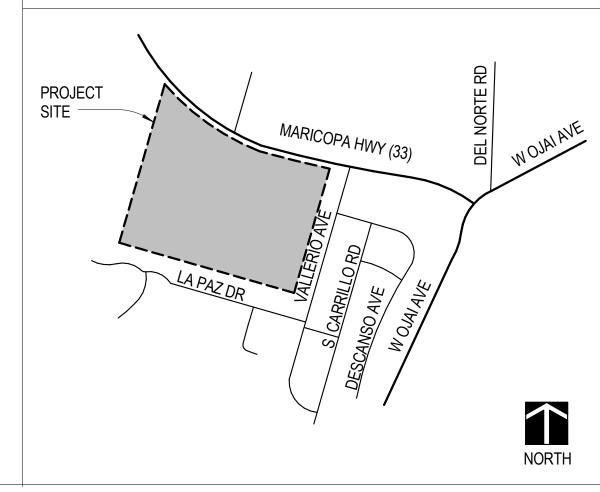



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OJAI **UNIFIED** SCHOOL DISTRICT

NORDHOFF HIGH SCHOOL **ROOFING PROJECT**

1401 MARICOPA HWY, OJAI, CA 93023

100% CDs


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TITLE SHEET

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17761.11 01/10/2019 Drawn by Checked by CY Sheet Number

G-000



SHEET GENERAL NOTES

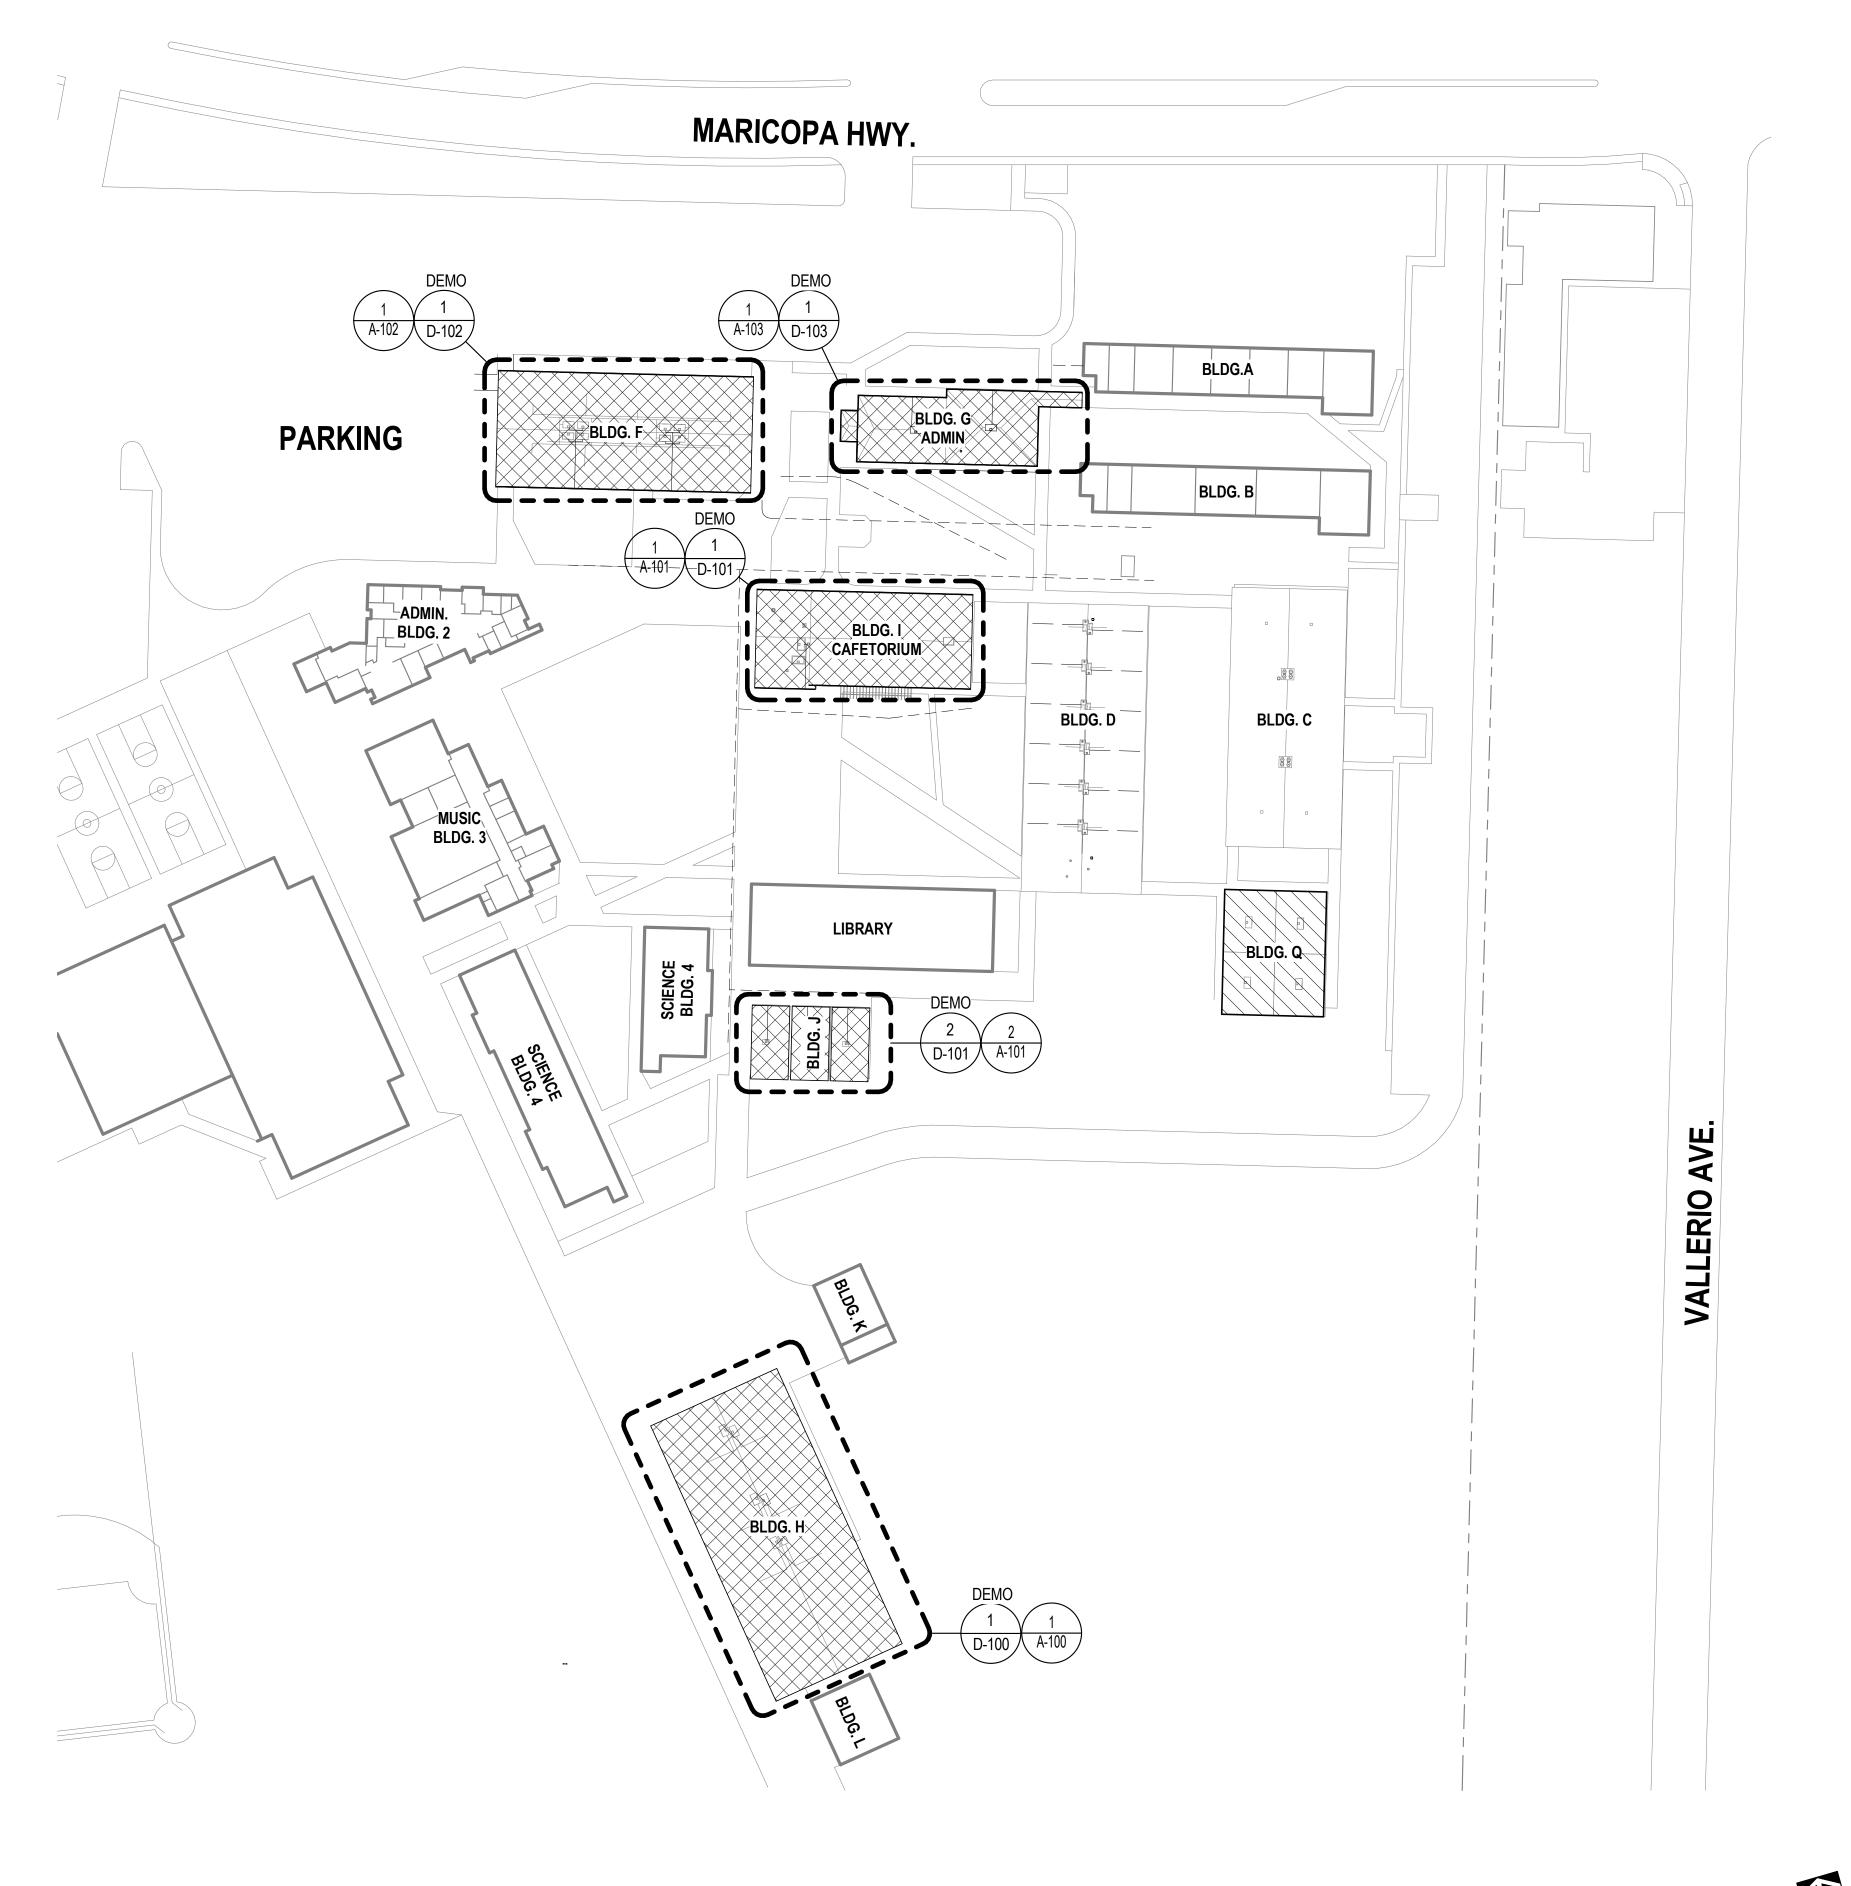LEGEND

 PROTECT ADJACENT STRUCTURES, EQUIPMENT, VEHICLES ETC. FROM OVERSPRAY

REMOVE AND REPLACE ROOF

ROOF RESTORATION (STANDING SEAM MATAL

ROOFING)



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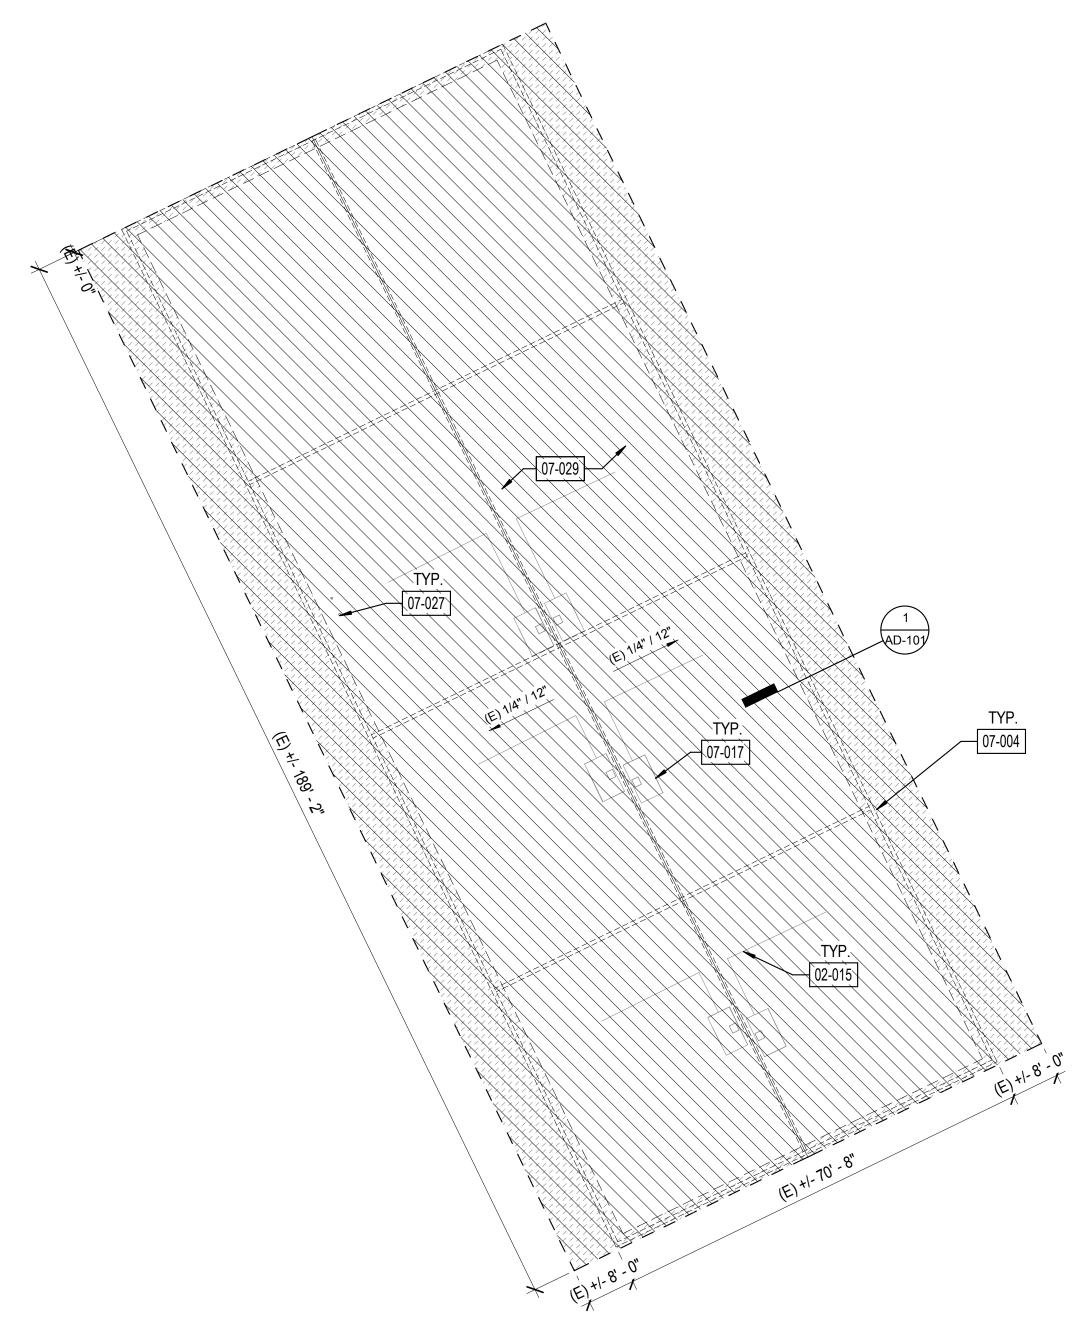
SITE PLAN

Date 01/10/2019
Drawn by CLD
Checked by CY
Sheet Number

AS-100

OVERALL SITE PLAN

1" = 60'-0"



ROOF DEMOLITION PLAN - BLDG H

SHEET GENERAL NOTES

- EXISTING ROOF DEMOLITION REQUIRES REMOVAL OF ROOF MEMBRANE.
- AFTER REMOVAL OF ROOFING, THE ARCHITECT WILL REVIEW THE EXISTING PLYWOOD SUBSTRATE. IF PORTIONS OF PLYWOOD REQUIRE REPLACEMENT, THE ARCHITECT WILL IDENTIFY AND PROVIDE WRITTEN DIRECTION TO THE CONTRACTOR TO AUTHORIZE THE WORK. SUCH COSTS WILL BE APPLIED **AGAINST ALLOWANCE NO. 1.**
- EXISTING ROOFING MATERIALS SCHEDULED FOR DEMOLITION HAVE BEEN TESTED AND BEEN FOUND NOT TO CONTAIN ASBESTOS. THIS DOES NOT GUARANTEE THAT ALL ROOFING MATERIALS WILL BE FREE OF ASBESTOS. IF ASBESTOS IS FOUND, COMPLY WITH ALL LOCAL, STATE, AND FEDERAL REQUIREMENTS FOR ASBESTOS ABATEMENT.
- DO NOT CUT INTO EXISTING PLYWOOD ROOF SHEATHING DURING ROOFING DEMOLITION. ANY PLYWOOD CUT SHALL BE REPLACED AT THE CONTRACTOR'S EXPENSE.
- DETACH UTILITIES FROM SUPPORTS AND TEMPORARILY SUPPORT AS REQUIRED TO REMOVE AND REPLACE ROOFING.
- REMOVE ALL EXISTING ROOF JACKS AT PIPE OR CONDUIT PENETRATIONS AND PREP TO RECEIVE NEW SEALED PENETRATION PER DETAIL 6/AD-100.
- VERIFY ON FIELD LOCATION OF MECHANICAL EQUIPMENT AND & TYPE OF UTILITY.

LEGEND

ASSUMED ROOF SHEATHING

REMOVE AND REPLACE ROOF

REPLACEMENT AT EAVES/ **EDGES**

(E) EXHAUST FAN

(E) VENT PIPE THROUGH ROOF

ROOF VENT

_ _ _ _ _ _ _ _

(E) SKYLIGHT

DEMOLISH (E) ITEM

(E) WALL BELOW

KEYNOTE LEGEND

PROTECT IN PLACE (E) UTILITY LINE 07-004

LINE OF (E) WALL BELOW

07-017 PROTECT IN PLACE (E) HVAC UNIT, DETACH & TEMPORARILY SUPPORT UNIT AS REQUIRED FOR ROOFING WORK

07-027 PROTECT IN PLACE (E) ROOF VENT PIPE

07-029 DEMOLISH (E) ROOF



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OJAI UNIFIED SCHOOL **DISTRICT**

NORDHOFF HIGH SCHOOL ROOFING **PROJECT**

1401 MARICOPA HWY, OJAI, CA 93023

100% CDs

No. Description

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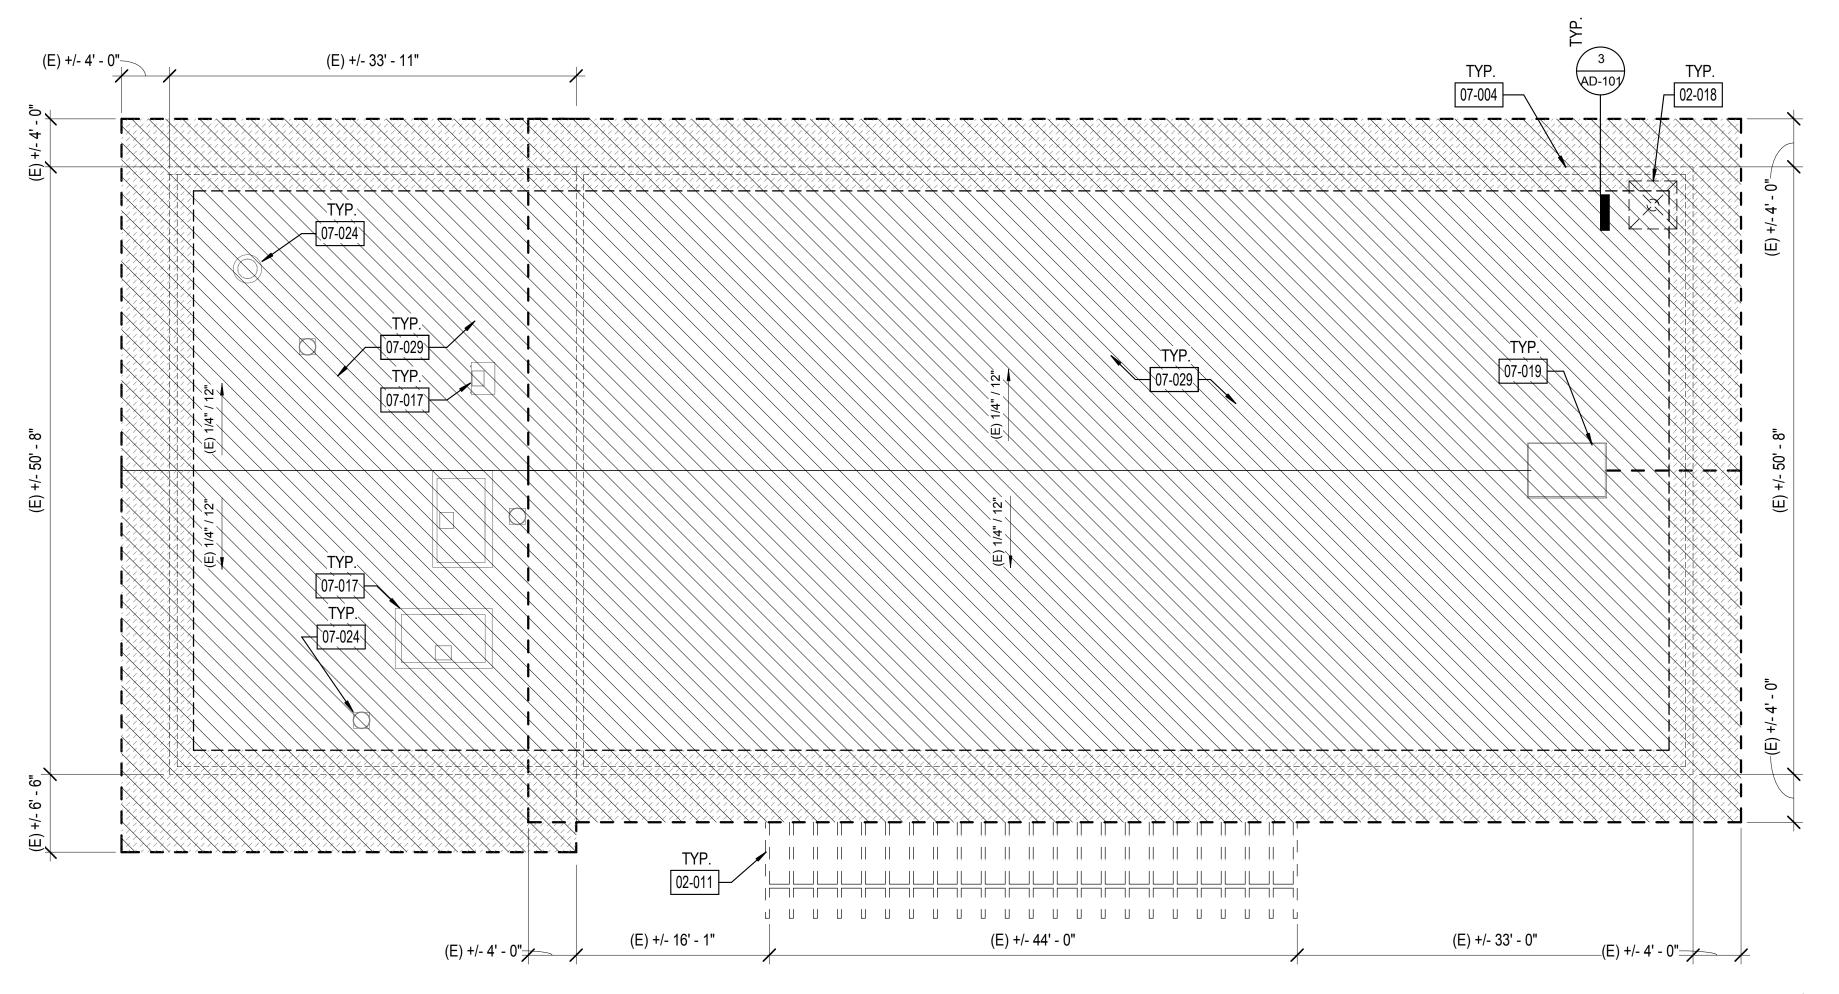
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BLDG H -ROOF DEMOLITION **PLAN**

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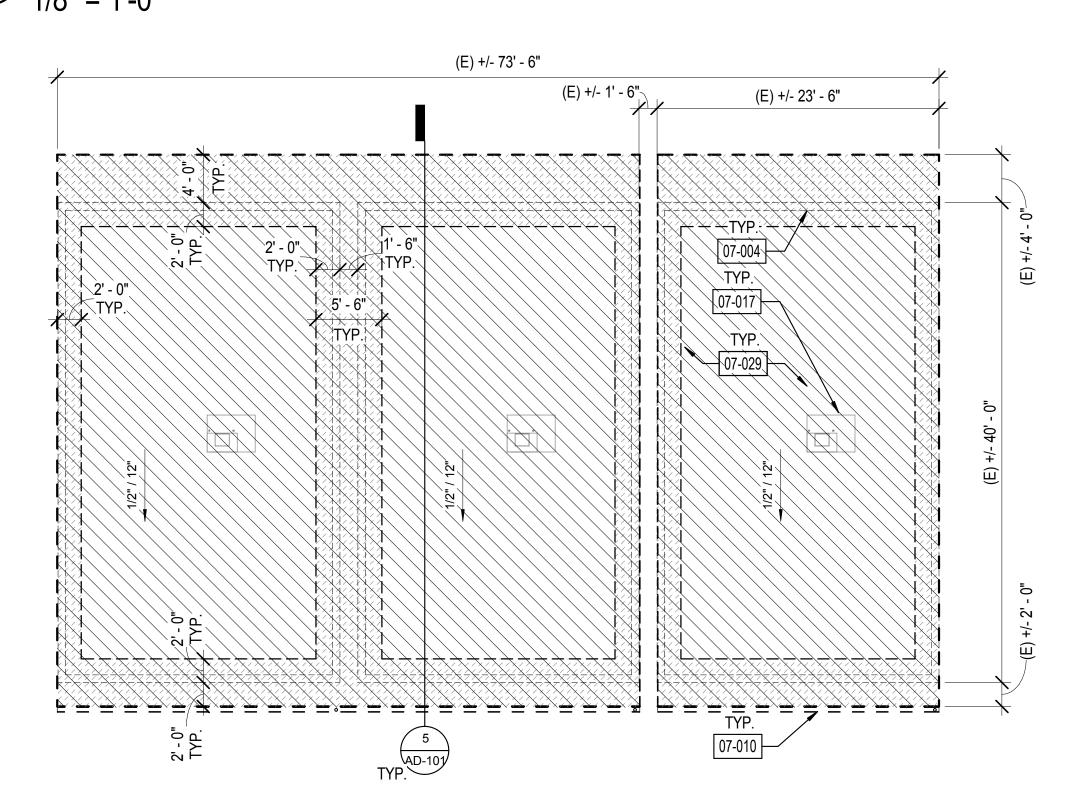
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ROOF DEMOLITION PLAN - BLDG I






 $2 \frac{\text{ROOF DEMOLITION PLAN - BLDG J}}{1/8" = 1'-0"}$




SHEET GENERAL NOTES

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- DETACH UTILITIES FROM SUPPORTS AND TEMPORARILY SUPPORT AS REQUIRED TO REMOVE AND REPLACE ROOFING.
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- VERIFY ON FIELD LOCATION OF MECHANICAL EQUIPMENT AND & TYPE OF UTILITY.

LEGEND

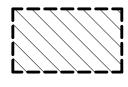

REMOVE AND REPLACE ROOF

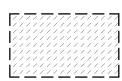

ASSUMED ROOF SHEATHING REPLACEMENT AT EAVES/ **EDGES**

(E) EXHAUST FAN

(E) VENT PIPE THROUGH ROOF

(E) SKYLIGHT

ROOF VENT

(E) WALL BELOW

DEMOLISH (E) ITEM

KEYNOTE LEGEND

DEMOLISH (E) TRELLIS DEMOLISH (E) ANTENA LINE OF (E) WALL BELOW

REMOVE (E) GUTTER AND (E) DOWNSPOUT

PROTECT IN PLACE (E) HVAC UNIT, DETACH & TEMPORARILY

SUPPORT UNIT AS REQUIRED FOR ROOFING WORK

PROTECT IN PLACE (E) ROOF HATCH PROTECT IN PLACE (E) EXHAUST FAN

07-029


DEMOLISH (E) ROOF



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OJAI UNIFIED SCHOOL DISTRICT

NORDHOFF HIGH SCHOOL ROOFING **PROJECT**


1401 MARICOPA HWY, OJAI, CA 93023

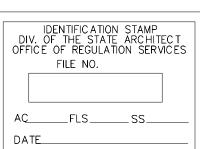100% CDs

No.	Description	Date

BLDG I & J -ROOF **DEMOLITION PLANS**

17761.11 01/10/2019 Checked by CY Sheet Number

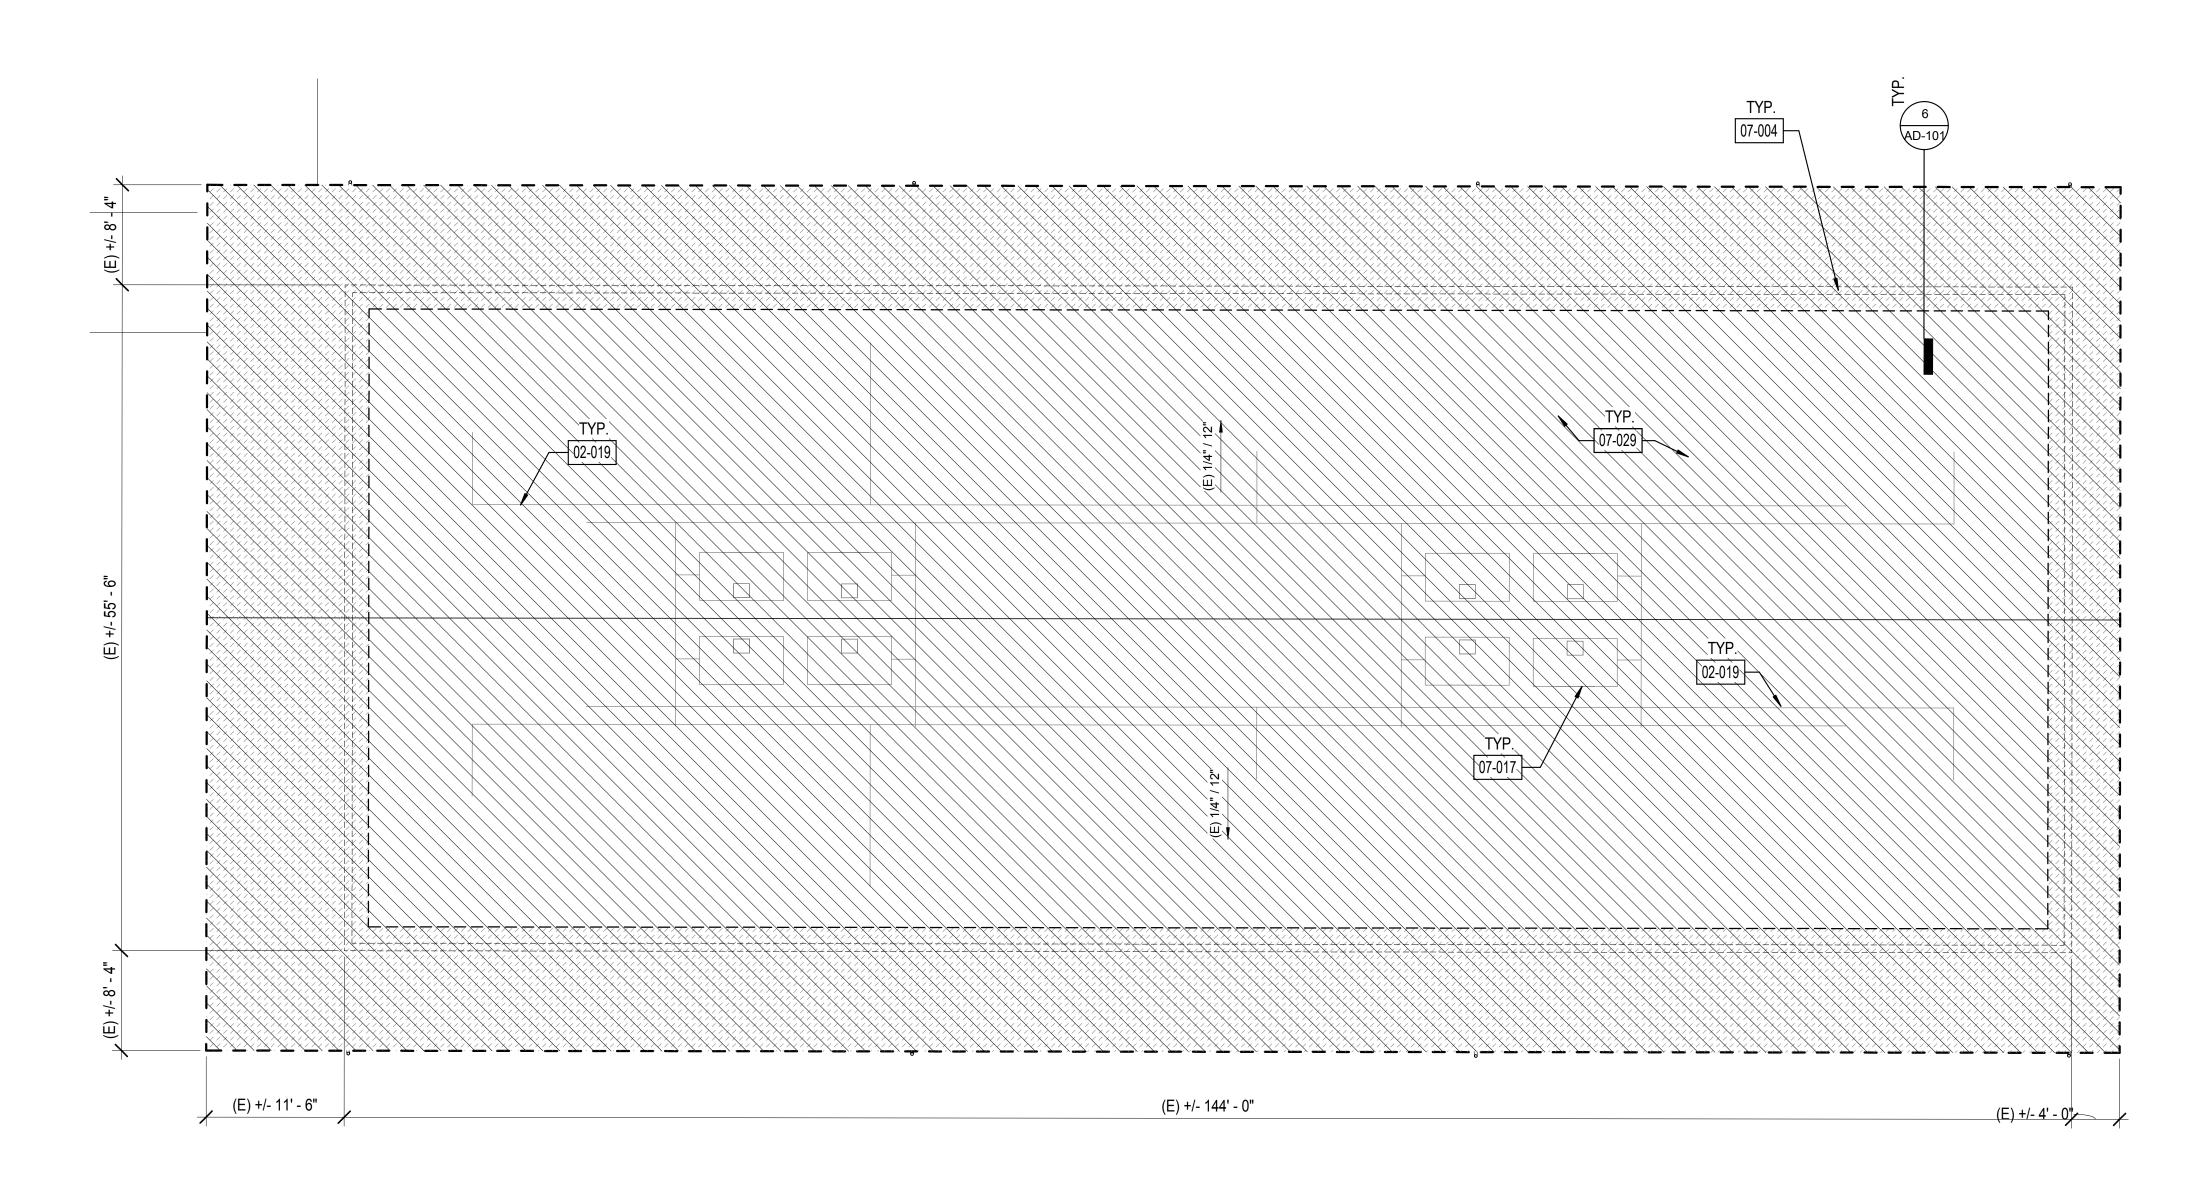

 $1 \frac{\text{ROOF DEMOLITION PLAN - BLDG F}}{1/8" = 1'-0"}$



SHEET GENERAL NOTES

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LEGEND

REMOVE AND REPLACE ROOF

ASSUMED ROOF SHEATHING REPLACEMENT AT EAVES/

- - (E) EXHAUST FAN

(E) SKYLIGHT

- (E) VENT PIPE THROUGH ROOF
- **ROOF VENT**
- _ _ _ _ _ _ _ _

(E) WALL BELOW DEMOLISH (E) ITEM

KEYNOTE LEGEND

PROTECT IN PLACE (E) ELECTRICAL LINES 07-004

LINE OF (E) WALL BELOW

07-017 PROTECT IN PLACE (E) HVAC UNIT, DETACH & TEMPORARILY SUPPORT UNIT AS REQUIRED FOR ROOFING WORK 07-029

DEMOLISH (E) ROOF

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NORDHOFF HIGH SCHOOL ROOFING **PROJECT**

1401 MARICOPA HWY, OJAI, CA 93023

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No.	Description	Date

Sheet Name

BLDG F -ROOF DEMOLITION **PLAN**

17761.11 01/10/2019 Drawn by CY

Checked by Sheet Number

1 ROOF DEMOLITION PLAN - BLDG G 1/8" = 1'-0"



SHEET GENERAL NOTES

- EXISTING ROOF DEMOLITION REQUIRES REMOVAL OF ROOF MEMBRANE.
- AFTER REMOVAL OF ROOFING, THE ARCHITECT WILL REVIEW THE EXISTING PLYWOOD SUBSTRATE. IF PORTIONS OF PLYWOOD REQUIRE REPLACEMENT, THE ARCHITECT WILL IDENTIFY AND PROVIDE WRITTEN DIRECTION TO THE CONTRACTOR TO AUTHORIZE THE WORK. SUCH COSTS WILL BE APPLIED AGAINST ALLOWANCE NO. 1.
- EXISTING ROOFING MATERIALS SCHEDULED FOR DEMOLITION HAVE BEEN TESTED AND BEEN FOUND NOT TO CONTAIN ASBESTOS. THIS DOES NOT GUARANTEE THAT ALL ROOFING MATERIALS WILL BE FREE OF ASBESTOS. IF ASBESTOS IS FOUND, COMPLY WITH ALL LOCAL, STATE, AND FEDERAL REQUIREMENTS FOR ASBESTOS ABATEMENT.
- DO NOT CUT INTO EXISTING PLYWOOD ROOF SHEATHING DURING ROOFING DEMOLITION. ANY PLYWOOD CUT SHALL BE REPLACED AT THE CONTRACTOR'S EXPENSE.
- DETACH UTILITIES FROM SUPPORTS AND TEMPORARILY SUPPORT AS REQUIRED TO REMOVE AND REPLACE ROOFING.
- REMOVE ALL EXISTING ROOF JACKS AT PIPE OR CONDUIT PENETRATIONS AND PREP TO RECEIVE NEW SEALED PENETRATION PER DETAIL 6/AD-100.
- VERIFY ON FIELD LOCATION OF MECHANICAL EQUIPMENT AND & TYPE OF UTILITY.

LEGEND



(E) EXHAUST FAN

(E) VENT PIPE THROUGH ROOF

(E) SKYLIGHT

ROOF VENT (E) WALL BELOW _____

DEMOLISH (E) ITEM

KEYNOTE LEGEND

LINE OF (E) WALL BELOW

07-017 PROTECT IN PLACE (E) HVAC UNIT, DETACH & TEMPORARILY SUPPORT UNIT AS REQUIRED FOR ROOFING WORK

07-024 PROTECT IN PLACE (E) EXHAUST FAN


07-029 DEMOLISH (E) ROOF 07-032

DEMOLISH (E) MECH CURB

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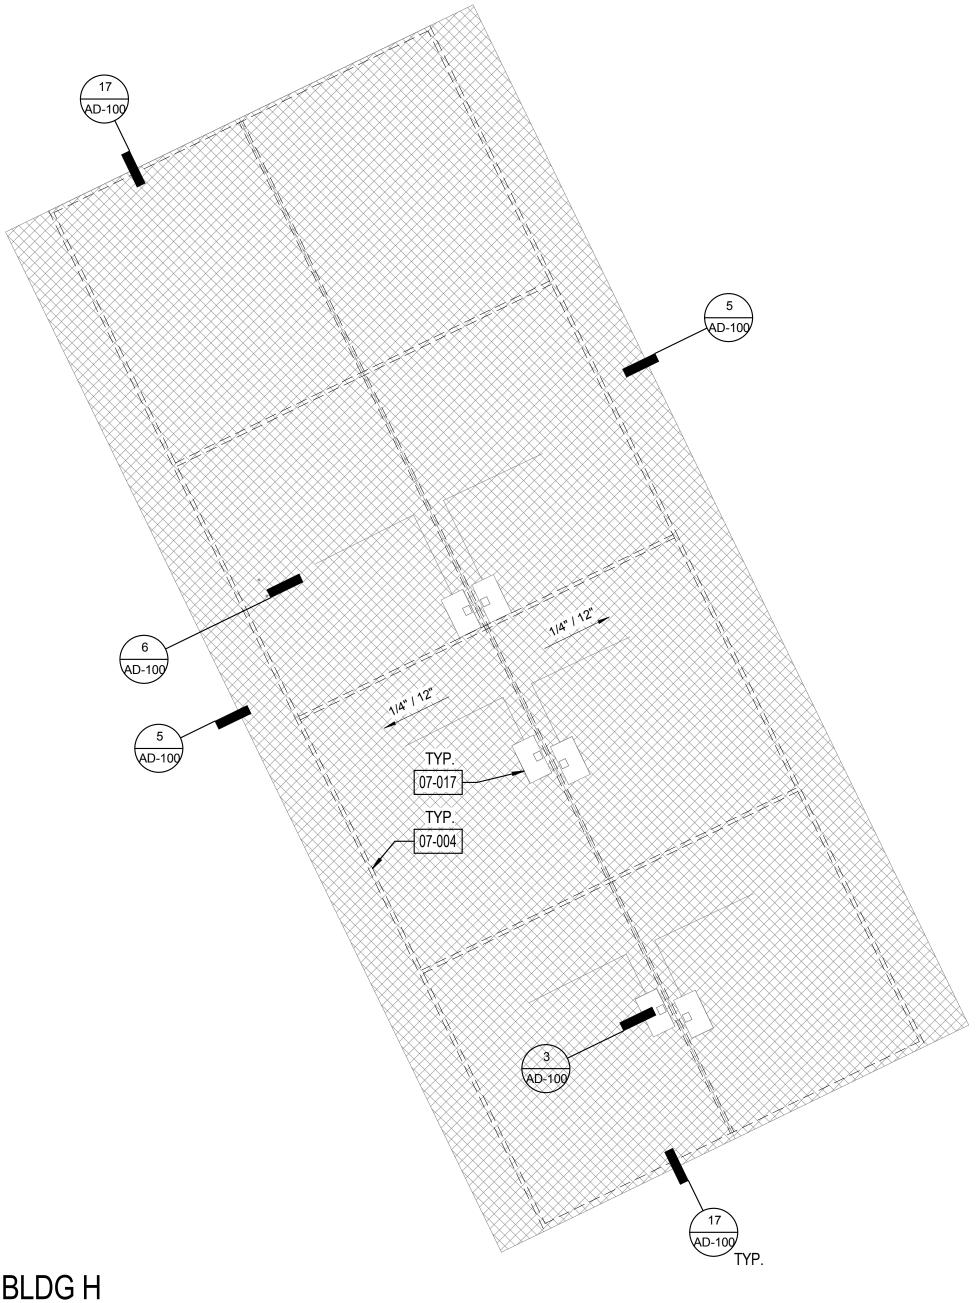
No.	Description	Date

BLDG G -ROOF

Sheet Name

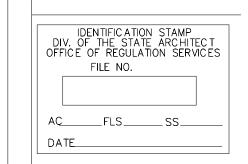DEMOLITION PLANS 17761.11

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Drawn by	CLD
Checked by	CY
Sheet Number	



- NORT

1) ROOF PLAN - BLDG H 1/16" = 1'-0"

SHEET GENERAL NOTES

- 1. ALL ITEMS ARE NEW UNLESS OTHERWISE NOTED.
- 2. ANY ROOFING MEMBERS OBSERVED TO BE COMPROMISED TO BE REPLACED IN COMPLIANCE WITH DSA-APPROVED EXISTING CONDITION DRAWINGS.
- INSTALL PRECAST POLYMER CURB AT ALL PIPING ROOF PENETRATIONS PER DETAIL 6/AD-100.
- 4. VERIFY ON FIELD LOCATION OF MECHANICAL EQUIPMENT AND & TYPE OF UTILITY.

LEGEND

DEMOLISH (E) 4" CONC. WALK FOR DOWNSPOUD LINE AND PATCH TO MATCH EXISTING.

CLASS A MODIFIED BITUMEN ROOFING OVER (E) DECKING. REFER TO 11/AD-100 FOR ASSEMBLY.

P.A. PLANTER AREA

(E) EXHAUST FAN


(E) EXHAUST FAN
(E) VENT PIPE THROUGH ROOF

(E) SKYLIGHTROOF VENT

---- (E) WALL BELOW

DOWNSPOUT CON

DOWNSPOUT CONNECTION TO (E) STORM DRAIN, REFER TO 13/AD-101

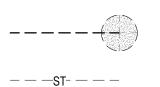

DOWNSPOUT TO (E) LANDSCAPE/GRAVEL, REFER TO 13/AD-101

(E) STORM DRAIN LINE, U.O.N.

KEYNOTE LEGEND

07-004 LINE OF (E) WALL BELOW

PROTECT IN PLACE (E) HVAC UNIT, DETACH & TEMPORARILY SUPPORT UNIT AS REQUIRED FOR ROOFING WORK



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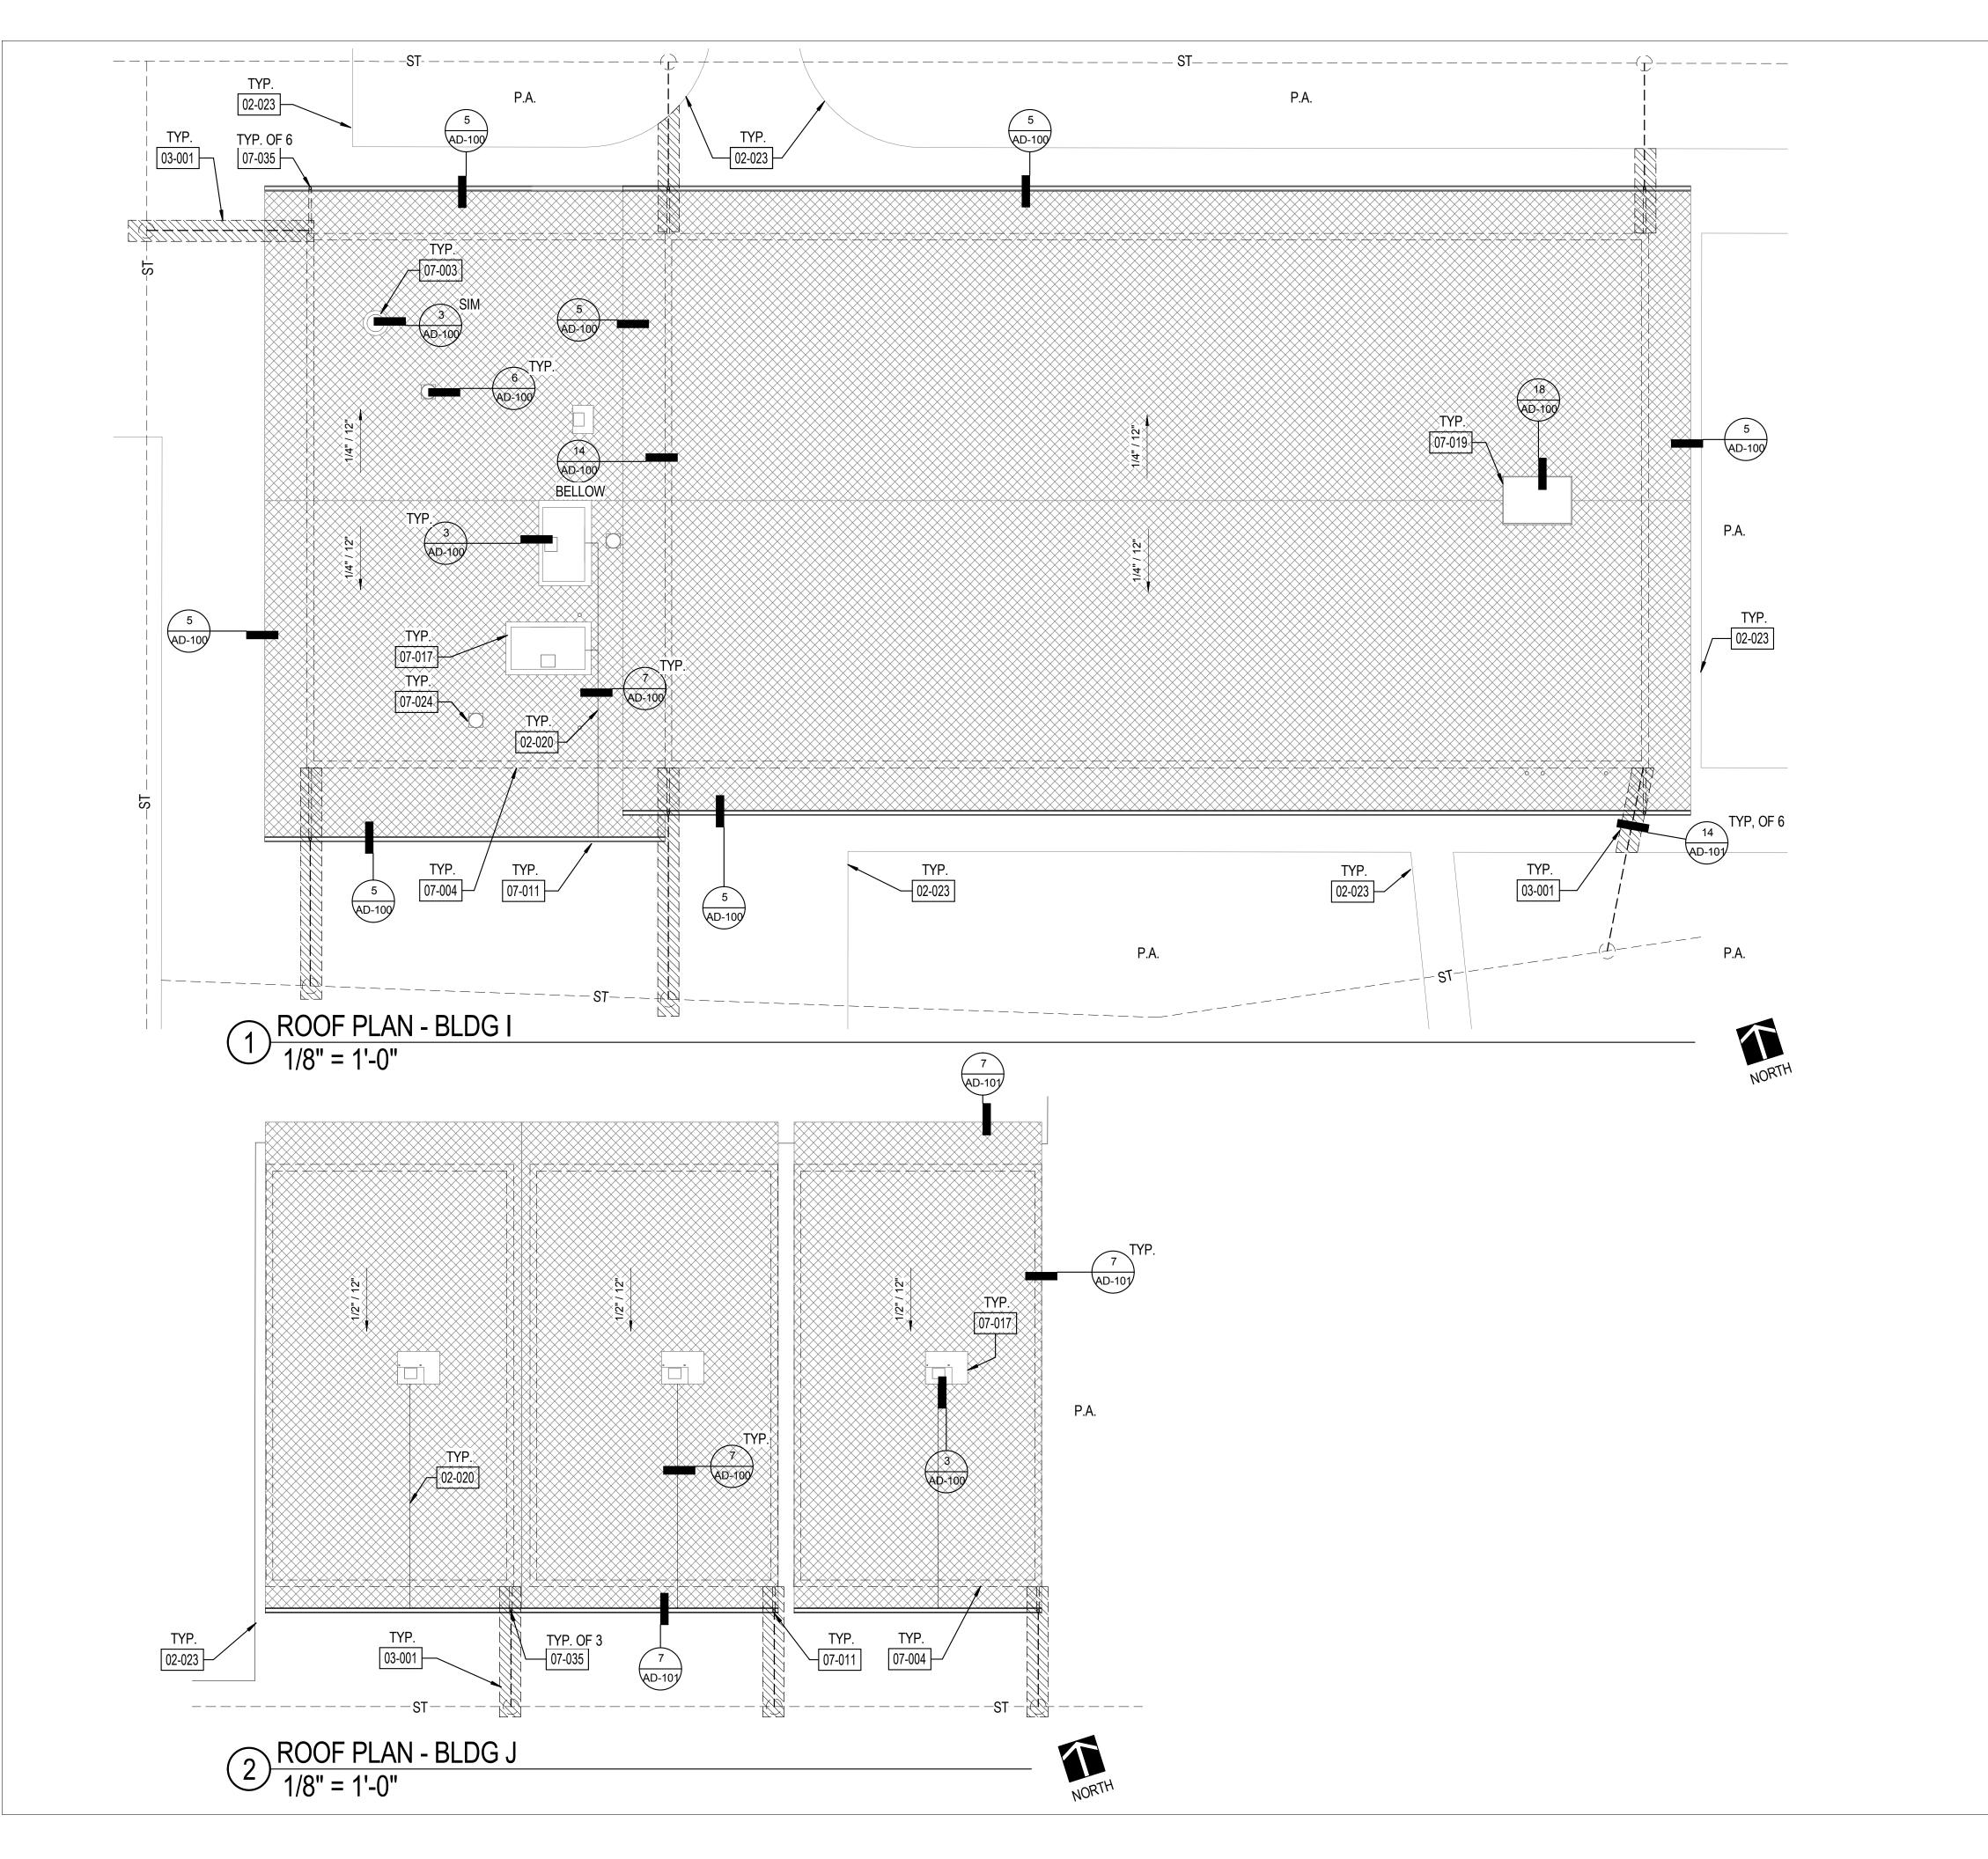
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BLDG H -ROOF PLAN

	17761.11
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Sheet Number	


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SHEET GENERAL NOTES


- ALL ITEMS ARE NEW UNLESS OTHERWISE NOTED.
- ANY ROOFING MEMBERS OBSERVED TO BE COMPROMISED TO BE REPLACED IN COMPLIANCE WITH DSA-APPROVED EXISTING CONDITION DRAWINGS.
- INSTALL PRECAST POLYMER CURB AT ALL PIPING ROOF PENETRATIONS PER DETAIL 6/AD-100.
- VERIFY ON FIELD LOCATION OF MECHANICAL EQUIPMENT AND & TYPE OF UTILITY.

LEGEND



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DEMOLISH (E) 4" CONC. WALK FOR DOWNSPOUD LINE AND PATCH TO MATCH EXISTING.

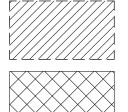

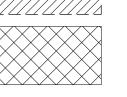
CLASS A MODIFIED BITUMEN ROOFING OVER (E) DECKING. REFER TO 11/AD-100 FOR ASSEMBLY.



(E) EXHAUST FAN (E) VENT PIPE THROUGH ROOF



DOWNSPOUT CONNECTION TO (E) STORM DRAIN, REFER TO 13/AD-101

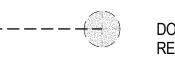

DOWNSPOUT TO (E) LANDSCAPE/GRAVEL, REFER TO 13/AD-101

(E) STORM DRAIN LINE, U.O.N. ---ST----

KEYNOTE LEGEND

02-020 INSTALL CONDENSATE LINE WITH TURN DOWN INTO GUTTER

02-023 PROTECT IN PLACE (E) CONC. WALK

DEMOLISH (E) 4" CONC. WALK FOR DOWNSPOUD LINE AND 03-001 PATCH TO MATCH EXISTING.

07-003 PROTECT IN PLACE (E) ROOF VENT LINE OF (E) WALL BELOW

07-004 07-011 INSTALL GUTTER AND DOWNSPOUT

PROTECT IN PLACE (E) HVAC UNIT, DETACH & TEMPORARILY SUPPORT UNIT AS REQUIRED FOR ROOFING WORK

PROTECT IN PLACE (E) ROOF HATCH 07-024 PROTECT IN PLACE (E) EXHAUST FAN

07-035 **GUTTER**



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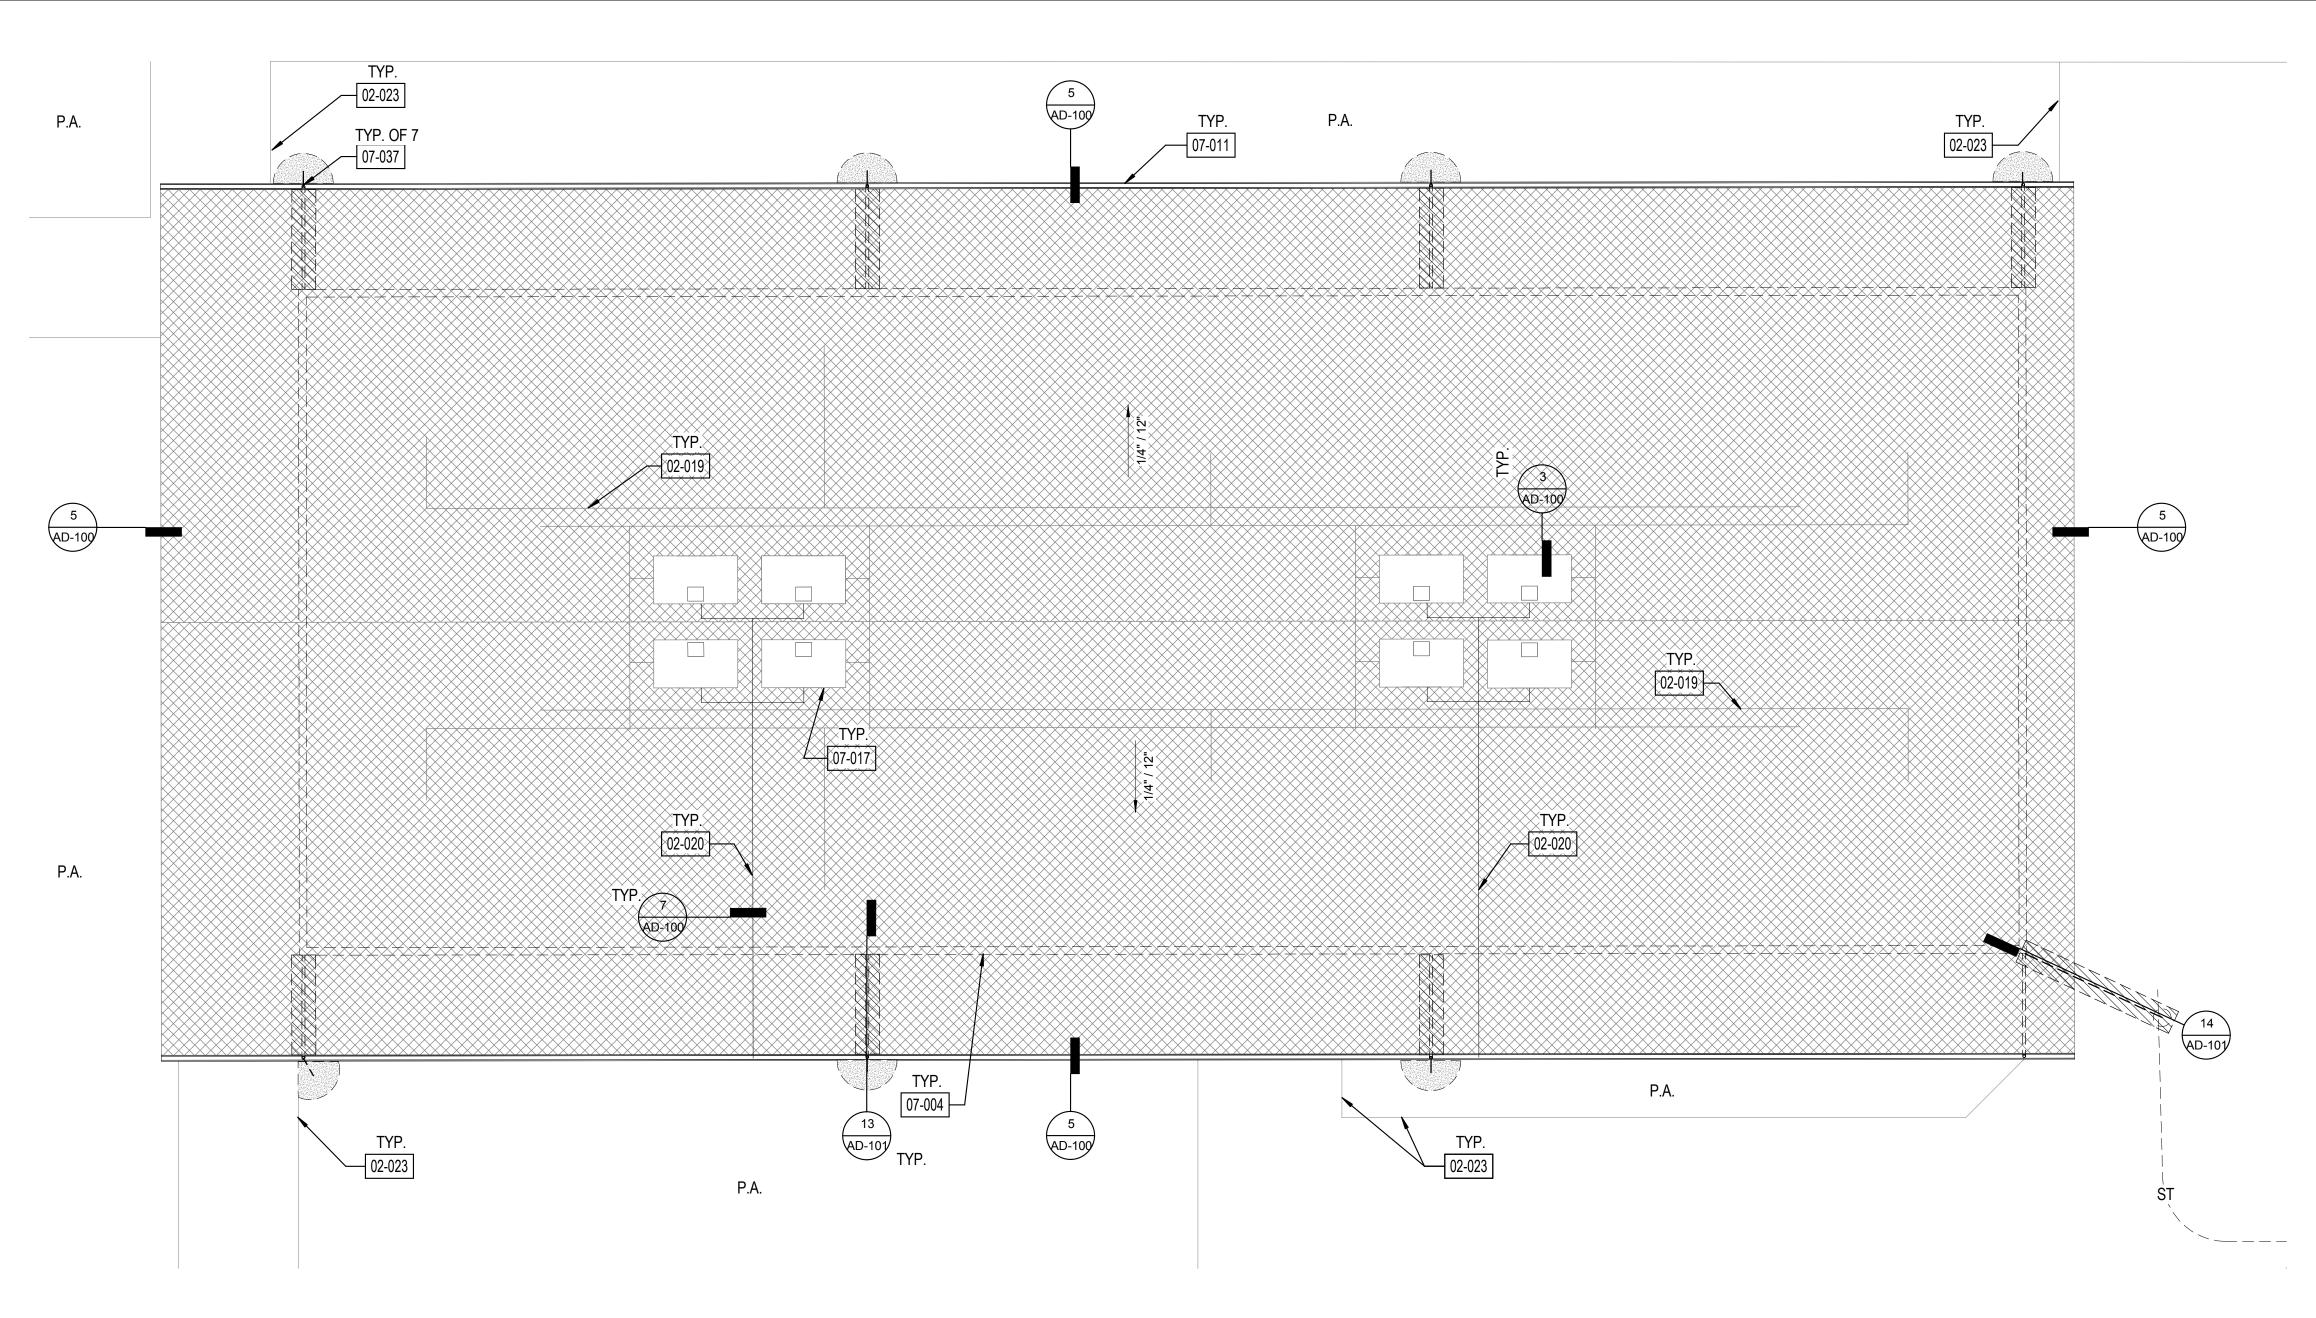
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BLDG I & J -**ROOF PLANS**

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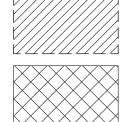
A-101



 $1 \frac{\text{ROOF PLAN - BLDG F}}{1/8" = 1'-0"}$

- ANY ROOFING MEMBERS OBSERVED TO BE COMPROMISED TO BE REPLACED IN COMPLIANCE WITH DSA-APPROVED EXISTING
- PENETRATIONS PER DETAIL 6/AD-100.

LEGEND



 $---\!-\!\mathrm{ST}\!----$

DEMOLISH (E) 4" CONC. WALK FOR DOWNSPOUD LINE AND PATCH TO MATCH EXISTING.

CLASS A MODIFIED BITUMEN ROOFING OVER (E) DECKING. REFER TO 11/AD-100 FOR ASSEMBLY.

P.A. PLANTER AREA (E) EXHAUST FAN

(E) VENT PIPE THROUGH ROOF

(E) SKYLIGHT **ROOF VENT** (E) WALL BELOW _____

DOWNSPOUT CONNECTION TO (E) STORM DRAIN, REFER TO 13/AD-101

(E) STORM DRAIN LINE, U.O.N.

DOWNSPOUT TO (E) LANDSCAPE/GRAVEL, -----REFER TO 13/AD-101

02-019 PROTECT IN PLACE (E) ELECTRICAL LINES

02-020 INSTALL CONDENSATE LINE WITH TURN DOWN INTO GUTTER

02-023

PROTECT IN PLACE (E) HVAC UNIT, DETACH & TEMPORARILY SUPPORT UNIT AS REQUIRED FOR ROOFING WORK



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BLDG F -**ROOF PLAN**

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A-102

SHEET GENERAL NOTES

ALL ITEMS ARE NEW UNLESS OTHERWISE NOTED.

CONDITION DRAWINGS. 3. INSTALL PRECAST POLYMER CURB AT ALL PIPING ROOF

VERIFY ON FIELD LOCATION OF MECHANICAL EQUIPMENT AND & TYPE OF UTILITY.

KEYNOTE LEGEND


PROTECT IN PLACE (E) CONC. WALK

07-004 LINE OF (E) WALL BELOW

INSTALL GUTTER AND DOWNSPOUT

07-017

INSTALL DOWNSPOUT, REFER TO SPECS. 07-037

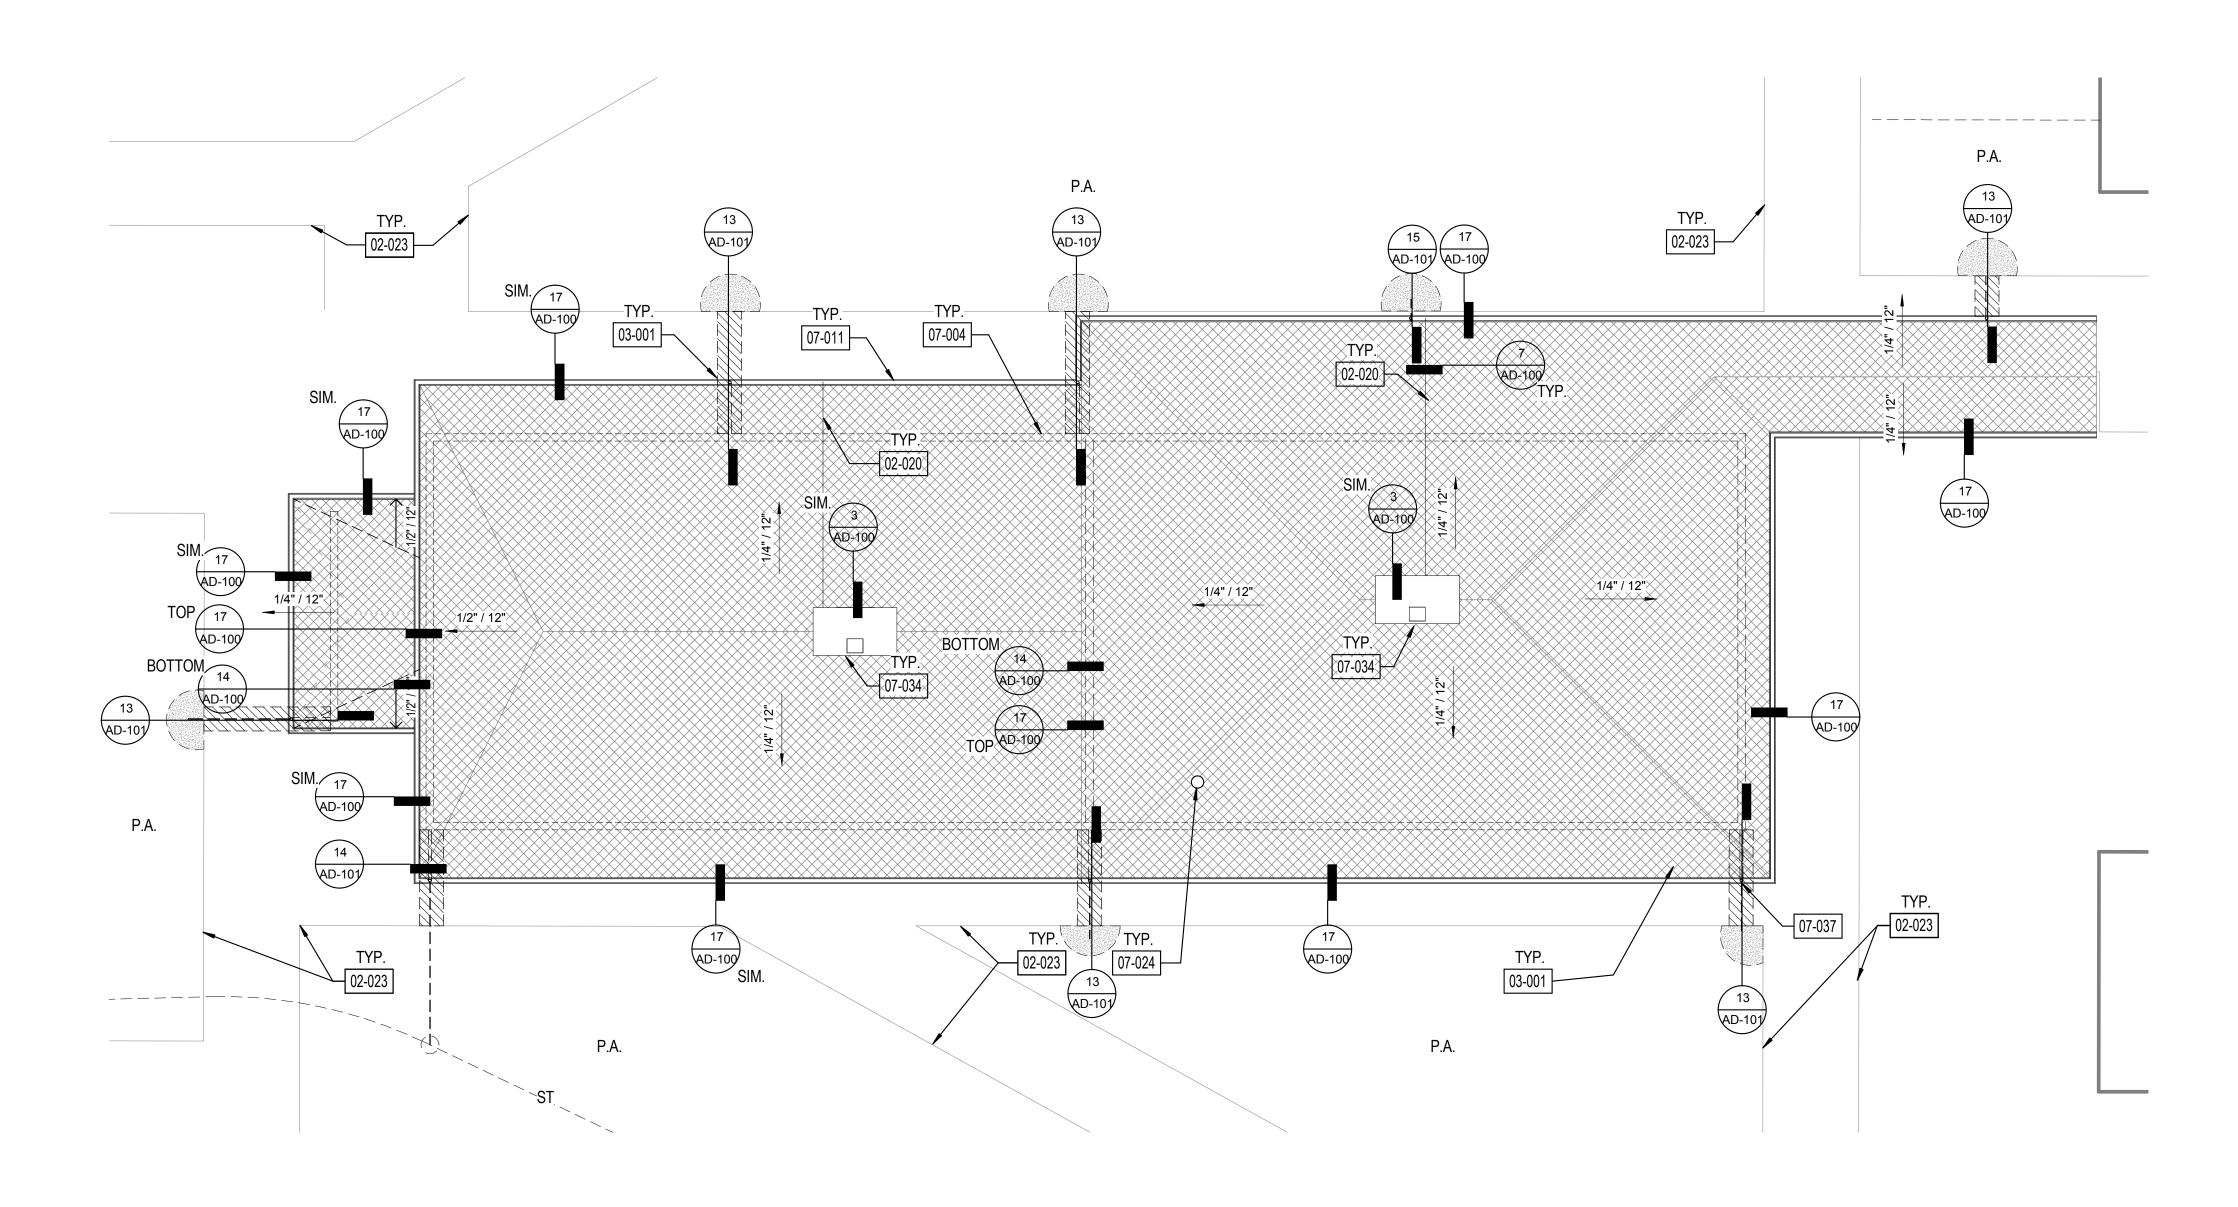


1 ROOF PLAN - BLDG G 1/8" = 1'-0"



SHEET GENERAL NOTES

- 1. ALL ITEMS ARE NEW UNLESS OTHERWISE NOTED.
- ALE ITEMS ARE NEW ONLESS OTHERWISE NOTED.
 ANY ROOFING MEMBERS OBSERVED TO BE COMPROMISED TO BE REPLACED IN COMPLIANCE WITH DSA-APPROVED EXISTING CONDITION DRAWINGS.
- INSTALL PRECAST POLYMER CURB AT ALL PIPING ROOF PENETRATIONS PER DETAIL 6/AD-100.
- 4. VERIFY ON FIELD LOCATION OF MECHANICAL EQUIPMENT AND & TYPE OF UTILITY.

LEGEND

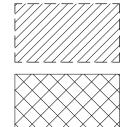

DEMOLISH (E) 4" CONC. WALK FOR DOWNSPOUD LINE AND PATCH TO MATCH EXISTING.

CLASS A MODIFIED BITUMEN ROOFING OVER (E) DECKING. REFER TO 11/AD-100 FOR ASSEMBLY.

P.A.

PLANTER AREA (E) EXHAUST FAN

(E

(E) VENT PIPE THROUGH ROOF

(E) SKYLIGHT

ROOF VENT

(E) WALL BELOW

DOWNSPOUT CONNECTION TO (E) STORM DRAIN, REFER TO 13/AD-101

(E) STORM DRAIN LINE, U.O.N.

DOWNSPOUT TO (E) LANDSCAPE/GRAVEL, REFER TO 13/AD-101

KEYNOTE LEGEND

02-020 INSTALL CONDENSATE LINE WITH TURN DOWN INTO GUTTER

02-023 PROTECT IN PLACE (E) CONC. WALK

DEMOLISH (E) 4" CONC. WALK FOR DOWNSPOUD LINE AND PATCH TO MATCH EXISTING.

07-004 LINE OF (E) WALL BELOW

03-001

07-011 INSTALL GUTTER AND DOWNSPOUT

07-024 PROTECT IN PLACE (E) EXHAUST FAN

07-034 PROVIDE NEW MECH CURB

07-037 INSTALL DOWNSPOUT, REFER TO SPECS.

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BLDG G -ROOF PLANS


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A-103



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	ADD 01	3/8/2018	

ROOF **DETAILS** -

TYPICAL 17761.11

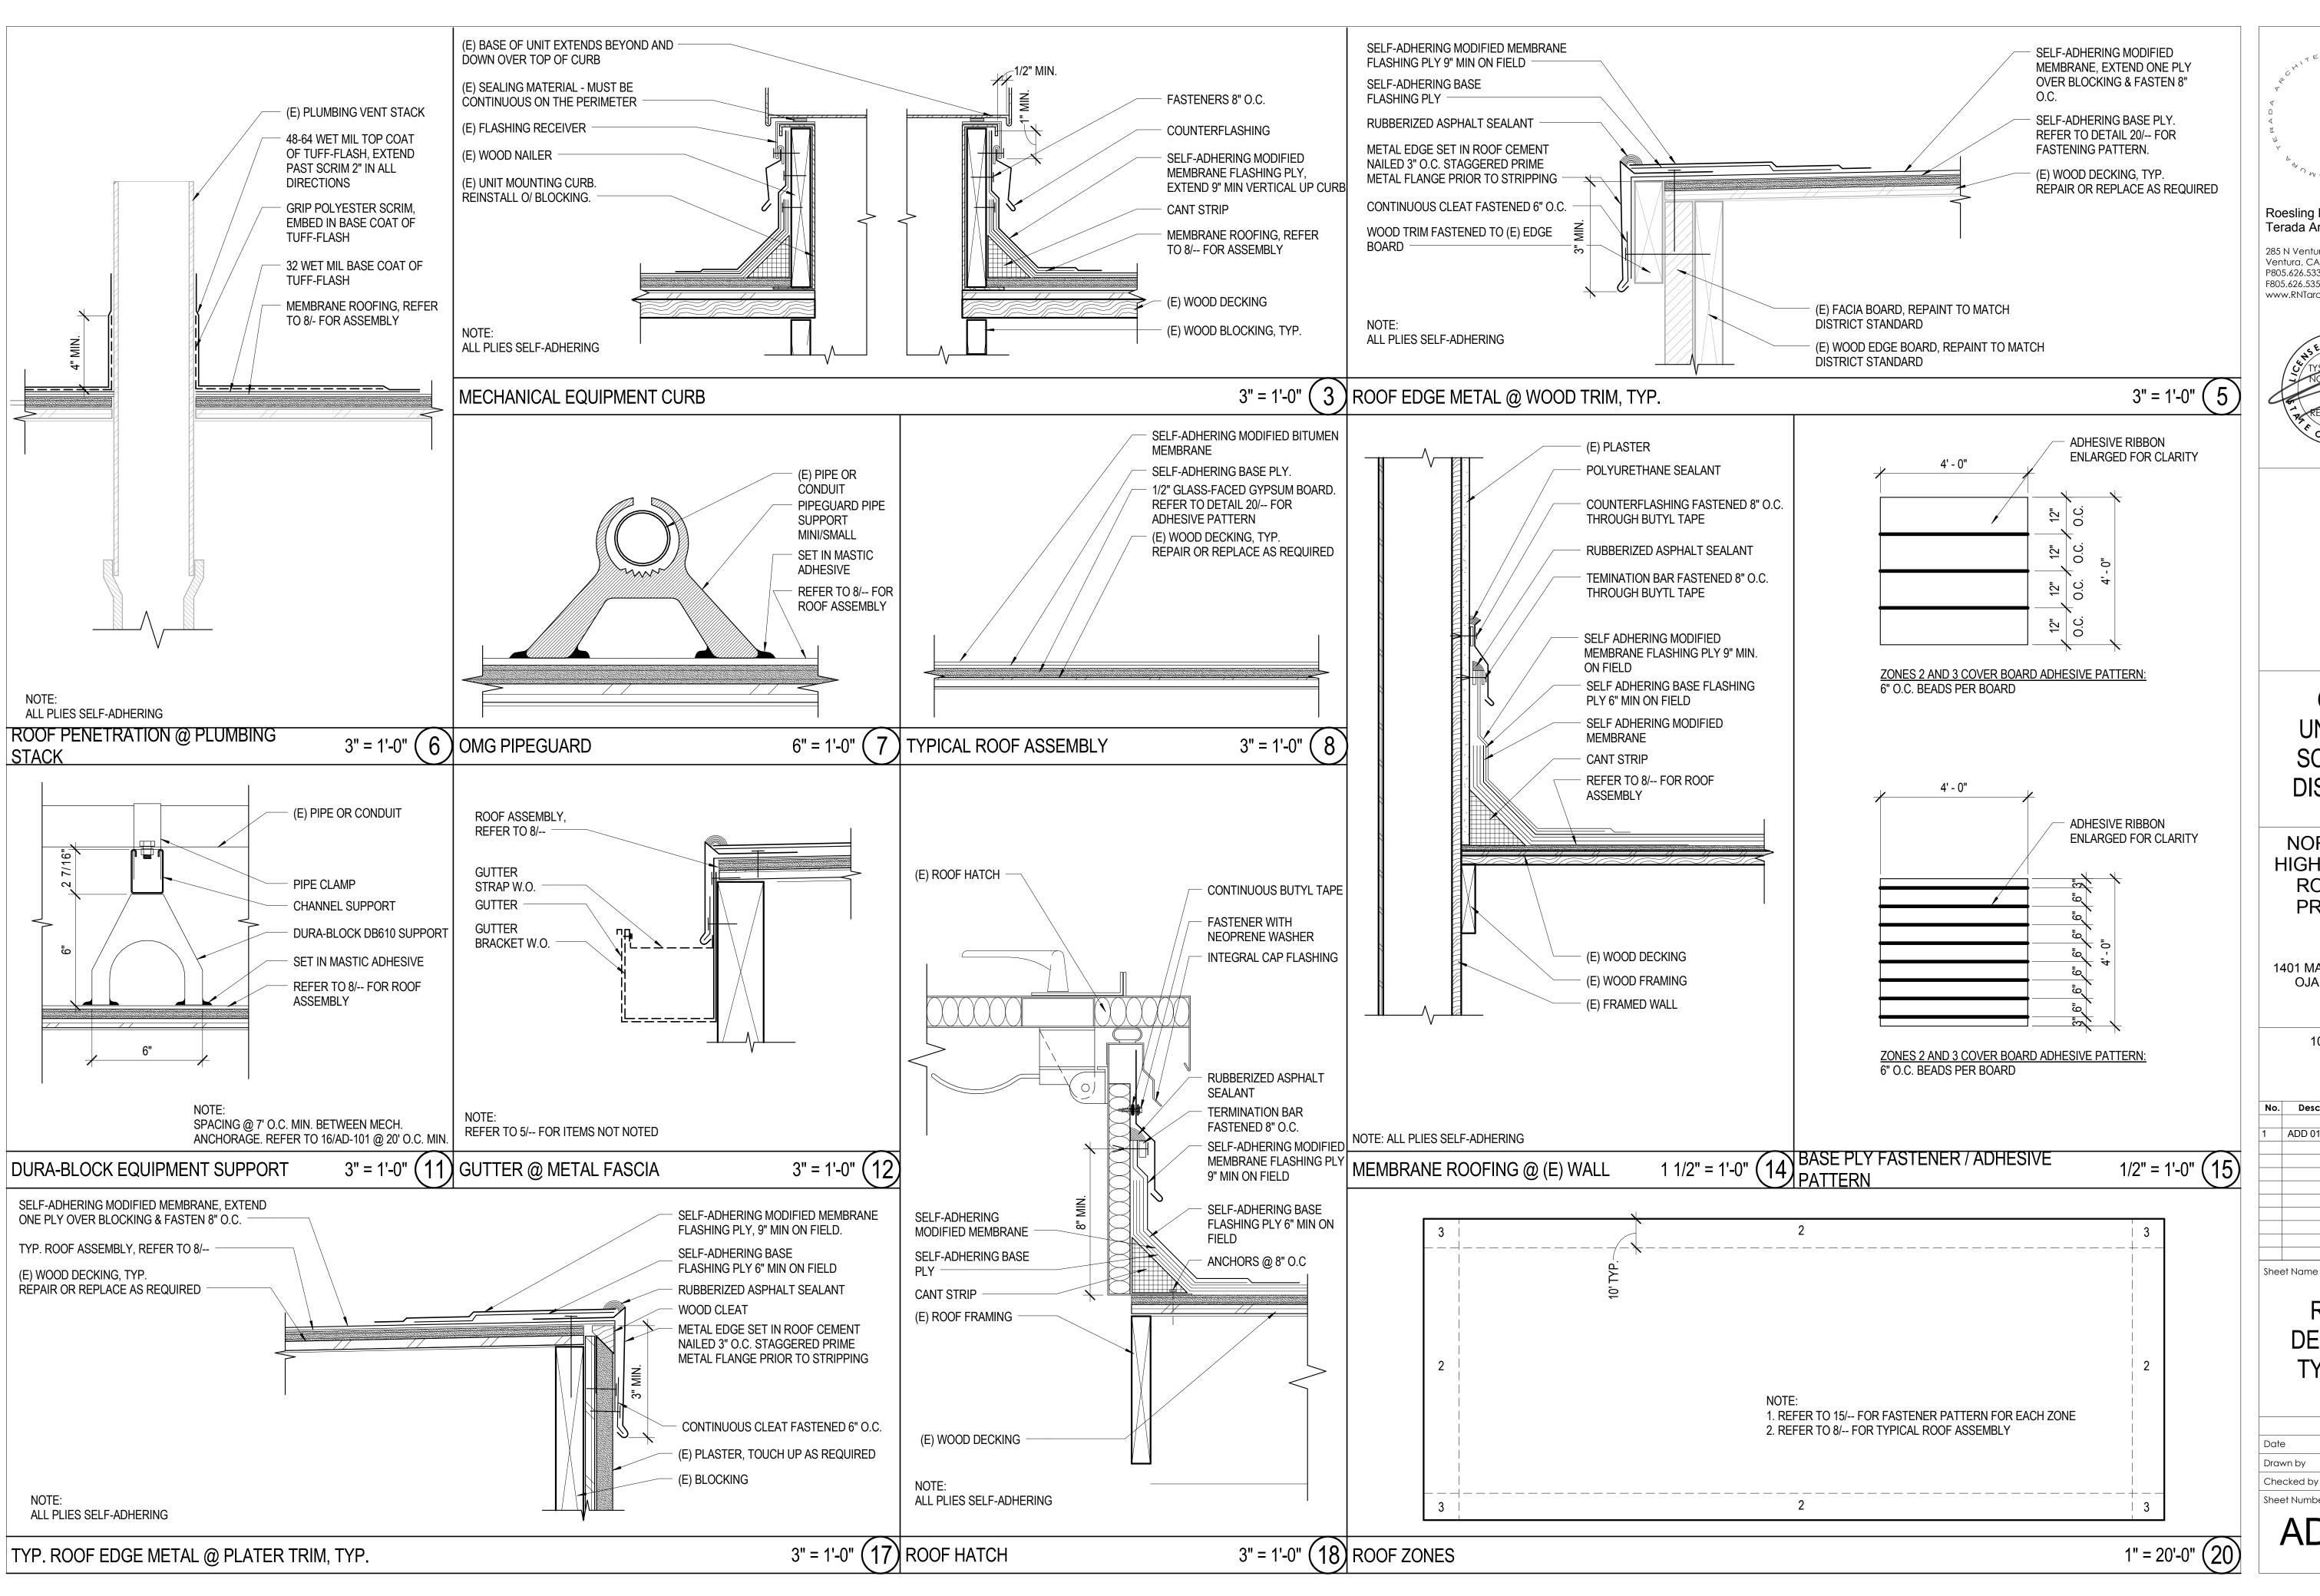01/10/2019 Drawn by CLD Checked by CY Sheet Number

AD-100

