Kendall County Courthouse Roofing 2019 Kendall County Yorkville, Illinois

o o

o o

А

•

Е

۰

F

0

0

IL

o o

С

D

۰

•

G

Н



o o

o o

ARCHITECTURAL


A1.11 A2.00

ROOF PLAN AND DETAILS DETAILS - GENERAL - SYMBOLS AND ABBREVIATIONS

ISSUED FOR BID - 07-03-19



o o

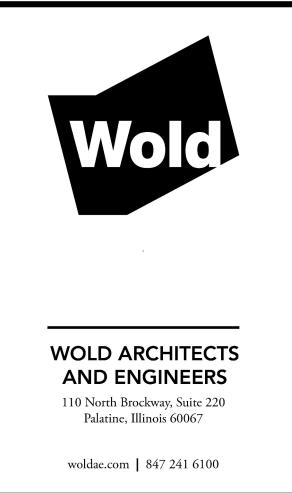



3

I.

4

I.

5

1

(F2) COPING DETAIL - NTS NOT TO SCALE

1

I.

1

Ц

Α

г


2

I.




UP - MATCH TRIM FINISH


I.

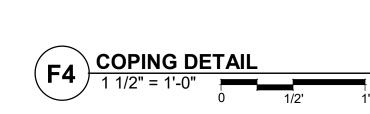



I.

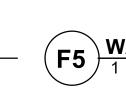

I

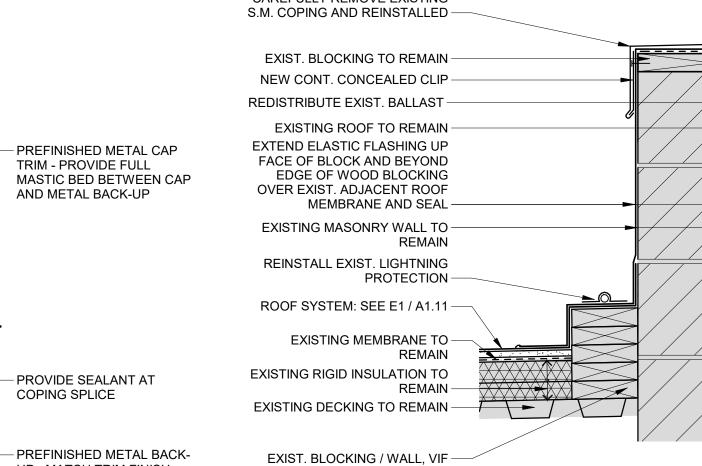

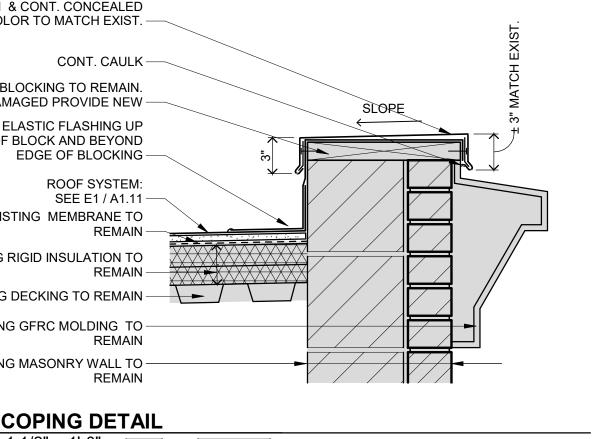

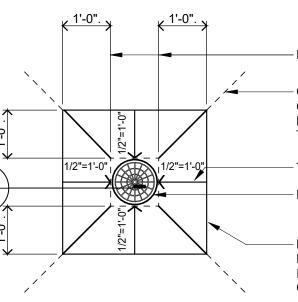

6

1

- EDGE OF DRAIN

I.


- CUT EXISTING MEMBRANE AT 45°. EXTEND CUT 6" BEYOND NEW INSULATION. FOLD BACK EXISTING MEMBRANE UNTIL NEW TAPERED INSULATION IS INSTALLED - TAPERED INSULATION

7


- REPLACE ROOF DRAIN BASKET

- REMOVE EXISTIG INSULATION AROUND ROOF DRAIN. INSTALL NEW TAPERED INSULATION AND COVER BOARD AT A SLOPE OF 1/2" PER 1'-0"

ROOF DRAIN TYPICAL SUMP PUMP

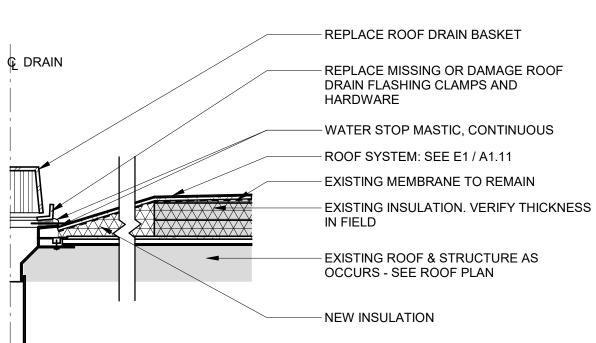

ROOF DRAIN SUMP SECTION

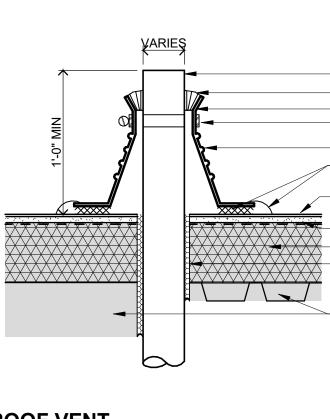

(C5) ROOF VENT

ertЧ И И И И И ™∩ * * * * * * * * * * * * * * * * * * -

DISCONNECT, REMOVE AND REINSTALL EXISTING EQUIPMENT - S.M. COUNTER FLASHING - CONT. BEAD OF SEALANT OVER FASTENER - BLOCKING AS REQUIRED

- EXISTING VENT STACK - ELASTOMERIC SEALANT

REQUIREMENTS

PREFORMED PIPE FLASHING BOOT

- STAINLESS STEEL CLAMPING RING

- PREFORMED PIPE FLASHING BOOT - ATTACHMENT PER ROOFING MFR

- ROOF SYSTEM SEE E1 / A1.11

- FILL VOIDS W/ URETHANE FOAM INSULATION

- STRUCTURE AS OCCURS


- EXISTING MEMBRANE TO REMAIN

- EXISTING INSULATION TO REMAIN

- ELASTIC FLASHING WRAPPED OVER CURB - ROOF SYSTEM: SEE E1 / A1.11 - EXISTING MEMBRANE TO REMAIN EXISTING ROOF CURB - VERIFY HEIGHT IN FIELD

- EXISTING RIGID INSULATION TO REMAIN STRUCTURE AS OCCURS

ackslash CURB DETAIL

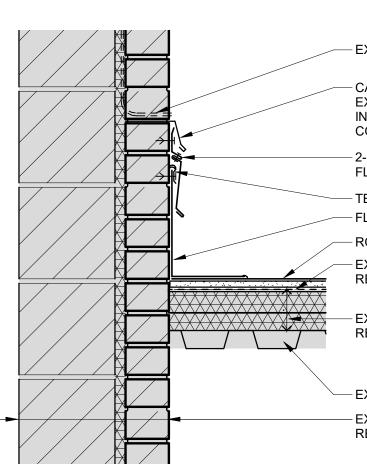

INSTALLATION OF 2-PIECE COUNTERFLASHING

FLASHING

- FLASHING MEMBRANE - ROOF SYSTEM: SEE E1 / A1.11

- EXISTING DECKING TO REMAIN - EXISTING MASONRY WALL TO

ROOF DEMOLITION GENERAL NOTES:

1. __ ROOF DEMOLITION INCLUDES REMOVING EXISTING BALLAST. REMOVING EXISTING FLASHING / COUNTER FLASHING AT CURBS, WALLS, PIPE PENETRATIONS AND PARAPET INCLUDING SEALANTS, FASTENERS AND ASSOCIATED ACCESSORIES - SEE HATCHED AREAS AND DETAILS. EXISTING ROOFING MEMBRANE TO REMAIN IN PLACE OVER EXISTING INSULATION UNLESS NOTED OTHERWISE. CONTRACTOR TO DISABLE EXISTING MEMBRANE IN ONE OF THE FOLLOWING METHODS PER MANUFACTURER'S RECOMMENDATION: SLIT THE EXISTING MEMBRANE ON A 10'X10' GRID PATTERN OR CUT AND REMOVE 4" DIAMETER CORE IN EXISTING MEMBRANE EVERY 100 S.F. PRIOR TO INSTALLATION OF NEW COVER BOARD TO ALLOW ANY TRAPPED VAPOR TO BE RELEASED.

8

- DEMOLITION NOTES ARE PROVIDED AS A GUIDE ONLY. CONTRACTOR TO VERIFY EXISTING CONDITIONS AND EXAMINE DRAWINGS AND DETAILS TO DETERMINE EXTENT AND LIMITS OF DEMOLITION REQUIRED TO ACCOMODATE NEW CONSTRUCTION.
- CONTRACTOR IS RESPONSIBLE FOR COORDINATION OF ALL ASPECTS OF DEMOLITION. CONTRACTOR TO REVIEW ALL DRAWINGS FOR ADDITIONAL DETAILS AND CONSTRUCTION SEQUENCING NOTES.
- 4. DEMOLITION CONTRACTOR SHALL CAREFULLY REMOVE CONSTRUCTION DESIGNATED FOR DEMOLITION TO MINIMIZE EXTENT OF DAMAGES TO ADJACENT SURFACE. CONTRACTOR IS RESPONSIBLE FOR REPAIR OF ALL DAMAGE CREATED DUE TO CONSTRUCTION.
- 5. __ CONTRACTOR IS RESPONSIBLE FOR CONTAINMENT AND CLEANING OF CONSTRUCTION DUST AND DEBRIS DURING AND AFTER ANY DEMOLITION OR INSTALLMENT OF WORK.
- 6. PROTECT EXISTING ROOFTOP MECHANICAL UNITS AND ASSOCIATED PIPING DURING ALL WORK.
- 7. ____ SWEEP ALL ROOF SURFACES TO REMOVE ALL DEBRIS AND DIRT FOR SMOOTH ROOFING AREA PRIOR TO INSTALLATION OF SINGLE PLY ROOFING SYSTEM.

ROOF PLAN GENERAL NOTES:

- 1. ____ NEW ROOF SYSTEM: INCLUDES SINGLE PLY MEMBRANE ON 1/2" INSULATION RECOVER BOARD OVER EXISTING ROOF MEMBRANE. FASTEN 1/2" INSULATION RECOVER BOARD THRU EXISTING ROOFING SYSTEM TO THE EXISTING METAL DECK.
- 2. ____ FIELD VERIFY ALL EXISTING CONDITIONS.
- MECHANICAL ITEM LOCATIONS ARE SHOWN FOR REFERENCE ONLY. CONTRACTOR TO FIELD VERIFY EXACT LOCATIONS.
- 4. CONTRACTOR IS RESPONSIBLE FOR MAINTAINING AN INSULATED, WEATHERTIGHT ENCLOSURE FOR THE DURATION OF CONSTRUCTION.
- 5. __ CONTRACTOR RESPONSIBLE FOR REPAIRING ANY BUILDING AND SITE DAMAGE FROM CONSTRUCTION ACTIVITIES TO ORIGINAL CONDITION.
- 6. __ INSPECT EXISTING ROOF FOR ANY WET INSULATION AND RUSTED / UNSOUND METAL DECK, REPLACE WITH LIKE MATERIAL ON UNIT PRICE BASIS.
- 7. TEST ROOF DRAIN AFTER COMPLETION OF ROOF WORK.

ROOF LEGEND

RD	ROOF DRAIN
	ROOF EXHAUST
○ PV-X	VENT STACK, PIPE OR CONDUIT
	EXISTING SKYLIGHT
\bigvee	CRICKET FOR POSITIVE DRAINAGE
\longrightarrow	SLOPE OF TAPERED INSULATION, VERIFY IN THE FIELD
\longrightarrow	SLOPED STRUCTURE
	BASE BID: NEW ROOF SYSTEM (APPROX. ± 6000 SQ. FT.)
	ALTERNATE 1: NEW ROOF SYSTEM (APPROX. ± 500 SQ. FT.)

NOT IN CONTRACT NIC

ROOF PLAN KEY NOTES:

- (1) EXISTING SHEET METAL COPING TO BE REMOVED AND REPLACED TO ALLOW FOR INSTALLATION OF NEW MEMBRANE. NEW TO MATCH EXISTING PROFILE.
- 2) CAREFULLY REMOVE EXISTING SHEET METAL COPING AND REINSTALLED TO ALLOW FOR

INSTALLATION OF NEW MEMBRANE.

- (3) PROVIDE WALKWAY PAD AND SPLASHBLOCKS AT DOWNSPOUT DISCHARGE.
- 4 EXISTING ROOF DRAIN LOCATIONS ADJUST HEIGHT / PROVIDE EXTENSION AS REQUIRED TO MATCH NEW INSULATION / RECOVER BOARD THICKNESS.
- 5) DISCONNECT, REMOVE AND REINSTALL AND RECONNECT EXIST. HVAC UNIT. RAISE CURB, SEE E5 / A1.11, PROVIDE METAL COUNTERFLASHING. CONTRACTOR RESPONSIBLE FOR EXTENSION OF DUCTWORK, GAS AND / OR ELECTRICAL, AS OCCURS.
- 6) REMOVE EXISTING LIGHTNING PROTECTION AND REINSTALL. REMOVAL AND REINSTALLATION SHALL BE BY CERTIFIED LIGHTNING PROTECTION CONTRACTOR.
- (7) RUN MEMBRANE UP THE FACE OF WALL BELOW EXISTING GFRC MOLDING CAP AND SEAL.
- (8) PROVIDE PREFINISHED METAL END WALL FLASHING, COPING END AND CORNER EDGE PIECE AS REQUIRED. PROVIDE SEALANT FOR A COMPLETE WEATHERTIGHT SYSTEM.

ISSUED FOR BID - 07-03-19

1


(F5) WALL TERMINATION DETAIL

REMAIN

- EXISTING WEEP VENT
- CAREFULLY PULL BACK EXISTING SM TO ALLOW FOR
- 2-PIECE SM. COUNTER
- TERMINATION BAR AND SEAL
- EXISTING MEMBRANE TO REMAIN
- EXISTING RIGID INSULATION TO REMAIN

I.



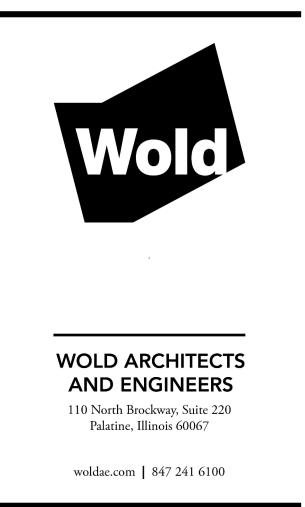

I hereby certify that this plan, specification or report was prepared by me or under my direct supervision and that I am a duly Licensed ARCHITECT under the laws of the State of Reg State

Arch Name License Number: Arch Num Date Issue Date Revisions Comm: 193019 Date: Issue Date Drawn: MAO Check: Checker North **ROOF PLAN AND** DETAILS

Scale: As indicated



	&	AND	FRP	FIBERGLASS REINFORCED PANEL	RUB	RUBBER
	@	AT	G BLK	GLAZED CONCRETE BLOCK	RWL	RAIN WATER LEADER
	ACT	ACOUSTICAL CEILING TILE	GA	GAUGE	SBD	SMART BOARD
	AF	ACCESS FLOORING	GB	GRAB BAR	SCHED	SCHEDULE
	AFF	ABOVE FINISHED FLOOR	GRD BLK	GROUND FACE CONCRETE BLOCK	SD	SOAP DISPENSER
	ALT #		GST	GLAZED STRUCTURAL TILE	SF	SQUARE FOOT (FEET)
	ALUM	ALUMINUM	GYP BD	GYPSUM BOARD	SF(#)	STOREFRONT TYPE
	AP	ACCESS PANEL	HCAP	HANDICAPPED	SIM	SIMILAR
^	AWC	ACOUSTICAL WALL COVERING	HM	HOLLOW METAL	SND	SANITARY NAPKIN DISP
A	AWF	ACOUSTICAL WALL FABRIC	HT	HOMOGENEOUS TILE	SNR	SANITARY NAPKIN REC
	AWP	ACOUSTICAL WALL PANEL	ID	INSIDE DIAMETER	SST	STAINLESS STEEL
	B BLK	BURNISHED CONCRETE BLOCK	INSUL	INSULATION	STN	STONE
	BLDG	BUILDING	L(#)	LOUVER TYPE	STRUCT	STRUCTURAL
	BRK	BRICK	LAV	LAVATORY	TBD	TACKBOARD
	C BLK	CONCRETE BLOCK	LINO	LINOLEUM	TEMP	TEMPORARY
	CG	CORNER GUARD	LVT	LUXURY VINYL TILE	TERR	TERRAZZO
	CIP	CAST-IN-PLACE	M/S	MIRROR WITH SHELF	TPH	TOILET PAPER HOLDER
	CJ	CONTROL JOINT	MATL	MATERIAL	TWC	TACKABLE WALLCOVER
	CL	CENTER LINE	MAX	MAXIMUM	TYP	TYPICAL
	CLG	CEILING	MBD	MARKERBOARD	UL	UNDERWRITER'S LABO
	СМ	CULTURED MARBLE	MECH	MECHANICAL	UNO	UNLESS NOTED OTHER
	CMU	CONCRETE MASONRY UNIT	MEF	MOSAIC EPOXY FLOORING	UR	URINAL
-	CONC	CONCRETE	MIN	MINIMUM	USF	URETHANE SLURRY FLO
	CONT	CONTINUOUS	MIR	MIRROR	V PLAS	VENEER PLASTER
	CPT	CARPET	MISC	MISCELLANEOUS	VAT	VINYL ASBESTOS TILE
	CRF	CHEMICAL RESISTANT FLOORING	NIC	NOT IN CONTRACT	VCT	VINYL COMPOSITION TI
	СТ	CERAMIC TILE	NO	NUMBER	VIF	VERIFY IN FIELD
	CTP	COUNTERTOP	NSF	NON-SLIP FLOORING	VTR	VENT THROUGH ROOF
	CU	CONDENSING UNIT	NTS	NOT TO SCALE	VWC	VINYL WALLCOVERING
	CUH	CABINET UNIT HEATER	OH	OVERHEAD	VWF	VINYL WALL FABRIC
	CW(#)	CURTAINWALL TYPE	P LAM	PLASTIC LAMINATE	W(#)	WINDOW TYPE
	DEMO	DEMOLITION	P TILE	PORCELAIN TILE	WC	WATER CLOSET
	DF	DRINKING FOUNTAIN	PLAS	PLASTER	WD	WOOD
	DIA	DIAMETER	PT	PAINT	WSCT	WAINSCOT
	DN	DOWN	PTD	PAINTED	WWF	WELDED WIRE FABRIC
В	E PT	EPOXY PAINT	PVC	POLYVINYL CHLORIDE		
D	EIFS	EXTERIOR INSULATION AND FINISH	PWP	PLASTIC (PHENOLIC) WALL PANEL		
		SYSTEM	QRT	QUARTZ		
	EJ	EXPANSION JOINT	QT	QUARRY TILE		
	ELEC	ELECTRICAL	R	RADIUS		
	ELEV	ELEVATION	RAF	RESILIENT ATHLETIC FLOORING		
	EPDM	ETHYLENE PROPYLENE DIENE MONOMER	RCP	REFLECTED CEILING PLAN		
	EWC	ELECTRIC WATER COOLER	RD	ROOF DRAIN		
	EXIST	EXISTING	RES	RESILIENT		
	EXP	EXPOSED	RF	RESINOUS FLOORING		
	FD	FLOOR DRAIN	RFT	RUBBER FLOOR TILE		
	FE	FIRE EXTINGUISHER	RH	RELIEF HOOD		
	FF&E	FIXTURES	RM	ROOM		
	FFE	FINISHED FLOOR ELEVATION	RTU	ROOF TOP UNIT		

I.

2


1

L

-

IL

SYMBOLS

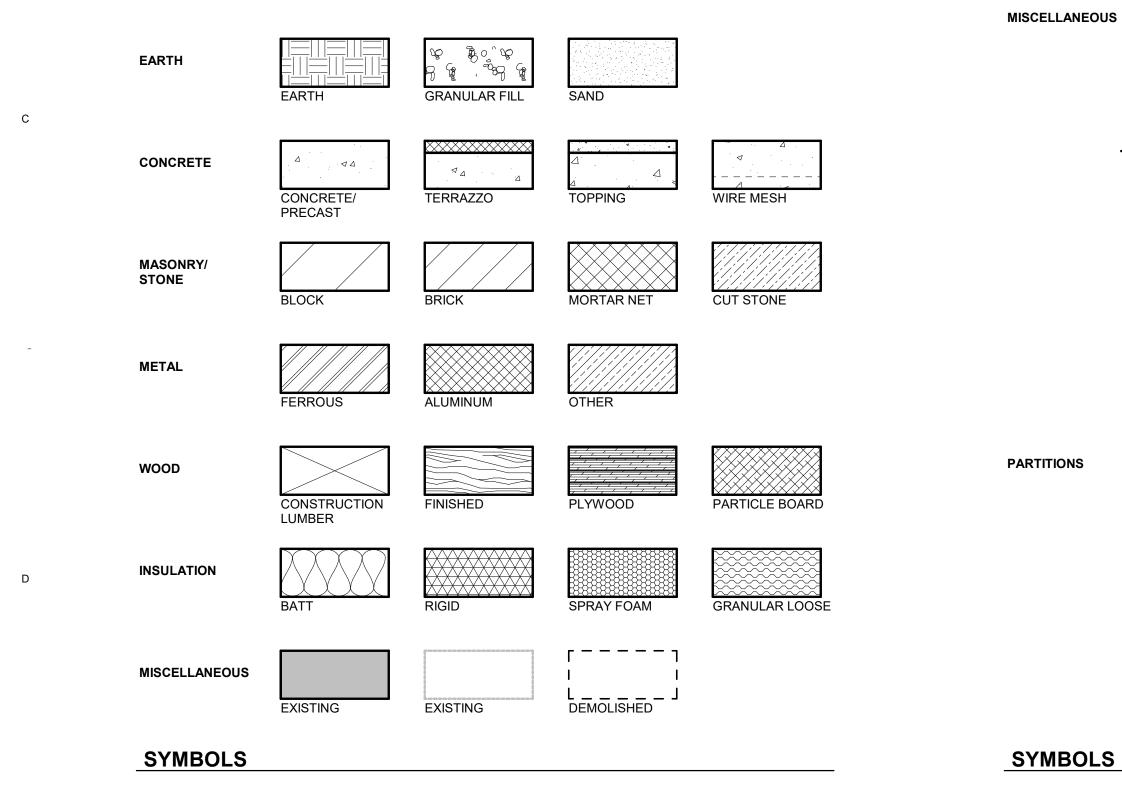

Α

-

F

-

Е

-

1

I.

3 I

EADER

I

DT (FEET) T TYPE

PKIN DISPENSER

APKIN RECEPTOR EEL

R HOLDER

ALLCOVERING

R'S LABORATORY ED OTHERWISE


LURRY FLOORING

STOS TILE OSITION TILE

LD

IGH ROOF COVERING FABRIC

E FABRIC

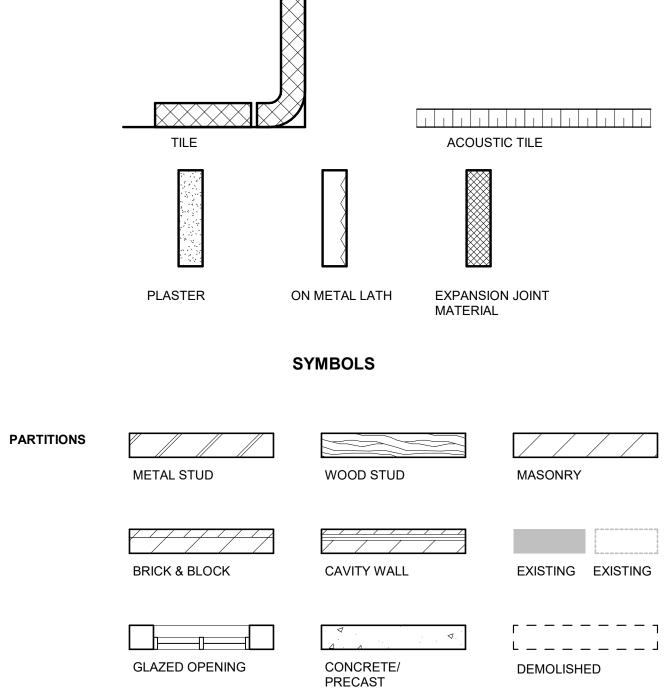

I

1

SYMBOLS

SECTIONS C1 A5.2xx DETAIL NO DRAWING NO 3 GRIDS ELEVATIONS INTERIOR EXTERIOR DETAIL NO C1 B1 A4.1xx DRWG NO A5.1xx OPENINGS, DEPRESSIONS OR AS NOTED D2 A4.2xx DETAIL NO DRAWING NO DETAIL REFERENCE NOTES, DIMENSIONS & 1 NOTES APPLY DETAIL KEYS APPLY FROM NOTED DETAIL MARKERBOARDS, TACKBOARDS, MAP RAILS LENGTH 8'-0" 8'-0" MBD LENGTH MATERIAL <2> TYPE MATCHLINE SYMBOLS

SYMBOLS

ABBREVIATIONS

1

4

6

ELEVATION	-
REVISIONS	2
ROOM NAME	OR 2 OR ART
OWNER INFO, AS	
CEILING HEIGHT CEILING MATL/ FIN	(8'-8") ACT 1/-
DOOR OR WDW SWING & NO	A102
	A102L
EXISTING WALL/ DOOR/ OTHER	
DEMOLISHED WALL/ DOOR/ OTHER	/
HINGE SIDE	
EXTERIOR WINDOWS	W1
STOREFRONT	(SF1)
CURTAINWALL	CW1
LOUVER	L1

1

I.

7

1


ISSUED FOR BID - 07-03-19

1



8

I.

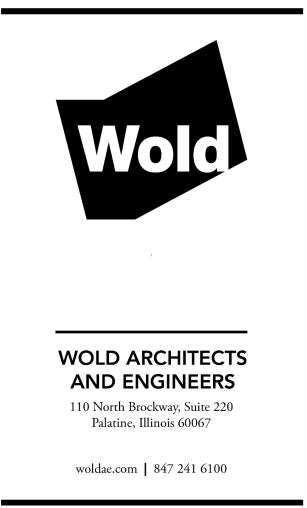


I hereby certify that this plan, specification or report was prepared by me or under my direct supervision and that I am a duly Licensed ARCHITECT under the laws of the State of Reg State

Arch Name Arch Num Date Issue Date License Number:

Revisions					
Description	Date	Num			

Comm: 193019 Date: Issue Date Drawn: MAO Check: Checker

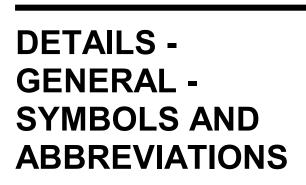

A2.00

Scale: As indicated