SOUTH QUINCY LIFT STATION REHABILITATION CITY OF QUINCY, ILLINOIS

PROJECT LOCATION: RADIO ROAD & REFINERY ROAD QUINCY, IL. 62305



Engineers • Architects • Surveyors

616 NORTH 24TH STREET QUINCY, IL 62301 PHONE: (217) 223-3670



PROJECT LOCATION MAP

NOT TO SCALE


GENERAL NOTES

- THE CONTRACTOR(S) SHALL CONFIRM CONDITIONS DESCRIBED HEREIN AND TELL THE ARCHITECT OF ANY DISCREPANCIES AND INTERFERENCES ENCOUNTERED PRIOR TO STARTING
- 2. THE CONTRACTOR(S) SHALL FIELD VERIFY EXISTING DIMENSIONS AND CONDITIONS AND TELL THE ARCHITECT OF ANY DISCREPANCIES AND INTERFERENCES ENCOUNTERED PRIOR TO STARTING WORK AFFECTED THEREBY.
- 3. THE CONTRACTOR(S) SHALL BE RESPONSIBLE FOR OSHA COMPLIANCE AND JOB SITE SAFETY.
- CONTRACTOR(S) SHALL VERIFY LOCATIONS OF ALL UTILITIES (TELEPHONE, DATA, GAS, ELECTRIC, SANITARY AND STORM SEWERS, ETC.) AT THE SITE BEFORE STARTING EXCAVATION OR CONSTRUCTION. THESE ITEMS SHALL BE MARKED AND PROTECTED.
- THE CONTRACTOR(S) SHALL REPORT ANY SUSPICIOUS MATERIALS (POTENTIALLY HAZARDOUS) AT THE SITE IMMEDIATELY TO THE OWNER FOR HIS/HER FURTHER ACTION. UNLESS NOTED SPECIFICALLY ON THE DRAWINGS OR PROJECT MANUAL, THE ARCHITECT/ENGINEER IS NOT AWARE OF ANY HAZARDOUS MATERIALS AND HAS NOT BEEN HIRED BY THE OWNER TO DEAL WITH SUCH.
- CONTRACTOR(S) SHALL TAKE PRECAUTIONS NECESSARY TO PROTECT ADJACENT PROPERTY FROM DAMAGE RESULTING FROM CONSTRUCTION OPERATIONS.
- 7. THE CONTRACTOR(S) SHALL SUBMIT EVIDENCE OF INSURANCE TO OWNER AND HAVE IT APPROVED AS ACCEPTABLE TO OWNER PRIOR TO STARTING WORK. OWNER AND ARCHITECT SHALL BE NAMED




PROJECT SITE

NOT TO SCALE

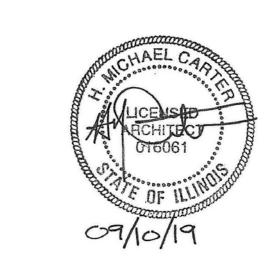

MICHAEL CARTER, A.I.A. LICENSED ARCHITECT STATE OF ILLINOIS LICENCE NO. 001.016061 LICENSE EXPIRES: 11/30/20

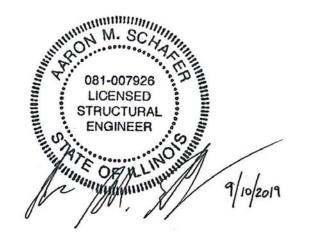

AARON SCHAFER, S.E. LICENSED STRUCTURAL ENGINEER STATE OF ILLINOIS LICENCE NO. 081-007926 LICENSE EXPIRES: 11/30/19

SHEET INDEX

SHEET									
G001	TITLE SHEET								
C100	LIFT STATION SITE PLAN								
A101	ROOF PLANS								
A102	ROOF DETAILS								
S001	STRUCTURAL NOTES								
S101	STRUCTURAL DEMOLITION PLAN & DETAILS								
S201	EXISTING BOTTOM SLAB PLAN								
S202	ELEVATED SLAB FRAMING PLAN								
S203	ELEVATED SLAB PLAN								
S301	STRUCTURAL DETAILS								
S501	ROOF FRAMING PLANS								
PD101	PROCESS PIPING DEMOLITION - PLAN VIEW BELOW ELEVATED SLAB								
P101	PROCESS IMPROVEMENTS - PLAN VIEW BELOW ELEVATED SLAB								
P201	PROCESS SECTIONS								
M101	MECHANICAL PLANS								
M201	MECHANICAL FLANS MECHANICAL ELEVATION &								
IVIZOT	SCHEDULES								
E101	ELECTRICAL DEMOLITION PLANS								
E102	ELECTRICAL & LIGHTING PLANS								
E501	ELECTRICAL ONE LINE DIAGRAM & PANEL SCHEDULES								



09/10/19

JOSEPH KNOCHEL, P.E. LICENSED PROFESSIONAL ENGINEER STATE OF ILLINOIS LICENCE NO. 062.062983 LICENSE EXPIRES: 11/30/19



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PROJECT NO. 19-0192 DRAWING ISSUED DATE: 09/10/19 SHEET G001

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SHEET TITLE

TITLE SHEET


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Author

FIELD BOOK

CHECK DATE



Lift Station Site Plan

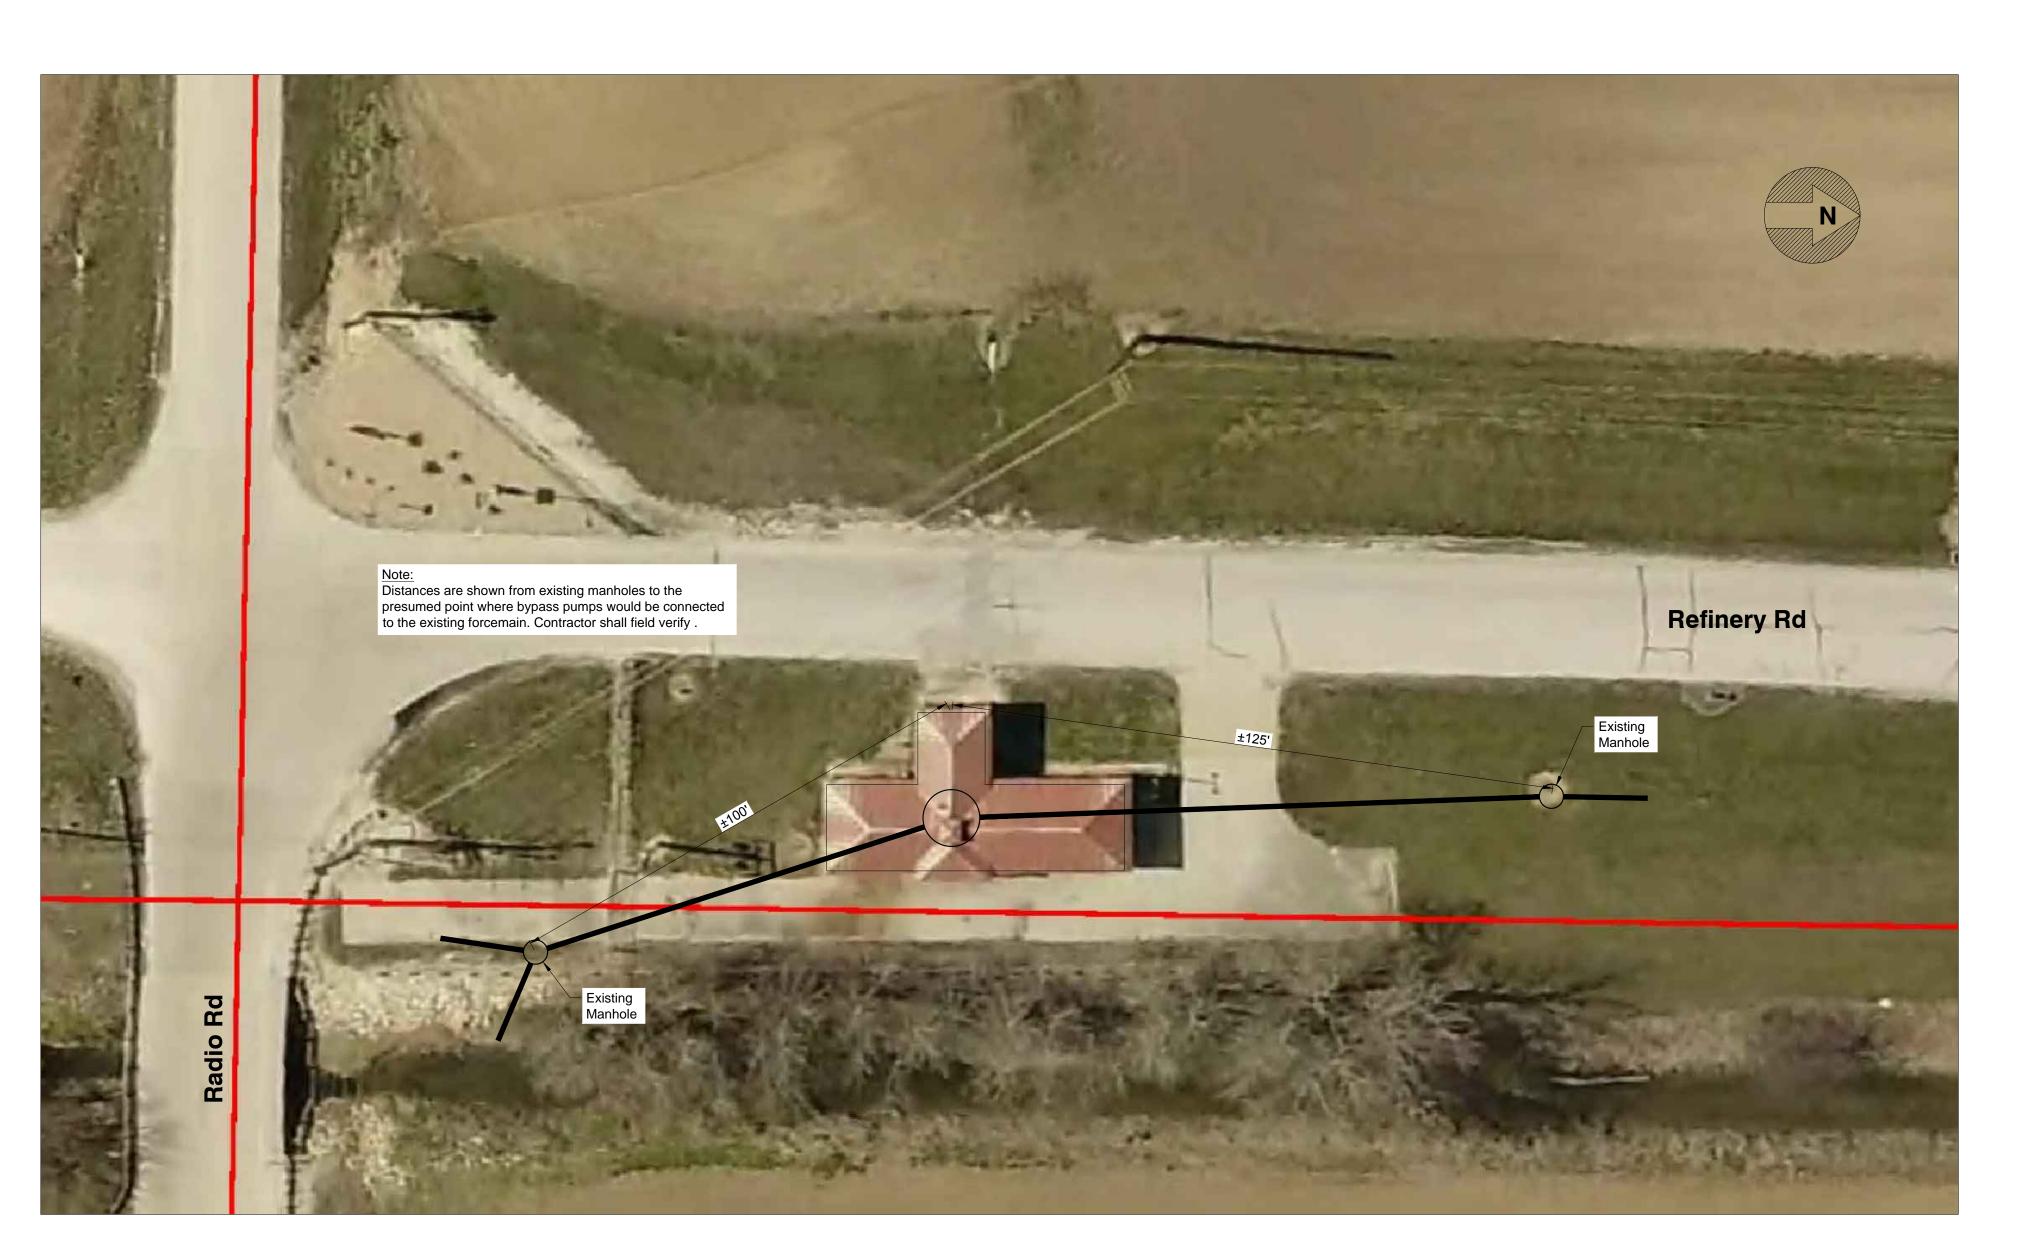Scale: 1" = 20'

1 Inch
Full Scale Drawing: 22x34"

Prepared for: Department of Utilities & Engineering City of Quincy, Illinois


2019 Sewage Collection
System Improvements
South Quincy Lift Station
Rehabilitation

Lift Station Site Plan

Date 09/10/19
Sheet Number
C100

3/16" = 1'-0"

ROOF PLAN - DEMOLITION

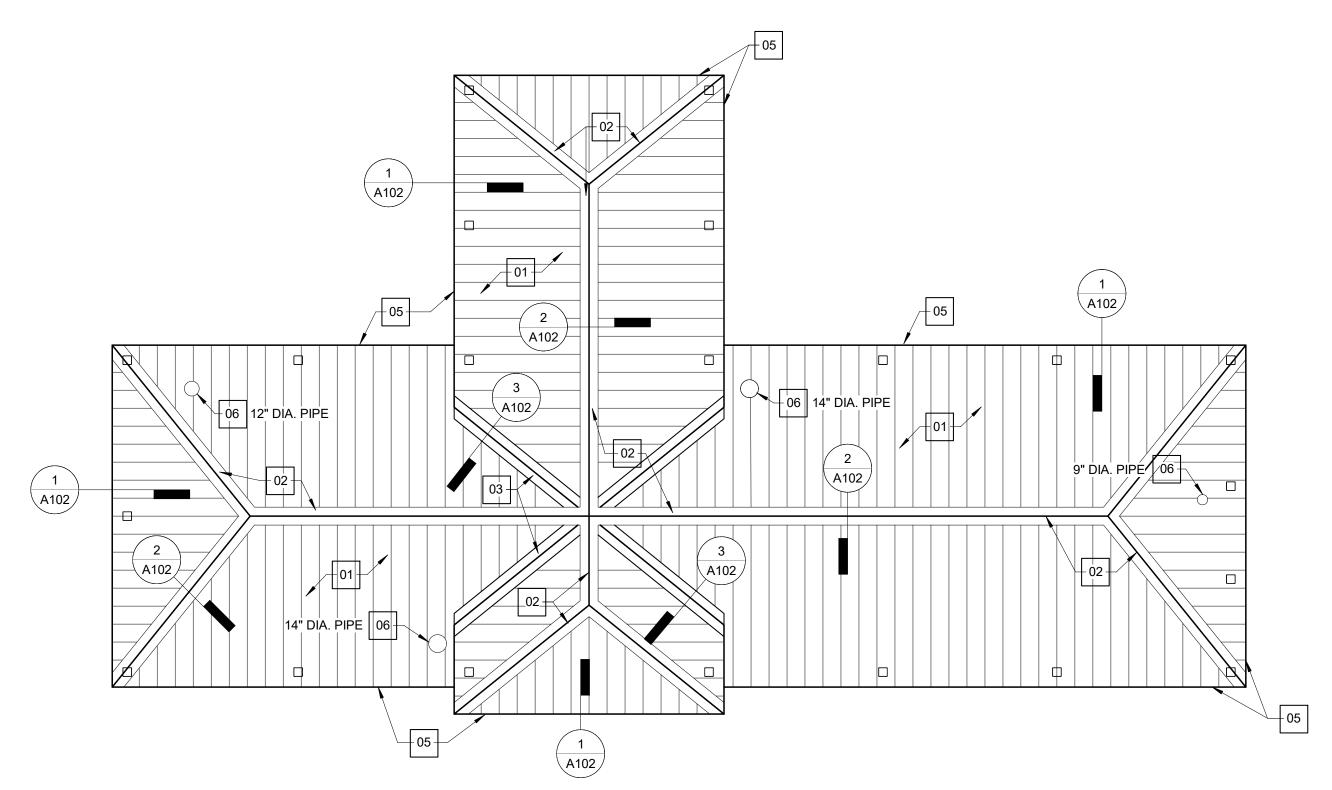

ROOF PLAN - RENOVATION
3/16" = 1'-0"

GENERAL DEMOLITION NOTES:

- O1 ALL MATERIALS NOTED TO BE REMOVED SHALL BE REMOVED IN THEIR ENTIRETY FROM SITE UNLESS RETAINED FOR OWNER (SEE GENERAL NOTE 02 THIS SHEET). ALL WASTE MATERIALS SHALL BE TRANSPORTED AND APPROPRIATELY DISPOSED-OF IN ACCORDANCE WITH APPLICABLE STATE AND FEDEBRAL LAWS.
- 02 CONTRACTOR TO OFFER OWNER RIGHT OF FIRST REFUSAL FOR ALL ITEMS NOTED TO BE REMOVED.

DEMOLITION NOTES:

INDICATES DEMO. NOTE KEYNOTED ON PLAN

01 REMOVE ALL EXISTING STANDING SEAM METAL ROOF PANELS THROUGHOUT.

2 REMOVE ALL EXISTING HIP AND VALLEY FLASHING THOUGHOUT, TYPICAL.

03 REMOVE CUPOLA IN ITS ENTIRETY AND DISCARD OFF-SITE.

ig/07igREMOVE EXISTING ROUND SHEET METAL VENT.

04 NOT USED.

REMOVE EXISTING SHEET METAL FASCIA AT ALL EAVES. EXISTING EAVE PURLIN MUST BE REMOVED TO REMOVE FASCIA.

06 REMOVE EXISTING STEEL CRANE BEAMS LOCATED UNDER ROOF FRAMING.

GENERAL RENOVATION NOTES:

- TO PREVENT GALVANIC CORROSION, PROVIDE 45 MIL EPDM MEMBRANE SEPERATOR WHERE NEW ALUMINUM SHEET METAL INTERFACES WITH EXISTING STEEL FRAMING.
- FOR NEW ALUMINUM STANDING SEAM ROOF PANELS TO BE INSTALLED OVER EXISTING STEEL PURLINS, BEARING PLATES MUST BE PLACED OVER PURLINS TO BE USED IN CONJUNCTION WITH ROOF PANEL SECUREMENT CLIPS. BEARING PLATES TO BE PROVIDED BY ALUMINUM ROOF PANEL MFGR.

RENOVATION KEYNOTES:

INDICATES NOTES KEYED ON SHEET FLOOR PLANS

- 01 INSTALL NEW PREFINISHED STANDING SEAM ALUMINUM ROOF PANELS OVER NEW STEEL PURLINS: SEE SPEC SECTION 07410.
- 02 INSTALL NEW VENTED RIDGE AND HIP FLASHING: BY ALUM. ROOF PANEL MFGR.: SEE DETAIL A102-2
- 03 INSTALL NEW VALLEY FLASHING: BY ALUM. ROOF PANEL MFGR.: SEE DETAIL A102-3
- 04 NOT USED.
- 05 INSTALL NEW ALUM. FASCIA AROUND PERIMITER OF BUILDING: SEE DETAIL A501-1
- 06 INSTALL NEW EPDM SQUARE BASE PIPE BOOT FOR PIPE DIAMETER INDICATED.

SOUTH QUINCY LIFT STATIC
REHABILITATION

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DESCRIPTION DATE APP

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Designer Author

FIELD FIELD BOOK

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ROOF PLANS

PROJECT NO.
19-0192


DRAWING ISSUED DATE:
09/10/2019

SHEET

\$HEET 101 DETAIL - FLASHING
3" = 1'-0"

SECUREMENT CLIP - .040 STANDING SEAM ALUM. ROOF PANEL - "Z" RETAINER CLOSURE SET IN CONTINUOUS BEAD OF SEALANT - .040" PREFIN. ALUM. VALLEY FLASHING

3 Valley Detail 3" = 1'-0"

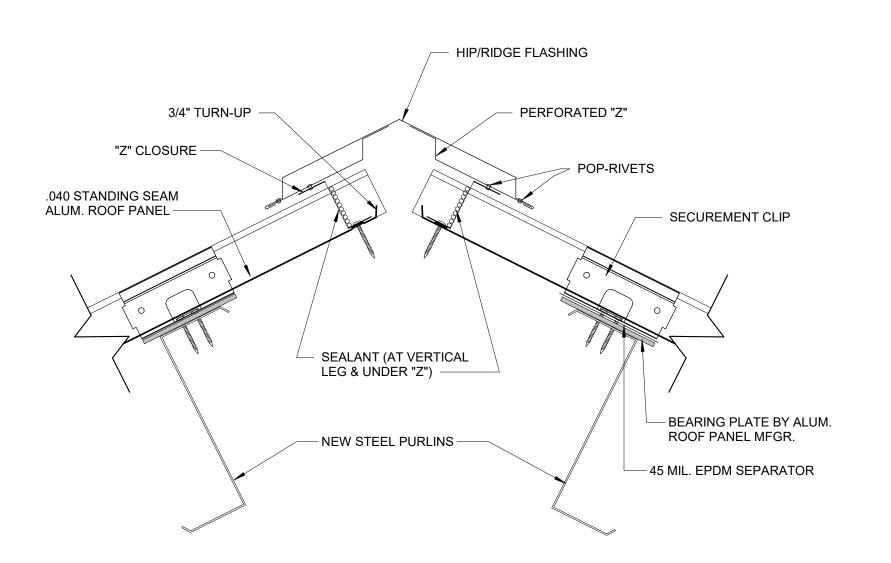

2 DETAIL - VENTED RIDGE & HIP FLASHING
3" = 1'-0"

NOIL SOUTH QUINCY LIFT STA REHABILITATION CITY OF QUINCY CITY OF QUINCY 730 MAINE STREET QUINCY, ILLINOIS

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ROOF DETAILS

PROJECT NO. **19-0192** DRAWING ISSUED DATE: 09/10/19 SHEET

A102

45 MIL. EPDM SEPARATOR -BEARING PLATE BY ALUM. ROOF PANEL MFGR. - NEW STEEL PURLINS

DESIGN CRITERIA (NON-SHELTER)

- Design Codes: a. International Building Code: IBC 2015 b. Minimum Design Loads for Buildings and Other Structures: ASCE 7-10 a. Risk Category II
- b. Live Load i. Floor LL = 100 psf c. Dead Load i. Floor LL = 100 psf

EXISTING WORK

- 1. Existing conditions shown or noted on the drawings were obtained from field measurements or existing drawings. If conditions other than those shown exist, immediately notify the Engineer before proceeding with the work at that location. All dimensions shall be field verified.
- 2. Use appropriate construction methods and equipment as necessary to support existing structures and
- to avoid over stressing the existing structures. 3. Existing framing is assumed to be in original condition. If deterioration has occurred notify the Engineer of Record.

GENERAL

- 1. The structure is designed to be self-supporting and stable after the building is fully completed. It is solely the contractor's responsibility to determine erection procedure and sequence and insure the safety of the construction personnel, public, building and its components parts, and adjacent buildings and properties. This includes the addition of whatever temporary or permanent shoring, bracing, needling, underpinning, or sheet piling, etc. that may be necessary to brace new construction, adjacent buildings, so that the structure is braced for wind, seismic, gravity, construction loads, etc. and that no horizontal or vertical settlement or any damage occurs to the adjacent existing structure. Temporary supports shall be maintained in place until permanents supports and/or shoring and bracing are installed.
- 2. Fall protection support from perimeter columns or walls shall be provided in accordance with OSHA requirements as required. Such material shall remain the contractor's property after the completion of the project.
- 3. It is the contractor's responsibility to enforce all applicable safety codes and regulations during all phases of construction. 4. The contractor shall perform all construction for the project in a manner and sequence that are based on accepted industry standards that recognize the interaction of the components that comprise the structure, without causing distress, unanticipated movements or irregular load paths as a result of the construction means and methods employed.
- 5. Construction loads shall not exceed design live loads. The contractor shall be responsible for all design required to support construction equipment used in constructing this project. Shoring and reshoring is the responsibility of the contractor.
- 6. Principal openings through the framing are shown on these drawings. The general contractor shall examine the structural and mechanical drawings for the required openings and shall verify size and location of all openings with the mechanical contractor. Providing all openings required by the mechanical, electrical, plumbing, or other trades shall be part of the general contract, whether or not shown in the structural drawings. Any deviation from the openings shown on the structural drawings shall be
- brought to the engineer's attention for review. 7. All contractors are required to examine the drawings and specifications carefully, visit the site and fully inform themselves as to all existing conditions and limitations, prior to agreeing to perform the work. Failure to visit the site and familiarize themselves with the existing conditions and limitations will in no way relieve the contractor from furnishing any materials or performing any
- 8. Details labeled "Typical Details" on drawings apply to situations occurring on the project that are the same or similar to those specifically details. Such details apply whether or not details are referenced at each location. Notify engineer of clarification regarding applicability of "Typical Details".

INSIDE DIAMETER

LONG LEG HORIZONTAL LONG LEG VERTICAL

LIGHT WEIGHT CONCRETE

PRE ENGINEERED METAL BUILDING

POUNDS PER SQUARE FOOT

PRESSURE TREATED

ROUGH OPENING

SCHEDULE

STEEL LINE

STANDARD STIFFENER

THROUGH

TO BE REMOVED TOP OF STEEL

U.N.O. UNLESS NOTED OTHERWISE

W.W.F. WELDED WIRE FABRIC

THICK

T.O.W. TOP OF WALL TYPICAL

VERT. VERTICAL

JOIST

LIVE LOAD

MAXIMUM

OPPOSITE HAND

MECH. MECHANICAL MINIMUM NUMBER

N.T.S. NOT TO SCALE

REINF. REINFORCING

STAGG. STAGGERED

9. Work these drawings with architectural, mechanical, and electrical drawings.

JST.

LG.

L.L.

MAX.

MIN. NO. (#)

OPNG.

PEMB

P.S.F.

P.T.

R.O. SCH. SIM.

STD. STIFF.

THRU.

T.B.R. T.O.S.

TYP.

work in accordance with drawings and specifications without additional cost to the owner.

10. Do not scale drawings.

ABBREVIATIONS

ARCH.

BOT.

BRDG.

CLR. CMU

COL.

CONC.

CTR. DBL.

E.W.

HGR.

ANCHOR BOLT

ARCHITECT

BUILDING

BOTTOM

BRIDGING

COLUMN

DOUBLE

DIAMETER

ELEVATION

FOUNDATION

FLOOR

GAUGE

HANGER

HEIGHT

GALVANIZED

HOLLOW CORE

CONCRETE

CONSTRUCTION JOINT

CONCRETE MASONRY UNIT

11. Should any of the general notes conflict with any details or instructions on plans, the strictest provision shall govern. 12. Omissions or conflicts between various elements of the drawings, notes and details shall be brought to the attention of the engineer and resolved before proceeding with the work.

CAST-IN-PLACE CONCRETE


- 1. All concrete construction shall conform to ACI 301, "Specification for Structural Concrete" and ACI 302, "Guide for Concrete Floor and Slab Construction", ACI 305 "Specification for Hot Weather Concreting" and ACI 306, "Standard Specification for Cold Weather Concreting", unless noted otherwise for the year referenced in the building code noted.
- 2. All detailing, fabrication and placing of reinforcing bars, unless otherwise noted, shall conform to ACI 318, "Building Code Requirements for Structural Concrete", ACI 117, "Specification for Tolerances for Concrete Construction and Materials", and the
- 3. Concrete shall be discharged at the site within 1 ½ hours after water has been added to the cement and aggregates. Addition of water to the mix at the project site will not be permitted. All water must be added at the batch plant. Slump may be adjusted only through the use of additional water reducing admixtures or high range water reducing admixture.
- 4. All concrete shall be placed without horizontal construction joints, except where specifically noted. 5. All exposed edges of concrete members shall be chamfered ¾ " unless shown otherwise.
- 6. The placement of sleeves, outlet boxes, box-outs, anchors, etc., for the mechanical, electrical and plumbing trades is the responsibility of the trade involved; however, any box-outs not covered by typical details in structural drawings shall be
- Reinforcing bars shall conform to ASTM A615, Grade 60, No tack welding of reinforcing in the field will be permitted. 8. Reinforcing bars for welded applications shall conform to ASTM A706, 60 ksi yield strength.
- 9. Wire bar supports shall be furnished for all reinforcing within slabs, inclusive of welded wire fabric. Bottom bars in slabs-on-grade may be supported by other suitable supports. Reinforcing shall be properly positioned prior to concrete placement and may not be re-positioned once concrete operations have begun. Wire bar and other types of supports shall be in accordance with the concrete reinforcing steel institute manual of standard practice.
- 10. Reinforcement shall be continuous through all construction joints unless otherwise noted on drawings.
- 11. All hooks shown on drawings shall be standard hooks, unless otherwise noted. 12. Where continuous bars are called for, they shall run continuously around corners and be lapped at necessary splices.
- Lap lengths shall be as given in the splice and development table.
- 13. In reinforced concrete walls, grade beams and trench footing provide corner dowels of same size and spacing as horizontal reinforcing. Dowels shall lap with horizontal reinforcing in each direction.
- 14. The following minimum concrete cover shall be provide for reinforcement, unless otherwise noted:
 - a. Earth formed and cast directly against soil 3" b. Cast against forms but exposed to earth and weather
 - #6 and Larger 2"
- #5 and Smaller 1 ½"
- c. Slabs and walls not exposed to earth or weather $-\frac{3}{4}$ " d. Others - 2"
- 15. All structural concrete shall have a 4000 psi minimum compressive strength at age 28 days. 16. SPLICE LENGTHS:
- 1'-7" 2'-0" 2'-6" 3'-6" 4'-0" #8 4'-6" #9
- a. When lapping two different size bars, use the lap dimension of the smaller bar or the anchorage dimension of the larger bar, use whichever dimension is larger.


STRUCTURAL STEEL

- 1. Detailing, fabrication and erection shall conform to the AISC Specifications and Standard Code of Practice for the year referenced in the building code noted, except as modified by these notes and the project specifications.
- 2. Steel shall conform to the following grades unless otherwise noted:
- a. Plate, Angles, M, S and C Shapes ASTM A36 (Fy=36 ksi)
- b. Bolts ASTM 325-n, 3/4" diameter minimum. c. Washers – ASTM F436
- d. Epoxy Shall be: HILTI HIT-HY 200-A; OR DEWALT/POWERS AC100+ GOLD; or approved equal.
- e. Welding Electrodes E70xx
- 3. All structural steel shall be primed and panted per Painting Specification. Field touch up Primer and Paint. 4. All welding shall be in accordance with the "Structural Welding Code", AWS D1.1, Latest Edition.
- 5. Splicing of structural members where not detailed on the drawings is prohibited with our prior approval of the structural engineer.

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 $\overline{\underline{o}}$ SOUTH QUINCY LIFT STA REHABILITATION CITY OF QUINCY 730 MAINE STREET QUINCY, ILLINOIS AMS AMS FIELD BOOK KTH 8/7/2019 SHEET TITLE STRUCTURAL NOTES PROJECT NO. 19-0192 DRAWING ISSUED DATE: 08/07/2019 SHEET S001



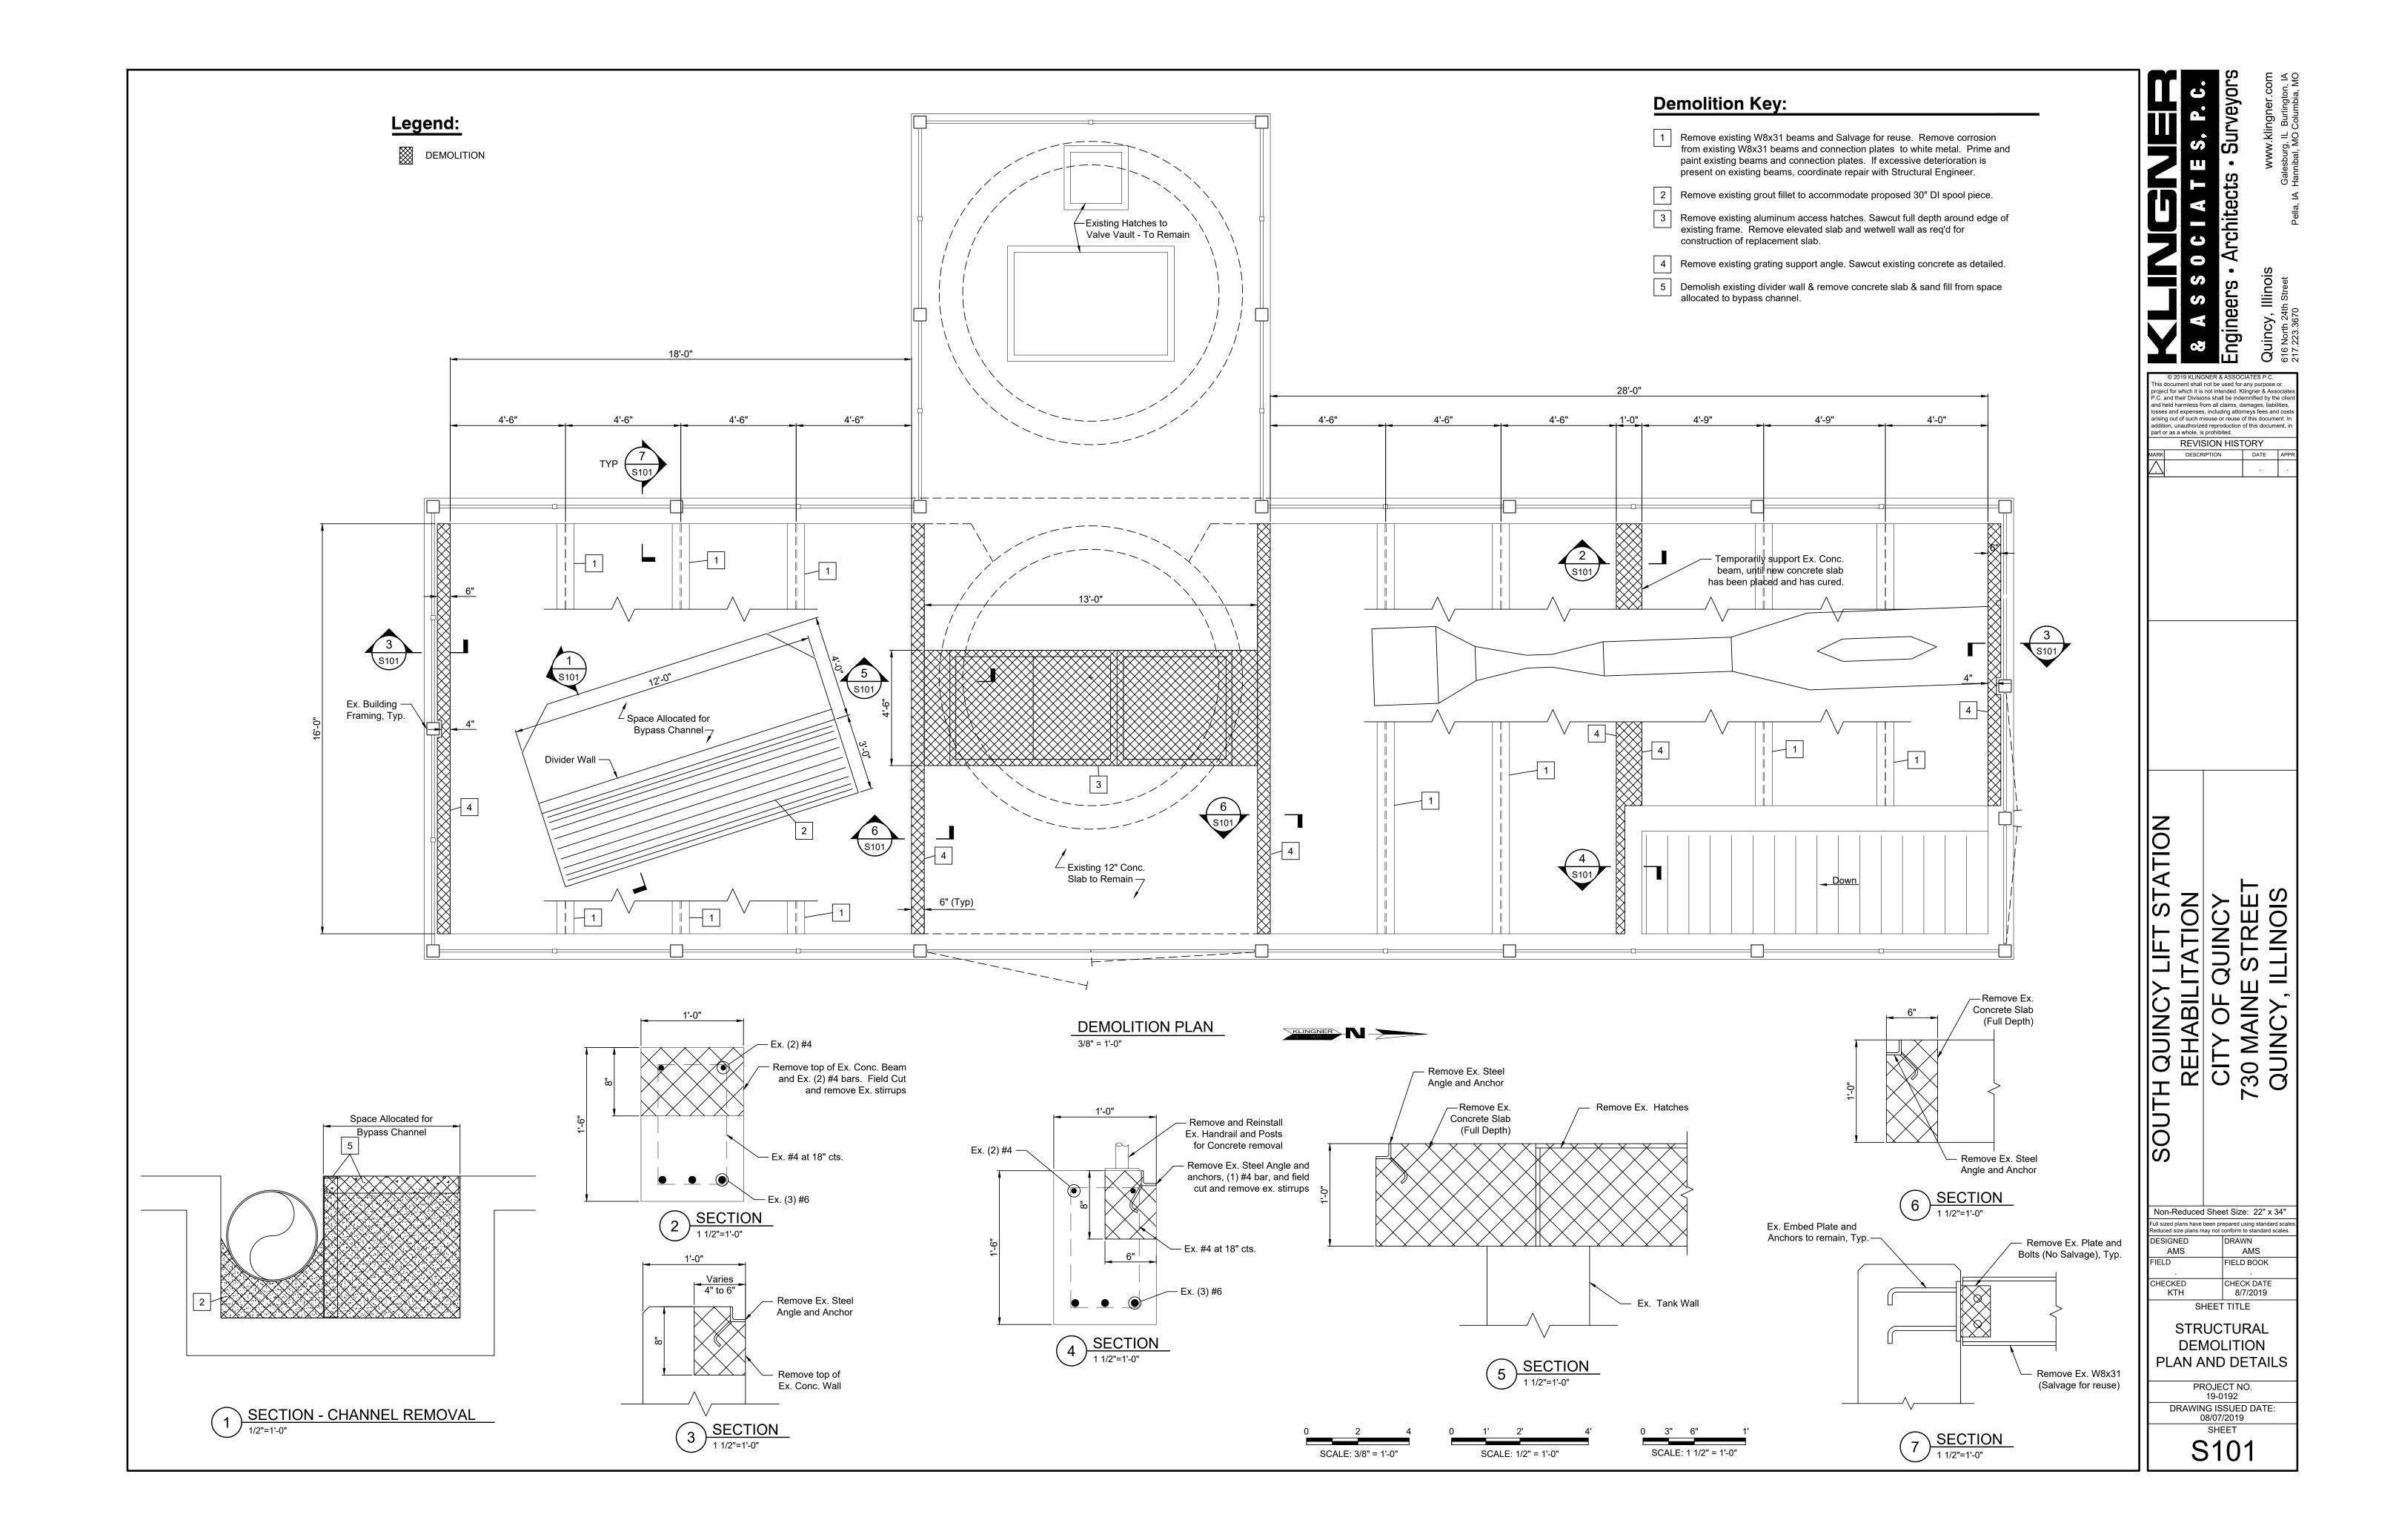
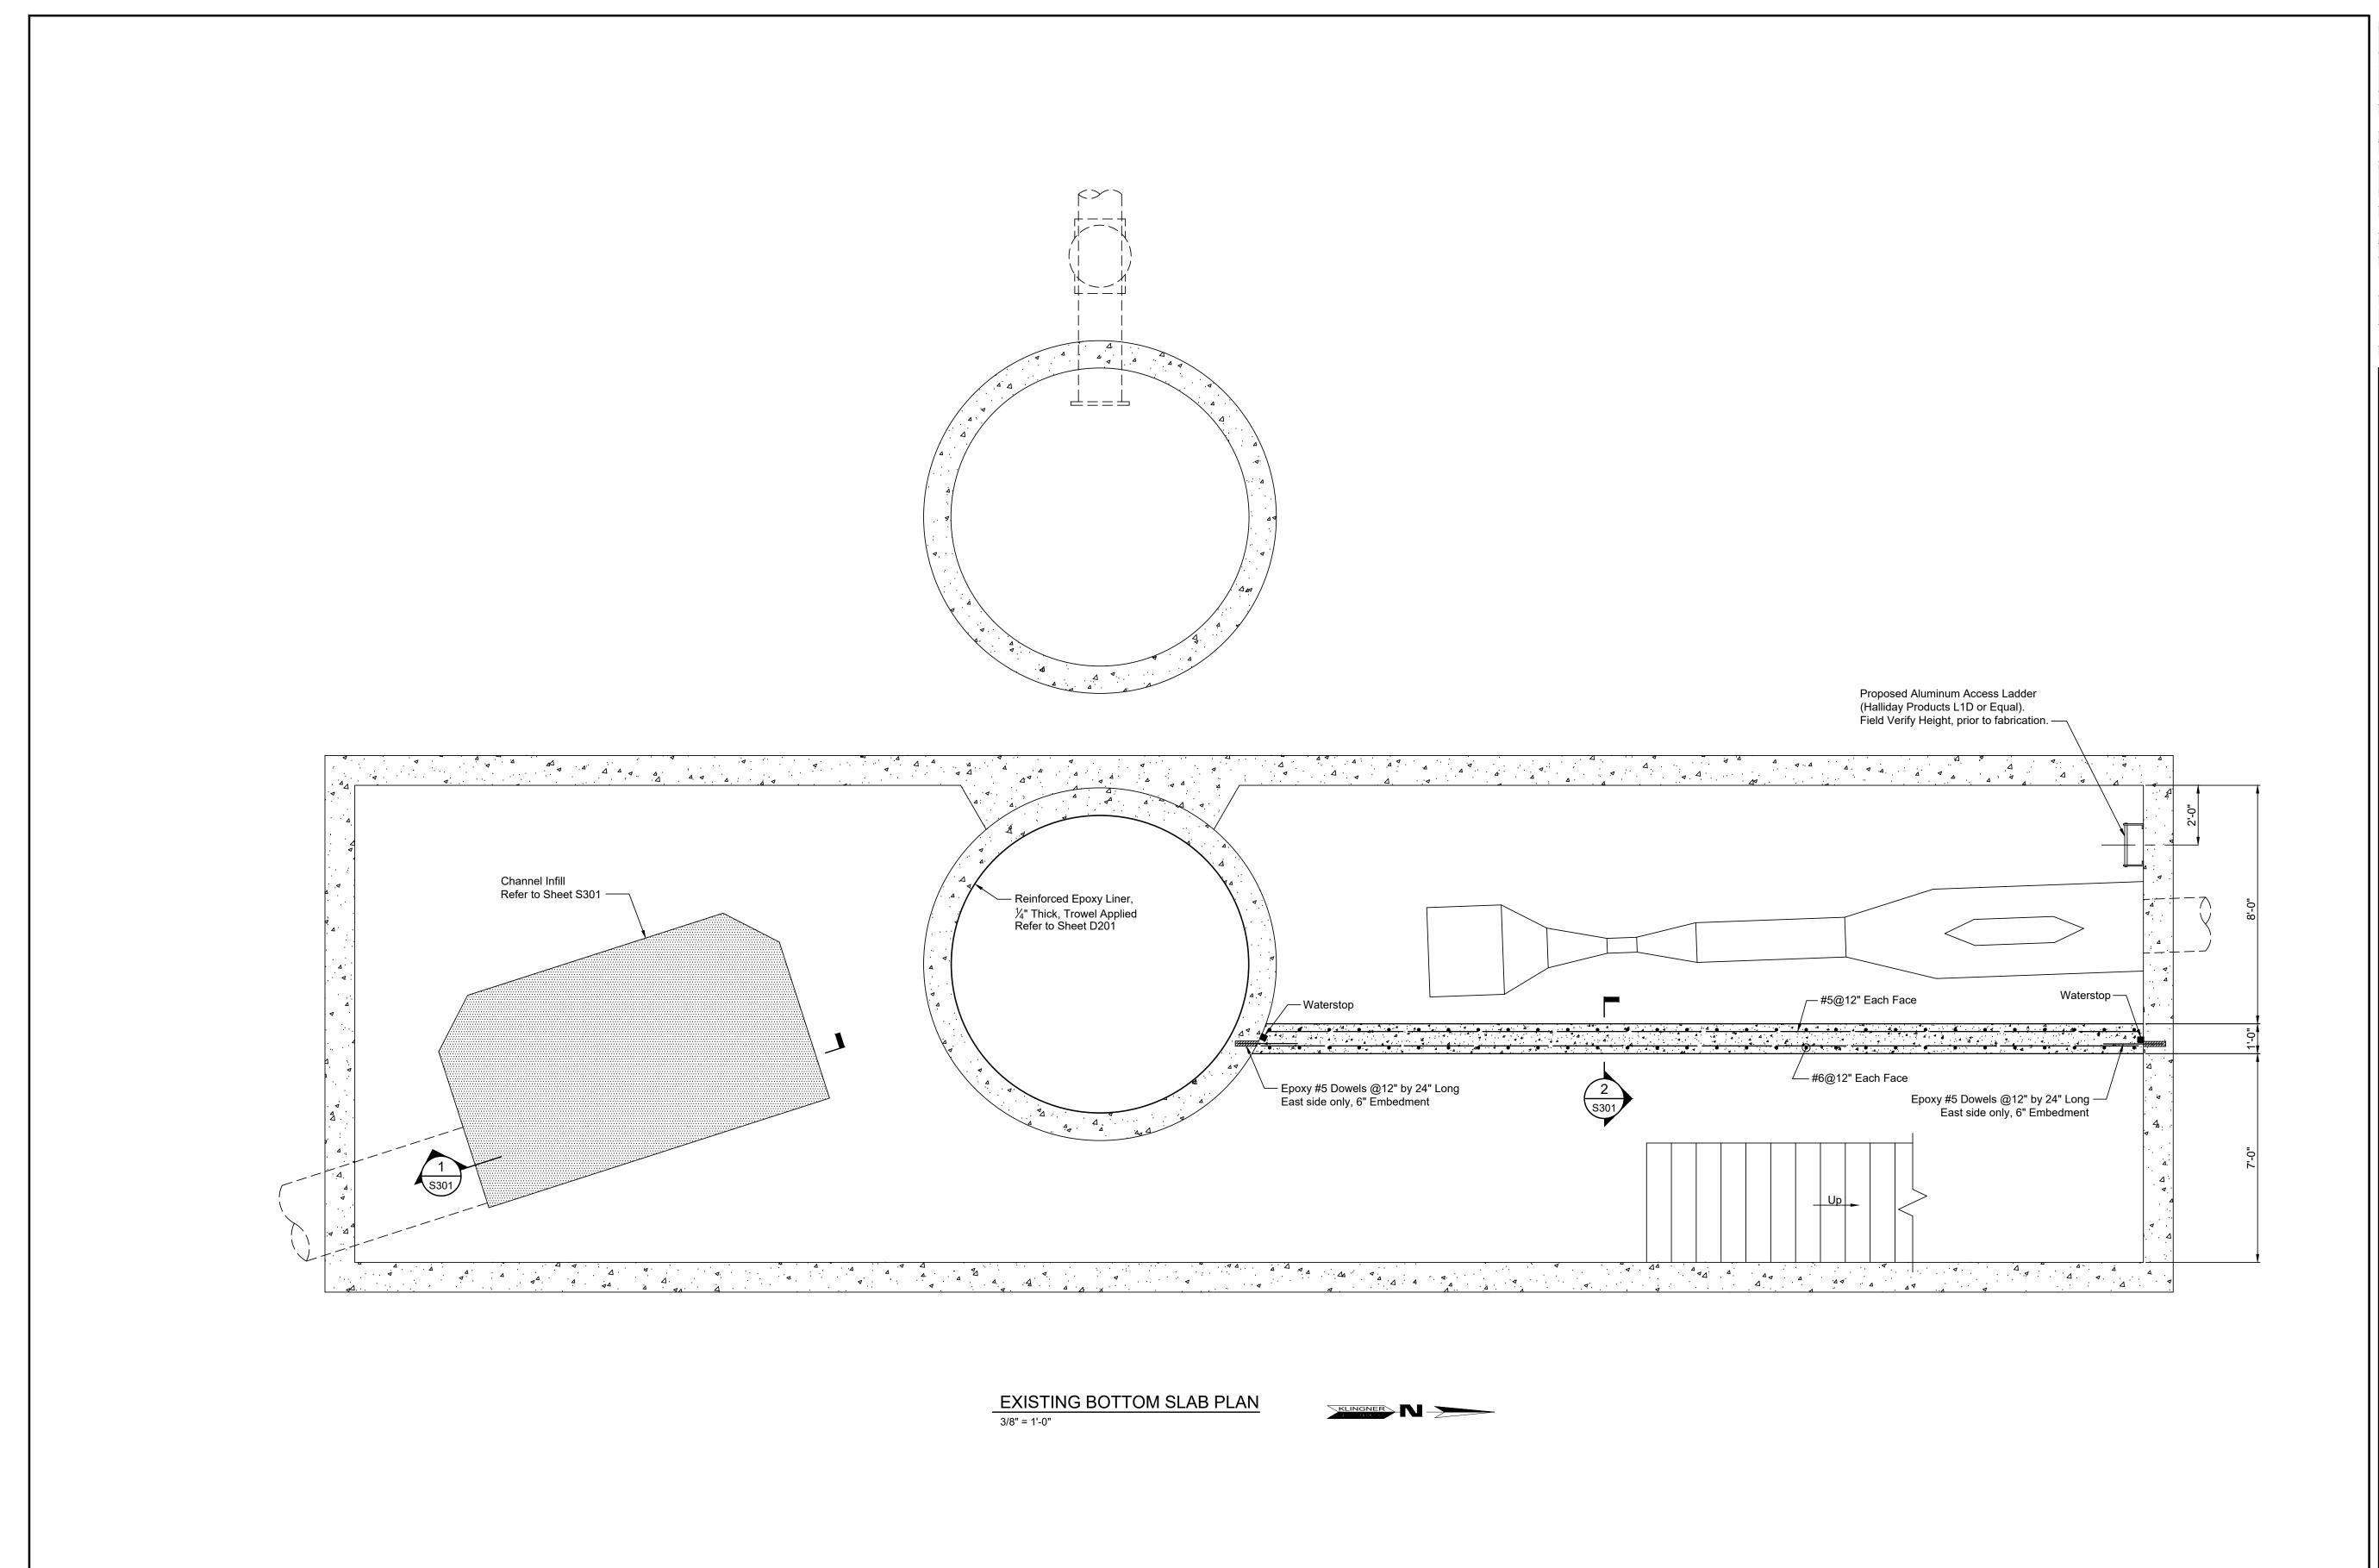
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Gallesburg II Burlington, IA

Gallesburg III Burlington, III

SOUTH QUINCY LIFT STATION
REHABILITATION
CITY OF QUINCY
730 MAINE STREET
QUINCY, ILLINOIS

Non-Reduced Sheet Size: 22" x 34"

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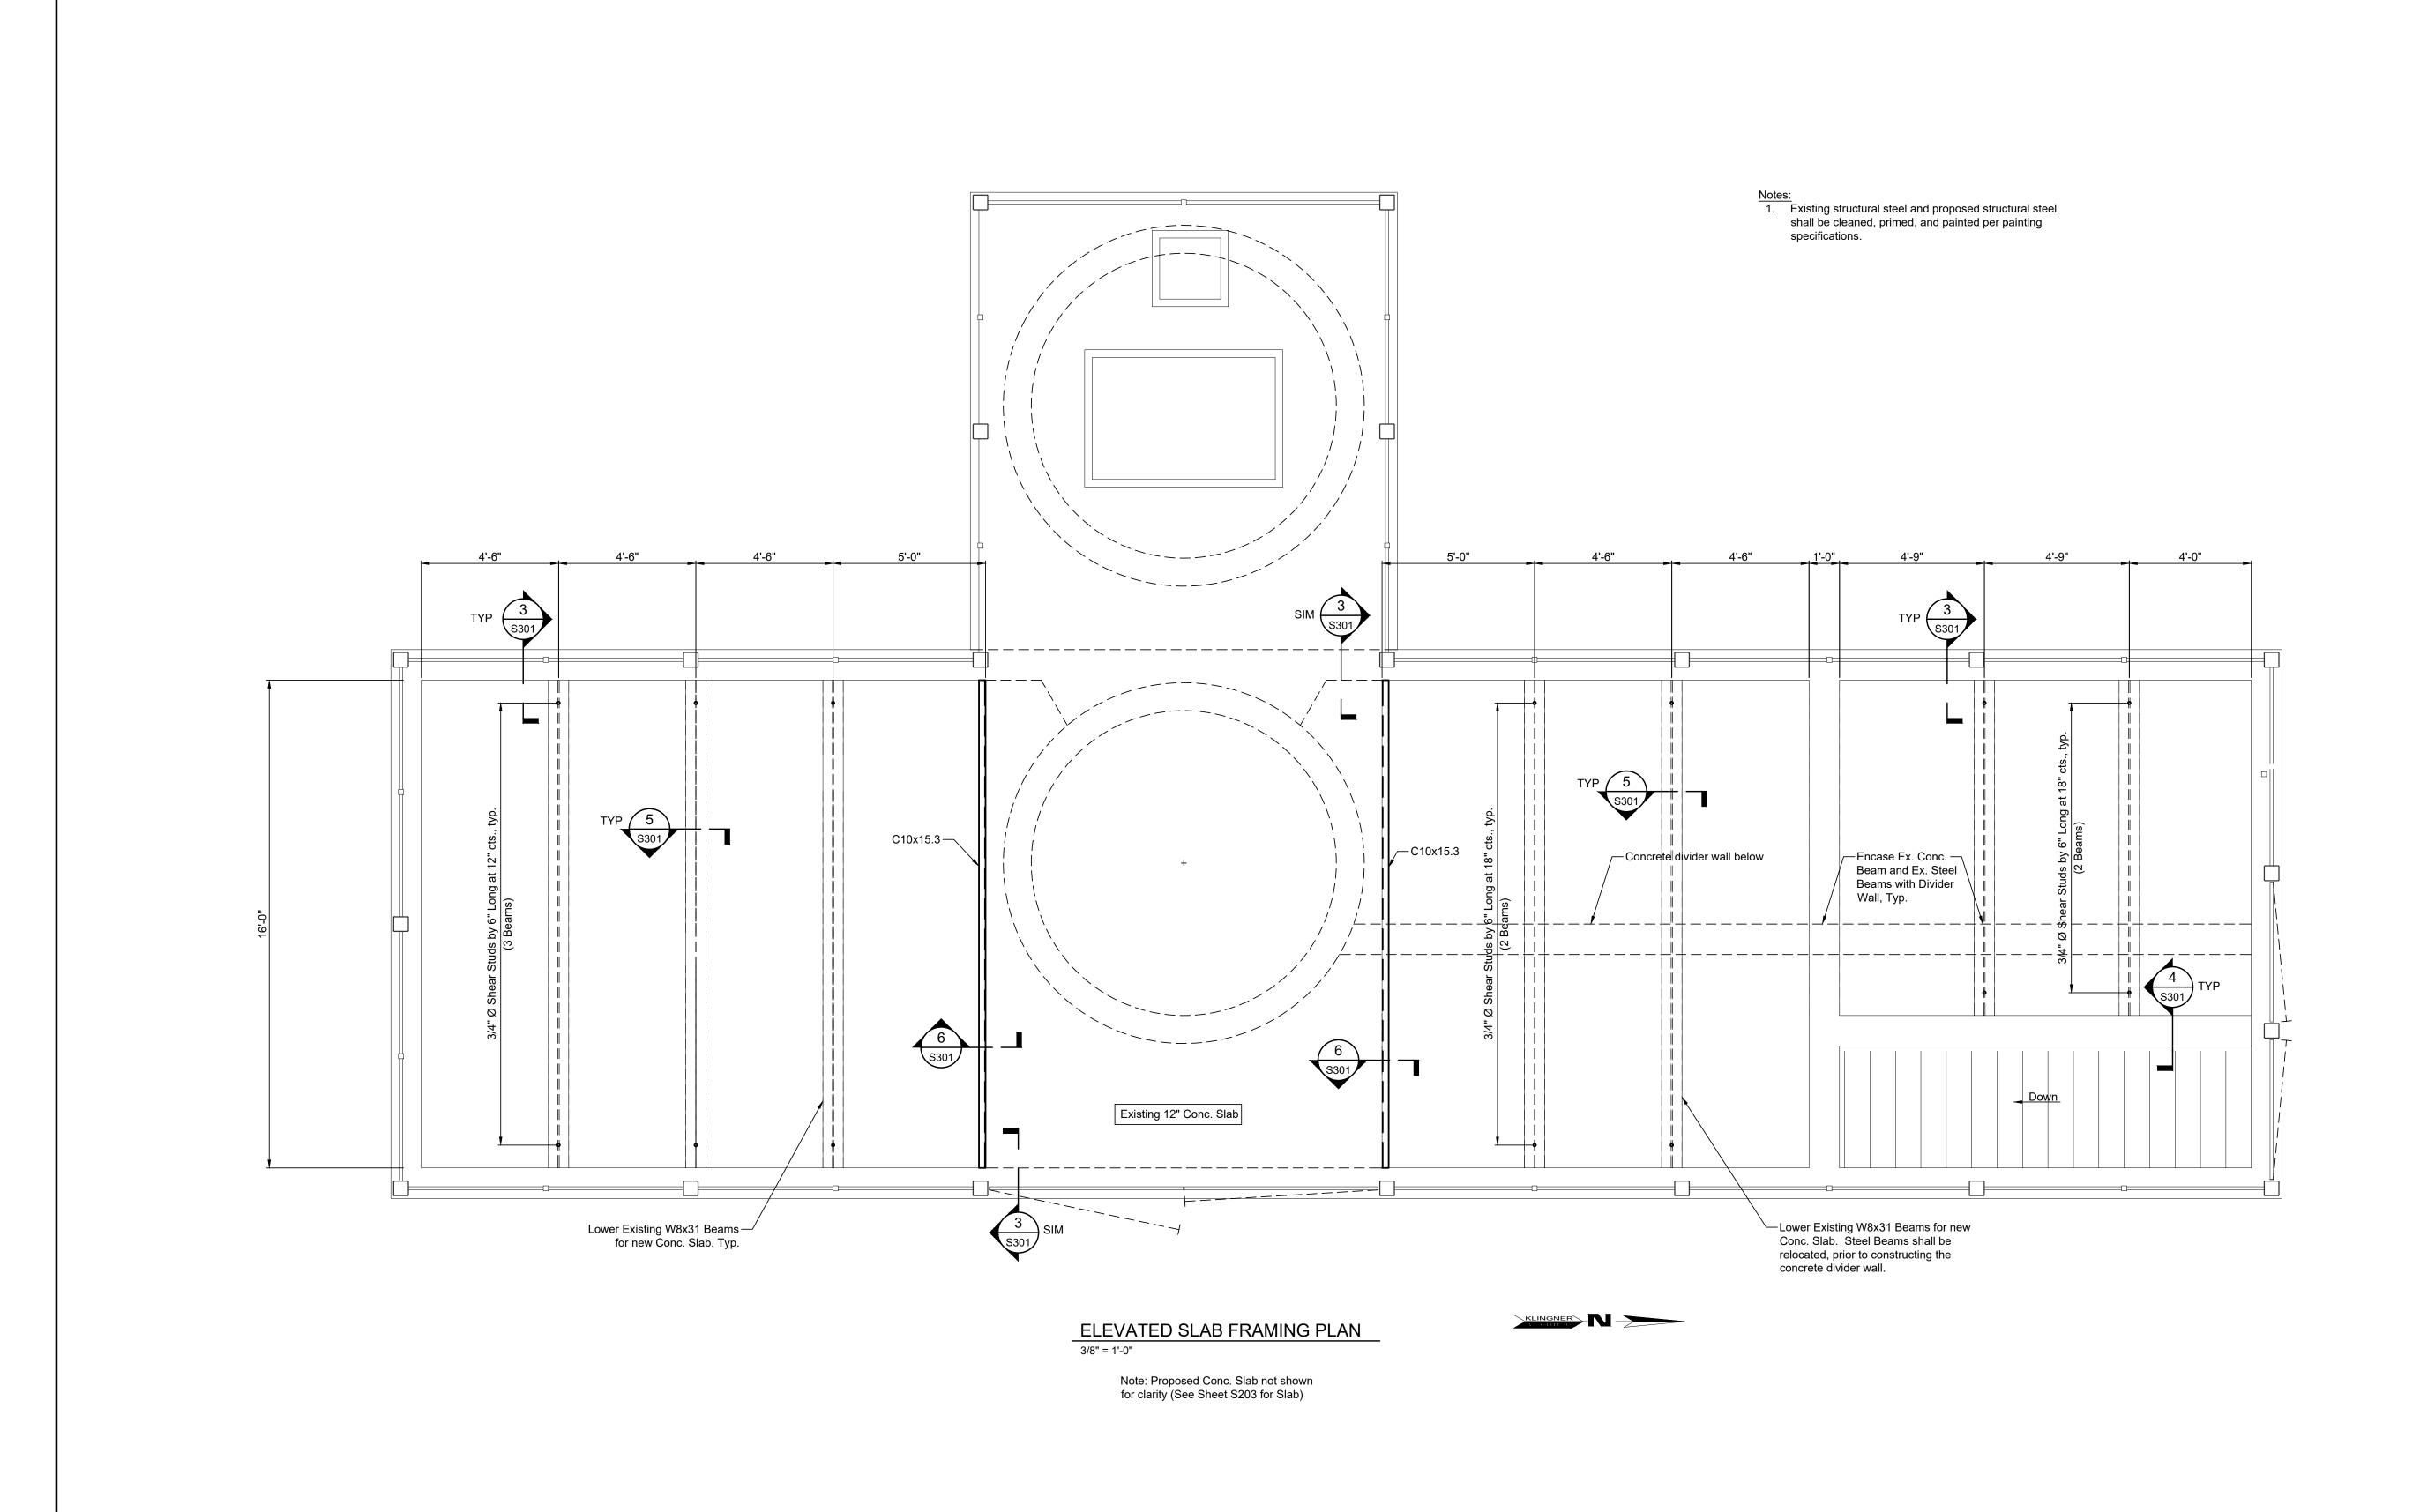
CHECKED CHECK DATE 8/7/2019

SHEET TITLE
EXISTING
BOTTOM
SLAB PLAN

PROJECT NO. 19-0192 DRAWING ISSUED DATE: 08/07/2019 SHEET

S201

SCALE: 3/8" = 1'-0"




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SHEET

S202

SCALE: 3/8" = 1'-0"



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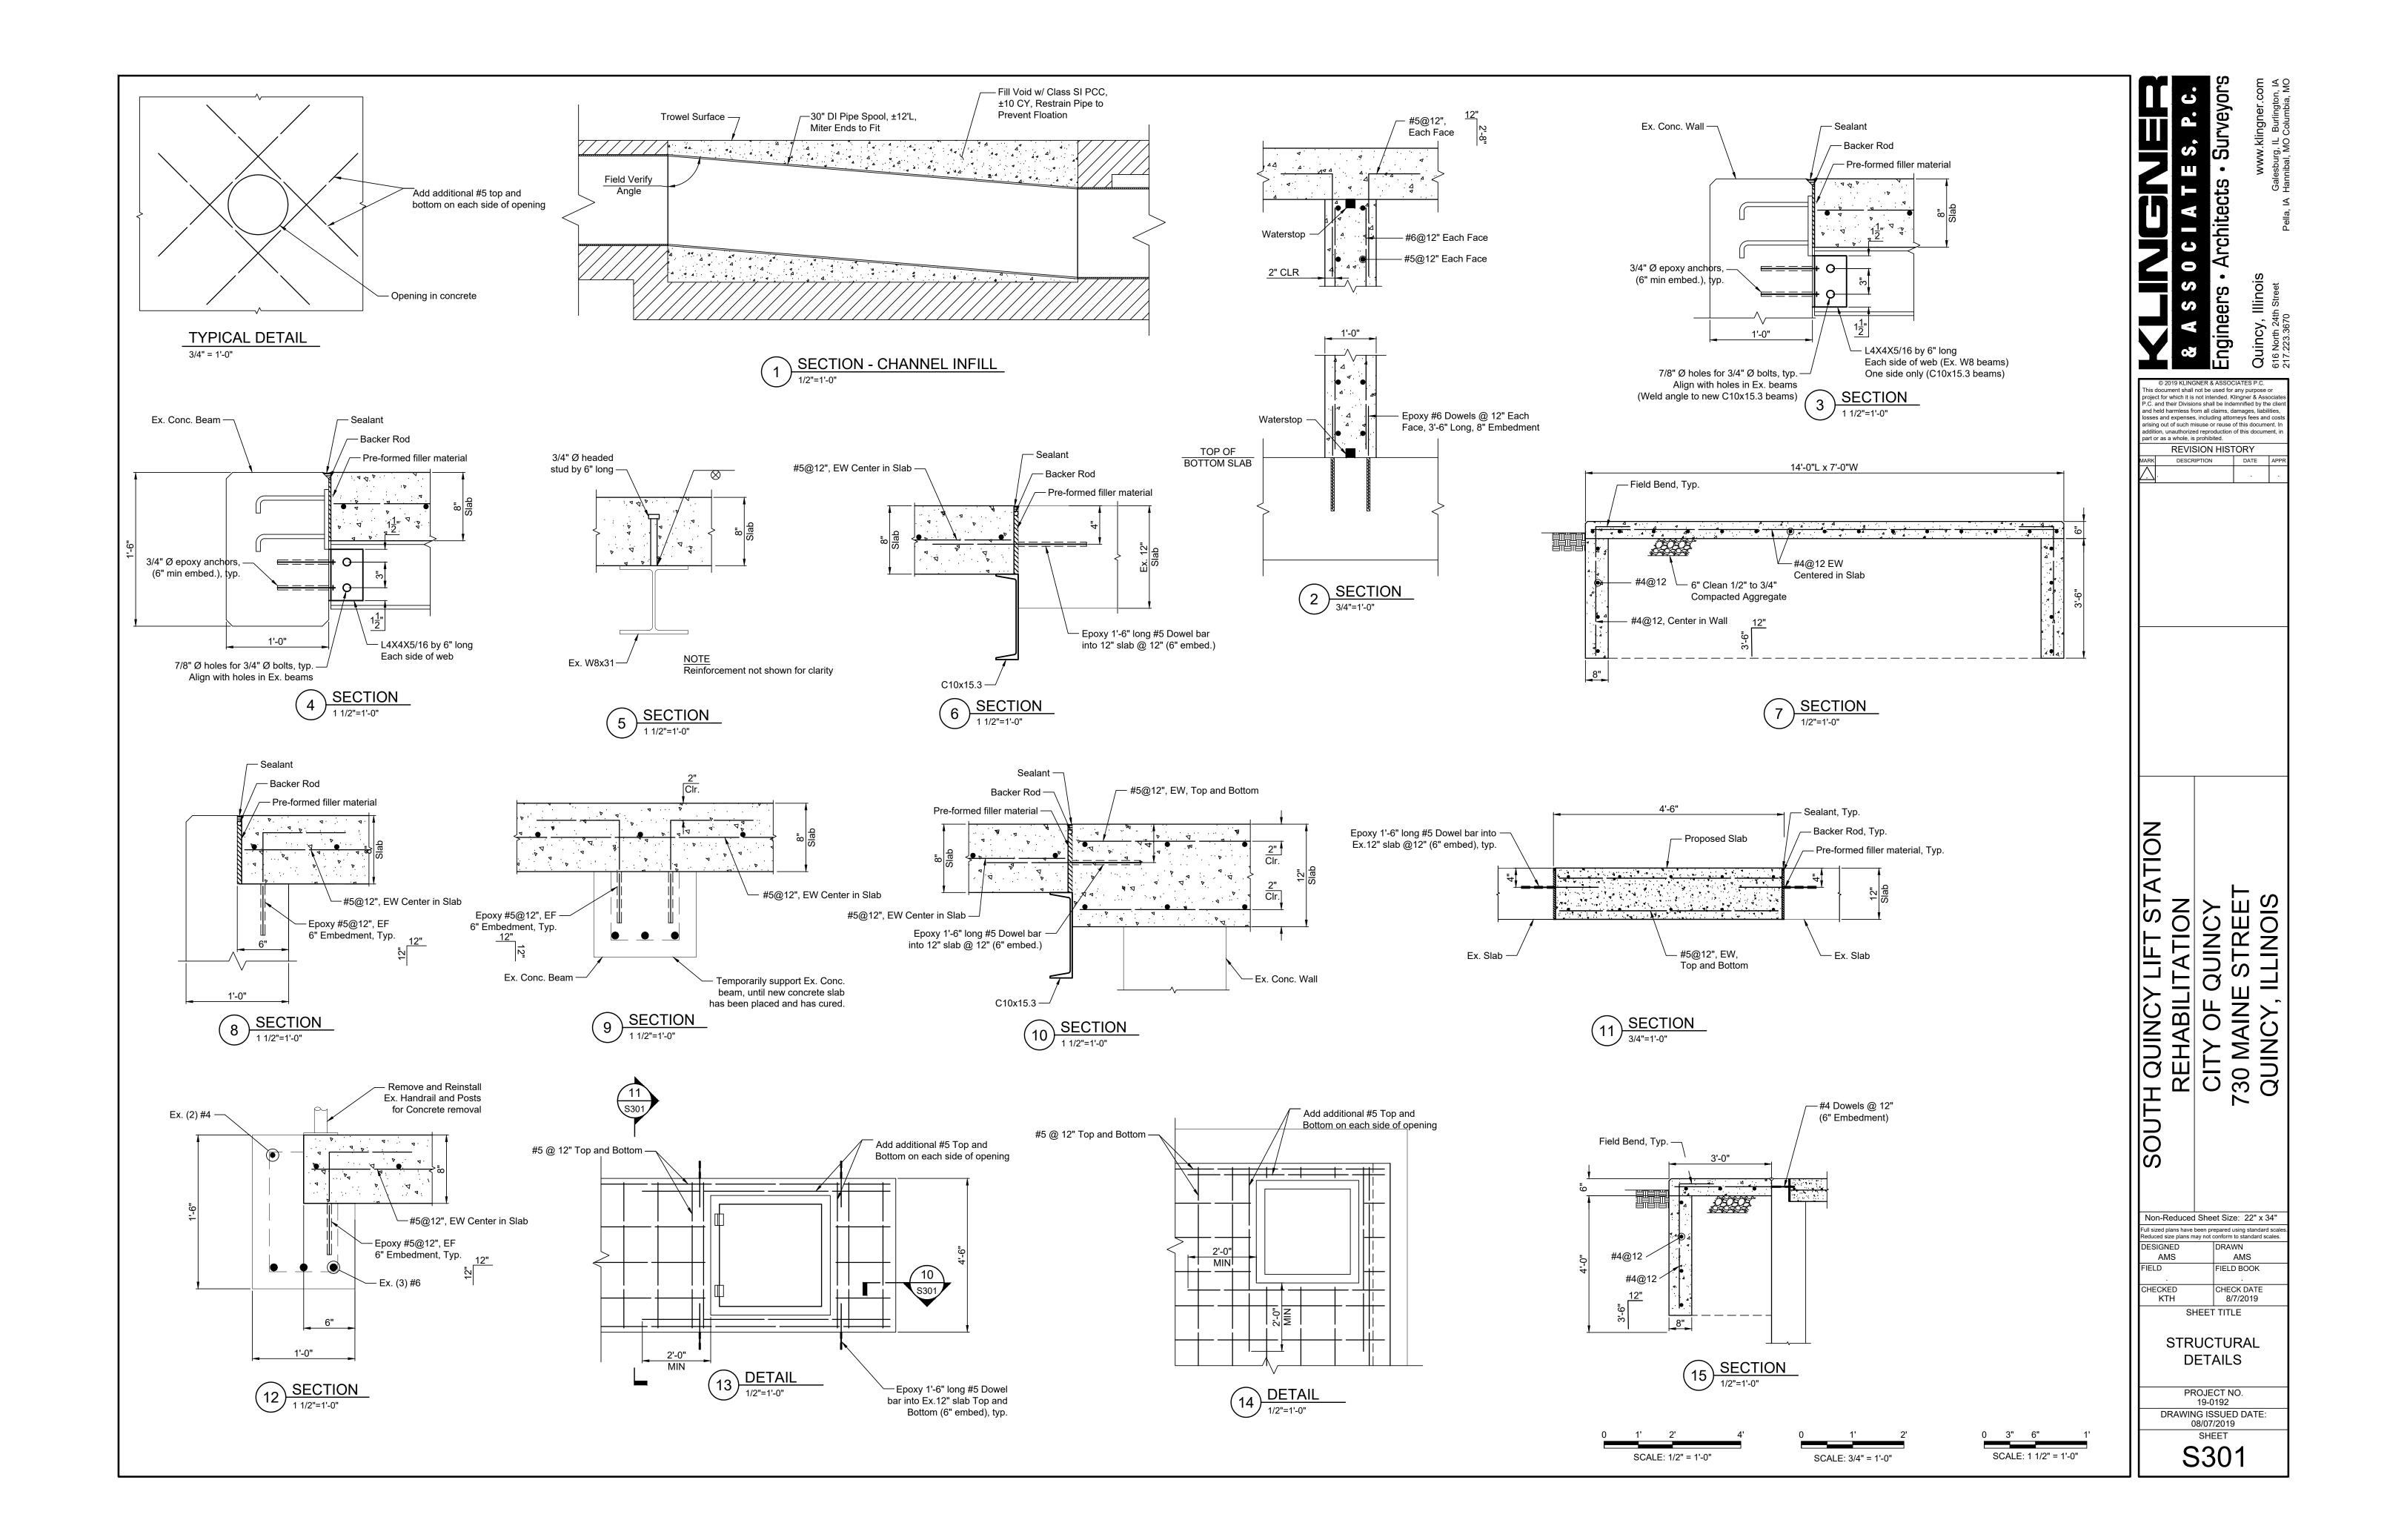
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AMS AMS FIELD BOOK CHECKED KTH CHECK DATE 8/7/2019 SHEET TITLE ELEVATED SLAB PLAN PROJECT NO. 19-0192 DRAWING ISSUED DATE: 08/07/2019 SHEET

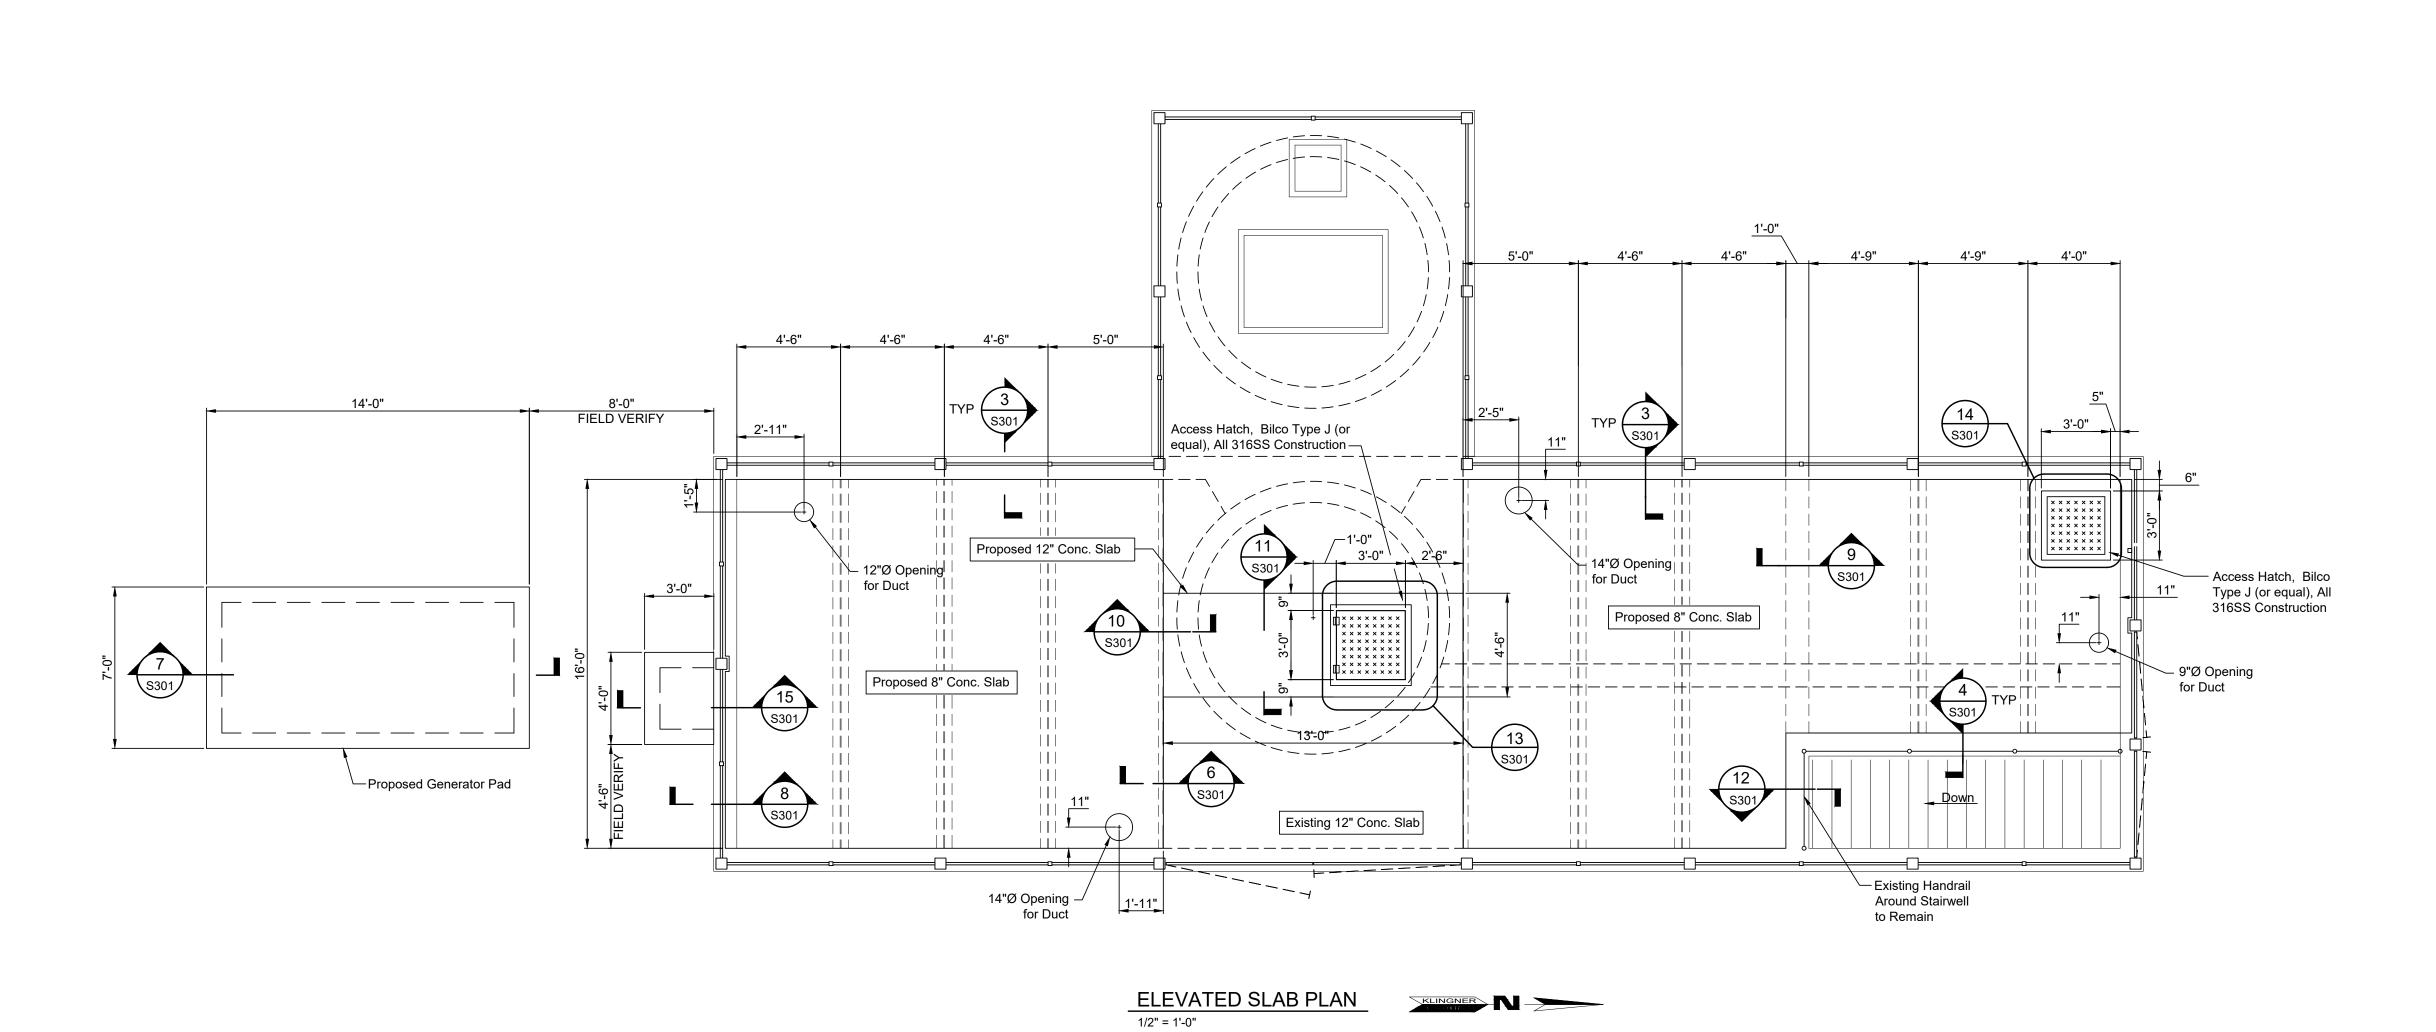S203

SCALE: 1/2" = 1'-0"



 LEGEND

 EX. BEAMS
 ———

 EX. 8 1/2" PURLIN


 EX. 8 1/2" EAVE STRUT

2 7yp 2 1yp Ex. Partin Typ.

EXISTING LOWER ROOF FRAMING PLAN


Roof Rehabilitation Key:

- Remove existing Roof Purlins and Eave Strusts and replace with member of equal or greater size. No Salvage. Prime and paint new Purlins and Struts, per specifications.
- Prime and paint existing beams, columns, and connection plates, per specifications. If excessive deterioration is present on existing steel members, coordinate repair with Structural Engineer.

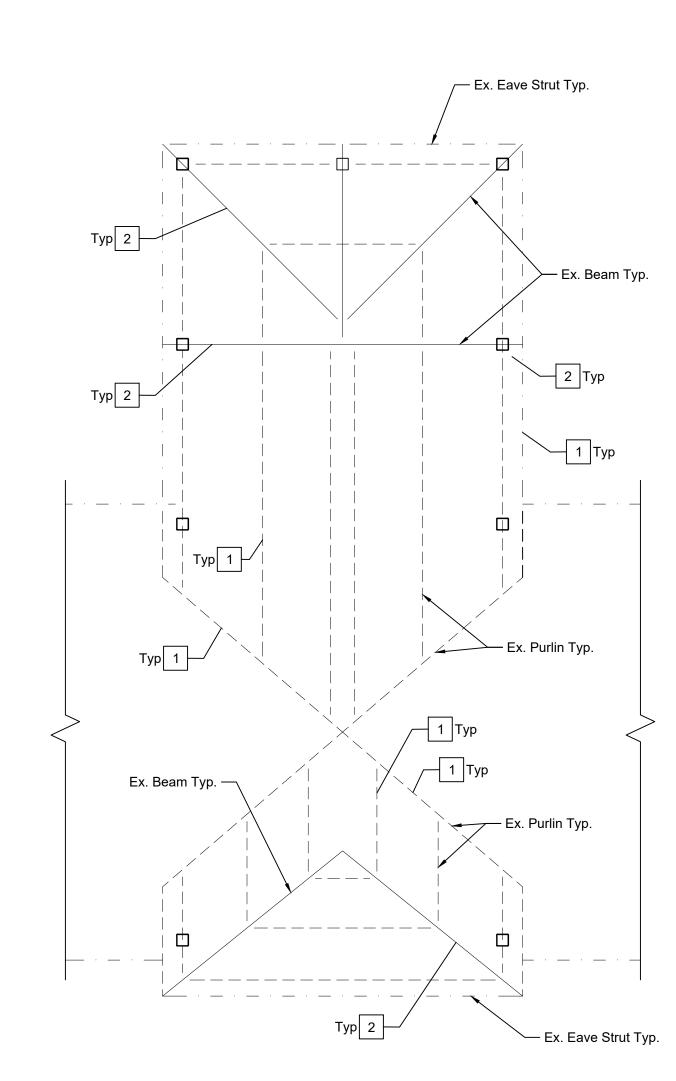

EXISTING UPPER ROOF FRAMING PLAN

1/4" = 1'-0"

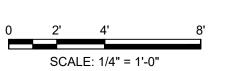

& A S S O C I A T E S, P. C. Engineers · Architects · Surveyor

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AMS FIELD BOOK

CHECK DATE 9/12/2019


SHEET TITLE

ROOF FRAMING PLANS

PROJECT NO. 19-0192 DRAWING ISSUED DATE: 09/12/2019

S501


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Piping Demolition below Elevated Slab

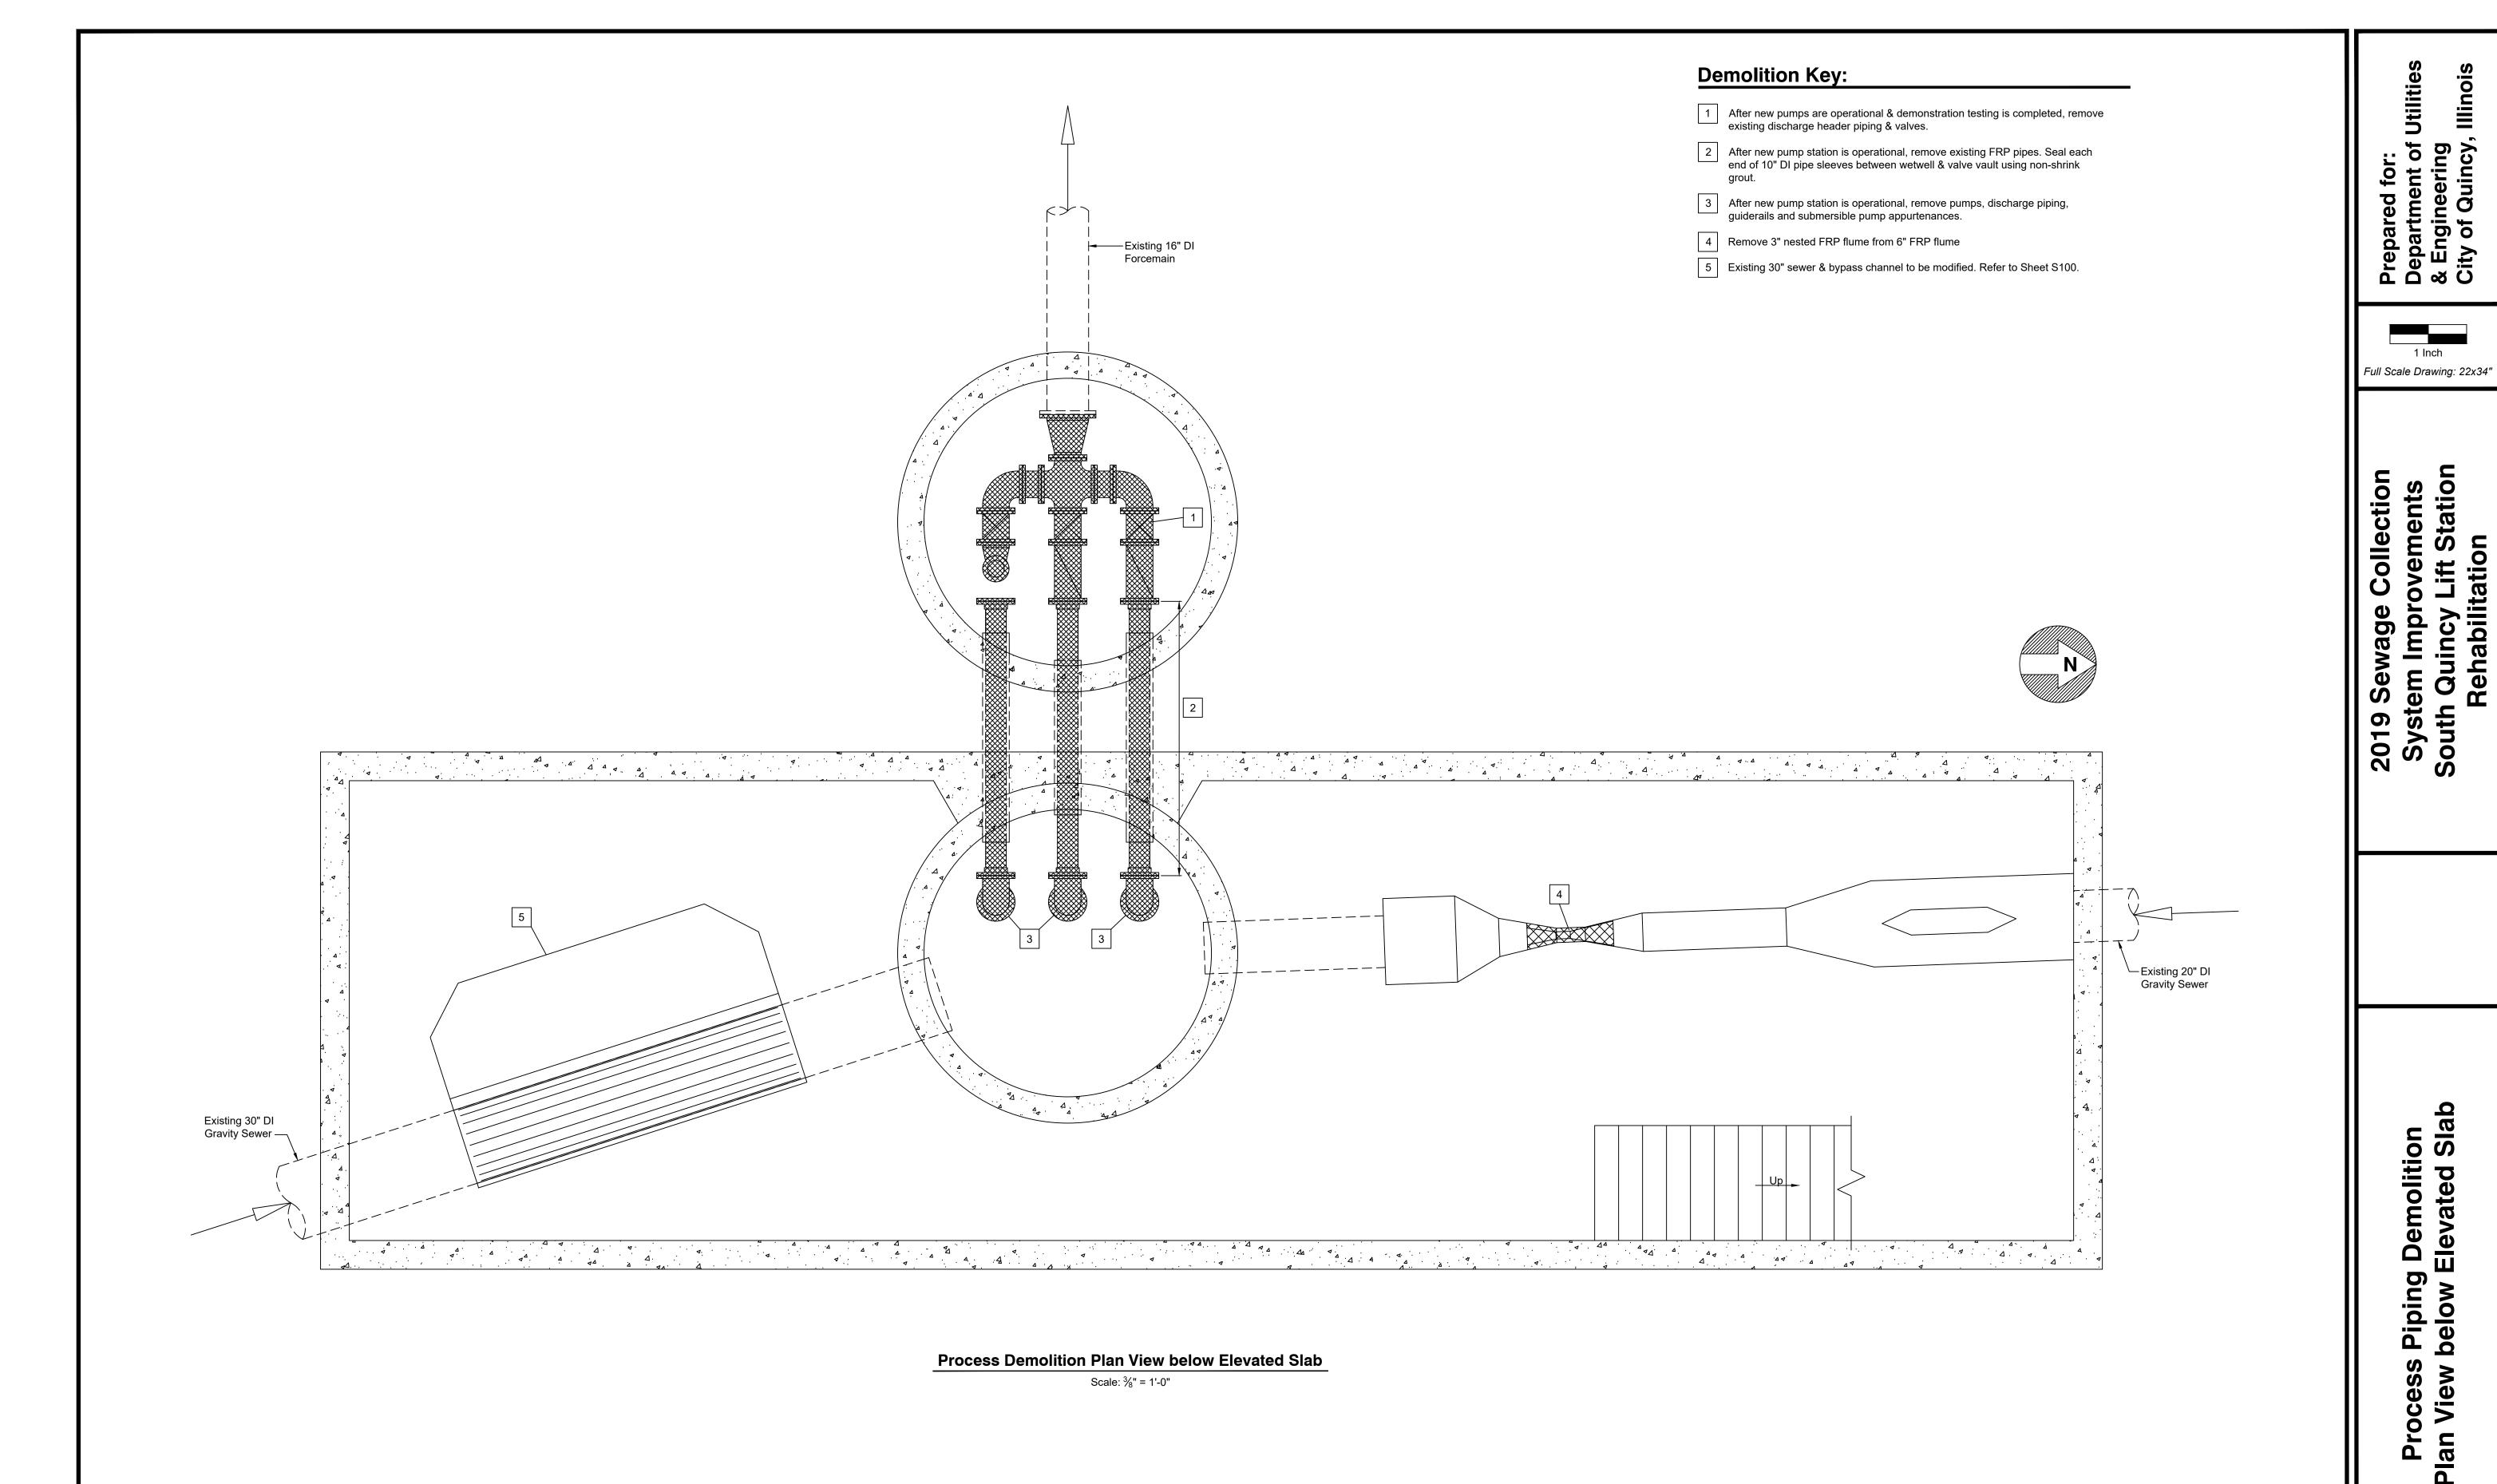Date 09/10/19 Sheet Number

PD100



Prepared for: Department of Utilities & Engineering City of Quincy, Illinois

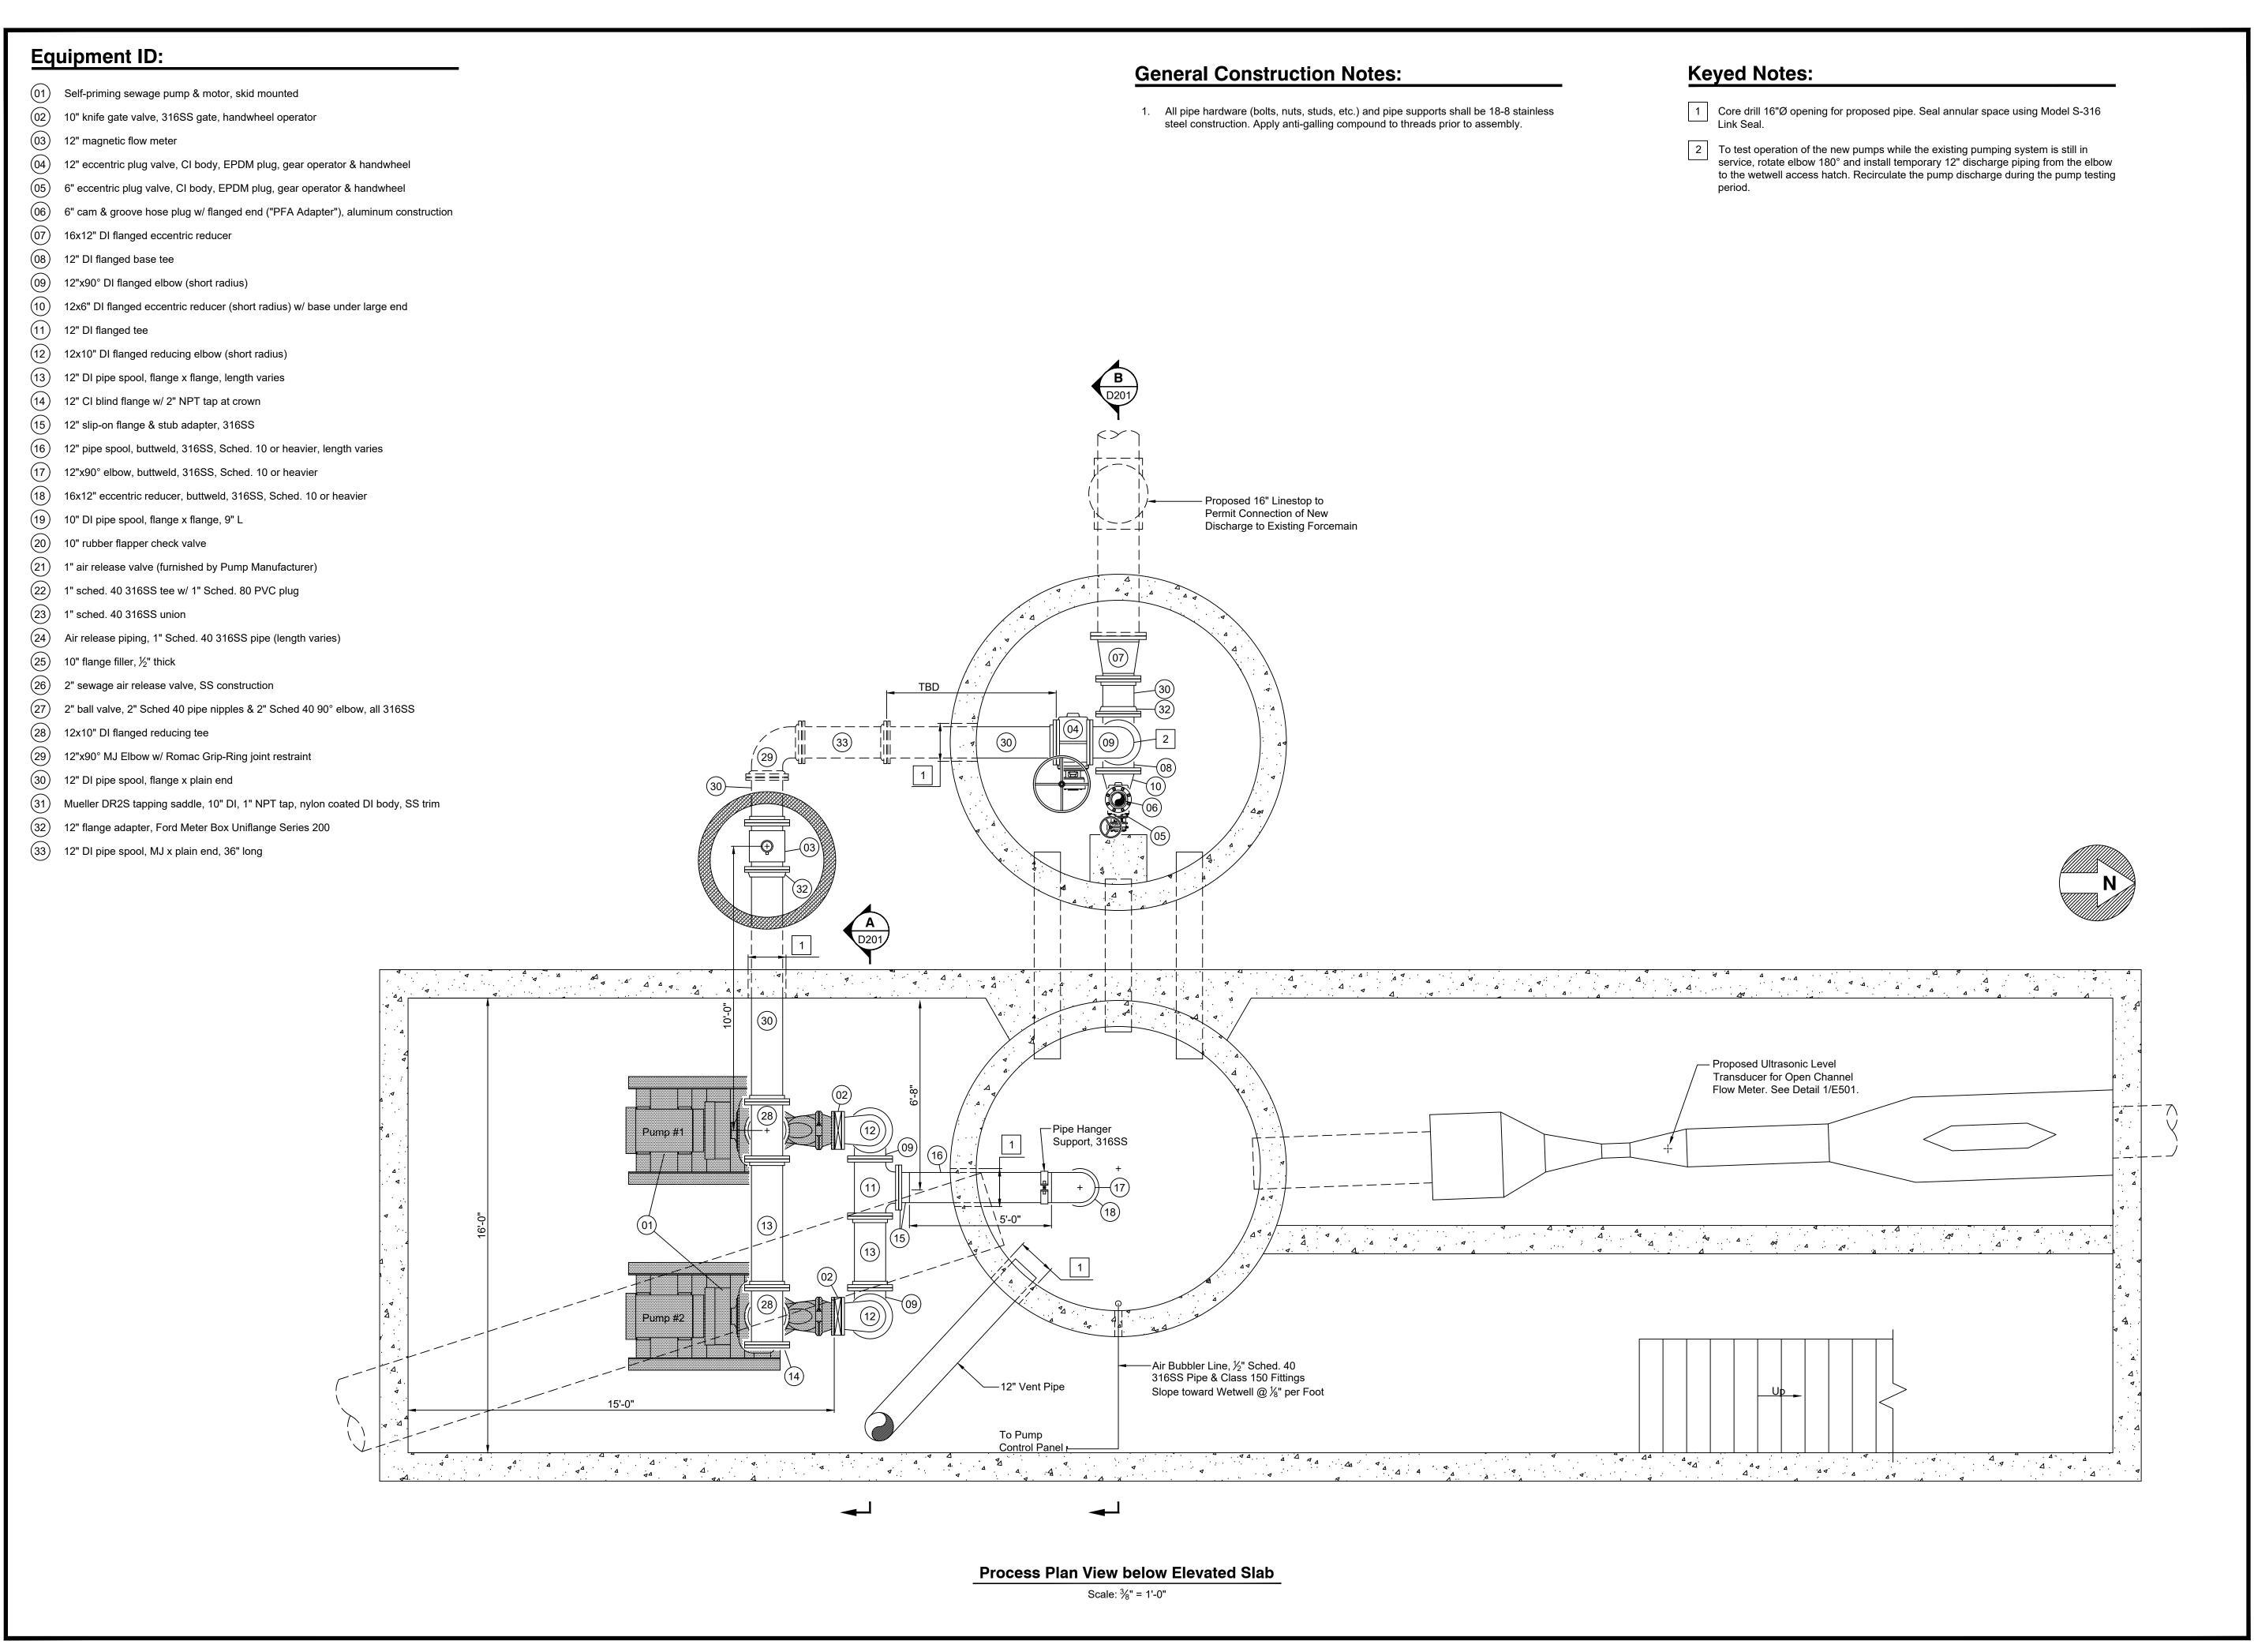
1 Inch
Full Scale Drawing: 22x34'


2019 Sewage Collectic System Improvements South Quincy Lift Static

> Process Improvements n View below Elevated Slab


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P10




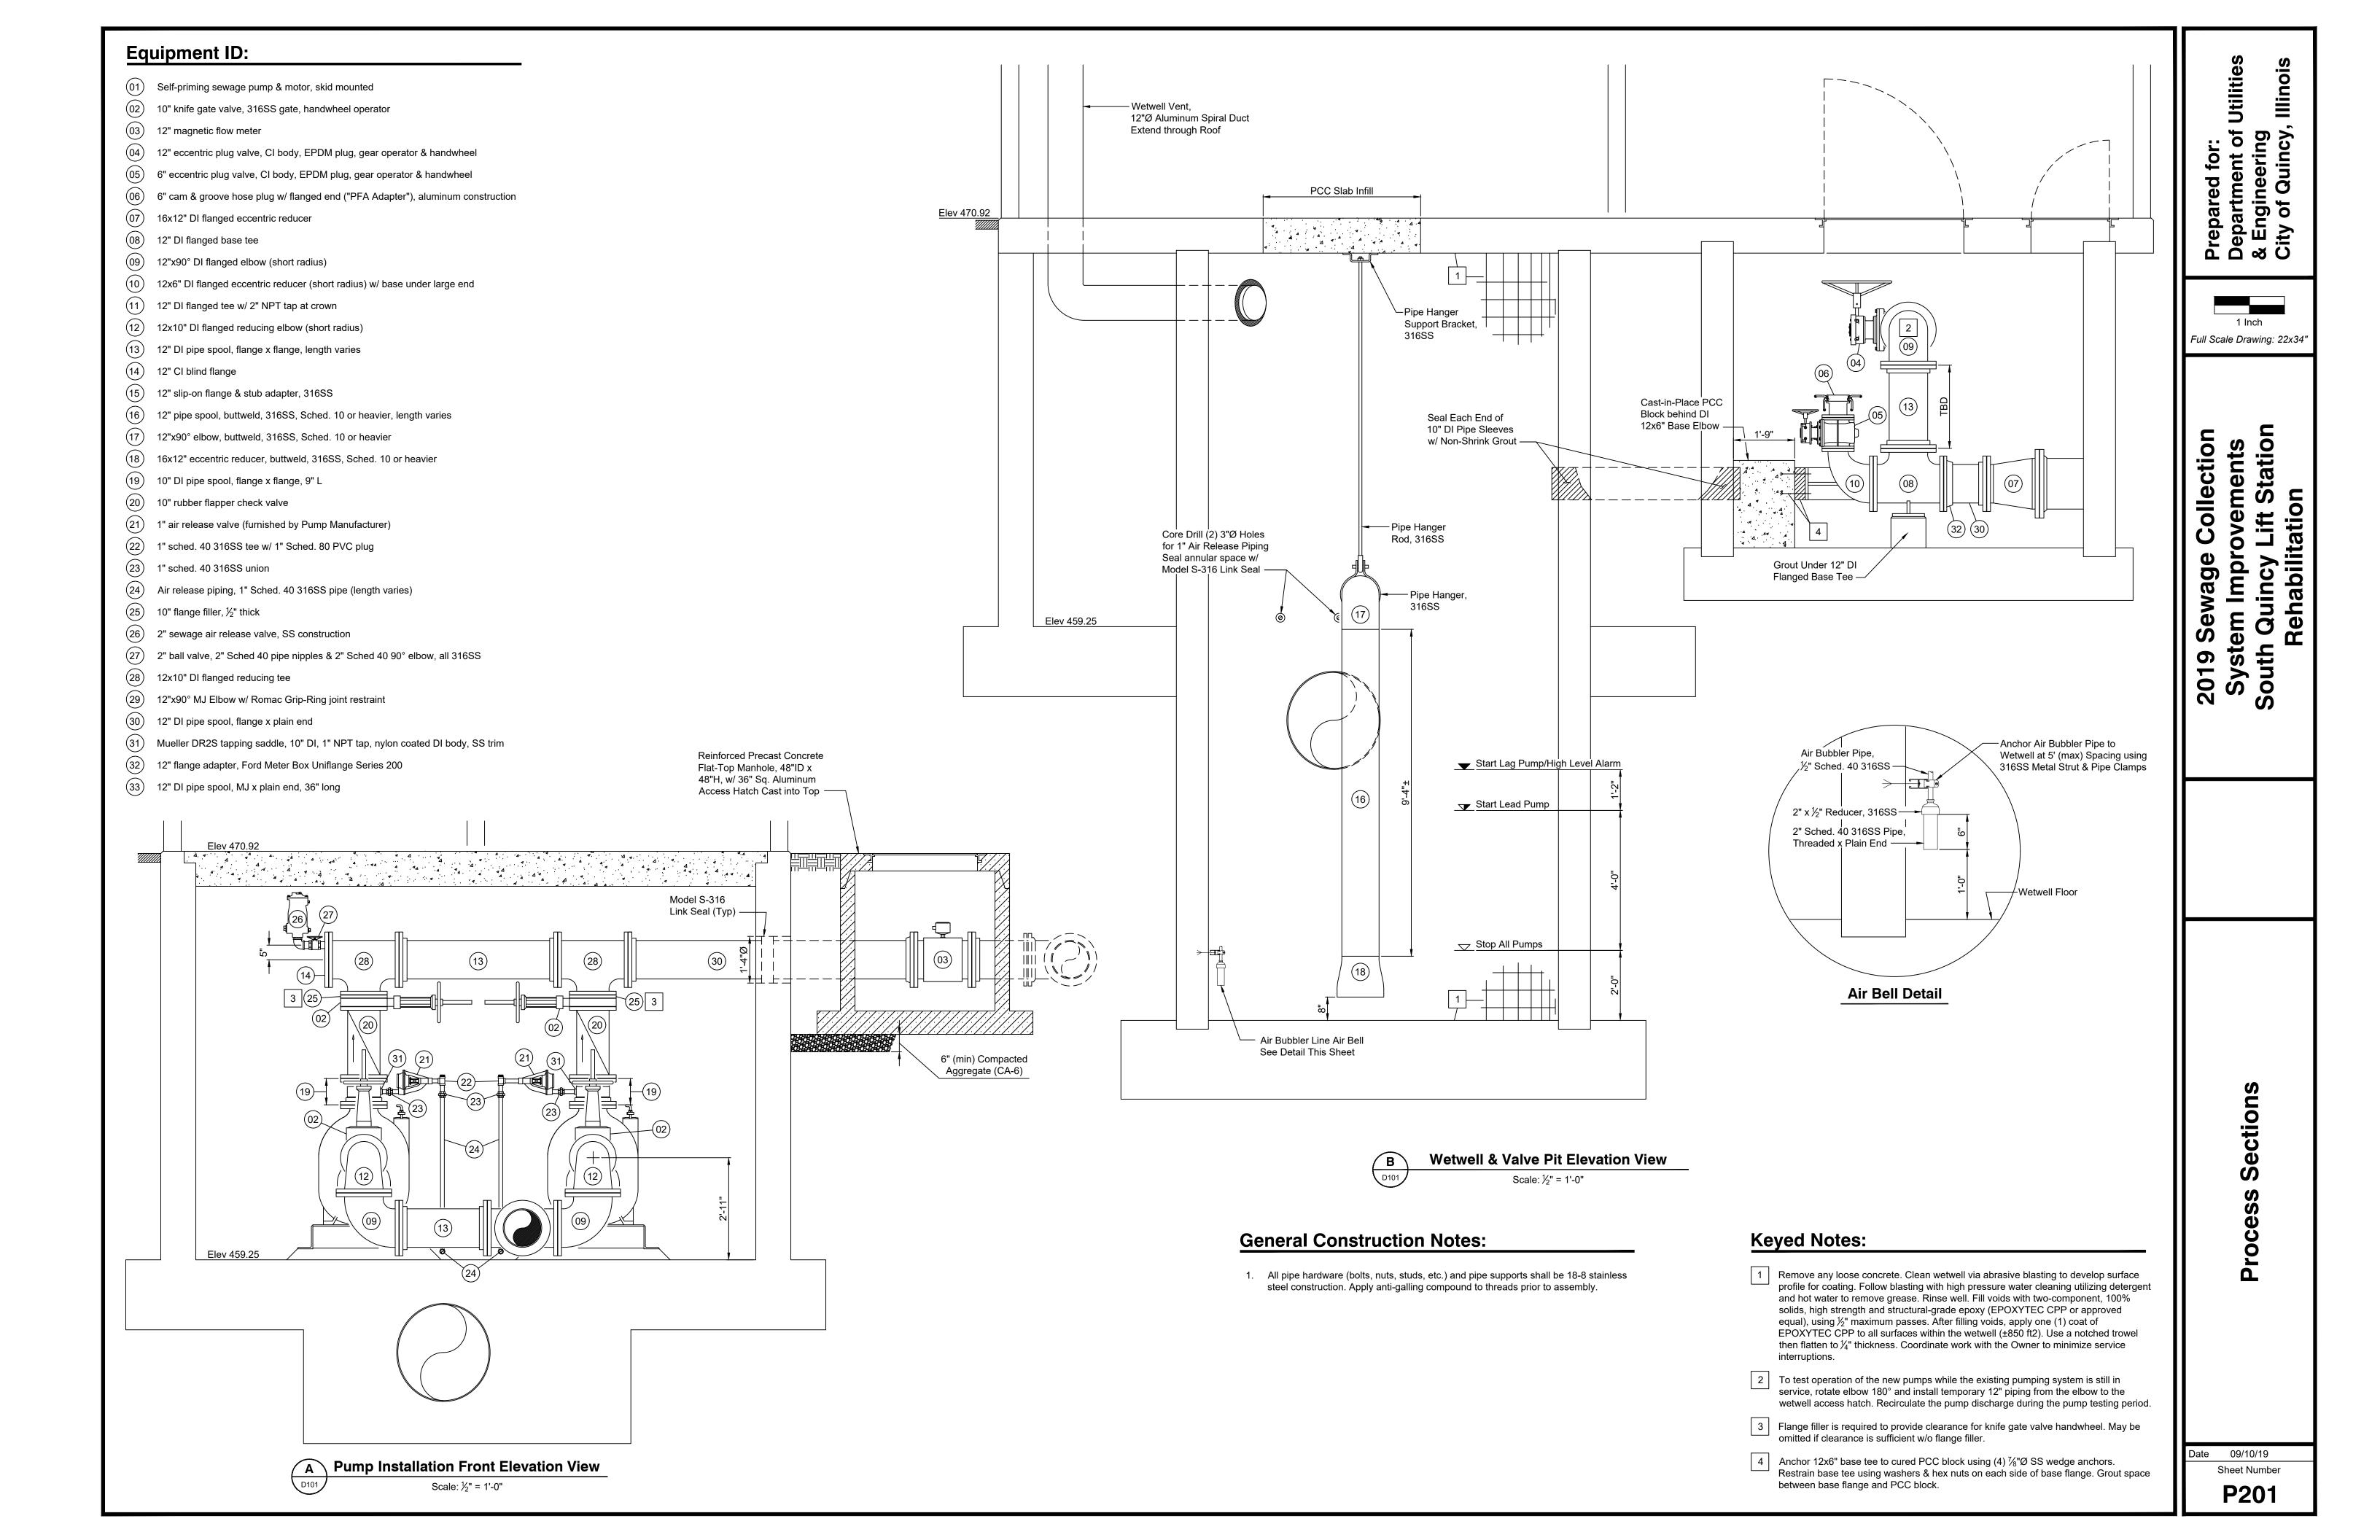

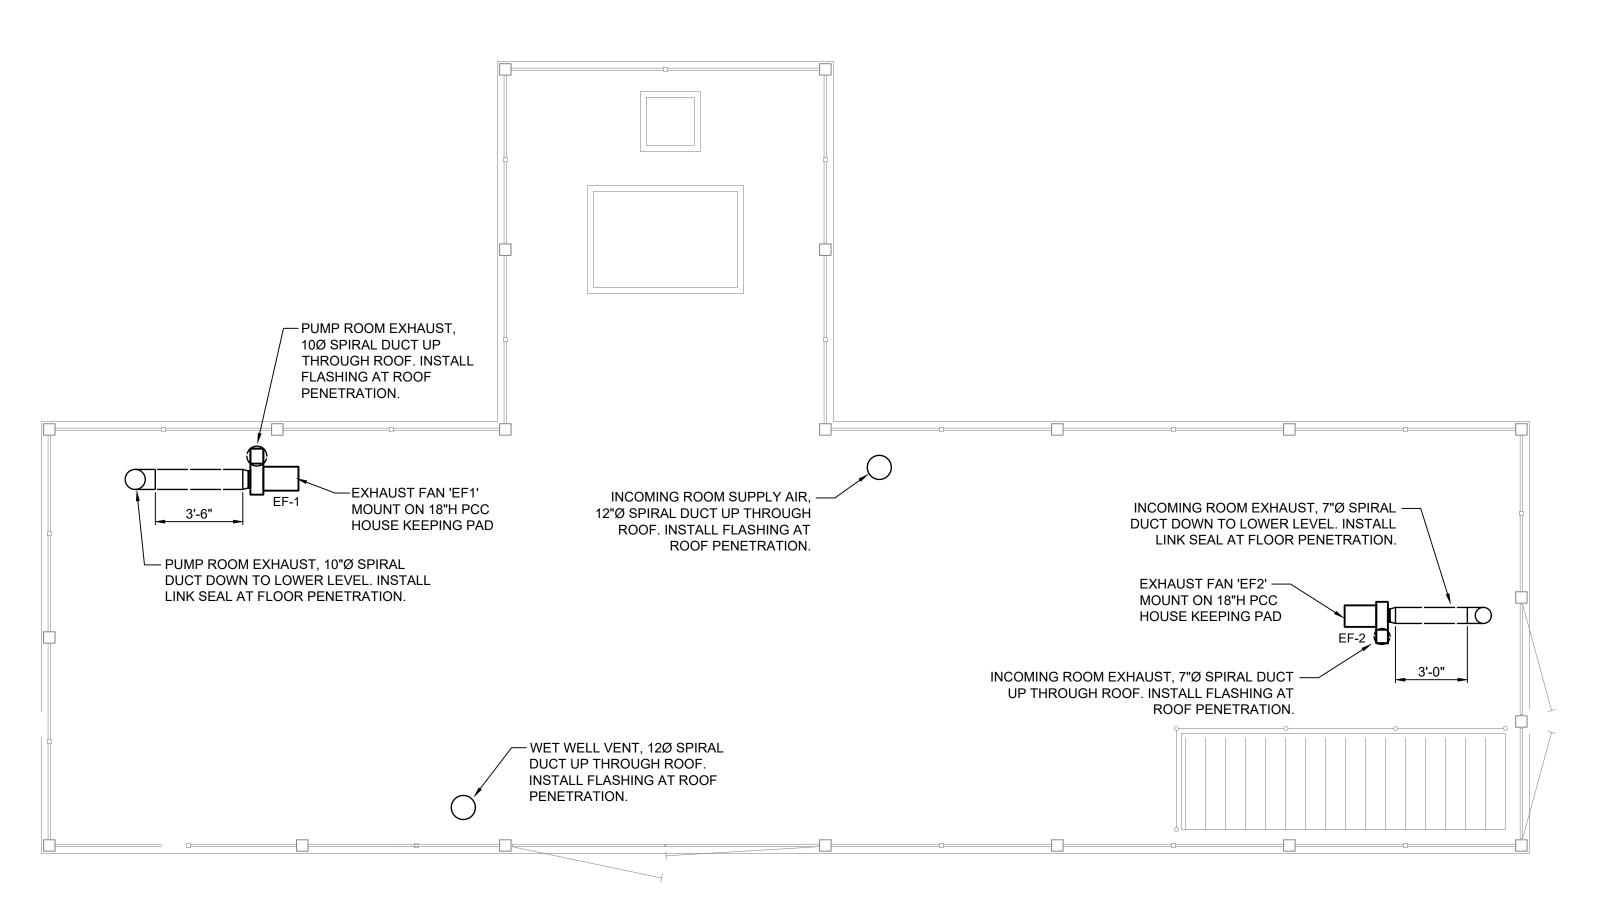MECHANICAL PLAN - MAIN LEVEL 1/4" = 1'-0"

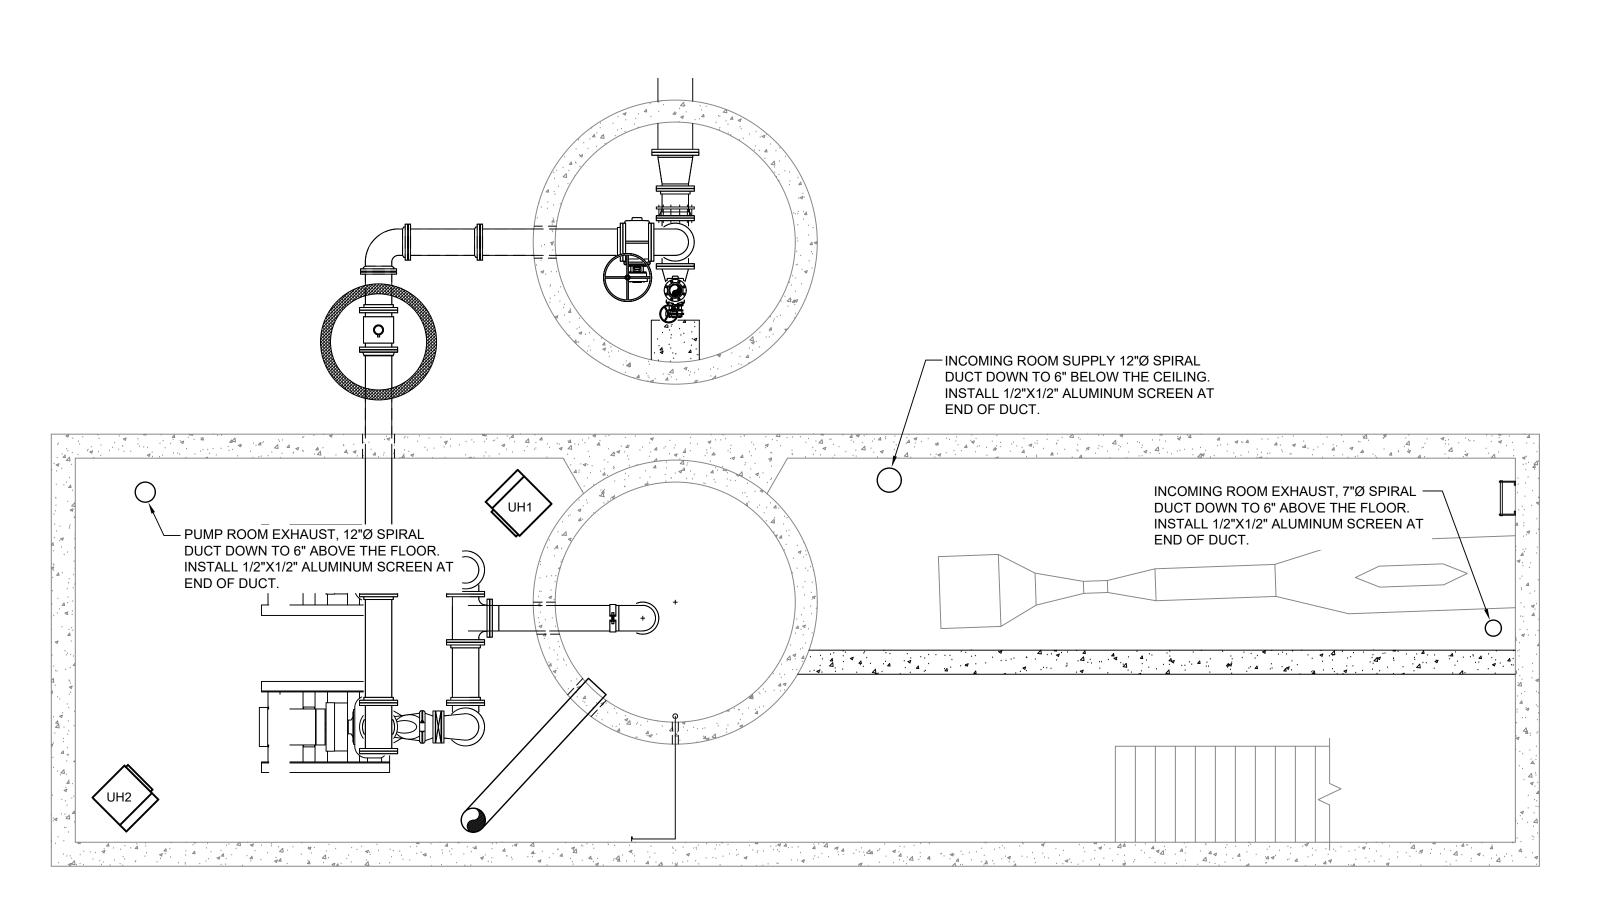

MECHANICAL PLAN - LOWER LEVEL

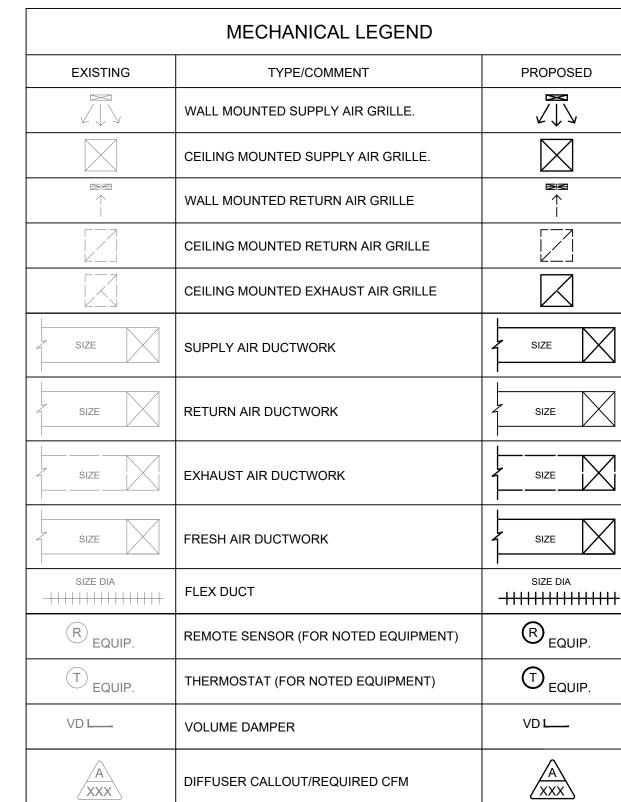

MECHANICAL NOTES:

- 1. APPLICABLE STANDARDS: NFPA 90A, NFPA 90B, SMACNA, ASHRAE, AND ALL OTHER STATE AND LOCAL CODES. DEVICES, APPARATUS, SYSTEMS, AND INSTALLATIONS SHALL BE ENTIRELY SUITABLE AND SAFE FOR EACH INTENDED APPLICATION AND BE IN FULL COMPLIANCE WITH APPLICABLE STANDARDS, REQUIREMENTS, RULES, REGULATIONS, CODES, STATUTES, ORDINANCES, ETC. OF MUNICIPAL, COUNTY, AND STATE GOVERNMENTS, OWNER'S INSURANCE COMPANY, LOCAL UTILITIES, AND LABOR REGULATIONS. ALL MECHANICAL INSTALLATIONS SHALL ALSO COMPLY WITH THE
- MANUFACTURER'S RECOMMENDATIONS/INSTRUCTIONS 2. LOW PRESSURE DUCTWORK SHALL COMPLY WITH THE LATEST APPLICABLE SHEET METAL AND AIR CONDITIONING CONTRACTORS ASSOCIATION (SMACNA) STANDARDS AND RECOMMENDATIONS.
- 3. HANG DUCTWORK IN ACCORDANCE WITH SMACNA RECOMMENDATIONS. SUPPORT DIRECTLY FROM STRUCTURE.
- 4. MECHANICAL EQUIPMENT SUCH AS RTUS, MAUS, FANS, ETC. SHALL BE FURNISHED AS INDICATED IN EQUIPMENT SCHEDULES.
- 5. MECHANICAL CONTRACTOR SHALL BE RESPONSIBLE FOR ALL MECHANICAL WIRING, INCLUDING CONTROLS FOR STATS, RTUs, EXHAUST FANS, DAMPERS, ETC.
- 6. TESTING AND BALANCING SHALL BE PERFORMED BY AN INDEPENDENT TAB CONTRACTOR WITH AT LEAST FIVE YEARS OF EXPERIENCE AND UNDER THE SUPERVISION OF A LICENSED ENGINEER.

GENERAL DUCT CONSTRUCTION NOTES:

- 1. SPIRAL DUCT SHALL BE MANUFACTURED FROM ALUMINUM ALLOY 3003, 0.032" MINIMUM WALL THICKNESS, WITH 5/8" FLANGES ROLL FORMED DIRECTLY ON THE ENDS OF THE SPIRAL DUCT AND FITTINGS. PIPE AND FITTINGS SHALL BE JOINTED USING A NEOPRENE GASKET AND BARREL CLAMP. DUCT SHALL BE E-Z FLANGE JR. SPIRAL PIPE SYSTEM AS MANUFACTURED BY SHEET METAL CONNECTORS INC. (ROCKFORD, IL) OR EQUAL.
- 2. SEAL ANNULAR SPACE THROUGH FLOOR PENETRATIONS USING LINK SEAL MODEL S-316, OR EQUAL.

KL	INGNER	N	
0	2'	4'	8'
	SCAI	LE: 1/4" =	1'-0"

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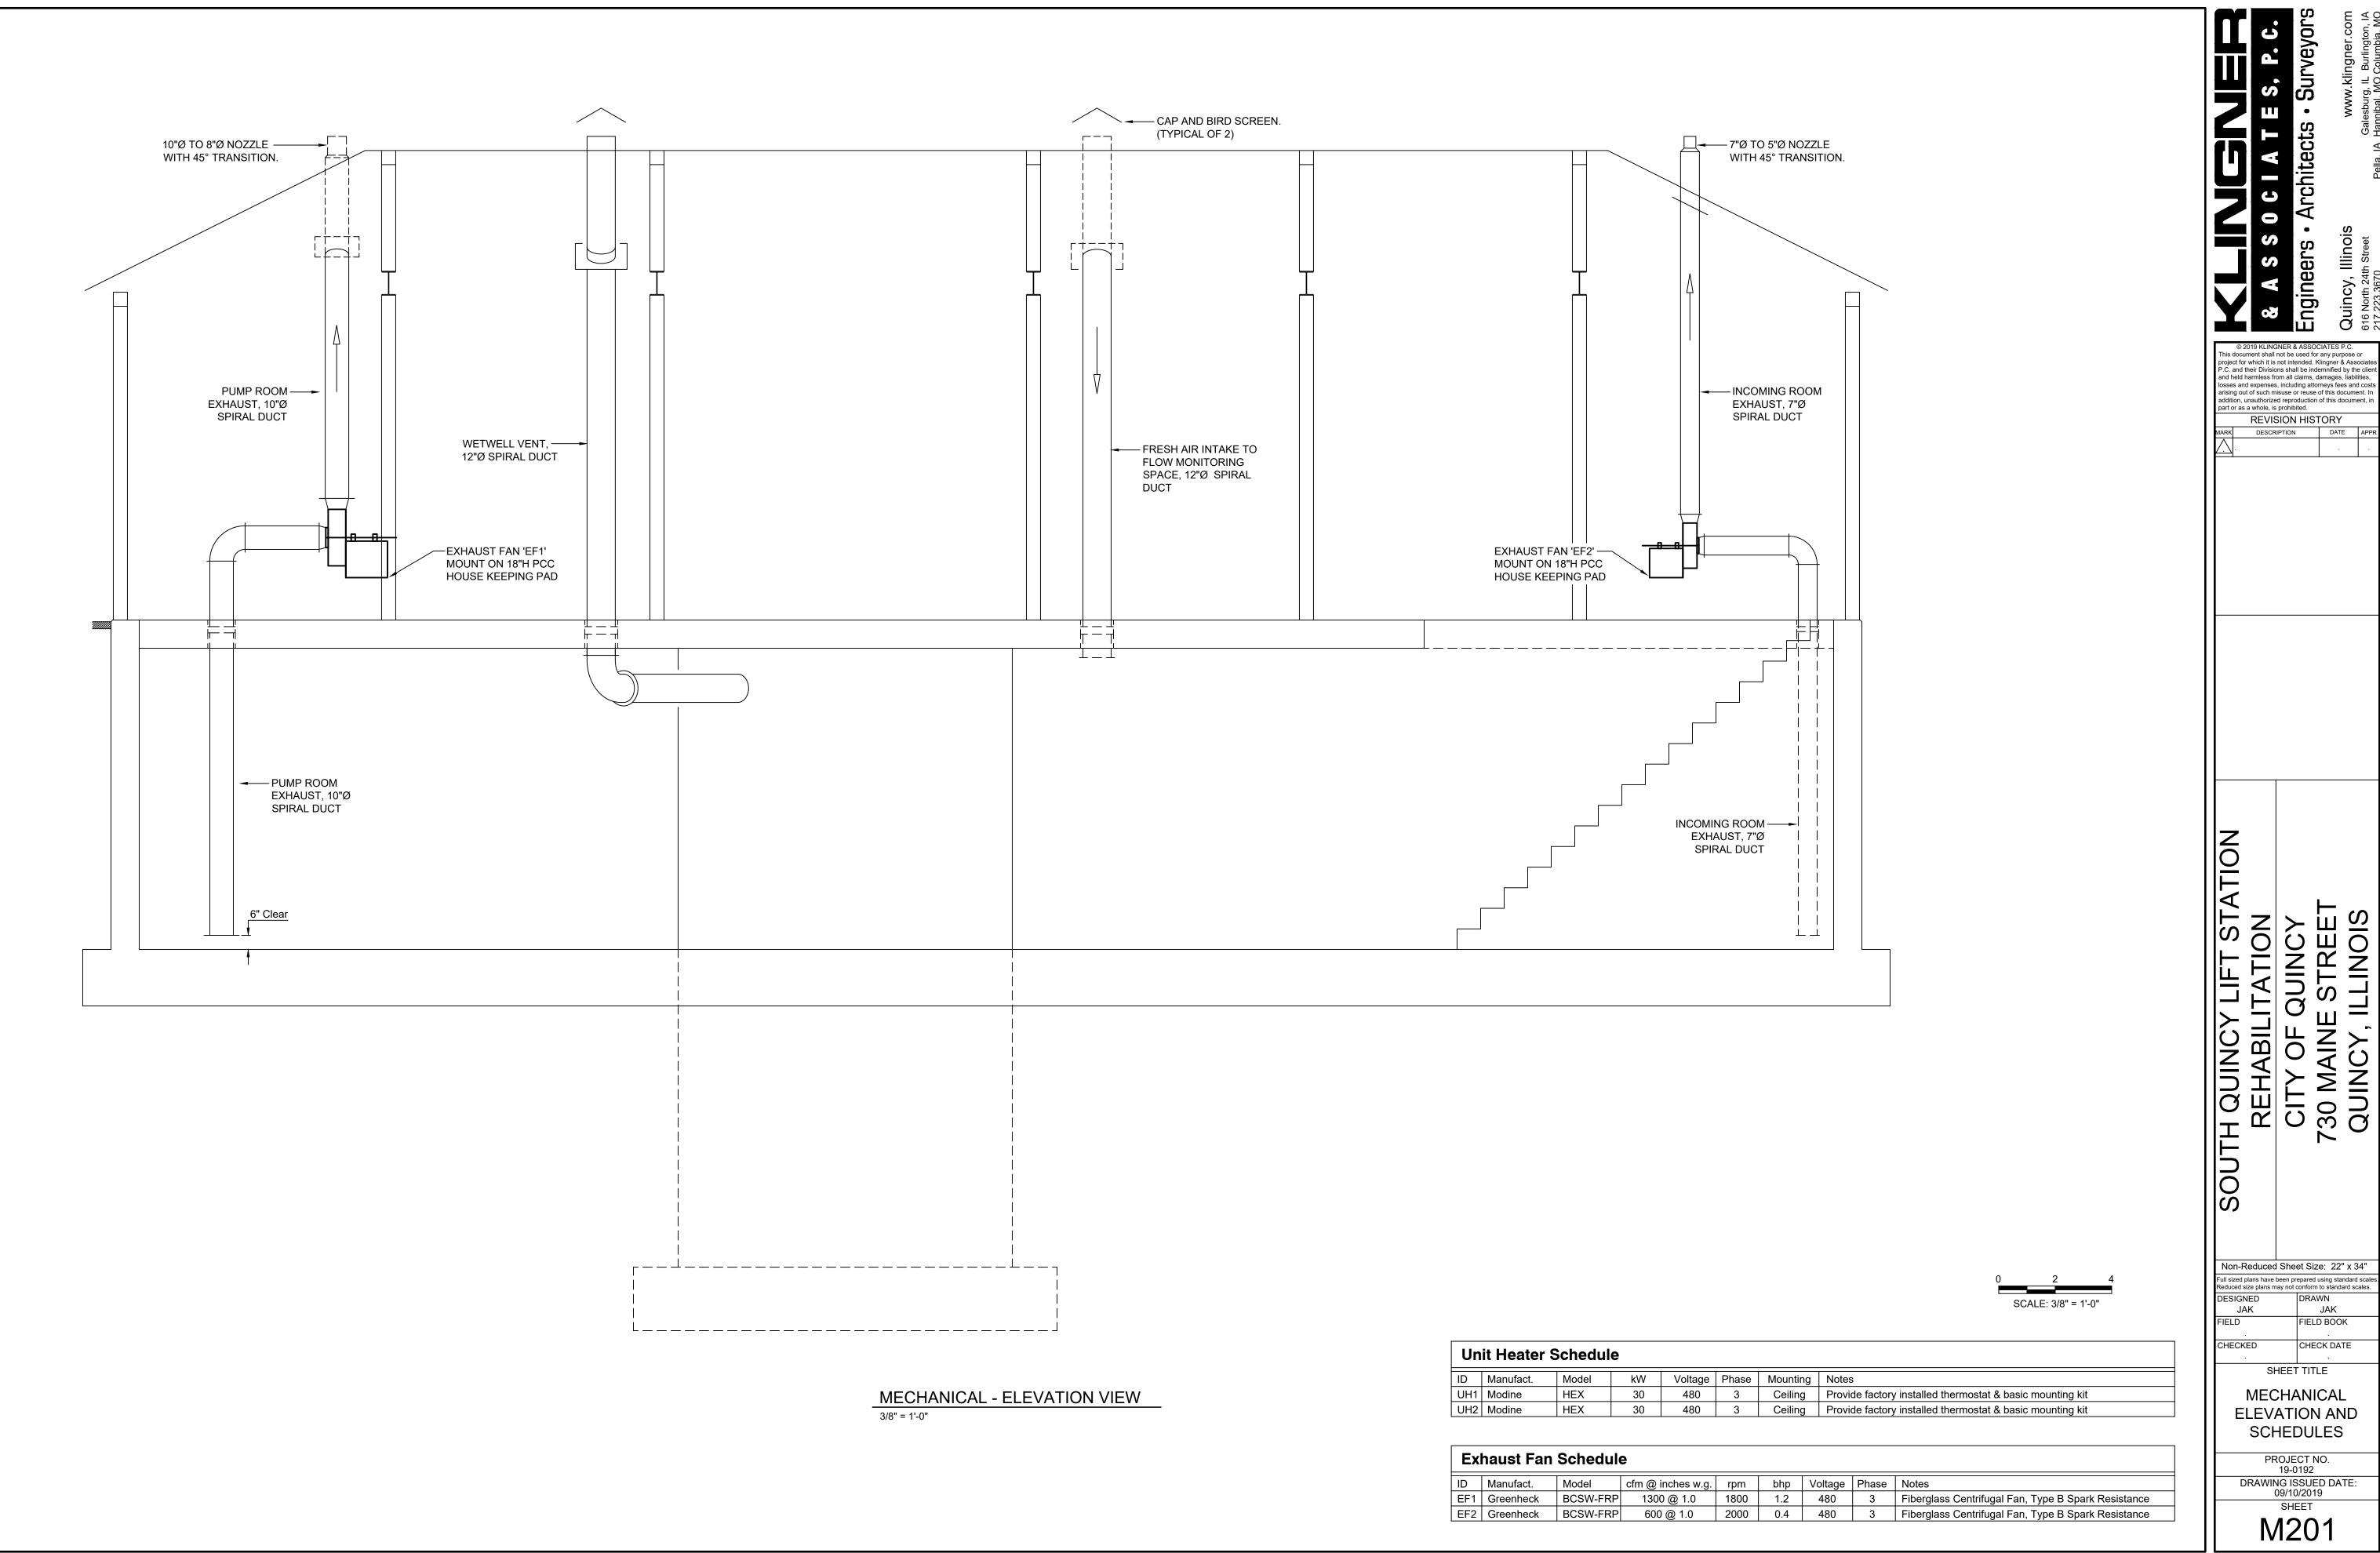
Non-Reduced Sheet Size: 22" x 34" Full sized plans have been prepared using standard sca Reduced size plans may not conform to standard scales DESIGNED JAK FIELD BOOK CHECKED CHECK DATE

> SHEET TITLE **MECHANICAL**

> > PLANS

PROJECT NO. DRAWING ISSUED DATE: 09/10/2019

SHEET M101




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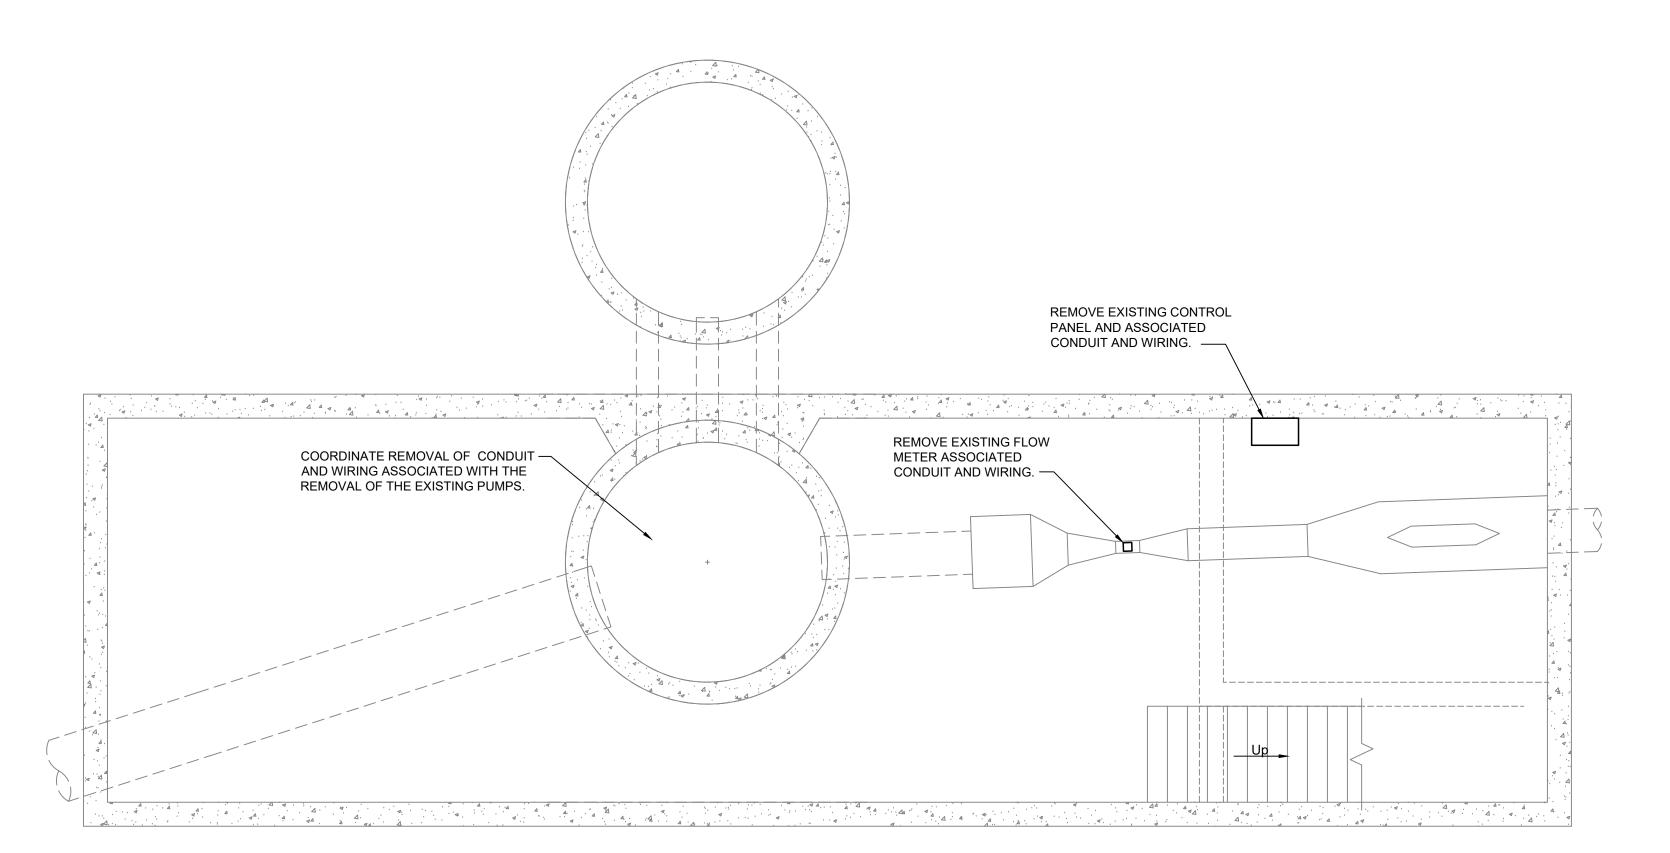
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SHEET TITLE MECHANICAL **ELEVATION AND** SCHEDULES

PROJECT NO. 19-0192 DRAWING ISSUED DATE: 09/10/2019

SHEET M201



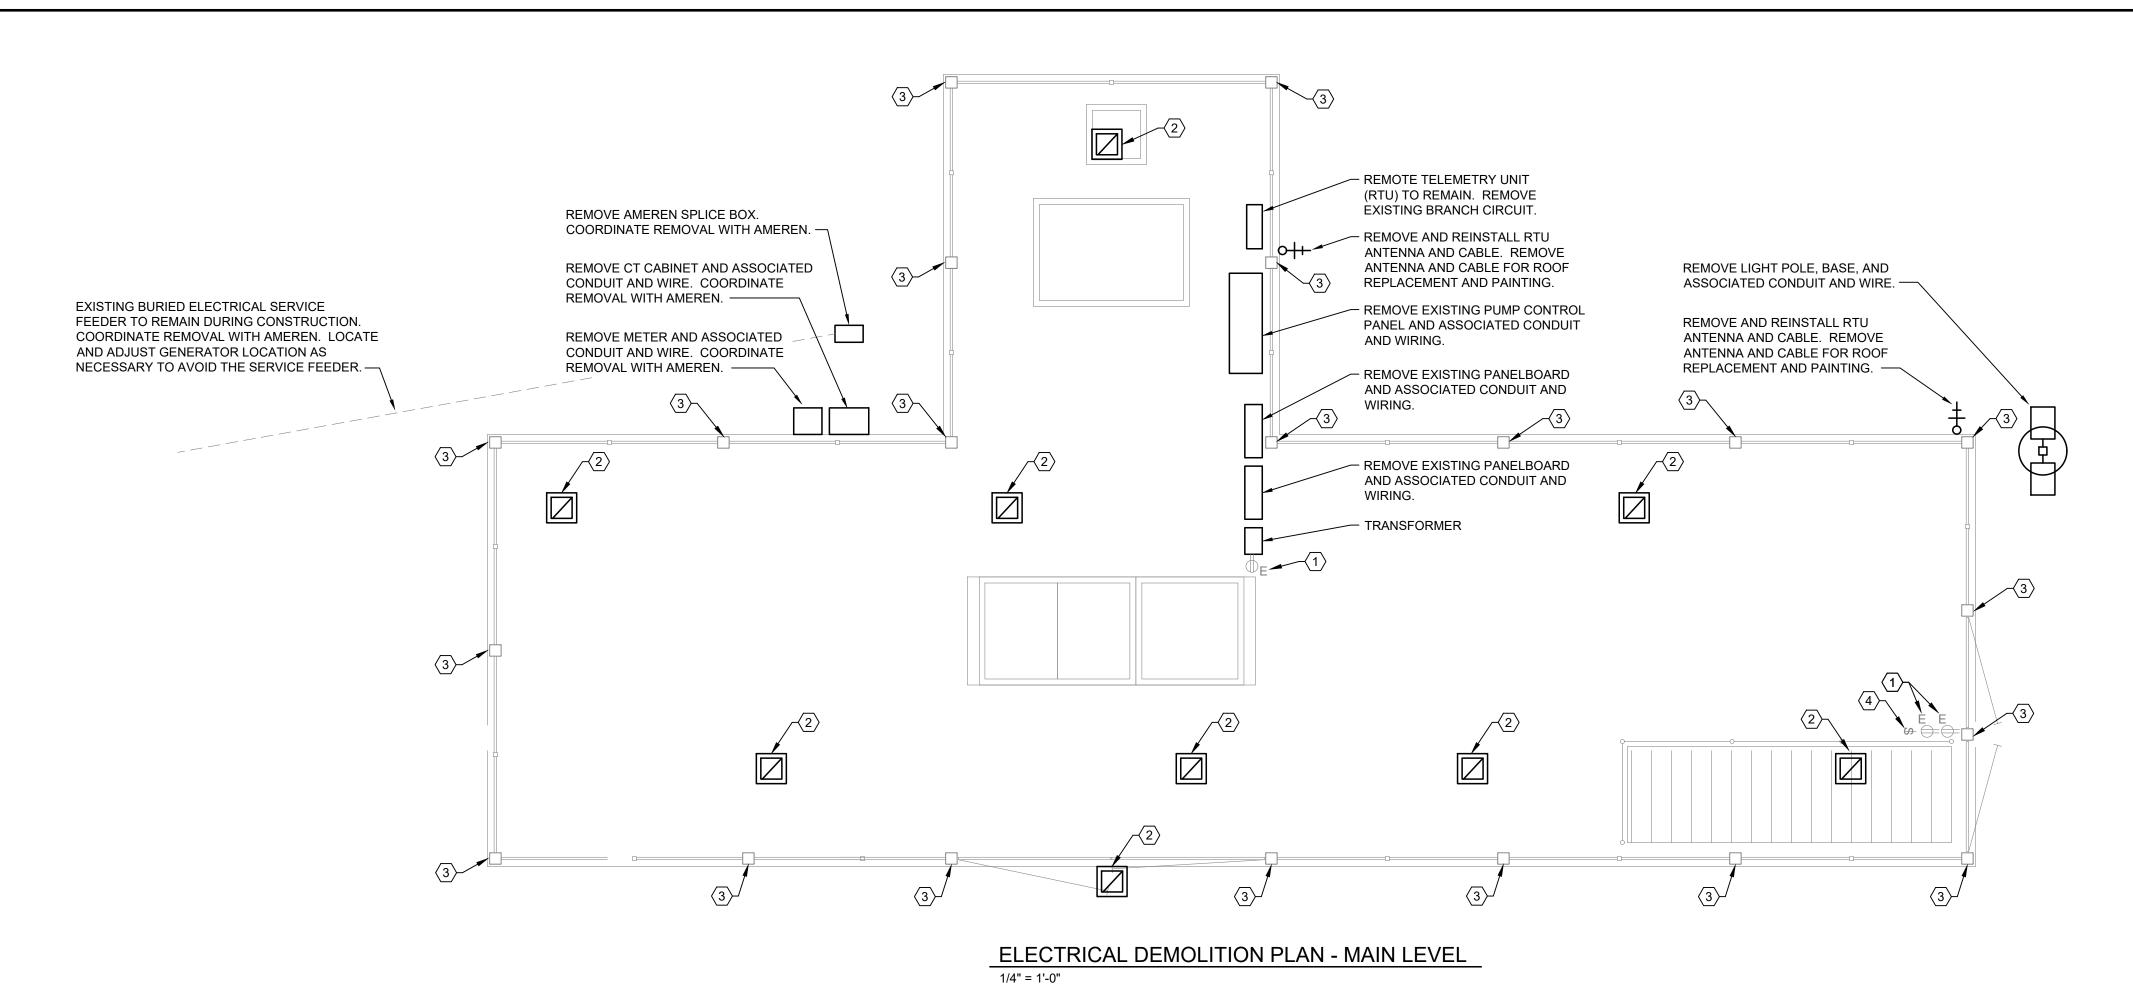

ELECTRICAL DEMOLITION PLAN - LOWER LEVEL

	ELECTRICAL SYMBOLS	
EXISTING	TYPE/COMMENT	PROPOSED
\$	LIGHT SWITCH.	\$
\$X	LIGHT SWITCH, x-WAY.	\$ _X
•	FLOOR BOX WITH DUPLEX RECEPT.	•
\bigcirc	FLOOR BOX FOR DATA/COMMUNICATION	0
\triangle	WALL BOX FOR TELEPHONE	Δ
A	WALL BOX FOR DATA/COMMUNICATION	A
⊕ E	DUPLEX RECEPTACLE OUTLET	₩
⊕BC GFC	GROUND FAULT CIRCUIT INTERRUPTER	⊕ [©] GF
\Rightarrow_{Q}^{M}	WEATHER PROOF RECEPTACLE OUTLET - INSTALL 18" ABOVE PROPOSED GRADE AS SHOWN ON BUILDING ELEVATIONS	⊕8
	QUAD RECEPTACLE OUTLET	
=①	JUNCTION BOX	=0
M	MOTOR CONNECTION	™
4	ELECTRICAL DISCONNECT, NEMA 4X FOR ALL LOCATIONS	L
X-##	CIRCUITING NOTATION: X DENOTES PANEL AND ## DENOTES CIRCUIT NUMBER.	X-1
\/	DENOTES CIRCUITING FOR STANDARD ELECTRICAL DEVICES.	


ELECTRICAL NOTES:

- 1. APPLICABLE STANDARDS: NFPA-70, NFPA-101, STATE BUILDING CODES, AND THE OCCUPATIONAL SAFETY AND HEALTH ACT (OSHA) OF 1971 AND ALL AMENDMENTS THERETO; EQUIPMENT, DEVICES, APPARATUS, SYSTEMS, AND INSTALLATIONS SHALL BE ENTIRELY SUITABLE AND SAFE FOR EACH INTENDED APPLICATION AND BE IN FULL COMPLIANCE WITH APPLICABLE STANDARDS, REQUIREMENTS, RULES, REGULATIONS, CODES, STATUTES, ORDINANCES, ETC., OF MUNICIPAL, COUNTY, AND STATE GOVERNMENTS, OWNER'S INSURANCE COMPANY, LOCAL UTILITIES, AND LABOR REGULATIONS. NOTHING CONTAINED IN THESE PLANS AND SPECIFICATIONS SHALL BE CONSTRUED TO CONFLICT WITH THESE LAWS, CODES, AND ORDINANCES.
- 2. DRAWINGS ARE SCHEMATIC AND SHOW APPROXIMATE LOCATIONS OF ELECTRICAL EQUIPMENT. EXACT LOCATIONS SHALL BE COORDINATED BY THE CONTRACTOR AND VERIFIED IN THE FIELD PRIOR TO ROUGH-IN.
- 3. INSTALLATIONS WHICH INCLUDE ELECTRICAL FIXTURES, DEVICES, CONDUIT, SWITCHES, PANELS, HANGERS, WIRE, CABLE, STANDARDS, ETC., MUST BE ENTIRELY SUITABLE FOR TEMPERATURES, HUMIDITY, DAMP AREAS, VOLTAGE, FREQUENCY, AND ALL INSTALLATION CONDITIONS ENCOUNTERED.
- 4. INSTALLATION MUST BE ENTIRELY SAFE IN EVERY RESPECT, AND MUST NOT CREATE ANY CONDITIONS OF ANY KIND WHICH WILL BE HARMFUL TO ANY OCCUPANT OF THE BUILDING. IF CONTRACTOR BELIEVES THAT INSTALLATION WILL NOT BE SAFE FOR ALL PEOPLE, HE/SHE SHALL SO REPORT IN WRITING TO ENGINEER BEFORE ANY EQUIPMENT IS PURCHASED OR WORK IS INSTALLED, GIVING EXACT RECOMMENDATIONS, AND REASONS FOR THEM.
- 5. GROUNDING: ALL GROUNDING SHALL BE IN STRICT ACCORDANCE WITH THE LATEST EDITION OF THE NATIONAL ELECTRICAL CODE (NEC).
- 6. INSTALLATION OF ELECTRICAL DEVICES SHALL BE COORDINATED WITH OTHER TRADES AS NECESSARY TO PREVENT ANY CONFLICTS DURING CONSTRUCTION.
- 7. LIGHTING: FURNISH AND INSTALL ALL LIGHTING FIXTURES COMPLETE WITH LAMPS IN ACCORDANCE WITH THE LIGHTING FIXTURE SCHEDULE SHOWN ON THE DRAWINGS. ALL UNITS SHALL BE COMPLETE WITH SUSPENSION ACCESSORIES, CANOPIES, SOCKETS, LOUVERS, FRAMES, AND ROUGH-IN BOXES, WIRED AND ASSEMBLES TO FURNISH A COMPLETE WORKABLE SYSTEM.
- 8. LOW VOLTAGE CONDUIT AND JUNCTION BOXES SHALL BE INSTALLED BY THE ELECTRICAL CONTRACTOR.
- EQUIPMENT GROUNDING CONDUCTORS SHALL BE PULLED WITH ALL BRANCH CIRCUITS. CONDUIT SHALL NOT BE USED AS A GROUND U.N.O.
 ELECTRICAL CONTRACTOR SHALL FURNISH AND INSTALL ALL MATERIALS,
- ACCESSORIES, TOOLS, EQUIPMENT, TRANSPORTATION, LABOR, SERVICES AND OPERATIONS NECESSARY FOR A COMPLETE ELECTRICAL SYSTEM.

 11.ELECTRICAL CONTRACTOR SHALL OBTAIN ALL NECESSARY PERMITS AND
- ARRANGE FOR ALL INSPECTIONS REQUIRED BY STATE OR LOCAL AUTHORITIES.
- 12. MATERIALS MUST BE NEW, IN FIRST CLASS CONDITION.
- 13. CONDUIT SHALL BE SEPARATELY HUNG AND ANCHORED, FREE TO EXPAND AND CONTRACT QUIETLY, WITHOUT IMPOSING STRAINS ON STRUCTURE, DEVICES, AND EQUIPMENT. CONDUIT SHALL BE RUN PARALLEL OR PERPENDICULAR TO BUILDING LINES.
- 14. CONTRACTOR SHALL PERFORM EXCAVATION REQUIRED TO INSTALL HIS WORK.

ELECTRICAL KEY NOTES (AS NOTED ON THIS SHEET ONLY)

- (1) REMOVE EXISTING RECEPTACLE AND ASSOCIATED CONDUIT AND WIRE.
- (2) REMOVE EXISTING LIGHT FIXTURE AND ASSOCIATED CONDUIT AND WIRE.
- REMOVE EXISTING GROUND RING CONNECTIONS TO STRUCTURAL STEEL. PREPARE BURIED GROUND RING LOOP FOR REUSE.
- (4) REMOVE LIGHT SWITCH AND ASSOCIATED CONDUIT AND WIRE.

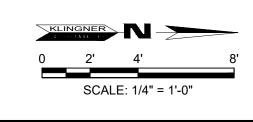

SOUTH QUINCY LIFT STATION

Non-Reduced Sheet Size: 22" x 34"

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DESIGNED DRAWN JAK
FIELD DESIGNED CHECKED CHECK DATE

SHEET TITLE

ELECTRICAL DEMOLITON

OUNCY, ILLINOIS

PLANS

PROJECT NO.

DRAWING ISSUED DATE: 09/10/2019 SHEET

E101


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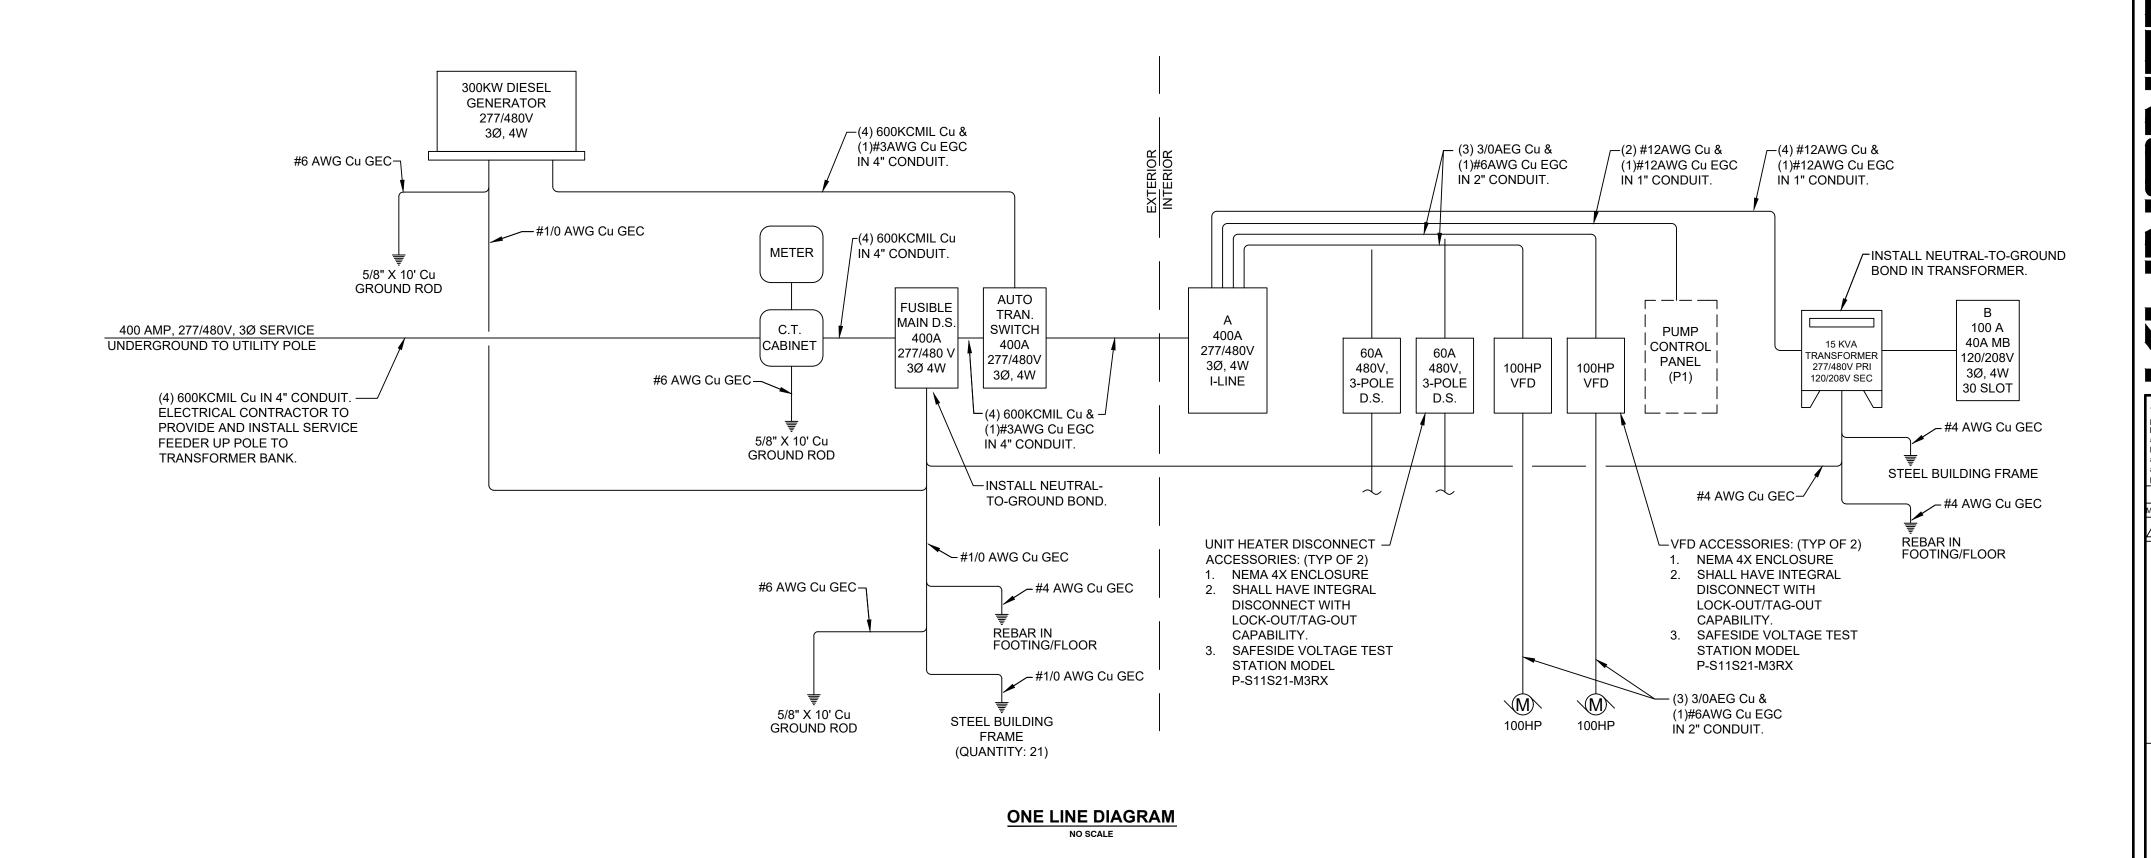
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REVISION HISTORY

DESCRIPTION





LI	GHTING SC	CHEDULE								
ID	Manufact.	Model	Lamp Type	Voltage	Watts	Mounting	Notes			
V	Metalux	Vaportite LED	4' Linear LED	120	55	Chain	Provide SS latches			
Х	Crouse-Hinds	Champ MLL	4' Linear LED	120	72	Ceiling	Hazardous location rated			
L	Lumark	XTOR Crosstour	Area/Site LED	120	38	Wall	Photocell control			

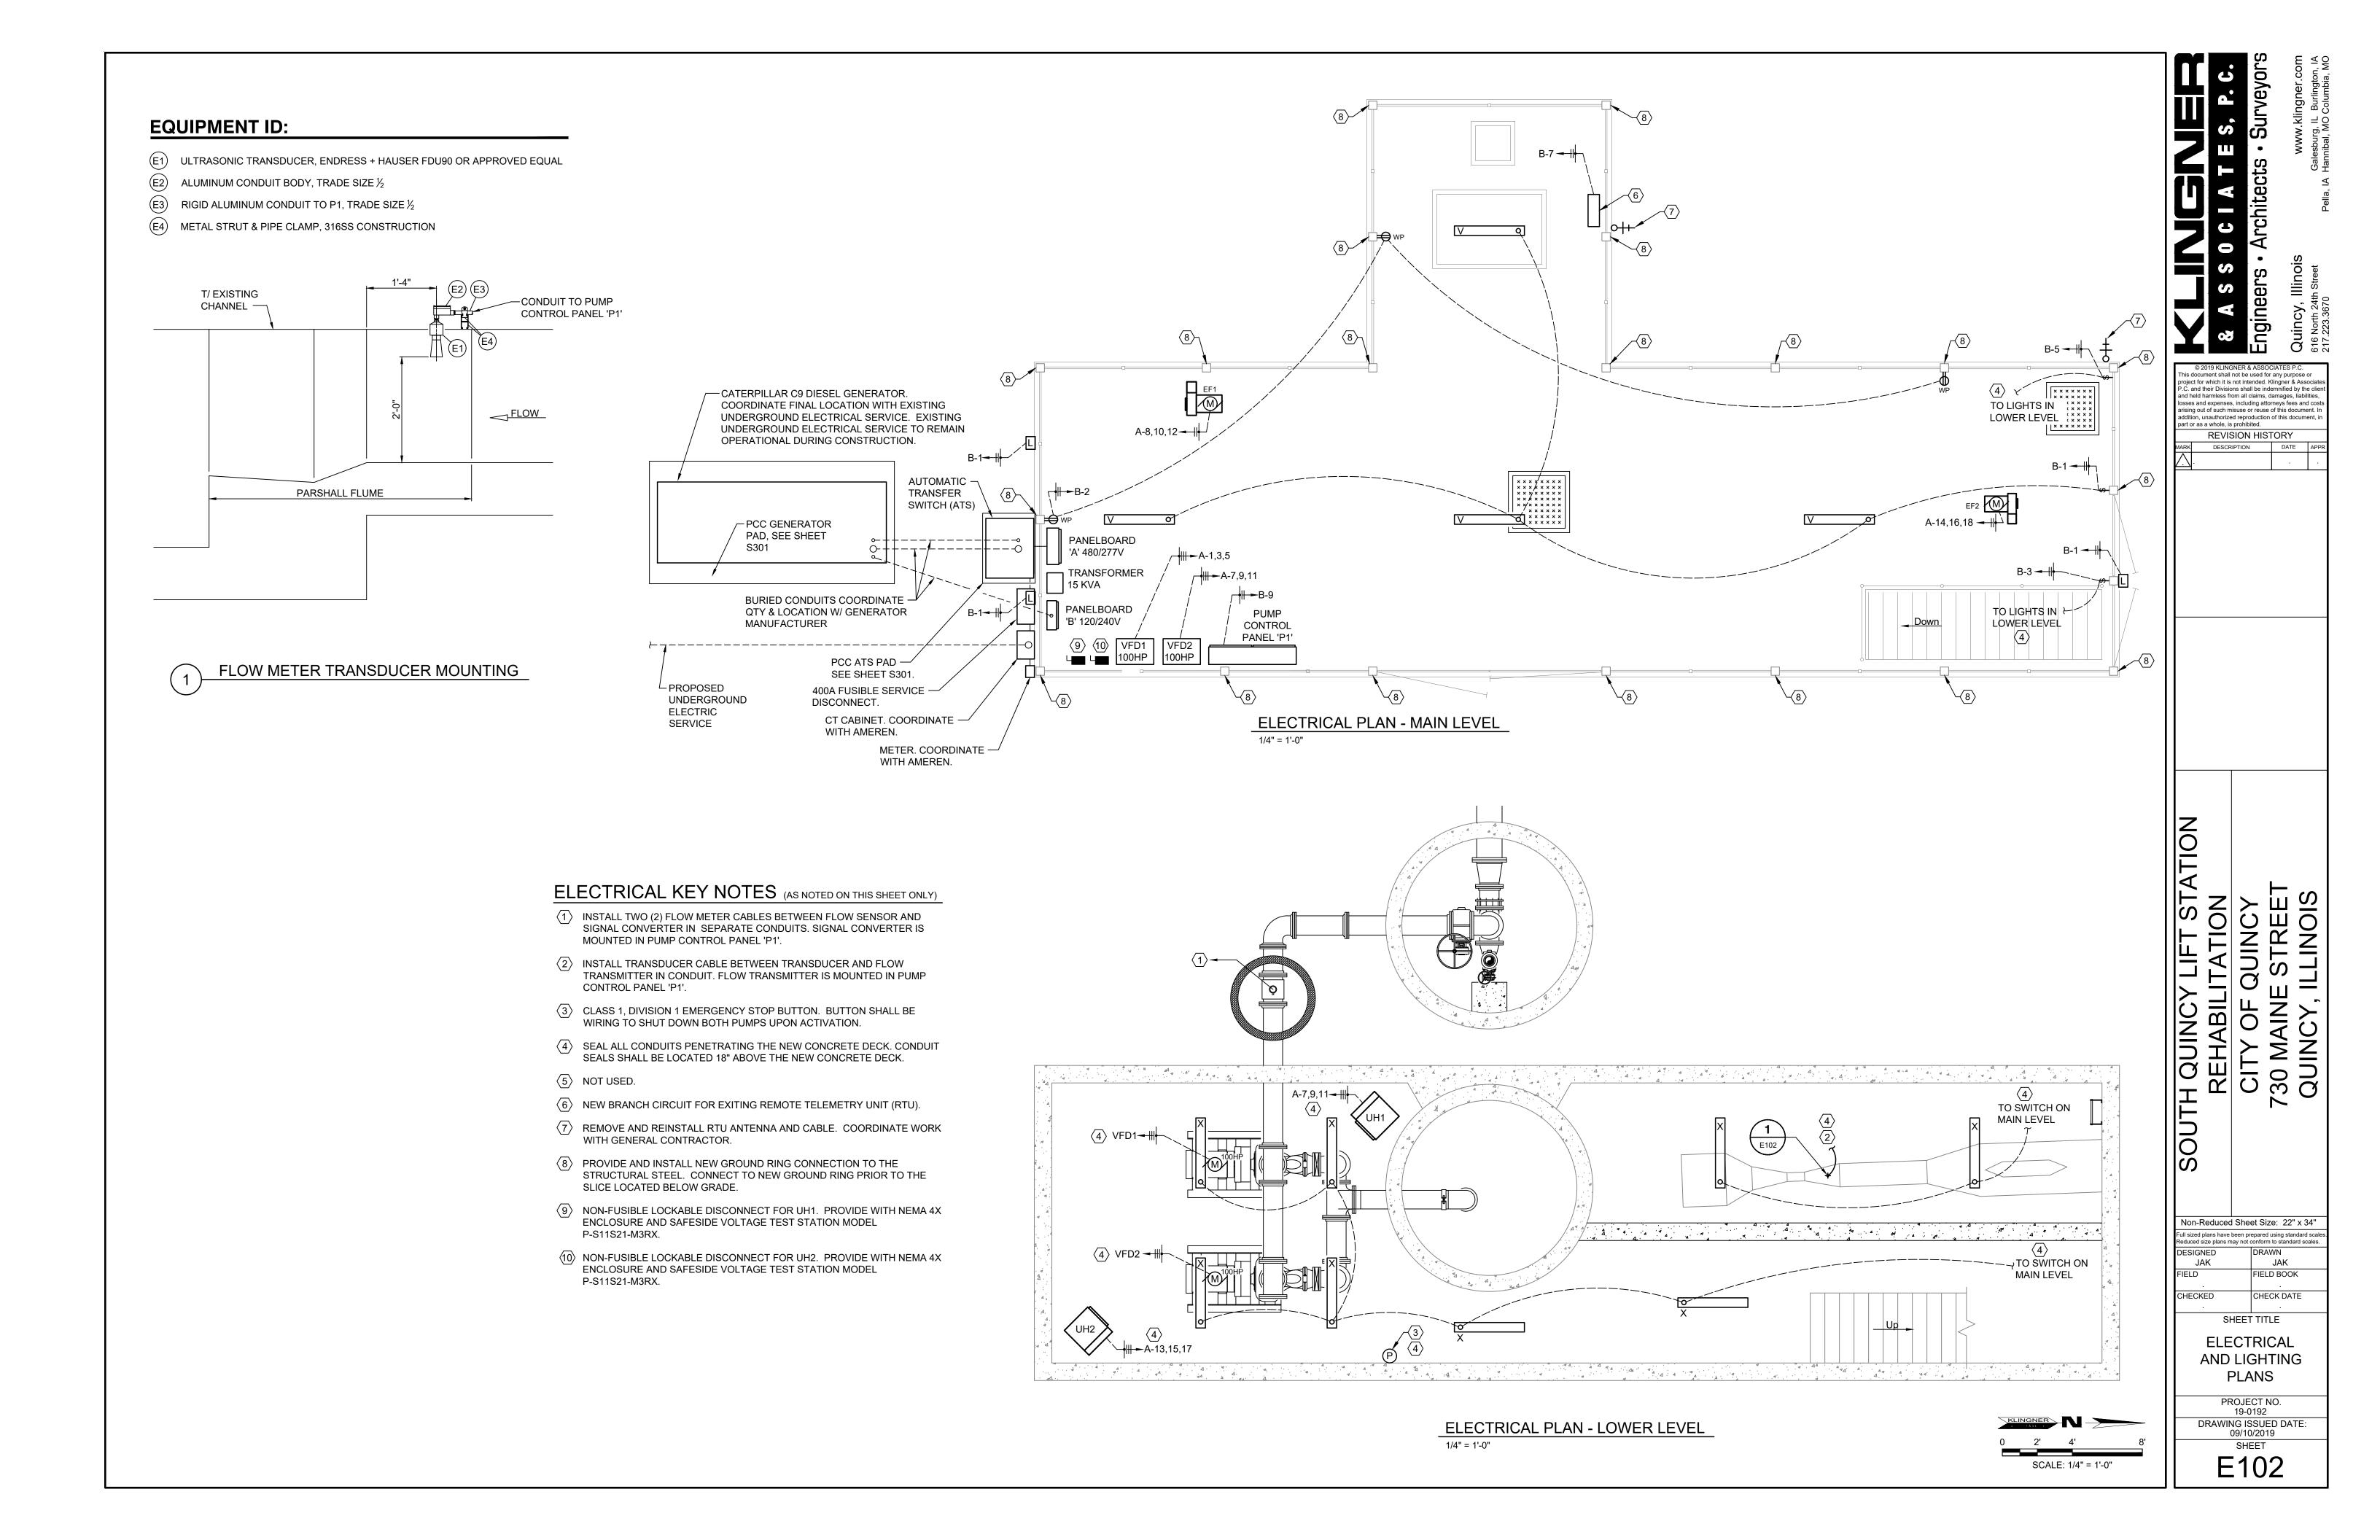ELE	ECTRICAL PANEL:	Α							Area Serve	Ell I OTATION	
Location: EXTERIOR		SUR	FACE	400 A Fault Ra		277/480 V 3 Ph 4 Wire ing: 65,000A			MAIN LUG ONLY NEMA 4X ENCLOSURE		
		Brkr.			Lo	ad			Brkr.		
No.	Description	Amps	Α	В	С	С	В	Α	Amps	Description No.	
1			34364					5000		2	
3	VFD1 - PUMP #1	200		34364			5000		20	TRANSFORMER T1 4	
5					5000 20 TRANSFORMER T1 34364 5000 831 20 EXHAUST FAN EF-1 34364 831 443	6					
7			34364					831	20	8	
9	VFD2 - PUMP #2	200		34364			831				
11					34364	831				12	
13			10000					443		14	
15	UNIT HEATER UH-1	50		10000			443		20		
17					10000	443				18	
13			10000							14	
15	UNIT HEATER UH-2	50		10000							
17										18	
			78728	78728	78728	6274	6274	6274			
	Totals	Phas	se A	Pha	se B	Pha	se C	Total Wa	attage(\	VA Capacity	
		34364 5000									

ELECTRICAL PANEL: B Area LIGHTS AND RECEPTACLES Served:									ES		
Location: EXTERIOR		SURI	FACE	100 A 277/48 Fault Rating: 42,0						WITH 40A MAIN BREAKER NEMA 4X ENCLOSURE	
		Brkr.			Lo	ad			Brkr.		
lo.	Description	Amps	Α	В	С	С	В	Α	Amps	Description	No.
1	LIGHTS - MAIN LEVEL	20	296					540	20	RECEP	TACLES 2
3	LIGHTS - PUMP ROOM LOWER LEVEL	20		420			2500		50	GENE	RATOR 4
5	LIGHTS - INCOMMING ROOM - LOWER	20			140	2500			50	GLINE	6
7	REMOTE TELIMITRY UNIT	20	500						20		SPARE 8
9	PUMP CONTROL PANEL P1	20		500					20		SPARE 10
1	SPARE	20							20		SPARE 12
3	SPACE										SPACE 14
5	SPACE										SPACE 16
7	SPACE										SPACE 18
9	SPACE										SPACE 20
21	SPACE										SPACE 22
23	SPACE										SPACE 24
25	SPACE										SPACE 26
	SPACE										SPACE 28
29	SPACE										SPACE 30
			796	920	140	2500	2500	540			
_	Totals	Phas	e A	Phas	se B	Pha	se C	Total Wa	ttage(V	A Capacity	
_		133	36	34	20	26	40	73	396	33255	

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SOUTH QUINCY LIFT STAT
REHABILITATION
CITY OF QUINCY
730 MAINE STREET
QUINCY, ILLINOIS

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ELECTRICAL ONE LINE DIAGRAM AND PANEL SCHEDULES PROJECT NO. 19-0192

DRAWING ISSUED DATE: 09/10/2019 SHEET E501