CITY OF GEORGETOWN

KAMINSKI STREET (PROJECT NO. 1511) AND HEYWARD STREET (PROJECT NO. 1509) WATER IMPROVEMENTS

GEORGETOWN, SC GEORGETOWN COUNTY

DRAWING INDEX:


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GENERAL CONSTRUCTION NOTES:

- 1. CONTRACTOR TO VERIFY ALL INFORMATION CONTAINED HEREIN PRIOR TO CONSTRUCTION AND NOTIFY ENGINEER OR OWNER OF ANY DISCREPANCY PRIOR TO CONSTRUCTION.
- 2. ALL CONSTRUCTION, METHODS, MATERIALS, AND WORKMANSHIP SHALL CONFORM TO CITY OF GEORGETOWN PUBLIC SERVICES DEPARTMENT SPECIFICATIONS, LATEST EDITION. WHERE CONFLICT OCCURS BETWEEN CONSTRUCTION PLANS, SPECIFICATIONS, AND/OR FIELD CONDITIONS, CONTRACTOR IS TO CONTACT ENGINEER OR OWNER FOR CLARIFICATION PRIOR TO CONSTRUCTION.
- 3. CONTRACTOR TO COORDINATE WITH OWNER AND ENSURE ALL APPLICABLE CONSTRUCTION AND LAND
- 4. CONTRACTOR TO NOTIFY CITY OF GEORGETOWN WATER UTILITY DEPARTMENT A MINIMUM OF 48 HOURS BEFORE ANY WATER WORK IS TO BEGIN.
- 5. CONTRACTOR TO NOTIFY SCE&G CONSTRUCTION & ENGINEERING REPRESENTATIVE (DAVID ETHRIDGE, 843-745-7511) A MINIMUM OF 48 HOURS BEFORE ANY WATER WORK IS TO BEGIN. THIS REPRESENTATIVE SHALL BE PRESENT DURING THE CROSSING OF BLACK RIVER ROAD, AS THERE IS A 4" STEEL GAS MAIN ON THE EASTERN SIDE THAT IS CRITICAL.
- 6. IN ALL AREAS WHERE THE PROPOSED WATER LINES CROSS AN EXISTING STORM DRAIN, THE CONTRACTOR SHALL HAVE THE CROSSING INSPECTED BY SCDOT'S GEORGETOWN MAINTENANCE OFFICE PRIOR TO BACKFILLING. SCDOT RESERVES THE RIGHT TO REQUEST ANY EXPOSED JOINTS TO BE RESEALED BEFORE IT IS COVERED.
- 7. ALL PROPOSED CONSTRUCTION ACTIVITY SHALL BE CONFINED TO THE RIGHT OF WAY.
- 8. NO GRAND TREES WILL BE REMOVED DURING THE CONSTRUCTION OF THIS PROJECT.
- 9. CONTRACTOR SHALL SUBMIT SHOP DRAWINGS TO THE ENGINEER ON ALL MATERIALS PRIOR TO PURCHASE.
- 10. ALL WORK PERFORMED IN CONNECTION WITH THE SCDOT ROAD ENCROACHMENT PERMIT MUST COMPLY WITH SCDOT'S UTILITY ACCOMMODATION MANUAL.
- 11. CONTRACTOR SHALL SUBMIT CALCULATIONS FOR JACK AND BORE OPERATIONS TO THE SCDOT FOR REVIEW PRIOR TO CONSTRUCTION, IF REQUIRED.
- 12. CONTRACTOR SHALL WARRANT ALL REPAIRED OR DISTURBED SURFACE AREAS (ROADWORK AND SIDEWALKS) FOR A PERIOD OF TWO YEARS AFTER FINAL ACCEPTANCE.
- 13. ALL TRAFFIC CONTROLS WITHIN WORK ZONE MUST MEET THE CRITERIA OF THE LATEST EDITION OF THE MANUAL OF UNIFORM TRAFFIC CONTROL DEVICES (MUTCD).
- 14. CONTRACTOR SHALL ADEQUATELY PROTECT ALL EXCAVATED AREAS FROM PEDESTRIAN TRAFFIC.
- 15. CONTRACTOR SHALL COMPLY WITH ALL OSHA REQUIREMENTS.
- 16. HORIZONTAL DATUM USED IS NAD83. VERTICAL DATUM USED IS NAVD88.







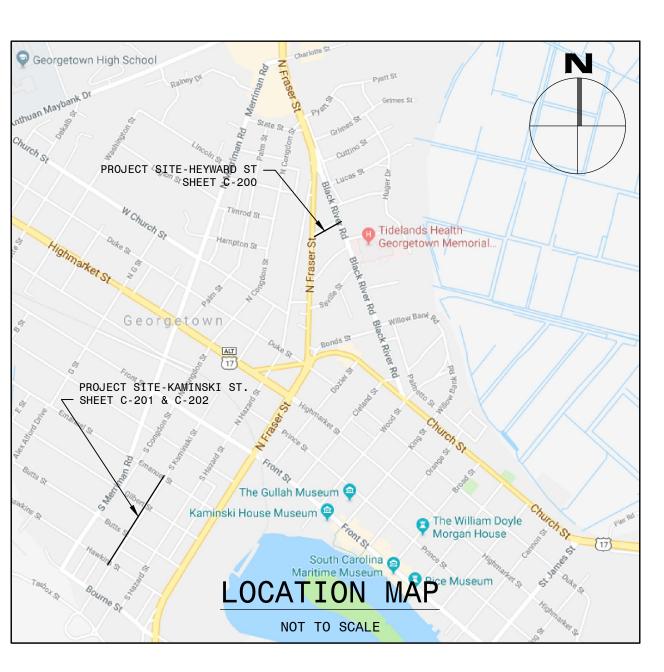

LOCATOR SERVICES:

PRIOR TO EXCAVATION, CONTRACTOR SHALL ARRANGE FOR LOCATING AND MOVING, IF NECESSARY. UNDERGROUND UTILITIES AS FOLLOWS:

GAS LINES SOUTH CAROLINA ELECTRIC AND GAS CO. - 1-800-251-7234

DOMINION CAROLINA GAS TRANSMISSION - 803-206-0940

WATER/SEWER CITY OF GEORGETOWN - 843-545-4500

ELEC. POWER CITY OF GEORGETOWN - 843-545-4600

TELEPHONE LINES HORRY TELEPHONE - 843-369-7399

T.V. CABLES TIME WARNER - MURRELS INLET - 855-272-2862 FRONTIER COMM. (FORMERLY VERIZON) - 843-536-7203

PALMETTO UTILITY PROTECTION SERVICES (PUPS) 803-939-1117

WATER NOTES:

- ALL WATER SERVICES AFFECTED BY THIS CONSTRUCTION SHALL BE MAINTAINED THROUGHOUT TH DURATION OF THIS PROJECT.
- 2. WATER INSTALLATION SHALL BE IN ACCORDANCE WITH "TEN STATES STANDARDS," SCDHEC AND COG STANDARDS.
- 3. CONTRACTOR SHALL SCHEDULE A PRE-CONSTRUCTION MEETING WITH COG AT LEAST 72 HOURS PRIOR T BEGINNING WORK.
- 4. CONTRACTOR SHALL VERIFY THE LOCATION AND ELEVATION OF ALL EXISTING UTILITIES PRIOR TO BEGINNING OR CONTINUING WORK. ANY DEVIATIONS FROM THE CONSTRUCTION PLANS SHALL NEED TO BE APPROVED IN WRITING BY COG REPRESENTATIVE.
- 5. CONTRACTOR SHALL VERIFY ALL EXISTING WATER PIPE DIAMETER AND MATERIAL BEFORE ANY PURCHASE OF MATERIAL IS MADE FOR CONNECTIONS.
- 6. CONNECTIONS TO EXISTING WATER SYSTEM SHALL BE MADE IN THE PRESENCE OF COG PUBLIC WATER UTILITY REPRESENTATIVE WITH AT LEAST 72 HOURS ADVANCED NOTICE.
- 7. ALL WATER LINES SHALL HAVE A MINIMUM COVER OF 36".
- 8. A MINIMUM CLEARANCE OF 18" SHALL BE MAINTAINED FROM ALL OTHER EXISTING UTILITIES. THE PROPOSED WATER LINE SHALL PASS ABOVE ANY EXISTING SANITARY SEWER PIPE OR INFRASTRUCTURE.
- 9. WATER SERVICE AND SEWER SERVICE FOR EACH LOT SHALL MAINTAIN A MINIMUM 5' OF SEPARATION,
- 10. THE MINIMUM REQUIRED SPACING BETWEEN ANY NEW WATER LINE AND ANY EXISTING GAS LINE (MAIN OR SERVICE) IS 6 INCHES VERTICAL AND 12 INCHES HORIZONTAL. THIS DISTANCE IS MEASURED FROM OUTER EDGE OF PIPE (ONE UTILITY) TO OUTSIDE EDGE OF PIPE (OTHER UTILITY).
- 11. ANY EXISTING WATER MAIN (WITH NOMINAL DIAMETER OF 4 INCHES OR GREATER) UNDERNEATH OF A SCDOT ROADWAY THAT IS TO BE ABANDONED SHALL BE CAPPED OUTSIDE OF THE EDGE OF PAVEMENT AND FILLED WITH NON-SHRINK FLOWABLE FILL PER SCDOT STANDARDS.
- 12. USE 45° OR FLATTER BENDS WHEN GOING UNDER RCP, AND DO NOT INSTALL VALVES, HYDRANTS, OR SERVICES ON DEEP PIPE SECTIONS.
- 13. DEFLECT WATER LINES IN LIEU OF FITTINGS IN ACCORDANCE WITH THE PIPE MANUFACTURER'S SPECIFICATIONS.
- 14. ALL FITTINGS, VALVES AND HYDRANTS SHALL BE PROVIDED WITH RESTRAINED JOINT FITTINGS PER COG REQUIREMENTS.
- 15. WATER SERVICE STUBOUTS & SERVICE TEE SHALL BE INSTALLED WITHIN THE RIGHT-OF-WAY OR GENERAL UTILITY EASEMENT (GUE).
- 16. BEFORE THE WATER MAIN IS PLACED INTO SERVICE, THE CONTRACTOR SHALL CONDUCT AND SUCCESSFULLY COMPLETE PRESSURE TESTING AND LEAKAGE TESTING IN ACCORDANCE WITH AWWA'S STANDARD ON HYDROSTATIC TESTING (AWWA C600), AND THIS PROJECTS SPECIFICATIONS.
- 17. BEFORE THE WATER MAIN IS PLACED INTO SERVICE, THE CONTRACTOR SHALL SUCCESSFULLY CONDUCT DISINFECTION IN ACCORDANCE WITH AWWA'S STANDARD ON DISINFECTING WATER MAINS (AWWA C651), THIS PROJECTS SPECIFICATIONS, AND AS REQUIRED BY SCDHEC.
- 18. CONTRACTOR SHALL SCHEDULE ALL REQUIRED TESTS AND INSPECTIONS WITH A COG REPRESENTATIVE AT LEAST 72 HOURS IN ADVANCE. A SET OF RECORD DRAWINGS SHALL BE PROVIDED TO COG PUBLIC WATER UTILITY REPRESENTATIVE FOR FINAL INSPECTION.
- 19. CONTRACTOR SHALL KEEP A RED-LINED SET OF THE CONSTRUCTION DRAWINGS ON SITE AT ALL TIMES.



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672 Marina Dr. Suite 204, Charleston, SC 29492

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TITLE SHEET

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SHEET 1 OF 12

STANDARD EROSION CONTROL NOTES:

- 1. IF NECESSARY, SLOPES, WHICH EXCEED EIGHT (8) VERTICAL FEET SHOULD BE STABILIZED WITH SYNTHETIC OR VEGETATIVE MATS, IN ADDITION TO HYDROSEEDING. IT MAY BE NECESSARY TO INSTALL TEMPORARY SLOPE DRAINS DURING CONSTRUCTION. TEMPORARY BERMS MAY BE NEEDED UNTIL THE SLOPE IS BROUGHT TO GRADE.
- 2. STABILIZATION MEASURES SHALL BE INITIATED AS SOON AS PRACTICABLE IN PORTIONS OF THE SITE WHERE CONSTRUCTION ACTIVITIES HAVE TEMPORARILY OR PERMANENTLY CEASED, BUT IN NO CASE MORE THAN FOURTEEN (14) DAYS AFTER WORK HAS CEASED. EXCEPT AS STATED BELOW.
- WHERE STABILIZATION BY THE 14TH DAY IS PRECLUDED BY SNOW COVER OR FROZEN GROUND CONDITIONS STABILIZATION MEASURES MUST BE INITIATED AS SOON AS PRACTICABLE.
- WHERE CONSTRUCTION ACTIVITY ON A PORTION OF THE SITE IS TEMPORARILY CEASED, AND EARTH-DISTURBING ACTIVITIES WILL BE RESUMED WITHIN 14 DAYS, TEMPORARY STABILIZATION MEASURES DO NOT HAVE TO BE INITIATED ON THAT PORTION OF THE SITE.
- 3. ALL SEDIMENT AND EROSION CONTROL DEVICES SHALL BE INSPECTED ONCE CALENDAR EVERY WEEK. IF PERIODIC INSPECTION OR OTHER INFORMATION INDICATES THAT A BMP HAS BEEN INAPPROPRIATELY, OR INCORRECTLY, THE PERMITTEE MUST ADDRESS THE NECESSARY REPLACEMENT OR MODIFICATION REQUIRED TO CORRECT THE BMP WITHIN 48 HOURS OF IDENTIFICATION.
- 4. PROVIDE SILT FENCE AND/OR OTHER CONTROL DEVICES, AS MAY BE REQUIRED, TO CONTROL SOIL EROSION DURING UTILITY CONSTRUCTION. ALL DISTURBED AREAS SHALL BE CLEANED, GRADED, AND STABILIZED WITH GRASSING IMMEDIATELY AFTER THE UTILITY INSTALLATION. FILL, COVER, AND TEMPORARY SEEDING AT THE END OF EACH DAY ARE RECOMMENDED. IF WATER IS ENCOUNTERED WHILE TRENCHING, THE WATER SHOULD BE FILTERED TO REMOVE ANY SEDIMENTS BEFORE BEING PUMPED BACK INTO ANY WATERS OF THE STATE.
- 5. ALL EROSION CONTROL DEVICES SHALL BE PROPERLY MAINTAINED DURING ALL PHASES OF CONSTRUCTION UNTIL THE COMPLETION OF ALL CONSTRUCTION ACTIVITIES AND ALL DISTURBED AREAS HAVE BEEN STABILIZED. ADDITIONAL CONTROL DEVICES MAY BE REQUIRED DURING CONSTRUCTION IN ORDER TO CONTROL EROSION AND/OR OFFSITE SEDIMENTATION. ALL TEMPORARY CONTROL DEVICES SHALL BE REMOVED ONCE CONSTRUCTION IS COMPLETE AND THE SITE IS STABILIZED.
- 6. THE CONTRACTOR MUST TAKE NECESSARY ACTION TO MINIMIZE THE TRACKING OF MUD ONTO PAVED ROADWAY(S) FROM CONSTRUCTION AREAS AND THE GENERATION OF DUST. THE CONTRACTOR SHALL DAILY REMOVE MUD/SOIL FROM PAVEMENT, AS MAY BE REQUIRED.
- 7. RESIDENTIAL SUBDIVISIONS REQUIRE EROSION CONTROL FEATURES FOR INFRASTRUCTURE AS WELL AS FOR INDIVIDUAL LOT CONSTRUCTION. INDIVIDUAL PROPERTY OWNERS SHALL FOLLOW THESE PLANS DURING CONSTRUCTION OR OBTAIN APPROVAL OF AN INDIVIDUAL PLAN IN ACCORDANCE WITH S.C REG. 72-300 ET SEQ. AND SCR100000.
- 8. TEMPORARY DIVERSION BERMS AND/OR DITCHES WILL BE PROVIDED AS NEEDED DURING CONSTRUCTION TO PROTECT WORK AREAS FROM UPSLOPE RUNOFF AND/OR TO DIVERT SEDIMENT-LADEN WATER TO APPROPRIATE TRAPS OR STABLE OUTLETS.
- 9. ALL WATERS OF THE STATE (WOS), INCLUDING WETLANDS, ARE TO BE FLAGGED OR OTHERWISE CLEARLY MARKED IN THE FIELD. A DOUBLE ROW OF SILT FENCE IS TO BE INSTALLED IN ALL AREAS WHERE A 50-FOOT BUFFER CAN'T BE MAINTAINED BETWEEN THE DISTURBED AREA AND ALL WOS. A 10-FOOT BUFFER SHOULD BE MAINTAINED BETWEEN THE LAST ROW OF SILT FENCE AND ALL WOS.
- 10. LITTER, CONSTRUCTION DEBRIS, OILS, FUELS, AND BUILDING PRODUCTS WITH SIGNIFICANT POTENTIAL FOR IMPACT (SUCH AS STOCKPILES OF FRESHLY TREATED LUMBER) AND CONSTRUCTION CHEMICALS THAT COULD BE EXPOSED TO STORM WATER MUST BE PREVENTED FROM BECOMING A POLLUTANT SOURCE IN STORM WATER DISCHARGES.
- 11. A COPY OF THE SWPPP, INSPECTIONS RECORDS, AND RAINFALL DATA MUST BE RETAINED AT THE CONSTRUCTION SITE OR A NEARBY LOCATION EASILY ACCESSIBLE DURING NORMAL BUSINESS HOURS, FROM THE DATE OF COMMENCEMENT OF CONSTRUCTION ACTIVITIES TO THE DATE THAT FINAL STABILIZATION IS REACHED.
- 12. INITIATE STABILIZATION MEASURES ON ANY EXPOSED STEEP SLOPE (3H:1V OR GREATER) WHERE LAND-DISTURBING ACTIVITIES HAVE PERMANENTLY OR TEMPORARILY CEASED, AND WILL NOT RESUME FOR A PERIOD OF 7 CALENDAR DAYS.
- 13. MINIMIZE SOIL COMPACTION AND, UNLESS INFEASIBLE, PRESERVE TOPSOIL.
- 14. MINIMIZE THE DISCHARGE OF POLLUTANTS FROM EQUIPMENT AND VEHICLE WASHING, WHEEL WASH WATER, AND OTHER WASH WATERS. WASH WATERS MUST BE TREATED IN A SEDIMENT BASIN OR ALTERNATIVE CONTROL THAT PROVIDES EQUIVALENT OR BETTER TREATMENT PRIOR TO DISCHARGE;
- 15. MINIMIZE THE DISCHARGE OF POLLUTANTS FROM DEWATERING OF TRENCHES AND EXCAVATED AREAS. THESE DISCHARGES ARE TO BE ROUTED THROUGH APPROPRIATE BMPS (SEDIMENT BASIN, FILTER BAG, ETC.).
- 16. THE FOLLOWING DISCHARGES FROM SITES ARE PROHIBITED:
- WASTEWATER FROM WASHOUT OF CONCRETE, UNLESS MANAGED BY AN APPROPRIATE CONTROL;
- WASTEWATER FROM WASHOUT AND CLEANOUT OF STUCCO, PAINT, FORM RELEASE OILS, CURING COMPOUNDS AND OTHER CONSTRUCTION MATERIALS;
- FUELS, OILS, OR OTHER POLLUTANTS USED IN VEHICLE AND EQUIPMENT OPERATION AND MAINTENANCE;
- AND SOAPS OR SOLVENTS USED IN VEHICLE AND EQUIPMENT WASHING.
- 17. AFTER CONSTRUCTION ACTIVITIES BEGIN, INSPECTIONS MUST BE CONDUCTED AT A MINIMUM OF AT LEAST ONCE EVERY CALENDAR WEEK AND MUST BE CONDUCTED UNTIL FINAL STABILIZATION IS REACHED ON ALL AREAS OF THE CONSTRUCTION SITE.
- 18. IF EXISTING BMPS NEED TO BE MODIFIED OR IF ADDITIONAL BMPS ARE NECESSARY TO COMPLY WITH THE REQUIREMENTS OF THIS PERMIT AND/OR SC'S WATER QUALITY STANDARDS, IMPLEMENTATION MUST BE COMPLETED BEFORE THE NEXT STORM EVENT WHENEVER PRACTICABLE. IF IMPLEMENTATION BEFORE THE NEXT STORM EVENT IS IMPRACTICABLE, THE SITUATION MUST BE DOCUMENTED IN THE SWPPP AND ALTERNATIVE BMPS MUST BE IMPLEMENTED AS SOON AS REASONABLY POSSIBLE.
- 19. A PRE-CONSTRUCTION CONFERENCE MUST BE HELD FOR EACH CONSTRUCTION SITE WITH AN APPROVED ON-SITE SWPPP PRIOR TO THE IMPLEMENTATION OF CONSTRUCTION ACTIVITIES. FOR NON-LINEAR PROJECTS THAT DISTURB 10 ACRES OR MORE THIS CONFERENCE MUST BE HELD ON-SITE UNLESS THE DEPARTMENT HAS APPROVED OTHERWISE.

TREE PROTECTION NOTES:

- 1. NO PROTECTED (ACCORDING TO CITY OF GEORGETOWN'S ARTICLE XII:TREE PROTECTION REGULATIONS) TREES SHALL BE REMOVED DURING THE CONSTRUCTION OF THIS PROJECT.
- 2. PROTECTIVE BARRICADES SHALL BE PLACED AROUND ALL PROTECTED TREES (ACCORDING TO CITY OF GEORGETOWN'S ARTICLE XII:TREE PROTECTION REGULATIONS) LOCATED IN THE CONSTRUCTION AREA PRIOR TO COMMENCEMENT OF ANY WORK, AND SHALL REMAIN IN PLACE UNTIL CONSTRUCTION ACTIVITIES ARE COMPLETE.
- 3. PROTECTIVE BARRICADES SHALL BE ERECTED A MINIMUM DISTANCE FROM THE BASE OF A PROTECTED TREE ACCORDING TO THE
- 3.1. FOR PROTECTED TREES UNDER TEN INCHES DBH, PROTECTIVE BARRICADES SHALL BE PLACED A MINIMUM DISTANCE OF FIVE FEET FROM THE BASE OF EACH PROTECTED TREE, OR TO THE DRIP LINE, WHICHEVER IS GREATER.
- 3.2. FOR PROTECTED THREES GREATER THAN TEN INCHES DBH, PROTECTIVE BARRICADES SHALL BE PLACED A MINIMUM DISTANCE OF TEN FEET FROM THE BASE OF EACH PROTECTED TREE, OR TO THE DRIP LINE, WHICHEVER IS GREATER.
- 4. LOCATION OF TREE PROTECTION SHALL BE FIELD DETERMINED BASED ON PROXIMITY TO ROAD, SIDEWALK, ETC.
- 5. IF CONSTRUCTION ACTIVITIES WILL CONFLICT WITH THE TREE ROOT SYSTEM, A TREE EXPERT (ANY INDIVIDUAL LICENSED AS OR WHO IS OTHERWISE PRACTICING LANDSCAPE ARCHITECTURE, ARBORIST, FORESTER, OR HORTICULTURIST) SHALL BE CONSULTED PRIOR TO THE ACTIVITY TO MINIMIZE IMPACT TO TREE. IF TREE IS DAMAGED, CONTRACTOR SHALL IMMEDIATELY CONSULT WITH TREE EXPERT AND THE CITY OF GEORGETOWN FOR TREE REPAIR.
- 6. ALL ROOTS TO BE REMOVED DURING CONSTRUCTION SHALL BE SEVERED CLEAN AND A 2" LAYER OF MULCH SHALL BE APPLIED OVER THE SURFACE OF EXPOSED ROOTS DURING CONSTRUCTION.
- 7. MODERATE FILL CAN BE TOLERATED WITHIN A TREE'S CRITICAL ROOT ZONE WITH THE PROPER UTILIZATION OF AN AERATION SYSTEM. COMMERCIALLY AVAILABLE SYSTEMS ARE SUBJECT TO REVIEW BY THE CITY GROUNDS MAINTENANCE SUPERVISOR.
- 8. CONTRACTOR SHALL AVOID DAMAGE TO TREE LIMBS. IF PRUNING IS NECESSARY, THE CITY OF GEORGETOWN'S GROUND MAINTENANCE SUPERVISOR MUST FIRST BE CONSULTED.
- 9. ALL PRUNING OF TREES SHALL BE DONE BY A QUALIFIED TREE SERVICE DURING CONSTRUCTION ACCORDING TO THE TREE CARE INDUSTRY ASSOCIATION'S PRUNING STANDARDS FOR SHADE TREES.
- 10. THE AREA WITHIN THE PROTECTIVE BARRICADE SHALL REMAIN FREE OF ALL BUILDING MATERIALS, DIRT OR OTHER CONSTRUCTION MATERIALS, DEBRIS, MACHINERY, VEHICLES, AND CONSTRUCTION ACTIVITIES.

LEGEND:

—— FO —— UNDERGROUND FIBER OPTICS

—— G —— UNDER GROUND GAS LINE

— ESMT — EASEMENT LINES

—— SS —— SANITARY SEWER

—— FM —— FORCE MAIN

----- SD ----- STORM DRAIN

---- W ---- WATER MAIN

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FENCELINE


----- RIGHT-OF-WAY LINES

EXISTING PROPOSED TBM (TEMPORARY BENCH MARK) WATER VALVE 3/4" OPEN TOP PIPE FOUND FIRE HYDRANT 3/4" ROD FOUND --- W --- NEW 6" WATER MAIN C900 PCV 5/8" REBAR FOUND ————— PROPOSED WATER MAIN PROFILE REBAR FOUND — LOD — LIMIT OF DISTURBANCE GROUND CONTOUR JACK & BORE PIT LIGHT POLE STEEL CASING MAIL BOX OPEN CUT ROAD OR DRIVEWAY KXXXXXX ROAD SIGN PATCH/OVERLAY REQUIRED SEWER MANHOLE TREE PROTECTION WATER METER ---- SF ---- SILT FENCE FIRE HYDRANT — LOD — LIMIT OF DISTURBANCE WATER VALVE SEDIMENT TUBE GRATE INLET TYPE A INLET PROTECTION **GUY WIRES** "SIDEWALK CLOSED" SIGN POWER POLES SUPPORTED BY SCDOT TYPE 2 BARRICADE ---- OHP ---- POWER LINES ** * * * * TEMPORARY FENCING

ABBREVIATIONS:


COG	CITY OF GEORGETOWN PUBLIC WATER UTILITY	UGF0	UNDERGROUND FIBER OPTICS
W&S	WESTON & SAMPSON	HDD	HORIZONTAL DIRECTIONAL DRILL
SCDHEC	SOUTH CAROLINA DEPARTMENT OF HEALTH AND ENVIRONMENTAL CONTROL	SF	SILT FENCE
SCDOT	SOUTH CAROLINA DEPARTMENT OF TRANSPORTATION	EOP	EDGE OF PAVEMENT
AWWA	AMERICAN WATER WORKS ASSOCIATION	RCP	REINFORCED CONCRETE PIPE (STORM)
TBM	TEMPORARY BENCH MARK	DIP	DUCTILE IRON PIPE
WV	WATER VALVE	HDPE	HIGH DENSITY POLYETHYLENE PIPE
WM	WATER MAIN	PVC	POLYVINYL CHLORIDE
HYD	FIRE HYDRANT	AC	ASBESTOS CEMENT
GV	GAS VALVE	MJ	MECHANICAL JOINT
ОНР	OVERHEAD POWER	DBH	DIAMETER BREAST HEIGHT
UGE	UNDERGROUND ELECTRIC	DW	DOGWOOD TREE
		GUM	GUM TREE
		HIC	HICKORY TREE
		LO	LIVE OAK TREE
		MAG	MAGNOLIA TREE

TREE PROTECTION:

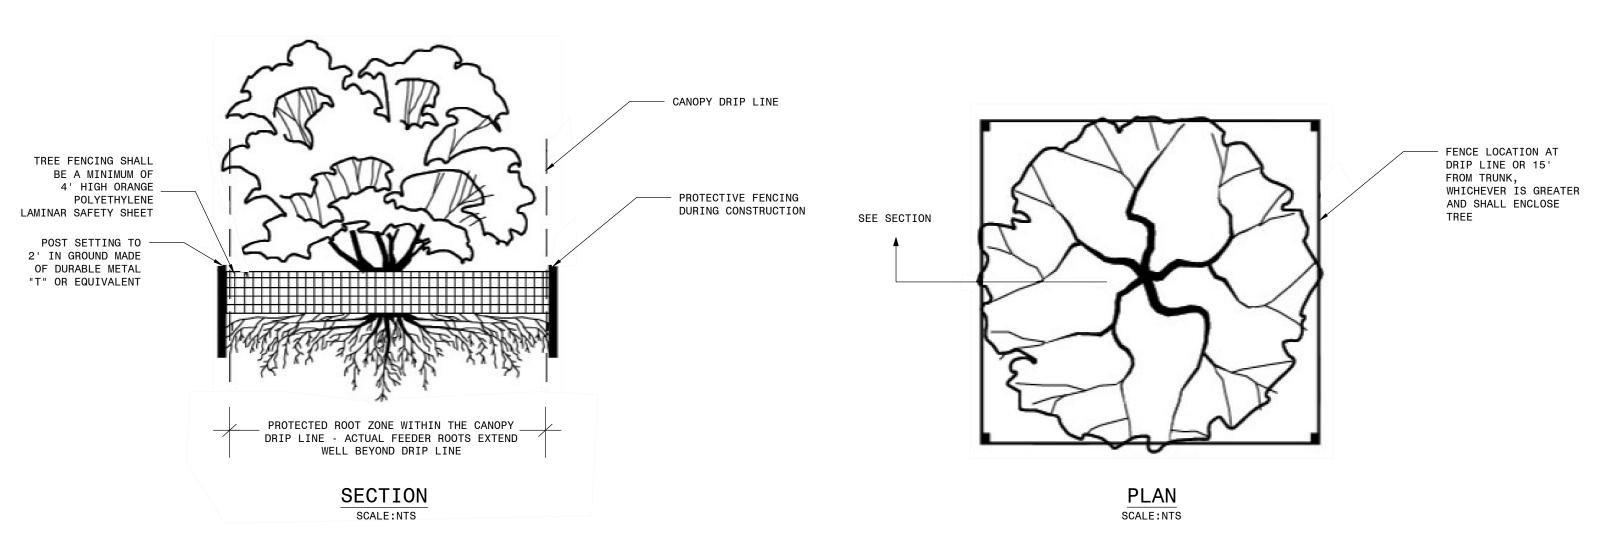

04-17-12018 1000 O 0 SHEET 2 of 12

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FILTER FABRIC BURIAL DETAIL

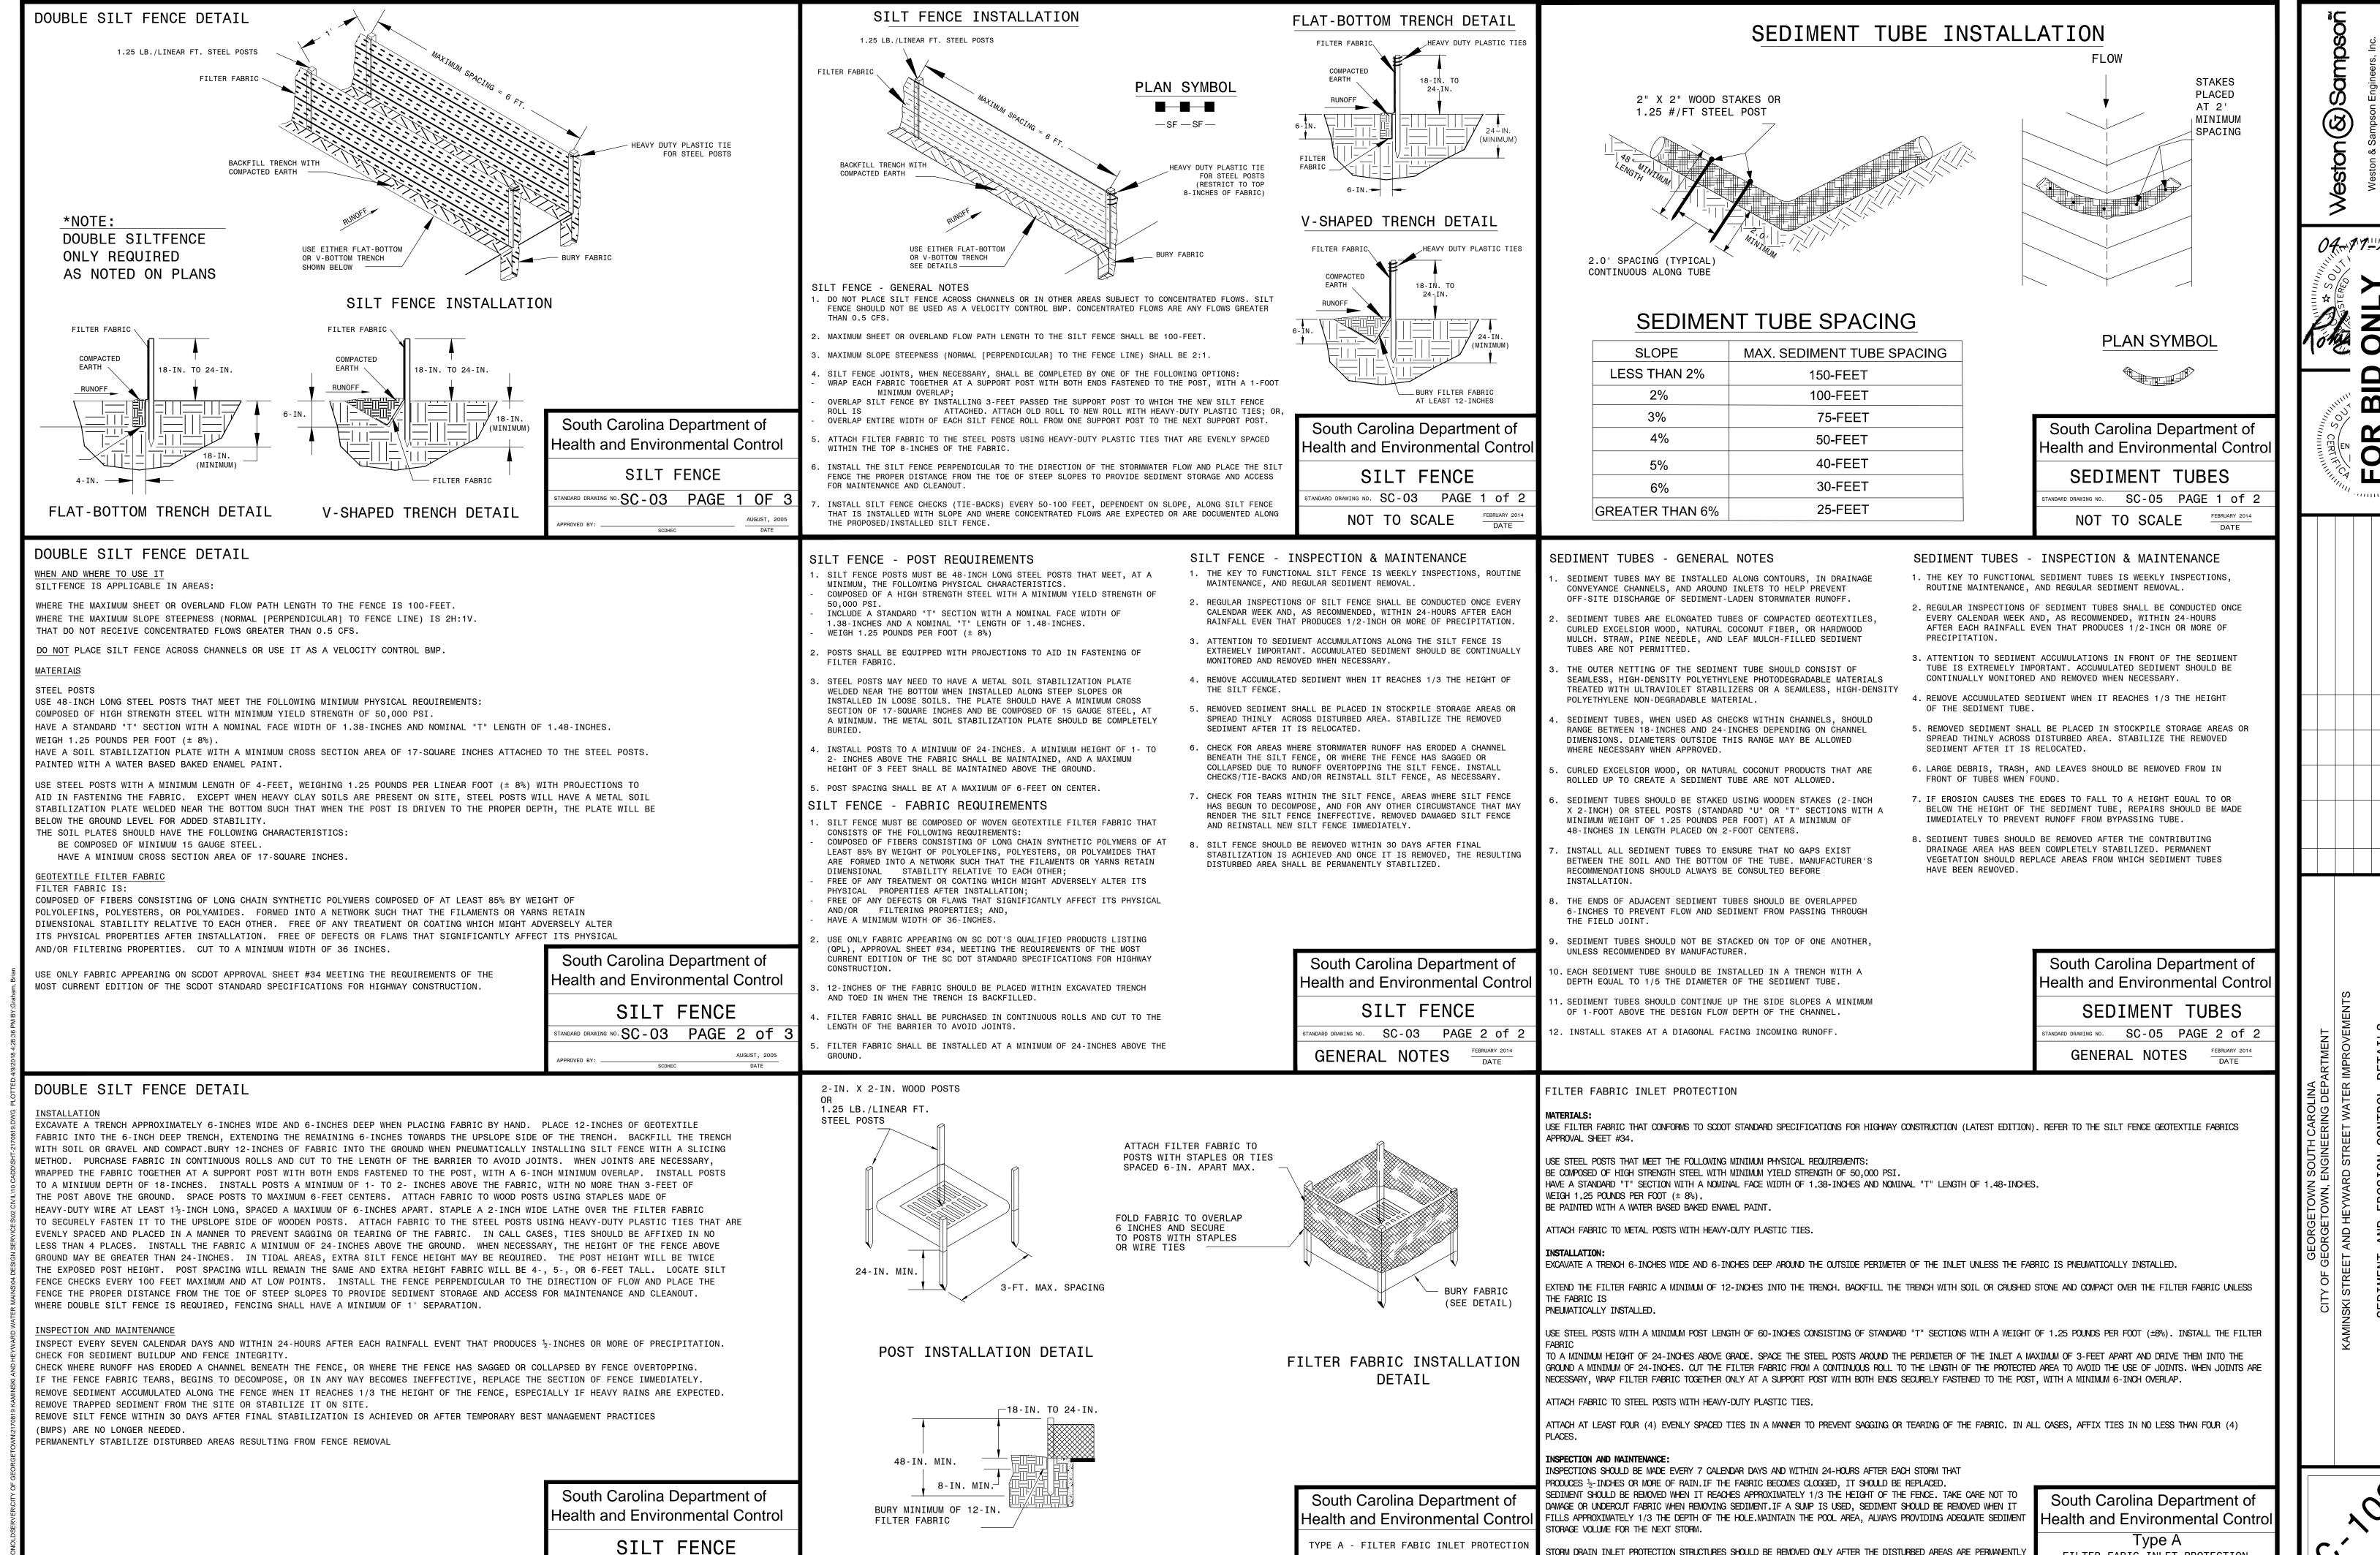STANDARD DRAWING NO. SC-03 Page 3 of 3

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FILTER FABIC INLET PROTECTION

ANDARD DRAWING NO. SC-07 Page 2 of 2


STORM DRAIN INLET PROTECTION STRUCTURES SHOULD BE REMOVED ONLY AFTER THE DISTURBED AREAS ARE PERMANENTLY


GRADE THE DISTURBED AREA TO THE ELEVATION OF THE DROP INLET STRUCTURE CREST. USE APPROPRIATE PERMANENT

STABILIZED. REMOVE ALL CONSTRUCTION MATERIAL AND SEDIMENT, AND DISPOSE OF THEM PROPERLY.

STABILIZATION METHODS TO STABILIZE BARE AREAS AROUND THE INLET.

tandard drawing no. SC-07 Page 1 of 2

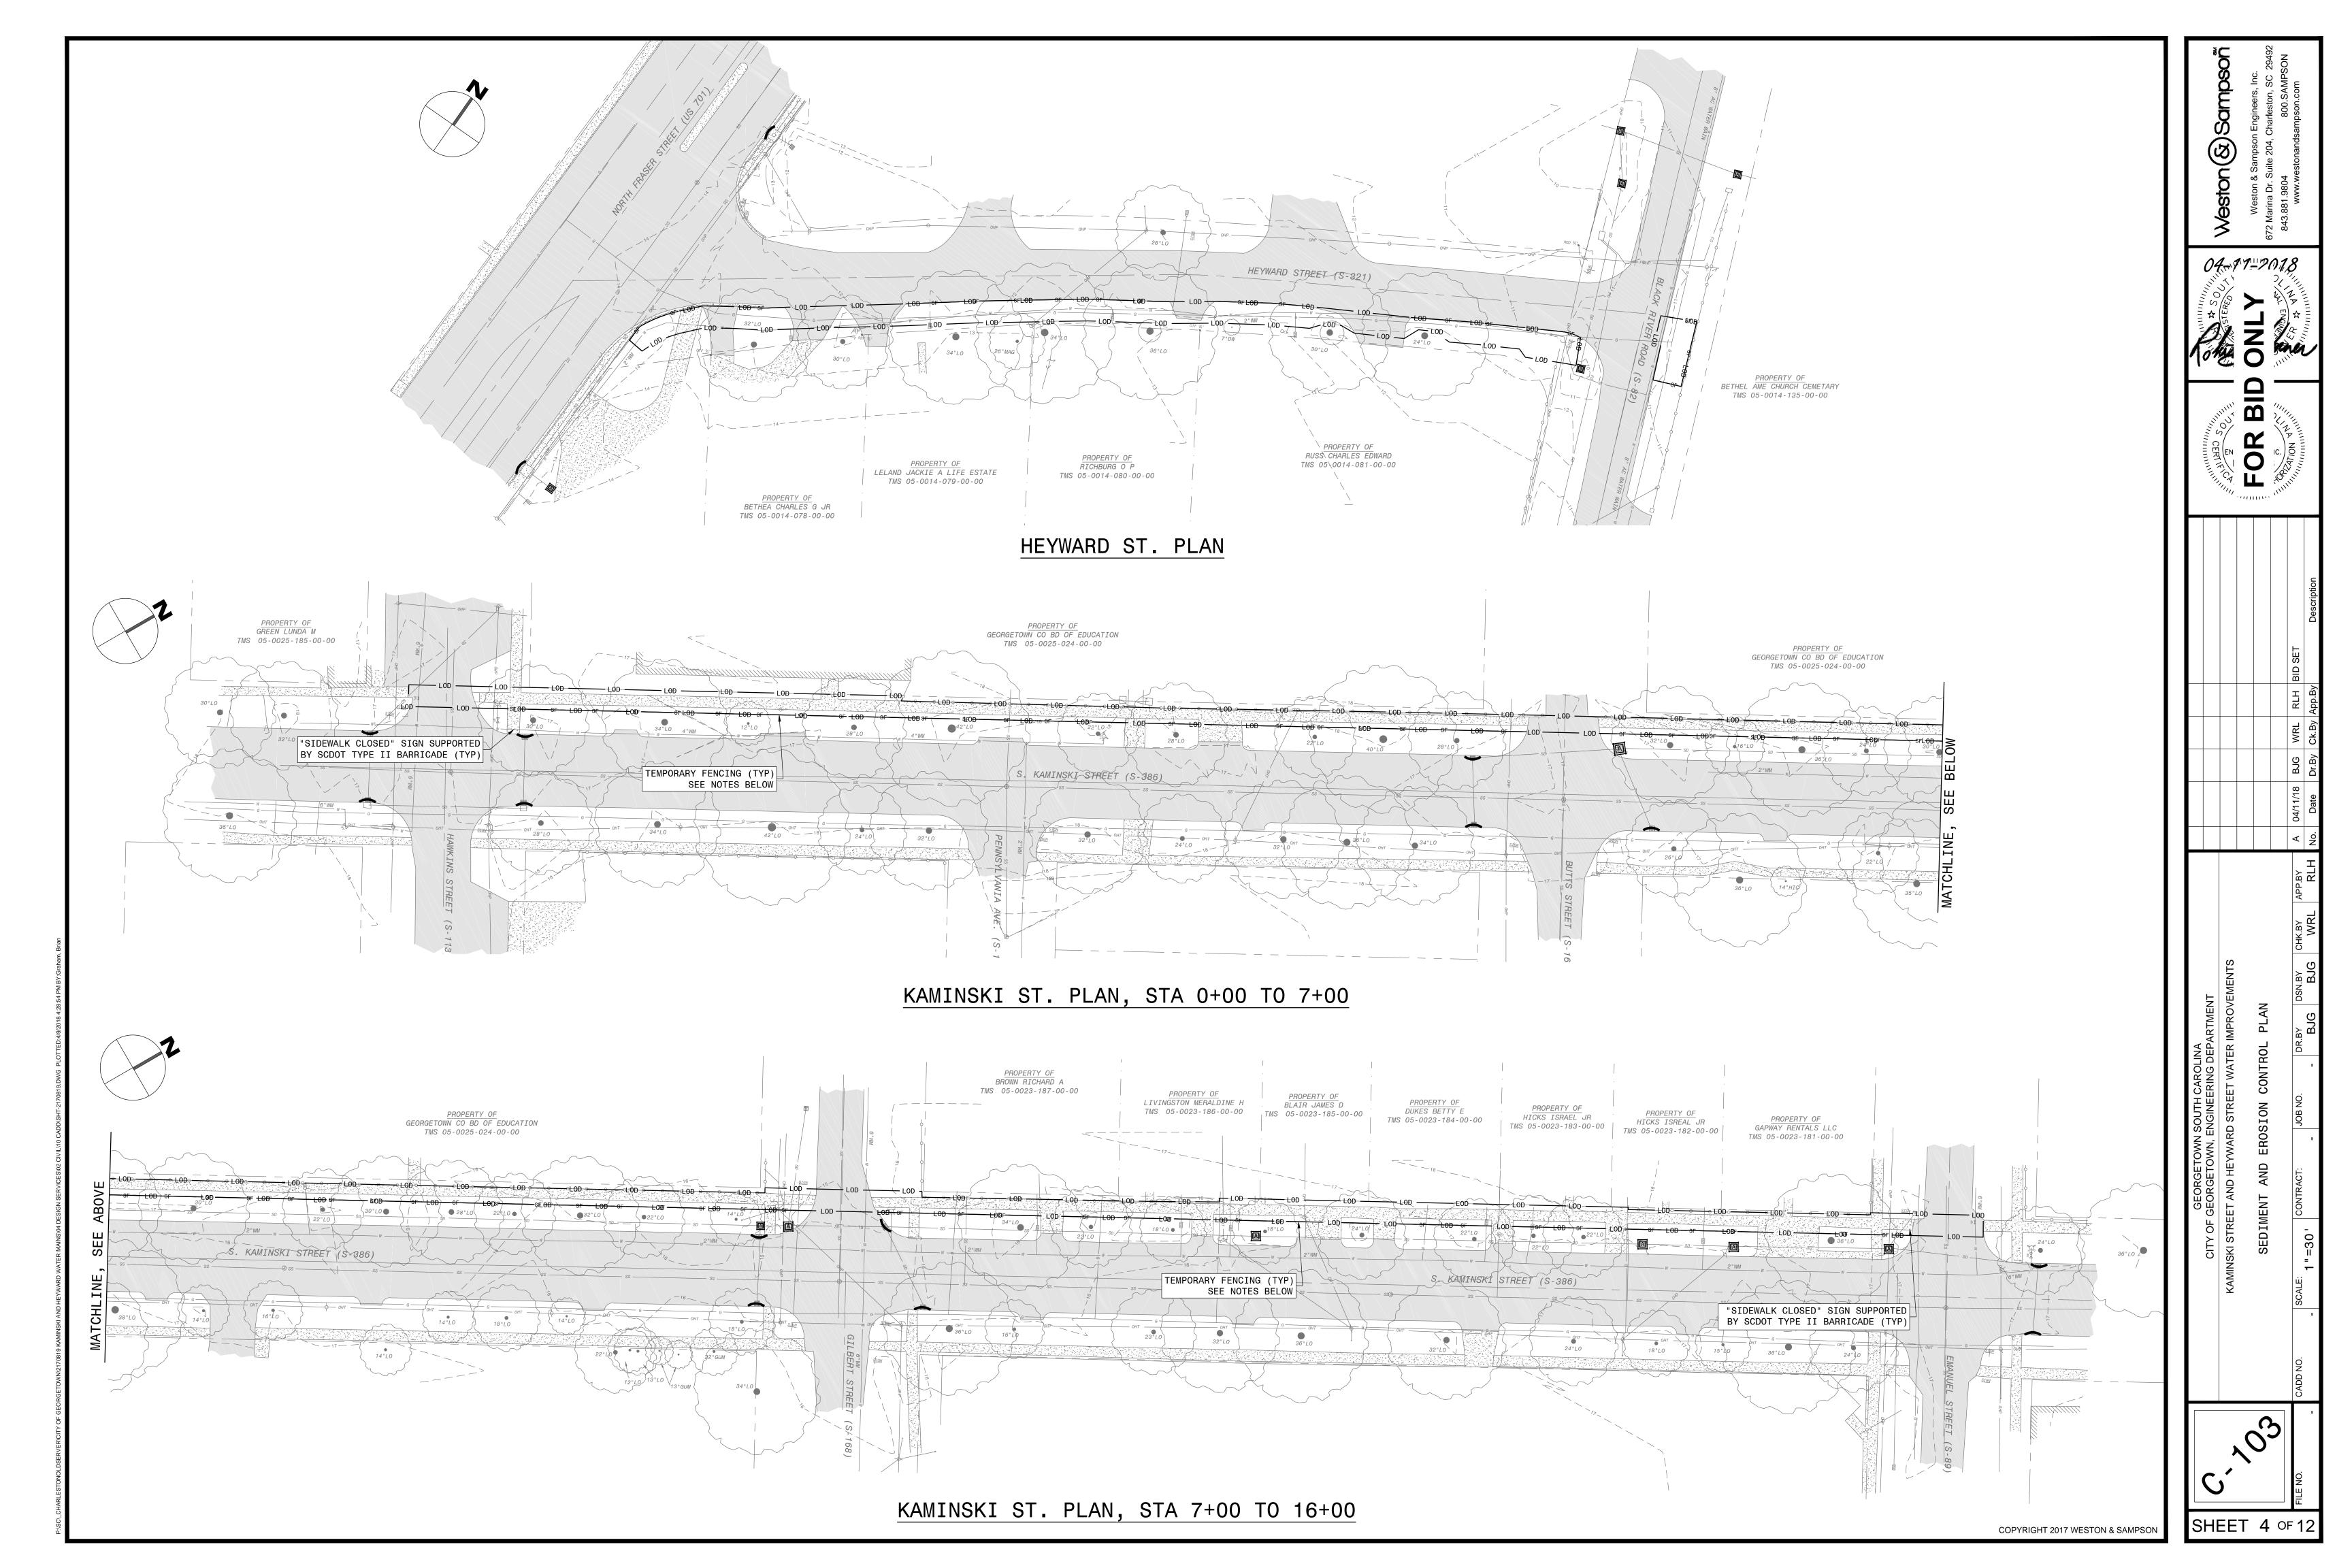

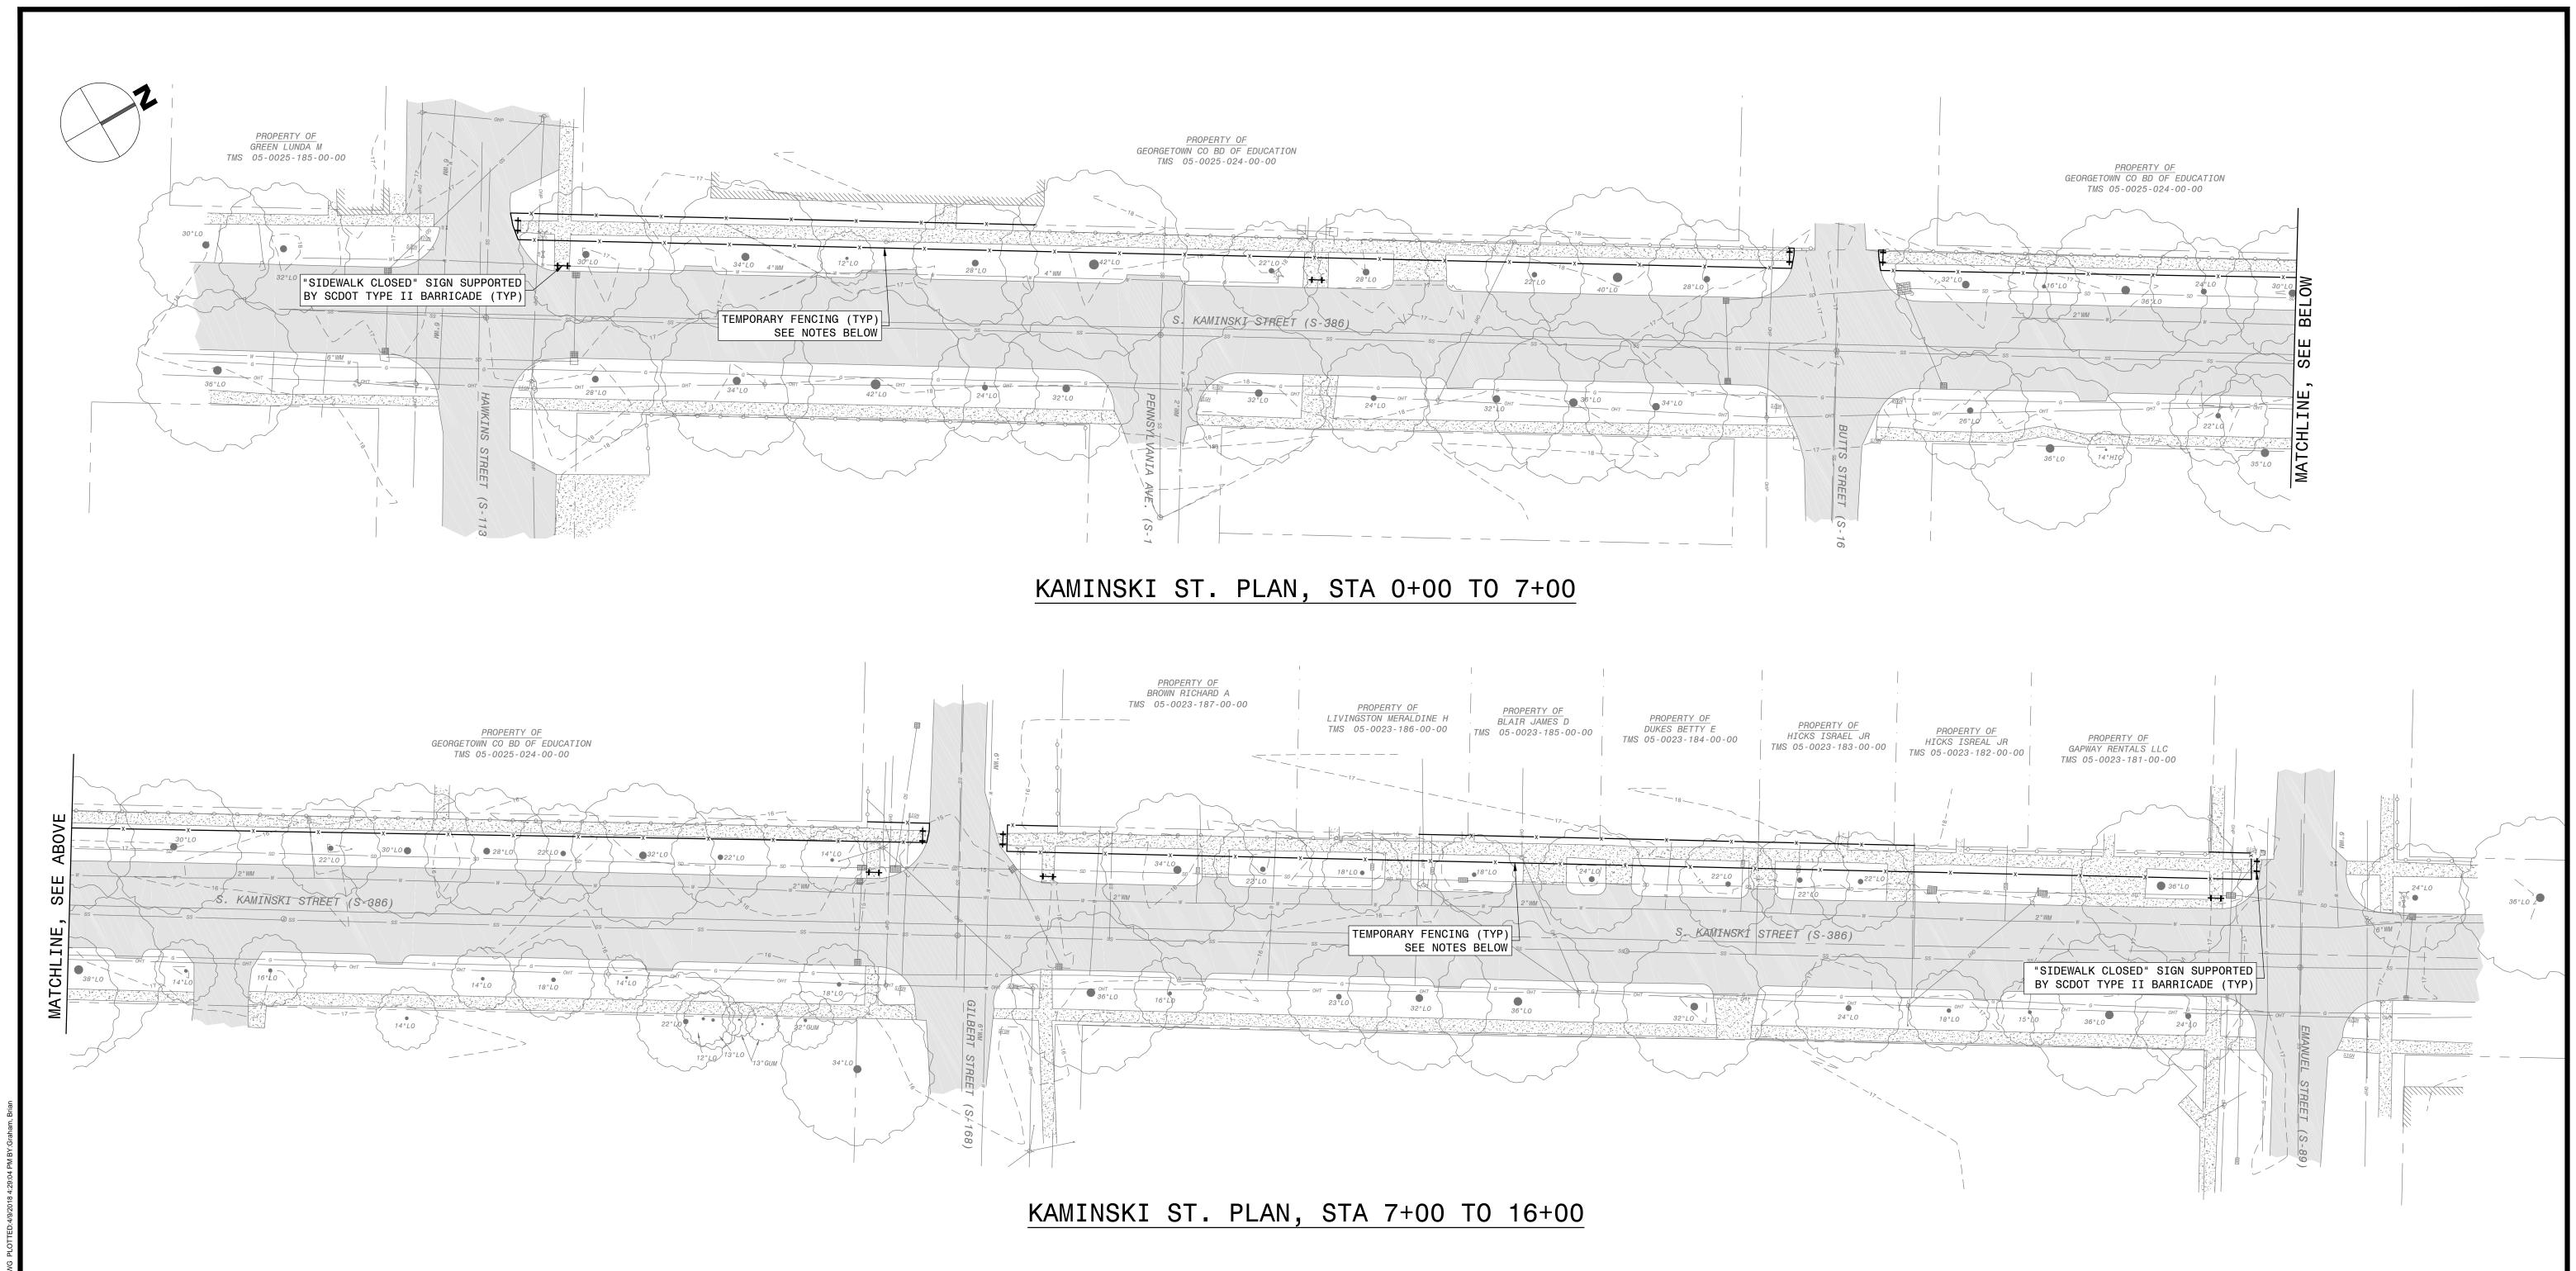

SIDEWALK CLOSED

TEMPORARY FENCING NOTES:

1. FENCING SHALL BE A MINIMUM OF 4 FEET HIGH ORANGE POLYETHYLENE LAMINAR SAFETY SHEET.
2. POST SHALL BE SET 2 FEET INTO THE GROUND AND BE MADE OF A DURABLE METAL "T" OR EQUIVALENT.

SIGNAGE NOTES:


1. "SIDEWALK CLOSED" SIGNS SHOULD BE INSTALLED AT THE BEGINNING OF THE CLOSED SIDEWALK, AT THE INTERSECTIONS PRECEDING THE CLOSED SIDEWALK, AND ELSEWHERE ALONG THE CLOSED SIDEWALK AS NEEDED.

3. TEMPORARY FENCING SHALL BE IN PLACE AROUND ANY EXCAVATION WHICH HAS THE POTENTIAL FOR PEDESTRIAN TRAFFIC.


2. SIGN SHALL BE SUPPORTED BY A SCDOT TYPE II BARRIER.

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						BID SET	Description
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06"L0 2						A 04/11/18 BJG	No. Date
	GEORGETOWN SOUTH CAROLINA CITY OF GEORGETOWN, ENGINEERING DEPARTMENT	KAMINSKI STREET AND HEYWARD STREET WATER IMPROVEMENTS		PEDESTRIAN SAFETY PLAN		CADD NO. SCALE: CONTRACT: JOB NO. DR.BY DSN.BY CHK.BY APP.BY	- 1"=30' BJG BJG WRL RLH
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04-17-2018

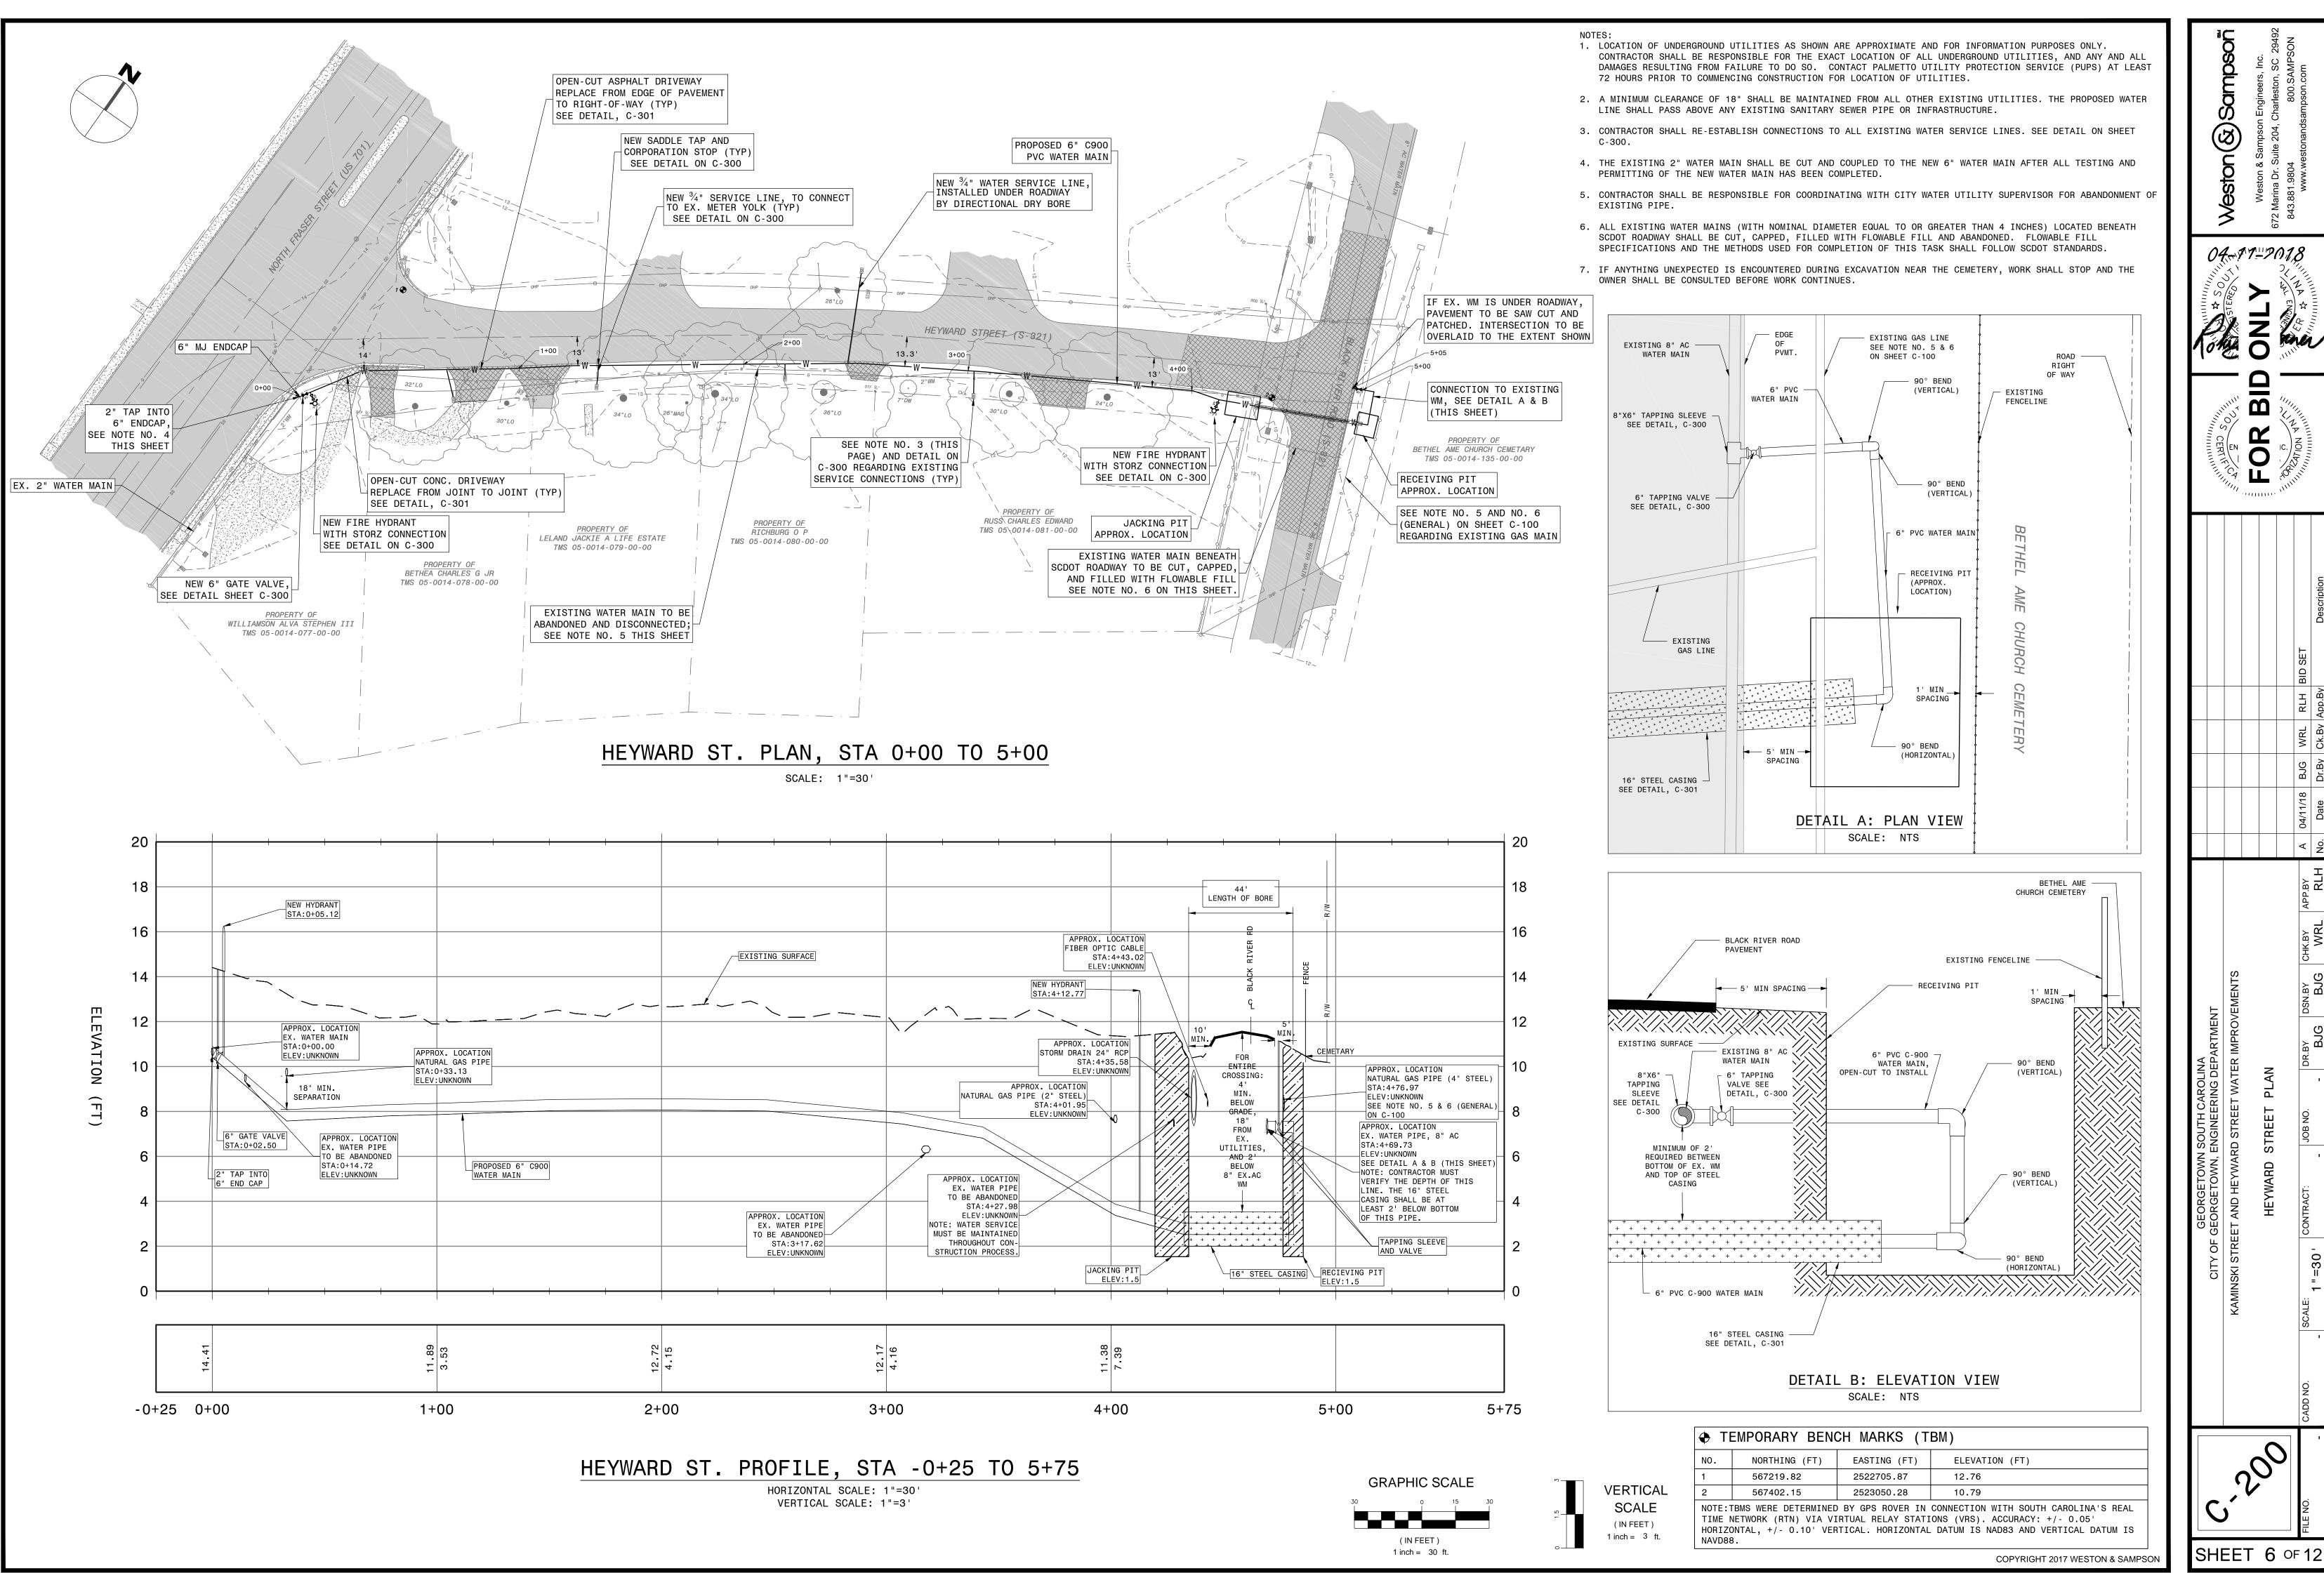

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24 NEW HYDRANT STA:4+92.75 22 22 NEW HYDRANT EXISTING SURFACE STA:0+36.46 20 TAPPING SLEEVE AND VALVE SEPARATION APPROX. LOCATION SANITARY SEWER PIPE APPROX. LOCATION PROPOSED 6" C900 STA:2+71.54 _SANITARY SEWER PIPE 6" GATE VALVE WATER MAIN ELEV:UNKNOWN STA:0+15.72 STA:5+05.00 ELEV: UNKNOWN APPROX. LOCATION EX. WATER MAIN STA:0+00.01 ELEV:UNKNOWN

KAMINSKI ST. PROFILE, STA -0+25 TO 7+00

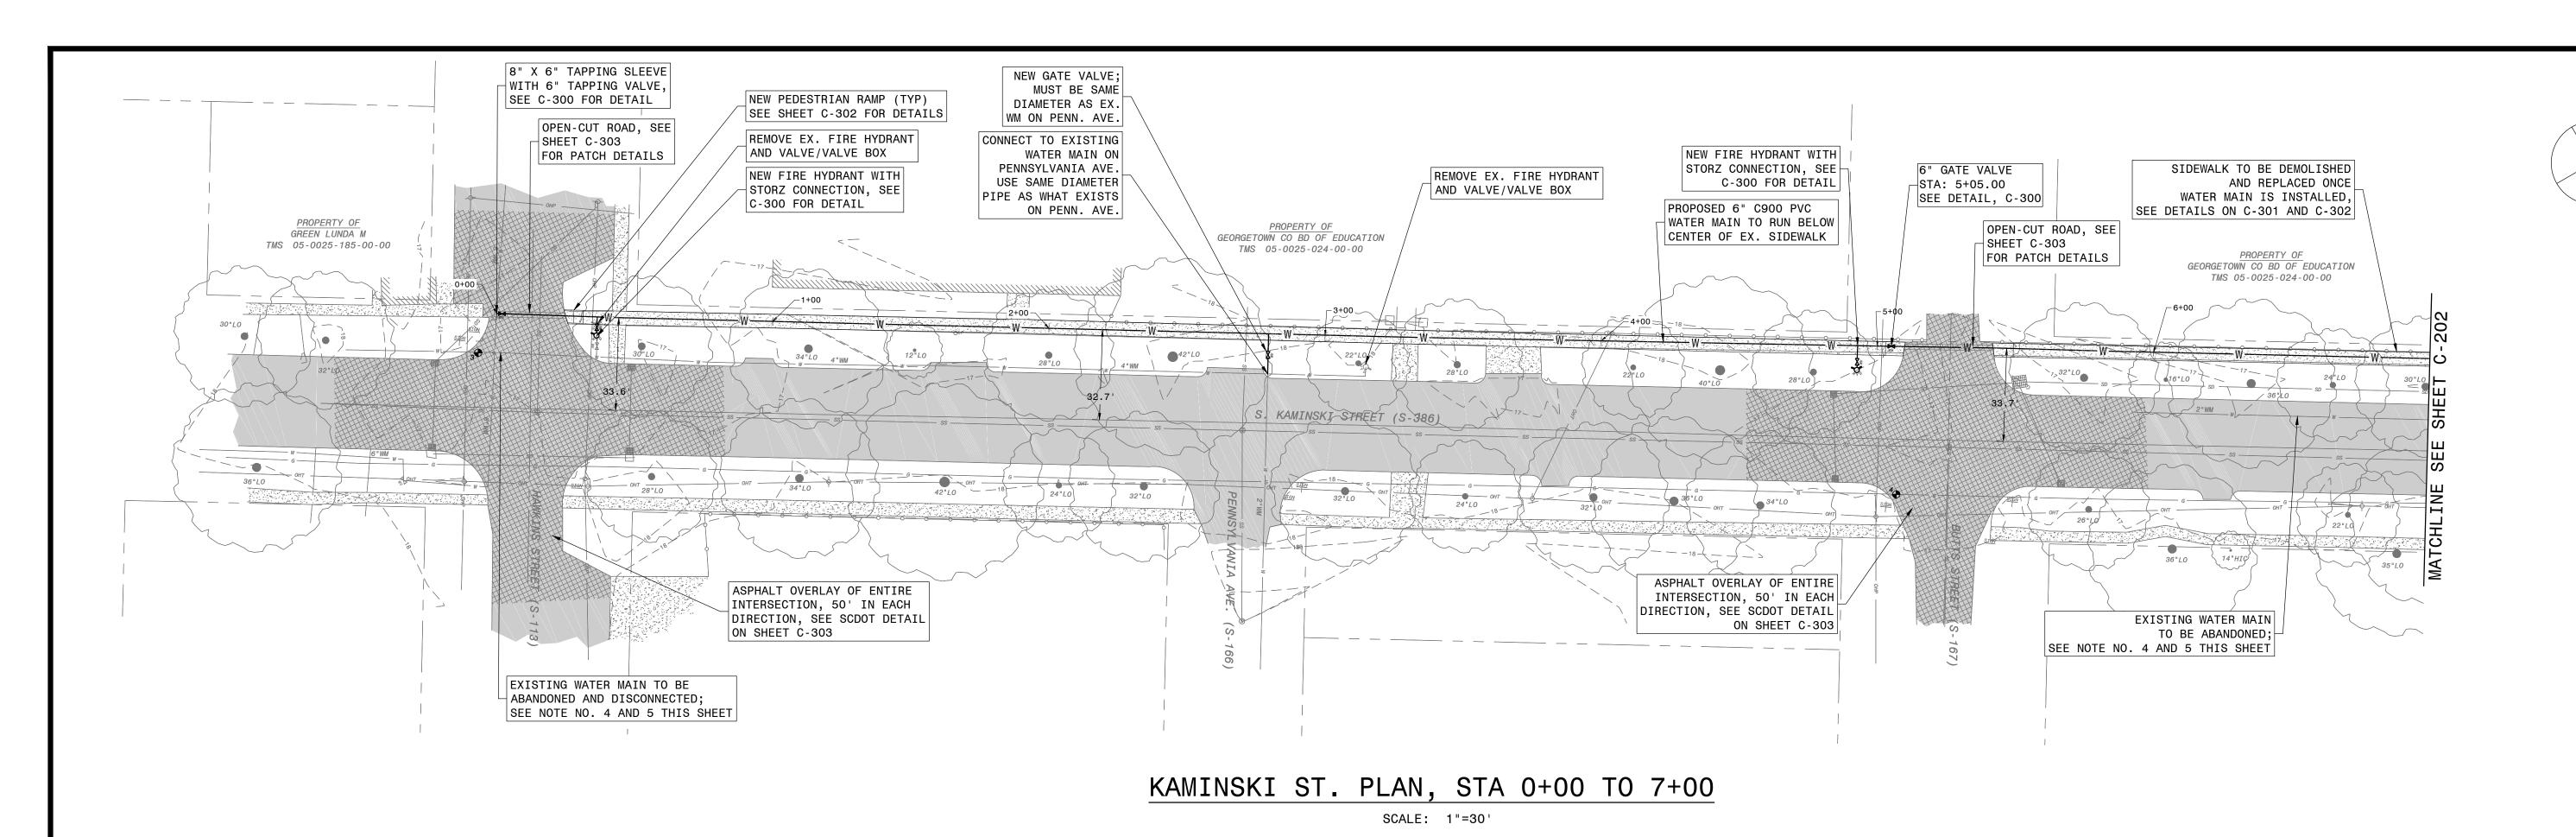4+00

HORIZONTAL SCALE: 1"=30'

VERTICAL SCALE: 1"=3'

3+00

1. LOCATION OF UNDERGROUND UTILITIES AS SHOWN ARE APPROXIMATE AND FOR INFORMATION PURPOSES ONLY. CONTRACTOR SHALL BE RESPONSIBLE FOR THE EXACT LOCATION OF ALL UNDERGROUND UTILITIES, AND ANY AND ALL DAMAGES RESULTING FROM FAILURE TO DO SO. CONTACT PALMETTO UTILITY PROTECTION SERVICE (PUPS) AT LEAST 72 HOURS PRIOR TO COMMENCING CONSTRUCTION FOR LOCATION OF UTILITIES.


1+00

2+00

- 2. A MINIMUM CLEARANCE OF 18" SHALL BE MAINTAINED FROM ALL OTHER EXISTING UTILITIES. THE PROPOSED WATER LINE SHALL PASS ABOVE ANY EXISTING SANITARY SEWER PIPE OR INFRASTRUCTURE.
- 3. CONTRACTOR SHALL RE-ESTABLISH CONNECTIONS TO ALL EXISTING WATER SERVICE LINES. SEE DETAIL ON SHEET C-300.
- 4. CONTRACTOR SHALL BE RESPONSIBLE FOR COORDINATING WITH CITY WATER UTILITY SUPERVISOR FOR ABANDONMENT OF EXISTING PIPE.

-0+25 0+00

ALL EXISTING WATER MAINS (WITH NOMINAL DIAMETER EQUAL TO OR GREATER THAN 4 INCHES) LOCATED BENEATH SCDOT ROADWAY THAT ARE TO BE ABANDONED SHALL BE CUT, CAPPED, AND FILLED WITH FLOWABLE FILL. SPECIFICATIONS AND THE METHODS USED FOR COMPLETION OF THIS TASK SHALL FOLLOW SCDOT STANDARDS.

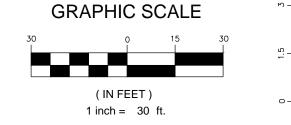

M —	VERTICAL			
رن	SCALE			
-	(IN FEET)			
	1 inch = 3 ft.			

5+00

6+00


NAVD88.

NO.	NORTHING (FT)	EASTING (FT)	ELEVATION (FT)
3	562159.66	2519649.53	16.82
4	562578.58	2519950.57	16.92

7+00


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	weston(&) sampson	Weston & Sampson Engineers, Inc.	672 Marina Dr. Suite 204, Charleston, SC 29492 843.881.9804 800.SAMPSON	www.westonandsamp	
O'III OS & RANGO CERTALITA		FOR BID ONLY	,,,,,	SULLY A A A A A A A A A A A A A A A A A A	
GEORGETOWN SOUTH CAROLINA CITY OF GEORGETOWN, ENGINEERING DEPARTMENT	KAMINSKI STREET AND HEYWARD STREET WATER IMPROVEMENTS	KAMINSKI STREFT STA 0+00 TO STA 7+00 PLAN		CADD NO. SCALE: CONTRACT: JOB NO. DR.BY DSN.BY CHK.BY APP.BY A 04/11/18 BJG WRL RLH BID SET	- 1"=30' - BJG WRL RLH No. Date Dr.By Ck.By App.By Description
C	<u>(</u>	20		FILE NO.	

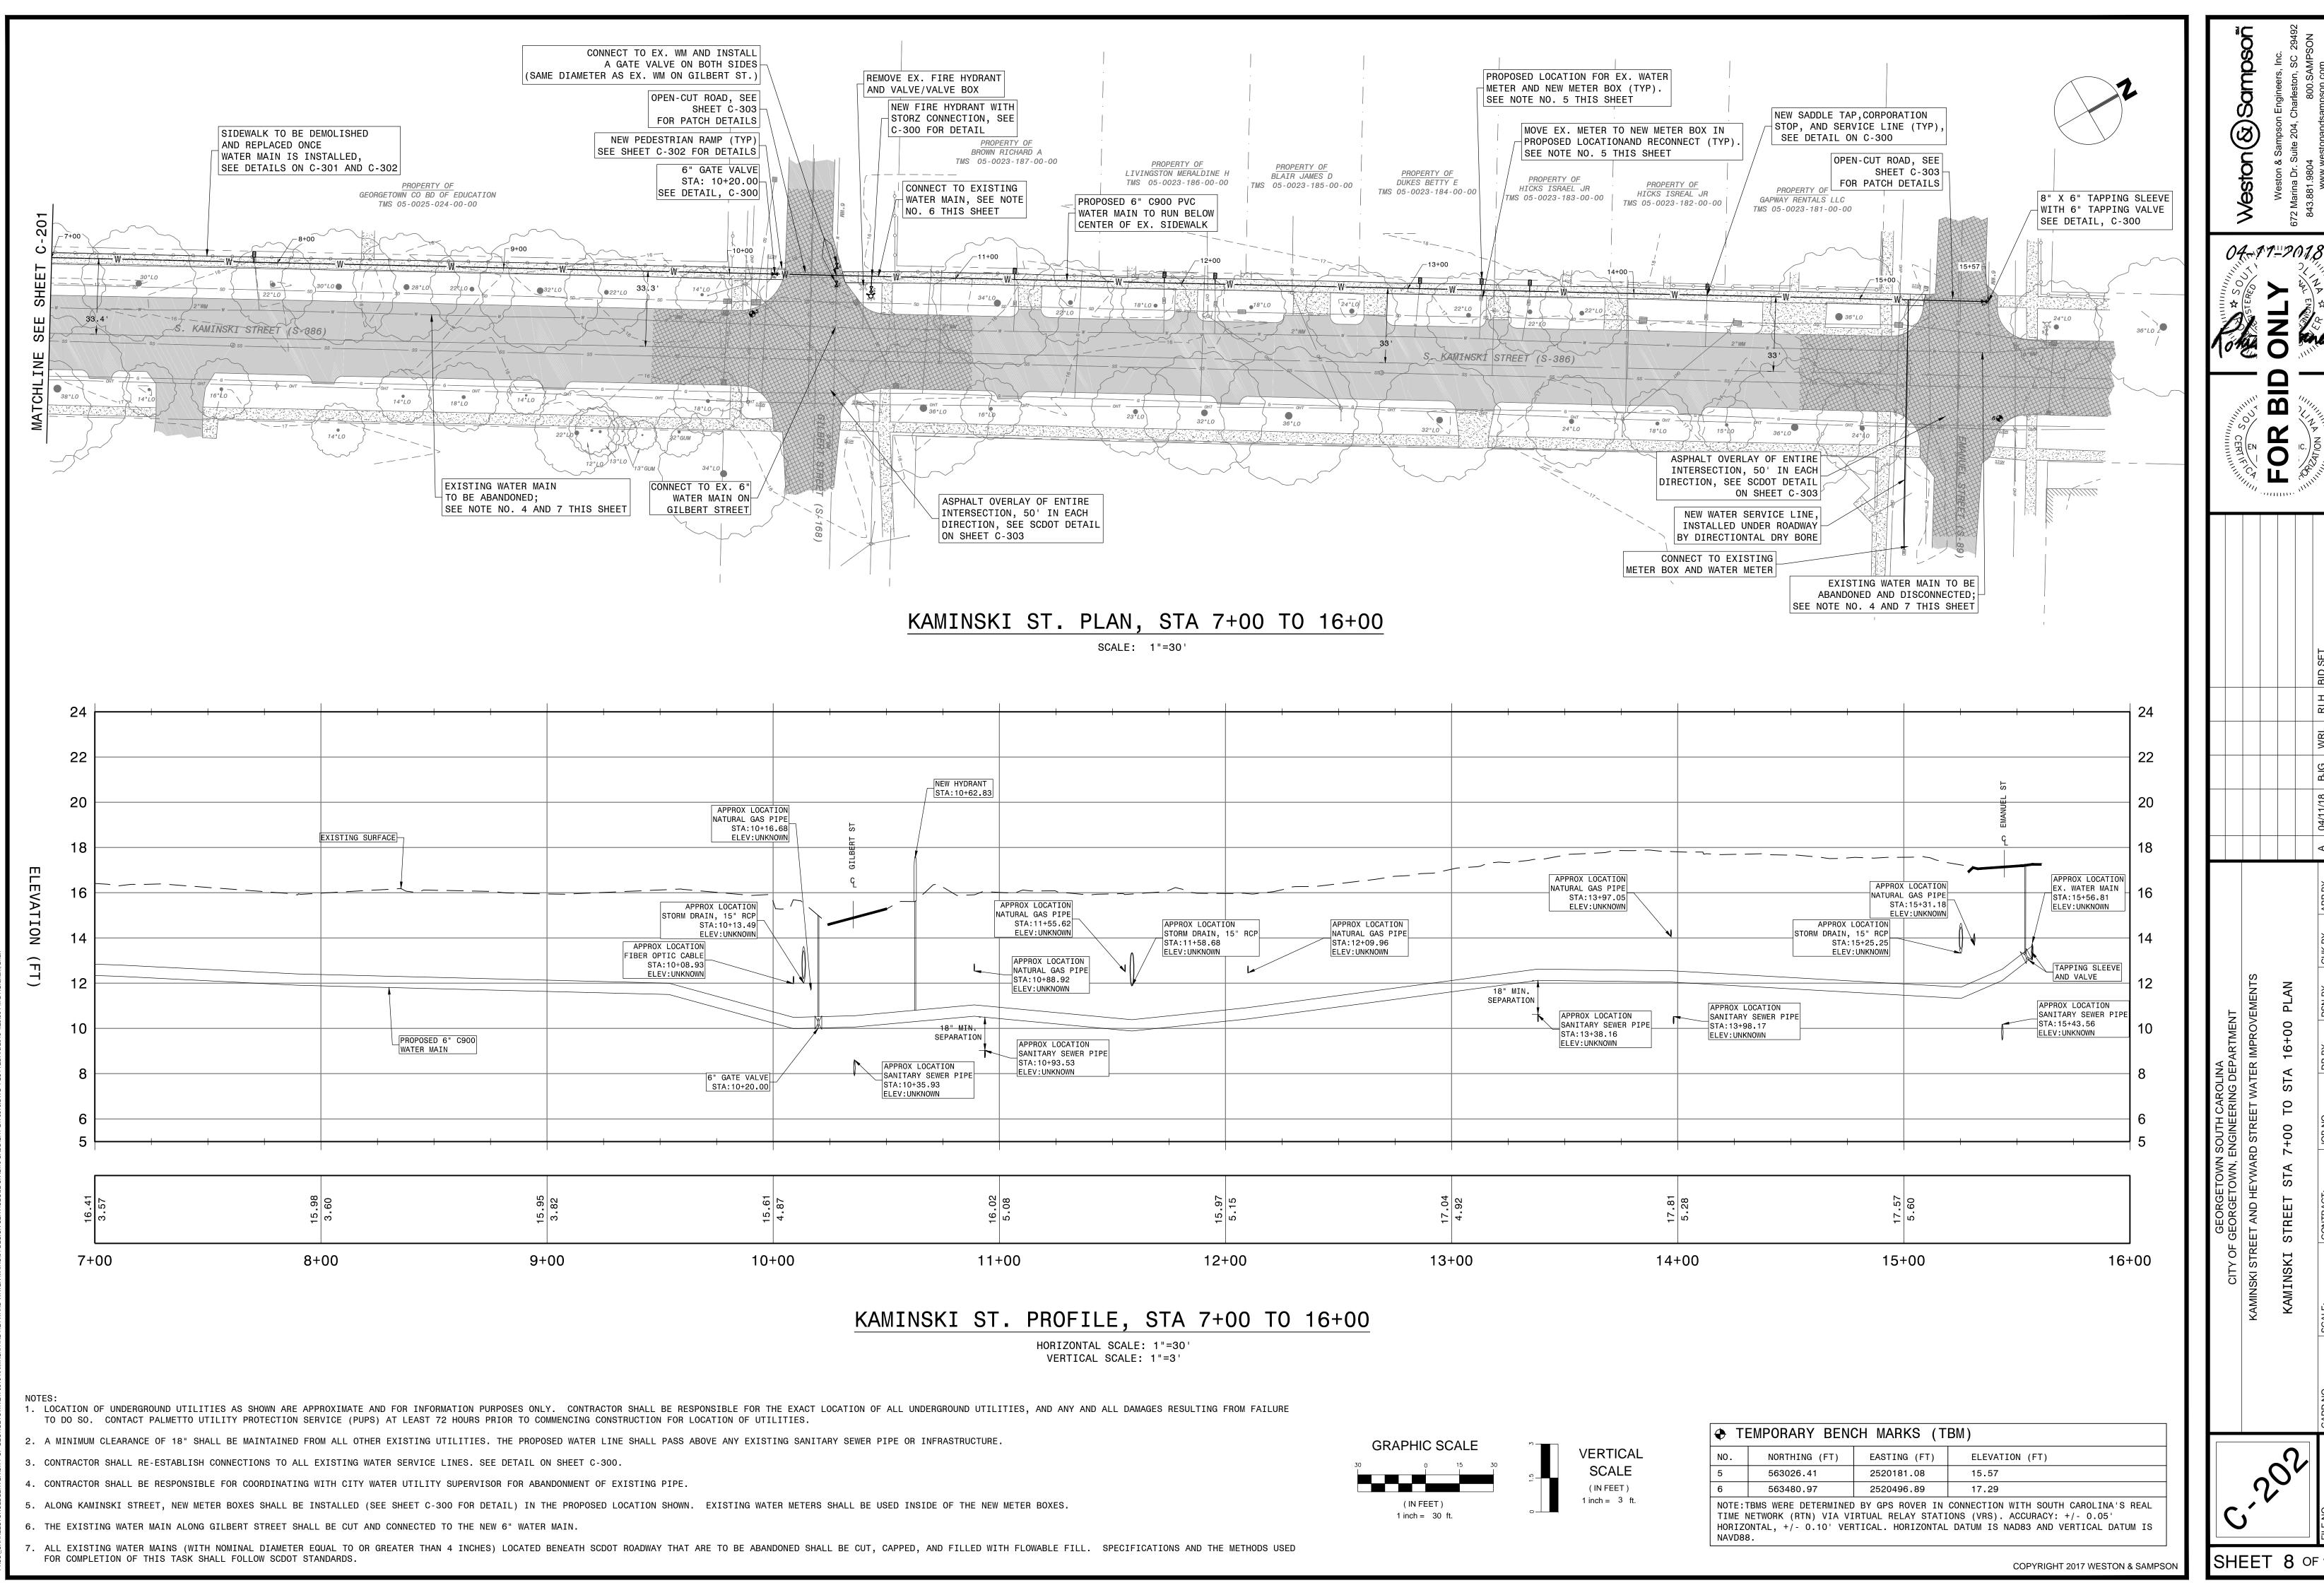

SHEET 8 OF 12

0

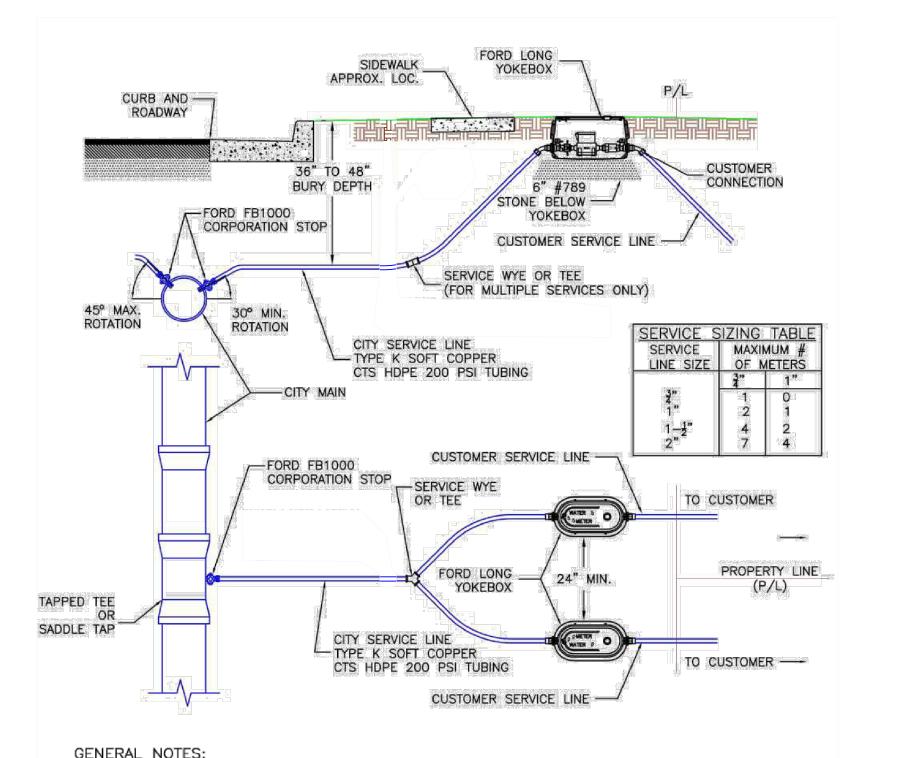

1. REFER TO STANDARD DETAIL "TYPICAL TRENCH" AND "UTILITY MAIN IN PAVED DRIVE" FOR BEDDING REQUIREMENTS. ALL PROPERTIES SHALL BE SERVED BY AT LEAST ONE INDIVIDUAL AND SEPARATE METER. NO MORE THAN TWO PROPERTIES MAY BE SERVED FROM A SINGLE TAP ON THE CITY MAIN 4. WATER METER REMOTE READ NODES SHALL BE: 4.1. SUPPLIED BY THE CITY 4.2. ITRON WATER METER NODE W/ITRON I/O CABLE, MODEL 10255X42G21 4.3. ITRON WATER MODULE LID LOCK & ADAPTOR KIT, MODEL CT-NO-0089 METERS SHALL BE: CITY OF GEORGETOWN, SC 5.1. SUPPLIED BY THE CITY 5.2. BADGER RECORDALL DISC METERS 5.1.1. ₹ METER — MODEL 25 STANDARD DETAIL 5.1.2. 1" METER - MODEL 55 3/4" & 1" WATER SERVICE METER BOXES SHALL BE 6.1. LOCATED IN AREAS NOT SUBJECT TO VEHICULAR TRAFFIC 6.2. FORD LONG YOKEBOX

N.T.S.

CHECKED

PAVED AREAS _____ NON-PAVED AREAS VALVE COVER INSCRIBED--24"x24"x6" 3000 PSI AS APPROPRIATE CONCRETE COLLAR CAST IRON, ROADWAY TYPE, EXTENSION VALVE BOX (INSIDE SCREW) DIP SLEEVE AS REQUIRED -----LOCATE WIRE - TWO (2) PAIRS OF INSULATED METALLIC 10 GAUGE SOLID DUCT TAPE - 5 PER PIPE-COPPER WIRE (TYP.) EACH JOINT MINIMUM PAIR HEADING ON OPPOSITE DIRECTIONS -WATER DISTRIBUTION MAIN

-MECHANICAL RESTRAINED

REFER TO STANDARD TRENCH DETAILS FOR BEDDING AND BACKFILL

6.1.1. ₹" METER - LYLBB-244-244-TP-NL

6.1.2. 1" METER - LYLBB-144-444-TP-NL

REQUIREMENTS 2. ISOLATION VALVES SHALL BE

2.1. MUELLER SQUARE NUT FOR VALVES 2" AND GREATER THAN 2"

ISOLATION VALVE-


- 2.2. HAMMOND FOR VALVES LESS THAN 2" 3. ALL JOINTS SHALL BE MECHANICALLY RESTRAINED. THRUST BLOCK ARE NOT PERMITTED.
- OPERATING NUT SHALL BE WITHIN 12" OF GRADE, EXTENSION TO BE PROVIDED AS REQUIRED.
- 5. VALVE EXTENSION SHALL BE MECHANICALLY ATTACHED AND SHALL HAVE A STAINLESS STEEL PIN AT THE VALVE AND SHEAR PIN ONLY AT THE OPERATING NUT.
- 6. EXTENSION ON VALVE BOX SHALL BE SET TO RESERVE 1/2 OF THE ADJUSTMENT LENGTH FOR FUTURE USE.


8. LOCATING WIRES:


8.1. ALL PVC PIPE SHALL REQUIRE TWO PAIRS OF INSULATED METALLIC LOCATING WIRES (10 GAUGE SOLID COPPER) TAPED WITH 2" WIDE DUCT TAPE TO TOP CENTERLINE OF THE PIPE AT EVERY JOINT AND AT 4 ADDITIONAL EQUALLY SPACED POINTS PER LENGTH OF PIPE. 8.2. LOCATING WIRES TO TERMINATE 4" ABOVE VALVE BOX AND FOLDED BACK INSIDE BOX AND PLUGGED

- PIPE AND PLUGGED LOCATING WIRES SHALL BE CAPABLE OF DETECTION BY A CABLE LOCATOR AND PASS A FIELD
- CONDUCTIVITY TEST, OBSERVED BY THE CITY, FROM END TO END OF WIRES.
- 8.4. SPLICES SHALL BE CAPABLE OF COMPLETE SUBMERSION, SUCH AS BUTT SPLICE WITH RAYCHEM
- 8.5. NO MORE THAN ONE SPLICE IN LOCATING WIRES BETWEEN VALVES IS ALLOWED.

CITY OF GEORGETOWN, SC						
STANDARD DETAIL ISOLATION VALVE & VALVE BOX						
UPDATED SCALE NO. N.T.S.						
DRAWN	CHECKED					

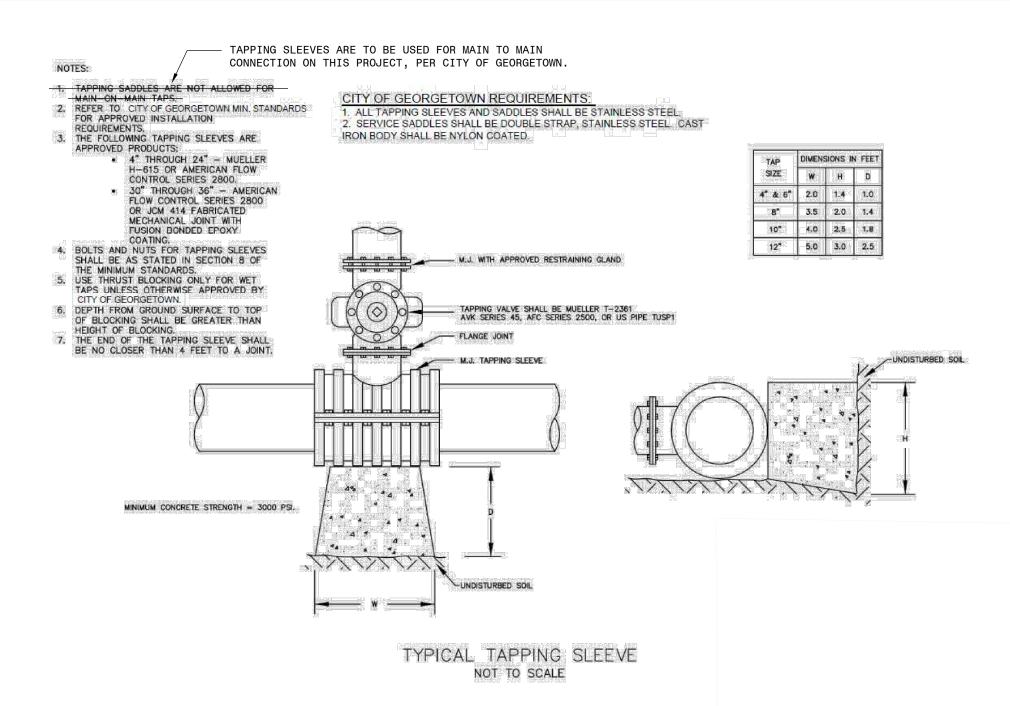

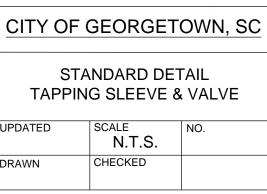

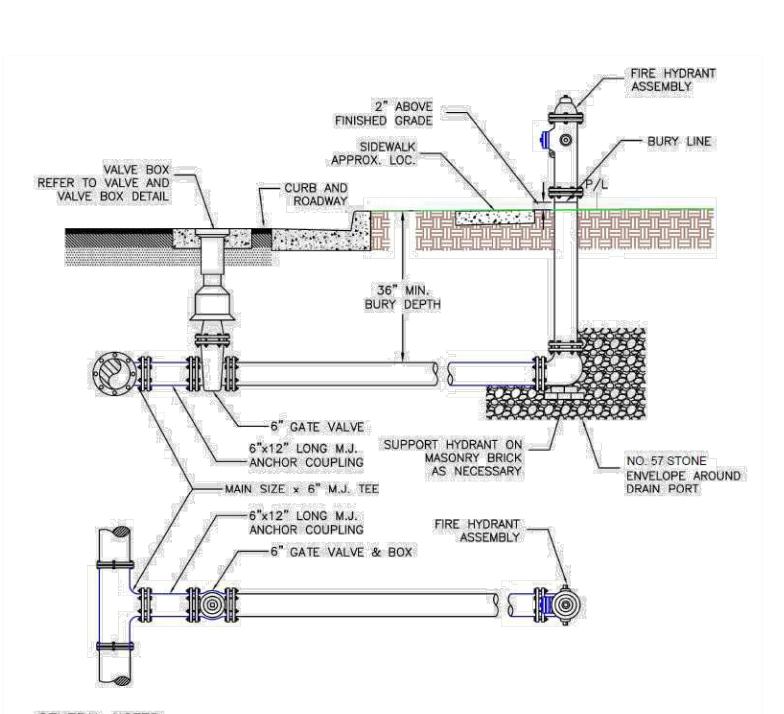


CENERAL NOTES: 1. REFER TO STANDARD DETAIL "TYPICAL TRENCH" AND "UTILITY MAIN IN PAVED DRIVE" FOR BEDDING


2. FIRE HYDRANTS ASSEMBLY SHALL BE MULLER SUPER CENTURION A423-5-1/4" FIRE HYDRANT ASSEMBLY WITH INTEGRAL STORZ PUMPER CONNECTION ON THE PUMPER NOZZLE. OR APPROVED EQUAL PROVIDE A MINIMUM OF 36" CLEAR SPACE AROUND ALL HYDRANTS

SET HYDRANT WITH PUMPER NOZZLE FACING THE STREET AND BURY LINE 2" ABOVE FINISHED GRADE.

5. ISOLATION VALVE SHALL BE MULLER SQUARE NUT 6" MECHANICAL JOINT, RESILIENT SEAT GATE VALVE WITH VALVE BOX. REFER TO STANDARD DETAIL "ISOLATION VALVE AND VALVE BOX". 6. ALL JOINTS SHALL BE MECHANICALLY RESTRAINED. THRUST BLOCK ARE NOT PERMITTED.

CITY OF GEORGETOWN, SC						
STANDARD DETAIL FIRE HYDRANT						
UPDATED SCALE NO. N.T.S.						
DRAWN						

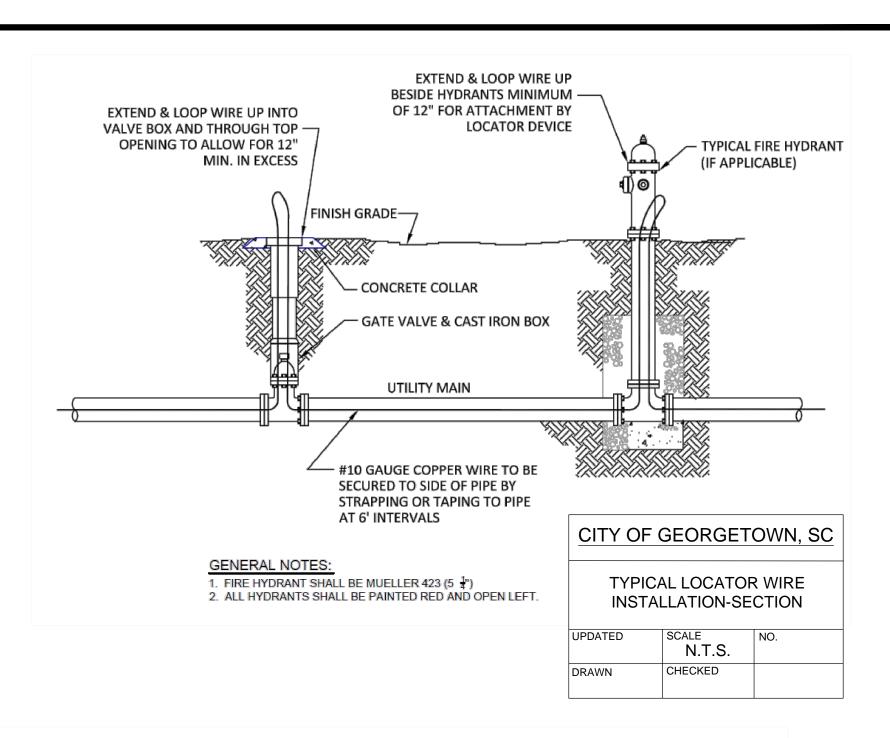

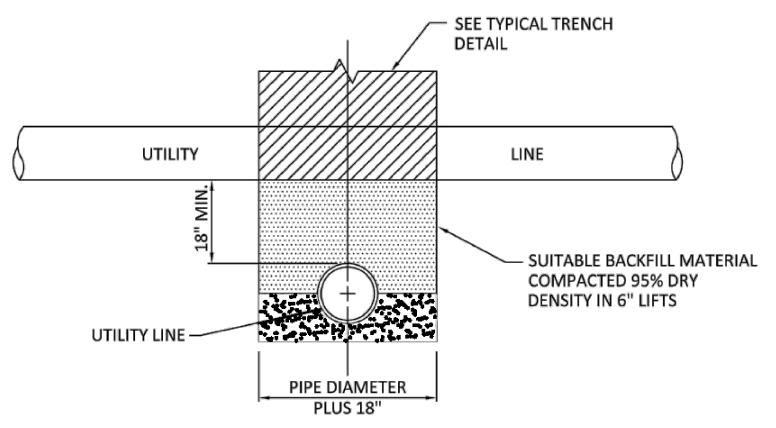


- UTILITY LINES IN THIS DRAWING CONSIST OF WATER,
- WASTEWATER, AND STORMWATER LINES. 2. WATER LINE AND WASTEWATER UTILITY LINE SHALL BE PVC UNLESS VERTICAL SEPARATION DISTANCE BETWEEN LINES ARE LESS THAN 18", THEN USE DIP.

3. ALL UTILITY LINES SHALL BE CENTERED TO ALLOW FOR THE

GREATEST DISTANCE BETWEEN PIPE JOINTS. 4. MATERIAL BETWEEN LINES SHALL BE COMPACTED TO PREVENT SETTLING OF ABOVE PIPING.

CITY OF	GEORGE	TOWN, SC				
UTILITY LINE CROSSING NO. 1						
UPDATED SCALE NO. N.T.S.						
DRAWN	CHECKED					

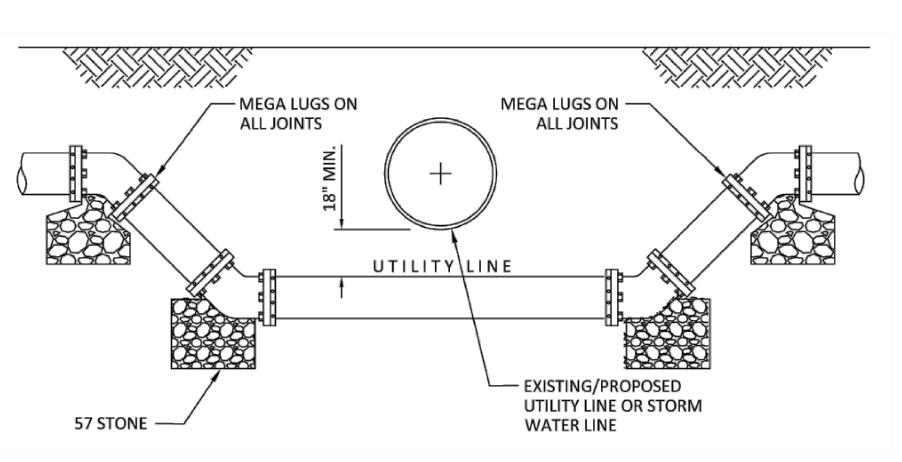



NOTES:

- USE PVC UNLESS SEPARATION DISTANCE BETWEEN WATER AND SANITARY SEWER LINE IS LESS THAN 18". IF SEPARATION
- DISTANCE CAN NOT BE MAINTAINED, THEN USE D.I.P. IF CROSSING A STORM PIPE, PROPOSED UTILITY LINE SHALL ALSO BE OFFSET A MINIMUM OF 36" HORIZONTALLY FROM END OF STORM PIPE.
- WHEN POSSIBLE, POTABLE WATER LINE SHALL CROSS ABOVE SANITARY SEWER LINE.

CITY OF GEORGETOWN, SC					
UTILITY LINE CROSSING NO. 2					
UPDATED	N.T.S.	NO.			


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- 1. ALL REPAIRS TO BE IN ACCORDANCE WITH SCDOT SPECIFICATIONS AND THESE SPECIFICATIONS. TRENCH SHALL BE BACKFILLED AND THOROUGHLY TAMPED WITH SUITABLE MATERIAL TO THE LEVEL OF THE
- 3. REPAIRS BY THE CONTRACTOR SHALL BE CONDUCTED WITH THE LEAST INTERFERENCE TO TRAFFIC.
- 4. WHERE EXISTING ASPHALT IS INSUFFICIENT THICKNESS TO DEVELOP A TIGHT SEAL WITH THE NEW SURFACE, OVERLAP EXISTING SURFACE AS PER SPECIFICATIONS.
- SEE SPECS. FOR UTILITY LINE BEDDING/BACKFILL REQUIREMENTS. 5. 3'-0" MINIMUM COVER FOR WATER MAINS AND WASTEWATER LINES.
- 7. ASPHALT DRIVEWAYS IN SCDOT RIGHT-OF-WAY TO BE RESURFACED FROM EDGE OF PAVEMENT TO THE
- RIGHT-OF-WAY LINE. 8. INSTALL 10"BASE COURSE TO TOP OF EXISTING ASPHALT. EXCAVATE 2" BASE COURSE TO PLACE ASPHALT COURSE (TYPE 3) FLUSH TO EXISTING ASPHALT.

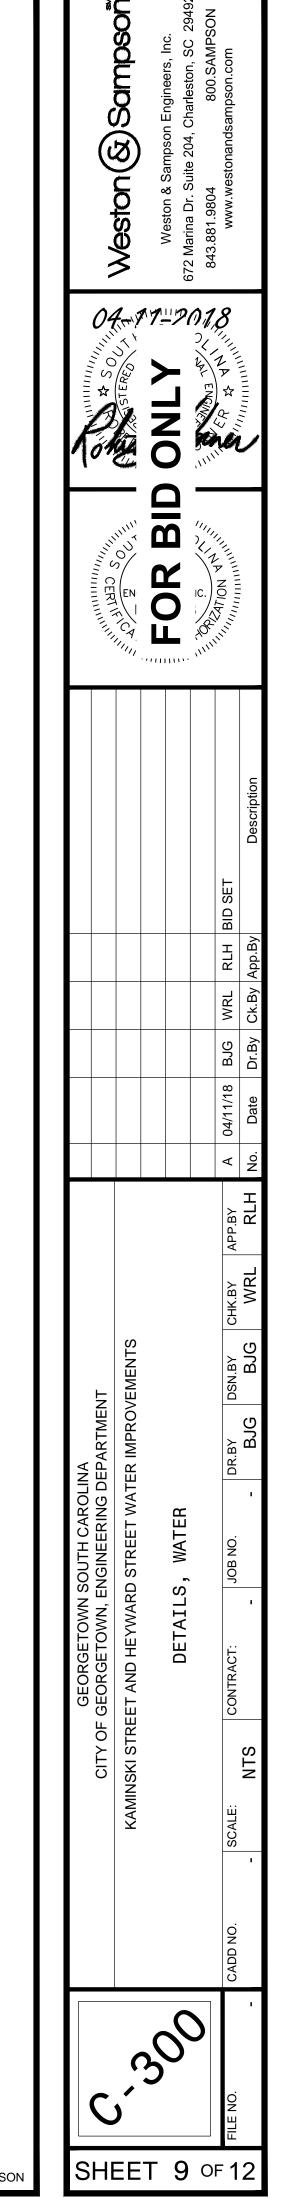CITY OF GEORGETOWN, SC							
DRIVE	UTILITY UNDER ASPHALT DRIVEWAY / NON SCDOT PAVED ROAD						
UPDATED SCALE NO. N.T.S.							
DRAWN	CHECKED						

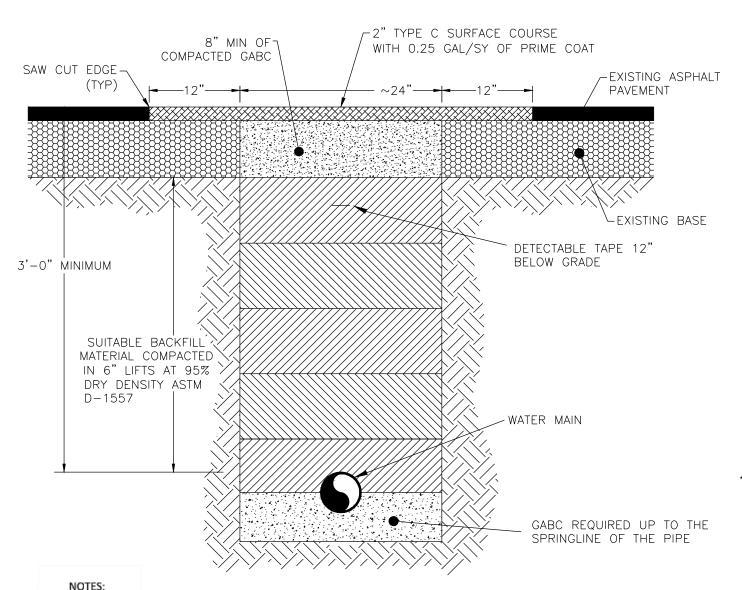

1. DEPTH FROM GROUND SURFACE TO TOP OF BLOCKING SHALL BE GREATER THAN HEIGHT OF BLOCKING. 2. THRUST BLOCK DIMENSIONS TO BE VERIFIED BY THE ENGINEER BASED ON SOIL BEARING CAPACITY.

SIZE A B A B A B A B

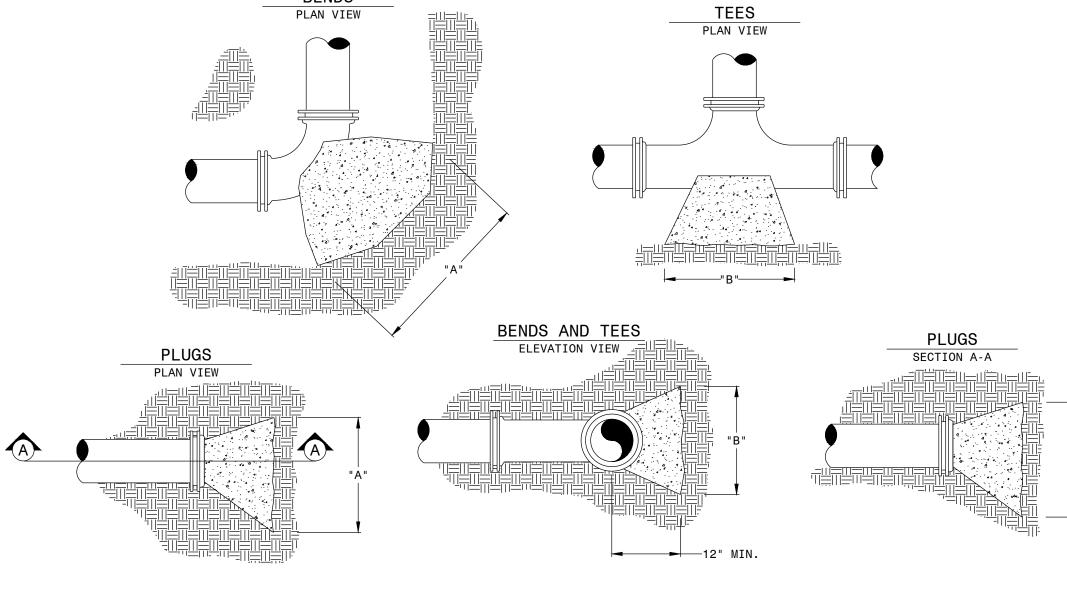6" | 24" | 18" | 30" | 18" | 24" | 16" | 24" | 16" | 24" | 16"

90° BENDS 45° BENDS 22.5° BENDS 11.25° BENDS


THRUST BLOCK DETAIL NOT TO SCALE

	HORIZONTAL BENDS						
Nominal			PVC				
Pipe Size (in)	90° Bends L (ft)	45° Bends L (ft)	22.5° Bends L (ft)	11.25° Bends L (ft)	Valves or Dead Ends L (ft)		
6	28	10	5	2	70		
8	36	14	6	3	90		

VERTICAL OFFSETS			
Nominal	PVC		
Pipe	UPPER BEND	LOWER BEND	
Size (in)	45° Bends	45° Bends	
, ,	L (ft)	L (ft)	
6	28	4	
8	36	5	

- 1. THIS SCHEDULE SHALL BE UTILIZED ON ALL WATER MAINS. ALL FITTINGS SHALL BE RESTRAINED TO THE LENGTHS INDICATED IN THE ABOVE TABLE, AT A MINIMUM.
- 2. ASSUMPTIONS: SAFETY FACTOR=1.5, TEST PRESSURE=150 PSI, SOIL TYPE=GM OR SM, TRENCH TYPE 3, DEPTH OF COVER=36" 3. BENDS AND VALVES SHALL BE RESTRAINED ON EACH SIDE OF THE FITTING.
- 4. VERTICAL OFFSETS: ARE APPROXIMATELY 3 FEET OF COVER ON TOP AND APPROXIMATELY 8 FEET OF COVER ON THE BOTTOM. ALL BENDS ARE ASSUMED TO BE 45° BENDS.
- 5. DEVIATIONS FROM THESE CONDITIONS MUST BE BASED ON THE ABOVE PARAMETERS.


RESTRAINED JOINT TABLE

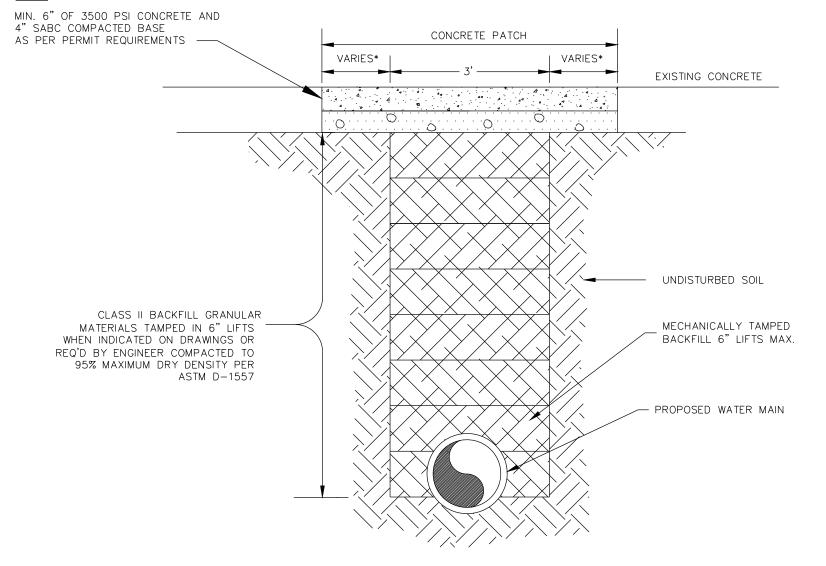

*ALL CONCRETE DRIVEWAYS THAT ARE CUT ARE CUT SHALL BE REPLACED FROM JOINT TO JOINT. NOTE: 1. REFER TO SCDOT PERMIT FOR ADDITIONAL REQUIREMENTS.


2. CONCRETE SECTION SHALL EXTEND 12" GREATER THAN TRENCH WIDTH ON EACH SIDE.

CITY OF GEORGETOWN, SC					
WATER MAIN UNDER CONCRETE DRIVEWAY					
UPDATED	N.T.S.	NO.			
DRAWN	CHECKED				

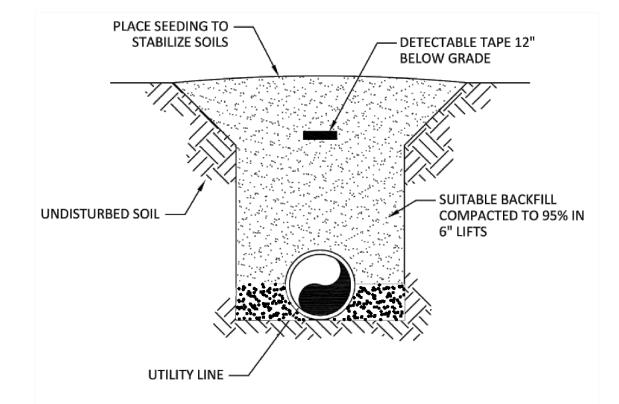

1. FOR THE UTILITY LINE INSTALLATION THROUGH DRIVEWAYS REFER TO THE ASPHALT PAVEMENT REPAIR DETAIL.

CITY OF GEORGETOWN, SC				
TYPICAL TRENCH IN GRASSED AREA				
UPDATED 10/02/14	SCALE N.T.S.	NO.		
DRAWN A.J.K	CHECKED			

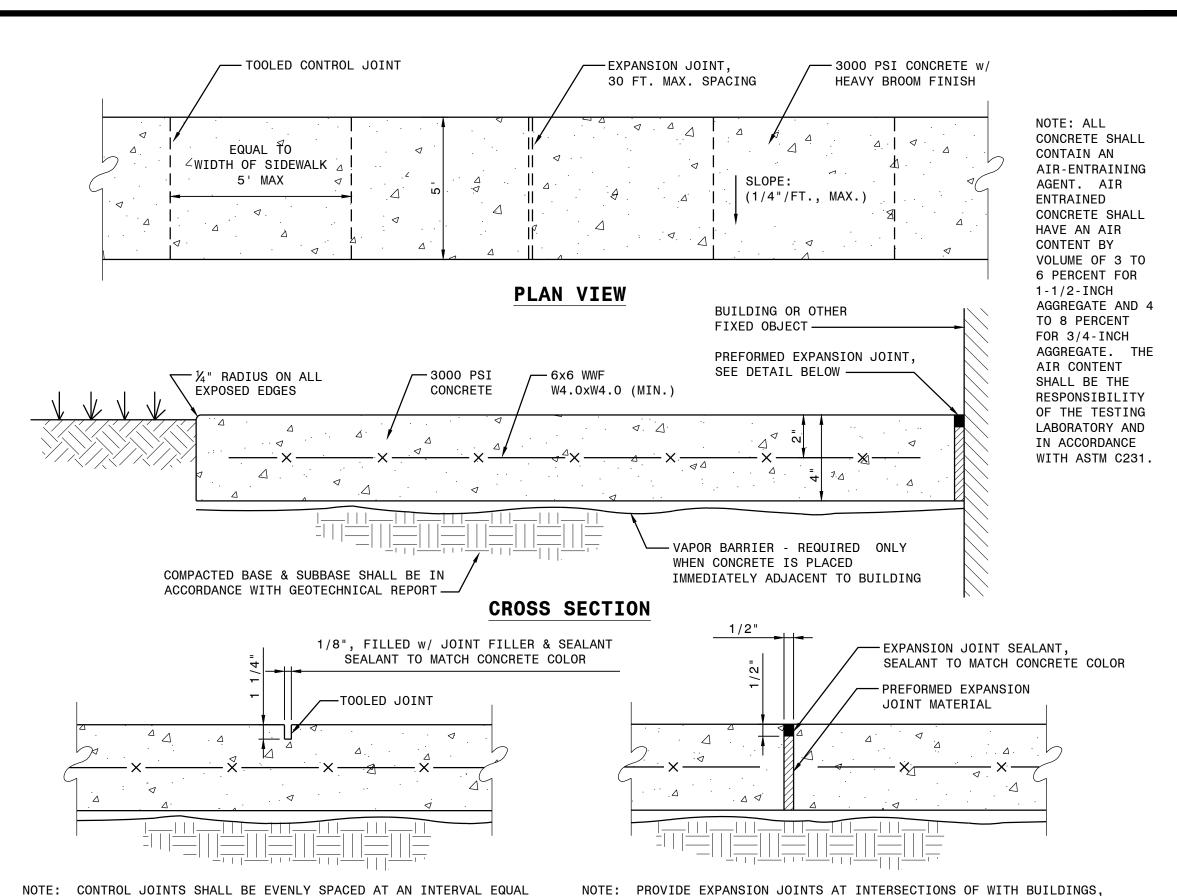

CONTROL JOINT (CJ)

TO THE WIDTH OF THE SIDEWALK. FOR CONCRETE PADS, EVENLY SPACE THE

PREFORMED EXPANSION JOINT (PEJ)

CARRIER

(INCHES)

PIPE SIZE

OTHER WALKS, AND WITH ANY OTHER FIXED STRUCTURES. SPACING ON RUNS

RESTRAINED | MINIMUM | MINIMUM

SIZE

(INCHES)

16

NOTE: ACTUAL THICKNESS SHALL BE

BASED ON AN EVALUATION OF THE

REQUIRED JACKING FORCES.

DETERMINED BY THE CASING INSTALLER

CASING

THICKNESS

(INCHES)

0.250

0.281

JOINT PVC | CASING

CONCRETE WALK DETAIL NOT TO SCALE


OF CONCRETE SHALL BE 30' MAXIMUM.

NOTES:

- 1. REFER TO APPLICABLE PERMIT FOR MINIMUM REQUIREMENTS GOVERNING HIGHWAY UNDERCROSSINGS.
- 2. THE MINIMUM DIAMETER AND THICKNESS OF THE CASING PIPE SHALL BE AS LISTED IN THE TABLE
- SHOWN IN THIS DETAIL. 3. SEE AGENCY PERMIT FOR LENGTH AND DEPTH REQUIREMENTS.

JOINTS TO CREATE SQUARE PANELS.


- 4. IN CASE OF A CONFLICT BETWEEN THIS DETAIL, AND A PERMIT, THE STRICTEST REQUIREMENT SHALL
- 5. PERFORM ALL EXCAVATION AND BACKFILLING ACTIVITIES IN ACCORDANCE WITH THE OCCUPATIONAL SAFETY AND HEALTH ACT OF 1970 (PL 91-597), AS AMENDED.
- 6. USE CASING SPACERS (SEE DETAIL) TO MOVE CARRIER PIPE INTO CASING PIPE. SPACING OF SPACERS WILL BE DICTATED BY THE LENGTH OF CASING PIPE AND NUMBER OF JOINTS OF CARRIER PIPE. USE A MINIMUM OF 2 SPACERS PER JOINT OF PIPE OR 1 SPACER PER 10'.
- 7. AT NO TIME DURING THE BORING AND JACKING OPERATION SHALL THE AUGER HEAD BE ALLOWED TO EXTEND OUT IN FRONT OF THE CASING BEING INSTALLED.
- 8. THE BORING AND JACKING OF THE CASING PIPE SHALL BE A CONTINUOUS INSTALLATION, WITH NO WELDING OF THE CASING UNDER THE TRAVEL LANE PAVEMENT AND IN ACCORDANCE WITH THE APPLICABLE ENCROACHMENT PERMIT.
- 9. CONTRACTOR SHALL SUBMIT PLANS AND SPECIFICATIONS FOR DEWATERING TO THE ENGINEER FOR APPROVAL PRIOR TO BEGINNING THE PROCESS (FOR RAILWAYS, RAILWAY AUTHORITY MUST APPROVE ALSO). IT WILL BE THE SOLE JUDGEMENT OF DOT OR RAILWAY AUTHORITY AS TO WHEN THE OPERATION CAN BE
- 10.BORED INSTALLATIONS SHALL HAVE A BORED HOLE NO MORE THAN 1-INCH GREATER THAN OUTSIDE DIAMETER OF THE CASING PIPE.
- 11.JOINTS BETWEEN LENGTHS SHALL BE COMPLETELY WELDED IN ACCORDANCE WITH AMERICAN WELDING SOCIETY RECOMMENDED PROCEDURES.
- 12.SEAL CASING ENDS WITH TYPE II CONCRETE GROUT AND CONCRETE BRICKS, SO AS TO PREVENT THE ENTRANCE OF SOIL. LEAVE A GAP TO ALLOW LEAKAGE TO PASS IN CASE OF A MAIN BREAK.

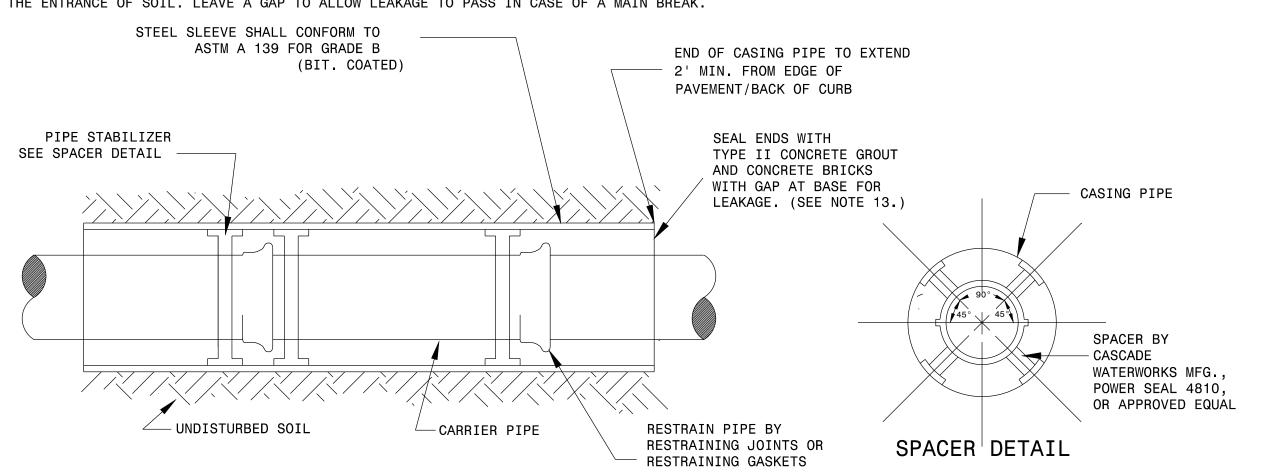

JACK AND BORE DETAIL NOT TO SCALE

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04-17-12018

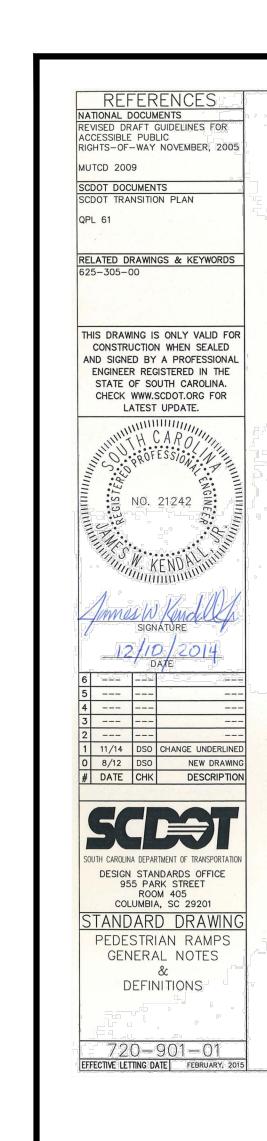

ENGINEER FOR REVIEW WHEN NON STANDARD RAMPS ARE USED.

1.05 SEE STANDARD DRAWING 626-305-00 FOR CROSSWALK MARKING STYLES.

OF THE REFUGE TO DELINEATE WHERE ISLAND BEGINS AND ENDS.

PEDESTRIAN TRAVELS THROUGH THE REFUGE FACING THE ONCOMING TRAFFIC.

PARTITION AND FLAT FOR AT LEAST 1' BEHIND THE RAMP PARTITION

WARNINGS IF SPECIFIED IN THE PLANS OR SPECIAL PROVISIONS.

CONTRAST BETWEEN THE ADJACENT MATERIALS.


A RAMP GREATER THAN 15' LONG.

5.00 REFUGE ISLANDS/RASIED MEDIANS

THROUGH THE RAMP.

20.00 DETECTABLE WARNINGS

15.00 DRAINAGE

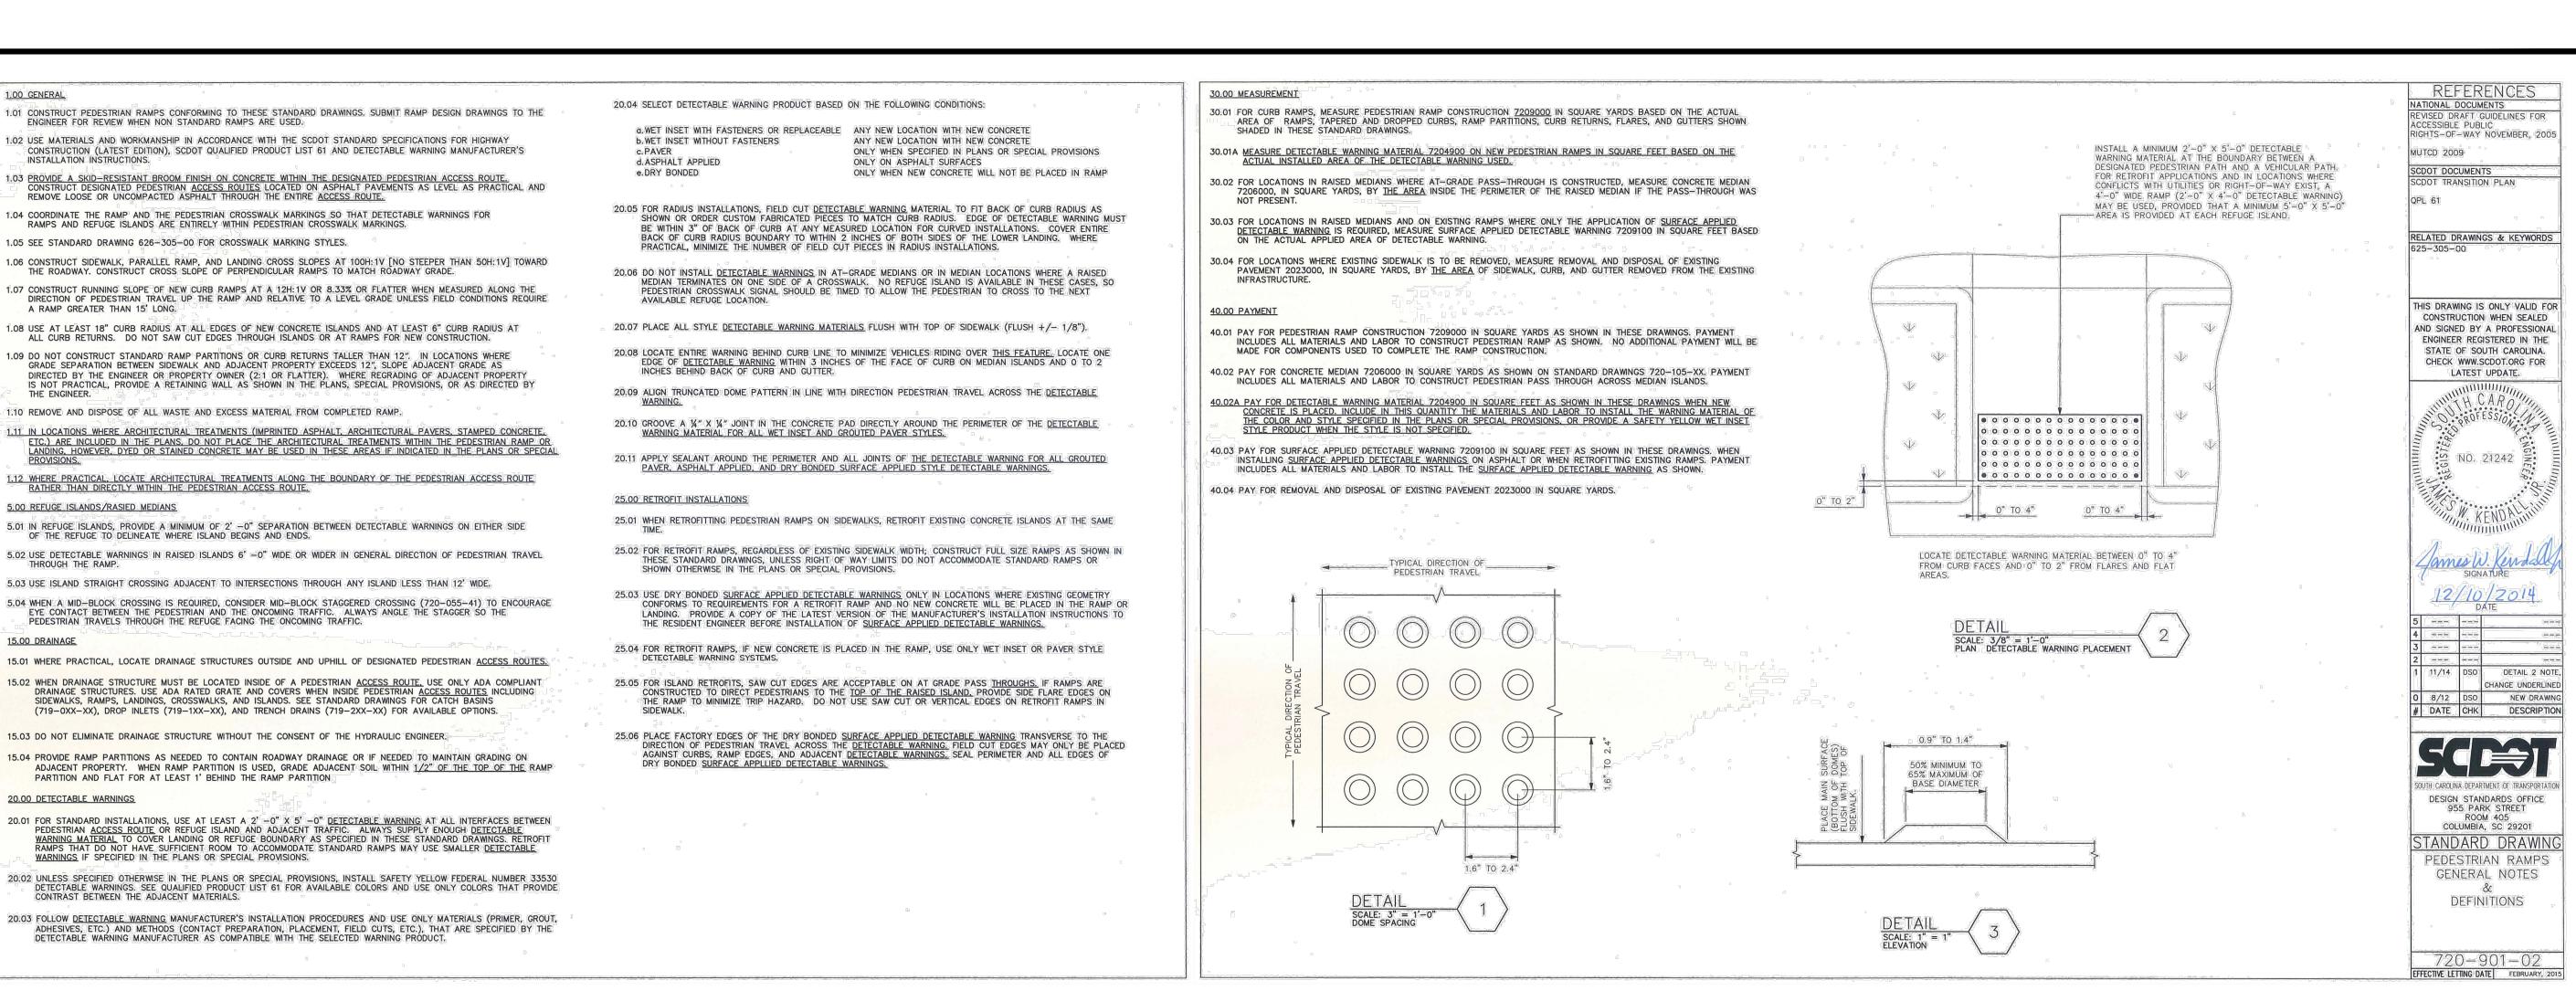

ROAD GRADE

CROSS SLOPE


(OR FLATTER)


PARALLEL RAMP


(RAMP & CROSS SLOPE)

LANDING/SIDEWALK


PERPENDICULAR RAMP (RAMP & ROAD GRADE)

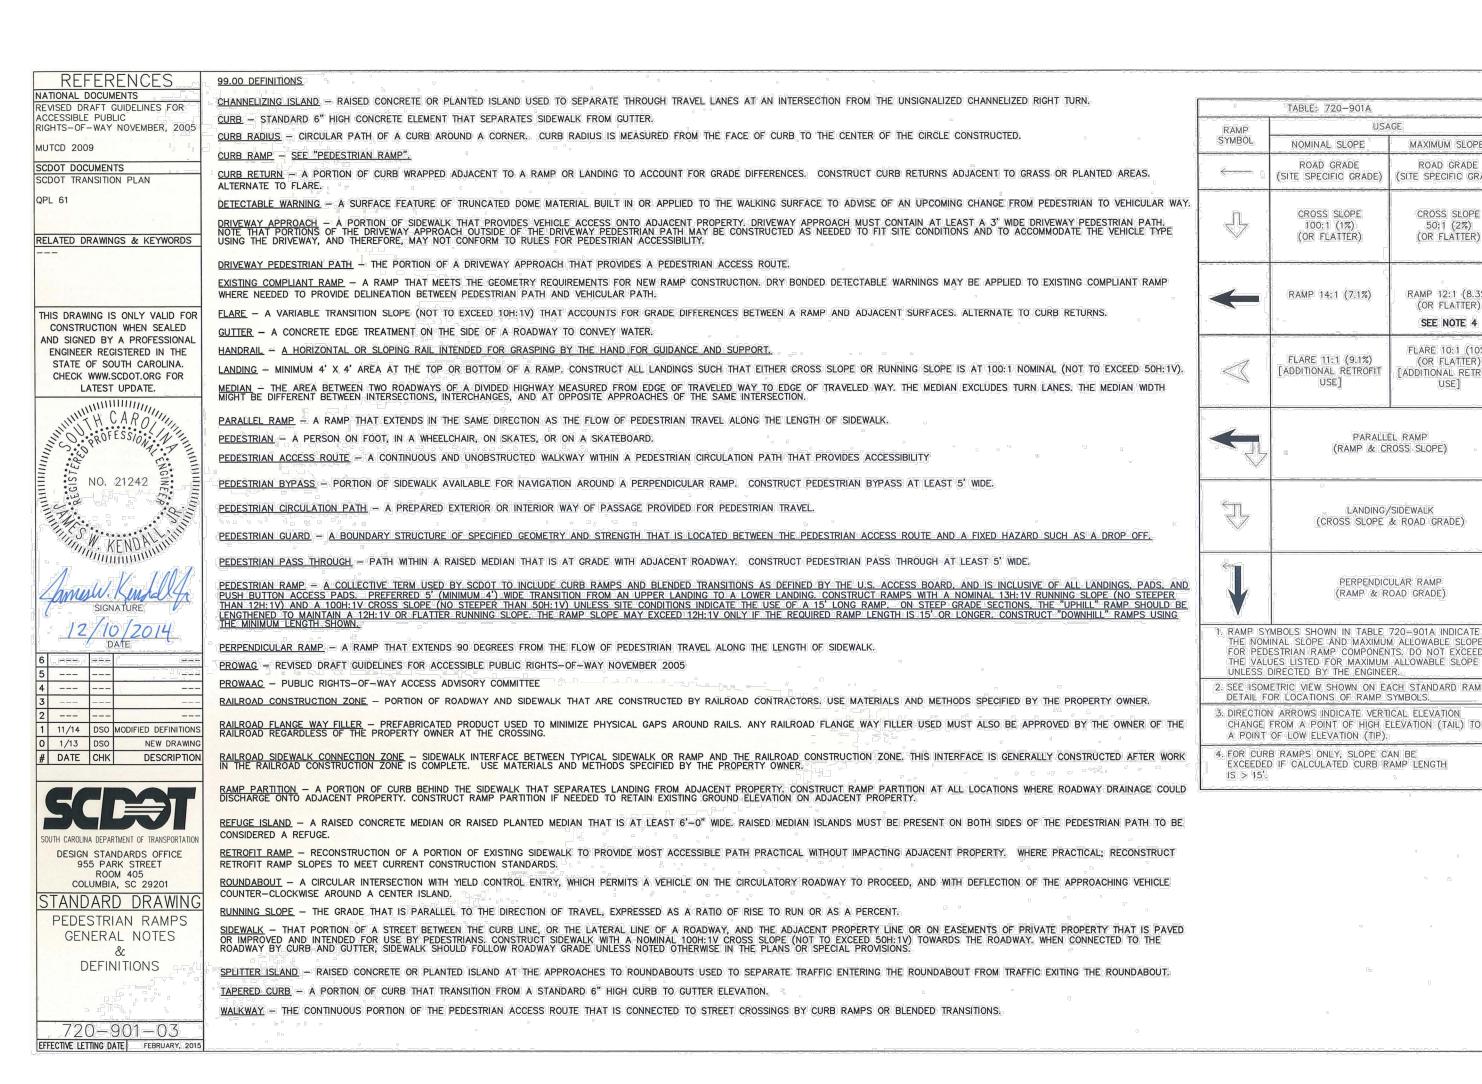


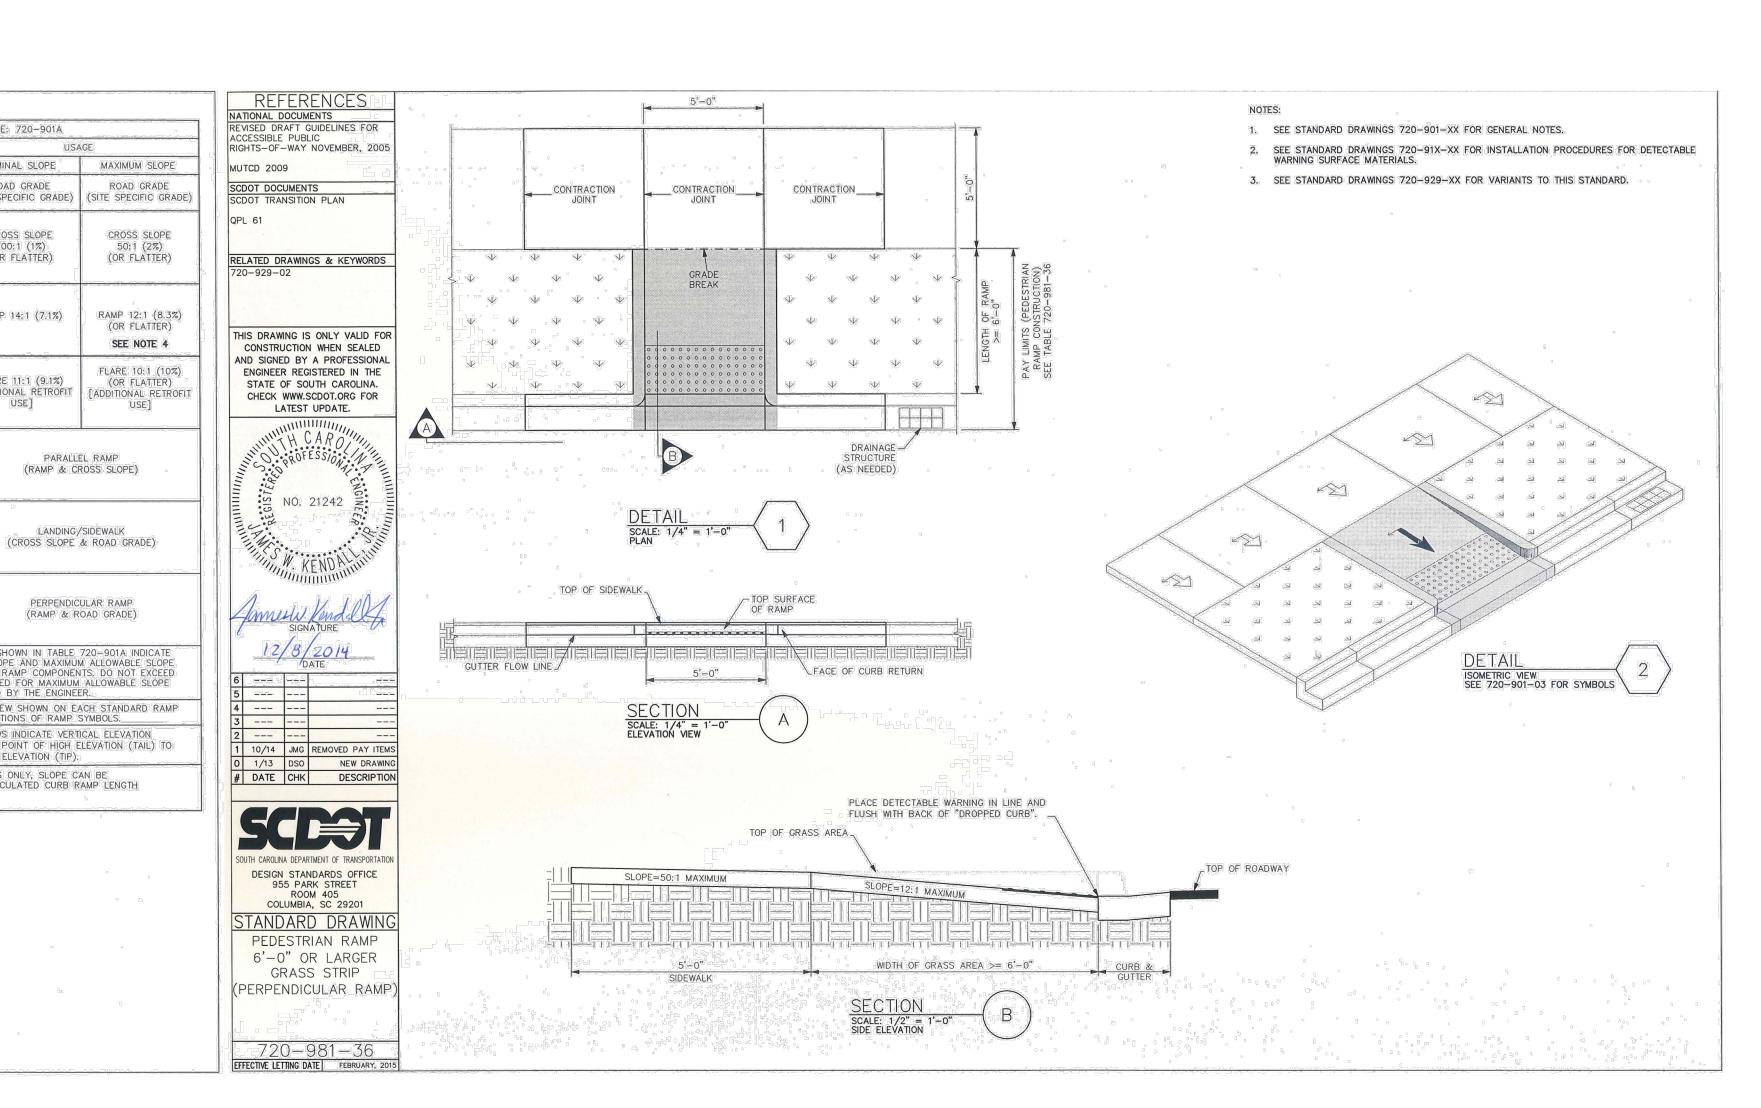

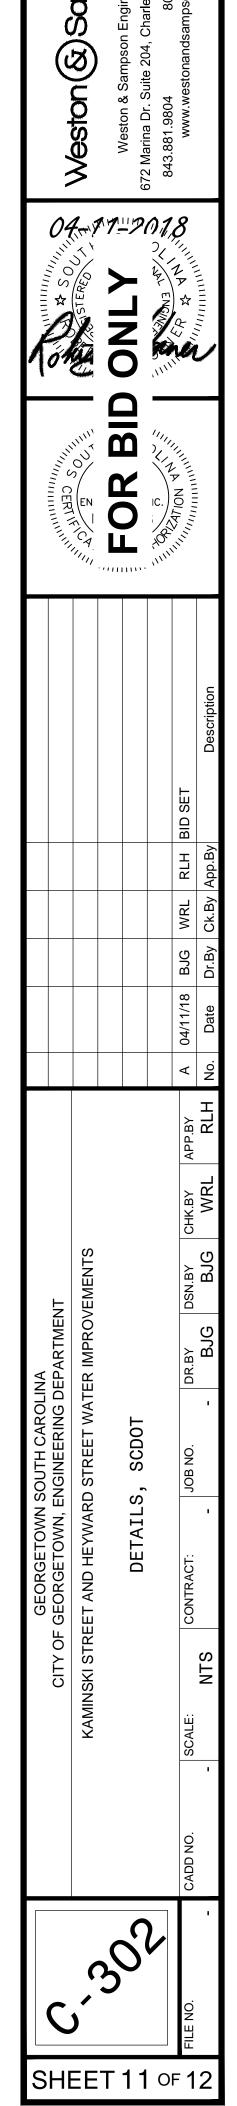

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NOTE

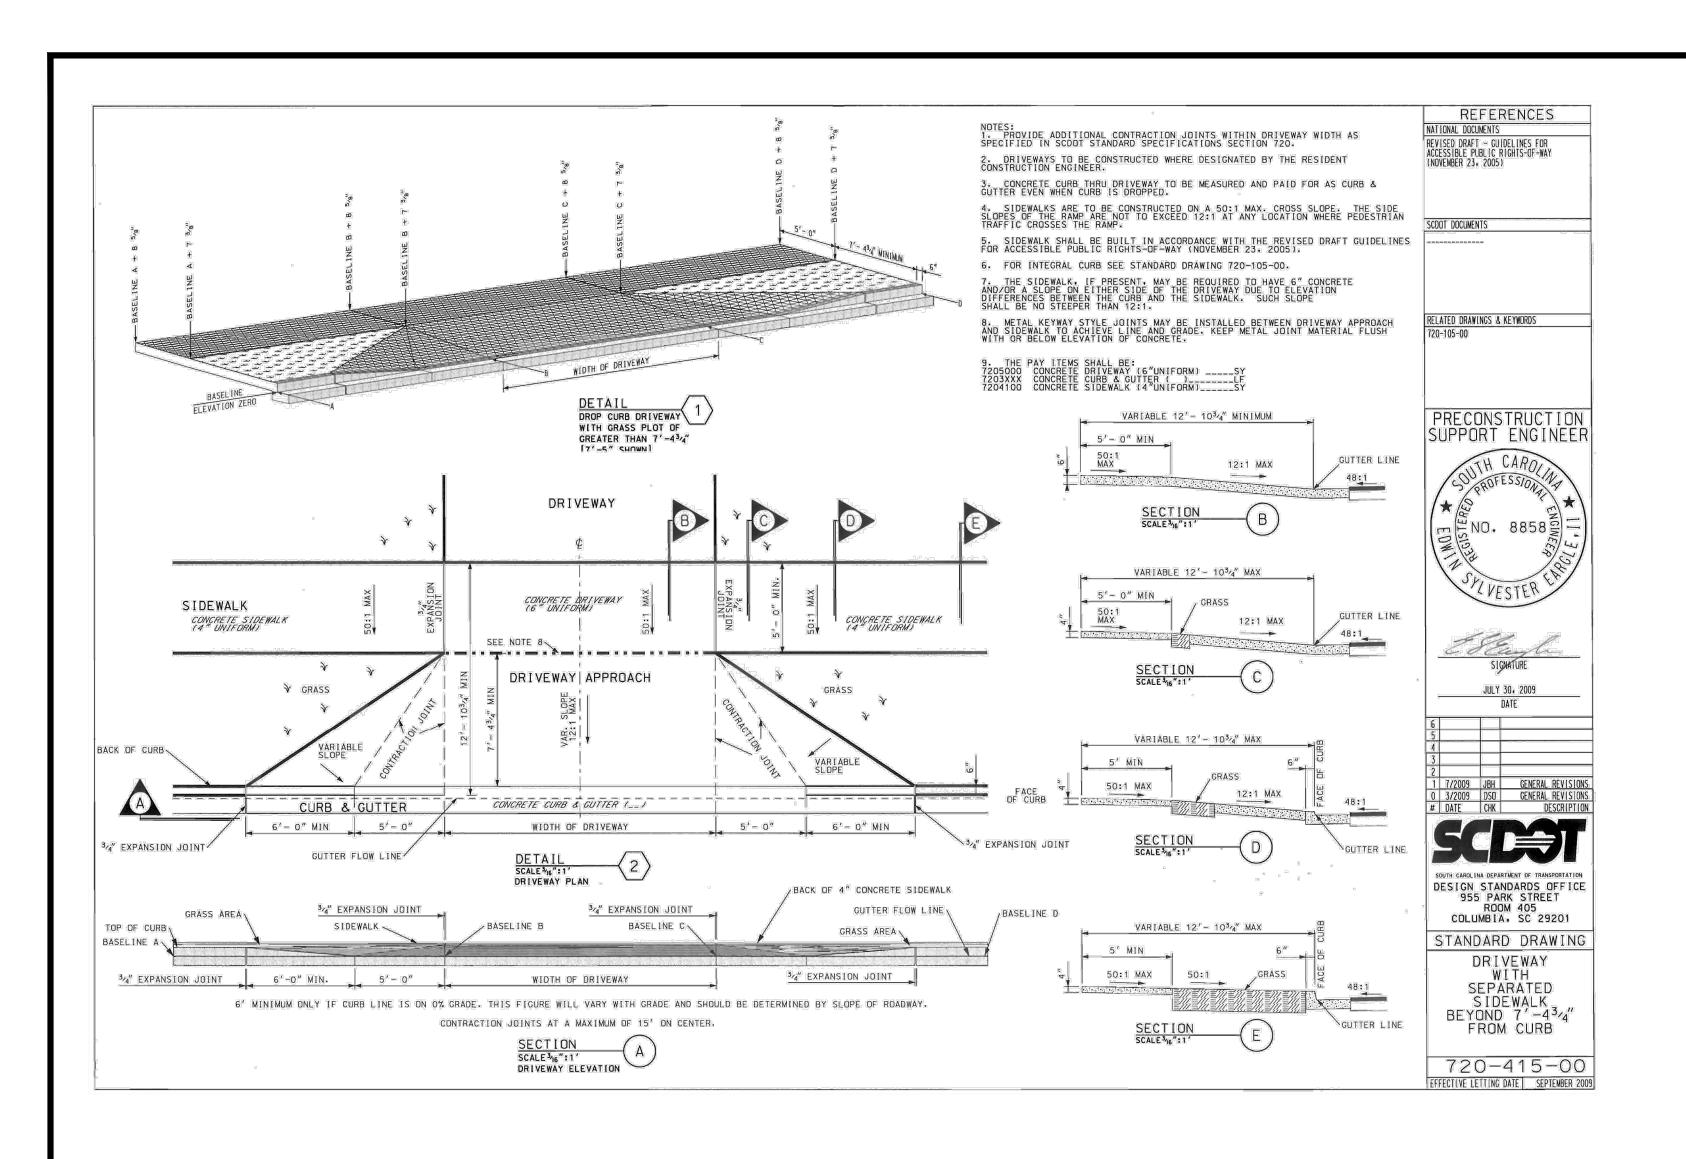- PAVEMENT CUT TO EXTEND 6" BEYOND EDGES OF TRENCH AS SHOWN. PAVEMENT SHALL BE CUT TO TRUE LINE AND REMOVED BEFORE TRENCH IS CUT. ALL PAVEMENT REPAIRS TO BE IN ACCORDANCE WITH ROAD AGENCY SPECS.
- ROAD AGENCY MAY REQUIRE A CUT & PATCH OF TRENCH AREA AND AN OVERLAY OF ENTIRE APRON OR ENTRANCE FROM THE EDGE OF THE MAIN ROAD TO THE EDGE OF THE ROAD RIGHT-OF-WAY (SEE ENCROACHMENT PERMIT).
- 3. WHERE EXISTING PAVEMENT IS INSUFFICIENT THICKNESS TO DEVELOP TIGHT SEAL WITH NEW SURFACE, NEW PAVEMENT SHALL LAP EXISTING SURFACE WITH AT LEAST A 10' OVERLAP ON BOTH SIDES FOR SMOOTH TRANSITION OR AS PER SPEC'S. OF ROAD AGENCY.

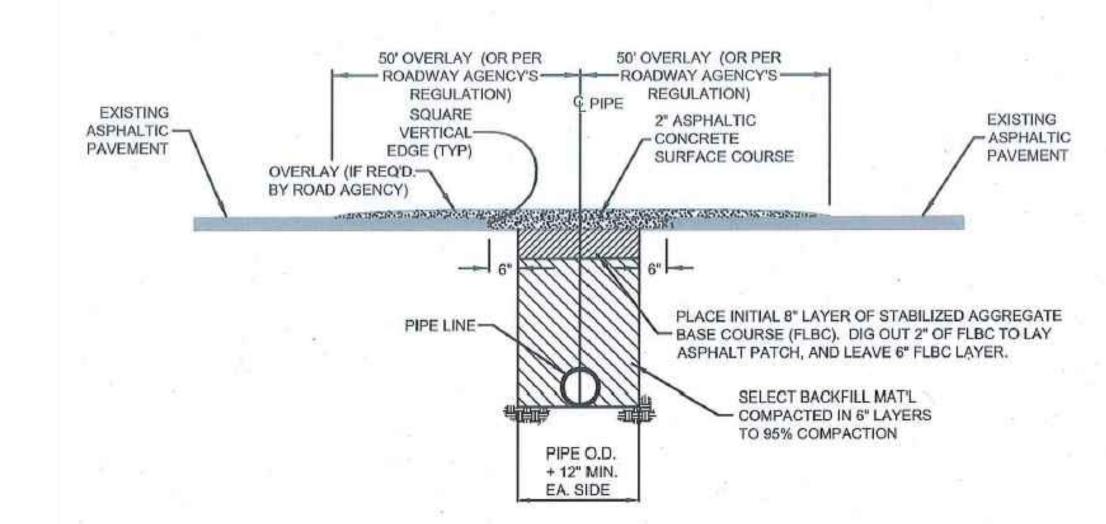SCDOT OPEN CUT REPAIR FOR LOW VOLUME ASPHALT PAVEMENT					
DRAWN	CHECKED				