#### SHEET DESCRIPTION

- 1 COVER SHEET
- 2 LEGEND
- GENERAL NOTES, SPECIFICATIONS & TYPICAL SECTION
- 4-8 PLAN
- 9 DETAILS
- 10-13 CROSS SECTIONS
- 14-18 MAINTENANCE OF TRAFFIC



PROJECT LOCATION MAP

GOVERNING STANDARDS AND SPECIFICATIONS:
FI ORIDA DEPARTMENT OF TRANSPORTATION MANUAL OF UNIFORM MINIMUM STANDARDS FOR DESIGN, CONSTRUCTION AND MAINTENANCE FOR STREETS AND HIGHWAYS DATED 2016, AS AMENDED BY CONTRACT DOCUMENTS.

GOVERNING STANDARDS AND SPECIFICATIONS: FLORIDA DEPARTMENT OF TRANSPORTATION, FY 2019/2020 STANDARD PLANS AND REVISED INDEX DRAWINGS AS APPENDED HEREIN, AND JANUARY 2020 STANDARD SPECIFICATIONS FOR ROAD AND BRIDGE CONSTRUCTION LATEST EDITION; AS AMENDED BY CONTRACT DOCUMENTS.

HIGHLANDS COUNTY TECHNICAL STANDARDS MANUAL, THROUGH RESOLUTION 14-15-60. http://cms2.revize.com/revize/highlandscounty/document\_center/LDRS%20thru%20Ord%2017-18-15%20(7-25-18).pdf

PLANS PREPARED BY HIGHLANDS COUNTY ENGINEERING DEPARTMENT

ATTENTION IS DIRECTED TO THE FACT THAT THESE PLANS MAY HAVE BEEN ALTERED IN SIZE BY REPRODUCTION. THIS MUST BE CONSIDERED WHEN OBTAINING SCALED DATA


# HIGHLANDS COUNTY BOARD OF COUNTY COMMISSIONERS CONSTRUCTION PLANS **FOR**

THUNDERBIRD ROAD WEST SIDEWALK EXTENSION HIGHLANDS COUNTY PROJECT NO. 15010 FINANCIAL PROJECT ID# 433203-1-58-01 (FEDERAL FUNDS)





STATE LAW REQUIRES EXCAVATORS TO CALL 811 BEFORE DIGGING PER THE "UNDERGROUND FACILITY DAMAGE PREVENTION AND SAFETY ACT" CHAPTER 556, FLORIDA STATUTES. FAILURE TO CALL CAN RESULT IN FINES FROM \$250 TO \$5,000.

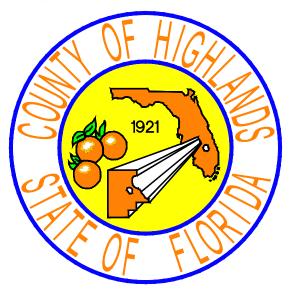

# **CLINTON HOWERTON, JR., P.E. COUNTY ENGINEER**

ENGINEER OF RECORD JAMES D. LANGFORD, JR., P.E.

RIGHT-OF-WAY WIDTH = VARIES FROM 68' TO 85' WIDTH APPROXIMATE PROJECT LENGTH = 2,587 LF (0.489 MILE) POSTED SPEED LIMIT = 45 MPH

### **UTILITY COMPANIES**

HIGHLANDS COUNTY TRAFFIC

505 S. COMMERCE AVE.

COMCAST CABLE 3010 HERRING AVE. SEBRING, FL 33870 (863) 273-8556

CENTURY LINK

924 MEMORIAL DR.

(863) 452-3185

AVON PARK, FL 33825

SEBRING, FLORIDA 33870 EDDIE CARDONA (863) 402-6877

DUKE ENERGY-FLORIDA 2051 OLD SCENIC HWY. LAKE WALES, FL 33898 MARK MANNER (863) 678-4476

368 S. COMMERCE AVE. SEBRING, FLORIDA 33870 BOB BOGGUS (863) 471-5100

	HIGHLANDS COUNTY PROJECT NO. 15010		
	BASE BID		
TASK NO.	ITEM DESCRIPTION	QUANTITY	UNIT
1	MOBILIZATION	1	LS
2	BONDS & INSURANCE	1	LS
3	CONSTRUCTION SURVEY STAKING INCLUDING AS-BUILT	1	LS
4	TESTING	1	LS
5	MAINTENANCE OF TRAFFIC	1	LS
6	SEDIMENT BARRIER TEMPORARY	2,437	LF
7	CLEARING AND GRUBBING INCLUDING TREE REMOVAL	1	LS
8	REMOVAL OF EXISTING ASPHALT PAVEMENT ROADWAY	110	SY
9	MAILBOX REMOVE AND RELOCATE	7	EA
10	REGULAR EXCAVATION	600	CY
11	REGULAR EMBANKMENT	400	CY
1.0	STABILIZATION, TYPE B, LBR 40, 12" COMPACTED THICKNESS SIDE STREET	2.170	CV
12	CONSTRUCTION & 8' SHOULDER	2,178	SY
13	OPTIONAL BASE, BASE GROUP 4, 6" COMPACTED THICKNESS	270	SY
14	OPTIONAL BASE, BASE GROUP 6, 8" COMPACTED THICKNESS	110	SY
15	SUPERPAVE ASPHALTIC CONCRETE, 1 1/2" THICK, RAP 30% MAXIMUM	12	TN
16	18" x 12" REINFORCED CONCRETE PIPE (RCP)	50	LF
17	15" HIGH DENSITY POLYETHYLENE PIPE (HDPE)	150	LF
18	MITERED END SECTION	6	EA
19	SIDEWALK CONCRETE, 4" THICK, 3,000 PSI MIN	1,350	SY
20	DRIVEWAY CONCRETE, 6" THICK, INCLUDE 6"x6"W1.4xW1.4 WWM, 3,000 PSI MIN	270	SY
21	CONCRETE DRAINAGE STRUCTURE (S-1), SEE DETAILS	5	EA
22	DETECTABLE WARNING, YELLOW, EMBEDDED	80	SF
23	PERFORMANCE TURF (SOD)	6,000	SY
24	SINGLE POST SIGN, F & I, STOP (R1-1), 30" x 30" & TWO (2), D3-1	3	AS
25	SINGLE POST SIGN, F & I, W1-R 30"x30" & W13-1P (15 MPH) 18" x 18"	1	AS
26	TEMPORARY PAINTED PAVEMENT MARKINGS, STD, WHITE, SOLID, 12"	170	LF
27	TEMPORARY PAINTED PAVEMENT MARKINGS, STD, WHITE, SOLID, 24"	27	LF
28	THERMOPLASTIC, STANDARD, WHITE, SOLID, 12"	170	LF
29	THERMOPLASTIC, STANDARD, WHITE, SOLID, 24"	27	LF

	PROJECT CONTROL POINTS				
Point Number	Easting	Northing	Elevation	Description	
5000	493225.3650'	1151256.3750'	161.51'	Set Iron Rod w/ cap stamped "Highlands County"	
5001	492398.43201	1151256.2110'	164.68'	Set Iron Rod w/ cap stamped "Highlands County"	
5002	491351.9530'	1151278.2980'	167.34'	Set Iron Rod w/ cap stamped "Highlands County"	
5003	490401.6090'	1151276.8390'	169.60'	Set Iron Rod w/ cap stamped "Highlands County"	

		REVISIONS	
DATE	BY	DESCRIPTION	
2-19-19	BWD	REVISED PER FDOT COMMENTS	
2-5-2020	DMN	REVISED STANDARDS AND SPECIFICATIONS DATES	
			ı

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## DRAWN BY: DOUG NIETUBICZ CHECKED BY: J.D. LANGFORD, P.E. FOR BID IN CHARGE:

STATUS


HIGHLANDS COUNTY ENGINEERING DEPARTMENT 505 S. COMMERCE AVENUE SEBRING, FLORIDA 33870

APPROVED BY: JAMES D. LANGFORD, JR., P.E. FLORIDA REGISTRATION NO.: 78402

# THUNDERBIRD ROAD WEST SIDEWALK EXTENSION

SCALE:		
HORIZ.	N/A	
VERT.	N/A	
PROJECT		RE
SHEE	T 1 OF	18

**COVER SHEET** DATE:

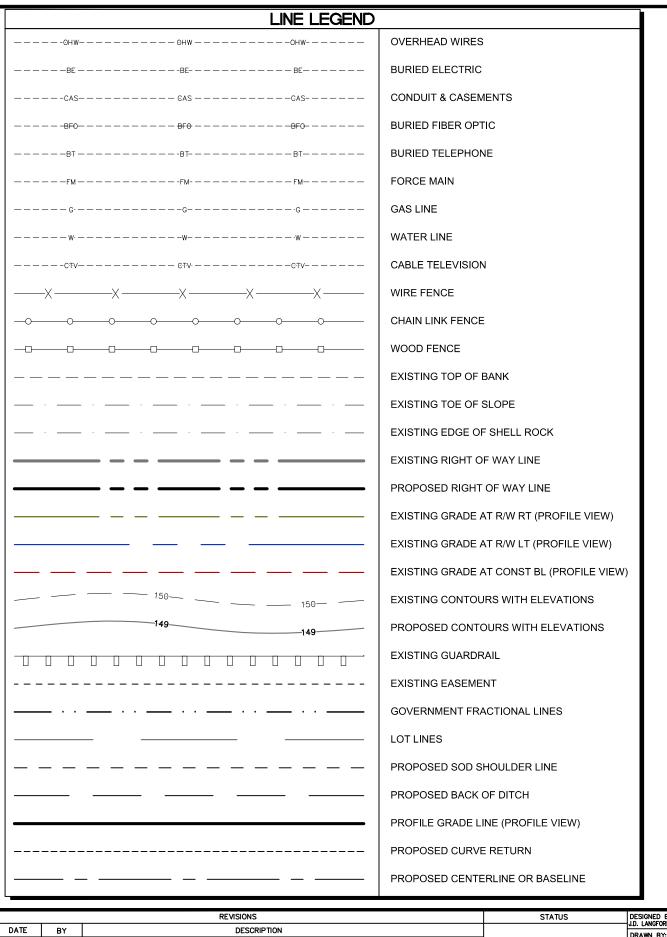

SY	MBOL LEGEND
<b>\Phi</b>	BENCHMARK
•	CONCRETE MONUMENT
0	IRON ROD OR IRON PIPE
•	NAIL AND DISK
$\Diamond$	CLEANOUT
EM	ELECTRIC METER
₽E	FLAG ELECTRIC
₽FO	FLAG FIBER OPTIC
P°	FLAG GAS
Sss	FLAG SEWER
<b>P</b>	FLAG TELEPHONE
<b>P</b> *	FLAG WATER
¥	FIRE HYDRANT
8∝	GAS VALVE
EB	ELECTRIC BOX
⊞	TELEPHONE BOX
₽	TELEVISION BOX
TS	TRAFFIC SIGNAL BOX
/xw\	PEDESTRIAN CROSSWALK
<b>\$</b>	LIGHT POLE
<b>(</b>	MANHOLE DRAINAGE
M	MANHOLE OTHER
<b>S</b>	MANHOLE SEWER
①	MANHOLE TELEPHONE
	MONITORING WELL
b	UTILITY POLE
0	WATER METER
<b>×</b>	WATER VALVE
0	WELL
+0.0	EXISTING GRADE SHOT
+0.00	PROPOSED ELEVATIONS
0	BOLLARD
	MAIL BOX
<del>-</del> 0	SIGN
Ð	MITERED END SECTION
$\leftarrow$	GUY ANCHOR

	ABBREVIATIONS
A.D.	ALGEBRAIC DIFFERENCE
BFS	BEGIN FULL SUPER
BL	BASELINE
BNC	BEGIN NORMAL CROWN
СМР	CORRUGATED METAL PIPE
CONC.	CONCRETE
CONST.	CONSTRUCTION
EFS	END FULL SUPER
ELEV	ELEVATION
ENC	END NORMAL CROWN
EXIST.	EXISTING
HDPE	HIGH DENSITY POLYETHYLENE PIPE
LC	LONG CHORD
LT	LEFT
MES	MITERED END SECTION
PAVT	PAVEMENT
PC	POINT OF CURVATURE
PGL	PROFILE GRADE LINE
PROP.	PROPOSED
PT	POINT OF TANGENCY
PVC	POINT OF VERTICAL CURVE
PVI	POINT OF VERTICAL INTERSECTION
PVT	POINT OF VERTICAL TANGENCY
R/W	RIGHT OF WAY
RC	REVERSE CROWN
RCP	REINFORCED CONCRETE PIPE
RT	RIGHT
STA	STATION
TYP	TYPICAL

*	CEDAR TREE
0	CITRUS TREE
	CYPRESS TREE
器	MAGNOLIA TREE
	MAPLE TREE
£43	OAK TREE
*	PALM TREE
*	PINE TREE
9	TREE
	TREE A
*	TREE B
**	TREE C
**	TREE D

DR	AINAC	<del>涯 LE</del>	<u>GEND</u>

	EXISTING PIPES & STRUCTURES
D=====	PROPOSED PIPES & STRUCTURES

STATUS	REVISIONS		
	DESCRIPTION	BY	DATE
1			

C:\PROJECTS\2015\15009 Thunderbird Rd Sidewalk - Cornet to Grand Prix\All Drawings\\_Details Legend 15009 Thunderbird Rd Sidewalk.dwg, West Legend, Nietubicz, Douglas Acad 1-7 Black.ctb

DRAWN BY: DOUG NIETUBICZ CHECKED BY: J.D. LANGFORD, P.E.

IN CHARGE: J.D. LANGFORD, P.E.

HIGHLANDS COUNTY ENGINEERING DEPARTMENT 505 S. COMMERCE AVENUE

SEBRING, FLORIDA 33870

APPROVED BY: JAMES D. LANGFORD, JR., P.E. FLORIDA REGISTRATION NO.: 78402



DATE:

THUNDERBIRD ROAD WEST SIDEWALK EXTENSION LEGEND

SCALE: HORIZ. VERT. N/A	
PROJECT NO. 15010	REV. 0
SHEET 2 OF	18

# GENERAL NOTES AND SPECIFICATIONS

#### GENERAL CONSTRUCTION NOTES

- The Contractor shall be responsible for furnishing all material and labor to construct the facility as shown and described in the construction documents.
- The Contractor shall be responsible for obtaining all required construction bonds prior to construction.
- The Contractor shall have available at the job site at all times one copy of the construction documents including plans, specifications, and special conditions and copies of any required construction permits.
- 4. Any discrepancies on the drawings shall be immediately brought to the attention of the Highlands County Project Manager before commencing work. No field changes or deviations from design are to be made without prior approval of the Highlands County Project
- 5. Contractor shall submit a construction schedule to the Highlands County Project Manager prior to commencement of construction.
- Contractor shall coordinate proposed driveway construction with affected property owners.
- Contractor shall repair and/or replace all disturbed irrigation. Contractor shall coordinate this activity with affected property owners. EROSION CONTROL
- The Contractor shall grade the site to the elevations indicated and shall regrade washouts where they occur after every rainfall event until sod is well established or adequate stabilization occurs.
- 2. Contractor shall denote on plan the temporary parking and storage area which shall also be used as the equipment maintenance and cleaning area, employee parking area, and area for locating toilet facilities
- All wash water (concrete trucks, vehicle cleaning, equipment cleaning, etc.) shall be detained and properly treated and disposed
- The Contractor shall be responsible for the control of dust and dirt rising and scattering in the air during construction and shall provide water sprinkling or other suitable methods of control. The Contractor shall comply with all governing regulations pertaining to environmental
- The use of motor oils and other petroleum based or toxic liquids for dust suppression operations is prohibited.
- Sod must be installed and maintained on exposed slopes within 48 hours of completing final grading, and at any other time as necessary, to prevent erosion, sedimentation or turbid discharges.
- 7. Stabilization practices should be initiated as soon as practical, but in no case more than 7 days where construction has temporarily ceased
- All materials spilled, dropped, washed or tracked from vehicles onto roadways or into storm drains must be removed as soon as possible.
- 9. On-site & off-site soil stockpile and borrow areas shall be protected from erosion and sedimentation through implementation of best management practices.
- 10. Slopes shall be left in a roughened condition during the grading phase to reduce runoff velocities and erosion.
- 11. Due to grade changes during the development of the project, the Contractor shall be responsible for adjusting the erosion control measures (silt fence, etc.) to prevent erosion.
- 12. All construction shall be stabilized at the end of each working day, this includes back filling of trenches for utility construction and placement of gravel or bituminous paving for road construction.
- 13. The contractor shall install sediment barrier as shown on plans within the perimeter of the project site.

#### SURVEY AND STAKEOUT

- 1. Existing section corners and ¼ Section corners, and other land markers or monuments located within proposed construction are to be referenced prior to construction and reset after construction. The Contractor shall have this work done by a registered Professional Land Surveyor at the Contractor's expense (Florida Registration). Any public land corner within the limits of construction is to be protected. If a corner monument is in danger of being destroyed and has not been properly referenced, the Contractor should notify the County Surveyor, without delay, by telephone (863-402-6877).
- Benchmark data is North American Vertical Datum of 1988 (NAVD 88).
- Any NGVD-29 monument within the limits of construction is to be protected. If in danger of damage, the Contractor should notify: Geodetic Information Center, Attn: Mark Maintenance Section N/CG-162, 6001 Executive Boulevard, Rockville, Maryland 20852. Telephone (301) 443-8319.
- Grades shown are the finished grades, unless otherwise indicated.
- The Contractor shall remove survey stakes and erosion control items prior to the completion of the contract.
- The Contractor shall be responsible for submitting to the Highlands County Project Manager a certified record survey signed and sealed by a Professional Land Surveyor registered in the state of Florida depicting the actual field location of all constructed improvements that are required by the jurisdictional agencies for the certification process. All survey costs will be the Contractor's responsibility.

# UTILITIES

- 1. It is the Contractor's responsibility to contact the various utility companies which may have buried or aerial utilities within or near the construction area before commencing work. The Contractor shall call 811 to provide 48 hours minimum notice to all utility companies in advance of any excavation involving their utilities so that a company representative can be present. A list of the utility companies which the Contractor MUST call before commencing work is provided in these construction plans. This list serves as a guide only and is not intended to limit the utility companies which the contractor may wish to notify.
- 2. Existing utilities shown are located according to the information available to the Engineer at the time of the topographic survey and have not been independently verified by the Owner or the Engineer. Guarantee is not made that all existing underground utilities are shown or that the location of those shown are entirely accurate. Finding the actual location of any existing utilities is the Contractor's responsibility and shall be done before he/she commences any work in the vicinity. Furthermore, the Contractor shall be fully responsible for any and all damages due to the Contractor's failure to exactly locate and preserve any and all underground utilities. The Owner or Engineer will assume no liability for any damages sustained or cost incurred because of the operations in the vicinity of existing utilities or structures, nor for temporary bracing and shoring of same. If it is necessary to shore, brace, swing or relocate a utility, the utility company or department affected shall be contacted and their permission obtained regarding the method to use for such work. In addition, the Contractor shall be responsible to verify if "other" utilities (Not shown in the plans) exist within the area of construction. Should there be utility conflicts, The Contractor shall inform the Engineer and notify the respective utility owners to resolve utility conflicts and utility adjustments as required.
- The Contractor is to use caution when working in or around areas of overhead transmission lines or underground utilities.
- Prior to commencement of any excavation, the contractor shall comply with Florida Statute 553.851 for the protection of underground gas pipelines.
- All valves within area of construction or disturbed by construction to be adjusted to finished grade. Replace valve collars and boxes as necessary

#### CLEARING AND GRUBBING

Contractor shall clear and grub all areas unless otherwise indicated, removing trees, stumps, roots, muck, existing pavement, existing concrete and all other deleterious material.

#### PAVING, GRADING AND DRAINAGE

- 1. Where new pavements meets the existing pavement, the Contractor shall saw cut the existing pavement a minimum 2" deep for a smooth and straight joint and match the existing pavement elevation with the proposed pavement unless otherwise indicated.
- All cut or fill slopes shall be 4 (horizontal): 1 (vertical) or flatter unless otherwise shown.
- Existing drainage structures within construction limits shall remain unless noted otherwise.
- Contractor is responsible for repairing any existing concrete or asphalt areas that are disturbed during construction.

&:\PROLECTS\2015\15009 Thunderbird Rd Sidewalk - Comet to Grand Prix\All Drawings\Cover General Notes Details 15009 Thunderbird Rd Updates 3-20-20.dwg, GENERAL NOTES WEST, Dorey, Bruce Colors As Black Except Gray Colors.ctb

#### PAVEMENT MARKING AND SIGNAGE

- Stop bars shall be 24" white stripes.
- 2. Temporary pavement markings shall be provided by the end of each day's operation.
- All pavement markings and signage shall be installed in accordance with the Manual on Uniform Traffic Control Devices (MUTCD), 2009 Edition.
- Sign substrate shall be aluminum.
- Traffic signs shall be mounted on 3" diameter post with "Z" bar brackets.
- Sign post underground support shall be 6" aluminum "Z" bar brackets (no concrete).
- All removed sign assemblies shall be brought by the contractor to the Highlands County Traffic Operations Office located at 4300 George Blvd., Sebrina, FL 33875.

# SOD


- 1. All disturbed areas within the project limits shall be sodded with "like kind" sod. The areas on which sod is to be placed shall be thoroughly wetted prior to and after placement is complete. No addition of top soil material is required prior to placement.
- 2. All sod materials shall be subject to inspection by the Highlands County Project Manager prior to placement. Any sod with noxious weeds and grasses including tropical soda apple, shall be rejected for use on the spot.
- All areas within the project site shall be sodded unless indicated in these construction plans.

#### TESTING

FLORIDA REGISTRATION NO.: 78402

- 1. Contractor shall perform, at his own expense, any and all tests required by the specifications and/or any agency having jurisdiction. A copy of the test results shall be provided to the Highlands County Project Manager.
- The Highlands County Project Manager shall inspect all construction and is authorized to call to the attention of the Contractor any failure of work or materials to conform with the plans and specifications.
- 3. All copies of compaction, concrete and other required test results are to be sent to the Highlands County Project Manager directly from the testing agency.

	CONTRACTOR REQUIRED QUALITY CONTR	OL MATERIALS TESTING
Si	dewalk Construction: IN-SITU SOIL TESTING REQUIR	EMENTS (6" COMPACTED THICKNESS)
TEST NAME	QUALITY CONTROL	ACCEPTANCE
DENSITY	ONE (1) PER LIFT, TEN (10) TOTAL	Minimum density of 95% of AASHTO T99 density.
Construction M	lethod: Compact area directly under the sidewalk and one	(1) foot beyond each side of the sidewalk to a depth
Residenti	al Driveways: OPTIONAL BASE GROUP 4 TESTING R	EQUIREMENTS (6" COMPACTED THICKNESS)
TEST NAME	QUALITY CONTROL	ACCEPTANCE
DENSITY	ONE (1) PER LIFT PER DRIVEWAY, SIX (6) TOTAL	Minimum density of 95% of AASHTO T99 Density.
THICKNESS	ONE (1) PER LIFT PER DRIVEWAY, SIX (6) TOTAL	Compacted lift thickness = 6", tolerance = 0.5"
Optional Base	Group 4 Construction Method: Construct the base in one	(1) equal lift with a compacted lift thickness of six (6)
Shoulder Co	nstruction: TYPE B STABILIZATION (LBR 40) TESTING	REQUIREMENTS (12" COMPACTED THICKNESS)
TEST NAME	QUALITY CONTROL	ACCEPTANCE
		Minimum density of 95% of the Modified Procto
DENSITY	ONE (1) PER LIFT, TEN (10) TOTAL	maximum density as determined by FM 1-T 180
		Method D
THICKESS	ONE (1) PER LIFT, TEN (10) TOTAL	Compacted lift thickness = 12", tolerance = 0.5"

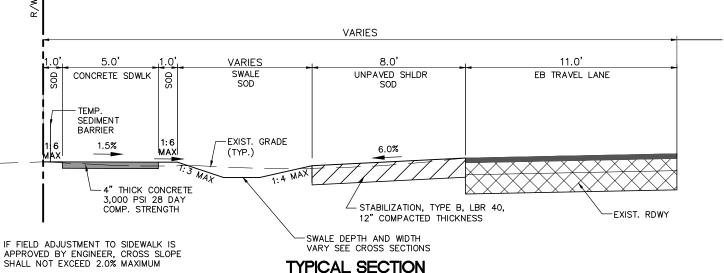


CONCRETE SIDEWALK CONSTRUCTION FROM STA 2+22.25 TO STA 28+08.44


REVISIONS		STATUS	DESIGNED BY: J.D. LANGFORD, P.E.	HIGHLANDS COUNTY	
DATE	BY	DESCRIPTION		<u> </u>	
2-19-19	BWD	REMOVED NOTE PER FDOT COMMENTS		DOUG NIETUBICZ	ENGINEERING DEPARTMENT
3-18-2020	DMN	REVISED TYPICAL SECTION AND ADDED NOTE.	FOR BID	CHECKED BY: J.D. LANGFORD, P.E.	505 S. COMMERCE AVENUE
			7	IN CHARGE:	SEBRING, FLORIDA 33870
				J.D. LANGFORD, P.E.	APPROVED BY: JAMES D. LANGFORD, JR., P.E. DATE:





THUNDERBIRD ROAD WEST SIDEWALK EXTENSION


SCALE: HORIZ. N/A VERT. N/A	
PROJECT NO. 15010	RE
SHEET 3 OF	18

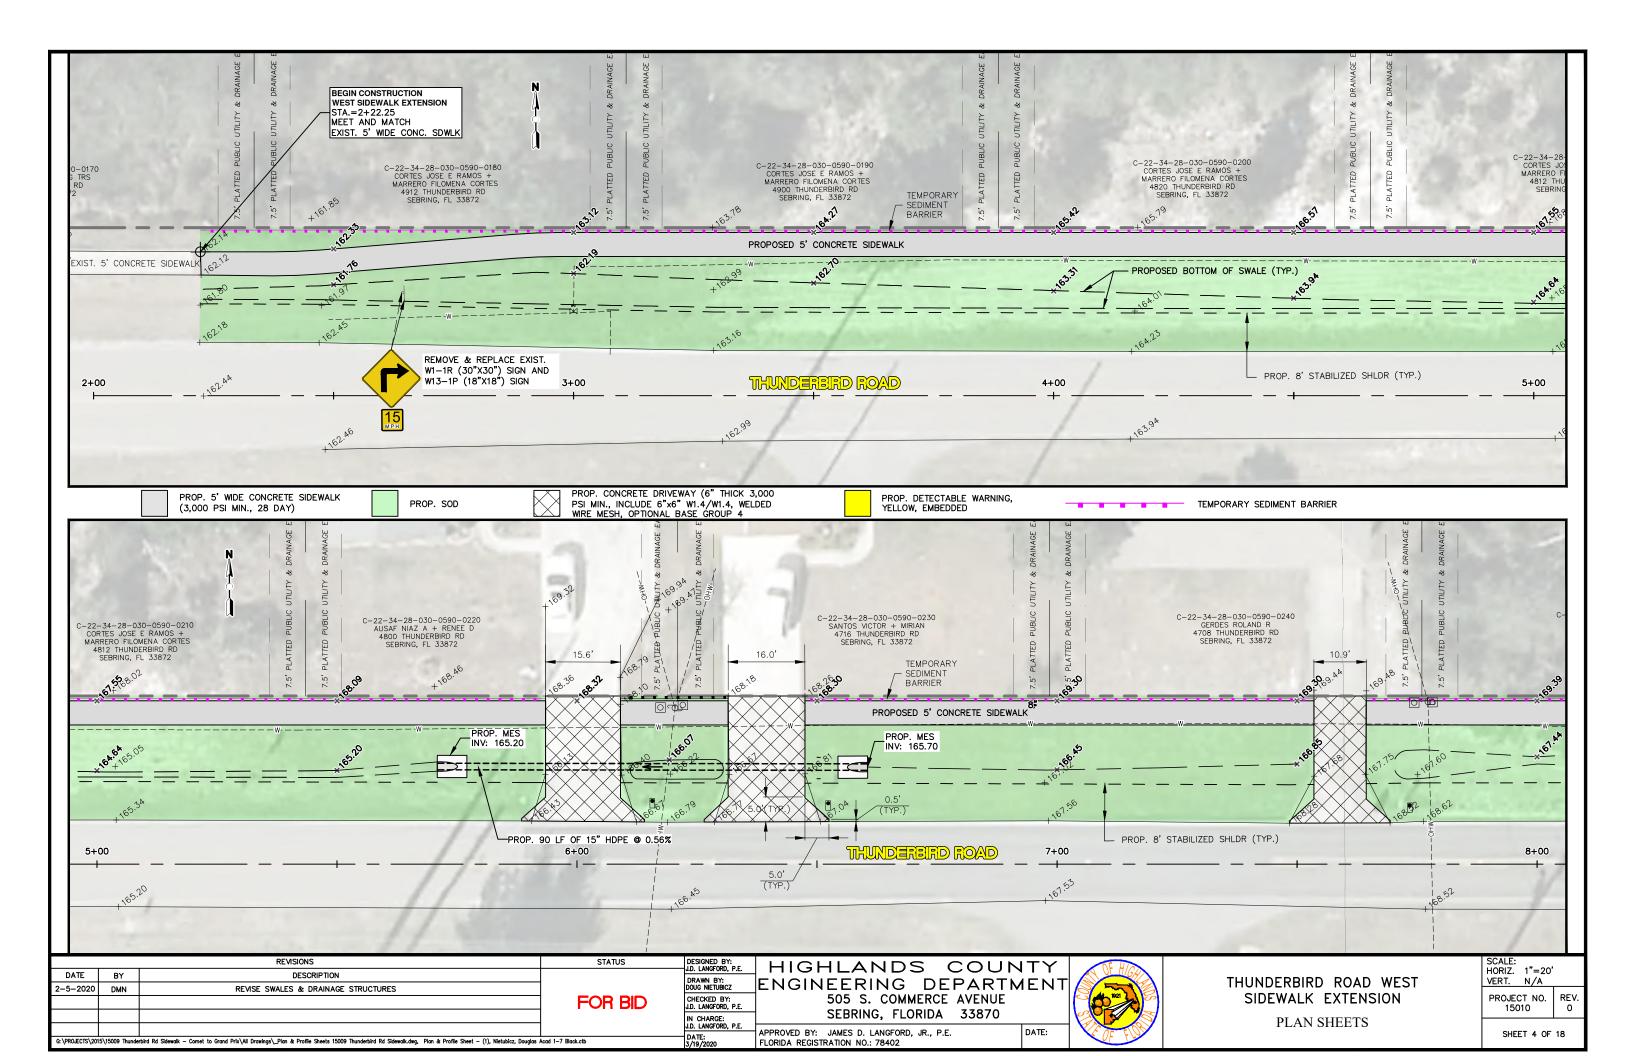

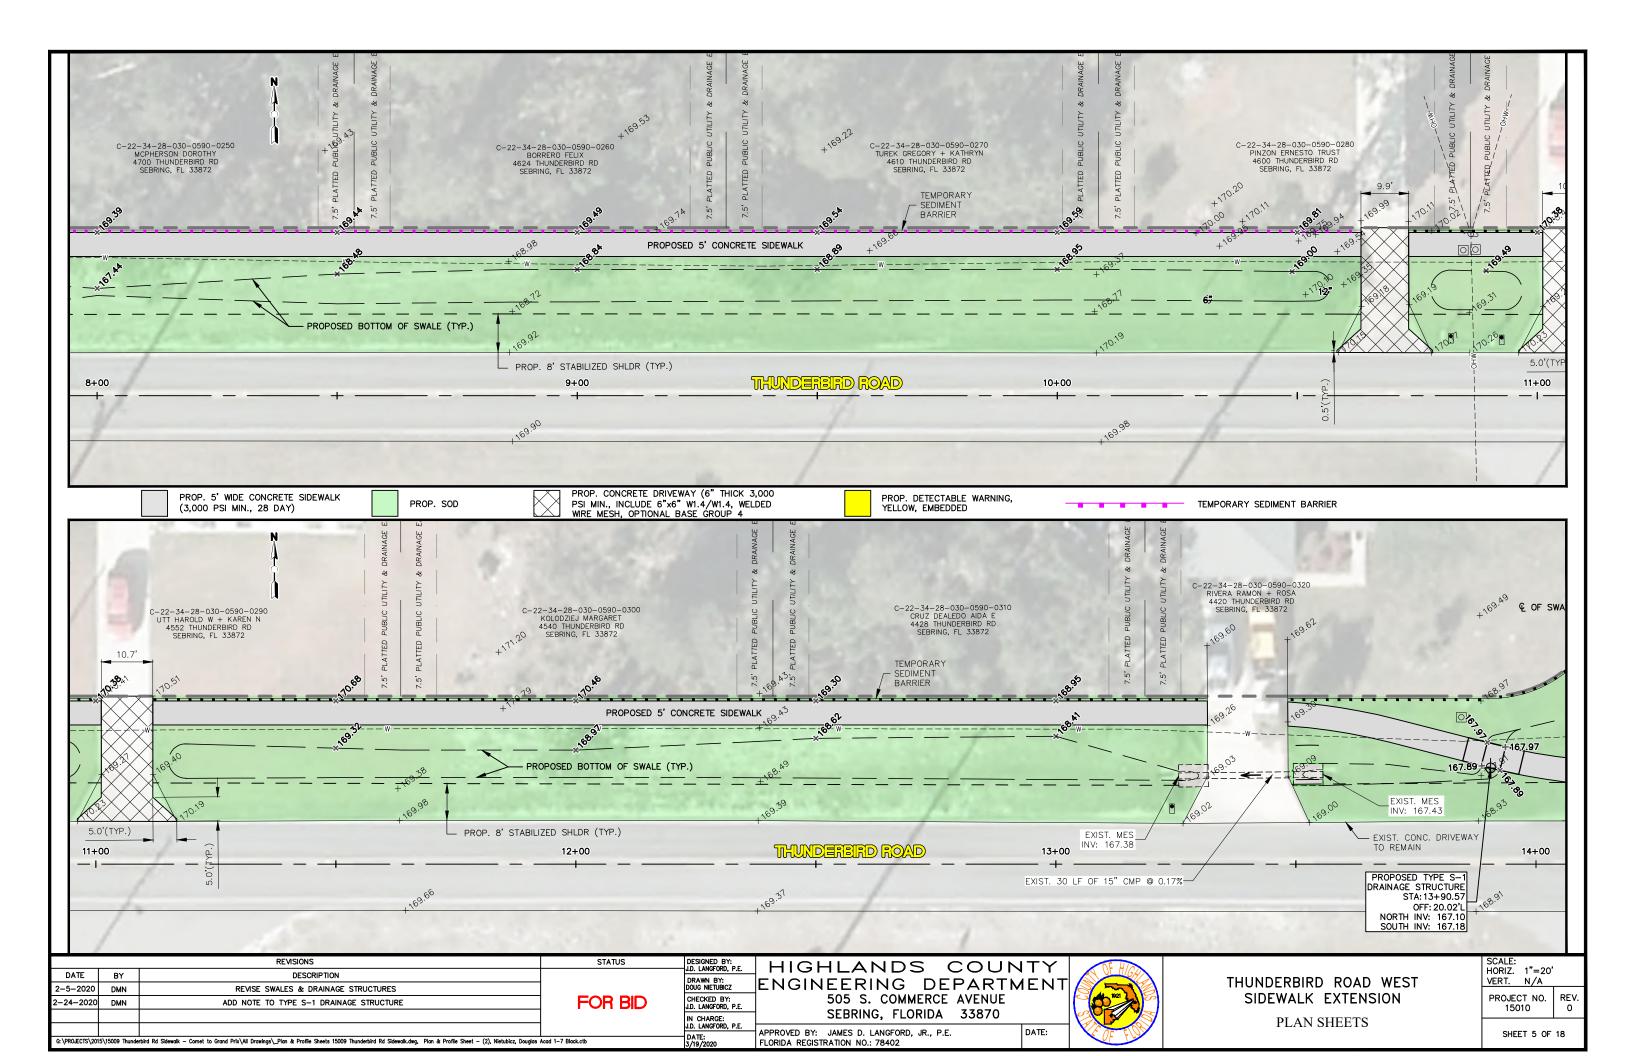

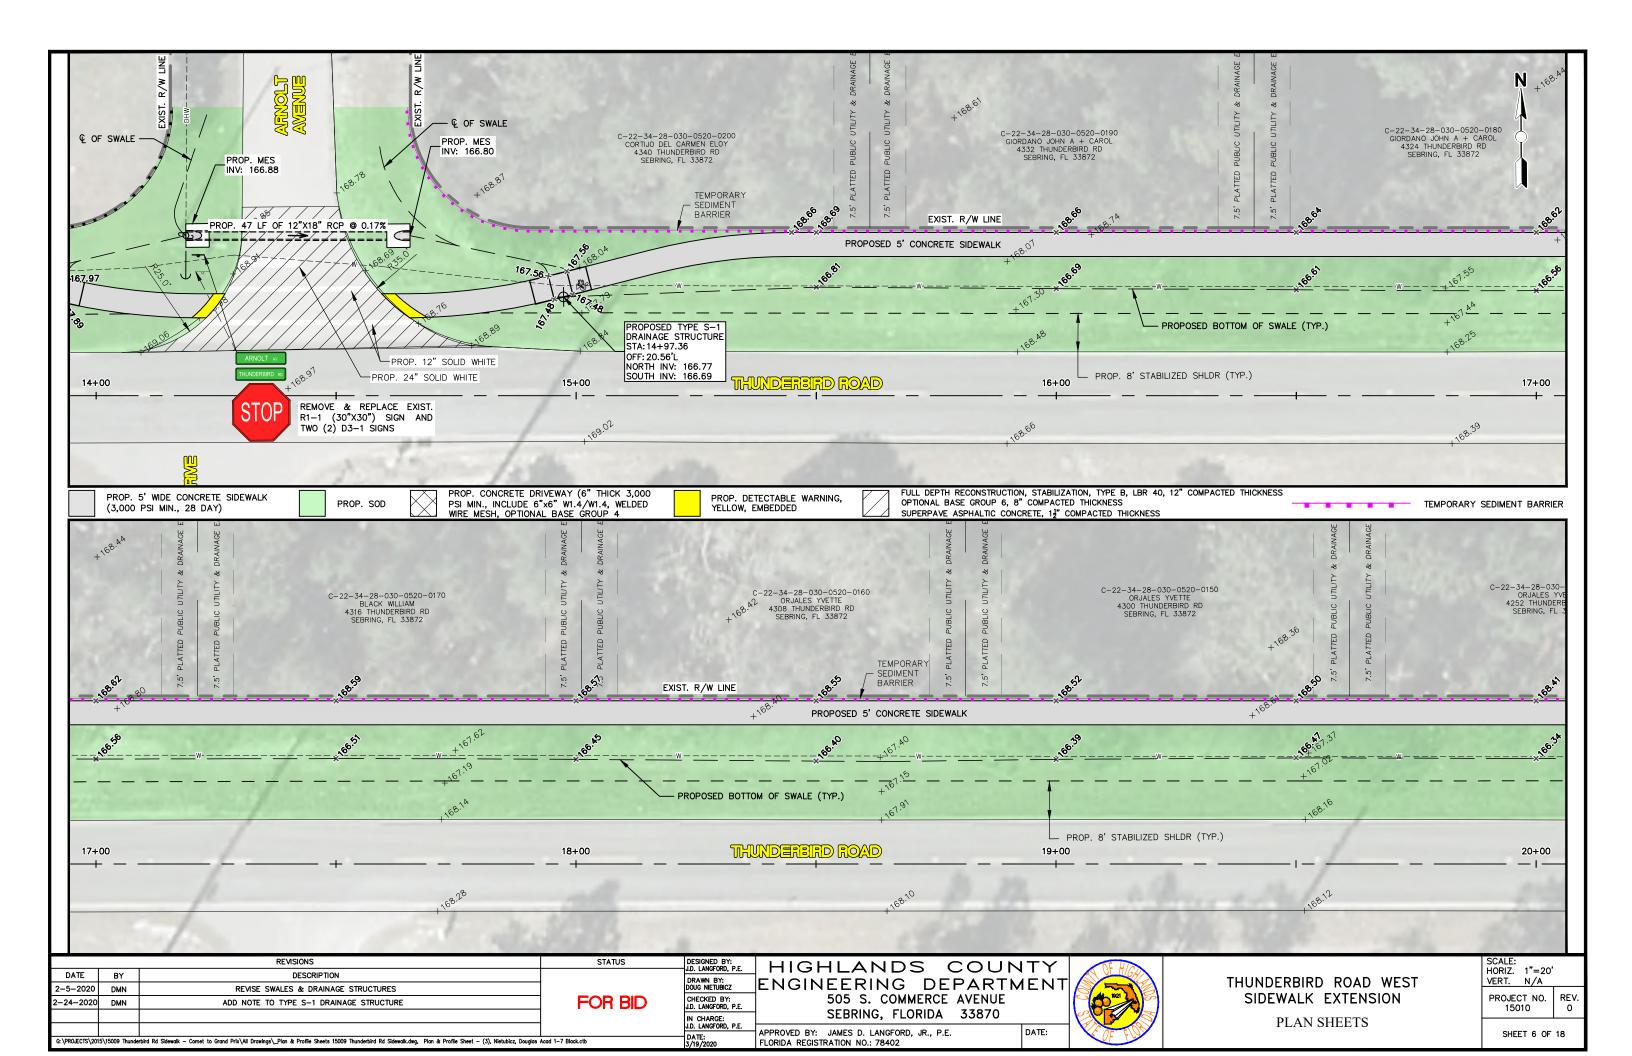

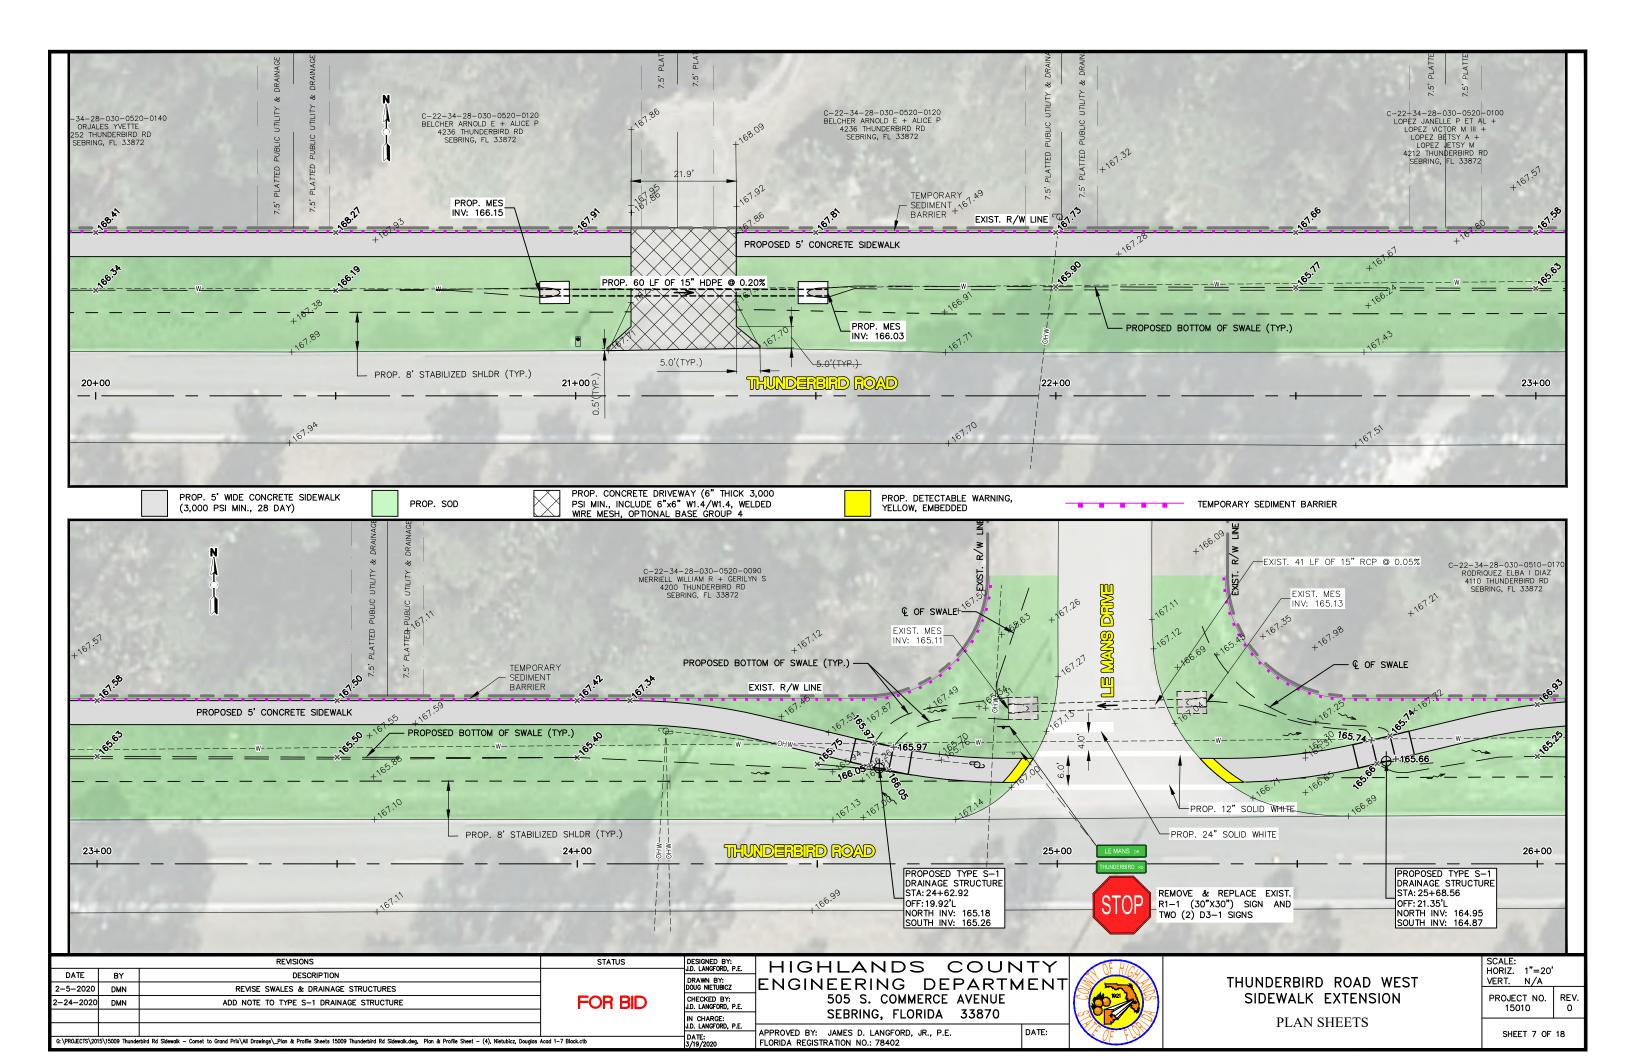

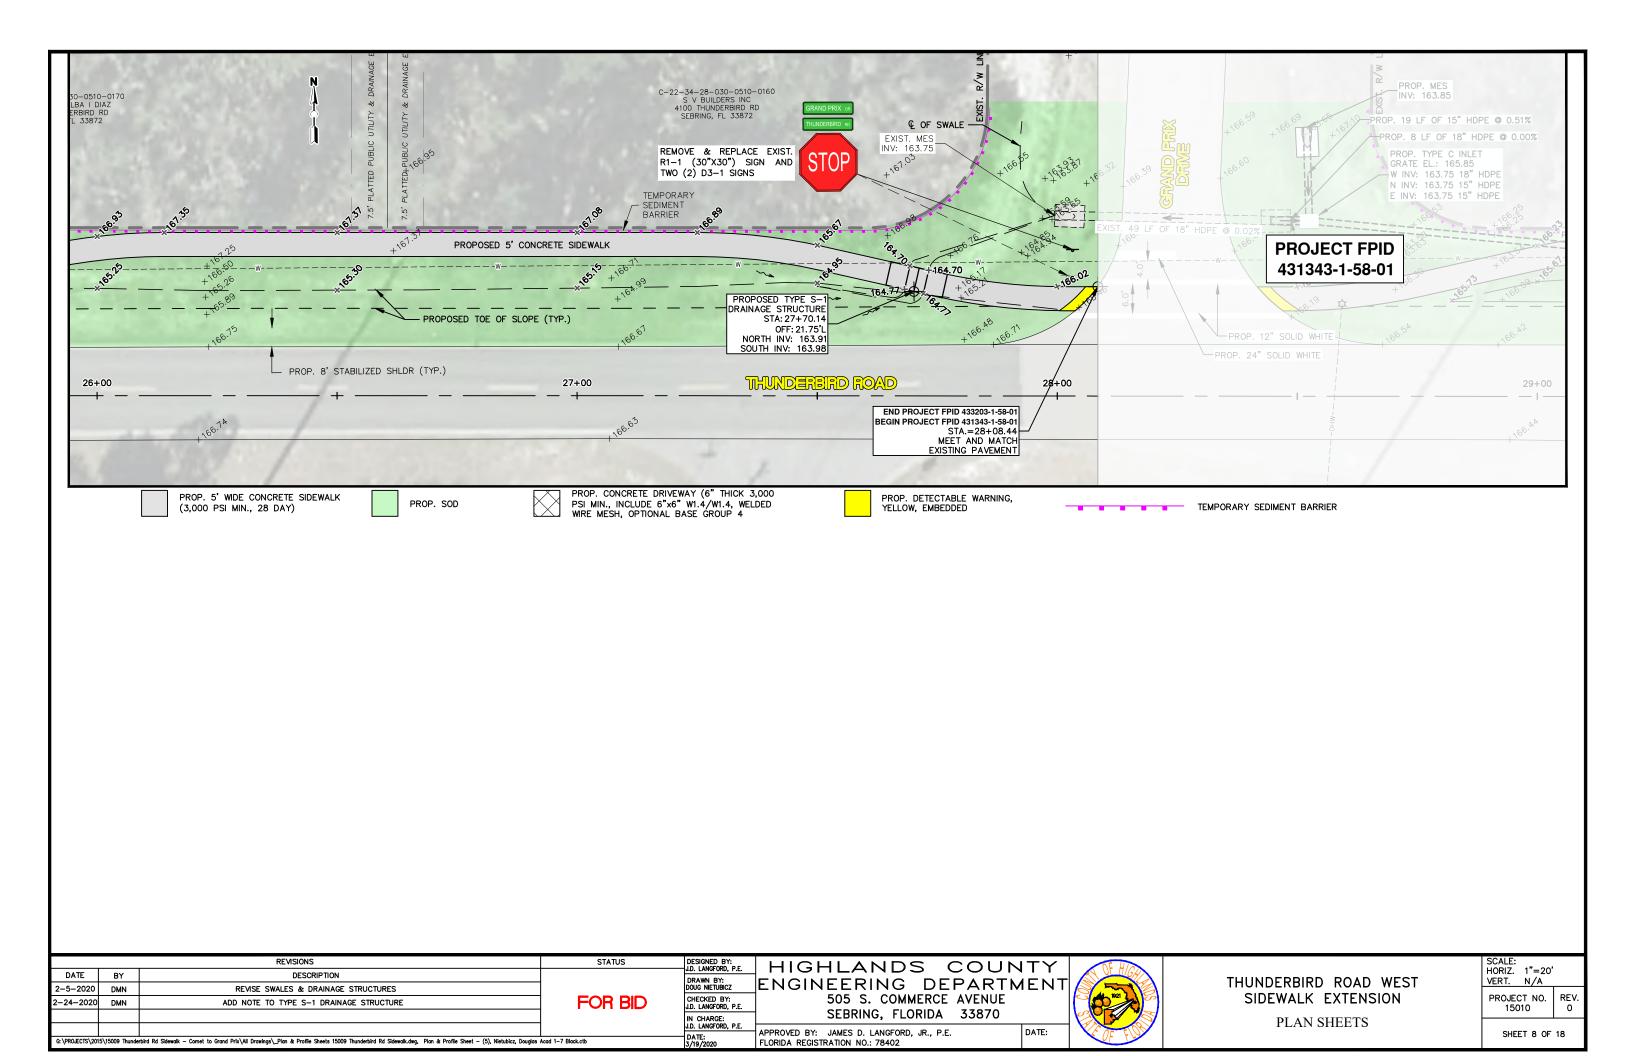

# DRAINAGE STRUCTURE S-1 NOT TO SCALE (6) #4 REBAR (6) #4 REBAR 6' IN LENGTH. THEY SHOULD BE PLACED 5.25" BELOW THE SIDEWALK SURFACE. TOP VIEW NOTE: USE A MINIMUM OF 60,000 PSI REBAR AND 3,000 PSI CONCRETE (6) #4 REBAR 10" MAX-SIDE VIEW 4" THICK BOTTOM

BY DESCRIPTION  I CHECKED BY					
DATE BY DESCRIPTION  DRAWN BY: DOUG NETURE  CHECKED B: LOL LANGFORD  IN CHARGE: LOL LANGFORD  DATE:			REVISIONS	STATUS	
FOR BID  CHECKED B  JD. LANGFORD  IN CHARGE: JD. LANGFORD  DATE:	DATE	2	DESCRIPTION		J.D. LANGFORD
FOR BID CHECKED B JD. LANGFORD IN CHARGE: JD. LANGFORD JD	DAIL	ום	DESCRIPTION		DRAWN BY:
J.D. LANGFORD IN CHARGE: J.D. LANGFORD DATE:					DOUG NIETUBIO
J.D. LANGFORD IN CHARGE: J.D. LANGFORD DATE:					CHECKED BY
IN CHARGE: JD. LANGFORD  DATE:					
J.D. LANGFORD  DATE:					
DATE					
					J.D. LANGFORD
					DATE:

DRAWN BY: YOUG NIETUBICZ CHECKED BY: .D. LANGFORD, P.E. CHARGE: ). LANGFORD, P.E.


HIGHLANDS COUNTY ENGINEERING DEPARTMENT
505 S. COMMERCE AVENUE SEBRING, FLORIDA 33870


APPROVED BY: JAMES D. LANGFORD, JR., P.E. FLORIDA REGISTRATION NO.: 78402





THUNDERBIRD ROAD WEST SIDEWALK EXTENSION **DETAILS** 


SCALE: HORIZ. 1"=5' VERT. N/A	
PROJECT NO. 15010	REV 0
SHEET 9 OF	18

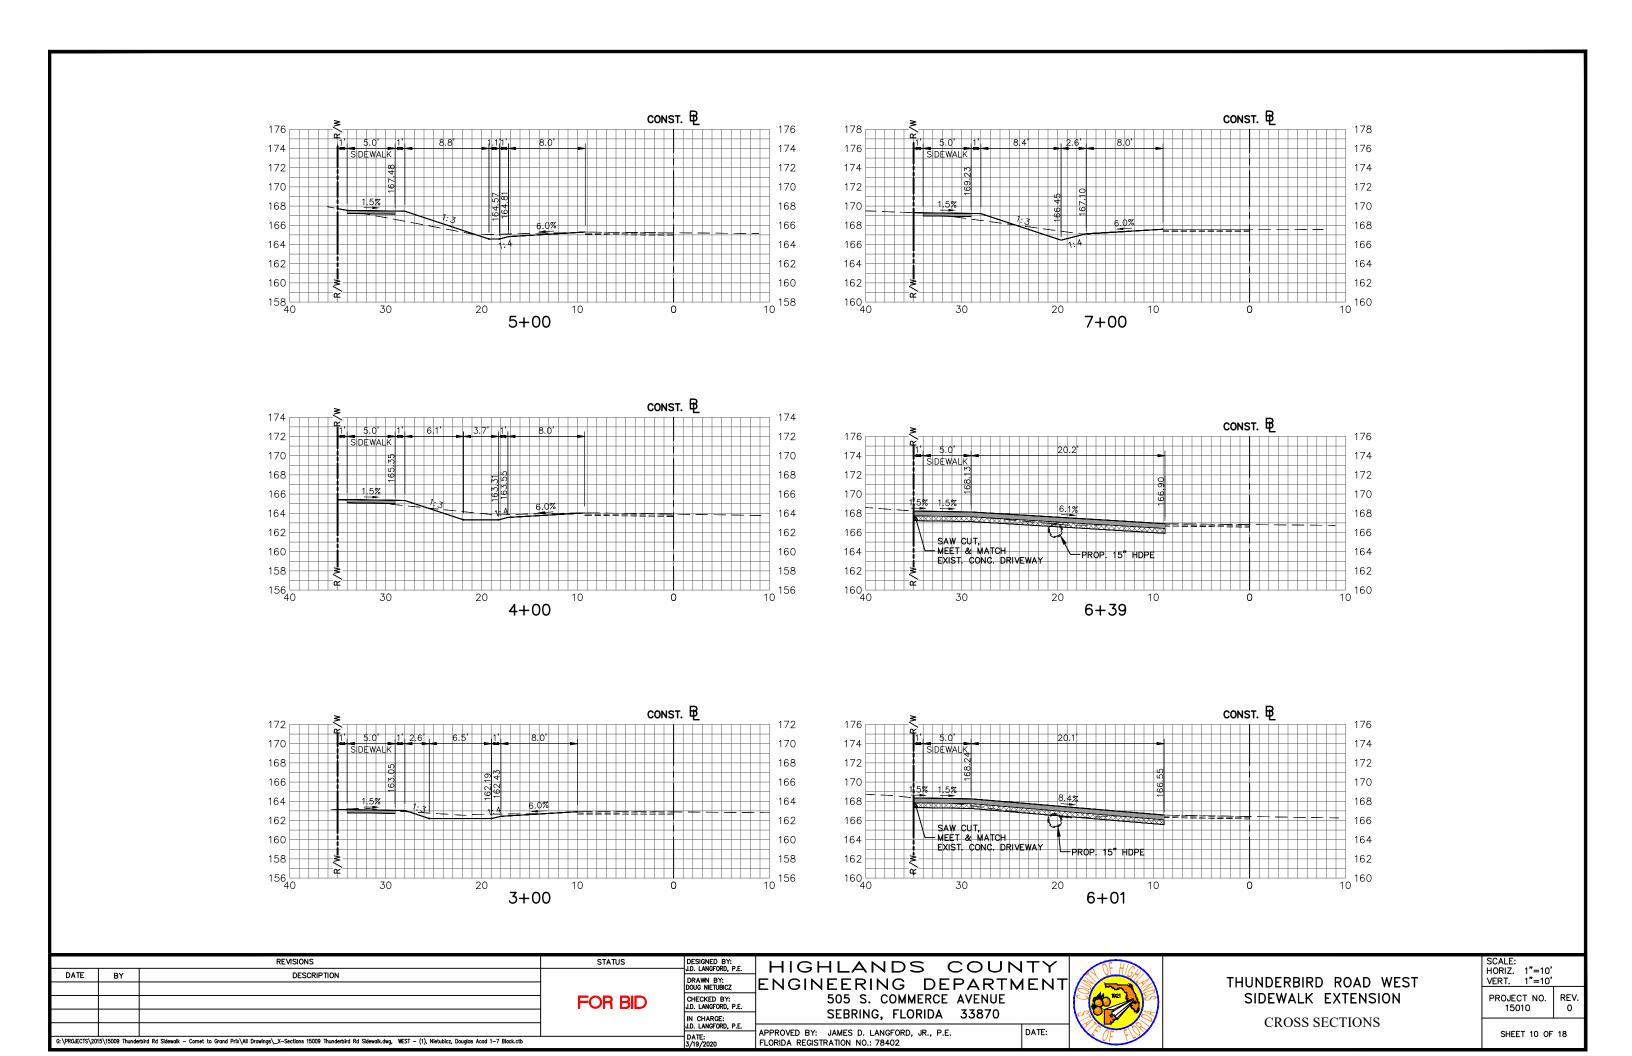


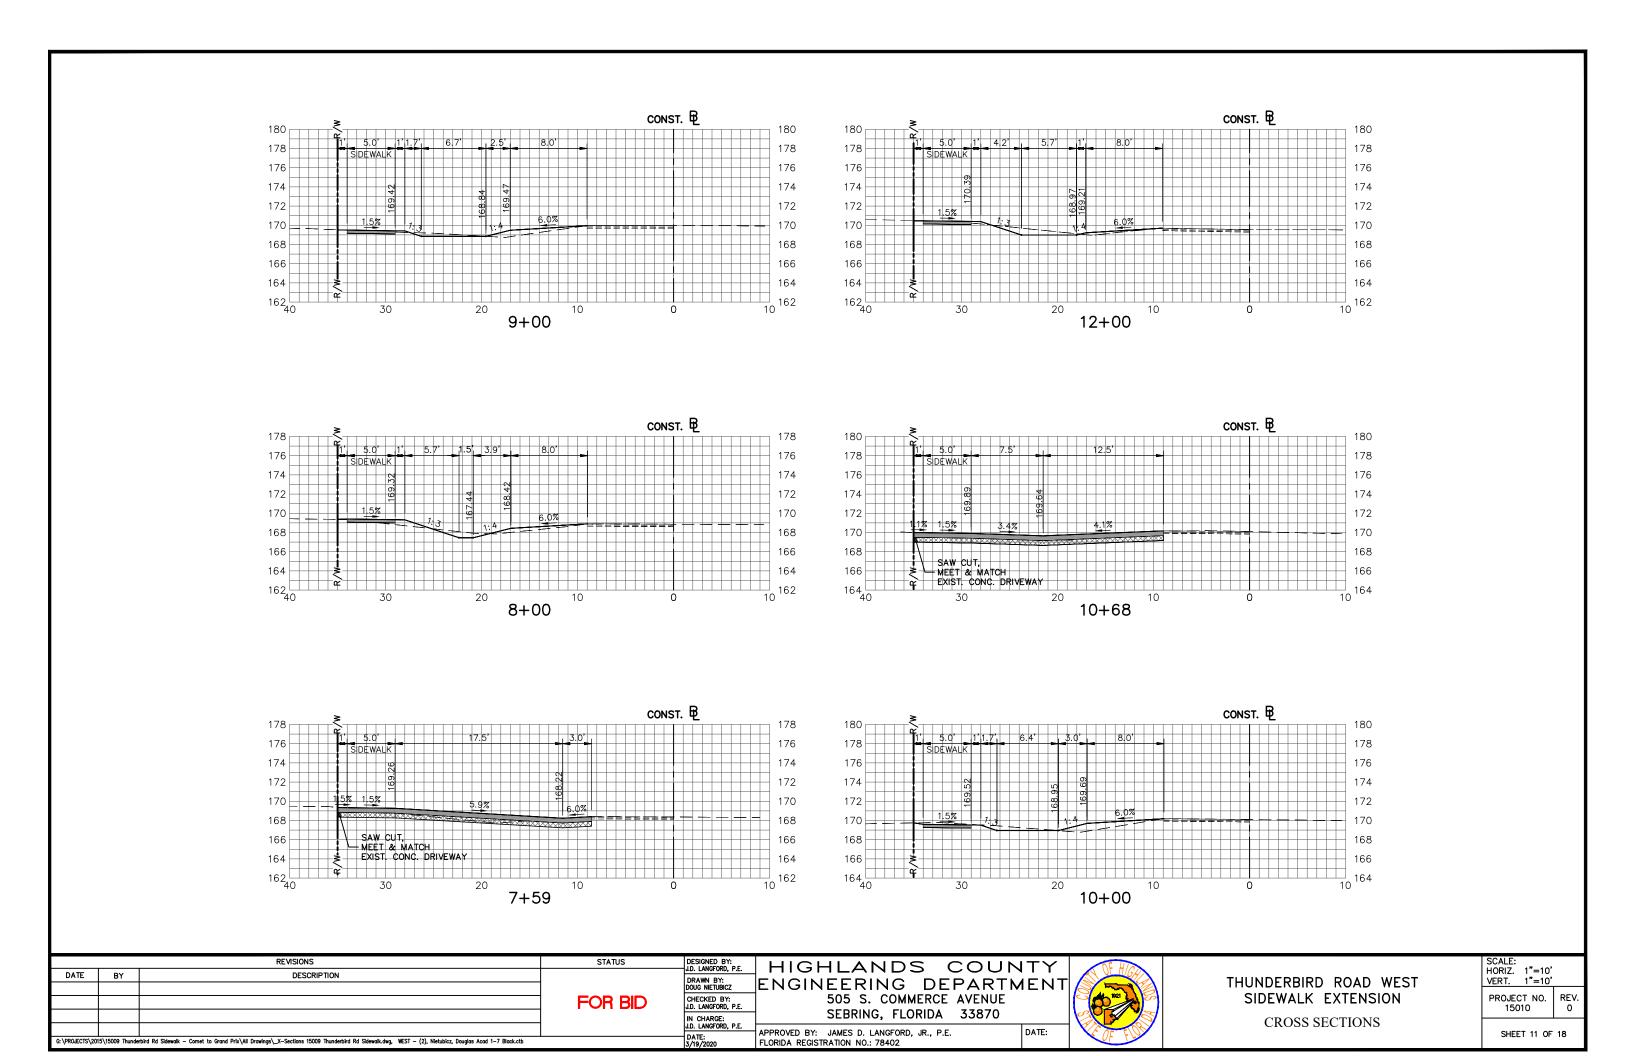


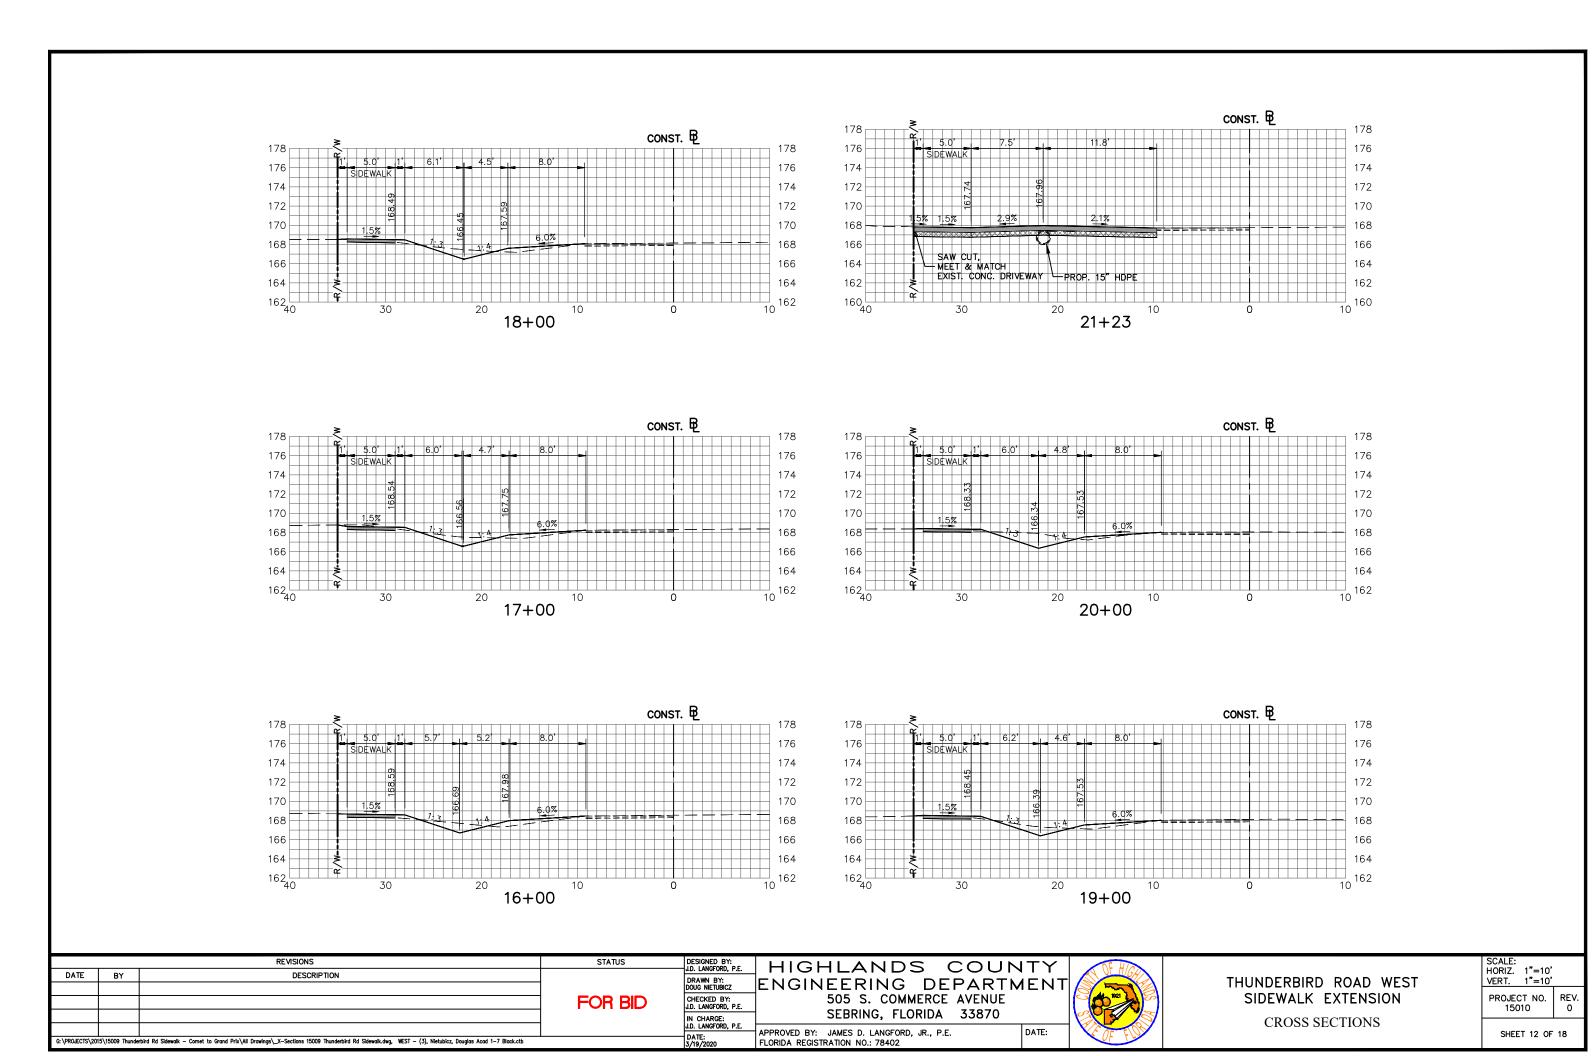


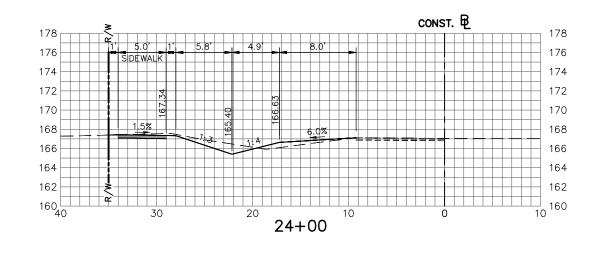

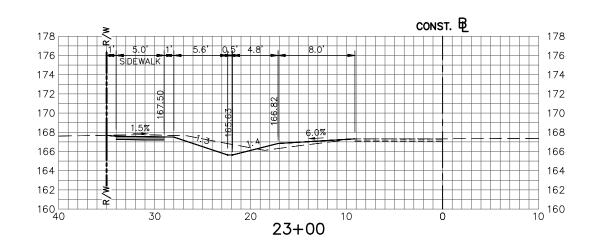

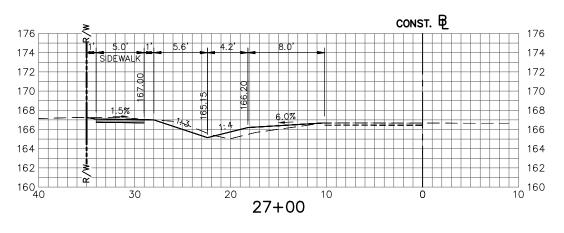

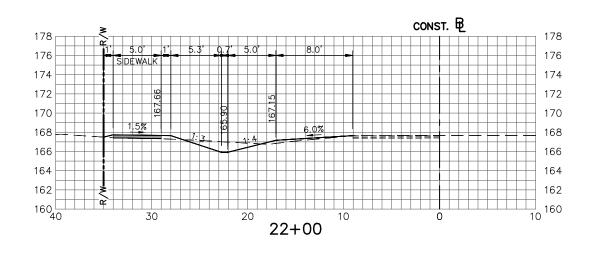

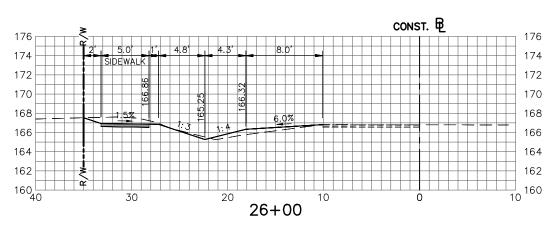

STATUS	REVISIONS		
	DESCRIPTION	BY	DATE
FOR BID			

DESIGNED BY:
JD. LANGFORD, P.E.
DRAWN BY:
DOUG NIETUBICZ
CHECKED BY:
JD. LANGFORD, P.E.
IN CHARGE:
JD. LANGFORD, P.E.

HIGHLANDS COUNTY
ENGINEERING DEPARTMENT
505 S. COMMERCE AVENUE
SERRING FLORIDA 33870

SEBRING, FLORIDA 33870


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FLORIDA REGISTRATION NO.: 78402





THUNDERBIRD ROAD WEST SIDEWALK EXTENSION CROSS SECTIONS

SCALE: HORIZ. 1"=10' VERT. 1"=10'	
PROJECT NO. 15010	RE\ 0

SHEET 13 OF 18

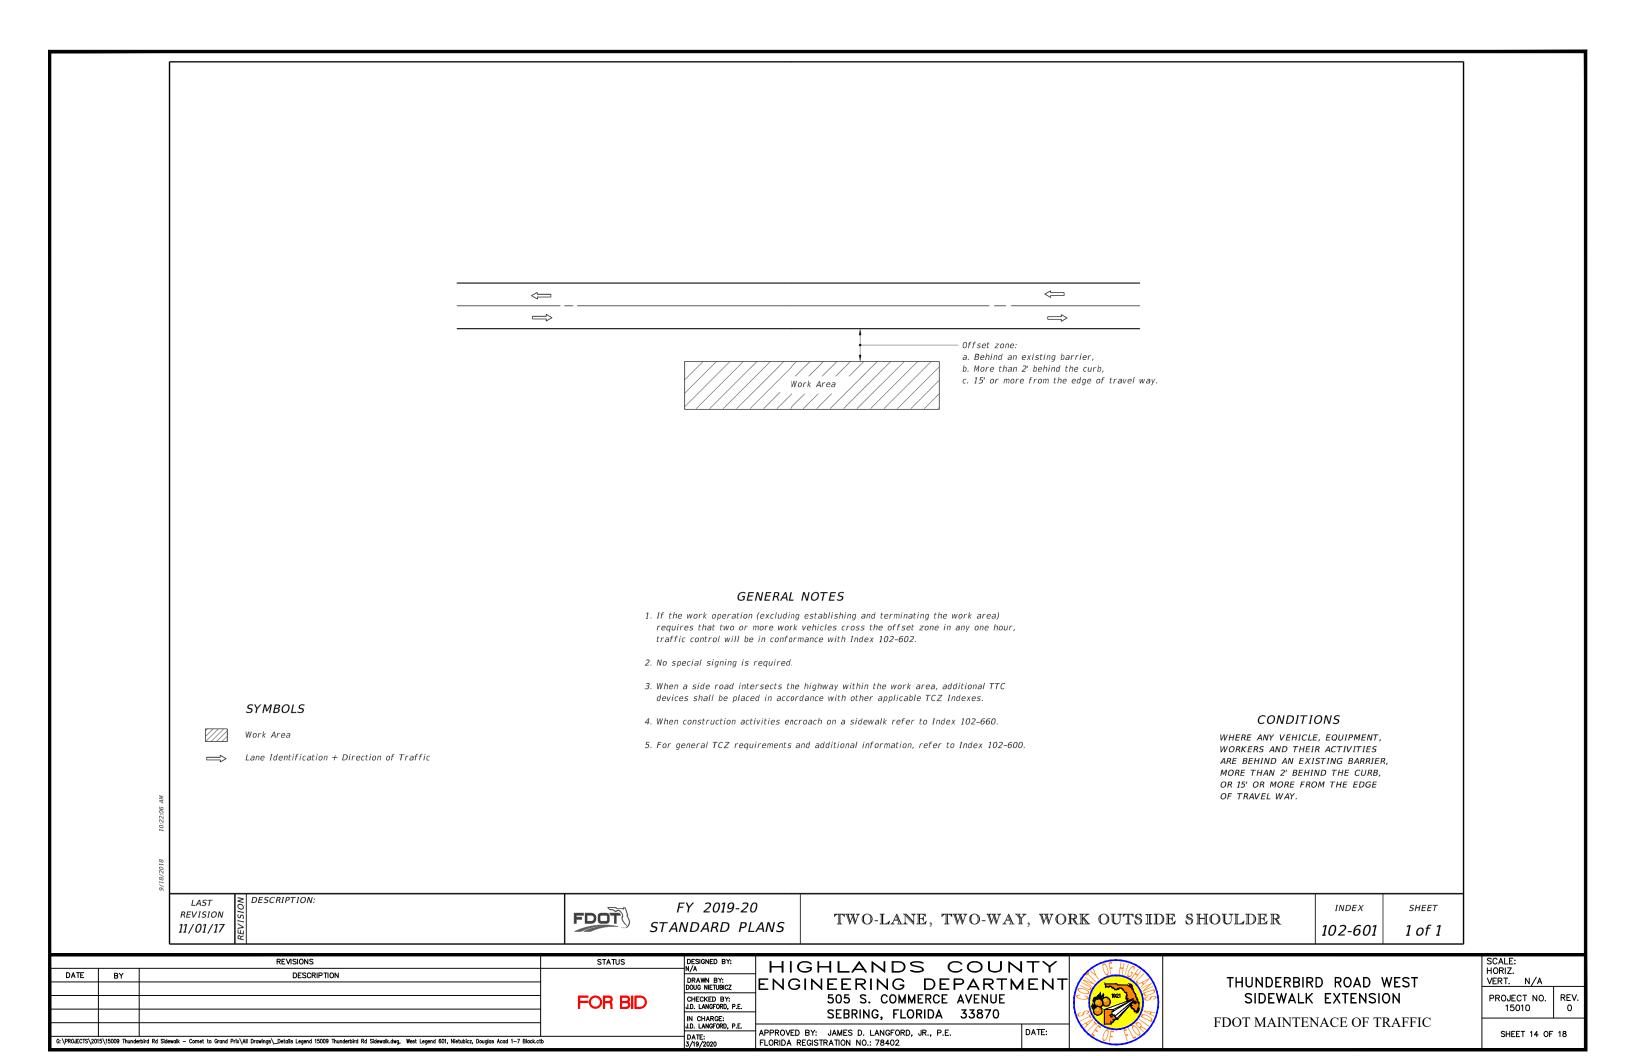

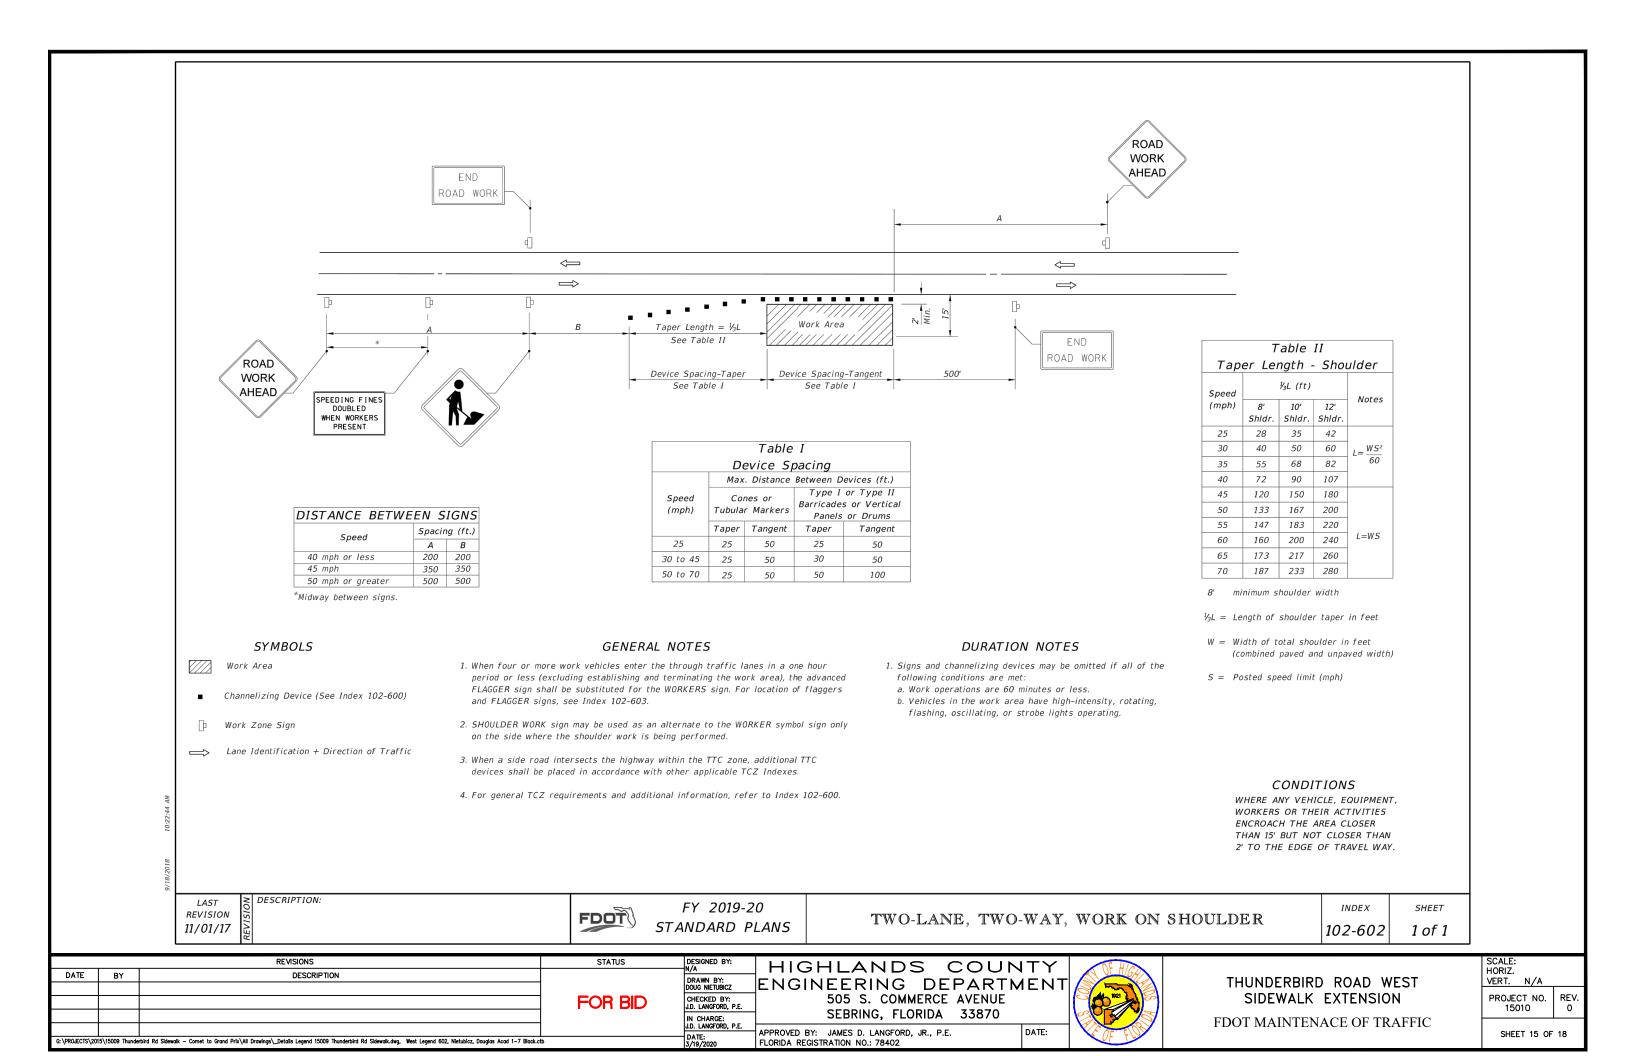

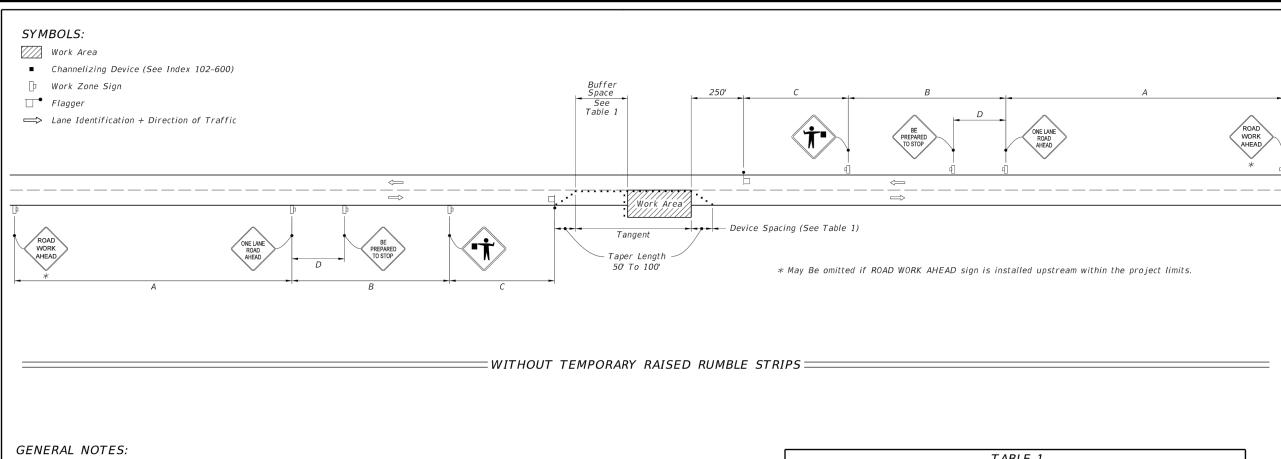

- 1. Special Conditions may be required in accordance with these notes and the following sheets:
- A. Railroad Crossings:
  a. If an active railroad crossing is located closer to the Work Area than the queue length plus 300 feet, extend the Buffer Space as shown on
- b. If the queuing of vehicles across an active railroad crossing cannot be avoided, provide a uniformed traffic control officer or flagger at the highway-rail grade crossing to prevent vehicles from stopping within the highway-rail grade crossing, even if automatic train warning devices are in place.
- B. If the Work Area encroaches on the Centerline, use the Layout for Temporary Lane Shift to Shoulder on Sheet 3 only if the Existing Paved Shoulder width is sufficient to provide for an 11' lane between the Work Area and the Edge of Existing Paved Shoulder. Reduce the posted speed when appropriate.
- 2. Temporary Raised Rumble Strips:
- A. Use when both of the following conditions are met concurrently: a. Existing Posted Speed is 55 mph or greater;
- b. Work duration is greater than 60 minutes.
- B. Use a consistent Strip color throughout the work zone.
- C. Place each Rumble Strip Set transversely across the lane at locations
- D. Use Option 1 or Option 2 as shown on Sheet 2. Use only one option throughout work zone.
- 3. Additional one-way control may be provided by the following means:
- A. Flag-carrying vehicle; B. Official vehicle:
- . Pilot vehicles;

When flaggers are the sole means of one-way control, the flaggers must be in sight of each other or in direct communication at all times.

- 4. When a side road intersects the highway within the TTC zone, place additional TTC devices in accordance with other applicable TCZ Indexes.
- 5. The two channelizing devices directly in front of the work area may be omitted provided vehicles in the work area have high-intensity rotating, flashing, oscillating, or strobe lights operating
- When Buffer Space cannot be attained due to geometric constraints, use the greatest attainable length, not less than 200 ft, for posted speeds greater than 25 mph.
- 7. ROAD WORK AHEAD and the BE PREPARED TO STOP signs may be omitted if all of the following conditions are met
- A. Work operations are 60 minutes or less. B. Speed limit is 45 mph or less.
- C. There are no sight obstructions to vehicles approaching the work area for a distance equal to the Buffer Space shown in Table 1.

  D. Vehicles in the work area have high-intensity, rotating, flashing, oscillating,
- or strobe lights operating.
- E. Volume and complexity of the roadway has been considered.
- F. If a railroad crossing is present, vehicles will not queue across rail tracks.
- 8. See Index 102-600 for general TCZ requirements and additional information.
- 9. Automated Flagger Assistance Devices (AFADs) may be used in accordance with Specifications Section 102, 990 and the APL vendor drawings.

TABLE 1									
	DEVICE SPACING								
Posted Speed	Maximum Spacing of Cones or Tubular Markers		Maximum Spacing of Type I or Type II Barricades/Panels/Drums		Distance Between Signs				Buffer Space
	On a Taper	On a Tangent	On a Taper	On a Tangent	A	В	С	D	
25	20'	50 <sup>'</sup>	20'	50'	200'	200'	200'	100'	155'
30	20'	50 <sup>'</sup>	20'	50'	200'	200'	200'	100'	200'
35	20'	50'	20'	50'	200'	200'	200'	100'	250'
40	20'	<i>50</i> '	20'	50'	200'	200'	200'	100'	305'
45	20'	50 <sup>,</sup>	20'	50'	350'	350'	350'	175'	360'
50	20'	<i>50</i> '	20'	100'	500'	500'	500'	250'	425'
55	20'	50 <sup>'</sup>	20'	100'	2640'	1500'	1000'	500'	495'
60	20'	50'	20'	100'	2640'	1500'	1000'	500'	570'
65	20'	<i>50</i> ′	20'	100'	2640'	1500'	1000'	500'	645'
70	20'	50'	20'	100'	2640'	1500'	1000'	500'	730'

# **CONDITIONS**

WHERE ANY VEHICLE, EQUIPMENT, WORKERS OR THEIR ACTIVITIES ENCROACH THE AREA BETWEEN THE CENTERLINE AND A LINE 2' OUTSIDE THE EDGE OF TRAVEL WAY.

LAST REVISION 11/01/17

≥ DESCRIPTION:

FDOT

FY 2019-20 STANDARD PLANS

TWO-LANE, TWO-WAY, WORK WITHIN THE TRAVEL WAY INDEX

SHEET 1 of 3

102-603 STATUS DESIGNED BY HIGHLANDS COUNTY

REVISIONS				
DATE	BY	DESCRIPTION		

G:\PROLECTS\2015\15009 Thunderbird Rd Sidewalk - Cornet to Grand Prix\All Drawings\\_Details Legend 15009 Thunderbird Rd Sidewalk.dwg, West Legend 603, Nietubicz, Douglas Acad 1-7 Black.ctb

FOR BID


DRAWN BY: DOUG NIETUBICZ ENGINEERING DEPARTMENT 505 S. COMMERCE AVENUE CHECKED BY: J.D. LANGFORD, P.E. SEBRING, FLORIDA 33870 IN CHARGE: J.D. LANGFORD, P.E.


APPROVED BY: JAMES D. LANGFORD, JR., P.E. DATE: THUNDERBIRD ROAD WEST SIDEWALK EXTENSION

HORIZ. VERT. N/A REV. PROJECT NO. 15010

SHEET 16 OF 18

FDOT MAINTENACE OF TRAFFIC

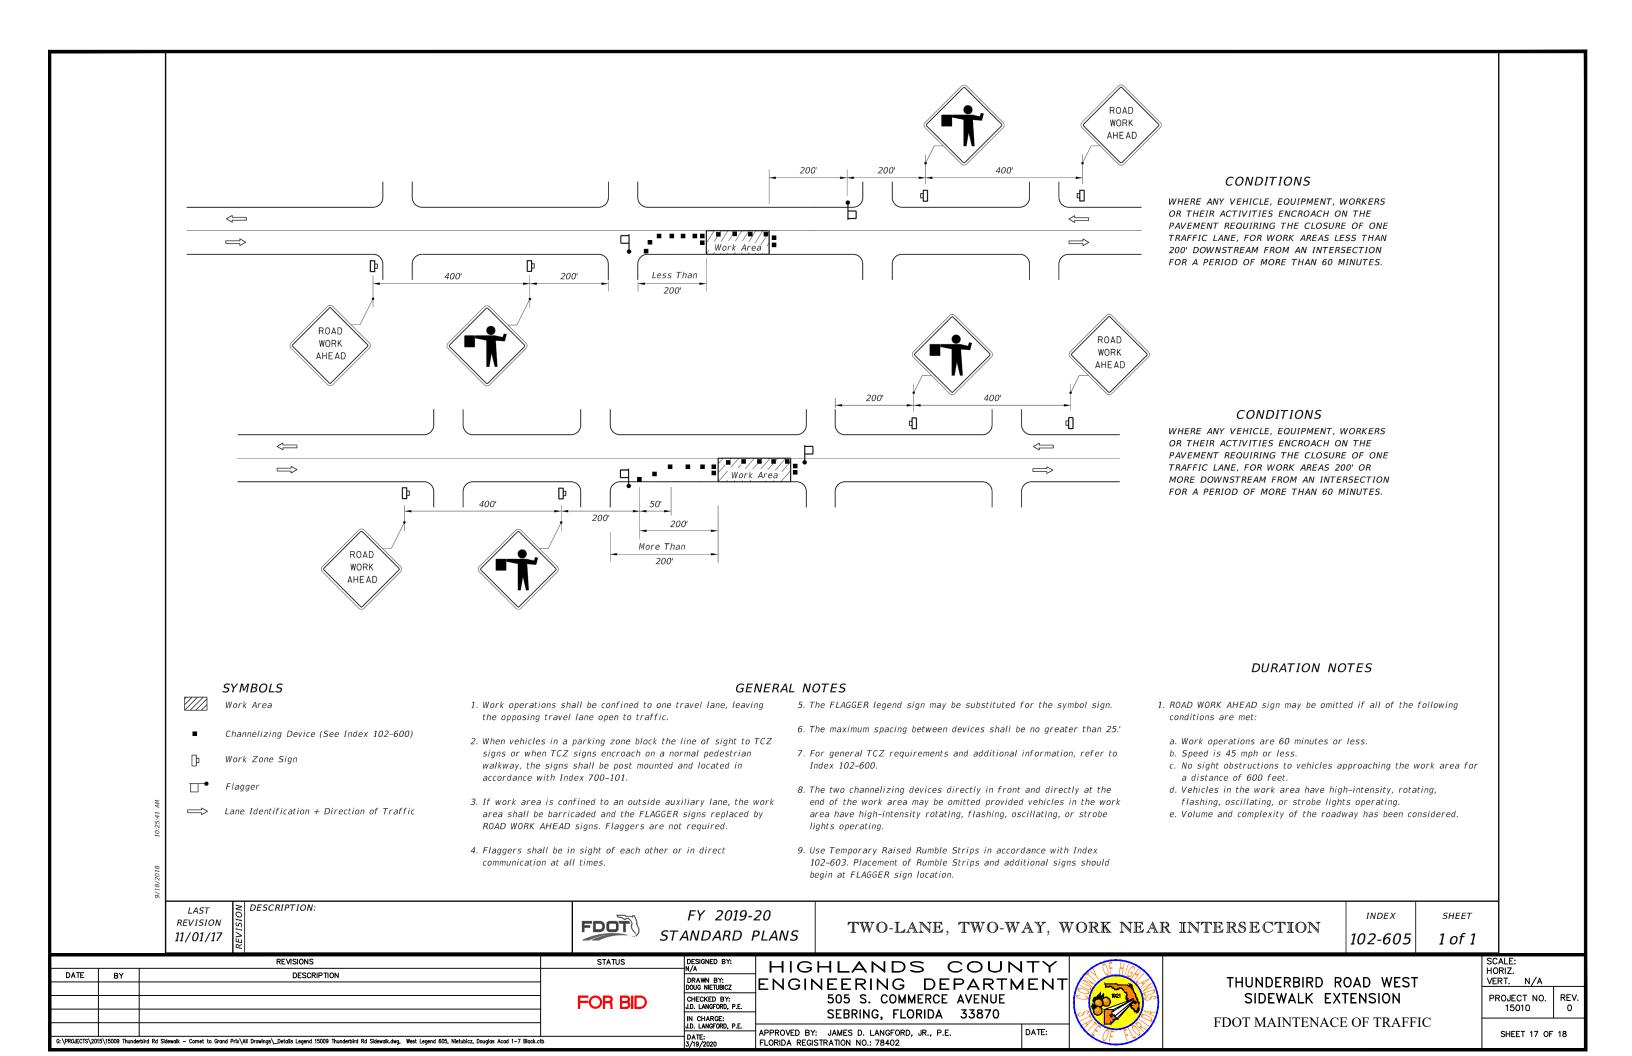

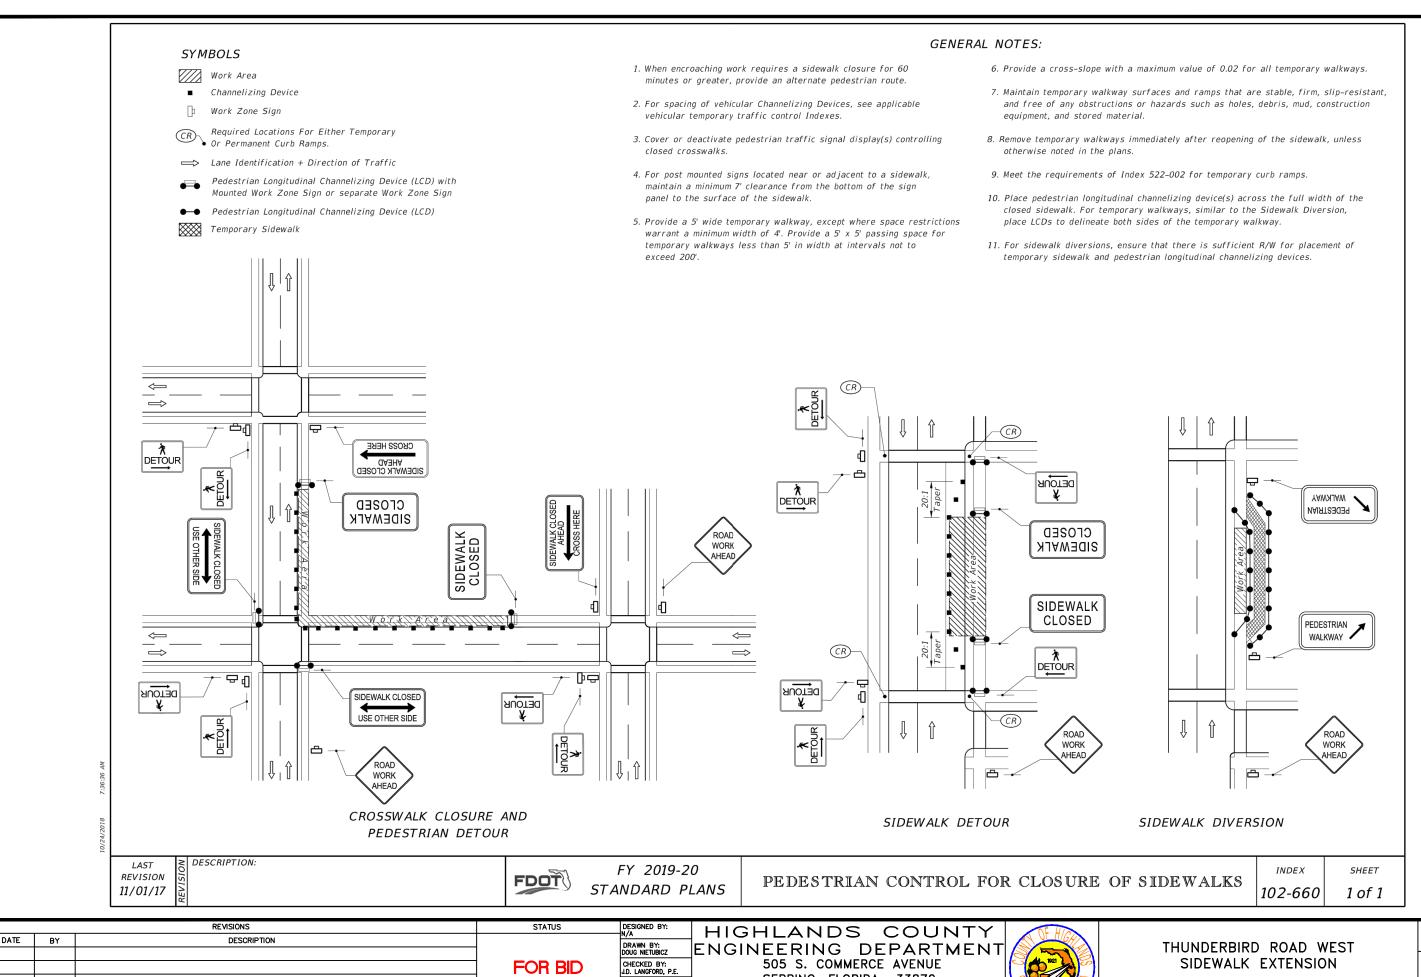

IN CHARGE: J.D. LANGFORD, P.E.

DATE: 3/19/2020

FDOT MAINTENACE OF TRAFFIC

SCALE: HORIZ. VERT. N/A PROJECT NO. 15010 REV. 0

SHEET 18 OF 18

SEBRING, FLORIDA 33870 APPROVED BY: JAMES D. LANGFORD, JR., P.E. DATE: