

## **DESIGN PROFESSIONAL IN GENERAL** RESPONSIBLE CHARGE STATEMENT

THE PATH OF TRAVEL (POT) IDENTIFIED IN THESE CONSTRUCTION DOCUMENTS MEETS THE REQUIREMENTS OF THE CURRENT APPLICABLE CALIFORNIA BUILDING CODE (CBC) ACCESSIBILITY PROVISIONS FOR PATH OF TRAVEL REQUIREMENTS FOR ALTERATIONS, ADDITIONS, AND STRUCTURAL REPAIRS. AS PART OF THE DESIGN OF THIS PROJECT, THE POT WAS EXAMINED AND ANY ELEMENTS, COMPONENTS OR PORTIONS OF THE POT THAT WERE DETERMINED TO BE NONCOMPLIANT WITH THE CBC HAVE BEEN IDENTIFIED AND THE CORRECTIVE WORK NECESSARY TO BRIND THEM INTO COMPLIANCE HAS BEEN INCLUDED WITHIN THE SCOPE OF THIS PROJECT'S WORK THROUGH DETAILS, DRAWINGS AND SPECIFICATIONS INCORPORATED INTO THESE CONSTRUCTION DOCUMENTS. ANY NONCOMPLIANT ELEMENTS, COMPONENTS OR PORTIONS OF THE POT THAT WILL NOT BE CORRECTED BY THIS PROJECT BASED ON VALUATION THRESHOLD LIMITATIONS OR A FINDING OF UNREASONABLE HARDSHIP ARE INDICATED IN THESE CONSTRUCTION DOCUMENTS.

DURING CONSTRUCTION, IF POT ITEMS WITHIN THE SCOPE OF THE PROJECT REPRESENTED AS CBC COMPLIANT ARE FOUND TO BE NONCONFORMING BEYOND REASONABLE CONSTRUCTION TOLERANCES, THE ITEMS SHALL BE BROUGHT INTO COMPLIANCE WITH THE CBC AS PART OF THIS PROJECT BY MEANS OF A CONSTRUCTION CHANGE DOCUMENT.

HARTMANNARCHITECTURESTUDIO.COM 430 S. CARRILLO RD. OJAI, CALIFORNIA 93023 (805) 530-5559

CONSULTANTS:

AGENCY APPROVAL:

### SYMBOL LEGEND

ACCESSIBLE PATH OF TRAVEL

PATH OF TRAVEL (P.O.T.) AS INDICATED, IS A COMMON BARRIER FREE ACCESS ROUTE WITHOUT ANY ABRUPT VERTICAL CHANGES EXCEEDING <sup>1</sup>/<sub>2</sub> INCH BEVELED AT 1:2 MAXIMUM SLOPE, EXCEPT THAT LEVEL CHANGES DO NOT EXCEED 1/4 INCH VERTICAL AND IS AT LEAST 48" WIDE. THE PATH SURFACE IS SLIP RESISTANT, STABLE, FIRM, AND SMOOTH. PASSING SPACES (11B-403.5.3) AT LEAST 60 INCHES BY 60 INCHES ARE LOCATED NOT MORE THAN 200 FEET APART. PARTS OF P.O.T. WITH CONTINUOUS GRADIENTS HAVE 60 INCH LEVEL AREAS (11B-403.7) NOT MORE THAN 400 FEET APART. THE CROSS-SLOPE DOES NOT EXCEED 2 PERCENT AND SLOPE IN THE DIRECTION OF TRAVEL IS LESS THAN 5 PERCENT UNLESS OTHERWISE INDICATED. P.O.T. SHALL BE MAINTAINED FREE OF OVERHANGING OBSTRUCTIONS TO 80 INCHES MINIMUM (11B-307.4) AND PROTRUDING OBJECTS GREATER THAN 4 INCHES PROJECTION FROM WALL AND ABOVE 27 INCHES AND LESS THAN 80 INCHES (11B-307.2). ARCHITECT SHALL VERIFY PATH OF TRAVEL CONFORMS WITH THE ABOVE. IF GATES OCCUR ALONG THE PATH OF TRAVEL, THEY MUST COMPLY WITH THE ACCESSIBLE REQUIREMENTS PER CBC 2019.





# MATILIJA MIDDLE SCHOOL LIBRARY RENOVATION

OJAI UNIFIED SCHOOL DISTRICT 414 E. OJAI AVE. OJAI, CA 93023 (805) 640-4300 ATTN: ADAM DUTTER, BOND MANAGER adutter@ojaiusd.org

PROJECT ADDRESS:

MATILIJA MIDDLE SCHOOL 703 EL PASEO RD. OJAI, CA 93023

ISSUE:		
MARK	DATE	DESCRIPTION

PROJECT INFORMATION: PROJECT NUMBER: PROJECT PHASE: DRAWN BY: REVIEWED BY:

SITE PLAN

2020.032


CD


DATE: 01/22/2021

SITE PLAN


CAMPUS BUILDING INFO								
BUILDING NAME	DSA APP. NOS. / A#'s	USE	OCCUPANCY	CONSTRUCTION TYPE	FIRE SPRINKLERS			
BUILDING A	9320 / 5155 / 03-107896	CLASSROOMS	E	III-B	NO			
BUILDING B	03-119638	DINING HALL / KITCHEN	А	V-B	YES			
BUILDING C	1926 / 9388 / 51555 / 03-107301	CLASSROOMS / ADMINISTRATION	H III-B		NO			
BUILDING D	9230 / 51555	CLASSROOM	E	V-B	NO			
BUILDING E	9231 / 03-118467	LOCKER ROOM	E	V-B	NO			
BUILDING F	1926 / 51555 / 104381 / 03-107301	AUDITORIUM / CLASSROOMS	Е	III-B PART				
BUILDING G	37821 / 03-107896	CLASSROOMS	E	V-B	NO			
BUILDING H	26247	CLASSROOMS	E	V-B	NO			
BUILDING I	28247	CLASSROOMS	E	V-B	NO			
BUILDING J	28346	CLASSROOMS	E	V-B	NO			
BUILDING K	3294 / 5346 / 51555 / 12116 / 03-118467	GYMNASIUM	Е	V-B	NO			
D 43 // 104 /			<u>_</u>					


PAVILION 03-118002 ASSEMBLY NOTE: A#03-119638 - NEW DINING HALL AND KITCHEN) IS CURRENTLY UNDER CONSTRUCTION. MOST RECENT PROJECT AT THIS CAMPUS (A#03-118467) WAS CLOSED ON 7/29/20.

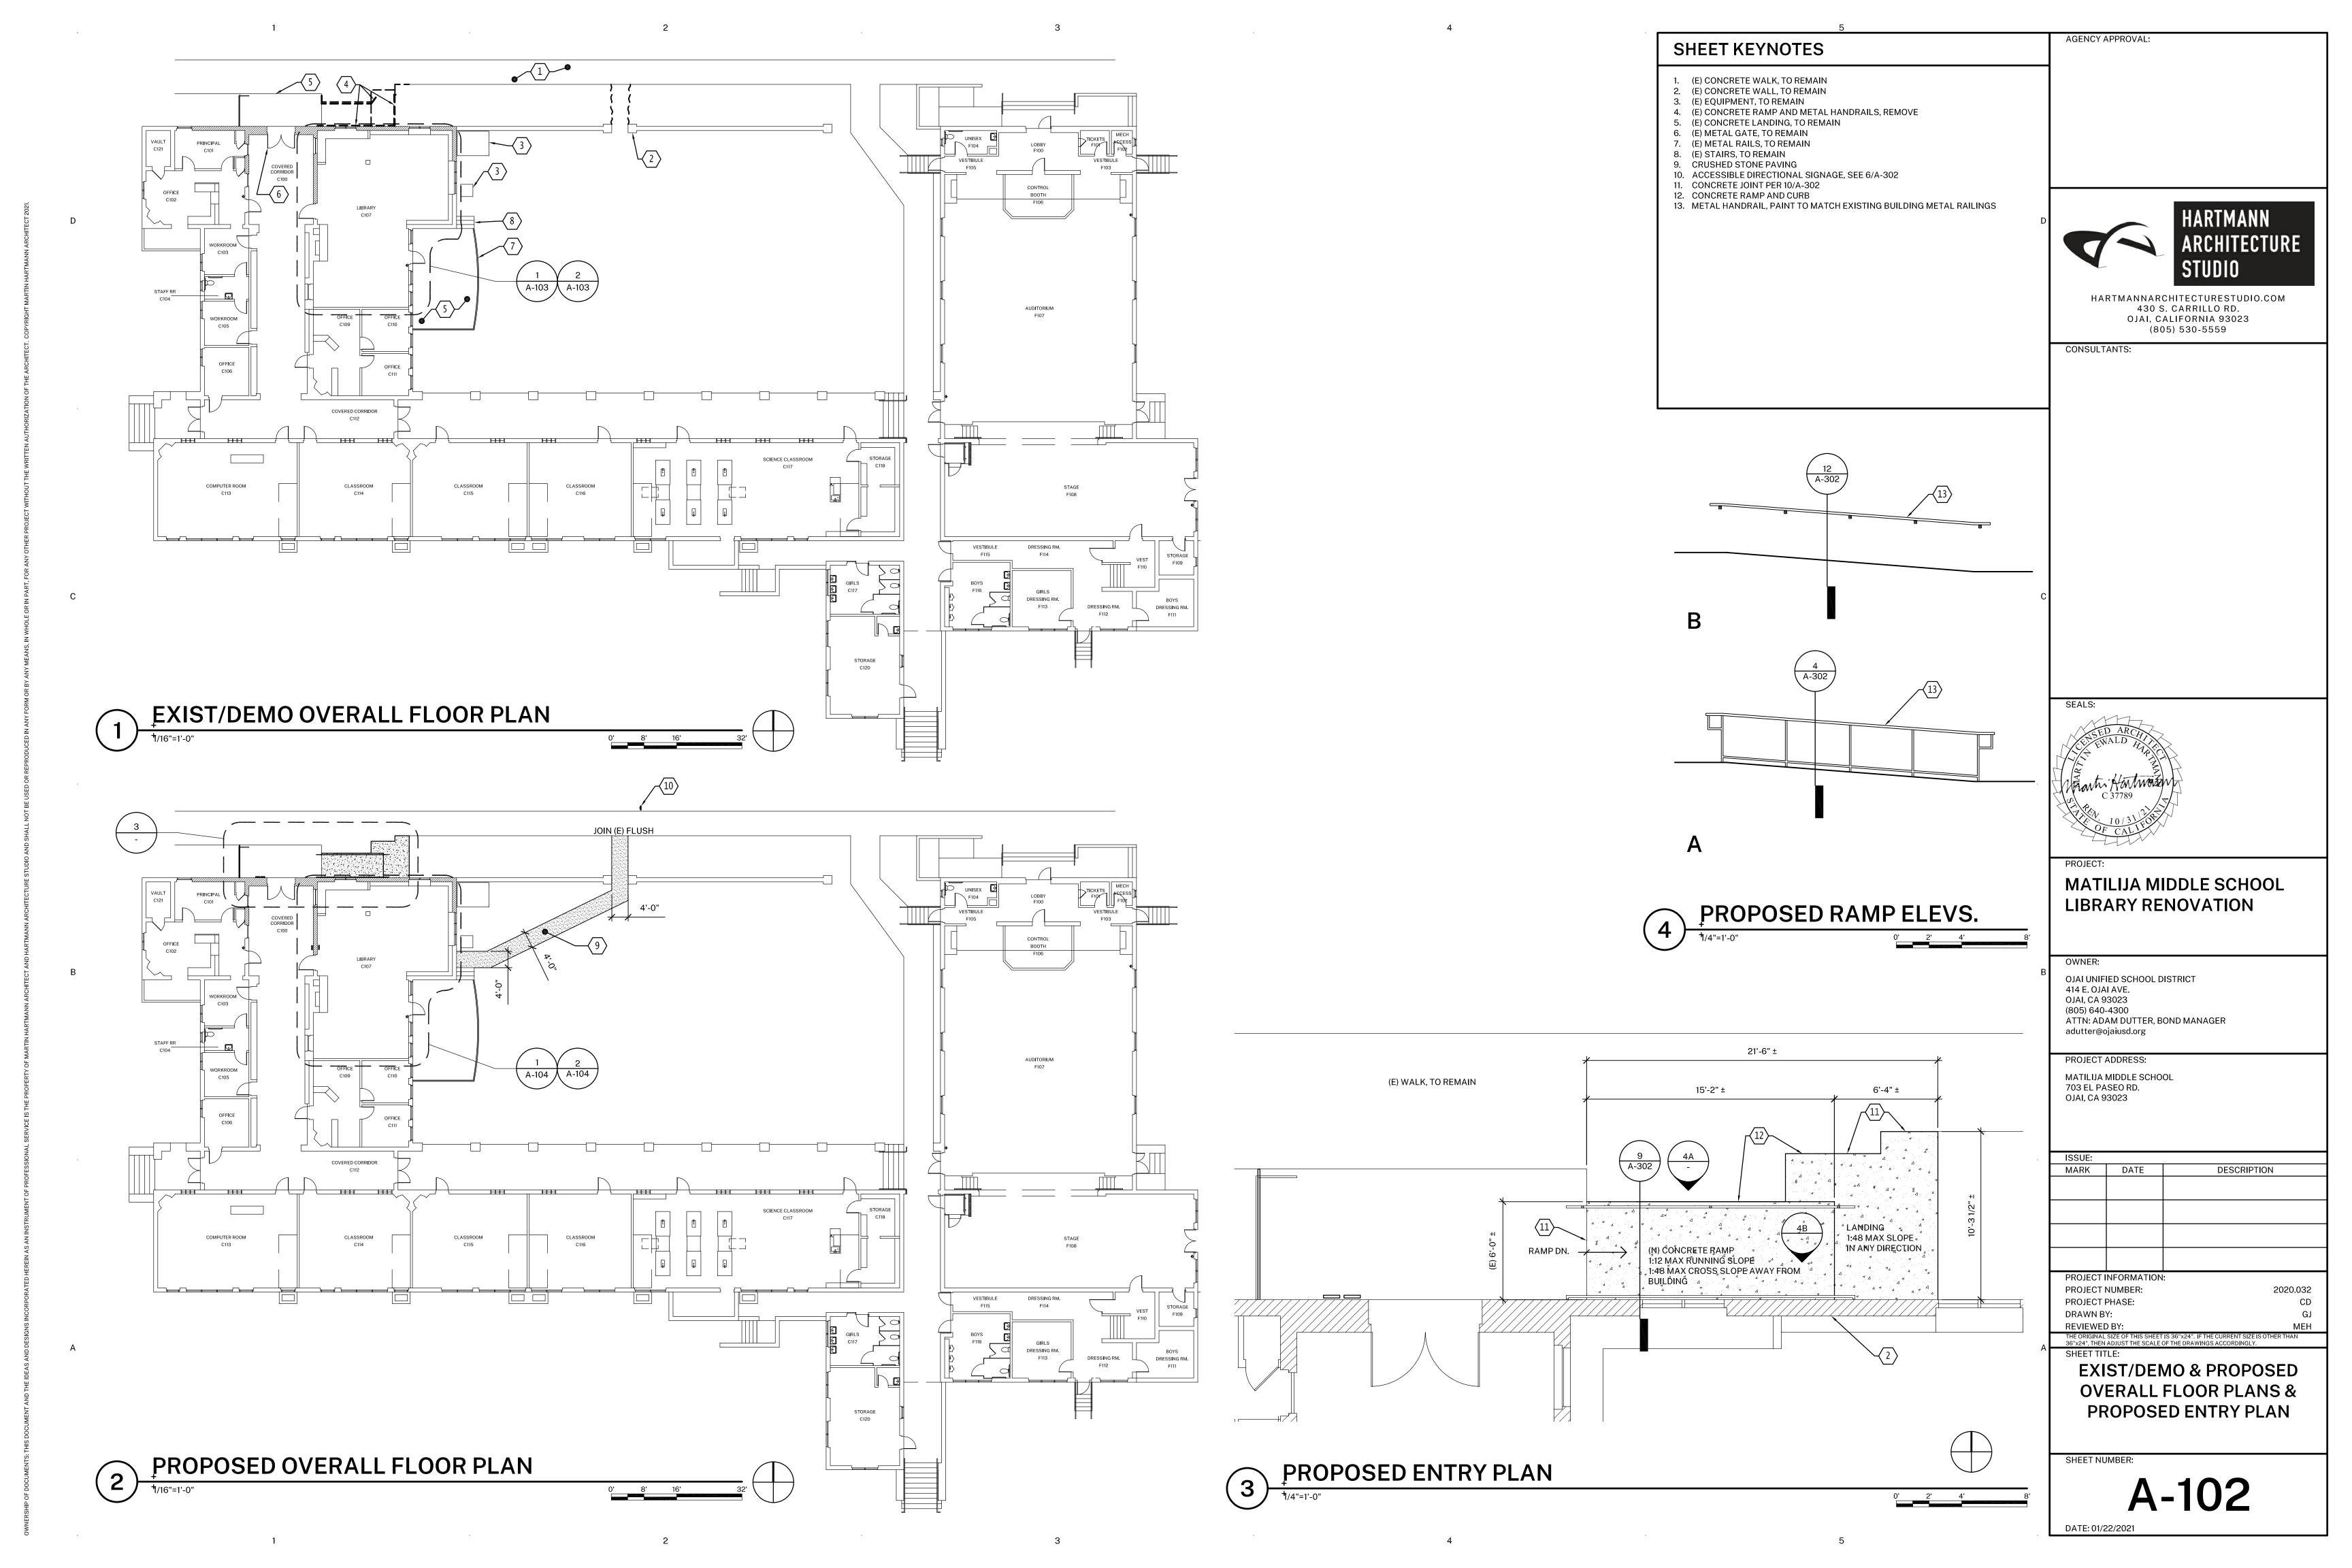


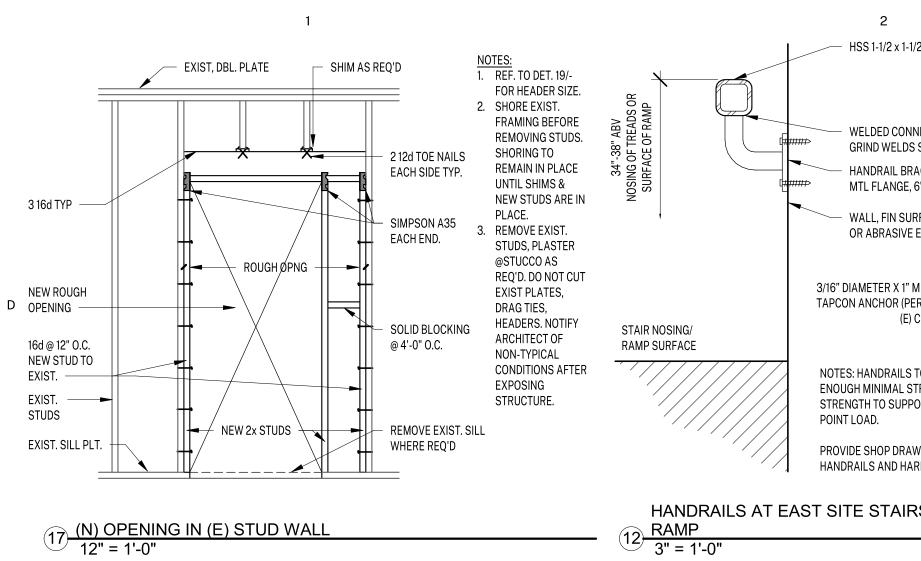

 ADD SHEATING TO MATCH EXIST. (WHERE OCCURS)

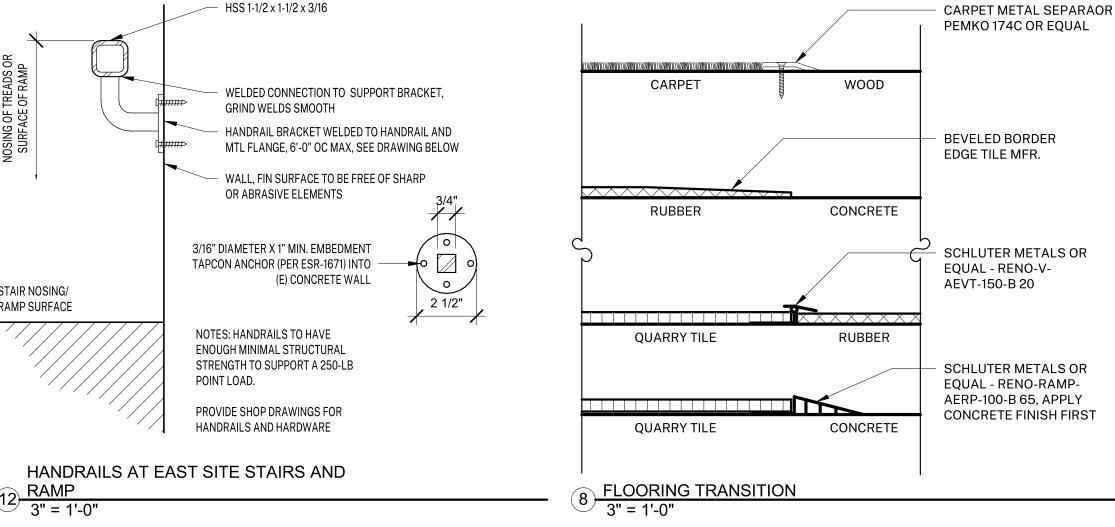

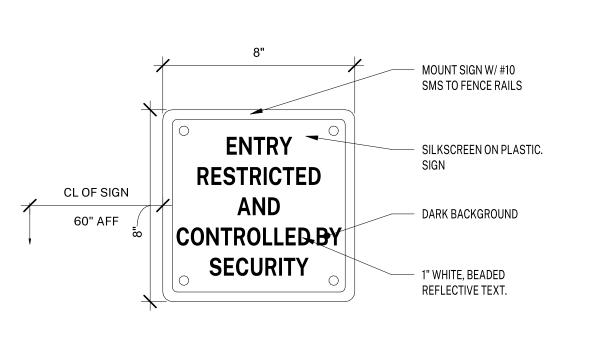

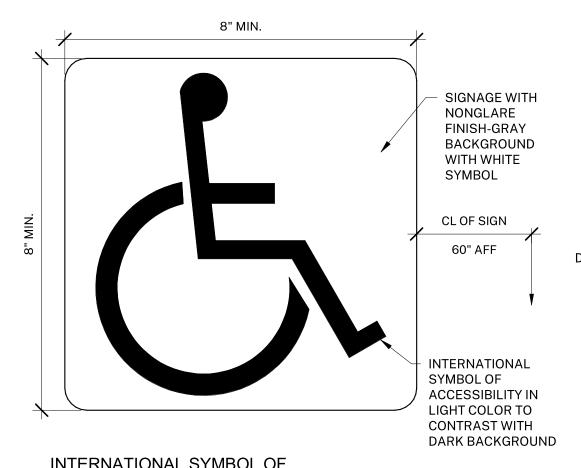




AGENCY APPROVAL:


CONSULTANTS:

INTERNATIONAL SYMBOL OF

PULL SIDE


SCHOOL ENTRY GATE SIGNAGE 3" = 1'-0"

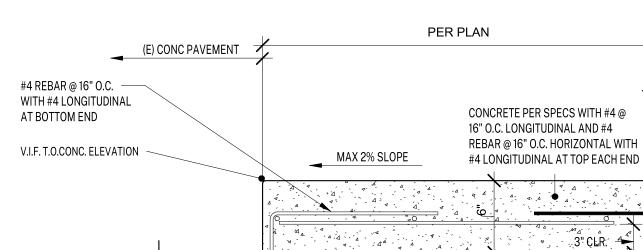

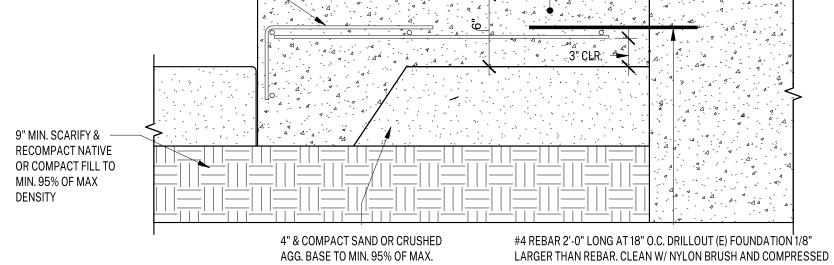


(E) CONCRETE WALL TO REMAIN

(E) CONCRETE

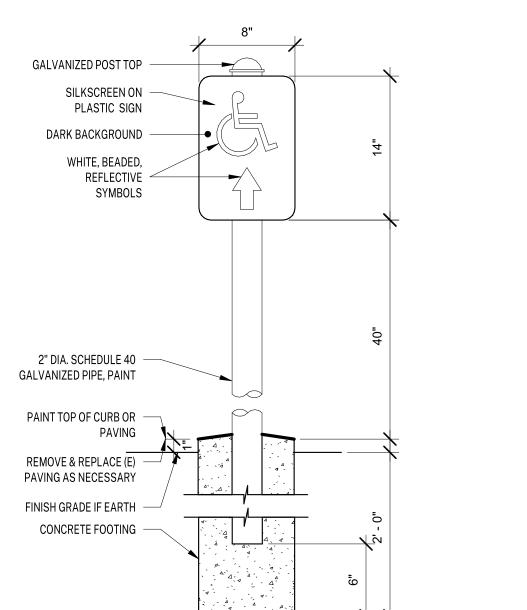


8" DIA

6 ACCESSIBLE DIRECTIONAL SIGN 1 1/2" = 1'-0"

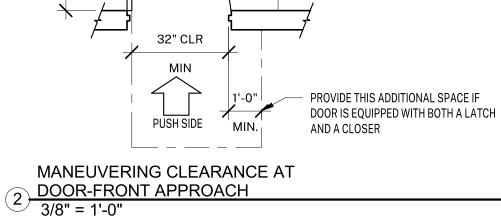

MIN.

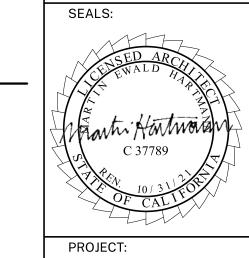

OWNER:

OJAI UNIFIED SCHOOL

OJAI, CA 93023

(805)640-4300

MANAGER

DISTRICT414 E. OJAI AVENUE

EMAIL: adutter@ojaiusd.org

MATILIJA MIDDLE SCHOOL

PROJECT ADDRESS:

703 EL PASEO ROAD

OJAI, CA 93023

ISSUE:


MARK


CONTACT: ADAM DUTTER, BOND

DATE

**MATILIJA MIDDLE SCHOOL** 

LIBRARY RENOVATION

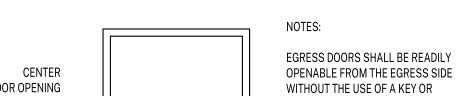

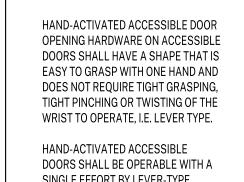


SINGLE EFFORT BY LEVER-TYPE HARDWARE, PANIC BARS, PUSH-PULL , FIN FI R ACTIVATING BARS OR OTHER HARDWARE.

MAXIMUM EFFORT TO OPERATE DOORS SHALL NOT EXCEED 5 LBF FOR EXTERIOR AND INTERIOR DOORS.

CLEAR AT ENTERIOR DOORS

(24" PREFERRED)

	ACCESSIBLE DOOR OPERATIONAL
2	REQUIREMENTS
.) 7	

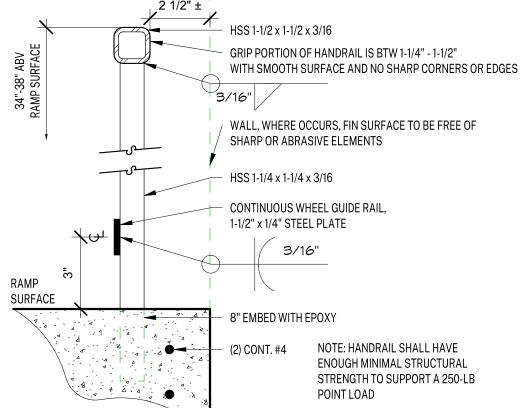



4 HANDRAIL AT BUILDING RAMP
3" = 1'-0"


### **HEADER SCHEDULE** HEADER d (NOMINAL) TO - 4'-11" WIDTH OF STUD x 4 5'-0" - 6'-11" WIDTH OF STUD x 6 7'-0" - 9'-5" WIDTH OF STUD x 8 9'-6" - 12'-0" WIDTH OF STUD x 10 FOR SPANS GREATER THAN 12' HEADER SHALL BE AS DIRECTED BY STRUCTURAL ENGINEER. (2) 16d EACH END EACH PIECE (TYP.)


TYPICAL MINIMUM HEADERS FOR 19 INTERIOR NON-BEARING WALLS
6" = 1'-0"

NAILING SCHEDULE				NAIL DIMENSIONS	
		(1)	NAIL	DIAMETER	LENGTH
CONNECTION	NAILING	(2)			
JOIST TO SILL OR GIRDER, TOE NAIL	(3) - 8d		20d	0.192"	4"
BLOCKING TO JOIST, EACH END	(2) - 16d				
SOLE PLATE TO JOIST OR BLOCKING, FACE NAIL	16d AT 16" O.C.		16d	0.162"	3-1/2"
TOP PLATE TO STUD, END NAIL	(2) - 16d				
STUD TO SOLE PLATE, TOE NAIL	(4) - 8d		10d	0.148"	3"
DOUBLE STUDS, FACE NAIL	16d AT 24" O.C.				
DOUBLE TOP PLATES, FACE NAIL	16d AT 16" O.C.		8d	0.131"	2-1/2"
TOP PLATES, LAPS & INTERSECTIONS. FACE NAIL	(4) - 16d (OR AS SPECIFIED)		00	0.101	L-1/L
CONTINUOUS HEADER, TWO PIECES	16d @ 16" (ALONG EA. EDGE)				
CEILING JOISTS TO PLATE, TOE NAIL	(3) - 8d				
CONT. HEADER TO STUD, TOE NAIL	(4) - 8d				
CEILING JOISTS, LAPS OVER PARTITIONS, FACE	(3) - 16d				
NAIL					
CEILING JOISTS TO PARALLEL RAFTERS, FACE	(3) - 16d				
NAIL					
RAFTER TO PLATE	(3) - 8d				
1" BRACE TO EA. STUD & PLATE, FACE NAIL	(2) - 8d (OR AS SPECIFIED)				
BUILT-UP CORNER STUDS	16d at 24" O.C.	·D)			
BUILT-UP GIRDERS & BEAMS	20d @ 32" O.C. (tTOP & BOTT. AND STAGGERE	.D)			
DI VILLOOD EL COD O DOCE CHEATHING	(2) - 20d @ ENDS				
PLYWOOD FLOOR & ROOF SHEATHING	JOIST TO SILLL OR GIRDER, TOE NAIL				
NOTES:					
<ol> <li>MINIMUM NAILING ONLY. SEE DE</li> </ol>	TAILS FOR LOCATIONS WHERE				
OTHER NAILING IS SPECIFIED.					
2. COMMON NAILS CONFORMING T	O ASTM F1667 TO BE USED				
THROUGHOUT U.N.O.					
3. NAILS SPACED AT 6" O.C. AT EDO	SES 12" O.C. AT INTERMEDIATE				
SUPPORTS (10" O.C. AT INTERME	•				
SUPPORTS (IU O.C. AT INTERME	DIATE SUPPORTS FOR FLOORS).				
NAILING SCHEDU					

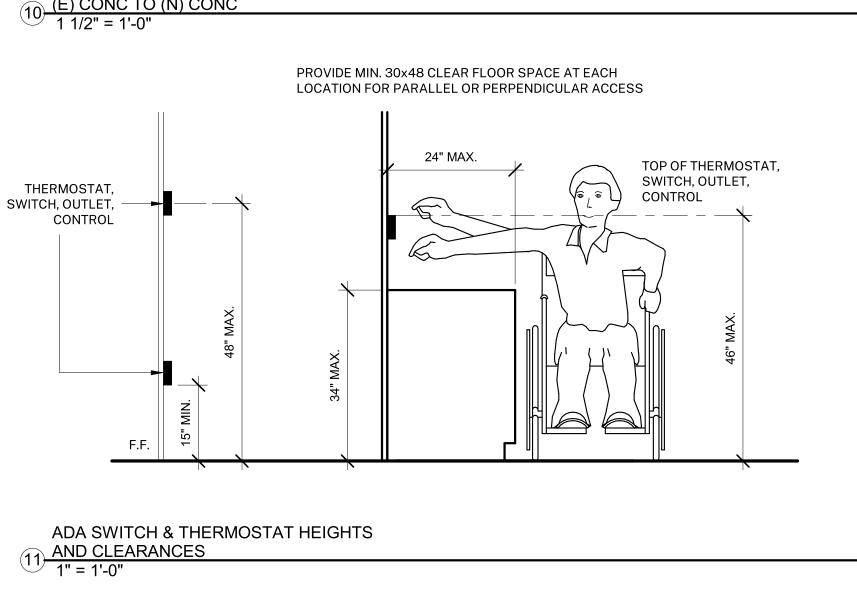


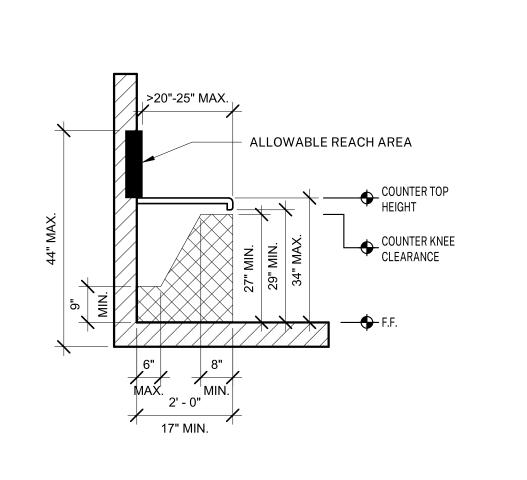

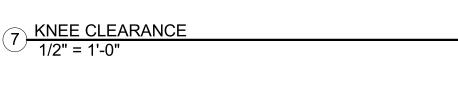

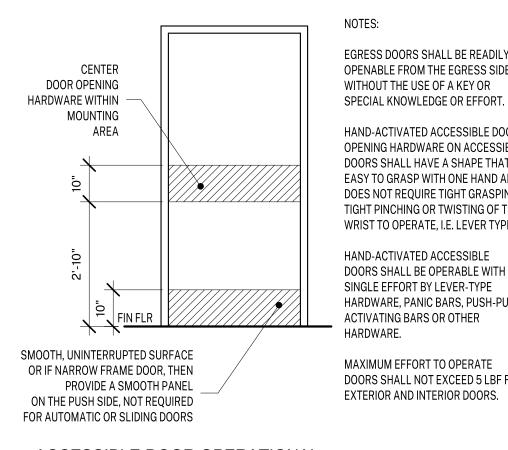



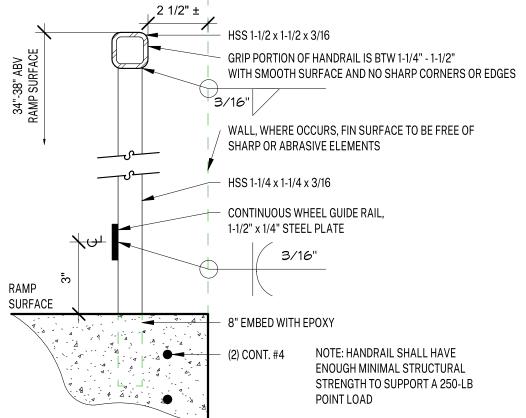


SHEET NUMBER:


**A-302** 

DATE: 1/22/2021 7:39:17 PM


||HEADER | EXIST. 2x STUDS @ 16" O.C. NEW 2x W/16d @ 8" O.C. (2) 8d TOE NAILS ea. SIDE TYP. NEW 2x W/16d @ 8" O.C. EXISTING OPENING NEW 2x P.T.D.F. SILL PL. TO BE FILLED IN. ON DRY PACK AS REQ'D NEW 2x @ 16" O.C. TOP OF EXISTING AT BEARING WALL: FOUNDATION -1/4"Ø, x 3-1/2" HILTI 'KH-EZ EXIST. SILL PLATE [ICC ESR-3027] @ 24" o.c., EMBED 1-5/8" (MIN. 3 REQ'D.) AT NON -BEARING WALL: EXISTING FOUNDATION EF. TO STRUCTURAL **ENEAL NOTES** 

18 FILL EXISTING OPENING IN STUD WALL
12" = 1'-0"

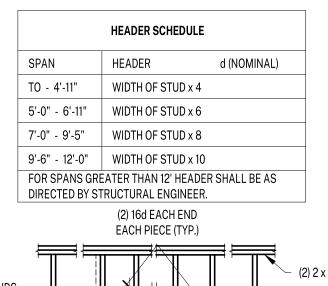

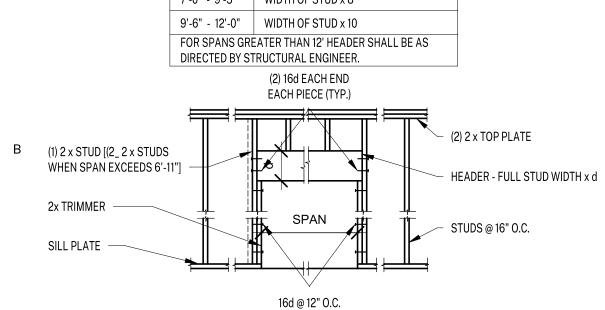

STAGGERED

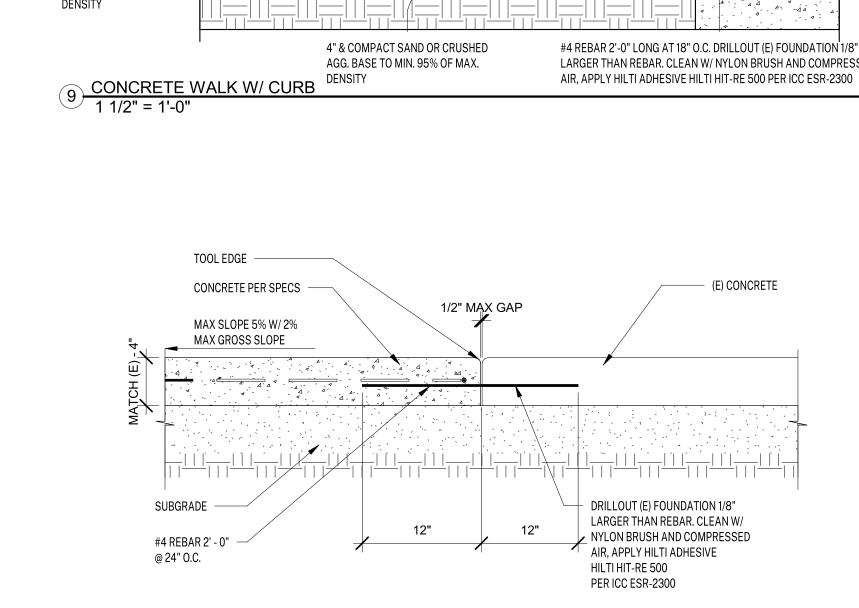

(E) CONC TO (N) CONC 1 1/2" = 1'-0"

PROJECT INFORMATION: PROJECT NUMBER: 2020.032 PROJECT PHASE: CD

DESCRIPTION

PBS/MH DRAWN BY: REVIEWED BY:

THE ORIGINAL SIZE OF THIS SHEET IS 36"x24". IF THE CURRENT SIZE IS OTHER THAN 36"x24", THEN ADJUST THE SCALE OF THE DRAWINGS ACCORDINGLY. SHEET TITLE:

**DETAILS**