
ST. JOHNS RIVER WATER MANAGEMENT DISTRICT UPPER ST. JOHNS RIVER BASIN STRUCTURE 96 REHABILITATION BREVARD COUNTY, FLORIDA

NGVD 1929


ALL ELEVATIONS DEPICTED HEREIN REFERENCE NGVD 1929 UNLESS OTHERWISE NOTED. THE CONVERSION FACTOR TO NAVD 1988 IS -1.47.

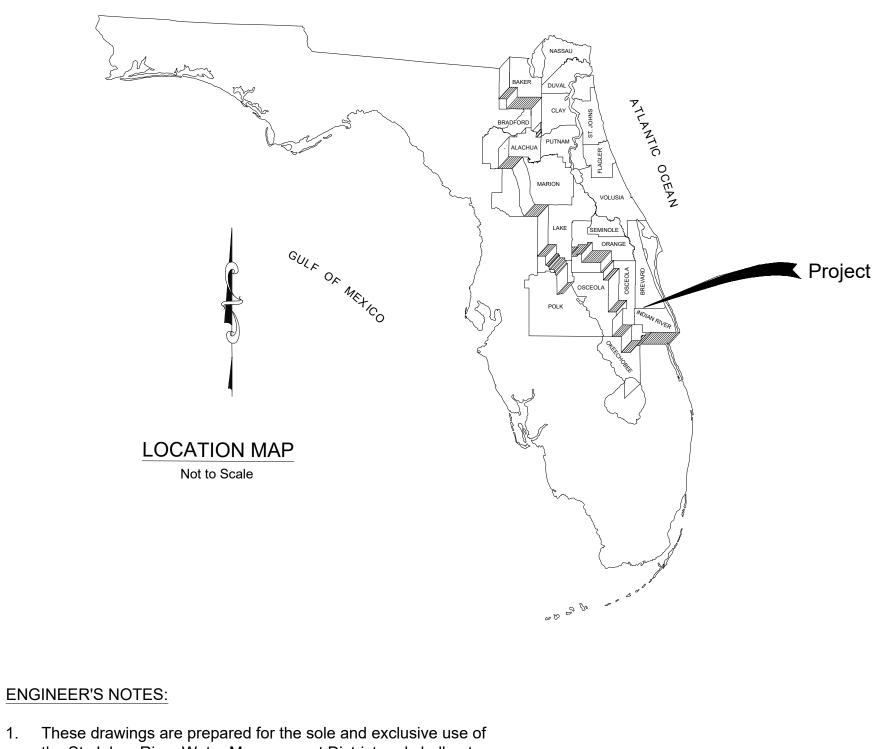

the St. Johns River Water Management District and shall not be relied upon by any other entity or individual.

Reproductions of these drawings are "NOT VALID WITHOUT THE SIGNATURE AND THE ORIGINAL SEAL OF A FLORIDA LICENSED ENGINEER."

\triangle	ISSUED FOR BID	N.J.G.	05/14/21	W.R.C.	05/14/21
NO.	REVISION	BY	DATE	APPROVED	DATE

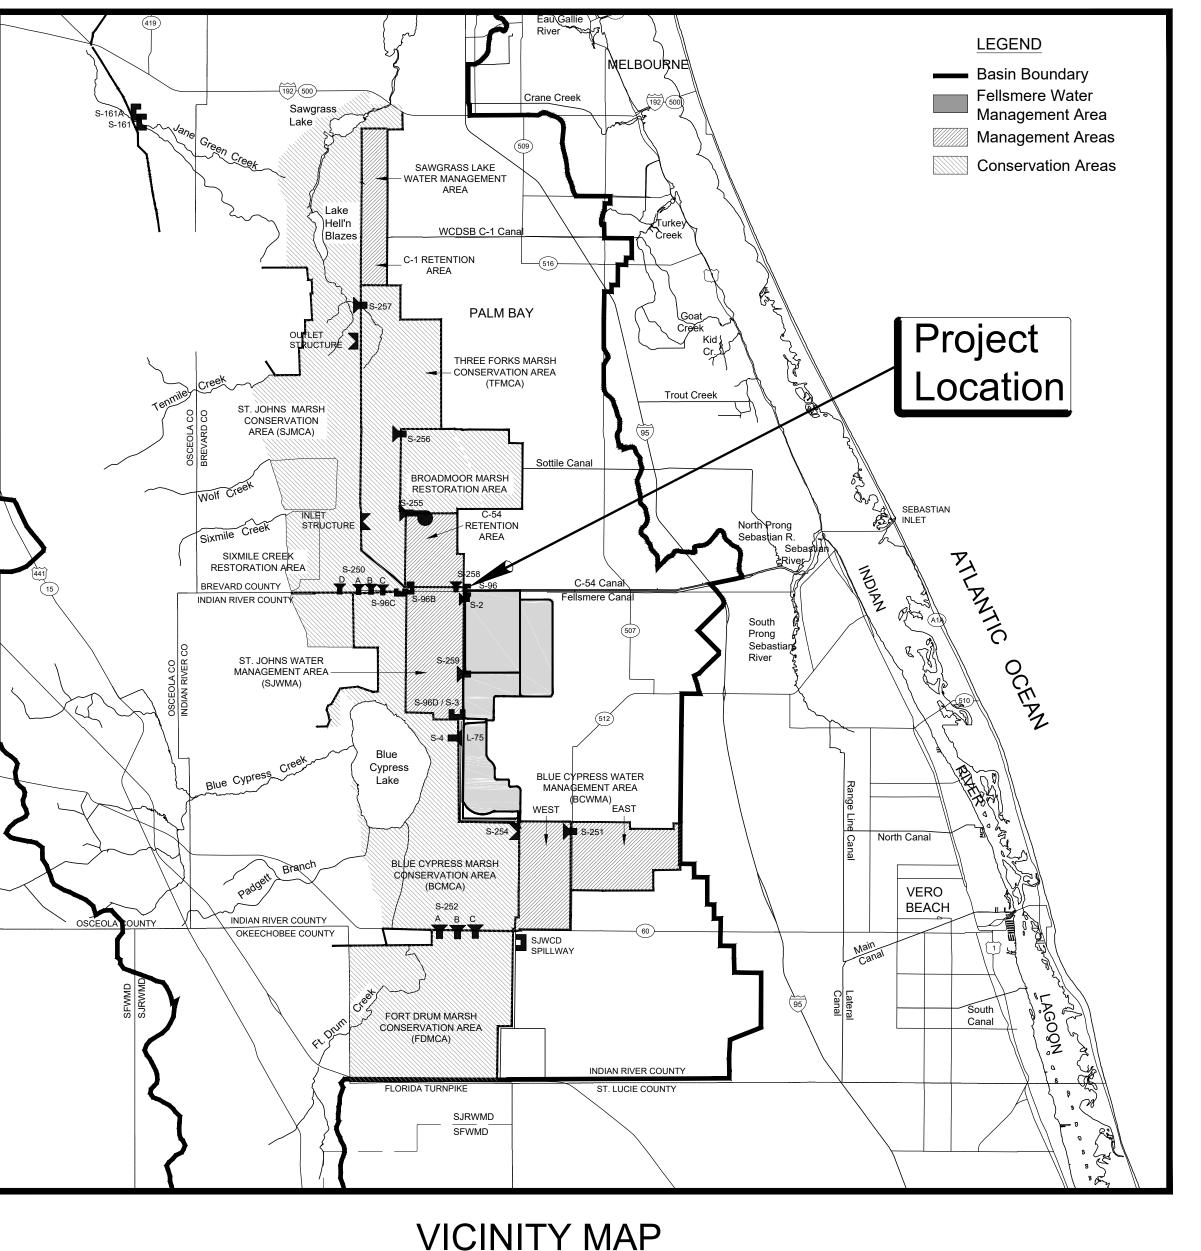

NOT TO SCALE



INDEX OF PLANS


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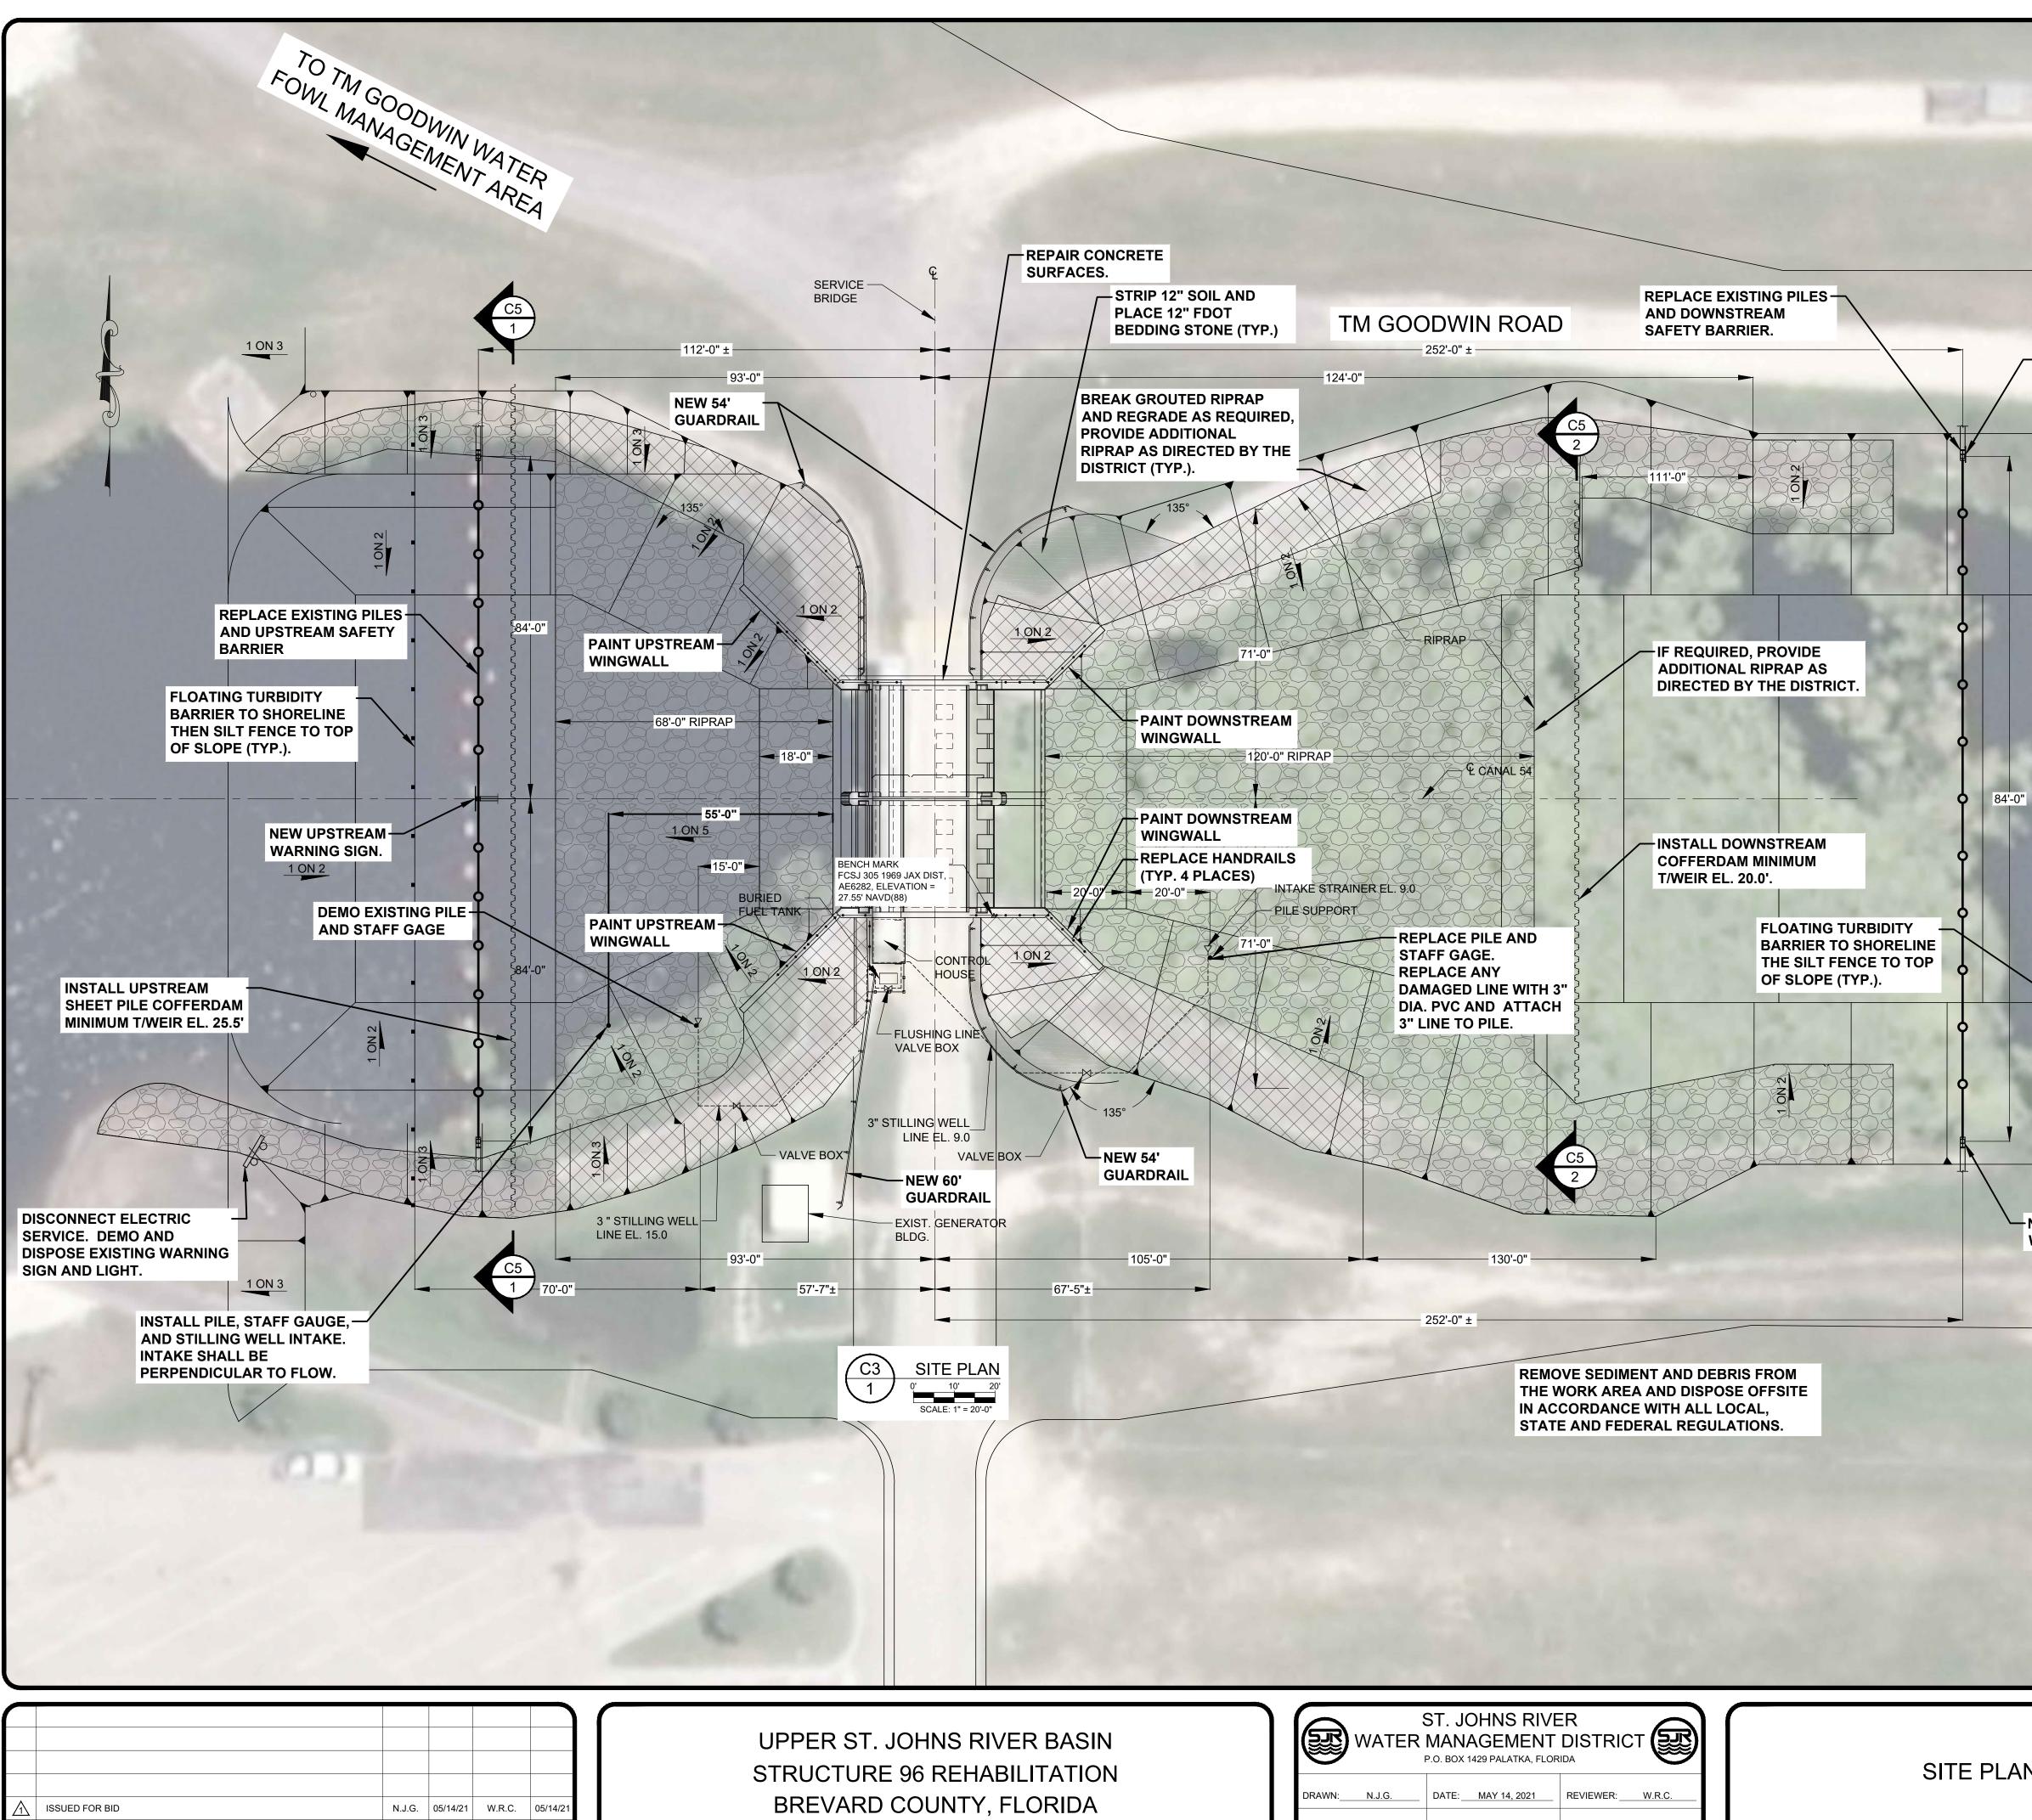
SHEET TITLE C1 **COVER SHEET & VICINITY MAP**

- C2 SITE PLAN C3
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- S26 NEW CABLE DRUM HOIST
- S27 GATE REHABILITATION ELEVATION, SECTIONS, DETAILS & NOTES

FOR BID PURPOSES ONLY **NOT FOR CONSTRUCTION**

CERTIFICATION:	DRAWING FILENAME:
	S-96 PLAN.dwg
	SHEET:
WILLIAM R. COTE	
P.E. NUMBER:53746	
DATE: MAY 14, 2021	C1



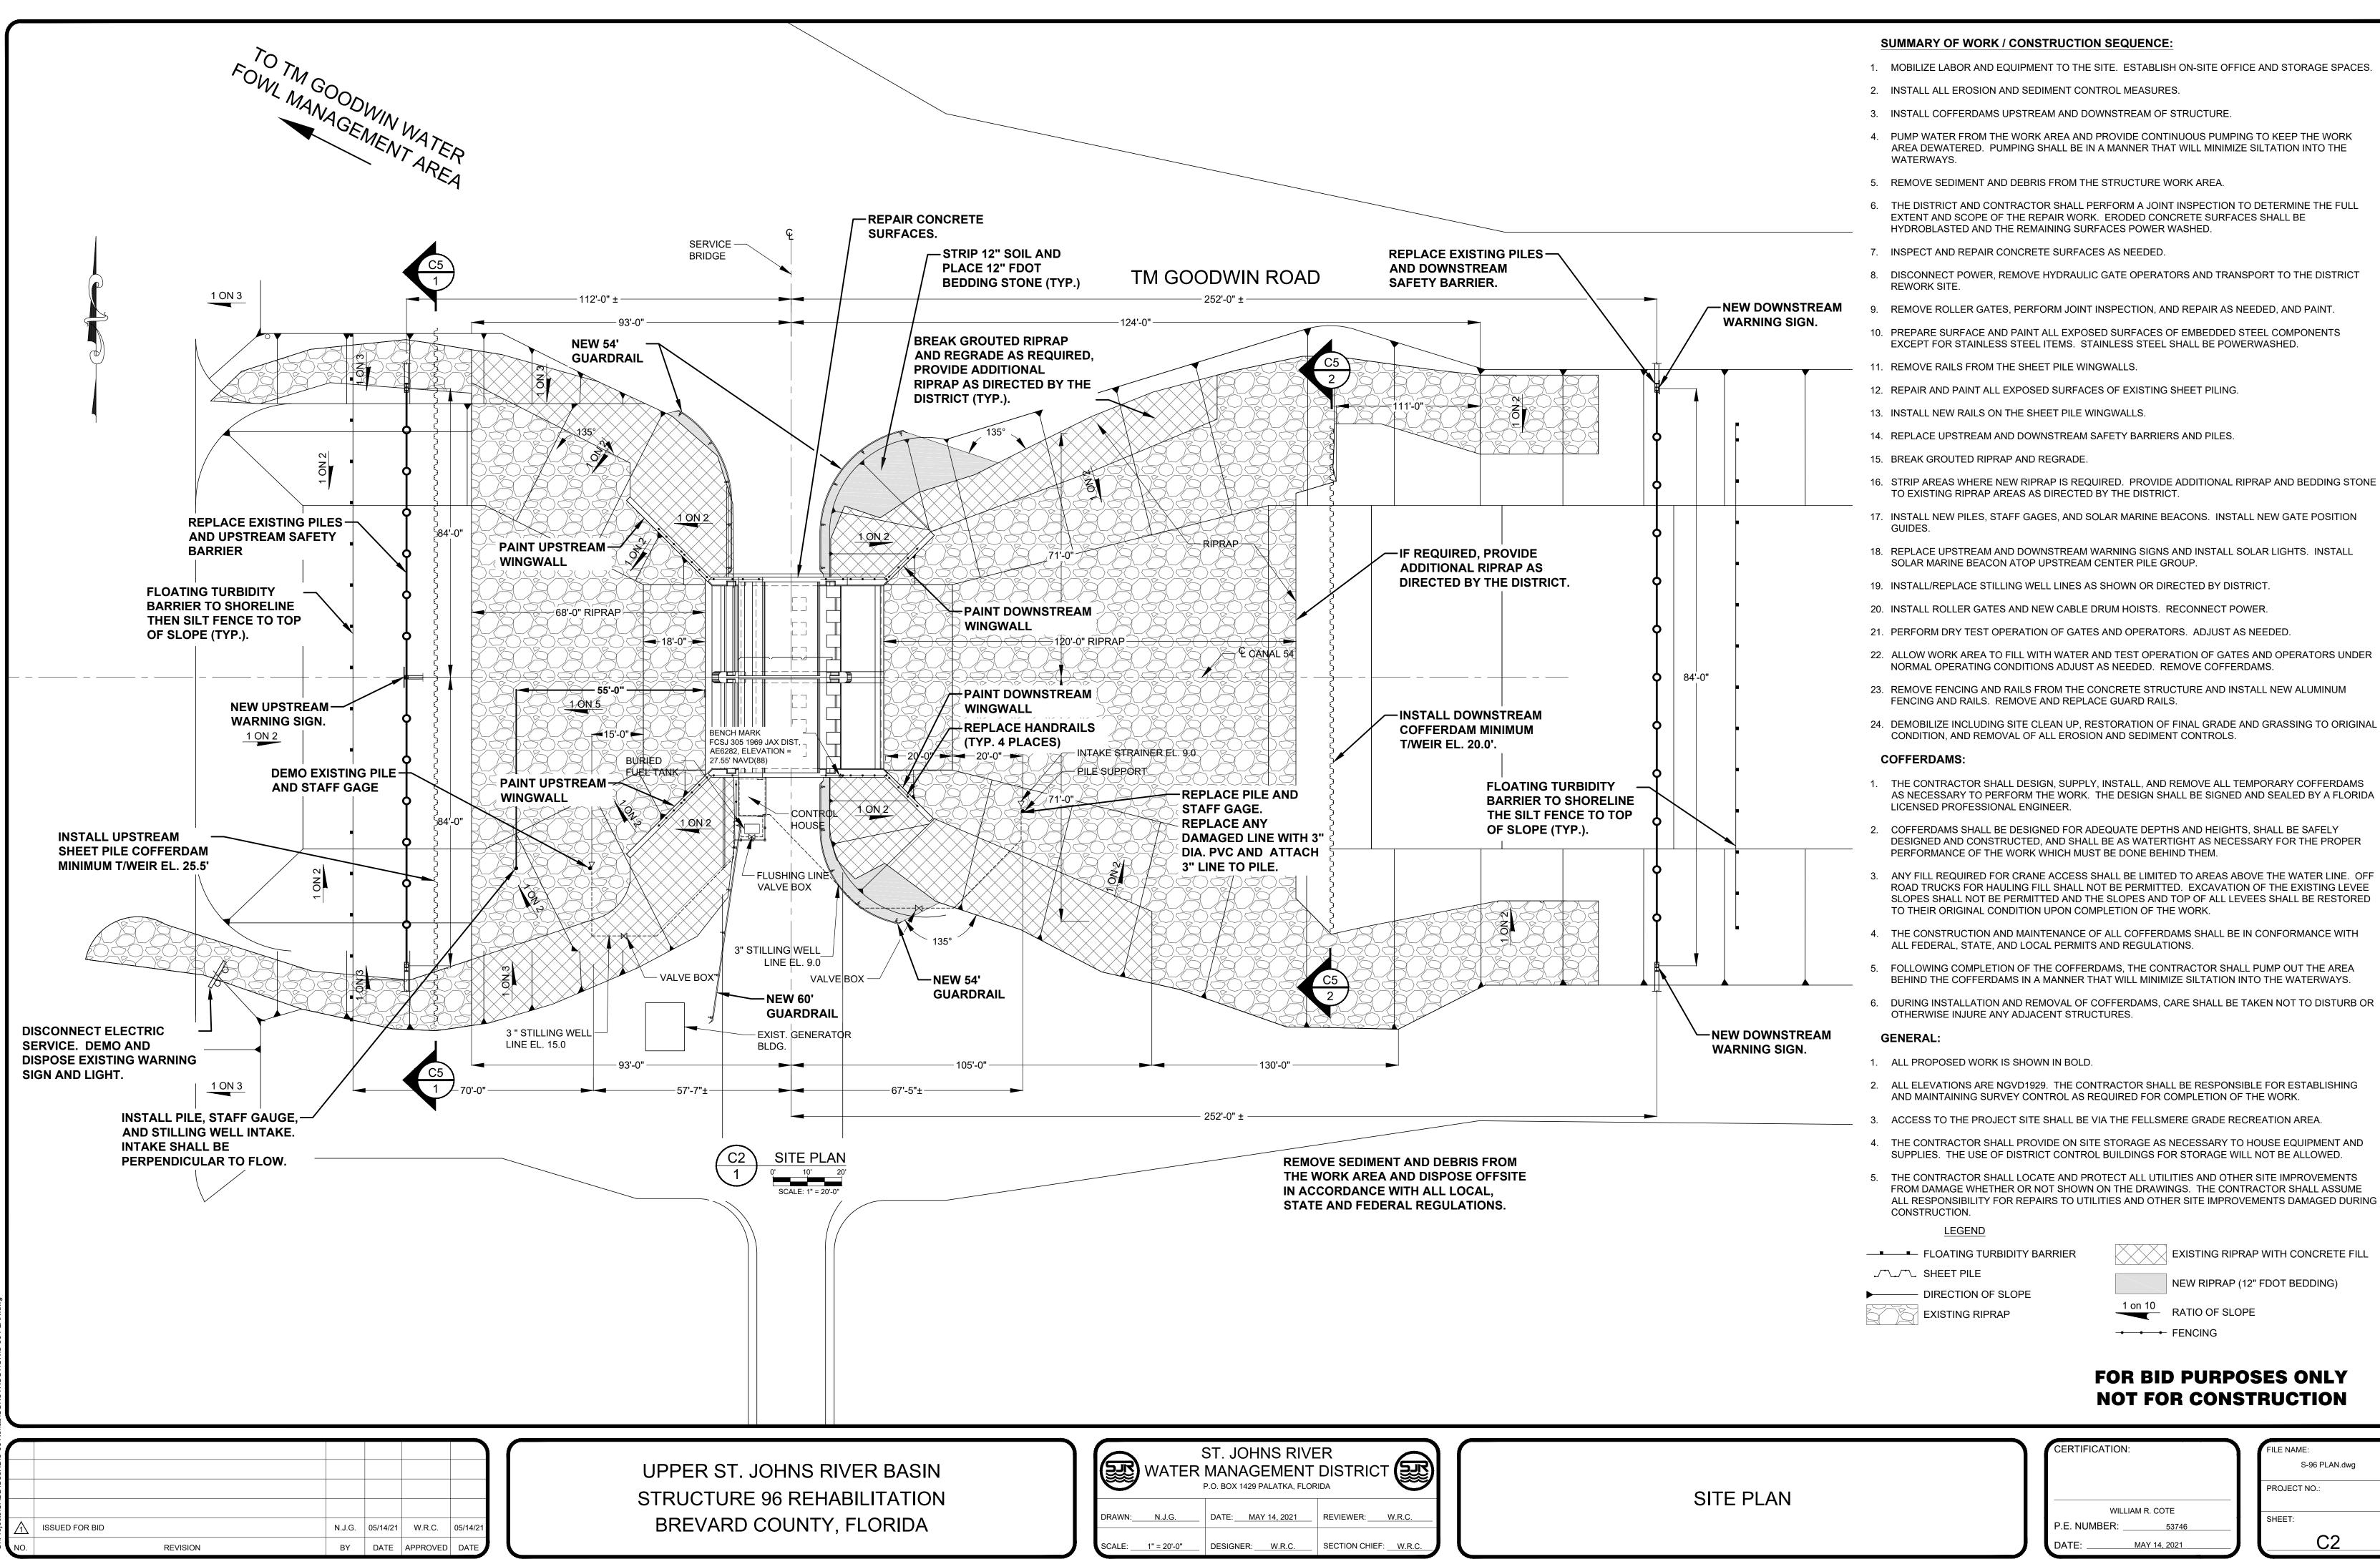


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BY DATE APPROVED DATI

WATER	ST. JOHNS RIVE MANAGEMENT P.O. BOX 1429 PALATKA, FLOR	DISTRICT (ST)		
DRAWN: N.J.G.	DATE: MAY 14, 2021	REVIEWER: W.R.C.		
SCALE:1" = 20'-0"	DESIGNER: W.R.C.	SECTION CHIEF: W.R.C.		

- NEW DOWNSTREAM WARNING SIGN.

LEGEND

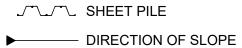

EXISTING RIPRAP



EXISTING RIPRAP WITH CONCRETE FILL

NEW RIPRAP (12" FDOT BEDDING)

1 on 10 RATIO OF SLOPE

------ FENCING

FOR BID PURPOSES ONLY **NOT FOR CONSTRUCTION**

SITE PLAN (WITH AERIAL)


WARNING SIGN.

WIL	LIAM R. COTE
P.E. NUMBER:	53746
DATE:	MAY 14, 2021


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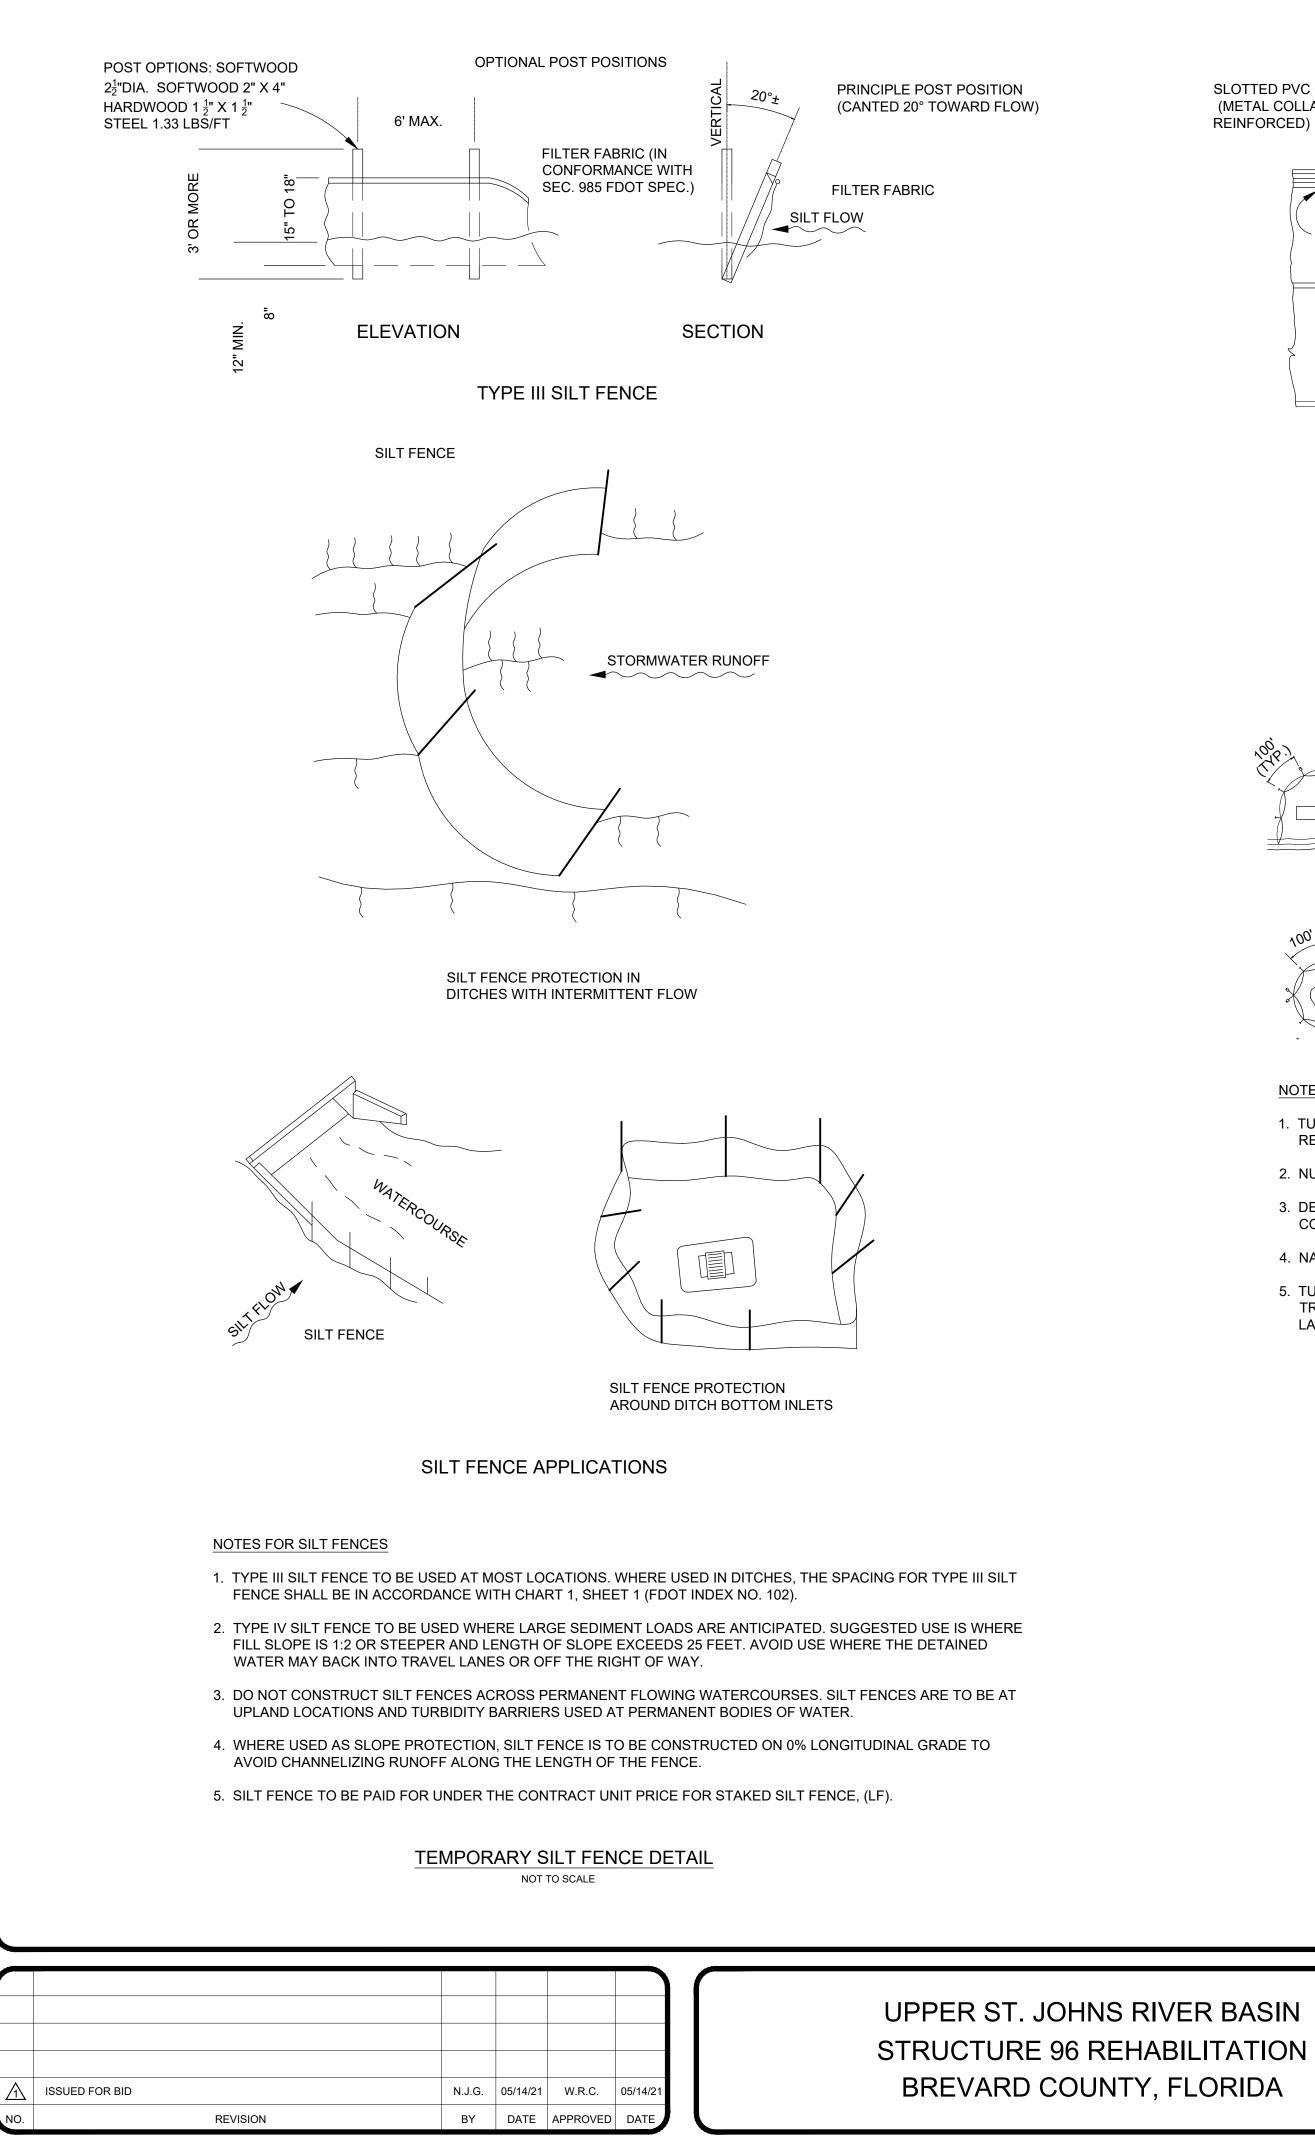



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DRAWN: N.J.G.	DATE:MAY 14, 20	021 REVIEWER: W.R.C.
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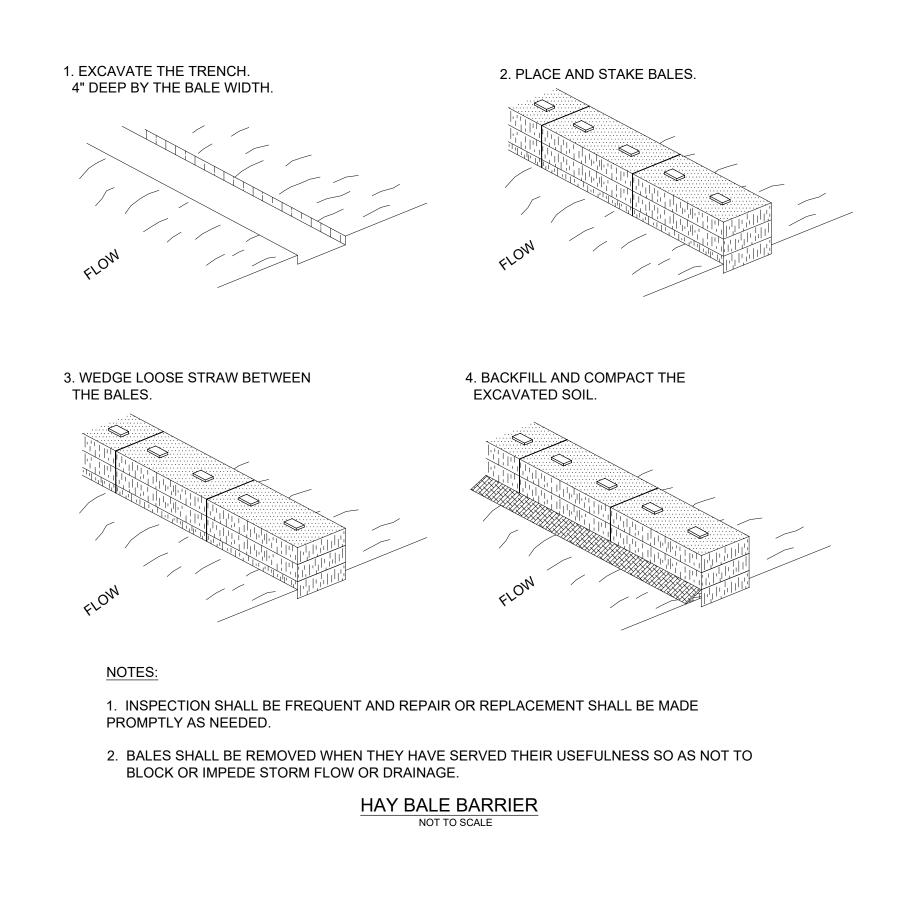
FOR BID PURPOSES ONLY **NOT FOR CONSTRUCTION**

CERTIFICATION:	FILE NAME:
	S-96 PLAN.dwg
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WILLIAM R. COTE	
P.E. NUMBER:53746	SHEET:
DATE: MAY 14, 2021	_) \ C5_

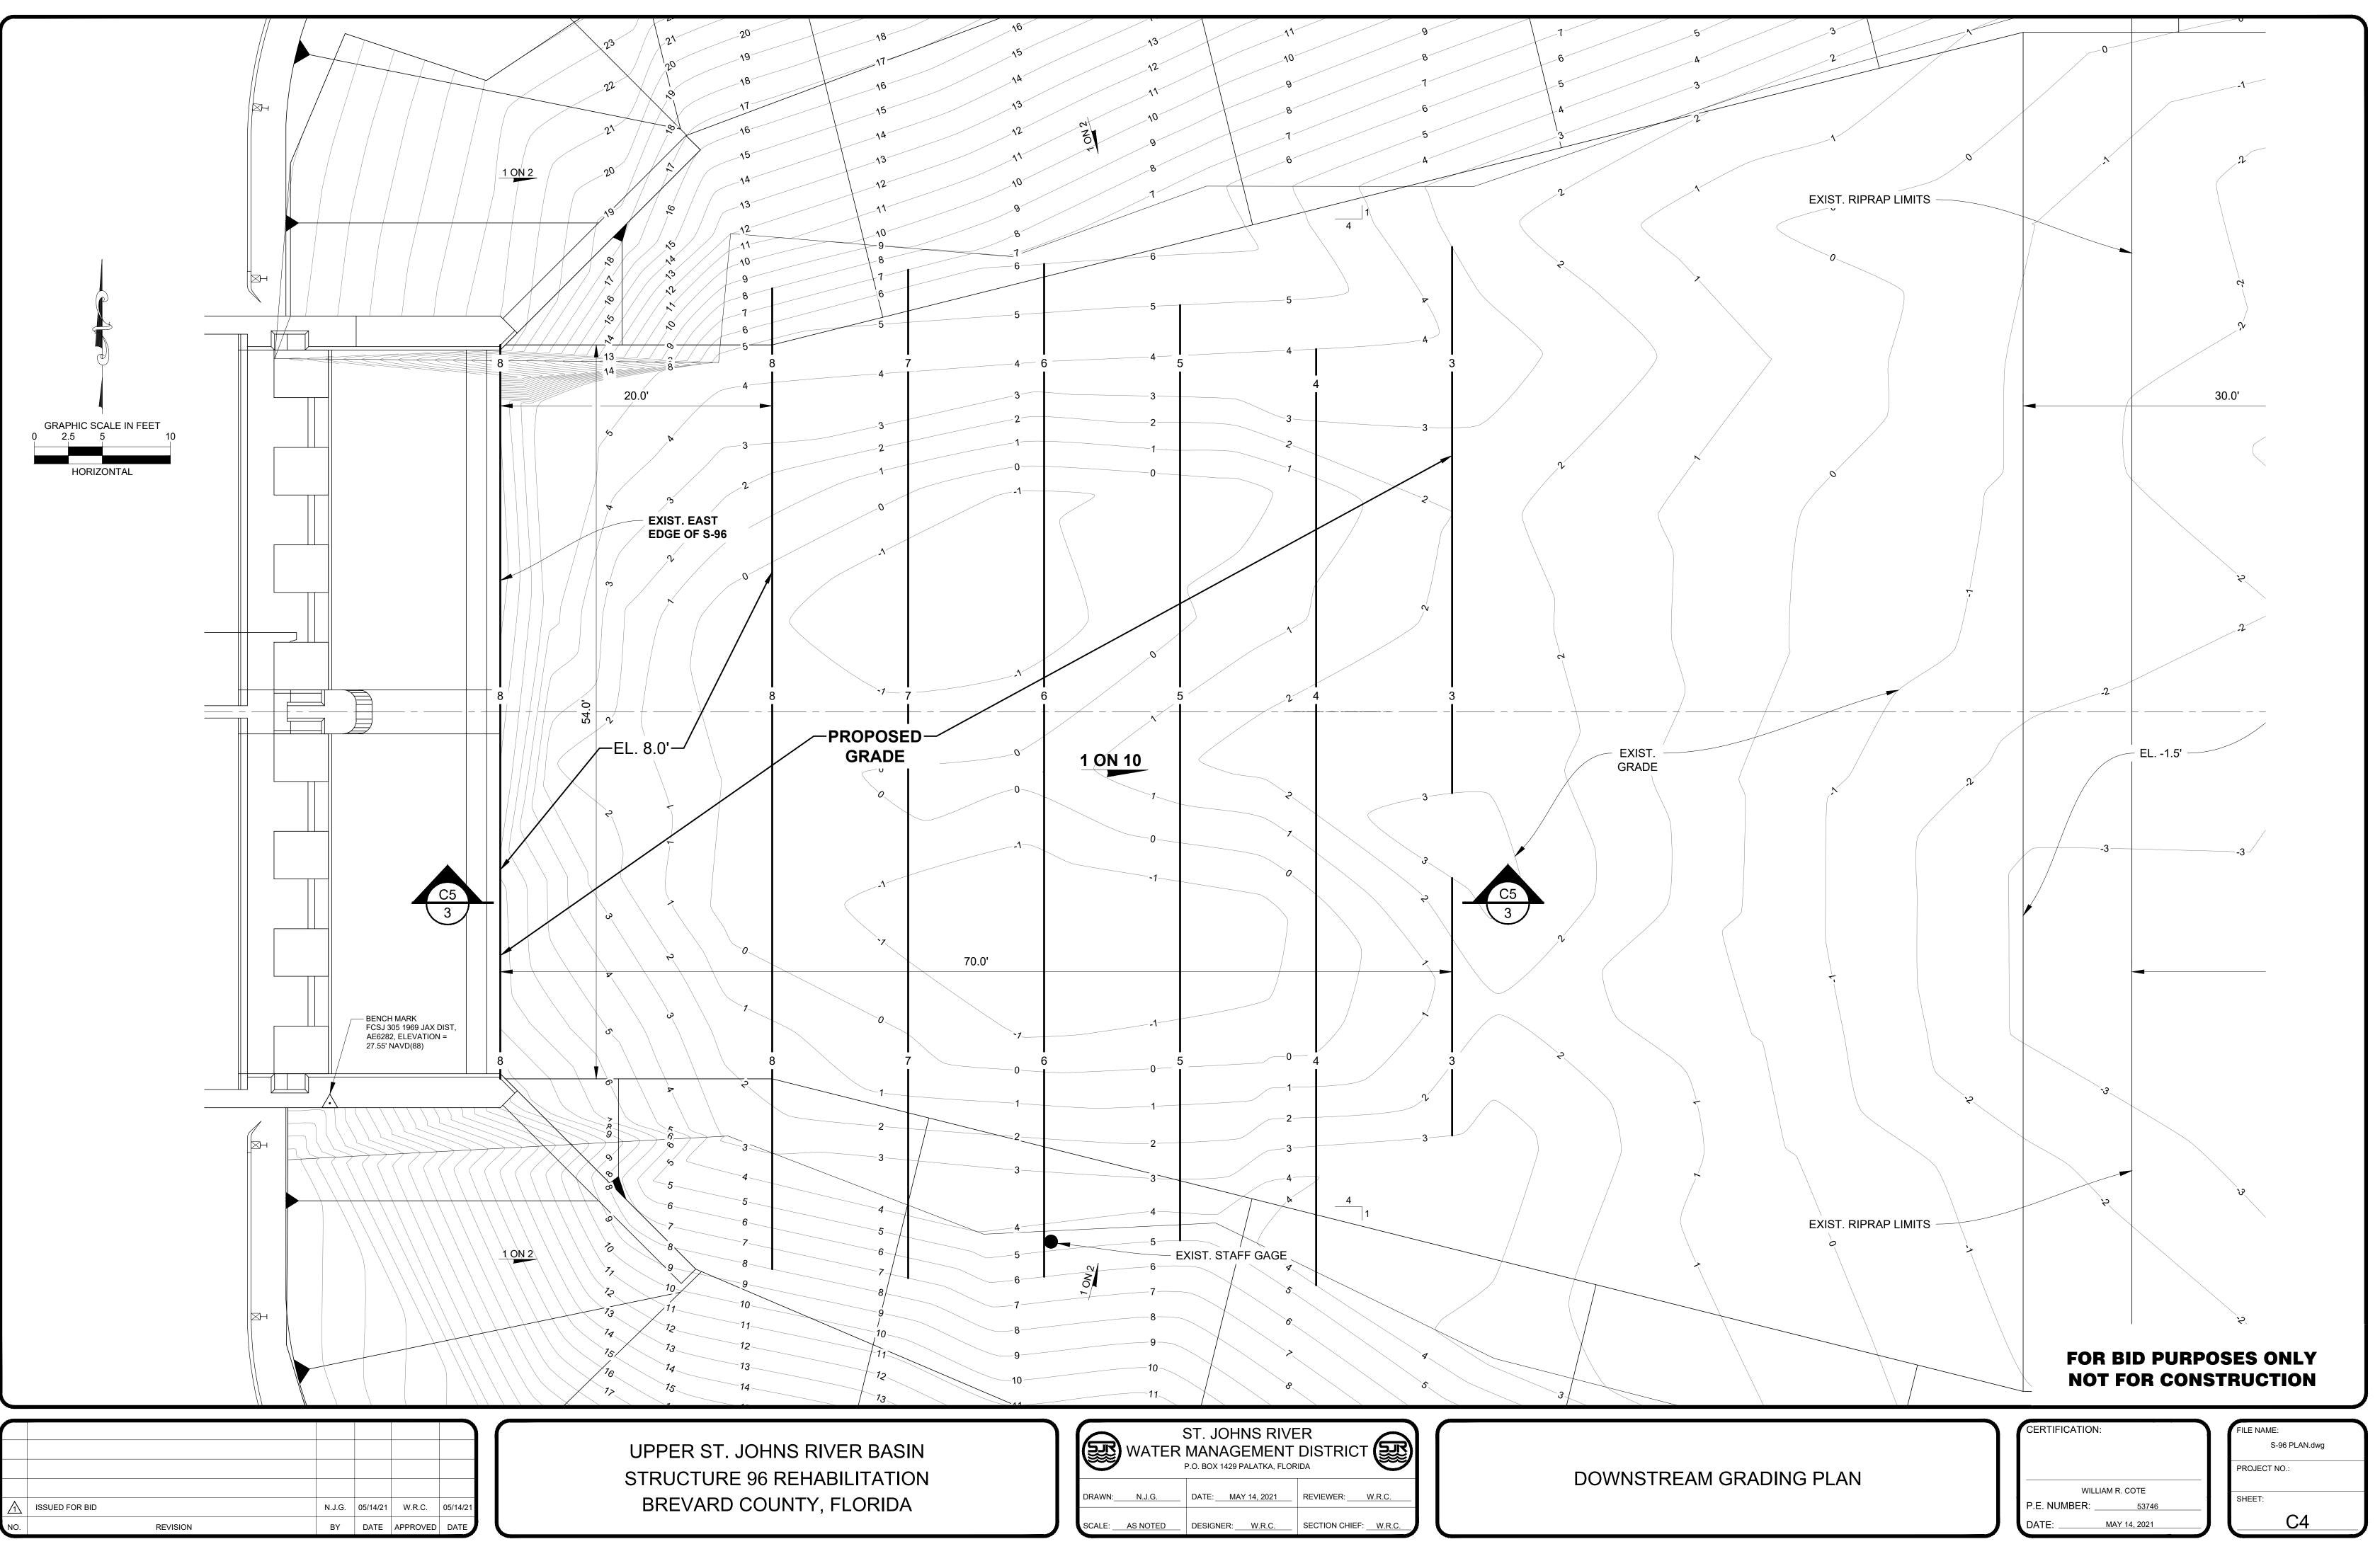

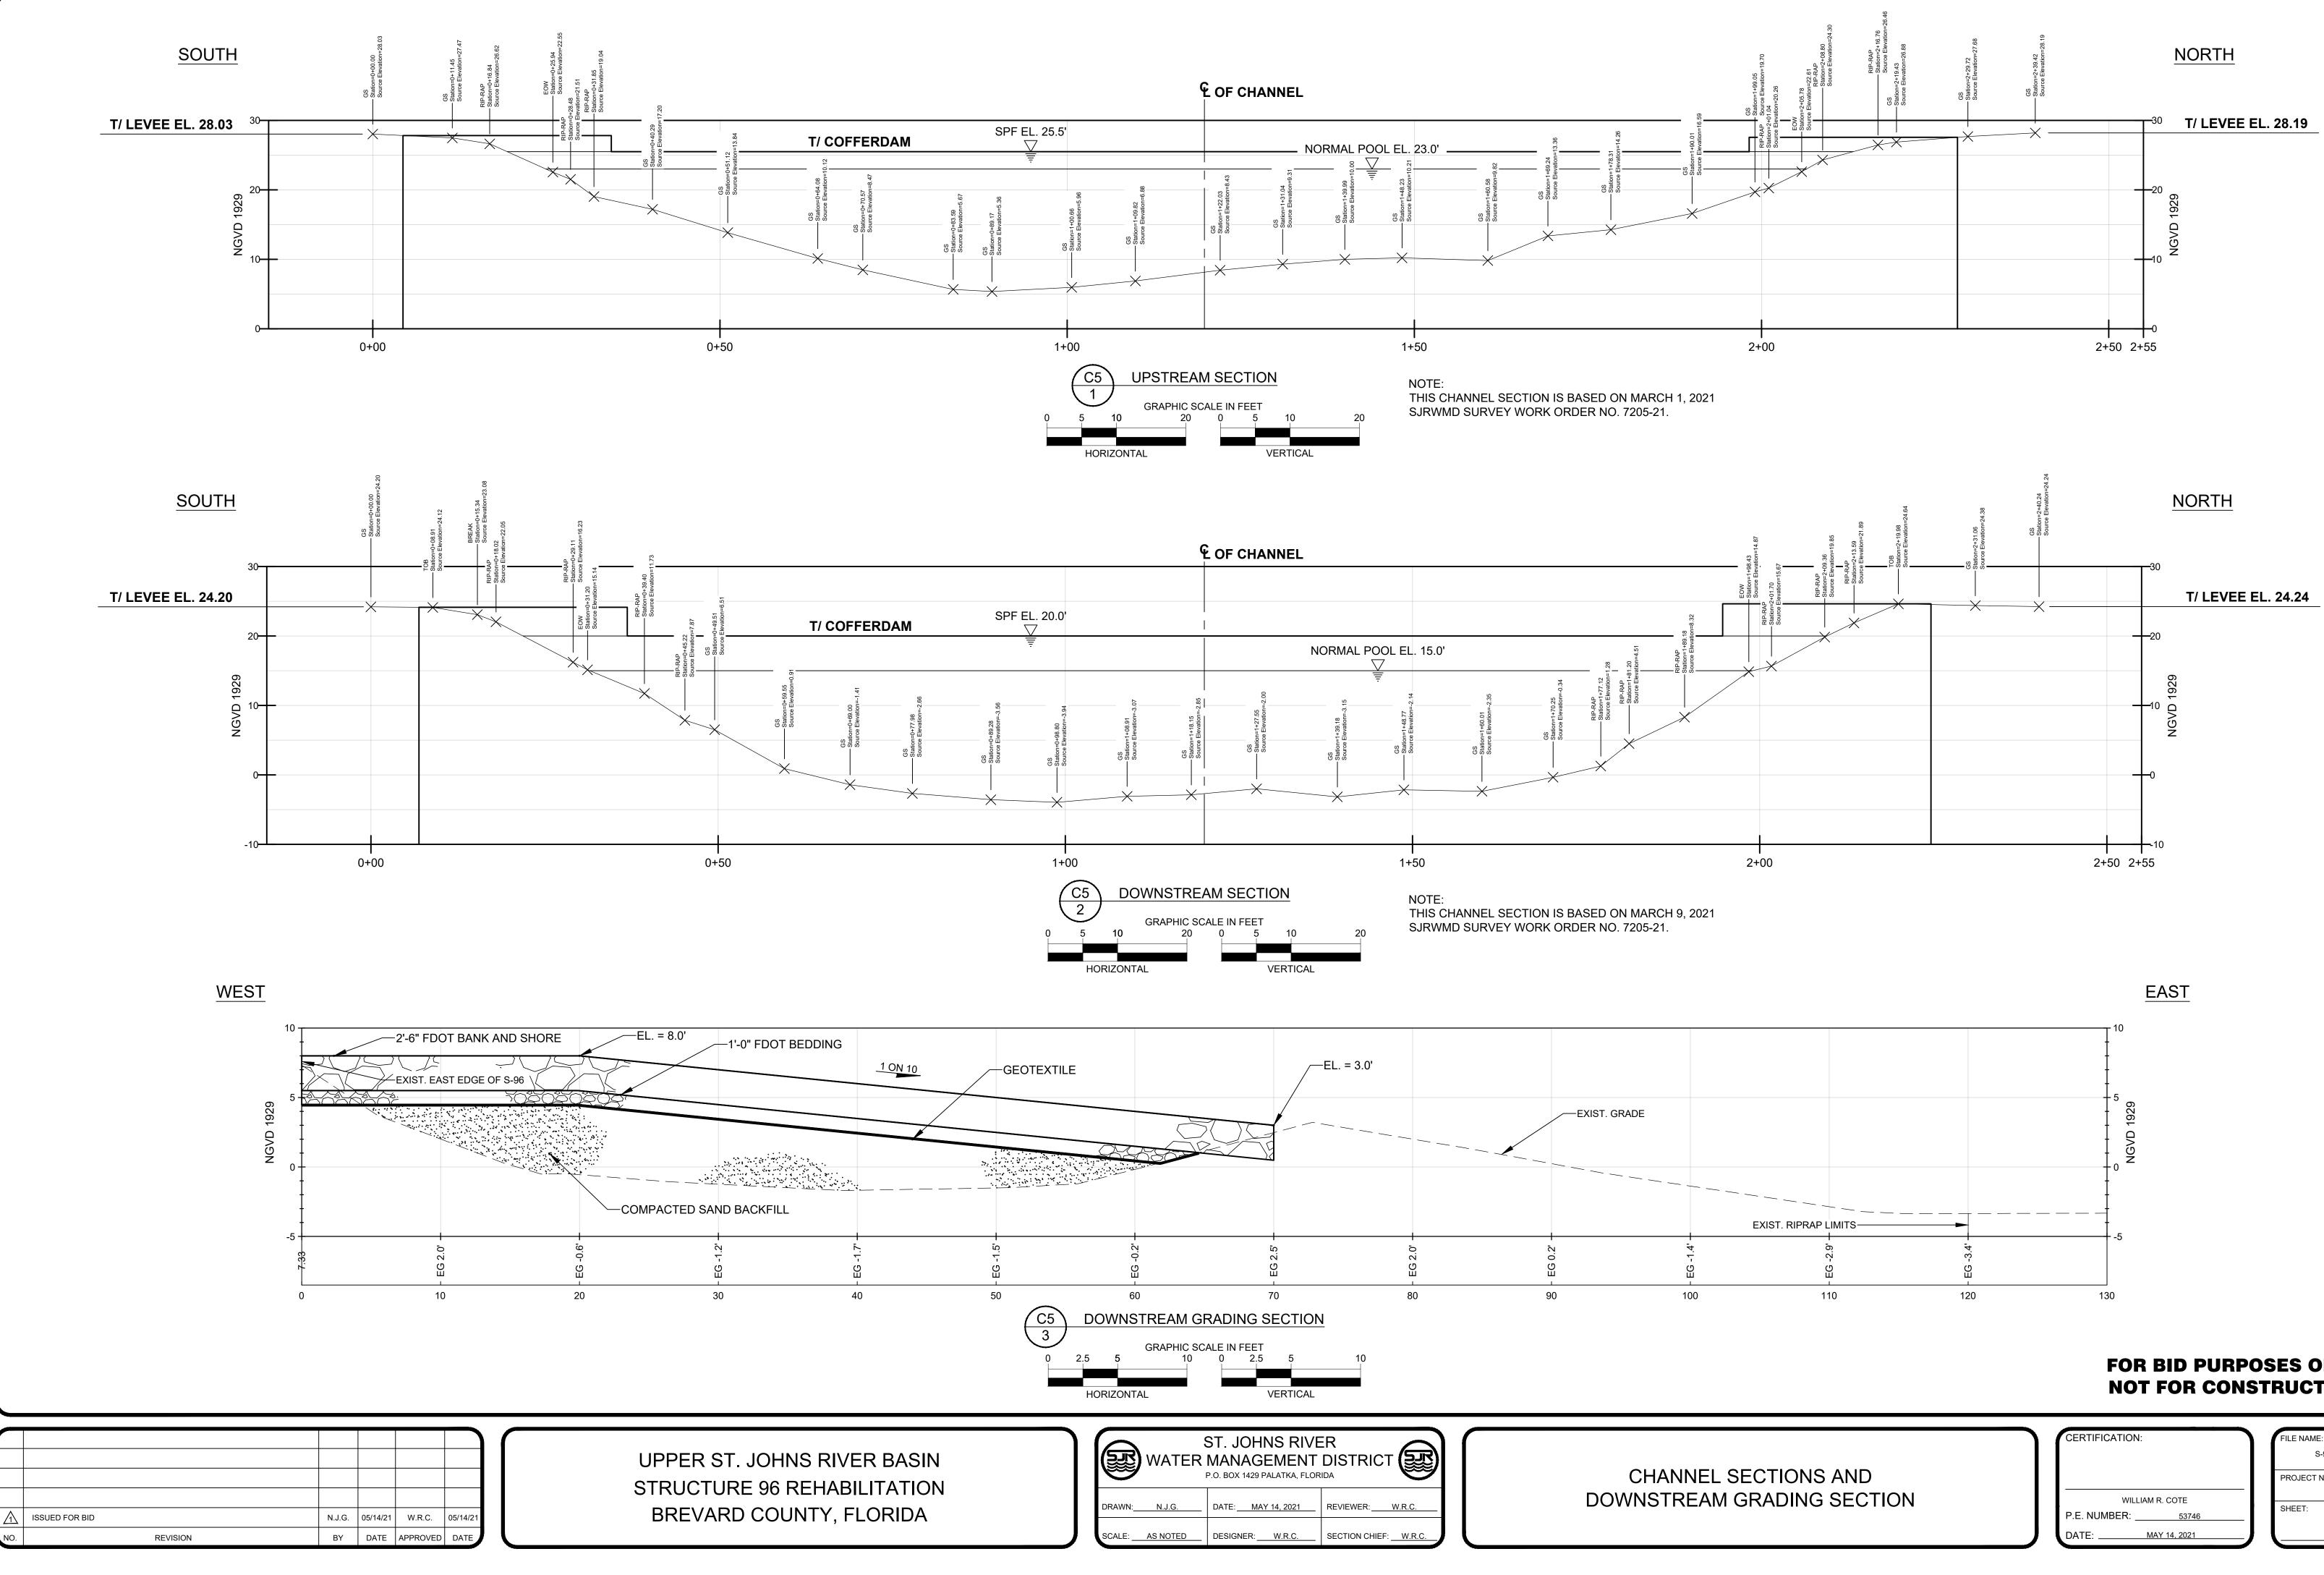

SCALE: AS NOTED DESIGNER: W.R.C. SECTION CHIEF: W.R.C.

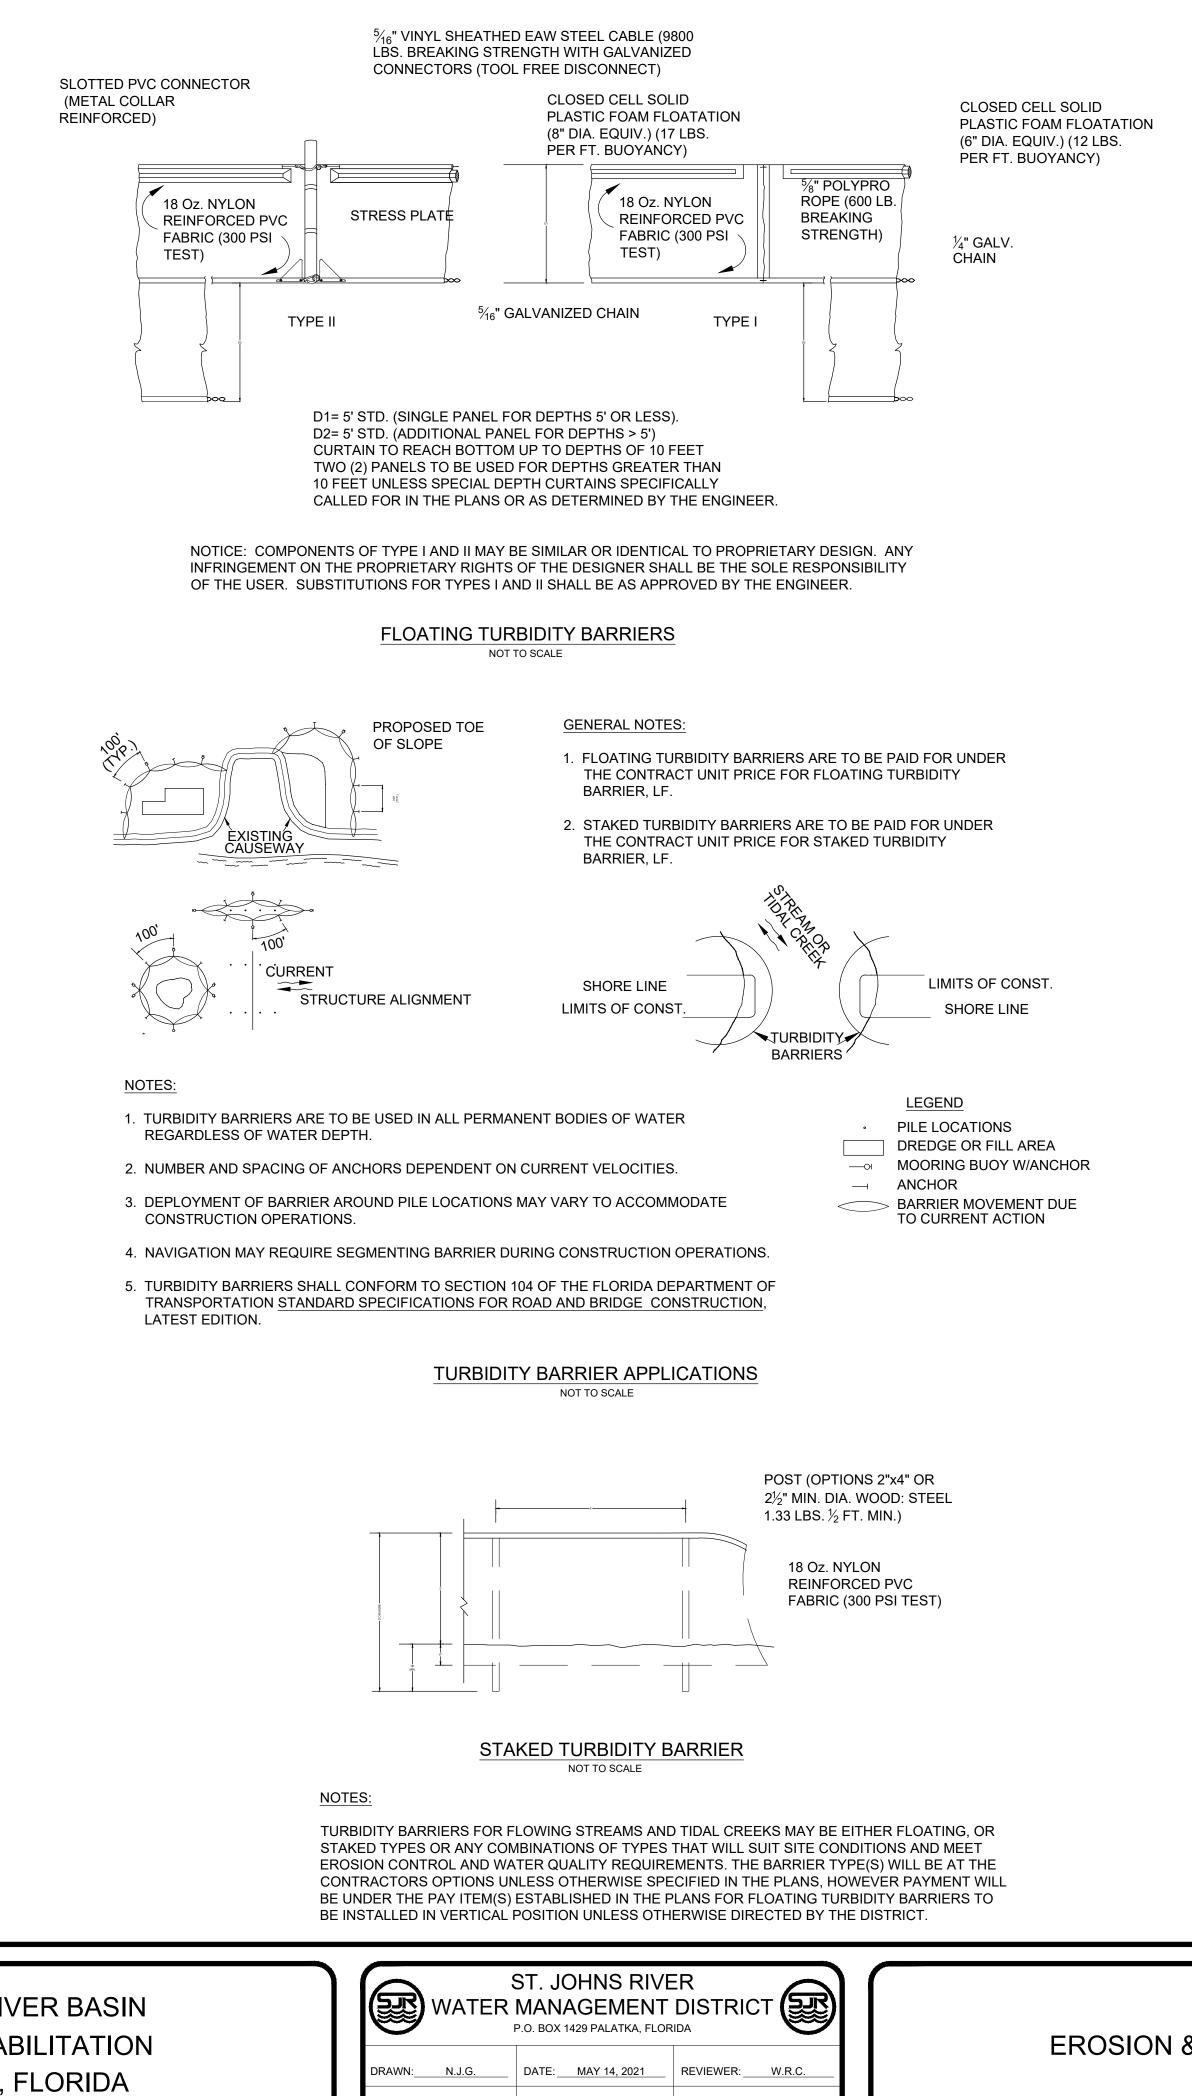

EROSION AND SEDIMENT CONTROL NOTES:

- 1. THE CONTRACTOR IS RESPONSIBLE FOR REMOVING SILT FROM SITE IF NOT REUSABLE ON-SITE AND ASSURING PLAN ALIGNMENT AND GRADE IN ALL WORK AT COMPLETION OF CONSTRUCTION.
- 2. ON-SITE PROTECTION IN ADDITION TO THE ABOVE MUST BE PROVIDED THAT WILL NOT PERMIT SILT TO LEAVE THE PROJECT CONFINES DUE TO UNSEEN CONDITIONS OR ACCIDENTS.
- 3. THE FILTER BARRIER SHALL BE ENTRENCHED AND BACKFILLED. A TRENCH SHALL BE EXCAVATED TO A MINIMUM DEPTH OF 8 INCHES. THE EXCAVATED SOIL SHALL BE BACKFILLED AND COMPACTED AGAINST THE FILTER BARRIER.
- 4. SILT FENCES AND FILTER BARRIERS SHALL BE INSPECTED IMMEDIATELY AFTER EACH RAINFALL AND AT LEAST DAILY DURING PROLONGED RAINFALL. ANY REQUIRED REPAIRS SHALL BE MADE IMMEDIATELY.
- 5. SHOULD THE FABRIC ON A SILT FENCE OR FILTER BARRIER DECOMPOSE OR BECOME INEFFECTIVE PRIOR TO THE END OF THE EXPECTED USABLE LIFE AND THE BARRIER STILL BE NECESSARY, THE FABRIC SHALL BE REPLACED IMMEDIATELY.
- 6. ANY SEDIMENT DEPOSITS REMAINING IN PLACE AFTER THE SILT FENCE OR FILTER BARRIER IS NO LONGER REQUIRED SHALL BE DRESSED TO CONFORM WITH THE EXISTING GRADE, PREPARED AND GRASSED.
- 7. THE CONTRACTOR IS RESPONSIBLE FOR FOLLOWING THE BEST EROSION AND SEDIMENT CONTROL PRACTICES AS OUTLINED IN THE PLANS, SPECIFICATIONS, PERMITS, AND ST. JOHNS RIVER WATER MANAGEMENT DISTRICT CRITERIA.
- 8. FOR ADDITIONAL INFORMATION ON SEDIMENT AND EROSION CONTROL REFER TO THE FLORIDA DEVELOPMENT MANUAL - A GUIDE TO SOUND LAND AND WATER MANAGEMENT FROM THE STATE OF FLORIDA DEPARTMENT OF ENVIRONMENTAL PROTECTION (F.D.E.P.) CHAPTER 6, LATEST EDITION.
- 9. ALL DISTURBED AREAS SHALL BE GRASSED, FERTILIZED, WATERED AND MAINTAINED UNTIL A PERMANENT VEGETATIVE COVER IS ESTABLISHED. GRASSING SHALL CONFORM TO THE REQUIREMENTS OF SECTIONS 570 AND 981 THRU 983 OF THE FLORIDA DEPARTMENT OF TRANSPORTATION STANDARD SPECIFICATION FOR ROAD AND BRIDGE CONSTRUCTION, LATEST EDITIONS. NOTE THAT OTHER GRASSING ALTERNATIVES MAY BE USED WITH PRIOR DISTRICT APPROVAL.

FOR BID PURPOSES ONLY NOT FOR CONSTRUCTION

CERTIFICATION:

WILLIAM R. COTE P.E. NUMBER: 53746 MAY 14, 2021 DATE

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C6

EROSION & SEDIMENT CONTROL

NOTE SPECIFICATIONS:

REFERENCE DOCUMENTS:

- 1. AS-BUILT DRAWINGS PREPARED BY THE US ARMY CORPS OF ENGINEERS, "STRUCTURE 96", DATED AUGUST 1970. THE BORING LOGS AND GRADATION CURVES ARE INCLUDED IN THESE DRAWINGS.
- 2. REPORTS PREPARED BY ARDAMAN & ASSOCIATES, INC., "ENGINEERING EVALUATION OF CONCRETE CONDITION AND STEEL SHEET PILE WING WALL THICKNESS, STRUCTURE S-96", DATED AUGUST 30, 2013 AND JUNE 25, 2014.

- 8. ISOLATED SPALLS SHALL BE HAND PATCHED WITH TAMMS STRUCTURAL MORTAR AS MANUFACTURED BY THE EUCLID CHEMICAL COMPANY, OR **GENERAL**: APPROVED EQUAL. EDGES OF SPALLS SHALL BE SAWCUT DURING SURFACE PREPARATION TO A MINIMUM DEPTH OF 1/2 INCH. THE REPAIR AREA SHALL NOT BE LESS THAN 1/8" IN DEPTH. SUBSTRATE SHALL BE SATURATED SURFACE DRY (SSD) WITH NO STANDING WATER DURING APPLICATION 1. THE CONTRACTOR SHALL BE RESPONSIBLE TO FAMILIARIZE HIMSELF WITH THE NATURE AND EXTENT OF THE CONTRACT DOCUMENTS, SCOPE OF THE PREPARED CONCRETE SUBSTRATE SHALL BE PRIMED WITH A BRUSH OR SPRAY APPLIED COAT OF DURALPREP AC. THE PRIMER COAT OF WORK, LOCAL CONDITIONS, ALL FEDERAL, STATE, AND LOCAL LAWS, RULES, AND REGULATIONS THAT MAY AFFECT THE WORK. THE CONTRACTOR DURALPREP AC MUST BE ALLOWED TO THOROUGHLY DRY BEFORE APPLICATION OF THE TAMMS STRUCTURAL MORTAR. ALTERNATIVELY, AN SSD SHALL PROVIDE A GANTT CHART SCHEDULE FOR ALL THE PROPOSED WORK PRIOR TO THE START OF CONSTRUCTION. CONCRETE SURFACE CAN BE PRIMED WITH A SCRUB COAT OF TAMMS STRUCTURAL MORTAR FOR HAND APPLICATIONS. THE REPAIR MUST BE MADE BEFORE THE SCRUB COAT DRIES OUT.
- 2. THE EXISTING CONDITIONS REPRESENTED IN THESE DRAWINGS AND THE REFERENCED DRAWINGS ARE BELIEVED TO BE ACCURATE ACCORDING TO THE INFORMATION AVAILABLE TO THE DISTRICT. HOWEVER, IT IS THE SOLE RESPONSIBILITY OF THE BIDDER (CONTRACTOR) TO VERIFY ALL EXISTING 9. OPEN CRACKS IN CONCRETE SHALL BE SAWCUT 1/4-INCH WIDE X 1/4-INCH DEEP AND REPAIRED WITH TAMMS STRUCTURAL MORTAR. APPLY A PRIMER CONDITIONS AND REPORT ANY DISCREPANCIES TO THE DISTRICT PRIOR TO SUBMITTAL OF THE BID. COAT OF DURALPREP AC OR A SCRUB COAT OF TAMMS STRUCTURAL MORTAR TO THE CONCRETE SUBSTRATE PRIOR TO PATCHING.

3. PERMITS:

- THE CONTRACTOR SHALL COMPLY WITH THE CONDITIONS CONTAINED IN THE FOLLOWING PERMITS WHICH HAVE BEEN OBTAINED BY THE DISTRICT:
- U.S. DEPARTMENT OF THE ARMY, CORPS OF ENGINEERS, NATIONWIDE PERMIT.

THE CONTRACTOR SHALL OBTAIN ANY AND ALL REMAINING PERMITS AS REQUIRED FOR THE CONSTRUCTION OF THE PROJECT. THE CONTRACTOR SHALL OBTAIN AN NPDES PERMIT IF HIS CONSTRUCTION ACTIVITIES WILL DISTURB AN ACRE OR MORE OF LAND.

- 11. ERODED CONCRETE SURFACES SHALL BE REPAIRED WITH TAMMS STRUCTURAL MORTAR. APPLICATION MAY BE BY TROWEL OR LOW PRESSURE FLORIDA DEPARTMENT OF ENVIRONMENTAL PROTECTION, NOTICED GENERAL PERMIT. WET SPRAY PROCESS. AN EVAPORATION RETARDANT, SUCH AS EUCOBAR AS MANUFACTURED BY THE EUCLID CHEMICAL COMPANY, OR APPROVED EQUAL, SHALL BE USED IF REQUIRED BY WEATHER CONDITIONS. SURFACE PREPARATION, APPLICATION, AND CURING SHALL BE IN ACCORDANCE WITH THE MANUFACTURER SPECIFICATIONS. THE REPAIR AREA SHALL NOT BE LESS THAN 1/8" IN DEPTH. SUBSTRATE SHALL BE SSD WITH NO STANDING WATER DURING APPLICATION. FOR HAND APPLICATION, THE PREPARED CONCRETE SUBSTRATE SHALL BE PRIMED WITH A BRUSH OR SPRAY APPLIED COAT OF DURALPREP AC. THE PRIMER COAT OF DURALPREP AC MUST BE ALLOWED TO THOROUGHLY DRY BEFORE APPLICATION OF THE TAMMS 4. THE CONTRACTOR SHALL CARRY OUT ALL CONSTRUCTION OPERATIONS IN A MANNER WHICH DOES NOT CAUSE VIOLATIONS OF STATE WATER STRUCTURAL MORTAR. ALTERNATIVELY, AN SSD CONCRETE SURFACE CAN BE PRIMED WITH A SCRUB COAT OF TAMMS STRUCTURAL MORTAR FOR QUALITY STANDARDS. THE CONTRACTOR SHALL PROVIDE ALL TEMPORARY EROSION AND SEDIMENT CONTROL MEASURES (SILT FENCE, HAY BALES, HAND APPLICATIONS. THE REPAIR MUST BE MADE BEFORE THE SCRUB COAT DRIES OUT. AT NO TIME SHALL THE REPAIR MORTAR MIX BE ALLOWED TURBIDITY BARRIER, ETC.) AS REQUIRED FOR COMPLIANCE WITH FEDERAL, STATE, AND LOCAL LAWS, RULES, AND REGULATIONS. TO EXCEED 90 DEGREES FAHRENHEIT. COLD WATER SHALL BE USED IN THE MIX AS REQUIRED TO MAINTAIN THE PROPER TEMPERATURE.
- 5. ALL ERODIBLE GROUND AREAS AND SLOPES DISTURBED DURING CONSTRUCTION SHALL BE REVEGETATED WITH SOD, MULCH, SEED, WETLAND 12. CURING: ALL MORTAR REPAIRS SHALL BE WATER CURED FOR 7 DAYS FOLLOWING APPLICATION. MOIST CURE IMMEDIATELY AFTER FINISHING WITH SPECIES. OR OTHERWISE APPROPRIATELY STABILIZED WITHIN 72 HOURS AFTER COMPLETION OF THE CONSTRUCTION ACTIVITY AND AT ANY OTHER WET BURLAP AND POLYETHYLENE OR A FINE MIST OF WATER. IF NECESSARY, PROTECT NEWLY APPLIED MATERIAL FROM DIRECT SUNLIGHT, WIND, TIME AS NECESSARY TO PREVENT VIOLATIONS OF STATE WATER QUALITY STANDARDS. ANY DISTURBED SLOPES STEEPER THAT 4:1 SHALL BE RAIN, AND FROST. AT NO TIME DURING THIS INITIAL CURING PERIOD SHALL THE MORTAR BE ALLOWED TO DRY. FOLLOWING THE 7-DAY CURING PERIOD SODDED. AND WHILE THE REPAIR IS STILL SATURATED, THE SURFACE OF THE REPAIR SHALL RECEIVE TWO COATS OF THE SPECIFIED PROTECTIVE COATING.
- 6. THE CONTRACTOR SHALL PROVIDE THE NECESSARY WATER CONTROL SUCH THAT ALL CONSTRUCTION IS PERFORMED IN THE DRY. FOR THE 13. FOLLOWING COMPLETION OF MORTAR REPAIRS, ALL CONCRETE SURFACES SHALL BE COATED WITH SIKATOP 144 (CEMENT-GRAY COLOR), AS PURPOSES OF THIS WORK, THE TERM "DRY" SHALL BE DEFINED AS SURFACES FREE OF MOISTURE, STANDING WATER, FLOWING WATER, RAIN, OR MANUFACTURED BY SIKA CORPORATION, OR APPROVED EQUAL, TO PROVIDE A UNIFORM APPEARANCE. APPLICATION SHALL BE WITH BRUSHES, GROUNDWATER SEEPAGE EXCEPT AS OTHERWISE NOTED IN THE CONTRACT DOCUMENTS OR AS OTHERWISE APPROVED BY THE DISTRICT. THE ROLLERS, OR HOPPER-TYPE SPRAY EQUIPMENT. SURFACE SHALL BE SSD BEFORE APPLICATION. APPLY A MINIMUM OF TWO COATS, 8-16 MILS DFT CONTRACTOR SHALL TAKE ALL PRECAUTIONS NECESSARY TO CONTROL THE FLOW OF WATER. PER COAT, SUCH THAT THE SURFACE HAS A UNIFORM APPEARANCE. MOIST CURE WITH WET BURLAP AND POLYETHYLENE OR A FINE MIST OF WATER FOR A MINIMUM OF 3 DAYS IN AREAS THAT WILL BE SUBJECT TO IMMERSION.
- 7. THE CONTRACTOR SHALL PROTECT ALL UTILITIES AND OTHER SITE IMPROVEMENTS FROM DAMAGE WHETHER OR NOT SHOWN ON THE DRAWINGS THE CONTRACTOR SHALL ASSUME ALL RESPONSIBILITY FOR REPAIRS TO UTILITIES AND OTHER SITE IMPROVEMENTS DAMAGED DURING 14. SUBMITTALS: BEFORE BEGINNING ANY REPAIR WORK, THE CONTRACTOR SHALL SUBMIT A DETAILED LIST OF THE EQUIPMENT, PROCEDURES, AND CONSTRUCTION. ADDITIONALLY, THE WORK WILL BE CONSIDERED COMPLETE ONLY AFTER ALL RUBBISH AND UNUSED MATERIAL DUE TO OR MATERIALS PROPOSED FOR USE IN CONCRETE REPAIR TO THE DISTRICT FOR APPROVAL. CONNECTED WITH THE WORK HAS BEEN REMOVED AND THE PREMISES LEFT IN A CONDITION SATISFACTORY TO THE DISTRICT.
- 8. THE CONTRACTOR SHALL REPAIR ALL AREAS DISTURBED DURING CONSTRUCTION TO ITS ORIGINAL OR BETTER CONDITION.
- 9. THE CONTRACTOR SHALL PROVIDE ALL SAFETY AND TRAFFIC CONTROL NECESSARY FOR ACCESS TO THE SITE AND WORK WITHIN THE PROJECT LIMITS.
- 1. TESTING LABORATORY: THE CONTRACTOR SHALL RETAIN AN INDEPENDENT TESTING LABORATORY, APPROVED BY THE DISTRICT, FOR THE SAMPLING 10. THE CONTRACTOR SHALL COORDINATE ACTIVITIES AND COOPERATE WITH OTHER CONTRACTORS AND DISTRICT PERSONNEL PERFORMING WORK AND TESTING OF THE REPAIR MORTAR AND CAST IN PLACE CONCRETE. THE LABORATORY'S INSPECTORS SHALL HAVE FREE ACCESS TO ALL POINTS WITHIN THE PROJECT LIMITS. WHERE CONCRETE MATERIALS ARE STORED, PROPORTIONED, MIXED AND PLACED.
- 11. CONSTRUCTION INSPECTION WILL BE PERFORMED BY THE DISTRICT. THE CONTRACTOR SHALL NOTIFY THE DISTRICT AT LEAST 48 HOURS PRIOR TO THE REQUIRED TIME OF INSPECTION FOR EACH AND EVERY PHASE OF WORK.
- 12. THE CONTRACTOR SHALL MAINTAIN A COMPLETE SET OF CONTRACT DOCUMENTS INCLUDING DRAWINGS AND SPECIFICATIONS AT THE JOB SITE CLEARLY MARKED TO REFLECT ALL AS-BUILT CONDITIONS. UPON COMPLETION OF THE PROJECT. THE CONTRACTOR SHALL SUBMIT THESE ANNOTATED DRAWINGS AND SPECIFICATIONS TO THE DISTRICT. CONTRACTOR SHALL ALSO SUBMIT AN AS-BUILT SURVEY SIGNED AND SEALED BY A FL LICENSED LAND SURVEYOR.

CONCRETE REPAIR:

- 1. THE SCOPE AND EXTENT OF ALL CONCRETE REPAIR WORK SHALL BE FIELD DETERMINED DURING THE JOINT INSPECTION BY THE DISTRICT AND THE 4. REPAIR MORTAR COMPRESSIVE STRENGTH: THE REPAIR MATERIAL SHALL ATTAIN A MINIMUM 28-DAY COMPRESSIVE STRENGTH OF 7000 PSI CONTRACTOR. THE CONTRACTOR SHALL ARRANGE FOR, AND PROVIDE, THE SERVICES OF THE PRODUCT MANUFACTURER'S TECHNICAL COMPRESSION STRENGTH OF A SAMPLE SHALL BE DETERMINED BY THE AVERAGE OF THE THREE (3) SAMPLES TESTED AT TWENTY-EIGHT (28) DAYS. REPRESENTATIVE FOR THIS MEETING TO REVIEW AND DISCUSS THE REPAIR SCOPE OF WORK, TECHNIQUES, AND PROCEDURES. THE PRODUCT COMPLIANCE WITH THE STRENGTH REQUIREMENTS OF THESE SPECIFICATIONS SHALL BE VERIFIED IF THE AVERAGE COMPRESSIVE STRENGTH OF REPRESENTATIVE SHALL ALSO BE PRESENT FOR AN INITIAL CONCRETE REPAIR OPERATION SITE VISIT FOR THE PURPOSE OF CONFIRMING THAT THE THREE (3) CONSECUTIVE SAMPLES IS NOT LESS THAN THE SPECIFIED STRENGTH FOR THE CLASS OF CONCRETE, PROVIDED NO INDIVIDUAL SAMPLE CONTRACTOR'S PERSONNEL ARE PROPERLY APPLYING THE REPAIR MATERIAL AND TO WITNESS THE FIRST APPLICATION OF EACH TYPE OF REPAIR SHALL HAVE A STRENGTH TEST RESULT THAT FALLS BELOW THE SPECIFIED STRENGTH BY MORE THAN SEVEN-HUNDRED (700) PSI. CONCRETE WHICH MATERIAL INSTALLED. FAILS TO MEET STRENGTH REQUIREMENTS SHALL BE FURTHER TESTED AS PROVIDED IN ACI 318 AT THE EXPENSE OF CONTRACTOR OR SHALL BE REMOVED AS DETERMINED BY THE DISTRICT.
- 2. THE CONTRACTOR SHALL INSPECT AND PROBE CONCRETE SURFACES TO IDENTIFY AND LOCATE ALL AREAS OF DETERIORATION. REPAIR AREAS SHALL INCLUDE CONCRETE FOUND TO BE CRACKED, SPALLED, OR OTHERWISE SHOWING EVIDENCE OF DISINTEGRATION OR STRUCTURAL FAILURE.
- SIEVE. 5. CONCRETE CYLINDER TESTS: CONCRETE CYLINDERS SHALL BE TAKEN AND TESTED IN ACCORDANCE WITH ASTM C39 "STANDARD TEST METHOD FOR COMPRESSIVE STRENGTH OF CYLINDRICAL CONCRETE SPECIMENS." SAMPLING FREQUENCY FOR CONCRETE SHALL BE FOR EACH FIFTY (50) CUBIC 3. SURFACE PREPARATION: ALL ERODED, DAMAGED, DETERIORATED, LOOSENED, OR UNBONDED PORTIONS OF EXISTING CONCRETE SHALL BE YARDS OR PORTION THEREOF OF CONCRETE PLACED EACH DAY. THE LABORATORY SHALL TAKE A SAMPLE FROM A BATCH OF ITS SELECTION AS THE REMOVED BY HIGH PRESSURE HYDROBLASTING (8000-15000 PSI) TO ACHIEVE A SOUND EXPOSED AGGREGATE SURFACE WITH A MINIMUM SURFACE CONCRETE IS BEING PLACED. NO WATER SHALL BE ADDED OR OTHER CHANGE MADE IN ANY BATCH AFTER IT HAS BEEN SAMPLED. IN ADDITION TO PROFILE EQUAL TO CSP 6 - 9 IN ACCORDANCE WITH ICRI GUIDELINE 310.2. THE PRODUCT REPRESENTATIVE SHALL INSPECT AND APPROVE IN WRITING OTHER TESTS, THE LABORATORY WILL MAKE A SET OF FIVE (5) STANDARD COMPRESSION CYLINDERS FROM EACH SAMPLE, ONE (1) OF WHICH WILL BE THAT THE SURFACE PREPARATION IS ACCEPTABLE FOR THE APPLICATION OF THE REPAIR PRODUCTS. GENERALLY, THE CONCRETE AREAS TO BE TESTED AT SEVEN (7) DAYS AND THREE (3) TESTS AT TWENTY-EIGHT (28) DAYS AND AN ADDITIONAL SAMPLE SHALL BE TESTED AT 56 DAYS IF DEEMED UPWARD. HYDROBLASTED WILL BE TO A DEPTH OF LESS THAN 1 INCH. THE FINAL EXTENT OF THE HYDRODEMOLITION AREA WILL BE DETERMINED DURING NECESSARY. CONSTRUCTION AS DICTATED BY THE EXISTING CONDITIONS ENCOUNTERED.

REMOVAL OF DETERIORATED CONCRETE BY MECHANICAL MEANS SUCH AS BUSH HAMMERING, JACK HAMMERING, SCABBLER, OR OTHER APPROPRIATE MEANS MAY BE USED SUBJECT TO DISTRICT APPROVAL. IF MECHANICAL METHODS ARE USED, THE SURFACES SHALL BE FINISHED BY HYDROBLASTING, SHOTBLASTING, OR WET SANDBLASTING WITH NON-METALLIC ABRASIVES TO REMOVE ANY MICROFRACTURED SURFACES RESULTING FROM THE INITIAL REMOVAL PROCESS.

THE BOUNDARIES BETWEEN THE ERODED AND SOUND CONCRETE SURFACES SHALL BE SAWCUT AS SHOWN ON THE DRAWINGS IN ORDER TO PROVIDE A SMOOTH TRANSITION FOR THE MORTAR REPAIR AREAS.

ALL REPAIR SURFACES SHALL BE THOROUGHLY CLEANED WITH WATER UNDER PRESSURE. THE SURFACE MUST BE CLEAN AND FREE OF LOOSE CONCRETE, LAITANCE, DIRT, GREASE, FORM OIL, EFFLORESCENCE, PAINT, AND ANY OTHER FOREIGN MATERIAL.

- 4. CONCRETE SURFACE REPAIRS MAY GENERALLY CONSIST OF EITHER HAND-APPLIED OR MACHINE APPLIED METHODS.
- 5. ALL SURFACE PREPARATION AND APPLICATION SHALL BE IN ACCORDANCE WITH THE MANUFACTURER SPECIFICATIONS. CONTRACTOR SHALL CONSULT IN THE FIELD WITH MANUFACTURER AND DISTRICT PRIOR TO SURFACE PREPARATION AND REPAIR. FOR SPECIFIC SURFACE PREPARATION REQUIREMENTS, REFER TO INTERNATIONAL CONCRETE REPAIR INSTITUTE (ICRI) GUIDELINE NO. 03732.
- 6. ALL LOOSE SCALE, RUST, CORROSION BY PRODUCTS, OR CONCRETE SHALL BE REMOVED FROM EXPOSED REINFORCING STEEL (REBAR) BY 2. WELDING SHALL BE IN ACCORDANCE WITH THE AMERICAN WELDING SOCIETY (AWS) "STRUCTURAL WELDING CODE" AWS D1.1. MECHANICAL CLEANING METHODS. REBAR EXPOSED FOR MORE THAN ONE-THIRD OF ITS CIRCUMFERENCE SHALL BE COMPLETELY EXPOSED TO PROVIDE 1-INCH MINIMUM CLEARANCE BETWEEN THE REBAR AND THE CONCRETE. DAMAGED OR DETERIORATED REBAR SHALL BE REMOVED AND 3. ALL STRUCTURAL AND MISCELLANEOUS STEEL SHALL BE NEW AND CONFORM TO THE REQUIREMENTS OF THE AMERICAN SOCIETY OF TESTING AND REPLACED. REPLACEMENT REBAR SHALL BE GRADE 60 DEFORMED BILLET STEEL BARS CONFORMING TO ASTM A-615. REINFORCEMENT SPLICES MATERIALS (ASTM) STANDARD A36 UNLESS NOTED OTHERWISE. SHALL BE AS FOLLOWS:

BAR SIZE	SPLICE LENGTH (IN)			
#3	12			
#4	12			
#5	15			
#6	18			
#7	24			
#8	30			

-					
\wedge	ISSUED FOR BID	N.J.G.	05/14/21	W.R.C.	05/14/21
NO.	REVISION	BY	DATE	APPROVED	DATE

UPPER ST. JOHNS STRUCTURE 96 REH **BREVARD COUNT**

ALTERNATIVELY, MECHANICAL SPLICES MAY BE USED SUBJECT TO DISTRICT APPROVAL.

- 7. ALL EXPOSED AND REPLACEMENT REBAR SHALL BE COATED WITH DURALPREP AC AS MANUFACTURED BY THE EUCLID CHEMICAL COMPANY, OR APPROVED EQUAL, PRIOR TO PATCHING WITH THE REPAIR MORTAR.
- 10. CRACKS WITH FLOWING WATER SHALL BE REPAIRED WITH CHEMICAL GROUT AS DETAILED ON THE DRAWINGS PRIOR TO CONCRETE SURFACE REPAIR. CUT AND REMOVE EXCESS CHEMICAL GROUT PRIOR TO CONCRETE REPAIR. WHEN SEALING VERTICAL CRACKS, BEGIN AT THE BOTTOM AND WORK UP. WHERE WATER FLOW IS PRESENT, BEGIN INJECTING CRACK AT THE POINT OF LEAST FLOW AND WORK TOWARDS AREA OF HEAVIEST FLOW. CHEMICAL GROUT SHALL BE HYDRO ACTIVE FLEX AS MANUFACTURED BY DE NEEF CONSTRUCTION CHEMICALS, INC., OR APPROVED EQUAL.

15. POTABLE WATER SHALL BE USED FOR THE FINAL CLEANING OF CONCRETE SURFACES, FOR MIXING WITH REPAIR PRODUCTS, AND FOR CURING REPAIRED SURFACES. CONTRACTOR SHALL BE RESPONSIBLE FOR PROCURING POTABLE WATER AS REQUIRED FOR COMPLETION OF THE PROJECT.

CONCRETE TESTING SERVICES:

- 2. TEST SCHEDULING: CONTRACTOR SHALL ADVISE THE LABORATORY WITH TWENTY-FOUR (24) HOURS ADVANCE NOTICE OF THE TIME AND LOCATION OF ALL REPAIR MORTAR AND CONCRETE PLACEMENT OR OTHERWISE MAKE ARRANGEMENTS WITH THE LABORATORY SO THAT SAMPLES MAY BE OBTAINED.
- 3. REPAIR MORTAR CUBE TESTS: CUBE SAMPLES (2" MORTAR CUBES) SHALL BE TAKEN AND TESTED IN ACCORDANCE WITH ASTM C109 "STANDARD TEST METHOD FOR COMPRESSIVE STRENGTH OF HYDRAULIC CEMENT MORTARS." CUBE TESTING SHALL INCLUDE ONE (1) AT 7-DAYS AND THREE (3) AT 28-DAYS. TWO (2) ADDITIONAL SAMPLES SHALL BE TESTED AT 56 DAYS IF DEEMED NECESSARY. SAMPLING FREQUENCY FOR CUBES SHALL BE ONE PER DAY OR A MINIMUM OF ONE PER WORK AREA, WHICHEVER IS GREATER. THE WORK AREAS ARE DEFINED AS EACH SEPARATE WALL AND FLOOR

- 6. CONCRETE COMPRESSIVE STRENGTH: CAST-IN-PLACE CONCRETE SHALL ATTAIN A MINIMUM 28-DAY COMPRESSIVE STRENGTH OF 5500 PSI COMPRESSION STRENGTH OF A SAMPLE SHALL BE DETERMINED BY THE AVERAGE OF THE THREE (3) CYLINDERS TESTED AT TWENTY-EIGHT (28) DAYS. COMPLIANCE WITH THE STRENGTH REQUIREMENTS OF THESE SPECIFICATIONS SHALL BE VERIFIED IF THE AVERAGE COMPRESSIVE STRENGTH OF THREE (3) CONSECUTIVE SAMPLES IS NOT LESS THAN THE SPECIFIED STRENGTH FOR THE CLASS OF CONCRETE, PROVIDED NO INDIVIDUAL SAMPLE SHALL HAVE A STRENGTH TEST RESULT THAT FALLS BELOW THE SPECIFIED STRENGTH BY MORE THAN FIVE HUNDRED (500) PSI. CONCRETE WHICH FAILS TO MEET STRENGTH REQUIREMENTS MAY BE FURTHER TESTED AS PROVIDED IN ACI 318 AT THE EXPENSE OF CONTRACTOR OR SHALL BE REMOVED AS DETERMINED BY DISTRICT'S PROJECT MANAGER.
- 7. REPORTS: THE TESTING LABORATORY SHALL SUBMIT A REPORT OF EACH TEST MADE, SIGNED AND SEALED BY A FLORIDA LICENSED PROFESSIONAL ENGINEER. INDIVIDUAL TEST REPORTS SHALL BE SUBMITTED TO THE DISTRICT AS SOON AS THEY ARE AVAILABLE. A FINAL REPORT THAT SUMMARIZES THE TESTING AND SAMPLING PROCEDURES AND COMPILES ALL THE INDIVIDUAL TESTS SHALL ALSO BE SUBMITTED TO THE DISTRICT UPON CONCLUSION OF THE WORK.

STEEL:

- 1. STRUCTURAL STEEL DESIGN, FABRICATION, AND ERECTION SHALL BE IN ACCORDANCE WITH THE AMERICAN INSTITUTE OF STEEL CONSTRUCTION (AISC) "SPECIFICATION FOR THE DESIGN, FABRICATION AND ERECTION OF STRUCTURAL STEEL FOR BUILDINGS", LATEST EDITION.
- 4. ALL BOLTS SHALL BE STAINLESS STEEL CONFORMING TO ASTM A276, TYPE 304. THE SIZE AND LOCATION OF REPLACEMENT BOLTS SHALL MATCH EXISTING UNLESS NOTED OTHERWISE.
- 5. ALL WELDING SHALL UTILIZE E70XX LOW-HYDROGEN ELECTRODES UNLESS NOTED OTHERWISE.
- 6. ALL REMOVABLE STEEL ITEMS WHICH WERE PREVIOUSLY GALVANIZED SHALL BE REMOVED AND REPLACED WITH STAINLESS STEEL TYPE 304.
- 7. FIELD CORRECTING OF FABRICATED STEEL SHALL NOT BE PERMITTED ON MAJOR STRUCTURAL MEMBERS WITHOUT PRIOR APPROVAL OF THE DISTRICT.

RIVER BASIN HABILITATION		ST. JOHNS RIVER WATER MANAGEMENT DISTRICT					
Y. FLORIDA	DF	RAWN:	N.J.G.	DATE: MAY 14, 2021	REVIEWER:W.R.C.		
	sc	CALE:	NONE	DESIGNER: W.R.C.	SECTION CHIEF:W.R.C.		

REPAIR OF EXISTING STEEL SHEET PILING WING WALLS:

MANUAL".

FIRST COAT (PRIMER): DURA-PLATE 235 4-8 MILS DFT SECOND COAT: DURA-PLATE 235 4-8 MILS DFT THIRD (FINAL) COAT: DURA-PLATE 235 4-8 MILS DFT

COLOR SHALL BE LIGHT GRAY. CONTRACTOR SHALL SUBMIT COLOR SAMPLES FOR DISTRICT APPROVAL. SURFACE PREPARATION AND APPLICATION SHALL BE IN ACCORDANCE WITH THE PAINT MANUFACTURER SPECIFICATIONS.

- SECOND COAT:

RIPRAP SYSTEM SPECIFICATIONS:



1. EXCAVATE EXISTING RIPRAP AND BEDDING STONE ADJACENT TO THE SHEET PILING WALLS DOWN TO THE SUBGRADE.

2. INSPECT AND REPAIR STEEL SHEET PILING AS NEEDED.

3. PREPARE AND PAINT ALL EXPOSED SHEET PILING SURFACES. REFER TO NOTES FOR PAINTS AND PROTECTIVE COATINGS.

4. AFTER PAINTING, REPLACE THE RIPRAP. SUPPLEMENT WITH ADDITIONAL RIPRAP AND BEDDING STONE AS DIRECTED BY THE DISTRICT.

PAINTS AND PROTECTIVE COATINGS:

1. ALL STEEL SHALL BE PRIMED AND PAINTED IN ACCORDANCE WITH THE STEEL STRUCTURES PAINTING COUNCIL (SSPC) "STEEL STRUCTURES PAINTING

2. PREPARE SURFACES AND PAINT ALL EXPOSED STEEL COMPONENTS. ITEMS TO BE PAINTED INCLUDE STRUCTURAL STEEL, SHEET PILING WING WALLS, AND ALL EMBEDDED STEEL (EXCLUDING STAINLESS STEEL AND ALUMINUM ITEMS).

3. STEEL SURFACE PREPARATION SHALL BE AS FOLLOWS:

STRUCTURAL STEEL, SHEET PILING, AND EMBEDDED STEEL: SSPC-10 NEAR WHITE BLAST CLEANING.

THE USE OF 100% SILICA BLAST MEDIA SHALL NOT BE ALLOWED ON THE CONSTRUCTION SITE. BLAST MEDIA IF USED ON SITE WILL BE SUBJECT TO APPROVAL BY THE DISTRICT.

DURING SURFACE PREPARATION, CONTRACTOR SHALL TAKE APPROPRIATE MEASURES TO CAPTURE PAINT PARTICLES AND BLAST MEDIA AND DISPOSE OFFSITE AT A MUNICIPAL OR COMMERCIAL LANDFILL.

WHERE LEAD PAINT IS FOUND TO BE PRESENT, APPROPRIATE REMOVAL MEASURES SHALL BE UNDERTAKEN IN ACCORDANCE WITH ALL STATE AND FEDERAL REGULATORY REQUIREMENTS.

4. PROTECTIVE COATING FOR STRUCTURAL STEEL AND SHEET PILING SHALL BE AS MANUFACTURED BY SHERWIN-WILLIAMS, OR EQUAL, AS FOLLOWS:

5. PROTECTIVE COATING FOR ALL EMBEDDED GALVANIZED ITEMS SHALL BE AS FOLLOWS:

FIRST COAT (PRIMER): WASSER MC-ZINC 3-5 MILS DFT S-W DURA-PLATE 235 4-8 MILS DFT THIRD (FINAL) COAT: S-W DURA-PLATE 235 4-8 MILS DFT

SURFACE PREPARATION AND APPLICATION SHALL BE IN ACCORDANCE WITH THE PAINT MANUFACTURER SPECIFICATIONS.

BRIDGE EXPANSION JOINT CAULK:

1. THE CAULK FOR THE BRIDGE EXPANSION JOINT SHALL BE SIKAFLEX-2C SL AS MANUFACTURED BY SIKA CORPORATION, OR EQUAL.

1. PROVIDE RUBBLE RIPRAP, BEDDING STONE, AND GEOTEXTILE FABRIC AT THE LOCATIONS SHOWN ON THE DRAWINGS. THE WORK SHALL BE IN ACCORDANCE WITH FLORIDA DEPARTMENT OF TRANSPORTATION STANDARD SPECIFICATION FOR ROAD AND BRIDGE CONSTRUCTION, (FDOT) LATEST EDITION, CONFORMING TO FDOT SECTIONS 514, 530, AND 985, UNLESS OTHERWISE NOTED HEREIN.

2. GEOTEXTILE FABRIC WHERE REQUIRED SHALL BE MIRAFI FILTERWEAVE WOVEN NO. FW 404 (OR APPROVED EQUAL) AND SHALL COMPLY WITH THE REQUIREMENTS SECTION 514 OF THE FLORIDA DEPARTMENT OF TRANSPORTATION STANDARD SPECIFICATION FOR ROAD AND BRIDGE CONSTRUCTION, LATEST EDITION. ADDITIONALLY, THE GEOTEXTILE FABRIC MATERIAL SHALL CONFORM TO THE REQUIREMENTS FDOT TYPE D-2 OF THE FDOT SPECIFICATION SECTION 985. INSTALLATION SHALL BE IN ACCORDANCE WITH THE MANUFACTURERS SPECIFICATIONS.

3. BEDDING STONE SHALL BE IN ACCORDANCE WITH THE REQUIREMENTS OF SECTION 530 OF THE FLORIDA DEPARTMENT OF TRANSPORTATION STANDARD SPECIFICATION, LATEST EDITION. THE FINAL BLANKET THICKNESS SHALL BE A MINIMUM OF 12 INCHES. THE MINIMUM UNIT WEIGHT O STONE SHALL BE 145 PCF (SATURATED SURFACE DRY).

4. RUBBLE RIPRAP SHALL COMPLY WITH THE REQUIREMENTS OF FDOT SECTION 530-2.1.3.1 BANK AND SHORE PROTECTION OR 530-2.1.3.2 DITCH LINING, AS DIRECTED BY THE DISTRICT. THE MATERIAL SHALL BE WELL-GRADED, SOUND AND DURABLE, AND SHALL HAVE A MINIMUM SPECIFIC GRAVITY OF 2.3. THE MATERIAL SHALL BE FREE OF CRACKS, SOFT SEAMS OR OTHER STRUCTURAL DEFECTS. THE PIECES SHALL BE ROUGHLY ANGULAR, AND THE LOT SHALL REASONABLY FREE OF THIN, FLAT OR ELONGATED PIECES. CONSTRUCTION METHODS SHALL BE IN ACCORDANCE WITH FDOT SPECIFICATIONS SECTION 530.

5. COMPACTED SAND BACKFILL WHERE REQUIRED SHALL CONSIST OF CLEAN SAND CLASSIFIED AS SW OR SP WITH LESS THAN 5% PASSING THE NO. 200

6. CONSTRUCTION REQUIREMENTS: ALL SLOPES TO BE TREATED WITH RIPRAP SHALL BE TRIMMED TO THE LINES AND GRADES INDICATED BY THE PLANS OR DIRECTED BY THE DISTRICT. THE SUBGRADE PREPARATION SHALL BE IN ACCORDANCE WITH THE EARTHWORK SPECIFICATIONS. ALL OUTER EDGES AND THE TOP OF RIPRAP WHERE THE RIPRAP TERMINATES SHALL BE FORMED SO THAT THE SURFACE OF THE RIPRAP WILL BE EMBEDDED AND EVEN WITH THE SURFACE OF THE GROUND AND/OR SLOPE. ALL RIPRAP CONSTRUCTION SHALL BEGIN AT THE BOTTOM OF THE SLOPE AND PROGRESS

PLACE A MINIMUM 12-INCH THICK LAYER OF BEDDING STONE UNDER ALL RUBBLE RIPRAP WITHOUT PUNCTURING OR TEARING THE GEOSYNTHETIC MATERIAL. REMOVE AND REPLACE GEOTEXTILE FABRIC DAMAGED AS A RESULT OF CONSTRUCTION OPERATIONS.

PLACE RIPRAP FORMING A COMPACT LAYER CONFORMING TO THE NEAT LINES AND THICKNESS SPECIFIED ON THE DRAWINGS. ENSURE THAT RIPRAP DOES NOT SEGREGATE SO THAT SMALLER PIECES EVENLY FILL THE VOIDS BETWEEN THE LARGER PIECES.

FOR BID PURPOSES ONLY **NOT FOR CONSTRUCTION**

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WILLIAM	R. COTE
P.E. NUMBER:	53746

MAY 14, 2021


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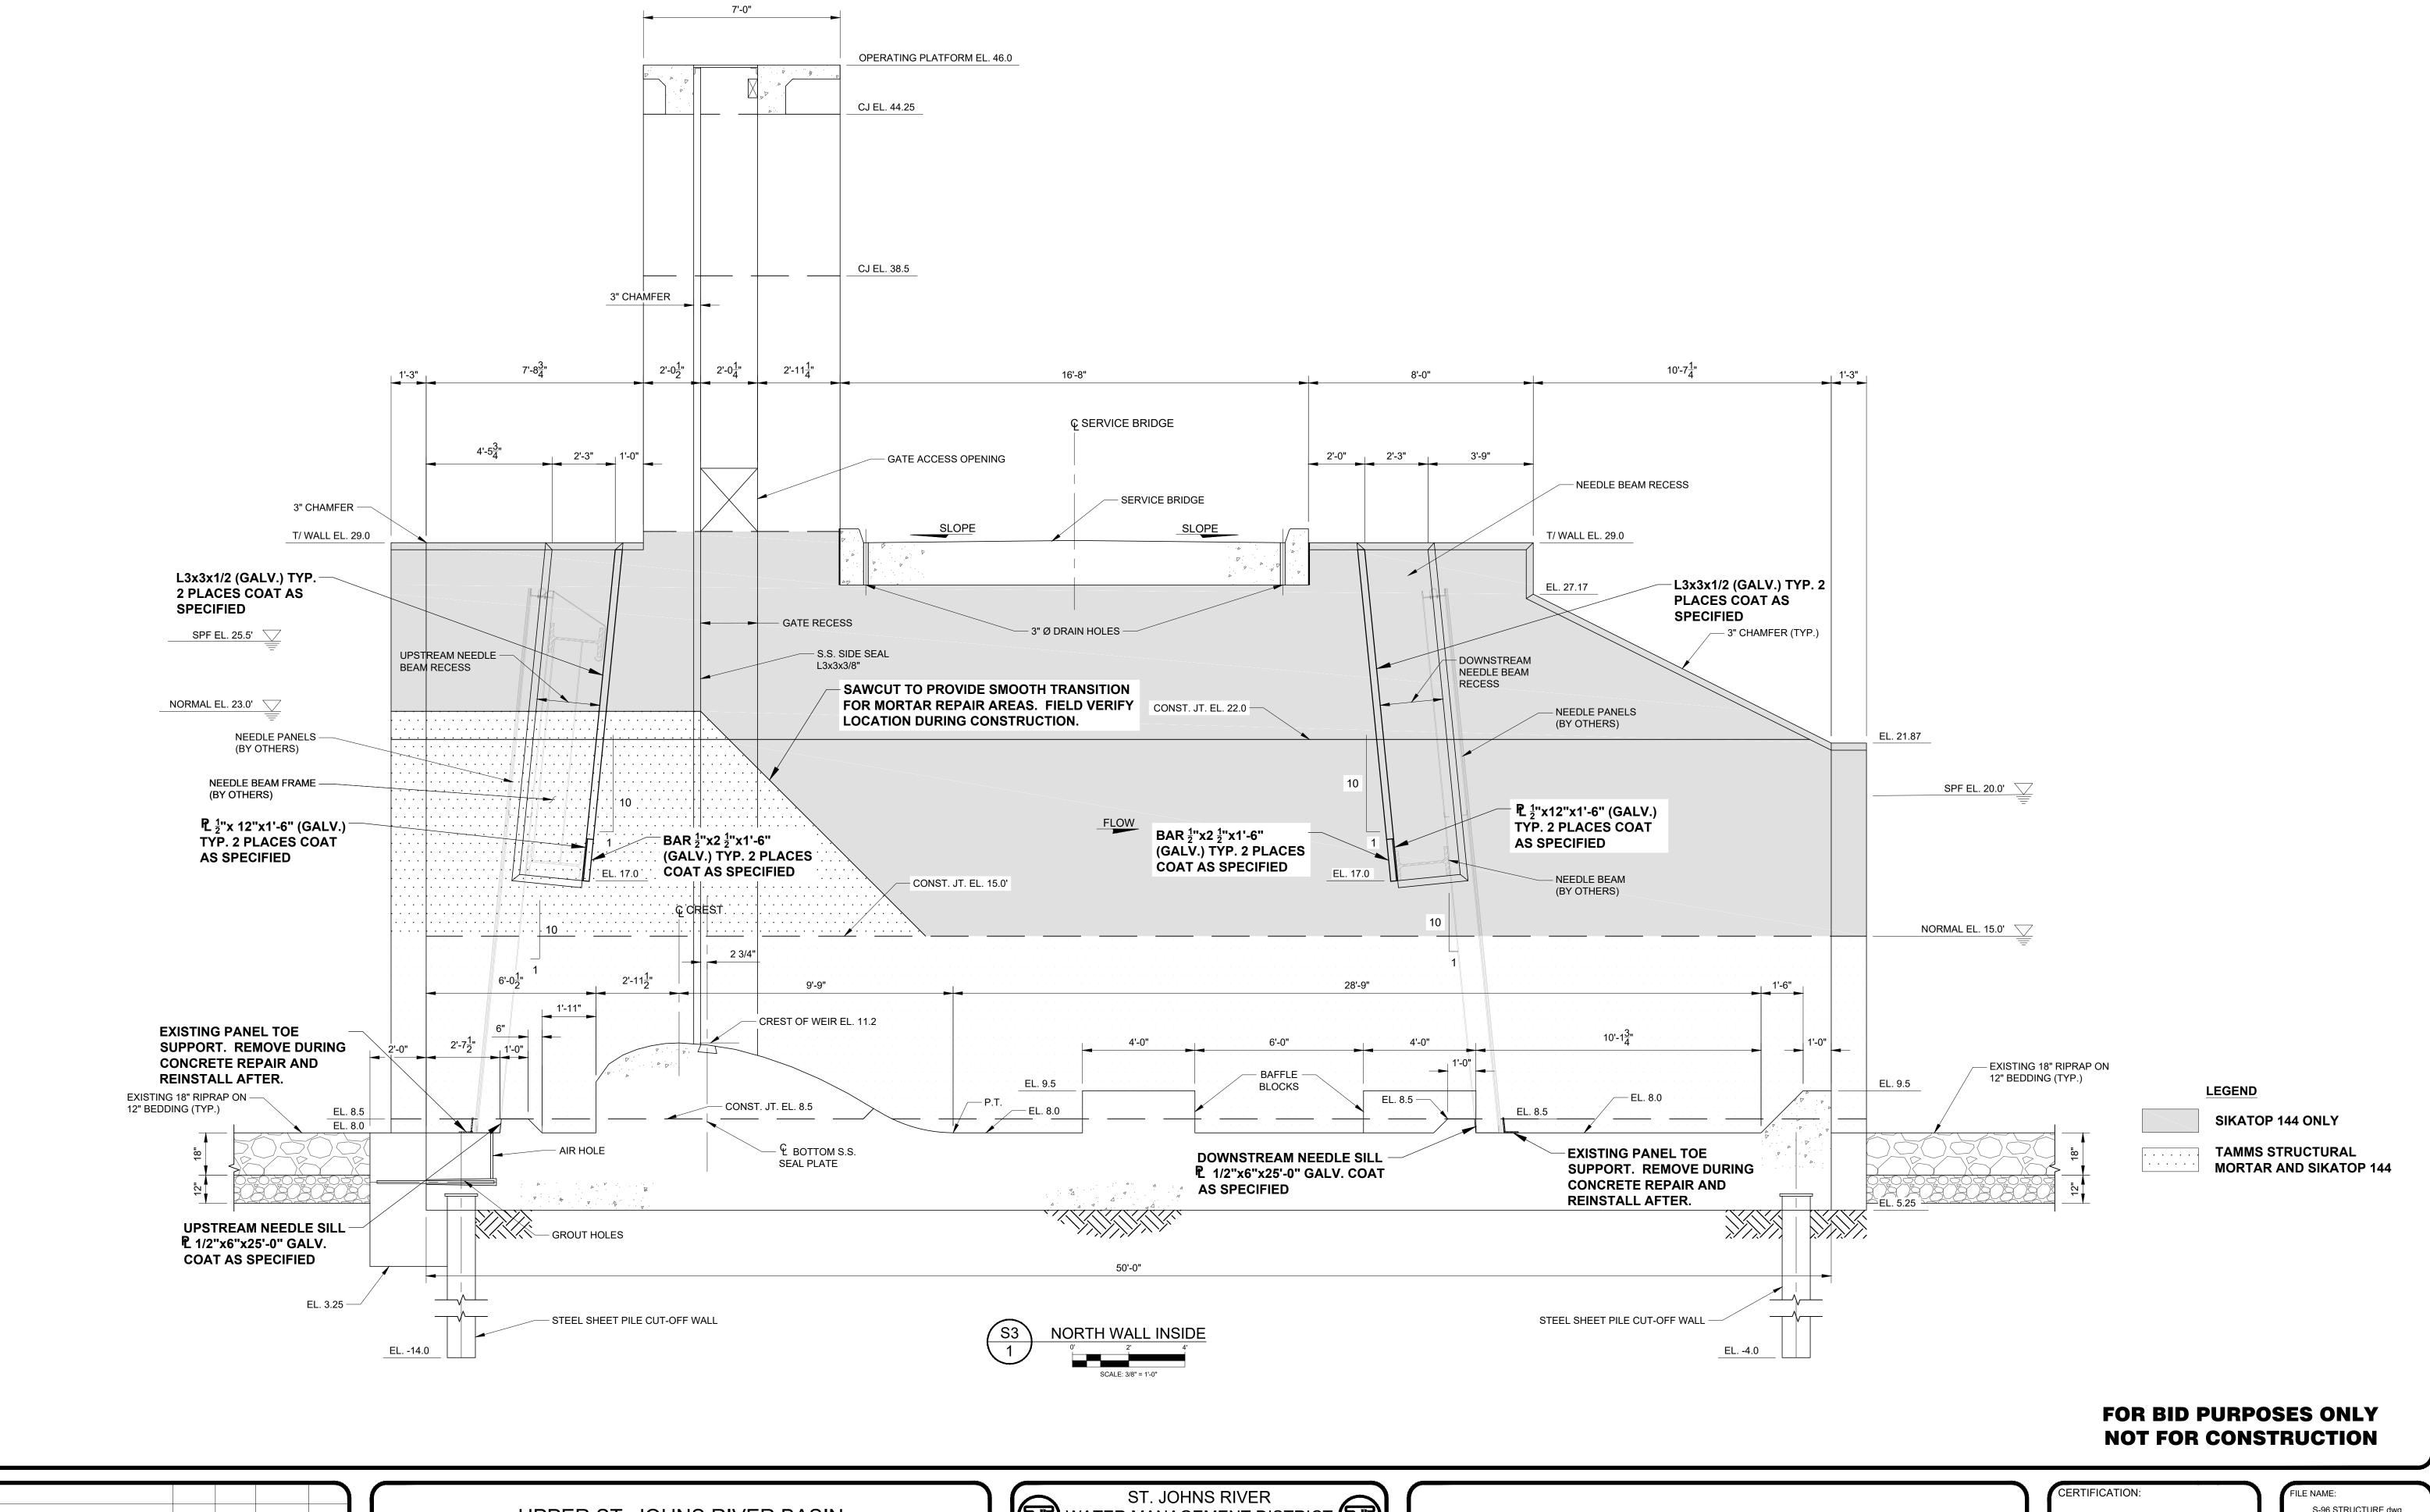
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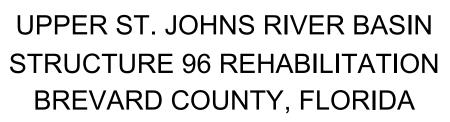
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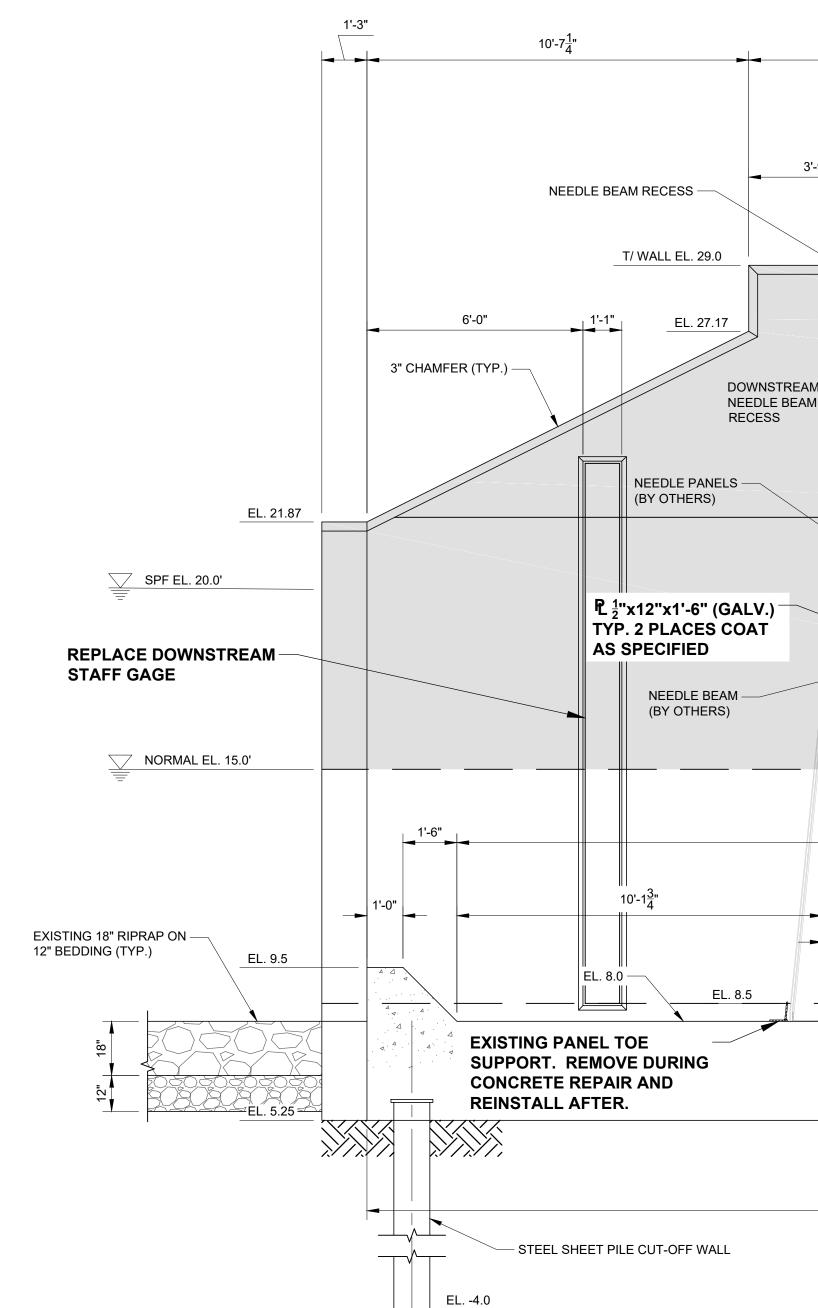
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DRAWN: N.J.G.	DATE:MAY 14, 2021	REVIEWER: W.R.C.
SCALE: AS NOTED	DESIGNER: W.R.C.	SECTION CHIEF: W.R.C.


CONCRETE REPAIR - NORTH WALL INSIDE

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P.E. NUMBER:53746	SHEET:
DATE: MAY 14, 2021	J L S3

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JOHNS RIVER BASIN E 96 REHABILITATION COUNTY, FLORIDA

WATER	ST. JOHNS RIVE MANAGEMENT P.O. BOX 1429 PALATKA, FLOR	DISTRICT (SEC)		
DRAWN: N.J.G.	DATE: <u>MAY 14, 2021</u>	REVIEWER: W.R.C.		
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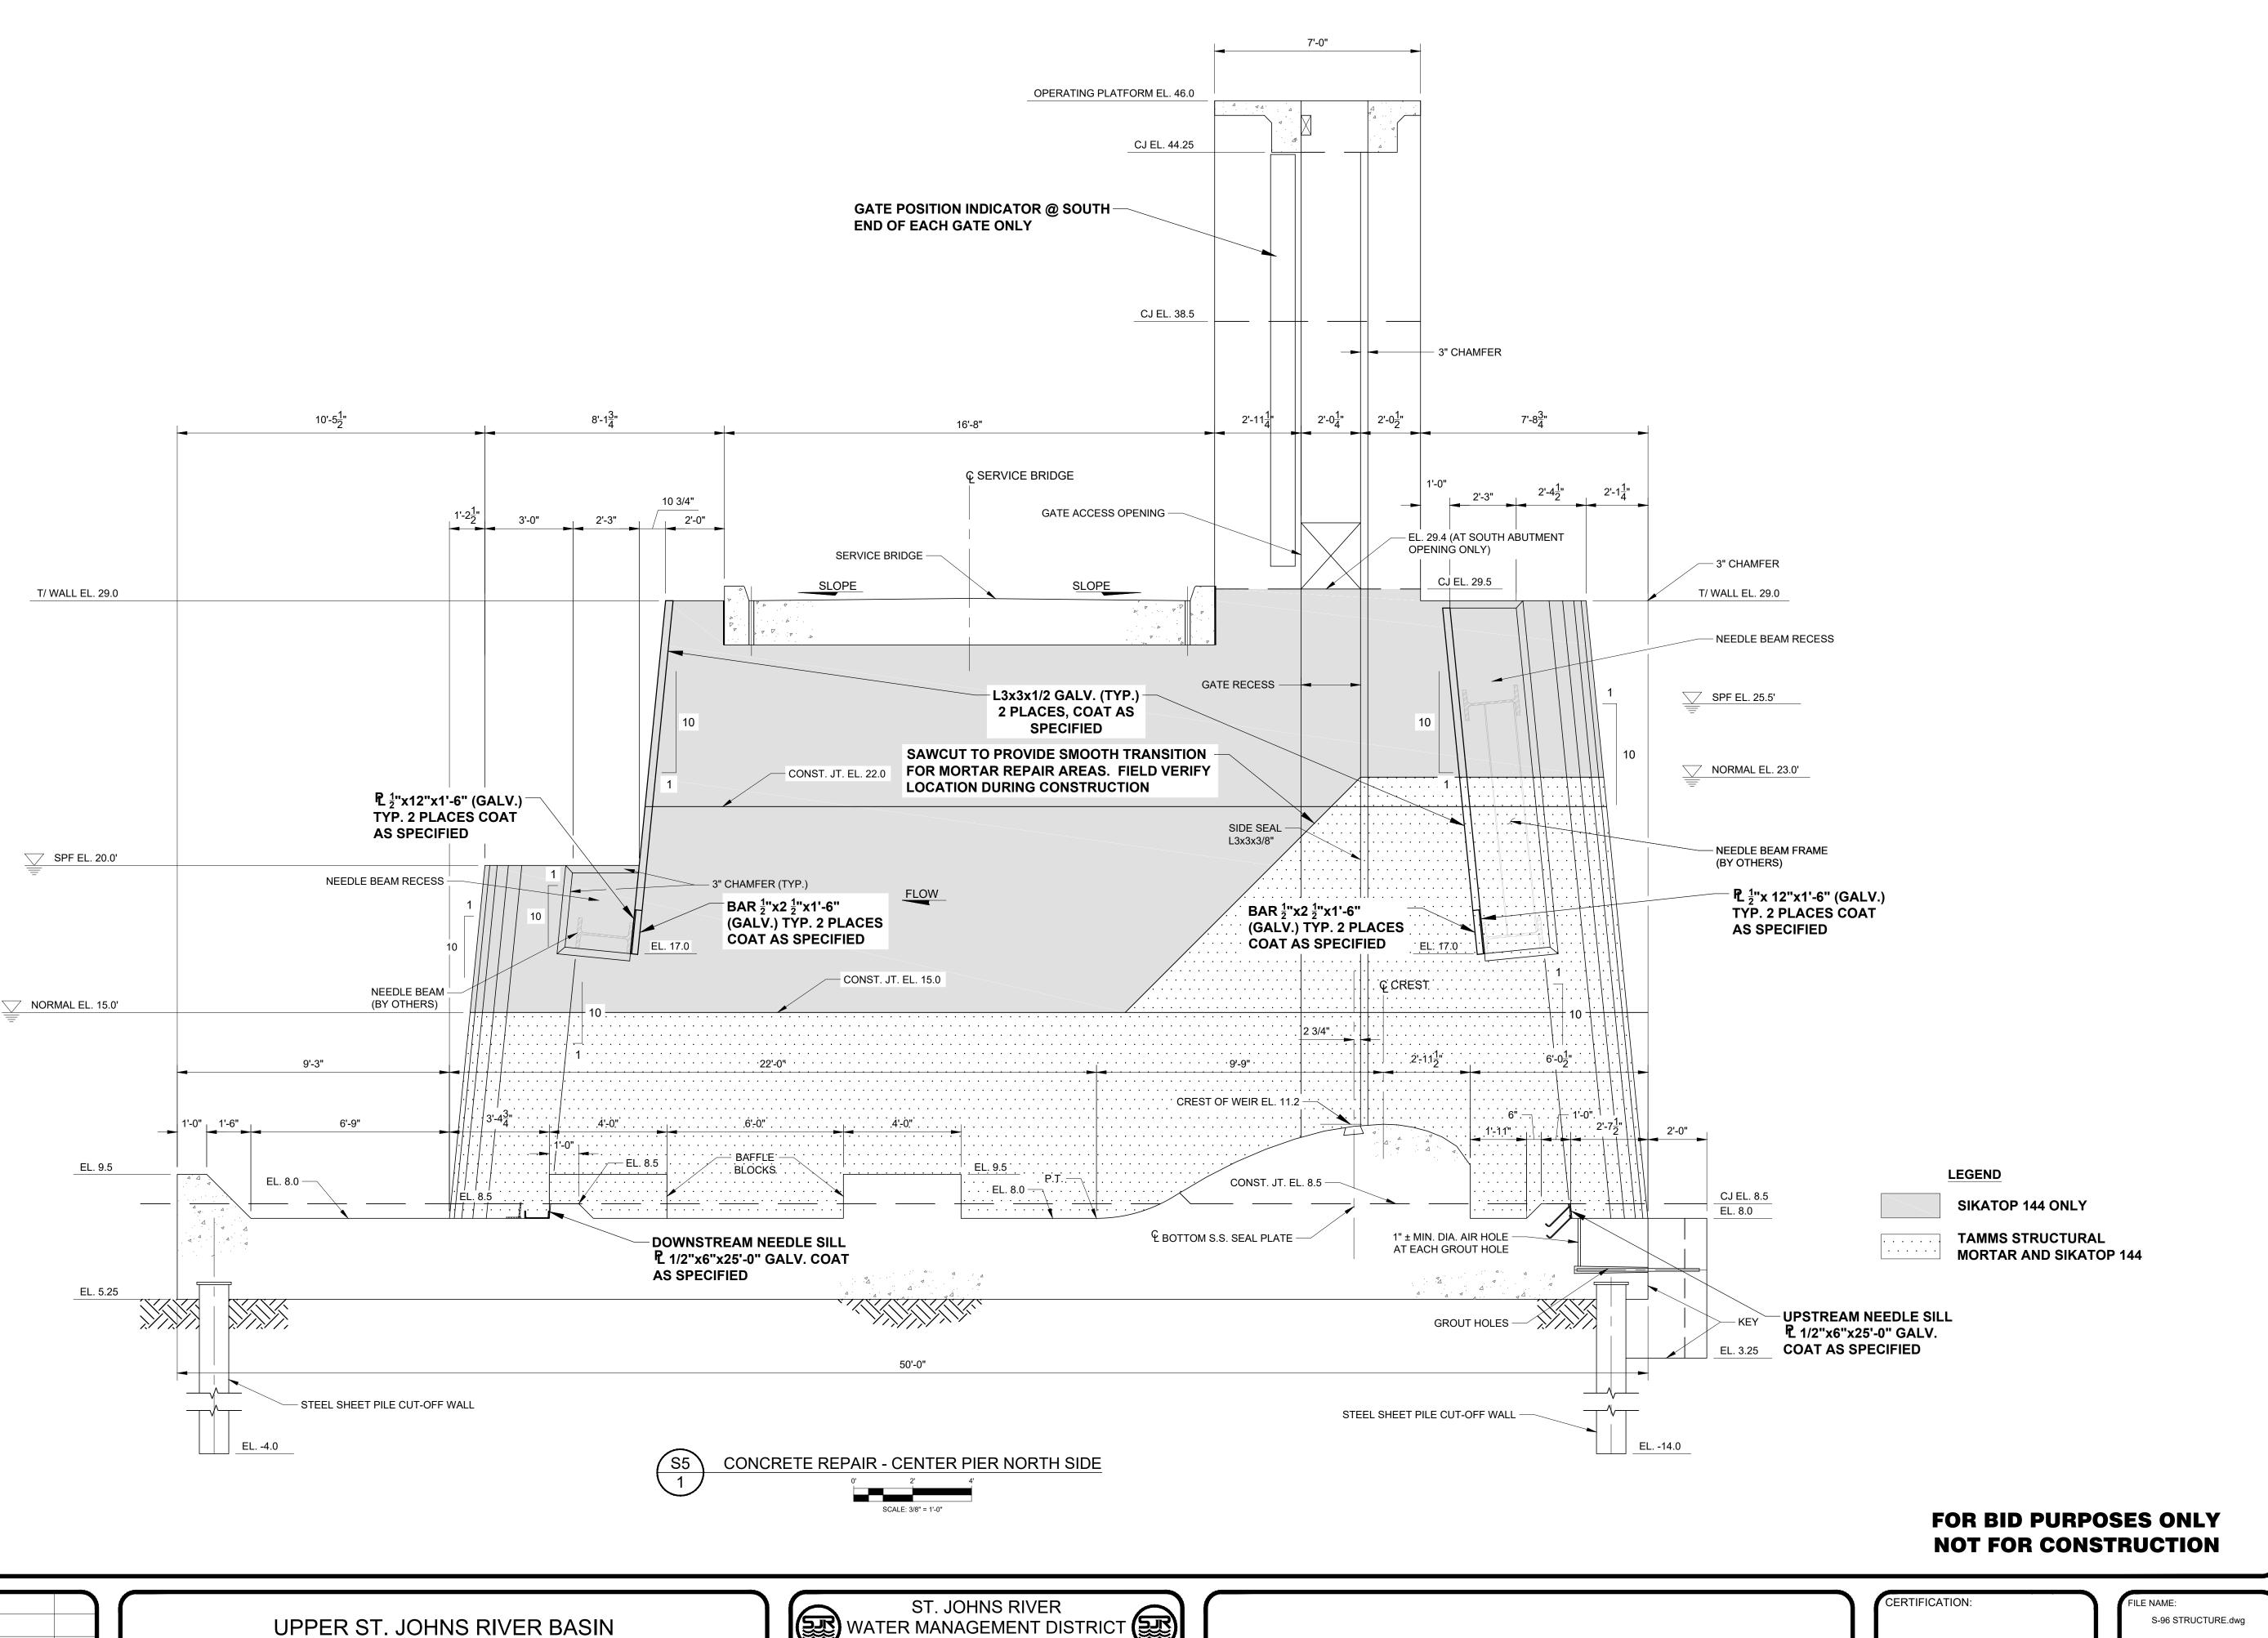
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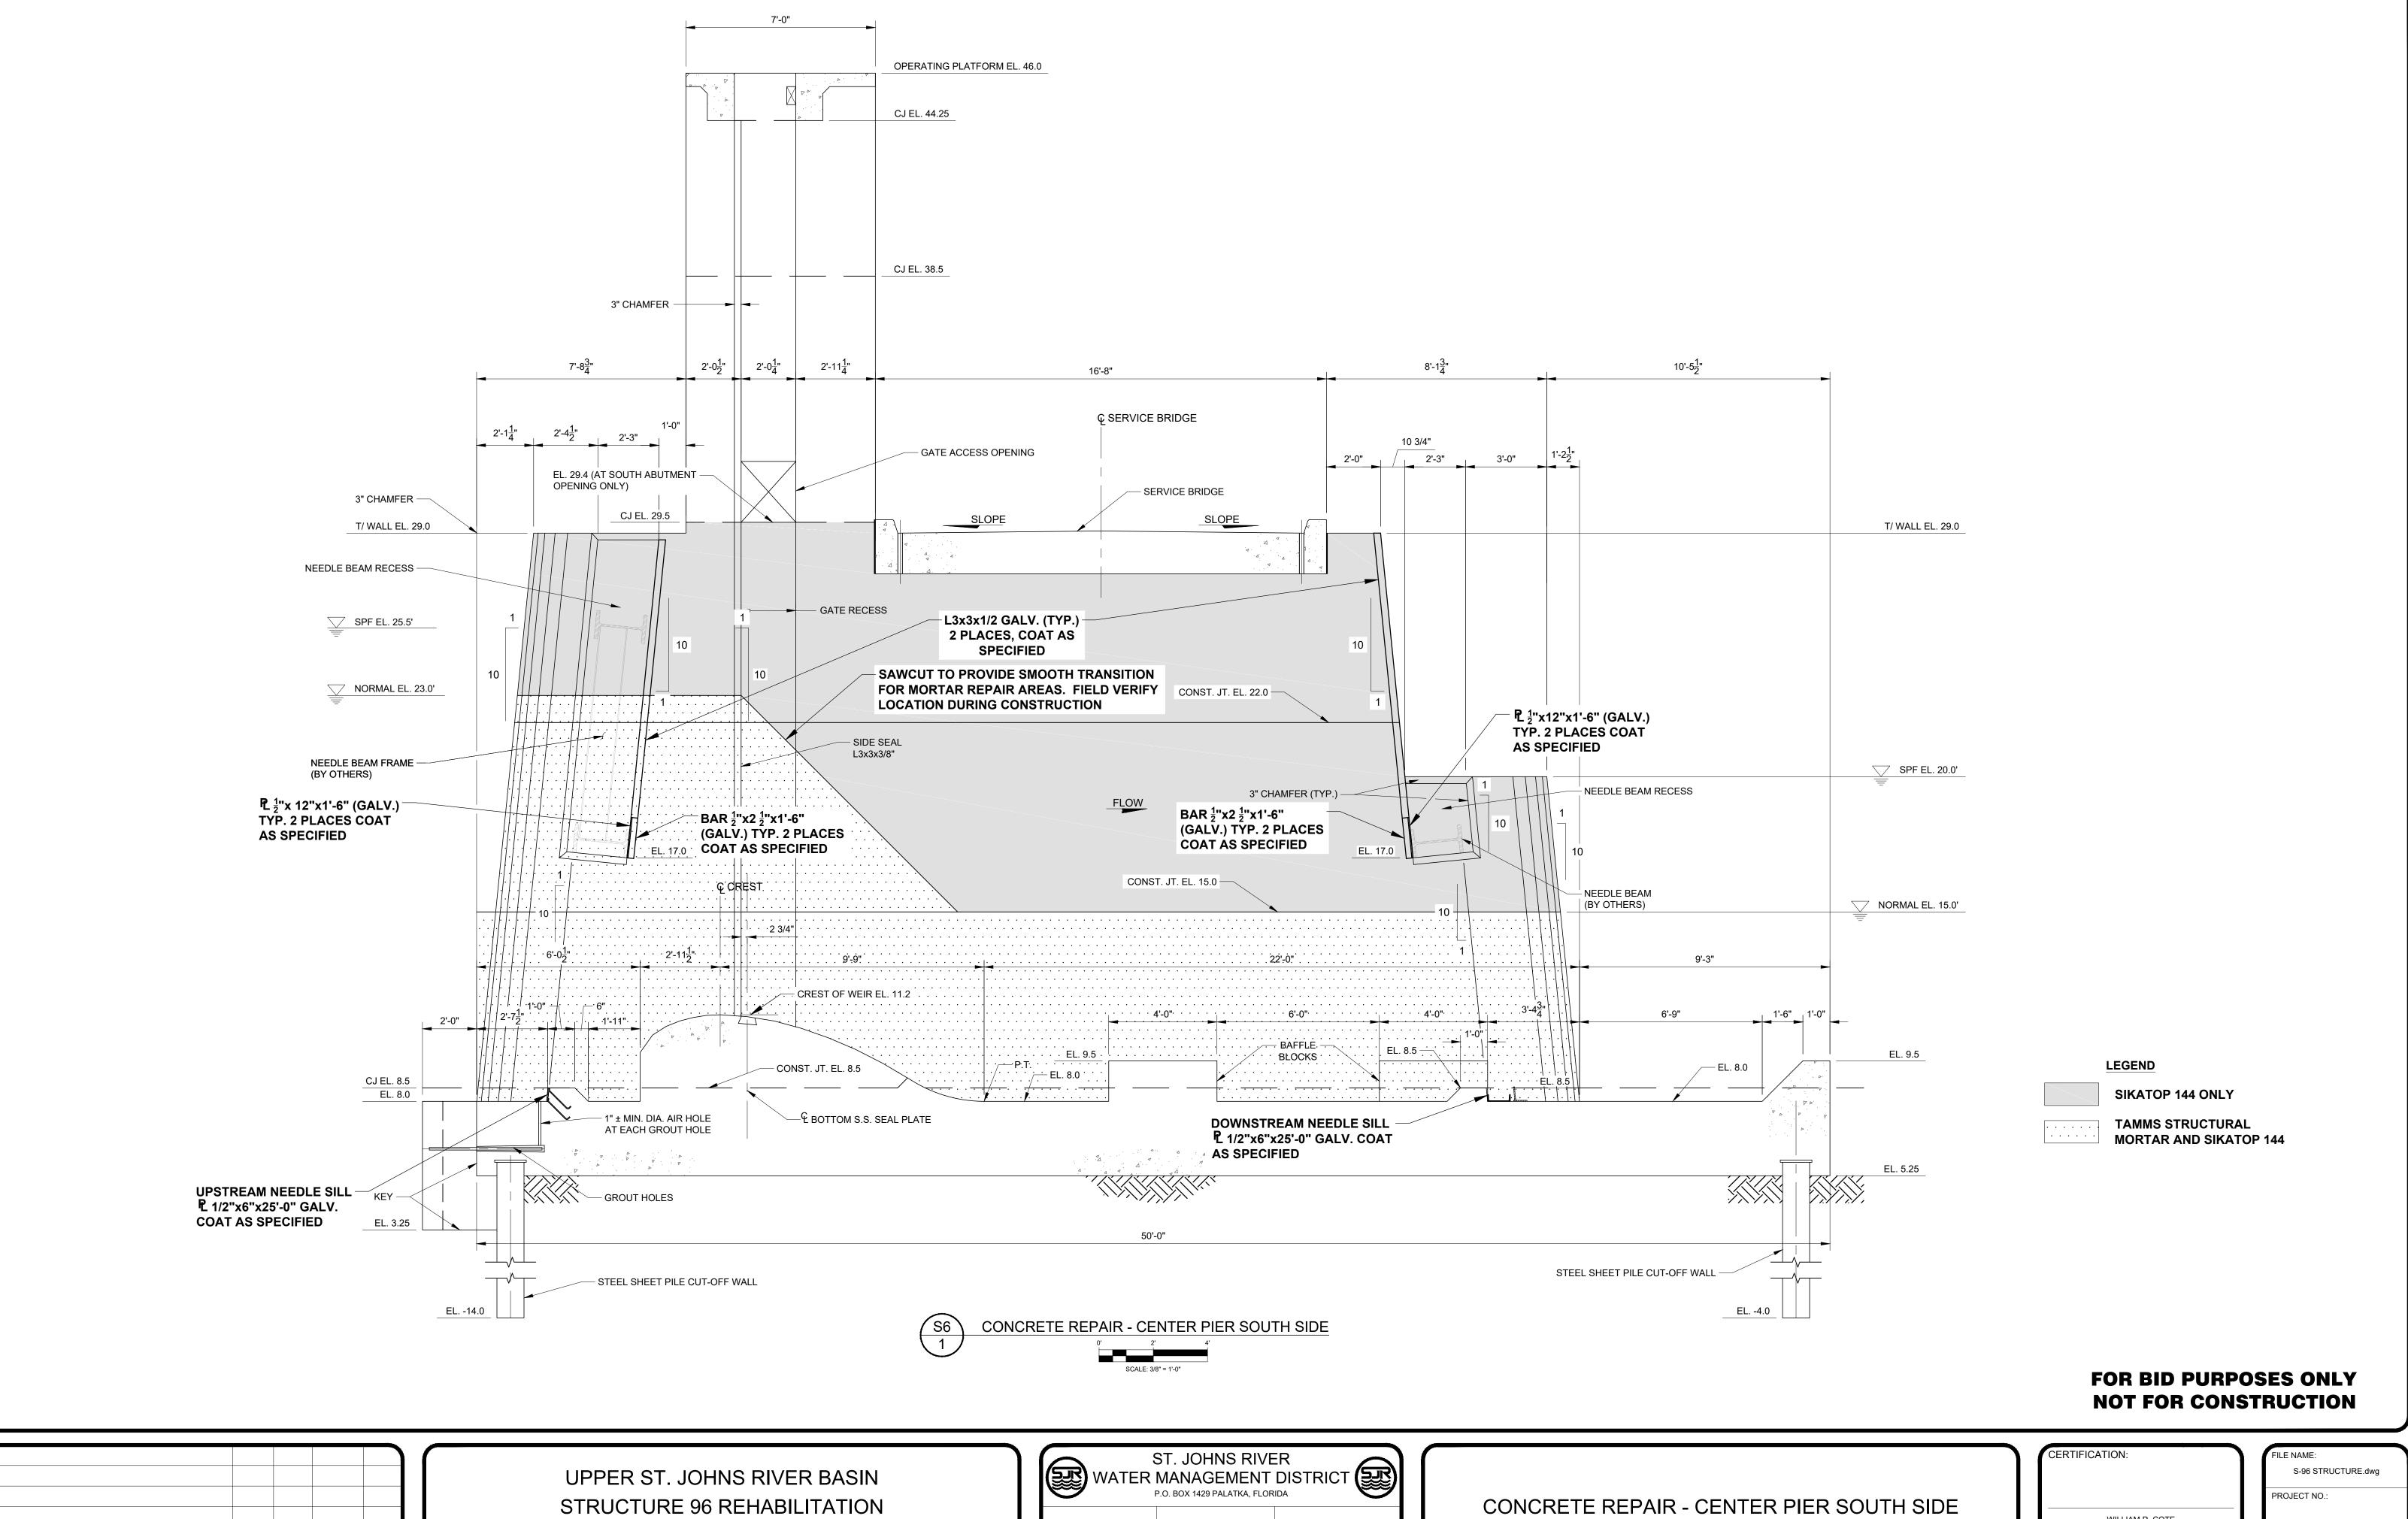
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CONCRETE REPAIR - CENTER PIER NORTH SIDE
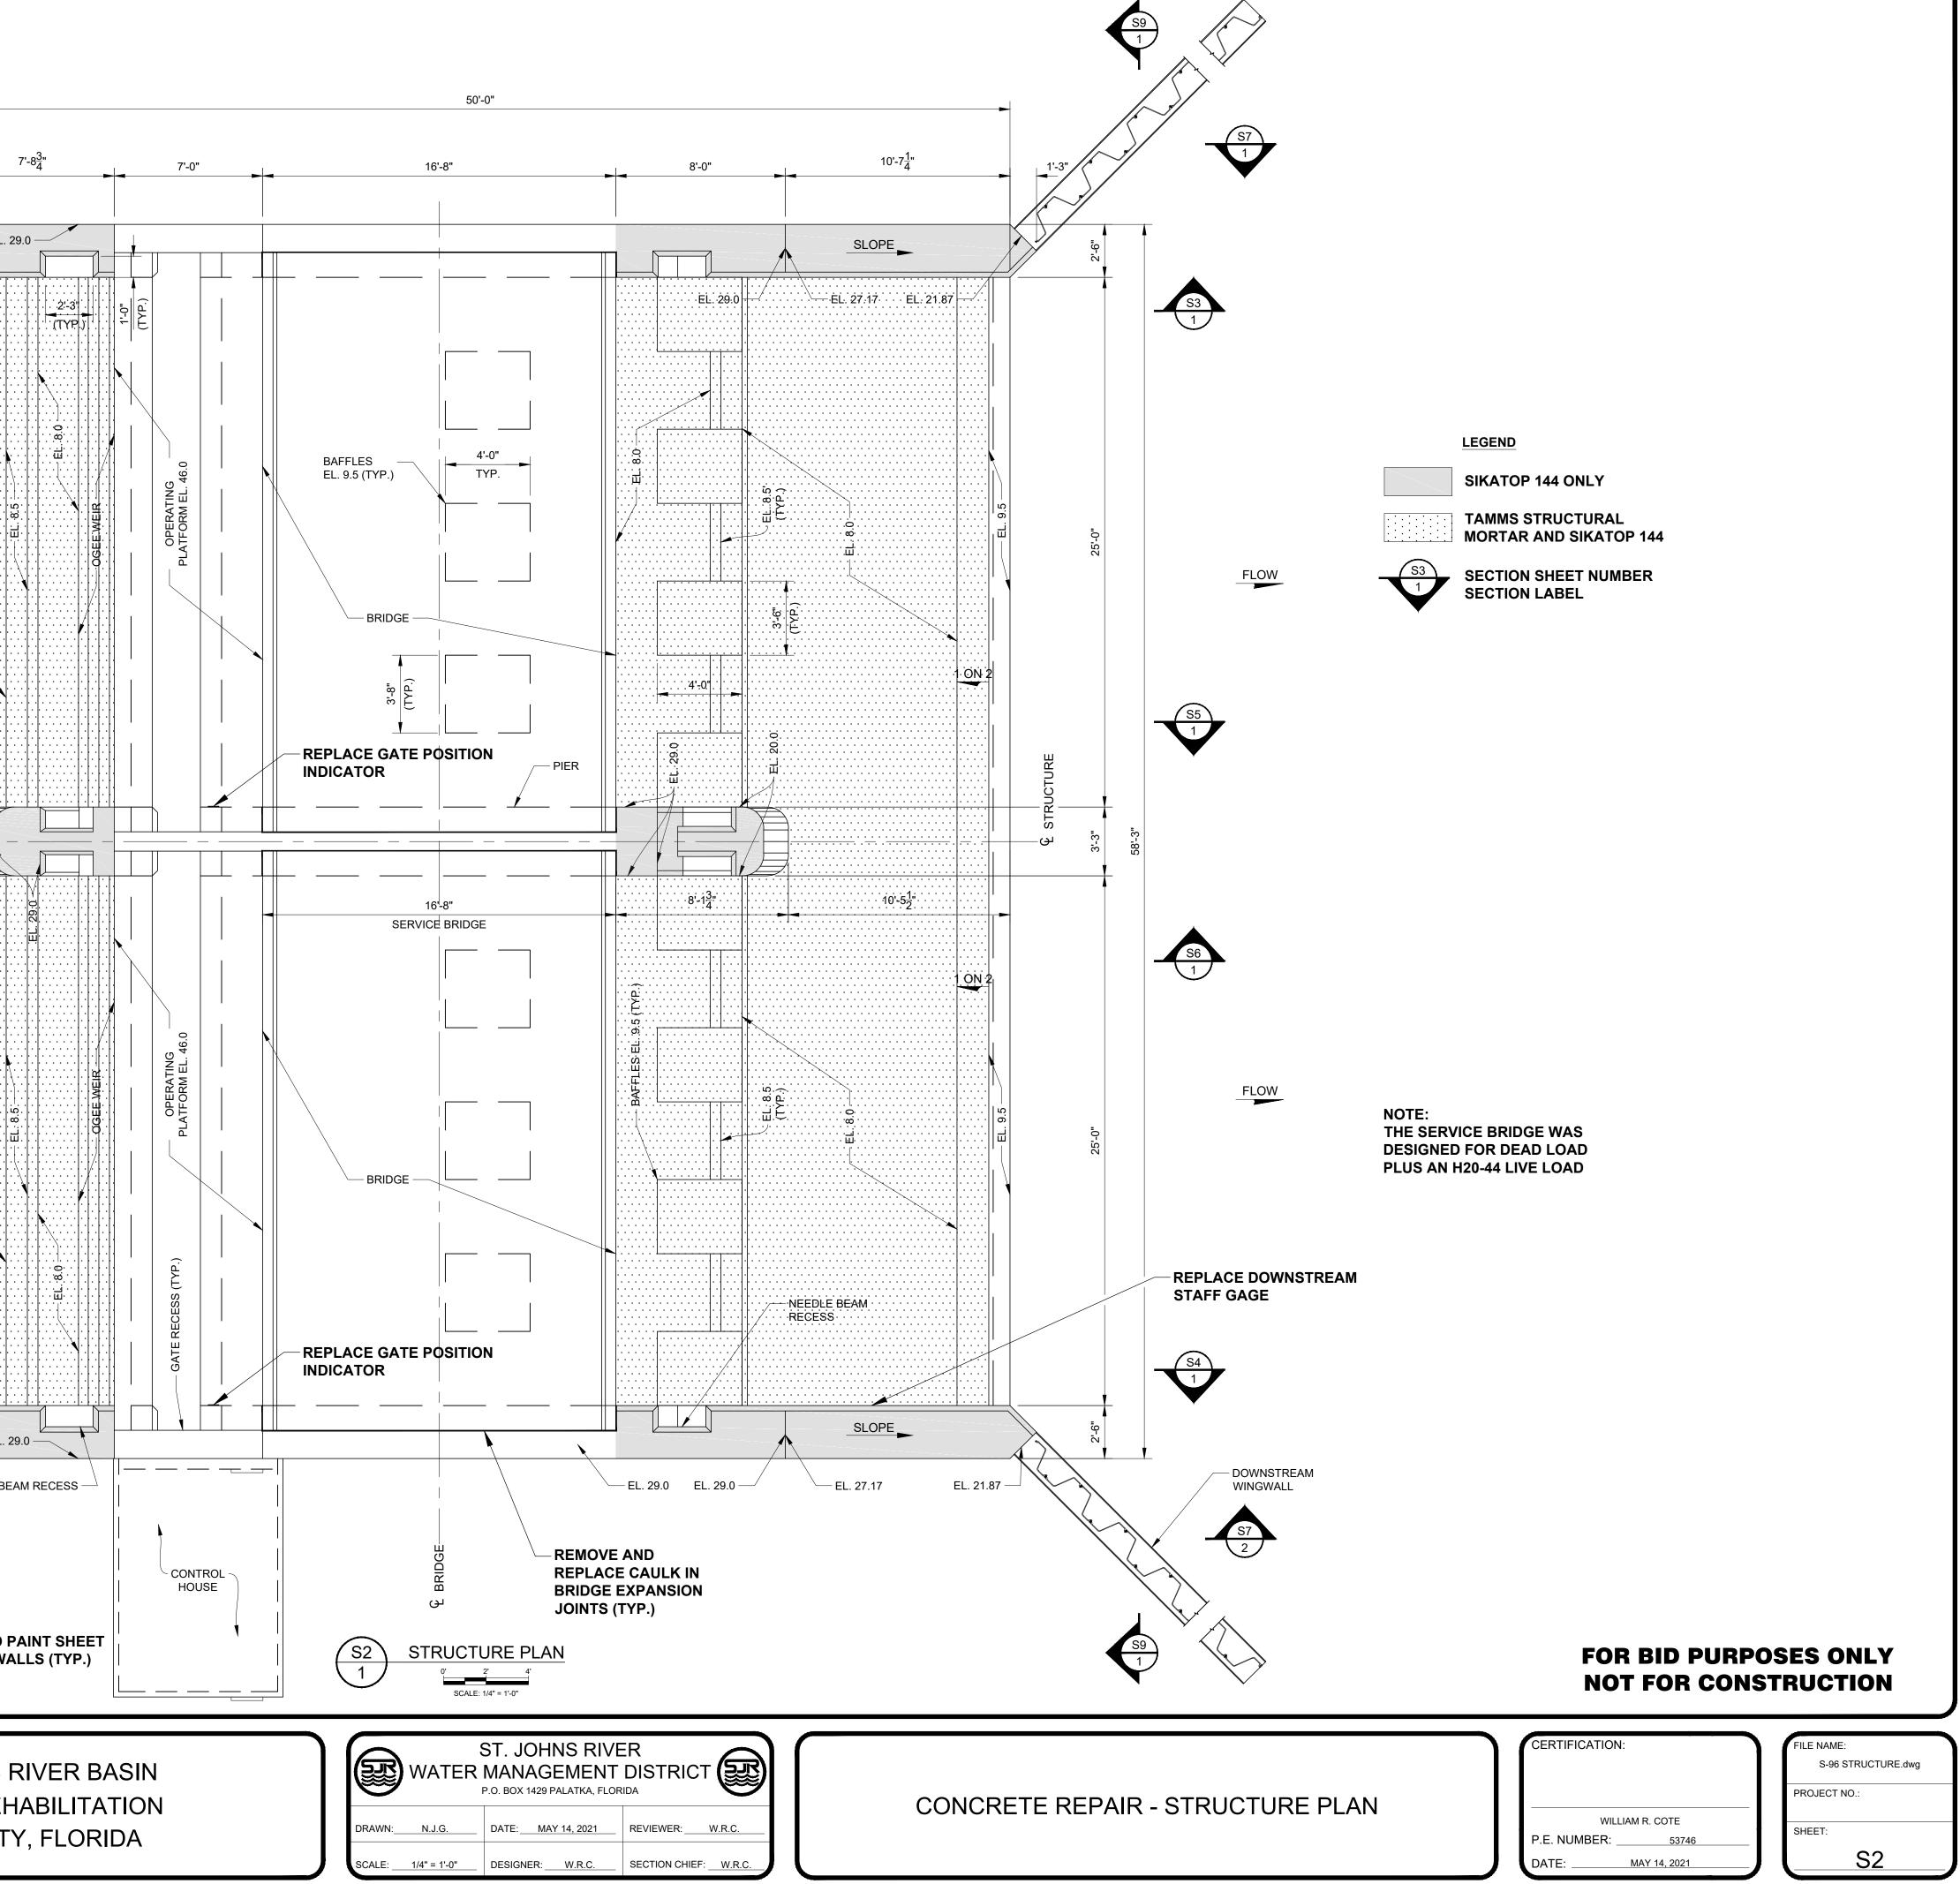
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DATE: MAY 14, 2021 REVIEWER: W.R.C.
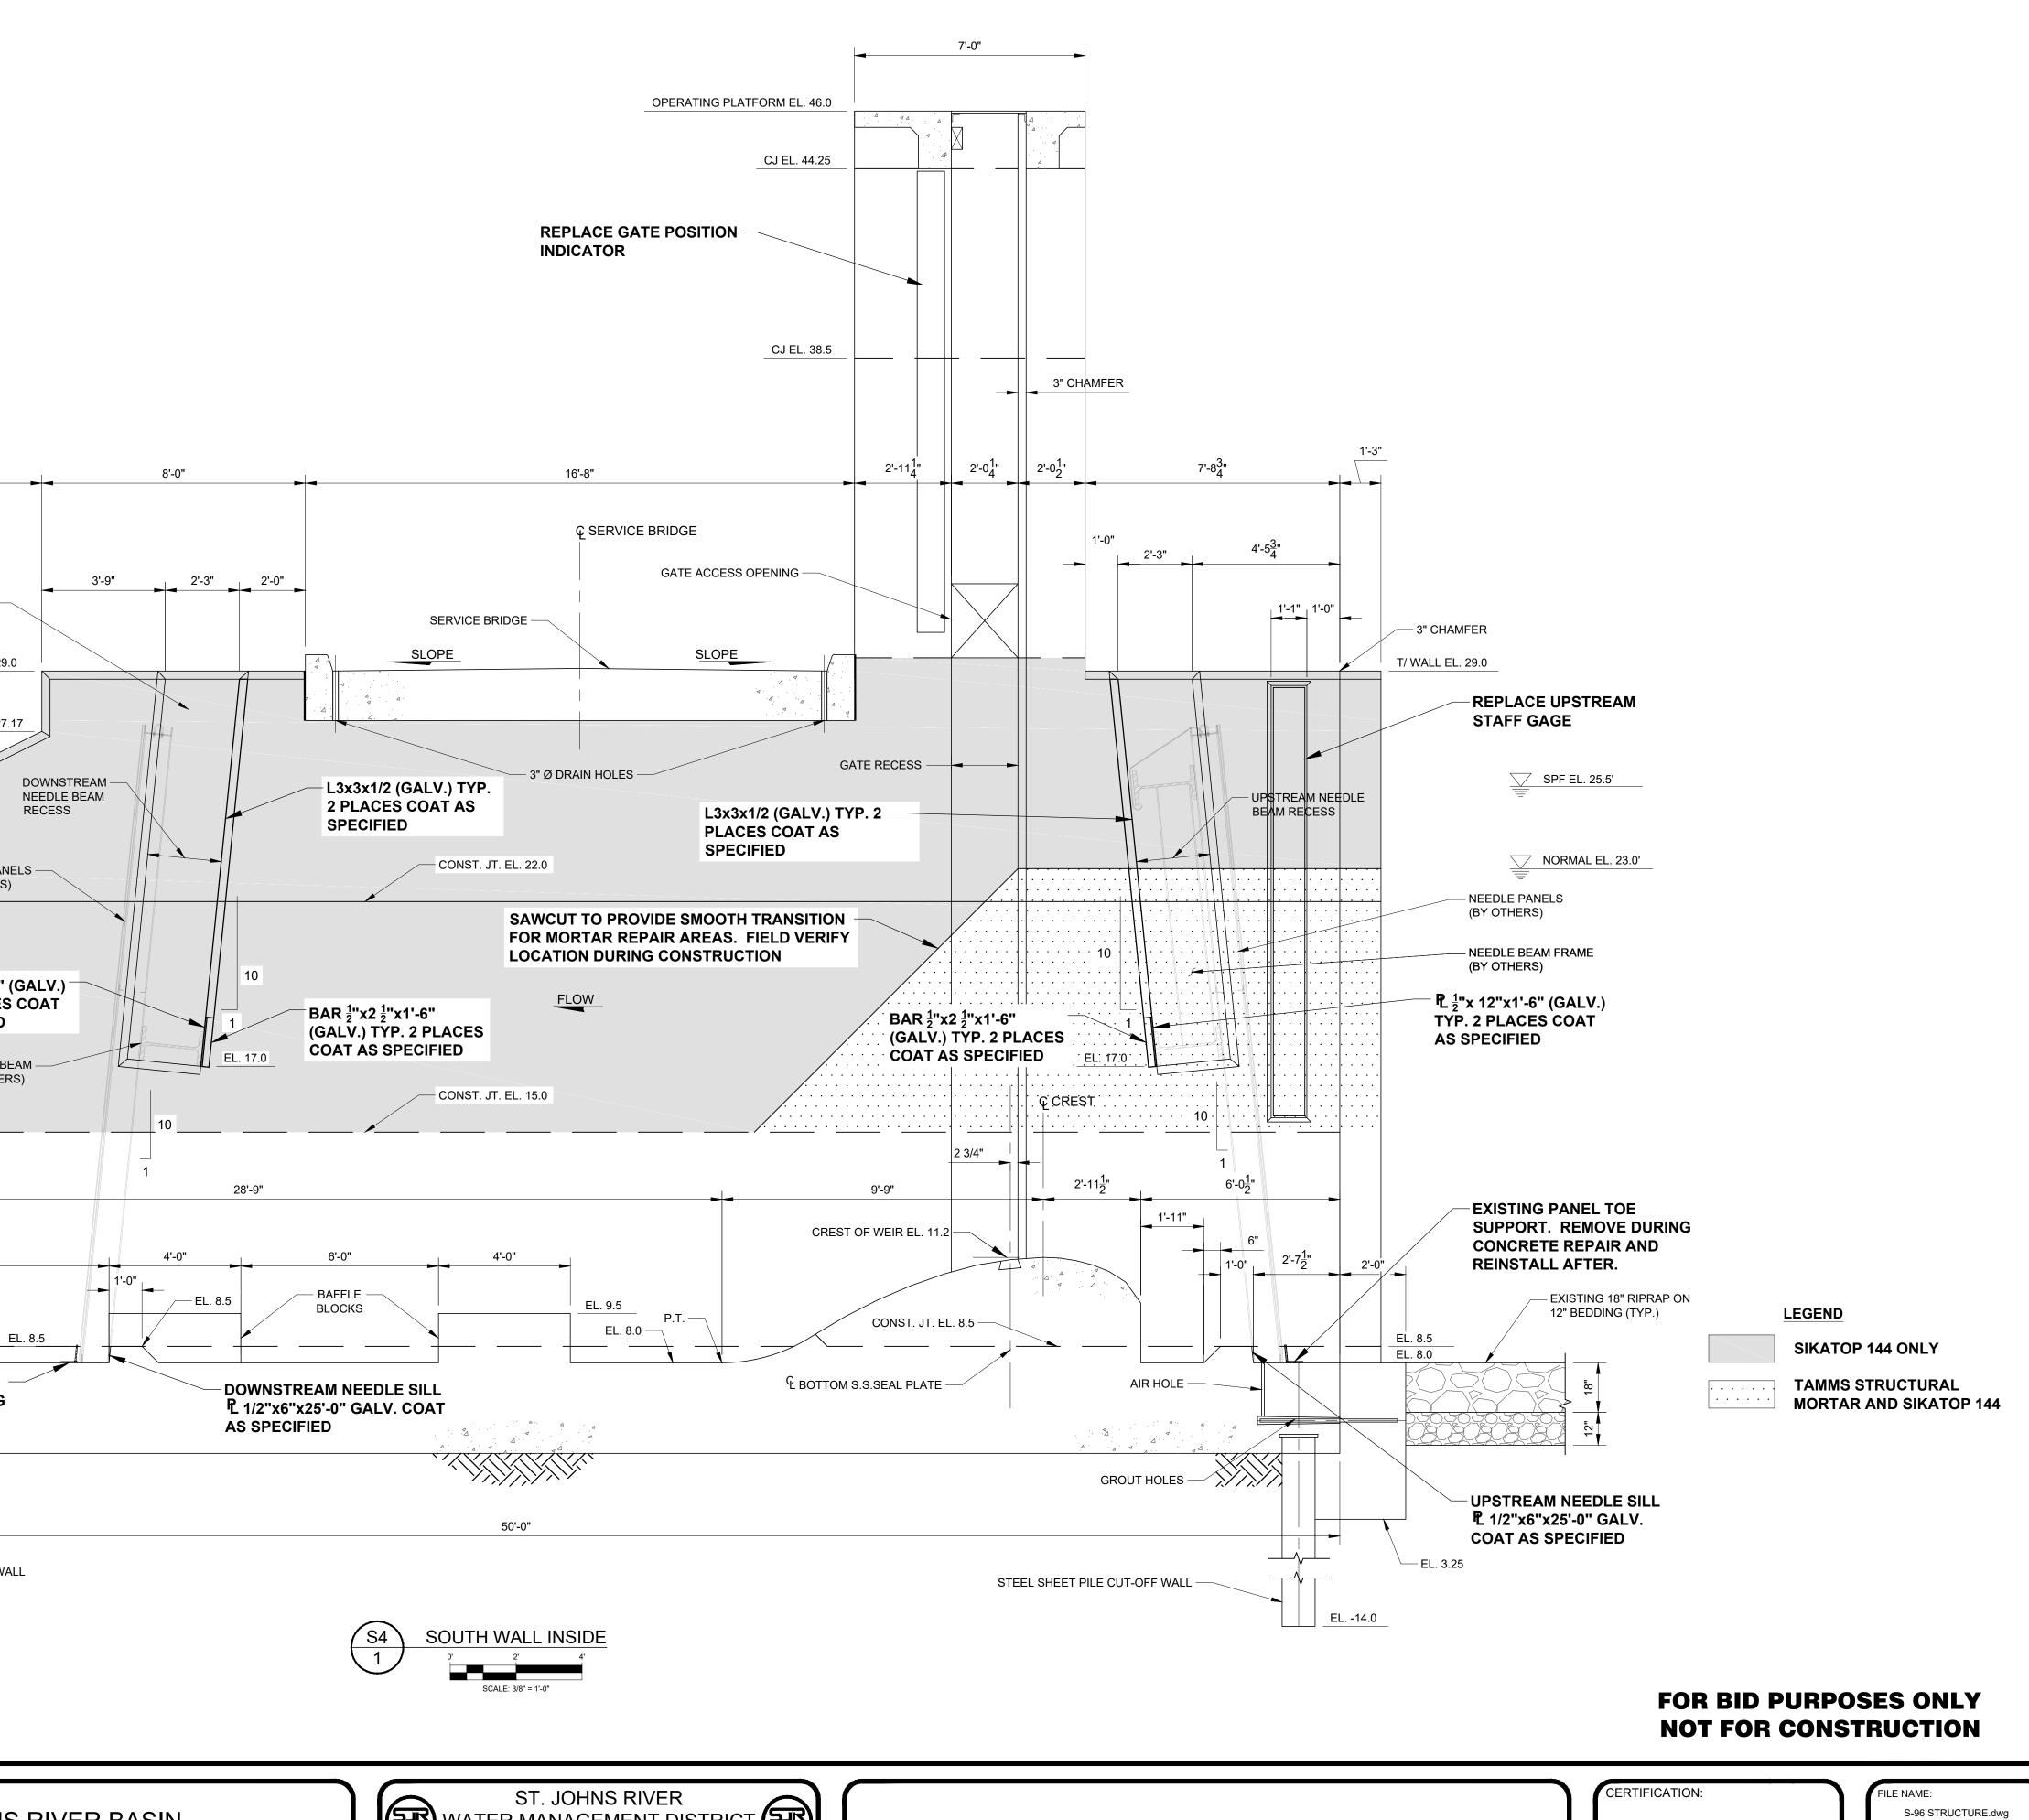
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DRAWN: N.J.G.

BREVARD COUNTY, FLORIDA


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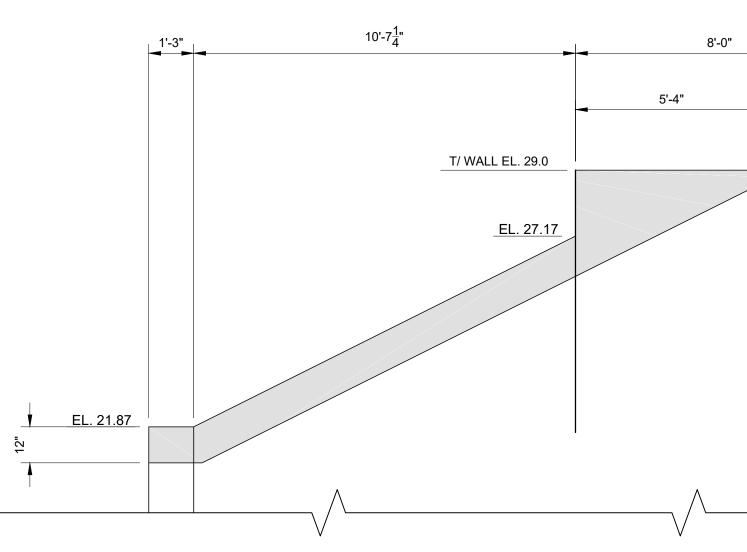
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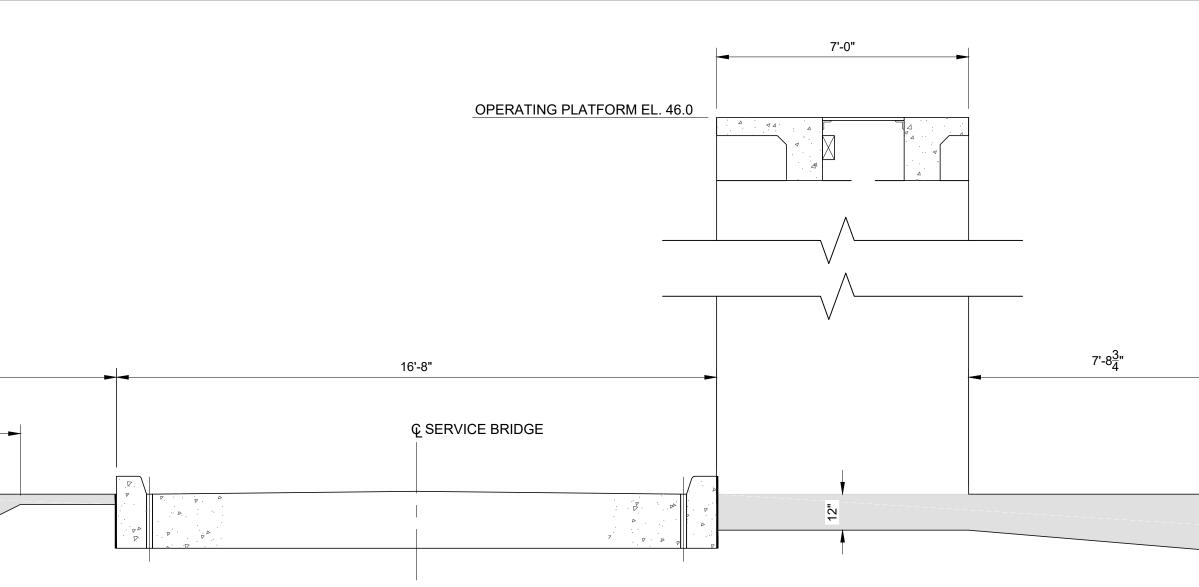
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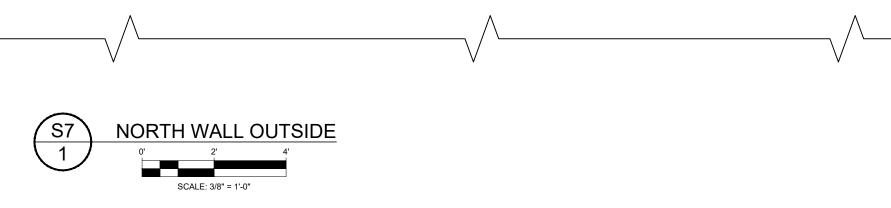
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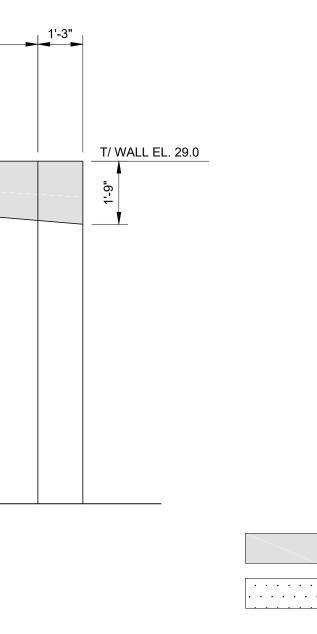
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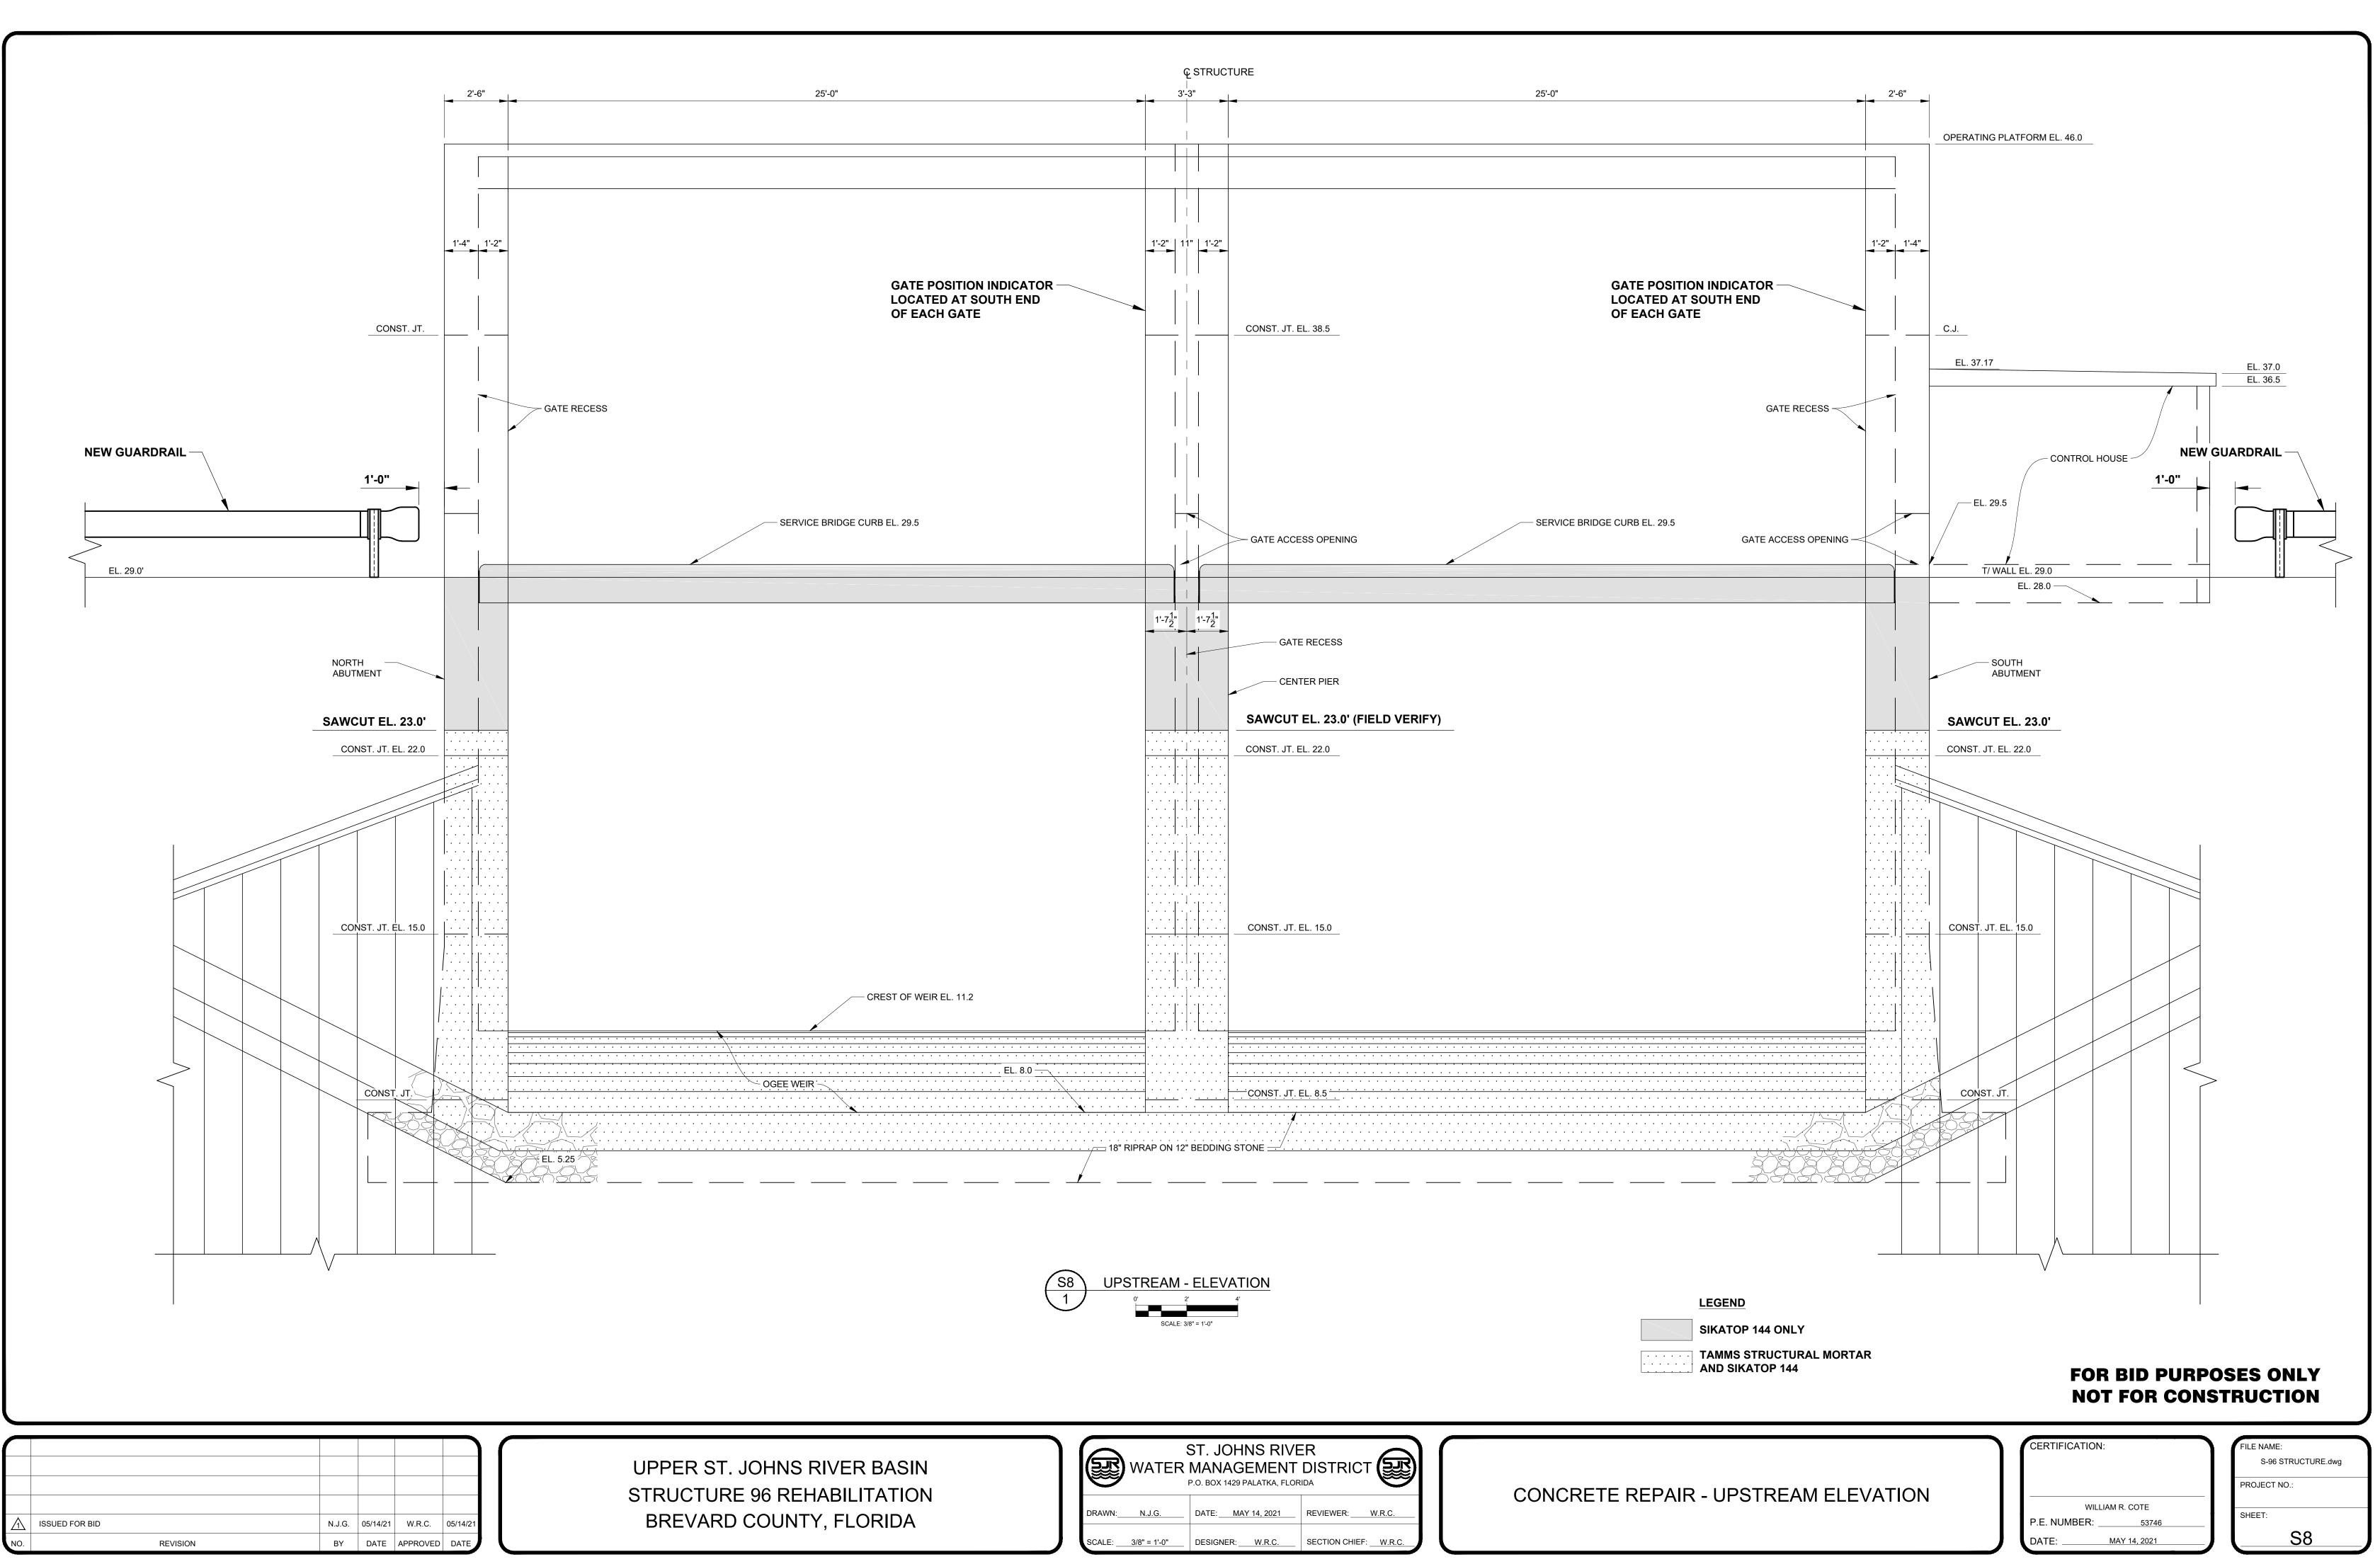
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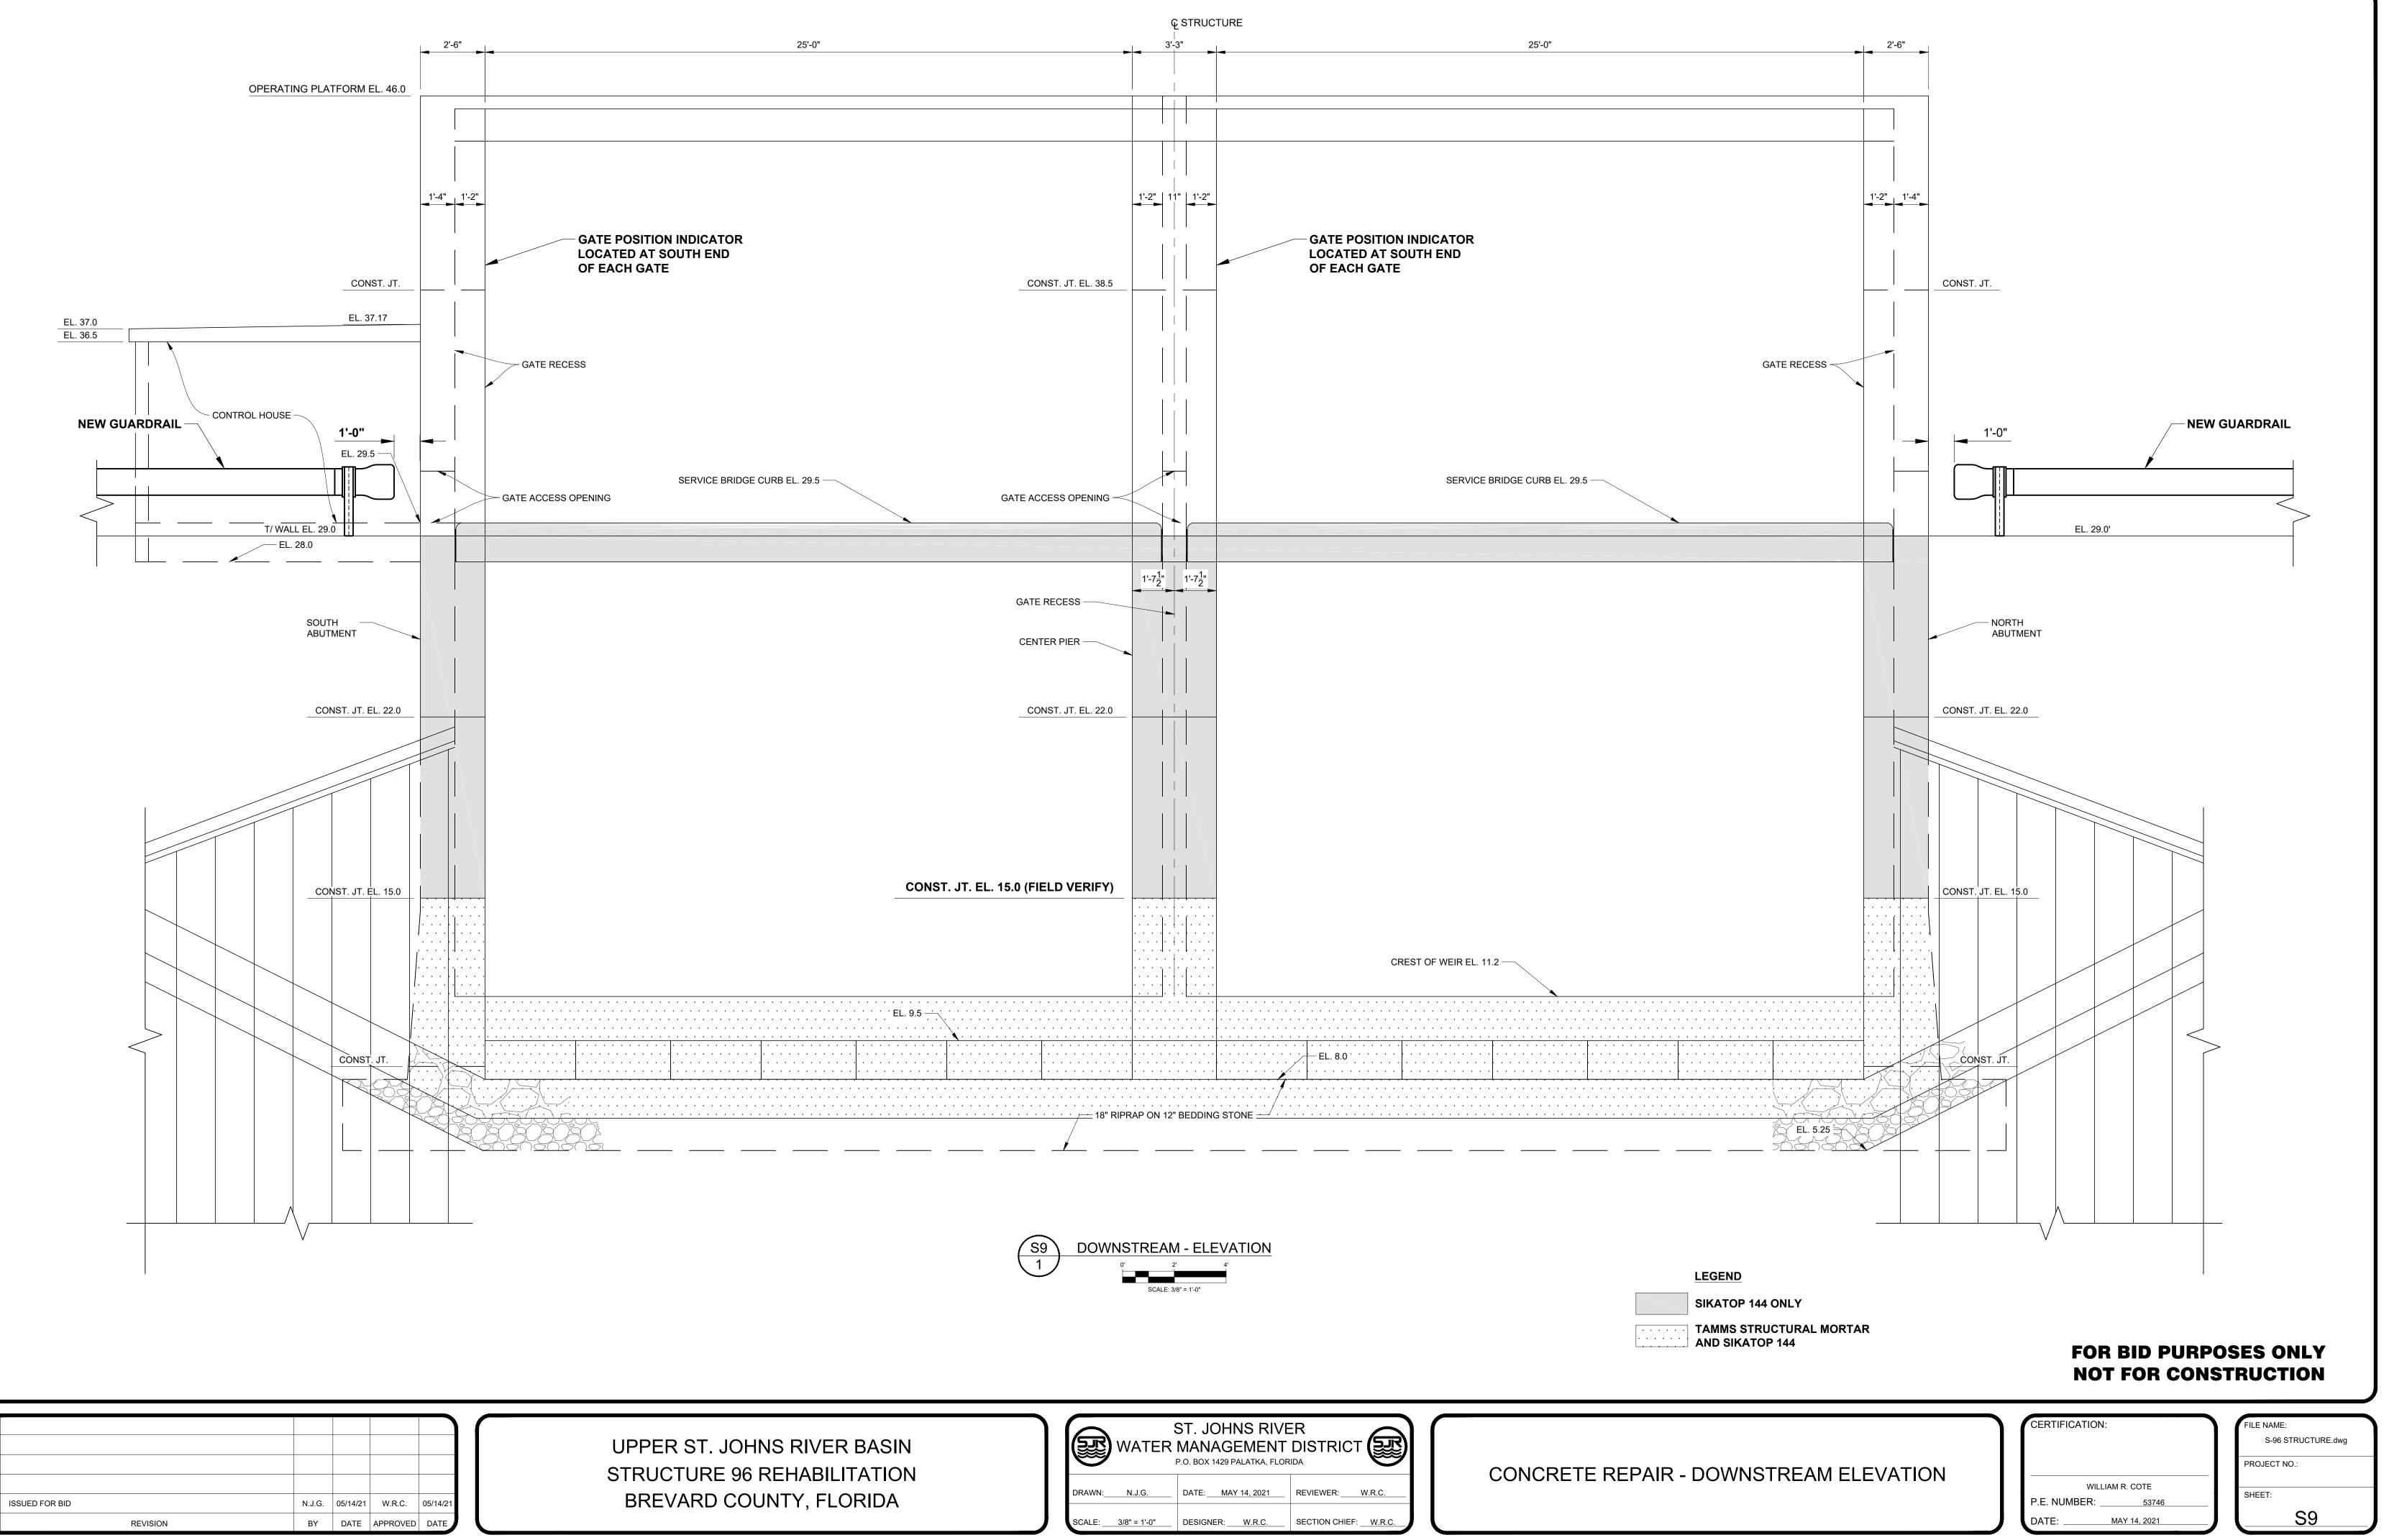
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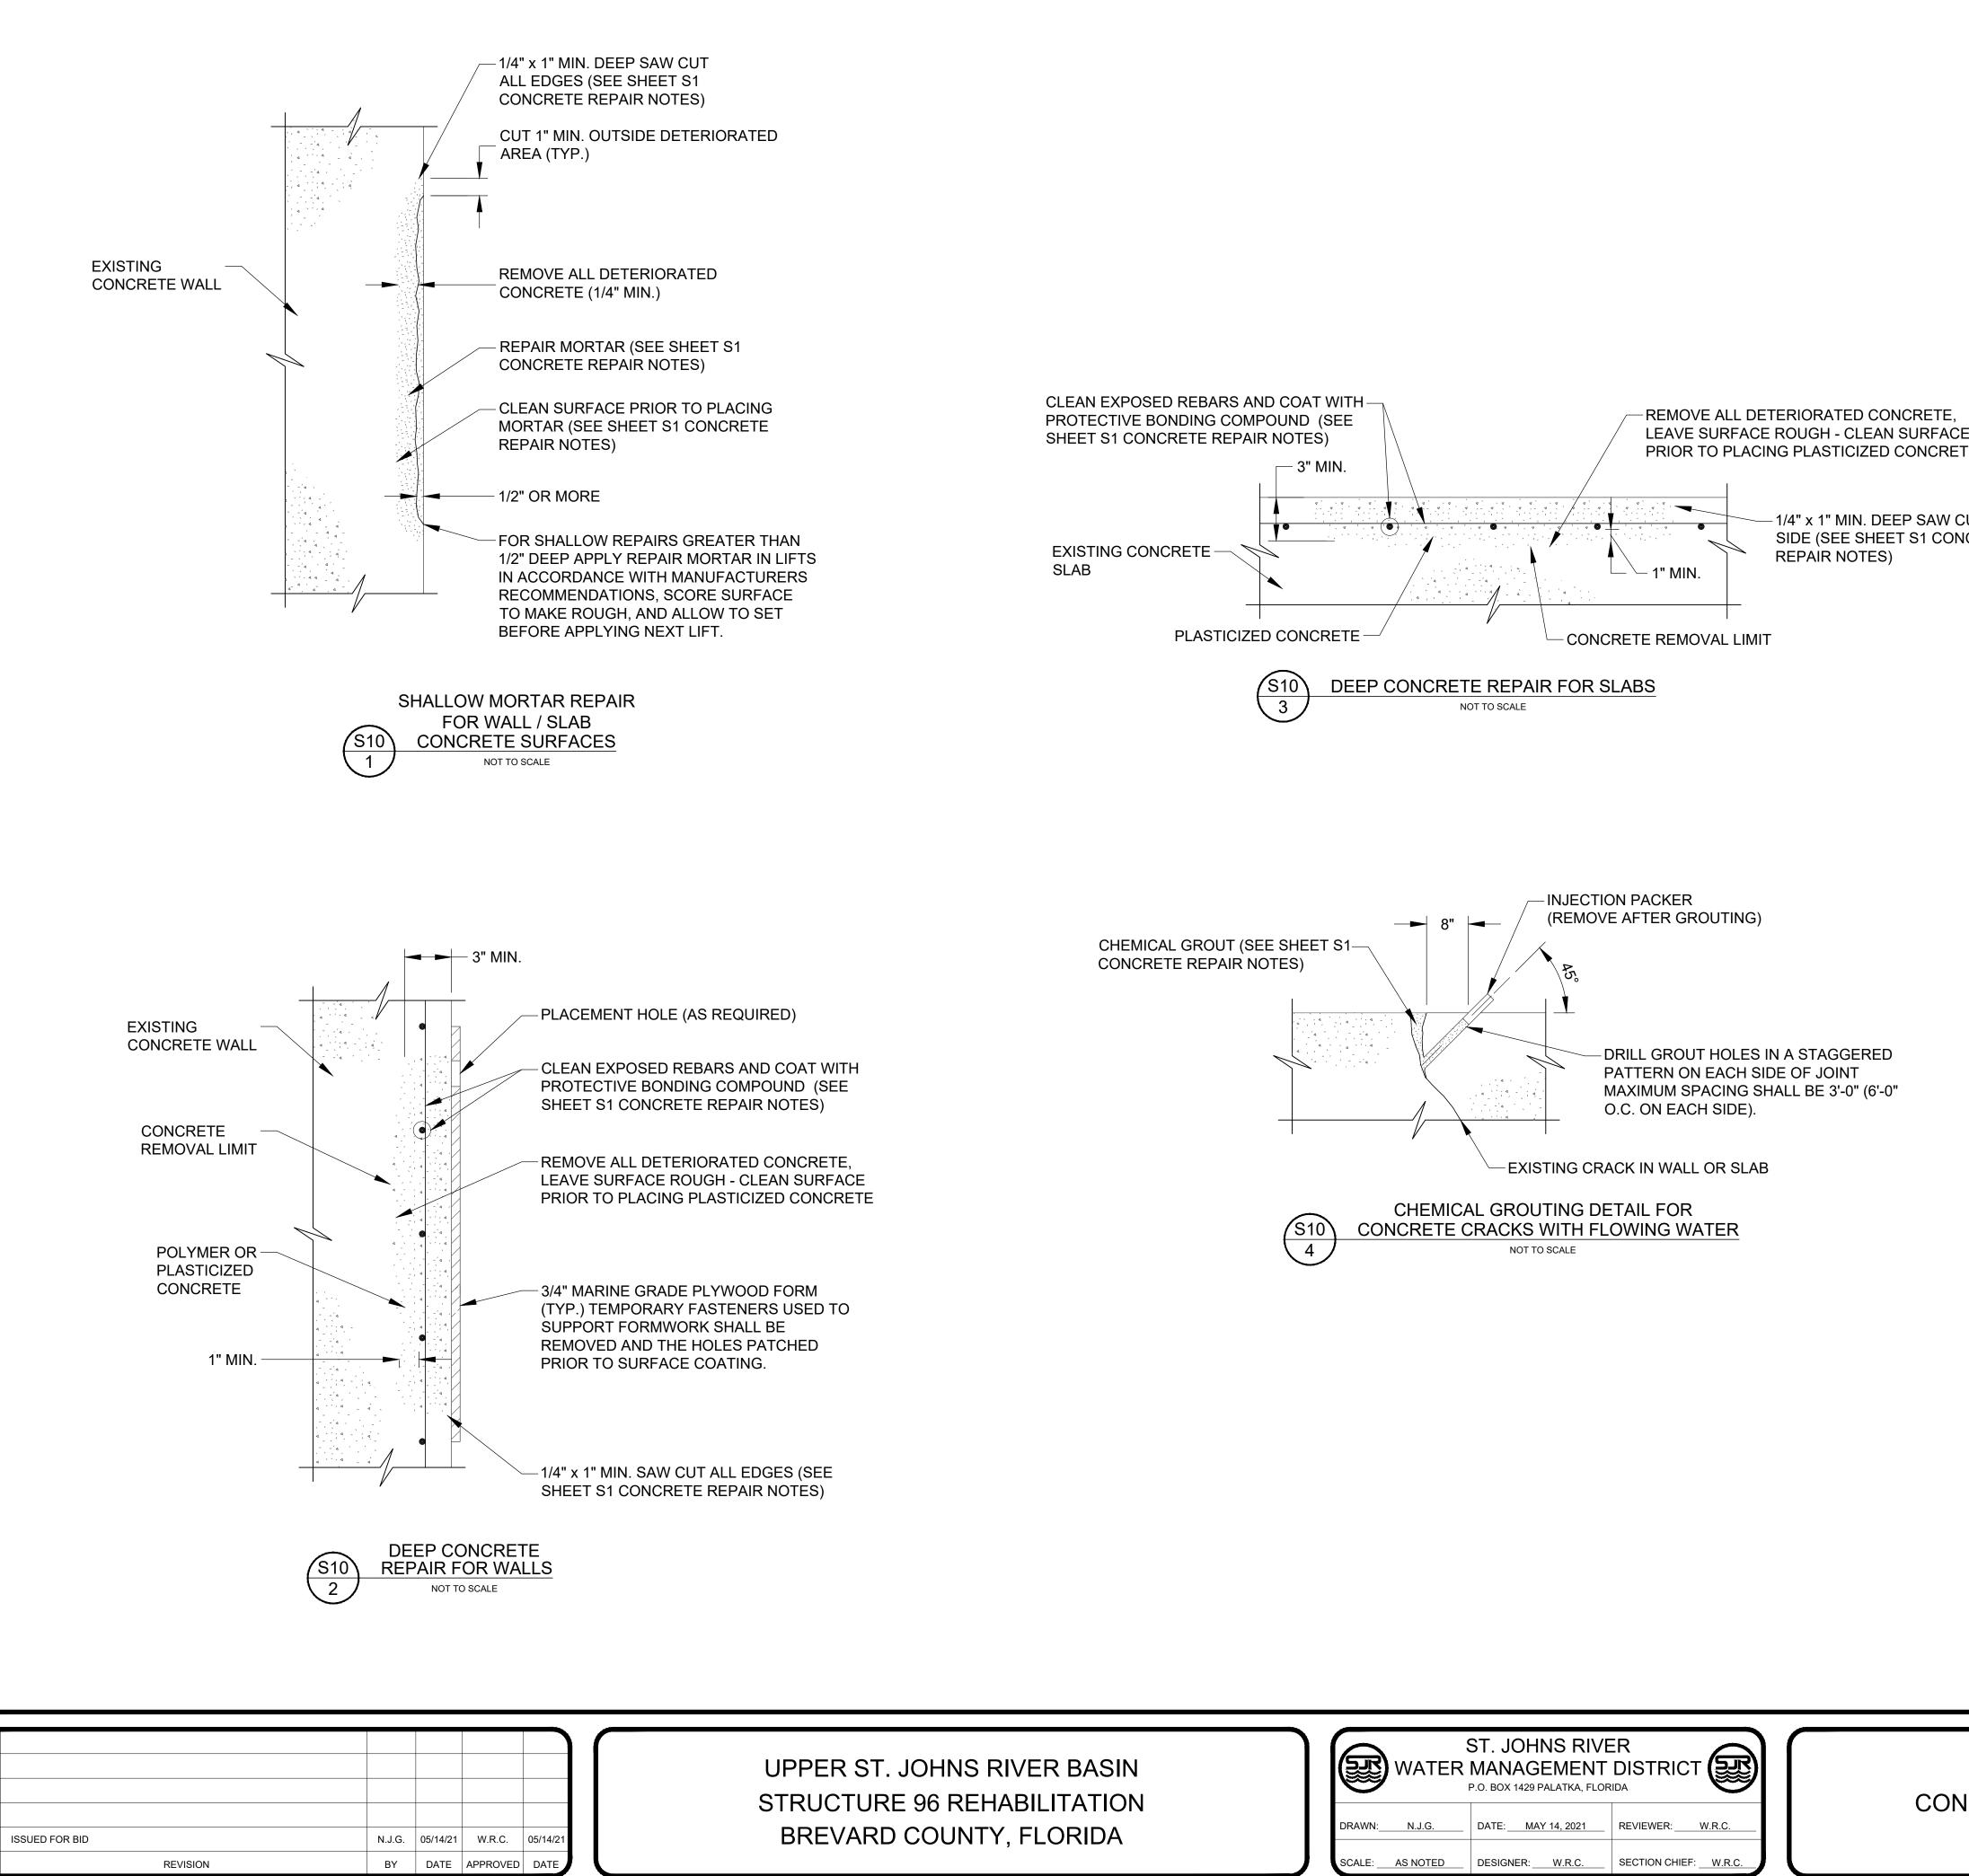
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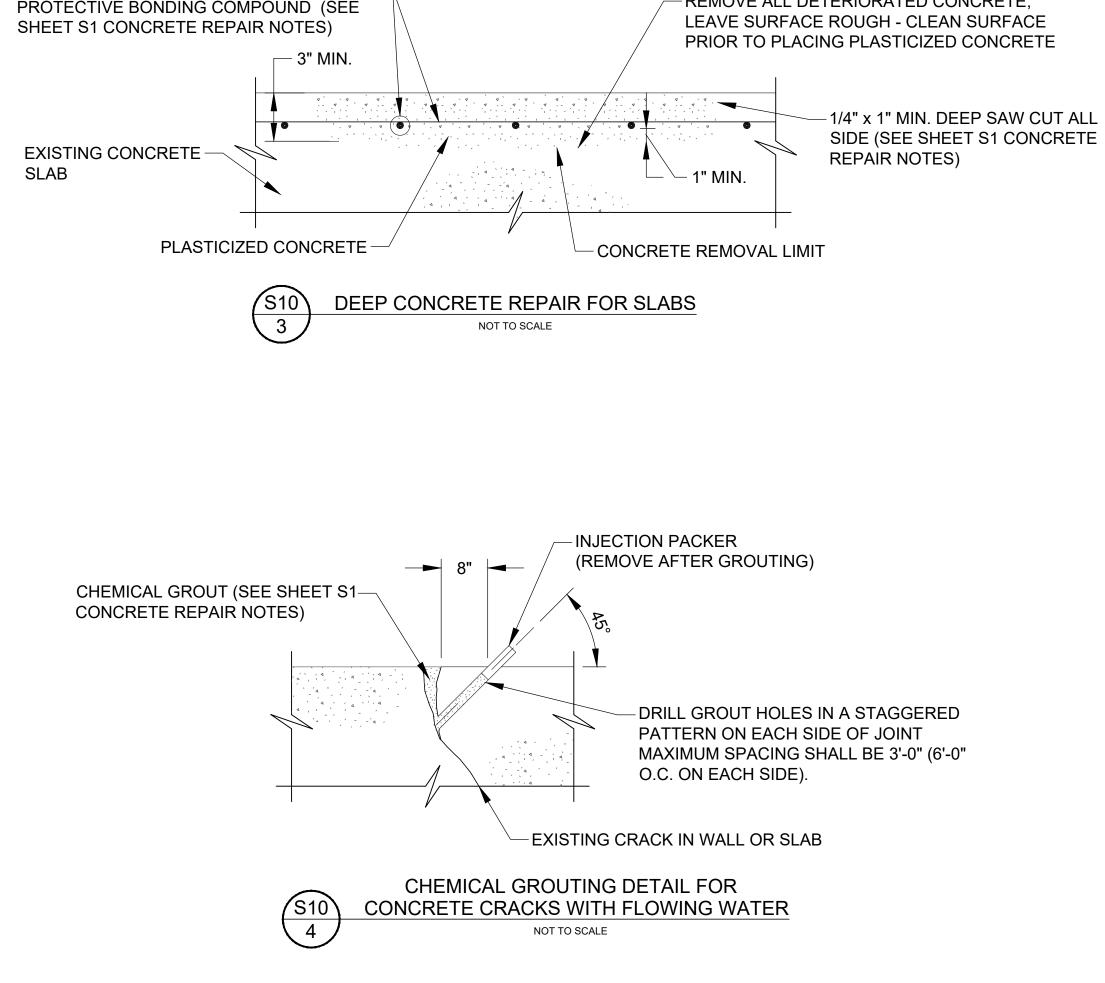
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P.E. NUMBER:	53746
DATE:	MAY 14, 2021

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CONCRETE:

- 1. ALL CONCRETE WORK SHALL BE IN ACCORDANCE WITH THE FLORIDA DEPARTMENT OF TRANSPORTATION STANDARD SPECIFICATIONS FOR ROAD AND BRIDGE CONSTRUCTION, LATEST EDITION, SECTION 400 WITH SUPPLEMENTS AND ALL PERTINENT SPECIFICATIONS CONTAINED THEREIN.
- 2. ALL CONCRETE SHALL ATTAIN A MINIMUM 28-DAY COMPRESSIVE STRENGTH OF 5,500 PSI. PORTLAND CEMENT SHALL BE TYPE II IN ACCORDANCE WITH ASTM C-150. CONCRETE SHALL BE AIR ENTRAINED WITH TOTAL AIR AS PERCENT BY VOLUME OF CONCRETE EQUAL TO 4%. THE AIR ENTRAINING ADMIXTURE SHALL BE MICRO AIR, AS MANUFACTURED BY MASTER BUILDERS, OR EQUAL, CONFORMING TO ASTM C-260. THE AGGREGATES SHALL CONFORM TO ASTM C-33 AND SHALL HAVE A 3/4-INCH MAXIMUM SIZE.
- 3. REINFORCING STEEL SHALL BE GRADE 60 DEFORMED BILLET STEEL BARS CONFORMING TO ASTM A-615.
- 4. THE MINIMUM CLEAR CONCRETE COVER FOR REINFORCEMENT SHALL BE 3 INCHES FOR FORMED SURFACES AND 4.5 INCHES FOR CONCRETE CAST AGAINST EARTH.
- 5. CRACKS WITH FLOWING WATER SHALL BE REPAIRED WITH CHEMICAL GROUT AS DETAILED PRIOR TO CONCRETE SURFACE REPAIR. CUT AND REMOVE EXCESS CHEMICAL GROUT PRIOR TO CONCRETE REPAIR. WHEN SEALING VERTICAL CRACKS, BEGIN AT THE BOTTOM AND WORK UP. WHERE WATER FLOW IS PRESENT, BEGIN INJECTING CRACK AT THE POINT OF LEAST FLOW AND WORK TOWARDS AREA OF HEAVIEST FLOW. CHEMICAL GROUT SHALL BE HYDRO ACTIVE FLEX AS MANUFACTURED BY DENEEF CONSTRUCTION CHEMICALS, INC., OR APPROVED EQUAL.

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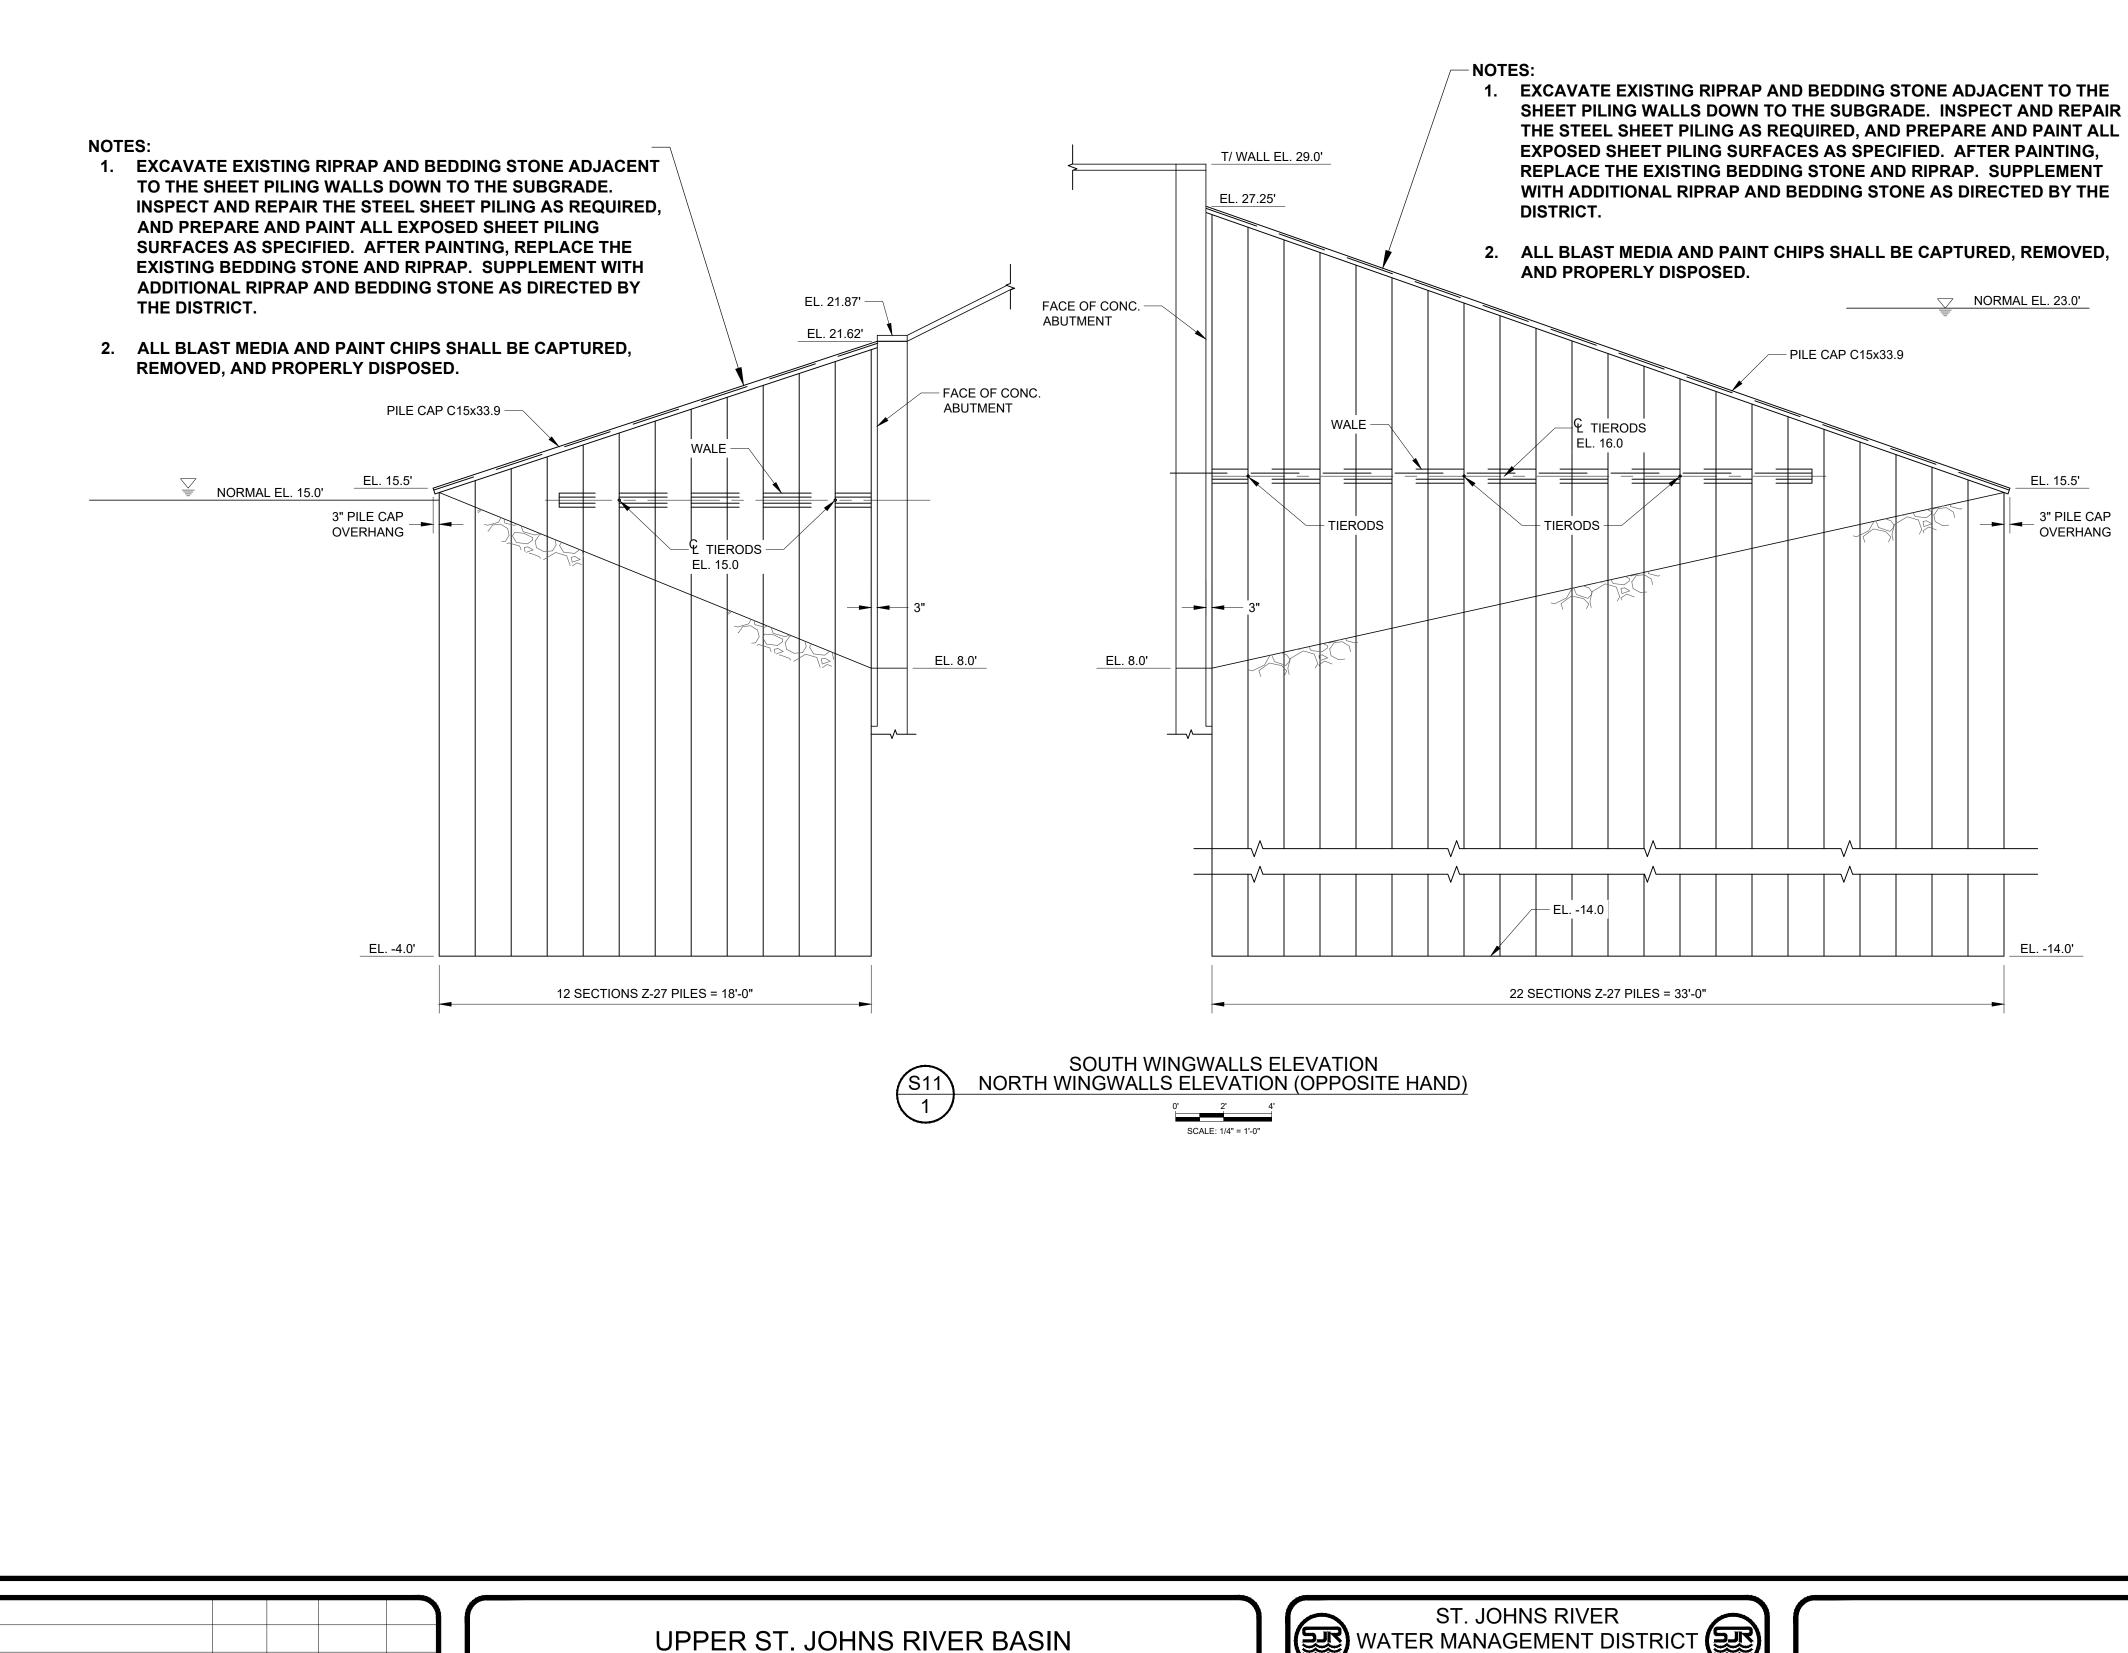
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P.E. NUMBER:	53746

MAY 14, 2021
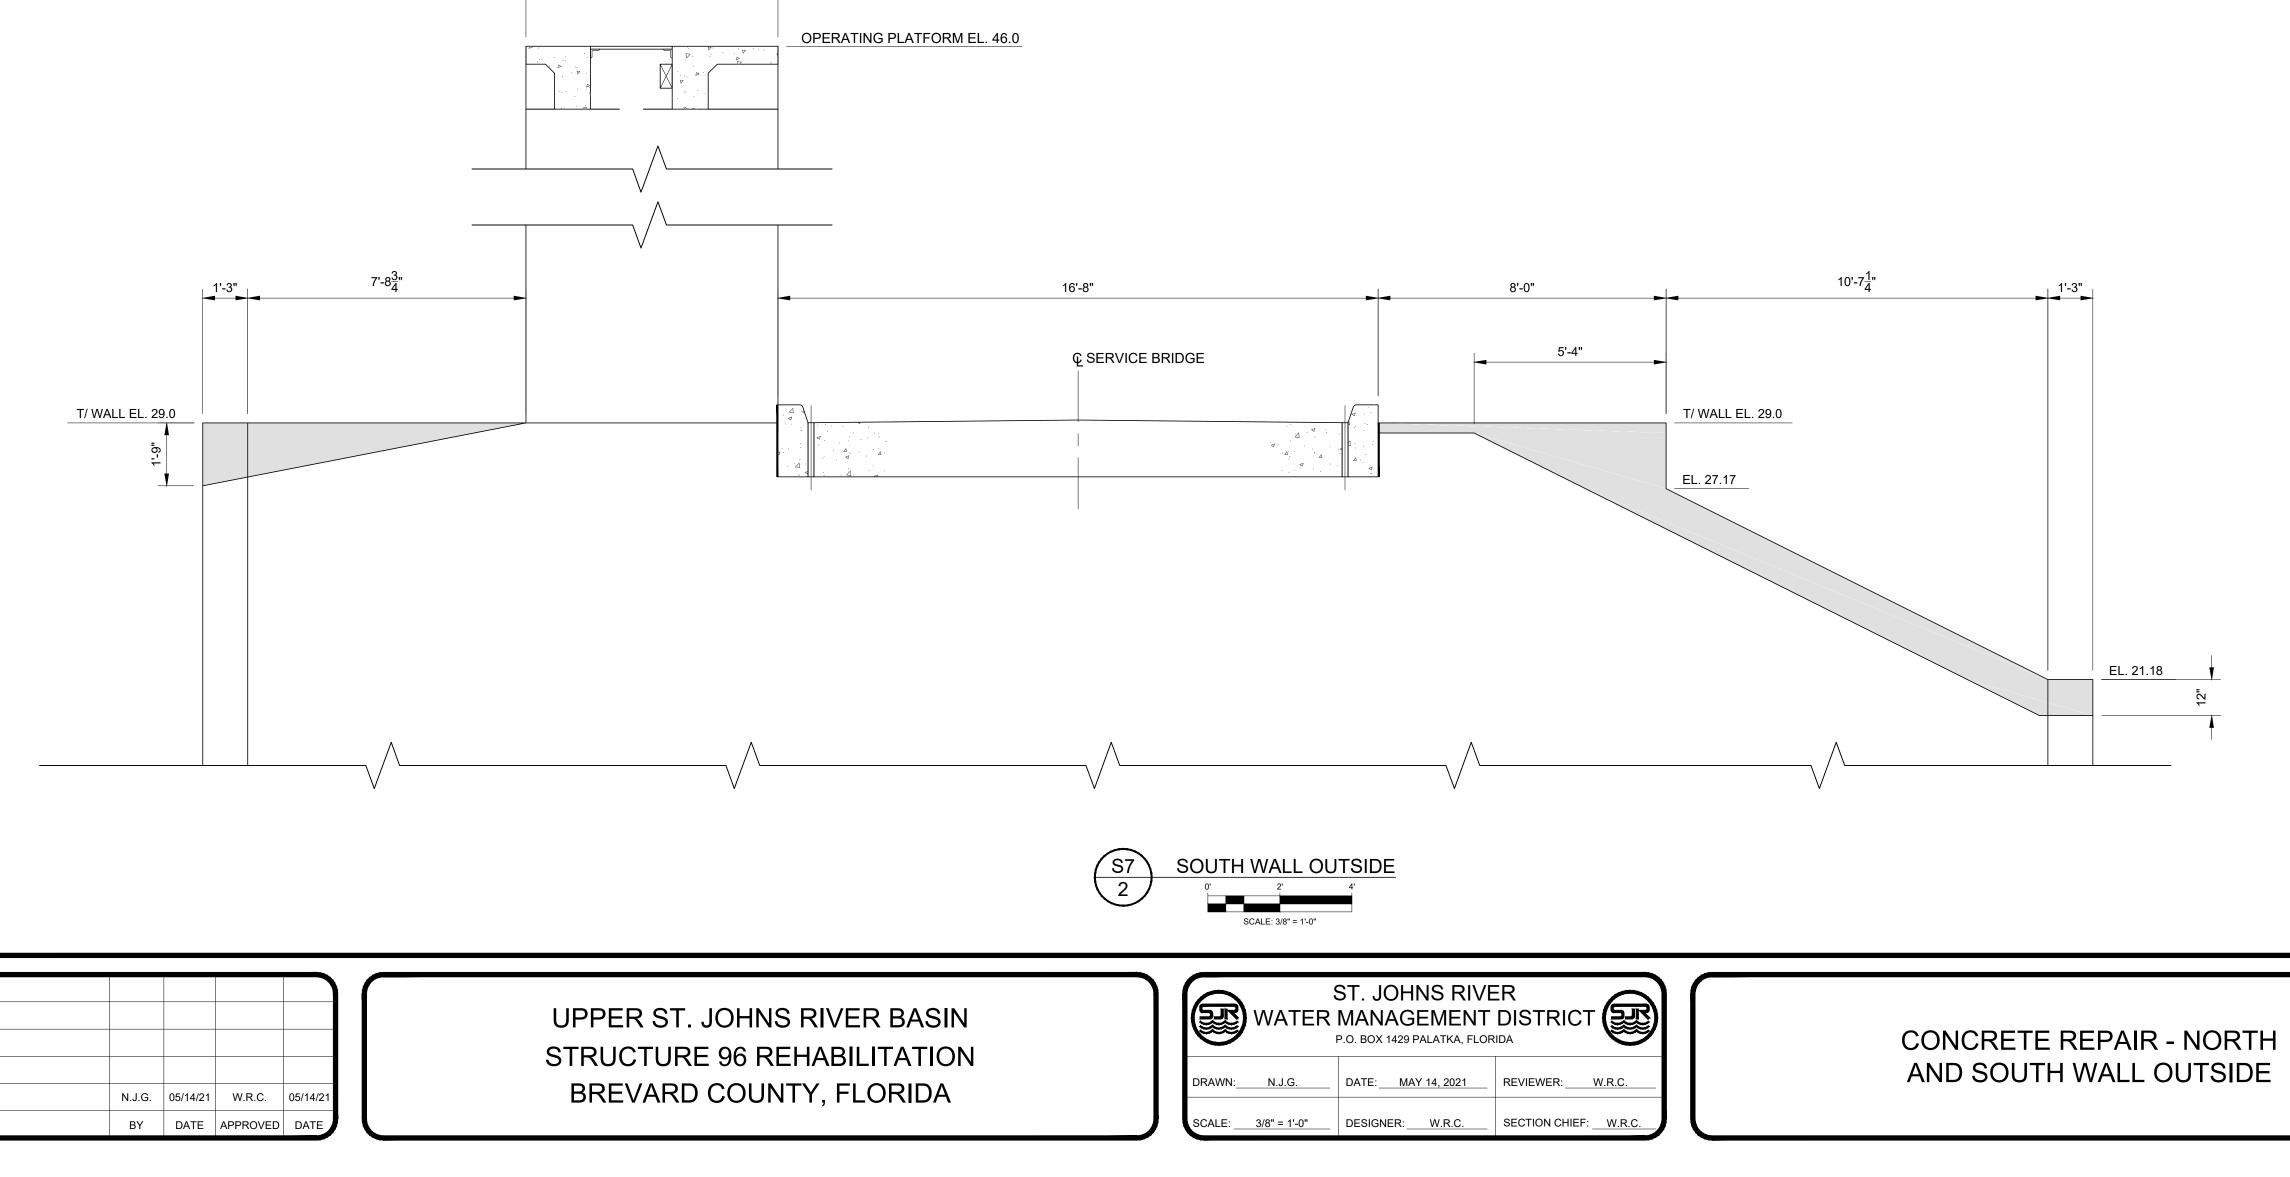
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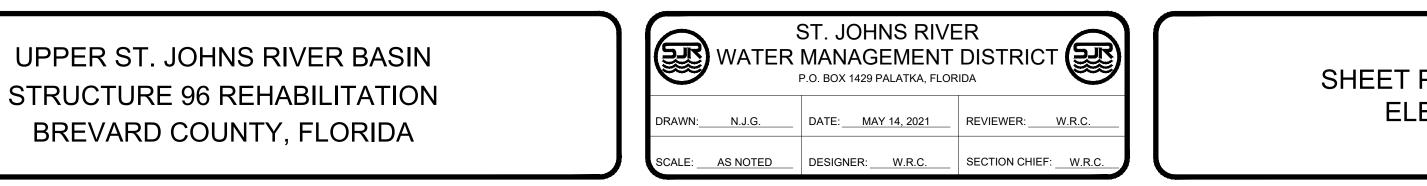
CONCRETE REPAIR - TYPICAL DETAILS


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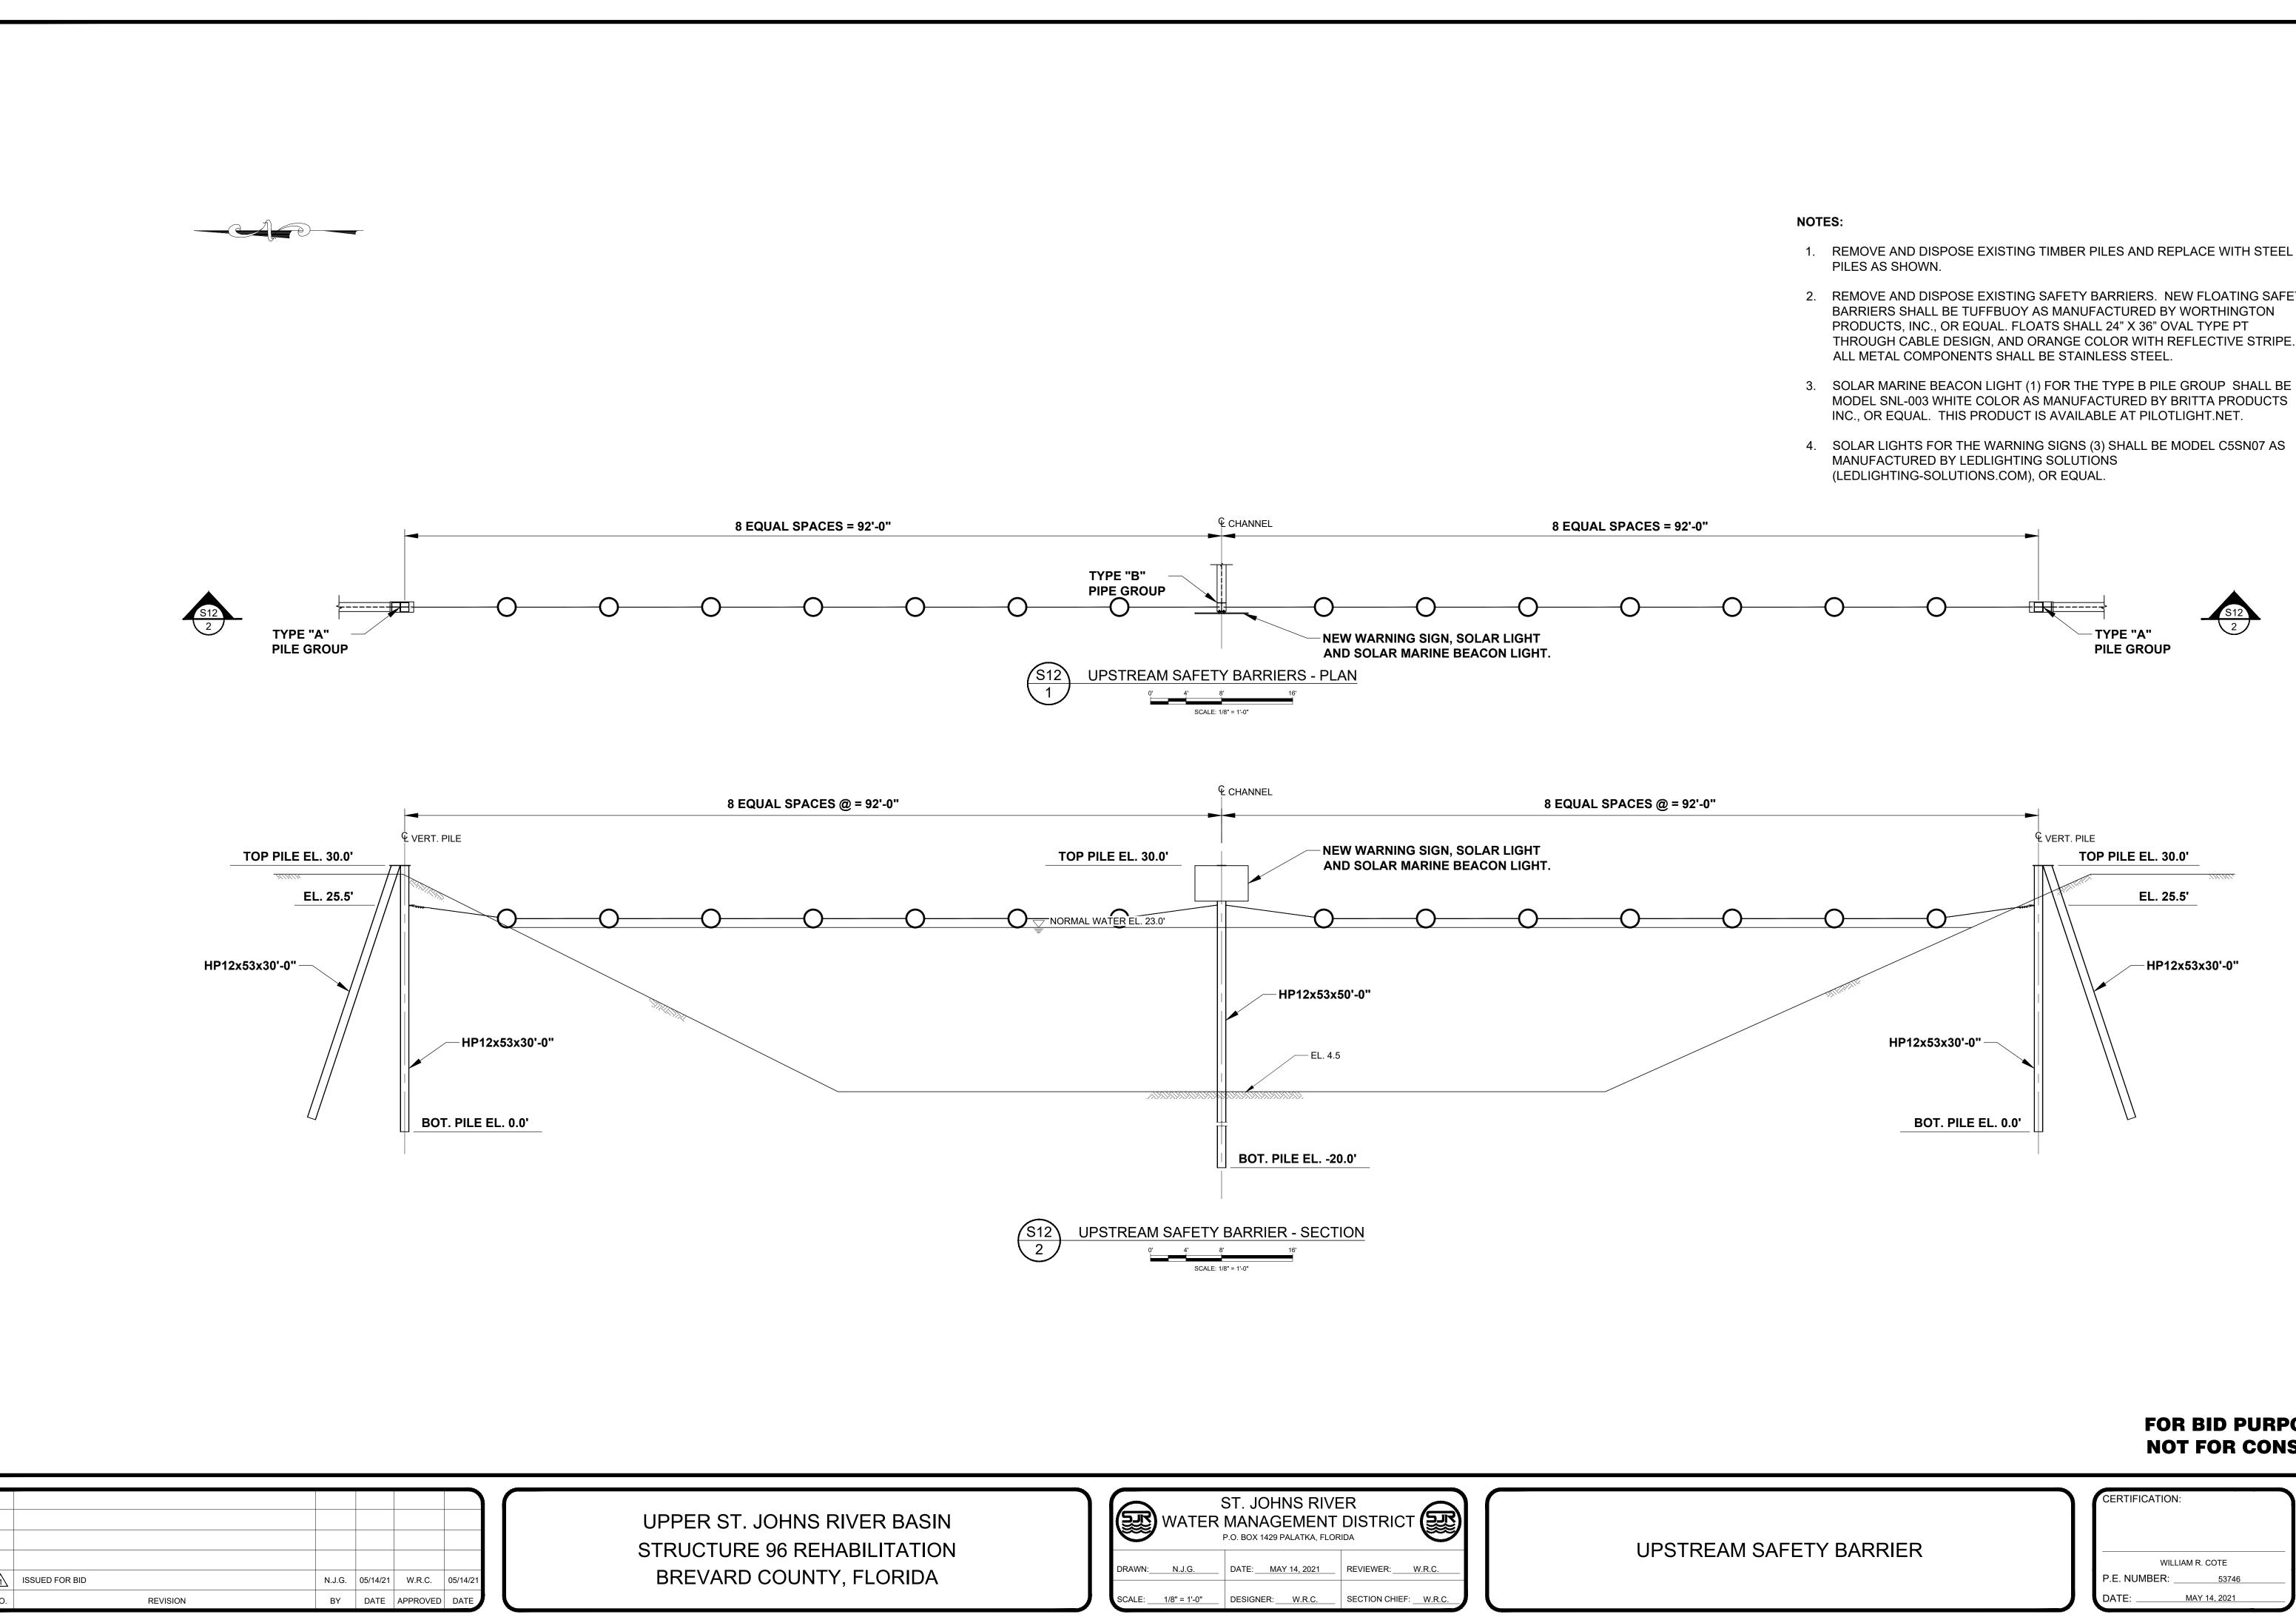
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SHEET PILING REPAIR - WINGWALL **ELEVATION AND DETAILS**

WILI	LIAM R. COTE
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DATE:	MAY 14, 2021

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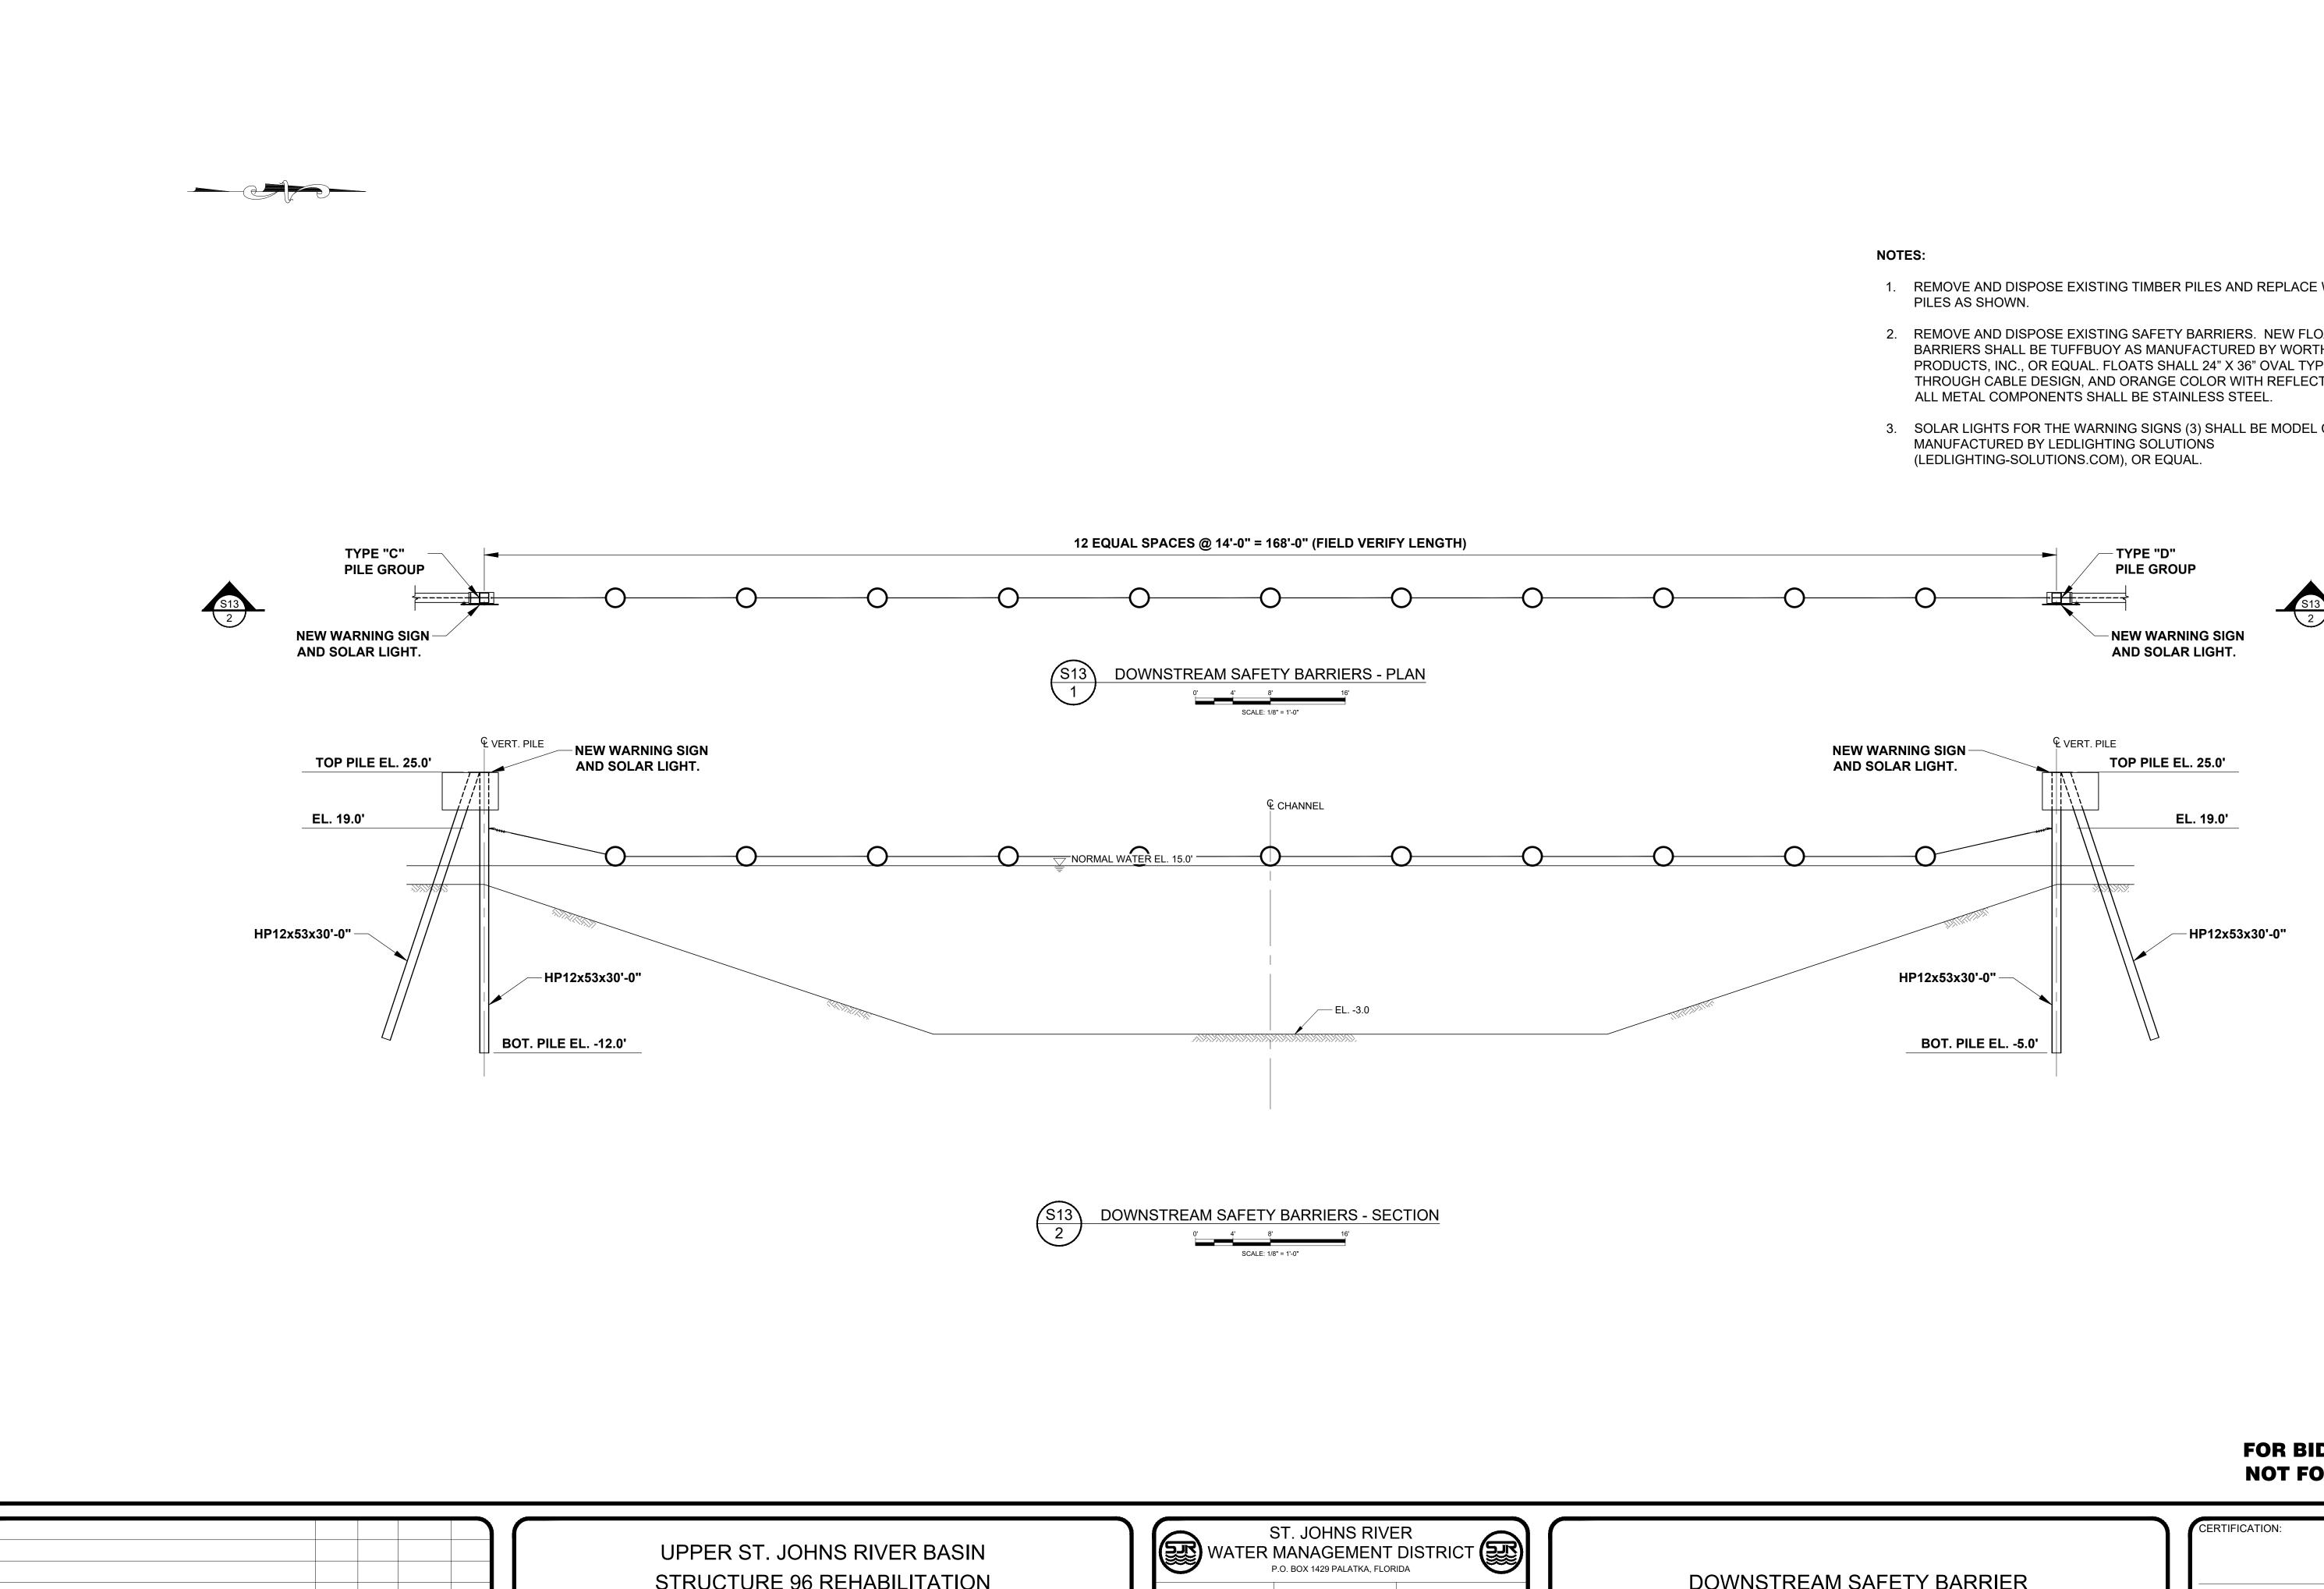


S RIVER BASIN	R	WATER	ST. JOHNS RIVE MANAGEMENT p.o. box 1429 palatka, flor	DISTRICT		UPS	
EHABILITATION NTY, FLORIDA	DRAWN: SCALE:	N.J.G. 1/8" = 1'-0"	DATE: MAY 14, 2021 DESIGNER: W.R.C.		<u>R.C.</u> W.R.C.	UFS	1 Г

- 1. REMOVE AND DISPOSE EXISTING TIMBER PILES AND REPLACE WITH STEEL
- 2. REMOVE AND DISPOSE EXISTING SAFETY BARRIERS. NEW FLOATING SAFETY BARRIERS SHALL BE TUFFBUOY AS MANUFACTURED BY WORTHINGTON THROUGH CABLE DESIGN, AND ORANGE COLOR WITH REFLECTIVE STRIPE.
- MODEL SNL-003 WHITE COLOR AS MANUFACTURED BY BRITTA PRODUCTS
- 4. SOLAR LIGHTS FOR THE WARNING SIGNS (3) SHALL BE MODEL C5SN07 AS
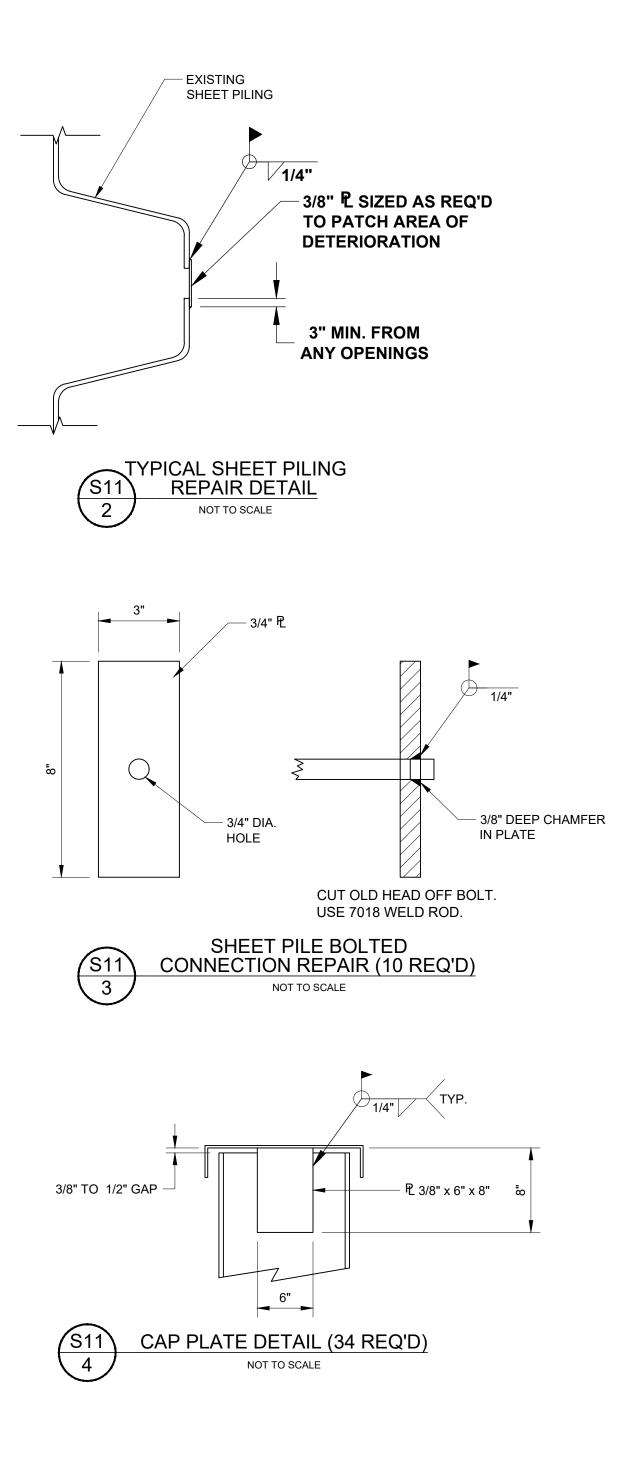
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SAFETY BARRIER	CERTIFICATION:	FILE NAME: S-96 STRUCTURE.dw		
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STRUCTURE 96 REH BREVARD COUNT

ITY, FLORIDA	WATER M P.O RAWN: N.J.G. D	D. BOX 1429 PALATKA, FLORI	DISTRICT (SEC)	DOWNST

- 1. REMOVE AND DISPOSE EXISTING TIMBER PILES AND REPLACE WITH STEEL
- 2. REMOVE AND DISPOSE EXISTING SAFETY BARRIERS. NEW FLOATING SAFETY BARRIERS SHALL BE TUFFBUOY AS MANUFACTURED BY WORTHINGTON PRODUCTS, INC., OR EQUAL. FLOATS SHALL 24" X 36" OVAL TYPE PT THROUGH CABLE DESIGN, AND ORANGE COLOR WITH REFLECTIVE STRIPE.
- 3. SOLAR LIGHTS FOR THE WARNING SIGNS (3) SHALL BE MODEL C5SN07 AS


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STREAM SAFETY BARRIER



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REHABILITATION NTY, FLORIDA	DRAWN:	N.J.G.	DATE: N	IAY 14, 2021	REVIEWER:	W.R.C.
	SCALE:1	1" = 1'-0"	DESIGNER:	W.R.C.	SECTION CHIE	F: <u>W.R.C.</u>

UPSTREAM PILE G

NOTE SPECIFICATIONS:

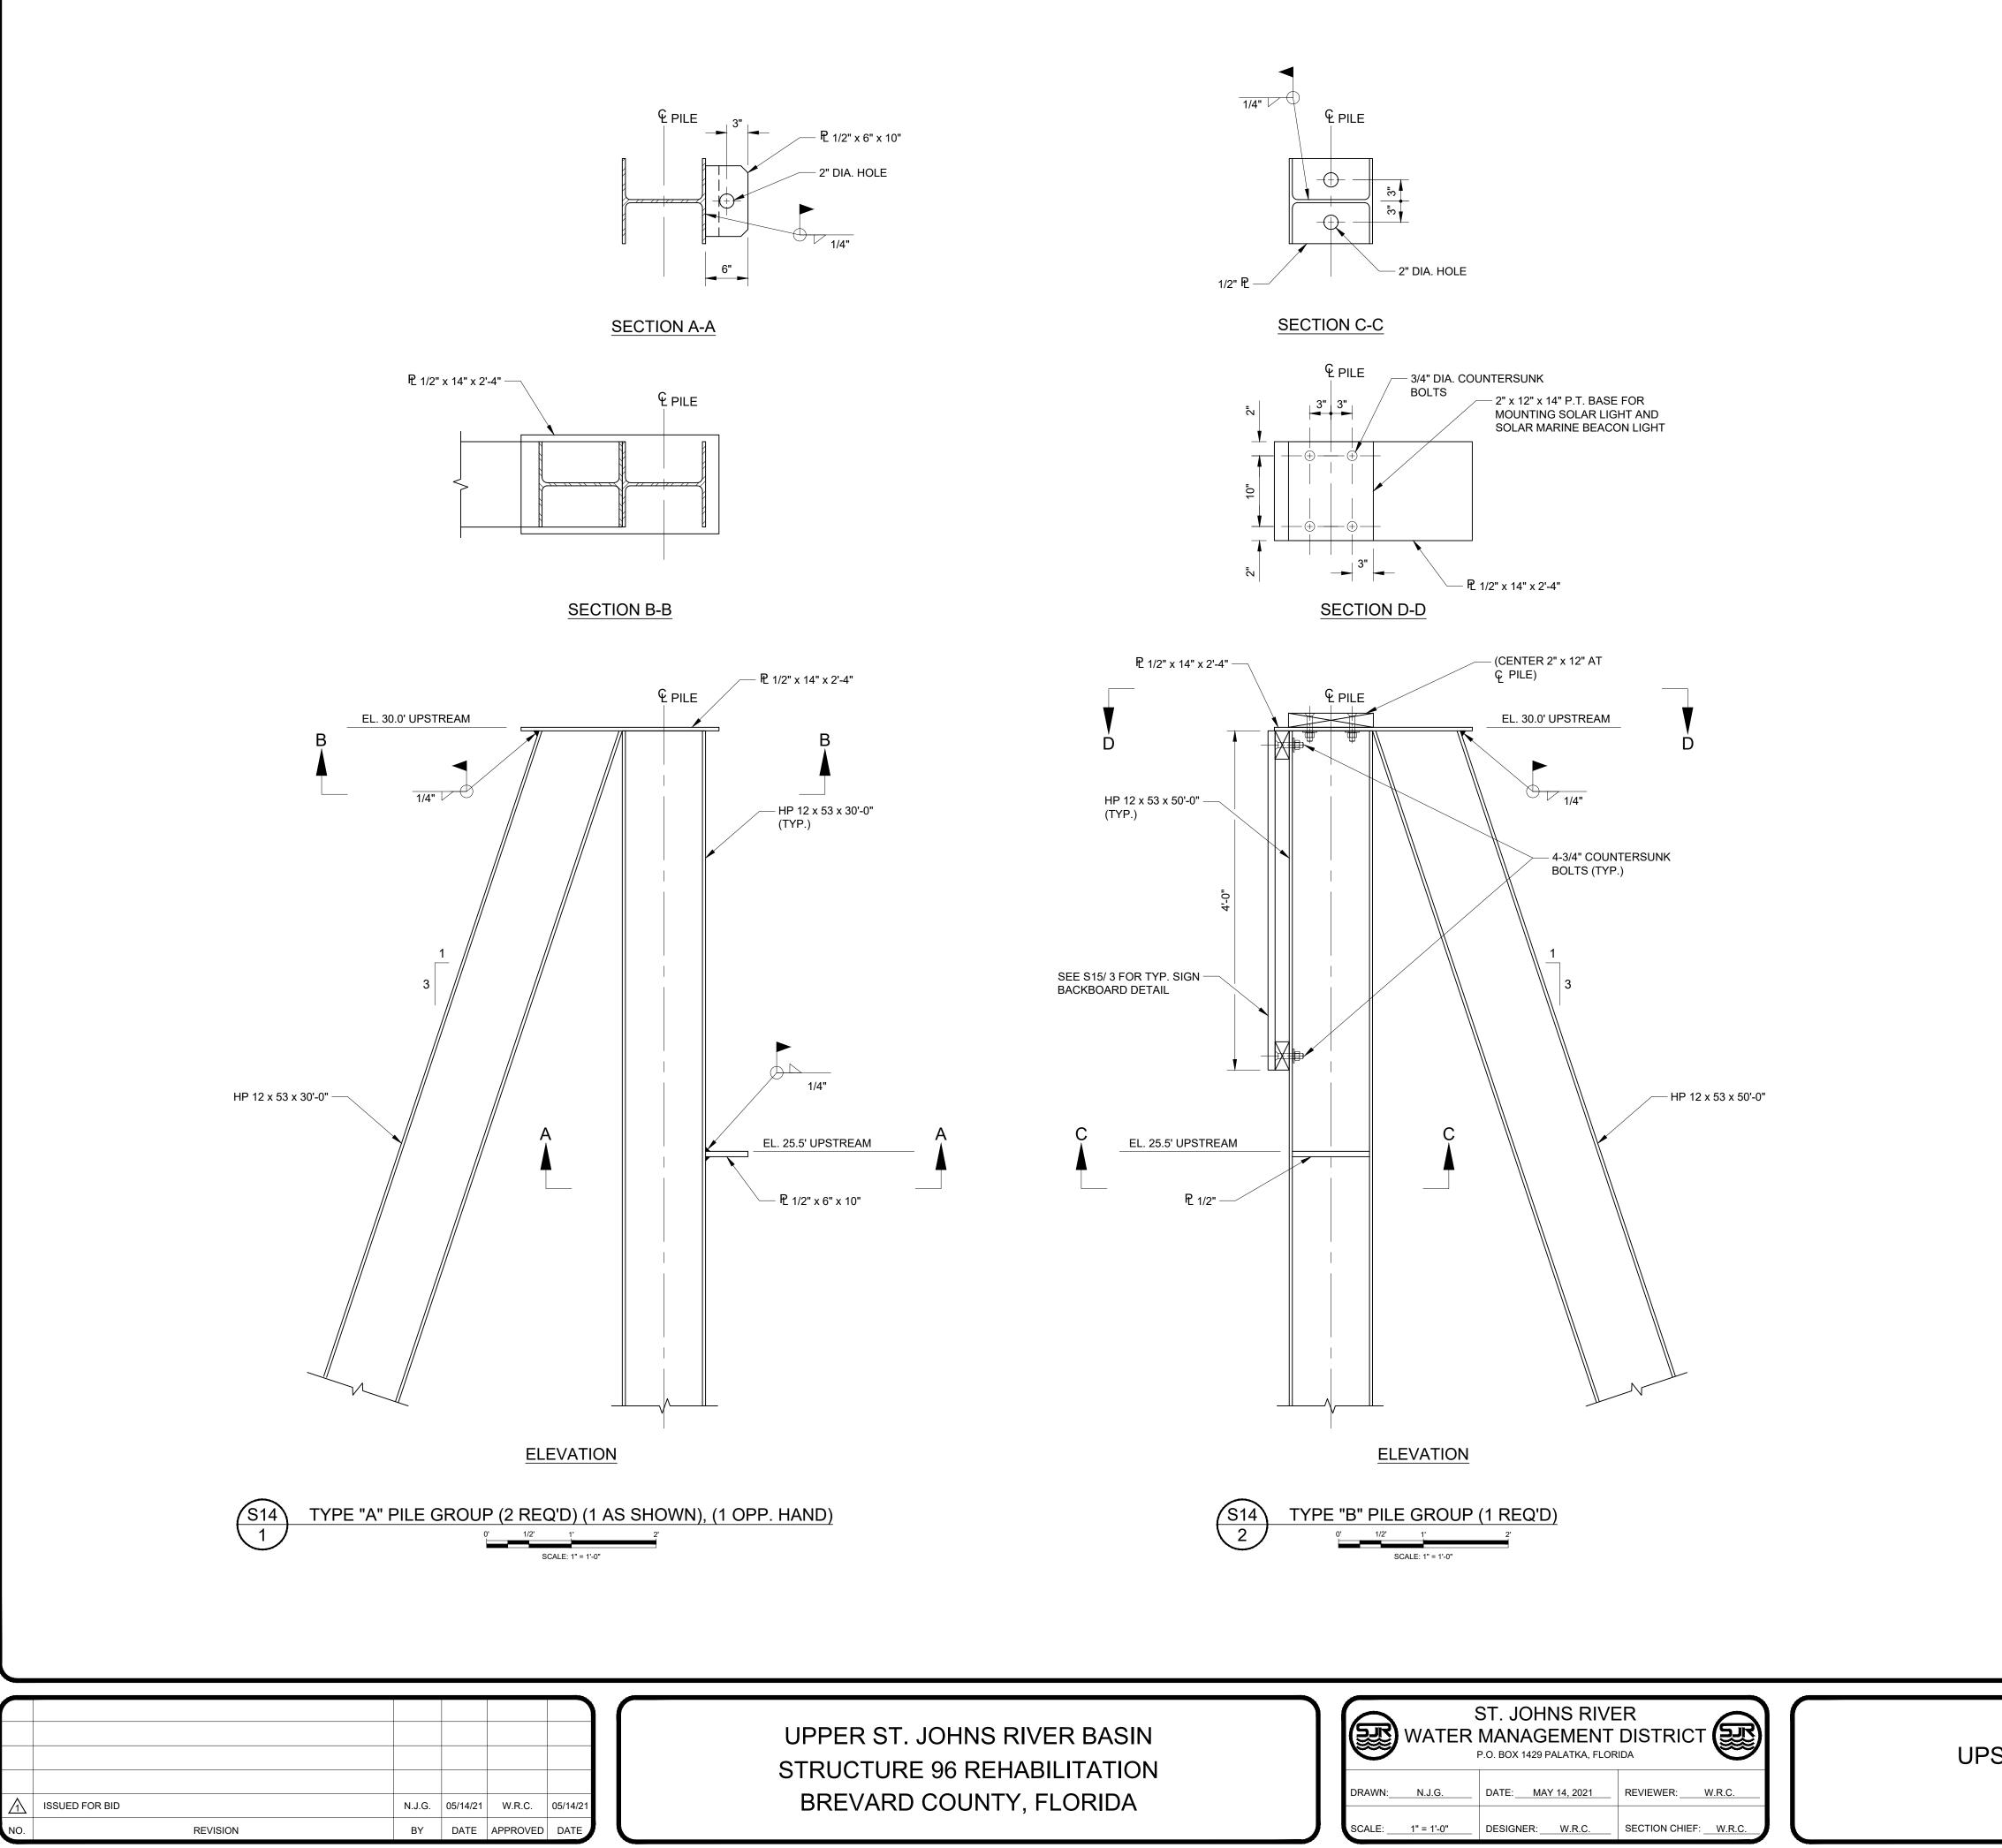STRUCTURAL STEEL:

- 1. STRUCTURAL STEEL DESIGN, FABRICATION, AND ERECTION SHALL BE IN ACCORDANCE WITH THE AMERICAN INSTITUTE OF STEEL CONSTRUCTION (AISC) "SPECIFICATION FOR THE DESIGN, FABRICATION AND ERECTION OF STRUCTURAL STEEL FOR BUILDINGS", LATEST EDITION.
- 2. ALL STRUCTURAL AND MISCELLANEOUS STEEL SHALL BE NEW AND CONFORM TO THE REQUIREMENTS OF THE AMERICAN SOCIETY OF TESTING AND MATERIALS (ASTM) STANDARD A36 UNLESS NOTED OTHERWISE.
- 3. WELDING SHALL BE IN ACCORDANCE WITH THE AMERICAN WELDING SOCIETY (AWS) "STRUCTURAL WELDING CODE" AWS D1.1. ALL WELDING SHALL UTILIZE E70XX ELECTRODES UNLESS NOTED OTHERWISE.

PAINTS AND PROTECTIVE COATINGS:

- 1. ALL STEEL SHALL BE PRIMED AND PAINTED IN ACCORDANCE WITH THE STEEL STRUCTURES PAINTING COUNCIL (SSPC) "STEEL STRUCTURES PAINTING MANUAL". STEEL SURFACE PREPARATION SHALL BE SSPC-10 NEAR WHITE BLAST CLEANING.
- 2. PROTECTIVE COATING FOR STRUCTURAL STEEL SHALL BE AS MANUFACTURED BY SHERWIN-WILLIAMS, OR EQUAL, AS FOLLOWS:
- FIRST COAT (PRIMER): DURA-PLATE 235, 4-8 MILS DFT SECOND COAT: DURA-PLATE 235, 4-8 MILS DFT THIRD (FINAL) COAT: DURA-PLATE 235, 4-8 MILS DFT COLOR: LIGHT GRAY
- SURFACE PREPARATION AND APPLICATION SHALL BE IN ACCORDANCE WITH THE PAINT MANUFACTURER SPECIFICATIONS.

FOR BID PURPOSES ONLY **NOT FOR CONSTRUCTION**

I TYPE A AND TYPE B
GROUP DETAILS


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WIL	LIAM R. COTE
P.E. NUMBER:	53746


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FILE NAME:
S-96 STRUCTURE.dwg
PROJECT NO.:

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WATER	ST. JOHNS RIVE MANAGEMENT	
DRAWN: N.J.G.	P.O. BOX 1429 PALATKA, FLOR DATE:	IDA
SCALE: AS NOTED	DESIGNER: W.R.C.	SECTION CHIEF: W.R.C.



WAT	ST. JOHNS F ER MANAGEME P.O. BOX 1429 PALATKA	NT DISTRICT
DRAWN: N.J.G.	DATE:MAY 14, 202	1 REVIEWER: W.R.C.
SCALE: AS NOTE	DESIGNER: W.R.C	SECTION CHIEF: W.R.C.

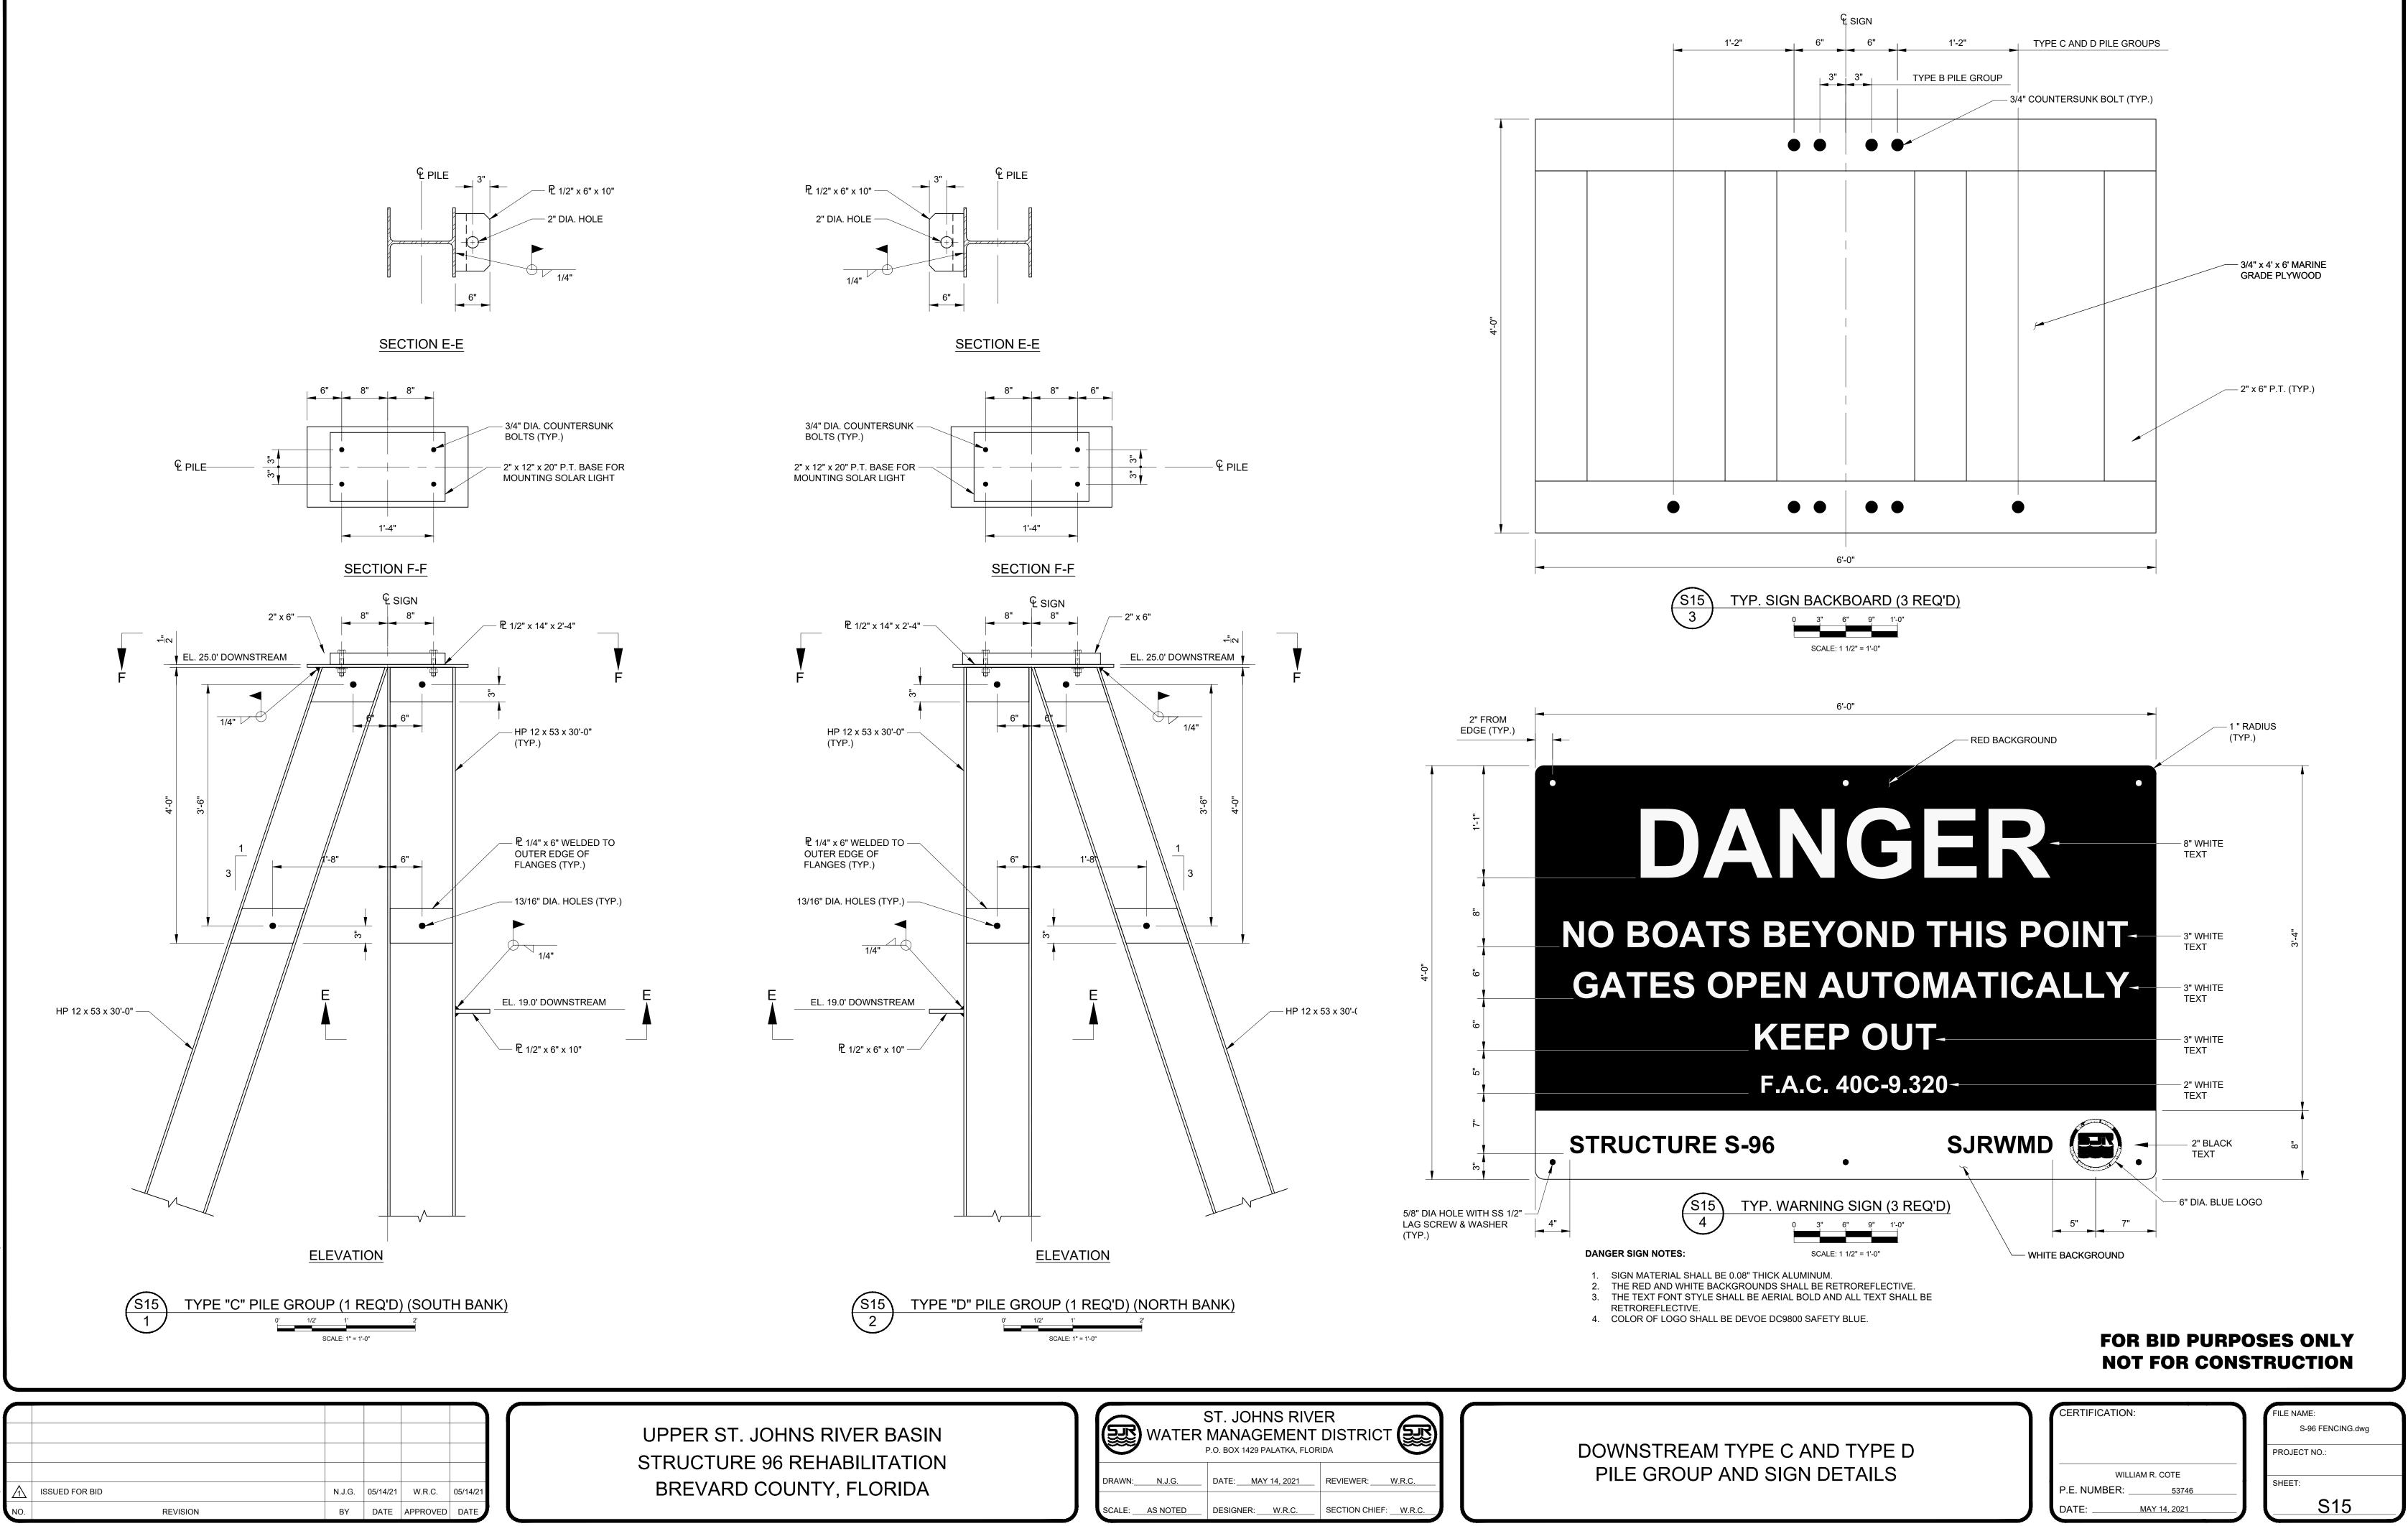NEW STAFF GAUGES & GATE PO

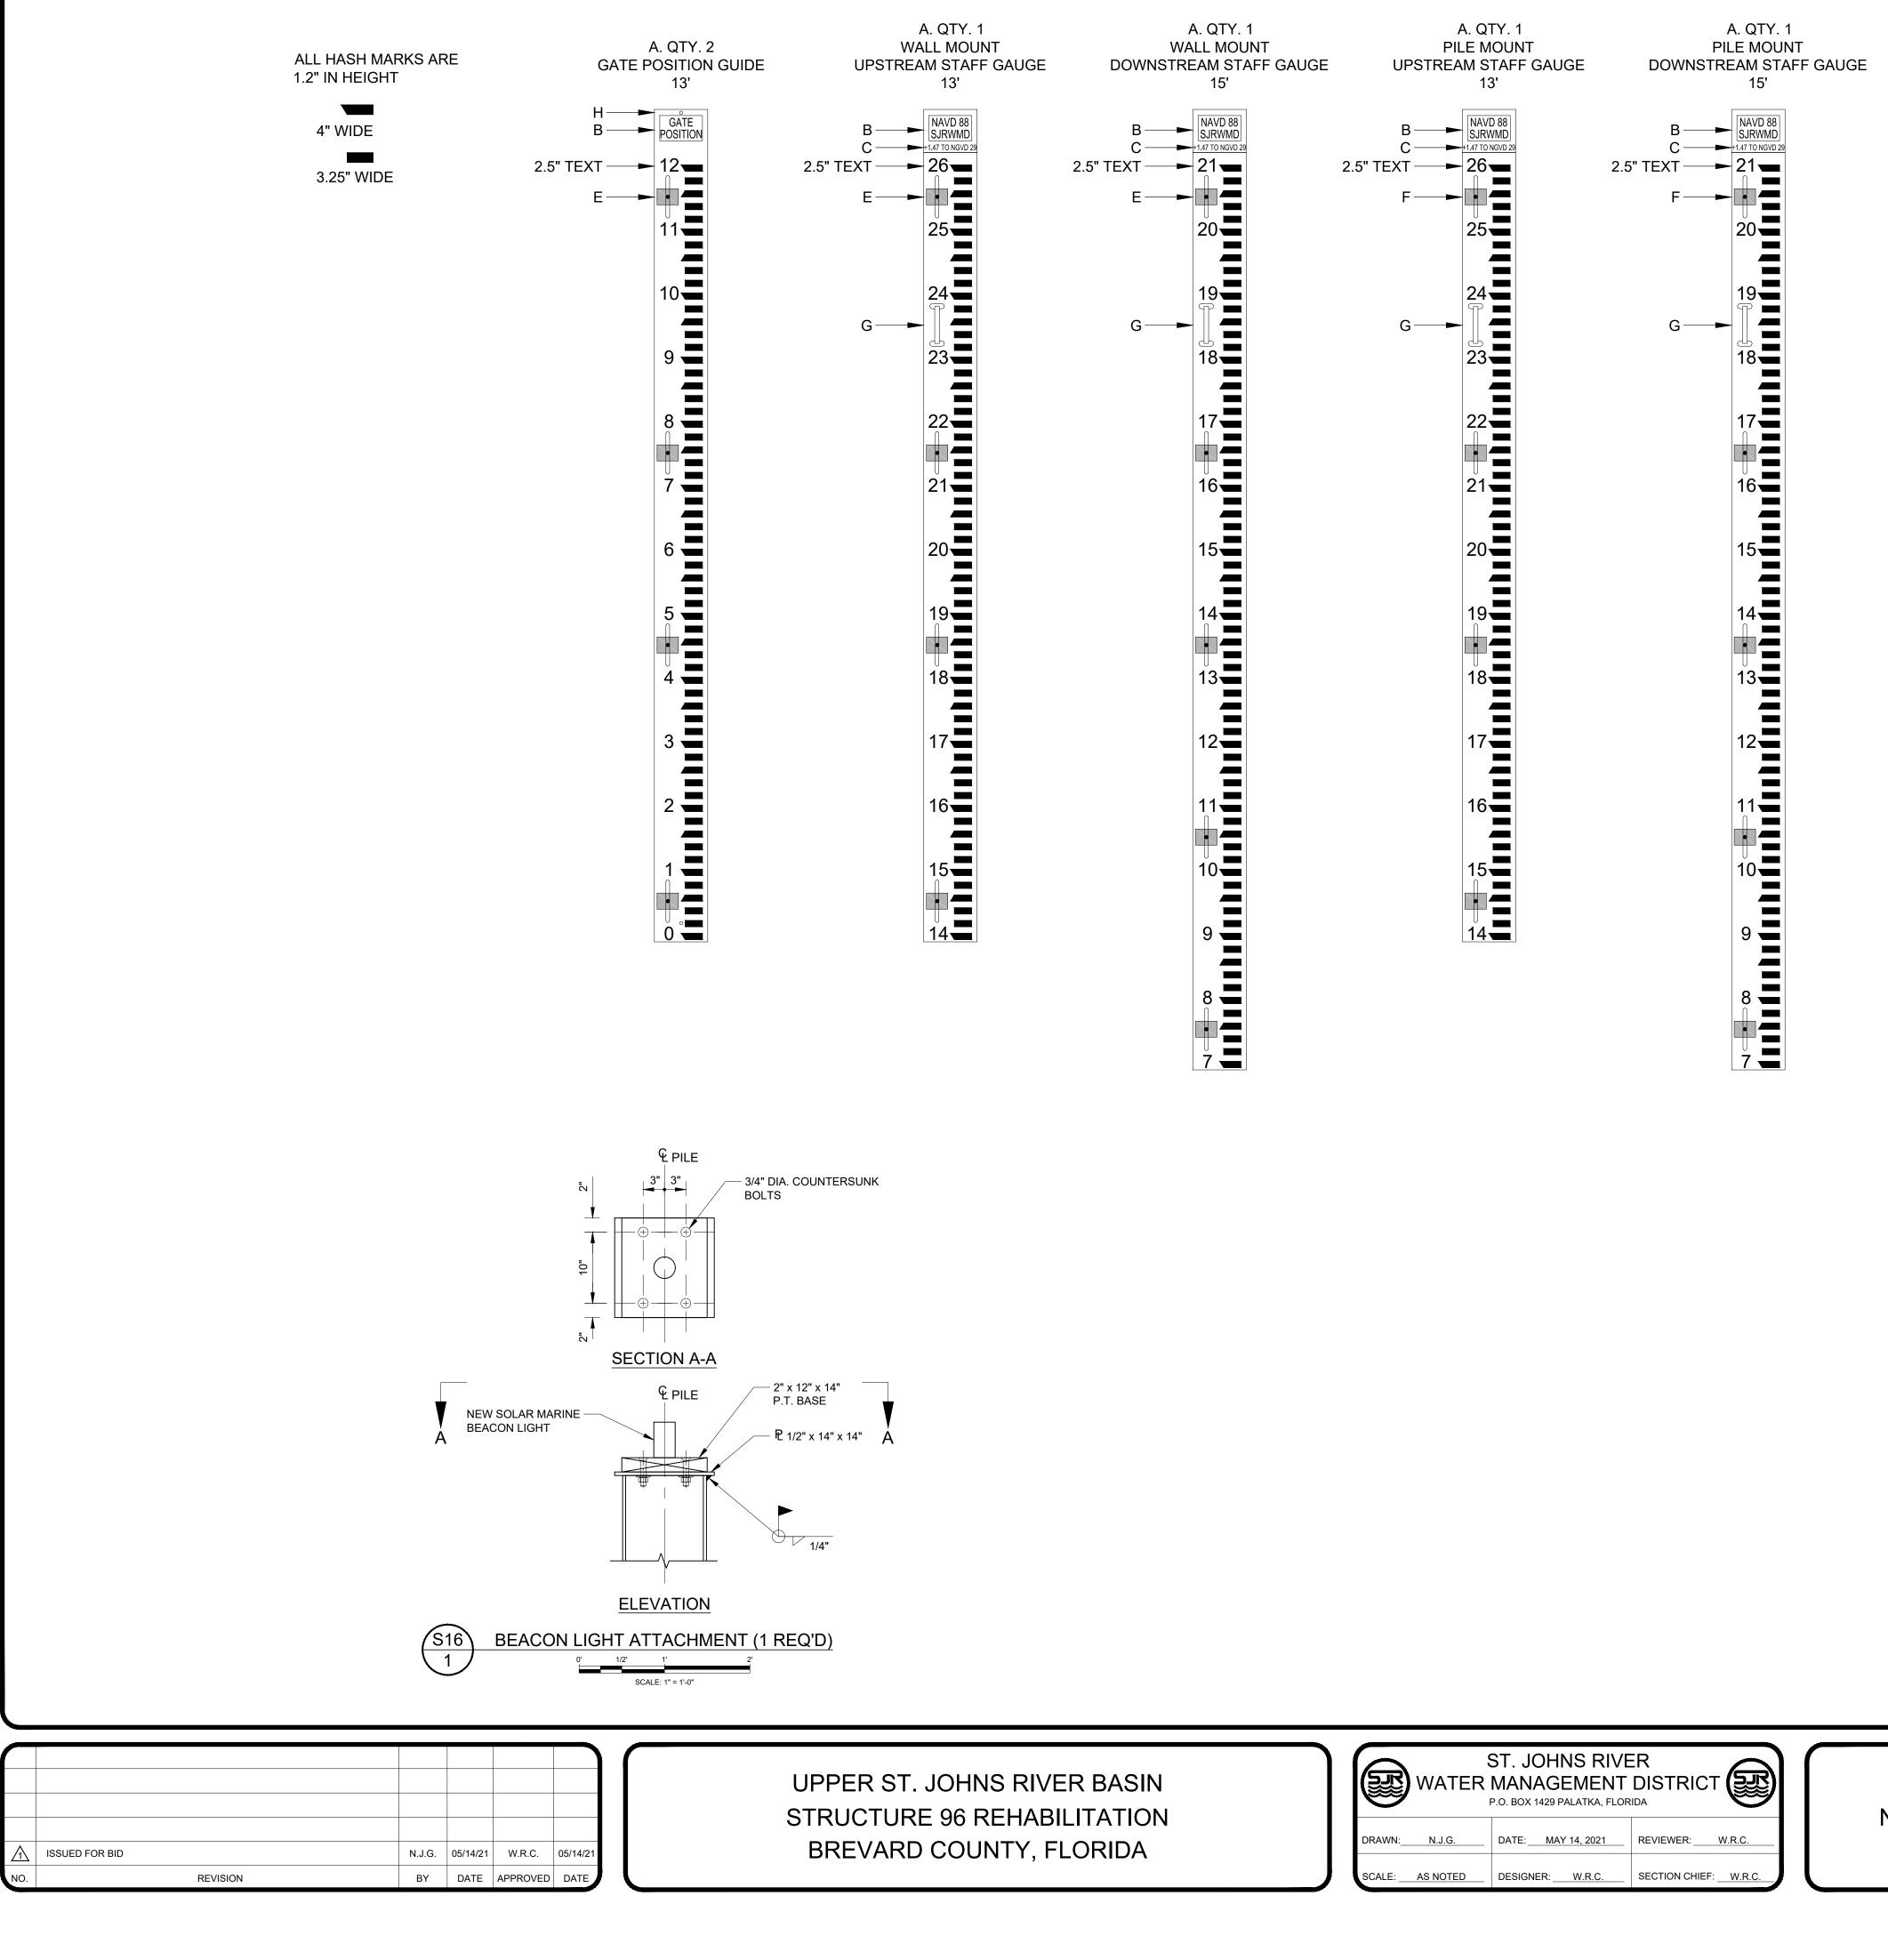MATERIALS KEY:

- A. STAFF GAUGES AND GATE POSITION GUIDES: 2"X10" (1.5"X9.5") MADE FROM TANGENT TECHNOLOGIES POLYFORCE RECYCLED PLASTIC LUMBER, WHITE OVER BLACK, OR EQUAL.
- B. TITLE PLAQUE INSERT: WHITE WITH RED LETTERING.
- C. NGVD29 OFFSET = +1.47
- D. STAFF GAUGE SPLICE LINES (IF REQUIRED).
- E. WALL MOUNTED STAFF GAUGES AND GATE POSITION GUIDES: ALL SLOTS ARE 0.6875"x7.3125". THRU HOLES ARE 5/8" DIAMETER. PROVIDE SS WASHERS 1/4"X3"X4" AND SS CONCRETE ANCHORS.
- F. PILE MOUNTED STAFF GAUGES: ALL SLOTS ARE 0.6875"x7.3125". THRU HOLES ARE 5/8" DIAMETER. PROVIDE SS WASHERS 1/4"X3"X4" AND SS HEX HEAD THRU-BOLT 5/8"X4" FOR MOUNTING TO H-PILES.
- G. 8" SS CLEAT MOUNTED WITH THREADED INSERTS.
- H. 5/16" DIAMETER THRU HOLE WITH CONCRETE SCREW.

HARDWARE:


ALL HARDWARE SHALL BE STAINLESS STEEL.

SOLAR LIGHTS:

SOLAR MARINE BEACON LIGHTS (2) FOR THE STAFF GAUGE PILES SHALL BE MODEL SNL-003 WHITE COLOR AS MANUFACTURED BY BRITTA PRODUCTS INC., OR EQUAL. THIS PRODUCT IS AVAILABLE AT PILOTLIGHT.NET.


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ELEVATIONS ON THIS SHEET ARE IN NAVD88. NAVD88 = NGVD29 - 1.47 FEET.

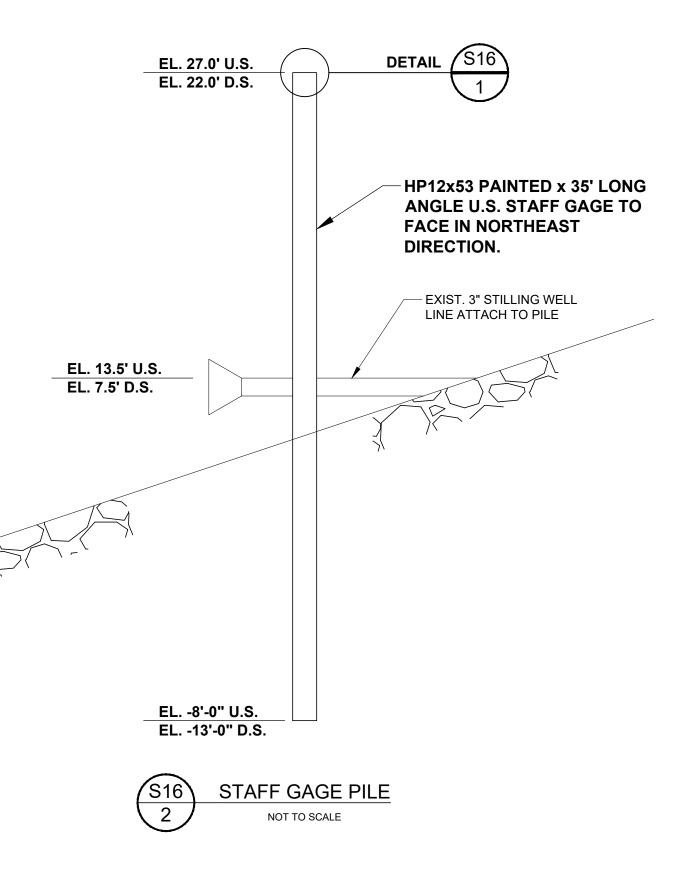

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	CERTIFICATION:	FILE NAME: S-96 FENCING.dwg
OSITION GUIDES		PROJECT NO.:
	WILLIAM R. COTE P.E. NUMBER: 53746	SHEET:
	DATE:	S16



- 2. VEHICULAR GATE POSTS: 3.5" NOMINAL DIAMETER SCHEDULE 40 PIPE, ASTM B241, ALUMINUM

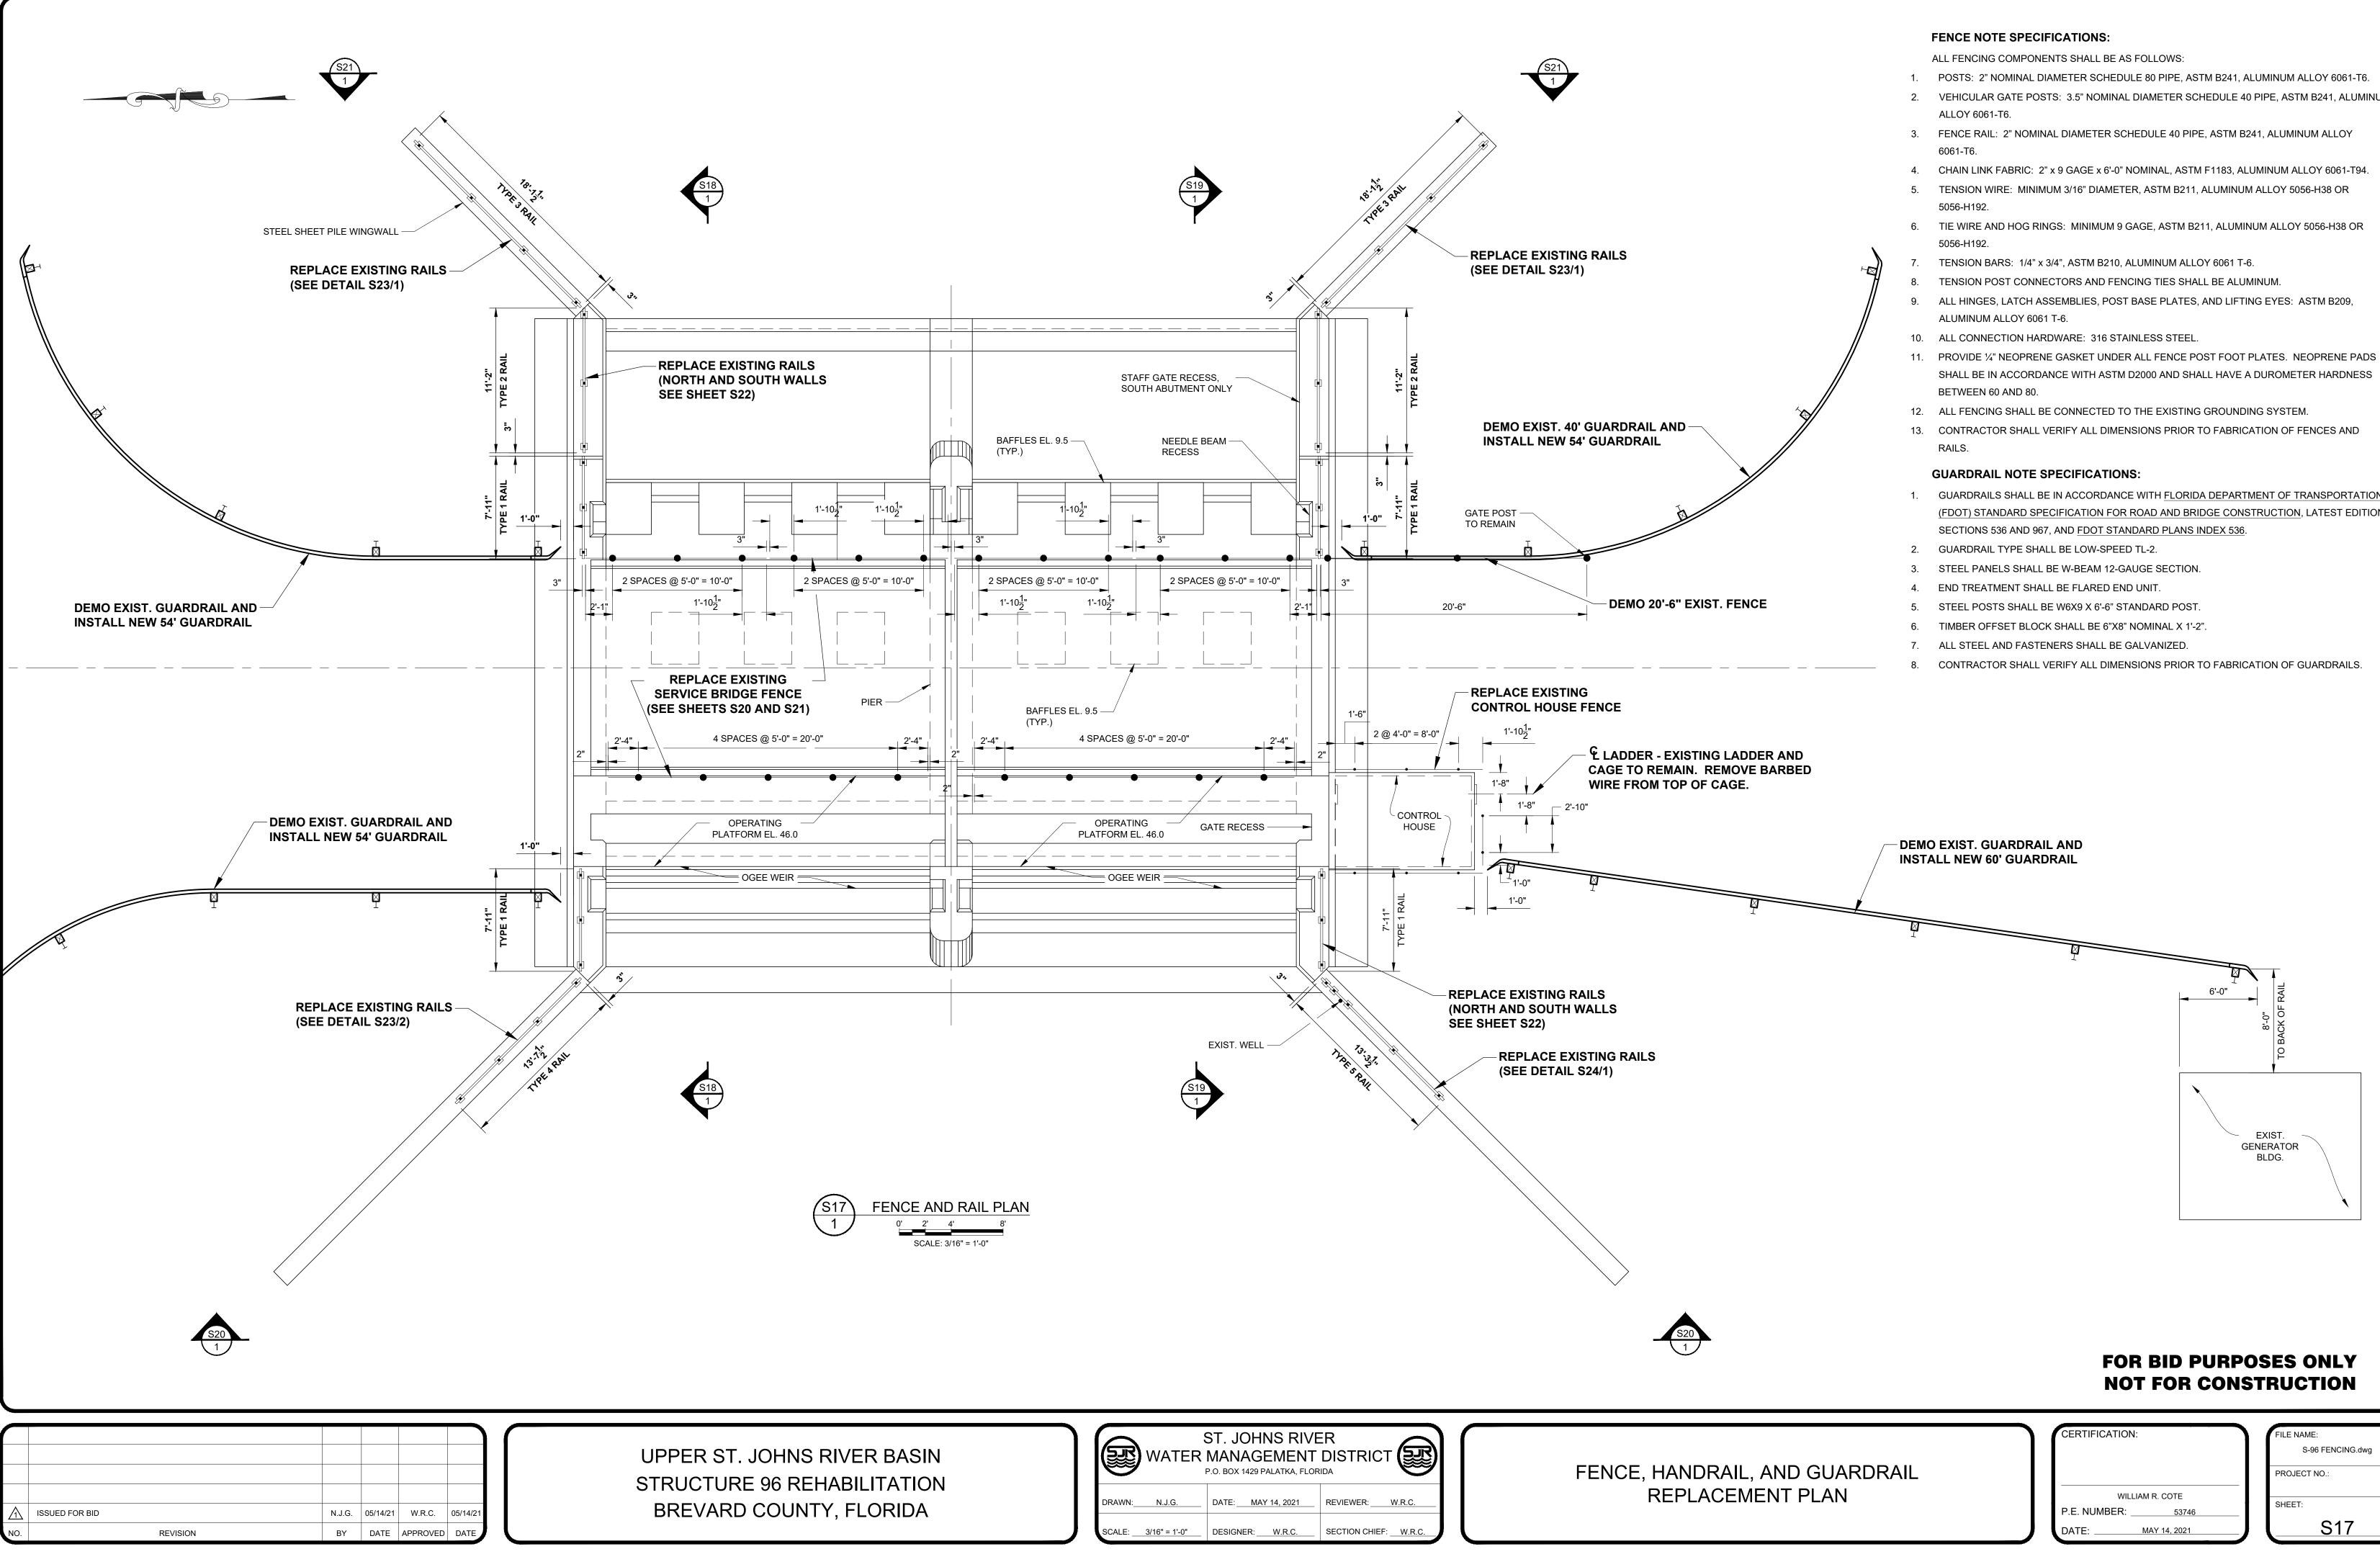- GUARDRAILS SHALL BE IN ACCORDANCE WITH FLORIDA DEPARTMENT OF TRANSPORTATION (FDOT) STANDARD SPECIFICATION FOR ROAD AND BRIDGE CONSTRUCTION, LATEST EDITION,


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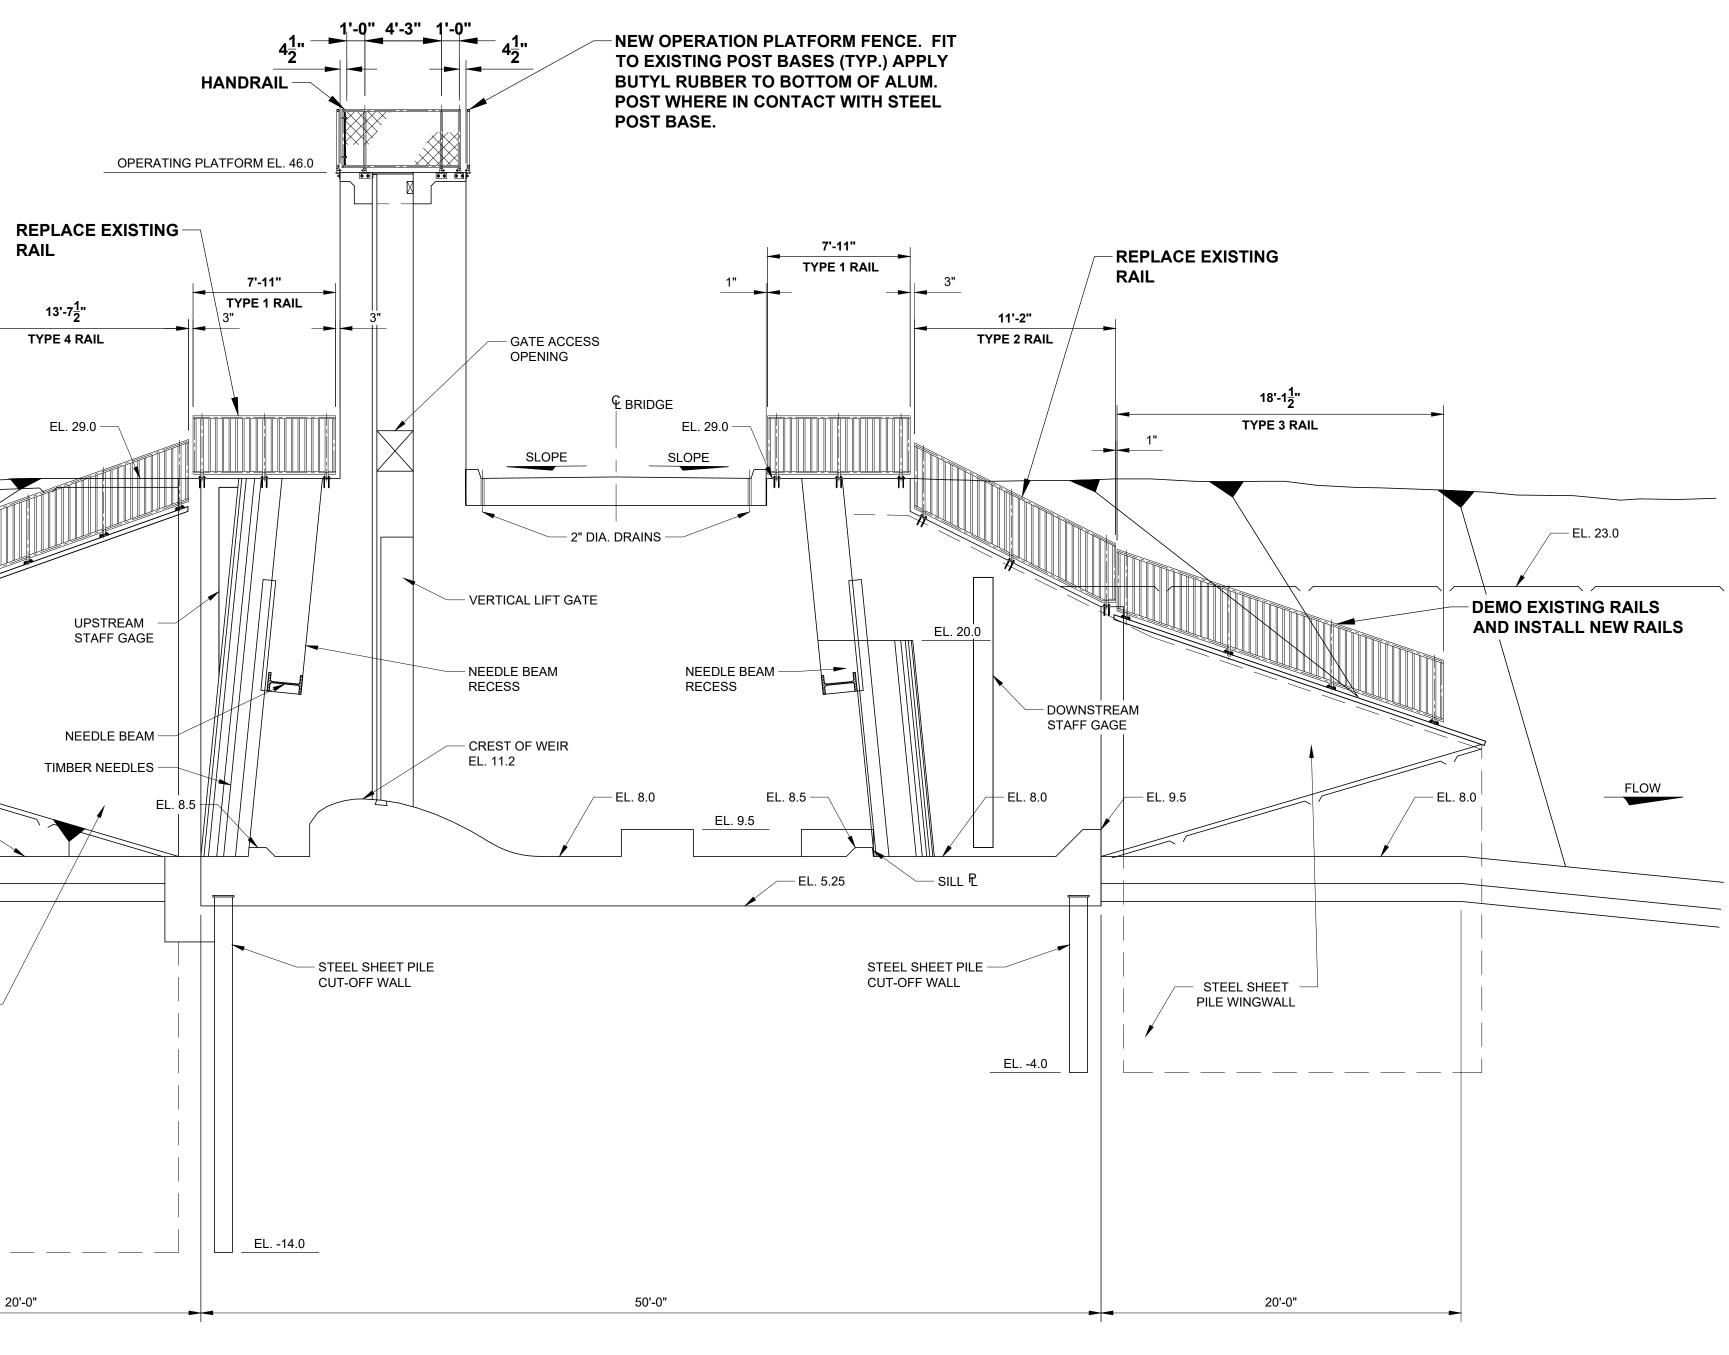
WIL	LIAM R. COTE	
P.E. NUMBER:	53746	
DATE:	MAY 14, 2021	

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7	ISSUED FOR BID	N.J.G.	05/14/21	W.R.C.	05/14/21
).	REVISION	BY	DATE	APPROVED	DATE

UPPER ST. JOHNS STRUCTURE 96 REI BREVARD COUNT



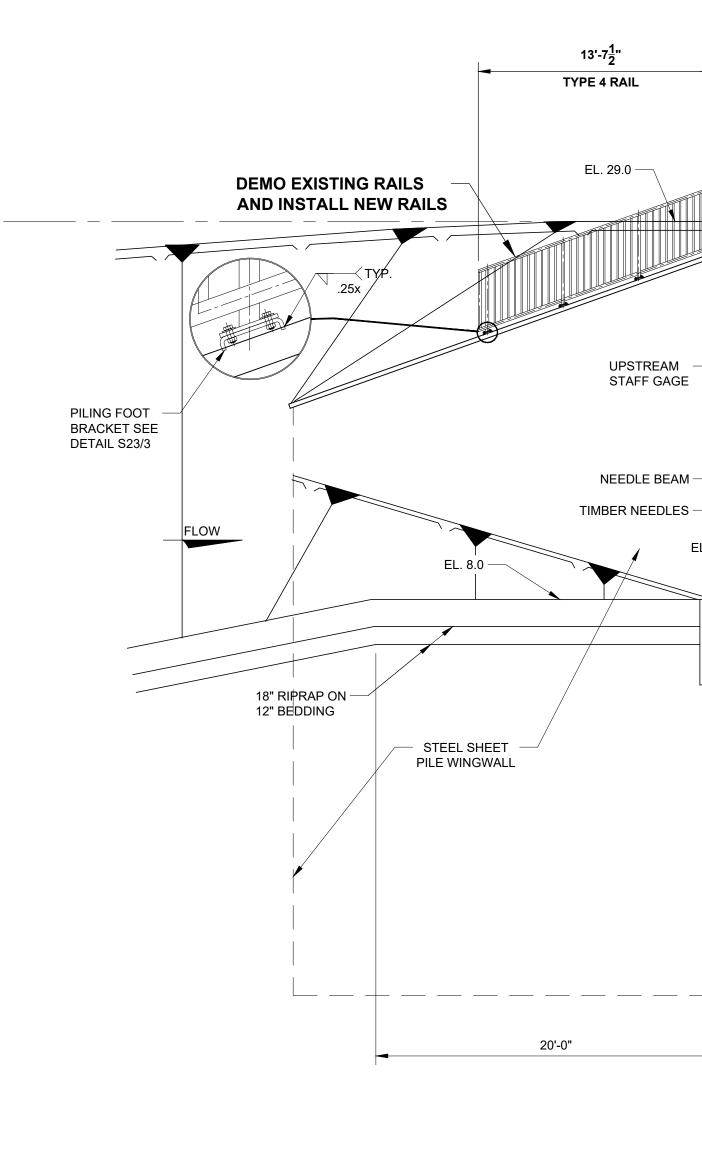

S18 SECTION - INSIDE NORTH ABUTMENT 1 0' 2' 4' 8' SCALE: 3/16" = 1'-0"

NS RIVER BASIN REHABILITATION	ST. JOHNS RIVER WATER MANAGEMENT DISTRICT	NEW N
INTY, FLORIDA	DRAWN: N.J.G. DATE: MAY 14, 2021 REVIEWER: W.R.C.	
	SCALE: 3/16" = 1'-0 DESIGNER: W.R.C. SECTION CHIEF: W.R.C.	

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P.E. NUMBER: _	53746
DATE:	MAY 14, 2021

FILE NAME:
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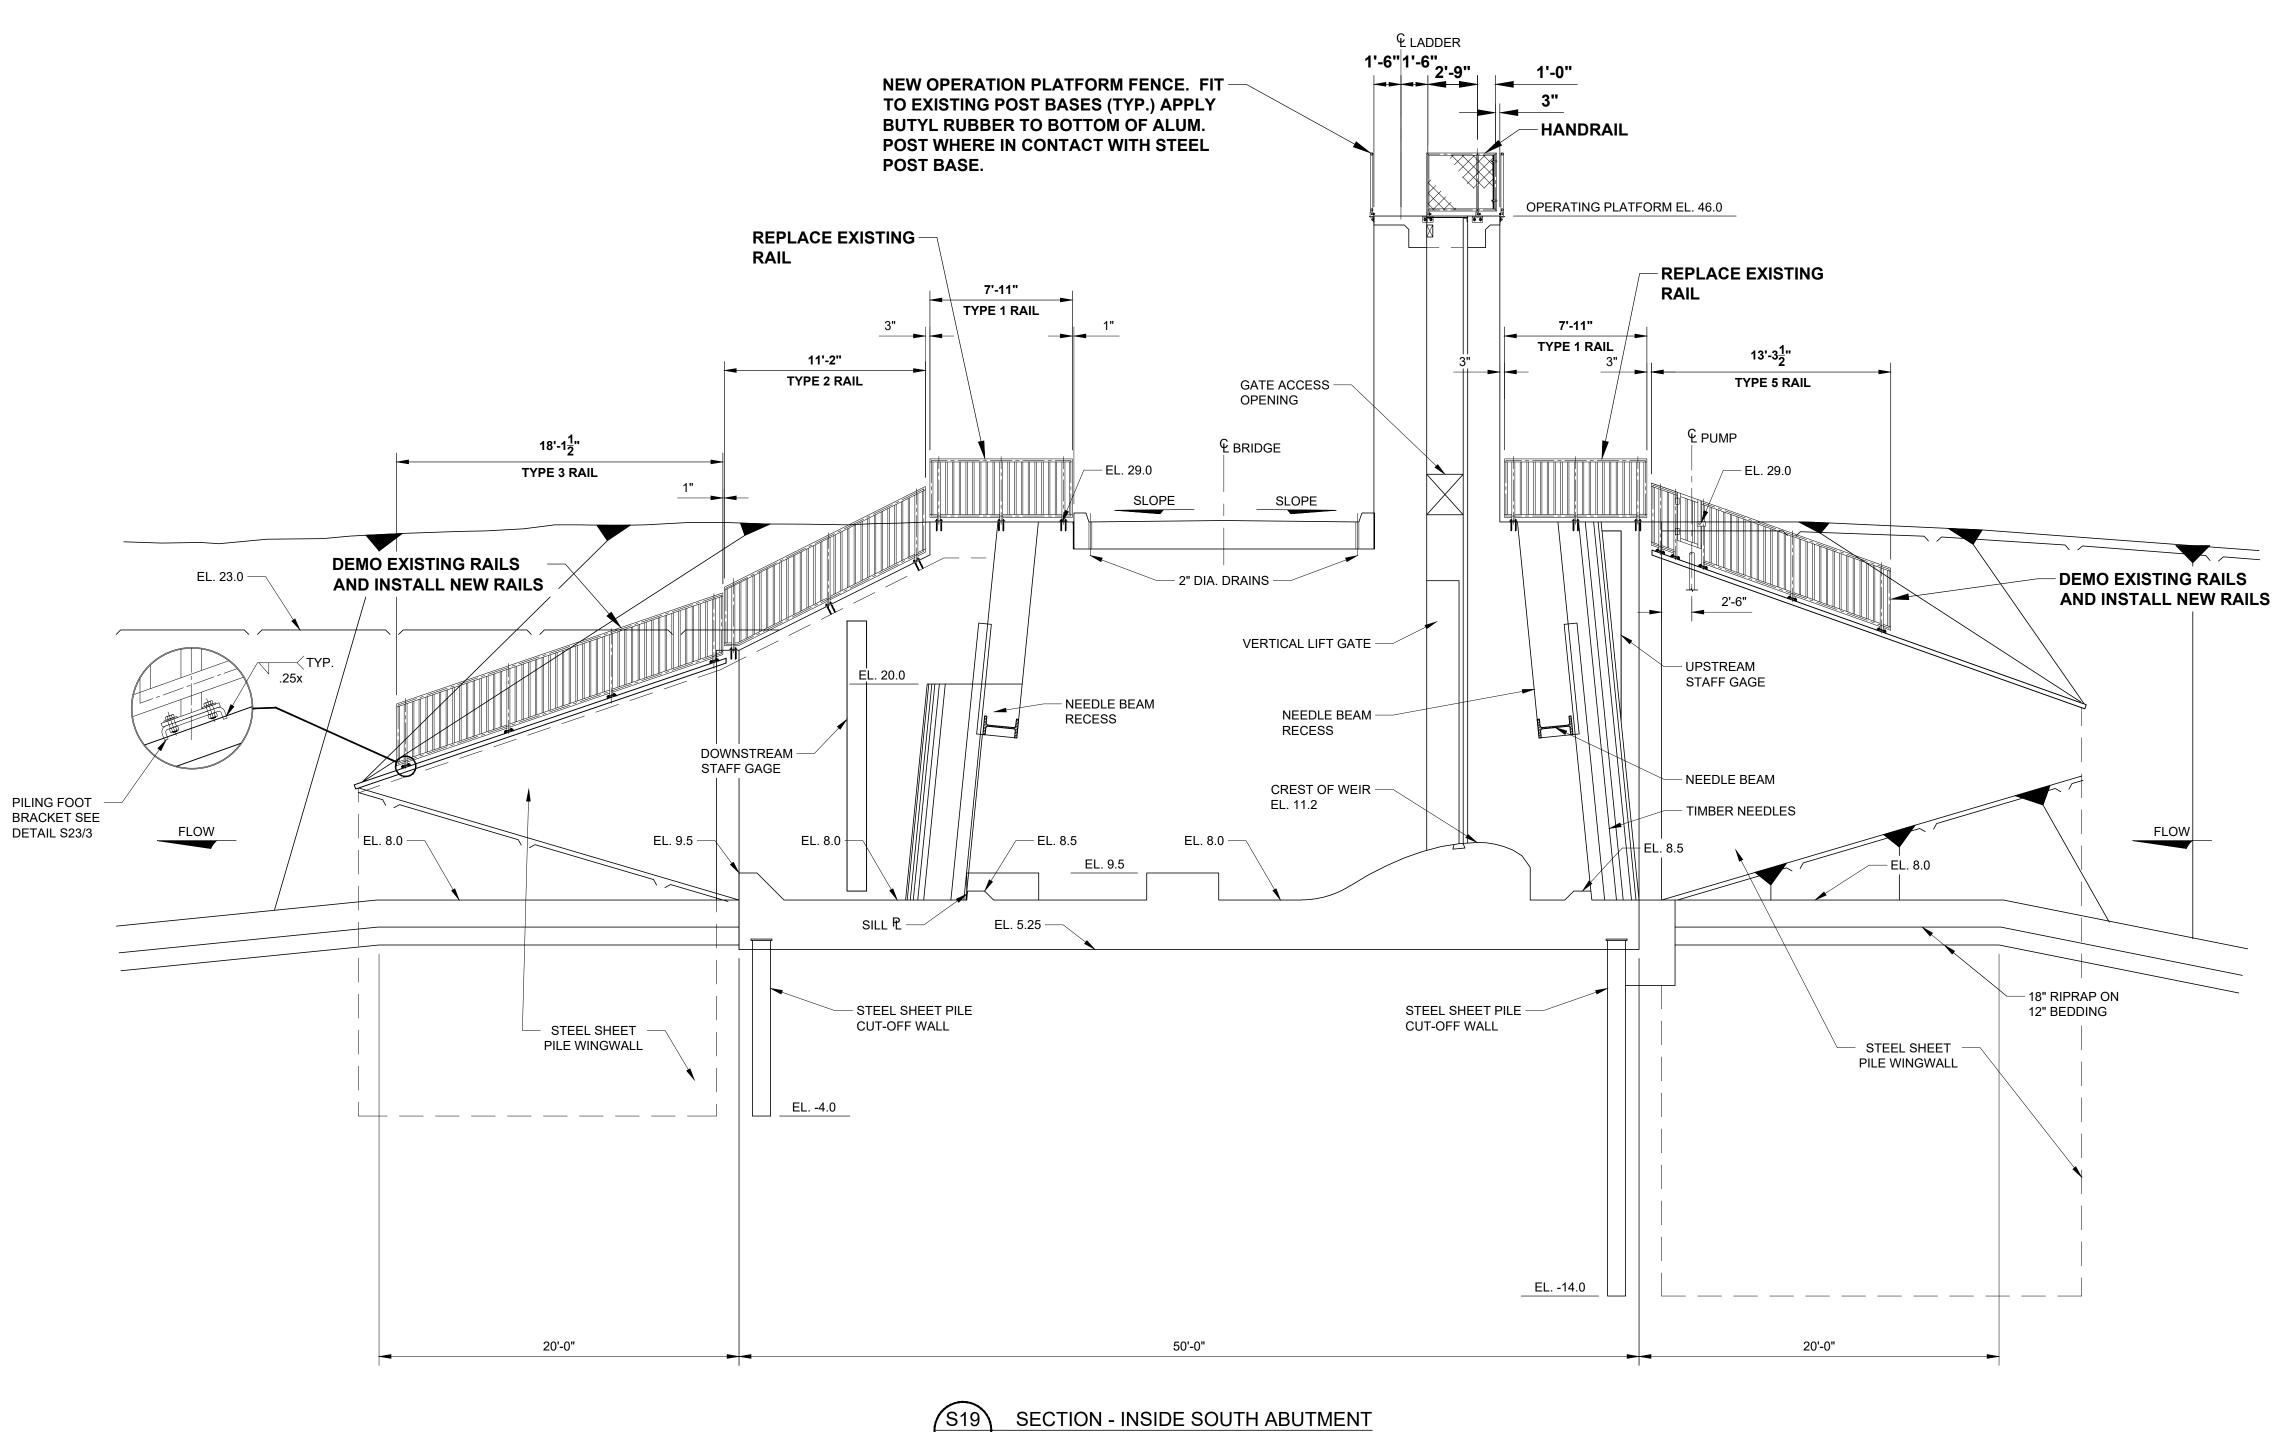
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NORTH WALL FENCE AND HANDRAILS

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UPPER ST. JOHNS
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ISSUED FOR BID	N.J.G.	05/14/21	W.R.C.	05/14/
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SECTION - INSIDE SOUTH ABUTMENT 2' 4' SCALE: 3/16" = 1'-0"

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ST. JOHNS RIVER WATER MANAGEMENT DISTRICT **BRIVER BASIN** EHABILITATION DRAWN: N.J.G. DATE: MAY 14, 2021 REVIEWER: W.R.C. ITY, FLORIDA

FOR BID PURPOSES ONLY **NOT FOR CONSTRUCTION**

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WILLIAM R. COTE			
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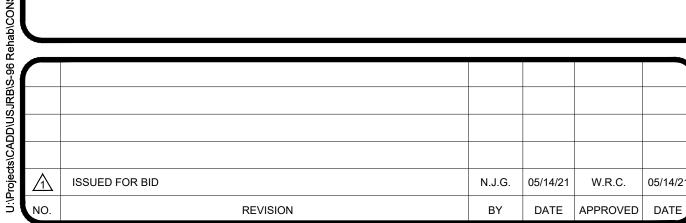
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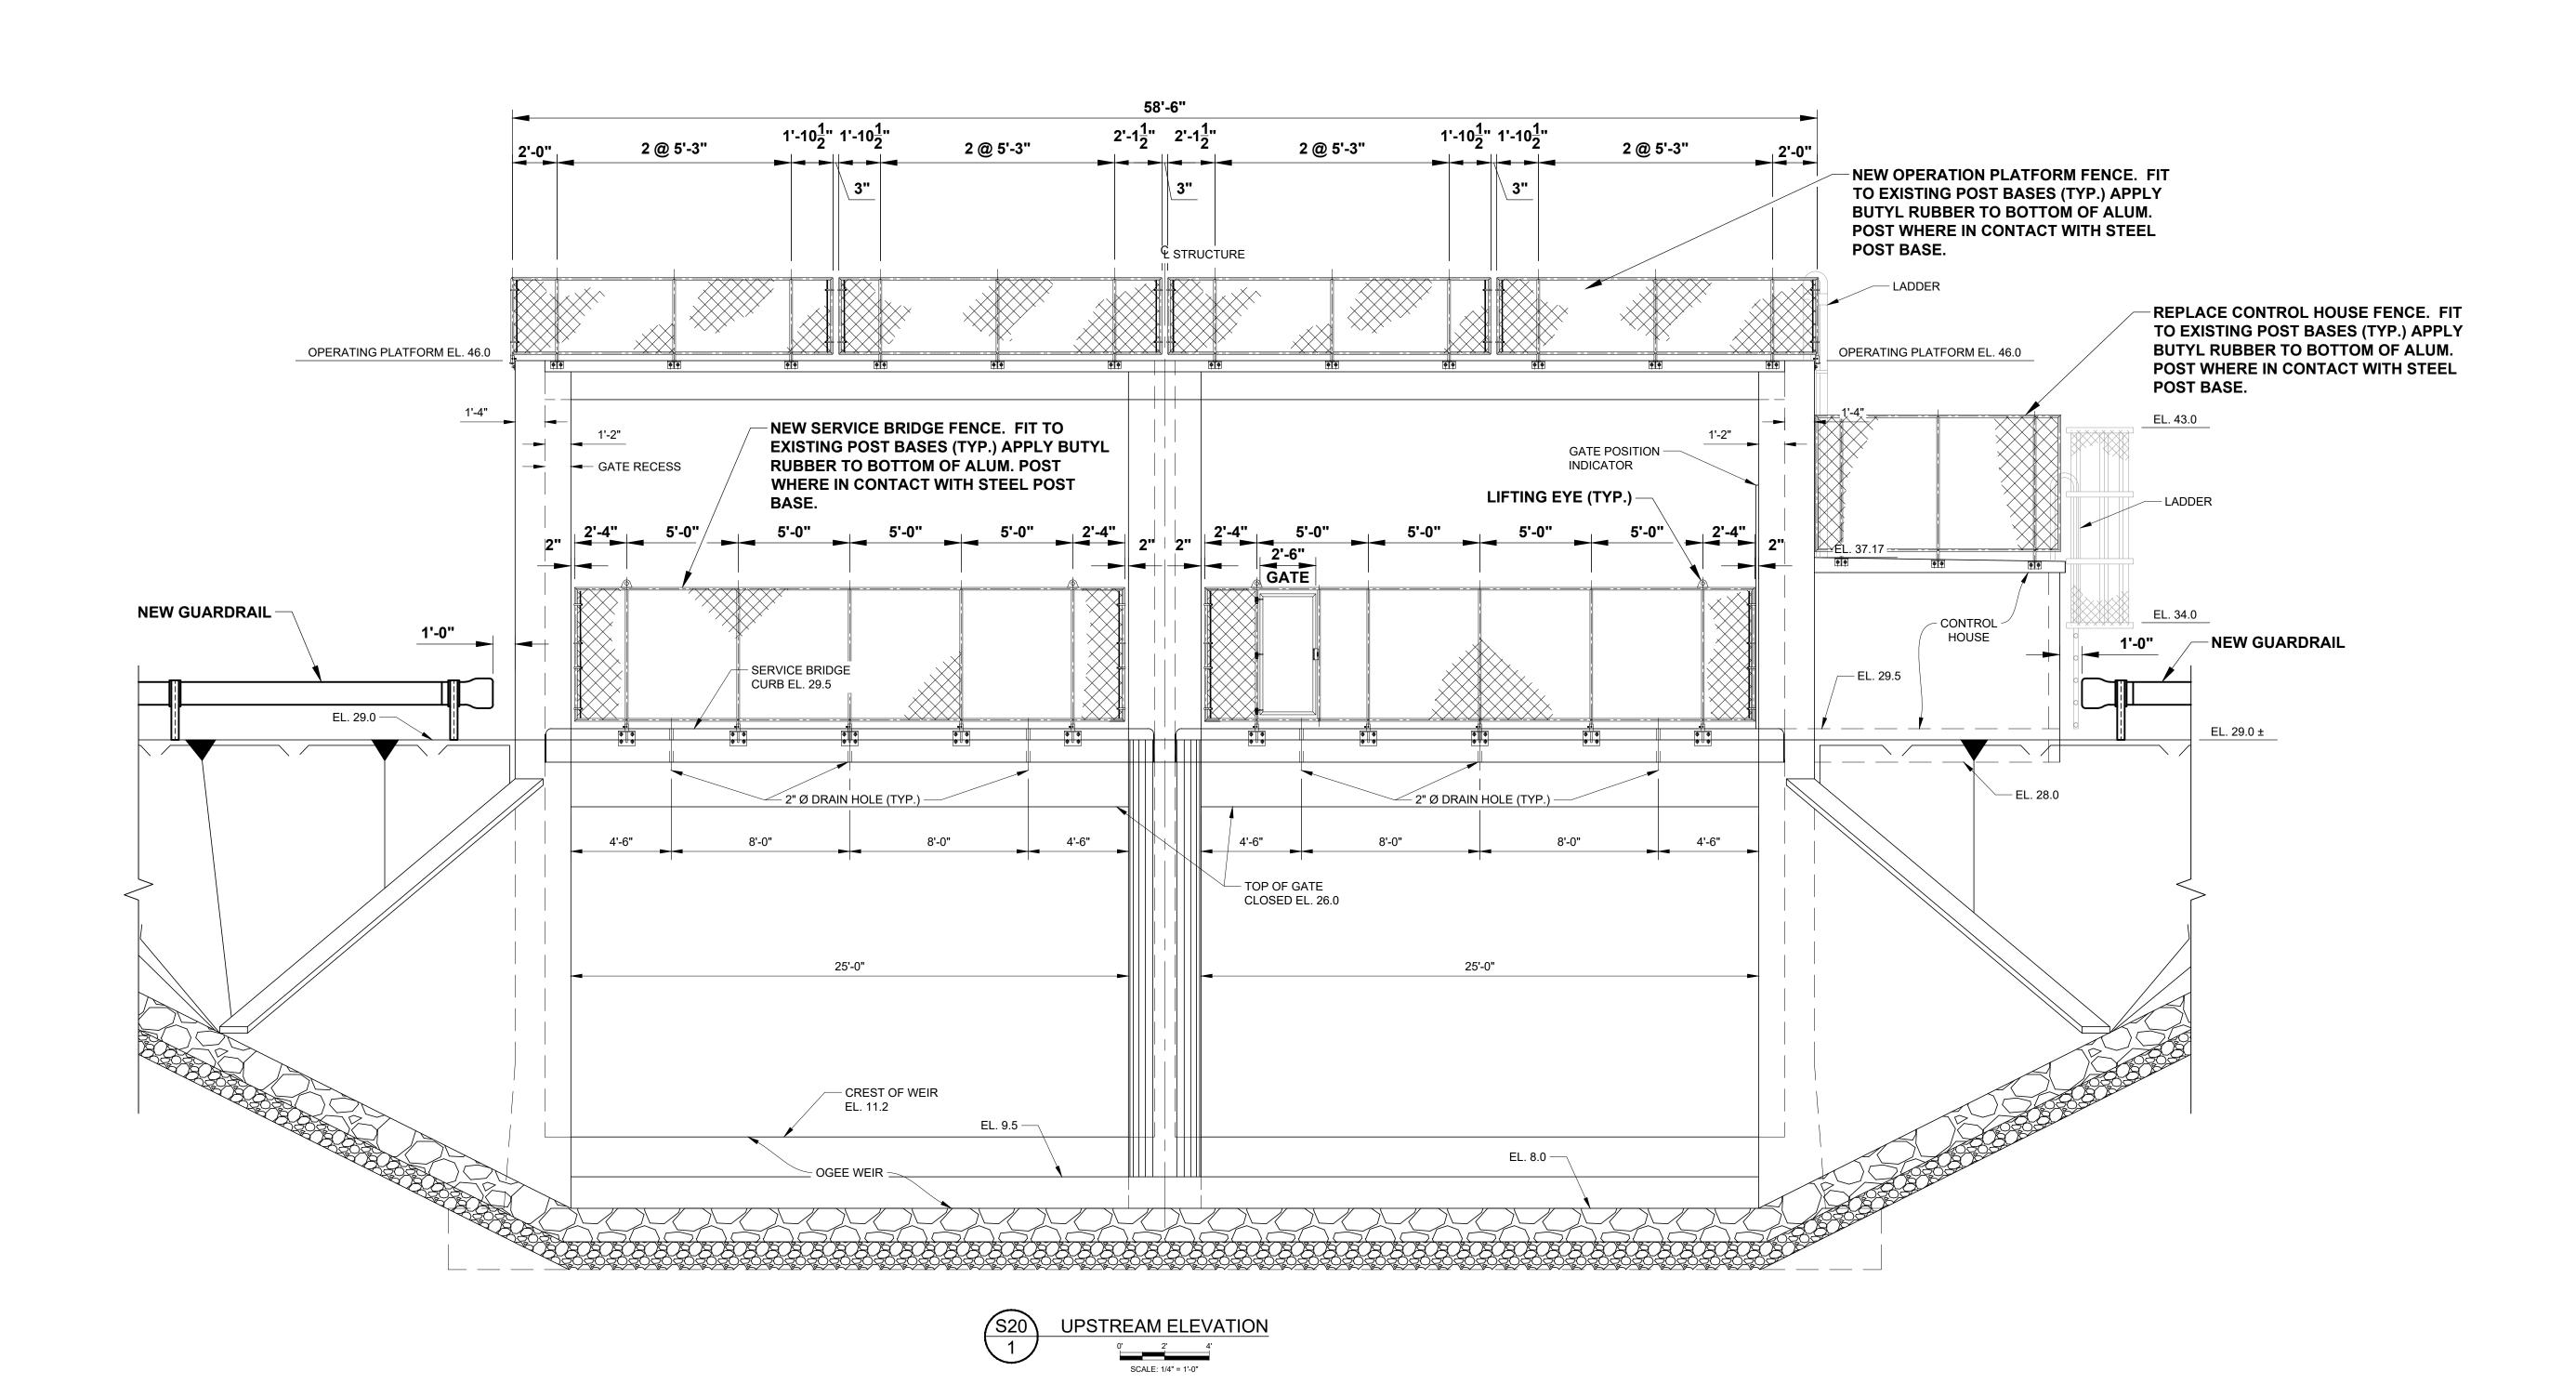
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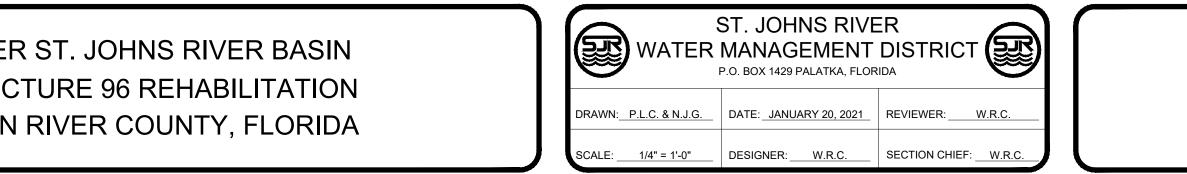
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NEW SOUTH WALL FENCE AND HANDRAILS

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BY	DATE	APPROVED	DATE	







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NEW UPSTREAM FENCE ELEVATION

WIL	LIAM R. COTE
P.E. NUMBER:	53746
DATE:	JANUARY 20, 2021


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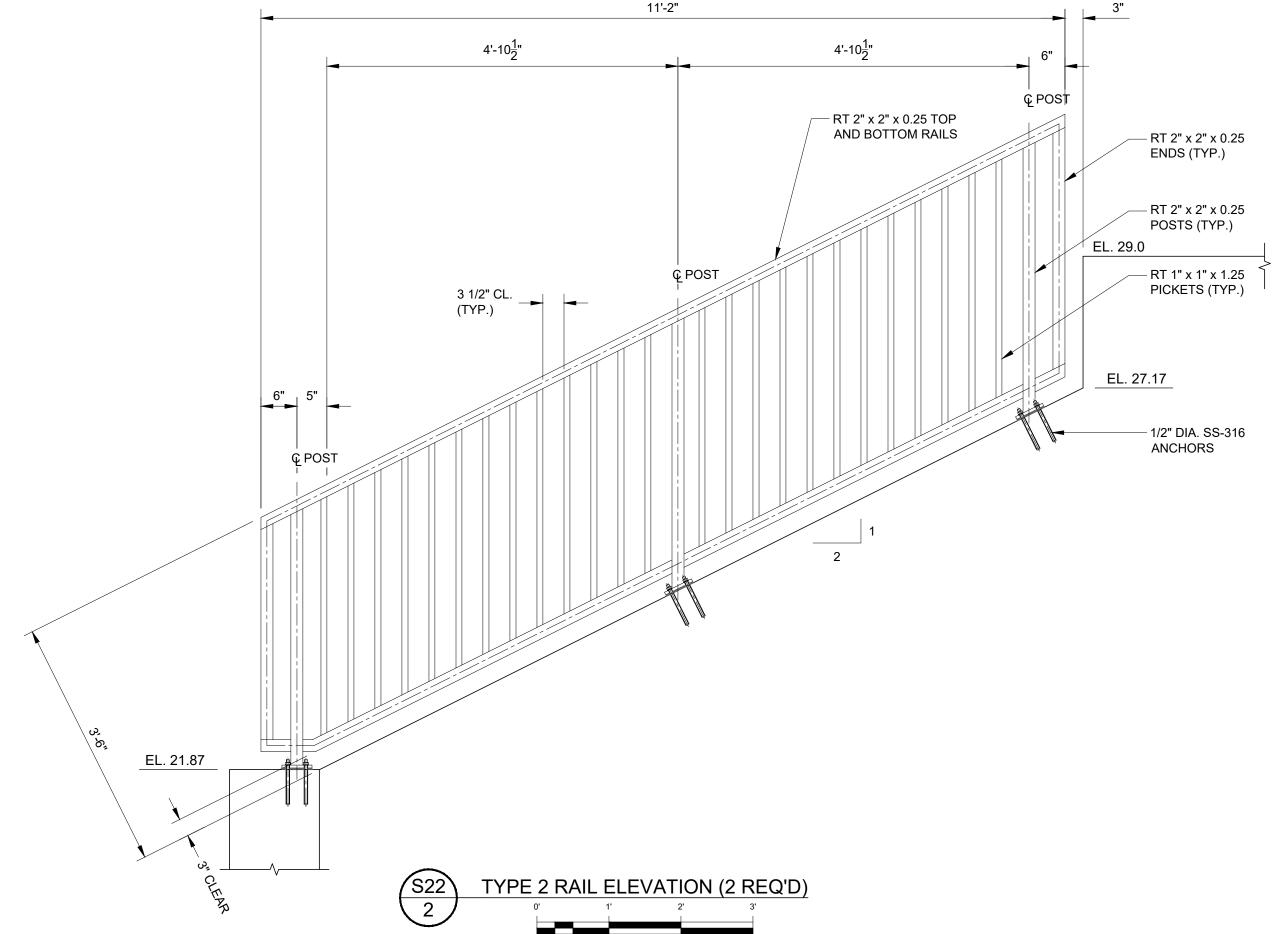
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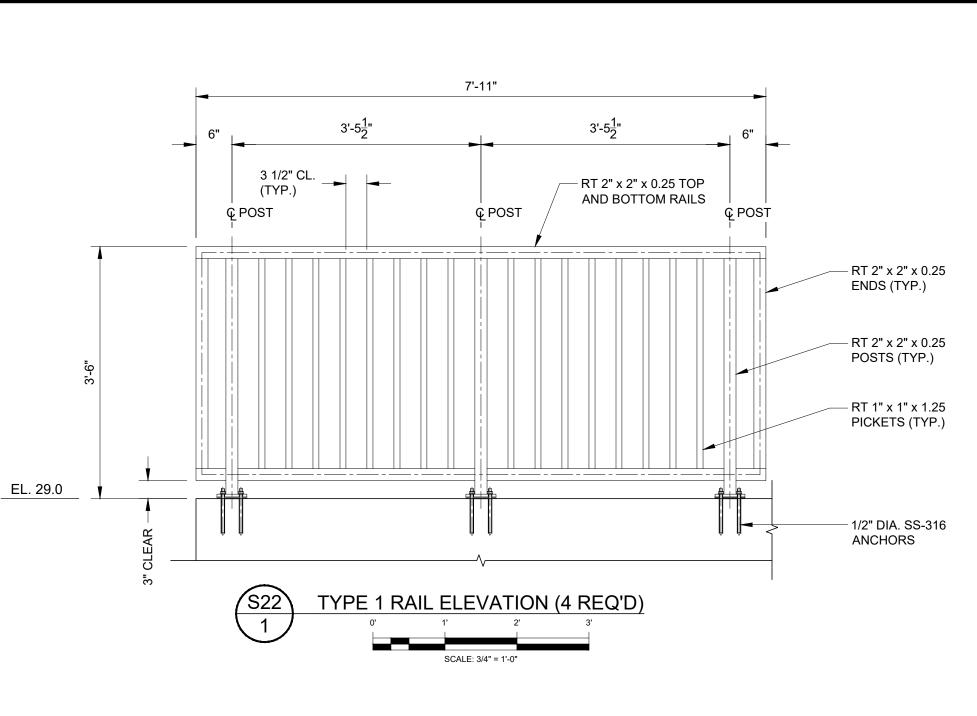
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SCALE: 3/4" = 1'-0

S RIVER BASIN EHABILITATION	WATER	ST. JOHNS RIVER MANAGEMENT DISTRICT	ту
TY, FLORIDA	DRAWN: N.J.G. SCALE: AS NOTED	DATE:MAY 14, 2021 REVIEWER:W.R.C. DESIGNER:W.R.C. SECTION CHIEF:W.R.C.	



ALUMINUM PEDESTRIAN RAIL NOTE SPECIFICATIONS:

1. STRUCTURAL ALUMINUM DESIGN AND FABRICATION SHALL BE IN ACCORDANCE WITH THE ALUMINUM ASSOCIATION, INC. "SPECIFICATIONS FOR ALUMINUM STRUCTURES", LATEST EDITION.

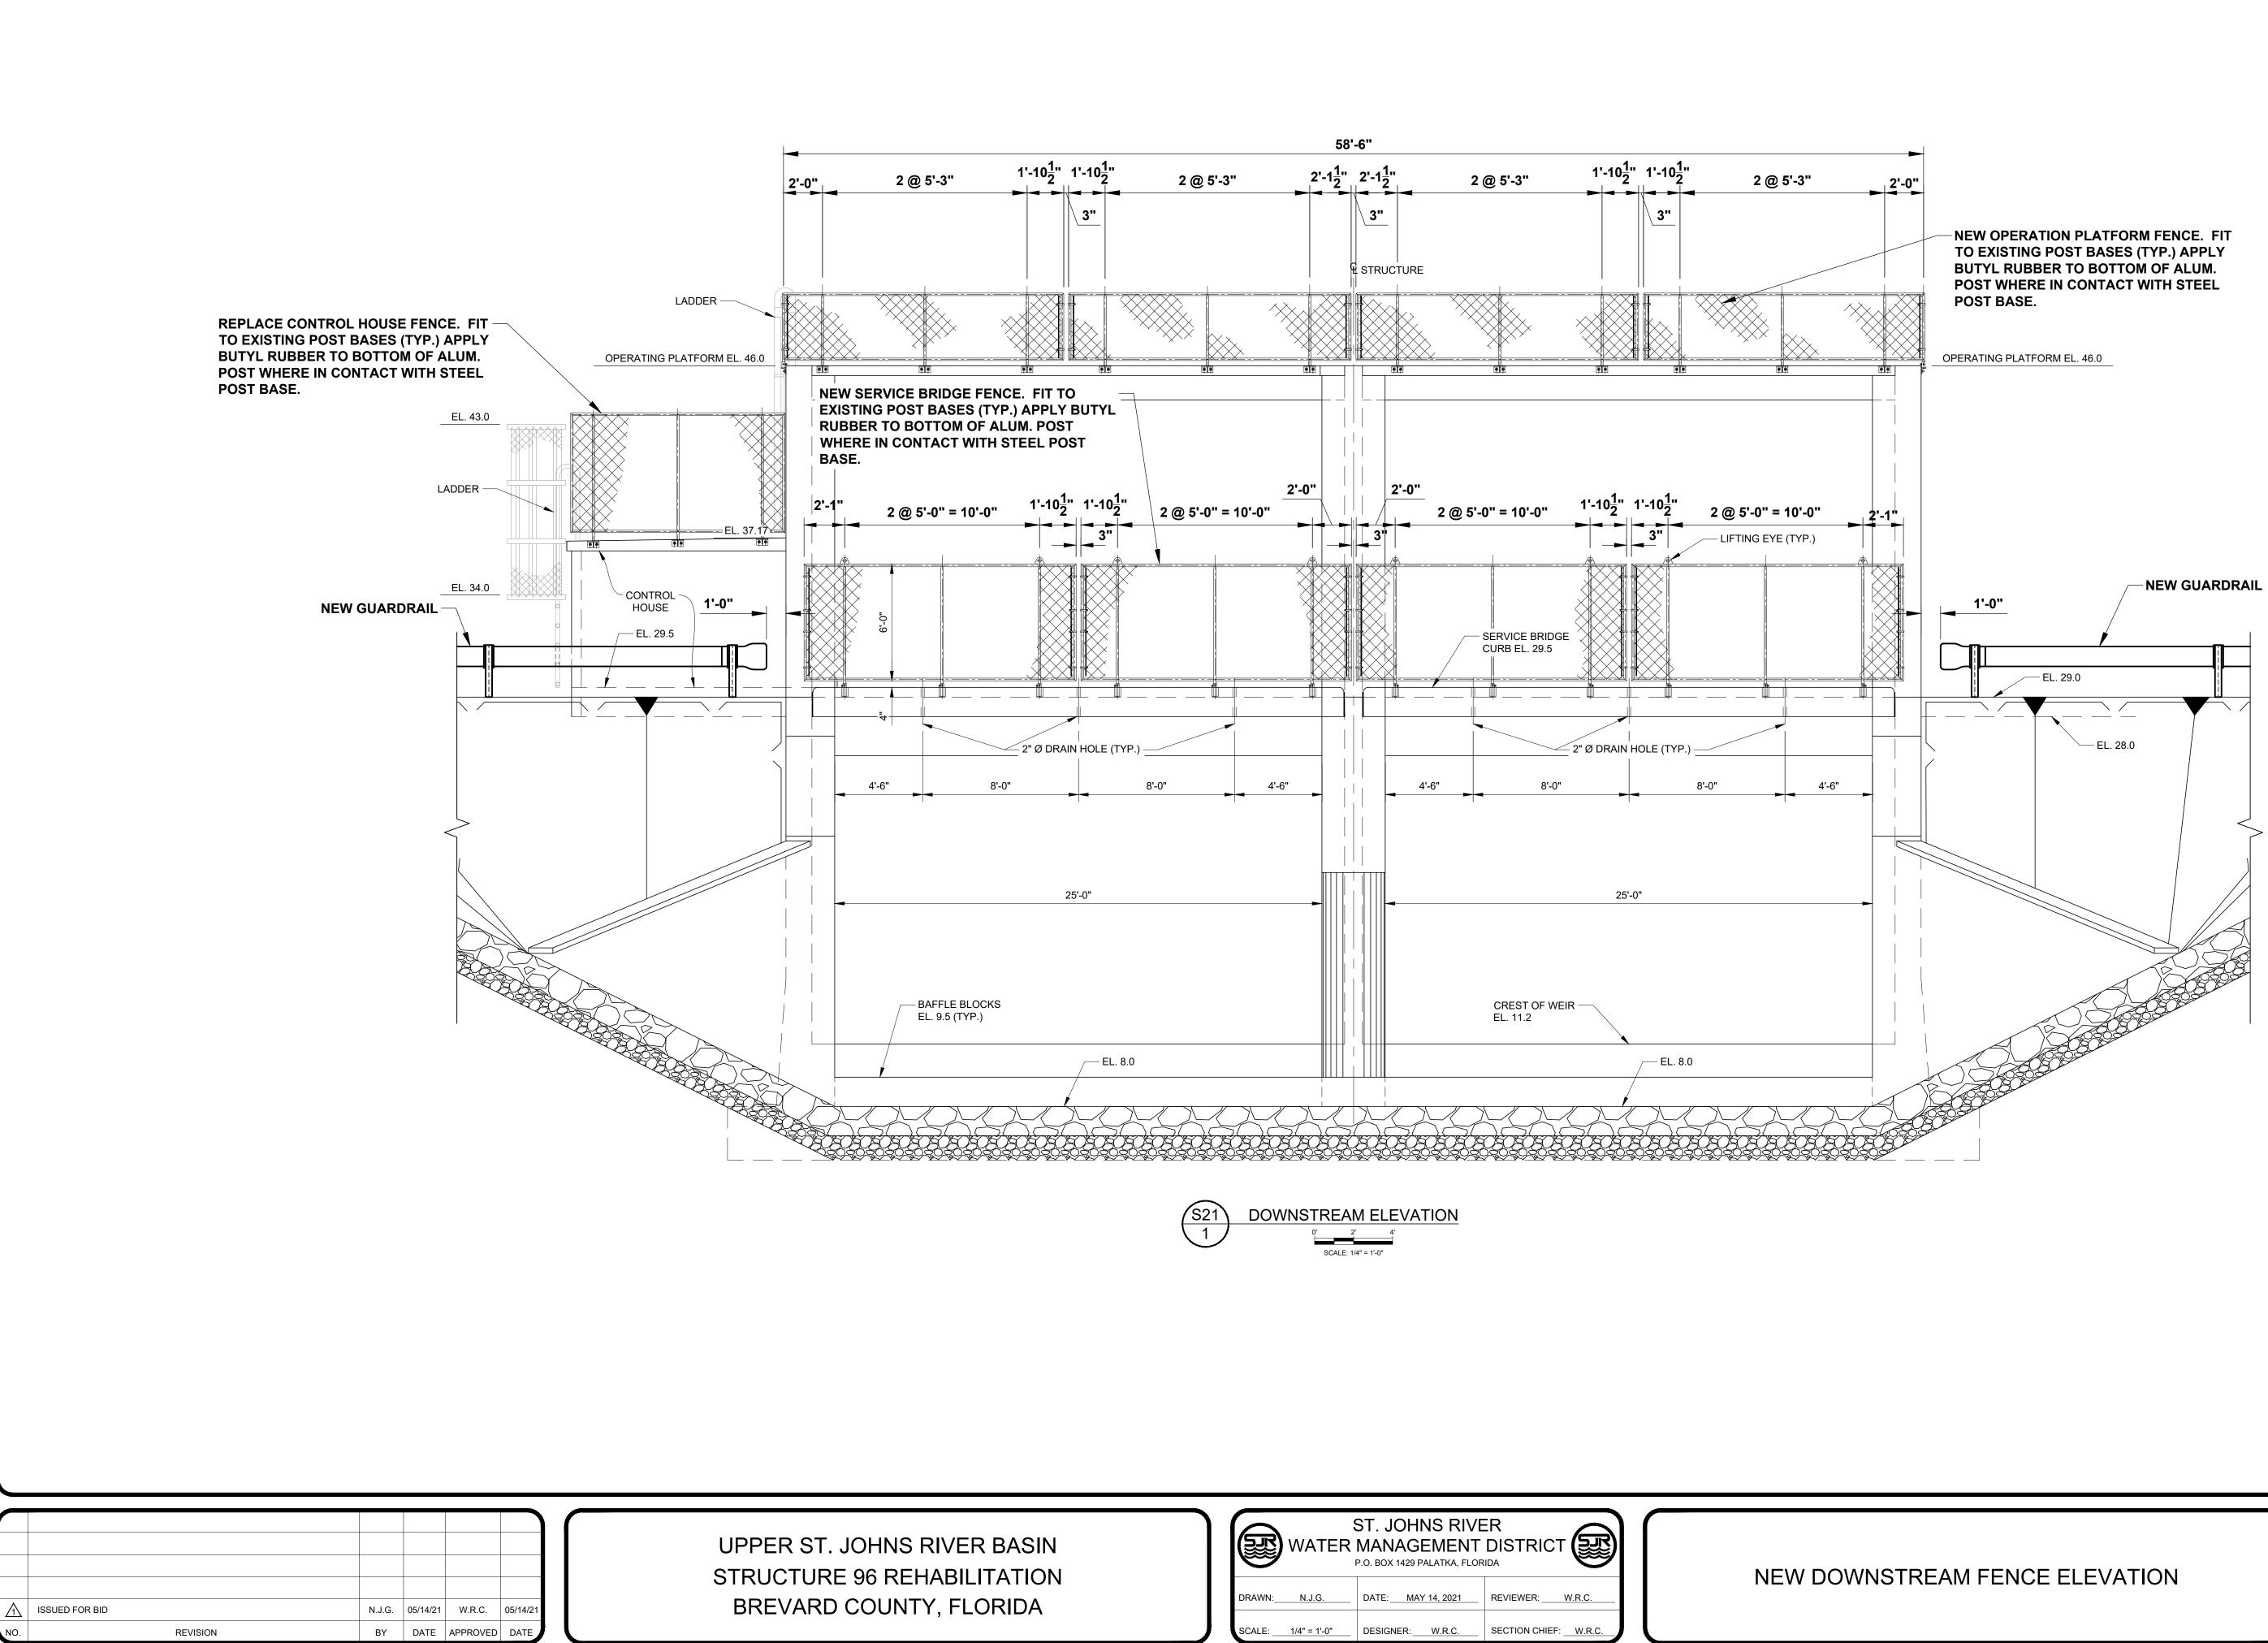2. WELDING SHALL BE IN ACCORDANCE WITH THE AMERICAN WELDING SOCIETY (AWS) "STRUCTURAL WELDING CODE - ALUMINUM" AWS D1.2.

3. ALUMINUM STRUCTURAL SHAPES SHALL BE NEW AND CONSIST OF ALLOY 6061-T6 CONFORMING TO THE REQUIREMENTS OF THE AMERICAN SOCIETY OF TESTING AND MATERIALS (ASTM) STANDARD B308.

4. ALUMINUM BARS, RODS, AND WIRE SHALL BE NEW AND CONSIST OF ALLOY 6061-T6 CONFORMING TO THE REQUIREMENTS OF ASTM STANDARD B211.

5. ALUMINUM PLATE SHALL BE NEW AND CONSIST OF ALLOY 5052-H32 CONFORMING TO THE REQUIREMENTS OF ASTM STANDARD B209.

6. ALL BOLTS, NUTS, AND WASHERS SHALL CONSIST OF SS316 STAINLESS STEEL CONFORMING TO THE REQUIREMENTS OF ASTM STANDARDS F593 AND F594.


7. ALL WELDING SHALL UTILIZE ER4043 FILLER ALLOY AND SHALL BE SHOP WELDED TO THE GREATEST EXTENT POSSIBLE.

8. ALL WELDED JOINTS SHALL BE GROUND SMOOTH.

9. THE ALUMINUM RAILING SHALL BE MILL FINISH.

10. PROVIDE 1/4-INCH NEOPRENE PADS UNDER ALL RAIL POST BASE PLATES. NEOPRENE PADS SHALL BE IN ACCORDANCE WITH ASTM D2000 AND SHALL HAVE A DUROMETER HARDNESS BETWEEN 60 AND 80.

11. ALL RAILS SHALL BE CONNECTED TO THE EXISTING GROUNDING SYSTEM. ANY ADDITIONAL GROUNDING WIRES THAT ARE REQUIRED SHALL MATCH THE EXISTING.

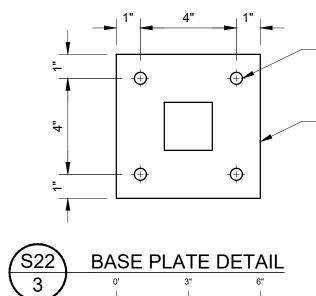

SCALE: 3" = 1'-0"

– 1/2" DIA. SS-316 ANCHORS

– BASE ⅊ 1/2" x 6" x 6" AND 1/4" NEOPRENE PAD



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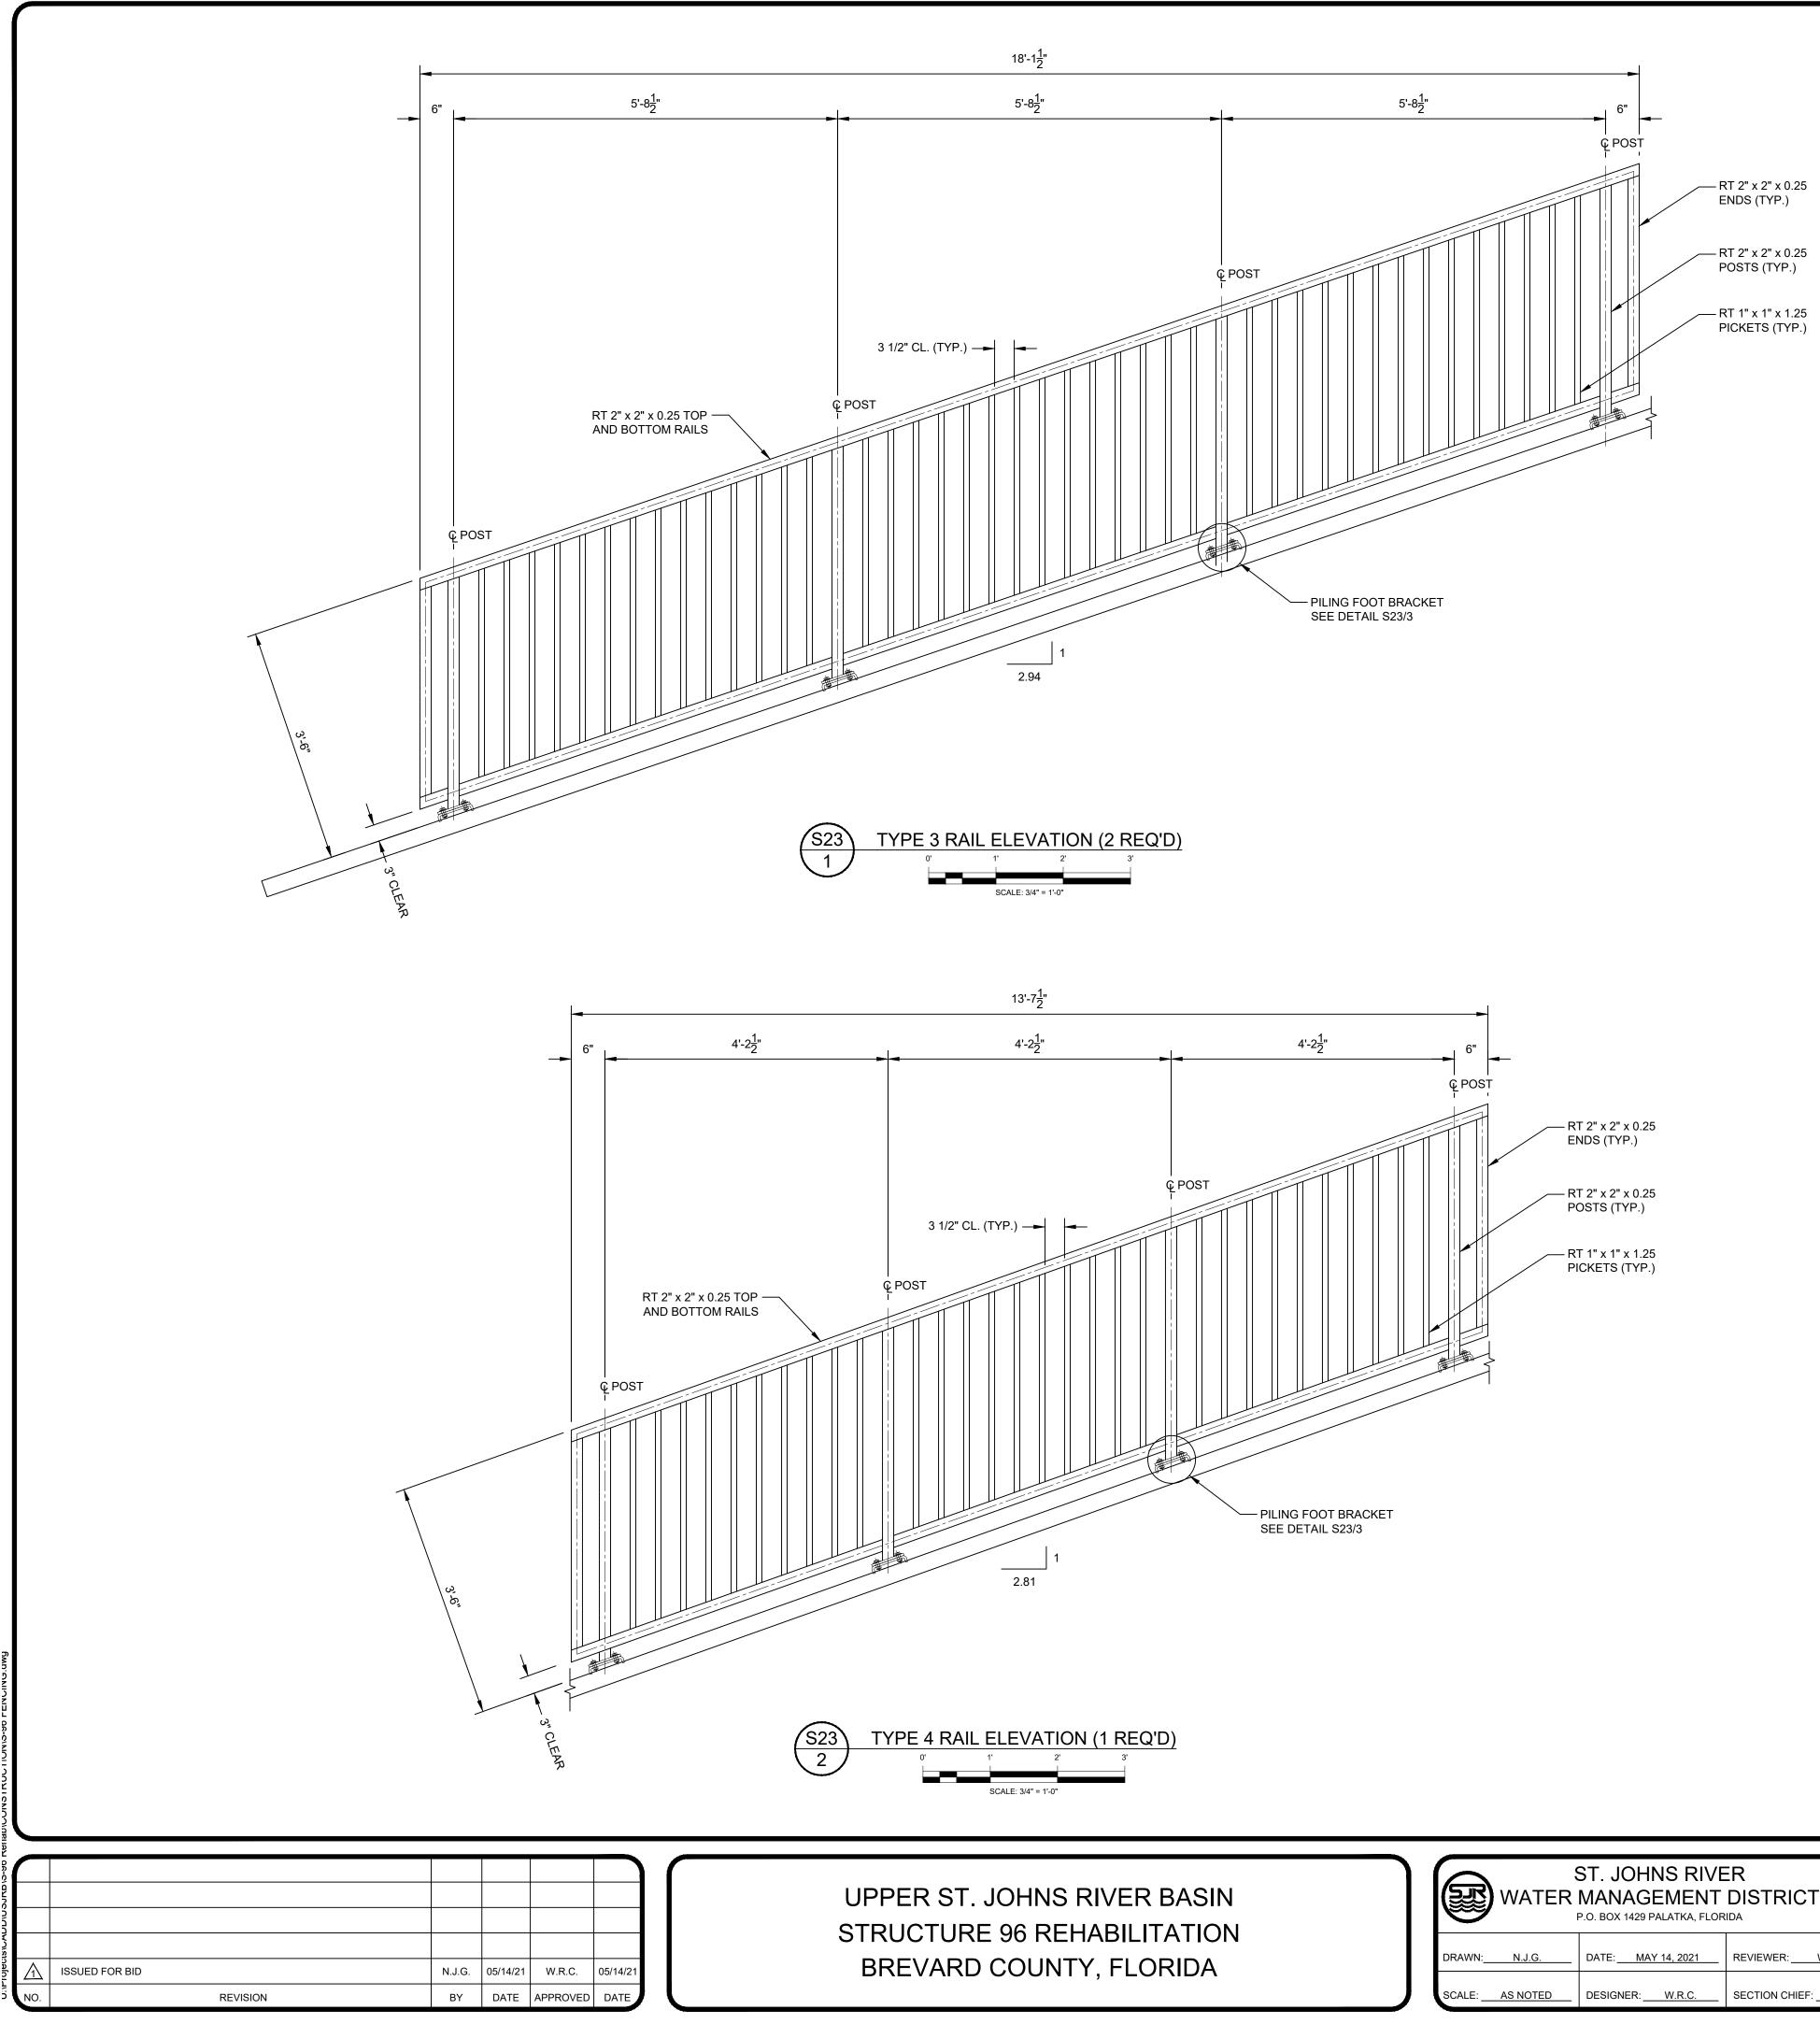
WILLIAM R. COTE P.E. NUMBER: _ 53746 MAY 14, 2021 DATE:


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YPE 1 AND TYPE 2 HANDRAILS

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TABILITATION TY, FLORIDA	DRAWN: N.J.G. SCALE: AS NOTED	DATE:MAY 14, 2021 DESIGNER:W.R.C.	REVIEWER: W.R.C. SECTION CHIEF: W.R.C.	

TYPE 3 AND TYPE 4 HANDRAILS


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WIL	LIAM R. COTE
P.E. NUMBER:	53746
DATE:	MAY 14, 2021

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7	ISSUED FOR BID	N.J.G.	05/14/21	W.R.C.	05/14/21
	REVISION	BY	DATE	APPROVED	DATE

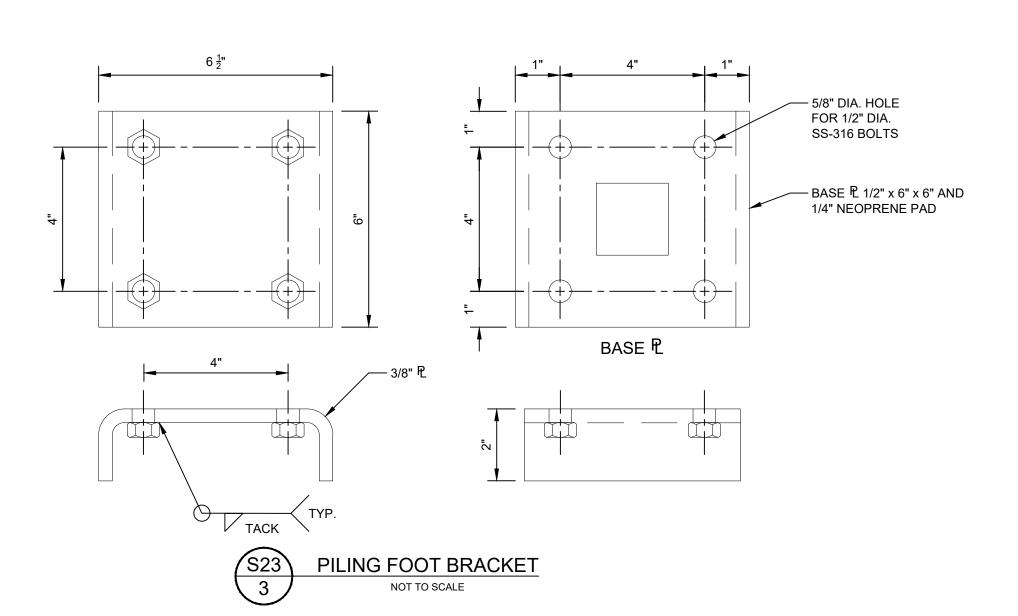UPPER ST. JOHNS RIVER BASIN STRUCTURE 96 REHABILITATION BREVARD COUNTY, FLORIDA



WATER MANAGEMENT DISTRICT							
DRAWN: N.J.G.	DATE:MAY 14, 2021	REVIEWER: W.R.C.					
SCALE: AS NOTED	DESIGNER: W.R.C.	SECTION CHIEF: W.R.C.					

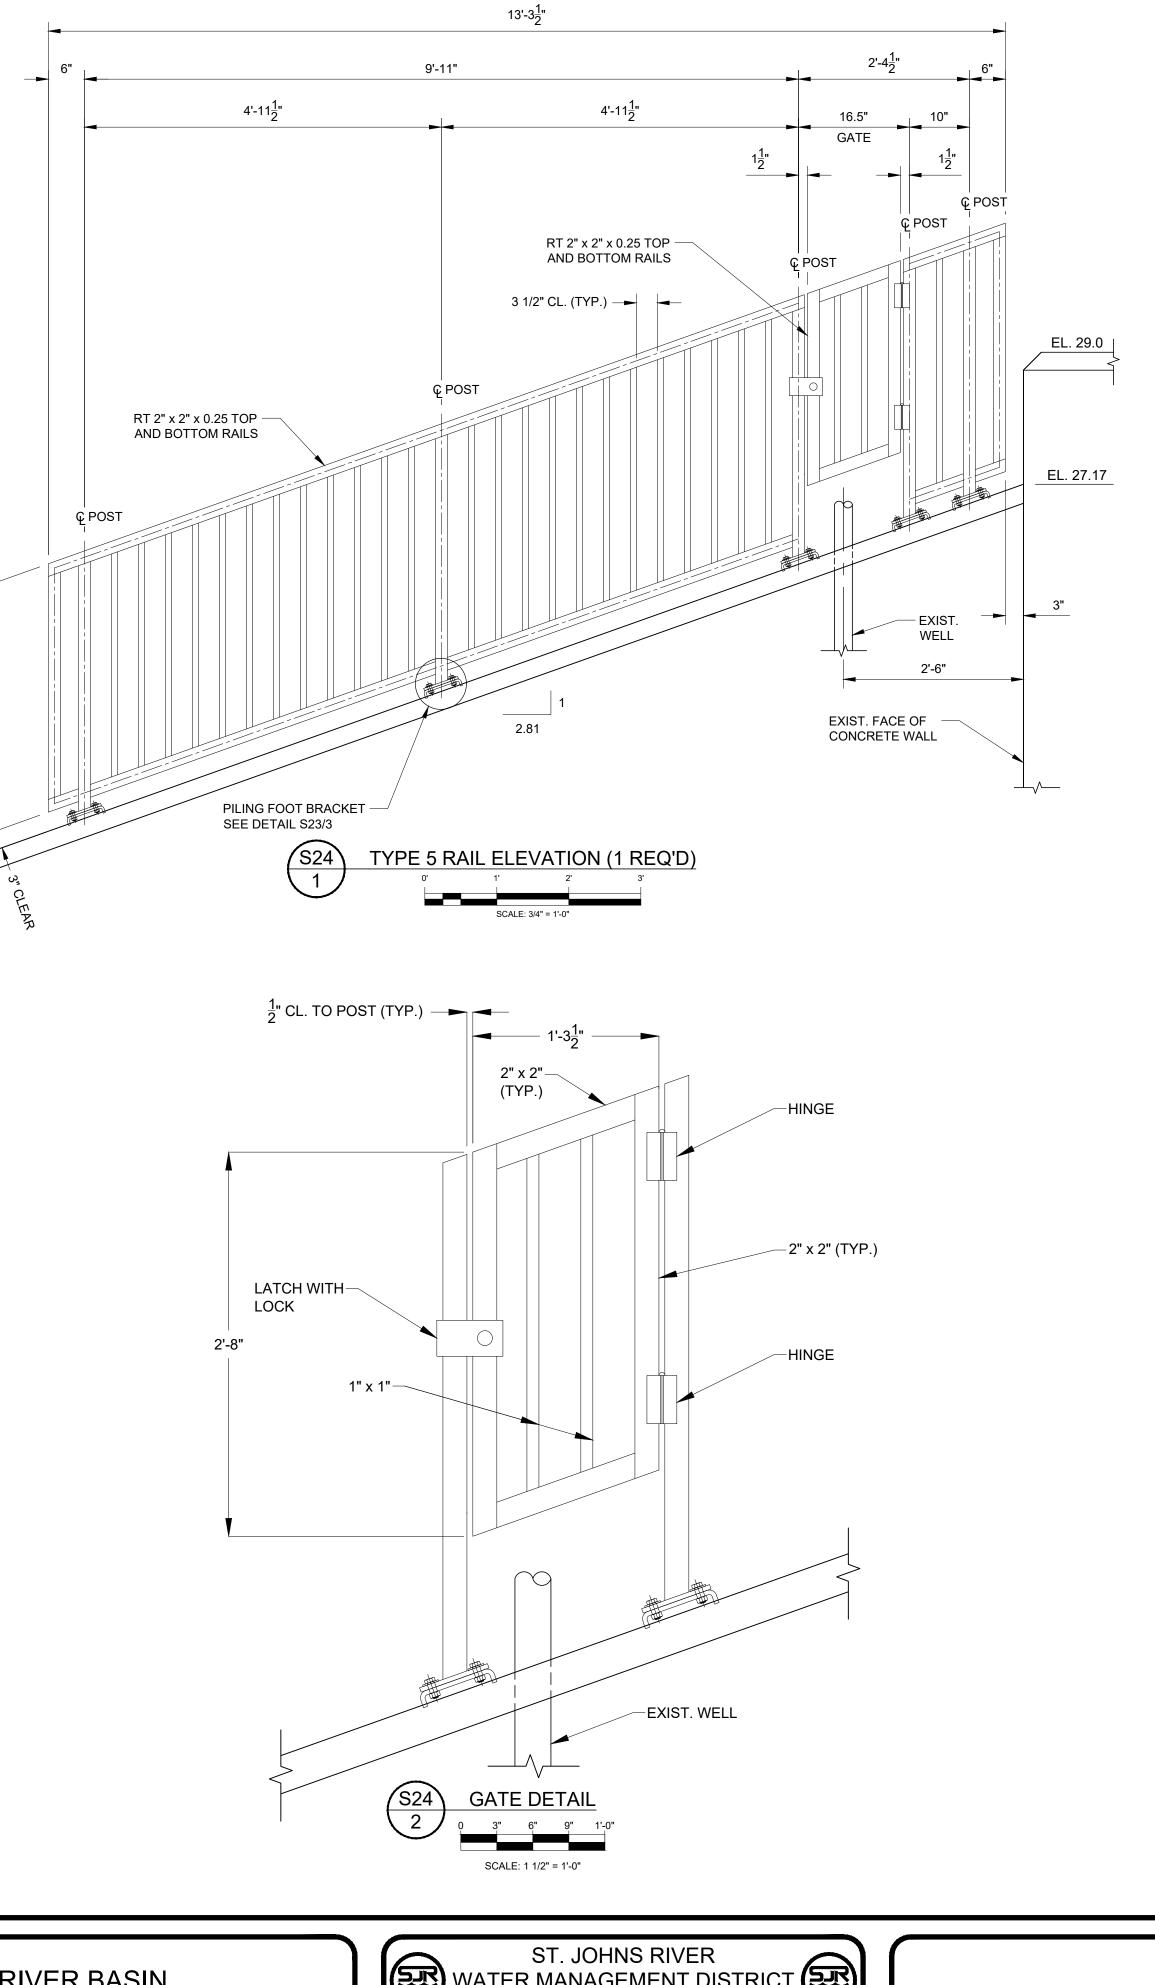TYPE

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P.E. NUMBER:	53746						
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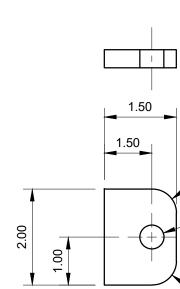
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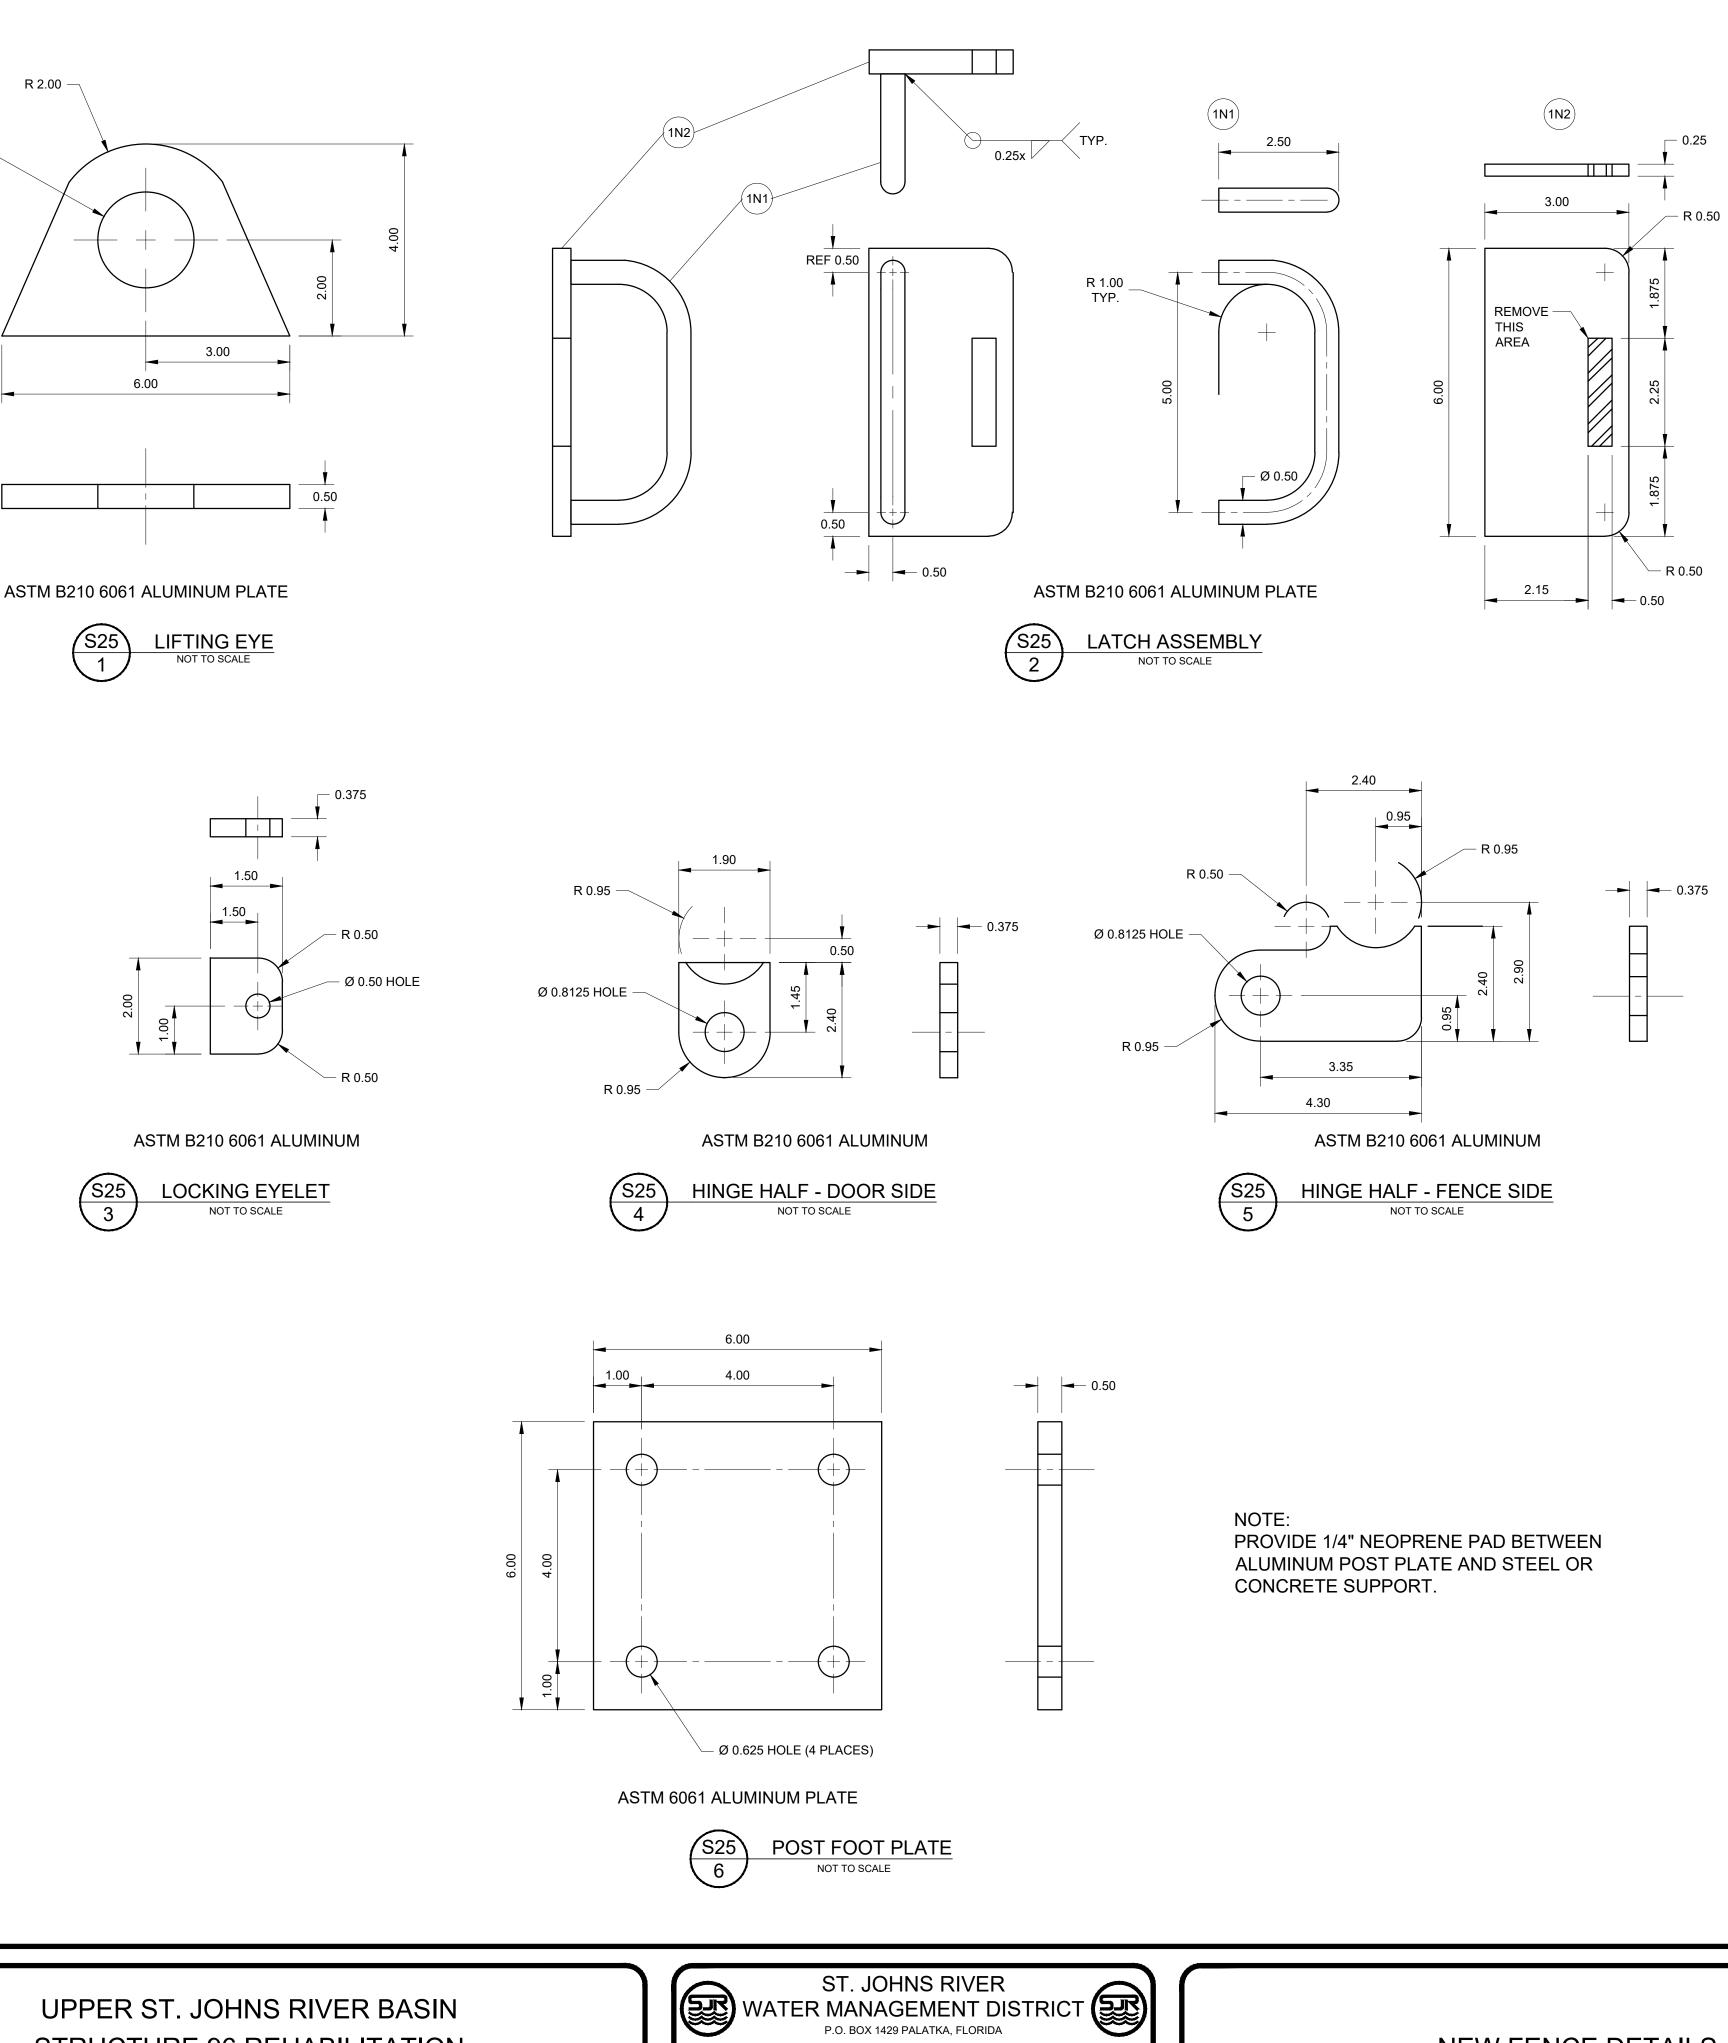
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REVISION	BY	DATE	APPROVED	DATE
	ISSUED FOR BID REVISION			

STRUCTURE 96 REHABILITATION BREVARD COUNTY, FLORIDA











DRAWN: N.J.G. DATE: MAY 14, 2021 REVIEWER: W.R.C.

SCALE: AS NOTED DESIGNER: W.R.C. SECTION CHIEF: W.R.C.

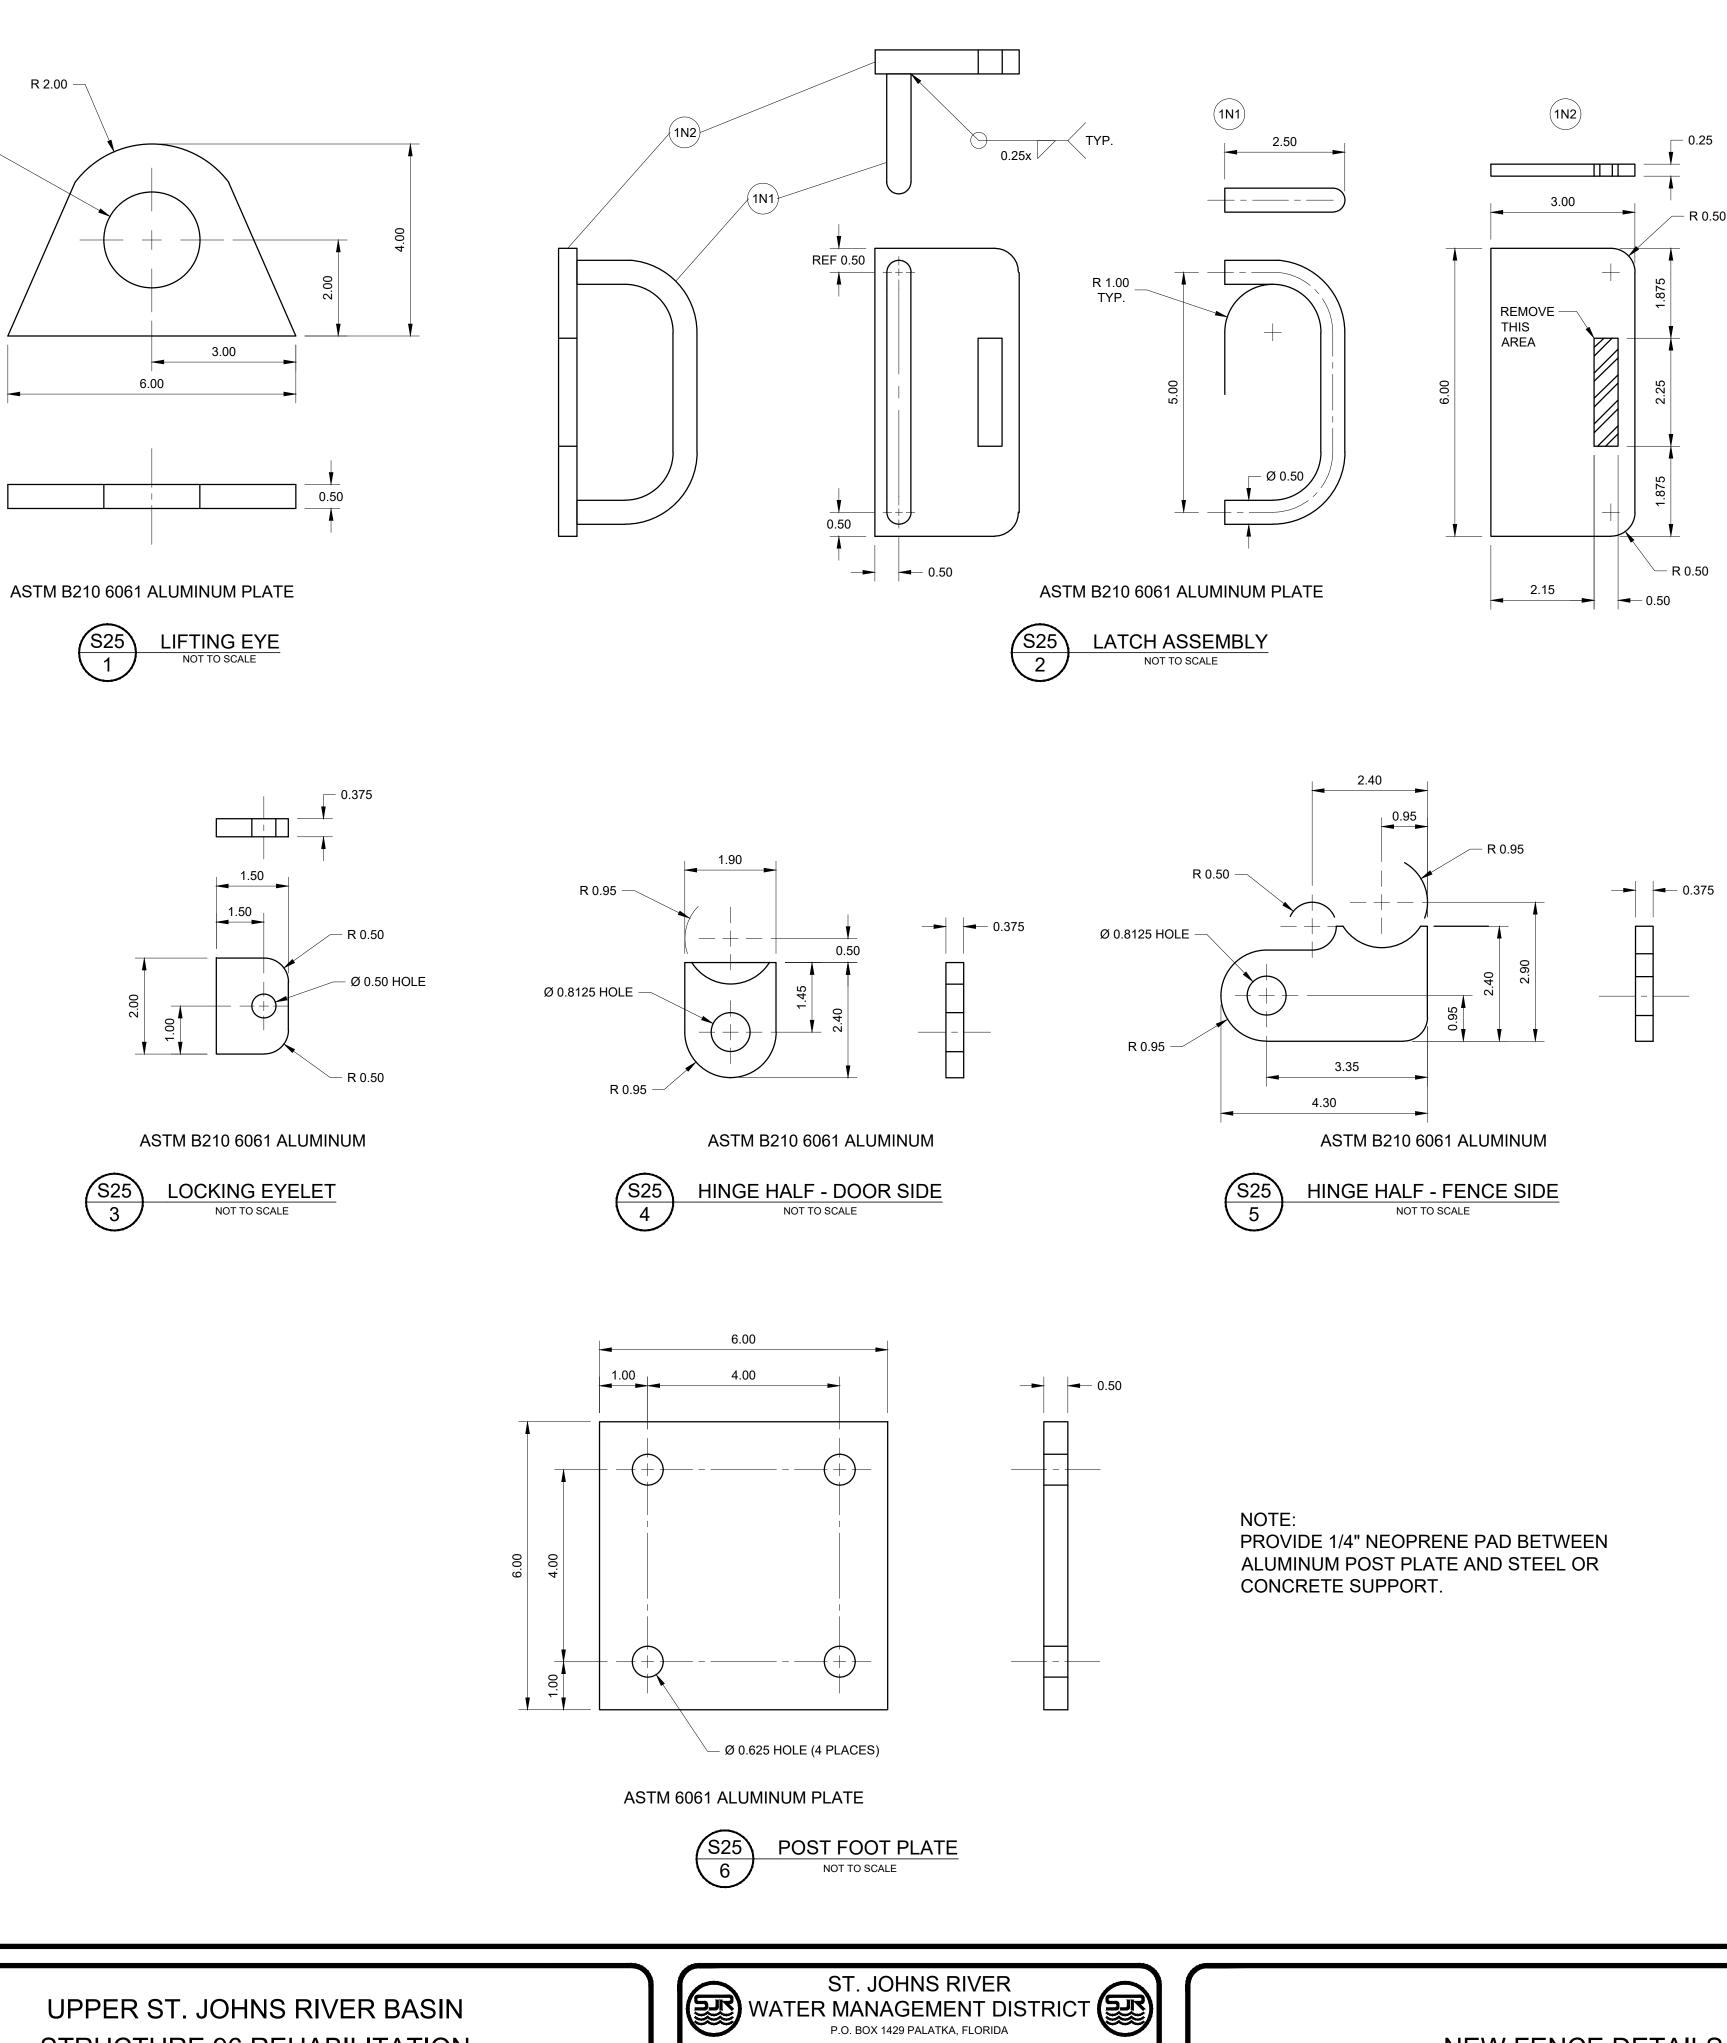

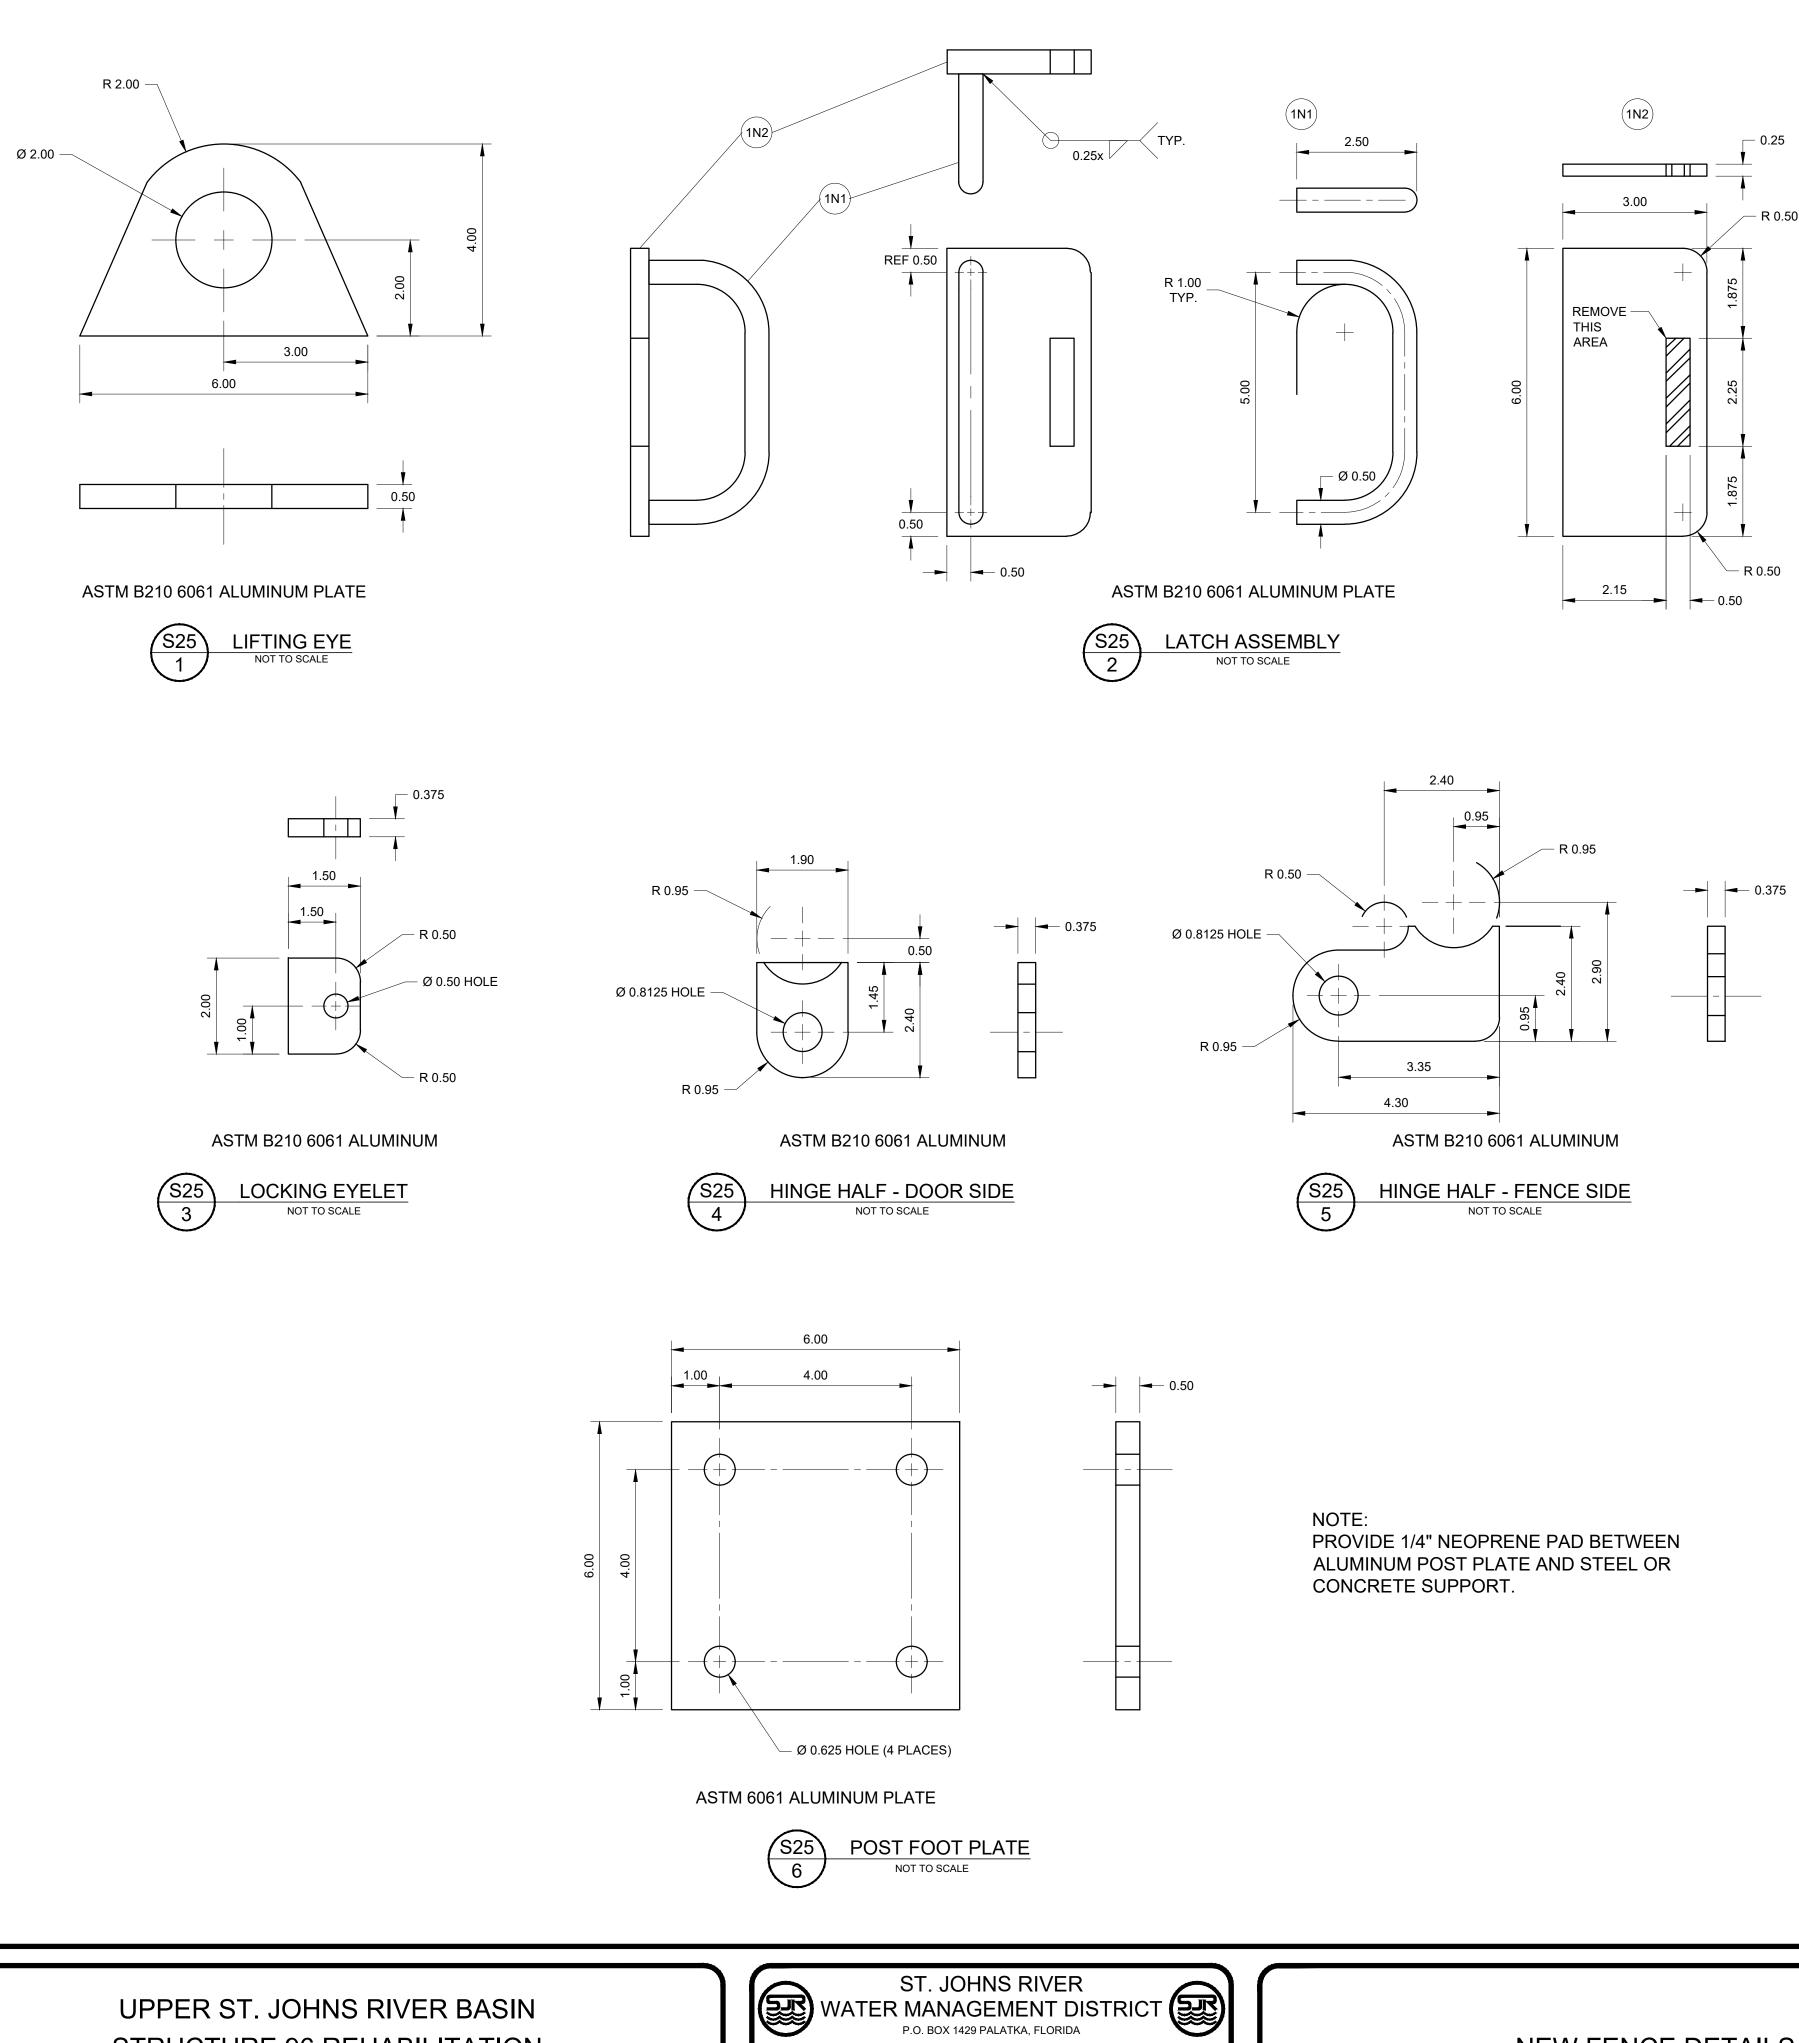

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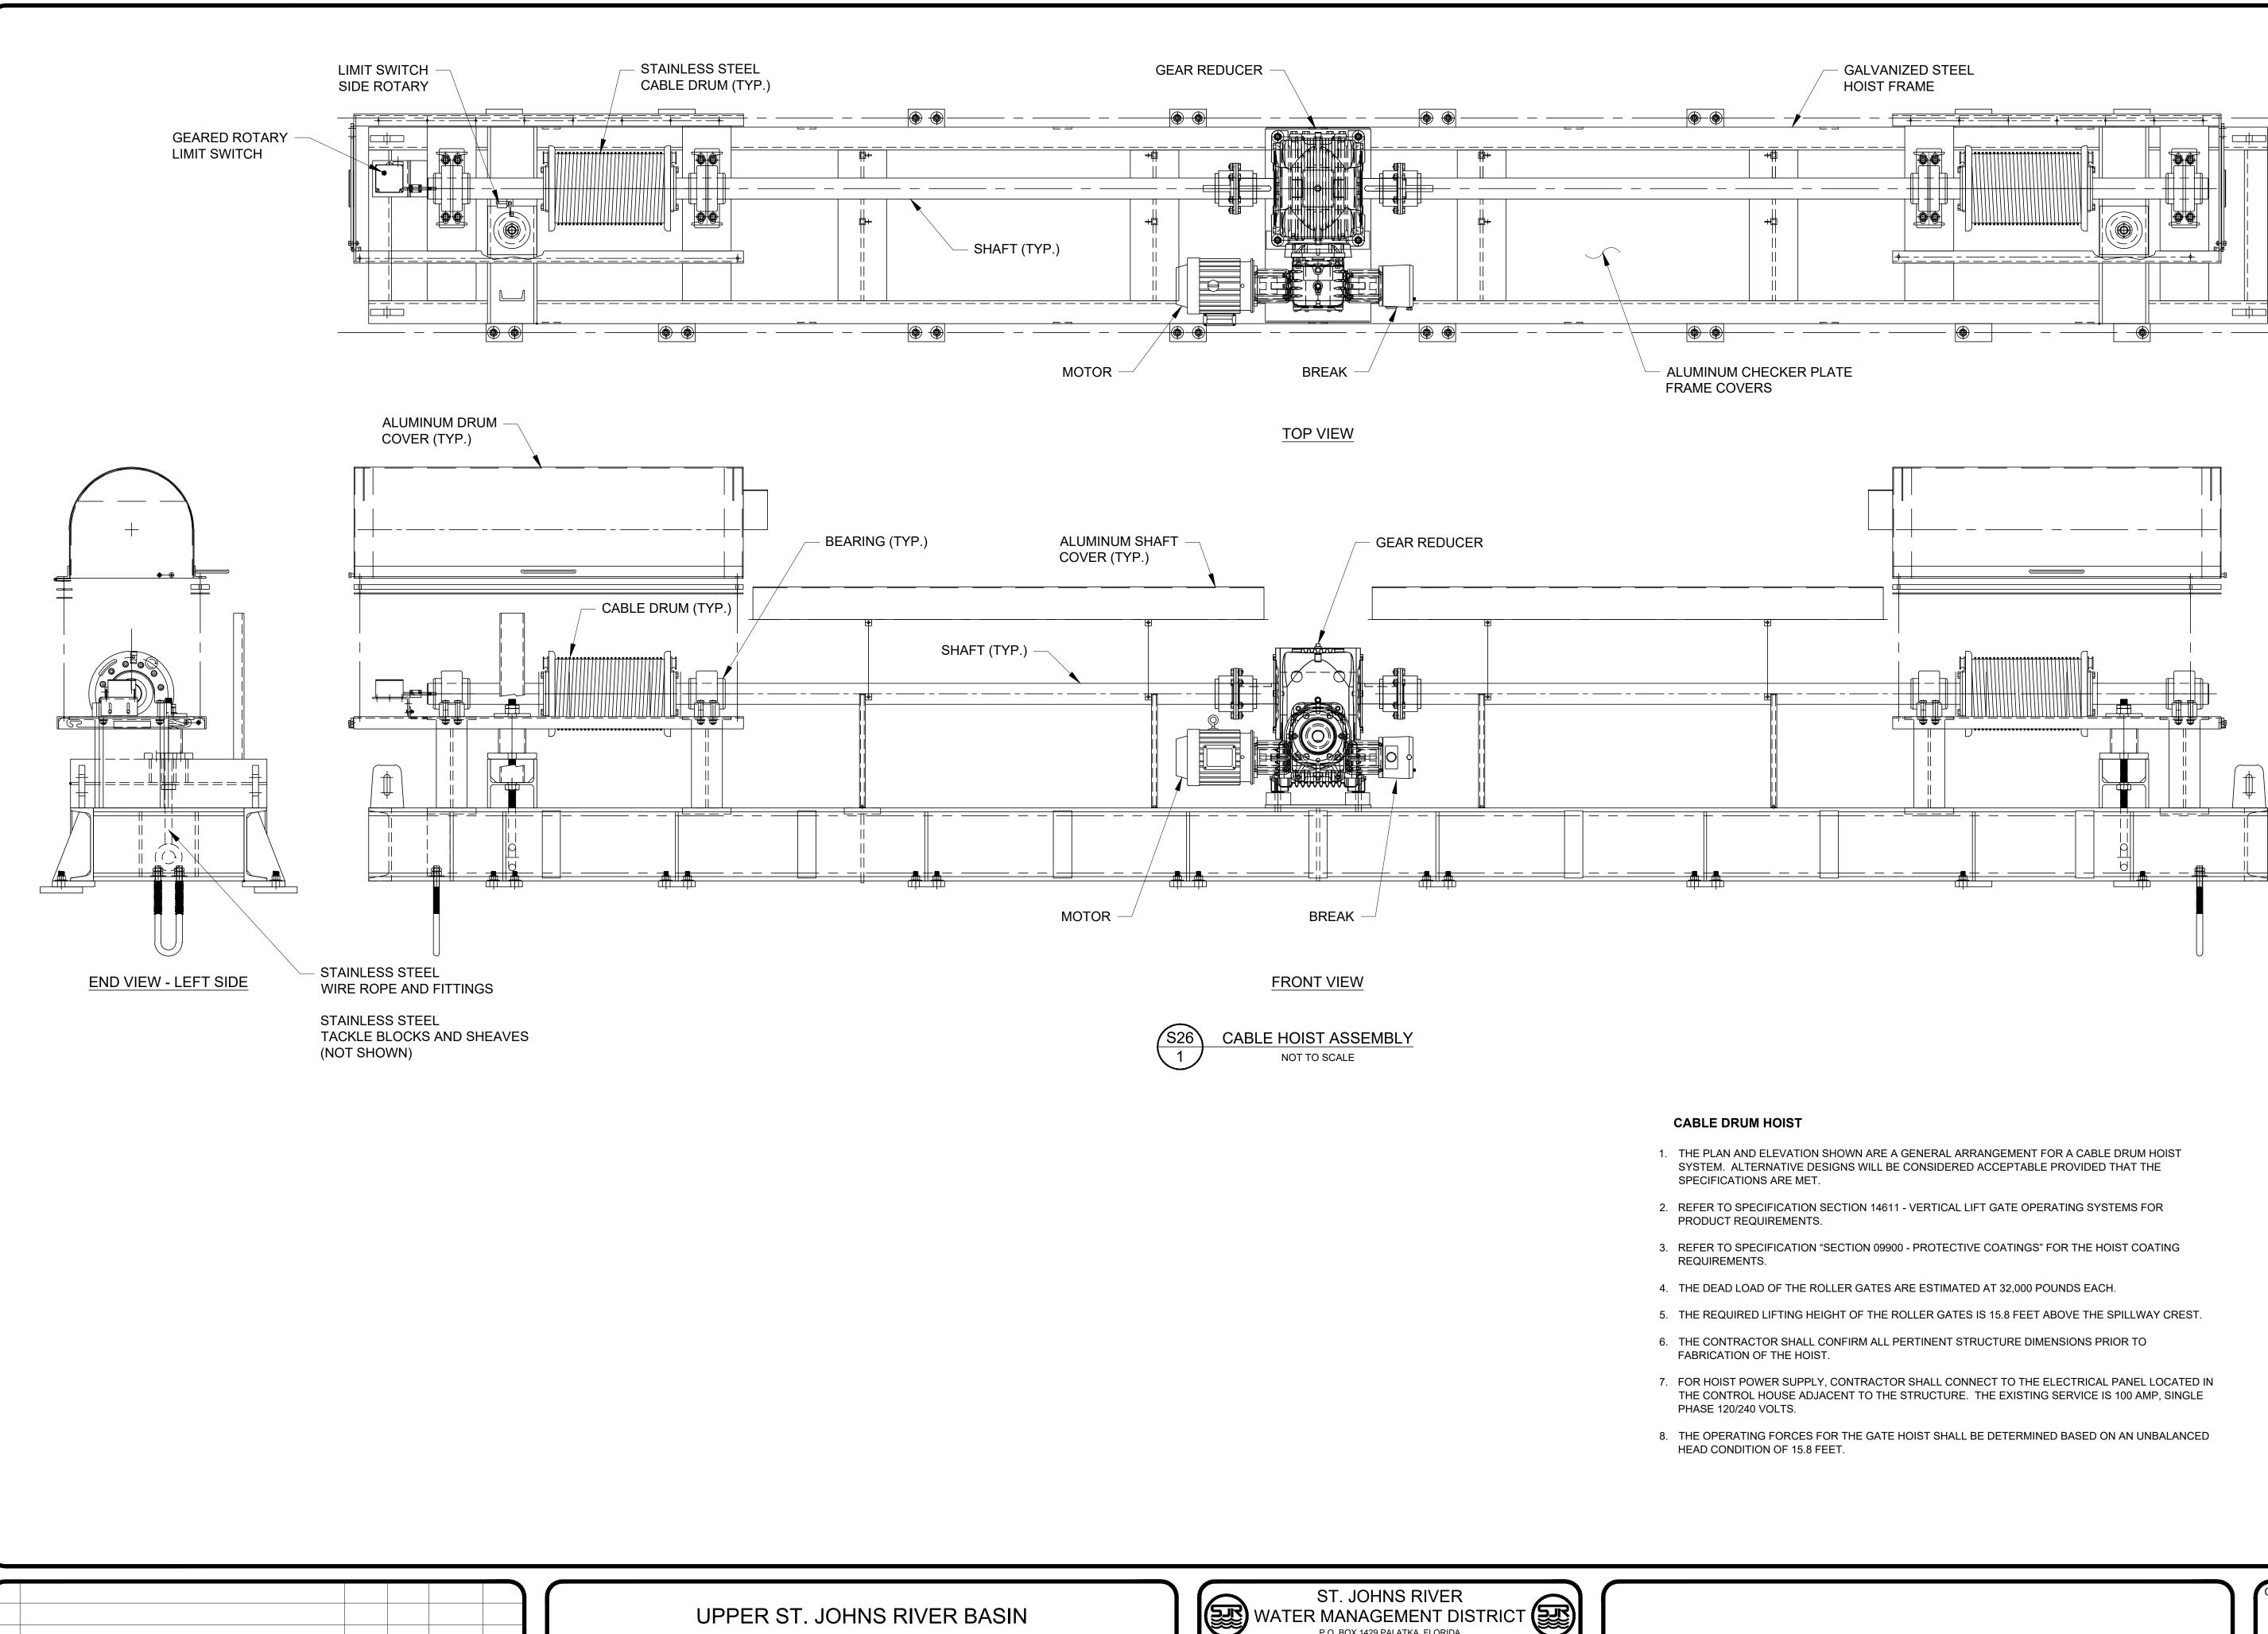
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WILL	IAM R. COTE
P.E. NUMBER: _	53746
DATE:	MAY 14, 2021

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NEW FENCE DETAILS

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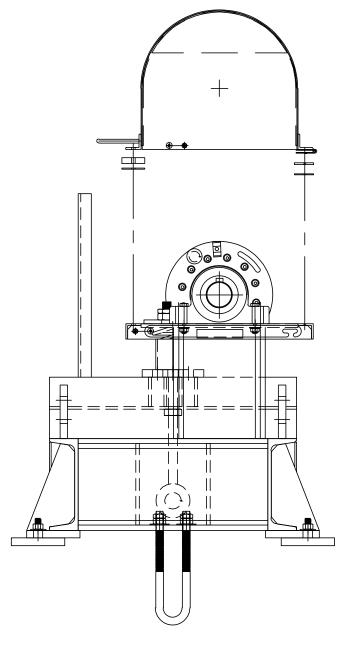


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STRUCTURE 96 REF BREVARD COUN

RIVER BASIN		ST. JOHNS RIVER WATER MANAGEMENT DISTRICT P.O. BOX 1429 PALATKA, FLORIDA				NE
EHABILITATION TY, FLORIDA	DRAWN:	N.J.G.	DATE: <u>MAY 14, 2021</u> DESIGNER: <u>W.R.C.</u>	REVIEWER: W.R.C.		



END VIEW - RIGHT SIDE

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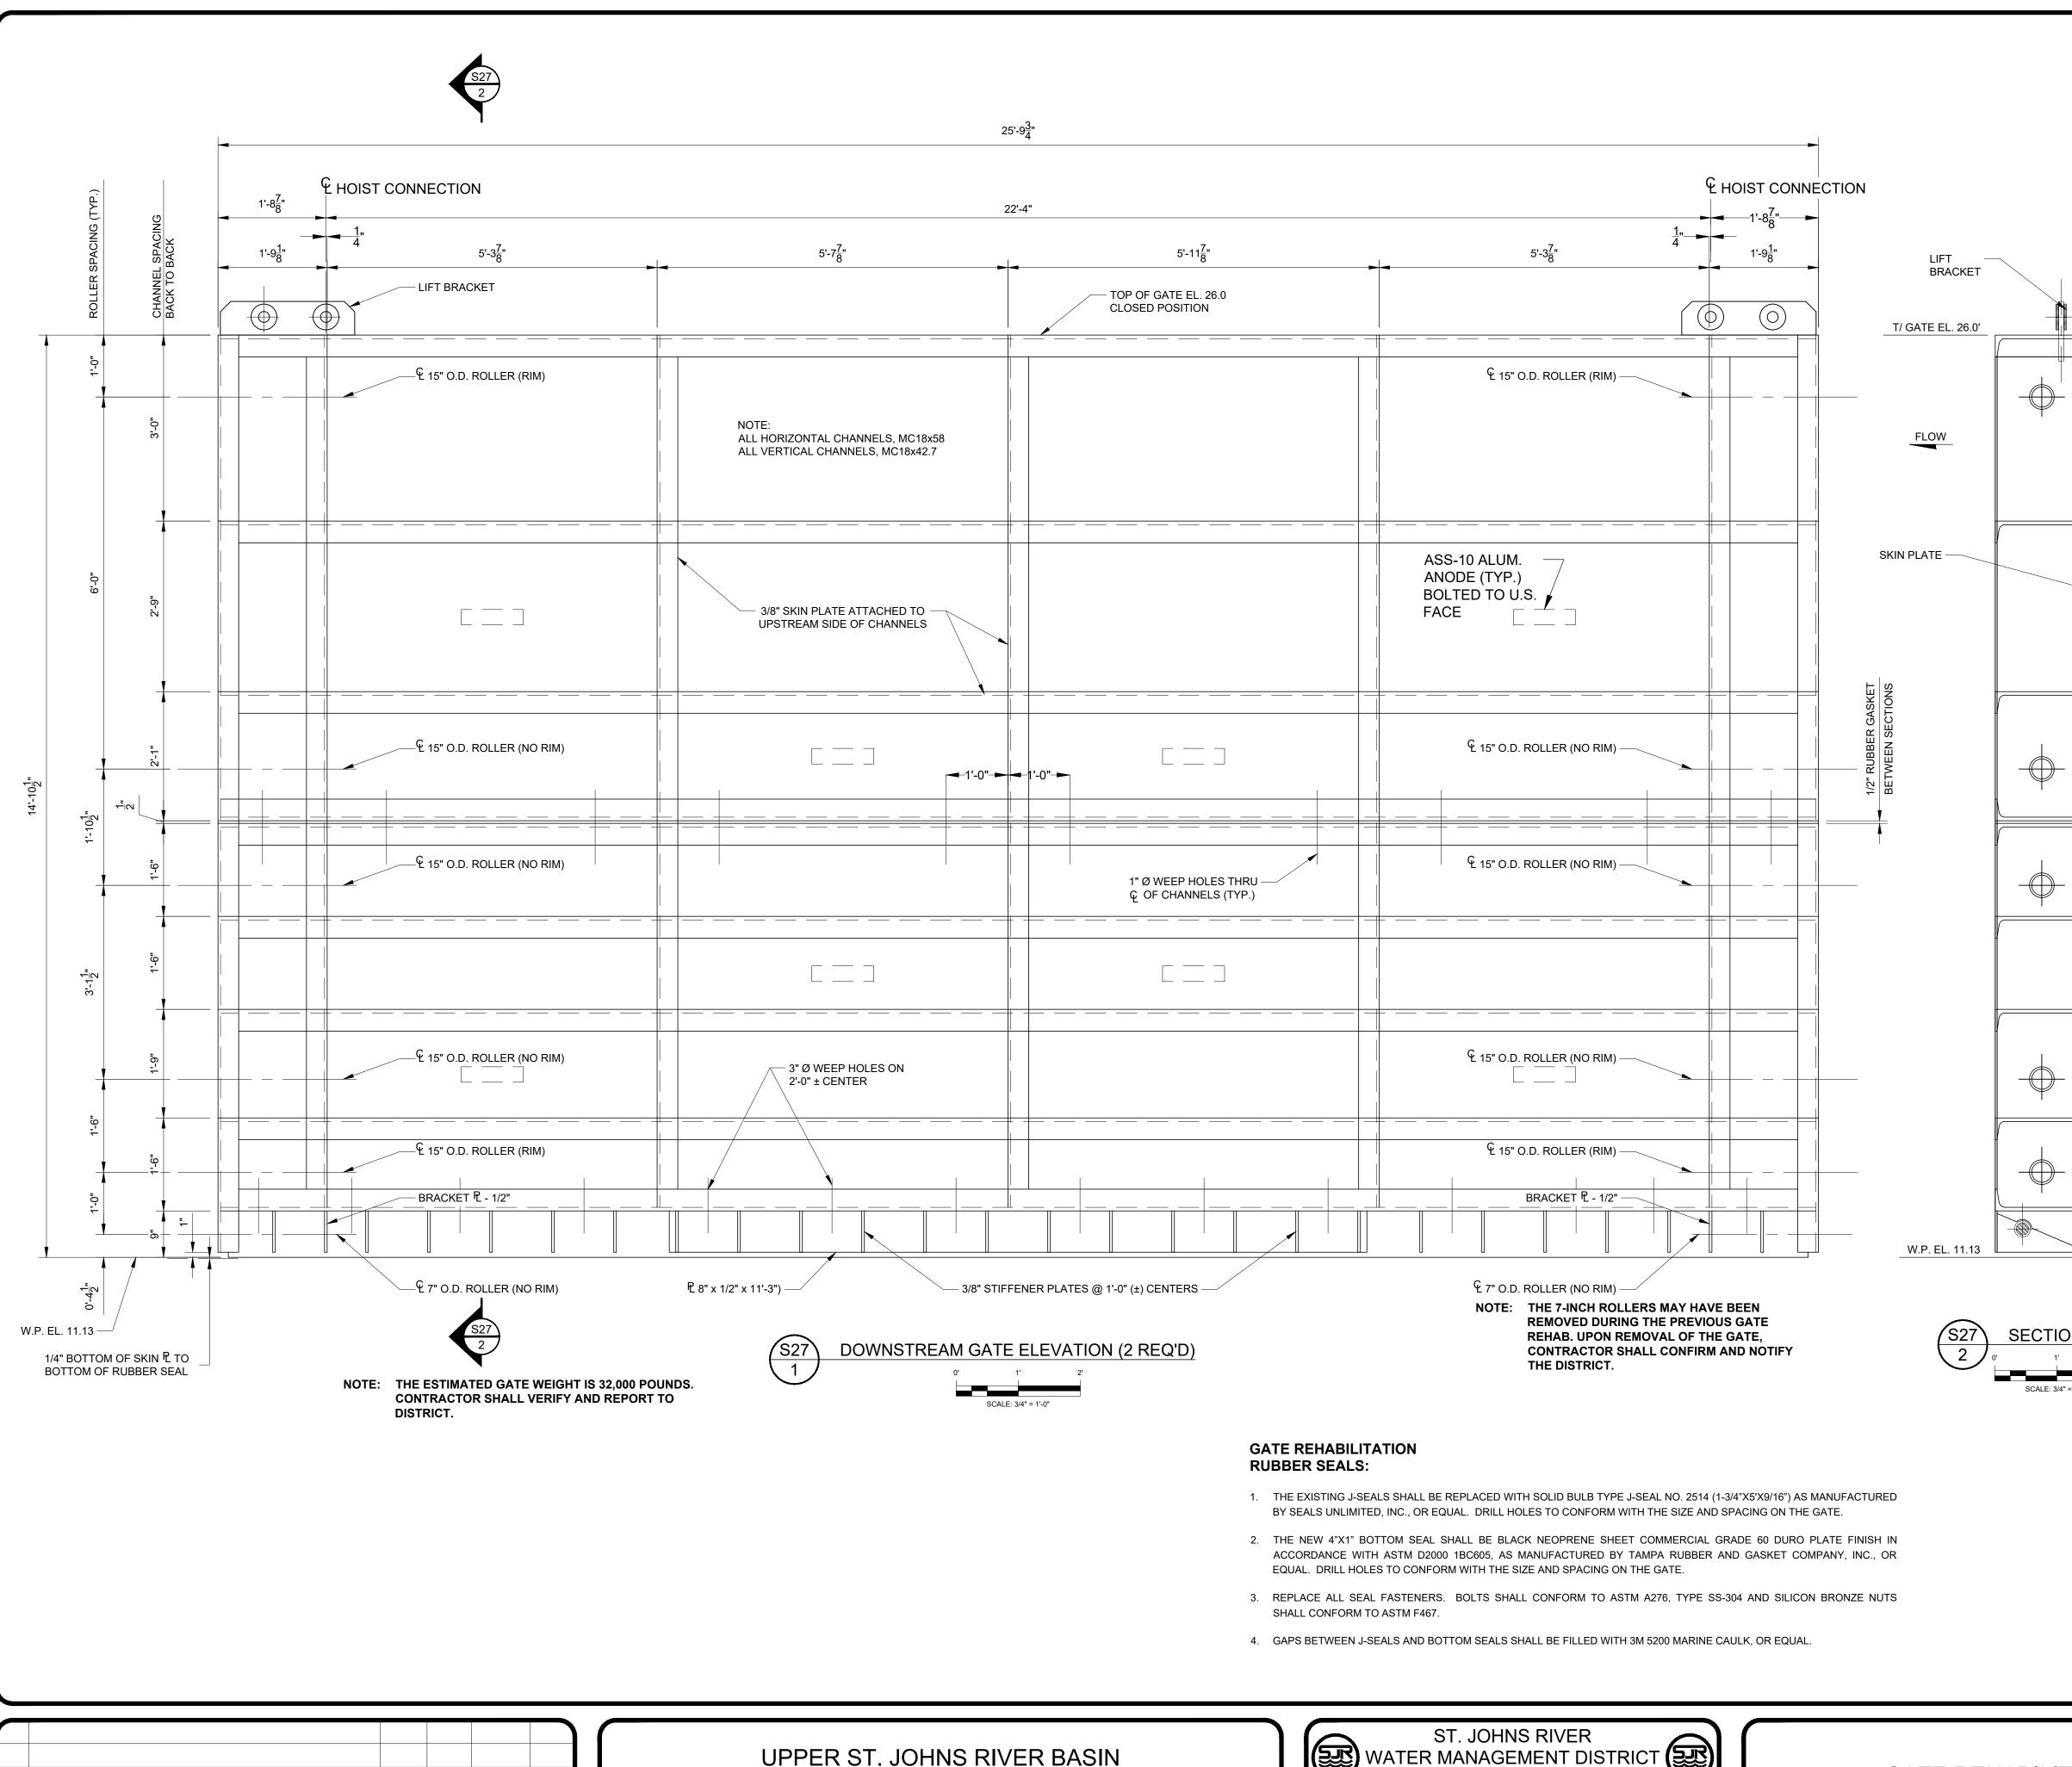
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WILLIAM R. COTE P.E. NUMBER: 53746 DATE: MAY 14, 2021

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W CABLE DRUM HOIST



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\wedge	ISSUED FOR BID	N.J.G.	05/14/21	W.R.C.	05/14/21
NO.	REVISION	BY	DATE	APPROVED	DATE

STRUCTURE 96 REHABILITATION BREVARD COUNTY, FLORIDA

WATER	ST. JOHNS RIVER WATER MANAGEMENT DISTRICT		
DRAWN: N.J.G.	DATE:MAY 14, 2021	REVIEWER: W.R.C.	
SCALE: AS NOTED	DESIGNER: W.R.C.	SECTION CHIEF: W.R.C.	

GATE REHABILITATION STRUCTURAL STEEL:

- 1. STRUCTURAL STEEL DESIGN, FABRICATION, AND ERECTION SHALL BE IN ACCORDANCE WITH THE AMERICAN INSTITUTE OF STEEL CONSTRUCTION (AISC) "SPECIFICATION FOR THE DESIGN, FABRICATION AND ERECTION OF STRUCTURAL STEEL FOR BUILDINGS", NINTH EDITION.
- 2. WELDING SHALL BE IN ACCORDANCE WITH THE AMERICAN WELDING SOCIETY (AWS) "STRUCTURAL WELDING CODE" AWS D1.1.
- 3. ALL STRUCTURAL AND MISCELLANEOUS STEEL SHALL BE NEW AND CONFORM TO THE REQUIREMENTS OF THE AMERICAN SOCIETY OF TESTING AND MATERIALS (ASTM) STANDARD A36 UNLESS NOTED OTHERWISE.
- 4. ALL BOLTS SHALL BE STAINLESS STEEL CONFORMING TO ASTM A276, TYPE 304. THE SIZE AND LOCATION OF REPLACEMENT BOLTS SHALL MATCH EXISTING UNLESS NOTED OTHERWISE.
- 5. ALL WELDING SHALL UTILIZE E70XX LOW-HYDROGEN ELECTRODES UNLESS NOTED OTHERWISE.
- 6. FIELD CORRECTING OF FABRICATED STEEL SHALL NOT BE PERMITTED ON MAJOR STRUCTURAL MEMBERS WITHOUT PRIOR APPROVAL OF THE DISTRICT.

GATE OVERHAUL:

 $-\bigcirc$

- 1. DISCONNECT POWER. PRESSURE WASH THE GATES TO REMOVE ALL ORGANIC GROWTH, LOOSE PARTICLES, AND OTHER EXTRANEOUS MATERIALS.
- 2. MARK ALL GATE COMPONENTS PRIOR TO REMOVAL FOR EASE OF REASSEMBLY.
- 3. REMOVE GREASE LINES AND FITTINGS FROM THE ROLLER GATE. REMOVE OLD HYDRAULIC LINES, EVACUATE AND GROUT.
- 4. REMOVE ALL SHEAVE HANGERS, SHEAVES, AND SHEAVE PINS FROM HOIST COFFINS. DISASSEMBLE THE HOIST LIFT SYSTEMS.
- 5. REMOVE THE HOIST SYSTEMS AND ROLLER GATES FROM THE STRUCTURE. AT THE CONTRACTOR'S OPTION, THE DISTRICT'S REWORK SITE AND/OR GATE SUPPORT BRACING MAY BE USED FOR THE GATE REHABILITATION. THE REWORK SITE IS LOCATED AT 9555 SOUTH BABCOCK ROAD, PALM BAY, FL. THE CONTRACTOR SHALL PROVIDE A PORTABLE TOILET IF THE REWORK SITE IS UTILIZED.
- 6. REMOVE RAILS AND SPLICE BARS AS REQUIRED. WHEN REMOVING RAILS, CARE SHALL BE TAKEN TO MEASURE AND DOCUMENT SHIM THICKNESS AT EACH LOCATION. CLEAN OR REPLACE WITH SS-304 SAME SIZE AND NUMBER OF SHIMS, AS NEEDED. REPLACE RAILS AND RAIL CLIPS USING ASCE 60# RAIL AND NO. 106 RAIL CLIPS, IF REQUIRED. REPLACE ALL NUTS WITH SILICON BRONZE NUTS CONFORMING TO ASTM F467.
- 7. REMOVE ALL BOLTS, RETAINING PLATES, AND SEALS FROM THE ROLLER GATES.
- 8. REMOVE WHEELS FROM THE ROLLER GATE.
- 9. PRESS OUT SHAFTS WITH PORTA POWER WHILE MAKING SURE NOT TO DAMAGE GATE STRUCTURE. IF SHAFTS ARE NOT MOVING, USE HEAT ON COLLARS WHILE PRESSING OUT.
- 10. INSPECT WHEELS, COLLARS, AXLES, AND BEARINGS AND REPAIR AS NEEDED.
- 11. ALL GATE COLLARS SHALL BE INSPECTED AND REPLACED IF NECESSARY. IF COLLARS NEED TO BE REPLACED, ABRASIVE BLASTING AROUND THE COLLAR IS REQUIRED TO PREPARE FOR INSTALLATION OF THE NEW COLLAR.
- 12. WHEELS SHALL BE BLASTED, INSPECTED, AND TURNED DOWN IF NECESSARY FOR BANDING. IF REQUIRED, THE BANDS SHALL BE SIZED AND THE WHEEL PLACED IN AN OVEN OVERNIGHT IN PREPARATION OF THE WELDING PROCESS. AFTER WELDING, THE WHEEL SHALL BE COOLED SLOWLY TO PREVENT FRACTURING OF THE WELDS AND THEN MACHINED TO THE REQUIRED DIAMETER.
- 13. AXLES AND WHEELS SHALL BE MEASURED FOR "THORDON THORPLAS" BEARING FABRICATION. THE "THORDON THORPLAS" BEARINGS SHALL BE INSERTED AND THE WHEELS BLASTED AND PAINTED. THE CONTRACTOR SHALL COORDINATE WITH THE BEARING MANUFACTURER IN DETERMINING THE PROPER SIZING OF THE BEARINGS.
- 14. AXLES SHALL BE ABRASIVE BLASTED (EXCEPT FOR STAINLESS STEEL) AND INSPECTED FOR SERVICEABILITY. IF NECESSARY, THE AXLES SHALL BE REPAIRED. UPON COMPLETION, AXLES SHALL BE BLASTED AND PAINTED.
- 15. INSPECT ALL COMPONENTS TO ENSURE THEY ARE CLEAN OF DEBRIS AND GREASE.
- 16. MARK THE WEIGHT OF THE GATE ON THE TOP CHANNEL USING A FILLET WELD.
- 17. ALL STEEL COMPONENTS (EXCEPT FOR STAINLESS STEEL ITEMS) SHALL BE BLASTED AND PAINTED. ITEMS TO BE PAINTED SHALL INCLUDE THE ROLLER GATES, WHEELS, SEAL RETAINING PLATES, AND RAILS,
- 18. REASSEMBLE THE ROLLER GATES, INCLUDING THE WHEELS, SEALS, RETAINING PLATES, AND ALL NEW HARDWARE.
- 19. PROVIDE AND INSTALL CATHODIC PROTECTION ANODES AT THE LOCATIONS SHOWN. ANODES SHALL BE ASS-10 CONFORMING TO MIL SPEC A-24779. THE ANODE MOUNTING STRAP SHALL HAVE 5/8" DRILLED HOLES AND SHALL BE BOLTED TO THE UPSTREAM FACE OF THE GATE WITH 1/2" DIAMETER SS-304 BOLTS. THE CONTACT SURFACES BETWEEN THE GATE AND THE ANODES SHALL BE BARE METAL. THE ANODES SHALL NOT BE PAINTED.
- 20. REINSTALL RAILS. REPLACE SHIMS OF SAME SIZE WITH SS-304 PLATES AS REQUIRED. REPLACE ANCHOR BOLTS OF SAME SIZE WITH SS-304 BOLTS AS REQUIRED.
- 21. REINSTALL THE COMPLETED ROLLER GATES AND HOIST SYSTEMS. RECONNECT POWER.
- 22. PERFORM DRY TEST OPERATION OF GATES. ADJUST AS NEEDED.
- 23. TEST OPERATION OF GATES UNDER NORMAL OPERATING CONDITIONS. ADJUST AS NEEDED.

PAINTS AND PROTECTIVE COATINGS:

- 1. ALL STEEL SHALL BE PRIMED AND PAINTED IN ACCORDANCE WITH THE STEEL STRUCTURES PAINTING COUNCIL (SSPC) "STEEL STRUCTURES PAINTING MANUAL".
- 2. STEEL SURFACE PREPARATION SHALL BE AS FOLLOWS:

SSPC-10 NEAR WHITE BLAST CLEANING. ALL BLAST MEDIA AND PAINT CHIPS SHALL BE CAPTURED, REMOVED, AND PROPERLY DISPOSED.

3. PAINT SHALL BE BY THE WASSER CORPORATION, OR EQUAL, AS FOLLOWS:

FIRST COAT: SECOND COAT: THIRD COAT:

FOURTH COAT:

MC-ZINC 100 GRAY MC-TAR 100 RED MC-TAR 100 BLACK

3-5 MILS DFT MINIMUM 5-7 MILS DFT MINIMUM 5-7 MILS DFT MINIMUM MC-LUSTER 100 SILVER 2-4 MILS DFT MINIMUM

SURFACE PREPARATION AND APPLICATION SHALL BE IN ACCORDANCE WITH THE PAINT MANUFACTURER SPECIFICATIONS.

FOR BID PURPOSES ONLY NOT FOR CONSTRUCTION

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FILE NAME: S-96 GATE REPAIR.dwg PROJECT NO .:

GATE REHABILITATION ELEVATION,
SECTIONS, DETAILS & NOTES

SCALE: 3/4" = 1'-0

. NUMBER: <u>53746</u>	WILLIAM R. COTE		
CE: MAY 14, 2021	NUMBER:	53746	
	re.	MAY 14 2021	

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