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	29. Where not specifically described in any of the notes or specifications, Workmanship shall conform to the methods and operations of best STANDARDS AND ACCEPTED PRACTICES OF THE RESPECTIVE TRADE.	AB ANCHOR BOLT AGOVE ACY ASOVE ASOVE ASOVE ASOVE ASTOVE AS ABOVE AS ABOVE PASSIVED I LOOR AF A ABOVE PASSIVED I LOOR AF ABOVE PASSIVED I LOOP ADJACATURE AND AUTOMATIC AUTOMATIC AUTOMATIC BOD BOARD AUTOMATIC BOD BOARD BOAR	1. THE DRAWINGS AND SPECIFICATIONS AND ALL COMES IMPRIOR. ARE LEGAL INSTRUMENTS OF SERVICE FOR THE USE OF THE OWNER AND AUTHORIZED SERVICES. AND AUTHORIZED SERVICES AND AUTHORIZED SERVICES. AND AUTHORIZE	AS NOTIO PROMOTE THE POWERTON PROJECT. 31. REQUIRED EXITS, EXISTING STRUCTURAL LEGIMENTS, THE PROTECTION DEVICES AND SANTAYS ASPECTATIONS SHALL BE MANYAMARD AT ALL TIMES TORRING THE PROJECT OF THE PRO	I. IIII ACCORDANCE WITH PERTINENT ITEMS OF THESE NOTES AND THOSE ITEMS SO IMMOCATED ON THE DRAWINGS "CAREFULLY" DEMOLISH AND REMOVED. 9. ALL EXISTING CONDITIONS REPRESHIED MUST BE VERIFIED IN THE FIELD. 3. IIIS ADDRAWED TO MINISTER SHEED MUST BE VERIFIED IN THE FIELD. 3. IIIS ADDRAWED TO MINISTER SHEED MUST BE VERIFIED IN THE FIELD. 3. IIIS ADDRAWED TO MINISTER SHEED MUST BE VERIFIED IN THE FIELD. 3. IIIS ADDRAWED TO MINISTER SHEED MUST BE VERIFIED IN THE FIELD. 4. IIIS ADDRAWED THE MEDISSAY CHARTS AND WHO ARE COMMETELY FAMILLAR WITH THE SPECIED REQUIRED MUST AND THE METHODS NEEDED FOR PROPER REPECTIONANCE OF THE WORK. 4. SURFACE CONDITIONS EXAMINE THE AREAS AND CONDITIONS UNDER WHICH WORK WILL BE PREPORMED. CORRECT CONDITIONS SHEED FOR PROPER CONDITIONS AND THE WORK OF THE ORDER OF THE WORK. 5. DEMOLITION BY CAREFULLY THE WORK OF THE ORDER ON THE METHOD SHEED FOR PROPER CONDITIONS AND THE WORK OF THE ORDER ON THE WORK O	GENERAL G. 000 TITLE SHEET ARCHITECTURAL A-001 SPECIFICATIONS A-002 SPECIFICATIONS A-002 SPECIFICATIONS A-102 SPECIFICATIONS A-103 SPECIFICATIONS A-104 SPECIFICATIONS A-105 SPECIFICATIONS A-106 SPECIFICATIONS A-107 SPECIFICATIONS A-108 SPECIFICATIONS A-108 SPECIFICATIONS A-108 SPECIFICATIONS A-108 SPECIFICATIONS A-109 SPECIFICATIONS A-110 SPECIFICATIONS A-111 SPECIFICATIONS A-112 SPECIFICATIONS A-112 SPECIFICATIONS A-113 SPECIFICATIONS A-114 ADMINISTRATIONS A-115 SPECIFICATIONS A-116 SPECIFICATIONS A-117 ATHLETIC FELDS A-119 SITE FEATURES & MISCELLANEOUS A-119 SITE FEATURES & MISCELLANEOUS A-110 SPECIFICATIONS APPLIES AND A SPECIFICATIONS A-111 AND A SPECIFICATIONS A-112 SPECIFICATIONS A-113 AND A SPECIFICATIONS A-114 A SPECIFICATIONS A-115 SPECIFICATIONS A-116 SPECIFICATIONS A-117 A SPECIFICATIONS A-118 A SPECIFICATIONS A-119 SITE FEATURES & MISCELLANEOUS A-119 SITE FEATURES & MISCELLANEOUS A-119 SITE FEATURES & MISCELLANEOUS A-110 SPECIFICATIONS A-111 AND A SPECIFICATIONS A-111 AND A SPECIFICATIONS A-112 CALIFORNIA BUILDING CODE (CALIC) A-114 A SPECIFICATION AND	ARCHITECTURE STUDIO HARTMANNARCHITECTURESTUDIO.COM 430 S. CARRILLO RD. 0JAI. CALIFORNIA 93023 (805) 798-2253 CONSULTANTS: PROJECT: NORDHOFF HS CAMPUS- WIDE EXTERIOR PAINTING OWNER: 0JAILUNIFIED SCHOOL DISTRICT 414 EAST 0JAI AVENUE 0JAIL CA 93023 (805) 640-4300 CONTACT: ADAM DUTTER EMAIL: adulter@qjailusd.org PROJECT ADDRESS: NORDHOFF HIGH SCHOOL 1401 MARICOPA HIGHWAY 0JAIL CA 93023 ISSUE: MARK DATE DESCRIPTION PROJECT INFORMATION: PROJECT NUMBER: 04COND DRAWN BY: REVEWEND BY: MR. REVEWEND BY: SHEET NUMBER: SHEET TITLE SHEET SHEET NUMBER:

430 S. CARRILLO RD OJAI, CA 93023 C. Summary of Work: 1. Nordhoff High School (PROJ# 2020-1730) 1401 Maricopa Highway, Ojai, CA 93023

a. Repaint: (1) Building A (2) Building B (3) Building C (4) Building D (5) Building F (6) Building G (7) Building H (8) Building I (9) Building J (10) Building K (11) Building L (12) Building N (13) Building O (14) Admin Building (15) Music Building (16) Science Buildings

(17) Athletic Field Stuctures (18) Accessory Structures as Indicated D. Bid Documents are available online at the Ojai Unified School District's Website (https://www.ojaiusd.org/page/construction-projects)

1.1 OCCUPATIONAL SAFETY AND HEALTH ACT REQUIREMENTS: A. During the entire construction period, it shall be the responsibility of the Contractor to maintain conditions at the Project site so as to meet in all respects the requirements of the Federal Occupational Safety and Health Administration (OSHA) and the California Occupational Safety and Health Administration (CAL-OSHA). These provisions shall cover the Contractor's employees and all other persons working upon or visiting the site. To this end, the Contractor shall inform himself and his representatives of Federal OSHA and California OSHA standards.

1.2 COORDINATION REQUIREMENTS:

A. It is the Contractor's responsibility to coordinate the Work so as to minimize conflicts and optimize efficiency.

B. Coordinate scheduling, submittals, and Work of the various Sections of Specifications to assure efficient and orderly sequence of installation of interdependent construction elements, with provisions for accommodating items installed later.

1.3 BUILDING SYSTEM COORDINATION:

A. Notify Architect if conditions are uncovered which would prevent the completed project from conforming to the requirements of the Work. B. Materials/Systems: As specified. Verify compatibility with District-wide standard systems. C. "NIC" construction is indicated and specified herein as an aid to the Contractor in scheduling the amount of time and materials necessary for the

completion of the Contract. 1.4 DISTRICT OCCUPANCY:

> A. The District will occupy the campus during the entire period of construction. Cooperate with the District in all construction operations including the following to minimize conflict and to facilitate District usage. B. If and when it should be necessary for the Contractor to impact the day-today operations of District's functions in order to pursue the Work, the Contractor shall furnish at least 14 days notice to the District and coordinate the means and timing to avoid, minimize, or circumvent such impacts. The District reserves the right to assess and anticipate such impacts and the right to stop or postpone the Work until a mutually satisfactory time and means can be agreed upon. The Contractor shall include costs for delays caused by normal school operations and scheduled special events.

1.5 CONTRACTOR'S USE OF THE PREMISES:

A. The Contractor shall limit his use of the premises for construction activities and for storage, to allow for District occupancy. B. The Contractor shall be responsible for the following: 1. Coordinate the use of the premises under the direction of the

District. 2. Assume full responsibility for the protection and safekeeping of products under this Contract which are stored at the site. 3. Move stored products that are under the Contractor's control, which interfere with operations of the District.

4. Obtain and pay for the use of additional storage or construction areas needed for operations.

1.6 COORDINATION OTHER DISTRICT CONTRACTORS:

A. The District may have separate contractors or vendors working on the site at the time of this project. The Contractor shall coordinate work activities to not interfere with other District work.

PART 2 - PRODUCTS (Not Applicable)

PART 3 - EXECUTION (Not Applicable)

SECTION 01 21 00 - ALLOWANCES

PART 1 - GENERAL 1.1 SUMMARY

> A. Section Includes: Allowances which the Contractor shall provide for designated construction activities in the Work and in his/her bid. B. Related Documents 1. Section 01 26 00: Modification procedures

1.2 DESCRIPTION OF REQUIREMENTS

A. Definitions and Explanations: Certain requirements of the construction related to each allowance are indicated and specified. The allowance has been established instead of additional requirements for that construction, and further requirements thereof will be issued by Change Order. B. Contingency Allowance: Contingency allowance shall be used only as directed for District's purposes, and only by change orders which designate amounts to be charged to contingency allowance. Contractor's related costs are not included in the Contract sum (other than allowance itself) for construction so ordered to be charged to contingency allowance. The change orders will include costs and reasonable overhead/profit margins. At time of project closeout, unused amounts remaining in contingency allowance shall be credited to the District by change order.

PART 2 - PRODUCTS (Not Applicable)

PART 3 - EXECUTION

3.1 SCHEDULE OF ALLOWANCES A. Allowance No. 1: The Contractor shall include in the bid an allowance of \$15,000 for repair of miscellaneous existing conditions, including, but not limited to the replacement of existing stucco, plywood paneling, unsatisfactory dimensional lumber not otherwise identified in the drawings.

SECTION 01 26 00 - MODIFICATION PROCEDURES

PART 1 - GENERAL

A. Section Includes: Procedures for processing Change Orders.

1.2 CHANGE INITIATION PROCEDURES:

A. The Contractor may initiate a change by submittal of a request to the Architect describing the proposed change with a statement of the reasons or the change and the effect on the Contract Sum and the Contract Time with full documentation.

B. The Architect may issue a Price Modification Request (PMR), signed by the District, instructing the Contractor to proceed with a change in the Work, for subsequent inclusion in a Change Order. The directive will describe changes in the Work, and will designate method of determining changes in Contract

Sum and/or Contract Time. C. The Architect may issue Supplemental Instructions for minor changes that will not affect Contract Sum or Contract Time. The Contractor shall sign and return the original copy of the form to the Architect.

1.3 CONTRACTOR'S PROPOSALS AND DOCUMENTATION: A. In response to each PMR issued by the Architect, submit an itemized quotation detailing all changes in Contract Sum and Contract Time. Upon

request, the Contractor shall provide additional data, including the following, to support the quotation. 1. Quantities of products, labor, and equipment.

Taxes, insurance, and bonds. 3. Overhead and profit.

4. Justification for change in Contract Time. 5. Credit for deletions from the Contract, similarly documented.

6. Quotation shall include all components necessary, whether or not specifically described, to complete the work, such as, but is not limited to, cutting, patching and painting, additional power supply required for equipment, etc. By failing to provide quotation for component(s) of the work without prior notification to the District that additional quotation(s) to be furnished at a later date, the Contractor waives all claims for extra costs for such component(s)

required to complete the work. B. If additional costs necessitated by a Construction Change Directive are indicated to be paid on a time and materials basis, provide additional data, including the following, after completing the Change.

1. Date and number of Change Authorization. 2. Dates and times work was performed and by whom.

3. Time records and wage rates paid. 4. Invoices and receipts for products, equipment, and subcontracts. 1.4 EXECUTION OF CHANGE ORDERS:

A. The Architect will issue Change Orders on AIA Form G701 for signatures of parties as provided in the Conditions of the Contract. B. On fixed price Change Orders, changes in Contract Sum and Contract Time

C. On time and material Change Orders, changes in Contract Sum and Contract Time will be determined by the District and Architect from the

will be based on the PMR and the Contractor's quotation as accepted by the

Contractor's data. 1.5 CORRELATION OF CONTRACTOR SUBMITTALS:

A. Promptly revise the Schedule of Values, and Application for Payment forms to record each authorized Change Order as a separate line item and adjust the Contract Sum as shown on the Change Order. B. Promptly revise Progress Schedules to reflect changes in Contract Time, revise subschedules to adjust times for other items of Work affected by the change and resubmit.

C. Promptly enter changes on the Project Record Documents.

PART 2 - PRODUCTS (Not Applicable)

PART 3 - EXECUTION (Not Applicable)

SECTION 09 01 90.52 - MAINTENANCE REPAINTING

PART 1 - GENERAL

1.1 SUMMARY

A. Section includes maintenance repainting as follows: 1. Patching substrates.

2. Repainting. a. Concrete

b. Metal, galvanized and ungalvanized c. Wood, dimensional and panel d. Portland cement plaster (stucco) – existing

1.2 UNIT PRICES A. Work of this Section contributes to the amount specified in Section 012100 "Allowances."

1.3 DEFINITIONS

A. Gloss Level 1: Not more than 5 units at 60 degrees and 10 units at 85 degrees, according to ASTM D523. B. Gloss Level 2: Not more than 10 units at 60 degrees and 10 to 35 units at

85 degrees, according to ASTM D523. C. Gloss Level 3: 10 to 25 units at 60 degrees and 10 to 35 units at 85

degrees, according to ASTM D523. D. Gloss Level 4: 20 to 35 units at 60 degrees and not less than 35 units at 85 degrees, according to ASTM D523.

E. Gloss Level 5: 35 to 70 units at 60 degrees, according to ASTM D523. F. Gloss Level 6: 70 to 85 units at 60 degrees, according to ASTM D523. G. Gloss Level 7: More than 85 units at 60 degrees, according to ASTM D523.

1.4 PREINSTALLATION MEETINGS

A. Preinstallation Conference: Conduct conference at Project site.

1.5 ACTION SUBMITTALS

A. Product Data: For each type of product. B. Samples: For each type of paint system and each pattern, color, and gloss.

1. Label each Sample for location and application. C. Product List: Printout of current "MPI Approved Products List" for each MPI-product category specified in paint systems, with the proposed product highlighted.

1.6 INFORMATIONAL SUBMITTALS

A. Color Matching Certificate: For computer-matched colors.

PART 2 - PRODUCTS

2.1 PREPARATORY CLEANING MATERIALS

A. Water: Potable. B. Hot Water: Water heated to a temperature of 140 to 160 deg F (60 to 71

C. Detergent Solution: Solution prepared by mixing 2 cups (0.5 L) of tetrasodium pyrophosphate (TSPP), 1/2 cup (125 mL) of laundry detergent that contains no ammonia, 5 quarts (5 L) of 5 percent sodium hypochlorite bleach, and 15 quarts (15 L) of warm water for every 5 gal. (20 L) of solution required. Or, apply Jasco TSP No-Rinse Substitute. Follow manufacturer's

instructions for mixing and application. D. Mildewcide: Commercial proprietary mildewcide or a job-mixed solution prepared by mixing 1/3 cup (80 mL) of household detergent that contains no ammonia, 1 quart (1 L) of 5 percent sodium hypochlorite bleach, and 3 quarts (3 L) of warm water.

E. Abrasives for Ferrous Metal Cleaning: Aluminum oxide paper, emery paper, fine steel wool, steel scrapers, and steel-wire brushes of various sizes. F. Rust Remover: Manufacturer's standard phosphoric acid-based gel formulation, also called "naval jelly," for removing corrosion from iron and

2.2 PAINT REMOVERS

A. Low-Odor, water based paste paint remover: Manufacturer's standard low odor, water-rinsable, water based paste, gel, or foamed emulsion formulation for removing paint from masonry, stone, wood, plaster, or metal as required to suit Project; and containing no methanol or methylene chloride

2.3 PAINT, GENERAL

A. Material Compatibility: 1. Provide materials for use within each paint system that are compatible with one another and substrates indicated, under conditions of service and application as demonstrated by

manufacturer, based on testing and field experience. 2. For each coat in a paint system, provide products recommended in writing by manufacturers of topcoat for use in paint system and on

substrate indicated. B. Colors: Match District-standard paint manufacturer and Campus-standard colors as indicated in drawings:

COLOR 1 - WHITE - Match SW 7013- Ivory Lace

COLOR 2 - BLUE - Match SW 6804- Dignity Blue

COLOR 3 - YELLOW - Match SW 6904- Gusto Gold 2.4 PAINT MATERIALS, GENERAL

A. MPI Standards: Provide products that comply with MPI standards indicated and that are listed in its "MPI Approved Products List." B. Transition Coat: Paint manufacturer's recommended coating for use where a residual existing coating is incompatible with the paint system.

2.5 PAINT MATERIALS

C. Wood Primers:

A. Primers and Sealers: 1. Primer Sealer, Latex, Alkali Resistant, Exterior: MPI #3.

1. Primer, Rust-Inhibitive, Water Based: MPI #107. 2. Primer, Galvanized, Water Based: MPI #134.

1. Primer, Latex for Exterior Wood: MPI #6. D. Water-Based Paints: 1. Latex, Exterior Low Sheen (Gloss Levels 3-4): MPI #15.

E. Floor Coatings: 1. Floor Paint, Latex, Low Gloss (Maximum Gloss Level 3): MPI #60.

2.6 PATCHING MATERIALS

A. Wood-Patching Compound: Two-part, epoxy-resin, wood-patching compound; knife-grade formulation as recommended in writing by manufacturer for type of wood repair indicated, tooling time required for the detail of work, and site conditions. Compound shall be designed for filling voids in damaged wood materials that have deteriorated from weathering and decay. Compound shall be capable of filling deep holes and spreading to

B. Metal-Patching Compound: Two-part, polyester-resin, metal-patching compound; knife-grade formulation as recommended in writing by manufacturer for type of metal repair indicated, tooling time required for the detail of work, and site conditions. Compound shall be produced for filling metal that has deteriorated from corrosion. Filler shall be capable of filling deep holes and spreading to feather edge. C. Cementitious Patching Compounds: Cementitious patching compounds

and repair materials specifically manufactured for filling cementitious substrates and for sanding or tooling prior to repainting; formulation as recommended in writing by manufacturer for type of cementitious substrate indicated, exposure to weather and traffic, the detail of work, and site conditions.

PART 3 - EXECUTION

3.1 MAINTENANCE REPAINTING, GENERAL A. Execution of the Work: In repainting surfaces, disturb them as minimally

as possible and as follows: 1. Remove failed coatings and corrosion and repaint. a. Lead Paint: Many school buildings on campus were constructed before 1978 and any disturbance to existing paint will require appropriate testing for existing lead paint and appropriate removal of disturbed lead paint by an EPA certified contractor. Refer to the contract language.

2. Verify that substrate surface conditions are suitable for repainting. 3. Allow other trades to repair items in place before repainting. B. Mechanical Abrasion: Where mechanical abrasion is needed for the work, use gentle methods, such as scraping and lightly hand sanding, that will not abrade softer substrates, reducing clarity of detail.

C. Heat Processes: Do not use torches, heat guns, or heat plates

A. Examine substrates and conditions, with Installer present, for compliance with requirements for maximum moisture content and other conditions affecting performance of painting work. Comply with paint manufacturer's

written instructions for inspection. B. Maximum Moisture Content of Substrates: Do not begin application of coatings unless moisture content of exposed surface is below the maximum value recommended in writing by paint manufacturer and not greater than the following maximum values when measured with an electronic moisture

meter appropriate to the substrate material: 1. Concrete or Fiber Cement: 12 percent. 2. Masonry (Clay and CMU): 12 percent.

3. Portland Cement Plaster: 12 percent. 4. Wood: 15 percent. C. Alkalinity: Do not begin application of coatings unless surface alkalinity is within range recommended in writing by paint manufacturer. Conduct alkali testing with litmus paper on exposed plaster, cementitious, and masonry

surfaces.

3.3 PREPARATORY CLEANING A. General: Use the gentlest, appropriate method necessary to clean surfaces in preparation for painting. Clean all surfaces, corners, contours,

B. Detergent Cleaning: Wash surfaces by hand using clean rags, sponges, and bristle brushes. Scrub surface with detergent solution and bristle brush until soil is thoroughly dislodged and can be removed by rinsing. Use small brushes to remove soil from joints and crevices. Dip brush in solution often to ensure that adequate fresh detergent is used and that surface remains wet. Rinse with water applied by clean rags or sponges.

C. Solvent Cleaning: Use solvent cleaning to remove oil, grease, smoke, tar, and asphalt from painted or unpainted surfaces before other preparation work. Wipe surfaces with solvent using clean rags and sponges. If necessary, spot-solvent cleaning may be employed just prior to commencement of paint application, provided enough time is allowed for complete evaporation. Use clean solvent and clean rags for the final wash to ensure that all foreign materials have been removed. Do not use solvents, including primer thinner

and turpentine, that leave residue. D. Mildew: Clean off existing mildew, algae, moss, plant material, loose paint, grease, dirt, and other debris by scrubbing with bristle brush or sponge and detergent solution. Scrub mildewed areas with mildeweide. Rinse with water applied by clean rags or sponges. E. Chemical Rust Removal:

1. Remove loose rust scale with specified abrasives for ferrous-metal cleaning. 2. Apply rust remover with brushes or as recommended in writing by

manufacturer. 3. Allow rust remover to remain on surface for period recommended in writing by manufacturer or as determined by preconstruction testing. Do not allow extended dwell time. 4. Wipe off residue with mineral spirits and either steel wool or soft rags, or clean with method recommended in writing by manufacturer

5. Dry immediately with clean, soft cloths. Follow direction of grain in 6. Prime immediately to prevent rust. Do not touch cleaned metal

to remove residue.

surface until primed.

F. Mechanical Rust Removal: 1. Remove rust with specified abrasives for ferrous-metal cleaning. Clean to bright metal. 2. Wipe off residue with mineral spirits and either steel wool or soft

3. Dry immediately with clean, soft cloths. Follow direction of grain in

4. Prime immediately to prevent rust. Do not touch cleaned metal surface until primed.

3.4 PAINT REMOVAL

A. General: Remove paint where existing paint adherence or surface integrity has failed. Where cleaning methods have been attempted and further removal of the paint is required because of incompatible or unsatisfactory surfaces for repainting, remove paint to extent required by conditions. 1. Brushes: Use brushes that are resistant to chemicals being used. a. Metal Substrates: If using wire brushes on metal, use brushes of same metal composition as metal being treated.

b. Wood Substrates: Do not use wire brushes. 2. Spray Equipment: Use spray equipment that provides controlled application at volume and pressure indicated, measured at nozzle. Adjust pressure and volume to ensure that spray methods do not damage surfaces.

a. Equip units with pressure gages b. Unless otherwise indicated, hold spray nozzle at least 6 inches (150 mm) from surface and apply material in horizontal, back-and-forth sweeping motion, overlapping previous strokes to produce uniform coverage.

c. For chemical spray application, use low-pressure tank or chemical pump suitable for chemical indicated, equipped with nozzle having a cone-shaped spray. d. For water-spray application, use fan-shaped spray tip that disperses water at an angle of 25 to 50 degrees. e. For heated water-spray application, use equipment

capable of maintaining temperature between 140 and 160 deg F (60 and 71 deg C) at flow rates indicated. B. Paint Removal with Hand Tools: Remove paint manually using hand-held scrapers, wire brushes, sandpaper, and metallic wool as appropriate for the substrate material.

C. Paint Removal with Low-Odor, water based paste paint remover: 1. Apply thick coating of paint remover to dry, painted surface with natural-fiber cleaning brush, deep-nap roller, or large paintbrush. Apply in one or two coats according to manufacturer's written 2. Allow paint remover to remain on surface for period recommended

in writing by manufacturer or as determined by preconstruction 3. Rinse with water applied by low-pressure spray to remove chemicals and paint residue.

manufacturer to remove chemicals and paint residue. 5. Repeat process if necessary to remove all paint.

4. Use mechanical methods recommended in writing by

3.5 SUBSTRATE REPAIR A. General: Repair substrate surface defects that are inconsistent with the surface appearance of adjacent materials and finishes. B. Wood Substrate:

> 1. Repair wood defects including dents and gouges more than 1/8 inch (3 mm) in size and all holes and cracks by filling with woodpatching compound and sanding smooth. Reset or remove protruding 2. Where existing paint is allowed to remain, sand irregular buildup

of paint, runs, and sags to achieve a uniformly smooth surface. C. Cementitious Material Substrate: 1. General: Repair defects including dents and chips more than 1/4 inch (6 mm) in size and all holes and cracks by filling with cementitious patching compound and sanding smooth. Remove

protruding fasteners. 2. New and Bare Plaster: Neutralize surface of plaster with mild acid solution as recommended in writing by paint manufacturer. In lieu of acid neutralization, follow manufacturer's written instruction for primer or transition coat over alkaline plaster surfaces. 3. Concrete, Cement Plaster, and Other Cementitious Products: Remove efflorescence, chalk, dust, dirt, grease, oils, and release agents. If surfaces are too alkaline to paint, correct this condition

before painting. 1. Preparation: Treat repair locations by wire-brushing and solvent cleaning. Use chemical or mechanical rust removal method to clean

2. Defects in Metal Surfaces: Repair non-load-bearing defects in existing metal surfaces, including dents and gouges more than 1/8 inch (3 mm) deep or 1/2 inch (13 mm) across and all holes and cracks by filling with metal-patching compound and sanding smooth. Remove burrs and protruding fasteners. 3. Priming: Prime iron and steel surfaces immediately after repair to prevent flash rusting. Stripe paint corners, crevices, bolts, welds, and

sharp edges. Apply two coats to surfaces that are inaccessible after

completion of the Work.

3.6 PAINT APPLICATION, GENERAL A. Prepare surfaces to be painted according to the Surface-Preparation Schedule and with manufacturer's written instructions for each substrate condition

B. Apply a transition coat over incompatible existing coatings. C. Metal Substrate: Stripe coat corners, crevices, bolts, welds, and sharp edges before applying full coat. Apply two coats to surfaces that are inaccessible after completion of the Work. Tint stripe coat different than the main coating and apply with brush. D. Blending Painted Surfaces: When painting new substrates patched into existing surfaces or touching up missing or damaged finishes, apply coating

system specified for the specific substrate. Apply final finish coat over entire

surface from edge to edge and corner to corner.

3.7 FIELD QUALITY CONTROL A. Manufacturer's Field Service: Engage paint-remover manufacturer's factory-authorized service representative for consultation and Project-site inspection and to provide on-site assistance when requested by Architect.

3.8 CLEANING AND PROTECTION

A. At end of each workday, remove rubbish, empty cans, rags, and other discarded materials from Project site. B. Protect work of other trades against damage from paint application. Correct damage to work of other trades by cleaning, repairing, replacing, and refinishing, as approved by Architect, and leave in an undamaged condition. C. At completion of construction activities of other trades, touch up and restore damaged or defaced painted surfaces.

3.9 SURFACE-PREPARATION SCHEDULE

written instructions

A. General: Before painting, prepare surfaces for painting according to applicable requirements specified in this schedule. 1. Examine surfaces to evaluate each surface condition according to paragraphs below. 2. Where existing degree of soiling prevents examination, preclean

surface and allow it to dry before making an evaluation. 3. Repair substrate defects according to "Substrate Repair" Article. B. Surface Preparation for MPI DSD 0 Degree of Surface Degradation: 1. Surface Condition: Existing paint film in good condition and tightly

adhered. 2. Paint Removal: Not required. 3. Preparation for Painting: Wash surface by detergent cleaning; use solvent cleaning where needed. Roughen or degloss cleaned

surfaces to ensure paint adhesion according to paint manufacturer's

C. Surface Preparation for MPI DSD 1 Degree of Surface Degradation: 1. Surface Condition: Paint film cracked or broken but adhered. 2. Paint Removal: Scrape by hand-tool cleaning methods to remove loose paint until only tightly adhered paint remains. 3. Preparation for Painting: Wash surface by detergent cleaning; use other cleaning methods for small areas of bare substrate if required. Roughen, degloss, and sand the cleaned surfaces to ensure paint adhesion and a smooth finish according to paint manufacturer's written instructions.

D. Surface Preparation for MPI DSD 2 Degree of Surface Degradation: 1. Surface Condition: Paint film loose, flaking, or peeling. 2. Paint Removal: Remove loose, flaking, or peeling paint film by hand-tool or chemical paint-removal methods.

3. Preparation for Painting: Wash surface by detergent cleaning; use solvent cleaning where needed. Use other cleaning methods for small areas of bare substrate if required. Sand surfaces to smooth remaining paint film edges. Prepare bare cleaned surface to be painted according to paint manufacturer's written instructions for substrate construction materials.

E. Surface Preparation for MPI DSD 3 Degree of Surface Degradation: 1. Surface Condition: Paint film severely deteriorated. 2. Paint Removal: Completely remove paint film by hand-tool or chemical paint-removal methods. Remove rust. 3. Preparation for Painting: Prepare bare cleaned surface according to paint manufacturer's written instructions for substrate construction materials.

F. Surface Preparation for MPI DSD 4 Degree of Surface Degradation: 1. Surface Condition: Missing material, small holes and openings, and deteriorated or corroded substrate. 2. Substrate Preparation: Repair, replace, and treat substrate according to "Substrate Repair" Article. 3. Preparation for Painting: Sand substrate surfaces to smooth remaining paint film edges and prepare according to paint manufacturer's written instructions for substrate construction materials. Remove rust. 4. Painting: Paint as required for MPI DSD 2 degree of surface degradation.

3.10 EXTERIOR MAINTENANCE REPAINTING SCHEDULE A. Cementitious Substrates Horizontal:

1. Latex System: MPI REX 3.1 system: a. Prime Coat: For MPI DSD 1 degree of surface degradation, touch up with topcoat. b. Prime Coat: For MPI DSD 2 degree of surface degradation, spot prime with Primer, Alkali Resistant, Water Based,

c. Prime Coat: For MPI DSD 3 degree of surface degradation, fully prime coat with Primer, Alkali Resistant, Water Based, d. Intermediate Coat: Latex, exterior, matching topcoat. e. Topcoat: Floor Paint, Latex, exterior, low sheen (Gloss Level 3), MPI #60.

f. Color: Match colors indicated on Drawings. B. Cementitious/composite Substrates Vertical: 1. Latex System: MPI REX 3.2 system:

> a. Prime Coat: For MPI DSD 1 degree of surface degradation, touch up with topcoat. b. Prime Coat: For MPI DSD 2 degree of surface degradation, spot prime with Primer, Alkali Resistant, Water Based, MPI #3.

c. Prime Coat: For MPI DSD 3 degree of surface degradation, fully prime coat with Primer, Alkali Resistant, Water Based, d. Intermediate Coat: Latex, exterior, matching topcoat. e. Topcoat: Latex, Exterior, low sheen (Gloss Level 3),

f. Color: Match colors indicated on Drawings.

C. Ferrous Metal Substrates:: 1. Latex System: MPI REX 5.1 system over a transition coat where a. Prime Coat: For MPI DSD1 degree of surface degradation,

> touch up with topcoat. b. Prime Coat: For MPI DSD 2 degree of surface degradation, spot prime with Primer, Rust-Inhibitive, Water Based. c. Prime Coat: For MPI DSD 3 degree of surface degradation, fully prime coat with Primer, Rust-Inhibitive, Water Based, MPI #107.

d. Intermediate Coat: Latex, exterior, matching topcoat.

e. Topcoat: Latex, Exterior, low sheen (Gloss Level 3), MPI #15. f. Color: Match colors indicated on Drawings. D. Galvanized Ferrous Metal Substrates::

1. Latex System: MPI REX 5.3 system over a transition coat where a. Prime Coat: For MPI DSD 1 degree of surface degradation, touch up with topcoat. b. Prime Coat: For MPI DSD 2 degree of surface degradation,

c. Prime Coat: For MPI DSD 3 degree of surface degradation, fully prime coat with Primer, Galvanized, Water Based, MPI #134. d. Intermediate Coat: Latex, exterior, matching topcoat. e. Topcoat: Latex, Exterior, low sheen (Gloss Level 3),

MPI #15. b. Color: Match colors indicated on Drawings.

E. Wood Paneling and Plywood: 1. Latex System: MPI REX 6.4 system. a. Prime Coat: For MPI DSD 1 degree of surface degradation, touch up with topcoat. b. Prime Coat: For MPI DSD 2 degree of surface degradation, spot prime with Primer, Latex for Exterior Wood, MPI #6.

spot prime with Primer, Galvanized, Water Based, MPI #134.

c. Prime Coat: For MPI DSD 3 degree of surface degradation, fully prime coat with Primer, Latex for Exterior Wood, d. Intermediate Coat: Latex, exterior, matching topcoat. e. Topcoat: Latex, Exterior, low sheen (Gloss Level 3),

MPI #15.

f. Color: Match colors indicated on Drawings. F. Dimensional Wood: 1. Latex System: MPI REX 6.3A system. a. Prime Coat: For MPI DSD 1 degree of surface degradation, touch up with topcoat. b. Prime Coat: For MPI DSD 2 degree of surface degradation,

> spot prime with Primer, Latex for Exterior Wood, MPI #6. c. Prime Coat: For MPI DSD 3 degree of surface degradation, fully prime coat with Primer, Latex for Exterior Wood, d. Intermediate Coat: Latex, exterior, matching topcoat. e. Topcoat: Latex, Exterior, low sheen (Gloss Level 3),

f. Color: Match colors indicated on Drawings. G. Portland Cement Plaster:

MPI #15.

1. Latex System: MPI REX 9.1 system: a. Prime Coat: For MPI DSD 1 degree of surface degradation, touch up with topcoat. b. Prime Coat: For MPI DSD 2 degree of surface degradation, spot prime with Primer, Alkali Resistant, Water Based,

> c. Prime Coat: For MPI DSD 3 degree of surface degradation, fully prime coat with Primer, Alkali Resistant, Water Based, MPI #3. d. Intermediate Coat: Latex, exterior, matching topcoat. e. Topcoat: Latex, Exterior, low sheen (Gloss Level 3),

f. Color: Match colors indicated on Drawings.

AGENCY APPROVAL:



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CONSULTANTS:

SEALS:

PROJECT:

NORDHOFF HS CAMPUS-WIDE EXTERIOR PAINTING

OWNER:

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PROJECT ADDRESS:

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1401 MARICOPA HIGHWAY

OJAI, CA 93023 ISSUE: MARK DATE DESCRIPTION

PROJECT INFORMATION: PROJECT NUMBER: 2020.031 PROJECT PHASE: 04CONDOC

THE ORIGINAL SIZE OF THIS SHEET IS 36"x24". IF THE CURRENT SIZE IS OTHER THAN 36"x24", THEN ADJUST THE SCALE OF THE DRAWINGS ACCORDING! V SHEET TITLE:

MEH

SPECIFICATIONS

SHEET NUMBER:

DATE: 08/18/2020

DRAWN BY:

REVIEWED BY:

SECTION 09 91 13 PAINTING

1.01 DESCRIPTION: Division 1 applies to this section. Provide and perform painting,

A. Work In This Section: Principal items include:

2. Painting of interior surfaces, except as otherwise specified. 3. Painting of exterior surfaces, except as otherwise specified. B. Related Work Not In This Section:

1. Shop prime coats and factory finishes. 2. Painting specified as work of other sections.

3. Caulking and sealants. C. Surfaces Not To Be Painted:

1. Non-ferrous metal work (other than zinc-coated surfaces) and plated metal, unless particular items are specified to be painted. 2. Stone surfaces.

3. Exterior concrete walls and surfaces unless particular items are specified to be

4. Surfaces concealed in walls and above solid ceilings. 5. Non-metallic walking surfaces unless specifically shown or specified to be painted.

6. Factory finished surfaces.

7. Ceramic tile and plastic surfaces.

9. Galvanized fencing.

11. Surfaces indicated not to be painted.

12. Surfaces specified to be finish painted under other sections.

1.02 COMPLIANCE WITH REGULATIONS: All materials shall comply with the current rules and regulations of the local air quality management district, with the rules regarding volatile organic compounds, and with FDA rules and regulations for dangerous materials in paint.

A. List of Paint Materials: Prior to submittal of samples, submit a complete list of proposed paint materials, identifying each material by manufacturer's name, product name and number, including primers, thinners, and coloring agents, together with manufacturers' catalog data fully describing each material as to contents, recommended usage, and preparation and application methods. Identify surfaces to receive various paint materials. Do not deviate from approved list.

B, Color Samples: Prior to preparing samples, obtain color and gloss selections and instructions. Using materials from approved list, prepare and submit 8-1/2" by 11" samples of each complete opaque paint finish. C. Natural or Stain Finish Samples: Prepare samples on 12" squares of the same

be finished with each material, color, and gloss, in locations as directed. Prime and intermediate coats shall extend one foot beyond finish coat on each sample in at least 2 directions. Obtain approval of each sample prior to proceeding with the work. Leave the samples in place, with removable tags, until completion of the work. All

E. Certificates: Submit certificate showing that all products meet the requirements of paragraph "Compliance with Regulations" above.

1.04 JOB CONDITIONS: A. Protection: Protect all painting while in progress and cover and protect adjoining surfaces and property of others from damage. Exercise care to prevent paint from contacting surfaces not to be painted. During painting of exterior work, cover windows, doors, concrete, and other surfaces not to be painted.

B. Examination of Surfaces: Examine surfaces to be painted or finished under this Section and verify satisfactory condition. Unsatisfactory conditions shall be corrected before application of the first coat of paint.

C. Weather Conditions: Apply paint to clean, dry, prepared surfaces. Do not apply exterior paint during rainy, damp, foggy, or excessively hot and/or windy weather. Arrange for temporary heat and ventilation for interior painting. D. Precaution: Place rags and waste in self-closing metal containers, removed from

site at the end of each day. Do not let rags and waste accumulate. 1.07 EXTRA STOCK: A. Provide a one gallon container of each paint color and surface texture to Owner at

B. Label each container with color, texture, and original application locations, in

to the manufacturer's label.

PART 2 - PRODUCTS 2.01 ACCEPTABLE MANUFACTURERS:

Dunn-Edwards Corp. (Basis of Design) 4885 E. 52nd Place

Los Angeles CA, 90058 (323) 771-3330 Benjamin Moore & Co. 51 Chestnut Ridge Road

(888) 236-6667 Vista Paint Corporation 2020 Orangethorpe Avenue, Suite 210

Fullerton CA 92831 (323) 397-9000 FAX (323) 883-0273

PART 3 - EXECUTION 3.01 WORKMANSHIP: Apply painting materials in accordance with manufacturer's instructions by brush or roller; spray painting is not allowed without specific approval in each case. Apply each coat at the proper consistency, free of brush or roller marks, sags, runs, or other evidence of poor workmanship. Do not lap paint on glass, hardware, and other surfaces not to be painted; apply masking as required. Sand between enamel coats. Apply painting materials in accordance with manufacturer's 3.02 PREPARATION OF SURFACES: Properly prepare surfaces to receive finishes. A. Concrete: Fill cracks, holes, and other blemishes with Portland cement patching plaster or a stiff paste mixed of finish paint and fine sand, finished to match adjoining surfaces. Remove glaze by sanding, wire brushing, or light brush-off sandblasting. Neutralize all alkali conditions according to the paint manufacturer's directions. Dry surfaces to receive breathing type latex paints at least two weeks, free of visible moisture. Dry the surfaces to receive oil, alkyd, or epoxy based paint until the moisture content does not exceed 8% when tested with an electronic moisture-measuring instrument. B. Masonry: Repair minor holes and cracks with a stiff paste of finish paint and fine

sand or vinyl type block filler. Report major or unsightly defects for correction. Neutralize all alkali and efflorescence according to paint manufacturer's directions,

C. Exterior Plaster: Fill hairline cracks with Portland cement patching material; report larger cracks for correction. Test and ensure plaster is sufficiently dry to receive the D. Gypsum Wallboard: Touch-up minor defects with spackle and sand smooth and

flush. Report other defects as specified. Verify that skim coat specified in Section 09250 is properly applied. If not, apply one heavy coat of skim coat material specified in Section 09250, over entire surface by brush or roller. E. Shop Coated Metal: Degrease and clean of foreign matter. Clean and spot prime field connections, welds, soldered joints, burned, or abraded portions with same

F. Uncoated Ferrous Metal: Degrease and clean of dirt, rust, mill scale, and all other foreign matter using power tool rotary brushes to achieve a clean surface consistent with SSPC-SP3. Remove pits and welding slag, and clean surfaces to bright metal before priming. Apply metal primer not more than three hours after preparation. G. Galvanized Metal: Eliminate contaminants and stabilize zinc film by solvent wiping or sweep blasting, as appropriate, followed by not less than one coat of wash primer of type specified in Paint Schedule hereafter, to provide suitable surface for finish painting. Allow to dry. Prepare a representative surface, not smaller than 24" square,

or 36" by length of section, as applicable, and obtain approval prior to proceeding. 1. Solvent wiping: Remove oil and grease with rags or brushes saturated in trisodium phosphate or similar alkaline detergent. For heavier soil, use MEK, or equivalent proprietary cleaner. Do not use vinegar or acetic acid. 2. Sweep blasting: Use aluminum/magnesiumsilicate, limestone or other nonmetallic blast media to expose pure zinc. 3. Wash primer: Spray apply one coat of specified wash primer after other preparation is complete, to thickness of 0.5 mils. Allow to dry 60 minutes, and

apply top coating in not more than 4 hours, If this time is exceeded for any

reason, reapply wash primer prior to applying finish paint.

H.Enameled Woodwork: Remove handling marks and effects of exposure to moisture with a thorough sanding overall surfaces of the exposed portions, using at least 150 grit of finer sandpaper and thoroguhly clean all surfaces before applying sealer. After priming, putty nail holes, cracks, or other defects with putty matching color of finish paint. Cover knots and sappy areas with shallac or approved knot sealer. Sand each base coat smooth when dry.

I. Transparent Finished Woodwork: Remove handling marks and effects of exposure to moisture with a thorough sanding parallel to the grain of the wood, over all surfaces of the exposed portions, including interiors of cases and drawers, using at least 150 grit or finer sandpaper and thoroughly clean all surfaces before applying sealer. Repair all defects with filler tinted to match stain or wood color, as required, after first coat of sanding sealer and remove all smears. J. Fixtures, Equipment, and Flardware Items: Coordinate with the work of other

sections, and coordinate removal of fixtures, equipment, and hardware as required to perform painting. Items to be removed include, without limitation: signs and graphics; switch and receptacle plates; escutcheons and plates; all surface-mounted equipment; free-standing equipment blocking access; grilles and louvers at ducts opening into finished spaces; and other items as required and directed. Surfaces Not Mentioned: Prepare surfaces according to recommendations of the

paint manufacturer and as approved. K. Surfaces Not Mentioned: Prepare surfaces according to recommendations of the paint manufacturer and as approved.

L. Moisture Content: Measure moisture at surfaces using an electronic moisture

Do not apply finishes unless moisture is below the following maximums:

1. Exterior Plaster and Concrete: 15 percent

2. Exterior Wood: 19 percent 12 percent Interior Wood:4. 1 5 percent 3. Interior Gypsum Wallboard: measured in accordance with ASTM D2016

3.03 COATS: The number of paint coats specified to be applied are minimum. Apply additional coats if required to obtain complete hiding and approved results. Ensure acceptable paint finishes of uniform color, free from cloudy or mottled areas and evident thinness on arises. "Spot" or undercoat surfaces as necessary to produce such results. Tint each coat a slightly different shade of finish color to permit identification. Conform to the approved Samples. Obtain approval of each coat before applying next coat; otherwise, apply an additional coat over entire surface involved at no additional contract cost.

3.04 COLORS: The numbers given in the following schedule indicate the types of paints required for each surface, identified by their number in white. The actual paint to be applied on each surface shall be the same material in the color or colors as selected, and as approved on submitted samples. Allow for the use of several colors in each room or space, and for doors, frames, dadoes, trim and other items to be finished in different colors.

3.05 DEGREE OF GLOSS: Degrees of gloss shown on drawings and herein specified are approximate only. The exact degree of gloss required for each surface will be determined. Materials shall meet the following requirements for degree of gloss, when tested according to ASTM D523, using Gardner Laboratory 60 degree gloss meter after 14 days

/S.		
	NOMENCLATURE	PERCENTAGE OF GLOSS
	FLAT	LESS THAN 10
	SUEDE OR EGGSHELL	25 - 55
	SATIN OR SEMI-GLOSS	55 - 70
	GLOSS OR HIGH GLOSS	MORE THAN 70

3.06 MISCELLANEOUS PAINTING:

A. Fire Extinguisher and Fire Hose Cabinets and Fire Alarm Bells: Apply 2 coats of paint finish, inside and out, matching finish and color of adjoining areas, unless otherwise noted or directed.

B. Weatherstripping and Sound Seals. Paint exposed metal surfaces to match the door frame, whether or not unfinished, furnished with factory prime coat, or factory treated for paint adhesion.

C. Doors: Seal top and bottom edges after cleaning with coat of primer. Where the faces of the doors differ in color or finish, finish the edges to match the face visible when the door is open. Coat cutouts for hinges, edges of lockset holes and strikes same as for first coat.

D. Access doors and panels: Generally, paint same color as surrounding walls and

E. Louvers and glazed frames in wood and metal doors: Unless otherwise directed. paint 3 coats, colors to match doors.

G. Door Trim and Prime Coated Hinges: Paint trim to match door and paint hinges to match frame only where hinges are currently painted. Do not paint unfinished hinges. H. Speaker Grilles: Paint to match surrounding surfaces unless specified otherwise. I. Miscellaneous. For any items not specifically indicated or specified that require a paint finish, apply 3 coats of paint as directed.

3.07 CLEANING AND TOUCH-UP WORK. Make a detailed inspection of paint finishes after all painting is completed, remove spatterings of paint from the adjoining surfaces, and make good all damage that may be caused by cleaning operations. Carefully touch-up all abraded, stained, or otherwise disfigured painting, as approved, and leave entire painting in first-class condition.

1	<u>I AB</u> EXTERIOR PAIN	<u>LE 1</u> TING SCHEDULE	<u>.</u>
SURFACE, COATS	DUNN-EDWARDS	BENJAMIN MOORE	VISTA PAINT
PLASTER & CONCRETE (100% ACRYLIC FLAT) FIRST COAT SECOND COAT THIRD COAT	ESPR00 - EFF-STOP PREMIUM SSH10 - SPARTASHIELD10 SSH10 - SPARTASHIELD10	023 FRESH START PRIMER 105 MOORLIFE FLAT 105 MOORLIFE FLAT	4600 UNIPRIME 2000 DURATONE 2000 DURATONE
CONCRETE UNIT MASONRY 100% ACRYLIC FLAT FIRST COAT SECOND COAT THIRD COAT	SBSL00-SMOOTHBLOC-FIL SELECT SSH10 - SPARTASHIELD10 SSH10 - SPARTASHIELD10	285 LATEX BLOCK FILL 105 MOORLIFE FLAT 105 MOORLIFE FLAT	040 BLOCK KOTE 2000 DURATONE 2000 DURATONE
FERROUS METAL 100% ACRYLIC SEMIGLOSS ENAMEL FIRST COAT SECOND COAT THIRD COAT	BRPR00-BLOC-RUST PREMIUM SSH10 - SPARTASHIELD10 SSH10 - SPARTASHIELD10	M)4 ACRYLIC METAL PRIMER 096 MOORGLO 096 MOORGLO	4800 METAL PRO PRIMER 8400 CAREFREE 8400 CAREFREE
GALVANIZED METAL, 100% ACRYLIC SEMI-GLOSS ENAMEL PRETREAT FIRST COAT SECOND COAT THIRD COAT	SC-ME01 - KRUD KUTTER METRL CLEAN AND ETCH UGPR00 - ULTRAGRIP PREMIUM SSH10 - SPARTASHIELD10 SSH10 - SPARTASHIELD10	JASCO PREP N'PRIME M04 ACRYLIC METAL PRIMER 096 MOORGLO 096 MOORGLO	JASCO PREP N'PRIME 4800 METAL PRO PRIMEF 8400 CAREFREE 8400 CAREFREE
WOOD - PAINTED, 100% ACRYLIC SEMI-GLOSS ENAMEL FIRST COAT SECOND COAT THIRD COAT	EZPR00 - E-Z PRIME PREMIUM SSH10 - SPARTASHIELD10 SSH10 - SPARTASHIELD10	023 FRESH START PRIMER 096 MOORGLO 096 MOORGLO	4200 TERMINATOR 8400 CAREFREE 8400 CAREFREE
WOOD, SEMI-TRANSPARENT STAIN FIRST COAT SECOND COAT	CABOT STAIN (IF REQUIRED) SEMI-SOLID	C329 WOOD STAIN C329 WOOD STAIN	OLYMPIC ST STAIN OLYMPIC ST STAIN
	TAB INTERIOR ENAM		
SURFACE, COATS	DUNN-EDWARDS	BENJAMIN MOORE	VISTA PAINT
100% ACRYLIC FINISH, GLOSS	SWLL50 SPARTAWALL60	309 IMPERVEX	8500 CAREFREE
100% ACRYLIC FINISH, SEMI- GLOSS WALLS AND CEILINGS ONLY NON-BLICKING, FOR DOORS AND WINDOWS	W6160E VERBAGLO SWLL50 SPARTAWALL60	276 MOORCRAFT 333 REGAL AQUAGLO	7000 ACRIGLO 8400 CAREFREE
100% ACRYLIC FINISH, EGGSHELL	W6Z50E VERSASATIN	277 SUPER SPEC PEARL	1700 COVERALL
	TAB INTERIOR PAINT		
SURFACE, COATS	DUNN-EDWARDS	BENJAMIN MOORE	VISTA PAINT
WOOD, SEMI-TRANSPARENT STAIN FIRST COAT SECOND COAT	SWLL50 SPARTAWALL60 SWLL50 SPARTAWALL60	215 REGAL WALL SATIN 215 REGAL WALL SATIN	8100 CAREFREE 8100 CAREFREE
CONCRETE UNIT MASONRY, ACRYLIC FLAT FINISH FIRST COAT SECOND COAT	SB5L00 - SMOOTH BLOCK- FIL SELECT ENAMEL FINISH	205 BLOCK FILLER 215 REGAL WALL SATIN	040 BLOCK KOTE 8100 CAREFREE
THIRD COAT	ENAMEL FINISH	215 REGAL WALL SATIN	8100 CAREFREE

C435 BENWOOD LOW LUSTER DEFTHANE SATIN CLEA

MO4ACRYLIC METAL RIMER 4800 METAL PRO

ENAMEL FINISH ENAMEL FINISH

ENAMEL FINISH ENAMEL FINISH

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CONSULTANTS:

SEALS:

PROJECT:

NORDHOFF HS CAMPUS-WIDE EXTERIOR **PAINTING**

OWNER:

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ISSUE:		
MARK	DATE	DESCRIPTION
PROJECT	INFORMATION	√ :
PROJECT	NUMBER:	2020.031
PROJECT PHASE:		04CONDOC
DRAWN B	Y:	PB

REVIEWED BY: THE ORIGINAL SIZE OF THIS SHEET IS 36"x24". IF THE CURRENT SIZE IS OTHER THAN 36"x24", THEN ADJUST THE SCALE OF THE DRAWINGS ACCORDINGLY


SPECIFICATIONS

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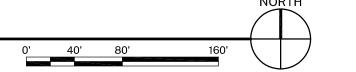
DATE: 08/18/2020

SHEET TITLE:



SITE PLAN

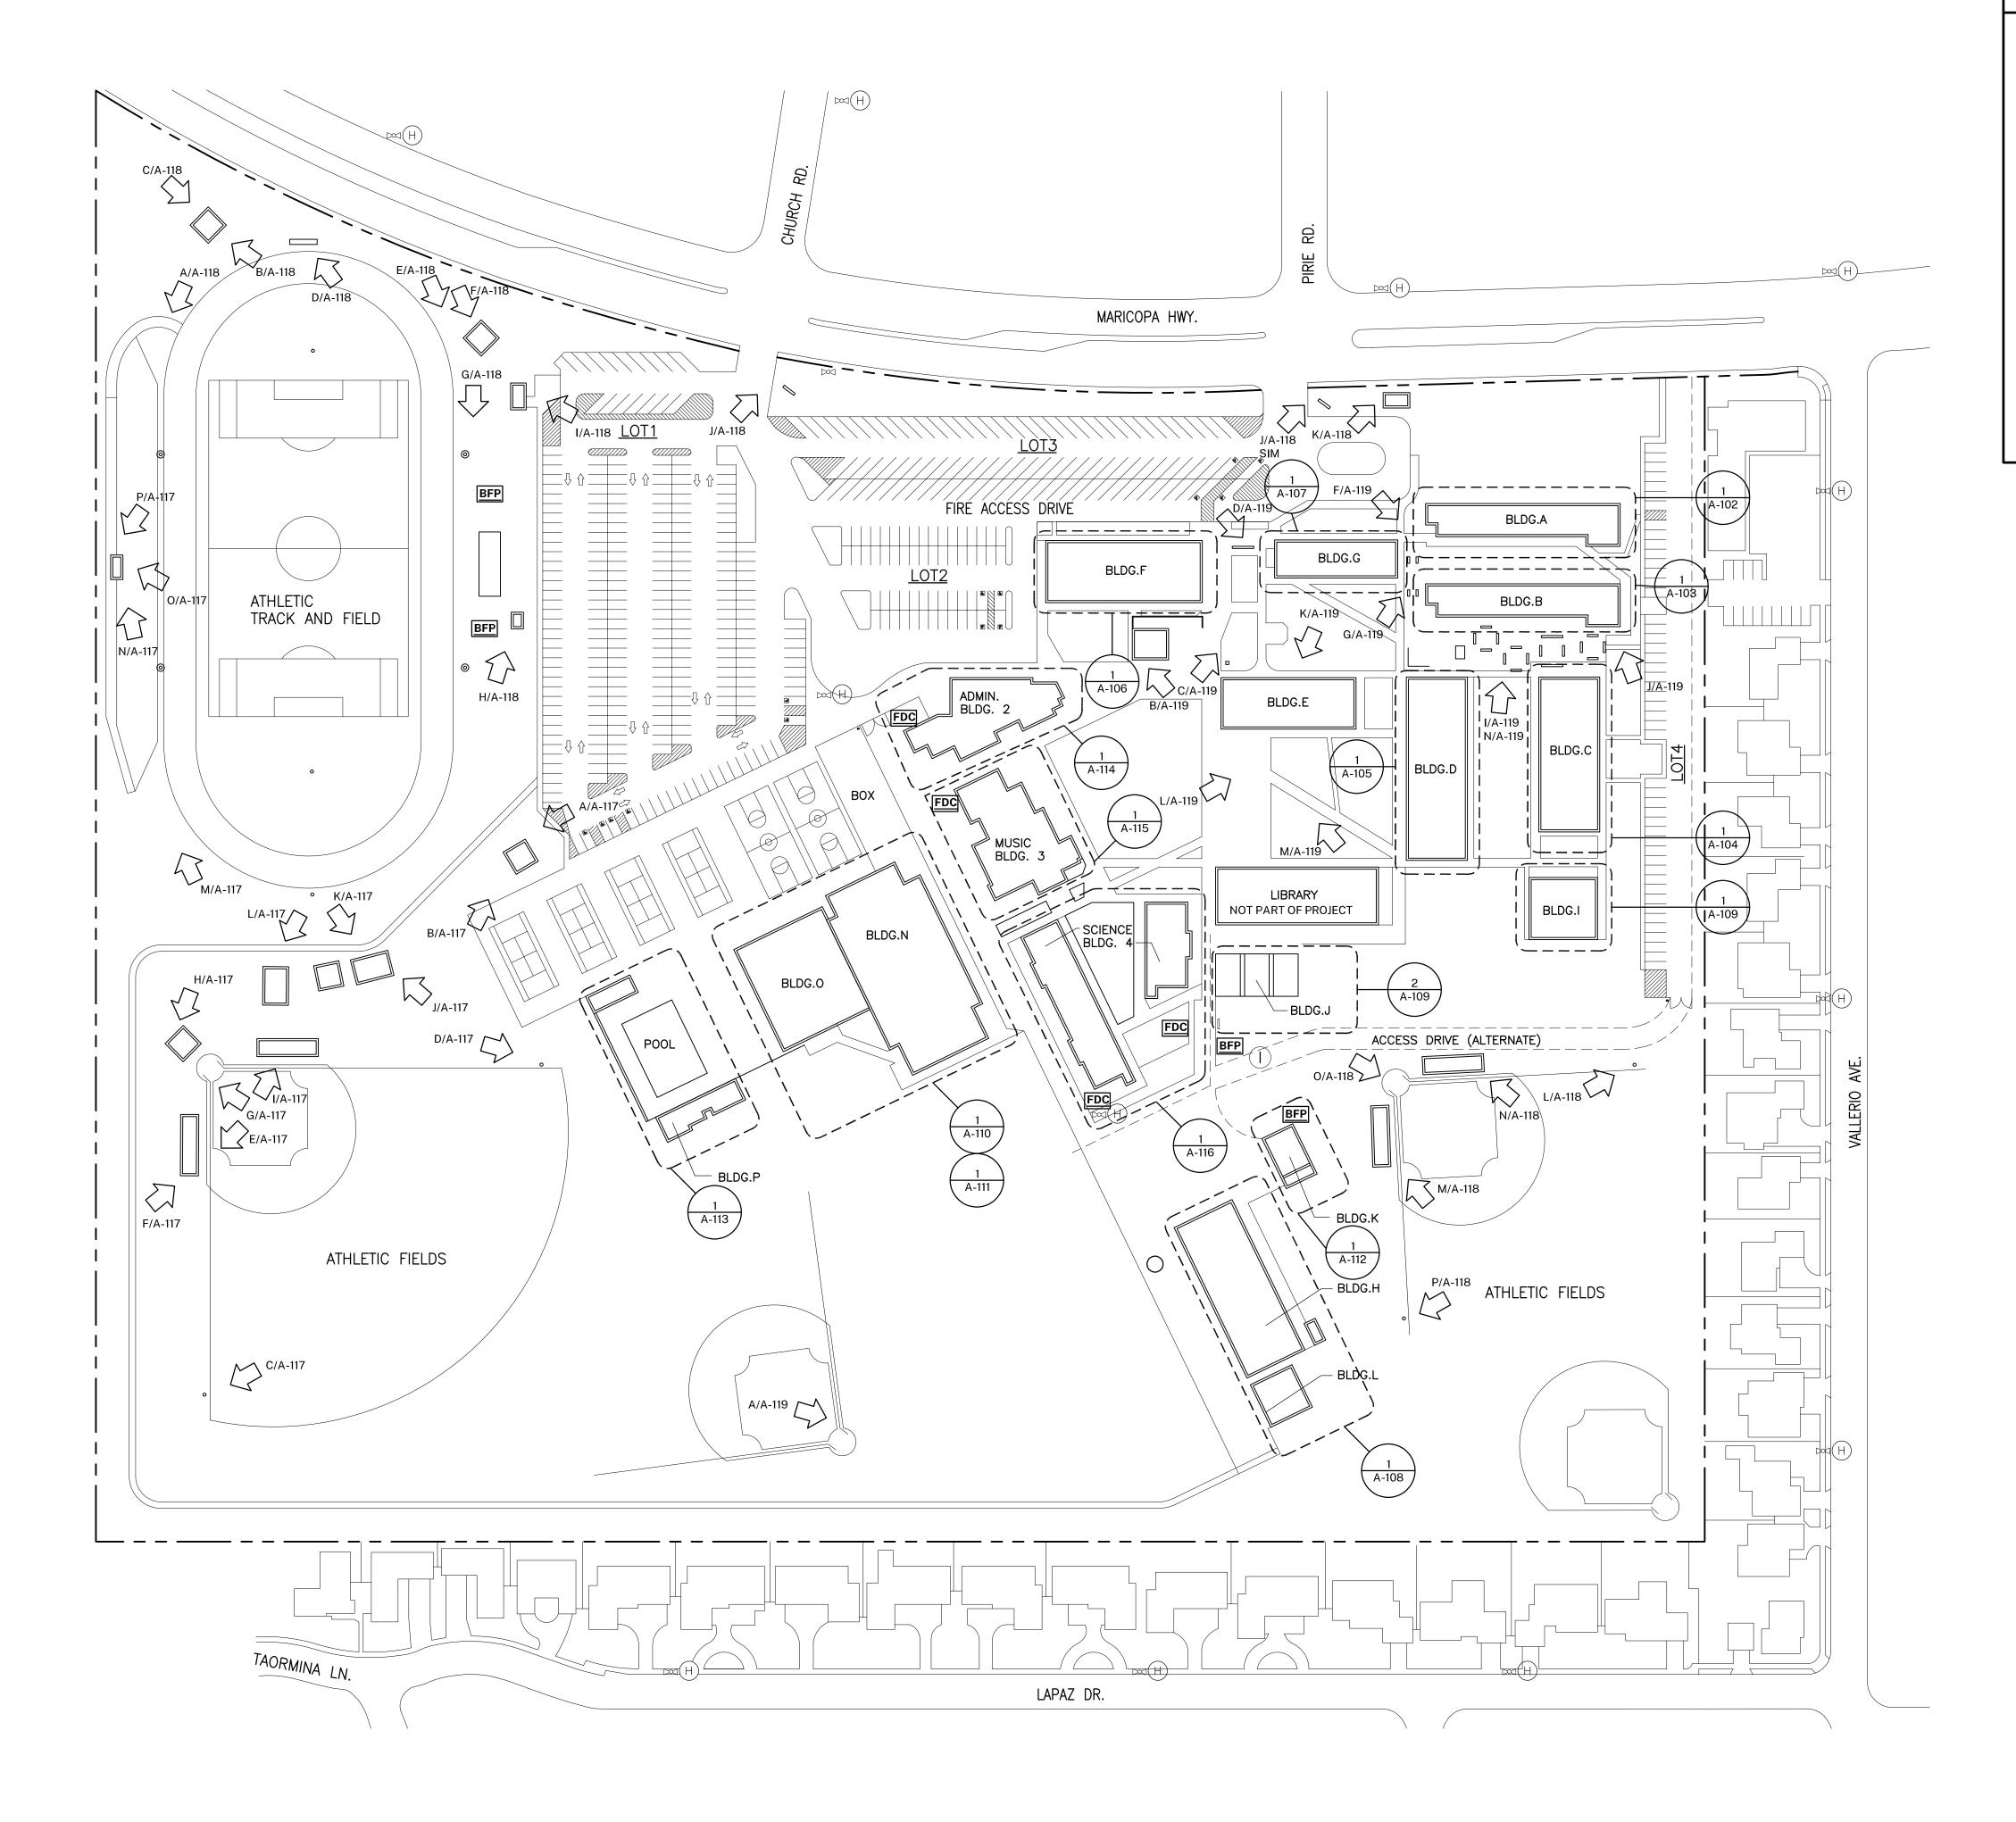†"=80'-0"



SYMBOL LEGEND

DOM (H)

PREP / PRIME / PAINT: EXISTING ON-CAMPUS FIRE HYDRANTS. COLOR = MATCH EXISTING "YELLOW"



PREP / PRIME / PAINT: EXISTING ON-CAMPUS BACKFLOW PREVENTION DEVICES. COLOR = MATCH EXISTING



PREP / PRIME / PAINT: EXISTING ON-CAMPUS FIRE DEPARTMENT CONNECTIONS. COLOR = "RED" MATCH



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ISSUE:		
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04CONDOC

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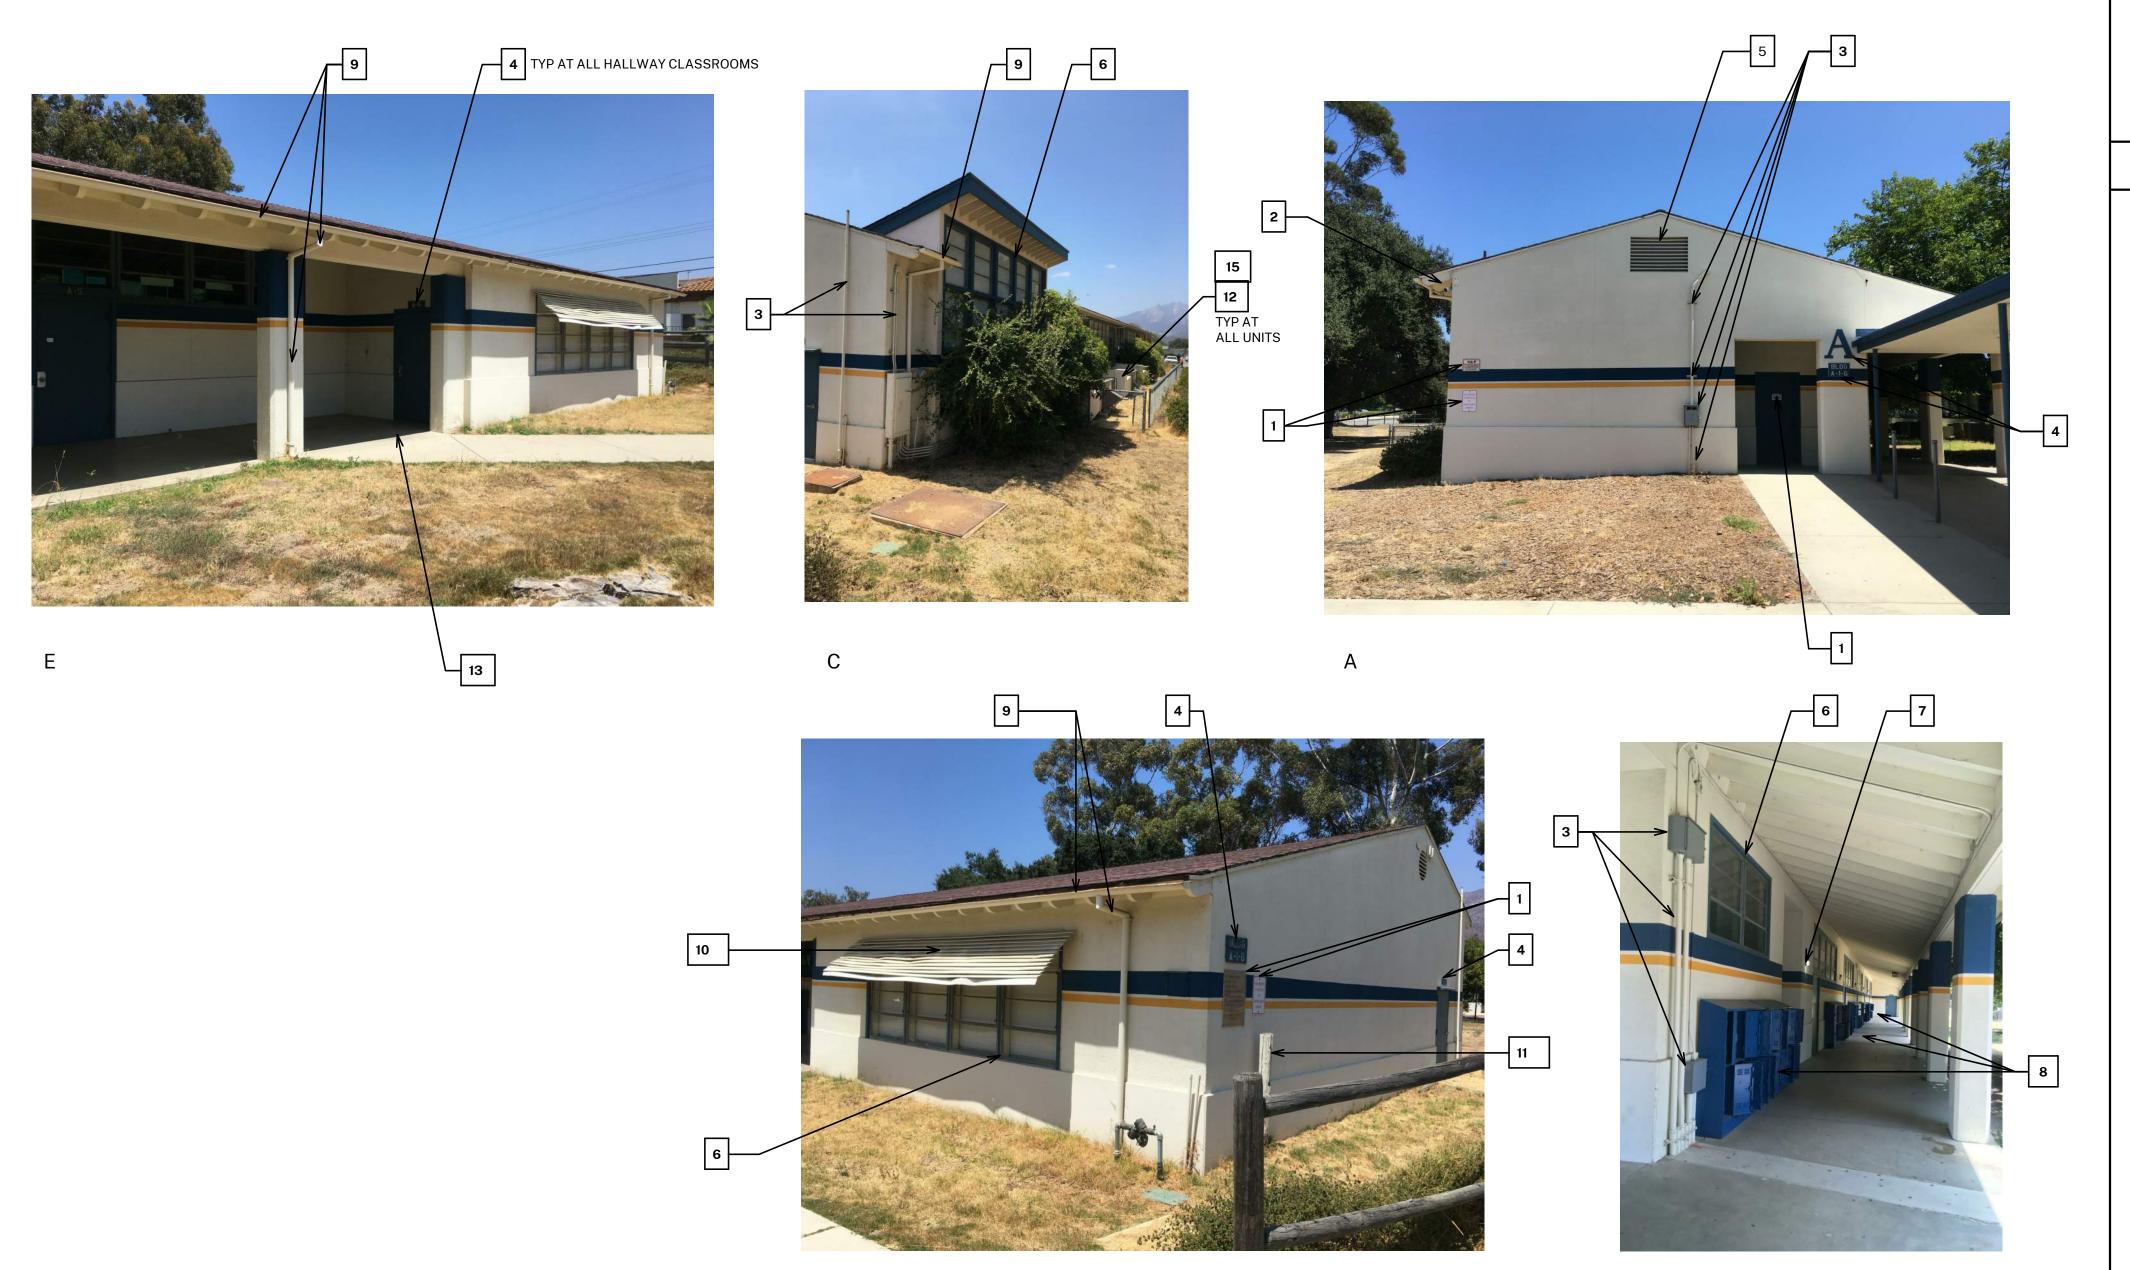
SHEET TITLE.

SITE PLAN

SHEET NUMBER:

DATE: 08/18/2020

A-10¹



- BUILDING PLANS ARE SCHEMATIC TO ONLY SHOW APPROXIMATE OVERALL BUILDING DIMENSIONS, DOOR QUANTITIES AND APPROXIMATE DOOR LOCATIONS AND ARE PROVIDED AS A CONVENIENCE FOR BIDDING. FIELD VERIFY CONDITIONS PRIOR TO BID. REFER TO SHEET KEYNOTES, PHOTOS, AND LEGENDS FOR ADDITIONAL INFORMATION.
- ALL EXISTING PAINTED EXTERIOR SURFACES OF BUILDINGS INCLUDED IN THE SCOPE OF WORK ARE TO BE REPAINTED TO MATCH THE EXISTING PAINTED COLOR AS DETAILED IN THESE DRAWINGS AND SPECIFICATIONS UNLESS NOTED OTHERWISE.
- ALL EXISTING UNPAINTED EXTERIOR SURFACES ARE TO REMAIN UNPAINTED UNLESS NOTED OTHERWISE. PROTECT IN PLACE ALL UNPAINTED SURFACES.
- CAREFULLY PRUNE SHRUBS AND PLANTS AND REMOVE WEEDS AND PLANTINGS AT BASE OF WALL TO BARE EARTH TO ALLOW FOR COMPLETE WALL COVERAGE.
- WINDOW FRAMES, MULLIONS, AND SEALANTS TO BE PAINTED COLOR 2.

COLOR LEGEND & NOTES

COLOR 1 - WHITE - Match SW 7013- Ivory Lace

COLOR 2 - BLUE - Match SW 6804- Dignity Blue

COLOR 3 - YELLOW - Match SW 6904- Gusto Gold

PHOTOS WITH KEYNOTES ARE CREATED ELECTRONICALLY AND ARE INTENDED TO BE VIEWED IN COLOR TO SEE LOCATIONS OF COLORS ON THE BUILDINGS. CONTRACTOR SHALL FIELD VERIFY ACTUAL LOCATIONS AND DIMENSIONS OF COLORS PRIOR TO BID.

SYMBOL LEGEND



EXISTING DOOR: FIELD VERIFY SIZES AND CONDITIONS, PAINT DOOR WARNING STRIPING ON LANDING AT ALL OUTSWINGING EXTERIOR DOORS U.N.O. PAINT EXTERIOR DOOR FACE, FRAME EXTERIOR AND INTERIOR JAMB TO FACE OF DOOR STOP.



EXISTING RESTROOM DOOR: FINISH AND STRIPING AS NOTED FOR TYPICAL EXTERIOR DOORS ABV. FIELD VERIFY SIZES AND CONDITIONS. APPLY RESTROOM IDENTIFICATION DOOR SIGNAGE ON

SHEET KEYNOTES

NOTE: NOT ALL KEYNOTES **USED ON EVERY SHEET**

- REMOVE / PAINT WALL / REINSTALL: EXISTING SIGN PROTECT IN PLACE: EXISTING SECURITY CAMERA TYPICAL AT ALL LOCATIONS
- PREP / PRIME / PAINT: UTILITY CONDUITS AND CABINETS TO MATCH WALL BEYOND. CONTINUE STRIPING OVER CONDUITS AND CABINETS WHERE OCCURS.
- PREP / PRIME / PAINT: EXISTING SIGNAGE IN PLACE
- PREP / PRIME / PAINT: EXISTING LOUVERS, TYPICAL PREP / PRIME / PAINT: GALVANIZED METAL WINDOW FRAME & WOOD TRIM. TYPICAL AT ALL WINDOWS THIS BUILDING. FIELD VERIFY LOCATIONS AND
- DIMENSIONS PRIOR TO BID. REMOVE / PAINT WALL / REINSTALL: LIGHT FIXTURE ESCUTCHEON PLATE OR LIGHT FIXTURE ITSELF TO WALL SURFACE BEHIND. TYPICAL AT ALL LIGHT
- REMOVE / WASH/ PREP / PRIME / PAINT / REINSTALL: ALL EXISTING LOCKERS
- IN THIS WING. PAINT ALL EXTERIOR SIDES, DOORS AND DOOR RETURNS ONLY. PROTECT UNPAINTED LOCKER HARDWARE.
- PREP / PRIME / PAINT: EXISTING GUTTERS AND DOWNSPOUTS. MATCH EXISTING WALL COLOR BEYOND.
- REMOVE / DISCARD: EXISTING METAL AWNING
- REMOVE / DISCARD WOODEN POST FILL IN HOLE
- PROTECT IN PLACE: EXISTING HVAC UNITS AND DUCTWORK
- PREP / PRIME / PAINT: DOOR SWING SAFETY STRIPING. TYPICAL AT ALL DOORS THIS BUILDING U.N.O.
- PROTECT IN PLACE: EXISTING LIGHT FIXTURE / SPEAKER / FIRE ALARM
- PREP / PRIME / PAINT: EXISTING HVAC DUCTWORK WHERE ALREADY PAINTED. TYPICAL AT THIS BUILDING. PROTECT IN PLACE: EXISTING MURAL. PAINT WALLS AROUND MURAL TO
- MATCH EXISTING BUILDING COLOR SCHEME. TOUCH-UP/REPAINT MURALS WHERE PAINTED TO MATCH EXISTING. PROTECT IN PLACE: EXISTING DRINKING FOUNTAIN PREP / PRIME / PAINT: EXISTING PAINTED DRINKING FOUNTAIN CANE
- DETECTION RAILS REMOVE / PAINT WALL / REINSTALL: EXISTING DISPLAY CASES
- REMOVE / DISCARD: EXISTING SIGN
- REMOVE / PAINT WALL / REINSTALL: EXISTING BENCHES
- PROTECT IN PLACE: EXISTING UNFINISHED CONCRETE OR CMU PREP / PRIME / PAINT: EXISTING CONCRETE / CMU WALL
- PREP / PRIME /PAINT: EXISTING METAL FENCE & GATE PROTECT IN PLACE: EXISTING MECHANICAL EQUIPMENT PROTECT IN PLACE: EXISTING GALVANIZED WINDOW FRAMES. TYPICAL AT ALL WINDOWS THIS BUILDING. PREP / PRIME / PAINT ALL PAINTED WINDOW
- PREP / PRIME / PAINT: EXISTING ROLL-UP DOOR PREP / PRIME / PAINT: EXISTING STORAGE CONTAINER
- PREP / PRIME / PAINT: EXISTING WOOD BENCH / SEATS AND SLEEERS. BID ALTERNATE #3: - REMOVE / REPLACE / PREP / PRIME / PAINT: EXISTING WOODEN BENCHES, SEATS AND 4x DECAY-RESISTANT SLEEPERS.
- PREP / PRIME / PAINT: EXISTING CMU WALLS. PAINT INSIDE AND OUTSIDE OF
- ENCLOSURE AND DOORS. PREP / PRIME / PAINT: ENTIRETY OF METAL CANOPY
- PAINT COLOR 2 PAINT COLOR 3
- REMOVE / PREP / PAINT/ REINSTALL: EXISTING DOOR OR WINDOW METAL
- SECURITY GRATING PATCH / REPAIR / PREP / PRIME / PAINT: EXISTING PLASTER
- PREP / PRIME / PAINT: EXISTING GRAPHICS ON NORTH SIDE OF GYM WALL. ADD COLOR 3 BORDER AROUND 'N.' BID ALTERNATE #1 - PROVIDE AND INSTALL EXTERIOR ADHESIVE WALL GRAPHICS TO MATCH EXISTING.
- PREP / PRIME / PAINT: METAL PARAPET WALL CAP PREP / PRIME / PAINT: PLASTERED ROOF TOP EQUIPMENT SCREEN WALLS INSIDE AND OUT
- PAINT COLOR 1 CONTINUE EXISTING STRIPING AROUND ENTIRE PERIMETER OF BUILDING
- INCLUDING RECESSED DOOR AND WINDOW RETURNS BASEBALL AND SOFTBALL DUGOUTS - PROTECT IN PLACE: EXISTING MELAMINE SHELVES. DO NOT PAINT. PREP / PRIME / PAINT: EXISTING WOOD
- SHELVES. PREP / PRIME / PAINT: EXISTING POLE
- PREP / PRIME / PAINT: EXISTING HADRAIL
- BID ALTERNATE #2 -PAINT (4) FOOTBALL FIELD LIGHTING STANDARDS PREP / PRIME / PAINT: EXISTING WOOD BACKSTOP BOTH SIDES. REMOVE / REPLACE EXISTING WOOD BACKSTOP WITH DECAY-RESISTANT

SIMILARLY SIZED WOOD AND CORROSION-RESISTANT HARDWARE. PREP /

PRIME / PAINT: BOTH SIDES PRIOR TO INSTALLATION.

AGENCY APPROVAL:



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SEALS:

PROJECT:

NORDHOFF HS CAMPUS-WIDE EXTERIOR **PAINTING**

OJAI UNIFIED SCHOOL DISTRICT 414 EAST OJAI AVENUE OJAI, CA 93023 (805) 640-4300 CONTACT: ADAM DUTTER

EMAIL: adutter@ojaiusd.org

PROJECT ADDRESS:

NORDOFF HIGH SCHOOL 1401 MARICOPA HIGHWAY OJAI, CA 93023

ISSUE:		
MARK	DATE	DESCRIPTION

2020.031

04CONDOC

PROJECT INFORMATION: PROJECT NUMBER: PROJECT PHASE: DRAWN BY:

REVIEWED BY: THE ORIGINAL SIZE OF THIS SHEET IS 36"x24". IF THE CURRENT SIZE IS OTHER THAN 36"x24", THEN ADJUST THE SCALE OF THE DRAWINGS ACCORDINGLY.

SHEET TITLE: **BUILDING A**

DATE: 08/18/2020

SHEET NUMBER: A-102

- BUILDING PLANS ARE SCHEMATIC TO ONLY SHOW APPROXIMATE OVERALL BUILDING DIMENSIONS, DOOR QUANTITIES AND APPROXIMATE DOOR LOCATIONS AND ARE PROVIDED AS A CONVENIENCE FOR BIDDING. FIELD VERIFY CONDITIONS PRIOR TO BID. REFER TO SHEET KEYNOTES, PHOTOS, AND LEGENDS FOR ADDITIONAL INFORMATION.
- ALL EXISTING PAINTED EXTERIOR SURFACES OF BUILDINGS INCLUDED IN THE SCOPE OF WORK ARE TO BE REPAINTED TO MATCH THE EXISTING PAINTED COLOR AS DETAILED IN THESE DRAWINGS AND SPECIFICATIONS UNLESS NOTED OTHERWISE.
- ALL EXISTING UNPAINTED EXTERIOR SURFACES ARE TO REMAIN UNPAINTED UNLESS NOTED OTHERWISE. PROTECT IN PLACE ALL UNPAINTED
- CAREFULLY PRUNE SHRUBS AND PLANTS AND REMOVE WEEDS AND PLANTINGS AT BASE OF WALL TO BARE EARTH TO ALLOW FOR COMPLETE WALL COVERAGE.
- WINDOW FRAMES, MULLIONS, AND SEALANTS TO BE PAINTED COLOR 2.

COLOR LEGEND & NOTES

COLOR 1 - WHITE - Match SW 7013- Ivory Lace

COLOR 2 - BLUE - Match SW 6804- Dignity Blue

COLOR 3 - YELLOW - Match SW 6904- Gusto Gold

PHOTOS WITH KEYNOTES ARE CREATED ELECTRONICALLY AND ARE INTENDED TO BE VIEWED IN COLOR TO SEE LOCATIONS OF COLORS ON THE BUILDINGS. CONTRACTOR SHALL FIELD VERIFY ACTUAL LOCATIONS AND DIMENSIONS OF COLORS PRIOR TO BID.

SYMBOL LEGEND



EXISTING DOOR: FIELD VERIFY SIZES AND CONDITIONS, PAINT DOOR WARNING STRIPING ON LANDING AT ALL OUTSWINGING EXTERIOR DOORS U.N.O. PAINT EXTERIOR DOOR FACE, FRAME EXTERIOR AND INTERIOR JAMB TO FACE OF DOOR STOP.



EXISTING RESTROOM DOOR: FINISH AND STRIPING AS NOTED FOR TYPICAL EXTERIOR DOORS ABV. FIELD VERIFY SIZES AND CONDITIONS. APPLY RESTROOM IDENTIFICATION DOOR SIGNAGE ON EXTERIOR AND INTERIOR

SHEET KEYNOTES

NOTE: NOT ALL KEYNOTES **USED ON EVERY SHEET**

- REMOVE / PAINT WALL / REINSTALL: EXISTING SIGN PROTECT IN PLACE: EXISTING SECURITY CAMERA TYPICAL AT ALL LOCATIONS
- PREP / PRIME / PAINT: UTILITY CONDUITS AND CABINETS TO MATCH WALL BEYOND. CONTINUE STRIPING OVER CONDUITS AND CABINETS WHERE
- PREP / PRIME / PAINT: EXISTING SIGNAGE IN PLACE
- PREP / PRIME / PAINT: EXISTING LOUVERS, TYPICAL PREP / PRIME / PAINT: GALVANIZED METAL WINDOW FRAME & WOOD TRIM. TYPICAL AT ALL WINDOWS THIS BUILDING. FIELD VERIFY LOCATIONS AND
- REMOVE / PAINT WALL / REINSTALL: LIGHT FIXTURE ESCUTCHEON PLATE OR LIGHT FIXTURE ITSELF TO WALL SURFACE BEHIND. TYPICAL AT ALL LIGHT FIXTURES U.N.O.
- REMOVE / WASH/ PREP / PRIME / PAINT / REINSTALL: ALL EXISTING LOCKERS IN THIS WING. PAINT ALL EXTERIOR SIDES, DOORS AND DOOR RETURNS
- ONLY. PROTECT UNPAINTED LOCKER HARDWARE. PREP / PRIME / PAINT: EXISTING GUTTERS AND DOWNSPOUTS. MATCH
- EXISTING WALL COLOR BEYOND. REMOVE / DISCARD: EXISTING METAL AWNING
- REMOVE / DISCARD WOODEN POST FILL IN HOLE
- PROTECT IN PLACE: EXISTING HVAC UNITS AND DUCTWORK PREP / PRIME / PAINT: DOOR SWING SAFETY STRIPING. TYPICAL AT ALL
- DOORS THIS BUILDING U.N.O. PROTECT IN PLACE: EXISTING LIGHT FIXTURE / SPEAKER / FIRE ALARM
- PREP / PRIME / PAINT: EXISTING HVAC DUCTWORK WHERE ALREADY
- PAINTED. TYPICAL AT THIS BUILDING. PROTECT IN PLACE: EXISTING MURAL. PAINT WALLS AROUND MURAL TO MATCH EXISTING BUILDING COLOR SCHEME. TOUCH-UP/REPAINT MURALS WHERE PAINTED TO MATCH EXISTING.
- PROTECT IN PLACE: EXISTING DRINKING FOUNTAIN
- PREP / PRIME / PAINT: EXISTING PAINTED DRINKING FOUNTAIN CANE DETECTION RAILS
- REMOVE / PAINT WALL / REINSTALL: EXISTING DISPLAY CASES
- REMOVE / DISCARD: EXISTING SIGN
- REMOVE / PAINT WALL / REINSTALL: EXISTING BENCHES
- PROTECT IN PLACE: EXISTING UNFINISHED CONCRETE OR CMU PREP / PRIME / PAINT: EXISTING CONCRETE / CMU WALL
- PREP / PRIME /PAINT: EXISTING METAL FENCE & GATE PROTECT IN PLACE: EXISTING MECHANICAL EQUIPMENT PROTECT IN PLACE: EXISTING GALVANIZED WINDOW FRAMES. TYPICAL AT

ALL WINDOWS THIS BUILDING. PREP / PRIME / PAINT ALL PAINTED WINDOW

- PREP / PRIME / PAINT: EXISTING ROLL-UP DOOR PREP / PRIME / PAINT: EXISTING STORAGE CONTAINER
- PREP / PRIME / PAINT: EXISTING WOOD BENCH / SEATS AND SLEEERS. **BID** ALTERNATE #3: - REMOVE / REPLACE / PREP / PRIME / PAINT: EXISTING WOODEN BENCHES, SEATS AND 4x DECAY-RESISTANT SLEEPERS.
- PREP / PRIME / PAINT: EXISTING CMU WALLS. PAINT INSIDE AND OUTSIDE OF ENCLOSURE AND DOORS.
- PREP / PRIME / PAINT: ENTIRETY OF METAL CANOPY
- PAINT COLOR 2 PAINT COLOR 3 33.
 - REMOVE / PREP / PAINT/ REINSTALL: EXISTING DOOR OR WINDOW METAL
- SECURITY GRATING PATCH / REPAIR / PREP / PRIME / PAINT: EXISTING PLASTER PREP / PRIME / PAINT: EXISTING GRAPHICS ON NORTH SIDE OF GYM WALL. ADD COLOR 3 BORDER AROUND 'N.' BID ALTERNATE #1 - PROVIDE AND
- INSTALL EXTERIOR ADHESIVE WALL GRAPHICS TO MATCH EXISTING. PREP / PRIME / PAINT: METAL PARAPET WALL CAP PREP / PRIME / PAINT: PLASTERED ROOF TOP EQUIPMENT SCREEN WALLS INSIDE AND OUT
- PAINT COLOR 1 CONTINUE EXISTING STRIPING AROUND ENTIRE PERIMETER OF BUILDING INCLUDING RECESSED DOOR AND WINDOW RETURNS
- BASEBALL AND SOFTBALL DUGOUTS PROTECT IN PLACE: EXISTING MELAMINE SHELVES. DO NOT PAINT. PREP / PRIME / PAINT: EXISTING WOOD SHELVES.
- PREP / PRIME / PAINT: EXISTING POLE
- PREP / PRIME / PAINT: EXISTING HADRAIL BID ALTERNATE #2 -PAINT (4) FOOTBALL FIELD LIGHTING STANDARDS
- PREP / PRIME / PAINT: EXISTING WOOD BACKSTOP BOTH SIDES. REMOVE / REPLACE EXISTING WOOD BACKSTOP WITH DECAY-RESISTANT SIMILARLY SIZED WOOD AND CORROSION-RESISTANT HARDWARE. PREP / PRIME / PAINT: BOTH SIDES PRIOR TO INSTALLATION.


AGENCY APPROVAL:



HARTMANNARCHITECTURESTUDIO.COM 430 S. CARRILLO RD. OJAI, CALIFORNIA 93023 (805) 530-5559

CONSULTANTS:

SEALS:

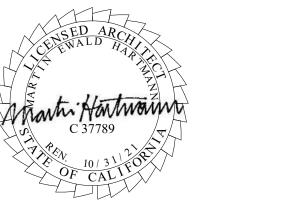

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SHEET TITLE:

BUILDING B

SHEET NUMBER:

A-103





CAREFULLY REMOVE DAMAGED SECTIONS OF FASCIA BOARDS, SISTER NEW REDWOOD 2x BLKG AND FASCIA BOARDS TO ALL JOISTS AND BLOCKING WITHIN BAY WITH STICH NAILING. NAILING PER CBC TABLE 2304.10.1. DO NOT CUT ROOF JOISTS.







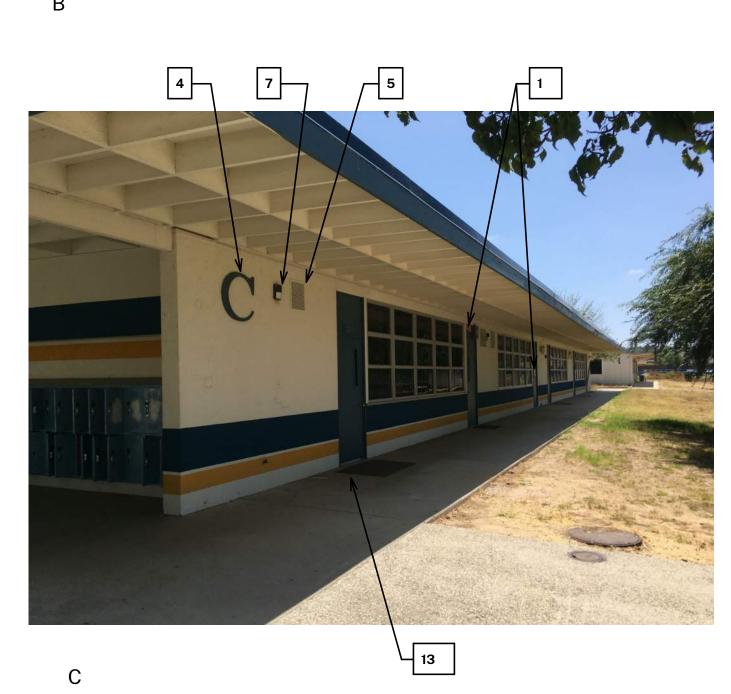

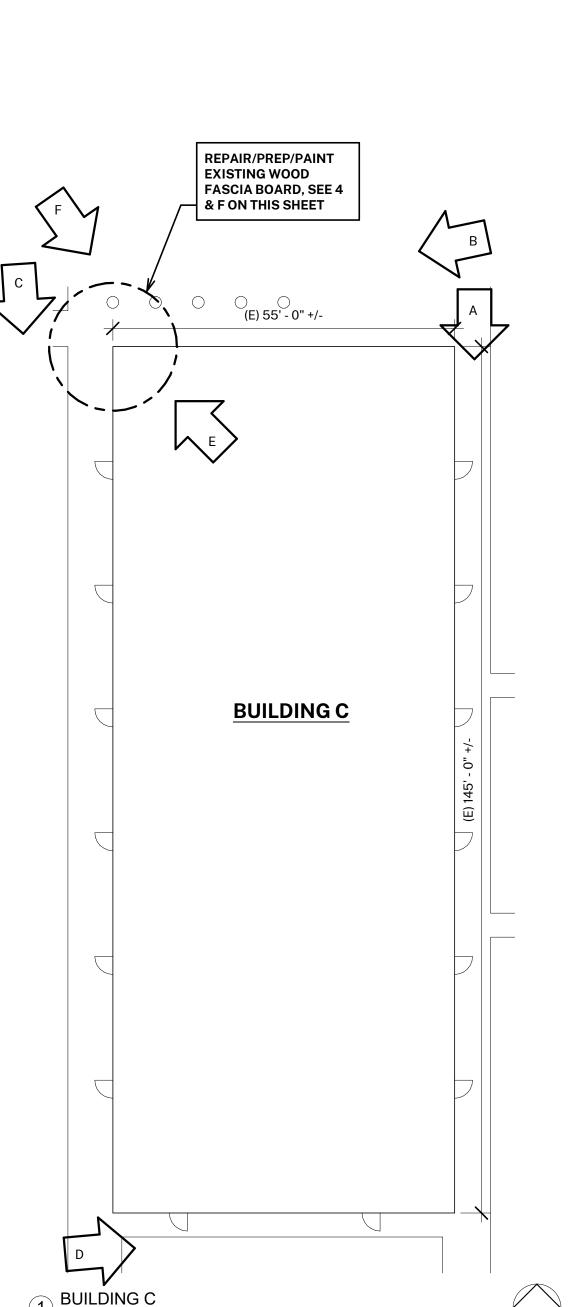

[/] 1/16" = 1'-0"

GENERAL NOTES

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UNLESS NOTED OTHERWISE. ALL EXISTING UNPAINTED EXTERIOR SURFACES ARE TO REMAIN UNPAINTED UNLESS NOTED OTHERWISE. PROTECT IN PLACE ALL UNPAINTED

CAREFULLY PRUNE SHRUBS AND PLANTS AND REMOVE WEEDS AND PLANTINGS AT BASE OF WALL TO BARE EARTH TO ALLOW FOR COMPLETE WALL COVERAGE.

WINDOW FRAMES, MULLIONS, AND SEALANTS TO BE PAINTED COLOR 2.

COLOR LEGEND & NOTES

COLOR 1 - WHITE - Match SW 7013- Ivory Lace

COLOR 2 - BLUE - Match SW 6804- Dignity Blue

COLOR 3 - YELLOW - Match SW 6904- Gusto Gold

PHOTOS WITH KEYNOTES ARE CREATED ELECTRONICALLY AND ARE INTENDED TO BE VIEWED IN COLOR TO SEE LOCATIONS OF COLORS ON THE BUILDINGS. CONTRACTOR SHALL FIELD VERIFY ACTUAL LOCATIONS AND DIMENSIONS OF COLORS PRIOR TO BID.

SYMBOL LEGEND



EXISTING DOOR: FIELD VERIFY SIZES AND CONDITIONS, PAINT DOOR WARNING STRIPING ON LANDING AT ALL OUTSWINGING EXTERIOR DOORS U.N.O. PAINT EXTERIOR DOOR FACE, FRAME EXTERIOR AND INTERIOR JAMB TO FACE OF DOOR STOP.



EXISTING RESTROOM DOOR: FINISH AND STRIPING AS NOTED FOR TYPICAL EXTERIOR DOORS ABV. FIELD VERIFY SIZES AND CONDITIONS. APPLY RESTROOM IDENTIFICATION DOOR SIGNAGE ON

SHEET KEYNOTES

NOTE: NOT ALL KEYNOTES **USED ON EVERY SHEET**

REMOVE / PAINT WALL / REINSTALL: EXISTING SIGN PROTECT IN PLACE: EXISTING SECURITY CAMERA TYPICAL AT ALL

PREP / PRIME / PAINT: UTILITY CONDUITS AND CABINETS TO MATCH WALL BEYOND. CONTINUE STRIPING OVER CONDUITS AND CABINETS WHERE

PREP / PRIME / PAINT: EXISTING SIGNAGE IN PLACE

PREP / PRIME / PAINT: EXISTING LOUVERS, TYPICAL PREP / PRIME / PAINT: GALVANIZED METAL WINDOW FRAME & WOOD TRIM. TYPICAL AT ALL WINDOWS THIS BUILDING. FIELD VERIFY LOCATIONS AND

DIMENSIONS PRIOR TO BID. REMOVE / PAINT WALL / REINSTALL: LIGHT FIXTURE ESCUTCHEON PLATE OR LIGHT FIXTURE ITSELF TO WALL SURFACE BEHIND. TYPICAL AT ALL LIGHT

REMOVE / WASH/ PREP / PRIME / PAINT / REINSTALL: ALL EXISTING LOCKERS IN THIS WING. PAINT ALL EXTERIOR SIDES, DOORS AND DOOR RETURNS ONLY. PROTECT UNPAINTED LOCKER HARDWARE.

PREP / PRIME / PAINT: EXISTING GUTTERS AND DOWNSPOUTS. MATCH

EXISTING WALL COLOR BEYOND.

REMOVE / DISCARD: EXISTING METAL AWNING

REMOVE / DISCARD WOODEN POST FILL IN HOLE PROTECT IN PLACE: EXISTING HVAC UNITS AND DUCTWORK PREP / PRIME / PAINT: DOOR SWING SAFETY STRIPING. TYPICAL AT ALL

DOORS THIS BUILDING U.N.O. PROTECT IN PLACE: EXISTING LIGHT FIXTURE / SPEAKER / FIRE ALARM

PREP / PRIME / PAINT: EXISTING HVAC DUCTWORK WHERE ALREADY PAINTED. TYPICAL AT THIS BUILDING.

PROTECT IN PLACE: EXISTING MURAL. PAINT WALLS AROUND MURAL TO MATCH EXISTING BUILDING COLOR SCHEME. TOUCH-UP/REPAINT MURALS

WHERE PAINTED TO MATCH EXISTING. PROTECT IN PLACE: EXISTING DRINKING FOUNTAIN PREP / PRIME / PAINT: EXISTING PAINTED DRINKING FOUNTAIN CANE DETECTION RAILS

REMOVE / PAINT WALL / REINSTALL: EXISTING DISPLAY CASES

REMOVE / DISCARD: EXISTING SIGN REMOVE / PAINT WALL / REINSTALL: EXISTING BENCHES PROTECT IN PLACE: EXISTING UNFINISHED CONCRETE OR CMU

PREP / PRIME / PAINT: EXISTING CONCRETE / CMU WALL PREP / PRIME /PAINT: EXISTING METAL FENCE & GATE PROTECT IN PLACE: EXISTING MECHANICAL EQUIPMENT

26. PROTECT IN PLACE: EXISTING GALVANIZED WINDOW FRAMES. TYPICAL AT ALL WINDOWS THIS BUILDING. PREP / PRIME / PAINT ALL PAINTED WINDOW

PREP / PRIME / PAINT: EXISTING ROLL-UP DOOR

PREP / PRIME / PAINT: EXISTING STORAGE CONTAINER

PREP / PRIME / PAINT: EXISTING WOOD BENCH / SEATS AND SLEEERS. **BID** ALTERNATE #3: - REMOVE / REPLACE / PREP / PRIME / PAINT: EXISTING WOODEN BENCHES, SEATS AND 4x DECAY-RESISTANT SLEEPERS. PREP / PRIME / PAINT: EXISTING CMU WALLS. PAINT INSIDE AND OUTSIDE OF

ENCLOSURE AND DOORS. PREP / PRIME / PAINT: ENTIRETY OF METAL CANOPY

32. PAINT COLOR 2

33. PAINT COLOR 3

REMOVE / PREP / PAINT/ REINSTALL: EXISTING DOOR OR WINDOW METAL 34.

SECURITY GRATING PATCH / REPAIR / PREP / PRIME / PAINT: EXISTING PLASTER PREP / PRIME / PAINT: EXISTING GRAPHICS ON NORTH SIDE OF GYM WALL. ADD COLOR 3 BORDER AROUND 'N.' BID ALTERNATE #1 - PROVIDE AND

INSTALL EXTERIOR ADHESIVE WALL GRAPHICS TO MATCH EXISTING. PREP / PRIME / PAINT: METAL PARAPET WALL CAP PREP / PRIME / PAINT: PLASTERED ROOF TOP EQUIPMENT SCREEN WALLS

INSIDE AND OUT PAINT COLOR 1

CONTINUE EXISTING STRIPING AROUND ENTIRE PERIMETER OF BUILDING INCLUDING RECESSED DOOR AND WINDOW RETURNS

MELAMINE SHELVES. DO NOT PAINT. PREP / PRIME / PAINT: EXISTING WOOD

42. PREP / PRIME / PAINT: EXISTING POLE PREP / PRIME / PAINT: EXISTING HADRAIL

BID ALTERNATE #2 -PAINT (4) FOOTBALL FIELD LIGHTING STANDARDS PREP / PRIME / PAINT: EXISTING WOOD BACKSTOP BOTH SIDES.

BASEBALL AND SOFTBALL DUGOUTS - PROTECT IN PLACE: EXISTING

REMOVE / REPLACE EXISTING WOOD BACKSTOP WITH DECAY-RESISTANT SIMILARLY SIZED WOOD AND CORROSION-RESISTANT HARDWARE. PREP / PRIME / PAINT: BOTH SIDES PRIOR TO INSTALLATION.

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SHEET TITLE:

BUILDING C

SHEET NUMBER:

DATE: 08/18/2020

A-104

PAINT EXTENTS OF

THIS POST & RAIL FENCE COLOR 2

GENERAL NOTES

BUILDING PLANS ARE SCHEMATIC TO ONLY SHOW APPROXIMATE OVERALL BUILDING DIMENSIONS, DOOR QUANTITIES AND APPROXIMATE DOOR LOCATIONS AND ARE PROVIDED AS A CONVENIENCE FOR BIDDING. FIELD VERIFY CONDITIONS PRIOR TO BID. REFER TO SHEET KEYNOTES, PHOTOS, AND LEGENDS FOR ADDITIONAL INFORMATION.

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ALL EXISTING UNPAINTED EXTERIOR SURFACES ARE TO REMAIN UNPAINTED UNLESS NOTED OTHERWISE. PROTECT IN PLACE ALL UNPAINTED

CAREFULLY PRUNE SHRUBS AND PLANTS AND REMOVE WEEDS AND PLANTINGS AT BASE OF WALL TO BARE EARTH TO ALLOW FOR COMPLETE WALL COVERAGE.

WINDOW FRAMES, MULLIONS, AND SEALANTS TO BE PAINTED COLOR 2.

COLOR LEGEND & NOTES

COLOR 1 - WHITE - Match SW 7013- Ivory Lace

COLOR 2 - BLUE - Match SW 6804- Dignity Blue

COLOR 3 - YELLOW - Match SW 6904- Gusto Gold

PHOTOS WITH KEYNOTES ARE CREATED ELECTRONICALLY AND ARE INTENDED TO BE VIEWED IN COLOR TO SEE LOCATIONS OF COLORS ON THE BUILDINGS. CONTRACTOR SHALL FIELD VERIFY ACTUAL LOCATIONS AND DIMENSIONS OF COLORS PRIOR TO BID.

SYMBOL LEGEND



EXISTING DOOR: FIELD VERIFY SIZES AND CONDITIONS, PAINT DOOR WARNING STRIPING ON LANDING AT ALL OUTSWINGING EXTERIOR DOORS U.N.O. PAINT EXTERIOR DOOR FACE, FRAME EXTERIOR AND INTERIOR JAMB TO FACE OF DOOR STOP.



EXISTING RESTROOM DOOR: FINISH AND STRIPING AS NOTED FOR TYPICAL EXTERIOR DOORS ABV. FIELD VERIFY SIZES AND CONDITIONS. APPLY RESTROOM IDENTIFICATION DOOR SIGNAGE ON EXTERIOR AND INTERIOR

SHEET KEYNOTES

NOTE: NOT ALL KEYNOTES **USED ON EVERY SHEET**

REMOVE / PAINT WALL / REINSTALL: EXISTING SIGN

PROTECT IN PLACE: EXISTING SECURITY CAMERA TYPICAL AT ALL PREP / PRIME / PAINT: UTILITY CONDUITS AND CABINETS TO MATCH WALL BEYOND. CONTINUE STRIPING OVER CONDUITS AND CABINETS WHERE

PREP / PRIME / PAINT: EXISTING SIGNAGE IN PLACE

PREP / PRIME / PAINT: EXISTING LOUVERS, TYPICAL

PREP / PRIME / PAINT: GALVANIZED METAL WINDOW FRAME & WOOD TRIM. TYPICAL AT ALL WINDOWS THIS BUILDING. FIELD VERIFY LOCATIONS AND

DIMENSIONS PRIOR TO BID. REMOVE / PAINT WALL / REINSTALL: LIGHT FIXTURE ESCUTCHEON PLATE OR LIGHT FIXTURE ITSELF TO WALL SURFACE BEHIND. TYPICAL AT ALL LIGHT

FIXTURES U.N.O. REMOVE / WASH/ PREP / PRIME / PAINT / REINSTALL: ALL EXISTING LOCKERS IN THIS WING. PAINT ALL EXTERIOR SIDES, DOORS AND DOOR RETURNS

ONLY. PROTECT UNPAINTED LOCKER HARDWARE.

PREP / PRIME / PAINT: EXISTING GUTTERS AND DOWNSPOUTS. MATCH EXISTING WALL COLOR BEYOND.

REMOVE / DISCARD: EXISTING METAL AWNING

REMOVE / DISCARD WOODEN POST FILL IN HOLE

PROTECT IN PLACE: EXISTING HVAC UNITS AND DUCTWORK PREP / PRIME / PAINT: DOOR SWING SAFETY STRIPING. TYPICAL AT ALL DOORS THIS BUILDING U.N.O.

PROTECT IN PLACE: EXISTING LIGHT FIXTURE / SPEAKER / FIRE ALARM

PREP / PRIME / PAINT: EXISTING HVAC DUCTWORK WHERE ALREADY PAINTED. TYPICAL AT THIS BUILDING. PROTECT IN PLACE: EXISTING MURAL. PAINT WALLS AROUND MURAL TO

MATCH EXISTING BUILDING COLOR SCHEME. TOUCH-UP/REPAINT MURALS WHERE PAINTED TO MATCH EXISTING. PROTECT IN PLACE: EXISTING DRINKING FOUNTAIN PREP / PRIME / PAINT: EXISTING PAINTED DRINKING FOUNTAIN CANE

REMOVE / PAINT WALL / REINSTALL: EXISTING DISPLAY CASES

REMOVE / DISCARD: EXISTING SIGN REMOVE / PAINT WALL / REINSTALL: EXISTING BENCHES PROTECT IN PLACE: EXISTING UNFINISHED CONCRETE OR CMU

PREP / PRIME / PAINT: EXISTING CONCRETE / CMU WALL 24. PREP / PRIME /PAINT: EXISTING METAL FENCE & GATE

PROTECT IN PLACE: EXISTING MECHANICAL EQUIPMENT 26. PROTECT IN PLACE: EXISTING GALVANIZED WINDOW FRAMES. TYPICAL AT ALL WINDOWS THIS BUILDING. PREP / PRIME / PAINT ALL PAINTED WINDOW

PREP / PRIME / PAINT: EXISTING ROLL-UP DOOR

PREP / PRIME / PAINT: EXISTING STORAGE CONTAINER PREP / PRIME / PAINT: EXISTING WOOD BENCH / SEATS AND SLEEERS. **BID** ALTERNATE #3: - REMOVE / REPLACE / PREP / PRIME / PAINT: EXISTING

WOODEN BENCHES, SEATS AND 4x DECAY-RESISTANT SLEEPERS. PREP / PRIME / PAINT: EXISTING CMU WALLS. PAINT INSIDE AND OUTSIDE OF ENCLOSURE AND DOORS.

PREP / PRIME / PAINT: ENTIRETY OF METAL CANOPY

32. PAINT COLOR 2

33. PAINT COLOR 3

REMOVE / PREP / PAINT/ REINSTALL: EXISTING DOOR OR WINDOW METAL

SECURITY GRATING PATCH / REPAIR / PREP / PRIME / PAINT: EXISTING PLASTER PREP / PRIME / PAINT: EXISTING GRAPHICS ON NORTH SIDE OF GYM WALL.

ADD COLOR 3 BORDER AROUND 'N.' **BID ALTERNATE** #1 - PROVIDE AND INSTALL EXTERIOR ADHESIVE WALL GRAPHICS TO MATCH EXISTING. PREP / PRIME / PAINT: METAL PARAPET WALL CAP PREP / PRIME / PAINT: PLASTERED ROOF TOP EQUIPMENT SCREEN WALLS

PAINT COLOR 1

CONTINUE EXISTING STRIPING AROUND ENTIRE PERIMETER OF BUILDING

INCLUDING RECESSED DOOR AND WINDOW RETURNS BASEBALL AND SOFTBALL DUGOUTS - PROTECT IN PLACE: EXISTING MELAMINE SHELVES. DO NOT PAINT. PREP / PRIME / PAINT: EXISTING WOOD

SHELVES. 42. PREP / PRIME / PAINT: EXISTING POLE

PREP / PRIME / PAINT: EXISTING HADRAIL

BID ALTERNATE #2 -PAINT (4) FOOTBALL FIELD LIGHTING STANDARDS PREP / PRIME / PAINT: EXISTING WOOD BACKSTOP BOTH SIDES.

REMOVE / REPLACE EXISTING WOOD BACKSTOP WITH DECAY-RESISTANT SIMILARLY SIZED WOOD AND CORROSION-RESISTANT HARDWARE. PREP / PRIME / PAINT: BOTH SIDES PRIOR TO INSTALLATION.

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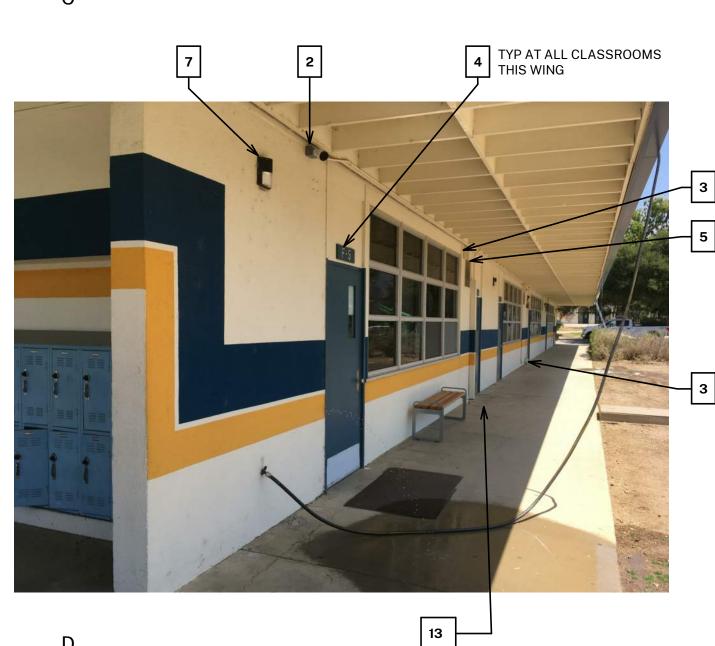
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BUILDING D

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PROTECT-IN-PLACE: STONE VEHICULAR BARRIERS TYPICAL.

GENERAL NOTES

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- WALL COVERAGE. WINDOW FRAMES, MULLIONS, AND SEALANTS TO BE PAINTED COLOR 2.

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EXISTING RESTROOM DOOR: FINISH AND STRIPING AS NOTED FOR TYPICAL EXTERIOR DOORS ABV. FIELD VERIFY SIZES AND CONDITIONS. APPLY RESTROOM IDENTIFICATION DOOR SIGNAGE ON **EXTERIOR AND INTERIOR**

SHEET KEYNOTES

NOTE: NOT ALL KEYNOTES **USED ON EVERY SHEET**

- REMOVE / PAINT WALL / REINSTALL: EXISTING SIGN PROTECT IN PLACE: EXISTING SECURITY CAMERA TYPICAL AT ALL
- PREP / PRIME / PAINT: UTILITY CONDUITS AND CABINETS TO MATCH WALL BEYOND. CONTINUE STRIPING OVER CONDUITS AND CABINETS WHERE
- PREP / PRIME / PAINT: EXISTING SIGNAGE IN PLACE
- PREP / PRIME / PAINT: EXISTING LOUVERS, TYPICAL PREP / PRIME / PAINT: GALVANIZED METAL WINDOW FRAME & WOOD TRIM. TYPICAL AT ALL WINDOWS THIS BUILDING. FIELD VERIFY LOCATIONS AND DIMENSIONS PRIOR TO BID.
- REMOVE / PAINT WALL / REINSTALL: LIGHT FIXTURE ESCUTCHEON PLATE OR LIGHT FIXTURE ITSELF TO WALL SURFACE BEHIND. TYPICAL AT ALL LIGHT
- REMOVE / WASH/ PREP / PRIME / PAINT / REINSTALL: ALL EXISTING LOCKERS IN THIS WING. PAINT ALL EXTERIOR SIDES, DOORS AND DOOR RETURNS ONLY. PROTECT UNPAINTED LOCKER HARDWARE.
- PREP / PRIME / PAINT: EXISTING GUTTERS AND DOWNSPOUTS. MATCH
- EXISTING WALL COLOR BEYOND.
- REMOVE / DISCARD: EXISTING METAL AWNING REMOVE / DISCARD WOODEN POST FILL IN HOLE
- PROTECT IN PLACE: EXISTING HVAC UNITS AND DUCTWORK PREP / PRIME / PAINT: DOOR SWING SAFETY STRIPING. TYPICAL AT ALL
- DOORS THIS BUILDING U.N.O. PROTECT IN PLACE: EXISTING LIGHT FIXTURE / SPEAKER / FIRE ALARM
- PREP / PRIME / PAINT: EXISTING HVAC DUCTWORK WHERE ALREADY
- PAINTED. TYPICAL AT THIS BUILDING. PROTECT IN PLACE: EXISTING MURAL. PAINT WALLS AROUND MURAL TO MATCH EXISTING BUILDING COLOR SCHEME. TOUCH-UP/REPAINT MURALS
- WHERE PAINTED TO MATCH EXISTING. PROTECT IN PLACE: EXISTING DRINKING FOUNTAIN
- PREP / PRIME / PAINT: EXISTING PAINTED DRINKING FOUNTAIN CANE DETECTION RAILS
- REMOVE / PAINT WALL / REINSTALL: EXISTING DISPLAY CASES REMOVE / DISCARD: EXISTING SIGN
- REMOVE / PAINT WALL / REINSTALL: EXISTING BENCHES PROTECT IN PLACE: EXISTING UNFINISHED CONCRETE OR CMU
- PREP / PRIME / PAINT: EXISTING CONCRETE / CMU WALL
- PREP / PRIME /PAINT: EXISTING METAL FENCE & GATE PROTECT IN PLACE: EXISTING MECHANICAL EQUIPMENT PROTECT IN PLACE: EXISTING GALVANIZED WINDOW FRAMES. TYPICAL AT
- ALL WINDOWS THIS BUILDING. PREP / PRIME / PAINT ALL PAINTED WINDOW
- PREP / PRIME / PAINT: EXISTING ROLL-UP DOOR
- PREP / PRIME / PAINT: EXISTING STORAGE CONTAINER
- PREP / PRIME / PAINT: EXISTING WOOD BENCH / SEATS AND SLEEERS. **BID** ALTERNATE #3: - REMOVE / REPLACE / PREP / PRIME / PAINT: EXISTING WOODEN BENCHES, SEATS AND 4x DECAY-RESISTANT SLEEPERS. PREP / PRIME / PAINT: EXISTING CMU WALLS. PAINT INSIDE AND OUTSIDE OF
- **ENCLOSURE AND DOORS.**
- PREP / PRIME / PAINT: ENTIRETY OF METAL CANOPY
- PAINT COLOR 2 PAINT COLOR 3
- REMOVE / PREP / PAINT/ REINSTALL: EXISTING DOOR OR WINDOW METAL SECURITY GRATING
- PATCH / REPAIR / PREP / PRIME / PAINT: EXISTING PLASTER PREP / PRIME / PAINT: EXISTING GRAPHICS ON NORTH SIDE OF GYM WALL. ADD COLOR 3 BORDER AROUND 'N.' BID ALTERNATE #1 - PROVIDE AND INSTALL EXTERIOR ADHESIVE WALL GRAPHICS TO MATCH EXISTING.
- PREP / PRIME / PAINT: METAL PARAPET WALL CAP PREP / PRIME / PAINT: PLASTERED ROOF TOP EQUIPMENT SCREEN WALLS
- INSIDE AND OUT PAINT COLOR 1 CONTINUE EXISTING STRIPING AROUND ENTIRE PERIMETER OF BUILDING
- INCLUDING RECESSED DOOR AND WINDOW RETURNS BASEBALL AND SOFTBALL DUGOUTS - PROTECT IN PLACE: EXISTING MELAMINE SHELVES. DO NOT PAINT. PREP / PRIME / PAINT: EXISTING WOOD
- PREP / PRIME / PAINT: EXISTING POLE PREP / PRIME / PAINT: EXISTING HADRAIL
- BID ALTERNATE #2 -PAINT (4) FOOTBALL FIELD LIGHTING STANDARDS PREP / PRIME / PAINT: EXISTING WOOD BACKSTOP BOTH SIDES.
- REMOVE / REPLACE EXISTING WOOD BACKSTOP WITH DECAY-RESISTANT SIMILARLY SIZED WOOD AND CORROSION-RESISTANT HARDWARE. PREP / PRIME / PAINT: BOTH SIDES PRIOR TO INSTALLATION.

AGENCY APPROVAL:



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CONSULTANTS:

SEALS:

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OJAI UNIFIED SCHOOL DISTRICT 414 EAST OJAI AVENUE OJAI, CA 93023 (805) 640-4300 CONTACT: ADAM DUTTER

EMAIL: adutter@ojaiusd.org

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NORDOFF HIGH SCHOOL 1401 MARICOPA HIGHWAY OJAI, CA 93023

ISSUE:		
MARK	DATE	DESCRIPTION

2020.031

04CONDOC

PROJECT INFORMATION: PROJECT NUMBER: PROJECT PHASE: DRAWN BY:


REVIEWED BY:

THE ORIGINAL SIZE OF THIS SHEET IS 36"x24". IF THE CURRENT SIZE IS OTHER THAN 36"x24", THEN ADJUST THE SCALE OF THE DRAWINGS ACCORDINGLY. SHEET TITLE:

BUILDING F

SHEET NUMBER:

A-106 DATE: 08/18/2020

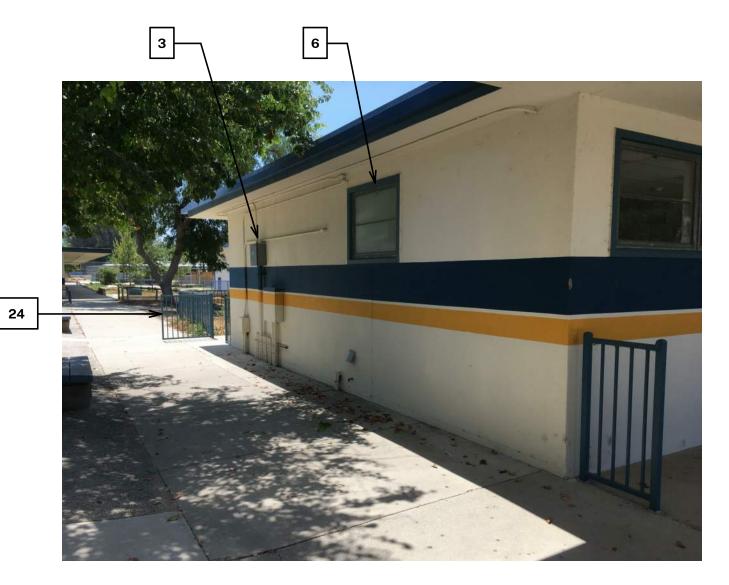











- BUILDING PLANS ARE SCHEMATIC TO ONLY SHOW APPROXIMATE OVERALL BUILDING DIMENSIONS, DOOR QUANTITIES AND APPROXIMATE DOOR LOCATIONS AND ARE PROVIDED AS A CONVENIENCE FOR BIDDING. FIELD VERIFY CONDITIONS PRIOR TO BID. REFER TO SHEET KEYNOTES, PHOTOS, AND LEGENDS FOR ADDITIONAL INFORMATION.
- ALL EXISTING PAINTED EXTERIOR SURFACES OF BUILDINGS INCLUDED IN THE SCOPE OF WORK ARE TO BE REPAINTED TO MATCH THE EXISTING PAINTED COLOR AS DETAILED IN THESE DRAWINGS AND SPECIFICATIONS
- UNLESS NOTED OTHERWISE. ALL EXISTING UNPAINTED EXTERIOR SURFACES ARE TO REMAIN UNPAINTED UNLESS NOTED OTHERWISE. PROTECT IN PLACE ALL UNPAINTED
- CAREFULLY PRUNE SHRUBS AND PLANTS AND REMOVE WEEDS AND PLANTINGS AT BASE OF WALL TO BARE EARTH TO ALLOW FOR COMPLETE

5. WINDOW FRAMES, MULLIONS, AND SEALANTS TO BE PAINTED COLOR 2. COLOR LEGEND & NOTES

COLOR 1 - WHITE - Match SW 7013- Ivory Lace

COLOR 2 - BLUE - Match SW 6804- Dignity Blue

COLOR 3 - YELLOW - Match SW 6904- Gusto Gold

PHOTOS WITH KEYNOTES ARE CREATED ELECTRONICALLY AND ARE INTENDED TO BE VIEWED IN COLOR TO SEE LOCATIONS OF COLORS ON THE BUILDINGS. CONTRACTOR SHALL FIELD VERIFY ACTUAL LOCATIONS AND DIMENSIONS OF COLORS PRIOR TO BID.

SYMBOL LEGEND



EXISTING DOOR: FIELD VERIFY SIZES AND CONDITIONS, PAINT DOOR WARNING STRIPING ON LANDING AT ALL OUTSWINGING EXTERIOR DOORS U.N.O. PAINT EXTERIOR DOOR FACE, FRAME EXTERIOR AND INTERIOR JAMB TO FACE OF DOOR STOP.



EXISTING RESTROOM DOOR: FINISH AND STRIPING AS NOTED FOR TYPICAL EXTERIOR DOORS ABV. FIELD VERIFY SIZES AND CONDITIONS. APPLY RESTROOM IDENTIFICATION DOOR SIGNAGE ON EXTERIOR AND INTERIOR

SHEET KEYNOTES

NOTE: NOT ALL KEYNOTES **USED ON EVERY SHEET**

- REMOVE / PAINT WALL / REINSTALL: EXISTING SIGN
- PREP / PRIME / PAINT: UTILITY CONDUITS AND CABINETS TO MATCH WALL BEYOND. CONTINUE STRIPING OVER CONDUITS AND CABINETS WHERE

PROTECT IN PLACE: EXISTING SECURITY CAMERA TYPICAL AT ALL

- PREP / PRIME / PAINT: EXISTING SIGNAGE IN PLACE
- PREP / PRIME / PAINT: EXISTING LOUVERS, TYPICAL PREP / PRIME / PAINT: GALVANIZED METAL WINDOW FRAME & WOOD TRIM. TYPICAL AT ALL WINDOWS THIS BUILDING. FIELD VERIFY LOCATIONS AND
- DIMENSIONS PRIOR TO BID. REMOVE / PAINT WALL / REINSTALL: LIGHT FIXTURE ESCUTCHEON PLATE OR LIGHT FIXTURE ITSELF TO WALL SURFACE BEHIND. TYPICAL AT ALL LIGHT
- REMOVE / WASH/ PREP / PRIME / PAINT / REINSTALL: ALL EXISTING LOCKERS IN THIS WING. PAINT ALL EXTERIOR SIDES, DOORS AND DOOR RETURNS ONLY. PROTECT UNPAINTED LOCKER HARDWARE.
- PREP / PRIME / PAINT: EXISTING GUTTERS AND DOWNSPOUTS. MATCH
- EXISTING WALL COLOR BEYOND. REMOVE / DISCARD: EXISTING METAL AWNING
- REMOVE / DISCARD WOODEN POST FILL IN HOLE PROTECT IN PLACE: EXISTING HVAC UNITS AND DUCTWORK
- PREP / PRIME / PAINT: DOOR SWING SAFETY STRIPING. TYPICAL AT ALL DOORS THIS BUILDING U.N.O.
- PROTECT IN PLACE: EXISTING LIGHT FIXTURE / SPEAKER / FIRE ALARM
- PREP / PRIME / PAINT: EXISTING HVAC DUCTWORK WHERE ALREADY
- PAINTED. TYPICAL AT THIS BUILDING. PROTECT IN PLACE: EXISTING MURAL. PAINT WALLS AROUND MURAL TO MATCH EXISTING BUILDING COLOR SCHEME. TOUCH-UP/REPAINT MURALS
- WHERE PAINTED TO MATCH EXISTING. PROTECT IN PLACE: EXISTING DRINKING FOUNTAIN PREP / PRIME / PAINT: EXISTING PAINTED DRINKING FOUNTAIN CANE
- DETECTION RAILS
- REMOVE / PAINT WALL / REINSTALL: EXISTING DISPLAY CASES
- REMOVE / DISCARD: EXISTING SIGN REMOVE / PAINT WALL / REINSTALL: EXISTING BENCHES
- PROTECT IN PLACE: EXISTING UNFINISHED CONCRETE OR CMU PREP / PRIME / PAINT: EXISTING CONCRETE / CMU WALL
- PREP / PRIME /PAINT: EXISTING METAL FENCE & GATE
- PROTECT IN PLACE: EXISTING MECHANICAL EQUIPMENT
- PROTECT IN PLACE: EXISTING GALVANIZED WINDOW FRAMES. TYPICAL AT ALL WINDOWS THIS BUILDING. PREP / PRIME / PAINT ALL PAINTED WINDOW
- 27. PREP / PRIME / PAINT: EXISTING ROLL-UP DOOR PREP / PRIME / PAINT: EXISTING STORAGE CONTAINER 29. PREP / PRIME / PAINT: EXISTING WOOD BENCH / SEATS AND SLEEERS. **BID**
- WOODEN BENCHES, SEATS AND 4x DECAY-RESISTANT SLEEPERS. PREP / PRIME / PAINT: EXISTING CMU WALLS. PAINT INSIDE AND OUTSIDE OF

ALTERNATE #3: - REMOVE / REPLACE / PREP / PRIME / PAINT: EXISTING

- ENCLOSURE AND DOORS. PREP / PRIME / PAINT: ENTIRETY OF METAL CANOPY
- PAINT COLOR 2
- PAINT COLOR 3 REMOVE / PREP / PAINT/ REINSTALL: EXISTING DOOR OR WINDOW METAL
- SECURITY GRATING PATCH / REPAIR / PREP / PRIME / PAINT: EXISTING PLASTER PREP / PRIME / PAINT: EXISTING GRAPHICS ON NORTH SIDE OF GYM WALL. ADD COLOR 3 BORDER AROUND 'N.' BID ALTERNATE #1 - PROVIDE AND
- INSTALL EXTERIOR ADHESIVE WALL GRAPHICS TO MATCH EXISTING.
 PREP / PRIME / PAINT: METAL PARAPET WALL CAP
- PREP / PRIME / PAINT: PLASTERED ROOF TOP EQUIPMENT SCREEN WALLS INSIDE AND OUT PAINT COLOR 1
- CONTINUE EXISTING STRIPING AROUND ENTIRE PERIMETER OF BUILDING INCLUDING RECESSED DOOR AND WINDOW RETURNS
- BASEBALL AND SOFTBALL DUGOUTS PROTECT IN PLACE: EXISTING MELAMINE SHELVES. DO NOT PAINT. PREP / PRIME / PAINT: EXISTING WOOD
- PREP / PRIME / PAINT: EXISTING POLE
- PREP / PRIME / PAINT: EXISTING HADRAIL
- BID ALTERNATE #2 -PAINT (4) FOOTBALL FIELD LIGHTING STANDARDS PREP / PRIME / PAINT: EXISTING WOOD BACKSTOP BOTH SIDES.
- REMOVE / REPLACE EXISTING WOOD BACKSTOP WITH DECAY-RESISTANT SIMILARLY SIZED WOOD AND CORROSION-RESISTANT HARDWARE. PREP / PRIME / PAINT: BOTH SIDES PRIOR TO INSTALLATION.

AGENCY APPROVAL:



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CONSULTANTS:

SEALS:

PROJECT:

NORDHOFF HS CAMPUS-WIDE EXTERIOR **PAINTING**

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ISSUE:		
MARK	DATE	DESCRIPTION

2020.031

04CONDOC

PROJECT INFORMATION: PROJECT NUMBER: PROJECT PHASE:

DRAWN BY:

REVIEWED BY: THE ORIGINAL SIZE OF THIS SHEET IS 36"x24". IF THE CURRENT SIZE IS OTHER THAN 36"x24", THEN ADJUST THE SCALE OF THE DRAWINGS ACCORDINGLY.

SHEET TITLE: **BUILDING G**

SHEET NUMBER:

A-107



- 1. BUILDING PLANS ARE SCHEMATIC TO ONLY SHOW APPROXIMATE OVERALL BUILDING DIMENSIONS, DOOR QUANTITIES AND APPROXIMATE DOOR LOCATIONS AND ARE PROVIDED AS A CONVENIENCE FOR BIDDING. FIELD VERIFY CONDITIONS PRIOR TO BID. REFER TO SHEET KEYNOTES, PHOTOS, AND LEGENDS FOR ADDITIONAL INFORMATION.
- ALL EXISTING PAINTED EXTERIOR SURFACES OF BUILDINGS INCLUDED IN THE SCOPE OF WORK ARE TO BE REPAINTED TO MATCH THE EXISTING PAINTED COLOR AS DETAILED IN THESE DRAWINGS AND SPECIFICATIONS
- UNLESS NOTED OTHERWISE.

 3. ALL EXISTING UNPAINTED EXTERIOR SURFACES ARE TO REMAIN UNPAINTED UNLESS NOTED OTHERWISE. PROTECT IN PLACE ALL UNPAINTED
- SURFACES.
 CAREFULLY PRUNE SHRUBS AND PLANTS AND REMOVE WEEDS AND
 PLANTINGS AT BASE OF WALL TO BARE EARTH TO ALLOW FOR COMPLETE
- WALL COVERAGE.
 WINDOW FRAMES, MULLIONS, AND SEALANTS TO BE PAINTED COLOR 2.

COLOR LEGEND & NOTES

COLOR 1 - WHITE - Match SW 7013- Ivory Lace

COLOR 2 - BLUE - Match SW 6804- Dignity Blue

COLOR 3 - YELLOW - Match SW 6904- Gusto Gold

1. PHOTOS WITH KEYNOTES ARE CREATED ELECTRONICALLY AND ARE INTENDED TO BE VIEWED IN COLOR TO SEE LOCATIONS OF COLORS ON THE BUILDINGS. CONTRACTOR SHALL FIELD VERIFY ACTUAL LOCATIONS AND DIMENSIONS OF COLORS PRIOR TO BID.

SYMBOL LEGEND



EXISTING DOOR: FIELD VERIFY SIZES AND CONDITIONS, PAINT DOOR WARNING STRIPING ON LANDING AT ALL OUTSWINGING EXTERIOR DOORS U.N.O. PAINT EXTERIOR DOOR FACE, FRAME EXTERIOR AND INTERIOR JAMB TO FACE OF DOOR STOP.



EXISTING RESTROOM DOOR: FINISH AND STRIPING AS NOTED FOR TYPICAL EXTERIOR DOORS ABV. FIELD VERIFY SIZES AND CONDITIONS. APPLY RESTROOM IDENTIFICATION DOOR SIGNAGE ON EXTERIOR AND INTERIOR

SHEET KEYNOTES

DIMENSIONS PRIOR TO BID.

NOTE: NOT ALL KEYNOTES USED ON EVERY SHEET

- REMOVE / PAINT WALL / REINSTALL: EXISTING SIGN
- PREP / PRIME / PAINT: UTILITY CONDUITS AND CABINETS TO MATCH WALL BEYOND. CONTINUE STRIPING OVER CONDUITS AND CABINETS WHERE

PROTECT IN PLACE: EXISTING SECURITY CAMERA TYPICAL AT ALL

- PREP / PRIME / PAINT: EXISTING SIGNAGE IN PLACE
- PREP / PRIME / PAINT: EXISTING LOUVERS, TYPICAL
 PREP / PRIME / PAINT: GALVANIZED METAL WINDOW FRAME & WOOD TRIM. TYPICAL AT ALL WINDOWS THIS BUILDING. FIELD VERIFY LOCATIONS AND
- 7. REMOVE / PAINT WALL / REINSTALL: LIGHT FIXTURE ESCUTCHEON PLATE OR LIGHT FIXTURE ITSELF TO WALL SURFACE BEHIND. TYPICAL AT ALL LIGHT FIXTURES U.N.O.
- FIXTURES U.N.O.
 REMOVE / WASH/ PREP / PRIME / PAINT / REINSTALL: ALL EXISTING LOCKERS
 IN THIS WING. PAINT ALL EXTERIOR SIDES, DOORS AND DOOR RETURNS
- ONLY. PROTECT UNPAINTED LOCKER HARDWARE.
 PREP / PRIME / PAINT: EXISTING GUTTERS AND DOWNSPOUTS. MATCH
 EXISTING WALL COLOR BEYOND.
- REMOVE / DISCARD: EXISTING METAL AWNING
- REMOVE / DISCARD WOODEN POST FILL IN HOLE
- PROTECT IN PLACE: EXISTING HVAC UNITS AND DUCTWORK
 PREP / PRIME / PAINT: DOOR SWING SAFETY STRIPING. TYPICAL AT ALL DOORS THIS BUILDING U.N.O.
- 4. PROTECT IN PLACE: EXISTING LIGHT FIXTURE / SPEAKER / FIRE ALARM DEVICE
- 5. PREP / PRIME / PAINT: EXISTING HVAC DUCTWORK WHERE ALREADY PAINTED. TYPICAL AT THIS BUILDING.
- 16. PROTECT IN PLACE: EXISTING MURAL. PAINT WALLS AROUND MURAL TO MATCH EXISTING BUILDING COLOR SCHEME. TOUCH-UP/REPAINT MURALS WHERE PAINTED TO MATCH EXISTING.
- 17. PROTECT IN PLACE: EXISTING DRINKING FOUNTAIN
 18. PREP / PRIME / PAINT: EXISTING PAINTED DRINKING FOUNTAIN CANE
- 19. REMOVE / PAINT WALL / REINSTALL: EXISTING DISPLAY CASES
- 20. REMOVE / DISCARD: EXISTING SIGN
 21. REMOVE / PAINT WALL / REINSTALL: EXISTING BENCHES
- 22. PROTECT IN PLACE: EXISTING UNFINISHED CONCRETE OR CMU
- 3. PREP / PRIME / PAINT: EXISTING CONCRETE / CMU WALL 4. PREP / PRIME /PAINT: EXISTING METAL FENCE & GATE
- 25. PROTECT IN PLACE: EXISTING MECHANICAL EQUIPMENT
 26. PROTECT IN PLACE: EXISTING GALVANIZED WINDOW FRAMES. TYPICAL AT ALL WINDOWS THIS BUILDING. PREP / PRIME / PAINT ALL PAINTED WINDOW TRIM
- PREP / PRIME / PAINT: EXISTING ROLL-UP DOOR
- 28. PREP / PRIME / PAINT: EXISTING STORAGE CONTAINER
- 29. PREP / PRIME / PAINT: EXISTING WOOD BENCH / SEATS AND SLEEERS. <u>BID</u>

 <u>ALTERNATE #3: REMOVE / REPLACE / PREP / PRIME / PAINT: EXISTING</u>

 WOODEN BENCHES, SEATS AND 4x DECAY-RESISTANT SLEEPERS.

 PREP / PRIME / PAINT: EXISTING CMU WALLS. PAINT INSIDE AND OUTSIDE OF
- ENCLOSURE AND DOORS.

 31. PREP / PRIME / PAINT: ENTIRETY OF METAL CANOPY
- PREP / PRIME / PAINT: ENTIRETY OF METAL CANOPY
 PAINT COLOR 2
- . PAINT COLOR 3
- 34. REMOVE / PREP / PAINT/ REINSTALL: EXISTING DOOR OR WINDOW METAL SECURITY GRATING
- 5. PATCH / REPAIR / PREP / PRIME / PAINT: EXISTING PLASTER
 6. PREP / PRIME / PAINT: EXISTING GRAPHICS ON NORTH SIDE OF GYM WALL.
 ADD COLOR 3 BORDER AROUND 'N.' <u>BID ALTERNATE #1 PROVIDE AND INSTALL EXTERIOR ADHESIVE WALL GRAPHICS TO MATCH EXISTING.</u>
- 7. PREP / PRIME / PAINT: METAL PARAPET WALL CAP

 B. PREP / PRIME / PAINT: PLASTERED ROOF TOP EQUIPMENT SCREEN WALLS
 INSIDE AND OUT
- INSIDE AND OUT

 PAINT COLOR 1

 CONTINUE EXISTING STRIPING AROUND ENTIRE PERIMETER OF BUILDING
- INCLUDING RECESSED DOOR AND WINDOW RETURNS

 BASEBALL AND SOFTBALL DUGOUTS PROTECT IN PLACE: EXISTING
 MELAMINE SHELVES. DO NOT PAINT. PREP / PRIME / PAINT: EXISTING WOOD
- SHELVES.

 42 PRED / PRIME / PAINT: EXISTING POLI
- 42. PREP / PRIME / PAINT: EXISTING POLE43. PREP / PRIME / PAINT: EXISTING HADRAIL
- BID ALTERNATE #2 -PAINT (4) FOOTBALL FIELD LIGHTING STANDARDS
 PREP / PRIME / PAINT: EXISTING WOOD BACKSTOP BOTH SIDES.
 REMOVE / REPLACE EXISTING WOOD BACKSTOP WITH DECAY-RESISTANT
- 6. REMOVE / REPLACE EXISTING WOOD BACKSTOP BOTH SIDES.
 6. REMOVE / REPLACE EXISTING WOOD BACKSTOP WITH DECAY-RESISTANT SIMILARLY SIZED WOOD AND CORROSION-RESISTANT HARDWARE. PREP / PRIME / PAINT: BOTH SIDES PRIOR TO INSTALLATION.

AGENCY APPROVAL:



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CONSULTANTS:

SEALS:

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OF CALLED

SED ARCHIVE

OF CALLED

PROJECT:

NORDHOFF HS CAMPUS-WIDE EXTERIOR PAINTING

OWNER:

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ISSUE:			
MARK	DATE	DESCRIPTION	
PROJECT	PROJECT INFORMATION:		

2020.031

04CONDOC

PROJECT INFORMATION:
PROJECT NUMBER:
PROJECT PHASE:
DRAWN BY:
REVIEWED BY:

THE ORIGINAL SIZE OF THIS SHEET IS 36"x24". IF THE CURRENT SIZE IS OTHER THAN 36"x24", THEN ADJUST THE SCALE OF THE DRAWINGS ACCORDINGLY.

BUILDING H & L

SHEET NUMBER:

DATE: 08/18/2020

SHEET TITLE:

A-108

BUILDING PLANS ARE SCHEMATIC TO ONLY SHOW APPROXIMATE OVERALL BUILDING DIMENSIONS, DOOR QUANTITIES AND APPROXIMATE DOOR LOCATIONS AND ARE PROVIDED AS A CONVENIENCE FOR BIDDING. FIELD VERIFY CONDITIONS PRIOR TO BID. REFER TO SHEET KEYNOTES, PHOTOS, AND LEGENDS FOR ADDITIONAL INFORMATION.

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UNLESS NOTED OTHERWISE. ALL EXISTING UNPAINTED EXTERIOR SURFACES ARE TO REMAIN UNPAINTED UNLESS NOTED OTHERWISE. PROTECT IN PLACE ALL UNPAINTED

CAREFULLY PRUNE SHRUBS AND PLANTS AND REMOVE WEEDS AND PLANTINGS AT BASE OF WALL TO BARE EARTH TO ALLOW FOR COMPLETE WALL COVERAGE.

COLOR LEGEND & NOTES

COLOR 1 - WHITE - Match SW 7013- Ivory Lace

COLOR 2 - BLUE - Match SW 6804- Dignity Blue

COLOR 3 - YELLOW - Match SW 6904- Gusto Gold

PHOTOS WITH KEYNOTES ARE CREATED ELECTRONICALLY AND ARE INTENDED TO BE VIEWED IN COLOR TO SEE LOCATIONS OF COLORS ON THE BUILDINGS. CONTRACTOR SHALL FIELD VERIFY ACTUAL LOCATIONS AND DIMENSIONS OF COLORS PRIOR TO BID.

SYMBOL LEGEND



EXISTING DOOR: FIELD VERIFY SIZES AND CONDITIONS, PAINT DOOR WARNING STRIPING ON LANDING AT ALL OUTSWINGING EXTERIOR DOORS U.N.O. PAINT EXTERIOR DOOR FACE, FRAME EXTERIOR AND INTERIOR JAMB TO FACE OF DOOR STOP.



EXISTING RESTROOM DOOR: FINISH AND STRIPING AS NOTED FOR TYPICAL EXTERIOR DOORS ABV. FIELD VERIFY SIZES AND CONDITIONS. APPLY RESTROOM IDENTIFICATION DOOR SIGNAGE ON EXTERIOR AND INTERIOR

SHEET KEYNOTES

NOTE: NOT ALL KEYNOTES **USED ON EVERY SHEET**

REMOVE / PAINT WALL / REINSTALL: EXISTING SIGN

PROTECT IN PLACE: EXISTING SECURITY CAMERA TYPICAL AT ALL PREP / PRIME / PAINT: UTILITY CONDUITS AND CABINETS TO MATCH WALL

BEYOND. CONTINUE STRIPING OVER CONDUITS AND CABINETS WHERE

PREP / PRIME / PAINT: EXISTING SIGNAGE IN PLACE PREP / PRIME / PAINT: EXISTING LOUVERS, TYPICAL

PREP / PRIME / PAINT: GALVANIZED METAL WINDOW FRAME & WOOD TRIM. TYPICAL AT ALL WINDOWS THIS BUILDING. FIELD VERIFY LOCATIONS AND DIMENSIONS PRIOR TO BID.

REMOVE / PAINT WALL / REINSTALL: LIGHT FIXTURE ESCUTCHEON PLATE OR LIGHT FIXTURE ITSELF TO WALL SURFACE BEHIND. TYPICAL AT ALL LIGHT

REMOVE / WASH/ PREP / PRIME / PAINT / REINSTALL: ALL EXISTING LOCKERS IN THIS WING. PAINT ALL EXTERIOR SIDES, DOORS AND DOOR RETURNS

ONLY. PROTECT UNPAINTED LOCKER HARDWARE. PREP / PRIME / PAINT: EXISTING GUTTERS AND DOWNSPOUTS. MATCH

EXISTING WALL COLOR BEYOND.

REMOVE / DISCARD: EXISTING METAL AWNING

REMOVE / DISCARD WOODEN POST FILL IN HOLE

PROTECT IN PLACE: EXISTING HVAC UNITS AND DUCTWORK PREP / PRIME / PAINT: DOOR SWING SAFETY STRIPING. TYPICAL AT ALL DOORS THIS BUILDING U.N.O.

PROTECT IN PLACE: EXISTING LIGHT FIXTURE / SPEAKER / FIRE ALARM

PREP / PRIME / PAINT: EXISTING HVAC DUCTWORK WHERE ALREADY PAINTED. TYPICAL AT THIS BUILDING.

PROTECT IN PLACE: EXISTING MURAL. PAINT WALLS AROUND MURAL TO MATCH EXISTING BUILDING COLOR SCHEME. TOUCH-UP/REPAINT MURALS

WHERE PAINTED TO MATCH EXISTING. PROTECT IN PLACE: EXISTING DRINKING FOUNTAIN PREP / PRIME / PAINT: EXISTING PAINTED DRINKING FOUNTAIN CANE DETECTION RAILS

REMOVE / PAINT WALL / REINSTALL: EXISTING DISPLAY CASES REMOVE / DISCARD: EXISTING SIGN REMOVE / PAINT WALL / REINSTALL: EXISTING BENCHES

PROTECT IN PLACE: EXISTING UNFINISHED CONCRETE OR CMU PREP / PRIME / PAINT: EXISTING CONCRETE / CMU WALL PREP / PRIME /PAINT: EXISTING METAL FENCE & GATE

PROTECT IN PLACE: EXISTING MECHANICAL EQUIPMENT PROTECT IN PLACE: EXISTING GALVANIZED WINDOW FRAMES. TYPICAL AT ALL WINDOWS THIS BUILDING. PREP / PRIME / PAINT ALL PAINTED WINDOW

27. PREP / PRIME / PAINT: EXISTING ROLL-UP DOOR

PREP / PRIME / PAINT: EXISTING STORAGE CONTAINER 29. PREP / PRIME / PAINT: EXISTING WOOD BENCH / SEATS AND SLEEERS. **BID** ALTERNATE #3: - REMOVE / REPLACE / PREP / PRIME / PAINT: EXISTING

WOODEN BENCHES, SEATS AND 4x DECAY-RESISTANT SLEEPERS. PREP / PRIME / PAINT: EXISTING CMU WALLS. PAINT INSIDE AND OUTSIDE OF

ENCLOSURE AND DOORS. PREP / PRIME / PAINT: ENTIRETY OF METAL CANOPY

PAINT COLOR 2

PAINT COLOR 3

REMOVE / PREP / PAINT/ REINSTALL: EXISTING DOOR OR WINDOW METAL SECURITY GRATING

PATCH / REPAIR / PREP / PRIME / PAINT: EXISTING PLASTER PREP / PRIME / PAINT: EXISTING GRAPHICS ON NORTH SIDE OF GYM WALL. ADD COLOR 3 BORDER AROUND 'N.' BID ALTERNATE #1 - PROVIDE AND

INSTALL EXTERIOR ADHESIVE WALL GRAPHICS TO MATCH EXISTING. PREP / PRIME / PAINT: METAL PARAPET WALL CAP PREP / PRIME / PAINT: PLASTERED ROOF TOP EQUIPMENT SCREEN WALLS

MELAMINE SHELVES. DO NOT PAINT. PREP / PRIME / PAINT: EXISTING WOOD

INSIDE AND OUT PAINT COLOR 1

CONTINUE EXISTING STRIPING AROUND ENTIRE PERIMETER OF BUILDING INCLUDING RECESSED DOOR AND WINDOW RETURNS BASEBALL AND SOFTBALL DUGOUTS - PROTECT IN PLACE: EXISTING

PREP / PRIME / PAINT: EXISTING POLE PREP / PRIME / PAINT: EXISTING HADRAIL

BID ALTERNATE #2 -PAINT (4) FOOTBALL FIELD LIGHTING STANDARDS

PREP / PRIME / PAINT: EXISTING WOOD BACKSTOP BOTH SIDES. REMOVE / REPLACE EXISTING WOOD BACKSTOP WITH DECAY-RESISTANT SIMILARLY SIZED WOOD AND CORROSION-RESISTANT HARDWARE. PREP / PRIME / PAINT: BOTH SIDES PRIOR TO INSTALLATION.


AGENCY APPROVAL:



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CONSULTANTS:

SEALS:

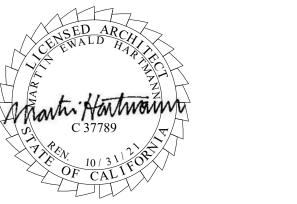

PROJECT:

NORDHOFF HS CAMPUS-WIDE EXTERIOR **PAINTING**

OJAI UNIFIED SCHOOL DISTRICT 414 EAST OJAI AVENUE OJAI, CA 93023 (805) 640-4300 CONTACT: ADAM DUTTER

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ISSUE:		
MARK	DATE	DESCRIPTION

PROJECT INFORMATION: PROJECT NUMBER: PROJECT PHASE:

DRAWN BY: REVIEWED BY:

THE ORIGINAL SIZE OF THIS SHEET IS 36"x24". IF THE CURRENT SIZE IS OTHER THAN 36"x24", THEN ADJUST THE SCALE OF THE DRAWINGS ACCORDING! Y. SHEET TITLE:

BUILDINGS I & J

2020.031

04CONDOC

SHEET NUMBER: A-109

- BUILDING PLANS ARE SCHEMATIC TO ONLY SHOW APPROXIMATE OVERALL BUILDING DIMENSIONS, DOOR QUANTITIES AND APPROXIMATE DOOR LOCATIONS AND ARE PROVIDED AS A CONVENIENCE FOR BIDDING. FIELD VERIFY CONDITIONS PRIOR TO BID. REFER TO SHEET KEYNOTES, PHOTOS, AND LEGENDS FOR ADDITIONAL INFORMATION.
- ALL EXISTING PAINTED EXTERIOR SURFACES OF BUILDINGS INCLUDED IN THE SCOPE OF WORK ARE TO BE REPAINTED TO MATCH THE EXISTING PAINTED COLOR AS DETAILED IN THESE DRAWINGS AND SPECIFICATIONS UNLESS NOTED OTHERWISE.
- ALL EXISTING UNPAINTED EXTERIOR SURFACES ARE TO REMAIN UNPAINTED UNLESS NOTED OTHERWISE. PROTECT IN PLACE ALL UNPAINTED
- CAREFULLY PRUNE SHRUBS AND PLANTS AND REMOVE WEEDS AND PLANTINGS AT BASE OF WALL TO BARE EARTH TO ALLOW FOR COMPLETE WALL COVERAGE.
 - WINDOW FRAMES, MULLIONS, AND SEALANTS TO BE PAINTED COLOR 2.

COLOR LEGEND & NOTES

COLOR 1 - WHITE - Match SW 7013- Ivory Lace

COLOR 2 - BLUE - Match SW 6804- Dignity Blue

COLOR 3 - YELLOW - Match SW 6904- Gusto Gold

PHOTOS WITH KEYNOTES ARE CREATED ELECTRONICALLY AND ARE INTENDED TO BE VIEWED IN COLOR TO SEE LOCATIONS OF COLORS ON THE BUILDINGS. CONTRACTOR SHALL FIELD VERIFY ACTUAL LOCATIONS AND DIMENSIONS OF COLORS PRIOR TO BID.

SYMBOL LEGEND



EXISTING DOOR: FIELD VERIFY SIZES AND CONDITIONS, PAINT DOOR WARNING STRIPING ON LANDING AT ALL OUTSWINGING EXTERIOR DOORS U.N.O. PAINT EXTERIOR DOOR FACE, FRAME EXTERIOR AND INTERIOR JAMB TO FACE OF DOOR STOP.



EXISTING RESTROOM DOOR: FINISH AND STRIPING AS NOTED FOR TYPICAL EXTERIOR DOORS ABV. FIELD VERIFY SIZES AND CONDITIONS. APPLY RESTROOM IDENTIFICATION DOOR SIGNAGE ON EXTERIOR AND INTERIOR

SHEET KEYNOTES

NOTE: NOT ALL KEYNOTES **USED ON EVERY SHEET**

- REMOVE / PAINT WALL / REINSTALL: EXISTING SIGN PROTECT IN PLACE: EXISTING SECURITY CAMERA TYPICAL AT ALL
- PREP / PRIME / PAINT: UTILITY CONDUITS AND CABINETS TO MATCH WALL BEYOND. CONTINUE STRIPING OVER CONDUITS AND CABINETS WHERE
- PREP / PRIME / PAINT: EXISTING SIGNAGE IN PLACE PREP / PRIME / PAINT: EXISTING LOUVERS, TYPICAL
- PREP / PRIME / PAINT: GALVANIZED METAL WINDOW FRAME & WOOD TRIM. TYPICAL AT ALL WINDOWS THIS BUILDING. FIELD VERIFY LOCATIONS AND DIMENSIONS PRIOR TO BID.
- REMOVE / PAINT WALL / REINSTALL: LIGHT FIXTURE ESCUTCHEON PLATE OR LIGHT FIXTURE ITSELF TO WALL SURFACE BEHIND. TYPICAL AT ALL LIGHT
- FIXTURES U.N.O. REMOVE / WASH/ PREP / PRIME / PAINT / REINSTALL: ALL EXISTING LOCKERS IN THIS WING. PAINT ALL EXTERIOR SIDES, DOORS AND DOOR RETURNS
- ONLY. PROTECT UNPAINTED LOCKER HARDWARE. PREP / PRIME / PAINT: EXISTING GUTTERS AND DOWNSPOUTS. MATCH
- EXISTING WALL COLOR BEYOND. REMOVE / DISCARD: EXISTING METAL AWNING
- REMOVE / DISCARD WOODEN POST FILL IN HOLE
- PROTECT IN PLACE: EXISTING HVAC UNITS AND DUCTWORK PREP / PRIME / PAINT: DOOR SWING SAFETY STRIPING. TYPICAL AT ALL DOORS THIS BUILDING U.N.O.
- PROTECT IN PLACE: EXISTING LIGHT FIXTURE / SPEAKER / FIRE ALARM DEVICE
- PREP / PRIME / PAINT: EXISTING HVAC DUCTWORK WHERE ALREADY PAINTED. TYPICAL AT THIS BUILDING.
- PROTECT IN PLACE: EXISTING MURAL. PAINT WALLS AROUND MURAL TO MATCH EXISTING BUILDING COLOR SCHEME. TOUCH-UP/REPAINT MURALS WHERE PAINTED TO MATCH EXISTING.
- PROTECT IN PLACE: EXISTING DRINKING FOUNTAIN PREP / PRIME / PAINT: EXISTING PAINTED DRINKING FOUNTAIN CANE
- DETECTION RAILS
- REMOVE / PAINT WALL / REINSTALL: EXISTING DISPLAY CASES
- REMOVE / DISCARD: EXISTING SIGN
- REMOVE / PAINT WALL / REINSTALL: EXISTING BENCHES PROTECT IN PLACE: EXISTING UNFINISHED CONCRETE OR CMU
- PREP / PRIME / PAINT: EXISTING CONCRETE / CMU WALL PREP / PRIME /PAINT: EXISTING METAL FENCE & GATE
- PROTECT IN PLACE: EXISTING MECHANICAL EQUIPMENT
- PROTECT IN PLACE: EXISTING GALVANIZED WINDOW FRAMES. TYPICAL AT
- ALL WINDOWS THIS BUILDING. PREP / PRIME / PAINT ALL PAINTED WINDOW
- PREP / PRIME / PAINT: EXISTING ROLL-UP DOOR
- PREP / PRIME / PAINT: EXISTING STORAGE CONTAINER
- PREP / PRIME / PAINT: EXISTING WOOD BENCH / SEATS AND SLEEERS. **BID** ALTERNATE #3: - REMOVE / REPLACE / PREP / PRIME / PAINT: EXISTING WOODEN BENCHES, SEATS AND 4x DECAY-RESISTANT SLEEPERS.
- PREP / PRIME / PAINT: EXISTING CMU WALLS. PAINT INSIDE AND OUTSIDE OF ENCLOSURE AND DOORS.
- PREP / PRIME / PAINT: ENTIRETY OF METAL CANOPY
- 32. PAINT COLOR 2
- 33. PAINT COLOR 3 REMOVE / PREP / PAINT/ REINSTALL: EXISTING DOOR OR WINDOW METAL
- SECURITY GRATING PATCH / REPAIR / PREP / PRIME / PAINT: EXISTING PLASTER PREP / PRIME / PAINT: EXISTING GRAPHICS ON NORTH SIDE OF GYM WALL. ADD COLOR 3 BORDER AROUND 'N.' BID ALTERNATE #1 - PROVIDE AND
- INSTALL EXTERIOR ADHESIVE WALL GRAPHICS TO MATCH EXISTING. PREP / PRIME / PAINT: METAL PARAPET WALL CAP PREP / PRIME / PAINT: PLASTERED ROOF TOP EQUIPMENT SCREEN WALLS
- CONTINUE EXISTING STRIPING AROUND ENTIRE PERIMETER OF BUILDING
- INCLUDING RECESSED DOOR AND WINDOW RETURNS BASEBALL AND SOFTBALL DUGOUTS - PROTECT IN PLACE: EXISTING MELAMINE SHELVES. DO NOT PAINT. PREP / PRIME / PAINT: EXISTING WOOD
- SHELVES. PREP / PRIME / PAINT: EXISTING POLE
- PREP / PRIME / PAINT: EXISTING HADRAIL
- BID ALTERNATE #2 -PAINT (4) FOOTBALL FIELD LIGHTING STANDARDS PREP / PRIME / PAINT: EXISTING WOOD BACKSTOP BOTH SIDES.
- REMOVE / REPLACE EXISTING WOOD BACKSTOP WITH DECAY-RESISTANT SIMILARLY SIZED WOOD AND CORROSION-RESISTANT HARDWARE. PREP / PRIME / PAINT: BOTH SIDES PRIOR TO INSTALLATION.

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MARK	DATE	DESCRIPTION

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04CONDOC

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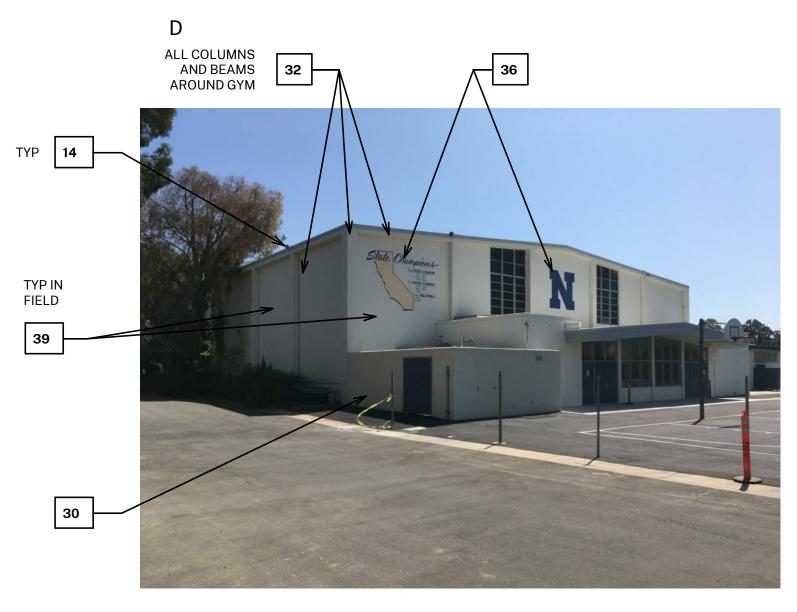
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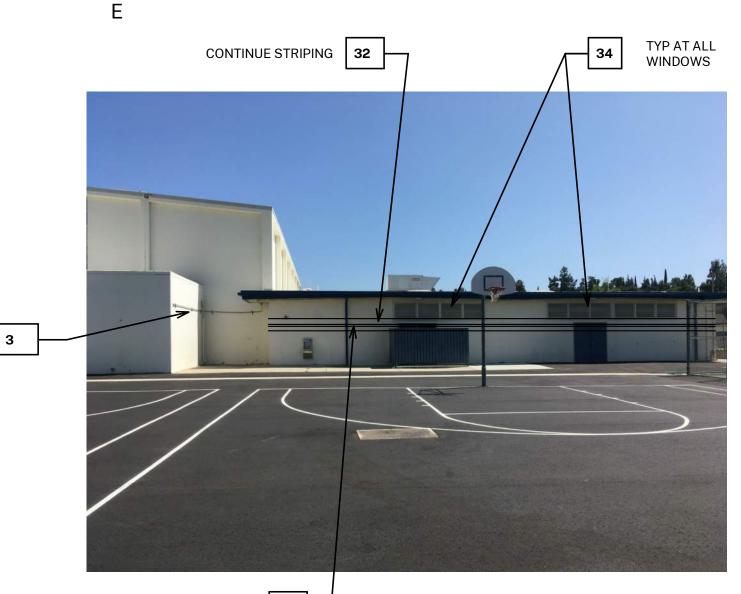
THE ORIGINAL SIZE OF THIS SHEET IS 36"x24". IF THE CURRENT SIZE IS OTHER THAN 36"x24", THEN ADJUST THE SCALE OF THE DRAWINGS ACCORDINGLY. SHEET TITLE:

BUILDINGS N & O

SHEET NUMBER:

A-110





33 -

GENERAL NOTES

- 1. BUILDING PLANS ARE SCHEMATIC TO ONLY SHOW APPROXIMATE OVERALL BUILDING DIMENSIONS, DOOR QUANTITIES AND APPROXIMATE DOOR LOCATIONS AND ARE PROVIDED AS A CONVENIENCE FOR BIDDING. FIELD VERIFY CONDITIONS PRIOR TO BID. REFER TO SHEET KEYNOTES, PHOTOS, AND LEGENDS FOR ADDITIONAL INFORMATION.
- 2. ALL EXISTING PAINTED EXTERIOR SURFACES OF BUILDINGS INCLUDED IN THE SCOPE OF WORK ARE TO BE REPAINTED TO MATCH THE EXISTING PAINTED COLOR AS DETAILED IN THESE DRAWINGS AND SPECIFICATIONS UNLESS NOTED OTHERWISE.
- UNLESS NOTED OTHERWISE.

 3. ALL EXISTING UNPAINTED EXTERIOR SURFACES ARE TO REMAIN UNPAINTED UNLESS NOTED OTHERWISE. PROTECT IN PLACE ALL UNPAINTED SURFACES.
- 4. CAREFULLY PRUNE SHRUBS AND PLANTS AND REMOVE WEEDS AND PLANTINGS AT BASE OF WALL TO BARE EARTH TO ALLOW FOR COMPLETE WALL COVERAGE.
- WALE GOVERNAGE.
 WINDOW FRAMES, MULLIONS, AND SEALANTS TO BE PAINTED COLOR 2.

COLOR LEGEND & NOTES

COLOR 1 - WHITE - Match SW 7013- Ivory Lace

COLOR 2 - BLUE - Match SW 6804- Dignity Blue

COLOR 3 - YELLOW - Match SW 6904- Gusto Gold

1. PHOTOS WITH KEYNOTES ARE CREATED ELECTRONICALLY AND ARE INTENDED TO BE VIEWED IN COLOR TO SEE LOCATIONS OF COLORS ON THE BUILDINGS. CONTRACTOR SHALL FIELD VERIFY ACTUAL LOCATIONS AND DIMENSIONS OF COLORS PRIOR TO BID.

SHEET KEYNOTES

NOTE: NOT ALL KEYNOTES USED ON EVERY SHEET

- REMOVE / PAINT WALL / REINSTALL: EXISTING SIGN
 PROTECT IN PLACE: EXISTING SECURITY CAMERA TYPICAL AT ALL
- LOCATIONS
 3. PREP / PRIME / PAINT: UTILITY CONDUITS AND CABINETS TO MATCH WALL BEYOND. CONTINUE STRIPING OVER CONDUITS AND CABINETS WHERE
- OCCURS.
 PREP / PRIME / PAINT: EXISTING SIGNAGE IN PLACE
- 5. PREP / PRIME / PAINT: EXISTING LOUVERS, TYPICAL
 6. PREP / PRIME / PAINT: GALVANIZED METAL WINDOW FRAME & WOOD TRIM.
 TYPICAL AT ALL WINDOWS THIS BUILDING. FIELD VERIFY LOCATIONS AND
 DIMENSIONS PRIOR TO BID.
- 7. REMOVE / PAINT WALL / REINSTALL: LIGHT FIXTURE ESCUTCHEON PLATE OR LIGHT FIXTURE ITSELF TO WALL SURFACE BEHIND. TYPICAL AT ALL LIGHT FIXTURES U.N.O.
- 8. REMOVE / WASH/ PREP / PRIME / PAINT / REINSTALL: ALL EXISTING LOCKERS IN THIS WING. PAINT ALL EXTERIOR SIDES, DOORS AND DOOR RETURNS ONLY. PROTECT UNPAINTED LOCKER HARDWARE.
- PREP / PRIME / PAINT: EXISTING GUTTERS AND DOWNSPOUTS. MATCH EXISTING WALL COLOR BEYOND.
- 0. REMOVE / DISCARD: EXISTING METAL AWNING
- REMOVE / DISCARD WOODEN POST FILL IN HOLE
 PROTECT IN PLACE: EXISTING HVAC UNITS AND DUCTWORK
- 13. PREP / PRIME / PAINT: DOOR SWING SAFETY STRIPING. TYPICAL AT ALL DOORS THIS BUILDING U.N.O.
 14. PROTECT IN PLACE: EXISTING LIGHT FIXTURE / SPEAKER / FIRE ALARM
- DEVICE

 15. PREP / PRIME / PAINT: EXISTING HVAC DUCTWORK WHERE ALREADY
- PREP / PRIME / PAINT: EXISTING HVAC DUCTWORK WHERE ALREAD PAINTED. TYPICAL AT THIS BUILDING.
- PROTECT IN PLACE: EXISTING MURAL. PAINT WALLS AROUND MURAL TO MATCH EXISTING BUILDING COLOR SCHEME. TOUCH-UP/REPAINT MURALS WHERE PAINTED TO MATCH EXISTING.
- 17. PROTECT IN PLACE: EXISTING DRINKING FOUNTAIN
- 8. PREP / PRIME / PAINT: EXISTING PAINTED DRINKING FOUNTAIN CANE DETECTION RAILS
- DETECTION RAILS
 REMOVE / PAINT WALL / REINSTALL: EXISTING DISPLAY CASES
- D. REMOVE / DISCARD: EXISTING SIGN

 DEMOVE / DAINT WALL / REINSTALL: EXISTING BENCHES
- REMOVE / PAINT WALL / REINSTALL: EXISTING BENCHES
 PROTECT IN PLACE: EXISTING UNFINISHED CONCRETE OR CMU
- PREP / PRIME / PAINT: EXISTING CONCRETE / CMU WALL
 PREP / PRIME /PAINT: EXISTING METAL FENCE & GATE
- PROTECT IN PLACE: EXISTING MECHANICAL EQUIPMENT
- PROTECT IN PLACE: EXISTING GALVANIZED WINDOW FRAMES. TYPICAL AT ALL WINDOWS THIS BUILDING. PREP / PRIME / PAINT ALL PAINTED WINDOW
- 27. PREP / PRIME / PAINT: EXISTING ROLL-UP DOOR
- 28. PREP / PRIME / PAINT: EXISTING STORAGE CONTAINER
 29. PREP / PRIME / PAINT: EXISTING WOOD BENCH / SEATS AND SLEEERS. BID
- ALTERNATE #3: REMOVE / REPLACE / PREP / PRIME / PAINT: EXISTING
 WOODEN BENCHES, SEATS AND 4x DECAY-RESISTANT SLEEPERS.

 PREP / PRIME / PAINT: EXISTING CMU WALLS. PAINT INSIDE AND OUTSIDE OF
- ENCLOSURE AND DOORS.
 PREP / PRIME / PAINT: ENTIRETY OF METAL CANOPY
- . PREP / PRIME / PA 2. PAINT COLOR 2
- 33. PAINT COLOR 334. REMOVE / PREP /
- REMOVE / PREP / PAINT/ REINSTALL: EXISTING DOOR OR WINDOW METAL SECURITY GRATING
- PATCH / REPAIR / PREP / PRIME / PAINT: EXISTING PLASTER
 PREP / PRIME / PAINT: EXISTING GRAPHICS ON NORTH SIDE OF GYM WALL.
- INSTALL EXTERIOR ADHESIVE WALL GRAPHICS TO MATCH EXISTING.
 PREP / PRIME / PAINT: METAL PARAPET WALL CAP
 PREP / PRIME / PAINT: PLASTERED ROOF TOP EQUIPMENT SCREEN WALLS

ADD COLOR 3 BORDER AROUND 'N.' BID ALTERNATE #1 - PROVIDE AND

- 38. PREP / PRIME / PAINT: PLASTERED ROOF TOP EQUIPMENT SCREEN INSIDE AND OUT
 39. PAINT COLOR 1
- O. CONTINUE EXISTING STRIPING AROUND ENTIRE PERIMETER OF BUILDING INCLUDING RECESSED DOOR AND WINDOW RETURNS

 BASEBALL AND SOFTBALL DUGOUTS PROTECT IN PLACE: EXISTING

MELAMINE SHELVES. DO NOT PAINT. PREP / PRIME / PAINT: EXISTING WOOD

- SHELVES.
 42. PREP / PRIME / PAINT: EXISTING POLE
- 42. PREP / PRIME / PAINT: EXISTING POLE
 43. PREP / PRIME / PAINT: EXISTING HADRAIL
- 44. BID ALTERNATE #2 -PAINT (4) FOOTBALL FIELD LIGHTING STANDARDS
 45. PREP / PRIME / PAINT: EXISTING WOOD BACKSTOP BOTH SIDES.
- 46. REMOVE / REPLACE EXISTING WOOD BACKSTOP WITH DECAY-RESISTANT SIMILARLY SIZED WOOD AND CORROSION-RESISTANT HARDWARE. PREP / PRIME / PAINT: BOTH SIDES PRIOR TO INSTALLATION.

AGENCY APPROVAL:



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SEALS:

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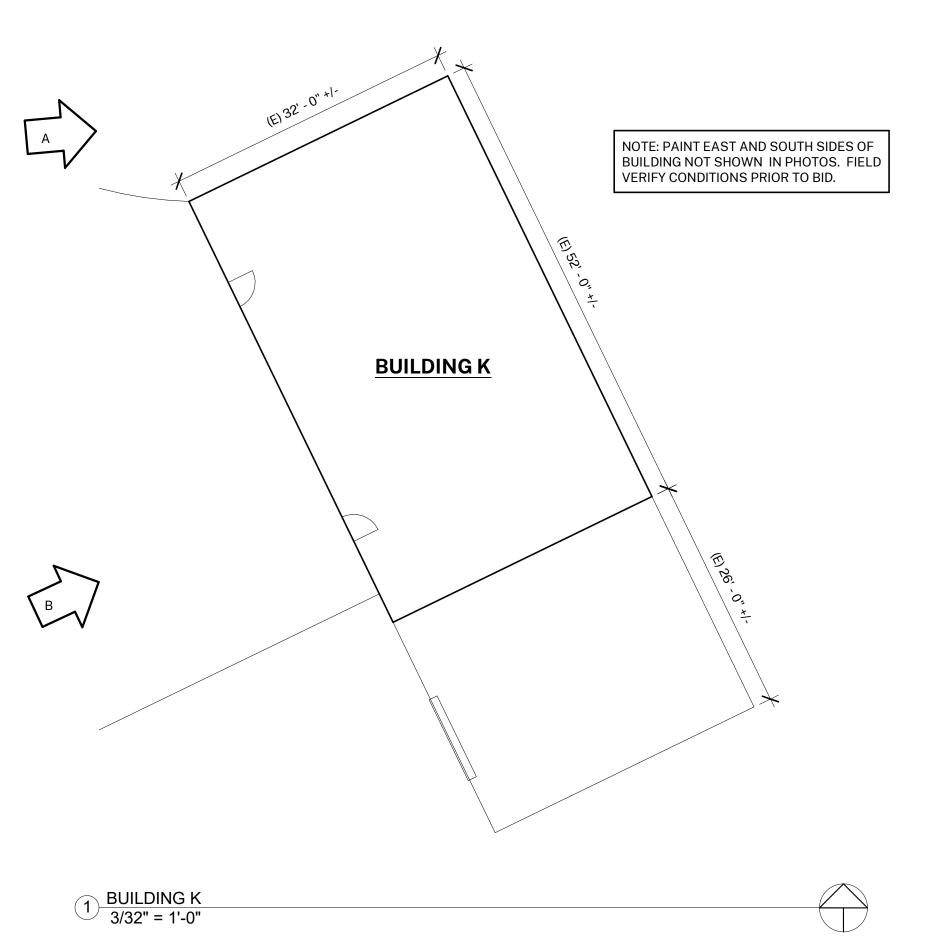
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ALL EXISTING PAINTED EXTERIOR SURFACES OF BUILDINGS INCLUDED IN THE SCOPE OF WORK ARE TO BE REPAINTED TO MATCH THE EXISTING PAINTED COLOR AS DETAILED IN THESE DRAWINGS AND SPECIFICATIONS UNLESS NOTED OTHERWISE.

ALL EXISTING UNPAINTED EXTERIOR SURFACES ARE TO REMAIN UNPAINTED UNLESS NOTED OTHERWISE. PROTECT IN PLACE ALL UNPAINTED

CAREFULLY PRUNE SHRUBS AND PLANTS AND REMOVE WEEDS AND PLANTINGS AT BASE OF WALL TO BARE EARTH TO ALLOW FOR COMPLETE

WALL COVERAGE. WINDOW FRAMES, MULLIONS, AND SEALANTS TO BE PAINTED COLOR 2.

COLOR LEGEND & NOTES

COLOR 1 - WHITE - Match SW 7013- Ivory Lace

COLOR 2 - BLUE - Match SW 6804- Dignity Blue

COLOR 3 - YELLOW - Match SW 6904- Gusto Gold

PHOTOS WITH KEYNOTES ARE CREATED ELECTRONICALLY AND ARE INTENDED TO BE VIEWED IN COLOR TO SEE LOCATIONS OF COLORS ON THE BUILDINGS. CONTRACTOR SHALL FIELD VERIFY ACTUAL LOCATIONS AND DIMENSIONS OF COLORS PRIOR TO BID.

SYMBOL LEGEND



EXISTING DOOR: FIELD VERIFY SIZES AND CONDITIONS, PAINT DOOR WARNING STRIPING ON LANDING AT ALL OUTSWINGING EXTERIOR DOORS U.N.O. PAINT EXTERIOR DOOR FACE, FRAME EXTERIOR AND INTERIOR JAMB TO FACE OF DOOR STOP.



EXISTING RESTROOM DOOR: FINISH AND STRIPING AS NOTED FOR TYPICAL EXTERIOR DOORS ABV. FIELD VERIFY SIZES AND CONDITIONS. APPLY RESTROOM IDENTIFICATION DOOR SIGNAGE ON EXTERIOR AND INTERIOR

SHEET KEYNOTES

NOTE: NOT ALL KEYNOTES USED ON EVERY SHEET

REMOVE / PAINT WALL / REINSTALL: EXISTING SIGN PROTECT IN PLACE: EXISTING SECURITY CAMERA TYPICAL AT ALL

LOCATIONS PREP / PRIME / PAINT: UTILITY CONDUITS AND CABINETS TO MATCH WALL BEYOND. CONTINUE STRIPING OVER CONDUITS AND CABINETS WHERE

PREP / PRIME / PAINT: EXISTING SIGNAGE IN PLACE

PREP / PRIME / PAINT: EXISTING LOUVERS, TYPICAL PREP / PRIME / PAINT: GALVANIZED METAL WINDOW FRAME & WOOD TRIM. TYPICAL AT ALL WINDOWS THIS BUILDING. FIELD VERIFY LOCATIONS AND

DIMENSIONS PRIOR TO BID. REMOVE / PAINT WALL / REINSTALL: LIGHT FIXTURE ESCUTCHEON PLATE OR LIGHT FIXTURE ITSELF TO WALL SURFACE BEHIND. TYPICAL AT ALL LIGHT FIXTURES U.N.O.

REMOVE / WASH/ PREP / PRIME / PAINT / REINSTALL: ALL EXISTING LOCKERS IN THIS WING. PAINT ALL EXTERIOR SIDES, DOORS AND DOOR RETURNS

ONLY. PROTECT UNPAINTED LOCKER HARDWARE. PREP / PRIME / PAINT: EXISTING GUTTERS AND DOWNSPOUTS. MATCH

EXISTING WALL COLOR BEYOND. REMOVE / DISCARD: EXISTING METAL AWNING

REMOVE / DISCARD WOODEN POST FILL IN HOLE

PROTECT IN PLACE: EXISTING HVAC UNITS AND DUCTWORK

PREP / PRIME / PAINT: DOOR SWING SAFETY STRIPING. TYPICAL AT ALL DOORS THIS BUILDING U.N.O.

PROTECT IN PLACE: EXISTING LIGHT FIXTURE / SPEAKER / FIRE ALARM

PREP / PRIME / PAINT: EXISTING HVAC DUCTWORK WHERE ALREADY

PAINTED. TYPICAL AT THIS BUILDING. PROTECT IN PLACE: EXISTING MURAL. PAINT WALLS AROUND MURAL TO MATCH EXISTING BUILDING COLOR SCHEME. TOUCH-UP/REPAINT MURALS

WHERE PAINTED TO MATCH EXISTING. PROTECT IN PLACE: EXISTING DRINKING FOUNTAIN PREP / PRIME / PAINT: EXISTING PAINTED DRINKING FOUNTAIN CANE

DETECTION RAILS REMOVE / PAINT WALL / REINSTALL: EXISTING DISPLAY CASES

REMOVE / DISCARD: EXISTING SIGN

REMOVE / PAINT WALL / REINSTALL: EXISTING BENCHES PROTECT IN PLACE: EXISTING UNFINISHED CONCRETE OR CMU

PREP / PRIME / PAINT: EXISTING CONCRETE / CMU WALL

PREP / PRIME /PAINT: EXISTING METAL FENCE & GATE

PROTECT IN PLACE: EXISTING MECHANICAL EQUIPMENT PROTECT IN PLACE: EXISTING GALVANIZED WINDOW FRAMES. TYPICAL AT ALL WINDOWS THIS BUILDING. PREP / PRIME / PAINT ALL PAINTED WINDOW

27. PREP / PRIME / PAINT: EXISTING ROLL-UP DOOR

28. PREP / PRIME / PAINT: EXISTING STORAGE CONTAINER 29. PREP / PRIME / PAINT: EXISTING WOOD BENCH / SEATS AND SLEEERS. **BID** ALTERNATE #3: - REMOVE / REPLACE / PREP / PRIME / PAINT: EXISTING

WOODEN BENCHES, SEATS AND 4x DECAY-RESISTANT SLEEPERS. PREP / PRIME / PAINT: EXISTING CMU WALLS. PAINT INSIDE AND OUTSIDE OF ENCLOSURE AND DOORS.

PREP / PRIME / PAINT: ENTIRETY OF METAL CANOPY

PAINT COLOR 2

PAINT COLOR 3

REMOVE / PREP / PAINT/ REINSTALL: EXISTING DOOR OR WINDOW METAL SECURITY GRATING

PATCH / REPAIR / PREP / PRIME / PAINT: EXISTING PLASTER PREP / PRIME / PAINT: EXISTING GRAPHICS ON NORTH SIDE OF GYM WALL. ADD COLOR 3 BORDER AROUND 'N.' BID ALTERNATE #1 - PROVIDE AND

INSTALL EXTERIOR ADHESIVE WALL GRAPHICS TO MATCH EXISTING. PREP / PRIME / PAINT: METAL PARAPET WALL CAP 38. PREP / PRIME / PAINT: PLASTERED ROOF TOP EQUIPMENT SCREEN WALLS

INSIDE AND OUT PAINT COLOR 1

CONTINUE EXISTING STRIPING AROUND ENTIRE PERIMETER OF BUILDING INCLUDING RECESSED DOOR AND WINDOW RETURNS BASEBALL AND SOFTBALL DUGOUTS - PROTECT IN PLACE: EXISTING MELAMINE SHELVES. DO NOT PAINT. PREP / PRIME / PAINT: EXISTING WOOD

SHELVES. PREP / PRIME / PAINT: EXISTING POLE

PREP / PRIME / PAINT: EXISTING HADRAIL

BID ALTERNATE #2 -PAINT (4) FOOTBALL FIELD LIGHTING STANDARDS

PREP / PRIME / PAINT: EXISTING WOOD BACKSTOP BOTH SIDES. REMOVE / REPLACE EXISTING WOOD BACKSTOP WITH DECAY-RESISTANT SIMILARLY SIZED WOOD AND CORROSION-RESISTANT HARDWARE. PREP / PRIME / PAINT: BOTH SIDES PRIOR TO INSTALLATION.

AGENCY APPROVAL:



HARTMANNARCHITECTURESTUDIO.COM 430 S. CARRILLO RD. OJAI, CALIFORNIA 93023 (805) 530-5559

CONSULTANTS:

SEALS:

NORDHOFF HS CAMPUS-WIDE EXTERIOR PAINTING

OJAI UNIFIED SCHOOL DISTRICT 414 EAST OJAI AVENUE OJAI, CA 93023 (805) 640-4300 CONTACT: ADAM DUTTER

PROJECT ADDRESS:

NORDOFF HIGH SCHOOL 1401 MARICOPA HIGHWAY OJAI, CA 93023

EMAIL: adutter@ojaiusd.org

ISSUE:		
MARK	DATE	DESCRIPTION
I	l	

2020.031

04CONDOC

PROJECT INFORMATION: PROJECT NUMBER: PROJECT PHASE: DRAWN BY:


REVIEWED BY: THE ORIGINAL SIZE OF THIS SHEET IS 36"x24". IF THE CURRENT SIZE IS OTHER THAN 36"x24", THEN ADJUST THE SCALE OF THE DRAWINGS ACCORDINGLY.

BUILDING K

SHEET NUMBER:


DATE: 08/18/2020


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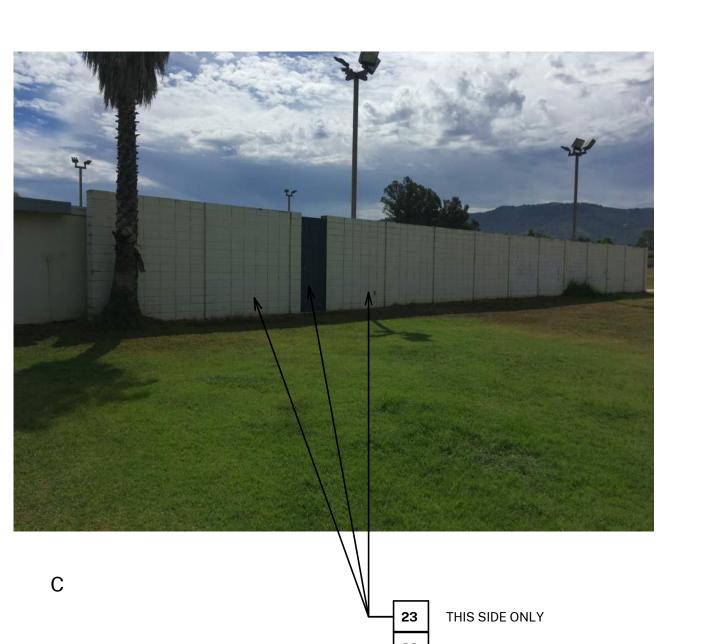


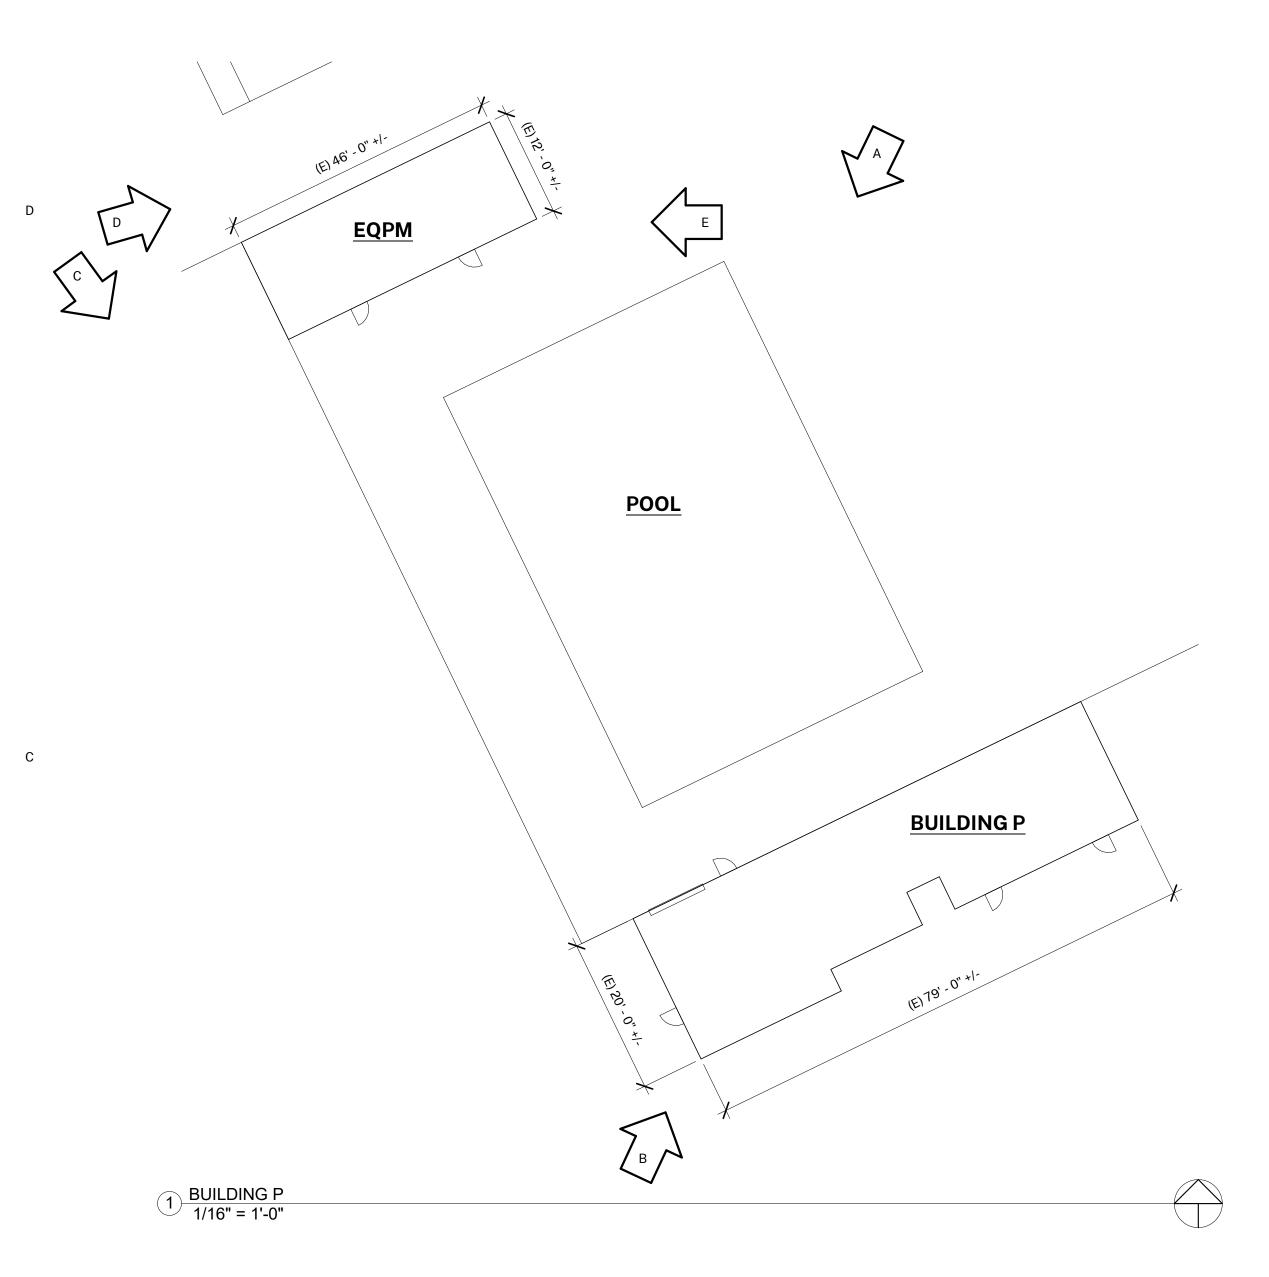





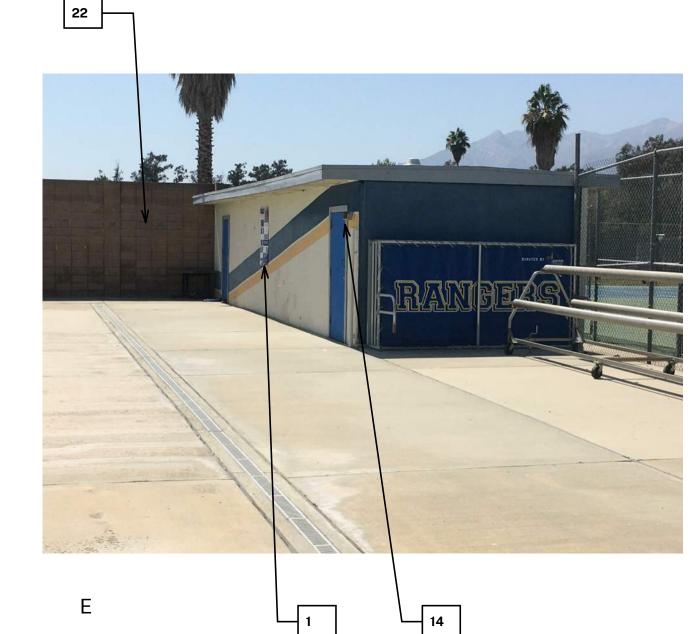

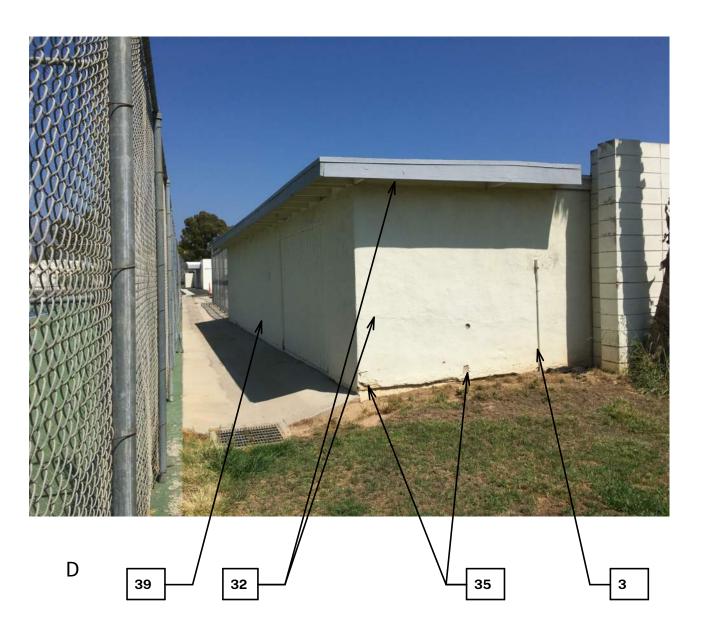

BUILDING PLANS ARE SCHEMATIC TO ONLY SHOW APPROXIMATE OVERALL

BUILDING DIMENSIONS, DOOR QUANTITIES AND APPROXIMATE DOOR LOCATIONS AND ARE PROVIDED AS A CONVENIENCE FOR BIDDING. FIELD VERIFY CONDITIONS PRIOR TO BID. REFER TO SHEET KEYNOTES, PHOTOS, AND LEGENDS FOR ADDITIONAL INFORMATION. ALL EXISTING PAINTED EXTERIOR SURFACES OF BUILDINGS INCLUDED IN

THE SCOPE OF WORK ARE TO BE REPAINTED TO MATCH THE EXISTING PAINTED COLOR AS DETAILED IN THESE DRAWINGS AND SPECIFICATIONS UNLESS NOTED OTHERWISE.

ALL EXISTING UNPAINTED EXTERIOR SURFACES ARE TO REMAIN UNPAINTED UNLESS NOTED OTHERWISE. PROTECT IN PLACE ALL UNPAINTED

CAREFULLY PRUNE SHRUBS AND PLANTS AND REMOVE WEEDS AND

PLANTINGS AT BASE OF WALL TO BARE EARTH TO ALLOW FOR COMPLETE WALL COVERAGE. WINDOW FRAMES, MULLIONS, AND SEALANTS TO BE PAINTED COLOR 2.

COLOR LEGEND & NOTES

COLOR 1 - WHITE - Match SW 7013- Ivory Lace

COLOR 2 - BLUE - Match SW 6804- Dignity Blue

COLOR 3 - YELLOW - Match SW 6904- Gusto Gold

PHOTOS WITH KEYNOTES ARE CREATED ELECTRONICALLY AND ARE INTENDED TO BE VIEWED IN COLOR TO SEE LOCATIONS OF COLORS ON THE BUILDINGS. CONTRACTOR SHALL FIELD VERIFY ACTUAL LOCATIONS AND DIMENSIONS OF COLORS PRIOR TO BID.

SYMBOL LEGEND



EXISTING DOOR: FIELD VERIFY SIZES AND CONDITIONS, PAINT DOOR WARNING STRIPING ON LANDING AT ALL OUTSWINGING EXTERIOR DOORS U.N.O. PAINT EXTERIOR DOOR FACE, FRAME EXTERIOR AND INTERIOR JAMB TO FACE OF DOOR STOP.



EXISTING RESTROOM DOOR: FINISH AND STRIPING AS NOTED FOR TYPICAL EXTERIOR DOORS ABV. FIELD VERIFY SIZES AND CONDITIONS. APPLY RESTROOM IDENTIFICATION DOOR SIGNAGE ON **EXTERIOR AND INTERIOR**

SHEET KEYNOTES

NOTE: NOT ALL KEYNOTES **USED ON EVERY SHEET**

REMOVE / PAINT WALL / REINSTALL: EXISTING SIGN

PREP / PRIME / PAINT: UTILITY CONDUITS AND CABINETS TO MATCH WALL BEYOND. CONTINUE STRIPING OVER CONDUITS AND CABINETS WHERE

PROTECT IN PLACE: EXISTING SECURITY CAMERA TYPICAL AT ALL

PREP / PRIME / PAINT: EXISTING SIGNAGE IN PLACE

PREP / PRIME / PAINT: EXISTING LOUVERS, TYPICAL PREP / PRIME / PAINT: GALVANIZED METAL WINDOW FRAME & WOOD TRIM. TYPICAL AT ALL WINDOWS THIS BUILDING. FIELD VERIFY LOCATIONS AND

DIMENSIONS PRIOR TO BID. REMOVE / PAINT WALL / REINSTALL: LIGHT FIXTURE ESCUTCHEON PLATE OR LIGHT FIXTURE ITSELF TO WALL SURFACE BEHIND. TYPICAL AT ALL LIGHT

FIXTURES U.N.O. REMOVE / WASH/ PREP / PRIME / PAINT / REINSTALL: ALL EXISTING LOCKERS

IN THIS WING. PAINT ALL EXTERIOR SIDES, DOORS AND DOOR RETURNS ONLY. PROTECT UNPAINTED LOCKER HARDWARE. PREP / PRIME / PAINT: EXISTING GUTTERS AND DOWNSPOUTS. MATCH

EXISTING WALL COLOR BEYOND. REMOVE / DISCARD: EXISTING METAL AWNING

REMOVE / DISCARD WOODEN POST FILL IN HOLE

PROTECT IN PLACE: EXISTING HVAC UNITS AND DUCTWORK PREP / PRIME / PAINT: DOOR SWING SAFETY STRIPING. TYPICAL AT ALL DOORS THIS BUILDING U.N.O.

PROTECT IN PLACE: EXISTING LIGHT FIXTURE / SPEAKER / FIRE ALARM

PREP / PRIME / PAINT: EXISTING HVAC DUCTWORK WHERE ALREADY

PAINTED. TYPICAL AT THIS BUILDING. PROTECT IN PLACE: EXISTING MURAL. PAINT WALLS AROUND MURAL TO MATCH EXISTING BUILDING COLOR SCHEME. TOUCH-UP/REPAINT MURALS WHERE PAINTED TO MATCH EXISTING.

PROTECT IN PLACE: EXISTING DRINKING FOUNTAIN PREP / PRIME / PAINT: EXISTING PAINTED DRINKING FOUNTAIN CANE

DETECTION RAILS REMOVE / PAINT WALL / REINSTALL: EXISTING DISPLAY CASES

REMOVE / DISCARD: EXISTING SIGN

REMOVE / PAINT WALL / REINSTALL: EXISTING BENCHES PROTECT IN PLACE: EXISTING UNFINISHED CONCRETE OR CMU

PREP / PRIME / PAINT: EXISTING CONCRETE / CMU WALL PREP / PRIME /PAINT: EXISTING METAL FENCE & GATE PROTECT IN PLACE: EXISTING MECHANICAL EQUIPMENT

PROTECT IN PLACE: EXISTING GALVANIZED WINDOW FRAMES. TYPICAL AT ALL WINDOWS THIS BUILDING. PREP / PRIME / PAINT ALL PAINTED WINDOW

PREP / PRIME / PAINT: EXISTING ROLL-UP DOOR

PREP / PRIME / PAINT: EXISTING STORAGE CONTAINER PREP / PRIME / PAINT: EXISTING WOOD BENCH / SEATS AND SLEEERS. **BID**

ALTERNATE #3: - REMOVE / REPLACE / PREP / PRIME / PAINT: EXISTING WOODEN BENCHES, SEATS AND 4x DECAY-RESISTANT SLEEPERS. PREP / PRIME / PAINT: EXISTING CMU WALLS. PAINT INSIDE AND OUTSIDE OF ENCLOSURE AND DOORS.

PREP / PRIME / PAINT: ENTIRETY OF METAL CANOPY

PAINT COLOR 2 32.

PAINT COLOR 3 REMOVE / PREP / PAINT/ REINSTALL: EXISTING DOOR OR WINDOW METAL SECURITY GRATING

PATCH / REPAIR / PREP / PRIME / PAINT: EXISTING PLASTER PREP / PRIME / PAINT: EXISTING GRAPHICS ON NORTH SIDE OF GYM WALL. ADD COLOR 3 BORDER AROUND 'N.' BID ALTERNATE #1 - PROVIDE AND

INSTALL EXTERIOR ADHESIVE WALL GRAPHICS TO MATCH EXISTING. PREP / PRIME / PAINT: METAL PARAPET WALL CAP 38. PREP / PRIME / PAINT: PLASTERED ROOF TOP EQUIPMENT SCREEN WALLS

INSIDE AND OUT PAINT COLOR 1 CONTINUE EXISTING STRIPING AROUND ENTIRE PERIMETER OF BUILDING

INCLUDING RECESSED DOOR AND WINDOW RETURNS BASEBALL AND SOFTBALL DUGOUTS - PROTECT IN PLACE: EXISTING MELAMINE SHELVES. DO NOT PAINT. PREP / PRIME / PAINT: EXISTING WOOD

SHELVES. 42. PREP / PRIME / PAINT: EXISTING POLE

PREP / PRIME / PAINT: EXISTING HADRAIL

BID ALTERNATE #2 -PAINT (4) FOOTBALL FIELD LIGHTING STANDARDS PREP / PRIME / PAINT: EXISTING WOOD BACKSTOP BOTH SIDES. REMOVE / REPLACE EXISTING WOOD BACKSTOP WITH DECAY-RESISTANT

SIMILARLY SIZED WOOD AND CORROSION-RESISTANT HARDWARE. PREP / PRIME / PAINT: BOTH SIDES PRIOR TO INSTALLATION.

AGENCY APPROVAL:



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04CONDOC

PROJECT INFORMATION: PROJECT NUMBER: PROJECT PHASE: DRAWN BY: **REVIEWED BY:**

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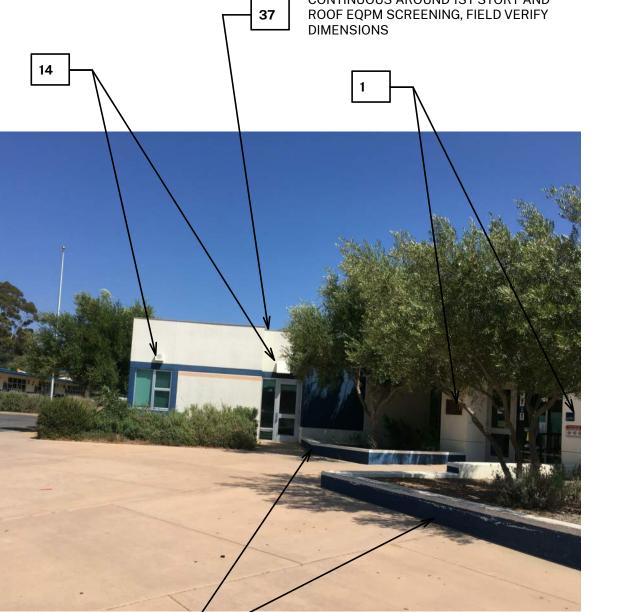
BUILDING P


SHEET NUMBER:


DATE: 08/18/2020

SHEET TITLE:

A-113



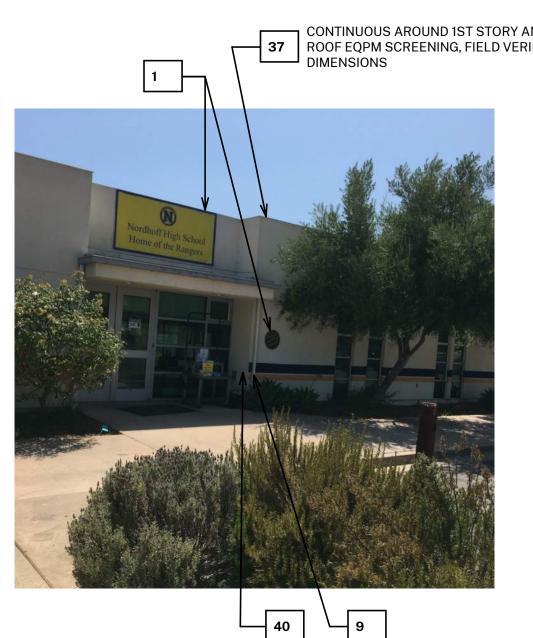

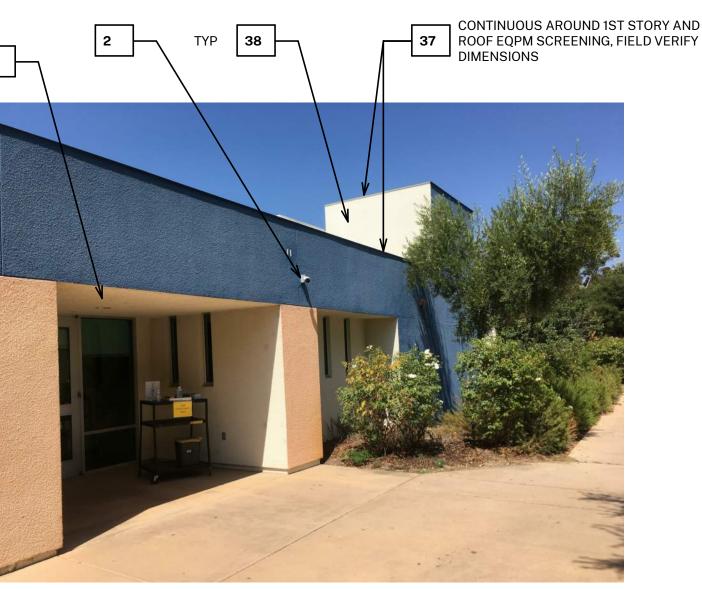

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- ALL EXISTING UNPAINTED EXTERIOR SURFACES ARE TO REMAIN UNPAINTED UNLESS NOTED OTHERWISE. PROTECT IN PLACE ALL UNPAINTED
- CAREFULLY PRUNE SHRUBS AND PLANTS AND REMOVE WEEDS AND PLANTINGS AT BASE OF WALL TO BARE EARTH TO ALLOW FOR COMPLETE
- WALL COVERAGE. WINDOW FRAMES, MULLIONS, AND SEALANTS TO BE PAINTED COLOR 2.

COLOR LEGEND & NOTES

COLOR 1 - WHITE - Match SW 7013- Ivory Lace

COLOR 2 - BLUE - Match SW 6804- Dignity Blue

COLOR 3 - YELLOW - Match SW 6904- Gusto Gold

PHOTOS WITH KEYNOTES ARE CREATED ELECTRONICALLY AND ARE INTENDED TO BE VIEWED IN COLOR TO SEE LOCATIONS OF COLORS ON THE BUILDINGS. CONTRACTOR SHALL FIELD VERIFY ACTUAL LOCATIONS AND DIMENSIONS OF COLORS PRIOR TO BID.

SYMBOL LEGEND



EXISTING DOOR: FIELD VERIFY SIZES AND CONDITIONS, PAINT DOOR WARNING STRIPING ON LANDING AT ALL OUTSWINGING EXTERIOR DOORS U.N.O. PAINT EXTERIOR DOOR FACE, FRAME EXTERIOR AND INTERIOR JAMB TO FACE OF DOOR STOP.



EXISTING RESTROOM DOOR: FINISH AND STRIPING AS NOTED FOR TYPICAL EXTERIOR DOORS ABV. FIELD VERIFY SIZES AND CONDITIONS. APPLY RESTROOM IDENTIFICATION DOOR SIGNAGE ON EXTERIOR AND INTERIOR

SHEET KEYNOTES

NOTE: NOT ALL KEYNOTES USED ON EVERY SHEET

- REMOVE / PAINT WALL / REINSTALL: EXISTING SIGN PROTECT IN PLACE: EXISTING SECURITY CAMERA TYPICAL AT ALL
- LOCATIONS PREP / PRIME / PAINT: UTILITY CONDUITS AND CABINETS TO MATCH WALL BEYOND. CONTINUE STRIPING OVER CONDUITS AND CABINETS WHERE OCCURS.
- PREP / PRIME / PAINT: EXISTING SIGNAGE IN PLACE PREP / PRIME / PAINT: EXISTING LOUVERS, TYPICAL
- PREP / PRIME / PAINT: GALVANIZED METAL WINDOW FRAME & WOOD TRIM. TYPICAL AT ALL WINDOWS THIS BUILDING. FIELD VERIFY LOCATIONS AND DIMENSIONS PRIOR TO BID.
- REMOVE / PAINT WALL / REINSTALL: LIGHT FIXTURE ESCUTCHEON PLATE OR LIGHT FIXTURE ITSELF TO WALL SURFACE BEHIND. TYPICAL AT ALL LIGHT
- REMOVE / WASH/ PREP / PRIME / PAINT / REINSTALL: ALL EXISTING LOCKERS IN THIS WING. PAINT ALL EXTERIOR SIDES, DOORS AND DOOR RETURNS
- ONLY. PROTECT UNPAINTED LOCKER HARDWARE. PREP / PRIME / PAINT: EXISTING GUTTERS AND DOWNSPOUTS. MATCH
- EXISTING WALL COLOR BEYOND. REMOVE / DISCARD: EXISTING METAL AWNING
- REMOVE / DISCARD WOODEN POST FILL IN HOLE PROTECT IN PLACE: EXISTING HVAC UNITS AND DUCTWORK
- PREP / PRIME / PAINT: DOOR SWING SAFETY STRIPING. TYPICAL AT ALL DOORS THIS BUILDING U.N.O.
- PROTECT IN PLACE: EXISTING LIGHT FIXTURE / SPEAKER / FIRE ALARM
- PREP / PRIME / PAINT: EXISTING HVAC DUCTWORK WHERE ALREADY
- PAINTED. TYPICAL AT THIS BUILDING. PROTECT IN PLACE: EXISTING MURAL. PAINT WALLS AROUND MURAL TO MATCH EXISTING BUILDING COLOR SCHEME. TOUCH-UP/REPAINT MURALS
- WHERE PAINTED TO MATCH EXISTING. PROTECT IN PLACE: EXISTING DRINKING FOUNTAIN
- PREP / PRIME / PAINT: EXISTING PAINTED DRINKING FOUNTAIN CANE
- DETECTION RAILS REMOVE / PAINT WALL / REINSTALL: EXISTING DISPLAY CASES
- REMOVE / DISCARD: EXISTING SIGN
- REMOVE / PAINT WALL / REINSTALL: EXISTING BENCHES PROTECT IN PLACE: EXISTING UNFINISHED CONCRETE OR CMU
- PREP / PRIME / PAINT: EXISTING CONCRETE / CMU WALL
- PREP / PRIME /PAINT: EXISTING METAL FENCE & GATE PROTECT IN PLACE: EXISTING MECHANICAL EQUIPMENT PROTECT IN PLACE: EXISTING GALVANIZED WINDOW FRAMES. TYPICAL AT
- ALL WINDOWS THIS BUILDING. PREP / PRIME / PAINT ALL PAINTED WINDOW
- PREP / PRIME / PAINT: EXISTING ROLL-UP DOOR PREP / PRIME / PAINT: EXISTING STORAGE CONTAINER
- ALTERNATE #3: REMOVE / REPLACE / PREP / PRIME / PAINT: EXISTING WOODEN BENCHES, SEATS AND 4x DECAY-RESISTANT SLEEPERS.

PREP / PRIME / PAINT: EXISTING WOOD BENCH / SEATS AND SLEEERS. BID

- PREP / PRIME / PAINT: EXISTING CMU WALLS. PAINT INSIDE AND OUTSIDE OF ENCLOSURE AND DOORS.
- PREP / PRIME / PAINT: ENTIRETY OF METAL CANOPY
- 32. PAINT COLOR 2 33. PAINT COLOR 3
 - REMOVE / PREP / PAINT/ REINSTALL: EXISTING DOOR OR WINDOW METAL SECURITY GRATING
- PATCH / REPAIR / PREP / PRIME / PAINT: EXISTING PLASTER PREP / PRIME / PAINT: EXISTING GRAPHICS ON NORTH SIDE OF GYM WALL.
- ADD COLOR 3 BORDER AROUND 'N.' BID ALTERNATE #1 PROVIDE AND INSTALL EXTERIOR ADHESIVE WALL GRAPHICS TO MATCH EXISTING. PREP / PRIME / PAINT: METAL PARAPET WALL CAP
- PREP / PRIME / PAINT: PLASTERED ROOF TOP EQUIPMENT SCREEN WALLS
- PAINT COLOR 1 CONTINUE EXISTING STRIPING AROUND ENTIRE PERIMETER OF BUILDING INCLUDING RECESSED DOOR AND WINDOW RETURNS
- BASEBALL AND SOFTBALL DUGOUTS PROTECT IN PLACE: EXISTING MELAMINE SHELVES. DO NOT PAINT. PREP / PRIME / PAINT: EXISTING WOOD SHELVES.
- PREP / PRIME / PAINT: EXISTING POLE
- PREP / PRIME / PAINT: EXISTING HADRAIL
- BID ALTERNATE #2 -PAINT (4) FOOTBALL FIELD LIGHTING STANDARDS PREP / PRIME / PAINT: EXISTING WOOD BACKSTOP BOTH SIDES.
- REMOVE / REPLACE EXISTING WOOD BACKSTOP WITH DECAY-RESISTANT SIMILARLY SIZED WOOD AND CORROSION-RESISTANT HARDWARE. PREP / PRIME / PAINT: BOTH SIDES PRIOR TO INSTALLATION.

AGENCY APPROVAL:



HARTMANNARCHITECTURESTUDIO.COM 430 S. CARRILLO RD. OJAI, CALIFORNIA 93023 (805) 530-5559

CONSULTANTS:

SEALS:

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CONTACT: ADAM DUTTER

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PROJECT ADDRESS:

OJAI, CA 93023

NORDOFF HIGH SCHOOL 1401 MARICOPA HIGHWAY

ISSUE:			
MARK	DATE	DESCRIPTION	

2020.031

04CONDOC

PROJECT INFORMATION: PROJECT NUMBER: PROJECT PHASE:

DRAWN BY: **REVIEWED BY:**

THE ORIGINAL SIZE OF THIS SHEET IS 36"x24". IF THE CURRENT SIZE IS OTHER THAN 36"x24", THEN ADJUST THE SCALE OF THE DRAWINGS ACCORDINGLY. SHEET TITLE:

ADMIN BUILDING

SHEET NUMBER:

A-114

- BUILDING PLANS ARE SCHEMATIC TO ONLY SHOW APPROXIMATE OVERALL BUILDING DIMENSIONS, DOOR QUANTITIES AND APPROXIMATE DOOR LOCATIONS AND ARE PROVIDED AS A CONVENIENCE FOR BIDDING. FIELD VERIFY CONDITIONS PRIOR TO BID. REFER TO SHEET KEYNOTES, PHOTOS, AND LEGENDS FOR ADDITIONAL INFORMATION.
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- ALL EXISTING UNPAINTED EXTERIOR SURFACES ARE TO REMAIN UNPAINTED UNLESS NOTED OTHERWISE. PROTECT IN PLACE ALL UNPAINTED
- CAREFULLY PRUNE SHRUBS AND PLANTS AND REMOVE WEEDS AND PLANTINGS AT BASE OF WALL TO BARE EARTH TO ALLOW FOR COMPLETE WALL COVERAGE.
- WINDOW FRAMES, MULLIONS, AND SEALANTS TO BE PAINTED COLOR 2.

COLOR LEGEND & NOTES

COLOR 1 - WHITE - Match SW 7013- Ivory Lace

COLOR 2 - BLUE - Match SW 6804- Dignity Blue

COLOR 3 - YELLOW - Match SW 6904- Gusto Gold

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SYMBOL LEGEND



EXISTING DOOR: FIELD VERIFY SIZES AND CONDITIONS, PAINT DOOR WARNING STRIPING ON LANDING AT ALL OUTSWINGING EXTERIOR DOORS U.N.O. PAINT EXTERIOR DOOR FACE, FRAME EXTERIOR AND INTERIOR JAMB TO FACE OF DOOR STOP.



EXISTING RESTROOM DOOR: FINISH AND STRIPING AS NOTED FOR TYPICAL EXTERIOR DOORS ABV. FIELD VERIFY SIZES AND CONDITIONS. APPLY RESTROOM IDENTIFICATION DOOR SIGNAGE ON EXTERIOR AND INTERIOR

SHEET KEYNOTES

NOTE: NOT ALL KEYNOTES **USED ON EVERY SHEET**

- REMOVE / PAINT WALL / REINSTALL: EXISTING SIGN PROTECT IN PLACE: EXISTING SECURITY CAMERA TYPICAL AT ALL
- PREP / PRIME / PAINT: UTILITY CONDUITS AND CABINETS TO MATCH WALL BEYOND. CONTINUE STRIPING OVER CONDUITS AND CABINETS WHERE
- PREP / PRIME / PAINT: EXISTING SIGNAGE IN PLACE
- PREP / PRIME / PAINT: EXISTING LOUVERS, TYPICAL PREP / PRIME / PAINT: GALVANIZED METAL WINDOW FRAME & WOOD TRIM. TYPICAL AT ALL WINDOWS THIS BUILDING. FIELD VERIFY LOCATIONS AND
- DIMENSIONS PRIOR TO BID. REMOVE / PAINT WALL / REINSTALL: LIGHT FIXTURE ESCUTCHEON PLATE OR LIGHT FIXTURE ITSELF TO WALL SURFACE BEHIND. TYPICAL AT ALL LIGHT
- REMOVE / WASH/ PREP / PRIME / PAINT / REINSTALL: ALL EXISTING LOCKERS IN THIS WING. PAINT ALL EXTERIOR SIDES, DOORS AND DOOR RETURNS
- ONLY. PROTECT UNPAINTED LOCKER HARDWARE.
- PREP / PRIME / PAINT: EXISTING GUTTERS AND DOWNSPOUTS. MATCH EXISTING WALL COLOR BEYOND.
- REMOVE / DISCARD: EXISTING METAL AWNING REMOVE / DISCARD WOODEN POST FILL IN HOLE
- PROTECT IN PLACE: EXISTING HVAC UNITS AND DUCTWORK PREP / PRIME / PAINT: DOOR SWING SAFETY STRIPING. TYPICAL AT ALL
- DOORS THIS BUILDING U.N.O. PROTECT IN PLACE: EXISTING LIGHT FIXTURE / SPEAKER / FIRE ALARM
- PREP / PRIME / PAINT: EXISTING HVAC DUCTWORK WHERE ALREADY
- PAINTED. TYPICAL AT THIS BUILDING. PROTECT IN PLACE: EXISTING MURAL. PAINT WALLS AROUND MURAL TO MATCH EXISTING BUILDING COLOR SCHEME. TOUCH-UP/REPAINT MURALS WHERE PAINTED TO MATCH EXISTING.
- PROTECT IN PLACE: EXISTING DRINKING FOUNTAIN PREP / PRIME / PAINT: EXISTING PAINTED DRINKING FOUNTAIN CANE
- DETECTION RAILS
- REMOVE / PAINT WALL / REINSTALL: EXISTING DISPLAY CASES REMOVE / DISCARD: EXISTING SIGN
- REMOVE / PAINT WALL / REINSTALL: EXISTING BENCHES PROTECT IN PLACE: EXISTING UNFINISHED CONCRETE OR CMU
- PREP / PRIME / PAINT: EXISTING CONCRETE / CMU WALL
- PREP / PRIME /PAINT: EXISTING METAL FENCE & GATE PROTECT IN PLACE: EXISTING MECHANICAL EQUIPMENT PROTECT IN PLACE: EXISTING GALVANIZED WINDOW FRAMES. TYPICAL AT ALL WINDOWS THIS BUILDING. PREP / PRIME / PAINT ALL PAINTED WINDOW
- PREP / PRIME / PAINT: EXISTING ROLL-UP DOOR
- PREP / PRIME / PAINT: EXISTING STORAGE CONTAINER PREP / PRIME / PAINT: EXISTING WOOD BENCH / SEATS AND SLEEERS. **BID** ALTERNATE #3: - REMOVE / REPLACE / PREP / PRIME / PAINT: EXISTING
- WOODEN BENCHES, SEATS AND 4x DECAY-RESISTANT SLEEPERS. PREP / PRIME / PAINT: EXISTING CMU WALLS. PAINT INSIDE AND OUTSIDE OF **ENCLOSURE AND DOORS.**
- PREP / PRIME / PAINT: ENTIRETY OF METAL CANOPY
- 32. PAINT COLOR 2 33. PAINT COLOR 3
- REMOVE / PREP / PAINT/ REINSTALL: EXISTING DOOR OR WINDOW METAL
- SECURITY GRATING PATCH / REPAIR / PREP / PRIME / PAINT: EXISTING PLASTER
- PREP / PRIME / PAINT: EXISTING GRAPHICS ON NORTH SIDE OF GYM WALL. ADD COLOR 3 BORDER AROUND 'N.' BID ALTERNATE #1 - PROVIDE AND INSTALL EXTERIOR ADHESIVE WALL GRAPHICS TO MATCH EXISTING.
- PREP / PRIME / PAINT: METAL PARAPET WALL CAP PREP / PRIME / PAINT: PLASTERED ROOF TOP EQUIPMENT SCREEN WALLS INSIDE AND OUT
- PAINT COLOR 1 CONTINUE EXISTING STRIPING AROUND ENTIRE PERIMETER OF BUILDING
- INCLUDING RECESSED DOOR AND WINDOW RETURNS BASEBALL AND SOFTBALL DUGOUTS - PROTECT IN PLACE: EXISTING MELAMINE SHELVES. DO NOT PAINT. PREP / PRIME / PAINT: EXISTING WOOD SHELVES.
- PREP / PRIME / PAINT: EXISTING POLE
- PREP / PRIME / PAINT: EXISTING HADRAIL
- BID ALTERNATE #2 -PAINT (4) FOOTBALL FIELD LIGHTING STANDARDS PREP / PRIME / PAINT: EXISTING WOOD BACKSTOP BOTH SIDES.

REMOVE / REPLACE EXISTING WOOD BACKSTOP WITH DECAY-RESISTANT SIMILARLY SIZED WOOD AND CORROSION-RESISTANT HARDWARE. PREP / PRIME / PAINT: BOTH SIDES PRIOR TO INSTALLATION.

AGENCY APPROVAL:



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NORDOFF HIGH SCHOOL 1401 MARICOPA HIGHWAY OJAI, CA 93023

MARK DATE DESCRIPTION

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MUSIC BUILDING

DATE: 08/18/2020

SHEET TITLE:

SHEET NUMBER: A-115

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- ALL EXISTING PAINTED EXTERIOR SURFACES OF BUILDINGS INCLUDED IN THE SCOPE OF WORK ARE TO BE REPAINTED TO MATCH THE EXISTING PAINTED COLOR AS DETAILED IN THESE DRAWINGS AND SPECIFICATIONS UNLESS NOTED OTHERWISE.
- ALL EXISTING UNPAINTED EXTERIOR SURFACES ARE TO REMAIN UNPAINTED UNLESS NOTED OTHERWISE. PROTECT IN PLACE ALL UNPAINTED
- CAREFULLY PRUNE SHRUBS AND PLANTS AND REMOVE WEEDS AND PLANTINGS AT BASE OF WALL TO BARE EARTH TO ALLOW FOR COMPLETE
- WALL COVERAGE. WINDOW FRAMES, MULLIONS, AND SEALANTS TO BE PAINTED COLOR 2.

COLOR LEGEND & NOTES

COLOR 1 - WHITE - Match SW 7013- Ivory Lace

COLOR 2 - BLUE - Match SW 6804- Dignity Blue

COLOR 3 - YELLOW - Match SW 6904- Gusto Gold

PHOTOS WITH KEYNOTES ARE CREATED ELECTRONICALLY AND ARE INTENDED TO BE VIEWED IN COLOR TO SEE LOCATIONS OF COLORS ON THE BUILDINGS. CONTRACTOR SHALL FIELD VERIFY ACTUAL LOCATIONS AND DIMENSIONS OF COLORS PRIOR TO BID.

SYMBOL LEGEND



EXISTING DOOR: FIELD VERIFY SIZES AND CONDITIONS, PAINT DOOR WARNING STRIPING ON LANDING AT ALL OUTSWINGING EXTERIOR DOORS U.N.O. PAINT EXTERIOR DOOR FACE, FRAME EXTERIOR AND INTERIOR JAMB TO FACE OF DOOR STOP.



EXISTING RESTROOM DOOR: FINISH AND STRIPING AS NOTED FOR TYPICAL EXTERIOR DOORS ABV. FIELD VERIFY SIZES AND CONDITIONS. APPLY RESTROOM IDENTIFICATION DOOR SIGNAGE ON EXTERIOR AND INTERIOR

SHEET KEYNOTES

NOTE: NOT ALL KEYNOTES **USED ON EVERY SHEET**

- REMOVE / PAINT WALL / REINSTALL: EXISTING SIGN
- PROTECT IN PLACE: EXISTING SECURITY CAMERA TYPICAL AT ALL
- PREP / PRIME / PAINT: UTILITY CONDUITS AND CABINETS TO MATCH WALL BEYOND. CONTINUE STRIPING OVER CONDUITS AND CABINETS WHERE
- PREP / PRIME / PAINT: EXISTING SIGNAGE IN PLACE
- PREP / PRIME / PAINT: EXISTING LOUVERS, TYPICAL
- PREP / PRIME / PAINT: GALVANIZED METAL WINDOW FRAME & WOOD TRIM. TYPICAL AT ALL WINDOWS THIS BUILDING. FIELD VERIFY LOCATIONS AND DIMENSIONS PRIOR TO BID.
- REMOVE / PAINT WALL / REINSTALL: LIGHT FIXTURE ESCUTCHEON PLATE OR LIGHT FIXTURE ITSELF TO WALL SURFACE BEHIND. TYPICAL AT ALL LIGHT FIXTURES U.N.O.
- REMOVE / WASH/ PREP / PRIME / PAINT / REINSTALL: ALL EXISTING LOCKERS IN THIS WING. PAINT ALL EXTERIOR SIDES, DOORS AND DOOR RETURNS
- ONLY. PROTECT UNPAINTED LOCKER HARDWARE. PREP / PRIME / PAINT: EXISTING GUTTERS AND DOWNSPOUTS. MATCH
- EXISTING WALL COLOR BEYOND. REMOVE / DISCARD: EXISTING METAL AWNING
- REMOVE / DISCARD WOODEN POST FILL IN HOLE
- PROTECT IN PLACE: EXISTING HVAC UNITS AND DUCTWORK PREP / PRIME / PAINT: DOOR SWING SAFETY STRIPING. TYPICAL AT ALL
- DOORS THIS BUILDING U.N.O.
- PROTECT IN PLACE: EXISTING LIGHT FIXTURE / SPEAKER / FIRE ALARM
- PREP / PRIME / PAINT: EXISTING HVAC DUCTWORK WHERE ALREADY
- PAINTED. TYPICAL AT THIS BUILDING. PROTECT IN PLACE: EXISTING MURAL. PAINT WALLS AROUND MURAL TO
- MATCH EXISTING BUILDING COLOR SCHEME. TOUCH-UP/REPAINT MURALS WHERE PAINTED TO MATCH EXISTING.
- PROTECT IN PLACE: EXISTING DRINKING FOUNTAIN
- PREP / PRIME / PAINT: EXISTING PAINTED DRINKING FOUNTAIN CANE
- DETECTION RAILS REMOVE / PAINT WALL / REINSTALL: EXISTING DISPLAY CASES REMOVE / DISCARD: EXISTING SIGN
- REMOVE / PAINT WALL / REINSTALL: EXISTING BENCHES
- PROTECT IN PLACE: EXISTING UNFINISHED CONCRETE OR CMU
- PREP / PRIME / PAINT: EXISTING CONCRETE / CMU WALL PREP / PRIME /PAINT: EXISTING METAL FENCE & GATE
- PROTECT IN PLACE: EXISTING MECHANICAL EQUIPMENT
- PROTECT IN PLACE: EXISTING GALVANIZED WINDOW FRAMES. TYPICAL AT ALL WINDOWS THIS BUILDING. PREP / PRIME / PAINT ALL PAINTED WINDOW
- PREP / PRIME / PAINT: EXISTING ROLL-UP DOOR
- PREP / PRIME / PAINT: EXISTING STORAGE CONTAINER PREP / PRIME / PAINT: EXISTING WOOD BENCH / SEATS AND SLEEERS. BID
- ALTERNATE #3: REMOVE / REPLACE / PREP / PRIME / PAINT: EXISTING WOODEN BENCHES, SEATS AND 4x DECAY-RESISTANT SLEEPERS.
- PREP / PRIME / PAINT: EXISTING CMU WALLS. PAINT INSIDE AND OUTSIDE OF **ENCLOSURE AND DOORS.**
 - PREP / PRIME / PAINT: ENTIRETY OF METAL CANOPY
- PAINT COLOR 2
- PAINT COLOR 3
- REMOVE / PREP / PAINT/ REINSTALL: EXISTING DOOR OR WINDOW METAL SECURITY GRATING
- PATCH / REPAIR / PREP / PRIME / PAINT: EXISTING PLASTER PREP / PRIME / PAINT: EXISTING GRAPHICS ON NORTH SIDE OF GYM WALL. ADD COLOR 3 BORDER AROUND 'N.' BID ALTERNATE #1 - PROVIDE AND
- INSTALL EXTERIOR ADHESIVE WALL GRAPHICS TO MATCH EXISTING. PREP / PRIME / PAINT: METAL PARAPET WALL CAP
- PREP / PRIME / PAINT: PLASTERED ROOF TOP EQUIPMENT SCREEN WALLS INSIDE AND OUT
- PAINT COLOR 1
- CONTINUE EXISTING STRIPING AROUND ENTIRE PERIMETER OF BUILDING
- INCLUDING RECESSED DOOR AND WINDOW RETURNS BASEBALL AND SOFTBALL DUGOUTS - PROTECT IN PLACE: EXISTING MELAMINE SHELVES. DO NOT PAINT. PREP / PRIME / PAINT: EXISTING WOOD
- SHELVES. PREP / PRIME / PAINT: EXISTING POLE
- PREP / PRIME / PAINT: EXISTING HADRAIL
- BID ALTERNATE #2 -PAINT (4) FOOTBALL FIELD LIGHTING STANDARDS
- PREP / PRIME / PAINT: EXISTING WOOD BACKSTOP BOTH SIDES. REMOVE / REPLACE EXISTING WOOD BACKSTOP WITH DECAY-RESISTANT SIMILARLY SIZED WOOD AND CORROSION-RESISTANT HARDWARE. PREP / PRIME / PAINT: BOTH SIDES PRIOR TO INSTALLATION.

AGENCY APPROVAL:



HARTMANNARCHITECTURESTUDIO.COM 430 S. CARRILLO RD. OJAI, CALIFORNIA 93023 (805) 530-5559

CONSULTANTS:

SEALS:



NORDHOFF HS CAMPUS-WIDE EXTERIOR PAINTING

OJAI UNIFIED SCHOOL DISTRICT 414 EAST OJAI AVENUE OJAI, CA 93023 (805) 640-4300

PROJECT ADDRESS:

CONTACT: ADAM DUTTER

EMAIL: adutter@ojaiusd.org

NORDOFF HIGH SCHOOL 1401 MARICOPA HIGHWAY OJAI, CA 93023

1330E:		
MARK	DATE	DESCRIPTION

2020.031

04CONDOC

PROJECT INFORMATION: PROJECT NUMBER:

PROJECT PHASE: DRAWN BY: **REVIEWED BY:**

SHEET TITLE:

THE ORIGINAL SIZE OF THIS SHEET IS 36"x24". IF THE CURRENT SIZE IS OTHER THAN 36"x24", THEN ADJUST THE SCALE OF THE DRAWINGS ACCORDINGLY.

SCIENCE BUILDING

SHEET NUMBER: A-116



BUILDING PLANS ARE SCHEMATIC TO ONLY SHOW APPROXIMATE OVERALL BUILDING DIMENSIONS, DOOR QUANTITIES AND APPROXIMATE DOOR LOCATIONS AND ARE PROVIDED AS A CONVENIENCE FOR BIDDING. FIELD VERIFY CONDITIONS PRIOR TO BID. REFER TO SHEET KEYNOTES, PHOTOS,

> AND LEGENDS FOR ADDITIONAL INFORMATION. ALL EXISTING PAINTED EXTERIOR SURFACES OF BUILDINGS INCLUDED IN THE SCOPE OF WORK ARE TO BE REPAINTED TO MATCH THE EXISTING PAINTED COLOR AS DETAILED IN THESE DRAWINGS AND SPECIFICATIONS

UNLESS NOTED OTHERWISE. ALL EXISTING UNPAINTED EXTERIOR SURFACES ARE TO REMAIN UNPAINTED UNLESS NOTED OTHERWISE. PROTECT IN PLACE ALL UNPAINTED

CAREFULLY PRUNE SHRUBS AND PLANTS AND REMOVE WEEDS AND PLANTINGS AT BASE OF WALL TO BARE EARTH TO ALLOW FOR COMPLETE

WALL COVERAGE. WINDOW FRAMES, MULLIONS, AND SEALANTS TO BE PAINTED COLOR 2.

AGENCY APPROVAL:

HARTMANNARCHITECTURESTUDIO.COM 430 S. CARRILLO RD. OJAI, CALIFORNIA 93023 (805) 530-5559

CONSULTANTS:

COLOR LEGEND & NOTES

COLOR 1 - WHITE - Match SW 7013- Ivory Lace

COLOR 2 - BLUE - Match SW 6804- Dignity Blue

COLOR 3 - YELLOW - Match SW 6904- Gusto Gold

PHOTOS WITH KEYNOTES ARE CREATED ELECTRONICALLY AND ARE INTENDED TO BE VIEWED IN COLOR TO SEE LOCATIONS OF COLORS ON THE BUILDINGS. CONTRACTOR SHALL FIELD VERIFY ACTUAL

LOCATIONS AND DIMENSIONS OF COLORS PRIOR TO BID.

SHEET KEYNOTES

NOTE: NOT ALL KEYNOTES **USED ON EVERY SHEET**

REMOVE / PAINT WALL / REINSTALL: EXISTING SIGN PROTECT IN PLACE: EXISTING SECURITY CAMERA TYPICAL AT ALL

LOCATIONS PREP / PRIME / PAINT: UTILITY CONDUITS AND CABINETS TO MATCH WALL BEYOND. CONTINUE STRIPING OVER CONDUITS AND CABINETS WHERE

PREP / PRIME / PAINT: EXISTING SIGNAGE IN PLACE

PREP / PRIME / PAINT: EXISTING LOUVERS, TYPICAL PREP / PRIME / PAINT: GALVANIZED METAL WINDOW FRAME & WOOD TRIM. TYPICAL AT ALL WINDOWS THIS BUILDING. FIELD VERIFY LOCATIONS AND

DIMENSIONS PRIOR TO BID. REMOVE / PAINT WALL / REINSTALL: LIGHT FIXTURE ESCUTCHEON PLATE OF LIGHT FIXTURE ITSELF TO WALL SURFACE BEHIND. TYPICAL AT ALL LIGHT

FIXTURES U.N.O. REMOVE / WASH/ PREP / PRIME / PAINT / REINSTALL: ALL EXISTING LOCKERS IN THIS WING. PAINT ALL EXTERIOR SIDES, DOORS AND DOOR RETURNS

ONLY. PROTECT UNPAINTED LOCKER HARDWARE. PREP / PRIME / PAINT: EXISTING GUTTERS AND DOWNSPOUTS. MATCH

EXISTING WALL COLOR BEYOND.

REMOVE / DISCARD: EXISTING METAL AWNING

REMOVE / DISCARD WOODEN POST FILL IN HOLE PROTECT IN PLACE: EXISTING HVAC UNITS AND DUCTWORK PREP / PRIME / PAINT: DOOR SWING SAFETY STRIPING. TYPICAL AT ALL

DOORS THIS BUILDING U.N.O. PROTECT IN PLACE: EXISTING LIGHT FIXTURE / SPEAKER / FIRE ALARM

PREP / PRIME / PAINT: EXISTING HVAC DUCTWORK WHERE ALREADY

PAINTED. TYPICAL AT THIS BUILDING. PROTECT IN PLACE: EXISTING MURAL. PAINT WALLS AROUND MURAL TO MATCH EXISTING BUILDING COLOR SCHEME. TOUCH-UP/REPAINT MURALS

WHERE PAINTED TO MATCH EXISTING. PROTECT IN PLACE: EXISTING DRINKING FOUNTAIN PREP / PRIME / PAINT: EXISTING PAINTED DRINKING FOUNTAIN CANE

DETECTION RAILS REMOVE / PAINT WALL / REINSTALL: EXISTING DISPLAY CASES

REMOVE / DISCARD: EXISTING SIGN REMOVE / PAINT WALL / REINSTALL: EXISTING BENCHES PROTECT IN PLACE: EXISTING UNFINISHED CONCRETE OR CMU

PREP / PRIME / PAINT: EXISTING CONCRETE / CMU WALL PREP / PRIME /PAINT: EXISTING METAL FENCE & GATE PROTECT IN PLACE: EXISTING MECHANICAL EQUIPMENT PROTECT IN PLACE: EXISTING GALVANIZED WINDOW FRAMES. TYPICAL AT

ALL WINDOWS THIS BUILDING. PREP / PRIME / PAINT ALL PAINTED WINDOW PREP / PRIME / PAINT: EXISTING ROLL-UP DOOR

PREP / PRIME / PAINT: EXISTING STORAGE CONTAINER PREP / PRIME / PAINT: EXISTING WOOD BENCH / SEATS AND SLEEERS. **BID** ALTERNATE #3: - REMOVE / REPLACE / PREP / PRIME / PAINT: EXISTING WOODEN BENCHES, SEATS AND 4x DECAY-RESISTANT SLEEPERS.

PREP / PRIME / PAINT: EXISTING CMU WALLS. PAINT INSIDE AND OUTSIDE OF ENCLOSURE AND DOORS. PREP / PRIME / PAINT: ENTIRETY OF METAL CANOPY

PAINT COLOR 2

PAINT COLOR 3 33.

REMOVE / PREP / PAINT/ REINSTALL: EXISTING DOOR OR WINDOW METAL

SECURITY GRATING PATCH / REPAIR / PREP / PRIME / PAINT: EXISTING PLASTER PREP / PRIME / PAINT: EXISTING GRAPHICS ON NORTH SIDE OF GYM WALL.

INSTALL EXTERIOR ADHESIVE WALL GRAPHICS TO MATCH EXISTING. PREP / PRIME / PAINT: METAL PARAPET WALL CAP PREP / PRIME / PAINT: PLASTERED ROOF TOP EQUIPMENT SCREEN WALLS

ADD COLOR 3 BORDER AROUND 'N.' **BID ALTERNATE** #1 - PROVIDE AND

INSIDE AND OUT

PAINT COLOR 1 CONTINUE EXISTING STRIPING AROUND ENTIRE PERIMETER OF BUILDING INCLUDING RECESSED DOOR AND WINDOW RETURNS

BASEBALL AND SOFTBALL DUGOUTS - PROTECT IN PLACE: EXISTING MELAMINE SHELVES. DO NOT PAINT. PREP / PRIME / PAINT: EXISTING WOOD

PREP / PRIME / PAINT: EXISTING POLE PREP / PRIME / PAINT: EXISTING HADRAIL

BID ALTERNATE #2 -PAINT (4) FOOTBALL FIELD LIGHTING STANDARDS

PREP / PRIME / PAINT: EXISTING WOOD BACKSTOP BOTH SIDES. REMOVE / REPLACE EXISTING WOOD BACKSTOP WITH DECAY-RESISTANT SIMILARLY SIZED WOOD AND CORROSION-RESISTANT HARDWARE. PREP / PRIME / PAINT: BOTH SIDES PRIOR TO INSTALLATION.

SEALS:



PROJECT:

NORDHOFF HS CAMPUS-WIDE EXTERIOR **PAINTING**

OJAI UNIFIED SCHOOL DISTRICT 414 EAST OJAI AVENUE OJAI, CA 93023 (805) 640-4300 CONTACT: ADAM DUTTER

PROJECT ADDRESS:

NORDOFF HIGH SCHOOL 1401 MARICOPA HIGHWAY OJAI, CA 93023

EMAIL: adutter@ojaiusd.org

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04CONDOC

PROJECT INFORMATION: PROJECT NUMBER: PROJECT PHASE:

DRAWN BY: **REVIEWED BY:**

THE ORIGINAL SIZE OF THIS SHEET IS 36"x24". IF THE CURRENT SIZE IS OTHER THAN 36"x24", THEN ADJUST THE SCALE OF THE DRAWINGS ACCORDING! Y. SHEET TITLE:

ATHLETIC FIELDS

SHEET NUMBER: **A-117**

BUILDING PLANS ARE SCHEMATIC TO ONLY SHOW APPROXIMATE OVERALL BUILDING DIMENSIONS, DOOR QUANTITIES AND APPROXIMATE DOOR LOCATIONS AND ARE PROVIDED AS A CONVENIENCE FOR BIDDING. FIELD VERIFY CONDITIONS PRIOR TO BID. REFER TO SHEET KEYNOTES, PHOTOS, AND LEGENDS FOR ADDITIONAL INFORMATION.

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- UNLESS NOTED OTHERWISE. ALL EXISTING UNPAINTED EXTERIOR SURFACES ARE TO REMAIN UNPAINTED UNLESS NOTED OTHERWISE. PROTECT IN PLACE ALL UNPAINTED
- CAREFULLY PRUNE SHRUBS AND PLANTS AND REMOVE WEEDS AND PLANTINGS AT BASE OF WALL TO BARE EARTH TO ALLOW FOR COMPLETE WALL COVERAGE.
- WINDOW FRAMES, MULLIONS, AND SEALANTS TO BE PAINTED COLOR 2.

HARTMANNARCHITECTURESTUDIO.COM 430 S. CARRILLO RD. OJAI, CALIFORNIA 93023 (805) 530-5559

CONSULTANTS:

AGENCY APPROVAL:

COLOR LEGEND & NOTES

COLOR 1 - WHITE - Match SW 7013- Ivory Lace

COLOR 2 - BLUE - Match SW 6804- Dignity Blue

COLOR 3 - YELLOW - Match SW 6904- Gusto Gold

PHOTOS WITH KEYNOTES ARE CREATED ELECTRONICALLY AND ARE INTENDED TO BE VIEWED IN COLOR TO SEE LOCATIONS OF COLORS ON THE BUILDINGS. CONTRACTOR SHALL FIELD VERIFY ACTUAL LOCATIONS AND DIMENSIONS OF COLORS PRIOR TO BID.

NOTE: NOT ALL KEYNOTES **USED ON EVERY SHEET**

- REMOVE / PAINT WALL / REINSTALL: EXISTING SIGN PROTECT IN PLACE: EXISTING SECURITY CAMERA TYPICAL AT ALL
- LOCATIONS PREP / PRIME / PAINT: UTILITY CONDUITS AND CABINETS TO MATCH WALL BEYOND. CONTINUE STRIPING OVER CONDUITS AND CABINETS WHERE
- PREP / PRIME / PAINT: EXISTING SIGNAGE IN PLACE
- PREP / PRIME / PAINT: EXISTING LOUVERS, TYPICAL PREP / PRIME / PAINT: GALVANIZED METAL WINDOW FRAME & WOOD TRIM. TYPICAL AT ALL WINDOWS THIS BUILDING. FIELD VERIFY LOCATIONS AND
- DIMENSIONS PRIOR TO BID. REMOVE / PAINT WALL / REINSTALL: LIGHT FIXTURE ESCUTCHEON PLATE OF LIGHT FIXTURE ITSELF TO WALL SURFACE BEHIND. TYPICAL AT ALL LIGHT FIXTURES U.N.O.
- REMOVE / WASH/ PREP / PRIME / PAINT / REINSTALL: ALL EXISTING LOCKERS IN THIS WING. PAINT ALL EXTERIOR SIDES, DOORS AND DOOR RETURNS
- ONLY. PROTECT UNPAINTED LOCKER HARDWARE.
- PREP / PRIME / PAINT: EXISTING GUTTERS AND DOWNSPOUTS. MATCH EXISTING WALL COLOR BEYOND.
- REMOVE / DISCARD: EXISTING METAL AWNING REMOVE / DISCARD WOODEN POST FILL IN HOLE
- PROTECT IN PLACE: EXISTING HVAC UNITS AND DUCTWORK PREP / PRIME / PAINT: DOOR SWING SAFETY STRIPING. TYPICAL AT ALL
- DOORS THIS BUILDING U.N.O. PROTECT IN PLACE: EXISTING LIGHT FIXTURE / SPEAKER / FIRE ALARM
- PREP / PRIME / PAINT: EXISTING HVAC DUCTWORK WHERE ALREADY PAINTED. TYPICAL AT THIS BUILDING.
- PROTECT IN PLACE: EXISTING MURAL. PAINT WALLS AROUND MURAL TO MATCH EXISTING BUILDING COLOR SCHEME. TOUCH-UP/REPAINT MURALS WHERE PAINTED TO MATCH EXISTING.
- PROTECT IN PLACE: EXISTING DRINKING FOUNTAIN PREP / PRIME / PAINT: EXISTING PAINTED DRINKING FOUNTAIN CANE DETECTION RAILS
- REMOVE / PAINT WALL / REINSTALL: EXISTING DISPLAY CASES REMOVE / DISCARD: EXISTING SIGN
- REMOVE / PAINT WALL / REINSTALL: EXISTING BENCHES
- PROTECT IN PLACE: EXISTING UNFINISHED CONCRETE OR CMU
- PREP / PRIME / PAINT: EXISTING CONCRETE / CMU WALL PREP / PRIME /PAINT: EXISTING METAL FENCE & GATE
- PROTECT IN PLACE: EXISTING MECHANICAL EQUIPMENT PROTECT IN PLACE: EXISTING GALVANIZED WINDOW FRAMES. TYPICAL AT ALL WINDOWS THIS BUILDING. PREP / PRIME / PAINT ALL PAINTED WINDOW
- PREP / PRIME / PAINT: EXISTING ROLL-UP DOOR
- PREP / PRIME / PAINT: EXISTING STORAGE CONTAINER PREP / PRIME / PAINT: EXISTING WOOD BENCH / SEATS AND SLEEERS. BID ALTERNATE #3: - REMOVE / REPLACE / PREP / PRIME / PAINT: EXISTING
- WOODEN BENCHES, SEATS AND 4x DECAY-RESISTANT SLEEPERS. PREP / PRIME / PAINT: EXISTING CMU WALLS. PAINT INSIDE AND OUTSIDE OF ENCLOSURE AND DOORS.
- PREP / PRIME / PAINT: ENTIRETY OF METAL CANOPY
- PAINT COLOR 2
- 33. PAINT COLOR 3
 - REMOVE / PREP / PAINT/ REINSTALL: EXISTING DOOR OR WINDOW METAL
- SECURITY GRATING PATCH / REPAIR / PREP / PRIME / PAINT: EXISTING PLASTER PREP / PRIME / PAINT: EXISTING GRAPHICS ON NORTH SIDE OF GYM WALL.
- ADD COLOR 3 BORDER AROUND 'N.' BID ALTERNATE #1 PROVIDE AND INSTALL EXTERIOR ADHESIVE WALL GRAPHICS TO MATCH EXISTING. PREP / PRIME / PAINT: METAL PARAPET WALL CAP
- PREP / PRIME / PAINT: PLASTERED ROOF TOP EQUIPMENT SCREEN WALLS INSIDE AND OUT
- PAINT COLOR 1 CONTINUE EXISTING STRIPING AROUND ENTIRE PERIMETER OF BUILDING
- INCLUDING RECESSED DOOR AND WINDOW RETURNS BASEBALL AND SOFTBALL DUGOUTS - PROTECT IN PLACE: EXISTING MELAMINE SHELVES. DO NOT PAINT. PREP / PRIME / PAINT: EXISTING WOOD
- PREP / PRIME / PAINT: EXISTING POLE
 - PREP / PRIME / PAINT: EXISTING HADRAIL BID ALTERNATE #2 -PAINT (4) FOOTBALL FIELD LIGHTING STANDARDS
- PREP / PRIME / PAINT: EXISTING WOOD BACKSTOP BOTH SIDES.
- REMOVE / REPLACE EXISTING WOOD BACKSTOP WITH DECAY-RESISTANT SIMILARLY SIZED WOOD AND CORROSION-RESISTANT HARDWARE. PREP / PRIME / PAINT: BOTH SIDES PRIOR TO INSTALLATION.

PROJECT:

SEALS:

NORDHOFF HS CAMPUS-WIDE EXTERIOR **PAINTING**

OJAI UNIFIED SCHOOL DISTRICT 414 EAST OJAI AVENUE OJAI, CA 93023 (805) 640-4300 CONTACT: ADAM DUTTER

PROJECT ADDRESS:

NORDOFF HIGH SCHOOL 1401 MARICOPA HIGHWAY OJAI, CA 93023

EMAIL: adutter@ojaiusd.org

MARK	DATE	DESCRIPTION
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PROJECT INFORMATION: PROJECT NUMBER: PROJECT PHASE:

DRAWN BY: **REVIEWED BY:**

THE ORIGINAL SIZE OF THIS SHEET IS 36"x24". IF THE CURRENT SIZE IS OTHER THAN 36"x24", THEN ADJUST THE SCALE OF THE DRAWINGS ACCORDINGLY.

SHEET TITLE: ATHLETIC FIELDS

2020.031

04CONDOC

SHEET NUMBER:

A-118

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UNLESS NOTED OTHERWISE. ALL EXISTING UNPAINTED EXTERIOR SURFACES ARE TO REMAIN UNPAINTED UNLESS NOTED OTHERWISE. PROTECT IN PLACE ALL UNPAINTED

CAREFULLY PRUNE SHRUBS AND PLANTS AND REMOVE WEEDS AND PLANTINGS AT BASE OF WALL TO BARE EARTH TO ALLOW FOR COMPLETE WALL COVERAGE.

WINDOW FRAMES, MULLIONS, AND SEALANTS TO BE PAINTED COLOR 2.

AGENCY APPROVAL:



HARTMANNARCHITECTURESTUDIO.COM 430 S. CARRILLO RD. OJAI, CALIFORNIA 93023 (805) 530-5559

CONSULTANTS:

COLOR LEGEND & NOTES

COLOR 1 - WHITE - Match SW 7013- Ivory Lace

COLOR 3 - YELLOW - Match SW 6904- Gusto Gold

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COLOR 2 - BLUE - Match SW 6804- Dignity Blue

SHEET KEYNOTES

NOTE: NOT ALL KEYNOTES **USED ON EVERY SHEET**

REMOVE / PAINT WALL / REINSTALL: EXISTING SIGN PROTECT IN PLACE: EXISTING SECURITY CAMERA TYPICAL AT ALL

LOCATIONS PREP / PRIME / PAINT: UTILITY CONDUITS AND CABINETS TO MATCH WALL BEYOND. CONTINUE STRIPING OVER CONDUITS AND CABINETS WHERE

PREP / PRIME / PAINT: EXISTING SIGNAGE IN PLACE

PREP / PRIME / PAINT: EXISTING LOUVERS, TYPICAL PREP / PRIME / PAINT: GALVANIZED METAL WINDOW FRAME & WOOD TRIM. TYPICAL AT ALL WINDOWS THIS BUILDING. FIELD VERIFY LOCATIONS AND

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FIXTURES U.N.O. REMOVE / WASH/ PREP / PRIME / PAINT / REINSTALL: ALL EXISTING LOCKERS IN THIS WING. PAINT ALL EXTERIOR SIDES, DOORS AND DOOR RETURNS

ONLY. PROTECT UNPAINTED LOCKER HARDWARE.

PREP / PRIME / PAINT: EXISTING GUTTERS AND DOWNSPOUTS. MATCH

EXISTING WALL COLOR BEYOND.

REMOVE / DISCARD: EXISTING METAL AWNING REMOVE / DISCARD WOODEN POST FILL IN HOLE

PROTECT IN PLACE: EXISTING HVAC UNITS AND DUCTWORK PREP / PRIME / PAINT: DOOR SWING SAFETY STRIPING. TYPICAL AT ALL DOORS THIS BUILDING U.N.O.

PROTECT IN PLACE: EXISTING LIGHT FIXTURE / SPEAKER / FIRE ALARM

PREP / PRIME / PAINT: EXISTING HVAC DUCTWORK WHERE ALREADY

PAINTED. TYPICAL AT THIS BUILDING. PROTECT IN PLACE: EXISTING MURAL. PAINT WALLS AROUND MURAL TO MATCH EXISTING BUILDING COLOR SCHEME. TOUCH-UP/REPAINT MURALS

WHERE PAINTED TO MATCH EXISTING. PROTECT IN PLACE: EXISTING DRINKING FOUNTAIN PREP / PRIME / PAINT: EXISTING PAINTED DRINKING FOUNTAIN CANE DETECTION RAILS

REMOVE / PAINT WALL / REINSTALL: EXISTING DISPLAY CASES REMOVE / DISCARD: EXISTING SIGN

REMOVE / PAINT WALL / REINSTALL: EXISTING BENCHES PROTECT IN PLACE: EXISTING UNFINISHED CONCRETE OR CMU

PREP / PRIME / PAINT: EXISTING CONCRETE / CMU WALL PREP / PRIME /PAINT: EXISTING METAL FENCE & GATE PROTECT IN PLACE: EXISTING MECHANICAL EQUIPMENT PROTECT IN PLACE: EXISTING GALVANIZED WINDOW FRAMES. TYPICAL AT

ALL WINDOWS THIS BUILDING. PREP / PRIME / PAINT ALL PAINTED WINDOW PREP / PRIME / PAINT: EXISTING ROLL-UP DOOR

PREP / PRIME / PAINT: EXISTING STORAGE CONTAINER PREP / PRIME / PAINT: EXISTING WOOD BENCH / SEATS AND SLEEERS. BID ALTERNATE #3: - REMOVE / REPLACE / PREP / PRIME / PAINT: EXISTING WOODEN BENCHES, SEATS AND 4x DECAY-RESISTANT SLEEPERS.

PREP / PRIME / PAINT: EXISTING CMU WALLS. PAINT INSIDE AND OUTSIDE OF ENCLOSURE AND DOORS.

PREP / PRIME / PAINT: ENTIRETY OF METAL CANOPY

PAINT COLOR 2 33.

PAINT COLOR 3 REMOVE / PREP / PAINT/ REINSTALL: EXISTING DOOR OR WINDOW METAL

SECURITY GRATING PATCH / REPAIR / PREP / PRIME / PAINT: EXISTING PLASTER PREP / PRIME / PAINT: EXISTING GRAPHICS ON NORTH SIDE OF GYM WALL.

INSTALL EXTERIOR ADHESIVE WALL GRAPHICS TO MATCH EXISTING. PREP / PRIME / PAINT: METAL PARAPET WALL CAP PREP / PRIME / PAINT: PLASTERED ROOF TOP EQUIPMENT SCREEN WALLS

ADD COLOR 3 BORDER AROUND 'N.' BID ALTERNATE #1 - PROVIDE AND

INSIDE AND OUT

PAINT COLOR 1 CONTINUE EXISTING STRIPING AROUND ENTIRE PERIMETER OF BUILDING INCLUDING RECESSED DOOR AND WINDOW RETURNS BASEBALL AND SOFTBALL DUGOUTS - PROTECT IN PLACE: EXISTING

MELAMINE SHELVES. DO NOT PAINT. PREP / PRIME / PAINT: EXISTING WOOD PREP / PRIME / PAINT: EXISTING POLE

PREP / PRIME / PAINT: EXISTING HADRAIL

BID ALTERNATE #2 -PAINT (4) FOOTBALL FIELD LIGHTING STANDARDS

PREP / PRIME / PAINT: EXISTING WOOD BACKSTOP BOTH SIDES. REMOVE / REPLACE EXISTING WOOD BACKSTOP WITH DECAY-RESISTANT SIMILARLY SIZED WOOD AND CORROSION-RESISTANT HARDWARE. PREP / PRIME / PAINT: BOTH SIDES PRIOR TO INSTALLATION.

SEALS:

PROJECT:

NORDHOFF HS CAMPUS-WIDE EXTERIOR **PAINTING**

OJAI UNIFIED SCHOOL DISTRICT 414 EAST OJAI AVENUE OJAI, CA 93023 (805) 640-4300 CONTACT: ADAM DUTTER EMAIL: adutter@ojaiusd.org

PROJECT ADDRESS:

NORDOFF HIGH SCHOOL 1401 MARICOPA HIGHWAY OJAI, CA 93023

1330E.		
MARK	DATE	DESCRIPTION

2020.031

04CONDOC

PROJECT INFORMATION: PROJECT NUMBER: PROJECT PHASE:

DRAWN BY: **REVIEWED BY:**

THE ORIGINAL SIZE OF THIS SHEET IS 36"x24". IF THE CURRENT SIZE IS OTHER THAN 36"x24", THEN ADJUST THE SCALE OF THE DRAWINGS ACCORDING! Y. SHEET TITLE:

> SITE FEATURES & **MISCELLANEOUS**

SHEET NUMBER:

A-119

BENCH & SLEEPERS COLOR 2

29 (2) 4 x 10 x 20 FT