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4A	PROPERTY STRIP MAP	1
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6–9	PLAN AND PROFILE SHEETS	4
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		TOTAL 41

Hydraulic Design Reference for these plans is the: 2009

Edition of SCDOT's "Requirements for Hydraulic Design Studies"

Design Reference for these plans is the:

3R

These Plans Were Designed Using "3R" Principles From the 2017 Roadway Design Manual


٢				
	ENVIRONMENTA	L PERMIT INFO	ORMATION	
	USACE PERMIT	YES	_X_NO	
	NEPA DOCUMENT	YES	_X_NO	
	401 CERTIFICATION	YES	_X_NO	
	OCRM CAP	YES	_X_NO	
	NAVIGABLE WATERSSC	uscg	USACE	_X_N/A

3 DAYS BEFORE DIGGING IN SOUTH CAROLINA

CALL 811

SOUTH CAROLINA 811 (SC811) WWW.SC811.COM ALL UTILITIES MAY NOT BE A MEMBER OF SC811

> RAILROAD INVOLVEMENT? YES (NO)

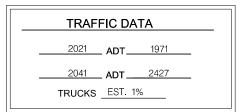


CITY OF BEAUFORT



PLAN AND PROFILE OF ALLISON ROAD (S-7-159)

FROM: SPANISH MOSS TRAIL
TO: RIBAUT ROAD

- ALLISON ROAD (S-7-159) BEGIN CONSTRUCTION STA.II+03.39 COTTAGE FARM DR (L-2858) END CONSTRUCTION STA.24+17.92 ALLISON RD (S-7-159)

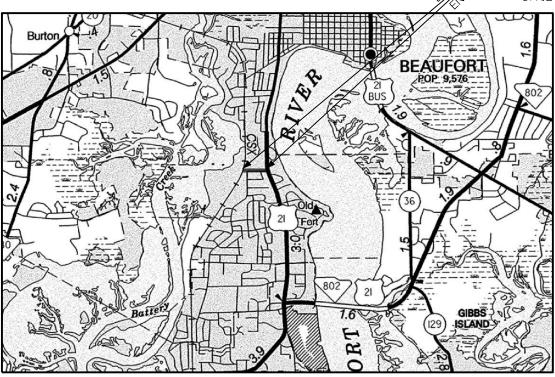

LAYOUT

BEAUFORT COUNTY

	ALLISON ROAD	TOTAL (MILES)
NET LENGTH OF ROADWAY	0.25	0.25
NET LENGTH OF BRIDGES	_	-
NET LENGTH OF PROJECT	0.25	0.25
LENGTH OF EXCEPTIONS	_	_
GROSS LENGTH OF PROJECT	0.25	0.25

EQUALITIES IN STATIONING: NONE

NOTE: EXCEPT AS MAY OTHERWISE BE SPECIFIED ON THE PLANS OR IN THE SPECIAL PROVISIONS, ALL MATERIALS AND WORKMANSHIP ON THIS PROJECT SHALL TO CONFORM WITH SOUTH CAROLINA DEPARTMENT OF TRANSPORTATION STANDARD SPECIFICATIONS FOR HIGHWAY CONSTRUCTION (2007 EDITION) AND STANDARD DRAWINGS FOR ROAD CONSTRUCTION IN EFFECT AT THE TIME OF LETTING.

CONSULTING ENGINEERING FIRM

TEINFRASTRUCTURECONSULTING & ENGINEERING

NPDES PERMIT INFORMATION				
	rea =			
Begin Latitude	ate Location of Roadway is 32°24'52"N 80°41'34"W			
	32°24'52"N 80°41'18"W			
Hydrai	ulic and NPDES Design provided by: I.C.E.			
1	may be obtained from the			

BEAUFORT

THE INITIALS ABOVE DO NOT RELIEVE THE ENGINEER OF RECORD OF THE RESPONSIBILITY TO DESIGN THIS PROJECT IN ACCORDANCE WITH ALL APPLICABLE CRITERIA.

SCDOT REVIEW	 DF-WAY DATE	CONSTF INITIAL	
PRECONSTRUCTION SUPPORT - ROAD			
PRECONSTRUCTION SUPPORT - STRUCTURES			
RPG - DESIGN MANAGER			
RPG - PROGRAM MANAGER			

THE INITIALS ABOVE DO NOT RELIEVE THE ENGINEER OF RECORD OF THE RESPONSIBILITY TO DESIGN THIS PROJECT IN ACCORDANCE WITH ALL APPLICABLE CRITERIA.

For Right Of Way A	Acquisition:
Consultant Engineer of Record	Date
Regional Production Engineer	 Date

ENGINEER OF RECORD	
ISSUED FOR BI	D
FOR CONSTRUCTION:	DATE

STATE	COUNTY	FILE NO.	PROJECT NO.	ROUTE NO.	SHEET NO,
SC	BEAUFORT			S-7-159	2

SUMMARY OF ESTIMATED QUANTITIES

PAYITEM	DESCRIPTION	QUANTITY	UNIT
1031000	MOBILIZATION	1	LS
1032010	BONDS AND INSURANCE	1	LS
1050800	CONSTRUCTION STAKES, LINES & GRADES	1	EA
1071000	TRAFFIC CONTROL	1	LS
1090200	AS-BUILT CONSTRUCTION PLANS	1	LS
2011000	CLEARING & GRUBBING WITHIN RIGHT OF WAY	1	LS
2021010	REMOVAL & DISPOSAL OF EXISTING DROP INLET	1	EA
2023000	REMOVAL & DISPOSAL OF EXISTING PAVEMENT	285	SY
2024100	REMOVAL & DISPOSAL OF EXISTING CURB	16	LF
2027000	REMOVAL & DISPOSAL OF EXISTING CONCRETE	5	CY
2031000	UNCLASSIFIED EXCAVATION	5	CY
2033000	BORROW EXCAVATION	241	CY
2081001	FINE GRADING	989	SY
3069900	MAINTENANCE STONE	97	TON
4011004	LIQUID ASPHALT BINDER PG64-22	23	TON
4013990	MILLING EXISTING ASPHALT PAVEMENT (VARIABLE)	1,267	SY
4030340	HOT MIX ASPHALT SURFACE COURSE TYPE C	361	TON
6021120	PERMANENT CONSTRUCTION SIGNS (GROUND MOUNTED)	148	SF
6250005	4" WHITE BROKEN LINES -(GAPS EXCLUDED)-FAST DRY PAINT	49	LF
6250010	4" WHITE SOLID LINES (PVT. EDGE LINES)-FAST DRY PAINT	36	LF
6250015	8"WHITE SOLID LINES(CROSSWALK&CHANNELIZATION)FAST DRY PAINT	294	LF
6250025	24" WHITE SOLID LINES (STOP/DIAGONAL LINES)-FAST DRY PAINT	128	LF
6250030	WHITE SINGLE ARROW (LEFT, STRAIGHT, RIGHT)-FAST DRY PAINT	1	EA
6250040	WHITE COMBINATION ARROW(STR.& RT.OR STR.& LT.)FAST DRY PAINT	1	EA
6250110	4"YELLOW SOLID LINE(PVT.EDGE&NO PASSING ZONE)-FAST DRY PAINT	2,059	LF
6271005	4" WHITE BROKEN LINES(GAPS EXCL.)THERMOPLASTIC- 90 MIL.	49	LF
6271010	4" WHITE SOLID LINES (PVT. EDGE LINES) THERMO 90 MIL.	36	LF
6271015	8" WHITE SOLID LINES THERMOPLASTIC - 125 MIL.	294	LF
6271025	24" WHITE SOLID LINES (STOP/DIAG LINES)-THERMO125 MIL	128	LF
6271030	WHITE SINGLE ARROWS (LT, STRGHT, RT) THERMO125 MIL.	1	EA
6271040	WHITE COMBINATION ARROWS(STR&RT.OR STR<)THERMO-125MIL	1	EA
6271074	4" YELLOW SOLID LINES(PVT.EDGE LINES) THERMO-90 MIL.	2,059	LF
6301100	PERMANENT YELLOWPAVEMENT MARKERS BI-DIR4"X4"	13	EA
6510105	FLAT SHEET, TYPE III, FIXED SIZE	27	SF
6531210	U-SECTION POST FOR SIGN SUPPORTS - 3P	14	LF
6650900	FURNISH & INSTALL ELECTRICAL SERVICE CONNECTIONS	1	EA
6651091	SINGLE DECORATIVE LIGHT POLE WITH SINGLE LIGHT	14	EA
675027Y	FURNISH & INSTALL 4.0" SCHD 80 PVC CONDUIT(DIRECTION BORED)	100	LF
6760020	2" SCHEDULE 80 HDPE CONDUIT	1435	LF
6770319	NO. 8 COPPER WIRE, 1 CONDUCTOR, 600V, TYPE RHH, RHW, USE	6005	LF
6800530	17"X30"X28"D.ELEC.FLUSH UNDGRD.ENCLOSURE-(STR.POLY.CONC.)HD	2	EA

PAYITEM	DESCRIPTION	QUANTITY	UNIT
6888110	INSTALL STREET LIGHT LUMINAIRE	14	EA
7143618	18" SMOOTH WALL PIPE	176	LF
7143642	42" SMOOTH WALL PIPE	12	LF
7143648	48" SMOOTH WALL PIPE	576	LF
7192021	DROP INLET (24" X 36") WITH STANDARD 4' X 4' BOX	8	EA
7192108	MANHOLE WITH STANDARD 5' X 5' BOX	1	EA
7204100	CONCRETE SIDEWALK (4" UNIFORM)	985	SY
7204900	DETECTABLE WARNING MATERIAL	25	SF
7209000	PEDESTRIAN RAMP CONSTRUCTION	15	SY
8041020	RIP-RAP (CLASS B)	63	TON
8048210	GEOTEXTILE FOR EROSION CONTROL UNDER RIPRAP(CLASS 2)TYPE C	84	SY
8091010	RIGHT OF WAY MARKER (REBAR AND CAP)	2	EA
8091050	RIGHT OF WAY PLAT	1	LS
8100100	PERMANENT COVER	0.672	ACRE
8100200	TEMPORARY COVER	0.336	ACRE
8101105	COMPOST	181	CY
8104005	FERTILIZER (NITROGEN)	67	LB
8104010	FERTILIZER (PHOSPHORIC ACID)	67	LB
8104015	FERTILIZER (POTASH)	67	LB
8105005	AGRICULTURAL GRANULAR LIME	1345	LB
8109050	SELECTIVE WATERING	54300	GAL
8109901	MOWING	2.017	ACRE
8110001	LANDSCAPING	1	LS
8152004	INLET STRUCTURE FILTER - TYPE F (WEIGHTED)	208	LF
8152006	INLET STRUCTURE FILTER- TYPE F (NON-WEIGHTED)	208	LF
8153000	SILT FENCE	2610	LF
8153090	REPLACE/REPAIR SILT FENCE	261	LF
8154050	REMOVAL OF SILT RETAINED BY SILT FENCE	652	LF
8156200	CLEANING INLET STRUCTURE FILTERS	16	EA
8156490	STABILIZED CONSTRUCTION ENTRANCE	550	SY
	UTILITY DUCT BANK SYSTEM	2144	LF
	DUCT BANK 6" TURN-OUT/ TURN-UP - ELECTRIC (GROUTED)	20	EA
	DUCT BANK 3" TURN-OUT/ TURN-UP - ELECTRIC (GROUTED)	50	EA
	DUCT BANK 2" TURN-OUT/ TURN-UP - ELECTRIC (GROUTED)	24	EA
	DUCT BANK 4" TURN-OUT/ TURN-UP - COMMUNICATION (NOT GROUTED)	20	EA
	DUCT BANK 4" TURN-OUT/ TURN-UP - COMMUNICATION (NOT GROUTED)	44	EA
	3" SERVICE CONDUIT	1532	LF
	METER CONVERSIONS (OVERHEAD TO UNDERGROUND)	18	EA



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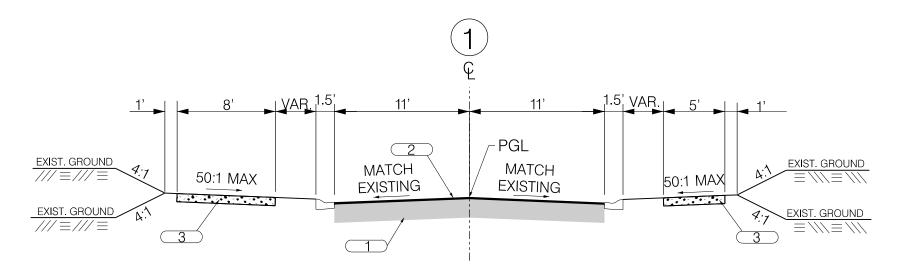
BEUAFORT COUNTY CITY OF BEAUFORT

ALLISON ROAD (S-7-159) SUMMARY OF ESTIMATED QUANTITIES

HEET 2 SCALE: NT

TYPICAL SECTION






USE THIS SECTION ON COTTAGE FARM DRIVE (L-2858) STA. 11+03.39 TO STA. 12+86.00

NOTES:


MILL AND OVERLAY REMAINDER OF ROADWAY IN CURB & GUTTER SECTIONS. SEE PLAN SHEETS FOR FURTHER DETAIL.

CURB RAMPS AND DETECTABLE WARNING SURFACES ARE TO BE CONSTRUCTED IN ACCORDANCE WITH THE SCDOT STANDARD DRAWINGS. SEE PLANS FOR LOCATIONS OF SIDEWALK CURB RAMPS AND DETECTABLE WARNING SURFACES.

SIDEWALK IS TO BE PLACED 0.5' WITHIN EXISITING RIGHT OF WAY.

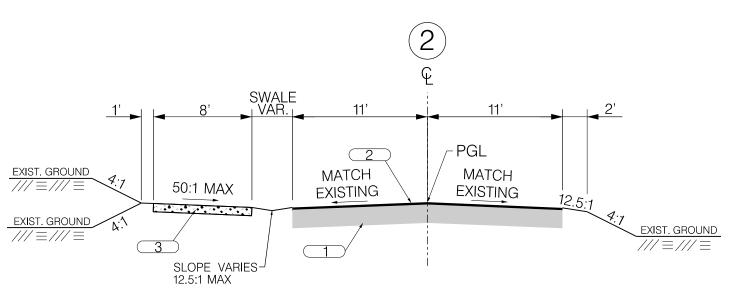

USE THIS SECTION ON ALLISON ROAD (S-7-159) STA. 12+86.00 TO STA. 15+82.00 STA. 18+26.00 TO STA. 22+21.12

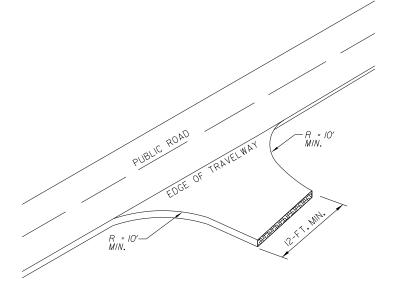

ALL DRIVEWAY RADIIWILL BE 10' MINIMUM AND ALL DRIVEWAY WIDTHS WILL BE 12' MINIMUM UNLESS OTHERWISE NOTED ON PLANS.
FOR DRIVEWAYS, USE 400 PSY OF SURFACE COURSE TYPE C ON TOP OF 25 TONS OF MAINTENANCE STONE PER 100 SY.

DRIVEWAY DETAIL

SCALE: N.T.S.


	EXISTING PAVEMENT - RETAIN
2	HOT MIX ASPHALT CONCRETE SURFACE COURSE TYPE C (150 PSY)
3	CONCRETE SIDEWALK (4" UNIFORM)

RTE. S-7-	159 DESIGN	SPEED						
MPH	FROM STA.	TO STA.						
30	10 + 97.48	24 + 17.92						
EXCEP1	TIONS TO DESIGN	SPEED						
FUNCTIONAL CLASSIFICATION								
	LIBBANI COLLECTOR)						

4					E	BEAUFORT COUNTY
3					(CITY OF BEAUFORT
2						
1					ΔΙΙΙ	ISON ROAD (S-7-159)
REV. NO.	BY	DATE	DESCR	IPTION OF REVISION		CAL SECTION SHEET
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TYPICAL SECTION



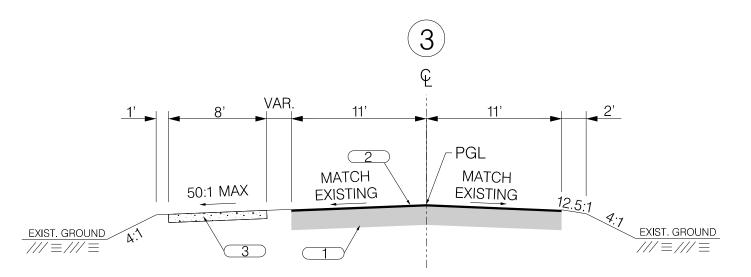

USE THIS SECTION ON ALLISON ROAD (S-7-159) STA. 15 + 82.00 TO STA. 18 + 26.00

NOTES:

MILL AND OVERLAY REMAINDER OF ROADWAY IN CURB & GUTTER SECTIONS. SEE PLAN SHEETS FOR FURTHER DETAIL.

CURB RAMPS AND DETECTABLE WARNING SURFACES ARE TO BE CONSTRUCTED IN ACCORDANCE WITH THE SCDOT STANDARD DRAWINGS. SEE PLANS FOR LOCATIONS OF SIDEWALK CURB RAMPS AND DETECTABLE WARNING SURFACES.

SIDEWALK IS TO BE PLACED 0.5' WITHIN EXISITING RIGHT OF WAY.

1	EXISTING PAVEMENT – RETAIN
2	HOT MIX ASPHALT CONCRETE SURFACE COURSE TYPE C (150 PSY)
3	CONCRETE SIDEWALK (4" UNIFORM)

RTE. S-7-	159 DESIGN	SPEED				
MPH	FROM STA.	TO STA.				
30	10 + 97.48	24 + 17.92				
EXCEPT	EXCEPTIONS TO DESIGN SF					
FUNCTIONAL CLASSIFICATION						
	URBAN COLLECTOR					

4 BEAUFORT COUNTY	
	I
3 CITY OF BEAUFORT	
2	
ALLISON ROAD (S-7-159)	
REV. NO. BY DATE DESCRIPTION OF REVISION TYPICAL SECTION SHEET	
DESIGNED BY: DATE	
DRAWN BY: DATE	
CHECKED BY: DATE SHEET 3A SCALE: NTS	

STATE	COUNTY	FILE NO.	PROJECT NO.	ROUTE NO.	SHEET NO.
SC	BEAUFORT			S-7-159	4

RIGHT OF WAY DATA SHEET

					ОВ	TAIN							PERM	ISSION	(YES)		
TRACT NO.	PROPERTY OWNER	TAX MAP REFERENCE	TOTAL TRACT ACRES	OUTFALL DITCH	LEFT	RIGHT	TOTAL	REMAINDER LEFT ACRES ^A	REMAINDER RIGHT ACRES ^A	DATE ACQUIRED	TYPE OF INSTRUMENT	OUTFALL DITCH	SLOPE	DRAINAGE STRUCTURE	EROSION CONTROL	ENTRANCE CONSTRUCTION	REMARKS
4	LITTLE CAPERS PROPERTIES LLC	R120-005-000-0186	0.6										YES		YES	YES	
5	MARY ELIZABETH DOBYNS COATES	R120-005-000-0184											YES		YES	YES	
6	TANGER R. CRASE	R120-005-000-0183	0.49										YES		YES	YES	
7	PETER R. SMITH	R120 005 000 0182	0.57										YES		YES	YES	
8	OLIVER S. SPENCER	R120-005-000-180A	0.58										YES		YES	YES	
9	GANELLE R. POLK HECK	R120-005-000-0180	0.93									YES	YES		YES	YES	
10	DAVID STILWELL & BRITTANY STILWELL	R120 005 000 178B											YES		YES	YES	
11	TIMOTHY E. & KAREN L. KEANE	R120-005-000-178A	0.35										YES			YES	
12	ENID STEEDLY BATES TRUSTEE (ENID STEEDLY BATES REVOCABLE TRUST)	R120-005-000-0177											YES		YES	YES	
13	BEAUFORT COUNTY MEMORIAL HOSPT	R120-005-000-0175	4.76										YES			YES	
16	CESSNA HOLDINGS LLC	R120-005-000-0376															
17	DONALD J & CHERYL RICHARDSON	R120-005-000-0279															
18	PATRICA MATHERS	R120-005-000-269A	0.47			75 SF (0.002 AC)	75 SF (0.002 AC)		0.468				YES		YES		TRACT ACERAGE MEASURED IN CAD
19	DAVID E. & MERRILY C. SUMERA	R120-005-000-0269														YES	
20	CHUCK A. MCLEOD	R120-005-000-269B														YES	
21	SWL PROPERTIES LLC	R120-005-000-0268														YES	
22	GERALD D. & CATHY L. BROWN	R120-005-000-0266														YES	
23	1026 RIBAUT RD LLC	R120-005-000-0236	7.76										YES	YES	YES	YES	
24	SUE MONTA SAILORS	R120-005-000-0234														YES	
25	H. FRED KUHN SR. & EMMA JEAN KUHN	R120-005-000-0233														YES	
26	BEAUFORT MEMORIAL HOSPITAL	R120-005-000-0232	1.42													YES	


NOTES:
TOTAL OBTAIN INCLUDES HIGHLAND,
MARSH AND OUTFALL DITCHES.
OBTAINS WILL BE SHOWN IN
SOUARE FEET AND ACRES. ACRES
WILL BE SHOWN IN PARENTHESES
UNDER SOUARE FEET. IN RURAL
AREAS OBTAINS MAY BE SHOWN
IN ACRES ONLY. OUTFALL DITCHES
WILL BE SHOWN IN ACRES ONLY.

SHOW REMAINDER IN SQUARE FEET WHEN LESS THAN 0.25 ACRE.



4							BEAUFOR'	T COUN	ITY
3							CITY OF I	BEAUFC	RT
2									
1							ALLISON RO	AD (S-	7–159
REV. NO.	BY	DATE	DES	SCRIPTION OF REVISION			RIGHT OF WAY		
DESIGNE	:D BY:		DATE	_					
DRAWN	BY:		DATE	_					
CHECKE	D BY:		DATE	_	SHEET	4		SCALE:	NTS
			·	·			·		

ROAD (S-7-159) WAY DATA SHEET

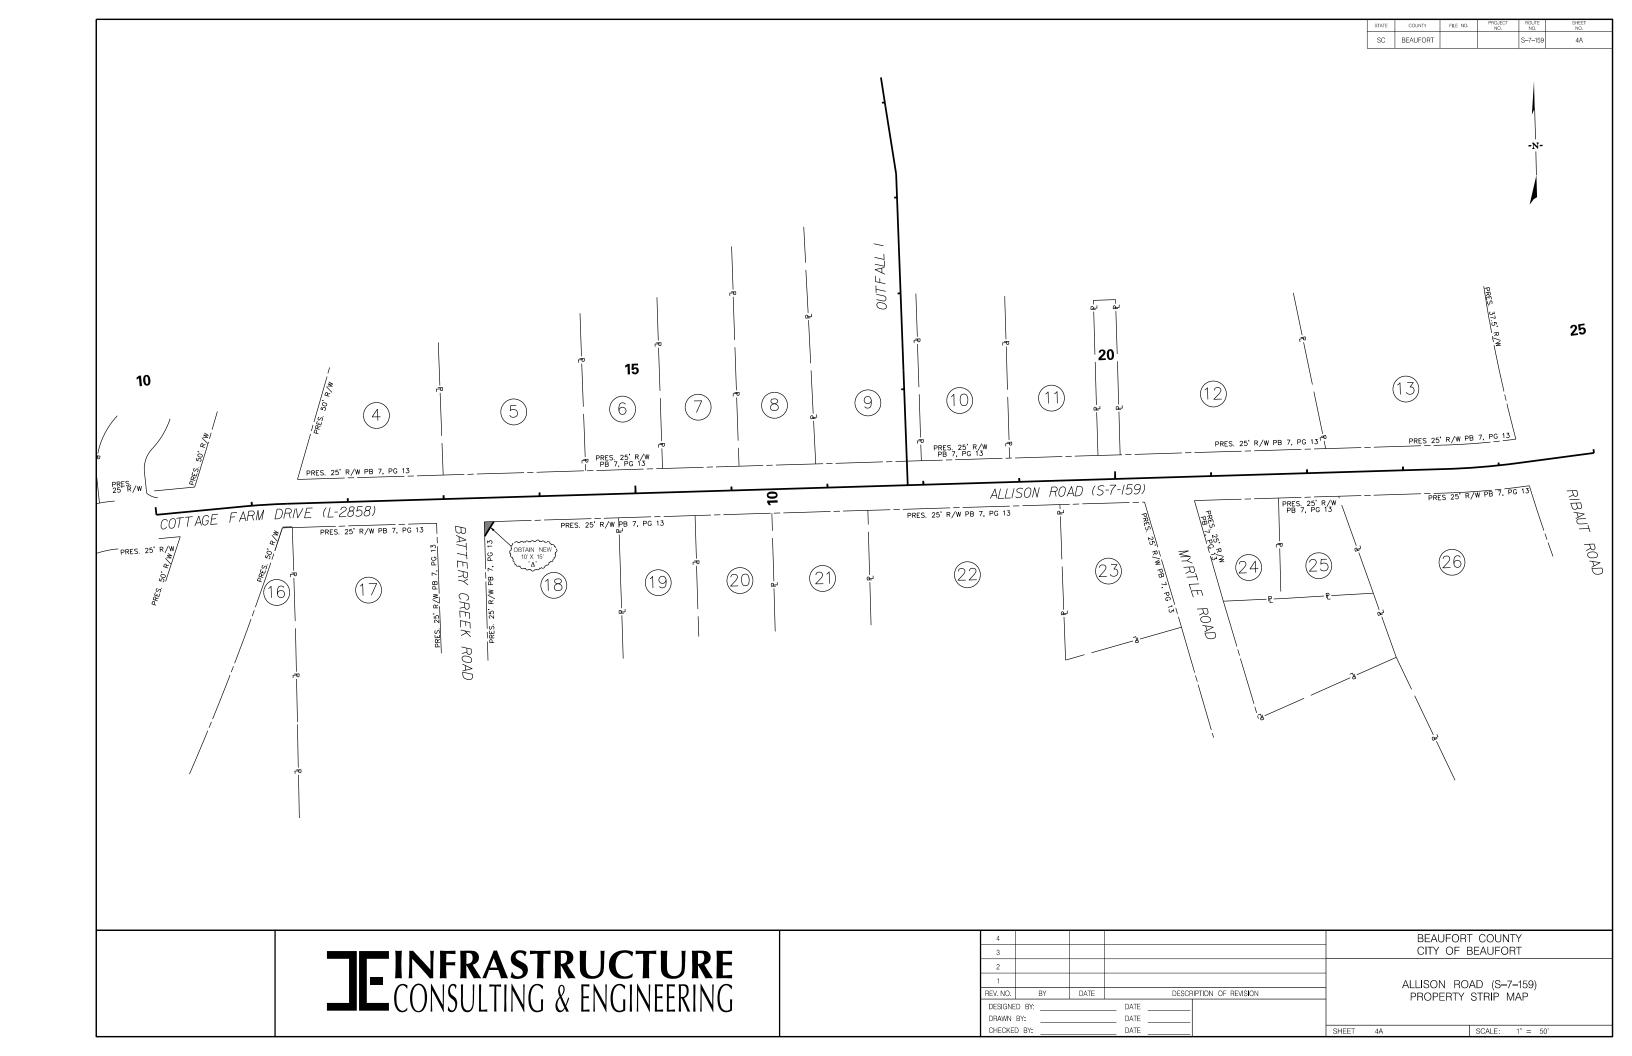

GENERAL NOTES

GENERAL CONSTRUCTION NOTES:

THE CITY ENGINEER MUST SPECIFICALLY AUTHORIZE CHANGES INVOLVING INCREASED COST OF

THE LOCATIONS OF EXISTING UTILITIES SHOWN ON THE PLANS HAVE BEEN DETERMINED FROM AVAILABLE INFORMATION AND ARE PROVIDED FOR THE CONVENIENCE OF THE CONTRACTOR. THE ENGINEER ASSUMES NO RESPONSIBILITY FOR THE ACCURACY OR COMPLETENESS OF THE UTILITIES INFORMATION SHOWN ON THE DRAWINGS. IT IS THEREFORE THE CONTRACTOR'S RESPONSIBILITY TO CONFIRM THAT THE PROPER COORDINATION WITH THE VARIOUS UTILITY OWNERS HAS BEEN PERFORMED.

THE CONTRACTOR SHALL COOPERATE WITH THE UTILITY OWNERS DURING RELOCATION OPERATIONS, THE CONTRACTOR SHALL EXERCISE CAUTION WHEN CROSSING AN UNDERGROUND UTILITY WHETHER SHOWN ON THE DRAWINGS OR LOCATED BY THE UTILITY COMPANY. COST OF DAMAGES TO ANY UTILITIES AS A RESULT OF CONSTRUCTION SHALL BE THE RESPONSIBILITY OF THE CONTRACTOR.

ALL WORKMANSHIP AND MATERIALS USED ON THIS PROJECT SHALL CONFORM TO THE SCDOT STANDARD SPECIFICATIONS FOR HIGHWAY CONSTRUCTION (2007 EDITION), SCDOT 2007 SUPPLEMENTAL SPECIFICATIONS, SCDOT SUPPLEMENTAL TECHNICAL SPECIFICATIONS IN EFFECT AT THE TIME OF LETTING, AND SCDOT 2009 STANDARD DRAWINGS EXCEPT WHERE OTHERWISE NOTED IN THE PLANS

ALL EXISTING ROAD SIGNS AFFECTED BY CONSTRUCTION ACTIVITIES SHALL BE RETAINED, RELOCATED, OR REMOVED AS DIRECTED BY ENGINEER. PAYMENT FOR THIS WORK SHALL BE INCLUDED IN THE LUMP SUM COST FOR CLEARING AND GRUBBING.

ALL NEW SIGNS SHALL BE PLACED IN ACCORDANCE WITH THE MANUAL ON UNIFORM TRAFFIC CONTROL DEVICES AND SCDOT STANDARD DRAWINGS. NEW 2P & 3P SIGN SUPPORTS REQUIRED FOR RELOCATED SIGNS WILL BE PAID PER LINEAR FOOT INSTALLED AND ACCEPTED.

THE CONTRACTOR SHALL FURNISH, INSTALL, AND MAINTAIN ALL NECESSARY PROVISIONS FOR TRAFFIC CONTROL FOR THE DURATION OF THE PROJECT. THESE PROVISIONS, AS IN EACH CASE IS APPLICABLE, WILL CONFORM TO THE REQUIREMENTS CONTAINED IN THE SCDOT STANDARD SPECIFICATIONS, STANDARD DRAWINGS, SUPPLEMENTAL SPECIFICATIONS, SPECIAL PROVISIONS, THE FEDERAL HIGHWAY ADMINISTRATION MANUAL ON UNIFORM TRAFFIC CONTROL DEVICES, AND AS DIRECTED BY THE ENGINEER. THE CONTRACTOR SHALL SUBMIT THE TRAFFIC CONTROL PLAN TO THE COUNTY FOR APPROVAL BEFORE BEGINNING CONSTRUCTION.

THE LUMP SUM COST FOR TRAFFIC CONTROL SHALL INCLUDE ALL WORK AS DIRECTED ABOVE. THIS LUMP SUM COST SHALL INCLUDE TEMPORARY CONSTRUCTION SIGNS, BARRICADES, DRUMS, CONES, LIGHTS, AND OTHER ITEMS AS REQUIRED TO COMPLETE THIS WORK.

CONTRACTOR SHALL REFER TO SCDOT STD. DWG. 605-010-02 FOR PLACEMENT OF PERMANENT CONSTRUCTION SIGNS. THIS PROJECT REQUIRES ONE (1) SCHEME C AND THREE (3) SCHEME E (SEE SHEETS PMI-PM3 FOR PLACEMENT LOCATIONS). SIGNS SHALL BE PAID FOR PER SQUARE FOOT INSTALLED AND ACCEPTED UNDER THE BID ITEM FOR PERMANENT CONSTRUCTION SIGNS.

EROSION CONTROL NOTES:

IF NECESSARY, SLOPES, WHICH EXCEED EIGHT (8) VERTICAL FEET SHOULD BE STABILIZED WITH SYNTHETIC OR VEGETATIVE MATS, IN ADDITION TO HYDROSEEDING, IT MAY BE NECESSARY TO INSTALL TEMPORARY SLOPE DRAINS DURING CONSTRUCTION, TEMPORARY BERMS MAY BE NEEDED UNTIL THE SLOPE IS BROUGHT TO GRADE.

STABILIZATION MEASURES SHALL BE INITIATED AS SOON AS PRACTICABLE IN PORTIONS OF THE SITE WHERE CONSTRUCTION ACTIVITIES HAVE TEMPORARILY OR PERMANENTLY CEASED, BUT IN NO CASE MORE THAN FOURTEEN (14) DAYS AFTER WORK HAS CEASED, EXCEPT AS STATED BELOW.

A) WHERE STABILIZATION BY THE 14TH DAY IS PRECLUDED BY SNOW COVER OR FROZEN GROUND CONDITIONS STABILIZATION MEASURES MUST BE INITIATED AS SOON AS PRACTICAL. B) WHERE CONSTRUCTION ACTIVITY ON A PORTION OF THE SITE IS TEMPORARILY CEASED, AND EARTH-DISTURBING ACTIVITIES WILL BE RESUMED WITHIN 14 DAYS, TEMPORARY STABILIZATION MEASURES DO NOT HAVE TO BE INITIATED ON THAT PORTION OF THE SITE.

ALL SEDIMENT AND EROSION CONTROL DEVICES SHALL BE INSPECTED ONCE EVERY CALENDAR WEEK, IF PERIODIC INSPECTION OR OTHER INFORMATION INDICATES THAT A BMP HAS BEEN INAPPROPRIATELY OR INCORRECTLY INSTALLED, THE PERMITTEE MUST ADDRESS THE NECESSARY REPLACEMENT OR MODIFICATION TO CORRECT THE BMP WITHIN 48 HOURS OF IDENTIFICATION.

PROVIDE SILT FENCE ANDOR OTHER CONTROL DEVICES, AS MAY BE REQUIRED, TO CONTROL SOIL EROSION DURING UTILITY CONSTRUCTION. ALL DISTURBED AREAS SHALL BE CLEANED, GRADED, AND STABILIZED WITH GRASSING IMMEDIATELY AFTER THE UTILITY INSTALLATION. FILL, COVER, AND TEMPORARY SEEDING AT THE END OF EACH DAY ARE RECOMMENDED. IF WATER IS ENCOUNTERED WHILE TRENCHING, THE WATER SHOULD BE FILTERED TO REMOVE ANY SEDIMENTS BEFORE BEING PUMPED BACK INTO ANY WATERS OF THE STATE.

EROSION CONTROL NOTES (CONTINUED):

ALL EROSION CONTROL DEVICES SHALL BE PROPERLY MAINTAINED DURING ALL PHASES OF CONSTRUCTION UNTIL THE COMPLETION OF ALL CONSTRUCTION ACTIVITIES AND ALL DISTURBED AREAS HAVE BEEN STABILIZED. ADDITIONAL CONTROL DEVICES MAY BE REQUIRED DURING CONSTRUCTION IN ORDER TO CONTROL EROSION ANDOR OFFSITE SEDIMENTATION. ALL TEMPORARY CONTROL DEVICES SHALL BE REMOVED ONCE CONSTRUCTION IS COMPLETE AND THE SITE IS STABILIZED.

THE CONTRACTOR MUST TAKE NECESSARY ACTION TO MINIMIZE THE TRACKING OF MUD ONTO PAVED ROADWAY(S) FROM CONSTRUCTION AREAS AND THE GENERATION OF DUST. THE CONTRACTOR SHALL DAILY REMOVE MUDSOIL FROM PAVEMENT, AS MAY BE REQUIRED.

RESIDENTIAL SUBDIVISIONS REQUIRE EROSION CONTROL FEATURES FOR INFRASTRUCTURE AS WELL AS FOR INDIVIDUAL LOT CONSTRUCTION. INDIVIDUAL PROPERTY OWNERS SHALL FOLLOW THESE PLANS DURING CONSTRUCTION OR OBTAIN APPROVAL OF AN INDIVIDUAL PLAN IN ACCORDANCE WITH S.C. REG. 72–300 ET SEQ. AND SCR100000.

TEMPORARY DIVERSION BERMS ANDOR DITCHES WILL BE PROVIDED AS NEEDED DURING CONSTRUCTION TO PROTECT WORK AREAS FROM UPSLOPE RUNOFF ANDOR TO DIVERT SEDIMENT-LADEN WATER TO APPROPRIATE TRAPS OR STABLE OUTLETS.

ALL WATERS OF THE STATE (WOS), INCLUDING WETLANDS, ARE TO BE FLAGGED OR OTHERWISE CLEARLY MARKED IN THE FIELD A DOUBLE ROW OF SILT FENCE IS TO BE INSTALLED IN ALL AREAS WHERE A 50-FOOT BUFFER CANNOT BE MAINTAINED BETWEEN THE DISTURBED AREA AND ALL WOS. A 10-FOOT BUFFER SHOULD BE MAINTAINED BETWEEN THE LAST ROW OF SILT FENCE AND ALL WOS.

LITTER, CONSTRUCTION DEBRIS, OILS, FUELS, AND BUILDING PRODUCTS WITH SIGNIFICANT POTENTIAL FOR IMPACT (SUCH AS STOCKPILES OF FRESHLY TREATED LUMBER) AND CONSTRUCTION CHEMICALS THAT COULD BE EXPOSED TO STORM WATER MUST BE PREVENTED FROM BECOMING A POLLUTANT SOURCE IN STORM WATER DISCHARGES.

A COPY OF THE SWPPP, INSPECTION RECORDS, AND RAINFALL DATA MUST BE RETAINED AT THE CONSTRUCTION SITE OR A NEARBY LOCATION EASILY ACCESSIBLE DURING NORMAL BUSINESS HOURS, FROM THE DATE OF COMMENCEMENT OF CONSTRUCTION ACTIVITIES TO THE DATE THAT FINAL STABILIZATION IS REACHED.

INITIATE STABILIZATION MEASURES ON ANY EXPOSED STEEP SLOPE (3H:1V OR GREATER) WHERE LAND-DISTURBING ACTIVITIES HAVE PERMANENTLY OR TEMPORARILY CEASED, AND WILL NOT RESUME FOR A PERIOD OF 7 CALENDAR DAYS.

MINIMIZE SOIL COMPACTION AND UNLESS INFEASIBLE, PRESERVE TOPSOIL.

MINIMIZE THE DISCHARGE OF POLLUTANTS FROM EQUIPMENT AND VEHICLE WASHING, WHEEL WASH WATER, ANDOTHER WASH WATERS, WASH WATERS MUST BE TREATED IN A SEDIMENT BASIN OR ALTERNATIVE CONTROL THATPROVIDES EQUIVALENT OR BETTER TREATMENT PRIOR TO DISCHARGE.

THE FOLLOWING DISCHARGES FROM SITES ARE PROHIBITED:

- WASTEWATER FROM WASHOUT OF CONCRETE, UNLESS MANAGED BY AN APPROPRIATE CONTROL;
 WASTEWATER FROM WASHOUT AND CLEANOUT OF STUCCO, PAINT, FORM RELEASE OILS, CURING COMPOUNDS AND OTHER CONSTRUCTION MATERIALS;
- FUELS, OILS OR OTHER POLLUTANTS USED IN VEHICLE AND EQUIPMENT OPERATION AND
- MAINTENANCE; AND - SOAPS OR SOLVENTS USED IN VEHICLE AND EQUIPMENT WASHING.

AFTER CONSTRUCTION ACTIVITIES BEGIN, INSPECTION MUST BE CONDUCTED AT A MINIMUM OF AT LEAST ONCE EVERY CALENDAR WEEK AND MUST BE CONDUCTED UNTIL FINAL STABILIZATION IS REACHED ON ALL AREAS OF THE CONSTRUCTION SITE.

IF EXISTING BMPS NEED TO BE MODIFIED OR IF ADDITIONAL BMPS ARE NECESSARY TO COMPLY WITH THE REQUIREMENTS OF THIS PERMIT ANDOR SC'S WATER QUALITY STANDARDS, IMPLEMENTATION MUST BE COMPLETED BEFORE THE NEXT STORM WATER EVENT WHENEVER PRACTICABLE, THE SITUATION MUST BE DOCUMENTED IN THE SWPPP AND ALTERNATIVE BMPS MUST BE IMPLEMENTED AS SOON AS REASONABLY POSSIBLE.

A PRE-CONSTRUCTION CONFERENCE MUST BE HELD FOR EACH CONSTRUCTION SITE WITH AN APPROVED ON-SITE SWPPP PRIOR TO THE IMPLEMENTATION OF CONSTRUCTION ACTIVITIES. FOR NON-LINEAR PROJECTS THAT DISTURB 10 ACRES OR MORE THIS CONFERENCE MUST BE HELD ON-SITE UNLESS THE DEPARTMENT AS APPROVED OTHERWISE.

THE CONTRACTOR IS REQUIRED TO IDENTIFY AND MAINTAIN AN ON-SITE CONCRETE WASHDOWN AREA THAT MEETS ALL REQUIREMENTS / BMPS OF SCDHEC. APPROVED WASHOUT AREAS MAY INCLUDE SECTIONS OF SIDEWALK THAT HAVE BEEN FORMED AND THAT ARE LOCATED AHEAD OF THE CURRENT CONCRETE POUR. THE CONTRACTOR WILL BE RESPONSIBLE FOR REMOVAL OF CONCRETE REMNANTS AND PREPARING THE SUBGRADE IN THESE AREAS PRIOR TO PLACEMENT OF THE NEXT DAYS CONCRETE POUR.

SEQUENCE OF CONSTRUCTION

1. OBTAIN NPDES COVERAGE FROM DHEC AND FINAL MS4 APPROVAL FROM THE CITY OF BEAUFORT DEPARTMENT OF PUBLIC WORKS.

BEAUFORT

2. NOTIFY SC DHEC REGIONAL OFFICE AND THE CITY OF BEAUFORT DEPARTMENT OF PUBLIC WORKS 48 HOURS PRIOR TO ANY LAND DISTRUBING ACTIVITIES.

3. INSTALL TREE PROTECTION AND DELINEATE CLEARING LIMITS.

4. CLEARING & GRUBBING ONLY AS NECESSARY FOR INSTALLATION OF PERIMETER CONTROLS (E.G. SILT FENCE).

5. INSTALL PERIMETER CONTROLS (E.G. SILT FENCE).

6. PROVIDE SITE DRAINAGE WITH DIVERSION DITCHES, SWALES AND DRAINS.

7. CLEARING AND GRUBBING OF SITE (SEDIMENT & EROSION CONTROL MEASURES FOR THESE AREAS MUST ALREADY BE INSTALLED.

8. STRIP TOP SOIL AND STOCKPILE FOR LATER USE ON SHOULDERS AND SLOPES PER SECTION 209 OF THE STANDARD SPECIFICATIONS. "ALL DISTURBED AREA [ANY AREA OF LAND THAT WILL BE DISTURBED DURING CONSTRUCTION, THAT INCLUDES CLEARING, GRUBBING, STOCK PILING AND INSTALLATION OF ANY BMPS (SILT FENCE, SWALES, CHECK DAMS, ETC] MUST BE INCLUDED WITHIN THE LIMITS OF DISTURBANCE."

9. ROUGH GRADING.

10. INSTALL STORM DRAINAGE.

11. ASPHALT PAVING.

12. CONSTRUCT SIDEWALK.

13. FINISH GRADING AND FINAL GRASSING AND LANDSCAPING.

14. MAINTAIN ALL SEDIMENT AND EROSION CONTROL DEVICES FOR THE EXTENT OF THE PROJECT.

15. REMOVAL OF SEDIMENT CONTROLS AFTER SITE HAS BEEN STABILIZED.

16. CONTACT THE CITY OF BEAUFORT DEPARTMENT OF PUBLIC WORKS FOR FINAL PROJECT INSPECTION.

17. FILE NOTICE OF TERMINATION.

INCLUSION ITEMS

OTEXTILE FOR EROSION CONTROL LINDER RIPRAD(CLASS 2)TYPE C

ROADWAY ITEMS		
MOBILIZATION	1.000 LS	PER CONTRACT DOCUMENTS
BONDS AND INSURANCE	1.000 LS	PER CONTRACT DOCUMENTS
CONSTRUCTION STAKES, LINES & GRADES	1.000 EA	PER CONTRACT DOCUMENTS
TRAFFIC CONTROL	1.000 LS	PER CONTRACT DOCUMENTS
AS-BUILT CONSTRUCTION PLANS	1.000 LS	PER CONTRACT DOCUMENTS
CLEARING & GRUBBING WITHIN ROADWAY	1.000 LS	WHERE DIRECTED BY ENGINEER
REMOVAL & DISPOSAL OF EXISTING DROP INLET	1.000 EA	FOR REM. & DISPOSAL OF EXISTING DROP INLET
REMOVAL & DISPOSAL OF EXISTING PAVEMENT	284.906 SY	FOR REM. & DISPOSAL OF EXISTING PAVEMENT
REMOVAL & DISPOSAL OF EXISTING CURB	16.459 LF	FOR REM. & DISPOSAL OF EXISTING CURB
REMOVAL & DISPOSAL OF EXISTING CONCRETE	4.945 CY	FOR REM. & DISPOSAL OF EXISTING CONCRETE
UNCLASSIFIED EXCAVATION	5.000 CY	FOR DRIVES, STRIPPING, AND OUTFALL DITCHES
BORROW EXCAVATION	241.000 CY	BACK FILL FOR PIPE REMOVAL AND WHERE DIRECTED BY THE ENGINEE
MAINTENANCE STONE	96.588 TON	FOR DRIVEWAYS
LIQUID ASPHALT BINDER PG64-22	22.750 TON	FOR HOT MIX ASPHALT
MILLING EXISTING ASPHALT PAVEMENT (VARIABLE)	1266.925 SY	WHERE DIRECTED BY ENGINEER
HOT MIX ASPHALT SURFACE COURSE TYPE C	82.836 TON	FOR DRIVEWAYS AND OVERRUN
DETECTABLE WARNING MATERIAL	25.380 SF	WHERE DIRECTED BY ENGINEER
STABILIZED CONSTRUCTION ENTRANCE	550.000 SY	WHERE DIRECTED BY ENGINEER
EDOCION CONTROL ITEMS		


63 000 TON


FOR PIPE ENDS


EROSION CONTROL ITEMS


GEOTEXTILE FOR EROSION CONTROL UNDER RIFRAF (CLASS 2)1 THE C	84.000 S f	FOR ALL DISTURBED AREAS
PERMANENT COVER	0.672 ACRE	FOR ALL DISTURBED AREAS
TEMPORARY COVER	0.336 ACRE	FOR ALL DISTURBED AREAS
COMPOST	180.774 CY	FOR ALL DISTURBED AREAS
FERTILIZER (NITROGEN)	67.230 LB	FOR ALL DISTURBED AREAS
FERTILIZER (PHOSPHORIC ACID)	67.230 LB	FOR ALL DISTURBED AREAS
FERTILIZER (POTASH)	67.230 LB	FOR ALL DISTURBED AREAS
AGRICULTURAL GRANULAR LIME	1344.600 LB	FOR ALL DISTURBED AREAS
SELECTIVE WATERING	54300.000 GAL	FOR ALL DISTURBED AREAS
MOWING	2.017 ACRE	FOR ALL DISTURBED AREAS
INLET STRUCTURE FILTER - TYPE F (WEIGHTED)	208.000 LF	FOR INLET STRUCTURES
INLET STRUCTURE FILTER- TYPE F (NON-WEIGHTED)	208.000 LF	FOR INLET STRUCTURES
SILT FENCE	2609.550 LF	FOR TEMPORARY EROSION CONTROL
REPLACE/REPAIR SILT FENCE	260.955 LF	FOR TEMPORARY EROSION CONTROL
REMOVAL OF SILT RETAINED BY SILT FENCE	652.388 LF	FOR REMOVAL OF SILT


4						BEAUFOR ⁻	COUNTY
3						CITY OF E	BEAUFORT
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1						ALLISON RO	AD (S-7-159)
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STATE	COUNTY	FILE NO.	PROJECT NO.	ROUTE NO.	SHEET NO.
SC	BEAUFORT			S-7-159	10

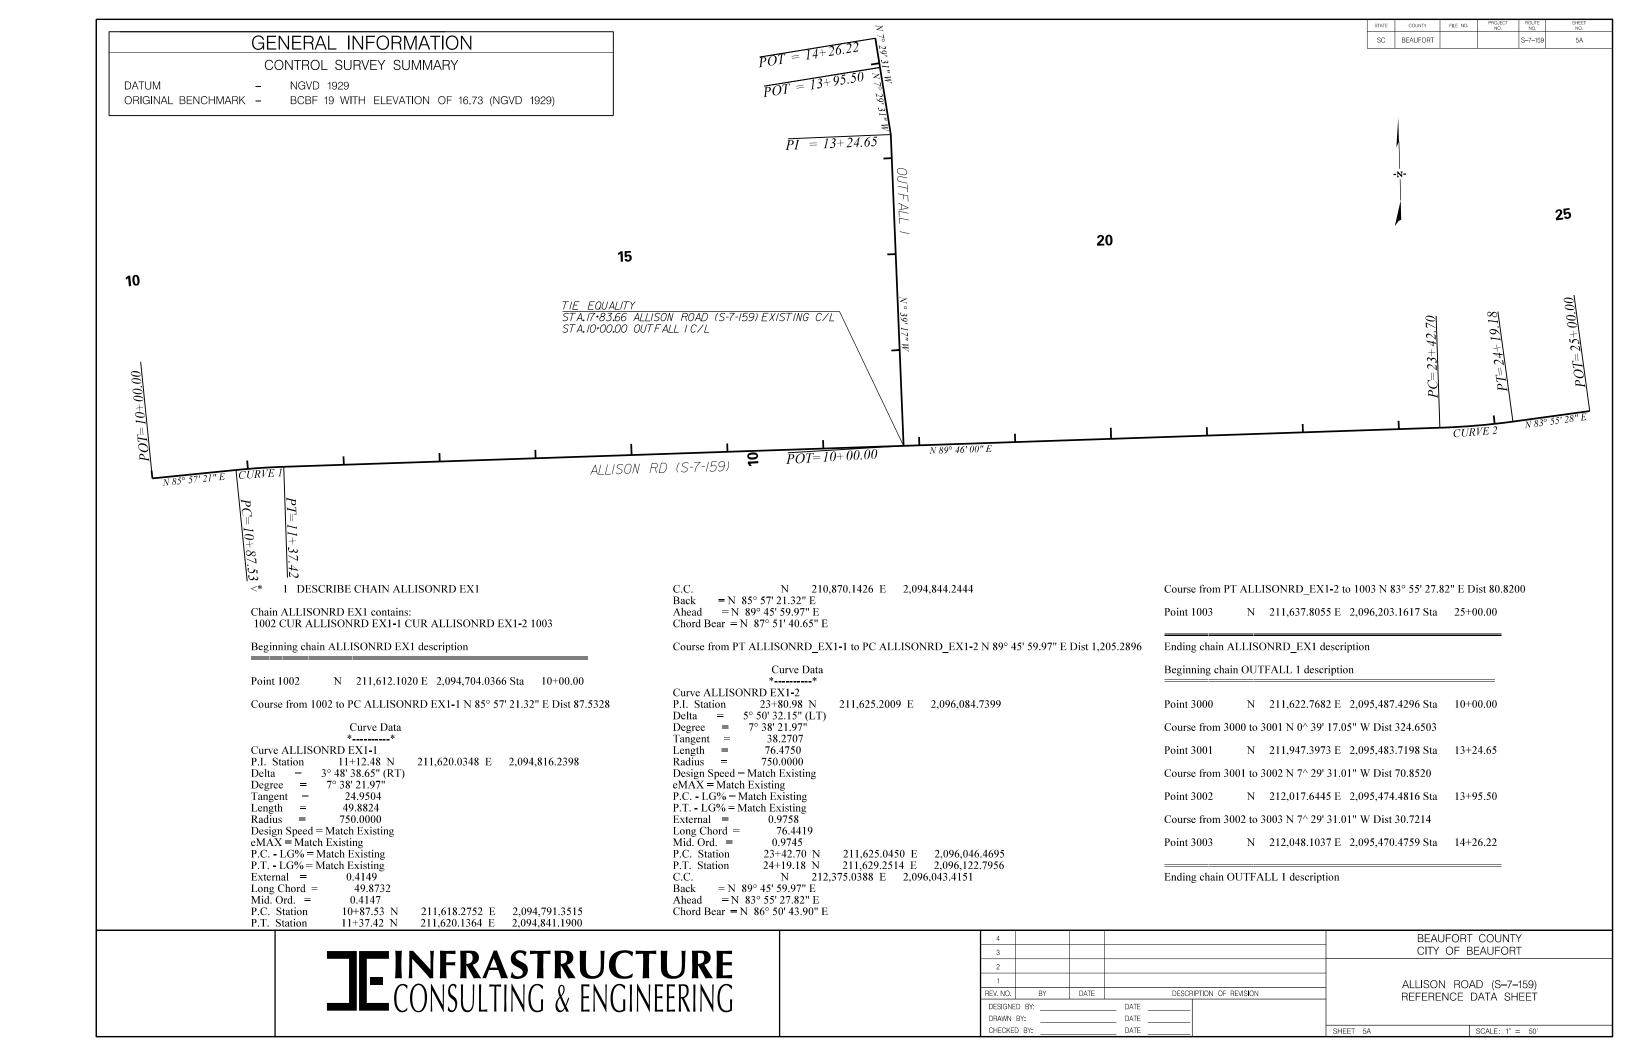DRAINAGE PIPE TABLE

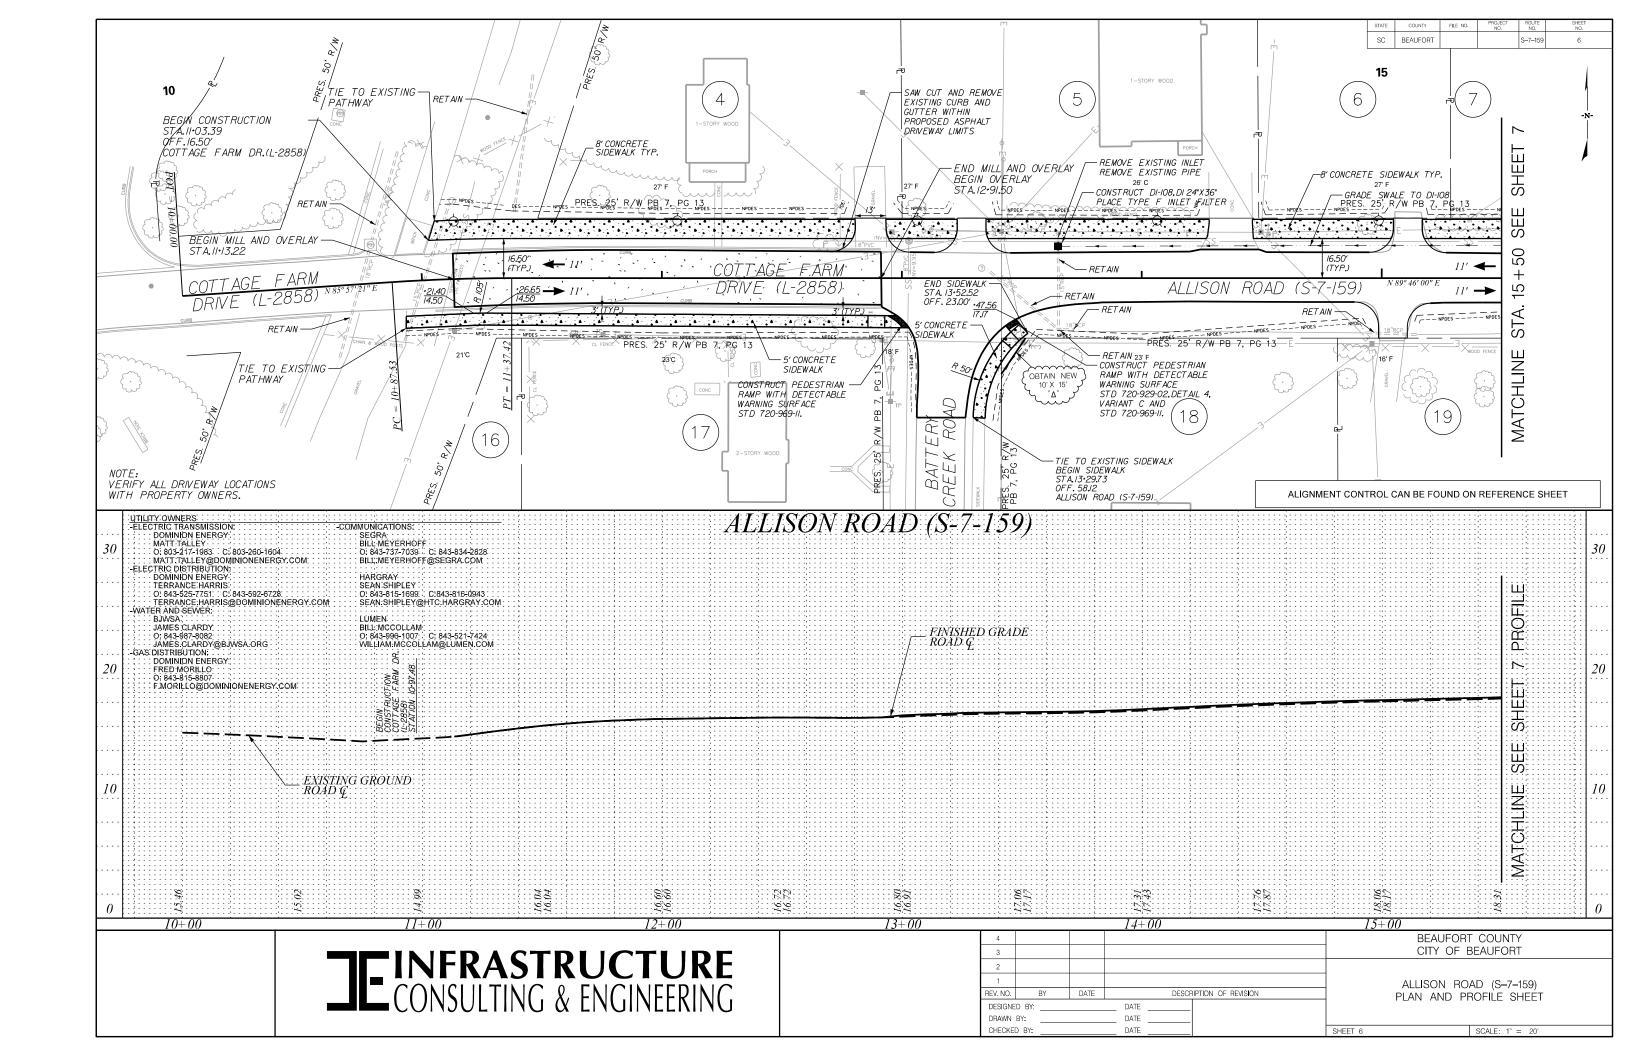			Geor	metry			Upstream				Downstream			Fill H	leight	Joint		
System ID	Link - ID	Diameter	No. of	Pipe	Slope	Node	Node	Node	Link Invert	Node	Node	Node	Link Invert	Upstream	Downstream	Pressure	RCP	Built
		(in)	Barrels	Length	(%)		Description	Station	(ft)		Description	Station	(ft)	(ft)	(ft)	(psi)	Class	٧
Α	NP-100	48	1	340	0.3	DI-100	D.I. 24"X36" W/5'X5' BOX	17+83.78	5.30	0-1	OPEN PIPE	17+81.27	4.30	13.7	0.0	13	Ш	
Α	NP-101	48	1	91	0.3	DI-101	D.I. 24"X36" W/5'X5' BOX	18+78.51	5.58	DI-100	D.I. 24"X36" W/5'X5' BOX	17+83.78	5.30	13.4	13.7	13	Ш	
Α	NP-102	18	1	26	1.9	DI-102	D.I. 24"X36"	18+77.85	14.50	DI-101	D.I. 24"X36" W/5'X5' BOX	18+78.51	14.00	4.6	5.0	13	Ш	
Α	NP-103	48	1	142	0.3	DI-103	D.I. 24"X36" W/5'X5' BOX	20+25.00	6.01	DI-101	D.I. 24"X36" W/5'X5' BOX	18+78.51	5.58	14.7	13.4	13	Ш	
Α	NP-104	18	1	26	2.7	DI-104	D.I. 24"X36"	20+31.43	16.20	DI-103	D.I. 24"X36" W/5'X5' BOX	20+25.00	15.50	4.5	5.2	13	Ш	
Α	NP-105	42	1	10	0.5	JB-105	JUNCT BOX W/MH (5'x5')	20+25.00	6.06	DI-103	D.I. 24"X36" W/5'X5' BOX	20+25.00	6.01	14.9	14.7	13	Ш	
Α	NP-106	18	1	99	0.3	DI-106	D.I. 24"X36"	21+27.60	15.20	DI-103	D.I. 24"X36" W/5'X5' BOX	20+25.00	14.90	5.6	5.8	13	Ш	
Α	NP-107	18	1	25	0.5	DI-107	D.I. 24"X36"	21+31.83	15.33	DI-106	D.I. 24"X36"	21+27.60	15.20	5.5	5.6	13	Ш	

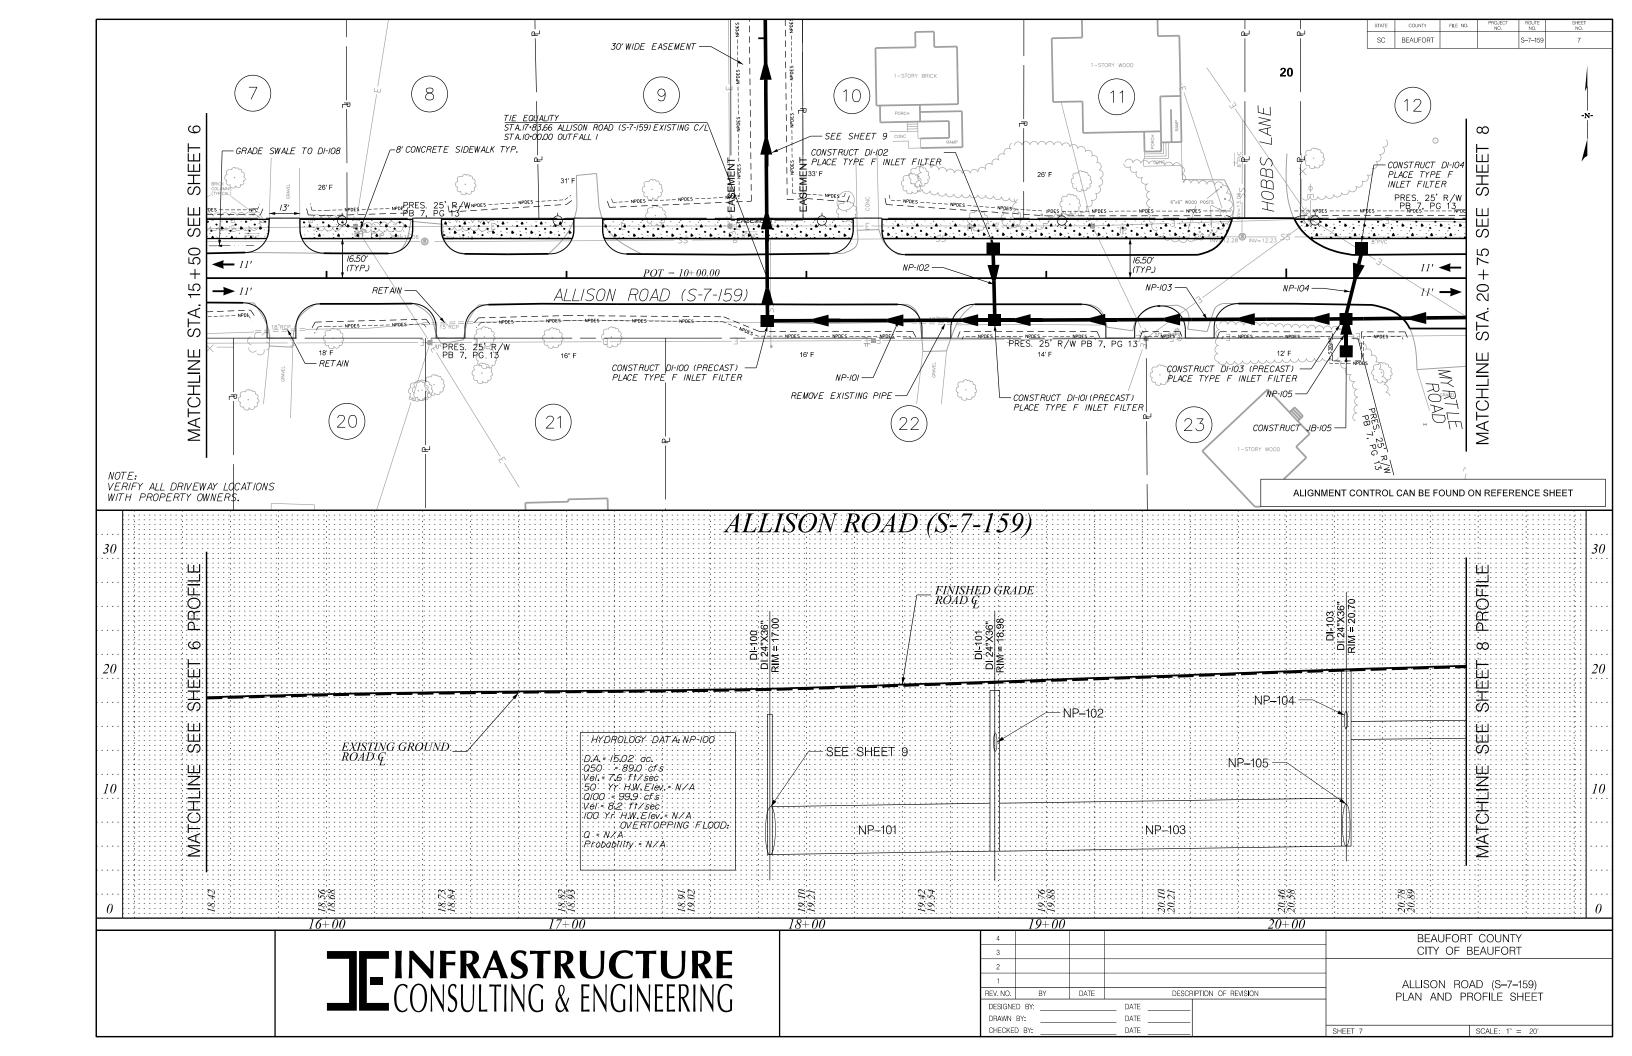
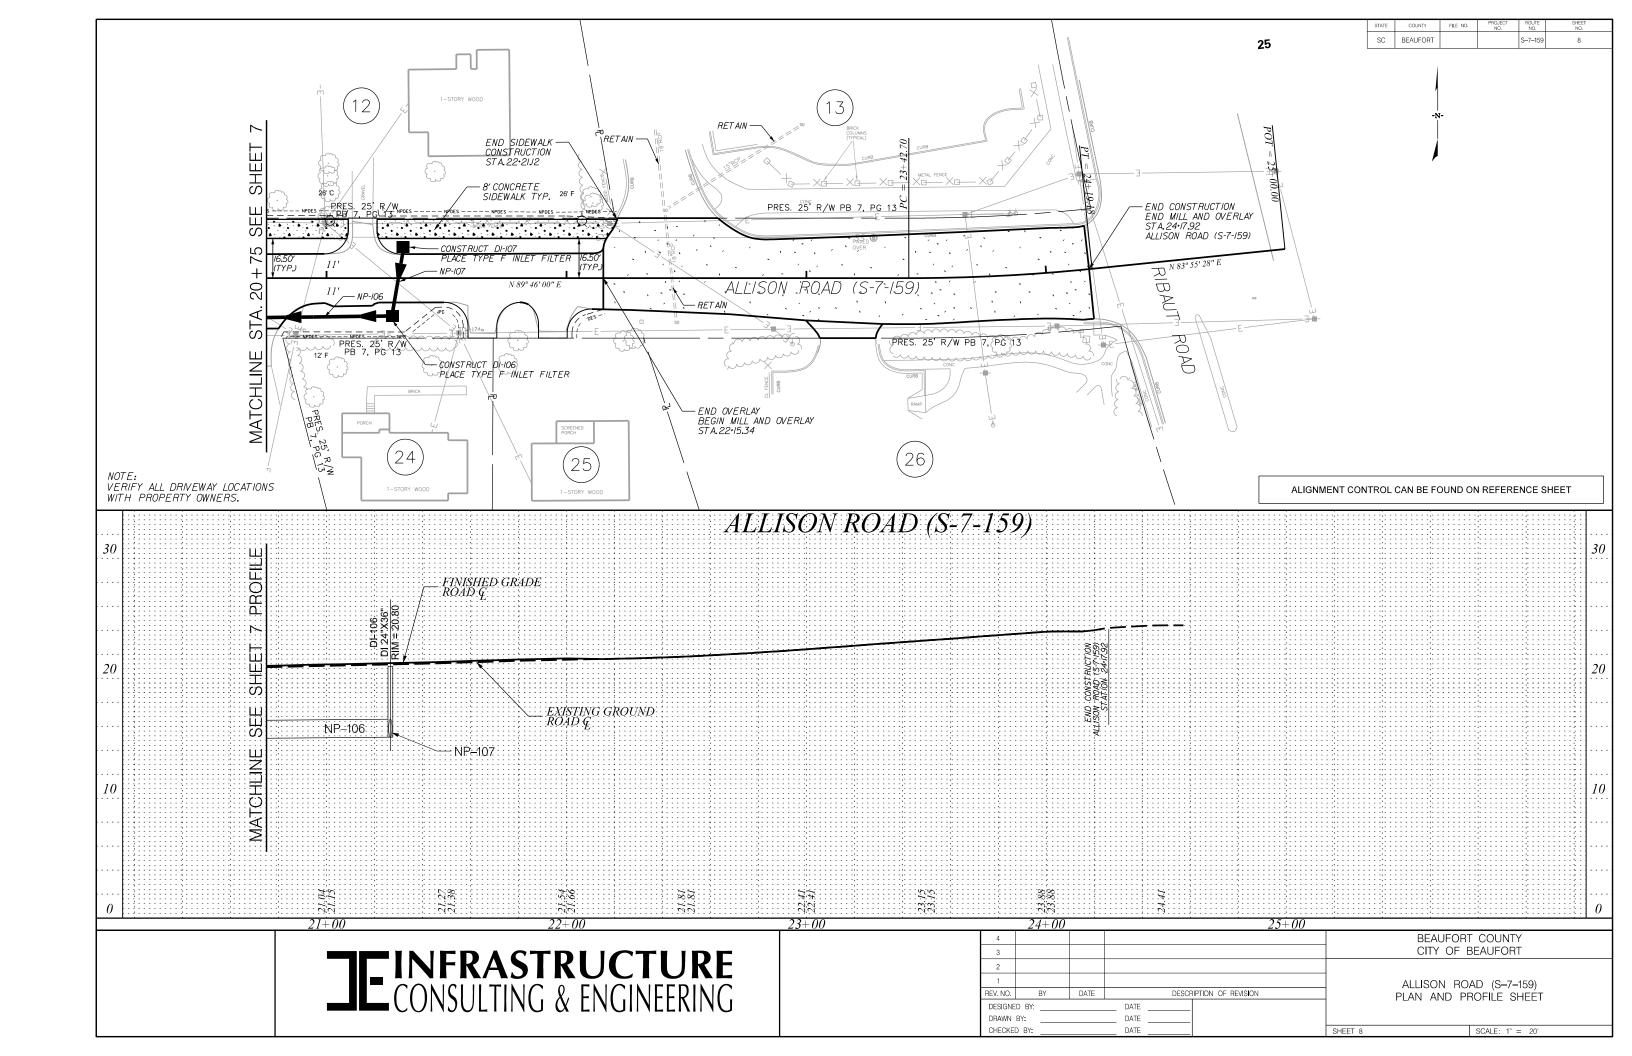
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1						ALLISON RO	AD (S-7-159)
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NOTES:

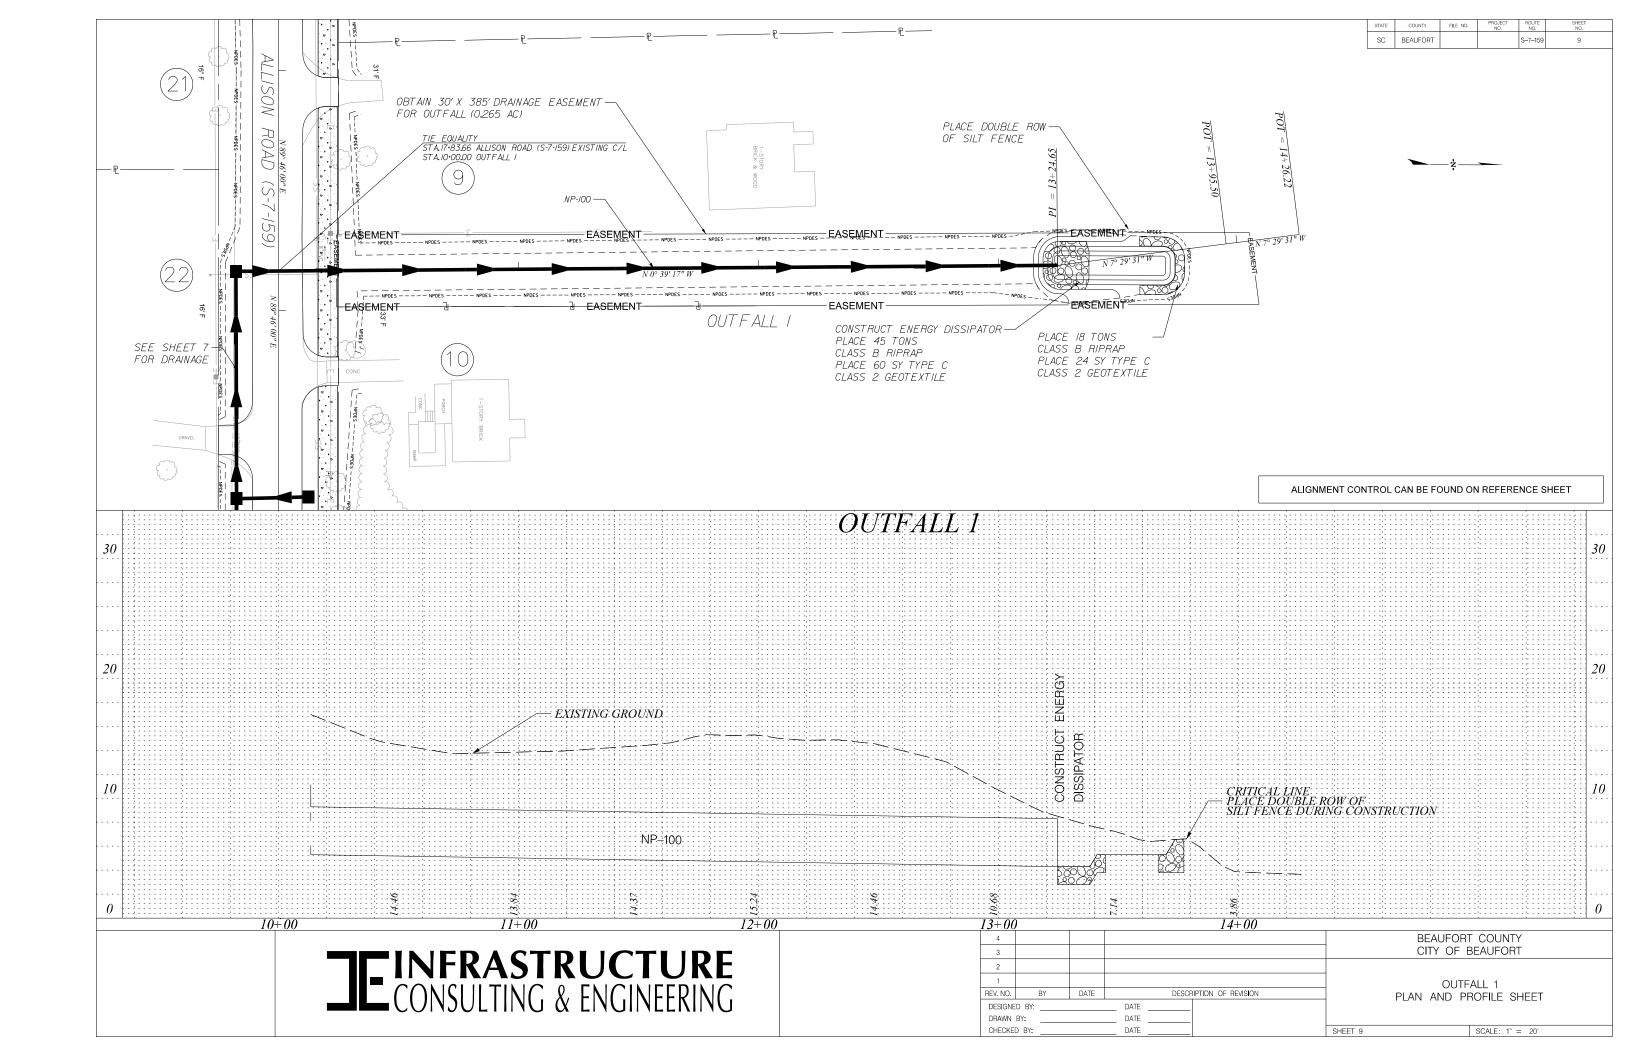- 1. ALL WORK AND MATERIALS SHALL BE DONE IN ACCORDANCE WITH THE 2007 SOUTH CAROLINA DOT STANDARD SPECIFICATIONS FOR HIGHWAY CONSTRUCTION, SCDOT SUPPLEMENTAL SPECIFICATIONS - ROADWAY LIGHTING, NATIONAL ELECTRICAL CODE AND NATIONAL ELECTRIC SAFETY CODE.
- 2. CONTACT TERRANCE HARRIS WITH DOMINION ENERGY FOR SERVICE POINT COORDINATION: TERRANCE.HARRIS@DOMINIONENERGY.COM: (843) 592-6728.
- 3. CONTRACTOR SHALL BE AWARE OF OVERHEAD POWER LINES DURING CONTRUCTION.
- 4. CONDUIT ACCESSORIES SUCH AS EXPANSION JOINTS, ELBOWS, LB'S, FLEXIBLE CONDUIT, ETC SHALL BE INCLUDED IN THE PRICE BID FOR CONDUIT.
- 5. LUMINAIRE MANUFACTURER SHALL PROVIDE A TEN YEAR WRITTEN WARRANTY FOR PARTS AND DEFECTIVE WORKMANSHIP ON LUMINAIRES.
- 6. ALL PITS USED FOR INSTALLED PUSHED (JACKED) CASINGS UNDER EXISTING ROADWAYS SHALL HAVE A MINIMUM OF FIVE FEET BETWEEN EDGE OF SHOULDER. LOCATIONS AS SHOWN ARE APPROXIMATE AND MAY BE SHIFTED AS NECESSARY TO MEET CLEARANCE REQUIREMENTS. CONTRACTOR SHALL FOLLOW MUTCD, SCDOT STANDARD DRAWINGS, AND SCDOT REQUIREMENTS FOR ALL TRAFFIC CONTROL RELATED WORK.
- 7. ALL ELECTRICAL CONNECTIONS SHALL BE MADE ABOVE GRADE INSIDE POLE BASES OR JUNCTION BOXES. NO UNDERGROUND SPLICING ALLOWED.
- 8. CONTRACTOR SHALL VERIFY THE LOCATION OF ALL UTILITIES PRIOR TO INSTALLATION, ANY DAMAGE TO EXISTING UTILITIES SHALL BE REPAIRED BY THE CONTRACTOR AT NO ADDITIONAL COST.
- 9. THE CONTRACTOR SHALL PROVIDE THE SERVICE POLE UNLESS OTHERWISE NOTED. THE SERVICE RISER AND LATERAL, WEATHERHEAD, WATERPROOF ENCLOSURES, CIRCUIT BREAKERS, LIGHTNING ARRESTER, AND THE NECESSARY WIRING FOR CONNECTING TO THE POWER SOURCE, SHALL BE INCLUDED UNDER THE "ELECTRICAL SERVICE CONNECTIONS" PAY ITEM.

POLE DATA TABLE

			Conton /	Chast	Fixture	No of	Δ		
Pole	Sta. No.	Offset	Center / Base Line	Sheet No.	Mounting Height	No. of Lum's	Arm Length	Circuit	Installation Notes
P1	11+13.94	23.99' LT	COTTAGE FARM DRIVE	LL2	16'	1	N/A		
P2	12+06.46	24.00' LT	COTTAGE FARM DRIVE	LL2	16'	1	N/A		
Р3	13+06.46	24.00' LT	ALLISON ROAD	LL2	16'	1	N/A		
P4	14+06.46	24.00' LT	ALLISON ROAD	LL2	16'	1	N/A		
P5	14+98.72	24.00' LT	ALLISON ROAD	LL2	16'	1	N/A		
P6	16+06.47	24.00' LT	ALLISON ROAD	LL3	16'	1	N/A		
P7	16+96.35	24.00' LT	ALLISON ROAD	LL3	16'	1	N/A		
P8	18+06.47	24.00' LT	ALLISON ROAD	LL3	16'	1	N/A		
P9	19+06.47	24.00' LT	ALLISON ROAD	LL3	16'	1	N/A		
P10	20+12.02	24.00' LT	ALLISON ROAD	LL3	16'	1	N/A		
P11	21+01.47	24.00' LT	ALLISON ROAD	LL4	16'	1	N/A		
P12	22+06.47	24.00' LT	ALLISON ROAD	LL4	16'	1	N/A		
P13	23+02.90	24.00' LT	ALLISON ROAD	LL4	16'	1	N/A		
P14	24+03.36	24.00' LT	ALLISON ROAD	LL4	16'	1	N/A		

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LEGEND:

PROPOSED DECORATIVE POLE, 14' POLE, 16' MOUNTING HEIGHT. WITH LED LUMINAIRE.
LUMINAIRES SHALL BE (OR APPROVED EQUAL)

- HOLOPHANE MDLE2 P40 40K AS 3 BK RBK CH FBK PR202427 (7280 LUMENS, 77 W, 4000K)

POLE SHALL BE (OR APPROVED EQUAL) - HOLOPHANE CHA14F4J16P07ABGBK CHA16 BRKWAY KIT FGIUS BK

EXISTING PAD MOUNTED TRANSFORMER (DOMINION ENERGY)

PROPOSED SERVICE CABINET. SEE CONSTRUCTION DETAILS ON SHEET LL5.



PROPOSED PULL BOX. SEE CONSTRUCTION DETAILS ON SHEET LL9.



DIRECTIONAL BORE, SIZE AND TYPE AS SHOWN.

CONDUIT AND CABLE SCHEDULE


- (A) CABLE AND CONDUIT PROVIDED AND INSTALLED BY DOMINION ENERGY.
- (B) 2" SCH 80 PVC CONDUIT WITH 3 #8 AND 1 #8 GND, INSTALLED IN TRENCH.
- © 2" SCH 80 PVC CONDUIT WITH 3 #8 AND 1 #8 GND, PULLED IN 4" CASING (STEEL OR HDPE), DIRECTIONALLY BORED.


	ELECTRICAL ITEMS		
6650900	ELECTRIC SERVICE CONNECTIONS	1	EA
6651091	SINGLE DECORATIVE LIGHT POLE	14	EA
6888110	INSTALL STREET LIGHT LUMINAIRE	14	EA
675027Y	4.0"SCHED80 PVC COND-DIR.BORED	100	LF
6760020	2.0" SCHEDULE 80 PVC CONDUIT	1435	LF
6770319	#8Cu,1,600V,RHH,RHW,USE	6005	LF
6800530	17X30X28D.ELEC.UNGRD.ENCLOS/HD	2	EA






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TO BE FURNISHED, INSTALLED AND MAINTAINED BY DOMINION ENERGY:

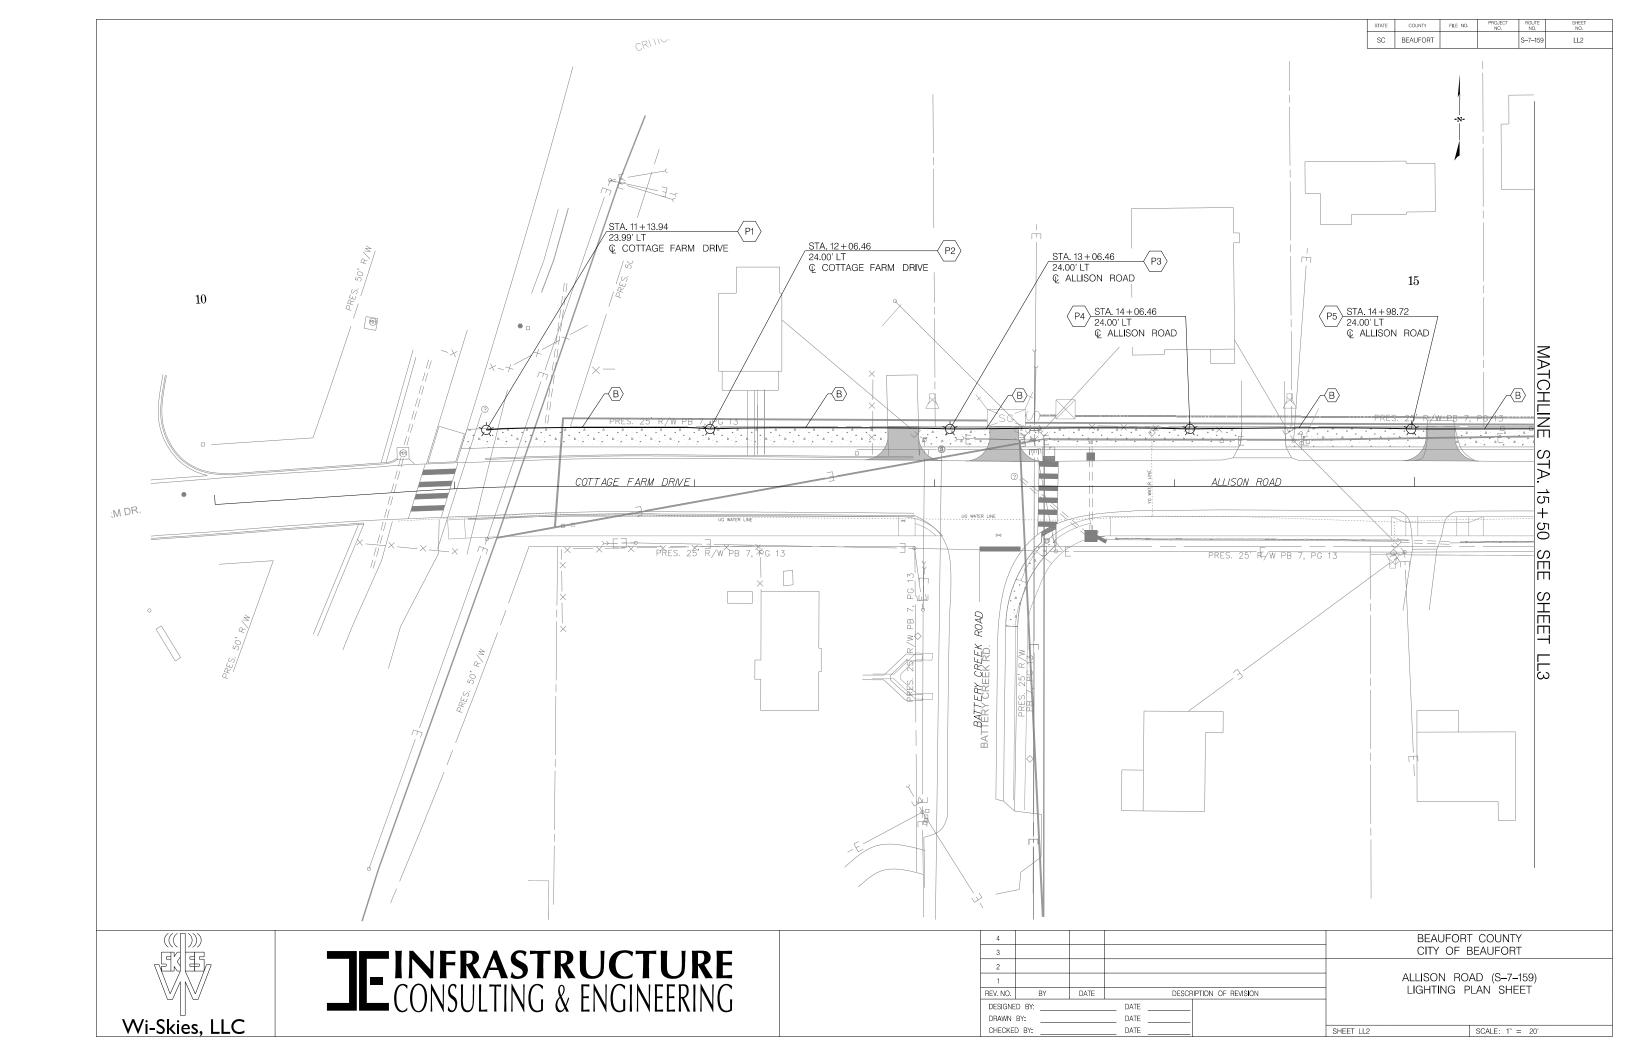1 DESCRIPTION METER

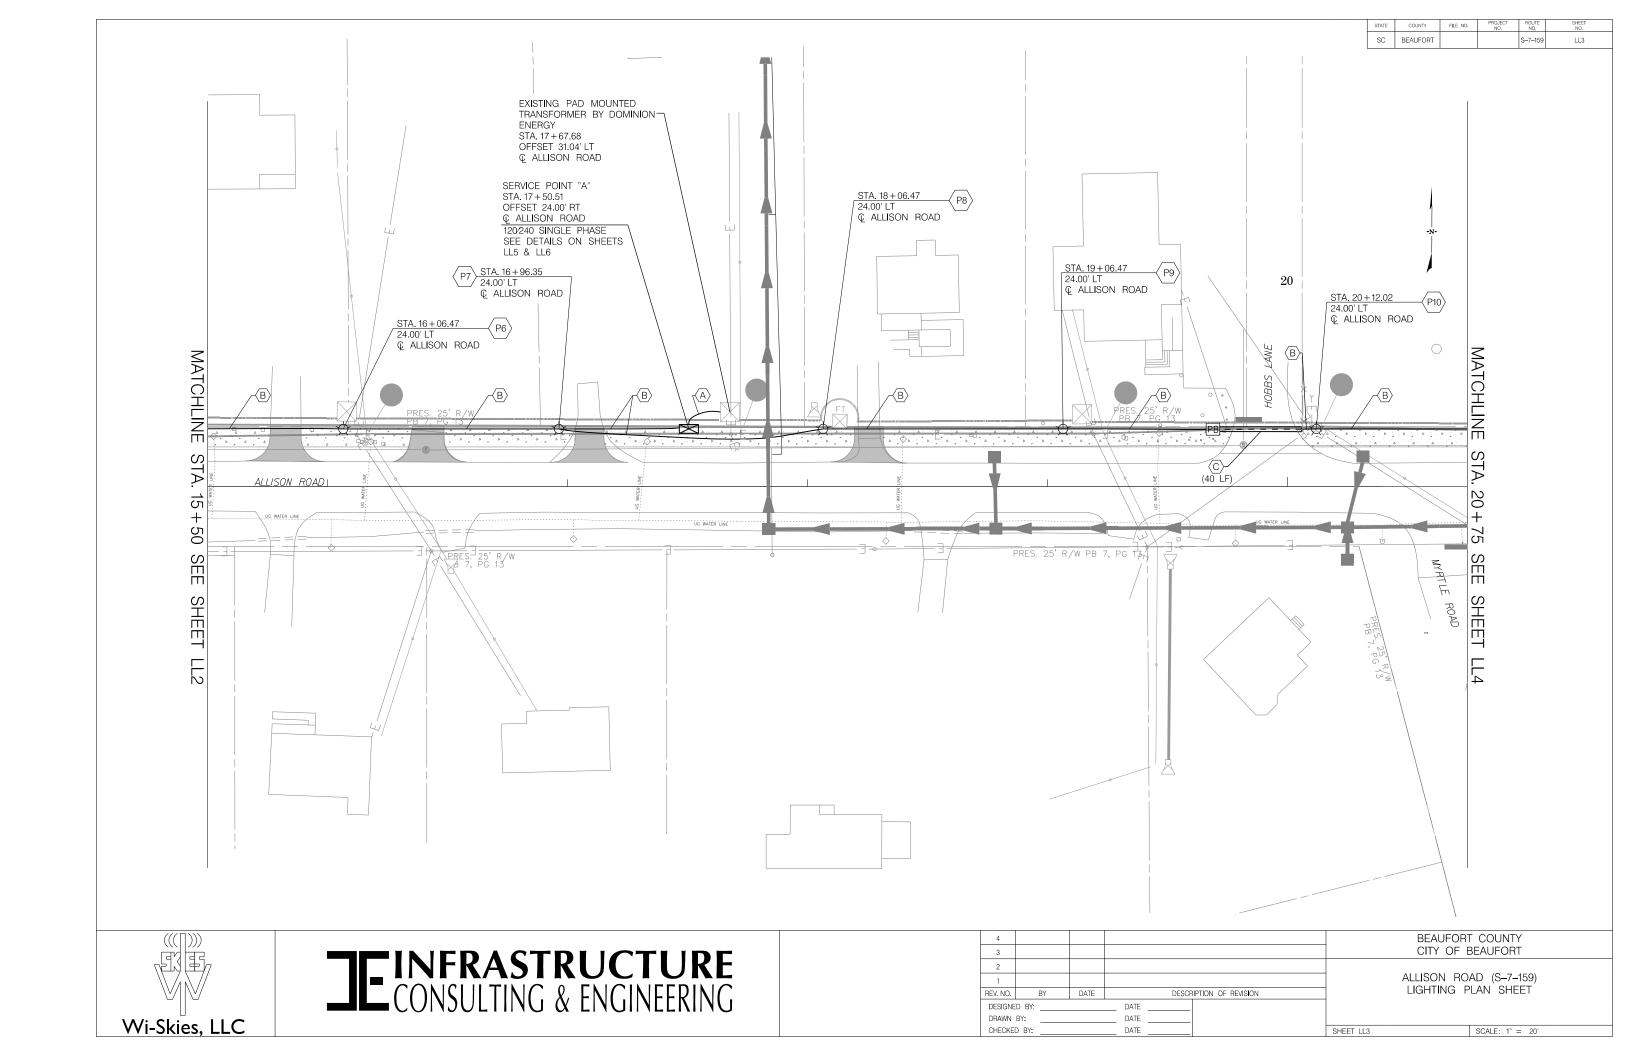SERVICE (SOURCE) CONDUCTORS

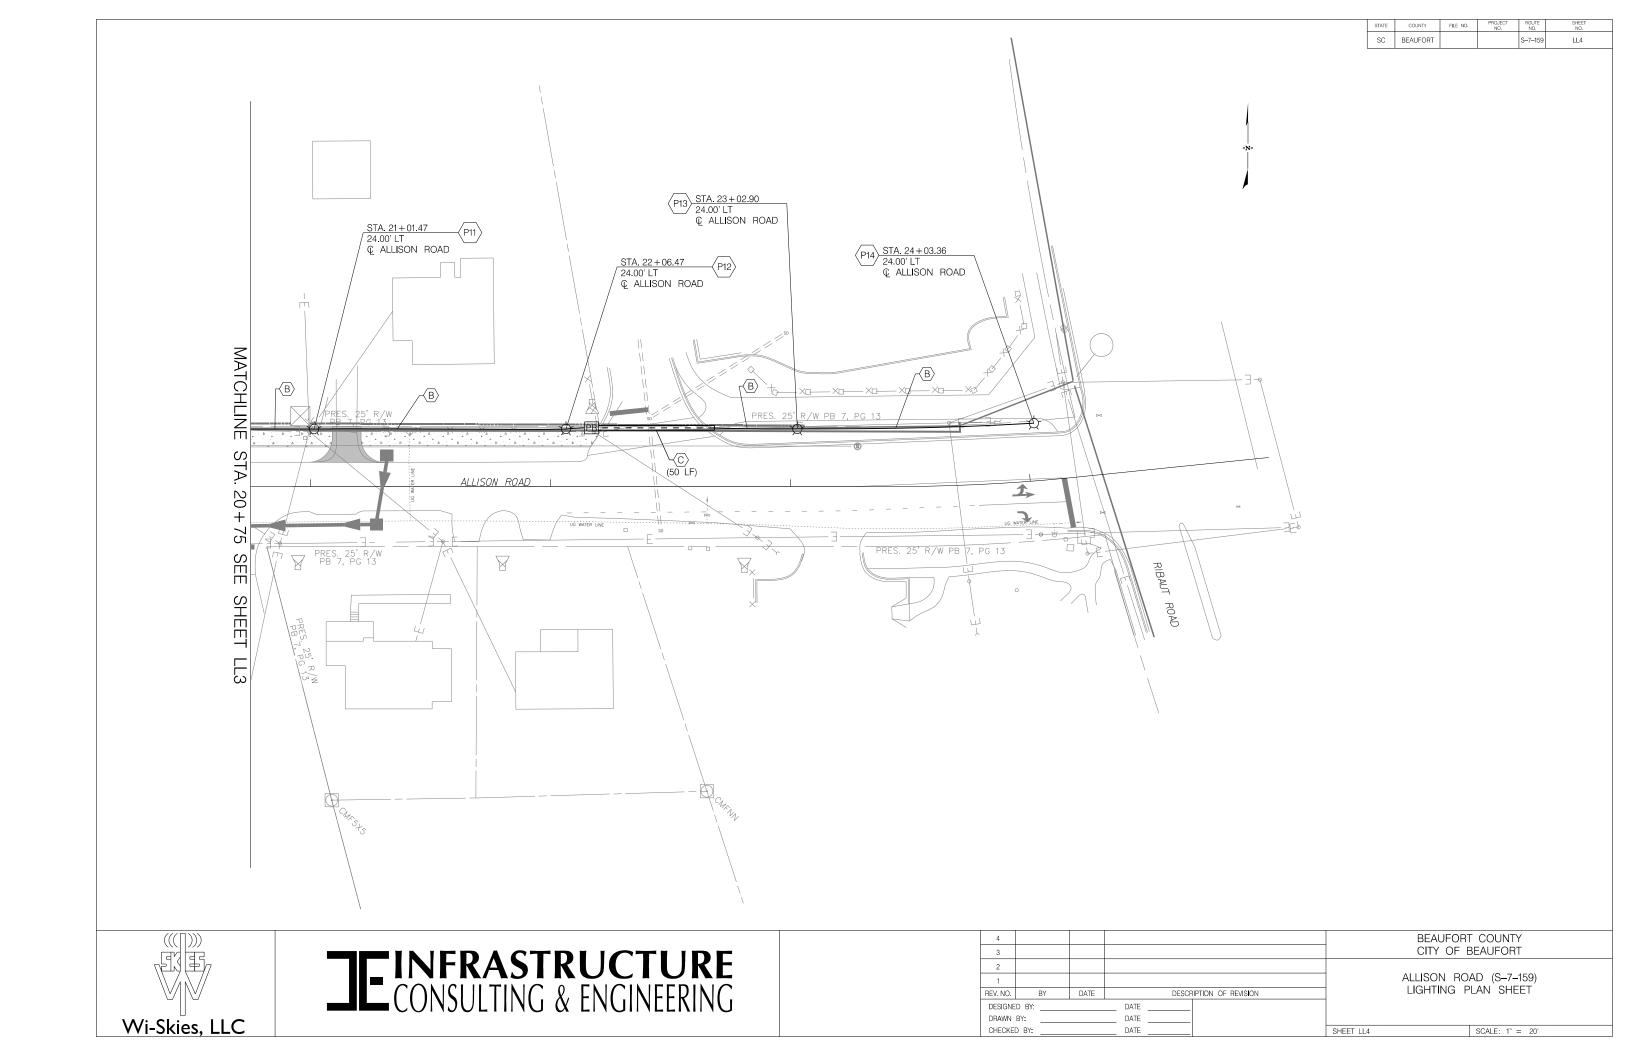TO BE FURNISHED, INSTALLED AND MAINTAINED BY CUSTOMER:

CABINET AND CIRCUIT BREAKER(S)

CONDUIT (GALVANIZED IRON OR PVC) 2 INCH MIN DIAMETER

GROUND ROD (5/8" X 8' GALVANIZED OR COPPER CLAD) PIPE STRAPS (SECURELY ATTACHING CONDUIT)

COPPER GROUND WIRE #6 MIN. (ALUMINUM NOT ACCEPTABLE)


SERVICE CONDUCTORS

METER SOCKET (RINGLESS AND UL APPROVED)

TREATED TIMBER / POLE

ADDRESS OR LOT NUMBER (PERMANENTLY MARKED ON METER SOCKET COVER)

- 1. SOURCE SIDE CONNECTIONS IN METER SOCKET TO BE MADE BY DOMINION ENERGY. LOAD SIDE CONNECTIONS IN METER SOCKET TO BE MADE BY CUSTOMER.
- 2. METER POLE MUST BE SPOTTED BY COMPANY REPRESENTATIVE AND CANNOT BE INSTALLED FURTHER THAN 125 FEET FROM COMPANY POLE/TRANSFORMER.
- 3. GROUNDING CONDUCTOR (ITEM 7) TO BE SECURELY ATTACHED TO STRUCTURE.
- 4. ENTIRE ASSEMBLY TO MEET COMPANY, NEC AND LOCAL CODE REQUIREMENTS.
- 5. CALL PALMETTO UTILITIES PROTECTION SERVICE (PUPS) AT 811 BEFORE YOU DIG.

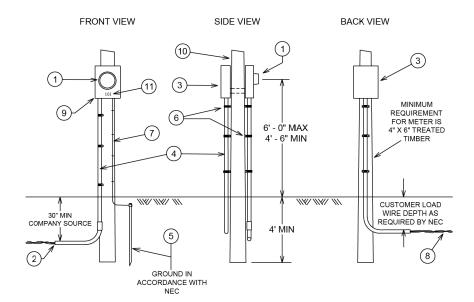

SERVICE POINT ELEVATION



IEINFRASTRUCTURE CONSULTING & ENGINEERING

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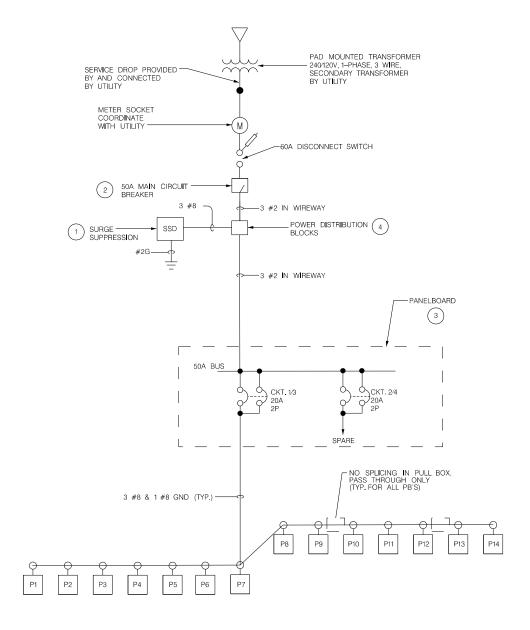
ALLISON ROAD (S-7-159) LIGHTING PLAN SHEET SERVICE PEDESTAL WITH METER DETAIL

NOT TO SCALE

BEAUFORT COUNTY

CITY OF BEAUFORT






LEGEND

THERMAL MAGNETIC MOLDED
CASE CIRCUIT BREAKER

SSD SURGE SUPPRESSOR

NOTES

- SURGE SUPPRESSOR SHALL BE SUITABLE FOR CONNECTION TO 120240V, I PHASE SERVICE. THE SURGE SUPPRESSOR SHALL HAVE MINIMUM SURGE CURRENT RATING OF 130,000A PER PHASE AND SHALL PROVIDE L-L, L-N & N-G PROTECTION. THE SURGE SUPPRESSOR SHALL HAVE RED STATUS LED AND SHALL BE U.L. 1449 AND 1283 LISTED. SURGE SUPPRESSOR SHALL BE PROVIDED BY SQUARE D. EATON OR APPROVED EQUAL AND SHALL BE NIPPLE CONNECTED TO THE MAIN BREAKER.
- 2 MAIN CIRCUIT BREAKER SHALL BE MOLDED CASE, THERMAL MAGNETIC TYPE AND SHALL INCLUDE INSULATED, GROUNDABLE NEUTRAL ASSEMBLY. BREAKER SHALL HAVE 60 AMP FRAME AND 50 AMP OVERCURRENT RATING. BREAKER SHALL HAVE 65KVA AT 240V INTERRUPTING RATING. THE BREAKER SHALL BE UL LISTED AS SUITABLE FOR SERVICE EQUIPMENT AND SHALL BE SUPPLIED BY SQUARE D, EATON OR APPROVED EQUAL.
- 3 PANELBOARD SHALL BE 240120V,1 PHASE, 3 WIRE WITH COPPER BUSBARS, RATINGS SHALL BE AS INDICATED ON DRAWNINGS. A GROUND BUS SHALL BE PROVIDED IN THE PANEL. THE PANEL SHALL HAVE A MINIMUM SHORT CIRCUIT RATING OF 10,000A R.M.S. SYMMETRICAL, THE PANEL SHALL HAVE HINGED DOOR AND DEADFRONT CONSTRUCTION AND MANUFACTURED BY SQUARE D, EATON OR APPROVED EQUAL.
- POWER DISTRIBUTION BLOCKS USED TO DISTRIBUTE WIRES FROM INPUT BETWEEN THE MAIN CIRCUIT BREAKER, SURGE SUPPRESSOR AND THE LIGHTING CONTACTOR. THE BLOCKS NEED TO ACCEPT CABLES RANGING FROM #10 TO #8 AWG.

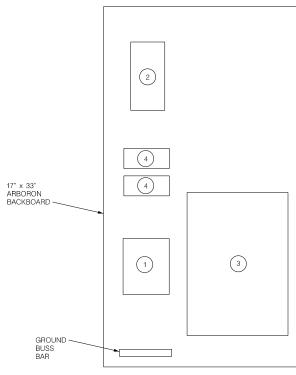


SERVICE PEDESTAL


SYSTEM SINGLE LINE DIAGRAM - SERVICE POINT "A"




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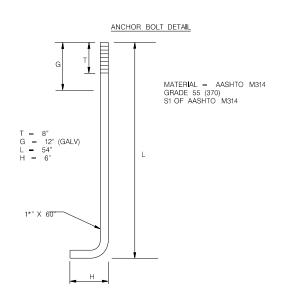

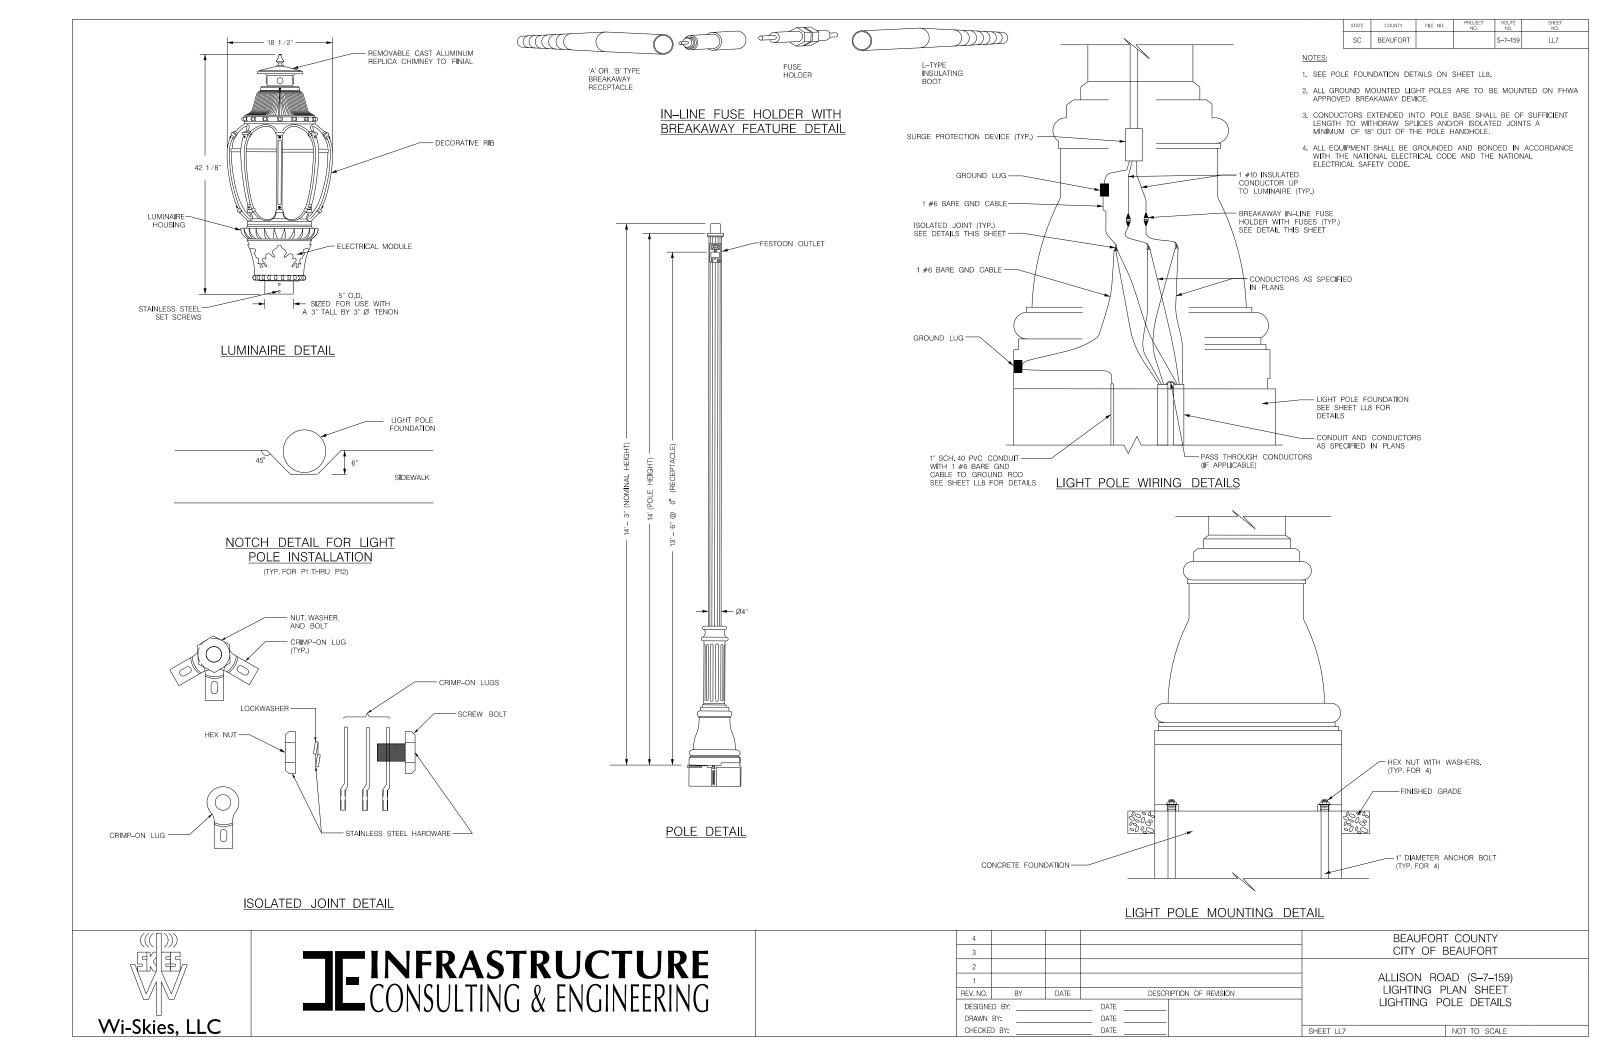
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SC	BEAUFORT			S-7-159	LL8



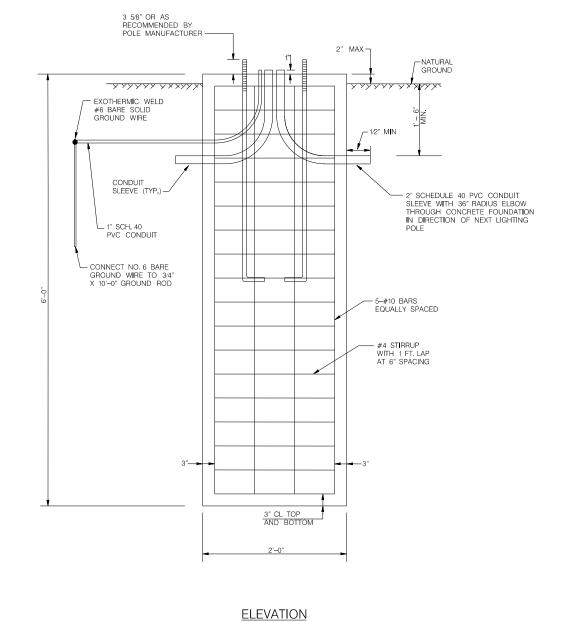
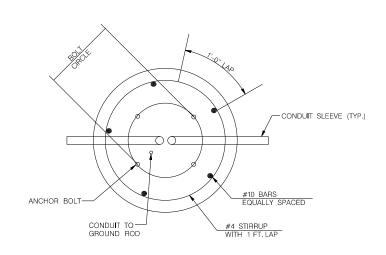
<u>PLAN</u>



EACH 2'X 6' FOUNDATION REQUIRES: 0,70 CU, YDS, CLASS A CONCRETE AND 114 LBS OF BAR REINFORCING STEEL. THESE ARE CONSIDERED INCIDENTAL TO COST OF FOUNDATION.




IEINFRASTRUCTURE CONSULTING & ENGINEERING


4						BEAUFOR ⁻	COUNTY
3						CITY OF E	BEAUFORT
2							
1						ALLISON RO	
REV. NO.	BY	DATE	DESCR	RIPTION OF REVIS I ON		LIGHTING F	
DESIGNE	D BY:		DATE			POLE FOUNDA	ATION DETA
DRAWN	BY:		DATE				
CHECKE	D BY:		DATE		SHEET LL8		NOT TO SCALE


TY OF BEAUFORT SON ROAD (S–7–159) HTING PLAN SHEET FOUNDATION DETAILS

STATE	COUNTY	FILE NO.	PROJECT NO.	ROUTE NO.	SHEET NO.
SC	BEAUFORT			S-7-159	LL9

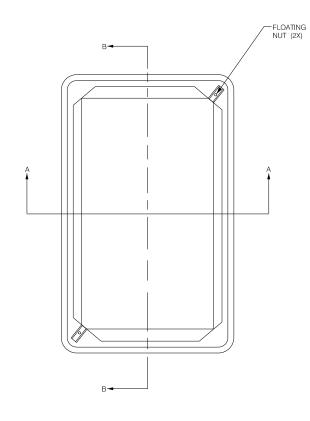





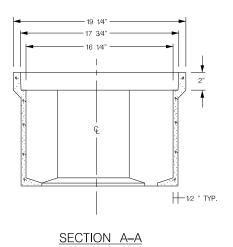

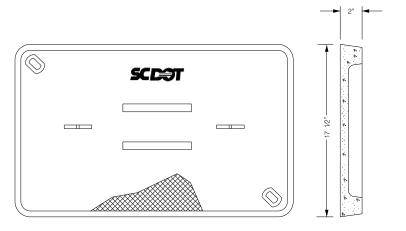

POLYMER CONCRETE COVER

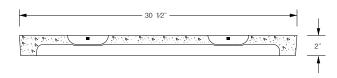

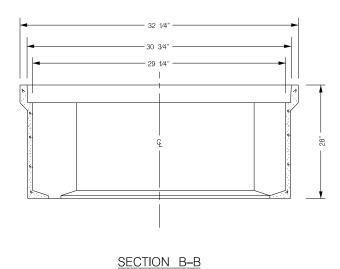

NOTES

- 1) POLYMER BOX TOP AND FRAME MAY HAVE A DIFFERENT CROSS SECTION THAN WHAT IS SHOWN.
- THERE SHALL BE NO CABLE SPLICING WITHIN PULL BOX. PULL BOX SHALL BE USED ONLY AS A CABLE PASS THROUGH.
- 3) ALL PULL BOXES SHALL HAVE SCDOT ELECTRIC LOGO CAST ON THE LID.



TEINFRASTRUCTURECONSULTING & ENGINEERING

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ALLISON ROAD (S-7-159) LIGHTING PLAN SHEET JUNCTION BOX /PULL BOX DETAILS

BEAUFORT COUNTY

CITY OF BEAUFORT

LL9 NOT TO SCALE

STATE	COUNTY	FILE NO.	PROJECT NO.	ROUTE NO.	SHEET NO.
SC	BEAUFORT			S-7-159	PH1

PROPOSED DECORATIVE POLE, 16' MOUNTING HEIGHT.
WITH LED LUMINAIRE.
LUMINAIRES SHALL BE (OR APPROVED EQUAL)

- HOLOPHANE MDLE2 P40 40K AS 3 BK RBK CH FBK PR202427
(7280 LUMENS, 77 W, 4000K)
POLE SHALL BE (OR APPROVED EQUAL)

- HOLOPHANE CHA14F4J16P07ABGBK CHA16 BRKWAY KIT FGIUS BK

- LIGHT LOSS FACTOR = 0.90

Photometric Summ	Photometric Summary - HOLOPHANE MDLE2 P40 40K AS 3 BK RBK CH FBK PR202427											
(7280 LUMENS, 77 W, 4000K)												
Label	CalcType	Units	Avg Illuminance (fc)	Max Illuminance (fc)	Min Illuminance (fc)	EAvg/EMin						
Sidewalk Horiz	Illuminance	Fc	0.64	1.47	0.31	2.06						

AASHTO:

INTERMEDIATE SIDEWALK, R1 CLASSIFICATION: 0.6 FC AVG HORIZ, 4.0 AVG/MIN..



IEINFRASTRUCTURE CONSULTING & ENGINEERING


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REV. NO.	BY	DATE	DESCRIPTION OF REVISION	
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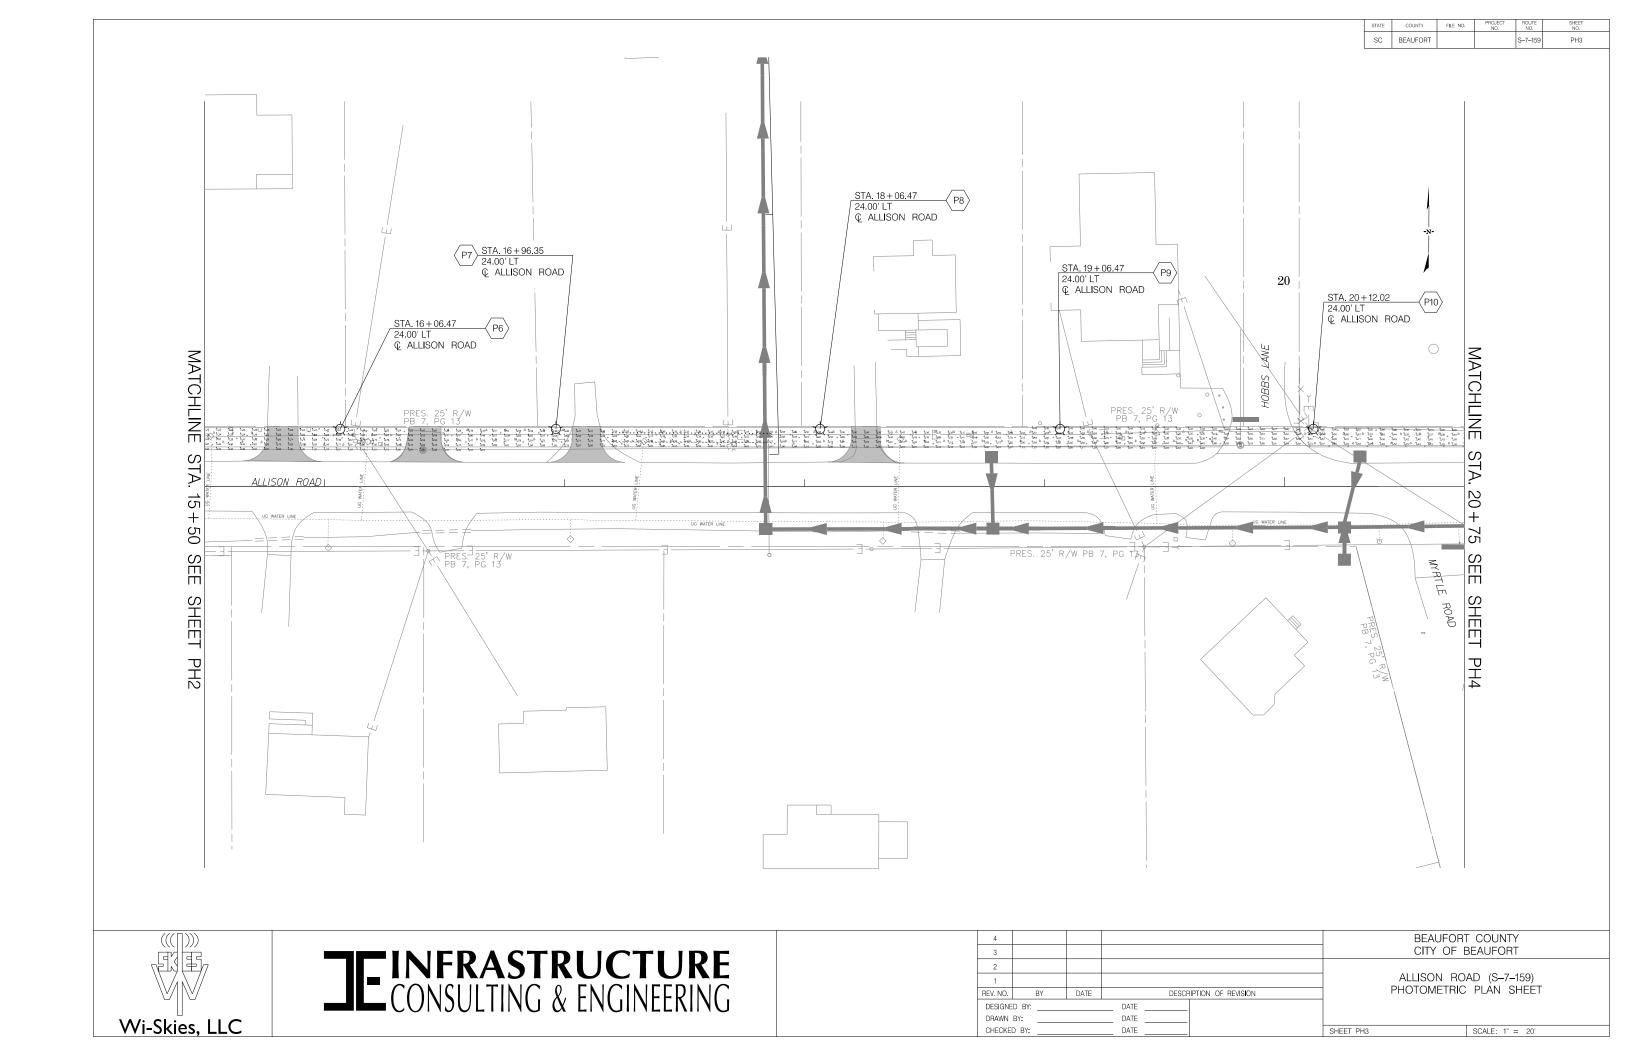
ALLISON ROAD (S-7-159) PHOTOMETRIC SUMMARY


BEAUFORT COUNTY


CITY OF BEAUFORT


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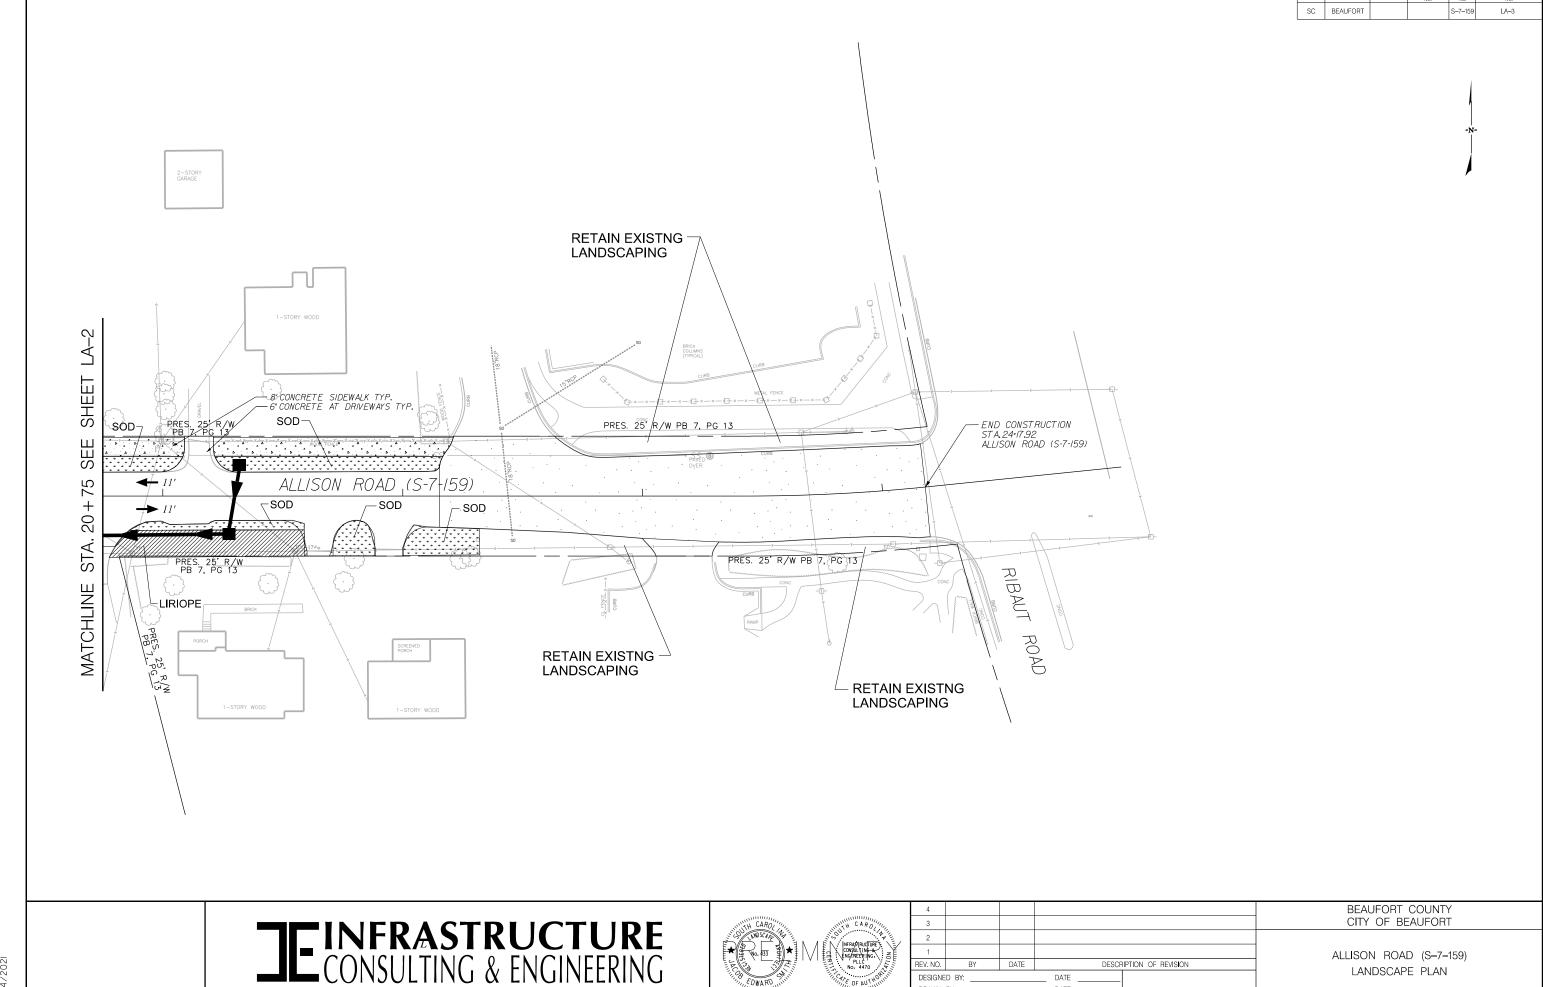




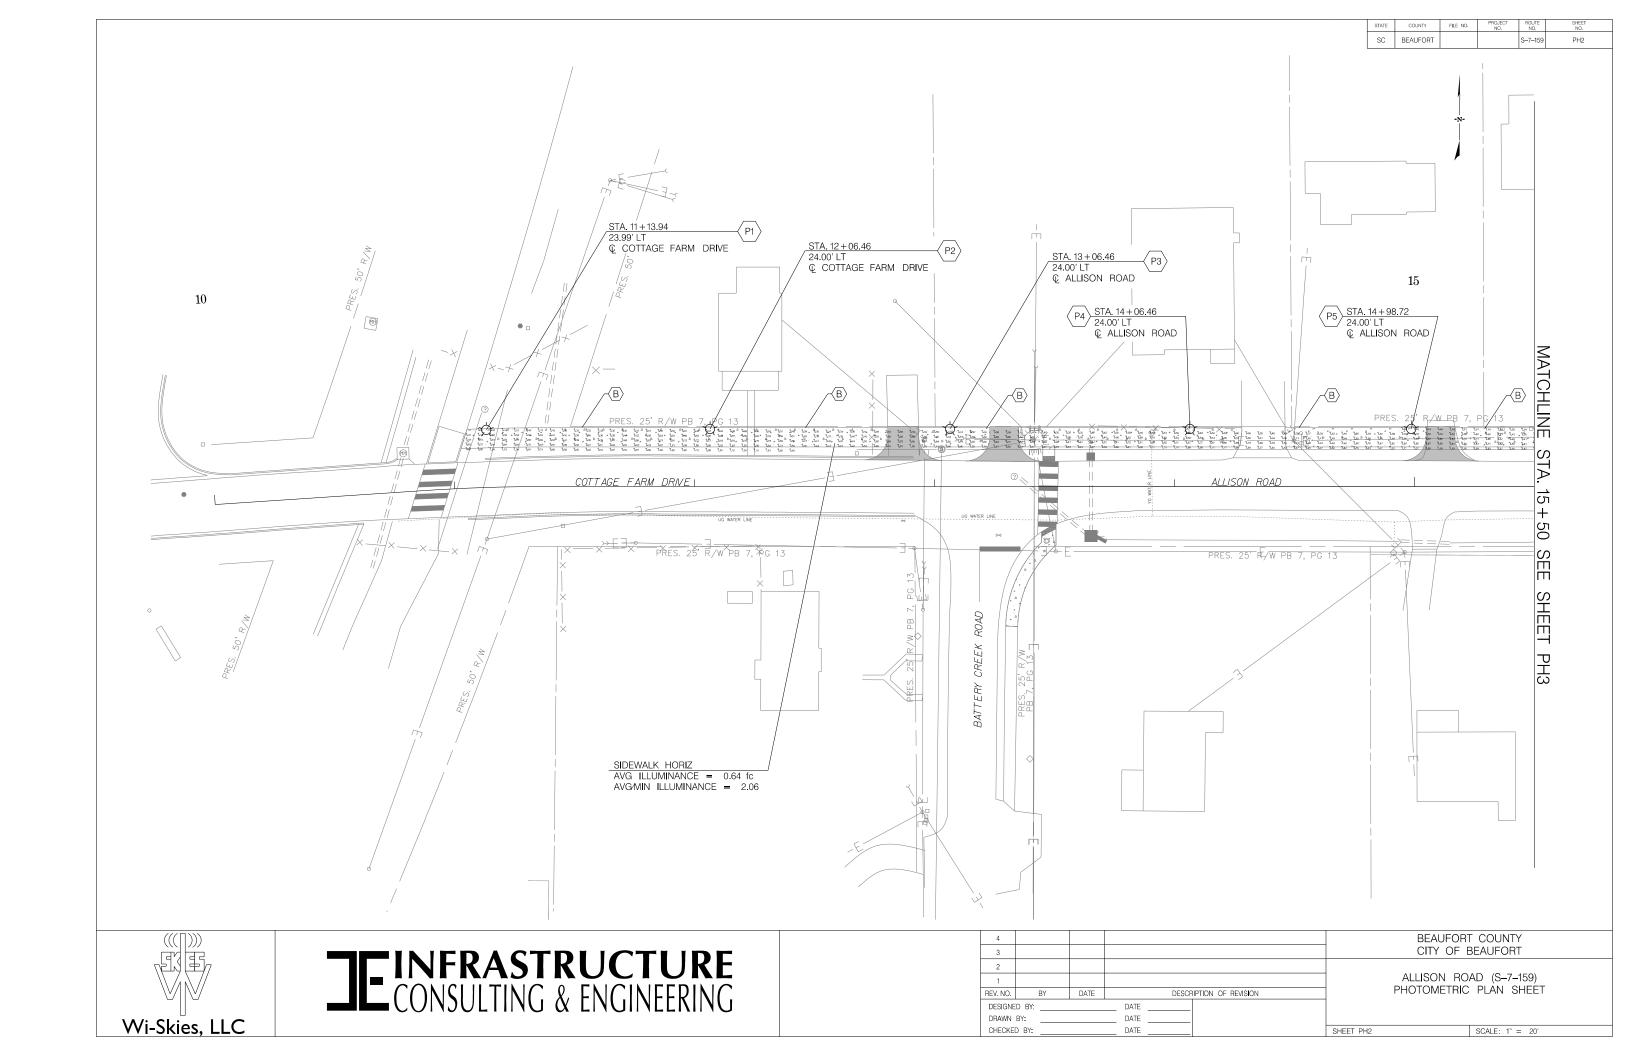

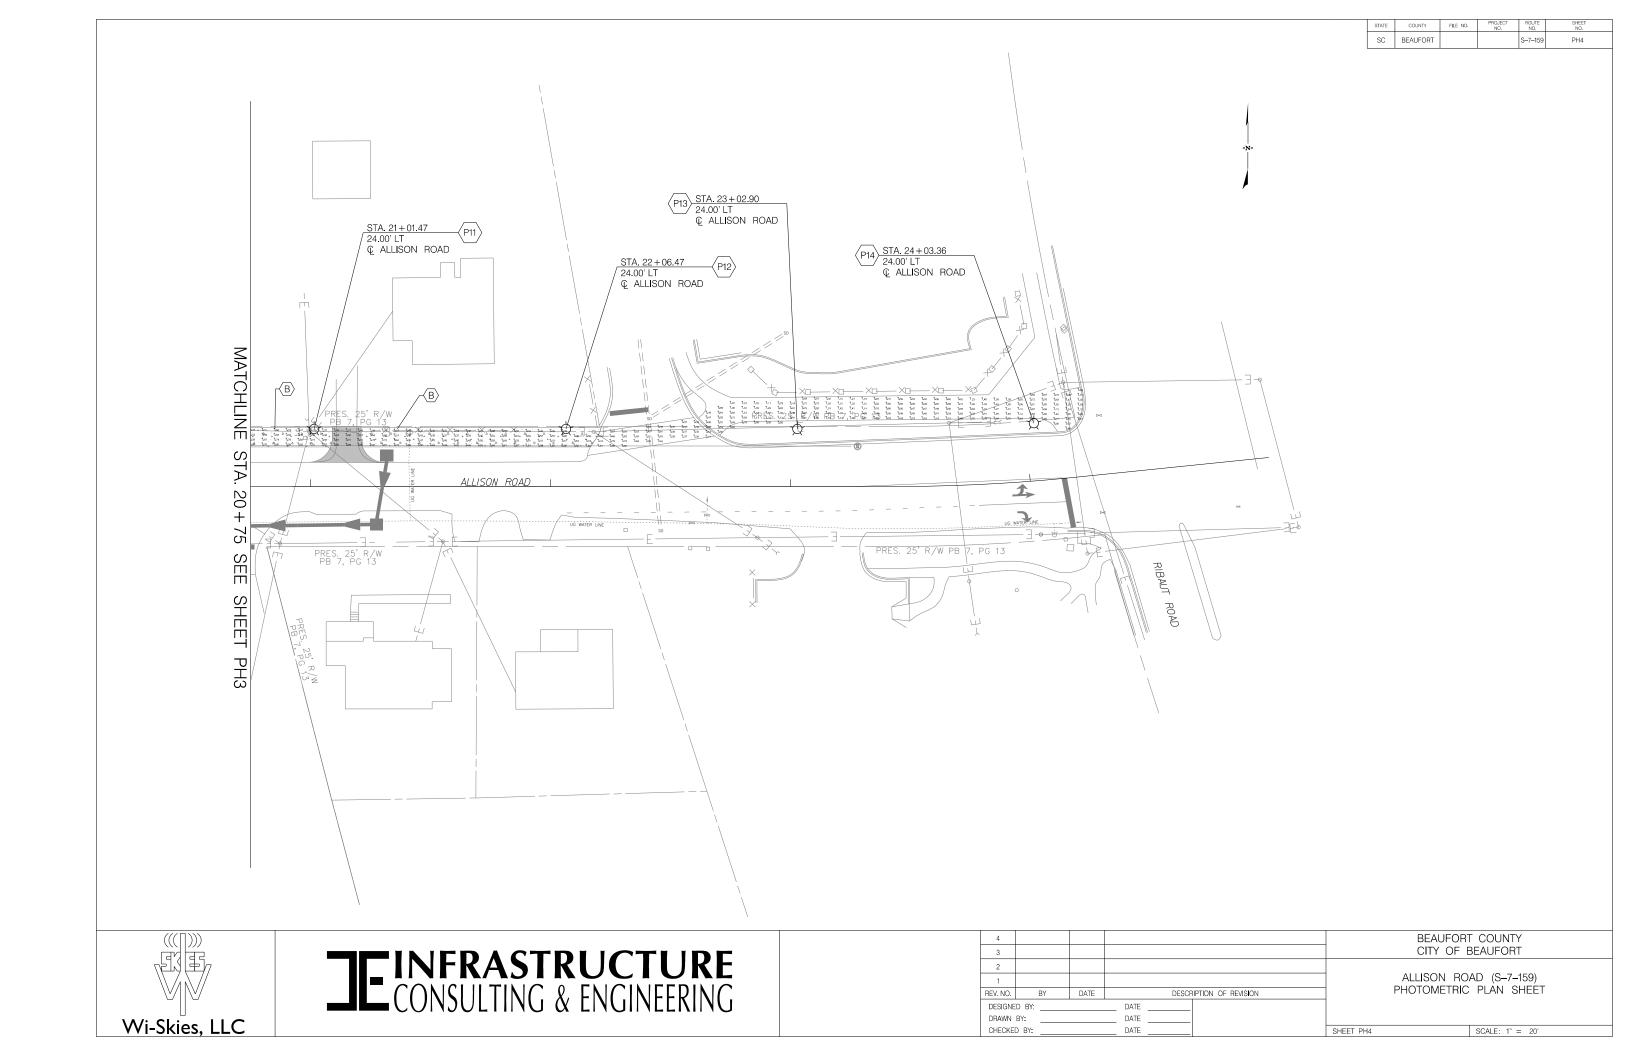

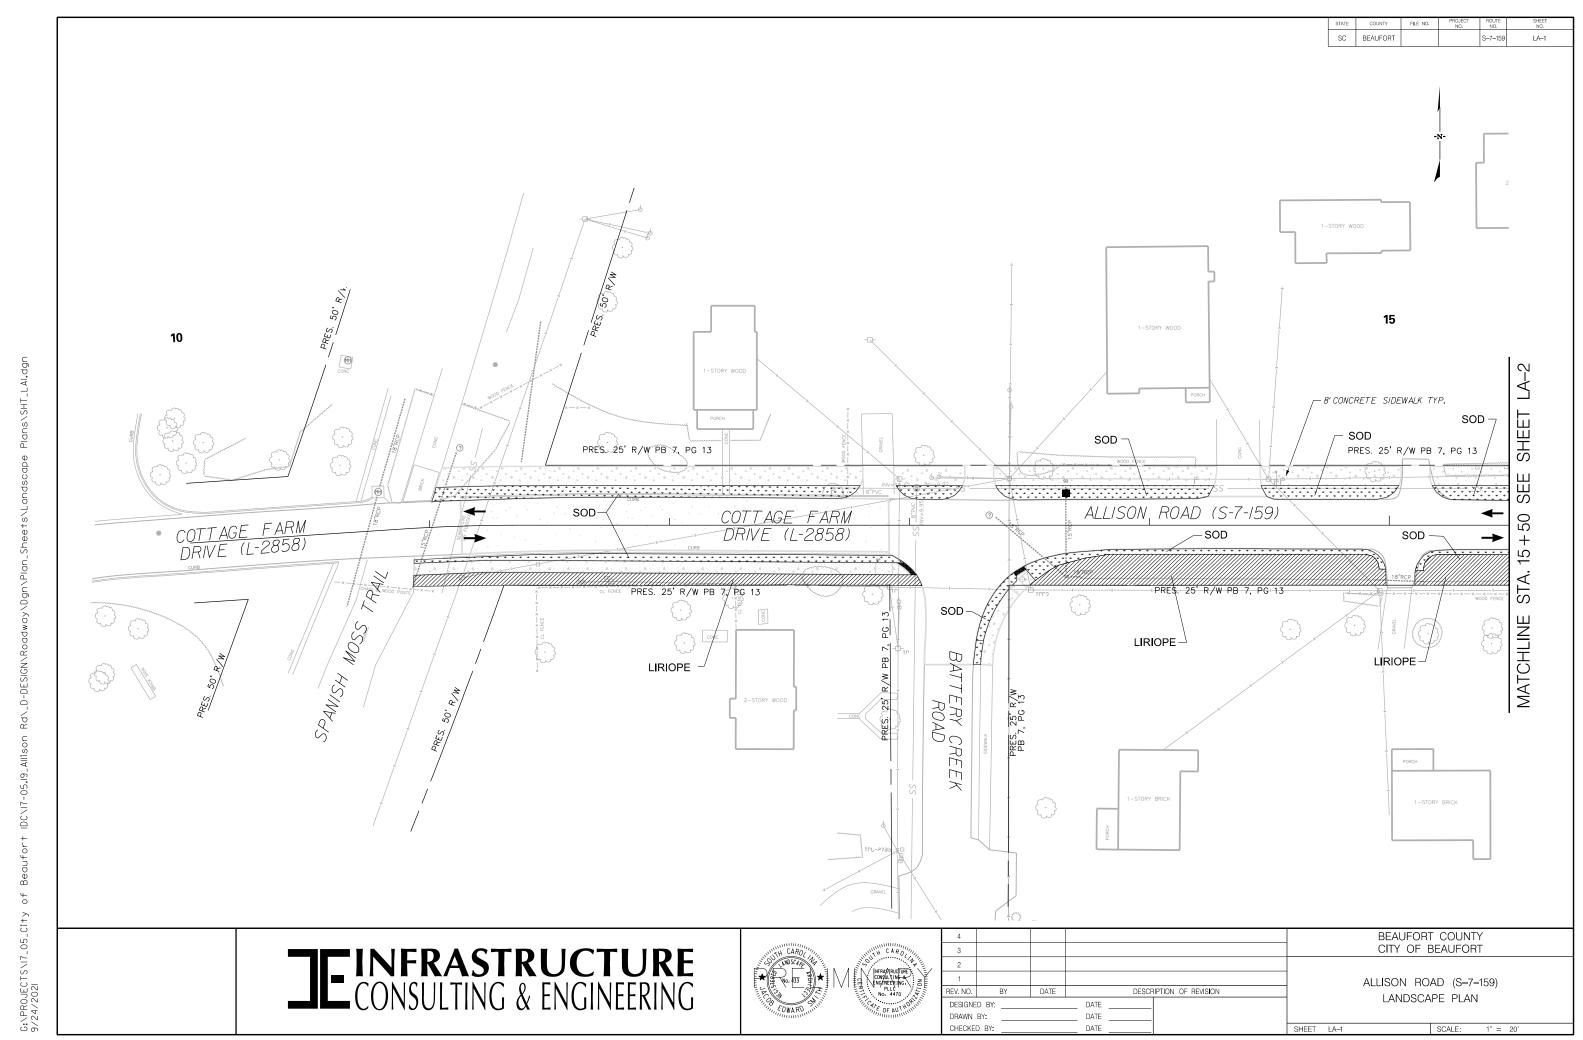

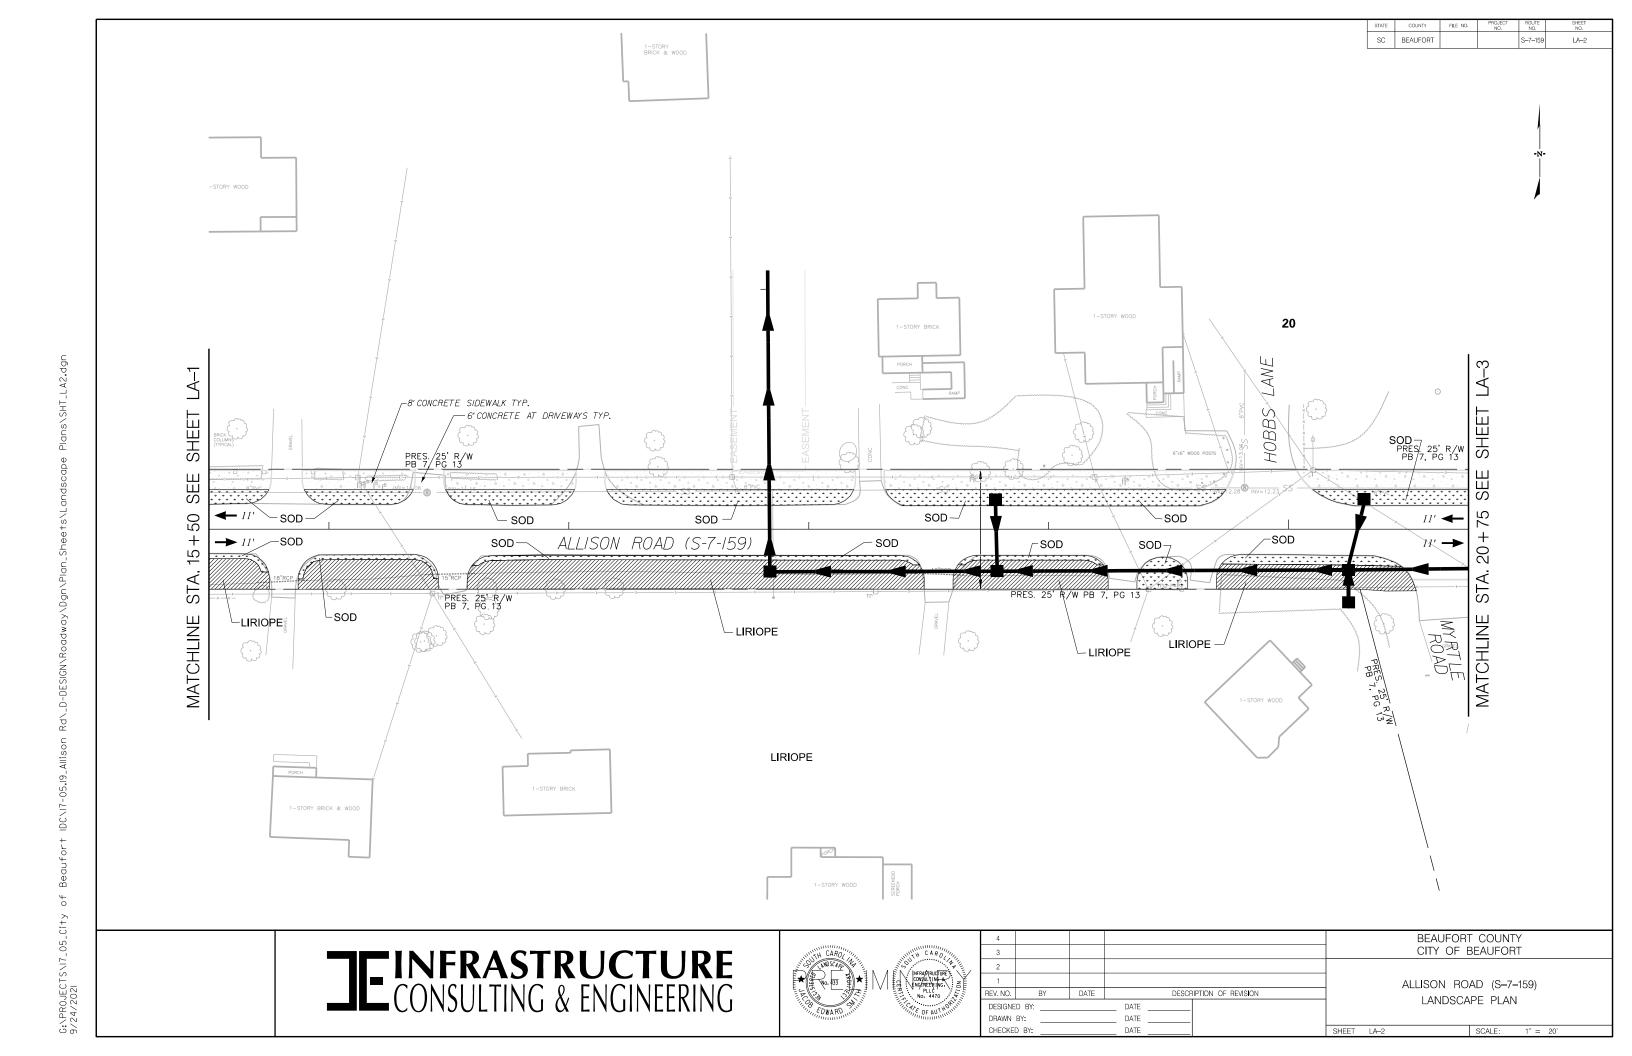

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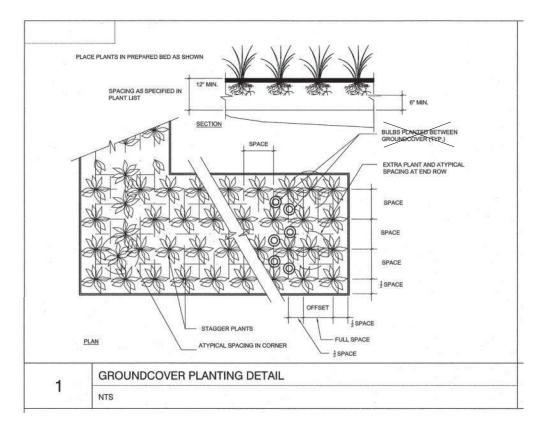
DESCRIPTION OF REVISION

ALLISON ROAD (S-7-159)

LANDSCAPE PLAN

SHEET LA-3

of Beaufort IDCNI7-05,19_Allison Rd_D-DESIGN\Roadway\Dgn\Plan_Sheets\Landscape Plans\SHT_LA3,dgn G:\PROJECTS\\7_05_C1+y 9/24/202|



GENERAL NOTES

- 1.REQUIREMENTS FOR THE MEASUREMENTS, BRANCHING, GRADING, QUALITY, BALLING AND BURLAPPING OF PLANTS IN THE PLANT LIST GENERALLY FOLLOWS OR EXCEEDS A CODE OF STANDARDS CURRENTLY RECOMMENDED BY THE AMERICAN ASSOCIATION OF NURSERYMEN, INC. IN THE AMERICAN STANDARDS FOR NURSERYSTOCK (ASNS).
- 2.ALL PLANTS SHALL HAVE A WELL FORMED HEAD WITH MINIMUM CALIPER, HEIGHT AND SPREAD OF THE SIDE BRANCHES AS SHOWN ON THE PLANT LIST. TRUNKS SHALL BE UNDAMAGED AND SHAPE SHALL BE TYPICAL OF THE SPECIES.
- 3.MEASUREMENT OF CONIFER HEIGHT SHALL INCLUDE NOT MORE THAN FIFTY (50) PERCENT OF THIS YEARS VERTICAL GROWTH (TOPCANDLE).
- 4.THE LANDSCAPE CONTRACTOR IS HEREBY NOTIFIED OF THE EXISTENCE OF UNDERGROUND UTILITIES WITHIN THE LIMITS OF THE PROJECT AREA.
 THE CONTRACTOR SHOULD VERIFY THE EXACT LOCATION OF ALL UTILITY LINES PRIOR TO COMMENCEMENT OF DIGGING OPERATIONS. THE CONTRACTOR
 IS RESPONSIBLE FOR LOCATING, PROTECTING, AND REPAIRING ALL DAMAGE TO BUILDINGS, UTILITIES, PAVEMENT, AND CURB GUTTER. ANY REPAIRS
 SHALL BE DONE PROMPTLY AT CONTRACTORS EXPENSE.
- 5.THE CONTRACTOR WILL BE RESPONSIBLE FOR STAKING AND LAYOUT OF PLANTINGS ON THIS PROJECT. THE LANDSCAPE ARCHITECT OR OWNER SHALL BE ADVISED WHEN STAKES ARE READY FOR INSPECTION ON VARIOUS PLANTING AREAS. ALL LAYOUT WORK SHALL BE INSPECTED AND APPROVED BY THE LANDSCAPE ARCHITECT AND OWNER PRIOR TO OPENING ANY PLANTING PITS.
- 6.IT IS THE RESPONSIBILITY OF THE LANDSCAPE CONTRACTOR TO VERIFY THAT EACH EXCAVATED TREE OR SHRUB PIT WILL PERCOLATE (DRAIN) PRIOR TO ADDING TOPSOIL AND INSTALLING TREES OR SHRUBS. THE CONTRACTOR SHALL FILL THE BOTTOM OF HOLES WITH SIX (6) INCHES OF WATER. THIS WATER SHOULD PERCOLATE WITHIN A TWENTY FOUR (24) HOUR PERIOD.
- 7.SHOULD THE LANDSCAPE CONTRACTOR ENCOUNTER UNSATISFACTORY SURFACE OR SUBSURFACE DRAINAGE CONDITIONS, SOIL DEPTH, LATENT SOILS, HARDPANS, STEAM OR OTHER UTILITY LINES OR OTHER CONDITIONS THAT WILL JEOPARDIZE THE HEALTH AND VIGOR OF THE PLANTS, HE MUST ADVISE THE LANDSCAPE ARCHITECT IN WRITING OF THE CONDITIONS PRIOR TO INSTALLING THE PLANTS. OTHERWISE, THE LANDSCAPE CONTRACTOR WARRANTS THAT THE PLANTING AREAS ARE SUITABLE FOR PROPER GROWTH AND DEVELOPMENT OF THE PLANTS TO BE INSTALLED.
- 8. THE LANDSCAPE CONTRACTOR SHALL BE RESPONSIBLE FOR CLEANING UP THE SITE AT THE COMPLETION OF THE PROJECT AND SHALL MAINTAIN THE SITE IN A REASONABLY NEAT AND CLEAN STATE THROUGHOUT THE INSTALLATION PROCESS. STREETS AND PAVED AREAS SHALL BE CLEANED REGULARLY TO REMOVE CONSTRUCTION MATERIALS AND OTHER DEBRIS RESULTING FROM WORK OF THE PROJECT.
- 9. PLANTS SHALL BE GUARANTEED FOR A MINIMUM OF ONE (1) FULL YEAR AFTER THE FORMAL ACCEPTANCE OF THE PLANTING BY THE OWNER AND SHALL BE ALIVE AND IN SATISFACTORY GROWTH AT THE END OF THE GUARANTEE PERIOD. ANY PLANT NOT IN A HEALTHY AND VIGOROUS STATE AT THE END OF THE GUARANTEE PERIOD SHALL BE REPLACED AT NO COST TO THE OWNER. PLANTS SEVERELY DAMAGED BY VANDALS ARE NOT SUBJECT TO REPLACEMENT BY THE CONTRACTOR.
- IO. REPLACEMENTS OF DEAD OR UNSATISFACTORY MATERIAL SHALL BE MADE AS SPECIFIED IN THE PLANT LIST. THE OWNER OR LANDSCAPE ARCHITECT SHALL INSPECT REPLACED PLANTS WHEN ALL REPLACEMENTS HAVE BEEN MADE. REPLACEMENTS ARE TO BE ALIVE AND IN A HEALTHY CONDITION WHEN THE REPLACEMENTS ARE COMPLETE. REPLACEMENTS ARE NOT SUBJECT TO AN ADDITIONAL GUARANTEE, BUT THE LANDSCAPE CONTRACTOR SHALL CONSULT WITH THE LANDSCAPE ARCHITECT ON REASON FOR PLANT DECLINE / DEATH AND HOW TO AVOID FUTURE INSTANCES.
- 11. SHOULD THE CONTRACTOR NOT MAKE REPLACEMENTS IN A SATISFACTORY AND TIMELY FASHION IN ACCORDANCE WITH THE PLANTING NOTES, THE OWNER, AFTER PROPER NOTIFICATION TO THE CONTRACTOR MAY UTILIZE THE FUNDS OF THE RETAINAGE TO HAVE THE REPLACEMENTS MADE BY ANOTHER CONTRACTOR, IN ACCORDANCE WITH THE SPECIFICATIONS
- 12. NO EXCAVATED PLANTING PITS SHALL BE LEFT UNATTENDED OVERNIGHT.
- 13. PLANT MATERIAL QUANTITIES PROVIDED ARE FOR REFERENCE ONLY AND THE CONTRACTOR IS RESPONSIBLE FOR THE ACTUAL MATERIAL TAKE OFFS. DISCREPANCIES BETWEEN QUANTITIES SHOWN ON THE PLANTING PLAN AND THOSE IN THE PLANT LIST SHALL BE BROUGHT TO THE ATTENTION OF THE LANDSCAPE ARCHITECT FOR CLARIFICATION. IF CLARIFICATION OF DISCREPANCIES FROM THE LANDSCAPE ARCHITECT IS NOT POSSIBLE, THE QUANTITIES SHOWN ON THE PLANTING PLAN SHALL TAKE PRECEDENCE.



NOTES: 1) COST OF MULCH TO BE INCLUDED IN UNIT PRICE FOR TREES.

SHRUBS, AND GROUNDCOVER.


PLANT LIST - ALL SHEETS


KEY	SYMBOL	BOTANICAL NAME	COMMON NAME	SIZE	BALL/ CONT.	QUANTITY EACH
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SOD		CENTIPEDE SOD	CENTIPEDE SOD	SY		1000 (SY)


- 14. REMOVE BURLAP / STRAPPING AND WIRE BASKET FROM TOP OF ROOT BALL ON TREES.
- 15. REMOVE PAPER, PLASTIC, OR METAL AROUND ROOTBALLS OF SHRUBS.
- 16. DO NOT WRAP TREES.
- 17. WATER ALL PLANT MATERIAL IMMEDIATELY AFTER PLANTING, FOR TREES, WATER IN ONCE AFTER BACKFILLING OF THE PLANTING HOLE, THEN WATER IN AGAIN UPON BRINGING BACKFILL TO FINAL GRADE.
- 18. TREE GUYING MATERIAL SHALL BE 'ARBOR TIE' OR EQUIVALENT. IF TREE GUYING IS NECESSARY.ALL SHALL BE REMOVED AFTER ONE YEAR.
- 19. ALL PLANT BEDS TO BE MULCHED WITH 3" OF DOUBLE SHREDDED HARDWOOD MULCH. TWO (2) APPLICATIONS OF MULCH, ONE IMMEDIATELY FOLLOWING PLANT INSTALLATION AND THE OTHER AT END OF THE ONE (1) YEAR ESTABLISHMENT PERIOD. ALL PLANT BEDS SHALL RECEIVE 5.0 OZ OF WEED FABRIC. COST OF MULCH AND WEED FABRIC TO BE INCLUSIVE IN UNIT PRICE OF ALL PLANTINGS.
- 20. ALL AREAS OF PLANTING, INCLUDING AREAS OF GRASS SEEDING AND SOD, SHALL BE GRADED TO PROVIDE POSITIVE DRAINAGE AND SHALL BE PROVIDED APPROPRIATE SOILS OR THE PROPOSED PLANTINGS. THE LANDSCAPE CONTRACTOR SHALL ADJUST PH AND / OR SOIL FERTILITY BY UNIFORMLY INCORPORATING REQUIRED SOILS CONDITIONING MATERIALS AT THE RATE AND DEPTH DETERMINED BY THE ANALYSIS OF THE SOIL TEST (AS REQUIRED IN 3.02 AND 3.12 OF THE LANDSCAPING SPECIFICATIONS). EACH SOILS TEST SHALL BE SPECIFIC TO THE PROPOSED PLANT MATERIAL TO BE INSTALLED IN A GIVEN AREA.
- 21. ALL EXISTING VEGETATION WITHIN AREAS TO BE PLANTED / SODDED / SEEDED SHALL BE REMOVED PRIOR TO PLANTING / SODDING / SEEDING. ALL AREAS INDICATED TO BE GRASS SEED SHALL BE HYDRO SEEDED PER THE GRASSING SPECIFICATIONS FOR PERMANENT STABILIZATION.
- 22. CONTRACTOR IS RESPONSIBLE FOR PROVIDING NECESSARY WATERING FOR ALL PLANT MATERIAL DURING ESTABLISHMENT PERIOD. THERE WILL BE NO SEPARATE PAY APP. NUMBER PROVIDED.
- 23. CONTRACTOR SHALL INCLUDE ONE (1) YEAR MAINTENANCE/ WATERING OF PLANT MATERIAL IN THE COST OF THE PROJECT.
- 24.ALL PROPOSED PLANTINGS SHALL BE A MINIMUM OF A 1.5' OFFSET FROM THE EDGE OF THE ADJACENT BACK OF CURB, SIDEWALK, OR PROPOSED HARDSCAPE SURFACE TO NEAREST OUTSIDE EDGE OF THE PROPOSED PLANTINGS.



4							T COUNTY BEAUFORT
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1						ALLISON BO	AD (S-7-159)
REV. NO.	BY	DATE	DES	CRIPTION OF REVISION			DETAILS SHEET
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STATE	COUNTY	FILE NO.	PROJECT NO.	ROUTE NO.	SHEET NO.
SC	BEAUFORT			S-7-159	EC1

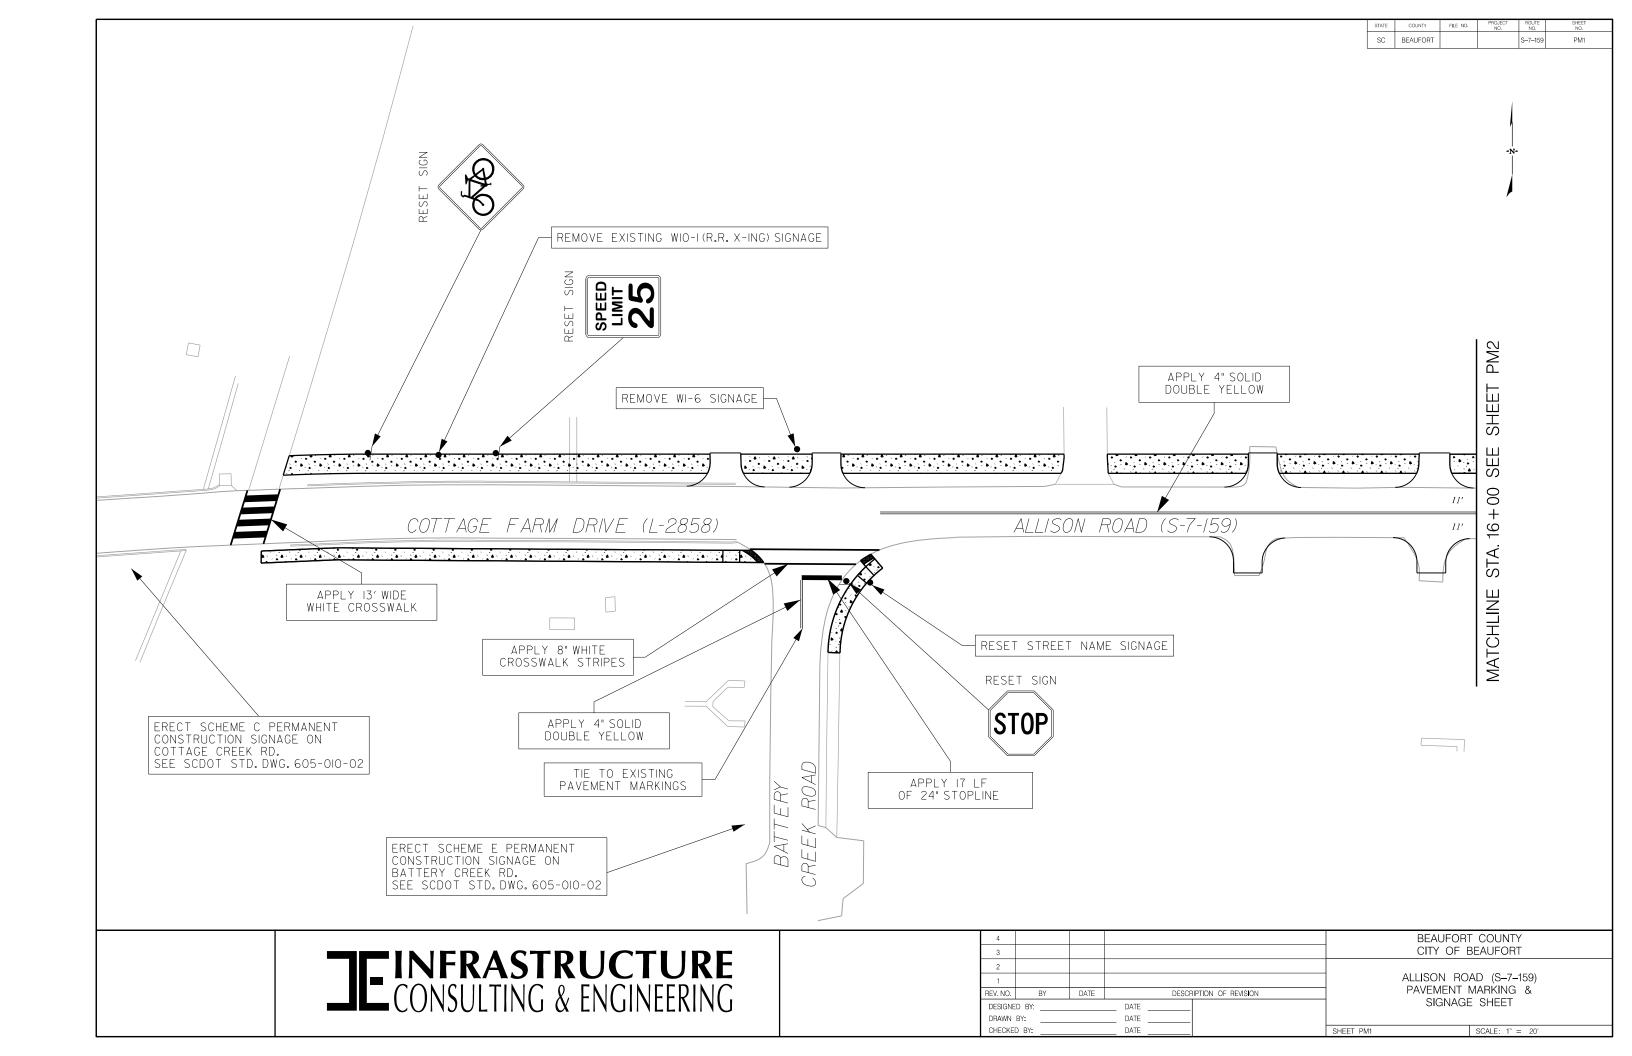SCDIT

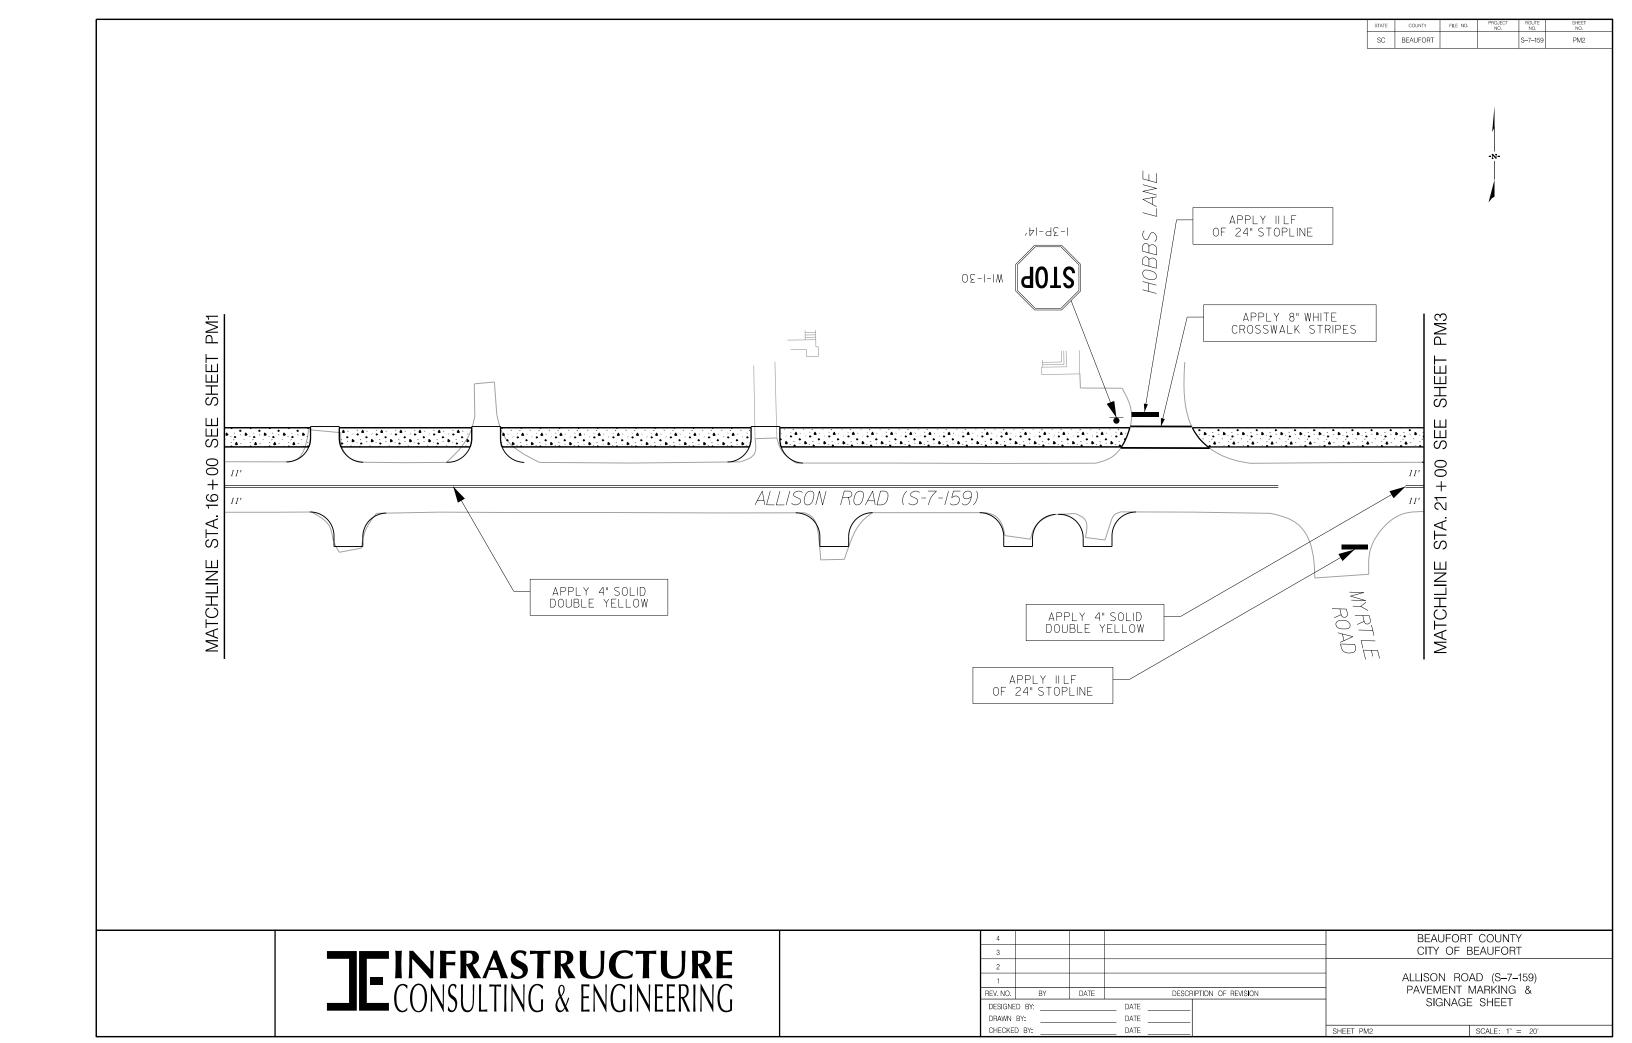ROAD / ROUTE

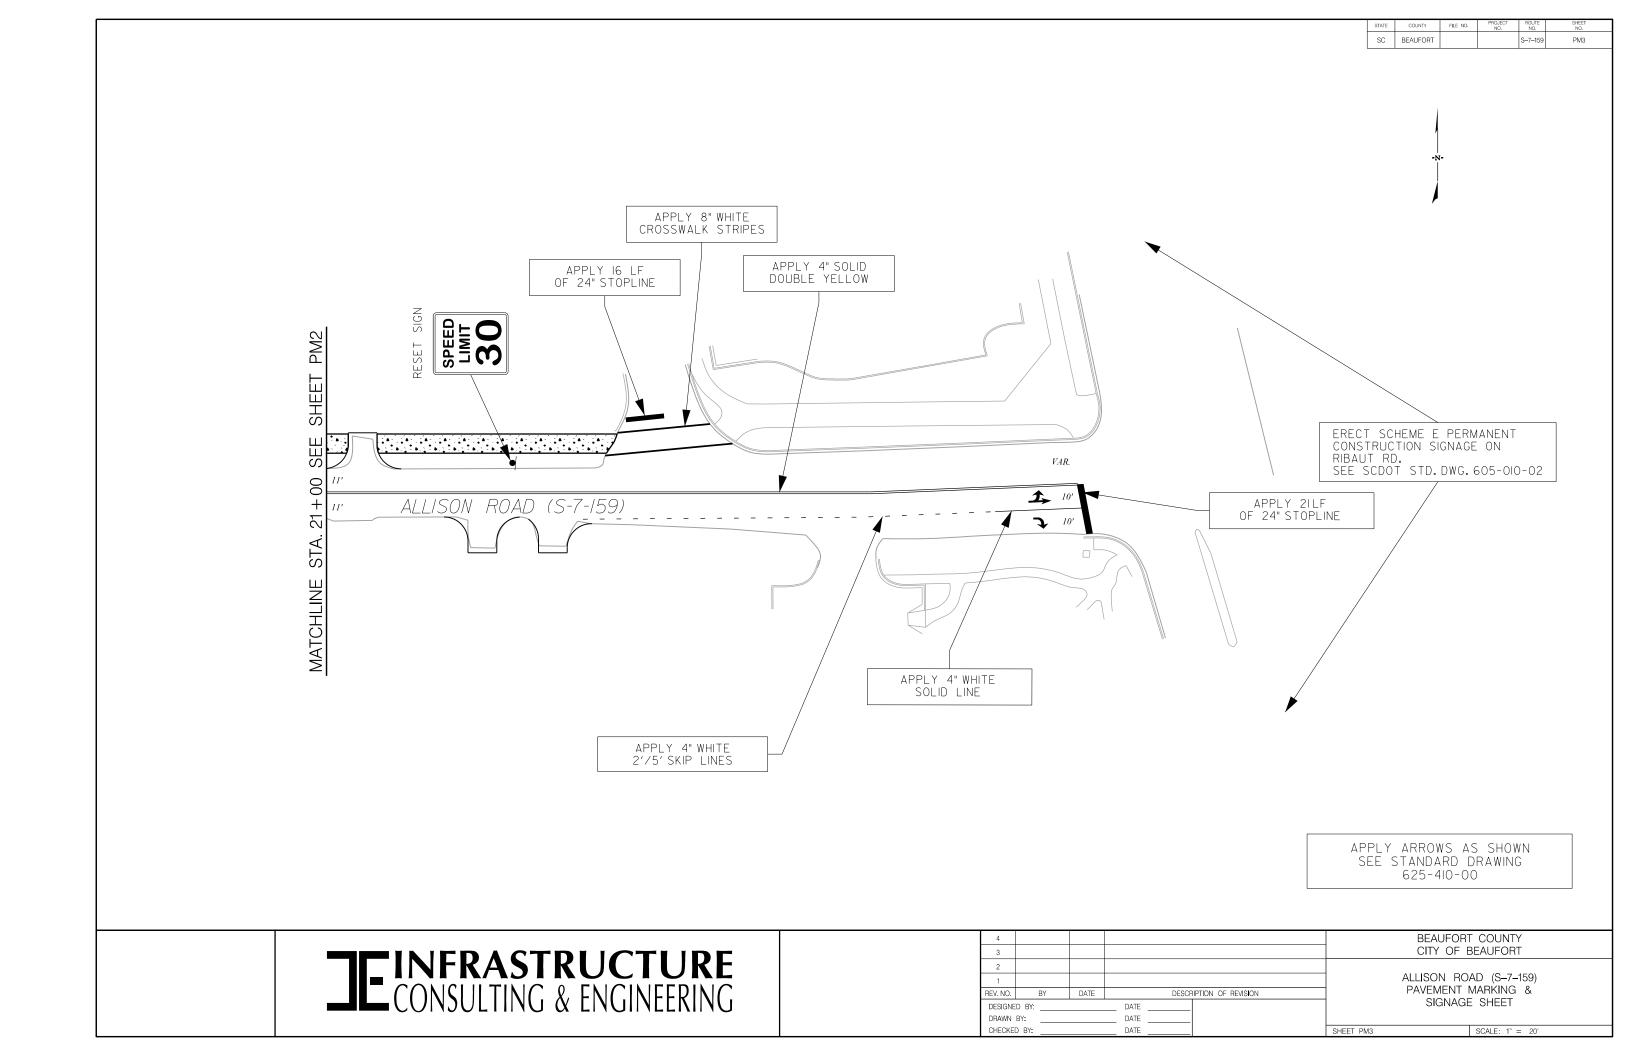EROSION CONTROL DATA SHEET

outh Carolina Department of Transportation											
RECEIVING WATERS											
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ROAD / ROUTE	STATION	SIDE	RECEIVING WATERS	RECEIVING WATERS							
S-7-159	17+85	LT	TRIB TO BATTERY CRK	BATTERY CREEK							

SIDE

STATION

DEPTH OF MAT

	SOIL TYPES										
ROAD / ROUTE	STATION TO STATION		SOIL PARTICLE SIZE (COARSE / FINE)	ZONE							
S-7-159	10+97	24+18	FINE	COASTAL PLAINS							

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Allison Rd_D-DESIGN\Roadway\Dgn\Basefiles\[Allison\Rd_ECDS\]	NO	ROAD / ROUTE	STATION	SIDE	DRAINED OR NOT DRAINED	LENGTH OF SILT BASIN	WIDTH OF SILT BASIN	DAM HEIGHT		SPILLWAY BOTTOM	DAM BOTTOM WIDTH	RIP RAP CLASS	TOTAL STORAGE VOLUME	SEDIMENT STORAGE HEIGHT	OUTFALL CHANNEL WIDTH	OUTFALL CHANNEL DEPTH	OUTFALL CHANNEL LENGTH
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	TEMPORARY EROSION CONTROL BLANKET												
ROAD / ROUTE	E STATION TO SIDE BLANKET BOTTOM X:1		MSY										
				(FT) WIDTH (FT)	FRONT	BACK							
							TOTAL						

SEDIMENT TUBES IN DITCHES								
ROAD / ROUTE	OUTE STATION TO STATION		SIDE AVERAGE LENGTH		SPACING (FT)	TOTAL	COMMENTS	
					TO T			
TOTAL								




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	REV. NO.	BY	DATE		DESCR	IPTION OF REVISION	
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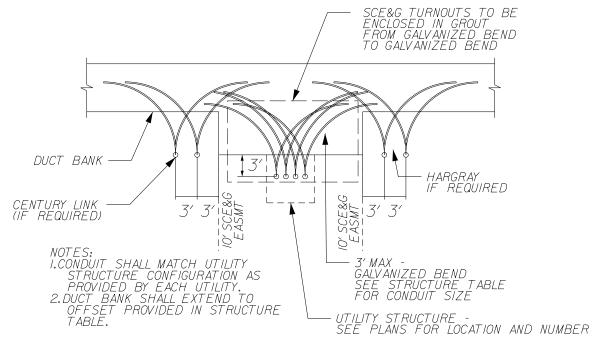
BEAUFORT COUNTY CITY OF BEAUFORT

ALLISON ROAD (S-7-159) EROSION CONTROL DATA SHEET

EET EC1 SCALE: NTS





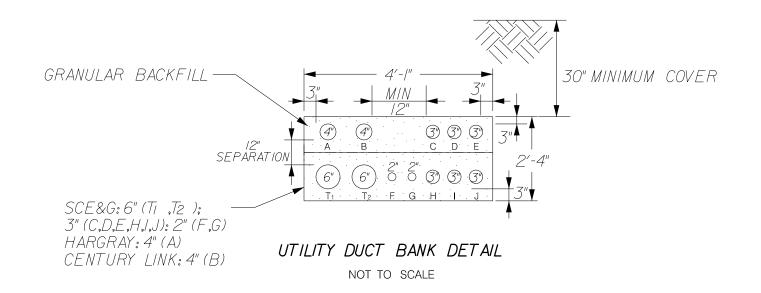

UTILITY DUCT BANK TO STRUCTURE DETAIL (TYPICAL)

NOT TO SCALE

UTILITY DUCT BANK NOTES:


1. CABINET LOCATIONS SHOWN ON RELOCATION PLANS ARE SCHEMATICS AS PROVIDED BY UTILITIES. THESE SHALL BE VERIFIED BY OWNERS PRIOR TO CONSTRUCTION OF DUCT BANK.

2. DUCT BANK PROFILE ALIGNMENT AND EXISTING PIPES TO BE RETAINED SHALL BE FIELD VERIFIED TO ELIMINATE CONFLICTS.


3. CONTRACTOR SHALL SUBMIT TRANSITION PLAN FOR CHANGES IN CONDUIT CONFIGURATIONS AND INTERSECTIONS WITH SIDE ROAD DUCT BANKS TO THE ENGINEER FOR APPROVAL 14 DAYS PRIOR TO INSTALLATION.

4. EXTEND CONDUIT BEYOND PAVEMENT. CURB AND SIDWALKS.

5. ALL SCEAS TURNOUTS SHOULD BE ENCASED IN GROUT FROM I' BEYOND TURNOUT TO 18" (MAX) BEYOND BASE OF TURNOUTS.

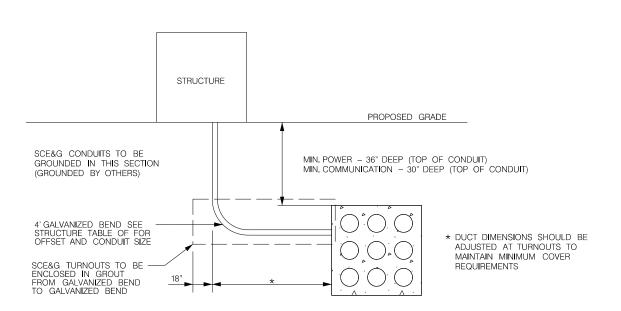

TURN UP DETAIL NOT TO SCALE

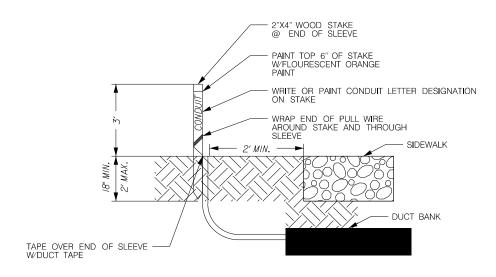

CONDUIT TERMINAL
NOT TO SCALE

3					BEAUFOR' CITY OF E	T COUNTY BEAUFORT	
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1					ALLISON BO	AD (S-7-159)	
REV. NO.	BY	DATE	DESCRIPTION OF REVISION		DUCT BANK		
DESIGNED BY: DATE					DETAILS		
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