



3 REFLECTED CEILING PLAN  
SCALE: 1/4" = 1'-0"

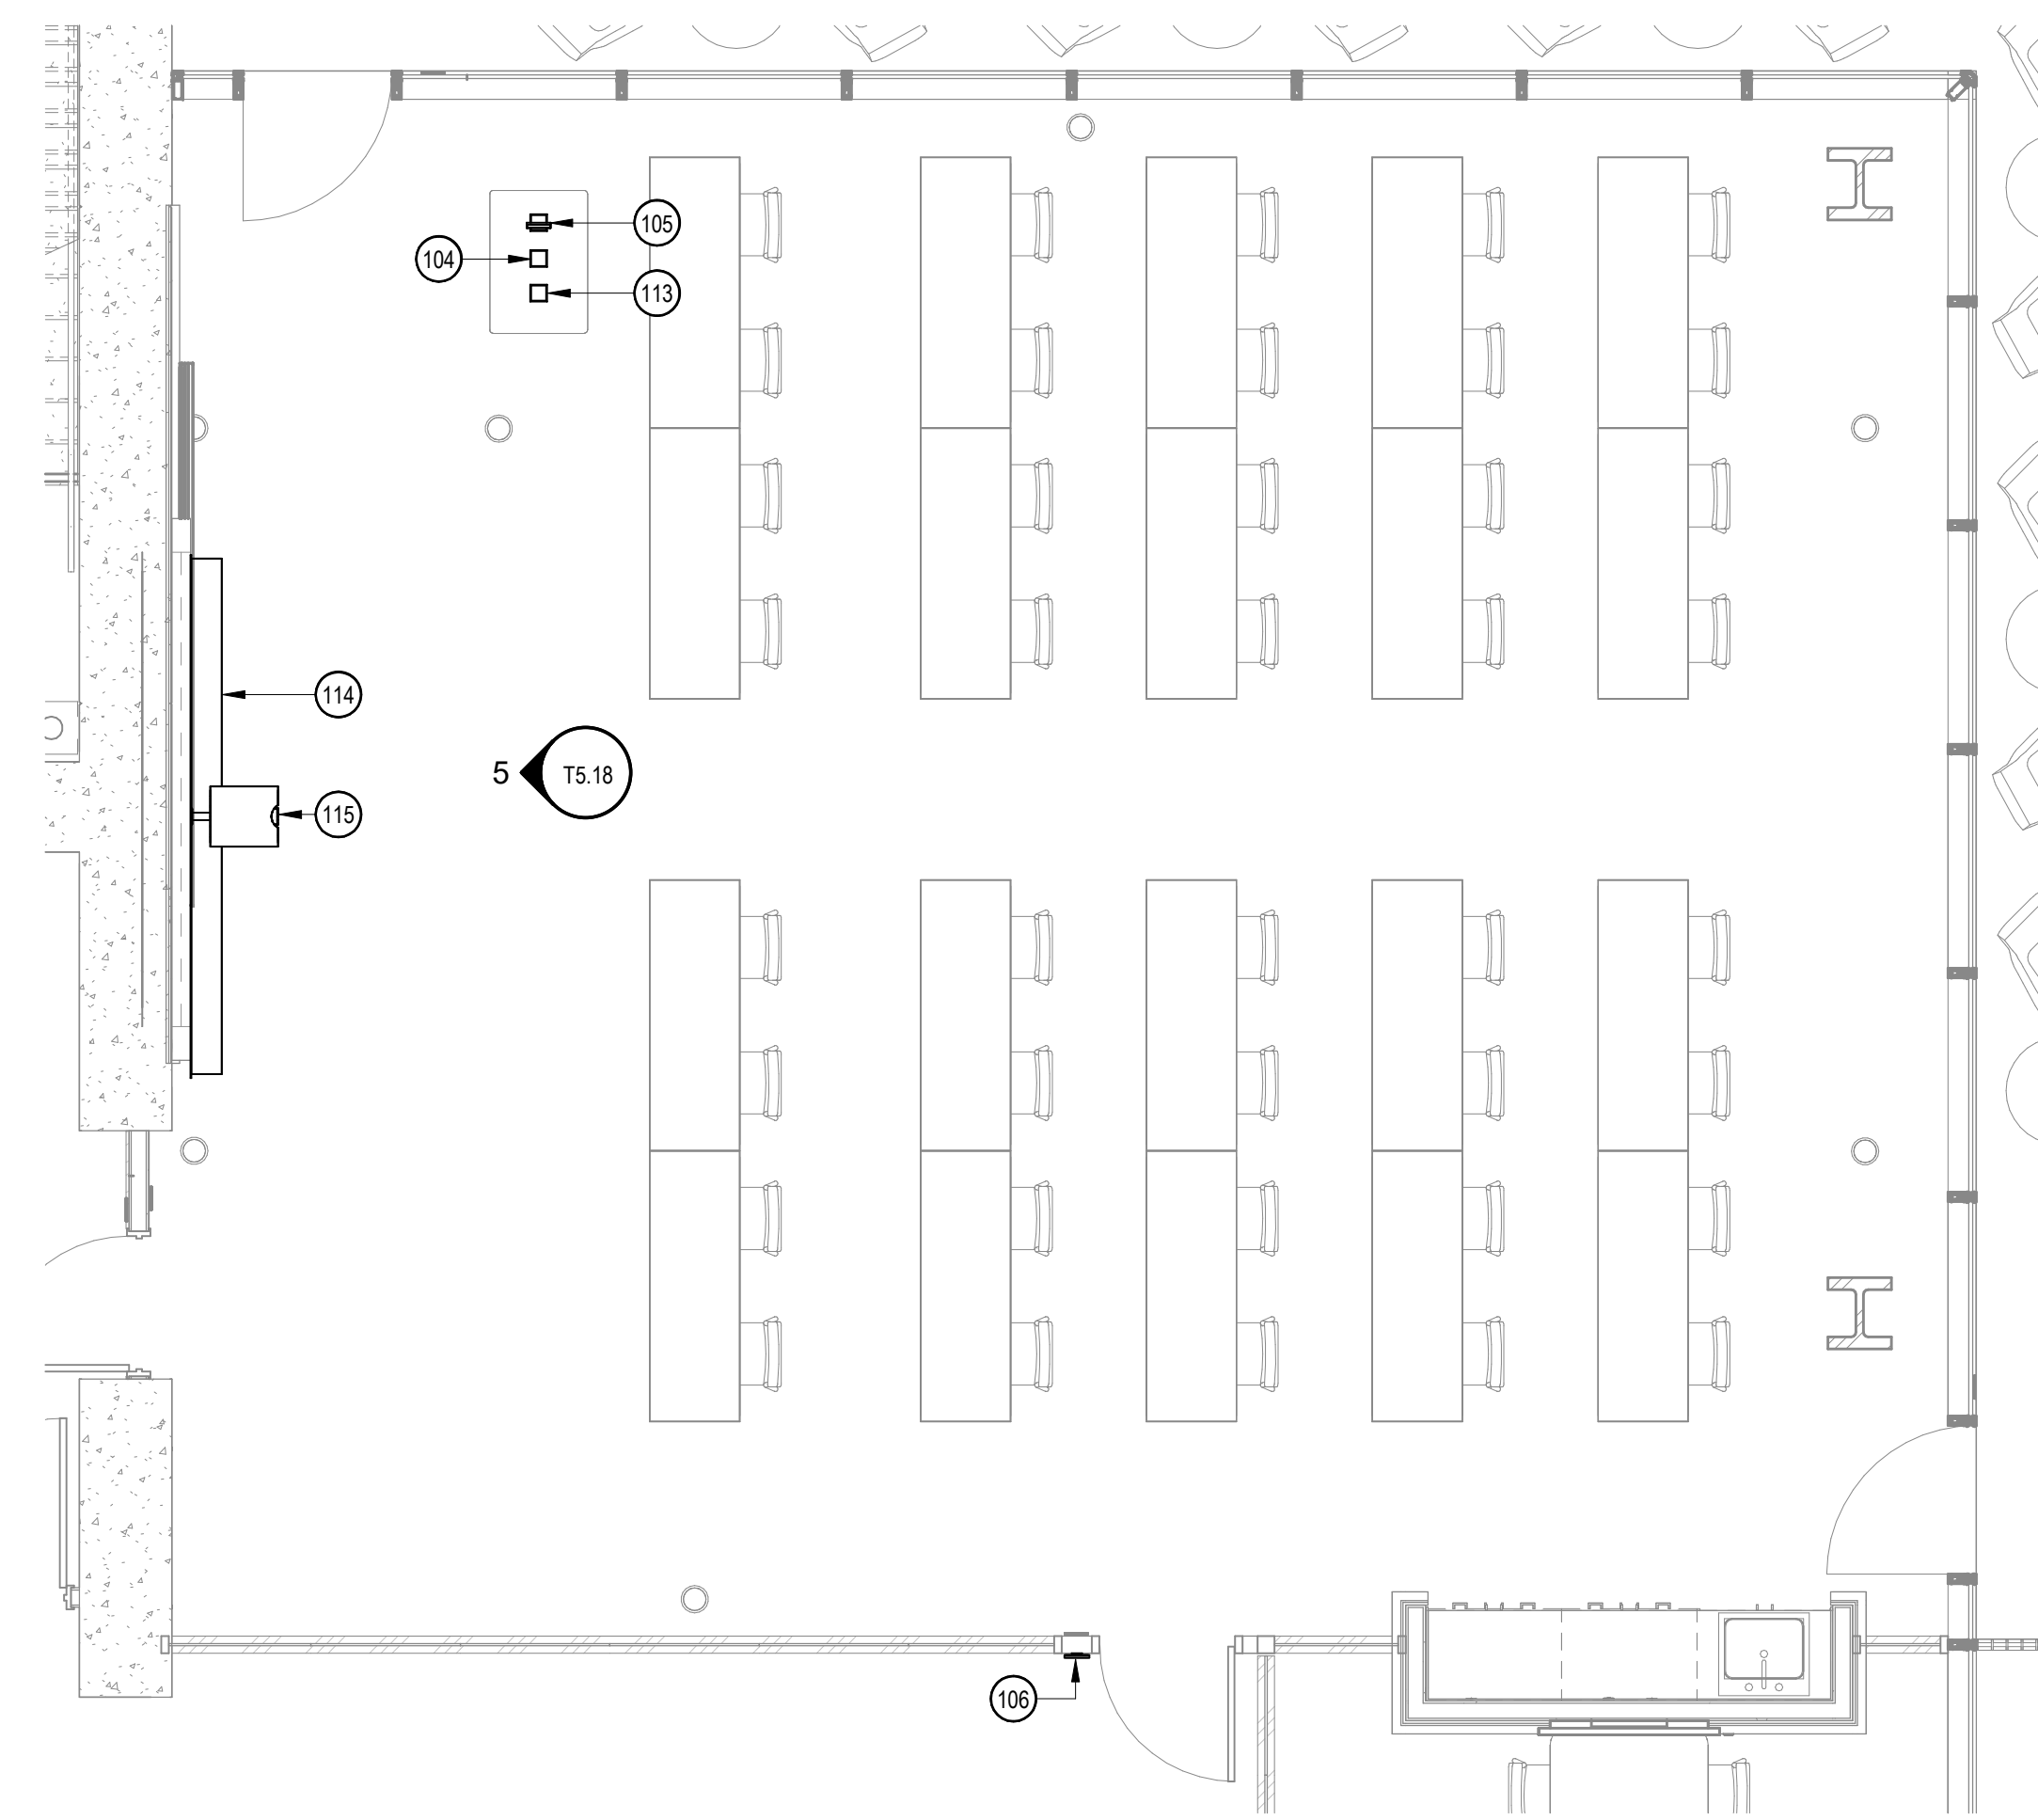


2 EQUIPMENT PLAN  
SCALE: 1/4" = 1'-0"

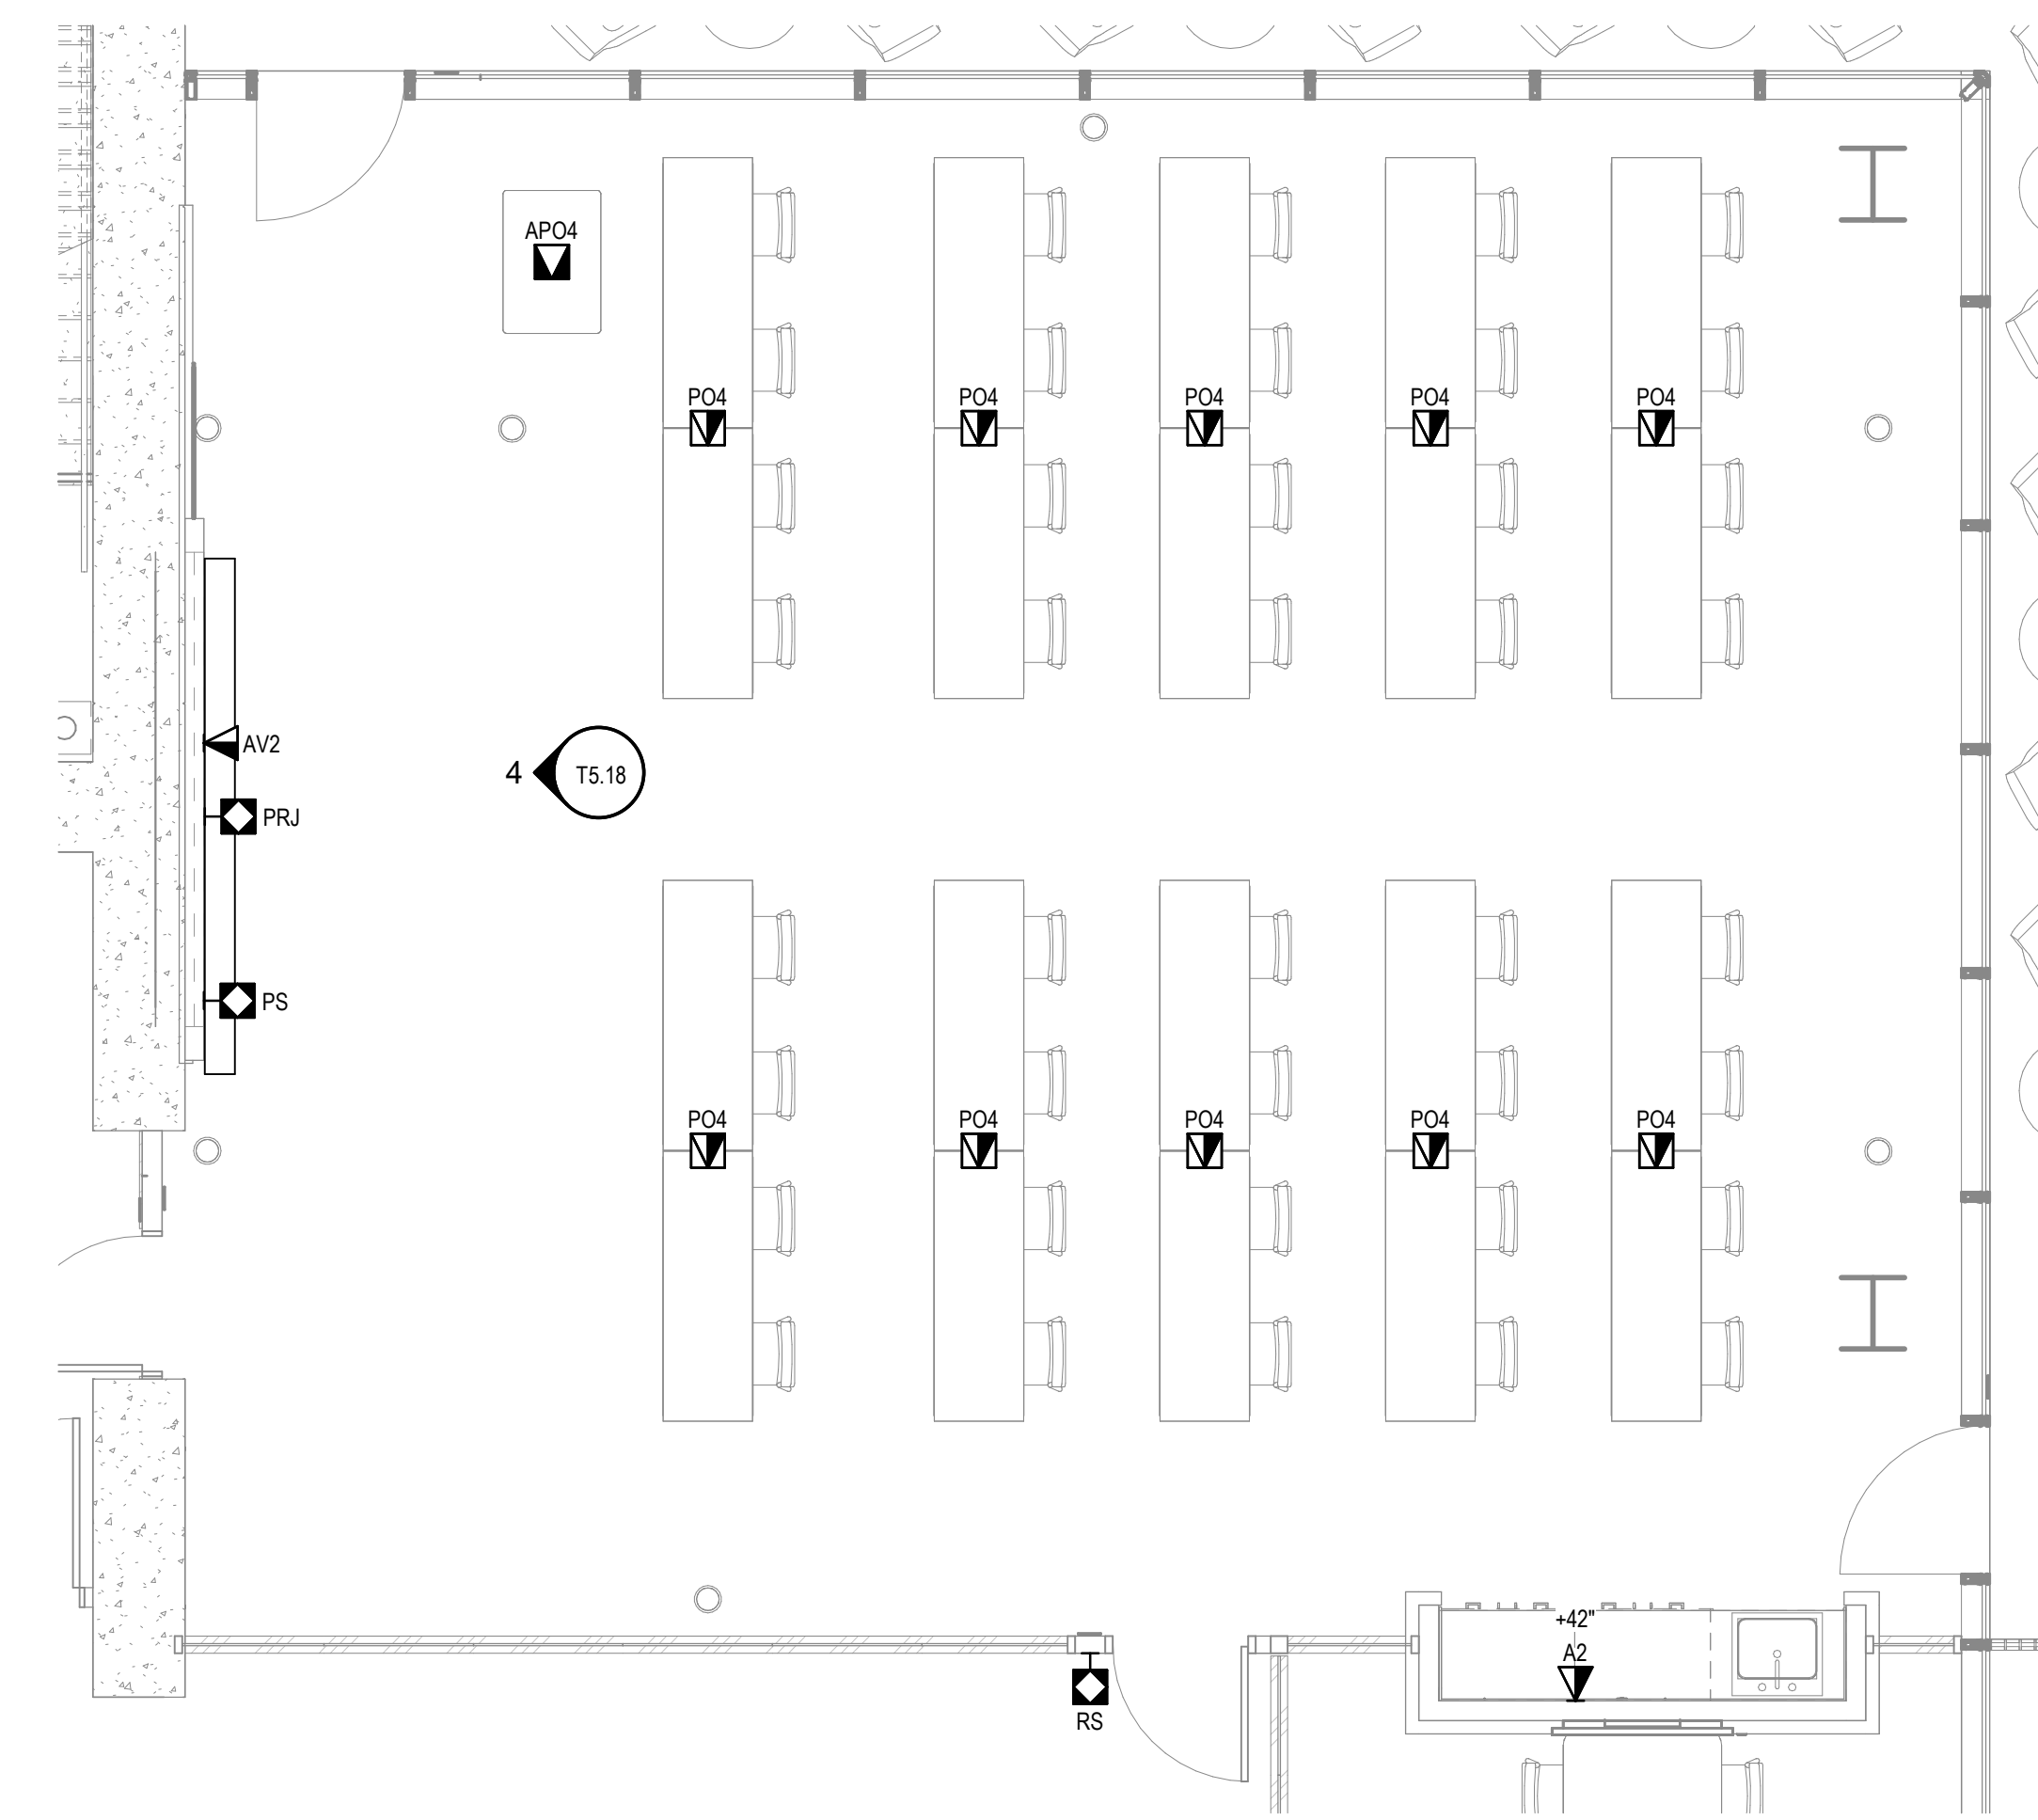


1 INFRASTRUCTURE ELEVATION  
SCALE: 1/4" = 1'-0"

- ### SHEET NOTES
- REFER TO ARCHITECTURAL PLANS FOR EXACT LOCATIONS OF OUTLETS, DEVICES, AND EQUIPMENT. ALSO REFER TO ELECTRICAL PLANS TO COORDINATE FINAL LOCATIONS OF OUTLETS, DEVICES, AND EQUIPMENT.
  - REFER TO OVERALL PLANS FOR TELECOM DEVICES SERVING LOCATIONS.
  - REFER TO SHEET T02 FOR PATHWAY REQUIREMENTS.
  - ALIGN CENTER OF DISPLAY TO CENTERLINE OF FURNITURE. REFER TO ARCHITECTURAL DRAWINGS FOR THE FURNITURE LOCATION.
  - REFER TO OVERALL PLANS FOR PROJECTION SCREEN LOCATIONS. CENTER PROJECTOR TO PROJECTOR SCREEN Laterally.
  - SEE INSTALLATION DETAIL IN THIS SET.

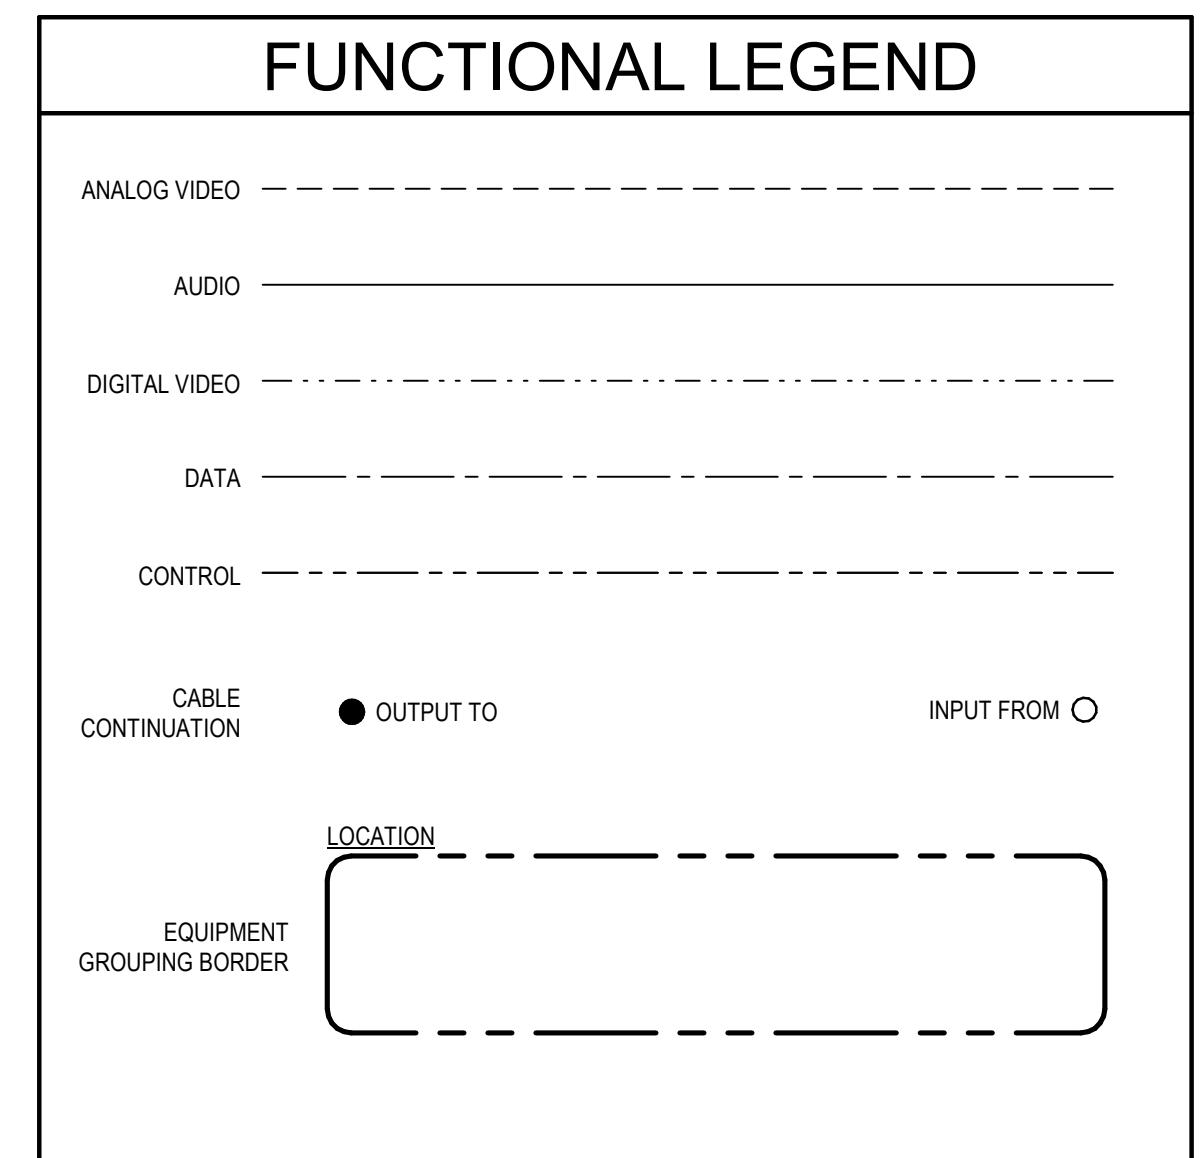


### AV EQUIPMENT LIST


ID	DESCRIPTION
104	ASSISTIVE LISTENING PLATE
105	CONTROL PANEL
106	ROOM SCHEDULER
113	INTERFACE PLATE
114	WALL MOUNTED PROJECTION SCREEN
115	PROJECTOR

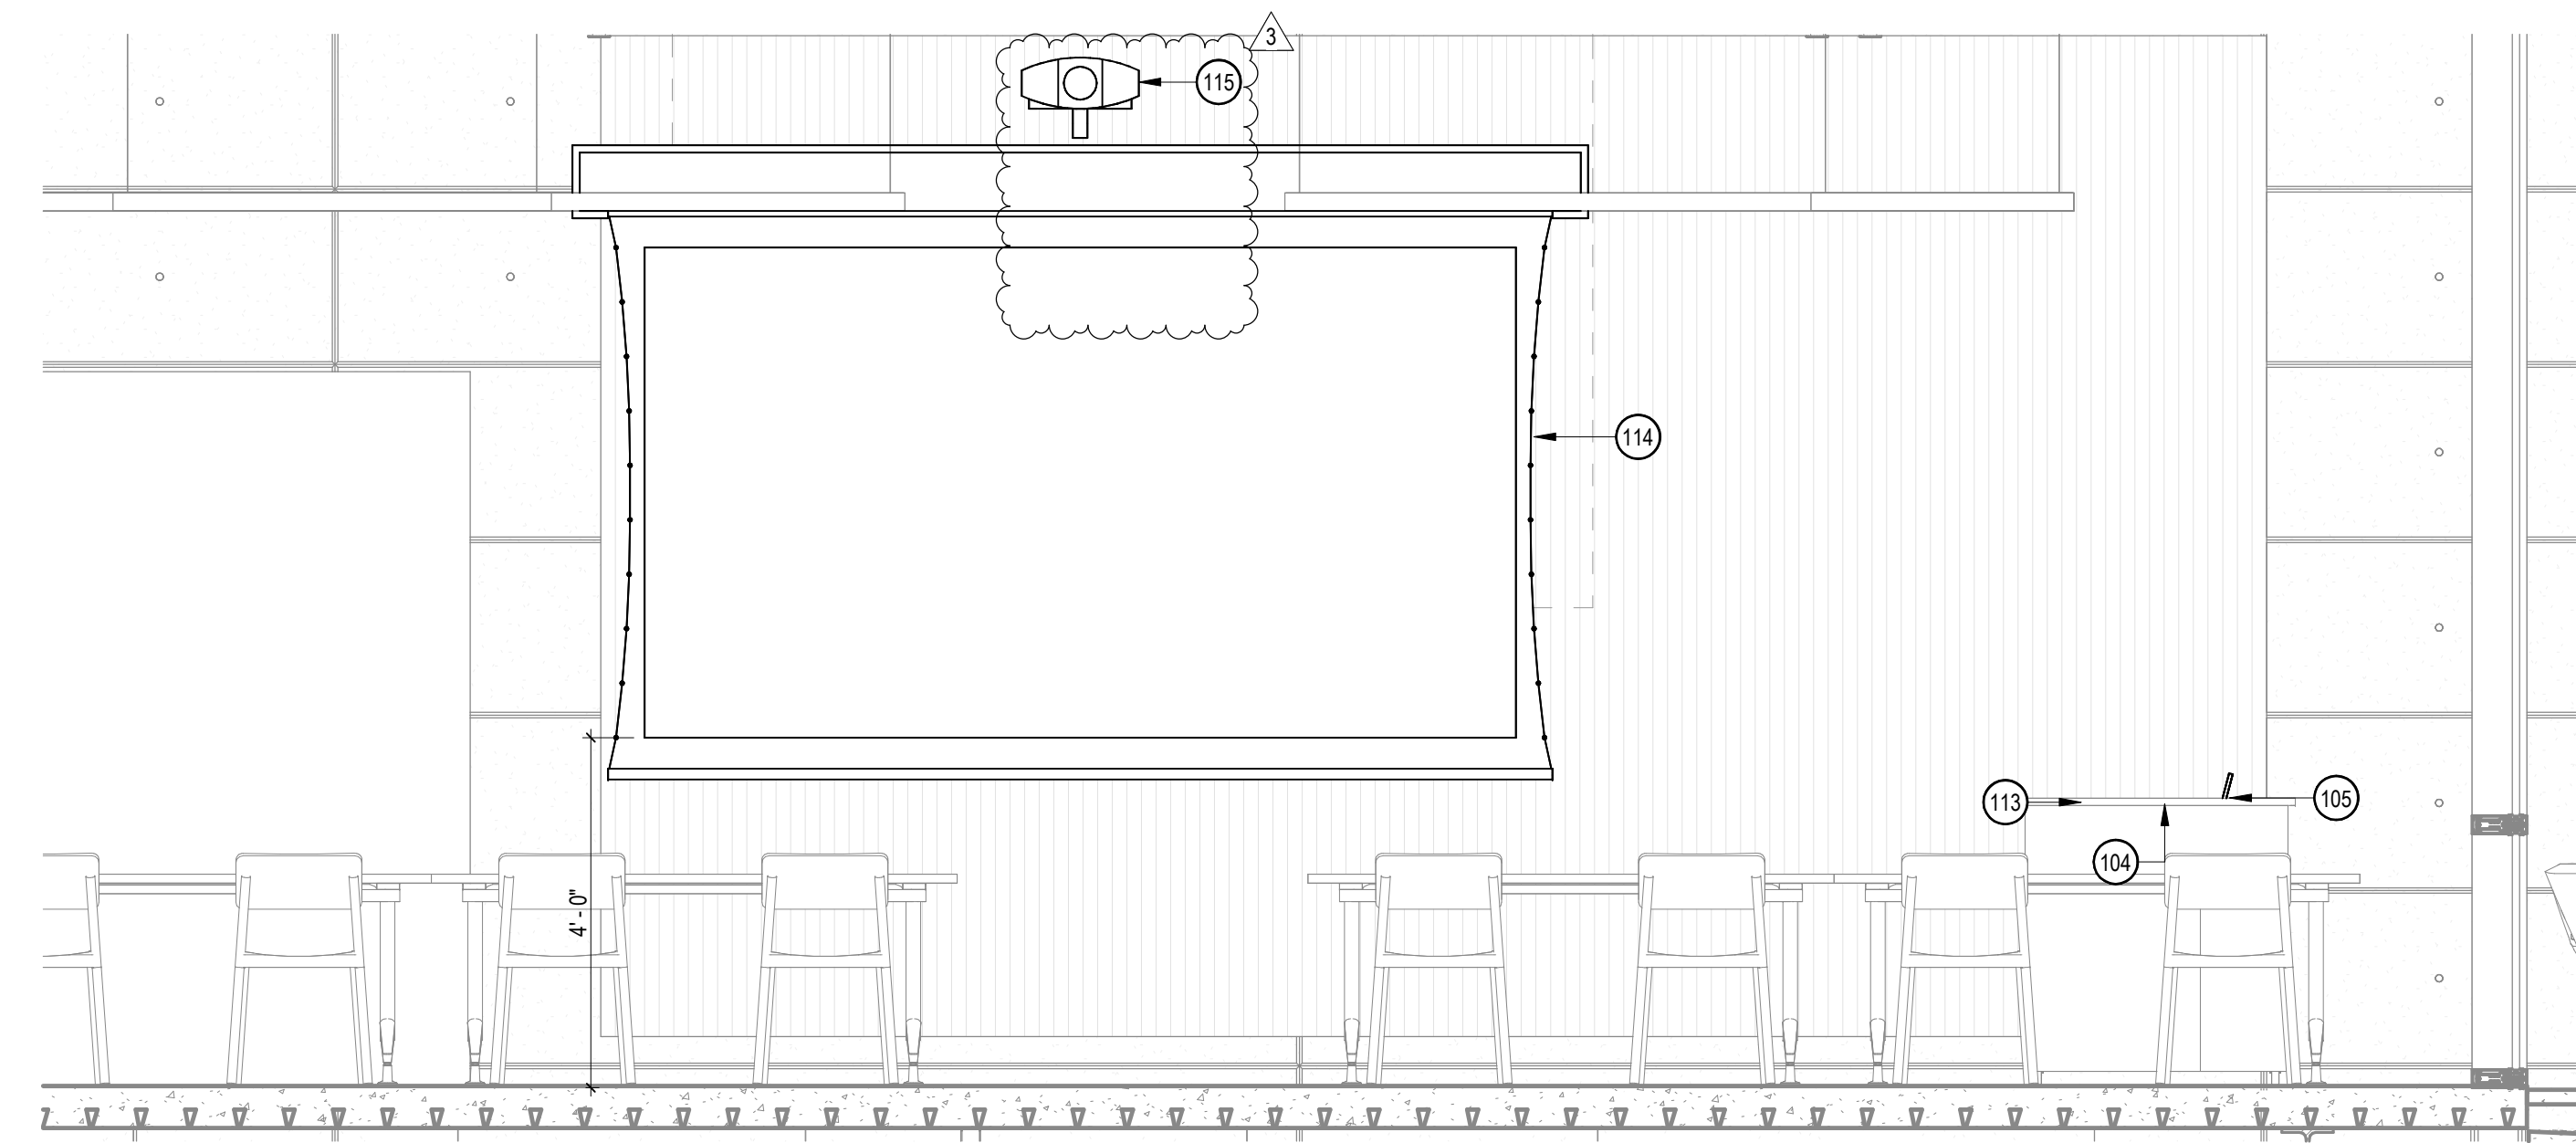


5 EQUIPMENT ELEVATION  
SCALE: 1/2" = 1'-0"

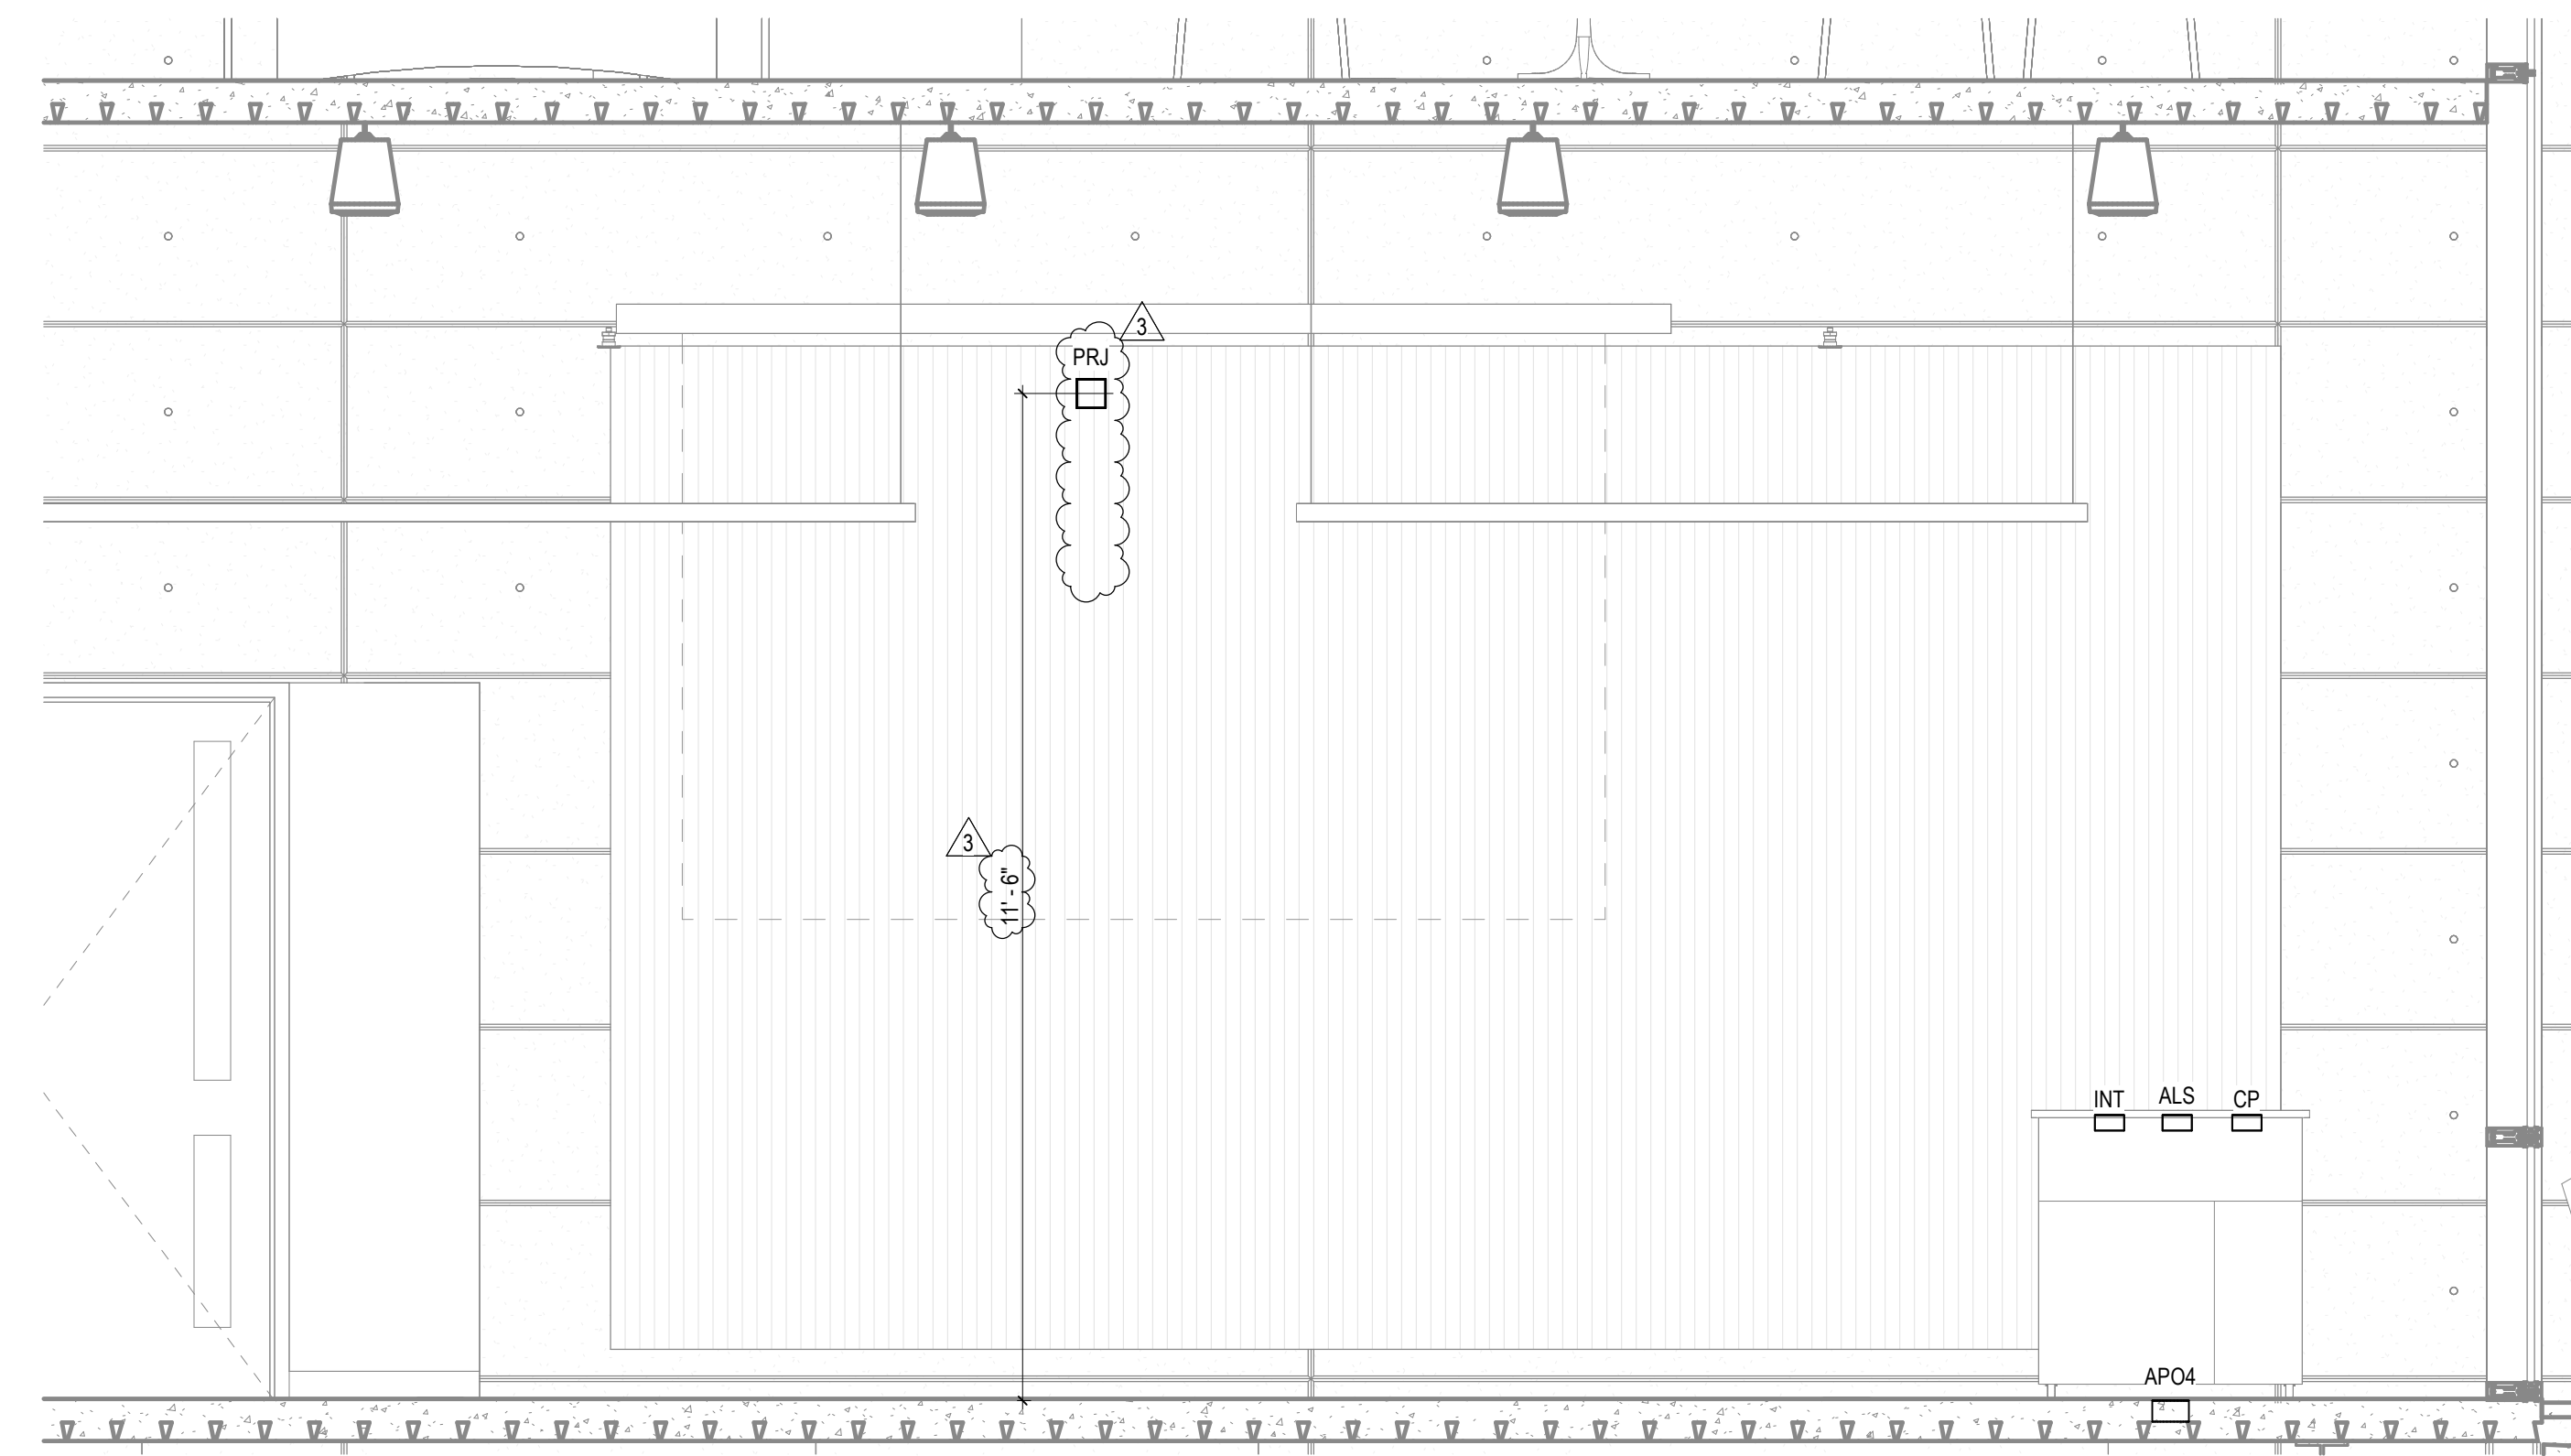

4 INFRASTRUCTURE ELEVATION  
SCALE: 1/2" = 1'-0"

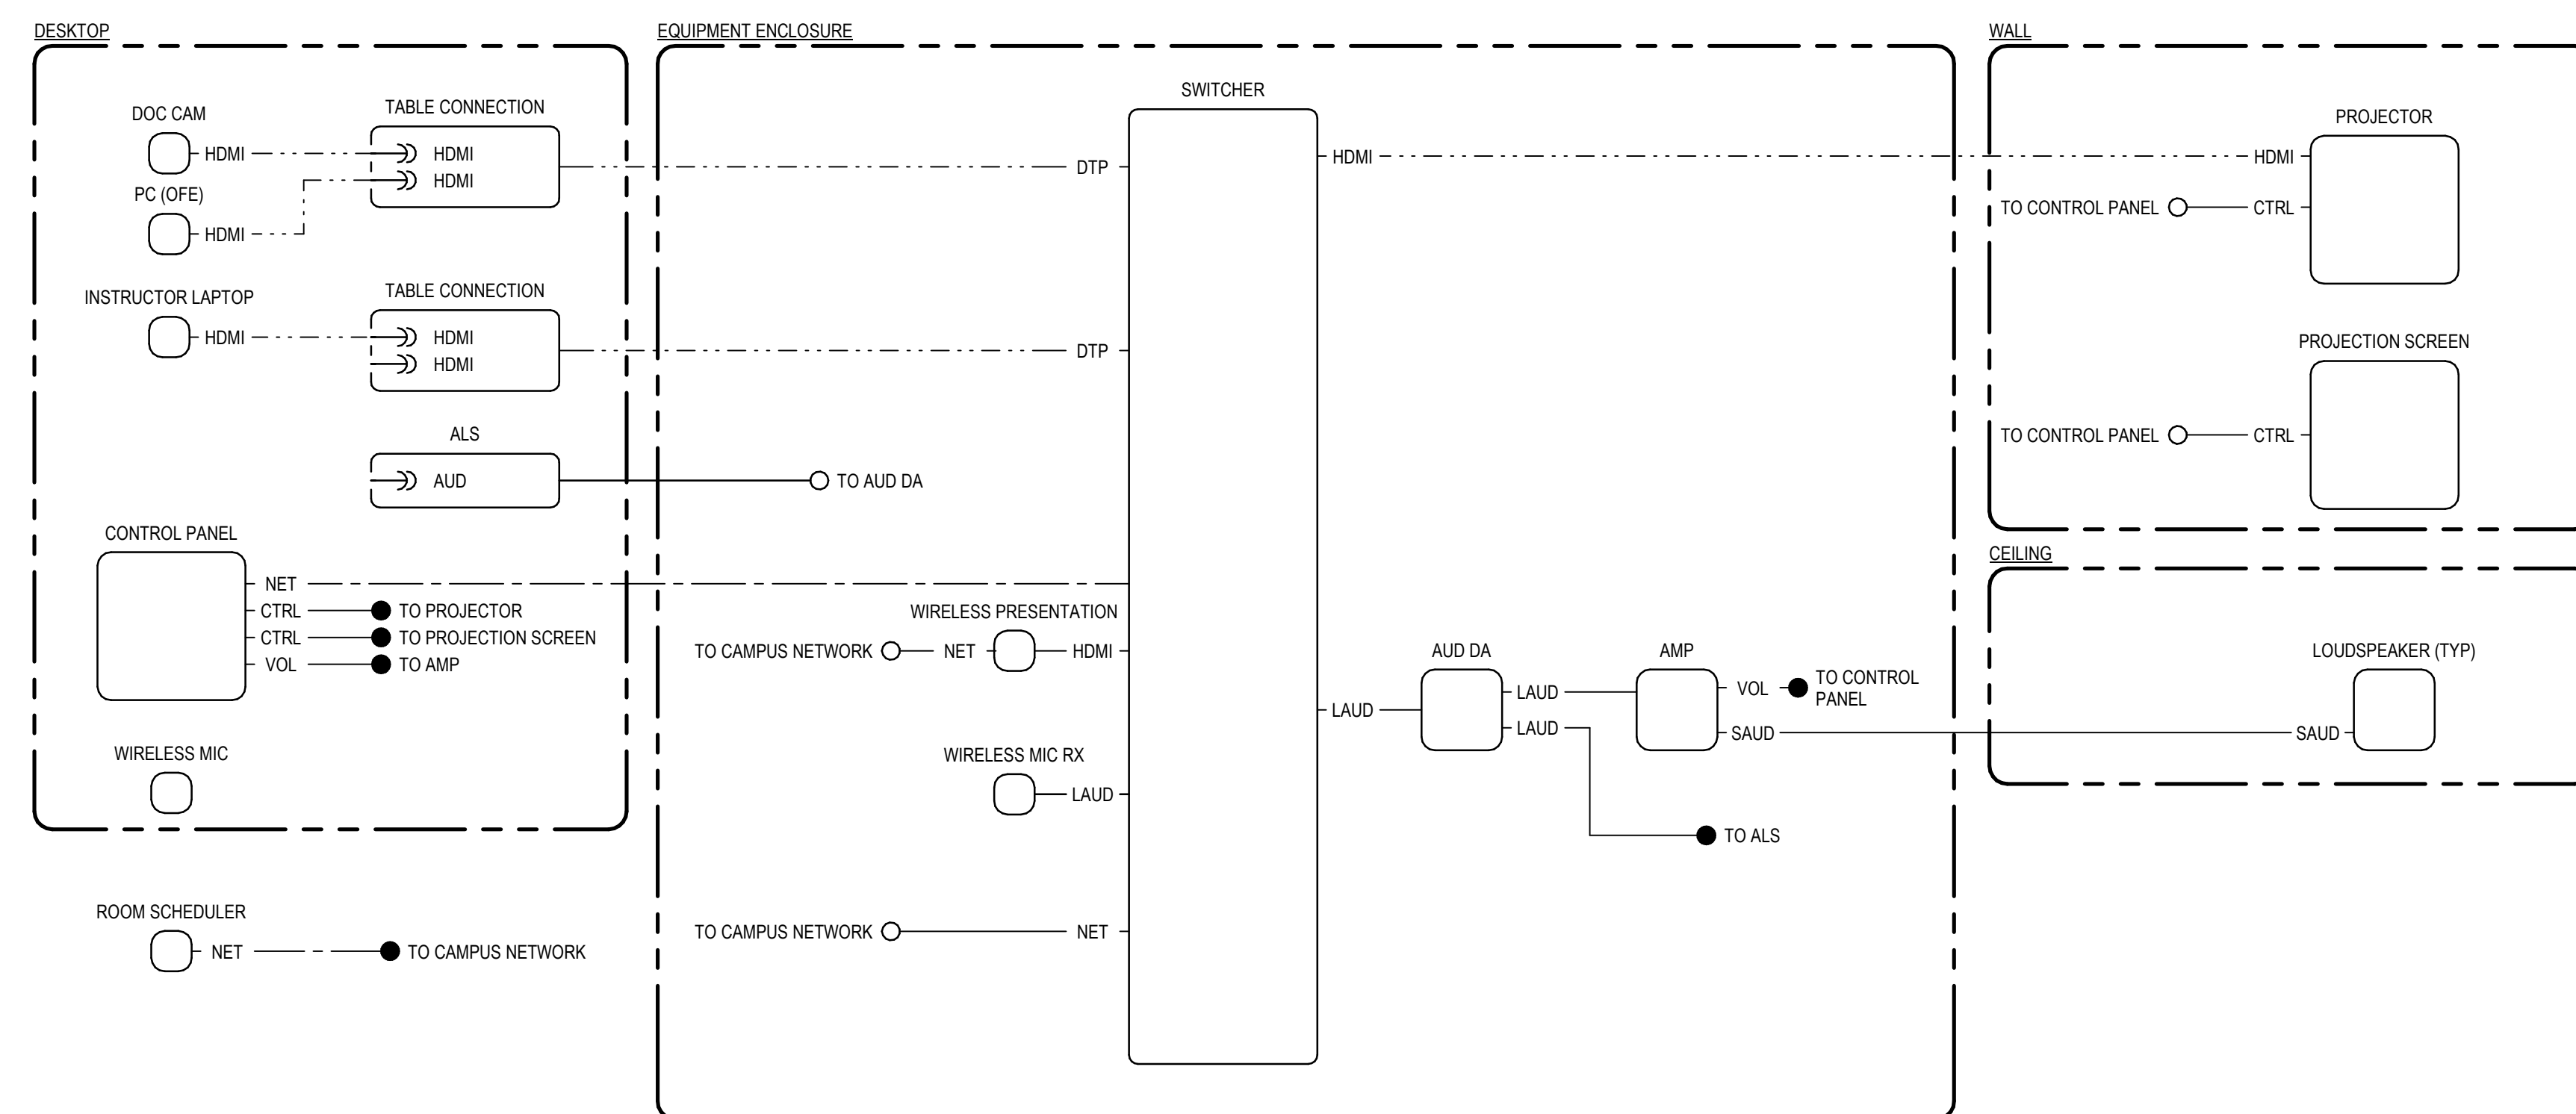

7 AUDIOVISUAL FUNCTIONAL DIAGRAM  
SCALE: NONE

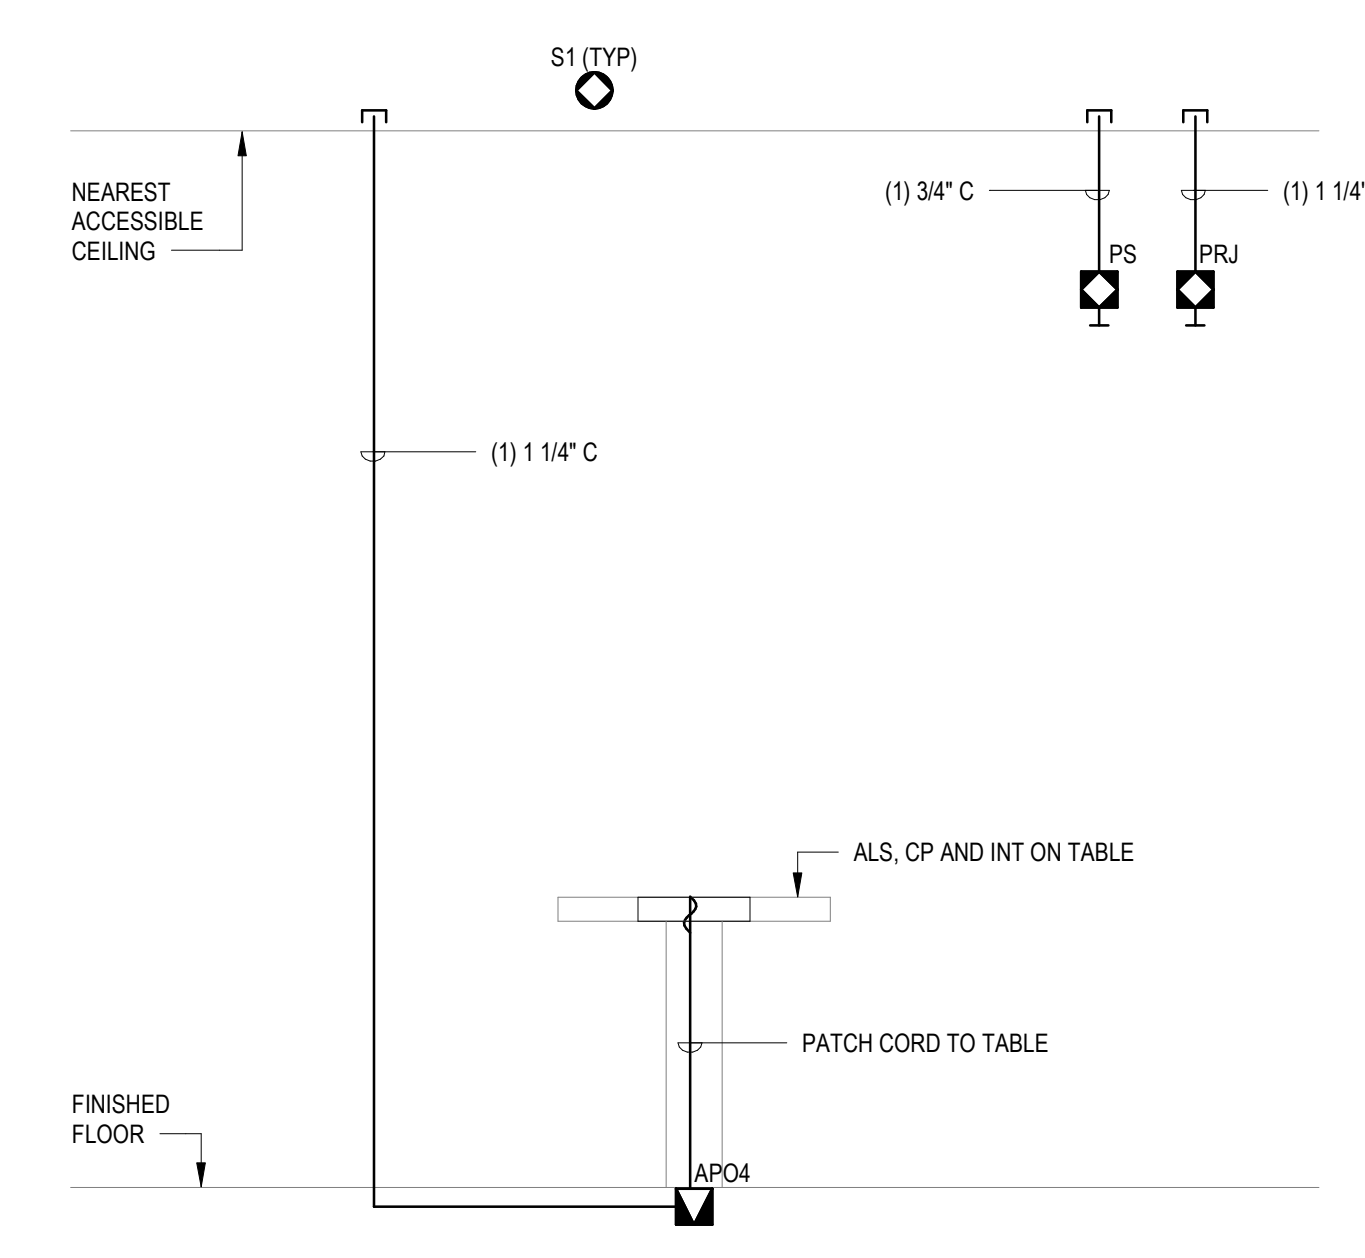

6 AV PATHWAY DIAGRAM  
SCALE: 1/2" = 1'-0"

APPROVALS

**NOLL & TAM**  
ARCHITECTS

729 Heinz Avenue  
Berkeley, CA 94710  
tel 510.542.2200  
fax 510.542.2201

**CAVAGNERO**  
MARK CAVAGNERO ASSOCIATES ARCHITECTS  
1845 KATEMERE STREET, SUITE 200  
SAN FRANCISCO, CALIFORNIA 94111  
www.cavagnero.com

SEAL

**TEECOM**

1322 Broadway  
Oakland, CA  
94612  
www.teecom.com

PROJECT TITLE

**Peralta Community College District  
Laney Library & Learning Resource Center (Building 100 Replacement)**

900 Fallon Street, Oakland, CA 94607

ISSUE FOR BID

ISSUE DATE: 03/31/2023  
NAT. JOB NUMBER: 21942  
REVISIONS:  
DATE: 05/16/2024  
DESCRIPTION: Addendum No. 03

DRAWN BY: JA CHECKED BY: DM  
SHEET TITLE:  
**ENLARGED ROOM PLAN - CLASSROOM - TYPE 3**

SHEET NUMBER

**T5.18**

S:\2023\23-240151 PM - Autodesk Docs\PCDD Laney Library LDC\PCDD Laney Library LDC - TEECOM.rvt