PROVIDE BACKBOARDS ON WALLS OF ROOM AS SHOWN, STARTING AT 6" AFF TO 8'-6" AFF. MASK FIRE RATING STAMP PRIOR TO PAINTING. USE FLUSH FASTENERS FOR MOUNTING PROVIDE RADIUS DROP OUTS WHERE CABLES TRANSITION DOWNWARD FROM OVERHEAD HORIZONTAL CABLE TRAY. 3. LABEL RACKS AND PATCH PANELS. 4. CABLE TRAY DEPTH REFERS TO TRAY'S LOADING DEPTH.

SHEET NOTES

REFER TO ELECTRICAL DRAWINGS FOR ELECTRICAL CIRCUITS/OUTLETS AND LIGHTING

PROVIDE PLASTIC BUSHINGS ON EXPOSED ENDS OF CONDUIT AND SLEEVES, WHETHER

7. PATHWAYS SHOWN ARE DEDICATED FOR TELECOMMUNICATIONS CABLING ONLY, UON.

8. LABEL CONDUITS AT BOTH ENDS. LABEL MUST INDICATE CONDUIT'S DEDICATED USE FOR TELECOMMUNICATIONS AND AUDIOVISUAL CABLING AND LOCATION OF THE CONDUIT'S FAR

NEATLY BUNDLE (DRESS CABLE LONGITUDINALLY) AND SUPPORT (USING FASTENERS AND TIES DESCRIBED IN SPECS AND DRAWINGS) TELECOMMUNICATIONS CABLES ONTO OVERHEAD

CABLE TRAY OR RUNWAY. NEATLY BUNDLE AND SUPPORT TELECOMMUNICATIONS CABLES

ONTO VERTICALLY MOUNTED CABLES RUNWAY WHEN RISING FROM FLOOR SLEEVES OR

TELECOMMUNICATIONS CABLES INTO THE BACK OF THE VERTICAL CABLE MANAGEMENT

VERTICAL MANAGEMENT SECTIONS TO THE TERMINATION POSITION. MAXIMUM BUNDLE SIZE:

10. THE QUANTITY OF PATCH PANELS SHOWN ON THE ELEVATIONS IS FOR REFERENCE ONLY. IT IS THE RESPONSIBILITY OF THE TELECOM CONTRACTOR TO DETERMINE THE EXACT QUANTITY

SECTIONS USING APPROVED TIES. DRESS TELECOMMUNICATIONS CABLES FROM THE

11. TERMINATE ALL SECURITY STRUCTURED CABLING ON A DISCRETE PATCH PANEL IN THE

NUMBERED NOTES

PROVIDE FIRESTOP UL SYSTEM # W-L-3306 AS INDICATED ON SHEET T0.02. 2X4 FIRESTOP SLEEVES STACKED ABOVE EACH OTHER, (8) TOTAL PATHWAY INTO USER SPACE. REFER TO PLANS FOR PATHWAY TYPE AND ROUTES. ALIGN WITH WIRE MESH

FIELD FABRICATED TEE WITH PRE-MANUFACTURED RADIUS KIT. TRIM END OF RADIUS KIT IF NEEDED TO FIT AVAILABLE SPACE BETWEEN TEE AND FIRST CABLE DROP-OUT TO

PATHWAY FROM IDF-2.1. REFER TO THE PATHWAYS RISER DIAGRAM FOR TYPE AND

PLACE DATA CONNECTIONS IN 2-PORT SURFACE MOUNT BOX, COORDINATE EXACT LOCATION WITH SECURITY CONTRACTOR PRIOR TO PROVISION.

FOR COORDINATION AND REFERENCE ONLY, REFER TO MECHANICAL PLANS FOR

(2) 4" CONDUITS FOR COORDINATION AND REFERENCE ONLY, REFER TO ELECTRICAL PLANS FOR DETAILS.

SYMBOL LEGEND

- WALL MOUNTED TYPE AS NOTED

7'H x 6"W VERTICAL CABLE MANAGER, DOUBLE-SIDED WITH DOORS INSTALLATION: END OF RACK BAY

7'H x 12"W VERTICAL CABLE MANAGER, DOUBLE-SIDED WITH DOORS

INSTALLATION: 7'-6" AFF TO BOTTOM OF RUNWAY (DO NOT ATTACH TO RACKS)

INSTALLATION: ON WALL FROM TOP OF TIER-2 CABLE TRAY TO BOTTOM OF EZ-PATH

INSTALLATION: ON WALL FROM TOP OF 4" CONDUITS TO TOP OF TIER-2 CABLE TRAY

DEDICATED HARDWARE CIRCUITS. REFER AND COORDINATE WITH ELECTRICAL

INSTALLATION: (2) WALL MOUNTED, REFER TO SHEET 8/T9.00 FOR INSTALLATION DETAILS

003 19"W x 7'H UNIVERSAL EQUIPMENT RACK WITH SEISMIC GUSSET KIT

INSTALLATION: 1'-0" AFF TO BOTTOM OF PLYWOOD

INSTALLATION: DECK ANCHORED 3/4" FIRE-RETARDANT PLYWOOD

INSTALLATION: BETWEEN RACKS

FIRESTOP DEVICES

025 24" FIBER CABLE SLACK REELS

202 2" CONDUIT TO CABLE TRAY
210 ACCESS CONTROL SYSTEM EN
211 POWER SUPPLY

216 2" CHASE NIPPLE 217 FIRE INTERFACE REI

TIER-1 - 12"W HORIZONTAL CABLE RUNWAY

016 TIER-2 - 18"W x 4"D WIRE MESH CABLE TRAY INSTALLATION: 8'-6" AFF TO BOTTOM OF CABLE TRAY

INSTALLATION: 8' TO BOTTOM OF BUSBAR 022 18"W VERTICAL CABLE RUNWAY WITH STANDOFFS

12"W VERTICAL CABLE RUNWAY WITH STANDOFFS

ACCESS CONTROL SYSTEM ENCLOSURE

4"x4"x32" SCREW COVER GUTTER

4"x4"x60" SCREW COVER GUTTER

FIRE INTERFACE RELAY SECURITY

- BACK EQUIPMENT ALLOWANCE

BACK WORKING

PLANE, TYP

WORKING

FRONT

\_\_\_\_ 3/4" PLYWOOD

EQUIPMENT ALLOWANCE

DESCENDING FROM CEILING SLEEVES USING APPROVED TIES. NEATLY BUNDLE

REQUIREMENTS.

VISIBLE OR NOT.

OF PATCH PANELS IN EACH IDF.

CABLE TRAY IN USER SPACE.

BACK WORKING

FRONT WORKING CLEARANCE

EQUIPMENT PANEL

SECURITY

VCM. REFER TO 4/T9.00 FOR DETAILS.

SECURITY RACK.

APPROVALS

ARCHITECTS

729 Heinz Avenue Berkeley, CA 94710 tel 510.542.2200 fax 510.542.2201

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TEECOM

PROJECT TITLE

Peralta Community College District Laney Library & (Building 100 Replacement)

**ISSUE FOR BID** 

# DATE DESCRIPTION 1 04/18/2024 Addendum No. 01

**ENLARGED ROOM PLAN** - EF/BDF-1.1


SHEET NUMBER


OVERHEAD PLAN - TIER 2


SCALE: 1/2" = 1'-0"

TWO-WAY COMM SYSTEM L — — — J

REFERENCE PLAN

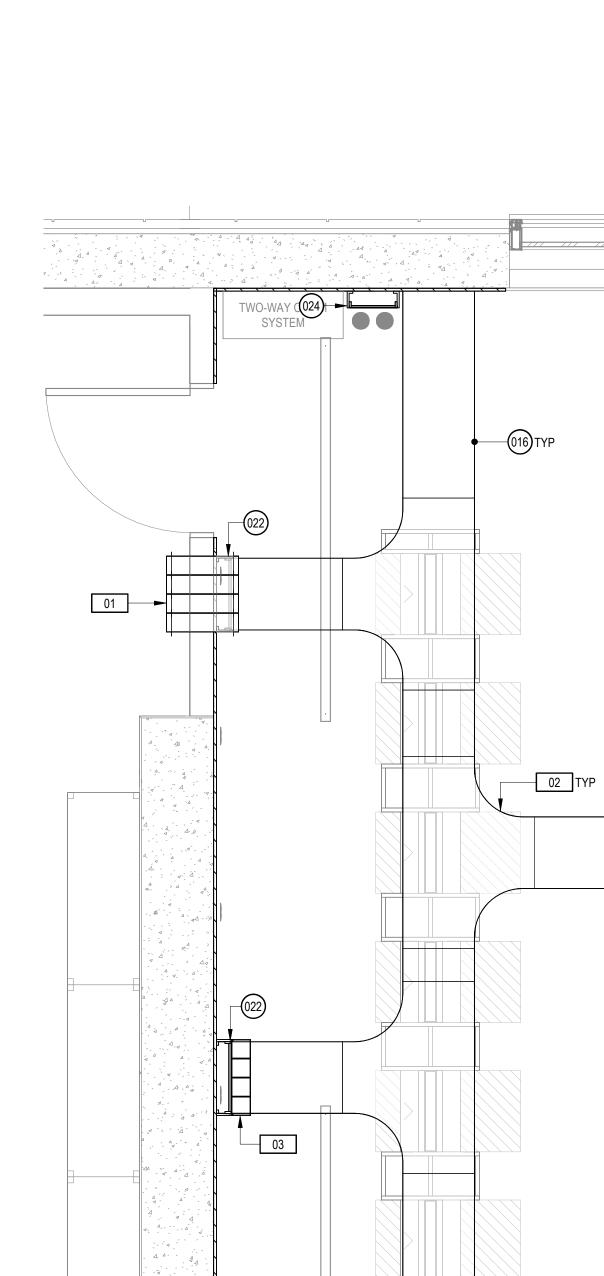

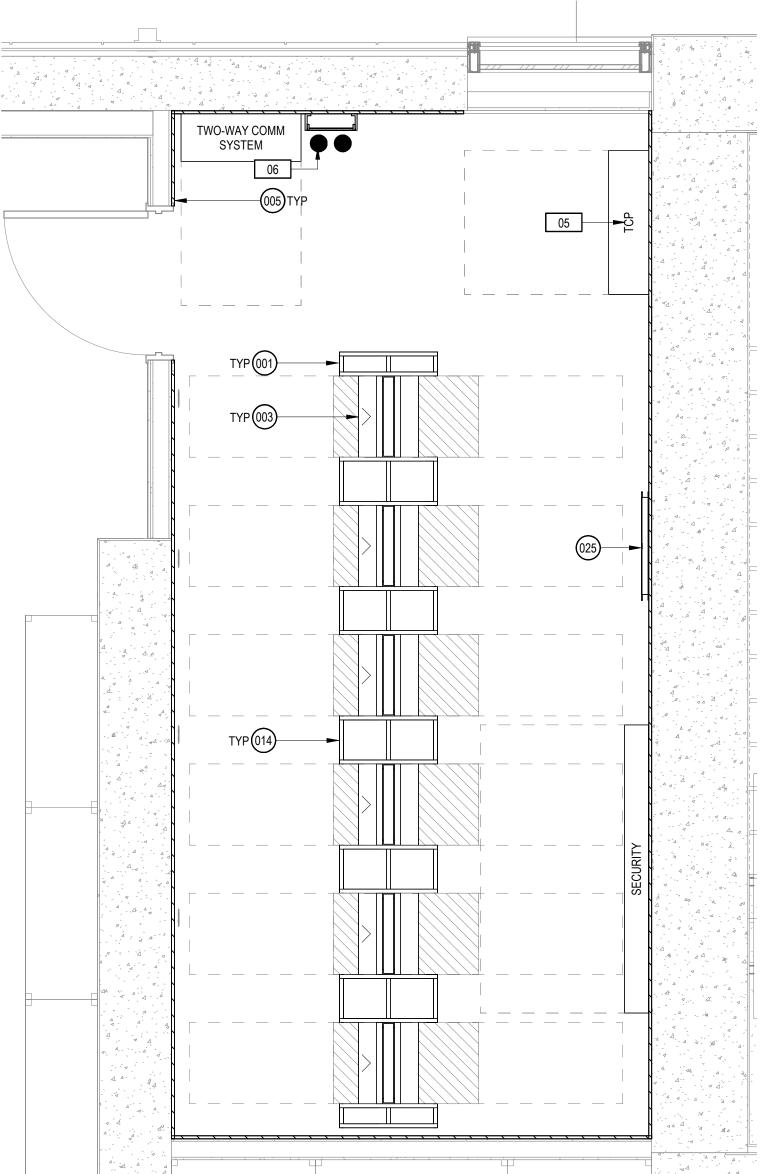

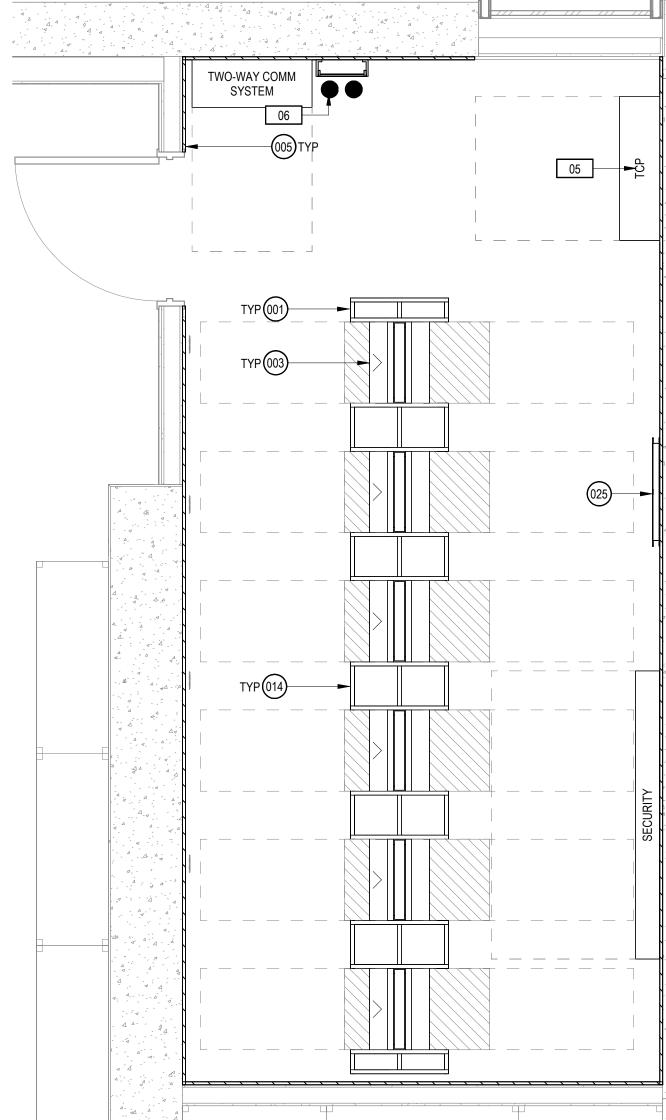


**EQUIPMENT PLAN** 

OVERHEAD PLAN - TIER 1

SCALE: 1/2" = 1'-0"

SYSTEM

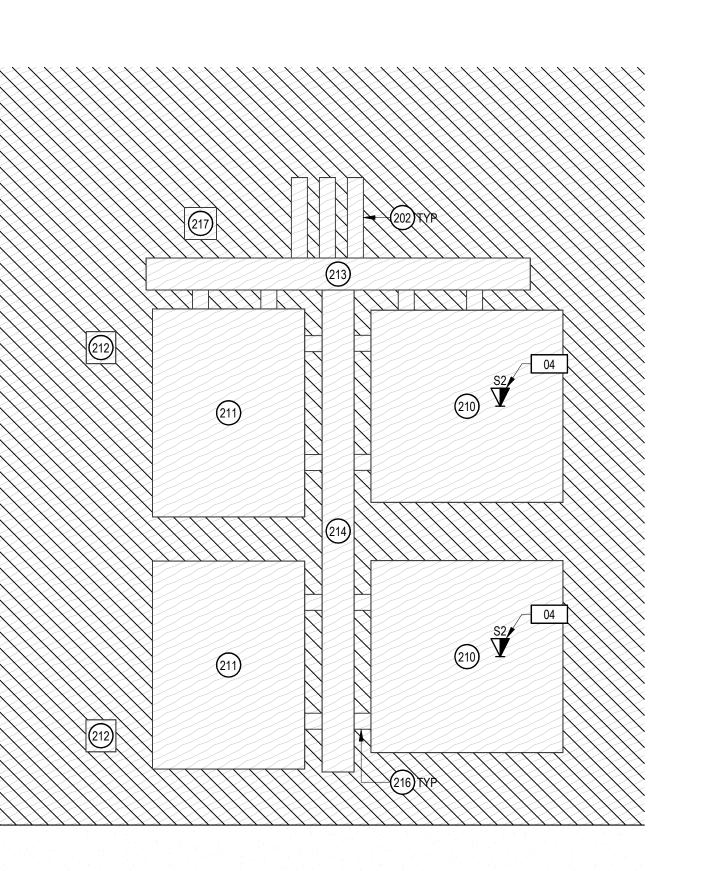

SECURITY PANEL ELEVATION

SCALE: 1" = 1'-0"

TECHNOLOGY EQUIPMENT LIST

Resource Center

900 Fallon Street, Oakland, CA

ISSUE DATE 03/31/2023 N&T JOB NUMBER

DRAWN BY JA CHECKED BY DM

T5.01A