




NEW COLUMN/FOUNDATION PLAN
SCALE: 1/2" = 1'-0"

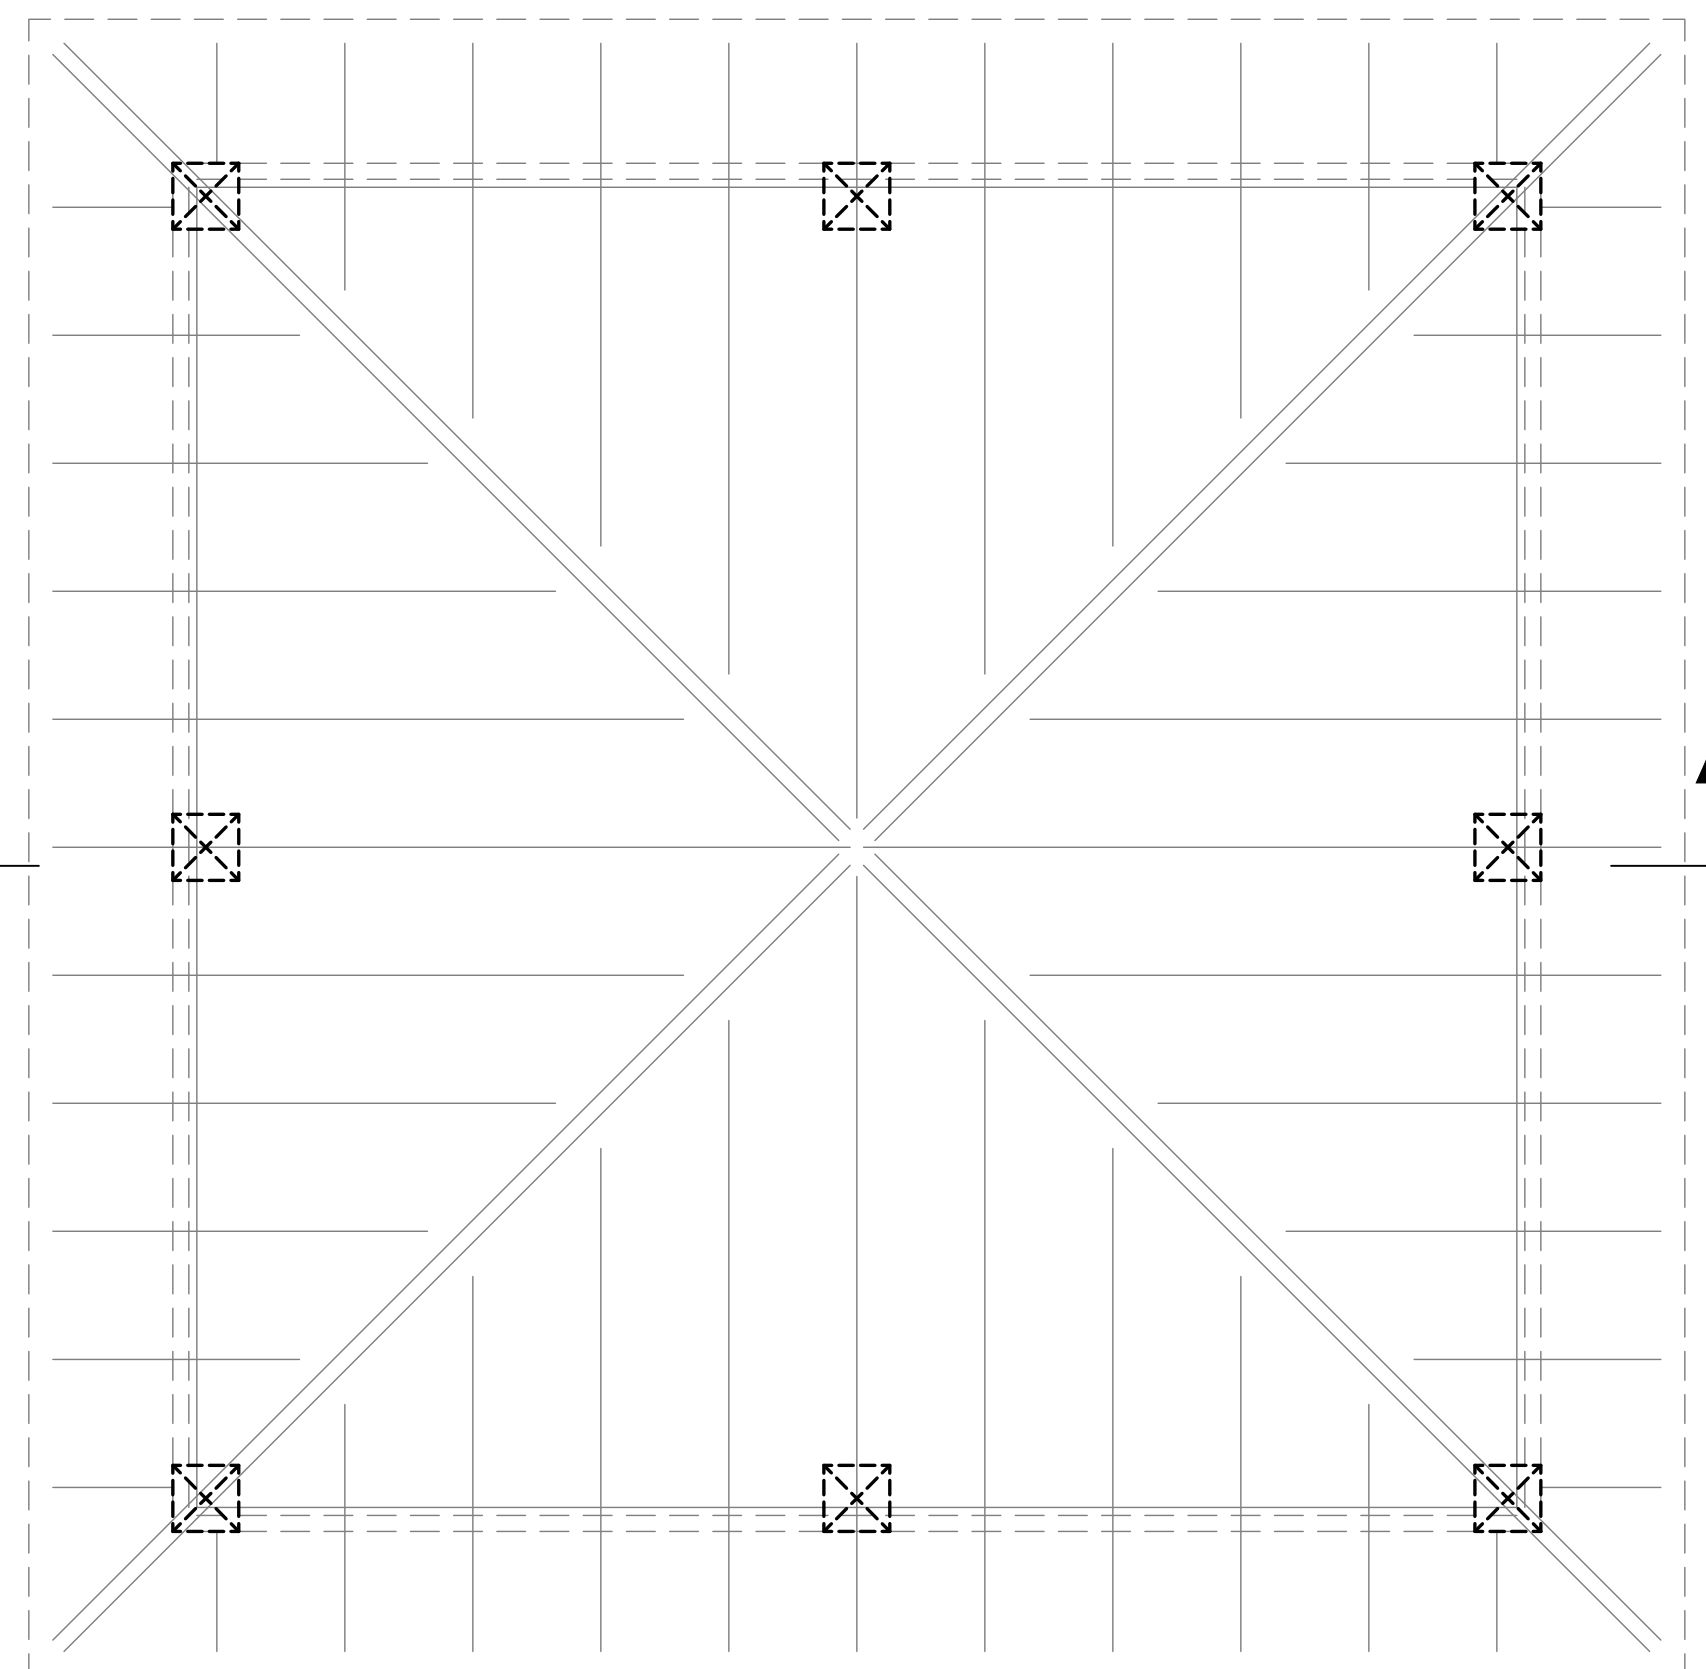


NEW ROOF PLAN
SCALE: 1/2" = 1'-0"

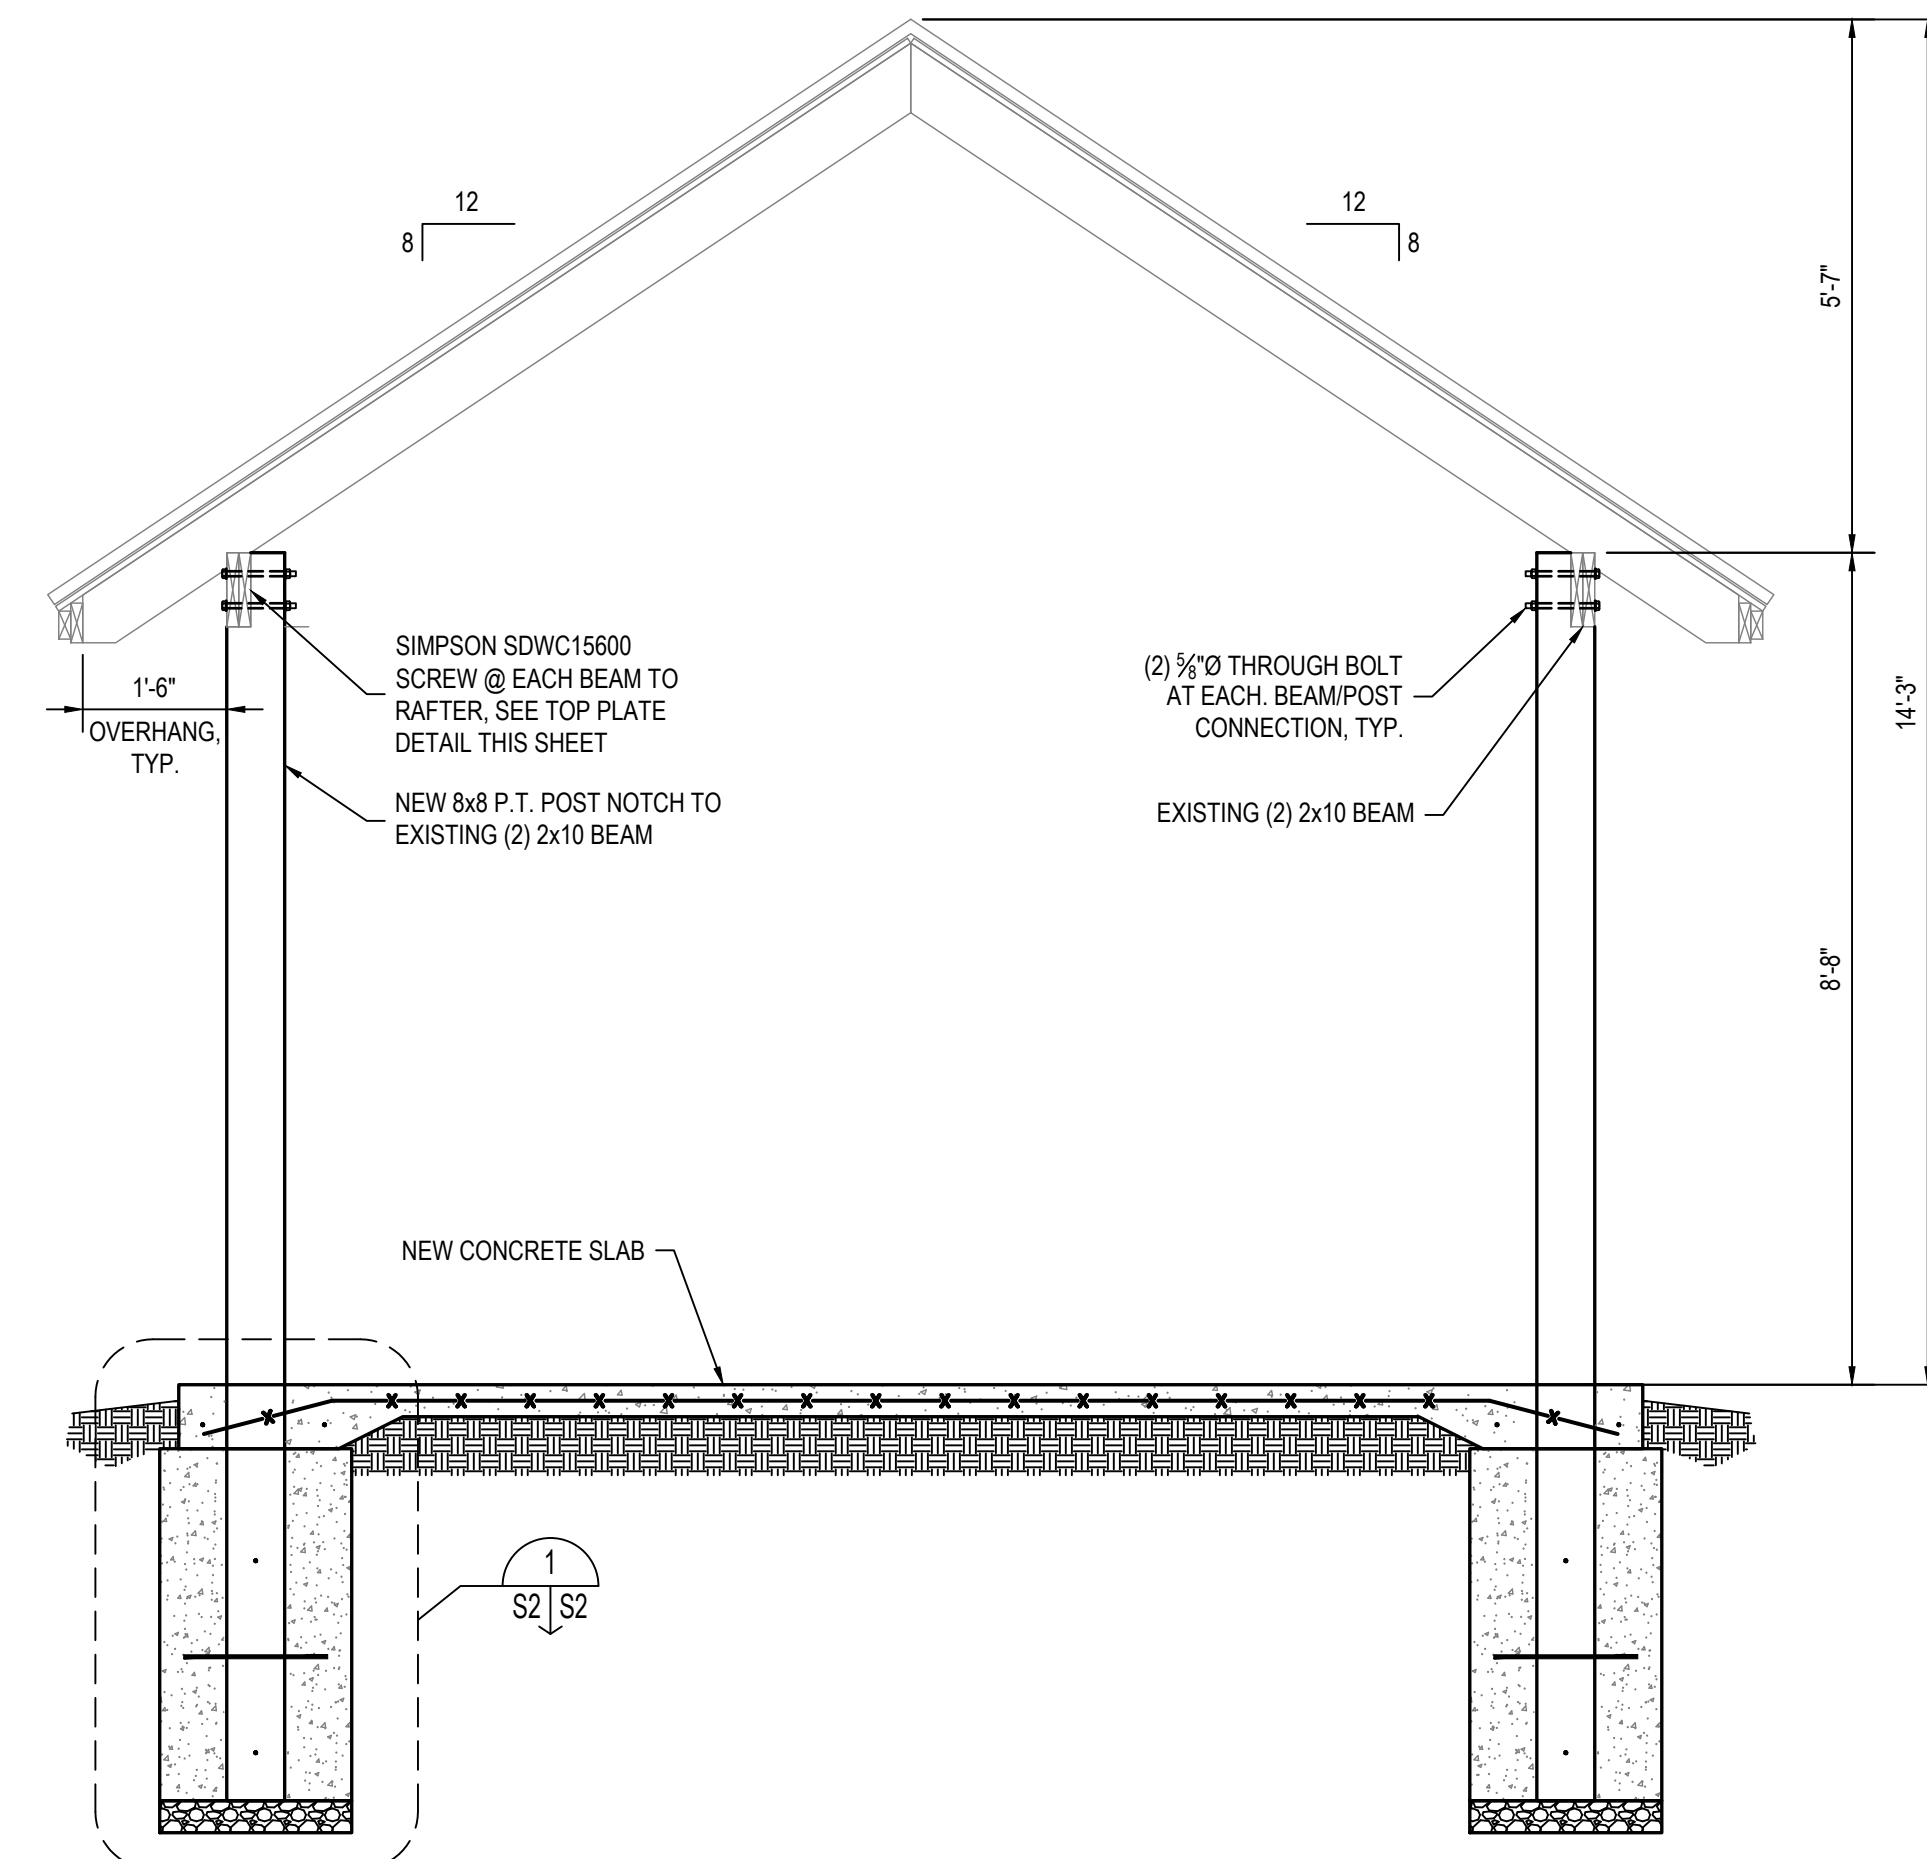


SECTION
SCALE: 1/2" = 1'-0" B S2 | S2

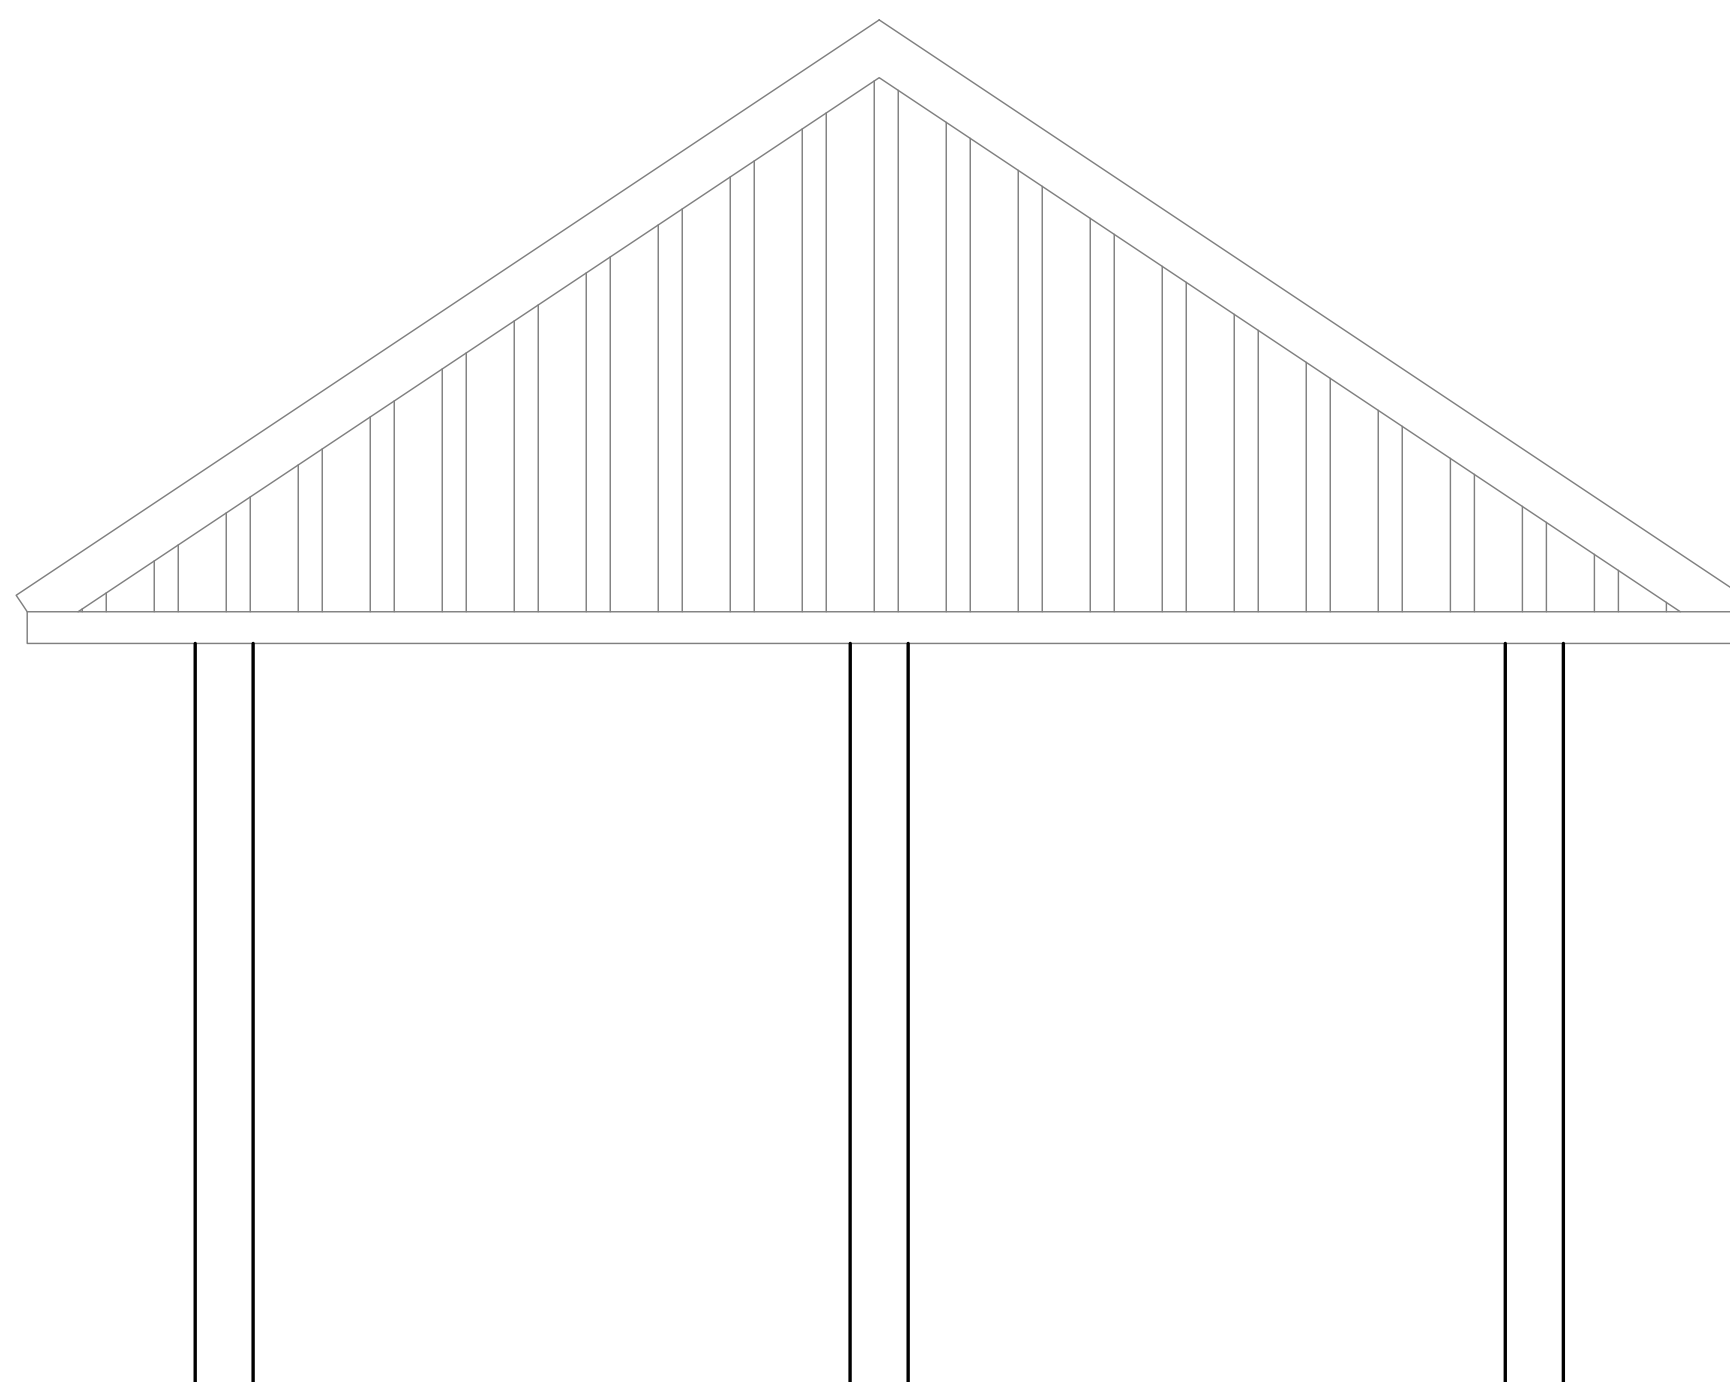

NEW ELEVATION
SCALE: 1/2" = 1'-0"

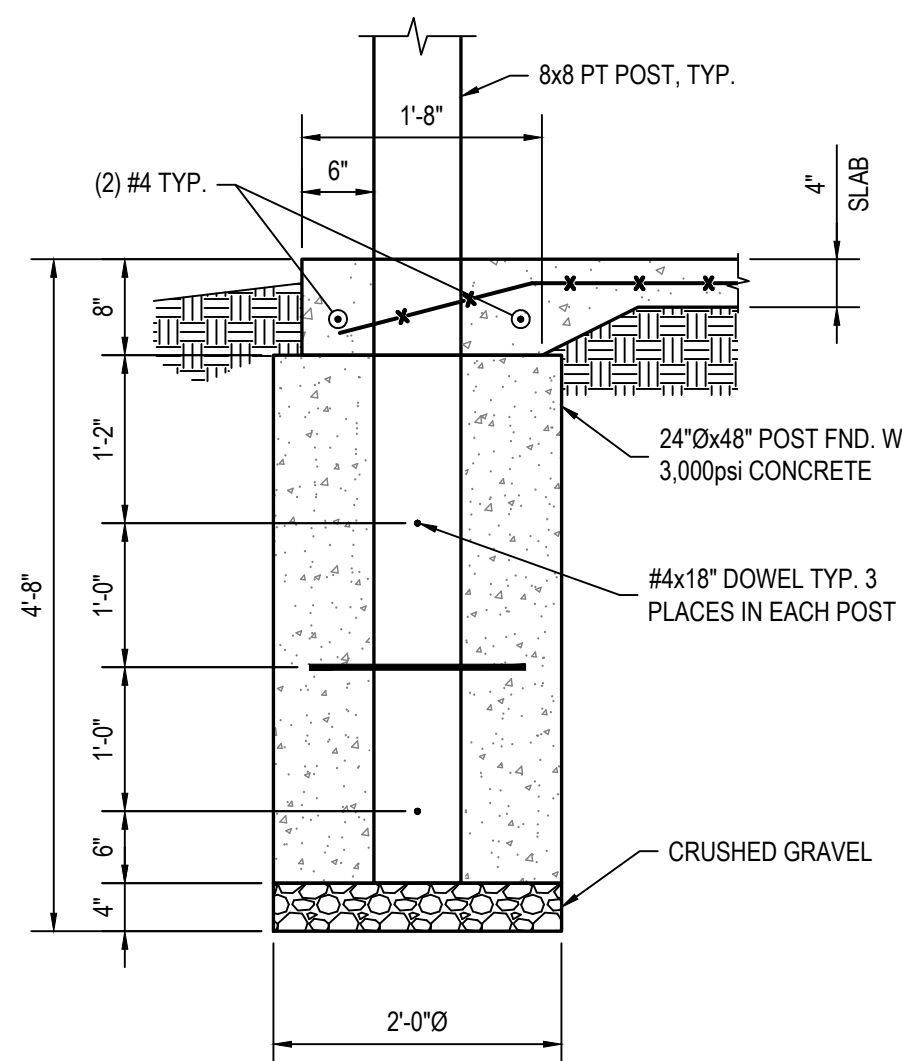

DETAIL
SCALE: 3/4" = 1'-0" 1 S2 | S2

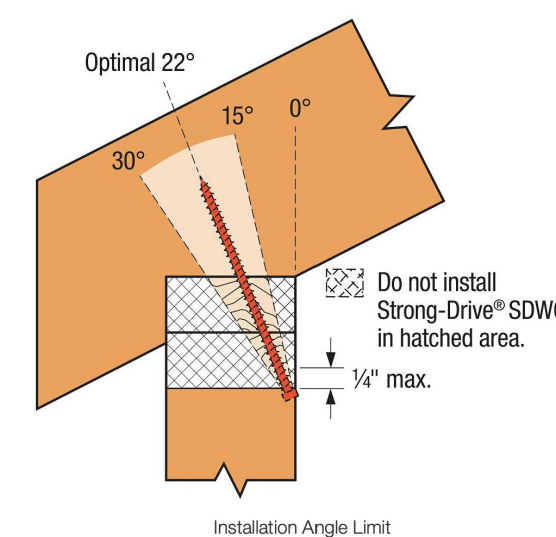

TOP PLATE DETAIL
N.T.S.

CODE/DESIGN CRITERIA:

- STRUCTURE IS DESIGNED IN ACCORDANCE WITH THE INTERNATIONAL BUILDING CODE, 2018 EDITION, WITH LATEST AMENDMENTS.
- GRAVITY LOADS
 - UNIFORM ROOF LIVE LOADS (REDUCED AS ALLOWED BY THE BUILDING CODE) ROOF 20 PSF
- WIND LOADS:
 - DESIGN WIND SPEED = 150 MPH
 - RISK CATEGORY I
 - WIND EXPOSURE B, MEAN ROOF HEIGHT IS < 15 FEET
 - OPEN STRUCTURE IN ACCORDANCE WITH ASCE 7-16 CHAPTER 27
- ESTIMATED DEFLECTIONS (IN INCHES) ARE AS FOLLOWS:


ROOF MEMBERS:	LIVE LOAD	DEAD + LIVE LOAD
	L/360 OR 1 IN.	L/240

WHERE, L = SPAN LENGTH (IN INCHES) BETWEEN CENTERLINES OF SUPPORTS. (FOR CANTILEVERS, L IS TWICE THE LENGTH OF THE CANTILEVER.)

REV.	DESCRIPTION	DATE	BY	CHK'D
A	ISSUED FOR PERMIT	07/27/23	TAS	TS

Sawyer Design Build
ENGINEERS • BUILDERS
11741A COUNTY ROAD 54
DAPHNE, ALABAMA
251-776-4571

**FOLEY KIDS PARK
PAVILION RELOCATION**
PINE STREET FOLEY, ALABAMA

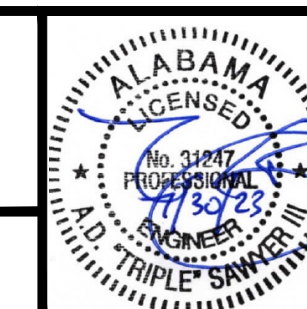

NEW PLANS AND ELEVATIONS		S2	
SHEET TITLE:	ENGINEER: TS	CHECK DATE: 07/25/23	SHEET NUMBER: SHEET: ... OF ...
DRAFTER: TAS	DRAWN DATE: 07/24/23	NOTED	23.024
SCALE: 2x/34 ORIGINAL		JOB NO. REV: A	